

Trustees Scott Ruggles Liz Fessler Smith Andrea C Voorheis Michael Powell

PLANNING COMMISSION MEETING

LOCATION: TOWNSHIP ANNEX, 7527 HIGHLAND ROAD, WHITE LAKE, MI 48383 THURSDAY, JUNE 20, 2024 – 6:30 PM

White Lake Township | 7525 Highland Rd | White Lake, MI 48383 | Phone: (248) 698-3300 | www.whitelaketwp.com

AGENDA

- 1. ROLL CALL
- 2. PLEDGE OF ALLEGIANCE
- 3. APPROVAL OF AGENDA
- 4. APPROVAL OF MINUTES
 - A. May 16, 2024
- 5. CALL TO THE PUBLIC (FOR ITEMS NOT ON THE AGENDA)
- 6. PUBLIC HEARING
 - A. 12-16-200-030 Rezoning Request

Location: Property described as Parcel Number 12-16-200-030,located south of Hitchcock Road, on the west side of Haley Road, consisting of approximately 15 acres. Request: Applicant requests to rezone the parcel from AG (Agricultural) to SF (Suburban Farms) or any other appropriate zoning district.

Applicant: Lisa Gulda

7. CONTINUING BUSINESS

A. West Valley

Location: Identified as parcel 12-36-176-003, located on the west side of Union Lake Road, across from Carpathian Drive, and north of Cooley Lake Road, consisting of approximately 15 acres.

Currently zoned as (RM-1) Attached Single Family

Request: Final site plan re-approval
Applicant: Fairview Construction Company

- 8. NEW BUSINESS
- 9. OTHER BUSINESS
- 10. LIAISON'S REPORT
- 11. PLANNING CONSULTANT'S REPORT
- 12. DIRECTOR'S REPORT
- 13. COMMUNICATIONS
- 14. NEXT MEETING DATE:
- 15. ADJOURNMENT

Procedures for accommodations for persons with disabilities: The Township will follow its normal procedures for individuals with disabilities needing accommodations for effective participation in this meeting. Please contact the Township Clerk's office at (248) 698-3300 X-164 at least two days in advance of the meeting. An attempt will be made to make reasonable accommodations.

WHITE LAKE TOWNSHIP PLANNING COMMISSION MAY 16, 2024

CALL TO ORDER

Chairperson Seward called the meeting to order at 6:30 P.M.

Roll was called:

Present:

T. Joseph Seward, Chairperson Steve Anderson Debby Dehart Pete Meagher Matt Slicker Merrie Carlock, Vice Chairperson Mona Sevic Robert Seeley

Absent:

Scott Ruggles, Township Board Liaison

Others:

Sean O'Neil, Community Development Director Justin Quagliata, Staff Planner Hannah Kennedy-Galley, Recording Secretary

APPROVAL OF AGENDA

MOTION by Commissioner Seeley, seconded by Commissioner Anderson to approve the agenda as presented. The motion carried with a voice vote: (8 yes votes).

APPROVAL OF MINUTES

A. May 2, 2024

MOTION by Commissioner Carlock, seconded by Commissioner Seeley to approve the minutes as presented. The motion carried with a voice vote: (8 yes votes).

CALL TO THE PUBLIC (FOR ITEMS NOT ON THE AGENDA)

None.

PUBLIC HEARING

A. 9101 Highland - Rezoning Request

Location: Property described as 9101 Highland Road, identified as parcel number 12-23-227-003, located south of Highland Road, west of Sunnybeach Boulevard, consisting of approximately 5.02 acres.

Request: Applicant requests to rezone the parcel from R1-C (Single Family Residential) to RB (Restricted Business) or any other appropriate zoning district.

Applicant: Affinity 10 Investments, LLC

Staff Planner Quagliata briefly went the applicant's request.

Commissioner Sevic asked staff if there was an issue with ingress into the site. Staff Planner Quagliata said the updated traffic study met the standards of the Township. The applicant provided a Traffic Impact Study, which was above and beyond what was needed for a rezoning request. If the applicant were to move forward and a site plan was reviewed, the Township Traffic Engineer would also review the study.

Commissioner Carlock asked staff if the Restrictive Business was the most restrictive commercial zoning. Staff Planner Quagliata said no, Local Business was.

Chairperson Seward asked staff if the request was compliant with the new Master Plan. Staff Planner Quagliata confirmed.

Commissioner Carlock clarified that the old and new Master Plan called for the area to be commercially zoned. Staff Planner Quagliata said holding the property to a residential zoning was inconsistent with the Master Plan.

Reid Cooksey, Stonfield Engineering, was present. He said the new application was brought to the Planning Commission after taking the concerns of the community into account. He said he was looking to bring a development to a property that the Master Plan called to be zoned commercially. He was looking to bring a high-end commercial development to the Township.

Commissioner Meagher asked Mr. Cooksey what the feedback was from the residents. Mr. Cooksey said the two biggest issues were additional green space between the development and abutting properties, and more screening. The church was sold, and the developer owned the property now.

Commissioner Anderson asked staff if there was compliance regarding frontage on the site. Staff Planner Quagliata confirmed, the lot size standards for both area and width were met.

Chairperson Seward opened the public hearing at 6:53 P.M.

Tom Miller, Vice Present of Twin Lakes HOA, 9136 Sandy Ridge, said Twin Lakes had over 370 homes and there was only one way in and out of the subdivision. He felt the rezoning would cram too much into one location.

Aaron Greenblatt, 9055 Huron Bluffs Drive, spoke in regards to negative impact of the rezoning to the surrounding property values. He also voiced his concerns regarding additional traffic to the site causing traffic delays.

David Gian, President of the Twin Lakes Improvement Association, 9315 Steep Hollow, spoke regarding

the existing road conditions of Sunny Beach Boulevard. He believed the Township should eliminate some of the ingress/egress along M-59 in favor of cross access easements.

Theresa Johns, 9051 Steep Hollow Drive, asked how the neighbors reacted to the meeting with the development team. She stated the neighbors were not pleased and did react. She felt there was no concern for property values or traffic.

Rachel Cook, 9122 Sandy Ridge, had questions regarding the access management in the traffic study.

Susan Deihl, 9170 Twin Lakes, said she understood the reason for commercial zoning, but was concerned about the water quality with a new commercial development to the area. The neighborhood had significant water changes after the new car wash was developed.

Lisa Reaser, 515 Berry Patch, spoke regarding her concerns about the left hand turn onto M-59. She was greatly disappointed and opposed to creating a greater traffic hazard.

John Bem, 298 Shotwell, said the church and daycare center made for a great buffer to the neighborhood. He wanted to zoning of the property to remain residential.

Deb Skonieczny, 373 Shotwell, said the property values of the surrounding homes would drop. She said the Township was becoming a commercial strip of nothing but buildings.

Beverly Clancy Johnson, 8790 Twin Lakes Drive, spoke regarding the lack of traffic safety.

Maureen Kinsella, 605 Sunny Beach Drive, asked the Planning Commission to consider what the community benefits would be to this rezoning.

Chris Scholz, 987 Sunnybeach, was concerned about the traffic impact and lighting.

Sheldon Greenblatt, 9055 Huron Bluffs Drive, said the Planning Commission had heard many different perspectives. He said the rezoning should not be a single decision process.

Aaron Heiner, 987 Sunnybeach, recommended an 8' cinderblock wall. He did not want to see light pollution or hear noise pollution.

Gary Seifman, 8990 Huron Bluff Drive, said he was scared as to what could take place on the site.

Megan Scholz, 987 Sunnybeach, complained of the commercial traffic that surrounded her home and did not want more commercial development closer.

Dan Gottschall, 891 Sunnybeach, said he wanted to see the request tabled for another time. He was 77 years old, and said the Planning Commission was charged with effecting the Township for the present and the future.

Chairperson Seward closed the public hearing at 7:32 P.M.

Commissioner Carlock asked staff what the difference between Local and Restrictive Business would be. Staff Planner Quagliata said Local Business didn't allow drive thru windows or restaurants with drive thru windows.

Commissioner Meagher said the traffic light issue was a MDOT issue, and what would it take to get a traffic light. Director O'Neil said MDOT had standards that needed to be met, and a factor that was taken into account was accidents. Many years ago, the Taco Bell had given the Township a contribution towards a traffic light at the Sunnybeach intersection. Traffic mitigation was a site plan issue that would be reviewed during the site plan process.

Commissioner Dehart asked staff if the neighborhood was on community water or wells. Director O'Neil said it was wells. She added she was a proponent of cross access easements, and was there a way to utilize the adjacent driveway's driveway. Staff Planner Quagliata said the abutting property did not have an existing cross access. The developer could work with the daycare to create a cross access easement.

Commissioner DeHart said she did not like seeing the vacant Tim Horton's/Wendy's property, but had understood the owner was uncommunicative. Staff Planner Quagliata said it was the business owner's choice to have a dark building, the owner did not have the building for sale.

Commissioner Sevic asked staff if there was another appropriate zoning for the property. Staff Quagliata said yes, but in staff's opinion, Restrictive Business was the most appropriate district.

Mr. Cooksey addressed some of the resident questions. He said he wanted to work with the Township and community through a very long process. Traffic concerns and entrance would be addressed at site plan. The goal was if the daycare was ever redeveloped, there would be cross access. He added that there was positive feedback, but there was hesitance from the neighbors. The request was in line with the Master Plan. He said the development would not impact the community well water.

Director O'Neil said if the project were to go through the planning process, there would be standards the developer would adhere to and the Planning Commission could enforce, such as the landscaping and buffering. Nothing could be legally tied to tonight's request.

It was MOVED by Commissioner Seeley, seconded by Commissioner Meagher to recommend the Township Board approve the rezoning 9101 Highland Road, identified as parcel number 12-23-227-003 from R1-C Residential to RB Restricted Business. The motion carried with a roll call vote: (5 yes votes)

(Seeley/yes, Meagher/yes, Slicker/yes, Sevic/yes, Anderson/no, Seward/yes, Carlock/no, Dehart/no).

CONTINUING BUSINESS

None.

NEW BUSINESS

None.

OTHER BUSINESS

None.

LIAISON'S REPORT

The Triangle Trail was moving along, and near completion. Restoration of irrigation was being handled. Stanley Park construction would be underway soon. Rockin' the Farm would be held on July 20.

DIRECTOR'S REPORT

The Master Plan was approved. Gateway Crossing's preliminary site plan was approved. Construction on Elizabeth Lake Road would begin next week through October. The Civic Center page turns for the bid package was yesterday. Culver's would be going to the Township Board next week. Gateway Crossing would be going to the ZBA next week. The Zoning Ordinance amendments would be going to the Board for first reading.

Director O'Neil presented Mary Earley with a bound version of the Master Plan, along with a copy of the executive summary.

Staff Planner Quagliata's last day was today. He was moving on to become the Community Development Director at the city of Northville. He also passed the AICP exam yesterday. Congratulations, Justin!

COMMUNICATIONS

None.

NEXT MEETING DATE: June 6, 2024

ADJOURNMENT

MOTION by Commissioner Meagher, seconded by Commissioner Dehart, to adjourn at 8:23 P.M. The motion carried with a voice vote: (8 yes votes).

Director's Report

Project Name: 12-16-200-030 Rezoning

Description: Rezoning Request

Date on Agenda this packet pertains to: June 20, 2024

⊠Public Hearing	\square Special Land Use
⊠Initial Submittal	⊠Rezoning
☐Revised Plans	□Other:
□Preliminary Approval	
□Final Approval	

Contact	Consultants & Departments	Approval	Denial	Approved w/Conditions	Other	Comments
Sean O'Neil	Community Development Director				\boxtimes	Based on comments from the Planning Consultant
Matteo Passalacqua	Carlisle & Wortman Associates Inc	\boxtimes				See letter dated 06/3/2024



117 NORTH FIRST STREET SUITE 70 ANN ARBOR, MI 48104 734.662.2200 734.662.1935 FAX

Date: June 3, 2024

Rezoning Review For White Lake Township, Michigan

Applicant: Lisa Gulda

Project Name: Haley Road Rezoning

Location: Southwest corner of Hitchcock Road and Haley Road

Parcel ID: 12-16-200-030

Plan Date: May 28th, 2024

Current Zoning: AG, Agricultural District

Action Requested: Rezone to SF, Suburban Farms District

PROJECT DESCRIPTION


The Applicant is requesting a zoning change for the parcel located near the southwest corner of Hitchcock and Haley Roads for the purpose of establishing a unified zoning designation and splitting the lot into five (5) parcels. The lot is currently zoned both AG and SF per the White Lake 2022 zoning map last updated October 10th, 2022.

Aerial Photograph



NEIGHBORING ZONING AND LAND USE

Zoning

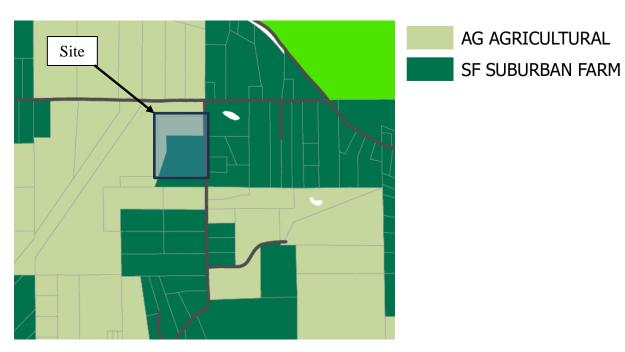

The zoning and existing land uses for the subject site and surrounding parcels are identified in the following table:

Direction	Zoning	Existing Use
North	AG – Agricultural	Vacant
South	SF – Suburban Farms	Vacant
East	SF – Suburban Farms	Single Family Homes
West	AG – Agricultural	Vacant

If approved, the parcel, and proposed lot splits, would conform to the lot size and dimension standards for SF. Permitted uses in the SF and AG zones are shown below. All residential uses are identical with AG allowing for more intense agricultural uses. These uses are conducive with the existing neighboring properties.

Zone	AG	SF		
Permitted Uses	Adult foster care family home	Adult foster care family home		
	Family day care homes	Family day care homes		
	Farms iv. Home occupation	Home occupation		
	Outdoor recreation uses, other public and private parks and similar outdoor recreation uses not listed in §4.38	Outdoor recreation uses, other public and private parks and similar outdoor recreation uses not listed in §4.38		
	Single-family detached dwellings	Single-family detached dwellings		
	Vegetable, fruit, flower and herb gardening	Private stable		
	Tree and shrub nurseries, not including landscape contractors	Tree and shrub nurseries; vegetable, fruit, flower and herb gardens		
	Private stable			
	Temporary roadside stand			
	Temporary agricultural uses			
	Temporary uses within a building			

Items to be addressed: None.

Haley Road Rezoning June 3, 2024

NATURAL FEATURES

The site is undeveloped and consists mainly of woodland clusters with intertwining open fields. No natural feature information was provided in the application. Below is our observed condition of the site.

Topography: The site appears relatively flat.

Wetlands: The Department of Environment, Great Lakes and Energy indicate wetlands

located along western border of the parcel.

Woodland: Several woodland clusters are onsite which are composed of mature trees and

vegetation.

Soils: Predominant soils are Marlette Loam and Fox Sandy Loam.

Water: The site is not within any regulated floodplains.

Items to be addressed: None.

MASTER PLAN

The Township's Master Plan is a comprehensive document that includes many elements that should be considered when determining rezoning requests. Pertinent sections to review include future land uses, as well as goals, objectives and strategies of the site(s) proposed for rezoning.

Future Land Use

Under the current Master Plan, the site is located in the Agricultural / Rural Residential district which is shown below:



We note that the Master Plan anticipates the site being a uniform designation. The description and example of uses (not an exhaustive list) for the Agricultural / Rural Residential District are:

<u>Description:</u> "Maintains agricultural land and rural living through large lots and limited residential development. Subdivision residential development is discouraged"

Example of Uses: "Large-lot single family, agriculture, farm-stands, cider mills"

Lot sizes are not prescribed in the Master Plan for future land use designations however the corresponding zoning districts associated with Agricultural / Rural Residential district are AG and SF.

Haley Road Rezoning June 3, 2024

No conflict exists with the Master Plan in the consideration of this parcel being rezoned to Suburban Farm.

Items to be addressed: None.

DEVELOPMENT POTENTIAL

If rezoned, the lot will allow for low density single family residential and accessory improvements as well as any other of the permitted uses listed earlier in this report and noted in Section 3.1.2 of the Zoning Ordinance. If the parcel is subdivided into separate lots conforming to SF standards, a maximum of five (5) lots could be created and permit the same improvements / uses as referenced above. Accounting for current market conditions and infrastructure, the likely use for the lot(s) would be single family residential homes.

REZONING STANDARDS

Section 7.9 of the White Lake Township Zoning Ordinance states that all proposed amendments to the provisions of the Ordinance or the Official Zoning Map shall be referred to the Planning Commission for public hearing and recommendation to the Township Board, prior to consideration thereof by the Township Board.

Section 7.13 of the White Lake Township Zoning Ordinance outlines the criteria the Planning Commission and Township Board are to utilize when assessing any petition for an amendment to the Official Zoning Map. Below is a review of the materials provided by the applicant as they relate to the proposed rezoning:

- A. Consistency with the goals, policies and future land use map of the White Lake Township Master Plan, including any subarea or corridor studies. If conditions have changed since the Master Plan was adopted, the consistency with recent development trends in the area.
 - **CWA Comment:** The Future Land Use Map from the Master Plan designates the subject site in the Agricultural / Rural Residential category, which aligns with the proposed SF zoning district and uses.
- B. Compatibility of the site's physical, geological, hydrological and other environmental features with the host of uses permitted in the proposed zoning district.
 - **CWA Comment:** The SF designation is compatible with the current natural environment as well as the low density development permitted in the zone.
- C. Evidence the applicant cannot receive a reasonable return on investment through developing the property with one (1) of the uses permitted under the current zoning.

- **CWA Comment:** No such evidence addressing this criterion was submitted with the application. We note that selling or developing lots with multiple zoning designations can be challenging based on the nature of the proposed use.
- D. The compatibility of all the potential uses allowed in the proposed zoning district with surrounding uses and zoning in terms of land suitability, impacts on the environment, density, nature of use, traffic impacts, aesthetics, infrastructure and potential influence on property values.
 - **CWA Comment:** No use is proposed as part of the rezoning request. In the event a use is proposed, the permitted and special land uses in the SF district are compatible with the surrounding uses and the nature of the uses anticipated in the Township Master Plan. Any use other than SF residential would require the submission of a site plan application to ensure zoning standards are met. Only the Township Assessor may provide comment on property values.
- E. The capacity of Township utilities and services sufficient to accommodate the uses permitted in the requested district without compromising the "health, safety and welfare" of the Township.
 - **CWA Comment:** The site is not serviced by public water and sanitary sewer. No additional Township services are anticipated as a result of rezoning to SF. We defer to the Director of Public Services and Township Engineering Consultant on any concerns with infrastructure or public safety services.
- F. The capability of the street system to safely and efficiently accommodate the expected traffic generated by uses permitted in the requested zoning district.
 - **CWA Comment:** Pursuant to Section 6.3.E of the zoning ordinance, the requirement for submittal of a rezoning traffic study was waived by the Community Development Department. Future requests for development, may require submittal of a traffic analysis.
- G. The apparent demand for the types of uses permitted in the requested zoning district in relation to the amount of land in the township currently zoned and available to accommodate the demand.
 - **CWA Comment:** Evidence of the demand in the Township for additional SF zoned property has not been submitted. However, the location is appropriate for property zoned as such, given the traffic, residential units, neighboring uses and general developmental density in the area.

H. The boundaries of the requested rezoning district are reasonable in relationship to its surroundings, and construction on the site will be able to meet the dimensional regulations for the zoning district listed in the Schedule of Regulations.

CWA Comment: Construction on the site is not proposed at this time. However, rezoning to SF to establish uniform development standards for the site is preferable. Factors that may impact future development of the site, such as, but not limited to, soils, topography, site layout, stormwater/drainage, and utilities would be considered at the time of a development proposal.

I. The requested zoning district is considered to be more appropriate from the township's perspective than another zoning district.

CWA Comment: The uses and development standards allowed in the SF district are appropriate for the site and are complementary to the AG district. A denser residential district proposal would be less appropriate for the site.

J. If the request is for a specific use, is rezoning the land more appropriate than amending the list of permitted or special land uses in the current zoning district to allow the use?

CWA Comment: The intent of the request is to apply uniform zoning so the lot can be divided. If approved, the permitted uses for the divided lots are conducive with the SF zoning designation.

K. The requested rezoning will not create an isolated and unplanned spot zone.

CWA Comment: No spot zoning is proposed. The surrounding and nearby areas are zoned AG, SF and ROS (Recreation and Open Space).

L. The request has not previously been submitted within the past one (1) year, unless conditions have changed or new information has been provided.

CWA Comment: This request is a new application.

M. An offer of conditions submitted as part of a conditional rezoning request shall bear a reasonable and rational relationship to the property for which rezoning is requested.

CWA Comment: No conditions were offered in the application.

N. Other factors deemed appropriate by the Planning Commission and Township Board.

CWA Comment: The Planning Commission and Township Board may also consider other factors which may be relevant to the rezoning request.

Items to be addressed: Any concerns from Township Engineering and Public Services should be addressed.

RECOMONDATION

The proposed rezoning is compatible with both the existing and future land uses/zoning, consistent with the Master Plan, and applies uniform zoning for the parcel. Pending any items needing clarification or resolution by the Township Engineer and Public Service departments, we recommend the proposed rezoning.

Respectfully,


CARLISLE/WORTMAN ASSOC., INC.

Matteo Passalacqua Community Planner

CHARTER TOWNSHIP OF WHITE LAKE COMMUNITY DEVELOPMENT DEPARTMENT 7525 Highland Road, White Lake, Michigan 48383-2900 248-698-3300, Ext. 163

APPLICATION TO REZONE PROPERTY

Date:5/28/24
Applicant: lisa Gulda,
Address: 5033 Thicket (ane, Clarkston, Mi 48346
Phone No.: 245-904-8571 Fax No.:
E-mail: li Sagalda Dhyaheo.com
Applicant's Interest in Property:
Property Owner:Owner's Address:
Phone No.: Fax No.:
Location of Property: Haley Rd - Vacant
Sidwell No(s).: 12-16-200-030
Total area of change: acres
l, the undersigned (owner, attorney, or option holder) hereby request that this property now classified
asAG District, be reclassified asSF District.
Applicant's Signature:
Please Print Name: LiSa Gulda
Required Attachments:1. Legal description of the property proposed to be rezoned.
2. Location map
3. Rezoning sign location map
4. Statement indicating why change is requested
5 Review fee (check navable to the Charter Township of White Lake)

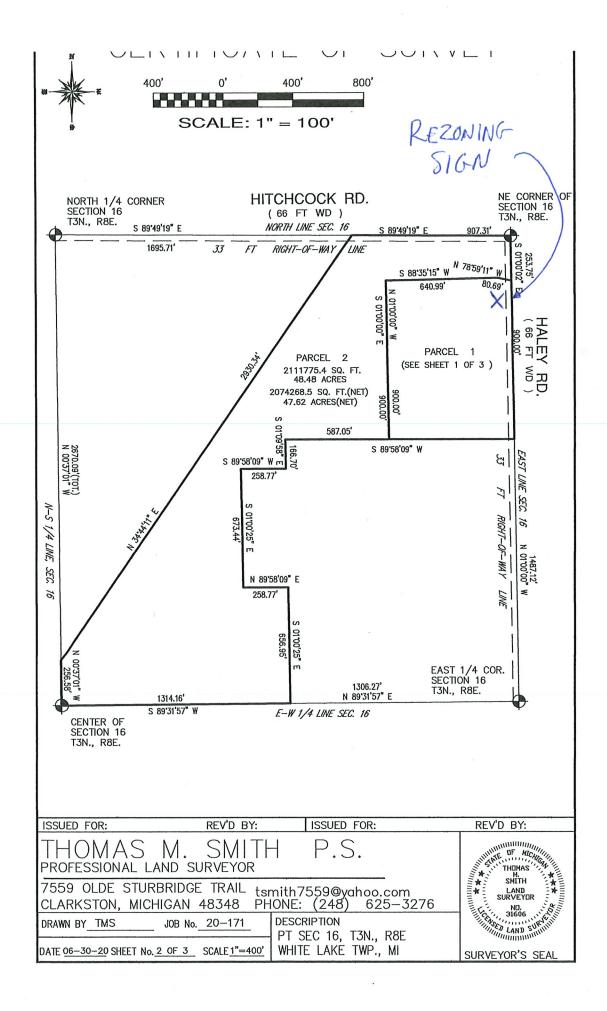

LEGAL DESCRIPTION-PARCEL 1:

PART OF THE NORTHEAST \$\frac{1}{2}\$ OF SECTION 16, T3N., R8E., WHITE LAKE TOWNSHIP, OAKLAND COUNTY, MICHIGAN, DESCRIBED AS BEGINNING AT A POINT LOCATED ON THE EAST LINE OF SECTION 16, DISTANT S 01'00'00"E, 253.75 FEET FROM THE NORTHEAST SECTION CORNER; THENCE CONTINUING S 01'00'00" E, ALONG SAID EAST LINE, 900.00 FEET; THENCE S 89'58'09" W, 720.00 FEET; THENCE N 01'00'00" W, 900.00 FEET; THENCE N 88'35'15" E, 640.99 FEET; THENCE S 78'59'11" E, 80.69 FEET TO THE POINT OF BEGINNING. SUBJECT TO THE RIGHTS OF THE PUBLIC IN HALEY ROAD. PARCEL CONTAINS 15.00 ACRES OF LAND.

LEGAL DESCRIPTION-PARCEL 2:

PART OF THE NORTHEAST \$\frac{1}{4}\$ OF SECTION 16, T3N., R8E., WHITE LAKE TOWNSHIP, OAKLAND COUNTY, MICHIGAN, DESCRIBED AS BEGINNING AT THE NORTHEAST CORNER OF SECTION 16; THENCE S 01'00'00"E, ALONG THE EAST LINE OF SAID SECTION 16, 253.75 FEET; THENCE N 78'59'11" W, 80.69 FEET; THENCE S 88'35'15" W, 640.99 FEET; THENCE S 01'00'00" E, 900.00 FEET; THENCE S 89'58'09" W, 587.05 FEET; THENCE S 01'09'58" E, 166.70 FEET; THENCE S 89'58'09" W, 258.77 FEET; THENCE S 01'00'25" E, 673.44 FEET; THENCE N 89'58'09" E, 258.77 FEET; THENCE S 01'00'25" E, 656.95 FEET TO THE EAST—WEST \$\frac{1}{4}\$ LINE OF SAID SECTION 16; THENCE S 89'31'57" W, ALONG SAID EAST—WEST \$\frac{1}{4}\$ LINE, 1314.16 FEET TO THE CENTER OF SECTION 16; THENCE N 00'37'01" W, ALONG THE NORTH—SOUTH \$\frac{1}{4}\$ LINE, 256.58 FEET; THENCE N 34'44'11" E, 2930.34 FEET TO THE NORTH LINE OF SAID SECTION 16 AND THE CENTERLINE OF HITCHCOCK ROAD(66 FT WD); THENCE S 89'49'19" E, ALONG SAID NORTH LINE, 907.31 FEET TO THE POINT OF BEGINNING. SUBJECT TO THE RIGHTS OF THE PUBLIC IN HITCHCOCK & HALEY ROADS(66 FT WD). PARCEL CONTAINS 48.48 ACRES OF LAND.


SURVEYORS CERTIFICATE:

I HEREBY CERTIFY THAT I HAVE SURVEYED THE PROPERTY DESCRIBED HEREON THAT THE PROPERTY LINES ARE AS SHOWN.

THOMAS M. SMITH

R.L.S. No. 31606

REV'D BY: ISSUED FOR: ISSUED FOR: REV'D BY: THE OF MICHENIA THOMAS SMITH Μ. PROFESSIONAL LAND SURVEYOR THOMAS HTIME 7559 OLDE STURBRIDGE TRAIL tsmith7559@yahoo.com CLARKSTON, MICHIGAN 48348 PHONE: (248) 625-3276 ND, 31606 SURVEYOR'S SEAL DESCRIPTION DRAWN BY TMS JOB No. 20-171 PT SEC 16, T3N., R8E DATE 06-30-20 SHEET No. 3 OF 3 SCALE N/A WHITE LAKE TWP., MI

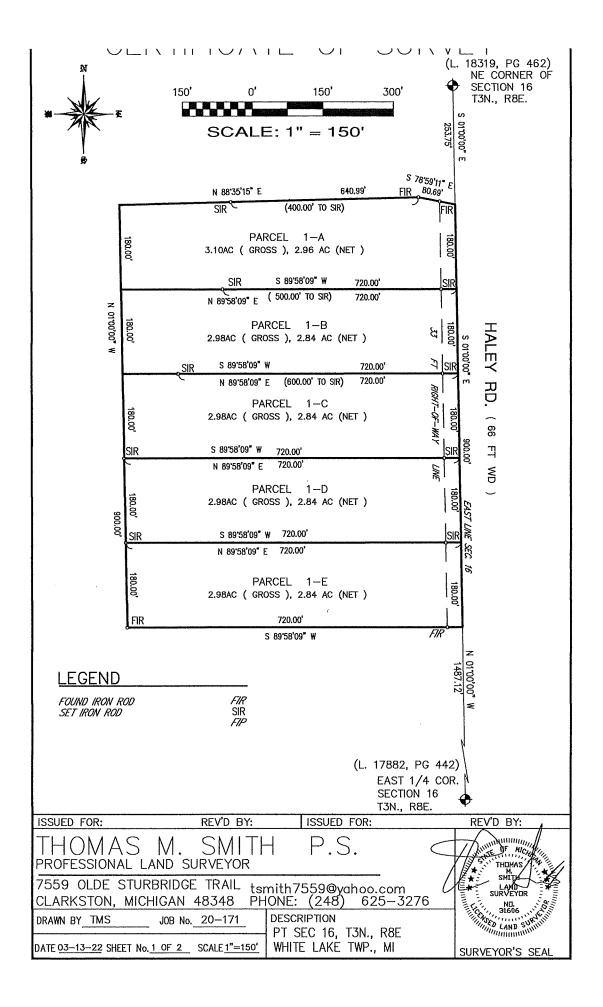

LEGAL DESCRIPTION-PARCEL 1-A:

PART OF THE NORTHEAST \$\frac{1}{4}\$ OF SECTION 16, T3N., R. 8E., WHITE LAKE TOWNSHIP, OAKLAND COUNTY, MICHIGAN, DESCRIBED AS BEGINNING AT A POINT LOCATED ON THE EAST LINE OF SAID SECTION 16, DISTANT S 01'00'00" E, 253.75 FEET FROM THE NORTHEAST CORNER OF SAID SECTION 16; THENCE CONTINUING S 01'00'00" E, ALONG SAID EAST LINE, 180.00 FEET; THENCE S 89'58'09" W, 720.00 FEET; THENCE N 01'00'00" W, 180.00 FEET; THENCE N 88'35'15" E, 640.99 FEET; THENCE S 78'59'11" E, 80.67 FEET TO THE POINT OF BEGINNING. SUBJECT TO THE RIGHTS OF THE PUBLIC IN THE EAST 33 FEET FOR ROAD PURPOSES. PARCEL CONTAINS 3.10 ACRES OF LAND

LEGAL DESCRIPTION—PARCEL 1—B:

PART OF THE NORTHEAST \$\frac{1}{4}\$ OF SECTION 16, T3N., R. 8E., WHITE LAKE TOWNSHIP, OAKLAND COUNTY, MICHIGAN, DESCRIBED AS BEGINNING AT A POINT LOCATED ON THE EAST LINE OF SAID SECTION 16, DISTANT S 01'00'00" E, 433.75 FEET FROM THE NORTHEAST CORNER OF SAID SECTION 16; THENCE CONTINUING S 01'00'00" E, ALONG SAID EAST LINE, 180.00 FEET; THENCE S 89'58'09" W, 720.00 FEET; THENCE N 01'00'00" W, 180.00 FEET; THENCE N 89'58'09" E, 720.00 FEET TO THE POINT OF BEGINNING. SUBJECT TO THE RIGHTS OF THE PUBLIC IN THE EAST 33 FEET FOR ROAD PURPOSES. PARCEL CONTAINS 2.98 ACRES OF LAND.

LEGAL DESCRIPTION-PARCEL 1-C:

PART OF THE NORTHEAST \$\frac{1}{4}\$ OF SECTION 16, T3N., R. 8E., WHITE LAKE TOWNSHIP, OAKLAND COUNTY, MICHIGAN, DESCRIBED AS BEGINNING AT A POINT LOCATED ON THE EAST LINE OF SAID SECTION 16, DISTANT S 01'00'00" E, 613.75 FEET FROM THE NORTHEAST CORNER OF SAID SECTION 16; THENCE CONTINUING S 01'00'00" E, ALONG SAID EAST LINE, 180.00 FEET; THENCE S 89'58'09" W, 720.00 FEET; THENCE N 01'00'00" W, 180.00 FEET; THENCE N 89'58'09" E, 720.00 FEET TO THE POINT OF BEGINNING. SUBJECT TO THE RIGHTS OF THE PUBLIC IN THE EAST 33 FEET FOR ROAD PURPOSES, PARCEL CONTAINS 2.98 ACRES OF LAND.

LEGAL DESCRIPTION—PARCEL 1—D:

PART OF THE NORTHEAST \$\frac{1}{2}\$ OF SECTION 16, T3N., R. 8E., WHITE LAKE TOWNSHIP, OAKLAND COUNTY, MICHIGAN, DESCRIBED AS BEGINNING AT A POINT LOCATED ON THE EAST LINE OF SAID SECTION 16, DISTANT S 01'00'00" E, 793.75 FEET FROM THE NORTHEAST CORNER OF SAID SECTION 16; THENCE CONTINUING S 01'00'00" E, ALONG SAID EAST LINE, 180.00 FEET; THENCE S 89'58'09" W, 720.00 FEET; THENCE N 01'00'00" W, 180.00 FEET; THENCE N 89'58'09" E, 720.00 FEET TO THE POINT OF BEGINNING. SUBJECT TO THE RIGHTS OF THE PUBLIC IN THE EAST 33 FEET FOR ROAD PURPOSES. PARCEL CONTAINS 2.98 ACRES OF LAND.

LEGAL DESCRIPTION-PARCEL 1-E:

PART OF THE NORTHEAST \$\frac{1}{2}\$ OF SECTION 16, T3N., R. 8E., WHITE LAKE TOWNSHIP, OAKLAND COUNTY, MICHIGAN, DESCRIBED AS BEGINNING AT A POINT LOCATED ON THE EAST LINE OF SAID SECTION 16, DISTANT S 01'00'00" E, 973.75 FEET FROM THE NORTHEAST CORNER OF SAID SECTION 16; THENCE CONTINUING S 01'00'00" E, ALONG SAID EAST LINE, 180.00 FEET; THENCE S 89'58'09" W, 720.00 FEET; THENCE N 01'00'00" W, 180.00 FEET; THENCE N 89'58'09" E, 720.00 FEET TO THE POINT OF BEGINNING. SUBJECT TO THE RIGHTS OF THE PUBLIC IN THE EAST 33 FEET FOR ROAD PURPOSES. PARCEL CONTAINS 2.98 ACRES OF LAND.

WE HEREBY CERTIFY that we have surveyed the property herein described and that we have placed marker irons at the corners of the parcel or as indicated in the above sketch and that we have complied with the survey requirements of Public Act 132 of 1970, as amended. Error of closure 1:66,550 bearings based on deed of record.

THOMAS M SMITH, PS #31606

ISSUED FOR:

REV'D BY:

ISSUED FOR:

THOMAS M. SMITH P.S.

PROFESSIONAL LAND SURVEYOR

7559 OLDE STURBRIDGE TRAIL tsmith7559@yahoo.com


CLARKSTON, MICHIGAN 48348 PHONE: (248) 625—3276

DRAWN BY TMS JOB No. 20—171 DESCRIPTION

DATE <u>03-13-22</u> SHEET No. <u>2 OF 2</u> SCALE <u>N/A</u>

PT SEC 16, T3N., R8E WHITE LAKE TWP., MI



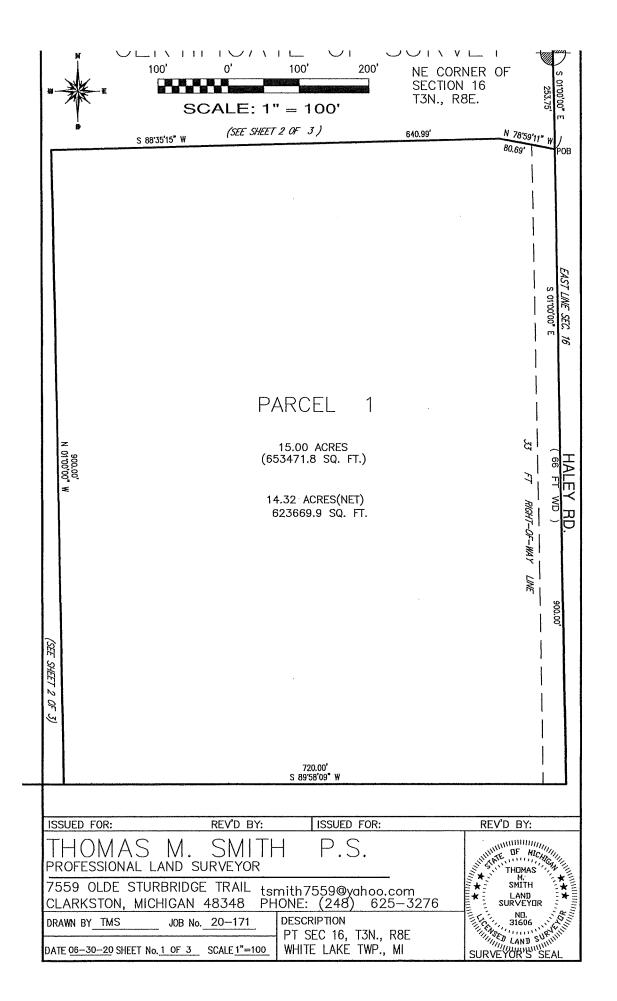

WHITE LAKE TOWNSHIP NOTICE OF PUBLIC HEARING

Notice is hereby given the Planning Commission of the Challet M. p of White Lake will hold a public hearing on **Thursday, June 20, 2024 at 6:30**P.M. at the Township Annex, 7527 Highland Road, White Lake, Michigan 48383, to consider the following changes to the zoning map:

Property identified as Parcel Number 12-16-200-030, located south of Hitchcock Road, on the west side of Haley Road, consisting of approximately 15 acres

Applicant requests to rezone the parcel from AG (Agricultural) to SF (Suburban Farms) or any other appropriate zoning district.

Persons interested are requested to be present. Pertinent information relative to this rezoning request is on file at the Community Development Department and may be examined at any time during the Township's summer business hours; Monday through Thursday, 8:00 a.m. through 5:00 p.m., and Friday from 8:00 a.m. through 12:00 p.m., (excluding holidays). Persons interested may visit the Community Development Department, contact the Community Development Department by telephone at 248-698-3300, ext. 5, or attend the Public Hearing on the date specified. Written comments are also welcome at 7525 Highland Road, White Lake, MI 48383. Individuals with disabilities requiring auxiliary aids or services should contact the Clerk's Office at least 5 days before the hearing.

Sean O'Neil, AICP
Community Development Director

Director's Report

Project Name: West Valley

Description: Final site plan re-approval

Date on Agenda this packet pertains to: June 20, 2024

☐ Public Hearing	\square Special Land Use
□Initial Submittal	\square Rezoning
⊠Revised Plans	□Other:
□Preliminary Approval	
⊠Final Approval	

Contact	Consultants & Departments	Approval	Denial	Approved w/Conditions	Other	Comments
Sean O'Neil	Planning Director			\boxtimes		Subject to all staff and consultant review comments being addressed.
DLZ	Engineering Consultant			\boxtimes		See letter dated 06/12/2024
Matteo Passalacqua	Carlisle Wortman Associates, Inc					See letter dated 06/10/2024.
John Holland	WLT Fire Chief			\boxtimes		See letter dated 06/10/2024.

June 12, 2024

Sean O' Neil, Director Community Development Department Charter Township of White Lake 7525 Highland Road White Lake, Michigan 48383

RE: West Valley – Final Site Plan and Final Engineering Plan – 9th Review

DLZ# 1845-0029-00

Dear Mr. O' Neil,

Our office has reviewed the above-mentioned revised plans prepared by Seiber, Keast, Lehner Engineering and dated June 3, 2024. These plans were reviewed for conformance with the Township Engineering Design Standards. Note that the plans have been modified to coordinate utility access and emergency access with the proposed Comfort Care development. We offer the following comments for your consideration:

Please note that comments from our April 10, 2024 review are in italics. Responses to those comments are in **bold**. New comments are in standard typeface.

The following comment from our Preliminary Site Plan review letter dated March 11, 2019 will also need to be addressed:

1. We defer to the Township Fire Department regarding access however we will note the proposed stub for future secondary emergency access appears as if it will burden parcel 12-36-176-002. Comment addressed; the above referenced stub remains however the applicant has provided an additional fire lane to the south west. We defer to the Fire Department on the fire lane configuration; however, we note some movements may be challenging for the larger fire vehicles. The Fire Department may want to ask for the turning radius of the largest fire trucks to be overlaid on the plans sheets to determine if the provided fire lane is sufficient. We note that the fire lane that was proposed near the southwest corner of the site has been removed from the plan and a paved emergency access connection to the Comfort Care site to the north is now shown. The proposed grading and coordination with the grading and alignment shown on the Comfort Care site appear acceptable.

4494 Elizabeth Lake Rd, Waterford, MI 48328 OFFICE 248.681.7800 ONLINE WWW.DLZ.COM




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We note that approval of West Valley is dependent on the emergency access being provided on the Comfort Care property. DLZ recommends that the secondary access to the south would be required as a condition of approval should the Comfort care facility not be constructed and available for secondary access use. The Township should consider if an escrow for construction of this access drive would be appropriate. Design engineer has stated that the Township Fire Department is accepting of the internal road network for fire truck access subject to demonstration that the internal West Valley street network can provide for a standard 40' long fire truck. A sheet demonstrating this was added to the plan set. An emergency vehicle access easement has also been provided and our office has reviewed the easement description for closure and have the following comments. We note that our previous comment above regarding the secondary access to the south and escrow remain.

T3N, R8E, SEC 36 PART OF SE 1/4 OF NW 1/4 BEG AT PT DIST N 87-30-53 E 1327.83 FT & FROM W 1/4 COR, TH N 02-36-44 16.50 FT, TH N 87-52-27 E 5.68 FT, TH N 02-43-01 W 720.81 FT, TH N 87-46-11 E 187.78 FT, TH S 40-09-00 E 340.79 FT, TH N 49-58-01 E 337.53 FT, TH S 39-13-06 E 3.56 FT, TH S 38-49-29 E 21.54 FT, TH ALG CURVE TO LEFT, RAD 1432.40 FT, CHORD BEARS S 44-58-31 E 307 FT, DIST OF 307.59 FT, TH S 58-02-33 E 513.63 FT, TH S 02-52-24 E 127.03 FT, TH S 00-40-48 W 16.85 FT, TH S 87-53-19 W 1312.16 FT TO BEG 15.14 A CORR 10-11-18





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The easement fits within the subject property, easement closes, and all the bearings and descriptions as described match the exhibit, with the exception of the one call above. To ensure access, the descriptions and exhibits should call out and qualify to the right of way line for Union Lake Road.

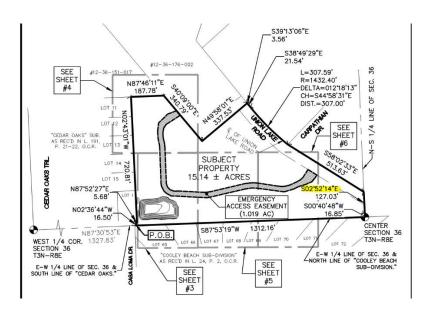FSP/FEP Comments-

General

Storm sewer, watermain, detention basin, and fire access lane, and a portion of decks are all
proposed within the existing Michigan Bell easement on the south side of the property. Provide
supporting documentation that these activities are allowable within this easement. Comment
remains as a notation. Applicant has provided a legal opinion from their attorney (letter dated
March 24, 2021, from Dykema Gossett PLLC) supporting the proposed activities are allowable
within the easement.

Grading/Paving

- 1. The grading has been reviewed for general conformance with Township standards. A more detailed review will be provided at the time of individual building construction plot plan submittal. Comment remains as a notation.
- 2. Sheet 26- The end sidewalk at the eastern end of the property should end short of where shown; the sidewalk end location and grades shall coordinate with that shown on Sheet C801 of the Comfort Care Plan. Comment partially addressed. The end sidewalk location along the eastern end of the property has not been revised. The sidewalk fronting Union Lake Road is now shown as 6' in width instead of 8' in width. This new width is acceptable by the Township; however, please update the following plan sheets: 1) Sheet 3- Proposed Improvements- Note 4- Change width from 8' to 6'; 2) Sheets 3,4,6, LS-2, and LS-3- Label on these sheets still notes 8' width.

Sanitary Sewer

1. The plans show a 20-foot-wide sanitary sewer easement which is acceptable. Easement exhibits shall be provided for review as attachments to the Township standard conveyance document. Easement exhibits have been provided for review; a review letter was sent out on 3-31-2021 under separate cover. Comment addressed. Our easement review letter dated July 8, 2021 indicates that all of our comments regarding the sanitary sewer easement exhibit have been addressed. Comment remains as a notation.



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2. Sheet 14- Pump Station Detail will be required to be updated per OCWRC comments (reference emails from OCWRC and the design engineer dated November 29, 2023 and December 5, 2023). Comment addressed. Pump Station Detail has been updated by the design engineer per OCWRC comments and SCADA control panel details sheets have now been added to the plans. Design engineer is currently waiting for confirmation of acceptance of revisions by OCWRC. OCWRC has approved the plans for both the gravity sewer and the pump station. Submittal to EGLE is in process.

Watermain

- 1. The plans show a 20-foot-wide watermain easement which is acceptable. Easement exhibits shall be provided for review as attachments to the Township standard conveyance document. Easement exhibits have been provided for review; a review letter was sent out on 3-31-2021 under separate cover. Comment addressed. Our easement review letter dated August 20, 2021, indicates that all of our comments regarding the watermain easement exhibit have been addressed. Comment remains as a notation.
- 2. We continue to note that the watermain connection to the north is dependent on construction of the watermain for the Comfort Care site. We defer to the Township with respect requiring an escrow to ensure that a watermain connection for this area shall be established in the event that the Comfort Care development does not proceed forward. Comment remains as a notation.

Stormwater Management

1. Due to the complexity of the storm water management system for this development as it now accommodates Comfort Care discharge, Lakepoint discharge, as well as the stormwater treatment for the West valley development DLZ will be reaching out a meeting to discuss the stormwater calculations as well as easement/maintenance agreement requirements. There is also confusion regarding the intent for receiving discharge from Comfort Care. The January 23, 2023 transmittal letter indicates that additional capacity was provided in the West Valley Storm System to accommodate the restricted flow from the Comfort Care Detention Basin however it only looks like this discharge will be received if the Comfort Care basin reaches overflow conditions, essentially making it a retention system without a positive outlet. Comment addressed. DLZ, Seiber Keast, and Township DPS and Planning personnel met to discuss these items for clarification. An additional plan sheet detailing the overall stormwater management system has been added to the plan set.

Comment remains as a notation.



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2. A Storm Water Management Facilities Easement, Maintenance Agreement and Lien document will need to be completed and exhibits provided for review. Easement exhibits have been provided for review; a review letter was sent out on 3-31-2021 under separate cover. Our August 20, 2021 easement review letter included the comment: 'Please ensure easement is recorded for benefit of Lake Pointe. This comment should be reviewed by the Township Attorney and be addressed on the Standard Storm Water Management Facilities Easement, Maintenance Agreement and Lien to enable the stormwater conveyance from Lake Pointe through West Valley without issues.'

With the latest revision, this comment needs to be expanded to also include reference to the Comfort Care development as the storm overflow from that development will discharge overland onto the West Valley property. Currently the easement exhibit metes and bounds description and the drawing dated April 2, 2021 do not show this easement. Comment remains.

A separate easement description and exhibit have now been provided for the overland stormwater discharge onto the West Valley development from the adjacent proposed Comfort Care development. The legal description of the easement closes; however, a couple of calls shall require revision. We have attached the document with the areas highlighted that will require revision. Comment addressed. Calls requiring revision have been updated.

We continue to defer to the Township Attorney regarding the storm water management agreement and language pertaining to conveyance of storm water from the Lake Pointe and Comfort Care developments through the West Valley development.

- 3. Show the additional off-site drainage path for the overland flow along Casa Loma Drive. Plan Sheet 5 shows this discharge flowing onto casa Loma Drive, but it is not clear where it will go from there. Comment remains outstanding. Although a few additional directional flow arrows have been provided to demonstrate the flow in Casa Loma Drive, please provide and clearly show the flow path down Casa Loma Drive as well as Cedar Island Drive the overland flow shall <u>ultimately</u> go. Comment addressed. Emergency overflow route down Casa Loma Drive is now shown on plan. Comment remains as a notation.
- 4. Our office met with the design engineer and Township Planning staff at the Township offices in approximately July of this year to discuss various stormwater management issues associated with this project. One item of discussion was regarding the previously approved wetland permit from EGLE as the proposed detention basin restricted discharge is conveyed via storm sewer along Cedar Island Road and discharged to a low area approximately 700' to the west. Historically, this area has been subject to flooding. The design engineer's environmental consultant has rendered an opinion dated August 14, 2023 that a wetland permit for the discharge from West Valley would not be required from EGLE but that the ultimate question as to jurisdiction is with EGLE. We note that a Part 303 permit has been previously issued by EGLE for this discharge, however the question of whether this



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permit would require modification due to the additional storm discharge from potential overland flows from West Valley and Comfort Care (through West Valley) would be subject to EGLE interpretation. Our office recommends that verification of wetland status as well as the consideration of potential additional flows to this low area be secured from EGLE as part of the site plan approval process. As a part of this verification, our office has reached out to EGLE for a decision and are currently awaiting a response. Since storm water flows from the Lake Pointe and Comfort Care developments flow through West Valley's storm management system to West Valley's ultimate outlet (wetlands to the west of West Valley), we are requesting confirmation from EGLE that they are aware of Lake Pointe's and Comfort Care's stormwater contributions to West Valley's ultimate stormwater outlet and that EGLE has evaluated and approves of this. This confirmation shall be required prior to final engineering approval for West Valley. We are currently awaiting a basin outflow analysis from the design engineer but note that the applicant has a permit for the discharge of the West Valley development from EGLE, the concern is in regard to the addition of the Lakepoint development and should not impede the West Valley development.

Required Permits and Approvals

The following permits and approvals will be required:

- 1. Permit from the Road Commission for all work within the Union Lake Road, Casa Loma Drive, and Cedar Island Road Right-Of-Ways. **Paving and utilities submitted to RCOC. Currently under review.**
- 2. SESC permit from OCWRC. Permit # 001074-2023-CO issued April 2, 2024.
- 3. A Notice of Coverage for Stormwater Discharge under the NPDES program as administered by the MDEQ is required. **Per design, engineer, this will be acquired after all other permits are secured.**
- 4. Watermain permit from EGLE. EGLE Permit #ACT-291560 was issued on 6/5/2024
- 5. Sanitary sewer permit from OCWRC including for the pump station. **OCWRC Permit # 0121-2021 was** approved 6/4/2024 (Permit Fee & Contractor Bond apply).
- 6. Sanitary sewer permit from EGLE. Submittal to EGLE is in process.
- 7. Executed Stormwater Maintenance Agreement and revised exhibit. Additional exhibit provided for Comfort Care retention basin overland flow. Please reference review comments for required revisions and request of Township Attorney opinion regarding agreement language. Exhibit revisions that were required by DLZ have been reviewed and have been found acceptable. Reference Comment 2 under 'Stormwater Management' above regarding Township Attorney opinion regarding agreement.



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- 8. Easement Exhibits for Sanitary Sewer and Watermain. **Received, reviewed, and recommended for approval by DLZ.**
- 9. An off-site agreement will be required for the proposed driveway paving adjacent to Cedar Island Road near the southwest corner of the site.

Recommendation

DLZ notes that the revisions to the plan set tie completion and ordinance compliance for this development to the Comfort Care development in terms of emergency access and watermain looping. There are a few very minor items referenced above that will need to be cleared up ahead of the Pre-Construction Meeting for the development, DLZ recommends approval subject to the completion of these outstanding items.

Please contact our office should you have any questions.

Sincerely,

DLZ Michigan

Michael Leuffgen, P.E.

Department Manager

Victoria Loemker, P.E. Senior Engineer

Cc: Hannah Kennedy- Galley, Community Development, via email
Aaron Potter, DPS Director, White Lake Township, via email
Nick Spencer, Building Official, White Lake Township via email
John Holland, Fire Marshall, White Lake Township, via email
Lisa Hamameh, Esq., RSJA Law

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117 NORTH FIRST STREET SUITE 70 ANN ARBOR, MI 48104 734.662.2200 734.662.1935 FAX

TO: Sean O'Neil, Community Development Director

FROM: Matteo Passalacqua, Associate Planner

DATE: June 10, 2024

RE: West Valley – Final Site Plan Backcheck #6

Mr. O' Neil,

We have conducted a review of the memo titled "West Valley – Final Site Plan Backcheck #6", dated April 2nd, 2024, as it relates to the West Lake development site plan dated August 23rd, 2019 and revised June 3rd, 2024. Below are our comments pertaining to the most recent items requiring attention from the applicant. Comments are listed in the order they were presented.

- 1. Revision dates for Sheets IRR 1 through 6 have been corrected to reflect May 29th, 2024.
- 2. Sheet LS 5 has a note stating "All site irrigation systems shall include a rain sensor or similar measure to ensure irrigation down not occur during or shortly after precipitation events." It is likely "down" is an error and is intended to state "does".
- 3. We note that Sheets LS 2 and 3 indicate that trees shall not be planted closer than four feet to a property line along the west and south property lines. We did not observe this note on the landscape sheets indicating such for the northern or eastern property lines.
- 4. Sheet LS 4 has a note stating "Trees identified for protection during construction and the means of protection shall be identified prior to final site plan. No construction shall occur until tree protection has been installed and approved by the Community Development Director."
- 5. The Plant Material Lists on Sheet LS 4 and 5 do not contain any type of pine tree.
- 6. Sheets LS 1 through 3 have notes indicating

Tree cluster/grouping planting notes:

1. typical 3 to 4 evergreen or canopy tree cluster grouping per same species

- 2. maximum of 8-evergreen tree cluster grouping per same species provided
- 3. maximum of 5-canopy tree cluster grouping per same species provided

It is unclear if this addresses the intent of the ordinance requirements.

- 7. A note on Sheet LS 4 states "Mulch 4" depth with double shredded hardwood bark natural in color. Leave 3" circle of bare soil at base of tree trunk to expose root flare."
- 8. Exterior construction materials have been indicated on Sheets A 201 and A 203. Materials listed include brick, asphalt shingles, horizontal siding and shake siding. Finish samples are provided on Sheet AS-1.
- 9. No sign lighting is indicated on Sheet LS 4. No lighting cut sheet is provided within the revised site plan.

ITEMS TO BE ADDRESSED

Based on the most current site plan revision dated May 14, 2024, the additional information is required for approval:

- 1. The note "trees shall not be planted closer than four feet to a property line" shall be added to the northern and eastern property lines.
- 2. The note "No more than two planted trees in a row shall be of the same species" should be added to Sheets LS 1 though 3.

Respectfully,

CARLISLE/WORTMAN ASSOC., INC.

Matteo Passalacqua Community Planner



Site / Construction Plan Review

To: Sean O'Neil, Planning Department Director

Date: 06/06/24

Project: West Valley

File #: N/A

Date on Plans: 02/13/24 (revision)

The Fire Department has the following comments with regard to the revised site plan submitted for the project known as West Valley:

1. This project has satisfied the Fire Department requirements as submitted. As a general note, we do request that the future "Secondary Access Drive" is designed to accommodate the turn radius requirements as shown on sheet 28.

John Holland
Fire Chief
Charter Township of White Lake
(248) 698-3993
jholland@whitelaketwp.com

Plans are reviewed using the International Fire Code (IFC), 2015 Edition and Referenced NFPA Standards.

LEGAL DESCRIPTION

THE LAND REFERRED TO IN THIS COMMITMENT IS DESCRIBED AS FOLLOWS: TOWNSHIP OF WHITE LAKE, COUNTY OF OAKLAND, STATE OF MICHIGAN: PART OF THE SOUTHEAST 1/4 OF NORTHWEST 1/4 OF SECTION 36, TOWN 3 NORTH, RANGE 8 EAST, WHITE LAKE TOWNSHIP, OAKLAND COUNTY, MICHIGAN, DESCRIBED AS: COMMENCING AT THE WEST 1/4 CORNER OF SAID SECTION 36; THENCE NORTH 87 DEGREES 30 MINUTES 53 SECONDS EAST 1327.83 FEET ALONG THE EAST-WEST 1/4 LINE OF SAID SECTION 36 AND THE SOUTH LINE OF "CEDAR OAKS", A SUBDIVISION AS RECORDED IN LIBER 191 OF PLATS, PAGES 21-22 TO THE POINT OF BEGINNING; THENCE ALONG THE EASTERLY LINE OF SAID "CEDAR OAKS" THE FOLLOWING THREE COURSES, 1) NORTH 02 DEGREES 36 MINUTES 44 SECONDS WEST 16.50 FEET, 2) NORTH 87 DEGREES 52 MINUTES 27 SECONDS EAST 5.68 FEET, AND 3) NORTH 02 DEGREES 43 MINUTES 01 SECONDS WEST 720.81 FEET TO THE NORTHEAST CORNER OF SAID "CEDAR OAKS"; THENCE NORTH 87 DEGREES 46 MINUTES 11 SECONDS EAST 187.78 FEET; THENCE SOUTH 40 DEGREES 09 MINUTES 00 SECONDS EAST 340.79 FEET; THENCE NORTH 49 DEGREES 58 MINUTES 01 SECONDS EAST 337.53 FEET; THENCE ALONG THE CENTERLINE OF UNION LAKE ROAD AS PREVIOUSLY SURVEYED BY DAVID P. SMITH AND ASSOCIATES, JOB NUMBER 03-050203, DATED SEPTEMBER 9, 2003 THE FOLLOWING THREE COURSES, 1) SOUTH 39 DEGREES 13 MINUTES 06 SECONDS EAST 3.56 FEET, 2) SOUTH 38 DEGREES 49 MINUTES 29 SECONDS EAST 21.54 FEET, AND 3) 307.59 FEET ALONG A NON-TANGENTIAL CURVE TO THE LEFT SAID CURVE HAVING A RADIUS OF 1432.40 FEET, A CENTRAL ANGLE OF 12 DEGREES 18 MINUTES 13 SECONDS. AND A CHORD WHICH BEARS SOUTH 44 DEGREES 58 MINUTES 31 SECONDS EAST 307.00 FEET; THENCE SOUTH 58 DEGREES 02 MINUTES PREVIOUSLY SURVEYED BY MCGINNIS ENGINEERING COMPANY, DATED OCTOBER 12 1973; THENCE SOUTH 02 DEGREES 52 MINUTES 24 SECONDS EAST 127.03 FEET ALONG THE NORTH-SOUTH 1/4 LINE OF SAID SECTION 36: THENCE SOUTH 00 DEGREES 40 MINUTES 48 SECONDS WEST 16.85 FEET TO THE CENTER OF SAID SECTION 36; THENCE SOUTH 87 DEGREES 53 MINUTES 19 SECONDS WEST 1312.16

FEET ALONG THE EAST-WEST 1/4 LINE OF SAID SECTION 36 AND THE NORTH LINE OF "COOLEY BEACH SUB-DIVISION" AS RECORDED IN LIBER 24 OF PLATS, PAGE 2

TAX PARCEL No.: 12-36-176-003

TO THE POINT OF BEGINNING. CONTAINING 15.14 ACRES.

GENERAL NOTES

- THE CONTRACTOR SHALL CONTACT THE TOWNSHIP ENGINEER AT (248) 334-9901 48 HOURS PRIOR TO BEGINNING OF CONSTRUCTION. THE CONTRACTOR SHALL KEEP THE INSPECTOR APPRAISED OF THE NEED FOR INSPECTION ON A DAY TO DAY BASIS. LACKING SPECIFIC SCHEDULING WITH THE INSPECTOR, THE CONTRACTOR SHALL GIVE 48 HOURS NOTICE TO THE TOWNSHIP ENGINEER PRIOR TO RECOMMENCING WORK REQUIRING INSPECTION. FAILURE TO INFORM THE INSPECTOR OR THE TOWNSHIP ENGINEER OF A WORK CANCELLATION MAY RESULT IN A ONE HALF DAY INSPECTION CHARGE TO THE DEVELOPER.
- 2. THE DEVELOPER SHALL CONTACT THE TOWNSHIP PLANNING DEPARTMENT AT (248) 698-3300 TO SCHEDULE A PRE-CONSTRUCTION MEETING. THE DEVELOPER'S PRIME SITE CONTRACTOR SHALL ATTEND. A COPY OF ALL PERMITS MUST BE SUBMITTED TO THE PLANNING DEPARTMENT PRIOR TO SCHEDULING THE MEETING.
- 3. ALL CONSTRUCTION MUST CONFORM TO THE CURRENT STANDARDS AND SPECIFICATIONS ADOPTED BY WHITE LAKE TOWNSHIP.
- 4. CONTRACTOR SHALL CONTACT MISS DIG AT 1-800-482-7171, 72 HOURS IN ADVANCE OF CONSTRUCTION, FOR EXISTING UNDERGROUND UTILITY LOCATIONS.
- 5. ALL SOIL EROSION AND SILTATION MUST BE CONTROLLED AND CONTAINED ON-SITE.
- 6. ALL EXCAVATION, INCLUDING ALL UTILITIES AND LEADS, UNDER OR WITHIN 1 ON 1 INFLUENCE OF ANY PAVEMENT (INCLUDING SIDEWALKS), EXISTING OR PROPOSED, OR WHERE SAND BACKFILL IS CALLED FOR ON THE PLAN, SHALL BE BACKFILLED AND COMPACTED WITH GRANULAR MATERIAL (SAND) MDOT CLASS II TO 95 PERCENT MAXIMUM UNIT DENSITY (ALL OTHERS 90 PERCENT).
- 7. THE CONTRACTOR IS RESPONSIBLE FOR ANY DAMAGE TO EXISTING UTILITIES AND FACILITIES. THE CONTRACTOR SHALL EXPOSE EXISTING UTILITIES AT THE PROPOSED UTILITY CROSSINGS PRIOR TO THE START OF UNDERGROUND CONSTRUCTION. ANY CONFLICTS WITH UTILITIES SHALL BE IMMEDIATELY REPORTED TO THE PROJECT ENGINEER.
- 8. WHERE TWO UTILITIES CROSS, INCLUDING SANITARY SEWER LEADS, PROVIDE POROUS GRADE "B" BACKFILL MATERIAL COMPACTED TO THE UNDERSIDE OF THE HIGHER UTILITY OR AS SPECIFIED ON THE DETAIL SHEET.
- 9. DUST CONTROL SHALL BE MAINTAINED AT ALL TIMES.
- 10. ANY MUD TRACKED ONTO UNION LAKE ROAD SHALL BE REMOVED DAILY.
- 11. IF DEWATERING IS DETERMINED TO BE REQUIRED, IT WILL BE THE RESPONSIBILITY OF THE CONTRACTOR TO IDENTIFY THE AREA TO BE DEWATERED, SUBMIT A DEWATERING PLAN TO THE WHITE LAKE TOWNSHIP ENGINEERING DIVISION FOR REVIEW, TO MONITOR AND TO DETERMINE THAT THERE WILL NOT BE ANY IMPACT TO ANY ADJOINING OR OFFSITE PROPERTIES DEWATERING PROCEDURES SHALL BE IN COMPLIANCE WITH WHITE LAKE
- 12. A ROAD COMMISSION FOR OAKLAND COUNTY RIGHT-OF-WAY PERMIT IS REQUIRED FOR ANY WORK WITHIN THE UNION LAKE ROAD AND CEDAR ISLAND ROAD RIGHTS-OF-WAY (OR ANY PUBLIC ROAD RIGHT-OF-WAY) AND/OR ANY TOWNSHIP EASEMENT.
- 13. CONTRACTOR SHALL FIELD VERIFY ALL EXISTING UTILITY LOCATIONS, INVERTS AND GRADES PRIOR TO THE START OF ANY WORK.
- 14. ALL PAVEMENT MARKINGS, TRAFFIC CONTROL SIGNS, AND PARKING SIGNS SHALL COMPLY WITH THE DESIGN AND PLACEMENT REQUIREMENTS OF THE 2011 MICHIGAN MANUAL ON UNIFORM TRAFFIC CONTROL DEVICES.
- 15. WHITE LAKE TOWNSHIP HAS NO RESPONSIBILITY TO IMPROVE OR MAINTAIN THE PRIVATE STREETS CONTAINED WITHIN OR PRIVATE STREETS PROVIDING ACCESS TO THE PROPERTY DESCRIBED IN THE PLAN.
- 16. IN ORDER TO VERIFY COMPLIANCE WITH APPROVED PLANS, FULL-TIME CONSTRUCTION OBSERVATION WILL GENERALLY BE REQUIRED DURING ALL PHASES OF UNDERGROUND SITE CONSTRUCTION INCLUDING INSTALLATION OF SANITARY SEWER, STORM SEWERS, DRAINS, WATER MAINS AND APPURTENANCES AS WELL AS PRIVATE STREET CURBING AND PAVING CONSTRUCTION. INTERMITTENT OBSERVATIONS WILL BE MADE FOR SITE GRADING, PARKING LOT CURBING AND PAVING, RETAINING WALL CONSTRUCTION AND OTHER SURFACE ACTIVITY.

ENGINEERING CONSTRUCTION PLANS FOR


WEST VALLEY

MULTI-FAMILY RESIDENTIAL COMMUNITY SECTION 36, T 3 NORTH, R 8 EAST, WHITE LAKE TOWNSHIP, OAKLAND COUNTY, MICHIGAN

APPLICANT:

JMF WHITE LAKE, L.L.C.

1700 WEST BIG BEAVER ROAD, SUITE 120 TROY, MI 48084 PHONE: 248-602-2220

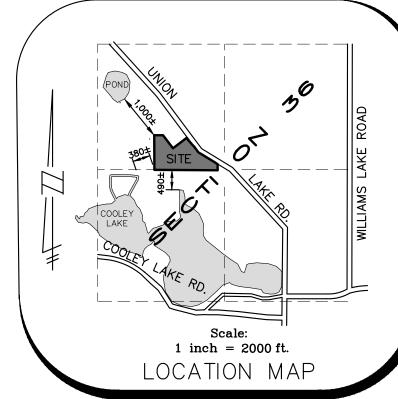

Scale: 1 inch = 100 ftSEIBER KEAST LEHNER ENGINEERING | SURVEYING

ARCHITECTURAL PLANS PROVIDED BY: ALEXANDER V. BOGAERTS AND ASSOCIATES, P.C.

2445 FRANKLIN ROAD BLOOMFIELD HILLS, MICHIGAN 48302 PHONE: 248.334.5000

CLINTON TOWNSHIP OFFICE FARMINGTON HILLS OFFICE 17001 NINETEEN MILE ROAD, SUITE 3 39205 COUNTRY CLUB DRIVE, SUITE C8 CLINTON TOWNSHIP, MI 48038 586.412.7050 FARMINGTON HILLS, MI 48331 248.308.3331

PROPERTY BOUNDARY & TOPO INFORMATION ALPINE ENGINEERING, INC.

> 46892 WEST ROAD, SUITE 109 NOVI, MICHIGAN 48377 PHONE: 248.926.3765

SEE SHEET 26 FOR R.C.O.C. NOTES

SEE SHEET 29 FOR LIST OF QUANTITIES

LANDSCAPE PLANS PROVIDED BY: FELINO PASCUAL & ASSOCIATES LANDSCAPE ARCHITECTURE 24333 ORCHARD LAKE ROAD, SUITE G FARMINGTON, MICHIGAN 48336

PHONE: 248.557.5588

3. REV SAN, ST. & PAV. PER OWNER 4. REVISE PER TWP. 6. REVISE PER TWP. REVISED WATER MAIN PER EGLE 7. REV PER OWNER, RCOC AND OCWRC 8. REVISED WATERMAIN FOR OWNER REVISED PER TOWNSHIP 11. REVISED PER TWP. 12. REVISED PER EGLE

B. REVSE PER TWP

4. REV. PER TWP.

DATE: 08-23-19 DESIGNED BY: A.A. CHECKED BY: J.E.

WATER MAIN PROFILES

SHEET INDEX

TOPOGRAPHIC AND DEMOLITION PLAN

WATER MAIN PROFILES PRESSURE REDUCING VALVE DETAILS AND NOTES SANITARY SEWER PUMP STATION DETAILS

ROAD, SANITARY SEWER & WATER MAIN PLAN

9.-10. ROAD, SANITARY SEWER, FORCE MAIN & WATER MAIN PLAN

SANITARY SEWER PUMP STATION CALCULATION CHARTS 16. OFF-SITE SANITARY DESIGN

17.-19. STORM SEWER PLAN 20.-22. STORM SEWER PROFILES 23.-24. DETENTION BASIN PLAN

COVER SHEET

COMPSITE UTILITY PLAN

DETAILED GRADING PLAN

PUMP STATION SITE PLAN

FORCE MAIN PROFILE

4.-6 GRADING AND S.E.S.C. PLAN

DRAINAGE DISTRIBUTION PLAN AND STORM SEWER CALCULATIONS OVERALL STORM WATER MANAGEMENT SYSTEM "WEST VALLEY & LAKE POINTE"

APPROACH PLAN SIGHT DISTANCE PLAN AT UNION LAKE ROAD EMERGENCY VEHICLE ROUTE

29.-ND2. NOTES AND DETAILS

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OCWRC STANDARD LIFT STATION DRAWINGS (ND3-ND8) LOW PRESSER SANITARY SEWER DETAILS AND NOTES (2)

DETAILS:

WHITE LAKE TOWNSHIP: SANITARY SEWER STANDARD DETAILS WATER MAIN STANDARD DETAILS STORM SEWER STANDARD DETAILS

OAKLAND COUNTY:

SOIL EROSION AND SEDIMENTATION CONTROL DETAILS

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IRR-1 IRRIGATION PLAN IRR-2 IRRIGATION PLAN IRR-3 IRRIGATION PLAN IRR-4 IRRIGATION PLAN IRR-5 IRRIGATION PLAN IRR-6 IRRIGATION NOTES & DETAILS

ARCHITECTURE PLANS:

A101 FIRST FLOOR PLANS A102 TYPICAL UNIT ELEVATION A200 BUILDING PLANS A201 BUILDING ELEVATIONS A203 BUILDING ELEVATIONS AS-1 SITE PLAN


BENCHMARKS:


BM#1 - CONCRETE MONUMENT AT SOUTHWEST CORNER OF ELEVATION 948.29 NAVD88


BM#2 - TELECOM MANHOLE COVER AT NORTHEAST CORNER OF CARPATHIAN DR. AND UNION LAKE RD. ELEVATION 984.75 NAVD88


BM#3 - TELECOM MANHOLE COVER ±485' WEST OF CENTER OF SECTION 36 ALONG THE SOUTH PROPERTY LINE. ELEVATION 962.72 NAVD88


REVISIONS

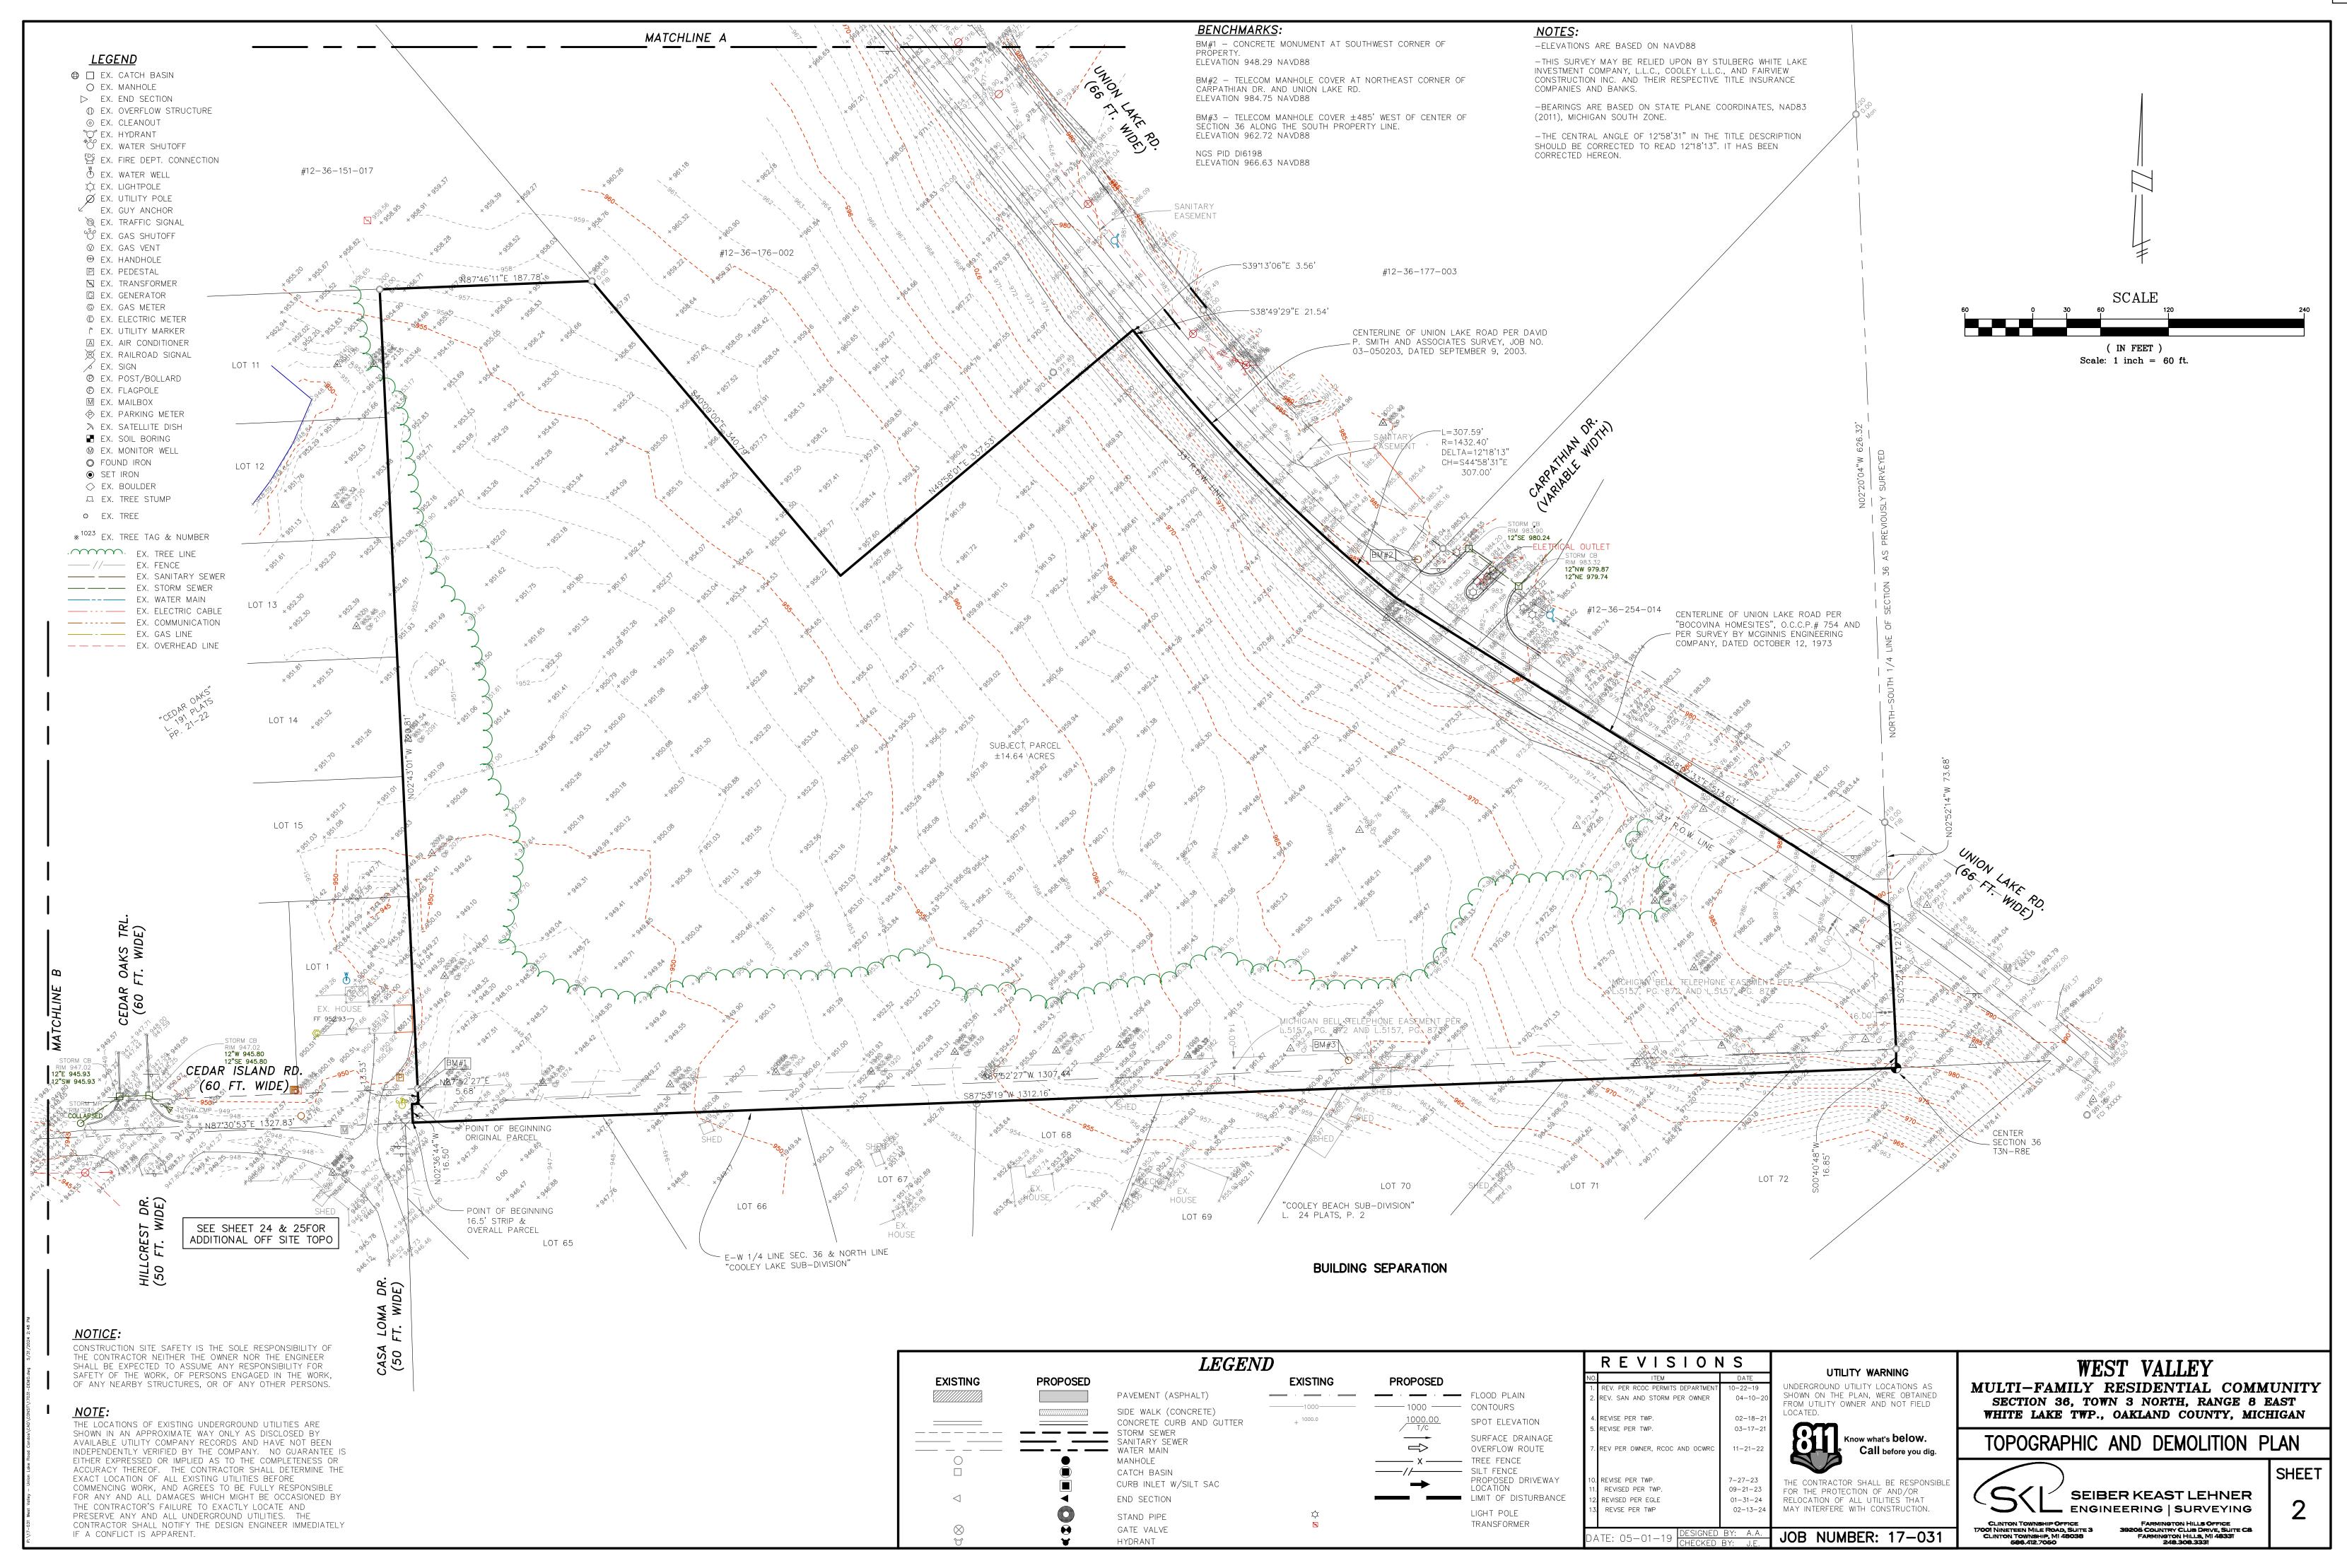


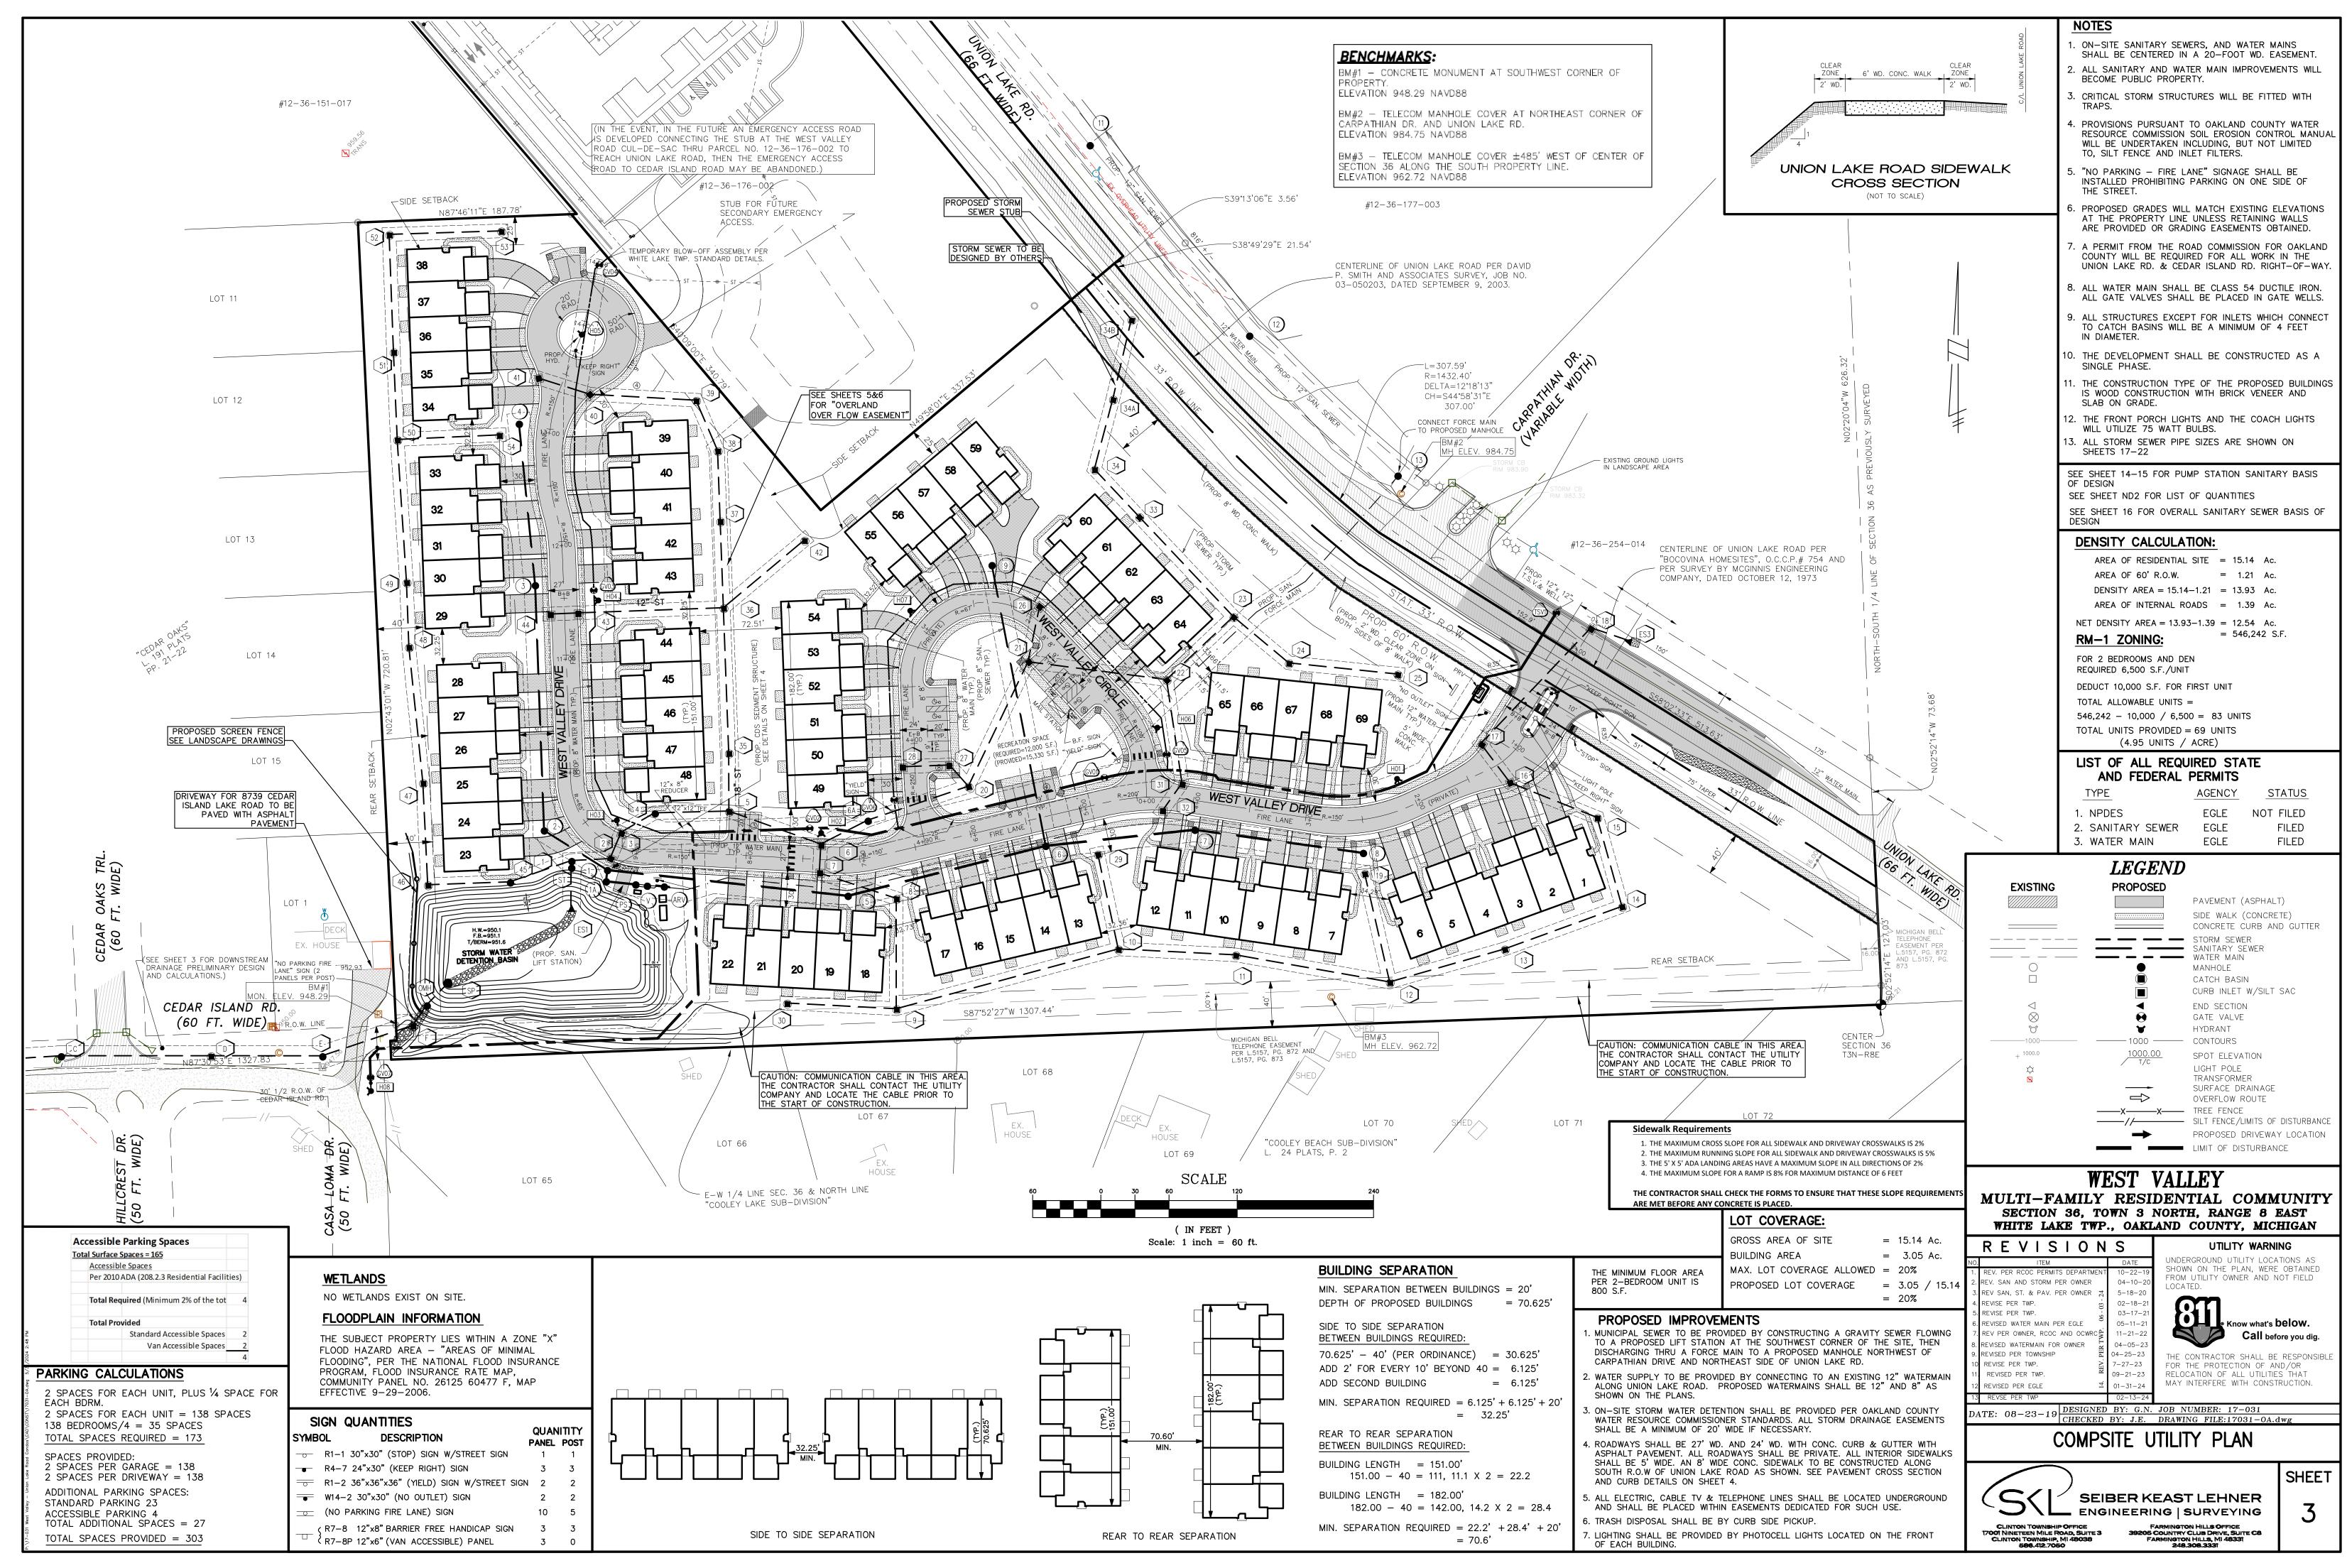


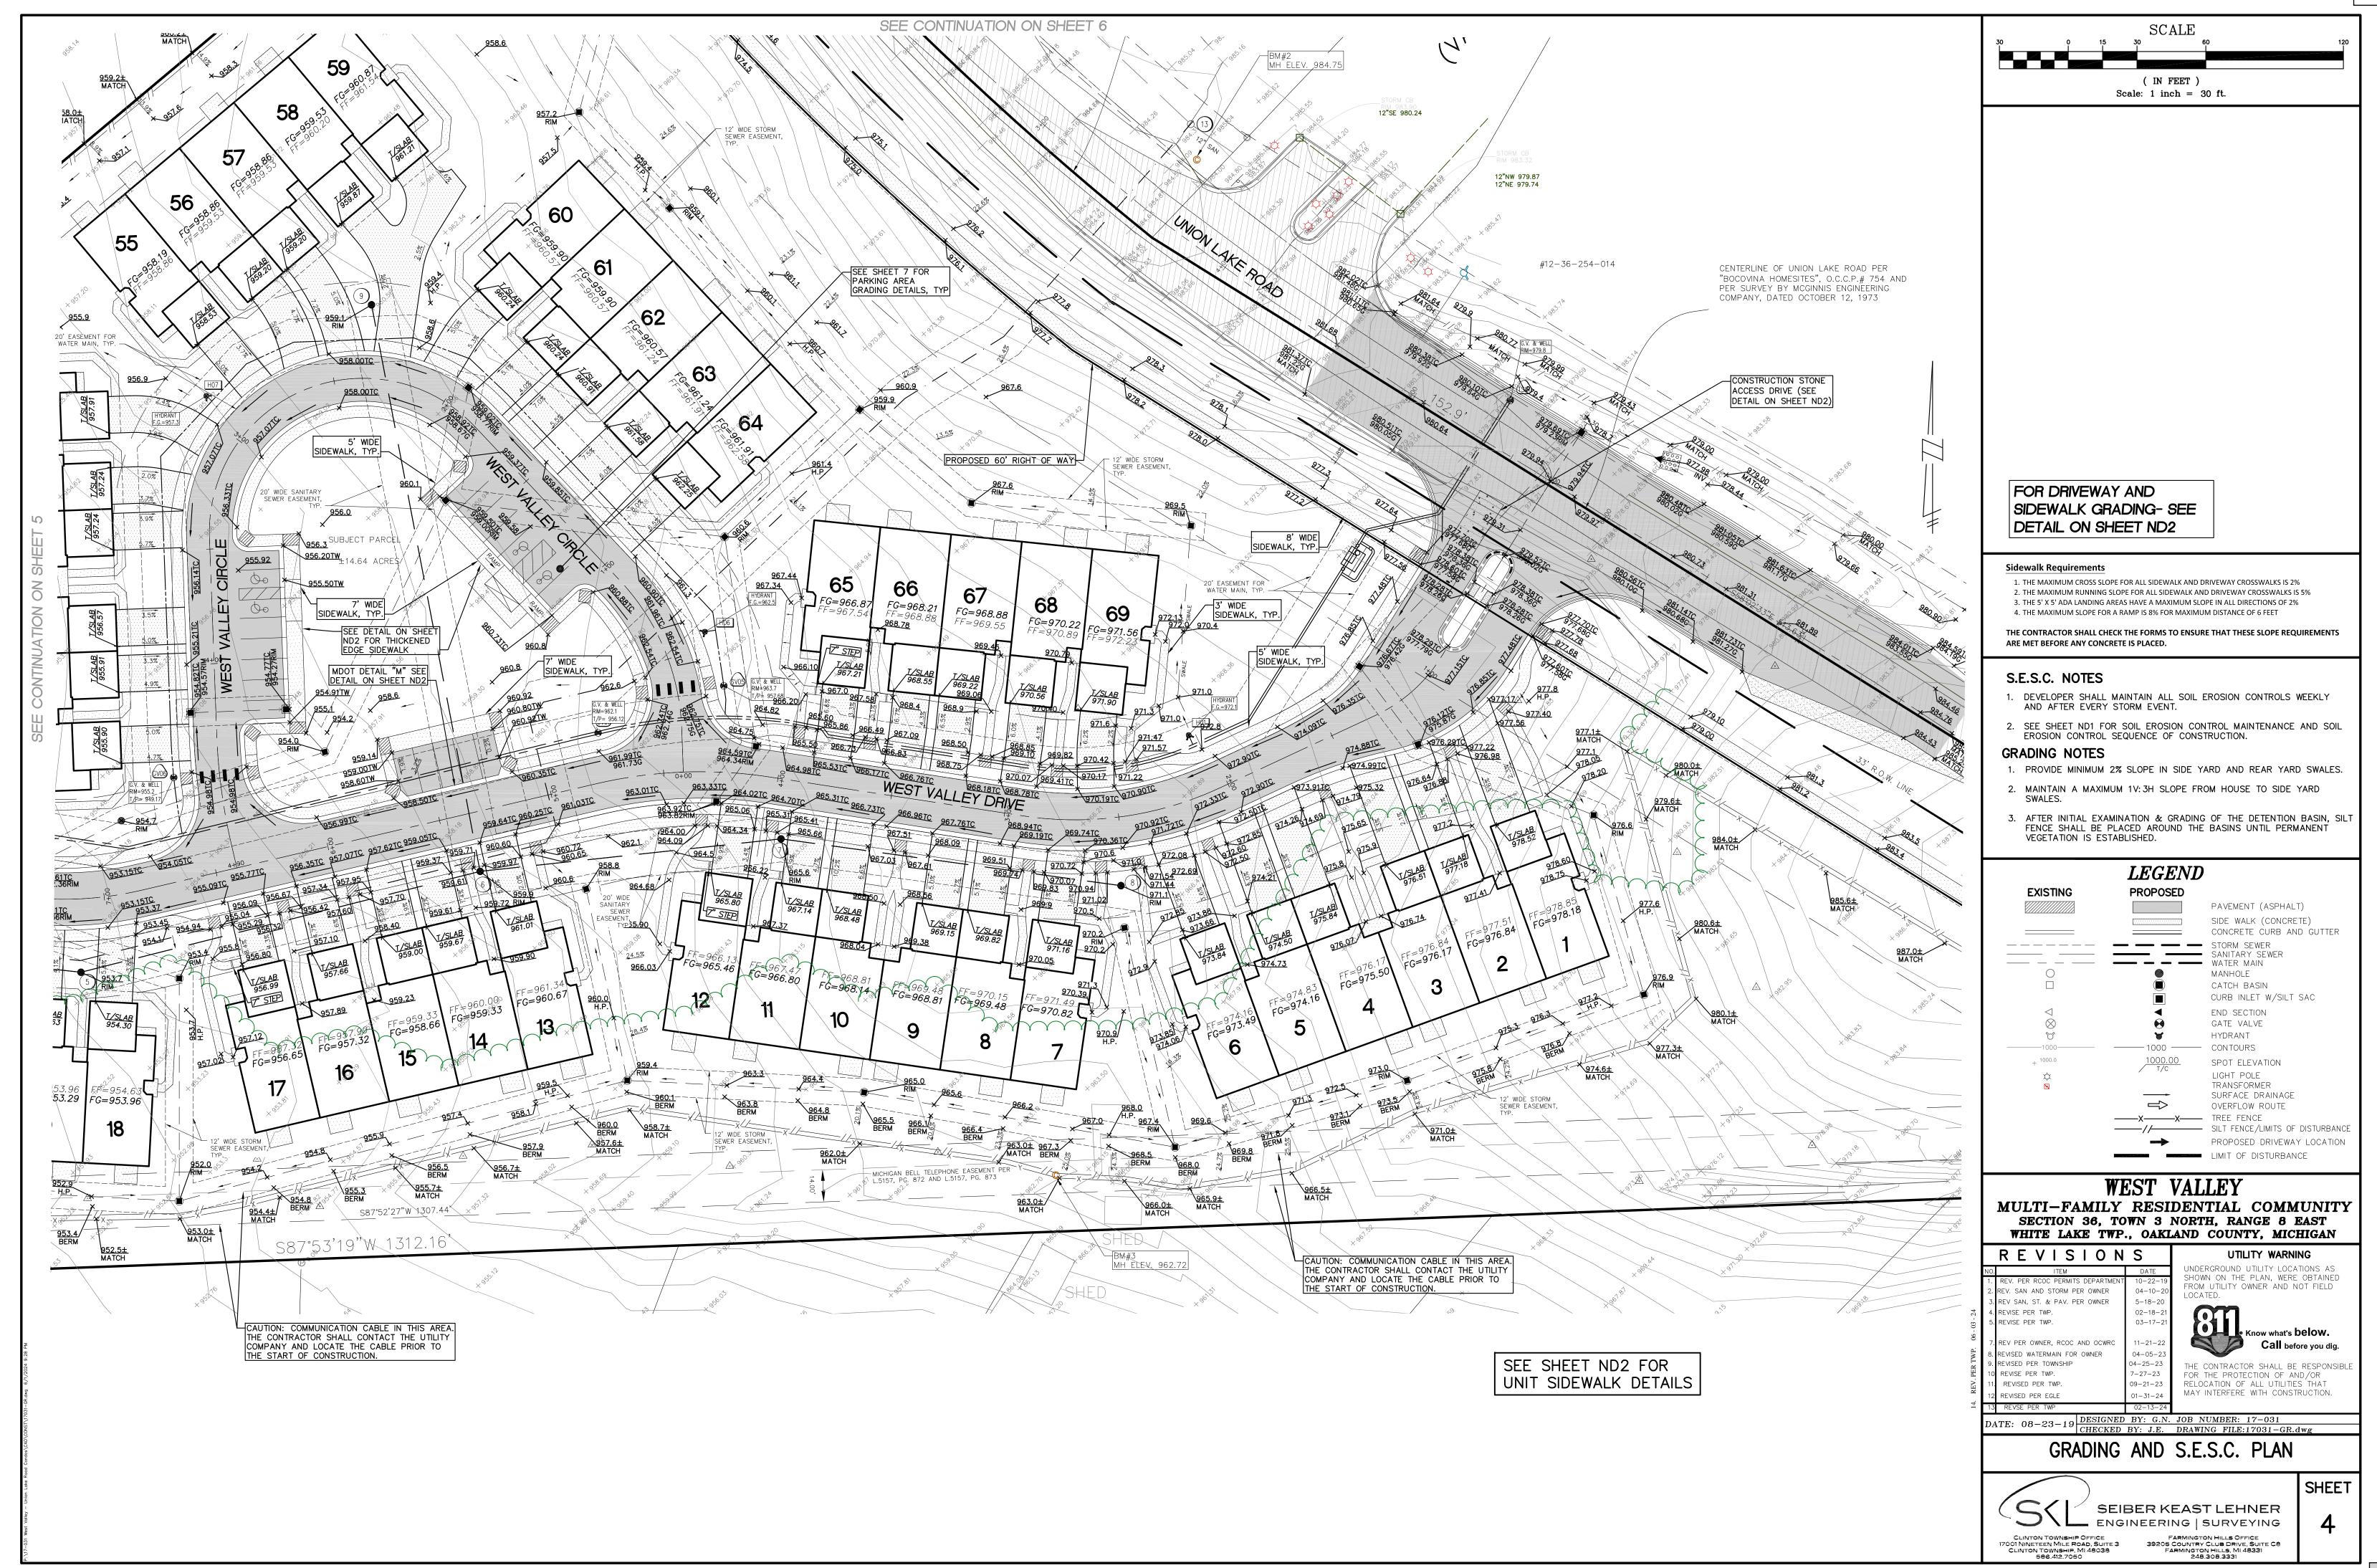


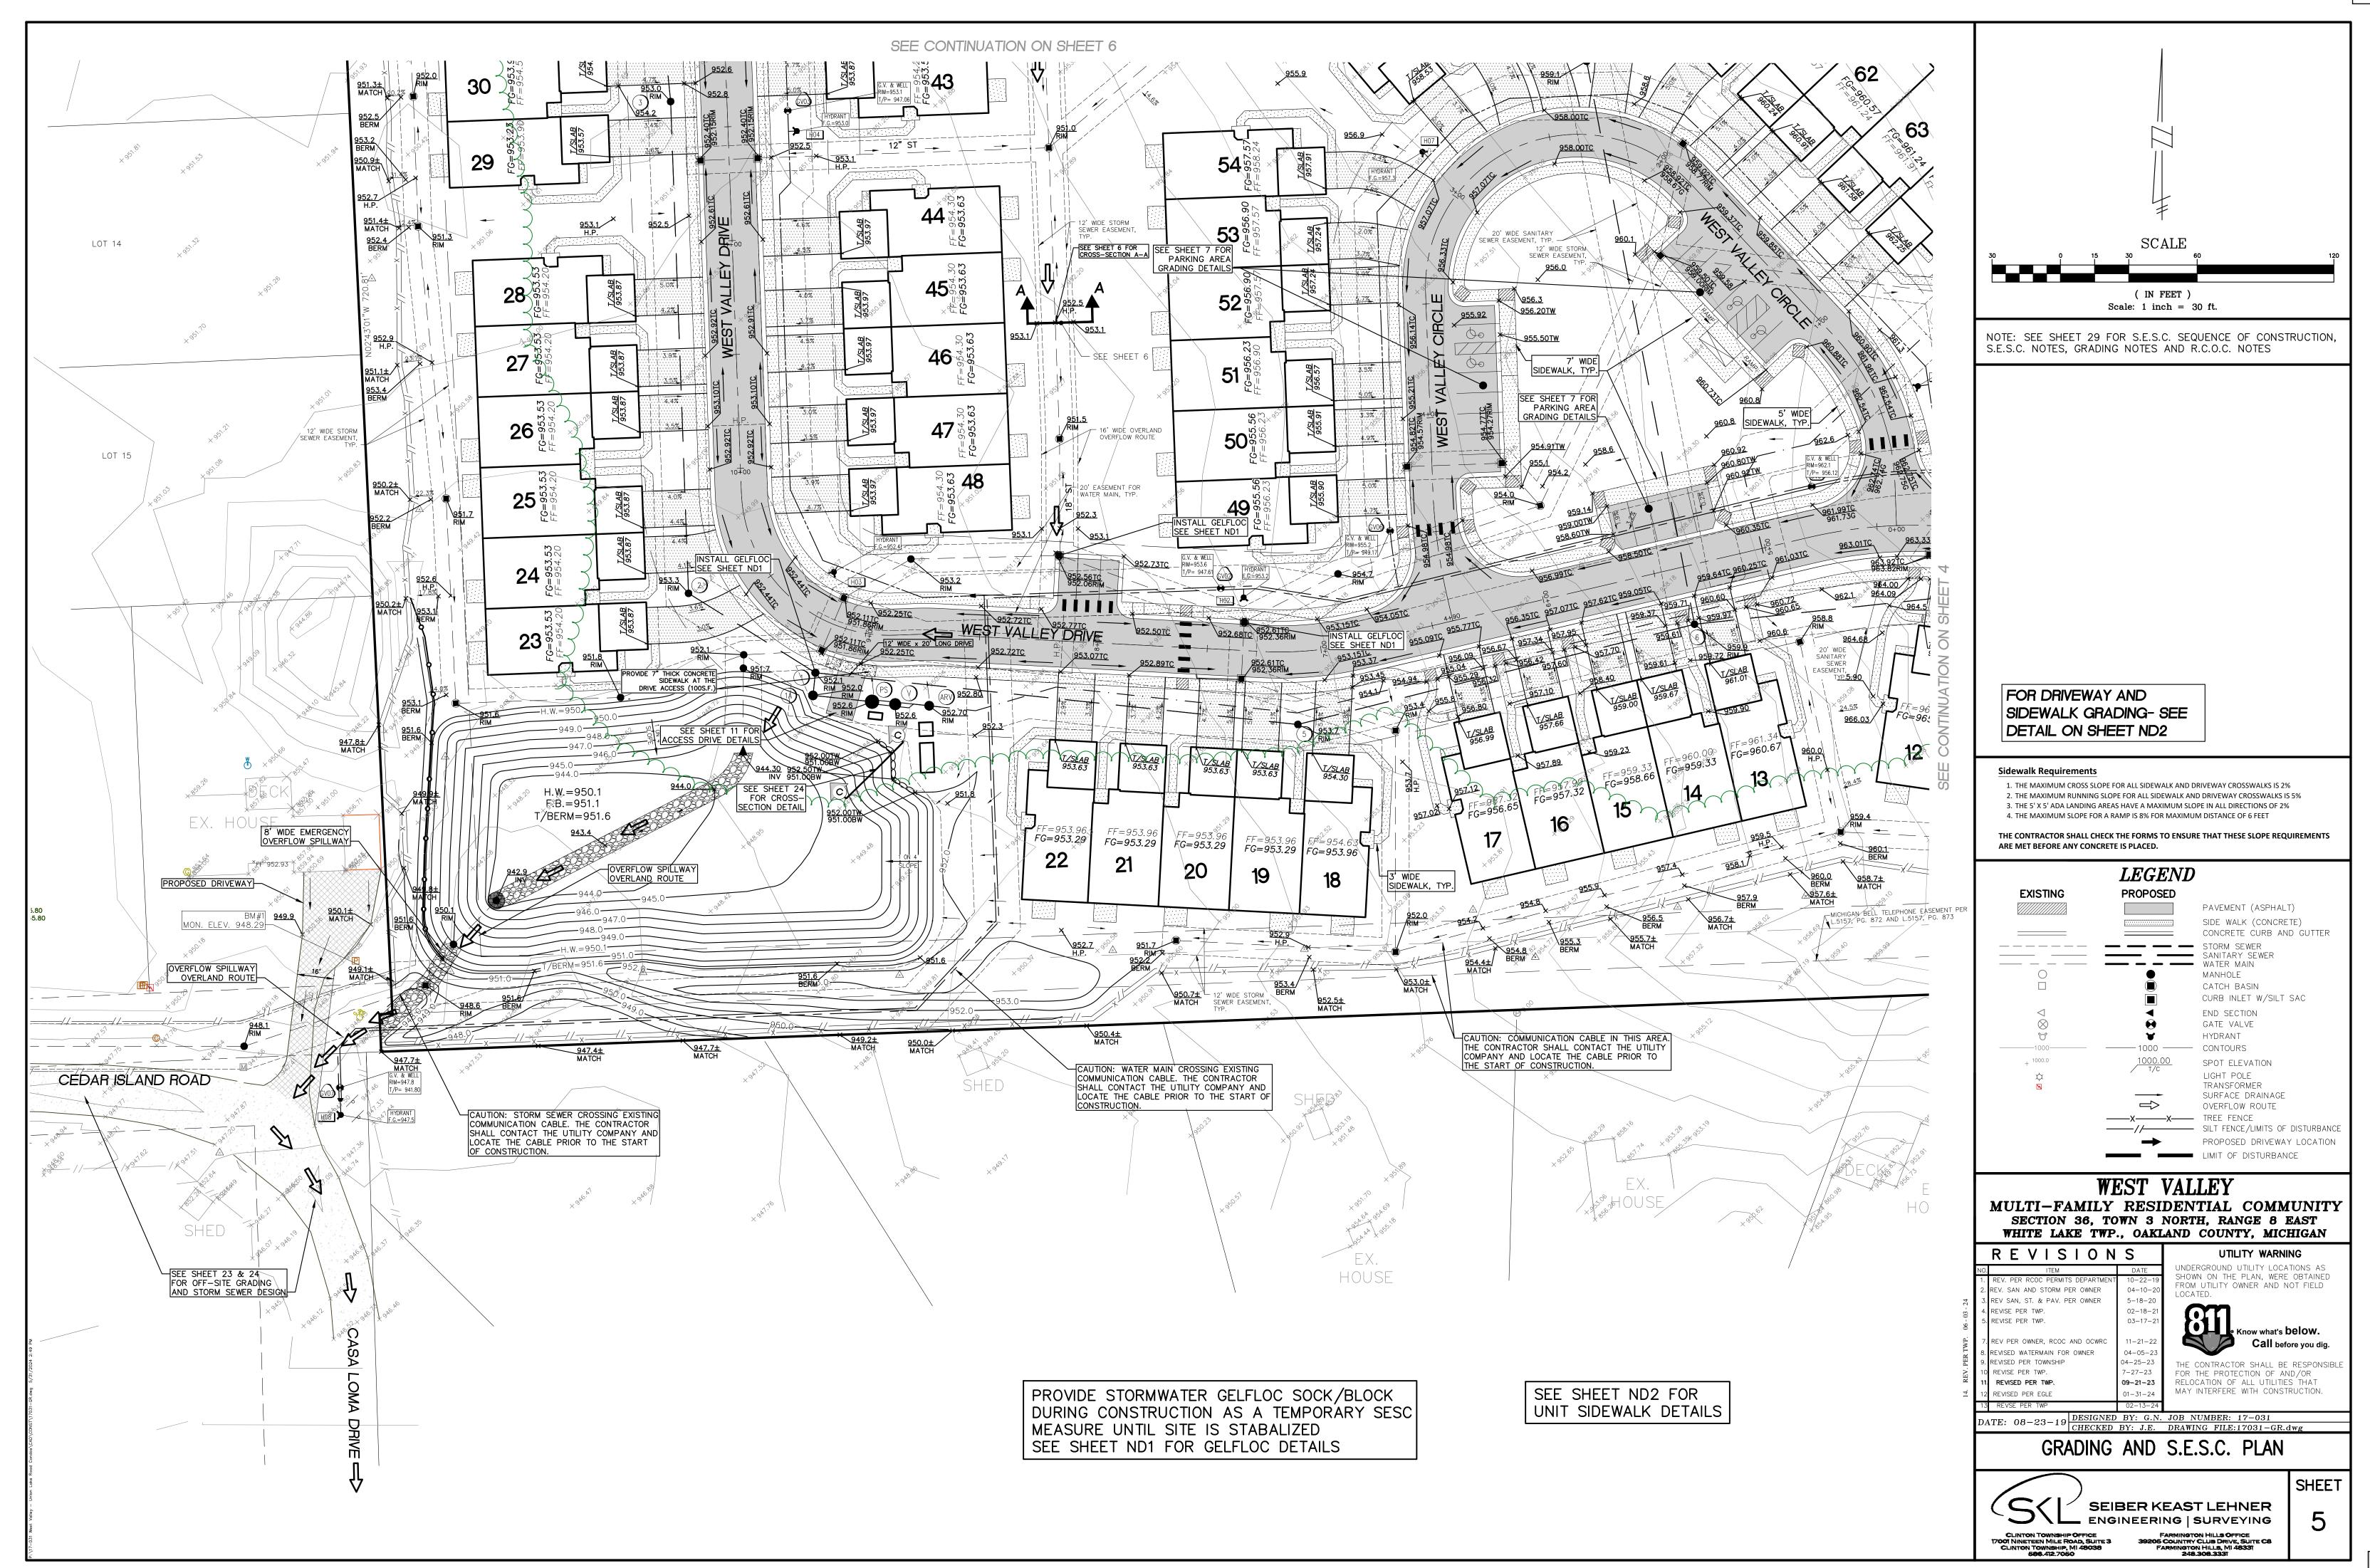


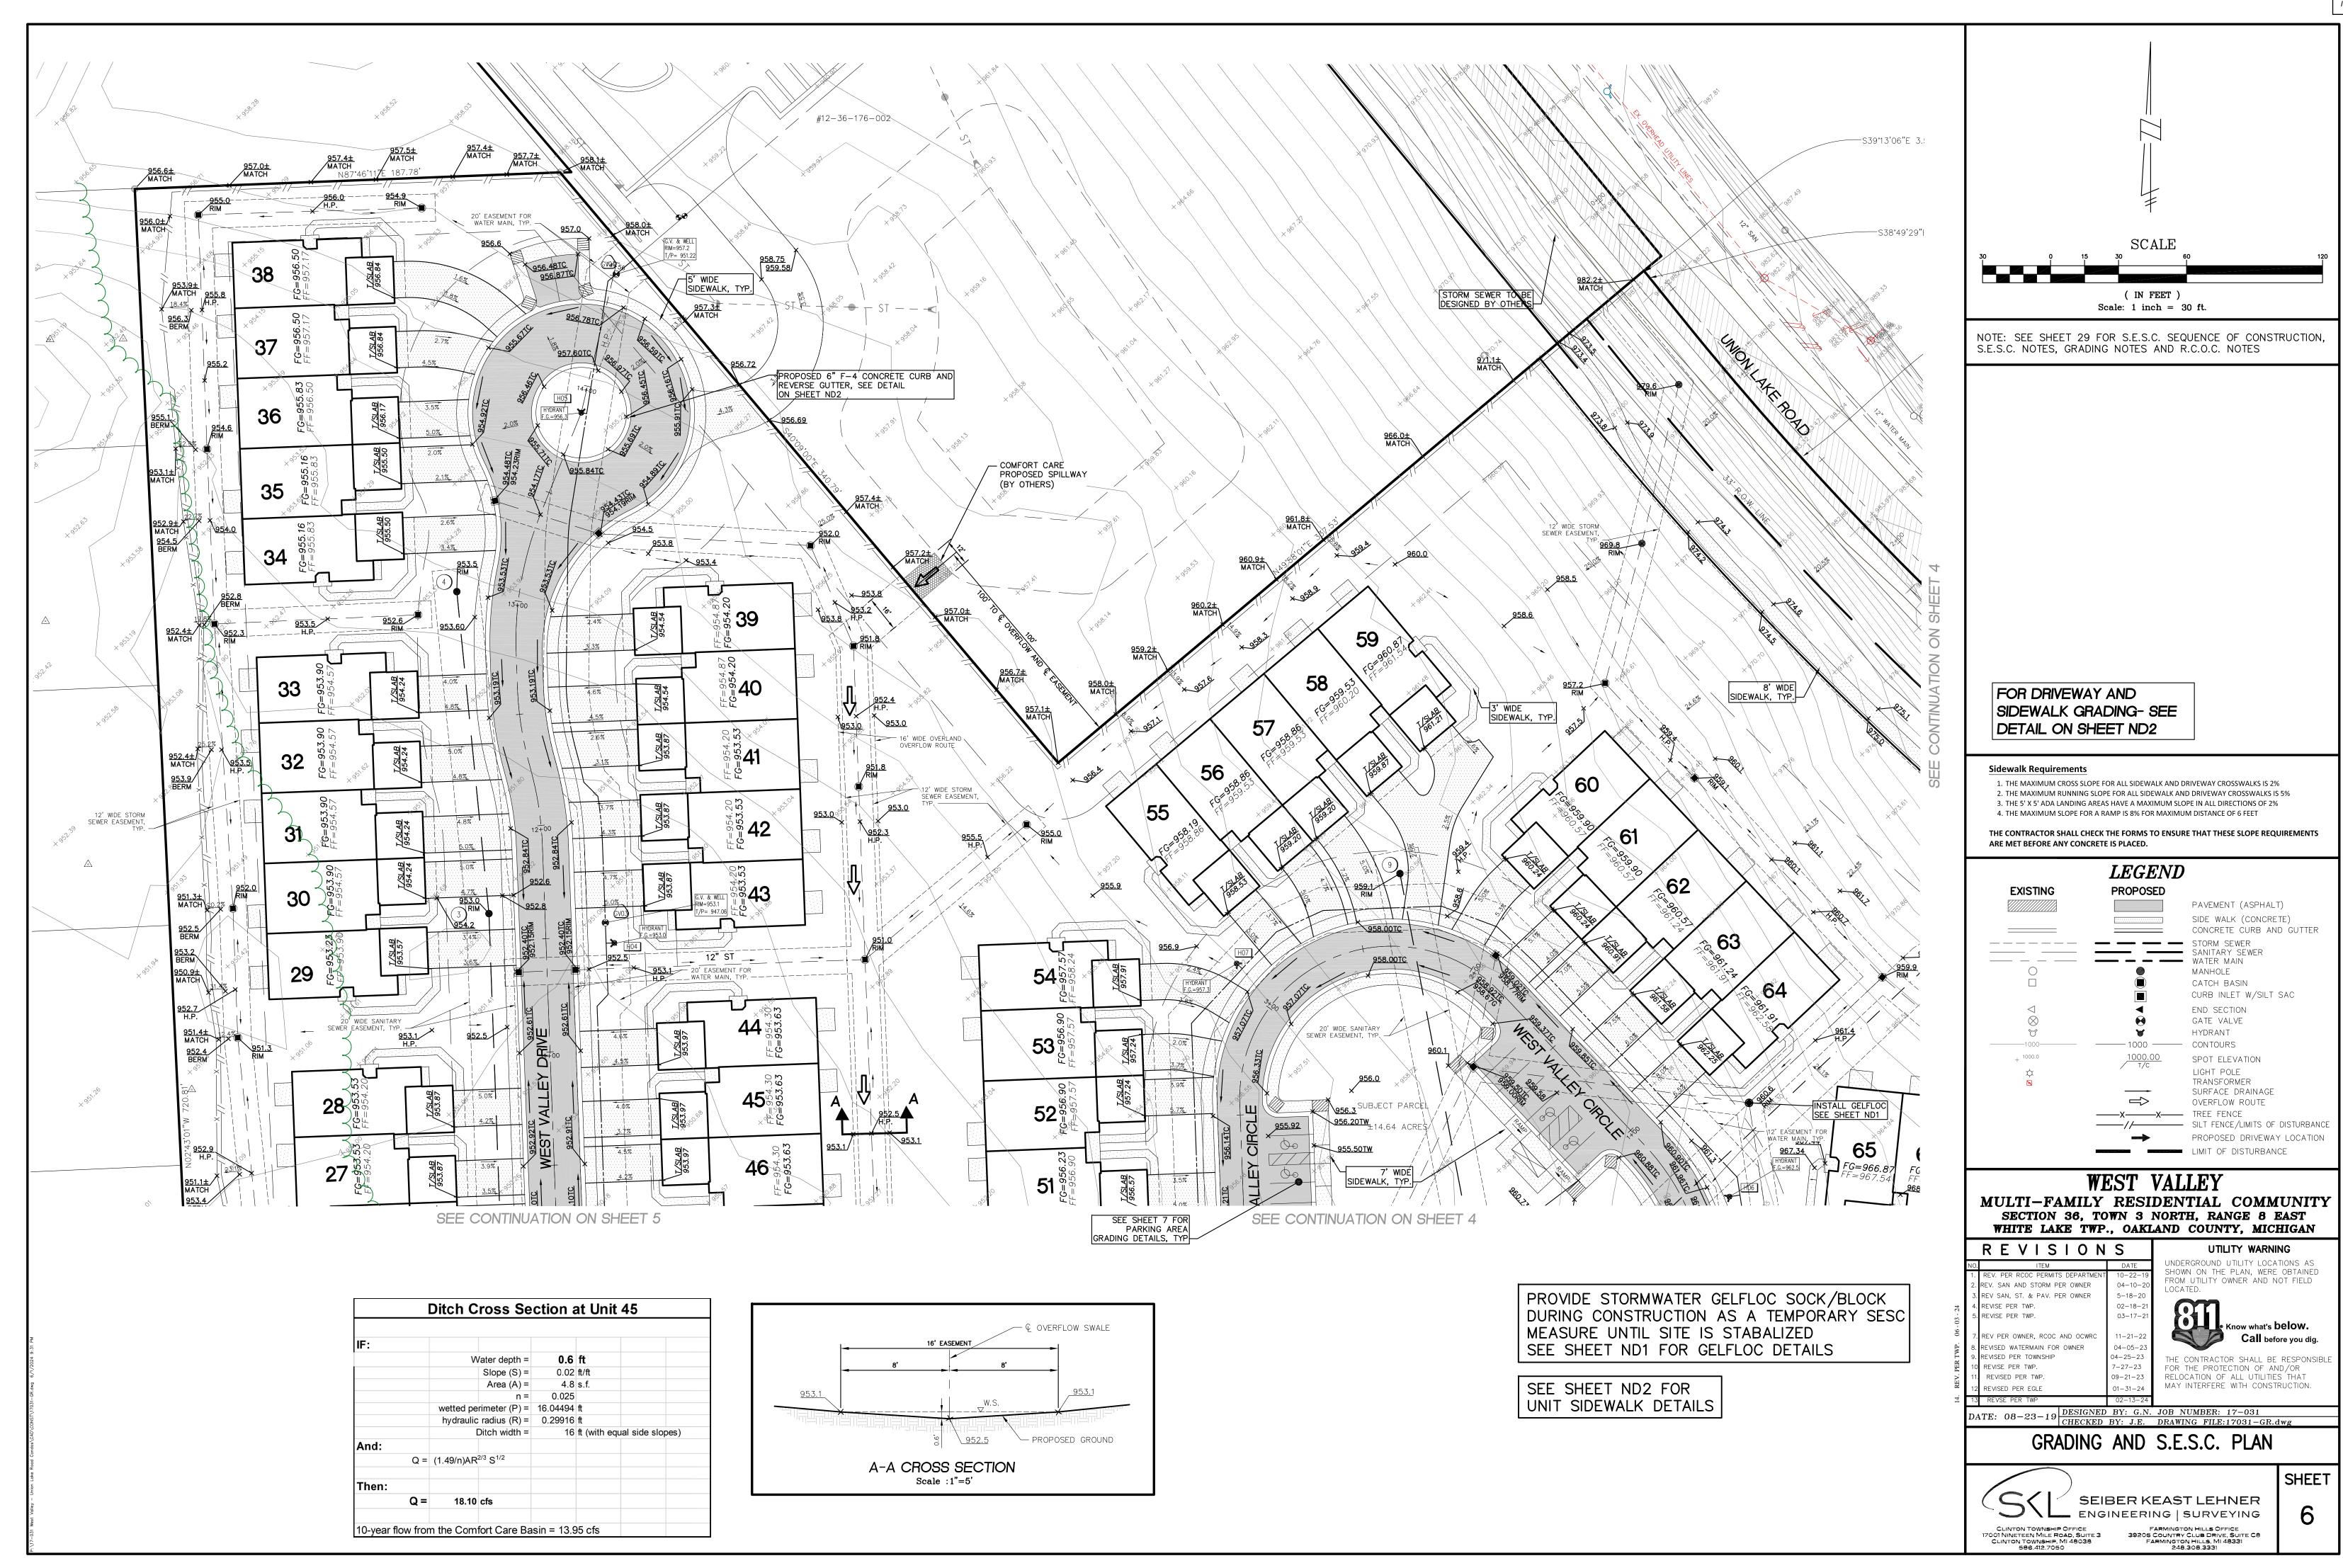


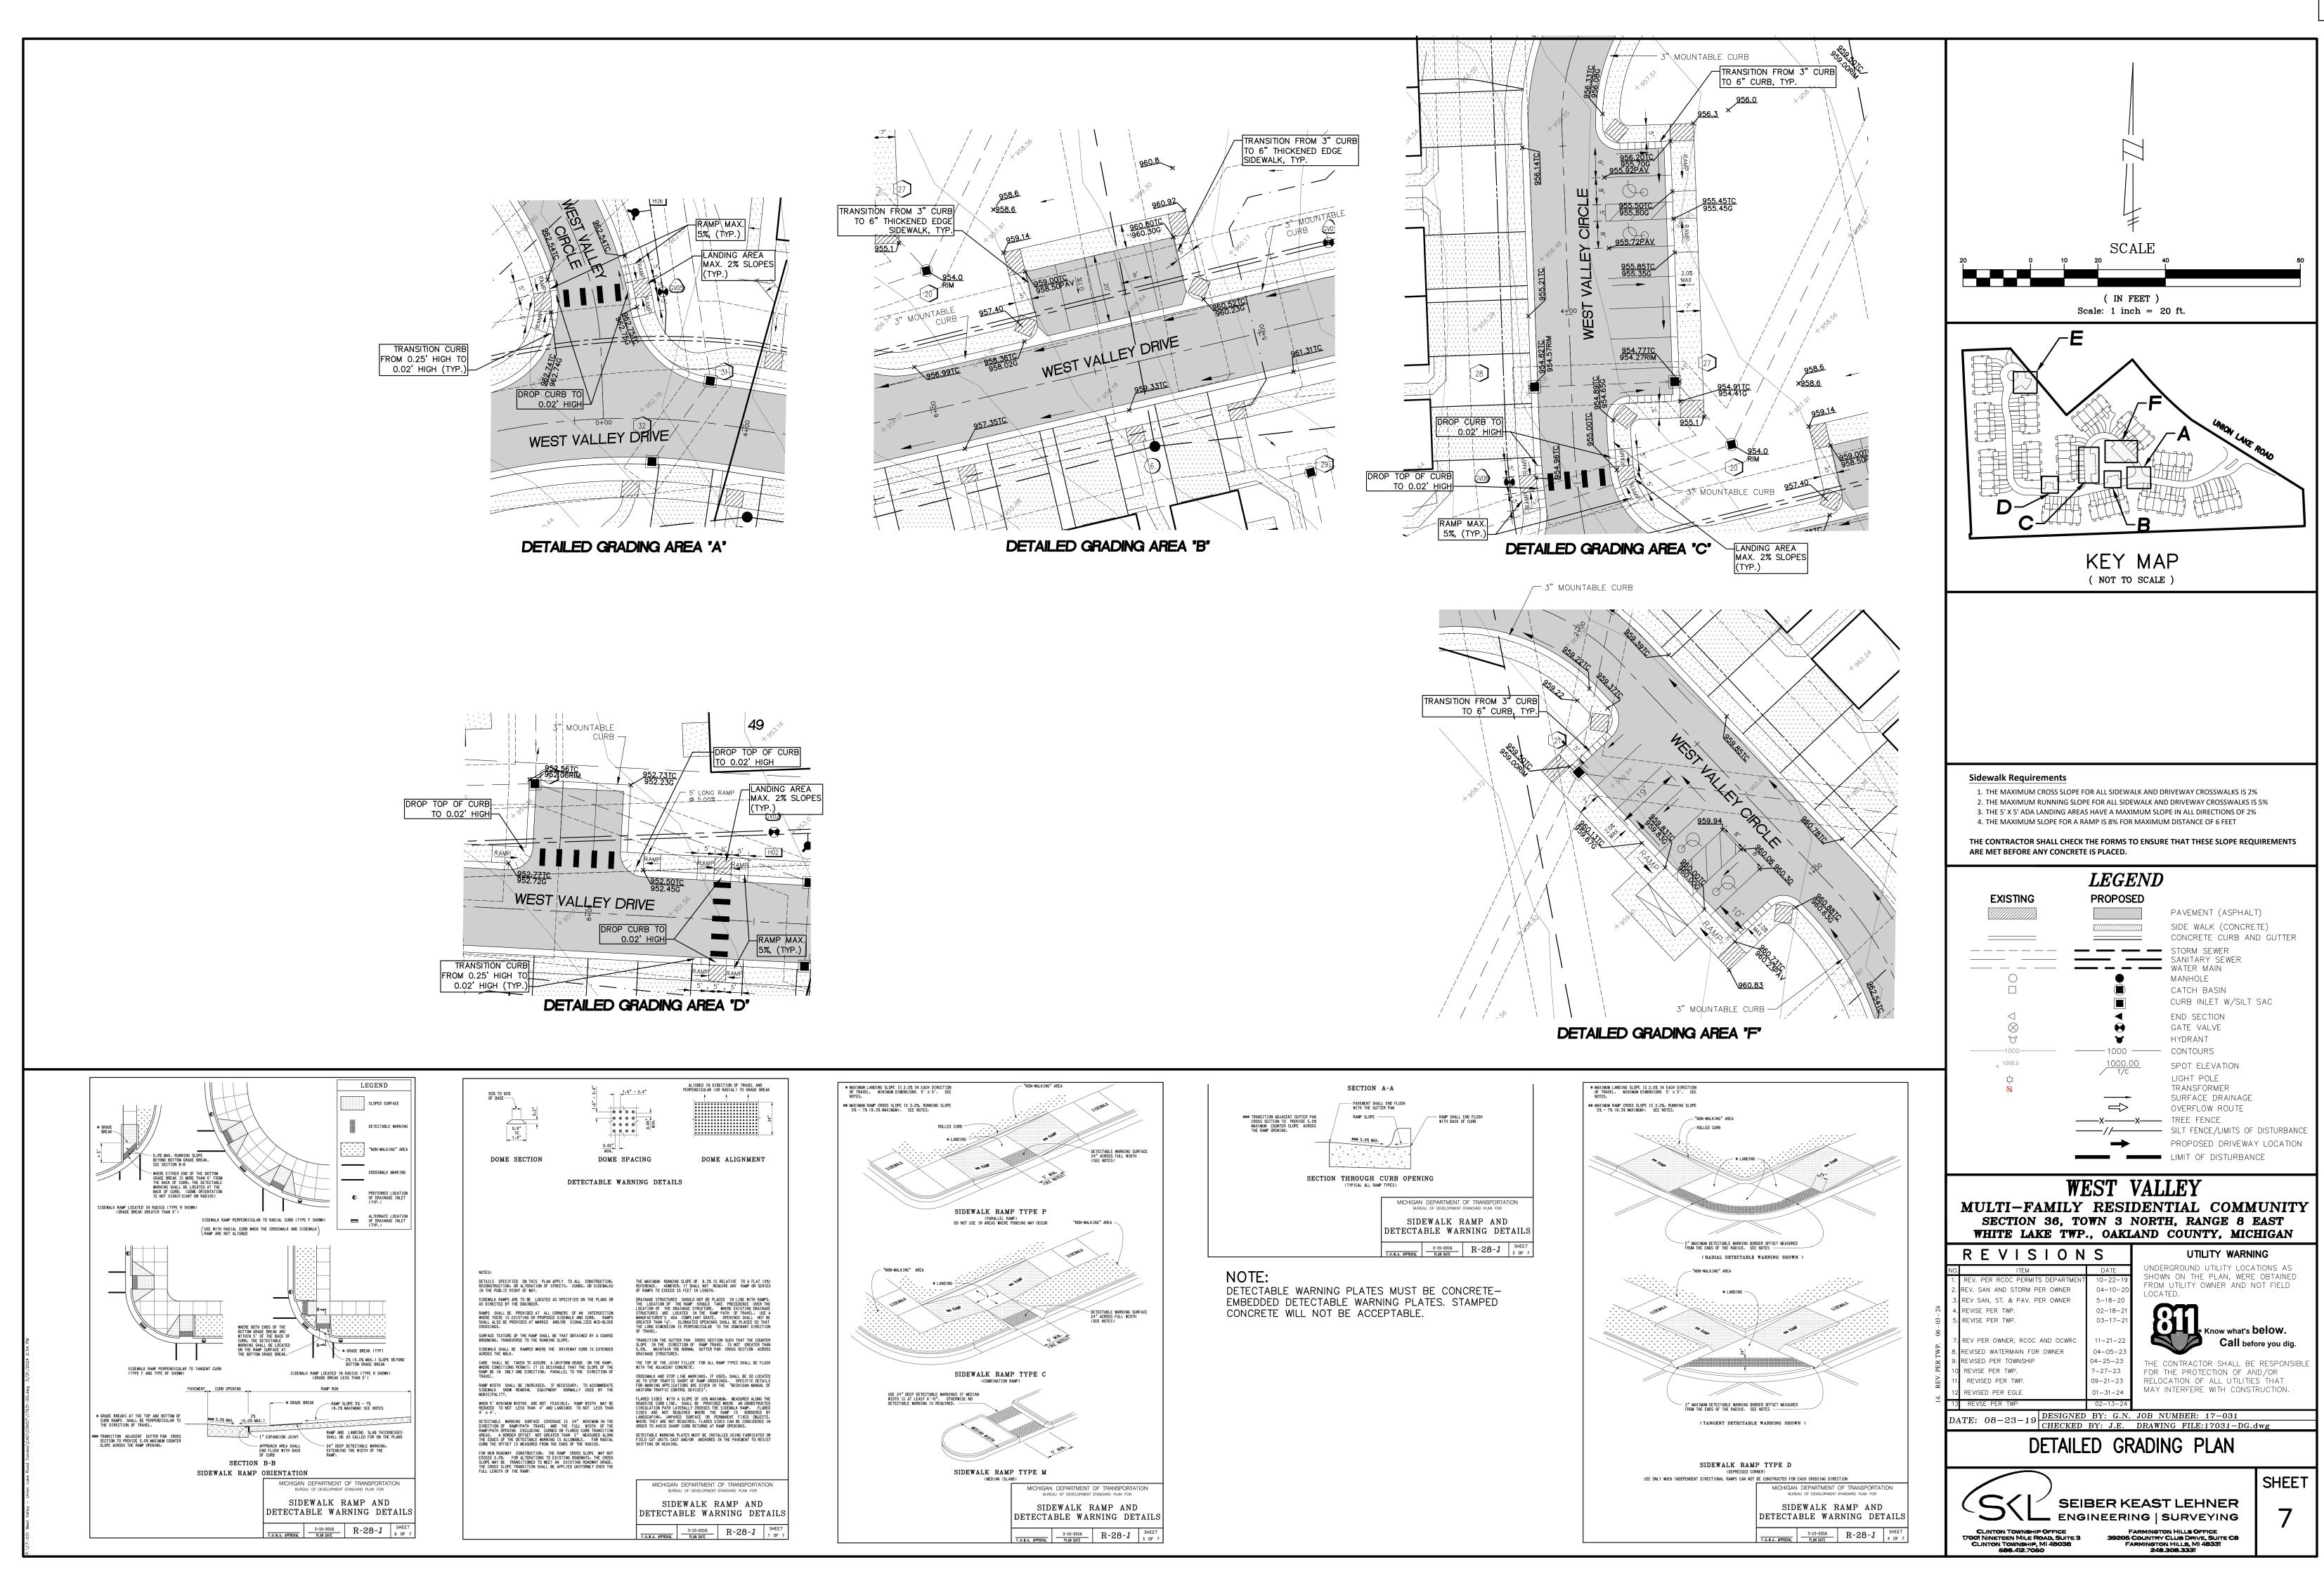


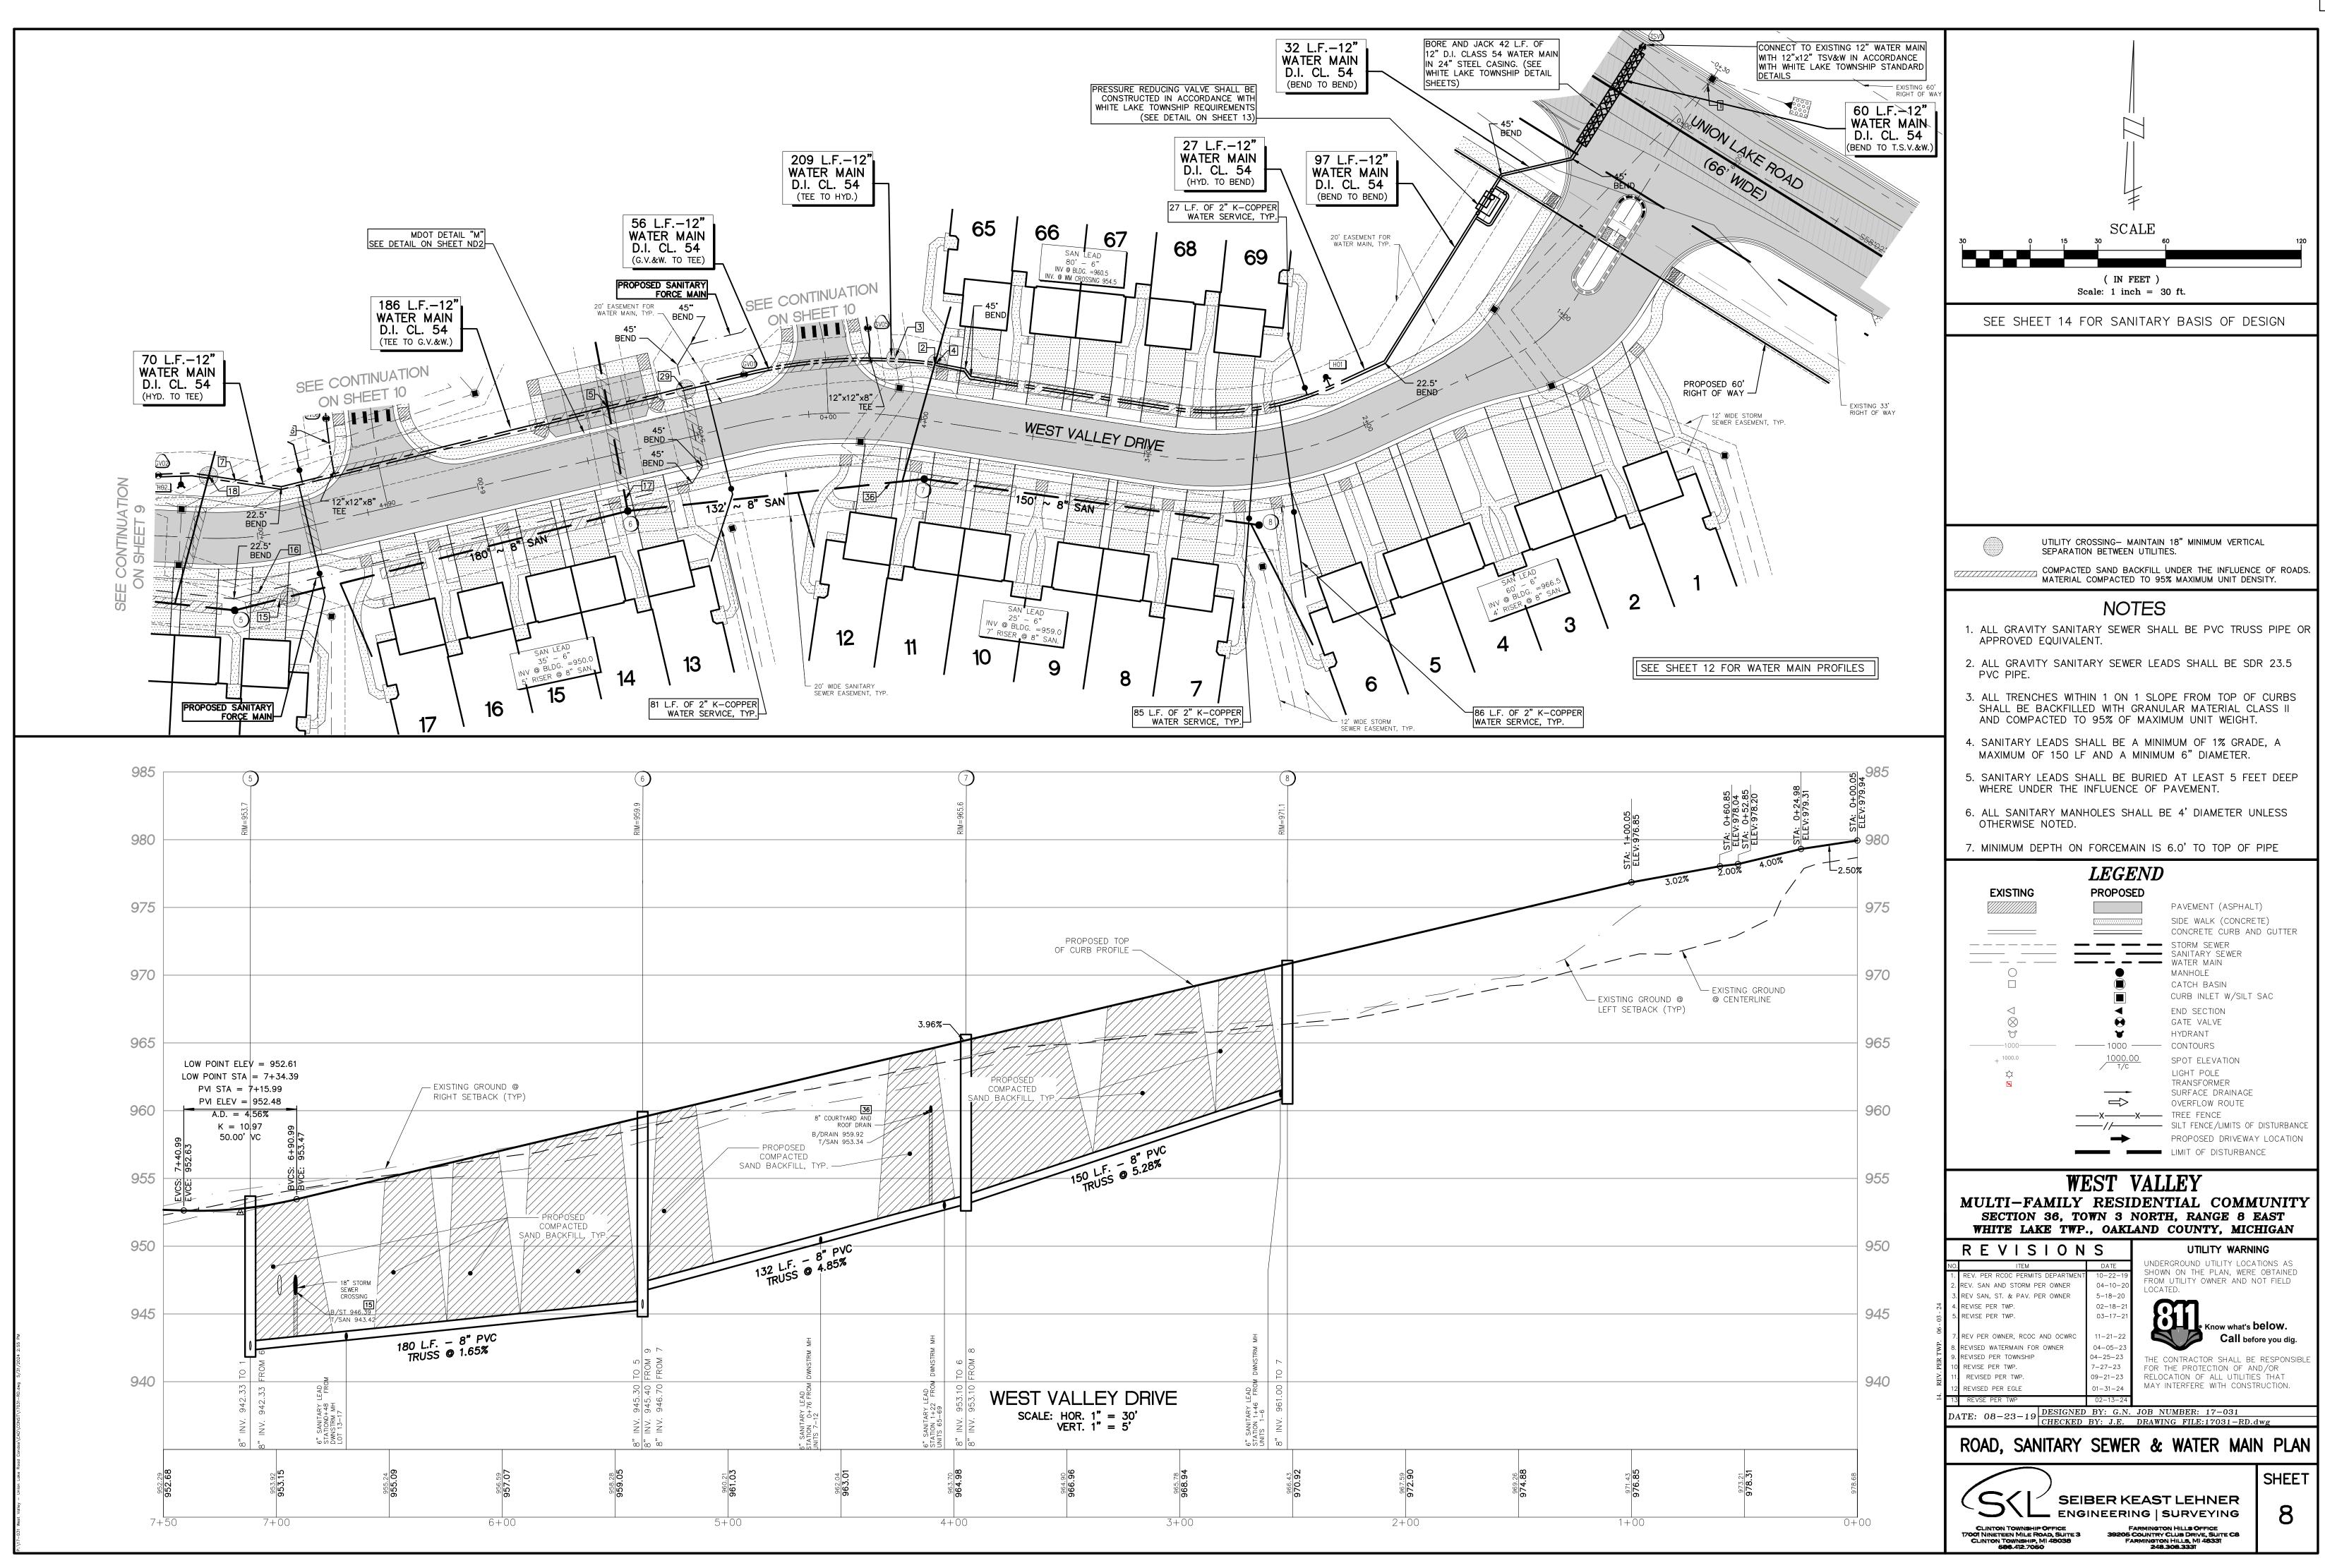


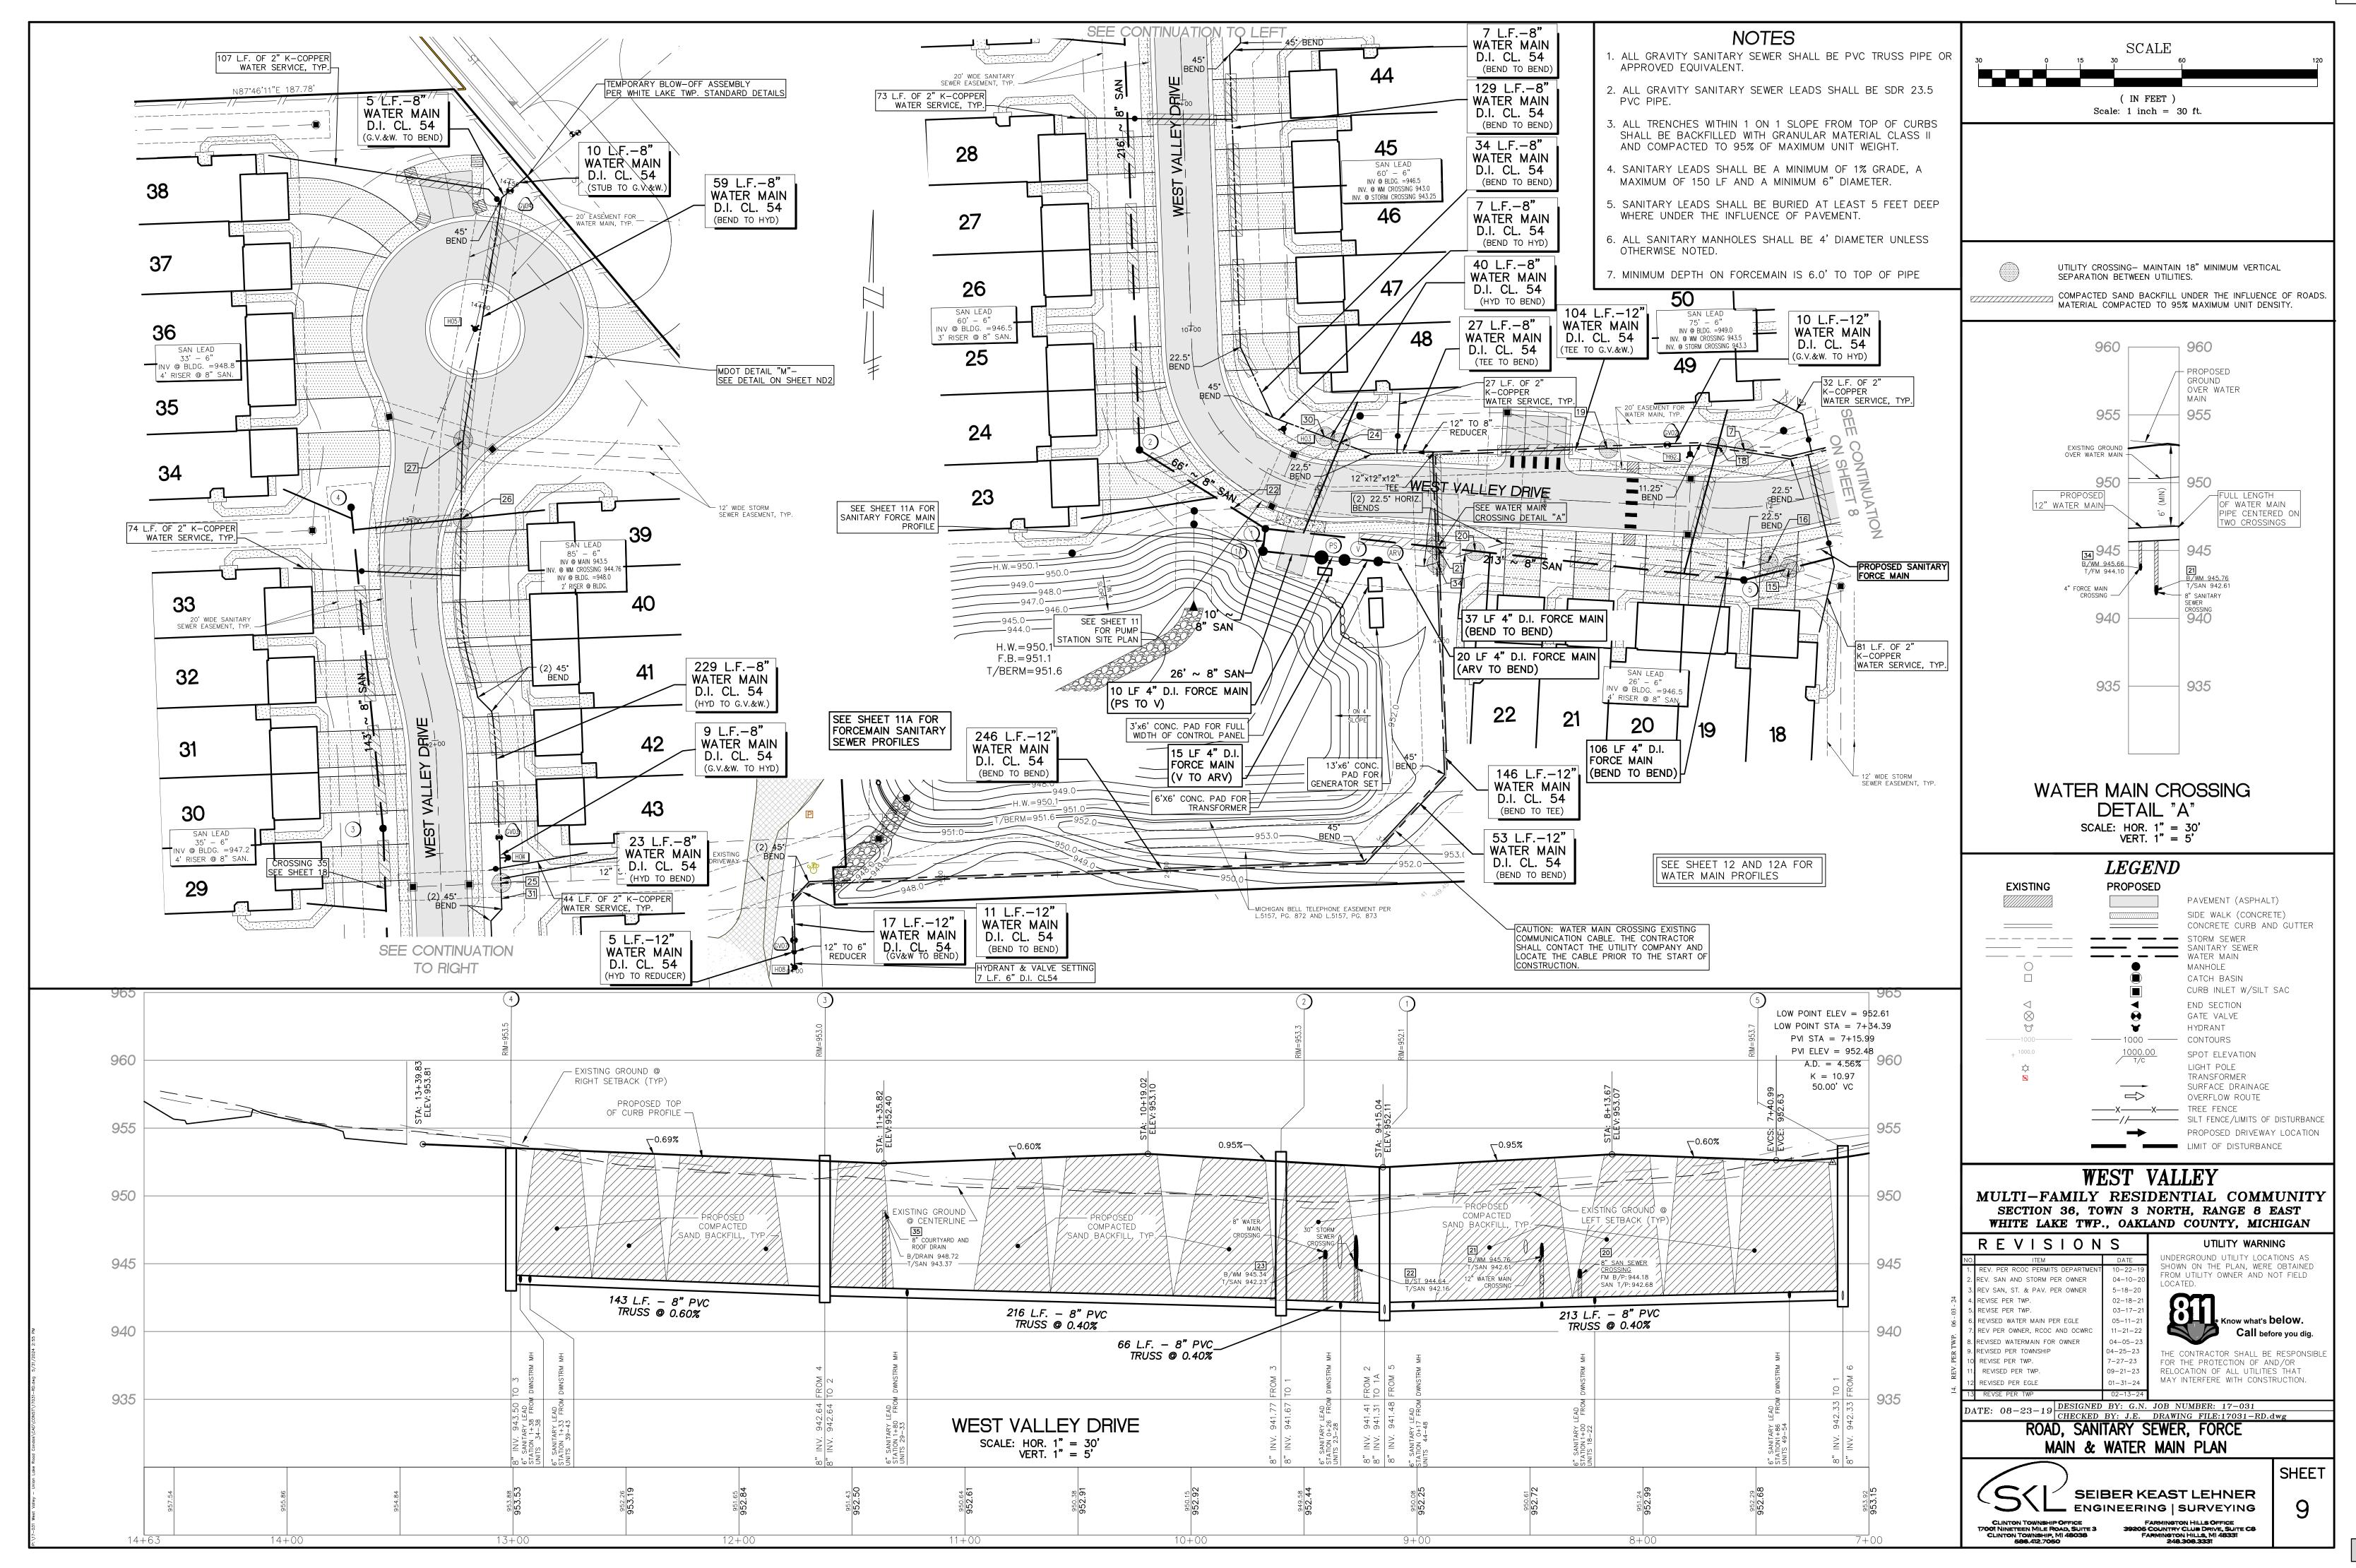


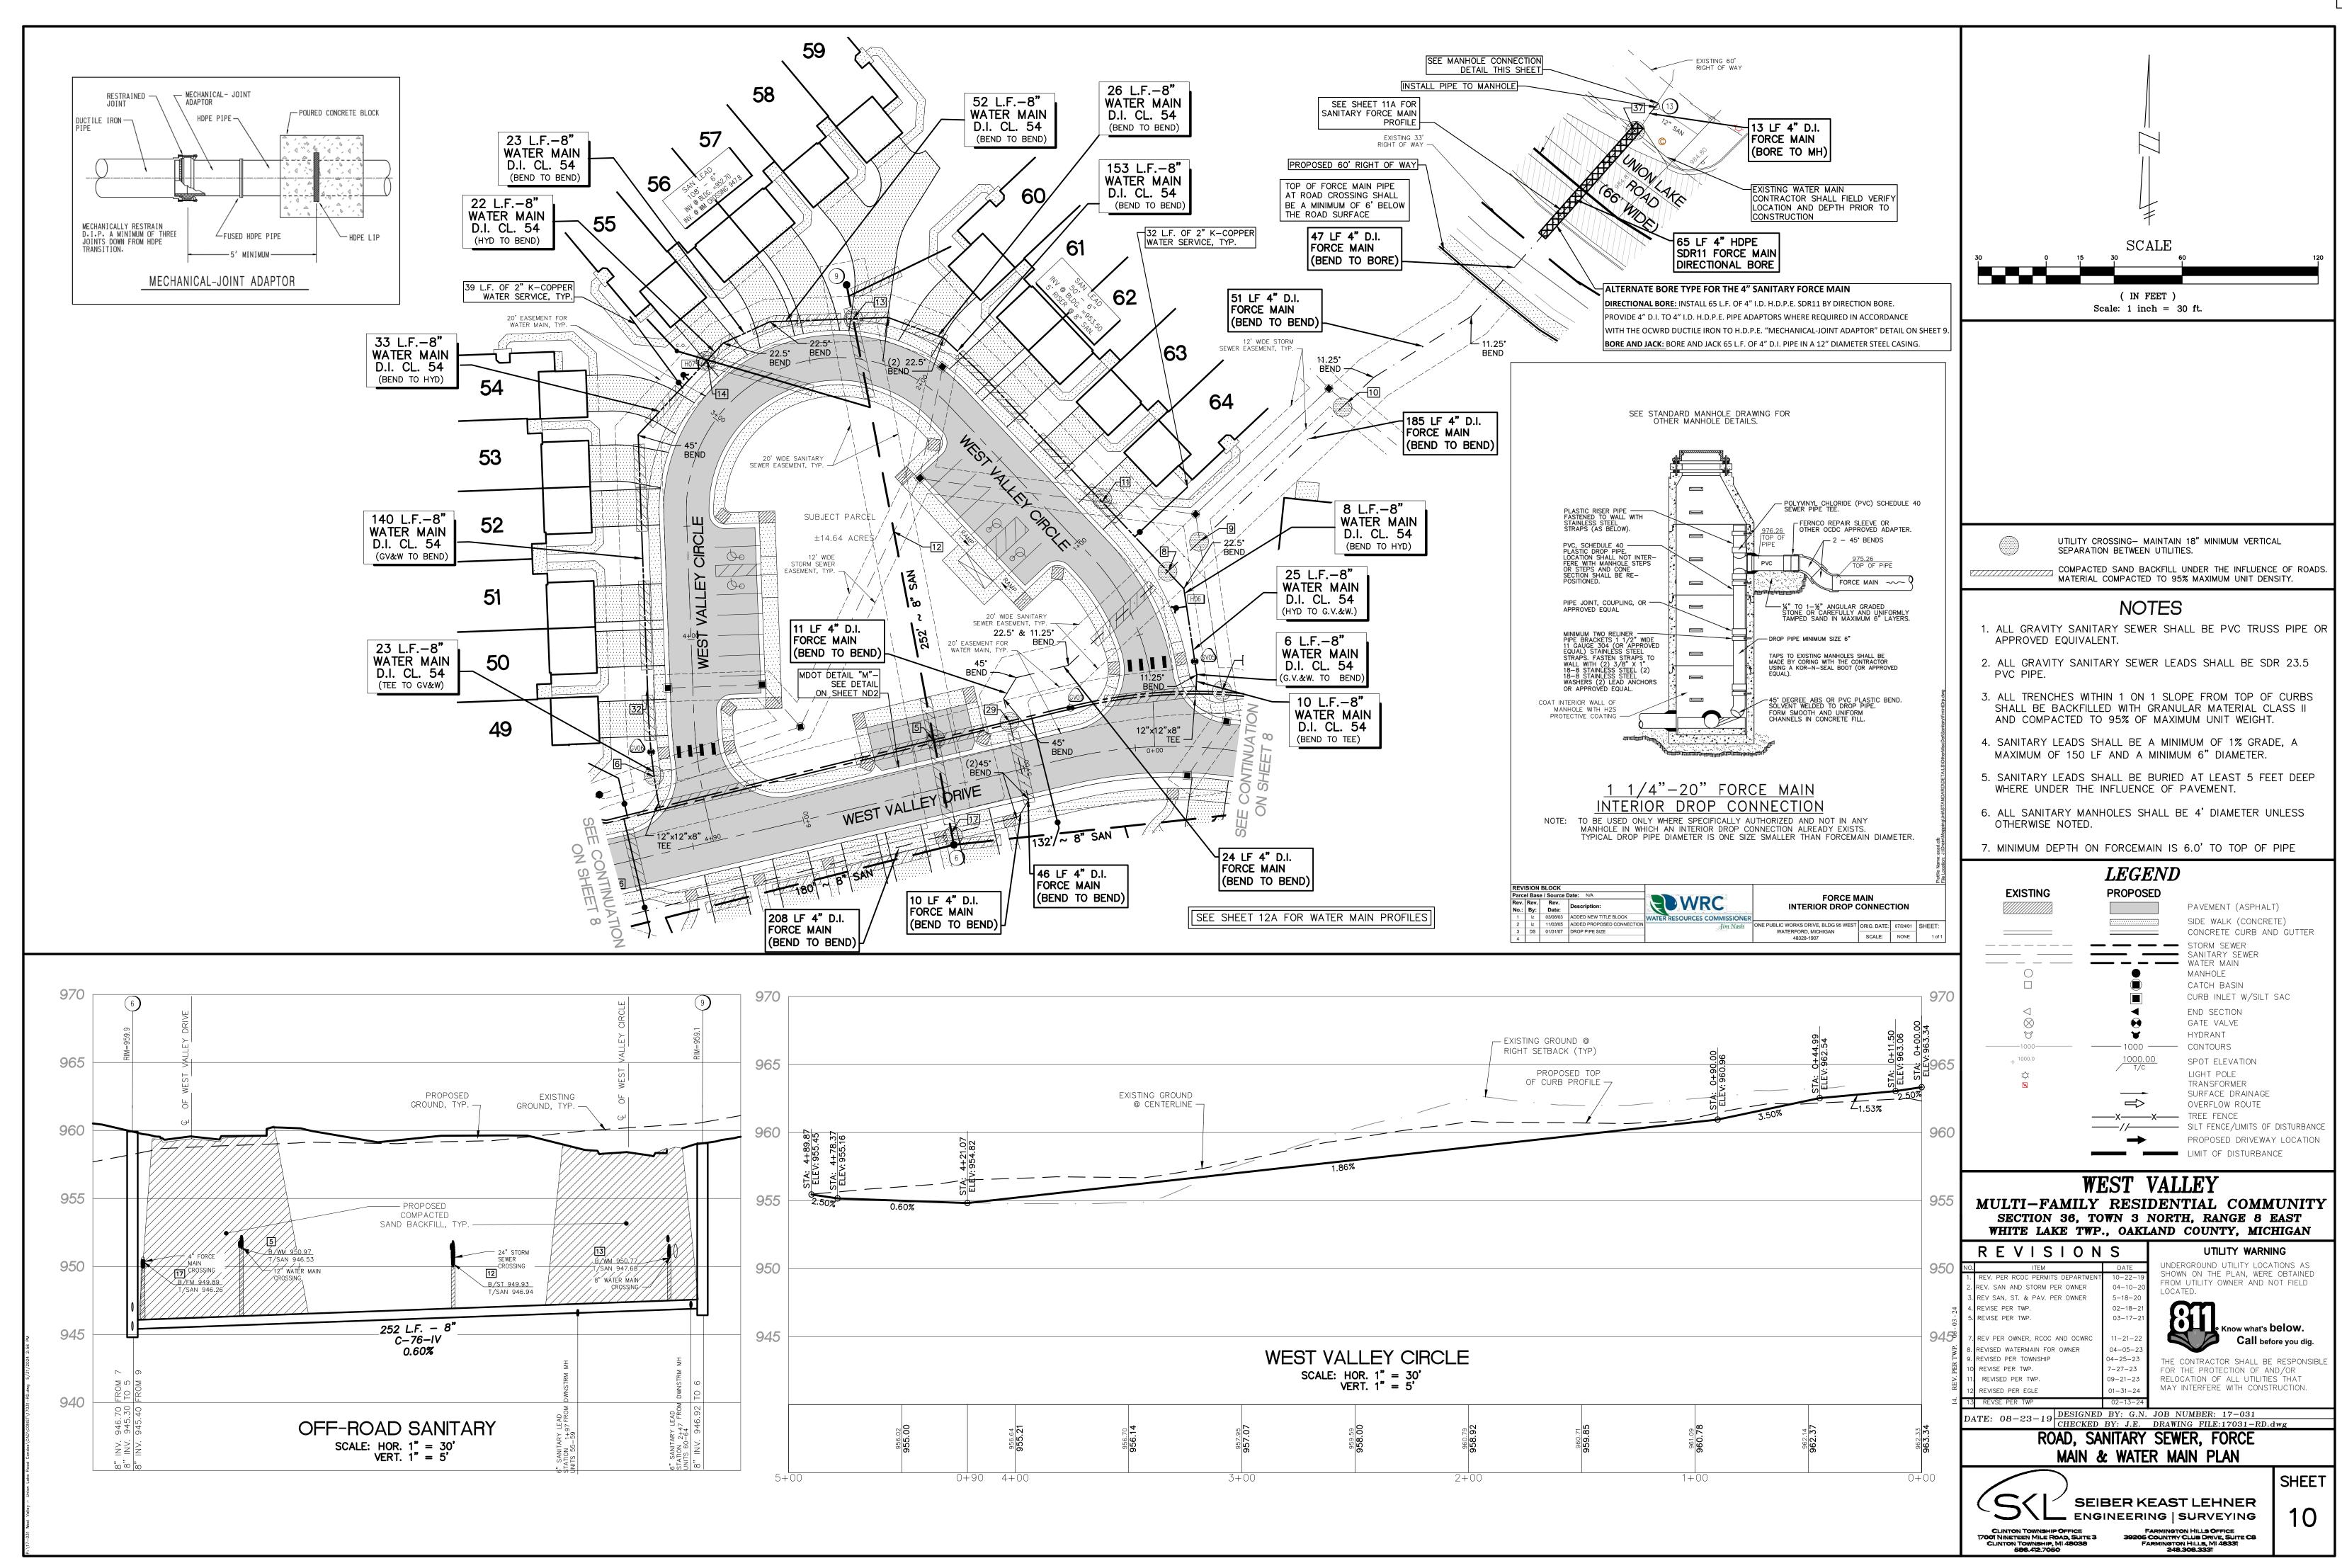


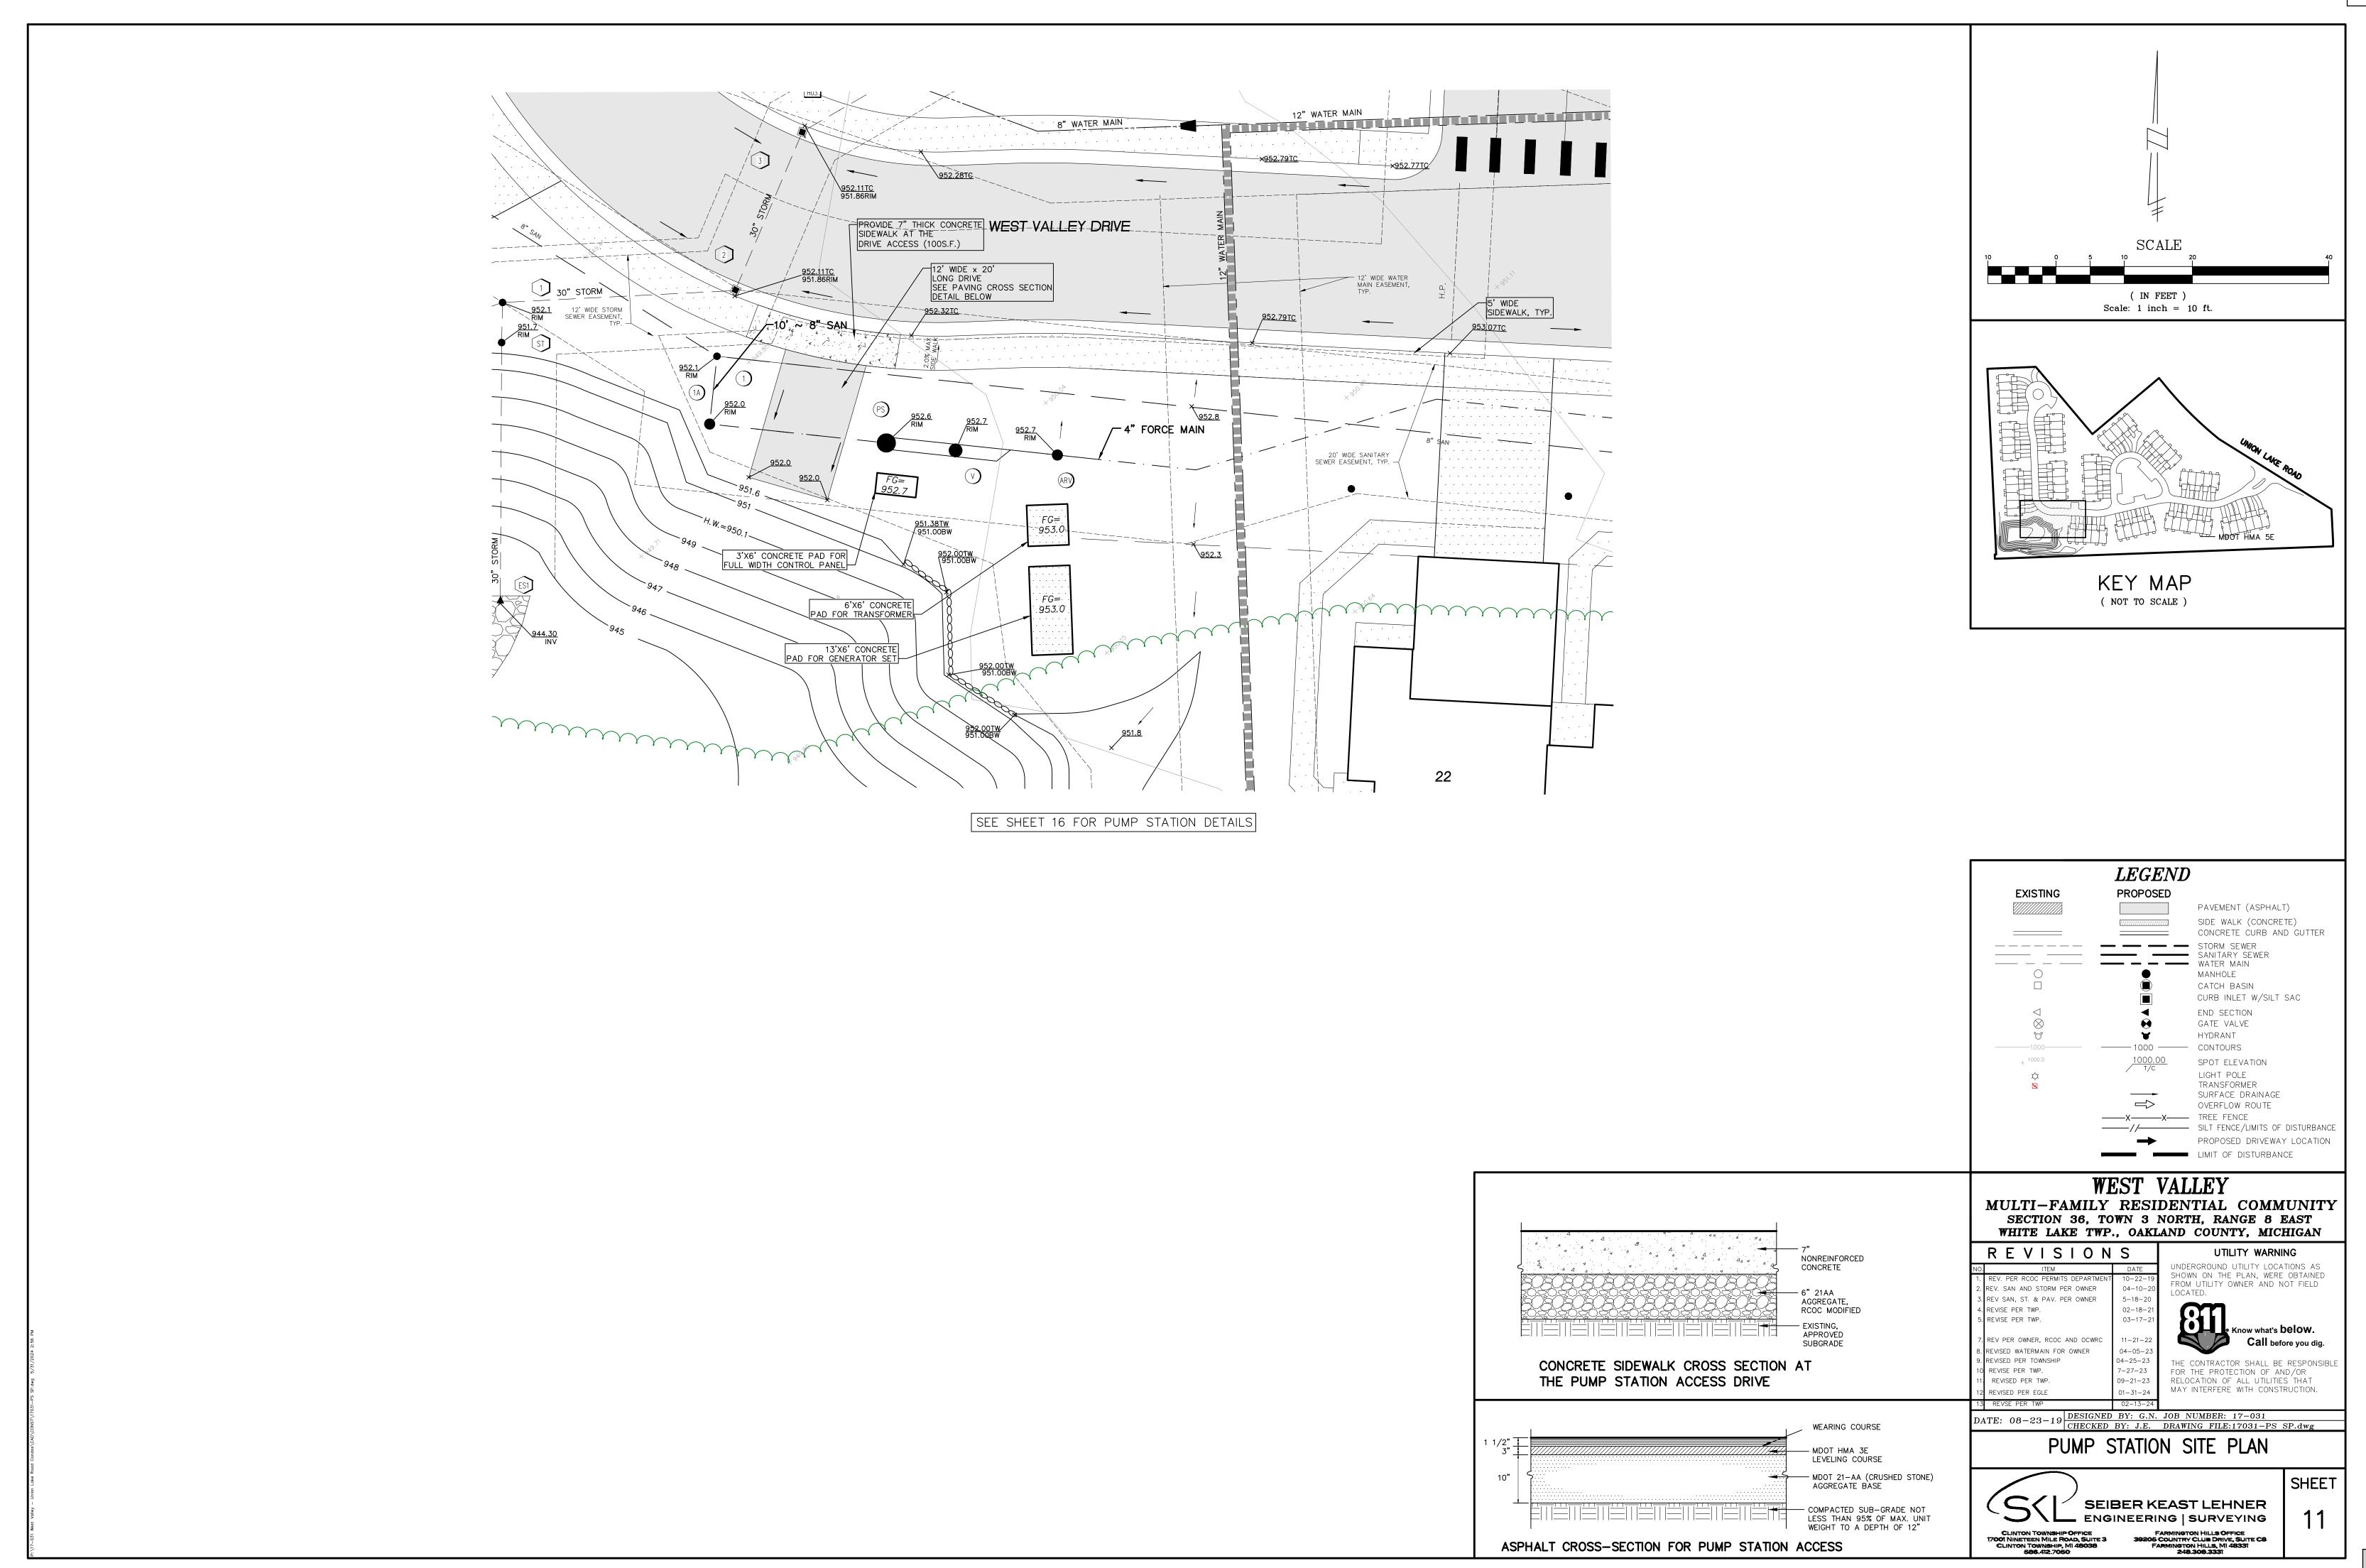


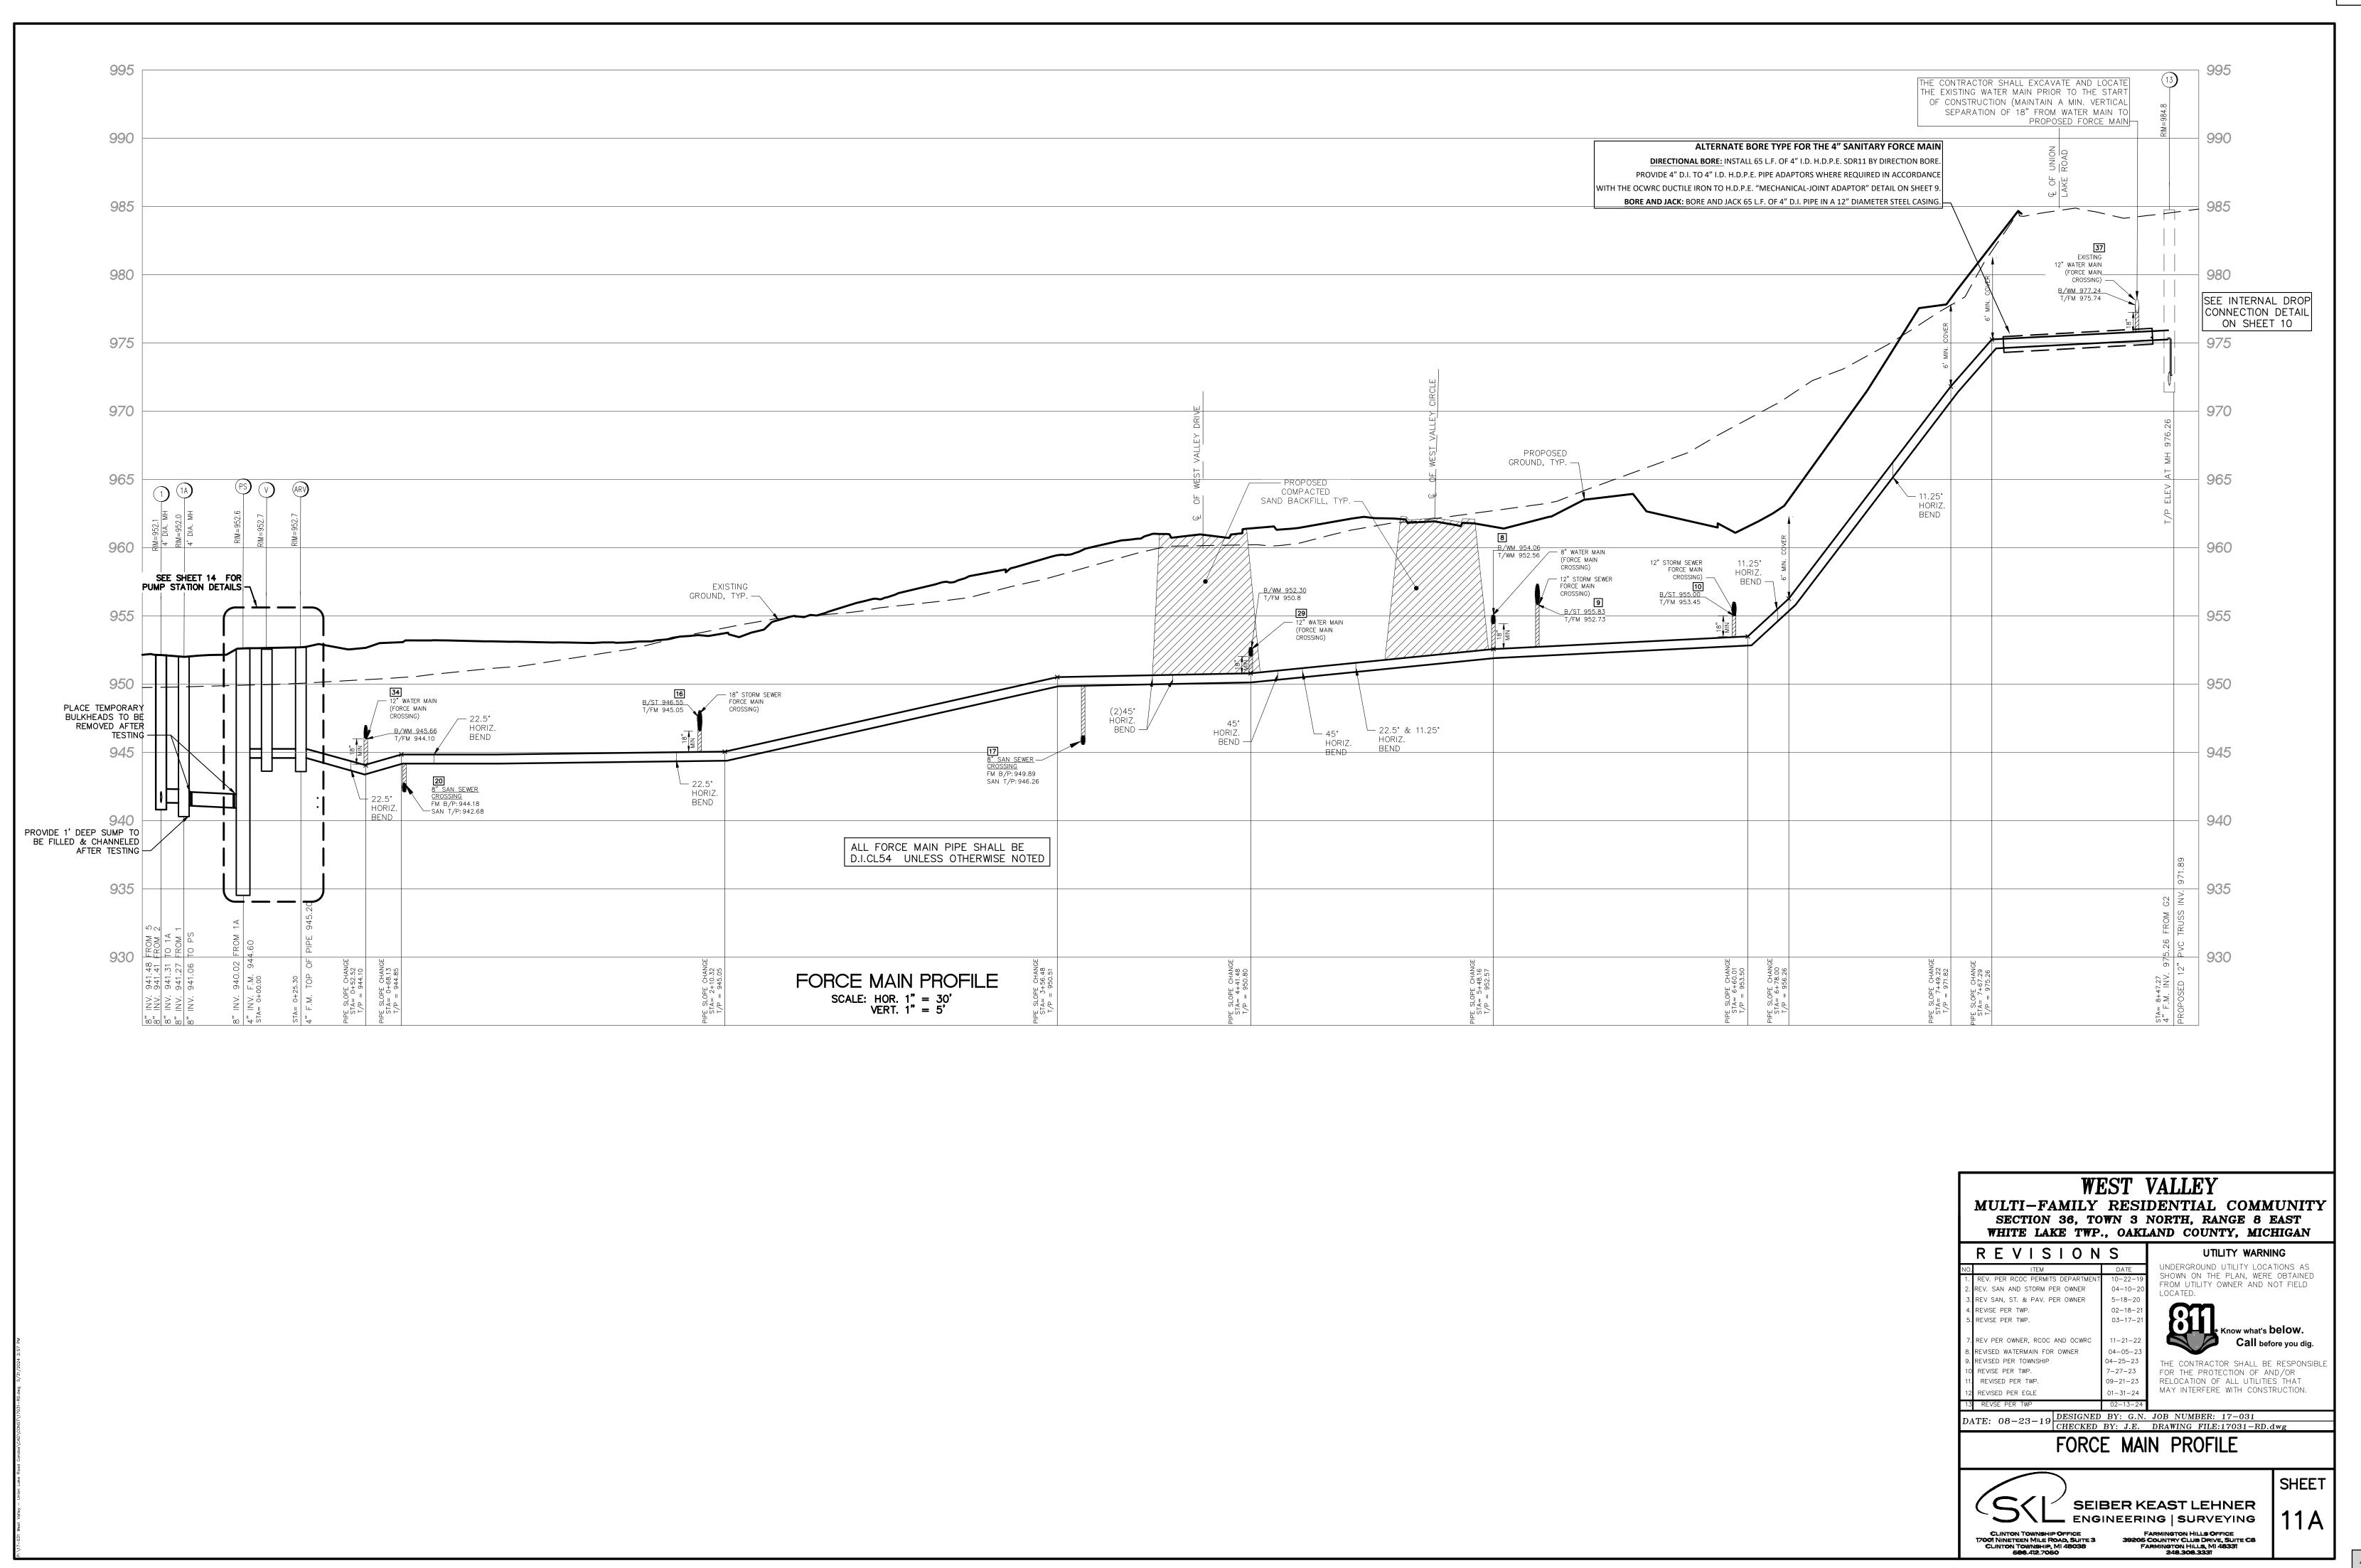


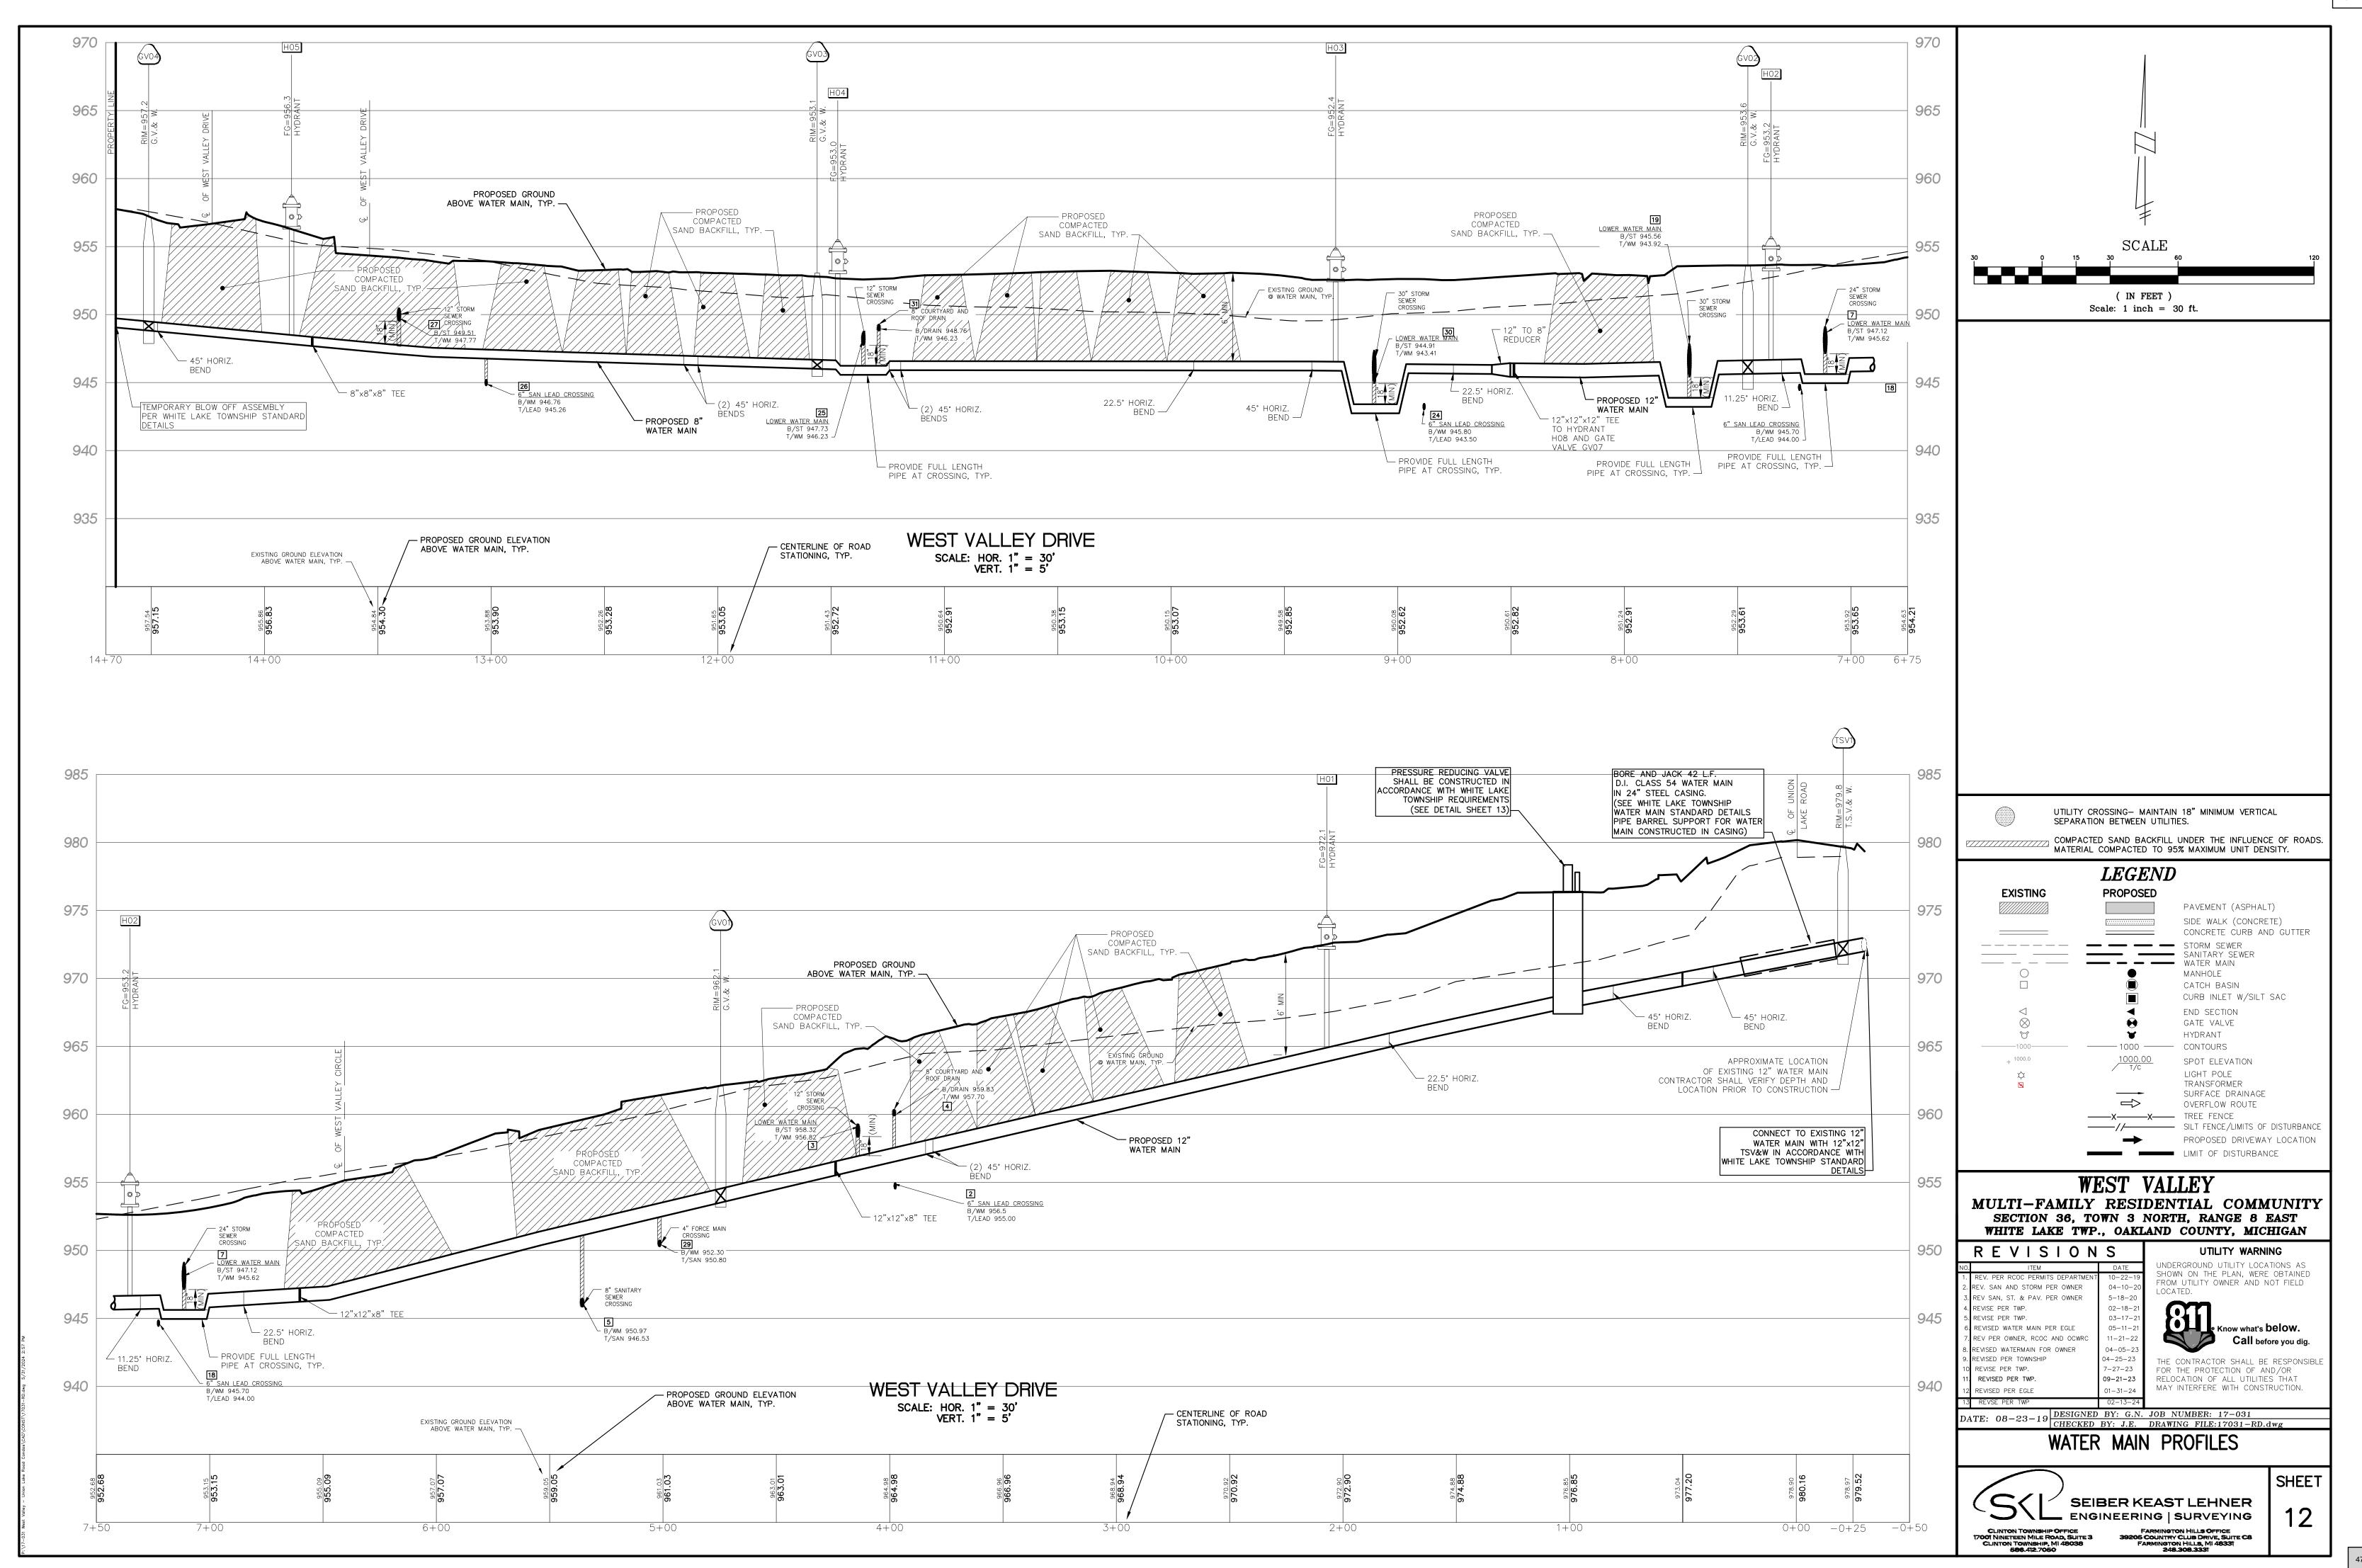

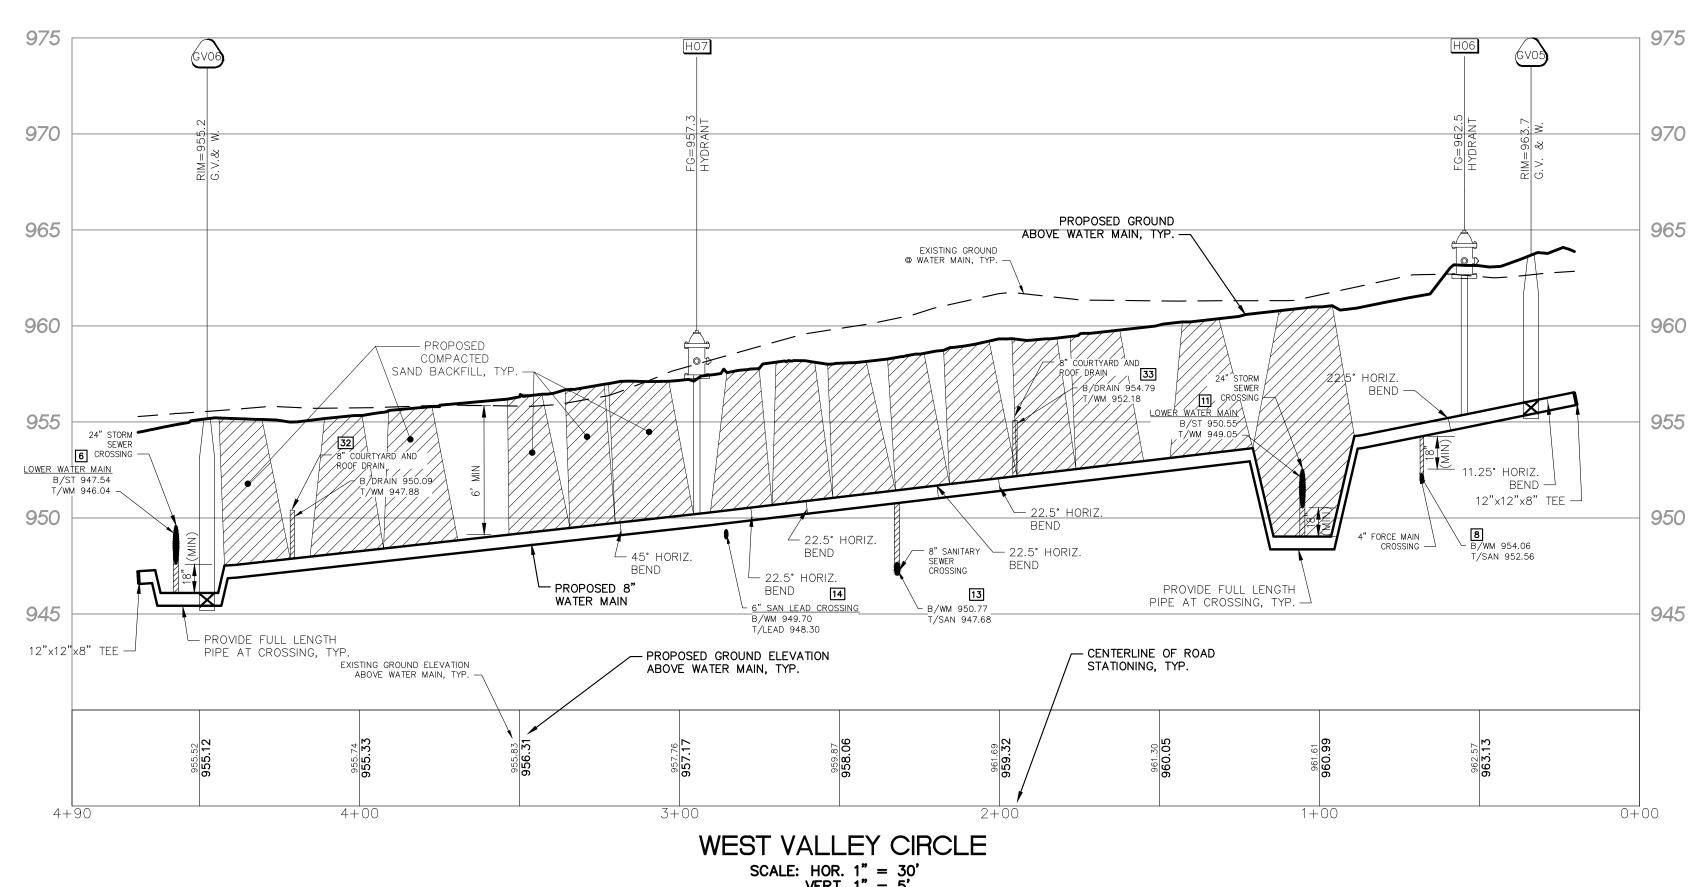

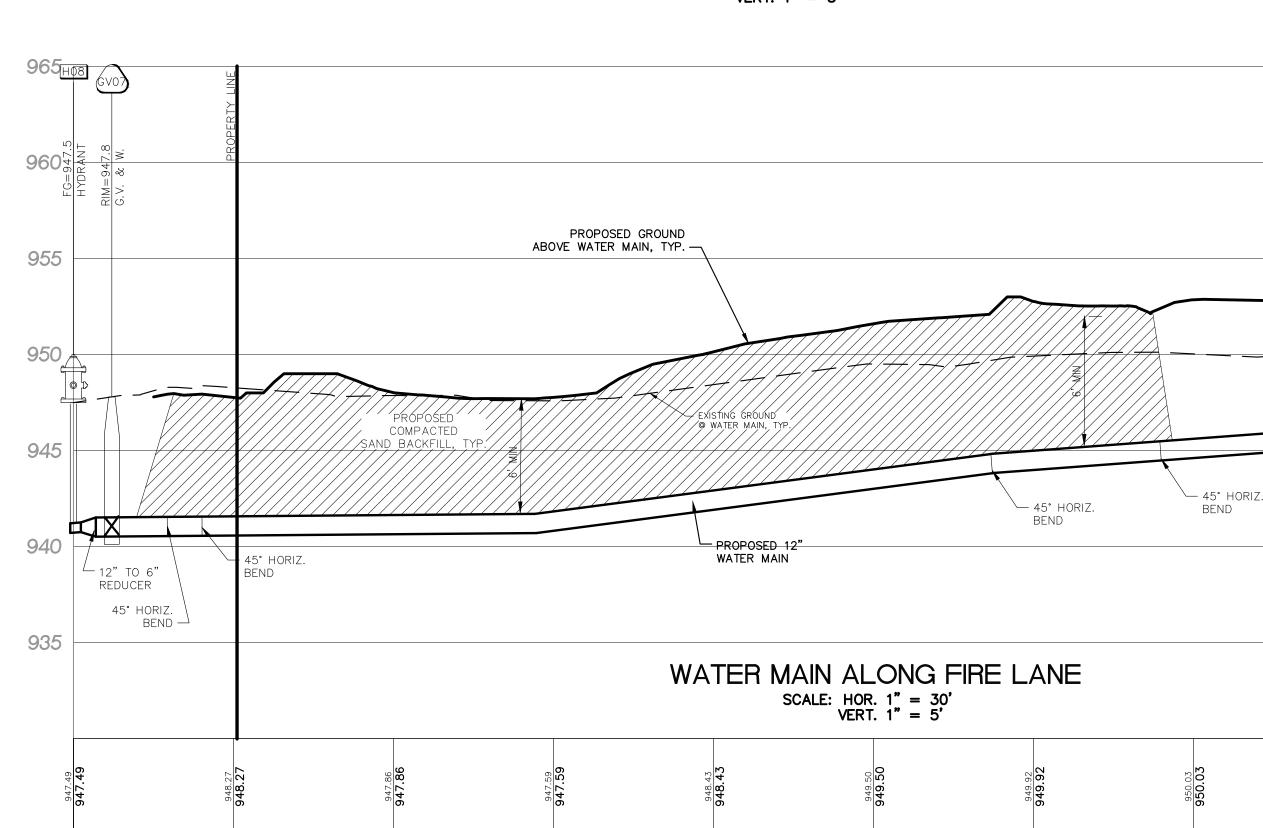


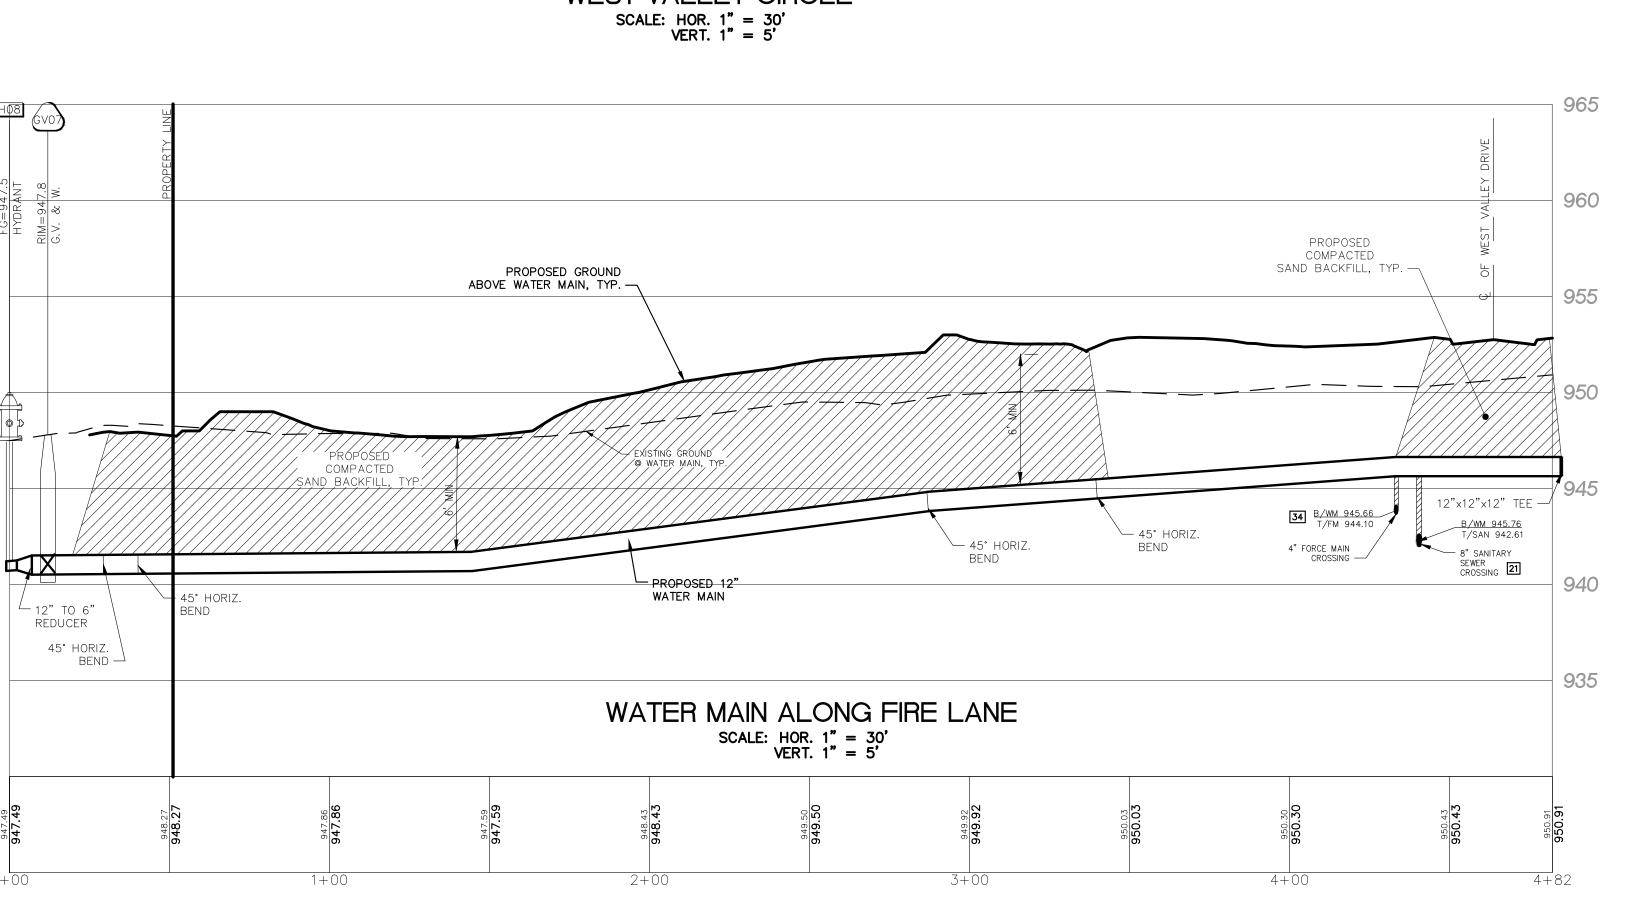

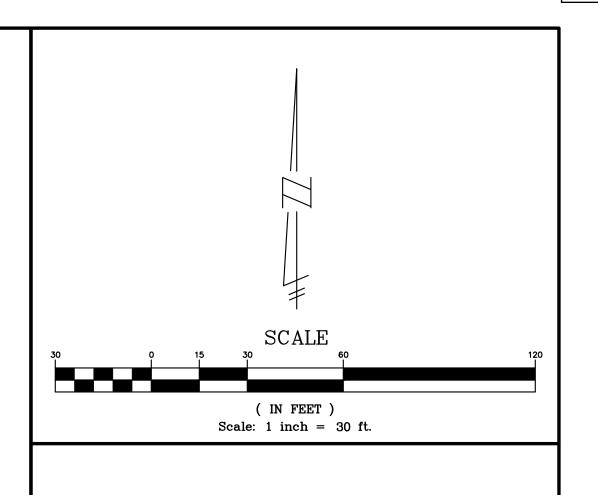

UTILITY CROSSING- MAINTAIN 18" MINIMUM VERTICAL SEPARATION BETWEEN UTILITIES.

COMPACTED SAND BACKFILL UNDER THE INFLUENCE OF ROADS. MATERIAL COMPACTED TO 95% MAXIMUM UNIT DENSITY.

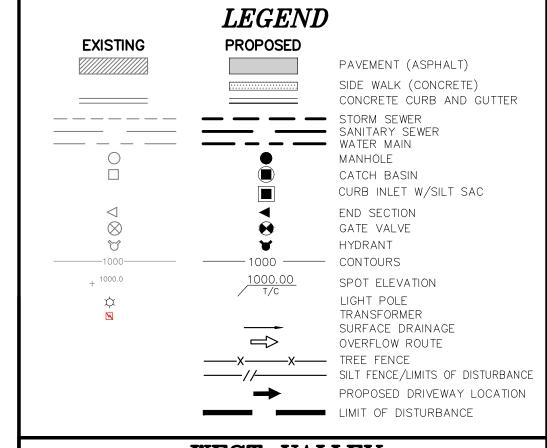

WEST VALLEY MULTI-FAMILY RESIDENTIAL COMMUNITY SECTION 36, TOWN 3 NORTH, RANGE 8 EAST WHITE LAKE TWP., OAKLAND COUNTY, MICHIGAN

	WHITE LAKE TWP	., OAKI	AND COUNTY, MICHIGAN
	REVISION	S	UTILITY WARNING
NO.	ITEM	DATE	UNDERGROUND UTILITY LOCATIONS AS
1.	REV. PER RCOC PERMITS DEPARTMENT	10-22-19	SHOWN ON THE PLAN, WERE OBTAINED
2.	REV. SAN AND STORM PER OWNER	04-10-20	FROM UTILITY OWNER AND NOT FIELD LOCATED.
3.	REV SAN, ST. & PAV. PER OWNER	5-18-20	EOCATED.
4.	REVISE PER TWP.	02-18-21	
5.	REVISE PER TWP.	03-17-21	} X4
6.	REVISED WATER MAIN PER EGLE	05-11-21	• Know what's below .
7.	REV PER OWNER, RCOC AND OCWRC	11-21-22	Call before you dig
8.	REVISED WATERMAIN FOR OWNER	04-05-23	oun perere you any
9.	REVISED PER TOWNSHIP	04-25-23	THE CONTRACTOR SHALL BE RESPONS
10	REVISE PER TWP.	7-27-23	FOR THE PROTECTION OF AND/OR
11.	REVISED PER TWP.	09-21-23	RELOCATION OF ALL UTILITIES THAT
12	REVISED PER EGLE	01-31-24	MAY INTERFERE WITH CONSTRUCTION.
13	REVSE PER TWP	02-13-24	

Know what's below. Call before you dig. CONTRACTOR SHALL BE RESPONSIBL THE PROTECTION OF AND/OR LOCATION OF ALL UTILITIES THAT

DATE: 08-23-19 DESIGNED BY: G.N. JOB NUMBER: 17-031
CHECKED BY: J.E. DRAWING FILE:17031-RD.dwg

WATER MAIN PROFILES



SEIBER KEAST LEHNER L ENGINEERING | SURVEYING FARMINGTON HILLS OFFICE 39205 COUNTRY CLUB DRIVE, SUITE C8 FARMINGTON HILLS, MI 48331 248.308.3331

SHEET

CROSSING #

10

12

13

14

16

17

18

19

24

25

26

27

29

30

32

33

PIPE BELOW 12" WM

6" SAN LEAD

12" WM

12" WM

8" SAN

8" WM

12" WM

4" FM

4" FM

4" FM

8" WM

8" SAN

8" SAN

6" SAN LEAD

8" SAN

4" FM

8" SAN

6" SAN LEAD

12" WM

8" SAN

8" SAN

8" SAN

6" SAN LEAD

8" WM

8"WM

6" SAN LEAD

4" FM

8" WM

8" WM

8" WM

8"WM

4" FM

8" SAN

8"SAN

EX. 12" WM

CROSSING TABLE

PIPE ABOVE

12"STORM

12" WM

12" STORM

8' DRAIN

12" WM

24" STORM

24" STORM

12" STORM

8" WM

12"STORM

24" STORM

24"STORM

8" WM

8" WM

18" STORM

18" STORM

4" FM

12" WM

30" STORM

4" FM

12" WM

30" STORM

8" WM

12" STORM

8" WM

12"STORM

12" WM

30" STORM

8" DRAIN

8" DRAIN

8" DRAIN

12" WM

8" DRAIN

8" DRAIN

4" FM

T/PIPE ELEV

971.00

955.00

956.82

957.70

946.53

946.04

945.62

952.56

952.73

953.45

949.05

946.94

947.68

948.30

943.42

945.05

946.26

944.00

943.92

942.68

942.61

942.16

943.50

946.23

945.26

947.77

950.80

943.41

946.23

947.88

952.18

944.10

943.37

953.34

977.24

B/PIPE ELEV

973.21

956.50

958.32

959.83

950.97

947.54 947.12

954.06

955.83

955.00

950.55

950.77

949.70

946.39

946.55

949.89

945.70

945.56

944.18

945.76

944.64

945.80

947.73

946.76

949.51

952.30

944.91

948.76

950.09

954.79

945.66

948.72

959.92

975.74

949.93

SEPERATION

1.50'

1.50'

1.50'

2.13'

4.44'

1.50'

1.50'

1.50'

3.10'

1.55'

1.50'

2.99'

3.09'

1.40'

2.97'

1.50'

3.63'

1.70'

1.64'

1.50'

3.15

2.48

2.30'

1.50'

1.50'

1.74'

1.50'

1.50'

2.53'

2.21


2.61'

1.56'

5.35

6.58'

1.50'

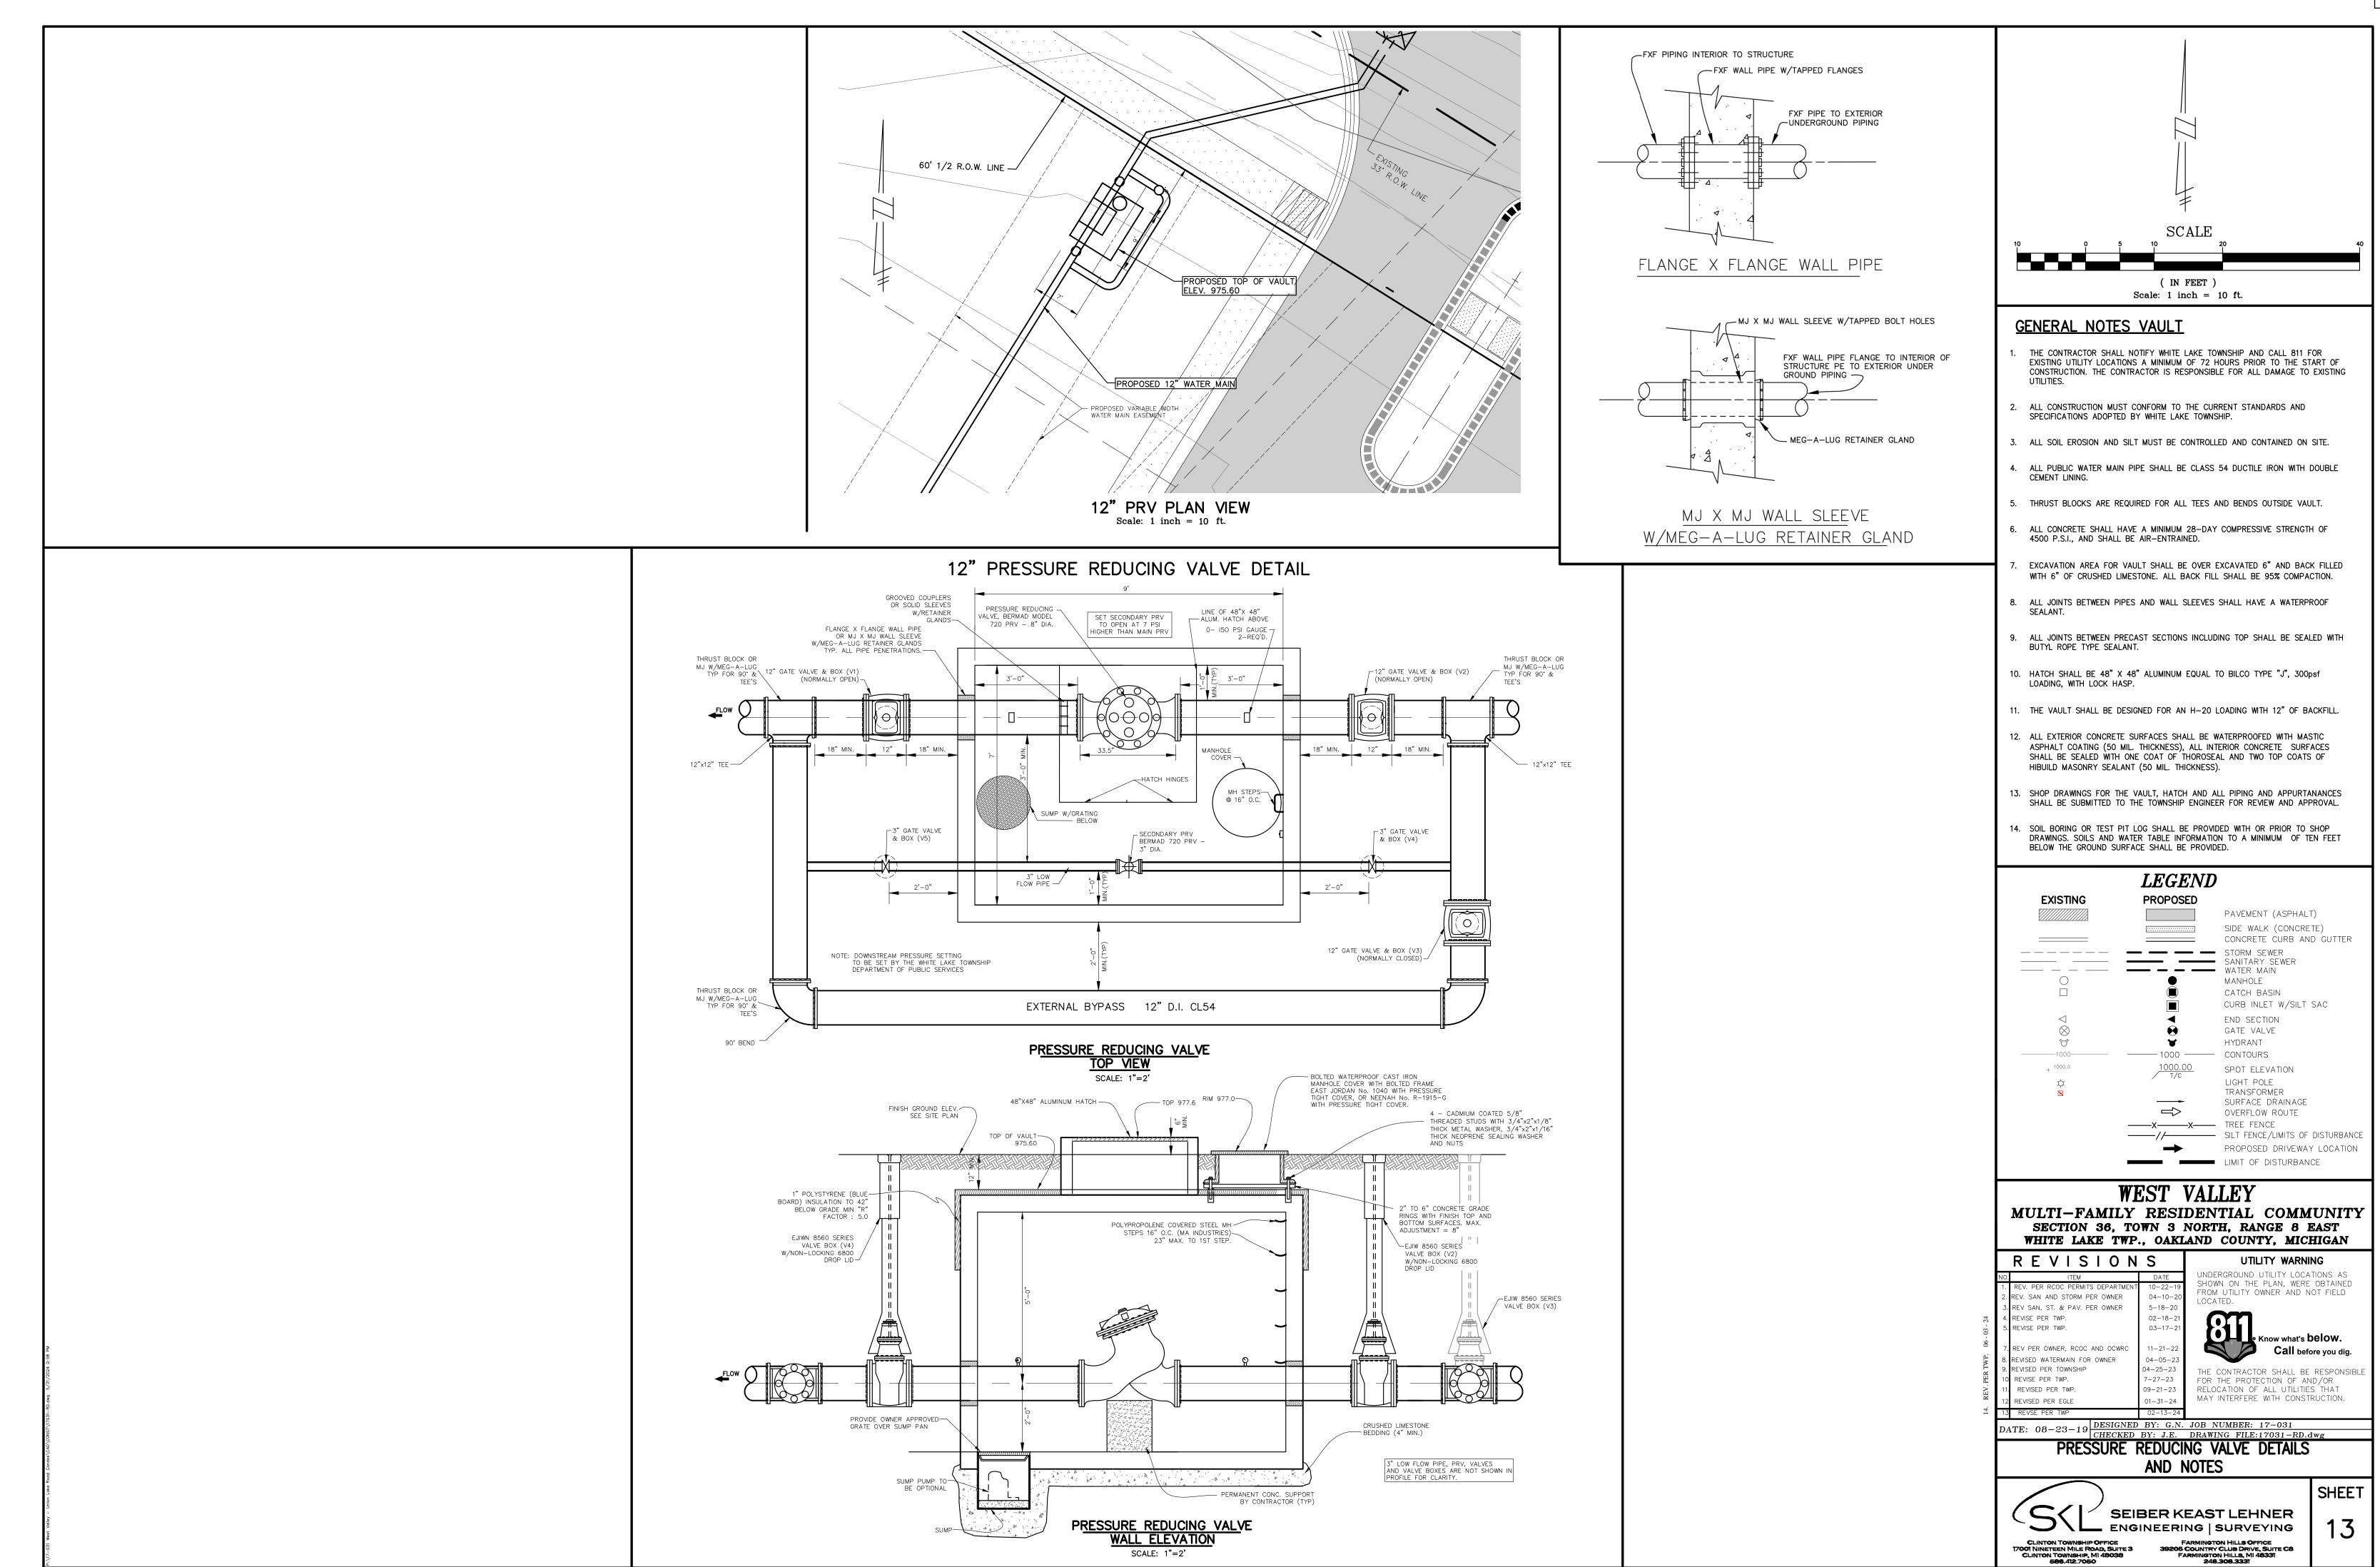

THE PUMP STATION IS PUBLIC AND SHALL

BE MAINTAINED IN ACCORDANCE WITH

OAKLAND COUNTY WATER RESOURCE

COMMISSIONER REQUIREMENTS

4. FLYGT MIX-FLUSH VALVE.

TOP VIEW

BASE SECTION

UTILITY WARNING

UNDERGROUND UTILITY LOCATIONS AS

FROM UTILITY OWNER AND NOT FIELD

SHOWN ON THE PLAN, WERE OBTAINED

THE CONTRACTOR SHALL BE RESPONSIB

FOR THE PROTECTION OF AND/OR

RELOCATION OF ALL UTILITIES THAT

MAY INTERFERE WITH CONSTRUCTION.

Know what's **below.**

Call before you dig.

SHEET

A - INSIDE EDGE OF

SIZING OF PIT TYPE, LOCATION AND ARRANGEMENT OF VALVES AND PIPHIO, ETC. ARE TO BE SPECIFIED BY THE CONSULTING ENGINEER AND ARE SUBJECT TO THEIR APPROVAL. REFERENCE GENERIC DUPLEX LIFT STATION LAYOUT

TOP VIEW

A - INSIDE EDGE OF CLEAR OPENING

BASE SECTION

REVISIONS

REV. SAN AND STORM PER OWNER

REV SAN, ST. & PAV. PER OWNER

REV PER OWNER, RCOC AND OCWRC

REVISED WATERMAIN FOR OWNER

REVISED PER TOWNSHIP

REVISED PER TWP.

REVISED PER EGLE

REVISE PER TWP.

REVISE PER TWP.

REVISE PER TWP.

Wet Well Fill Times for West Valley Flows:

1.0' Storage Volume & 6' I.D. =

(Pump On to Pump Off)

28.27 cf

211.51 gal

WEST VALLEY

SECTION 36, TOWN 3 NORTH, RANGE 8 EAST

WHITE LAKE TWP., OAKLAND COUNTY, MICHIGAN

04-25-23

7-27-23

09-21-23

SANITARY SEWER PUMP STATION DETAILS

SEIBER KEAST LEHNER

ENGINEERING | SURVEYING

FARMINGTON HILLS OFFICE :05 COUNTRY CLUB DRIVE, SUITE C8 FARMINGTON HILLS, MI 48331 248.308.3331

ATE: 08-23-19 DESIGNED BY: G.N. JOB NUMBER: 17-031

10' C-C SUMP PUMP DISCHARGE TO WET WELL ─ 18" DIA. X 6" DEEP SUMP CABLE HOLDER -PLAN VIEW PROVIDE CONC.(MIN 3500 PSI) THRUST BLOCKS AT ALL EXTERIOR BENDS (EXISTING) ALL PIPING OUTSIDE VALVE PIT SHALL BE MECHANICAL JOINT. SUMP PUMP - DOUBLE HUB COUPLING (TYP.) 4" PLUG VALVE 4" DIA. OPERATOR (TYP.) CONNECTION 8" INFLUENT LEVER ARM AND -WEIGHTED CHECK VALVE 4" DIA. 4" DIA. LINK-SEAL OR EQUIVALANT FOR - RESILIENT FLEXIBLE -ALL PIPING PENETRATIONS (TYP.) ONNECTION CAST INTO WALL (TYPICAL) 30" CLEAR PUMPS SHALL BE FLYGT MODEL NP 3085 SH3~ADAPTIVE 256 SUBMERSIBLE WASTEWATER PUMP WITH A 4" DISCHARGE TO DELIVER 116 GAL/MIN AGAINST AN OPERATING HEAD OF 52 FT WITH 4" D.I. EPOXY COATED STEEL VENT PIPE BILCO ALUMINUM H20 LOAD RATED COVER TYPE JDAL-ALUMINUM BILCO MODEL 4" D.I. EPOXY COATED STEEL VENT PIPE WITH STAINLESS STEEL BIRD SCREEN. WITH STAINLESS STEEL BIRD SCREEN. THE OPENING MUST BE 18" MIN. ABOVE GRADE.— AIR RELEASE VALVE RIM = 952.7 #JD-3AL H2O OR APPROVED FAQUA THE OPENING MUST BE 18" MIN. ABOVE GRADE. IN ACCESS MANHOLE SE (TYPICAL WETWELL& VALVE VALT) - - HOOK AND STAINLESS BILCO ALUMINUM H20 LOAD RATED COVER TYPE TYPICAL AIR VACUUM RELEASE VALVE ASSEMBLY DETAIL ON TH STEEL LIFTING CHAIN JDAL-ALUMINUM BILCO MODEL #JD-3AL H2O OF - REINFORCEMENT PER ACCESS COVER FOR SERVICING PUMP. MANUFACTURER'S - REINFORCEMENT PER APPROVED EAQUAL (TYPICAL WETWELL& VALVE OCWRC LOW PRESSURE SANITARY SEWER STANDARD DETAIL SHEET. (57"x32" CLEAR OPENING)— SPECIFICATIONS MANUFACTURER'S **SPECIFICATIONS** (30" x 48" CLEAR OPENING) REINFORCEMENT PER TOP OF COVER = 952.6TOP OF COVER = 952.6 ALL SELECTOR SWITCHES AND LIGHTS SHALL BE OIL TIGHT, INDUSTRIAL RATED WITH 10 AMP MANUFACTURER'S ____ PROVIDE NECESSARY PRECAST SPECIFICATIONS OPENINGS, 2 FOR PUMP POWER CORDS AND 1 FOR CONTROL LINES. HOLES SHALL BE MORTARED. SWITCH BRACKET A.S.T.M. A-48, CLASS 30 WITH NON SLIP TREAD, 16" O.C., 24"MAX. ABOVE FLOOR. 12. GAS TIGHT SEALS SHALL BE PROVIDED IN CONDUITS FROM WET WELLS AND LOCATED WITHIN PROP. LEVEL SENSOR - 4" FEMALE COUPLER, DIXON AND FLOAT SWITCHES MODEL #400-D-AL OR #400-B-AL AND 4" MALE ADAPTER DUST PLUG, DIXON EMERGENCY PUMP CONNECTION -MODEL #400-DP-AL 72" I.D. PRECAST RCP (ASTM C-478) (DRILL 1/8" HOLE IN CAP) WITH MODIFIED TONGUE AND GROOVE BAR BRACKET 'SUPER SEAL" JOINT----CP/DP/NP-3085 WEIGHTED CHECK VALVES 'DIA. FLANGED (CL 125) INTERIOR PIPING -- LINK-SEAL OR EQUIVALANT FOR ALL PIPING PENETRATIONS (TYP.) PIPING PENETRATIONS SHALL BE SMOOTH SURFACE, SEGMENTED Simplex ("LINK-SEAL" OR EQUAL) SLOPE TO — SUMP -FLANGE CONNECTION - DOUBLE HUB ACCESS. B. VALVE PIT - ITT FLYGHT HEAVY DUTY ANGLE FRAME COVER WITH 30"x48" CLEAR OPENING WITH A SAFE-HATCH ACCESS COVER FOR FALL PROTECTION. THE COVER SHALL BE SEE BY-PASS ASSEMBLY & PIPING BRACE -RESILIENT FLEXIBLE CHECK VALVES - APCO SERIES 100 RUBBER FLAPPER SWING CHECK VALVE WITH CAST IRON ACCESS MANHOLE DETAIL CONNECTION CAST INTO 8" INFLUENT INVERT ELEV. = 941.00 WALL (TYPICAL) <u>FINAL BUILDOUT PUMP ELEVATIONS</u> ALL INTERIOR PIPING SHALL BE 4" DIA. FLANGED (CL.125). ALL SUPPORT BRACKETS, GUIDE HIGH WATER ALARM ELEV. = 940.00 INITIAL BUILDOUT PUMP ELEVATIONS FOR LAG PUMP ON ELEV. = 939.50 WEST VALLEY DEVELOPMENT <u>PUMP ON ELEV. = 939.00</u> ACCORDANCE WITH THE N.E.C. REQUIREMENTS FOR CLASS 1, DIVISION 1, GROUP D HAZARDOUS PUMP OFF ELEV. = 936.50 1.00' STORAGE VOLUME DEPTH *NOTE: THE VALVE CHAMBER IS TO BE PLACED ON OW WATER ALARM ELEV. = 936.00 CONTRACTOR AND PUMP MANUFACTURER MUST COORDINATE THE LOCATION OF FLOATS AND UNDISTURBED SOILS TO PREVENT DIFFERENTIAL SETTLEMENT BETWEEN THE WET WELL AND THE VALVE CHAMBER. A 938.50 HIGH WATER ALARM ELEV. = ALSO WIRED FOR REDUNDANT PUMP O BUBBLER TO ENSURE THERE WILL NOT BE DISTURBANCE FROM PUMP SUCTION AND INFLUENT LEAN, FLOWABLE FILL MAY ALSO BE USED TO FILL THE EXCAVATION TO THE BOTTOM OF THE VALVE CHAMBER BASE LAG PUMP ON ELEV. = 938.00 "NOT TO SCALE" 937.50 PUMP ON ELEV. = SLAB. BACKFILL AS DIRECTED BY FIELD ENGINEER TO PREVENT FLOATING UNDER SATURATED CONDITIONS. PUMP OFF ELEV. = 936.50 **ELEVATION** PROP. FLYGT PUMP LOW WATER ALARM ELEV. = 936.00 THE ALARM SYSTEM SHALL CONTAIN A POWER BACK-UP IN THE CASE OF A POWER FAILURE, BOTTOM STATION ELEV. = 934.50 - REINFORCEMENT PER MANUFACTURER'S SPECIFICATIONS 124" O.D. PRECAST CONCRETE SLAB **Head Loss Calculation (4" Forcemain)** 4" Forcemain System Curves: Pump Station Initial Design for Pump Station Pump Station Compnoents c = 120Basis of Design 4" Equiv. 6" Equiv. 2.7 people/unit x 69 units * Multi Fmaily Unit Factor 0.6 41.4 units Pump Station Compnents for Head Loss 40.65 0.06 2.7 people/unit x 111.78 people Ordinary Entrance MULTI-FAMILY RESIDENTIAL COMMUNITY

NOTES

RELAYS FOR LEAK DETECTION DEVICES IN EACH PUMP SHALL BE PROVIDED AND DELIVERED

CONTROL CIRCUIT TO BE CONNECTED THROUGH HEAT SENSING SWITCHES IN THE PUMP AND

SHALL DISCONNECT THE CONTROL CIRCUIT IN CASE OF A HIGH TEMPERATURE CONDITION IN

CONTROL OF THE PUMPS SHALL BE BY MULTITRODE DUPLEX PUMP CONTROLLER, MODEL

#MSU-3MP, WITH ENERGY MONITORING & MOTOR PROTECTION, MULTITRODE LEVEL PROBE WITH INTRINSICALLY SAFE BARRIER, AND REDUNDANT INTRINSICALLY SAFE MERCURY FLOAT

3.44 HP - 3415 RPM MOTOR (230V, 3PH., VFD) OR APPROVED EQUAL.

CONTROL PANEL SHALL BE PROVIDED BY PUMP MANUFACTURER.

SWITCHES FOR HIGH AND LOW WATER LEVELS. PUMPS SHALL ALTERNATE AFTER EVERY CYCLE.

HOUR METERS SHALL BE PROVIDED FOR EACH PUMP.

CONTROL PANEL SHALL BE LOCATED ABOVE GROUND.

PANELS ON EACH SIDE TO MINIMIZE RACK FOOT PRINT.

PUMPS SHALL BE CAPABLE OF PASSING SPHERES AT LEAST 3" IN DIAMETER.

LOW WATER ALARM SHALL BE WIRED AS A REDUNDANT PUMP OFF SWITCH.

10. ELECTRIC POWER (110V) SHALL BE PROVIDED FOR MAINTENANCE AND SHALL BE GROUND

13. VOLTAGE AND AMPERAGE FROM CONTROL PANEL SHALL BE COMPATIBLE WITH MOTORS AND

UNI-STRUT RACK SHALL BE PROVIDED FOR CONTROL PANEL MOUNT, MOUNT CONTROL

17. PUMP STATION CONTROL PANEL SHALL CONFORM TO WHITE LAKE TOWNSHIP SPECIFICATIONS

COVERS A. PUMP STATION - ITT FLYGHT HEAVY DUTY ANGLE FRAME COVER WITH 32"x57"

CLEAR OPENING WITH A SAFE-HATCH ACCESS COVER FOR FALL PROTECTION. THE COVER

PROVIDED WITH A PADLOCK STYLE LOCKING DEVICE TO PREVENT UNAUTHORIZED ACCESS.

BODY AND COVER. MODEL 104 (4") SUPPLIED WITH BACKFLOW DEVICE AND FLOW CONTROL

RAILS, LIFTING CHAINS, LIFTING EYES, HOOKS, CABLE SUPPORT BRACKETS, AND MOUNTING

ALL ELECTRICAL EQUIPMENT AND WIRING WITHIN THE WET WELL SHALL BE INSTALLED IN

THE PUMP STATION AND APPURTENANCES ARE LOCATED TO PROVIDE 24-HOUR ACCESS.

ONE 40KW CUMMINGS DIESEL GENERATOR SET MODEL C40 D6 OR APPROVED EQUAL AND A

CUMMINGS AUTOMATIC TRANSFER SWITCH OTEC OPEN TRANSITION WITH A 225 AMP RATING

PLUG VALVES - 4" DEZURIK (OR APPROVED EQUAL) - HAND ACTIVATED.

HARDWARE WITHIN THE WET WELL SHALL BE STAINLESS STEEL.

LINK-SEAL OR EQUIVALENT FOR ALL PIPING PENETRATIONS

AND SHALL ALERT A 24-HOUR LOCATION OF POWER FAILURE.

THE ALARM SYSTEM SHALL ALERT A 24-HOUR LOCATION OF SEAL FAILURE.

SHALL BE PROVIDED WITH A PADLOCK STYLE LOCKING DEVICE TO PREVENT UNAUTHORIZED

AND SHALL INCLUDE VARIABLE FREQUENCY DRIVES (VFD'S) FOR PHASE CONVERSION.

COMPLETE REMOVAL OF PUMPS WITHOUT DISTURBING THE GAS TIGHT SEAL BETWEEN THE

14. A DISCONNECTION OF THE ELECTRIC POWER TO PUMP MUST BE PROVIDED TO ALLOW

SCADA EQUIPMENT TO BE PROVIDED PER WHITE LAKE TOWNSHIP SPECIFICATIONS.

THE ELECTRICAL CONTROL PANEL SHALL CONTAIN GAS—TIGHT SEALS.

PUMPS:

ELECTRICAL/CONTROL PANEL:

TO OWNER.

CONTACTS.

FAULT PROTECTED.

PUMP STATION/VALVE PIT

SEWER TURBULENCE.

WITHIN A NEMA 3R ENCLOSURE.

ALARM SYSTEM:


AUXILIARY POWER:


18" OF CONTROL PANEL


OTHER ELECTRICAL EQUIPMENT.


WET WELL AND THE CONTROL PANEL.


Ultimate Design for Pump Station 39.35 42.35 Parcel 12-36-176-002 2 Long Sweep Elbow Average Flow: Maximum Estimated REU for future build out - Assume 50 REUs 3 3" x 4" Reducer 0.22 48.46 111.78 people x 100 gal/cap/day 2.7 people/unit x 50 units 0.28 49.79 4 Pipe (Vertical) 13.25 52.79 11,178 GPD 18.56 0.33 18.56 54.91 135.0 people 5 Long Sweep Elbow 7.76 GPM 6 Pipe (Horizontal) 0.0173 CFS West Valey Development 69 units 7 Swing Check Valve Pump Operating Data: * Multi Fmaily Unit Factor 41.4 units Peak Factor: 8 Plug Valve (Gate) 34.48 ft 111.78 people 2.7 people/unit x 9 Standard Tee (18+SQRT(P/1000))/(4+SQRT(P/1000)) NPSH actual: 10 Pipe (Horizontal) 0.26 cfs Pump Flows: 116 gpm 4.23 (28,400 > Pop > 500) Total Ultimate Population = 246.78 people 11 4" x 4" Wye Average Flow: 4 (Pop < 500 people, 10 State Standard) <u>Ultimate Design</u> 246.78 people x 100 gal/cap/day 0.0873 sf 4 (Per 10 States Standards; Population < 500) 4" Equv. Len. = Area of 4" Pipe 24,678 GPD FM Velocity: 2.96 ft/s Peak Flow: 17.14 GPM Forcemain Component For Headloss PEAK FACTOR XAVERAGE FLOW Cycle Times: 0.0382 CFS 12 4" Gate Valve 44,712 GPD (min) 154.27 (gpm) 112.6 Peak Factor: 13 4" x 4" Tee 158.97 31 GPM (18+SQRT(P/1000))/(4+SQRT(P/1000)) 14 4" Gate Valve 30.85 36.20 5.35 Average 0.0692 CFS 4.23 (28,400 > Pop > 500) 18.86 15 4" - 45 deg bend (3 ea) 11.14 9.12 9.12 18.23 4 (Pop < 500 people, 10 State Standard) Max # Starts 16 4" - 22.5 degree bend (4 ea) Mimimum Flow 17 4" - 11.25 deg bend (2 ea) 0.2 * Avg Flow = 2,236 GPD Mimimum Flow = Initial Design - Fill Time for Build out of West Valley Peak Flow: 18 Pipe (Horizontal) 830 1.6 GPM 69 Units 98,712 GPD 0.0035 CFS Multi Family Unit Assignment Factor = 69 GPM 4" Equv. Len. = 874 L.F. 41.4 Units OCWRC Equivalent Units = 0.1527 CFS 2.7 People / Unit Population Density = 2.5' Storage Volume & 6' I.D. = 70.69 CF Mimimum Flow FM High Point = 976.5 ft 111.78 People Population = (Pump On to Pump Off) 528.77 GAL 0.2 * Avg Flow = 4,936 GPD 939.50 ft Average Flow: HW (Pump On) = Peak Flow Will Be Discharged at approximately 11,178 GPD 111.78 People * 100 Gal/Person/Day = 69 GPM = 3.4 GPM LW (LW Alam) = 936.50 ft 7.8 GPM (Ultimate Design) 0.0076 CFS 68.12 min > 30 min ** Since Fill Time Exceeds 30 min, set the "Pump On" Elevation to El. 938.0 (Lag Pump El. 938.5) to accommodate flows from West Valley.

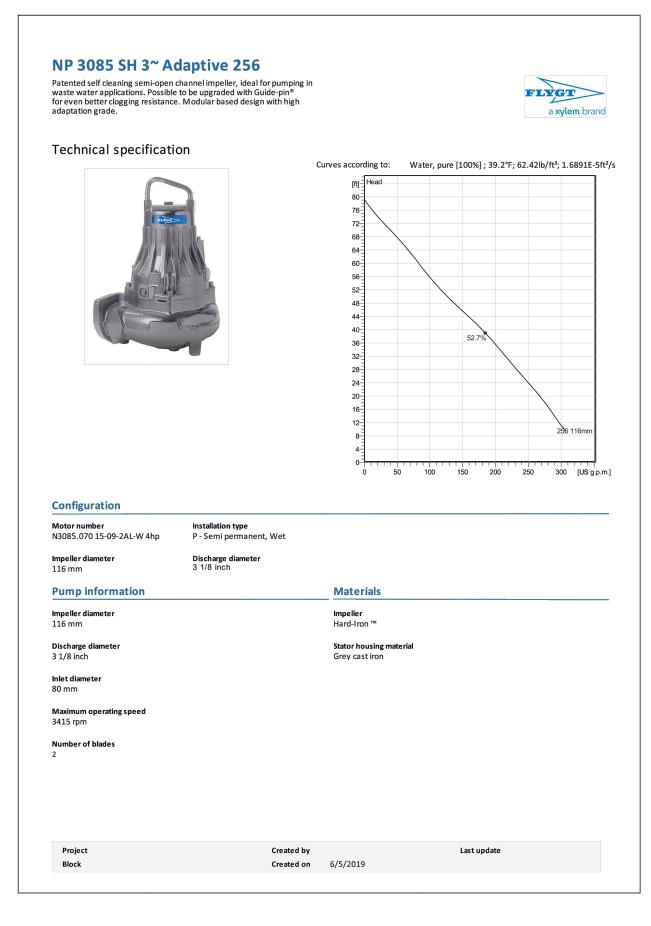


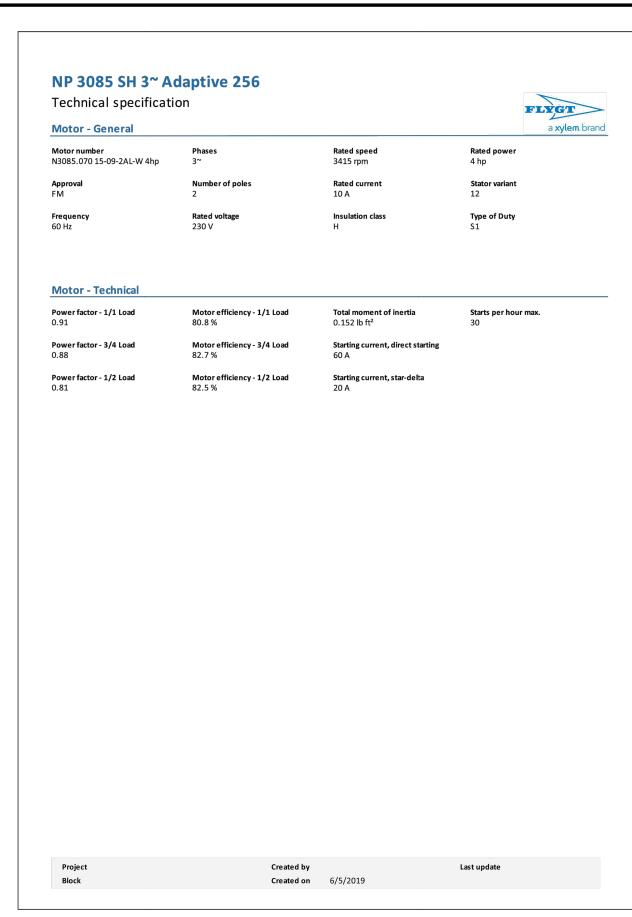


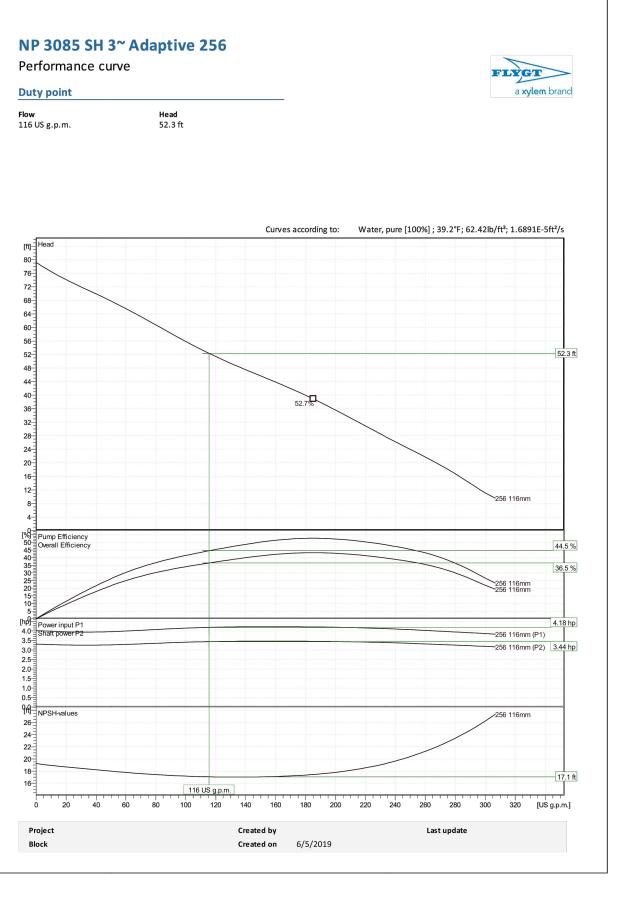


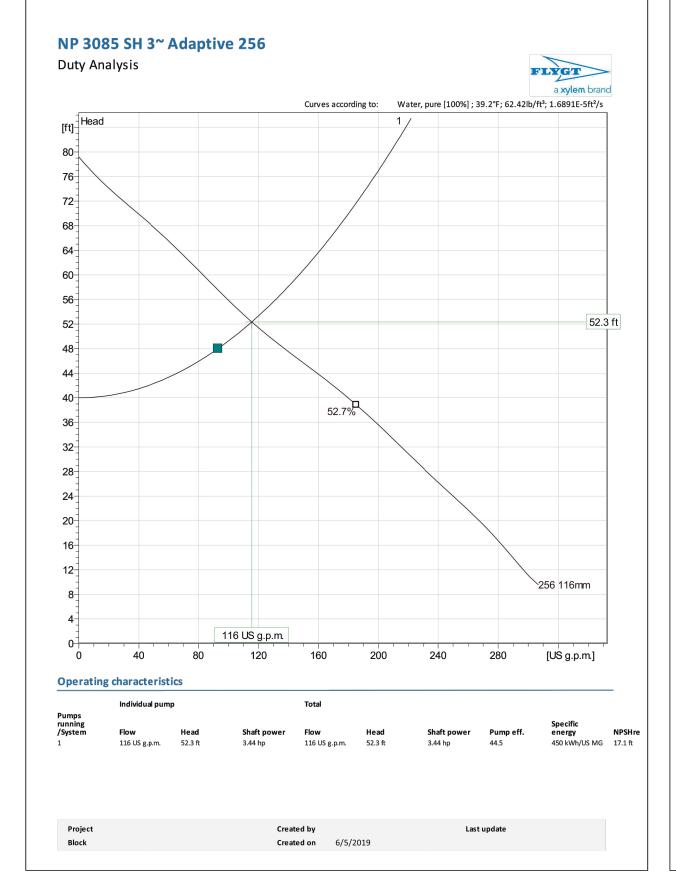


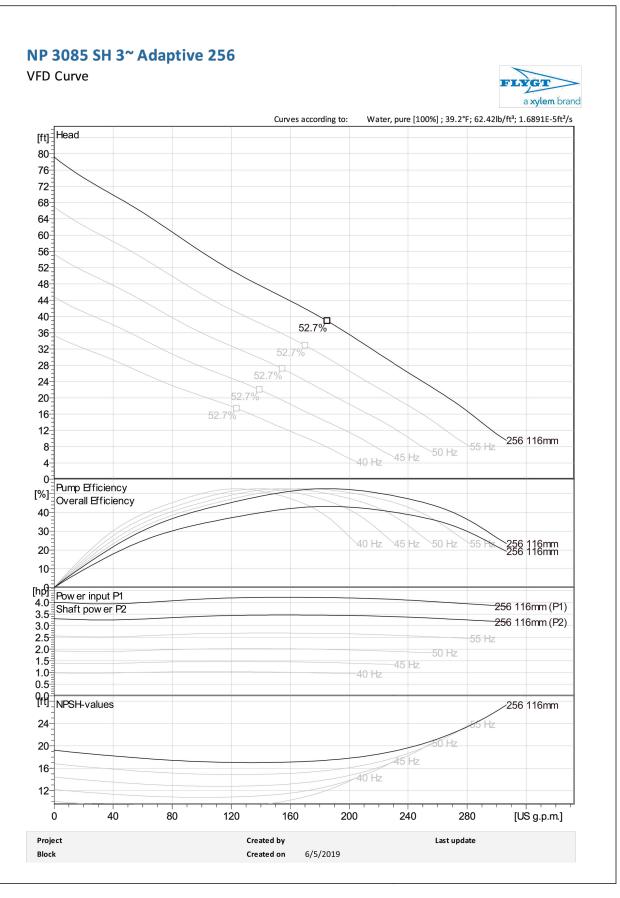


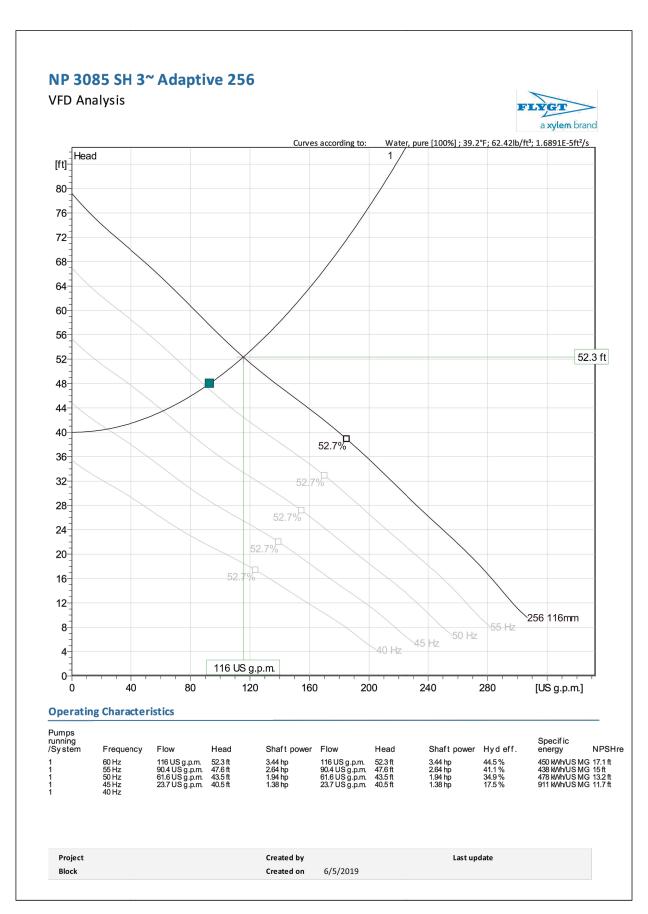


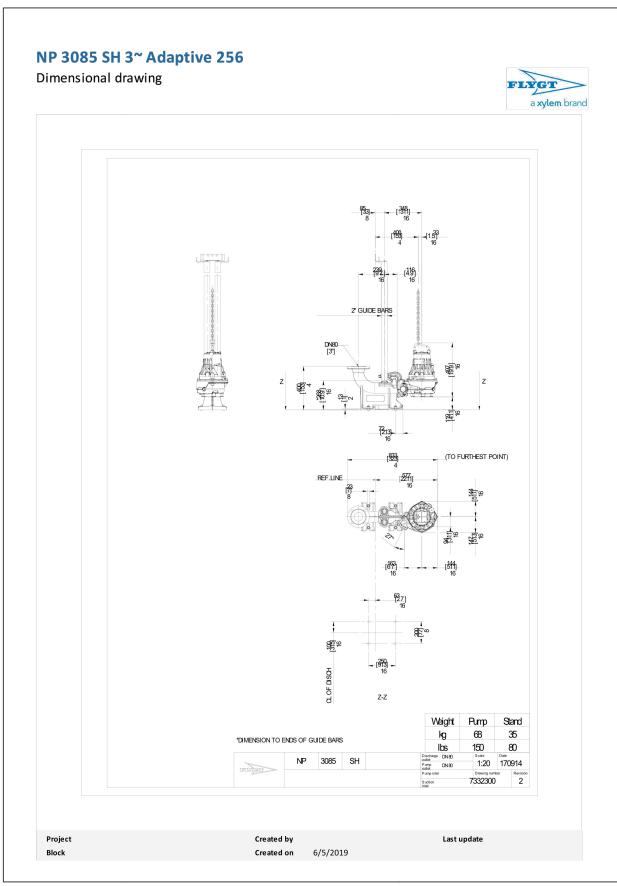

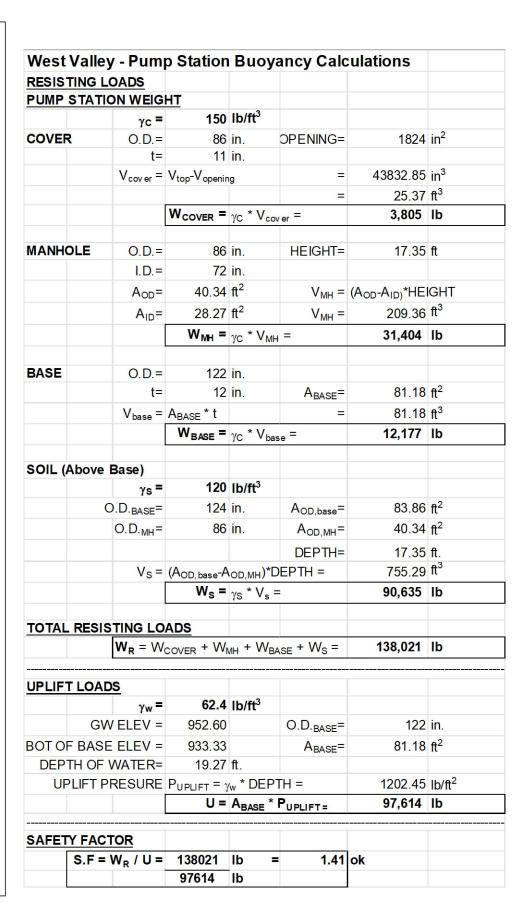


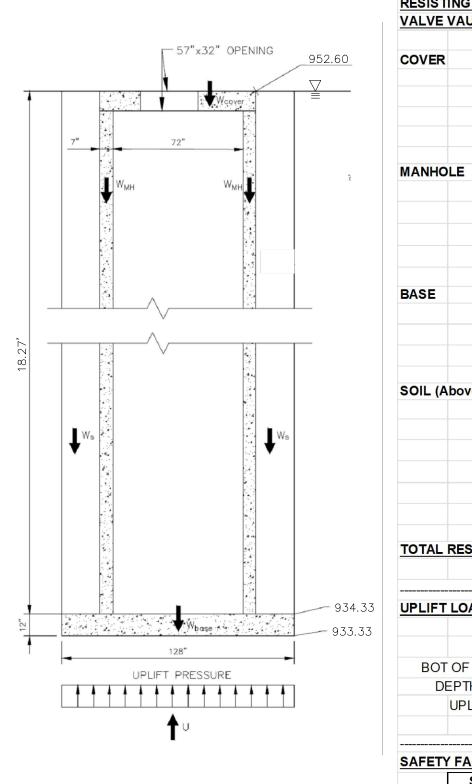

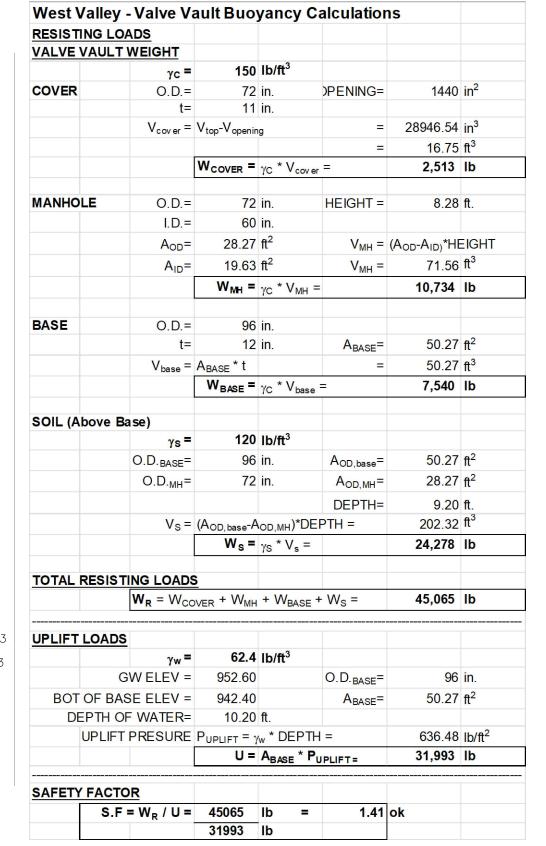

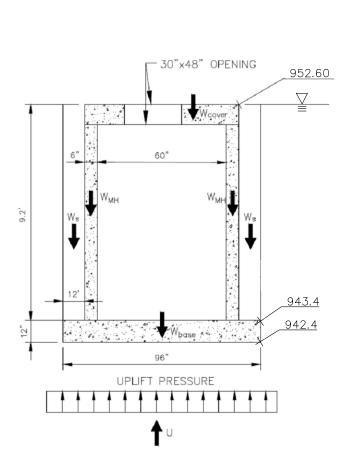



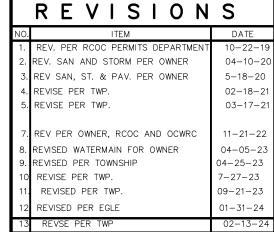

UTILITY WARNING UNDERGROUND UTILITY LOCATIONS AS SHOWN ON THE PLAN, WERE OBTAINED FROM UTILITY OWNER AND NOT FIELD Know what's below.

Call before you dig.

THE CONTRACTOR SHALL BE RESPONSIBLE FOR THE PROTECTION OF AND/OR RELOCATION OF ALL UTILITIES THAT MAY INTERFERE WITH CONSTRUCTION.


SHEET


DATE: 08-23-19 DESIGNED BY: G.N. JOB NUMBER: 17-031
CHECKED BY: J.E. DRAWING FILE:17031-PS.dwg SANITARY SEWER PUMP


STATION CALCULATION CHARTS





SEIBER KEAST LEHNER ENGINEERING | SURVEYING

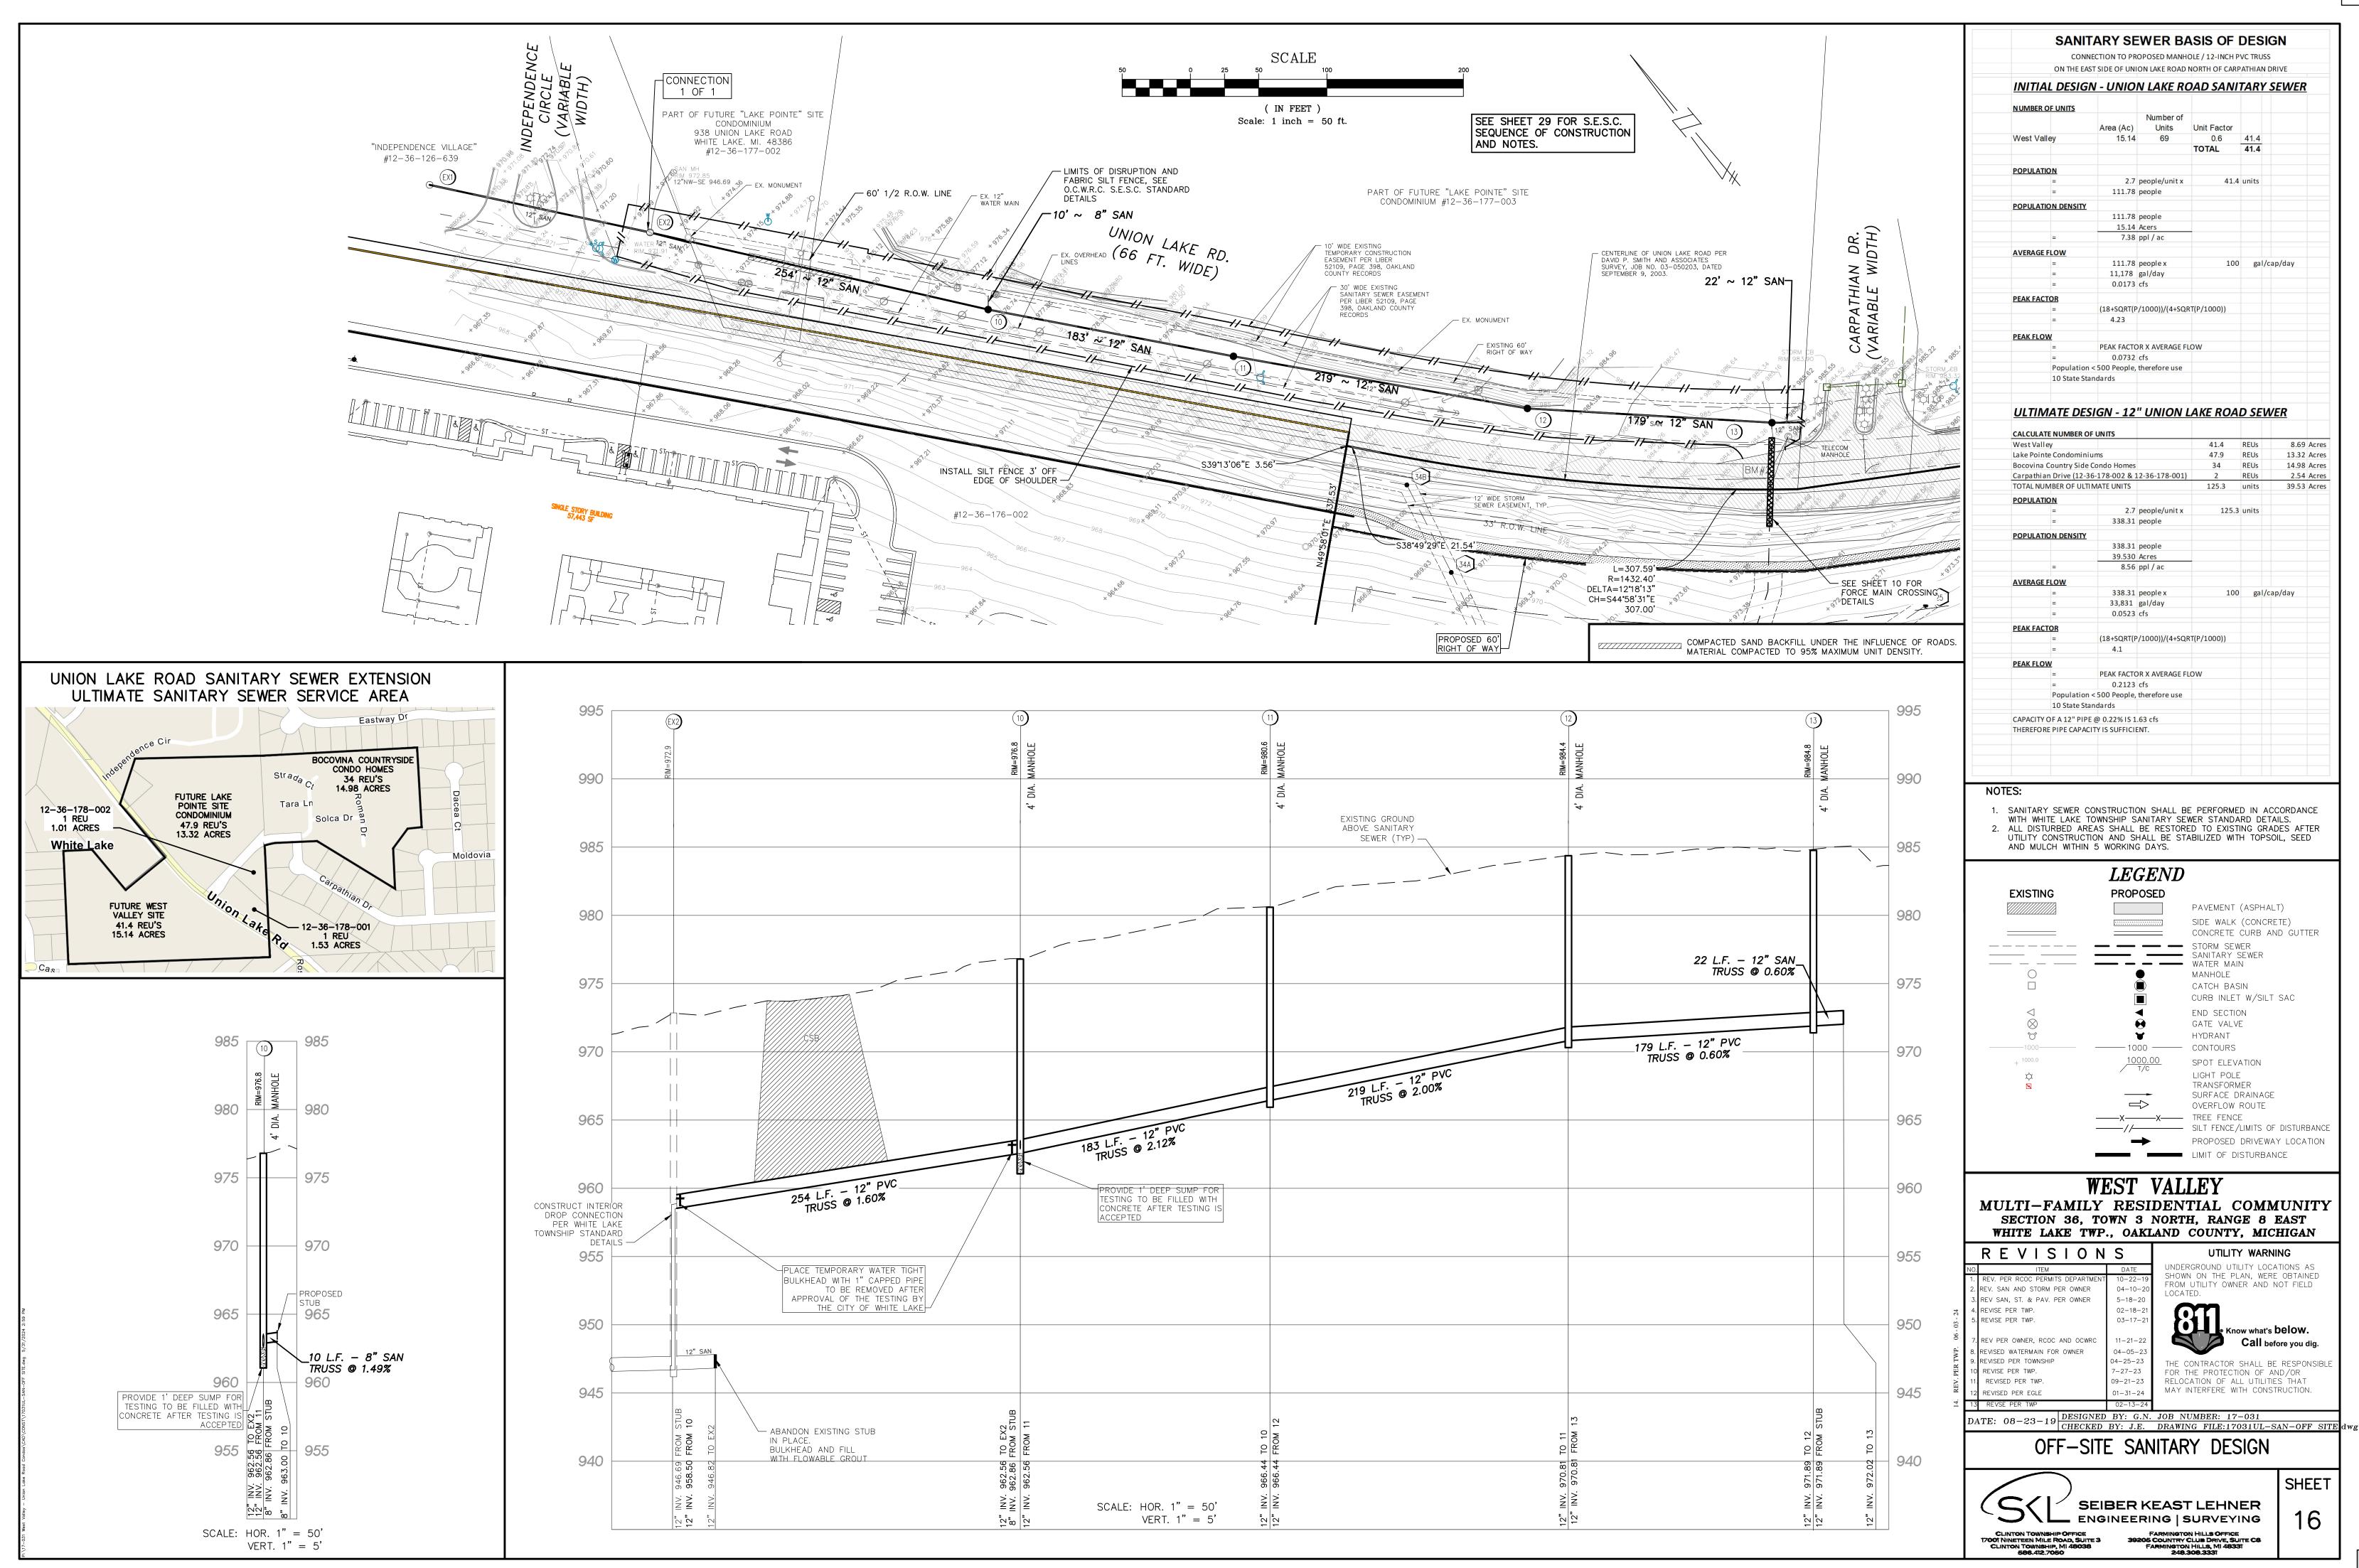


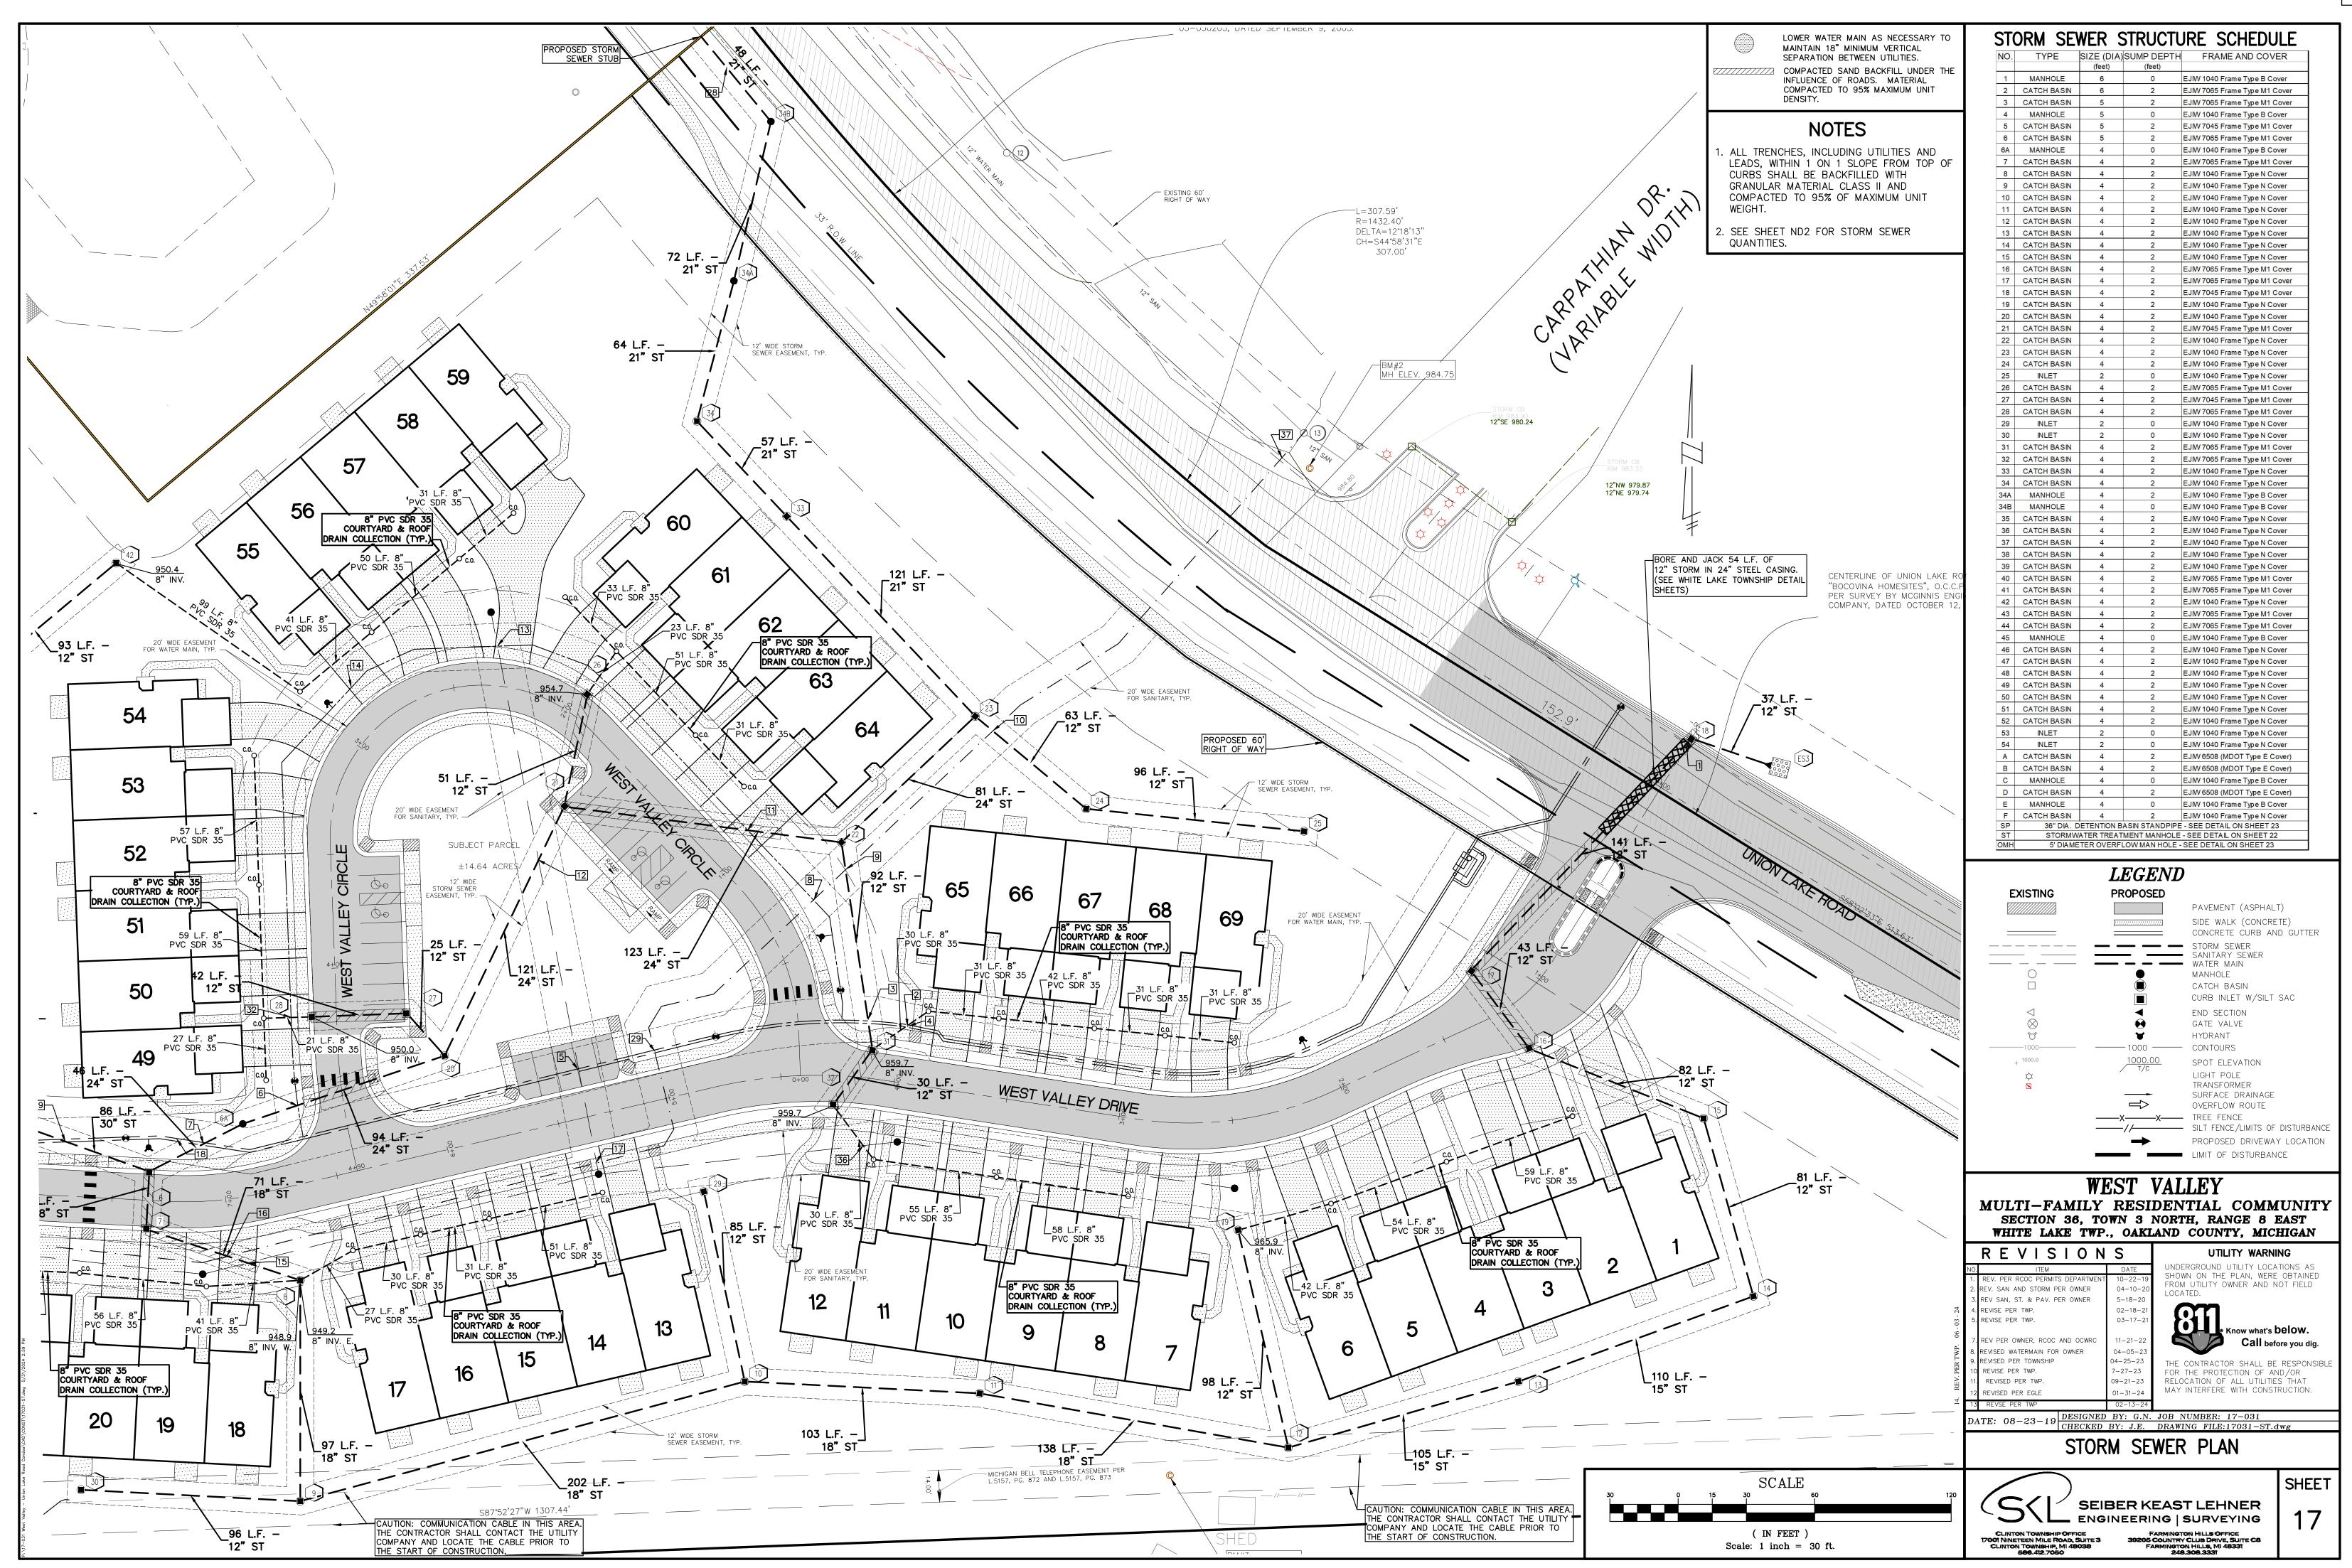


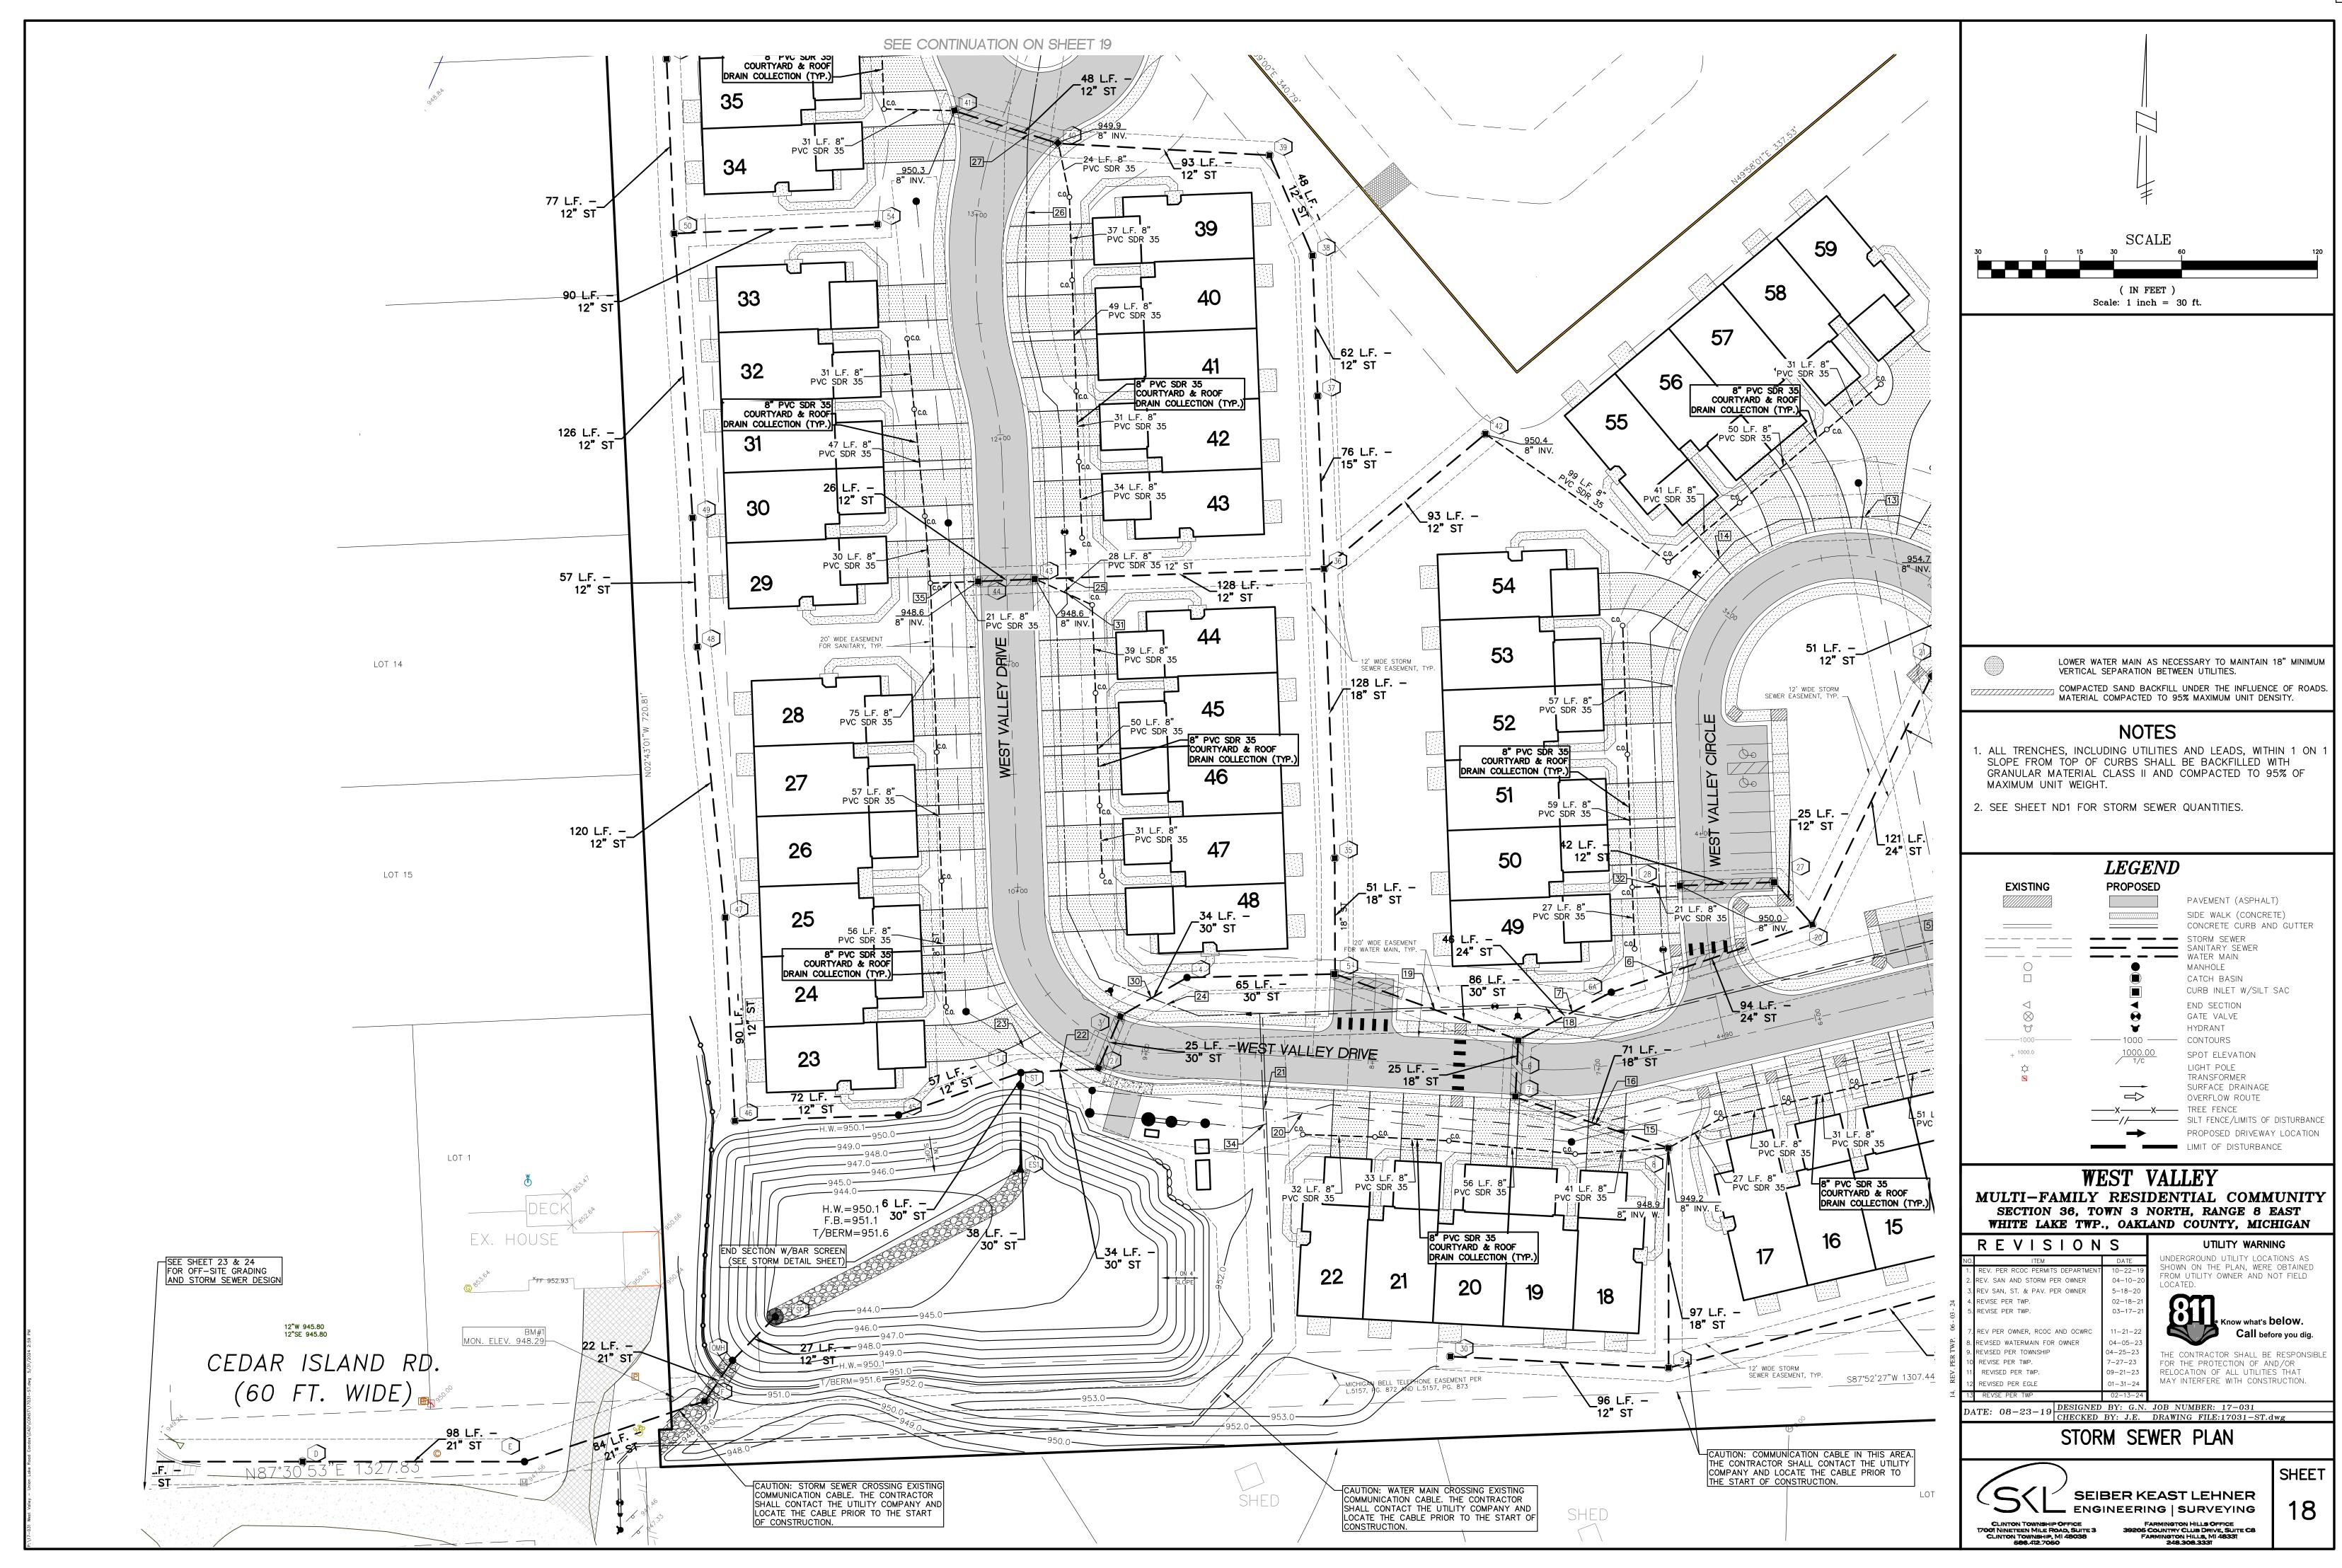

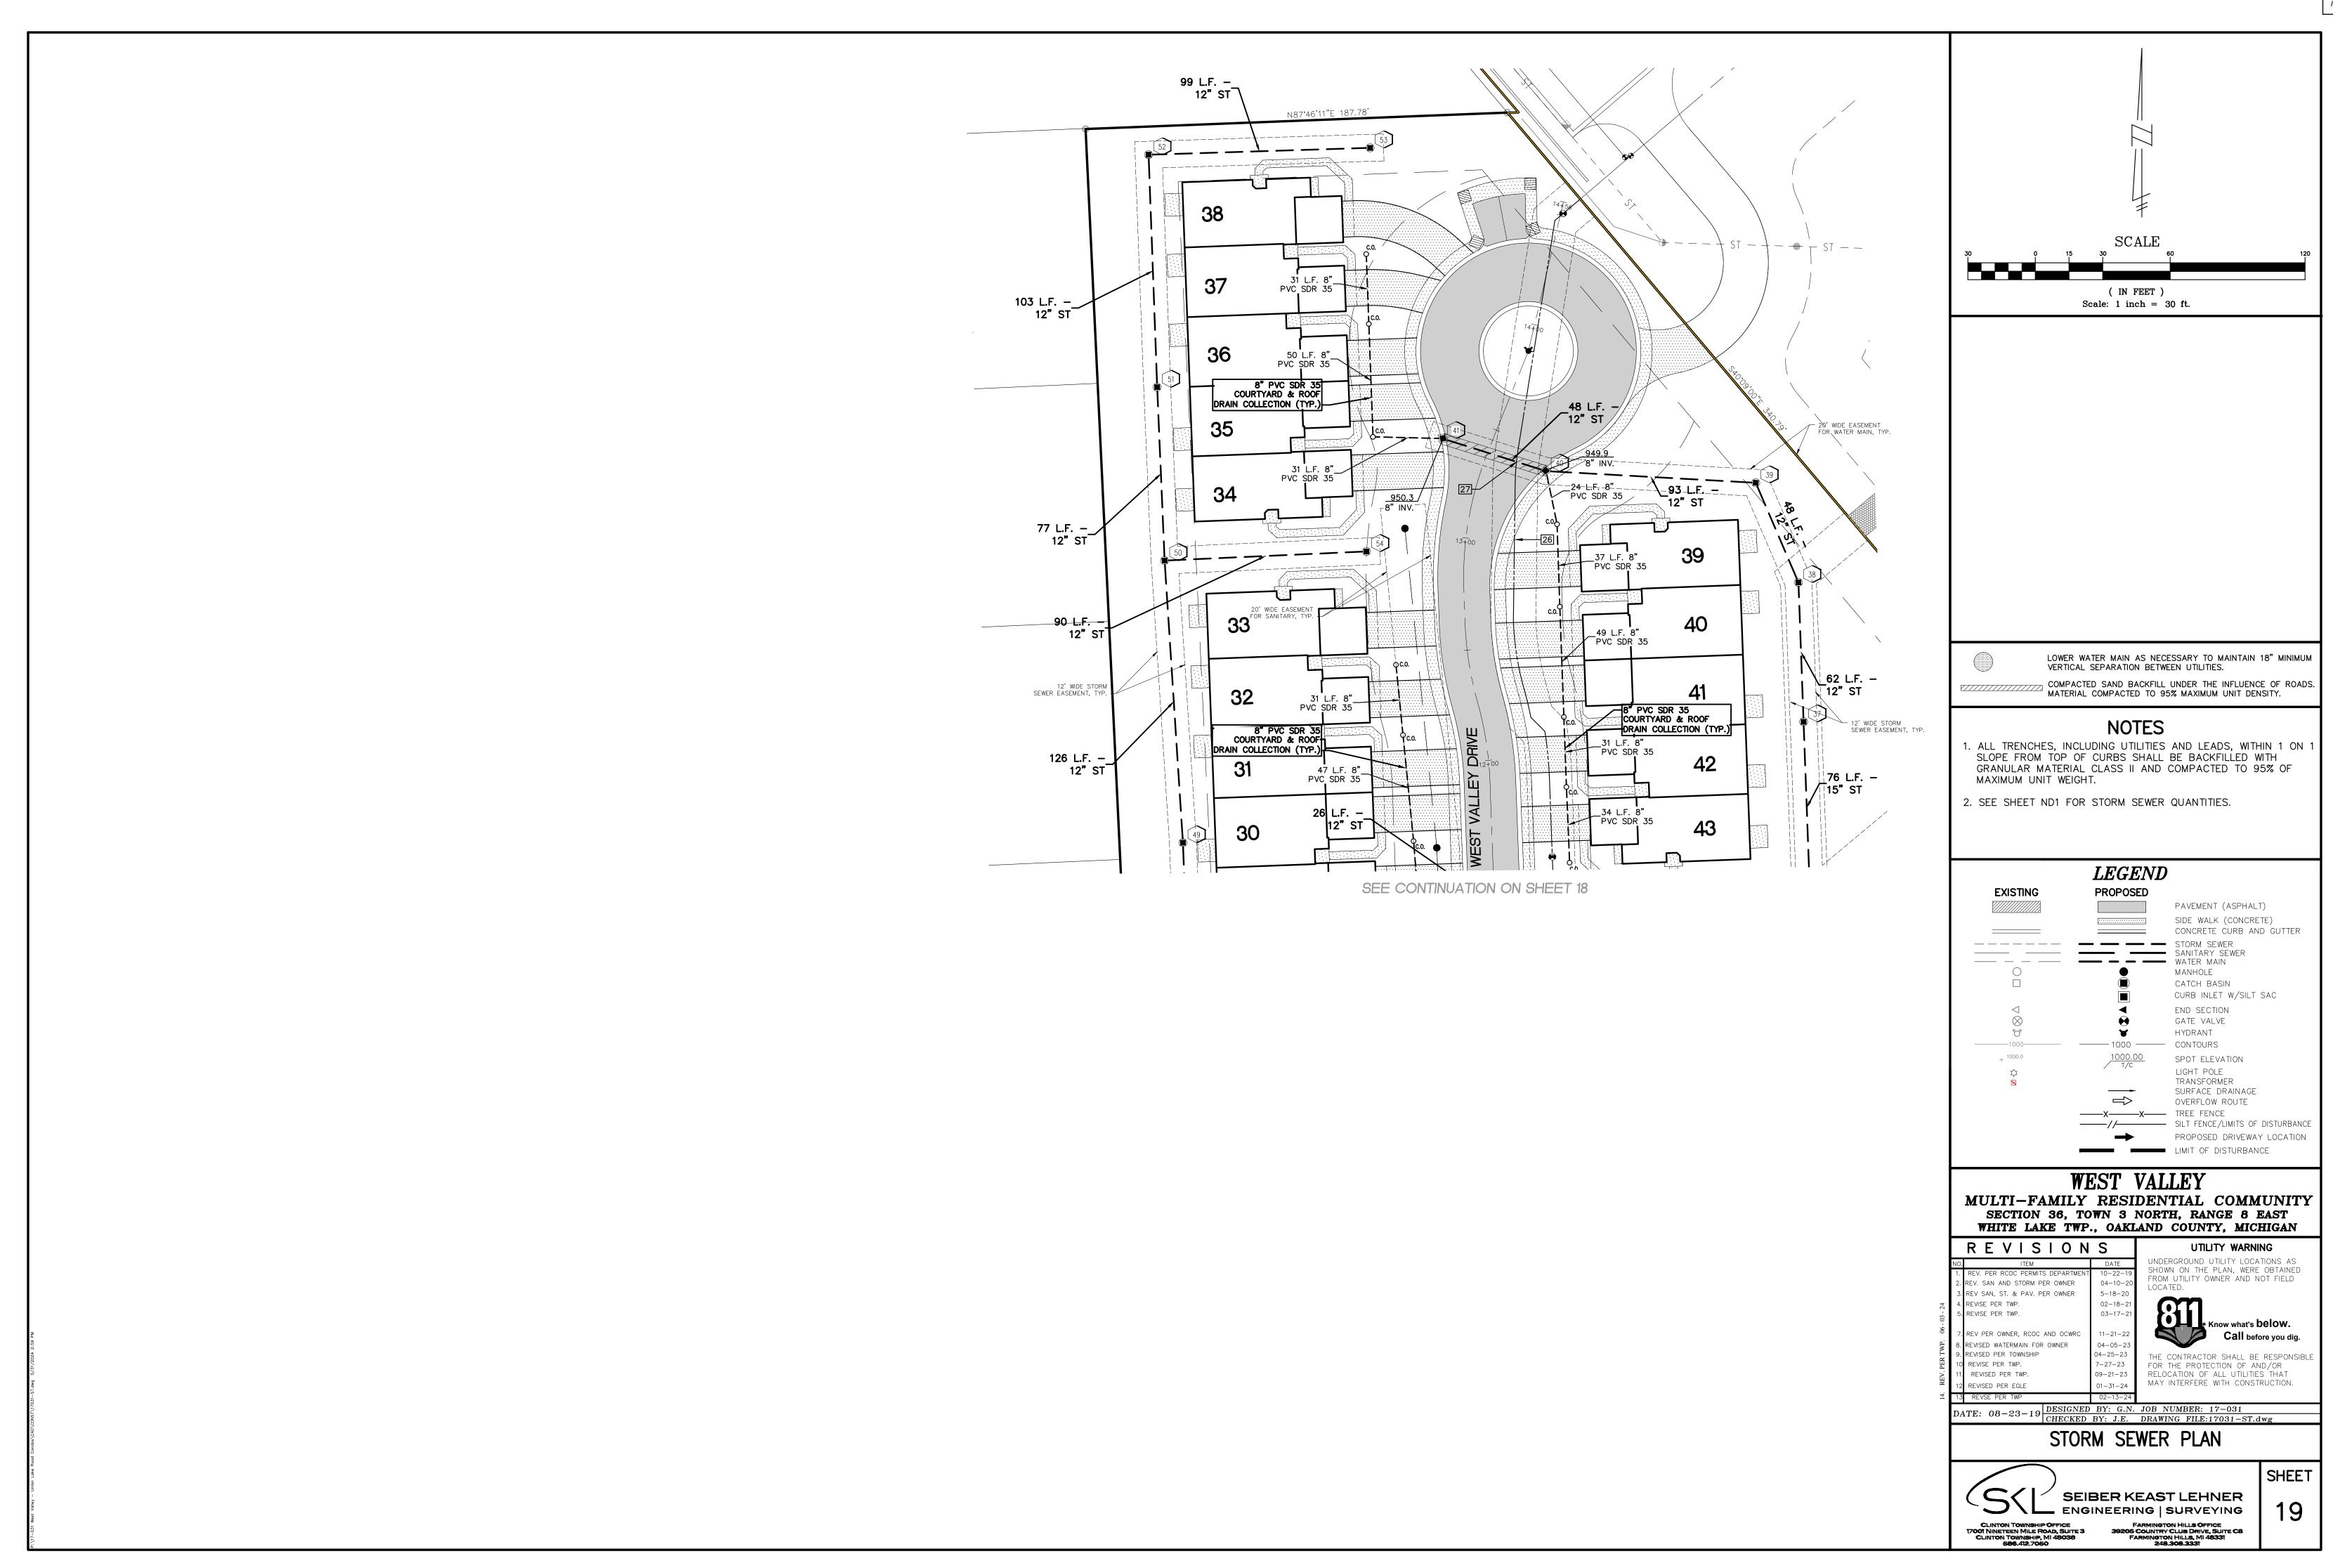

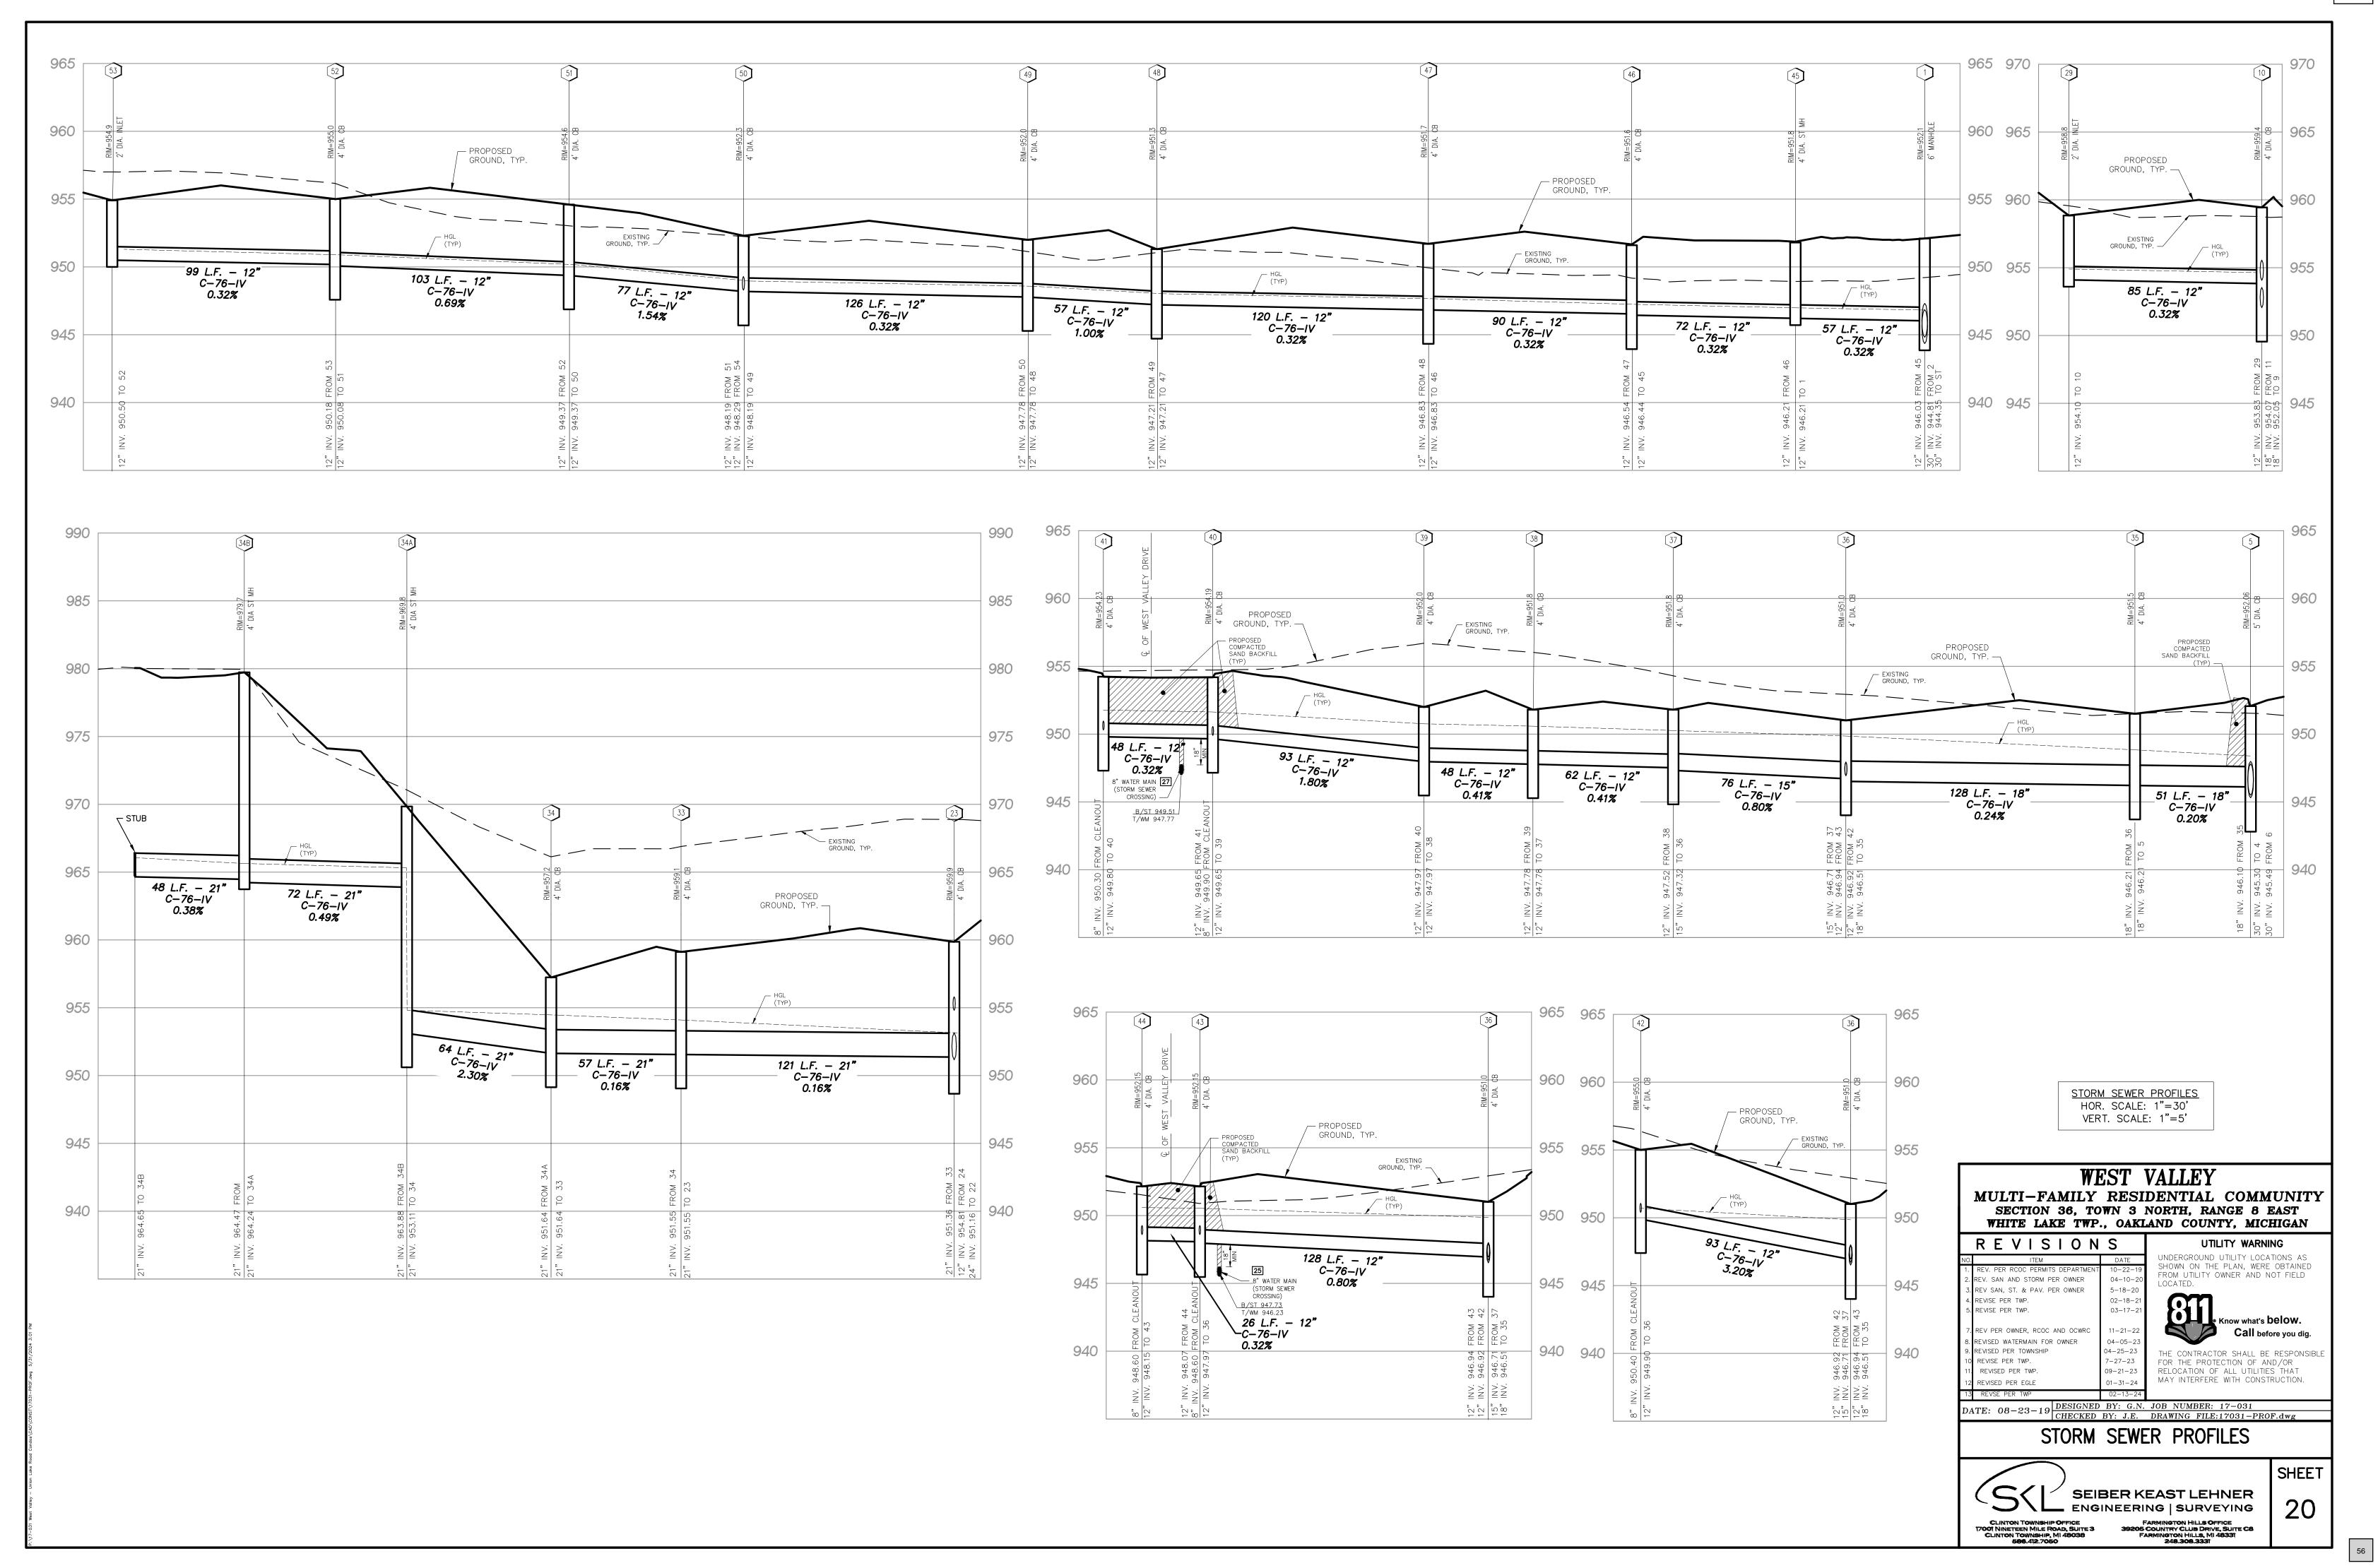

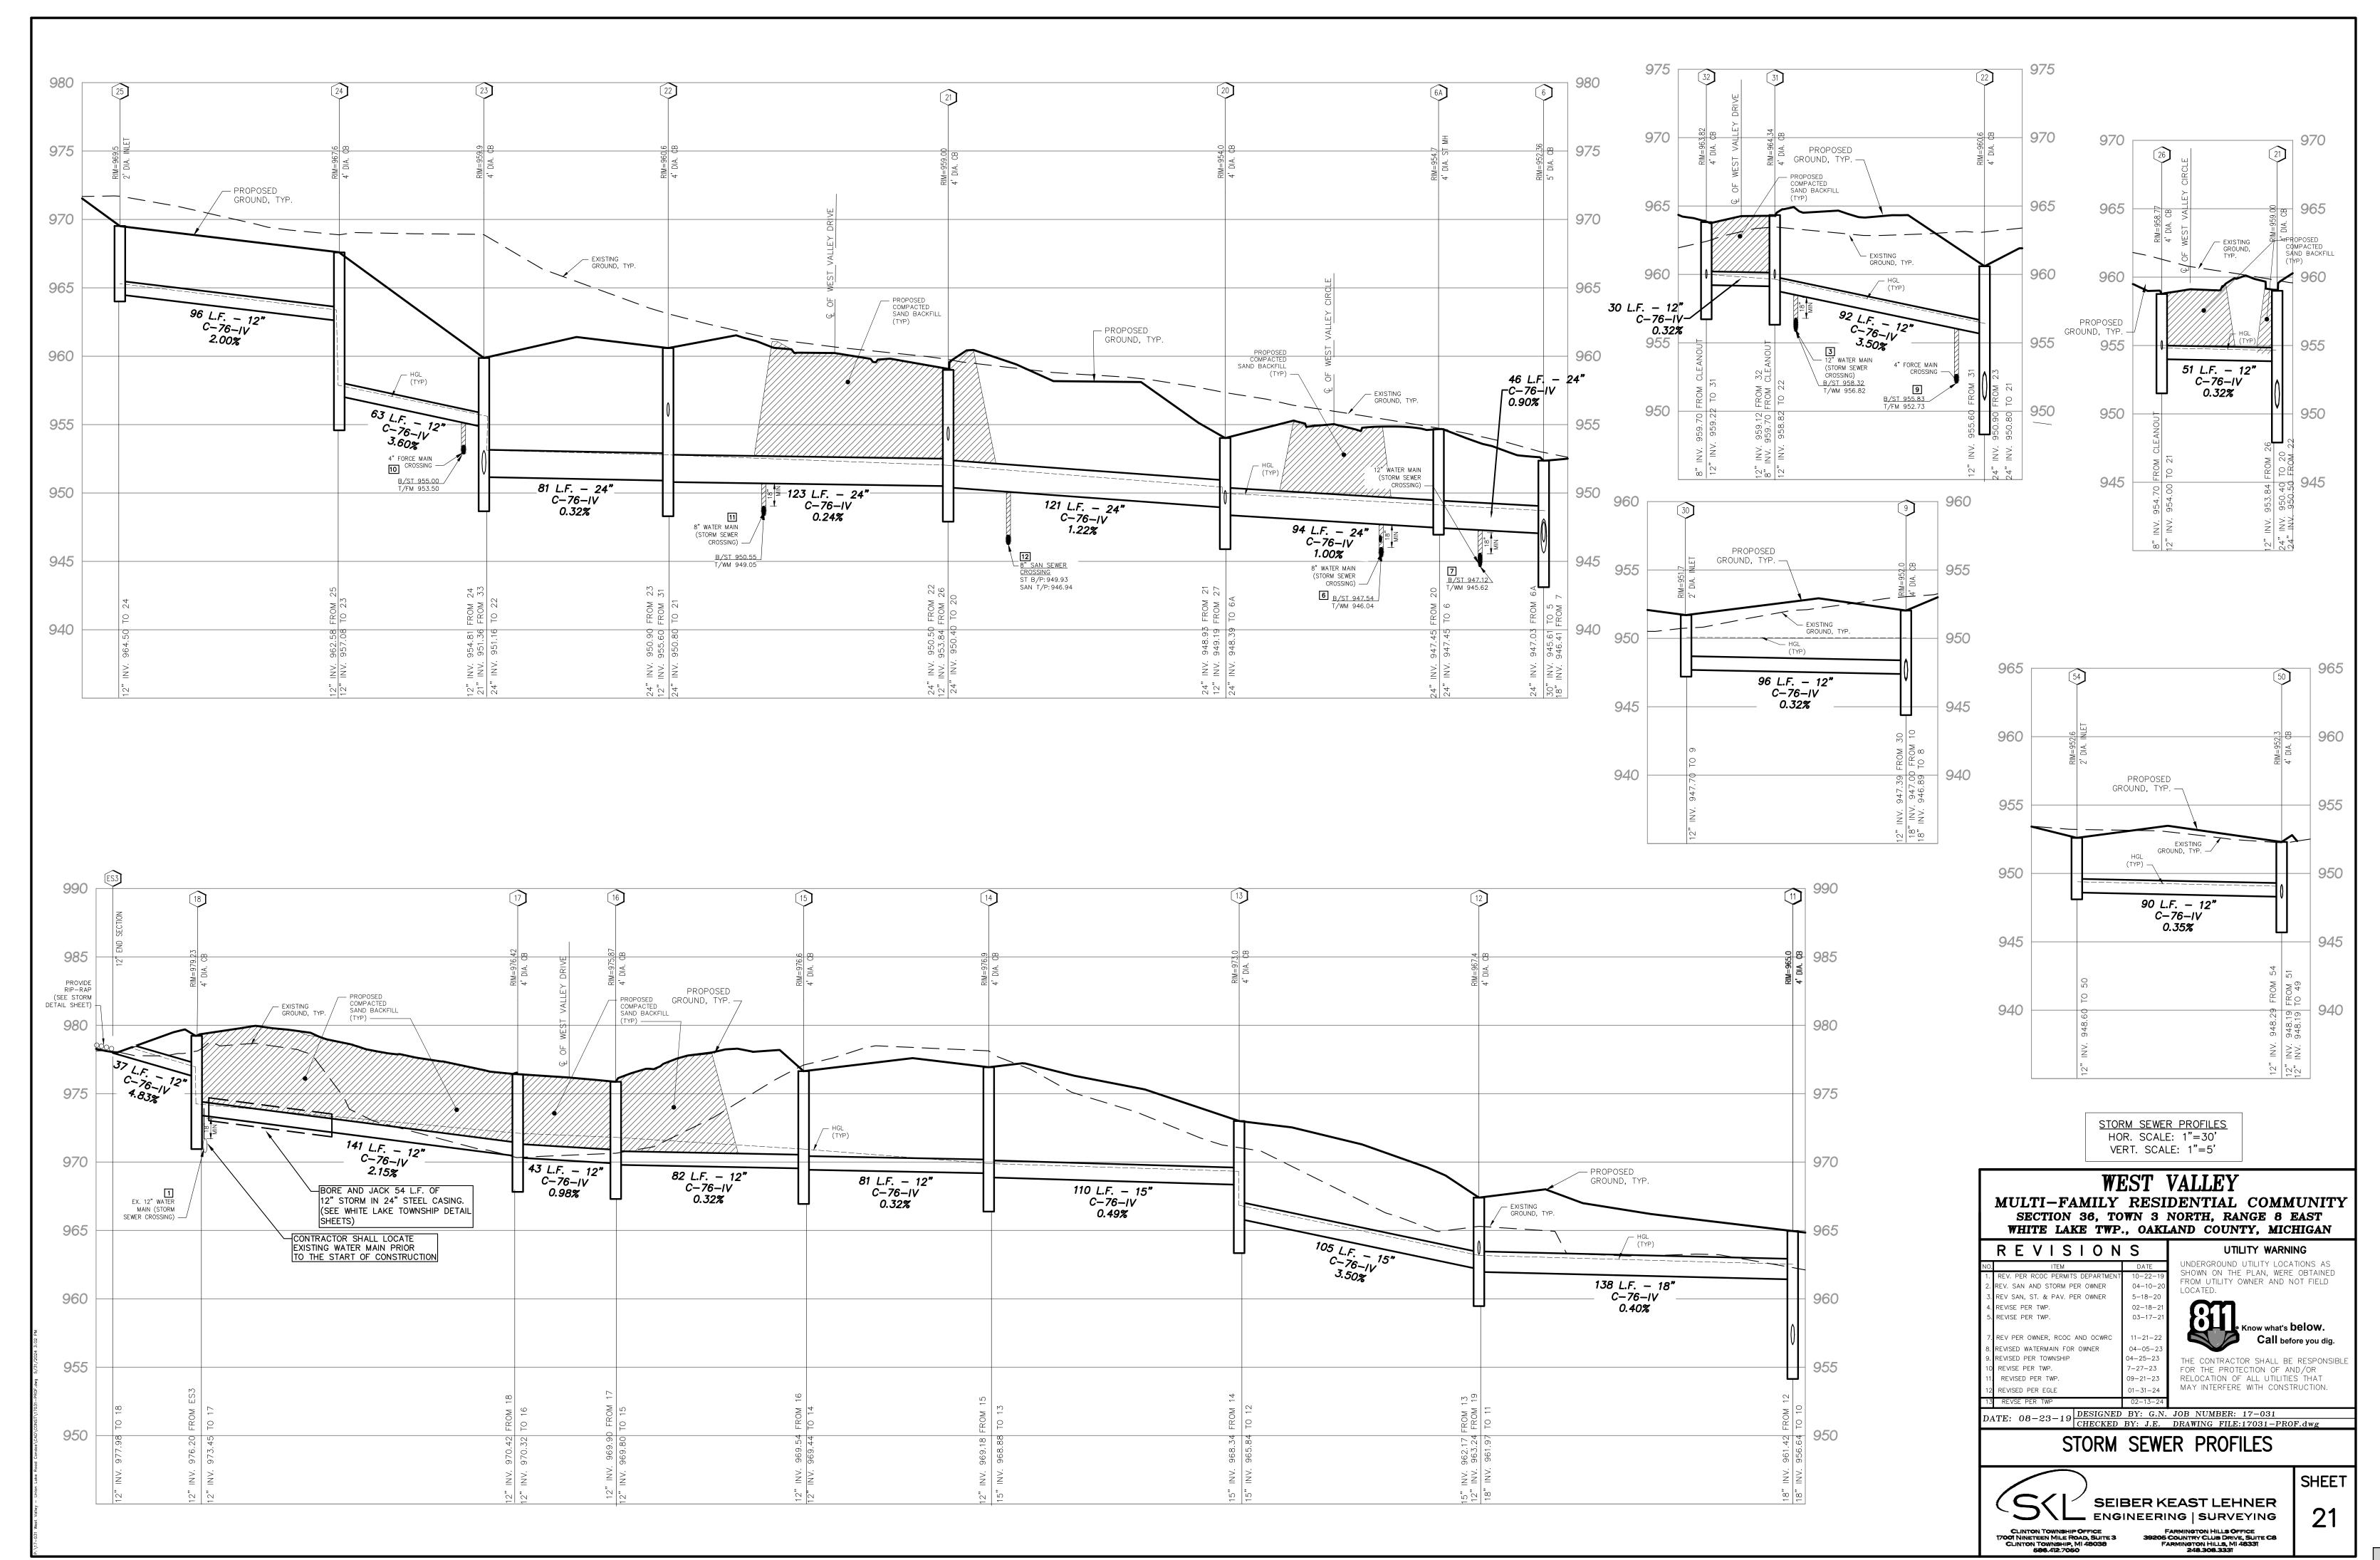

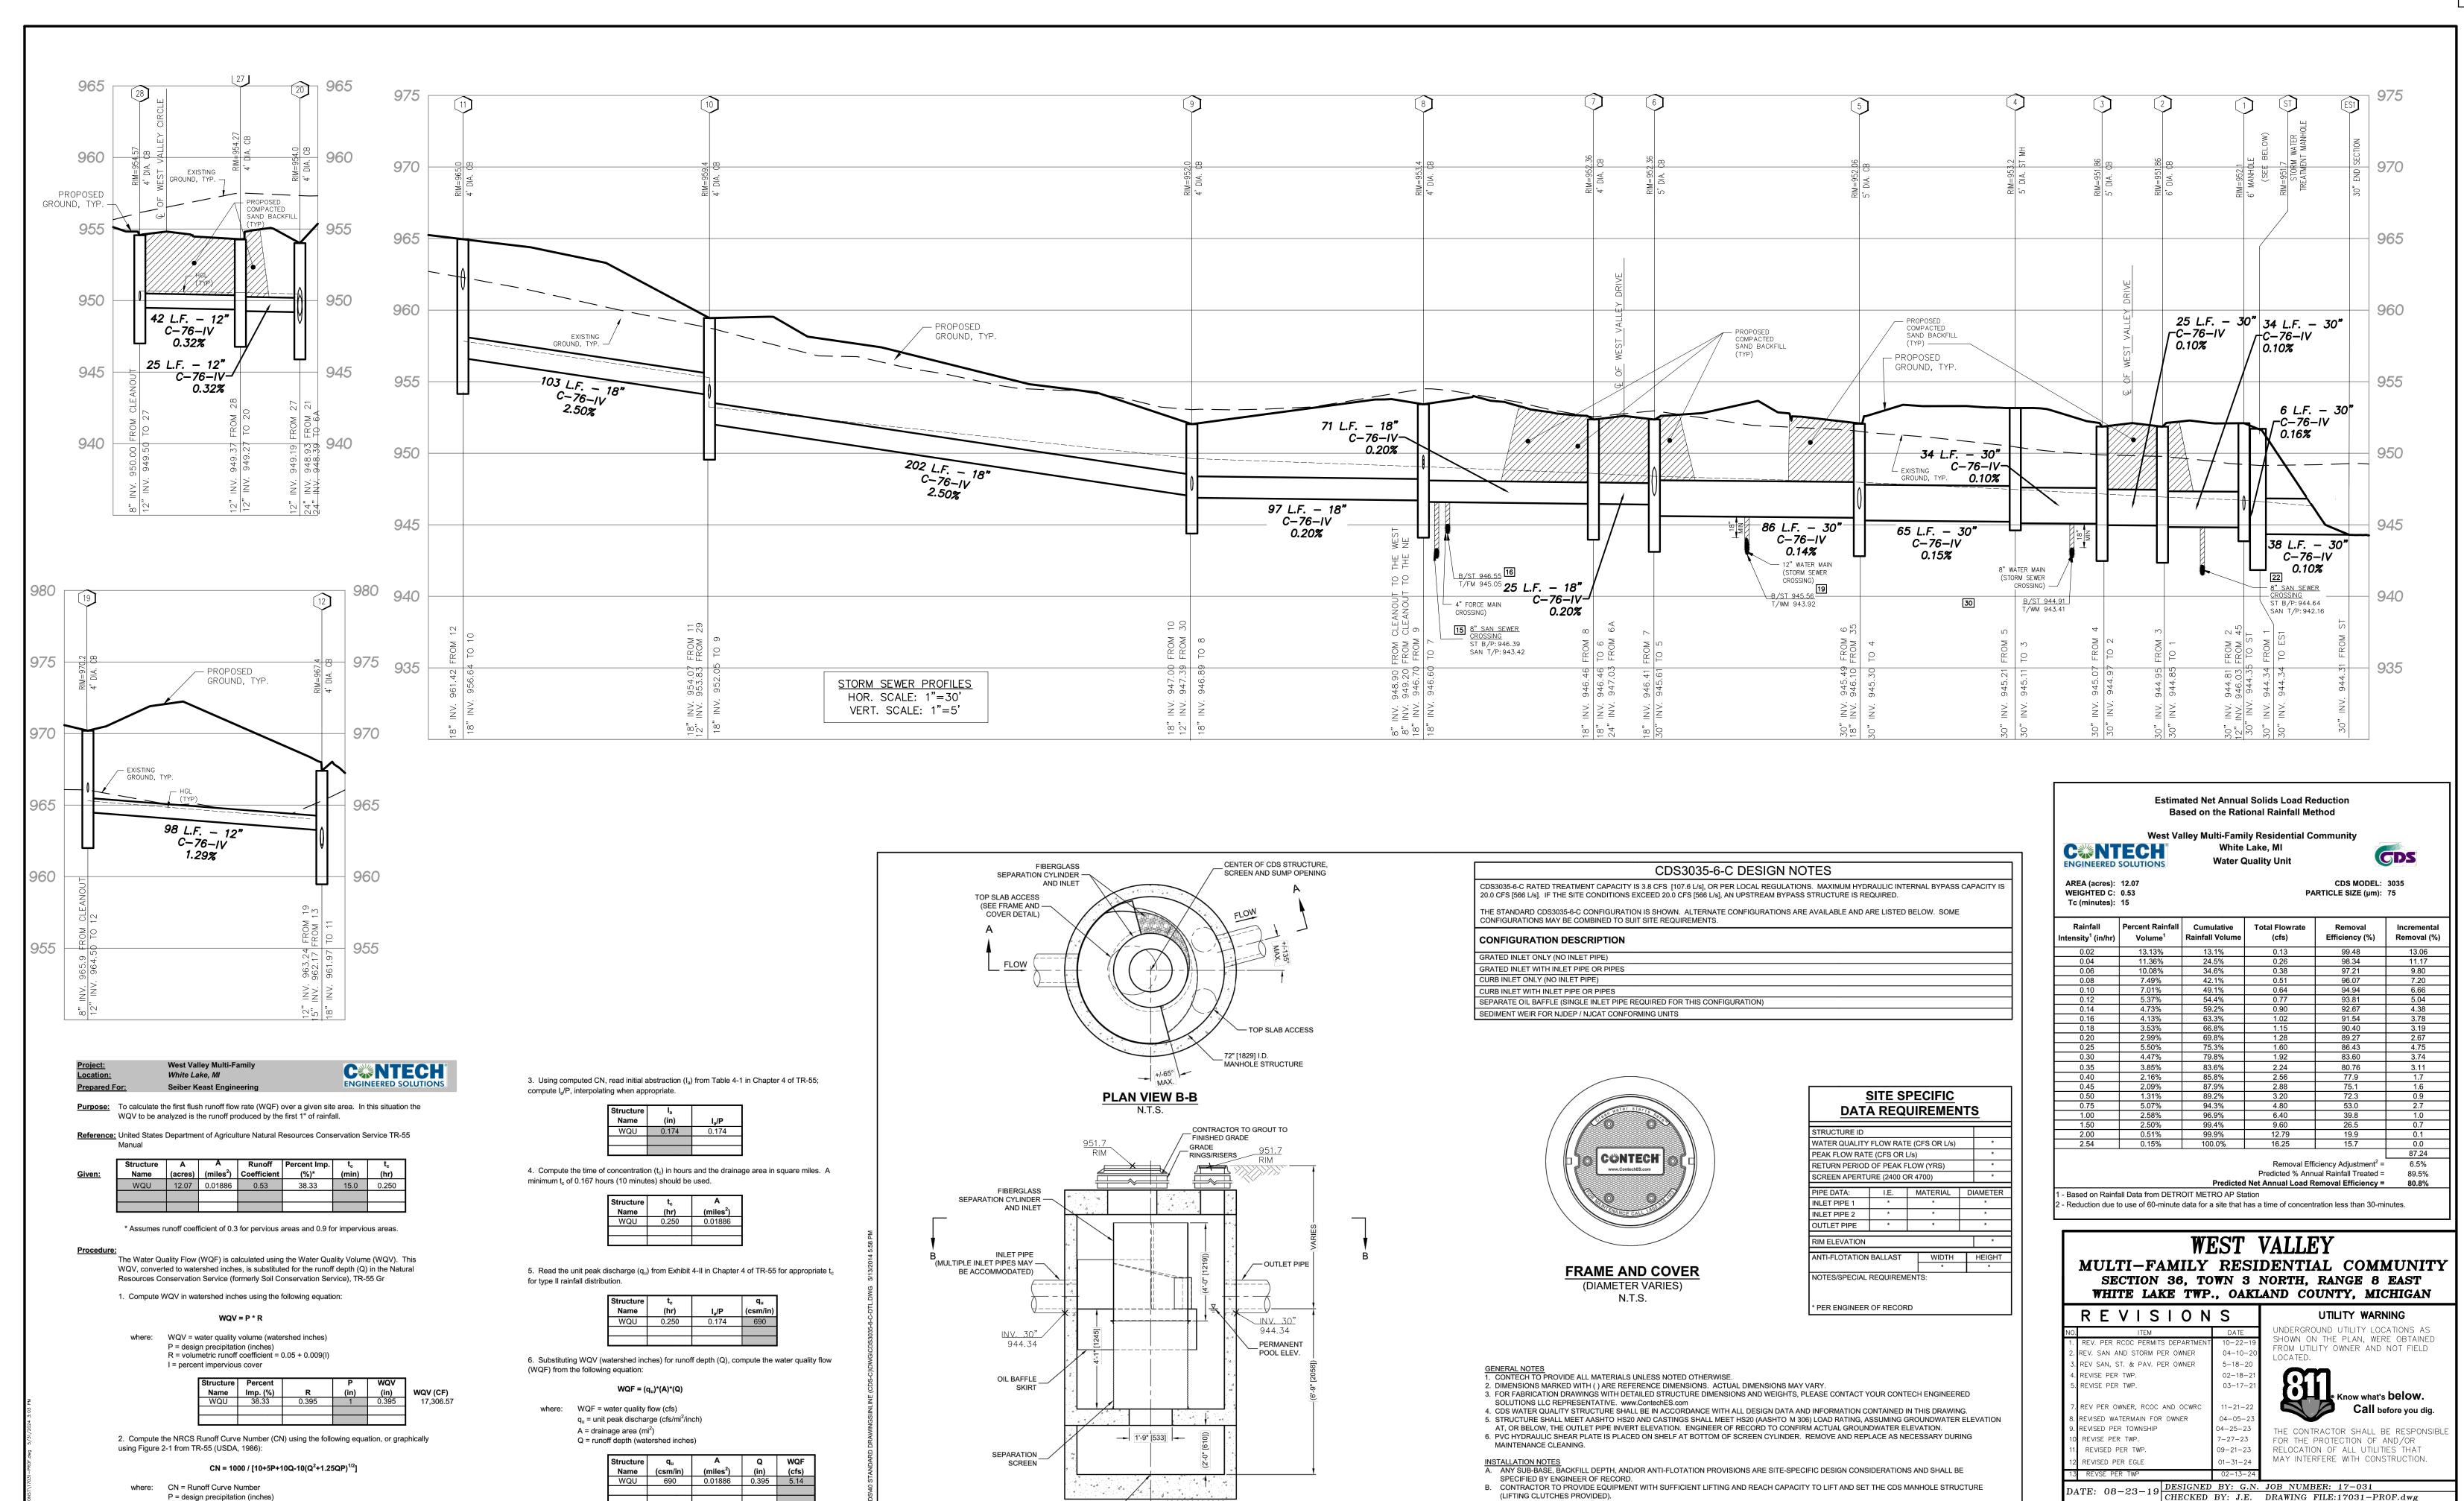

SOLIDS STORAGE

Q = runoff depth (watershed inches)

CONTRACTOR TO ADD JOINT SEALANT BETWEEN ALL STRUCTURE SECTIONS, AND ASSEMBLE STRUCTURE.

D. CONTRACTOR TO PROVIDE, INSTALL, AND GROUT PIPES. MATCH PIPE INVERTS WITH ELEVATIONS SHOWN.

SUGGESTED THAT ALL JOINTS BELOW PIPE INVERTS ARE GROUTED.

CONTECH

ENGINEERED SOLUTIONS LLC

www.ContechES.com

9025 Centre Pointe Dr., Suite 400, West Chester, OH 450

300-338-1122 513-645-7000 513-645-7993 FA

E. CONTRACTOR TO TAKE APPROPRIATE MEASURES TO ASSURE UNIT IS WATER TIGHT, HOLDING WATER TO FLOWLINE INVERT MINIMUM. IT IS

CDS3035-6-C

INLINE CDS

STANDARD DETAIL

5Ω


SHEET

STORM SEWER PROFILES

LE ENGINEERING | SURVEYING

SEIBER KEAST LEHNER

FARMINGTON HILLS OFFICE 205 COUNTRY CLUB DRIVE, SUITE C8 FARMINGTON HILLS, MI 48331 248.308.3331

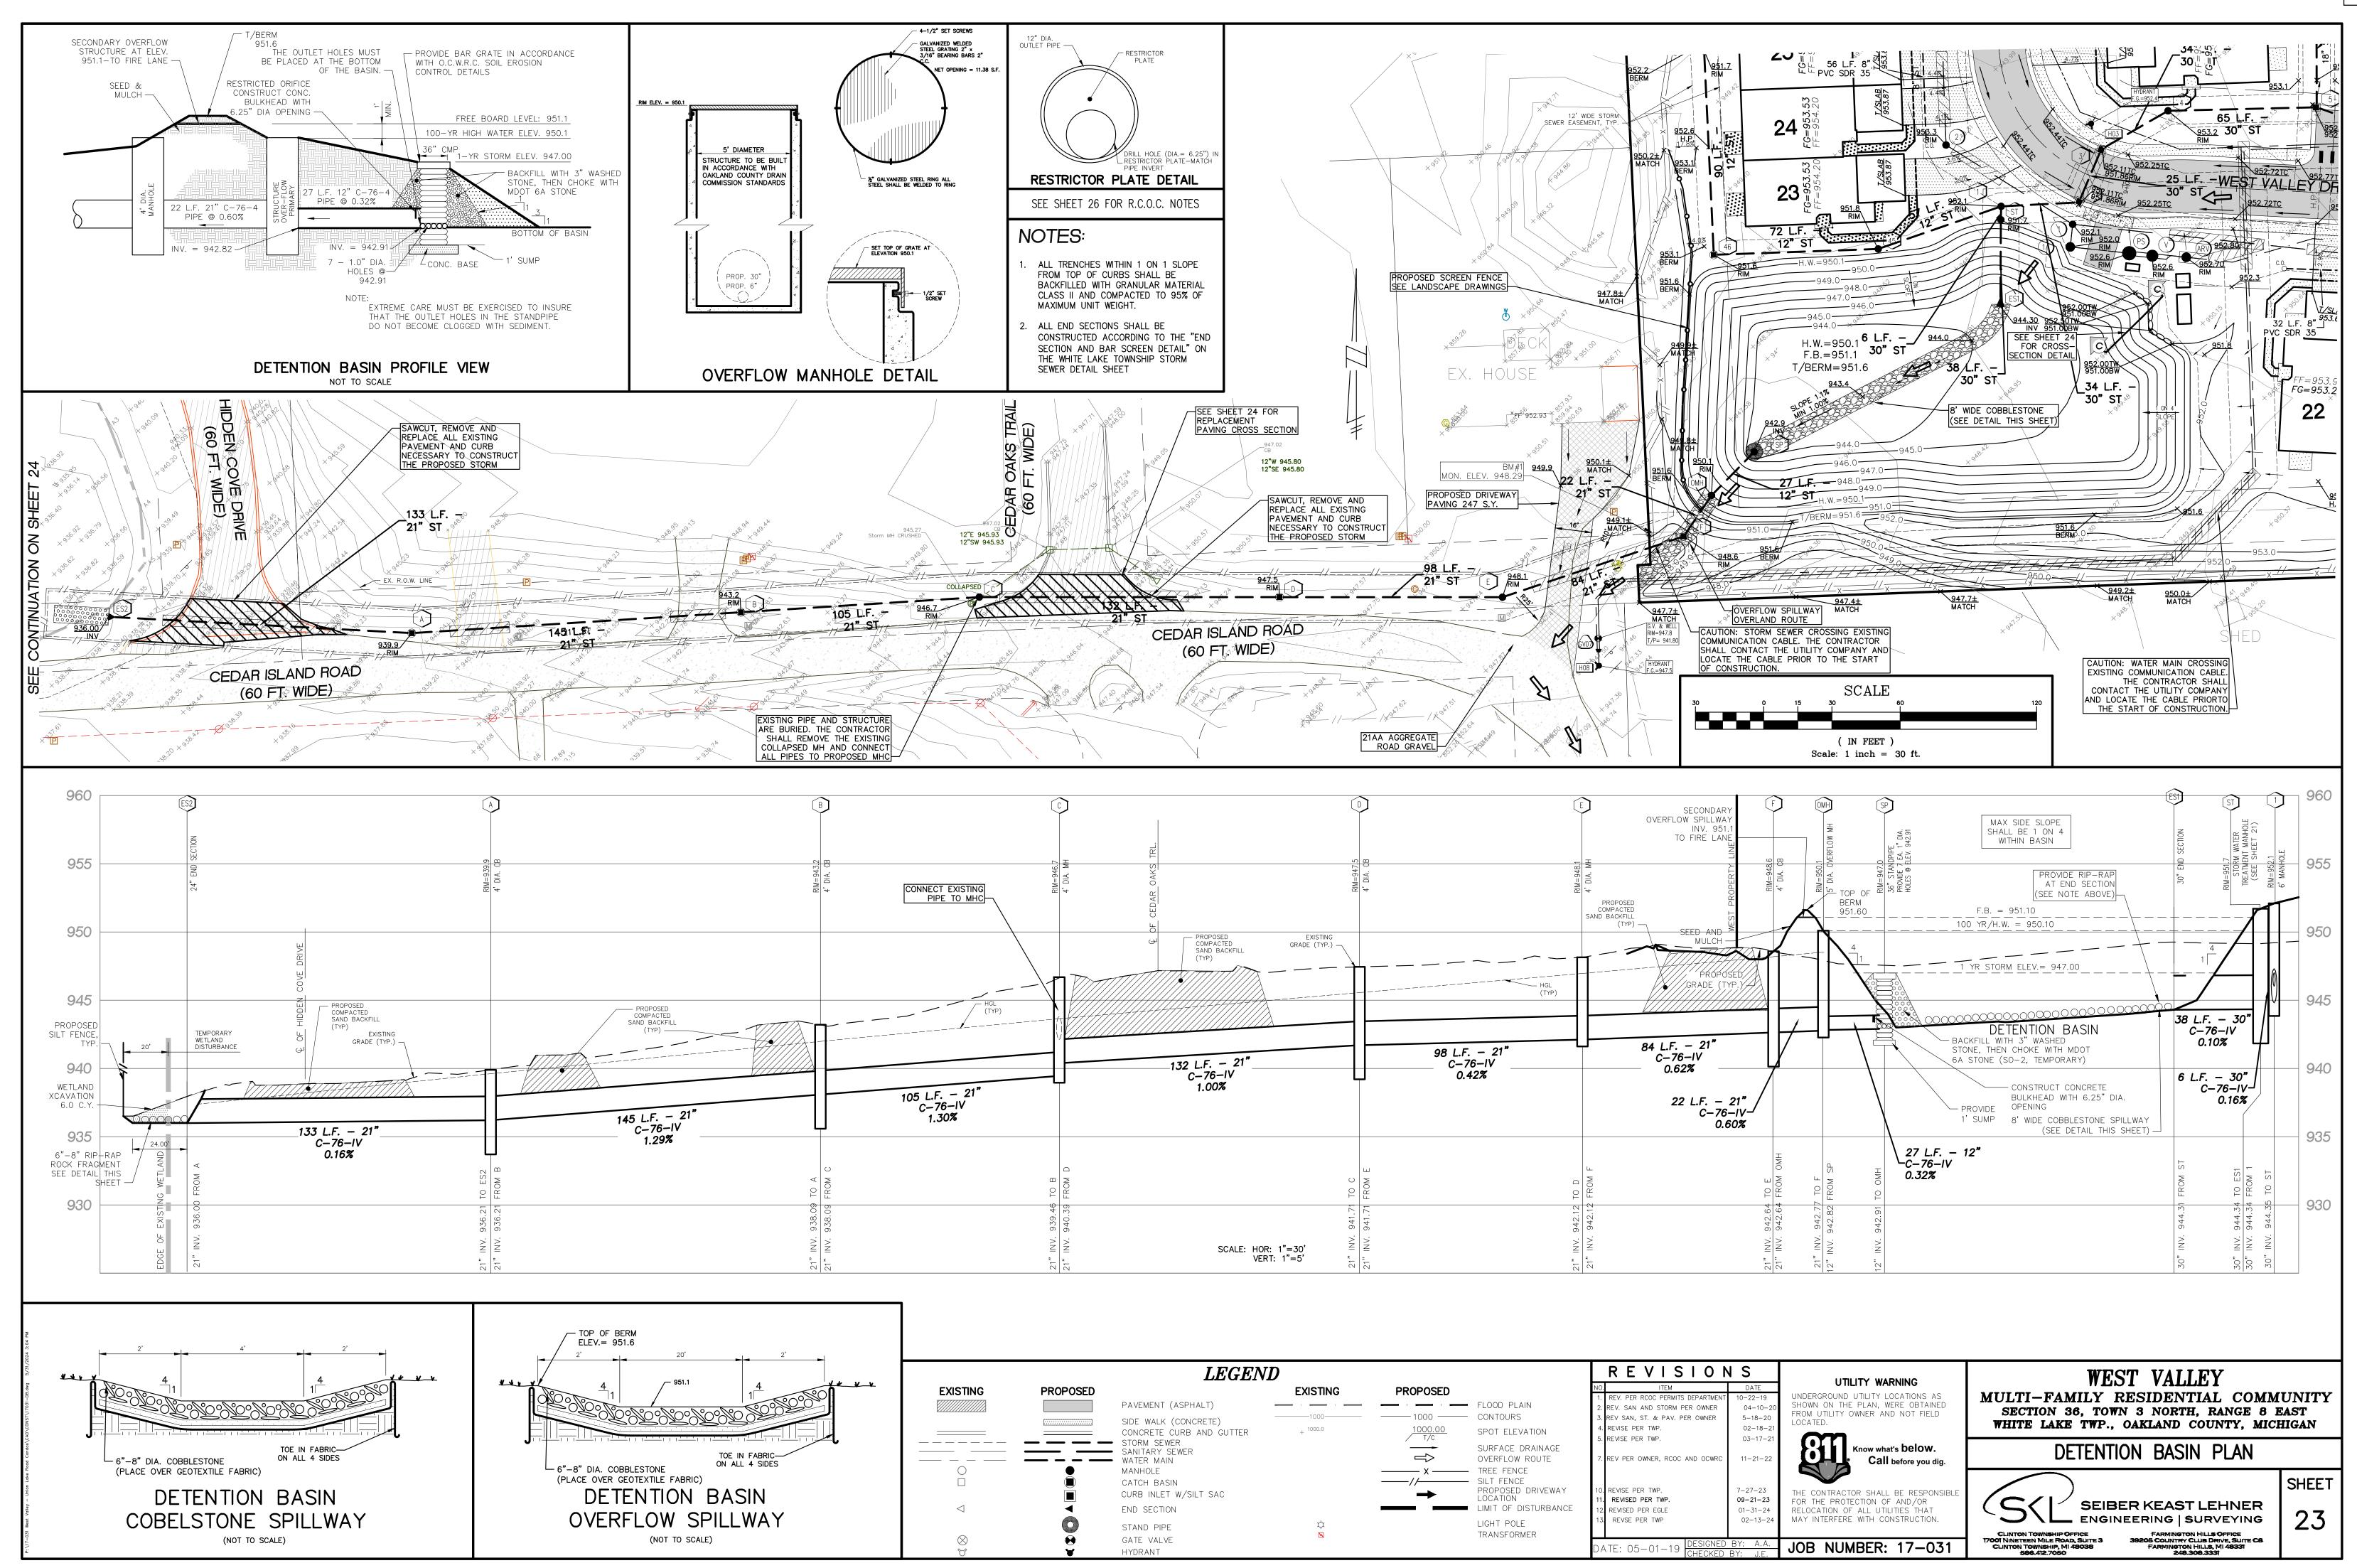



<u>HMA</u>

CROSS SECTION FOR CEDAR OAKS &

HIDDEN COVE PAVEMENT REPLACEMENT

___ 1.5" HMA 5E

SUBGRADE


— 10" 21AA AGGREGATE.


(6.5" UNDER CURB)

— EXISTING, APPROVED

RCOC MODIFIED

3" HMA 3E

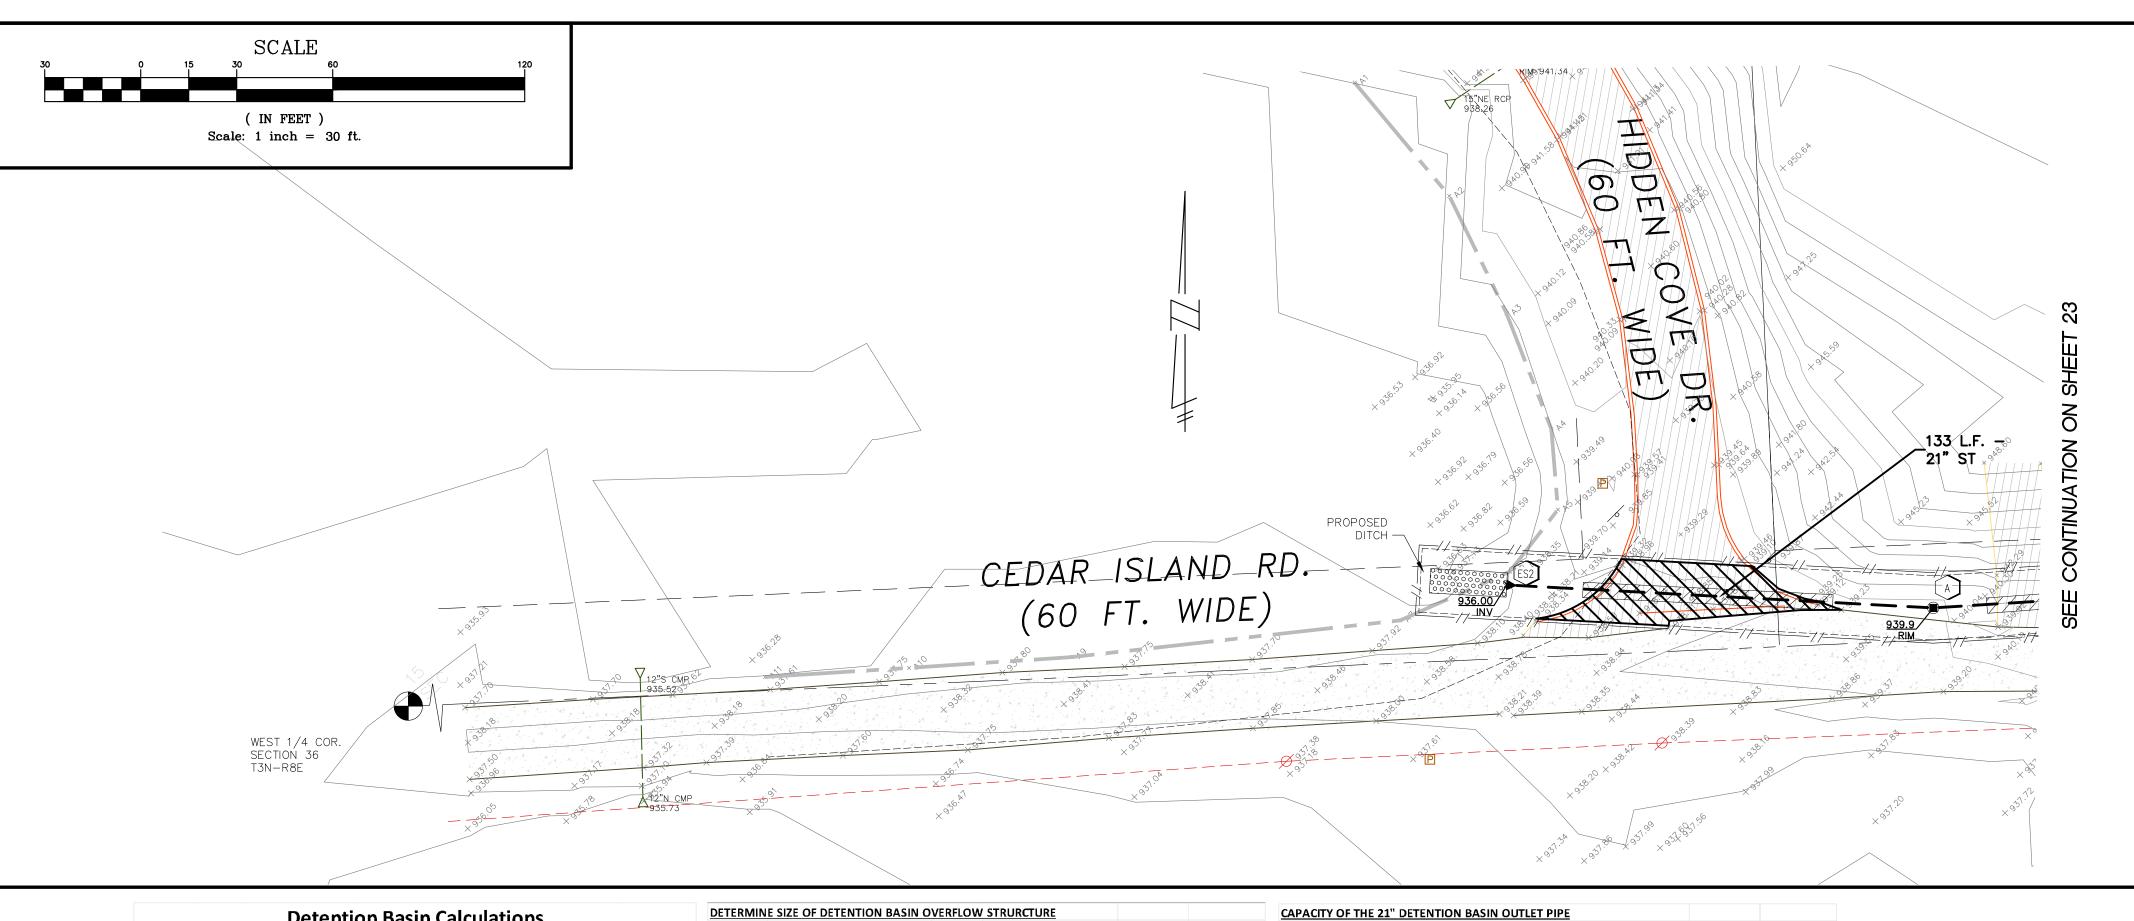

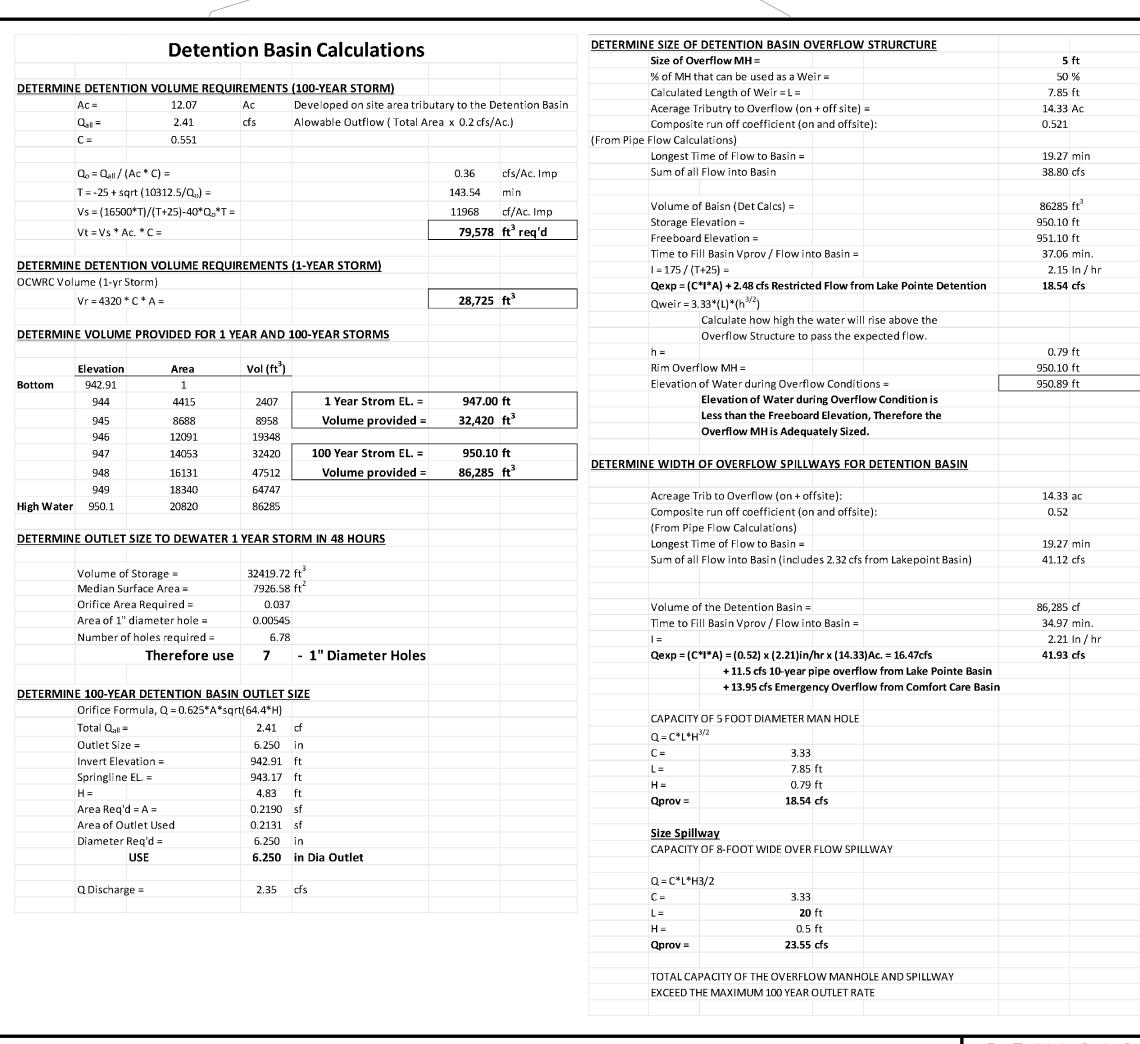


	CCVb - /C	1 A) 1 2.70 CI3 NC3(II	CCCU I TOW IT	JIII Lai	C I DITILE DE	CHUOH				
			18.54	cfs						
	Outlet Siz	e =	21.00	in						
	Invert Ele	vert Elevation =		ft						
	Springline	e EL. =	943.52	ft						
	H =		6.58	ft						
	Area Req'	d = A =	1.44	sf						
	Area of O	utlet Used	2.41	sf						
	Diameter Req'd = 21.00 in		in							
	Use		21.000	in Di	a Outlet					
				D:	0.0.040/	0.1				
	<u>Use 2</u>	I'' Diameter Over	flow Outlet	Pipe	<u>@ 0.24%</u>	Slope				
D-4	! !	1011 Factor 4	D.4.	4:	lan Da	- !				
Deteri	mine	'C" Factor f	or Det	enti	on Bas	sin				
DETERMI	DETERMINE "C" FACTOR					Area			С	
TOTAL AF	REA TRIB	UTARY TO DETEN	TION BASI	IN	=	12.07	Ac			
PAVING AREA (WALKS, DRIVE, ROAD)				=	3.50	Ac	@	0.80		
BUILDING AREA				=	3.05	Ac	@	0.90		
AWN AF	REA INCL	UDING DETENTIC	N BASIN A	ARE/	=	5.52	Ac	@	0.20	
			TOTALA	REA	=	12.07	Ac	@		
			Cavg	= A	* C / TOT	AL ACF	RES =		0.551	
"C" Fa	ctor C	alculations f	or Sum	of a	ll Flow	into B	asin			
			Area		"C"					
					_					
		ne Site - Open		0.25		20	0.05			
Area No	rth of th	ne Site - ROW		2.01	0.	38	0.76			
On Site			1	2.07	0.	55	6.65			
			1	4.33			7.46			

Average "C" = 0.521

Orifice Formula, Q = 0.625*A*sqrt(64.4*H)

Qexp = (C*I*A) + 2.48 cfs Restricted Flow from Lake Pointe Detention

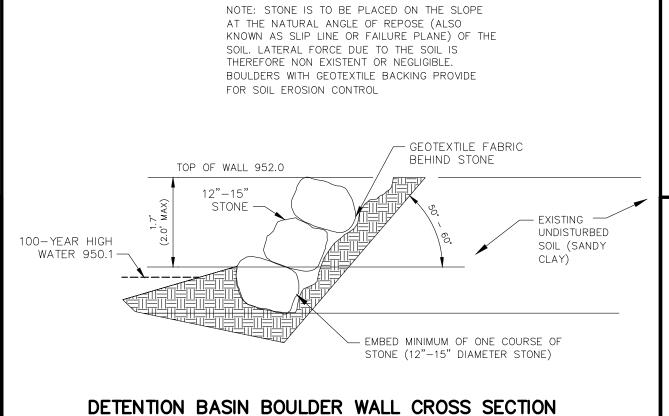

CROSS SECTION C-C

(SEE SHEET 23 FOR PLAN LOCATION)

LEGEND PROPOSED PROPOSED PAVEMENT (ASPHALT) - 1000 ---- CONTOURS SIDE WALK (CONCRETE) SPOT ELEVATION CONCRETE CURB AND GUTTER SURFACE DRAINAGE SANITARY SEWER OVERFLOW ROUTE ---- WATER MAIN TREE FENCE MANHOLE — SILT FENCE CATCH BASIN PROPOSED DRIVEWAY LOCATION CURB INLET W/SILT SAC END SECTION LIGHT POLE STAND PIPE TRANSFORMER GATE VALVE

REVISIONS /. SAN AND STORM PER OWNER REV SAN, ST. & PAV. PER OWNER 5-18-20 . REVISE PER TWP. REVISE PER TWP. 03-17-2 REV PER OWNER, RCOC AND OCWRC 11-21-22 REVISE PER TWP. THE CONTRACTOR SHALL BE RESPONSIBLE REVISED PER TWP. 09-21-23 FOR THE PROTECTION OF AND/OR REVISED PER EGLE 01-31-24 RELOCATION OF ALL UTILITIES THAT MAY INTERFERE WITH CONSTRUCTION. REVSE PER TWP 02-13-24

UTILITY WARNING UNDERGROUND UTILITY LOCATIONS AS SHOWN ON THE PLAN, WERE OBTAINED FROM UTILITY OWNER AND NOT FIELD Know what's **below.** Call before you dig.

JOB NUMBER: 17-031

WEST VALLEY MULTI-FAMILY RESIDENTIAL COMMUNITY SECTION 36, TOWN 3 NORTH, RANGE 8 EAST WHITE LAKE TWP., OAKLAND COUNTY, MICHIGAN

DETENTION BASIN PLAN

Area *C

6.65


= 2.80

= 2.74 = 1.10





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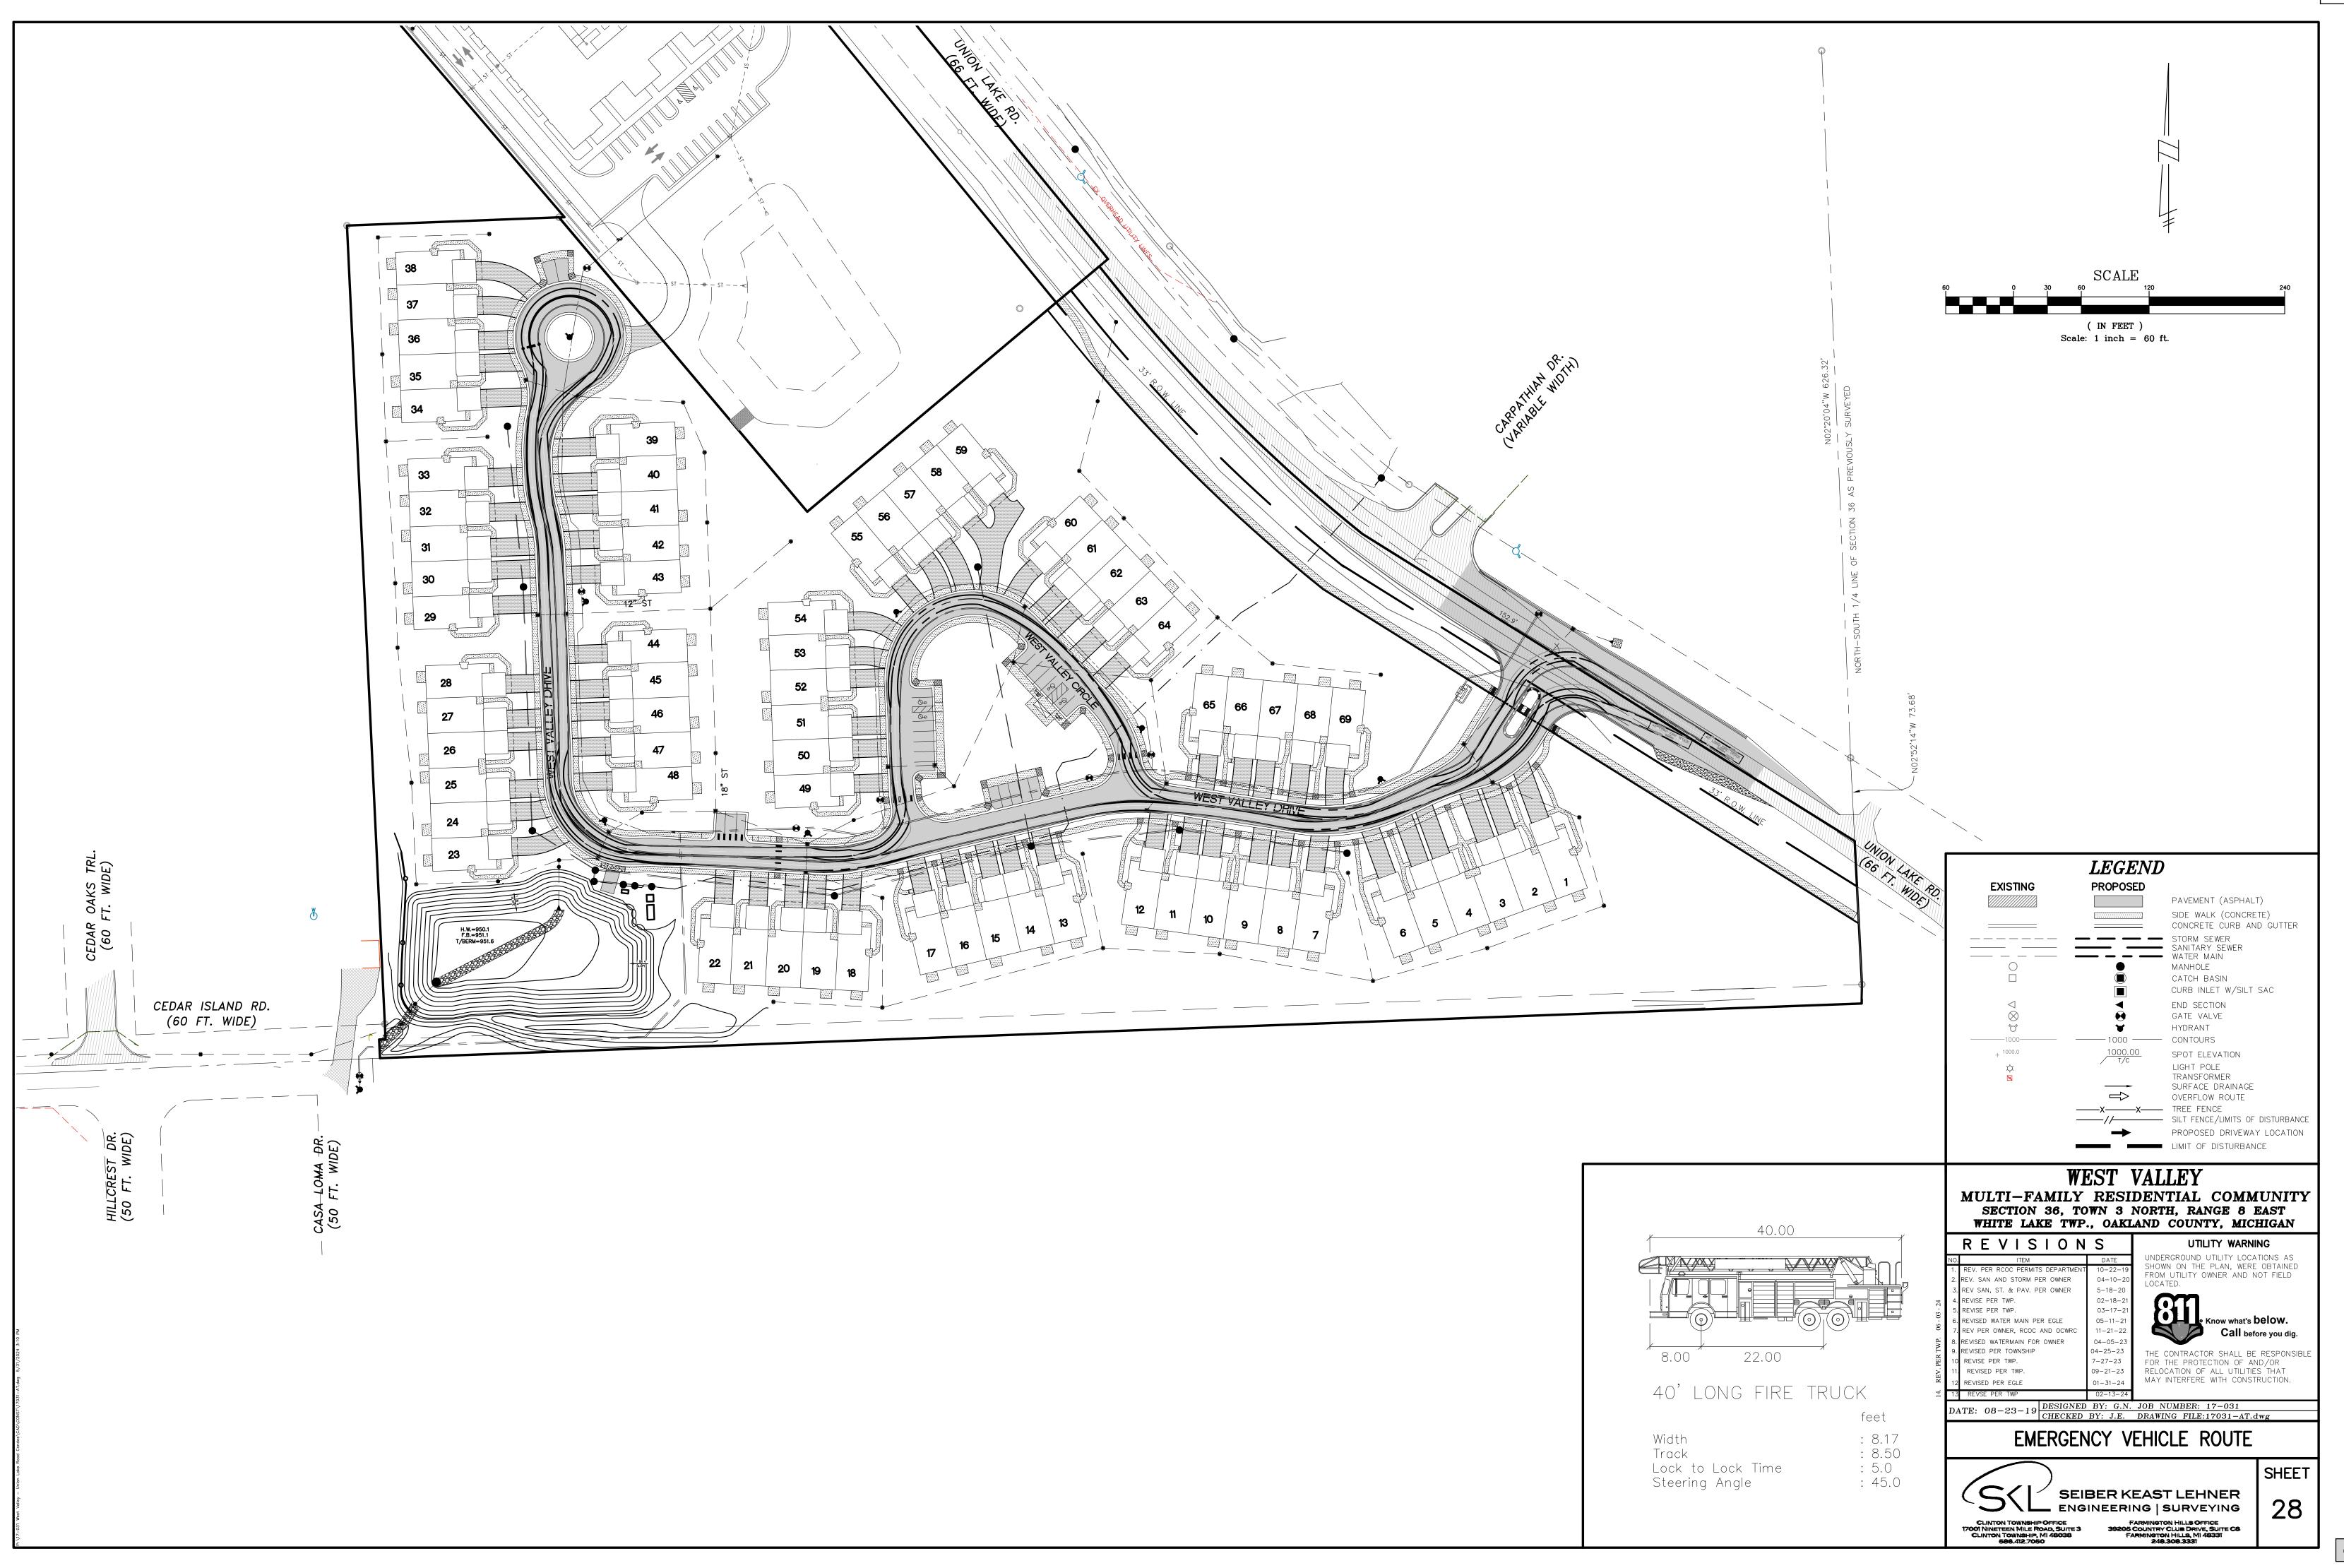
SHEET



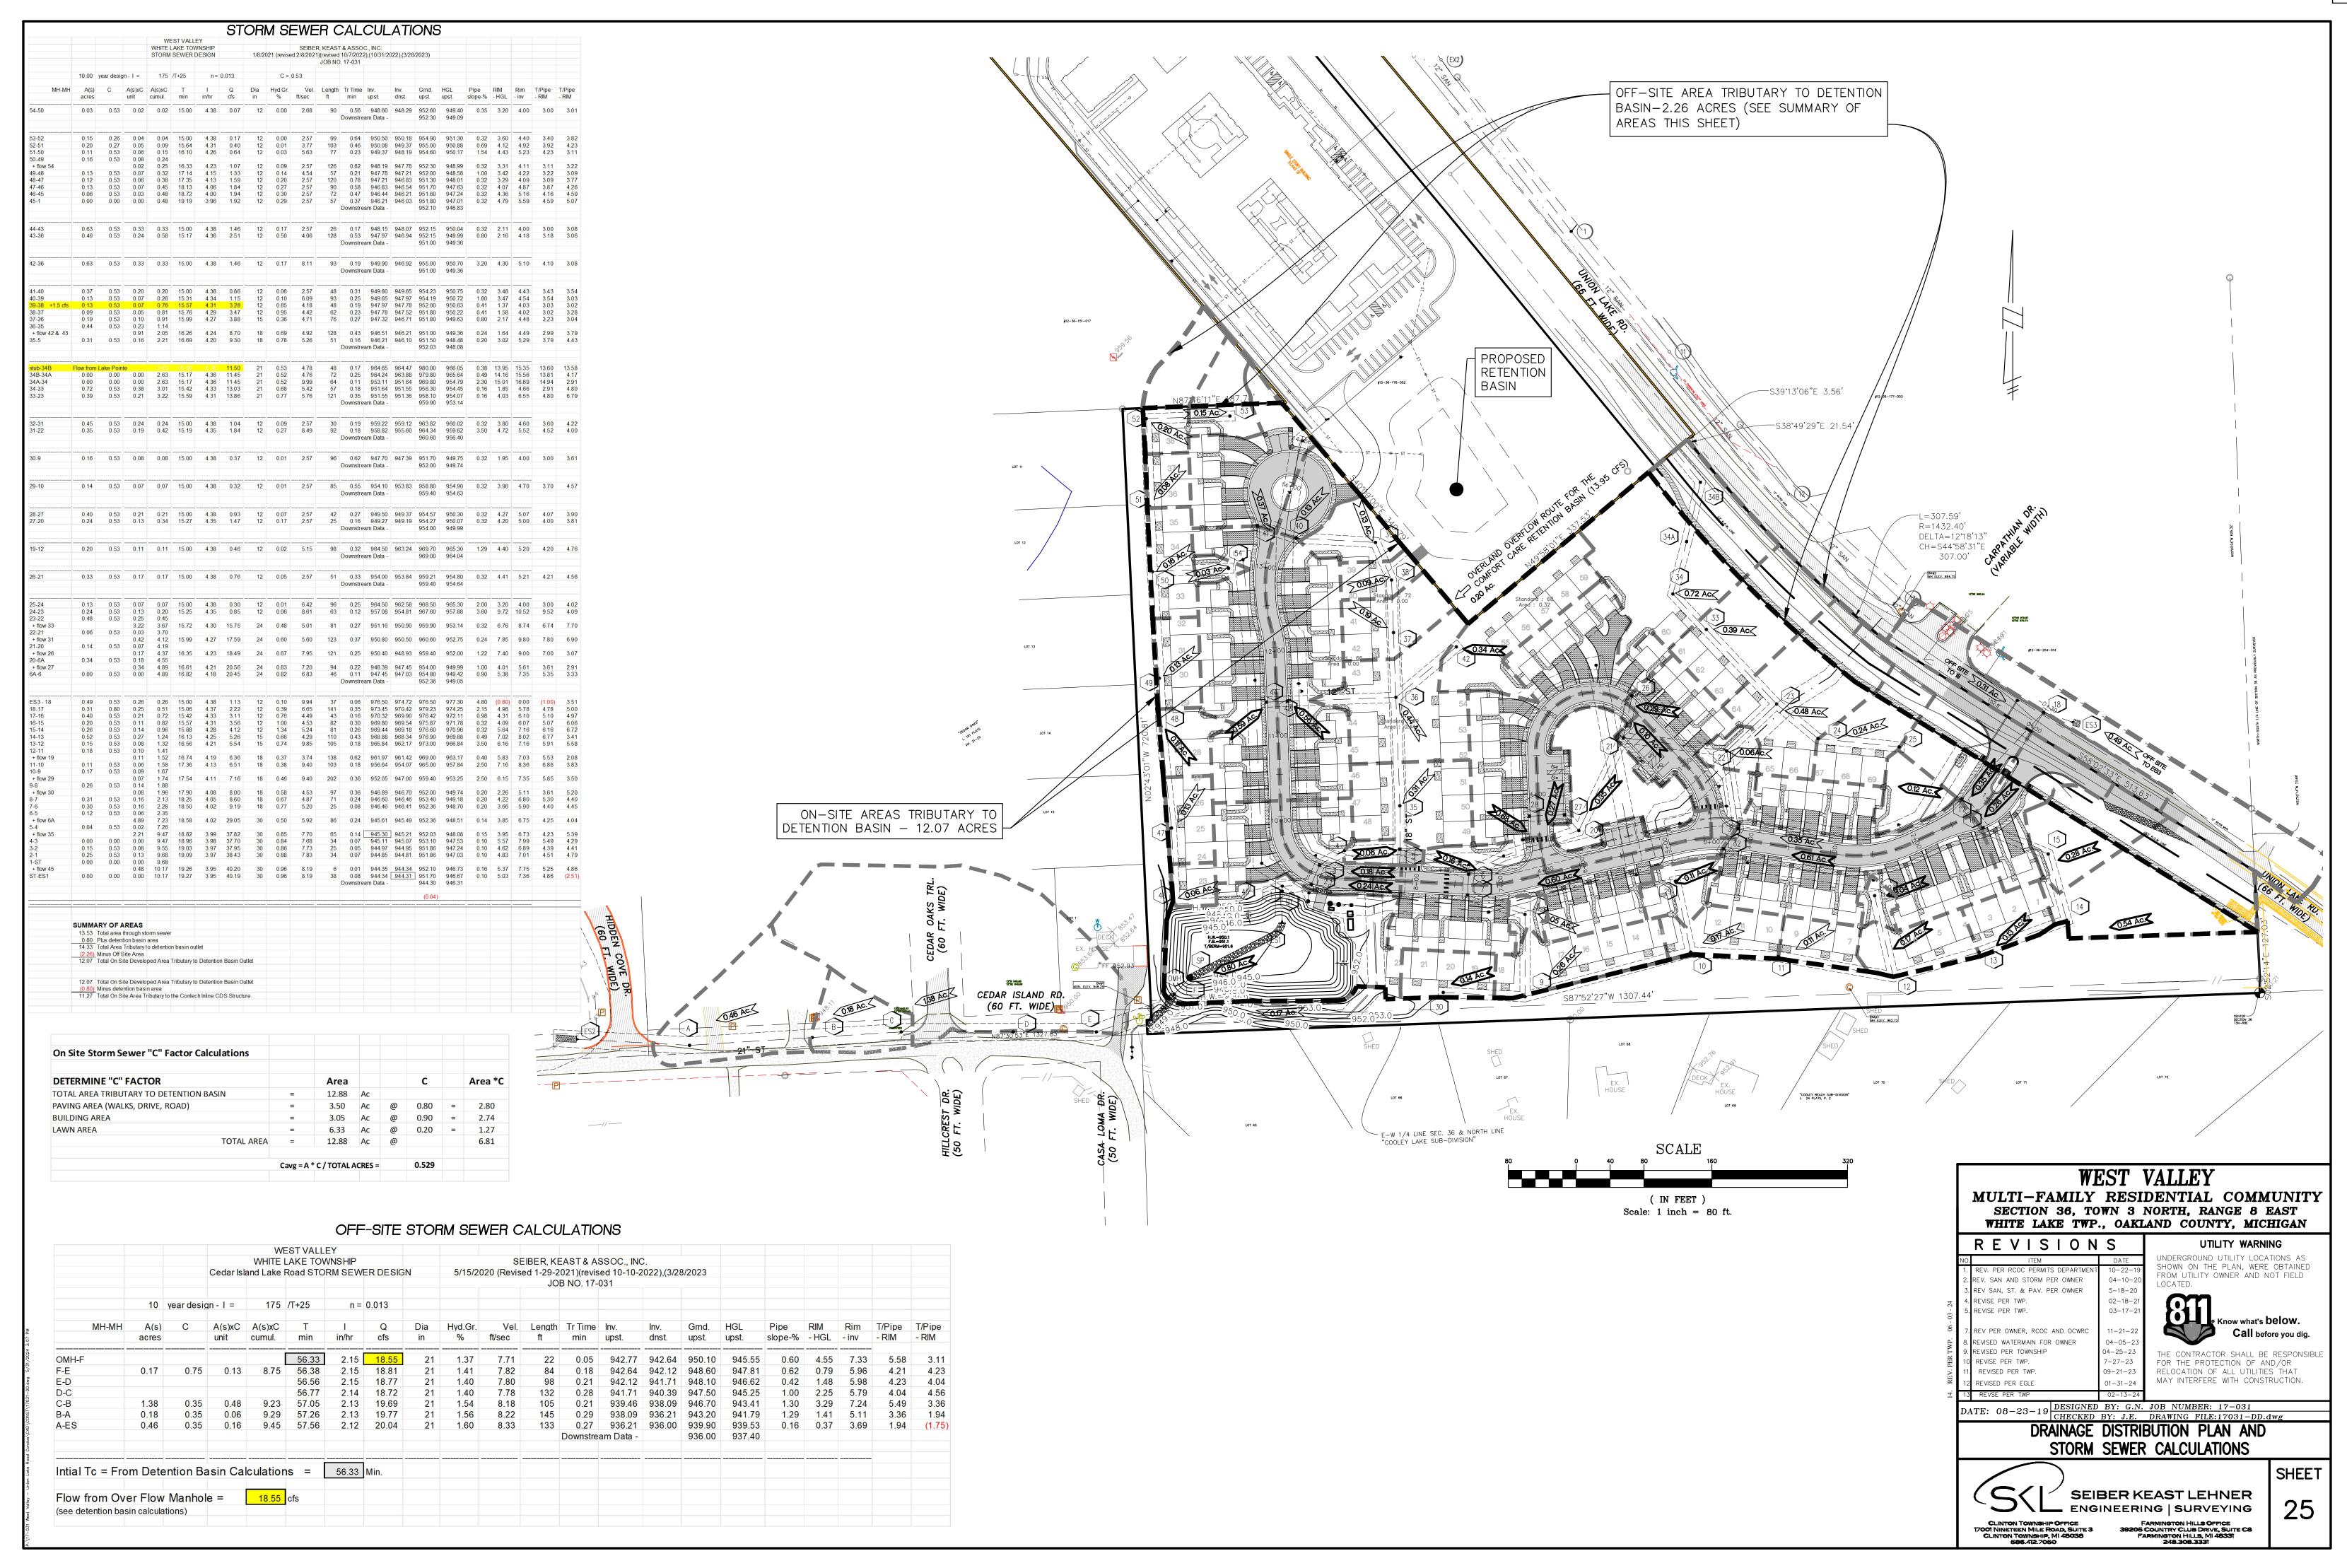



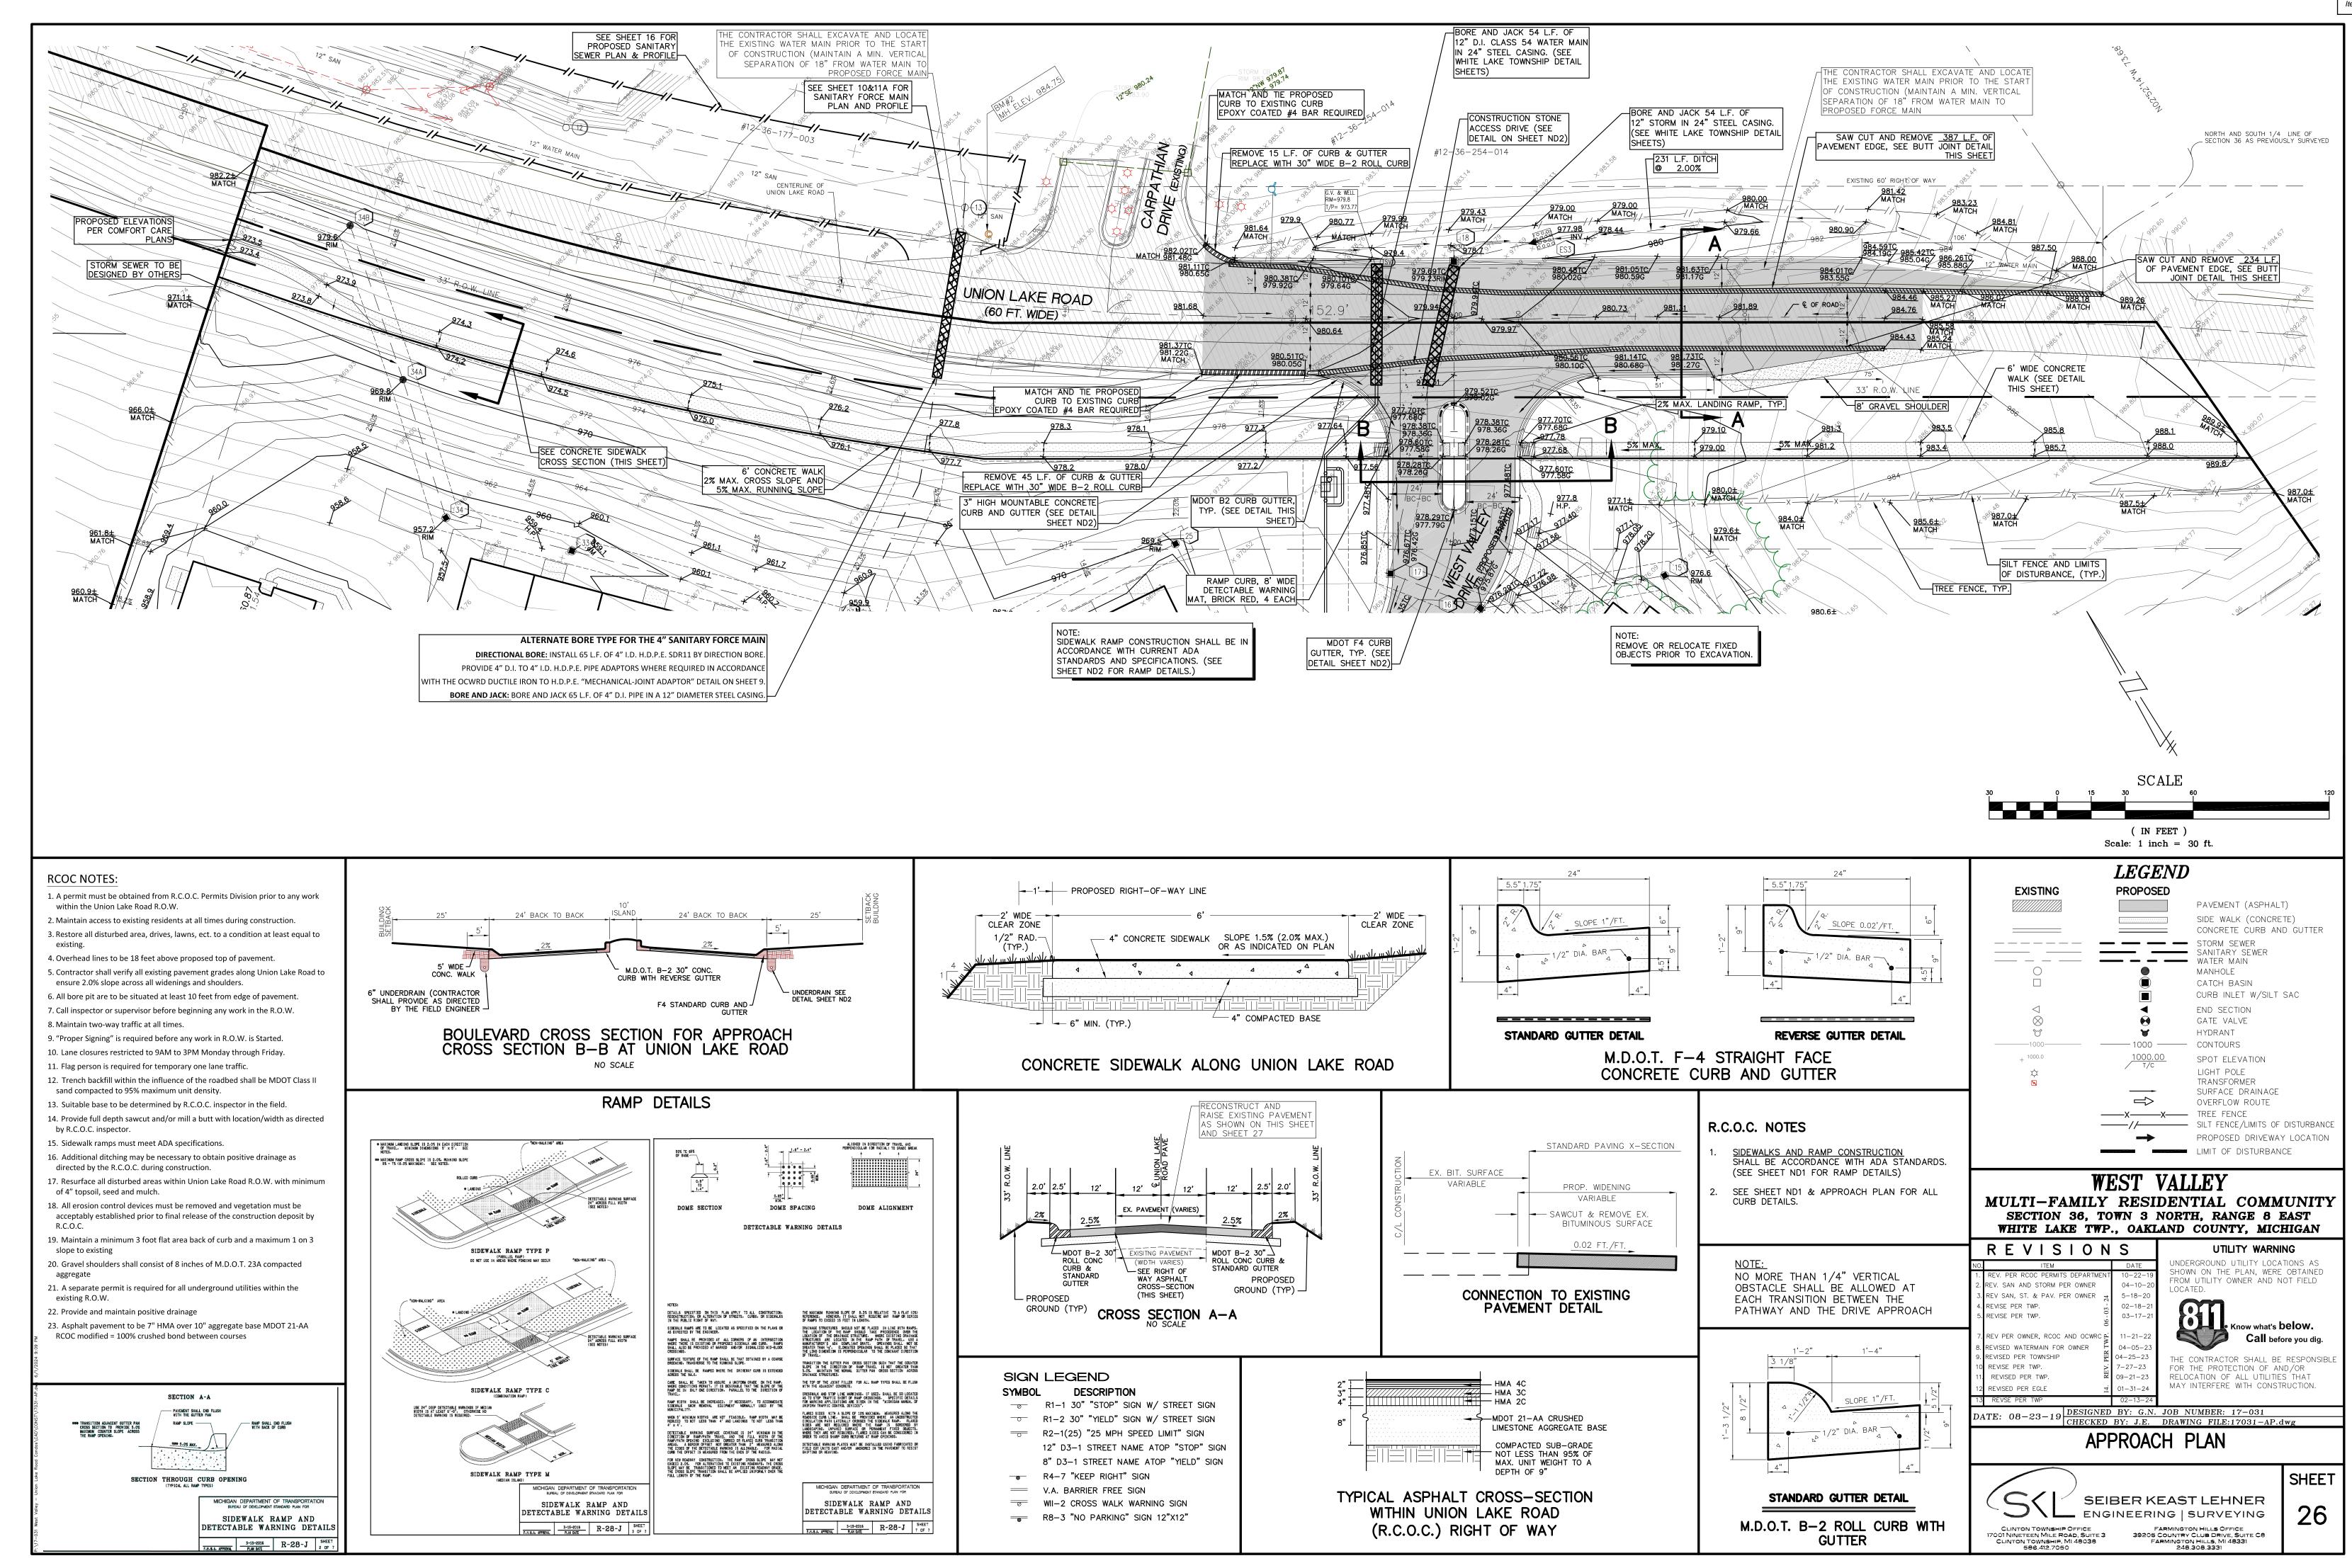

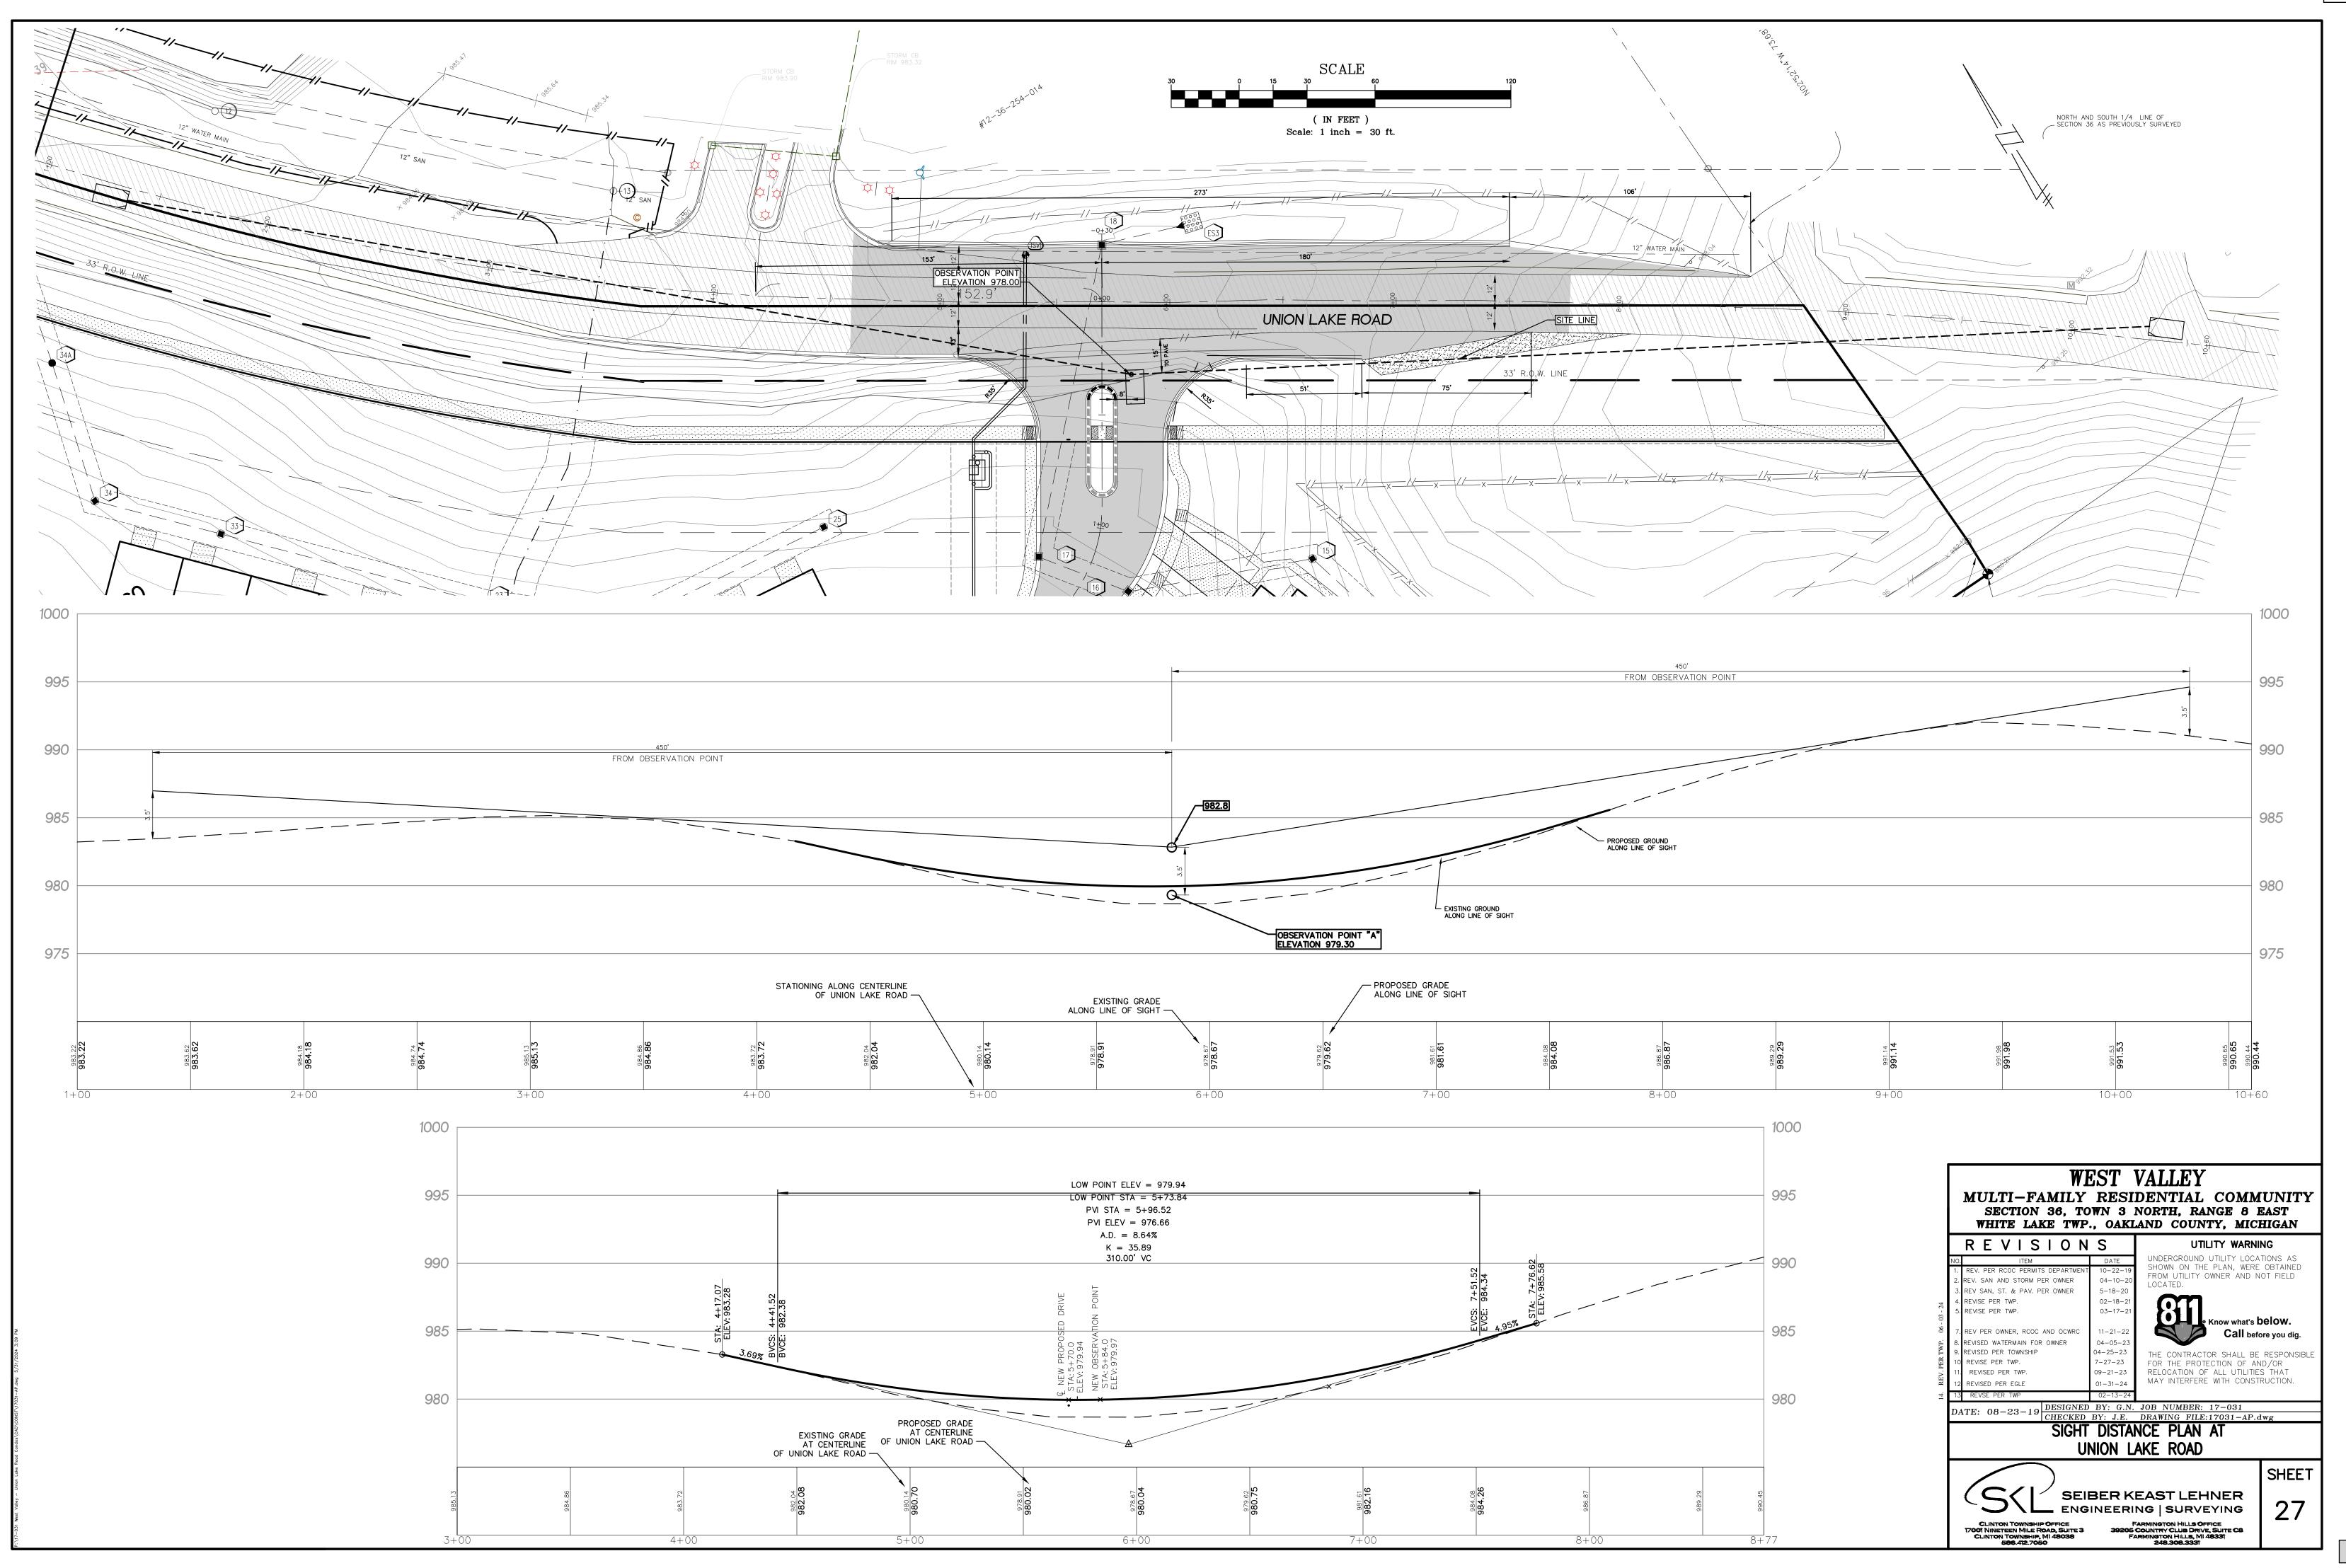

SOIL EROSION CONTROL NOTES

SACK TYPE FILTERS SHALL BE INSTALLED ON ALL CATCH BASINS AND INLETS.

ROADS ARE CLEAN & SWEPT THROUGHOUT THE ENTIRE CONSTRUCTION PERIOD.

- DEWATERING OF ANY KIND MUST BE FILTERED THROUGH VEGETATION, STONE OR "FILTER BAG".
- 3. IT IS THE DEVELOPER'S RESPONSIBILITY TO INSURE THE PROJECT STREETS AND ADJACENT
- 4. IT IS THE DEVELOPER'S RESPONSIBILITY TO GRADE AND STABILIZE DISTURBANCES DUE TO INSTALLATION OF PUBLIC UTILITIES (I.E. PHONE, GAS, ELECTRIC, CABLE, ETC.)
- THE DEVELOPER IS RESPONSIBLE FOR DUST CONTROL THROUGHOUT ALL PERIODS OF CONSTRUCTION. WATERING TANKS WILL BE AVAILABLE AT ALL TIMES TO BE USED ON ANY AREA WHERE DUST BECOMES A PROBLEM.
- PARKING OF VEHICLES, EQUIPMENT, OR STOCKPILING OF MATERIALS IS STRICTLY PROHIBITED ALONG OR WITHIN THE UNION LAKE ROAD RIGHT OF WAY AREA.
- ALL CULVERT END SECTIONS MUST CONTAIN GROUTED RIP-RAP IN ACCORDANCE WITH ORDINANCE
- 8. THE SOIL EROSION CONTROLS WILL BE MAINTAINED WEEKLY AND AFTER EVERY STORM EVENT BY

S.E.S.C. SEQUENCE OF CONSTRUCTION

- . INSTALL ALL SOIL EROSION AND TREE PROTECTION FENCING AS PER APPROVED PLANS. CLEAR ONLY WHAT IS NECESSARY TO INSTALL FENCING.
- 2. STRIP AND STOCKPILE TOPSOIL IN A LOCATION APPROVED BY THE OWNER/ENGINEER. PLACEMENT OF ADDITIONAL CONTROL MEASURES MUST BE INSTALLED ON AND AROUND THE STOCKPILE
- 3. CONSTRUCT DETENTION BASIN ALONG WITH APPLICABLE STORM SEWER (END-SECTIONS, SHORT STORM SEWER LENGTHS, STANDPIPE OUTLET FILTER). GRADE TO FINAL ELEVATIONS, DISTRIBUTE TOPSOIL, SEED AND STAKE STRAW MULCH BLANKETS ON THE SLOPES OF THE BASIN.
- 4. INSTALL UTILITIES (WATER MAIN, STORM SEWER, SANITARY SEWER) COMPLETE.
- 5. INSTALL, AS PER APPROVED PLANS, THE CATCH BASIN INLET FILTERS. INSPECT AND <u>MAINTAIN</u> FILTERS AS DIRECTED TO PREVENT CLOGGING AND UNNECESSARY FLOODING. INSTALL GELFLOC BLOCKS WHERE INDICATED AND MAINTAIN.
- 6. GRADE ROADWAY LIMITS AND INSTALL PAVEMENT COMPLETE.
- 7. INSTALL ALL PUBLIC UTILITIES (GAS, ELECTRIC, TELEPHONE, CABLE) COMPLETE.
- 8. STABILIZE TEMPORARILY OR PERMANENTLY ALL DISTURBED AREAS WITHIN FIVE (5) DAYS OF FINAL
- 9. INSPECT AND MAINTAIN ALL SOIL EROSION AND SEDIMENTATION CONTROL MEASURES WEEKLY AND AFTER EVERY STORM EVENT THROUGHOUT THE CONSTRUCTION OF THE PROJECT. REMOVAL OF CONTROL MEASURES MAY ONLY TAKE PLACE ONCE THE ENTIRE SITE IS FULLY STABILIZED. UPON FULL STABILIZATION IS COMPLETE, REMOVE THE STAND PIPE AND GRAVEL FILTER. THE DEVELOPER IS RESPONSIBLE FOR ALL SOIL EROSION CONTROL MEASURES.
- 10. VEGETATION MUST BE ACCEPTABLY ESTABLISHED PRIOR TO FINAL RELEASE OF THE CONSTRUCTION DEPOSIT BY THE ROAD COMMISSION FOR UNION LAKE ROAD.

SOIL EROSION CONTROL VIOLATIONS/CITATIONS

- ROUTINE INSPECTIONS WILL BE PERFORMED BY THE OAKLAND COUNTY WATER RESOURCE COMMISSION (O.C.W.R.C.) OR ITS AGENT ONCE A WEEK.
- UPON COMPLETION OF INSPECTION, IF THE SITE IS FOUND NOT TO BE IN COMPLIANCE WITH O.C.W.R.C.'S SOIL EROSION AND SEDIMENTATION CONTROL ORDINANCE, THEN THE PERMIT HOLDER/SIGNER WILL BE ISSUED, BY HAND, MAIL OR EMAIL. A "NOTICE OF EROSION CONTROL DEFICIENCY" LETTER, THAT WILL INCLUDE ALL CURRENT AND PERTINENT NON-COMPLIANCE ITEMS. THE SITE AND/OR DEVELOPMENT WILL HAVE A PRE-DETERMINED AMOUNT OF TIME, FROM THE DATE OF THE "NOTICE" TO RECTIFY THESE ITEMS.
- 3. IF ALL OF THE ITEMS HAVE NOT BEEN ADDRESSED AFTER THE ELAPSED TIME SPECIFIED, THE PERMIT HOLDER/SIGNER WILL RECEIVE A "NON—COMPLIANCE" LETTER, WHICH WILL INCLUDE A "NOTICE TO SHOW CAUSE".
- UPON RECEIPT OF THE "NON-COMPLIANCE" LETTER AND THE "NOTICE TO SHOW CAUSE", THE PERMIT HOLDER/SIGNER WILL ATTEND A SHOW CAUSE HEARING AS WELL AS PAY A RE-INSPECTION FEE IN THE AMOUNT OF \$250.00 TO THE O.C.W.R.C. FOR ADDITIONAL INSPECTIONS. HEARINGS AND REPORT FOLLOW UP. THE BEFORE MENTIONED ACTIVITIES MUST TAKE PLACE WITHIN 24 HOURS UPON RECEIPT OF THE LETTER. AFTER THE HEARING, THE PROJECT, DEVELOPMENT MAY BE ISSUED A "STOP WORK" ORDER.
- IF A CITATION IS ISSUED TO THE PERMIT HOLDER/SIGNER AFTER THE SHOW CAUSE HEARING, AN ADDITIONAL \$400.00 WILL BE PAID TO THEN O.C.W.R.C., FOR FOLLOW-UP INSPECTIONS, MEETINGS AND OTHER EXPENSES INCURRED.

DETENTION BASIN MAINTENANCE SCHEDULE:

THE PROPERTY OWNER IS RESPONSIBLE FOR THE MAINTENANCE OF THE SEDIMENT STRUCTURES. MAINTENANCE SHOULD BE PERFORMED FOLLOWING ANY STORM AND SHOULD INCLUDE:

- CHECKING THE DEPTH OF SEDIMENT DEPOSIT TO ENSURE THE CAPACITY OF THE SEDIMENT STRUCTURES IS ADEQUATE FOR STORM WATER AND SEDIMENT DEPOSITION, AND FOR THE REMOVING OF SEDIMENT.
- 2. CHECKING THE BASIN FOR PIPING, SEEPAGE, OR OTHER MECHANICAL DAMAGE.
- 3. CHECKING FOR THE PRESENCE OF ANY SOIL CAKING, WHICH WOULD PREVENT PROPER DRAINAGE FROM THE BASIN.
- ANY PROBLEM DISCOVERED DURING THE MAINTENANCE CHECKS SHOULD BE ADDRESSED
- SEDIMENT REMOVED DURING CLEANING SHOULD BE PLACED AT AN UPLAND AREA AND STABILIZED SO THAT IT DOES NOT RE-ENTER THE DRAINAGE COURSE

GROUND WATER NOTES

- IF THE STATIC GROUNDWATER LEVEL IS HIGHER THAN THE ELEVATION AT WHICH PROPOSED CONSTRUCTION WORK WILL TAKE PLACE, WHETHER DETERMINED BY INITIAL SOIL BORINGS OR DURING CONSTRUCTION, SO THAT IT WILL BE NECESSARY TO DEWATER AN AREA TO CONTINUE CONSTRUCTION. THEN THE WHITE LAKE TOWNSHIP WILL REQUIRE A WRITTEN DEWATERING PROCEDURE PROVIDED BY THE APPLICANT'S ENGINEER, PRIOR TO COMMENCEMENT OF THE DEWATERING OPERATION.
- IF GROUNDWATER IS ENCOUNTERED DURING CONSTRUCTION, THE CONTRACTOR MUST CONTACT WHITE LAKE DPS IN WRITING SHOWING NEED TO DEWATER PRIOR TO ANY FURTHER CONSTRUCTION.
- IF PROCEDURES ARE NOT SUBMITTED OR, ONCE APPROVED, ARE NOT ADHERED TO, THEN WHITE LAKE TOWNSHIP MAY TAKE ACTION TO SUSPEND DEWATERING ACTIVITIES AT THE PROJECT TO REQUIRE THE ADHERENCE TO PROCEDURES.

INSPECTION & MAINTENANCE SCHEDULE FOR SOIL EROSION CONTROL

GRADE STABILIZATION STRUCTURES SUCH AS: DROP CONTROL STRUCTURES; SIDE DRAINS (ENCLOSED); DROP INLET SPILLWAYS; DROP PIPES; STRAIGHT PIPES; TOEWALLS; DROP BOXES; CHUTES OR FLUMES (SOD, ROCK CONCRETE); EARTH EMBANKMENT STRUCTURES; DOWNDRAINS; SPILLWAYS SHALL BE MAINTAINED AS

BECAUSE GRADE STABILIZATION STRUCTURES ARE SUBJECT TO HIGH FLOW CONDITIONS, PERIODIC INSPECTIONS SHOULD BE PERFORMED TO ENSURE THAT EROSION IN NOT OCCURRING, AND THAT VEGETATION IS ADEQUATELY ESTABLISHED. THESE STRUCTURES SHOULD ALSO BE INSPECTED AFTER STORM EVENTS WHICH EXCEED THE DESIGN STORM.

THE DETENTION BASIN SHOULD BE INVESTIGATED TO ENSURE THAT THE CONCENTRATED FLOWS ARE NOT CAUSING EROSION INTO THE BOTTOM OF THE BASIN AND BLOCKING INFILTRATION. CHECK THE EMERGENCY BYPASS/OVERFLOW FOR FROSION CHECK THE STRUCTURES ITSELF FOR CRACKED CONCRETE UNEVEN OR EXCESSIVE SETTLING, PIPING AND PROPER DRAIN FUNCTIONING. REPAIR OR REPLACE FAILING STRUCTURES IMMEDIATELY. ADDRESS VEGETATION AND EROSION PROBLEMS AS SOON AS WEATHER PERMITS. OPEN STRUCTURES SHOULD BE SIGNED OR MARKED TO ALERT PEOPLE IN THE VICINITY ABOUT POTENTIAL DANGERS.

RIP-RAP

INSPECTIONS SHOULD BE MADE OF ALL RIP-RAPPED SITES IMMEDIATELY AFTER THE FIRST RAINFALL FOLLOWING INSTALLATION. THIS IS PARTICULARLY IMPORTANT IN AREAS WHERE RIP-RAP THAT IS DISPLACED DURING THE STORM WOULD IMPACT CULVERTS. THEREFORE, RIP-RAP SITES SHOULD BE CHECKED FOLLOWING STORMS. FSPFCIALLY THOSE WHICH ARE NEAR OR EXCEED STORM FREQUENCY USED IN THE DESIGN. DISPLACED RIP-RAP SHOULD BE REMOVED FROM ITS DOWNSTREAM LOCATION AND NEW RIP-RAP PLACE ACCORDING TO THE ENGINEERED

STORMWATER CONVEYANCE CHANNEL

AT MINIMUM, CHECK ALL CONSTRUCTED CHANNELS AFTER EACH STORM WHICH MEETS OR EXCEEDS THE DESIGN STORM. ON RIP-RAP LINED WATERWAYS, CHECK FOR SCOURING BELOW THE RIP-RAP LAYER. AND BE SURE THE STONES HAVE NOT BEEN DISPLACED BY THE FLOW. PARTICULAR ATTENTION SHOULD BE PAID TO THE OUTLET OF THE CHANNEL. IF EROSION IS OCCURRING, APPROPRIATE ENERGY DISSIPATION MEASURES SHOULD BE TAKEN. SEDIMENT SHOULD BE REMOVED FROM RIP-RAP LINED CHANNELS IF IT REDUCES THE CAPACITY OF THE CHANNEL.

WHEN VEGETATION STABILIZATION IS PROMPTLY AND EFFECTIVELY APPLIED, VERY LITTLE MAINTENANCE IS REQUIRED. THE GUIDELINES BELOW SHOULD BE FOLLOWED ON ALL SITES: (1) PERIODIC INSPECTIONS SHOULD BE DONE TO ENSURE EXCESSIVE EROSION HASN'T OCCURRED. IF RUN OFF OR WIND EROSION HAS OCCURRED, REDUCE THE SIDE OF SLOPES OF THE SPOIL PILE, OR STABILIZE THE SPOIL PILE WITH PIECES OF SOD LAID PERPENDICULAR TO THE SLOPE, AND STAKED. (2) WHEN FILTER FENCING IS USED AROUND A SPOIL PILE, PERIODIC CHECKS SHOULD BE MADE TO ENSURE THAT PIPING HAS NOT OCCURRED UNDER FENCING, AND TO ENSURE THE FENCE HAS NOT COLLAPSED DUE TO SOIL SLIPPING OR ACCESS BY CONSTRUCTION EQUIPMENT. REPAIR ANY DAMAGED FENCING IMMEDIATELY. (3) BERMS AT THE BASE OF THE SPOIL PILE WHICH BECOME DAMAGED SHOULD BE REPLACED.

CATCH BASIN FILTERS

EFFECTIVE FILTERS WILL COLLECT SEDIMENT, PARTICULARLY WHEN THE SOIL IS SANDY. THESE FILTERS MUST BE CLEANED PERIODICALLY, SO THEY DON'T BECOME CLOGGED AND CAUSE FLOODING CONDITIONS, PIPING, OR OVERTOPPING OF THE CONTROL STRUCTURES. MAINTENANCE OF THESE ITEMS REQUIRES INSPECTION WEEKLY OR AFTER EACH RAIN EVENT. ALSO, THESE ITEMS ARE REUSABLE IF MAINTAINED CORRECTLY. THEY CAN BE REMOVED, EMPTIED, CLEANED AND REPLACED WITHOUT PURCHASING NEW ONES.

BUFFER/FILTER STRIPS

(25' ENVIRONMENTAL SETBACKS) PERIODIC INSPECTIONS SHOULD BE DONE TO ENSURE THAT CONCENTRATED FLOWS HAVE NOT DEVELOPED, AND TO MAKE SURE THE VEGETATIVE COVER IS MAINTAINING ITS EFFECTIVENESS. IF THE INTEGRITY OF THE BUFFER/FILTER STRIP IS JEOPARDIZED BY UPLAND EROSION, OR IF CONCENTRATED FLOWS ARE CREATING RILLS OR GULLIES UP-SLOPE OF THE STRIP, ADDITIONAL BMP'S MAY NEED TO BE INSTALLED. IF THE BUFFER STRIP IS BEING JEOPARDIZED BY STREAM BANK EROSION, THEN THE CAUSE OF THE BANK EROSION NEEDS TO BE INVESTIGATED AND ACTIONS TAKEN TO ADDRESS THE CAUSES. DAMAGED STRIPS SHOULD BE REPAIRED AS SOON AS POSSIBLE. STRIPS DAMAGED DUE TO CONSTRUCTION UP-SLOPE OF THE BUFFER/FILTER SHOULD BE REPLANTED, AS NECESSARY, AFTER THE CAUSE OF THE DAMAGE IS ASSESSED AND ANY OTHER BMP'S ARE NEEDED ARE IMPLEMENTED.

SILT FENCE

SILT FENCES SHOULD BE INSPECTED IMMEDIATELY AFTER EACH RAINFALL AND SEVERAL TIMES DURING PROLONGED RAINFALLS. IF THE FENCE IS SAGGING OR THE SOIL HAS REACHED ONE HALF THE HEIGHT OF THE FABRIC, THE SOIL BEHIND THE FABRIC MUST BE REMOVED AND DISPOSED OF IN A STABLE UPLAND SITE. THE SOIL CAN BE ADDED TO THE SPOIL PILE. IF THE FABRIC IS BEING UNDERCUT (i.e. IF THE WATER IS SEEPING UNDER THE FENCE). THE FENCE SHOULD BE REMOVED AND REINSTALLED FOLLOWING THE GIVEN PROCEDURES. FABRIC WHICH DECOMPOSES OR OTHERWISE BECOMES INEFFECTIVE SHOULD BE REMOVED AND REPLACED WITH NEW FILTER FABRIC IMMEDIATELY. FILTER FENCES SHOULD BE REMOVED ONCE VEGETATION IS WELL ESTABLISHED AND THE UP-SLOPE AREA IS FULLY STABILIZED OR UNLESS OTHERWISE DIRECTED BY THE ENGINEER.

SEEDING, SODDING & MULCHING

SEEDED, SODDED OR MULCHED AREAS SHOULD BE CHECKED FOLLOWING EACH RAIN TO ENSURE THE MATERIAL IS STAYING IN PLACE. ADDITIONAL TACKING MATERIALS OR NETTING MAY BE NEEDED TO BE APPLIED TO HOLD THE AFOREMENTIONED MATERIALS IN PLACE. MAINTENANCE PROCEDURES SHOULD ALSO BE FOLLOWED FOR THE BMP'S WHICH WERE IMPLEMENTED TO KEEP ERODED SOIL OR CONCENTRATED RUNOFF AWAY FROM THESE TARGET AREAS.


ACCESS ROAD (UNION LAKE ROAD)

PROPER MAINTENANCE INCLUDE ADDING ADDITIONAL LAYERS OF STONE WHEN THE ORIGINAL STONE BECOMES COVERED WITH MUD. AFTER EACH STORM EVENT, INSPECT THE ROAD FOR EROSION AND MAKE ANY NECESSARY REPAIRS. IT IS ALSO IMPORTANT TO CHECK AND MAINTAIN ANY BMP'S WHICH ARE USED IN CONJUNCTION WITH THIS BMP, ESPECIALLY THOSE FOR DRAINAGE. ALL SEDIMENT DROPPED OR ERODED ONTO PUBLIC RIGHT-OF-WAY SHOULD BE REMOVED IMMEDIATELY BY

GELFLOC


GelFloc is the dry powder version of Chitosan. GelFloc is integrated into treatment systems as a sock. The GelFloc Sock is a geotextile tube filled with GelFloc powder, designed to dose the chitosan by dissolving the powder into water as it flows over the sock.


Dry sock systems

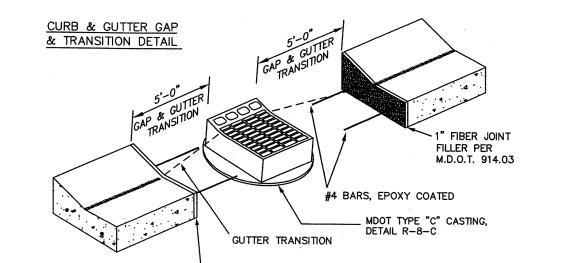


1" FIBER JOINT FILLER


PER M.D.O.T. 914.03

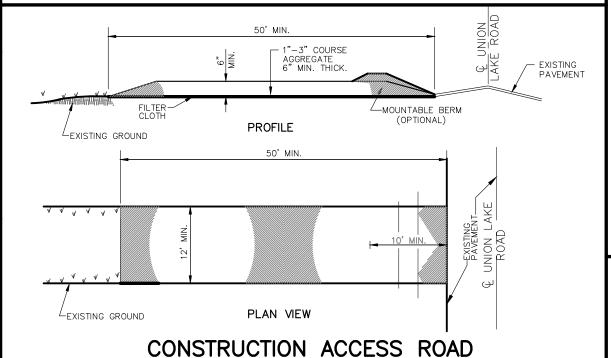

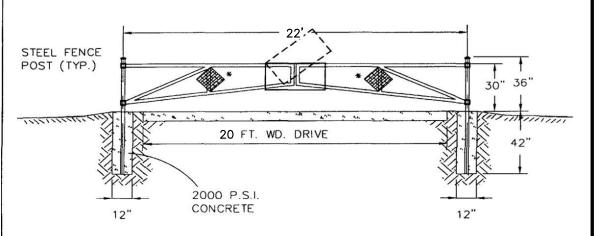


* AT EACH LOCATION, 2-12"x12" RED REFLECTORIZED DIAMOND PANELS, PLACED BACK TO BACK.

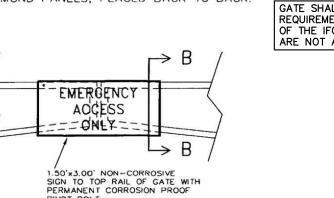


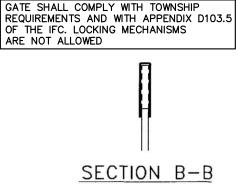


EMERGENCY ACCESS GATE

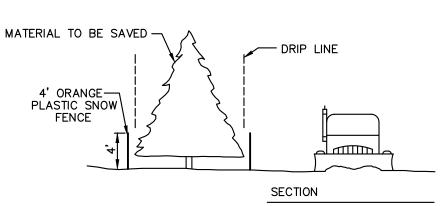

4' HIGH ORANGE PLASTIC SNOW FENCE TO BE INSTALLED AROUND DRIP LINE OF TREES TO BE SAVED PRIOR TO ANY LAND CLEARING OR CONSTRUCTION. NO CUTTING, FILLING OR TRESPASSING SHALL OCCUR INSIDE FENCED AREAS.

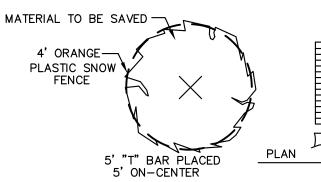

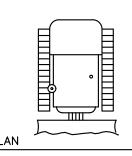


SNOW FENCE TREE PROTECTION DETAIL

GelFloc socks will dose approximately 100ppm at 150gpm flow. If a higher dose is required, or the system flow is higher, you can add additional socks in series. Each sock will treat approximately 100,000 gallons of water, and is highly variable based on flow rate, water temp, and turbulence of the water flowing over the sock.

Deployment method:


Passive and semi-passive treatment systems



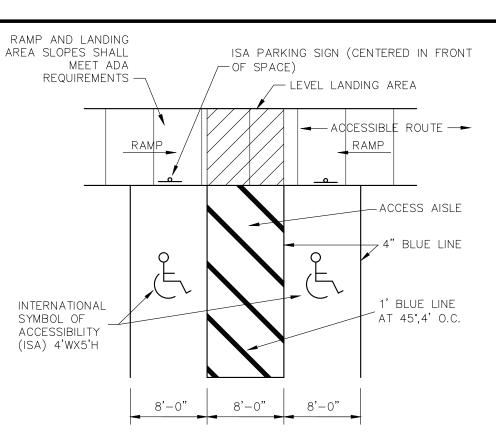

BARRIER-FREE PARKING SPACE LAYOUT VAN ACCESSIBLE

NOTE: BARRIER FREE SPACES SHALL BE LOCATED TO THE NEAREST ACCESSIBLE ENTRANCE ON AN ACCESSIBLE ROUTE. ONE (1) IN EVERY EIGHT (8) ACCESSIBLE SPACES, BUT NO LESS THAN ONE, SHALLBE SERVED BY AN ACCESS AISLE 8'-0" WIDE MINIMUM AND SHALL BE DESIGNATED "VAN ACCESSIBLE"

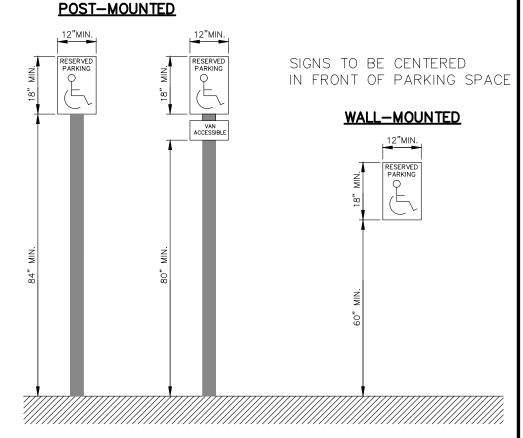

BARRIER-FREE RESERVED PARKING SIGNS

NOTE: ACCESSIBLE PARKING SPACE SIGNS SHALL HAVE A MINIMUM HEIGHT AND SIZE TO PERMIT THE SPACE TO BE EASILY IDENTIFIED AND ARE ELEVATED SUCH THAT THEY SHALL NOT PRESENT A HAZARD TO PERSONS WALKING NEAR THE SIGN.

HaloKlear.

GELFLOC NATURAL FLOCCULANT

Description

HaloKlear GelFloc products are formulated from natural flocculants. The patented design and concentrated formula delivers superior and consistent performance and is 100% biodegradable through enzymatic activity preventing

bioaccumulation. GelFloc can be used as a standalone treatment or in conjunction with HaloKlear DBP-2100 as part of the Dual Product System. GelFloc products have a proven track record of treating billions of gallons of stormwater

Industry Applications · Stormwater management

- Construction Remediation
- **Deployment Method**

GelFloc products can be used in several Best Management Practices (BMPs) including passive systems, semi-passive or active treatment system.

Packaging

6' segmented black material with yellow handle. 4 socks per bucket, individually bagged. Lot Number must be legible on each container. Available in 5-gallon pails.

Handling and Storage

All containers must be free of leaks, damage, and gross contamination. Product should be maintained between 40°F and 90°F. Keep from freezing.

For additional information contact Dober at: (800) 323-4983 info@dober.com www.dober.com/water treatment

Product Benefits

- All-natural
- No bioaccumulation

· Wide pH range

- Not soil specific
- Consistent performance Wide range of applications

Product Properties Appearance A fine, off-white powder

, ibb can an ico	remie, en mine perione.
Bulk Density	(freely settled) 0.217 gm/ml
Tap Density	0.252 gm/ml
рН	3.0 – 4.5 (3.5 as measured)
LC50 fish 1	22.8 mg/l Fathead Minnow

PRODUCT FACTS

Field Handling Recommendations

Refer to HaloKlear DPS Socks BMP Manual for Best Management Practices. For more information, contact your Dober representative.

Before handling this material read the corresponding Material Safety Data Sheet for safety and health data.

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SANITARY SEWER (West Valley) 1 6" PVC SDR 23.5 BUILDING LEAD 732 L.F. 2 8" PVC TRUSS SANITARY SEWER 1388 L.F. 3 4' DIA. MANHOLE 10 EA. 847 L.F. 4 4" FORCE MAIN 5 AIR RELEASE VALVE 1 EA. 6 5' MANHOLE VAULT 1 EA. 7 6' SAN MANHOLE PUMP STATION 1 EA. SANITARY SEWER (Union Lake Road) QUANTITY 1 8" PVC TRUSS SANITARY SEWER 10 L.F. 2 12" PVC TRUSS SANITARY SEWER 857 L.F. 3 4' DIA. MANHOLE 4 EA. **WATER MAIN** 1 8" WATER MAIN D.I. CL 54 1100 L.F. 2 12" WATER MAIN D.I. CL 54 1329 L.F. 3 HYDRANT, VALVE & BOX 8 EA. 4 12" TSV&W 1 EA. 5 8" GATE VALVE AND WELL 4 EA. 6 12" GATE VALVE AND WELL 3 EA. 7 12" PRESSURE REDUCING VALVE AND VAULT 1 EA. 8 2" K-Copper Water Service 788 L.F. STORM SEWER 1 8" PVC SDR 35 PIPE 2,039 L.F. 2 12" C-76 CL. 4 2,478 L.F. 3 15" C-76 CL. 4 291 L.F. 4 18" C-76 CL. 4 815 L.F. 5 21" C-76 CL. 4 1081 L.F. 6 24" C-76 CL. 4 465 L.F. 7 30" C-76 CL. 4 288 L.F. 8 2' DIA. INLET 5 EA. 46 EA. 9 4' DIA. CATCH BASIN 3 EA. 10 5' DIA. CATCH BASIN 11 6' DIA. CATCH BASIN 1 EA. 12 4' DIA. MANHOLE 6 EA. 13 5' DIA. MANHOLE 2 EA. 14 6' DIA MANHOLE 1 EA. 15 36" CMP STANDPIPE 1 EA. 16 12" CONC. END SECTION W/ RIP RAP 1 EA. 17 24" CONC. END SECTION W/ RIP RAP 1 EA. 1 EA. 18 30" CONC. END SECTION W/ RIP RAP 19 STORM WATER TREATMENT MANHOLE 1 EA. PAVING 1 ON SITE ROAD PAVEMENT (4" HMA ON 8" 21AA) 5,802 S.Y. 2 DRIVEWAY PAVE 8739 CEDAR ISLAND 3 3-INCH MOUNTABLE CURB 3,505 L.F. 4 ON SITE ROAD SIDEWALKS 19,788 S.F. 5 UNION LK RD ROW PAVE (9" HMA ON 8" 21AA) 1,926 S.Y. 6 MDOT TYPE B-2 CURB 405 L.F. 7 MDOT TYPE F-4 CURB 364 L.F. 8 UNION LK RD 8' WIDE PATHWAY 6781 S.F. **ESTIMATED QUANTITIES ARE FOR REFERENCE ONLY.** CONTRACTOR SHALL DETERMINE THE QUANTITIES OF WORK REQUIRED TO COMPLETE THE PROJECT UNION LAKE SANITARY SEWER EXTENSION **Quantity Summary** 1 8" PVC TRUSS SANITARY SEWER 10 L.F. 2 12" PVC TRUSS SANITARY SEWER 857 L.F. 4 EA. 3 4' DIA. MANHOLE 4 FABRIC SILT FENCE 1,808 L.F. 5 CONSTRUCTION ROAD ACCESS 1 EA. WEST VALLEY

WEST VALLEY

Estimated Quantity Summary

MULTI-FAMILY RESIDENTIAL COMMUNITY SECTION 36, TOWN 3 NORTH, RANGE 8 EAST WHITE LAKE TWP., OAKLAND COUNTY, MICHIGAN

REVISIONS REV. SAN AND STORM PER OWNER REV SAN, ST. & PAV. PER OWNER REVISE PER TWP. 02-18-2 REVISE PER TWP REV PER OWNER, RCOC AND OCWRO REVISED WATERMAIN FOR OWNER REVISED PER TOWNSHIP 04-25-23 REVISE PER TWP. 7-27-23 REVISED PER TWP. 9-21-23 REVISED PER EGLE

UTILITY WARNING JNDERGROUND UTILITY LOCATIONS AS SHOWN ON THE PLAN, WERE OBTAINED FROM UTILITY OWNER AND NOT FIELD Know what's **below**.

Call before you dig. THE CONTRACTOR SHALL BE RESPONSIE FOR THE PROTECTION OF AND/OR RELOCATION OF ALL UTILITIES THAT MAY INTERFERE WITH CONSTRUCTION.


ATE: 08-23-19 DESIGNED BY: G.N. JOB NUMBER: 17-031



SEIBER KEAST LEHNER ENGINEERING | SURVEYING FARMINGTON HILLS OFFICE 05 COUNTRY CLUB DRIVE, SUITE C8 FARMINGTON HILLS, MI 48331 248.308.3331

NOTES AND DETAILS

SHEET

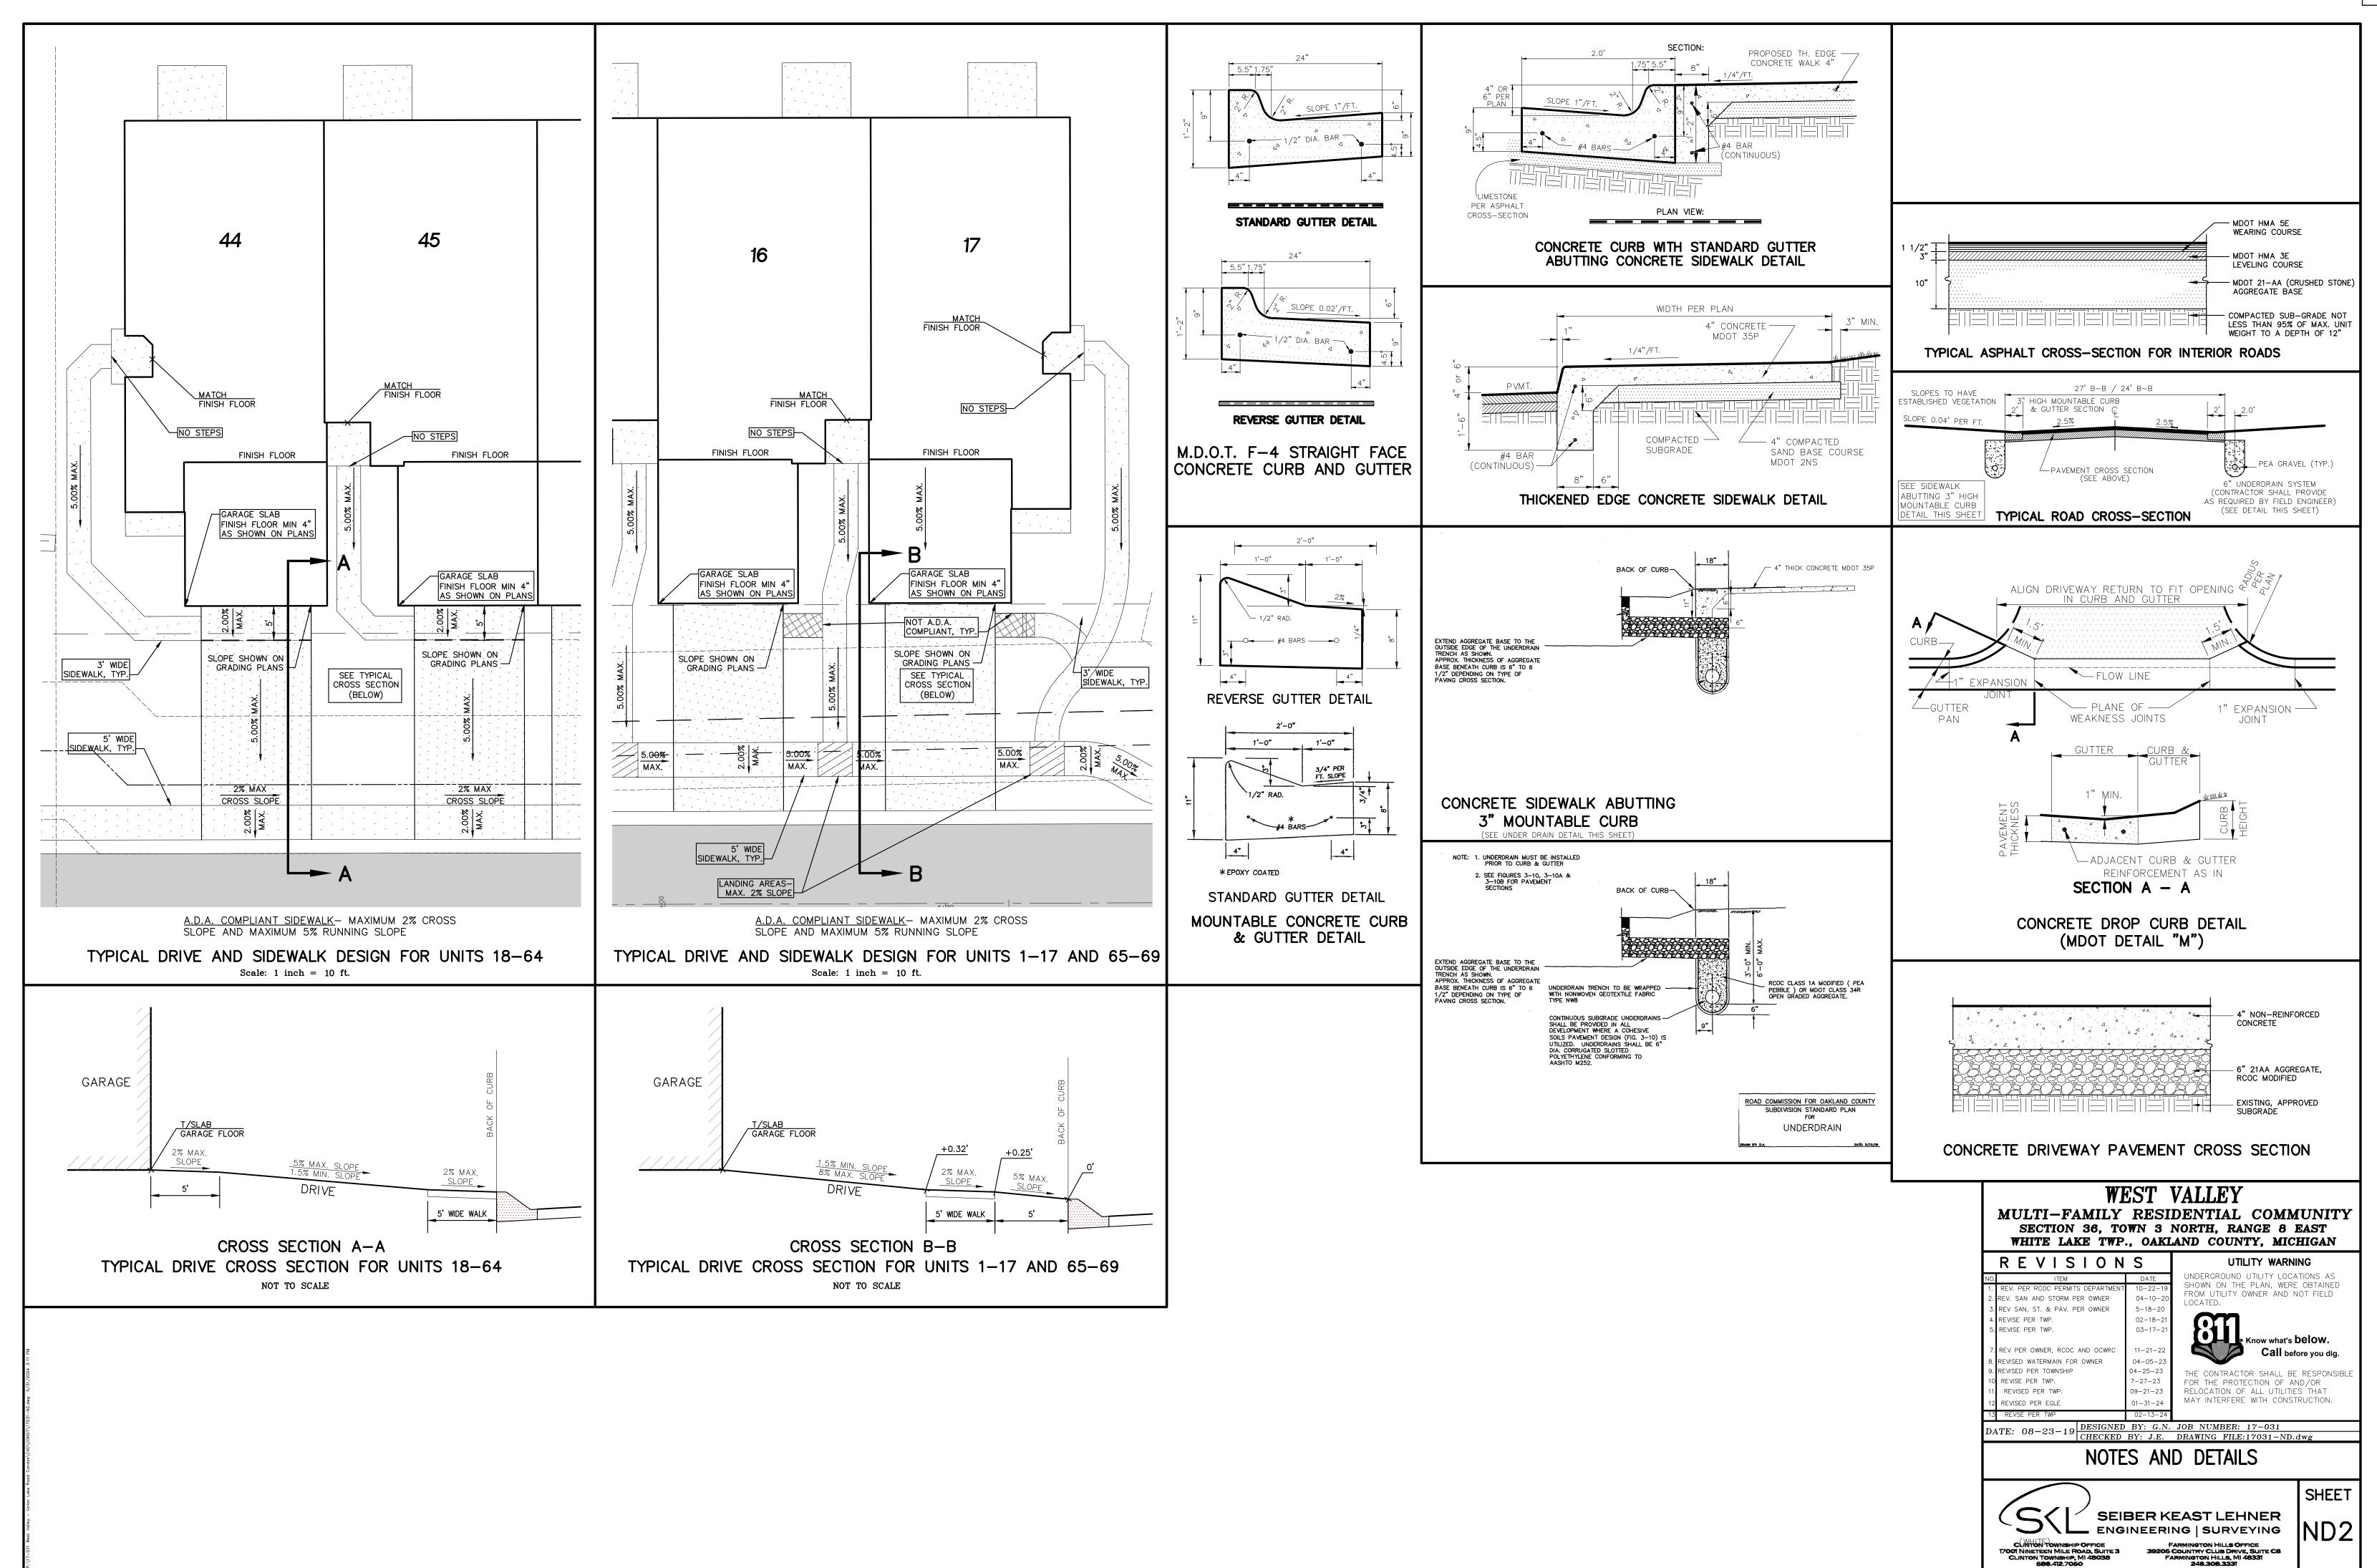



DAKLAND COUNTY WATER RESOURCE COMMISSION


STANDARD LIFT STATION DRAWINGS


SHEET #	DESCRIPTION
	SITE LAYOUT EXAMPLE
4422-23-01	UTILITY POWER AND PUMP WIRING
4422-23-02	120VAC POWER WIRING
4422-23-03	120VAC/24VDC CONTROL WIRING
4422-23-04	24VDC CONTROL POWER
4422-23-05	24VDC CONTROL POWER
4422-23-06	PLC I/O WIRING
4422-23-07	PLC I/O WIRING
4422-23-08	PLC I/O WIRING
4422-23-09	SPARE SHEET
4422-23-10	PLC SUBPLATE LAYOUT
4422-23-11	PLC PANEL LAYOUT


SHEET #	DESCRIPTION
4422-23-12	SCADA PANEL SUBPLATE LAYDUT
4422-23-13	SCADA PANEL ENCLUSURE LAYOUT
4422-23-14	SCADA PANEL BILL OF MATERIAL
4422-23-15	SPARE SHEET
4422-23-16	POWER/PUMP PANEL SUBPLATE LAYOUT
4422-23-17	POWER/PUMP PANEL ENCLOSURE LAYOUT
4422-23-18	POWER/PUMP PANEL BILL OF MATERIAL
4422-23-19	CONTROLS WIRING LEGEND
4422-23-20	ELECTRICAL ONE-LINE EXAMPLE
4422-23-21	EQUIPMENT INSTALLATION DETAILS
4422-23-22	WRC STANDARD DUPLEX PUMP STATION DETAILS

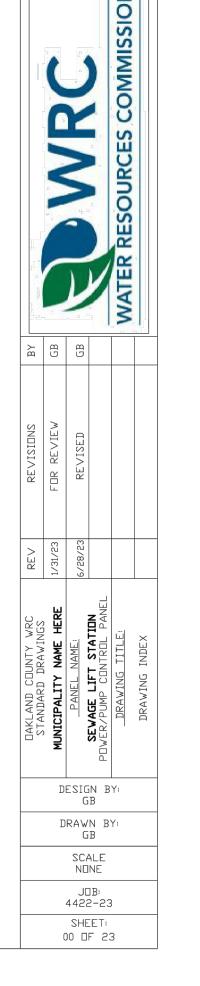


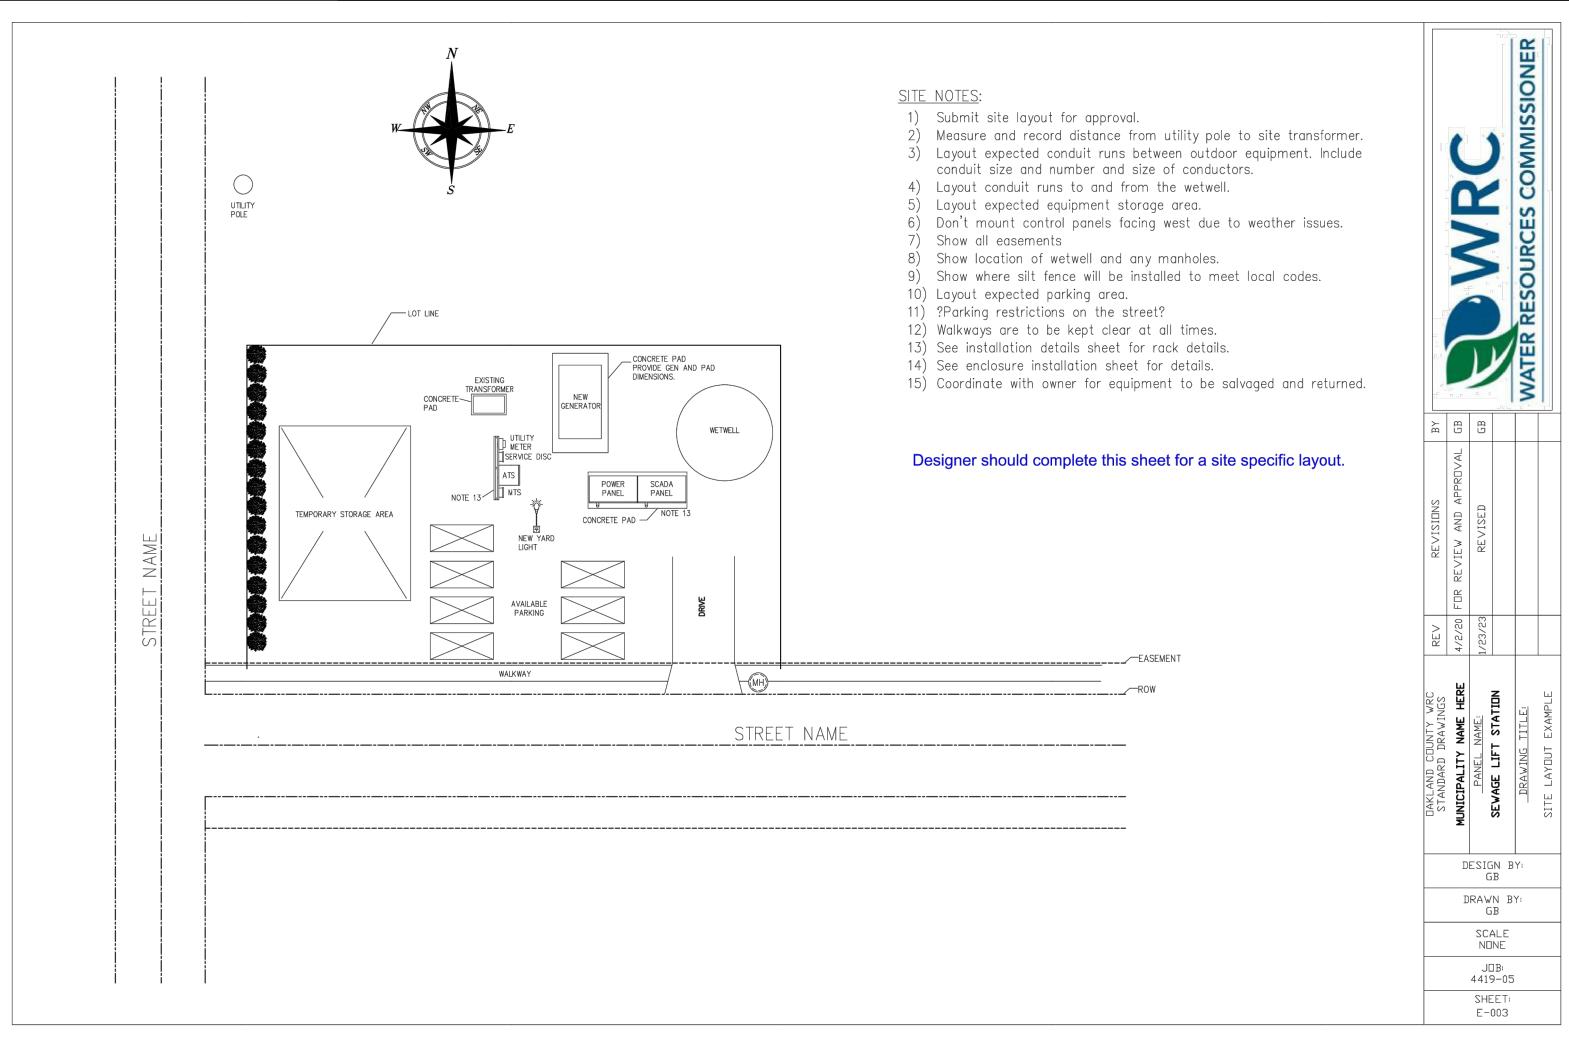


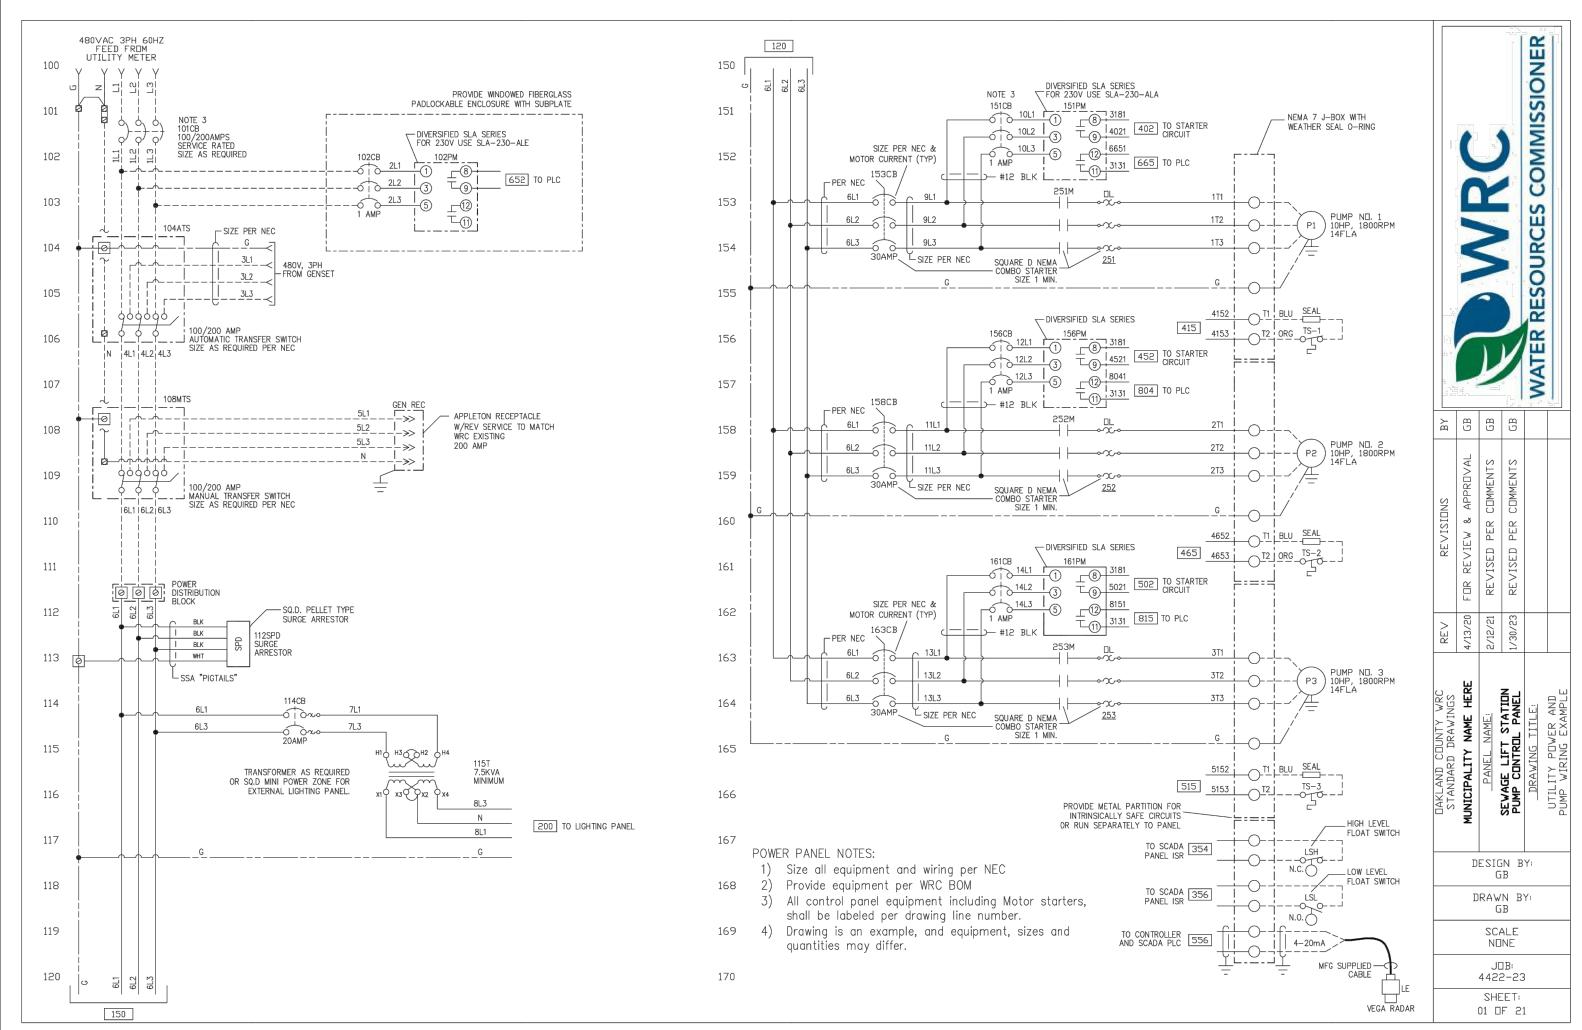


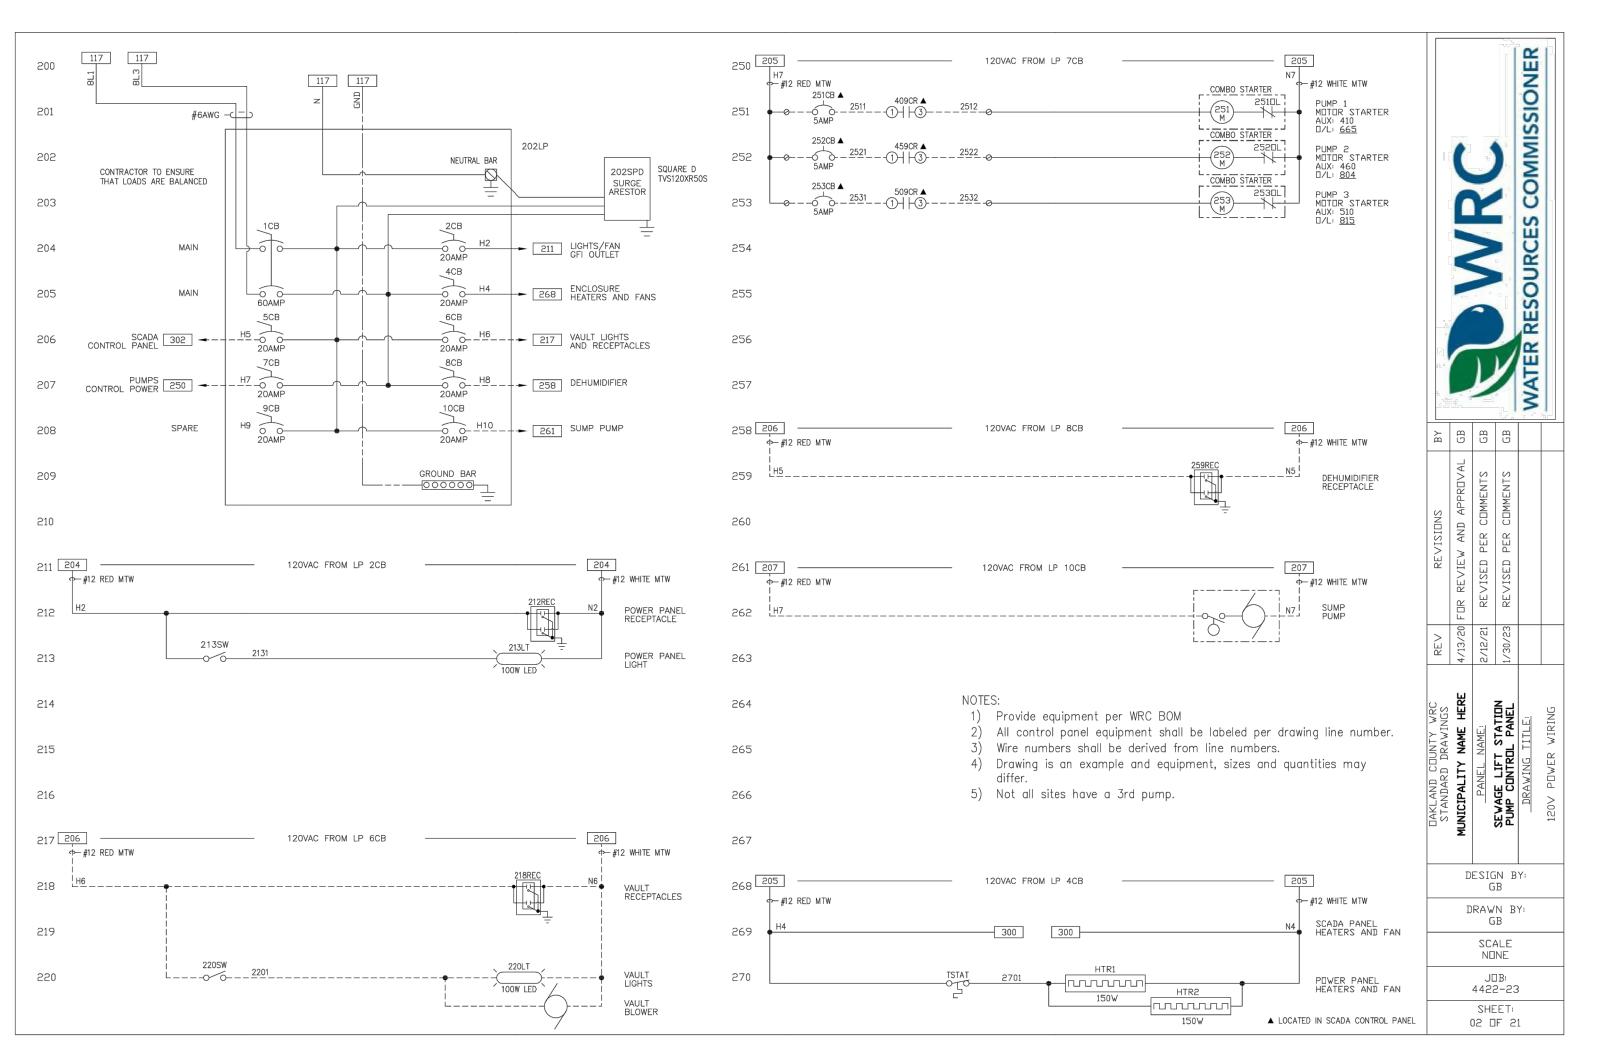


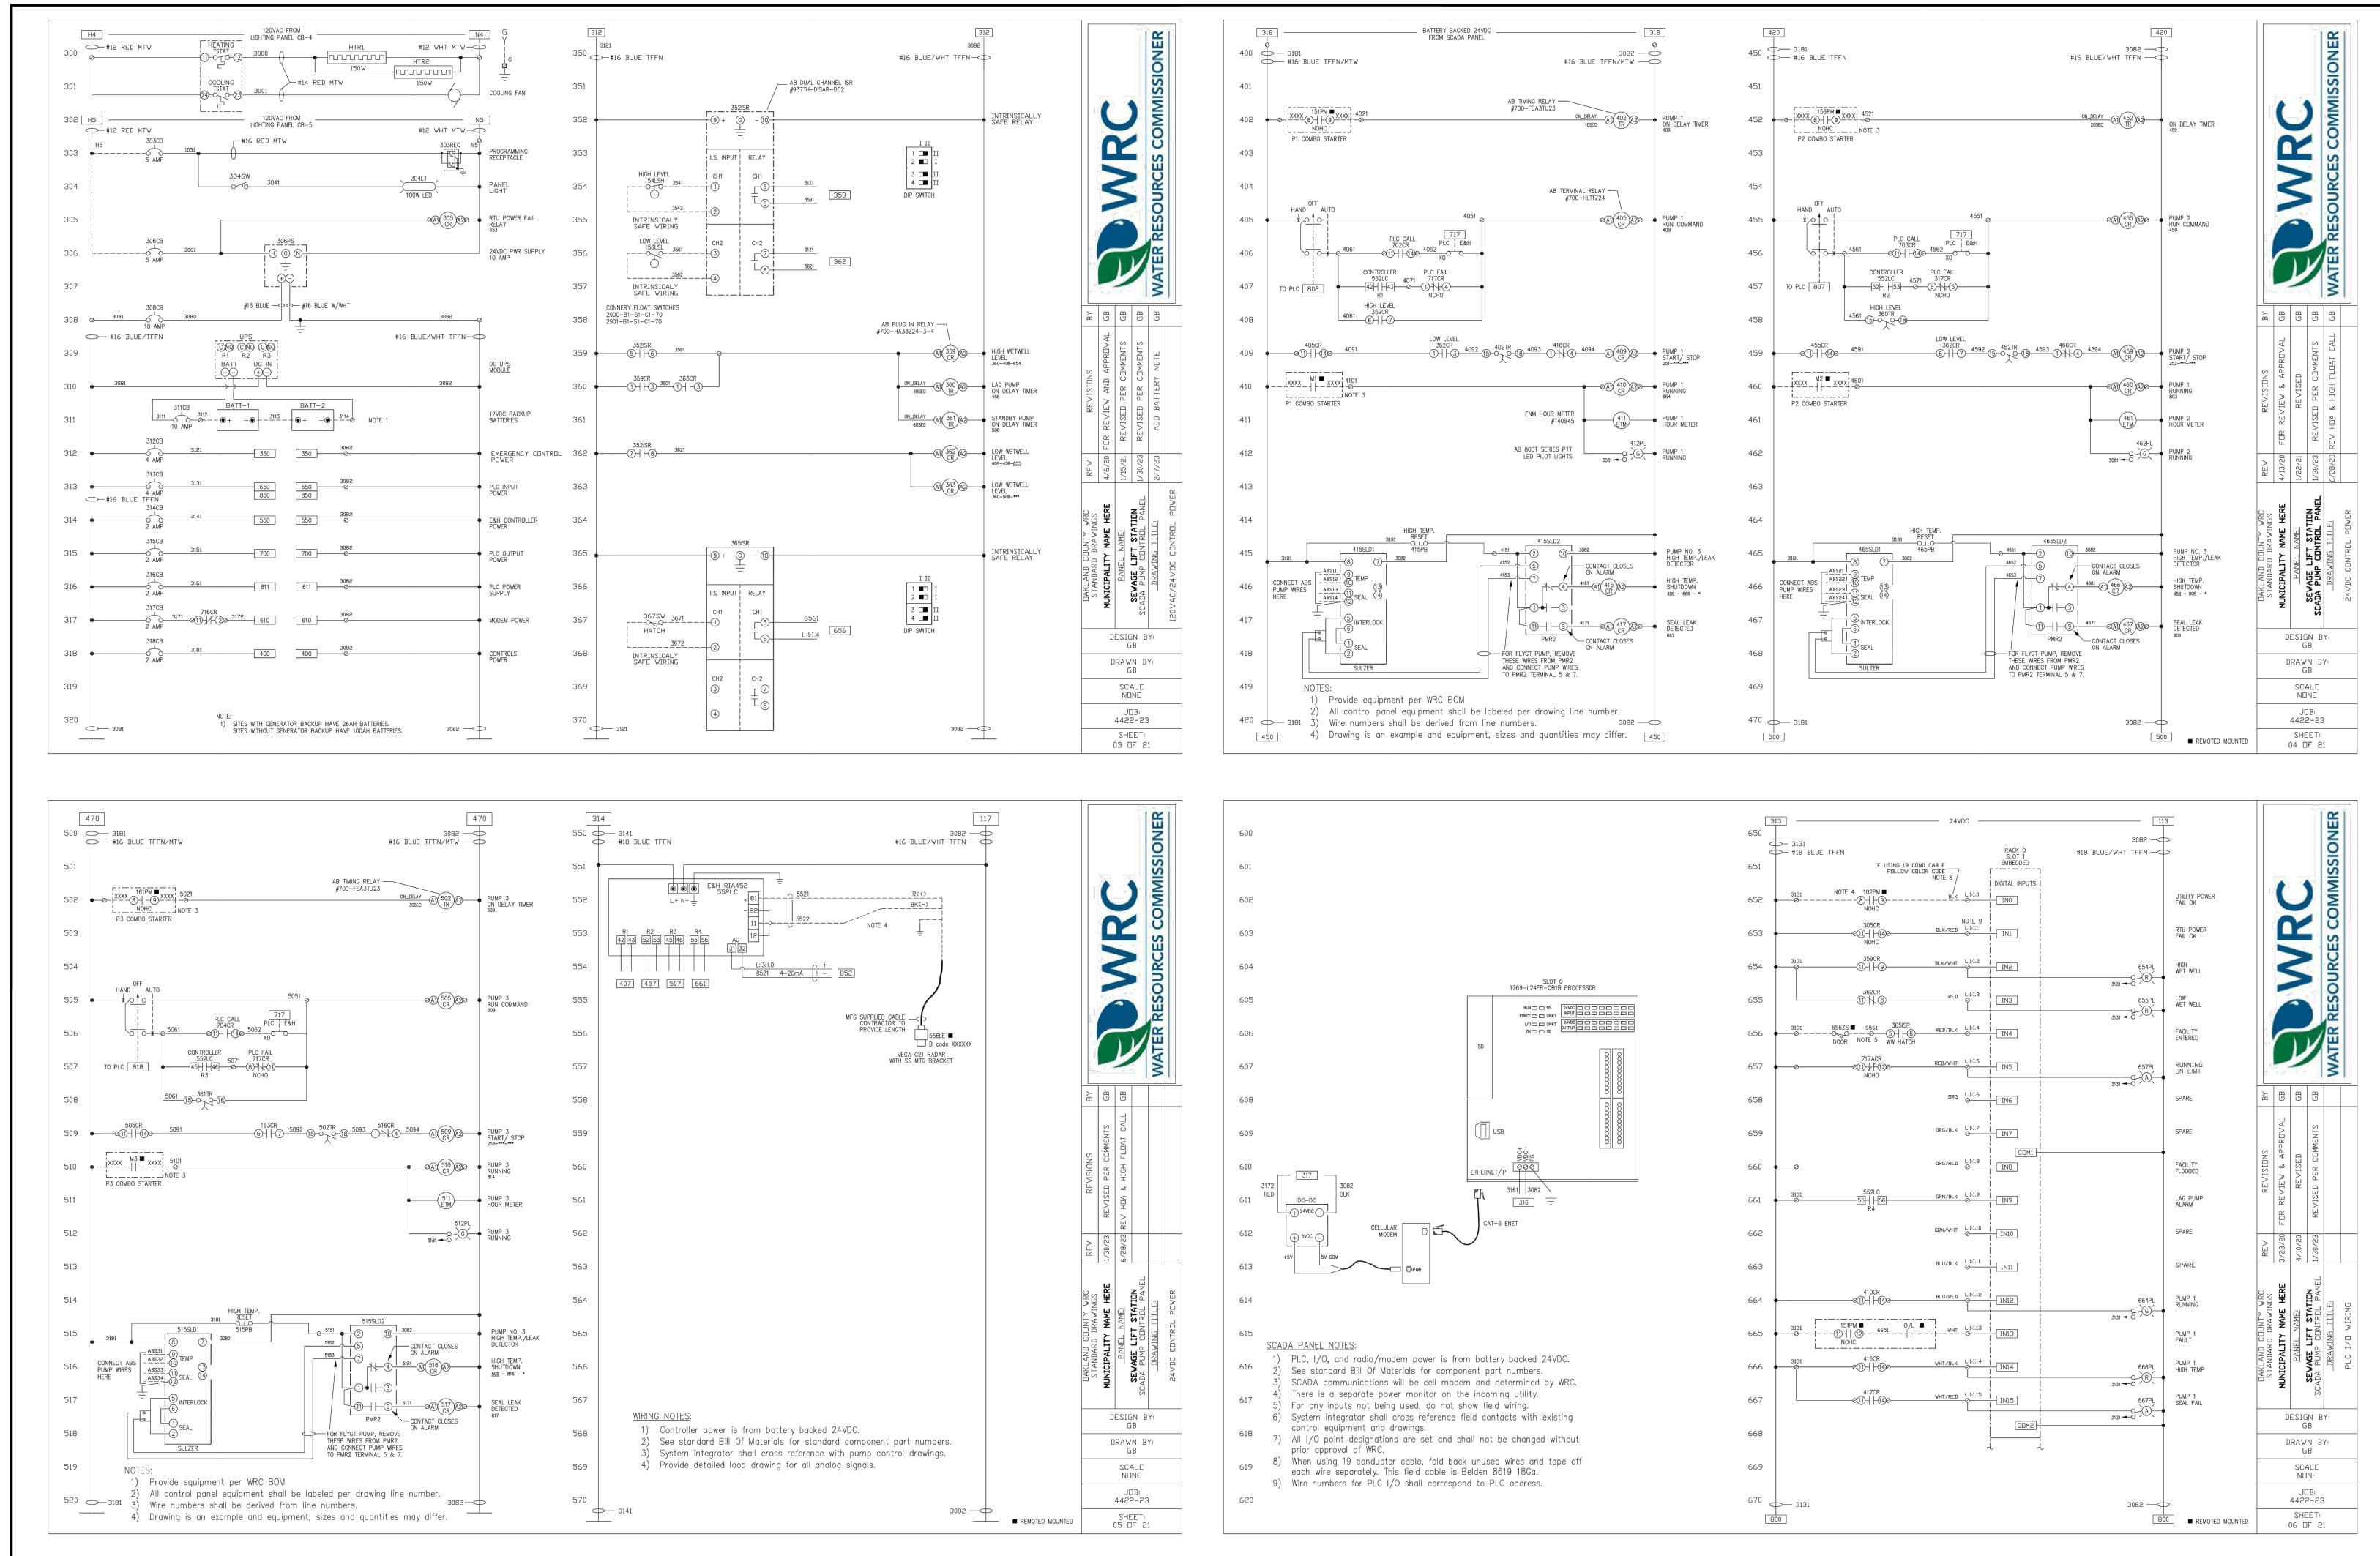


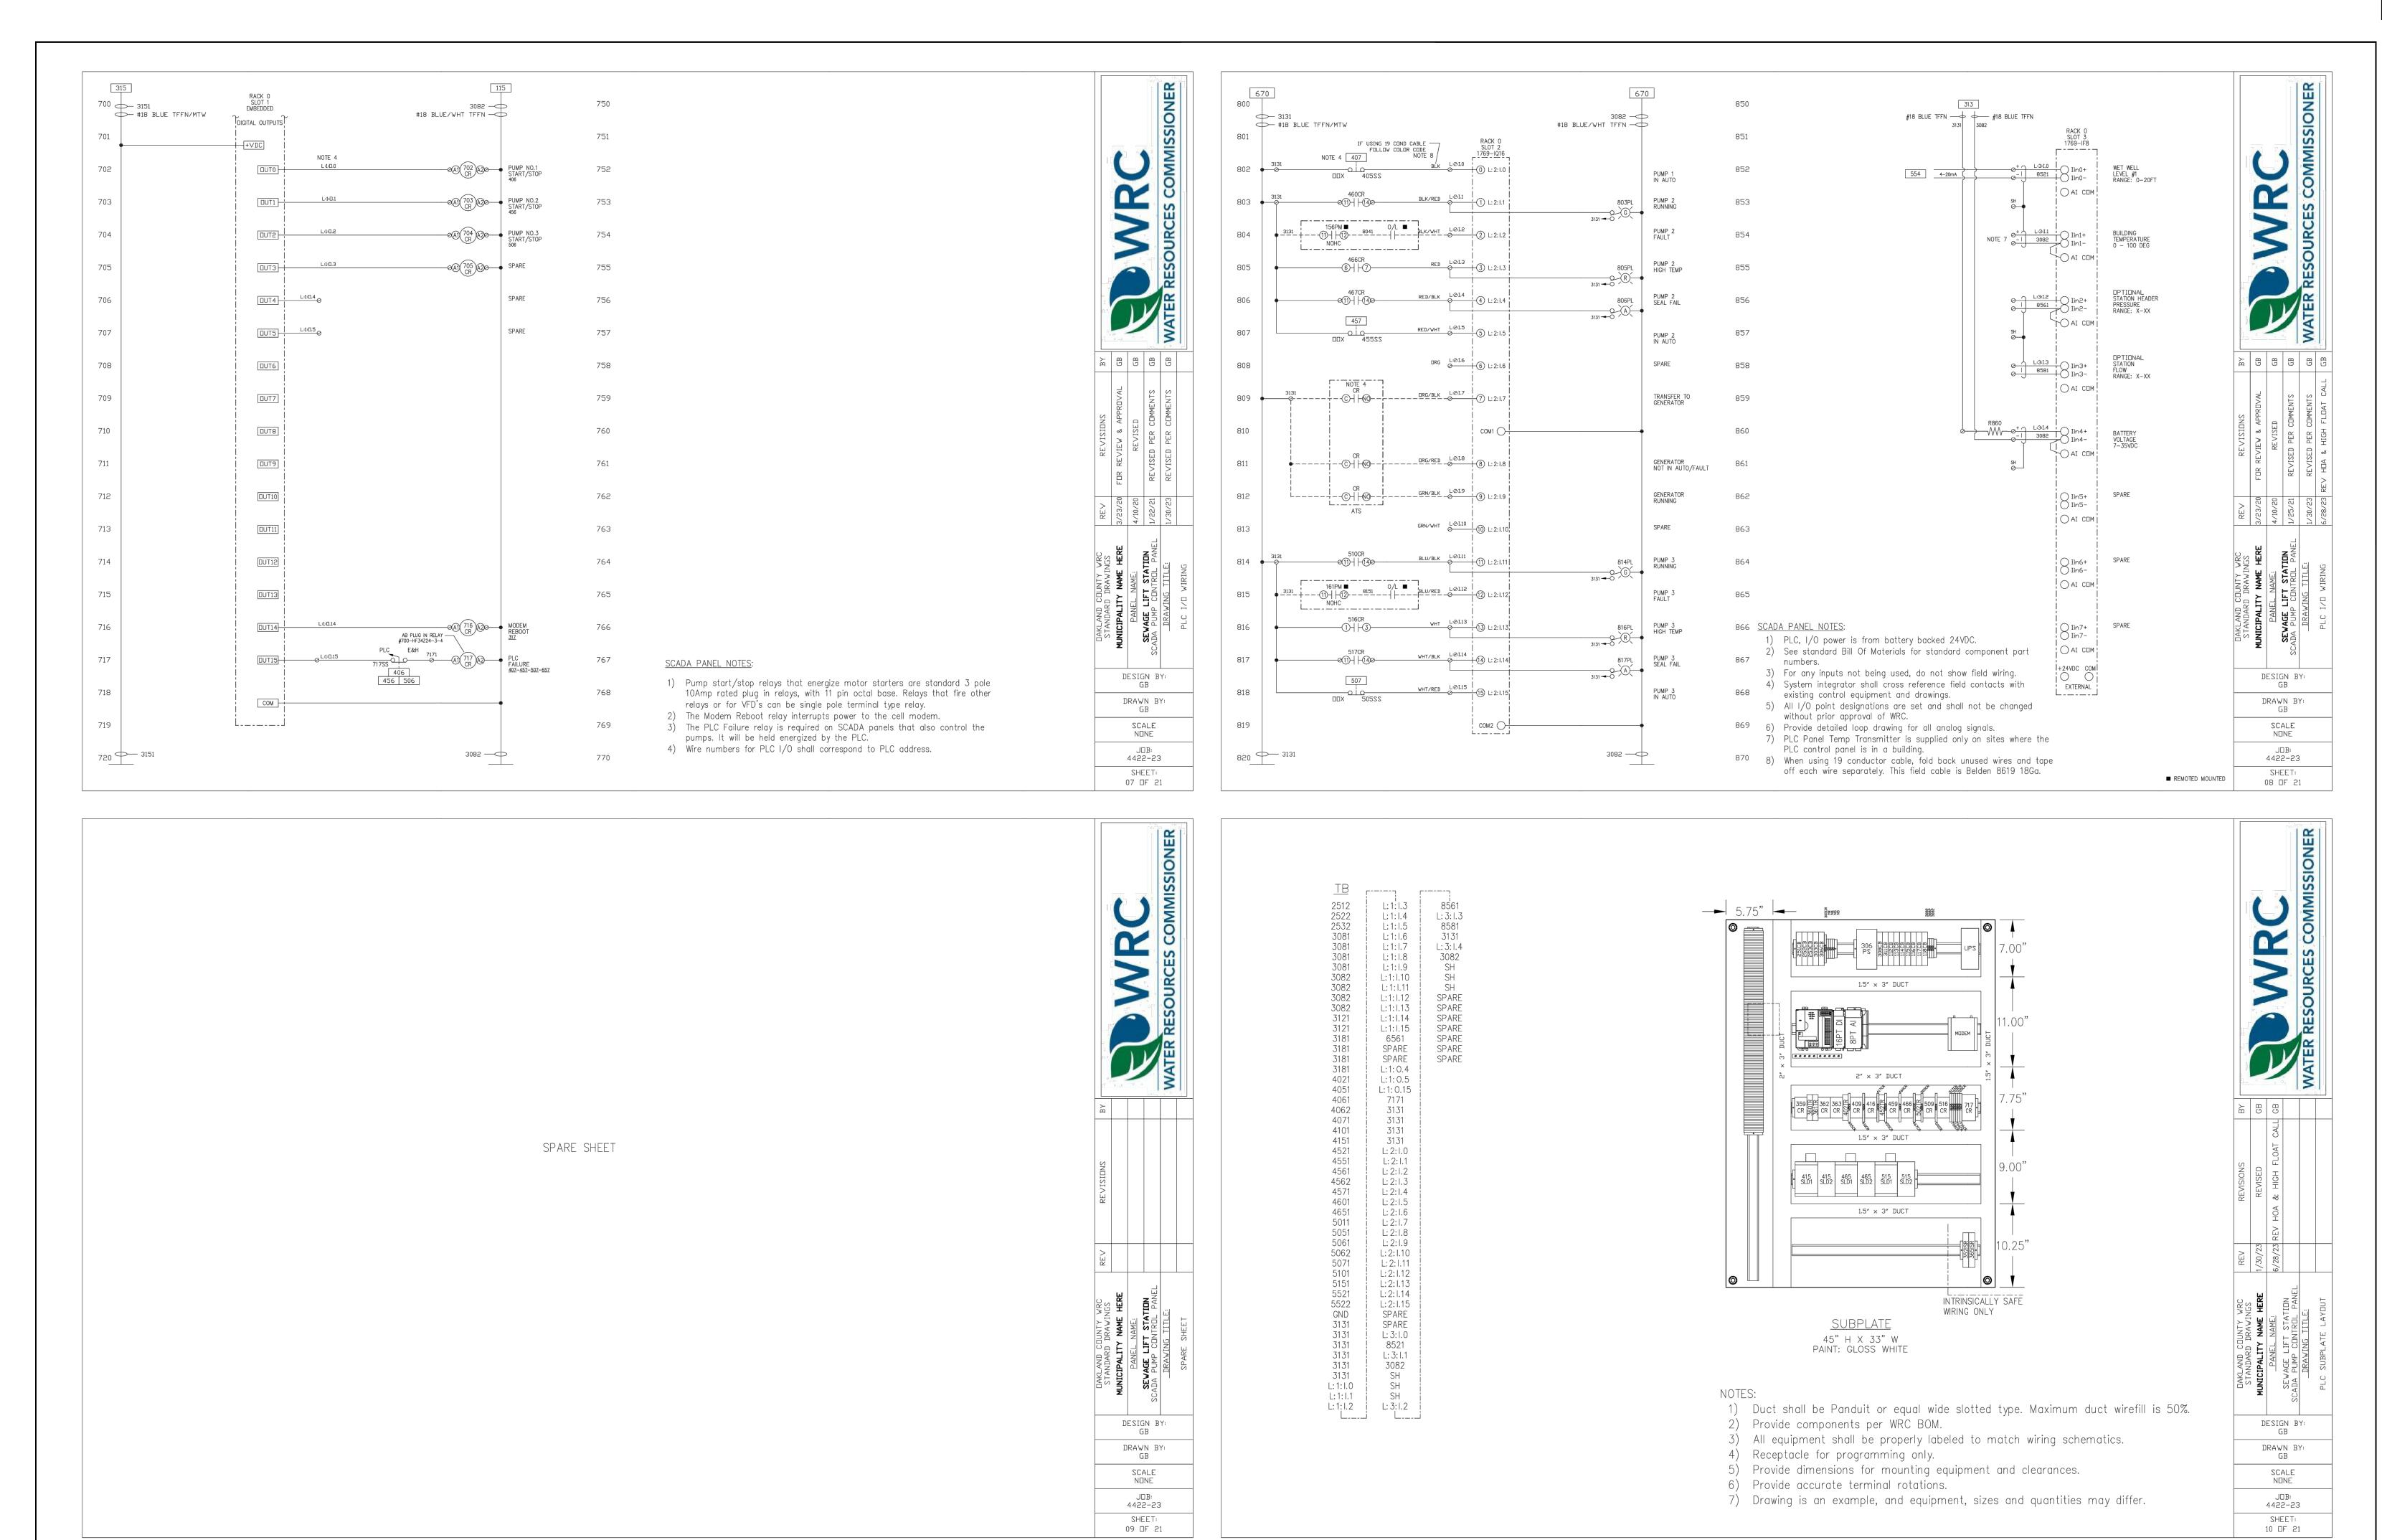


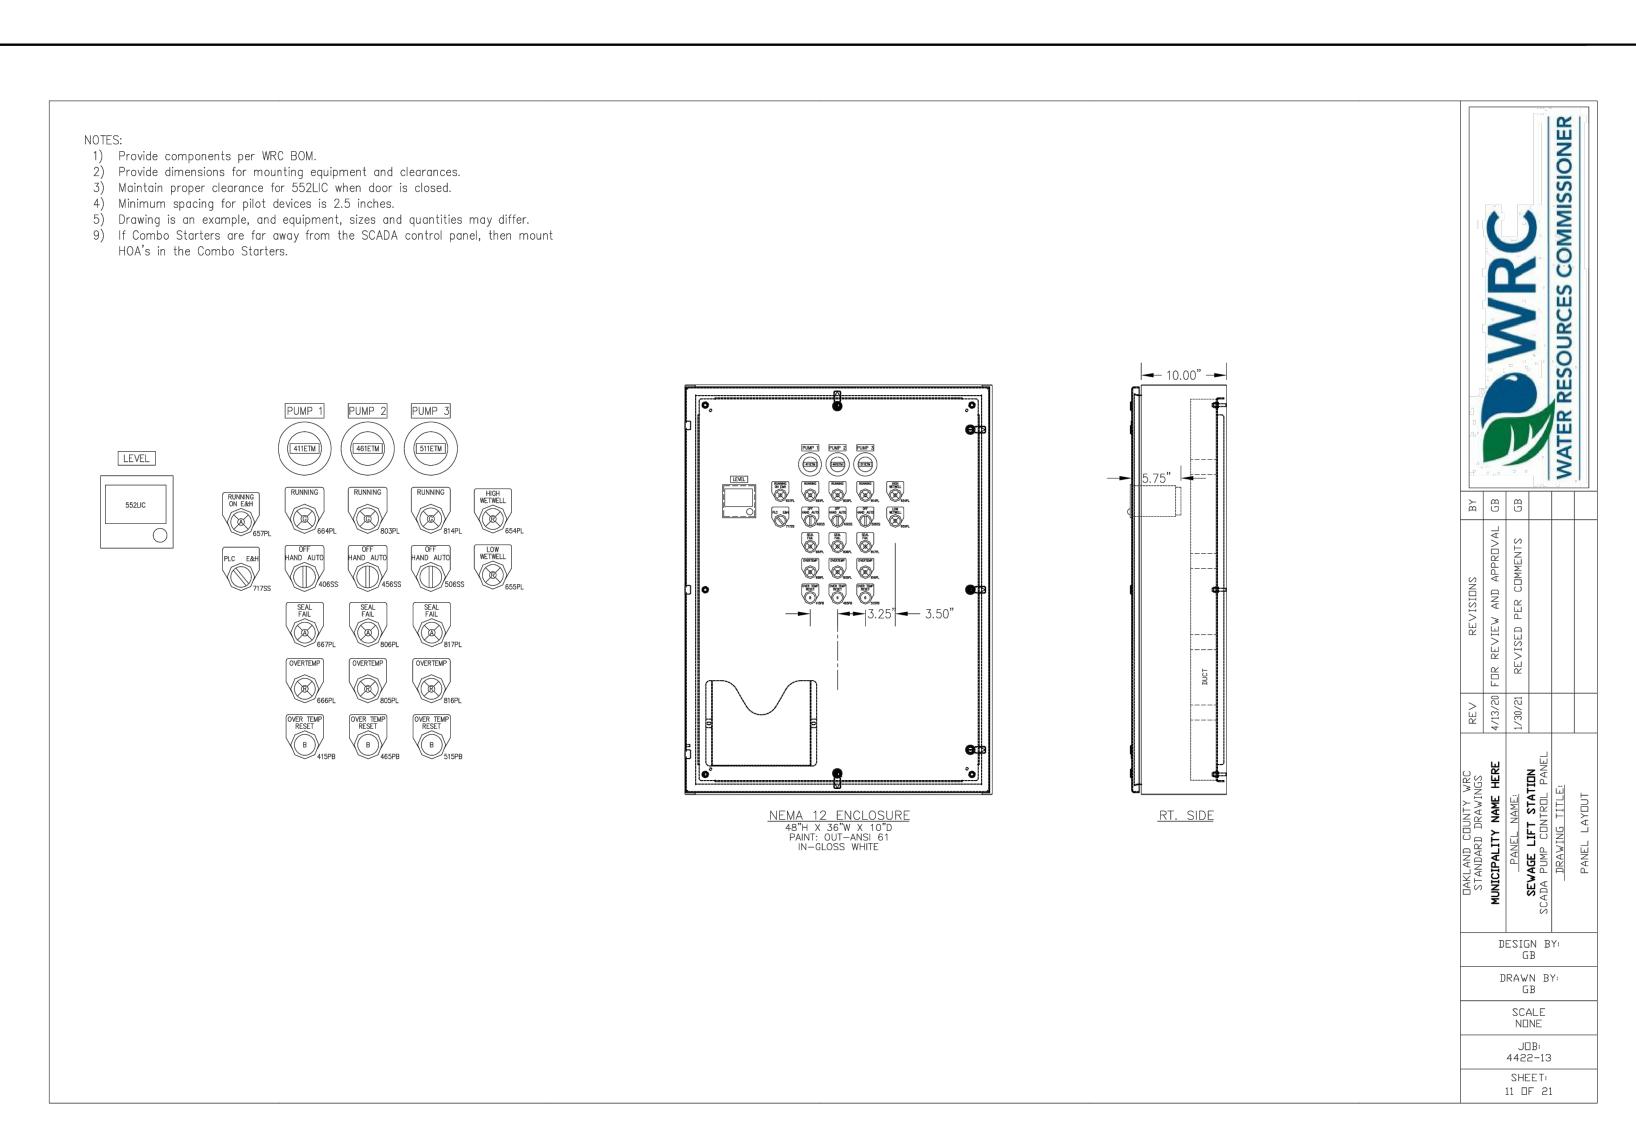


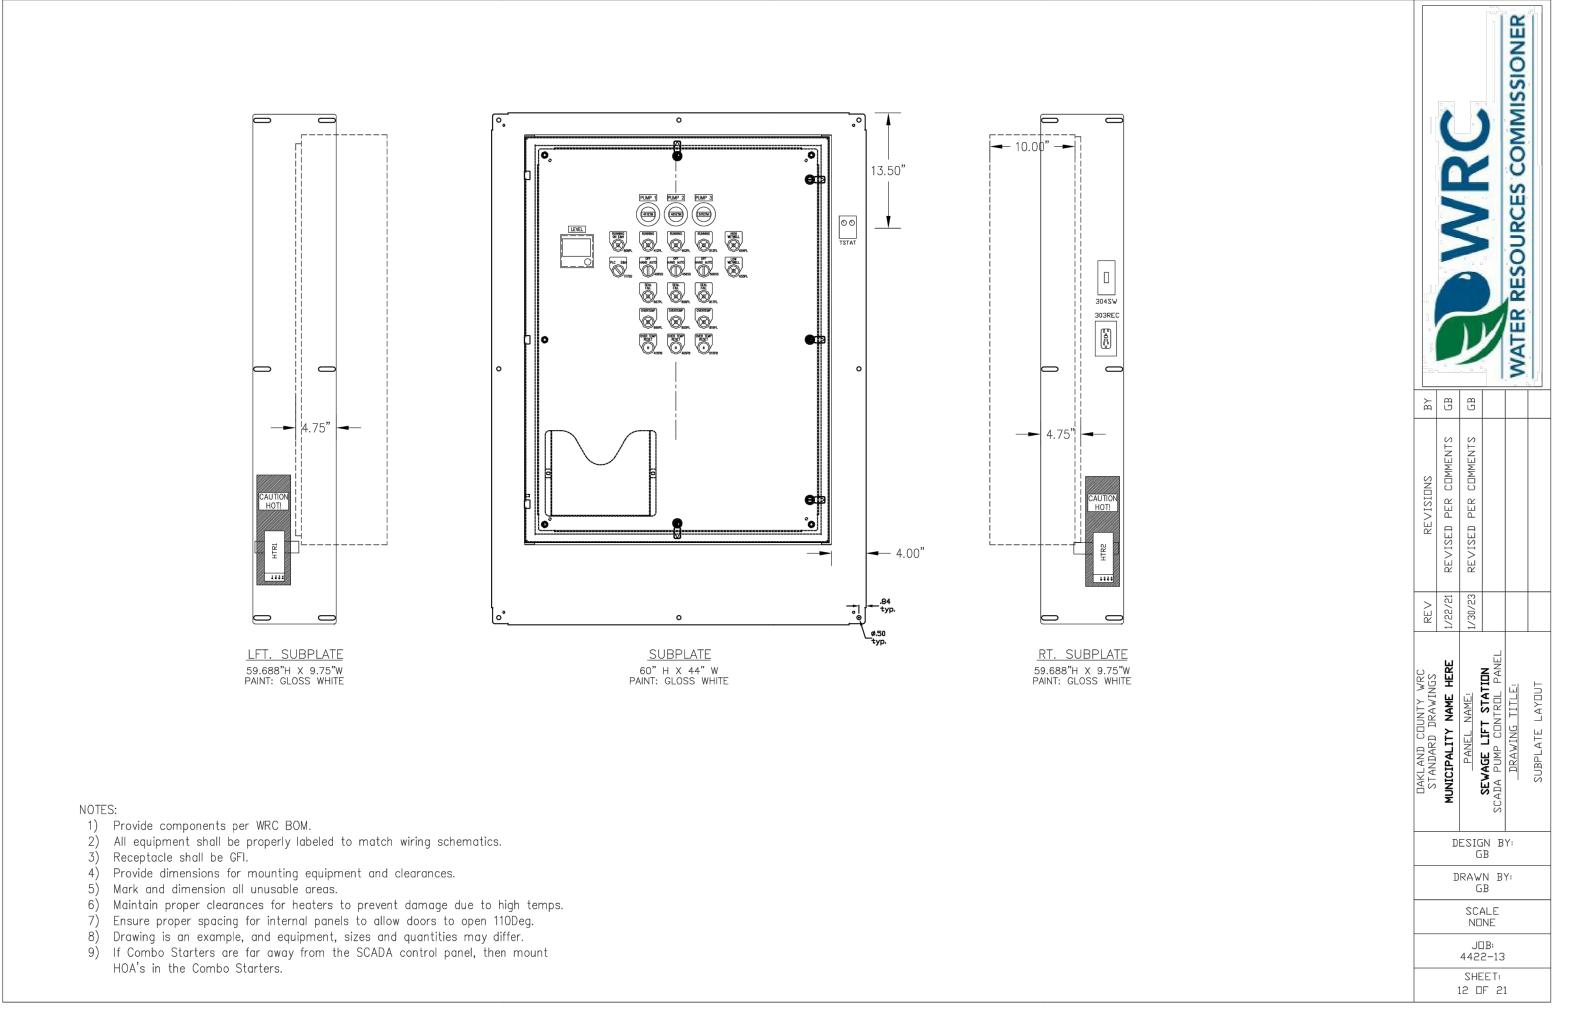


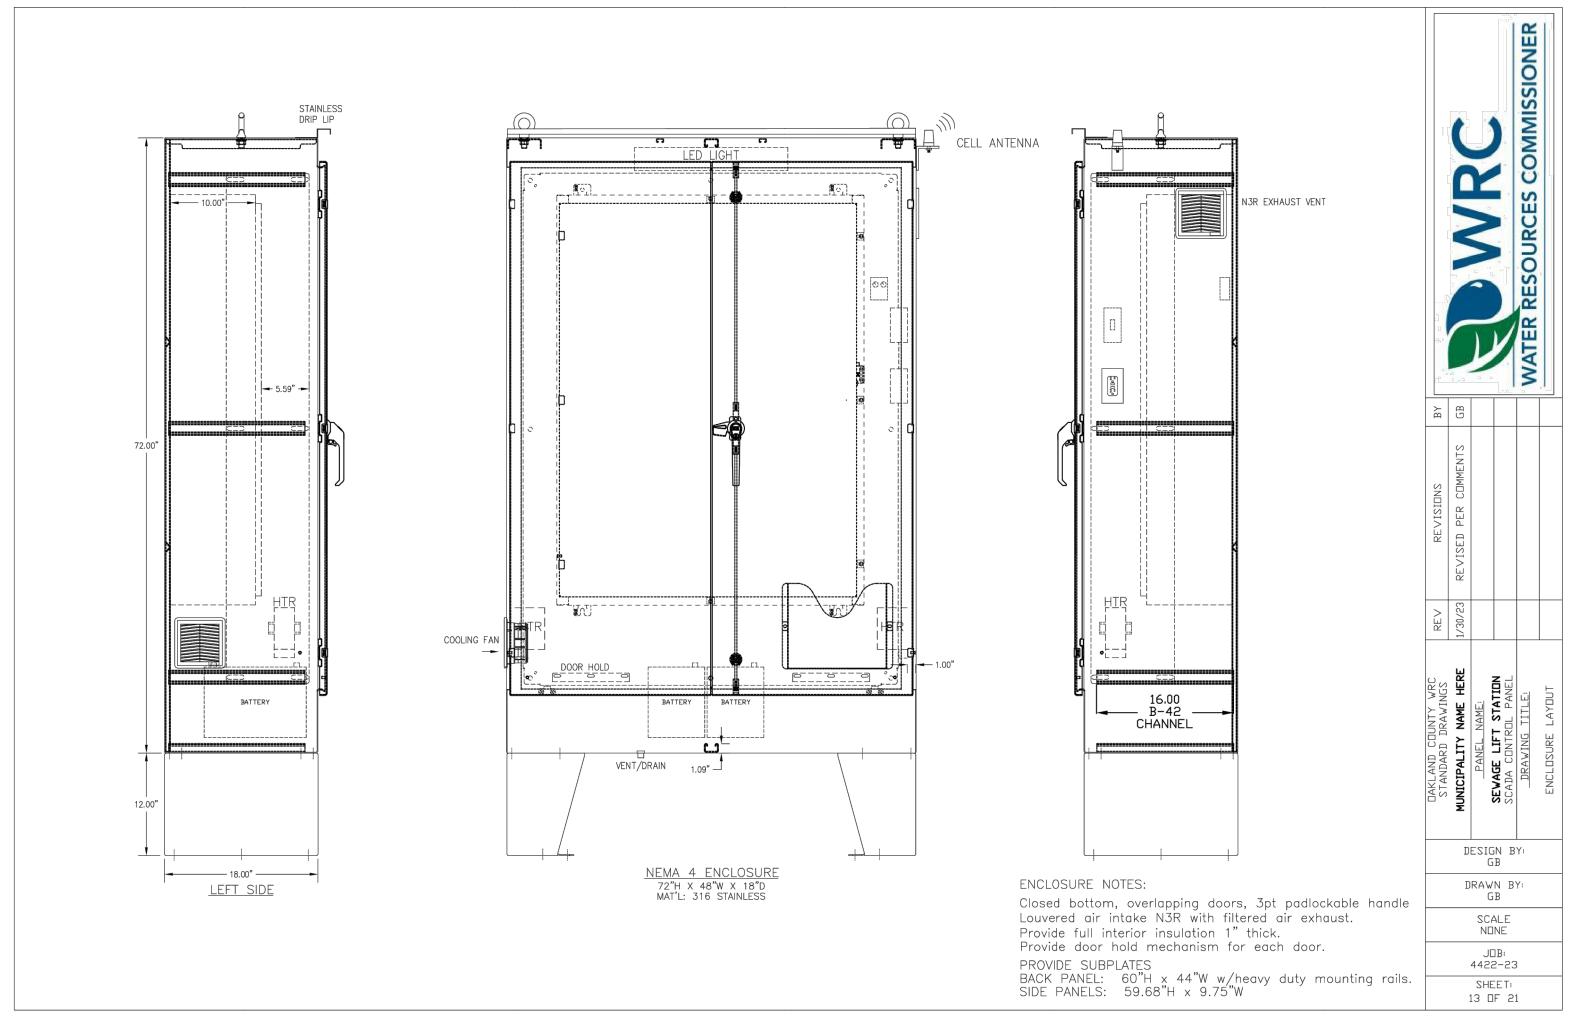


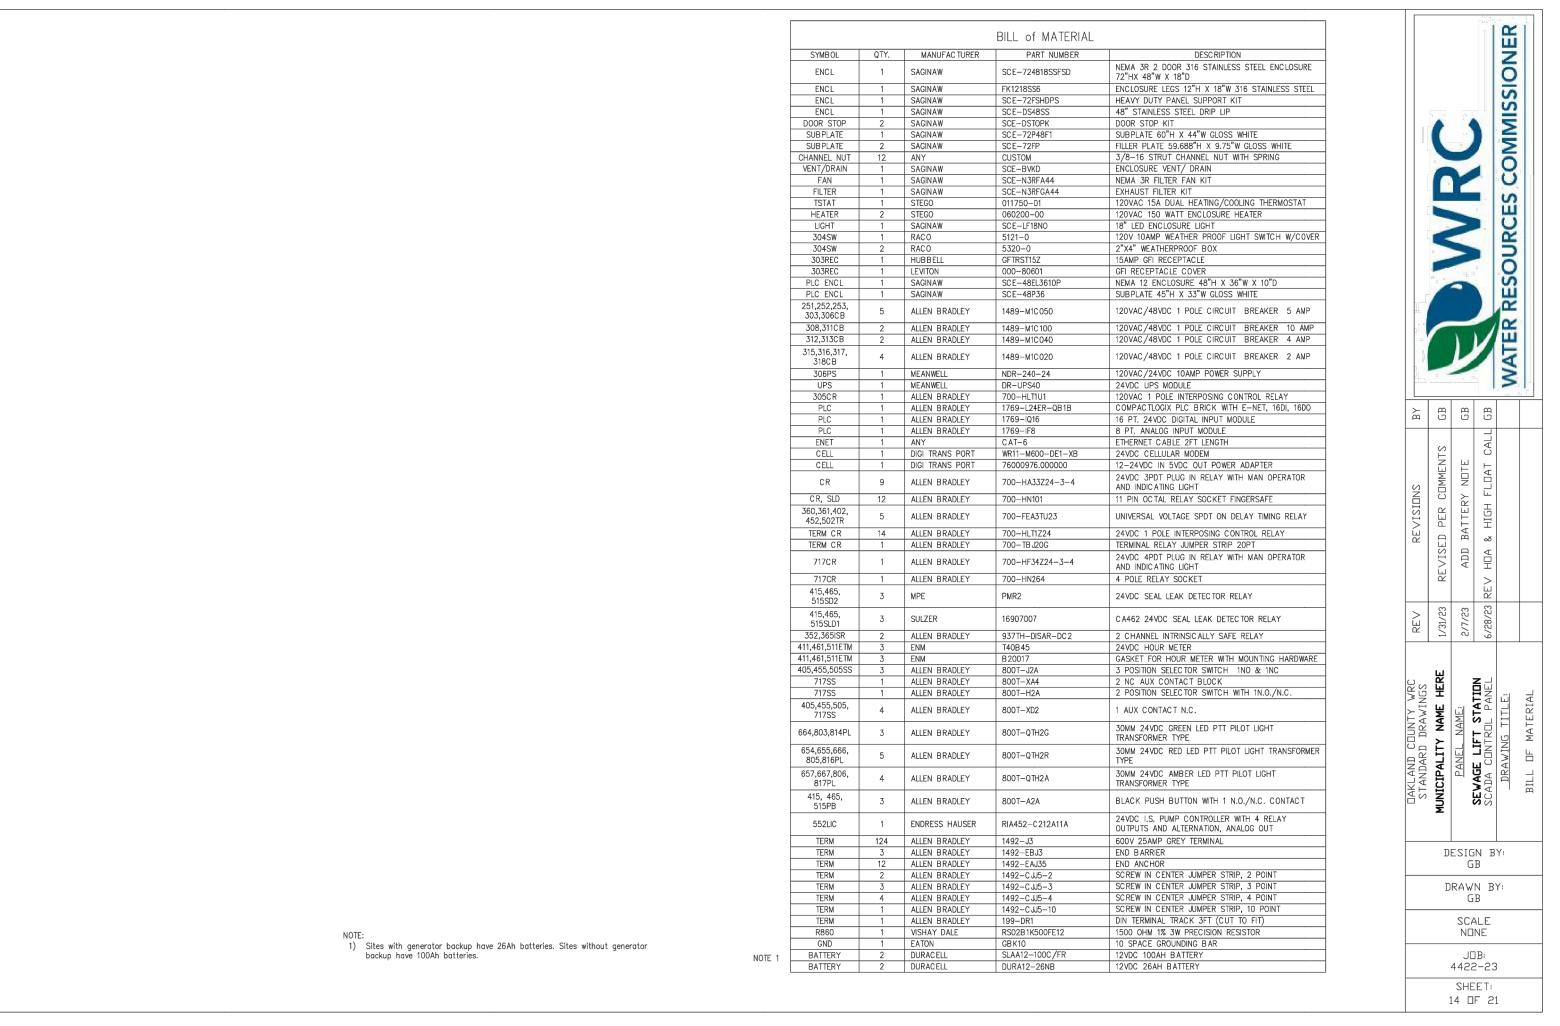


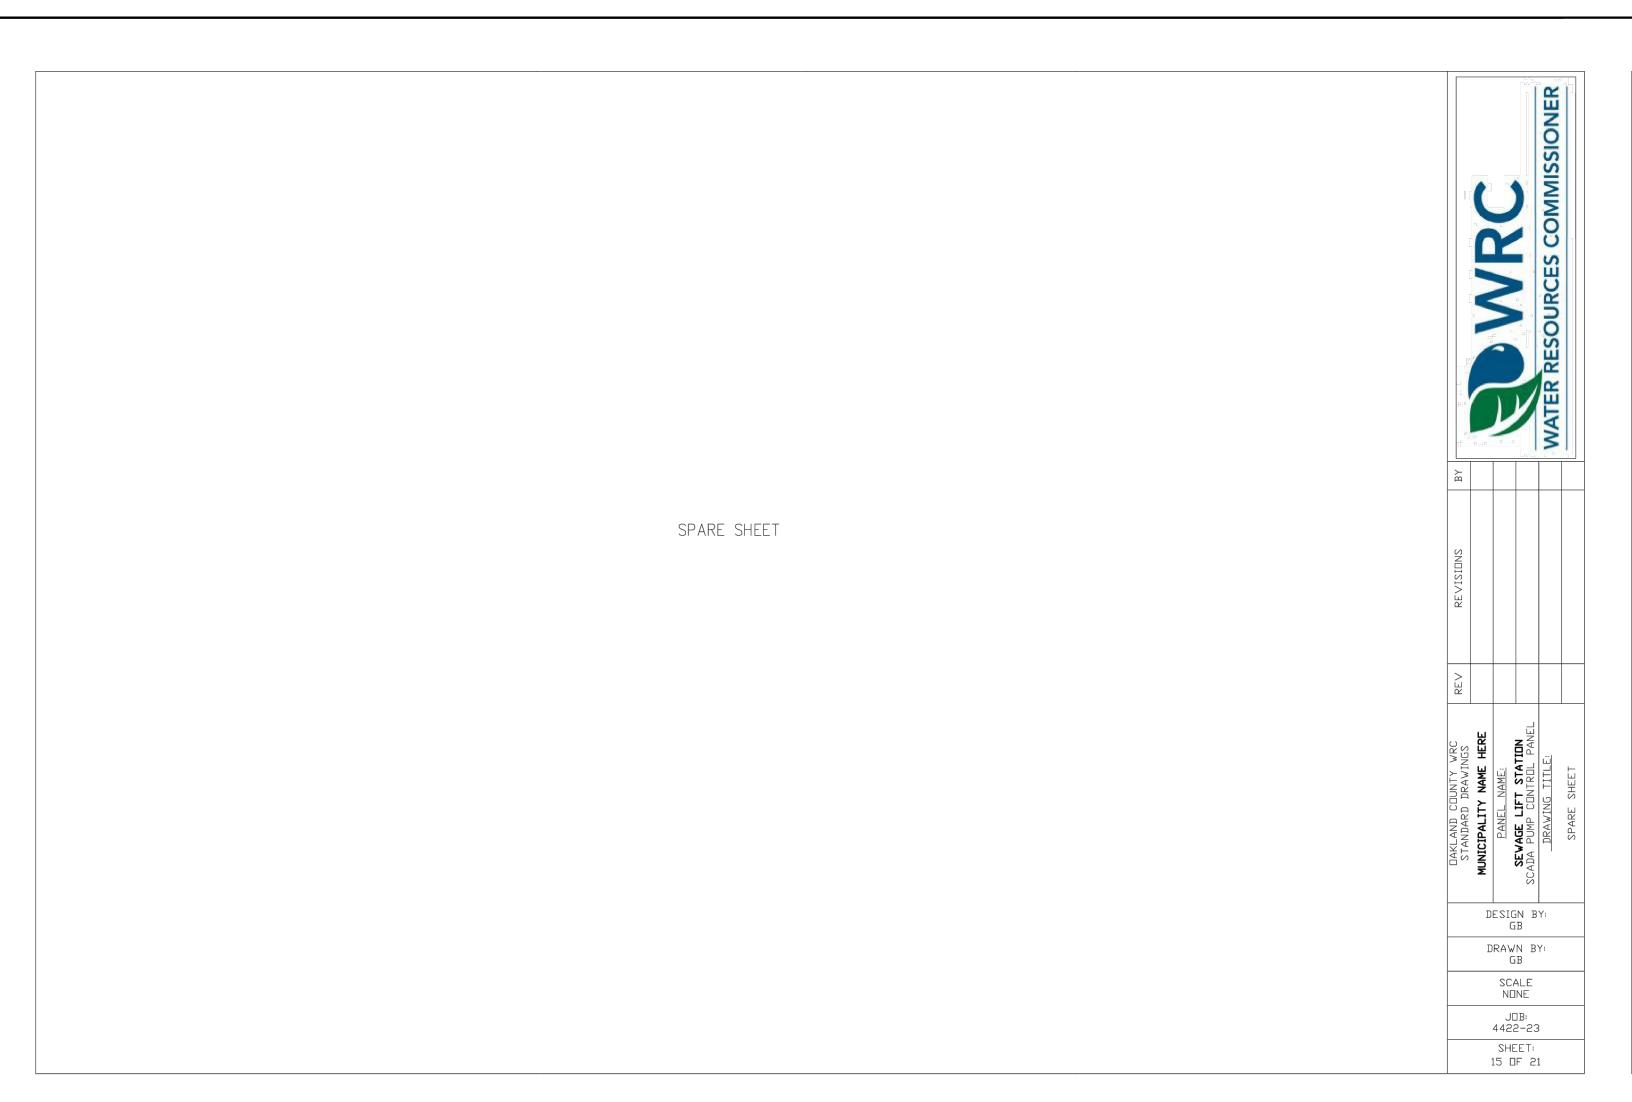


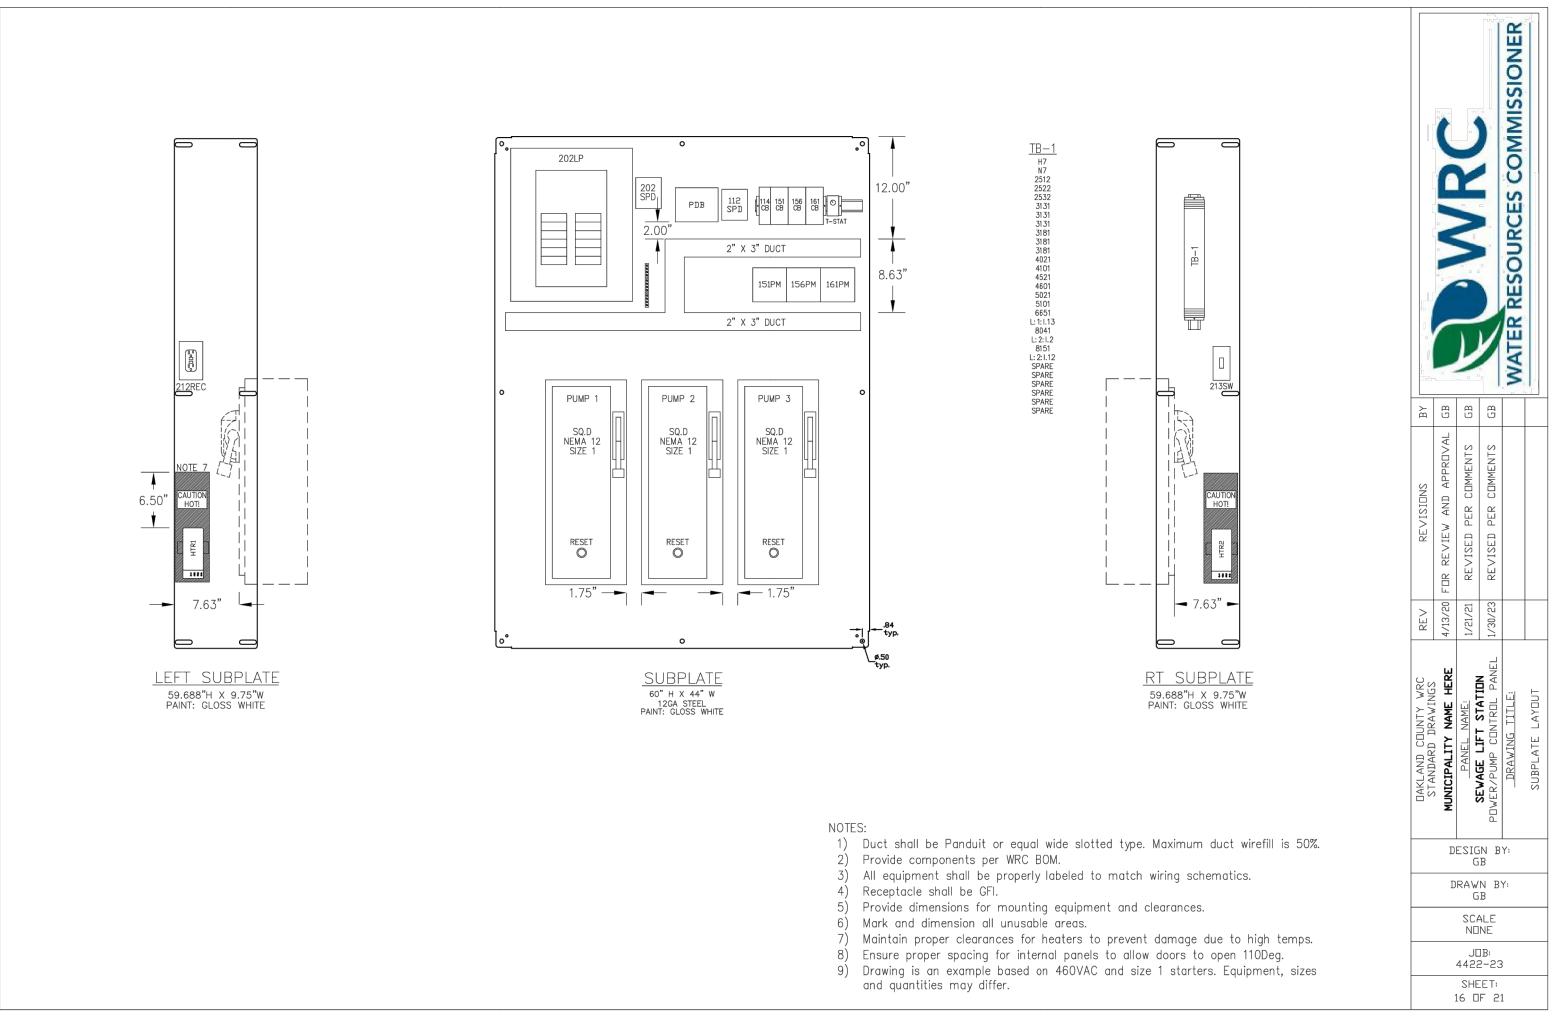


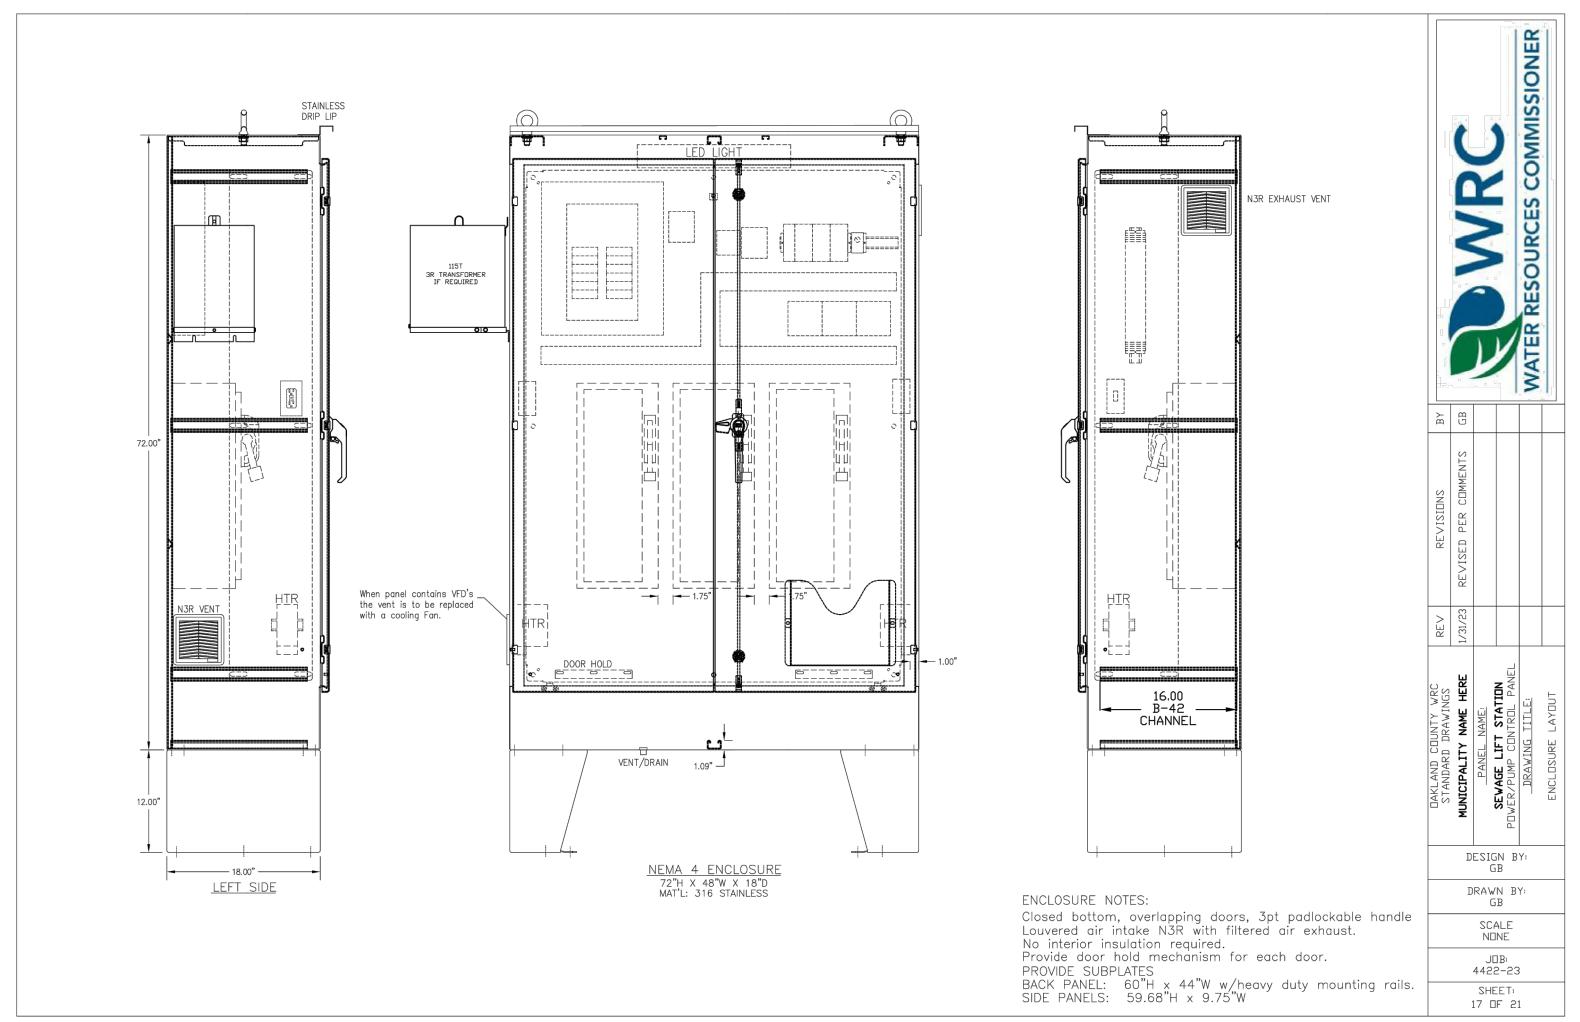


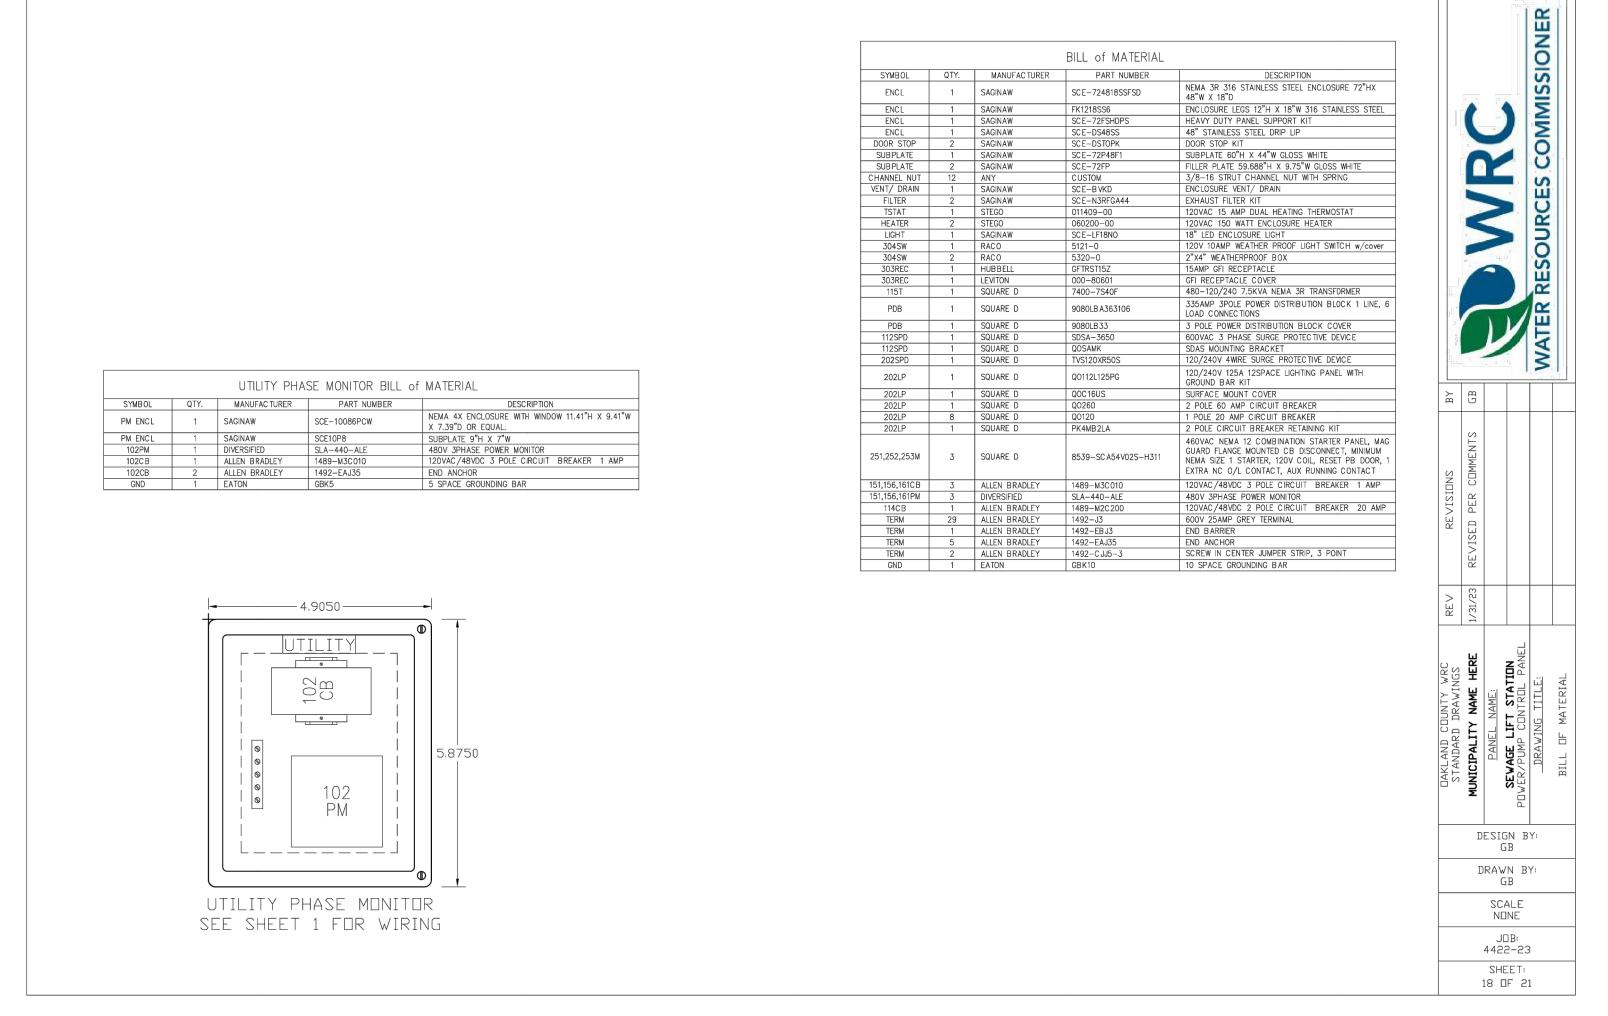


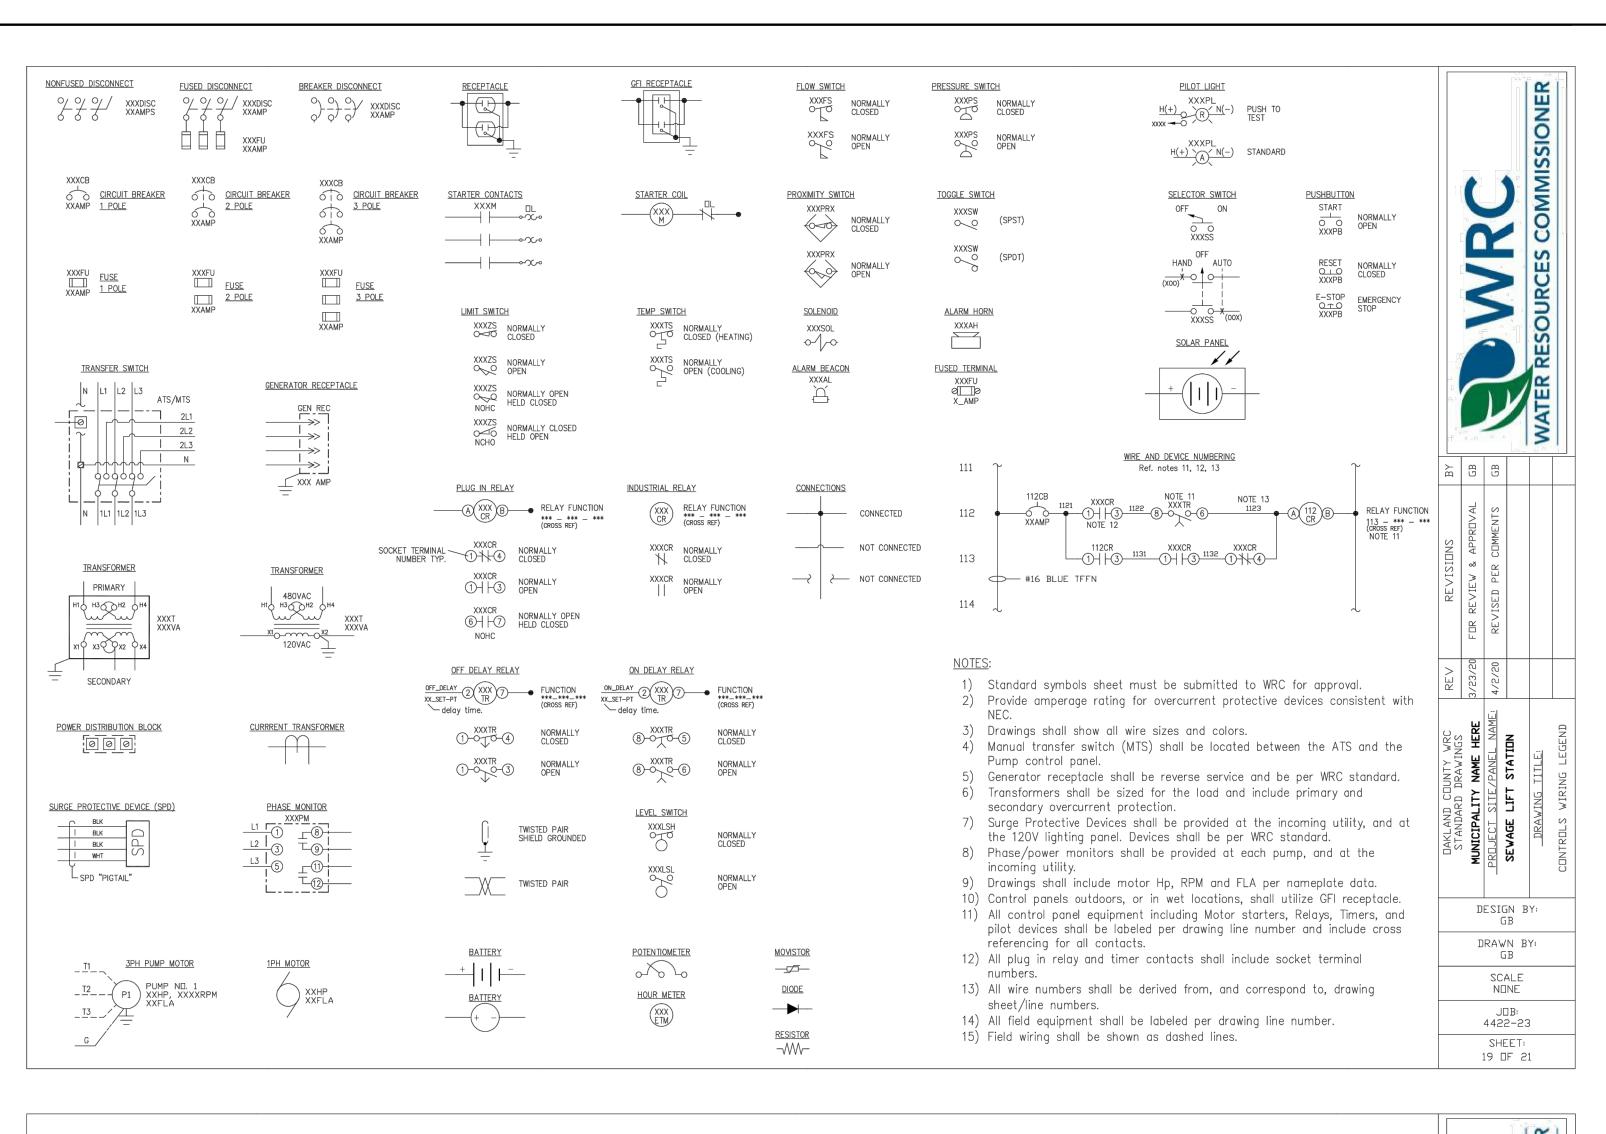

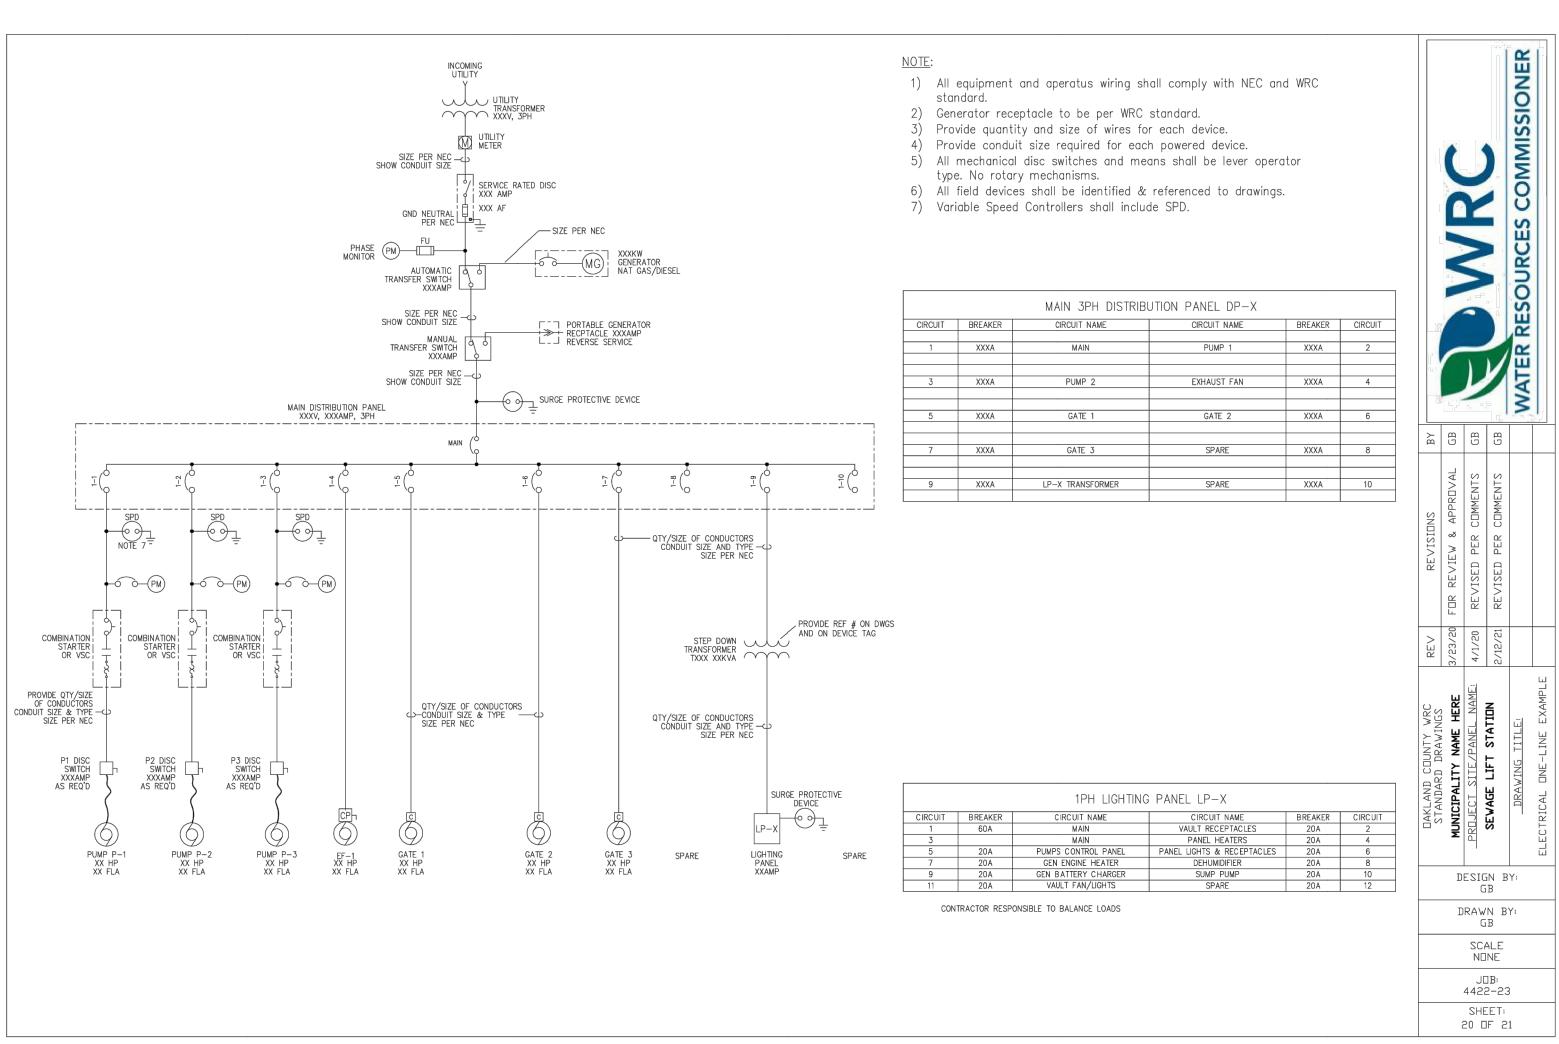


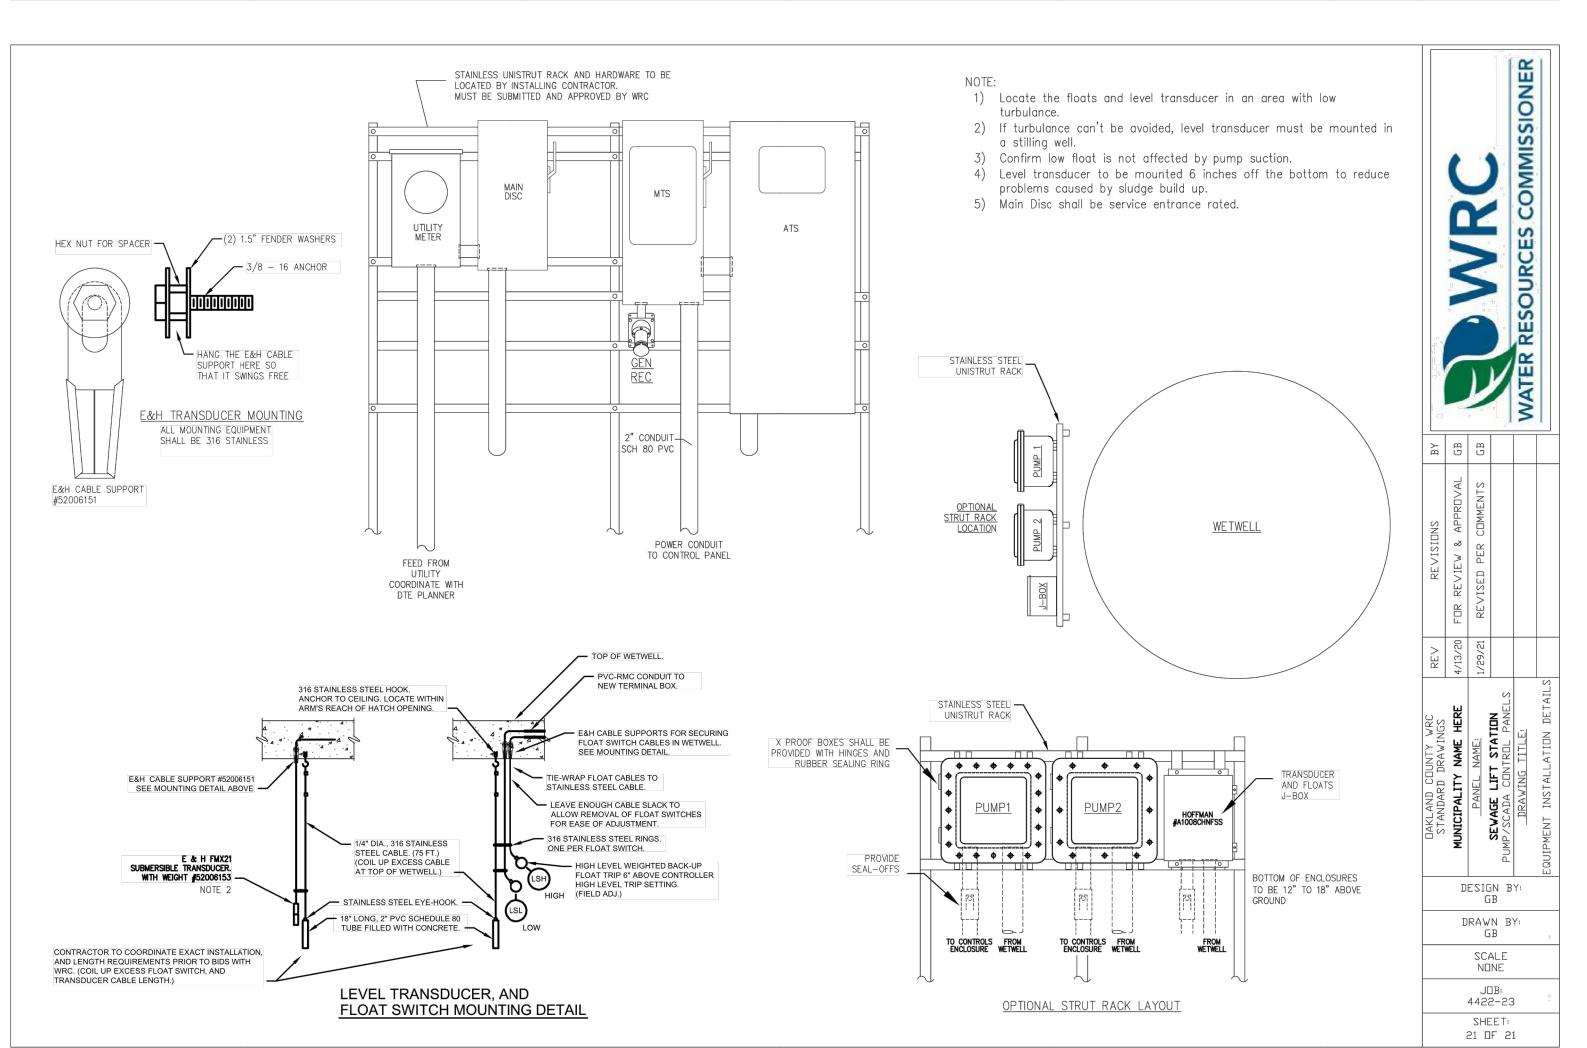

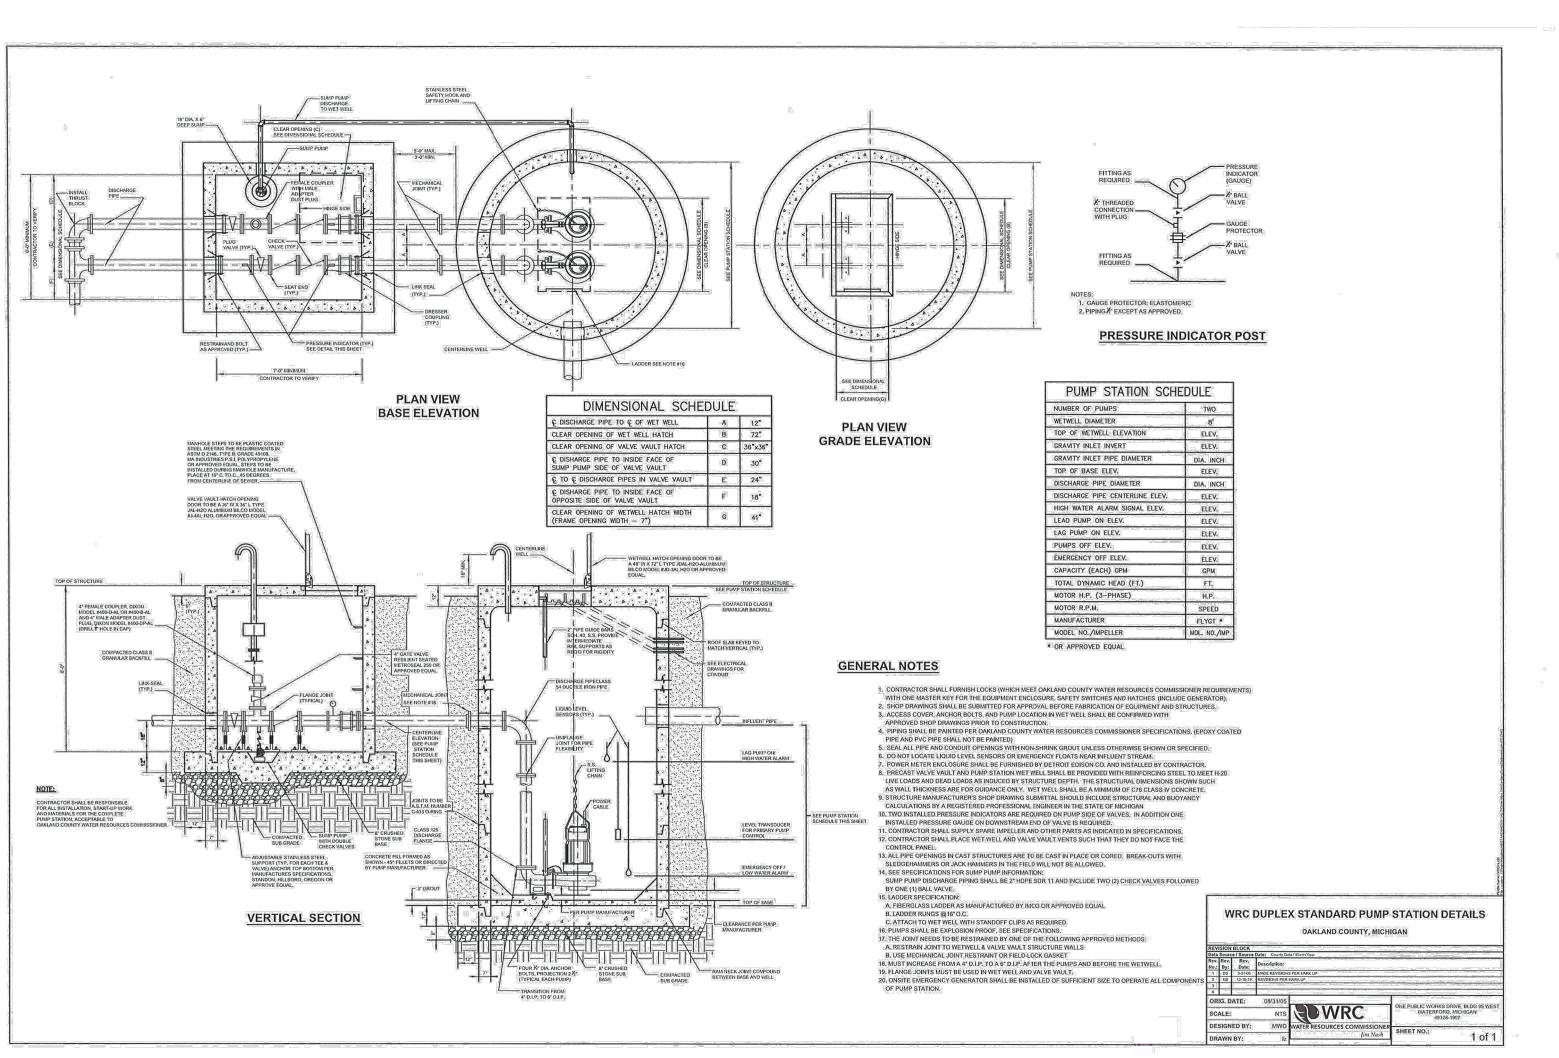

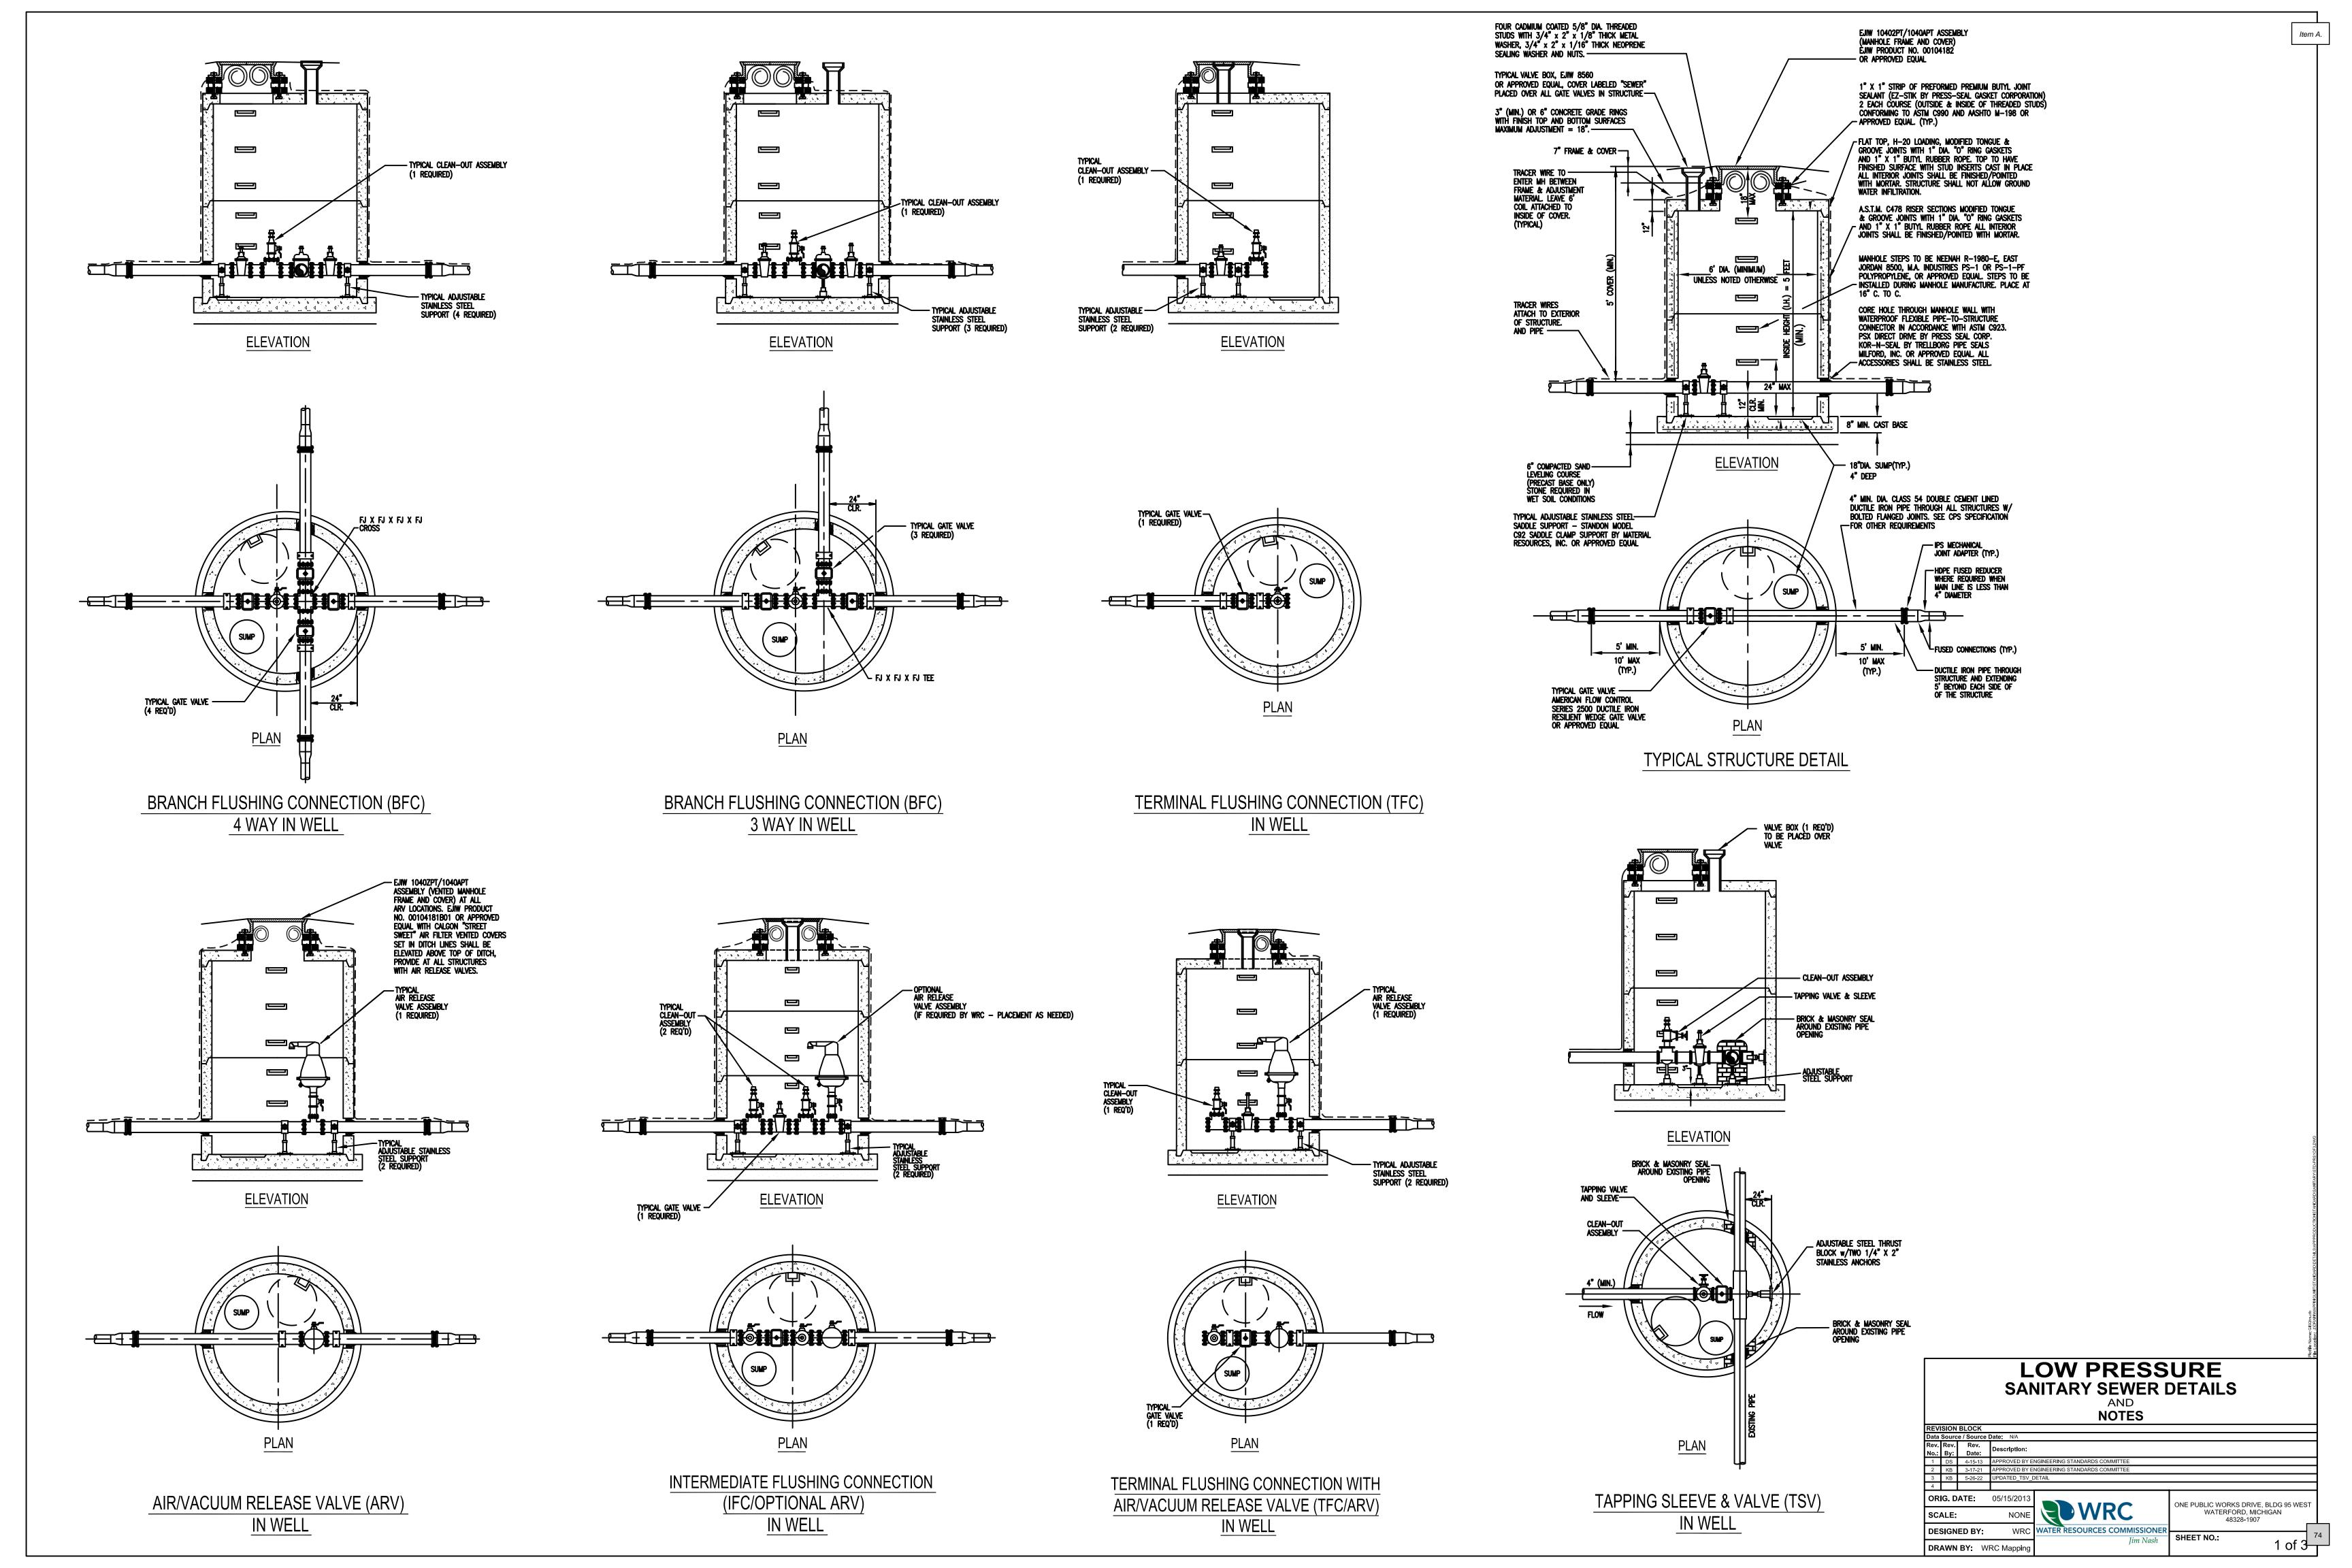


TYPICAL AIR VACUUM RELEASE VALVE ASSEMBLY

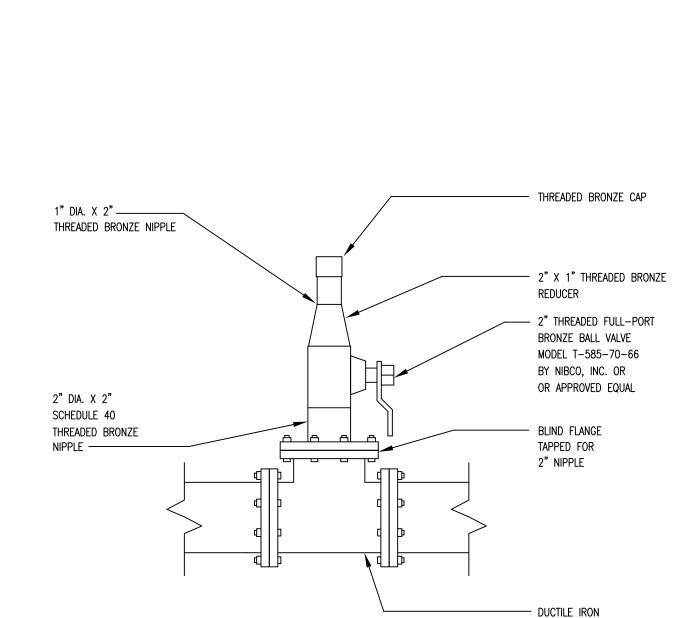


FULL TEE

FJ X FJ X FJ

TYPICAL CLEAN OUT ASSEMBLY

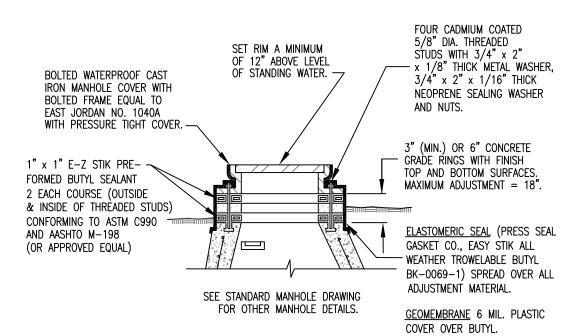


ADJUSTMENT DETAIL FOR MANHOLE TOPS WITHIN FLOOD PRONE AREAS

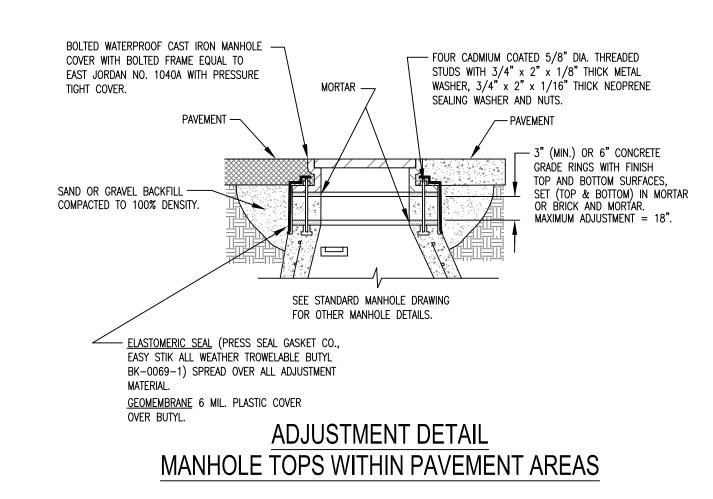

MANHOLE RIM ADJUSTMENT CHART

MANHOLE LOCATION	SET RIM ELEVATION
DITCH	12" ABOVE FINISH GRADE
FLOOD PLAIN	12" ABOVE STANDING WATER
GRAVEL ROAD / SHOULDER	6" BELOW FINISH GRADE
PAVEMENT / GREENBELT	FLUSH WITH FINISH GRADE

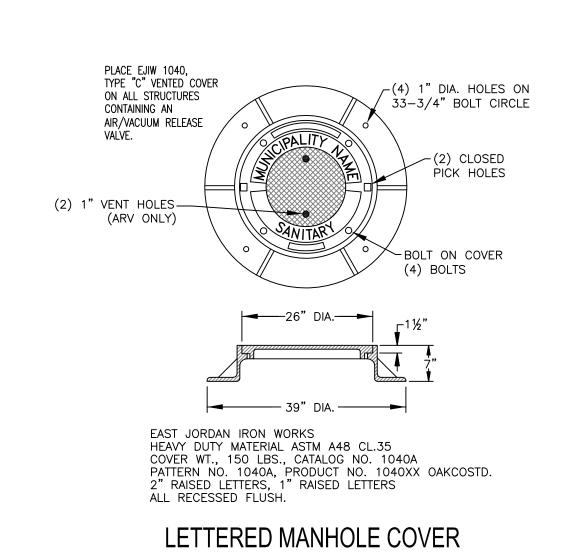


FOR LOCAL MUNICIPALITIES

CONSTRUCTION NOTES

- 1. ALL CONSTRUCTION SHALL CONFORM TO THE CURRENT STANDARDS AND SPECIFICATIONS OF THE LOCAL UNIT OF GOVERNMENT AND THE OAKLAND COUNTY WATER RESOURCES COMMISSIONER (WRC). ALL SANITARY SEWER CONSTRUCTION SHALL HAVE FULL—TIME INSPECTION SUPERVISED BY A PROFESSIONAL ENGINEER PROVIDED BY, OR CAUSED TO BE PROVIDED BY THE LOCAL UNIT OF GOVERNMENT.
- 2. AT ALL CONNECTIONS TO WRC SEWERS OR EXTENSIONS, AND BEFORE START OF CONSTRUCTION, THE CONTRACTOR MUST OBTAIN A SEWER INSPECTION PERMIT ISSUED BY WRC. SANITARY SEWER PERMIT CHARGES ARE IN ACCORDANCE WITH THE WRC CURRENT SCHEDULE OF FEES AS MODIFIED FROM TIME TO TIME. FAILURE TO PASS ANY TEST SEGMENT WILL RESULT IN AN ADDITIONAL CHARGE TO THE CONTRACTOR FOR EACH RETEST. IN ACCORDANCE WITH THE WRC CURRENT SCHEDULE OF FEES AS MODIFIED FROM TIME TO TIME. THE CONTRACTOR SHALL ALSO HAVE POSTED WITH WRC A \$5,000 SURETY BOND AND \$500 CASH BOND DEPOSIT. THE CONTRACTOR SHALL NOTIFY THE LOCAL UNIT OF GOVERNMENT AND THE WRC 24 HOURS PRIOR TO THE BEGINNING OF ANY CONSTRUCTION. FINAL ACCEPTANCE TESTS MUST BE WITNESSED BY WRC PERSONNEL AND MUST BE SCHEDULED IN ADVANCE BY THE LOCAL UNIT OF GOVERNMENT, OR IT'S AGENT.

Item A.

- 3. AT ALL CONNECTIONS TO MANHOLES ON WRC SEWERS, OR EXTENSIONS THERETO, DROP CONNECTIONS WILL BE REQUIRED WHEN THE DIFFERENCE IN INVERT ELEVATIONS EXCEEDS 24 INCHES.
- 4. TAPS TO EXISTING MANHOLES SHALL BE MADE BY CORING. BLIND DRILLING IS ONLY PERMITTED WITH PRE-APPROVAL FROM THE WRC OFFICE.
- 5. IF THE STRUCTURE FALLS WITHIN THE ROADBED OF A GRAVEL ROAD OR WITHIN THE UNPAVED SHOULDER OF A PAVED ROAD, THE COVER SHALL BE SIX INCHES (6") BELOW THE FINISHED GRAVEL SURFACE. IF THE STRUCTURE CONTAINS AN ARV/AVV THEN ADDITIONAL VENTING THROUGH THE MANHOLE WALL TO GREENBELT AREA SHALL BE
- 6. TWO 6-GAUGE SOLID OR STRANDED ANNEALED OR HARD COPPER TRACER WIRES WITH GREEN 45 MIL-THICK INSULATION (HMWPE) SHALL BE ATTACHED TO THE SEWER PIPE IN ACCORDANCE WITH CURRENT WRC SPECIFICATIONS. SPLICES SHALL BE MADE IN ACCORDANCE WITH MANUFACTURERS RECOMMENDATIONS. SPLICE SHALL THEN BE ATTACHED TO PIPE WITH TIES AND HEAT SHRINK-WRAPPED IN PLACE TO RE-ESTABLISH INSULATION ACROSS SPLICED LENGTH. ALL SPLICES SHALL REQUIRE TESTING OF THE ENTIRE LENGTH OF WIRE FOR CONTINUITY FROM STRUCTURE TO STRUCTURE. A MINIMUM LENGTH OF 6 FEET OF TRACER WIRE SHALL BE COILED AND LEFT ACCESSIBLE UNDER THE COVER OF ALL MANHOLES, SERVICE VALVE BOXES AND OTHER STRUCTURES AS DIRECTED BY THE ENGINEER. THE TRACER WIRE SHALL BE ATTACHED TO THE OUTSIDE OF THE MANHOLE DIRECTLY ABOVE THE PIPE AND SHALL ENTER THE MANHOLE BETWEEN THE MANHOLE COVER FRAME AND ADJUSTMENT MATERIAL. CONTRACTOR IS RESPONSIBLE FOR TESTING CONTINUITY OF TRACER WIRE FROM STRUCTURE TO STRUCTURE USING EQUIPMENT COMPATIBLE WITH OAKLAND COUNTY WATER RESOURCES COMMISSIONERS OFFICE OR LOCAL CITY/VILLAGE/TOWNSHIP MISS DIG LOCATING DEVICES. AT LEAST ONE OF THE TWO WIRES SHALL BE REQUIRED TO HAVE PASSED THE CONTINUITY TESTING REQUIREMENT.
- 7. ALL GRINDER DISCHARGE LINES SHALL BE 1.5" NOMINAL DIA. (COPPER TUBE SIZE C.T.S.) SDR 9 HDPE OR AN APPROVED EQUAL PIPE PER ASTM D2737 (STANDARD SPECIFICATION FOR POLYTHYLENE (PE) PLASTIC TUBING). MAINLINE FORCEMAINS TO BE HDPE SDR11 (IRON PIPE SIZE, I.P.S.)
- 8. NO GROUND WATER, STORM WATER, CONSTRUCTION WATER, DOWN SPOUT DRAINAGE, OR WEEP TILE DRAINAGE SHALL BE ALLOWED TO ENTER ANY SANITARY SEWER INSTALLATION.
- 9. PRIOR TO ANY EXCAVATION, THE CONTRACTOR SHALL TELEPHONE MISS DIG (800-482-7171) FOR THE LOCATION OF UNDERGROUND PIPELINE AND CABLE FACILITIES AND SHALL ALSO NOTIFY REPRESENTATIVES OF OTHER UTILITIES LOCATED IN THE VICINITY OF THE WORK.
- 10. AN 18 INCH MINIMUM VERTICAL SEPARATION AND 10 FOOT MINIMUM HORIZONTAL SEPARATION MUST BE MAINTAINED BETWEEN SANITARY SEWER AND WATER MAIN IN ACCORDANCE WITH RECOMMENDED STANDARDS FOR WASTEWATER FACILITIES. (i.e. 10 STATES STANDARDS).
- 11. FOR PIPING INSTALLED USING OPEN—CUT EXCAVATION, EXCAVATION METHODS, CONTROL AND DISPOSAL OF WATER, PIPE SUPPORT, AND BEDDING AND BACKFILLING SHALL BE IN ACCORDANCE WITH THE OCWRC LOW PRESSURE SEWER SPECIFICATIONS.
- 12. ALL PIPE SHALL BE HYDROSTATICALLY TESTED IN ACCORDANCE WITH THE OAKLAND COUNTY WATER RESOURCES COMMISSIONERS LOW PRESSURE SEWER SPECIFICATION (i.e. SECTION 33 33 00).
- 13. SEE OAKLAND COUNTY LOW PRESSURE SEWER SPECIFICATION (i.e. SECTION NO. 33 33 00) FOR ADDITIONAL REQUIREMENTS.

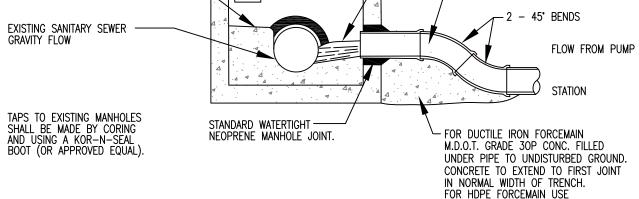

TRENCH WIDTH — MAX. 30"

NOTE: APPROVAL MAY BE GIVEN TO ALTERNATE

STANDARD EMBEDMENT

MATERIALS AND METHODS TO ACHIEVE

STANDARD BEDDING.

INSTALL CONC. BENCH IN BOTTOM

OF MANHOLE AS SHOWN TO EXISTING SEWER OUTLET —

2" - 12" I.D.

BEDDING & BACKFILL: 6" OF SAND TAMPED IN

PLACE FREE OF STONES OR HARD PARTICLES

LARGER THAN 1/2 INCH. BEDDING SHALL BE

TO A MINIMUM OF 90% MODIFIED PROCTOR.

COMPACTION SHALL BE INCREASED TO 95%

UNDER STREETS AND ROADS.

BEDDING

- FORM SMOOTH AND UNIFORM

CHANNELS IN CONCRETE FILL.


- TOP BENCH SHALL BE 2" ABOVE SPRINGLINE OF PIPE

- PROPOSED FORCE MAIN

STD. PLASTIC PIPE BEDDING


MECHANICALLY TAMPED IN PLACE FOR COMPACTION

FORCEMAIN DISCHARGE TO GRAVITY SEWER MANHOLE

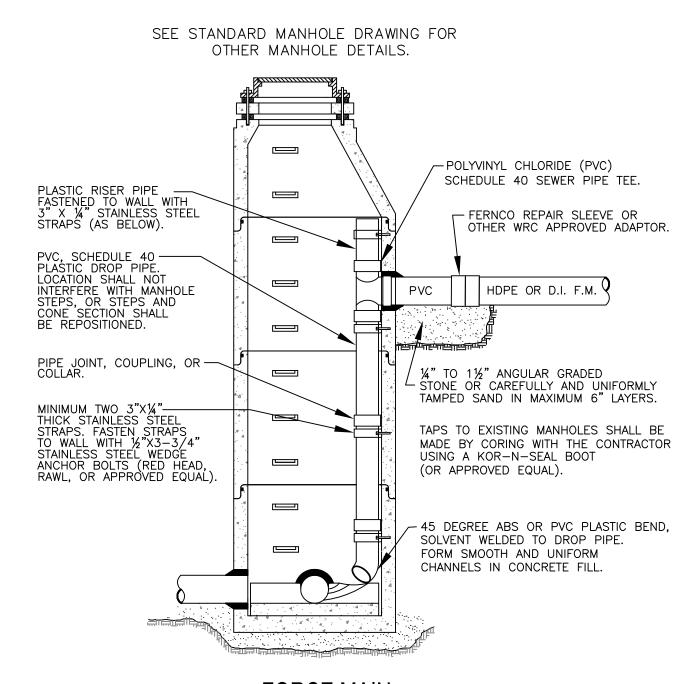

FORCE MAIN
INTERIOR DROP CONNECTION

NOTE: TO BE USED ONLY WHERE SPECIFICALLY AUTHORIZED AND NOT IN ANY MANHOLE IN WHICH AN INTERIOR DROP CONNECTION ALREADY EXISTS.

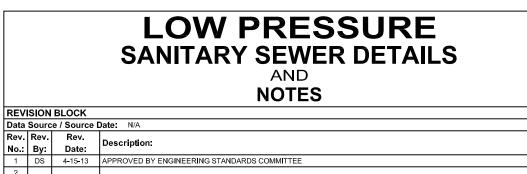

05/15/2013

NONE

WRC WATER RESOURCES COMMISSIONER

ORIG. DATE:

DESIGNED BY:

DRAWN BY: WRC Mapping

SCALE:

ONE PUBLIC WORKS DRIVE, BLDG 95 WEST
WATERFORD, MICHIGAN
48328-1907


SHEET NO.:

2 of 3 75

1. All construction shall conform to the current standards and specifications of the local unit of government and the Oakland County Water Resources Commissioner (OCWRC). All sanitary sewer construction shall have full time inspection supervised by a professional engineer provided by or caused to be provided by the local unit of government.

SANITARY SEWER CONSTRUCTION NOTES

- 2. At all connections to Oakland County Water Resources Commissioner's sewers or extensions, and before start of construction, the Contractor must obtain a Sewer Inspection Permit issued by the OCWRC. Gravity sewer permit charges are \$250.00 for each connection plus \$25.00 for each manhole constructed. Pressure sewer permit charges are \$250.00 per 2460 L.F. of force main with a minimum permit fee of \$250.00. Failure to pass any test segment will result in an additional charge to the Contractor for each retest, in accordance with the above price schedule. The Contractor shall also have posted with the OCWRC a \$5,000.00 surety bond and \$500.00 cash deposit. The Contractor shall notify the local unit of government and the OCWRC (248-858-1110) 24 hours prior to the beginning of any construction. Final acceptance tests must be witnessed by County personnel and must be scheduled by Municipality or It's consultant in advance with 24 hour notice at 248-858-1110.
- 3. No sewer installation shall have an infiltration or exfiltration exceeding 100 gallons per inch diameter per mile of pipe in a 24 hour period, and no single run of sewer between manholes shall exceed 100 gallons per inch diameter per mile. Air tests in lieu of infiltration tests shall be as specified in the OCWRC "Acceptance Tests", dated September, 1972. Only pipe and pipe joints approved by the Oakland County Water Resources Commissioner may be used for sanitary sewer construction.
- 4. Located in the first manhole upstream from the point of all connections to an existing OCWRC sewer, or extension thereto, a temporary 12—inch deep sump shall be provided in the first manhole above the connection which will be filled in after such successful completion of any acceptance test up to the standard fillet provided for the flow channel. A watertight bulkhead shall be provided on the downstream of the sump manhole.
- 5. All building leads and risers shall be 6-inch S.D.R. 23.5 ABS OR PVC pipe with chemically fused joints, or an approved equal pipe and joint. Sewer pipe wye shall contain factory installed premium joint material of an approved type compatible with that of the building lead pipe used. Building leads to be furnished with removable air tight and water—tight stoppers.
- 6. All rigid sewer pipe shall be installed in Class "B" bedding or better. All flexible, semi-flexible or composite sewer pipe shall be installed in conformance to the Oakland County Water Resources Commissioner specifications.
- 7. All new manholes shall have Oakland County Water Resources Commissioner approved flexible, water—tight seals where pipes pass through walls. Manholes shall be of precast sections with modified groove tongue and rubber gasket type joints. Precast manhole cone sections shall be Oakland County Water Resources Commissioner approved modified eccentric cone type. All manholes shall be provided with bolted, water-tight covers.
- 8. At all connections to manholes on Oakland County Water Resources Commissioner's sewers or extensions thereto drop connections will be required when the difference in invert elevations exceeds 18-inches. Outside drop connections only will be approved.
- 9. Taps to existing manholes shall be made by coring. The Contractor shall place a KOR-N-SEAL boot (or OCWRC approved equal) after coring is completed. Blind drilling will not be permitted in lieu of coring.
- 10. New manholes constructed directly on Oakland County Water Resources Commissioner's sewers shall be provided with covers reading "Oakland County — Sanitary" in raised letters. New manholes built over an existing sanitary sewer shall have monolithic poured bottoms.
- 11. No ground water, storm water, construction water, downspout drainage or weep tile drainage shall be allowed to enter any sanitary sewer installation.
- 12. Prior to excavation, the Contractor shall telephone MISS DIG (647-7344) for the location of underground pipeline and cable facilities, and shall also notify representatives of other utilities located in the vicinity of the work.
- 13. 18" minimum vertical separation and 10' minimum horizontal separation must be maintained between sanitary sewer and water main.
- 14. Manhole frame and cover shall be as follows: East Jordan heavy manhole cover, base flange type #1040 or Neenah Foundry heavy duty #R-1642 manhole frame. Solid lid cover shall be non-rocking and marked "WHITE LAKE TOWNSHIP SEWER DEPARTMENT.'

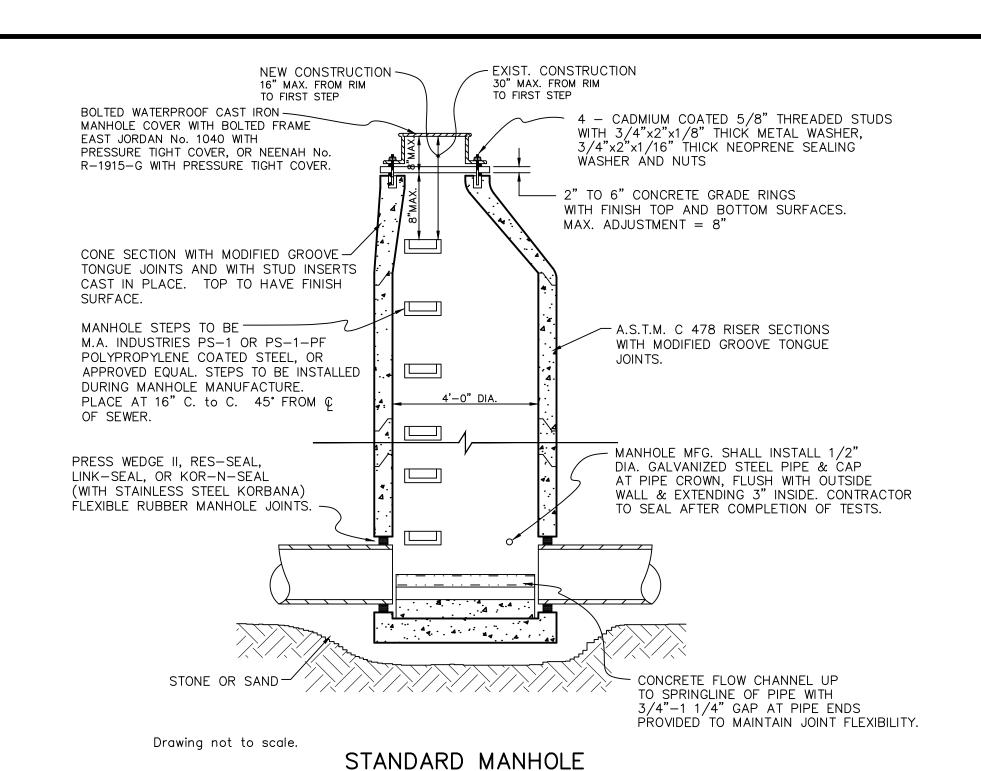

ON 8" THROUGH 24" DIAMETER SEWERS

30" MAX. FROM RIM

4 - CADMIUM COATED 5/8" THREADED STUDS

WITH 3/4"x2"x1/8" THICK METAL WASHER, 3/4"x2"x1/16" THICK NEOPRENE SEALING

WITH FINISH TOP AND BOTTOM SURFACES.

- A.S.T.M. C 478 RISER SECTIONS

WITH MODIFIED GROOVE TONGUE

MANHOLE MFG. SHALL INSTALL 1/2"

DIA. GALVANIZED STEEL PIPE & CAP

AT PIPE CROWN, FLUSH WITH OUTSIDE

TO SEAL AFTER COMPLETION OF TESTS.

WALL & EXTENDING 3" INSIDE. CONTRACTOR

BRICK COURSE PERMITTED

FOR CLOSURE OF OPENING

POURED IN PLACE

3500 PSI CONCRETE

WASHER AND NUTS

MAX. ADJUSTMENT = 8"

JOINTS.

12" MINIMUM TO

UNDISTURBED EARTH

·*········

2" TO 6" CONCRETE GRADE RINGS

TO FIRST STEP

NEW CONSTRUCTION —

16" MAX. FROM RIM

BOLTED WATERPROOF CAST IRON -

EAST JORDAN No. 1040 WITH

MANHOLE STEPS TO BE -

SURFACE.

OF SEWER.

ENCASEMENT 12"

MANHOLE COVER WITH BOLTED FRAME

PRESSURE TIGHT COVER, OR NEENAH No.

R-1915-G WITH PRESSURE TIGHT COVER.

CONE SECTION WITH MODIFIED GROOVE -

CAST IN PLACE. TOP TO HAVE FINISH

M.A. INDUSTRIES PS-1 OR PS-1-PF

POLYPROPYLENE COATED STEEL, OR

PLACE AT 16" C. to C. 45° FROM C

DURING MANHOLE MANUFACTURE.

PRE-CAST BOTTOM SECTION WITH

PIPE OPENINGS, ENCASED IN AND

POURED CONCRETE. MINIMUM

BOTTOM HALF OF PIPE

TO REMAIN IN PLACE

AS FLOW CHANNEL

STANDARD FLEXIBLE

MANHOLE JOINT

SUPPORTED BY 3500 P.S.I. FIELD-

TONGUE JOINTS AND WITH STUD INSERTS

APPROVED EQUAL. STEPS TO BE INSTALLED

Drawing not to scale.

SUMP MANHOLE FOR TESTING, CLEANING, AND DEWATERING

Drawing not to scale.

MANHOLE

JOINTS <

3/4"- 1 1/4" GAP TO BE PROVIDED

TO MAINTAIN JOINT FLEXIBILITY

FORM SMOOTH AND UNIFORM

CHANNELS IN CONCRETE FILL

CONCRETE FILL IN SUMP


AFTER COMPLETION OF


ACCEPTANCE TESTS

SEE STANDARD MANHOLE


DRAWING FOR OTHER

MANHOLE DETAILS

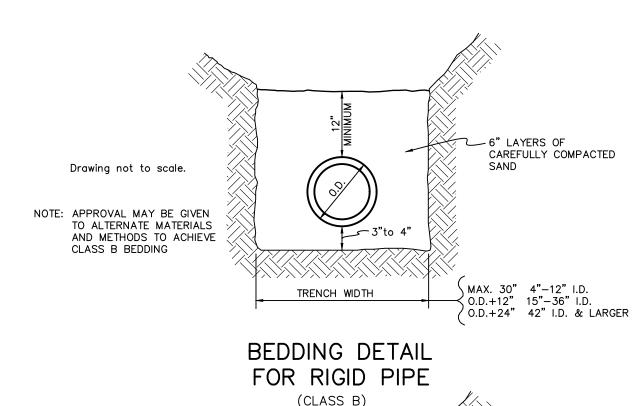

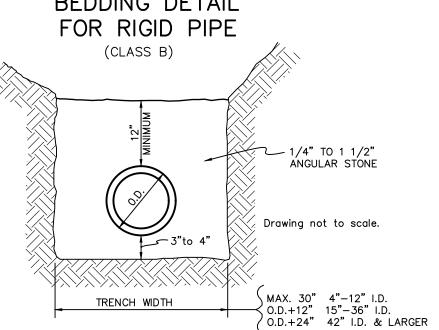

BEDDING DETAIL FOR FLEXIBLE PIPE

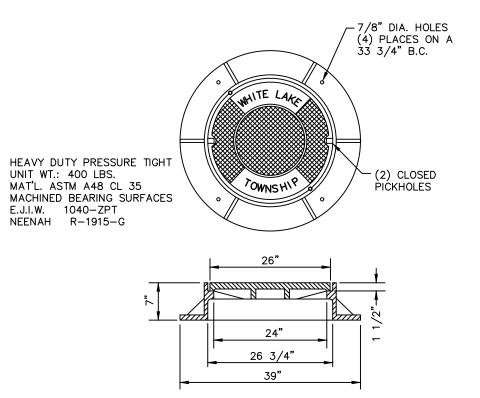

21" MAX. FROM RIM TO FIRST STEP \ FORM INSIDE MANHOLE-AND COMPLETELY FILL PAVEMENT GRADE SPACE WITH STIFF 6 BAG MIX CONCRETE, USING AIR-ENTRAINED CEMENT ADJUSTING SUPPORT NUT FOR O" MINIMUM -SETTING FRAME TO CORRECT 8" MAXIMUM . CADILLAC BRAND RUBBER WRAP FOR WATERTIGHTNESS. SEE STANDARD MANHOLE DRAWING FOR OTHER MANHOLE DETAILS. Drawing not to scale.

SKETCH OF MINIMUM MANHOLE REQUIREMENTS

ON MANHOLES CONSTRUCTED OVER EXISTING SEWERS

MANHOLE COVER & FRAME

SKIDS PLACED AT 1/2 -5

DIAMETER OF PIPE

Johnson&Anderson

Waterford, Michigan 48328 Muskegon, Michigan 49441 tel (248) 681-7800 fax (248) 681-2660

2291 Water Street, Suite 6 Port Huron, Michigan 48060 tel (231) 780-3100 fax (231) 780-3115 tel (810) 987-7820 fax (810) 987-7895

White Lake Township 7525 Highland Road (M-59) White Lake, Michigan 48383 248-698-3300



SANITARY SEWER STANDARD DETAILS HORZ. AS NOTED JOB NO. DATE ISSUED 09/11/97 SHEET NO.

VERT. -

MARK ADDENDUM/CHANGE ORDER DATE MARK ADDENDUM/CHANGE ORDER DATE MARK ADDENDUM/CHANGE ORDER DATE OCWRC COMMENTS 11/06/15 09/11/97 FIRST ISSUE UPDATED TITLE BLOCK 04/30/13 02/17/15 UPDATED NOTES

PIPE BARREL SUPPORT FOR SEWER

ALTERNATE TO DROP BOWL

CONE SECTION WITH MODIFIED

TOP TO HAVE FINISH SURFACE

TRANSITION SECTION MUST BE FIRST-

PVC, SCHEDULE 40 PLASTIC — DROP PIPE. LOCATION SHALL NOT

INTERFERE WITH MANHOLE STEPS,

MINIMUM TWO DURAN INC. RELINER STAINLESS STEEL ADJUSTABLE CLAMPING -

BRACKETS ATTACHED TO MANHOLE WALL

WITH TWO (EACH) 3/8" STAINLESS STEEL WEDGE ANCHORS, STAINLESS STEEL

WASHERS AND NUTS. MAXIMUM SPACING

PVC OR ABS PLASTIC DROP PIPE SHALL -

THAN PIPE ENTERING MANHOLE. LOCÁTION

1/4" TO 1-1/2" ANGULAR GRADED STONE OR CAREFULLY-

AND UNIFORMLY TAMPED SAND

6" ABOVE GRADE ↑

MARK ORANGE STAKE.

WITH BLACK MARKS

AT 1' INTERVALS TO

INDICATE DEPTH TO

LOT/UNIT NUMBER

REMOVABLE WATERTIGHT

BY PIPE AND JOINT

MANUFACTURER.

AND AIRTIGHT STOPPER AS

RECOMMENDED OR SUPPLIED

PLACE RISER AGAINST -

UNDISTURBED GROUND

TO AVOID SETTLEMENT

1/4" TO 1 1/2" ANGULAR GRADED STONE

PLACED AGAINST UNDISTURBED GROUND

FOR SUPPORT OF WYE PIPE AND RISER.

8" BRICK BULKHEAD SHALL

BE PLACED AT EACH END

SAND HAS BEEN PLACED.

THE CONTRACTOR SHALL

CEMENT BETWEEN SEWER

BLOW SAND OR SAND

PIPE AND CASING

DESIGN: OA

CHECKED: -

OF THE CASING PIPE AFTER

WHERE POSSIBLE.

BACKFILL WITH CARE

INVERT. MARK

ON STAKE.

BE ONE PIPE SIZE SMALLER (6" MIN.)

SHALL BE FLUSH WITH MANHOLE WALL

IN MAXIMUM 6" LAYERS.

AND NOT INTERFERE WITH MANHOLE

OR STEPS AND CONE SECTION

SHALL BE REPOSITIONED.

BETWEEN BRACKETS 10'

SECTION BELOW CONE.

TONGUE AND GROOVE JOINTS AND -

/==

_____5'-0" DIA. MIN.

INTERIOR DROP CONNECTION

2"x2" PRESSURE TREATED

~10' MINIMUM AT

PROPERTY LINE FOR

BASEMENT SERVICE

- MINIMUM 1/8"

FALL PER FOOT

√6" RISER

HOUSE/BUILDING LEAD DETAIL

4" MINIMUM CLEARANCE TO

OUTSIDE DIAMETER OF BELL

Drawing not to scale.

45° BEND

-LOCATION STAKE

MAXIMUM>

PLACED IN BACKFILL

WITH STUD INSERTS CAST IN PLACE.

(ON 5' DIA. OR LARGER MANHOLES ONLY) POLYVINYL

CHLORIDE (PVC) SEWER PIPE TEE (ASTM D-3034) OR

ACRILONITRILE-BUTADIENE-STYRENE (ABS) SEWER PIPE TEE

SECURE IN PLACE WITH 2 #8X1" SHEET METAL SCREWS AT

DURAN INC. RELINER INSIDE DROP BOWL ATTACHED TO

MANHOLE WALL WITH 4 3/8" STAINLESS STEEL WEDGE

BETWEEN DROP BOWL AND MANHOLE

WALL, PLACE (PRESS SEAL GASKET

TROWELABLE BUTYL, BK-0069-1).

BE MADE BY CORING WITH THE

TAPS TO EXISTING MANHOLES SHALL

-CONTRACTOR USING A KOR-N-SEAL

DRILL WILL ONLY BE PERMITTED IN

LIEU OF CORING WITH PRIOR WRC

BELOW TRANSITION SECTION.

-STONE OR CÁREFULLY AND

MAXIMUM 6" LAYERS.

UNDISTURBED GROUND

ALL HOUSE LEAD PIPE

MATERIAL AND JOINT

BACKFILL WITH STANDARD

FLEXIBLE PIPE BEDDING TO

TEE NOT

ALLOWED

Drawing not to scale.

UNLESS OTHERWISE SPECIFIED,

MINIMUM WALL THICKNESS 0.250.

BE TIGHTLY STRAPPED TO 4"x4"

CASING SIZES

ARRIER PIPE DIA. MIN. CASING PIPE DIA.

MINIMUM CASING PIPE SHALL

BE ASTM-C76 CLASS V OR

ASTM-A-139 GRADE B

SANITARY SEWER SHALL

CREOSOTED TIMBERS

GROOVES CUT

FOR STRAPS

A MAXIMUM 1:1 SLOPE

TO BE OCDPW APPROVED

UNIFORMLY TAMPED SAND IN

BOOT (OR APPROVED EQUAL). BLIND

ATTACH DROP BOWL TO DROP PIPE

USING FERNCO FLEXIBLE COUPLING

1/4" TO 1-1/2" ANGULAR GRADED

WITH STAINLESS STEEL STRAPS.

45° ABS OR PVC PLASTIC BEND,

SOLVENT WELDED TO DROP PIPE.

POINT FORM SMOOTH UNIFORM

CHANNEL IN CONCRETE FILL.

APPROVAL. ALL TAPS MUST BE MADE TEMPORARY SUMP BULKHEAD-

CO., EASY STIK ALL WEATHER


ANCHORS, STAINLESS STEEL WASHERS AND NUTS.

(ASTM D-2680) WITH REMOVABLE PIPE CAP, SLIP-ON FIT.

OPTIONAL CONSTRUCTION DETAILS

STANDARD DETAILS

DATE ISSUED SHEET NO.

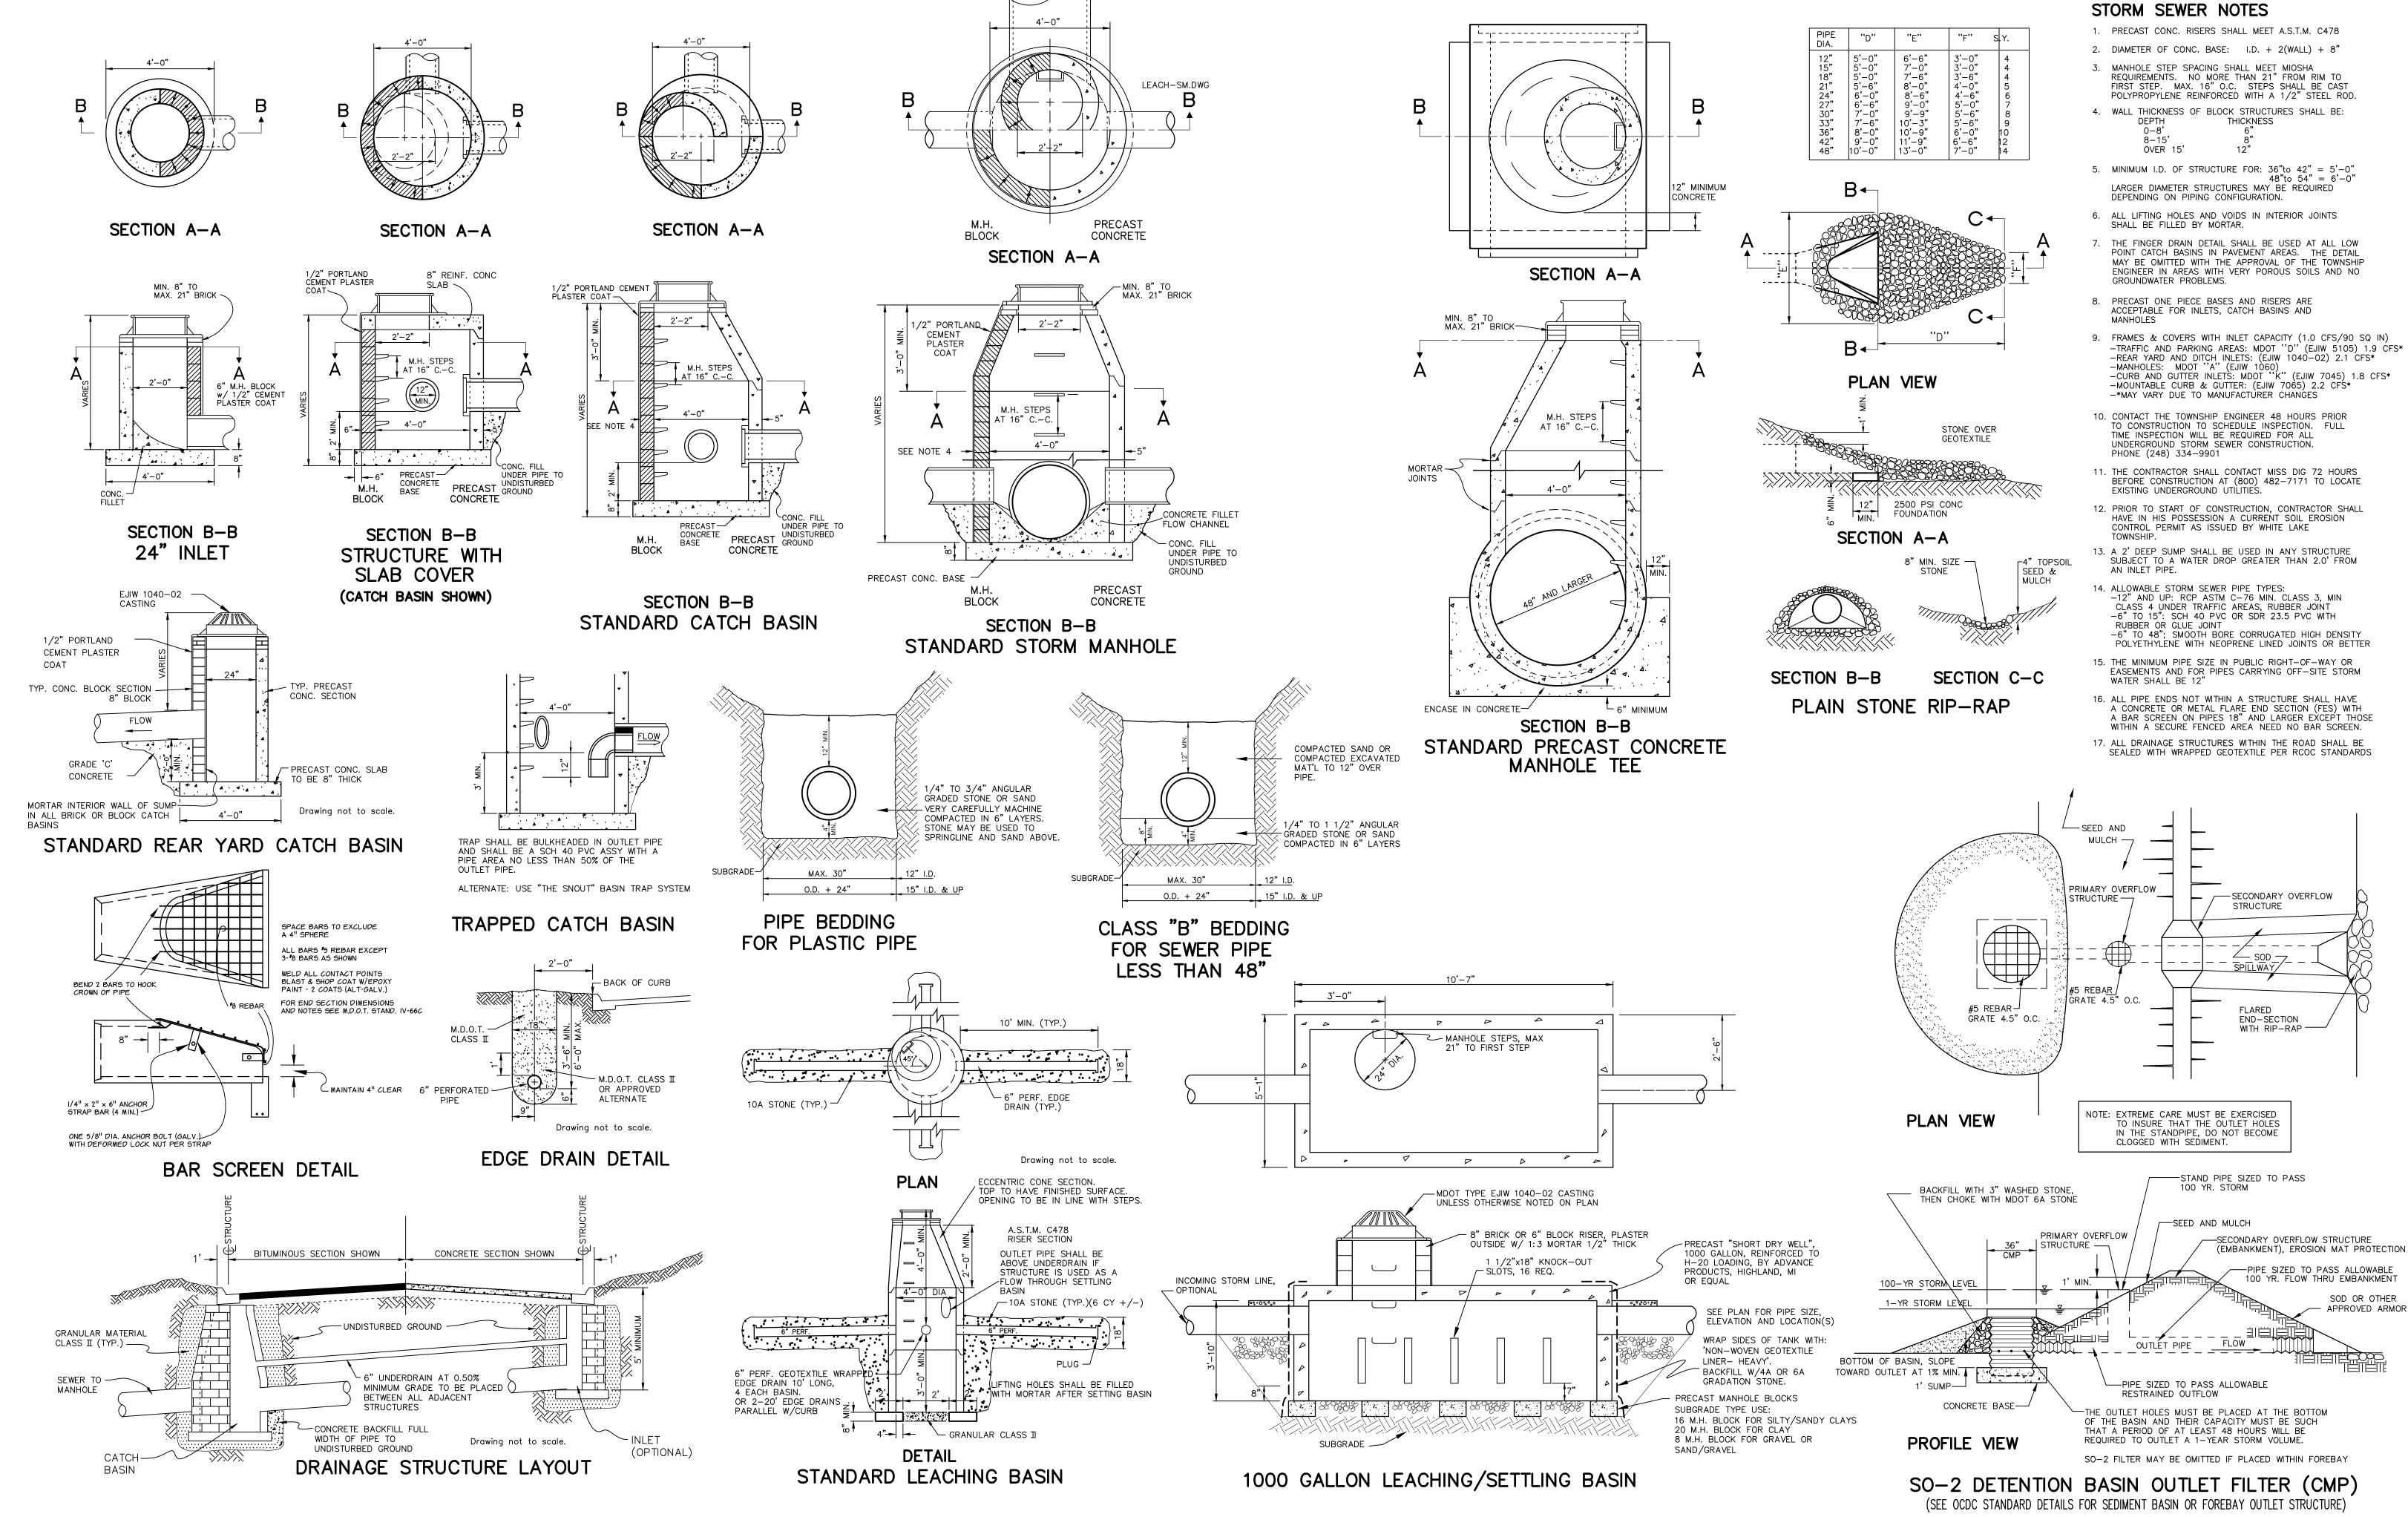

STORM SEWER

STANDARD DETAILS

JOB NO. DATE ISSUED 08/16/95 SHEET NO.

HORZ. AS NOTED

SCALE:

DRAWN: CAD DESIGN: OA

CHECKED: -

FIRST ISSUE

ADD SO-1

NEW BAR GRATE

MARK ADDENDUM/CHANGE ORDER DATE | MARK ADDENDUM/CHANGE ORDER DATE | MARK ADDENDUM/CHANGE ORDER DATE

10-03-02

12-17-03

UPDATED TITLE BLOCK

04/30/13


REVISE

REVISE

08/16/95

06-17-96

White Lake Township

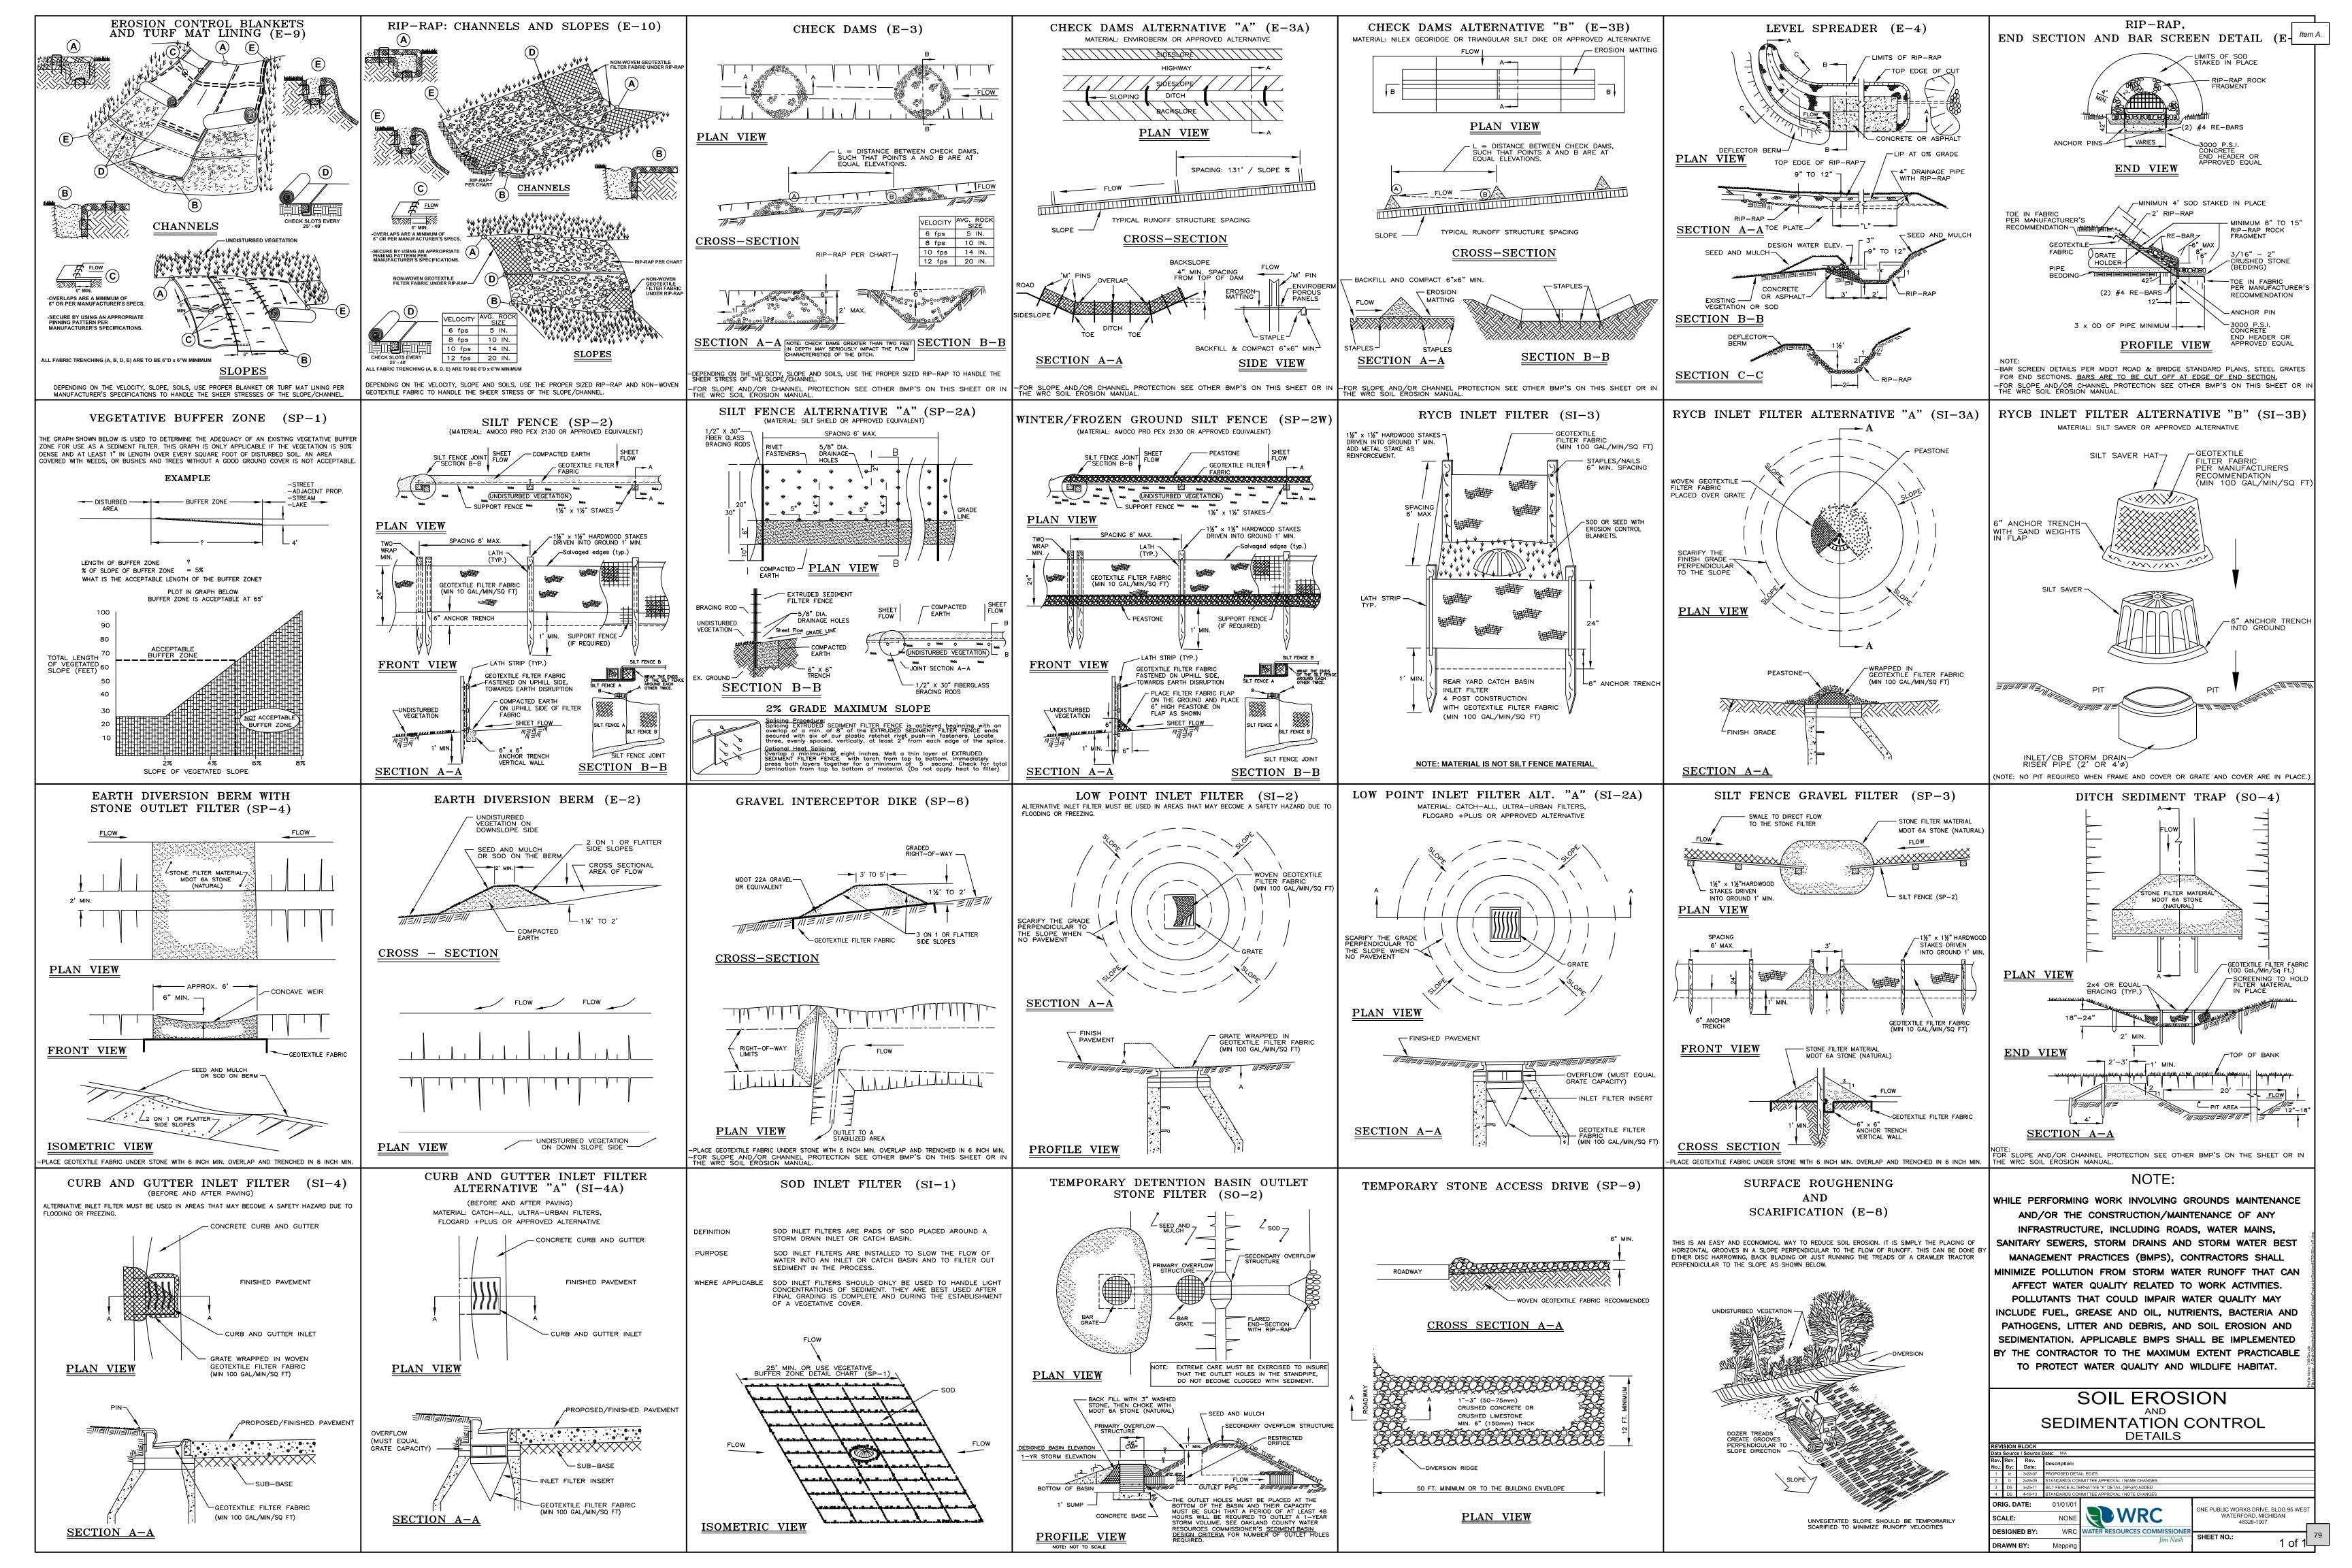

REQUIRED | PROVIDED

848'±

TOTAL LN.FT. OF GREENBELT FRONTAGE

VEGETATION FRONTAGE

848'+ GREENBELT FRONTAGE - 167'+ EXISTING WOOD &

(681' LN.FT. / 30 LN.FT. = 22.7 TREES)

ONE (I) DECIDUOUS OR EVERGREEN TREE PER 30 LN.FT.

JMF WHITE LAKE,

1700 W. BIG BEAVER ROAD SUITE 120 TROY, MI 48084

project: **WEST VALLEY**

project location: White Lake Twp. Michigan

Union Lake Road sheet title:

overall landscape planting detail

job no./issue/revision date: LS19.104.08 REVIEW 9-3-2019 LS19.104.09 SPA 9-28-2019 LS21.034.21 SPA 2-18-2021 LS21.034.21 COMMENTS 3-16-2021 LS23.083.07 COMMENTS 7-29-2023

LS23.083.11 COMMENTS 11-2-2023 LS24.032.02 UPDATES-TWP. 2-7-2024 LS24.032.05 UPDATES 5-29-2024

JP, DK, PH

checked by:

2-2-2024

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is either expressed or implied as to the completeness of accuracy. contractor shall be exclusively responsible for determining the exact location and elevation prior to the start

project no:


LS24.032.02

sheet no:






TREES SHALL BE LOCATED A MINIMUM 6' FROM ALL WATER MAIN, SANITARY, AND STROM SEWER. NO TREES TO BE PLANTED IN DRAINAGE SWALE

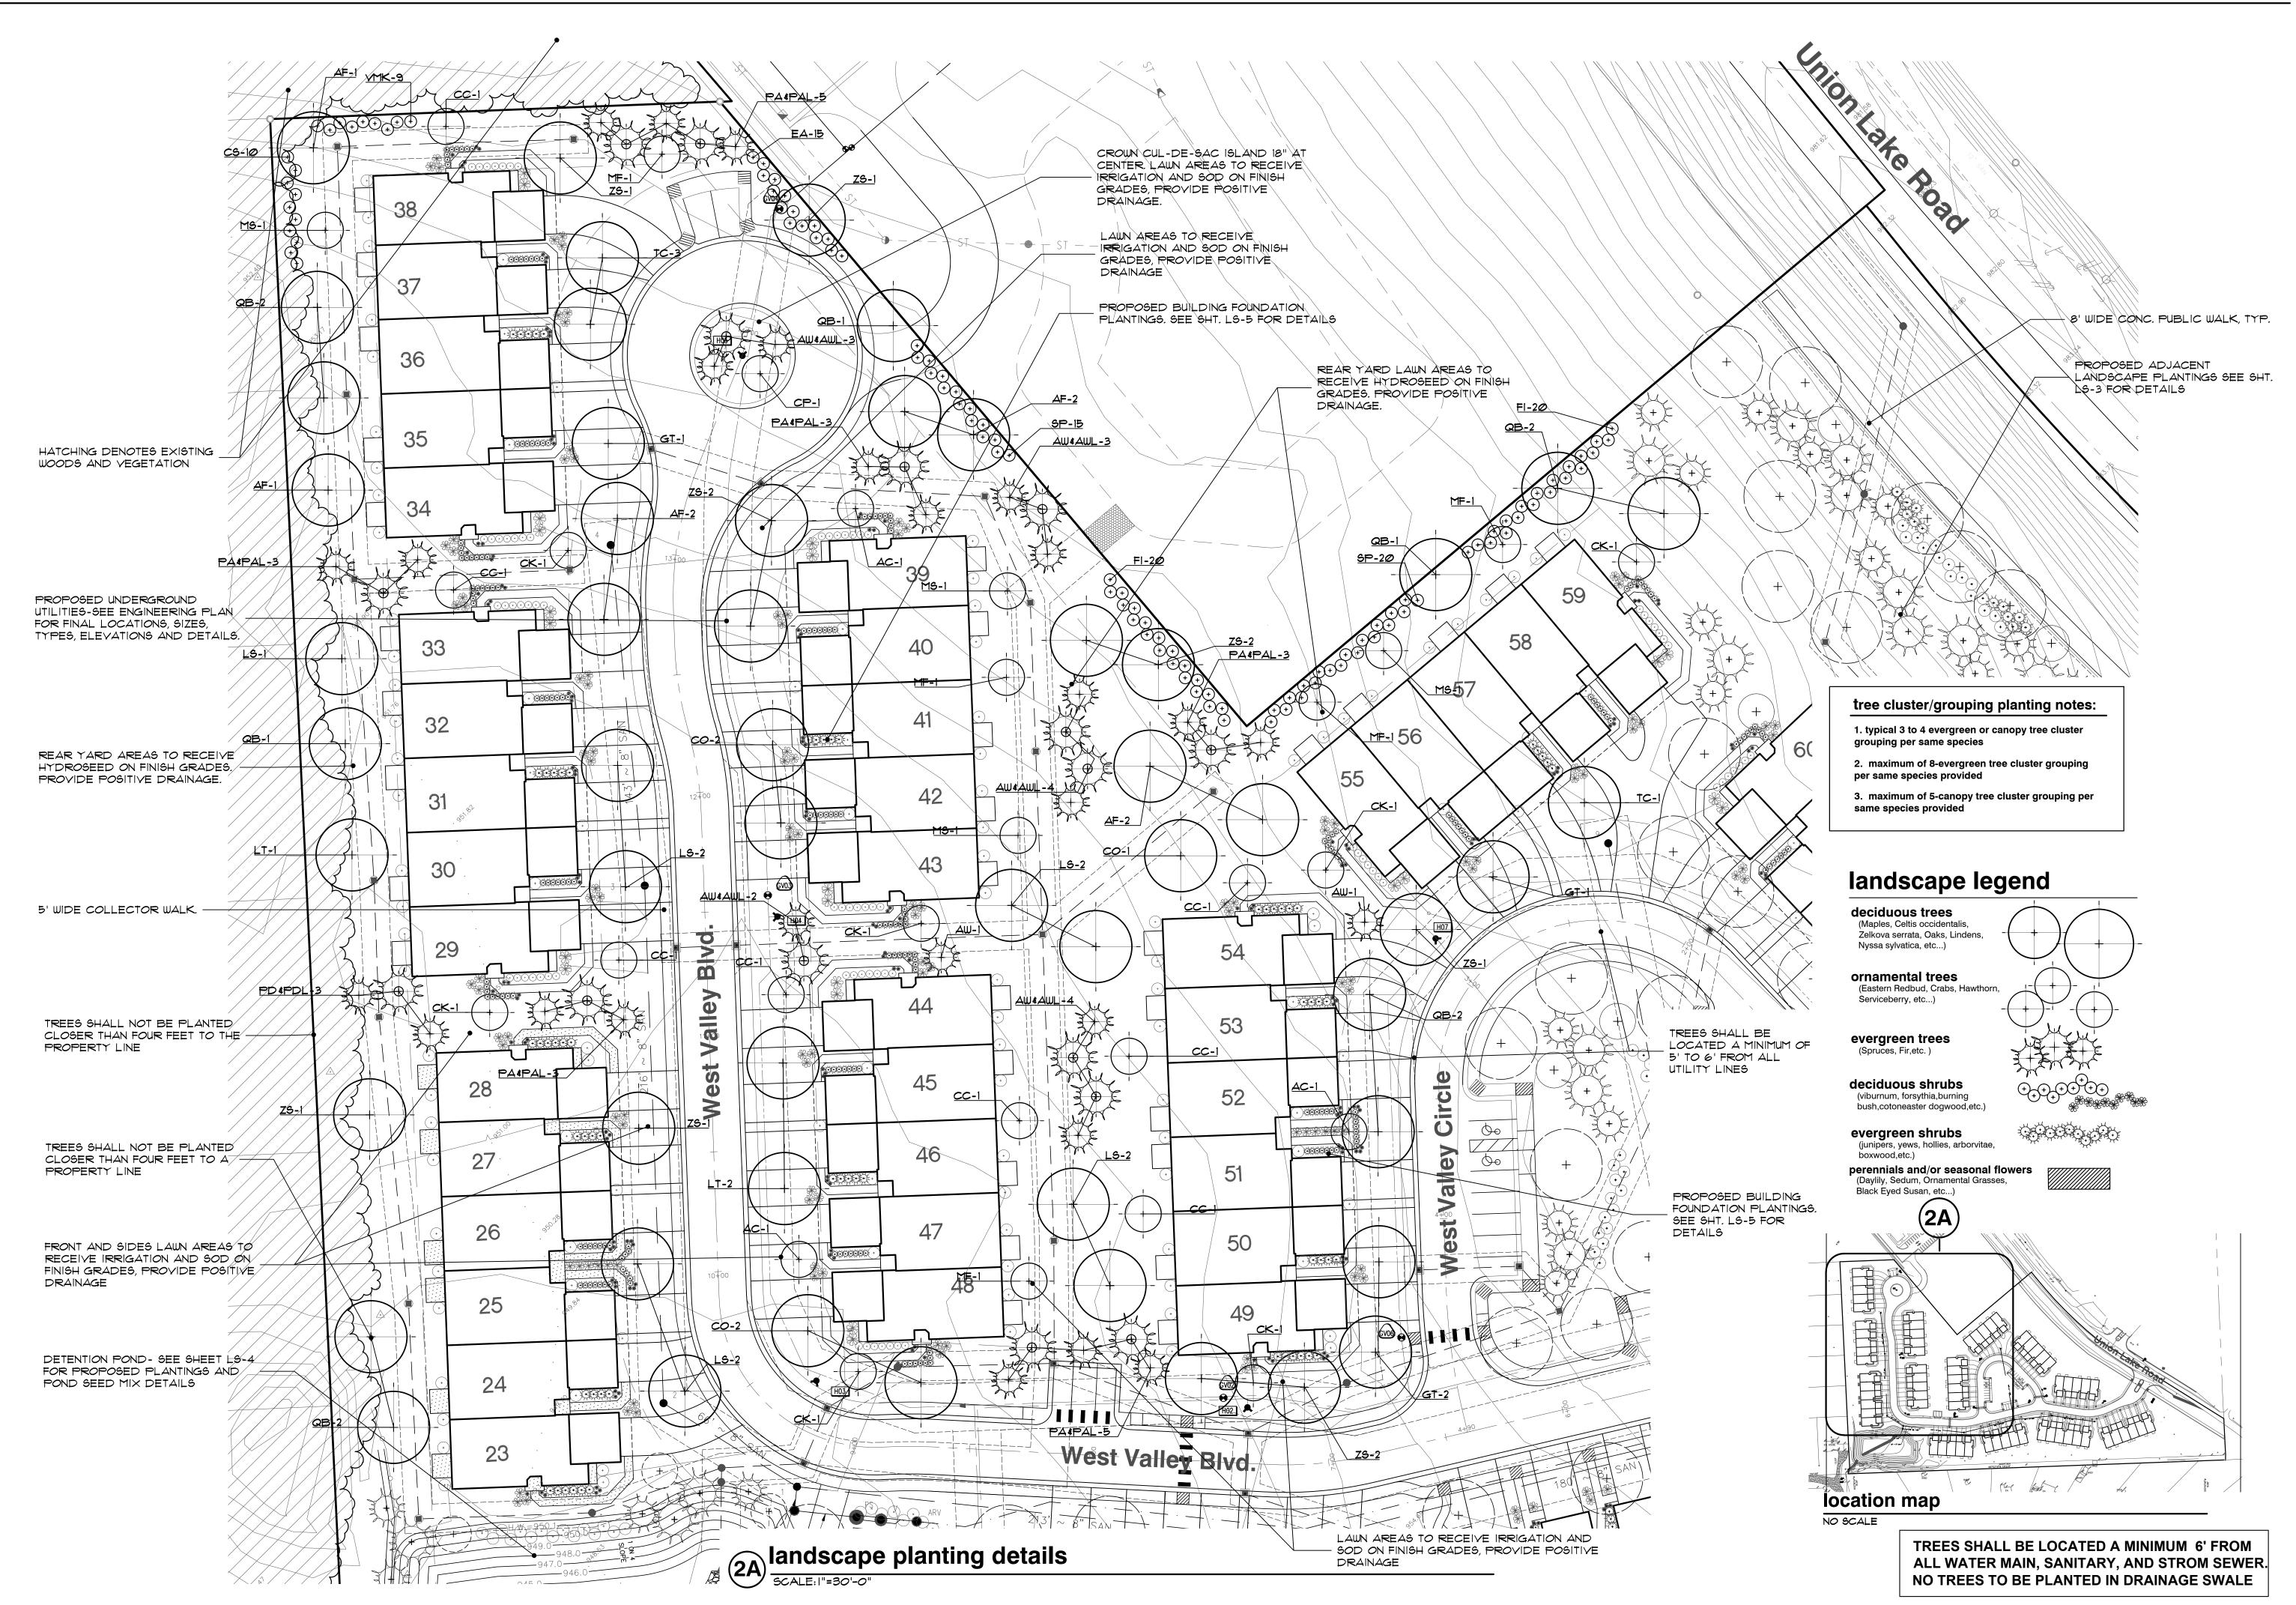

FELINO A. PASCUAL and ASSOCIATES

Community Land Planner and registered Landscape Architect
24333 Orchard Lake Rd, Suite G Farmington Hills, MI 48336 ph. (248) 557-5588 fax. (248) 557-5416

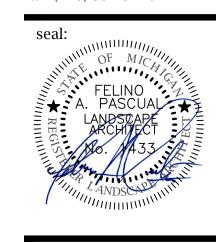

client:

JMF WHITE LAKE, LLC.

1700 W. BIG BEAVER ROAD SUITE 120 TROY, MI 48084

project:
WEST
VALLEY

project location:
White Lake Twp.,
Michigan

Union Lake Road sheet title:

landscape planting detail

job no./issue/revision date:

LS19.104.08 REVIEW 9-3-2019
LS19.104.09 SPA 9-28-2019
LS21.034.21 SPA 2-18-2021
LS21.034.21 COMMENTS 3-16-2021

 LS23.083.11
 UPDATES COMMENTS
 11-2-2023

 LS24.032.02
 UPDATES-TWP COMMENTS
 2-7-2024

 LS24.032.05
 UPDATES
 5-29-2024

LS23.083.07 COMMENTS 7-29-2023

drawn by: **JP, DK, PH**

checked by:

date: 2-2-2024

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and Associates

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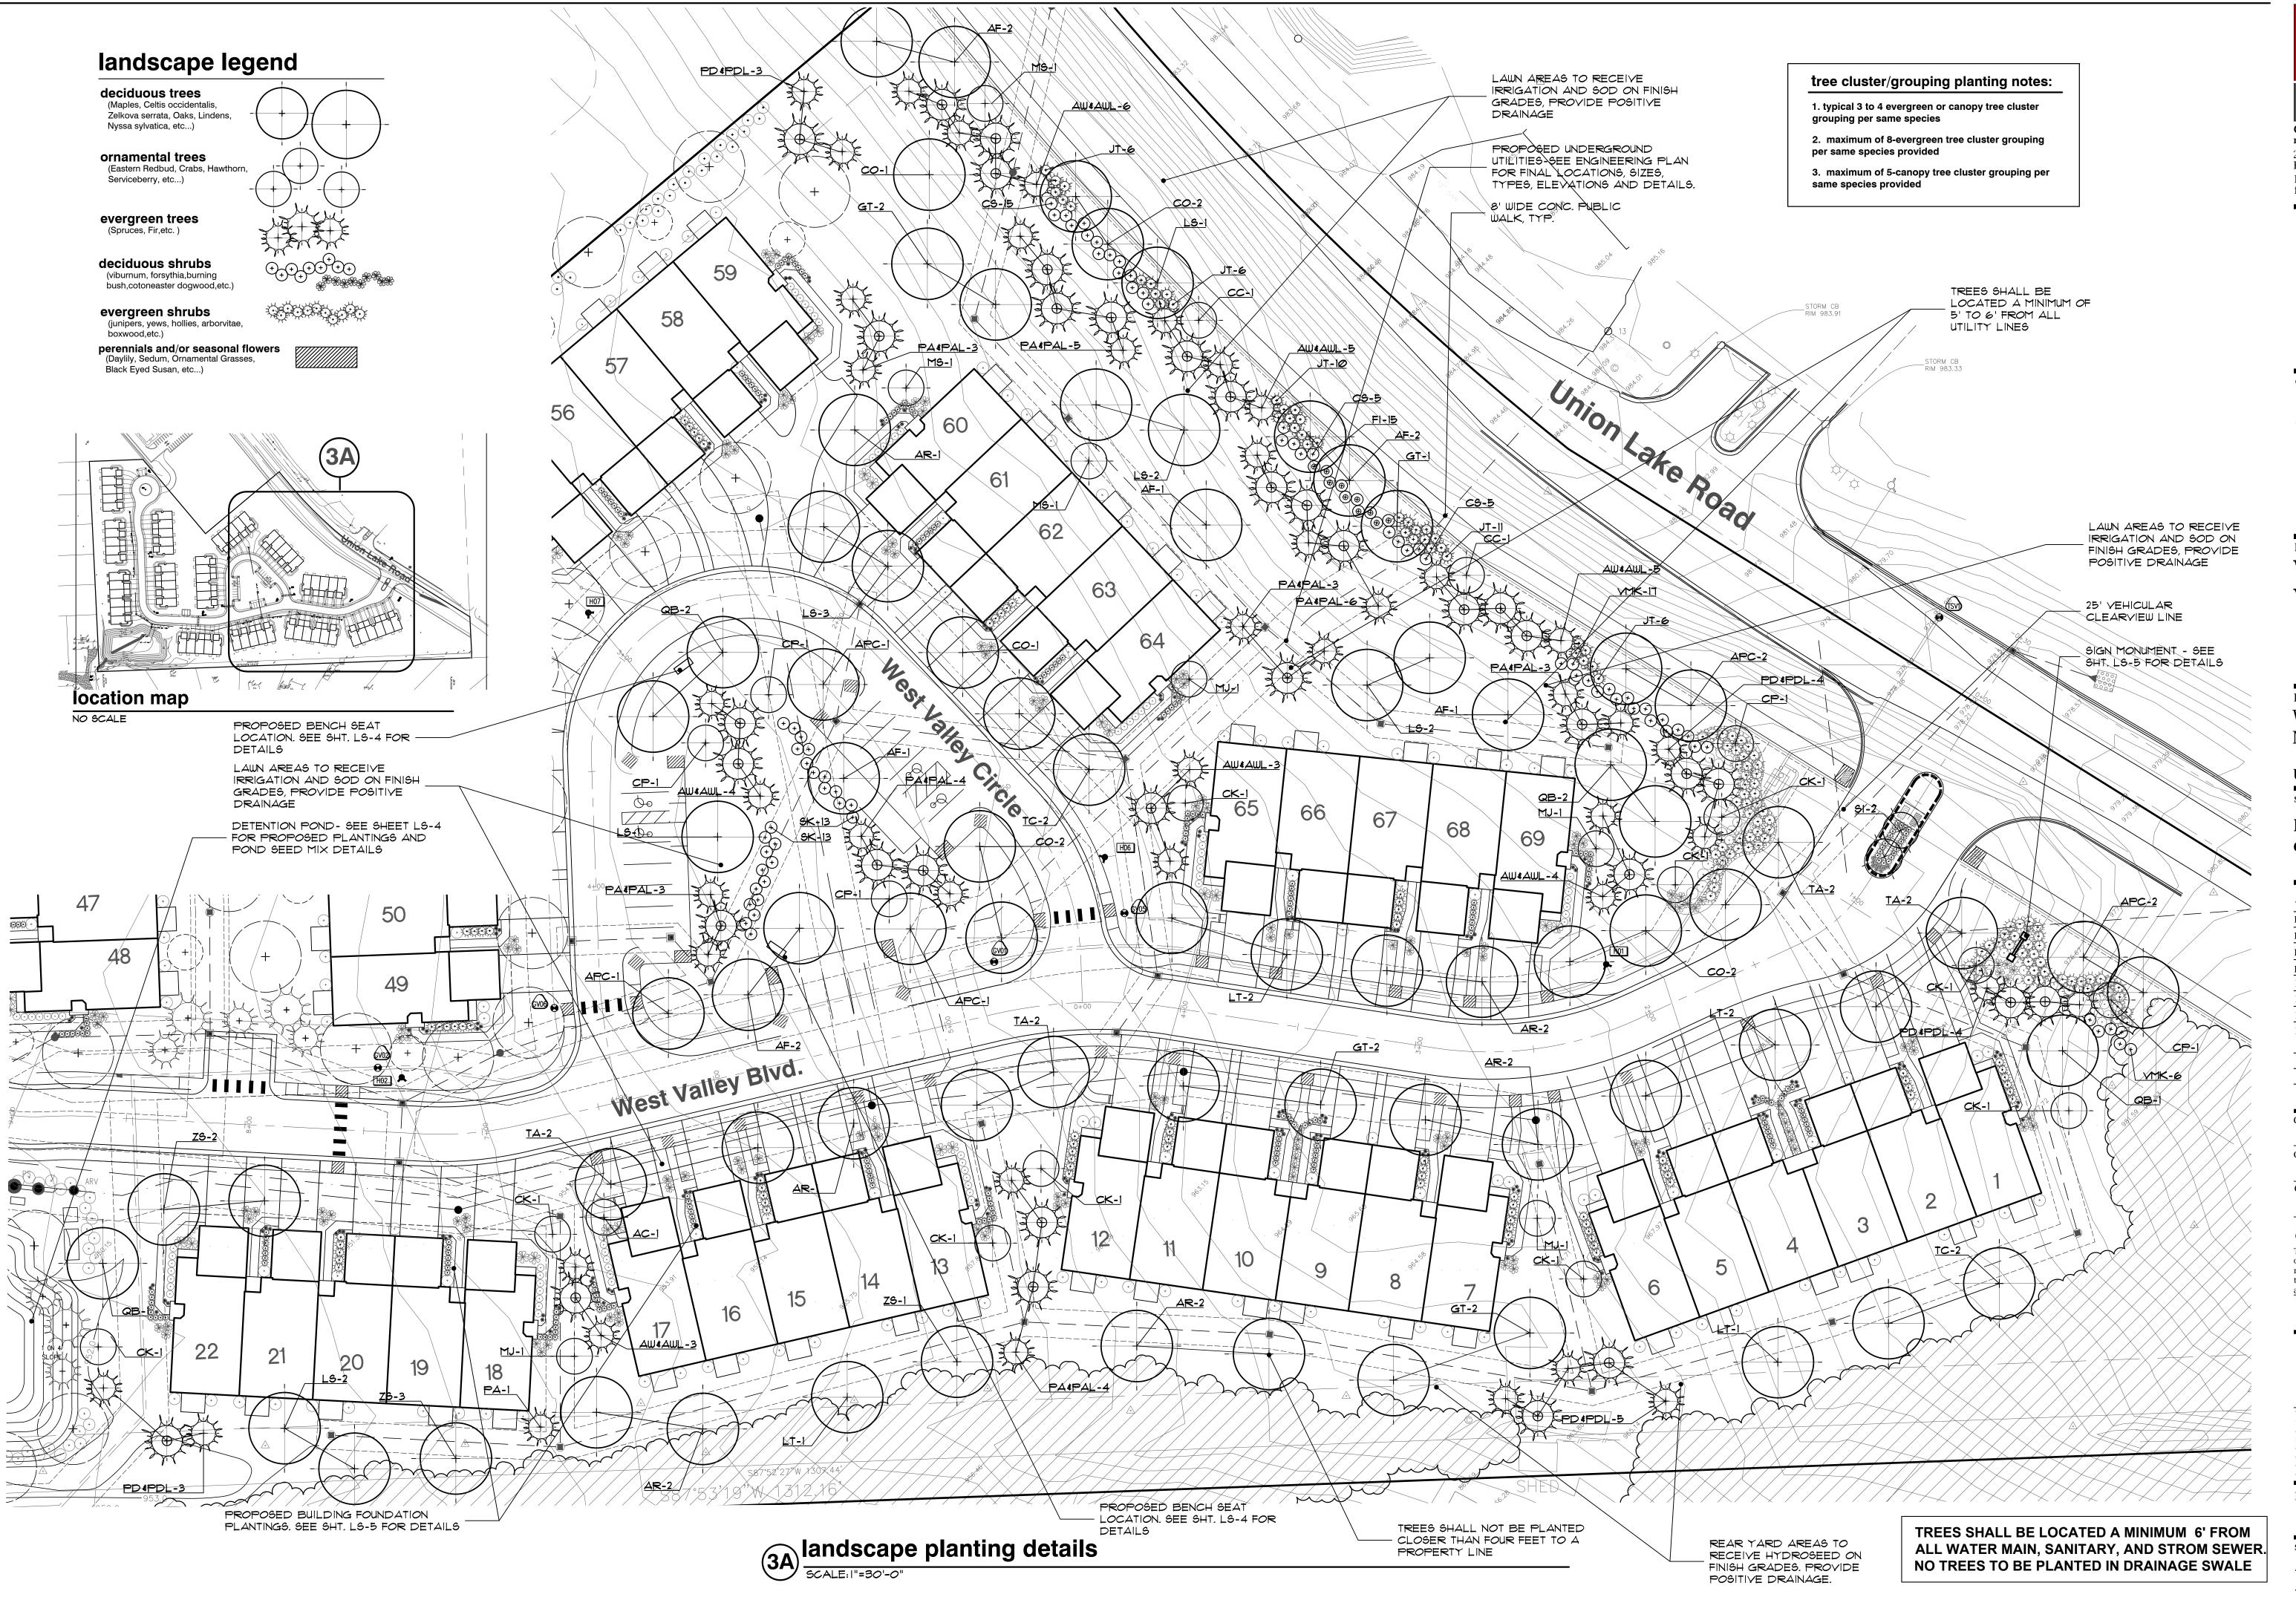
The location and elevations of existing underground utilities as shown on this drawing are only approximate. no guarantee is either expressed or implied as to the completeness of accuracy. contractor shall be exclusively responsible for determining the exact location and elevation prior to the start

project no:

LS24.032.02

of construction

sheet no:
LS-2 of 5





seal:

OF MICHAELING

FELINO

A. PASCUAL

ARCHITECT

ARCHITECT

ANDSCAPE

AN

client:

JMF WHITE LAKE, LLC.

1700 W. BIG BEAVER ROAD SUITE 120 TROY, MI 48084

project:
WEST
VALLEY

project location:
White Lake Twp.,
Michigan

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landscape planting detail

job no./issue/revision date:

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LS21.034.21 SPA 2-18-2021

LS21.034.21 COMMENTS 3-16-2021

LS23.083.07 COMMENTS 7-29-2023

LS23.083.11 CUPDATES 7-29-2023

LS24.032.02 UPDATES 11-2-2023

LS24.032.02 UPDATES TWP. COMMENTS 2-7-2024

LS24.032.05 UPDATES 5-29-2024

drawn by:
JP, DK, PH

checked by: **FP**

late:

2-2-2024

notice:
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3 WORKING DAYS
BEFORE YOU DIG
CALL MISS DIG
1-800-482-717
For free location of public utility lines

The location and elevations of existing underground utilities as shown on this drawing are only approximate. no guarantee is either expressed or implied as to the completeness of accuracy. contractor shall be exclusively responsible for determining the exact location and elevation prior to the start of construction

project no:

LS24.032.02


sheet no:
LS-3 of 5

plant material list

key	quant.	quant.	botanical name common name		size	comments
	LS-2	LS-3	LARGE AND SMALL DECIDUOUS TREES			
GT	4	7	GLEDITSIA TRI. INERMIS 'SKYCOLE'	SKYLINE LOCUST	2 1/2" BB	
TC	3	4	TILIA CORDATA 'GREENSPIRE'	GREENSPIRE LINDEN	2 1/2" BB	
LS	9	10	LIQUIDAMBAR STYRACIFLUA	AMERICAN SWEETGUM	2 1/2" BB	
ZS	11	4	ZELKOVA SERRATE 'VILLAGE GREEN'	VILLAGE GREEN ZELKOVA	2 1/2" BB	
TA		8	TILIA AMERICANA 'REDMOND'	REDMOND LINDEN	2 1/2" BB	
AR	_	10	ACER R. 'FRANK&RED'	RED SUNSET RED MAPLE	2 1/2" BB	
co	5	8	CELTIS OCCIDENTALIS	HACKBERRY	2 1/2" BB	
LT	3	6	LIRIODENDRON TULIPIFERA	TULIPTREE	2 1/2" BB	
QB	11	6	QUERCUS 'BICOLOR'	SWAMP WHITE OAK	2 1/2" BB	
ΔF	8	9	ACER X FREEMANII 'JEFF\$RED'	AUTUMN BLAZE RED MAPLE	2 1/2" BB	
APC	_	7	ACER P. 'CRIMSON KING'	CRIMSON KING NORWAY MAPLE	2 1/2" BB	
		<u> </u>				
cc	8	2	CERCIS CANADENSIS	EASTERN REDBUD (MULTI-STEM)	8' BB	(MULTI-STEM)
AC	3	1	AMELANCHIER CANADENSIS	SHADBLOW SERVICEBERRY	8' BB	(MULTI-STEM)
CK	٦	10	CORNUS KOUSA	KOUSA DOGWOOD	2" BB	
CP	1	5	CRATAEGUS PHAENOPYRUM	WASHINGTON HAWTHORN	2" BB	
MS	4	3	MALUS 'SNOWDRIFT'	SNOWDRIFT CRABAPPLE	2" BB	
MF	5	-	MALUS FLORIBUNDA	JAPANESE FLOWERING CRABAPPLE	2" BB	
MJ	-	4	MAGNOLIA LILIIFLORA 'JANE'	JANE MAGNOLIA	10' BB	(MULTI-STEM)
SI	-	2	SYRINGA RETICULATA 'IVORY SILK'	VORY SILK JAPANESE TREE LILAC	2" BB	
			SHRUBS			
EΑ	15	-	EUONYMUS ALATUS COMPACTA	DWARF WINGED BURNING BUSH	3' BB	60" SPACING O.C.
CS	10	25	CORNUS STOLONIFERA	REDTWIG DOGWOOD	3' BB	60" SPACING O.C.
VMK	9	23	VIBURNUM X.B. 'MOHAWK'	MOHAWK VIBURNUM	3' BB	60" SPACING O.C.
SK	-	26	SYRINGA PATULA 'MISS KIM'	MISS KIM DWARF LILAC	3' B.B.	48" SPACING O.C.
FI	40	10	FORSYTHIS X INTERMEDIA	BORDER FORSYTHIA	3' BB	60" SPACING O.C.
SP	35	-	SYRINGA X. 'PERSICA'	PERSIAN LILAC	3' BB	60" SPACING O.C.
JT	-	39	JUNIPERUS S. 'TAMARISAFOLIA'	TAM'S JUNIPER	24" BB	42" SPACING O.C.
			LARGE AND SMALL EVERGREENS			
ΔW	11	16	ABIES CONCOLOR	CONCOLOR WHITE FIR	8' BB	
AWL	7	13	ABIES CONCOLOR	CONCOLOR WHITE FIR	10' BB 0	
PA	14	18	PICEA ABIES	NORWAY SPRUCE	8' BB	
PAL	8	14	PICEA ABIES	NORWAY SPRUCE	10' BB 0	
PD	2	11	PICEA GLAUCA 'DENSATA'	BLACK HILLS SPRUCE	8' BB	
PDL	1	8	PICEA GLAUCA 'DENSATA'	BLACK HILLS SPRUCE	10' BB 0	



bench seating

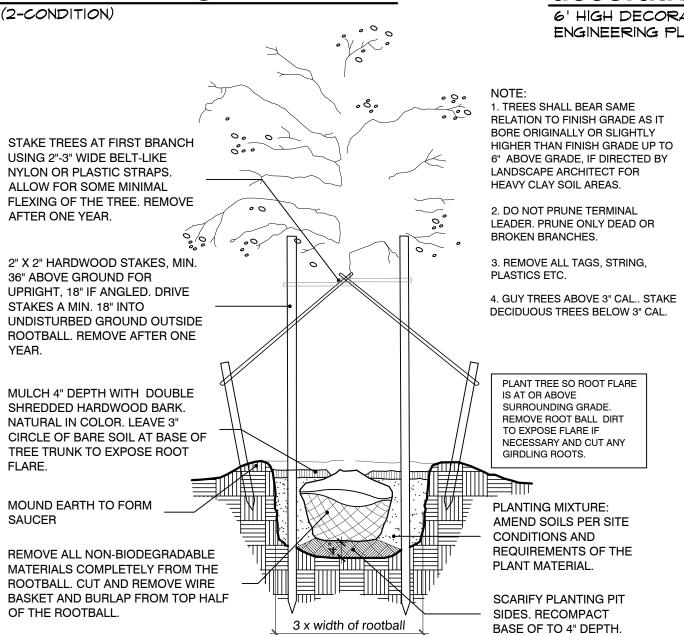

tree planting detail



decorative wood fence

6' HIGH DECORATIVE WOOD FENCE. SEE ENGINEERING PLANS FOR FINAL LOCATION.

> STAKE TREES AT FIRST BRANCH USING 2"-3" WIDE BELT- LIKE NYLON OR PLASTIC STRAPS. 1.EVERGREEN TREE SHALL BEAR ALLOW FOR SOME MINIMAL SAME RELATION TO FINISH GRADE FLEXING OF THE TREE. REMOVE AS IT BORE ORIGINALLY OR SLIGHTLY HIGHER THAN FINISH GRADE UP TO 6" AFTER ONE YEAR. ABOVE GRADE, IF DIRECTED BY LANDSCAPE ARCHITECT FOR HEAVY CLAY SOIL AREAS. 2" X 2" HARDWOOD STAKES, MIN. 36" ABOVE GROUND FOR 2. DO NOT PRUNE TERMINAL LEADER. UPRIGHT, 18" IF ANGLED. PRUNE ONLY DEAD OR BROKEN DRIVE STAKES A MIN. 18" BRANCHES. INTO UNDISTURBED GROUND **OUTSIDE ROOTBALL.** REMOVE AFTER ONE YEAR. MULCH 4" DEPTH WITH DOUBLE SHREDDED HARDWOOD BARK. NATURAL IN COLOR. LEAVE 3" PLANT TREE SO ROOT FLARE IS AT CIRCLE OF BARE SOIL AT BASE OR ABOVE SURROUNDING GRADE. REMOVE ROOT BALL DIRT TO OF TREE TRUNK TO EXPOSE EXPOSE FLARE IF NECESSARY AND ROOT FLARE. CUT ANY GIRDLING ROOTS. PLANTING MIXTURE: MOUND EARTH TO FORM AMEND SOILS PER SITE SAUCER CONDITIONS AND REQUIREMENTS OF THE PLANT MATERIAL REMOVE ALL NON-BIODEGRADABLE MATERIALS COMPLETELY FROM SCARIFY PLANTING PIT SIDES. THE ROOTBALL. CUT AND REMOVE RECOMPACT BASE OF TO 4"

3 x width of rootball

WIRE BASKET AND BURLAP FROM

evergreen planting detail

TOP HALF OF THE ROOTBALL.

AND/OR SITE CONDITIONS.

OTHER TRADES AND REPORT ANY UNACCEPTABLE JOB CONDITIONS TO OWNER PRIOR TO

PRECEDENCE OVER GRAPHIC REPRESENTATION, VERIFY ANY CONCERN-DISCREPANCY WITH LANDSCAPE ARCHITECT.

4. ALL CONSTRUCTION AND PLANT MATERIAL LOCATION TO BE ADJUSTED ON SITE IF NECESSARY

5. ALL SUBSTITUTIONS OR DEVIATIONS FROM THE LANDSCAPE PLAN MUST BE APPROVED BY WHITE LAKE TOWNSHIP AND LANDSCAPE ARCHITECT

6. ALL LARGE TREES AND EVERGREENS TO BE STAKED, GUYED AND WRAPPED AS DETAILED, SHOWN ON PLAN.

8. DIG SHRUB PITS 1' LARGER THAN SHRUB ROOT BALLS AND TREE PITS 2' LARGER THAN ROOT

9. NATURAL COLOR, FINELY DOUBLE SHREDDED HARDWOOD BARK MULCH REQUIRED FOR ALL

PLANTINGS.

TRUNK . 4" THICK BARK MULCH FOR SHRUBS AND 4" THICK BARK MULCH FOR PERENNIALS. II. PLANT MATERIAL QUALITY & INSTALLATION SHALL BE IN ACCORDANCE WITH THE CURRENT

13. ALL PLANTING AREAS TO BE PREPARED WITH APPROPRIATE SOIL MIXTURES AND

14. PLANT TREES AND SHRUBS GENERALLY NO CLOSER THAN THE FOLLOWING DISTANCES FROM SIDEWALKS, CURBS AND PARKING STALLS:

(CRAB, PINE, SPRUCE, ETC.) SHRUBS THAT ARE LESS THAN I FOOT TALL

15. NO TREES OR EVERGREENS TO BE INSTALLED OVER AND/OR WITHIN 5' TO 6' OF ANY PROPOSED OR EXISTING UTILITY LINES AS SHOWN ON THE OVERALL LANDSCAPE PLAN. SEE ENGINEERING PLANS FOR LOCATION AND DETAILS.

16. ALL LAWN AREAS AND LANDSCAPE BEDS TO BE FULLY IRRIGATED WITH AN AUTOMATIC UNDERGROUND SYSTEM. IRRIGATION SYSTEM TO HAVE SEPARTE ZONES FOR LAWN AREAS, PARKING ISLANDS, AND SHRUB BEDS WITH DIFFERENT CONTROL MOISTURE LEVEL ADJUSTMENT PER ZONE AS REQUIRED

17. UNLESS NOTED OTHERWISE, LANDSCAPE BEDS ADJACENT TO LAWN TO RECIEVE EDGING. EDGING SHALL BE 4" X 1/8" METAL (FINISH BLACK OR GREEN) OR APPROVED EQUAL AND TO BE INSTALLED WITH HORIZONTAL METAL STAKES AT 32" O.C. OR PER MANUFACTERER'S SPECIFICATION.

18. LANDSCAPE BEDS ADJACENT AND NEXT TO BUILDING SHALL BE EXCAVATED OF ALL BUILDING MATERIALS AND POOR SOILS A MIN. OF 12" DEPTH. BACK FILL WITH GOOD, MEDIUM TEXTURED PLANTING SOILS. ADD A MIN. 4" OF TOPSOIL OVERFILL TO FINISH GRADE. PROVIDE

general landscape notes:

. LANDSCAPE CONTRACTOR SHALL VISIT THE SITE, INSPECT EXISITING CONDITIONS, REVIEW PROPOSED PLANTINGS AND RELATED WORK, CONTACT THE OWNER AND/OR LANDSCAPE ARCHITECT WITH ANY CONCERNS OR DISCREPANCY BETWEEN THE PLAN, PLANT MATERIAL LIST,

2. PRIOR TO BEGINNING OF CONSTRUCTION ON ANY WORK, CONTRACTORS SHALL VERIFY LOCATIONS OF ALL ON SITE UTILITIES. GAS, ELECTRIC, TELEPHONE, CABLE TO BE LOCATED BY CONTACTING MISS DIG 1-800-482-1111. ANY DAMAGE OR INTERRUPTION OF SERVICES SHALL BE THE RESPONSIBILITY OF THE CONTRACTOR, COORDINATE ALL RELATED WORK ACTIVITIES WITH

3. NUMERICAL VALUE ON THE LANDSCAPE QUANTITIES SPECIFIED ON THE PLAN TAKE

1. PLANT BEDS TO BE DRESSED WITH MIN. 4" OF FINELY DOUBLE SHREDDED HARDBARK

BALL. BACK FILL WITH ONE PART TOP SOIL AND ONE PART SOIL FROM EXCAVATED PLANTING

10. REMOVE ALL TWINE, WIRE AND BURLAP FROM TREE AND SHRUB EARTH BALLS, AND FROM TREE TRUNKS, 4" THICK BARK MULCH FOR TREES IN 4' DIA, CIRCLE WITH 3" PULLED AWAY FROM

AMERICAN ASSOCIATION OF NURSERYMEN LANDSCAPE STANDARDS.

12. PROVIDE PEAT SOD FOR ALL NEW AND DISTURBED LAWN AREAS UNLESS NOTED OTHERWISE.

FERTILIZER BEFORE PLANT INSTALLATION.

a). SHADE TREES_ ORNAMENTAL AND EVERGREEN TREES

TRANSFORMER DOOR FRONT-

transformer pad planting detail

COMPANY-SERVICE PLANNING DEPARTMENT (9-17-98)

AND FINAL LOCATION PER DETROIT EDISON REQUIREMENTS.

TRANSFORMER PAD-

TRANSFORMER -

SCALE 1'=20'-0"

AND WIDE AT MATURITY_

POSITIVE DRAINAGE.

A MINIMUM OF 2' SEPARATION BETWEEN TRANSFORMER AND FULL GROWN SHRUBS AND TREES.

GROWTH. IF TRANSFORMER FACES TOWARDS THE HOUSE, THEN THE SAME CONDITIONS EXIST NO FULL GROWTH IN FRONT OF THE TRANSFORMER FOR AT LEAST A MINIMUM OF 8'. THERE ARE NO WAIVERS GRANTED TO THE ABOVE CONDITION. DETAIL PER THE DETROIT EDISON

SEE ENGINEERING PLANS FOR PROPOSED LOCATIONS. TOTAL NUMBER OF TRANSFORMERS

4. GUY EVERGREEN TREES ABOVE 12'

HARDWOOD BARK. NATURAL IN

COLOR. LEAVE 3" CIRCLE OF BARE

SOIL AT BASE OF TREE TRUNK TO

REMOVE COLLAR OF ALL FIBER

POTS. POTS SHALL BE CUT TO

PROVIDE FOR ROOT GROWTH.

REMOVE ALL NONORGANIC

CONTAINERS COMPLETELY.

SCARIFY PLANTING PITSIDES.

RECOMPACT BASE OF TO 4" DEPTH.

EXPOSE ROOT FLARE.

MOUND EARTH TO

FORM SAUCER

MULCH 4" DEPTH WITH DOUBLE SHREDDED

3. REMOVE ALL TAGS, STRING,

HEIGHT. STAKE EVERGEEN TREE

PLASTICS ETC.

GROUND COVERS ALLOWED UP TO TRANSFORMER PAD IF MAINTAINED BELOW 4" FULL

LANDSCAPE SCREENING

(Burning Bush, Viburnum, or Lilac)

3' CLEARANCE BOUNDARY AT

TRANSFORMER SIDES AND BACK

2' TYP. CLEARANCE BOUNDARY ALONG

TRANSFORMER DOOR FRONT

signage monument notes:

LOCATE AND STAKE ALL EXISTING

HEREIN IS SUBJECT TO APPROVAL, AND

PROPOSED PLANTINGS ADJACENT TO

PROPOSED ENTRY SIGN MONUMENTS,

4. VERIFY SOIL BEARING CAPACITY

CAPACITY FALLS BELOW STANDARD

REQUIREMENTS, CONSULT STRUCTURAL

ENGINEER FOR RECOMMENDATION OF FINAL ENTRY MONUMENT & PIER FOOTING

PRIOR TO TO ENTRY SIGN MONUMENT 4 PIER CONSTRUCTION. IF SOIL BEARING

PERMITS PERMITS TO BE OBTAINED

AND PROPOSED UTILITIES PRIOR TO

CONSTRUCTION, COORDINATE ANY

ADJUSTMENTS WITH ARCHITECT.

2. ALL INFORMATION CONTAINED

3. SEE LANDSCAPE PLAN FOR

PRIOR TO CONSTRUCTION.

1. SHRUB SHALL BEAR SAME RELATION TO FINISH

GRADE AS IT BORE ORIGINALLY OR SLIGHTLY

HIGHER THAN FINISH GRADE UP TO 4" ABOVE

2. PRUNE ONLY DEAD OR BROKEN BRANCHES.

FOR HEAVY CLAY SOIL AREAS.

3. REMOVE ALL TAGS, STRING,

shrub planting detail

PLASTICS AND OTHER MATERIALS

GRADE, IF DIRECTED BY LANDSCAPE ARCHITECT

PLANTING MIXTURE:

CONDITIONS AND

MATERIAL.

AMEND SOILS PER SITE

REQUIREMENTS OF THE PLANT

SHALL HAVE ENTIRE BED MASS

INSTALLED IN INDIVIDUAL HOLES.

REMOVE ALL NON-BIODEGRADABLE

ROOTBALL. CUT AND REMOVE WIRE

BASKET AND BURLAP FROM TOP

MATERIALS COMPLETELY FROM THE

EXCAVATED AND BACKFILLED

WITH APPROVED PLANT MIX.

PLANTS SHALL NOT BE

HALF OF THE ROOTBALL.

SHRUBS PLANTED IN BEDS


PIERS & FENCES.


DESIGN.

19. WATERING OF ALL PLANTS AND TREES TO BE PROVIDED IMMEDIATELY AND MULCHING WITHIN 24 HOURS AFTER INSTALLATION.

20. ALL TREE PITS TO BE TESTED FOR PROPER DRAINAGE PRIOR TO TREE PLANTING. PROVIDE APPROPRIATE DRAINAGE SYSTEM AS REQUIRED IF THE TREE PIT DOES NOT DRAIN

21. THE LANDSCAPE CONTRACTOR SHALL GUARANTEE ALL LANDSCAPE PLANT MATERIALS AND IRRIGATION INSTALLATION FOR A PERIOD OF TWO YEAR BEGINNING AFTER THE COMPLETION OF LANDSCAPE INSTALLTION DATE APPROVED BY THE TWP. OR LANDSCAPE ARCHITECT. THE CONTRACTOR SHALL REPLACE DURING AND AT THE END OF THE GUARANTEE PERIOD, ANY DEAD OR UNACCEPTABLE PLANTS, AS DETERMINED BY THE TOWNSHIP OR LANDSCAPE ARCHITECT, WITHOUT COST TO THE OWNER.

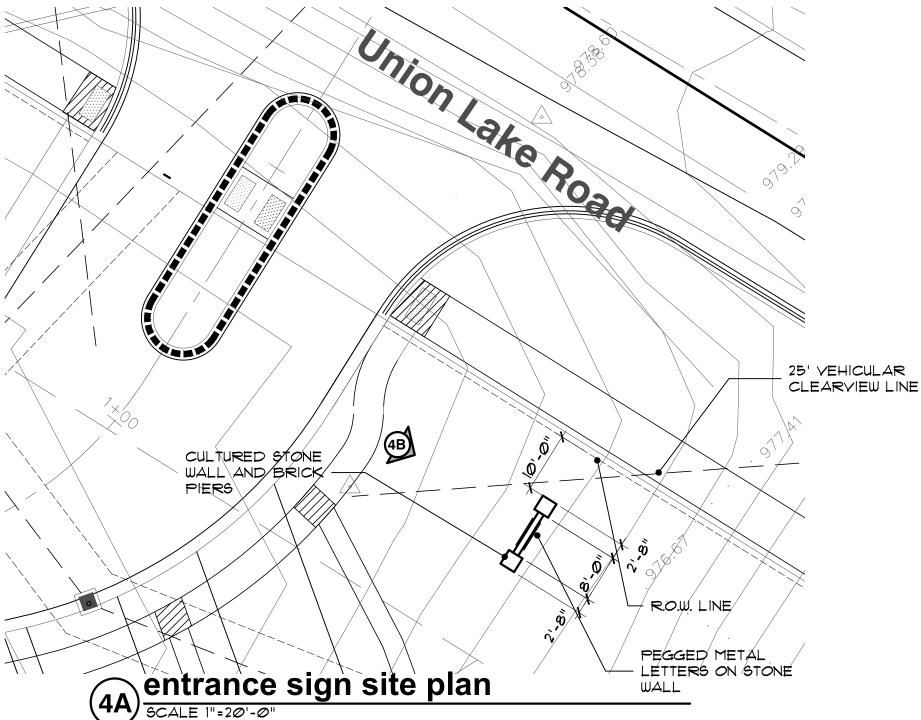

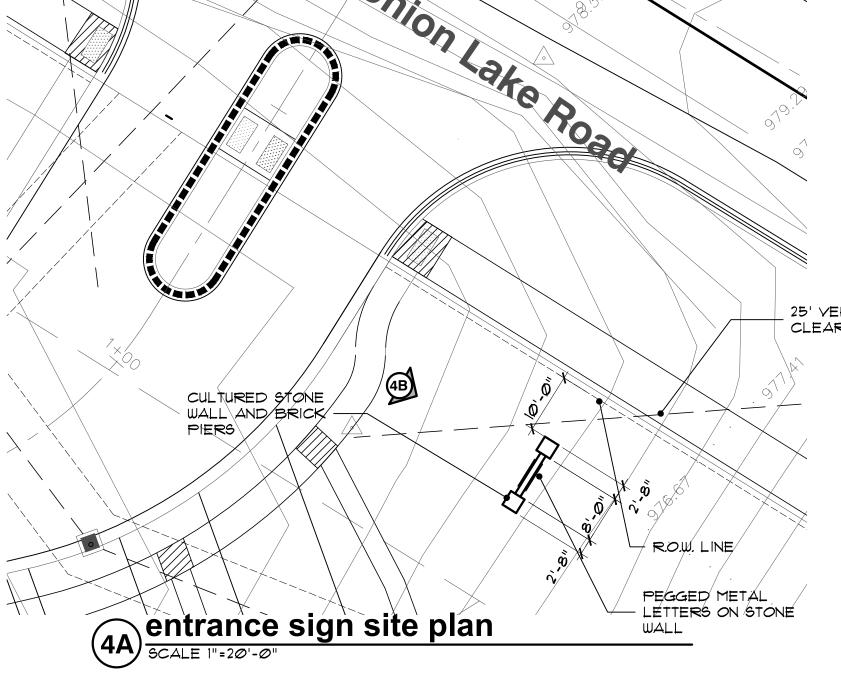


CULTURED STONE PEGGED METAL LETTERS LIMESTONE OR CAST ON STONE WALL (15 SQ.F. STONE PIER AND WALL SIGN AREA) BRICK PIER SIGN AREA LIMITS

(15 SF.FT.)

entrance sign elevation

TREES IDENTIFIED FOR PROTECTION DURING CONSTRUCTION AND THE MEANS OF PROTECTION SHALL BE IDENTIFIED PRIOR TO FINAL SITE PLAN. NO CONSTRUCTION SHALL OCCUR UNTIL TREE PROTECTION HAS BEEN INSTALLED AND APPROVED BY THE COMMUNITY DEVELOPMENT DIRECTOR.

> TREES SHALL BE LOCATED A MINIMUM 6' FROM ALL WATER MAIN, SANITARY, AND STROM SEWER NO TREES TO BE PLANTED IN DRAINAGE SWALE

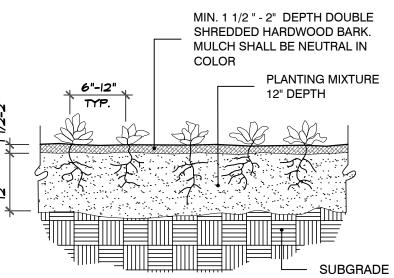

perennial planting detail

FELINO A. PASCUAI and ASSOCIATES **Community Land Planner and** registered Landscape Architect 24333 Orchard Lake Rd, Suite G Farmington Hills, MI 48336 ph. (248) 557-5588 fax. (248) 557-5416

client:

IMF WHITE LAKE,

1700 W. BIG BEAVER ROAD SUITE 120 TROY, MI 48084

project: **WEST VALLEY**

project location: White Lake Twp. Michigan

Union Lake Road sheet title:

plant material list and planting details

job no./issue/revision date: LS19.104.08 REVIEW 9-3-2019 LS19.104.09 SPA 9-28-2019 LS21.034.21 SPA 2-18-2021 LS21.034.21 COMMENTS 3-16-2021 LS23.083.07 COMMENTS 7-29-2023 LS23.083.11 COMMENTS 11-2-2023 LS24.032.02 UPDATES-TWP. 2-7-2024 LS24.032.05 UPDATES 5-29-2024

JP, DK, PH

2-2-2024

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project no:

LS24.032.02 sheet no:

of construction



FELINO A. PASCUAL and ASSOCIATES Community Land Planner and registered Landscape Architect 24333 Orchard Lake Rd, Suite G Farmington Hills, MI 48336 ph. (248) 557-5588 fax. (248) 557-5416

client:

West Valley Drive

DETENTION POND SIDE SLOPES TO

DETAILS

POND SEED MIX. SEE THIS SHT. FOR

JMF WHITE LAKE, LLC.

1700 W. BIG BEAVER ROAD SUITE 120 TROY, MI 48084

project: **WEST VALLEY**

project location: White Lake Twp., Michigan

Union Lake Road

sheet title:

overall landscape planting detail

job no./issue/revision date: LS19.104.08 REVIEW 9-3-2019 LS19.104.09 SPA 9-28-2019 LS21.034.21 SPA 2-18-2021

LS21.034.21 COMMENTS 3-16-2021 LS23.083.07 COMMENTS 7-29-2023 LS23.083.11 COMMENTS 11-2-2023 LS24.032.02 UPDATES-TWP. 2-7-2024 LS24.032.05 UPDATES 5-29-2024

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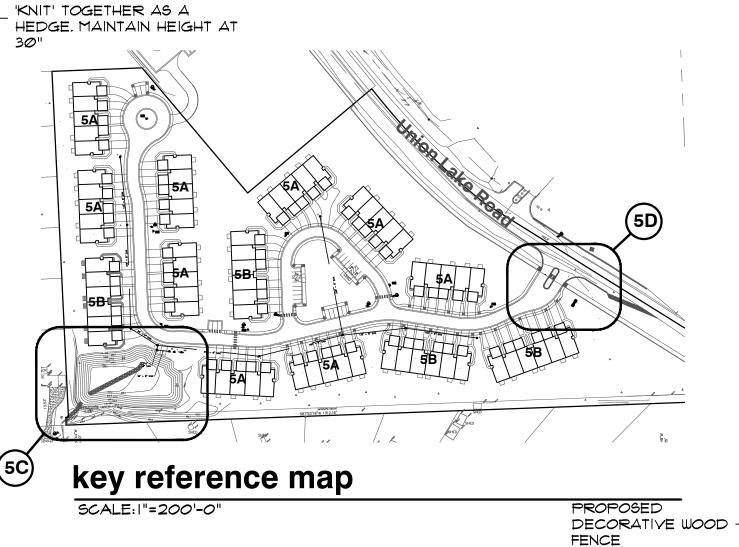
> 3 WORKING DAYS BEFORE YOU DIC CALL MISS DIG 1-800-482-7171

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of construction project no:

LS24.032.02

sheet no: LS-5



detention basin seed mix:

Sedge Meadow Mix: (Edge Zone) A mix of sedges, grasses and wildflowers recommended for soils that are saturated during most of the growing season. Use just above the normal waterline in the capillary zone in our Lake Edge Enhancement System.

YEWS TO BE ALLOWED TO

Sedge Meadow Mix oz/acre Carex comosa (Bristly Sedge) Carex cristatella (Crested Sedge) Carex frankii (Frank's Sedge) 2 Carex hystericina (Porcupine Sedge) Carex Iurida (Lurid Sedge) Carex stipata (Awl-Fruited Sedge) Carex tribuloides (Pointed Oval Sedge)

Liatris spicata (Dense Blazing Star) Lobelia cardinalis (Cardinal Flower) Lobelia siphilitica (Great Blue Lobelia) Penstemon digitalis (Foxglove Beardtongue) Pycnanthemum virginianum (Mountain Mint) Rudbeckia fulgida speciosa (Showy Black-Eyed Susan) Rudbeckia hirta (Black-Eyed Susan) Rudbeckia subtomentosa (Sweet Black-Eyed Susan) Silphium integrifolium (Rosinweed) Silphium perfoliatum (Cupplant) Silphium terebinthinaceum (Prairie Dock) Solidago patula (Swamp Goldenrod) Solidago riddellii (Riddell's Goldenrod)

Aster puniceus (Swamp Aster)

Cassia hebecarpa (Wild Senna)

Eupatorium perfoliatum (Boneset) Helenium autumnale (Autumn Sneezeweed

Aster umbellatus (Flat-topped Aster)

Eupatorium maculatum (spotted Joe-Pye Weed)

Verbena hastata (Blue Vervain) Vernonia fasciculata (Smooth Ironweed) Veronicastrum virginicum (Culver's Root) Zizia aurea (Golden Alexanders)

> NATIVESCAPE L.L.C P.O. BOX 122 MANCHESTER, MICHIGAN 48158 ph: 517.456.9696

PROPOSED UNDERGROUND

UTILITIES-SEE ENGINEERING PLAN

FOR FINAL LOCATIONS, SIZES, TYPES, ELEVATIONS AND DETAILS.

, www.nativescape.net

6 Carex vulpinoidea (Fox Sedge) 64 Elymus virginicus (Virginia Wild Rye) 6 Glyceria striata (Fowl Manna Grass) 8 Leersia oryzoides (Rice Cut Grass) 8 Panicum virgatum (Switchgrass) 2 Scirpus atrovirens (Dark Green Bulrush) Forbs oz/acre Alisma subcordatum (Water plantain) Angelica atropurpurea (Angelica) Aster novae-angliae (New England Aster)

Components per acre
8 lbs grasses and sedges, 3 lbs forbes annual cover: (Edge, Upland & Dry Upland Zones) $\underline{\mbox{50\% Temporary Grasses:}}$ will contain two of the following species. Avena sativa Annual Rye Lolium multiflorum Winter Wheat Triticum aestivum American Slough Grass Beckmannia syzigachne

ALL REQUIRED SITE IRRIGATION SYSTEMS SHALL INCLUDE A RAIN SENSOR OR SIMILAR MEASURE TO ENSURE IRRIGATION DOWN NOT OCCUR DURING OR SHORTLY AFTER PRECIPITATION EVENTS.

key	quant. 5A	quant. 5B	quant. 5C	quant. 5D	botanical name	common name	size	comments
					LARGE AND SMALL DECIDUOUS TREES			
LS	-	-	5	-	LIQUIDAMBAR STYRACIFLUA	AMERICAN SWEETGUM	2 1/2" BB	
QB	-	-	5	-	QUERCUS 'BICOLOR'	SWAMP WHITE OAK	2 1/2" BB	
СС	-	-	1	-	CERCIS CANADENSIS	EASTERN REDBUD (MULTI-STEM)	8' BB	(MULTI-STEM)
AC	-	-	1	-	AMELANCHIER CANADENSIS	SHADBLOW SERVICEBERRY	8' BB	(MULTI-STEM)
CK	-	-	1	-	CORNUS KOUSA	KOUSA DOGWOOD	2" BB	
					SHRUBS			
SK	18	20	-	-	SYRINGA PATULA 'MISS KIM'	MISS KIM DWARF LILAC	3' B.B.	
TO	18	12	-	-	THUJA OCCIDENTALIS 'NIGRA'	AMERICA DARK GREEN ARBORVITAE	3' B.B.	
НД	54	4	-	13	HYDRANGEA ANNABELLE	ANNABELLE HYDRANGEA	#3 CONT.	
HL	18	8	-	-	HYDRANGEA 'LINDSEY ANN'	LA DREAMIN HYDRANGEA	#3 CONT.	
LY	45	8	-	-	LIGUSTRUM X. VICARYI	GOLDEN VICARY PRIVET	#3 CONT.	60" O.C. SPACING
YC	18	16	-	-	VIBURNUM CARLESII	KOREAN SPICE FRAGRANT VIBURNUM	3' B.B	60" O.C. SPACING
5 G	54	24	-	-	SPIRAEA X.B. BUMALDA 'GOLDFLAME'	GOLDFLAME SPIREA	#3 CONT	
HE	9	24	-	12	HYDRANGEA M. 'GLOWING EMBERS'	GLOWING EMBERS HYDRANGEA	#3 CONT.	
FI	-	-	15	-	FORSYTHIS X INTERMEDIA	BORDER FORSYTHIA	3' BB	60" O.C. SPACING
CS	-	-	30	-	CORNUS STOLONIFERA	REDTWIG DOGWOOD	3' BB	60" O.C. SPACING
MK	36	16	30	5	VIBURNUM X.B. 'MOHAWK'	MOHAWK VIBURNUM	3' BB	
RA	126	24	-	-	RIBES ALPINUM "GREEN MOUND"	GREEN MOUND ALPINE CURRANT	#3 CONT	
					LARGE AND SMALL EVERGREENS			
BW	288	88	-	22	BUXUS S. 'VADAR VALLEY'	VADAR VALLEY BOXWOOD	18" BB	24" O.C. SPACING
TS	-	48	-	-	TAXUS . SEBIAN	SEBIAN YEW	24"-3Ø" BB	32" O.C. SPACING
TE	45	32	-	-	TAXUS X.M. 'EVERLOW'	EVERLOW YEW	24"-3Ø" BB	32" O.C. SPACING
JŤ	-	-	-	85	JUNIPERUS S. 'TAMARISAFOLIA'	TAMS JUNIPER	24"-3Ø" BB	42" O.C. SPACING
ΔW	-	-	4	-	ABIES CONCOLOR	CONCOLOR WHITE FIR	8' BB	
AWL	-	-	2	-	ABIES CONCOLOR	CONCOLOR WHITE FIR	10' BB 0	
PS	-	-	2	-	PICEA GLAUCA 'DENSATA'	BLACK HILLS SPRUCE	8' BB	
PSL	-	-	2	-	PICEA GLAUCA 'DENSATA'	BLACK HILLS SPRUCE	10' BB 0	
					PERENNIALS AND GRASSES			
GD	36	-	-	-	GERANIUM X. 'ROZANNE'	ROZANNE GERANIUM	8 / FLAT	
PAH	27	-	-	-	PENNISETUM ALOPECUROIDES 'HAMELN'	DWARF FOUNTAIN GRASS	#3 CONT.	
CKF	-	-	-	12	CALAMAGROSTIS X.A. 'KARL FOERSTER'	KARL FOERSTER FEATHER REED GRASS	#3 CONT.	
DLY	54	36	-	-	HEMEROCALLIS 'HAPPY RETURNS'	HAPPY RETURNS DAYLILY	#I CONT.	
						+		

NEON SEDUM

PATRIOT HOSTA

<u> SED-3</u>

plant material list

YEWS TO BE ALLOWED TO 'KNIT' TOGETHER AS A

HEDGE, MAINTAIN HEIGHT AT

#1 CONT.

#I CONT.

UNIT PATIO -

<u> 10-1</u>

RA-1

YEWS TO BE

YEWS TO BE

ALLOWED TO 'KNIT'

TOGETHER AS A

HEDGE, MAINTAIN

HEIGHT AT 30"

ALLOWED TO 'KNIT'

BOXWOOD TO BE ALLOWED

HEDGE, MAINTAIN HEIGHT AT

UNIT PATIO -

HOS-3

VC-2

TO 'KNIT' TOGETHER AS A

TOGETHER AS A HEDGE. MAINTAIN HEIGHT AT 30"

<u>YC-1</u>

<u> HOS-3</u>

<u> TO-1</u>

6-unit building

RA-6

DLY-3

building foundation planting details| SCALE: |"=20'-0" (4-CONDITIONS)

SEDUM X. 'NEON'

HOSTA 'PATRIOT'

48

24

HOS 54

(9-CONDITIONS)

SK-1

5-unit building

<u>SED-3</u> ₩

5A) building foundation planting details

SCALE: | "=20'-0"


SED-3

TO-1

TO-1

LV-2

<u>HA-3</u>

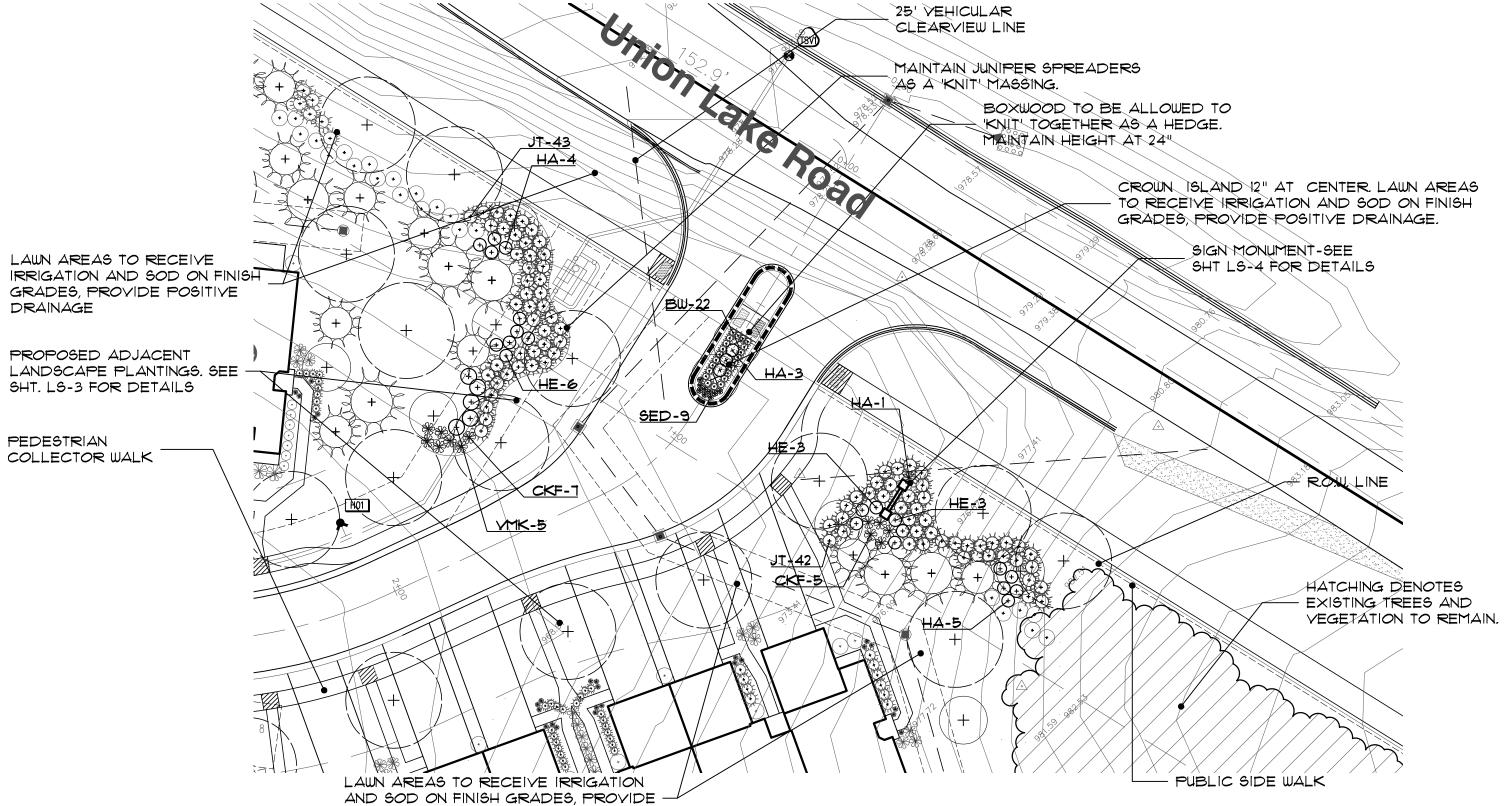

HATCHING DENOTES EXISTING TREES

tion pond

CS-15

detention pond landscape planting details

AND VEGETATION TO REMAIN.

LANDSCAPE PLANTINGS. SEE SHT.

PROPOSED ADJACENT

LS-3 FOR DETAILS

POSITIVE DRAINAGE (5D) entry landscape planting details SCALE: |"=30'-0"

TREES SHALL BE LOCATED A MINIMUM 6' FROM ALL WATER MAIN, SANITARY, AND STROM SEWER. NO TREES TO BE PLANTED IN DRAINAGE SWALE





JMF WHITE LAKE, LLC.

1700 W. BIG BEAVER ROAD SUITE 120 TROY, MI 48084

WEST VALLEY

project location: White Lake Twp., Michigan

Union Lake Road sheet title:

IRRIGATION PLAN

job no./issue/revision date: LS24.032.02 UPDATES 2-7-2024 LS24.032.05 UPDATES 5-29-2024

JP, DK, PH

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2-15-2024

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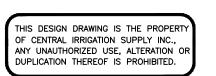


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project no:

LS24.032.02

sheet no:



Item A.

FELINO A. PASCUAL and ASSOCIATES Community Land Planner and registered Landscape Architect 24333 Orchard Lake Rd, Suite G Farmington Hills, MI 48336 ph. (248) 557-5588 fax. (248) 557-5416

seal:

<u>QTY</u>

104

42

44

163

34

41

24

<u>QTY</u>

100

174

<u>QTY</u>

10

15

<u>QTY</u>

33

62.5 l.f.

18,377 l.f.

797.5 l.f.

3,256 l.f.

140.2 l.f.

1,256 l.f.

32.9 l.f.

16,126 l.f.

JMF WHITE LAKE, LLC.

1700 W. BIG BEAVER ROAD SUITE 120 TROY, MI 48084

project: **WEST**

VALLEY

project location:

White Lake Twp.,

Michigan Union Lake Road

IRRIGATION PLAN

sheet title:

job no./issue/revision date:

LS24.032.02 UPDATES 2-7-2024 LS24.032.05 UPDATES 5-29-2024

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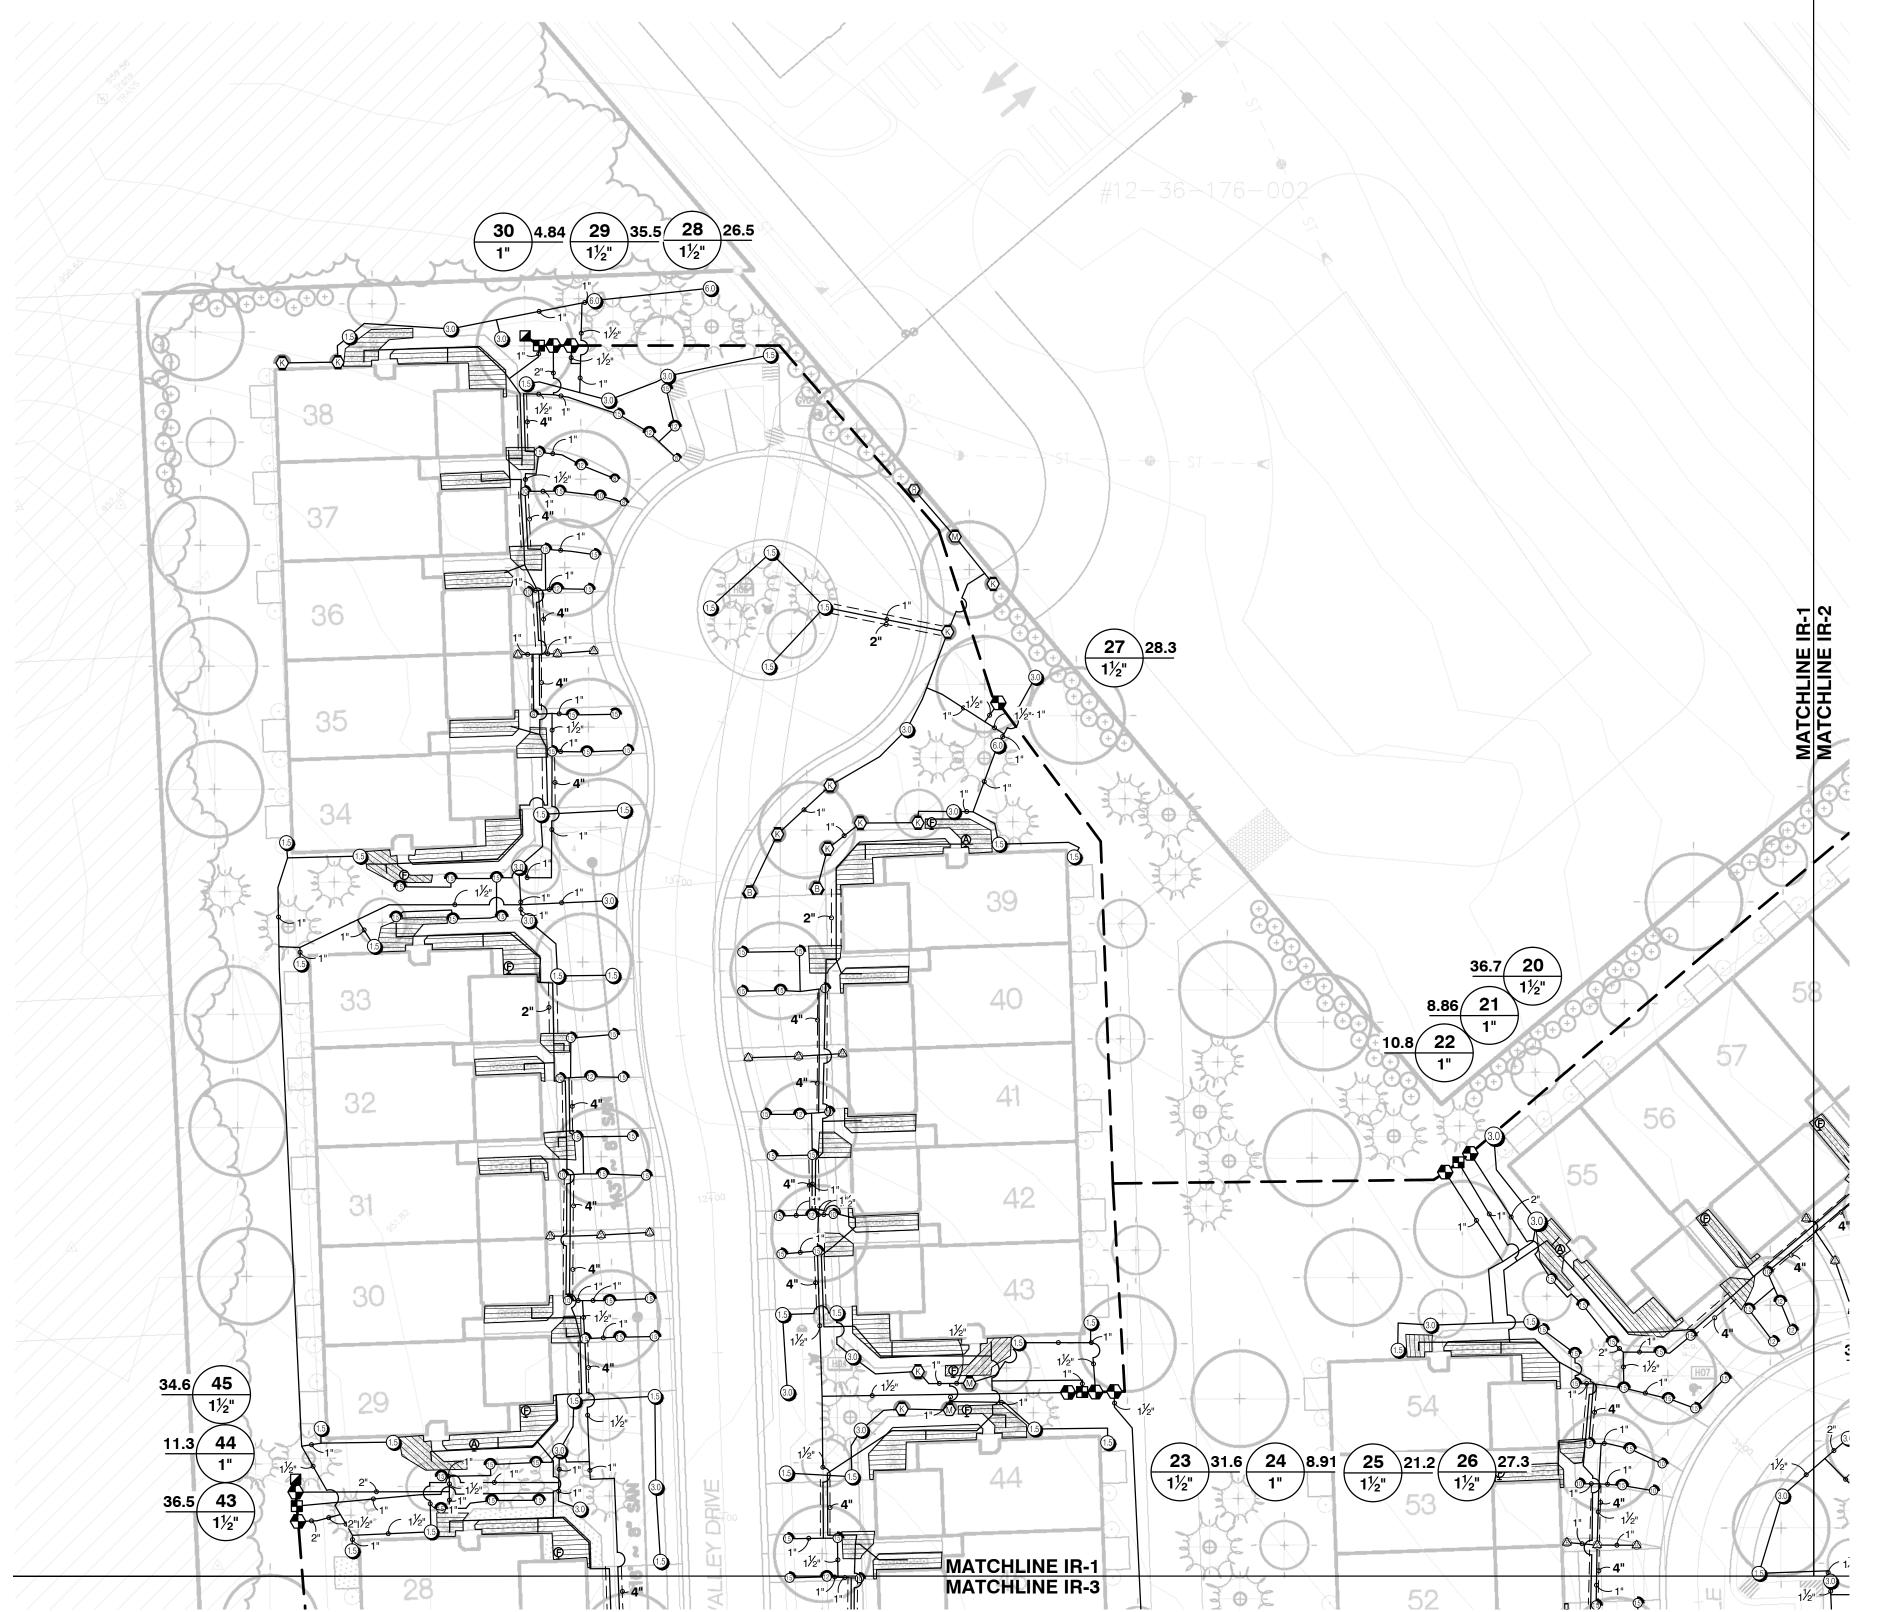
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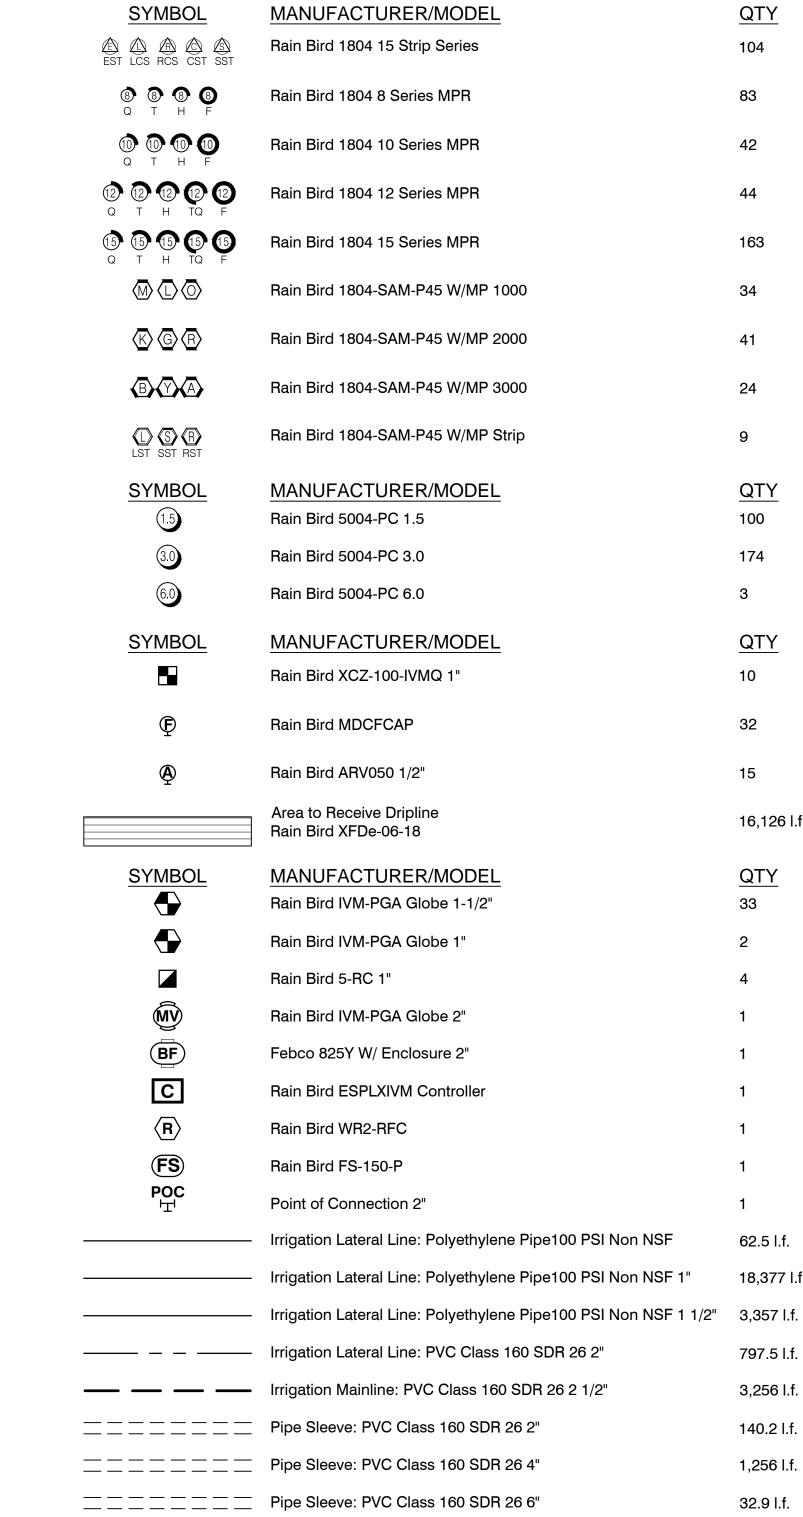
project no:

LS24.032.02

sheet no:







Valve Callout


Valve Number

IRRIGATION SCHEDULE

SYMBOL

PRIGATION PLAN

SCALE: | "=30'-0"

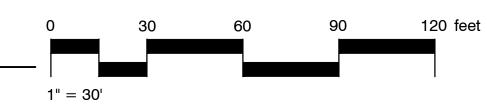



seal:

fax. (248) 557-5416

JMF WHITE LAKE, LLC.

1700 W. BIG BEAVER ROAD SUITE 120 TROY, MI 48084

project: **WEST VALLEY**

project location: White Lake Twp.,

Union Lake Road sheet title:

Michigan

IRRIGATION PLAN

job no./issue/revision date: LS24.032.02 UPDATES 2-7-2024

LS24.032.05 UPDATES 5-29-2024

JP, DK, PH checked by:

2-15-2024 notice:

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underground utilities as shown on this drawing are only approximate. no guarantee is either expressed or implied as to the completeness of accuracy. contractor shall be exclusively responsible for determining the exact location and elevation prior to the start

project no:

of construction

LS24.032.02

sheet no:



<u>QTY</u> EST LCS RCS CST SST Rain Bird 1804 15 Strip Series 104 8 8 8 8 83 Rain Bird 1804 8 Series MPR Rain Bird 1804 10 Series MPR 42 Rain Bird 1804 12 Series MPR 44 (5) (5) (5) (5) Rain Bird 1804 15 Series MPR 163 \bigcirc Rain Bird 1804-SAM-P45 W/MP 1000 34 $\langle K \rangle \langle \overline{G} \rangle \langle \overline{R} \rangle$ Rain Bird 1804-SAM-P45 W/MP 2000 41 $\overline{\mathbb{B}}\overline{\mathbb{Y}}\overline{\mathbb{A}}$ Rain Bird 1804-SAM-P45 W/MP 3000 24 LST SST RST Rain Bird 1804-SAM-P45 W/MP Strip **SYMBOL** <u>QTY</u> MANUFACTURER/MODEL 100 Rain Bird 5004-PC 1.5 Rain Bird 5004-PC 3.0 174 Rain Bird 5004-PC 6.0 3 SYMBOL <u>QTY</u> MANUFACTURER/MODEL 10 Rain Bird XCZ-100-IVMQ 1" Rain Bird MDCFCAP Rain Bird ARV050 1/2" Area to Receive Dripline 16,126 l.f. Rain Bird XFDe-06-18 SYMBOL MANUFACTURER/MODEL **QTY** Rain Bird IVM-PGA Globe 1-1/2" Rain Bird IVM-PGA Globe 1" Rain Bird 5-RC 1" Rain Bird IVM-PGA Globe 2" BF Febco 825Y W/ Enclosure 2" Rain Bird ESPLXIVM Controller Rain Bird WR2-RFC Rain Bird FS-150-P POC Point of Connection 2" Irrigation Lateral Line: Polyethylene Pipe100 PSI Non NSF 62.5 l.f. Irrigation Lateral Line: Polyethylene Pipe100 PSI Non NSF 1" 18,377 l.f. Irrigation Lateral Line: Polyethylene Pipe100 PSI Non NSF 1 1/2" 3,357 I.f. ——— — Irrigation Lateral Line: PVC Class 160 SDR 26 2" 797.5 l.f. --- Irrigation Mainline: PVC Class 160 SDR 26 2 1/2" 3,256 l.f. ______ Pipe Sleeve: PVC Class 160 SDR 26 2" 140.2 l.f. ______ Pipe Sleeve: PVC Class 160 SDR 26 4" 1,256 l.f. ______ Pipe Sleeve: PVC Class 160 SDR 26 6" 32.9 l.f. Valve Callout

MANUFACTURER/MODEL

SYMBOL

120 feet PARIGATION PLAN

SCALE: I"=30'-0" 1" = 30'

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CENTRAL

TURF & IRRIGATION SUPPLY



seal:

JMF WHITE LAKE, LLC.

1700 W. BIG BEAVER ROAD SUITE 120 TROY, MI 48084

project: **WEST VALLEY**

project location: White Lake Twp., Michigan

Union Lake Road

sheet title:

IRRIGATION PLAN

job no./issue/revision date: LS24.032.02 UPDATES 2-7-2024

LS24.032.05 UPDATES 5-29-2024

JP, DK, PH checked by:

date: 2-15-2024

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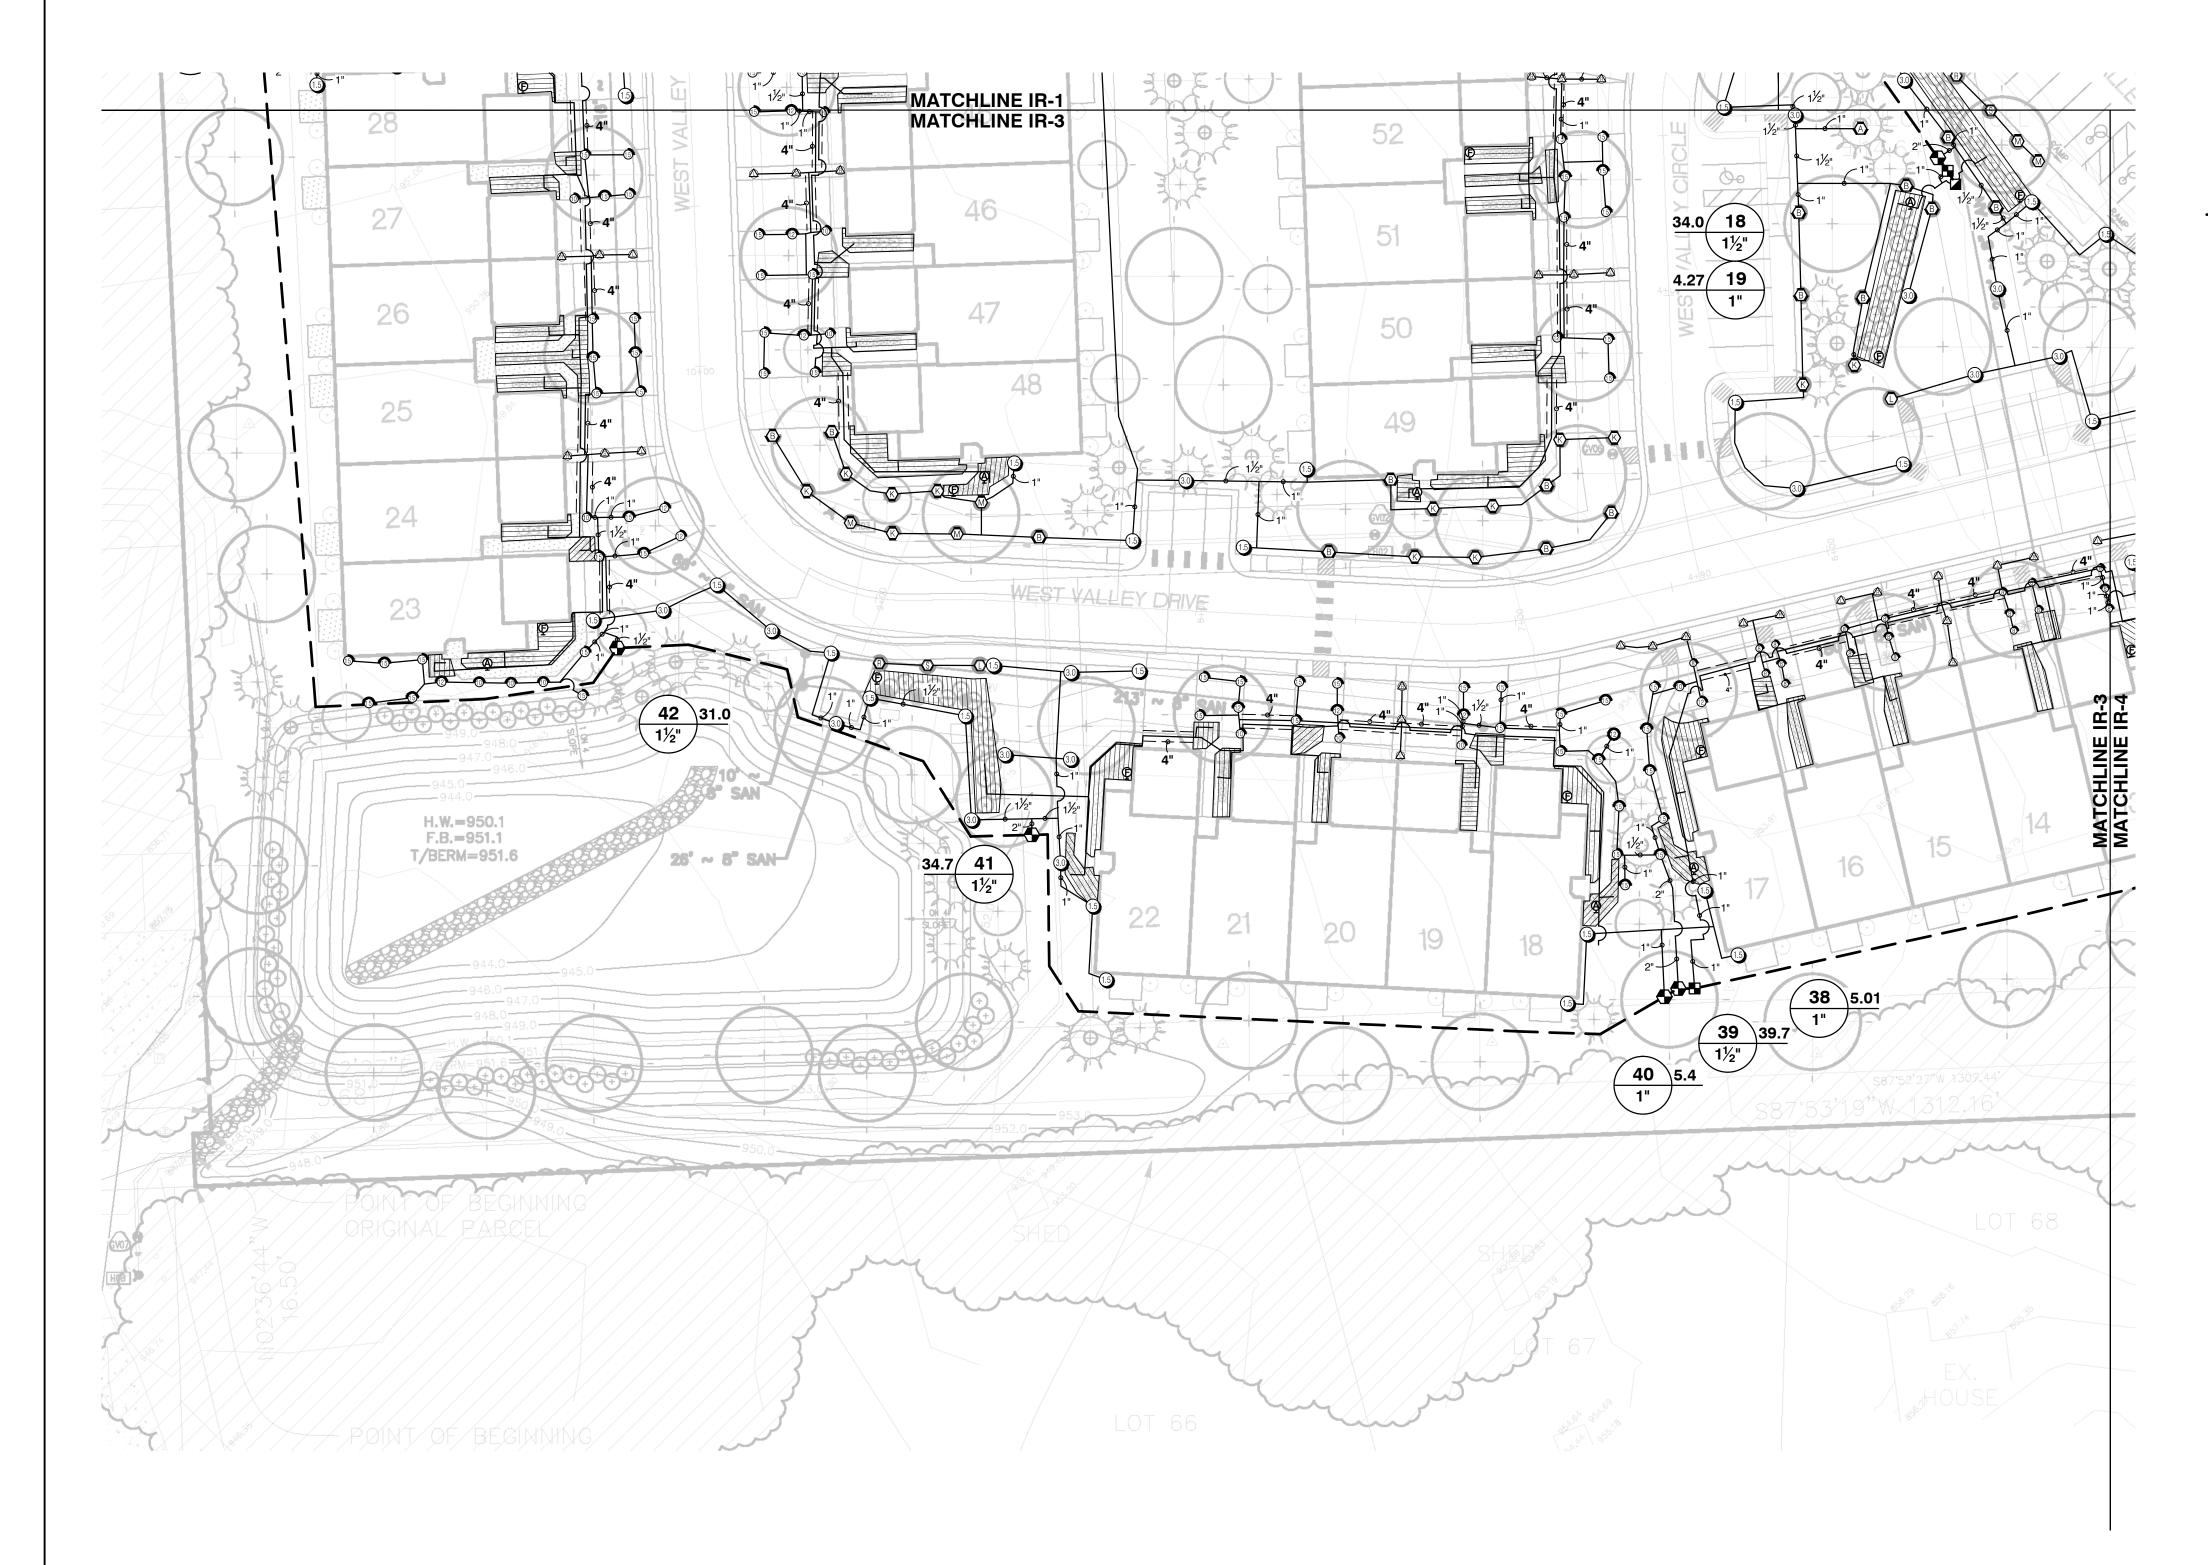


The location and elevations of existing underground utilities as shown on this drawing are only approximate. no guarantee is either expressed or implied as to the completeness of accuracy. contractor shall be exclusively responsible for determining the exact location and elevation prior to the start of construction

project no:

LS24.032.02

sheet no:



IRRIGATION SCHEDULE <u>QTY</u> SYMBOL MANUFACTURER/MODEL EST LCS RCS CST SST Rain Bird 1804 15 Strip Series 104 Rain Bird 1804 8 Series MPR Rain Bird 1804 10 Series MPR Rain Bird 1804 12 Series MPR Rain Bird 1804 15 Series MPR Rain Bird 1804-SAM-P45 W/MP 1000 Rain Bird 1804-SAM-P45 W/MP 2000 BYA Rain Bird 1804-SAM-P45 W/MP 3000 LST SST RST Rain Bird 1804-SAM-P45 W/MP Strip **SYMBOL** <u>QTY</u> MANUFACTURER/MODEL 1.5 100 Rain Bird 5004-PC 1.5 Rain Bird 5004-PC 3.0 174 6.0 Rain Bird 5004-PC 6.0 **SYMBOL** QTY MANUFACTURER/MODEL Rain Bird XCZ-100-IVMQ 1" Rain Bird MDCFCAP Rain Bird ARV050 1/2" Area to Receive Dripline 16,126 l.f. Rain Bird XFDe-06-18 QTY SYMBOL MANUFACTURER/MODEL Rain Bird IVM-PGA Globe 1-1/2" Rain Bird IVM-PGA Globe 1" Rain Bird 5-RC 1"

Rain Bird IVM-PGA Globe 2" BF Febco 825Y W/ Enclosure 2" Rain Bird ESPLXIVM Controller Rain Bird WR2-RFC Rain Bird FS-150-P Point of Connection 2" Irrigation Lateral Line: Polyethylene Pipe100 PSI Non NSF 62.5 l.f. Irrigation Lateral Line: Polyethylene Pipe100 PSI Non NSF 1" 18,377 l.f. Irrigation Lateral Line: Polyethylene Pipe100 PSI Non NSF 1 1/2" 3,357 I.f.

——— — Irrigation Lateral Line: PVC Class 160 SDR 26 2"

---- Irrigation Mainline: PVC Class 160 SDR 26 2 1/2"

______ Pipe Sleeve: PVC Class 160 SDR 26 4"

______ Pipe Sleeve: PVC Class 160 SDR 26 6"

Valve Callout

120 feet PARIGATION PLAN

SCALE: I"=30'-0" 1" = 30'

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797.5 l.f.

3,256 l.f.

140.2 l.f.

1,256 l.f.

32.9 l.f.



seal·

chent:

JMF WHITE LAKE, LLC.

1700 W. BIG BEAVER ROAD SUITE 120 TROY, MI 48084

project:
WEST
VALLEY

project location:
White Lake Twp.,
Michigan

Union Lake Road sheet title:

IRRIGATION PLAN

job no./issue/revision date:

LS24.032.02 COMMENTS 2-7-2024 LS24.032.05 UPDATES 5-29-2024

drawn by: **JP, DK, PH**

checked by:

da

2-15-2024

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3 WORKING DAYS
BEFORE YOU DI

CALL MISS DIG

1-800-482-71

For free location of public utility lines

The location and elevations of existing underground utilities as shown on this

The location and elevations of existing underground utilities as shown on this drawing are only approximate. no guarantee is either expressed or implied as to the completeness of accuracy, contractor shall be exclusively responsible for determining the exact location and elevation prior to the start of construction


project no:

LS24.032.02

sheet no:

2R-5 of 6



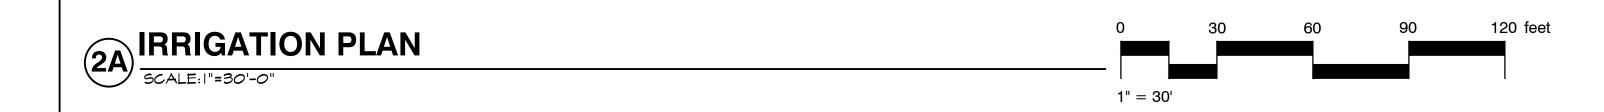



Item A.

ph. (248) 557-5588

fax. (248) 557-5416

1700 W. BIG BEAVER ROAD SUITE 120 TROY, MI 48084

project: **WEST VALLEY**

project location: White Lake Twp. Michigan

Union Lake Road sheet title:

IRRIGATION NOTES & DETAILS

job no./issue/revision date: LS24.032.02 COMMENTS 2-7-2024

LS24.032.05 UPDATES 5-29-2024

JP, DK, PH checked by:

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> 3 WORKING DAYS BEFORE YOU DIG CALL MISS DIG


___^1-800-482-7171 For free location of public utility lines The location and elevations of existing underground utilities as shown on this is either expressed or implied as to the

completeness of accuracy, contractor shall be exclusively responsible for determining the exact location and elevation prior to the start of construction

project no: LS24.032.02


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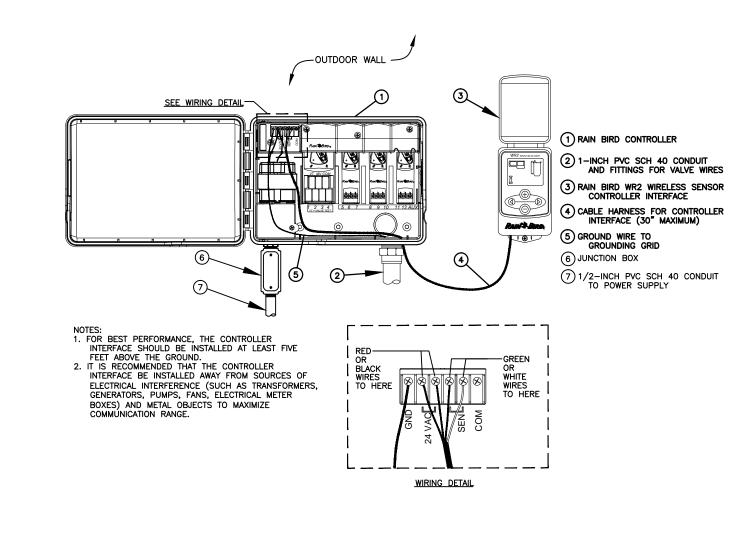


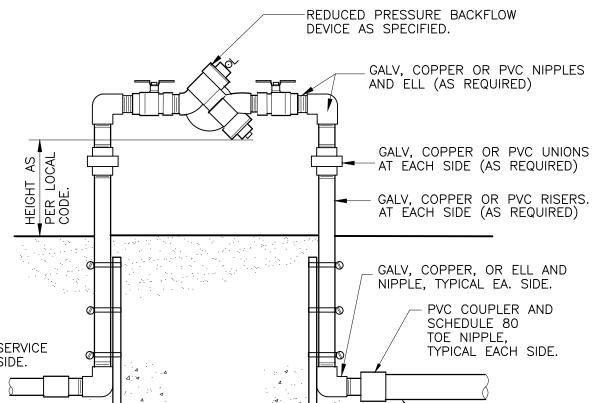

SERVICE SIDE. MAIN LINE, SIZE AS PER PLANS. CONCRETE OR REBAR (AS REQUIRED)

INSTALLATION MAY DIFFER PER LOCAL CODE



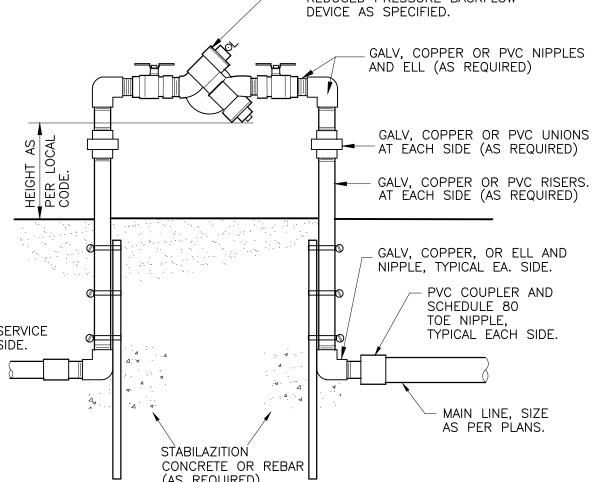

1804 SPRAY W/ MP ROTATOR NOZZLE DETAIL-FILE 5004 ROTOR HEAD WITH SWING PIPE

S1-RO-RAI-01

REDUCED PRESSURE BACKFLOW DEVICE STANDARD S1-BA-01

FINISHED GRADE.

SPECIFIED.

(1) TWO-WIRE CONTROLLER:

(2) JUNCTION BOX


- QUICK COUPLING VALVE AS

IRRIGATION SPECIFICATIONS

IRRIGATION SYSTEM DESIGN BASED ON 40 GPM AT 65 PSI.

WR2 WIRELESS RAIN SENSOR

- 2. IRRIGATION DESIGN IS FROM THE POINT OF CONNECTION(POC)ONLY. THE DESIGN IS BASED ON GALLONS PER MINUTE(GPM)AND POUNDS PER SQUARE INCH(PSI)FURNISHED BY OTHERS.
- 3. IRRIGATION CONTRACTOR IS TO VERIFY POINT OF CONNECTION IN THE FIELD. INSTALLER IS TO CONFIRM THE MINIMUM DISCHARGE REQUIREMENTS OF THE POINT OF CONNECTION AS INDICATED ON THE LEGEND PRIOR TO INSTALLATION.
- 4. THE PRESSURE REQUIREMENT AT THE POINT OF CONNECTION IS BASED ON NO MORE THAN 5 FEET OF ELEVATION CHANGE IN THE AREAS OF IRRIGATION.
- 5. ALL PRODUCTS SHALL BE INSTALLED IN ACCORDANCE WITH THE MANUFACTURER'S RECOMMENDATIONS AND ACCORDING TO LOCAL BUILDING, ELECTRICAL, AND PLUMBING CODES.
- 6. IRRIGATION CONTRACTOR WILL ARRANGE INSPECTIONS REQUIRED BY LOCAL AGENCIES AND ORDINANCES DURING THE COURSE OF CONSTRUCTION AS REQUIRED. ALL WIRING TO BE PER LOCAL CODE. BACKFLOW PREVENTION TO BE PER LOCAL CODE.
- 7. LOCATION OF IRRIGATION COMPONENTS SHOWN ON DRAWING IS APPROXIMATE. ACTUAL PLACEMENT MAY VARY SLIGHTLY AS REQUIRED TO ACHIEVE FULL, EVEN COVERAGE.
- 8. ALL SPRINKLER HEADS SHALL BE INSTALLED PERPENDICULAR TO FINISH GRADES. EXCEPT AS OTHERWISE INDICATED.
- 9. INSTALL IRRIGATION MAINS WITH A MINIMUM 18" OF COVER BASED ON FINISH GRADES. INSTALL IRRIGATION LATERALS WITH MINIMUM 12" OF COVER BASED ON FINISH GRADES.
- 10. PIPE LOCATIONS ARE DIAGRAMMATIC. VALVES AND MAINLINE SHOWN IN PAVED AREAS ARE FOR GRAPHIC CLARITY ONLY.
- 11. THE IRRIGATION CONTRACTOR SHALL COMPLY WITH PIPE SIZES AS
- 12. ALL WIRE SPLICES OR CONNECTIONS SHALL BE MADE WITH APPROVED WATERPROOF WIRE CONNECTIONS AND BE IN A VALVE OR SPLICE BOX.
- 13. ALL CONTROL WIRING DOWNSTREAM OF THE CONTROLLER IS TO BE 2 WIRE, UL APPROVED DIRECT BURY.
- 14. THE DESIGN IS BASED ON THE SITE INFORMATION AND/OR DRAWING SUPPLIED WITH THE DESIGN CRITERIA BEING SET(AREA TO BE IRRIGATED, EQUIPMENT MANUFACTURER AND MODEL TO BE USED, WATER SOURCE INFORMATION, ELECTRICAL POWER AVAILABILITY, ETC...). SITEONE LANDSCAPE SUPPLY BEARS NO RESPONSIBILITY OR LIABILITY FOR ANY ERRORS IN DESIGN OR INSTALLATION THAT ARISE DUE TO INACCURACIES IN THE ABOVE REFERENCED INFORMATION SUPPLIED TO SITEONE LANDSCAPE SUPPLY LANDSCAPES IN RELATION TO THIS PROJECT, UNLESS OTHERWISE NOTED.

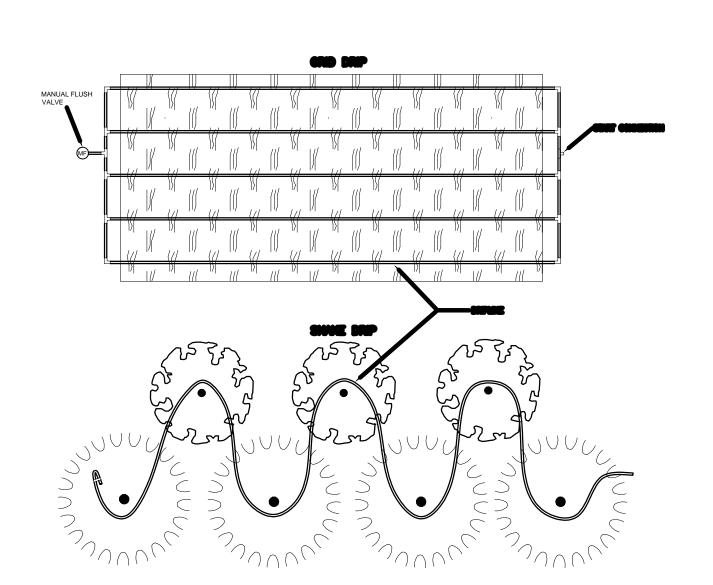

TYPICAL DRIP TUBING LAYOUT


FINISH GRADE

SWING PIPE


LATERAL PIPE


MODEL MPR40-06-CV

LATERAL TEE OR ELL

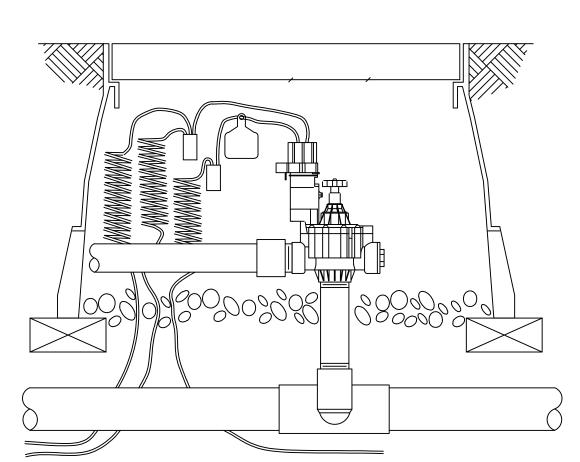


RAIN BIRD IVM-PGA VALVE

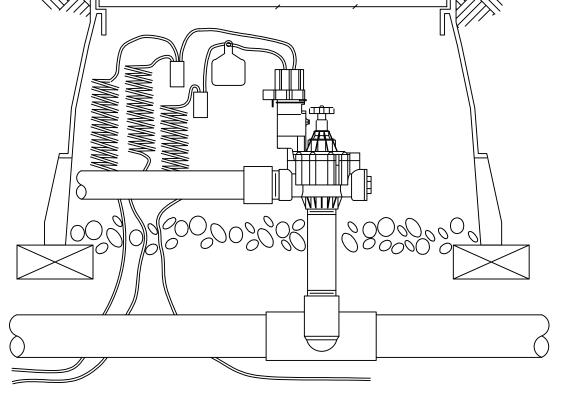


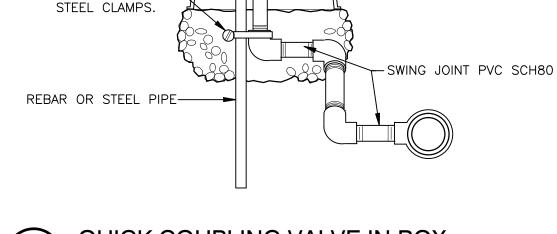

TWO STAINLESS

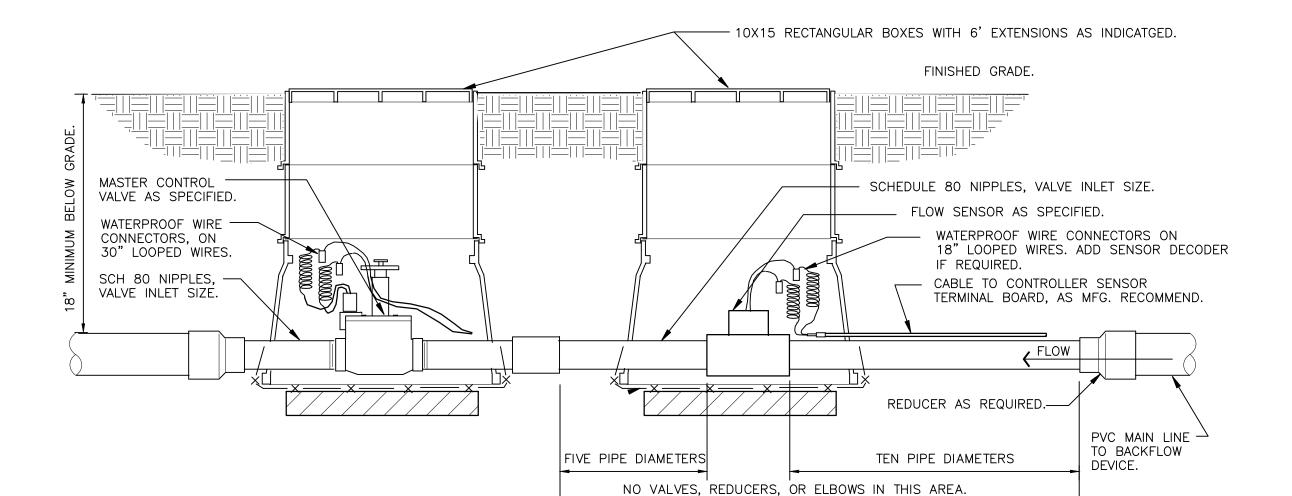

6

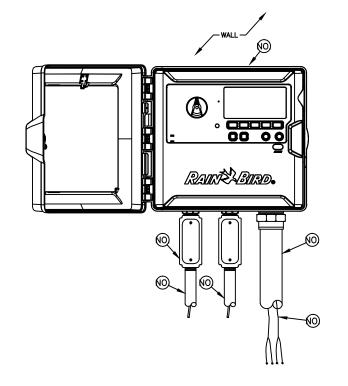

(5) MAXICABLE TWO—WIRE PATH TO FIELD DEVICES USE A DIFFERENT CABLE JACKET COLOR FOR EACH PATH. (6) 1-INCH CONDUIT AND FITTINGS FOR GROUND WIRE. ONLY FOR OUTDOOR INSTALLATIONS. WITH 60 STATIONS AND THE LMIVM—PRO WITH 240 STATIONS.

REFER TO THE CHART BELOW FOR DIFFERENCES BETWEEN THE REFER TO THE CHART BELOW FOR DIFFERENCES BETWEEN THE TWO MODELS.

2. USE STEEL CONDUIT FOR ABOVE GRADE AND SCH 40 PVC CONDUIT FOR BELOW GRADE CONDITIONS.

3. PROVIDE PROPER GROUNDING COMPONENTS TO ACHIEVE GROUND RESISTANCE OF 10 OHMS OR LESS. IF CONTROLLER IS MOUNTED INDOORS, USE POWER SUPPLY GROUND. KEY SPECIFICATIONS FEATURE |

RAIN BIRD ESP-LXIVM IN PLASTIC CABINET WITH WALL MOUNT. INSTALL CONTROLLER AND CABINET ON WALL PER

(3) 1-INCH CONDUIT AND FITTINGS FOR POWER SUPPLY WIRE (4) 2-INCH CONDUIT AND FITTINGS FOR TWO-WIRE CABLE

MANUFACTURER'S RECOMMENDATIONS.

S1-QU-01

ESP-LXIVM TWO-WIRE CONTROLLER IN PLASTIC CABINET


IASTER VALVE/FLOW SENSOR ASSEMBLY

S1-MI-03

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CENTSAL

TURF & IRRIGATION SUPPLY

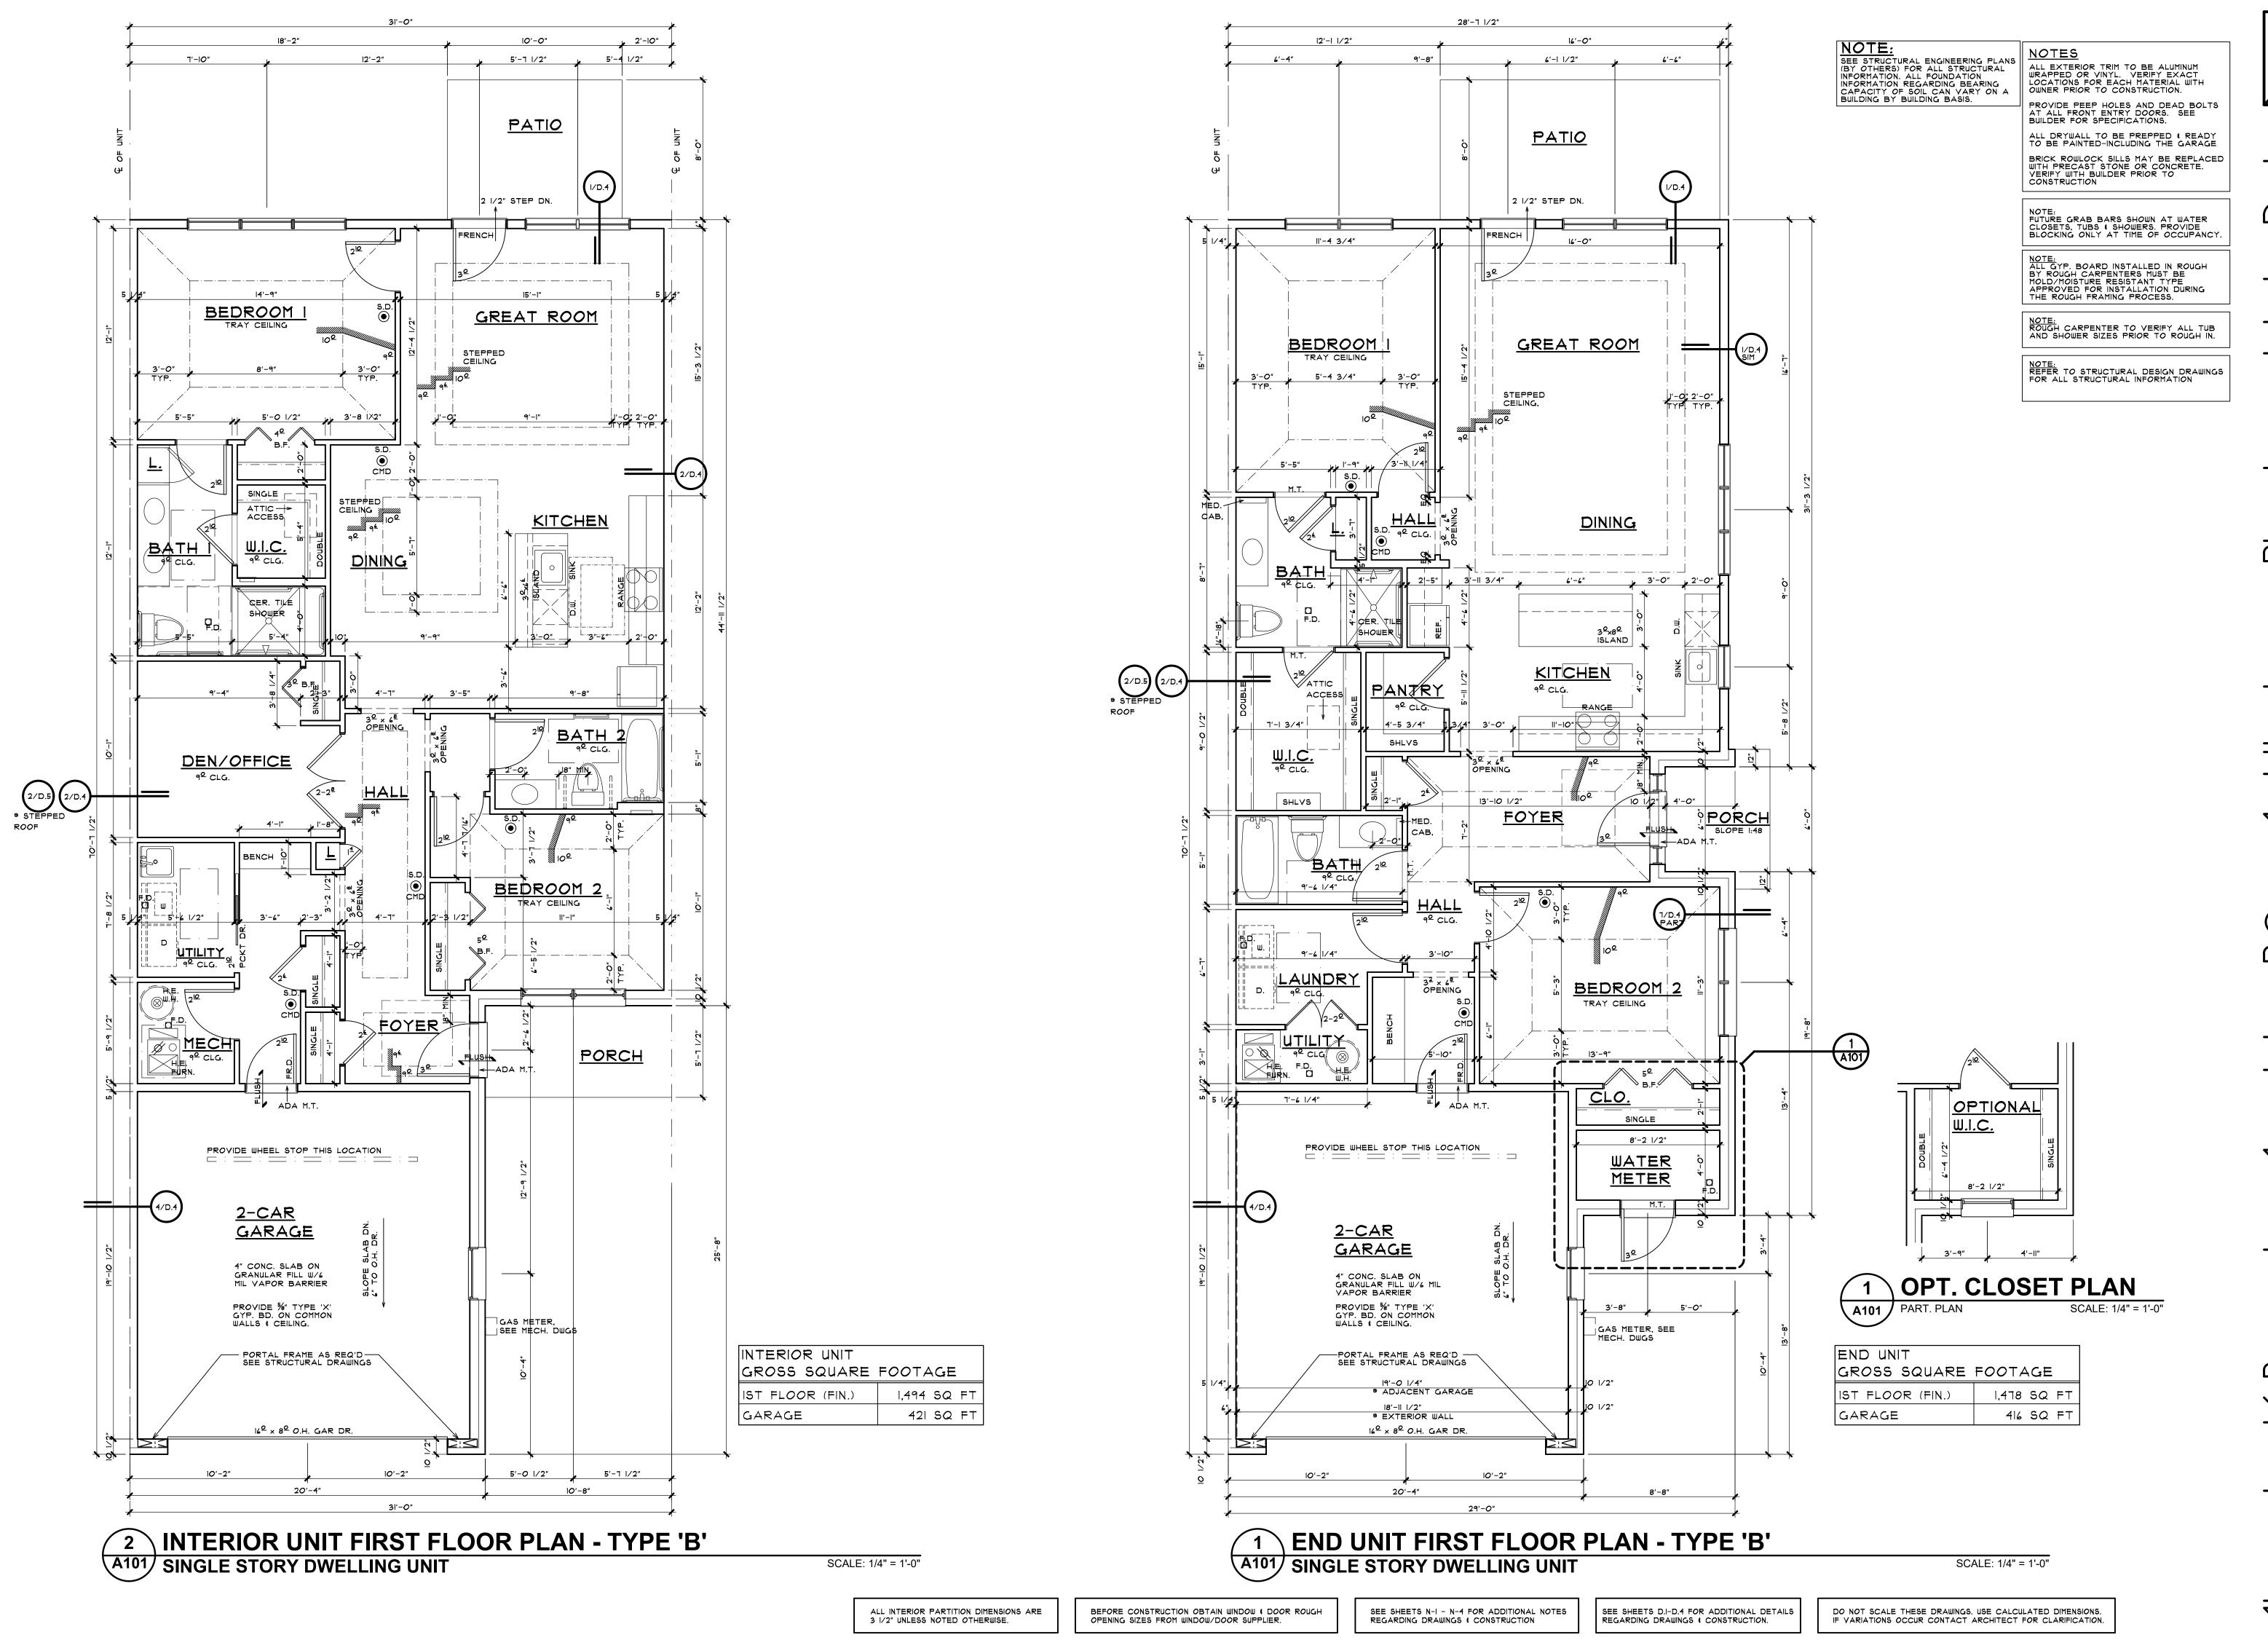

Sign T VALLEY BIDS \Box 8140

베를 OGAERTS + ASSOC. ■ PRELIMINARY

08-19-19

06-15-21 ☐ CONSTRUCTION

REVISIONS 22-10-18 OWNER

DRAWN BY MS / DA

AD FILENAME -UNITPLANS.DW0 DB NUMBER 💳

HEET NUMBER ---



S:\CURRENT\1client\Furnari\WHITE LAKE\WEST \ALLEY\04 DRAWINGS\8140 ELEV.dwg, 2/6/


ALL INTERIOR PARTITION DIMENSIONS ARE 3 1/2" UNLESS NOTED OTHERWISE.

BEFORE CONSTRUCTION OBTAIN WINDOW & DOOR ROUGH OPENING SIZES FROM WINDOW/DOOR SUPPLIER.

SEE SHEETS N-1 - N-4 FOR ADDITIONAL DETAILS REGARDING DRAWINGS & CONSTRUCTION


SEE SHEETS D.I-D.4 FOR ADDITIONAL NOTES REGARDING DRAWINGS & CONSTRUCTION.

DO NOT SCALE THESE DRAWINGS, USE CALCULATED DIMENSIONS.
IF VARIATIONS OCCUR CONTACT ARCHITECT FOR CLARIFICATION.

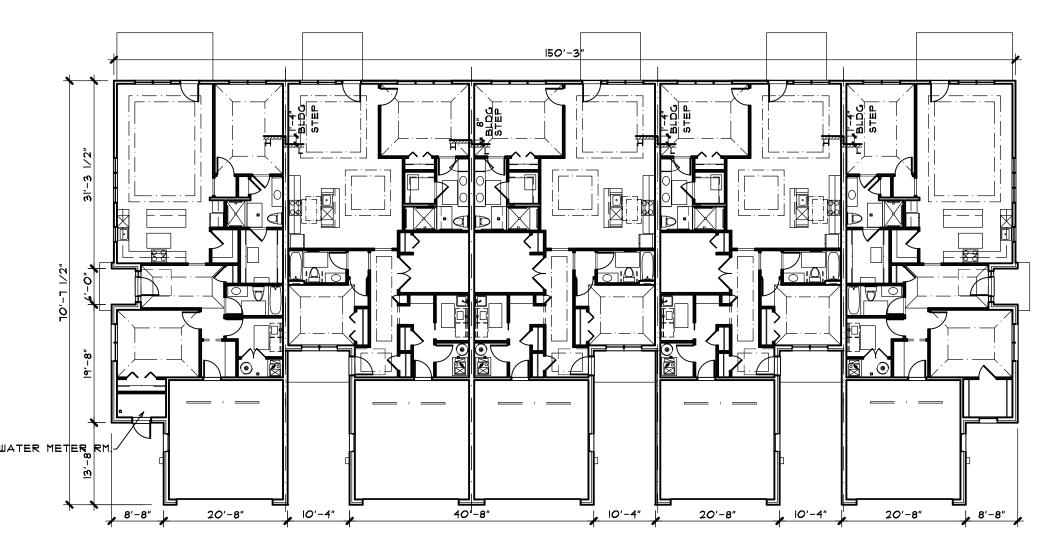


6 BUILDING C (UNIT 13-17) - FIRST FLOOR PLAN
A200 SINGLE STORY DWELLING UNIT

SCALE: 1/16" = 1'-0"

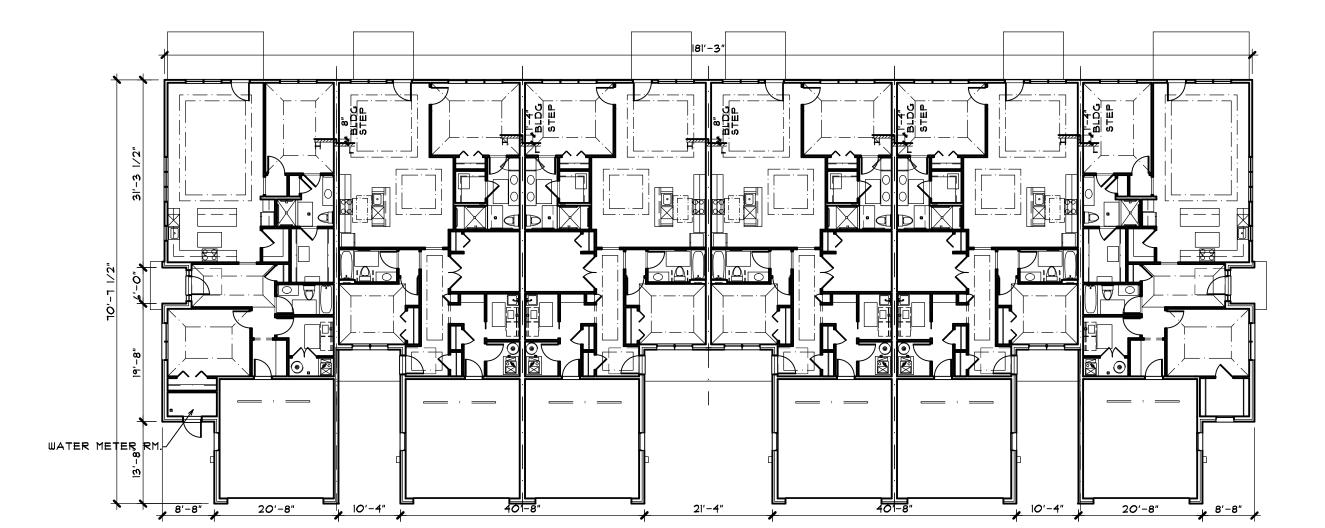


4 BUILDING B (UNIT 7-12) - FIRST FLOOR PLAN
A200 SINGLE STORY DWELLING UNIT

SCALE: 1/16" = 1'-0"

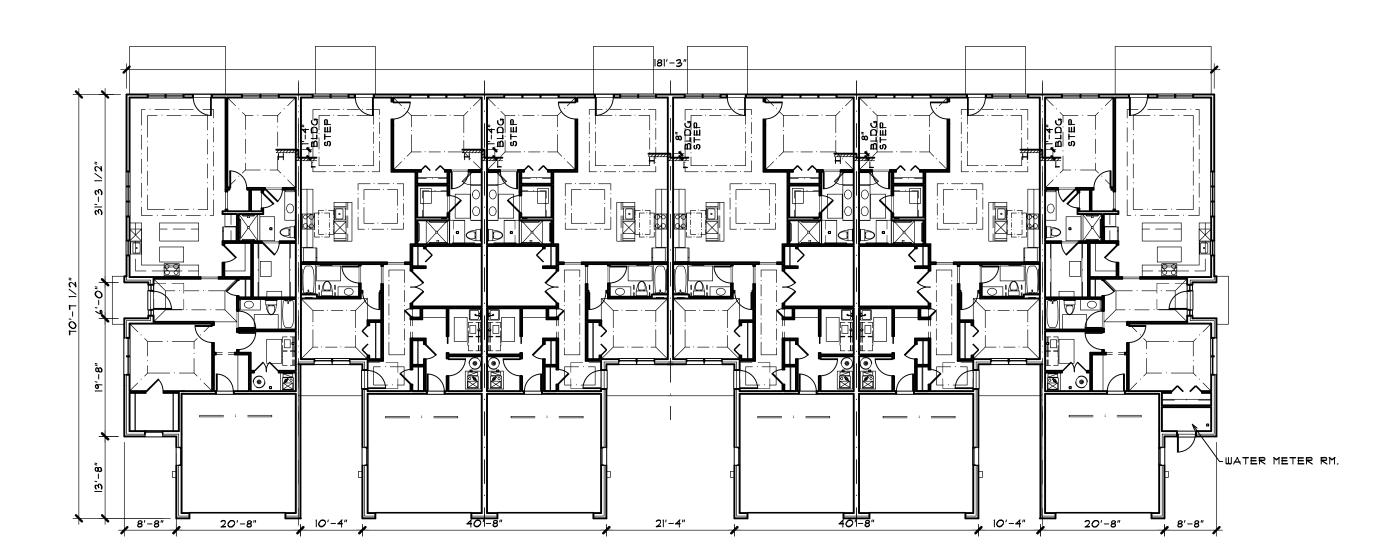


2 BUILDING A (UNIT 1-6) - FIRST FLOOR PLAN
A200 SINGLE STORY DWELLING UNIT

SCALE: 1/16" = 1'-0"

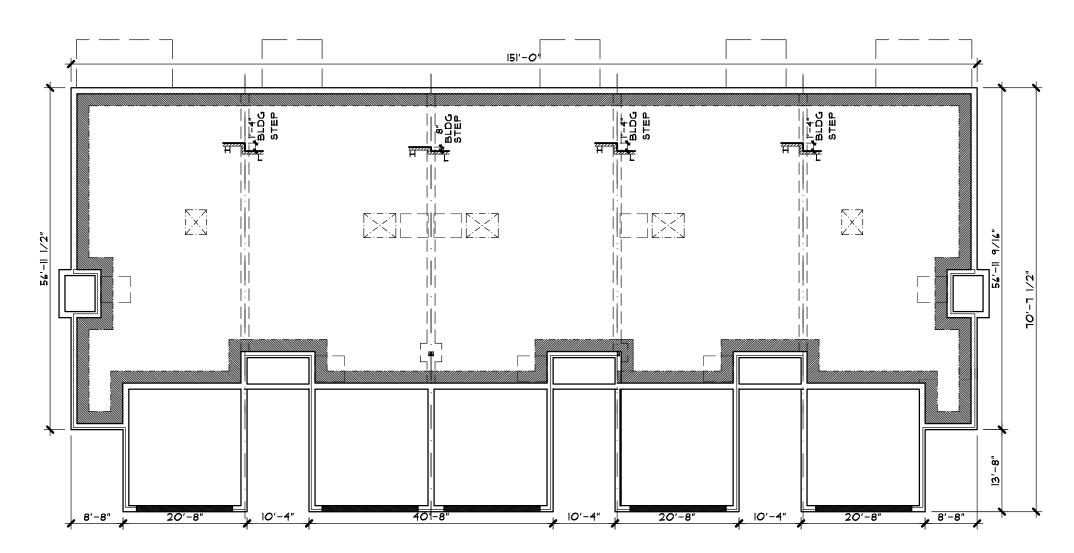


5 BUILDING C (UNIT 13-17) - FOUNDATION PLAN
A200 SINGLE STORY DWELLING UNIT

SCALE: 1/16" = 1'-0"

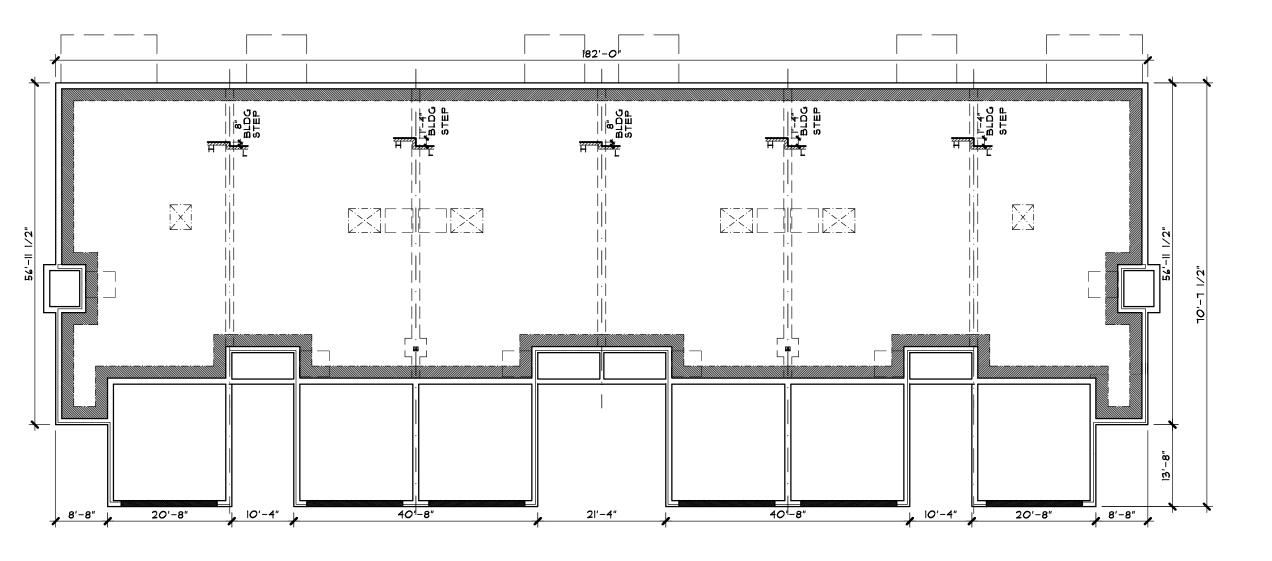

3 BUILDING B (UNIT 7-12) - FOUNDATION PLAN (A200) SINGLE STORY DWELLING UNIT

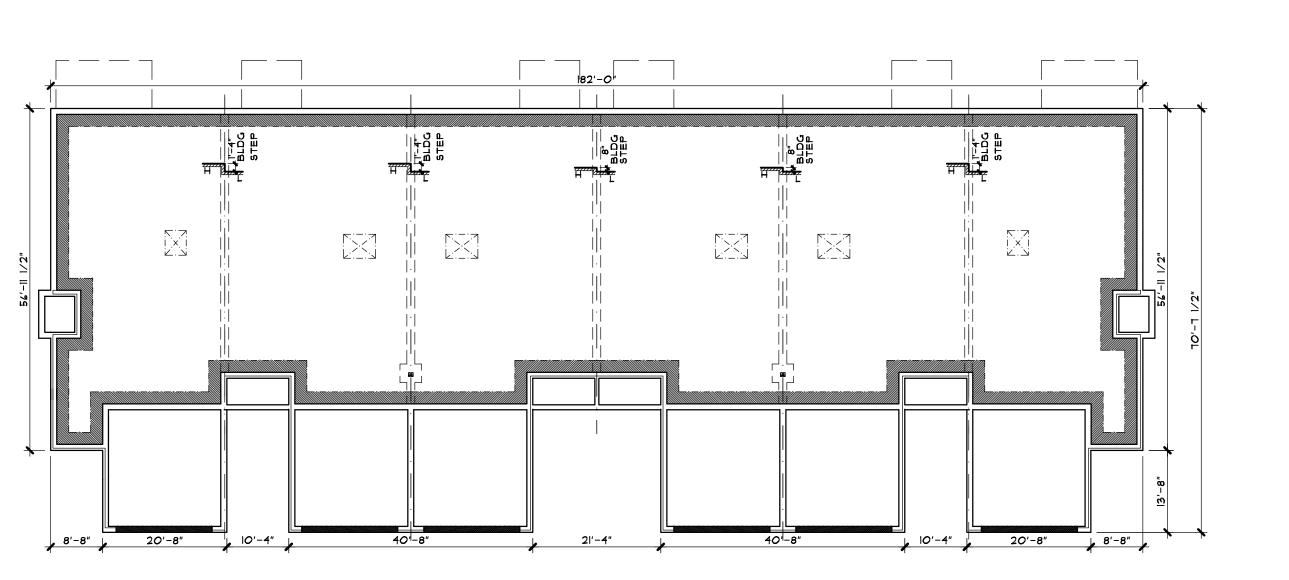

1 BUILDING A (UNIT 1-6) - FOUNDATION PLAN
A200 SINGLE STORY DWELLING UNIT

SCALE: 1/16" = 1'-0"

SEE SHEETS N-I - N-4 FOR ADDITIONAL NOTES REGARDING DRAWINGS & CONSTRUCTION

SEE SHEETS D.I-D.4 FOR ADDITIONAL DETAILS REGARDING DRAWINGS & CONSTRUCTION.

DO NOT SCALE THESE DRAWINGS. USE CALCULATED DIMENSIONS.

BUILDING \Box

NOTE:

REFER TO 1/4" SCALE UNIT PLANS FOR ALL NOTES, DIMENSIONS, DETAILS AND ALL ADDITIONAL INFORMATION NOT

SEE STRUCTURAL ENGINEERING PLANS (BY OTHERS) FOR ALL STRUCTURAL

REFER TO CIVIL ENGINEERING PLANS

INFORMATION ON BUILDING STEPS AND

ROOM LOCATION W/CIVIL PRIOR

INFORMATION. ALL FOUNDATION INFORMATION REGARDING BEARING CAPACITY OF SOIL CAN VARY ON A

BUILDING BY BUILDING BASIS.

(BY OTHERS) FOR ADDITIONAL

NOTE: CONFIRM WATER METER

TO CONSTRUCTION.

GRADING.

빌뒫 OGAERTS + ASSOC

■ PRELIMINARY 08-19-19

□ CONSTRUCTION

REVISIONS 22-10-18 OWNER


MS / DA UNITPLANS.DW0


DB NUMBER 🗖

ALL INTERIOR PARTITION DIMENSIONS ARE 3 1/2" UNLESS NOTED OTHERWISE.

BEFORE CONSTRUCTION OBTAIN WINDOW & DOOR ROUGH OPENING SIZES FROM WINDOW/DOOR SUPPLIER.

IF VARIATIONS OCCUR CONTACT ARCHITECT FOR CLARIFICATION.

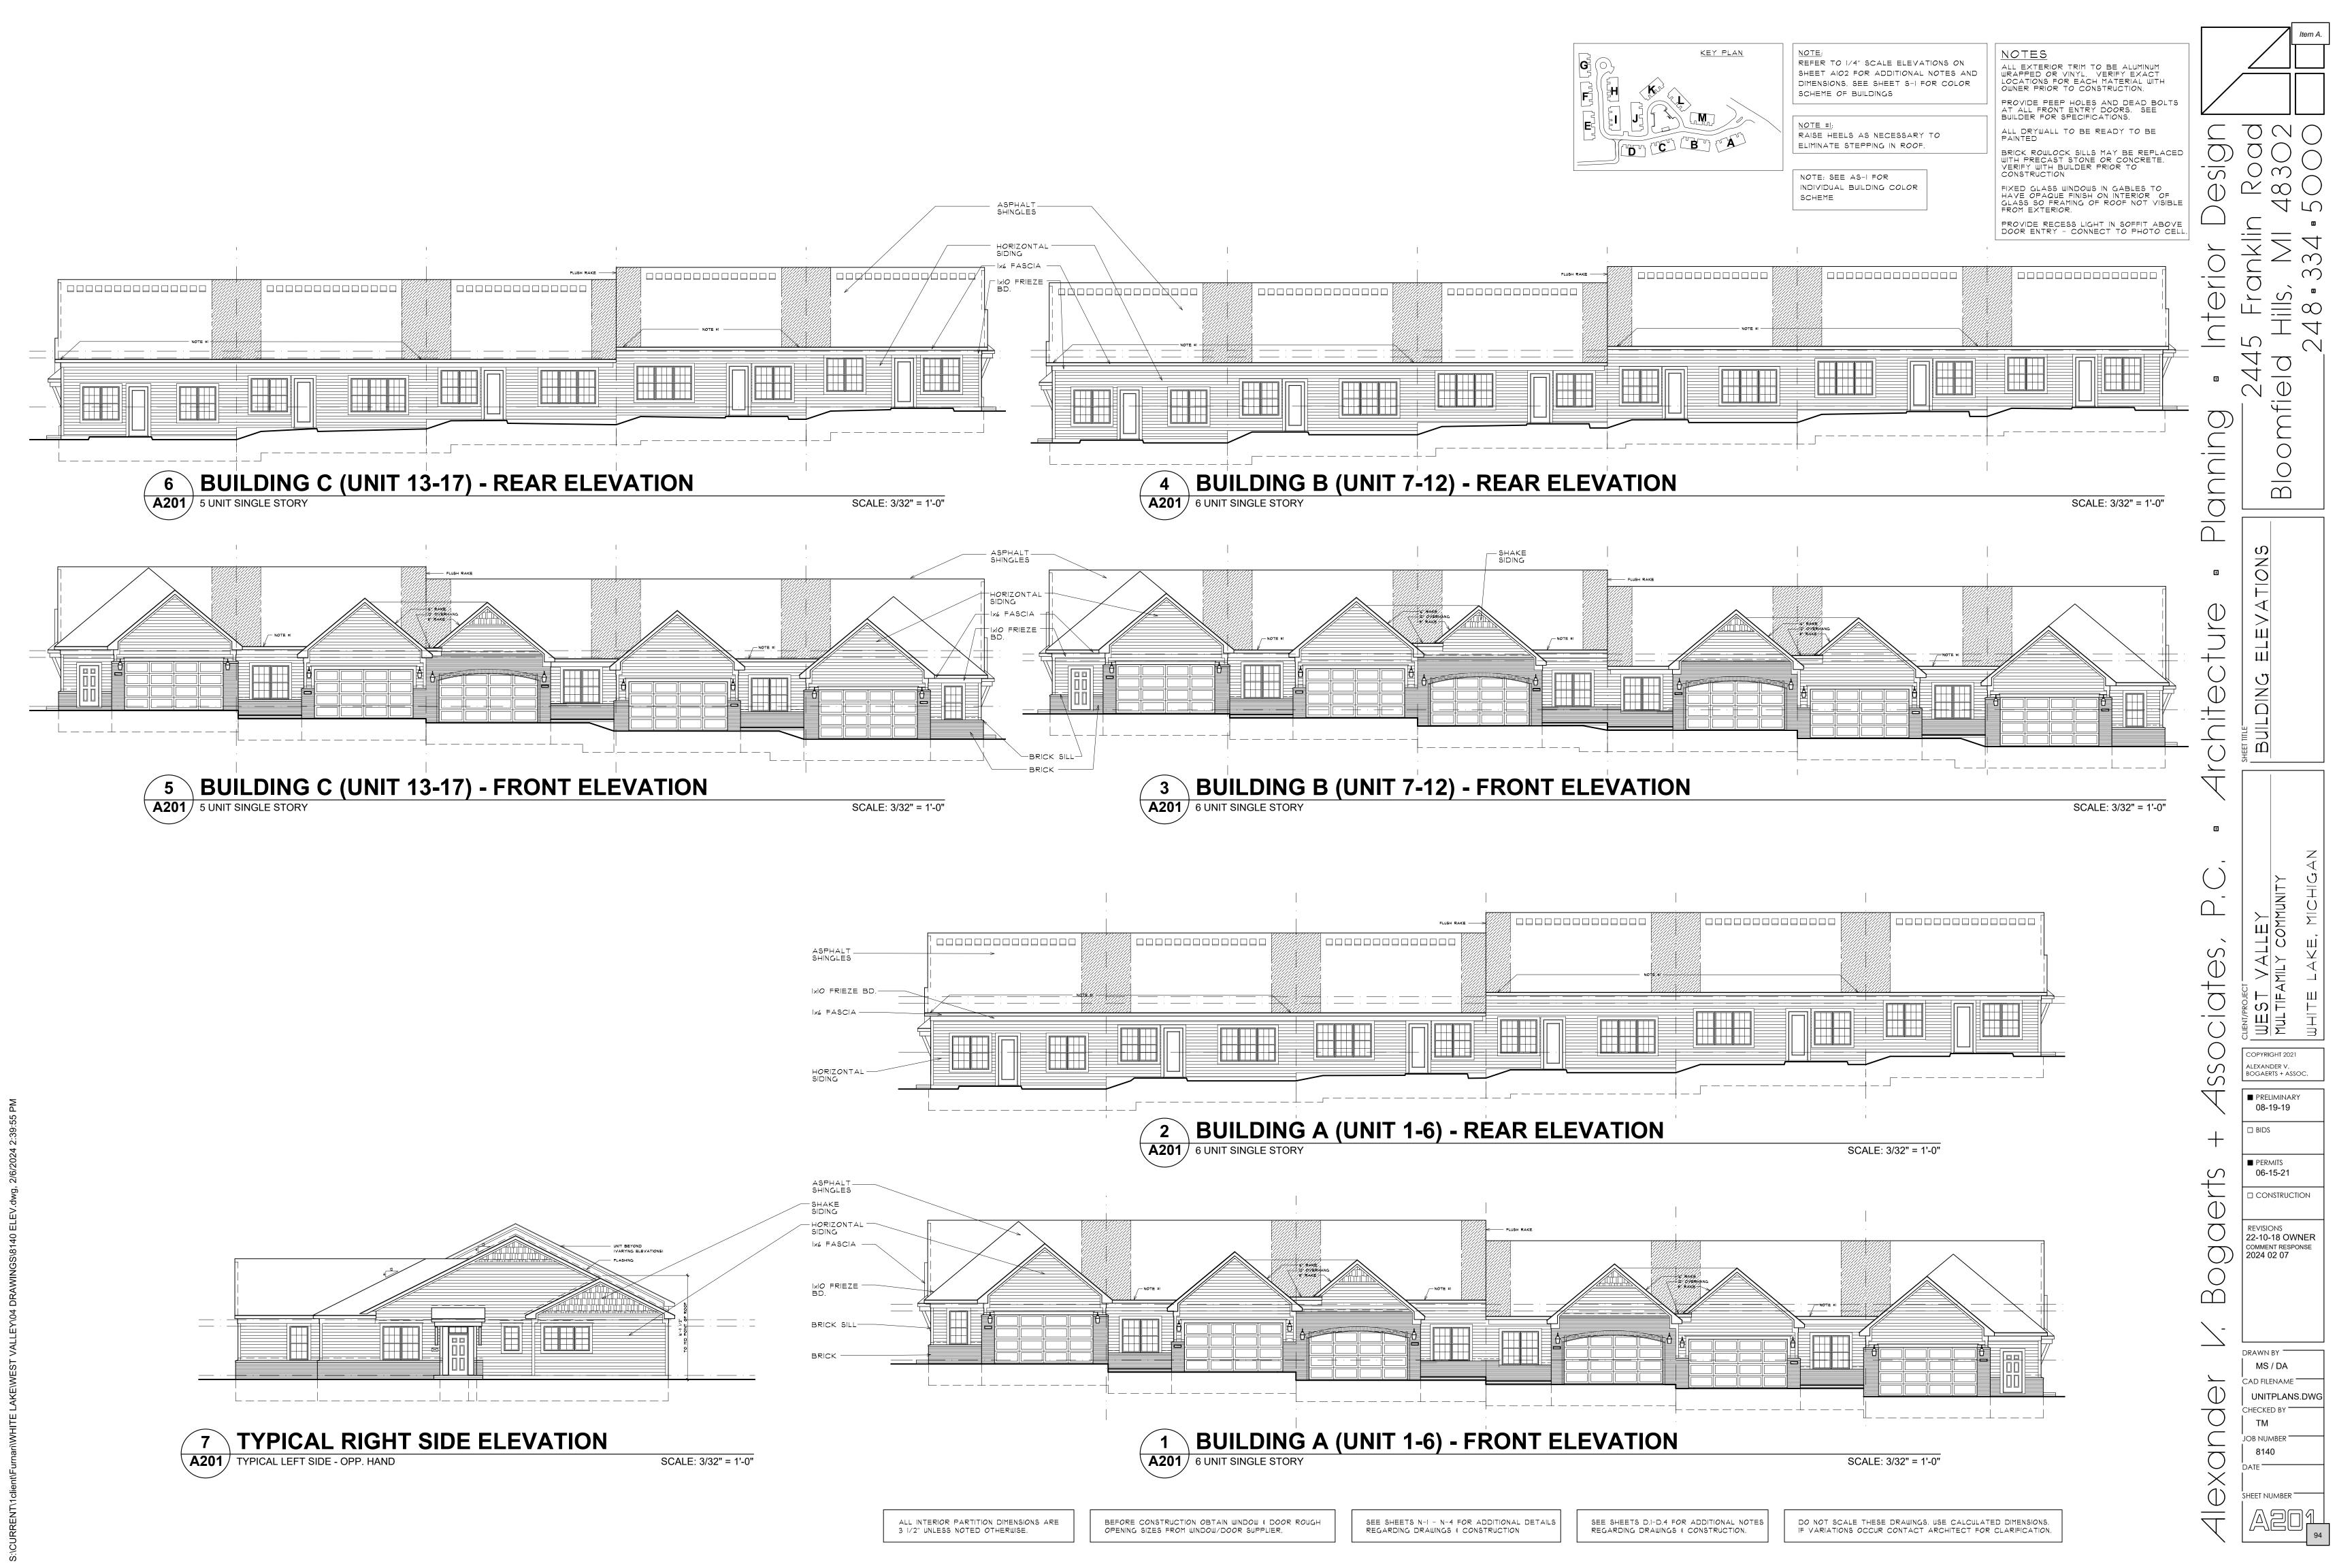

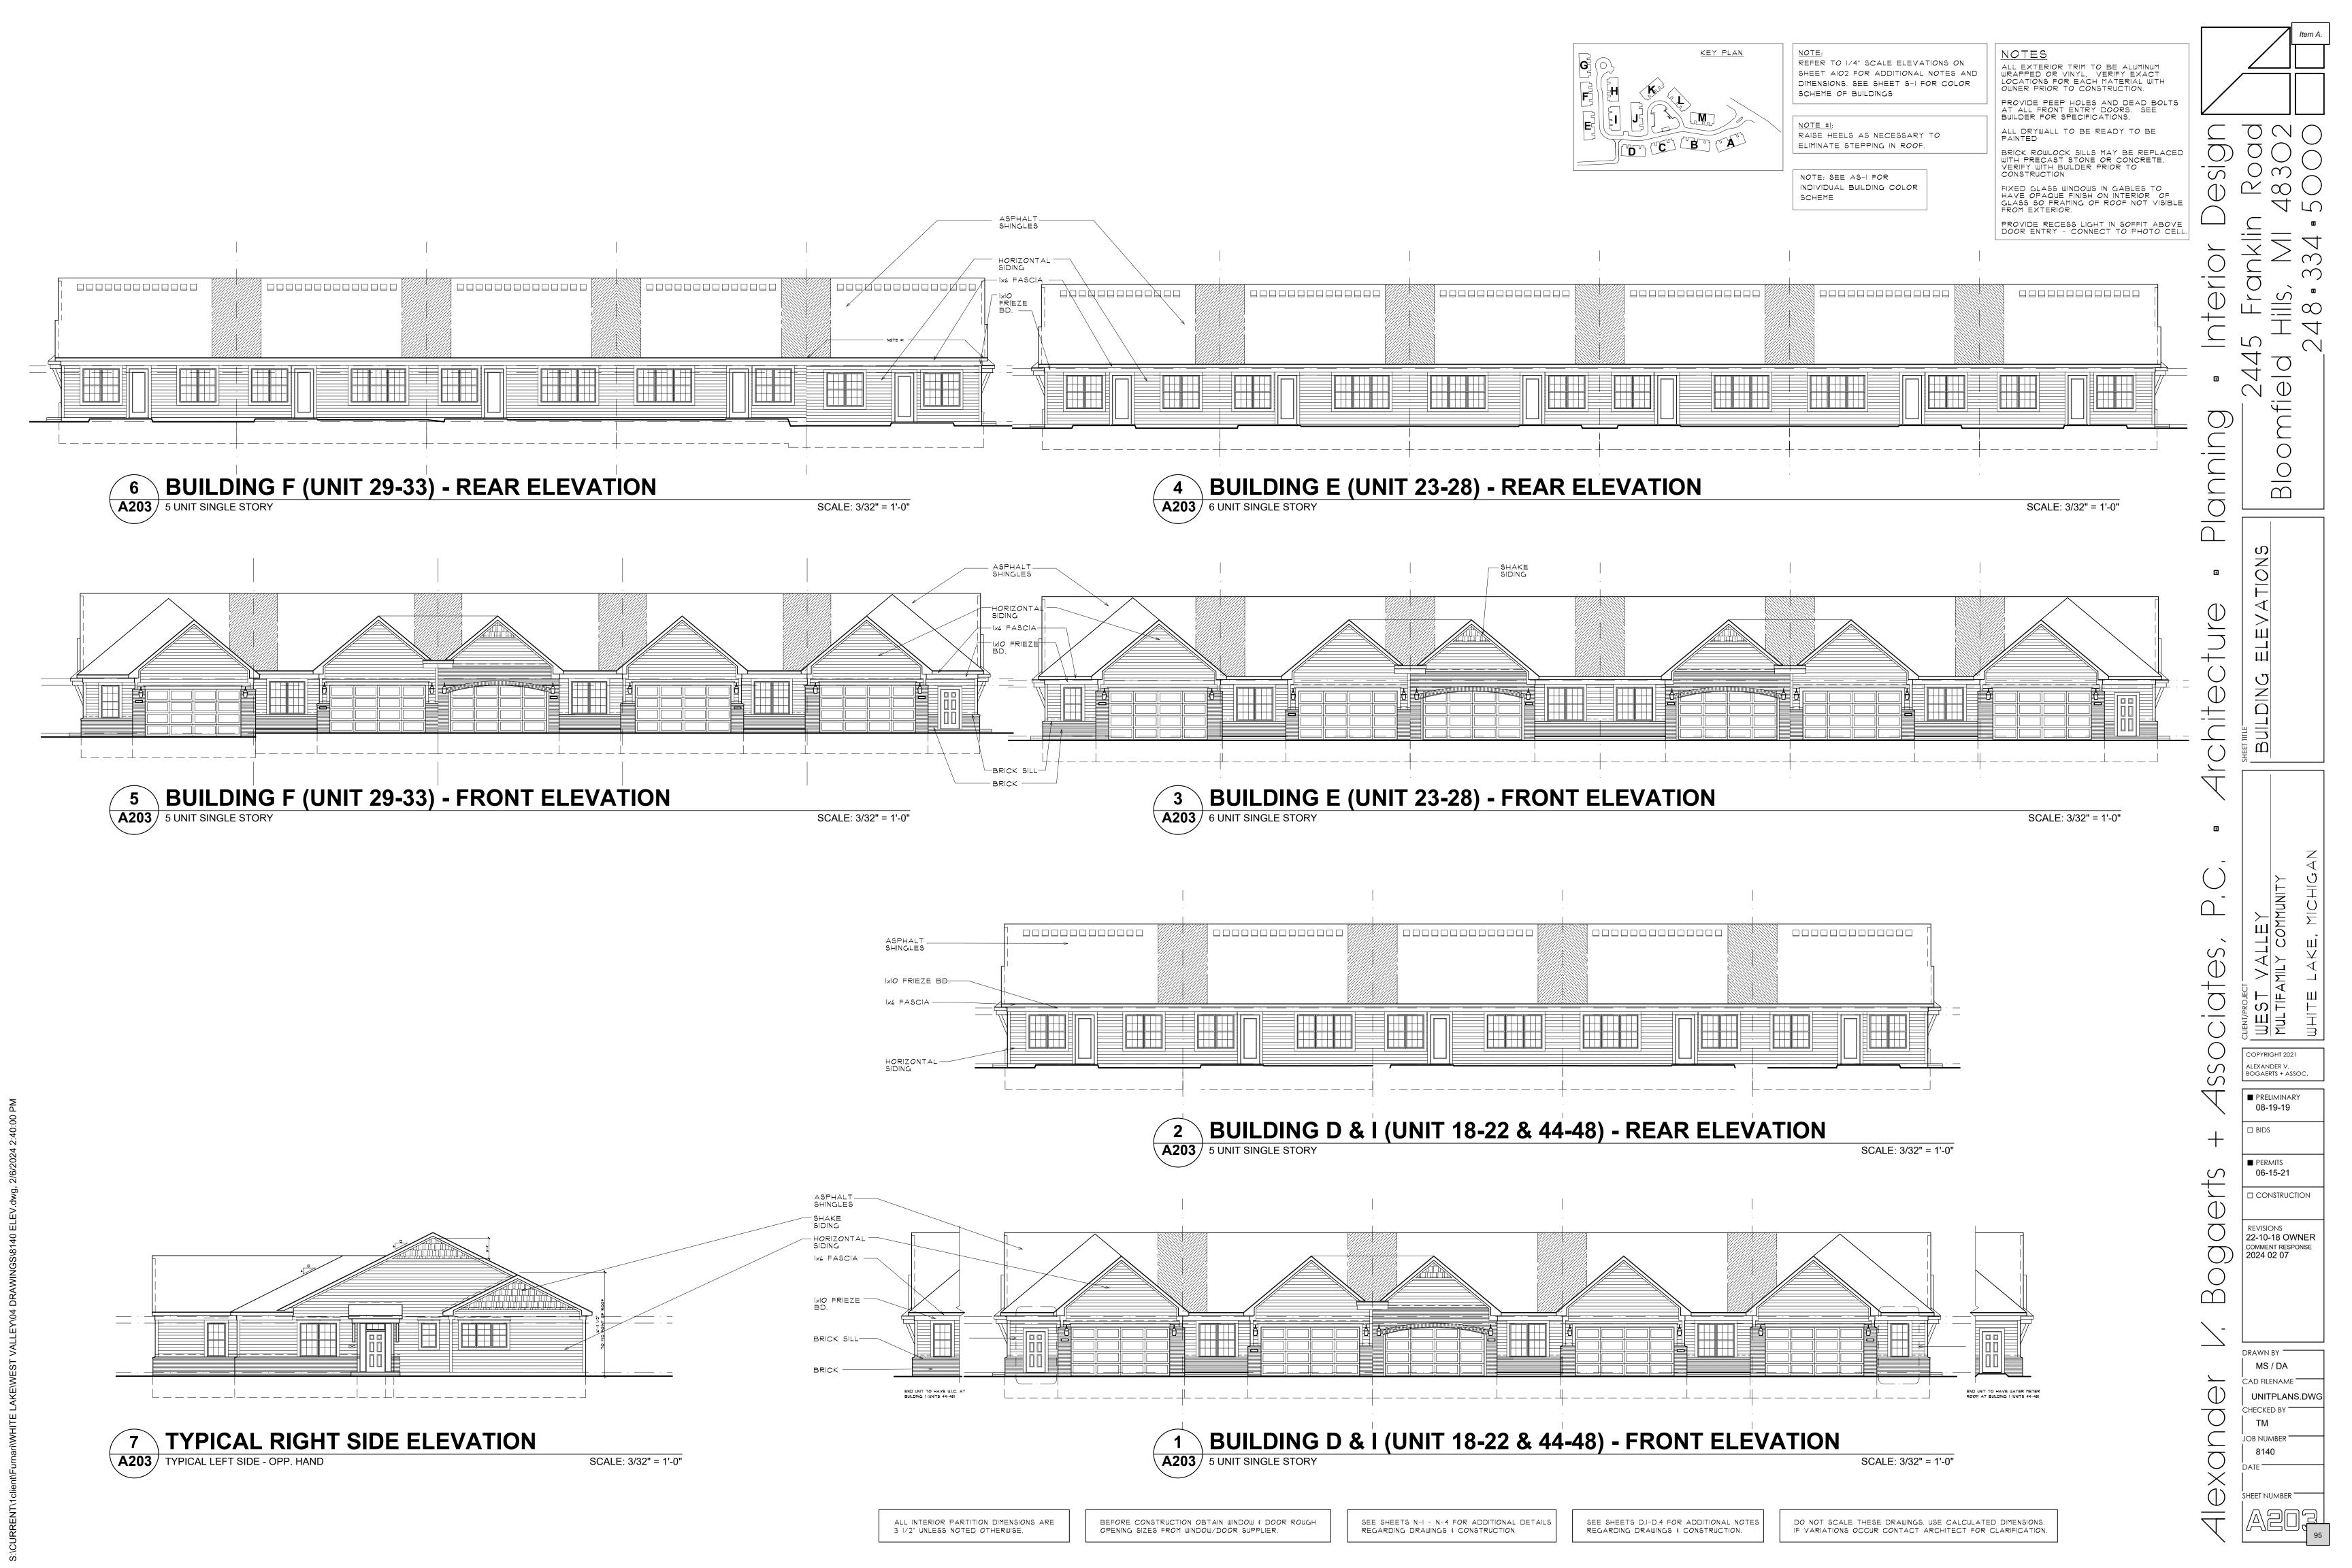



NOTE: SITE PLAN SHOWN FOR REFERENCE ONLY. REFER TO CIVIL ENGINEERING DRAWINGS FOR ALL ADDITIONAL INFORMATION.