



A G E N D A
CITY OF WAUPUN PLAN COMMISSION
Waupun City Hall – 201 E. Main Street, Waupun WI
Wednesday, December 08, 2021 at 4:30 PM

VIDEO CONFERENCE AND TELECONFERENCE

The Waupun Plan Commission will meet virtually at 4:30 pm on Wednesday, December 8, 2021 via Zoom. The Public may access the conference meeting online or by phone. Instructions to join the meeting are provided below:

To Join Zoom Meeting

<https://us02web.zoom.us/j/82212782546?pwd=Wk56ejlhYm0rY0k4aDN4cmsyMnNXZz09>

Meeting ID: 822 1278 2546

Passcode: 602095

By Phone: 1-312-626-6799 – Chicago

CALL TO ORDER

ROLL CALL

PERSONS WISHING TO ADDRESS THE PLAN COMMISSION--State name, address, and subject of comments. (2 Minutes)

No Public Participation after this point.

FUTURE MEETINGS AND GATHERING INVOLVING THE PLAN COMMISSION

CONSIDERATION - ACTION

1. Approve Minutes of the September 29, 2021 meeting.
2. Public Hearing - Ordinance Amendment to Section 16.01(10) of the Waupun Municipal Code.
3. Public Hearing - Conditional Use Permit Application of Scott Peters at 26 W. Main St. to operate a U-Haul Dealer and construct a 2 stall garage for small engine repair and vehicle service per Section 16.04(2)(d)(ix) and 16.04(2)(d)(vii) of the Waupun Municipal Code.
4. Public Hearing - Conditional Use Permit Application of Kaylee Morse at 906 W Main St. to operate a Doggie Day Care per section 16.04(3)(d)(v) of the Waupun Municipal Code.
5. Site Plan Review - Central Wisconsin Christian School - 301 Fox Lake Rd.
6. Site Plan Review - Veterans Memorial Wall - Shaler Park
7. Site Plan Review - Kwik Trip at 800 W Main St.
8. Site Plan Review - Waupun Public Utilities - 501 Fond du Lac St.

ADJOURNMENT

Upon reasonable notice, efforts will be made to accommodate disabled individuals through appropriate aids and services. For additional information, contact the City Clerk at 920-324-7915.



MINUTES
CITY OF WAUPUN PLAN COMMISSION MEETING
Waupun City Hall – 201 Main Street, Waupun, WI
Wednesday, September 29, 2021 at 4:30 p.m.

Plan Commission Members Present:

Jeff Daane
Jon Dobbratz
Jerry Medema
Julie Nickel
Elton TerBeest

Plan Commission Members Absent:

Jill Vanderkin, excused
Mike Matouschek, excused

Staff Present:

Susan Leahy Building Inspector/Zoning Administrator
Kathy Schlieve Administrator

Other:

Carla Clover
Patrick Beilfuss, Senior Planner, Cedar Corporation

CALL TO ORDER:

Mayor Nickel called the meeting of the Plan Commission to order at 4:30 p.m.

ROLL CALL:

Roll call and quorum determined.

PERSONS WISHING TO ADDRESS THE PLAN COMMISSION:

None present.

FUTURE MEETINGS AND GATHERINGS INVOLVING THE PLAN COMMISSION

CONSIDERATION-ACTION:

1. Approval of minutes of the August 25, 2021 meeting

A motion to approve the August 25, 2021 minutes was made by Dobbratz and seconded by TerBeest, passing unanimously.

2. Public Hearing – Rezoning Petition of Charles Clover to rezone 129 N. Madison St. from the B-6 Neighborhood Commercial District to the R-4 Central Area Single Family Residential District

Public Hearing commenced to hear the petition to rezone property located at 129 N Madison St from B-6 Neighborhood Commercial District to R-4 Central Area Single Family Residential District by Charles and Carla Clover. Carla Clover is present to explain that they purchased the property from Dr. Champion and wish to convert to residential property compatible with surrounding land use. No questions from the Board. Noone is present from the public to make comment during comment period.

A motion to close the public hearing was made by Dobbratz and seconded by Nickel, passing unanimously.

A motion to approve the Rezoning Petition of Charles Clover to rezone 129 N. Madison St. from B-6 Neighborhood Commercial District to the R-4 Central Area Single Family Residential District, as presented, was made by Dobbratz and seconded by TerBeest. Roll call: Dobbratz – Aye; Medema – Aye; Nickel – Aye; TerBeest – Aye; Daane – Aye. Motion passes 5-0.

3. Public Hearing – Ordinance to amend Chapter 16 of the Waupun Municipal Code

Public hearing commenced to consider amendments to residential zoning codes. Patrick Beilfuss, Senior Planner from Cedar Corporation, explains proposed changes which are being recommended in accordance with the city's comprehensive plan and housing study to address affordability needs within the community. Changes include a reduction in minimum lot size, zero lot line conditional use requirements, consolidation of R4 and R5 districts and renumbering of remaining districts, and the addition of accessory dwelling unit ordinance. No one is present to make public comment regarding the proposed changes.

Daane motion to close the public hearing; seconded by TerBeest, carried unanimously.

A motion to approve the Ordinance to amend Chapter 16 of the Waupun Municipal Code, as presented, was made by Dobbratz and seconded by Nickel. Discussion was had about the need to amend land use maps which must be updated to reflect proposed changes in the zoning district numbering. This is required before the ordinance can advance to council for approval. Roll Call: Medema – Aye; Nickel – Aye; TerBeest – Aye; Daane – Aye; Dobbratz – Aye. Carried 5-0.

4. CSM Review – 310 E. Main St.

A motion to approve the CSM for 310 E. Main St. was made by Ter Beest and seconded by Dobbratz. Roll Call: Nickel – Aye; TerBeest – Aye; Daane – Aye; Dobbratz – Aye; Medema- Aye. Carried 5-0.

5. CSM Review – Lot 25 Park Estates (1025/1027 Tanager St) and Lot 26 Park Estates (1029/1031 Tanager St.)

A motion to approve the CSM for Lot 25 Park Estates (1025/1027 Tanager St) and Lot 26 Park Estates (1029/1031 Tanager St.) was made by Ter Beest and seconded by Nickel. Roll Call: TerBeest – Aye; Daane- Aye; Dobbratz – Aye; Medema – Aye; Nickel – Aye. Carried 5-0.

6. CSM Review – Lot 29 Park Estates (1028/1030 Tanager St.)

Lot 29 Park Estates (1028/1030 Tanager St) was made by Dobbratz and seconded by Ter Beest. Roll Call: Daane – Aye; Dobbratz – Aye; Medema – Aye; Nickel – Aye; TerBeest – Aye. Carried 5-0.

ADJOURNMENT

The motion to adjourn was made by Dobbratz and seconded by Medema, passing unanimously. The meeting adjourned at 4:48 p.m.

NOTICE OF PUBLIC HEARING

NOTICE IS HEREBY GIVEN, that at a meeting of the Plan Commission of the City of Waupun, will be held on Wednesday the 8th day of December, 2021, at 4:30 o'clock in the P.M. there will be considered an ordinance to amend Chapter 16 of the Municipal Code of the City of Waupun.

The meeting will be held via Zoom. Instructions to join the zoom meeting are below:

To Join Zoom Meeting:

<https://us02web.zoom.us/j/82212782546?pwd=Wk56ejlhYm0rY0k4aDN4cmsyMnNXZz09>

Meeting ID: 822 1278 2546

Passcode: 602095

By Phone: 1-312-626-6799 – Chicago

ORDINANCE # 21 - ____

AN ORDINANCE TO AMEND CHAPTER SIXTEEN OF THE MUNICIPAL CODE OF THE CITY OF WAUPUN ENTITLED "ZONING ORDINANCE."

THE COMMON COUNCIL OF THE CITY OF WAUPUN ORDAINS:

SECTION 1: Section 16.01 (10) of the Municipal Code of the City of Waupun entitled "Zoning Map" is amended as follows:

All real estate in the City of Waupun Corporate Limits that is zoned R-5 Mixed Residential District is rezoned to the newly created R-4 Mixed Residential Zoning District.

All real estate in the City of Waupun Corporate Limits that is zoned in the R-6 Mobile Home District is rezoned to the R-5 Mobile Home District.

All real estate in the City of Waupun Corporate Limits that is zoned in the R-7 Single Family Manufactured Home District is rezoned to the R-6 Single-Family Manufactured Home District.

SECTION 2: This Ordinance shall be in full force and effect upon its passage and publication as provided by law.

Enacted this ____ day of _____, 2021.


Julie Nickel
Mayor

ATTEST:

Angela Hull
City Clerk

(Publish November 24 and December 1, 2021)


Zoning - Existing

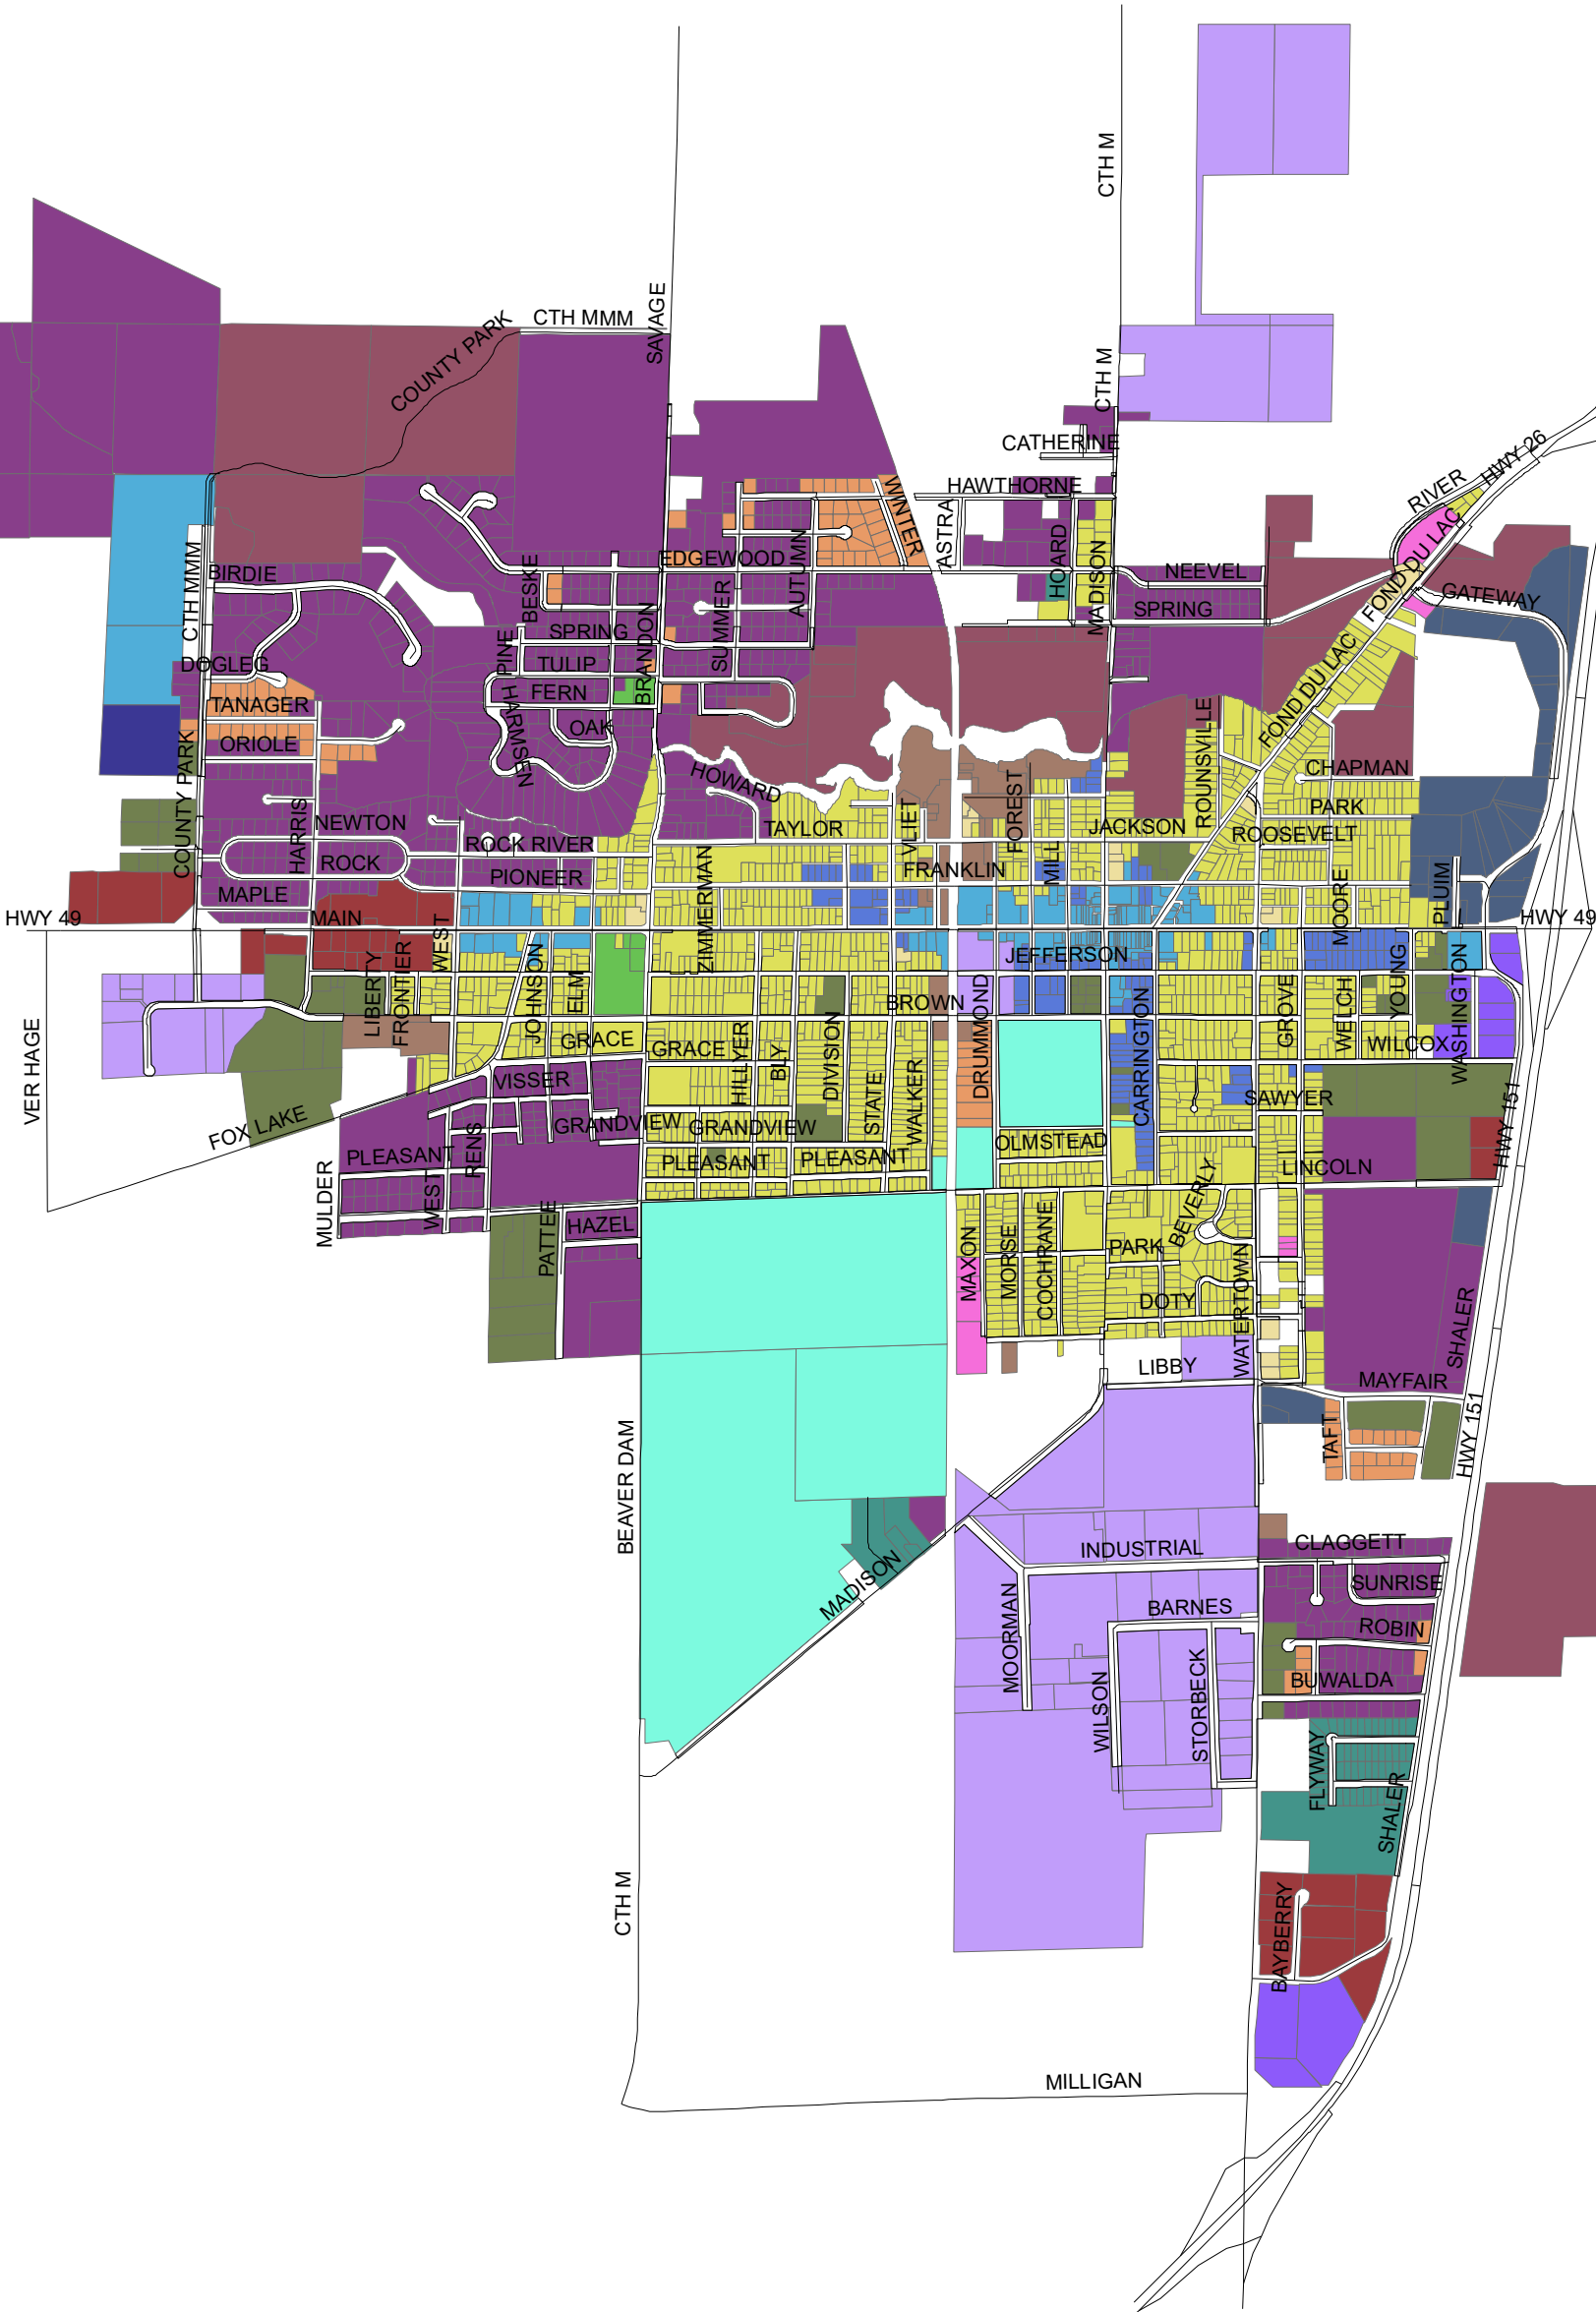

Legend

AG	
B-1	
B-2	
B-3	
B-4	
B-5	
B-6	
C	
IN	
M-1	
M-2	
PCD	
R-1	
R-2	
R-3	
R-4	
R-5	
R-6	
ROW	

Zoning - Proposed

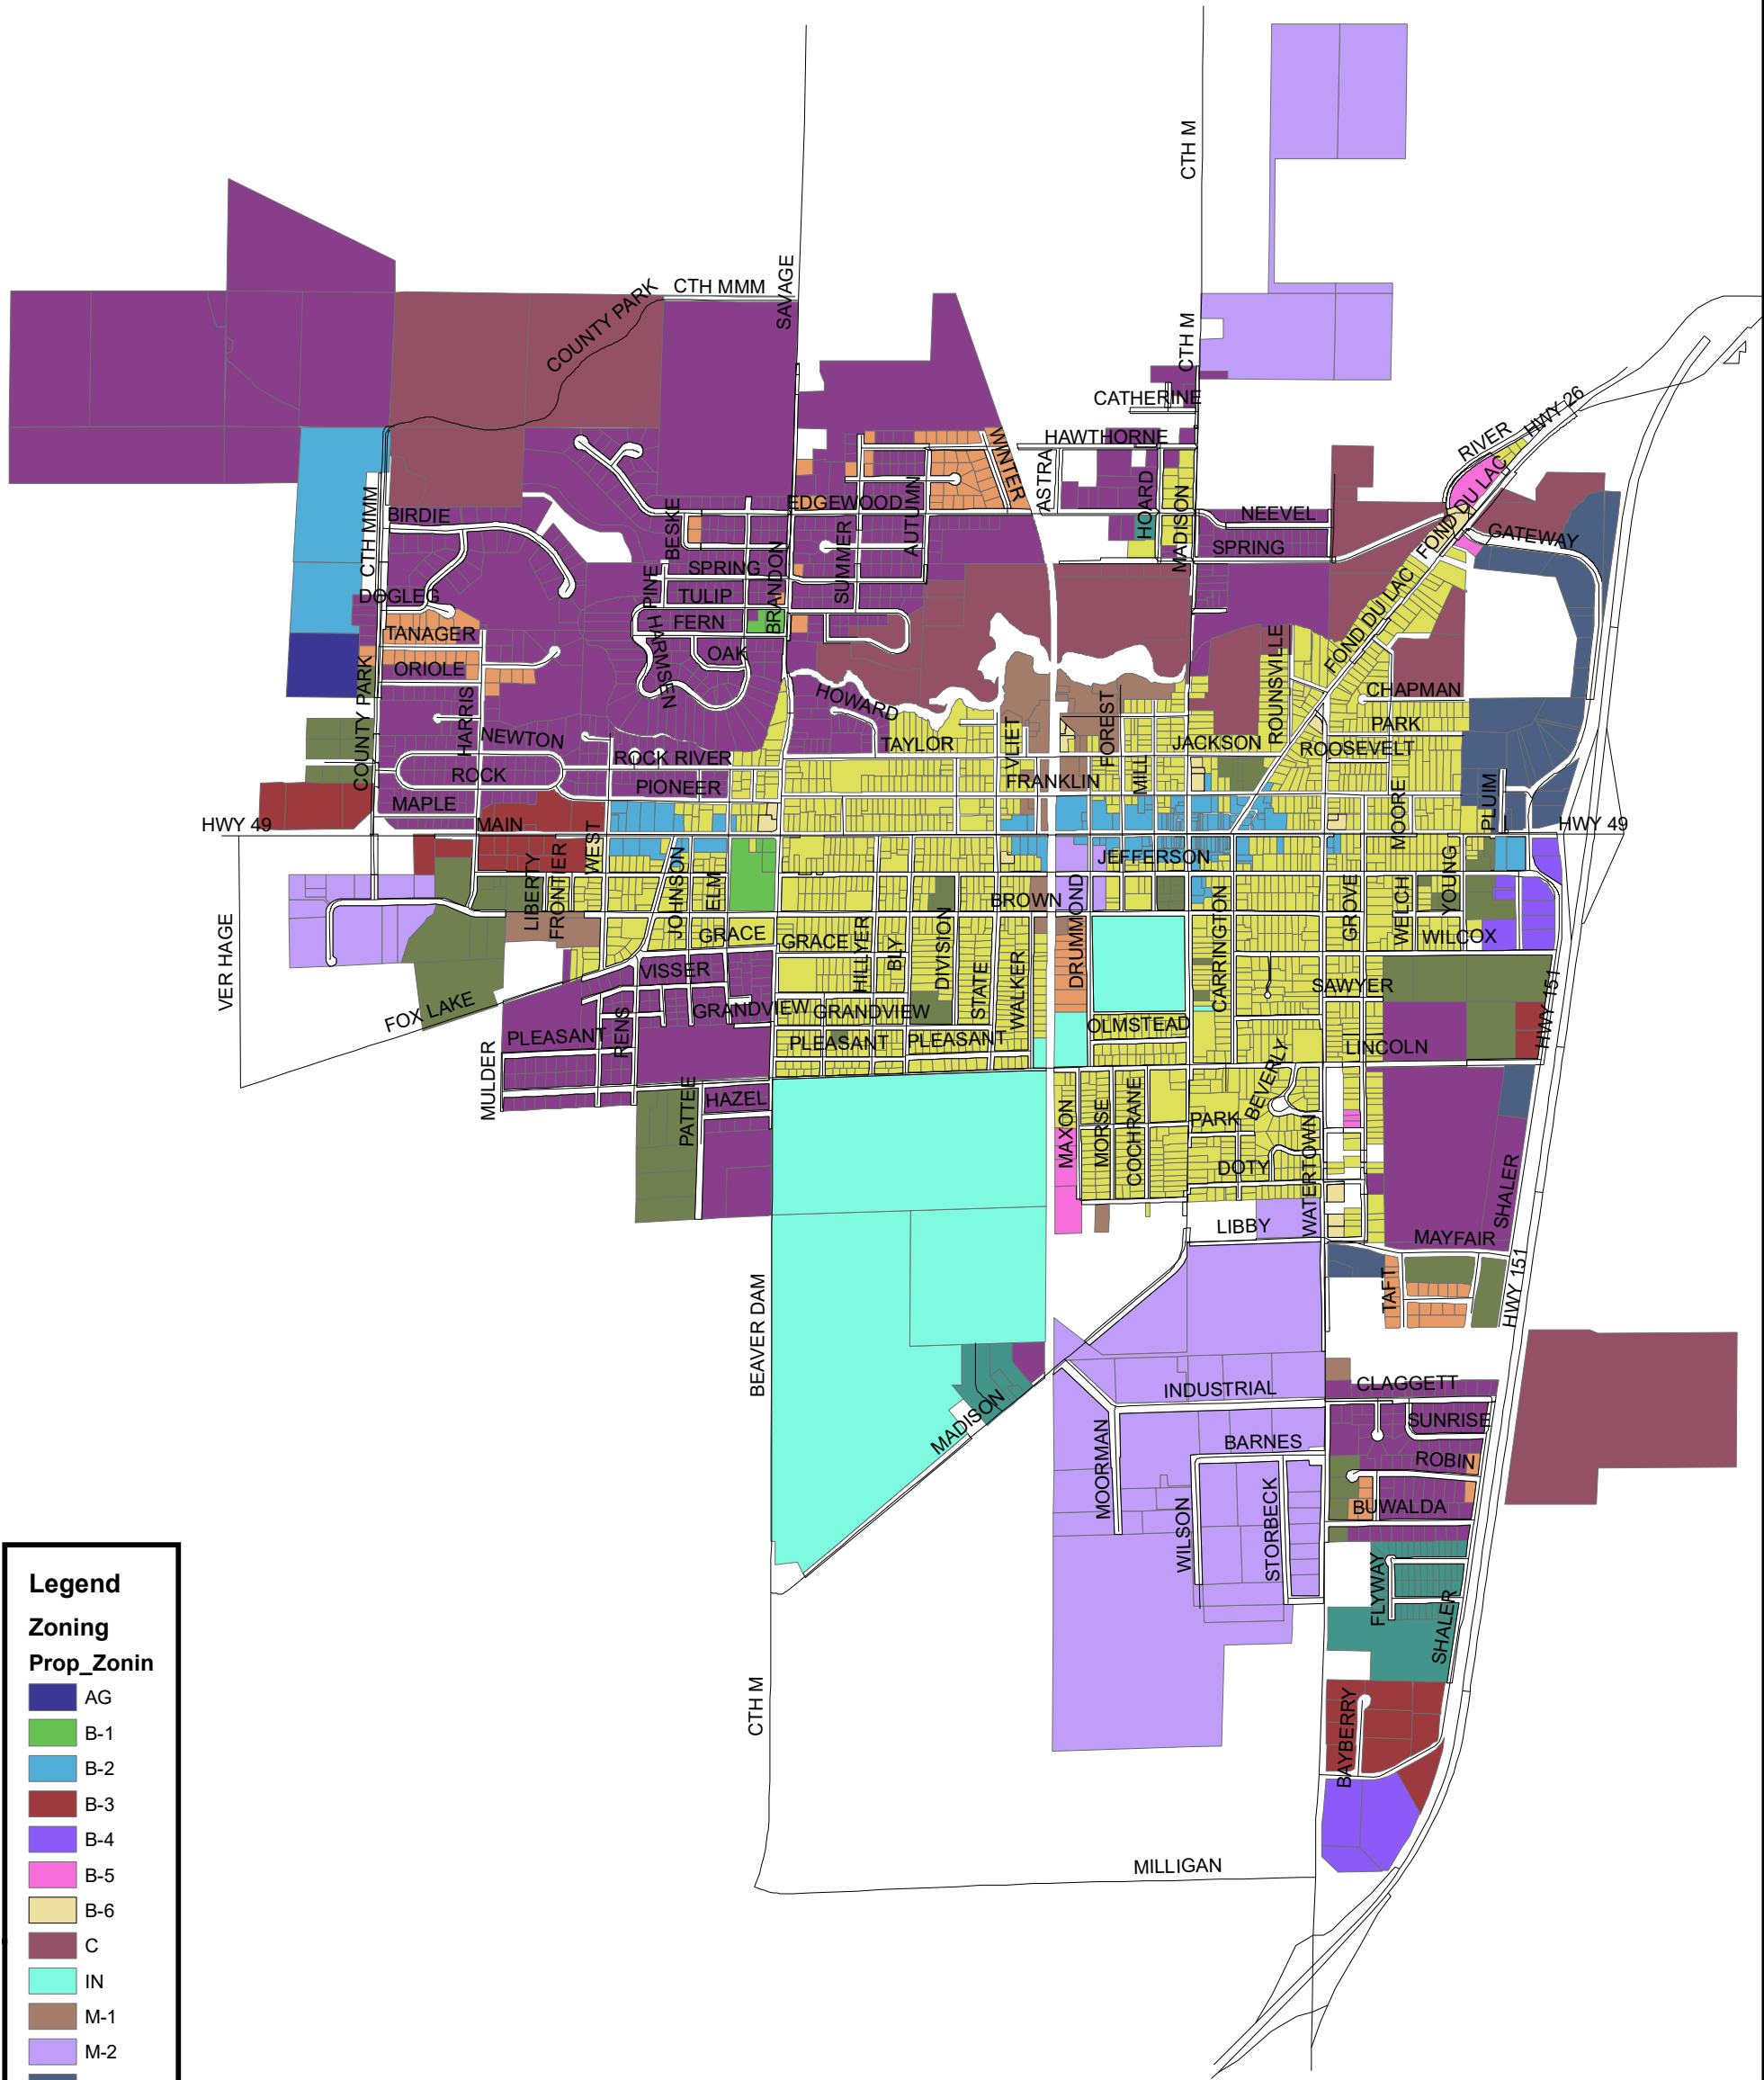

Legend

Zoning

Prop_Zonin

AG
B-1
B-2
B-3
B-4
B-5
B-6
C
IN
M-1
M-2
PCD
R-1
R-2
R-3
R-4
R-5
ROW



CITY OF WAUPUN BUILDING INSPECTOR
Waupun City Hall – 201 E. Main Street, Waupun WI
P: 920-324-7917 * F: 920-324-7939
www.cityofwaupun.org

NOTICE OF PUBLIC HEARING

NOTICE IS HEREBY GIVEN, that at a meeting of the Plan Commission of the City of Waupun, to be held via zoom on Wednesday the 8th day of December, 2021 at 4:30 O'clock in the P.M., there will be considered the application for a Conditional Use Permit of:

1. Scott Peters at 26 W. Main St. to operate a U-Haul Dealer and construct a 2 stall garage for small engine repair and vehicle service per Section 16.04(2)(d)(ix) and 16.04(2)(d)(vii) of the Waupun Municipal Code.
2. Kaylee Morse at 906 W. Main St. to operate a Doggie Day Care per section 16.04(3)(d)(v) of the Waupun Municipal Code.

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Meeting ID: 822 1278 2546

Passcode: 602095

By Phone: 1-312-626-6799

PLEASE TAKE FURTHER NOTICE that all persons desiring to be heard on the proposed Conditional Use in support thereof or in opposition thereto, must contact the Zoning Administrator prior to said meeting of the Plan Commission of the City of Waupun.

Dated this 12th day of November, 2021

Susan Leahy
Zoning Administrator
City of Waupun

(PUBLISH December 1, 2021)

Fee: \$150.00 Paid: \$150.00 Date: Nov. 19 2021



CITY OF WAUPUN
201 E. Main Street
WAUPUN, WISCONSIN 53963

Conditional Use Permit Application

Applicant Name: Scott Peters Phone # 920-296-7005

Address: W11726 Whooley Road E-mail: peters02@sbcglobal.net

City, State, Zip Waupun, WI 53963

Property Description and address:

26 West Main Street - Vacant Lot, partially concrete

Conditional Use Requested:

U-Haul Dealer - Open parking area for the use of U-haul trailers, Vans, car dollies, etc. for rent.
Owner also looking to construct ~~2x20~~ 2 stall garage for service installation of hitches, repairs, etc.

SMALL ENG AND LIGHT AUTO WORK AND SALES

Zoning Ordinance Section Involved:

16.04(2)(d)(ix)

16.04(2)(d)(vii)


Date Presented to Plan Commission: _____

CONDITIONAL USE: ☐ Granted ☐ Denied

Comments:

Signature of Applicant (s) Scott Peters

MAW ST

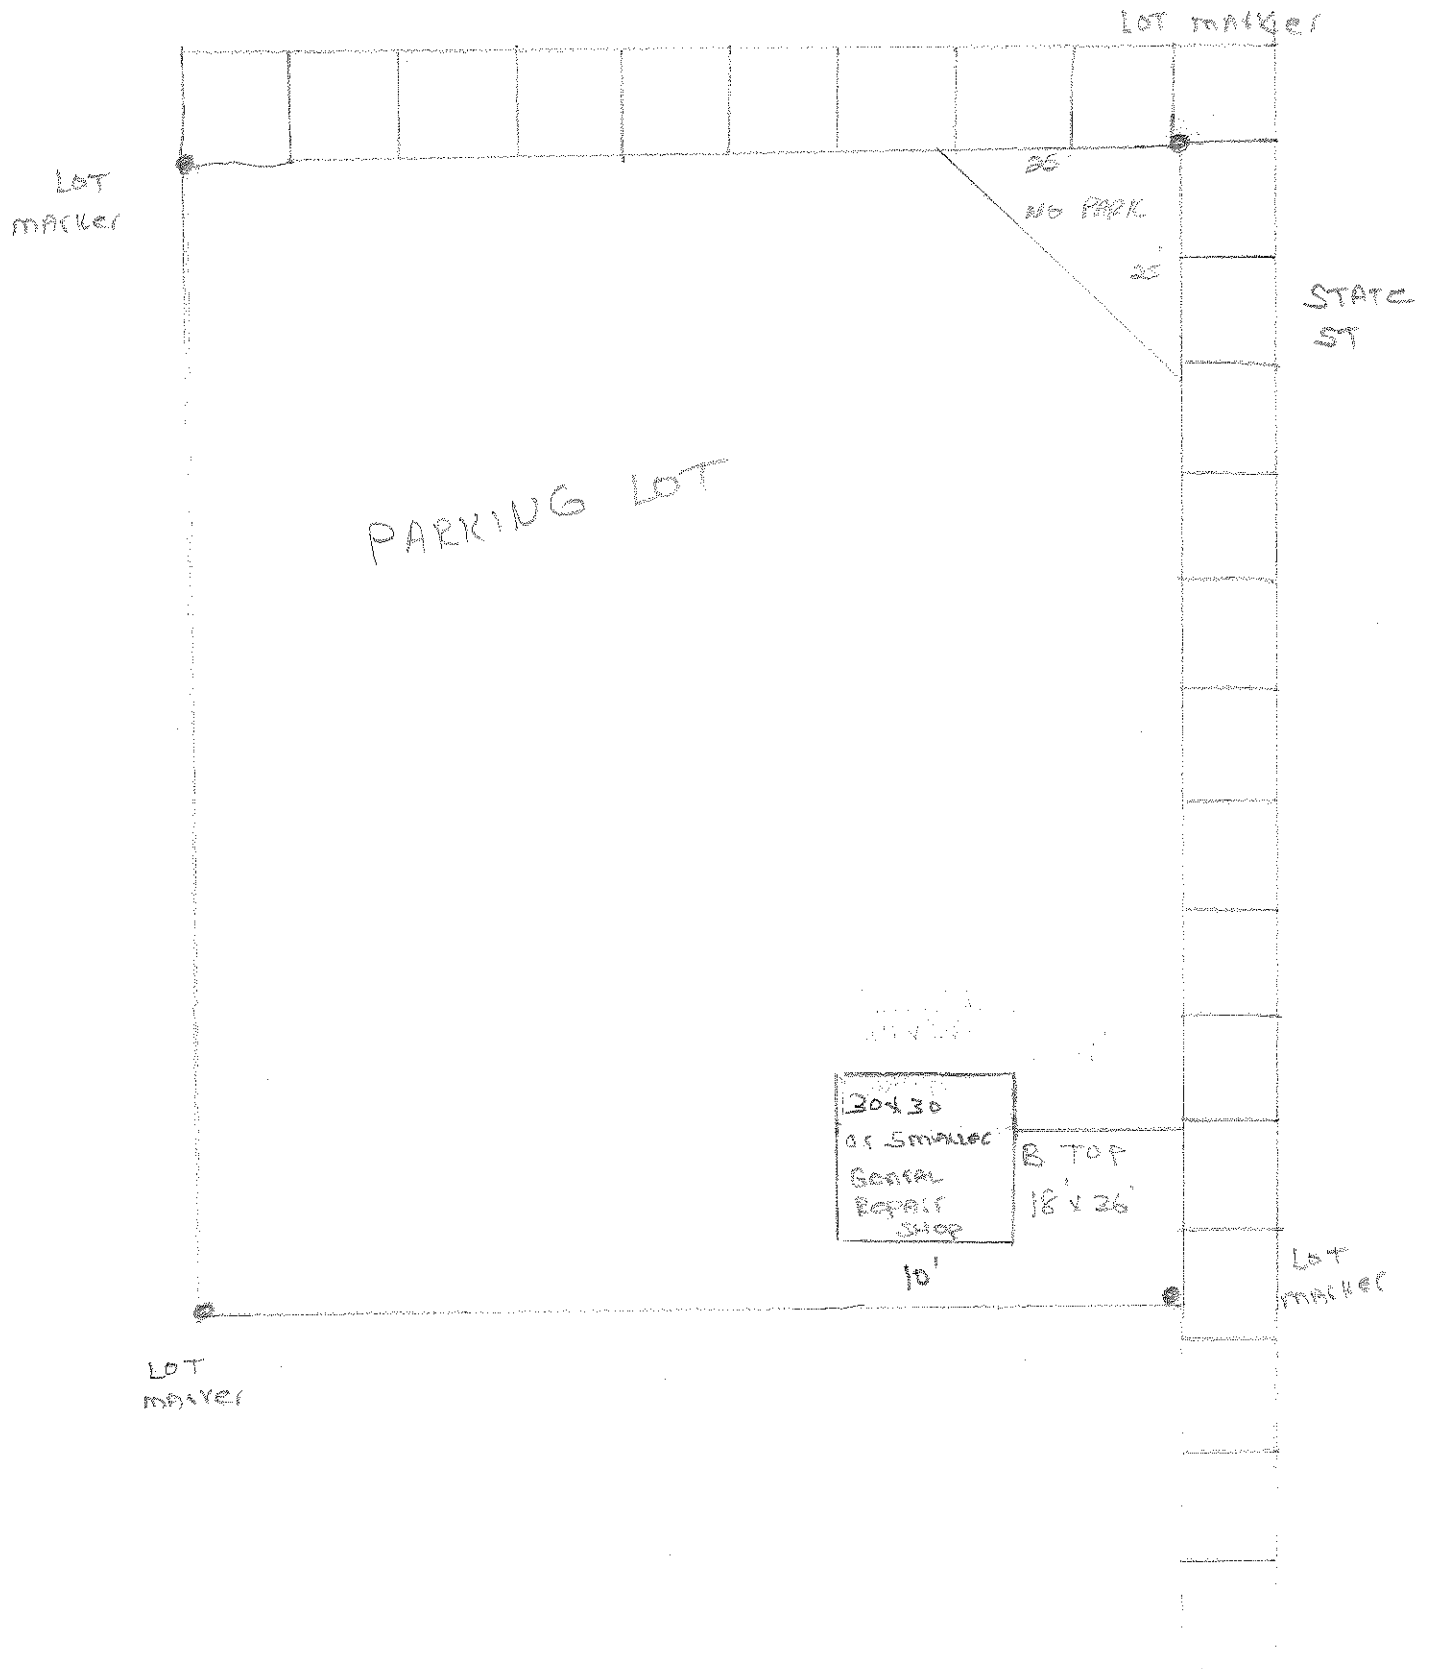


PRORATION: 331.79' ACTUAL/330' PLAT=1.005424/FOOT

THE WEST 51 FEET OF THE SOUTH 110 FEET OF LOT 5, IN
BLOCK 2 OF TAYLOR AND ACKERMAN'S ADDITION TO THE CITY
OF WAUPUN, FOND DU LAC COUNTY, WISCONSIN.

THE SOUTH 110 FEET OF LOT 6, IN BLOCK 2 OF TAYLOR AND
ACKERMAN'S ADDITION TO THE CITY OF WAUPUN, FOND DU LAC
COUNTY, WISCONSIN.

I, David H. Jacob, Professional Land Surveyor, hereby certify that on this date I have completed a survey of the above described property by order of Scott Peters, that I have found or set the lot corners as shown on this map and that this map is a true and correct representation thereof and shows the size and location of the property, its exterior boundaries, the location of all visible structures thereon and any apparent easements, roadways and visible encroachments, if any. This property may be subject to easements and restrictions of record which are not shown on this survey.

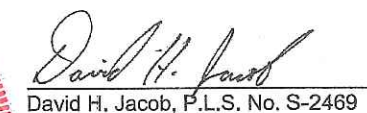


Project No. 211105
Date: 9-10-2021

- — 3/4" x 18" REBAR w/BUE PLASTIC CAP FOUND
- △ — MAG NAIL SET
- ⊗ — MAG NAIL FOUND
- ▲ — 1" IRON PIPE FOUND
- — 1" IRON ROD FOUND
- (158.24') — PLAT DIMENSIONS
- — OVERHEAD ELECTRIC LINES
- ⊘ — UTILITY POLE

S. 1/4 COR.
SEC. 32-14-15
NORTHEASTERLY OF
2 CHISELED Xs



W8057 Randallwood Lane, Fond du Lac, WI 54937
phone (920) 922-2908 fax (920) 922-7202

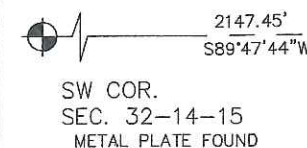

A horizontal graphic scale bar. It is divided into four equal segments. The first segment is black, the second is white, the third is black, and the fourth is white. Above the bar, the numbers 40', 0, 40', and 80 are placed at the segment boundaries. Below the bar, the word "SCALE" is on the left and "FEET" is on the right.



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PLEASE TAKE FURTHER NOTICE that all persons desiring to be heard on the proposed Conditional Use in support thereof or in opposition thereto, must contact the Zoning Administrator prior to said meeting of the Plan Commission of the City of Waupun.

Dated this 12th day of November, 2021

Susan Leahy
Zoning Administrator
City of Waupun

(PUBLISH December 1, 2021)

Fee: \$150.00

Paid: \$150.00

Date: Nov. 12, 2021



CITY OF WAUPUN
201 E. Main Street
WAUPUN, WISCONSIN 53963

Conditional Use Permit Application

Applicant Name: Kaylee Morse

Phone #920-210-9638

Address: N1695 School Street

E-mail: ~~kaleemorse1~~@outlook.com

Kaylee Morse

City, State, Zip Manchester, WI 53946

Property Description and address:

Parcel No. WPN-14-15-99-HB-053-00

906 West Main Street

Conditional Use Requested:

Doggie Day Care

Notes about business: Business hours: 7 am - 6 pm No overnight stays Kennels set up for misbaving dogs, safety is first priority. For barking - spray bottles & cintranela sprays. Potty stations in place due to no outside area. Building is 5000 sf so enough room to run. Will be installing mats for area and indoor fence.

Zoning Ordinance Section Involved:

16.04(3)(d)(v)

Date Presented to Plan Commission:

CONDITIONAL USE:


☐ Granted

☐ Denied


Comments:

Signature of Applicant (s)

Kaylee Morse

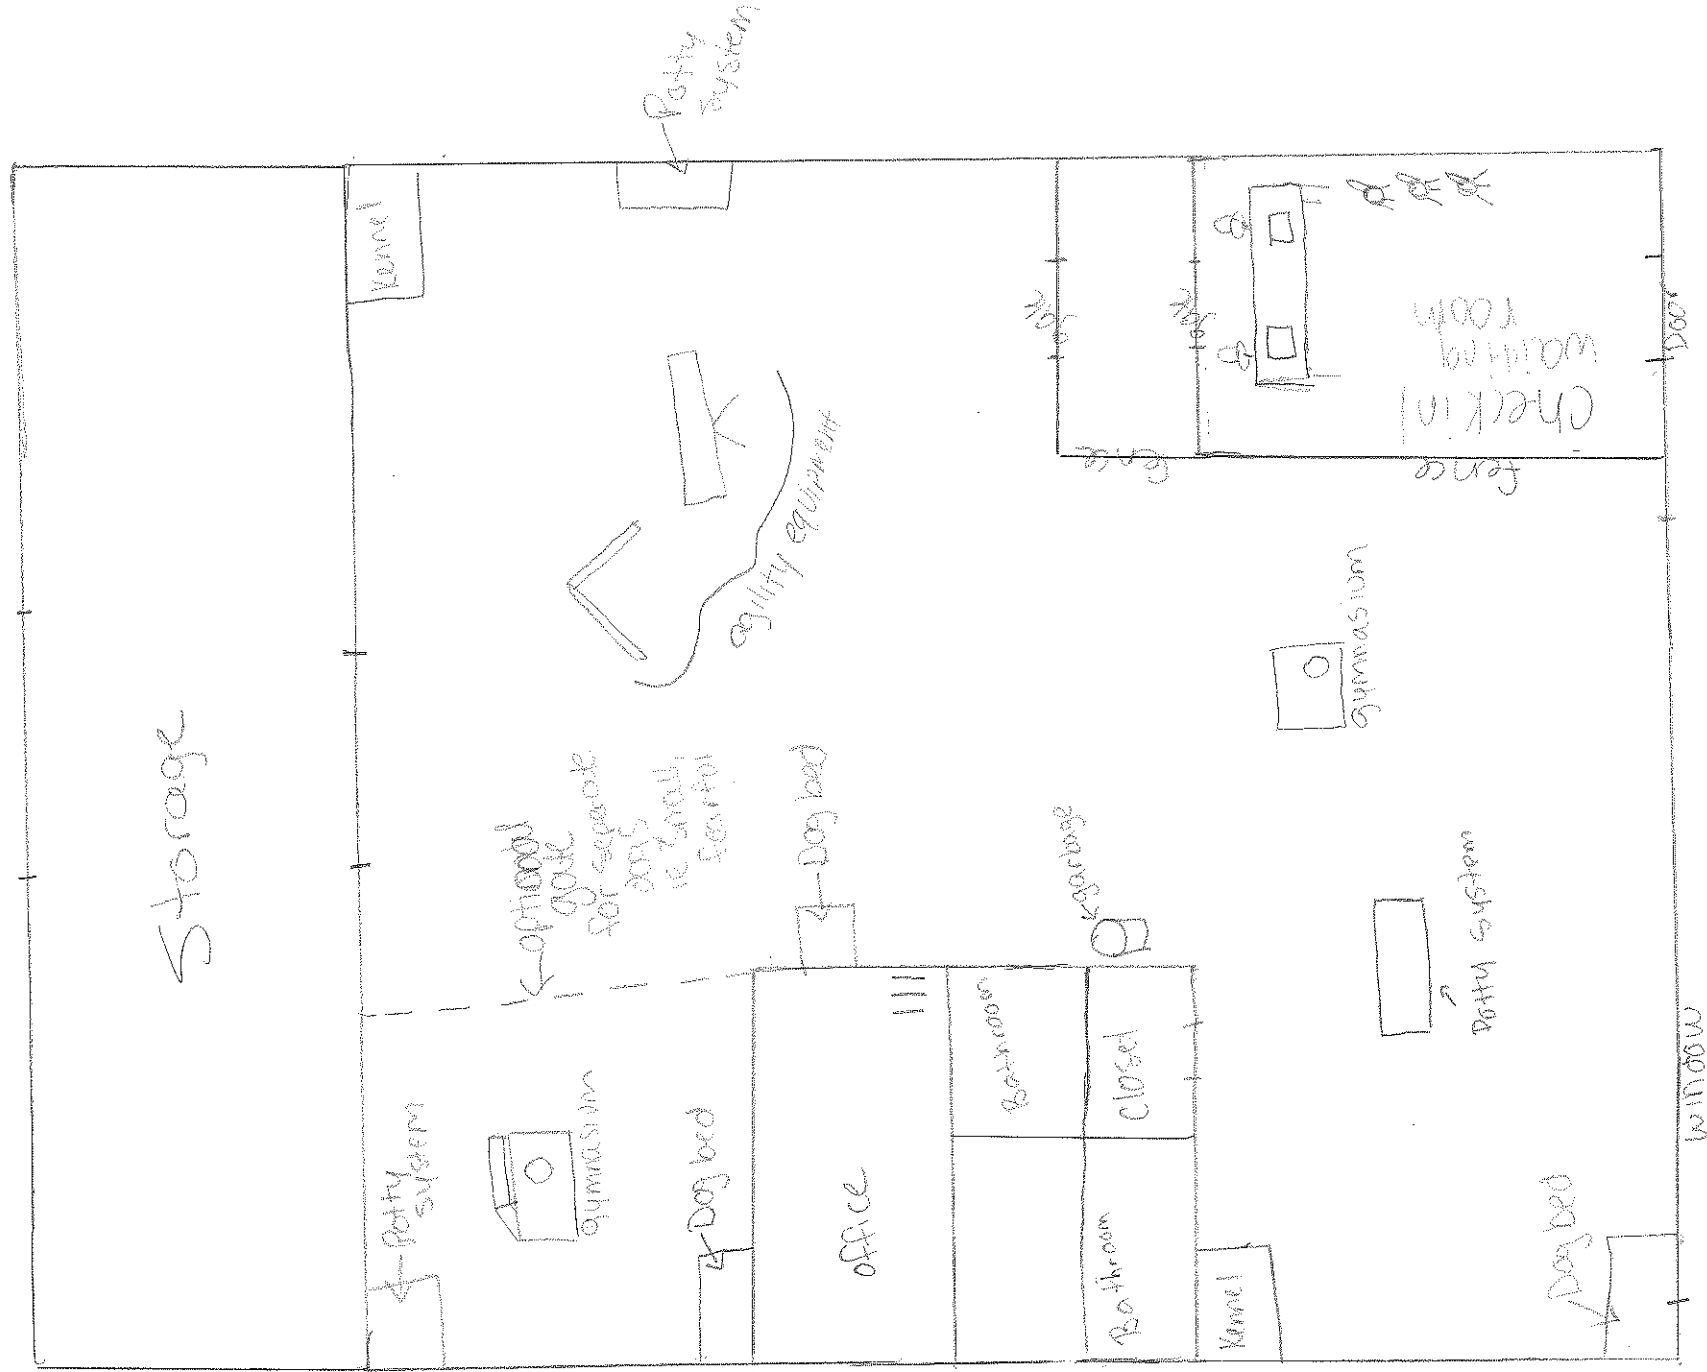

- Missing from photos
- cameras
 - Pet cam
 - Citronella collars / vests
 - decor

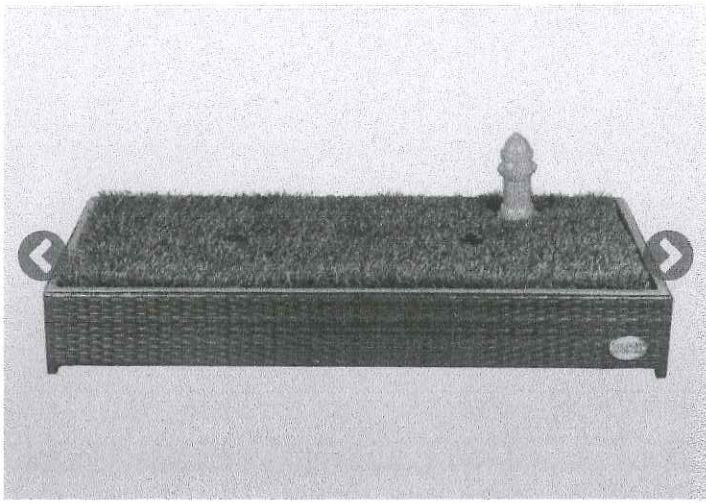



Porch Potty Premium


★★★★★ 71 reviews


\$100.00


Rest of info
for Doggie
Day Care

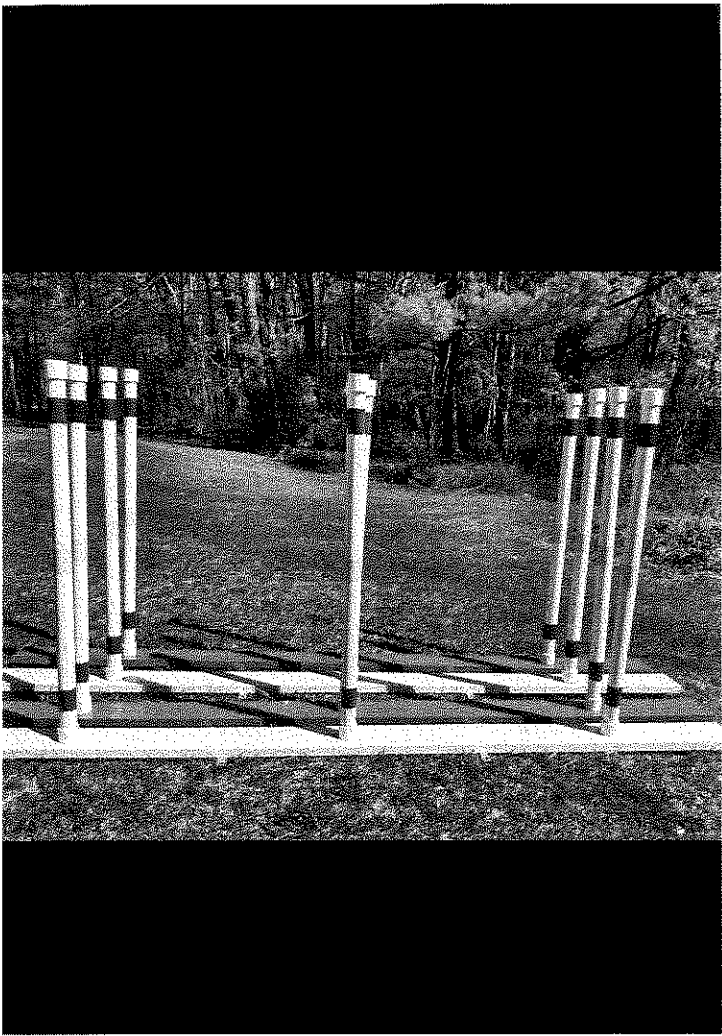

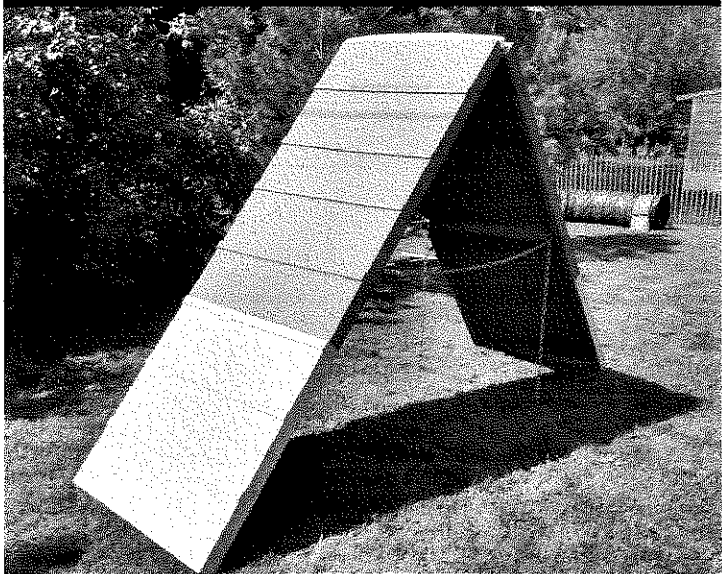

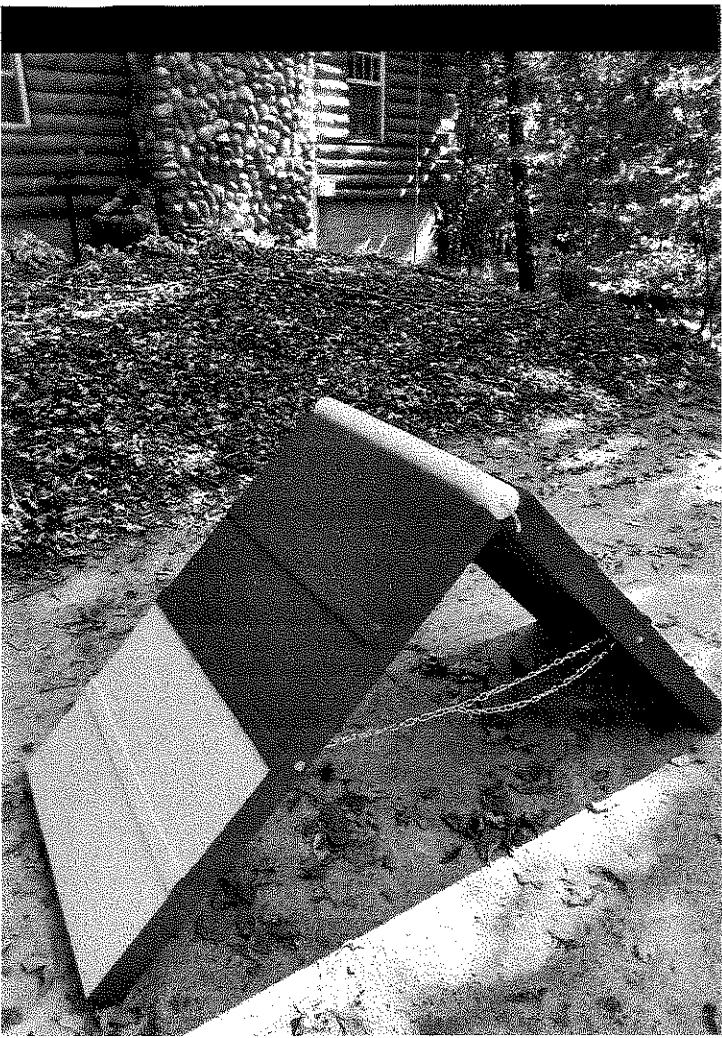

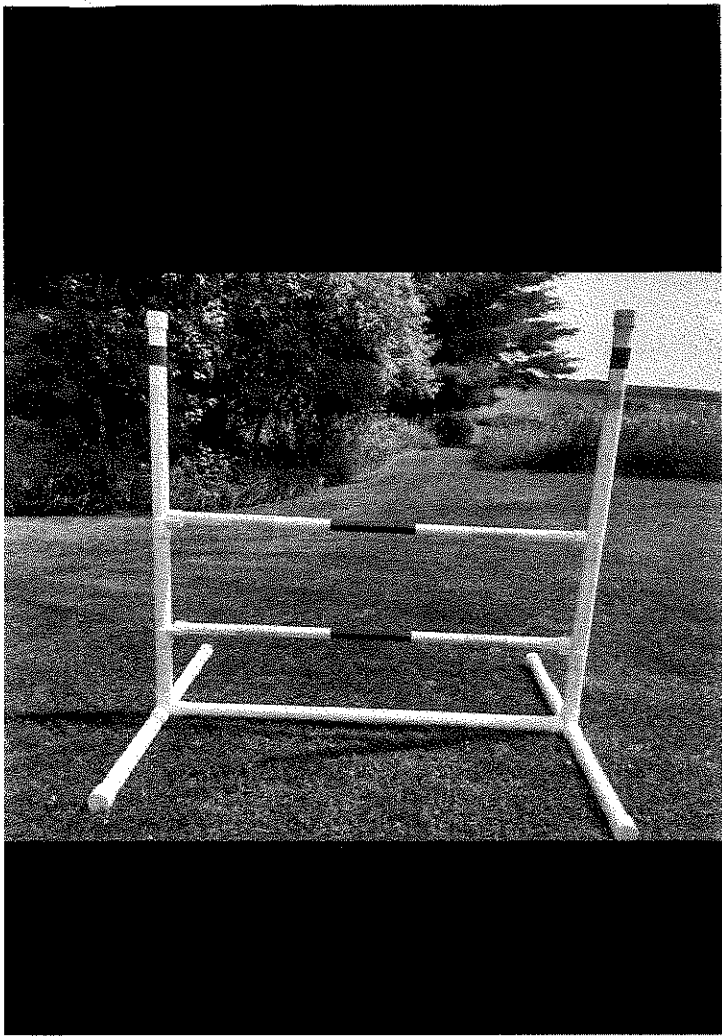

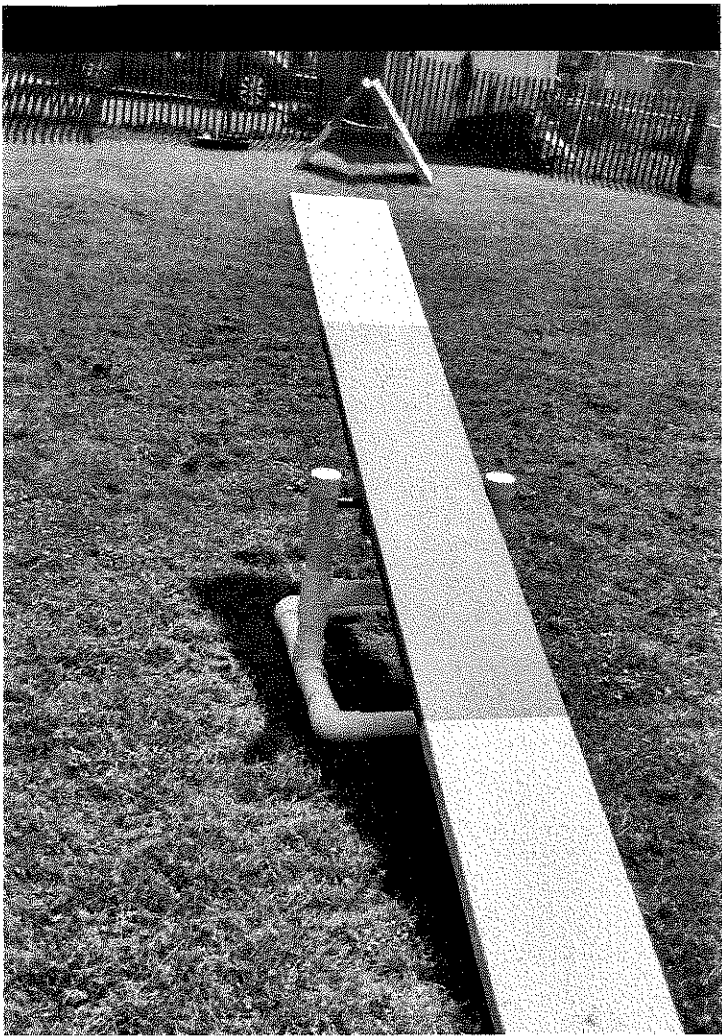

Auto Citronella Bark Collar for Dogs, [1 Can Citronella Spray
NO Remote] Spray Dog Training Collar, No Shock Humane
Citronella Dog Barking Collars, Safer Rechargeable Anti
Barking Control Collar



we have put in some very useful information for you to help you make the best choice for your dog

Color: **Black**



0.35 x 0.28 x 0.2 inches

- [Adjustable Sensitivity & Sprays Volume]: Our citronella bark collar has 2-level sensitivity and 2-level spray volume. You can choose the most suitable combination of sensitivity and spray volume according to the environment and the size of the dog. 【Please see the picture for the operation method】
- [Rechargeable & Waterproof]: The barking collar built-in Li-ion Polymer battery, rapid charge only needs 1.5~2.5 hours for 10 days of regular use. Waterproof design allows dogs to play in splash water or rain, but please don't soak it in the water (can't bathing or swimming).
- [Suit For Most of the Dogs]: We send 2 Reflective Nylon Collar Strap that can allow you to change your dog's appearance. The adjustable strap(3-21inch) makes the stop barking collar fits all sizes of dogs(8-120lbs). We recommend the use of the bark collar for dogs aged 6 months and weigh over 8 lbs. Fits small, medium & large dogs, except aggressive dogs/long nose dogs/smelling impaired dogs/long neck dogs.

© 2023 All Rights Reserved. Dog Bark Collar Citronella Bark Collar



Dog Bark Collar Citronella Bark Collar

CIVIL SHEET INDEX

CIVIL COVER AND SPECIFICATION SHEET

32 20 00 CONCRETE AND AGGREGATE BASE

[illegible]

32 30 00 LANDSCAPING AND SITE STABILIZATION

TOSOL CONTRACTOR TO PROVIDE A MINIMUM OF 0% OF TOSOL FOR ALL DISTURBED OPEN AREAS. REUSE SURFACE SOIL STOCKPILED ON SITE AND SUPPLEMENT WITH IMPORTED OR MANUFACTURED TOSOL FROM OFF SITE SOURCES TO MEET THE FOLLOWING REQUIREMENTS: TOSOL SHALL BE APPLIED TO ALL DISTURBED AREAS TO A MINIMUM OF 1.0 INCHES DEEP TO PREVENT EROSION AND TO PROMOTE SOIL REGENERATION AND GRASSING OF TOSOL. PROVIDE SOIL ANALYSIS BY A QUALIFIED SOIL TESTING LABORATORY AS REQUIRED TO VERIFY THE SUITABILITY OF TOSOL TO BE USED AS TOSOL AND TO DETERMINE THE NECESSARY SOIL AMENDMENTS. TOSOL SHALL BE PRESENT OF ATTRAZINE AND INFORM EXCEL ENGINEERING, INC. IF PRESENT PRIOR TO BIDDING PROJECT. TOSOL SHALL HAVE A PH RANGE OF 5.5 TO 6.5 TO CONTAIN A MINIMUM OF 5 PERCENT ORGANIC MATERIAL CONTENT AND SHALL BE FREE OF SALTS AND HEAVY METALS. TOSOL SHALL BE APPLIED TO ALL DISTURBED AREAS TO A MINIMUM OF 1.0 INCHES DEEP TO PREVENT EROSION AND TO PROMOTE SOIL REGENERATION AND GRASSING OF TOSOL. TOSOL INSTALLATION: LOOSEN SURFACE TO A MINIMUM DEPTH OF 6 INCHES AND REMOVE STONES LARGER THAN 1" IN DIAMETER. ALSO REMOVE ANY STICKS, RUBBER, AND OTHER EXTRANEOUS MATERIAL AND DEPOSE OF THEM OFF THE PROPERTY. SPREAD TOSOL TO A DEPTH OF 0" BUT NOT LESS THAN WHAT IS REQUIRED TO MEET FINISHED GRADES AFTER LIGHT SOILING AND NATURAL SETTLEMENT. DO NOT SPREAD TOSOL IF SUBGRADE IS FROZEN, MOIST, OR IN SEED LOSS AREAS.

PERMANENT GRASSING PERMANENT GRASS SHALL BE SEED WITH THE FOLLOWING ANALYSIS: 60% KENTUCKY BLUEGRASS (RGS 0.2-6.1 LB/1,000 S.F.), 30% PERENNIAL RYEGRASS (0.8-1.8 LB/1,000 S.F.), 15% FESCUE (0.4-0.8 LB/1,000 S.F.), STRAW AND MULCH SHALL BE Laid AT TOSOL/1,000 S.F. FERTILIZE AS FOLLOWS: TEST OR APPLY 5-10-10 OR EQUIVALENT AT 5.4 LB/1,000 S.F. SEE EROSION/MATTING SPECIFICATIONS AS REQUIRED. ALL SITE DISTURBED AREAS NOT DESIGNATED FOR OTHER LANDSCAPING AND SITE STABILIZATION METHODS SHALL BE SEED AS PERMANENT LAWN. NO BARE SPOTS SHALL BE LEFT UNCOVERED. FOLLOW PROCEDURES FOUND IN WQWV TECHNICAL SPECIFICATIONS 1058 & 1059.

TEMPORARY GRASSING TEMPORARY GRASS SHALL BE SEED WITH THE FOLLOWING ANALYSIS: 60% KENTUCKY BLUEGRASS (RGS 0.2-6.1 LB/1,000 S.F.), 30% PERENNIAL RYEGRASS (0.8-1.8 LB/1,000 S.F.), 15% FESCUE (0.4-0.8 LB/1,000 S.F.) AND 5% PERENNIAL RYEGRASS (RGS 0.100-1,000 S.F.). FERTILIZE AS FOLLOWS: TEST OR APPLY 5-10-10 OR EQUIVALENT AT 5.4 LB/1,000 S.F. SEE EROSION/MATTING SPECIFICATIONS AS REQUIRED. FOLLOW PROCEDURES FOUND IN WQWV TECHNICAL SPECIFICATIONS 1058 & 1059.

4. EROSION/MATTING

4.1 EROSION/MATTING ALL TEMPORARY SEEDING SHALL CONFORM TO THE FOLLOWING METHOD: 100% RYEGRASS AT 19 LB/1,000 S.F. STRAW AND MULCH SHALL BE Laid AT 0.5 LB/1,000 S.F. FERTILIZE AS PER TEST OR APPLY 5-10-10 OR EQUIVALENT AT 5.4 LB/1,000 S.F. SEE EROSION/MATTING SPECIFICATIONS AS REQUIRED. FOLLOW PROCEDURES FOUND IN WQWV TECHNICAL SPECIFICATIONS 1058 & 1059.

4.2 EROSION/MATTING ALL PERMANENT SEEDING SHALL CONFORM TO THE FOLLOWING METHOD: 100% RYEGRASS AT 19 LB/1,000 S.F. STRAW AND MULCH SHALL BE Laid AT 0.5 LB/1,000 S.F. FERTILIZE AS PER TEST OR APPLY 5-10-10 OR EQUIVALENT AT 5.4 LB/1,000 S.F. SEE EROSION/MATTING SPECIFICATIONS AS REQUIRED. FOLLOW PROCEDURES FOUND IN WQWV TECHNICAL SPECIFICATIONS 1058 & 1059.

4.3 EROSION/MATTING ALL PERMANENT SEEDING SHALL CONFORM TO THE FOLLOWING METHOD: 100% RYEGRASS AT 19 LB/1,000 S.F. STRAW AND MULCH SHALL BE Laid AT 0.5 LB/1,000 S.F. FERTILIZE AS PER TEST OR APPLY 5-10-10 OR EQUIVALENT AT 5.4 LB/1,000 S.F. SEE EROSION/MATTING SPECIFICATIONS AS REQUIRED. FOLLOW PROCEDURES FOUND IN WQWV TECHNICAL SPECIFICATIONS 1058 & 1059.

4.4 EROSION/MATTING ALL PERMANENT SEEDING SHALL CONFORM TO THE FOLLOWING METHOD: 100% RYEGRASS AT 19 LB/1,000 S.F. STRAW AND MULCH SHALL BE Laid AT 0.5 LB/1,000 S.F. FERTILIZE AS PER TEST OR APPLY 5-10-10 OR EQUIVALENT AT 5.4 LB/1,000 S.F. SEE EROSION/MATTING SPECIFICATIONS AS REQUIRED. FOLLOW PROCEDURES FOUND IN WQWV TECHNICAL SPECIFICATIONS 1058 & 1059.

4.5 EROSION/MATTING ALL PERMANENT SEEDING SHALL CONFORM TO THE FOLLOWING METHOD: 100% RYEGRASS AT 19 LB/1,000 S.F. STRAW AND MULCH SHALL BE Laid AT 0.5 LB/1,000 S.F. FERTILIZE AS PER TEST OR APPLY 5-10-10 OR EQUIVALENT AT 5.4 LB/1,000 S.F. SEE EROSION/MATTING SPECIFICATIONS AS REQUIRED. FOLLOW PROCEDURES FOUND IN WQWV TECHNICAL SPECIFICATIONS 1058 & 1059.

4.6 EROSION/MATTING ALL PERMANENT SEEDING SHALL CONFORM TO THE FOLLOWING METHOD: 100% RYEGRASS AT 19 LB/1,000 S.F. STRAW AND MULCH SHALL BE Laid AT 0.5 LB/1,000 S.F. FERTILIZE AS PER TEST OR APPLY 5-10-10 OR EQUIVALENT AT 5.4 LB/1,000 S.F. SEE EROSION/MATTING SPECIFICATIONS AS REQUIRED. FOLLOW PROCEDURES FOUND IN WQWV TECHNICAL SPECIFICATIONS 1058 & 1059.

4.7 EROSION/MATTING ALL PERMANENT SEEDING SHALL CONFORM TO THE FOLLOWING METHOD: 100% RYEGRASS AT 19 LB/1,000 S.F. STRAW AND MULCH SHALL BE Laid AT 0.5 LB/1,000 S.F. FERTILIZE AS PER TEST OR APPLY 5-10-10 OR EQUIVALENT AT 5.4 LB/1,000 S.F. SEE EROSION/MATTING SPECIFICATIONS AS REQUIRED. FOLLOW PROCEDURES FOUND IN WQWV TECHNICAL SPECIFICATIONS 1058 & 1059.

4.8 EROSION/MATTING ALL PERMANENT SEEDING SHALL CONFORM TO THE FOLLOWING METHOD: 100% RYEGRASS AT 19 LB/1,000 S.F. STRAW AND MULCH SHALL BE Laid AT 0.5 LB/1,000 S.F. FERTILIZE AS PER TEST OR APPLY 5-10-10 OR EQUIVALENT AT 5.4 LB/1,000 S.F. SEE EROSION/MATTING SPECIFICATIONS AS REQUIRED. FOLLOW PROCEDURES FOUND IN WQWV TECHNICAL SPECIFICATIONS 1058 & 1059.

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DIVISION 33 UTILITIES

33 10 00 SITE UTILI


[illegible]

CONSTRUCTION STAKING SERVICES

CONSTRUCTION STAKING SHALL BE COMPLETED BY EXCEL ENGINEERING AS REQUESTED BY THE CONTRACTOR AT THE CONTRACTOR'S EXPENSE. CONTRACTOR TO CONTACT RYAN WILGREEN AT 920-926-9800 OR RYAN.W@EXCELENGINEER.COM TO GET STAKING PRICE TO INCLUDE IN BID TO OWNER. PAYMENT OF STAKING COSTS ABOVE AND BEYOND THE BASE PRICE DUE TO RESTAKING WILL BE THE RESPONSIBILITY OF THE CONTRACTOR, NOT THE OWNER. CAD DRAWING FILES AND SURVEY CONTROL WILL NOT BE PROVIDED FOR STAKING PURPOSES.

GENERAL PROJECT NOTES

1. THE CONTRACTOR IS RESPONSIBLE FOR OBTAINING ALL WORK IN ROW PERMITS & ANY OTHER NECESSARY PERMITS FOR CONSTRUCTION.
2. CONTRACTOR TO ENSURE APPROVALS FOR CONSTRUCTION OF IMPROVEMENTS OVER CITY OWNED DRAINAGE EASEMENT AND PIPE IS APPROVED BY CITY.

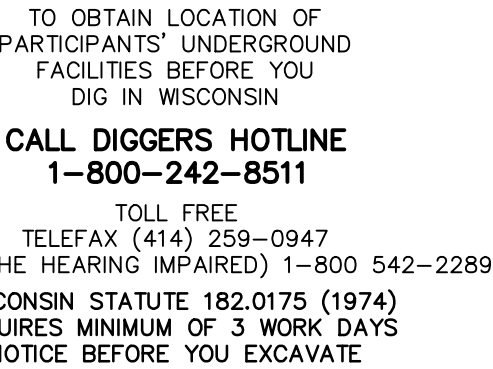COLLABORATION

PROPOSED BUS GARAGE FOR:
CENTRAL WISCONSIN CHRISTIAN SCHOOL
301 FOX LAKE ROAD • WAUPUN, WI 53963

PROFESSIONAL SEAL

WISCONSIN
ERIC
DRAZKOWSKI
0028356-006
FOND DU LAC
WISCONSIN
PROFESSIONAL ENGINEER


PRELIMINARY DATES	
OCT. 20, 2021	NOVEMBER 2021
NOV. 9, 2021	


NOT FOR CONSTRUCTION

JOB NUMBER
2132120

SHEET NUMBER

C0.1

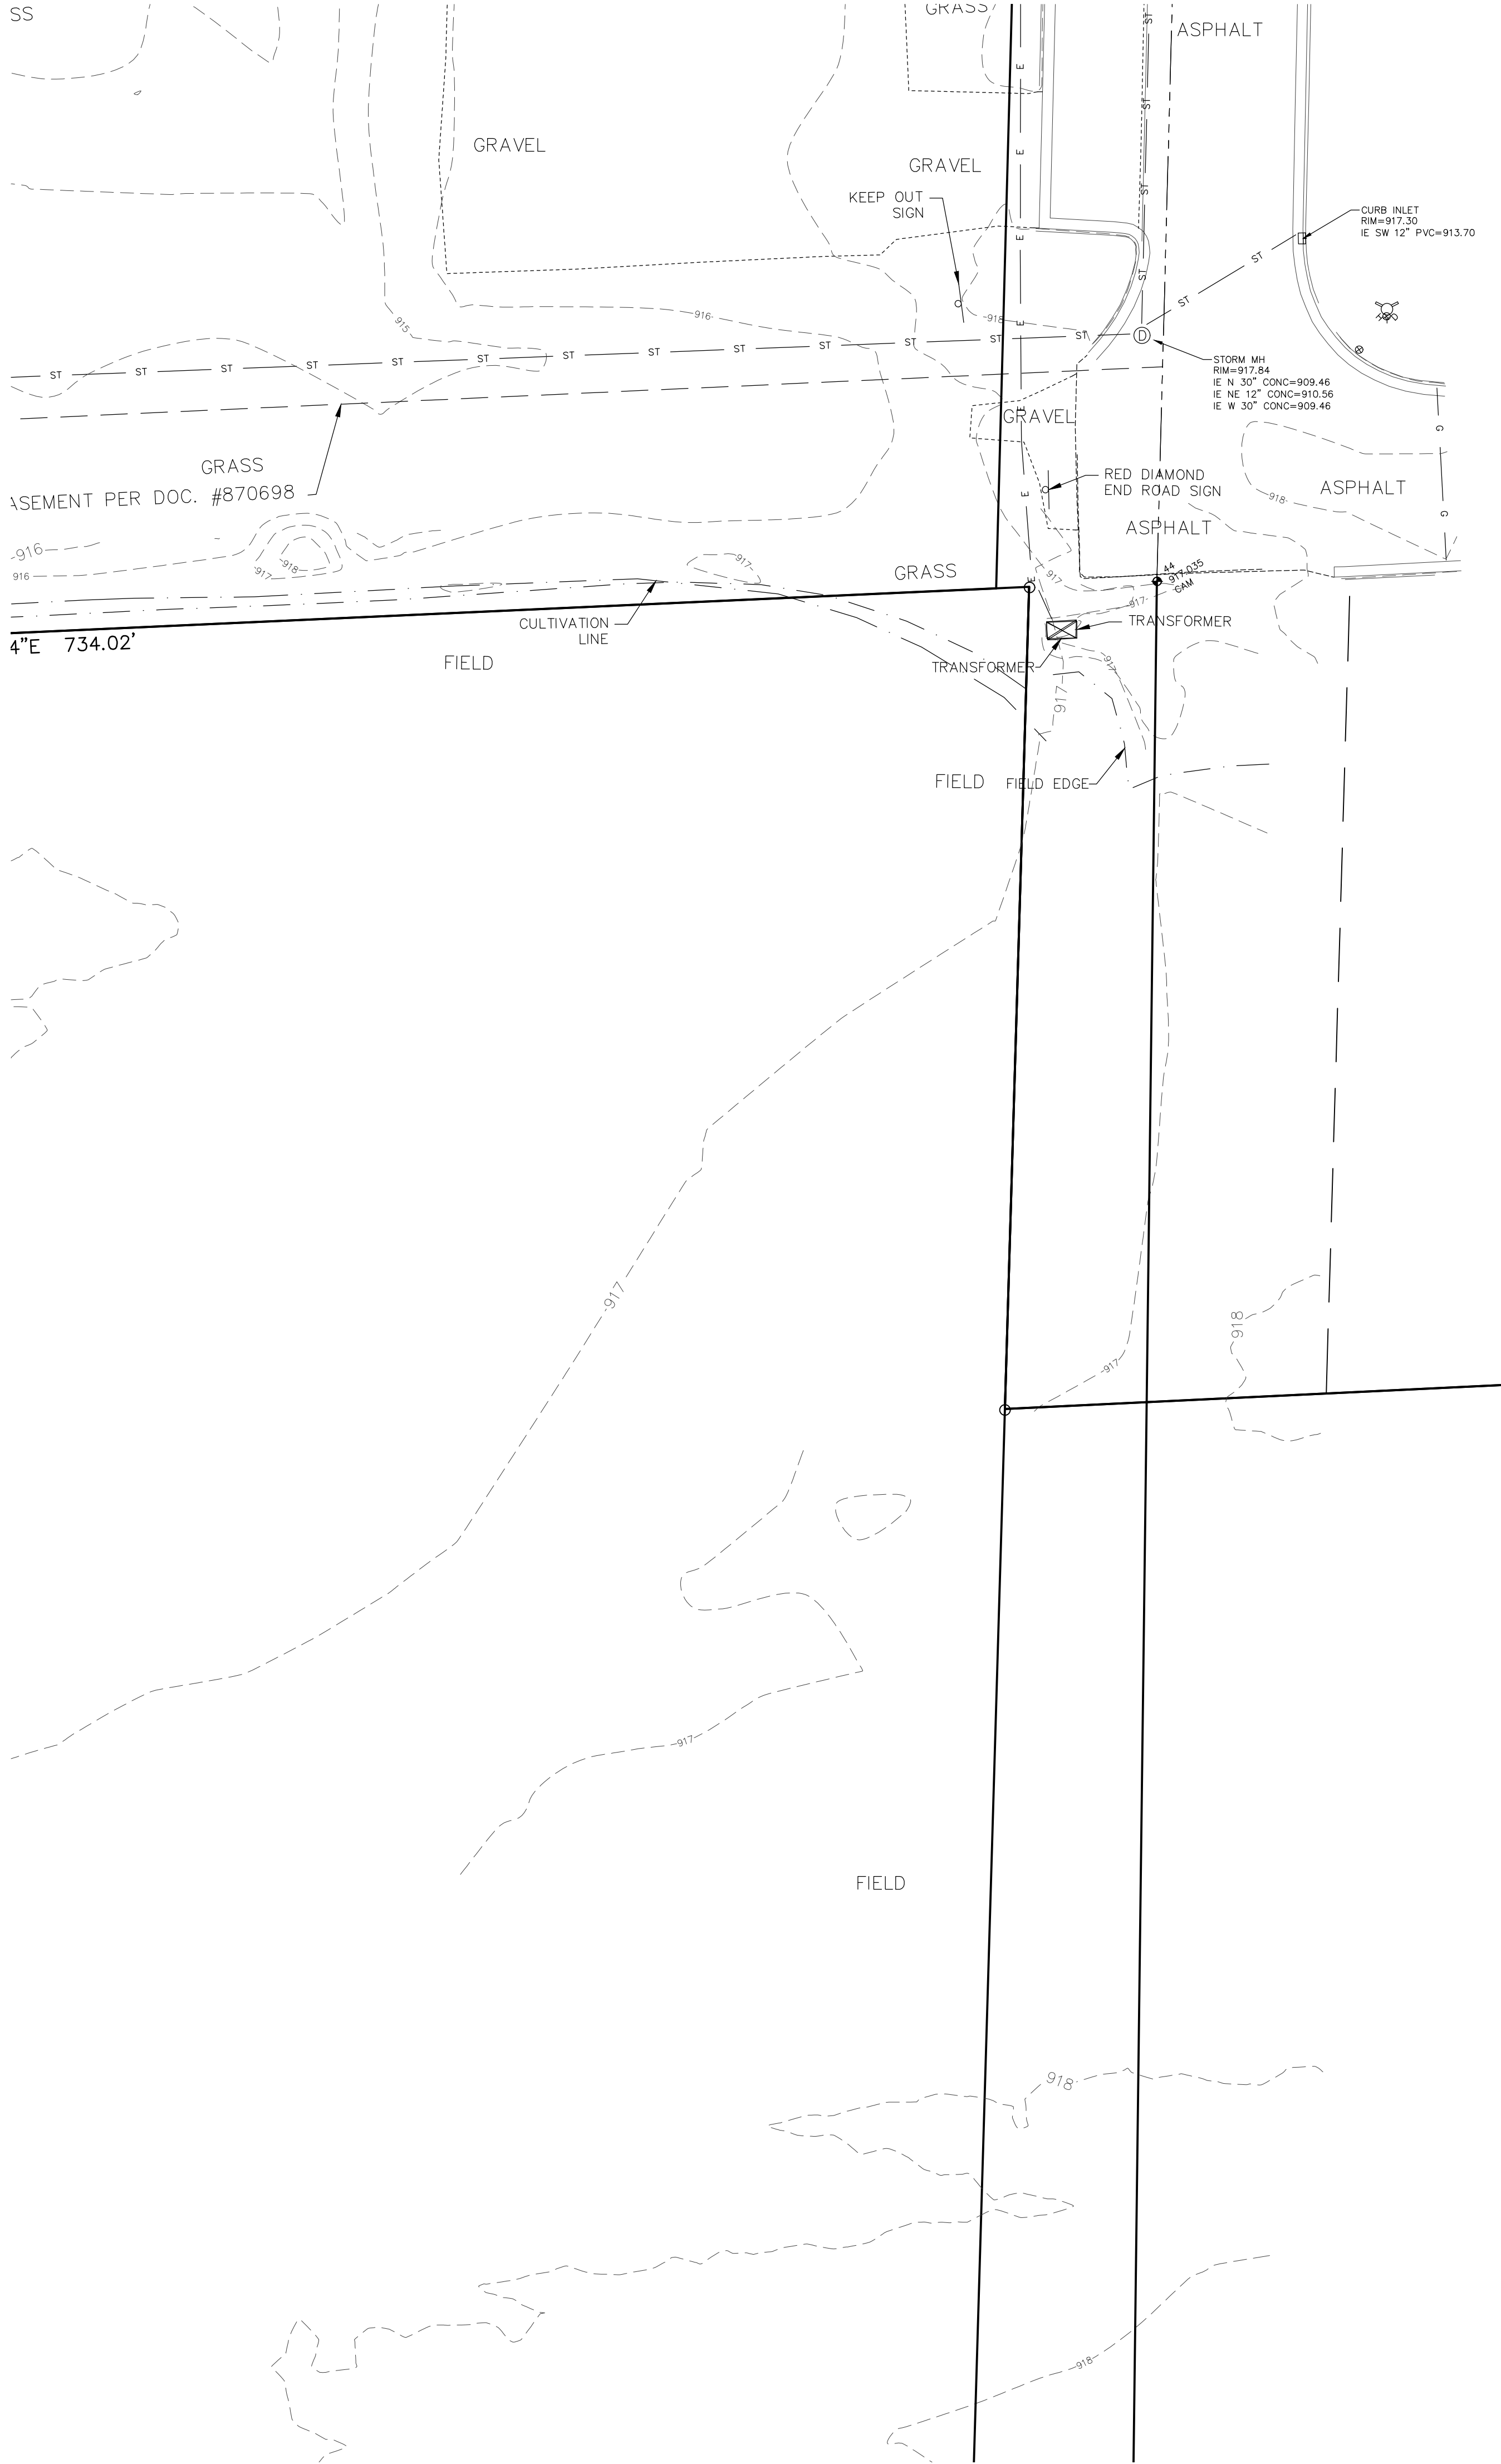

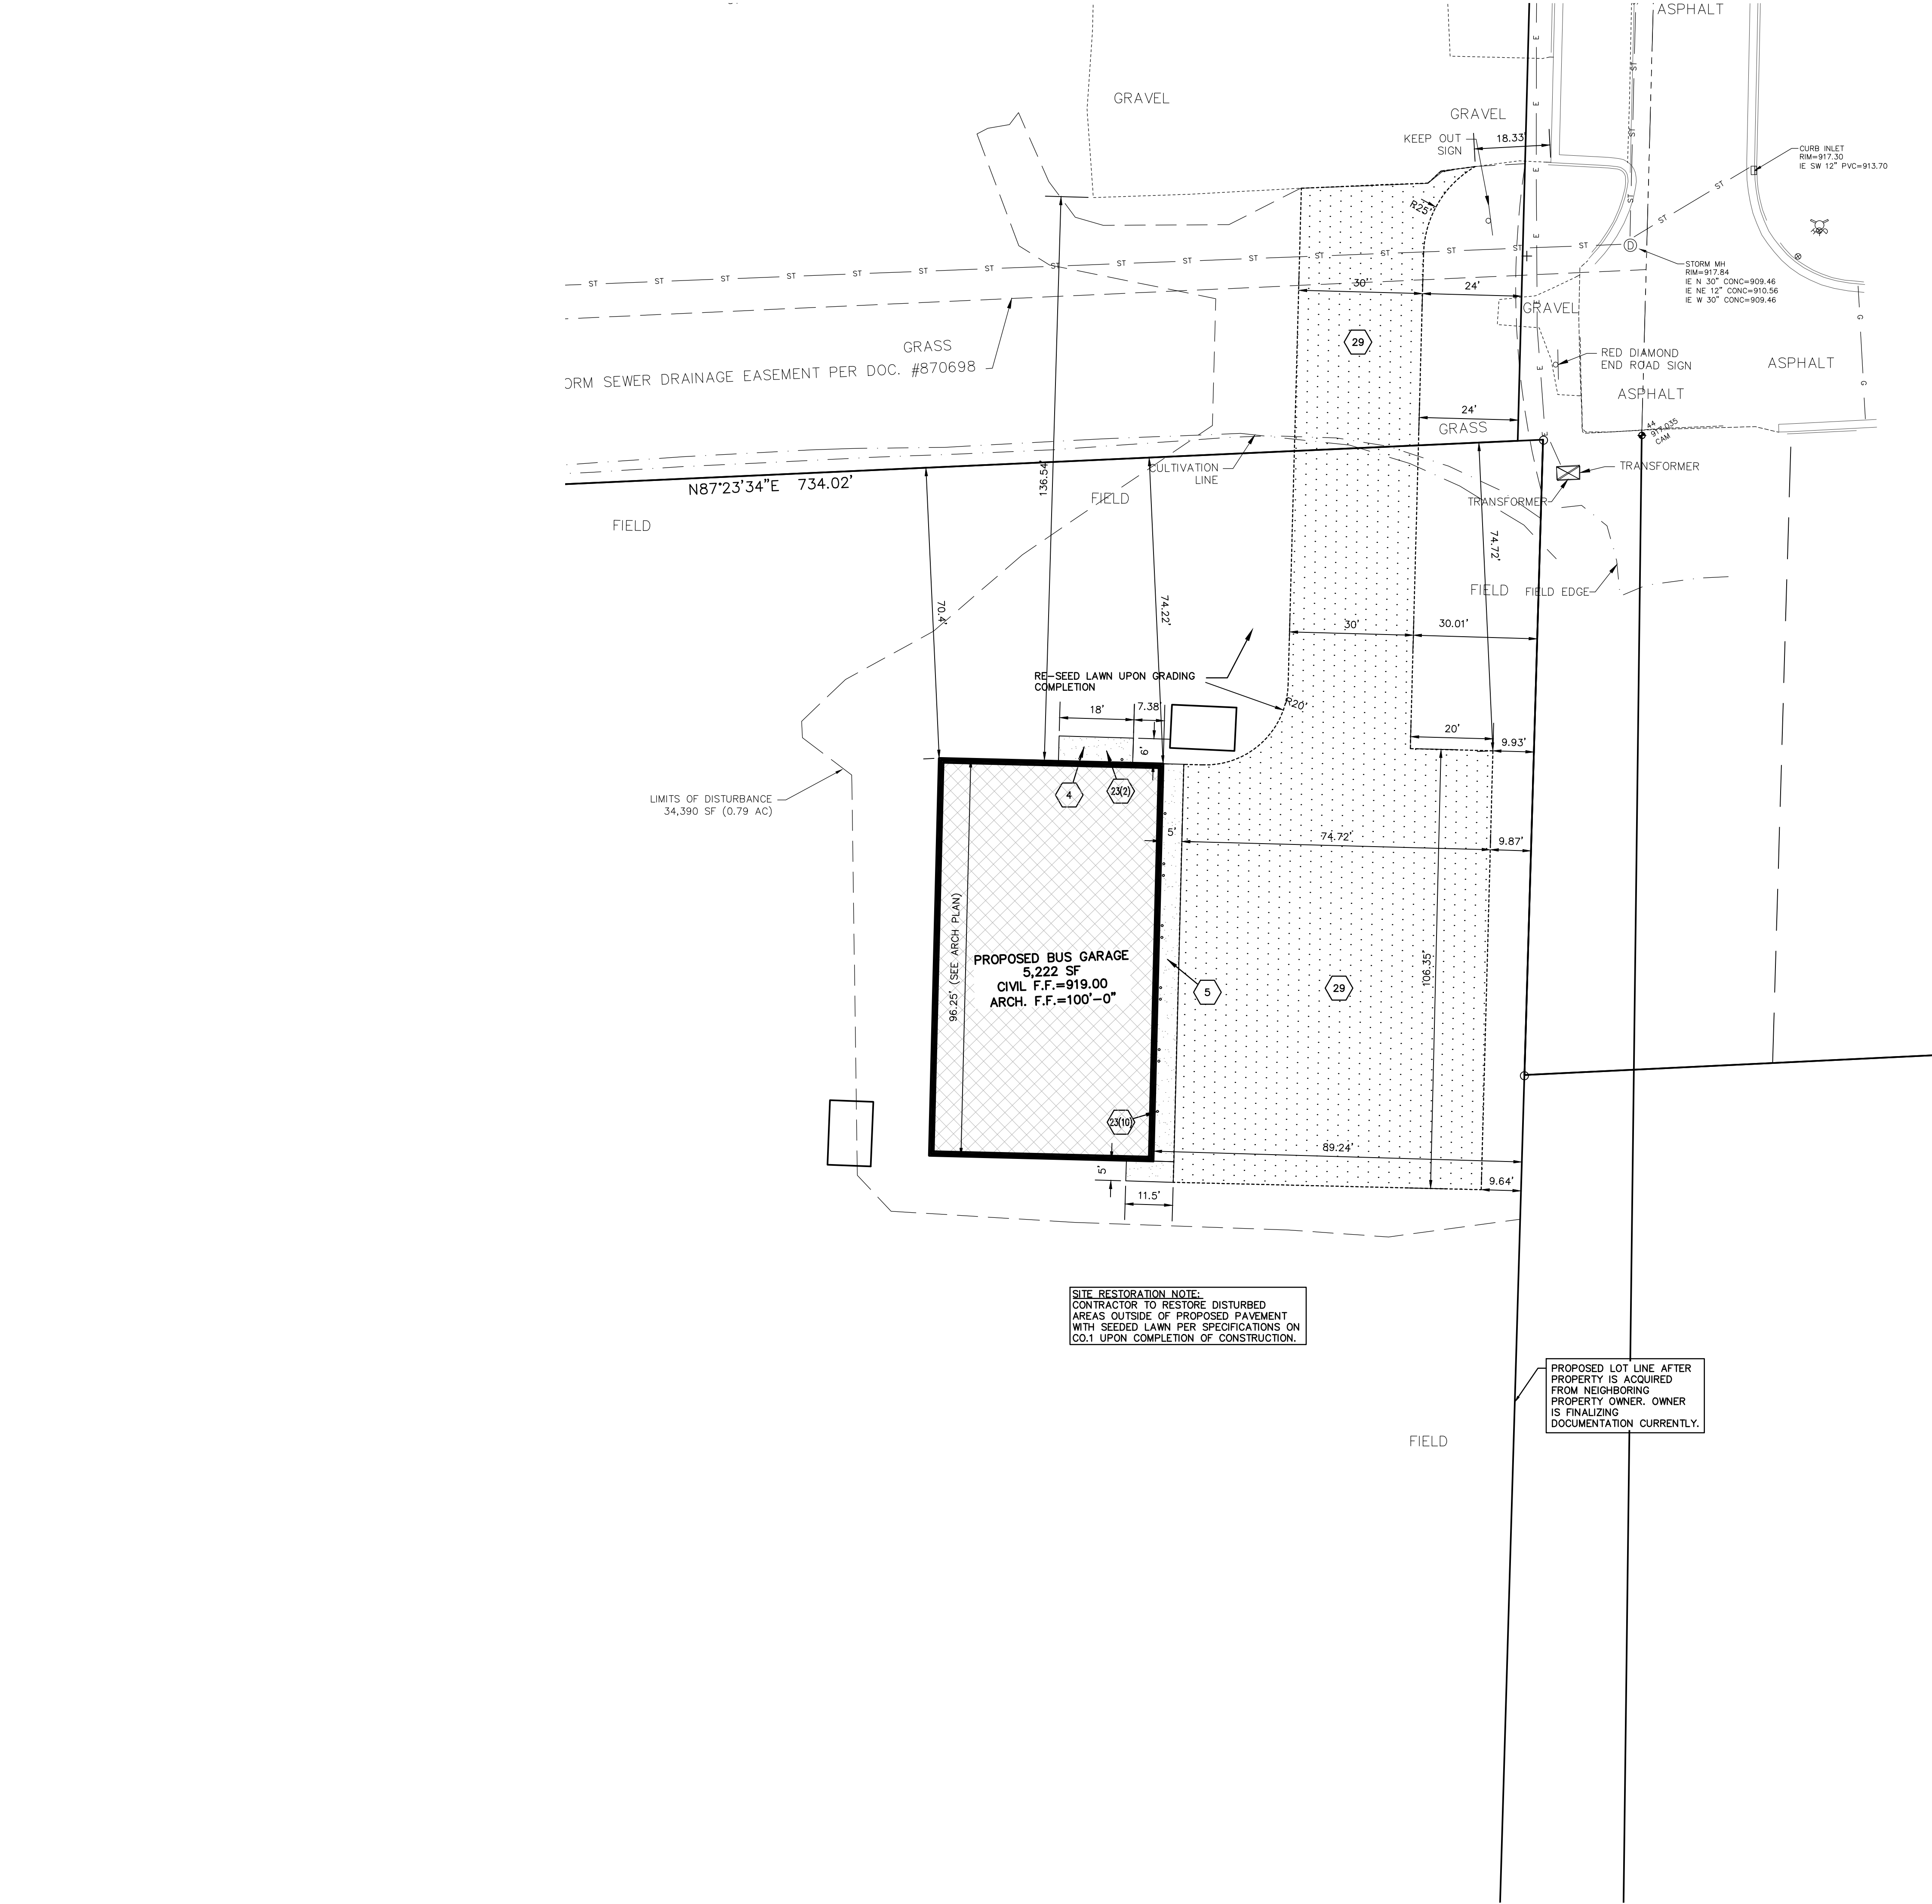

SPECIFICATION NOTE:
SEE SHEET C0.1 FOR PLAN
SPECIFICATIONS AND REQUIREMENTS

SITE INFORMATION (BUS GARAGE IMPROVEMENTS):

JURISTICTIION: TOWN OF CHESTER
PROPOSED USE: SCHOOL BUS GARAGE
AREA OF SITE DISTURBANCE: 34,390 S.F. (0.79 ACRES)
PROPOSED BUILDING HEIGHT: 21'-3"
SETBACKS: TOWN OF CHESTER: 10' TO SIDE YARDS FOR PRINCIPAL STRUCTURE

EXISTING SITE DATA (LIMITS OF DISTURBANCE)

	AREA (AC)	AREA (SF)	RATIO
PROJECT SITE	0.94	40,821	
BUILDING FLOOR AREA	0.00	0	0.0%
PAVEMENT (GRAVEL)	0.00	0	0.0%
TOTAL IMPERVIOUS	0.00	0	0.0%
LANDSCAPE/ OPEN SPACE	0.94	40,821	100.0%

PROPOSED SITE DATA (LIMITS OF DISTURBANCE)

	AREA (AC)	AREA (SF)	RATIO
PROJECT SITE	0.94	40,821	
BUILDING FLOOR AREA	0.12	5,222	12.8%
PAVEMENT (GRAVEL & CONC APRON)	0.38	16,489	40.4%
TOTAL IMPERVIOUS	0.50	21,711	53.2%
LANDSCAPE/ OPEN SPACE	0.44	19,110	46.8%


SITE PLAN KEYNOTES

3	CONCRETE SIDEWALK (TYP.)
4	LIGHT DUTY CONCRETE (TYP.)
5	HEAVY DUTY CONCRETE (TYP.)
23	6" CONCRETE BOLLARDS (SEE DETAIL ON C2.0 UNLESS SEPARATE DETAIL PROVIDED BY ARCH PLAN)
29	GRAVEL SECTION (TYP.)

X(X) IDENTIFICATION: KEYNOTE ITEM(QUANTITY) - IF NO () = QUANTITY IS 1

SITE RESTORATION NOTE:
CONTRACTOR TO RESTORE DISTURBED
AREAS OUTSIDE OF PROPOSED PAVEMENT
WITH SEEDED LAWN PER SPECIFICATIONS ON
C0.1 UPON COMPLETION OF CONSTRUCTION.

PROPOSED LOT LINE AFTER
PROPERTY IS ACQUIRED
FROM NEIGHBORING
PROPERTY OWNER. OWNER
IS FINALIZING
DOCUMENTATION CURRENTLY.

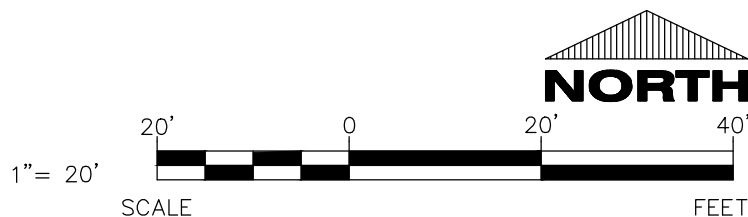

CIVIL SITE PLAN

EXCEL

ARCHITECTS • ENGINEERS • SURVEYORS

Always a Better Plan

100 Camelot Drive
Fond Du Lac, WI 54935
Phone: (920) 926-9800
www.EXCELENGINEER.com

COLLABORATION

WDS

CONSTRUCTION

PROJECT INFORMATION

PROPOSED BUS GARAGE FOR:
CENTRAL WISCONSIN CHRISTIAN SCHOOL
301 FOX LAKE ROAD • WAUPUN, WI 53963

PROFESSIONAL SEAL

PRELIMINARY DATES


OCT. 20, 2021
NOV. 9, 2021

JOB NUMBER

2132120

SHEET NUMBER

C1.1

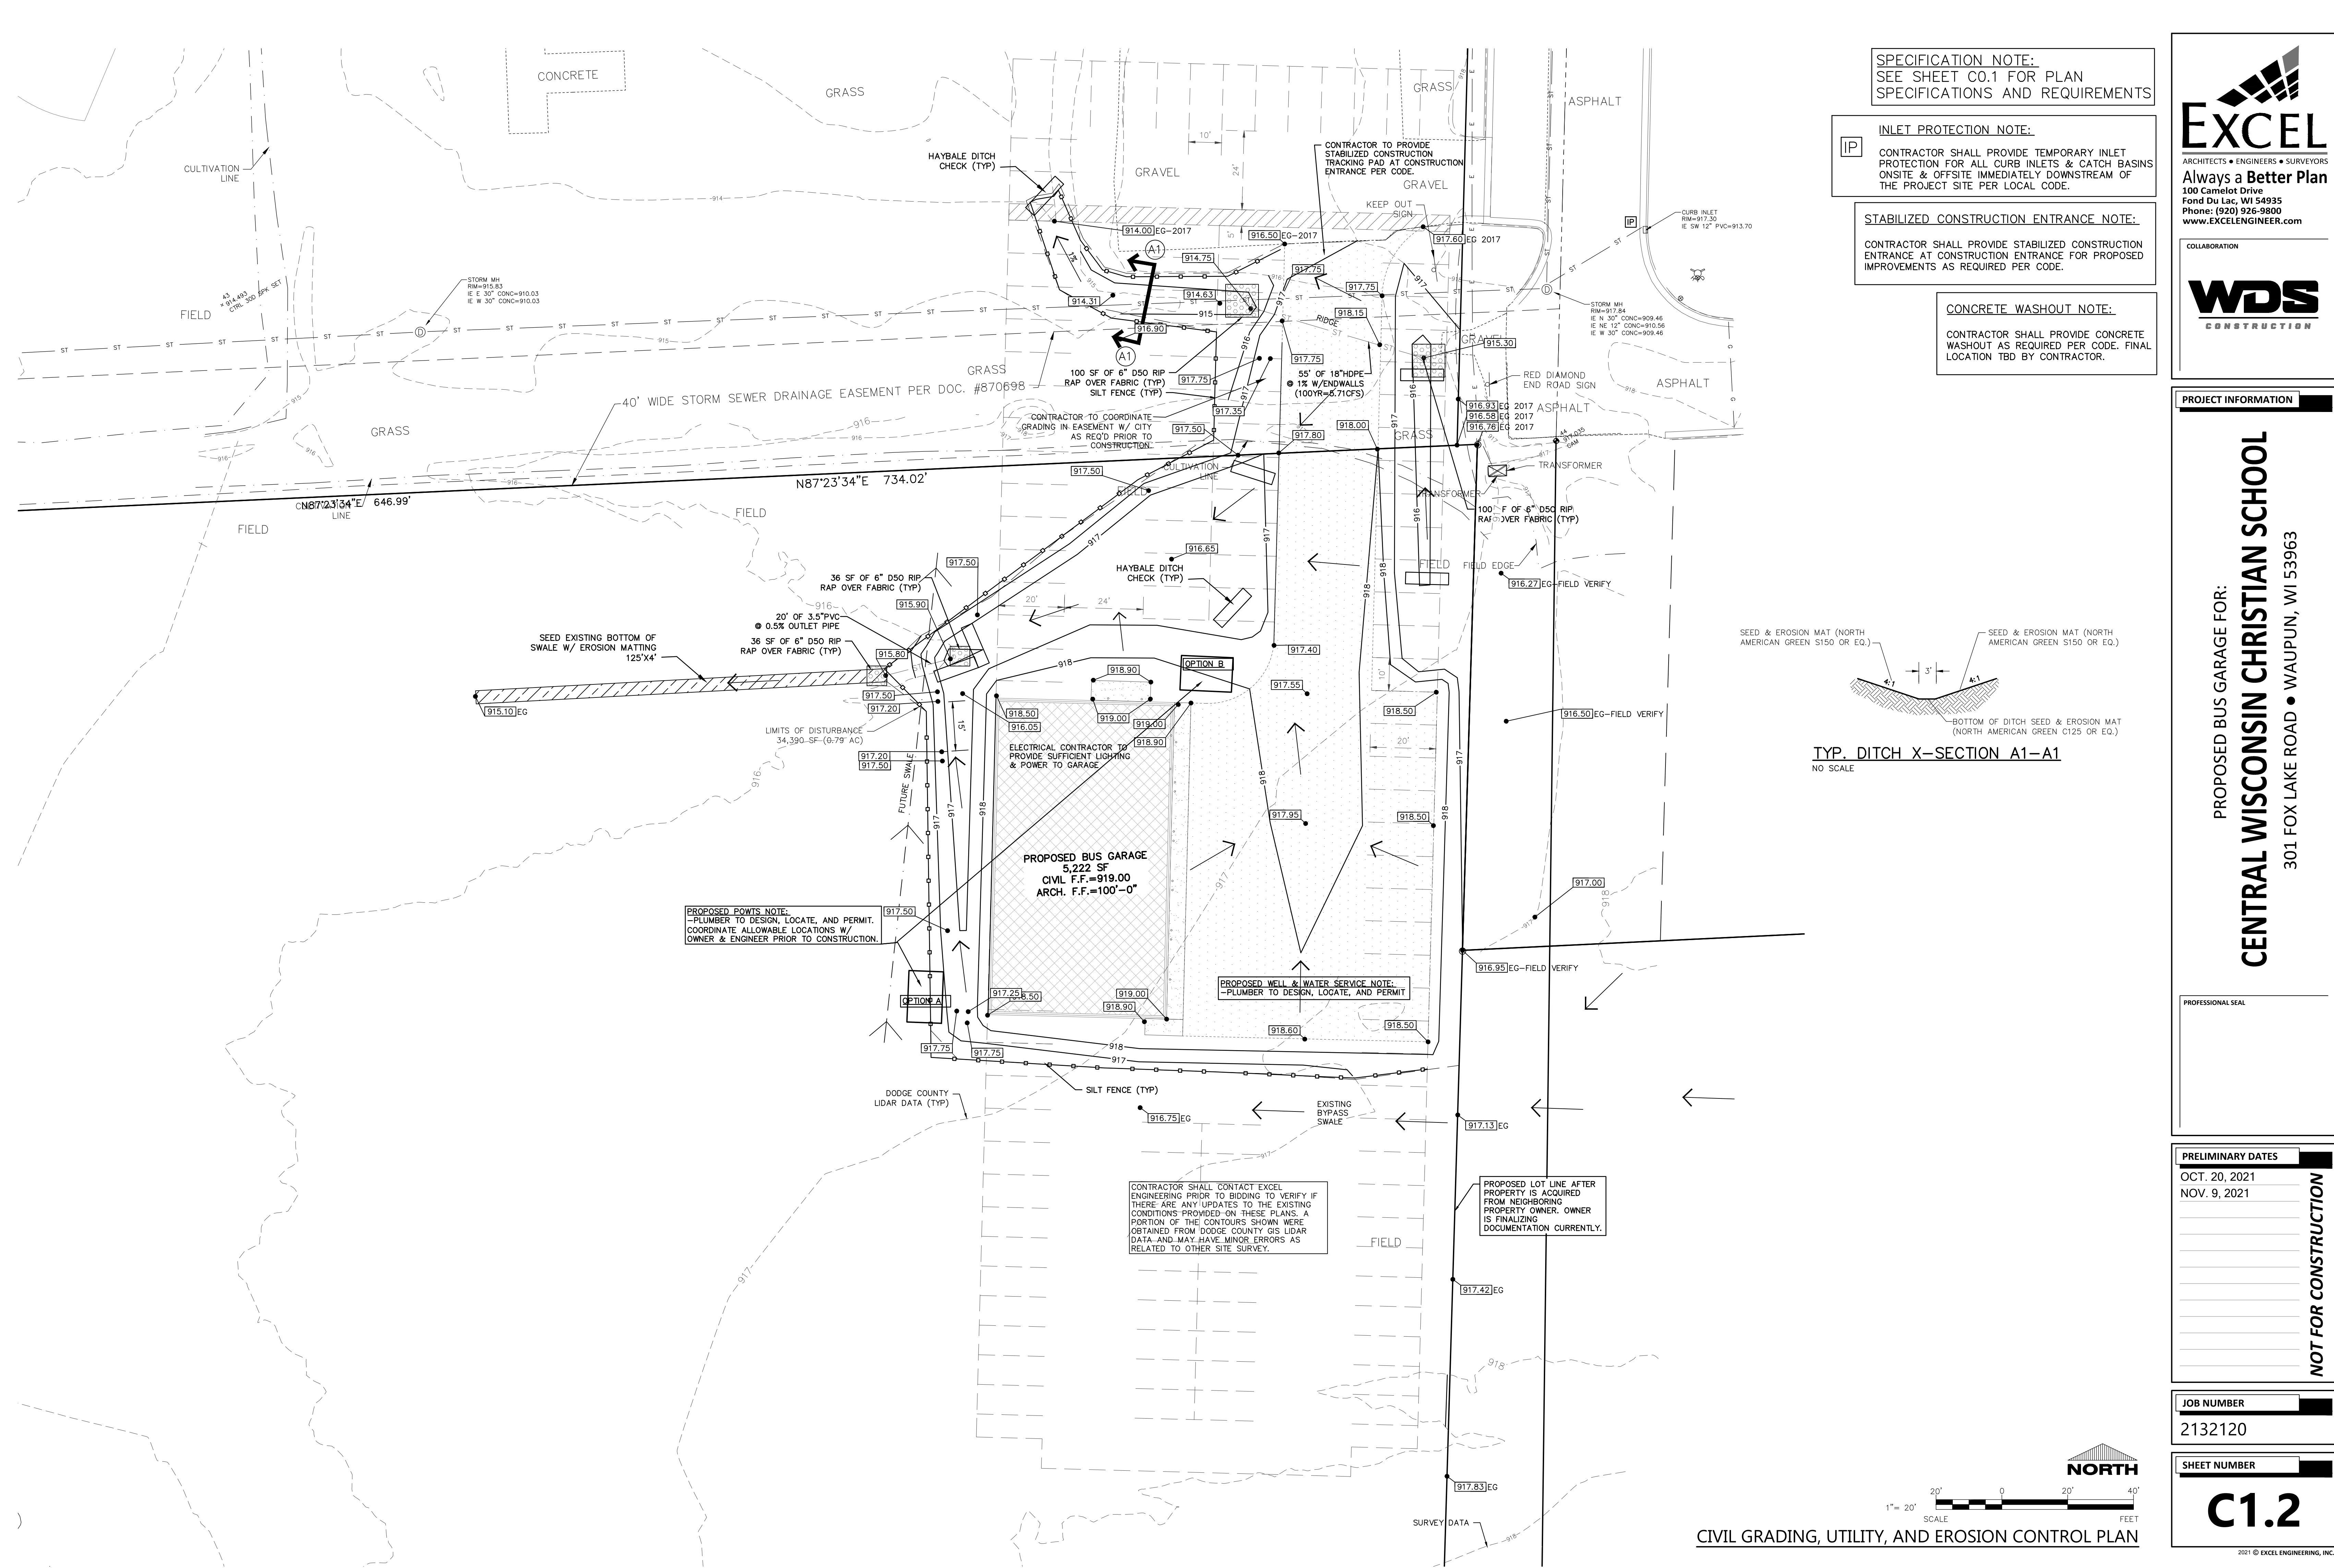


SPECIFICATION NOTE:
SEE SHEET C0.1 FOR PLAN
SPECIFICATIONS AND REQUIREMENTS

INLET PROTECTION NOTE:
CONTRACTOR SHALL PROVIDE TEMPORARY INLET
PROTECTION FOR ALL CURB INLETS & CATCH BASINS
ONSITE & OFFSITE IMMEDIATELY DOWNSTREAM OF
THE PROJECT SITE PER LOCAL CODE.

STABILIZED CONSTRUCTION ENTRANCE NOTE:
CONTRACTOR SHALL PROVIDE STABILIZED CONSTRUCTION
ENTRANCE AT CONSTRUCTION ENTRANCE FOR PROPOSED
IMPROVEMENTS AS REQUIRED PER CODE.

CONCRETE WASHOUT NOTE:
CONTRACTOR SHALL PROVIDE CONCRETE
WASHOUT AS REQUIRED PER CODE. FINAL
LOCATION TBD BY CONTRACTOR.

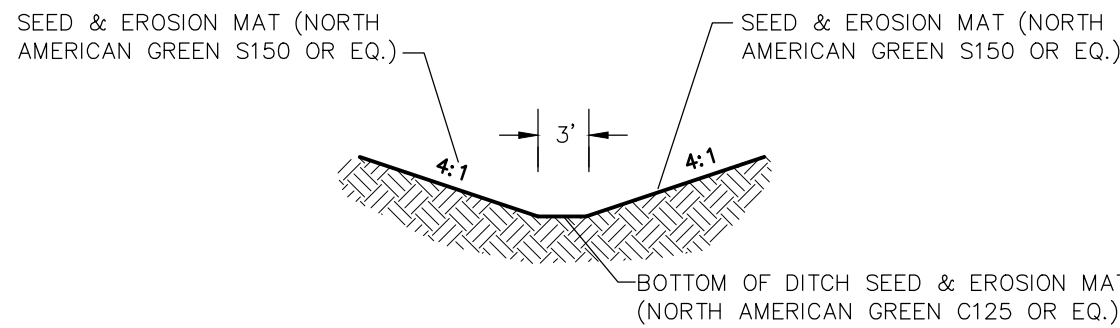

TYP. DITCH X-SECTION A1-A1
NO SCALE

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100 Camelot Drive
Fond Du Lac, WI 54935
Phone: (920) 926-9800
www.EXCELENGINEER.com

COLLABORATION

PROJECT INFORMATION

PROPOSED BUS GARAGE FOR:
CENTRAL WISCONSIN CHRISTIAN SCHOOL
301 FOX LAKE ROAD • WAUPUN, WI 53963

PROFESSIONAL SEAL

PRELIMINARY DATES

OCT. 20, 2021
NOV. 9, 2021

NOT FOR CONSTRUCTION

JOB NUMBER

2132120

SHEET NUMBER

C1.2

SPECIFICATION NOTE:
SEE SHEET C0.1 FOR PLAN
SPECIFICATIONS AND REQUIREMENTS

COLLABORATION

WDS
CONSTRUCTION

PROJECT INFORMATION

PROPOSED BUS GARAGE FOR:
CENTRAL WISCONSIN CHRISTIAN SCHOOL
301 FOX LAKE ROAD • WAUPUN, WI 53963

PROFESSIONAL SEAL

PRELIMINARY DATES

OCT. 20, 2021


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JOB NUMBER


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SHEET NUMBER


C2.0



6" PIPE BOLLARD DETAIL
NO SCALE

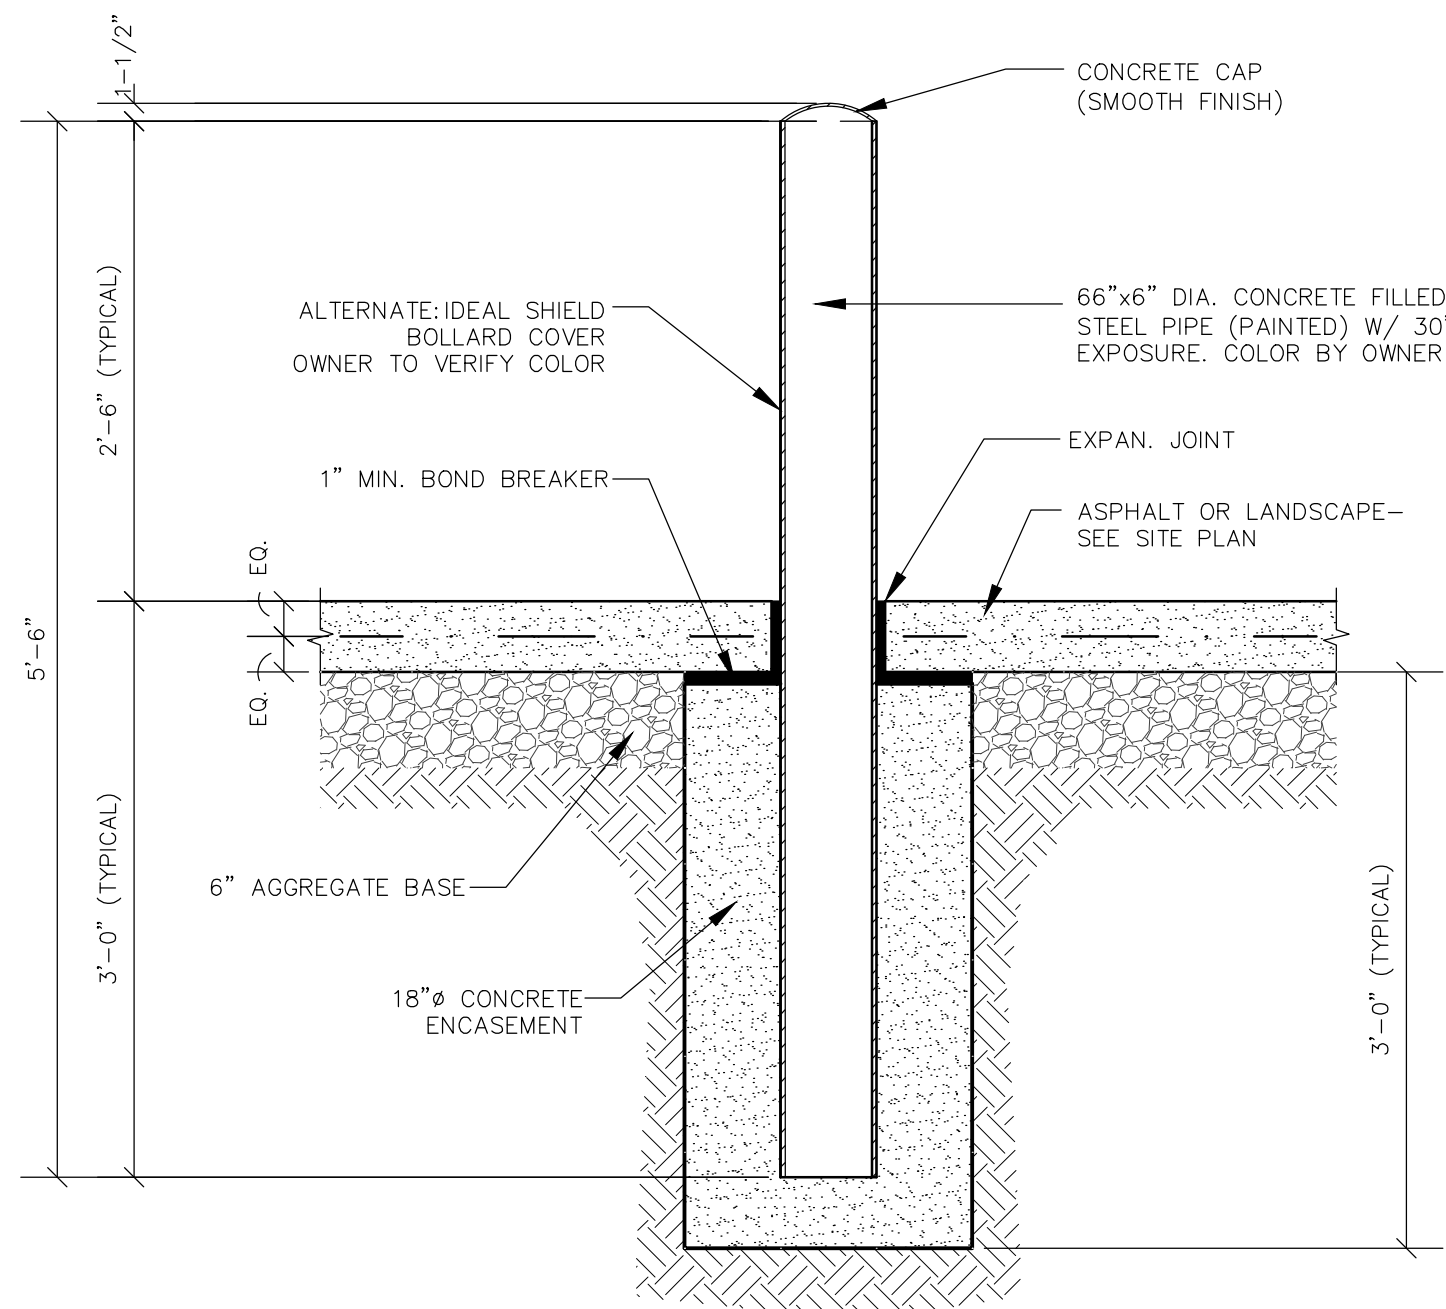


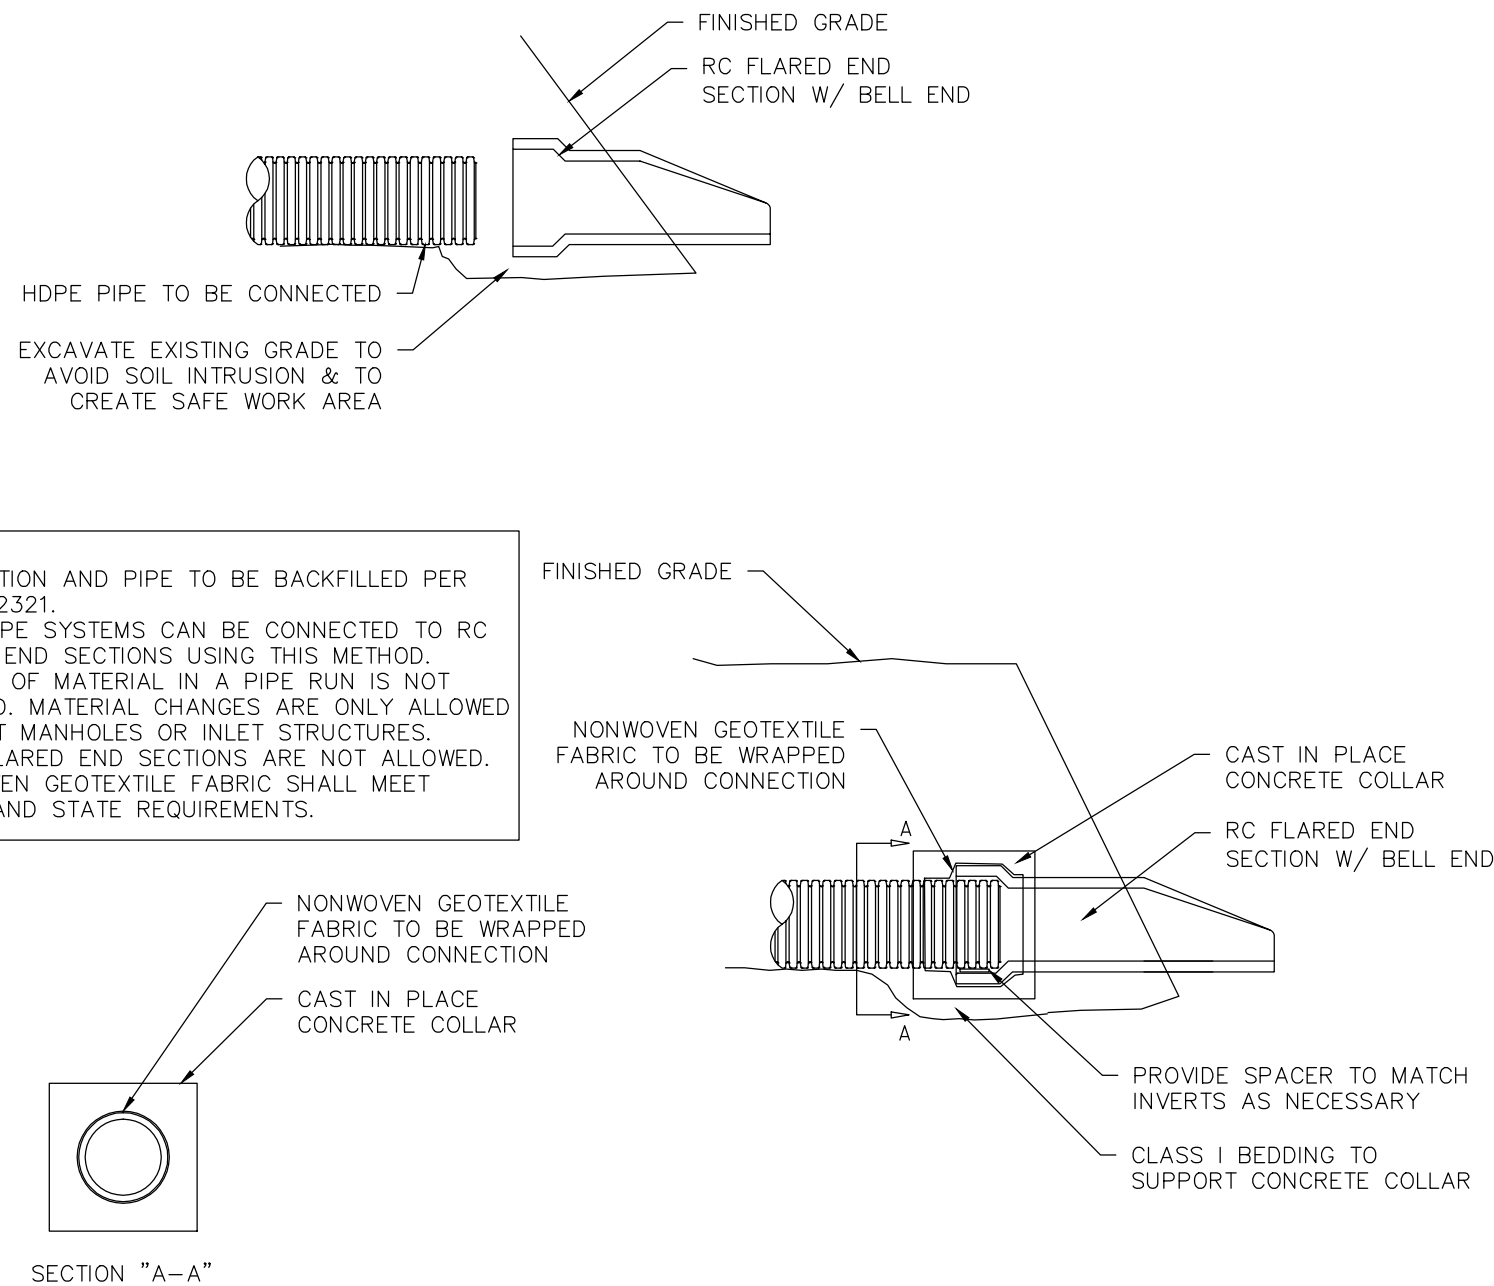**CONNECTION DETAIL FOR HDPE PIPE
TO RC FLARED END SECTION BELL END**
NO SCALE

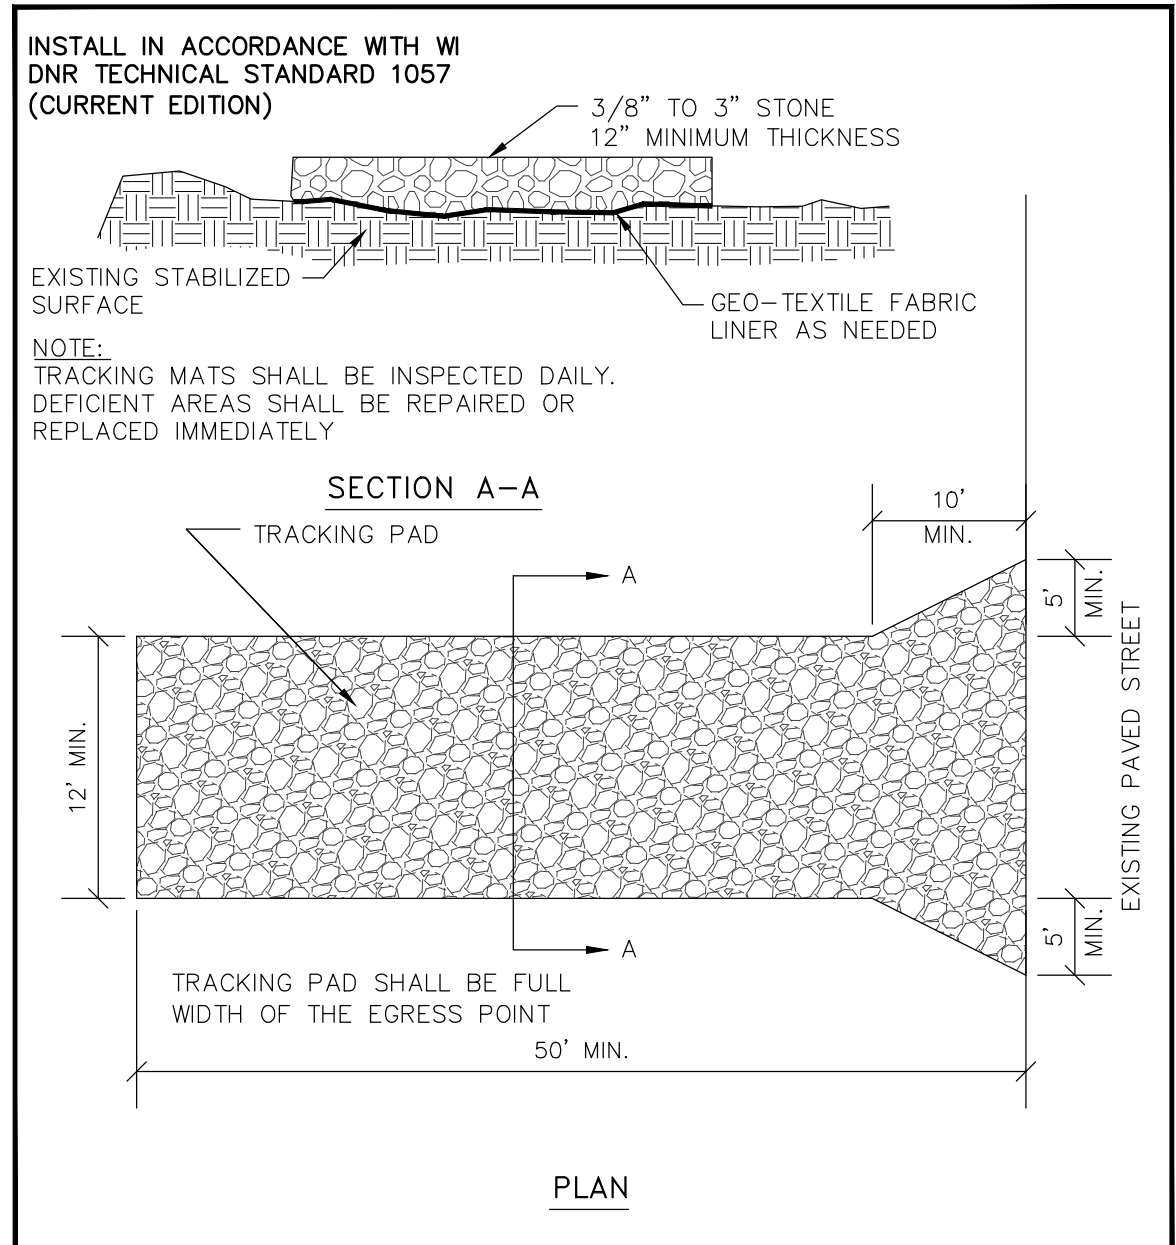


TRACKPAD DETAILS
NO SCALE

FIGURE 1. INLET PROTECTION TYPES A, B, C AND D

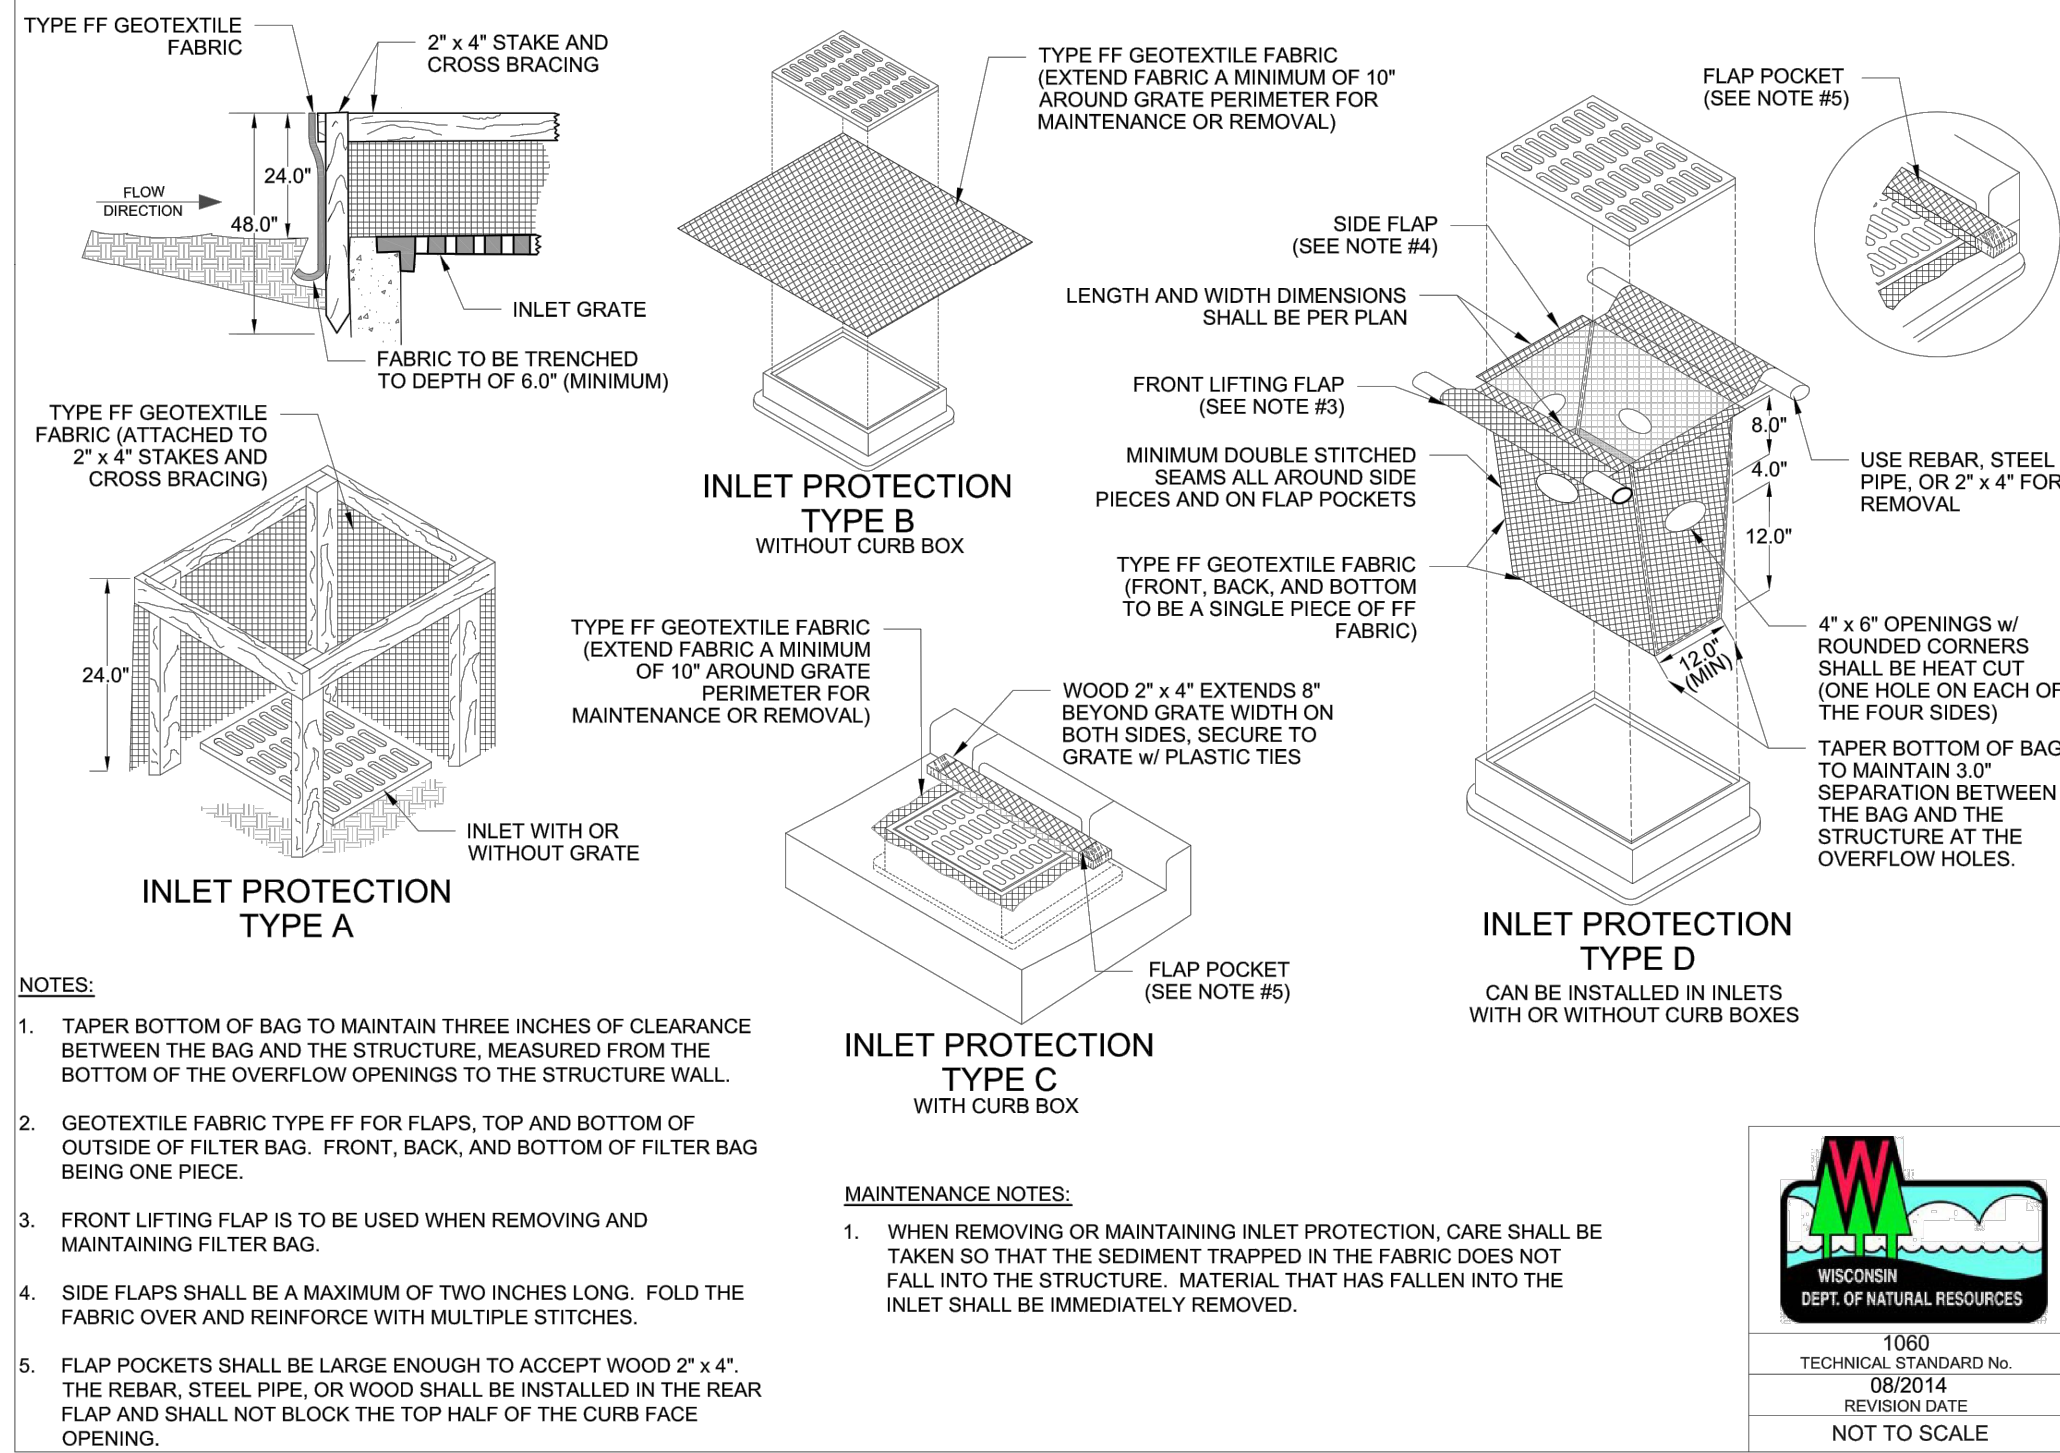

INLET PROTECTION DETAIL
NO SCALE

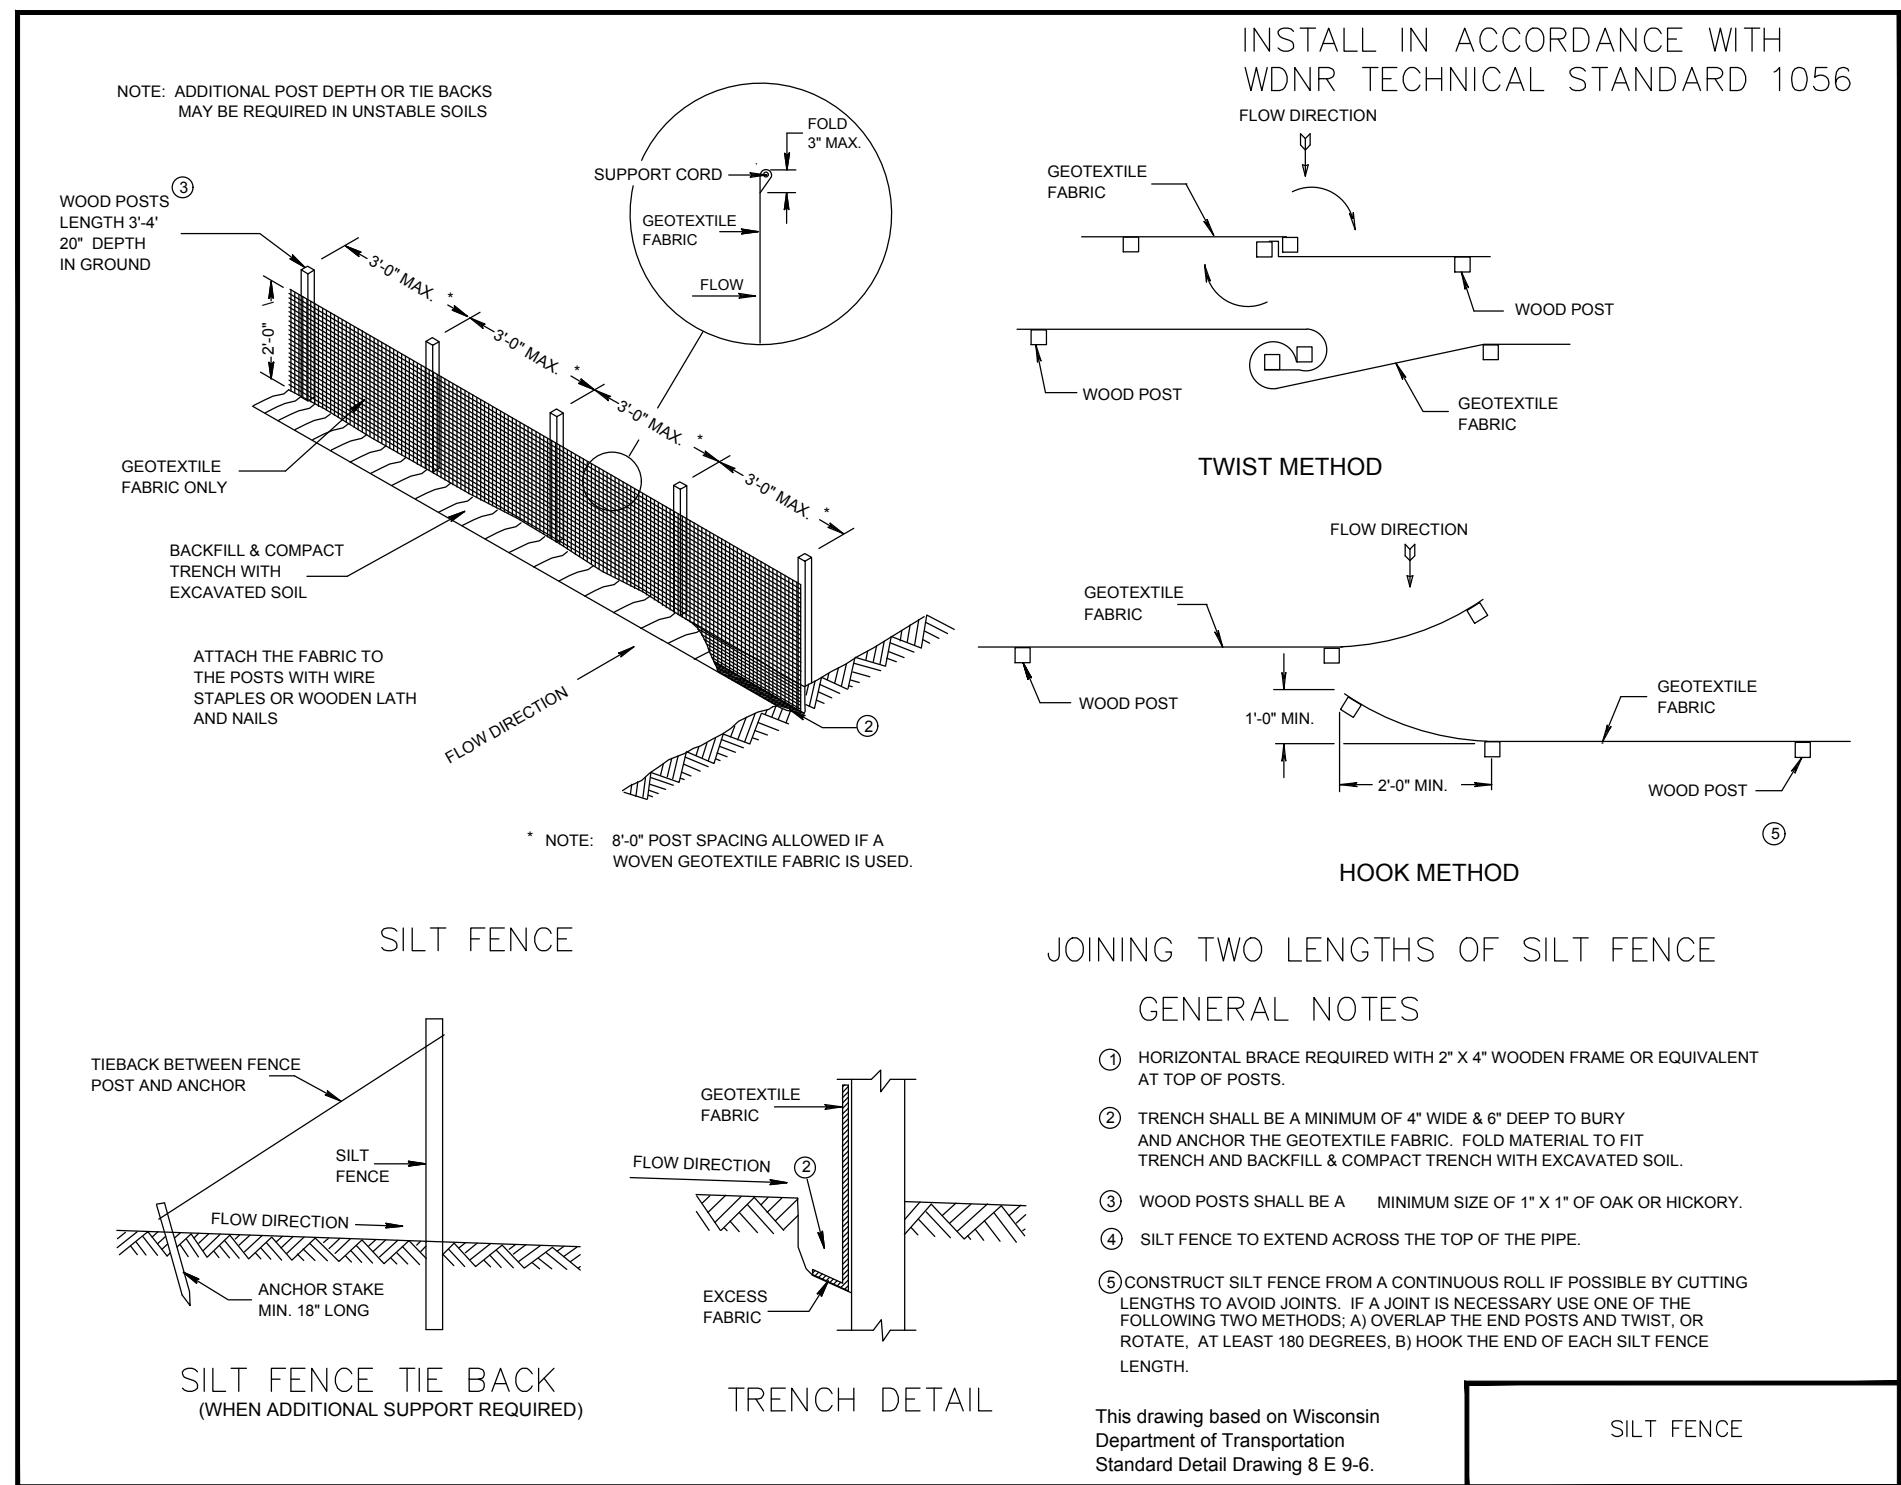

SILT FENCE - INSTALLATION DETAIL
NO SCALE



To: Jeff Daane., City of Waupun Director of Public Works
From: Eric Thompson, P.E.
Subject: Stormwater Management Plan Review – Kwik Trip Carwash Site
Date: November 15, 2021

MSA has completed a review of the stormwater management plan for the proposed CWC Bus Garage site, dated November 9, 2021, received November 10, 2021. The site is located at the west terminus of West Lincoln Street and is adjacent, but outside, the City's current corporate limits. This review has been undertaken at the direction of the City under its extraterritorial plat approval jurisdiction.

Upon review of the current submittal, it is our recommendation that the City approve the stormwater management plan contingent on receipt of a signed/executed long-term maintenance agreement for proposed on-site stormwater management features.

- 1.) **Development Classification:** The site is currently undeveloped and will be developed as a bus garage with a gravel parking lot and driveway. In total, approximately 0.40 acres of new impervious area will be created on a 0.72 acre site. The plan fits the description of a new development.
- 2.) **Peak Discharge Rate Control:** Because the plan is for a new development, there is a requirement to achieve post-development peak discharge rate control for the 1-, 2-, 10-, and 100-yr 24-hr rainfall events. Review of the development plans indicates that the site will achieve rate control standards for the 2-, 10-, and 100-yr events, but will exceed the existing 1-yr peak flow rate by 0.2 cfs (17%). This is a common occurrence on very small sites like this one and, as there are proposed on-site rate control BMPs with outlet structures about as small as is reasonable for the site, this level of rate control is viewed to be the Maximum Extent Practicable (MEP) for the site.
- 3.) **Water Quality Treatment:** Stormwater quality treatment will be provided for the site via a system of five vegetated drainage swales. No on-site infiltration assessment has been provided to support the design infiltration rates applicable to the swales; however, if it is assumed that the swales perform at least as well as other swales in the City assessed as part of the City's 2017 stormwater quality master plan, then this site will achieve an annual reduction in Total Suspended Solids (TSS) loads of 66% and an annual reduction in Total Phosphorus (TP) loads of 61%. While the TSS reduction is less than the 80% requirement for new development, the treatment levels provided for TSS as well as TP are well above the minimums required for the Rock River TMDL. Given limitations of on-site space and the fact that they are meeting the TMDL requirement, it is felt that the proposed meets the MEP standard.

MEMO

November 15, 2021


- 4.) **Infiltration:** The site as currently proposed will have an impervious area density of approximately 56%, qualifying the site as 'moderately impervious'. At this level of imperviousness the standard is to achieve 75% of predevelopment infiltration. Reflective of the assumed infiltration rate described in the previous point, the site will achieve in excess of 90% of predevelopment infiltration.
- 5.) **Drainage System Design.** Review of drainage system designs indicates that the proposed system of culverts has capacity to convey 100-yr peak flows safely through the site and into/out of stormwater management features.

It is noted that an 18" pipe is proposed under the driveway culvert at the end of W. Lincoln Street. Review of the capacity of this pipe indicates that it can convey 100-yr peak runoff rates without back-up onto private property, so long as it is maintained in good condition. Any obstruction to the inlet or degradation of the pipe condition may cause back-ups onto the adjacent residential lot on the south side of Lincoln Street.

- 6.) **Long Term Maintenance Agreement.** A long-term maintenance agreement should be prepared requiring the owner to routinely inspect and when indicated, maintain the swales and culverts comprising the on-site stormwater management practices. A recommended example document is attached. This document should be appended to the City's standard legal form.

West

South

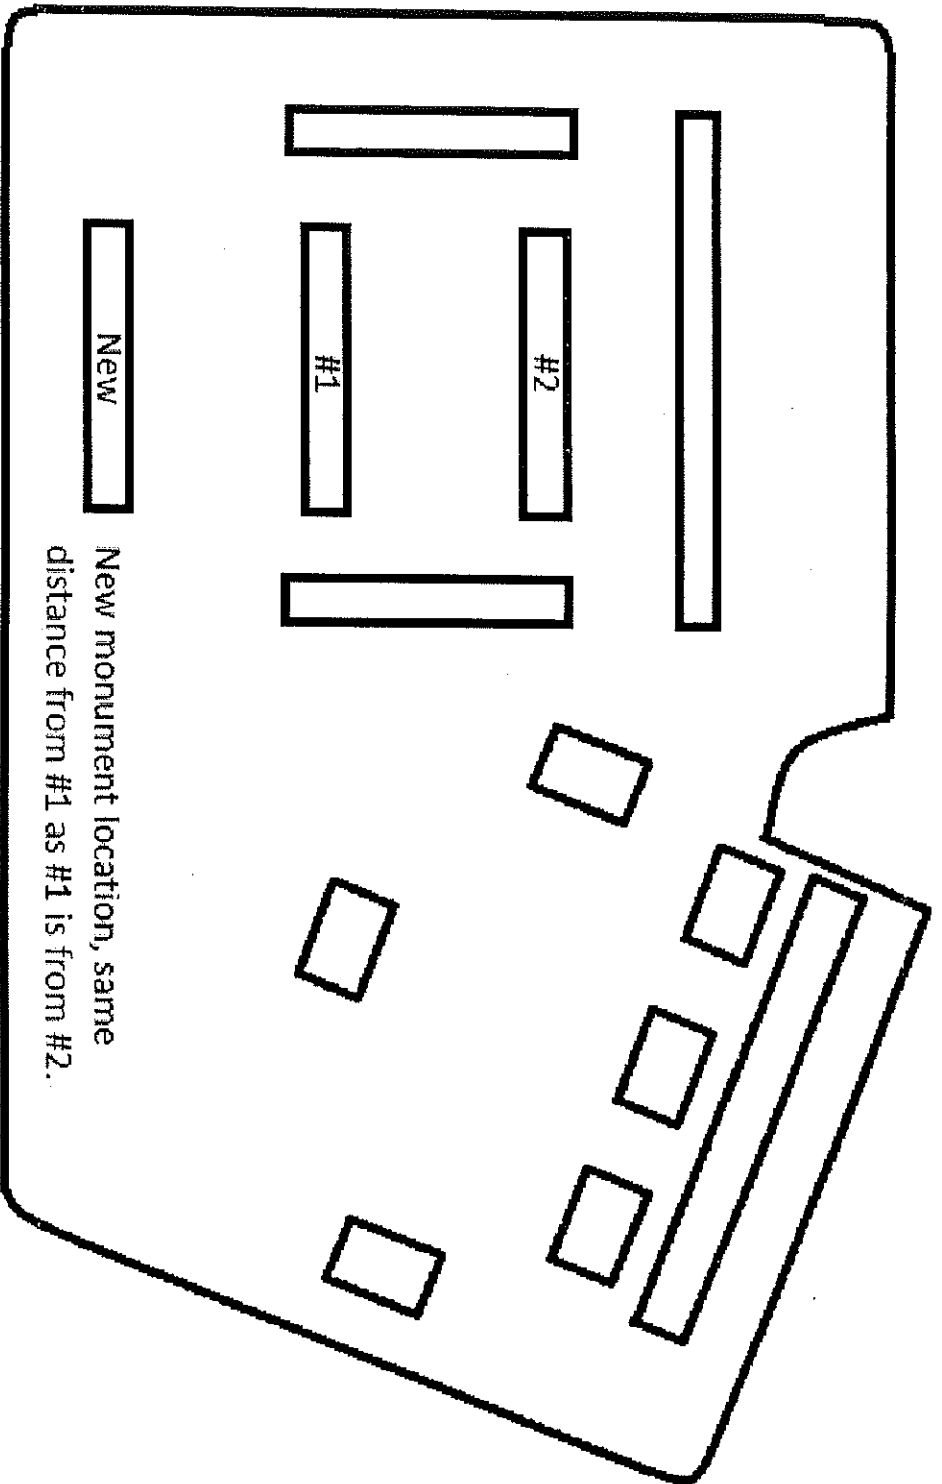

North

East

Robert Patrouille
210-7291
324-2049

WAUPUN AREA VETERANS MEMORIAL WALL



Our Waupun Area Veterans Memorial Wall is a tribute to all Waupun area Veterans who have served or are now serving their Country since the War of 1812 to the current War on Terrorism.

The Veterans Walls are located next to the existing War Memorial in Shaler Park, Waupun WI.

Amount of donation \$ _____

CUT HERE AND KEEP TOP PORTION FOR YOUR RECORDS

FORM FOR BUSINESS, ORGANIZATIONS OR PRIVATE DONATION

DONATION REQUEST PROGRAM STATEMENT

This project was started five (5) years ago as a Community Project and has been well supported in the past and currently by Waupun and Waupun area, Business, Organizations, and by private donations. We now have reached the time when another Wall Phase IV must be in place by early Spring 2010 as the current capacity of 1050 name spaces will be filled by Spring 2010.

At this time we must raise \$4700.00 to pay for the next Wall which will be delivered by September 2009.

WE REQUEST YOUR SUPPORT FOR THIS PROJECT ADDITION BY YOUR GENEROUS DONATIONS.

THANK YOU!

Make out check or money order to the Waupun Veterans Memorial Wall Fund and send to:

Waupun Veterans Memorial Wall Fund
National Bank of Waupun
210 E. Main St.
Waupun, WI 53963

For additional information call 324-2641, 324-4641 or 324-3491

Sponsored by the Waupun Community, its business', organizations, American Legion, and Veterans of Foreign Wars.

WAUPUN AREA VETERANS
MEMORIAL WALL PROJECT

NAME LOCATOR SYSTEM

PHASE I

WEST 20' WALL

#1 THRU #210 FRONT SIDE
#211 THRU #420 BACK SIDE

PHASE II

NORTH 10' WALL

#1 THRU #105 SOUTH SIDE
#211 THRU #315 NORTH SIDE

PHASE II

SOUTH 10' WALL

#316 THRU #420 SOUTH SIDE
#106 THRU #210 NORTH SIDE

PHASE III

CENTER 10' WALL

#1 THRU #105 EAST SIDE
#106 THRU #210 WEST SIDE

PHASE IV

EAST 10' WALL

#1 THRU #105 EAST SIDE
#106 THRU #210 WEST SIDE

NOTE: ALL NAMES ON WALLS BEGINNING FROM LEFT END OF WALL

EXAMPLE 1
20' WALL FRONT

1	16	31	46	61	76	91	106	121	136	151	166	181	196
15	30	45	60	75	90	105	120	135	150	165	180	195	210

EXAMPLE 2
10' WALL BACK

106	121	136	151	166	181	196
120	135	150	165	180	195	210

NOTE: 20' WALL HAS 210 NAMES ON EACH SIDE


10' WALLS HAVE 105 NAMES ON EACH SIDE

MEMORIAL WALL PROJECT LAYOUT





PHASE 1 20' WALL



PHASE 3 10' WALL

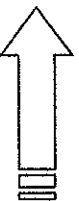

PHASE 2 10' WALLS

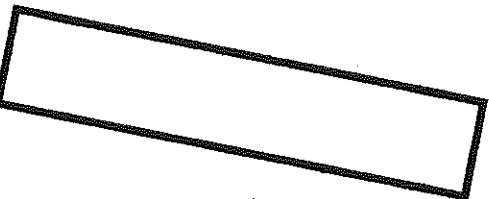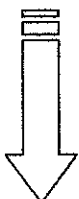

PHASE 4 10' WALL

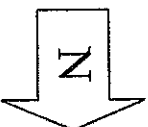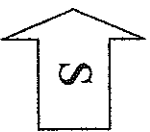


PODIUM





ALTA / NSPS LAND TITLE SURVEY

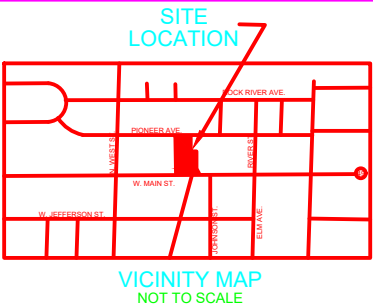

Legend of Symbols & Abbreviations

() RECORD INFORMATION	
BOUNDARY LINE	FLAG POLE
CENTERLINE	GAS METER
EXISTING EASEMENT	ELECTRIC METER
SECTION LINE	DECIDUOUS TREE
RIGHT-OF-WAY LINE	PINE TREE
WETLAND BOUNDARY	PEDESTAL
ABUTTING SURVEY	POWER POLE
SETBACK LINE	ROAD SIGN
UNDERGROUND ELECTRIC	WATER VALVE/GAS VALVE
UNDERGROUND TELEPHONE	HYDRANT
UNDERGROUND CABLE TV	LIGHT POLE
OVERHEAD ELECTRIC	CATCH BASIN/INLET
OVERHEAD TELEPHONE	STORM MANHOLE
OVERHEAD CABLE TV	SANITARY MANHOLE
SANITARY SEWER	BRUSH OR SHRUB
STORM SEWER	UTILITY POLE GUY ANCHOR
WATER LINE	GAS VENT
GAS LINE	MAIL BOX
CHAIN LINK FENCE	CURB STOP
WOOD FENCE	GUARD POST
FENCE LINE	A.C. - AIR CONDITIONER
RAILROAD TRACKS	FOUND 1" IRON PIPE
CONTOUR LINE	FOUND 1-1/4" REBAR
BRUSH LINE	FOUND 3/4" IRON REBAR
	SET CUT CROSS IN CONC.
	SET 1-1/4" BY 30" IRON ROD-4.30 LBS./FT.
	SET 3/4" BY 24" IRON ROD-1.50 LBS./FT.
	SET "MAG" NAIL
	SPOT ELEVATION

Setbacks

(c) (iv) Although there are no front yard or side yard setback requirements in the B-2 District, there shall be a requirement for those properties abutting Main Street and located between the railroad tracks and Carrington Street, applying to properties on both sides of said street, so that all buildings, all remodeling and all new construction conform to the building set back line as presently in existence, and that no sidewalks, alleys or public rights-of-way, as presently existing, shall be encroached upon.

Utility Notes

TICKET NO. 20161005825
TICKET NO. 20161005833
TICKET NO. 20161005843
TICKET NO. 20161005846

ALLIANT ENERGY
AT & T DISTRIBUTION
CHARTER COMMUNICATIONS
CITY OF WAUPUN
WAUPUN UTILITIES

BENCHMARK

TOP OF HYDRANT ELEV. =895.46
NORTH SIDE OF PIONEER AVENUE

Notes Corresponding to Schedule B

Commitment No.: 816020050 [Exceptions 1 through 10, 18 and 19 are general exceptions established by the Title Company].

ADDITIONAL EXCEPTIONS:

- Public Utility Easement and Access Restriction, as delineated on the recorded plat of Ousterling Plat.
- Easement granted to Wisconsin Telephone Company by an instrument recorded August 25, 1923, in Volume 208 of Mortgages at Page 374, as Document No. 131015.
- Contract for Easement regarding common driveway by and between Frank Ousterling and Clara Ousterling, his wife parties of the first part, Chris A. Schuchardt and Millie Schuchardt, his wife, parties of the second part and Carl C. Johnson and Helena M. Johnson, his wife, parties of the third part, recorded December 4, 1928, in Volume 231 of Mortgages at Page 640 as Document No. 159006 .
- Terms, conditions and restrictions regarding Joint Driveway as contained in Land Contract recorded November 3, 1978, in Volume 785 of Records at Page 302, as Document No. 342595.
- Right of Way Grant granted to Wisconsin Bell, Inc. by an instrument recorded on April 16, 1991, in Volume 1039 of Records at Page 441, as Document No. 490634. [THIS DOCUMENT COVERS THE ENTIRE PROPERTY]
- Easement Agreement For Egress and Ingress by and between Rohn T. Bishop and KT Real Estate Holdings LLC, a Delaware limited liability company, Successor to Convenience Store Investments, recorded November 24, 2014 as Document No.1045714. [NOTHING TO PLOT]
- Easement granted to The City of Waupun, a municipal corporation by an instrument recorded March 27, 2015, as Document No. 1050594. [THIS IS A TEMPORARY LIMITED EASEMENT FOR CONSTRUCTION]

[] - SURVEYOR'S COMMENTS

- PLOTTABLE EXCEPTIONS


Commitment No.: 816020051 [Exceptions 1 through 10 and 17 are general exceptions established by the Title Company].

ADDITIONAL EXCEPTIONS:

- Easement granted to Wisconsin Telephone Company by an instrument recorded August 25, 1923, in Volume 208 of Mortgages at Page 374, as Document No. 131015.
- Contract for Easement regarding common driveway by and between Frank Ousterling and Clara Ousterling, his wife parties of the first part, Chris A. Schuchardt and Millie Schuchardt, his wife, parties of the second part and Carl C. Johnson and Helena M. Johnson, his wife, parties of the third part, recorded December 4, 1928, in Volume 231 of Mortgages at Page 640 as Document No. 159006.
- Right of Way Grant granted to Wisconsin Bell, Inc. by an instrument recorded on March 8, 1991, in Volume 1036 of Records at Page 706, as Document No. 489158. [THIS DOCUMENT COVERS THE ENTIRE PROPERTY]
- Easement granted to City of Waupun, a Municipal Corporation by an instrument recorded December 22, 1997, in Volume 1345 of Records at Page 576, as Document No. 628625. [THIS IS A TEMPORARY LIMITED EASEMENT FOR CONSTRUCTION]
- Easement Agreement For Egress and Ingress by and between Rohn T. Bishop and KT Real Estate Holdings LLC, a Delaware limited liability company, Successor to Convenience Store Investments, recorded November 24, 2014 as Document No.1045714.
- Easement granted to The City of Waupun, a municipal corporation by an instrument recorded March 27, 2015, as Document No. 1050593. [THIS IS A TEMPORARY LIMITED EASEMENT FOR CONSTRUCTION]

[] - SURVEYOR'S COMMENTS

- PLOTTABLE EXCEPTIONS

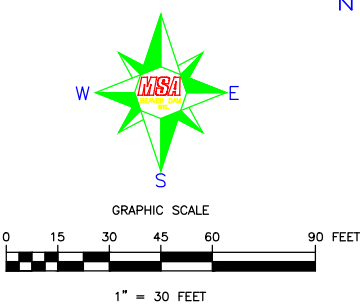

ZONING:
B-2 / CENTRAL BUSINESS DISTRICT.

FLOOD NOTE:

This property is in Zone "X" of the Flood Insurance Rate Map, Community Panel No. 55039C0413F, which bears an effective date of 11/04/2009.

PARKING SPACE TABLE	
TYPE OF SPACE	TOTAL EXISTING
REGULAR	14
ACCESSIBLE	1
TOTAL	15

TRANSPORTATION • MUNICIPAL DEVELOPMENT • ENVIRONMENTAL


201 Corporate Drive, Beaver Dam, WI 53986
608.744.4242 • FAX 608.744.4230 • Email: info@msa.com
WWW.MSA-ENGINEERS.COM

MSA

REVISION:	DATE:	BY:
DRAWN BY: D.L.L.	CHECKED BY: M.J.L.	SCALE: 1" = 30'
CADD FILE: 02235021.ALTA	PLOT DATE: 3-30-2016	PLOT TIME: 12:07 P.M.

ALTA/ACSM LAND TITLE SURVEY
KWIK TRIP STORES
800 & 732 WEST MAIN ST.
WAUPUN, WISCONSIN

PROJECT NO.
R.02235021.0
SHEET
1 OF 2

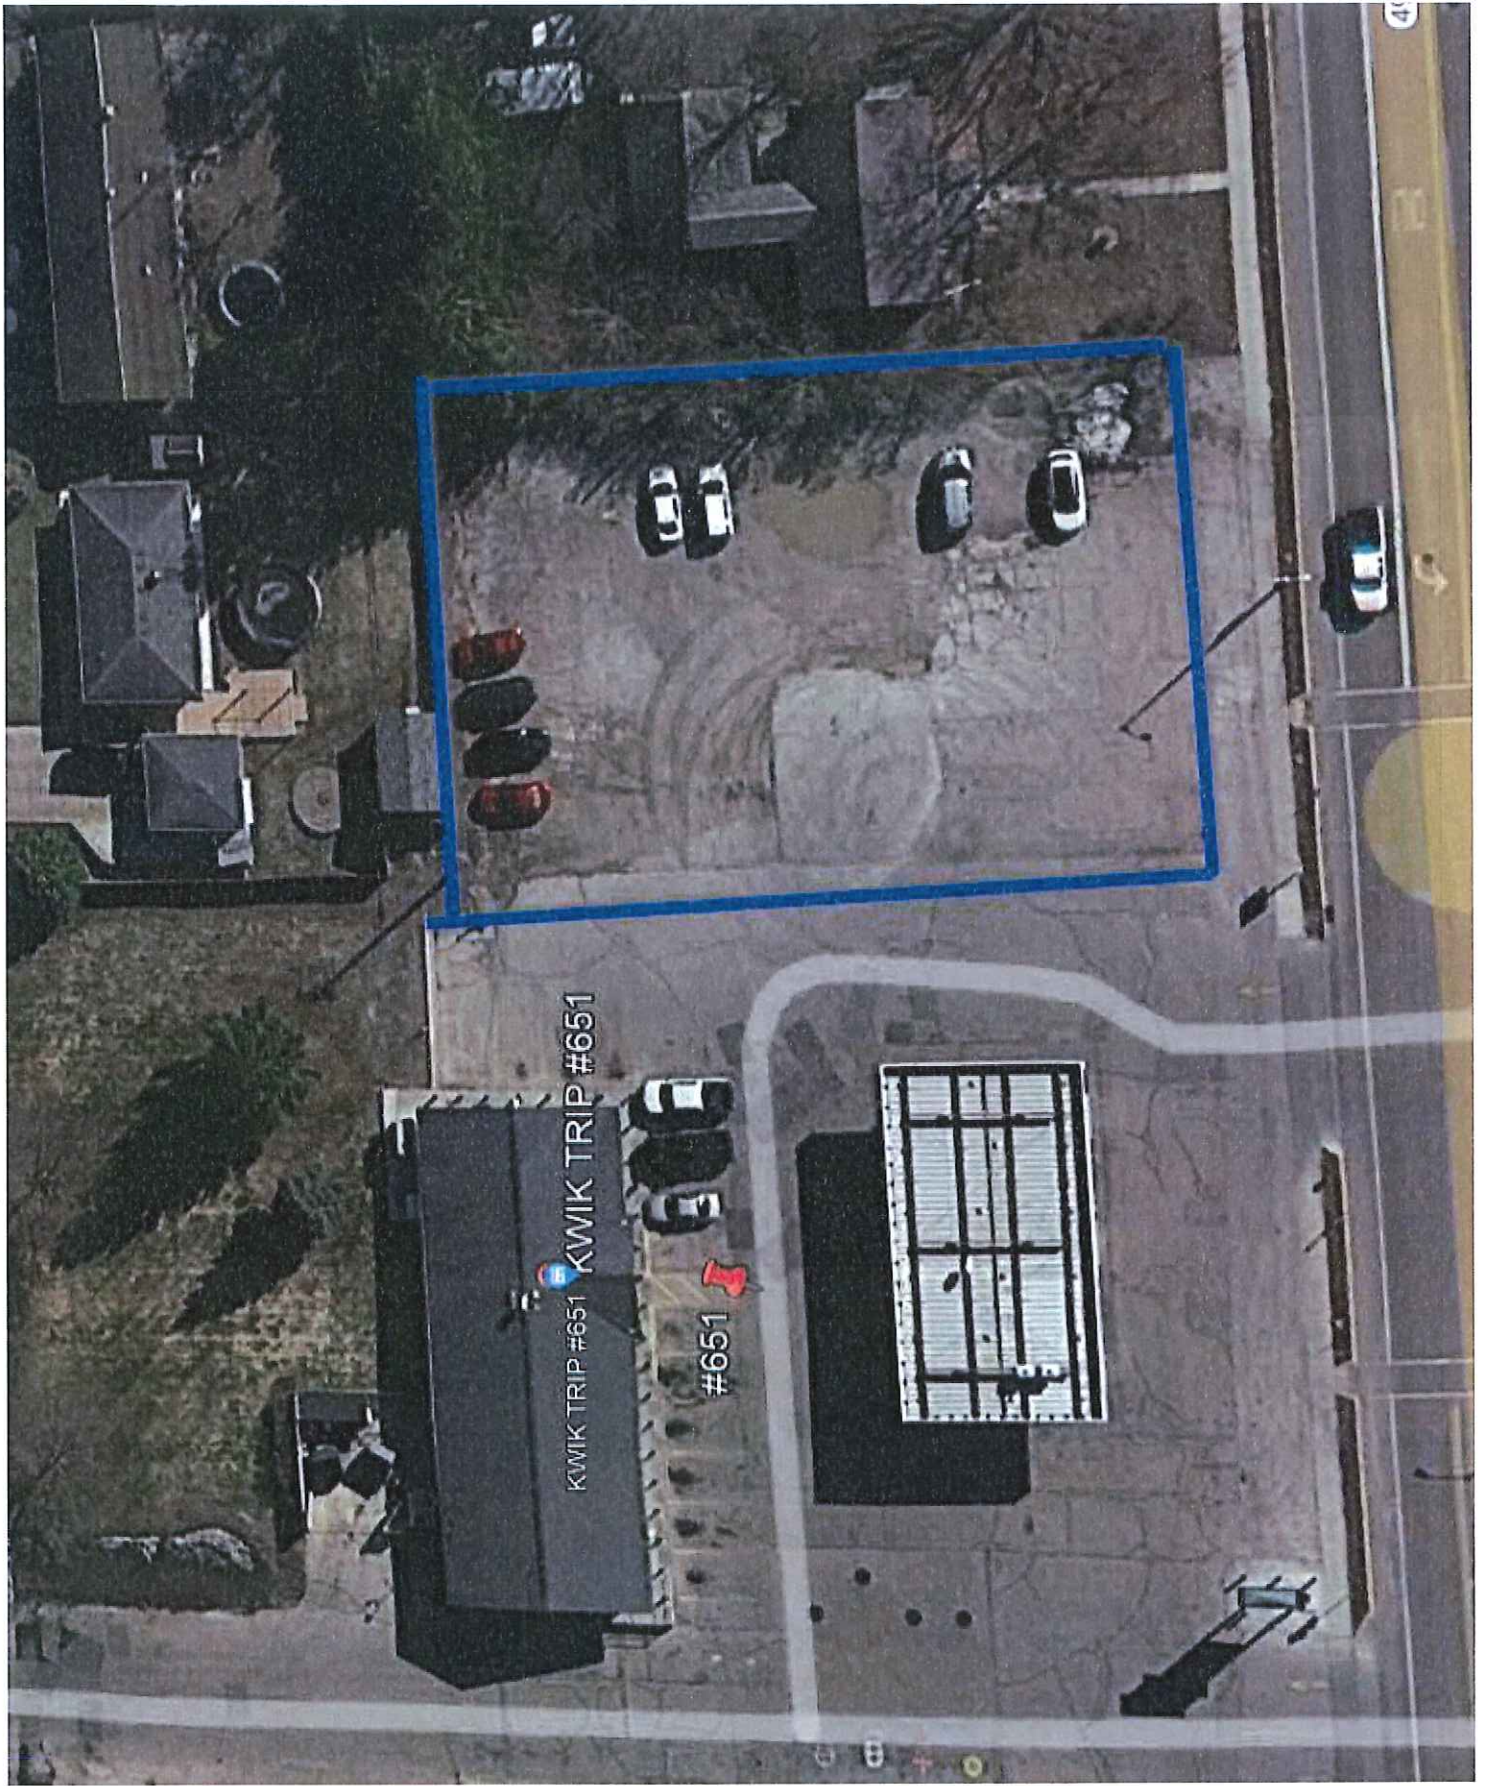


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Last Modified: 10 May 2021
Printed On: 5/13/2021 10:37 AM by JOHN STAHL
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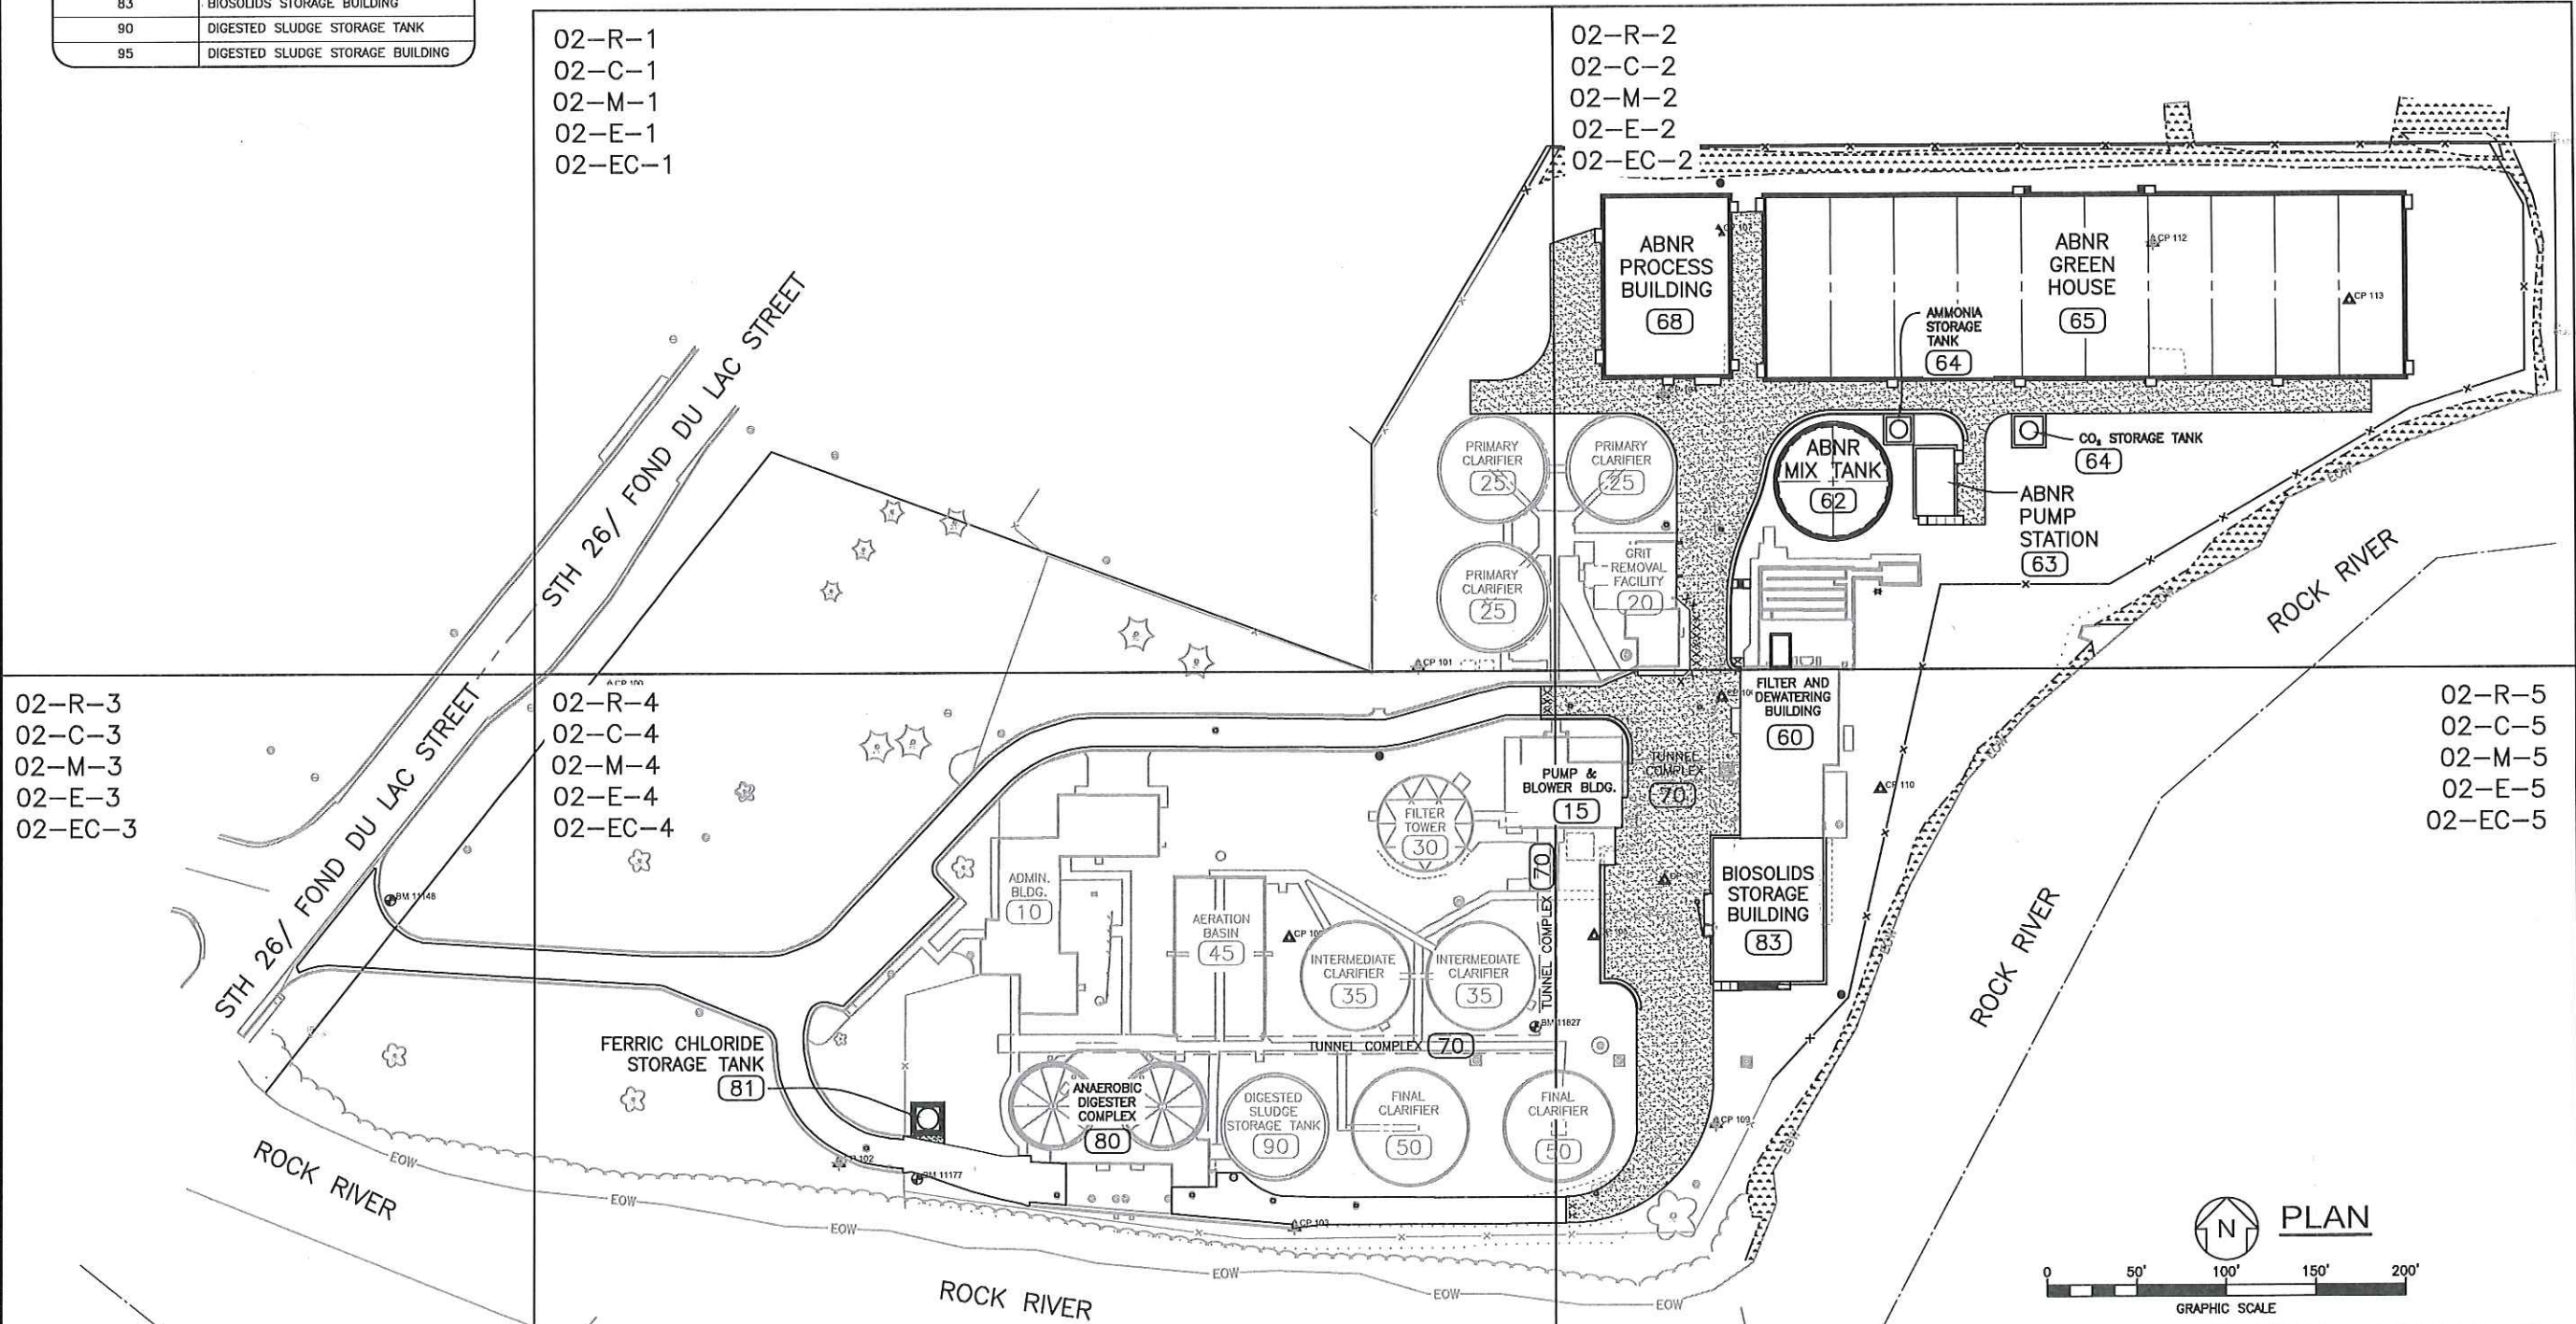
STRUCTURE LEGEND	
STRUCTURE NO.	STRUCTURE NAME
10	AMINISTRATION BUILDING
15	PUMP & BLOWER BUILDING
20	GRIT REMOVAL FACILITY
25	PRIMARY CLARIFIERS
30	FILTER TOWER
35	INTERMEDIATE CLARIFIERS
40	RAS FLUME STRUCTURE
45	AERATION BASIN
50	FINAL CLARIFIERS
60	FILTER & DEWATERING BUILDING
62	ABNR MIX TANK
63	ABNR PUMP STATION
64	AMMONIA & CO ₂ STORAGE TANKS
65	ABNR GREEN HOUSE
68	ABNR PROCESS BUILDING
70	TUNNEL COMPLEX
80	DIGESTER COMPLEX
81	FERRIC CHLORIDE STORAGE TANK
83	BIOSOLIDS STORAGE BUILDING
90	DIGESTED SLUDGE STORAGE TANK
95	DIGESTED SLUDGE STORAGE BUILDING


NEW STRUCTURE LOCATION INDEX			
STRUCTURE NO.	LOCATION POINT	NORTHING	EASTING
62	CENTERLINE OF TANK	601208.02	2308355.57
	NORTH QUADRANT	601239.60	2308355.57
63	NW CORNER OF FOUNDATION WALL	601226.35	2308402.15
	SW CORNER OF FOUNDATION WALL	601188.68	2308402.15
64 (NH ₃)	NW CORNER OF CONCRETE SLAB	601243.85	2308385.36
	NE CORNER OF CONCRETE SLAB	601243.85	2308399.36
64 (CO ₂)	NW CORNER OF CONCRETE SLAB	601243.85	2308456.99
	NE CORNER OF CONCRETE SLAB	601243.85	2308472.99
65	SW CORNER OF FOUNDATION WALL	601265.33	2308318.44
	SE CORNER OF FOUNDATION WALL	601265.34	2308675.10
68	NW CORNER OF FOUNDATION WALL	601367.33	2308228.44
	SW CORNER OF FOUNDATION WALL	601267.33	2308228.44
81	NW CORNER OF CONTAINMENT WALL	600862.94	2307842.13
	SW CORNER OF CONTAINMENT WALL	600847.60	2307842.13
* 83	SW CORNER OF FOUNDATION WALL	600929.74	2308287.90
	SE CORNER OF FOUNDATION WALL	600929.74	2308349.56

* FIELD VERIFY DIMENSIONS AFTER PARTIAL REMOVAL OF BUILDING 60.

<div> BENCHMARKS</div>				
BM NO.	DESCRIPTION/LOCATION	NORTHING	EASTING	ELEV.
BM 11148	FIRE HYDRANT AT NORTH SIDE OF PLANT ENTRANCE	600977.64	2307549.76	876.64
BM 11177	FIRE HYDRANT JUST INSIDE OF SOUTH GATE ENTRANCE	600821.61	2307843.78	874.01
BM 11827	FIRE HYDRANT AT THE SOUTHEAST SIDE THE INTERMEDIATE CLARIFIERS	600905.12	2308188.63	876.07

CONTROL/CHECK POINTS				
NO.	DESCRIPTION/LOCATION	NORTHING	EASTING	ELEV.
CP-100	AYRES PLASTIC CAP	601095.835	2307671.563	873.15
CP-101	AYRES PLASTIC CAP	601106.166	2308123.751	876.08
CP-102	RBR WITH YELLOW CAP	600830.880	2307800.461	872.60
CP-103	CP-103	600793.910	2308054.459	872.50
CP-104	AYRES PLASTIC CAP	601257.302	2308261.136	876.80
CP-105	AYRES PLASTIC CAP	600955.262	2308051.564	873.95
CP-106	8" SPIKE	601088.349	2308292.974	877.08
CP-107	8" SPIKE	601347.429	2308292.299	875.34
CP-108	8" SPIKE	600955.674	2308221.519	875.38
CP-109	SPIKE	600850.591	2308289.403	872.77
CP-110	SPIKE	601036.574	2308381.457	872.36
CP-111	PK NAIL	600986.340	2308261.007	875.28
CP-112	8" SPIKE	601340.673	2308534.915	875.03
CP-113	10" SPIKE	601308.000	2308644.522	896.96





WAUPUN UTILITIES
THE POWER OF COMMUNITY

Applied Technologies
Engineers-Architects

APVD	BY	REVISIONS AND RECORD OF ISSUE
K.R.H.	K.R.H.	CHANGE ORDER NO. 1

NO.	DATE	5-14-21
Δ		

WAUPUN UTILITIES
WWTP UPGRADE AND ABNR
WAUPUN, WI

SITE WORK
GENERAL
PLAN

VERIFY SCALES
LENGTH OF BAR IS 1" ON ORIGINAL DRAWING

1:2
PLOT SCALE, ADJUST SCALE(S) ACCORDINGLY

DESIGNED BY: K.R.H.

DRAWN BY: J.C.S.

CHECKED BY: K.R.H.

APPROVED BY: J.J.S.


PROJECT NO.
6353

DATE
JANUARY 2021


DRAWING NO.
02-G-1

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Last Modified: 25 January 2021
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MATCHLINE - SEE DRAWING 02-R-1

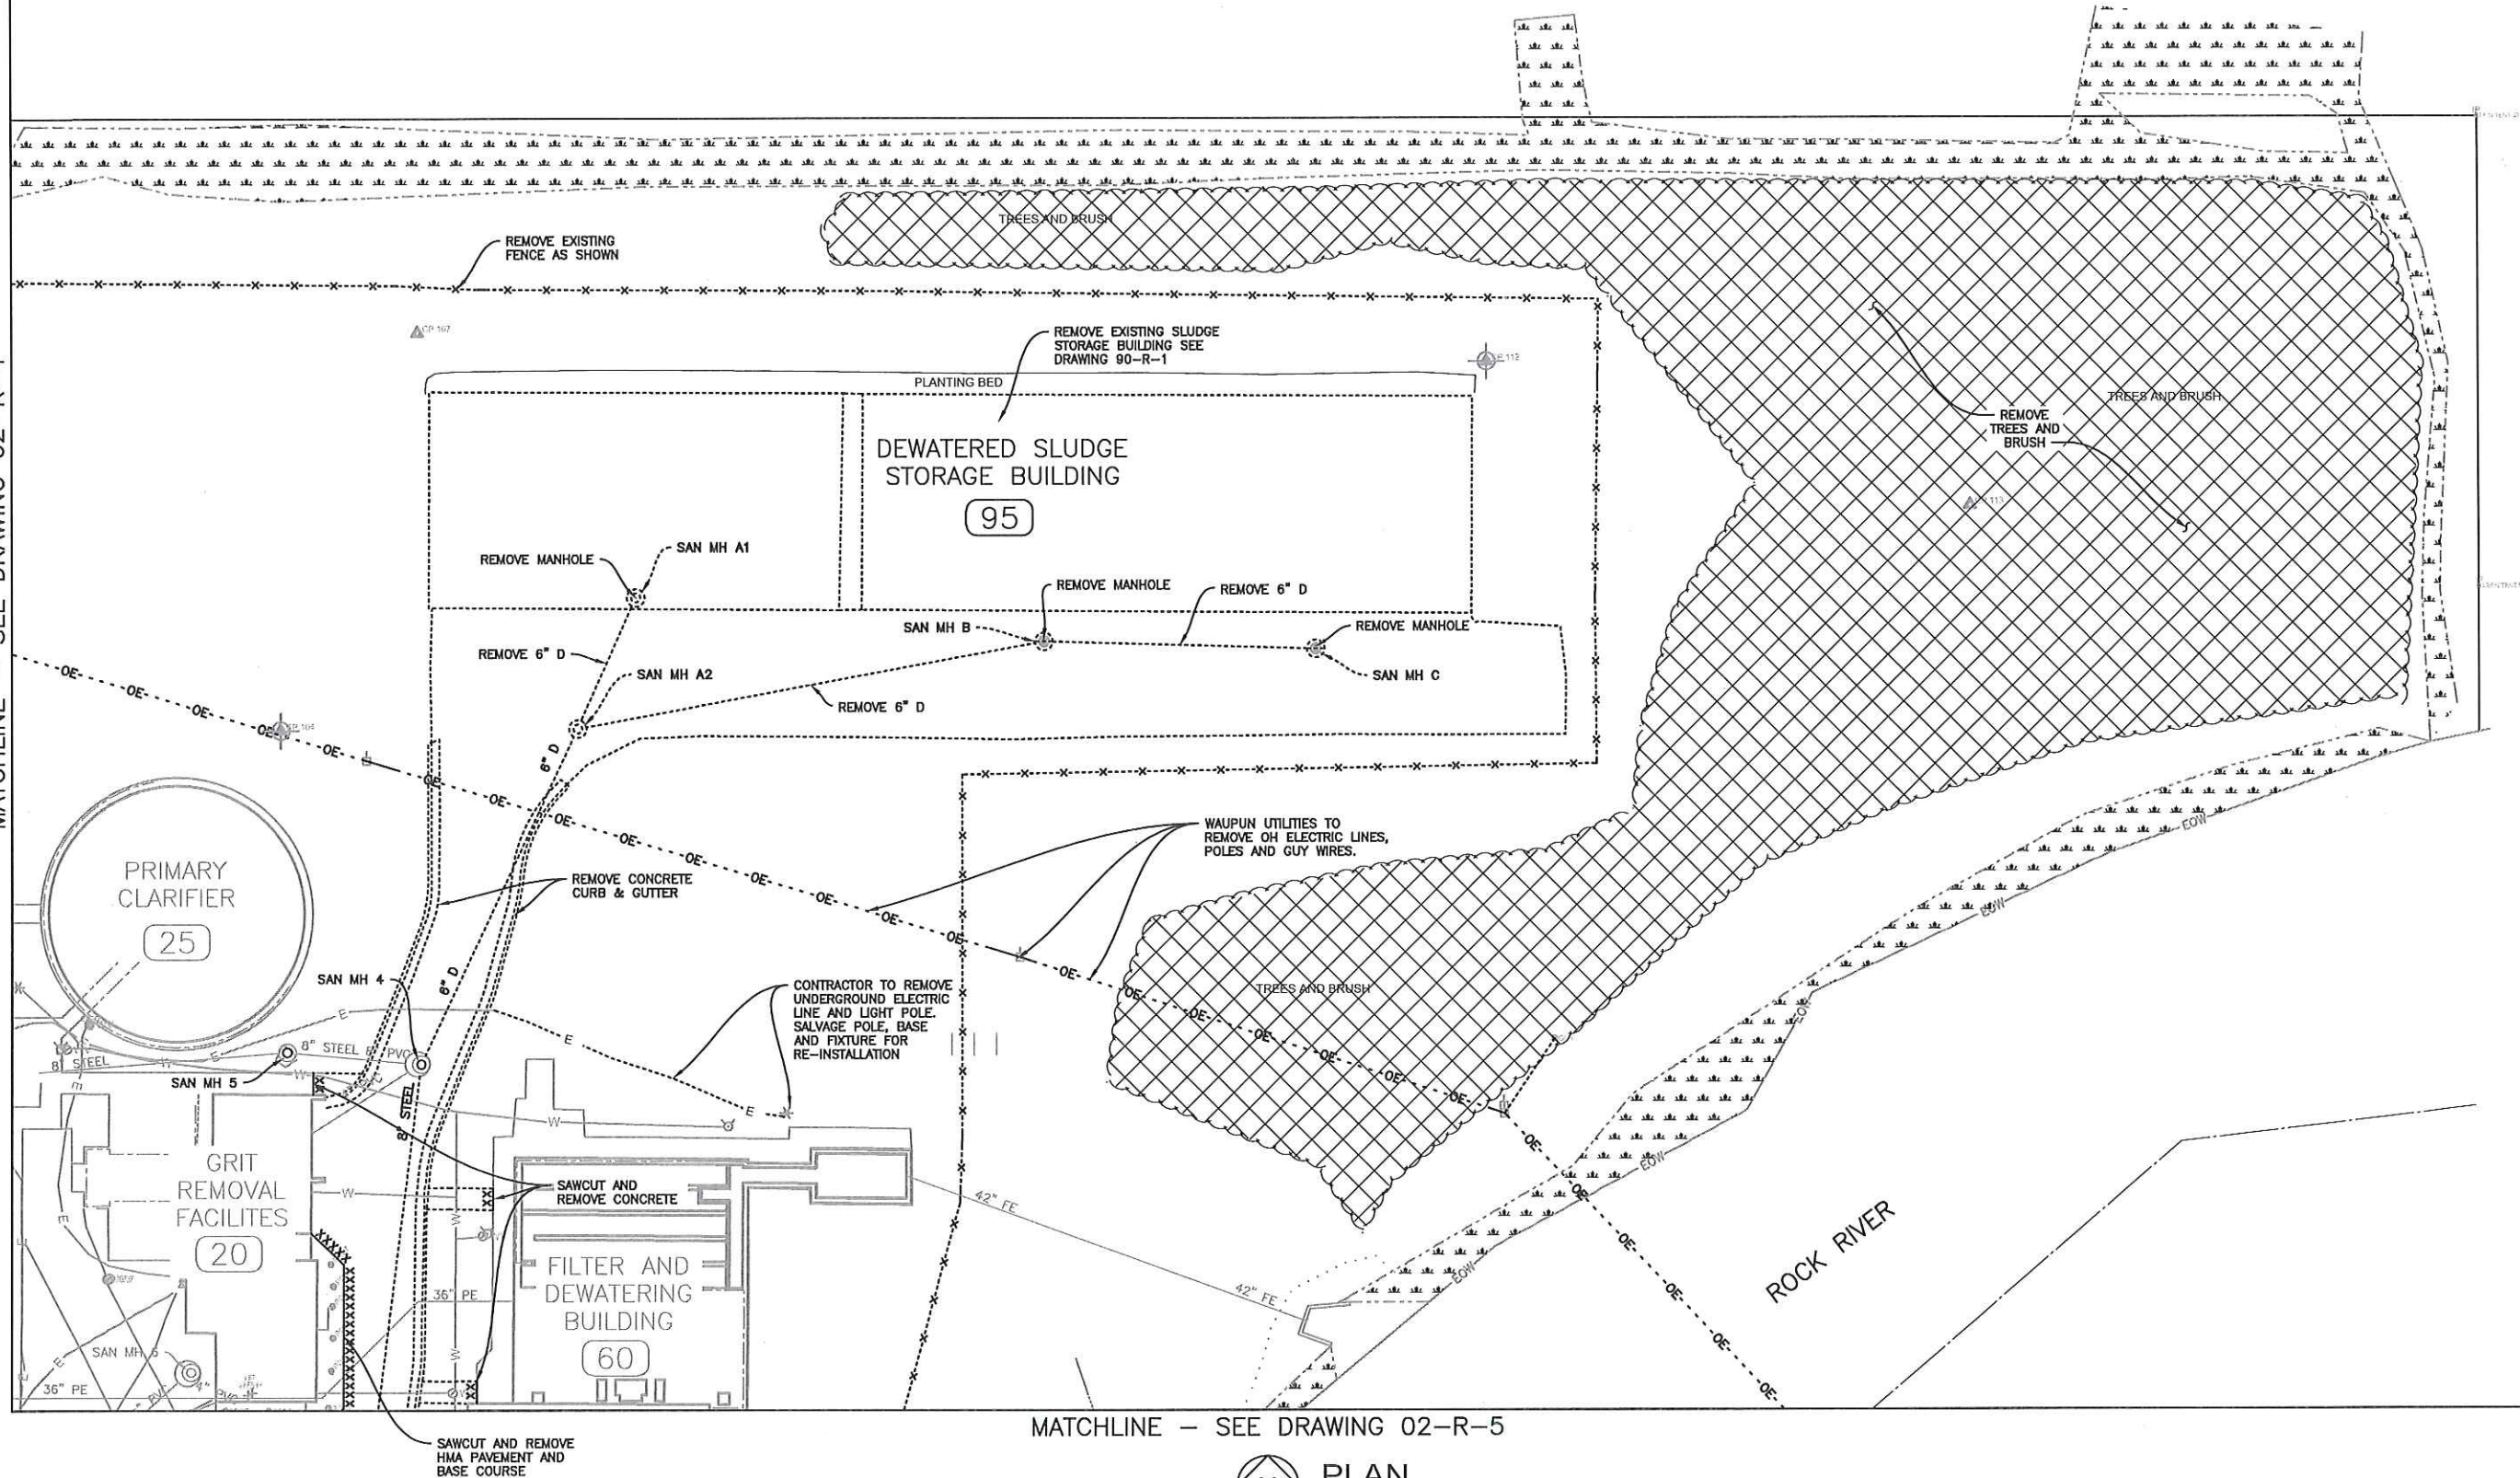

MATCHLINE - SEE DRAWING 02-R-5

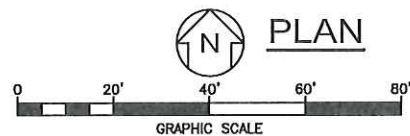

REMOVAL NOTES:

1. SCHEDULE DEMOLITION WORK AND TEMPORARY FACILITIES WITH OWNER AND/OR ENGINEER.
2. REMOVE PLANTING BED, TREES AND BRUSH.
3. REMOVE THE LIGHTING CONDUIT THAT CONFLICTS WITH ABNR.
4. PROVIDE RIGHT OF REFUSAL FOR ALL REMOVED EQUIPMENT TO WAUPUN UTILITIES.
5. SCHEDULE DEMOLITION WORK AND TEMPORARY FACILITIES WITH OWNER AND/OR ENGINEER.
6. BLIND FLANGE, CAP OR PLUG ALL ABANDONED PIPING.

WAUPUN UTILITIES
WWTP UPGRADE AND ABNR

WAUPUN, WI

SITE WORK
REMOVAL
PLAN

Applied Technologies
Engineers-Architects

NO. DATE REVISIONS AND RECORD OF ISSUE BY APVD

VERIFY SCALES
LENGTH OF BAR IS 1" ON ORIGINAL DRAWING

1:2
PLOT SCALE, ADJUST
SCALE(S) ACCORDINGLY

DESIGNED BY: K.R.H.

DRAWN BY: J.C.S.

CHECKED BY: K.R.H.

APPROVED BY: J.J.S.

PROJECT NO.
6353



DATE
JANUARY 2021

DRAWING NO.

02-R-2



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Last Modified: 25 January 2021

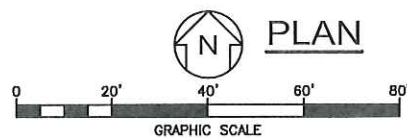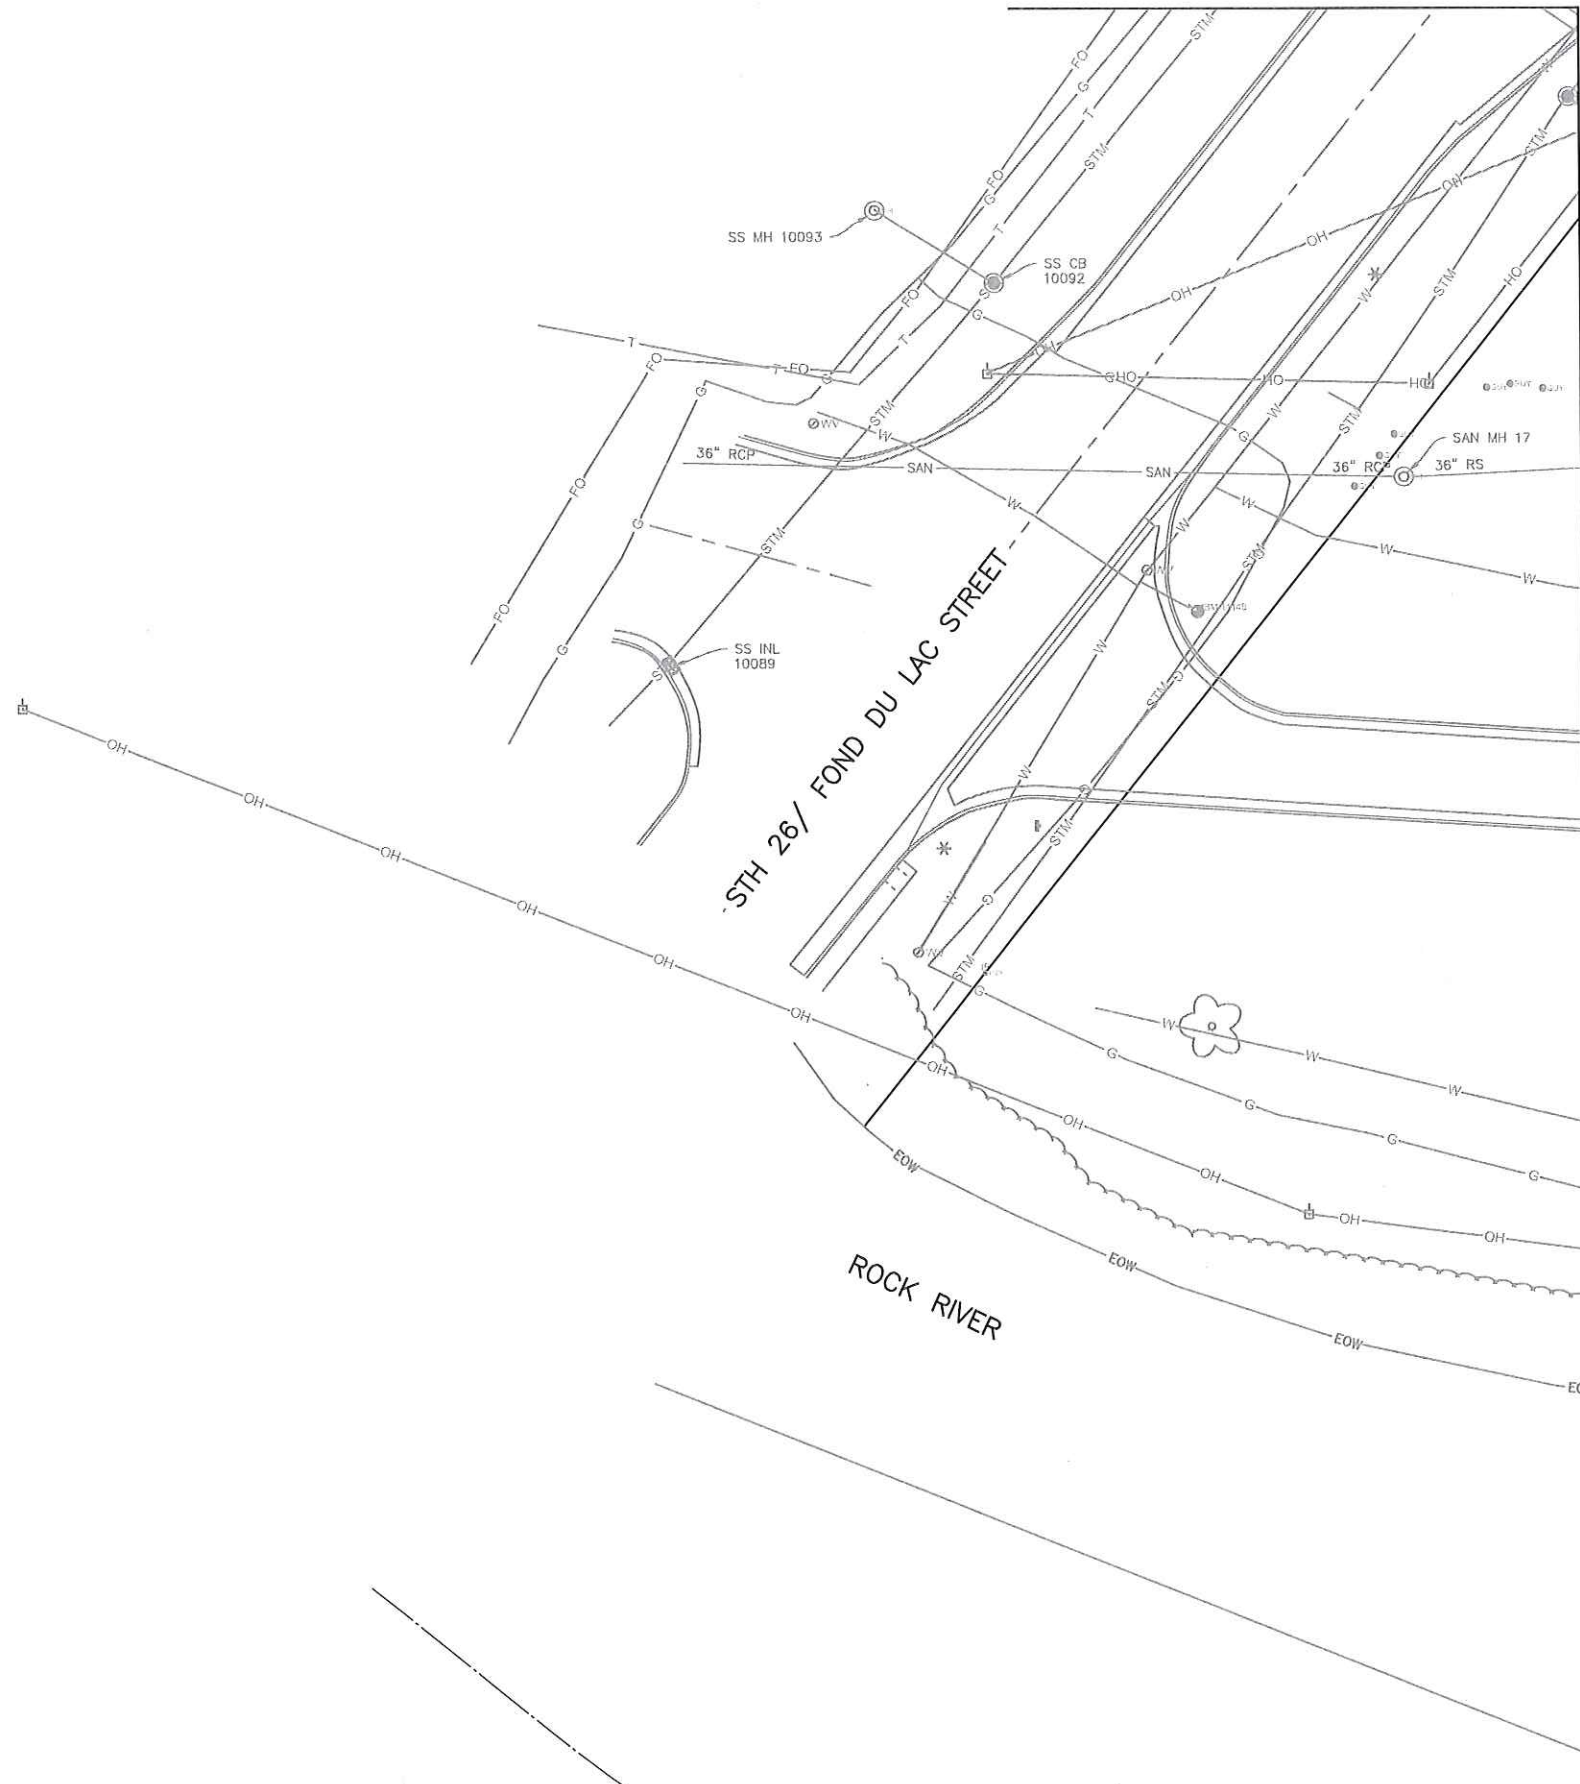

REMOVAL NOTES:


1. SCHEDULE DEMOLITION WORK AND TEMPORARY FACILITIES WITH OWNER AND/OR ENGINEER

MATCHLINE - SEE DRAWING 02-R-4


Applied Technologies Engineers-Architects				
NO.	DATE	REVISIONS AND RECORD OF ISSUE	BY	APVD
WAUPUN UTILITIES WWTP UPGRADE AND ABNR				
WAUPUN, WI				
SITE WORK REMOVAL PLAN				
VERIFY SCALES LENGTH OF BAR IS 1" = 1' ON ORIGINAL DRAWING 1:2 PLOT SCALE, ADJUST SCALE(S) ACCORDINGLY				
DESIGNED BY: K.R.H.				
DRAWN BY: J.C.S.				
CHECKED BY: K.R.H.				
APPROVED BY: J.J.S.				
PROJECT NO. 6353				
DATE JANUARY 2021				
DRAWING NO. 02-R-3				

PLTSCALE: 1
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Last Modified: 7 May 2021
Plotted On: 5/13/2021 10:37 AM by JOHN STAHL
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MATCHLINE - SEE DRAWING 02-R-3

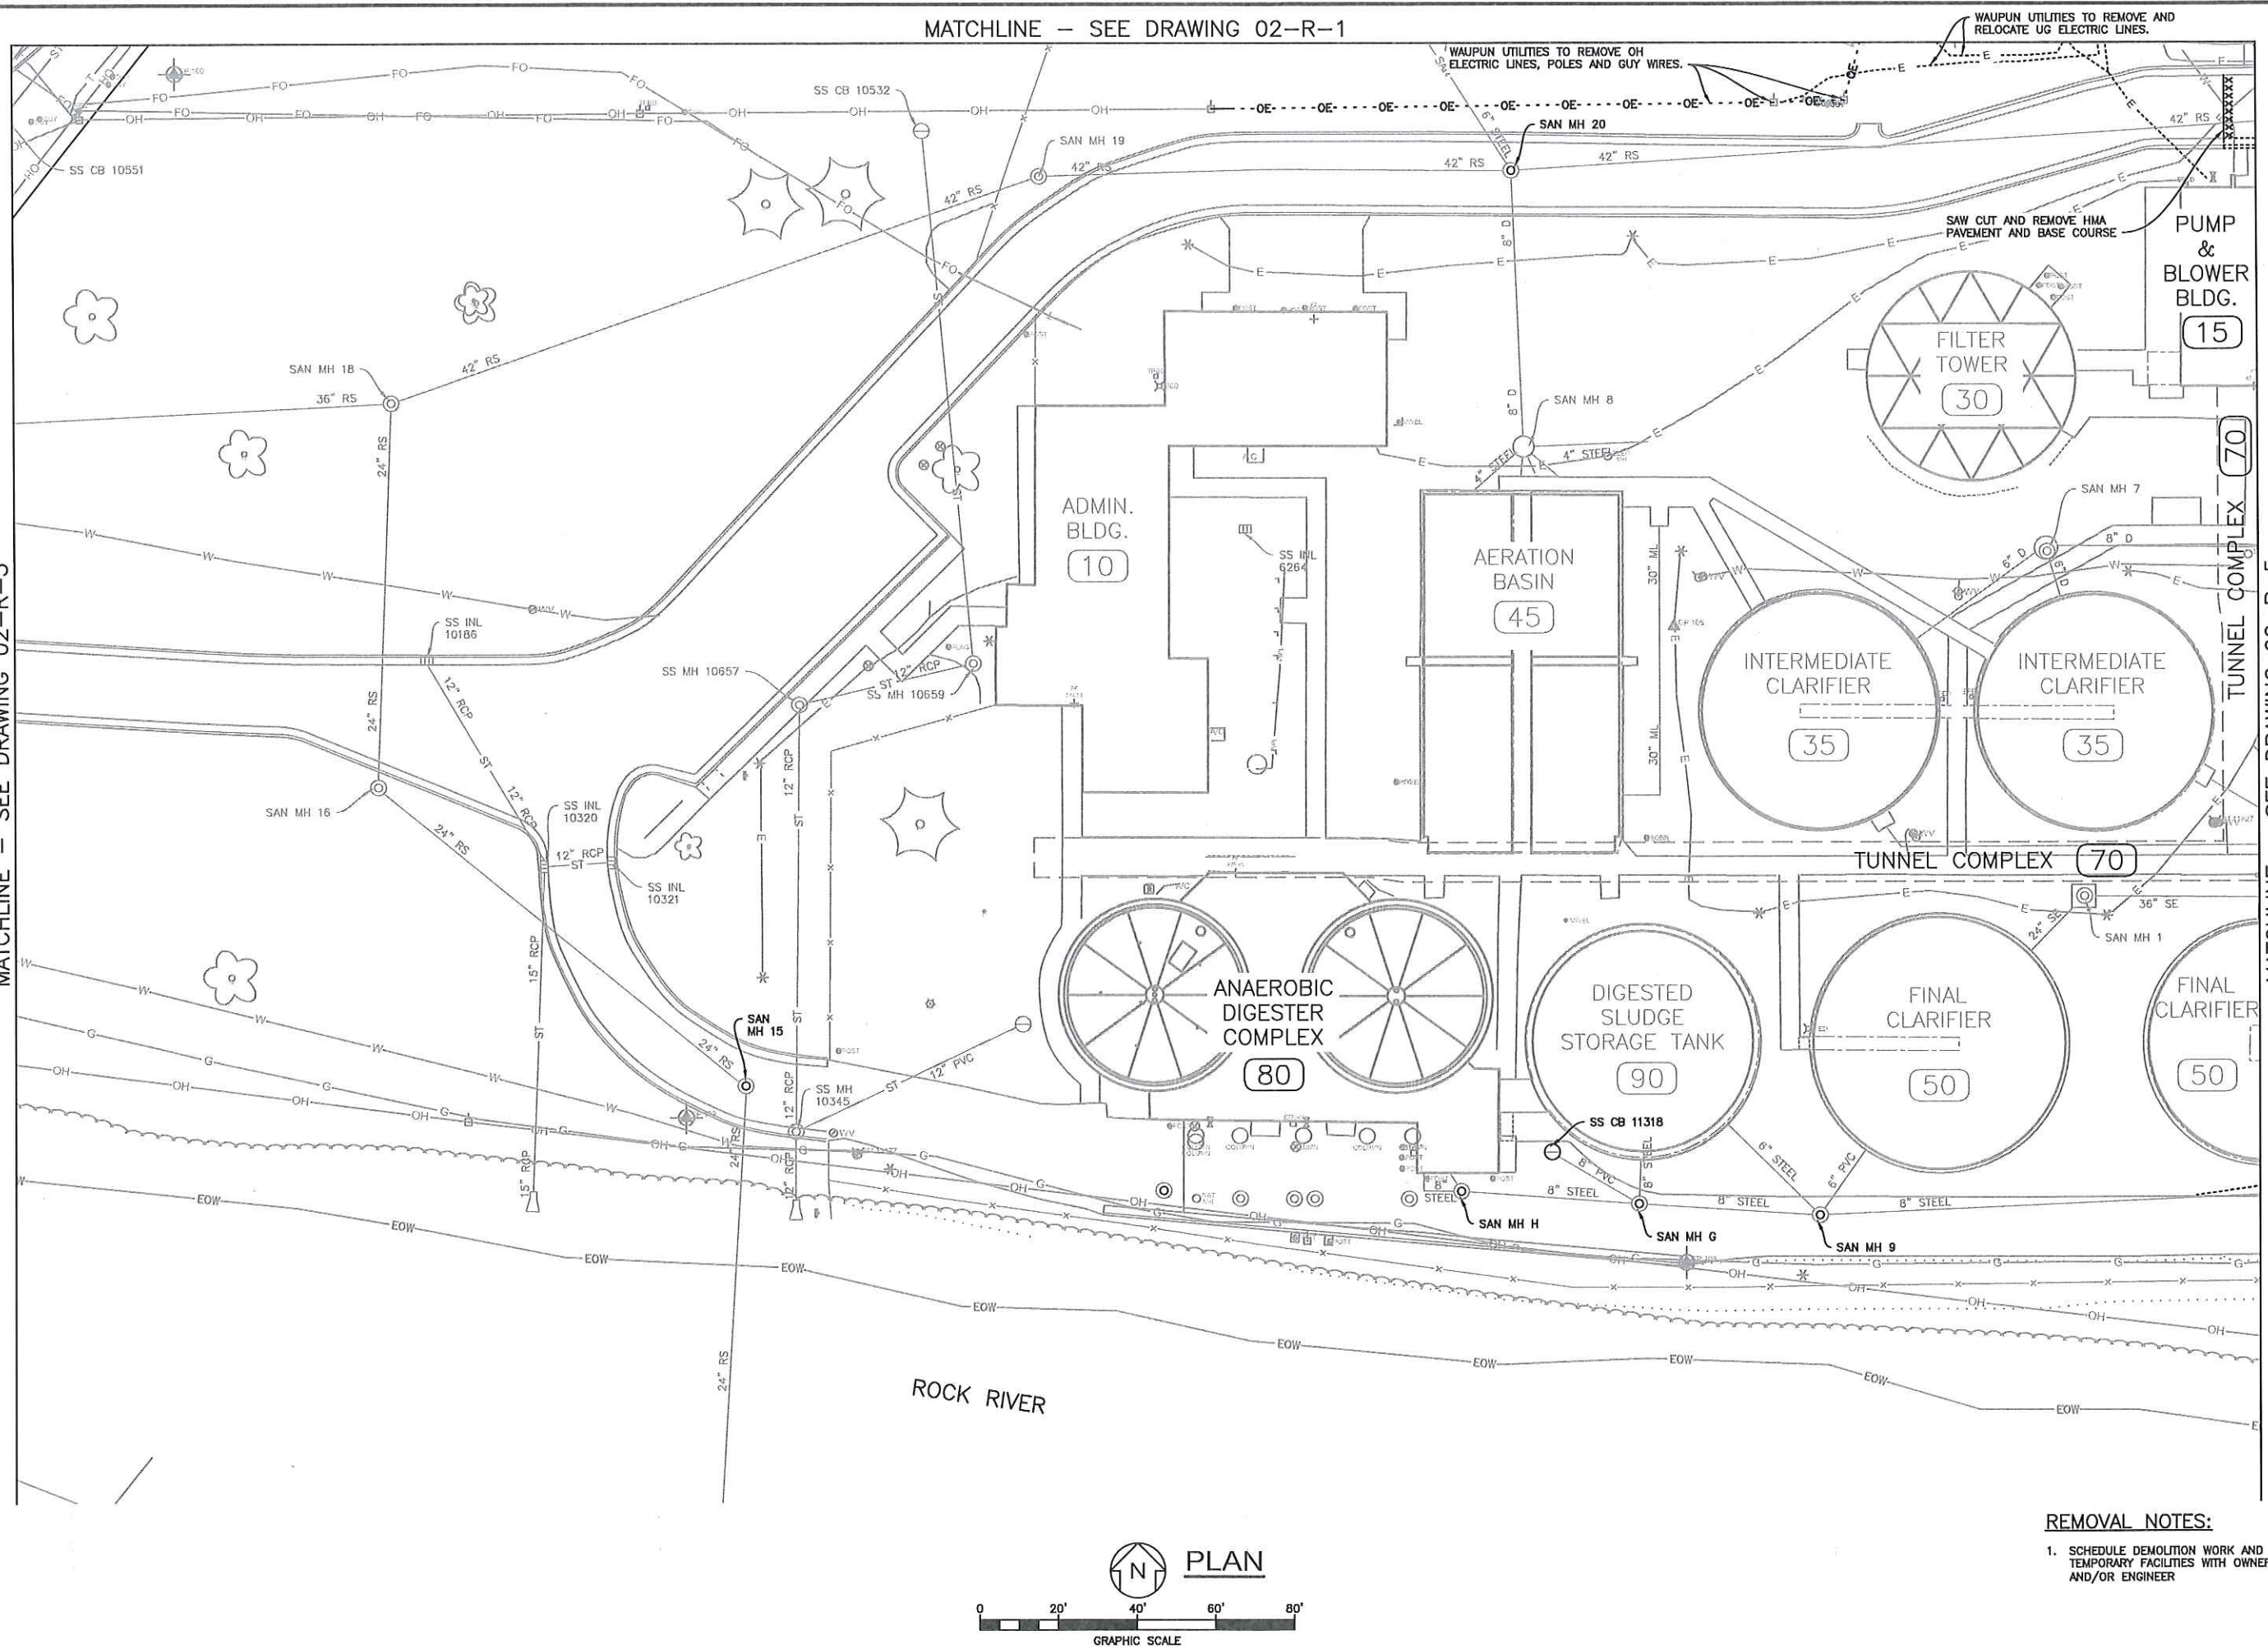

REMOVAL NOTES:
1. SCHEDULE DEMOLITION WORK AND TEMPORARY FACILITIES WITH OWNER AND/OR ENGINEER



Applied Technologies
Engineers-Architects

NO.	DATE	REVISIONS AND RECORD OF ISSUE	BY	APVD
Δ	5-14-21	CHANGE ORDER NO. 1	K.R.H.	K.R.H.

WAUPUN UTILITIES
WWTP UPGRADE AND ABNR

WAUPUN, WI
SITE WORK
REMOVAL
PLAN

VERIFY SCALES
LENGTH OF BAR IS 1"
ON ORIGINAL DRAWING

1:2
PLOT SCALE, ADJUST
SCALE(S) ACCORDINGLY

DESIGNED BY: K.R.H.

DRAWN BY: J.C.S.

CHECKED BY: K.R.H.

APPROVED BY: J.J.S.



PROJECT NO.
6353

DATE
JANUARY 2021

DRAWING NO.
02-R-4




PLTSCALE: 1 LTSCALE: 1
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Last Modified: 25 January 2021

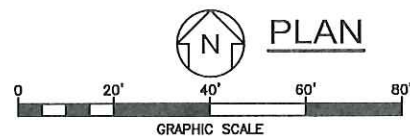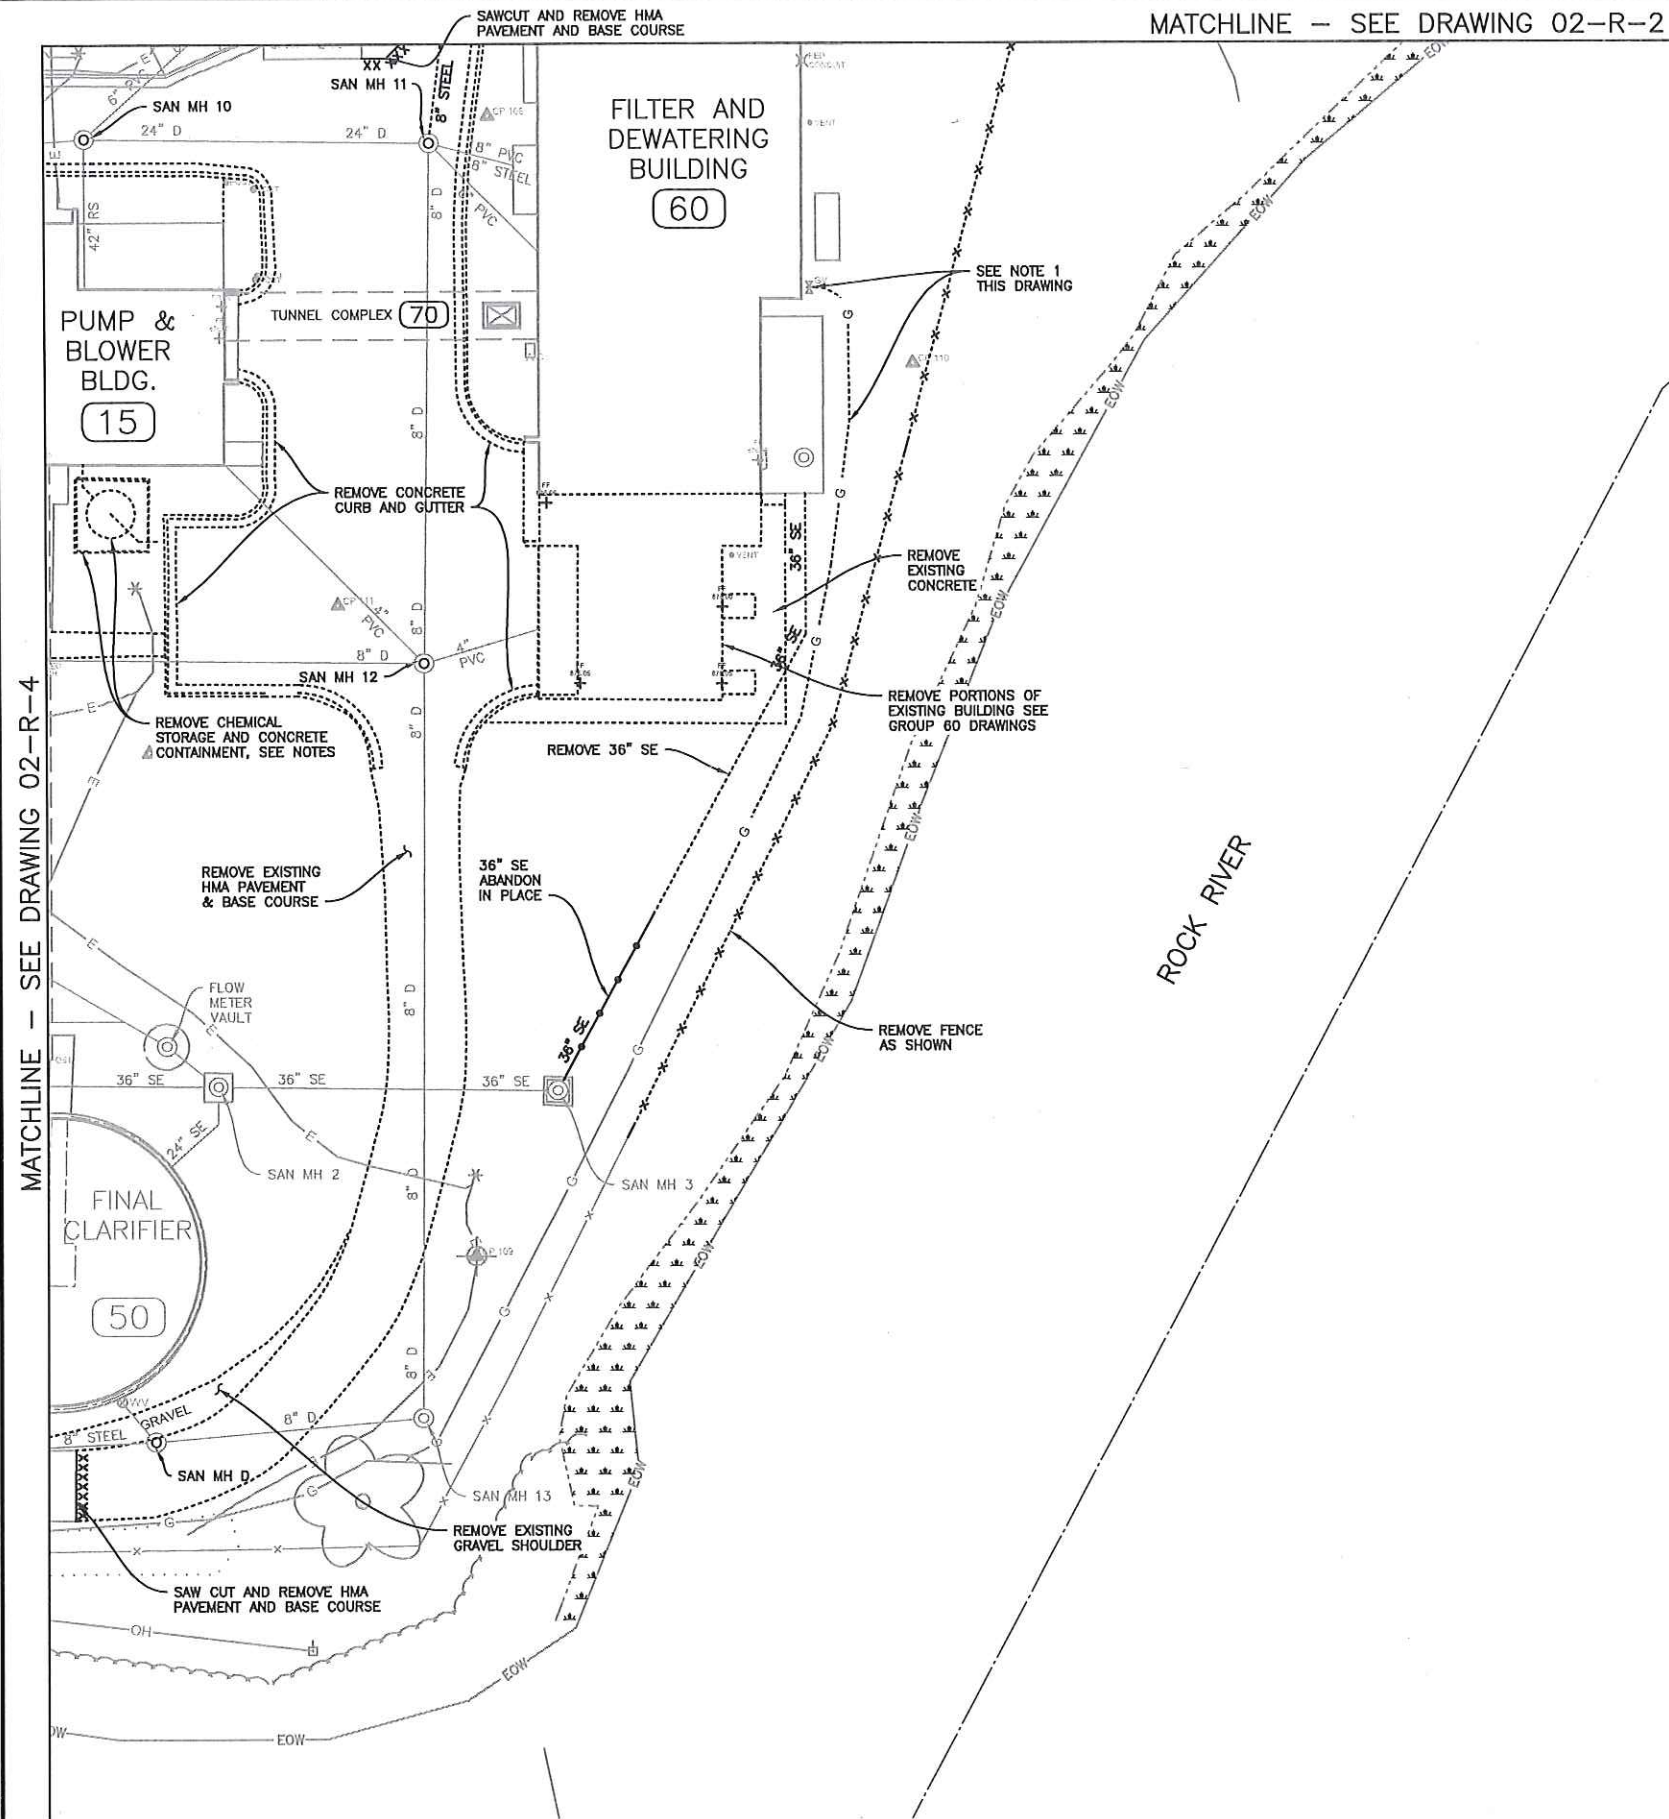


REMOVAL NOTES:

1. REMOVE NATURAL GAS LINE UP TO METER.
2. REPLACE NATURAL GAS LINE AS SHOWN ON 02-M-5.
3. PROVIDE RIGHT OF REFUSAL FOR ALL REMOVED EQUIPMENT TO WAUPUN UTILITIES
4. SCHEDULE DEMOLITION WORK AND TEMPORARY FACILITIES WITH OWNER AND/OR ENGINEER
5. BLIND FLANGE, CAP OR PLUG ALL ABANDONED PIPING.

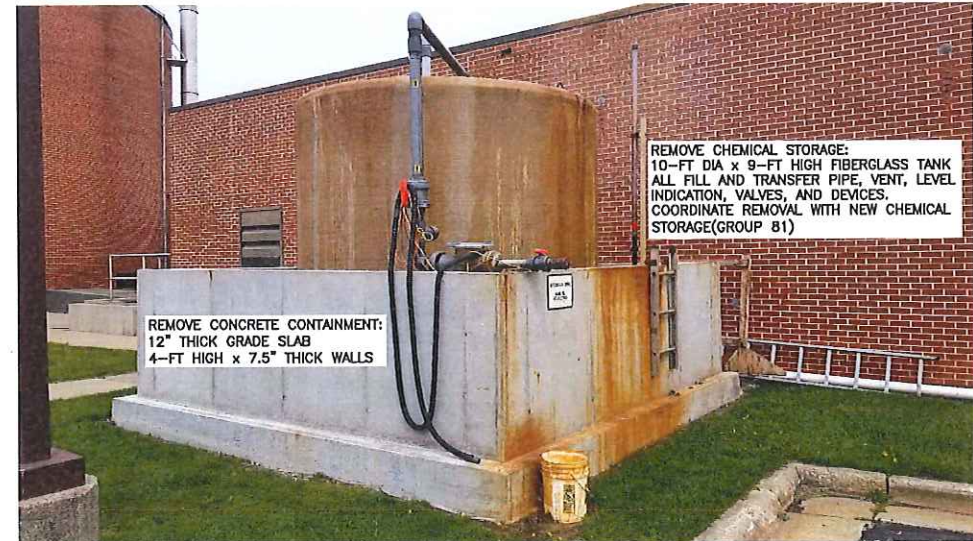

Applied Technologies Engineers-Architects			
NO.	DATE	REVISIONS AND RECORD OF ISSUE	BY
WAUPUN UTILITIES WWTP UPGRADE AND ABNR WAUPUN, WI SITE WORK REMOVAL PLAN			
VERIFY SCALES LENGTH OF BAR IS 1" ON ORIGINAL DRAWING 1:2 PLOT SCALE, ADJUST SCALE(S) ACCORDINGLY			
DESIGNED BY: K.R.H.			
DRAWN BY: J.C.S.			
CHECKED BY: K.R.H.			
APPROVED BY: J.J.S.			
PROJECT NO. 6353			
DATE JANUARY 2021			
DRAWING NO. 02-R-5			

PLTSCALE: 1" = 10' LTSCALE: 1" = 10' PLOTTED ON: 5/13/2021 10:38 AM BY JOHN STAHL
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Last Modified: 5 May 2021
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CATCH BASINS:

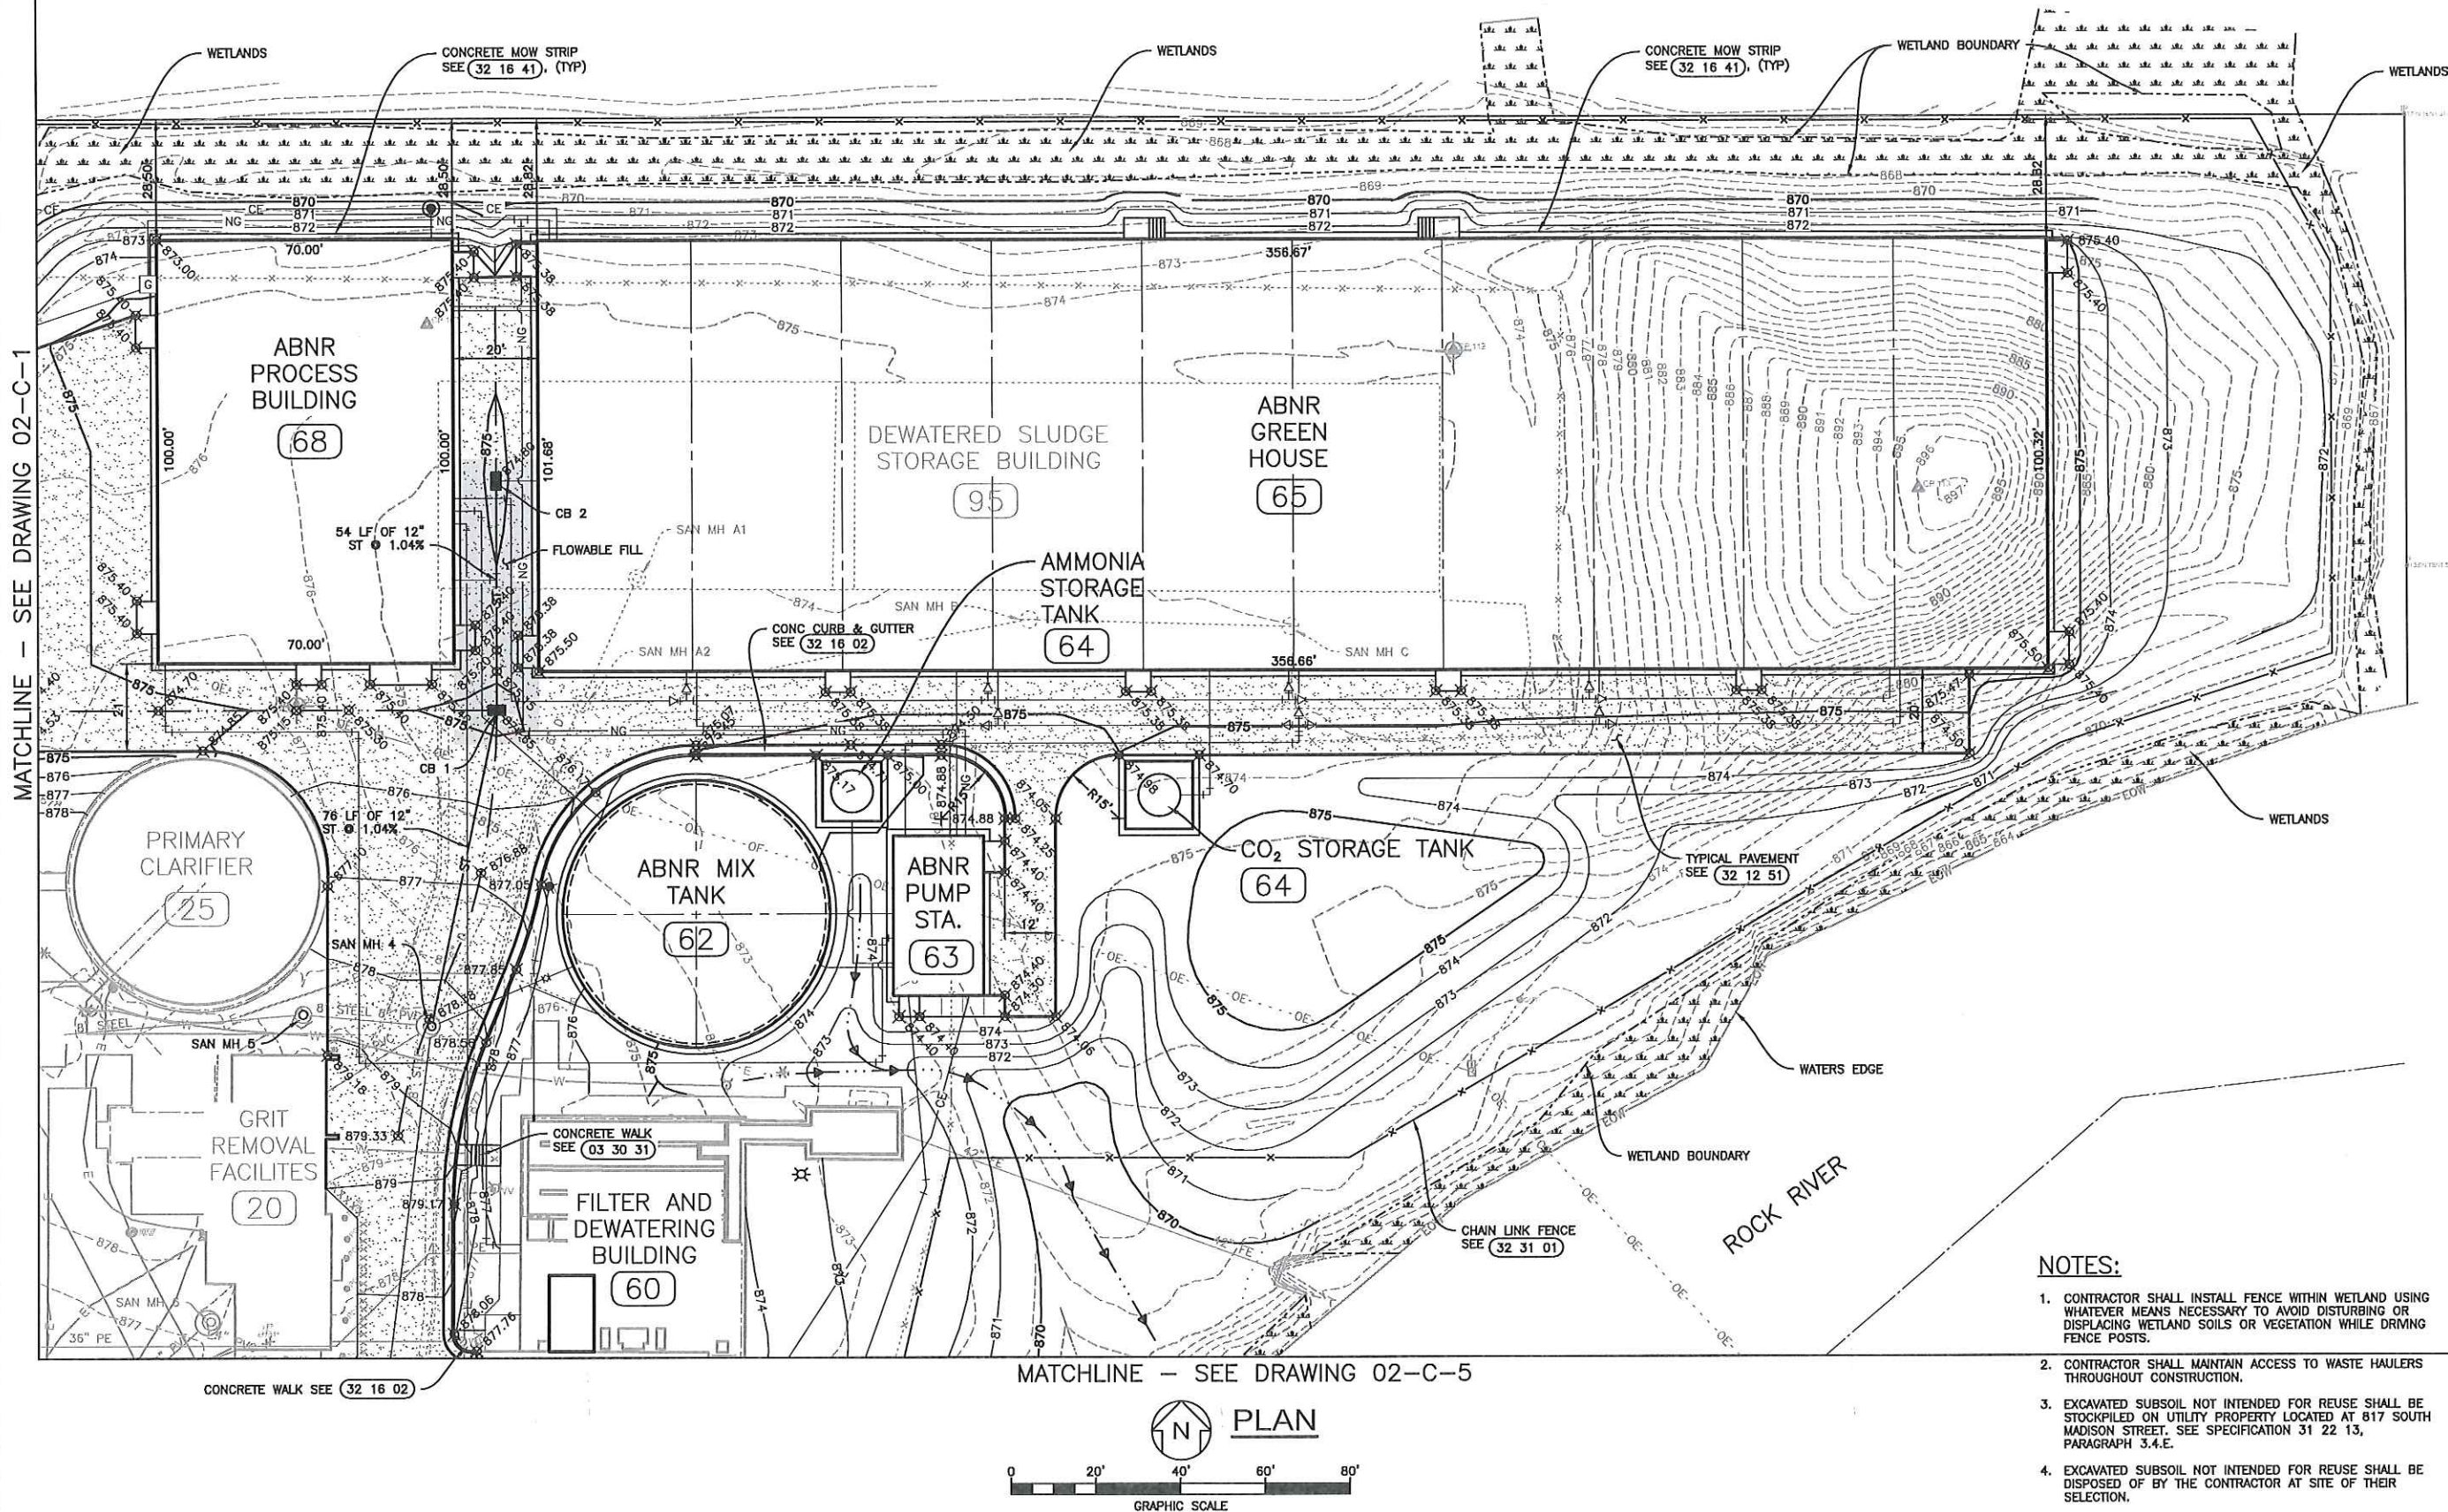CB-1
GRATE = 874.65
12" N&S = 870.24
8" W = 870.24

CB-2
GRATE = 874.80
12" S = 870.80
8" E = 871.30


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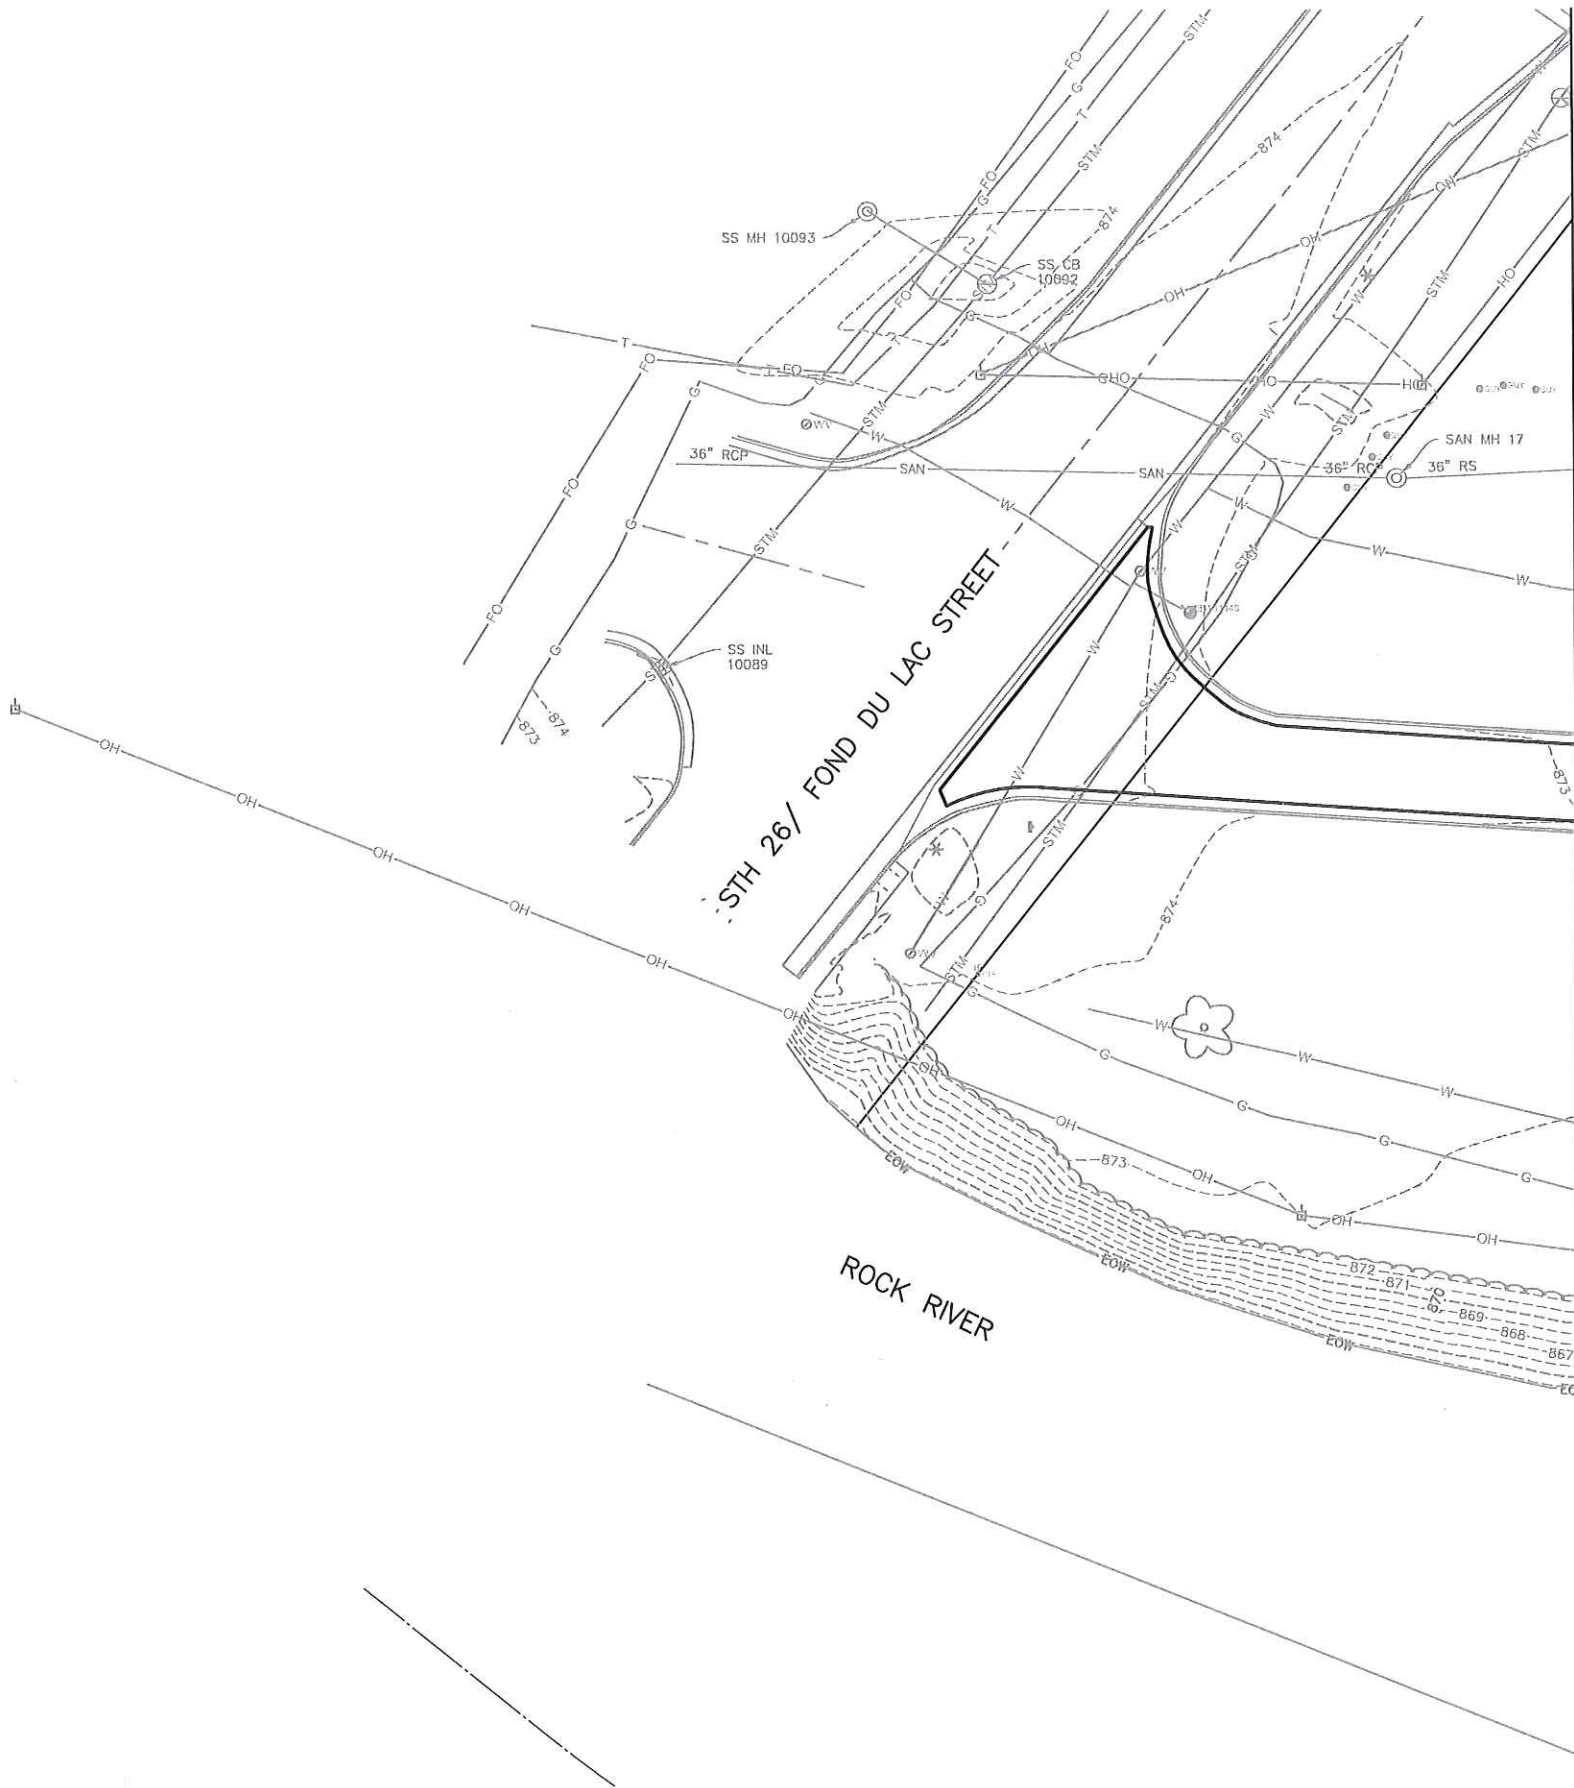
SAN MH 4
RIM ELEV=878.38 ADJUSTED
VALVE N IE=867.47' REMOVED
VALVE S IE=867.50' REMOVED
8" PVC W TOP IE=864.59'
8" PVC W1 BOTTOM IE=857.81'
4" PVC SW TOP IE=872.49'
4" PVC SW1 BOTTOM IE=857.79'
12" N = 869.45 (STORM)
15" S = 869.20 (PLANT DRAIN)


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RIM ELEV=878.24 ADJUSTED
8" STEEL E IE=864.84'
8" STEEL W IE=864.89'
VALVE SW IE=868.47'
VALVE SW1 IE=868.43'

NOTES:



- CONTRACTOR SHALL INSTALL FENCE WITHIN WETLAND USING WHATEVER MEANS NECESSARY TO AVOID DISTURBING OR DISPLACING WETLAND SOILS OR VEGETATION WHILE DRIVING FENCE POSTS.
- CONTRACTOR SHALL MAINTAIN ACCESS TO WASTE HAULERS THROUGHOUT CONSTRUCTION.
- EXCAVATED SUBSOIL NOT INTENDED FOR REUSE SHALL BE STOCKPILED ON UTILITY PROPERTY LOCATED AT 817 SOUTH MADISON STREET. SEE SPECIFICATION 31 22 13, PARAGRAPH 3.4.E.
- EXCAVATED SUBSOIL NOT INTENDED FOR REUSE SHALL BE DISPOSED OF BY THE CONTRACTOR AT SITE OF THEIR SELECTION.

	
APVD	K.R.H.
BY	W.A.H.
Applied Technologies Engineers-Architects	
REVISIONS AND RECORD OF ISSUE	ADDITION NO. 2 ADDITION NO. 3
DATE	2-23-21 2-26-21
NO.	△
WAUPUN UTILITIES WWTP UPGRADE AND ABNR	
WAUPUN, WI	
SITE WORK CIVIL PLAN	
VERIFY SCALES LENGTH OF BAR IS 1" ON ORIGINAL DRAWING 1:2 PLOT SCALE, ADJUST SCALE(S) ACCORDINGLY	
DESIGNED BY: W.A.H.	
DRAWN BY: J.C.S.	
CHECKED BY: K.R.H.	
APPROVED BY: J.J.S.	
PROJECT NO. 6353	
DATE JANUARY 2021	
DRAWING NO. 02-C-2	






WAUPUN UTILITIES
THE POWER OF COMMUNITY

 <p>Applied Technologies Engineers-Architects</p>		BY W.A.H.	APVD K.R.H.
NO. 		REVISIONS AND RECORD OF ISSUE CHANGE ORDER NO. 1	
DATE 5-14-21			
WAUPUN UTILITIES WWTP UPGRADE AND ABNR WAUPUN, WI		SITE WORK CIVIL PLAN	
VERIFY SCALES LENGTH OF BAR IS 1" ON ORIGINAL DRAWING 1:2 PLOT SCALE, ADJUST SCALE(S) ACCORDINGLY			
DESIGNED BY: W.A.H.			
DRAWN BY: J.C.S.			
CHECKED BY: K.R.H.			
APPROVED BY: J.J.S.			
PROJECT NO. 6353			
DATE JANUARY 2021			
DRAWING NO. 02-C-3			

MATCHLINE - SEE DRAWING 02-C-3

MATCHLINE - SEE DRAWING 02-C-1

TYPICAL PAVEMENT
SEE (32 12 51)

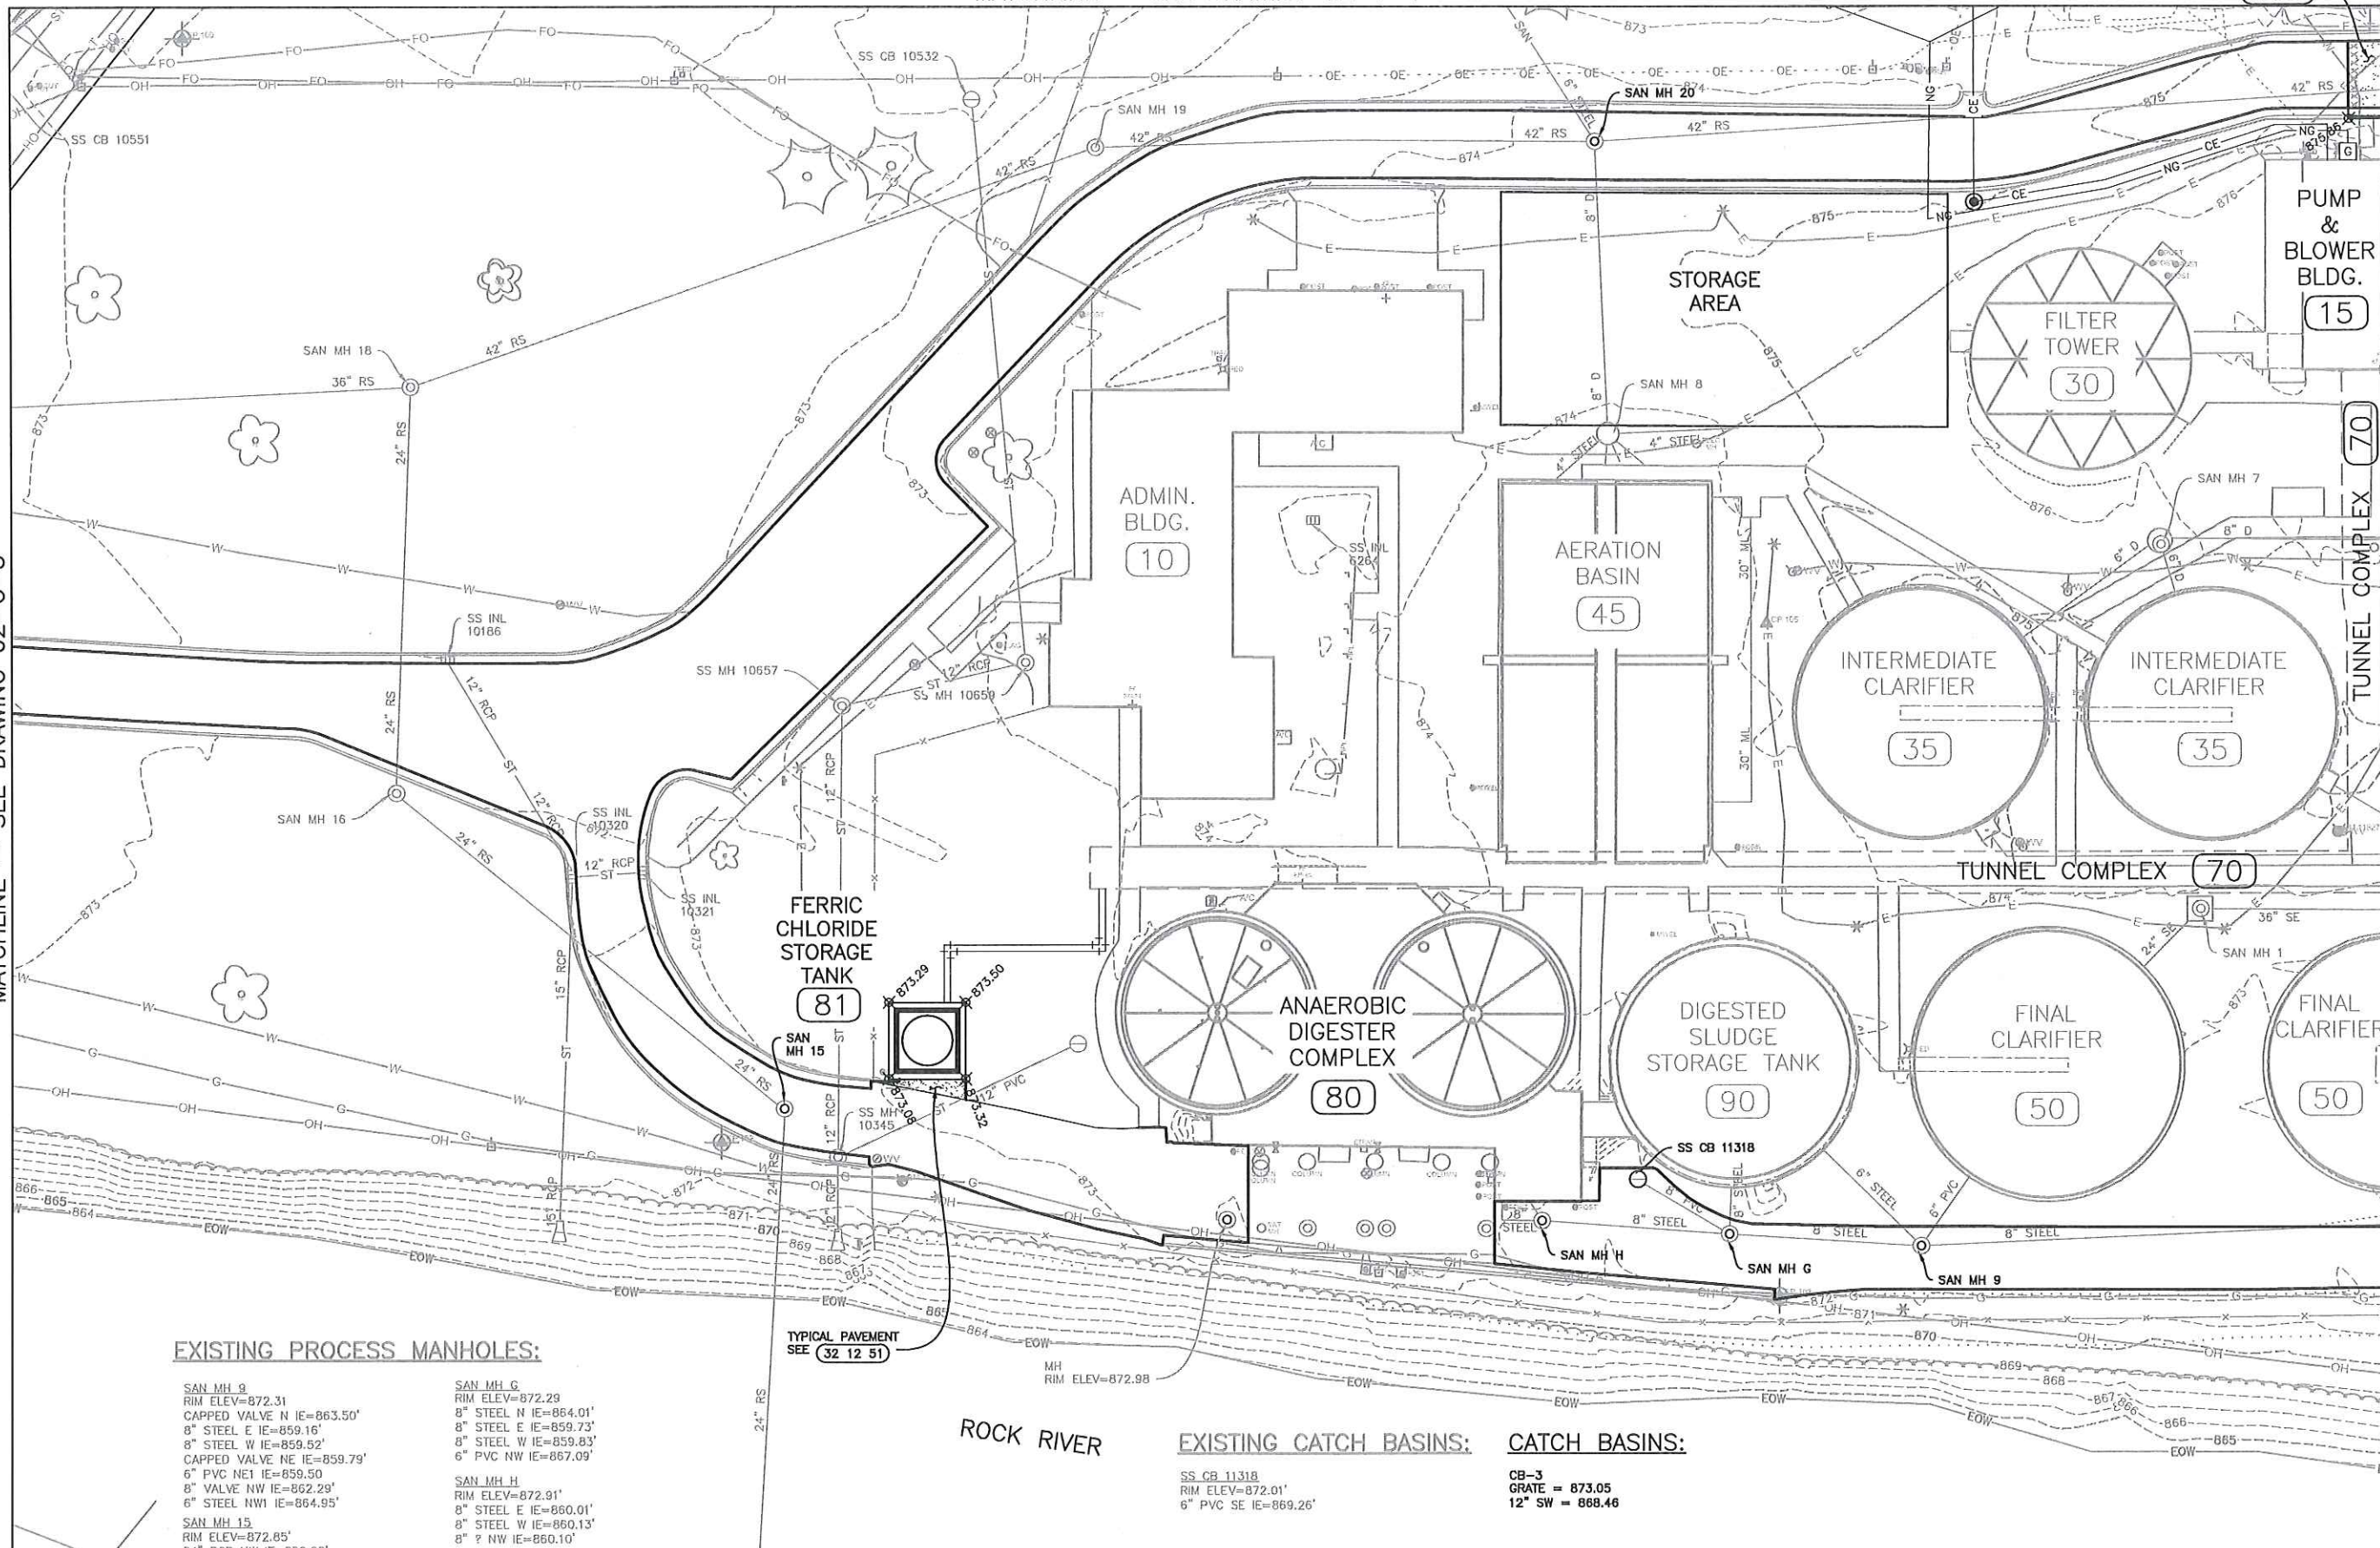

EXISTING PROCESS MANHOLES:

SAN MH 9
RIM ELEV=872.31
CAPPED VALVE N IE=863.50'
8" STEEL E IE=859.16'
8" STEEL W IE=859.52'
CAPPED VALVE NE IE=859.79'
6" PVC NE1 IE=859.50
8" VALVE NW IE=862.29'
6" STEEL NW1 IE=864.95'
SAN MH 15
RIM ELEV=872.85'
24" RCP NW IE=856.25'
18" RCP SE IE=856.45'
12" RCP S IE=856.38'
SAN MH 20
RIM ELEV=874.43
8" STEEL S IE=856.45'
42" RCP E IE=855.04'
42" RCP W IE=855.27'
6" STEEL NW IE=862.44'

SAN MH G
RIM ELEV=872.29
8" STEEL N IE=864.01'
8" STEEL E IE=859.73'
8" STEEL W IE=859.83'
6" PVC NW IE=867.09'

SAN MH H
RIM ELEV=872.91'
8" STEEL E IE=860.01'
8" STEEL W IE=860.13'
8" ? NW IE=860.10'

TYPICAL PAVEMENT
SEE (32 12 51)

ROCK RIVER

EXISTING CATCH BASINS:

SS CB 11318
RIM ELEV=872.01'
6" PVC SE IE=869.26'

CATCH BASINS:

CB-3
GRATE = 873.05
12" SW = 868.46

NOTE:

1. CONTRACTOR SHALL MAINTAIN ACCESS TO WASTE HAULERS THROUGHOUT CONSTRUCTION.

WAUPUN UTILITIES
WWTP UPGRADE AND ABNR

WAUPUN, WI

SITE WORK
CIVIL
PLAN

Applied Technologies
Engineers-Architects

NO.	DATE	REVISIONS AND RECORD OF ISSUE	BY	APVD
1	5-14-21	CHANGE ORDER NO. 1	W.A.H.	K.R.H.



VERIFY SCALES
LENGTH OF BAR IS 1" ON ORIGINAL DRAWING

1:2
PLOT SCALE, ADJUST
SCALE(S) ACCORDINGLY

DESIGNED BY: W.A.H.

DRAWN BY: J.C.S.

CHECKED BY: K.R.H.

APPROVED BY: J.J.S.

PROJECT NO.
6353



DATE
JANUARY 2021

DRAWING NO.

02-C-4

PLTSCALE: 1 LTSCALE: 1
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Last Modified: 7 May 2021
Plotted On: 5/13/2021 10:39 AM by JOHN STAHL
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MATCHLINE - SEE DRAWING 02-C-4

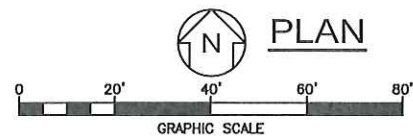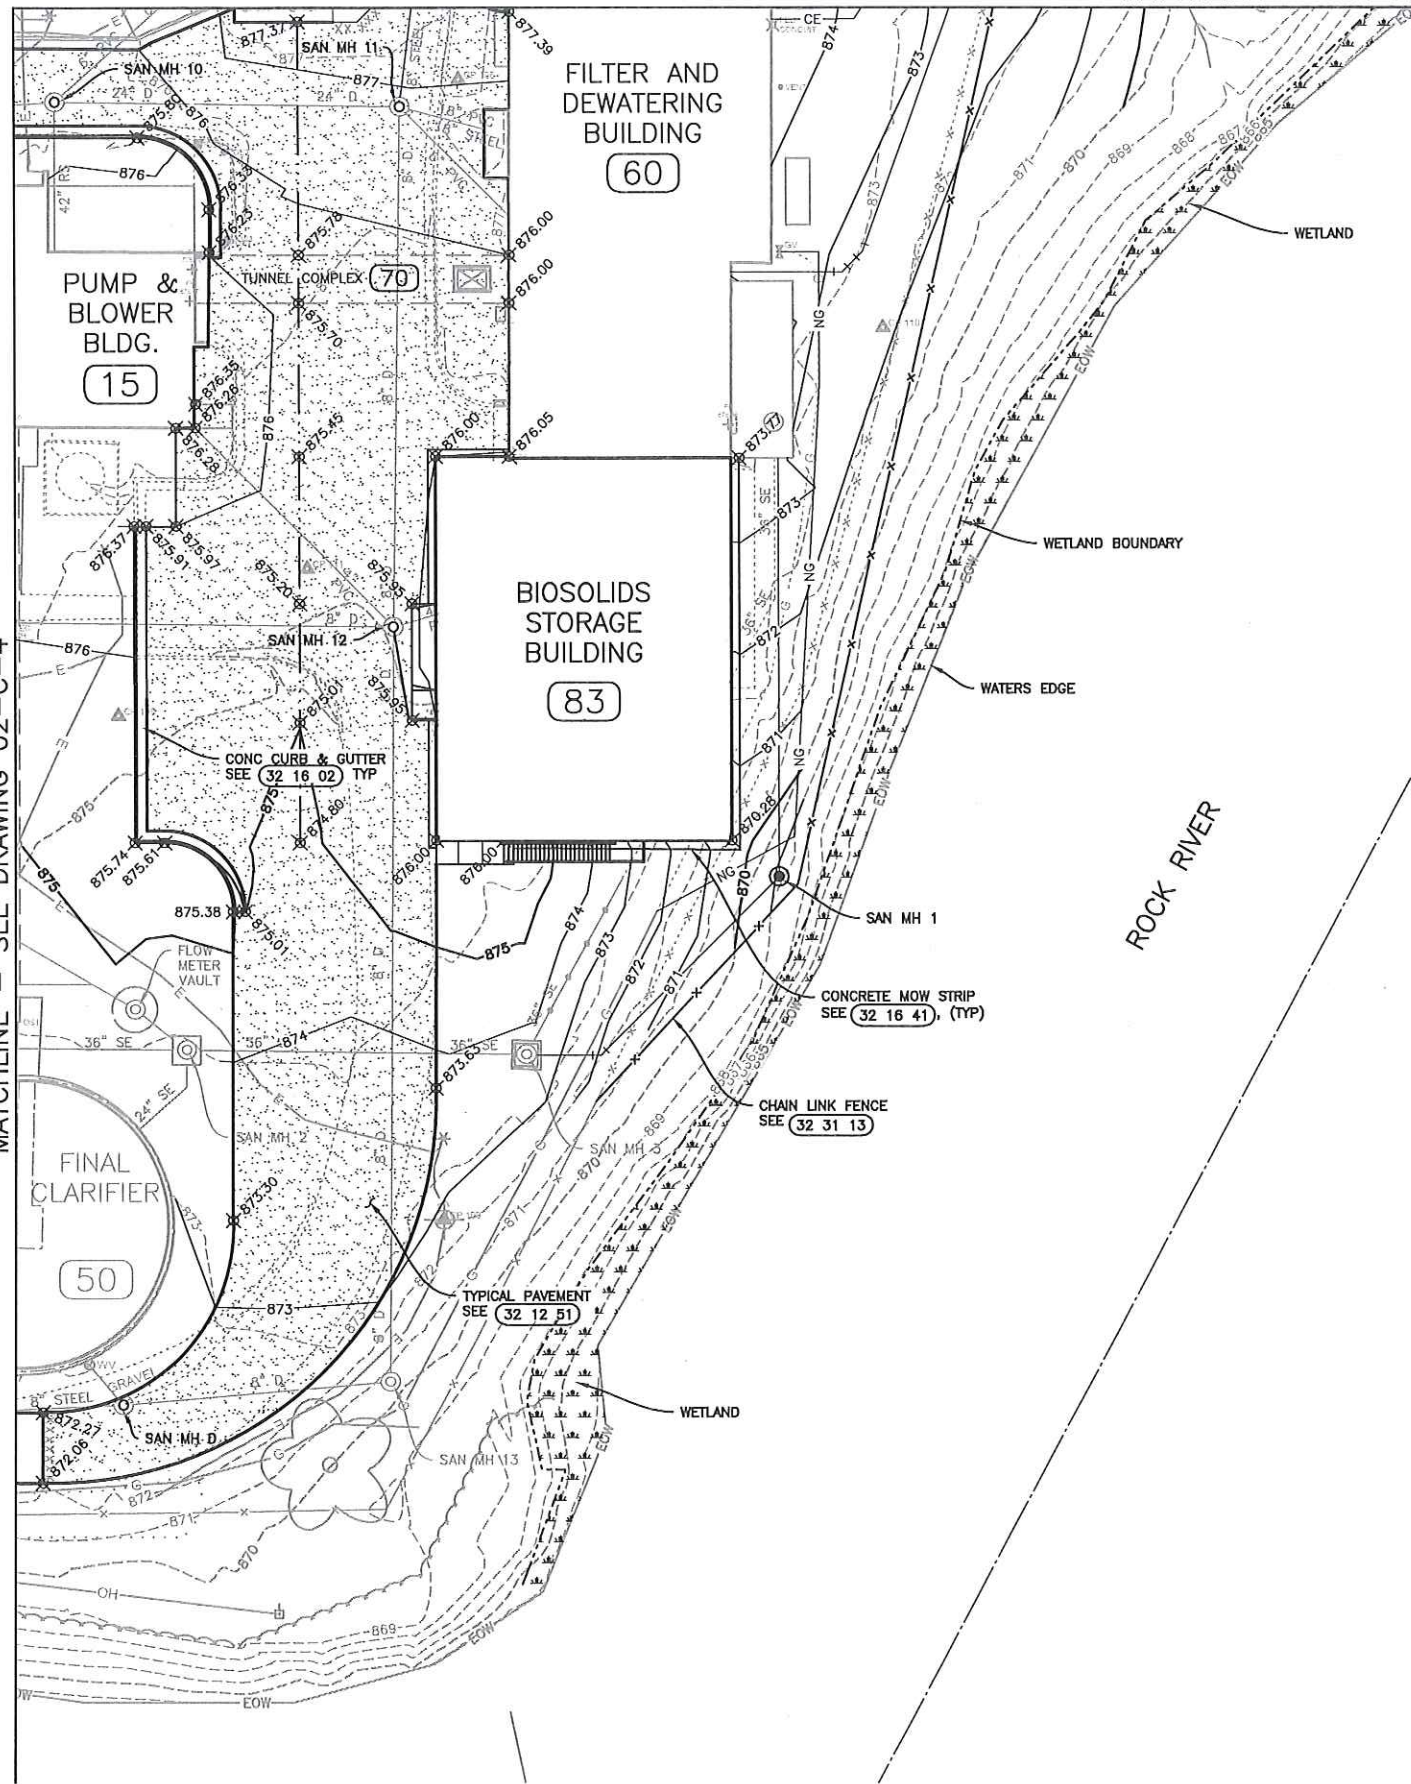

PLAN

EXISTING PROCESS MANHOLES:

SAN MH D
RIM ELEV=872.50
8" STEEL E IE=858.60'
8" STEEL W IE=858.66'
6" STEEL NW IE=859.80'



SAN MH 10
RIM ELEV=875.58 ADJUSTED
42" RCP S IE=854.82'
6" PVC NE IE=856.48'
6" PVC NE1 IE=866.42'
24" STEEL E IE=856.32'
42" RCP W IE=854.94'

SAN MH 11
RIM ELEV=876.90 ADJUSTED
6" STEEL N IE=856.84' REMOVED
8" STEEL S IE=856.77'
6" PVC SE IE=857.28'
18" PVC E TOP IE=869.89'
18" STEEL E1 BOTTOM IE=857.31'
24" STEEL W IE=856.69'
15" N = 868.16 (PLANT DRAIN)


SAN MH 12
RIM ELEV=875.82 ADJUSTED
? N IE=857.34'
? S IE=857.47'
4" PVC E IE=857.78'
8" STEEL W IE=858.28'
4" PVC NE IE=866.77'
4" PVC NW IE=857.81'
4" PVC NW1 IE=865.55'
4" SD SW IE = 870.20'


NOTE:

1. CONTRACTOR SHALL MAINTAIN ACCESS TO WASTE HAULERS THROUGHOUT CONSTRUCTION.

										WAUPUN UTILITIES WWTP UPGRADE AND ABNR									
NO.		DATE		REVISIONS AND RECORD OF ISSUE			BY		APVD										
Δ		5-14-21		CHANGE ORDER NO. 1			W.A.H.		K.R.H.										
WAUPUN, WI										SITE WORK CIVIL PLAN									
VERIFY SCALES LENGTH OF BAR IS 1"=1'-0" ON ORIGINAL DRAWING 1:2 PLOT SCALE, ADJUST SCALE(S) ACCORDINGLY																			
DESIGNED BY: W.A.H.																			
DRAWN BY: J.C.S.																			
CHECKED BY: K.R.H.																			
APPROVED BY: J.J.S.																			
PROJECT NO. 6353																			
DATE JANUARY 2021																			
DRAWING NO. 02-C-5																			

PS1:SCALE: 1 LTSCALE: 1
r:\shared folders\projects\6353 - waupun upgrade\11.0 graphics\11.3 drawings\02-M-1 PLAN.dwg
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Last Modified: 25 January 2021

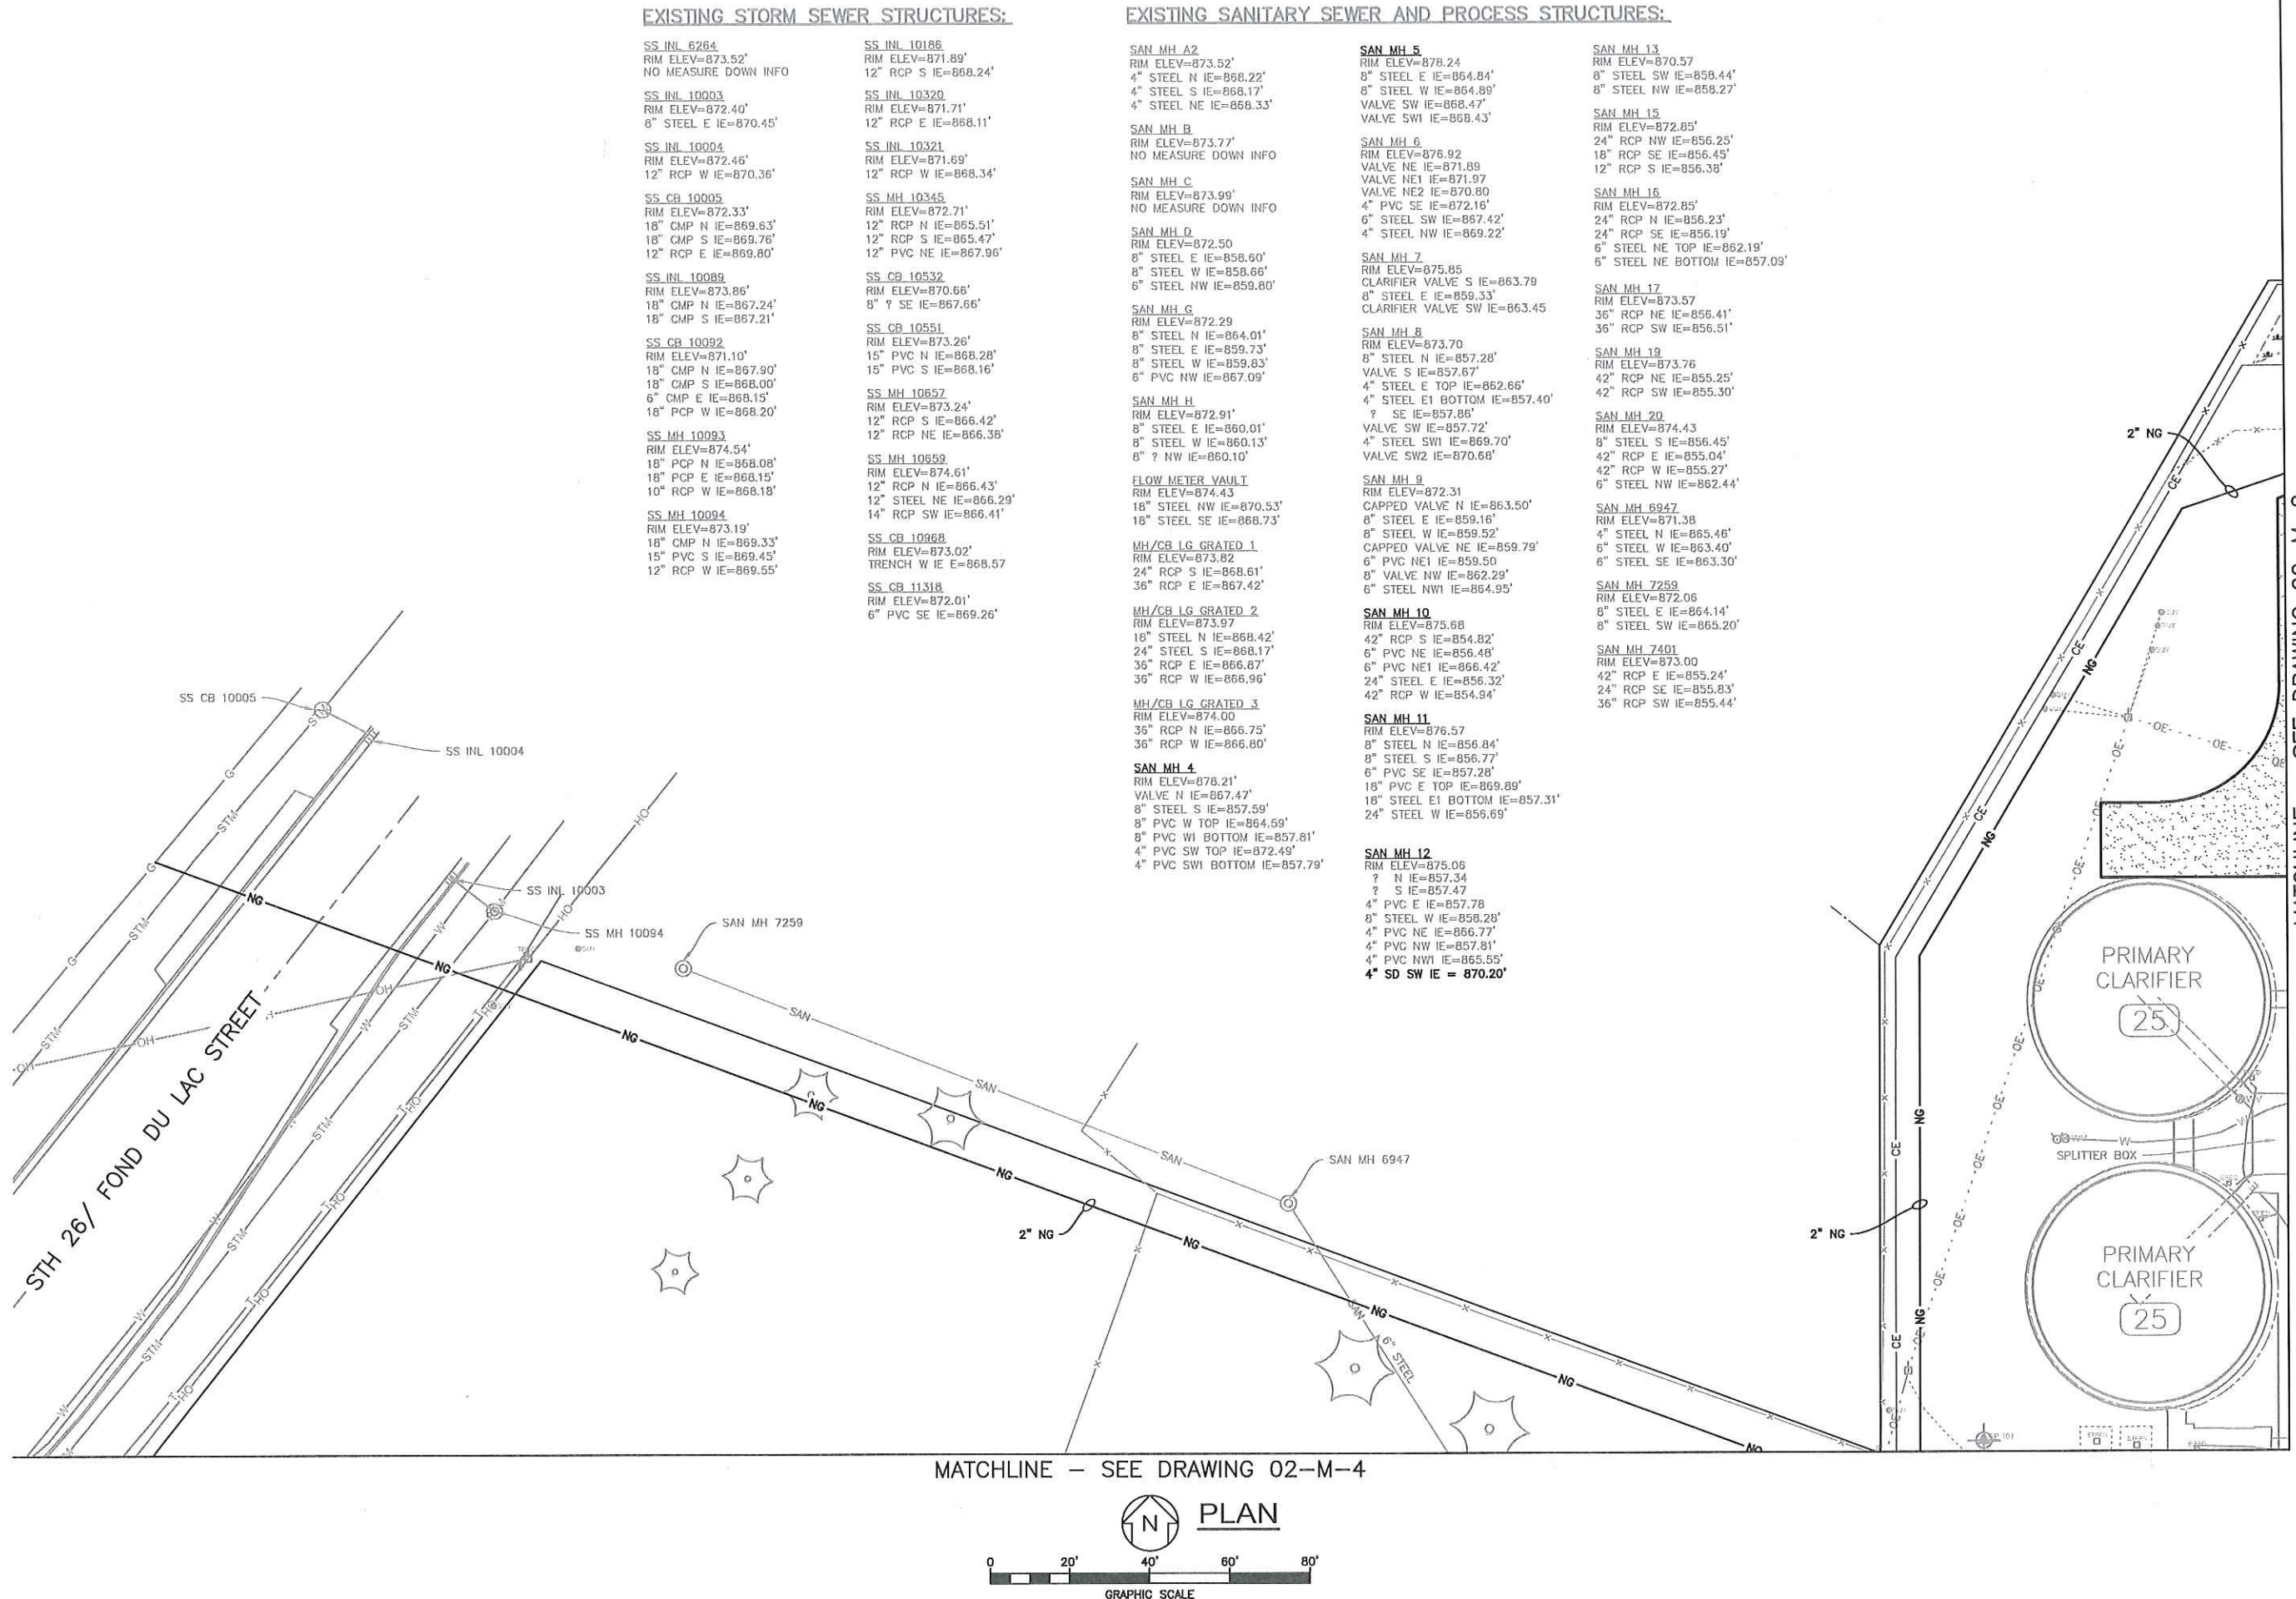



WAUPUN UTILITIES
THE POWER OF COMMUNITY

NO.	DATE	REVISIONS AND RECORD OF ISSUE	BY	APVD

WAUPUN UTILITIES
WWTP UPGRADE AND ABNR

WAUPUN, WI
SITE WORK
MECHANICAL PLAN

VERIFY SCALES
LENGTH OF BAR IS 1" ON ORIGINAL DRAWING

1:2
PLOT SCALE, ADJUST SCALE(S) ACCORDINGLY

DESIGNED BY: K.R.H.

DRAWN BY: J.C.S.

CHECKED BY: K.R.H.

APPROVED BY: J.J.S.

PROJECT NO.
6353


DATE
JANUARY 2021

DRAWING NO.
02-M-1

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Last Modified: 7 May 2021
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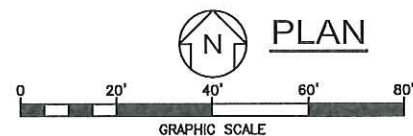
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
SAN MH 4
RIM ELEV=878.21'
~~VALVE N IE=867.47'~~ REMOVED
~~8" STEEL C IE=857.60'~~ REMOVED
8" PVC W TOP IE=864.59'
8" PVC W BOTTOM IE=857.81'
4" PVC SW TOP IE=872.49'
4" PVC SW BOTTOM IE=857.79'
12" N = 869.45 (STORM)
15" S = 869.20 (PLANT DRAIN)



MATCHLINE - SEE DRAWING 02-M-1

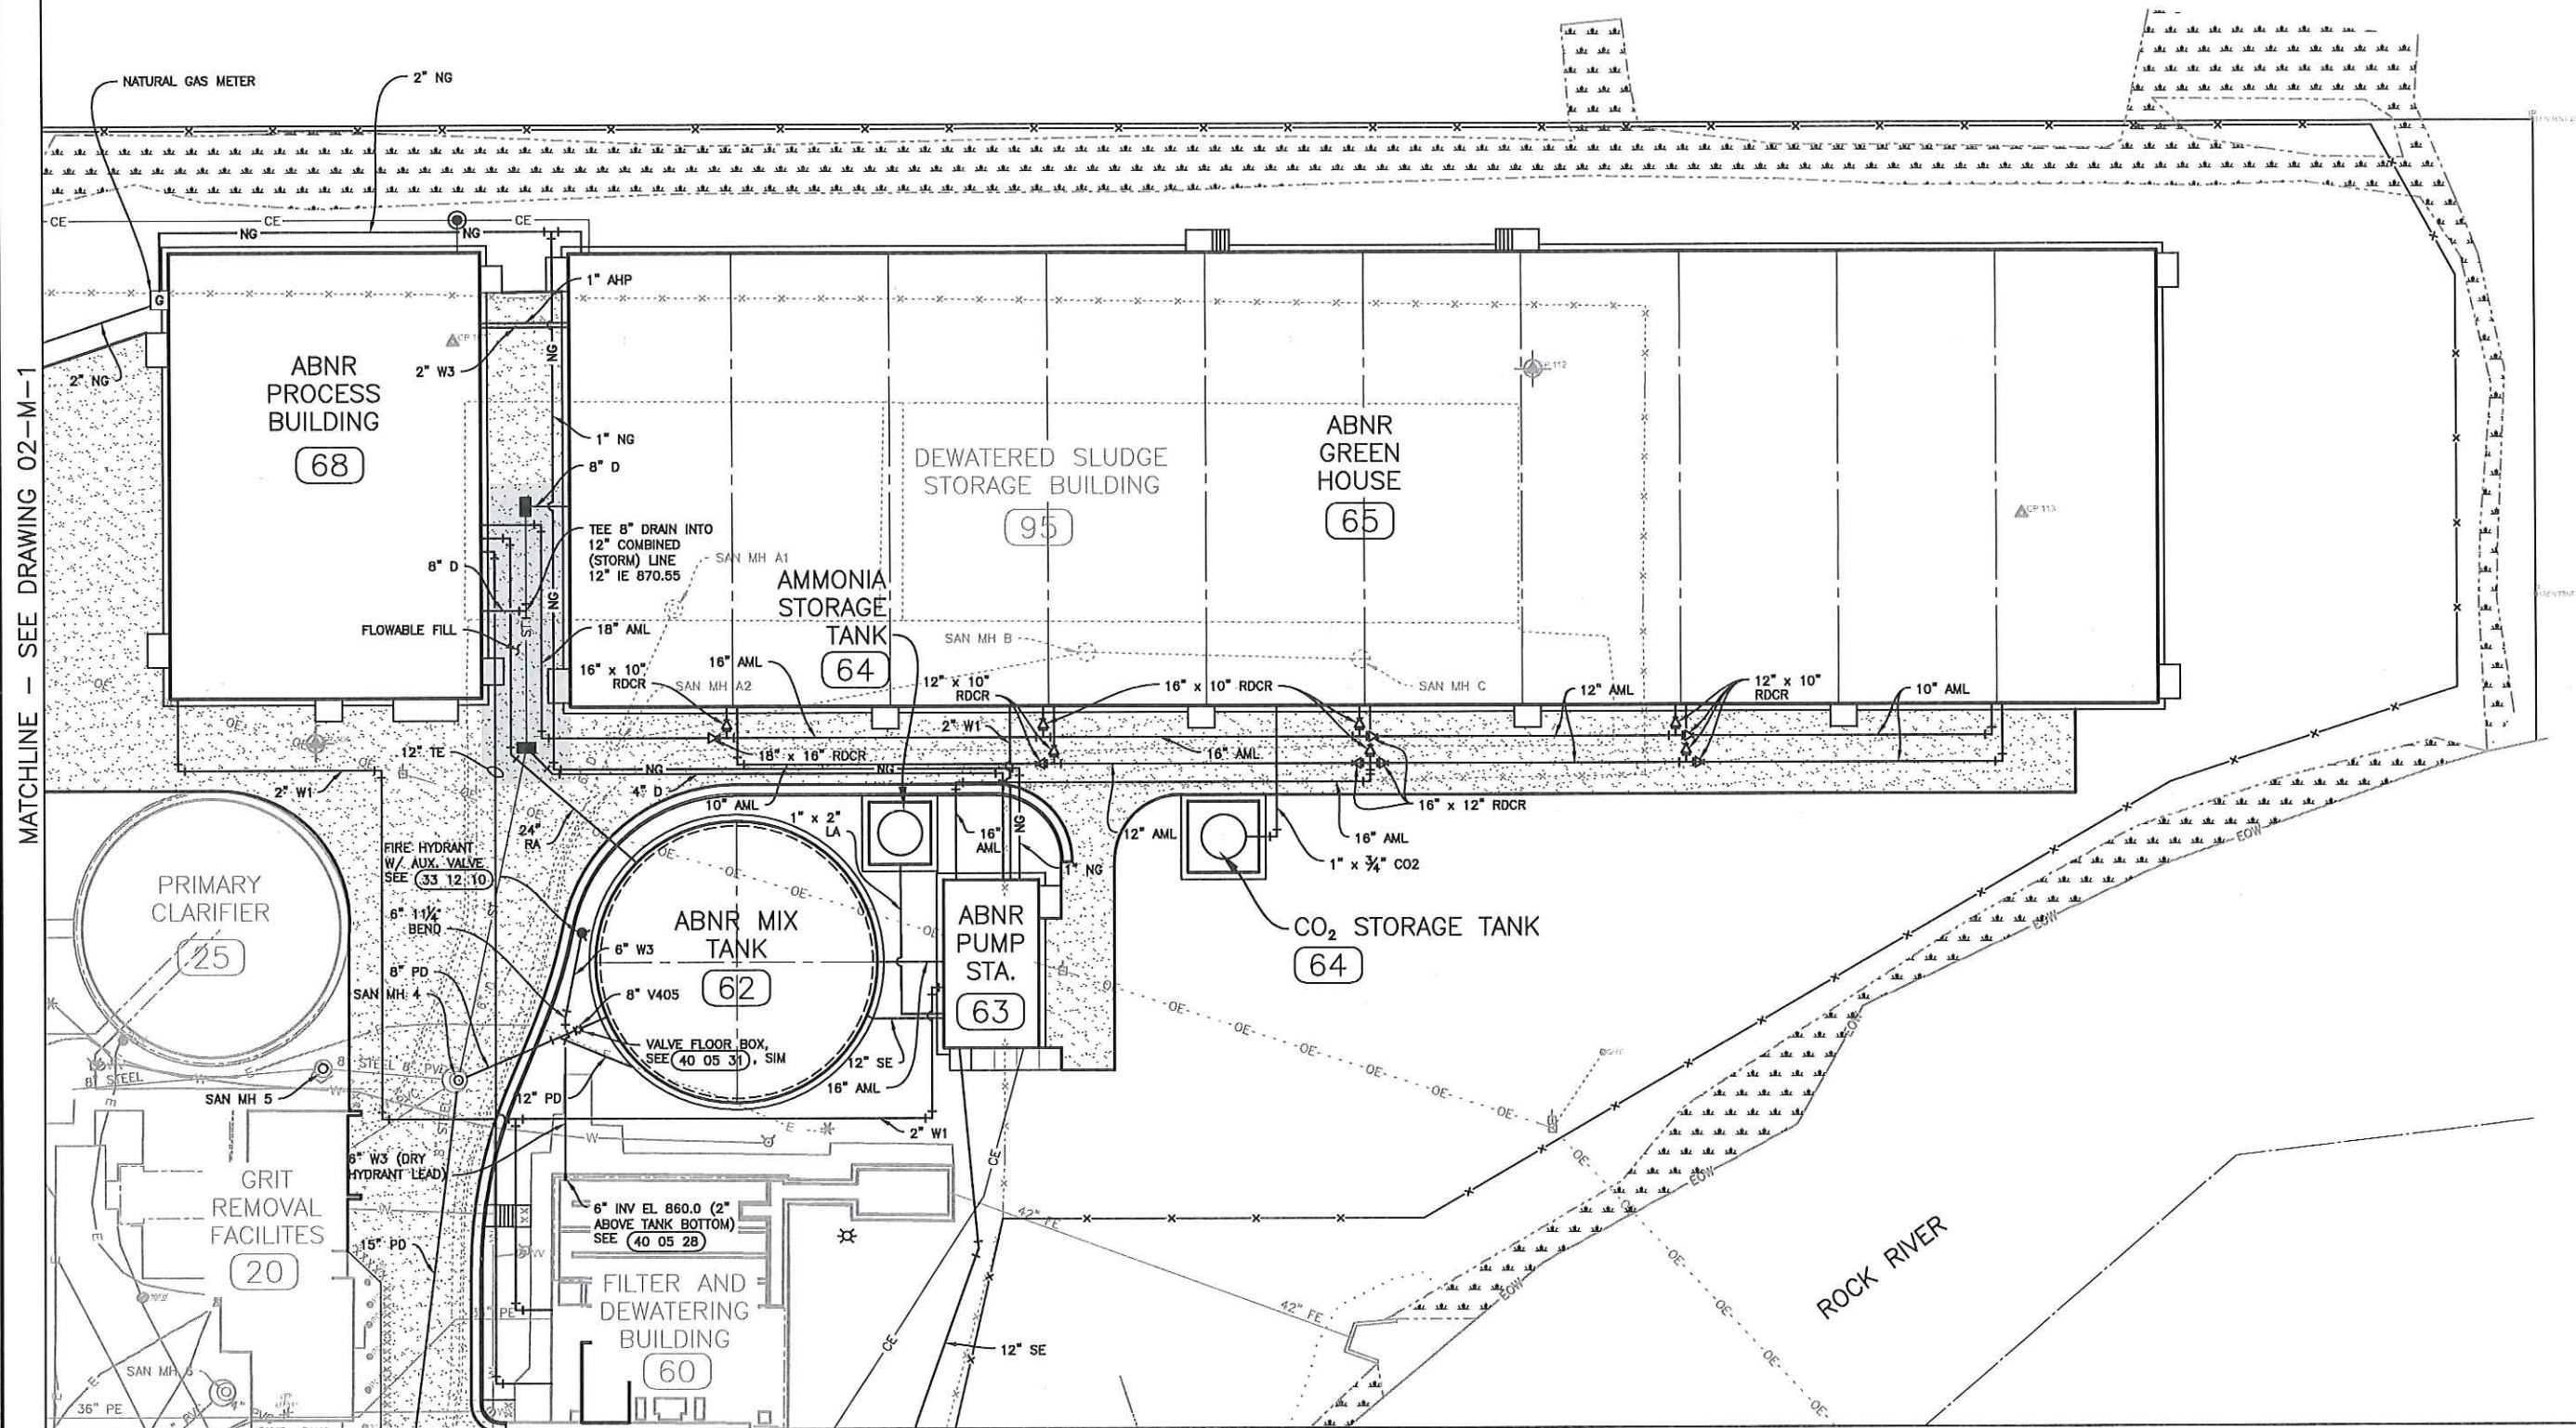MATCHLINE - SEE DRAWING 02-M-5





WAUPUN UTILITIES
THE POWER OF COMMUNITY

APVD	K.R.H.
BY	K.R.H.
REVISIONS AND RECORD OF ISSUE	
DATE	2-23-21 2-26-21 5-14-21
NO.	ADDENDUM NO. 2 ADDENDUM NO. 3 CHANGE ORDER NO. 1

WAUPUN UTILITIES
WWTP UPGRADE AND ABNR

WAUPUN, WI
SITE WORK
MECHANICAL PLAN

VERIFY SCALES
LENGTH OF BAR IS 1" ON ORIGINAL DRAWING

1:2
PLOT SCALE, ADJUST SCALE(S) ACCORDINGLY

DESIGNED BY: K.R.H.

DRAWN BY: J.C.S.



CHECKED BY: K.R.H.

APPROVED BY: J.J.S.



PROJECT NO.
6353

DATE
JANUARY 2021

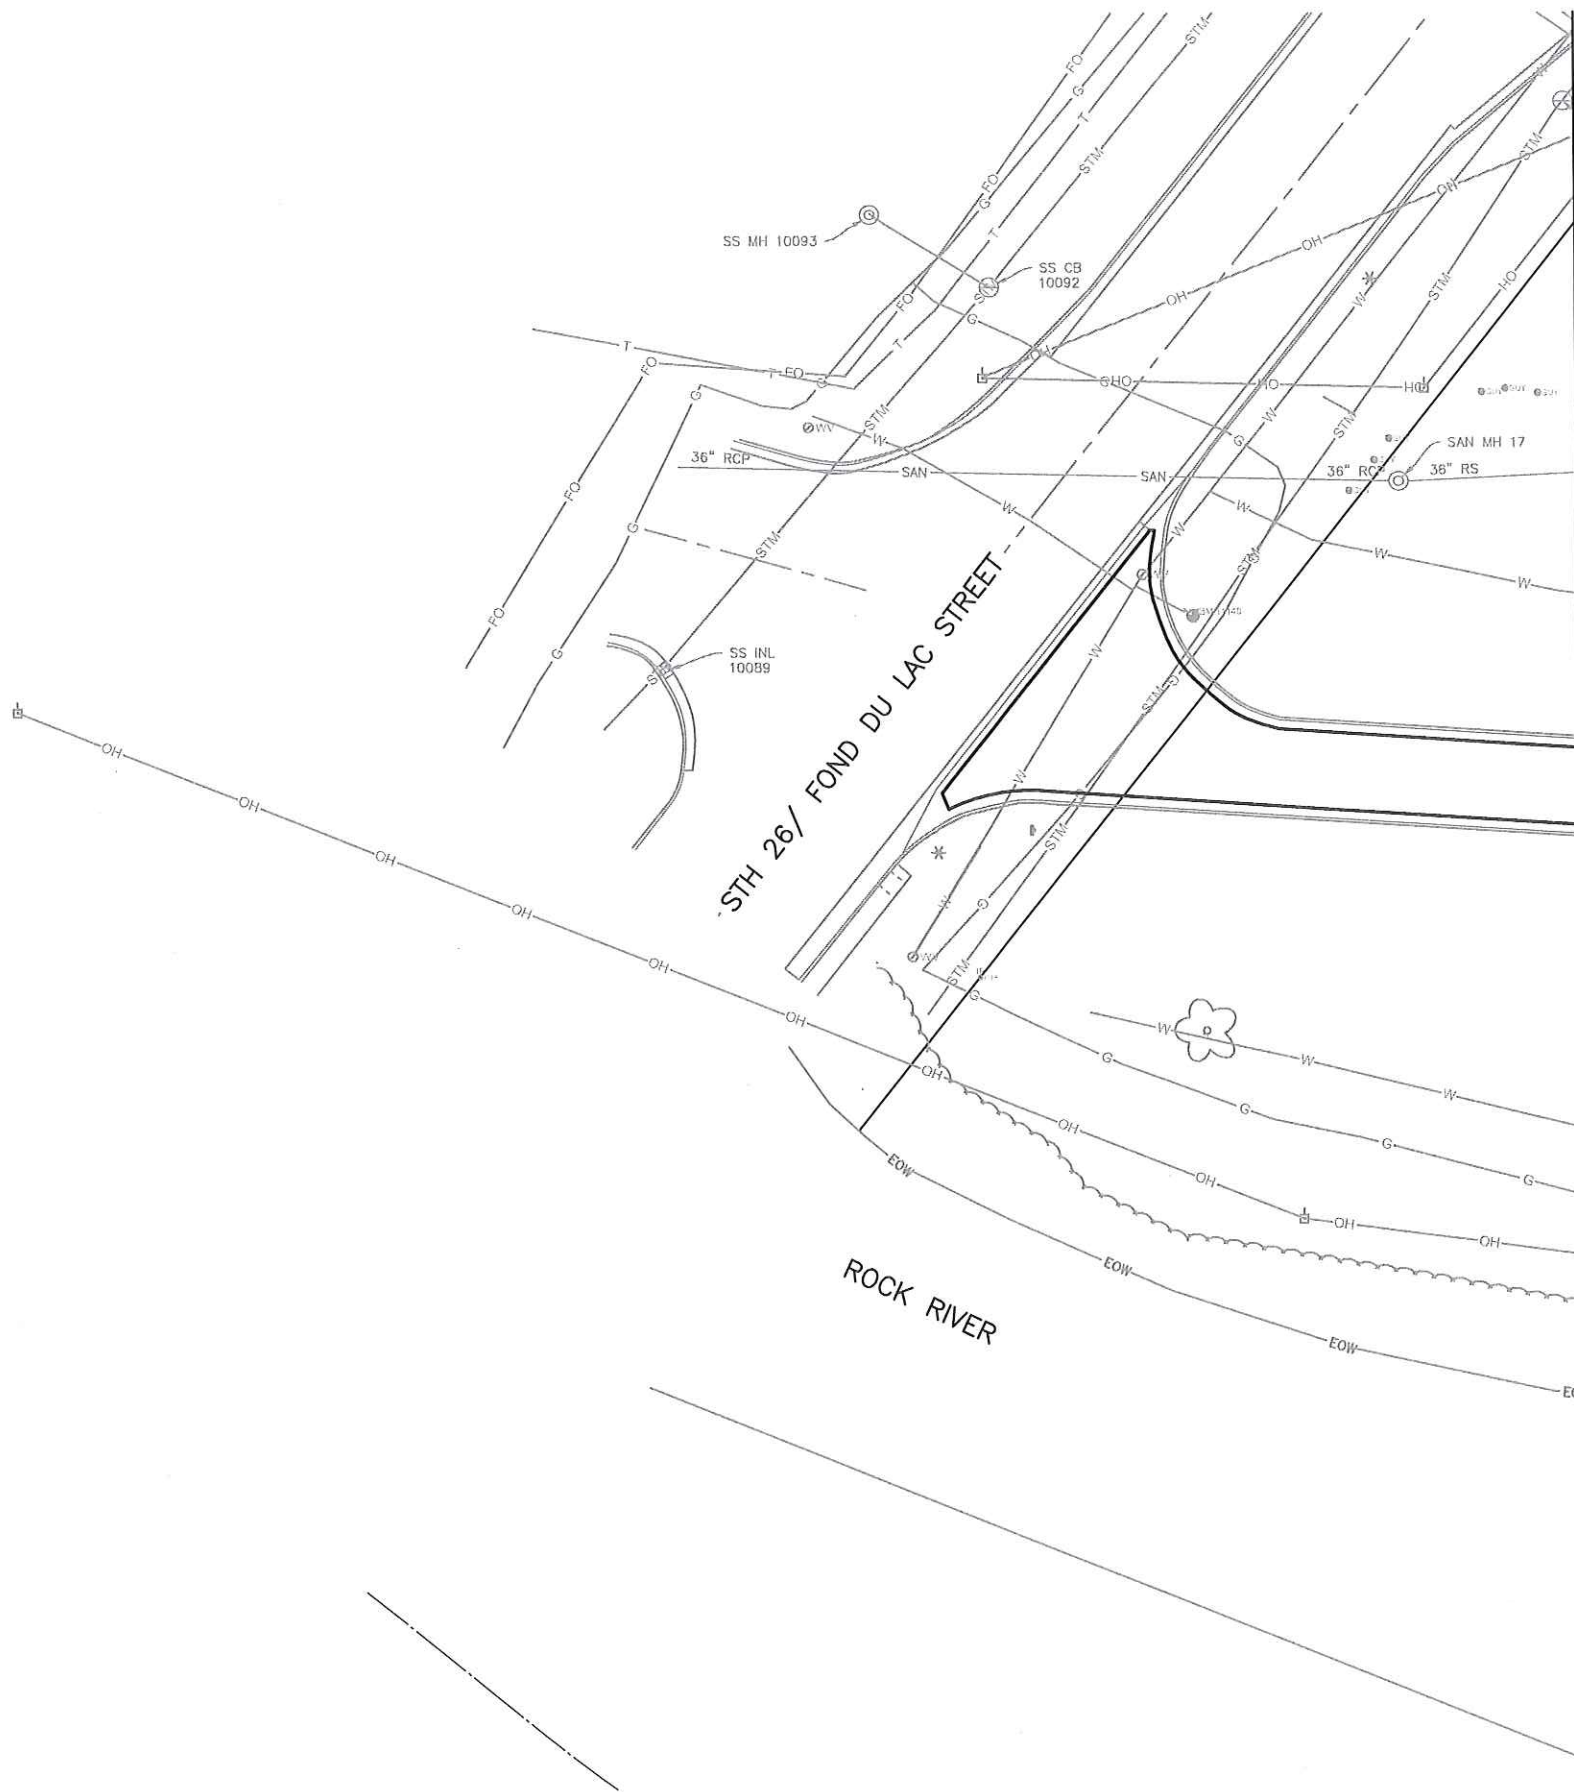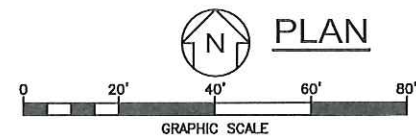DRAWING NO.
02-M-2




MATCHLINE - SEE DRAWING 02-M-4

		Applied Technologies Engineers-Architects		 WAUPUN UTILITIES THE POWER OF COMMUNITY	
WAUPUN UTILITIES WWTP UPGRADE AND ABNR <					



MATCHLINE — SEE DRAWING 02-M-2

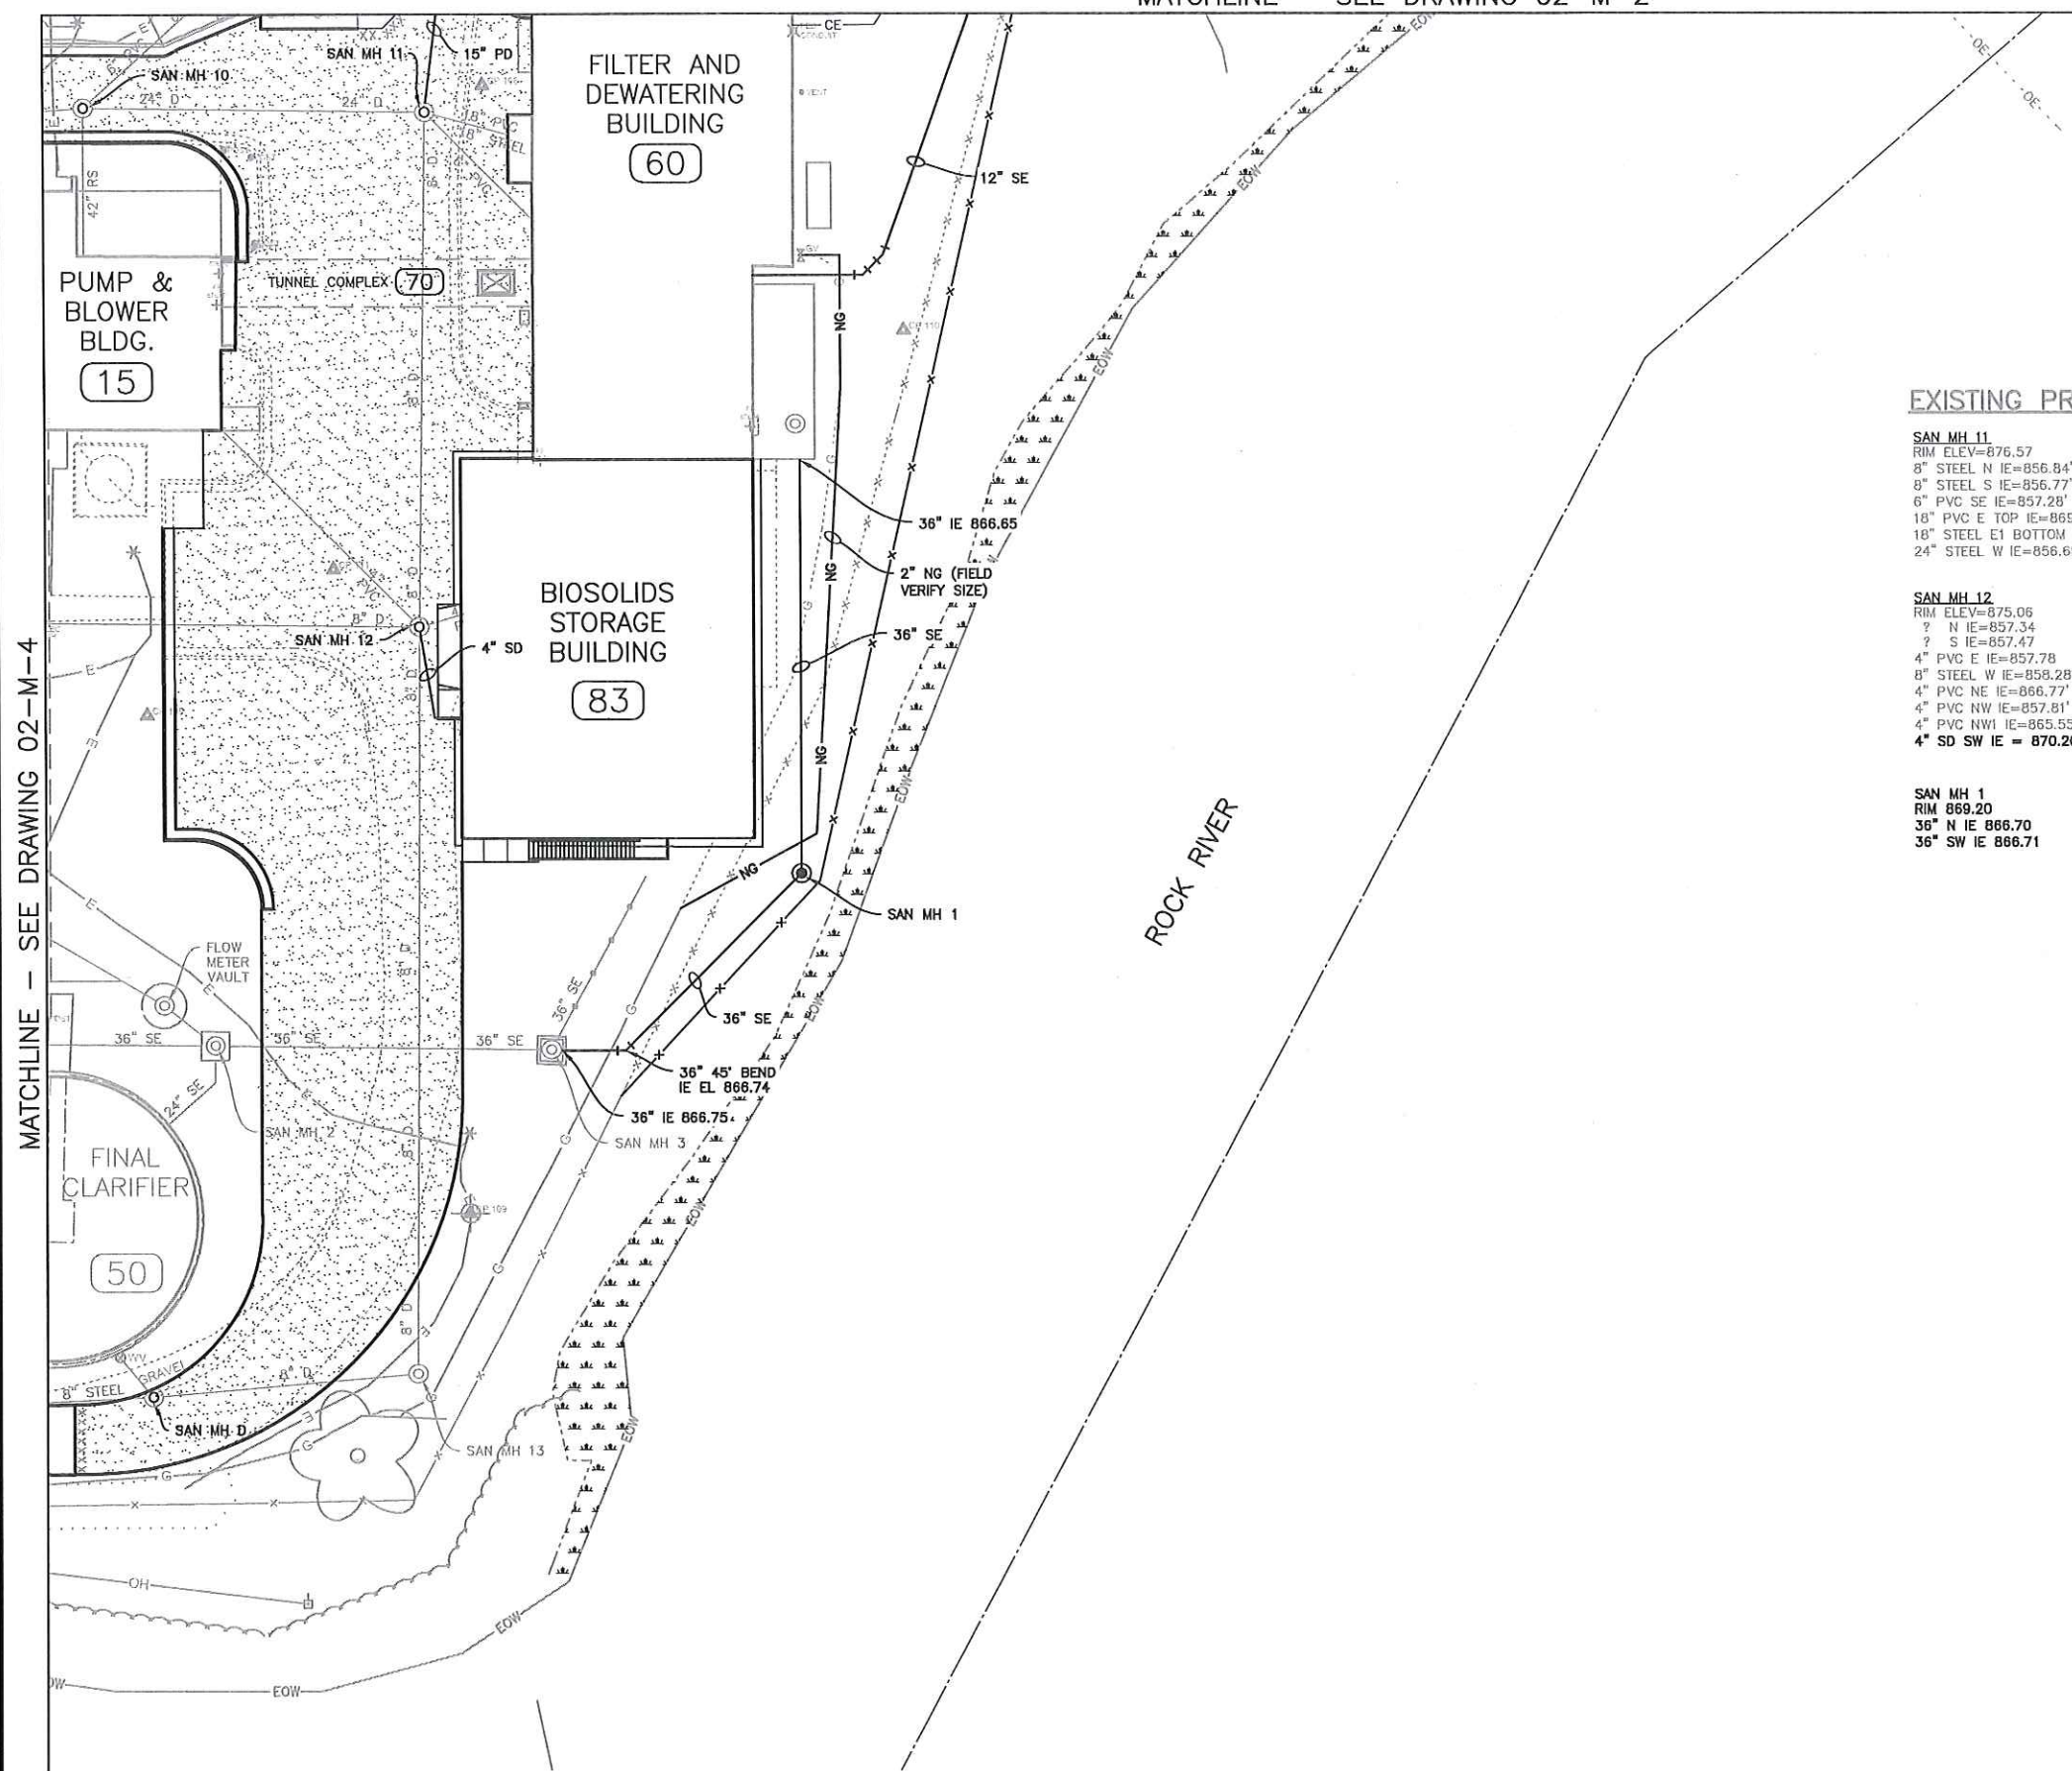

EXISTING PROCESS MANHOLES:


SAN MH 11
 RIM ELEV=876.57
 8" STEEL N IE=856.84'
 8" STEEL S IE=856.77'
 6" PVC SE IE=857.28'
 18" PVC E TOP IE=869.89'
 18" STEEL E1 BOTTOM IE=857.31'
 24" STEEL W IE=856.69'


SAN MH 12
 RIM ELEV=875.06
 ? N IE=857.34
 ? S IE=857.47
 4" PVC E IE=857.78
 8" STEEL W IE=858.28'
 4" PVC NE IE=866.77'
 4" PVC NW IE=857.81'
 4" PVC NW1 IE=865.55'
 4" SD SW IE = 870.20'

SAN MH 1
 RIM 869.20
 36" N IE 866.70
 36" SW IE 866.71

MATCHLINE — SEE DRAWING 02-M-4

PLTSCALE: 1 LTSCALE: 1
 r:\shared_folders\projects\6353 - waupun upgrade\1.0 graphics\02-M-5 PLAN.dwg
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WAUPUN UTILITIES
THE POWER OF COMMUNITY

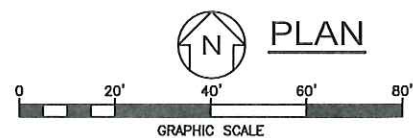Applied Technologies <small>Engineers-Architects</small>		BY	APVD
NO.	DATE	REVISIONS AND RECORD OF ISSUE	BY

WAUPUN UTILITIES
WWTP UPGRADE AND ABNR

WAUPUN, WI

SITE WORK
MECHANICAL
PLAN

VERIFY SCALES
LENGTH OF BAR IS 1" ON ORIGINAL DRAWING

1:2
PLOT SCALE, ADJUST SCALE(S) ACCORDINGLY

DESIGNED BY: K.R.H.

DRAWN BY: J.C.S.

CHECKED BY: K.R.H.


APPROVED BY: J.J.S.

PROJECT NO.
6353

DATE
JANUARY 2021

DRAWING NO.
02-M-5

PLTSCALE: 1 LTSCALE: 1
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Last Modified: 30 April 2021

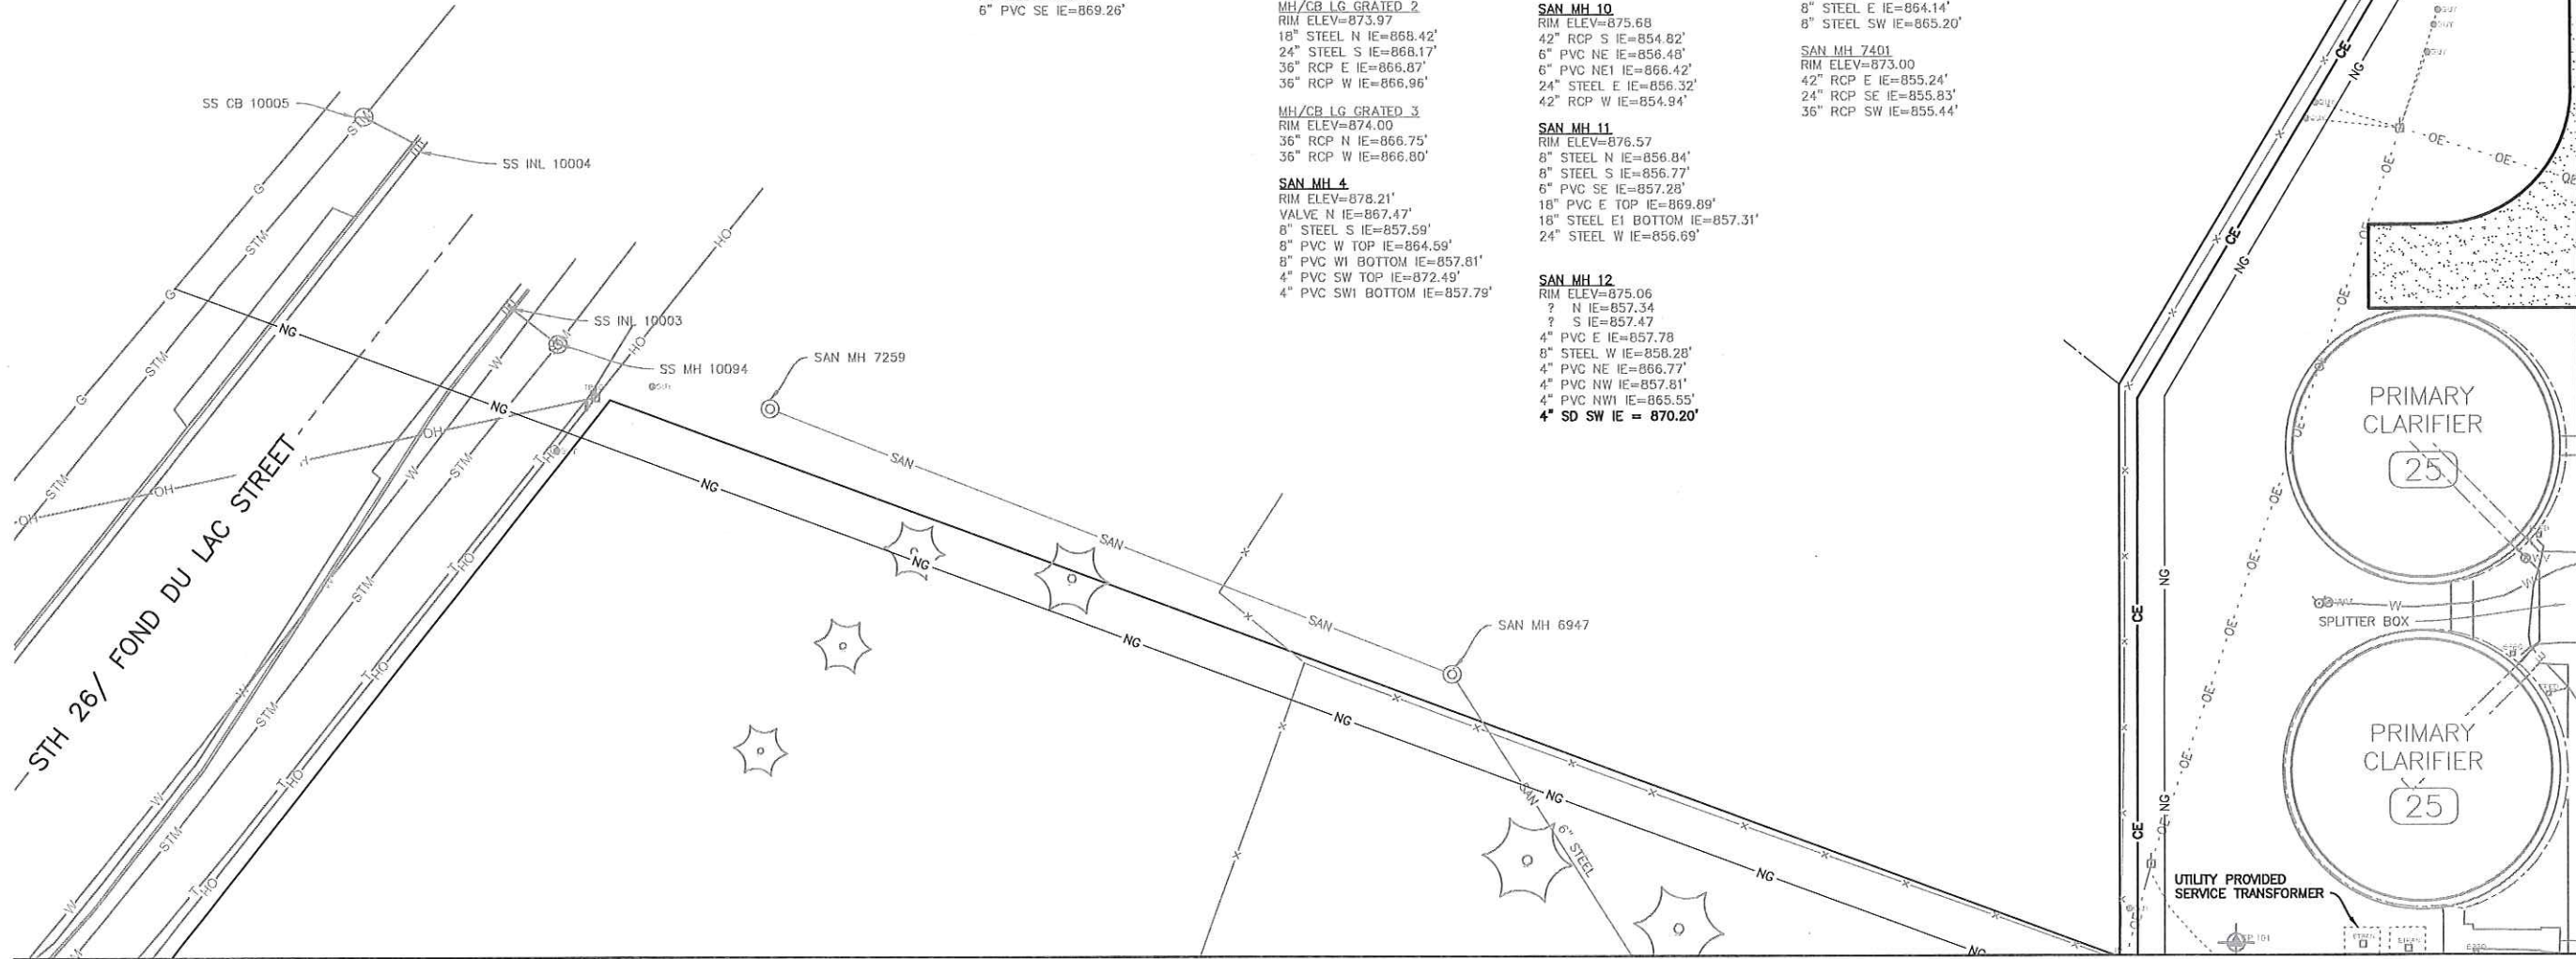

EXISTING STORM SEWER STRUCTURES:

SS INL 6264
RIM ELEV=873.52'
NO MEASURE DOWN INFO

SS INL 10003
RIM ELEV=872.40'
8" STEEL E IE=870.45'

SS INL 10004
RIM ELEV=872.46'
12" RCP W IE=870.36'

SS CB 10005
RIM ELEV=872.33'
18" CMP N IE=869.63'
18" CMP S IE=869.76'
12" RCP E IE=869.80'

SS INL 10089
RIM ELEV=873.86'
18" CMP N IE=867.24'
18" CMP S IE=867.21'

SS CB 10092
RIM ELEV=871.10'
18" CMP N IE=867.90'
18" CMP S IE=868.00'
6" CMP E IE=868.15'
18" PCP W IE=868.20'

SS MH 10093
RIM ELEV=874.54'
18" PCP N IE=868.08'
18" PCP E IE=868.15'
10" RCP W IE=868.18'

SS MH 10094
RIM ELEV=873.19'
18" CMP N IE=869.33'
15" PVC S IE=869.45'
12" RCP W IE=869.55'

SS INL 10186
RIM ELEV=871.89'
12" RCP S IE=868.24'

SS INL 10320
RIM ELEV=871.71'
12" RCP E IE=868.11'

SS INL 10321
RIM ELEV=871.69'
12" RCP W IE=868.34'

SS MH 10345
RIM ELEV=872.71'
12" RCP N IE=865.51'
12" RCP S IE=865.47'
12" PVC NE IE=867.96'

SS CB 10532
RIM ELEV=870.66'
8" ? SE IE=867.66'

SS CB 10551
RIM ELEV=873.26'
15" PVC N IE=868.28'
15" PVC S IE=868.16'

SS MH 10657
RIM ELEV=873.24'
12" RCP S IE=866.42'
12" RCP NE IE=866.38'

SS MH 10658
RIM ELEV=874.61'
12" RCP N IE=866.43'
12" STEEL NE IE=866.29'
14" RCP SW IE=866.41'

SS CB 10968
RIM ELEV=873.02'
TRENCH W IE=868.57

SS CB 11318
RIM ELEV=872.01'
6" PVC SE IE=869.26'

EXISTING SANITARY SEWER AND PROCESS STRUCTURES:

SAN MH A2
RIM ELEV=873.52'
4" STEEL N IE=868.22'
4" STEEL S IE=868.17'
4" STEEL NE IE=868.33'

SAN MH B
RIM ELEV=873.77'
NO MEASURE DOWN INFO

SAN MH C
RIM ELEV=873.99'
NO MEASURE DOWN INFO

SAN MH D
RIM ELEV=872.50'
8" STEEL E IE=858.60'
8" STEEL W IE=858.66'
6" STEEL NW IE=859.80'

SAN MH G
RIM ELEV=872.29'
8" STEEL N IE=864.01'
8" STEEL E IE=859.73'
8" STEEL W IE=859.83'
6" PVC NW IE=867.09'

SAN MH H
RIM ELEV=872.91'
8" STEEL E IE=860.01'
8" STEEL W IE=860.13'
8" ? NW IE=860.10'

FLOW METER VAULT
RIM ELEV=874.43'
18" STEEL NW IE=870.53'
18" STEEL SE IE=868.73'

MH/CB LG GRATED 1
RIM ELEV=873.82'
24" RCP S IE=868.61'
36" RCP E IE=867.42'

MH/CB LG GRATED 2
RIM ELEV=873.97'
18" STEEL N IE=868.42'
24" STEEL S IE=868.17'
36" RCP E IE=866.87'
36" RCP W IE=866.96'

MH/CB LG GRATED 3
RIM ELEV=874.00'
36" RCP N IE=866.75'
36" RCP W IE=866.80'

SAN MH 4
RIM ELEV=878.21'
VALVE N IE=867.47'
8" STEEL S IE=857.59'
8" PVC W TOP IE=864.59'
8" PVC W1 BOTTOM IE=857.81'
4" PVC SW TOP IE=872.49'
4" PVC SW1 BOTTOM IE=857.79'

SAN MH 5
RIM ELEV=878.24'
8" STEEL E IE=864.84'
8" STEEL W IE=864.89'
VALVE SW IE=868.47'
VALVE SW1 IE=868.43'

SAN MH 6
RIM ELEV=876.92'
VALVE NE IE=871.89'
VALVE NE2 IE=870.80'
4" PVC SE IE=872.16'
6" STEEL SW IE=867.42'
4" STEEL NW IE=869.22'

SAN MH 7
RIM ELEV=875.85'
CLARIFIER VALVE S IE=863.79'
8" STEEL E IE=869.33'
CLARIFIER VALVE SW IE=863.45'

SAN MH 8
RIM ELEV=873.70'
8" STEEL N IE=857.28'
VALVE S IE=857.67'
4" STEEL E TOP IE=862.66'
4" STEEL E1 BOTTOM IE=857.40'
? SE IE=857.86'
VALVE SW IE=857.72'
4" STEEL SW1 IE=869.70'
VALVE SW2 IE=870.68'

SAN MH 9
RIM ELEV=872.31'
CAPPED VALVE N IE=863.50'
8" STEEL E IE=859.16'
8" STEEL W IE=859.52'
CAPPED VALVE NE IE=859.79'
6" PVC NE1 IE=859.50'
8" VALVE NW IE=862.29'
6" STEEL NW1 IE=864.95'

SAN MH 10
RIM ELEV=875.68'
42" RCP S IE=854.82'
6" PVC NE IE=856.48'
6" PVC NE1 IE=866.42'
24" STEEL E IE=856.32'
42" RCP W IE=854.94'

SAN MH 11
RIM ELEV=876.57'
8" STEEL N IE=856.84'
8" STEEL S IE=856.77'
6" PVC SE IE=857.28'
18" PVC E TOP IE=869.89'
18" STEEL E1 BOTTOM IE=857.31'
24" STEEL W IE=856.69'

SAN MH 12
RIM ELEV=875.06'
? N IE=857.34'
? S IE=857.47'
4" PVC E IE=857.78'
8" STEEL W IE=858.28'
4" PVC NE IE=866.77'
4" PVC NW IE=857.81'
4" PVC NW1 IE=865.55'
4" SD SW IE=870.20'

SAN MH 13
RIM ELEV=870.57'
8" STEEL SW IE=858.44'
8" STEEL NW IE=858.27'

SAN MH 15
RIM ELEV=872.85'
24" RCP NW IE=856.25'
18" RCP SE IE=856.45'
12" RCP S IE=856.38'

SAN MH 16
RIM ELEV=872.85'
24" RCP N IE=856.23'
24" RCP SE IE=856.19'
6" STEEL NE TOP IE=862.19'
6" STEEL NE BOTTOM IE=857.09'

SAN MH 17
RIM ELEV=873.57'
36" RCP NE IE=856.41'
36" RCP SW IE=856.51'

SAN MH 18
RIM ELEV=873.76'
42" RCP NE IE=856.25'
42" RCP SW IE=855.30'


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RIM ELEV=874.43'
8" STEEL S IE=856.45'
42" RCP E IE=855.04'
42" RCP W IE=855.27'
6" STEEL NW IE=862.44'

SAN MH 6947
RIM ELEV=871.38'
4" STEEL N IE=865.46'
6" STEEL W IE=863.40'
6" STEEL SE IE=863.30'

SAN MH 7259
RIM ELEV=872.06'
8" STEEL E IE=864.14'
8" STEEL SW IE=865.20'

SAN MH 7401
RIM ELEV=873.00'
42" RCP E IE=855.24'
24" RCP SE IE=855.83'
36" RCP SW IE=855.44'

MATCHLINE - SEE DRAWING 02-E-4

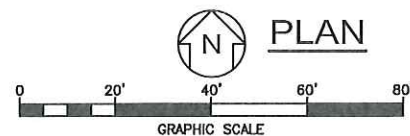

MATCHLINE - SEE DRAWING 02-E-2

APVD	K.R.H.
BY	G.A.G.
REVISIONS AND RECORD OF ISSUE	ADDENDUM NO. 1
DATE	2-19-21
NO.	Δ

Applied Technologies
Engineers-Architects

WAUPUN UTILITIES
WWTP UPGRADE AND ABNR
WAUPUN, WI
SITE WORK
ELECTRICAL
PLAN

VERIFY SCALES
LENGTH OF BAR IS 1" ON ORIGINAL DRAWING

1:2
PLOT SCALE, ADJUST
SCALE(S) ACCORDINGLY

DESIGNED BY: G.A.G.

DRAWN BY: J.C.S.

CHECKED BY: K.R.H.


APPROVED BY: J.J.S.

PROJECT NO.
6353

DATE
JANUARY 2021

DRAWING NO.
02-E-1


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Last Modified: 25 January 2021
Potted On: 5/13/2021 10:41 AM by JOHN STAHL
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

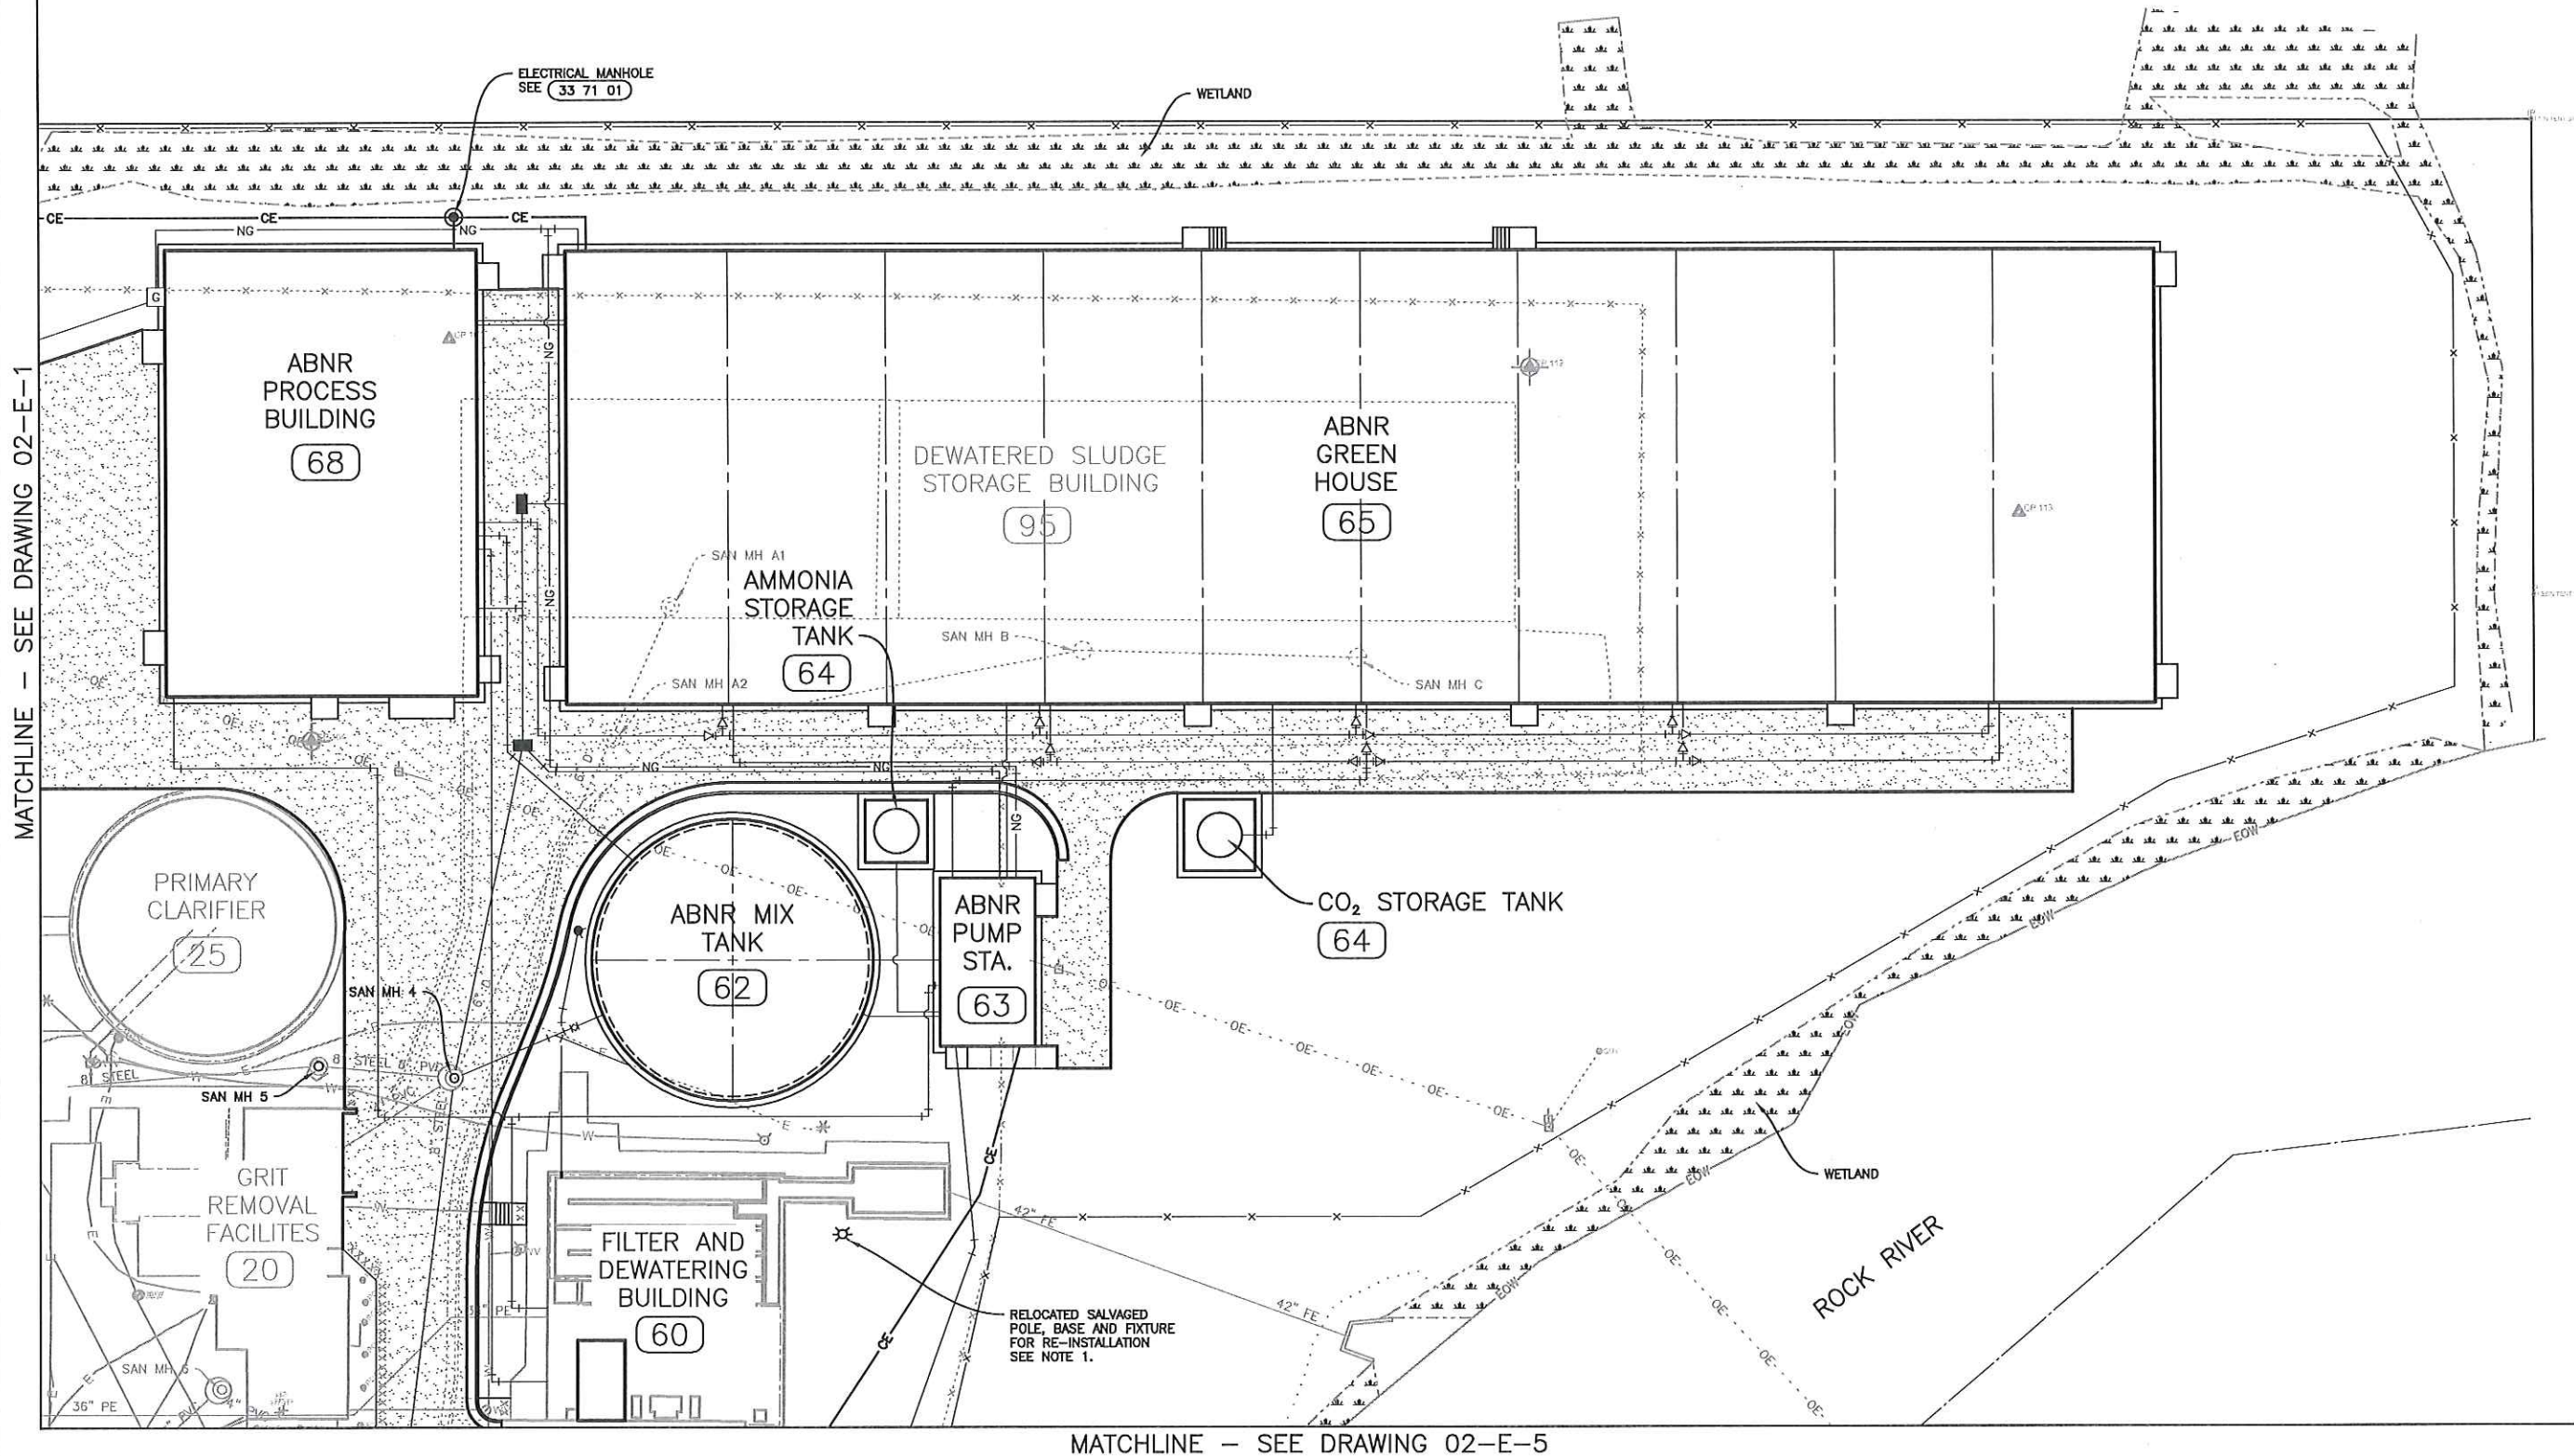
GENERAL NOTES:

1. RE-FEED THIS LIGHT POLE FROM A NEW 20A CIRCUIT BREAKER IN AN EXISTING BUILDING 60 LIGHTING PANEL. PROVIDE 2 #12, #12G IN 3/4" CONDUIT. PROVIDE PVC CONDUIT FOR DIRECT BURIED, AND GRS CONDUIT INSIDE OF BUILDING. CONTRACTOR SHALL ALSO REPLACE EXISTING FIXTURE PHOTOCELL WITH NEW.

MATCHLINE - SEE DRAWING 02-E-5



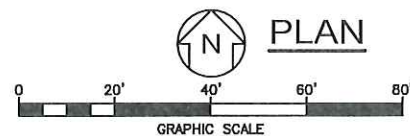

WAUPUN UTILITIES
THE POWER OF COMMUNITY

APVD	BY	REVISIONS AND RECORD OF ISSUE
NO.	DATE	

Applied Technologies
Engineers-Architects

WAUPUN UTILITIES
WWTP UPGRADE AND ABNR

WAUPUN, WI

SITE WORK ELECTRICAL PLAN

VERIFY SCALES
LENGTH OF BAR IS 1" ON ORIGINAL DRAWING

1:2
PLOT SCALE, ADJUST SCALE(S) ACCORDINGLY

DESIGNED BY: G.A.G.

DRAWN BY: J.C.S.



CHECKED BY: K.R.H.

APPROVED BY: J.J.S.

PROJECT NO.
6353

DATE
JANUARY 2021

DRAWING NO.
02-E-2

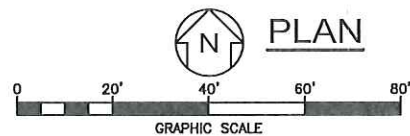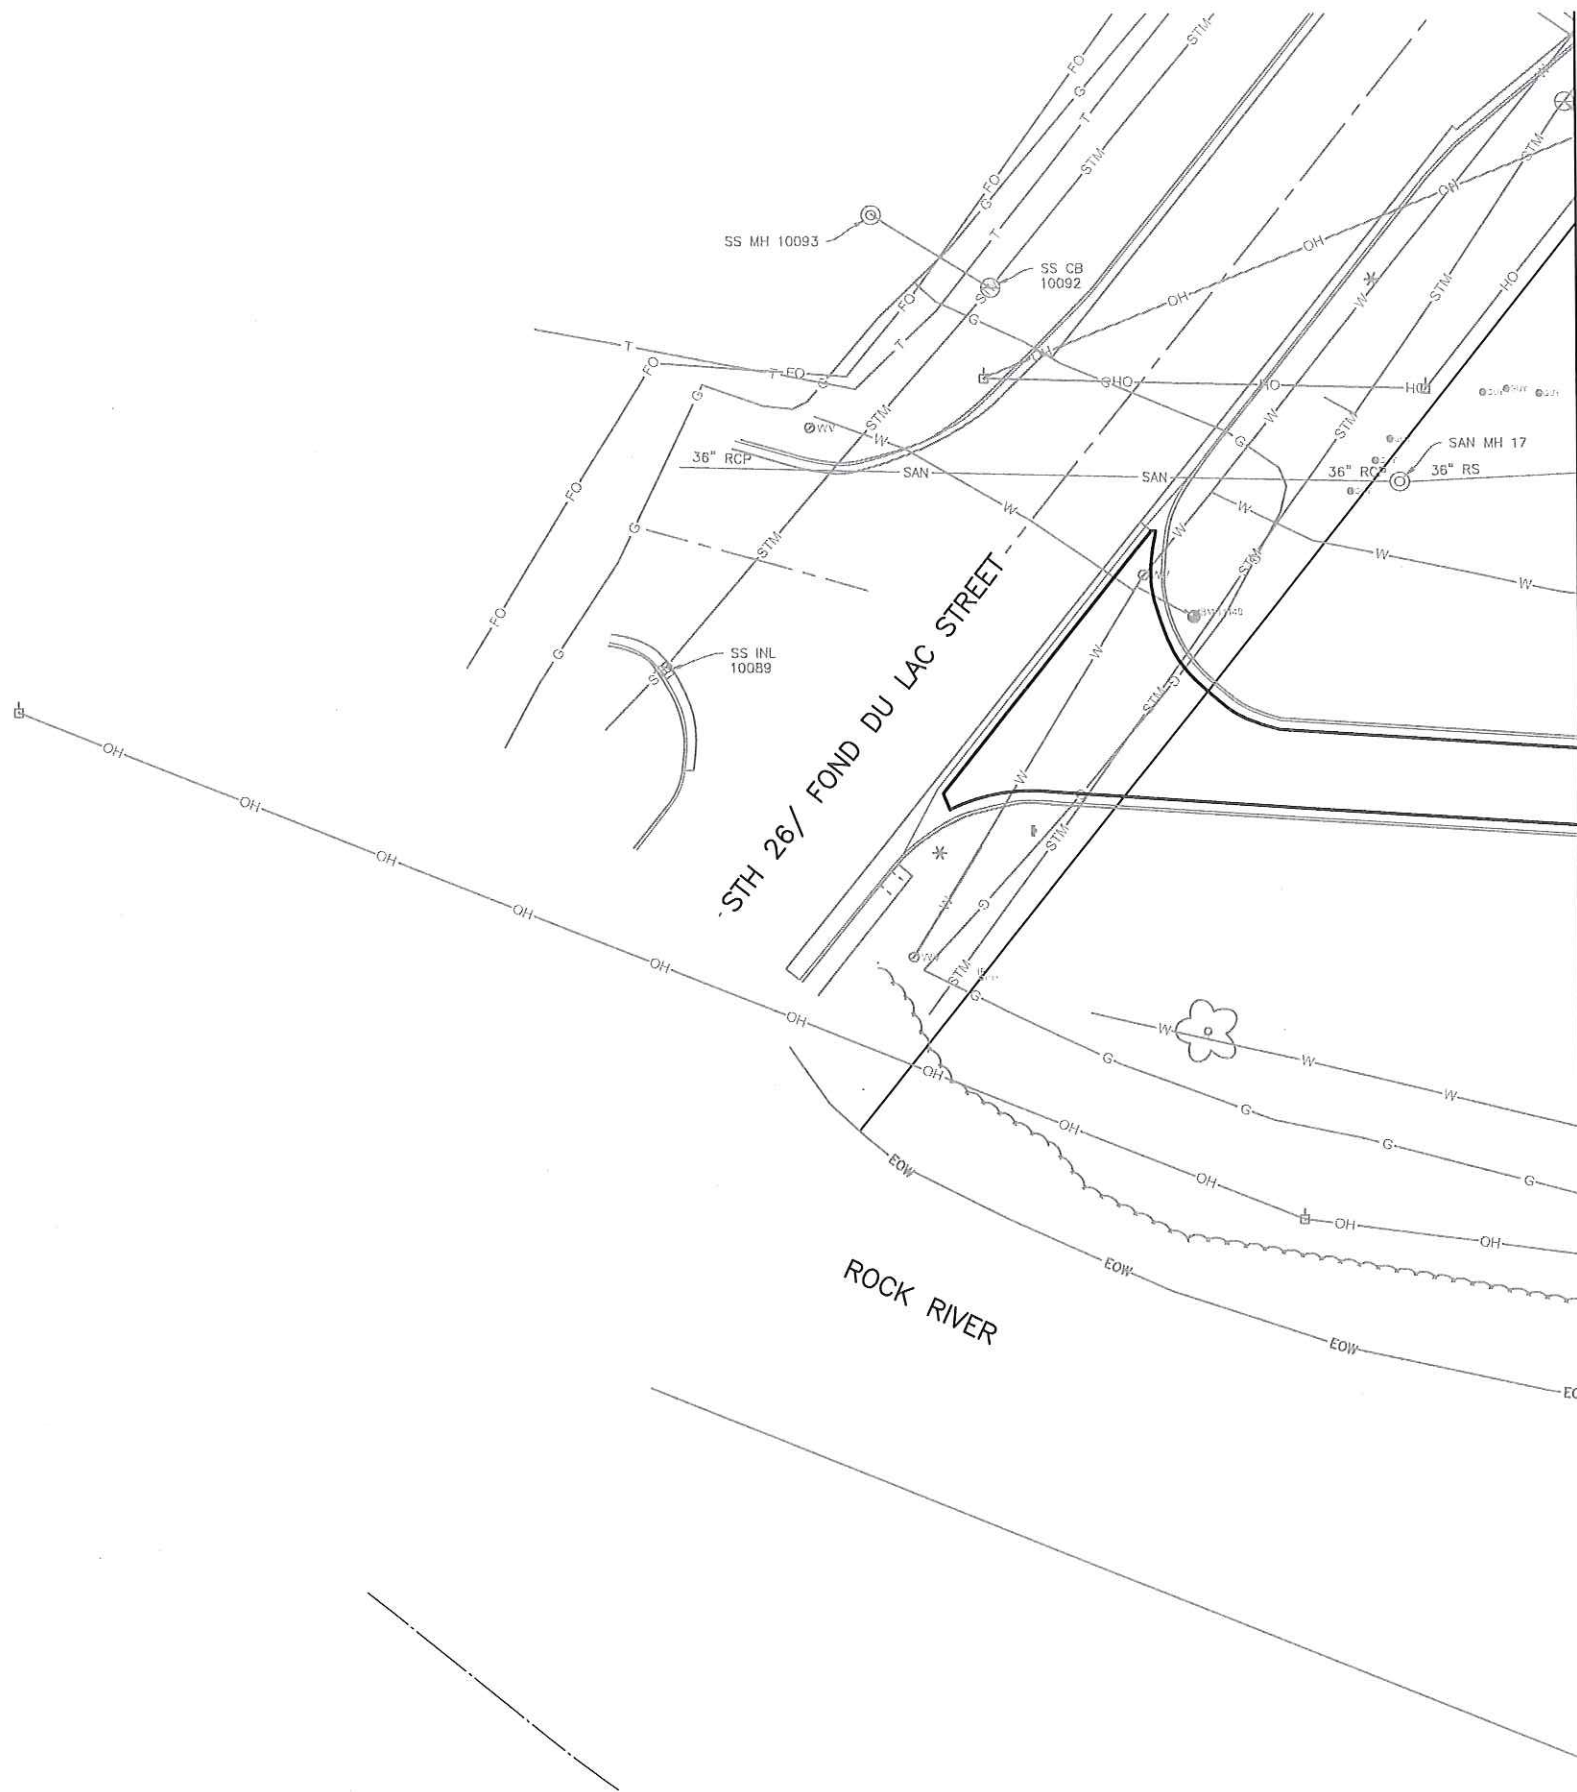

MATCHLINE - SEE DRAWING 02-E-4


Applied Technologies Engineers-Architects				
NO.	DATE	REVISIONS AND RECORD OF ISSUE	BY	APVD
<div>WAUPUN UTILITIES WWTP UPGRADE AND ABNR</div> <div>WAUPUN, WI SITE WORK ELECTRICAL PLAN</div>				
VERIFY SCALES LENGTH OF BAR IS 1" ON ORIGINAL DRAWING 1:2 PLOT SCALE, ADJUST SCALE(S) ACCORDINGLY				
DESIGNED BY: G.A.G.				
DRAWN BY: J.C.S.				
CHECKED BY: K.R.H.				
APPROVED BY: J.J.S.				
PROJECT NO. 6353				
DATE JANUARY 2021				
DRAWING NO. 02-E-3				

PSLTS: 1
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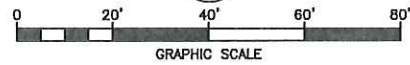
Last Modified: 7 May 2021

Plotted On: 5/13/2021 10:41 AM by JOHN STAHL


MATCHLINE - SEE DRAWING 02-E-3

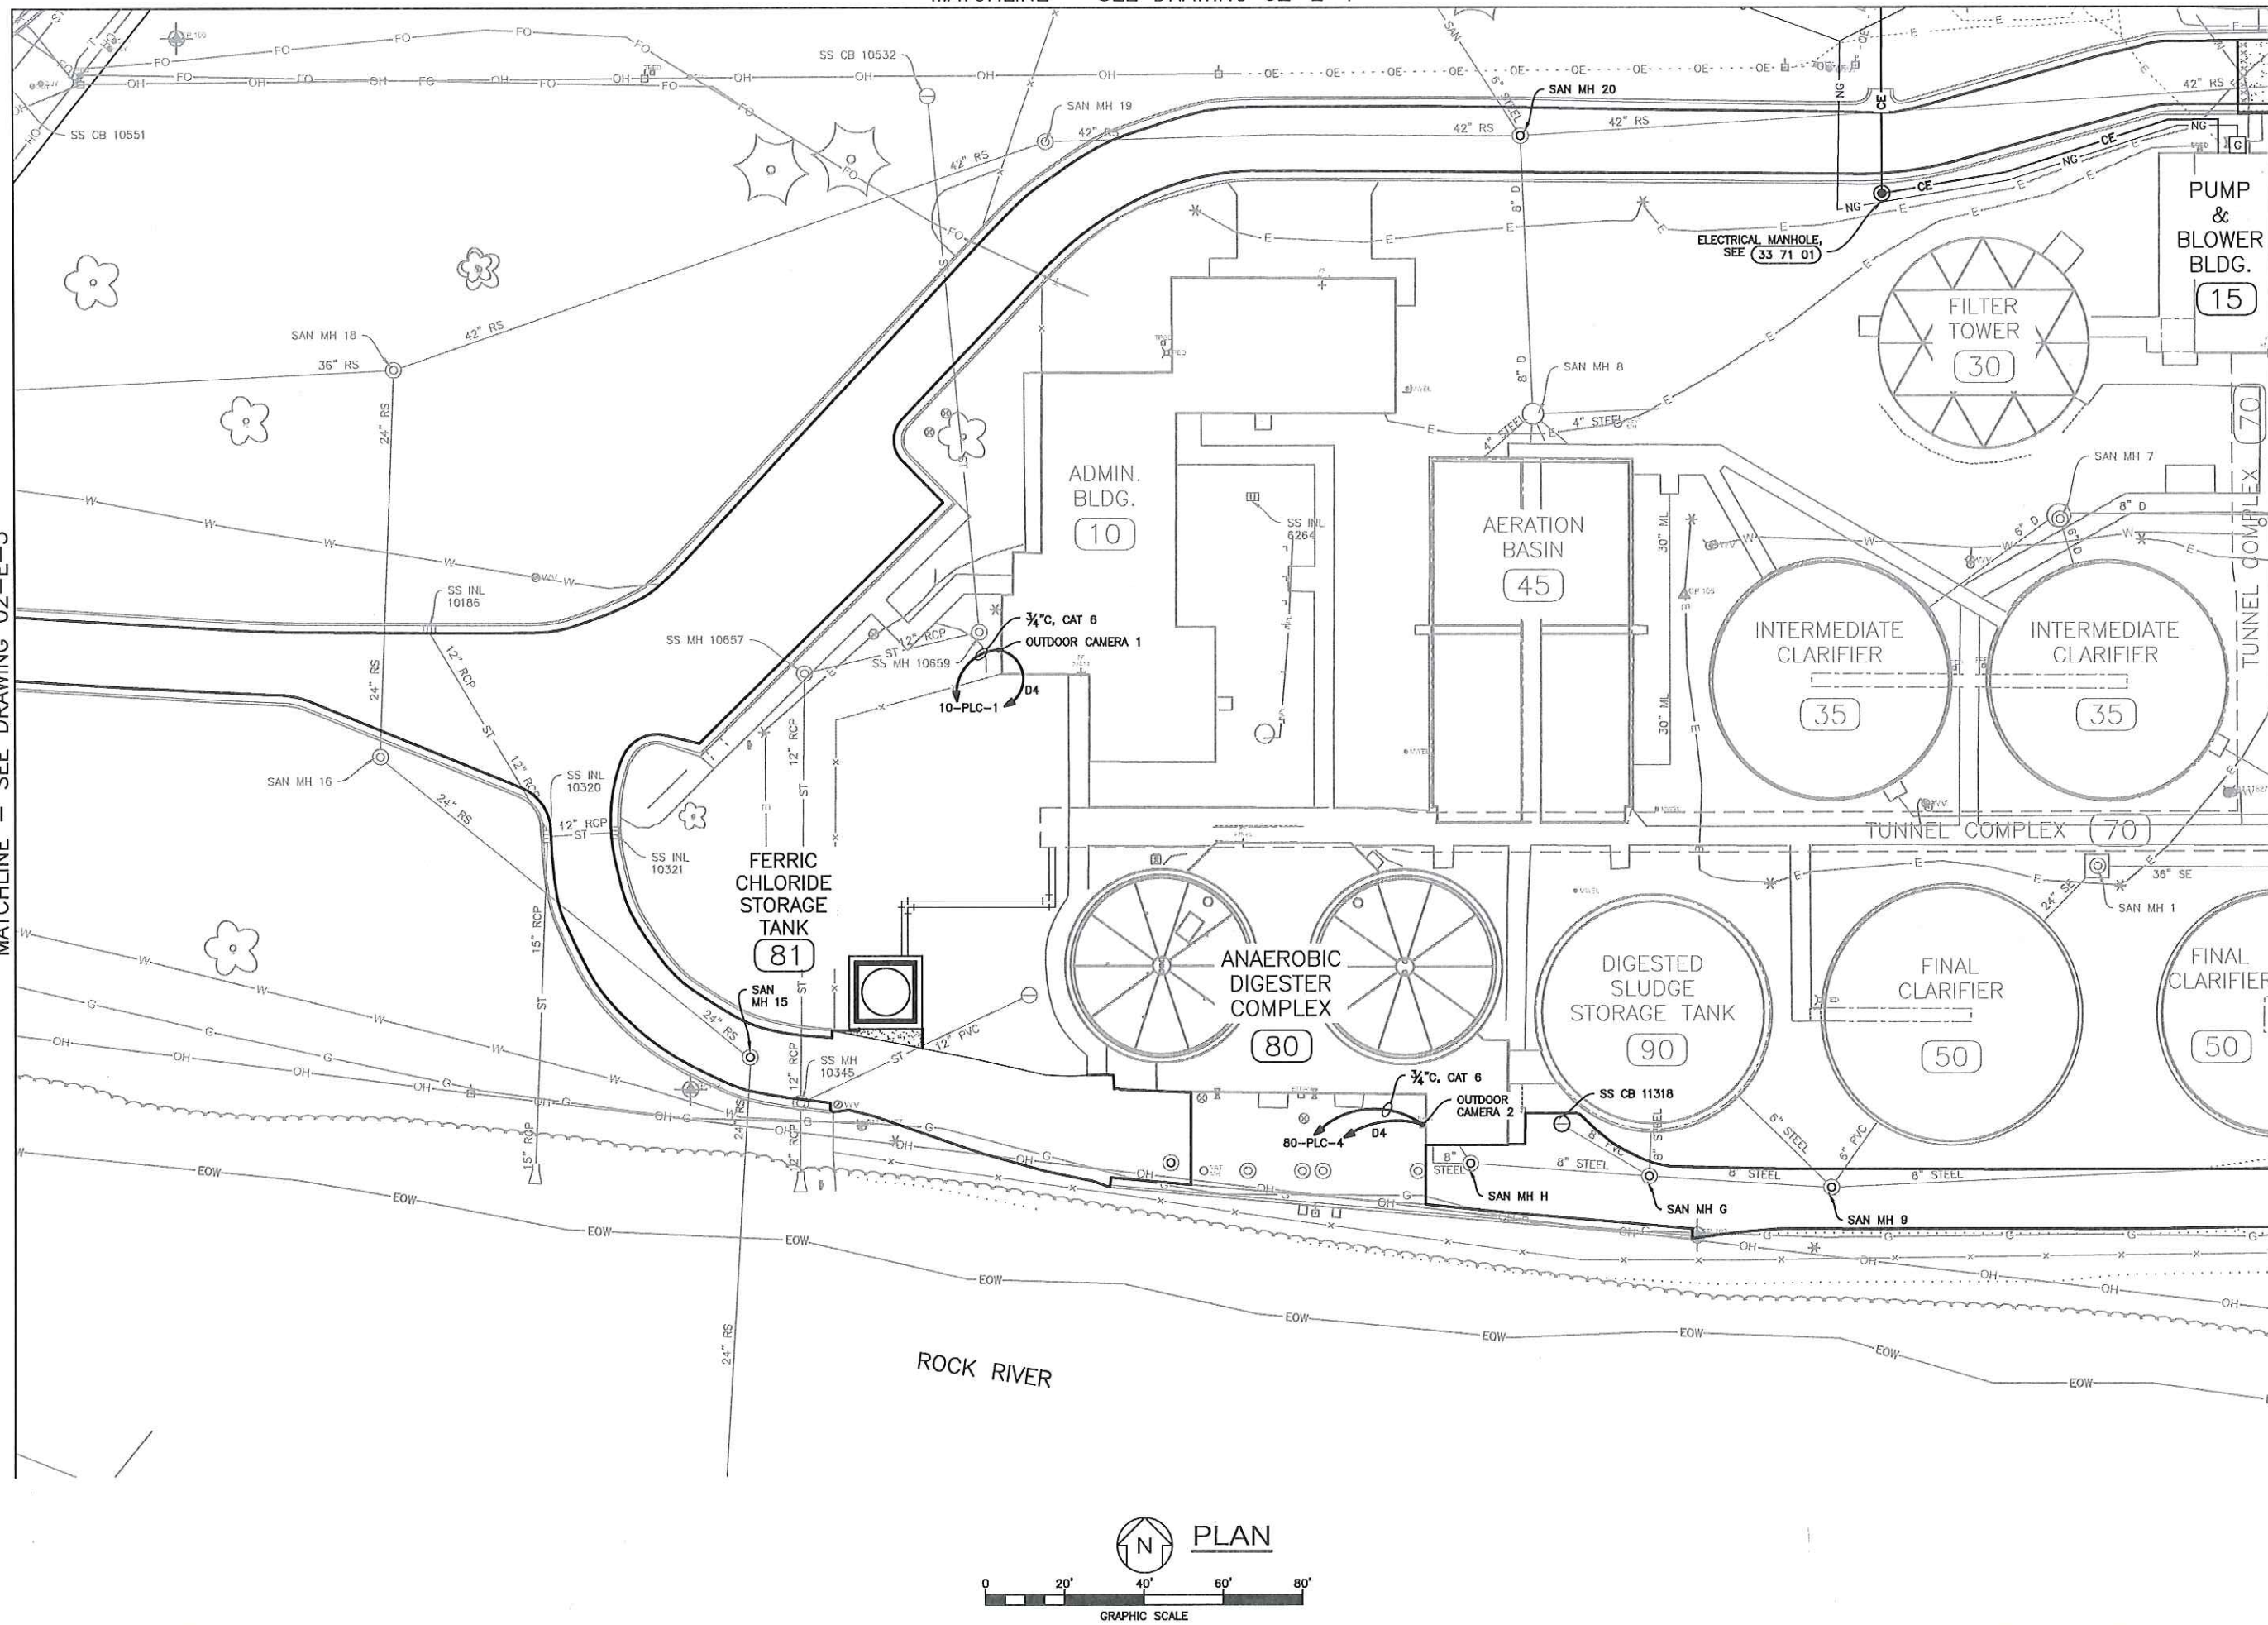

PLAN



MATCHLINE - SEE DRAWING 02-E-5



WAUPUN UTILITIES
THE POWER OF COMMUNITY

APVD	BY	REVISIONS AND RECORD OF ISSUE	DATE	NO.
K.R.H.	G.A.G.		5-14-21	Δ

Applied Technologies
Engineers-Architects

WAUPUN UTILITIES
WWTP UPGRADE AND ABNR
WAUPUN, WI
SITE WORK
ELECTRICAL
PLAN

VERIFY SCALES
LENGTH OF BAR IS 1"
ON ORIGINAL DRAWING

1:2
PLOT SCALE, ADJUST
SCALE(S) ACCORDINGLY

DESIGNED BY: G.A.G.

DRAWN BY: J.C.S.

CHECKED BY: K.R.H.

APPROVED BY: J.J.S.


PROJECT NO.
6353

DATE
JANUARY 2021


DRAWING NO.
02-E-4


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Last Modified: 25 January 2021
Plotted On: 5/13/2021 10:41 AM by JOHN STAHL
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MATCHLINE - SEE DRAWING 02-E-4

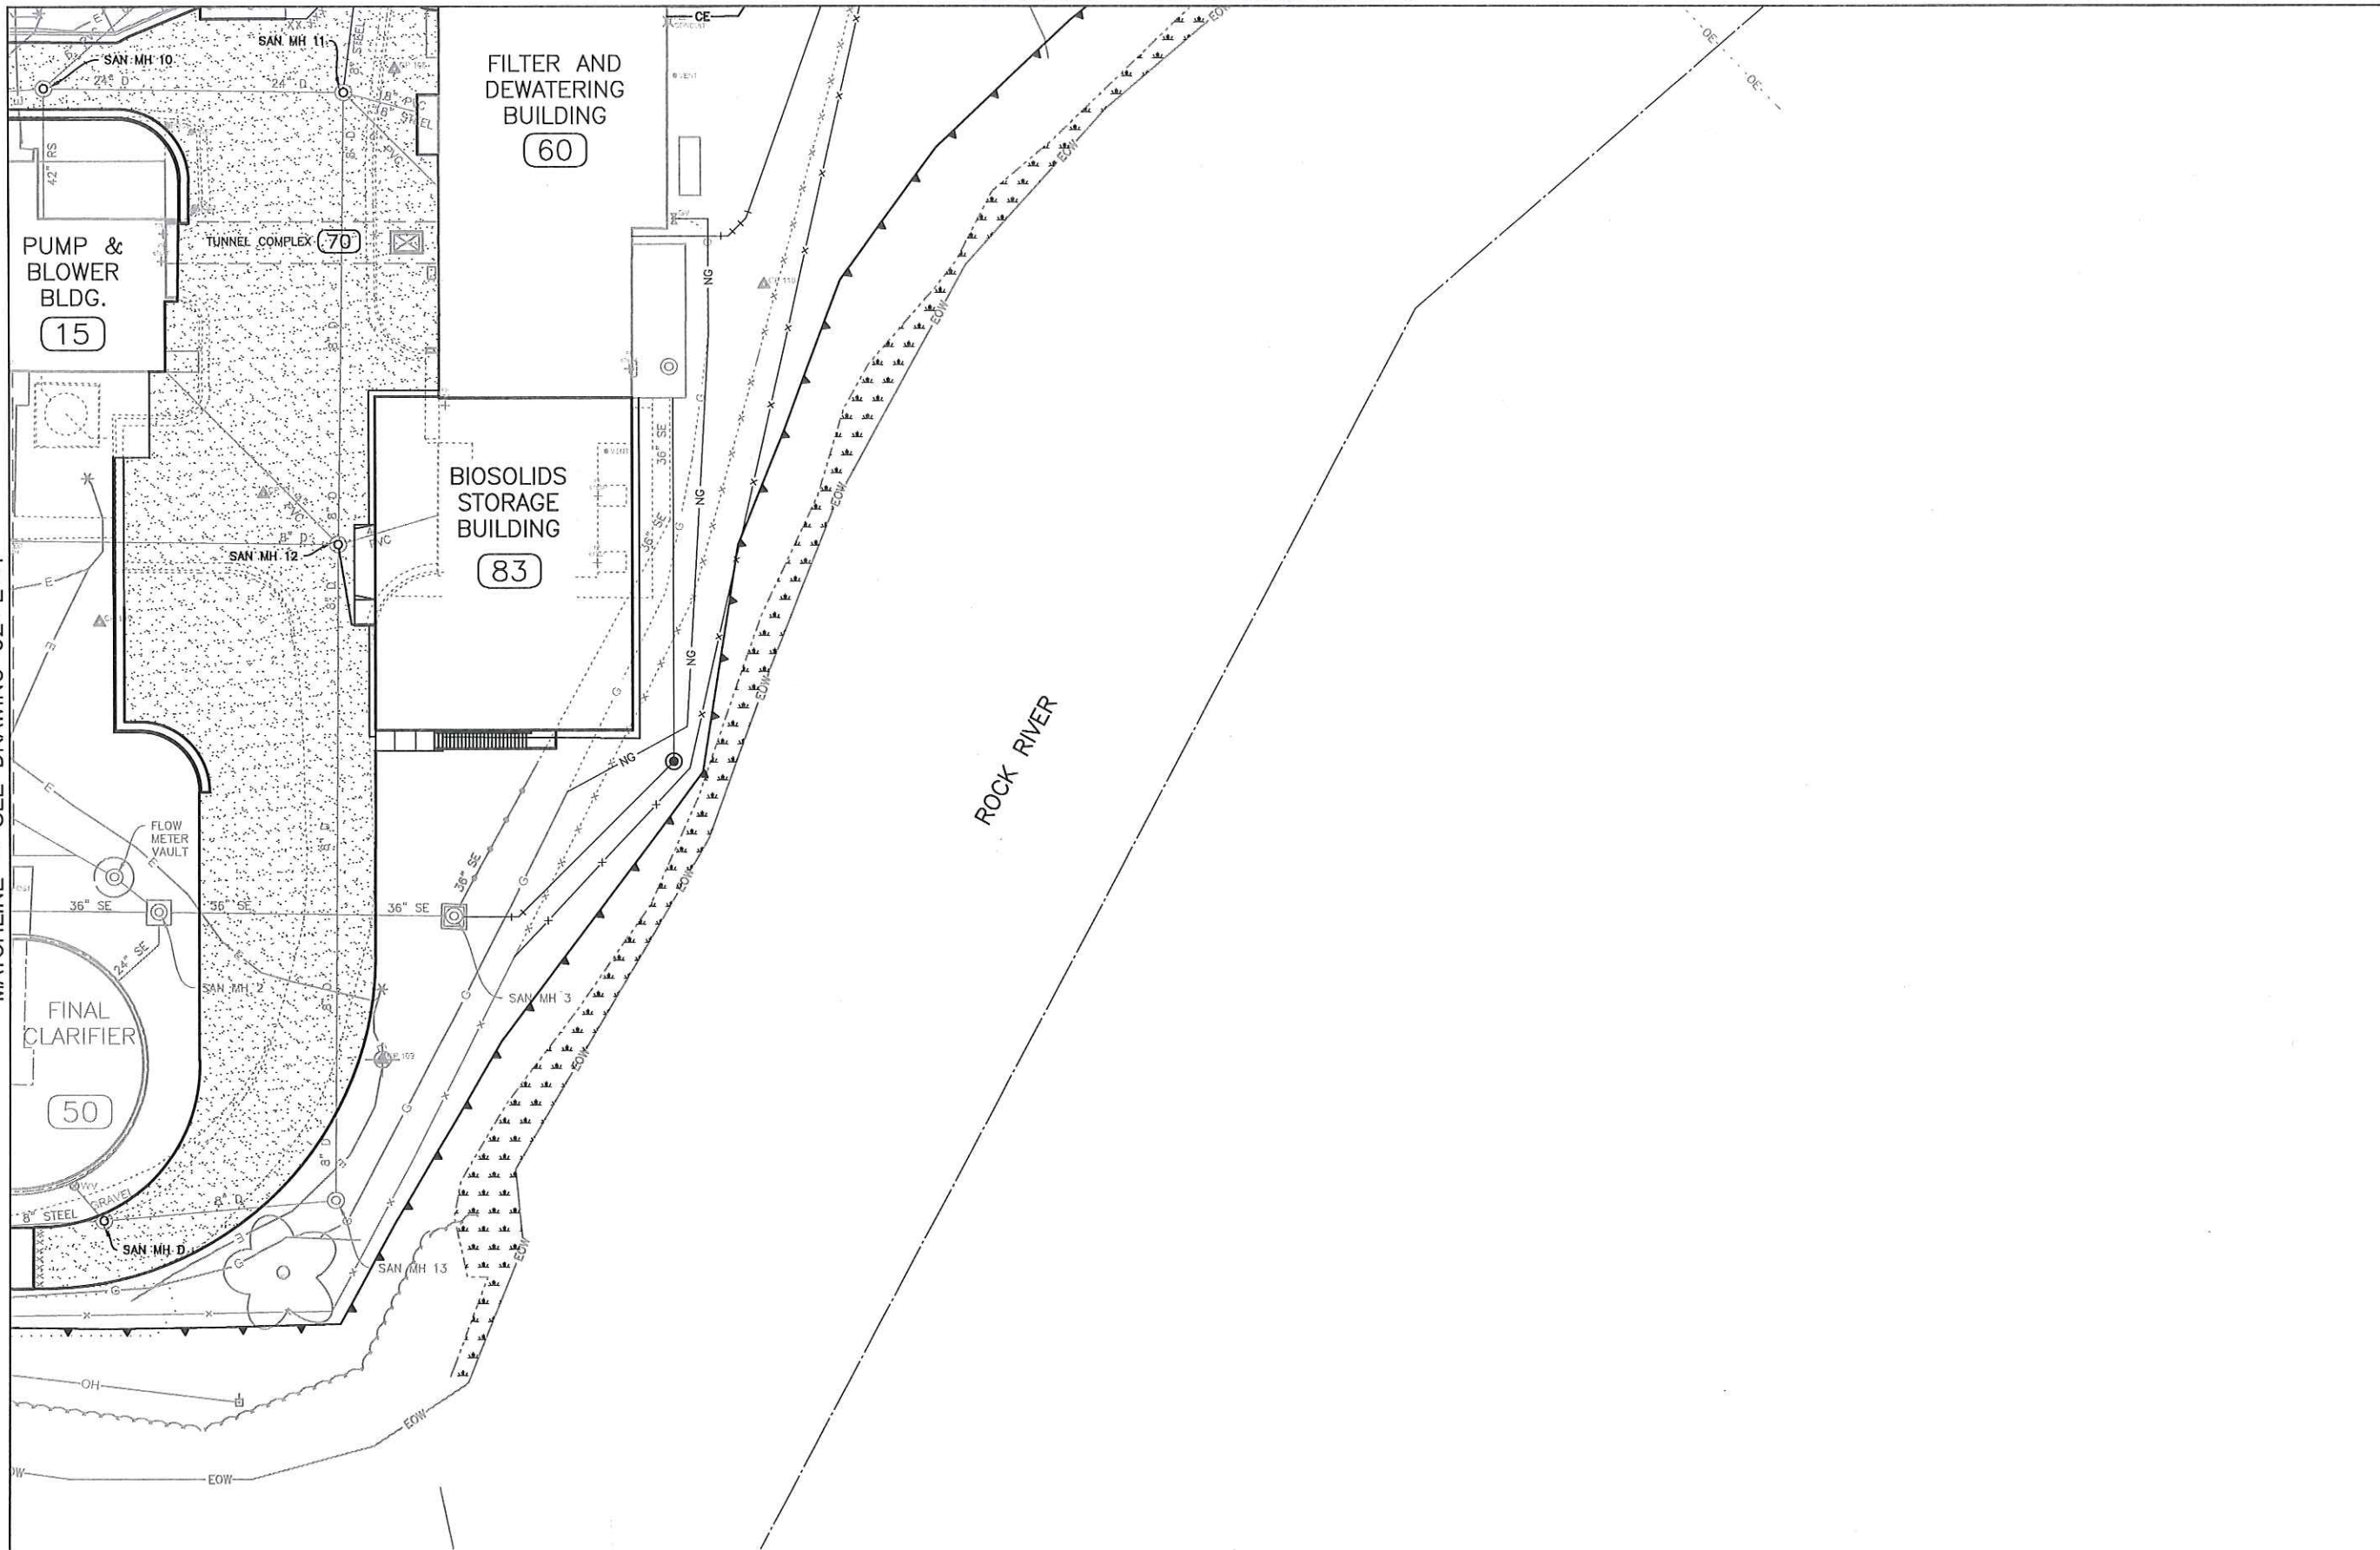

PLAN



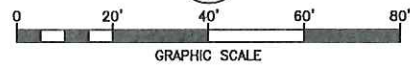

WAUPUN UTILITIES
THE POWER OF COMMUNITY

Applied Technologies Engineers-Architects		APVD	BY
REVISIONS AND RECORD OF ISSUE			
NO.	DATE		

WAUPUN UTILITIES WWTP UPGRADE AND ABNR WAUPUN, WI	WAUPUN UTILITIES SITE WORK ELECTRICAL PLAN
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VERIFY SCALES
LENGTH OF BAR IS 1"
ON ORIGINAL DRAWING
1:2
PLOT SCALE, ADJUST
SCALE(S) ACCORDINGLY

DESIGNED BY: G.A.G.
DRAWN BY: J.C.S.
CHECKED BY: K.R.H.
APPROVED BY: J.J.S.
PROJECT NO. 6353
DATE JANUARY 2021
DRAWING NO. 02-E-5

EROSION CONTROL NOTES:

1. SILT FENCE TO COMPLY WITH WDNR TECHNICAL STANDARD 1058.
2. CRUSHED STONE TRACKING PAD SHALL BE INSTALLED IF MATERIAL IS TRACKED OFF THE PROJECT SITE. PAD TO COMPLY WITH WDNR TECHNICAL STANDARD 1057.
3. SOIL STOCKPILES AND ANY AREAS REMAINING INACTIVE FOR MORE THAN 14 DAYS SHALL BE STABILIZED IN ACCORDANCE WITH WDNR TECHNICAL STANDARD 1059.
4. ALL SLOPES EXCEEDING 4H:1V SHALL BE EROSION MATTED WITH CLASS I TYPE B, URBAN ECRM IN ACCORDANCE WITH WDNR TECHNICAL STANDARD 1052.
5. PROVIDE CLASS I TYPE B ECRM FOR THE BOTTOM 8 FEET OF ALL DRAINAGEWAYS IN ACCORDANCE WITH WDNR TECHNICAL STANDARD 1053.
6. DE-WATERING SHALL BE IN ACCORDANCE WITH WDNR TECHNICAL STANDARD 1061.
7. ANY AREAS NOT PERMANENTLY STABILIZED BY OCTOBER 15TH/ REQUIRE THE APPLICATION OF WATER SOLUBLE ANIONIC POLYACRYLAMIDE (PAM) IN ACCORDANCE WITH WDNR TECHNICAL STANDARD 1050 AS A TEMPORARY BINDING AGENT TO REDUCE EROSION FOLLOWING THE PLACEMENT OF THE SEED AND MULCH.
8. INLET PROTECTION AS NOTED TO COMPLY WITH WDNR TECHNICAL STANDARD 1060
9. DITCH CHECKS SHALL COMPLY WITH WDNR TECHNICAL STANDARD 1062.
10. EXCEPT AS NOTED ALL DISTURBED AREAS SHALL BE COVERED WITH 4 INCHES OF TOPSOIL, SEEDED USING WOOT MIXTURE NO. 10 APPLIED AT A RATE OF 3 POUNDS PER THOUSAND SQUARE FEET, MULCHED AND COVERED WITH ECRM OR MULCH IMMEDIATELY FOLLOWING SEEDING IN ACCORDANCE WITH WDNR TECHNICAL STANDARD 1059.

CONSTRUCTION SEQUENCE

- A. INSTALL SILT FENCE AND TRACKING PAD
- B. CLEAR AND GRUB AS NECESSARY TO BEGIN WORK
- C. STRIP TOPSOIL NECESSARY TO CONSTRUCT THE PROPOSED FACILITIES.
- D. CONSTRUCTION OF BUILDINGS AND UNDERGROUND UTILITIES.
- E. MILL PORTION OF PAVEMENT NECESSARY TO COMPLETE THE WORK.
- F. PAVE ENTIRE SITE
- G. FINAL CLEAN UP OF ALL SITE AREAS.

EXISTING STORM SEWER STRUCTURES:

SS INL 6264
RIM ELEV=873.52'
NO MEASURE DOWN INFO

SS INL 10003
RIM ELEV=872.40'
8" STEEL E IE=870.45'

SS INL 10004
RIM ELEV=872.46'
12" RCP W IE=870.36'

SS CB 10005
RIM ELEV=872.33'
18" CMP N IE=869.63'
18" CMP S IE=869.76'
12" RCP E IE=869.80'

SS INL 10089
RIM ELEV=873.86'
18" CMP N IE=867.24'
18" CMP S IE=867.21'

SS CB 10092
RIM ELEV=871.10'
18" CMP N IE=867.90'
18" CMP S IE=868.00'
6" CMP E IE=868.15'
18" PCP W IE=868.20'

SS MH 10093
RIM ELEV=874.54'
18" PCP N IE=868.08'
18" PCP E IE=868.15'
10" RCP W IE=868.18'

SS MH 10094
RIM ELEV=873.19'
18" CMP N IE=869.33'
15" PVC S IE=869.45'
12" RCP W IE=869.55'

SS INL 10188
RIM ELEV=871.89'
12" RCP S IE=868.24'

SS INL 10320
RIM ELEV=871.71'
12" RCP E IE=868.11'

SS INL 10321
RIM ELEV=871.69'
12" RCP W IE=868.34'

SS MH 10345
RIM ELEV=872.71'
12" RCP N IE=865.51'
12" RCP S IE=865.47'
12" PVC NE IE=867.96'

SS CB 10532
RIM ELEV=870.66'
8" ? SE IE=867.66'

SS CB 10551
RIM ELEV=873.26'
15" PVC N IE=868.28'
15" PVC S IE=868.16'

SS MH 10657
RIM ELEV=873.24'
12" RCP S IE=866.42'
12" RCP NE IE=866.38'

SS MH 10659
RIM ELEV=874.61'
12" RCP N IE=866.43'
12" STEEL NE IE=866.29'
14" RCP SW IE=866.41'

SS CB 10968
RIM ELEV=873.02'
TRENCH W IE=868.57

SS CB 11318
RIM ELEV=872.01'
6" PVC SE IE=869.26'

EXISTING SANITARY SEWER AND PROCESS STRUCTURES:

SAN MH A2
RIM ELEV=873.52'
4" STEEL N IE=868.22'
4" STEEL S IE=868.17'
4" STEEL NE IE=868.33'

SAN MH B
RIM ELEV=873.77'
NO MEASURE DOWN INFO

SAN MH C
RIM ELEV=873.99'
NO MEASURE DOWN INFO

SAN MH D
RIM ELEV=872.50'
8" STEEL E IE=858.60'
8" STEEL W IE=858.66'
8" STEEL NW IE=859.80'

SAN MH G
RIM ELEV=872.29'
8" STEEL N IE=864.01'
8" STEEL E IE=859.73'
8" STEEL W IE=859.83'
6" PVC NW IE=867.09'

SAN MH H
RIM ELEV=872.91'
8" STEEL E IE=860.01'
8" STEEL W IE=860.13'
8" ? NW IE=860.10'

FLOW METER VAULT
RIM ELEV=874.43'
18" STEEL NW IE=870.53'
18" STEEL SE IE=868.73'

MH/CB LG GRATED 1
RIM ELEV=873.82'
24" RCP S IE=868.61'
36" RCP E IE=867.42'

MH/CB LG GRATED 2
RIM ELEV=873.97'
18" STEEL N IE=868.42'
24" STEEL S IE=868.17'
36" RCP E IE=866.87'
36" RCP W IE=866.96'

MH/CB LG GRATED 3
RIM ELEV=874.00'
36" RCP N IE=866.75'
36" RCP W IE=866.80'

SAN MH 4
RIM ELEV=870.24' 878.38 ADJUSTED
VALVE N IE=867.42' REMOVED
8" STEEL S IE=867.66' REMOVED
8" PVC W TOP IE=864.59'
8" PVC W1 BOTTOM IE=857.81'
4" PVC SW TOP IE=872.49'
4" PVC SW1 BOTTOM IE=857.79'
12" N = 869.45 (STORM)
15" S = 869.20 (PLANT DRAIN)

SAN MH 5
RIM ELEV=870.24' 878.50 ADJUSTED
8" STEEL E IE=864.84'
8" STEEL W IE=864.89'
VALVE SW IE=868.47'
VALVE SW1 IE=868.43'

SAN MH 6
RIM ELEV=876.92'
VALVE NE IE=871.89'
VALVE NE1 IE=871.97'
VALVE NE2 IE=870.80'
4" PVC SE IE=872.16'
6" STEEL SW IE=867.42'
4" STEEL NW IE=869.22'

SAN MH 7
RIM ELEV=875.85'
CLARIFIER VALVE S IE=863.79'
8" STEEL E IE=859.33'
CLARIFIER VALVE SW IE=863.45'

SAN MH 8
RIM ELEV=873.70'
8" STEEL N IE=857.28'
VALVE S IE=857.67'
4" STEEL E TOP IE=862.66'
4" STEEL E1 BOTTOM IE=857.40'
? SE IE=857.86'
VALVE SW IE=857.72'
4" STEEL SW1 IE=869.70'
VALVE SW2 IE=870.68'

SAN MH 9
RIM ELEV=872.31'
CAPPED VALVE N IE=863.50'
8" STEEL E IE=859.16'
8" STEEL W IE=859.52'
CAPPED VALVE NE IE=859.79'
6" PVC NE1 IE=858.50'
8" VALVE NW IE=862.29'
6" STEEL NW1 IE=864.95'

SAN MH 10
RIM ELEV=875.66' 875.58 ADJUSTED
42" RCP S IE=854.82'
6" PVC NE IE=856.48'
6" PVC NE1 IE=866.42'
24" STEEL E IE=856.32'
42" RCP W IE=854.94'

SAN MH 11
RIM ELEV=875.67' 876.90 ADJUSTED
8" STEEL N IE=856.84' REMOVED
8" STEEL S IE=856.77'
6" PVC SE IE=857.28'
18" PVC E TOP IE=869.89'
18" STEEL E1 BOTTOM IE=857.31'
24" STEEL W IE=856.69'
15" N = 868.16 (PLANT DRAIN)

SAN MH 12
RIM ELEV=875.66' 875.82 ADJUSTED
? N IE=857.34'
? S IE=857.47'
4" PVC E IE=857.78'
8" STEEL W IE=858.28'
4" PVC NE IE=866.77'
4" PVC NW IE=857.81'
4" PVC NW1 IE=865.55'
4" SD SW IE= 870.20'

SAN MH 13
RIM ELEV=870.57'
8" STEEL SW IE=858.44'
8" STEEL NW IE=858.27'

SAN MH 15
RIM ELEV=872.85'
24" RCP NW IE=856.25'
18" RCP SE IE=856.45'
12" RCP S IE=856.38'

SAN MH 16
RIM ELEV=872.85'
24" RCP N IE=856.23'
24" RCP SE IE=856.19'
6" STEEL NE TOP IE=862.19'
6" STEEL NE BOTTOM IE=857.09'

SAN MH 17
RIM ELEV=873.57'
36" RCP NE IE=856.41'
36" RCP SW IE=856.51'


SAN MH 19
RIM ELEV=873.76'
42" RCP NE IE=855.25'
42" RCP SW IE=855.30'

SAN MH 20
RIM ELEV=874.43'
8" STEEL S IE=856.45'
42" RCP E IE=855.04'
42" RCP W IE=855.27'
6" STEEL NW IE=862.44'

SAN MH 6947
RIM ELEV=871.38'
4" STEEL N IE=865.46'
6" STEEL W IE=863.40'
6" STEEL SE IE=863.30'


SAN MH 7259
RIM ELEV=872.06'
8" STEEL E IE=864.14'
8" STEEL SW IE=865.20'

SAN MH 7401
RIM ELEV=873.00'
42" RCP E IE=855.24'
24" RCP SE IE=855.83'
36" RCP SW IE=855.44'

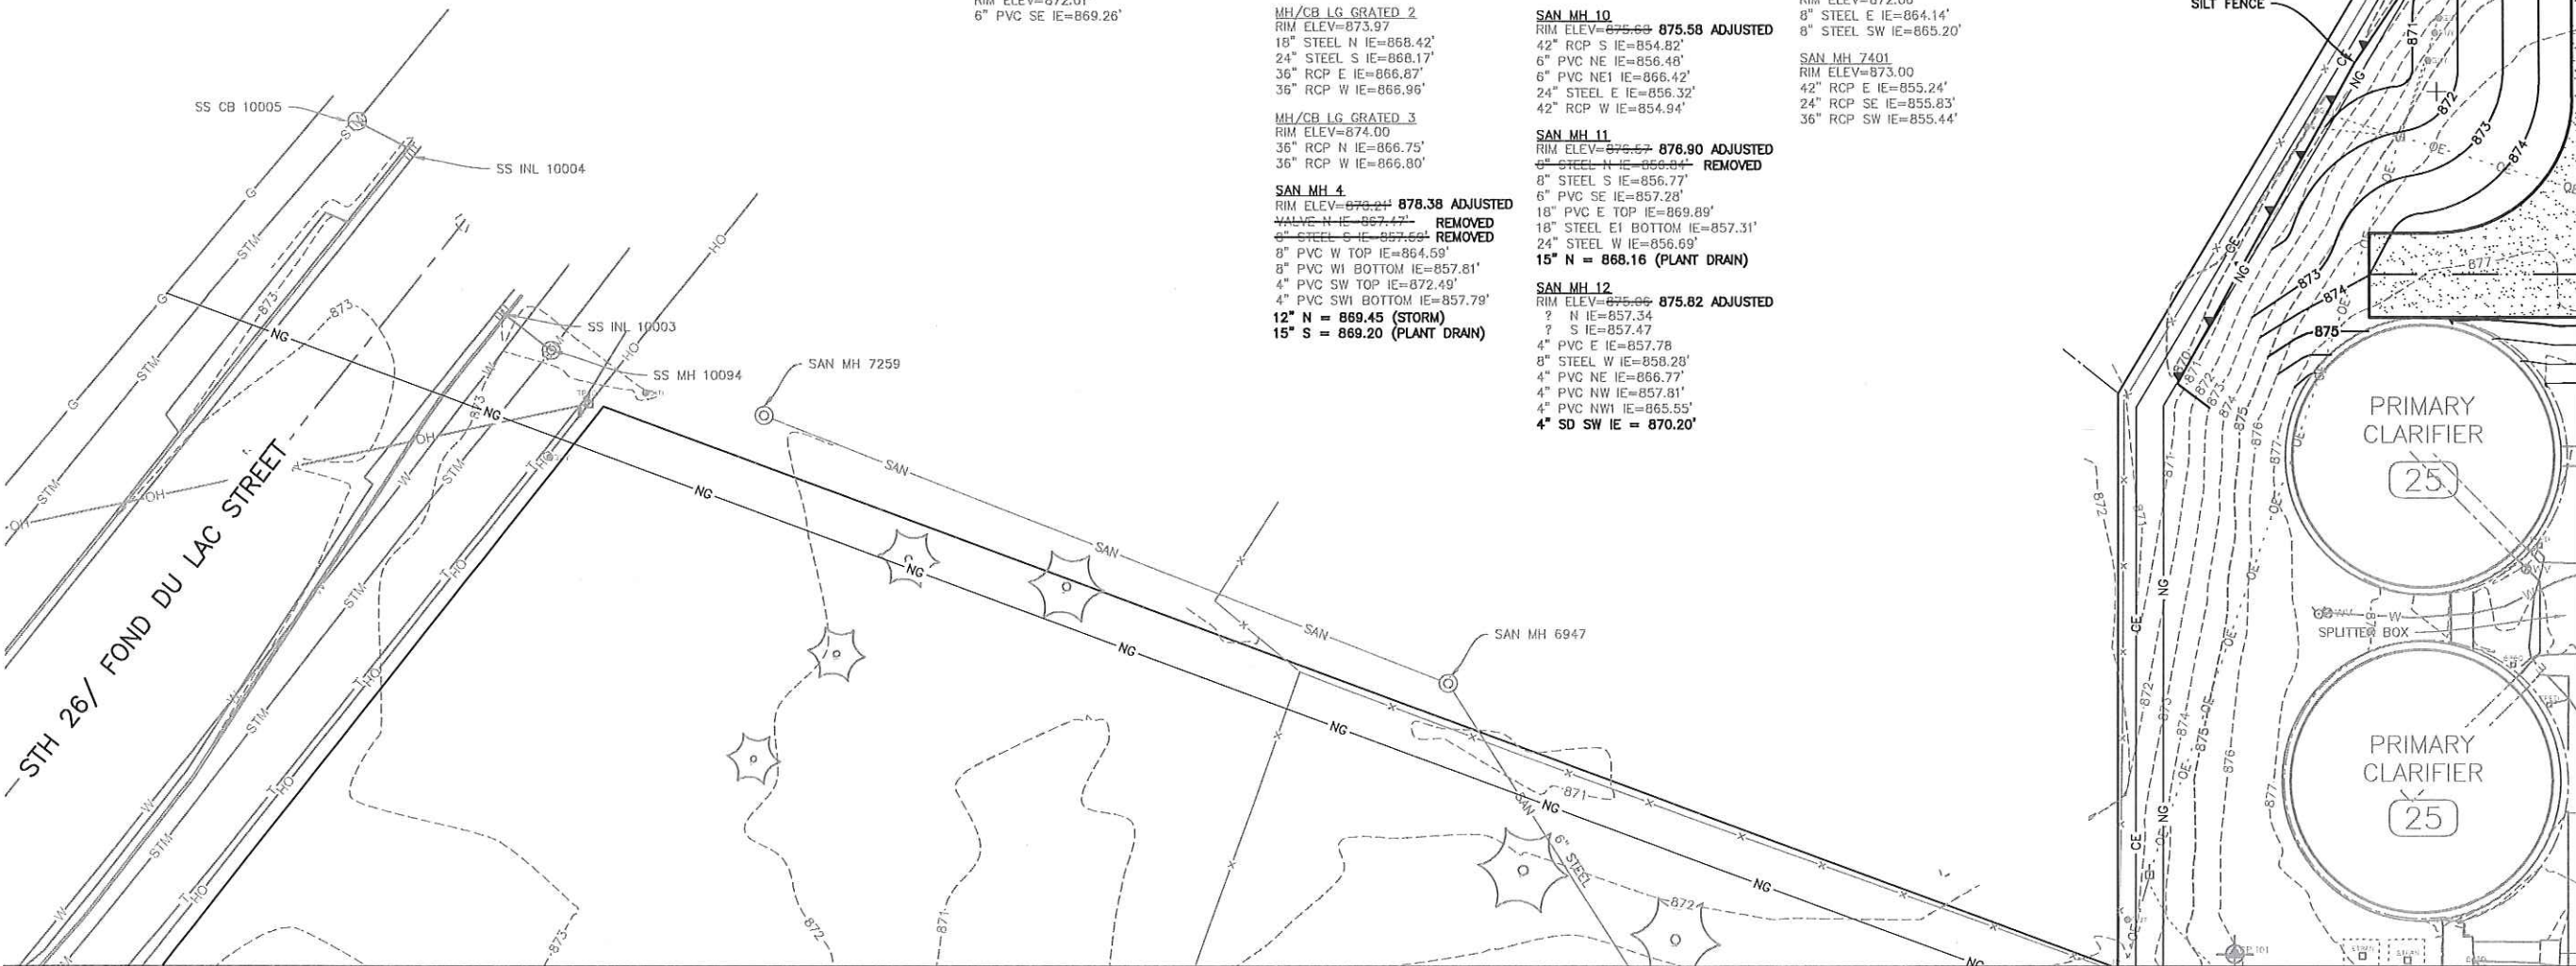

MATCHLINE - SEE DRAWING 02-EC-4

PLAN

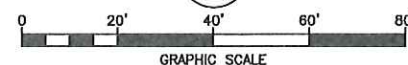

MATCHLINE - SEE DRAWING 02-EC-2


WAUPUN UTILITIES
WWTP UPGRADE AND ABNR
WAUPUN, WI
SITE WORK
EROSION CONTROL
PLAN

VERIFY SCALES
LENGTH OF BAR IS 1" ON ORIGINAL DRAWING
1:2
PLOT SCALE, ADJUST
SCALE(S) ACCORDINGLY
DESIGNED BY: W.A.H.
DRAWN BY: J.C.S.
CHECKED BY: K.R.H.
APPROVED BY: J.J.S.
PROJECT NO.
6353
DATE
JANUARY 2021
DRAWING NO.
02-EC-1

Applied Technologies
Engineers-Architects
NO. DATE REVISIONS AND RECORD OF ISSUE BY APVD




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Last Modified: 6 May 2021 Copyright © 2021 Applied Technologies, Inc.

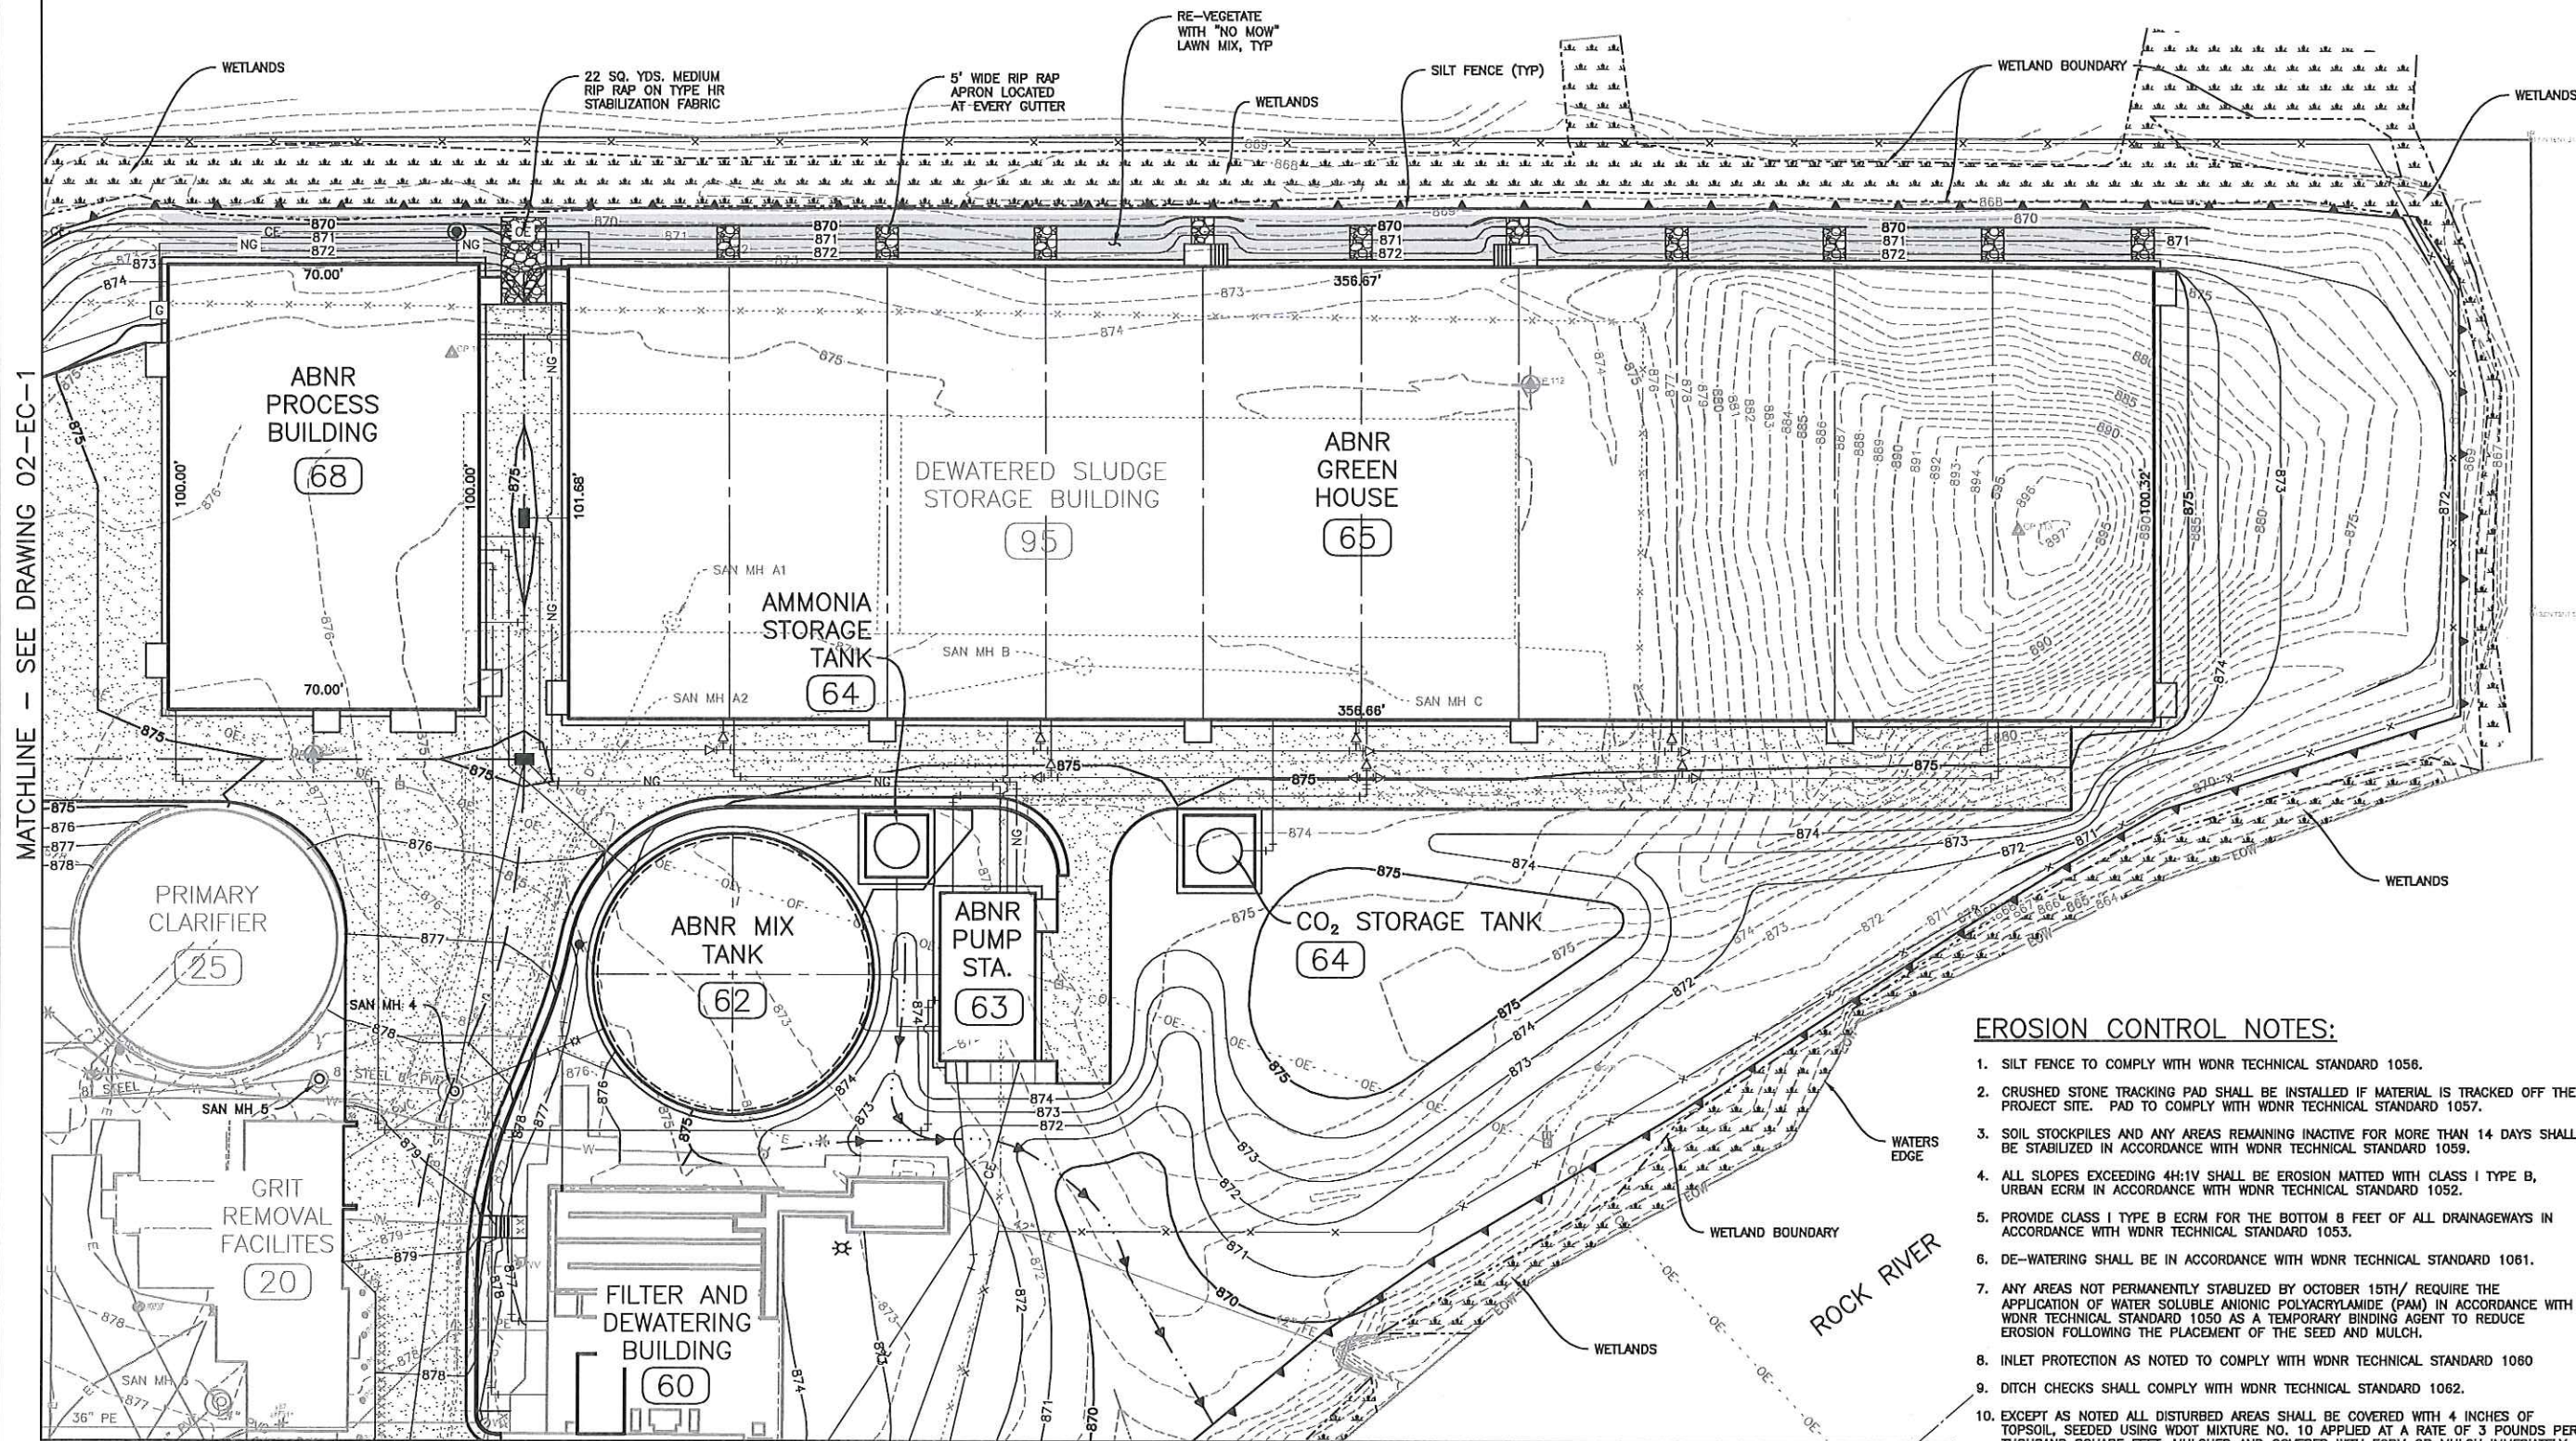

EROSION CONTROL NOTES:

1. SILT FENCE TO COMPLY WITH WDNR TECHNICAL STANDARD 1056.
2. CRUSHED STONE TRACKING PAD SHALL BE INSTALLED IF MATERIAL IS TRACKED OFF THE PROJECT SITE. PAD TO COMPLY WITH WDNR TECHNICAL STANDARD 1057.
3. SOIL STOCKPILES AND ANY AREAS REMAINING INACTIVE FOR MORE THAN 14 DAYS SHALL BE STABILIZED IN ACCORDANCE WITH WDNR TECHNICAL STANDARD 1059.
4. ALL SLOPES EXCEEDING 4H:1V SHALL BE EROSION MATTED WITH CLASS I TYPE B, URBAN ECM IN ACCORDANCE WITH WDNR TECHNICAL STANDARD 1052.
5. PROVIDE CLASS I TYPE B ECM FOR THE BOTTOM 8 FEET OF ALL DRAINAGEWAYS IN ACCORDANCE WITH WDNR TECHNICAL STANDARD 1053.
6. DE-WATERING SHALL BE IN ACCORDANCE WITH WDNR TECHNICAL STANDARD 1061.
7. ANY AREAS NOT PERMANENTLY STABILIZED BY OCTOBER 15TH/ REQUIRE THE APPLICATION OF WATER SOLUBLE ANIONIC POLYACRYLAMIDE (PAM) IN ACCORDANCE WITH WDNR TECHNICAL STANDARD 1050 AS A TEMPORARY BINDING AGENT TO REDUCE EROSION FOLLOWING THE PLACEMENT OF THE SEED AND MULCH.
8. INLET PROTECTION AS NOTED TO COMPLY WITH WDNR TECHNICAL STANDARD 1060.
9. DITCH CHECKS SHALL COMPLY WITH WDNR TECHNICAL STANDARD 1062.
10. EXCEPT AS NOTED ALL DISTURBED AREAS SHALL BE COVERED WITH 4 INCHES OF TOPSOIL SEEDING USING WDOT MIXTURE NO. 10 APPLIED AT A RATE OF 3 POUNDS PER THOUSAND SQUARE FEET, MULCHED AND COVERED WITH ECM OR MULCH IMMEDIATELY FOLLOWING SEEDING IN ACCORDANCE WITH WDNR TECHNICAL STANDARD 1059.

CONSTRUCTION SEQUENCE
A. INSTALL SILT FENCE AND TRACKING PAD
B. CLEAR AND GRUB AS NECESSARY TO BEGIN WORK
C. STRIP TOPSOIL NECESSARY TO CONSTRUCT THE PROPOSED FACILITIES.
D. CONSTRUCTION OF BUILDINGS AND UNDERGROUND UTILITIES.
E. MILL PORTION OF PAVEMENT NECESSARY TO COMPLETE THE WORK.
F. PAVE ENTIRE SITE
G. FINAL CLEAN UP OF ALL SITE AREAS.

 WAUPUN UTILITIES THE POWER OF COMMUNITY	
APVD	
BY	
REVISIONS AND RECORD OF ISSUE	
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DATE	
Applied Technologies Engineers-Architects	
WAUPUN UTILITIES WWTP UPGRADE AND ABNR WAUPUN, WI	
SITE WORK EROSION CONTROL PLAN	
VERIFY SCALES LENGTH OF BAR IS 1" ON ORIGINAL DRAWING 1:2 PLOT SCALE, ADJUST SCALE(S) ACCORDINGLY	
DESIGNED BY: W.A.H.	
DRAWN BY: J.C.S.	
CHECKED BY: K.R.H.	
APPROVED BY: J.J.S.	
PROJECT NO. 6353	
DATE JANUARY 2021	
DRAWING NO. 02-EC-2	