

## SITE PLAN REVIEW COMMITTEE MEETING AGENDA

MONDAY, APRIL 28, 2025 AT 1:30 PM

# COUNCIL CHAMBERS, SECOND FLOOR, MUNICIPAL BUILDING, 106 JONES STREET, WATERTOWN, WI 53094

## **Virtual Meeting**

Info: https://us06web.zoom.us/j/2371460557?pwd=UXjvqLXKCdw12jl4jl1b7GlUPaClat.1&omn=820634 18342 or call: 1-646-931-3860 and use Meeting ID: 237 146 0557 Passcode: 144391

All public participants' devices will be muted during the meeting except during the public comment period.

#### 1. CALL TO ORDER

#### 2. APPROVAL OF MINUTES

A. Review and take action: Site Plan Review minutes dated March 24, 2025

#### 3. BUSINESS

A. Review and take action: 1 E. Main Street Site Review of Plaza Phase II ADA Compliant Ramp and Stairs & 112 S. First Street Parking Lot Reconstruction

#### 4. ADJOURNMENT

Persons requiring other reasonable accommodations for any of the above meetings, may contact the office of the City Clerk at <a href="mailto:cityclerk@watertownwi.gov">cityclerk@watertownwi.gov</a> phone 920-262-4000

A quorum of any City of Watertown Council, Committee, Board, Commission, or other body, may be present at this meeting for observing and gathering of information only

#### SITE PLAN REVIEW COMMITTEE March 24, 2025

The Site Plan Review Committee met on the above date at 1:30 P.M. in the Council Chambers on the second floor of City Hall. The following members were present: Mayor Emily McFarland, Brian Zirbes, Mason Becker, Mike Jacek, Stacy Winkelman, Andrew Beyer, Nathan Williams, Maureen McBroom, Tim Hayden, and Thomas Koerner.

Also in attendance were Nikki Zimmerman, Mason Becker, Timothy Sullivan, Alex Josue Blandon Robles of Latinos Supermarket, Joel Vaness of Abacus Architects, Daniel Benninger, Jerry Heller and Deb Heller of D & J Sports Bar, Amber Yelk of Sassy Sweets, Bill Edington of Heritage Military Music Foundation, Tony Stenzel of Lakeside Construction, Eric Halbur and Mark McClintock of Abacus Architects, and Konrad Roznik and Chris Merlein of North Town Partners.

#### 1. Call to Order

The meeting was called to order by Chairperson Brian Zirbes.

#### 2. Approval of Minutes

A. Review and take action: Site Plan Review Minutes Dated February 24, 2025

Motion was made by Tim Hayden and seconded by Andrew Beyer to approve the minutes as submitted. Unanimously approved.

#### 3. Business

A. Review and take action: 100 E. Division Street initial review of site plan for zoning map amendment, planned development overlay map amendment, and zoning text amendment

Konrad Roznik of North Town Partners was present. The proposal is for a 65-unit apartment building with a mix of 1-3 bedroom units and 3 individual 3-bedroom town homes in a community called the Ox Bow. This would be a high-end housing community.

The following was presented by staff:

Building: A fire-rated wall - a full separation wall with no separation. The state would require a variance for

the opening in the parking garage since this spans county lines.

Water/Wastewater: Will this need a 6" service? If so, there is a 6" main and 4" lateral currently. The 4" would have to

be increased to the 6".

Stormwater: Stormwater plans will be needed. The approval would be contingent upon review of the

Stormwater & Erosion Control permit. DNR requirements will be in play with it being over 1 acre.

Engineering: Parking lot must meet all ADA requirements including handicap stalls, curb ramps, etc. The

concrete path along the riverside is intended for tenant use with potential future use for the public. The lighting plan shall be submitted. The southern end of the concrete path with be more of a plaza/walkway. The landscaping plan will not have any plantings in the right of way. The seawall

needs to be confirmed that the condition is appropriate for the river walk.

Fire: Page A302 of the plans mention a skywalk. There was verification that this will enclosed if it is

built. There were questions on the addressing. Sprinkler and fire systems will be in the design of

the second building.

Streets: Verified that there will be private garbage and recycling.

Parks: There will be Park Fees in Lieu of Dedication and Park Improvement Fees required.

Mayor: Is excited by this project.

Zoning: There should be some enhancing of the southern building entrance with a canopy similar is style

to the main entrance. This is the location the southern building will be addressed from. There will

be 1 main entrance but both entrances need to be clearly marked.

Motion made by Emily McFarland and seconded by Maureen McBroom to approve this item and forward to Plan Commission contingent upon:

- -Review and approval of the stormwater & erosion control permit.
- -State variance approval
- -Enhancing the southern entrance with scaled addressing
- -ADA compliance in the parking lot

Unanimously approved.

#### B. Review and take action: 1504 S. Church Street

Alex Josue Blandon Robles was present. There is currently a grocery store at this location. This approval is required for the restaurant portion which is also going to Plan Commission to obtain a conditional use permit.

The following was presented by staff:

Building: All fire, electrical, exit lighting and plumbing issues must be addressed with permits being

obtained.

Water/Wastewater: No comments.

Stormwater: No comments.

Engineering: No comments.

Fire: Needs to verify that the new hood that has been installed is correct and any other requirements

have been addressed.

Streets: No comments.

Motion made by Mike Jacek and seconded by Tim Hayden to approve this item and forward to Plan Commission. Contingent upon:

- -Approval of the hood system.
- -Fire Department inspection.
- -Submittal and approval of required permits with final inspections completed.

Unanimously approved.

## C. Review and take action: 116 W. Main Street retail bakery with customer seating

Amber Yelk was present. This is for a proposed bakery with customer seating.

The following was presented by staff:

Building: No comments.

Water/Wastewater: No comments.

Stormwater: No comments.

Engineering: No comments.

Fire: Asked about the convection oven. It is a fully ventless convection oven. Asked about the set of

stairs on the plans. These are accessible to the basement only. What is the distance between the stairs and the case? Is this ADA compliant? The case is actually 8' to the left and against the wall.

It meets ADA compliance.

Streets: No comments.

Mayor: Grateful for the downtown investment.

Motion made by Stacy Winkelman and seconded by Mike Jacek to approve this item and forward it to Plan Commission

Unanimously approved.

## D. Review and take action: 301 E. Main Street bar and grill

Jerry and Deb Heller were present. They are moving their bar and grill to this location.

The following was presented by staff:

Building: For any potential future work, ensure that permits are taken out.

Water/Wastewater: No comments.

Stormwater: No comments.

Engineering: No comments.

Fire: There is currently a Knox Box on the outside of the building that is currently 20' high. It should be

moved so that it's no higher than 6' high.

Streets: No comments.

Motion made by Emily McFarland and seconded by Stacy Winkelman to approve this item and forward it to Plan Commission contingent upon:

-Knox Box being moved to no higher than 6' for accessibility.

Unanimously approved.

#### E. Review and take action: 1013 S. Fifth Street review of storage building site plan

Tony of Lakeside Construction was present. The proposal is for construction of a 42' x 75' building to house a truck and trailer. The building will have a white roof with black trim.

The following was presented by staff:

Building: Plans must be approved by the State of Wisconsin. Then submit the building permit application

for review and approval.

Water/Wastewater: Verified that there will not be any installation of floor drains or water at this time.

Stormwater: The Erosion Control application has been received and is being reviewed.

Engineering: The east side of the building should have pavement rather than gravel. The access will be off of

S. Fifth Street which currently is an unimproved road. The department will review records to see if

there are any further requirements needed for this project.

Fire: Exit lights should have egress illumination to be built in or a separate unit and there should be a

fire extinguisher at each door.

Streets: No comments.

Motion made by Emily McFarland and seconded by Andrew Beyer to approve this item and forward it to Plan Commission contingent upon:

- -State of Wisconsin plan approval
- -Approval of the Erosion Control permit
- -Exit light illumination
- -Fire Extinguisher placement
- -Improved right of way

Unanimously approved.

#### F. Review and take action: 318 Union Street - Temporary Use

Owner Daniel Benninger was present. There was a fire at this location. The request is for a 33' trailer to be placed in the driveway of the property for the owner to live in until the fire renovations are completed.

The following was presented by staff:

Building: Verified that a temporary electrical service will be installed. Also stated that the proper backflow

prevention is included with any plumbing on the property. Also, the RV shall be placed off the property line as far as possible. Ensure permits are submitted for the temporary service and other

work for the fire renovation.

Water/Wastewater: No comments.

Stormwater: No comments.

Engineering: No comments.

Fire: No comments.

Streets: No comments.

Zoning:

The Temporary permit would be good for 6 months and then would need to be revisited, if needed.

Motion made by Mike Jacek and seconded by Emily McFarland to approve this item and forward it to Plan Commission contingent upon:

- -Location of the RV being close to the house
- -Submittal of the required permits.


Unanimously approved.

#### 4. Adjournment

Motion was made by Emily McFarland and seconded by Tim Hayden to adjourn. Unanimously approved.

Respectfully submitted, Nikki Zimmerman Recording Secretary

NOTE: These minutes are uncorrected, and any corrections made thereto will be noted in the proceedings at which these minutes are approved.

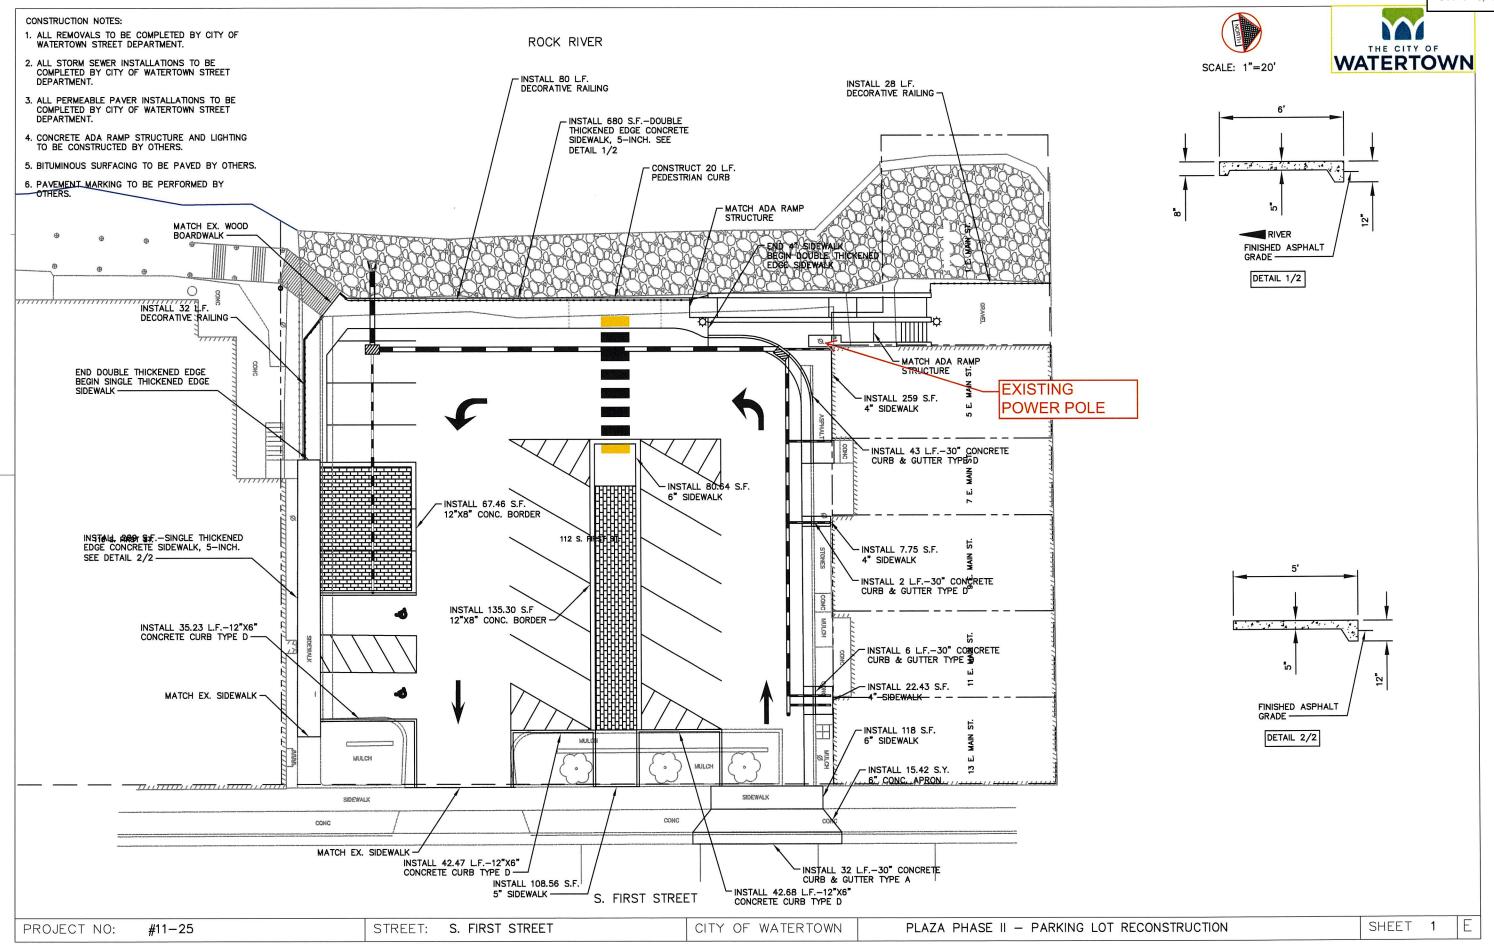

SHEET INDEX

TITLE SHEET

G-001 TITLE SHEET

COMBINED ARCHITECTURAL-STRUCTURAL

A-100 ADA RAMP SITE PLAN

A-101 ADA RAMP AND STAIR PLANS AND DETAILS


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E-100 ADA RAMP SITE PLAN - ELECTRICAL

E-101 ADA RAMP SITE PLAN - PHOTOMETRIC

E-601 ELECTRICAL SCHEDULES

E-901 ELECTRICAL SPECIFICATIONS



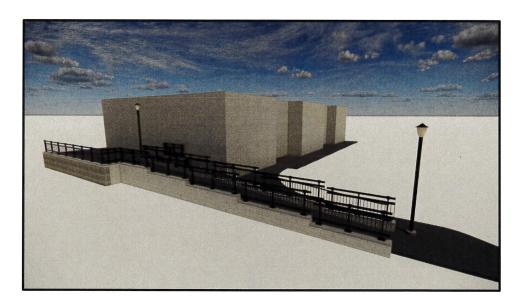

Project GRAEF relation all continuous for studies and other removed other endanger all compressions operated to any social feets or only port of only ME-FERC. Called in advocated to see any such E-FERS in Called so and occupancy of the reference Project. Without GRAEF space writing content. Called the Called so and occupancy of the relationship content or reason and occupancy of the content and in training out on E-FERS to any other stores on E-FERS and occupancy of the content and in the content of the cont

#### EXISTING PROJECT CONDITIONS

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24-25	CURT W HOFFMANN MINISTER WAS A STATE OF THE

REELS

Section 3, Item A.

275 West Wisconsin Avenue Suite 300 Milwaukee, WI 53203 414 / 259 1500

www.graef-usa.com

CITY OF WATERTOWN

PROJECT TITLE

PLAZA PHASE II - ADA COMPLIANT CONCRETE RAMP AND STAIR

1 EAST MAIN STREET WATERTOWN, WISCONSIN 53094

ISSU

01 2025-03-24 ADDENDUM#02

PROJECT INFORMATIO

PROJECT NUMBER: 2023-0158

DRAWN RY: RMG

CHECKED BY: CWH

PROVED BY: CWH

SCALE: AS NOTED

TITLE SHEET

SHEET TITLE:

SHEET NUMBER:

G-001

RAMP SLOPE
-SLOPE REQUIREMENTS
-SLOPE PROVIDED
-CROSS SLOPE REQUIRMENTS
-CROSS SLOPE PROVIDED

## FLOOR SURFACES -SURFACE REQUIREMENTS

= SLIP RESISTANT = CONCRETE WITH BROOM FINISH -SURFACE PROVIDED

## RAMP RUN AND LANDING REQUIREMENTS -RAMP RUN RISE REQUIREMENTS = 30" MAXIMUM RISE HEIGHT

-FAMP RUN RISE PROVIDED = 24"RISE HEIGHT
-CLEAR RUN WIDTH REQUIREMENT = 36" CLEAR
-CLEAR RUN WIDTH PROVIDED = 48" CLEAR -CLEAR KON WIDH REQUIREMENTS = 56° CLEAR
-CLEAR ROW WIDH PROVIDED = 48° CLEAR
-LANDING WIDTH PROVIDED = 48° CLEAR
-LANDING CLEAR LENGTH REQUIRED = 56° MINIMUM
-LANDING CLEAR LENGTH REQUIRED = 56° MINIMUM
-LANDING CLEAR LENGTH REPOVIDED = 56° CLEAR
-LANDING SEAL RENGTH PROVIDED = 56° CLEAR
-LANDING SEAL RENGTH PROVIDED = 56° CLEAR
-LANDING SEAL RENGTH PROVIDED = 56° CLEAR

HANDRAILS

HANDRAILS AND HANDRAIL SUPPORTS MUST BE OUTSIDE OF THE CLEAR MOTH.

RAMP RUNS WITH A RISE GREATER THAN 6 INCHES SHALL HAVE HANDRAILS COMPLYING WITH SECTION 950 OF 4117.1.

HANDRAILS NEED TO BE PROVIDED ON BOTH SIDES OF RAMPS AND STAIRS

HANDRAILS NEED TO BE CONTINUOUS WITHIN THE FULL LENGTH OF

-HANDRAILS NEED TO BE CONTINUOUS WITHIN THE FULL LENGTH OF EACH RAMP RUN OR STAIR FLIGHT.
-HANDRAIL HEIGHT TO TOP OF GRABBING SURFACE.
-HEIGHT FROM RAMP SURFACE.
- 434 - 38\*
-HEIGHT FROM TRAIT NOSING.
- 34\* - 38\*
-HANDRAILS SHALL BE AT A CONSISTENT HEIGHT
-CLEARANCE BETWIEGH HANDRAIL SURFACE AND ADJACENT SURFACES.

## STRUCTURAL DESIGN SPECIFICATIONS

FOOTINGS 3000 PSI FOUNDATION WALLS 4000 PSI SLABS ON GRADE 4000 PSI

REINFORCING STEEL SHALL CONFORM TO ASTM A615 GRADE 60.

 CONCRETE MASONRY UNITS SHALL CONFORM TO ASTM C90 NORMAL WEIGHT UNITS, MINIMUM COMPRESSIVE STRENGTH OF CONCRETE MASONRY UNITS SHALL BE f<sub>10</sub> = 2000 PSI. 5. MORTAR SHALL CONFORM TO ASTM C270 TYPE S.

6. MASONRY GROUT SHALL CONFORM TO ASTM C476, MINIMUM COMPRESSIVE STRENGTH SHALL BE  $\Gamma_2$  = 2000 PSI.

MINIMUM COMPRESSIVE STRENGTH OF CONCRETE MASONRY CONSTRUCTION SHALL BE fr. = 2000 PSI.

8. STRUCTURAL STEEL PLATES SHALL CONFORM TO THE FOLLOWING:

THICKNESS < 1/8" ASTM A 1011 CS TYPE 8 (OR APPROVED EQUAL)
9/16" 5 THICKNESS ≤ 4"ASTM A572 GRADE 50
THICKNESS > 4" ASTM A36"

9. ASSUMED BEARING CAPACITY FOR SPREAD FOOTINGS IS 1500 PSF 10. DESIGN LOADS:

FLOOR LIVE LOAD STAIRS AND EXIT WAYS

#### **EARTHWORK**

3. BACKFILL EVENLY ON EACH SIDE OF FOUNDATION WALLS AND RETAINING WALLS.

4. TOPSOIL AND FILL BELOW SLABS ON GROUND SHALL BE REMOVED. AGGREGATE BASE COURSE UNDER SLABS ON GROUND SHALL BE COMPACTED TO 6-INCH LAYERS (EXCEPT WHERE LOOSE FILL IS INDICATED ON DRAWINSS).

5, BACKFILL AGAINST EXTERIOR FOUNDATION WALLS SHALL BE COMPACTED TO MAXIMUM 64NCH

## CONCRETE

FORMWORK SHALL BE DESIGNED IN ACCORDANCE WITH THE ACI "MANUAL OF CONCRETE PRACTICE", LATEST EDITION.

REINFORCING STEEL SHALL BE DETAILED AND PLACED IN ACCORDANCE WITH THE ACI "MANUAL OF CONCRETE PRACTICE", LATEST EDITION, UNLESS OTHERWISE NOTED.

3, LAP ALL WALL BARS 30 DIAMETERS UNLESS OTHERWISE DETAILED, LAP WELDED WIRE MESH 6 INCHES

PROVIDE COLUMN AND WALL DOWELS OF THE SAME SIZE AND NUMBER AS THE RESPECTIVE COLUMN AND WALL REINFORCING UNLESS OTHERWISE DETAILED.

5. CONCRETE PROTECTION FOR REINFORCING BARS SHALL BE IN ACCORDANCE WITH THE "BUILDING CODE REQUIREMENTS FOR STRUCTURAL CONCRETE", ACI 318-14.

5. SLABS ON GRADE SHALL BE CAST ALLOWING A SUFFICIENT NUMBER OF JOINTS TO ADEQUATE, CONTROL SHRIPKAGE CRACKING, SANCULTING SHALL BE DONE AS SOON AS SANCULT WILL NO RAVEL CONCRETE OR WITHING A HOURS MAXIMUM OF INTIME POWERS OPERATION, MAXIMUM SIZE OF PANELS SHALL BE 15 FEET BY 15 FEET FOR 6-INCH SLAB ON GRADE.

7. EXTERIOR SLABS ON GRADE SHALL BE 6 INCHES THICK AND REINFORCED WITH 5x6-W2.1xW2.1 WELDED WIRE FABRIC.

8. ALLOW AT LEAST 24 HOURS BEFORE POURING ADJACENT WALL SECTIONS BETWEEN CONSTRUCTION JOINTS, MAXIMUM LENGTH OF POUR TO BE 40 FEET, UNLESS CRACK INDUCERS ARE USED AS DETAILED ON THE ORAWINS.

9. CONTRACTOR SHALL NOTIFY THE ENGINEER AT LEAST 24 HOURS PRIOR TO PLACING CONCRETE. 10, CONSTRUCTION JOINTS IN BEAMS, JOISTS OR SLABS TO BE LOCATED BETWEEN THE 1/4 POINT AND CENTERLINE OF SPAN, OR AS DIRECTED BY THE ENGINEER.

11, DO NOT PLACE OR CUT HOLES IN CONCRETE SLABS, BEAMS, WALLS OR COLUMNS WITHOUT PRIOR APPROVAL OF THE ENGINEER.

12. EXTERIOR EXPOSED CONCRETE SHALL BE AIR-ENTRAINED, AIR CONTENT SHALL BE 6 PERCENT (4/-1 1/2 PERCENT).

13. PIPES AND CONDUITS EMBEDDED IN OR PASSING THROUGH STRUCTURAL MEMBERS <u>MUST</u> BE APPROVED BY THE STRUCTURAL ENGINEER, PIPE AND CONDUITS EMBEDDED IN CONCRETE SHALL NOT BE LARGER THAN 2 NOHES IN OUTSIDE ON DAMETER AT THEIR WIDEST POINT OR FITTING OR 1/3 OF THE THICKNESS OF THE SLAB, BEAM OR WALL.

14, ELECTRICAL CONDUIT OR PIPES EMBEDDED IN OR PASSING THROUGH SLABS, BEAMS OR WALLS SHALL BE LOCATED AND PLACED SO THAT

THEY ARE NOT CLOSER THAN THREE DIAMETERS ON CENTER.
 THE CONCRETE COVER IS NOT LESS THAN 2 INCHES.
 THEY RUN BETWEEN REINFORCING AND DO NOT DISPLACE IT IN ANY MANNER.

15. ALUMINUM CONDUITS SHALL NOT BE PLACED IN CONCRETE.

16. CHAMFER ALL EXPOSED CONCRETE CORNERS, SEE ARCHITECTURAL/STRUCTURAL DRAWINGS FOR REQUIREMENTS.

17, CONCRETE SHALL BE TESTED BY THE OWNER'S TESTING LAB, REFER TO SPECIFICATIONS FOR REQUIREMENTS.

18. PROPER CURING PROCEDURES SHALL BE USED FOR SLAB ON GRADE TO PREVENT CURLING. 19. CALCIUM CHLORIDE SHALL NOT BE USED IN CONCRETE MIXES.

20. PROVIDE WATERSTOPS AT ALL CONSTRUCTION JOINTS BELOW THE WATER TABLE AND AS SHOWN ON DRAWINGS, SEE SPECIFICATIONS FOR ADDITIONAL INFORMATION.

#### CONCRETE MASONRY

3. CALCIUM CHLORIDE OR ADMIXTURES CONTAINING CALCIUM CHLORIDE SHALL NOT BE USED.

4. MASONRY WALLS SHALL BE ADEQUATELY BRACED TO RESIST WIND FORCES UNTIL PERMANENT DESIGN SUPPORTS ARE IN PLACE AND FUNCTIONAL BRACING SHALL BE DESIGNED BY THE CONTRACTOR.

5. PROVIDE DOWELS INTO FOUNDATION THE SAME SIZE AND NUMBER AS WALL REINFORCING. 5 LAP REINFORCING BARS 48 DIAMETERS

7. CONCRETE MASONRY WALLS SHALL BE REINFORCED AT EVERY OTHER BED JOINT WITH 3/16-INCH TRUSS TYPE JOINT REINFORCEMENT.

8. VERTICAL BARS SHOWN ON THE DESIGN DRAWINGS SHALL BE PLACED IN A CONTINUOUS UNOBSTRUCTED CELL OF NOT LESS THAN 3 INCHES BY 4 INCHES.


9. ALL BOND BEAMS AND PILASTERS SHALL BE REINFORCED AS SHOWN ON THE DESIGN DRAWINGS AND BILLED WITH GROUT

#### MISCELLANEOUS

VERIFY AND COORDINATE, WITH ALL CONTRACTORS, THE LOCATION OF ALL ARCHITECTURAL AND MECHANICAL APPURTENANCES AND OPENINGS;

3. CONTRACTOR SHALL PROVIDE SHOP DRAWINGS FOR THE FOLLOWING ITEMS PRIOR TO FABRICATION: REINFORCING BARS.

ADA RAMP SITE PLAN

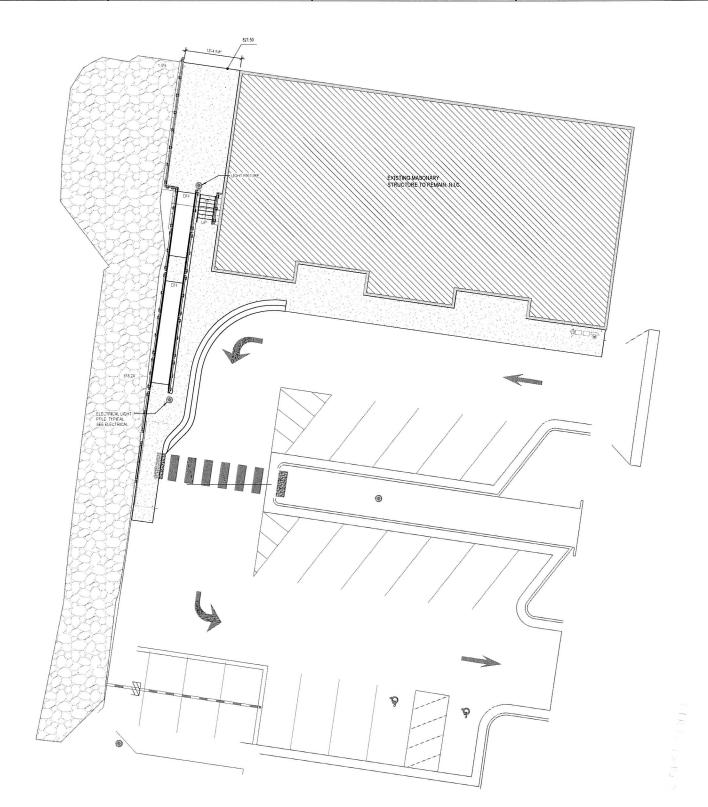

Section 3, Item A.

275 West Wisconsin Avenue, Suite 300 Milwaukee, WI 53203

www.graef-usa.com

CLIENT: CITY OF WATERTOWN

PROJECT TITLE:

PLAZA PHASE II - ADA COMPLIANT CONCRETE RAMP AND STAIR

1 EAST MAIN STREET WATERTOWN, WISCONSIN 53094

ISSUE

01 2025-03-24 ADDENDUM#02

PROJECT INFORMATION: PROJECT NUMBER: 2023-0158

DATE: 2025-03-24 RMG/GRC DRAWN BY: CHECKED BY: CWH/RCG


APPROVED BY: SCALE: AS NOTED


CWH/GRC


SHEET TITLE: ADA RAMP SITE PLAN


**A-100** 


8

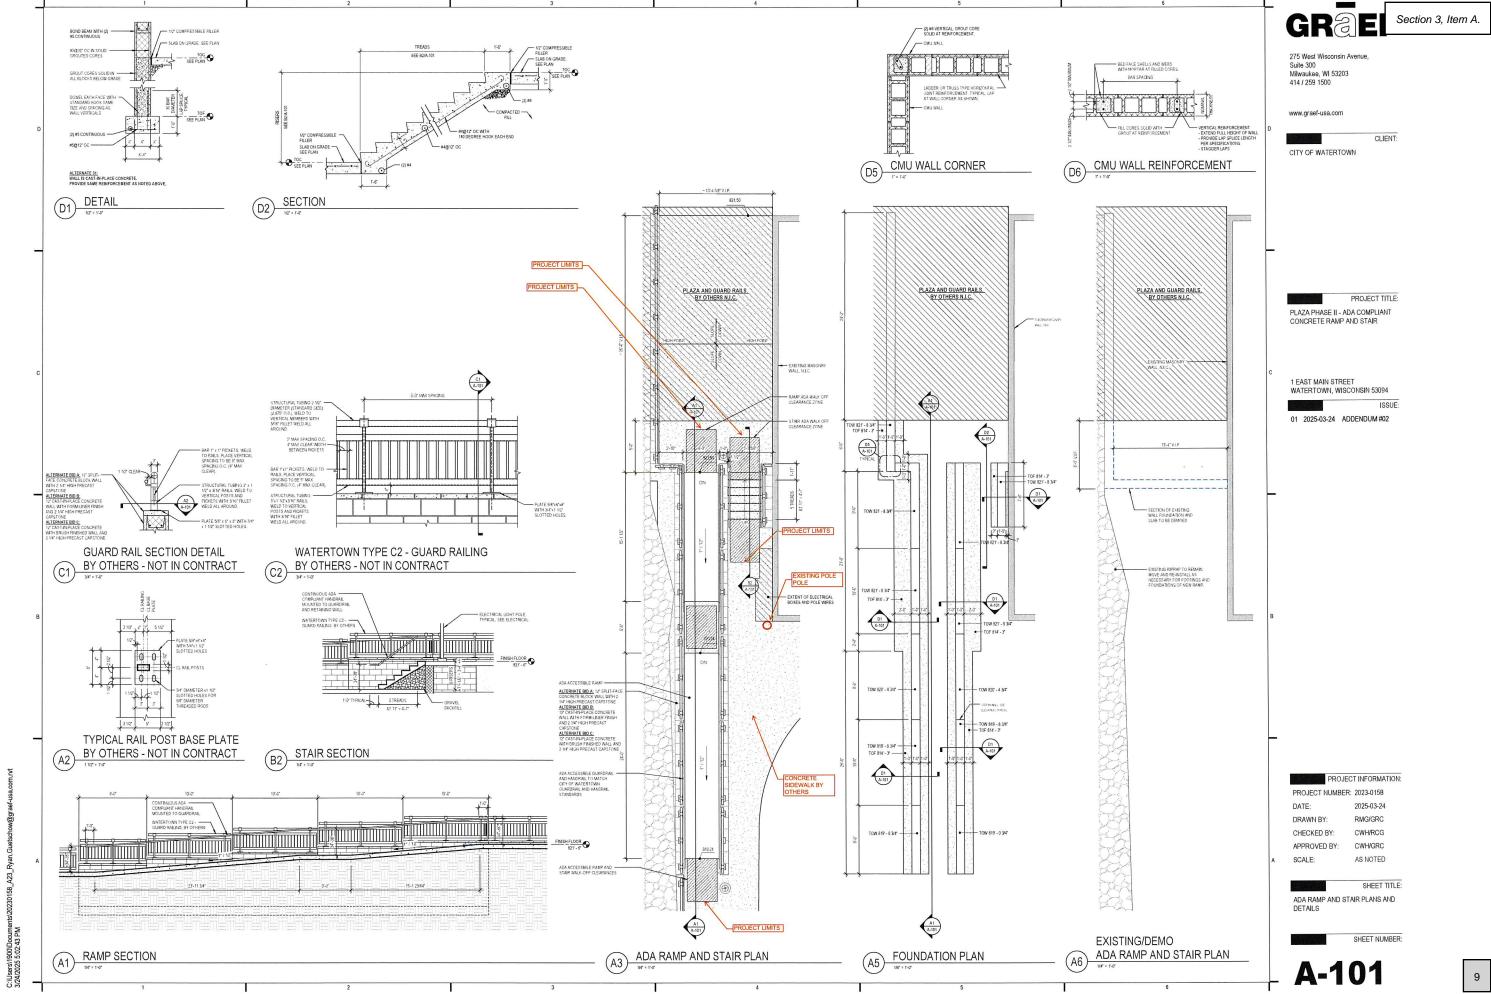

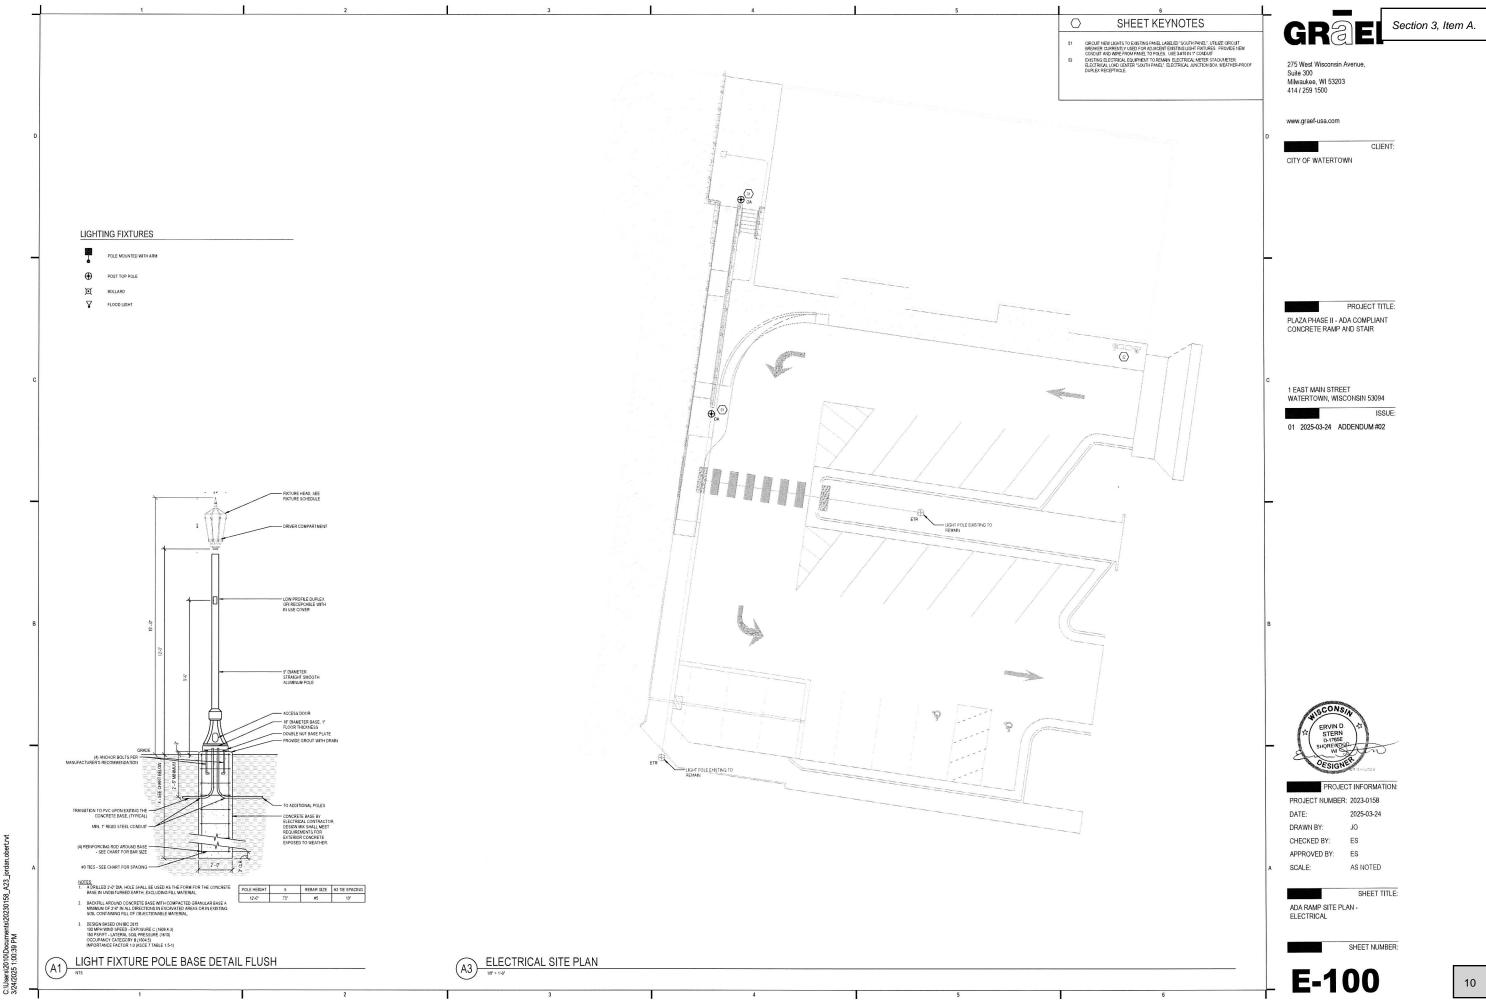

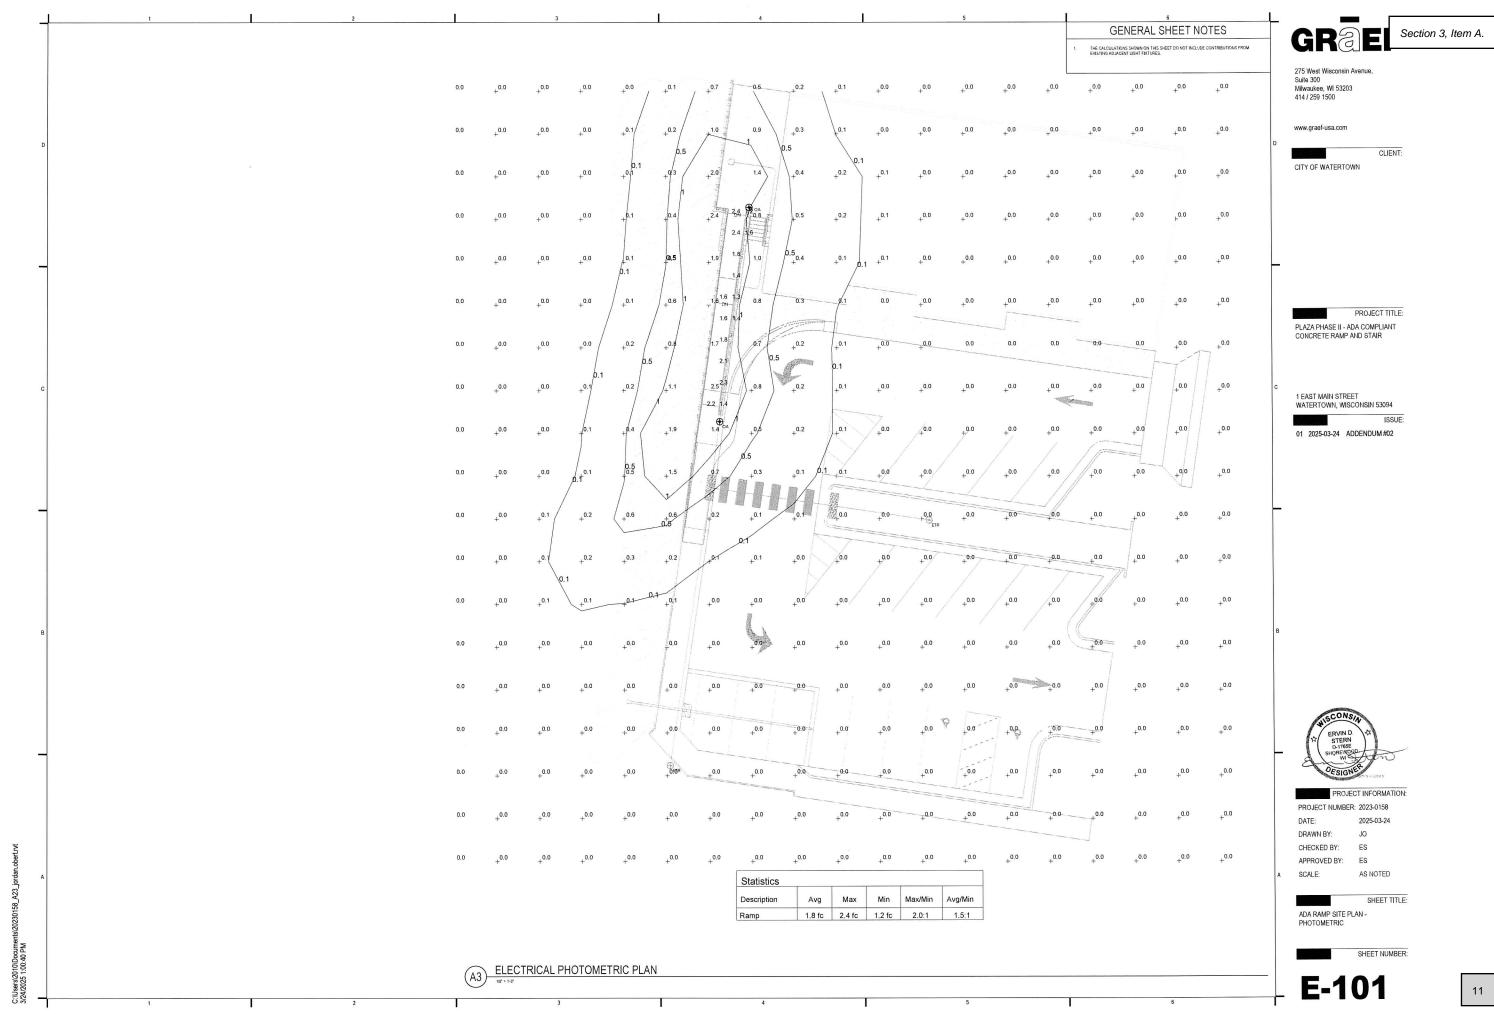

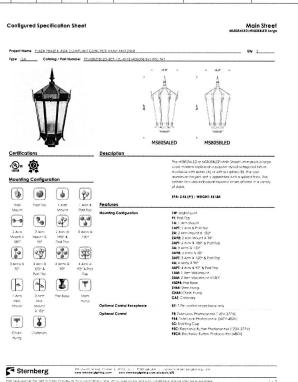

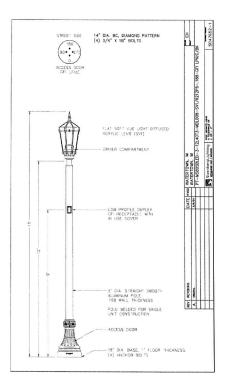

#### LIGHT FIXTURE SCHEDULE ABBREVIATIONS

NOTE: NOT ALL ABBREVIATIONS INDICATED HERE ARE USED IN THE SCHEDULE AND MAY NOT APPLY TO CURRENT PROJECT.

#### ACCESSORIES / DOOR / REFLECTOR / TRIM TYPE

ACCESSORIES DODOR REFLECTOR 7 TRIM.

8 - ASYMETRIC

8 - BAFFLE FERLECTOR

C - CONTRIVOUS BIN

D - DIRECT

DD - DOUBLE CASYFETE DOOR FRAME

DD - DOUBLE CASYFETE DOOR FRAME

DO - DOUBLE CASYFETE DOOR FRAME

S - STAMLESS STEEL TRIM AND DOOR STEEL TRIM STEEL

#### COLOR / FINISH

#### **DIMMING TYPE**

0-10-0,1 = 0-10 V 0,1%
0-10-1 = 0-10 V 1%
0-10-1 = 0-10 V 1%
0-10-10 = 0-10 V 10%
0-10-10 = 0-10 V 10%
0-10-10 = 0-10 V 10%
E = BILEVEL / SEP
E = ELDOLED
E = ELDOLED
D = DALI
D = DALI
D = DALI
D = DALI
L = LUTRON
N = NONE
O = 0SRAM
P = PHASE
RF = REVERSE PHASE

#### DRIVER LOCATION

I = INTEGRAL N = NONE R = REMOTE

#### LENS TYPE

G - CLEAR
D - BRIDD DOWN
H
N - NORE
R - REGRESSED
O - GPAL
P - POTTERN 12 ACRYLIC LENS - . 125' MINMUM THICKNESS
PA - PATTERN 12 ACRYLIC LENS - . 125' MINMUM THICKNESS

#### REQUIRED LISTINGS

## = IP ## RATED
AT = AIR TIGHT
C#D# = CLASS # DIVISION
DL = DAMP LOCATION
F = FIRE RATED
IC = ICRATED
IR = IMPACT RESISTANT
LR = LIGATURE RESISTANT
IR = TAMPER RESISTANT
WL = WHO LOCATION
WE = VANDAL RESISTANT
WL = WET LOCATION

#### MOUNTING MATERIAL

B = BRICK
C = CONCRETE BASE
DW = DRYWALL
ES = EXPOSED STRUCTURE
G = GROUND.
IG = LAY-H ORID
M = WETAL
S = STORE
T = TILE
Y = WARIES
W = WOOD

## MOUNTING TYPE

MOUNTING TITE

C + COVE

C + COVEN - PROVIDE ACCESSORY NIT

C + CATENARY

MP - MOROPOINT

MP - PERDAMI - HIGH STEP

PS - PERDAMI - HIGH STEP

PS - PERDAMI - SWAG

PO + POLE

TO - FTRACK - MOROPAIL - CLEYED

TO - TRACK - AMOROPAIL - FLESHEE

MF - MANUAL - MOROPAIL - STRAIGHT

MF - MANUAL - MOROPAIL -

#### SENSOR TYPE

D = DAYLIGHT SENSOR MO = MULTI-LEVEL OCCUPANCY SENSOR N = NONE O = OCCUPANCY SENSOR P = PHOTOCELL



Section 3, Item A.

275 West Wisconsin Avenue, Suite 300 Milwaukee, WI 53203 414 / 259 1500

#### www.graef-usa.com

CLIENT: CITY OF WATERTOWN

PROJECT TITLE:

PLAZA PHASE II - ADA COMPLIANT CONCRETE RAMP AND STAIR

1 EAST MAIN STREET WATERTOWN, WISCONSIN 53094

ISSUE:

01 2025-03-24 ADDENDUM#02

PROJECT INFORMATION

PROJECT NUMBER: 2023-0158 DATE: 2025-03-24

DRAWN BY: JO CHECKED BY: ES APPROVED BY: FS

SCALE: AS NOTED

SHEET TITLE: ELECTRICAL SCHEDULES

E-601

WORK INCLUDED IN CONTRACT
UPINTION OF ANY ARTICLE, OPERATION OR METHOD REQUIRES THA COMPACTOR SHALL PROVING SAME AND PERFORM EACH OPERATION COMPACTOR SHALL PROVING STATED COMPACTOR SHALL DO STREAMED SHALL PROVINGE ALL MATERIAL LARGE EQUIPMENT, AND TRANSPORTATION AS PROVINGE ALL MATERIAL LARGE EQUIPMENT AND TRANSPORTATION AS PROCESSARY TO COMPLETE PROJECT IN COMPLIANCE WITH CONTRACT DOCUMENTS IN REGIERAL WORK INCLUDES DEPETYTHING SSSENTIAL FOR COMPLETE ELECTRICAL SYSTEM IN OPERATING CROPE AS SHOWN ON DEPAYINGS AND MOCKET DISSPERIED FOR THE SHOWN ON DEPAYING AND MOCKET DISSPERIED FOR THE SHOWN ON DEPAYINGS AND MOCKET DISSPERIED FOR THE SHOWN ON DEPAYING AND MOCKET.

EXPENSIVE ALTERNATIVE

# BIDDING PROCEDURES BASE BID SHALL INCLUDE ALL LABOR, MATERIALS AND EQUIPMENT AS SHOWN ON CONSTRUCTION DRAWINGS AND AS REQUIRED AND SPECIFIED.

BASE BID SHALL NOT INCLUDE ANY CONDITIONS OR QUALIFYING STATEMENTS

PERMITS AND LICENSES

CONTRACTOR SHALL PREPARE AND SUBMIT REQUIRED APPLICATIONS AND DRIMMINGS FOR ALL CONSTRUCTION PERMITS AND APPROVALS TO AUTHOR DRAWINGS FOR ALL CONSTRUCTION PERMITS AND APPROVALS TO AUTHORITIE HAWNG JURISDICTION OVER PROJECT. ALL LICENSES AND PERMITS REQUIRED SHALL BE SECURED AND PAID FOR BY CONTRACTOR AND SHALL BE SECURED THE CONTRACTOR BEFORE STAFTING WORK.

MATERIALS SHALL HAVE UL OR ETL LABEL WHERE UL OR ETL STANDARD AND / OR TEST EXISTS

ALL EQUIPMENT SHALL BE INSTALLED IN ACCORDANCE WITH RECOGNIZED INDUSTRY STANDARDS AND SHALL FOLLOW EQUIPMENT MANUFACTURER'S PUBLISHED INSTRUCTIONS.

## MATERIALS AND EQUIPMENT MATERIALS AND EQUIPMENT REQUIRED SHALL BE NEW, UNLESS OTHERWISE

EQUIPMENT SUPPLIED SHALL BE BASED ON MATERIALS AND EQUIPMENT OF MANUFACTURERS SPECIFIED. NO SUBSTITUTIONS WILL BE ALLOWED.

SUBMITIALS
THE FOLLOWING EQUIPMENT SHALL BE SUBMITTED FOR REVIEW AND APPROVAL
BY THE ENGINEER
LIGHTING CONTROL DEVICES

CLEANING AND PAINTING
RUBBISH RESULTING FROM WORK SHALL BE REMOVED AND DISPOSED OF ON
DALY BASIS IN SUCH MANNER AS TO BE ACCEPTABLE TO CANNER

CONTRACTOR SHALL CLEAN ALL EXPOSED IRON WORK, INTERIOR AND EXTERIOR OF CARINETS AND PULL BOXES, ETC.

WHERE PAINTED SURFACES OF EQUIPMENT HAVE BEEN DAMAGED OR RUSTED DURING CONSTRUCTION. CONTRACTOR SHALL PAINT SAME TO MATCH FINAL.

# TESTS AND ACCEPTANCE OPERATION OF EQUIPMENT AND ELECTRICAL SYSTEMS DOES NOT CONSTITUACCEPTANCE OF WORK SY OWNER, FINAL ACCEPTANCE IS TO BE MADE AFTE CONTRACTOR HAS ADJUSTED HIS EQUIPMENT AND DEMONSTRATED THAT IT FULFILLS REQUIREMENTS OF DRAWINGS AND SPECIFICATIONS.

LIPON COMPLETION OF INSTALLATION, CONTRACTOR SHALL FLIBNISH CERTIFICATES OF APPROVAL AND OCCUPANCY PERMITS FROM AUTHORITIES HAWNS, CHARSCHIN, CONTRACTOR SHALL DEDOKSTRISTE THAT ALL MODING CONDITION, WITH PINCEDAY AND CONDITION STEEL AND IN PERSPECT DEPARTING CONDITION, WITH PINCEDAY AND CONDUST SHATE PROPERTY REPORTION WITHOUT SHEEP CONDITION, SHORTS, AND ENTIFIE INSTALLATION IS FREE FROM ANY PHYSICAL DEFECTS.

IN PRESENCE OF ENGINEER AND OWNER, CONTRACTOR SHALL DEMONSTRATE PROPER OPERATION OF ALL SYSTEMS.

## UNLESS OTHERWISE INDICATED, ALL WORK SHALL BE GUARANTEED FOR A MINIMUM OF ONE (1) YEAR AFTER DATE OF FINAL ACCEPTANCE

DEFINITIONS A/E - ARCHITECT AND / OR ENGINEER

PROVIDE - FURNISHED, INSTALLED, AND COMPLETELY WIRED AND CONNECTED BY ELECTRICAL CONTRACTOR

NEC - NATIONAL ELECTRICAL CODE

CONTRACTOR - PERSON OR GROUP RESPONSIBLE FOR PROJECT

#### ELECTRICAL SERVICE AND DISTRIBUTION

PROVIDE TEMPORARY SERVICE IN AREAS OF CONSTRUCTION FOR ALL TRADES.

EXISTING PERMANENT SERVICE SHALL REMAIN IN PLACE. NEW FEEDERS AND CIRCUIT BREAKER SHALL BE PROVIDED IN ACCORDANCE WITH DRAWINGS.

GROUNDING SHALL BE IN ACCORDANCE WITH ALL CODES.

CONTRACTOR TO PROVIDE ALL ARC FLASH LABELING ON ELECTRICAL COURMENT AS REQUIRED BY NFPA TOE, STANDARD FOR ELECTRICAL SAFETY IN THE WORKPLACE

PRODUCTS
ALL GROUNDING CONDUCTORS SHALL BE COPPER.

GROUND RODS SHALLBE COPPER-CLAD STEEL,  $\mathbb{N}^{\circ}$  DAAMETER,  $\mathbb{N}^{\circ}$  LONG.

NEUTRAL CONDUCTORS. WHITE, WHEN TWO OR MORE NEUTRALS ARE LOCATED IN ONE CONDUIT, INDIVIDUALLY IDENTIFY EACH WITH PROPER CIRCUIT NUMBER. MECHANICAL CONNECTIONS SHALL BE MADE WITH EXDTHERMIC WELDS OR WITH MECHANICAL CONNECTORS AT THE CONTRACTOR'S OPTION. MECHANICAL CONNECTORS SHALL BE BRONZE AND SHALL BE IRREVERSIBLE.

GROUND BUSSES SHALL BE 114" THICK BY 2" HIGH IN CROSS SECTION, LENGTHS AS INDICATED ON THE PLANS PRODUCTS
METAL CONDUIT:
RIGID METAL CONDUIT (RMC).

EXECUTION
REMOVE SURFACE CONTAMINANTS AT ALL CONNECTION POINTS.

GROUND ELECTRICAL SYSTEMS AND EQUIPMENT AS REQUIRED BY THE NEC, THE LOCAL UTILITY, AND LOCAL ORDINANCES.

PROVIDE SEPARATE GROUNDING CONDUCTOR WITH EACH FEEDER CONDUIT AND BRANCH CRCUIT CONDUIT. DO NOT RELY ON NETTA, RACEWAY AS THE SOLE EQUIPMENT GROUND FOR ELECTRICAL CIRCUITS. BOND GROUND CONDUCTOR AT BOTH ENDS OF RACWAYS WITH BOLTED GROUNDING LUGS.

#### FIRMLY ATTACH GROUNDS BEFORE CIRCUITS ARE ENERGIZED.

#### ELECTRICAL WIRING METHODS

BUILDING WIRE AND CABLE

PRODUCTS SINGLE CONDUCTOR INSULATED WIRE.

CCEPTABLE WIRING METHODS SHALL BE INDIVIDUAL CONDUCTORS IN CIRCULAR RACEWAYS. EXCEPTIONS ARE AS FOLLOWS. LUAR PACCHAVYS EXCEPTIONS ARE AS POLLOWS CONDUCTORS FOR SYSTEM RATE 93 YOU, IS NO LESS AND ROUTED IS AFFOR HOME OF SYSTEM RATE 93 YOU, IS NO LESS AND ROUTED AFFOR HOME RESEARCH DON'S TELECOMOUGHOUR PROPERTY IN UNROSSED DEVELOR PROPERTY OF THE SECRETION SHALL HAW INSULATION RATINGS COMPLANT WITH THE PREPAYENT IN THE CONDUCTIONS WESTELD UNDER THIS EXCEPTION SHALL HAW INSULATION RATINGS COMPLANT WITH THE PACE PROPRYILE TO THE CONDUCTIONS WHERE THE CONDUCTORS ARE LOCATED.

NOUCTORS FOR SYSTEMS RATED 50 VOLTS AND LESS AND ROUTED DVE ACCESSIBLE CELLINGS CONCEALED FROM VIEW MAY BE INSTALLED IN FREE AIR WITHOUT RACEWAYS AT THE CONTRACTOR'S OPTION

SOUD OR STRANDED CONDUCTOR FOR #10 AWG AND SMALLER, CONDUCTOR #8 AWG AND LARGER SMALL RESTRANDED.

INSULATION VOLTAGE RATING: 600 VOLTS, RATED 75" CELSIUS, UNLESS OTHERWISE INDICATED.

EXTERIOR LOCATIONS: USE ONLY BUILDING WIRE TYPE THW, OR USE INSULATION

WIRING CONNECTORS FOR CONDUCTORS #8 AWG AND LARGER SCLIDERLESS.

RUBBER INSULATING ELECTRICAL TAPE: SCOTCH 3M MODEL 23, 30-MIL TAPE.

CONDUCTOR SHALL NOT BE SMALLER THAN #14 AWG FOR CONTROL CIRCUITS.

ALL WIRES SHALL BE NEW, DELIVERED TO SITE IN UNBROKEN CARTONS, AND SHALL BE LESS THAN ONE YEAR OLD OUT OF MANUFACTURER'S STOCK.

DO NOT DRAW CONDUCTORS INTO CONDUITS UNTIL BUILDING IS ENCLOSED AND WATERTIGHT AND UNTIL WORK THAT MAY CAUSE CONDUCTOR DAMAGE HAS

EACH TAP JOINT, OR SPLICE IN CONDUCTORS 48 AWG AND LARGER SHALL BE TAPED WITH TWO HALF-LAP LAYERS OF VINYL PLASTIC ELECTRICAL TAPE AND FINISH WRAP OF COLOR CODING TAPE. WHERE REQUIRED BY THE NEC OR LOCAL CODES

CABLE SPLICES SHALL BE MADE ONLY IN DISTRIBUTION AND JUNCTION BOXES

NEATLY TRAIN AND BUNDLE WRING INSIDE BOXES, EQUIPMENT, AND PANELBOARDS.

COMPRESSION TYPE CONNECTORS, TOOL AND DIE APPLED, OF TYPE THAT WILL NOT LOOSEN UNDER VIBRATION OR NORMAL STRAINS, BURRIDY "HY-DENT" TYPE OR EQUIVALENT. SPLIT BOLT CONNECTORS ARE NOT ACCEPTABLE.

REVIEW PLANS OF OTHER TRADES AND IDENTIFY ANY AIR-HANDLING REVIEW PLANS OF OTHER TRADES AND IDENTIFY ANY AIR-ANGUING PLENUMS. CONDUCTORS INSTALLED UNDER THIS EXCEPTION SHALL HAVE INSULATION RATINGS COMPILANT WITH THE NEC, APPROPRIAT TO THE CONDITIONS WHERE THE CONDUCTORS ARE LOCATED.

EXTERIOR OUTLET BOXES SHALL BE CAST FERRALLOY, TYPE FD, CAST FERALLOY, FURNISH GASKETED COVER BY BOX MANUFACTURER. WHERE SPECIFICALLY INDICATED OTHERWISE ON THE DRAWINGS

## EXECUTION MINIMUM RACEWAY SIZE: 34". UNLESS OTHERWISE INDICATED.

SPLIT CRUSHED OR SCARRED CONDUIT IS NOT ACCEPTABLE. WELDED CONDUIT IS NOT ACCEPTABLE.

RACEWAY AND BOXES LOCATED AS INDICATED ON DRAWINGS, AND AT OTHER RACEWAY AND BOXES ARE SHOWN IN APPROXIMATE LOCATIONS U DIMENSIONED, PROVIDE RACEWAY TO COMPLETE WIRING SYSTEM

AULTIWIRE BRANCH CIRCUITS ARE NOT PERMITTED. EACH BRANCH CIRCU SHALL CONTIAN A DEDICATED NEUTRAL CONDUCTOR FOR EACH PHASE CONDUCTOR. A SINGLE NEUTRAL SHARED BETWEEN MULTIPLE PHASE CONDUCTORS ARE NOT PERMITTED.

INSTALL WIRE COLORS IN ACCORDANCE WITH FOLLOWING: BLACK AND RED FOR SINGLE PHASE CIRCUITS AT 120/240 VOLTS.

RACEWAYS AND BOXES

INTERMEDIATE METAL CONDUIT (IMC)

ELECTRICAL METALLIC TUBING (EMT).

SET SCREW STYLE FASTENERS.

RATED FOR 90° CELSIUS CARLE

DO NOT USE ALUMINIAN OR DIE CAST FITTINGS

BLACK, RED, AND BLUE FOR CIRCUITS AT 120 / 208 VOLTS SINGLE OR

METAL CONDUIT FITTINGS (BOX TERMINATORS AND COUPLINGS): STEEL OR MALLEABLE (RON, ZINC GALVANIZED, OR CADMILM PLATED.

BOX CONNECTORS SHALL HAVE NON-METALLIC INSULATED THROATS.

LICUID-TIGHT FLEXIBLE METAL CONDUIT (LFMC).
INTERLOCKED STEEL CONSTRUCTION WITH PVC SUNLIGHT RESISTAN
JACKET

PRODUCT DESCRIPTION: NEMA TC 2: SCHEDULE 40 OR 60 PVC, ULLISTED. AND AS REQUIRED BY NEC. SUNLIGHT RESISTANT.

FITTINGS AND CONDUIT BODIES: NEMA TC 3, SCHEDULE 40 OR 80, TO MATCH

INTERIOR OUTLET BOXES SHALL BE GALVANIZED STAMPED STEEL WITH PRE-PURCHED KNOCK OUTS. SIZE SHALL BE 4-11H6" SQUARE, 2-1/2 DEEP WINAUUN.

INDERGROUND (OUTSIDE) MORE THAN 5'-0" OUTSIDE FOUNDATION WALK PROVIDE SCHEDULE 40 NON-METALLIC CONDUIT, UNLESS OTHERWISE

ACCEPTABLE INSULATION TYPES:
CONCEALED OR EXPOSED DRY INTERIOR LOCATIONS, USE CRILY BUILDING
WIRE TYPE THW, THINN / THINN OR XHHW INSULATION UNDERGROUND (OUTSIDE) WITHIN 5 /7 FROM FOUNDATION WALL TO INSIDE OF BULDING PROVIDE RIGID STEEL CONDUIT, ONCE INSIDE BULDING PROVIDE STEEL CONDUIT, ONCE INSIDE BULDING PROVIDE STEEL CONDUIT, ONCE INSIDE RIGID.

PROSING BELOW GROUPE THROUGH BULDING FOUNDATION WALLS. UTILIZE LINK SEAL TYPE GASKETS OR COUNTAINT. WET OR DAMP INTERIOR LOCATIONS, USE ONLY BUILDING WIRE TYPE THW

WET, DAMP, AND OUTDOOR LOCATIONS, PROVIDE RIGID STEEL CONDUIT PROVIDE CAST METAL JUNCTION AND PULL BOXES.

UNDERGROUND LOCATIONS; USE ONLY BUILDING WIRE TYPE THIN, OR USE INSULATION. MIRING CONNECTORS FOR CONDUCTORS #10 AWG AND SMALLER. 3M SCOTCH-LOK COMPRESSION TYPE SOLDERLESS CONNECTORS WITH PLASTIC CUTER SUPPORT RACEWAY USING TWO-HOLE MALLEABLE IRON STRAPS, LAY-IN ADJUSTABLE HANGERS, CLEVIS HANGERS, OR SPLIT HANGERS. PROVIDE LI GAUGE STEEL FRAMING FOR RACEWAY TRAPEZE HANGERS OR FOR OTHER RACEWAY SUPPORT AS REQUIRED.

SECURE CONDUITS IN PLACE WITH MALLEABLE CORROSION-PROOF ALLOY STRAPS OR HANGERS, CONDUIT STRAPS USED IN CORROSIVE AREAS SHALL B PVC COATED.

DO NOT SUPPORT RACEWAY WITH WIRE OR PERFORATED PIPE STRAPS. REMOVE WIRE USED FOR TEMPORARY SUPPORTS.

EXECUTION CONDUCTOR SHALL NOT BE SMALLER THAN \$12 AWG FOR POWER AND LIGHTING

ROUTE INTERIOR RACEWAYS PARALLEL WITH OR PERPENDICULAR TO WALLS. CEILINGS, AND OTHER PRIMARY ARCHITECTURAL AND STRUCTURAL ELEMENTS.

OUT CONDUIT SQUARE USING SAW OR PIPE CUTTER: DE-BURR CUT ENDS. BRING CONDUIT TO SHOULDER OF FITTINGS. FASTEN SECURELY. JOIN NON-METALLIC CONDUIT USING CEMENT AS RECOMMENDED B MANUFACTURER. WIPE NON-METALLIC CONDUIT DRY AND CLEAN BI

JOINING, APPLY FULL EVEN COAT OF CEMENT TO ENTIRE AREA INSERTED IN FITTING, ALLOW JOINT TO CURE FOR MINIMUM 20 MINUTES. INSTALL CONDUIT HUBS TO FASTEN CONDUIT TO CAST BOXES IN DAMP AND WET

INSTALL NO MORE THAN EQUIVALENT OF THREE (3) 50 DEGREE BENDS BETVIEEN BOXES

INSTALL CONDUIT BODIES TO MAKE SHARP CHANGES IN DIRECTION, AS AROUND BEAMS.

SIZE CONDUIT, OUTLET BOXES, AND OTHER RACEWAY SYSTEM COMPONENTS IN ACCORDANCE WITH NEC REQUIREMENTS AS MINIMUM. INSTALL HYDRAULIC ONE-SHOT BENDER TO FABRICATE OR FACTORY ELBOWS FOR BENDS IN METAL CONDUIT LARGER THAN 2' SIZE.

AVOID MOISTURE TRAPS: INSTALL JUNCTION BOX WITH DRAIN FITTING AT LOW-

CONDUIT RUNS THAT EXTEND THROUGH AREAS OF DIFFERENT TEMPERATURE OR ATMOSPHERIC CONDITIONS OR THAT ARE PARTLY INDOORS AND PARTLY OUTCOORS SHALL BE SEALED DRAWED, AND INSTALLED IN MANKET THAT WILL PREVENT DRAWLOF OF COMPENSED OR ENTAPPED MOSTURE INTO CABINETS MOTORS, OR EQUIPMENT ENCLOSURES.

CONDUIT CONNECTIONS AT MOTORS AND OTHER EQUIPMENT THAT VIBRATES: PROVIDE LIQUID-TIGHT FLEXIBLE METAL CONDUIT

USE DOUBLE LOCKNUTS AND INSULATED BUSHINGS WITH THREADS FULLY

EXTERIOR UNDERGROUND DIRECT RURIED COMDUITS SHALL REPURIED AT DEPTH OF NOT LESS THAN 30' BELOW GRADE UNDERGROUND CONDUITS SHALL SLOPE 18" PER POOT FOR PROPER DRAINAGE. CONDUITS SHALL DRAIN TOWARD MANHOLES AND JUNCTION BOXES. CONDUITS SHALL NOT PITCH TO ELECTRICAL

INSTALL KNOCKOUT CLOSURES IN UNUSED OPENINGS IN BOXES

CLEAN EXPOSED SURFACES AND RESTORE FINISH FLECTRICAL RECEPTACLES

PROVIDE ALL WIRING DEVICE TYPES FROM A SINGLE MANUFACTURER.

FOR BIDDING PURPOSES, DEVICE COLOR AND DEVICE COVER PLATES IN FINISHED AREAS SHALL BE WHITE. VERIFY COLOR AND MATERIAL OF EXISTING DEVICES AND COVER PLATES AND PROVIDE NEW PLATES TO MATCH EXISTING

ARROW-HART, NO.

ACCEPTABLE MANUFACTURERS ARE:

PASS & SEYMOUR/LEGRAND

PICATION GRADE, 20 AMP DUPLEX. 125 VOLT, NEMA 5-20P HBL53CM62

GFCI RECEPTACLE: HEAVY DUTY: SPECIFICATION GRADE, SELF-TESTING, 20 AMP, 125 VOLT, NEMA S-20R. UL 2006 COMPLIANT, HUBBELL CAT. NO.

WEATHER-RESISTANT GFCI: EXTRA HEAVY-DUTY GRADE, 20 AMP DUPLEX. 125 VOLT, NEMA 5-20R, UL 2006 COMPLIANT, HUBBELL CAT, NO. GFR5362.

WEATHERPROOF COVERPLATE: GASKETED DIE CAST METAL PLATE WITH HINGED MAND GASKETED DEVICE COVERS, COVER SHALL ALLOW CORDS TO BE PLUGGED IN AND GOVER CLOSED, PROVIDE INTERNATIC CPHONOIC FOR SHOLLE DUPLEX RECEPTACLES OR WPHOMOIC FOR DOUBLE (QUAD) DUPLEX RECEPTACLES.

#### EXECUTION

INSTALL RECEPTACLES WITH GROUNDING POLE ON TOP.

CONNECT WIRING DEVICE GROUNDING TERMINAL TO OUTLET BOX WITH BONDING JUMPER AND BRANCH CIRCUIT FOURMENT GROUNDING CONDUCTOR

IN UNFINISHED AREAS MOUNTED OUTLETS. DO NOT USE TERMINALS ON WIRING DEVICES (HOT OR NEUTRAL) FOR

CONNECTIONS VIA WIRE CONNECTIONS AND PIGTALS.

PROVIDE A LAYER OF ELECTRICAL TAPE AROUND PERIMETER SIDES OF EACH
WRING DEVICE SO THAT TERMINATIONS ARE INSIDENTED.

WHERE GFI PROTECTED RECEPTACLES ARE INDICATED ON DRAWINGS, EACH RECEPTACLE, INDICATED SHALL BE A GFI RECEPTACLE. STANDARD RECEPTACLES PROTECTED WITH AN UPSTREAM GFI RECEPTACLE SHALL NOT BE

VERIEV FACH RECEPTACI E DEVICE IS ENERGIZED

TEST EACH RECEPTACLE DEVICE FOR PROPER POLARITY

TEST EACH GFCI RECEPTACLE DEVICE FOR PROPER OPERATION PLATE WITH A PERMANENT FRONT OF PLATE

#### LIGHTING FIXTURES

LIGHT FIXTURES WITH INTEGRAL LED'S SHALL BE PROVIDED WITH THE FOLLOWING COLOR CHARACTERISTICS. SEE LIGHTING FIXTURE SCHEDULE FOR NY EXCEPTIONS. LED'S WITH A COLOR RENGERING INDEX OF 80 OR HIGHER

## EXECUTION WHERE LAMPS ARE NEEDED, PROVIDE FIXTURES COMPLETE WITH INITIAL FILL OF LAMPS AS SCHEDULED. PROVIDE BALLASTS AS SPECIFIED.

CONTRACTOR SHALL VERIES CEILING CONSTRUCTION PRIOR TO ORDERING

CONTRACTOR SHALL NOTIFY THE ENGINEER OF ANY EXISTING CODE VIOLATIONS
OBSERVED DURING THE COURSE OF PERFORMING HIS WORK. THE ENGINEER
WILL DECIDE IF CORRECTIVE ACTION NEEDS TO BE TAKEN, CORRECTIVE ACTIONS THAT CHANGE THE SCOPE OF THE WORK WILL BE CONSIDERED A CHANGE ORDER AND WILL BE PROCESSED ACCORDINGLY.

EXISTING BUILDINGS SHALL REMAIN IN SERVICE DURING CONSTRUCTION

PRIOR TO DEMOLITION OR ALTERATION OF STRUCTURES, THE FOLLOWING SHALL BE ACCOMPLISHED: LL BE ACCOMPLISHED: OWNER RELEASE OF SUCH STRUCTURE.

DISCONNECTION OF ELECTRICAL POWER TO EQUIPMENT AND CIRCUITS REMOVED OR AFFECTED BY DEMOLITION WORK.

ELECTRICAL SERVICES REPOUTED OR SHUT OFF OUTSIDE AREA OF DEMOLITION.

COORD NATE SEQUENCING WITH OWNER AND OTHER CONTRACTORS. SURVEY AND RECORD CONDITION OF EXISTING FACILITIES TO REMAIN IN PLACE THAT MAY BE AFFECTED BY DEMOLITION OPERATIONS.

POWER OUTAGES AND INTERRUPTIONS IN BUILDING SYSTEMS SHALL BE HELD TO A MINIMUM AID SHALL BE DONE AT A TIME CONCEINENT TO GYMERE TIME OF ALL OUTAGES SHALL BE SCHEDULED WITH OWNER AND ALL OTHER TRADES AFFECTED BY OUTAGE AT LEAST TEN WORKING DAYS IN ADVANCE.

IDENTIFY SALVAGE ITEMS IN COOPERATION WITH OWNER, OWNER MAY KEEP ANY EQUIPMENT IN DENCLITION AREAS, CONTRACTOR SHALL DELIVER COUPMENT OMNER WAITS SALVAGED TO AREA IN BUILDING DESIGNATED BY OWNER, CONTRACTOR SHALL REMOVE ALL MATERIALS IN DEMOLISHED AREA NOT SALVAGED FROM ITE CONTRACTOR SHALL OBTAIN RELEASE OF ALL MATERIALS BEFORE DISPOSITION.

REMOVE ABANDONED CONDUIT, INCLUDING ABANDONED CONDUIT ABOVI ACCESSIBLE CHLINGS CUT CONDUIT CAST INTO CONCRETE STRUCTURE FLUSH WITH WALLS AND FLOORS. PATCH SURFACES AROUND CONDUITS

REMOVE CONDUIT, WIRE, BOXES, AND FASTENING DEVICES TO AVOID ANY INTERFERENCE WITH NEW INSTALLATION

DE-ENERGZE AND DISCONNECT ELECTRICAL SYSTEMS IN WALLS, FLOORS, AND CEILINGS SCHEDULED FOR REMOVAL.

REMOVE, RELOCATE, AND EXTEND EXISTING INSTALLATIONS TO ACCOMMODATE NEW CONSTRUCTION

AND SUPPORTS, AND ELECTRICAL IDENTIFICATION COMPONENTS, INCLUDING ABANDONED COMPONENTS ABOVE ACCESSIBLE CEILINGS. CUT FURFIORD SUPPORT FLEWENTS FLUSH WITH WALLS AND FLOORS

FEEDERS, BRANCH CIRCUITS, AND OTHER SYSTEM WIRING WHICH ARE TO REMAIN IN SERVICE BUT WHICH ARE PRESENTLY ROUTED THROUGH AREAS BEING DEMOUSHED SHALL BE REROUTED AROUND DEMOUTION AREA

WHERE EXISTING BRANCH CIRCUITS ARE TO BE EXTENDED OR MODIFIED, EXISTING COMDUIT THAT HAS NOT BEEN REMOVED MAY BE REUSED AT CONTRACTORS DISCRETION, ENSITING COMDUITS THAT ARE REMOVED FROM THERE EXISTING LOCATION SHALL NOT BE REUSED.

EXISTING WIRING MAY BE SPLICED AND USED TO EXTENT THAT IT WAS NOT REMOVED. EXISTING CONDUCTORS THAT HAVE BEEN REMOVED SHALL NOT BE REJISSED.

REMOVE AND PROTECT ITEMS REQUESTED BY OWNER TO BE SALVAGED AND TRANSPORT TO LOCATION ON SITE DESIGNATED BY OWNER.

CONTRACTOR SHALL TOUR DEMOLITION AREAS WITH OWNER TO DETERMINE STATUS OF ALL EQUIPMENT TO BE REMOVED DURING DEMOLITION. ALL EQUIPMENT THAT IS TO BE SALVAGED FOR REUSE BY THE OWNER SHALL BE REMOVED BY CONTRACTOR AND TRANSPORTED TO AN OWNER DESIGNATED STORAGE AREA ON SITE.

REMOVED EQUIPMENT SHALL BE DISPOSED OF BY CONTRACTOR UNLESS SPECIFICALLY OTHERWISE INDICATED ON DRAWINGS OR REQUESTED BY OWNER CONTRACTOR SHALL PROVIDE TRANSPORT FOR DISPOSAL.

MAY MAZABOONE MAZEDIALS DEMONED EDGAL SEDVACE AS DADT OF THE ANY HAZARDOUS MATERIALS REMOVED FROM SERVICE AS PART OF THIS PROJECT SHALL BE DISPOSED OF BY THE ELECTRICAL CONTRACTOR IN COMPLETE COMPLIANCE WITH ALL FEDERAL, STATE, AND LOCAL ENVIRONMENTAL LAWS. EXAMPLES OF SUCH MATERIALS WOULD INCLUDE LIGHT FIXTURE LAWS, MID LIGHT FIXTURE BALLASTS THAT CONTAIN REGULATED

REFER TO ARCHITECTURAL DEMOLITION PLANS FOR ADDITIONAL WORK, SUCH AS PAINTING, THAT WOULD REQUIRE THE ELECTRICAL CONTRACTOR TO MASK. TAPE, OR OTHERWISE PROTECT EXISTING ELECTRICAL ITEMS NOT SCHEDULED



Section 3. Item A.

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CLIENT CITY OF WATERTOWN

PROJECT TITLE:

PLAZA PHASE II - ADA COMPLIANT CONCRETE RAMP AND STAIR

1 FAST MAIN STREET WATERTOWN, WISCONSIN 53094

ISSUE

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STERN D-1765E

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AS NOTED

SHEET NUMBER:

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