

SITE PLAN REVIEW COMMITTEE MEETING AGENDA

MONDAY, JANUARY 22, 2024 AT 1:30 PM

COUNCIL CHAMBERS, SECOND FLOOR, MUNICIPAL BUILDING, 106 JONES STREET, WATERTOWN, WI 53094

By Phone or GoToMeeting: Members of the media and the public may attend by calling: (Toll Free): 1 866 899 4679 **Access Code:** 621-359-093 or https://meet.goto.com/621359093 All public participants' phones will be muted during the meeting except during the public comment period.

1. CALL TO ORDER

2. APPROVAL OF MINUTES

A. Review and take action: Site Plan Review minutes dated November 13, 2023

3. BUSINESS

- A. Review and take action: 806 R Elm Street heated storage shed
- B. Review and take action: 621 Bernard Street site plan for new fire station

4. ADJOURNMENT

Persons requiring other reasonable accommodations for any of the above meetings, may contact the office of the City Clerk at mdunneisen@watertownwi.gov, phone 920-262-4006

A quorum of any City of Watertown Council, Committee, Board, Commission, or other body, may be present at this meeting for observing and gathering of information only

Section 2. Item A.

SITE PLAN REVIEW COMMITTEE November 13, 2023

The Site Plan Review Committee met on the above date at 1:30 P.M. in the Council Chambers on the second floor of City Hall. The following members were present: Brian Zirbes of Building, Safety & Zoning; Maureen McBroom of Engineering and Stormwater Utility; Stacy Winkelman of the Street Department; Mike Zitelman of the Water/Wastewater Department; Strategic Initiatives and Development Coordinator Mason Becker; Doug Zwieg of Building, Safety & Zoning; and Anthony Rauterberg of the Fire Department. Also in attendance were Nikki Zimmerman, and G. R. Lyons of Lycon, Inc.

1. Call to Order

The meeting was called to order by Chairperson Brian Zirbes.

2. Approval of Minutes

A. Review and take action: Site Plan Review Minutes Dated September 11, 2023

Motion was made by Doug Zwieg and seconded by Anthony Rauterberg to approve the September 11, 2023 Site Plan Review minutes as submitted. Unanimously approved.

3. Business

A. Review and take action: W6911 Silver Creek Road – Remodel of redi-mix plant and construction of aggregate storage building

G. R. Lyons was present to explain the proposal to the committee members. The current plant is old and needs to be updated. The updates and the addition of an aggregate storage area will assist in meeting DNR standards, keeping items more easily accessible throughout the year, cut down on noise and dust, and will make the site more aesthetically pleasing.

The following was presented by staff:

Building: Submit a building permit with plans.

Fire: Ensure a Knox Box is installed.

Eng/Stormwater: With no new impervious area, there are no requirements that have to be met. Be sure to

adhere to post construction stormwater practices.

Streets: No comments.

Water/Wastewater: No comments.

Zoning: Lighting and landscaping plans have been submitted.

Motion was made by Doug Zwieg and seconded by Anthony Rauterberg to recommend approval of this proposal to Plan Commission with inclusion of the above comments.

Unanimously approved.

4. Adjournment

Motion was made by Maureen McBroom and seconded by Mike Zitelman to adjourn. Unanimously approved.

Respectfully submitted, Nikki Zimmerman Recording Secretary

NOTE: These minutes are uncorrected, and any corrections made thereto will be noted in the proceedings at which these minutes are approved.

HEATED STORAGE BUILDING WATERTOWN, WISCONS

OUTLINE SPECIFICATION

GENERAL CONDITIONS

THIS PLAN AND SPECIFICATION ARE INTENDED TO GIVE A DESCRIPTION OF THE WORK. HOWEVER, THE ALL CONTRACTORS SHALL VISIT THE SITE TO VERIFY EXISTING CONDITIONS AND ACCESS TO THE WORK AREA. THERE SHALL BE NO DEVIATIONS FROM THE PLANS AND SPECIFICATIONS WITHOUT THE WRITTEN CONSENT OF THE DESIGNER. THE CONTRACTOR IS TO CLARIFY ANY DISCREPANCIES WITH THE OWNER PRIOR TO BEGINNING WORK.

THE CONTRACTOR SHALL FURNISH ALL LABOR MATERIAL (INCLUDING TAXES) AND EQUIPMENT AS NECESSARY TO COMPLETE THE WORK. THE BUILDING PERMIT SHALL BE OBTAINED AND PAID FOR BY THE CONTRACTOR. ALL APPLICABLE FEDERAL, STATE AND LOCAL CODES, ORDINANCES AND REGULATIONS, INCLUDING THE REQUIREMENTS ANSI A117.1-2009 ARE HEREBY MADE A PART OF THESE SPECIFICATIONS AND SHALL BE COMPLIED WITH RELATIVE TO WORK UNDER THIS CONTRACT.

CONTACT "DIGGER'S HOTLINE" PRIOR TO ANY EXCAVATION WORK

REFERENCE TO MATERIALS OR SYSTEMS HEREIN BY NAME MAKE OR CATALOG NUMBER IS INTENDED TO ESTABLISH A STANDARD OF QUALITY AND STYLE, AND NOT TO LIMIT COMPETITION AND THE WORDS "OR APPROVED EQUIVALENT" ARE IMPLIED FOLLOWING EACH BRAND NAME, "OR APPROVED EQUIVALENT" MATERIALS SHALL BE APPROVED BY THE OWNER/DESIGNER PRIOR TO ACCEPTANCE FOR USE.

SHOP DRAWINGS FOR ALL STRUCTURAL ITEMS SHALL BE SUBMITTED TO THE DESIGNER FOR REVIEW. SHOP DRAWINGS AND SAMPLES FOR FINISHES AND NON-STRUCTURAL ITEMS ARE TO BE SUBMITTED TO THE OWNER FOR APPROVAL PRIOR TO INSTALLATION. ALL SHOP DRAWINGS SHALL BE REVIEWED AND STAMPED BY THE CONTRACTOR PRIOR TO SUBMITTING FOR APPROVAL.

DESIGN LIVE LOADS:

GROUND SNOW LOAD 30 PSF WIND LOAD 115 MPH MAIN FLOOR LIVE LOAD 250 PSF

<u>SITE WORK / EXCAVATION</u>

WORK TO PREPARE THE AREA FOR NEW FOUNDATIONS, CONCRETE APRONS AND FLOORS. NO TOPSOIL IS TO BE LEFT UNDER PAVED AREAS, BUILDING AREAS, OR FUTURE BUILDING AREAS. TOPSOIL IS THE PROPERTY OF THE OWNER; THE DISPOSAL OF SURPLUS IS TO BE DETERMINED BY THE OWNER. ANY OTHER UNSUITABLE MATERIAL WILL BE TRUCKED OFF THE SITE TO A SUITABLE DISPOSAL AREA.

PROVIDE EXCAVATION AND TRENCHING AS REQUIRED FOR FOUNDATION WORK AS SHOWN ON THE PLANS. ANY REQUIRED CUTS OR SUBSOIL EXCAVATION WILL BE ACCOMPLISHED TO MAINTAIN FINISH ELEVATIONS SHOWN. IMPORTED FILL TO BE PLACED IN 8" LIFTS COMPACTED TO 95% PROCTOR. PROVIDE LAST LIFT OF GRANULAR MATERIAL FOR THE INTERIOR FLOOR.

FOUNDATION TRENCH OR PIPING TRENCH BACKFILL INSIDE OF BUILDING OR UNDER DRIVE AND WALK AREAS IS TO BE GRANULAR MATERIAL. INCLUDE ALL ROUGH GRADING OF SITE.

ADJACENT PUBLIC ROAD SURFACES ARE TO BE KEPT FREE FROM TRACKED MUD AND DIRT.

DESIGN AND CONSTRUCTION OF ALL CAST-IN-PLACE CONCRETE WORK SHALL CONFORM TO ACI 318 AND CRSI STANDARDS.

DESIGN MIXES SHALL BE IN ACCORDANCE WITH ASTM C94.

1) STRENGTH TO BE MINIMUM 3,500 PSI AT 28 DAYS FOR FOOTINGS AND

WALLS. 2) STRENGTH TO BE MINIMUM 3,500 PSI AT 28 DAYS FOR SLABS ON GRADE.

3) STRENGTH TO BE MINIMUM 4,000 PSI AT 28 DAYS FOR COLUMNS, BEAMS AND STRUCTURAL SLABS.

4) SLUMP SHALL NOT EXCEED 4 INCHES 5) ALL CONCRETE EXPOSED TO WEATHER SHALL BE AIR-ENTRAINED WITH 4-7% AIR CONTENT. NO ADMIXTURES SHALL BE USED WITHOUT APPROVAL OF THE DESIGNER.

6) MAXIMUM AGGREGATE SIZE FOR FOOTING TO BE 1 1 /2" 7) MAXIMUM AGGREGATE SIZE FOR ALL OTHER WORK TO BE 3/4".

ALL REINFORCING BARS SHALL BE ASTM A615 GRADE 60. THICKNESS OF CONCRETE COVER OVER REINFORCEMENT SHALL BE NOT LESS THAN 3" WHERE CONCRETE IS DEPOSITED AGAINST THE GROUND WITHOUT THE USE OF FORMS AND NOT LESS THAN I 1/2" IN ALL OTHER LOCATIONS. ALL REINFORCING SHALL BE LAPPED 36 DIAMETERS FOR UP TO #6 BARS, 60 DIAMETERS FOR #1 TO #10 BARS OR AS NOTED ON THE DRAWINGS AND EXTENDED AROUND CORNERS WITH CORNER BARS. PLACING AND DETAILING OF STEEL REINFORCING AND REINFORCING SUPPORTS SHALL BE IN ACCORDANCE WITH CRSI AND ACI MANUAL AND STANDARD PRACTICES. THE REINFORCEMENT SHALL NOT BE PAINTED AND MUST BE FREE OF GREASE/OIL, DIRT OR DEEP RUST WHEN PLACED IN THE WORK. IF USED, ALL WELDED WIRE FABRIC SHALL MEET THE REQUIREMENT OF ASTM A185, AND SHALL BE PLACED IN CENTER OF SLAB UNLESS INDICATED OTHERWISE.

SAWCUT FLOOR SLAB AS SOON AS PRACTICABLE. SAWCUT SPACING TO BE NO MORE THAN 30 TIMES THE SLAB THICKNESS, WITH A MAXIMUM OF 15' ON CENTER. SAWCUT TO 1/4" OF SLAB DEPTH UNLESS EMBEDDED ITEMS PRECLUDE SUCH CUTTING DEPTH.

ROUGH LUMBER SHALL BE GRADED AND STAMPED WITH STRUCTURAL DESIGN VALUES. ALL OTHER LUMBER SPF CONSTRUCTION #2 OR BETTER. ALL WOOD BASE PLATES IN CONTACT WITH CONCRETE, MASONRY, GROUND OR EXPOSED TO THE WEATHER TO BE P.P.T. LUMBER (NON-ARSENIC).

CONFORM TO FASTENING SCHEDULE 2304.10.1 IN IBC2015

ENGINEERED WOOD TRUSSES

PROVIDE WOOD TRUSSES DESIGNED BY WISCONSIN LICENSED ENGINEER. INCLUDE STAMPED AND SEALED DRAWINGS LISTING ALL LOADINGS, AND TEMPORARY AND PERMANENT BRACING. PER IBC 2015 SECTION 2302.1.2, THE BRACING OF WOOD TRUSSES SHALL COMPLY TO THEIR APPROPRIATE ENGINEERED DESIGN. IN ADDITION TO IBC 2015 SECTIONS 2303.4.1 AND 2303.4.5, THE DESIGN, MANUFACTURE AND QUALITY ASSURANCE OF METAL-PLATE-CONNECTED WOOD TRUSSES SHALL BE IN ACCORDANCE WITH TPI-I.

FURNISH AND INSTALL 29 GA PRE-FINISHED RIBBED METAL WALL PANEL IN OWNER'S CHOICE OF COLOR(S). PROVIDE ALL APPROPRIATE TRIMS AND ACCESSORIES.

FURNISH AND INSTALL 29 GA PRE-FINISHED RIBBED METAL PANEL. PROVIDE ALL APPROPRIATE TRIMS AND ACCESSORIES. APPLY COMPATIBLE FLASHING AT CURBS, VENTS, PIPES, AND DRAINS, ETC., AS PER MANUFACTURER. DO NOT USE ASPHALTIC COMPOUNDS.

SEALANTS

CAULK AROUND ALL DOORS, VENT OPENINGS, WHERE DIFFERENT MATERIALS MEET, ROOF OPENINGS, EAVES, SOFFITS, JOINTS, AROUND PLUMBING FIXTURES, COUNTERTOPS, DOORFRAMES, ETC. AND AS REQUIRED FOR A WATERTIGHT CONNECTION. PROVIDE CAULK PER MANUFACTURERS RECOMMENDATIONS. CAULK TO BE INSTALLED AFTER FINISH IS APPLIED TO SURFACES PER MANUFACTURER.

DOORS AND FRAMES

FURNISH AND INSTALL ALL DOOR ASSEMBLIES AS INDICATED ON THE PLANS ALONG WITH ALL HARDWARE INDICATED AND THAT MAY BE REQUIRED FOR A COMPLETE JOB. ALL DOORS SHALL OPERATE SMOOTHLY WITHOUT BINDING, AND BE INSTALLED PLUMB AND TRUE. ALL HARDWARE SHALL FIT PROPERLY AND BE ADJUSTED AS REQUIRED.

DOORS AND FRAMES

FURNISH AND INSTALL ALL DOOR ASSEMBLIES AS INDICATED ON THE PLANS ALONG WITH ALL HARDWARE INDICATED AND THAT MAY BE REQUIRED FOR A COMPLETE JOB. ALL DOORS SHALL OPERATE SMOOTHLY WITHOUT BINDING, AND BE INSTALLED PLUMB AND TRUE. ALL HARDWARE SHALL FIT PROPERLY AND BE ADJUSTED AS REQUIRED.

OVERHEAD DOORS

FURNISH AND INSTALL COMMERCIAL GRADE OVERHEAD DOORS WITH ALL ACCESSORIES AND CONTROLS. ADJUST FOR PROPER OPERATION. PROVIDE POWER OPERATORS WITH 3-BUTTON CONTROLS.

ALL FINISH HARDWARE SHALL BE AS REQUIRED TO MEET REQUIREMENTS OF ANSI A117.1-2009.

FLOOR FINISHES EXPOSED CONCRETE FLOOR.

WALL AND CEILING FINISHES 29 GA RIBBED METAL WALL PANEL; AND OSB.

EXTERIOR MATERIALS ARE FACTORY PRE-FINISHED. TOUCH UP AS NECESSARY. PRIME AND PAINT INTERIOR GYPSUM BOARD SURFACES. STAIN, SEAL AND VARNISH INTERIOR WOOD TRIM IF NOT PRE-FINISHED.

FURNISH AND INSTALL EXTINGUISHERS PER N.F.P.A. MOUNT FIRE EXTINGUISHER NO HIGHER THAN 48" ABOVE FINISH FLOORS UNLESS LOCAL REGULATIONS REQUIRE DIFFERENT HEIGHT. ALL FIRE EXTINGUISHERS AND CABINETS TO MEET THE REQUIREMENTS OF ANSI A117.1-2009.

<u>PLUMBING WORK</u> NONE REQUIRED.

HEATING AND VENTILATION WORK

ALL HVAC WORK SHALL BE PERFORMED IN ACCORDANCE WITH STATE AND LOCAL CODES. HVAC PLANS ARE NOT A PART OF THIS PLAN SET.

EXIT DOORS SHALL BE MARKED BY AN APPROVED EXIT SIGN READILY VISIBLE FROM ANY DIRECTION OF EGRESS TRAVEL. PROVIDE TYPE WITH 90 MINUTE CONTINUED ILLUMINATION IN EVENT OF LINE POWER LOSS. CONFORM TO IBC1015 1006.4 - PROVIDE ONE (I) STAMPED, SIGNED AND SEALED PHOTOMETRIC CALCULATIONS FOR THE JOBSITE THAT DEMONSTRATE THAT THE PROPOSED EMERGENCY LIGHTING WILL PROVIDE AN INITIAL ILLUMINATION OF AT LEAST AN AVERAGE OF 1.0 FOOT-CANDLE, AND MINIMUM AT ANY POINT OF O.I FOOT-CANDLE. PHOTOMETRIC CALCULATIONS SHALL BE PROVIDED THAT DEMONSTRATE THE MAXIMUM TO MINIMUM ILLUMINATION UNIFORMITY RATIO OF 40:1 IS NOT EXCEEDED. THE ELECTRICAL WORK IS NOT A PART OF THIS PLAN SET.

HEATED STORAGE BUILDING, UNOCCUPIED **PROJECT** SCHLIEWE RENTALS, LLC OWNER 804 ELM STREET WATERTOWN, WI 53098 806R ELM STREET LOCATION MATERTOWN, WI DODGE COUNTY CITY OF WATERTOWN A.H.J. DODGE COUNTY STATE OF WISCONSIN NONE PREVIOUS TRANS ID CONTRACTOR T.B.D. 62 - COMMERCIAL ZONING **GOVERNING CODE** IBC 2015 CONSTRUCTION CLASS VB NON-SPRINKLERED S-I MODERATE HAZARD STORAGE **USE AND OCCUPANCY** II BUILDINGS AND OTHER STRUCTURES EXCEPT **RISK CATEGORY** THOSE LISTED IN RISK CATEGORY I, III AND IV **EXISTING AREA** O SF 4,992 SF **NEW AREA TOTAL AREA** 4,992 SF < 9,000 SF IBC 2015 TABLE 506.2 4,992 SF <= 5,000 SF IBC 2015 FIGURE 903.2 4,992 SF / 500 SF PER OCCUPANT = CAPACITY (IO) CALCULATED (O) IN USE; UNOCCUPIED 6.367 ACRES (LESS THAN I ACRE DISTURBED) MO PROPERTY AREA BUILDING IS CLEAR OF FLOOD PLAIN SLAB ON GRADE 250 PSF LL FLOOR LOADING LOAD EXPOSURE | IMP. | GUST TYPE II5 MPH 1.00 | 1.02 ENCLOSED IMP. | SLOPE | EXP. | THERMAL LOAD 30 PSF GROUND 0.9 SNOW 16.9 PSF ROOF HTD 0.86 1.10 CATEGORY IMP. USE SEISMIC BEARING CAPACITY | TYPE 3000 PSF PRESUMED

PAGE INDEX

TITLE SHEET WITH PROJECT DATA AND SPECIFICATIONS

C1.0

Al.O

A2.0

A3.0

A3.I

A4.0

| SITE OVERVIEW

PROJECT DATA

FLOOR PLAN JUN 28, 2021 FOUNDATION PLAN REVISIONS ROOF FRAMING PLAN SECTIONS 10/22/2021 DETAILS | ELEVATIONS copyright © 2021 **PROJECT** 21139 DANIELJ. PRUNUSKE PAGE E-25379 BEAVER DAM: WIS. .0

PROJE(


DATE

Section 3, Item A.

PROVIDE (1) 8' X 18' ACCESSIBLE PARKING STALL WITH ADJACENT 8' X 18' MANEUVERING SPACE. ROUTE TO PRIMARY ENTRANCE SHALL NOT HAVE A SLOPE GREATER THAN 1/4":12" IN ANY DIRECTION AT ANY LOCATION.

ON ACCESSIBLE ROUTE, PER ANSI AII7.I SEC 303.3, CHANGES IN LEVEL GREATER THAN 1/4", AND NOT MORE THAN 1/2" MAXIMUM IN HEIGHT, SHALL BE BEVELED WITH A SLOPE NOT STEEPER THAN 1:2. CHANGES IN ELEVATION GREATER THAN 1/2" SHALL BE RAMPED TO COMPLY WITH SEC 405 OR 406. SURFACES SHALL BE STABLE, FIRM AND SLIP RESISTANT PER 302.I. PROVIDE BUILDING OR POLE MOUNTED SIGN BEARING THE INTERNATIONAL SYMBOL OF ACCESSIBILITY. BOTTOM OF SIGN TO BE MINIMUM 60" ABOVE FINAL GRADE.

SITE OVERVIEW
NO SCALE

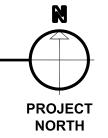

S, LLC

SCHLIEME RENTALS, LL 804 ELM STREET

ATED STORAGE BUILDIN

HEATED S.

806R ELM S


JUN 28, 2021 REVISIONS


REVISIONS 10/22/2021


copyright © 2021


PROJECT 21139


PAGE

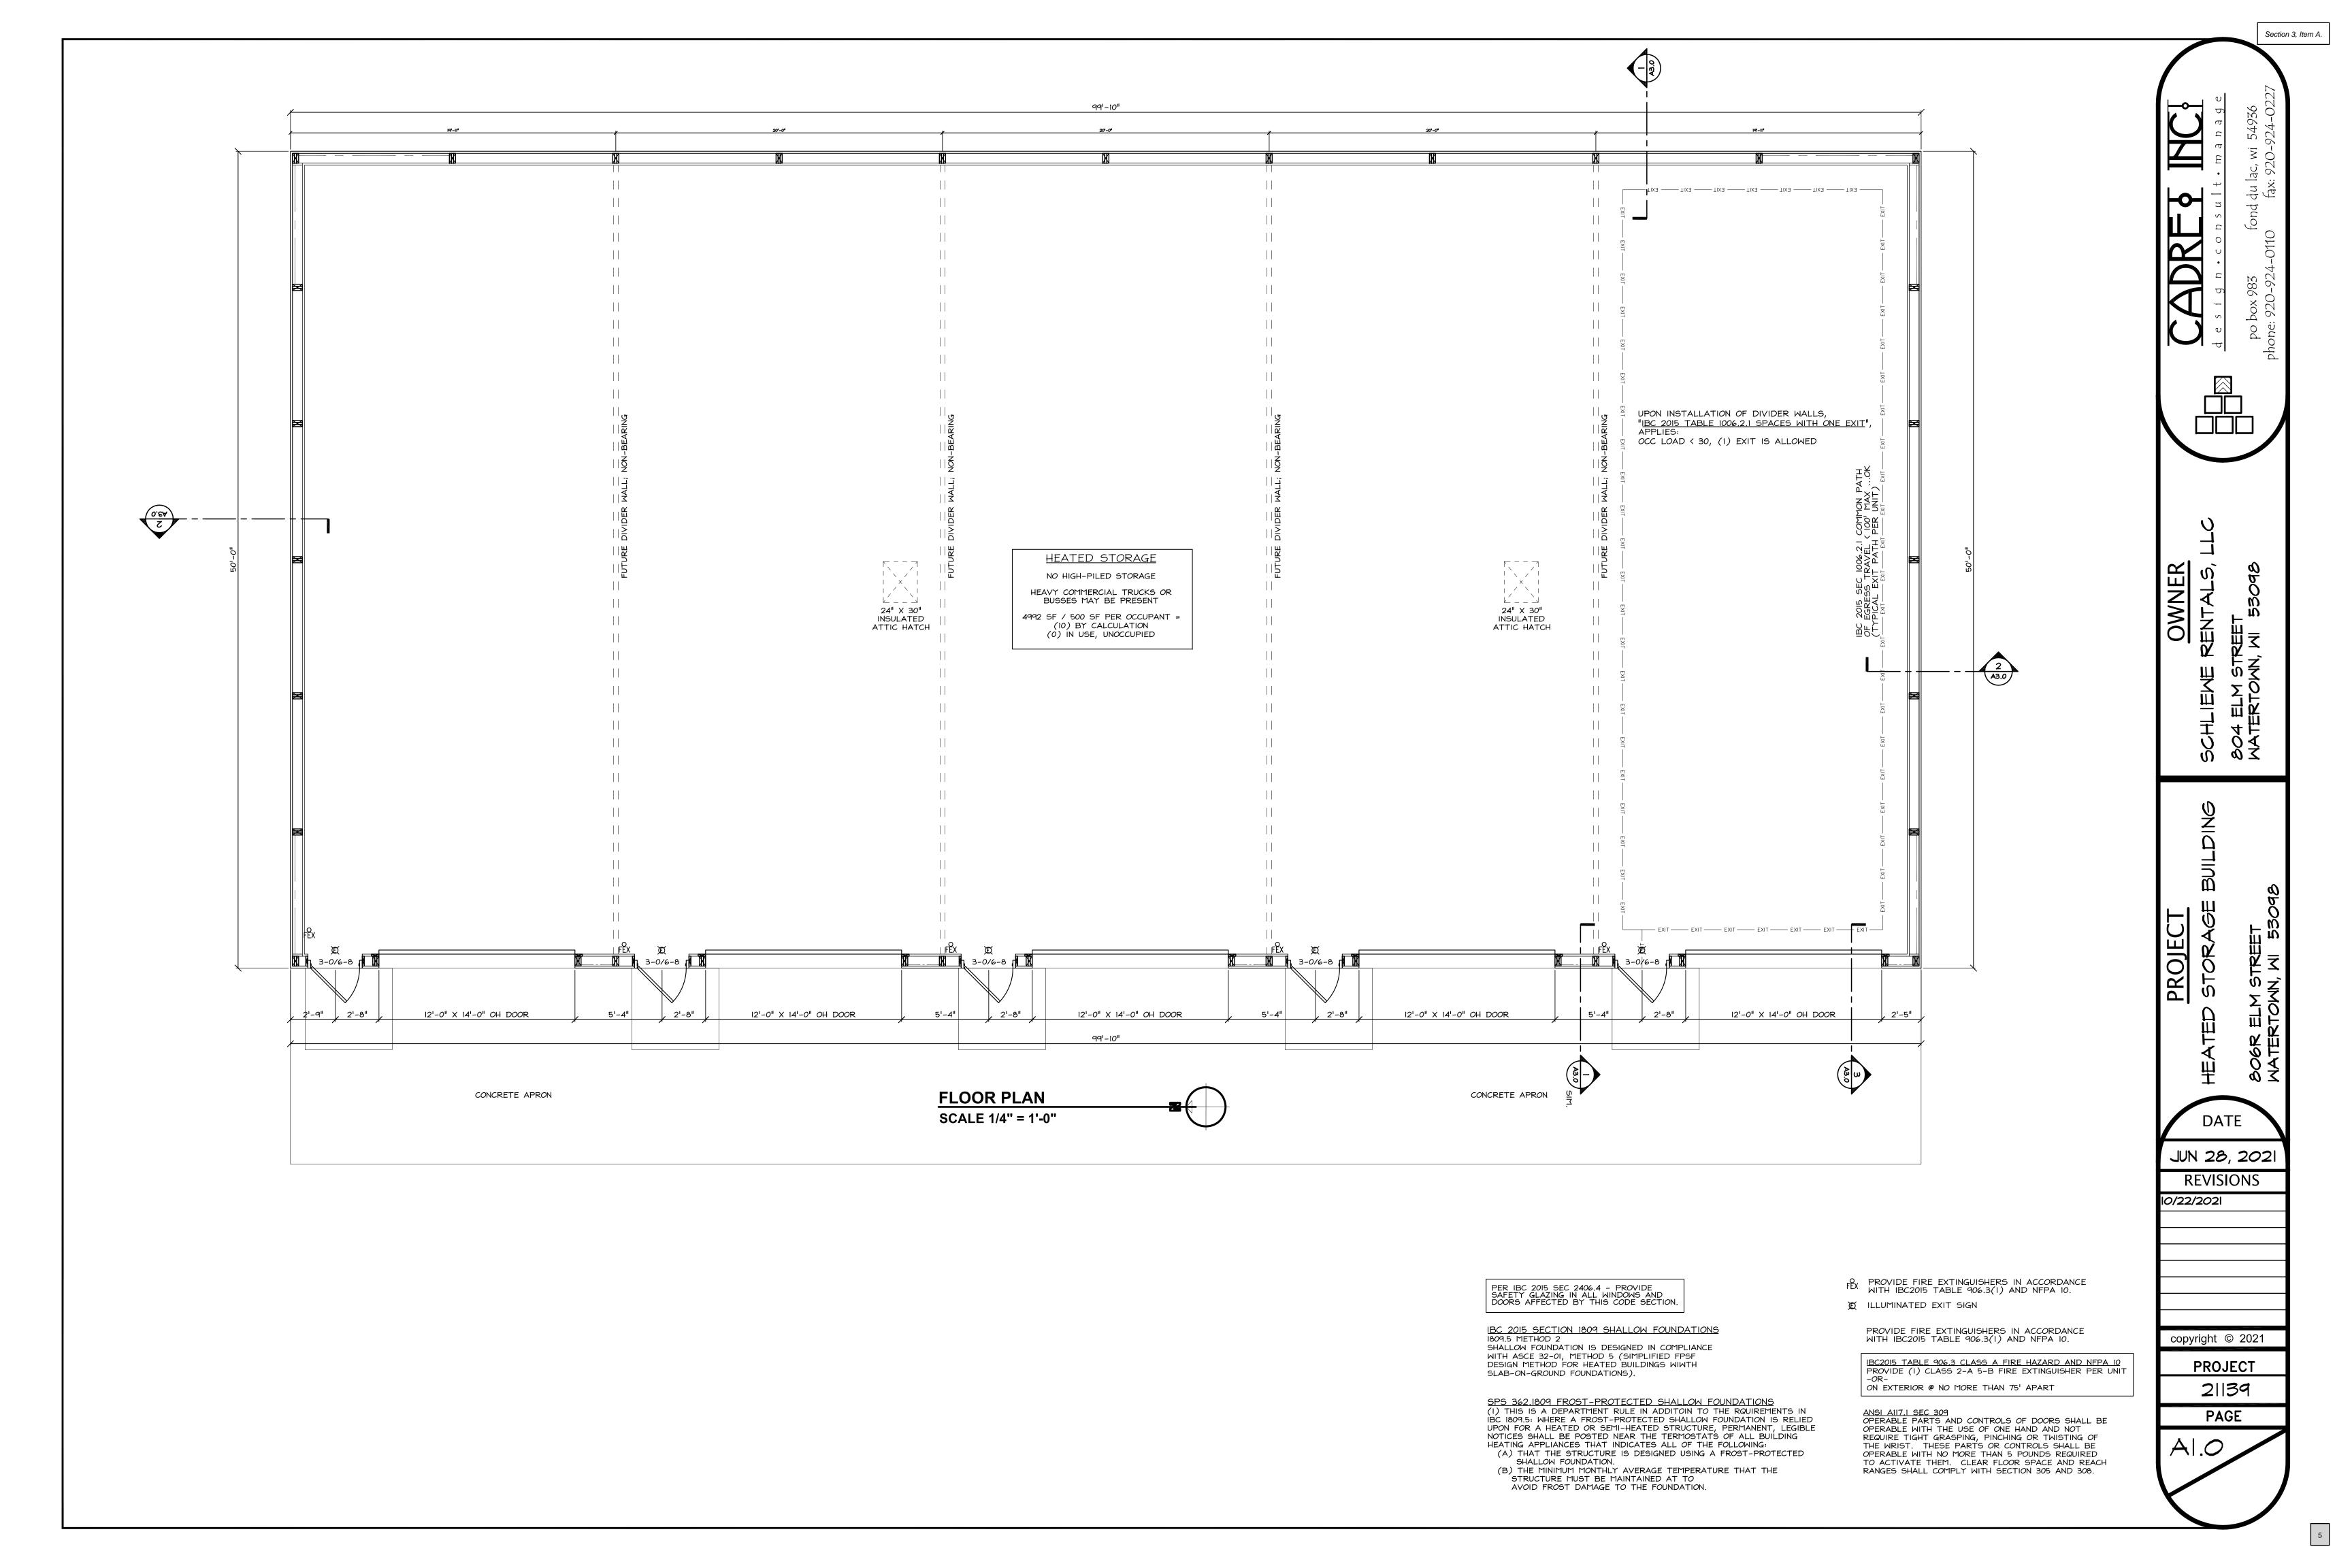


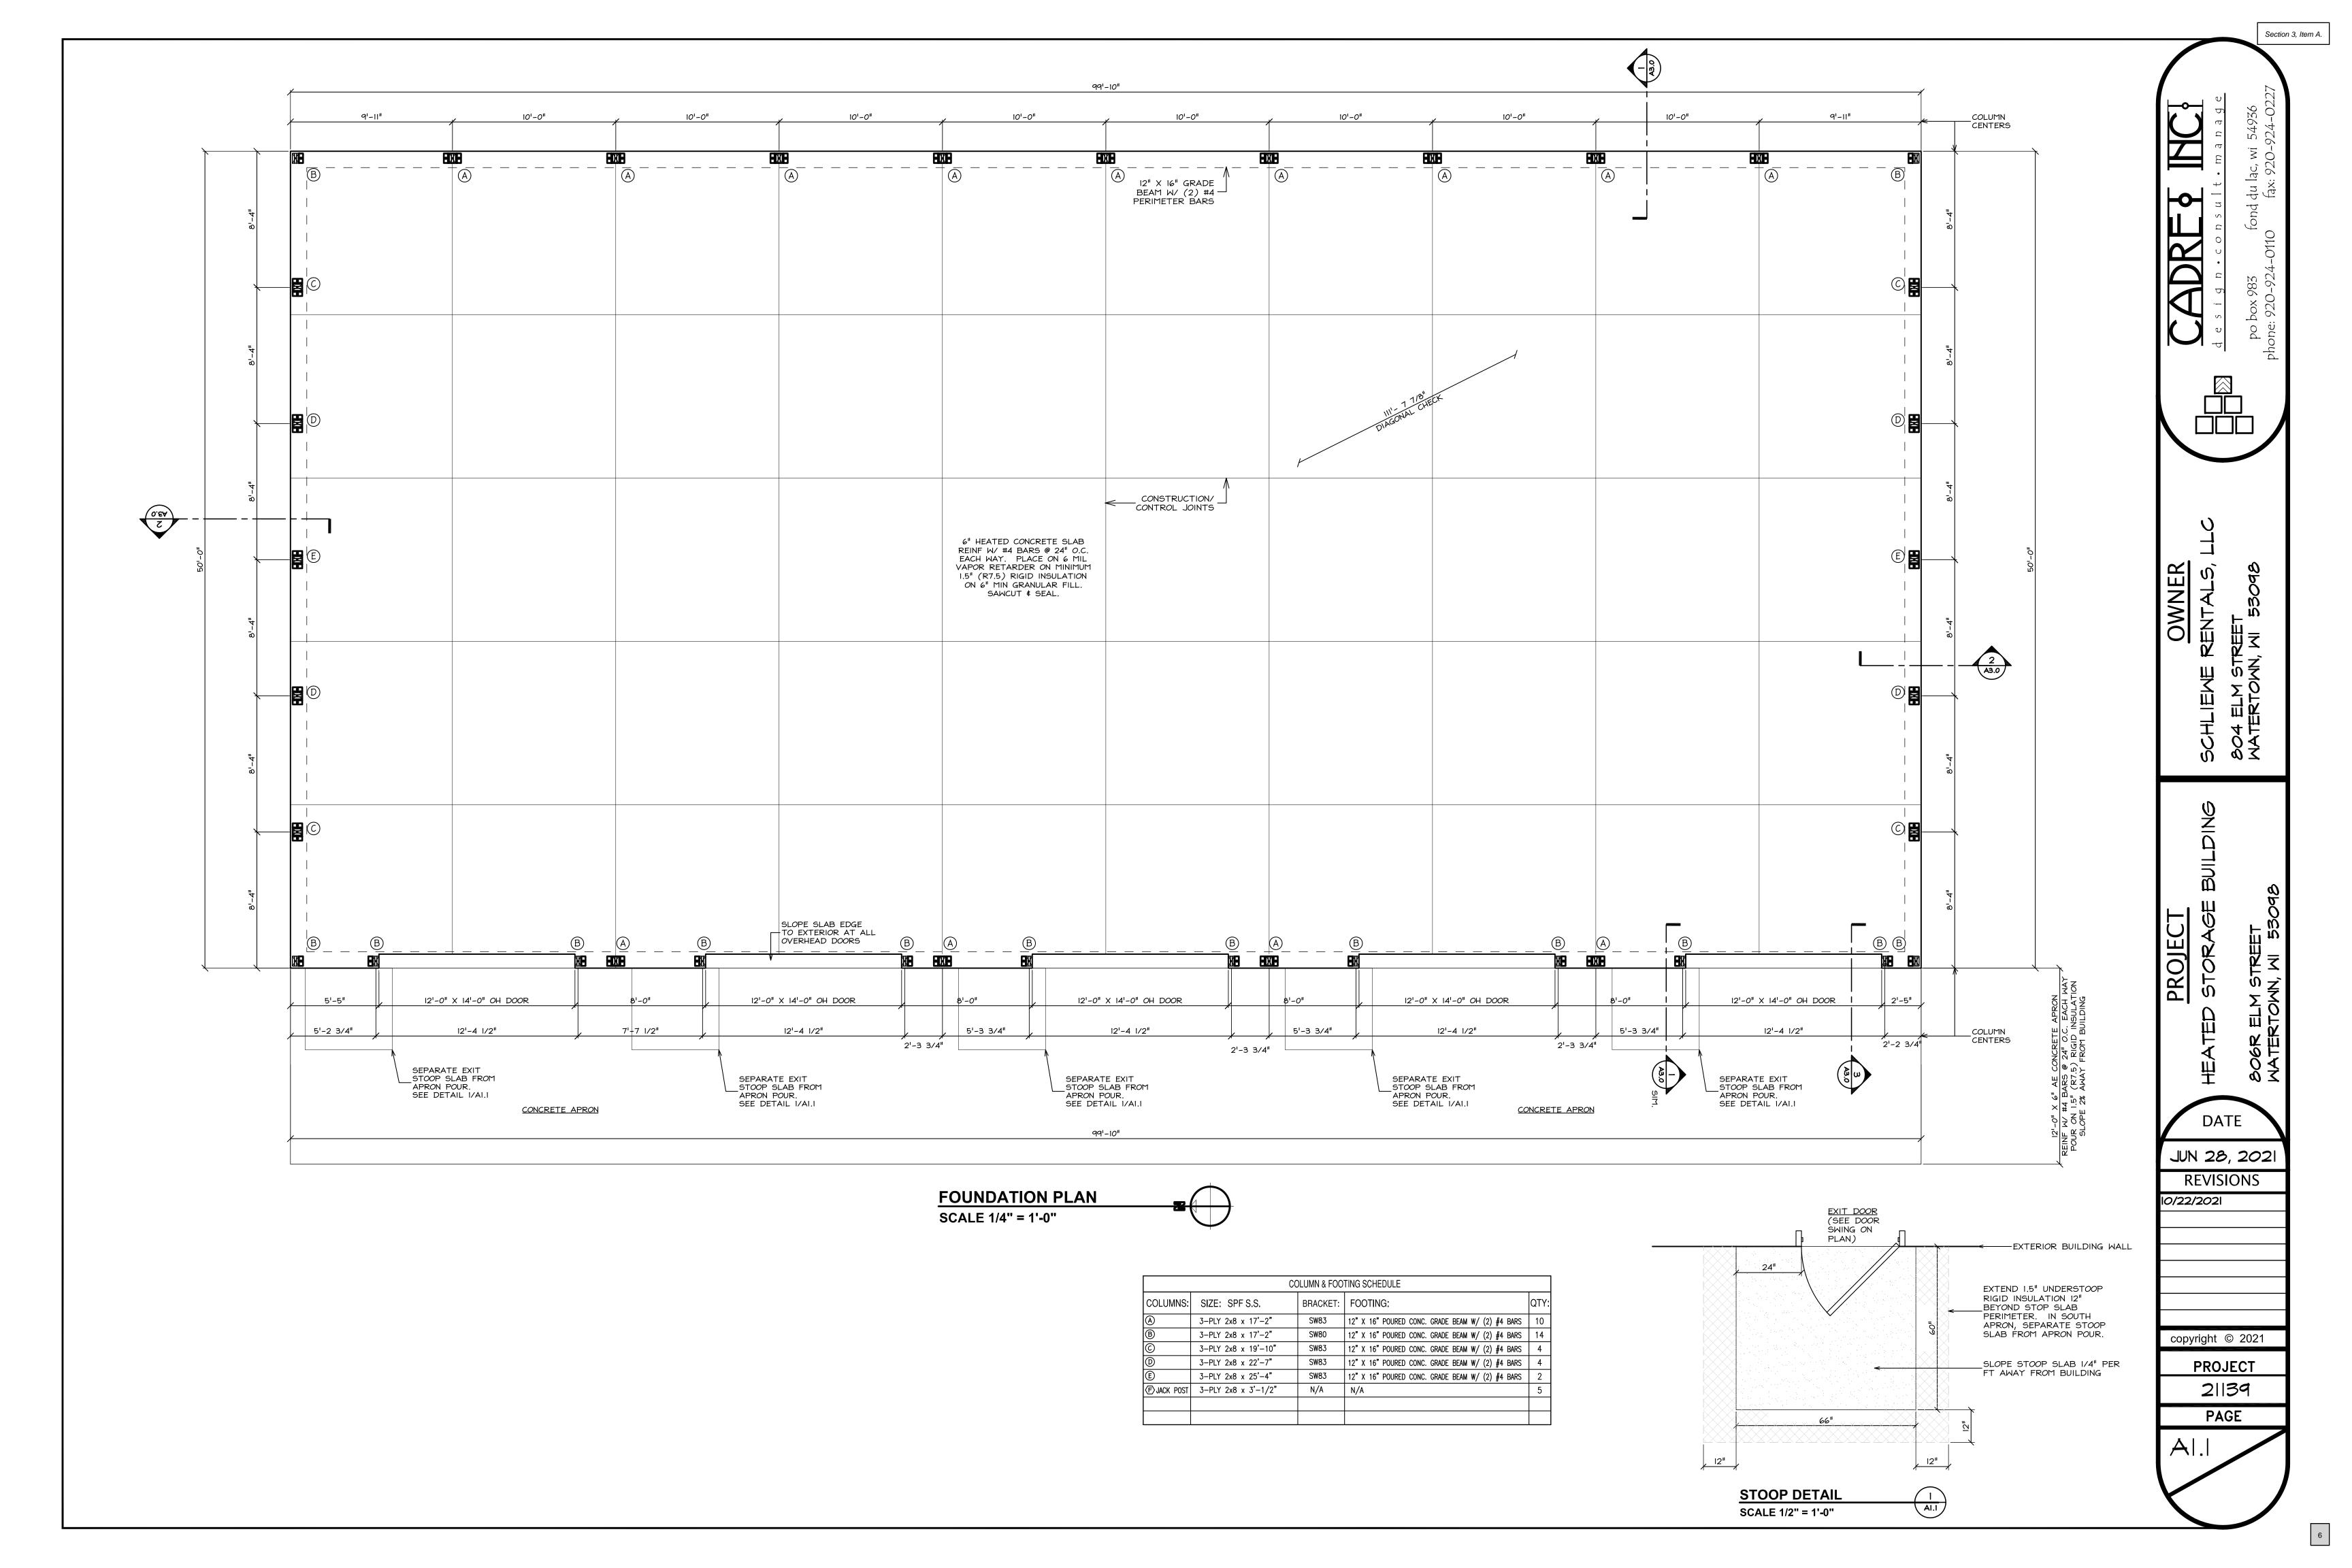

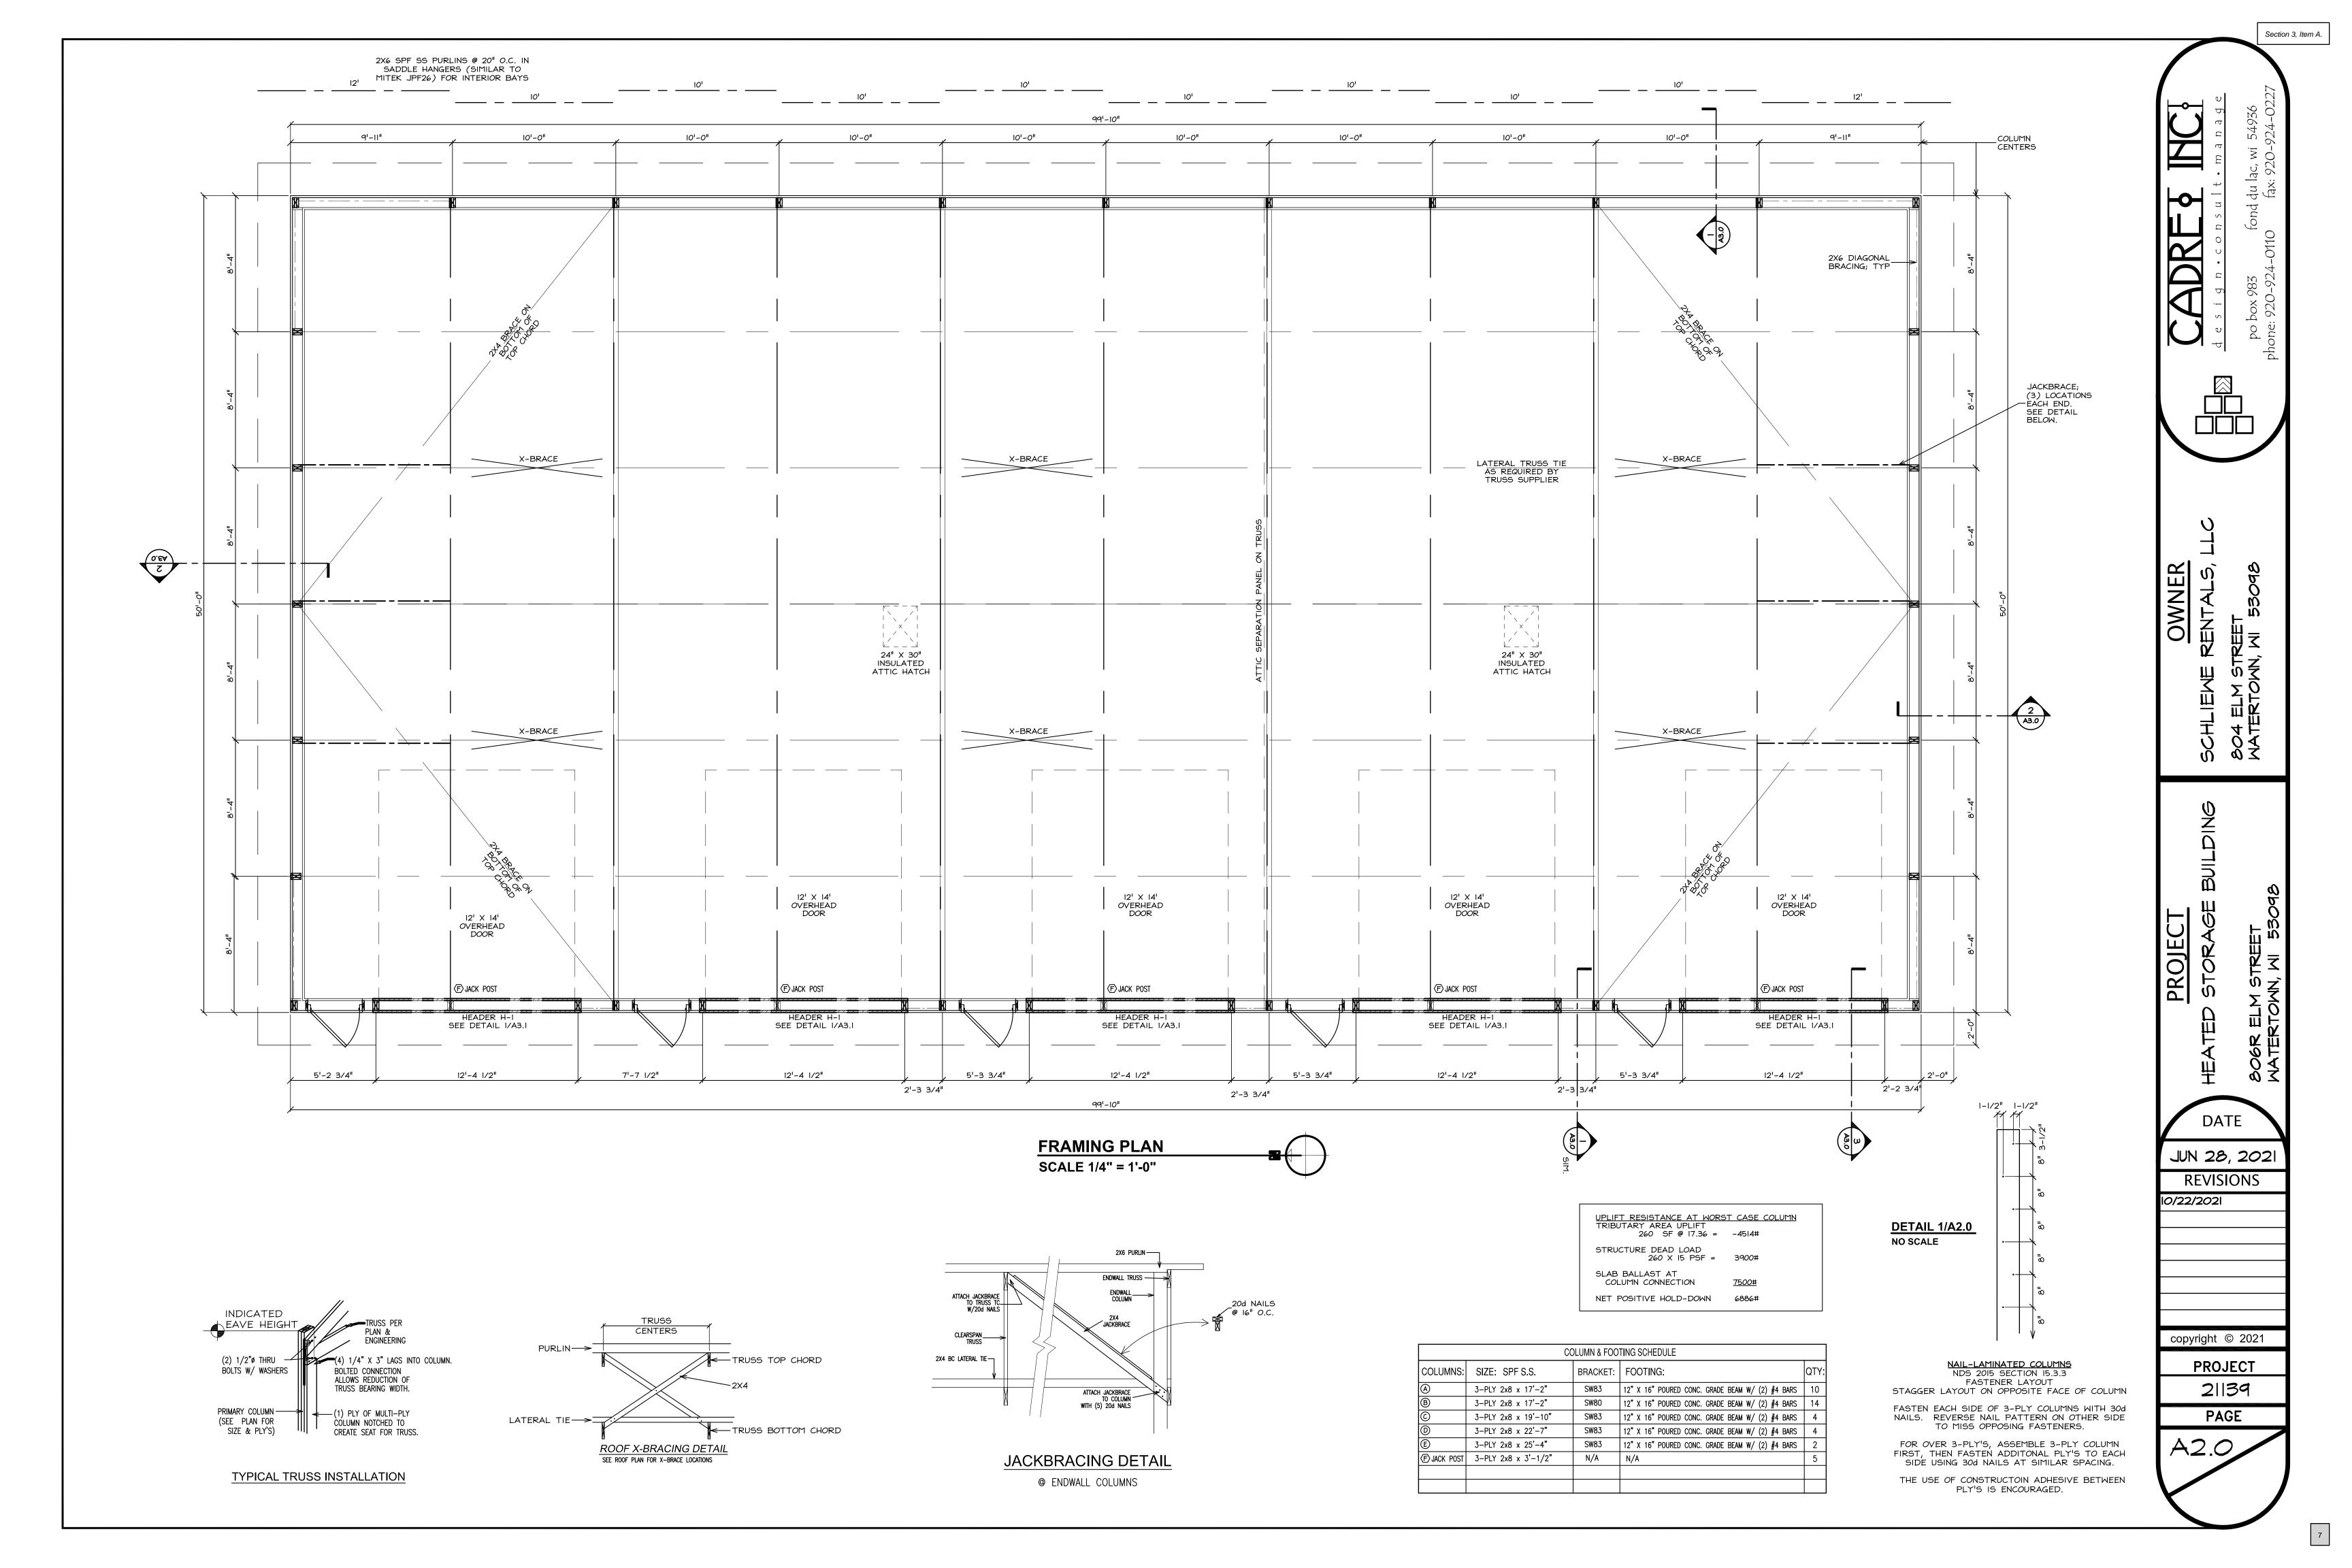

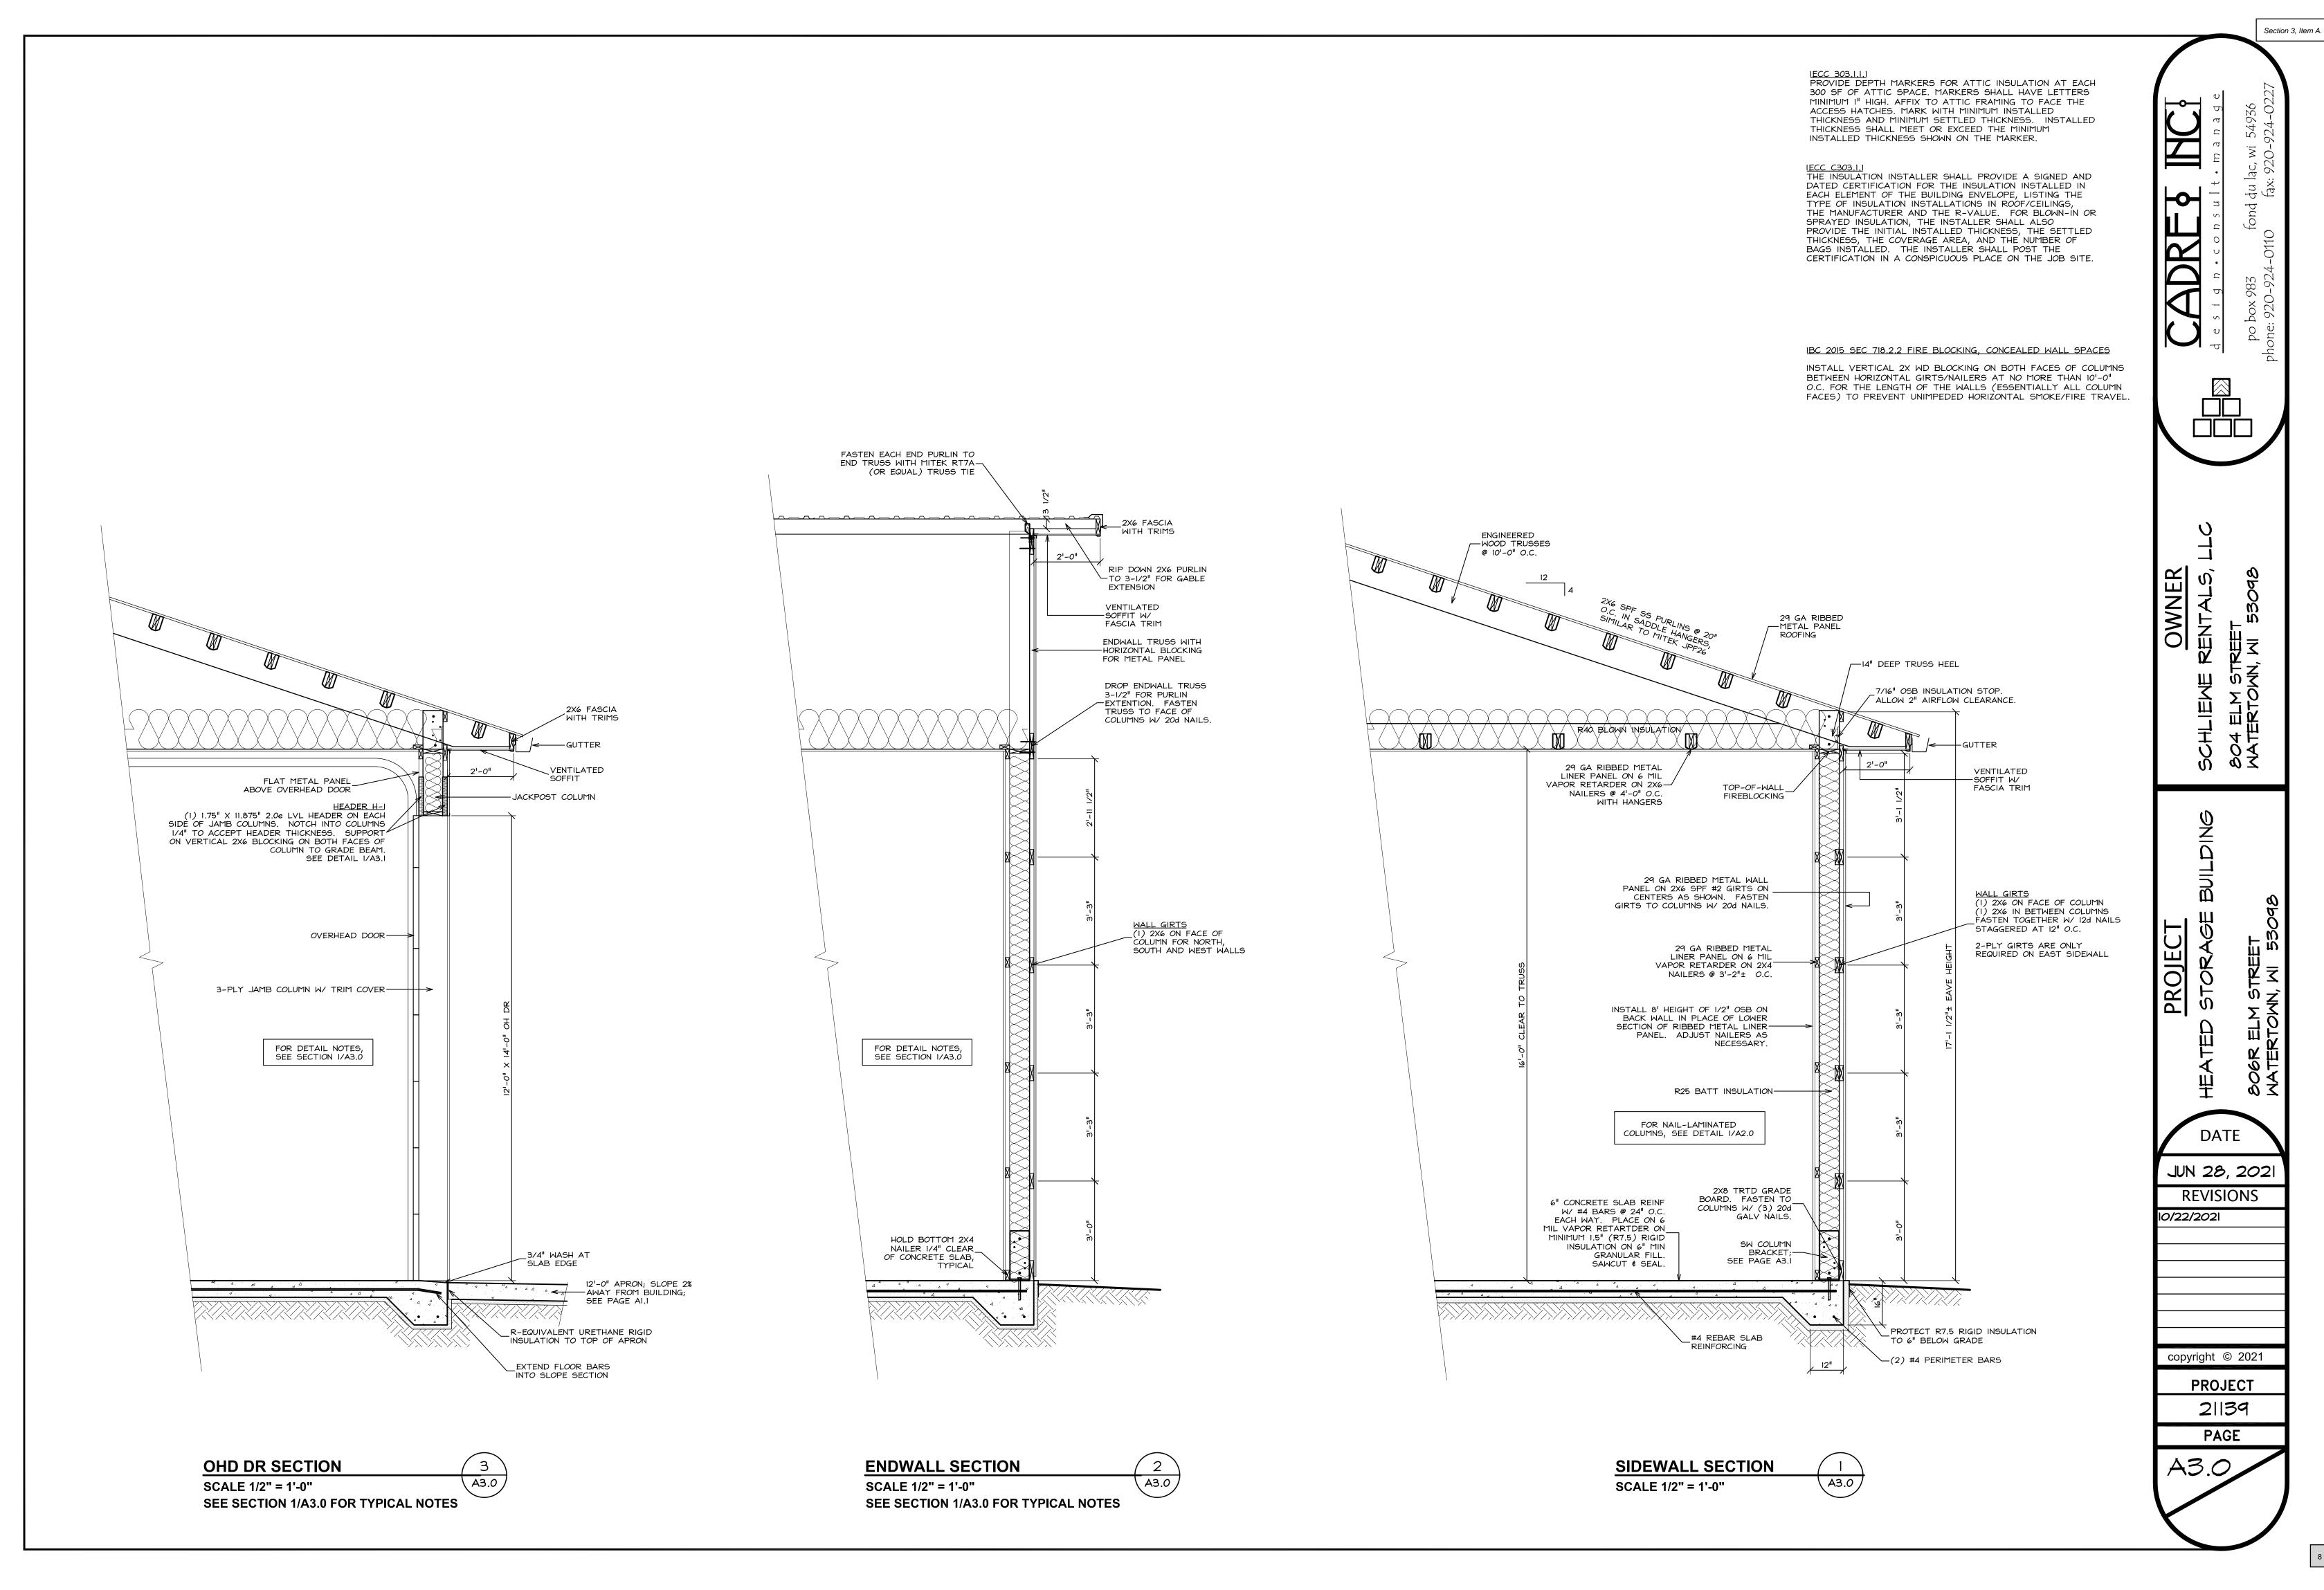

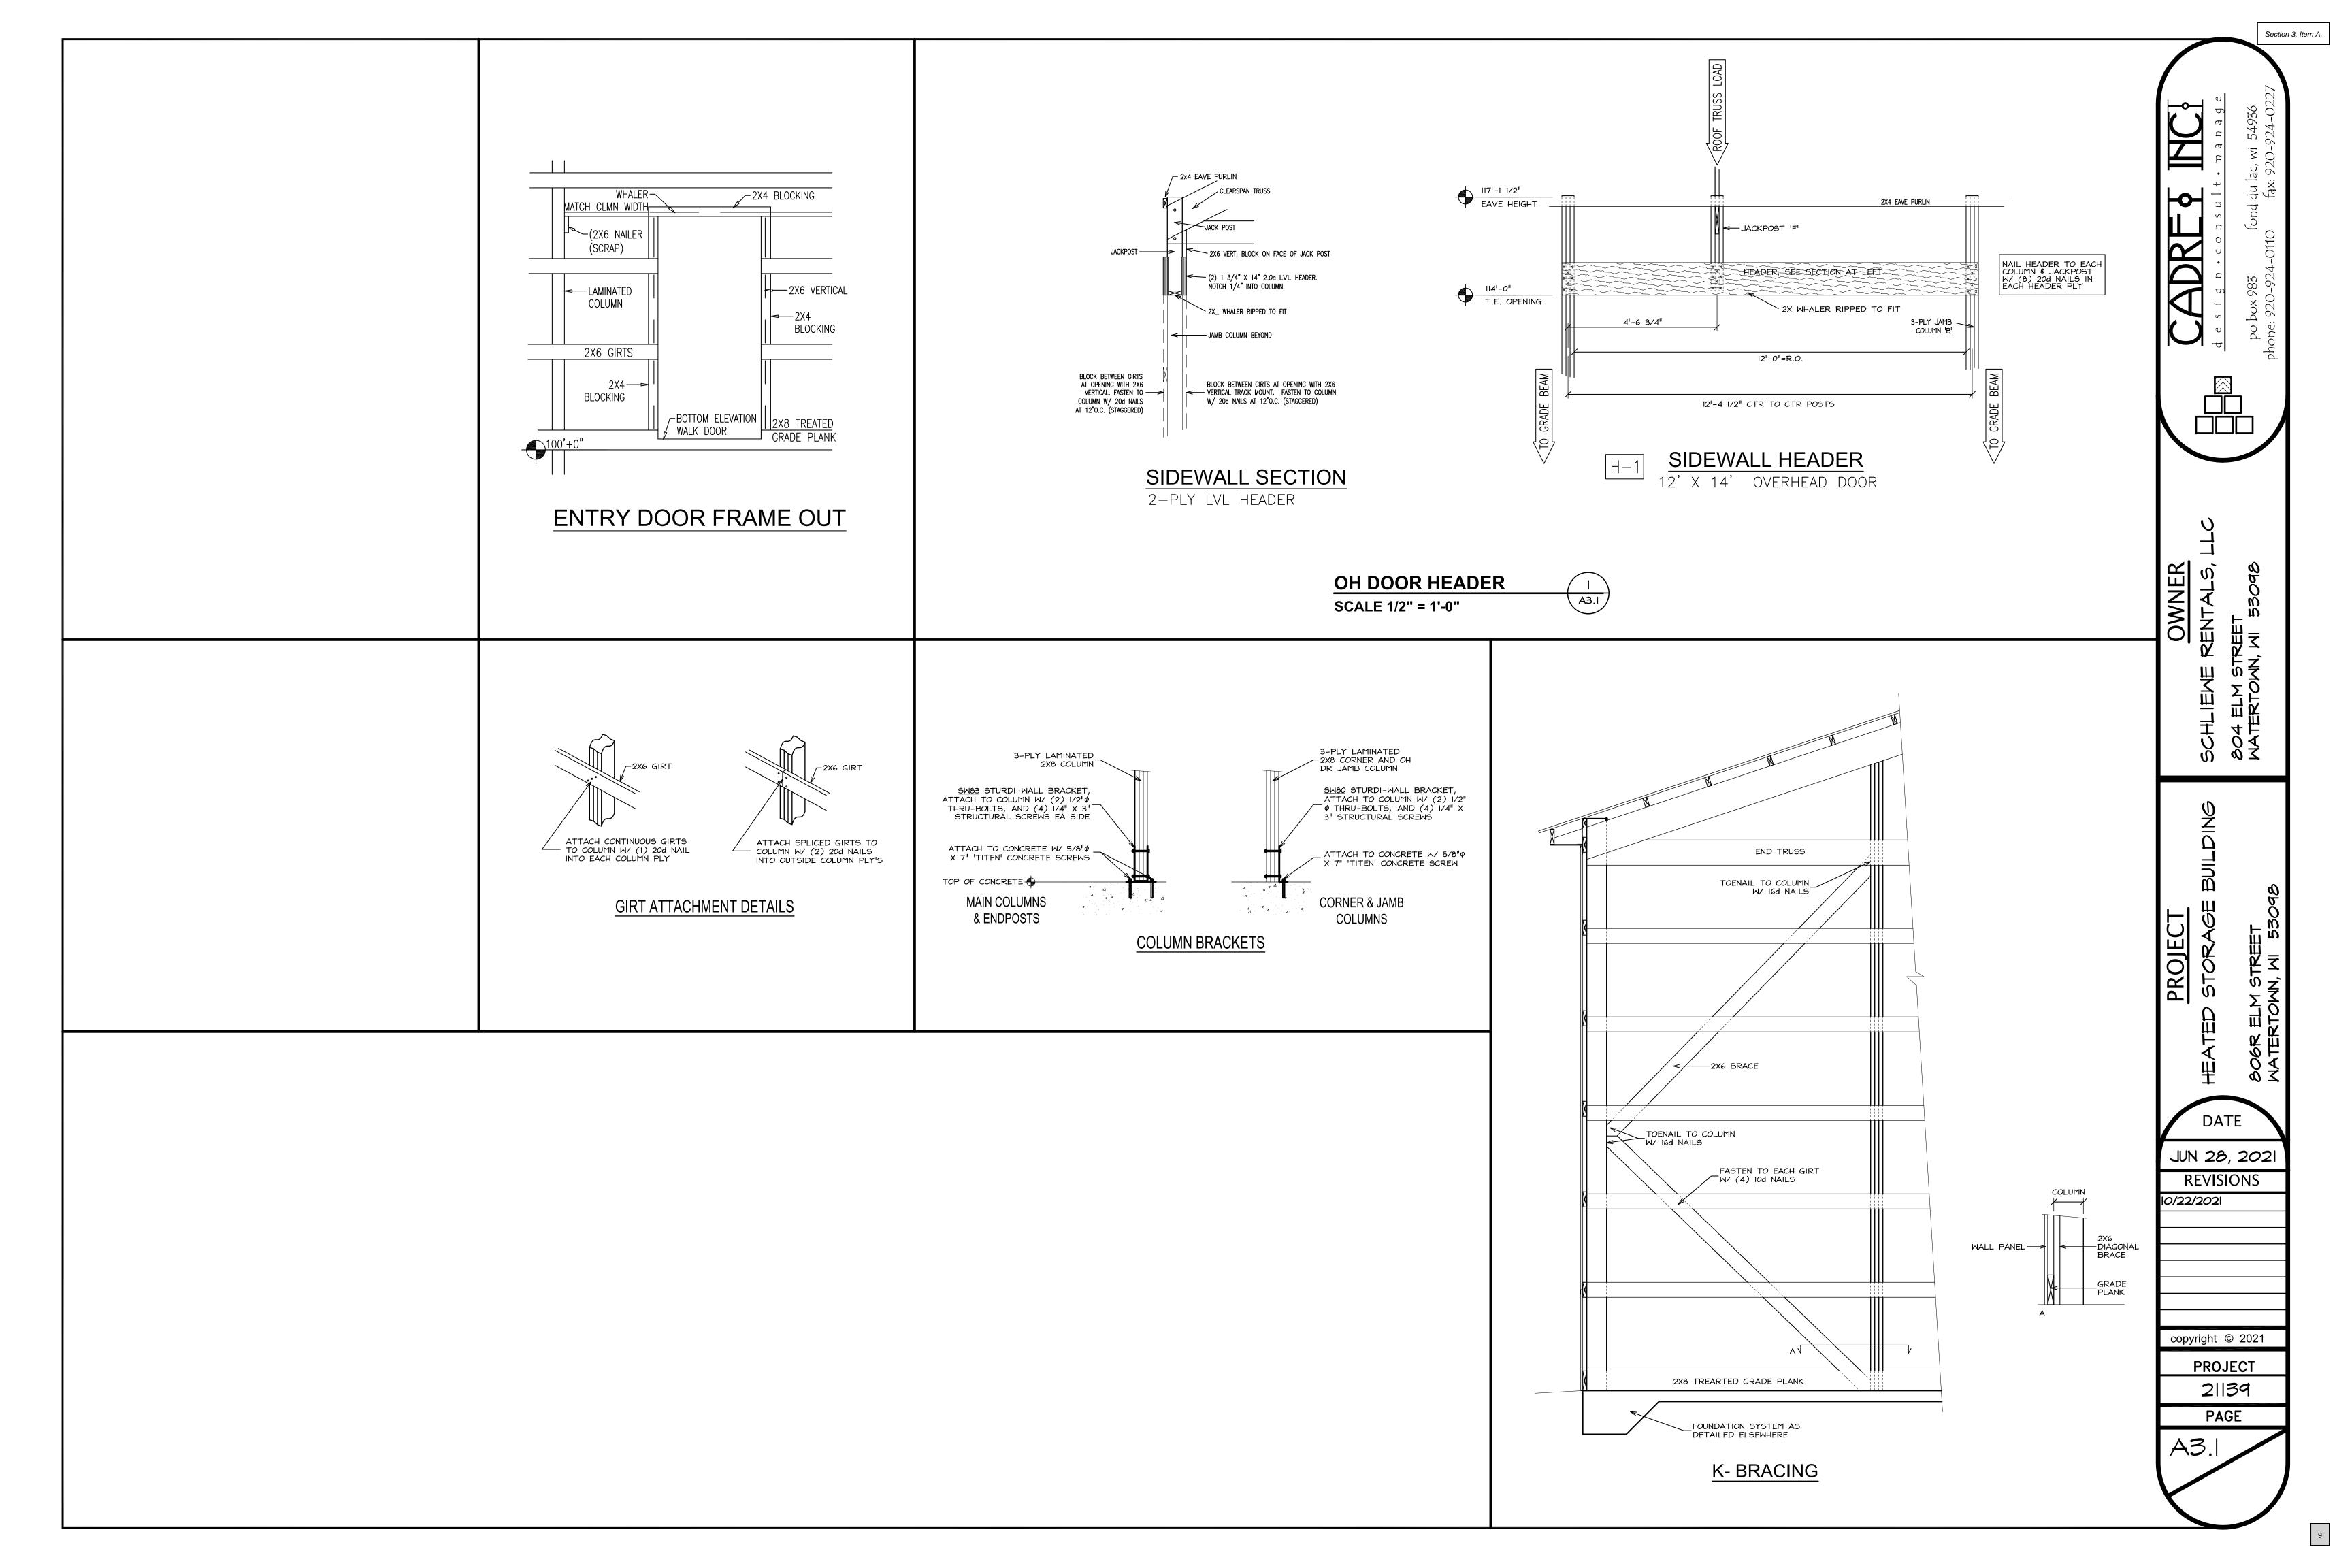

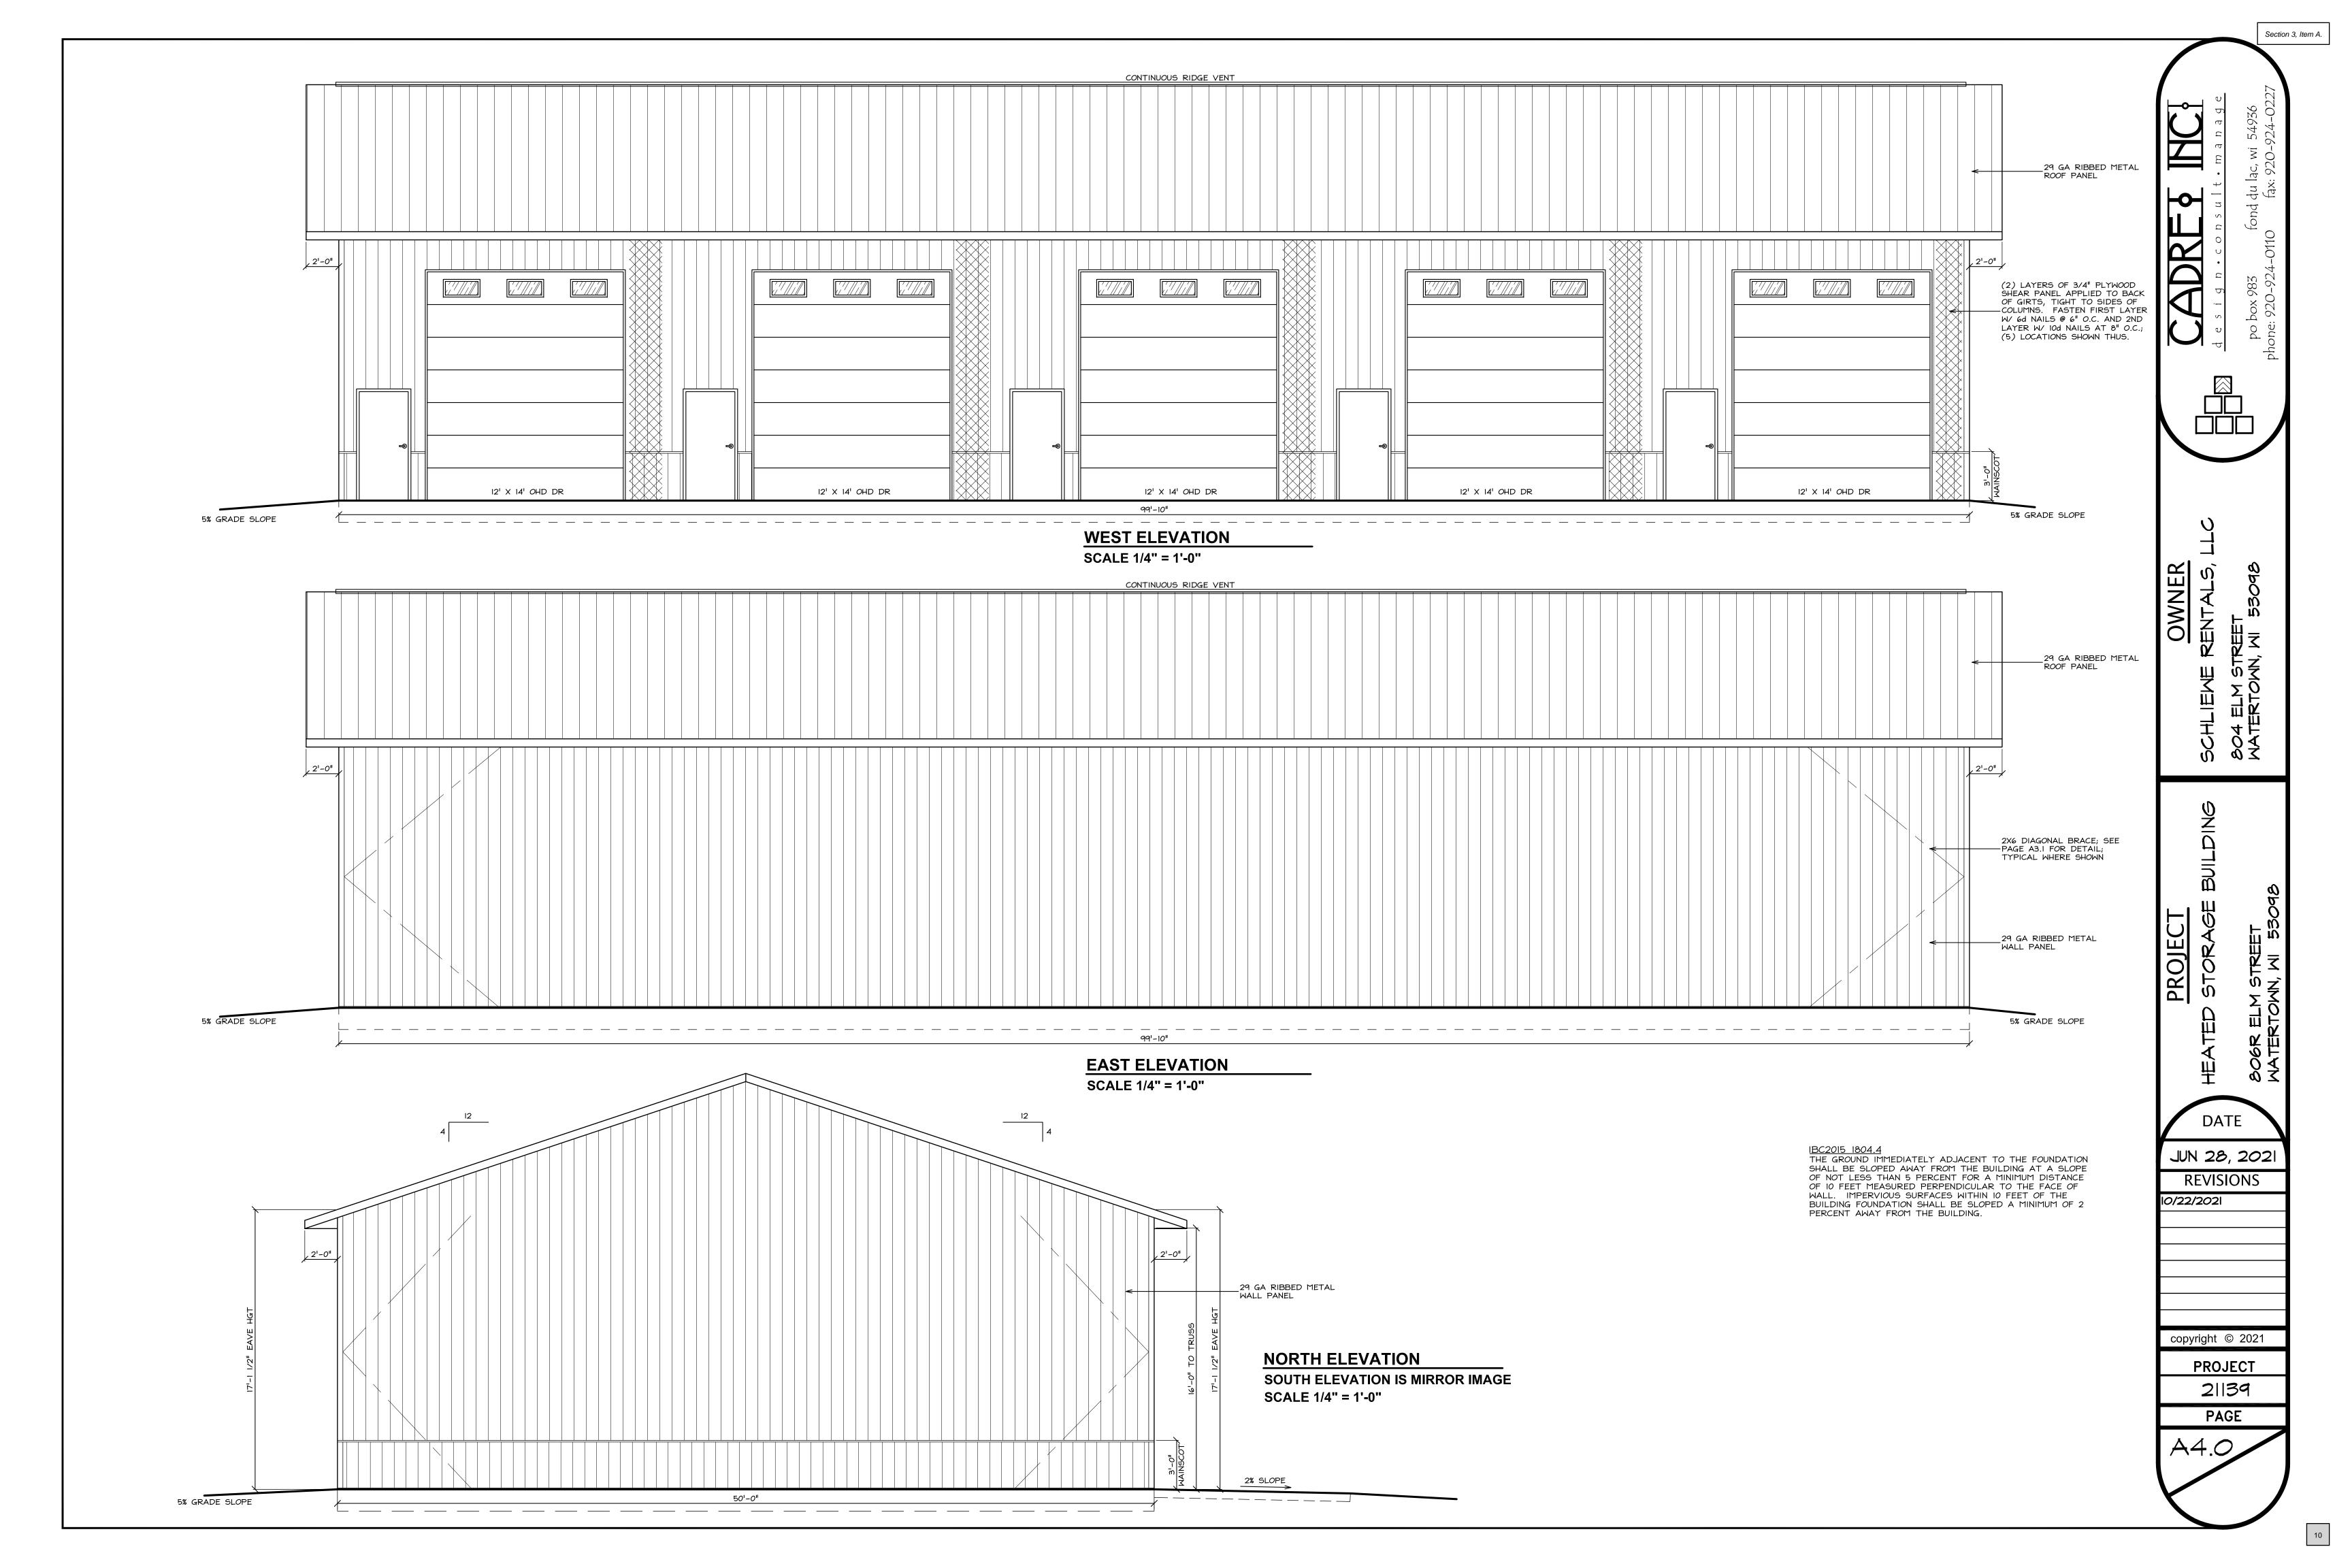





January 17, 2024

Site Plan Review / Plan Commission Watertown Fire Station Project

As part of the Site Plan Review application, below is a brief description of the project. In addition, we were forwarded a letter describing the necessary documentation for site plan review and plan commission approval for the proposed Watertown Fire Station project. A 'draft' set of documents had been sent January 8, 2024, with plans to update the set as they were further developed. Below we have attempted to address the issues noted in your letter. Thank you for your patience regarding this submission as we developed the necessary documentation.

Project Description

The proposed project is for a new Fire Station facility for the City's Fire Department. The plan is comprised of three separate buildings (Fire Station, Cold Storage, Training Tower) on the currently vacant 6.39 acre site. The fire station is planned to be a 34,787 square foot, two-story building housing the City's Fire Department. This building is designed to have a masonry exterior with varying heights and façade to break up the mass of the building. The cold storage building is planned to be a 3500 square foot, non-heated outbuilding constructed with a masonry material matching the fire station as well as metal panel of complementary color. This building will be used for housing additional equipment the Fire Department operates. The Training Tower is a 40' tall training amenity for the Fire Department. The building has a base footprint of 1116 square feet, and will reduce in floor area on the upper floors. Due to the use of the tower, it is planned to have a metal panel exterior.

Land Use and Zoning

There is no planned outdoor storage on the site adjacent to residential zoned properties.

Attached with this submission are the proposed Civil plans which show the buildings set back from the adjacent residential properties.

The proposed exterior materials for the fire station are an architectural concrete stone base coursing (wainscot) with concrete brick above. There is an alternate being built into the project to replace the concrete stone material with a decorative split-face CMU material if costs dictate, however, the preference will be to stick with the concrete stone if possible. A sample board of the concrete stone and brick will be made available to the review committee.

Exterior Construction and Materials Standards

As part of this submission is the application for a Conditional-Use Permit regarding the building materials for the Cold Storage building (Building B on plans) and the Training Tower.

The proposed materials for the Cold Storage building is an architectural concrete stone material wainscot coursing (roughly 3' high), matching the material being used on the adjacent fire station. Above this

Site Plan Review / Plan Commission January 17, 2024 Page 2

would be metal panel. As the manufacturer of this building has yet to be selected, the color for the metal panel is not finalized. This color would be chosen from the manufacturer's standard colors, with the intent for it colors to be muted and complementary to the adjacent fire station.

The proposed materials for the Training Tower would be a metal panel. Similar to the metal panel use on the Cold Storage Building, the color selected will be muted and complementary to the fire station.

Vehicle Access and Circulation

Attached with this submission is a site plan showing the ingress and egress for vehicular travel on the site. The main entrance and exit for the public will be off Bernard Street. This will also serve as the exit for responding fire apparatus. Returning apparatus will enter the site from Johnson Street. There is a planned connection between these two entrances to allow for vehicular circulation through the site.

Landscaping

Attached with this submission is the proposed landscaping plan.

Parking

The building is planned to hold (12) employees 24 hours a day, with an additional (5) employees working normal business hours. The office space of the facility makes up 7781 square feet of the building which would amount to an additional 16 parking spaces. The proposed site plan has 63 parking spaces shown.

Lighting

Attached with this submission is the proposed site plan photometrics along with lighting cutsheets.


Sincerely,

Mark Zvitkovits, AIA

MARL ZVITLOVITS

(Lic. WI)

x:\uz\w\watrn\172202\site plan review\012224 plan review\final\letter.docx

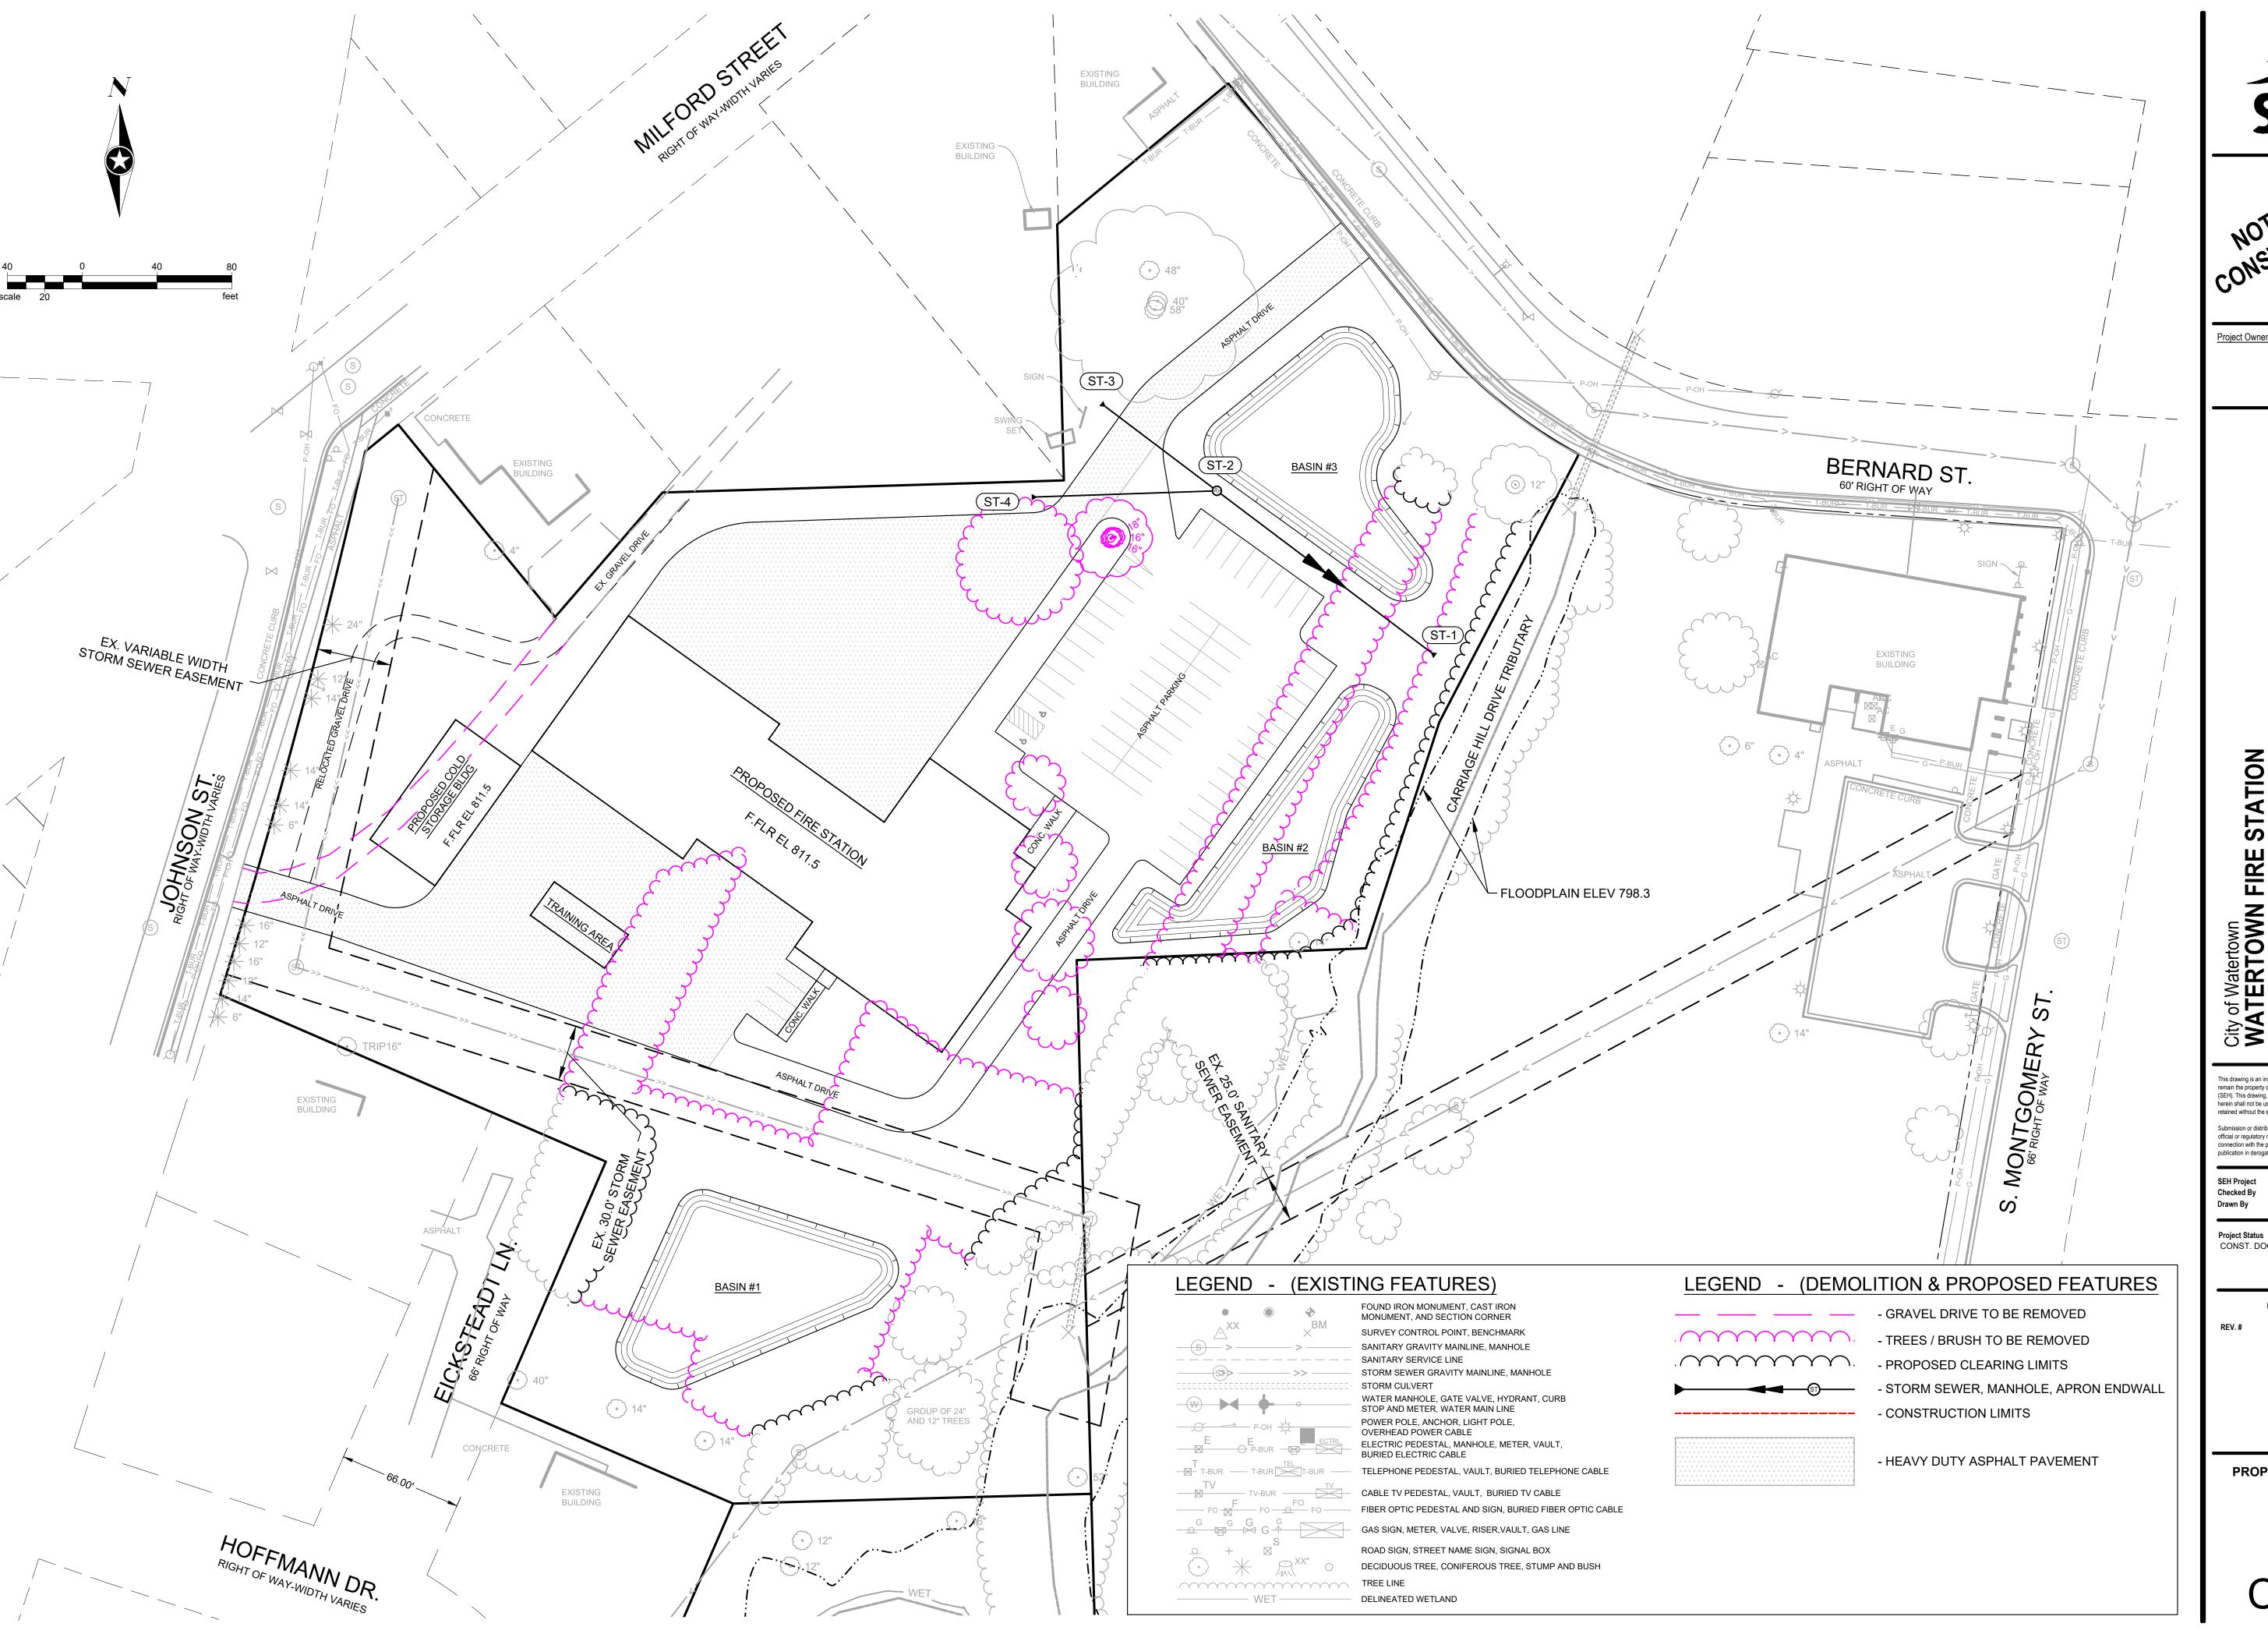

STATION City of Watertown

WATERTOWN FIRE S

ADDRESS

remain the property of Short Elliott Hendrickson, Inc. (SEH). This drawing, concepts and ideas contained herein shall not be used, reproduced, revised, or retained without the express written approval of SEH. Submission or distribution of this drawing to meet official or regulatory requirements or for purposes in connection with the project is not be construed as publication in derogation of any of the rights of SEH. WATRN_172202

Checked By


Issue Date CONST. DOC. 02/14/2024

REVISION SCHEDULE

DESCRIPTION

PROPOSED SITE PLAN

C 100₁₄

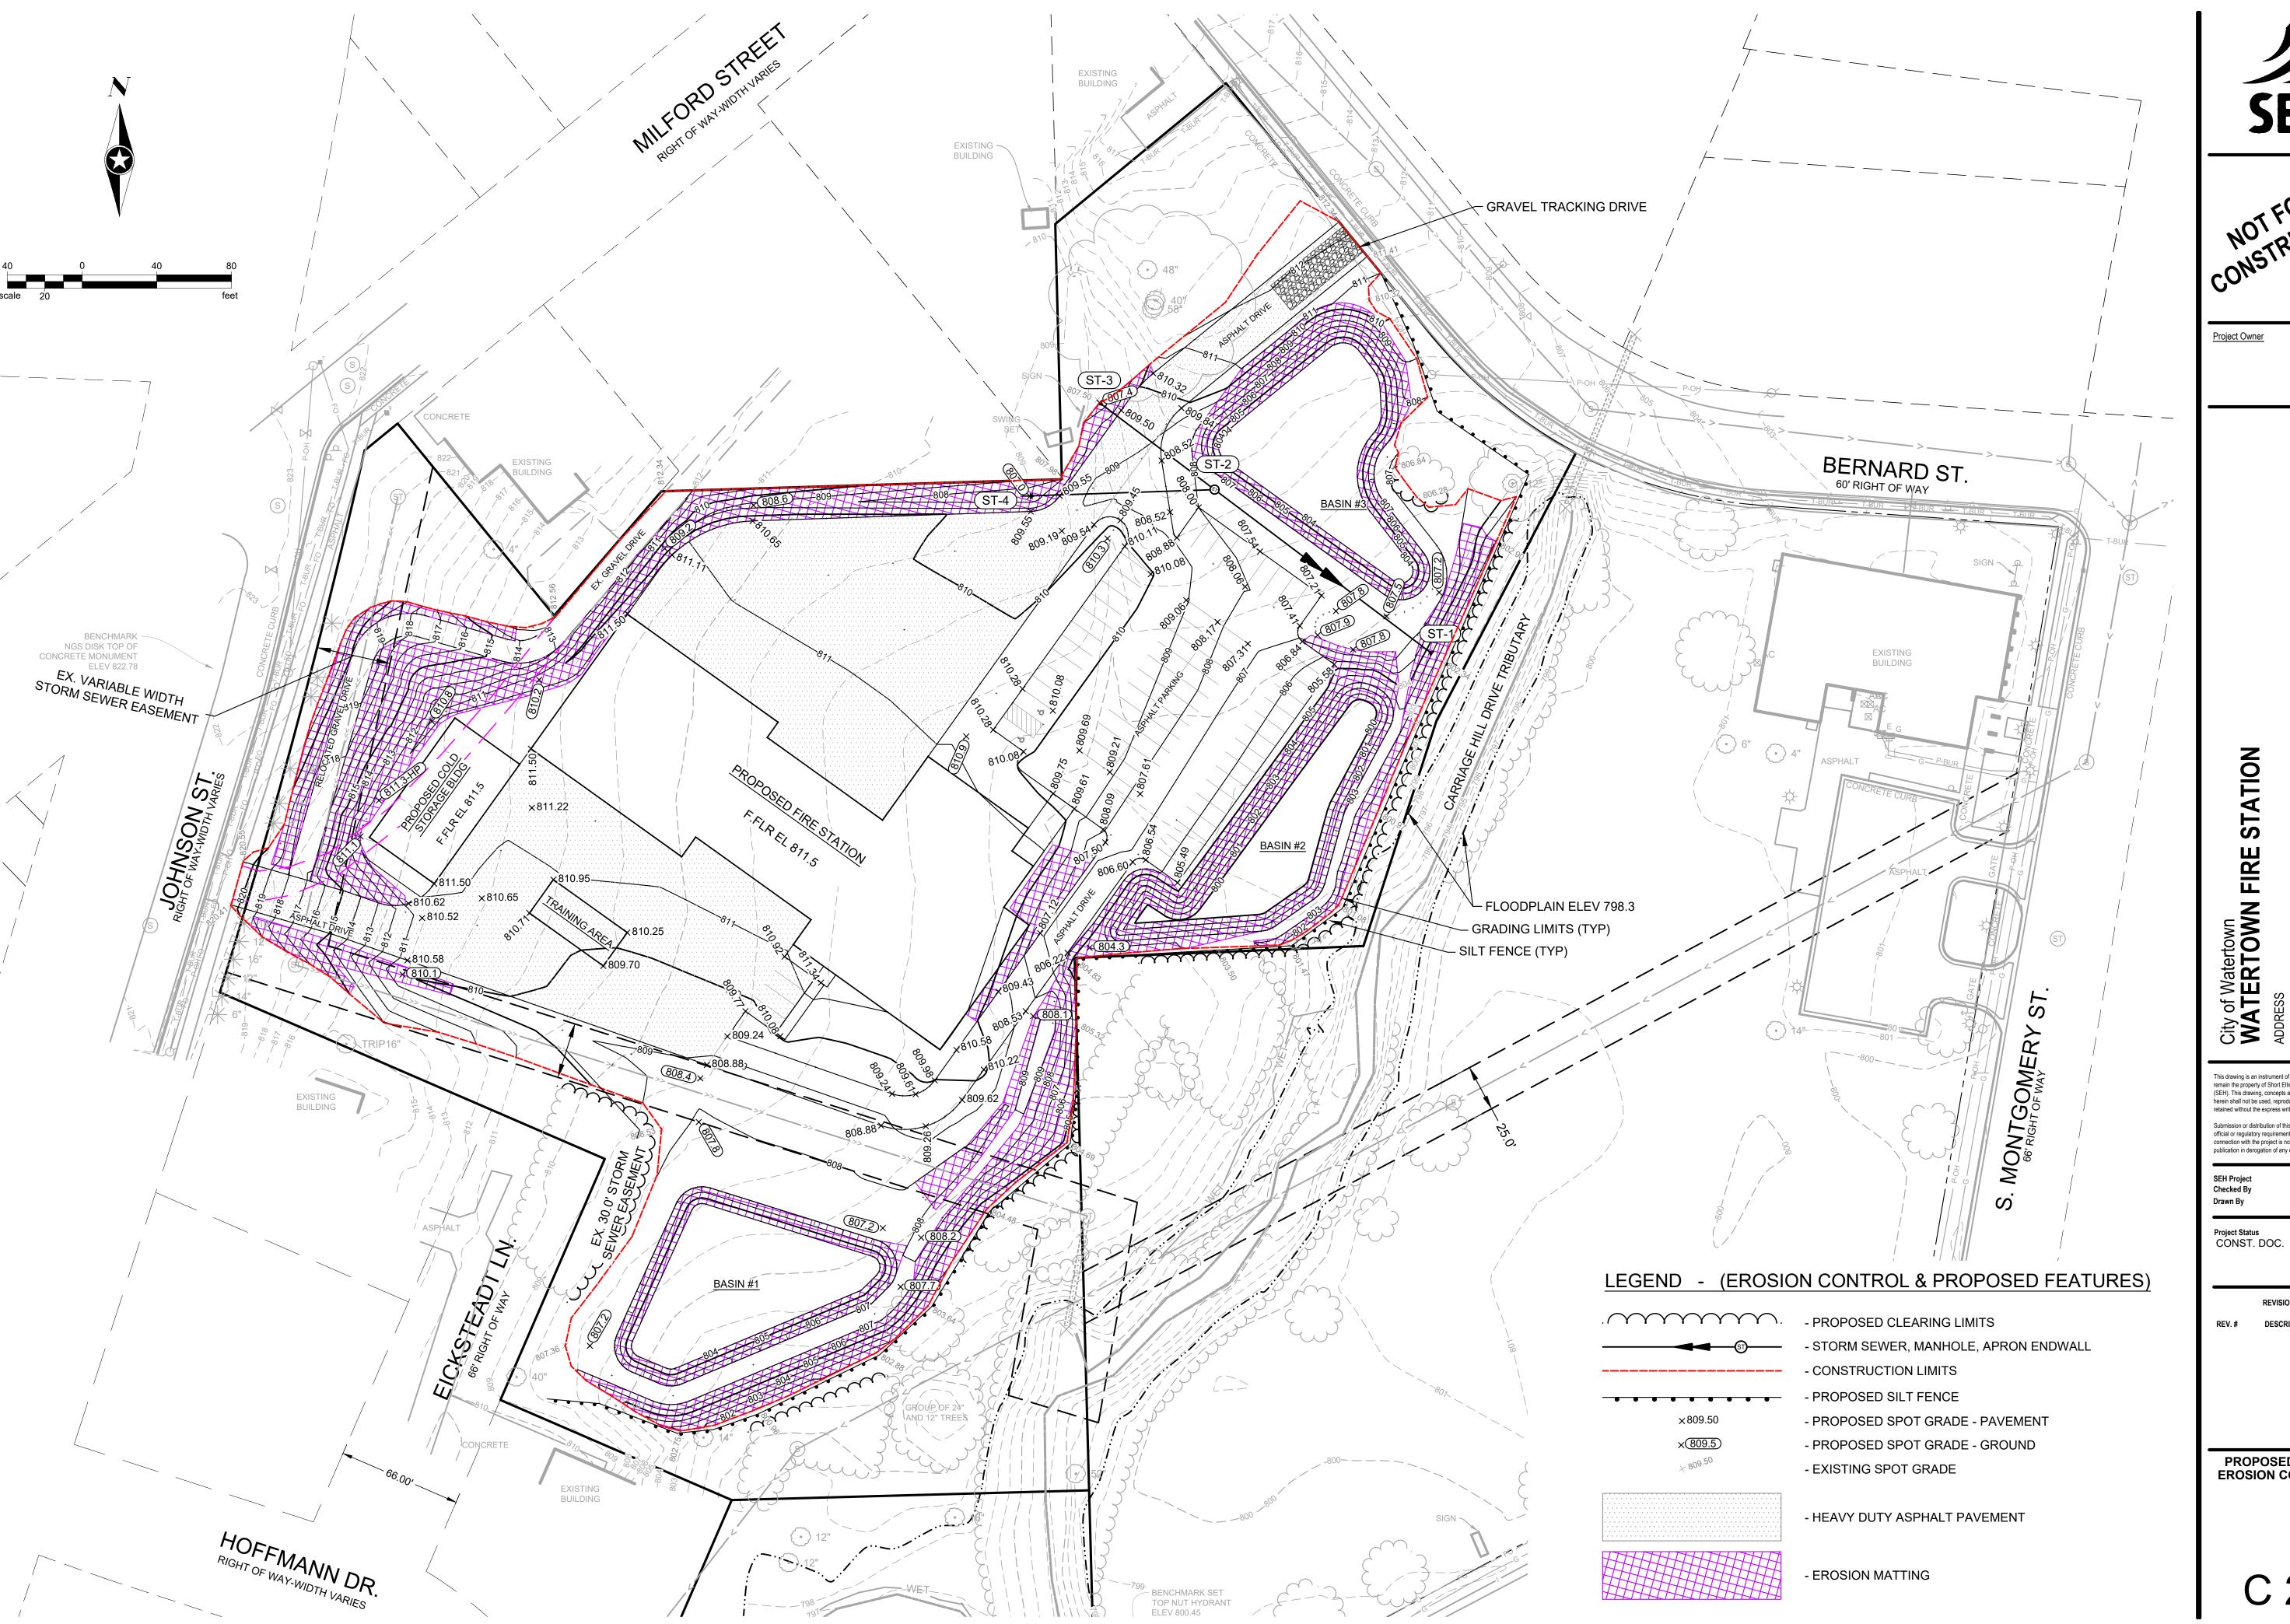



STATION

remain the property of Short Elliott Hendrickson, Inc. (SEH). This drawing, concepts and ideas contained herein shall not be used, reproduced, revised, or retained without the express written approval of SEH. Submission or distribution of this drawing to meet official or regulatory requirements or for purposes in connection with the project is not be construed as publication in derogation of any of the rights of SEH.

WATRN_172202


02/14/2024

REVISION SCHEDULE


DESCRIPTION

PROPOSED GRADING & EROSION CONTROL PLAN


C 200₁₅

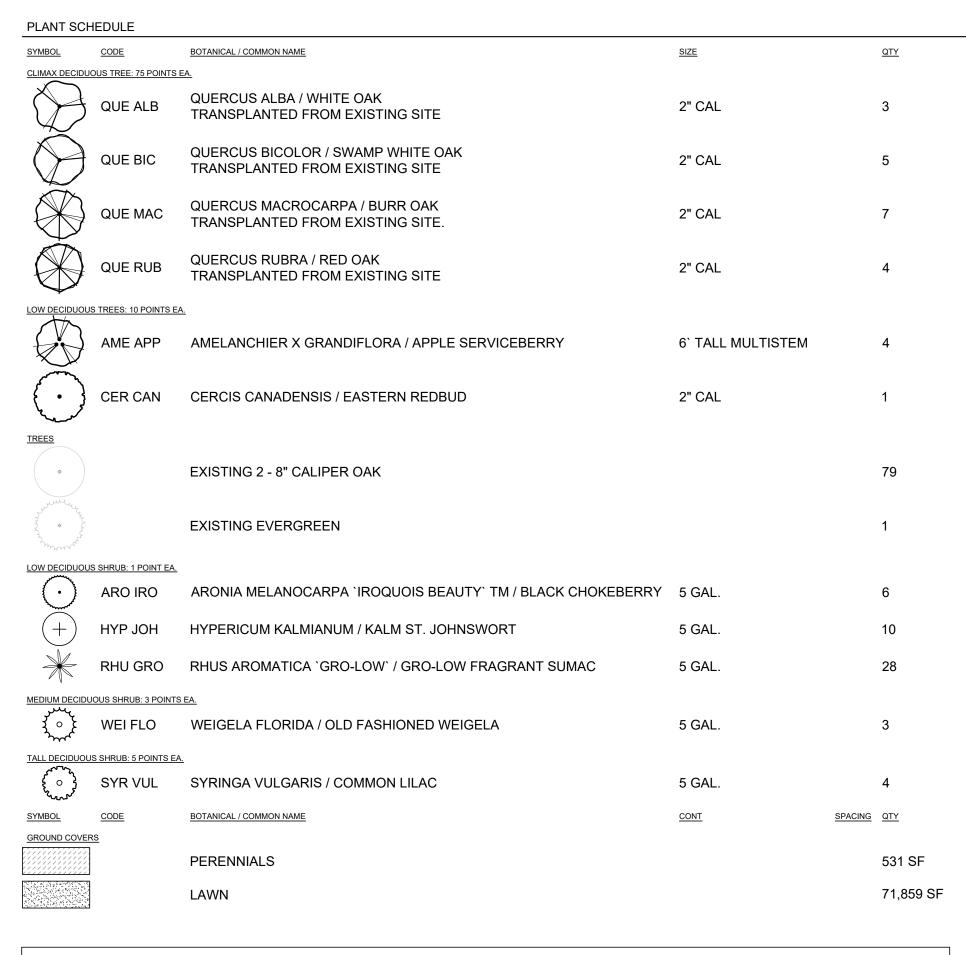

LANDSCAPE POINTS - CB CENTRAL BUSINESS ZONING DISTRICT					
	Building Foundation	Street Foundation	Paved Areas	Developed Lots	
Requirement	N/A	N/A	20 points per 20 parking stalls or 10,000 SF of parking area	N/A	
Measurement	N/A	N/A	79,281 SF total area paved for vehicles	N/A	
Points Required	N/A	N/A	158 points required, 64 points as shrubs, remainder as tall/climax trees, within 10' of pavement	N/A	
Points Provided	N/A	N/A		N/A	

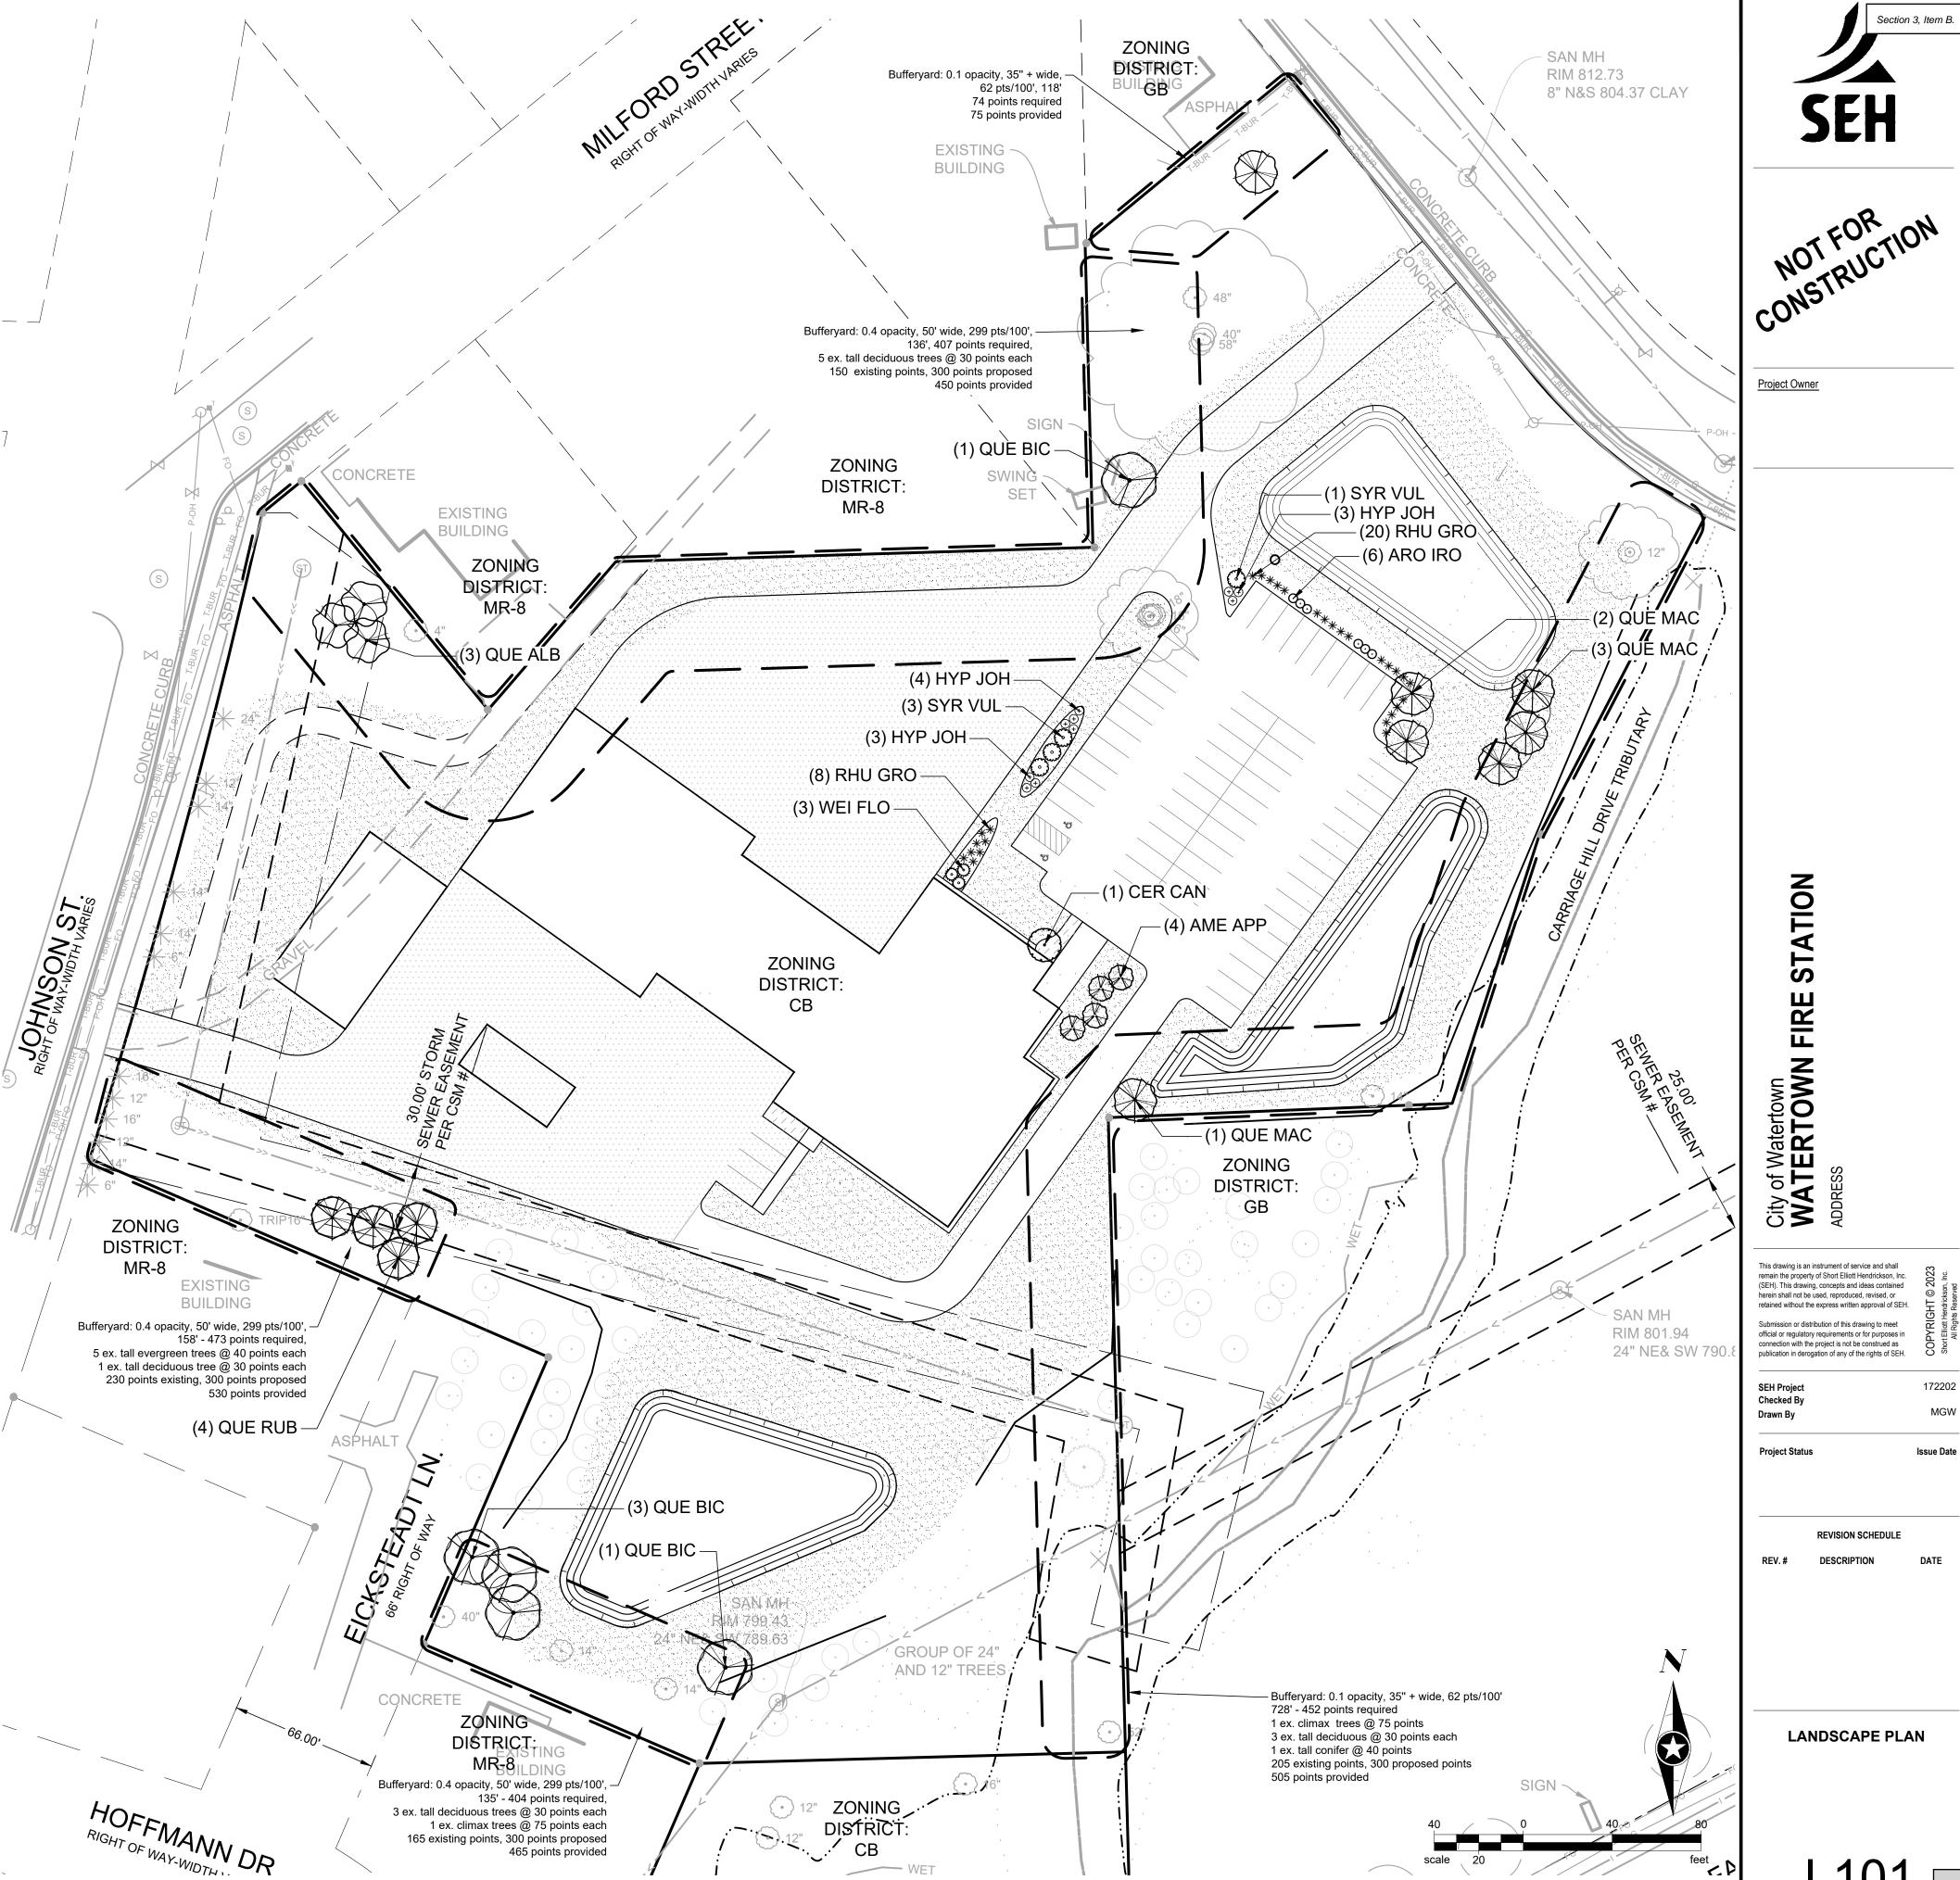


L101 16

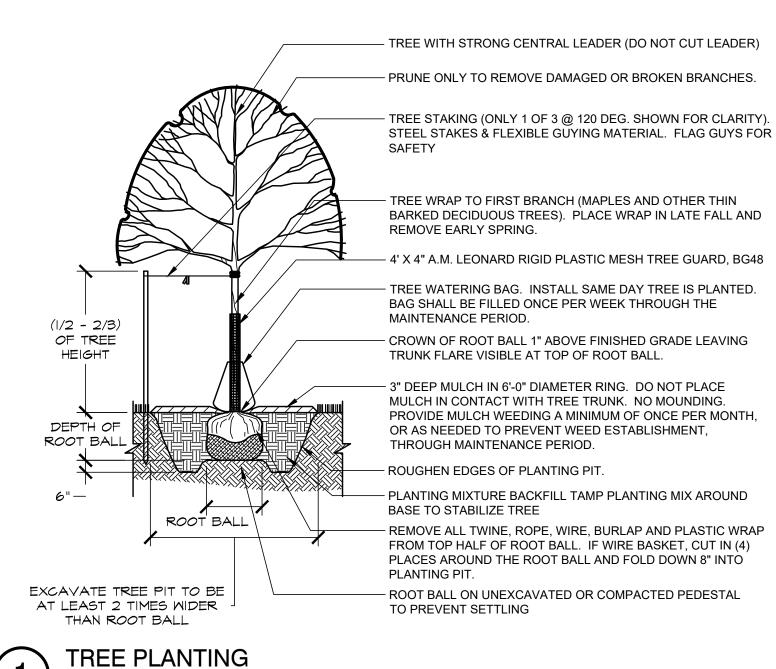

SHRUB PLANTING PRUNE ONLY TO REMOVE DEAD PER PLANT SPACING OR BROKEN BRANCHES BOTTOM OF ROOT FLARE FLUSH WITH FINISHED GRADE - 3" MULCH PLANTING MIXTURE HAND LOOSEN AND PULL ROOTS **OUT OF CONTAINER MATERIAL** TO PREVENT PLANT FROM BECOMING ROOT BOUND REMOVE ALL TWINE, ROPE, WIRE, BURLAP AND PLASTIC WRAP FROM TOP HALF OF ROOT BARE ROOT BURLAPPED CONTAINER SCARIFY 4" AND RECOMPACT SUBGRADE

SHRUB PLANTING

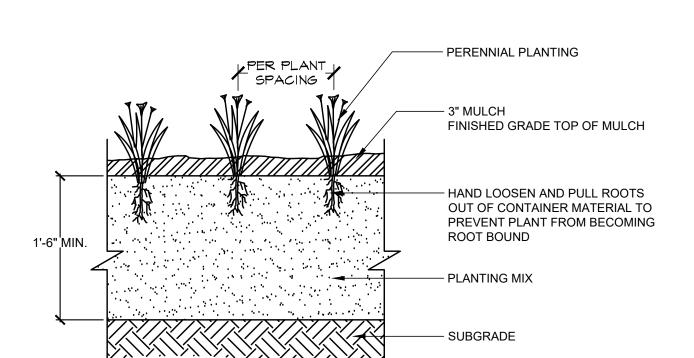

PERENNIAL PLANTING DETAIL 1" 1'-0"d 3293-01

PLANTING NOTES

329343-01

329333-04

- EXISTING TREES FOUND ON SITE SHALL BE PROTECTED AND SAVED UNLESS NOTED TO BE REMOVED OR ARE LOCATED IN AN AREA TO BE GRADED. QUESTIONS REGARDING EXISTING PLANT MATERIAL SHALL BE BROUGHT TO THE ATTENTION OF THE LANDSCAPE ARCHITECT PRIOR TO REMOVAL.
- 2. THE LAYOUT OF ALL PLANTING BEDS AND INDIVIDUAL TREES SHALL BE STAKED BY THE CONTRACTOR IN ADVANCE OF INSTALLATION. FLAGGING, STAKES, OR PAINT MAY BE USED TO DELINEATE LOCATIONS AS SCALED FROM THE PLANS. THE LANDSCAPE ARCHITECT WILL REVIEW THESE LOCATIONS WITH THE CONTRACTOR AND MAKE MINOR ADJUSTMENTS AS NECESSARY. BED LAYOUT SHALL ALSO INCLUDE PERENNIAL GROUPINGS BY SPECIES.
- THE CONTRACTOR IS RESPONSIBLE FOR INDEPENDENTLY DETERMINING THE PLANT
 MATERIAL QUANTITIES REQUIRED BY THE LANDSCAPE PLANS. REPORT ANY DISCREPANCIES
 TO THE LANDSCAPE ARCHITECT.
- 4. SALVAGE TOPSOIL FROM THE EARTHWORK AREAS AS APPROPRIATE AND/OR AS DIRECTED BY LANDSCAPE ARCHITECT AND STOCKPILE FOR REUSE IN LOCATION APPROVED BY OWNER.
- 5. AREAS UNDER PLANTING BEDS SHALL NOT CONTAIN COMPACTED AGGREGATE TO ALLOW FOR PROPER DRAINAGE AND GROWTH OF PLANT MATERIAL. REMOVE AGGREGATE AND PERFORM SUBSOILING AS NECESSARY TO OBTAIN LOOSE, FREE DRAINING SUBGRADE BELOW PLANTING BEDS. UNDESIRABLE CONDITIONS SHALL BE BROUGHT TO THE ATTENTION OF THE LANDSCAPE ARCHITECT PRIOR TO BEGINNING OF WORK. IT SHALL BE THE CONTRACTOR'S RESPONSIBILITY TO ENSURE PROPER SURFACE AND SUBSURFACE DRAINAGE IN ALL AREAS.
- 6. CONTRACTOR SHALL ENSURE THAT SOIL CONDITIONS AND COMPACTION ARE ADEQUATE TO ALLOW FOR PROPER DRAINAGE AROUND THE CONSTRUCTION SITE. UNDESIRABLE CONDITIONS SHALL BE BROUGHT TO THE ATTENTION OF THE LANDSCAPE ARCHITECT PRIOR TO BEGINNING OF WORK. IT SHALL BE THE CONTRACTOR'S RESPONSIBILITY TO ENSURE PROPER SURFACE AND SUBSURFACE DRAINAGE IN ALL AREAS.
- 7. ALL SEED & SOD AREAS SHALL RECEIVE A MINIMUM OF 6" DEPTH OF TOPSOIL.
- 8. ALL PLANTING BEDS SHALL RECEIVE 18" DEPTH OF PREPARED SOIL
- 9. SEED AND PLUG PLANTING SHALL OCCUR IN DESIGNATED PLANTING WINDOWS, SEE SPECIFICATIONS.
- 10. PAINT OR STAKE LIMITS OF SEEDING FOR REVIEW BY LANDSCAPE ARCHITECT & OWNER PRIOR TO SEEDING.
- 11. NEW SEEDED AREAS TO BE TREATED WITH HERBICIDE TO KILL ALL EXISTING GROUNDCOVER. THERE SHALL BE A MINIMUM OF TWO (2) APPLICATIONS SEPARATED BY 10 DAYS. IF ALL EXISTING GROUNDCOVER VEGETATION IS NOT KILLED WITHIN 10 DAYS OF 2ND APPLICATION, A 3RD APPLICATION IS REQUIRED.
- 12. ALL DISTURBED AREAS OUTSIDE THE LIMITS OF WORK SHALL BE RESTORED TO ORIGINAL OR BETTER CONDITION AT NO ADDITIONAL COST TO THE OWNER.
- 13. ALL PLANTING BEDS SHALL HAVE A SHOVEL CUT EDGE, UNLESS OTHERWISE SPECIFIED.
- 14. ALL PLANTING BEDS AND PLANTED TREES SHALL BE MULCHED WITH 3" DEEP SHREDDED HARDWOOD MULCH PER PLANTING DETAILS. MULCH SHALL BE CONSIDERED INCIDENTAL TO PLANT MATERIALS.
- 15. LAWN SEED SHALL BE ESTABLISHED BY THE CONTRACTOR TO A DENSE, GREEN CONSISTENT LAWN VOID OF ANY BARE OR PATCHY AREAS LARGER THAN 3" X 3".
- SEED PRIOR TO OCT. 15. IF SEEDED AFTER OCT. 15, MAINTAIN AND ESTABLISH LAWN UNTIL SPRING REVIEW.
- 17. NO PLANT MATERIAL SUBSTITUTIONS WILL BE ACCEPTED UNLESS APPROVAL BY THE LANDSCAPE ARCHITECT. ALL PLANT MATERIAL AND SEED SHALL BE PROVIDED FROM A NURSERY (WITHIN 200 MILES) WITH A SIMILAR PLANT HARDINESS ZONE AS PROJECT LOCATION.
- 18. CONTRACTOR IS RESPONSIBLE FOR ON-GOING MAINTENANCE OF ALL NEWLY INSTALLED MATERIALS UNTIL TIME OF OWNER ACCEPTANCE. ANY ACTS OF VANDALISM OR DAMAGE WHICH MAY OCCUR PRIOR TO OWNER ACCEPTANCE SHALL BE THE RESPONSIBILITY OF THE CONTRACTOR.



CONSTRUCTION

Project Owner

City of Watertown

WATERTOWN FIRE STATION

ADDRESS

This drawing is an instrument of service and shall remain the property of Short Elliott Hendrickson, Inc. (SEH). This drawing, concepts and ideas contained herein shall not the express and ideas contained herein shall not the express written approval of SEH.

Submission or distribution of this drawing to meet official or regulatory requirements or for purposes in connection with the project is not be construed as publication in derogation of any of the rights of SEH.

SEH Project

172202

Issue Date

Drawn By

Project Status


Checked By

REVISION SCHEDULE

REV. # DESCRIPTION

LANDSCAPE SCHEDULE, DETAIL, NOTES

L102 17

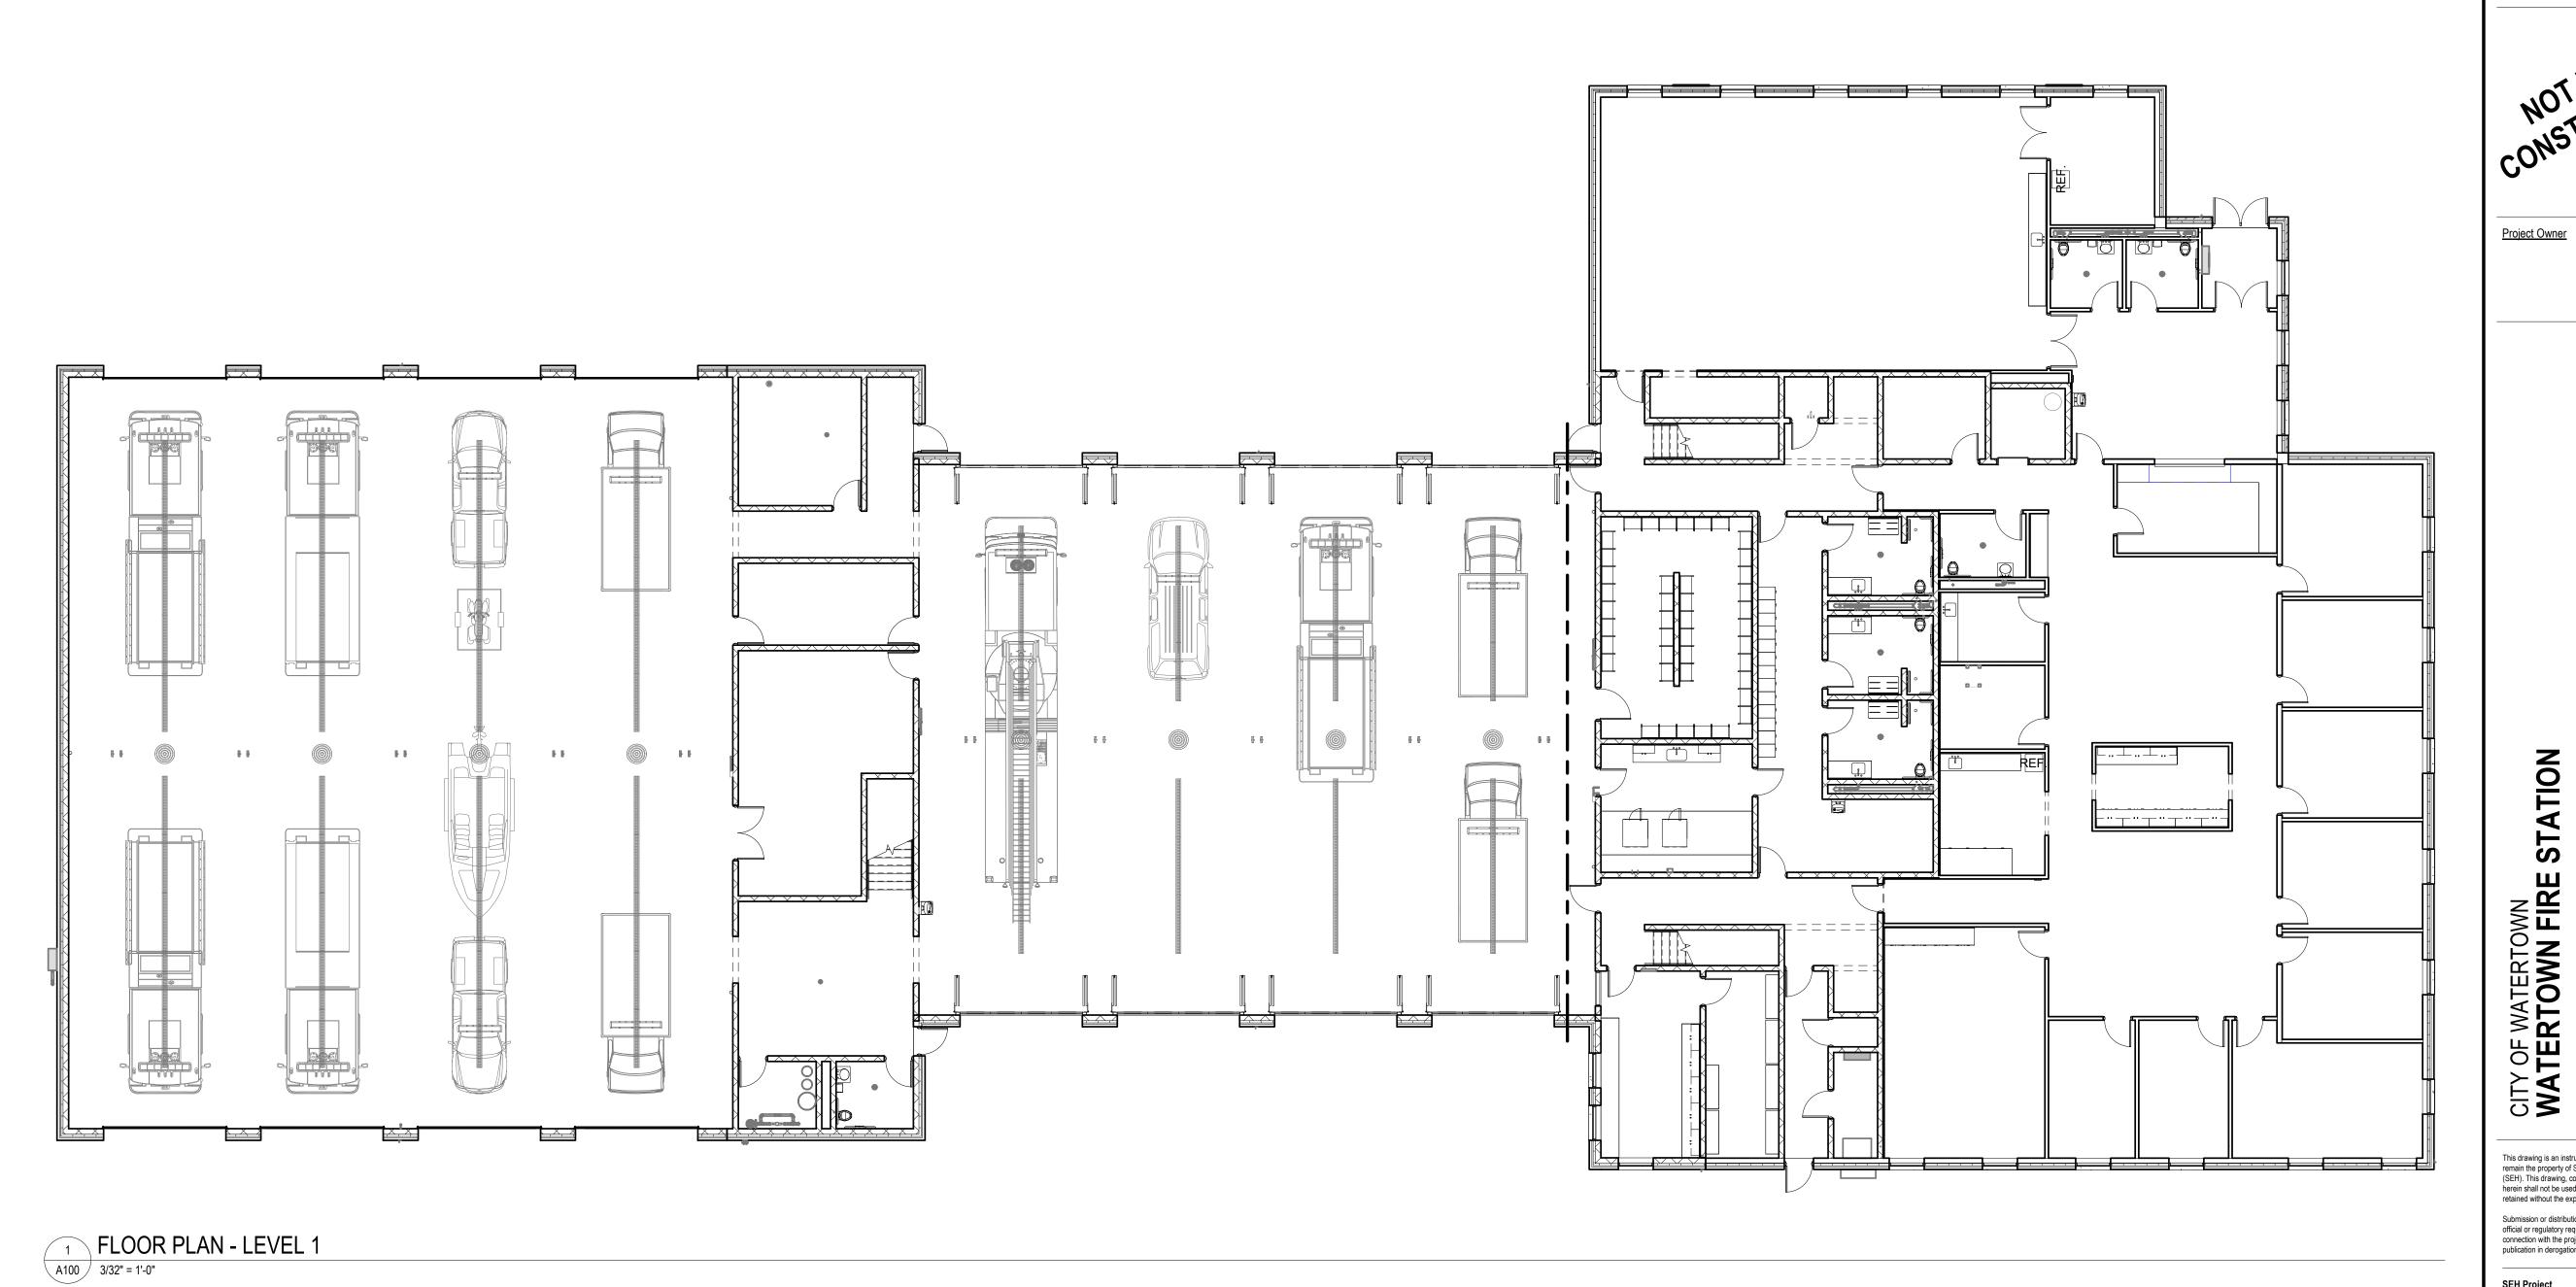


This drawing is an instrument of service and shall remain the property of Short Elliott Hendrickson, Inc. (SEH). This drawing, concepts and ideas contained herein shall not be used, reproduced, revised, or retained without the express written approval of SEH. Submission or distribution of this drawing to meet official or regulatory requirements or for purposes in connection with the project is not be construed as publication in derogation of any of the rights of SEH. SEH Project WATRN 172202 Checked By Checked By Drawn By Drawn By Project Status
CONSTRUCTION DOCUMENTS Issue Date 2/14/2024

REVISION SCHEDULE

REV. # DESCRIPTION DATE

OVERALL PLAN - BUILDING A - LEVEL 1

PROJECT NORTH

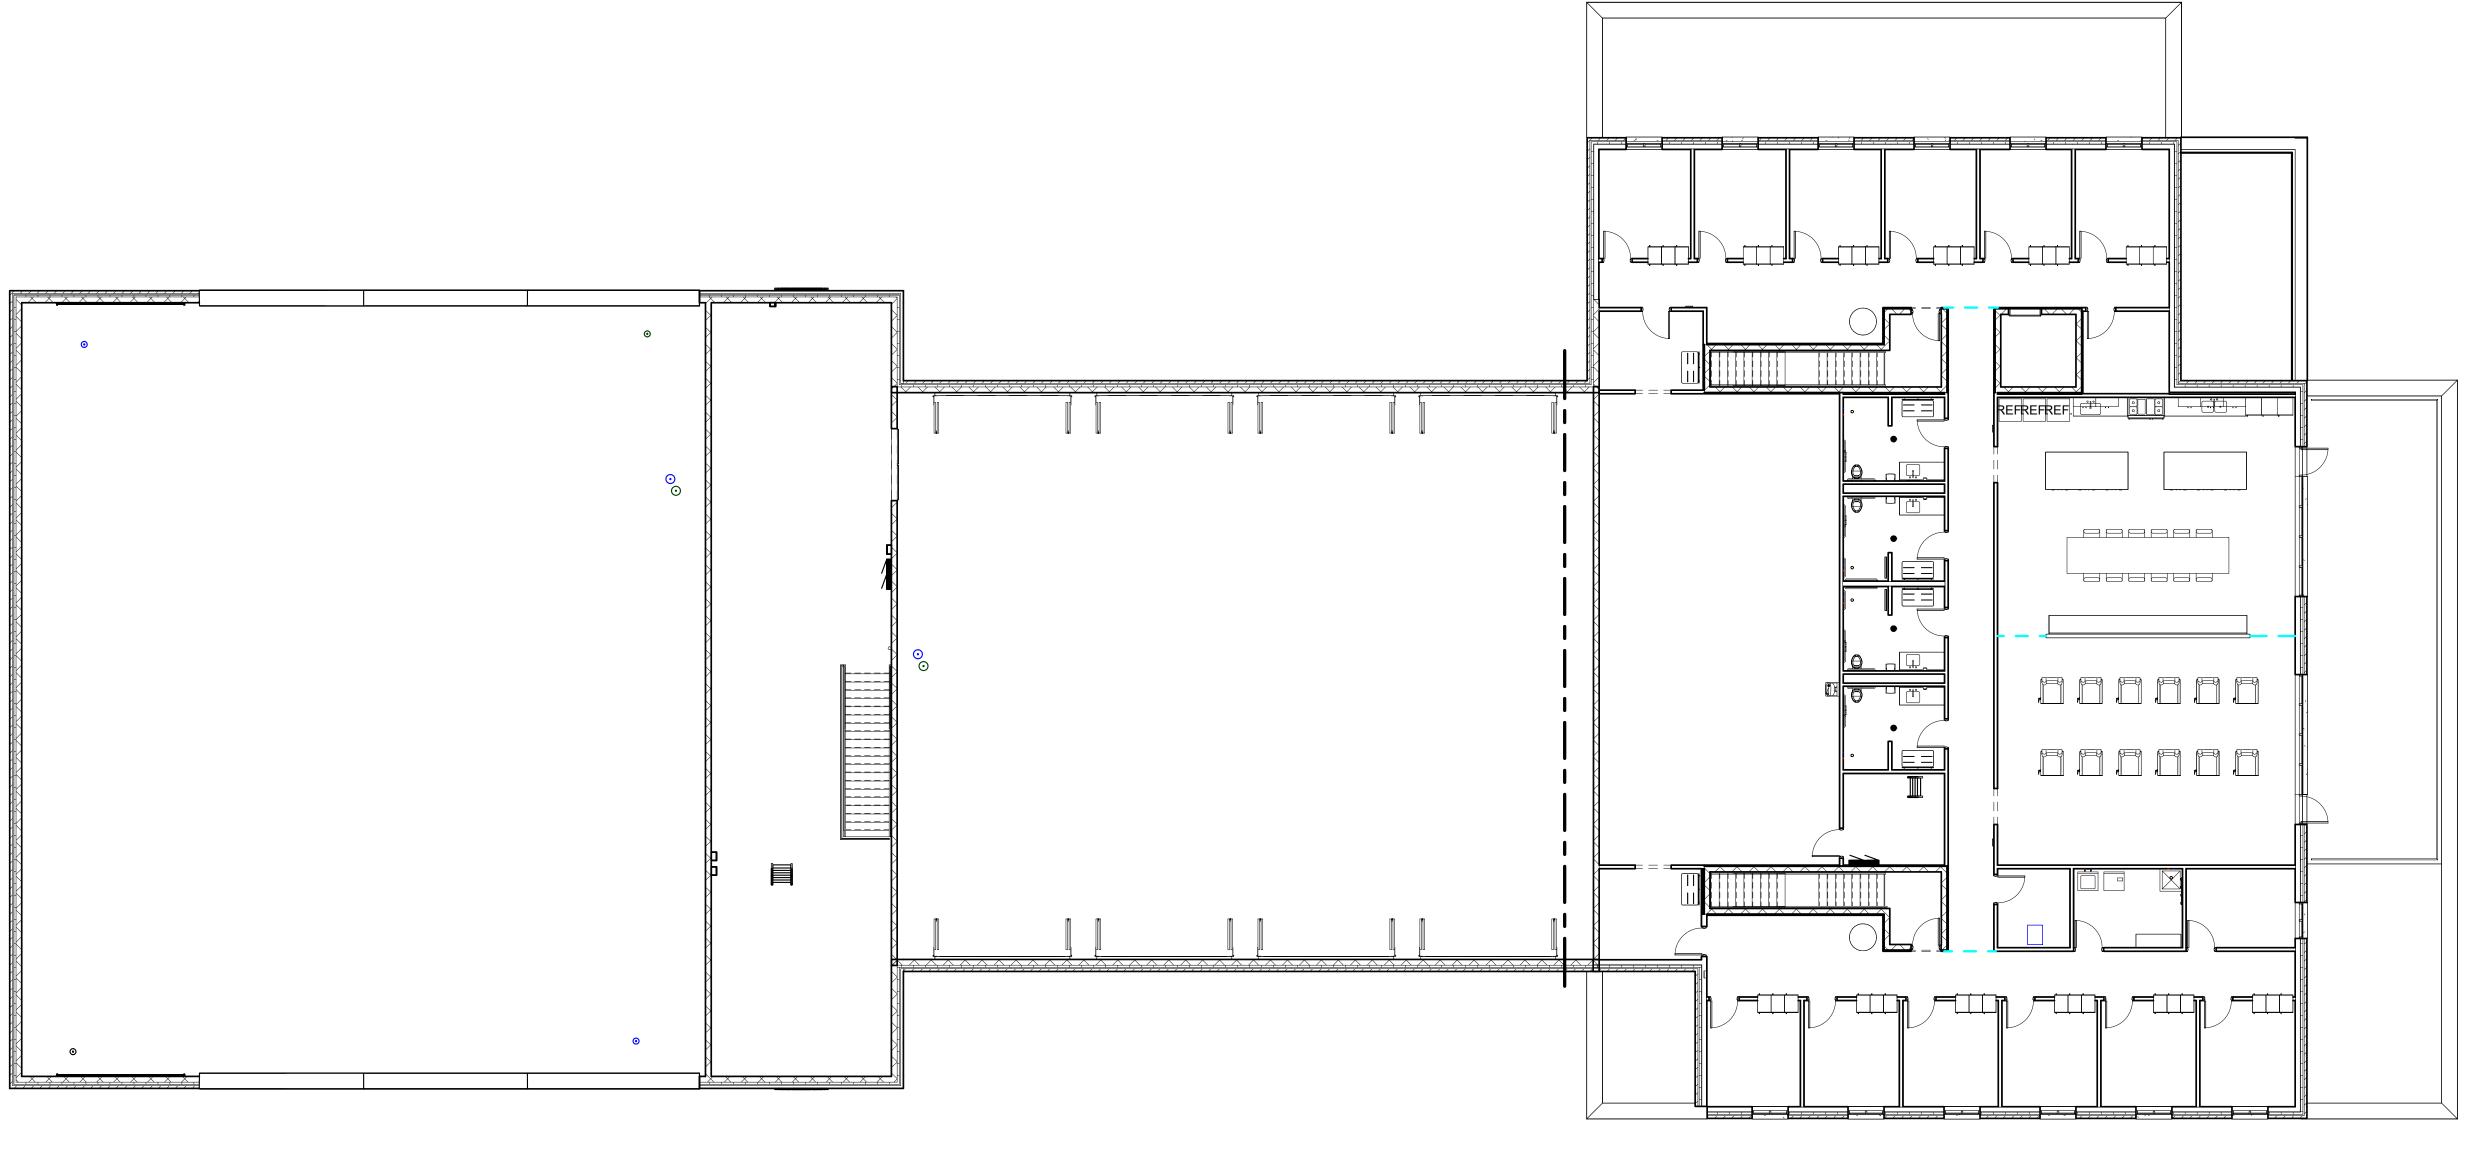





NOT FOR TON CONSTRUCTION

Project Owner

CITY OF WATERTOWN
WATERTOWN FIRE STATION

This drawing is an instrument of service and shall remain the property of Short Elliott Hendrickson, Inc. (SEH). This drawing, concepts and ideas contained herein shall not be used, reproduced, revised, or retained without the express written approval of SEH.

Submission or distribution of this drawing to meet official or regulatory requirements or for purposes in connection with the project is not be construed as publication in derogation of any of the rights of SEH.

WATRN 172202

Checked By Drawn By

Issue Date 2/14/2024

SEH Project
Checked By

Project Status
CONSTRUCTION DOCUMENTS

REVISION SCHEDULE

REV. # DESCRIPTION DATE

OVERALL PLAN - BUILDING A - LEVEL 2

PROJECT NORTH



CONSTRUCTION KEYNOTE LEGEND

- (1) CONCRETE FILLED METAL PAN STAIR
- (2) STEEL PIPE HANDRAIL, MOUNTED TO WALL
- (3) (3) THRU-WALL, PASS-THRU LOCKERS, SEE 9/A503xxxxxxx FOR DETAILS
- (4) TILE SHOWER, SEE XXXXXXXX FOR THRESHOLD DETAIL
- INSTALL GRAB BARS IN SHOWERS WITH TOP OF GRIPPING SURFACE AT 34" A.F.F.
- (6) WALL-MOUNTED WIRE SHELF, ULINE H-6723 OR EQUAL
- PROVIDE BLOCKING IN THIS WALL, 4 STUD CAVITIES W/ (2) 8" TALL BLOCKS EACH. VERIFY LOCATIONS W/ OWNER
- 8) SOLID SURFACE COUNTERTOP W/ 4 GROMMETS, VERIFY GROMMET
- LOCATIONS W/ OWNER, SEE 3/A503
- (9) BULLNOSE ALL OUTSIDE CORNERS OF CMU WALL
- (10) WALL MOUNTED STEEL SHIPS LADDER, SEE XXXXXXX
- (11) ROOF HATCH, LOCATE BETWEEN STEEL JOISTS (12) REMOVABLE RAILING, SEE XXXXXX FOR DETAIL

MODEL 23, WWW.SLIDEPOLE.COM

- (13) FIRE POLE, BASIS OF DESIGN: MCINTIRE BRASS WORKS, INC.
- (14) CUBICLES, N.I.C.
- (15) ROOF PAVERS, TYPICAL
- (16) PRECAST CONCRETE ROOF PAVERS ON PEDEDSTAL SUPPORTS
- (17) STAINLESS STEEL GUARDRAIL, SEE XXXXXXX
- (18) FURNITURE N.I.C.
- (19) PIPE BOLLARD, SEE STRUCTURAL FOR DETAIL
- (20) HOSE WASHER N.I.C.
- (21) GEAR DRYER N.I.C.
- PROVIDE DOOR BUMPER TO PROTECT ADJACENT WALL FROM PASS-THRU LOCKER DOOR, TYP.
- 23) 48" HIGH MIRROR ALONG ENTIRE WALL MOUNTED @ 36" A.F.F.
- (24) 31" DIAMETER MANHOLE COVER & RIM (NEENAH FOUNDRY MODEL
- R-1581-A), ENSURE THAT LOCATIONS ON BOTH LEVELS ARE ALIGNED (25) METAL PLATE TO COVER OPENING ABOVE STRINGER, WELD TO WIDE FLANGE, SEE 9 / A503
- (26) EQUIPMENT PAD, SEE STRUCTURAL FOR DETAILS
- 27) PROVIDE BLOCKING IN THIS WALL FOR FUTURE WALL-MOUNTED
- SHOWER SEAT, PROVIDED BY OWNER
- 28) SEE 7 / A504 FOR WALL RECESS DETAIL FOR UNDERCOUNTER DISHWASHER
- 29 SUMP GUARD RAIL, SEE 14 / A507
- 30 REFERENCE STRUCTURAL FOR INSULATION THICKNESS

Project Owner

STATION RTOWN **NN FIRE** CITY OF WATER WATER

remain the property of Short Elliott Hendrickson, Inc. (SEH). This drawing, concepts and ideas contained herein shall not be used, reproduced, revised, or retained without the express written approval of SEH Submission or distribution of this drawing to meet official or regulatory requirements or for purposes in connection with the project is not be construed as

WATRN 172202

Checked By

Drawn By

2/14/2024

Checked By

Project Status CONSTRUCTION DOCUMENTS

publication in derogation of any of the rights of SEH.

REVISION SCHEDULE

DESCRIPTION

FLOOR PLAN - BUILDING A -LEVEL 1





40'-0"

18'-0"

CONSTRUCTION KEYNOTE LEGEND

(1) CONCRETE FILLED METAL PAN STAIR

(2) STEEL PIPE HANDRAIL, MOUNTED TO WALL

(3) (3) THRU-WALL, PASS-THRU LOCKERS, SEE 9/A503xxxxxxx FOR

(4) TILE SHOWER, SEE XXXXXXXX FOR THRESHOLD DETAIL

(5) INSTALL GRAB BARS IN SHOWERS WITH TOP OF GRIPPING SURFACE AT 34" A.F.F.

(6) WALL-MOUNTED WIRE SHELF, ULINE H-6723 OR EQUAL

7 PROVIDE BLOCKING IN THIS WALL, 4 STUD CAVITIES W/ (2) 8" TALL BLOCKS EACH. VERIFY LOCATIONS W/ OWNER

(8) SOLID SURFACE COUNTERTOP W/ 4 GROMMETS, VERIFY GROMMET LOCATIONS W/ OWNER, SEE 3/A503

(9) BULLNOSE ALL OUTSIDE CORNERS OF CMU WALL

(10) WALL MOUNTED STEEL SHIPS LADDER, SEE XXXXXXX

(11) ROOF HATCH, LOCATE BETWEEN STEEL JOISTS

13) FIRE POLE, BASIS OF DESIGN: MCINTIRE BRASS WORKS, INC. MODEL 23, WWW.SLIDEPOLE.COM

(14) CUBICLES, N.I.C.

(15) ROOF PAVERS, TYPICAL

(16) PRECAST CONCRETE ROOF PAVERS ON PEDEDSTAL SUPPORTS

(17) STAINLESS STEEL GUARDRAIL, SEE XXXXXXX

(18) FURNITURE - N.I.C.

(19) PIPE BOLLARD, SEE STRUCTURAL FOR DETAIL

(20) HOSE WASHER - N.I.C.

(21) GEAR DRYER - N.I.C.

(22) PROVIDE DOOR BUMPER TO PROTECT ADJACENT WALL FROM PASS-THRU LOCKER DOOR, TYP.

23) 48" HIGH MIRROR ALONG ENTIRE WALL MOUNTED @ 36" A.F.F.

24) 31" DIAMETER MANHOLE COVER & RIM (NEENAH FOUNDRY MODEL R-1581-A), ENSURE THAT LOCATIONS ON BOTH LEVELS ARE ALIGNED

25) METAL PLATE TO COVER OPENING ABOVE STRINGER, WELD TO WIDE FLANGE, SEE 9 / A503

(26) EQUIPMENT PAD, SEE STRUCTURAL FOR DETAILS PROVIDE BLOCKING IN THIS WALL FOR FUTURE WALL-MOUNTED

SHOWER SEAT, PROVIDED BY OWNER 28) SEE 7 / A504 FOR WALL RECESS DETAIL FOR UNDERCOUNTER

DISHWASHER (29) SUMP GUARD RAIL, SEE 14 / A507

18'-0"

4'-0"

18'-0"

30 REFERENCE STRUCTURAL FOR INSULATION THICKNESS

Project Owner

CITY OF WATERTOWN WATERTOWN FIRE STATION

remain the property of Short Elliott Hendrickson, Inc. (SEH). This drawing, concepts and ideas contained herein shall not be used, reproduced, revised, or retained without the express written approval of SEH. Submission or distribution of this drawing to meet official or regulatory requirements or for purposes in connection with the project is not be construed as publication in derogation of any of the rights of SEH.

> WATRN 172202 Checked By Drawn By

CONSTRUCTION DOCUMENTS

REVISION SCHEDULE

DESCRIPTION

FLOOR PLAN - BUILDING A -LEVEL 1



LEVEL 1 FLOOR PLAN

5'-4"

18'-0"

18'-0"

A202 4

CONSTRUCTION KEYNOTE LEGEND

- 1 CONCRETE FILLED METAL PAN STAIR
- (2) STEEL PIPE HANDRAIL, MOUNTED TO WALL
- (3) (3) THRU-WALL, PASS-THRU LOCKERS, SEE 9/A503xxxxxxx FOR
- (4) TILE SHOWER, SEE XXXXXXXX FOR THRESHOLD DETAIL
- (5) INSTALL GRAB BARS IN SHOWERS WITH TOP OF GRIPPING SURFACE AT 34" A.F.F.
- (6) WALL-MOUNTED WIRE SHELF, ULINE H-6723 OR EQUAL
- (7) PROVIDE BLOCKING IN THIS WALL, 4 STUD CAVITIES W/ (2) 8" TALL BLOCKS EACH. VERIFY LOCATIONS W/ OWNER
- 8) SOLID SURFACE COUNTERTOP W/ 4 GROMMETS, VERIFY GROMMET LOCATIONS W/ OWNER, SEE 3/A503
- 9 BULLNOSE ALL OUTSIDE CORNERS OF CMU WALL
- (10) WALL MOUNTED STEEL SHIPS LADDER, SEE XXXXXXX
- (11) ROOF HATCH, LOCATE BETWEEN STEEL JOISTS
- (12) REMOVABLE RAILING, SEE XXXXXX FOR DETAIL
- (13) FIRE POLE, BASIS OF DESIGN: MCINTIRE BRASS WORKS, INC. MODEL 23, WWW.SLIDEPOLE.COM
- (14) CUBICLES, N.I.C.
- (15) ROOF PAVERS, TYPICAL
- (16) PRECAST CONCRETE ROOF PAVERS ON PEDEDSTAL SUPPORTS
- (17) STAINLESS STEEL GUARDRAIL, SEE XXXXXXX
- (18) FURNITURE N.I.C.
- (19) PIPE BOLLARD, SEE STRUCTURAL FOR DETAIL
- 20 HOSE WASHER N.I.C.
- (21) GEAR DRYER N.I.C.
- (22) PROVIDE DOOR BUMPER TO PROTECT ADJACENT WALL FROM PASS-THRU LOCKER DOOR, TYP.
- (23) 48" HIGH MIRROR ALONG ENTIRE WALL MOUNTED @ 36" A.F.F.
- (24) 31" DIAMETER MANHOLE COVER & RIM (NEENAH FOUNDRY MODEL R-1581-A), ENSURE THAT LOCATIONS ON BOTH LEVELS ARE ALIGNED
- (25) METAL PLATE TO COVER OPENING ABOVE STRINGER, WELD TO WIDE FLANGE, SEE 9 / A503
- (26) EQUIPMENT PAD, SEE STRUCTURAL FOR DETAILS
- (27) PROVIDE BLOCKING IN THIS WALL FOR FUTURE WALL-MOUNTED
- SHOWER SEAT, PROVIDED BY OWNER 28 SEE 7 / A504 FOR WALL RECESS DETAIL FOR UNDERCOUNTER
- DISHWASHER 29 SUMP GUARD RAIL, SEE 14 / A507
- 30 REFERENCE STRUCTURAL FOR INSULATION THICKNESS

Project Owner

RIOWN NO FIRE STATION CITY OF WATER WATER

remain the property of Short Elliott Hendrickson, Inc. (SEH). This drawing, concepts and ideas contained herein shall not be used, reproduced, revised, or retained without the express written approval of SEH Submission or distribution of this drawing to meet official or regulatory requirements or for purposes in connection with the project is not be construed as

WATRN 172202

Checked By

Drawn By

2/14/2024

Checked By

Project Status CONSTRUCTION DOCUMENTS

publication in derogation of any of the rights of SEH.

REVISION SCHEDULE

DESCRIPTION

FLOOR PLAN - BUILDING A -

LEVEL 2



FLOOR PLAN - LEVEL 2

A104 1/8" = 1'-0"

LEVEL 2 FLOOR PLAN

A104 1/8" = 1'-0"

CITY OF WATERTOWN
WATERTOWN FIRE STATION

This drawing is an instrument of service and shall remain the property of Short Elliott Hendrickson, Inc. (SEH). This drawing, concepts and ideas contained herein shall not be used, reproduced, revised, or retained without the express written approval of SEH.

Submission or distribution of this drawing to meet official or regulatory requirements or for purposes in connection with the project is not be construed as publication in derogation of any of the rights of SEH.

WATRN 172202

Checked By Drawn By

Issue Date 2/14/2024

SEH Project Checked By Drawn By

Project Status
CONSTRUCTION DOCUMENTS

CONSTRUCTION DOCUMENTS

REVISION SCHEDULE
REV. # DESCRIPTION

FLOOR PLAN - BUILDING B -LEVEL 1





remain the property of Short Elliott Hendrickson, Inc. (SEH). This drawing, concepts and ideas contained herein shall not be used, reproduced, revised, or retained without the express written approval of SEH Submission or distribution of this drawing to meet official or regulatory requirements or for purposes in connection with the project is not be construed as publication in derogation of any of the rights of SEH.

WATRN 172202

Checked By Drawn By

Issue Date


2/14/2024


CONSTRUCTION DOCUMENTS

REVISION SCHEDULE

DESCRIPTION


EXTERIOR ELEVATIONS -BUILDING A

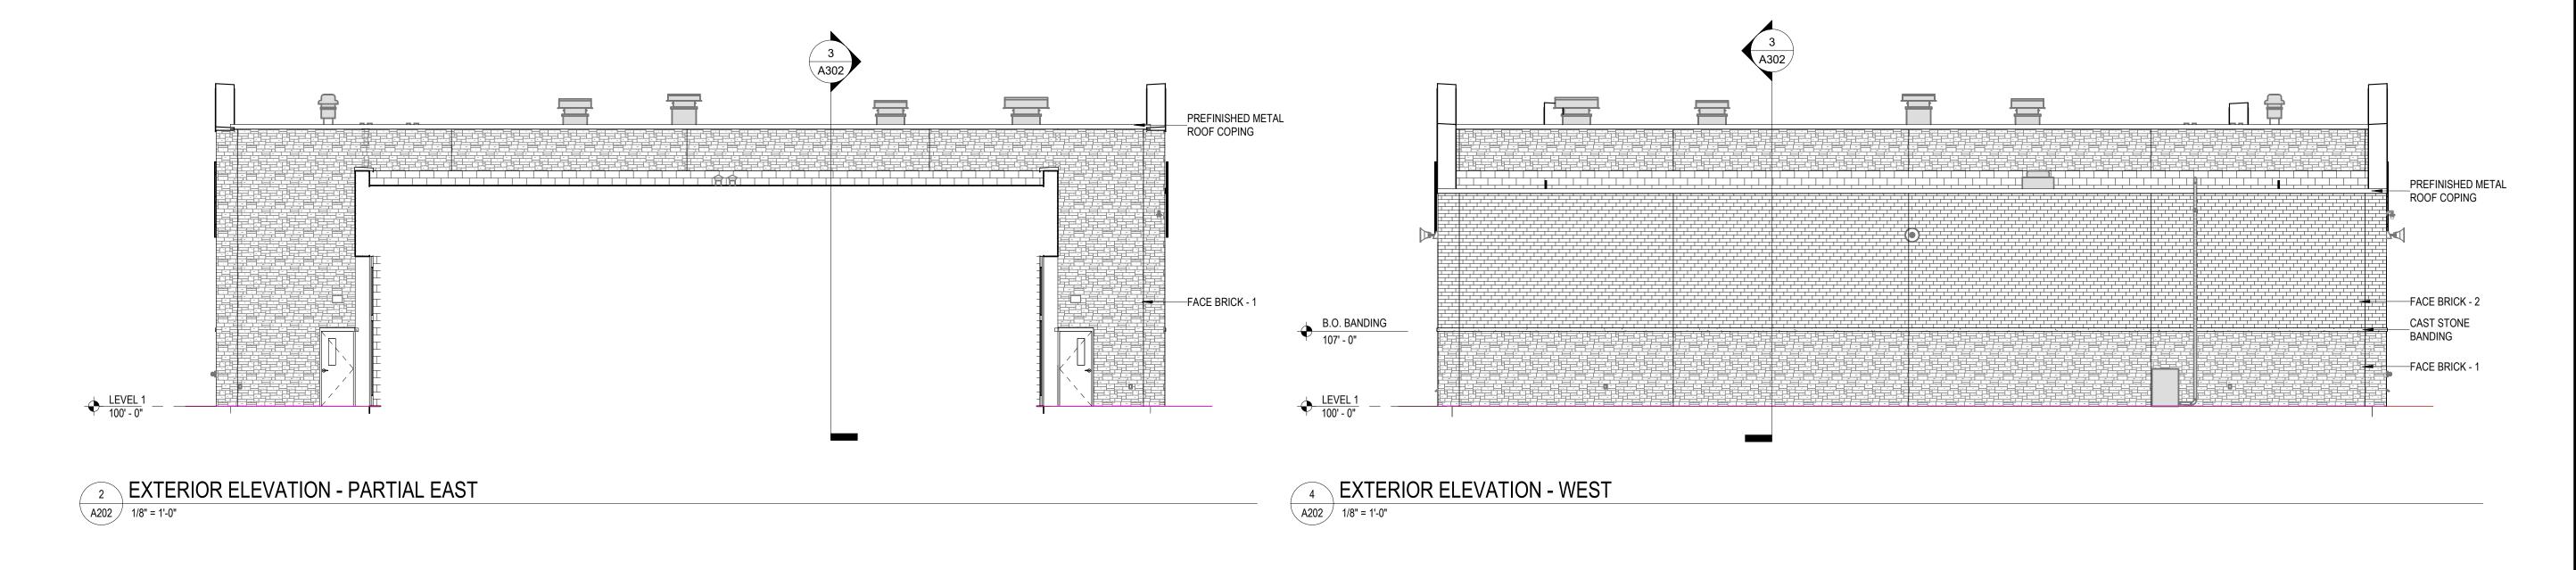

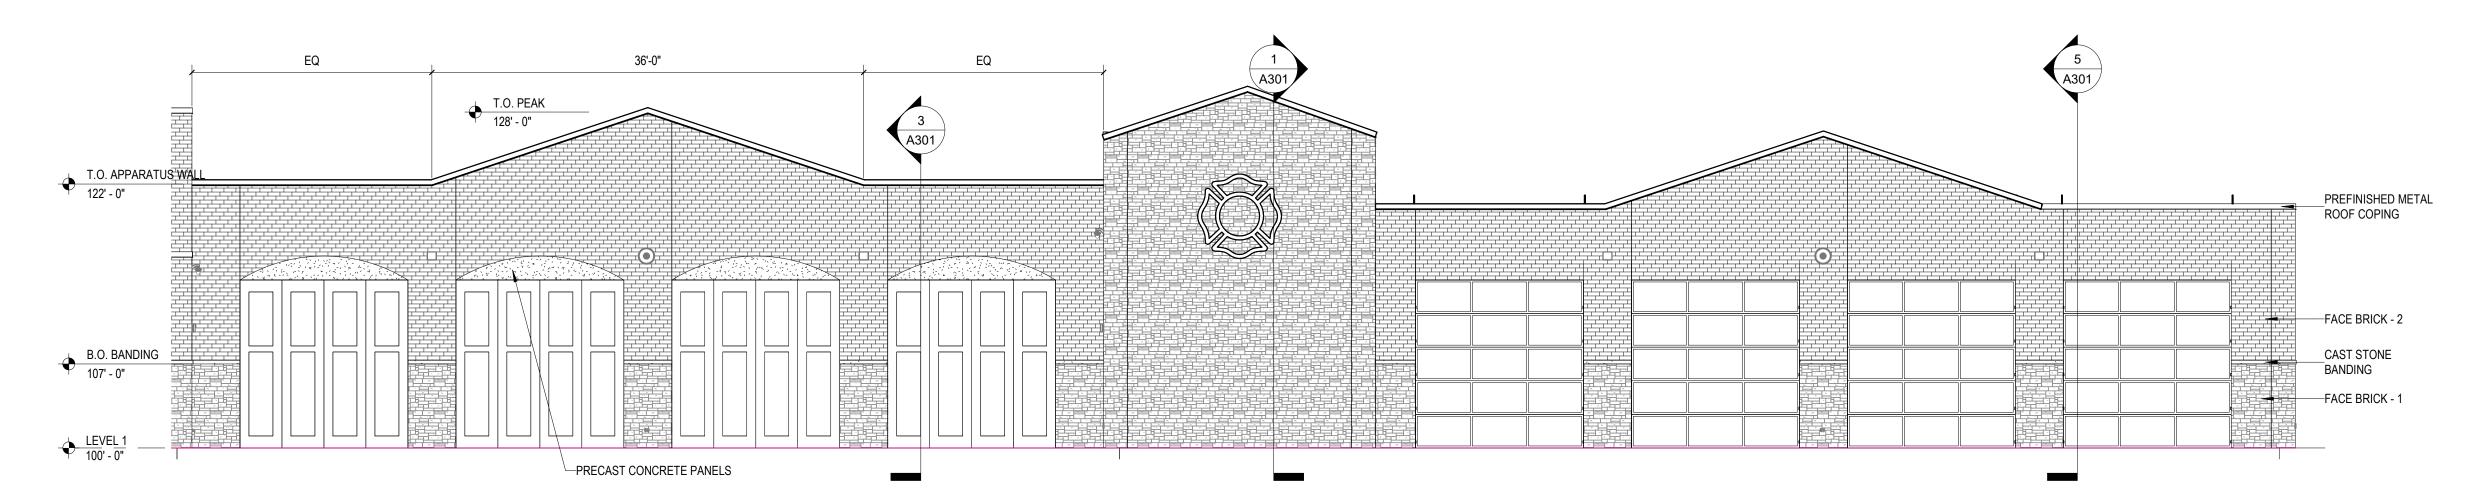

EXTERIOR ELEVATION - PARTIAL NORTH

1/8" = 1'-0"

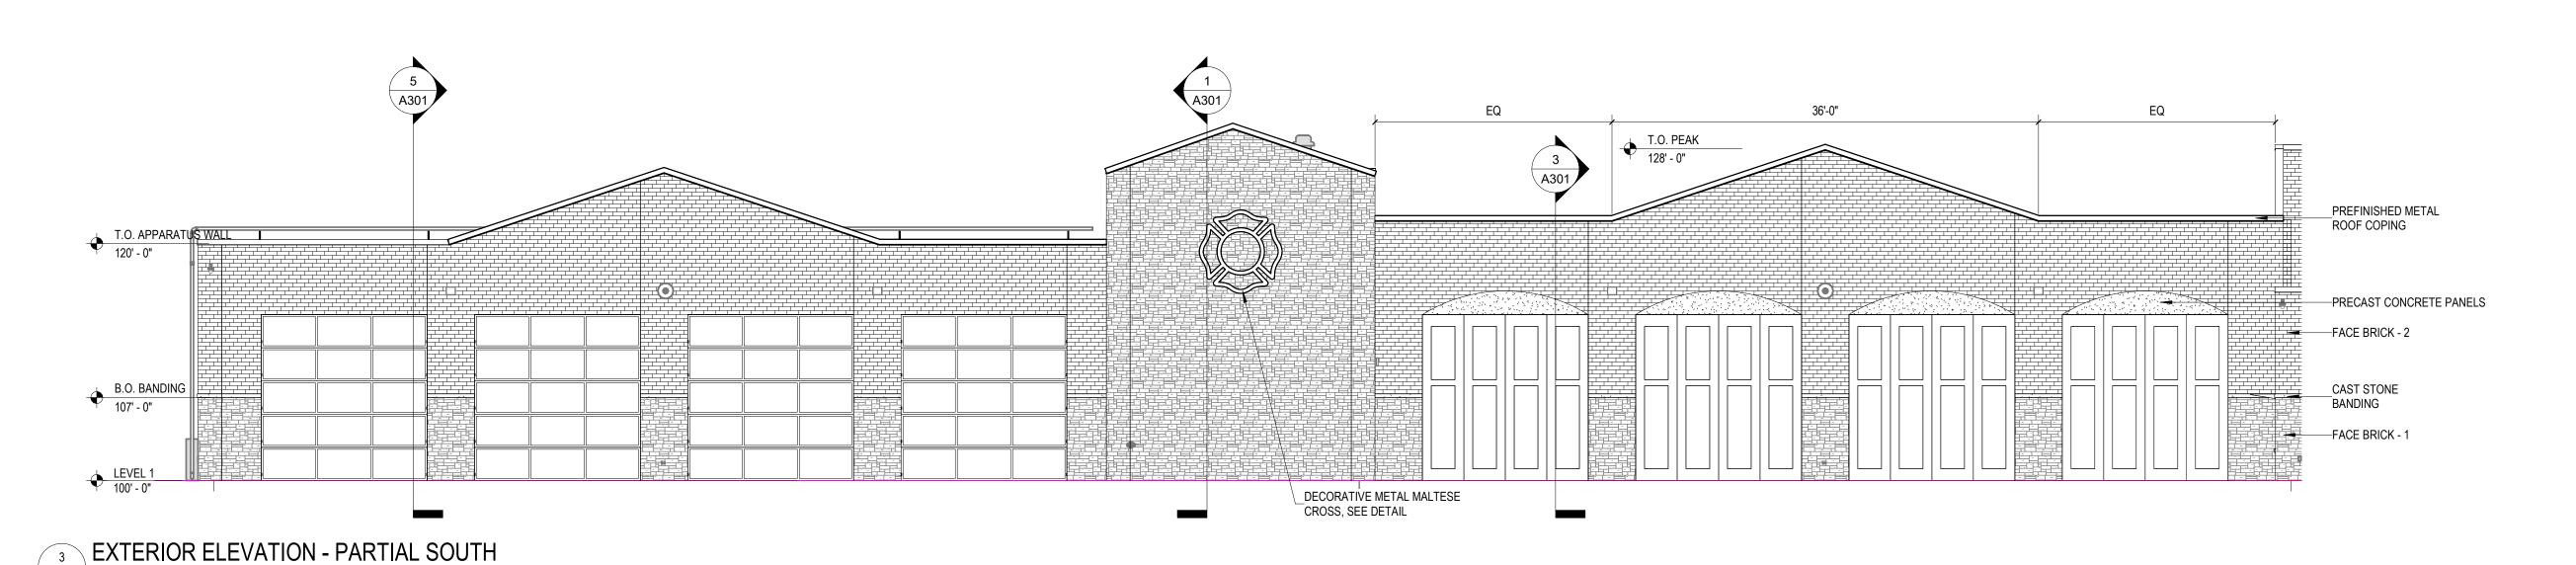

Section 3, Item

8

SEH

CONSTRUCTION

Project Owner

CITY OF WATERTOWN
WATERTOWN FIRE STATION

This drawing is an instrument of service and shall remain the property of Short Elliott Hendrickson, Inc. (SEH). This drawing, concepts and ideas contained herein shall not be used, reproduced, revised, or retained without the express written approval of SEH.

Submission or distribution of this drawing to meet official or regulatory requirements or for purposes in connection with the project is not be construed as publication in derogation of any of the rights of SEH.

WATRN 172202

Checked By Drawn By

Issue Date

2/14/2024

SEH Project Checked By Drawn By

Project Status
CONSTRUCTION DOCUMENTS

CONSTRUCTION DOCUMENTS


REVISION SCHEDULE

REV. # DESCRIPTION

EXTERIOR ELEVATIONS -BUILDING A

A202 [

A202 1/8" = 1'-0"

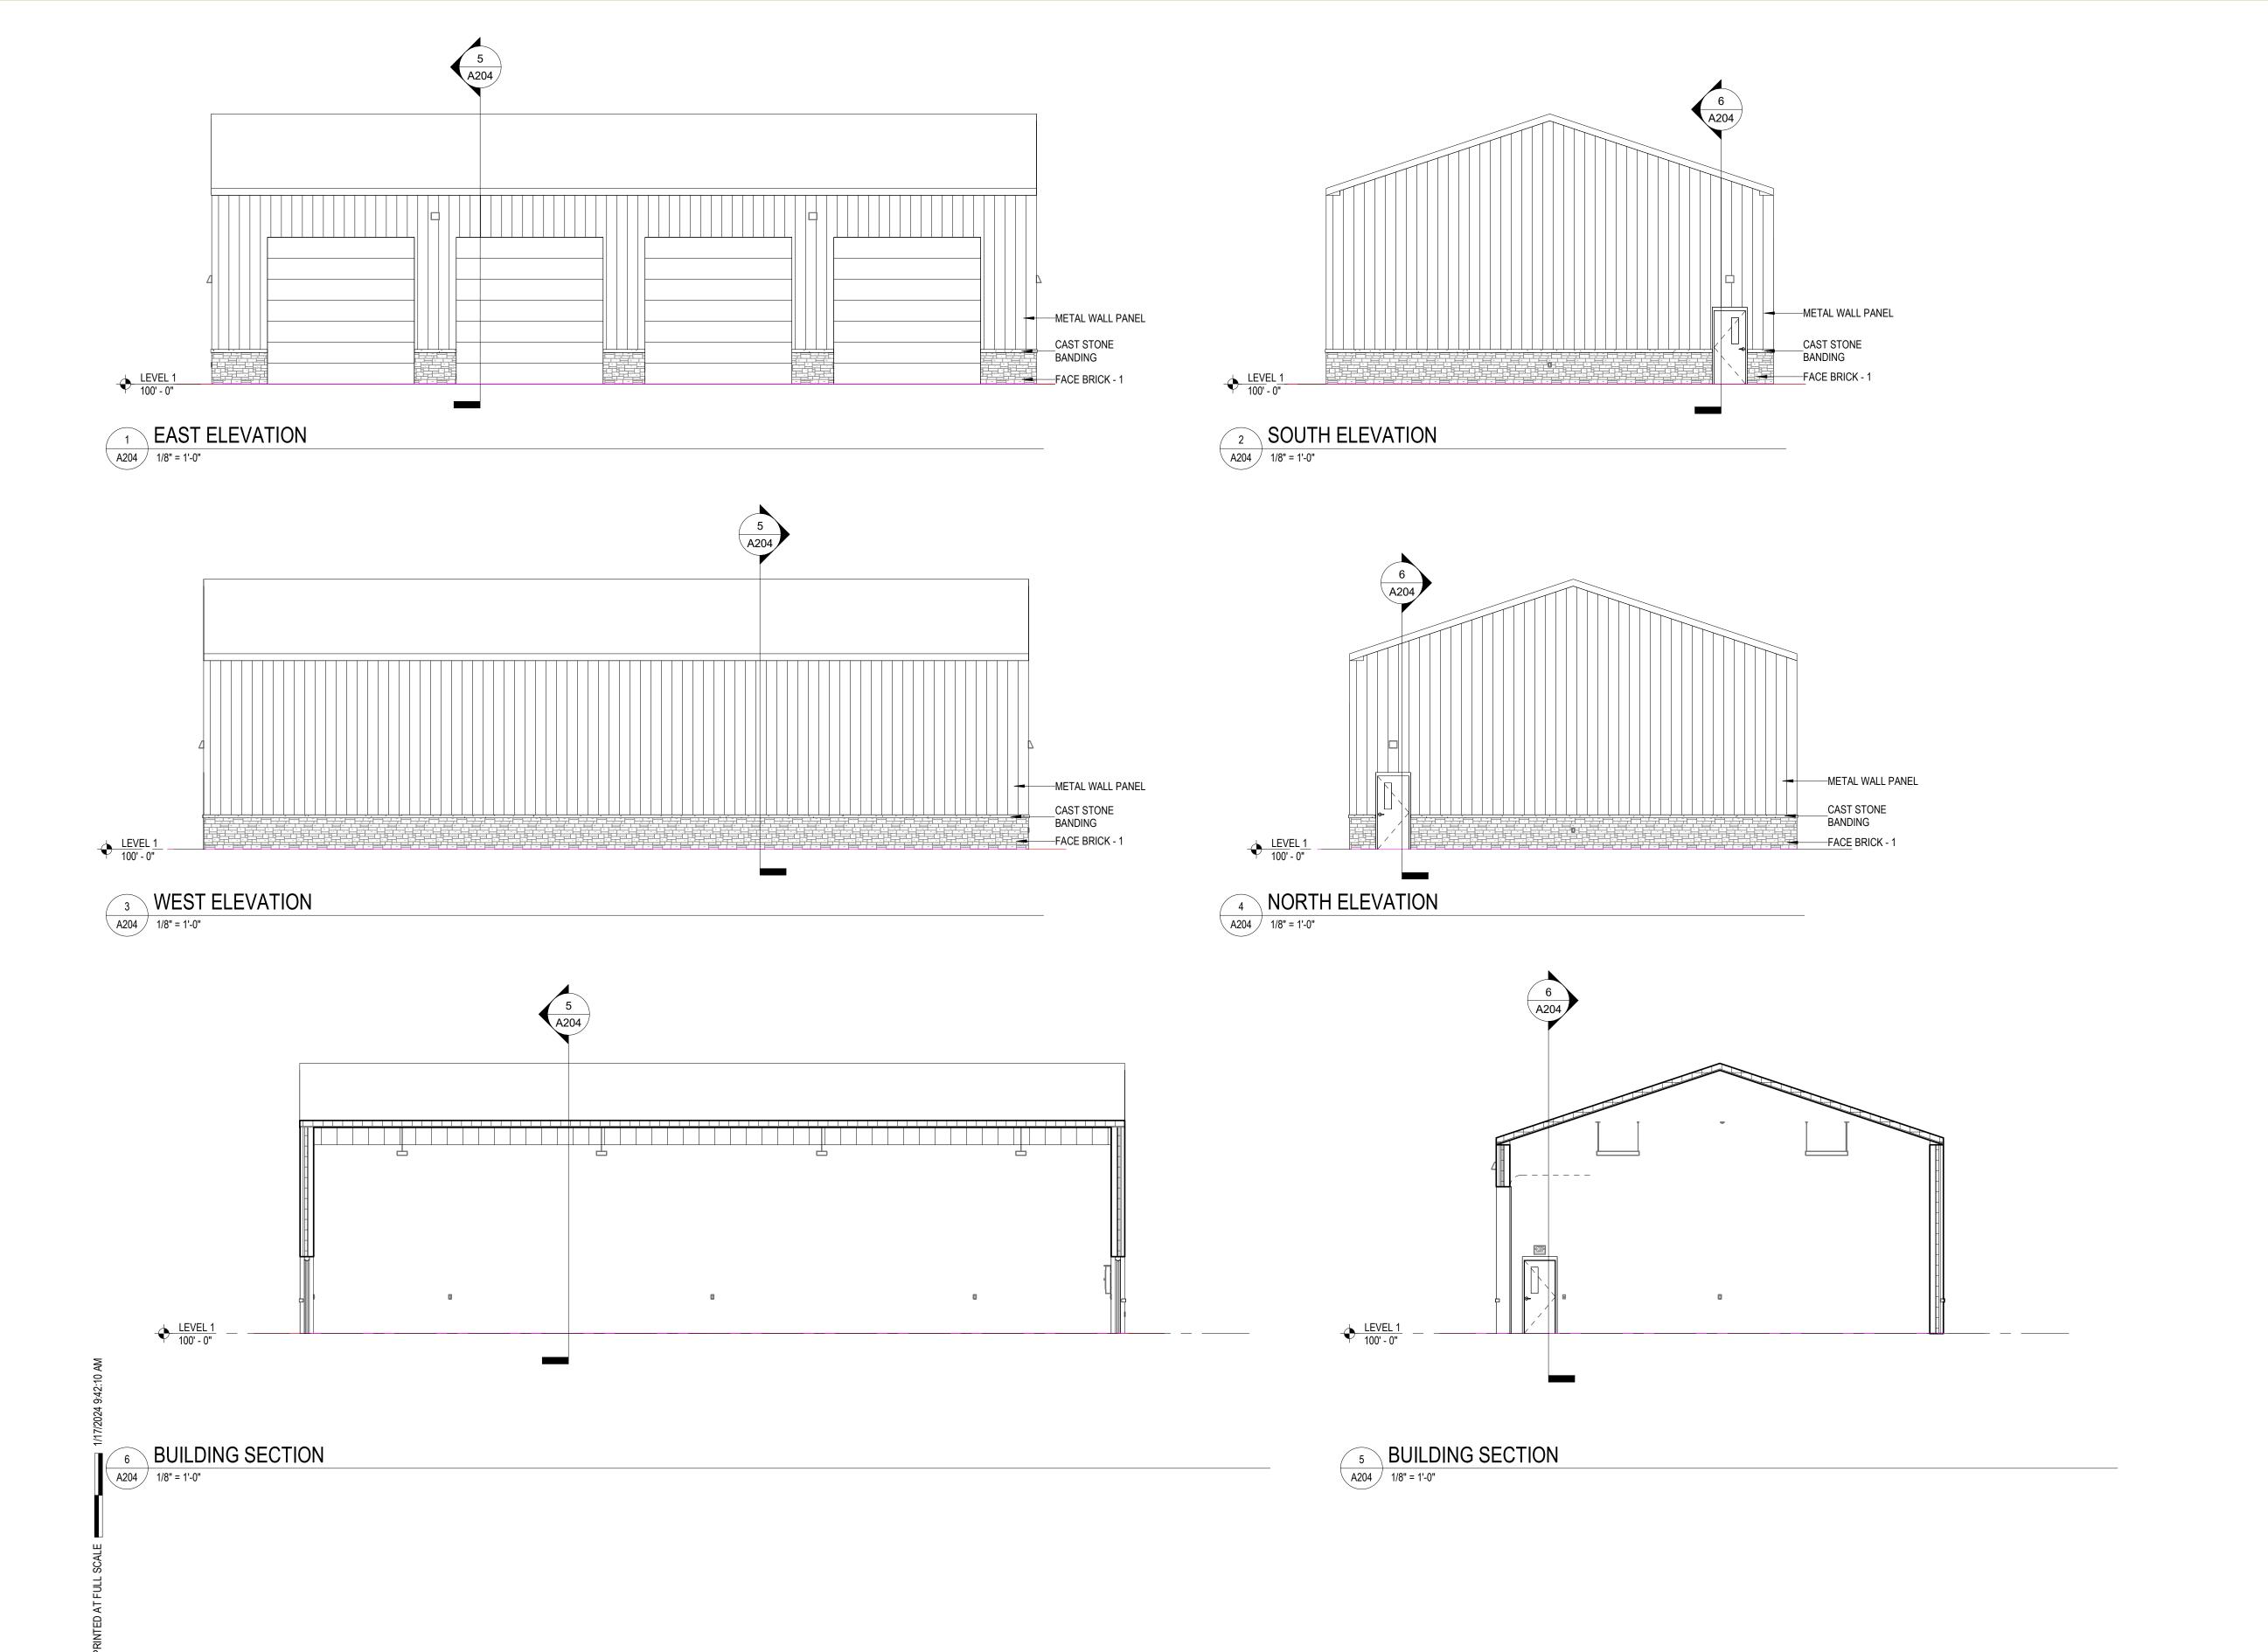



NOT FOR TON CONSTRUCTION

Project Owner

CITY OF WATERTOWN WATERTOWN FIRE STATION

This drawing is an instrument of service and shall remain the property of Short Elliott Hendrickson, Inc. (SEH). This drawing, concepts and ideas contained herein shall not be used, reproduced, revised, or retained without the express written approval of SEH.

Submission or distribution of this drawing to meet official or regulatory requirements or for purposes in connection with the project is not be construed as publication in derogation of any of the rights of SEH.

WATRN 172202

Checked By Drawn By

Issue Date

2/14/2024

SEH Project Checked By Drawn By

Project Status CONSTRUCTION DOCUMENTS

REV. # DESCRIPTION

REVISION SCHEDULE

EXTERIOR ELEVATIONS -BUILDING B

A204

CITY OF WATERTOWN
WATERTOWN FIRE STATION
621 BERNARD STREET

This drawing is an instrument of service and shall remain the property of Short Elliott Hendrickson, Inc. (SEH). This drawing, concepts and ideas contained herein shall not be used, reproduced, revised, or retained without the express written approval of SEH.

Submission or distribution of this drawing to meet official or regulatory requirements or for purposes in connection with the project is not be construed as publication in derogation of any of the rights of SEH.

SEH Project Checked By Drawn By

Project Status
CONSTRUCTION DOCUMENTS

WATRN 172202 Checked By Drawn By

Issue Date 2/14/2024

REVISION SCHEDULE

REV. # DESCRIPTION

3D LOW-RES VIEW

Δ703

CITY OF WATERTOWN WATERTOWN FIRE STATION

This drawing is an instrument of service and shall remain the property of Short Elliott Hendrickson, Inc. (SEH). This drawing, concepts and ideas contained herein shall not be used, reproduced, revised, or retained without the express written approval of SEH.

Submission or distribution of this drawing to meet official or regulatory requirements or for purposes in connection with the project is not be construed as publication in derogation of any of the rights of SEH. Checked By

Project Status

CONSTRUCTION DOCUMENTS

REVISION SCHEDULE

WATRN 172202


Checked By Drawn By

2/14/2024

DESCRIPTION

EXTERIOR MATERIALS

CLARITY

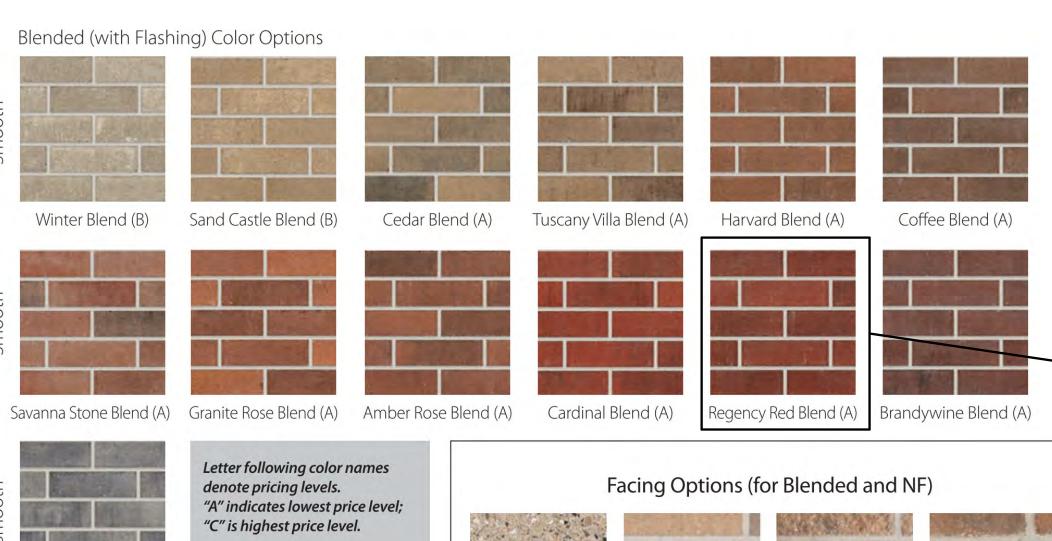



Colors, product data, and availability are subject to change without notice. Please confirm all details with a County Materials representative for availability in your area. Colors shown may vary from actual hues and should only be used as a guide. Refer to actual product samples for final color selection.



**See page 23 for burnished color options. Note: Rough Estate is no longer a Facing Option for Heritage Collection Designer Concrete Brick.

NF (No Flashing) Color Options Amber Rose (A) Cardinal (A) Regency Red (A) Harvard (A) Cinnabar (A) Brandywine (A)

Smokey Mountain (A)

Coffee (A)

*PREMIUM COLORS – NF (No Flashing)

Winter (A)

Graystone (A)



* Denotes product manufactured in Janesville, WI. All other Heritage colors are manufactured in Marathon, WI.

Note: All colors shown above are also available in Tumbled fin

Sable (A)

Slate (B)







NOT FOR TON CONSTRUCTION

Project Owner

WATRN 172202 Checked By Drawn By

2/14/2024

RENDERINGS

A705 [29]



NORTHEAST PERSPECTIVE



SOUTHWEST AERIAL

GLEON-SA1C-740-U- GALLEON AREA AND ROADWAY 16 466 1 118

1050mA LIGHTSQUARE WITH

FORWARD THROW OPTICS

16 LEDS AND TYPE IV

Statistics						
Description	Symbol	Avg	Max	Min	Max/Min	Avg/Min
BALCONY		2.5 fc	11.2 fc	0.1 fc	112.0:1	25.0:1
SITE CALC	+	0.4 fc	17.6 fc	0.0 fc	N/A	N/A

McGRAW-EDISON

Y4FTX2

LARGE PINE TREE

\$\frac{\psi_0.0}{\psi_0.0}\$\frac{\psi_0.0}{\

/ † †

*** Too *** To

| 100 | 100 
\$\frac{1}{2}.0\$ \$\frac{1}{0}.0\$ \$\frac{1}{0}.0

\$\frac{1}{40.0} \frac{1}{60.0} \frac

**O,Q **O,O **O,O

**OQ **O.0 *

 ***O.0 **O.0 **O.0

**** 0.0 *** 0.0 *** 0.0 *** 0.0 *** 0.

**\tag{7}.0. **\tag{7}.0. **\tag{7}.0. **\tag{7}.0. **\tag{8}.0. **\tag{9}.0. **\ta

Plan View
Scale - 1" = 40ft

+0.0 +0.0 +0.0 +0.0

+0.0 +0.0 +0.0 +0.0 +0.0

+0.0 +0.0 +0.0 +0.0 +0.0 +0.0 +0.0

T0.0 +0.0 +0.0 +0.0 +0.0 +0.0 +0.0

+0.0 +0.0 +0.0 +0.0 +0.0 +0.0 +0.0 CONCRETE 0.0 +0.0

\(\frac{1}{0.0} \\ \fr

RIM 821.22

EV 822.78

RIM 817.57

LOT 3 CSM 5745 +0.0 +0.0 +0.0 +0.0 +0.0 +0.0 \

PART OF

OUTLOT 7

- SAN MH RIM 812.73

8" N&S 804.37 CLAY

CSM 744

O
ATI
ST
FIRE
N N
RTO
ATE
\geq