

SITE PLAN REVIEW COMMITTEE MEETING AGENDA

MONDAY, FEBRUARY 12, 2024 AT 1:30 PM

COUNCIL CHAMBERS, SECOND FLOOR, MUNICIPAL BUILDING, 106 JONES STREET, WATERTOWN, WI 53094

By Phone or GoToMeeting: Members of the media and the public may attend by calling: (Toll Free): 1 877 309 2073 Access Code 145-282-749 or https://meet.goto.com/145282749 All public participants' phones will be muted during the meeting except during the public comment period.

1. CALL TO ORDER

2. APPROVAL OF MINUTES

A. Review and take action: Site Plan Review minutes dated January 22, 2024

3. BUSINESS

- A. Review and take action: 1110 S. Tenth Street & 1111 S. Tenth Street proposed salvage yard/recycling center
- B. Review and take action: 1722 S. Church Street Culver's addition
- C. Review and take action: 717 W. Main Street site plan for two proposed buildings

4. ADJOURNMENT

Persons requiring other reasonable accommodations for any of the above meetings, may contact the office of the City Clerk at mdunneisen@watertownwi.gov, phone 920-262-4006

A quorum of any City of Watertown Council, Committee, Board, Commission, or other body, may be present at this meeting for observing and gathering of information only

Section 2, Item A.

SITE PLAN REVIEW COMMITTEE January 22, 2024

The Site Plan Review Committee met on the above date at 1:30 P.M. in the Council Chambers on the second floor of City Hall. The following members were present: Mayor Emily McFarland; Brian Zirbes of Building, Safety & Zoning; Andrew Beyer of Engineering; Maureen McBroom of Stormwater Utility; Stacy Winkelman of the Street Department; Tim Hayden of the Water/Wastewater Department; Kristine Butteris of Park & Rec; Strategic Initiatives and Development Coordinator Mason Becker; Doug Zwieg of Building, Safety & Zoning; and Anthony Rauterberg of the Fire Department. Also in attendance were Nikki Zimmerman, TJ Schliewe, and Mark Zvitkovits.

1. Call to Order

The meeting was called to order by Chairperson Brian Zirbes.

2. Approval of Minutes

A. Review and take action: Site Plan Review Minutes Dated November 13, 2023

Motion was made by Doug Zwieg and seconded by Anthony Rauterberg to approve the November 13, 2023 Site Plan Review minutes as submitted. Unanimously approved.

3. Business

A. Review and take action: 806R Elm Street - heated storage shed

Applicant TJ Schliewe was present to describe the proposed project. The proposal is for a new 4,992 sf heated storage building which will be the same as the current on that is on site.

The following was presented by staff:

Building: No further requirements.

Fire: No further requirements.

Engineering: No further requirements.

Stormwater: Erosion control permit needed for any land disturbance over 3,000 sf. Post-construction

stormwater is being worked on by a contractor. The designer and applicant will get in touch with Maureen McBroom to ensure everything is being completed as needed.

Streets and Solid Waste: No further requirements.

Water/Wastewater: No further requirements.

Zoning: No further requirements.

Parks: No further requirements.

Motion was made by Doug Zwieg and seconded by Emily McFarland to recommend approval of this proposal to Plan Commission with inclusion of the two conditions identified by Maureen McBroom.

Unanimously approved.

B. Review and take action: 621 Bernard Street - site plan for new fire station

Updated plans were recently submitted for the new fire station. Mark Zvitkovits of SEH was present to answer questions.

The following was presented by staff:

Building: Final plans will have to be forwarded to the state for review.

Fire: No comments.

Engineering: No utility plan was submitted. Please submit one that shows items like grades, depths,

materials, etc. for review. The floodway should be delineated before construction begins. There shall be no filling in the floodway. Details on stormwater basins will have be

submitted.

Stormwater: An erosion control and stormwater permit will be required. Anything being turned into the

DNR with the NOI will also be required to be submitted to the City of Watertown. Verify

what type of stormwater treatment will be used (i.e. infiltration or biofilters with

underdrains). This will be required as soon as possible. A copy of the DNR NOI letter will

also be required.

Streets and Solid Waste: No comments.

Water/Wastewater: Utility specs need to be shared. Suggests the water loop through the property. The sew

line and size need to be indicated on the plans as well as what size meter hydrant meter could be placed on the hydrant that is being used at the sit purposes. Would be helpful for the Water Department for water loss logs.

Section 2, Item A.

meter will be discussed after the plans are submitted.

Zoning: Structures need to be 20' from residentially zoned property lines. The plans need to state

this. A conditional use permit will be required for the exterior of the storage building and training tower. Vehicle access and circulation need further information such as the driving lanes matching code and parking stalls being the correct width. Plans with measurements and details to meet 550-107 need to be submitted. Minimal landscaping requirements are met but it's suggested to increase the landscaping a bit more. The lighting plans will be

reviewed and feedback will be provided.

Parks & Forestry: Concerns on availability of different variations of oaks. There are about 20 trees that need

to be transplanted from the existing area. 2" trees are needed to be transplanted but there aren't enough there currently. There are many $1" - 1\frac{1}{2}"$ but not 2". Direction will be needed to see which trees will be kept. A tree protection during construction permit will be needed for those that will be kept in place during construction. The tree needs to be fenced 2' past the drip line (the canopy of the tree). There are multiple options if the $1 - 1\frac{1}{2}"$ trees. Is the plan to get nicer looking wood chips or use what Parks has? This will be discussed and placed on the final plan. Suggestion of some of the berry bushes at the

Towne Square being placed at the fire station.

Motion was made by Doug Zwieg and seconded by Kristine Butteris to recommend approval of this proposal to Plan Commission with inclusion of the above comments.

Unanimously approve with Mayor McFarland abstaining.

4. Adjournment

Motion was made by Emily McFarland and seconded by Andrew Beyer to adjourn. Unanimously approved.

Respectfully submitted, Nikki Zimmerman Recording Secretary

NOTE: These minutes are uncorrected, and any corrections made thereto will be noted in the proceedings at which these minutes are approved.

EXTERIOR LILGHTING

We will install three (3) exterior lights for security 150 watt metal halide LED lights, two on the south border focused north onto the yard area and one on the east focused west.

NOISE

Operation will only be during daylight hours. Any sound will not be continuous as the only sound is from modern cranes with no Detroit 2 cycle engines. Our modern hydraulic cranes are rated Plus 5 DBA ambient level.

VIBRATION

No equipment that vibrates the ground will be installed.

OFF STREET PARKING

Agreement with Lessor allows access of the .53 acre parking lot adjacent (110 South 19th Street)

LANDSCAPING

The lot is bordered by established trees on three sides with additional perennial plants which currently meets the landscaping requirements additionally the entire fenced lot will be screened.

AIR POLLUTION

As stated in our lease all operations are in compliance with the Environmental, Health, and SFETY Requirements. These include but are not limited to the Clean Air Act, 42 USC & 7401 et seq, the Clean Air Act, 22 USC and 1251 et seq., the Resource Conservation and Recovery Act, 42 USC & 6901 et seq., the Water Pollution Control Act, 33 USC & 1251 et seq., the Comprehensive Environmental Response Compensation and Liability Act., 42 & 9601 et seq.

DRAINAGE

Operations do not generate any water runoff or drainage of any kind.

Brian

Attached please find the landscaping plans for 1111 South Tenth and 1110 S Tenth Street.

The required 15% green space square footage is noted along with the existing square footage and additional proposed.

1110 S Tenth Street lot has 2992 sq. ft. of existing green space with the proposed additional square footage requirement of 408 sq. ft. planned for arborvitae on the west end of the south side.

1111 S Tenth Street has 16,044 sq. ft. of existing green space; the proposed additional square footage requirement will be filled with arborvitae on the fence line on the northerly end of the east side (abutting the school property); a climax tree will be added to the north side; arborvitae will be planted on the south as needed to complete the 18,705 sq. ft. requirement.

The points needed for street footage has also been determined:

The 1110 S Tenth Street lot has 120 ft. linear street footage requiring 21 points. The existing trees and shrubs exceed that at 1,509 points.

1111 South Tenth Street has 529 ft. linear street footage requiring 121 points. The existing trees and shrubs exceed that at 3,964.





Landscaping details:

1110 South Tenth

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Existing 2080 sq. ft. green on south

528 sq. ft. grass north/east

384 sq. ft. grass/ arborvitae/ash east (street frontage)

2992 sq. ft.
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Site contains 26 aspen, 1 maple, 7 ash, 6 American arborvitae, 3 junipers, grass.

Proposed required additional 400 sq. ft. additional arborvitae on south, west end parallel to rail road.

1111 South Tenth

Existing 3200 sq. ft. on east

10700 sq. ft. on south

2000 sq. ft. grass on north

64 sq. ft. in parking area west


80 sq. ft. perennial flowers/grass south & west of office

16044 sq. ft.

Site contains 16 pine, 86+ arborvitae, 3 birch, 8 maple, 11 ash, 2 spruce, 3 privet shrubs, Russian sage, tulips, Rubeckia.

Proposed required additional 2706 sq. ft.: 138 sq. ft. dense arborvitae on north of office, east; a maple north of office; 2600 sq. ft. arborvitae along appx. 350' south, parallel to rail.



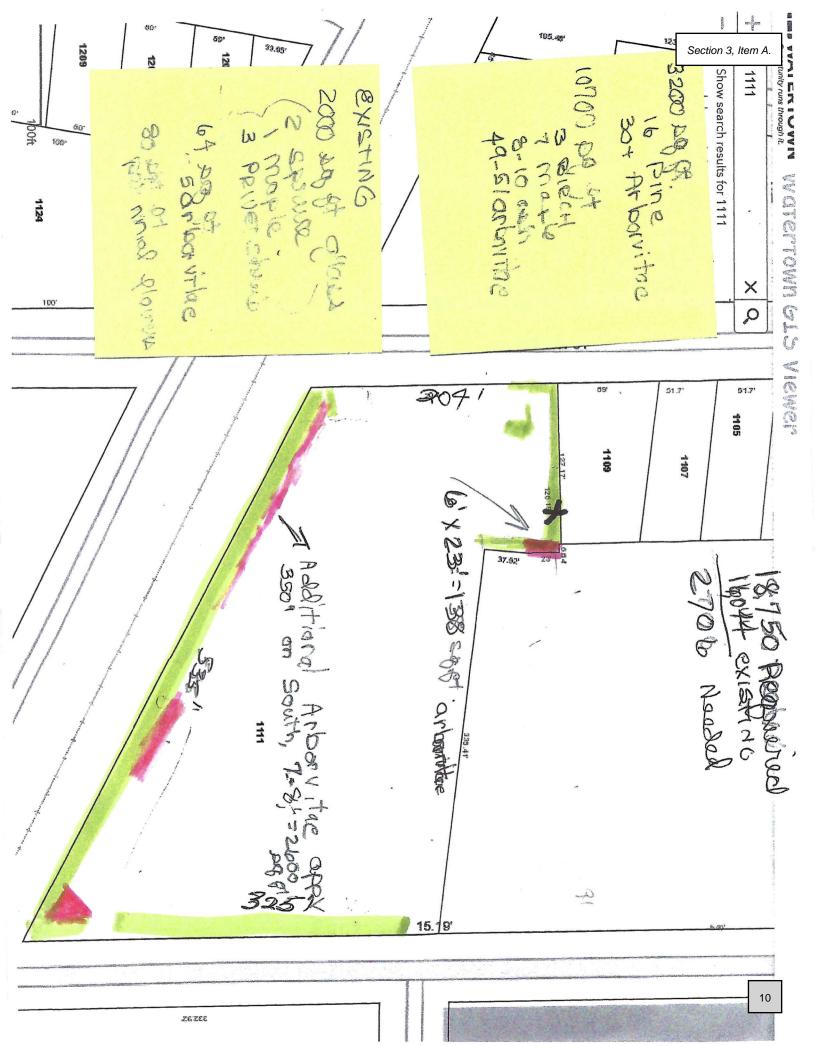

Reason for request to change 1111 South Tenth Street, Watertown, Wisconsin

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This 2.98 acres is *currently* zoned Heavy Industrial, surrounded by Heavy Industrial zoning; *we cannot* move the existing buildings 100' from the lot line.

This land was a recycling facility for over 50 years licensed by the State of Wisconsin.

It is bordered on all sides by parking lots and a rail road track. The rail line limits its desirable use for anything other than industrial use.

A recycling facility will serve the needs of the citizens of the City of Watertown and surrounding counties paying money for their scrap, saving valuable landfill space not to mention giving new life to the metal itself. There is a need for a recycling facility and this site fits that need.

The fact that this site is surrounded by industrial parking lots and the Webster employees' parking lots means no actual activity will occur with 100'.

The proposed facility will be a recycling collection point with daytime hours of operation.

We personally contacted the alderman for this district, Myron Moldenhauer, surrounding neighbors, businesses, and the Webster school principal, Brad Clark, informing them of the proposed return of a recycling facility to the site. Not a person objected -- in fact, they welcomed the return of a recycling facility and active use of the land.

1111 South Tenth Street is completely fenced (with fence to be completely screened) with s four large gates for truck access. It is located on a City truck route. Furthermore, it is bordered completely on its east and south sides with mature trees.

It is not a junkyard. It is a recycling center.





City Limits

Override 1

Parcels





City of Watertown Geographic Information System


1 inch = 140 feet

Printed on: Novembe 12
Author: Private Use

DISCLA MER: This map is not a substitute for an actual field survey or onsite investigation. The accuracy of this map is limited to the quality of the records from which it was assembled Other inherent inaccuracies occur during the compilation process.

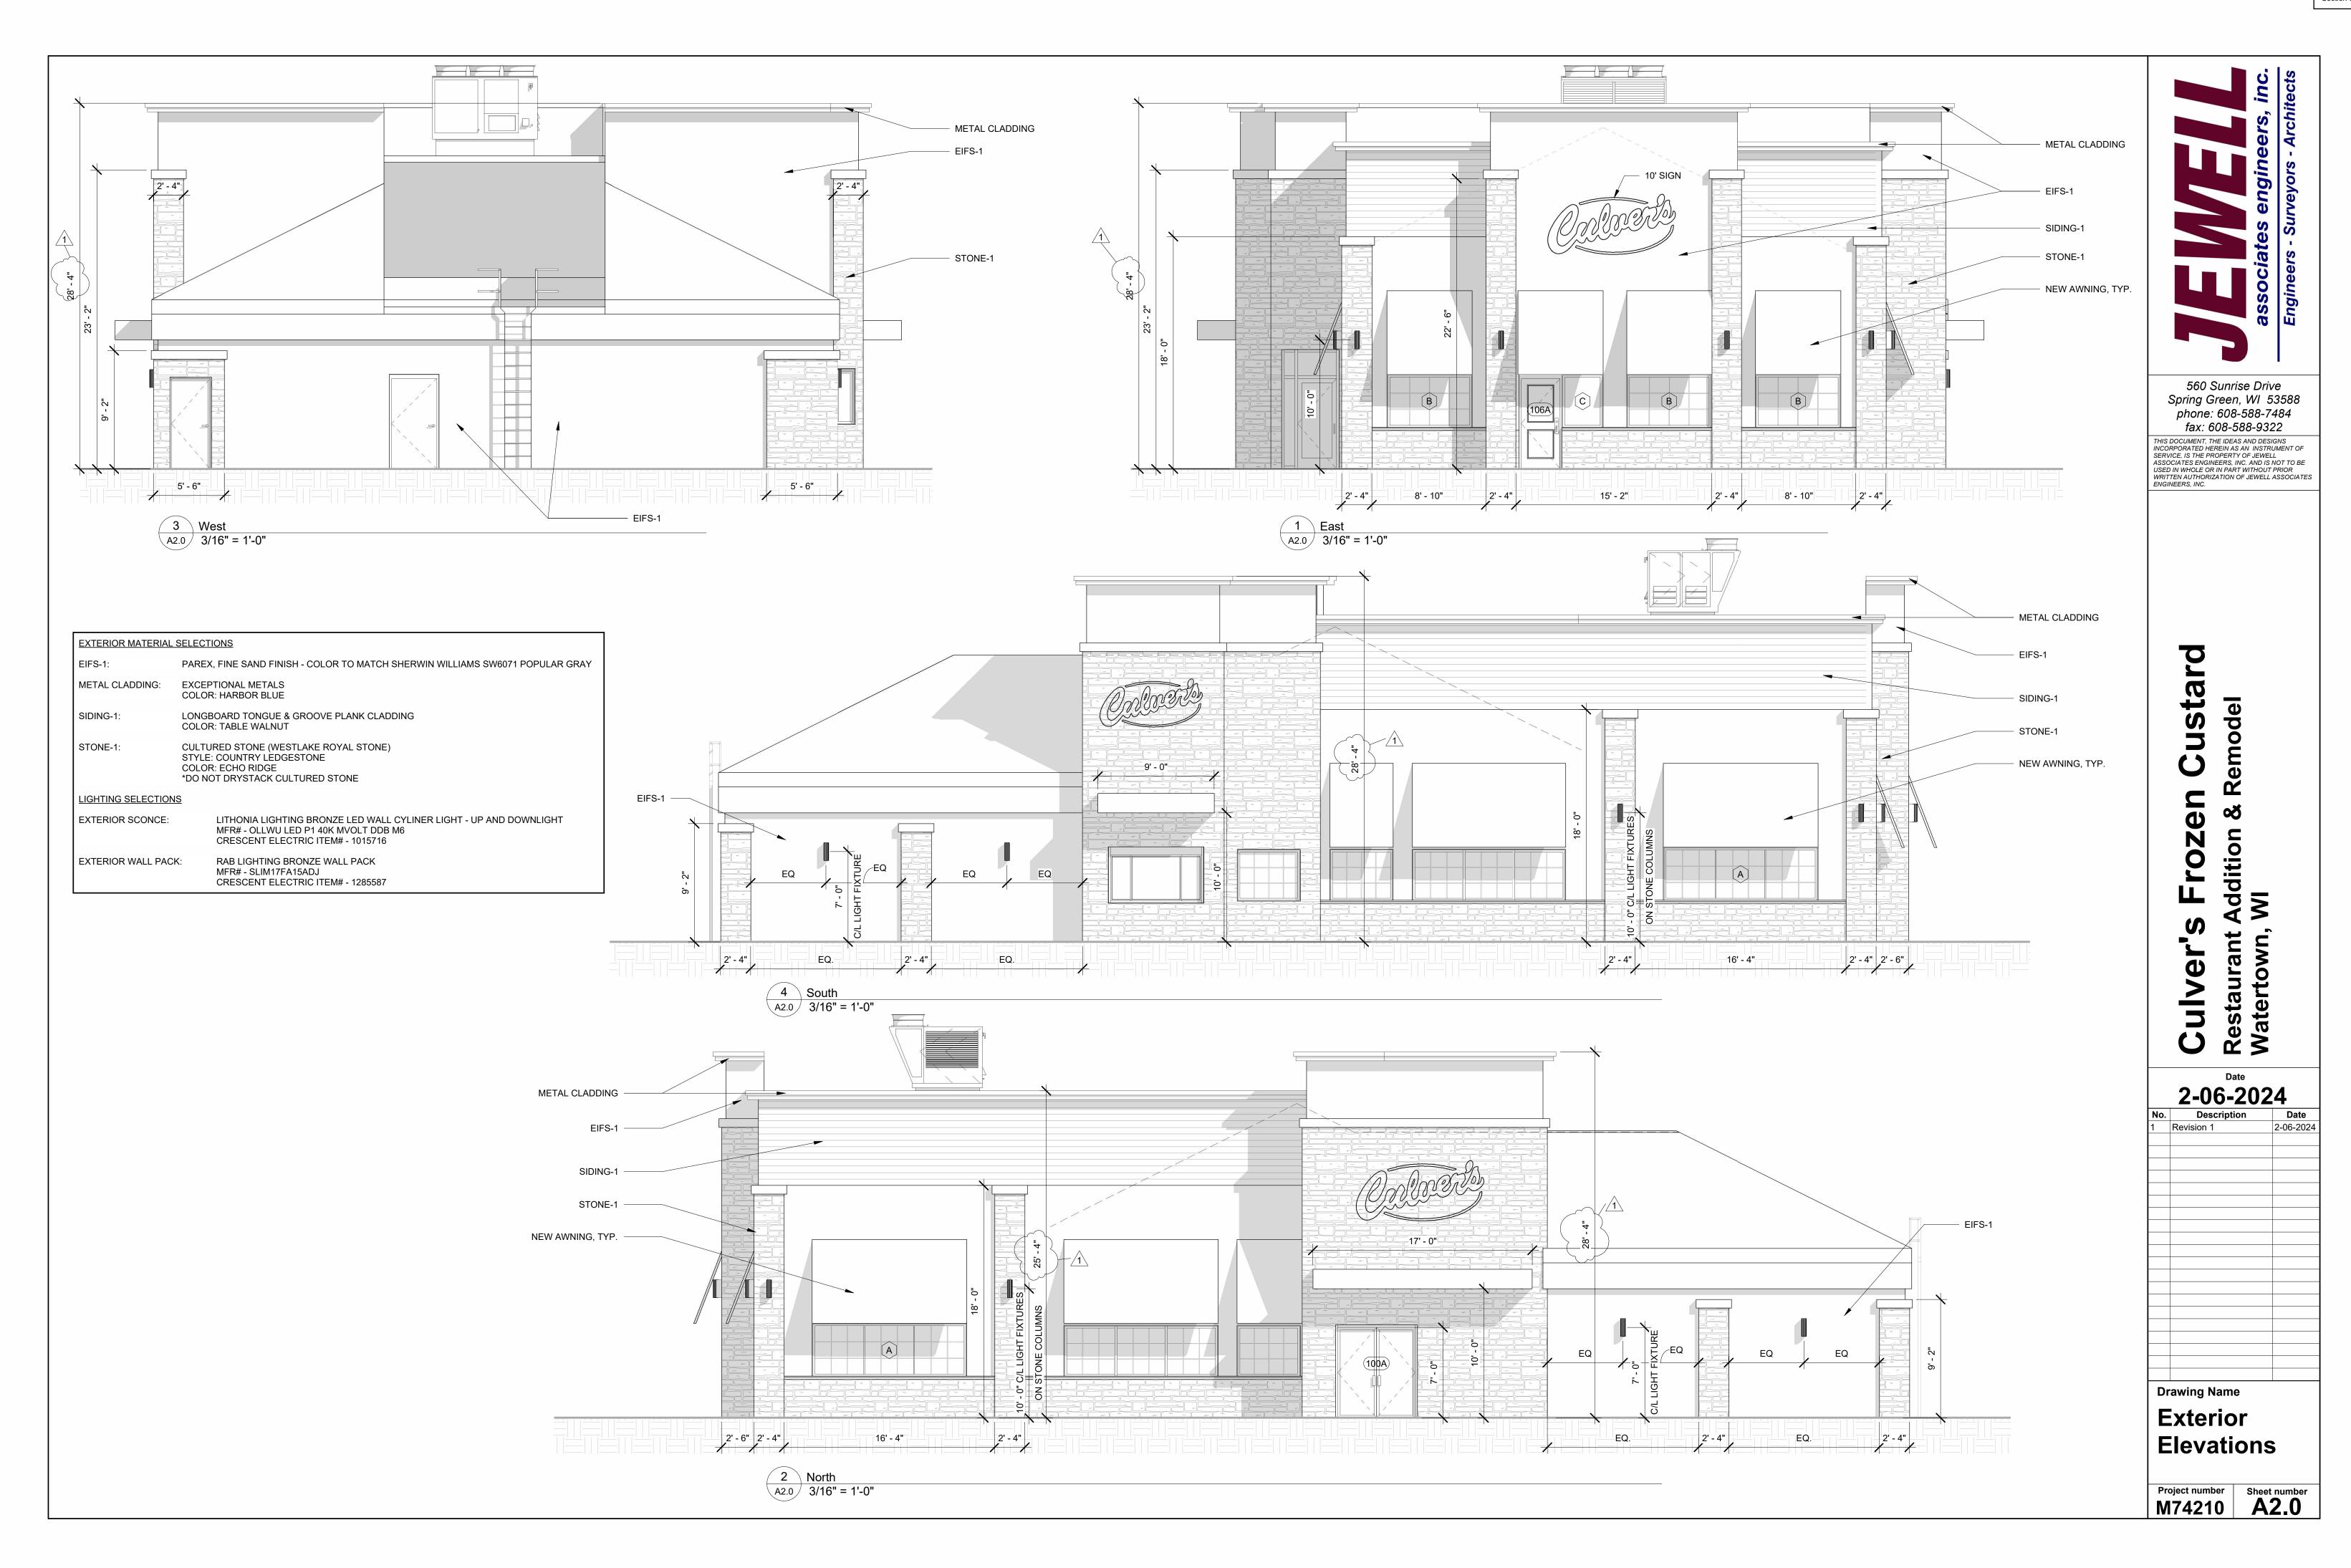

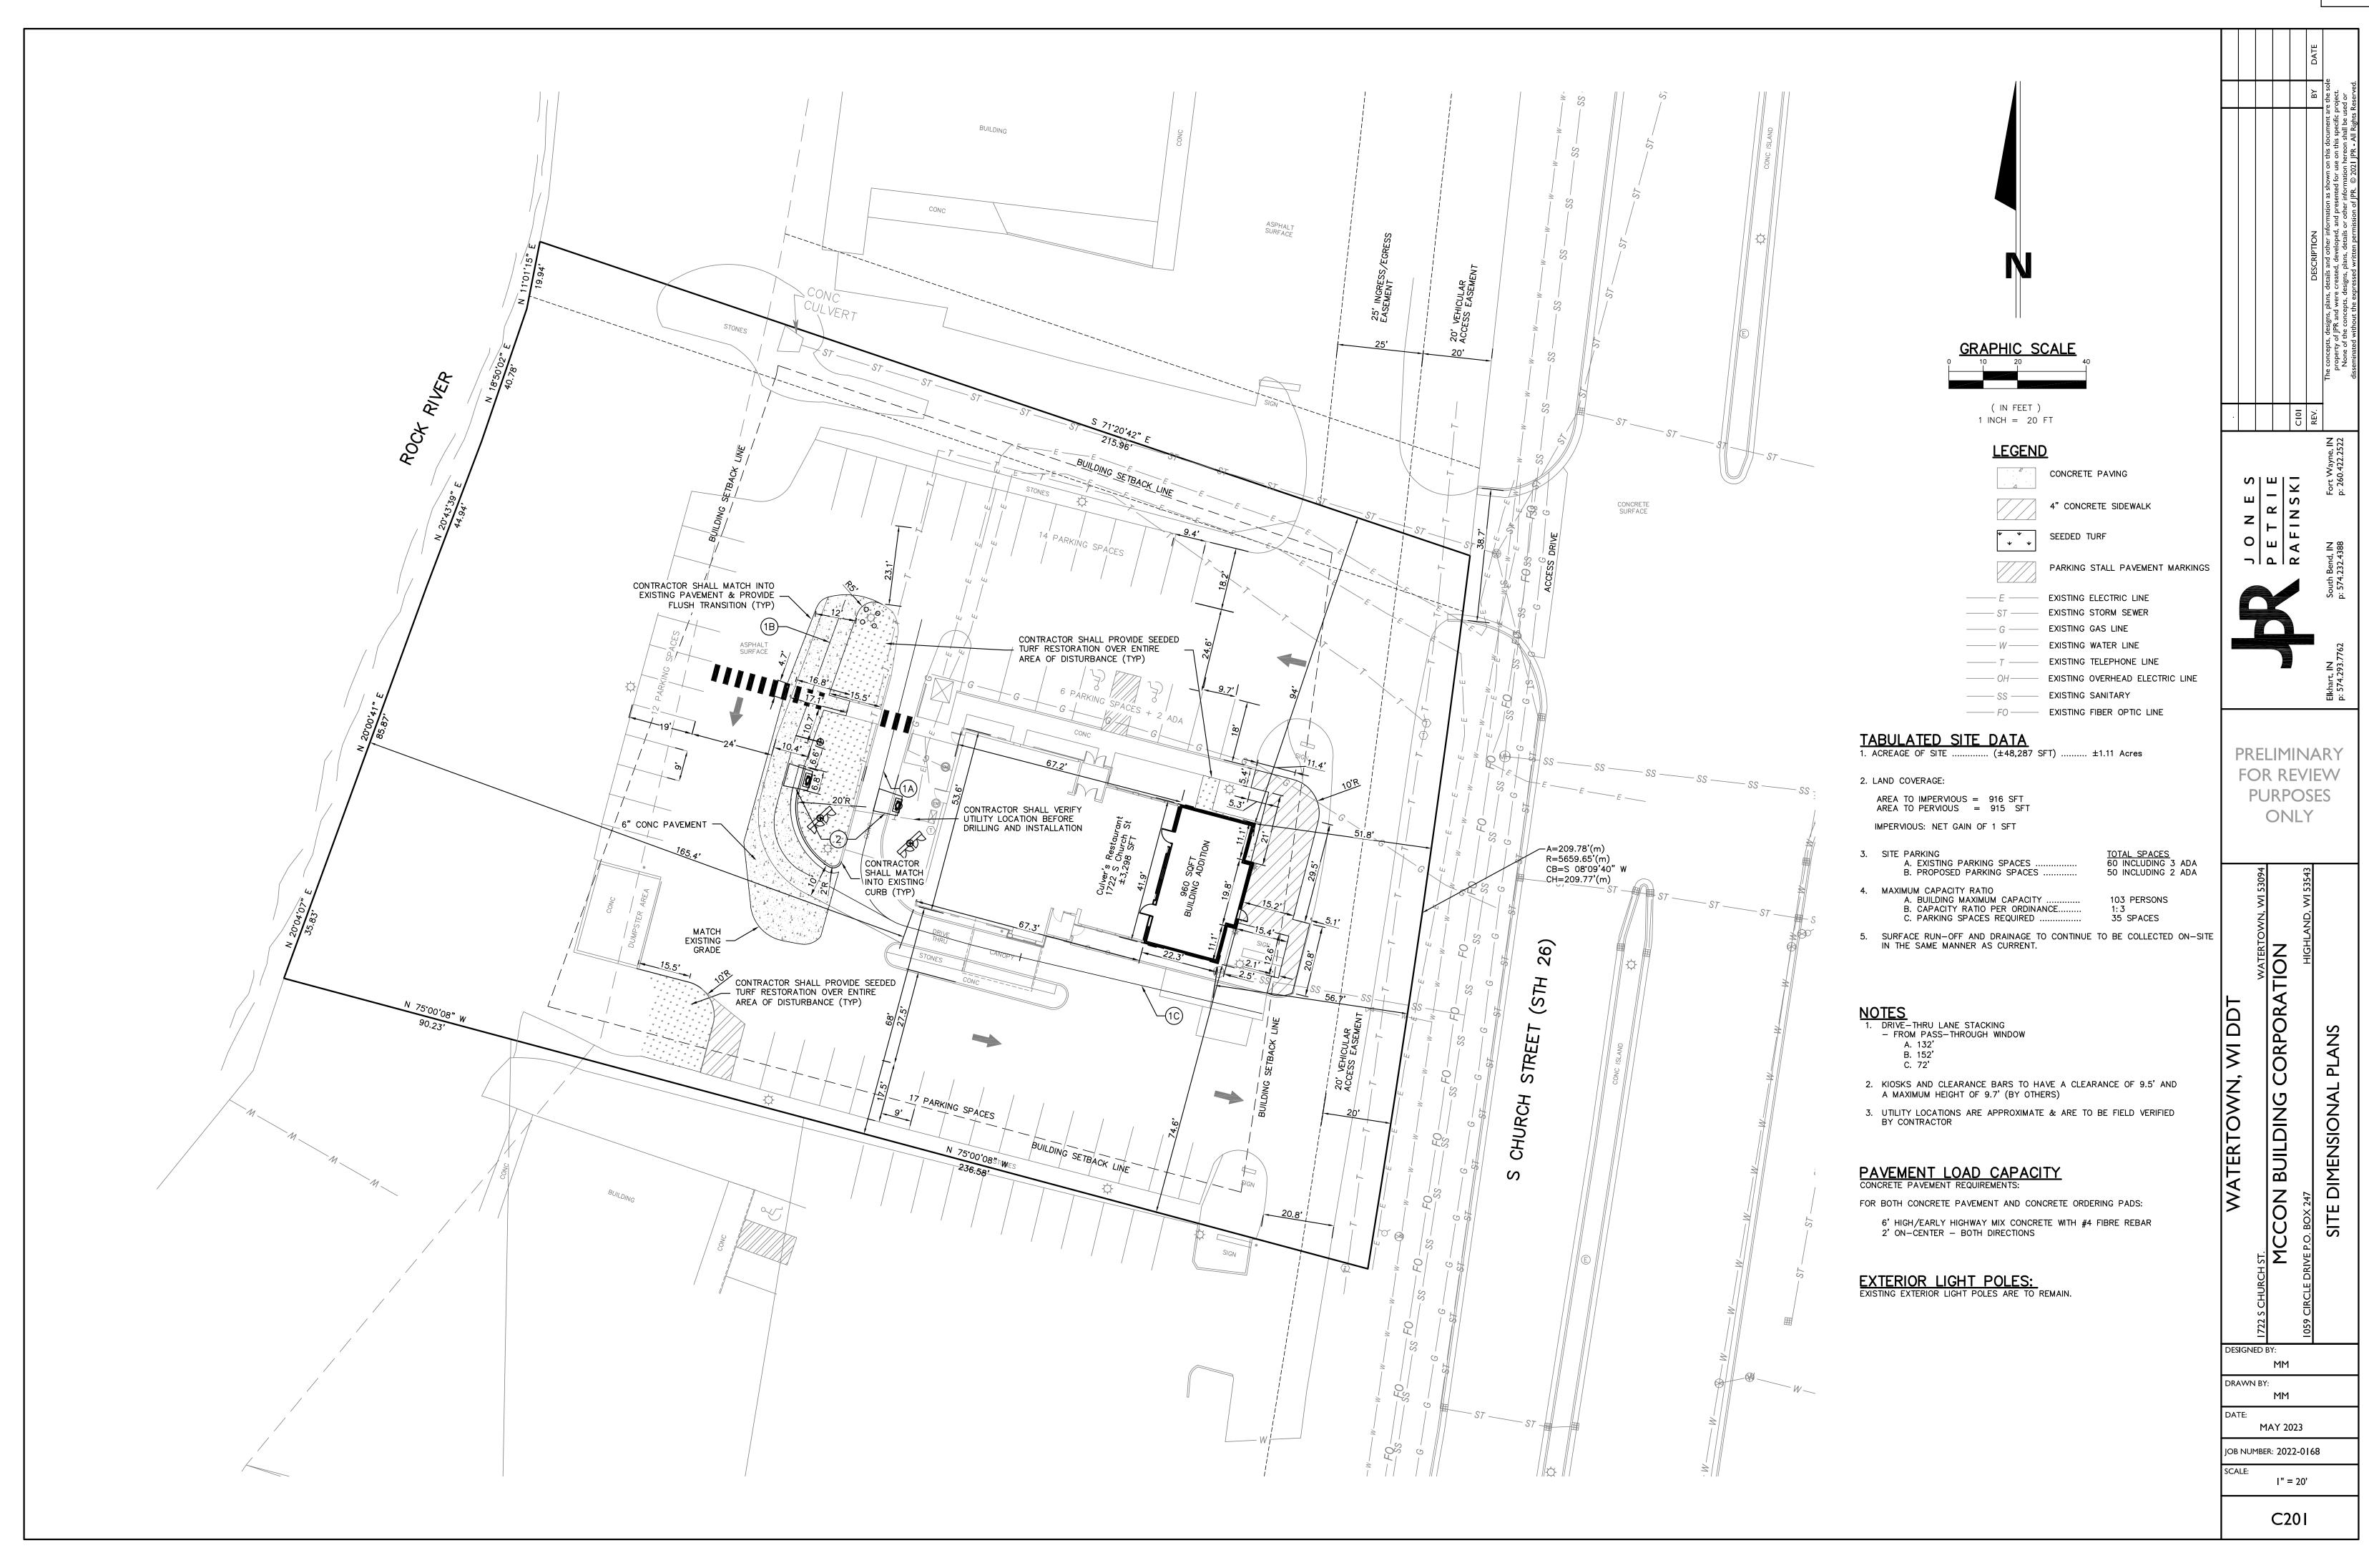

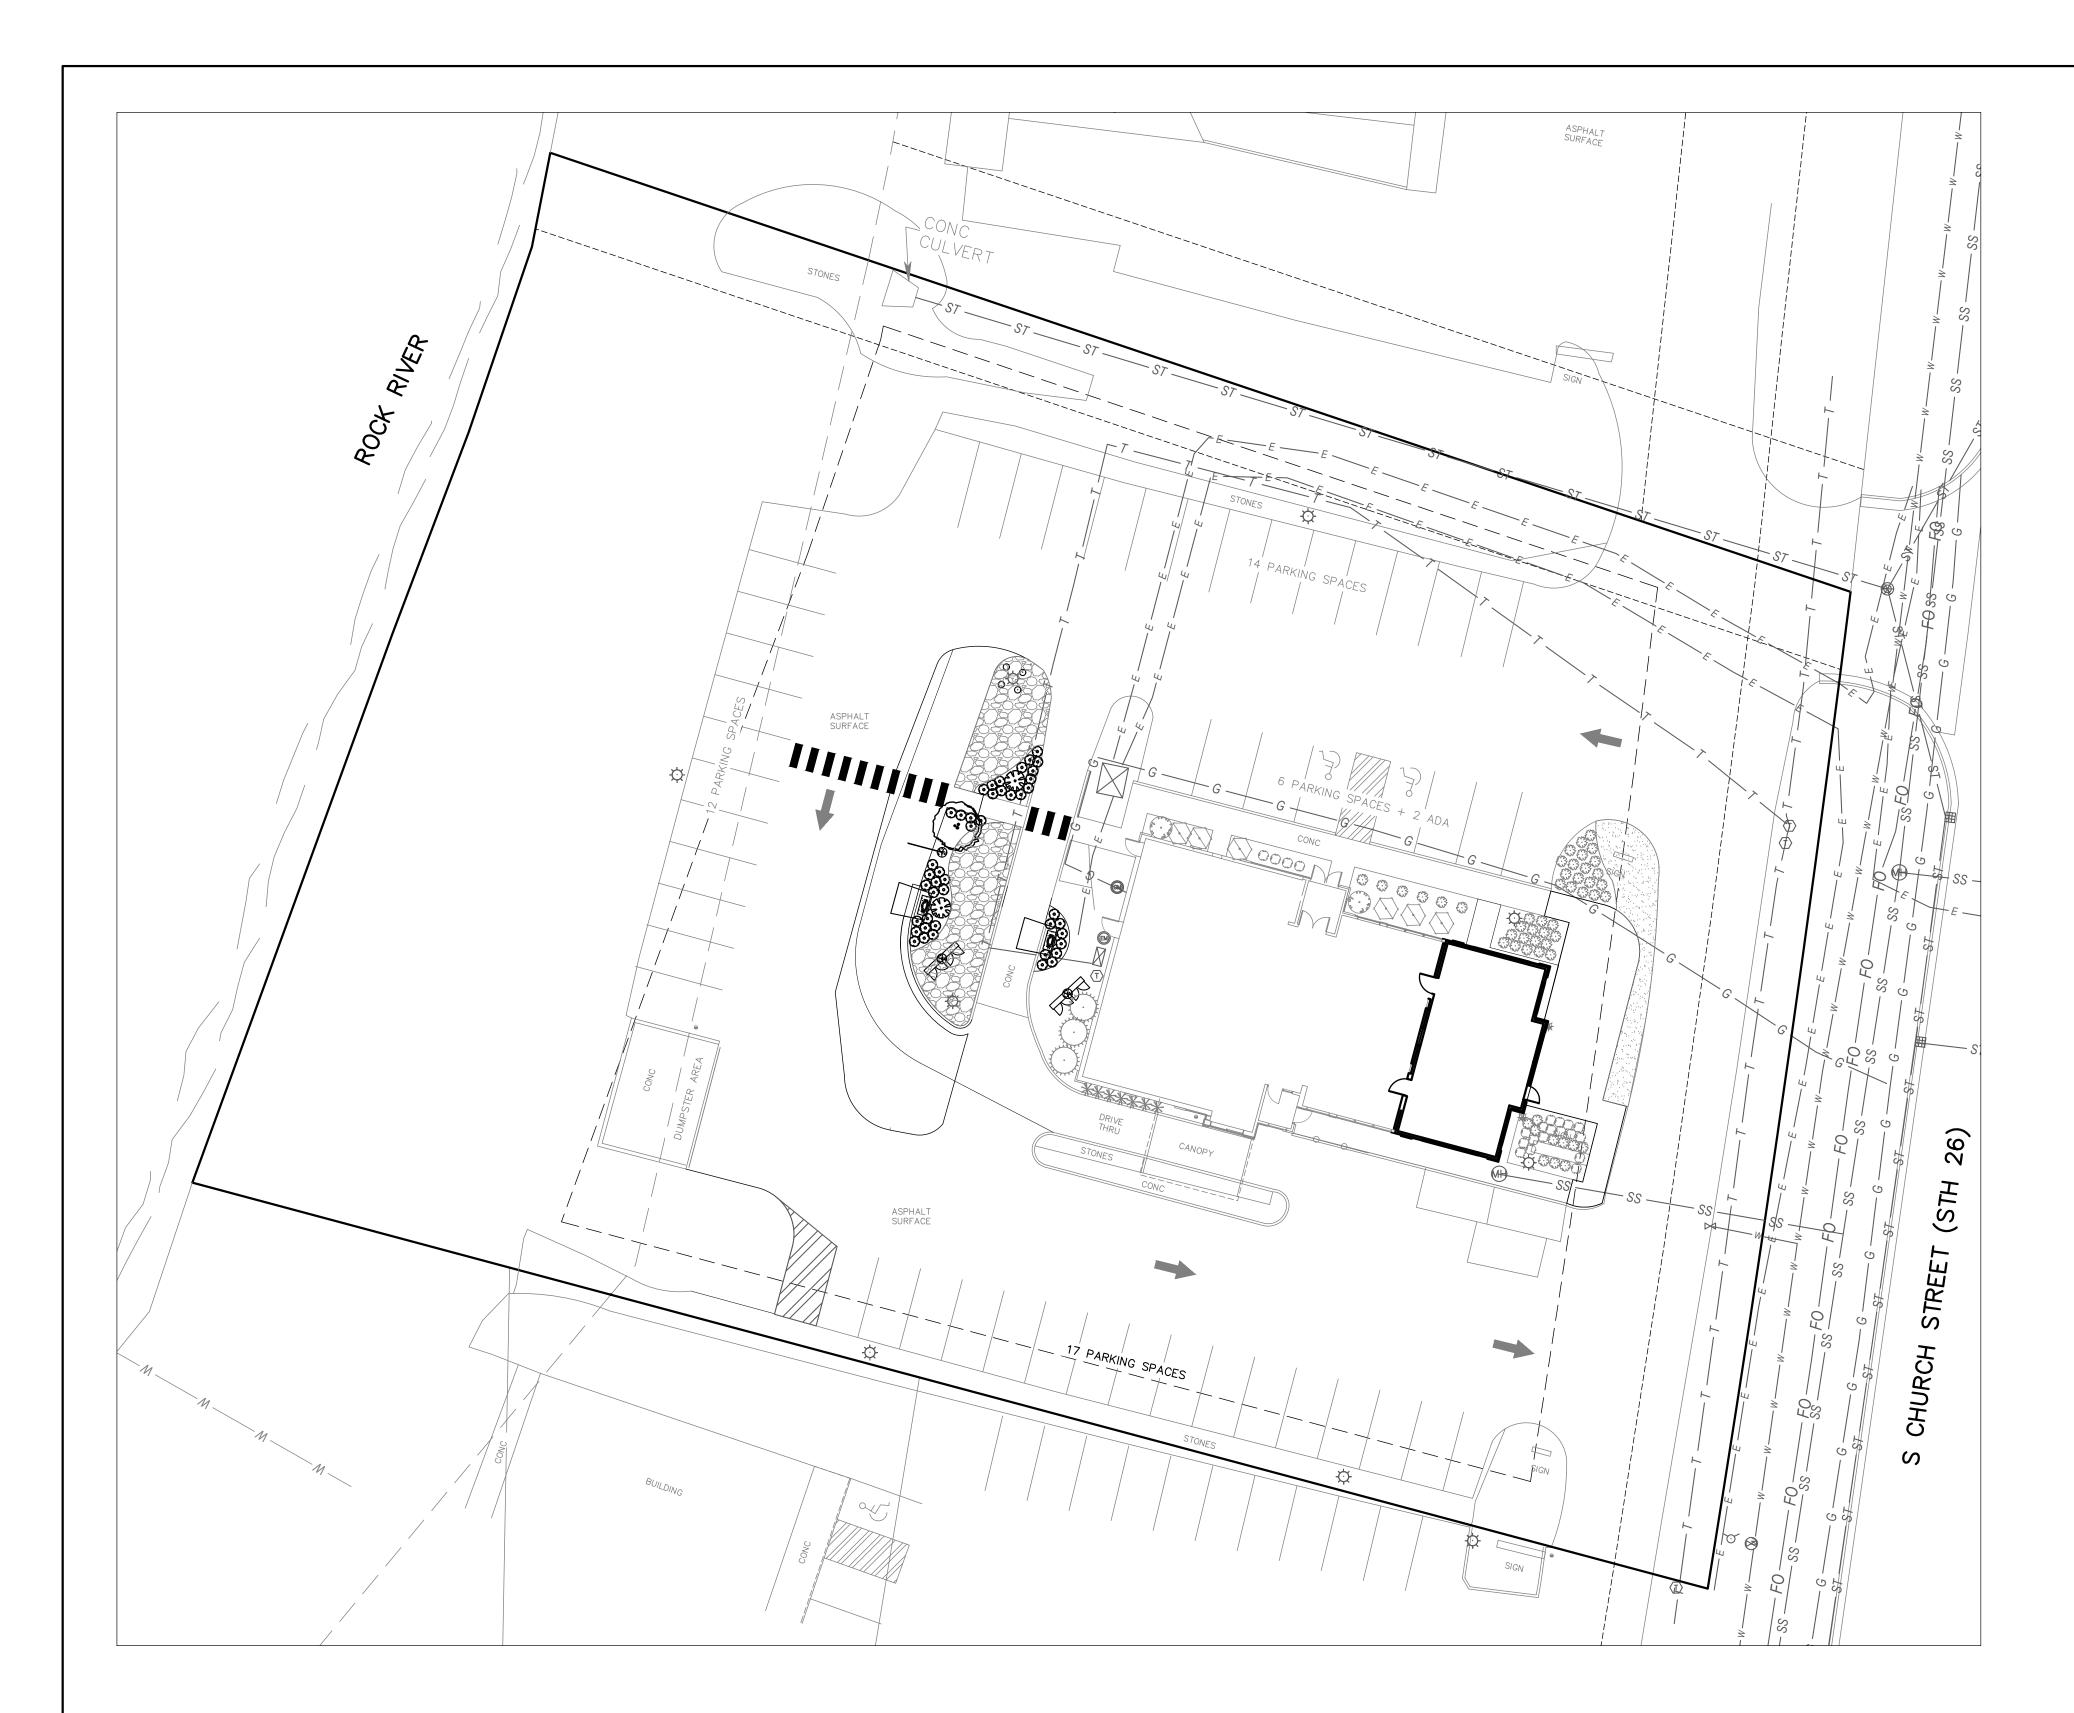

PLANT	MATERIAL	LIST

ID	BOTANICAL NAME	COMMON NAME	SIZE	QTY	ROOT	POINTS
EXISTIN	NG PLANTS					•
	PERENNIALS					
	GRASSES					
	SHRUBS					
PROPO	SED PLANTS					•
AS	ACER SACCHARUM 'GREEN MOUNTAIN'	GREEN MOUNTAIN SUGAR MAPLE	2 1/2" CAL		В & В	
AM	AMELANCHIER CANADENSIS 'AUTUMN BRILLIANCE'	AUTUMN BRILLIANCE SERVICEBERRY	2 1/2" CAL		В & В	
CA	CORNUS ALBA 'BAILHALO'	IVORY HALO DOGWOOD	NO. 5, 36" SPREAD MIN.		CONT.	
СН	COTONEASTER HORIZONTALIS	ROCKSPRAY COTONEASTER	NO. 5 36" SPREAD MIN.		CONT.	
JC	JUNIPERUS CHINENSIS 'PFITZER'	CHINESE JUNIPER	NO. 5 36" SPREAD MIN.		CONT.	
HP	HEMEROCALLIS 'PURPLE DE ORO'	PURPLE DE ORO DAYLILY	NO. 1 CONT.		CONT.	
				TOTAL	POINTS	

SEEDED TURF

----- LANDSCAPE EDGING

GENERAL LANDSCAPE NOTES

1. CONTRACTOR SHALL BE RESPONSIBLE TO VERIFY LOCATION OF ALL PRIVATE AND PUBLIC UTILITY LINES WHICH AFFECT THIS SITE. CONTRACTOR SHALL ALSO NOTIFY ALL UTILITY COMPANIES PRIOR TO THE COMMENCEMENT OF ANY SITE WORK.

2. CONTRACTOR SHALL REVIEW PLANTING SPECIFICATIONS AND PLANTING DETAILS BEFORE BEGINNING WORK.

3. CONTRACTOR SHALL VISIT THE PROJECT SITE AND BECOME FAMILIAR WITH CONDITIONS UNDER WHICH WORK SHALL BE IMPLEMENTED PRIOR TO

4. CONTRACTOR SHALL NOTIFY CONTRACT OFFICER OF ANY DISCREPANCIES IN THE EXISTING CONDITIONS OR WITHIN THE PLANS PRIOR TO BEGINNING WORK.

5. PLANTING BEDS SHALL HAVE FINISHED GRADES SMOOTHED TO ELIMINATE PONDING OR STANDING WATER. CONTRACTOR SHALL MAINTAIN A MINIMUM 2% DRAINAGE AWAY FROM BUILDINGS AND PAVING INTO DRAINAGE STRUCTURE OR TO STREET. CONTRACTOR SHALL NOTIFY OWNER IMMEDIATELY OF ANY CONFLICTS IN MAINTAINING DRAINAGE. IRRIGATION SYSTEM SHALL BE DESIGNED TO ELIMINATE OVERSPRAY ONTO BUILDINGS, STRUCTURES AND MONUMENT SIGNS.

6. CONTRACT OFFICER SHALL APPROVE ALL FINISH GRADING PRIOR TO PLACEMENT OF ANY PLANT MATERIAL.

7. CONTRACTOR SHALL IMMEDIATELY, UPON THE AWARD OF THE CONTRACT, LOCATE, ORDER AND PURCHASE (OR HAVE HELD) ALL PLANT MATERIAL REQUIRED BY THESE PLANS AND SPECIFICATIONS.

8. CONTRACTOR SHALL NOTIFY CONTRACT OFFICER FOR OBSERVATION AT THE FOLLOWING TIMES: -IRRIGATION MAINLINE AND LATERALS - PRIOR TO BACKFILL AND PRESSURE TEST

-TREE LOCATIONS - PRIOR TO PLANTING -IRRIGATION COVERAGE - PRIOR TO PLANT PLACEMENT

-PLANT APPROVAL AND SPOTTING - PRIOR TO PLANTING -PRE-MAINTENANCE APPROVAL

-POST-MAINTENANCE / FINAL APPROVAL

10. SHRUB AND GROUNDCOVER MASS QUANTITIES ARE SHOWN ON PLANS. UNDERPLANT ALL TREES WITH THE ADJACENT SHRUB AND/OR GROUNDCOVER AS INDICATED BY THE PLANS. PLANTS SHALL BE INSTALLED WITH TRIANGULAR SPACING. PLANT GROUNDCOVERS TO WITHIN 36"

11. PLANT SYMBOLS TAKE PRECEDENCE OVER PLANT QUANTITIES SPECIFIED. WHERE SHRUB SYMBOLS ARE MASSED, CONTRACTOR SHALL MAINTAIN A CONSISTENT ON CENTER, TRIANGULAR SPACING AS SPECIFIED IN LEGEND. CONTRACTOR SHALL VERIFY PLANT TOTALS FOR BID

9. CONTRACTOR SHALL BE HELD RESPONSIBLE FOR ANY REPAIRS MADE NECESSARY THROUGH THE ACTIONS/NEGLIGENCE OF THEIR CREW.

12. ALL ROCKS AND DEBRIS ONE INCH (1") AND LARGER SHALL BE REMOVED FROM PLANTING AREAS TO A DEPTH OF 1'-0" AND THEN FROM THE SITE TO A LEGAL SITE OF DISPOSAL. WHERE GRASS IS TO BE PLANTED, ALL ROCKS AND DEBRIS ONE HALF INCH (1/2") AND LARGER

13. PLANTING SOIL SHALL BE A THOROUGHLY GROUND AND BLENDED MIXTURE OF EQUAL PARTS OF THE FOLLOWING MATERIALS: ONE THIRD (1/3) TOPSOIL, ONE THIRD (1/3) PEAT MOSS AND ONE THIRD (1/3) SAND. ALL PLANTED AREAS SHALL RECEIVE A MINIMUM OF 6" OF TOPSOIL.

14. PRIOR TO PLANT INSTALLATION, CONTRACTOR SHALL IRRIGATE ALL PLANTING AREAS NORMALLY FOR TWO WEEKS TO GERMINATE WEEDS.

CONTRACTOR SHALL THEN APPLY CONTACT HERBICIDE TO WEEDS ONLY PER MANUFACTURER, MONSANTO 'ROUND-UP' OR APPROVED EQUAL. 15. PLANT MATERIAL MAY BE REJECTED AT ANY TIME BY CONTRACT OFFICER DUE TO CONDITION, FORM OR DAMAGE BEFORE OR AFTER

16. ALL PLANT MATERIAL TO BE PLANTED WITH PLANTING TABLETS ACCORDING TO THE MANUFACTURER'S INSTRUCTION AND AS FOLLOWS: -BALLED & BURLAPPED PLANT MATERIAL USE TWO (2) 21 GRAM TABLETS PER EACH 1/2" CALIPER

-7 GALLON CONTAINER PLANT MATERIAL, USE THREE (3) 21 GRAM TABLETS PER PLANT -5 GALLON CONTAINER PLANT MATERIAL, USE TWO (2) 21 GRAM TABLETS PER PLANT -3,2, AND 1 GALLON CONTAINER PLANT MATERIAL, USE ONE (1) 21 GRAM TABLETS PER PLANT

-PLANTING TABLETS SHALL BE AGRIFORM 20-10-5, PLANTING TABLETS PLUS MINORS STOCK NO. 90026 (21 GRAMS) OR APPROVED EQUAL.

17. ALL PLANT MATERIAL SHALL RECEIVE GRANULAR PLANT FOOD TO THE SURFACE OF THE PLANT BEDS INCLUDING GROUND COVER BEDS WHICH DO NOT CONTAIN MANURE OR PLANTING TABLETS. THE PLANT FOOD SHALL BE SPREAD OVER THE ROOT AREA STARTING 6" FROM THE TRUNK AND EXTENDING TO THE DRIP LINE OF EACH PLANT OR TO THE OUTER EDGE OF THE PLANT BED, WHICHEVER LARGER, AT THE RATE OF 2 POUNDS PER 100 SQ FT.

18. CONTRACTOR SHALL BE RESPONSIBLE FOR THE INSTALLATION OF ALL LANDSCAPE PLANT MATERIAL TO THE LATEST HORTICULTURAL PRACTICE STANDARDS.

19. ALL PLANTING BEDS SHALL HAVE A 3 INCH (3") DEPTH OF SHREDDED HARDWOOD MULCH APPLIED AFTER INSTALLATION OF PLANT MATERIAL. MULCH SHALL BE PEST & DISEASE FREE PLANT MATERIAL AND BE FREE OF TWIGS, LEAVES, STONES, CLAY OR OTHER FOREIGN MATERIAL. CONTRACTOR SHALL SUBMIT SAMPLE OF MULCH TO CONTRACT OFFICER FOR APPROVAL PRIOR TO INSTALLATION.

20. ALL DESIGNATED PERIMETER PLANTING AREAS SHALL HAVE 4 INCHES (4") PROFESSIONAL GRADE BLACK ANODIZED ALUMINUM EDGING INSTALLED PER MANUFACTURE'S SPECIFICATIONS.

21. CONTRACTOR SHALL BE RESPONSIBLE FOR A MINIMUM ONE (1) YEAR GUARANTEE TIME FOR THE REPLACEMENT OF ANY PLANT MATERIAL WHICH DIES AFTER THE DATE OF INSTALLATION ON SITE. THE REPLACEMENT PLANT MATERIAL SHALL BE EQUAL IN SIZE AND QUALITY TO THE PLANT MATERIAL SHOWN ON THE LANDSCAPE PLANS. ALL COSTS FOR THE REMOVAL OF DEAD PLANTS AND THEIR REPLACEMENTS SHALL BE BORNE BY THE CONTRACTOR.

22. SUBSTITUTIONS OF PLANT MATERIAL SHALL BE PERMITTED UPON WRITTEN SUBMISSION THAT SPECIFIED PLANT(S) ARE UNAVAILABLE OR UNACCEPTABLE DUE TO HARDINESS. SUBSTITUTE PLANT MATERIAL SHALL BE EQUAL IN SIZE, CHARACTERISTICS AND CONDITION OF MATERIAL BEING REPLACED. OWNER SHALL BE NOTIFIED AND APPROVE ALL SUBSTITUTIONS PRIOR TO THEIR INSTALLATION.

23. PRIOR TO PLANTING, CONTRACTOR SHALL SUBMIT IRRIGATION DESIGN DRAWINGS FOR REVIEW. IRRIGATION SYSTEM SHALL BE FULLY OPERATIONAL, AND ALL LANDSCAPE AREAS SHALL BE IRRIGATED, UNLESS DIRECTED OTHERWISE. IRRIGATION CONTRACTOR SHALL INSTALL ALL REQUIRED IRRIGATION STRUCTURES, PIPES, VALVES, ETC. WHICH ARE TO BE PLACED UNDER ANY PAVED AREAS PRIOR TO PAVEMENT INSTALLATION. IRRIGATION CONTRACTOR SHALL BE RESPONSIBLE FOR ALL COSTS INCURRED IF IRRIGATION EQUIPMENT IS REQUIRED TO BE INSTALLED AFTER PAVEMENT IS PLACED ON SITE. IRRIGATION CONTRACTOR SHALL HAVE ALL IRRIGATION PLANS APPROVED BY OWNER PRIOR TO ANY INSTALLATION. IRRIGATION CONTRACTOR IS RESPONSIBLE FOR COORDINATING WITH THE UTILITY CONTRACTOR FOR LOCATION OF IRRIGATION CONNECTION TO WATER SYSTEM.

24. CONTRACTOR SHALL INSPECT BACKFILL AND PLACEMENT OF TOPSOIL TO DETERMINE WHETHER OR NOT A "HARDPAN" SITUATION EXISTS OR COULD EXIST DUE TO PREVIOUS SOIL CONDITIONS, PLACEMENT OF AND COMPACTION OF FILL DURING CONSTRUCTION, OR ANY OTHER CONTRIBUTING FACTOR PRIOR TO INSTALLATION OF PLANT MATERIALS. IF SUCH A SITUATION IS FOUND OR ANTICIPATED, IT SHOULD BE BROUGHT TO THE ATTENTION OF JPR AND/OR OWNER IMMEDIATELY, AND PRIOR TO THE INSTALLATION OF PLANT MATERIAL, FOR A REMEDY. CONTRACTOR RESPONSIBLE FOR PLANT REPLACEMENT IF PLANT MATERIAL IS PLANTED IN A "HARDPAN" SITUATION.

25. DIMENSIONS FOR HEIGHTS, SPREAD AND CALIPER OF TREES SPECIFIED ON THE PLANT LIST ARE GENERAL GUIDES FOR THE MINIMUM DESIRED SIZE OF EACH PLANT. EACH PLANT SHALL HAVE A UNIFORM AND CONSISTENT SHAPE AS IT PERTAINS TO THE LATEST EDITION OF AMERICAN STANDARD FOR NURSERY STOCK. PLANT MATERIAL WHICH FAILS TO CONFORM TO THE SPECIFICATIONS IS SUBJECT TO REJECTION BY OWNER/JPR.

SEEDING NOTES

MANHATTAN PERENNIAL RYE NORLEA PERENNIAL RYE

BE DRILL SEEDED WITH THE FOLLOWING GRASS SEED MIXTURE: TYPE KENTUCKY BLUE GRASS <u>% BY WEIGHT</u> <u>% BY PURITY</u> <u>% BY GERMINATION</u> RED FESCUE

2. TURF SEED INSTALLATION: SOW SEED WITH DRILL SEEDING MACHINE. EVENLY DISTRIBUTE SEED BY SOWING EQUAL QUANTITIES IN TWO DIRECTIONS AT RIGHT ANGLES TO EACH OTHER.

DO NOT USE WET SEED OR SEED THAT IS MOLDY OR OTHERWISE DAMAGED. DO NOT SEED AGAINST EXISTING TREES. LIMIT EXTENT OF SEED TO OUTSIDE EDGE OF PLANTING SAUCER.

-SOW SEED AT A TOTAL RATE OF 4 LB/1000 SQ FT.

-RAKE SEED LIGHTLY INTO TOP 1/8 INCH OF SOIL, ROLL LIGHTLY, AND WATER WITH FINE SPRAY. -PROTECT SEEDED AREAS WITH SLOPES EXCEEDING 1:3 WITH EROSION-CONTROL BLANKETS INSTALLED AND

STAPLED ACCORDING TO MANUFACTURER'S WRITTEN INSTRUCTIONS. -PROTECT SEEDED AREAS WITH SLOPES NOT EXCEEDING 1:3 BY HYDROMULCH. SPREAD UNIFORMLY AT A

MINIMUM RATE OF 1 1/2 TONS/ACRE TO FORM A CONTINUOUS BLANKET OVER SEEDED AREAS.


3. SATISFACTORY SEEDED TURF: AT END OF MAINTENANCE PERIOD (90 DAYS), A HEALTHY, UNIFORM, CLOSE STAND OF GRASS HAS BEEN ESTABLISHED, FREE OF WEEDS AND SURFACE IRREGULARITIES, WITH COVERAGE EXCEEDING 90 PERCENT OVER ANY 10 SQ FT AND BARE SPOTS NOT EXCEEDING 3 INCHES BY 3 INCHES (3" X 3").

PLANT MATERIAL NOTES

1. ALL PLANT MATERIAL TO MEET AMERICAN STANDARDS FOR NURSERY STOCK, 1990 EDITION/ HORTIS THIRD 1076 CORNELL UNIVERSITY.

2. ALL LANDSCAPE AREAS TO BE 100% IRRIGATED WITH AN UNDERGROUND AUTOMATIC IRRIGATION SYSTEM.

3. PLANT CONTAINER SIZES ARE SHOWN AS GUIDELINES ONLY (MINIMUM HEIGHT AND SPREAD REQUIREMENTS RULE). PLANT HEIGHT AND SPREAD SPECIFICATIONS ARE MINIMUMS, ON CENTER (O.C.) SPECIFICATIONS ARE MAXIMUMS.

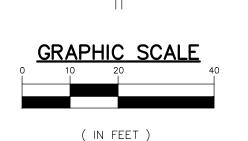

1 INCH = 20 FT



PRELIMINARY FOR REVIEW **PURPOSES**

DESIGNED BY: DRAWN BY: MM

MAY 2023

JOB NUMBER: 2022-0168

I" = 20'

C601

HAYES FAMILY AUTO 717 WEST MAIN STREET WATERTOWN, WI 53094


SP-1 SITE PLAN, DRAWING INDEX, SITE CALCS, EROSION CONTROL DETAILS SP-2 LANDSCAPE PLAN & SCHEDULE SP-3 SITE LIGHTING PLAN A-1 BLDG 'A' BLIGHTING SITE PLAN A-2 BLDG 'A' BLEVATIONS A-3 BLDG 'A' ELEVATIONS A-4 BLDG 'B' ELEVATIONS A-5 BLDG 'B' ELEVATIONS BLDG 'B' ELEVATIONS A-6 BLDG 'B' ELEVATIONS DRAWING INDEX:


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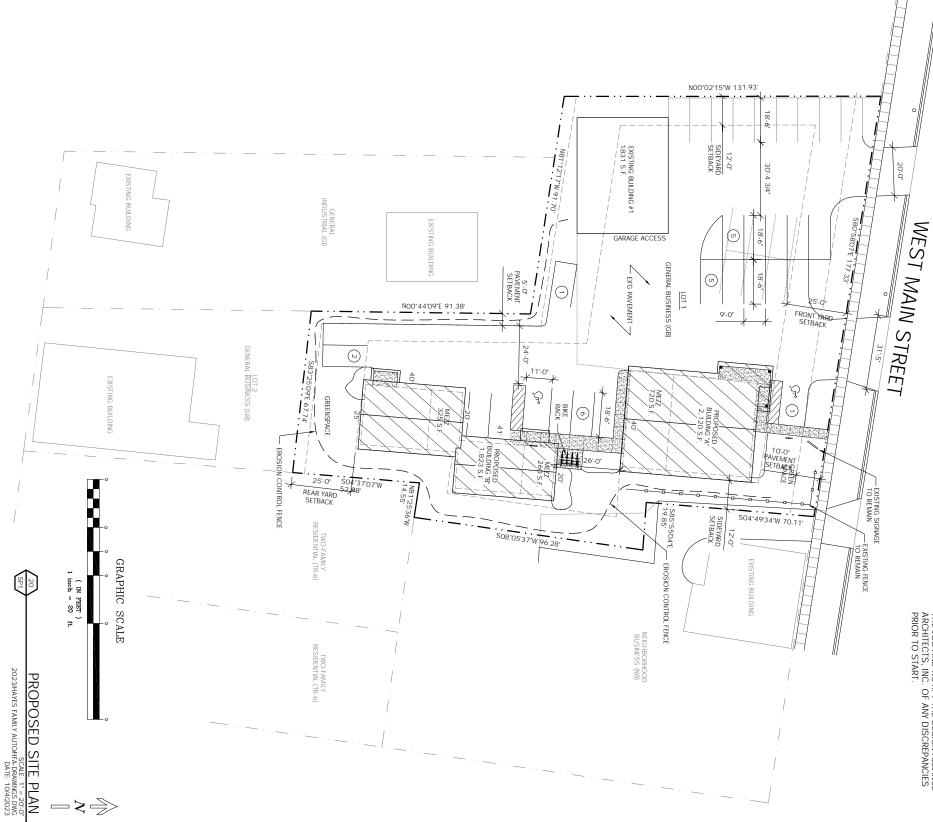
DEVELOPE SITE WITH TWO NEW BUILDINGS AND EXPANDED PARKING.

LOT 1, CSM 5807-33-098, DOC 1384903 EAGAL DESCRIPTION:

SITE AREA:	30,285 S.F.	(0.69 ACRE)
BUILDING FOOTPRINT AREA:	5,774 S.F.	(19.1%)
PARKING AREA:	15,921 S.F.	(52.6%)
SIDEWALK AREA:	918 S.F.	(3.0%)
GREEN SPACE AREA:	7,672 S.F.	(25.3%)
MPERVIOUS AREA:	22,613 S.F.	(74.7%)
BUILDING HEIGHT:		25'-8"
ZONED:	GB - GENI	GB - GENERAL BUSINESS



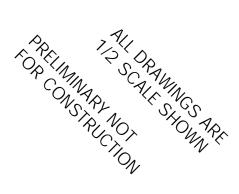

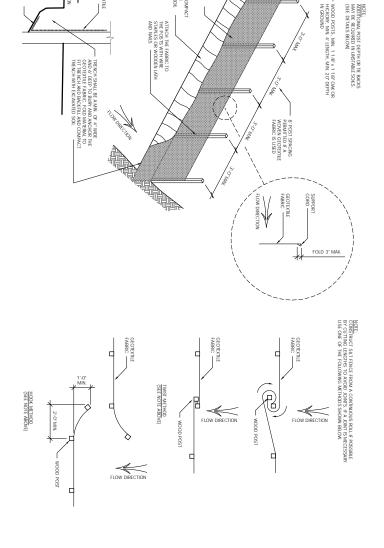

VERIFY ALL CONDITIONS AND DIMENSIONS ON THE JOB AND NOTIFY THE DESIGN ALLIANCE ARCHITECTS, INC. OF ANY DISCREPANCIES PRIOR TO START.

SP-

EROSION CONTROL DETAILS
SOLIE: N.T.S.
SOLIE:

DATE: 2/5/2024

DRAWN BY: CL

CHECKED BY: P.W. DRAWING INDEX
EROSION CONTROL DTL'S DRAWING NAMES PROJECT DATA SHEET NO. REVISIONS



7 ALL DRAWINGS ARE CONSTRUCTION

VERIFY ALL CONDITIONS AND DIMENSIONS ON THE JOB AND NOTIFY THE DESIGN ALLIANCE ARCHITECTS, INC. OF ANY DISCREPANCIES PRIOR TO START.

ANDSCAPE SCHEDULE & CALCS
SCALE NATS 2023/HAYES FAMILY AUTOMFA-DRAWINGS.DWG DATE: 10/4/2023

> Þ RACK

REMEAU VARD: 5 PTS PER 1,000 S.F. OF TOTAL GROSS FLORRARA -- 5,248 S.F. / 1,000 S.F. = 5.2 x.5 = 26 PTS PROVIDED: 1 MEDIUM DECUNOUS TREE 115 PTS = 15 PROWITS EXISTING LANDSCAPING LABELED 'A' SHOULD BE ADEQUATE TO FULLFILL THE GENERAL YARD REQUIREMENTS EXISTING LANDSCAPING LABELED 'A' SHOULD BE ADEQUATE TO FULLFILL THE GENERAL YARD REQUIREMENTS

BUFFER YARD: TR-6 = 0.4 107W + 5.8 pt/5 per 1000 - 6.68 / 5.9 pt/5 = 3.7 POINTS
BUFFER YARD: TR-6 + 0.4 107W + 91 Pt/5 per 1000 - 1.86 / 1001 - 1.86 x 91 Pt/5 = 170 POINTS
PROVIDED AT TR-6 - 6 LOW EVERGREEN TREES AT 12 Pt/5 = 172 POINTS
PROVIDED AT NB: 9 LOW EVERGREEN TREES AT 12 Pt/5 = 172 POINTS
TOTAL 180 POINTS

EXISTING BUILDING #1

FOUNDATION: 20 PTS PER 100'...

BLDG 'A': 186' / 100' = 1.9 x 20 PTS = 38 PTS x 1.5 = 57 POINTS PROVIDED: 9 MEDIUM EVERGREEN SHRUBS AT 5 PTS = 45 POINTS POINTS POINTS AT 5 PTS = 5 POINTS OF THE SHRUBS AT 3 PTS = 9 POINTS TOTAL 57 POINTS BLDG 'B': 242 / 100' = 2.4 x 20 PTS = 48 PTS x 1.5 = 72 POINTS PROVIDED: 3 MEDIUM EVERGREEN SHRUBS AT 5 PTS = 15 POINTS 15 MEDIUM DECIDIOUS SHRUBS AT 3 PTS = 45 POINTS 6 LOW EVERGREEN SHRUBS AT 3 PTS = 18 POINTS TOTAL 78 POINTS

PAVEMENT: 40 PTS PER 10,000 S.F. -- 16,028 S.F. / 10,000 S.F. = 1.6 x 40 PTS = 64 PTS x 1.5 = 96 POINTS PROVIDED: 12 MEDIUM EVERGREEN SHRUBS AT 3 PTS = 50 POINTS

10 LOW EVERGREEN SHRUBS AT 3 PTS = 30 POINTS

10 LOW EVERGREEN SHRUBS AT 3 PTS = 30 POINTS

10 LOW EVERGREEN SHRUBS AT 3 PTS = 30 POINTS

STREET TREES: 20 PTS PER 100'-- 177' / 100' = 1.8 × 20 = 36 POINTS PROVIDED: 1 TALL DECIDIOUS TREE AT 30 PTS = 30 POINTS PROVIDED: 1 MEDIUM DECIDIOUS TREE AT 15 PTS = 15 POINTS TOTAL 45 POINTS

QUANTITY 30 30 180 120 9 18 39 39WEST MAIN STREET *** Þ TO REMAIN

TYPE TYPE

EXISTING LANDSCAPING
EXISTING TREES TO BE REMOVED
BLACK MAPLE
AMUR CHOKECHERRY
ARBOR VITAE "PYRAMIDAL"
"NORTH POLE" ARBORVITAE
VIBURNUM CARLESII
TAMARRY SAVIN JUNIPER
TAXUS TAUNTONIT
KOREAN SPICE VIBURNUM

1 1/2" CAL 1 1/2" CAL 4" H 15-18"H 24"H 18"H 12"H 18"H

40° DIA 30° DIA 6° DIA 4° DIA 4° DIA 4° DIA 4° DIA 3° DIA

1 2 15 24 24 3 3 13 21

DESCRIPTION

PLANTING SIZE

MATURE SIZE

PLANTING SCHEDULE

LANDSCAPE PLAN SCALE: 11 = 20-0" 2023/HAYES FAMILY AUTOMFA-DRAWINGS.DWG DATE: 1014/2023	PREST) V	IC SCALE		
SP-2	DATE: 2/5/2024 DRAWN BY: CL CHECKED BY: P.W. SHEET NO.		REVISIONS	DRAWING NAMES LANDSCAPE PLAN & SCHEDULE

EXISTING BUILDING





DRAWING NAMES
EXISTING SITE PLAN

REVISIONS


REVISIONS


PROJECT DATA

DATE: 2/5/2024
DRAWN BY: CL
CHECKED BY: P.W.
SHEET NO.

SHEET NO.



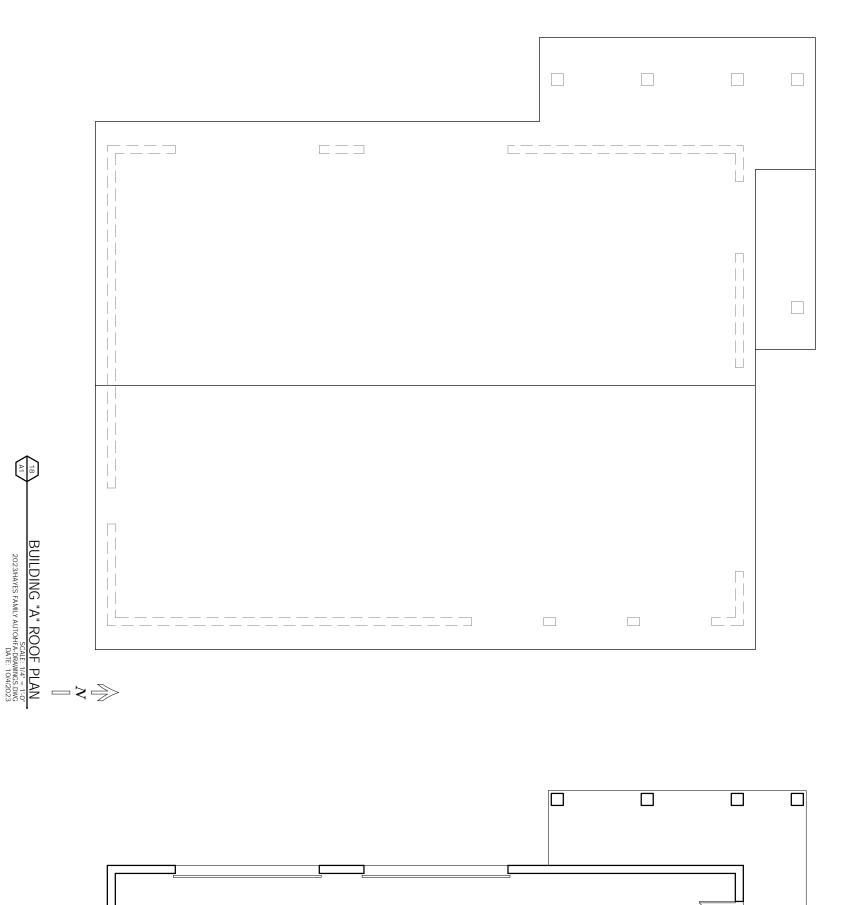

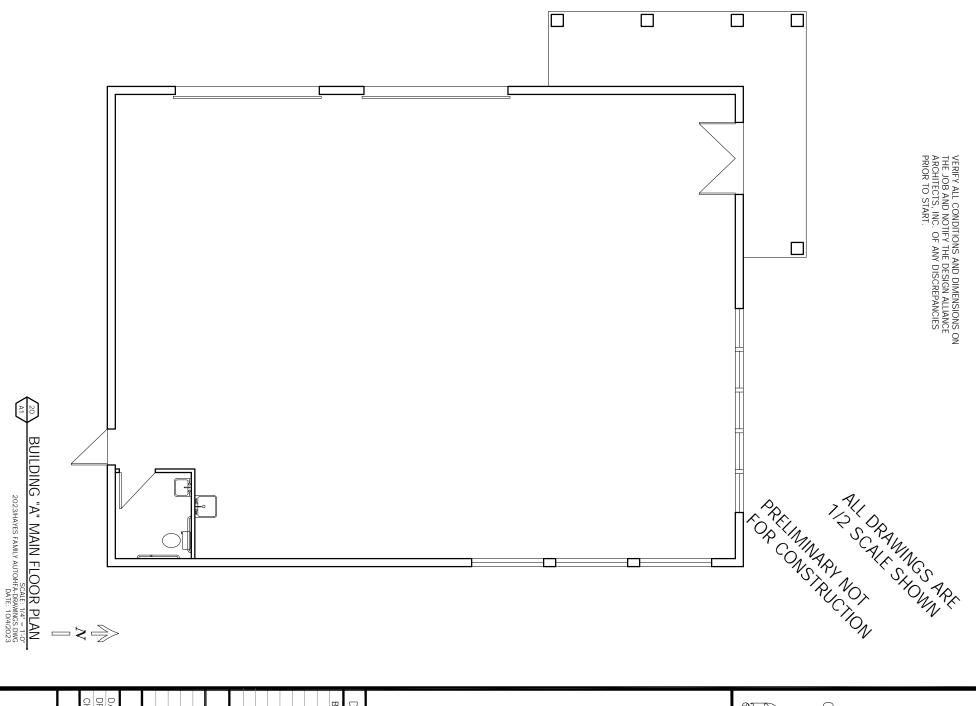

DRAWING NAMES
BUILDING "A" PLANS

REVISIONS

PROJECT DATA

PROJECT DATA


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DRAWN BY: CL

CHECKED BY: P.W.

SHEET NO.



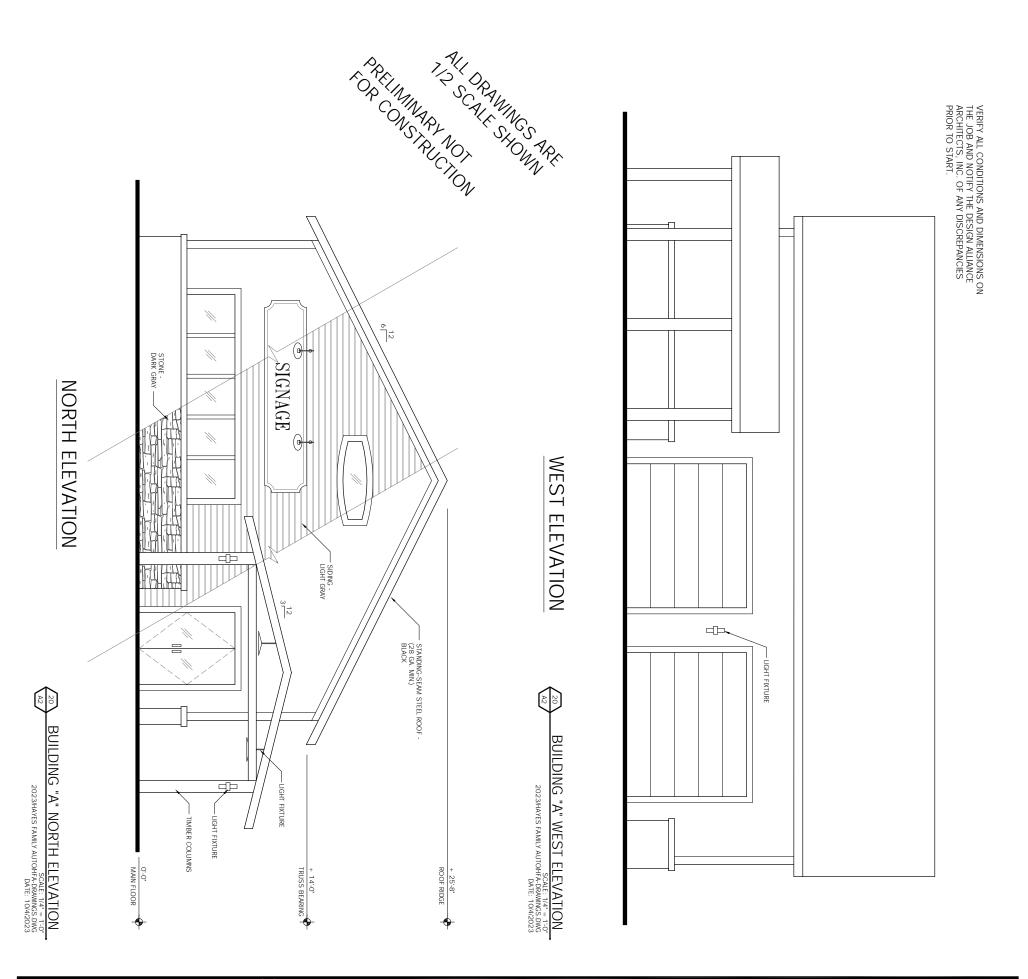

A-2

BUILDING "A" ELEVATIONS

BUILDING "A" ELEVATIONS

REVISIONS

PROJECT DATA

DATE: 2/5/2024


DRAWN BY: CL

CHECKED BY: P.W.

SHEET NO.





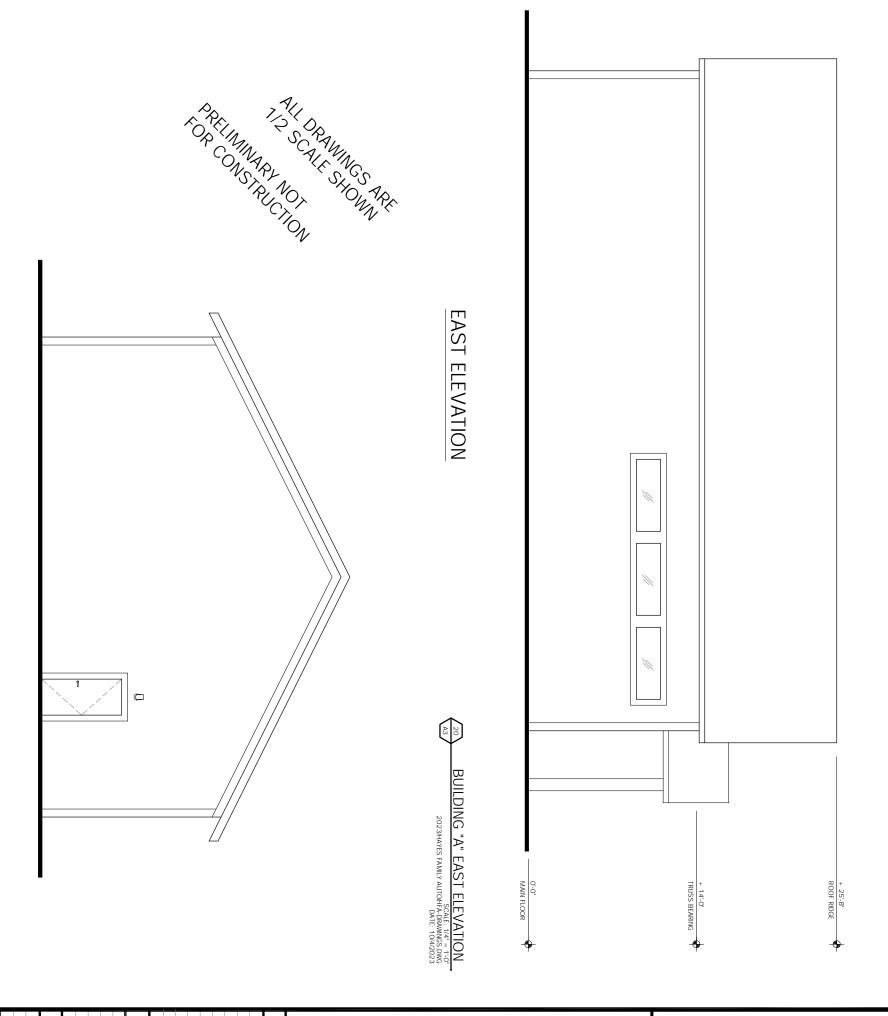

A-3

SHEET NO.

BUILDING "A" SOUTH ELEVATION
SCALE: 1/4" = 1*0"
2023/HAYES FAMILY AUTOHF A-DRWINGS DWG
DATE: 10/4/2023

SOUTH ELEVATION

BUILDING "A" ELEVATIONS

BUILDING "A" ELEVATIONS

REVISIONS

REVISIONS

PROJECT DATA


DATE: 2/5/2024


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CHECKED BY: P.W.


HAYES FAMILY AUTO SITE DEVELOPMENT 717 W MAIN STREET WATERTOWN, WI 53094 Allisonce
Architects, Inc.

1003 Madison Avenue
Fort Atkinson, WI (920) 563-3404



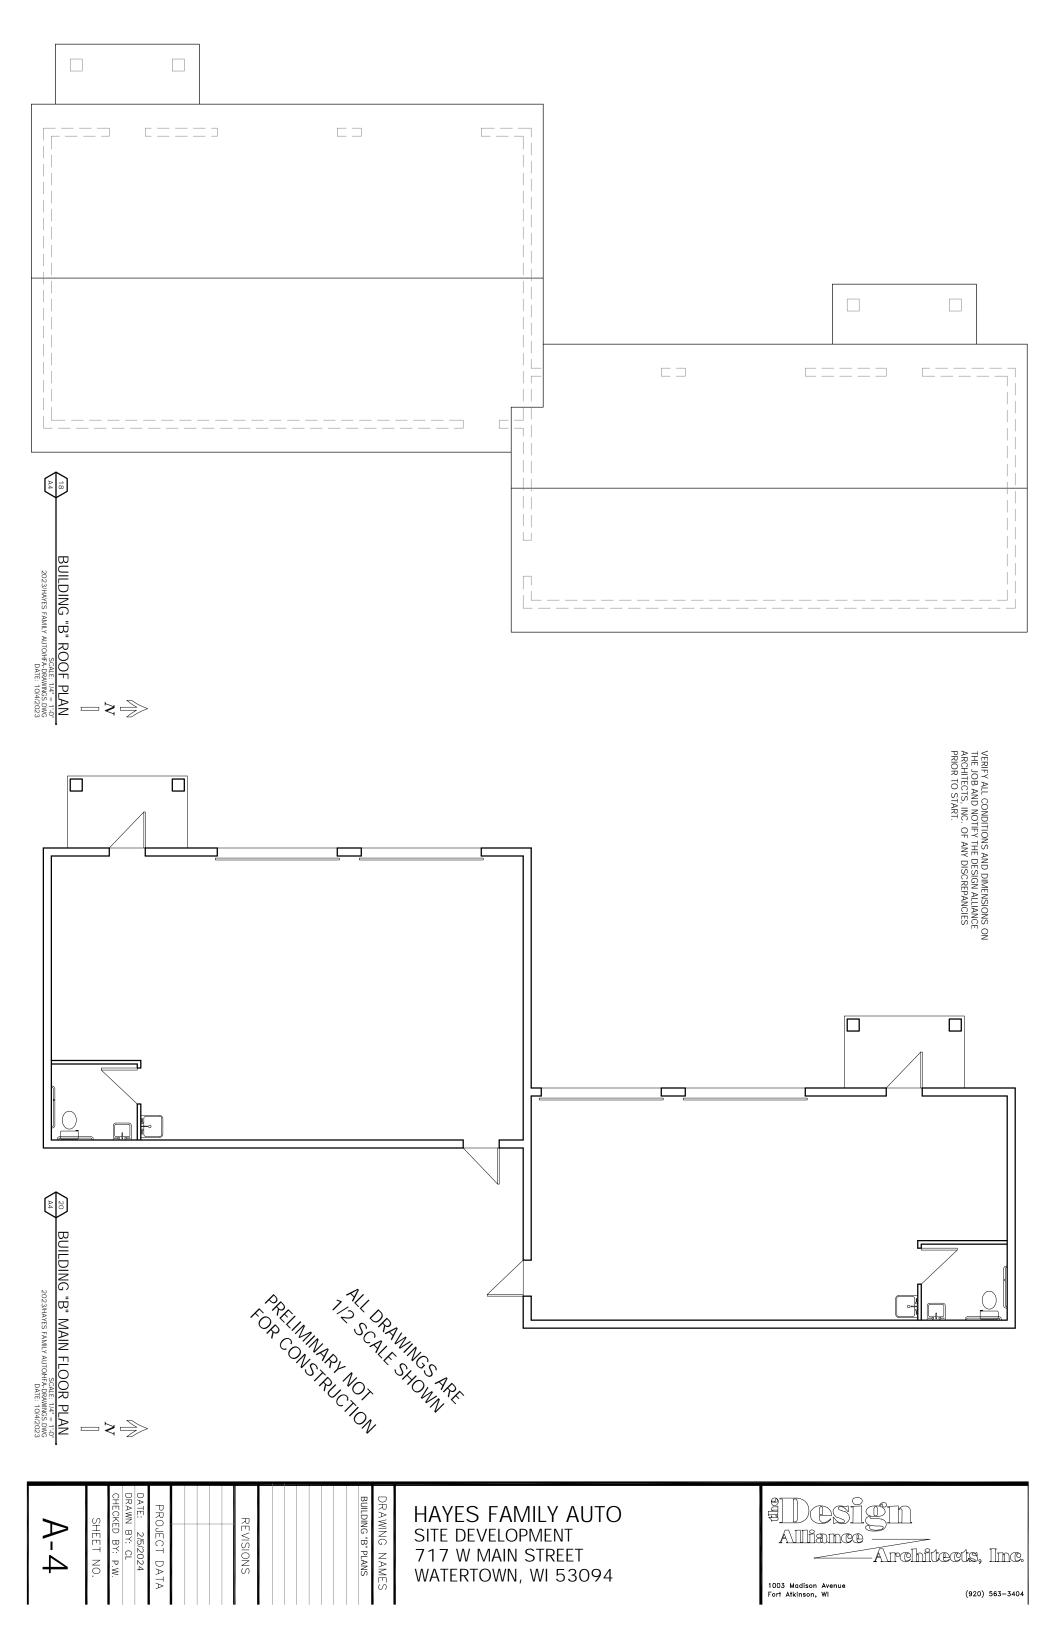

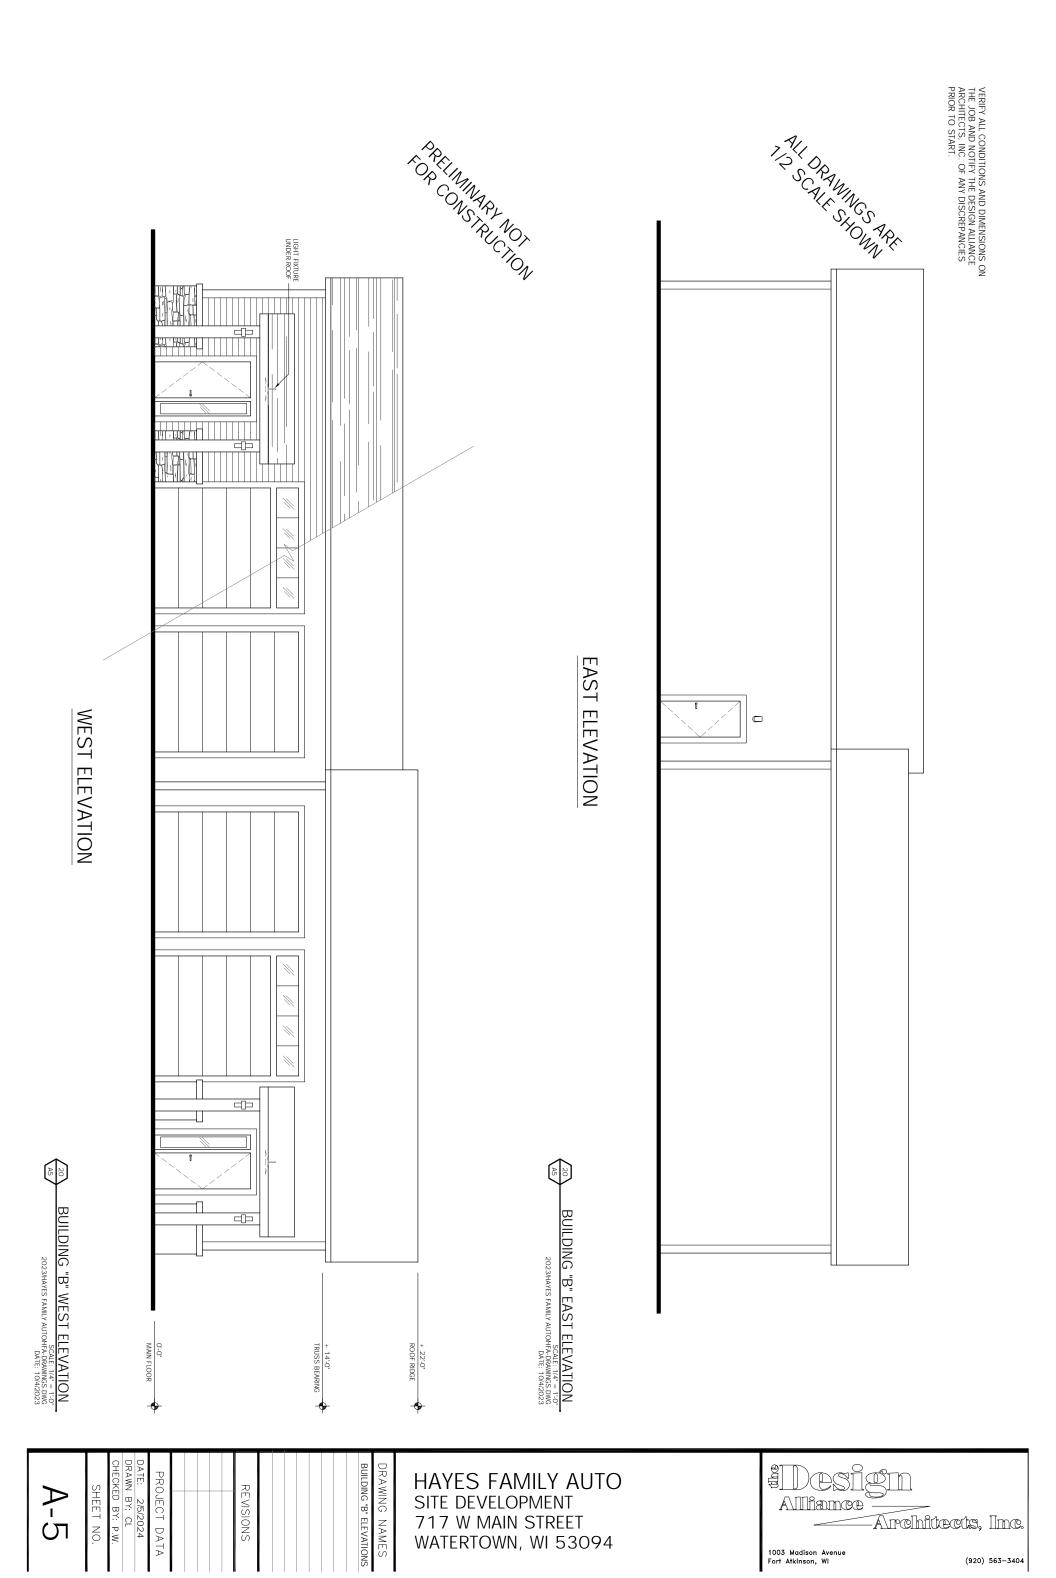PRIMINARY SCALE SHOWN ARE

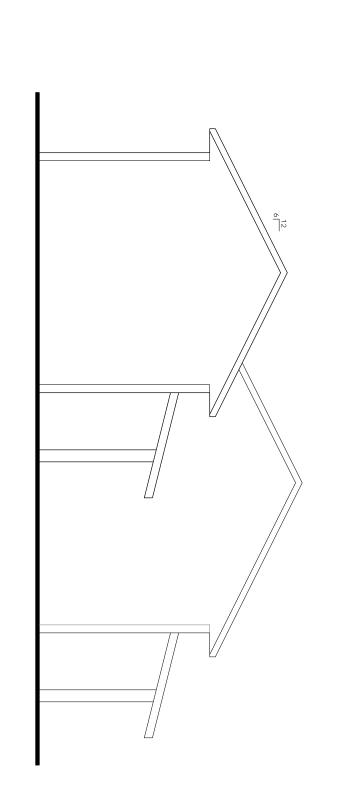


NORTH ELEVATION

BUILDING "B" NORTH ELEVATION

SCALE: 1/4" = 1'0'
2023HAYES FAMILY AUTOHFA-DRAWNIGS.SWG
DATE: 10/4/2023



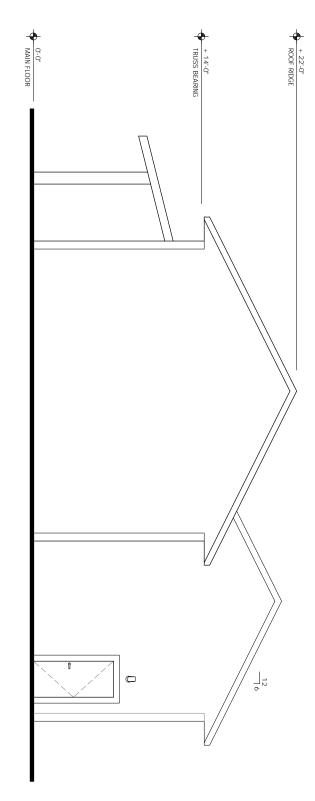

						1				_	_
A-6	SHEET NO.	CHECKED BY: P.W.	2/5/	PROJECT DATA		REVISIONS				BUILDING "B" ELEVATIONS	DRAWING NAMES

HAYES FAMILY AUTO SITE DEVELOPMENT 717 W MAIN STREET WATERTOWN, WI 53094


BUILDING "B" SOUTH ELEVATION

SCALE: 1/4" = 1'0'
2023HAYES FAMILY AUTOHFA-DRAWINGS DWG
DATE: 10/4/2023



HAYES FAMILY AUTC SITE DEVELOPMENT

717 WEST MAIN STREET WATERTOWN, WI 53094

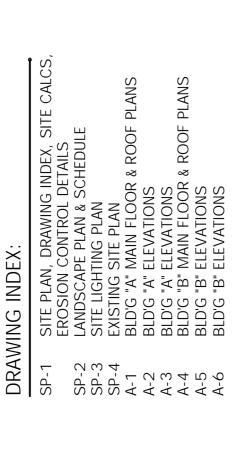


DEVELOPE SITE WITH TWO NEW BUILDINGS AND EXPANDED PARKING. PROJECT DESCRIPTION:

LOT 1, CSM 5807-33-098, DOC 1384903 LEAGAL DESCRIPTION:


.69 ACRE) (19.1%) 25'-8" GB - GENERAL BUSINESS 30,285 S.F. 5,774 S.F. 15,921 S.F. 918 S.F. 7,672 S.F. 22,613 S.F. EXISTING SITE INFORMATION:
SITE AREA:
BUILDING FOOTPRINT AREA: GREEN SPACE AREA:
IMPERVIOUS AREA:
BUILDING HEIGHT:
ZONED: PARKING AREA: SIDEWALK AREA:


(52.6%) (3.0%)




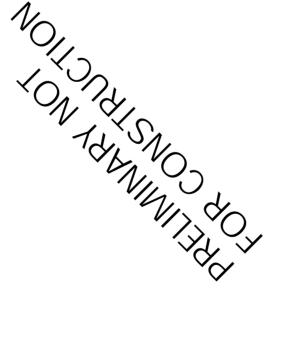



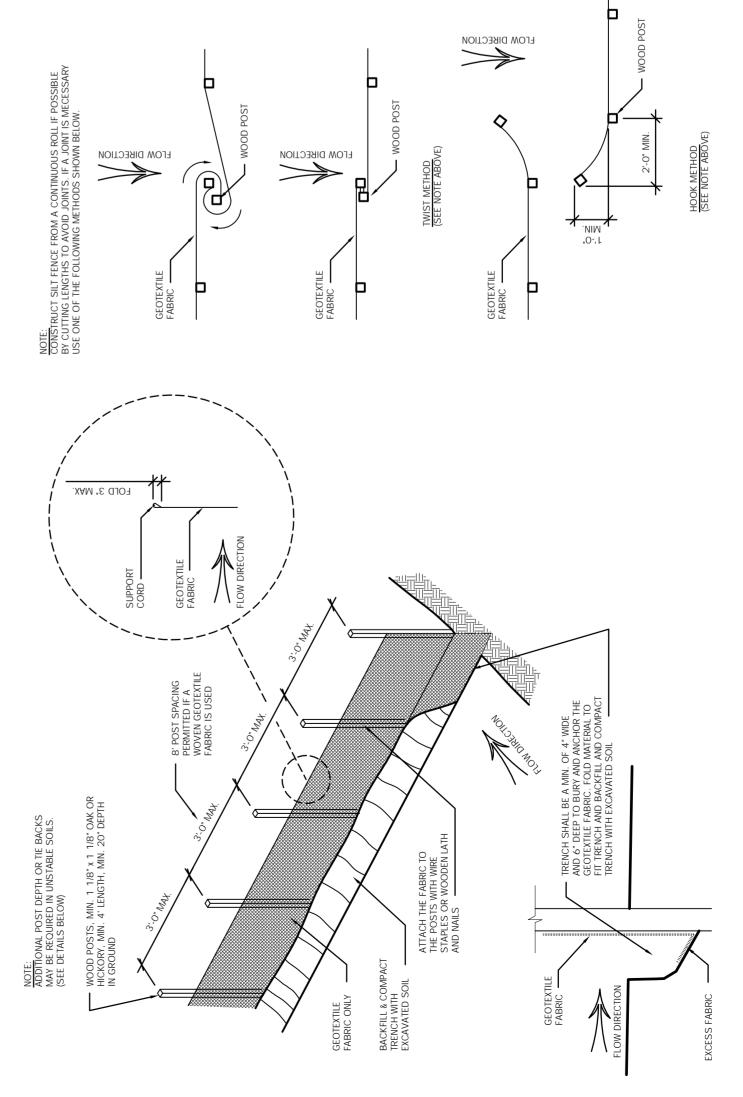

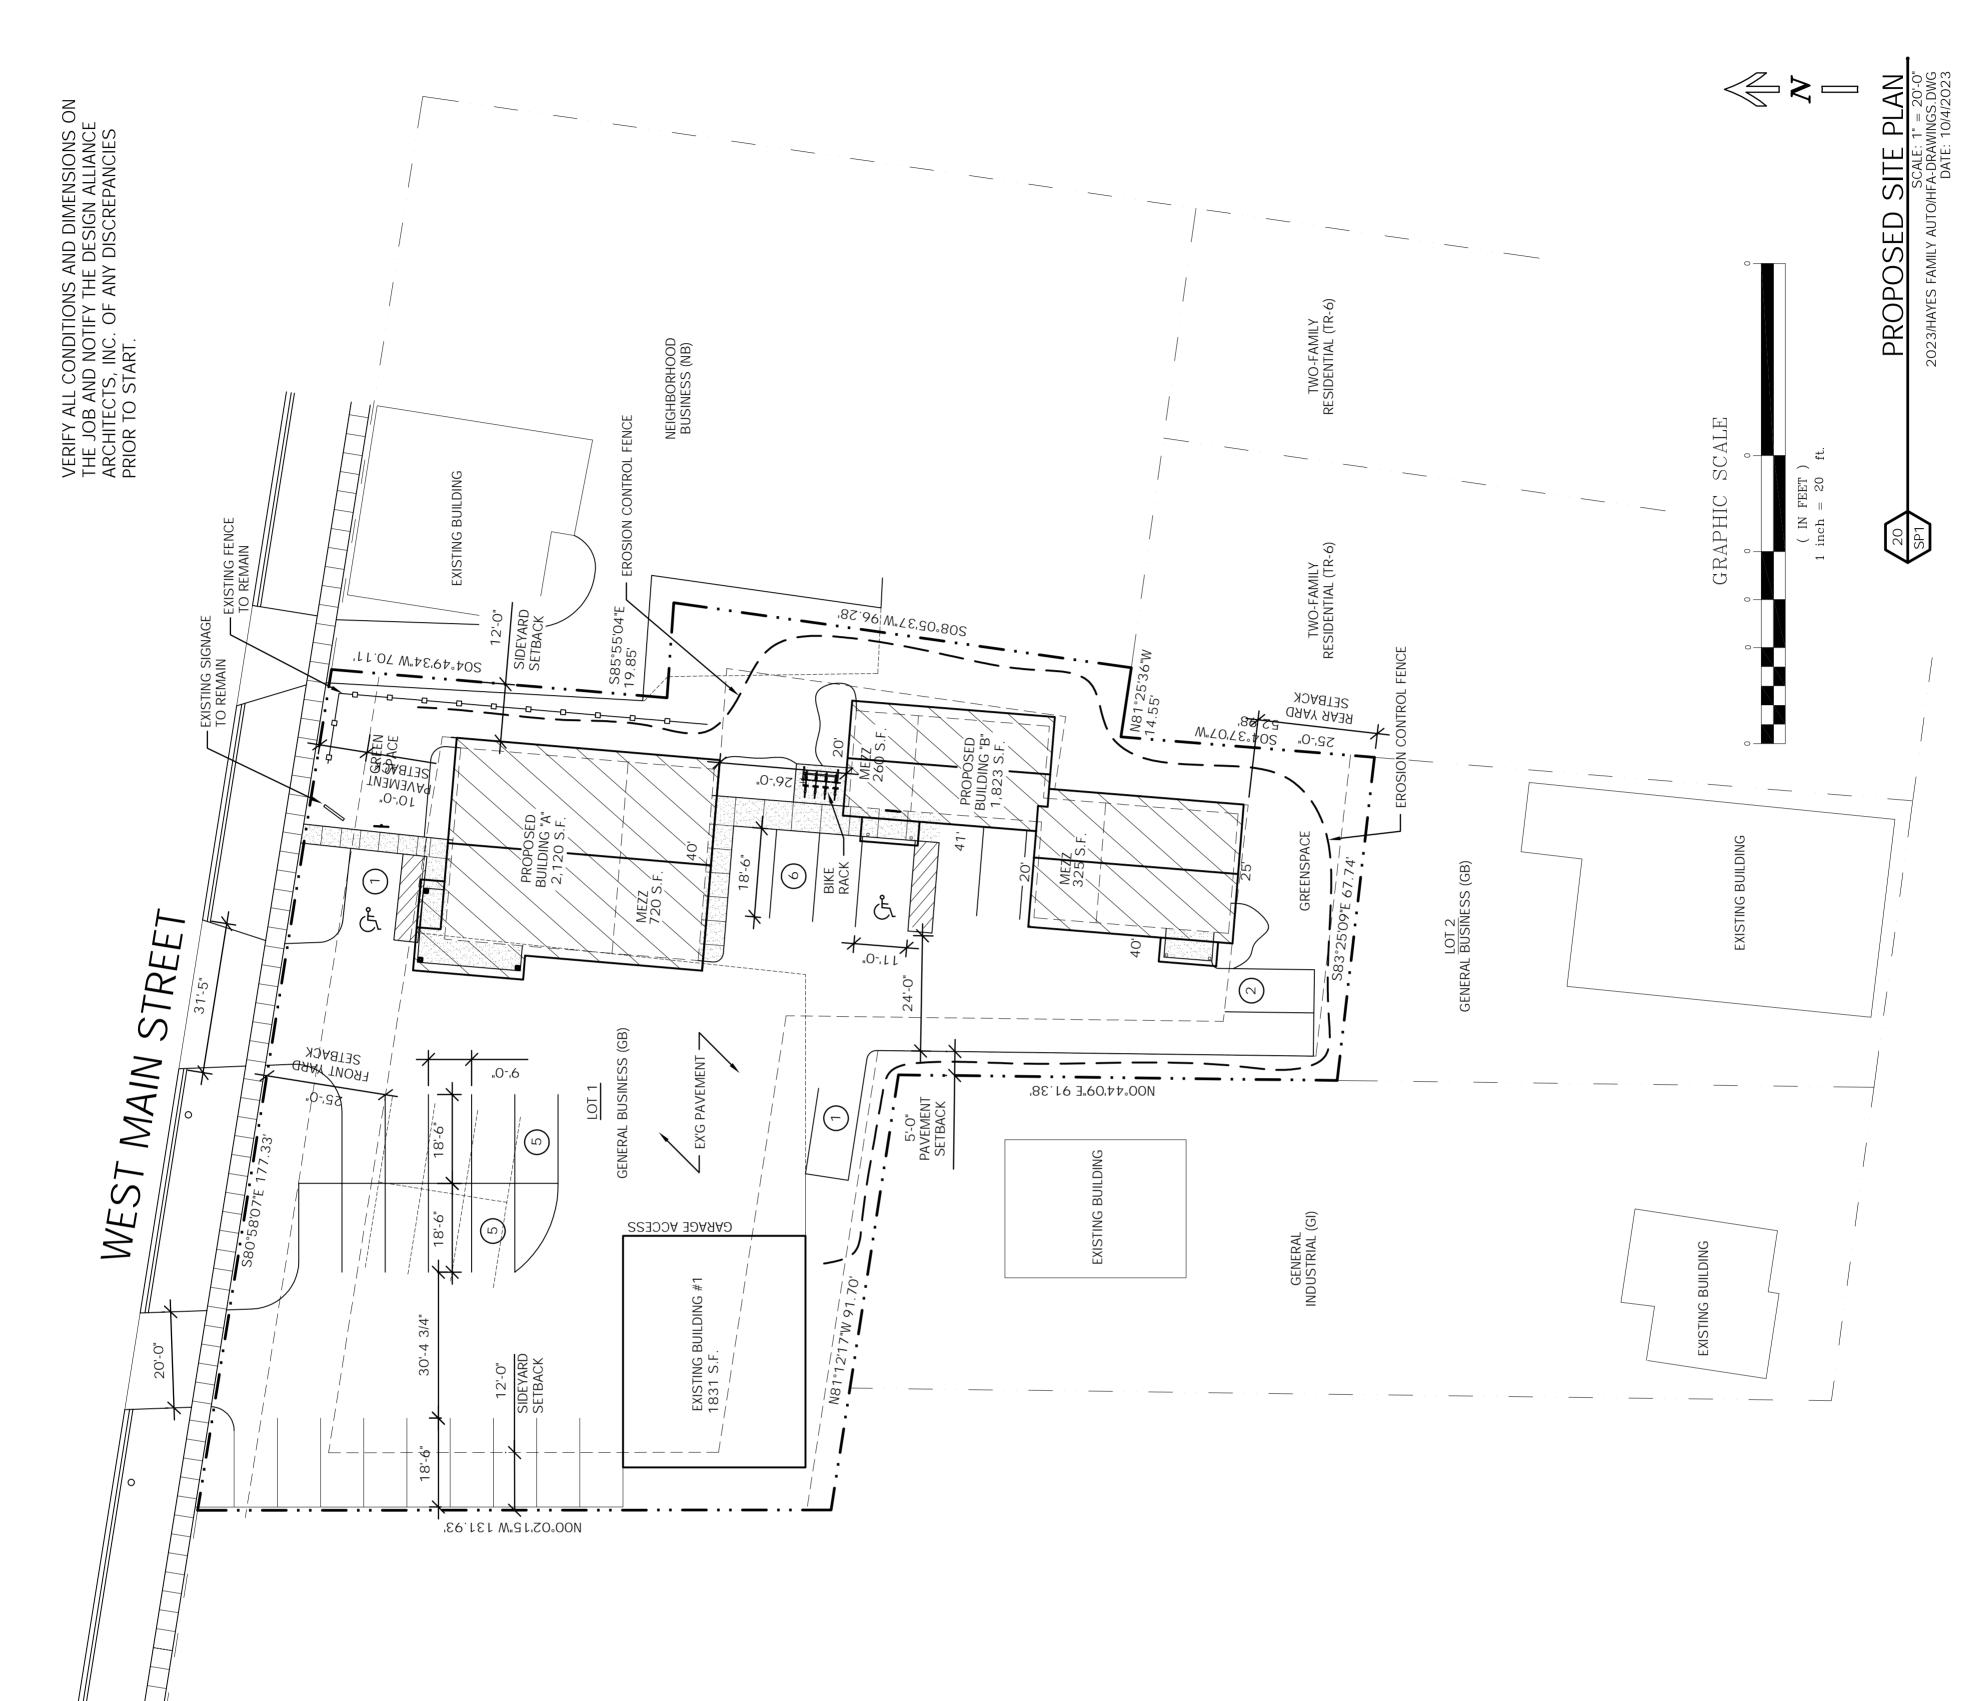


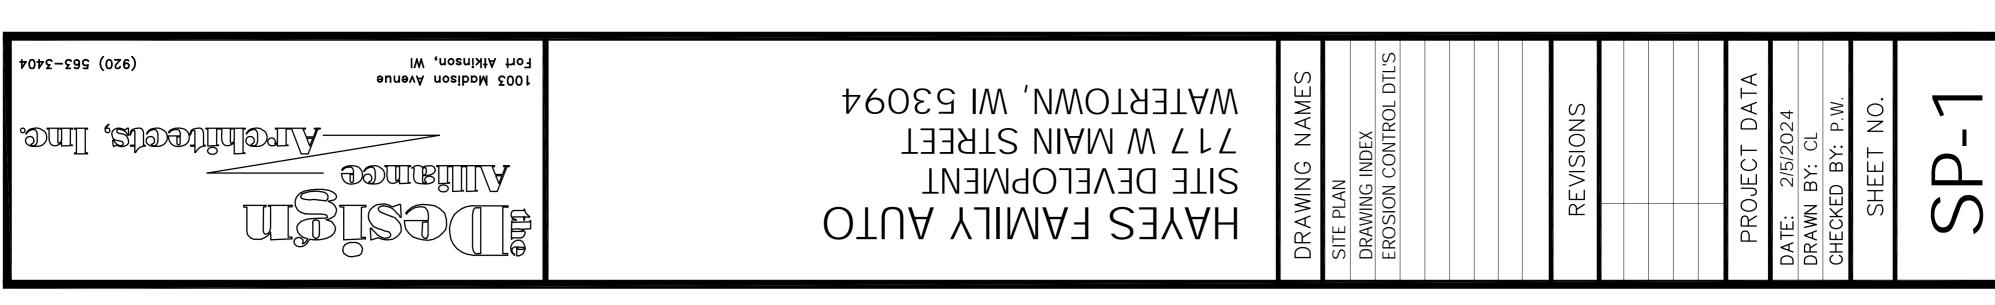

SCALE: N.I.S. 2023/HAYES FAMILY AUTO/HFA-DRAWINGS.DWG DATE: 10/4/2023

EROSION CONTROL DETAILS

27

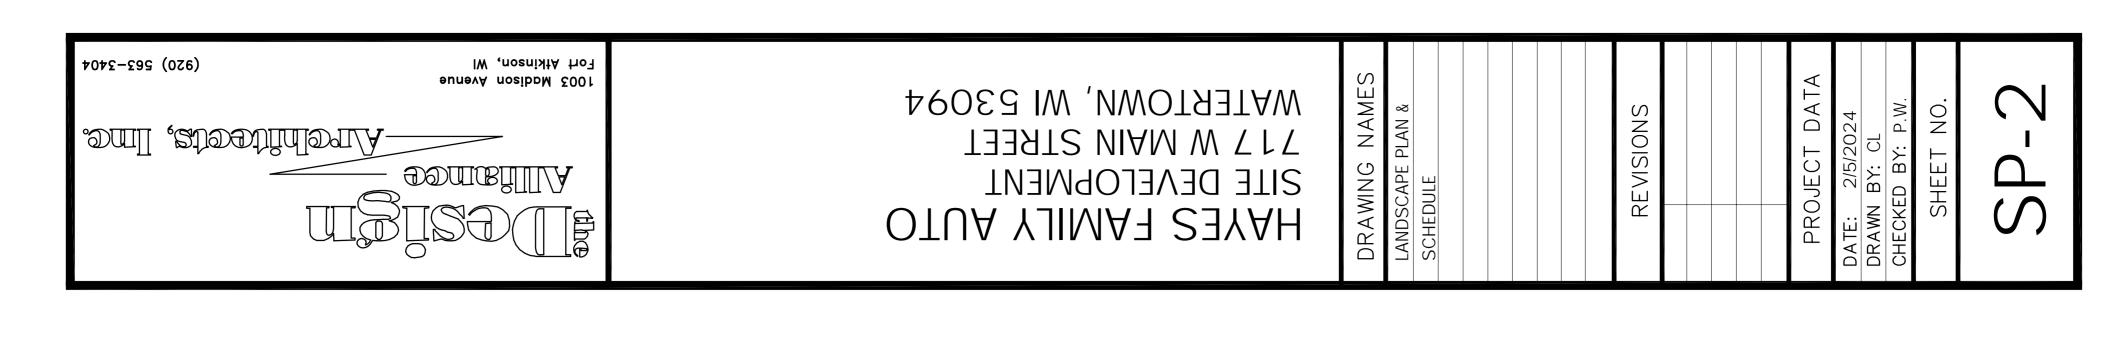



NOHONALSNOON AON

VERIFY ALL CONDITIONS AND DIMENSIONS ON THE JOB AND NOTIFY THE DESIGN ALLIANCE ARCHITECTS, INC. OF ANY DISCREPANCIES PRIOR TO START.

2023/HAYES FAMILY AUTO/HFA-DRAWINGS.DW DATE: 10/4/202

SCHEDULE

LANDSCAPE

GENERAL YARD: 5 PTS PER 1,000 S.F. OF TOTAL GROSS FLOOR AREA -- 5,248 S.F. / 1,000 S.F. = 5.2 x 5 = PROVIDED: 1 MEDIUM DECIDUOUS TREE AT 15 PTS = 15 POINTS
EXISTING LANDSCAPING LABELED "A" SHOULD BE ADEQUATE TO FULLFILL THE GENERAL YARD REQUIREMENTS

BUFFER YARD: TR-6 = 0.4 10'W + 53 PTS PER 100' -- 68'/100' = .68 x 53 PTS = 37 POINTS

NB = 0.1 10'W + 91 PTS PER 100' -- 186'/100' = 1.86 x 91 PTS = 170 POIN

PROVIDED AT TR-6: 6 LOW EVERGREEN TREES AT 12 PTS = 72 POINTS

PROVIDED AT NB: 9 LOW EVERGREEN TREES AT 12 PTS = 108 POINTS

TOTAL 180 POINTS

BLDG "B"; 242' / 100' = 2.4 x 20 PTS = 48 PTS x 1.5 = 72 POINTS PROVIDED: 3 MEDIUM EVERGREEN SHRUBS AT 5 PTS = 15 POINTS 15 MEDIUM DECIDUOUS SHRUBS AT 3 PTS = 45 POINTS 6 LOW EVERGREEN SHRUBS AT 3 PTS = 18 POINTS 78 POINTS

FOUNDATION: 20 PTS PER 100' -BLDG "A": 186' / 100' = 1.9 x 20 PTS = 38 PTS x 1.5 = 57 POINTS
PROVIDED: 9 MEDIUM EVERGREEN SHRUBS AT 3 PTS = 45 POINTS
1 MEDIUM DECIDUOUS SHRUBS AT 3 PTS = 3 POINTS
3 LOW EVERGREEN SHRUBS AT 3 PTS = 9 POINTS
TOTAL 57 POINTS

PAVEMENT: 40 PTS PER 10,000 S.F. -- 16,028 S.F. / 10,000 S.F. = 1.6 x 40 PTS = 64 PTS PROVIDED: 12 MEDIUM EVERGREEN SHRUBS AT 5 PTS = 60 POINTS 8 MEDIUM DECIDUOUS SHRUBS AT 3 PTS = 24 POINTS 10 LOW EVERGREEN SHRUBS AT 3 PTS = 30 POINTS TO LOW EVERGREEN SHRUBS AT 3 PTS = 114 POINTS

STREET TREES: 20 PTS PER 100' -- 177' / 100' = 1.8 x 20 = 36 POINTS PROVIDED: 1 TALL DECIDUOUS TREE AT 30 PTS = 30 POINTS 1 MEDIUM DECIDUOUS TREE AT 15 PTS = 15 POINTS TOTAL 45 POINTS

LANDSCAPE REQUIREMENTS:

TOTAL

QUANTITY

MATURE SIZE

PLANTING SIZE

PLANTING SCHEDULE

30 15 12 5 3 3 3 TOTAL


40' DIA 30' DIA 6' DIA 4' DIA 4' DIA 4' DIA 3' DIA

1 1/2" CAL 1 1/2" CAL 4' H 15-18"H 24'H 18"H 12"H 18"H

EXISTING LANDSCAPING
EXISTING TREES TO BE REMOVED
BLACK MAPLE
AMUR CHOKECHERRY
ARBOR VITAE 'PYRAMIDAL'
"NORTH POLE" ARBORVITAE
VIBURNUM CARLESII
TAMARIX SAVIN JUNIPER
TAXUS 'TAUNTONI'
KOREAN SPICE VIBURNUM

Revision No.


Designer
CL
Date
02/05/2024
Scale

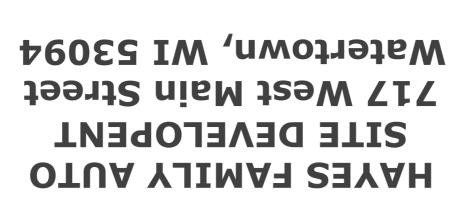



(950) 262-2404	1003 Middleon Avenue
ani atottinion	— expandrilla A———
W.	FDEZJE


TO THE STATE			GRAPHIC SCALE	(IN PEET)	
EXERSIS UNITY 11.4 4.1 0.8				EXISTING BUILDING	
COPERTY LINE 4.8	Input Power 180	42.159	9.02	111.4	27
# 3.9 PP PR	out 0.87	9 0.87	5 0.87	1 0.87	ute 0.87
## PROPERTYLING ## 1	nber Lamp nps Output Absolute	581	576	8201	Absolute
PROPERTY LINE	Numbe Lamps	T	7	1 TYPE	1 1 1 1 1 1 1 1 1 1 1 1 1 1 1 1 1 1 1
	Description Existing Light Fixture on Utility Pole	Existing Light on Building	OUTDOOR LED WALL CYLINDER DOWN LIGHT & 4000K NICHIA 219C	ASL EML25. LARGE BELL SHAPE CAST ALUMINUM HSG., WITH LED MODULE, 2, 4000K, 480VOLT DRIVERS.	CONFIGURED FROM C-Lite LED Gooseneck without Shade, Selectable Wattage (27W), 5000K
/Min Avg/Min .0:1 17.5:1	Catalog		OLLWD LED P1 40K MVOLT	EML25 63LED 525MA 4K GCF R2 480	C-WM-A-WDG-S4L-5K (27W)
Max Min Max/Mir 22.4 fc 0.2 fc 112.0:1	Manufacturer Lithonia Lighting	Lithonia Lighting	Lithonia Lighting	Lithonia Lighting	C-Lite
bol Avg	QTY 3	H		4	7
tics tion Symbol e #1 +	I Label	m	O	٥	ш
Statistics Description Calc Zone #1 Schedule	Symbol	< 0		< 0	< 0




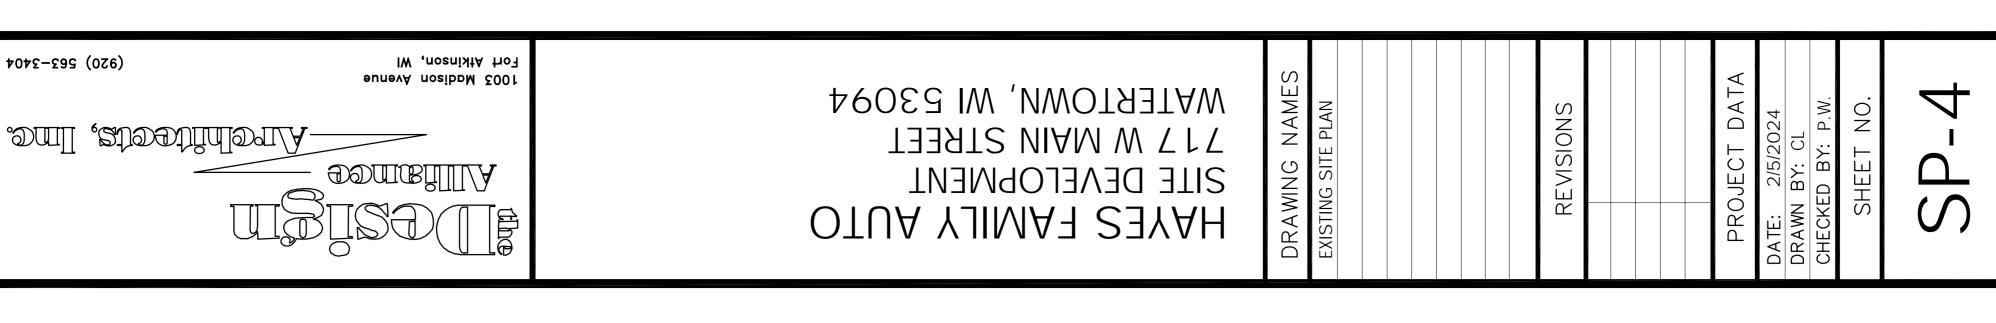

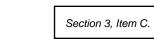


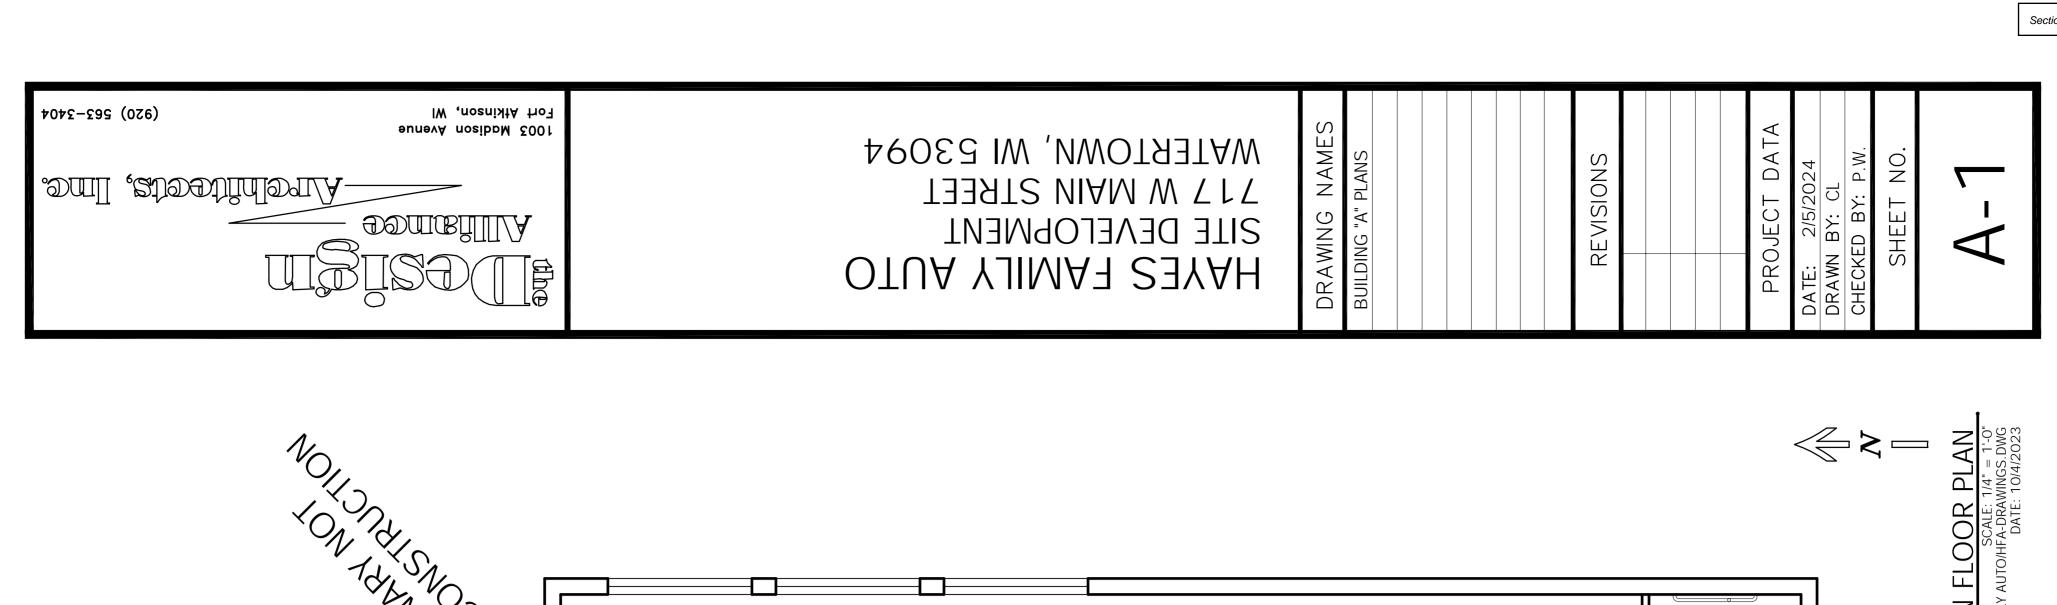


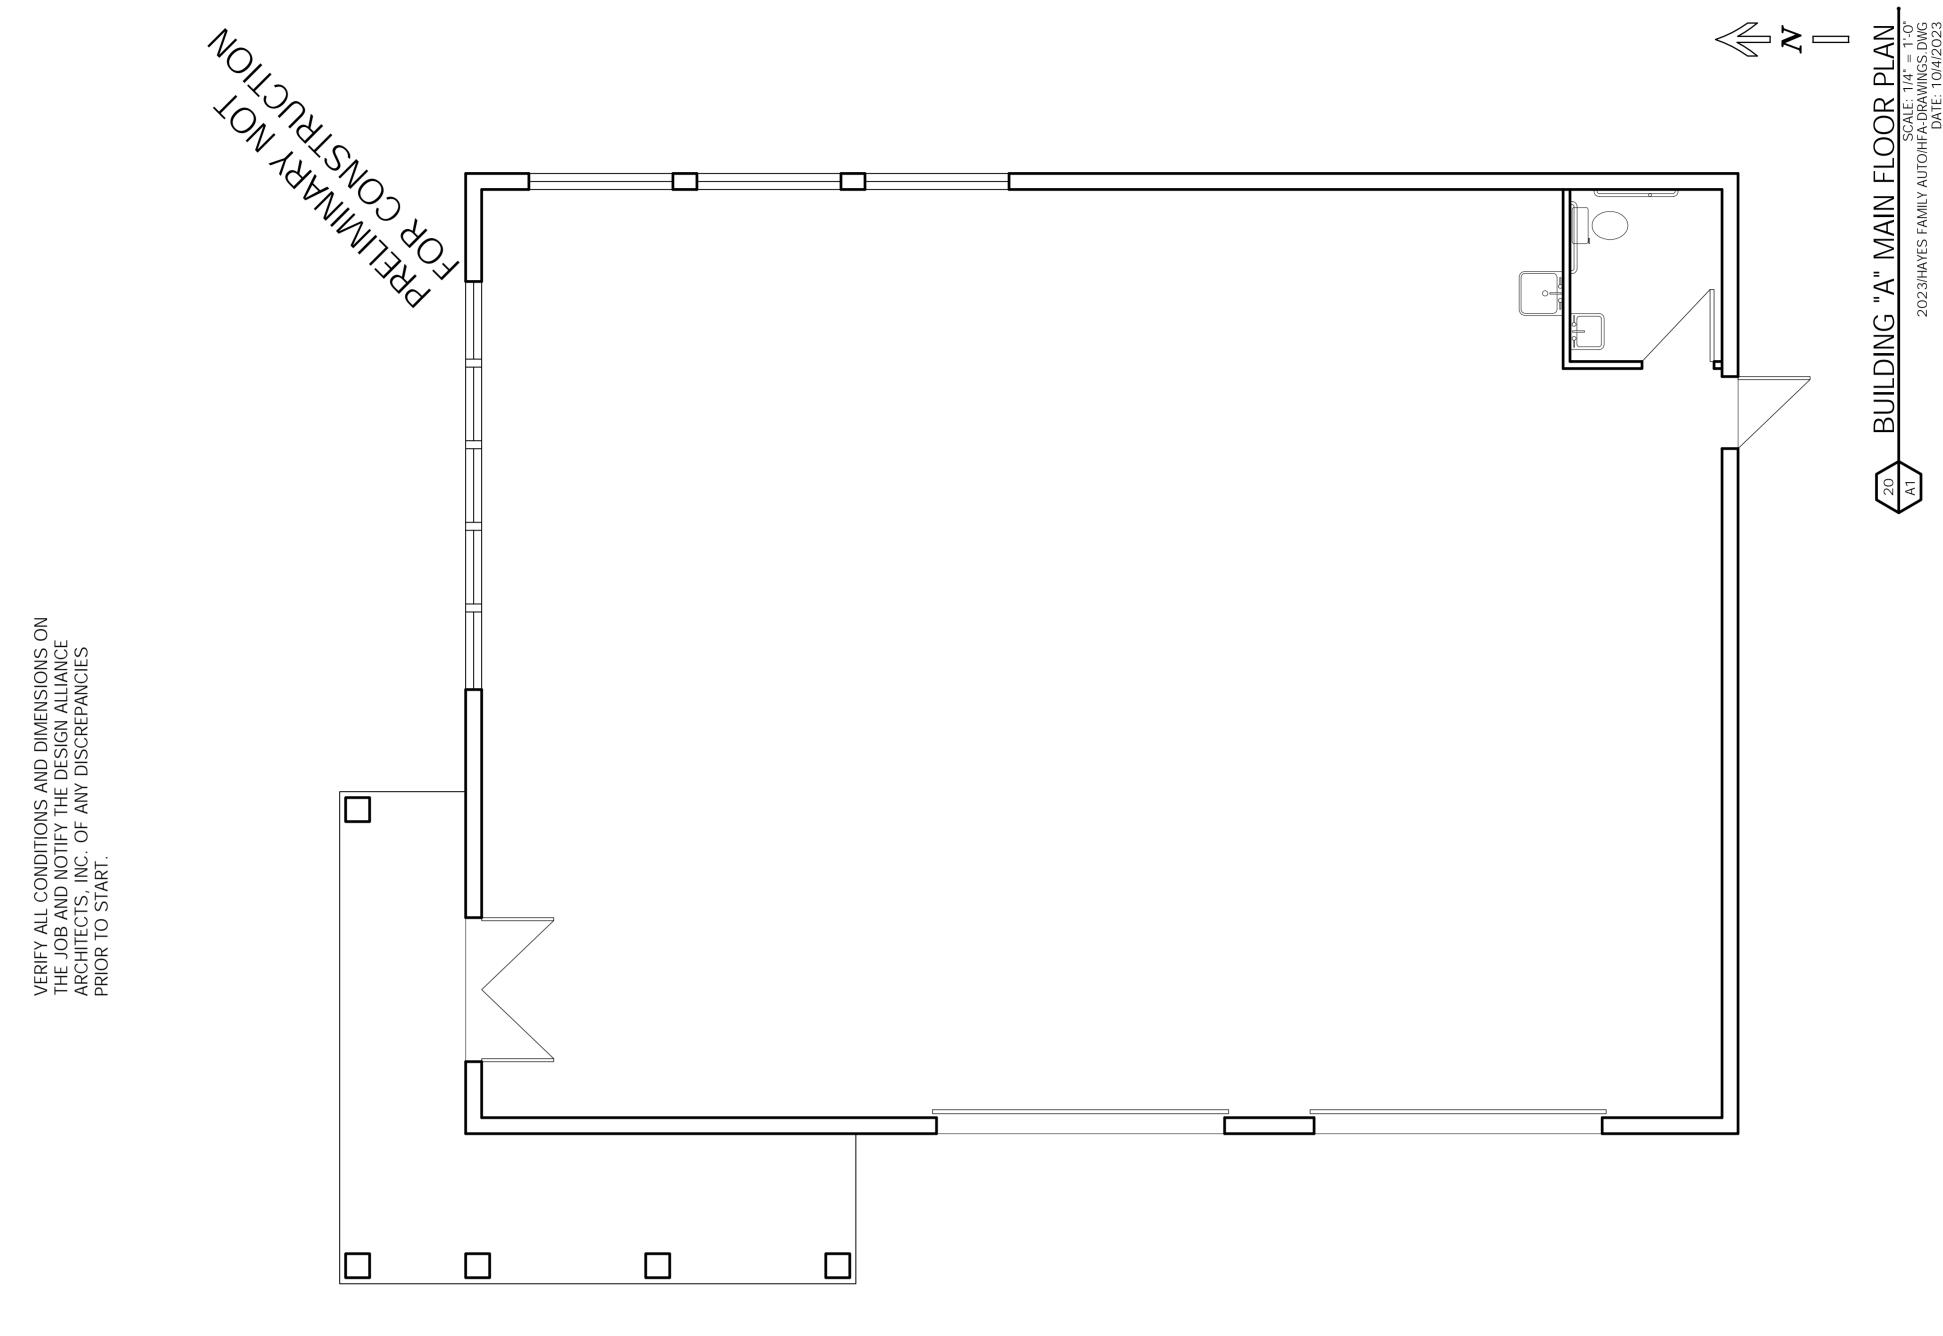

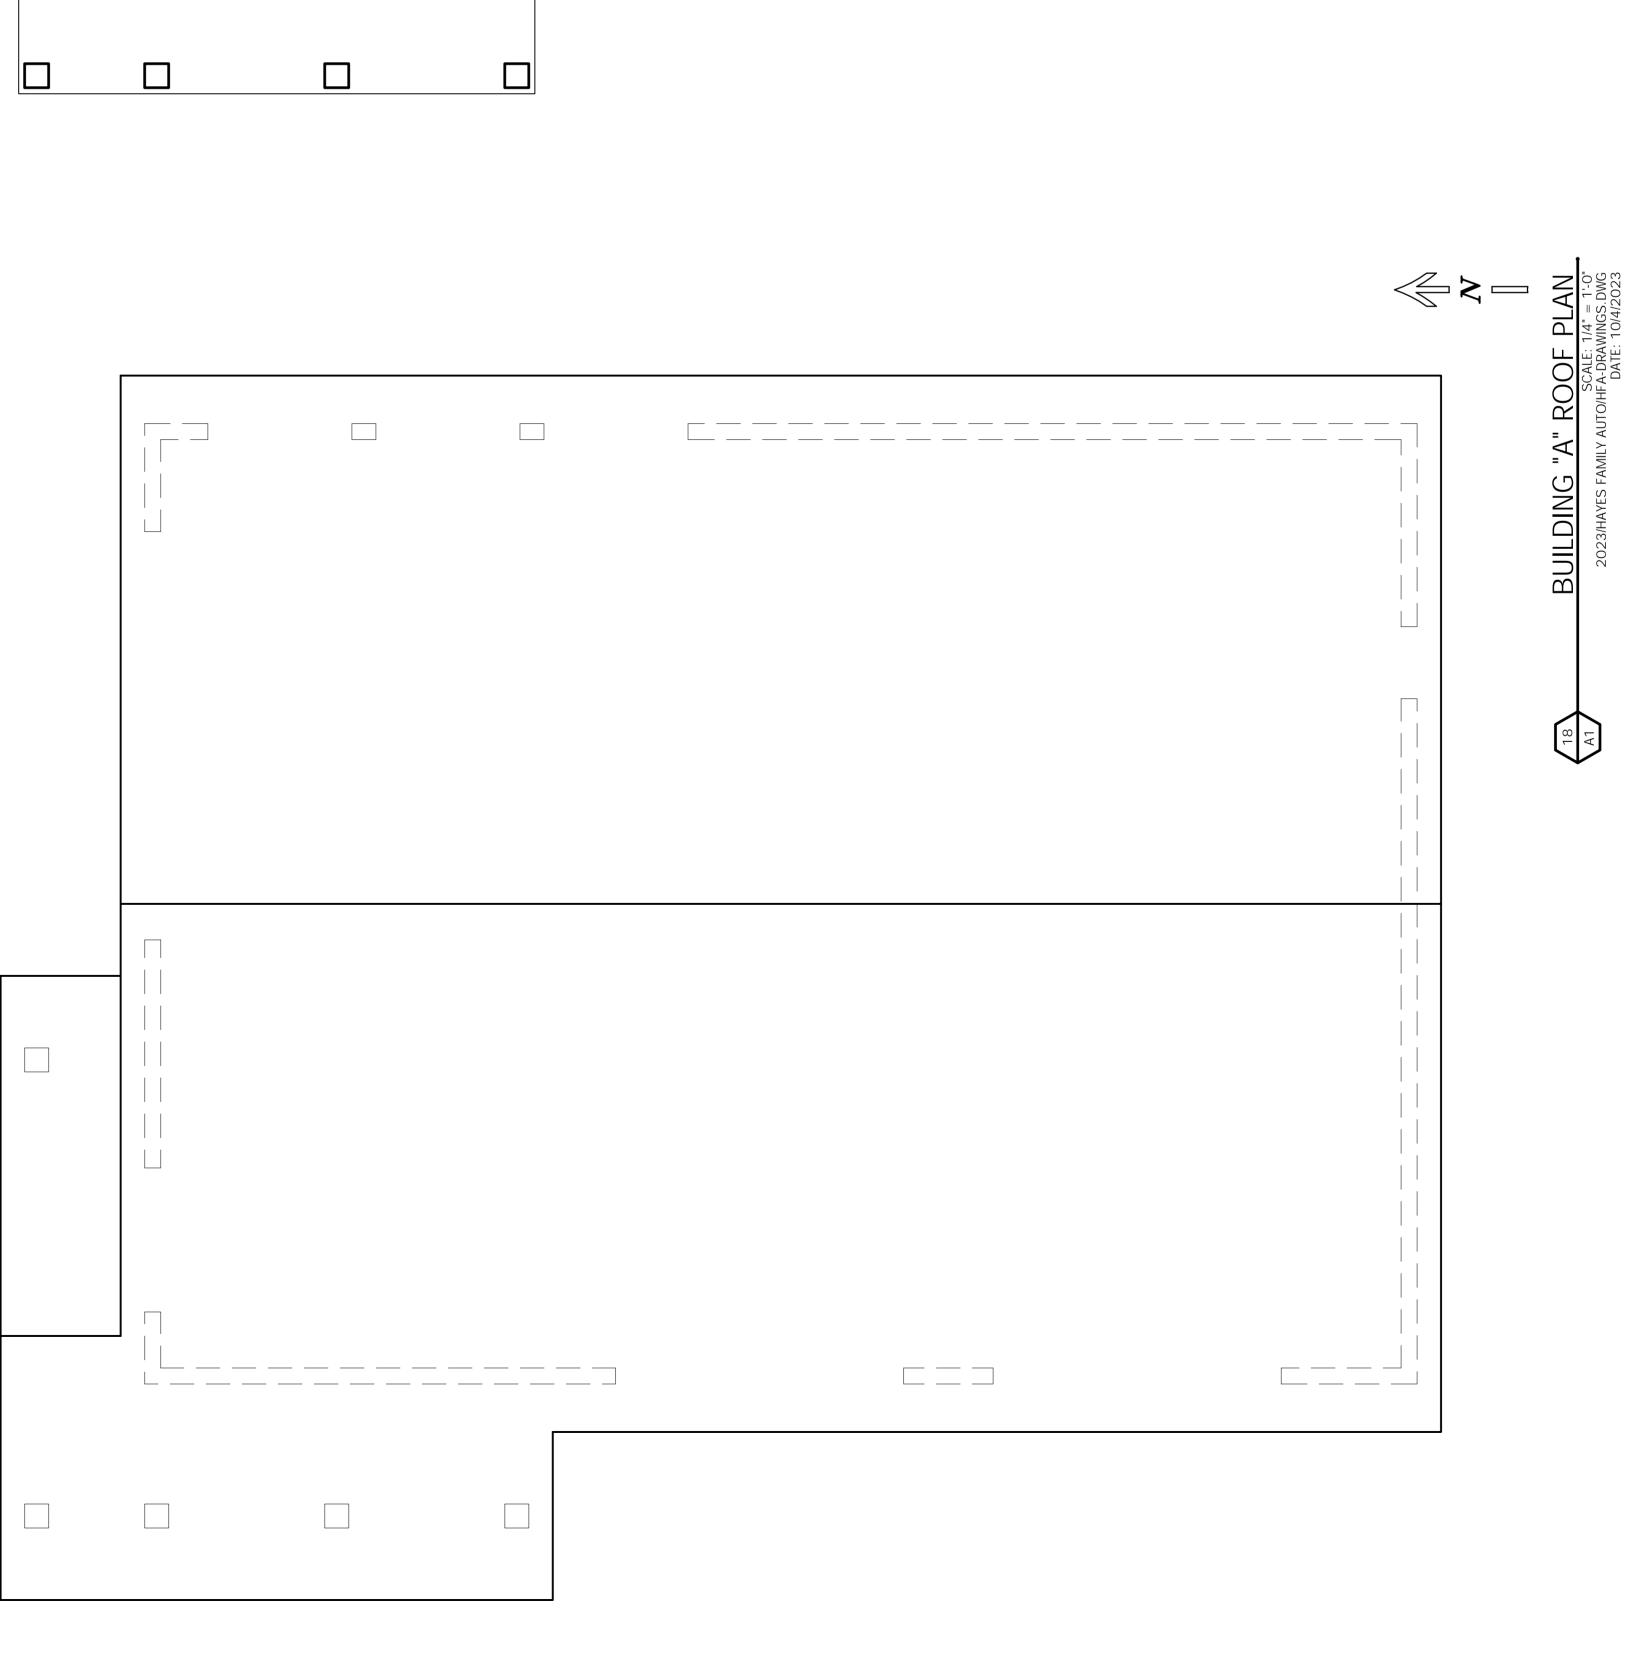




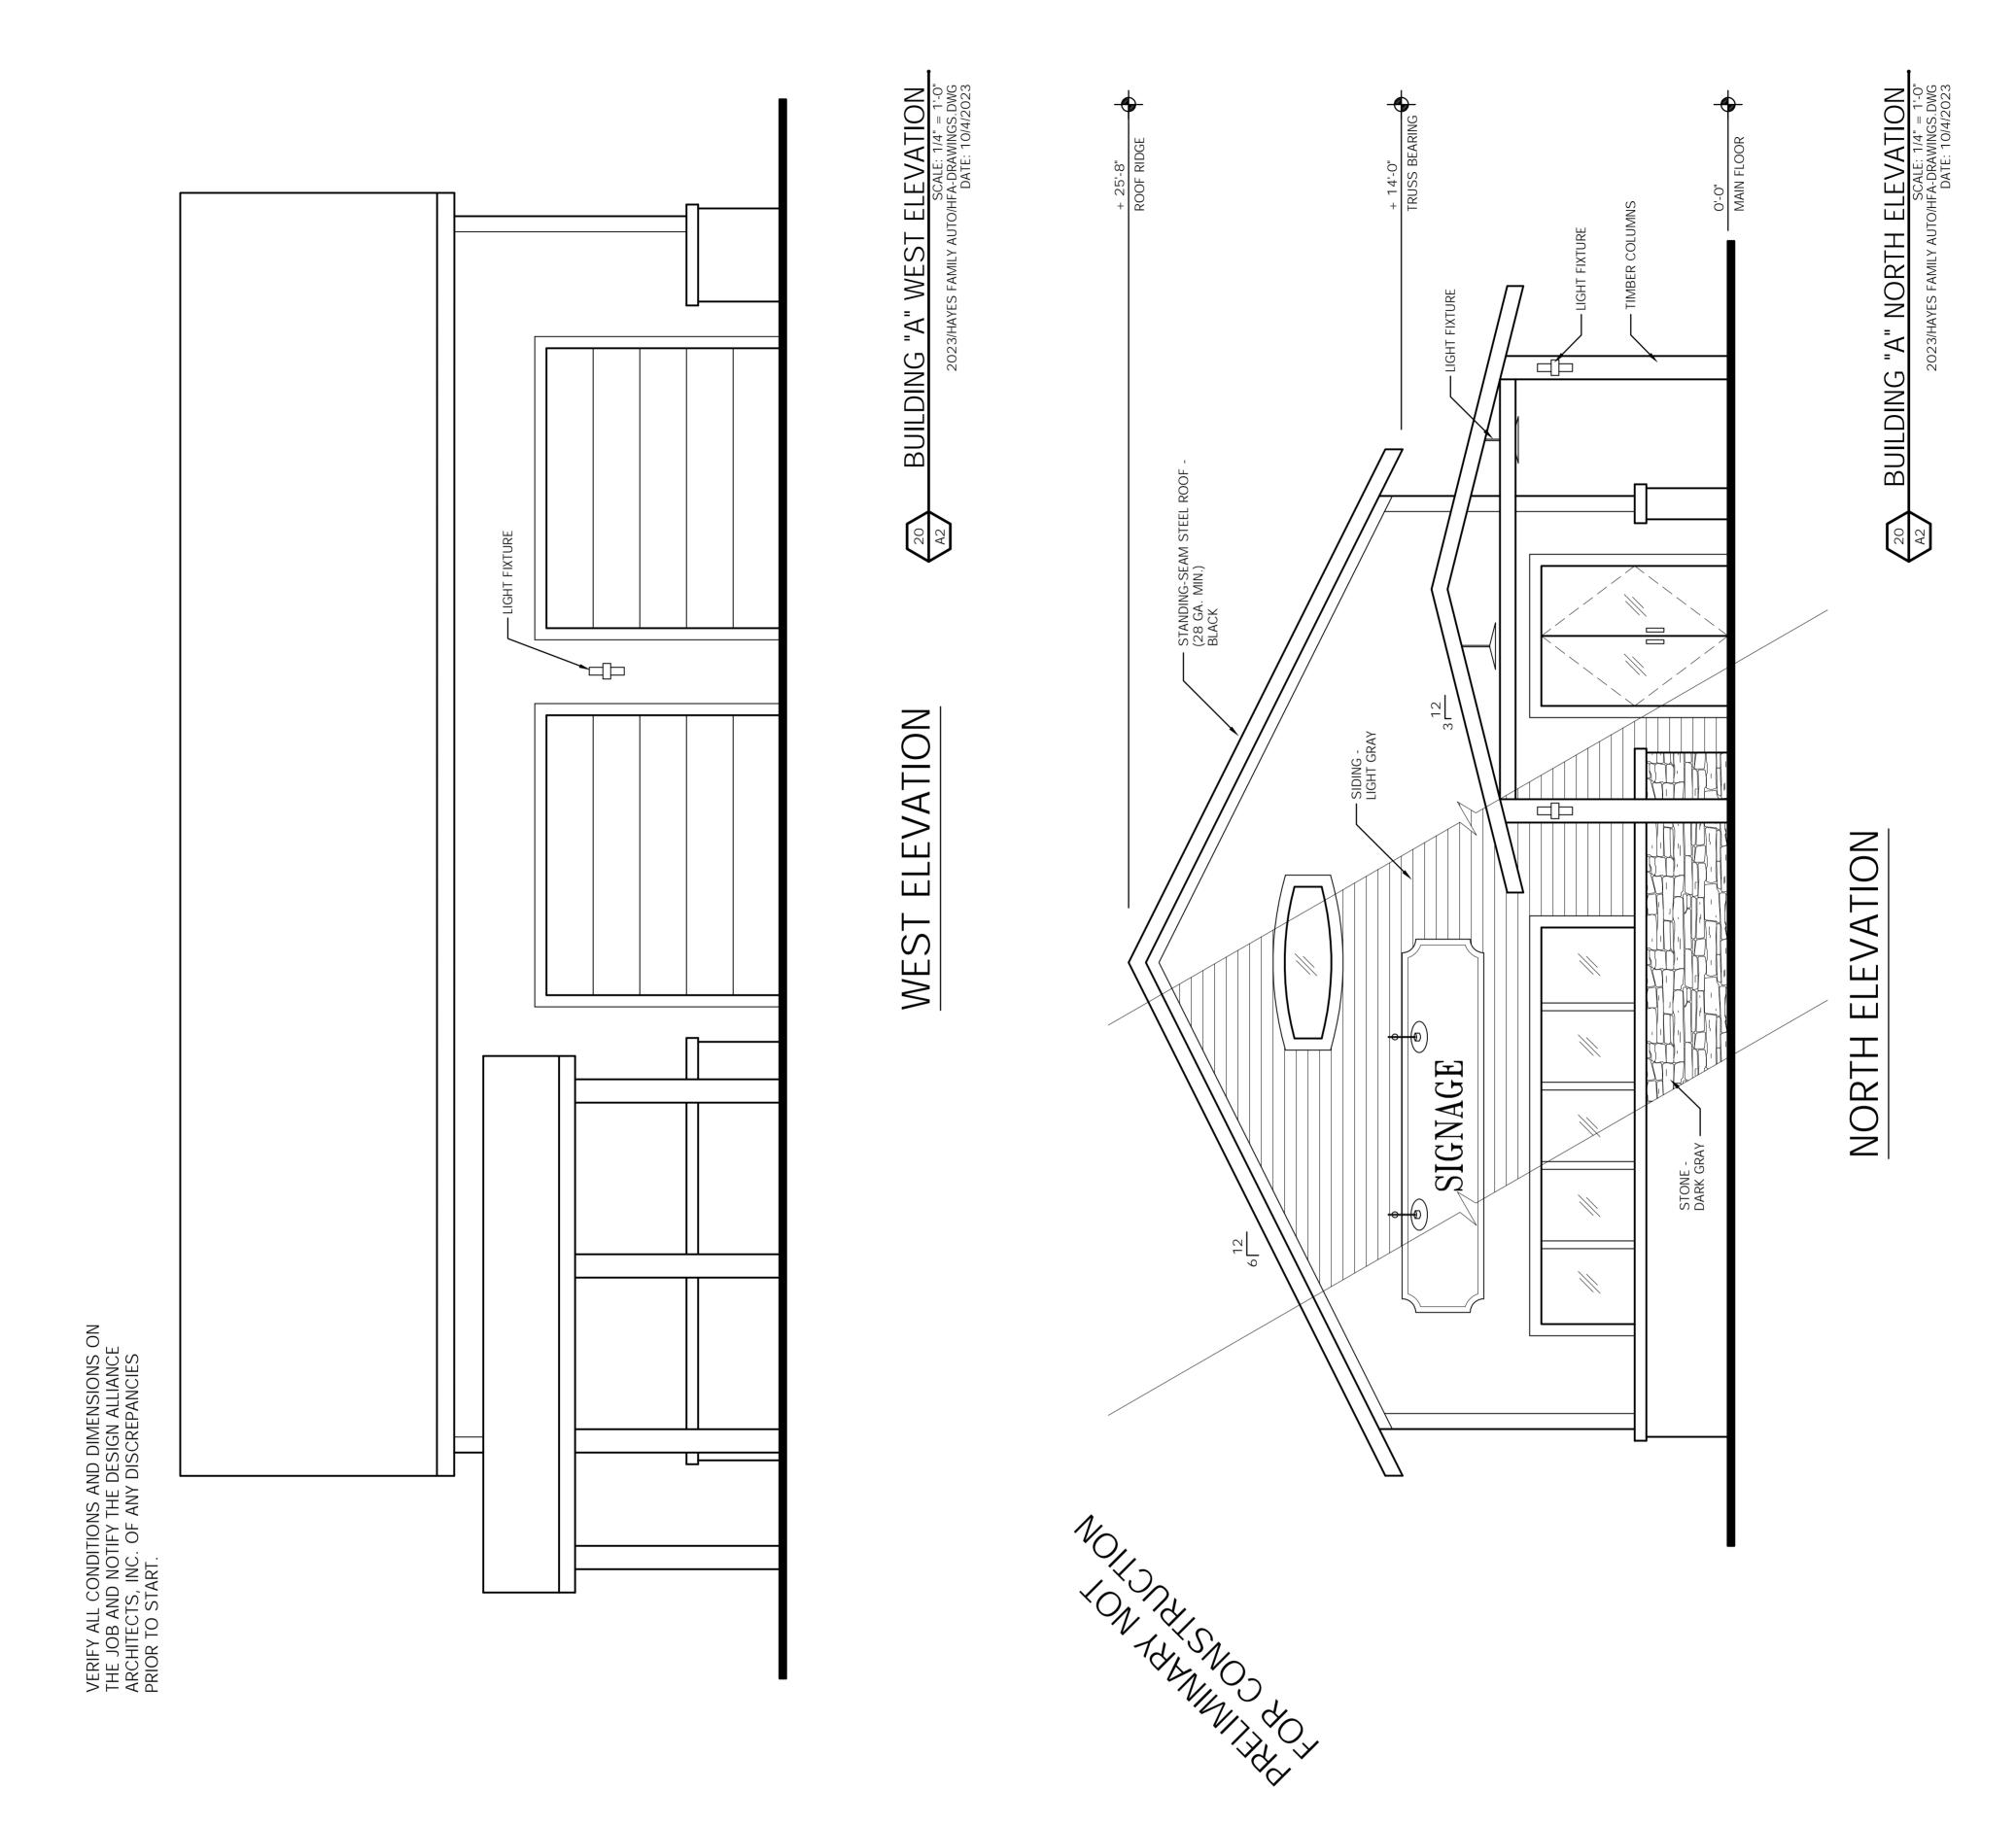

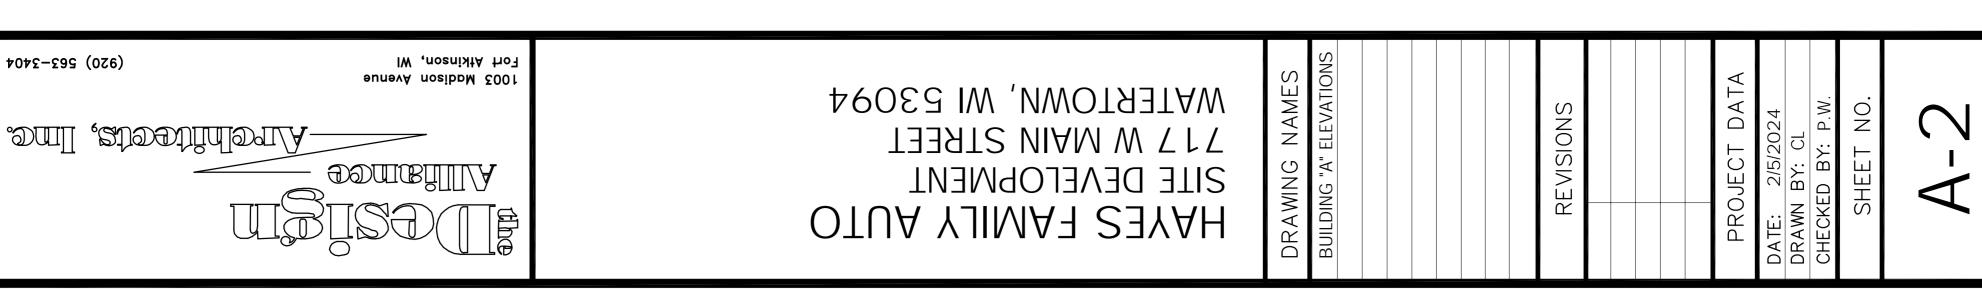


VERIFY ALL CONDITIONS AND DIMENSIONS ON THE JOB AND NOTIFY THE DESIGN ALLIANCE ARCHITECTS, INC. OF ANY DISCREPANCIES PRIOR TO START.

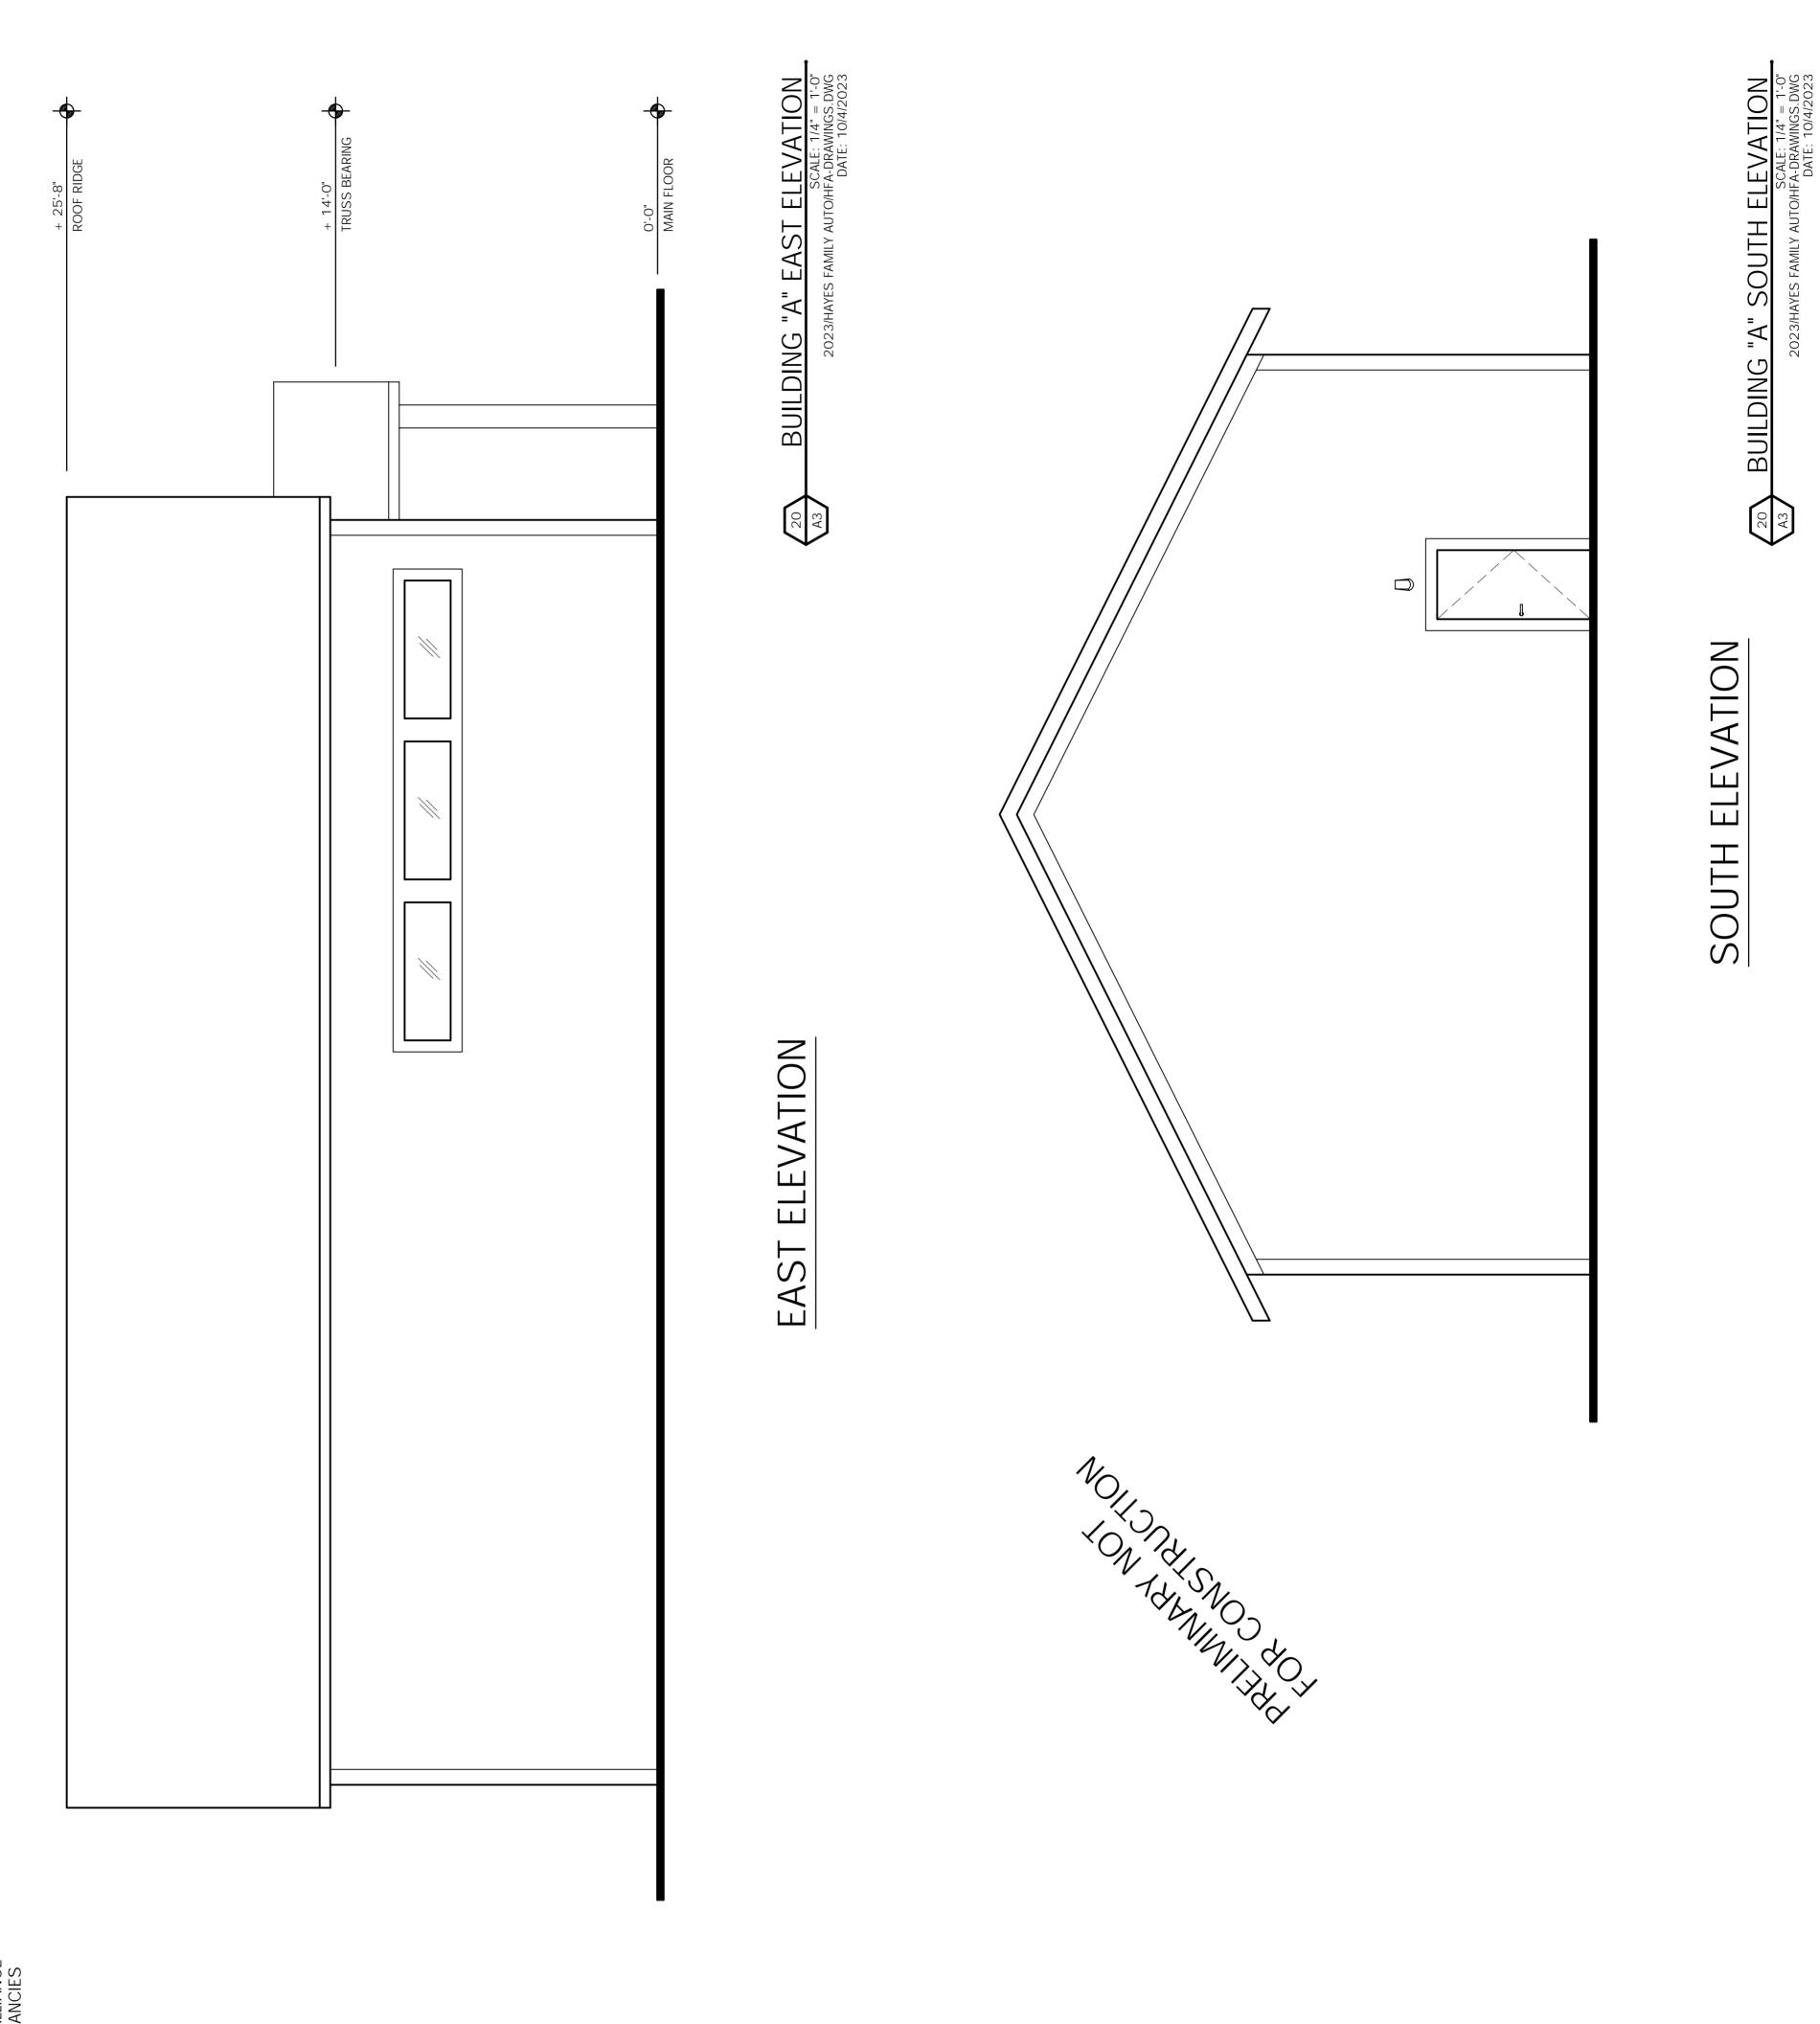


A Medison Avenue A tkinson, Wi (920) 563–3404	SITE DEVELOPMENT WATERTOWN, WI 53094	DRAWING NAMES BUILDING "A" ELEVATIONS	REVISIONS	PROJECT DATA DATE: 2/5/2024 DRAWN BY: CL CHECKED BY: P.W. SHEET NO. A-3
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Section 3, Item C.

32

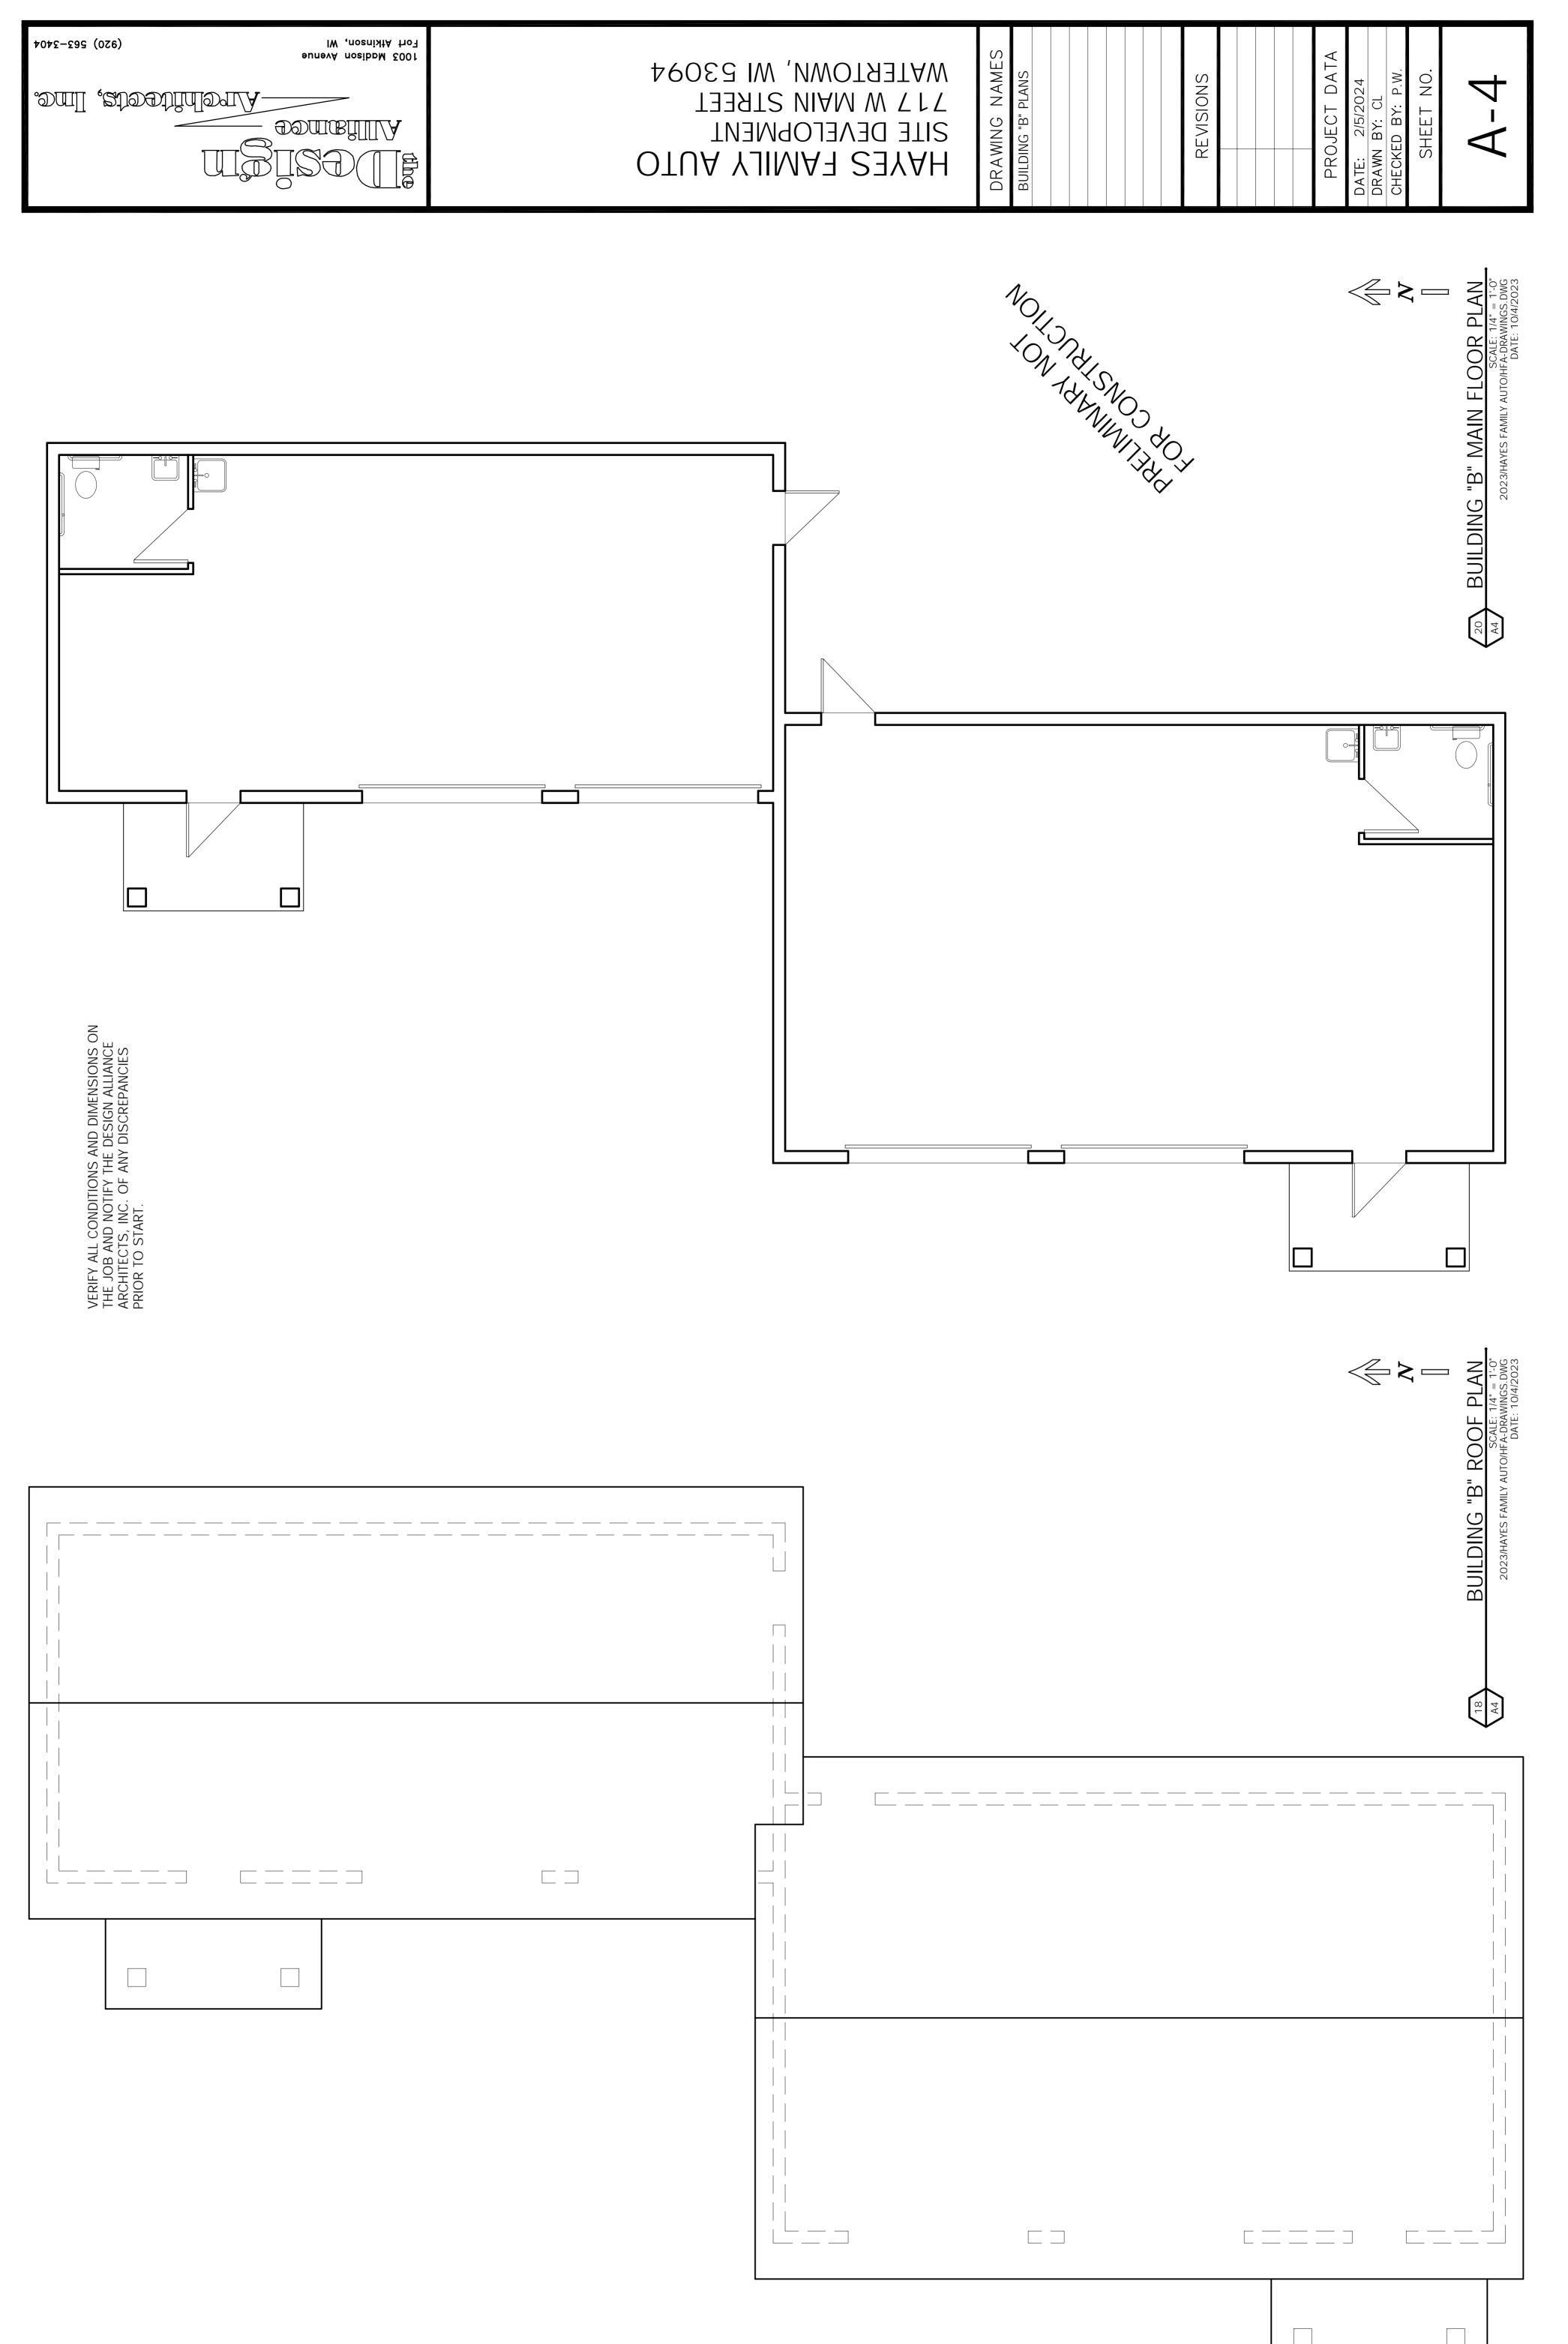

Section 3, Item C.

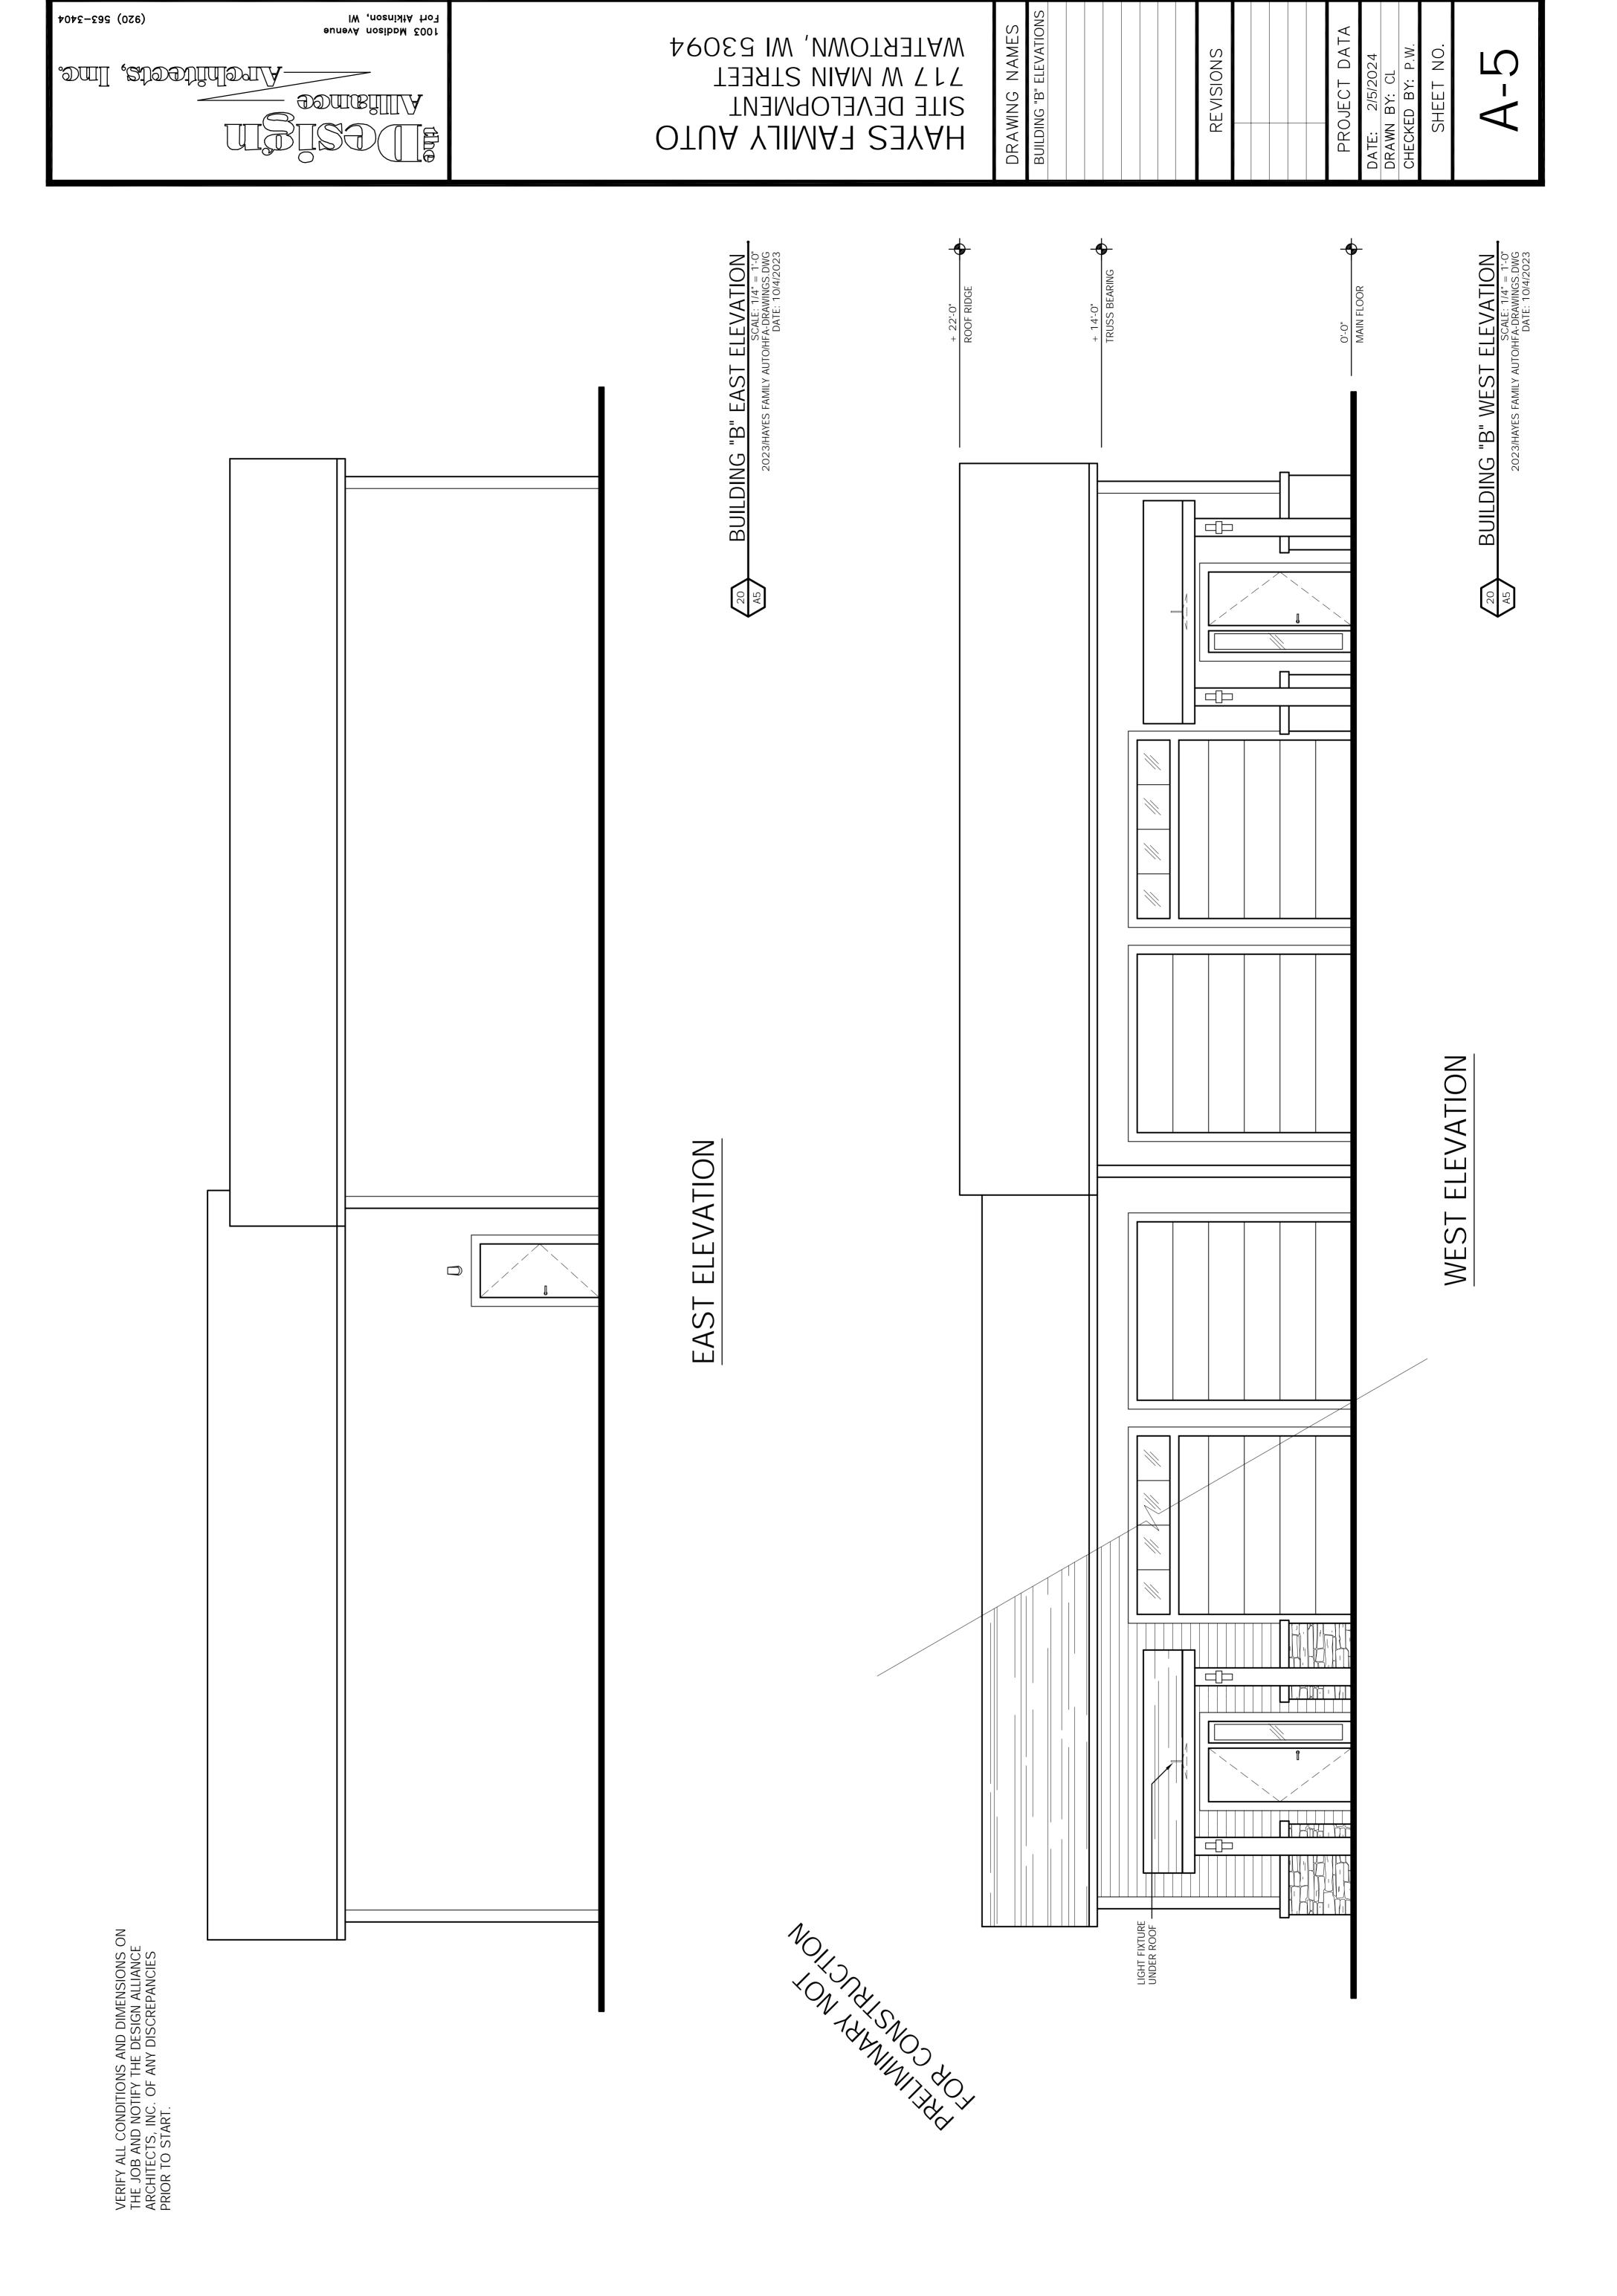

Section 3, Item C.

VERIFY ALL CONDITIONS AND DIMENSIONS ON THE JOB AND NOTIFY THE DESIGN ALLIANCE ARCHITECTS, INC. OF ANY DISCREPANCIES PRIOR TO START.




1003 Madison Avenue Fort Atkinson, WI

ODUBIII A

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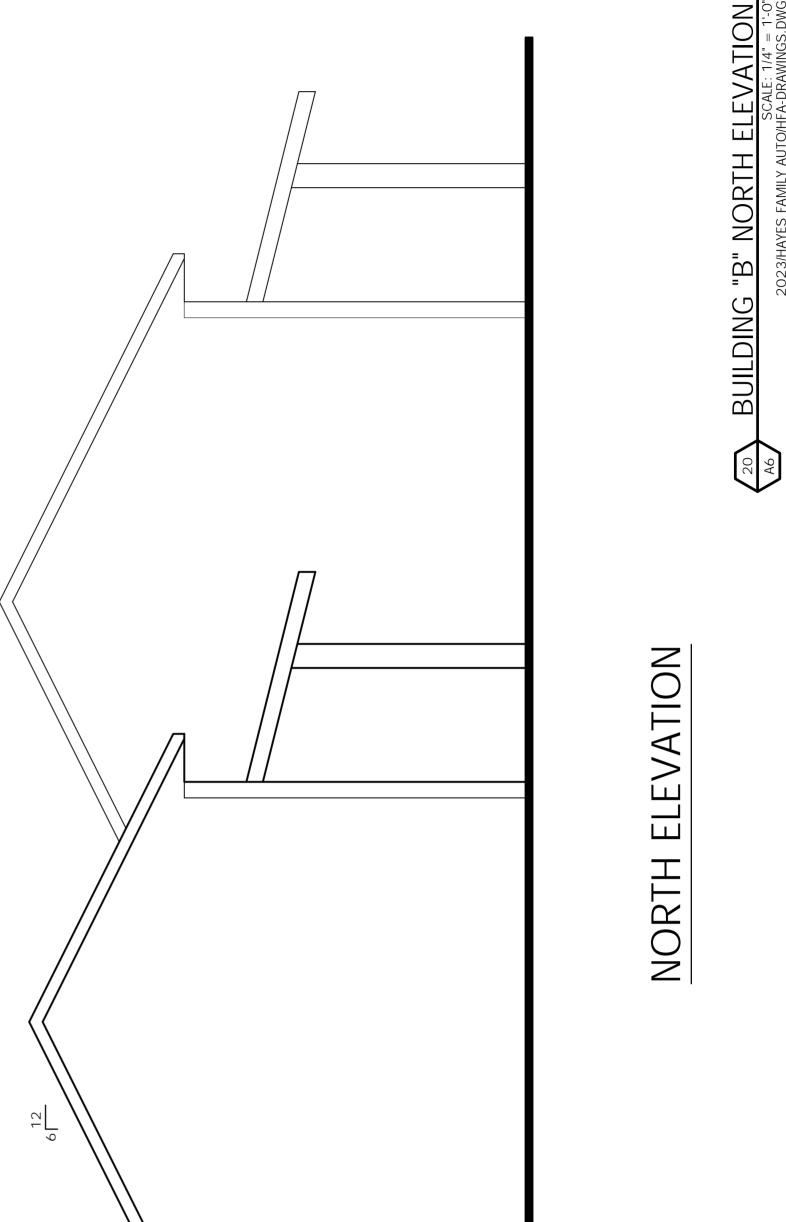


WATERTOWN, WI 53094

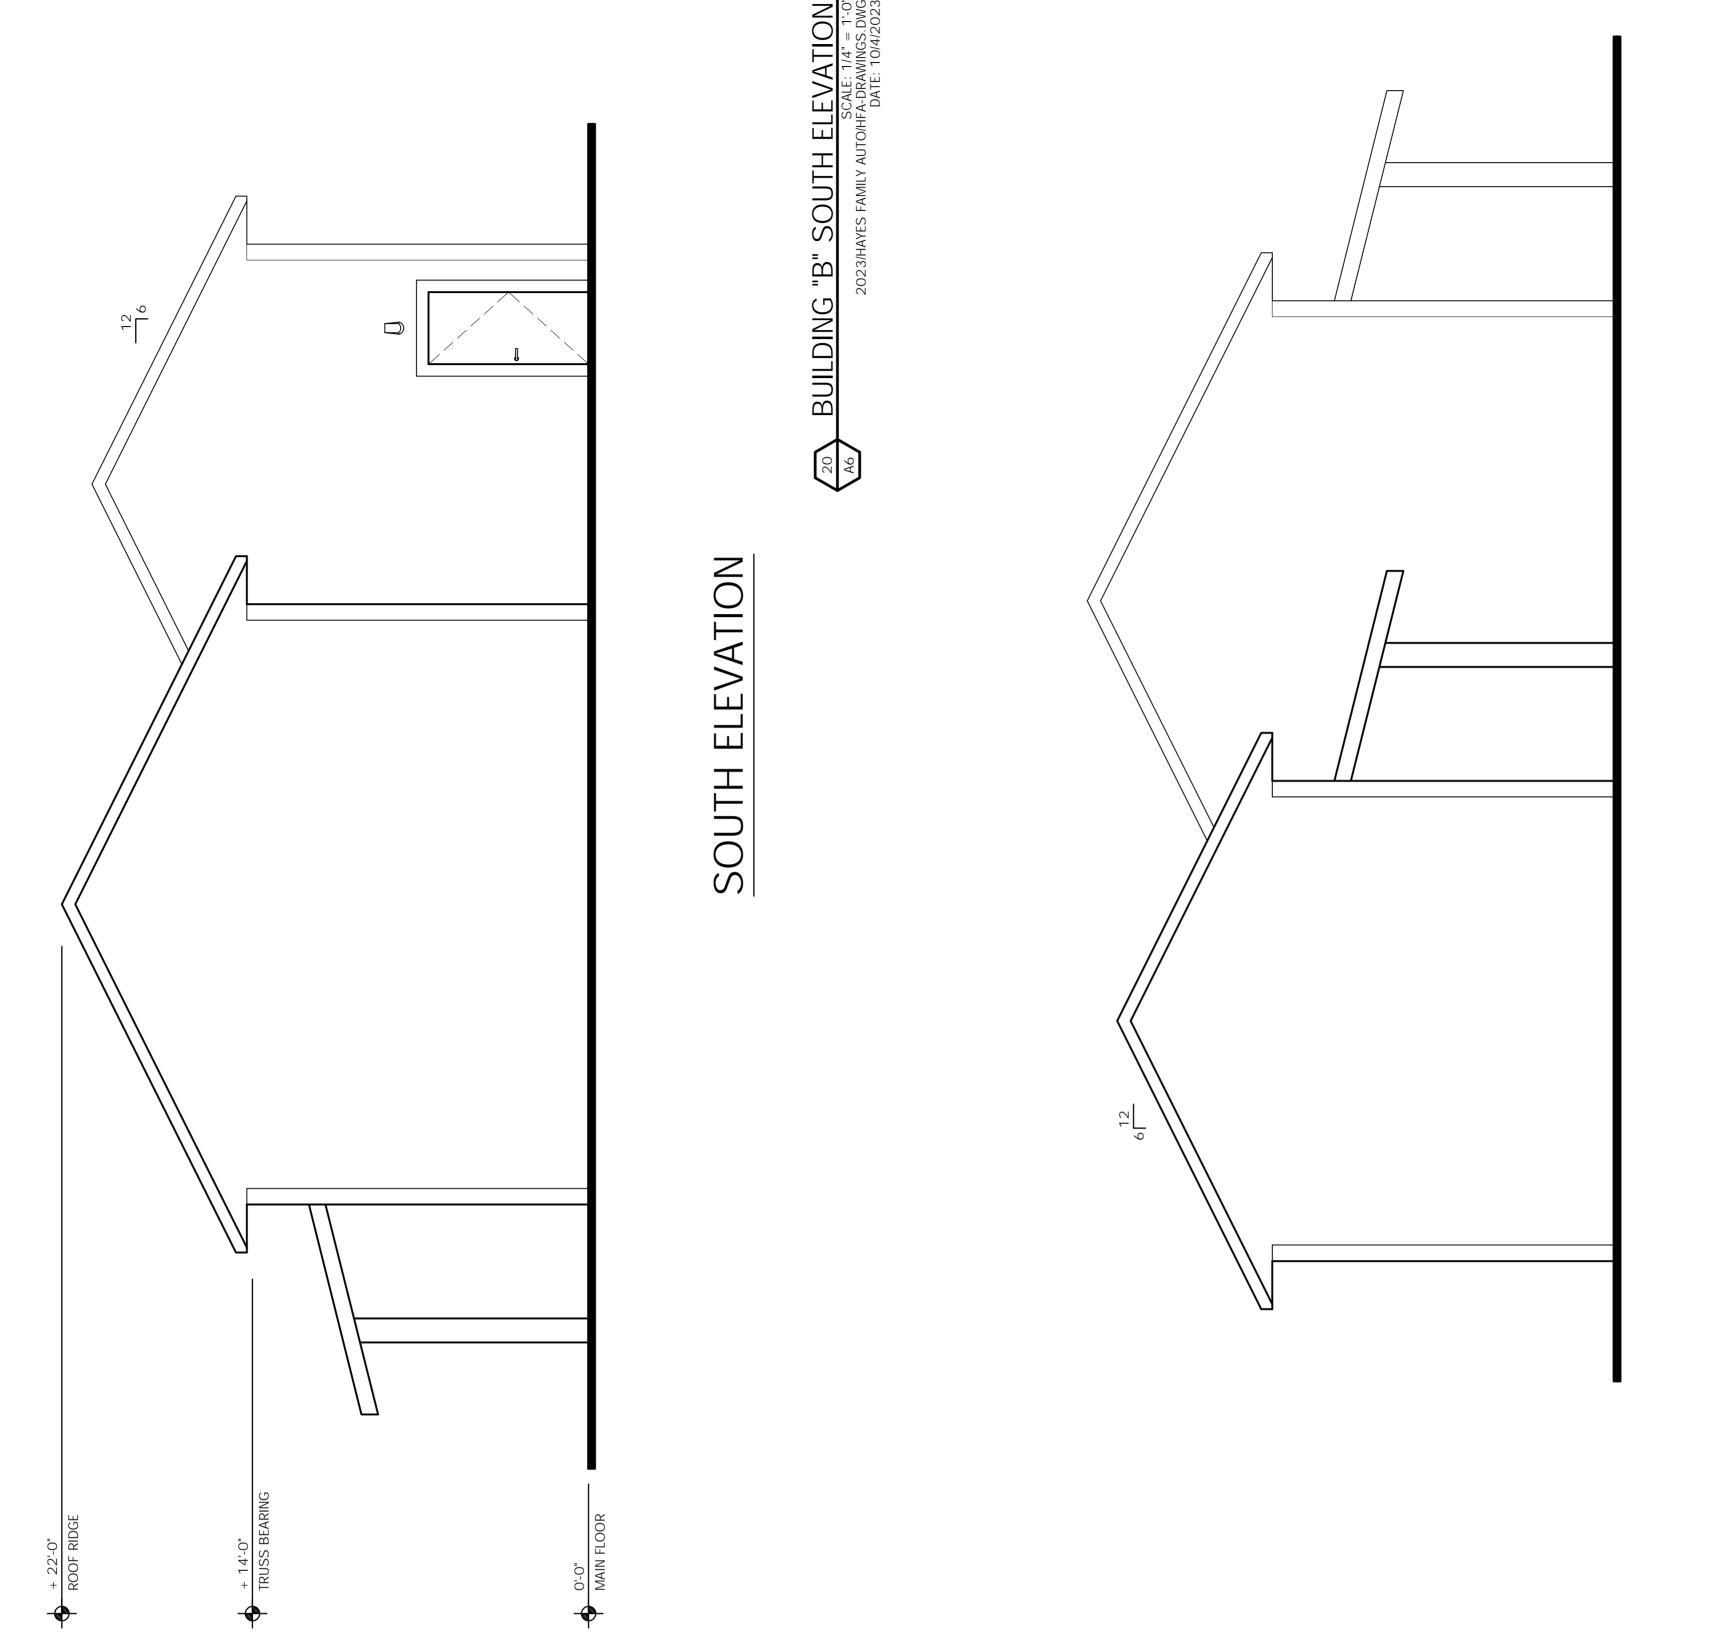HAYES FAMILY AUTO

717 W MAIN STREET

SITE DEVELOPMENT




REVISIONS

DRAWING NAMES
BUILDING "B" ELEVATIONS

SHEET NO. DATE: 2/5/2024
DRAWN BY: CL
CHECKED BY: P.W.

PROJECT

35

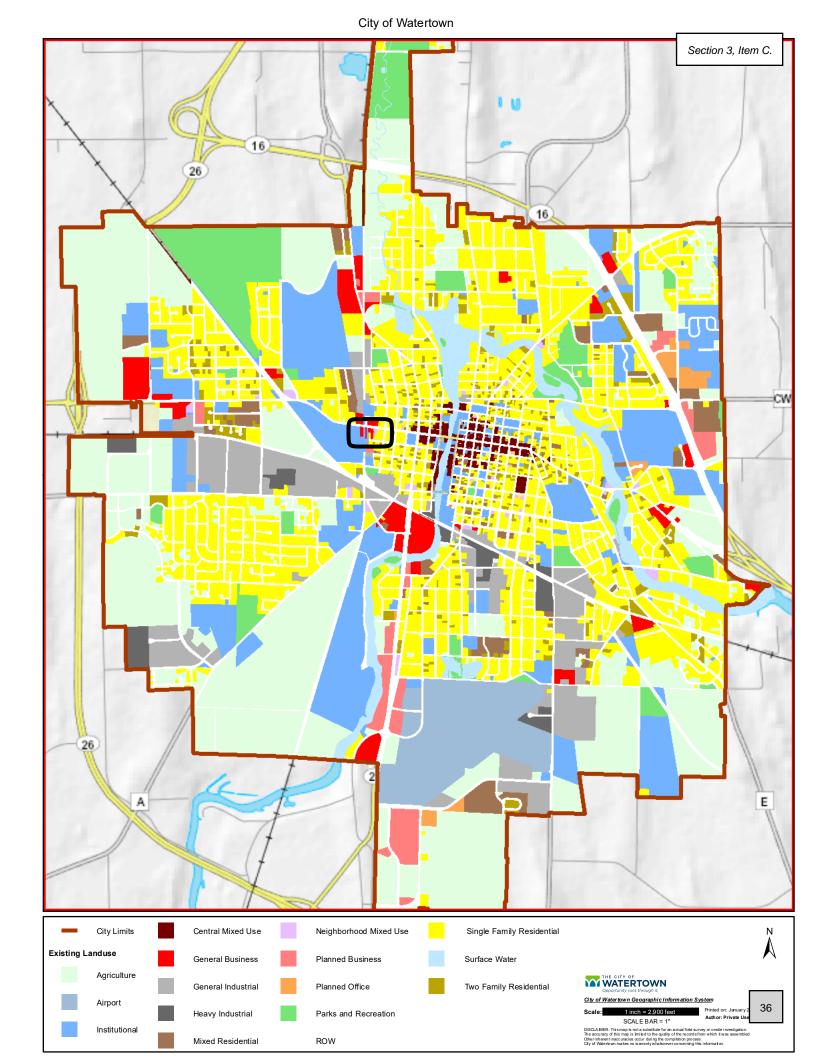

City of Watertown TR-6 722 Section 3, Item C. 22.44'S TIR-6 GB TR-6 UN 114' GB 115'+/-TR•6 60' T**F0-6**6 TR 6 327.22'S TR-6 92.18 123.5 120.86 721 717 NB TR-6 GB TR-61 TR**z67 GB**⁷³¹ 108 725 711 335.18 B TR-6 ³T**R**-6 PO 47.24 TR-6 UN ÿ TR-6 720 91.29 718 ; TR-6 TR-6 TR-6 GB TR•6 TR-6 710 132' 712 66' TR-6 40' 118 **% ТR-β₁**9 UN ÆΒ Parcels Multi-Family Residential-10 (MR-10) Planned Business (PB) Planned Unit Development (PUD) City Limits Senior Residential (SNR) General Business (GB) Conditional Zoning / Mixed Uses (COND) Zoning Central Business District (CB) WATERTOWN Rural Holding (RH) Multiple / Mixed Zoning (MULTI) Single-Family Residential (SR-4) City of Watertown Geographic Information System Planned Office and Institutional (PO) Planned Industrial (PI) Unknown (UN) Two-Family Residential (TR-6) Neighborhood Office (NO) General Industrial (GI) DISCLAIMER: This map is not a substitute for an actual field survey or ons The accuracy of this map is limited to the quality of the records from which Other inherent inaccuracies occur during the compilation process. Multi-Family Residential-8 (MR-8) Neighborhood Business (NB) Heavy Industrial (HI) City of Watertown makes no warranty whatsoever concerning this information