

SITE PLAN REVIEW COMMITTEE MEETING AGENDA

MONDAY, JUNE 09, 2025 AT 1:30 PM

COUNCIL CHAMBERS, SECOND FLOOR, MUNICIPAL BUILDING, 106 JONES STREET, WATERTOWN, WI 53094

Virtual Meeting

Info: https://us06web.zoom.us/j/2371460557?pwd=UXjvqLXKCdw12jl4jl1b7GlUPaClat.1&omn=880211 58642or call: 1-646-931-3860 and use Meeting ID: 237 146 0557 Passcode: 144391

All public participants' phones will be muted during the meeting except during the public comment period.

1. CALL TO ORDER

2. APPROVAL OF MINUTES

A. Review and take action: Site Plan Review minutes dated May 19, 2025

3. BUSINESS

A. Review and take action: 1901 Market Way fireworks sales

B. Review and take action: 510 Cole Street: Lift vestibule

4. ADJOURNMENT

Persons requiring other reasonable accommodations for any of the above meetings, may contact the office of the City Clerk at cityclerk@watertownwi.gov phone 920-262-4000

A quorum of any City of Watertown Council, Committee, Board, Commission, or other body, may be present at this meeting for observing and gathering of information only

SITE PLAN REVIEW COMMITTEE May 19, 2025

The Site Plan Review Committee met on the above date at 1:30 P.M. in the Council Chambers on the second floor of City Hall. The following members were present: Mayor Robert Stocks, Brian Zirbes – Building Safety & Zoning, Mike Jacek – Building Safety & Zoning, Tanya Reynen – Fire Department, Nathan Williams – Engineering, Maureen McBroom – Stormwater, Stacy Winkelman – Streets, Laura Bohlman – Police Department.

Also in attendance were Nikki Zimmerman of Building Safety & Zoning and Mason Becker, Gary Stueber, Stephen Zillmer, and Ryan Hepp.

1. Call to Order

The meeting was called to order by Chairperson Brian Zirbes.

2. Approval of Minutes

A. Review and take action: Site Plan Review Minutes Dated April 28, 2025

Motion was made by Mike Jacek and seconded by Tanya Reynen to approve the minutes as submitted. Unanimously approved.

3. Business

A. Review and take action: 907 Boomer Street – 917 Boomer Street – Proposed Vietnam Wall Project

Gary Stueber, Stephen Zillmer, and Ryan Hepp were present to explain the proposed mobile Vietnam Wall at 907 – 917 Boomer Street (Aero Park). The hope is to have this completed and in place by Veterans Day in November. This is about 80% of the size of the original in Washington, D.C. The maximum height is roughly 8' and there will be a fence around the wall as well. This has been approved at Airport Commission on Wednesday, May 14, 2025.

The following was presented by staff:

Building: Verified that the measurement on the drawing of 39' is from the back of the curb on "new Boomer

Street" to the wall.

Police: No comments.

Mayor: No comments.

Stormwater: An erosion control permit will be required for this project.

Engineering: An encroachment approval will be needed from Public Safety & Welfare because the old Boomer

Street has not been vacated. This will happen on June 4th at 5 p.m. Staff verified that the wall will not reduce any visibility. There is likely a water lateral and an electrical line that will be running under the wall to be aware of. There would be a contingency of approval of the Bureau of

Aeronautics approval of the wall height.

Zoning: Boomer Street has been moved, shown as "new Boomer Street" on the map. The minimum

setback should be 58' back from the centerline of the road to the wall.

Fire: No comments.

Streets: No comments.

Motion made and seconded to approve this item and forward to Plan Commission contingent upon the following conditions:

- 1. Obtain ROW encroachment approval from Public Safety & Welfare Committee.
- 2. Wall shall be setback at least 58 feet from the centerline of Boomer Street.
- 3. Obtain Bureau of Aeronautics approval of the wall placement and height.
- 4. Obtain approval of an Erosion Control Permit.

Unanimously approved.

4. Adjournment

Motion was made by Tanya Reynen and seconded by Mayor Stocks to adjourn. Unanimously approved.

Respectfully submitted, Nikki Zimmerman Recording Secretary

NOTE: These minutes are uncorrected, and any corrections made thereto will be noted in the proceedings at which these minutes are approved.



2608 SE J Street, Suite 8 Bentonville, AR 72716 Jimmy.Buchanan@walmart.com

August 2nd, 2024

To Whom It May Concern,

American Promotional Events, Inc. dba TNT Fireworks is an approved National Supplier to conduct fireworks promotions on our Walmart parking lots where this type of promotion is legal. All stores have been researched and approved by the Walmart Realty Department. Approximate time frame for the select stores approved for additional selling date promotions are:

- New Year's December 26th, 2024 to January 12th, 2025
- May 20th, 2025 to July 12th, 2025 with the exception of Utah which has an additional selling period through the end of July for Pioneer Days.

American Promotional Events, Inc. dba TNT Fireworks is authorized to sign for and obtain all necessary permits and/or licenses for the promotion and must display such permits and/or licenses at each stand/tent. Walmart grants permission for all patrons of the sale to utilize the restroom facilities at each participating store.

An American Promotional Events, Inc. dba TNT Fireworks representative will call you to introduce the company and discuss your participation in the event. Participation is encouraged and does add additional income to your other income account. Store Management must approve the store's participation and placement on the parking lot.

Thank you in advance for your cooperation in this matter and if you have any questions, please contact TNT Fireworks at 256-767-7142.


Best Regards,

Jimmy Buchanan Senior Manager

Walmart Retail Services

WAL-MART #1776 - 1901 MARKET WAY, WATERTOWN, WI


FWI 0028

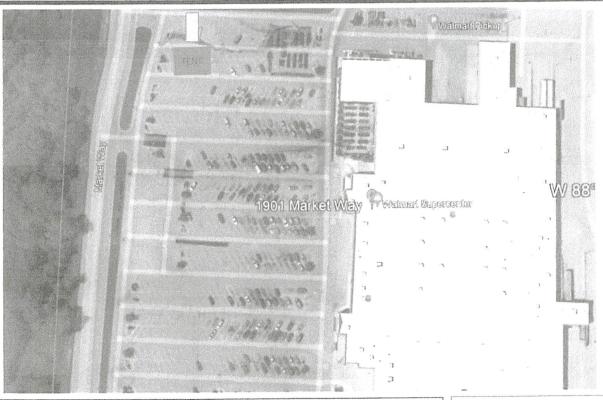

	3	and the second s	
TNT Fireworks Contact:	Store Manager spoke with:		
Name:Matt Sokol	Name:		TENT
Email Address:_sokolm@tntfireworks.com	Site Map reviewed: Yes / No (Circle)	TAINER	
Phone Number:_715-797-6885	Notes:	COL	
Date:3/15/2023			



20' x 40' Tent

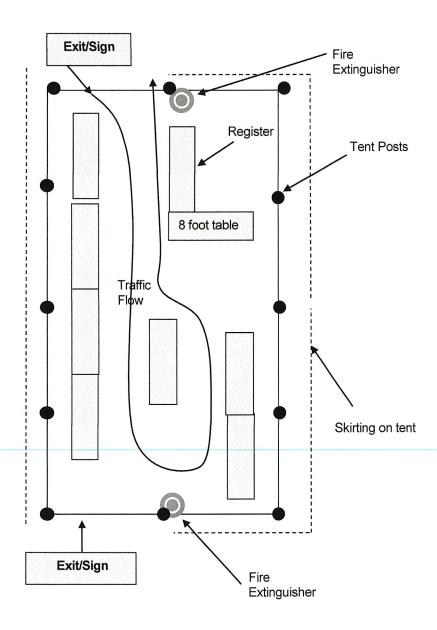

< Notes on Next Page >

List of Notes for Floor Plan

- * 20' x 40' = 800 square feet in area
- * 8 foot tables are used for displays
- * All aisles will be at least 4 feet wide in shopping floor space
- * 2 remote exits will have Lighted EXIT combo signs above them -
- * Tent openings/doorways will be at least 7 feet wide
- * Since all fireworks are 'packaged', the packaged fireworks act as a flame breaks (Code:
- 7.3.15.3.4) along with the 4 foot spaces between aisles
- * Exits will be available within the 35 foot requirement of each other (less than 35 feet from any point within the tent)
- * Fire extinguishers will be present one pressurized water type and a dry chemical with rating of at least 2A (10 lb)
- * Display area will not exceed 50% of the square footage of tent
- * "Fireworks No Smoking" signs will be posted near entrances/exits and visible from within the tent (minimum of 3)
- * "No Fireworks Discharge Within 300 Feet" signs will be posted on all four sides of the tent (facing outside)
- * Flame Certificates will be available on the tent showing flame resistance
- * Merchandise displayed within the perimeter of the sales area will not exceed 6 feet in height.
- * Evacuation Plan will be posted along with permits and sales tax license

List of Notes for Site Plan

- * Any generator used would be placed 20 feet away from tent when in operation
- * Parked Vehicles will be at least 10 feet away
- * Nearest gas station or retail propane-dispensing stations will be over 50 feet away
- * No flammable gas bulk dispensers will be within 300 feet
- * No other buildings or cfrs will be located within 20 feet
- * Extra storage of fireworks other than inside inventory, will be no less than 20 feet away
- * Fire department vehicle access is readily available



CERTIFICATE OF LIABILITY INSURANCE

11/1/2025

Section 3, Item A.

025 11/14/2024

THIS CERTIFICATE IS ISSUED AS A MATTER OF INFORMATION ONLY AND CONFERS NO RIGHTS UPON THE CERTIFICATE HOLDER. THIS CERTIFICATE DOES NOT AFFIRMATIVELY OR NEGATIVELY AMEND, EXTEND OR ALTER THE COVERAGE AFFORDED BY THE POLICIES BELOW. THIS CERTIFICATE OF INSURANCE DOES NOT CONSTITUTE A CONTRACT BETWEEN THE ISSUING INSURER(S), AUTHORIZED REPRESENTATIVE OR PRODUCER, AND THE CERTIFICATE HOLDER.

IMPORTANT: If the certificate holder is an ADDITIONAL INSURED, the policy(ies) must have ADDITIONAL INSURED provisions or be endorsed. If SUBROGATION IS WAIVED, subject to the terms and conditions of the policy, certain policies may require an endorsement. A statement on this certificate does not confer rights to the certificate holder in lieu of such endorsement(s).

this certificate does not confer rights t	o the	cert	ificate holder in lieu of si).			
PRODUCER Lockton Companies, LLC				CONTAC NAME:	CT				
DBA Lockton Insurance Broker	s, LL	C in	CA	PHONE (A/C, No	. Ext):		FAX (A/C, No):		
CA license #0F15767				E-MAIL ADDRES	39.				
3280 Peachtree Rd. NE, Ste. 10	00			ADDICE		LIDED(S) AEEOE	RDING COVERAGE		NAIC #
Atlanta GA 30305 (404) 460-3600				INCLIDE	RA: Centur				36951
INSURED American Promotional Events Inc.				INSURE		y Surcty C	Ompany		30731
DBA TNT Fireworks, Inc.	mo.			INSURE	RC:				
P.O. Box 1318				INSURE					
4511 Helton Drive				INSURE					
Florence AL 35630				INSURE					
COVERAGES CER	TIEI	ATE	NUMBER: 1349576		KF:		REVISION NUMBER:	VV	XXXXX
THIS IS TO CERTIFY THAT THE POLICIES					N ISSUED TO				
INDICATED. NOTWITHSTANDING ANY RE CERTIFICATE MAY BE ISSUED OR MAY EXCLUSIONS AND CONDITIONS OF SUCH	EQUIF PERT	REMEI	NT, TERM OR CONDITION THE INSURANCE AFFORD	OF ANY	CONTRACT	OR OTHER I	DOCUMENT WITH RESPECT TO	CT TO V	VHICH THIS
INSR TYPE OF INSURANCE	ADDL	SUBR WVD	POLICY NUMBER		POLICY EFF (MM/DD/YYYY)	POLICY EXP (MM/DD/YYYY)	LIMIT	s	
TV COMMERCIAL GENERAL LIABILITY	Y	N			20 20		EACH OCCURRENCE	\$ 1.00	0.000
A X COMMERCIAE GENERAL LIABILITY CLAIMS-MADE X OCCUR	1	IN	CCP1219465		12/1/2024	11/1/2025	DAMAGE TO RENTED PREMISES (Ea occurrence)	\$ 100	
							MED EXP (Any one person)	\$ Exc	luded
							PERSONAL & ADV INJURY	\$ 1,00	00,000
GEN'L AGGREGATE LIMIT APPLIES PER:							GENERAL AGGREGATE	\$ 2,00	00,000
POLICY PRO- X LOC							PRODUCTS - COMP/OP AGG	\$ 2.00	00,000
OTHER:								\$	
AUTOMOBILE LIABILITY			NOT APPLICABLE				COMBINED SINGLE LIMIT (Ea accident)	\$ XX	XXXXX
ANY AUTO							BODILY INJURY (Per person)		XXXXX
OWNED SCHEDULED							BODILY INJURY (Per accident)		
AUTOS ONLY AUTOS NON-OWNED							PROPERTY DAMAGE		XXXXX
AUTOS ONLY AUTOS ONLY							(Per accident)		XXXXX
UMPDELLALIAD	-		NOT I DRI IGI DI E						
UMBRELLA LIAB OCCUR			NOT APPLICABLE				EACH OCCURRENCE		XXXXX
EXCESS LIAB CLAIMS-MADE							AGGREGATE		XXXXX
DED RETENTION\$	-						DED OTH	\$ XX	XXXXX
WORKERS COMPENSATION AND EMPLOYERS' LIABILITY Y/N			NOT APPLICABLE				PER OTH- STATUTE ER		
ANY PROPRIETOR/PARTNER/EXECUTIVE OFFICER/MEMBER EXCLUDED?	N/A						E.L. EACH ACCIDENT		XXXXX
(Mandatory in NH)							E.L. DISEASE - EA EMPLOYEE	\$ XX	XXXXX
DESCRIPTION OF OPERATIONS below							E.L. DISEASE - POLICY LIMIT	\$ XX	XXXXX
DESCRIPTION OF OPERATIONS / LOCATIONS / VEHIC ADDITIONAL INSURED: FWI0028; PROPER WALMART STORES, INC. 702 SW 8TH STRI Certificate holder is an additional insured on the	TY È EET B	OCAT SENT(ED AT WALMART 1901 MA ONVILLE, AR 72716; GAB	ARKET RIEL M	WAY WATER CPIKE AND (TOWN, WI 5 GROUP;	3094;		
CERTIFICATE HOLDER				CANO	ELLATION				
13495768 CITY OF WATERTOWN 106 JONES STREET WATERTOWN WI 53094				THE	EXPIRATION	N DATE TH	DESCRIBED POLICIES BE C EREOF, NOTICE WILL CY PROVISIONS.		
				AUTHORIZED REPRESENTATIVE					



WISCONSIN DEPARTMENT OF REVENUE PO BOX 8902 MADISON, WI 53708-8902

000844

AMERICAN PROMOTIONAL EVENTS INC PO BOX 1318 FLORENCE AL 35631-1318

Contact Information:

2135 RIMROCK RD PO BOX 8902 MADISON, WI 53708-8902 ph: 608-266-2776 fax: 608-327-0235 email: DORBusinessTax@wisconsin.gov website: revenue.wi.gov

Letter ID

L1841472048



Wisconsin Business Tax Registration Certificate

Expiration date:

March 31, 2026

Legal/real name:

AMERICAN PROMOTIONAL EVENTS INC

- This certificate confirms that you are registered with the Wisconsin Department of Revenue for the tax types shown below.
- This registration certificate is not a seller's permit, and should not be used as proof that you hold a seller's permit.
- You may not transfer this certificate to any other individual or business.

Tax	Type
. 645.6	

Account Type

Number

Sales & Use Tax

Sales & Use Tax

456-0000426277-02


Moravian Church - Lift Vestibule


510 Cole St. Watertown, WI 53094





CONSTRUCTION DOCUMENTS LOCATION MAP VICINITY MAP SYMBOLS LEGEND SHEET INDEX 1-GENERAL FIRE HOSE CABINET

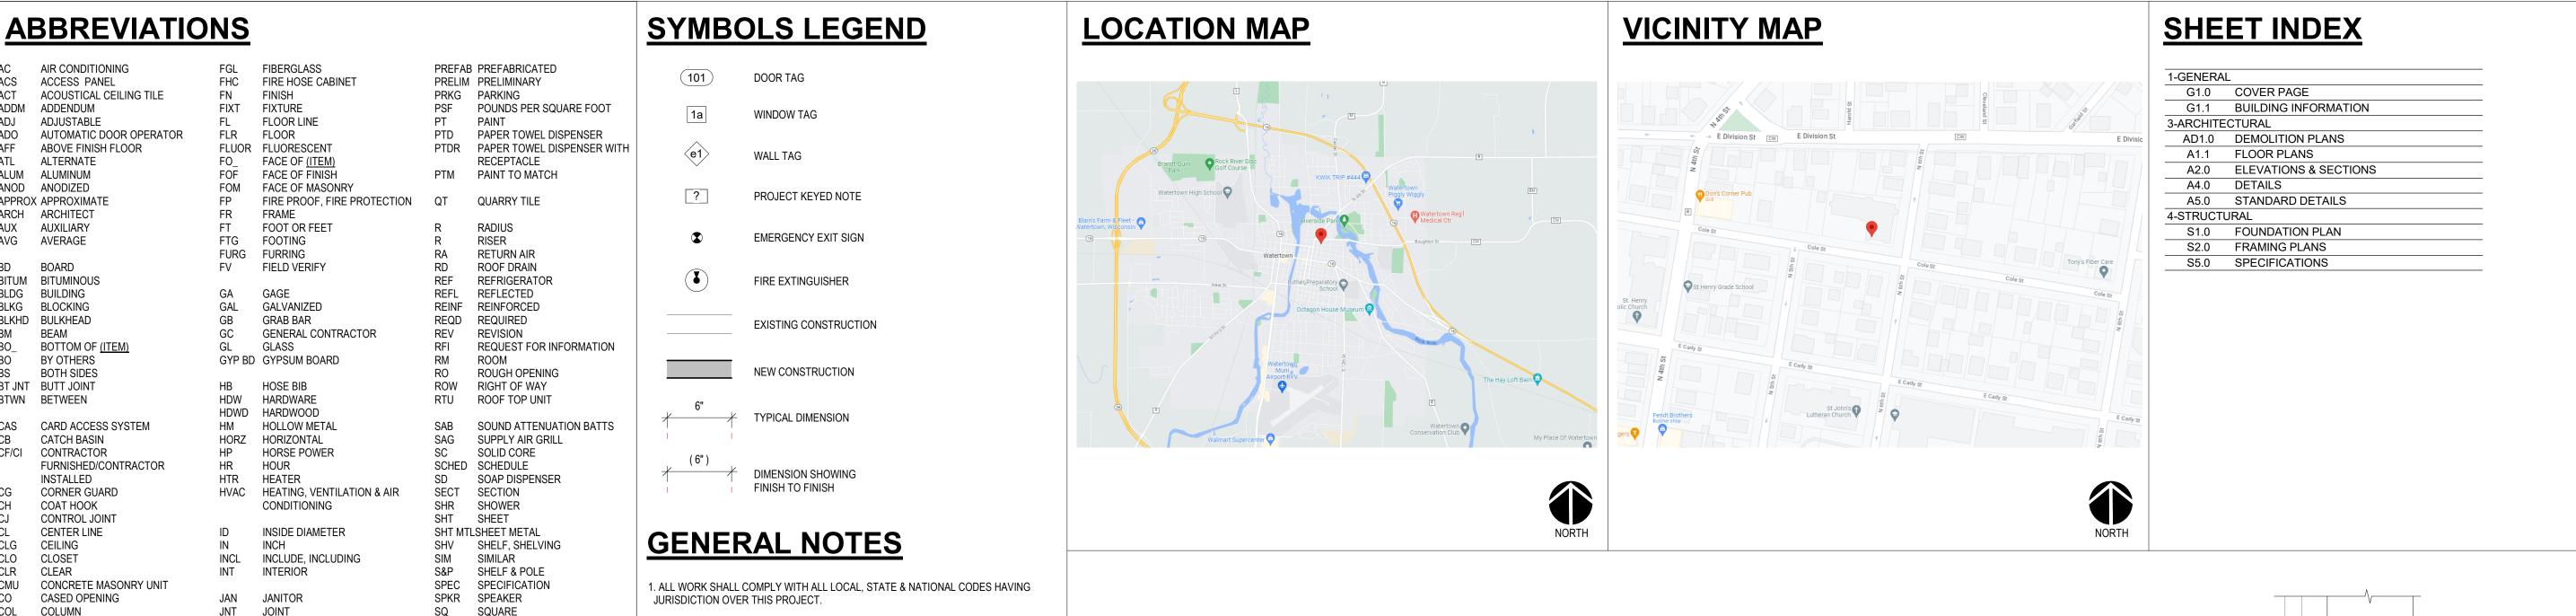

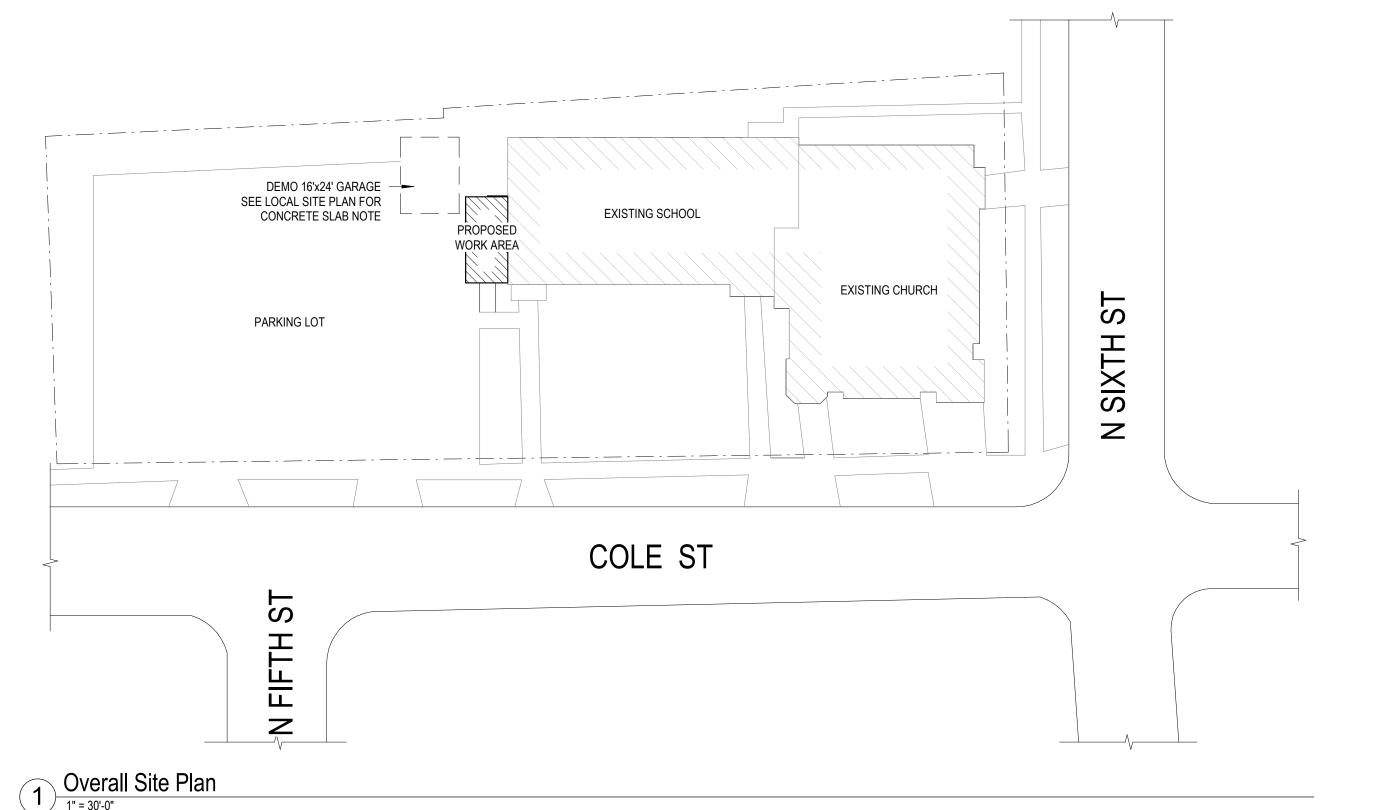

APPEARING HEREIN CONSTITUTE ORIGINAL AND UNPUBLISHED WORK OF THE DESIGN

USED OR DISCLOSED WITHOUT WRITTEN

Struckite

WAUKESHA, WI 53186 262.549.3222 - WWW.SRDINC.BIZ

Moravian Church - Lift Vestibule

510 Cole St. Watertown, WI 53094 **DESIGNER**/

SUPERVISING PROFESSIONAL StrucRite, Inc. Boyd E. Coleman, P.E. President, Engineer 707 N. Grand Ave. Suite 102 Waukesha, WI 53186 262.549.3222

REVISIONS No. DATE DESCRIPTION

CONSTRUCTION DOCUMENTS COVER PAGE

JOB NUMBER: 24191 ISSUED DATE 05.30.2025 DRAWN BY:

SHEET NUMBER:

BOTTOM OF (ITEM) BOTH SIDES BT JNT BUTT JOINT CAS CARD ACCESS SYSTEM CB CATCH BASIN CF/CI CONTRACTOR COLUMN CONC CONCRETE CONT CONTINUE, CONTINUOUS CORR CORRIDOR COURSE, COURSES CERAMIC TILE CENTER CUH CABINET UNIT HEATER ERECT APPLIED EXTERIOR FINISH SYSTEM DEMO DEMOLITION DEPRESSED DRINKING FOUNTAIN DIAMETER DIAGONAL DIMENSION DISP DISPENSER DIVISION DOWN DR OPNGDOOR OPENING DOWNSPOUT DRAIN TILE DISHWASHER DWR DRAWER EACH

ELECTRICAL/ELECTRICAL

ELECTRICAL PANEL

ELECTRIC STRIKE

EWC ELECTRIC WATER COOLER

EXISTING TO REMAIN

ELEV ELEVATOR

EMER EMERGENCY

EQUAL

EXH FN EXHAUST FAN

EXTERIOR

FIRE ALARM

FLOOR DRAIN

FINISH FACE

FIRE EXTINGUISHER

FIRE EXTINGUISHER CABINET

EXIST EXISTING

EXPO EXPOSED

EXP EXPANSION

EQUP EQUIPMENT

JNT JOINT KNOCK OUT KS KNEE SPACE LAV LAVATORY LBS POUND(S) LKR LOCKER LT WT LIGHT WEIGHT MAS MASONRY MATL MATERIAL MAX MAXIMUM MECH MECHANICAL MEDIUM MANUFACTUREF MANHOLE MIDDLE MINIMUM MIRR MIRROR MISC MISCELLANEOUS MASONRY OPENING MOP SERVICE BASIN MTD MOUNTED MTL METAL NOT IN CONTRACT NUMBER EXTERIOR INSULATION FINISH NOM NOMINAL NTS NOT TO SCALE SYSTEM EXPANSION JOINT **ELEVATION**

REFRIGERATOR UNDERWRITERS LABORATORY UNLESS NOTED OTHERWISE URINAL VARIABLE AIR VOLUME VAPOR BARRIER VINYL COMPOSITE TILE OVERALL VERT ON CENTER VERTICAL OUTSIDE DIAMETER VESTIBULE OF/CI OWNER FURNISHED/ VERIFY IN FIELD CONTRACTOR INSTALLED VAPOR RETARDER OFD OVERFLOW DRAIN OVERHEAD OPNG OPENING OPP OPPOSITE PED PEDESTAL

PERIM PERIMETER

PLBG PLUMBING

PLYWD PLYWOOD

PNL JNT PANEL JOINT

PROPERTY LINE

POC POINT OF CONNECTION

PLAM PLASTIC LAMINATE

PL PLATE

VINYL WALL COVERERING WATERCLOSET WIDE FLANGE WATER HEATER WITHOUT WORKSTATION WELDED WIRE FABRIC WWM WEEDED WIRE MESH YD YARD(S)

SOLID SURFACE

SOUND TRANSMISSION

TONGUE & GROOVE

TOP OF CONCRETE

TOP OF FOOTING

TOP OF PAVEMENT

TOILET PAPER DISPENSER

THICKNESS

TO OF (ITEM)

TOILET

TOS TOP OF STEEL

TOW TOP OF WALL

UCR UNDERCOUNTER

TYP TYPICAL

SERVICE SINK

COEFFICIENT

STANDARD

STEEL

STRUCT STRUCTURAL

SUSP SUSPENDED

TEMP TEMPORARY

TLT

STOR STORAGE

2. ALL WORK SHALL BE DONE IN ACCORDANCE WITH BUILDING REGULATIONS AND IN 3. DO NOT SCALE DRAWINGS

4. SEE GENERAL CONDITIONS OF THE CONTRACT FOR FULL SCOPE OF PROJECT

5. UNLESS NOTED OTHERWISE, ALL DETAILS, SECTION AND NOTES ON THE DRAWINGS ARE INTENDED TO BE TYPICAL FOR SIMILAR SITUATIONS ELSEWHERE

6. THE PLANS AND SPECIFICATIONS ARE INTENDED TO GIVE A DESCRIPTION OF THE WORK. NO DEVIATION FROM THE PLANS AND SPECIFICATIONS SHALL BE MADE WITHOUT THE WRITTEN CONSENT OF STRUCRITE, INC.

7. ANY DISCREPANCIES WITHIN THE CONTRACT DOCUMENTS SHALL BE BROUGHT TO THE ATTENTION OF STRUCRITE, INC. IN WRITING.

PRECLUDE OTHER WORK ASSOCIATED WITH THE CONTRACT WHICH MUST OCCUR IN THE VICINITY OF THE AREA OR THROUGH THE SPACE. 9. BEFORE COMMENCING WORK, THE CONTRACTOR SHALL VERIFY ALL DIMENSIONS

8. THE TERMS "NOT IN CONTRACT" OR "BY OWNER" OR "BY OTHERS" DO NOT

AND CONDITIONS IN THE FIELD. ANY DISCREPANCIES BETWEEN EXISTING CONDITIONS AND THE CONSTRUCTION DOCUMENTS SHALL BE BROUGHT TO THE ATTENTION OF STRUCRITE, INC PRIOR TO BIDDING.

CHANGES OR MODIFICATIONS MUST BE APPROVED BY STRUCRITE, INC. PRIOR TO PROCEEDING WITH WORK.

10. IF FIELD CONDITIONS NECESSITATE ANY CHANGES OR MODIFICATIONS, THE

11. ALL CHANGE ORDERS MUST BE APPROVED BY THE OWNER PRIOR TO PROCEEDING WITH ANY WORK. FAILURE TO FOLLOW THIS STEP MIGHT RESULT IN

12. THE GENERAL CONTRACTOR SHALL BE RESPONSIBLE FOR FINAL CLEAN-UP.

13. GENERAL AND SUB CONTRACTS SHALL EXERCISE ALL REASONABLE PRECAUTIONS FOR THE PROTECTION OF PERSONS AND PROPERTY ON THE SITE. ALL SAFETY PROVISIONS AND APPLICABLE LAWS FOR BUILDING AND CONSTUCTION CODES SHALL BE OBSERVED.

14. GENERAL CONTRACTOR SHALL SUBMIT SHOP DRAWINGS TO STRUCRITE INC. FOR APPROVAL BEFORE PROCEEDING WITH ANY FABRICATION OR INSTALLATION.

15. MANUFACTURES DIRECTIONS FOR APPLICATION, INSTALLATION AND METHODS SHALL BE FOLLOWED ARE HEREWITH MADE PART OF THE CONSTRUCTION

16. ALL WOOD IN CONTACT WITH CONCRETE OR MASONRY TO BE PRESSURE

Project Information

Energy Code: 2015 IECC
Project Title: Building Addition at lift
Location: Watertown, Wisconsin
Climate Zone: 6a

Project Type: Addition
Vertical Glazing / Wall Area: 22%

Construction Site: 510 Cole St Watertown, WI 53094 Owner/Agent: Moravian Church 510 Cole St Watertown, WI 53094

Designer/Contractor:
Boyd Coleman
StrucRite, Inc.
707 N. Grand Ave - Suite 102
Waukesha, WI 53186
262-549-3222
boydc@srdinc.biz

Report date: 04/16/25

Page 1 of 9

Building Area Floor Area

1-Accessible Lift Entrance (Religious Building): Nonresidential 135

Envelope Assemblies

Assembly	Gross Area or Perimeter	Cavity R-Value	Cont. R-Value	Proposed U-Factor	Budget U- Factor _(a)
Floor 1: Slab-On-Grade:Unheated, Vertical 4 ft., [Bldg. Use 1 - Accessible Lift Entrance] (d)	34	10 CH	10.0	0.480	0.540
Roof 1: Other Insulation Above Deck, [Bldg. Use 1 - Accessible Lift Entrance] (b)	280	***	***	0.040	0.032
NORTH Exterior Wall 1: Steel-Framed, 16" o.c., [Bldg. Use 1 - Accessible Lift Entrance]	68	19.0	0.0	0.109	0.064
SOUTH Exterior Wall 3: Steel-Framed, 16" o.c., [Bldg. Use 1 - Accessible Lift Entrance]	80	19.0	0.0	0.109	0.064
Door: Glass (> 50% glazing):Metal Frame, Entrance Door, Perf. Specs.: Product ID ns, SHGC 0.40, [Bldg. Use 1 - Accessible Lift Entrance] (c)	20	655	2000	0.450	0.770
Sidelight: Glass (> 50% glazing):Metal Frame, Entrance Door, Perf. Specs.: Product ID na, SHGC 0.40, [Bldg. Use 1 - Accessible Lift Entrance] (c)	12		***	0.450	0.770
WEST	400	40.0	0.0	0.400	0.004
Exterior Wall 2: Steel-Framed, 16" o.c., [Bldg. Use 1 - Accessible Lift Entrance]	128	19.0	0.0	0.109	0.064
Window: Metal Frame with Thermal Break:Fixed, Perf. Specs.: Product ID na, SHGC 0.40, [Bldg. Use 1 - Accessible Lift Entrance] (c)	28	222		0.300	0.360

(a) Budget U-factors are used for software baseline calculations ONLY, and are not code requirements.(b) 'Other' components require supporting documentation for proposed U-factors.

Project Title: Building Addition at lift

Data filename: G:\SRD Job Files\24191 Watertown Moravian Church Lift & Vestibule\Project Data\Code Info\Moravian_ComCheck.cck

c) Fenestration product performance must be certified in accordance with NFRC and requires supporting documentation.

Envelope PASSES: Design 3% better than code

(d) Slab-On-Grade proposed and budget U-factors shown in table are F-factors.

Envelope Compliance Statement

Compliance Statement: The proposed envelope design represented in this document is consistent with the building plans, specifications, and other calculations submitted with this permit application. The proposed envelope systems have been designed to meet the 2015 IECC requirements in COMcheck Version 4.1.5.5 and to comply with any applicable mandatory requirements listed in the Inspection Checklist.

Name - Title Signature Date

Project Title: Building Addition at lift
Data filename: G:\SRD Job Files\24191 Watertown Moravian Church Lift & Vestibule\Project Data\Code Page 2 of 9 Info\Moravian_ComCheck.cck

Architectural & Engineering Services 707 N. Grand Ave. - Suite 102 Waukesha, WI 53186 262.549.3222 - www.srdinc.biz

ACTUAL ETR

REQUIRED STAIR WIDTH | REQUIRED | ETR


TOTAL ACTUAL AREA 295 SQFT

TOTAL OCCUPANT LOAD 7 (AT ADDITION)

LIFE SAFETY ANALYSIS SUBMITTAL TYPE | ADDITION ACTUAL 12'-0" @ PROPOSED ADDITION MAXIMUM EXIT DISTANCE MAXIMUM 200'-0" TYPE OF CONSTRUCTION | IIB MAXIMUM COMMON PATH MAXIMUM 75'-0" ACTUAL 12'-0" NUMBER OF STORIES 2 ACTUAL 12'-0" MAXIMUM DEAD-END CORRIDOR MAXIMUM 25'-0" SPRINKLED NO TOTAL NUMBER OF EXITS | REQUIRED | 1 ACTUAL 1

FIRE SUPPRESSION REQUIRED EGRESS WIDTH REQUIRED 32" ACTUAL 36" @ PROPOSED ADDITION MAIN OCCUPANCY TYPE | A-3 FIRE ALARM YES ALL OCCUPANCY TYPES | E, A-3 ALARM TYPE | MANUAL WATER CLOSET-MALE | REQUIRED | ETR | PROVIDED | ETR OCCUPANCY SEPARATIONS | 1 HR FIRE RATED SHAFT ENCLOSURE WATER CLOSET-FEMALE REQUIRED ETR PROVIDED ETR INCIDENTAL USES LAVATORIES | REQUIRED | ETR | PROVIDED | ETR | ALLOWABLE AREA (ADDITION) ACTUAL AREA FOR 295 SQFT (INCLUDING ROOF OVERHANG) TUBS/SHOWERS | REQUIRED | ETR | PROVIDED | ETR ACTUAL AREA FOR 135 SQFT (ADDITION INTERIOR) DRINKING FOUNTAINS | REQUIRED | ETR | PROVIDED | ETR OTHER ACTUAL AREA FOR

SPRINKLER TYPE

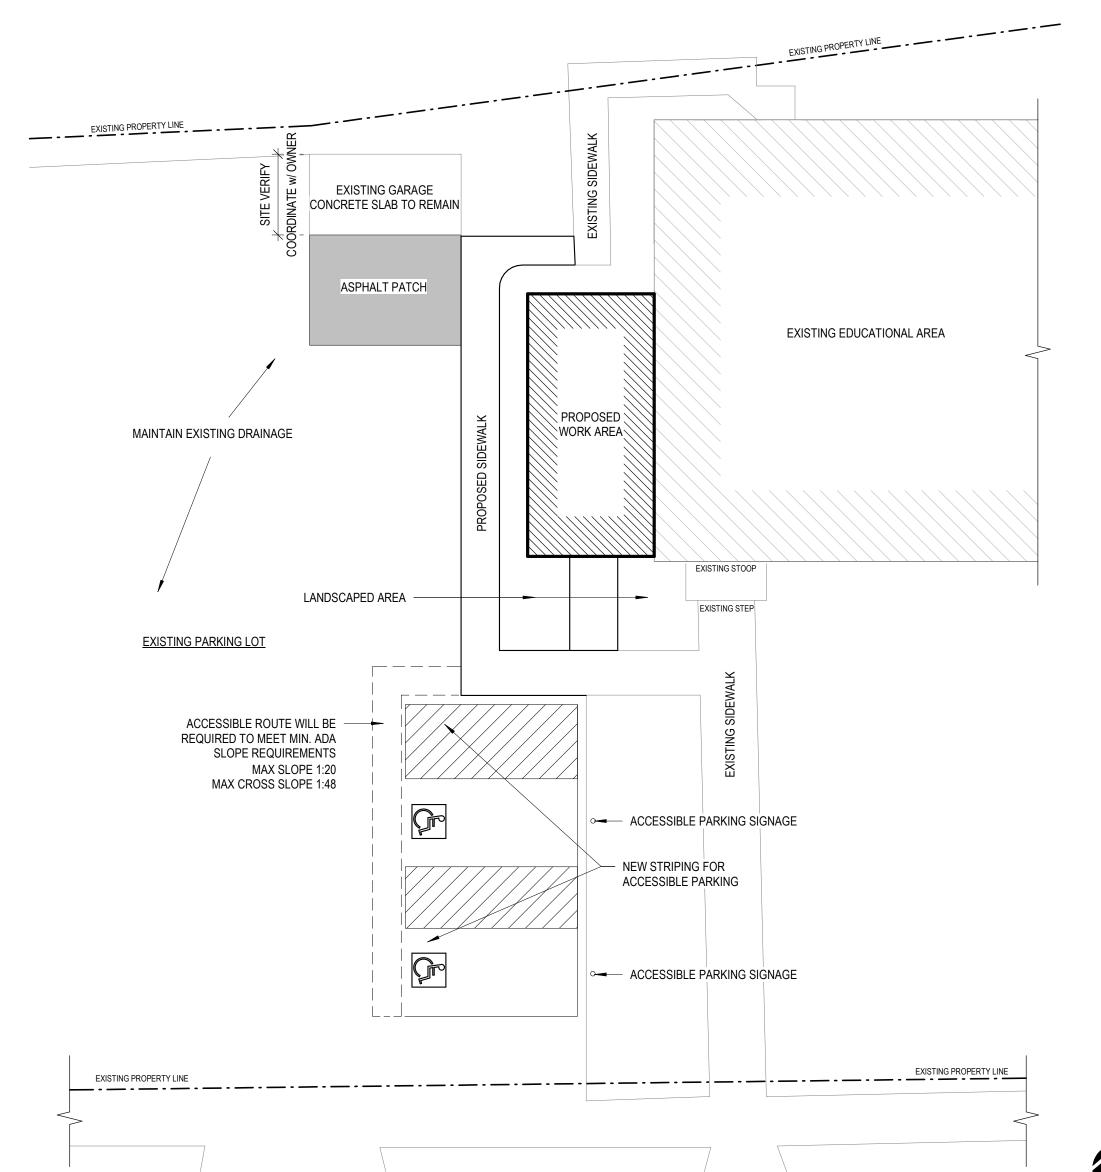



bravian Church - Lift Vestibule

REVISIONS

No. DATE DESCRIPTION

CONSTRUCTION DOCUMENTS

SHEET TITLE:
BUILDING INFORMATION

JOB NUMBER: 24191

ISSUED DATE: 05.30.2025


DRAWN BY:

SHEET NUMBER:


G1.


Local Site Plan




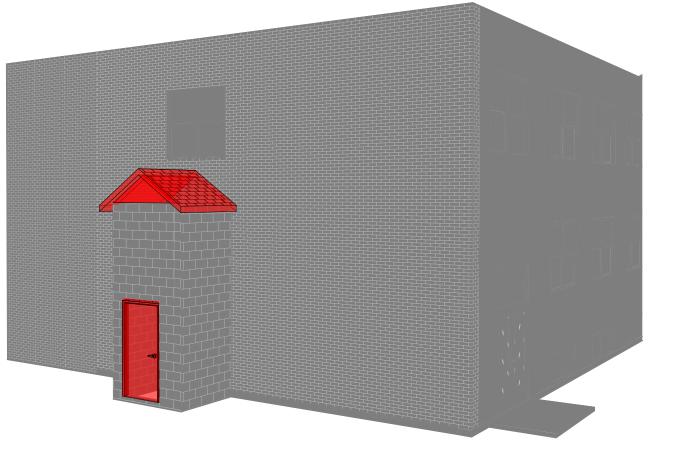



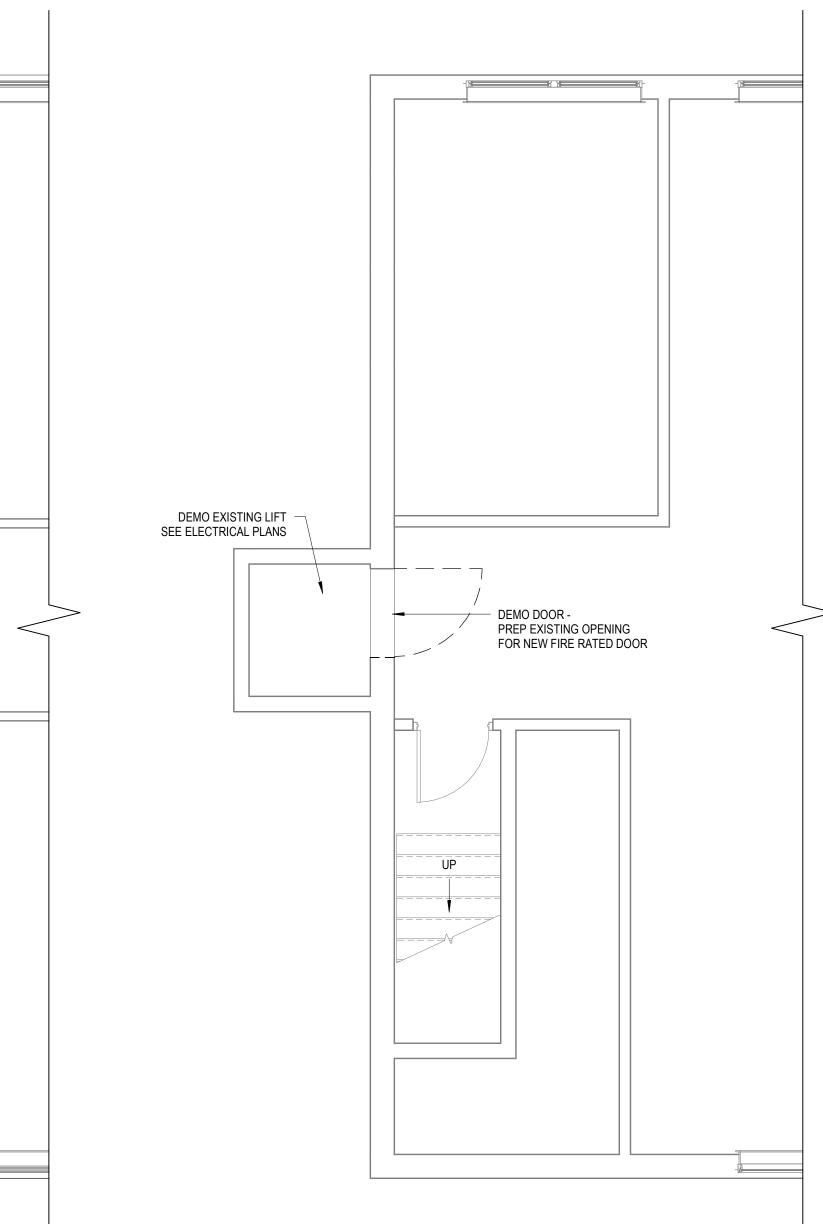

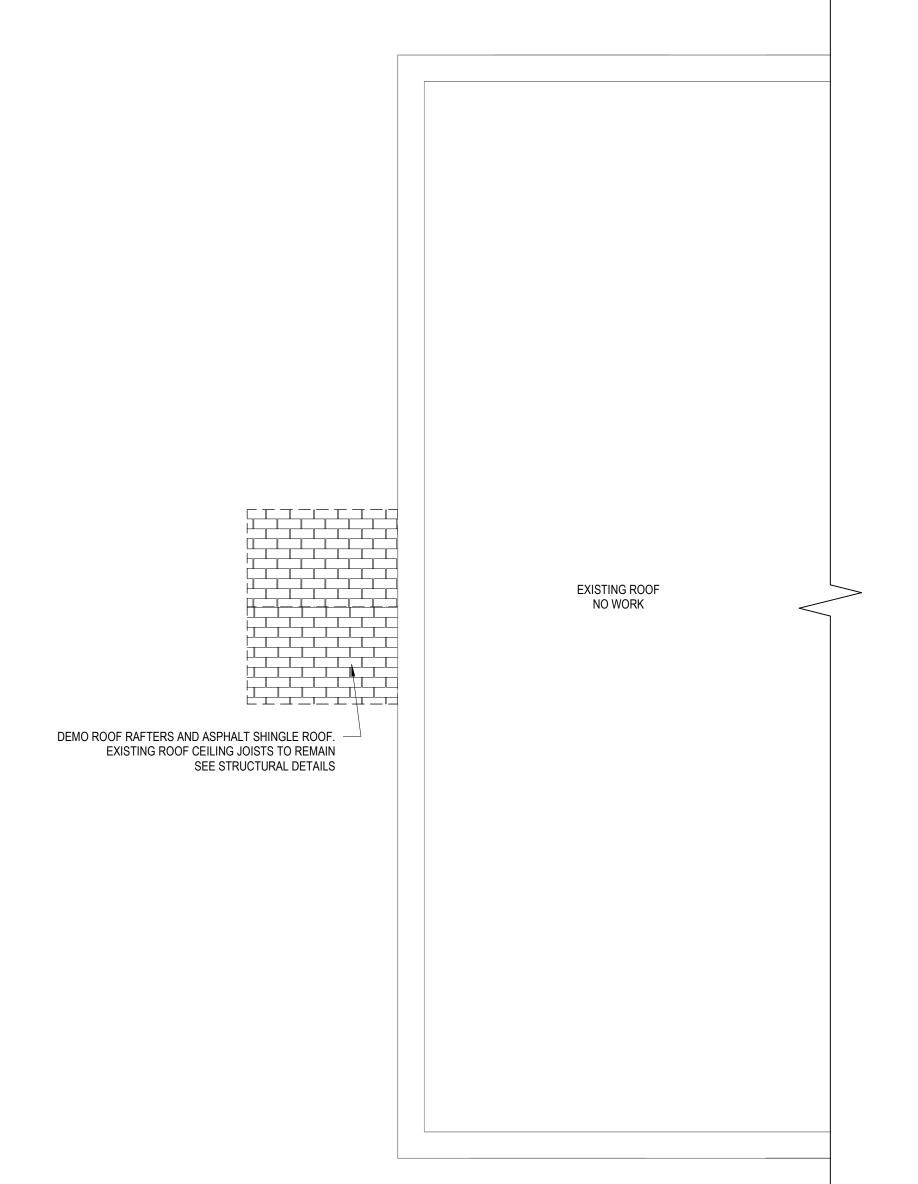

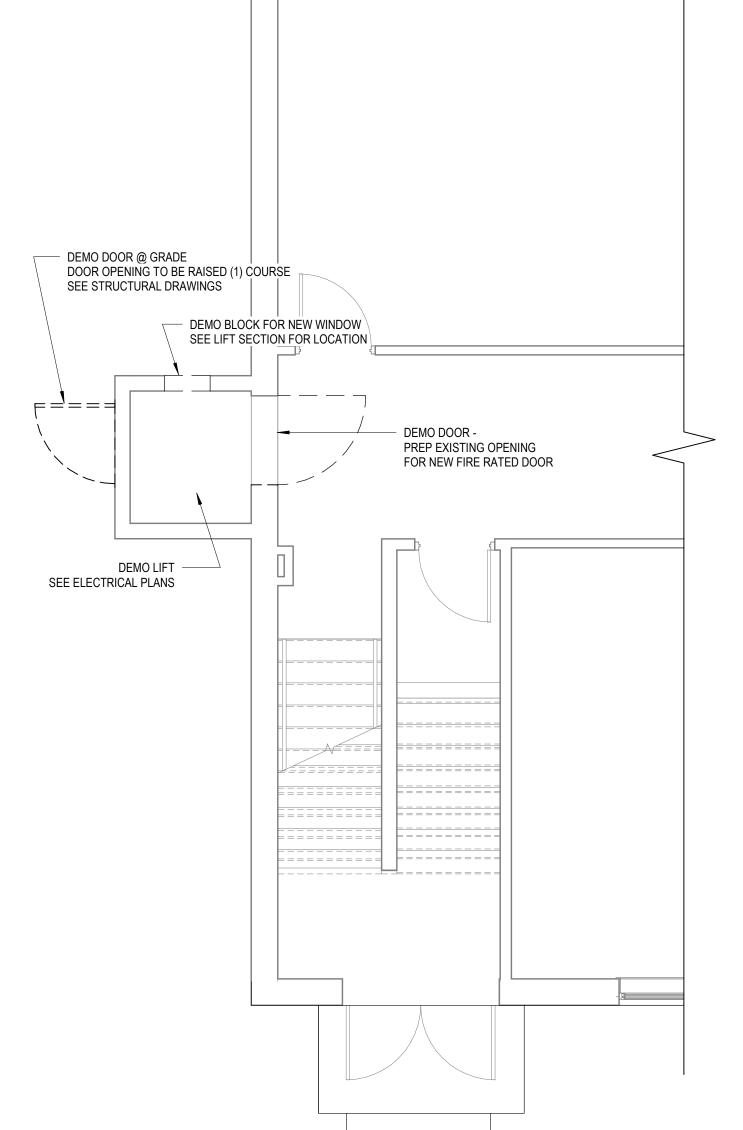

2 1st FLOOR - EXISTING / DEMO PLAN

1/4" = 1'-0"

1 BASEMENT - EXISTING / DEMO PLAN

NORTH

CONSTRUCTION DOCUMENTS


REVISIONS


No. DATE DESCRIPTION


DEMOLITION PLANS JOB NUMBER: 24191 ISSUED DATE: 05.30.2025

O

Mora

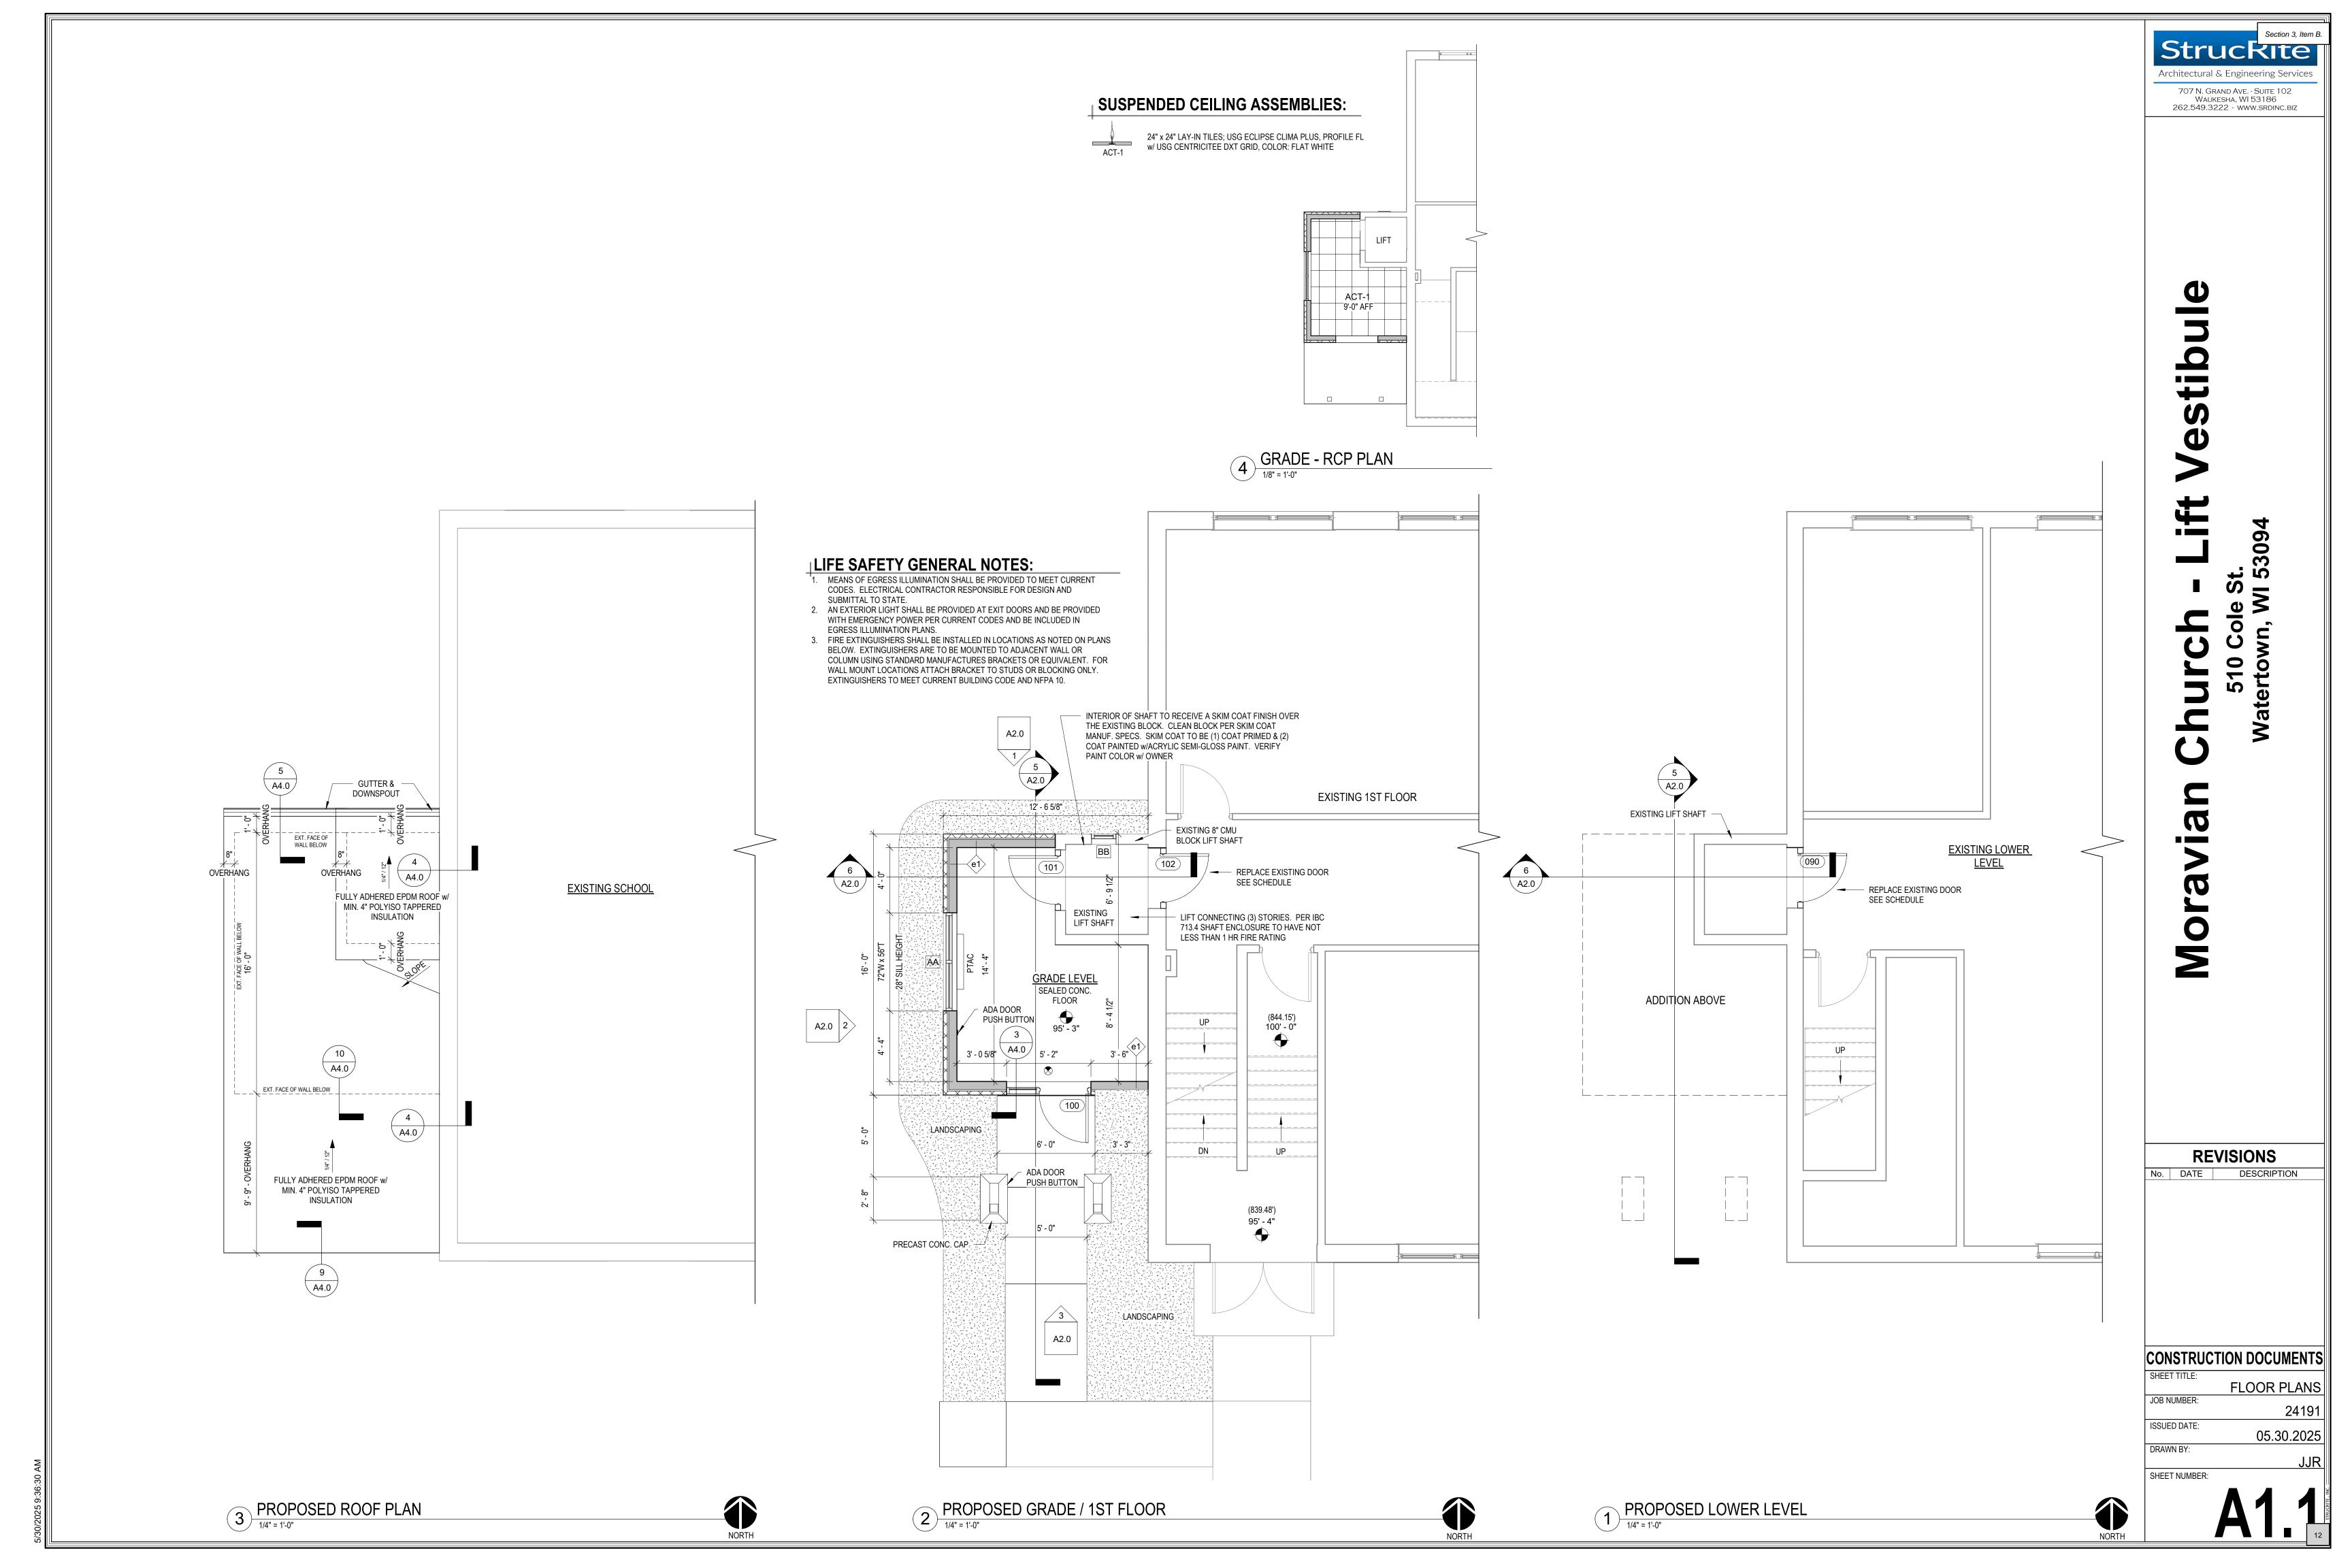

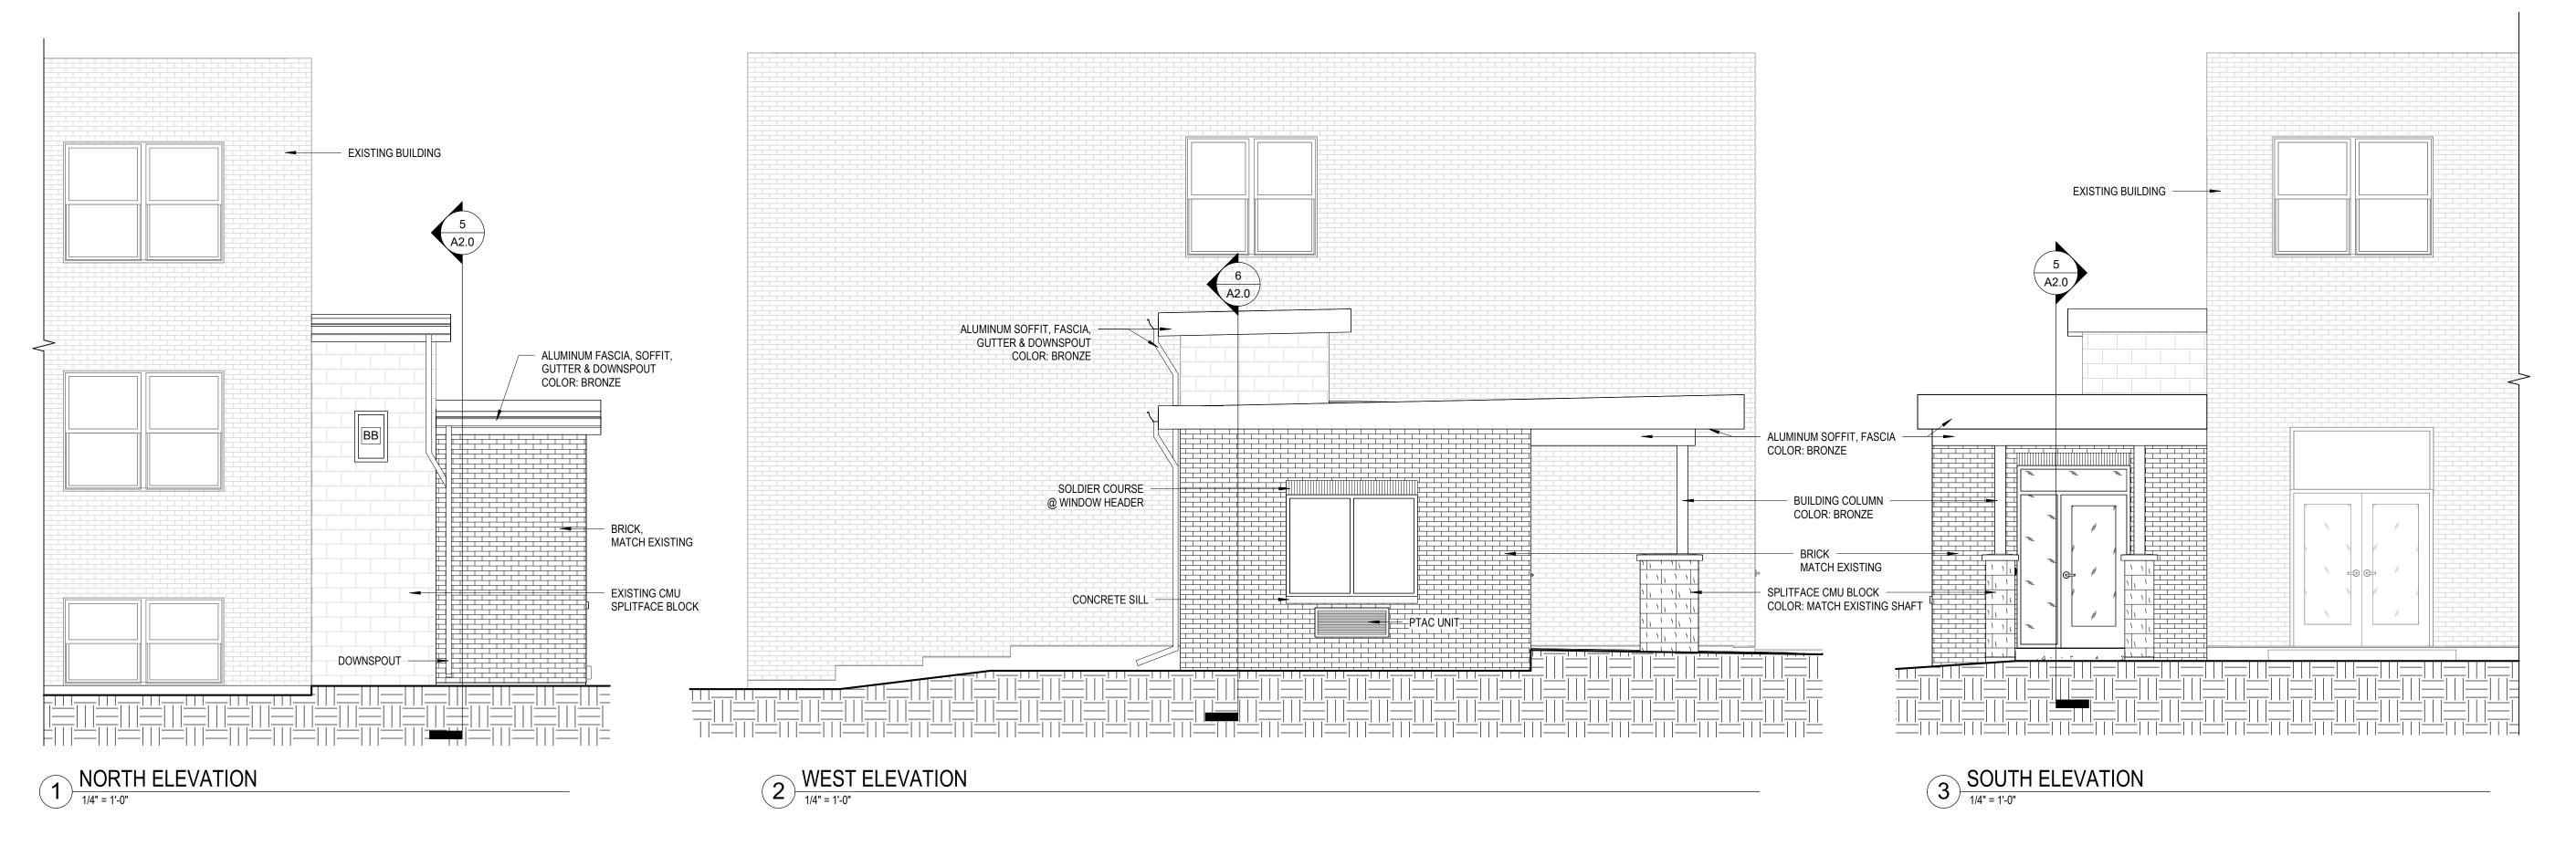

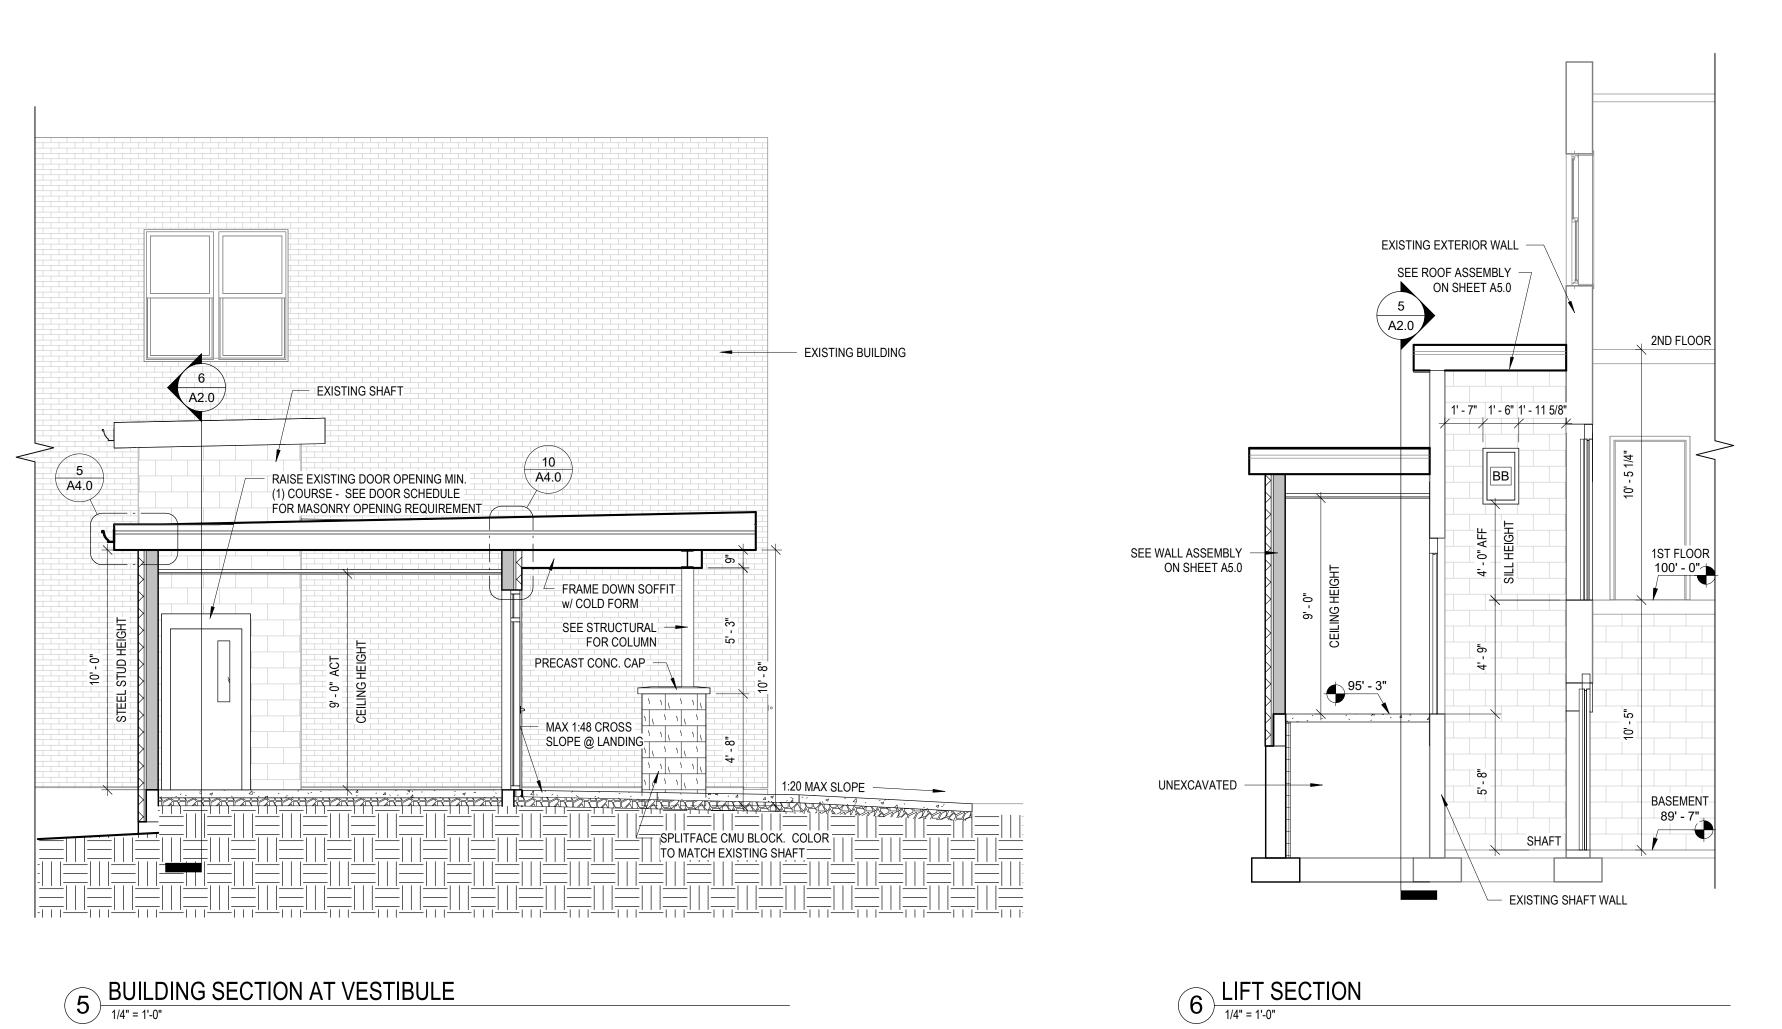

Moravian Church - Lift Vestibul 510 Cole St.

53094

REVISIONS

No. DATE DESCRIPTION

CONSTRUCTION DOCUMENTS

SHEET TITLE:
ELEVATIONS & SECTIONS

JOB NUMBER:

24191

ISSUED DATE:

05.30.2025

DRAWN BY:

JJR

SHEET NUMBER:


A2.0


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DETAILS JOB NUMBER: 24191 ISSUED DATE: 05.30.2025 DRAWN BY: SHEET NUMBER:

EXTERIOR SIDE INTERIOR SIDE VINYL GASKET THRESHOLD --BY DOOR FRAME MANUFACTURE **EXPANSION JOINT** w/ EXPANSION FELT

THRESHOLD AT ENTRY DOOR

1 1/2" = 1'-0"

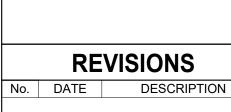MIN. R-19 BATT INSULATION

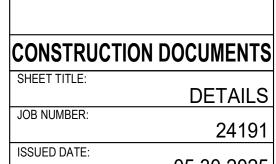SEE STRUCTURAL **DETAILS FOR**

FILL HEADER W/

1X BLOCKING @ HEAD

DRYWALL RETURN @

MIN. R-19 BATT INSULATION

SEE STRUCTURAL FOR

FRAMING MEMBERS &

2X BLOCKING AT JAMBS


DRYWALL RETURN @ HEAD AND JAMBS

DETAILS

HEAD AND JAMBS


BATT INSUL.

HEADER

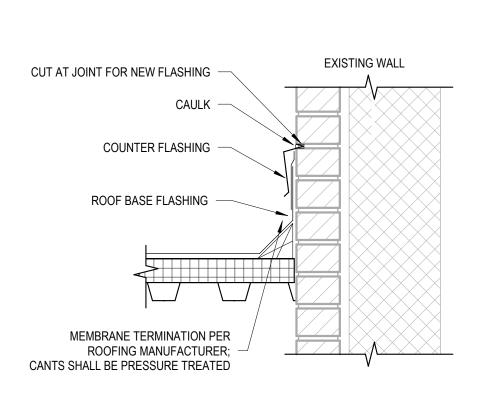


5 LOW EAVE INSULATING DETAIL
1 1/2" = 1'-0" ROOF AT EXISTING WALL

1 1/2" = 1'-0"

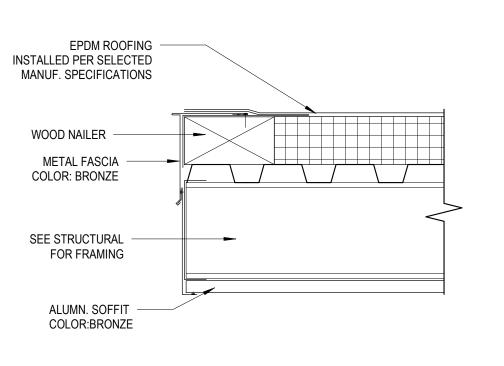

9 TYP. CANOPY EDGE DETAIL
1 1/2" = 1'-0"

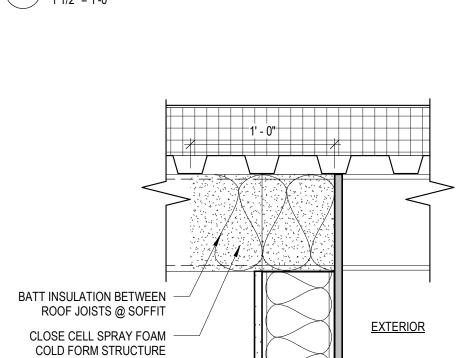

EPDM ROOFING

WOOD NAILER

INSTALLED PER SELECTED

GUTTER & DOWNSPOUT

MANUF. SPECIFICATIONS

BATT INSULATION BETWEEN

ROOF JOISTS @ SOFFIT

CLOSE CELL SPRAY FOAM COLD FORM STRUCTURE

ALUMN. FASCIA

COLOR: BRONZE


5/8" DENSEGLASS @ SOFFIT & FASCIA -

FREEZE BOARD WRAPPED w/ ALUMN

ALUMN. SOFFIT -COLOR:BRONZE

COLOR: BRONZE

10 INSULATION @ ROOF JOISTS ABOVE ENTRY DOOR

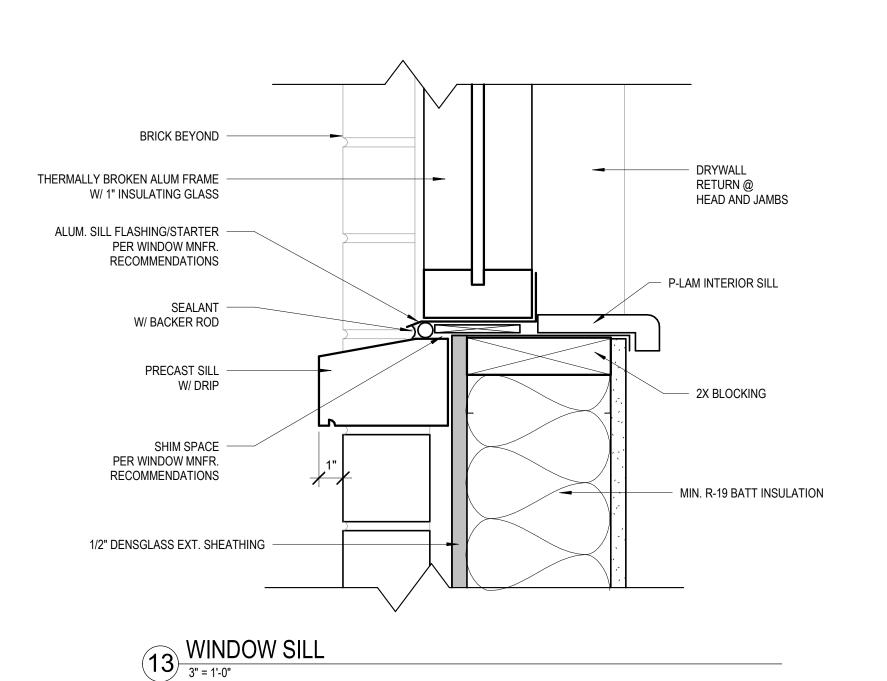

1/2" DENSGLASS EXT. SHEATHING

WINDOW HEAD

@ 24" C/C

SEALANT W/ BACKER ROD

SHIM SPACE

WINDOW HEAD

3" = 1'-0"

1/2" DENSGLASS EXT. SHEATHING

1" AIR SPACE

SEALANT W/ BACKER ROD

SHIM SPACE

8 WINDOW JAMB
3" = 1'-0"

PER WINDOW MNFR. RECOMMENDATIONS

THERMALLY BROKEN ALUM. FRAME w/ 1" INSULATING GLASS

PER WINDOW MNFR.

RECOMMENDATIONS

W/ 1" INSULATING GLASS

THERMALLY BROKEN ALUM. FRAME

MTL. DRIP EDGE


SEE STRUCTURAL

DRAWINGS FOR LINTEL

WEEPHOLE VENTILATOR

FLEXIBLE FLASHING


BRICK SOLDIER COURSE @

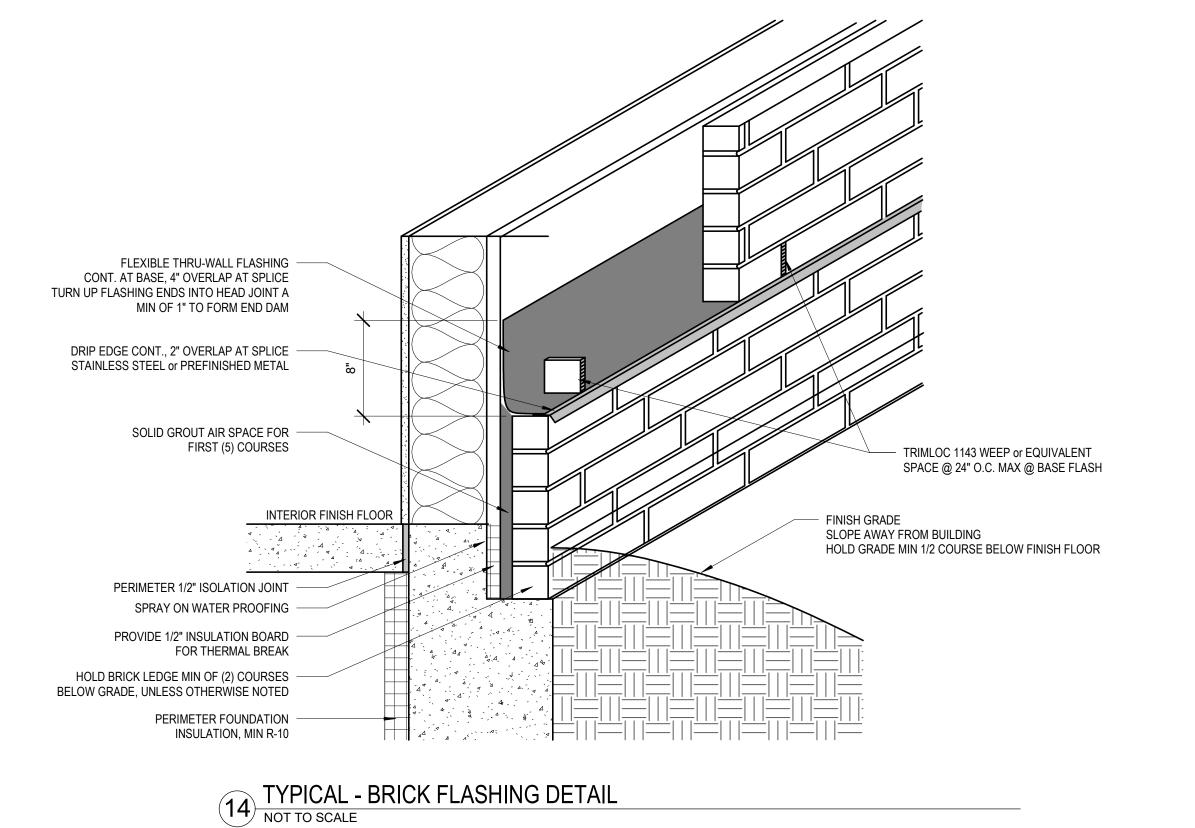

CONSTRUCTION DOCUMENTS


24191 ISSUED DATE: 05.30.2025


HARDWARE SET 60 MIN. EXISTING ROUGH OPENING IS 3'-8 1/2" x 6'-11 1/2" SEE DOOR HARDWARE TYPES 101,200,210,211,212, 213 60 MIN. EXISTING ROUGH OPENING IS 3'-8 1/2" x 6'-11 1/2" SEE DOOR HARDWARE TYPES STEEL PAINT 60 MIN. EXISTING ROUGH OPENING IS 3'-8 1/2" x 6'-11 1/2" SEE DOOR HARDWARE TYPES

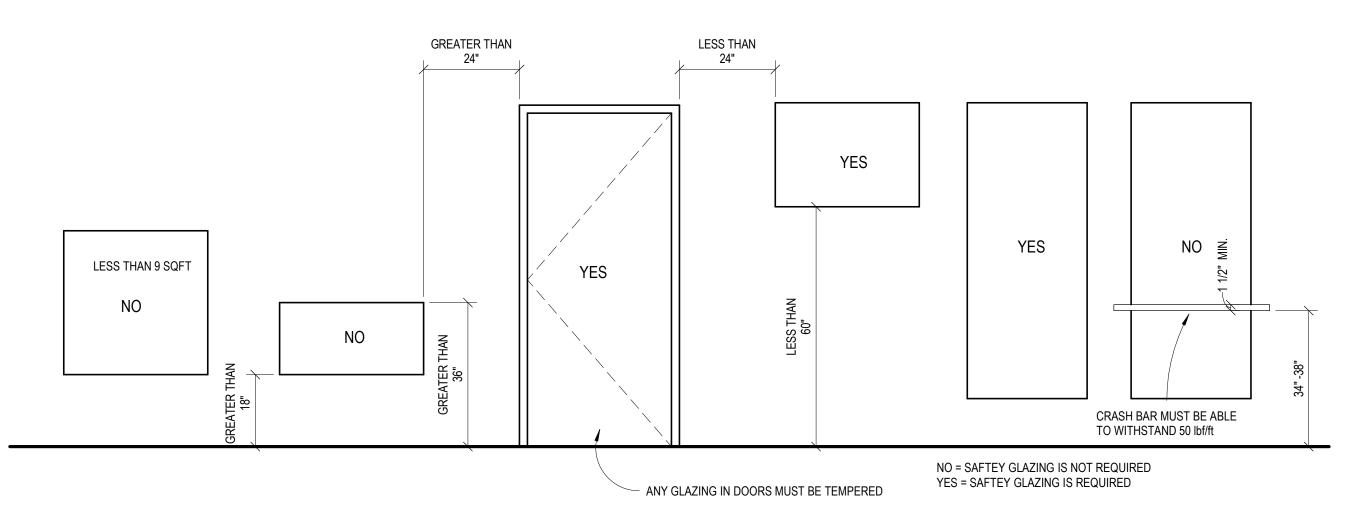

SAFETY GLAZING

EMERGENCY LIGHTING

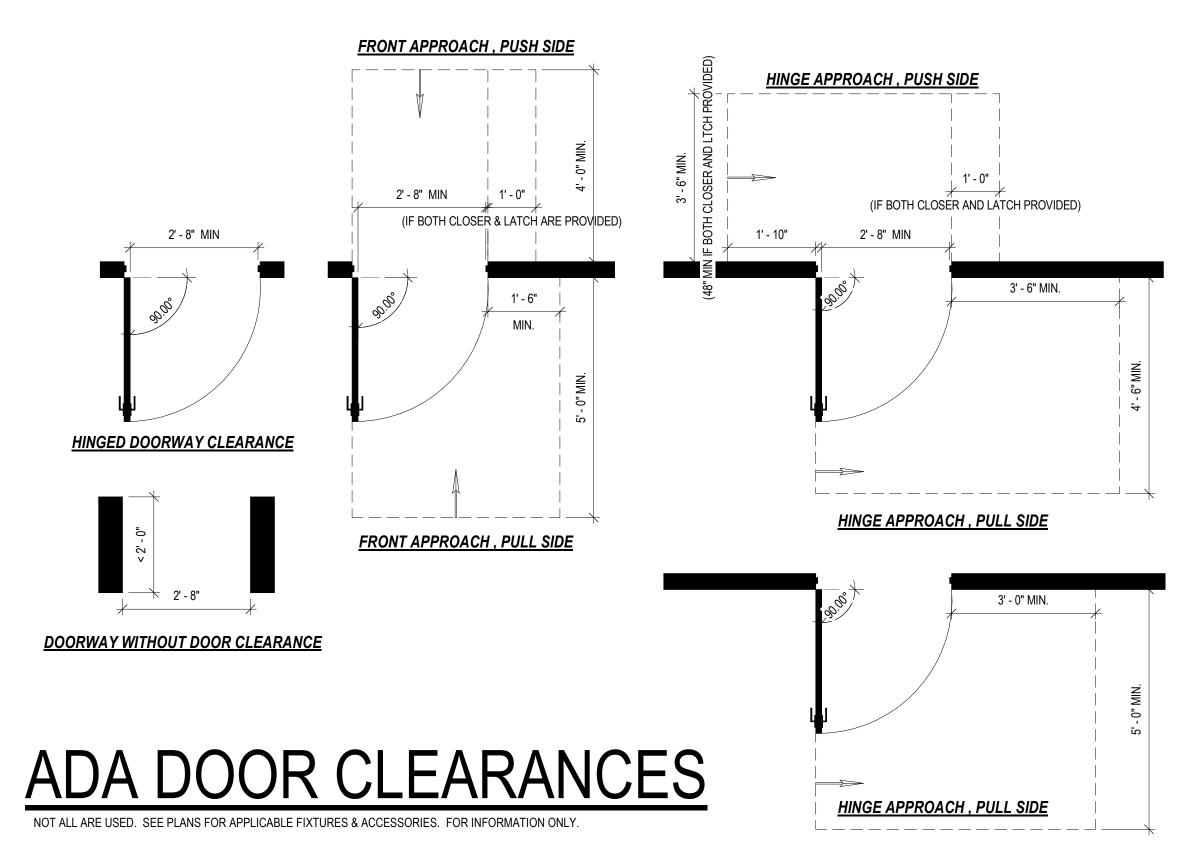

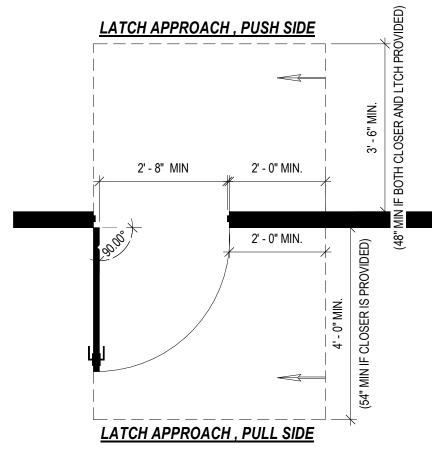

 LANDINGS TO BE PROVIDED AT ALL EGRESS DOORS. LANDING CLEARANCES TO MATCH "ADA DOOR CLEARANCES" UNLESS EGRESS DOOR IS "EXIT ONLY", THEN A CLEAR FLOOR SPACE OF 36"x60" IS REQUIRED AT THE LANDING.

FLOOR IDENTIFICATION SIGNS SHALL

LANDING IN COMPLIANCE WITH IBC

MOUNTED ON NEAREST ADJACENT WALL.

- EXITS SERVING AN ACCESSIBLE SPACE

STAIRWAY AND AT THE EXIT DISCHARGE

8. NOTIFY STRUCRITE OF ANY DISCREPANCIES.

BE PROVIDED AT EACH FLOOR

- ELEVATOR LANDINGS

- AREAS OF REFUGE

 THRESHOLDS AT DOORWAYS SHALL BE 1/2" MAX. IN HEIGHT LANDINGS SHALL HAVE A SLOPE & CROSS SLOPE NOT

STANDARD MOUNTING HEIGHT NOTES:

2. SIGN SHALL BE MOUNTED WHERE INDICATED. WHERE THERE IS NO

OBJECTS OR STANDING WITHIN THE SWING OF THE DOOR. 4. DIRECTIONAL SIGNAGE IS REQUIRED AT BUT NOT LIMITED TO:

WALL SPACE ADJACENT TO LATCH SIDE OF DOOR, SIGN SHALL BE

3. MOUNTING LOCATION FOR SIGNAGE SHALL BE SO THAT A PERSON MAY


5. TACTILE EXIT SIGNS SHALL BE PROVIDED AT EACH DOOR TO AN EXIT

6. FACILITIES AND ELEMENTS REQUIRED TO BE IDENTIFIED AS ACCESSIBLE SHALL INCLUDE THE INTERNATIONAL SYMBOL OF ACCESSIBILITY. 7. STANDARD MOUNTING HEIGHTS APPLY TO DRAWINGS UNLESS INDICATED

APPROACH WITHIN 3" OF SIGNAGE WITHOUT ENCOUNTERING PROTRUDING

1. ALL SIGNAGE SHALL MEET THE REQUIREMENTS OF ADA AND ANSI A117.1 SEC. 703.

LAZING TO MEET -H-60 PER IBC 716.3(2)

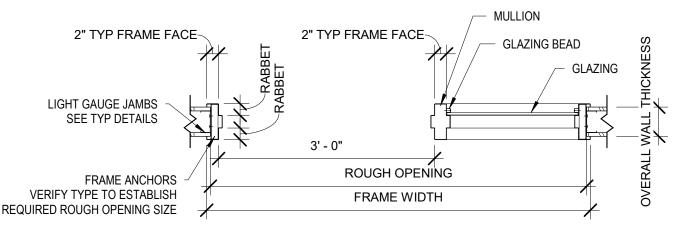

| LOCATION | WIDTH|HEIGHT|MATERIAL|FINISH|TYPE|R.O. WIDTH|R.O. HEIGHT|MATERIAL|FINISH|RATING|

1 TYP. DOOR JAMB w/ SIDELIGHT

|DOOR & DOOR FRAME NOTES:

DOOR PANEL

102 | LIFT - 1ST FLOOR | 2' - 11 3/4" | 6' - 8 1/2" | STEEL | PAINT | D | 3' - 8 1/2"

100 GRADE LEVEL 5' - 2" 8' - 4" STEEL

101 LIFT - GRADE 2' - 11 3/4" 6' - 8 1/2" STEEL

- ALL HOLLOW METAL FRAMES TO BE REINFORCED & PREPARED FOR HARDWARE. ALL WELDED FRAMES SHALL BE 16ga (MIN.)
- ALL HOLLOW METAL DOORS SHALL BE 18ga (MIN.) ALL EXTERIOR DOORS SHALL BE PROVIDED WITH WEATHERSTRIPPING.
- ALL DOOR THRESHOLDS SHALL NOT EXCEED 1/2" IN HEIGHT.
- ALL DOORS SHALL MEET A.D.A. REQUIREMENTS. PROVIDE LEVER TYPE HANDLES ON ALL DOORS
- PROVIDE CAULKING AT ALL DOOR FRAMES, WINDOWS & WHERE NOTED ON PLANS VERIFY w/ H.V.A.C. CONTRACTOR FOR DOOR UNDERCUTS & GRILLES.

WINDOW SCHEDULE

6' - 0" 4' - 8" 1 30" SILL HEIGHT

COMMENTS

1 FIRE RATING NOT REQUIRED -

PER 2015 IBC 713.6

- ALL SIGNAGE TO ME MOUNTED AT A.D.A. HEIGHT (SEE GENERAL SPECIFICATIONS). UNLESS NOTED OTHERWISE, ALL EXTERIOR WALK DOORS SHALL HAVE A U-FACTOR
- OF 0.45 OR BETTER.

WINDOW SIZE

1' - 6"

HEIGHT

2' - 4"

PANEL TYPES SEE SCHEDULE	0	SEE SCHEDULE 3'-8" VARIES	SEE SCHEDULE 11-0", VARIES		SEE SCHEDULE VARIES VARIES	LIFT DOORS GLAZING TO MEET D-H-60 PER IBC 71
Y.	<u>A</u>		<u>B</u>	<u>C</u>	<u>D</u>	
2" TYP FRAME FACE	RABBET 3BET 3BET 5. AAAA 1. AAAAA 1. AAAAA 1. AAAAAAA 1. AAAAAAAA	AME FACE	LAZING BEAD SS UNITED STATES AND SEAD SS UNITED SEAD SEAD SEAD SEAD SEAD SEAD SEAD SE	SPECIFIED BRANDS MAY BE	RDWARE TYPES: SUBSTITUTED WITH AN EQUIVALENT WITH OWN NISHES TO BE: #619 SATIN NICKEL	NER & ARCHITECT APPROVAL

DOOR SCHEDULE

7' - 4"

- DOOR HARDWARE NOTES: ALL HANDLES, PULLS, LATCHES, LOCKS, & OTHER PARTS ON ACCESSIBLE DOORS SHALL HAVE A SHAPE THAT IS EASY TO GRASP WITH ONE HAND & DOES NOT REQUIRE TIGHT GRASPING, PINCHING, OR TWISTING OF THE WRIST TO OPERATE. SUCH HARDWARE SHALL BE 34 INCHES MINIMUM TO 48 INCHES MAXIMUM ABOVE THE FLOOR OR GROUND. WHERE SLIDING DOORS ARE IN THE FULLY OPEN POSITION, OPERATING HARDWARE SHALL BE
- EXPOSED AND USABLE FROM BOTH SIDES. DOOR CLOSERS SHALL BE ADJUSTED SO THAT FROM AN OPEN POSITION OF 90 DEGREES, THE TIME TO MOVE THE DOOR TO AN OPEN POSITION OF 12 DEGREES SHALL BE 5 SECONDS

101 - VON DUPRIN DERIES 98-99 PANIC EXIT BAR FINISH: #628, ANODIZED ALUMINUM

212 - LOW PROFILE THRESHOLD, MEETS ANSI-117

200 - LCN 1000 SERIES, DOOR CLOSER

213 - ADA WIRED PUSH BUTTON

210 - DOOR SEALS

211 - DOOR SWEEP

@ EDUCATION WING OF EXISTING BUILDING

DOOR TO BE KEYED TO MATCH ADJACENT EXTERIOR DOOR

NOTE: LIFT DOOR HARDWARE PROVIDED WITH DOORS BY LIFT SUPPLIER

COMMENTS

- DOOR SWING HINGES SHALL BE ADJUSTED SO THAT THE OPEN POSITION OF 70 DEGREES, THE DOOR SHALL MOVE TO THE CLOSED POSITION IN 1.5 SECONDS MINIMUM, MEASURED
- UNDER AMBIENT CONDITIONS. FIRE DOORS SHALL HAVE THE MINIMUM OPENING FORCE ALLOWABLE BY THE APPROPRIATE AUTHORITY. THE MAXIMUM FORCE FOR PUSHING OPEN OR PULLING OPEN DOORS OTHER
 - THAN FIRE DOORS SHALL BE AS FOLLOWS: A. INTERIOR HINGED DOOR: 5.0 POUNDS (22.2N) B. SLIDING OR FOLDING DOOR: 5.0 POUNDS (22.2N)
- THESE FORCES DO NOT APPLY TO THE FORCE REQUIRED TO RETRACT LATCH BOLTS OR DISENGAGE OTHER DEVICES THAT HOLD THE DOOR IN A CLOSED POSITION.

WINDOW NOTES:

- GENERAL CONTRACTOR IS TO VERIFY THE REQUIRED ROUGH OPENING SIZE REQUIRED FOR EACH WINDOW, & THAT ALL OPENINGS HAVE BEEN PREPARED PER MANUFACTURER'S SPECIFICATIONS & PER THE DETAILS IN THIS DRAWING SET. 2. FIELD VERIFICATION OF EACH OPENING SHALL BE COORDINATED WITH WINDOW
- SUPPLIER PRIOR TO WINDOW INSTALLATION TO ENSURE PROPER FITTING. ALL GLAZING SYSTEMS TO BE PREFINISHED EXTRUDED ALUMINUM THERMALLY BROKEN FRAMES. FIRST FLOOR GLAZING TO BE INSTALLED FROM EXTERIOR SIDE. ALL GLAZING ABOVE FIRST FLOOR TO BE INSTALLED FROM INTERIOR SIDE.
- COLOR: ALUMINUM 4. SEE COMcheck FOR WINDOW U-VALUE REQUIREMENTS
- 5. WINDOW FRAME INSTALLATION TO FOLLOW MANUFACTURER'S SPECIFICATIONS & WINDOW DETAILS IN DRAWING SET.
- 6. PROVIDE SAFETY GLAZING WHERE REQUIRED BY CODE, SEE GUIDE ON A5.0


WALL & ROOF ASSEMBLIES:

1" AIR SPACE R-19 BATT INSULATION

5/8" GYP BOARD

EXTERIOR WALLS

e1 WALL THICKNESS: 11 3/4" SELECTED MANUFACTURES SPECIFICATIONS

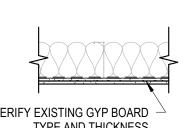

5/8" TYPE "X" GYP BOARD 5/8" TYPE "X" GYP BOARD 1 HR FIRE RATED FLOOR / CEILING ASSEMBLY - GA FILE NO. FC5406

ROOF ASSEMBLY @ LIFT

TOP SIDE EXISTING CEILING JOIST

EXISTING INSULATION

MIN. 6 MIL VAPOR BARRIER

FIRE HORN & STROBE & BATTERY PACK MOUNT SIGN (ADA BRAILLE/PICTORIAL) AT ALL TOILET ROOM DOORS ON ______ LATCH SIDE OF DOOR. SIZE OF SIGN TO BE DETERMINED BY ANSI CHAPTER 7 PROVIDE BLOCKING IN WALL MIN. AS REQUIRED TO ANCHOR MOUNTING BRACKET (TYP) PHONE JACK FIRE EXTINGUISHER HANDICAP ACCESSIBLE CABINET w/ 4" MAX WALL MOUNTED PHONE PROJECTION LIGHT SWITCH THERMOSTAT ELECTRICAL OUTLET 쪽 │ └FIRE ALARM **PULL STATION** PHONE JACK

STANDARD MOUNTING HEIGHTS

NOT ALL ARE USED. SEE PLANS FOR APPLICABLE FIXTURES & ACCESSORIES. FOR INFORMATION ONLY.

TAG SIDE STANDARD BRICK


*1/2" DENSGLASS (WEATHER BARRIER) 6" STEEL STUD - SEE STRUC. MIN. 6 MIL VAPOR BARRIER

*WEATHER BARRIER INSTALLED PER

VERIFY EXISTING GYP BOARD

TYPE AND THICKNESS

STANDARD DETAILS

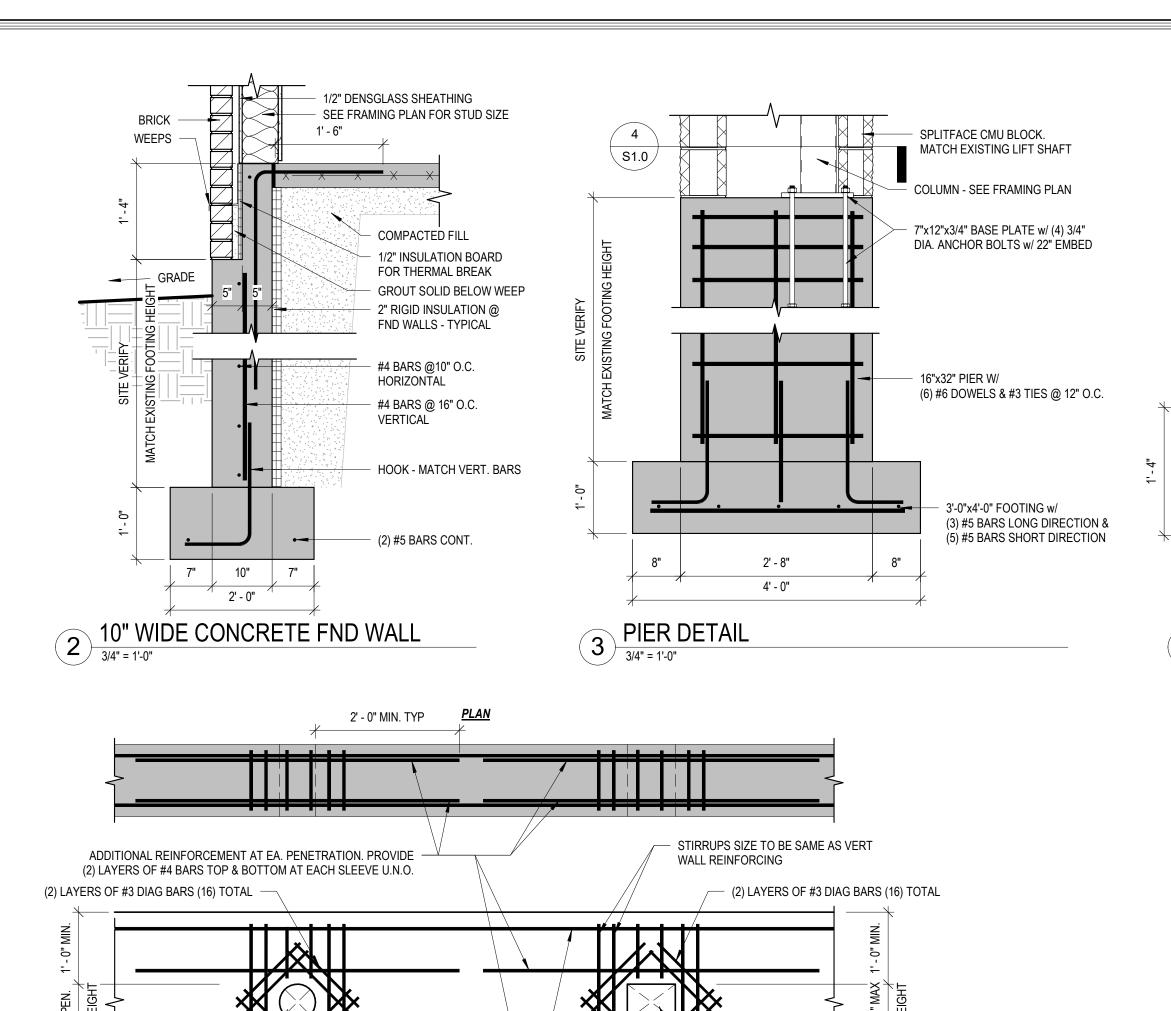

GENERAL CONTRACTOR TO COORDINATE LOCATION, SIZE & ELEVATION & INCLUDE HIS CONTRACT PRICE. ALL REQUIRED HORIZONTAL PENETRATIONS THROUGH CONCRETE WALLS WETHER SHOWN ON STRUCTURAL DRAWINGS OR NOT

WALL TOP & BOTTOM -

REINFORCING

ELEVATION

12" MAX

SQUARE OR RECTANGULAR OPENING


- WHERE WALL PENETRATIONS ARE REQUIRED BUT ARE NOT SPECIFICALLY DETAILED ON THE STRUCTURAL DRAWINGS, SUBMIT DRAWINGS, SHOWING DIMENSIONS & LOCATIONS OF ALL REQUIRED PENETRATIONS FOR REVIEW & APPROVAL CLEAR SPACING BETWEEN PENETRATIONS SHALL BE 24" MINIMUM UNLESS DESIGNED OTHERWISE BY ENGINEER. FOR LOCATIONS & OR SIZES OF PENETRATIONS NOT CONFORMING TO THE ABOVE CRITERIA & NOT OTHERWISE DETAILED
- ON THE STRUCTURAL DRAWINGS. CONTRACTOR SHALL COORDINATE REQUIRED ADDITIONAL REINFORCEMENT WITH THE ENGINEER ON THE SHOP DRAWINGS.


7 REINFORCING @ CONC. OPENINGS NOT TO SCALE

+

WIDTH


ROUND PENETRATION

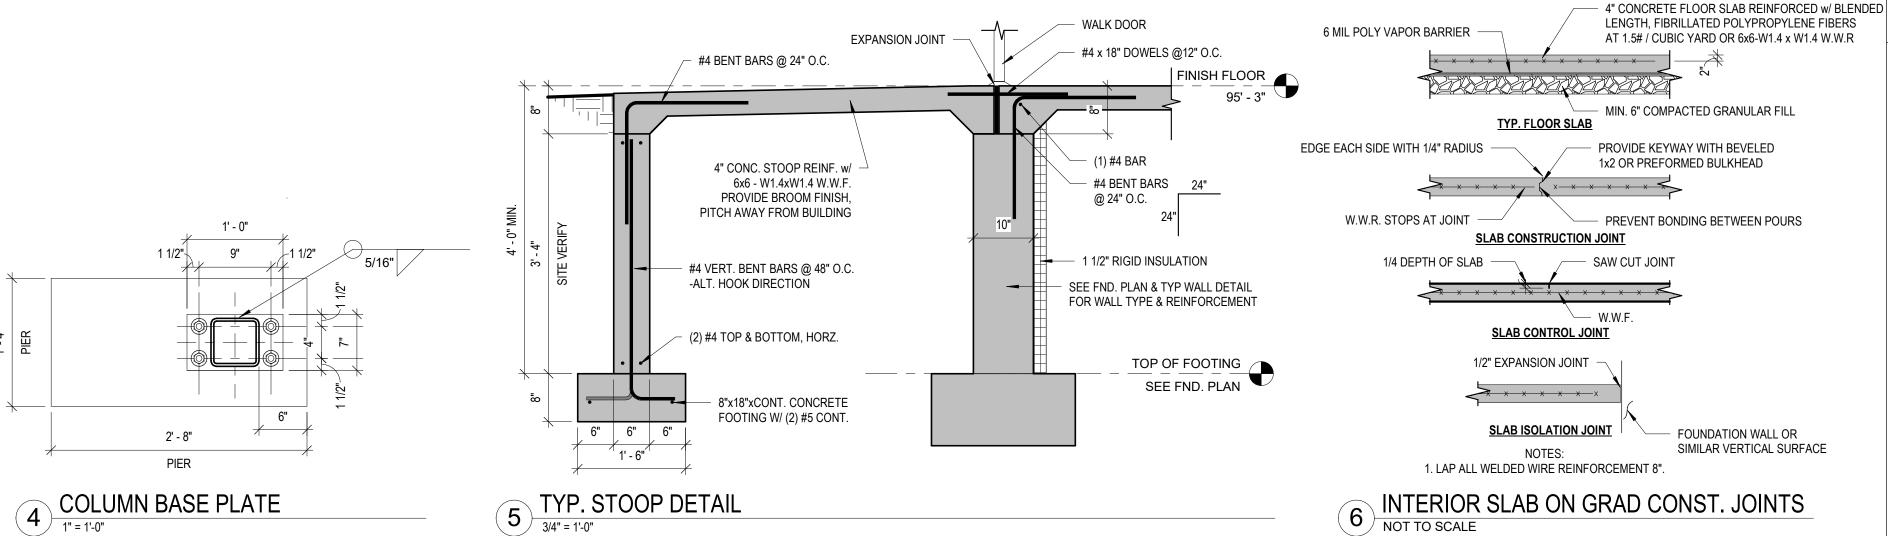

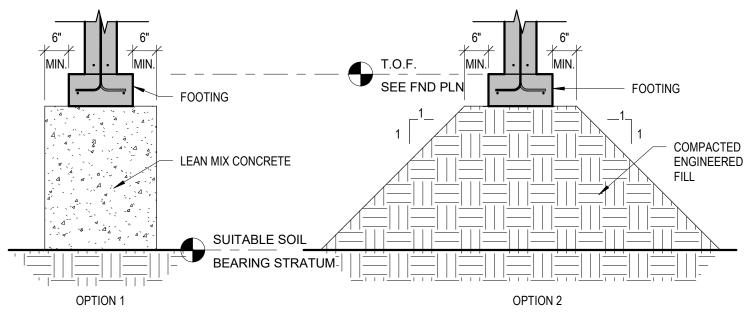

- SUITABLE SOIL BEARING STRATUM TO BE DETERMINED BY GEOTECHNICAL ENGINEER IN FIELD. - LEAN MIX CONCRETE f'c = 1000 PSI @ 28 DAYS MINIMUM. - COMPACTED ENGINEERED FILL TO BE PLACED IN 9" LIFTS MAXIMUM AND COMPACTED TO 95% MODIFIED PROCTOR. - SEE GEOTECHNICAL REPORT FOR ADDITIONAL INFORMATION - DETAILS APPLY TO CONTINUOUS STRIP FOOTINGS AND TO ISOLATED SPREAD FOOTINGS INCLUDING INTERIOR FOOTINGS.

8 TYP. FILL BELOW FOOTING NOT TO SCALE

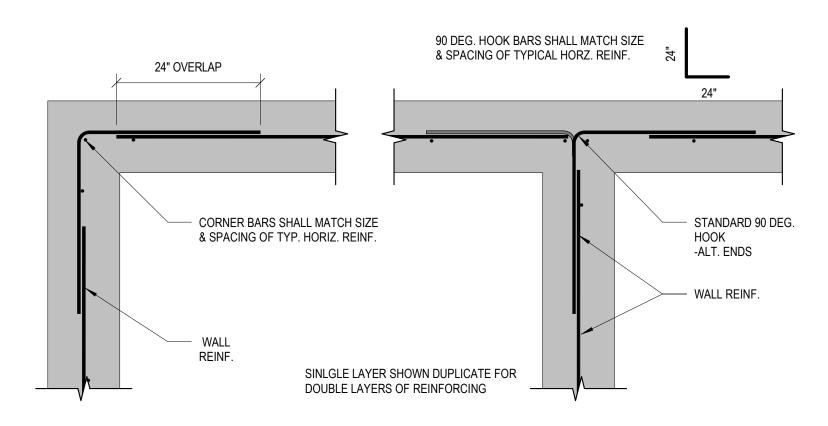

9 TYP CONC WALL CORNER REINF NOT TO SCALE

GENERAL FOUNDATION NOTES:


- FOUNDATION EXCAVATIONS SHALL BE KEPT FREE OF LOOSE MATERIAL & STANDING WATER & SHALL BE CHECKED & APPROVED BY THE GEOTECHNICAL ENGINEER BEFORE PLACEMENT OF ANY CONCRETE.
- FOUNDATION WALLS SHALL BE 10" THICK UNLESS NOTED OTHERWISE. WALL FOOTINGS ARE CONTINUOUS POURED CONCRETE WITH CONTINUOUS REINF.
- PLACED 3" CLEAR OF BOTTOM & SIDES PERIMETER INSULATION TO BE 1 1/2" RIGID INSULATION AGAINST INTERIOR FACE OF
- WALL. U.N.O. SEE FOUNDATION DETAILS. CONTRACTOR TO VERIFY ALL CONCRETE FLOOR FINISHES w/ OWNER.
- CONTRACTOR TO VERIFY ALL UNDERGROUND WORK PRIOR TO SLAB POURING.
- SEE SITE PLAN FOR ADDITIONAL CONCRETE WORK. SEE GEN. BLDG. SPEC's. FOR CONCRETE REQUIREMENTS.
- PROVIDE ISOLATION JOINTS TO ISOLATE COLUMNS & OTHER FLOOR PENETRATIONS. SEE DETAILS FOR CONTROL JOINT AT POURED CONCRETE WALLS.
- REFER TO ARCHITECTURAL DRAWINGS FOR ANY REQUIRED FLOOR DRAINS / SLAB PITCHES.

FOUNDATION WALL SCHEDULE					
MARK	MARK WIDTH REINFORCEMENT				
FW-1	FW-1 10" #4 BAR @ 16" O.C. VERT. CENTERED & #4 BAR @ 10" O.C. HORIZ.				
FW-2	V-2 6" SEE TYPICAL STOOP DETAIL				

	FOOTING SCHEDULE							
MARK	WIDTH	LENGTH	DEPTH	REINFORCEMENT				
F-1	3' - 0"	4' - 0"	1' - 0"	(3) #5 BARS LONG DIRECTION, (5) #5 BARS SHORT DIRECTION				

STRIP FOOTING SCHEDULE						
MARK	IARK WIDTH DEPTH		REINFORCEMENT			
SF-1 2' - 0" 1' - 0"		1' - 0"	(2) #5 BARS CONT.			
SF-2	1' - 6"	8"	(2) #5 BARS CONT.			

PIER SCHEDULE						
MARK	WIDTH	LENGTH	REINFORCEMENT			
P1	1' - 4"	2' - 8"	(6) #6 DOWELS & #3 TIES @ 12" O.C.			

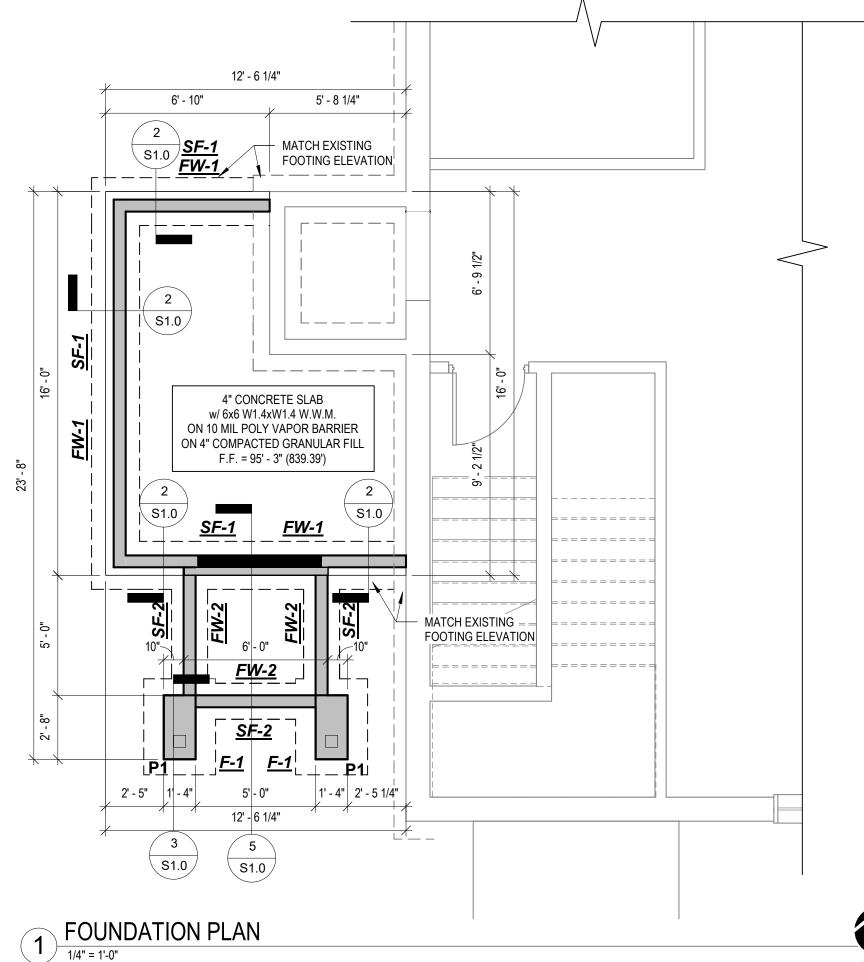

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Section 3, Item B.

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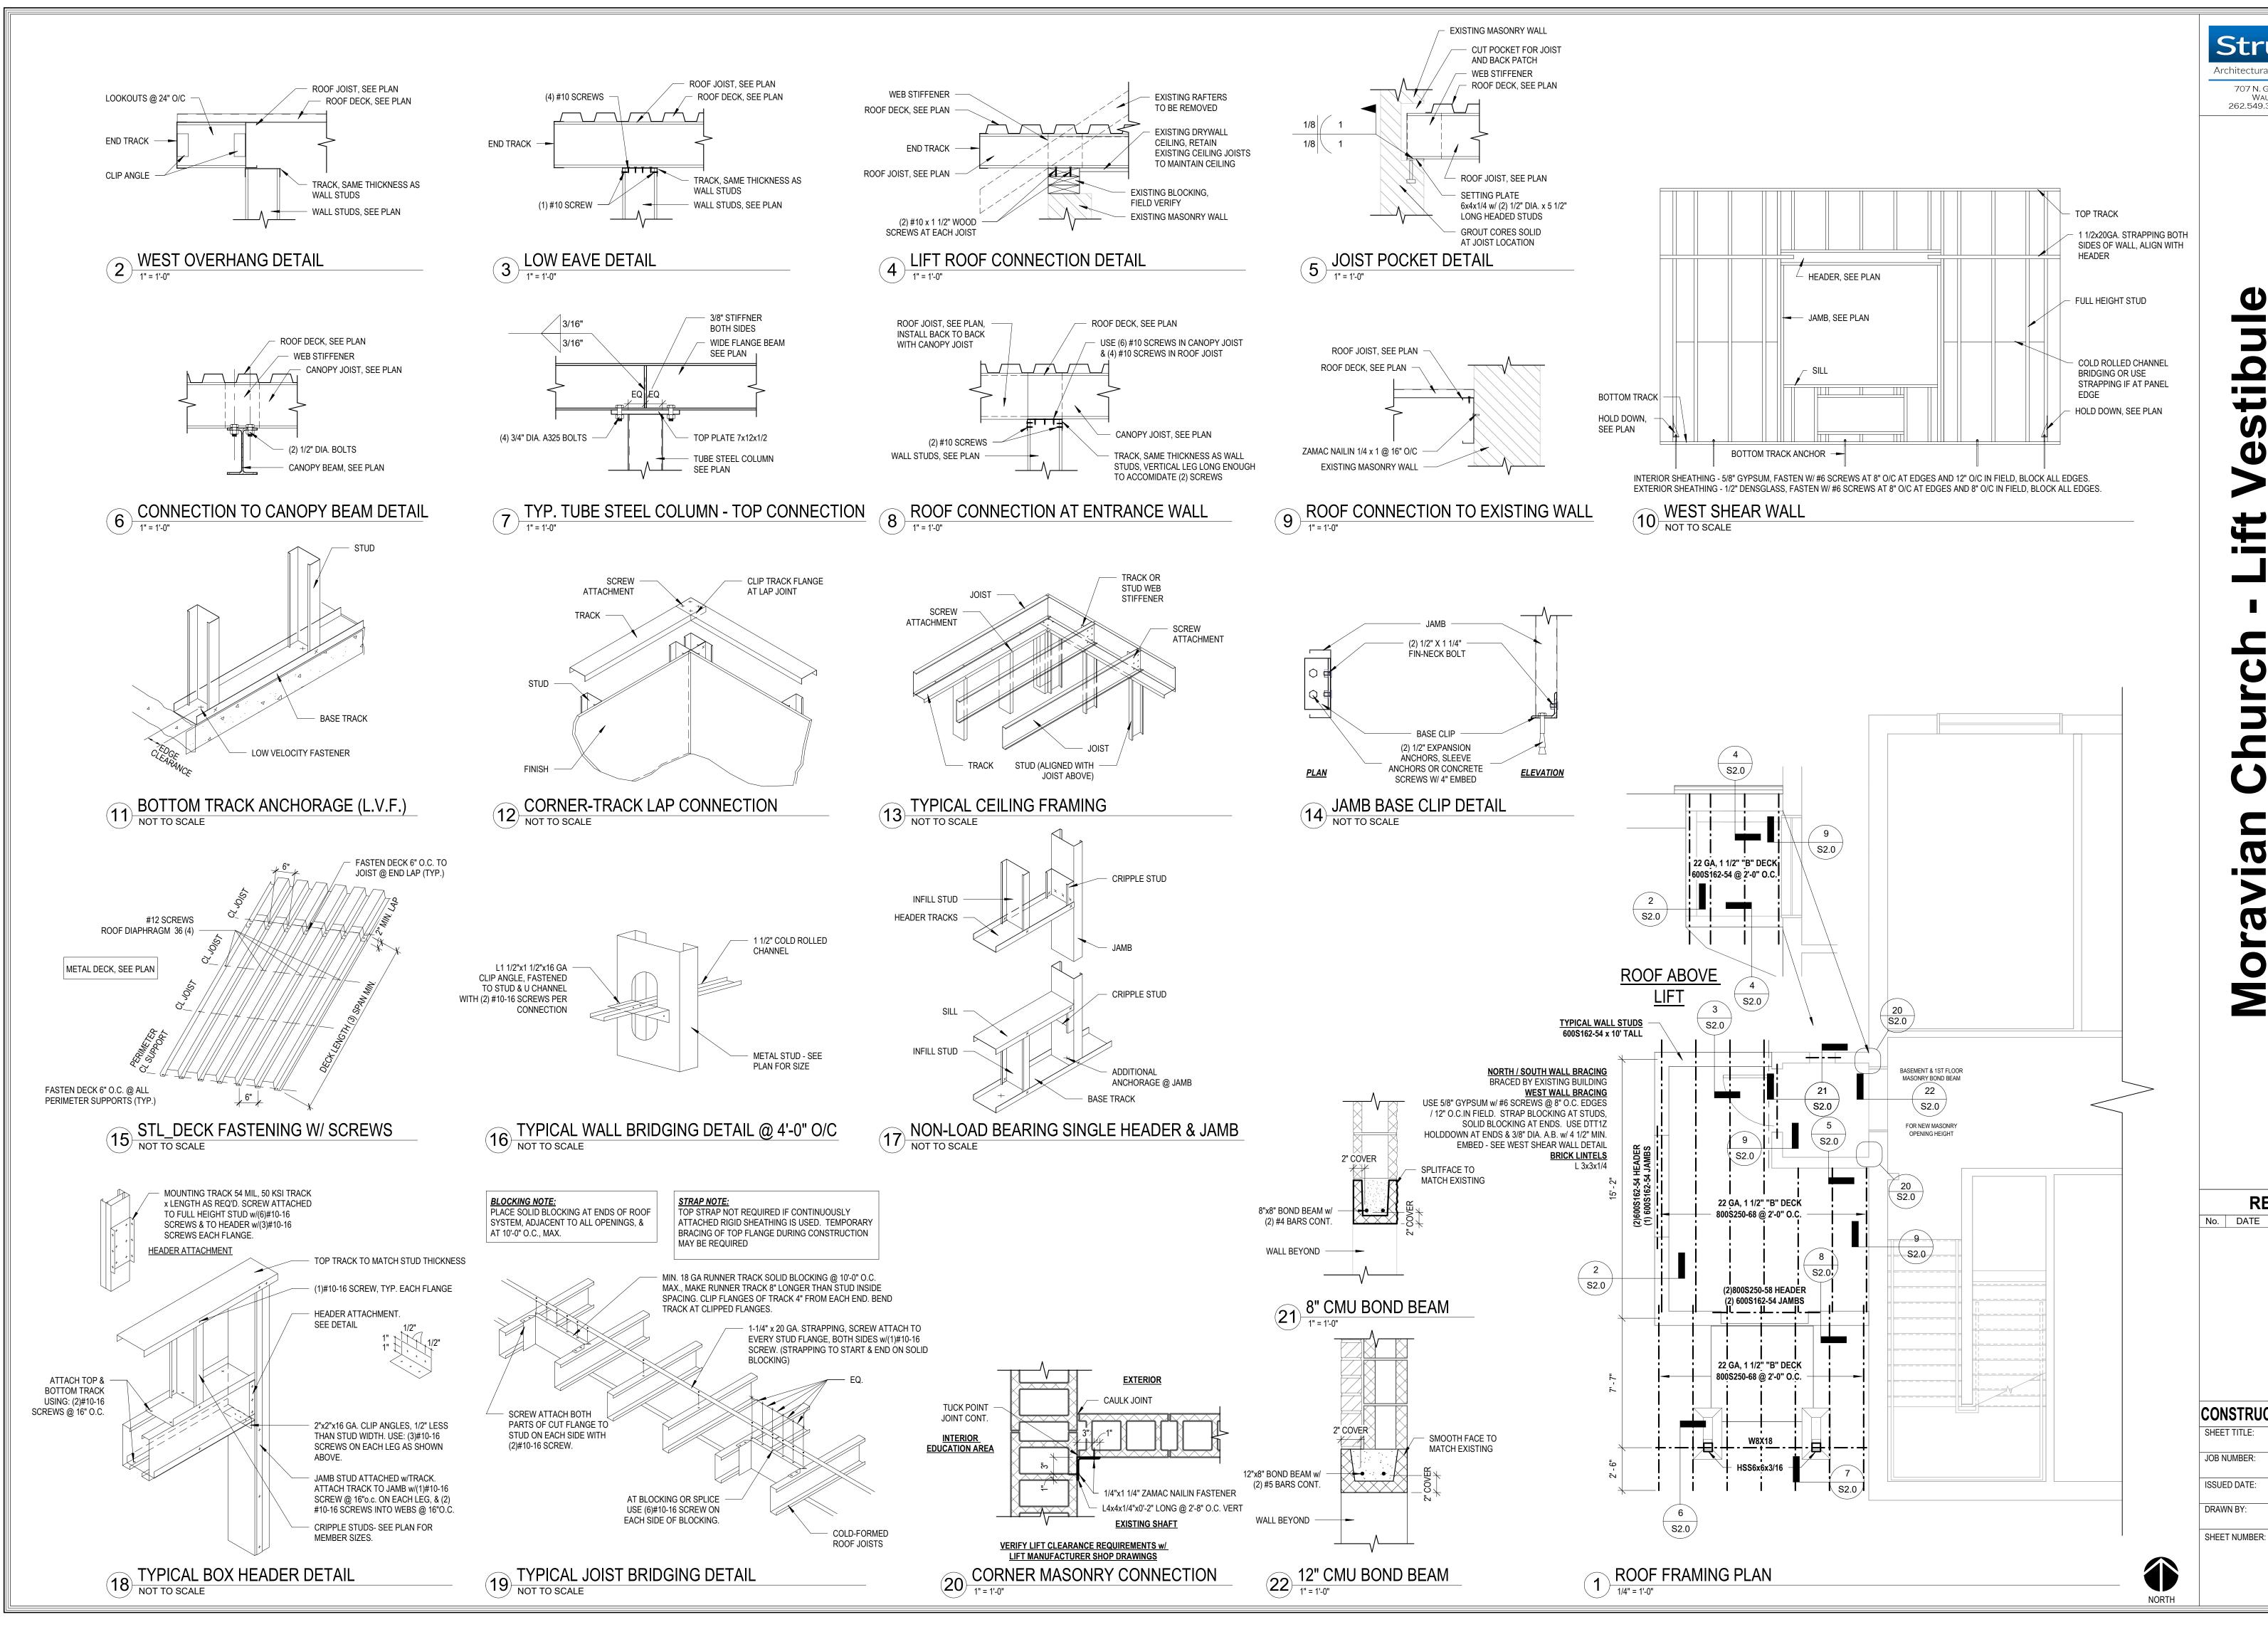
Architectural & Engineering Services

707 N. Grand Ave. - Suite 102 Waukesha, WI 53186 262.549.3222 - www.srdinc.biz

REVISIONS No. DATE DESCRIPTION

CONSTRUCTION DOCUMENTS FOUNDATION PLAN

JOB NUMBER: 24191 ISSUED DATE: 05.30.2025 DRAWN BY: SHEET NUMBER:





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REVISIONS No. DATE DESCRIPTION

CONSTRUCTION DOCUMENTS FRAMING PLANS JOB NUMBER: 24191 ISSUED DATE: 05.30.2025 DRAWN BY

NO CHANGES ARE TO BE MADE TO THESE PLANS WITHOUT THE KNOWLEDGE AND WRITTEN CONSENT OF THE ARCHITECT AND ENGINEER.

DESIGN CRITERIA

- A. IBC 2015
- B. ASCE 7-10

DESIGN METHOD

- A. NATIONAL DESIGN SPECIFICATION FOR WOOD CONSTRUCTION (NDS-2015)
- BUILDING CODE REQUIREMENTS FOR REINFORCED CONCRETE (ACI-318-2014);
- SPECIFICATION FOR THE DESIGN, FABRICATION AND ERECTION OF STRUCTURAL STEEL FOR BUILDINGS (AISC 13TH EDITION);
- SPECIFICATION FOR DESIGN OF COLD FORMED STRUCTURAL MEMBERS (AISI 2012);
- BUILDING CODE REQUIREMENTS AND SPECIFICATIONS FOR MASONRY STRUCTURES (TNS 402-13/ACI 530-13)

DESIGN LOADS

ROOF	30.0 PSF	GROUND SNOWLOAD
	21.0 PSF	ROOF SNOWw\Ct=1.0
	23.1 PSF	ROOF SNOWw\Ct=1.1
	25.2 PSF	ROOF SNOWw\Ct=1.2
		SEE DRAWINGS FOR SNOW DRIFTS AND UNBALANCED LOADING
	5 PSF	COLLATERAL LOAD
WIND	115 MPH	EXP B PER ASCE 7-10
		ENCLOSED BUILDINGS
SEISMIC	D	SITE CLASS
	II	SEISMIC GROUP
	SDS	7.8 %
	SD1_	7.50%
	В	SEISMIC USE GROUP
		· · · · · · · · · · · · · · · · · · ·

EROSION CONTROL NOTES

- GRADING AND DEVELOPMENT SITE DISTURBANCE SHALL CONFORM TO PLANS AND SPECIFICATIONS. TEMPORARY EROSION CONTROL METHODS AND SCHEDULE FOR IMPLEMENTATION SHALL BE REVIEWED BY THE ENGINEER PRIOR TO COMMENCING WORK.
- TEMPORARY EROSION CONTROL MEASURES SHALL CONFORM TO PRACTICES AND RECOMMENDATIONS OF THE WISCONSIN DEPARTMENT OF NATURAL RESOURCES AND BEST MANAGEMENT PRACTICES.
- EXPOSED SOIL FROM GRADING OPERATIONS SHALL BE RESEEDED WITHIN 7 DAYS. USE COMMON 65% KENTUCKY BLUEGRASS 20% FINE FESCUES 15% RYEGRASS SEED MIXTURE AT THE RATE 7 POUNDS PER 1000 SQUARE FEET AREA WITH STRAW OR BURLAP COVERING TO RETAIN SURFACE MOISTURE UNTIL NEW GRASS IS ESTABLISHED.
- PROPOSED ALTERNATE EROSION CONTROL MEASURES FROM THOSE DESCRIBED IN THE PLANS SHALL BE REVIEWED AND APPROVED BY THE ENGINEER.
- SOIL OR MUD TRACKED ONTO PUBLIC STREETS SHALL BE CLEANED AT THE END OF EACH WORK
- CONTRACTOR SHALL CONTACT DIGGERS HOTLINE AT LEAST 7 DAYS PRIOR TO ANY GRADING OR EXCAVATION TO LOCATE AND FLAG ALL EXISTING UNDERGROUND UTILITIES.
- UTILITIES IMPACTING THE CONSTRUCTION PLANS SHALL REQUIRE ADDITIONAL DESIGN WORK. REVIEW IMPACTS WITH THE ENGINEER.
- LOCATION OF ALL KNOWN UTILITIES SHALL BE RECORDED IN AS-BUILT PLANS AT COMPLETION OF
- GEOTEXTILE FABRIC USE MIRAFI FILTERWEAVE OR EQUIVALENT TO LINE TRENCHES. FABRIC SHALL BE CONTINUOUS. OVERLAP 12" MINIMUM FOR CONTINUITY. ADD A SEPARATE GEOTECH FABRIC COVER OVER THE TRENCH OVERLAPPING THE SIDE OF THE TRENCH 12". COVER FABRIC WITH 1-1/2" GRAVEL 3" – 6" DEEP.
- CHECKDAMS WHERE SHOWN IN PLAN SHALL BE CONSTRUCTED OF 2 LAYERS 90 MIL PLASTIC SHEET. WRAP THE SIDES AND BOTTOM OF THE TRENCH 12". SEE DETAIL.

SITE WORK:

- THE SOIL BEARING CAPACITY IS PRESUMED TO BE 2000 PSF. SOIL ENGINEERS TO VERIFY BEARING CAPACITY AND EXPLORE SUBGRADE TO A DEPTH OF 45' FOR UNSTABLE SOIL
- COMPLETE NORMAL CLEARING AND GRUBBING OPERATIONS OVER THE ENTIRE BUILDING PAD
- REMOVE UNSUITABLE MATERIAL BELOW FOUNDATION. THE DEPTH OF REMOVAL IS DICTATED BY THE UNSUITABLE SOILS ENCOUNTERED SUCH AS SILT, ORGANIC MATTER, ROOTS, VEGETATION AND RANDOM FILL MATERIALS, i.e. WOOD, SCRAP METAL, AND MUCK.
- FILL MATERIALS REQUIRED SHALL BE PLACED IN LIFTS NOT TO EXCEED 9" AND COMPACTED TO 95% RELATIVE COMPACTION AT OPTIMUM MOISTURE CONTENT WITHIN A DISTANCE OF 5 FEET BEYOND THE BUILDING EDGES.
- PLACE GRANULAR MATERIAL UNDER FOOTINGS & FLOOR SLABS: MINIMUMS 6"
- BASEMENT WALLS AND RETAINING WALL DESIGNS ARE PREDICATED ON ALL FINAL RESTRAINTS AS SHOWN IN PLANS COMPLETED <u>BEFORE</u> BACKFILLING OPERATIONS ARE FINALIZED.
- DIFFERENTIAL BACKFILLING BETWEEN INTERIOR AND EXTERIOR OF WALL WHERE OCCURS, SHALL NOT EXCEED 2 FEET.
- MECHANICAL CONTRACTORS ARE RESPONSIBLE TO COORDINATE PLUMBING AND ELECTRICAL SLAB OPENINGS, CONDUIT AND PIPE RUNS, BLOCKOUTS, AND ALL OTHER SLAB ADJUSTMENTS WITH THE CONCRETE CONTRACTOR.
- GENERAL CONTRACTOR SHALL REVIEW ALL CHANGES TO FOUNDATION PLANS AND DETAILS WITH THE STRUCTURAL ENGINEER.

FOUNDATION:

- THE SOIL BEARING CAPACITY IS PRESUMED TO BE 2000 PSF. SOIL ENGINEERS TO VERIFY BEARING CAPACITY AND EXPLORE SUBGRADE TO A DEPTH OF 45' FOR UNSTABLE SOIL CONDITIONS.
- COMPLETE NORMAL CLEARING AND GRUBBING OPERATIONS OVER THE ENTIRE BUILDING PAD
- REMOVE UNSUITABLE MATERIAL BELOW FOUNDATION. THE DEPTH OF REMOVAL IS DICTATED BY THE UNSUITABLE SOILS ENCOUNTERED SUCH AS SILT, ORGANIC MATTER, ROOTS, VEGETATION AND RANDOM FILL MATERIALS, i.e. WOOD, SCRAP METAL, AND MUCK.
- FOUNDATIONS SHALL BEAR ON UNDISTURBED SOIL WITH A CAPACITY OF 2000 PSF, OR ON COMPACTED FILL WITH A BEARING CAPACITY OF NOT LESS THAN 2000 PSF.
- FILL MATERIALS REQUIRED SHALL BE PLACED IN LIFTS NOT TO EXCEED 9" AND COMPACTED TO 95% RELATIVE COMPACTION AT OPTIMUM MOISTURE CONTENT WITHIN A DISTANCE OF 5 FEET BEYOND THE BUILDING EDGES
- WHEN USING COMPACTED FILL TO ACHIEVE THE PROPER GRADE FOR FOUNDATIONS, THE COMPACTED FILL SHALL HAVE A SLOPE OF NOT GREATER THAN 2' HORIZONTAL FOR EVERY 1'
- PLACE GRANULAR MATERIAL UNDER FOOTINGS & FLOOR SLABS: MINIMUM 6"
- BASEMENT WALLS AND RETAINING WALL DESIGNS ARE PREDICATED ON ALL FINAL RESTRAINTS AS SHOWN IN PLANS COMPLETED <u>BEFORE</u> BACKFILLING OPERATIONS ARE FINALIZED.
- DIFFERENTIAL BACKFILLING BETWEEN INTERIOR AND EXTERIOR OF WALL WHERE OCCURS, SHALL NOT EXCEED 2 FEET.
- MECHANICAL CONTRACTORS ARE RESPONSIBLE TO COORDINATE PLUMBING AND ELECTRICAL SLAB OPENINGS, CONDUIT AND PIPE RUNS, BLOCKOUTS, AND ALL OTHER SLAB ADJUSTMENTS WITH THE CONCRETE CONTRACTOR.
- GENERAL CONTRACTOR SHALL REVIEW ALL CHANGES TO FOUNDATION PLANS AND DETAILS WITH THE STRUCTURAL ENGINEER.

CONCRETE:

- TRANSIT MIXED CONCRETE SHALL CONFORM TO ASTM C94 SPECIFICATION FOR READY-MIXED CONCRETE.
- THE WATER CEMENT RATIO SHALL BE KEPT TO A MINIMUM, AND CONCRETE SLUMP SHALL NOT EXCEED 4 INCHES WHEN TESTED IN ACCORDANCE WITH ASTM C143.
- CONCRETE SHALL HAVE THE REQUIRED COMPRESSIVE STRENGTH AT 28 DAYS WHEN TESTED ACCORDING TO ASTMC39 AS FOLLOWS:

SLAB	4000 PSI
FOUNDATION	3000 PSI
TILT UP WALLS	SEE SHOP DRAWINGS
RETAINING WALLS	3000 PSI
GROUT FOR BASE PLATES	4000 PSI
DOCK WALLS	3000 PSI

- PORTLAND CEMENT SHALL CONFORM TO ASTM C150 SPECIFICATION FOR PORTLAND CEMENT.
- FINE AND COURSE AGGREGATES SHALL CONSIST OF CLEAN, HARD, STRONG AND DURABLE INERT MATERIAL, FREE OF INJURIOUS AMOUNTS OF DELETERIOUS SUBSTANCES AND CONFORM TO ASTM C33 SPECIFICATION FOR CONCRETE AGGREGATES.\
- MIXING WATER SHALL BE FREE OF ANY ACID, ALKALI, OIL OR ORGANIC MATERIAL THAT MAY INTERFERE WITH THE SETTING OF THE CEMENT.
- ALL EXTERIOR CONCRETE SHALL BE AIR-ENTRAINED. THE ENGINEER SHALL APPROVE ALL ADMIXTURES
- REINFORCING STEEL SHALL BE ASTM A615, GRADE 60, BARS TO BE WELDED SHALL BE IDENTIFIED AS GRADE 60W
- WELDED WIRE FABRIC OR GAGE AND SPACING SPECIFIED SHALL CONFORM TO THE
- REQUIREMENTS OF ASTM A82 MANUFACTURING AND WAREHOUSE AREA SLABS: 6x6-W2.9xW2.9 OFFICE AREA SLABS: 6x6-W1.4xW1.4
- REINFORCING SHALL HAVE THE MINIMUM COVER REQUIREMENTS AS INDICATED IN ACI-318, LATEST EDITION WITH THE FOLLOWING MINIMUM VALUES: CAST AGAINST AND PERMANENTLY EXPOSED TO EARTH: 3"
- FORM CAST AND PERMANENTLY EXPOSED TO EARTH OR WEATHER: 1-1/2" FOR #5 BAR AND SMALLER, AND 2" FOR #6 BAR AND LARGER.
- DIMENSIONS OF THE FINISHED PRODUCT SHALL BE WITHIN THE TOLERANCES OF ACI 117, LATEST
- ALL CONCRETE SHALL CURE A MINIMUM OF 7 DAYS. IF FORMS ARE REMOVED BEFORE THE END OF THE CURING PERIOD, COAT NEWLY EXPOSED SURFACES WITH LIQUID CURING COMPOUND.
- USE CURE-SEAL-HARDENER: ASHFORD FORMULA, ON THE FLOORS, A WATER-BASED CHEMICALLY REACTIVE PENETRATING SEALER AND HARDENER THAT SEALS BY DENSIFYING CONCRETE SO THAT WATER MOLECULES CANNOT PASS THROUGH BUT AIR AND WATER VAPOR CAN. AND ALLOWS CONCRETE TO ACHIEVE FULL COMPRESSIVE STRENGTH, MINIMIZING SURFACE CRAZING AND ELIMINATING DUSTING. INSTALL PER MANUFACTURES SPECIFICATIONS.
- (Specifier note optional spec info:) ABRASION RESISTANCE TO REVOLVING DISKS: AT LEAST A 32.5% IMPROVEMENT OVER UNTREATED SAMPLES WHEN TESTED IN ACCORDANCE WITH ASTM C779. SURFACE ADHESION: AT LEAST A 22% INCREASE IN ADHESION FOR EPOXY WHEN
- TESTED IN ACCORDANCE WITH ASTM D3359. HARDENING: AS FOLLOWS WHEN TESTED IN ACCORDANCE WITH ASTM C39: AFTER 7 DAYS: AN INCREASE OF AT LEAST 40% OVER UNTREATED SAMPLES. AFTER 28 DAYS: AN INCREASE OF AT LEAST 38% OVER UNTREATED SAMPLES
- COEFFICIENT OF FRICTION: 0.86 DRY, 0.69 WET, WHEN TESTED IN ACCORDANCE WITH ASTM C1028. REBOUND NUMBER: AN INCREASE OF AT LEAST 13.3% OVER UNTREATED SAMPLES
- WHEN TESTED IN ACCORDANCE WITH ASTM C805. LIGHT EXPOSURE DEGRADATION: NO EVIDENCE OF ADVERSE EFFECTS ON TREATED SAMPLES WHEN TESTED IN ACCORDANCE WITH ASTM G23.
- PROVIDE DOWELS IN WALL FOOTINGS WITH EQUAL SIZE AND SPACING AS VERTICAL WALL, UNLESS NOTED OTHERWISE.
- USE NON-SHRINK, NON-METALLIC GROUT UNDER BASE PLATES AS INDICATED ON THE
- THE CONCRETE CONTRACTOR SHALL COORDINATE ALL OTHER TRADES FOR SIZE AND LOCATION OF OPENINGS IN WALL AND FLOORS. ALL OPENINGS IN STRUCTURAL CONCRETE SHALL BE DETAILED OR APPROVED BY THE ENGINEER.
- PLACE STEEL REINFORCEMENT AS PER CRSI STANDARDS.

DRAWINGS.

- STEEL DESIGNATED CONTINUOUS (CONT.) #6 BARS OR SMALLER SHALL USE 33 INCH MINIMUM
- PROVIDE SAWCUT CONTROL JOINTS AS SHOWN IN FOUNDATION PLANS OR AT SPACING NOT GREATER THAN 3X THE SLAB THICKNESS. SAWCUTS SHALL BE 1/3 THE SLAB DEPTH. PLACE SAWCUTS 1-1/2 HRS TO 4 HRS AFTER FINISHING BEFORE CONCRETE BEGINS TO COOL.
- HAND TOOLED CONTROL JOINTS MAY BE SUBSTITUTED FOR SAWCUT CONTROL JOINTS.
- ALL CONSTRUCTION & CONTROL JOINTS THAT ARE REQUIRED TO BE SEALED SHALL BE DONE SO IN ACCORDANCE WITH INSTRUCTIONS OF APPROVED MATERIAL MANUFACTURER. ADJUST CONTROL & CONSTRUCTION JOINTS TO ACHIEVE INSTALLATION PER SEALANT MANUFACTURER'S
- ALL ANCHORS THAT WILL BE EPOXY EMBEDDED NEED TO BE INSTALLED PER THE MANUFACTURER'S SPECIFICATIONS AND STANDARDS. INSTALLER IS RESPONSIBLE FOR PROPER CLEAN OUT OF THE HOLE TO ENSURE THE HOLE IS DRY. INSTALLER IS TO NOTIFY ENGINEER IF VOIDS OR CRACKS ARE PRESENT IN THE DRILLED HOLE.

MASONRY/BRICK

- MASONRY CONSTRUCTION AND MATERIALS SHALL COMPLY WITH LOCAL AND STATE CODES REQUIREMENTS, SPECIFICATIONS OF NCMA, AND THE FOLLOWING:
 - UNITS SHALL BE FLUSH FACED AND/OR ARCHITECTURAL FACED AS SHOWN ON THE
 - UNITS SHALL BE EQUAL TO STANDARD OR SPECIAL SIZE CMU AS MANUFACTURED BY
 - PREMIER BLOCK CORPORATION AND HEBRON BRICK COMPANY CHIPPED, CRACKED AND BROKEN UNITS SHALL NOT BE USED.
 - UNITS SHALL MEET ASTM C90 AND SHALL BE DRY-BLOCK UNITS FOR EXTERIOR MASONRY
 - UNITS SHALL BE LAID IN RUNNING OR STACKED BOND (SEE DRAWINGS). SINGLE WYTHE OR BACKUP WYTHE WALLS SHALL HAVE STANDARD GALVANIZED "DUR-O-WAL" OR EQUAL LADDER TYPE REINFORCING AT 16" ON CENTER. LAP ALL REINFORCEMENT 6". VERTICAL AND HORIZONTAL REINFORCING BARS SHALL BE ASTM A615 GRADE 60.MORTAR SHALL BE CEMENT-LIME TYPE M OR S (fm=1800) WITH DRY-BLOCK ADDITIVE PER MANUFACTURERS RECOMMENDATIONS ON EXTERIOR MASONRY. USE TYPE M BELOW GRADE. TYPE S ABOVE GRADE.
 - UNITS SHALL HAVE CONCAVE TOOL JOINTS FOR WEATHER TIGHTNESS. JOINTS SHALL BE CLEAN, STRAIGHT, PLUMB, LEVEL AND UNIFORM.
 - ALL MASONRY WORK SHALL BE PERFORMED BY SKILLED WORKMEN IN A COMPETENT MANNER AND SHALL BE PROPERLY INSPECTED.
- POUR BOND BEAMS FULL WITH 2,000 PSI, GROUT PER ASTM C476 AND REINFORCE WITH MINIMUM 1 #4 DEFORMED REINFORCING BAR PER 4" THICKNESS OR AS DETAILED ON THE DRAWINGS. LAP LENGTHS OF HORIZONTAL BARS TO BE 48 BAR DIAMETERS. STRUCTURAL BOND BEAM LINTELS SHALL HAVE NO LAPPED SPLICES.
- WHERE PRECAST OR POURED IN PLACE REINFORCED MASONRY LINTELS ARE PROVIDED, MAINTAIN MINIMUM 8" SOLID BEARING ON EACH SIDE OF OPENING BY FILLING CORES WITH GROUT (3) COURSES BELOW BEARING OR AS INDICATED ON PLANS.
- WHERE DRAWINGS CALL FOR CORE OR CORES OF BLOCK TO BE REINFORCED VERTICALLY, TAKE CARE THAT SAID CORE(S) ARE KEPT CLEAR AND FREE OF MORTAR WHILE LAYING OF CMU. WHEN (2) BARS ARE TO BE PLACED IN ONE CORE, PROVIDE BAR POSITIONERS TO INSURE PROPER PLACEMENT OF REINFORCING. FILL CORE OR CORES OF CMU WITH 2000 PSI GROUT PER ASTM C476 WITH A SLUMP BETWEEN 8 AND 11 AND CONSOLIDATE BY PUDDLING OR VIBRATING. VIBRATING REQUIRED ON MASONRY LESS THAN 12" IN WIDTH, AND FOR LIFTS GREATER THAN 12" IN HEIGHT. VERTICAL LIFTS SHALL NOT BE MORE THAN 5'-0". VERTICAL REINFORCING BARS SHALL HAVE LAP LENGTHS OF 48 BAR DIAMETERS.
- PROVIDE 3/8" DIAMETER X 8" ANCHOR BOLTS AT 4'-0" ON CENTER FOR ALL PRESSURE TREATED ROUGH WOOD AT TOP OF MASONRY WALLS UNLESS NOTED OTHERWISE ON DRAWINGS.
- INSTALL WEEP VENTS AT TOP AND BOTTOM COURSE OF BLOCK, ABOVE LINTELS AND BOND BEAMS AT 32" ON CENTER OR AS INDICATED ON THE DRAWINGS.
- ALL EXTERIOR CONCRETE MASONRY SURFACES SHALL BE SEALED WITH (2) COATS TAMMS CHEM-STOP WATER REPELLENT SEALER UNLESS SPECIFIED ON THE DRAWINGS TO BE PAINTED. INSTALL PER MANUFACTURERS RECOMMENDATIONS.
- FLASHING SHALL BE PERM-A-BARRIER FLASHING BY W.R. GRACE WITH STAINLESS STEEL METAL DRIP EDGE OR EQUIVALENT. INSTALL FLASHING AT BOTTOM COURSE OF BLOCK, ABOVE OPENINGS AND ABOVE BOND BEAMS IN EXTERIOR WALLS. INSTALL PER MANUFACTURERS RECOMMENDATIONS.
- CONTROL JOINTS SHALL BE SPACED A MAXIMUM 30' ON CENTER AND 10' FROM CORNERS PER NCMA REQUIREMENTS, AT COLUMNS THAT ARE INSIDE THE WALL OR AS INDICATED ON PLANS. CONTROL JOINTS TO ALIGN WITH EXPOSED CONCRETE FOUNDATION WALL JOINTS IF APPLICABLE.
- PREMIUM COLOR MASONRY UNITS AS SELECTED UNLESS COLOR SCHEDULE AND AGGREGATE SHOWN WITHIN PLANS.

STRUCTURAL STEEL

- A. PRIME PAINT RED.
- ALL STRUCTURAL STEEL SHALL CONFORM TO THE APPLICABLE REQUIREMENTS OF ASTM AND SHALL BE FABRICATED AND ERECTED ACCORDING TO AISC SPECIFICATIONS.
- ALL SHOP AND FIELD BOLTED CONNECTIONS SHALL USE A325 BOLTS AND NUTS, UNLESS OTHERWISE NOTED. INSTALL BOLTS AND NUTS PER AISC.
- STEEL FABRICATOR & SUPPLIER SHALL DESIGN CONNECTION FOR THE LOADS INDICATED ON THE DRAWINGS. CONNECTIONS SHALL BE SHOP WELDED AND FIELD BOLTED.
- STEEL FABRICATOR & SUPPLIER SHALL SUBMIT DIGITAL (PDF) ERECTION/SHOP DRAWINGS FOR DESIGN CONCEPT APPROVAL.
- WELDING SHALL CONFORM TO THE LATEST EDITION OF AWS D1.1 AND ALL WELDERS ARE TO BE CERTIFIED.
- ANY FIELD MODIFICATIONS TO STEEL WILL REQUIRE APPROVAL BY THE ENGINEER OF RECORD.
- BASIC BOLTED CONNECTIONS ARE DESIGNED AS TYPE "BEARING N" UNLESS NOTED OTHERWISE.
- ALL STRUCTURAL STEEL SECTIONS AND WELDED PLATE MEMBERS ARE DESIGNED IN ACCORDANCE WITH THE AISC "SPECIFICATIONS FOR THE DESIGN, FABRICATION, AND ERECTION OF STRUCTURAL STEEL BUILDINGS" ALLOWABLE STRESS DESIGN, NINTH EDITION.
- ALL WELDING OF STRUCTURAL STEEL IS BASED ON AWS D1.1 "STRUCTURAL WELDING CODE".

K. MATERIAL SPECIFICATIONS:	
PLATE 1"-12" WIDE AND THROUGH 1.5" THICK	A572 GRADE 50, MODIFIED TO 55 KSI
OTHERS	A-36
BUILT-UP STRUCTURAL WEB MATERIAL	A-607 GRADE 55 OR A507 GRADE 50 w/MIN. YIELD OF 55 KSI
HOT-ROLLED STRUCTURAL	A992 GRADE 50
HSS STRUCTURAL TUBE	A500 GR. B (46 KSI RECT/42KSI ROUND)
STRUCTURAL PIPE	A53 GRADE B (35 KSI)
ROD BRACING	A-36
CABLE BRACING	EHS A475
WELDS	AWS/D1.1 E70XX
HIGH-STRENGTH BOLTS	A-325 OR A-490
MACHINE BOLTS	A-307 GRADE A OR SAE J429 GRADE 2

- THE GENERAL CONTRACTOR AND/OR ERECTOR IS RESPONSIBLE TO SAFELY AND PROPERLY ERECT [THE METAL BUILDING SYSTEM] IN CONFORMANCE WITH THESE DRAWINGS, OSHA REQUIREMENTS, AND [MBMA STANDARDS] PERTAINING TO PROPER ERECTION. THIS INCLUDES, BUT IS NOT LIMITED TO, THE CORRECT USE OF TEMPORARY GUYS AND BRACING WHERE NEEDED FOR SQUARING, PLUMBING, AND SECURING THE STRUCTURAL AND SECONDARY FRAMING. SECONDARY WALL FRAMING MEMBERS (GIRTS) ARE NOT DESIGNED TO FUNCTION AS A WORK PLATFORM OR PROVIDE SAFETY TIE OFF ATTACHMENT IN ACCORDANCE WITH OSHA REQUIREMENTS. SECONDARY ROOF FRAMING MEMBERS (PURLINS OR BAR JOISTS) ARE NOT DESIGNED TO PROVIDE SAFETY TIE OFF ATTACHMENT IN ACCORDANCE WITH OSHA REQUIREMENTS.
- ALL HIGH STRENGTH BOLTS ARE TYPE A325 AND ARE TO BE FULLY TIGHTENED BY AN ACCEPTABLE METHOD, SUCH AS "TURN OF THE NUT" METHOD. UNLESS NOTED OTHERWISE, BOLTS IN STANDARD HOLES DO NOT REQUIRE THE USE OF WASHERS, PER ASTM A325, SECTION
- ALL A307 MACHINE BOLTS ARE TO BE BROUGHT TO A "SNUG TIGHT" CONDITION TO ENSURE THAT THE MATERIALS IN THE JOINT ARE BROUGHT INTO GOOD CONTACT WITH EACH OTHER.
- WASHERS ARE REQUIRED AT ALL SLOTTED CONNECTIONS. AT HOLE TO SLOT CONNECTIONS, ONE WASHER IS REQUIRED ON THE SLOTTED SIDE. AT SLOT TO SLOT CONNECTIONS, TWO WASHERS ARE REQUIRED, ONE ON EACH SIDE OF THE CONNECTION.
- STRUCRITE, INC., SHALL BE NOTIFIED PRIOR TO ANY FIELD MODIFICATIONS. MODIFICATIONS SHALL BE APPROVED BY STRUCRITE, INC., BEFORE WORK IS UNDERTAKEN.
- Q. ALL WELDING MUST BE PERFORMED BY AWS CERTIFIED WELDERS WHO ARE QUALIFIED FOR THE WELDING PROCESSES AND POSITIONS INDICATED. ALL WORK MUST BE COMPLETED AND INSPECTED IN ACCORDANCE WITH THE APPLICABLE AWS SPECIFICATIONS. WELD ELECTRODES USED FOR THE SMAW (OR STICK) WELD PROCESS MUST BE 70 KSI STEEL AND LOW HYDROGEN CONTENT.

- ALL BRICK MATERIALS AND INSTALLATION SHALL COMPLY WITH LOCAL AND STATE CODES, AND SPECIFICATIONS OF THE BRICK INSTITUTE OF AMERICA (BIA). ALL BRICK WORK SHALL BE LAID IN CEMENT AND LIME MORTAR, WITH ALL BRICK FACES FULL BEDDED IN PLACE HAVING BOTH VERTICAL AND HORIZONTAL JOINTS ON STRAIGHT LINES. BRICK VENEER SHALL BE TIED TO MASONRY BACK-UP WITH HOHMANN & BARNARD, INC. LADDER TYPE #270 ADJUSTABLE EYE-WIRE REINFORCEMENT AT 16" ON CENTER VERTICALLY. USE HOHMANN & BARNARD 2 SEAL TIE @ 16" ON CENTER VERTICALLY MAX. 16" ON CENTER TO OTHER BACKUP MATERIALS OR AS NOTED ON DRAWINGS (MAX. 1.77 S.F. SPACING).
- PROVIDE A 3/8" CONTROL JOINT AT 20'-0" O.C. UNLESS SHOWN OTHERWISE ON PLANS.
- INSTALL WEEP VENTS AT TOP AND BOTTOM COURSE OF BRICK, AND ABOVE ALL OPENINGS IN EXTERIOR WALLS AT 16" ON CENTER OR AS INDICATED. FLASHING SHALL BE PERM-A-BARRIER FLASHING BY W.R. GRACE OR EQUAL WITH STAINLESS STEEL METAL DRIP EDGE. INSTALL FLASHINGS AT BOTTOM COURSE OF BRICK AND ABOVE ALL OPENINGS IN EXTERIOR WALLS.

HEATING AND VENTILATION WORK

REQUIREMENTS

- ALL WORK SHALL BE DONE IN STRICT ACCORDANCE WITH STATE AND LOCAL CODES.
- SEPARATE PLANS AND CALCULATIONS SHALL BE SUBMITTED BY CONTRACTOR FOR APPROVAL AS THE HEATING AND VENTILATING WORK IS NOT A PART OF THIS PLAN. ALL PENETRATIONS THROUGH RATED CONSTRUCTION SYSTEMS SHALL BE OF U.L.

APPROVED METHODS.

ELECTRICAL WORK

- ALL WORK SHALL BE DONE IN STRICT ACCORDANCE WITH STATE AND LOCAL CODES. SEPARATE PLANS AND CALCULATIONS SHALL BE SUBMITTED TO STATE AND LOCAL AGENCIES BY CONTRACTOR FOR APPROVAL AS THE ELECTRICAL WORK IS NOT A PART
- OF THIS PLAN ALL PENETRATIONS THROUGH RATED CONSTRUCTION SYSTEMS SHALL BE OF U.L. APPROVED METHODS
- AUTOMATIC SMOKE DETECTION SYSTEM (NOTE: DO NOT INCLUDE UNLESS REQUIRED) SMOKE DETECTION SYSTEM SHALL COMPLY WITH LOCAL, STATE, AND FEDERAL CODES, AND N.F.P.A. STANDARDS 71, 72B, 72C, 72D, 72E,
- AUTOMATIC DETECTION PRODUCTS SHALL BE AN APPROVED SYSTEM, MEETING FEDERAL, STATE AND LOCAL CODES.

ALL SMOKE DETECTORS SHALL BE BOTH AUDIBLE AND VISUAL AS REQUIRED BY THE

CAULK AROUND ALL WINDOWS, DOORS, VENT OPENINGS, WHERE DIFFERENT MATERIALS MEET, ROOF OPENINGS, EAVES, SOFFITS, JOINTS, COUNTERTOPS, DOOR FRAMES, ETC. AND AS REQUIRED FOR A WATERTIGHT CONNECTION. PROVIDE CAULK PER MANUFACTURERS RECOMMENDATIONS. CAULK TO BE TREMCO DYMERIC FOR FOOD PROCESSING FACILITIES OR FOOD PREP/FOOD STORAGE AREAS. CAULK TO BE INSTALLED AFTER FINISH IS APPLIED TO

FIRE EXTINGUISHERS

SURFACES PER MANUFACTURER.

SEALANTS

- REQUIREMENTS
 - CONTRACTOR TO FURNISH AND INSTALL EXTINGUISHERS PER LOCAL, STATE, AND FEDERAL CODES, AND N.F.P.A. NO.10-1978.
 - MOUNT FIRE EXTINGUISHER NOT HIGHER THAN 48" ABOVE FINISH FLOOR UNLESS LOCAL REGULATIONS REQUIRE DIFFERENT HEIGHT.
 - ALL FIRE EXTINGUISHERS AND CABINETS TO MEET THE REQUIREMENTS OF THE A.D.A.

STEEL ROOF DECK

- USE A MINIMUM 22GA PTD. 1-1/2 INCH WIDE RIB, UNLESS NOTED DIFFERENTLY ON THE DRAWINGS. PANEL TO SPAN A MINIMUM OF THREE SPANS AND ALLOW FOR A MINIMUM OF 3" OVERLAP AT
- DO NOT HANG OR ATTACH EQUIPMENT, MATERIALS, OR ANY LOADS TO THE METAL ROOF DECK. SEE DRAWINGS FOR FASTENER TYPE AND PATTERN.

CENTERLINE OF JOISTS.

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