



TOWN COUNCIL MEETING October 19, 2023 at 7:00 PM

950 Senoia Road, Tyrone, GA 30290

Eric Dial, Mayor

Gloria Furr, Mayor Pro Tem, Post 4

Linda Howard, Post 1

Melissa Hill, Post 2

Billy Campbell, Post 3

Brandon Perkins, Town Manager

Dee Baker, Town Clerk

Dennis Davenport, Town Attorney

I. CALL TO ORDER

II. INVOCATION

III. PLEDGE OF ALLEGIANCE

IV. PUBLIC COMMENTS: *Comments are limited to three (3) minutes. Please state your name & address. Comments that require a response may not be answered during this time. The Council or staff may respond at a later date.*

V. APPROVAL OF AGENDA

VI. CONSENT AGENDA: *All matters listed under this item are considered to be routine by the Town Council and will be enacted by one motion. There will not be separate discussion of these items. If discussion is desired, that item will be removed from the consent agenda and will be considered separately.*

1. Approval of the October 5,2023 meeting minutes.

VII. PRESENTATIONS

2. Employee Service Recognitions: David Moretz (10 years) and Lt. Philip Nelson (15 years). - **Brandon Perkins, Town Manager**

VIII. PUBLIC HEARINGS

IX. OLD BUSINESS

X. NEW BUSINESS

3. Consideration to approve the plans and start land acquisition for the 2023 Miscellaneous Cross Drain Replacements Project No: PW-2023-06. - **Scott Langford, Town Engineer / Public Works Director**

4. Consideration to approve the purchase of a new server for Police/Court Departments which includes the associated installation and migration of current data, **April Spradlin, Clerk of Court and Randy Mundy, Police Chief**
5. Consideration of an application for a Certificate of Appropriateness from applicant Steve Gulas for an extended stay hotel at parcel 0726-051 off Carriage Oaks Drive. **Phillip Trocquet, Community Development**

XI. PUBLIC COMMENTS: *The second public comment period is for any issue. Comments are limited to three (3) minutes. Please state your name & address. Comments that require a response may not be answered during this time. The Council or staff may respond at a later date.*

XII. STAFF COMMENTS

XIII. COUNCIL COMMENTS

XIV. EXECUTIVE SESSION

XV. ADJOURNMENT

TYRONE TOWN COUNCIL MEETING

MINUTES

October 05, 2023 at 7:00 PM

Eric Dial, Mayor

Gloria Furr, Mayor Pro Tem, Post 4

Brandon Perkins, Town Manager

Dee Baker, Town Clerk

Dennis Davenport, Town Attorney

Linda Howard, Post 1

Melissa Hill, Post 2

Billy Campbell, Post 3

Also present:

Lt. Eric DeLoose

I. CALL TO ORDER

II. INVOCATION

III. PLEDGE OF ALLEGIANCE

IV. PUBLIC COMMENTS: *Comments are limited to three (3) minutes. Please state your name & address. Comments that require a response may not be answered during this time. The Council or staff may respond at a later date.*

Mr. Dia Hunter who lives on O'Connell Street spoke about items 11 and 12 regarding the AMWaste contract and rate increase. He wondered why they were in that particular order. He hoped that there would be discussions on those items. He added that we have seen several increases and several contracts over the years. He hoped that there would be an opportunity to choose the right contractor in order to keep the fees down.

V. APPROVAL OF AGENDA

A motion was made to approve the agenda.

Motion made by Council Member Campbell, Seconded by Council Member Furr.
Voting Yea: Council Member Howard, Council Member Hill.

VI. CONSENT AGENDA: *All matters listed under this item are considered to be routine by the Town Council and will be enacted by one motion. There will not be separate discussion of these items. If discussion is desired, that item will be removed from the consent agenda and will be considered separately.*

1. Approval of the September 21, 2023 meeting minutes.
2. Consideration to approve Boing US Holdco, Inc.'s Stormwater Management Operations and Maintenance Agreement (for Take 5 Express Car Wash).
3. Consideration to approve Kenneth R. Spivey, Jr and Sylvia Spivey's Stormwater Management Operations and Maintenance Agreement (for Commercial Build Atlanta).

A motion was made to approve the consent agenda.

Motion made by Council Member Howard, Seconded by Council Member Campbell.
Voting Yea: Council Member Hill, Council Member Furr.

VII. PRESENTATIONS

VIII. PUBLIC HEARINGS

4. Consideration to hear a rezoning petition from applicant Michael Swift of a 4.43 Acre Tract with parcel number 0727-001 at property address 912 Tyrone Road from AR (Agricultural Residential) to R-18 (Residential 1800 s.f. min. home size).

Phillip Trocquet, Community Development

Mr. Trocquet stated that applicant and owner Michael Swift had petitioned to rezone 912 Senoia Road from AR (Agricultural Residential) to R-18 (1,800 s.f. min. home size). He stated that staff recommended that the rezoning be to R-12 (1,200 s.f. min. home size and added that the applicant agreed to the change. The difference between the two was 600 s.f. home size.

He added that the rezoning matched adjacent R-18 and R-12 properties. The parcel lies within the estate residential character area which allows low-density 1 acre lot development. The owner's intent was to parcel the existing house and split the lots not going below 1-acre each. Mr. Trocquet stated that if rezoned to R-12, the petition was consistent with the Town's Comprehensive Plan and Future Development Strategy. He stated that R-12 zoning was suitable adjoining other R-12 properties and did not significantly affect surrounding commercial properties.

He added that staff also determined that suitability with surrounding properties would be the same under R-12 zoning. He shared that it was staff's opinion that the current zoning did not provide similar economic use to other surrounding properties which could develop at 1-acre lot density.

Mr. Trocquet stated that it was staff's determination that R-12 zoning would not be excessively burdensome on existing infrastructure. He added that staff requested that any future lot divisions include shared driveways where feasible in order to reduce the number of curb cuts on Tyrone Road. He added that the Planning Commission recommended that the property be rezoned to R-12.

The applicant, Mr. Michael Swift shared that when he bought the property, the home was blighted and he renovated it. He saw a better use for the remaining land. He shared that he wished to place two homes on the land similar to the ones found in the Stone Crest subdivision. He moved to Tyrone 2 ½ years ago, loved the Town, and stated that he believed that the new homes would enhance that area.

Council Member Campbell inquired about curb cuts. Mr. Swift stated that there would be one on Tyrone Road and one on Farr Road. He added that he was considering a third lot

to the left, however, he was going to leave the 2.5 acres undisturbed. Mayor Dial asked Mr. Swift if had had any interest in developing properties that were 1,600 s.f.

Mr. Swift shared that he did not, he wished to develop a 3,500 s.f. home, anything smaller would be cost-prohibitive.

Mayor Dial opened the public hearing for anyone who wished to speak in support of the rezoning. No one spoke.

Mayor Dial opened the public hearing for anyone who wished to speak in opposition to the item. No one spoke.

A motion was made to approve the R-12 petition from applicant Michael Swift of the 4.43-acre tract with parcel number 0727-001 at 912 Tyrone Road.

Motion made by Council Member Campbell, Seconded by Council Member Howard.
Voting Yea: Council Member Hill, Council Member Furr.

5. Consideration of a text amendment to Sec. 113-191 of the zoning ordinance, Quality Growth Development District, to modify architectural and dimensional requirements. **Phillip Trocquet, Community Development**

Mr. Trocquet shared that the item was recurring and that one of the major text amendments called for in the Comprehensive Plan was to bolster the SR-74 Quality Growth District Overlay. The overlay called for higher architectural and landscaping standards but was found to be missing elements called for by citizens and Council. He added that although higher architectural and landscaping requirements were part of the current overlay, it had been noted that a revision to structures under 100,000 s.f. should have 70% of Class A materials, and structures over 100,000 s.f. should have at least 30% Class A materials. He stated that the Planning Commission and staff recommended approval.

Mayor Dial opened the public hearing for anyone who wished to speak in support of the text amendment. No one spoke.

Mayor Dial opened the public hearing for anyone who wished to speak in opposition to the text amendment. No one spoke.

A motion was made to approve the text amendment to Section 113-191 of the Zoning Ordinance, Quality Growth Development District, to modify architectural and dimensional requirements as stated.

Motion made by Council Member Campbell, Seconded by Council Member Hill.
Voting Yea: Council Member Howard, Council Member Furr.

IX. OLD BUSINESS

X. NEW BUSINESS

6. Consideration to Award professional engineering services for the 2022 Public Works Storage Building, Project Number PW-2022-14, to Keck and Wood, Inc. -
Scott Langford, Town Engineer / Public Works Director

Mr. Langford informed Council that the project was to replace the pole barn at 945 Senoia Road. The new Public Works maintenance storage building would be located next to the existing Public Works building at Handley Park. Keck and Wood would design the site work to include stormwater and utilities. Keck and Wood would also work with the Town and a metal building contractor who will be procured under a separate contract. He stated that the project was within the budget and the fee for the scope of work was not to exceed \$59,400.

Council Member Campbell asked for the total proposed budget for the project. He shared that it was well under \$400,000. Council Member Furr asked if the amount included everything. Mr. Langford shared that it would include design work for the site. He added that paperwork was submitted to legal counsel regarding a different form of procurement for the project. The new method was titled, indefinite delivery, indefinite quantity (IDIQ) of services. It was a statewide method that took a project from the design phase straight to a contractor which reduced time and advertising. At times, the method could save up to two months. If legal decided that was not sufficient, staff would go out for bids the traditional way. He added that the IDIQ method could also save the Town money.

Mr. Langford stated that the public works building was the exact building that Fairburn Fire used for their storage with the same process. Mr. Trocquet specified that the project before Council was only for the site work. Council Member Furr shared that it seemed like a large amount for a pole barn. Mr. Perkins clarified that it was a fully enclosed building with rollup bay doors. Mr. Langford informed Council that in the past, municipalities could hire a contractor and they would build the building. Today, there are more regulations in place regarding stormwater that the Town has to adhere to. Other factors were a security fence, gate, and geotechnical work. Mayor Dial asked if it would have plumbing. Mr. Langford stated that it would not have a restroom, however, it would have outside hydrants.

A motion was made to authorize the Mayor to execute the professional service contract with Keck and Wood for a fee not to exceed \$59,400 for the 2022 Public Works Storage Building, project number PW-2022-14.

Motion made by Council Member Furr, Seconded by Council Member Hill.
Voting Yea: Council Member Howard, Council Member Campbell.

7. Consideration to Award the 2024 Sidewalk Repair project PW-2024-03 to Aabby Group Incorporated. **Scott Langford, Town Engineer / Public Works Director**

Mr. Langford informed Council that the Town maintained sidewalks within the Town's rights-of-way. This year's project included sidewalk sections in Maple Shade, Tullamore, Ashpark, Laurel Forest, Farr Road, and two sections on Stonewyck Drive. He added that the Town designed, advertised, and bid the 2024 Sidewalk Repair Project PW2024-03. On September 20, 2023, the low bid was from Aabby Group, Inc. at \$58,562.60.

A motion was made to authorize the Mayor to execute the Agreement for 2024 Sidewalk Repair Project PW-2024-03 to Aabby Group Incorporated for \$58,562.60.

Motion made by Council Member Campbell, Seconded by Council Member Hill.
Voting Yea: Council Member Howard, Council Member Furr.

8. Consideration to approve a Resolution to amend the plumbing code for water efficiency. **Devon Boullion, Environmental Specialist**

Ms. Boullion shared that the resolution set out a series of findings to support some revisions to the plumbing code as adopted by the Town for water efficiency. The purpose of the revisions was to enact stricter standards pertaining to water efficiency as recommended by the Metropolitan North Georgia Water Planning District. She shared that the district updated its 2022 Water Resources Management Plan to require municipalities to adopt and maintain. The Metro Water District's water efficiency code required a local amendment to the Georgia state minimum standard plumbing code.

She shared that before them was a resolution that would be forwarded to the Georgia Department of Community Affairs (DCA) approving the proposed changes. After final approval for DCA, staff would present the revisions to Council to formally adopt the amendments to the state code.

Council Member Campbell asked for more clarification. Ms. Boullion explained that the state had requirements above what the Town required. Their scope included water planning for the region. The Town was in the upper Flint River basin watershed. She added that there was not enough groundwater downstream. The code update would require certain appliances and irrigation to be more efficient regarding water pressure.

Council Member Campbell asked if it would affect Mr. Swift as he built two new homes or already established homes. Ms. Boullion shared that it may affect anyone adding to their home with new appliances or a newly built home once DCA and Council approved the amendments.

Mayor Dial shared his personal concern about more regulations. Did the Town have the authority to deny the resolution if Council felt it was unreasonable? Ms. Boullion stated that ultimately if the Town did not comply with the DCA's standards, it could later affect receiving dam permits from the EPD. She added that she and Mr. Trocquet consulted

with the Town's contracted building inspector and they also reached out to other municipalities. The consensus was that the amendments were reasonable.

She added that mostly it pertained to definitions, design standards for irrigation, and kitchen faucet pressure.

Mayor Dial asked who was administering the standards, whether was it environmentalists or builders. Mr. Trocquet shared that regarding being strongarmed, oftentimes issues did have to be taken up the chain of command, however, the amendments were not overly burdensome. Most were practical such as the low-flow faucet. Usually, the Atlanta Regional Commission (ARC) would consult with many stakeholders before making amendments. Mr. Langford and Council Member Campbell began a discussion regarding Tyrone not having much water pressure to begin with. Mr. Langford stated that the amendments should not affect the main lines. Council Member Howard shared that it meant less water with the kitchen faucets and that was what was needed downstream, it made sense.

Mayor Dial shared that regarding the water wars, there was a judgment to reduce water and that was what was needed. Ms. Boullion shared that Georgia was involved with a suit but won the case with assistance from the Metro District's efforts to reduce flow rates. She added that as upgrades were made, the homeowner would be using less water reducing their cost in the future. Ms. Boullion shared that one change was the use of 2.2 gallons of water per minute instead of 2.5. Mr. Langford explained that with the correct shower head, the homeowner would still feel the pressure, but it would be a low flow.

A motion was made to authorize Mayor Dial to approve the Resolution to revise the local plumbing code for water efficiency.

Motion made by Council Member Campbell, Seconded by Council Member Howard.
Voting Yea: Council Member Hill, Council Member Furr.

9. Consideration to approve a resolution to authorize the Town Manager to apply for a Roadside Enhancement and Beautification Council (REBC) grant through the Georgia Department of Transportation. - **Brandon Perkins, Town Manager**

Mr. Perkins reminded everyone that he mentioned the item under staff comments at the last Council meeting where Council instructed him to move forward. The first step in the process would be to approve the attached resolution.

A motion was made to approve the Resolution to authorize the Town Manager to apply for a Roadside Enhancement and Beatification Council (REBC) grant through the Georgia Department of Transportation.

Motion made by Council Member Furr, Seconded by Council Member Campbell.
Voting Yea: Council Member Howard, Council Member Hill.

10. Consideration to approve Keck and Wood to complete a Roadside Enhancement and Beautification (REBC) grant application through the Georgia Department of

Transportation, to include conceptual drawings and cost estimates, on the Town's behalf. - **Brandon Perkins, Town Manager**

Mr. Perkins informed Council that the next course of action would be to obtain services from Keck & Wood for the application procedure. Services for the grant application through the Georgia Department of Transportation would include conceptual drawings and cost estimates. He added that Keck & Wood had worked on several Town projects including the Pickleball Court project and the upcoming Senoia to Spencer multiuse path expansion, they have been found to be a reliable partner. He shared that Keck & Wood's cost for the \$50,000 grant would be \$8,000, which would come from Assigned Funds. Keck & Wood would submit the application on the Town's behalf. Council Member Campbell asked how long the process would take. Mr. Perkins stated that it should only be a few weeks.

A motion was made to approve the proposal to have Keck and Wood prepare and submit a Roadside Enhancement and Beautification Council grant application to include conceptual drawings and cost estimates on the Town's behalf.

Motion made by Council Member Campbell, Seconded by Council Member Hill.
Voting Yea: Council Member Howard, Council Member Furr.

11. Consideration to approve an extension of the Town's Sanitation contract with AMWaste.
Brandon Perkins, Town Manager

Mr. Perkins addressed Mr. Hunter's concerns. Mr. Perkins explained that there was a timeframe to respond to the extension that process began in September, the letter for the increase came last week. He added that if the contract extension was not approved tonight, staff would go out for bid. Mayor Dial asked for clarification regarding an extension. Mr. Perkins explained that embedded within the previous contact AMWaste was allowed each year to request an increase. The last request was in 2021. There have been increases due to fuel cost increases but those had recently been removed.

Council Member Campbell asked what were their choices, were there other vendors. Mr. Perkins informed everyone that three years ago staff obtained four bids. The Town's former contractor bid in the high \$70's, two others were in the \$60's, and AMWaste was in the low \$50's per quarter. He added that he had also reached out unofficially to Pollard Residential Waste Services which stated that they would come to Town for \$72 a quarter, not including recycling. Newnan was using AMWaste and they were paying \$90 a quarter. Currently, AMWaste for Tyrone citizens includes bulk pickup, yard waste, and recycling.

Council Member Campbell inquired about AMWaste's track record with the Town. Mr. Perkins stated that in the beginning, it was rocky at least, as we were their first client in Georgia. They were mostly in Louisiana, Mississippi, and Alabama. He added that the first year was rough, last year they brought on a new vice president and district manager. Things are going well and we have a good relationship. Requests were being taken care of sometimes within the same day. Complaints had reduced significantly.

Mr. Perkins stated that citizens have asked from time to time if they could choose their own provider.

He shared that because the Town only had 2,300 homes, it would not be worth a contractor's time if they had to share the Town with 1-2 more vendors. Besides, the vendor would also have to pay the Town a franchise fee per customer. That would also mean more trucks on the roads every day. He gave the example, that if there was a hydraulic leak or garbage juice on the roads, it would be difficult to narrow down which contactor it was in order to clean up the spills. He added that with one provider, they also pick up the Town's facilities' trash at no additional cost. Mr. Perkins also added that while cleaning up the property adjacent to Shamrock Park, AMWaste's roll-off dumpsters were significantly lower than other vendors.

Mr. Perkins read a portion of his memo to Council for the record.

I am sure some citizens may wonder why the Town did not seek new contractors through the bidding process. Some reasons for that are as follows:

1. *Given AMWaste's current performance and extension option allowed under the current contract, we found it unnecessary to seek new bids. The current situation is working as it should.*
2. *It is understood that going out for bid would likely result in a substantial increase in costs for our citizens. For example, Pollard Sanitation advised us that they would be happy to service Tyrone as a sole provider for \$72 per quarter. It should be noted that Pollard's cost did not include recycling.*

He added that if the Town went out for bid, AMWaste could come back higher as did Republic when the current contract was bid. It would be prudent to stay with AMWaste, as the cost was lower and the service was currently efficient. Council Member Hill shared that she approved of their service. Council Member Campbell asked if there would be a guarantee of the \$63.87. Mr. Perkins stated that the cost increase would go into effect on January 1st and last for one year. AMWaste would have another opportunity for another increase request next October, based on the consumer index. Council Member Furr had a complaint regarding a bulk pick-up that was three weeks late. Mr. Perkins asked Council to please call him if there was an issue. She added that there was also a large hydraulic spill in her neighborhood. Mr. Perkins stated that he would report that to their representatives.

A motion was made to approve the extension of the Town's Sanitation contract with AMWaste.

Motion made by Council Member Campbell, Seconded by Council Member Howard.
Voting Yea: Council Member Hill, Council Member Furr.

12. Consideration of a request from AMWaste to implement a rate increase of 8.9%, based on the Consumer Price Index, from \$58.65 per quarter to \$63.87 per quarter. - **Brandon Perkins, Town Manager**

Mr. Perkins stated that AMWaste's contract provided them the ability to request rate adjustments on an annual basis when submitted by October 1st. The requests must be "reviewed against the rate of inflation as reported by the Department of Labor's Consumer Price Index for All Urban Consumers – U.S. City Average – Garbage and Trash Collection." He added that AMWaste submitted a written request for a rate increase on September 27, 2023, that indicated a CPI increase of 8.9%, which would raise the quarterly rate from \$58.65 to \$63.87.

He stated that in preparation for the item, staff conducted some limited research on local sanitation fees and found the following: -If they serviced Tyrone, Pollard Sanitation advised us that their rate would be \$72.00 per quarter with no recycling. -Newnan had a new contract with AMWaste and their residents were charged \$97.20 per quarter. -He reached out to Republic to ascertain their rates for Peachtree City customers and was quoted \$78.00 per quarter for trash and recycling, and an additional \$90.00 per quarter (optional) for bulk/yard waste service – AMWaste did not charge for this.

He stated that staff recommended approval and the increase would begin on January 1st.

Council Member Campbell shared that citizens would pay \$20.88 extra per year, but the other options would be even more. Mr. Perkins added that it also had to do with the small size of Tyrone, Fairburn paid less because they were larger.

A motion was made to implement a rate increase of 8.9% based on the Consumer Price Index from \$58.65 per quarter to \$63.87 per quarter.

Motion made by Council Member Campbell, Seconded by Council Member Howard.
Voting Yea: Council Member Hill, Council Member Furr.

13. Approval of \$4,300 Bruce Environmental Quote and Work Authorization Contract for asbestos remediation at 969 Senoia Road. **Phillip Trocquet, Community Development**

Mr. Trocquet informed everyone that after acquiring 969 Senoia Road, asbestos testing was performed on the house to determine if remediation was necessary. He shared that the test came back positive for sections of the home that require remediation. He added that after three quotes, Bruce Environmental came back lower than the rest. He stated that the quote was \$4,300 and their agreement had been approved by legal counsel. Mr. Perkins shared that Bruce Environmental had also removed the asbestos from the Tyrone Post Office. Council Member Campbell clarified that the quote included removal and disposal.

Mayor Dial asked how much the public works staff was saving the Town by demolishing the home and clearing the property. Mr. Trocquet stated that it was tens of thousands. A quote from Crawford Grading was \$50,000-\$60,000. Mayor Dial announced that if anyone saw any of the public works' staff give them a hug and tell them thank you.

A motion was made to approve the quote of \$4,300 from Bruce Environmental to perform asbestos abatement for 969 Senoia Road.

Motion made by Council Member Campbell, Seconded by Council Member Hill.
Voting Yea: Council Member Howard, Council Member Furr.

XI. PUBLIC COMMENTS: *The second public comment period is for any issue. Comments are limited to three (3) minutes. Please state your name & address. Comments that require a response may not be answered during this time. The Council or staff may respond at a later date.*

Jessica Whelan who lives on Valleywood Road, stated that she loved to see Council work and that she appreciated them. She inquired about a Finance topic from the Tyrone 101 class last week. She asked about an insurance claim at 881 Senoia Road. She asked when that section of the building would be restored. Mr. Perkins reminded everyone that during a freeze, the back offices of the building (not the museum) experienced significant damage due to several busted pipes. They had to rip out two feet of sheetrock and the ceilings were destroyed. When renovated, that area would be the recreation offices along with more programming areas.

Ms. Dorothy King who lives on Prestmoor Court spoke regarding rumors of the possibility of a hotel coming near the Southampton neighborhood. Mayor Dial shared that he would brief her after the meeting. Ms. King also inquired about the AMWaste fuel charge. Mr. Perkins explained that the fuel charge was recently backed off which was on a different scale than the Consumer Price Index. He added that it was tied to the Energy Information Administration (EIA). That cost fluctuation was listed in their contract so they did not need to come to Council when an increase was needed. He added that the fuel charge was calculated every quarter.

XII. STAFF COMMENTS

Ms. Baker gave Ms. Ciara Willis a shout-out for obtaining her Georgia Clerk Certification and added that she had worked very hard to obtain it.

Mr. Perkins announced that tomorrow night was the Strongman Competition at 5:00 p.m. followed by Action Wrestling and there would also be food trucks. He stated that Saturday was the Town's annual Founders Day Festival which would be kicked off by the 5K Road Race and the parade. He reminded everyone of the road closures for both events and to plan ahead. He shared that the day's festivities would end with a fireworks display. He asked if anyone knew of a resident with horses to notify them of the fireworks show. He added that he had already reached out to the Listons.

Mr. Langford gave a shout-out to the Museum staff, Recreation, and Library staff for their great presentations during the Tyrone 101 meeting.

XIII. COUNCIL COMMENTS

XIV. EXECUTIVE SESSION

A motion was made to move into Executive Session for one (1) real estate item.

Motion made by Council Member Furr, Seconded by Council Member Howard.
Voting Yea: Council Member Hill, Council Member Campbell.

A motion was made to reconvene.

Motion made by Council Member Campbell, Seconded by Council Member Howard.
Voting Yea: Council Member Hill, Council Member Furr.

XV. ADJOURNMENT

A motion was made to adjourn.

Motion made by Council Member Furr.
Voting Yea: Council Member Howard, Council Member Hill, Council Member Campbell.

The meeting adjourned at 8:26 p.m.

By: _____
Eric Dial, Mayor

Attest: _____
Dee Baker, Town Clerk



COUNCIL AGENDA ITEM COVER SHEET

Meeting Type: Council - Regular

Meeting Date: October 19, 2023

Agenda Item Type: New Business

Staff Contact: Scott Langford

STAFF REPORT

AGENDA ITEM:

Consideration to approve the plans and start land acquisition for the 2023 Miscellaneous Cross Drain Replacements Project No: PW-2023-06.

BACKGROUND:

This project is to replace drainage culvert infrastructure in the Town's rights-of-way and easements. The project consists of replacing 2 culverts on Anthony Drive, 2 on Brooks Drive, 1 on Castle Lake Drive, 1 on Handley Park, 1 on Julie Road, 2 on Laurelwood Road, 1 on Ridge Road, 1 on Strandhill Road, 1 catch basin on Farr Road at Taylor Ridge, and 1 on an easement in Pendleton. Staff is ready to move this into land acquisition phase with Legal Counsel upon Council's approval of the plans.

FUNDING:

General Funds – Public Works 100-40-52.2211

STAFF RECOMMENDATION:


Staff recommends approval of the plans for the 2023 Miscellaneous Cross Drain Replacements, Project number PW-2023-06 and to start land acquisition.

ATTACHMENTS:

See attached plans


PREVIOUS DISCUSSIONS:

None

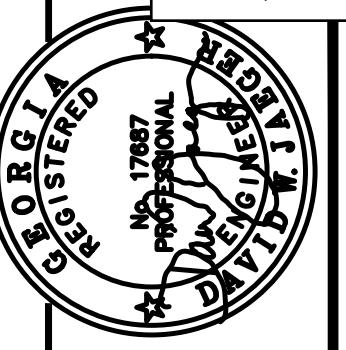

MISC. CROSS DRAIN REPLACEMENTS FOR TOWN OF TYRONE, GEORGIA

PROJECT NUMBER PW-20

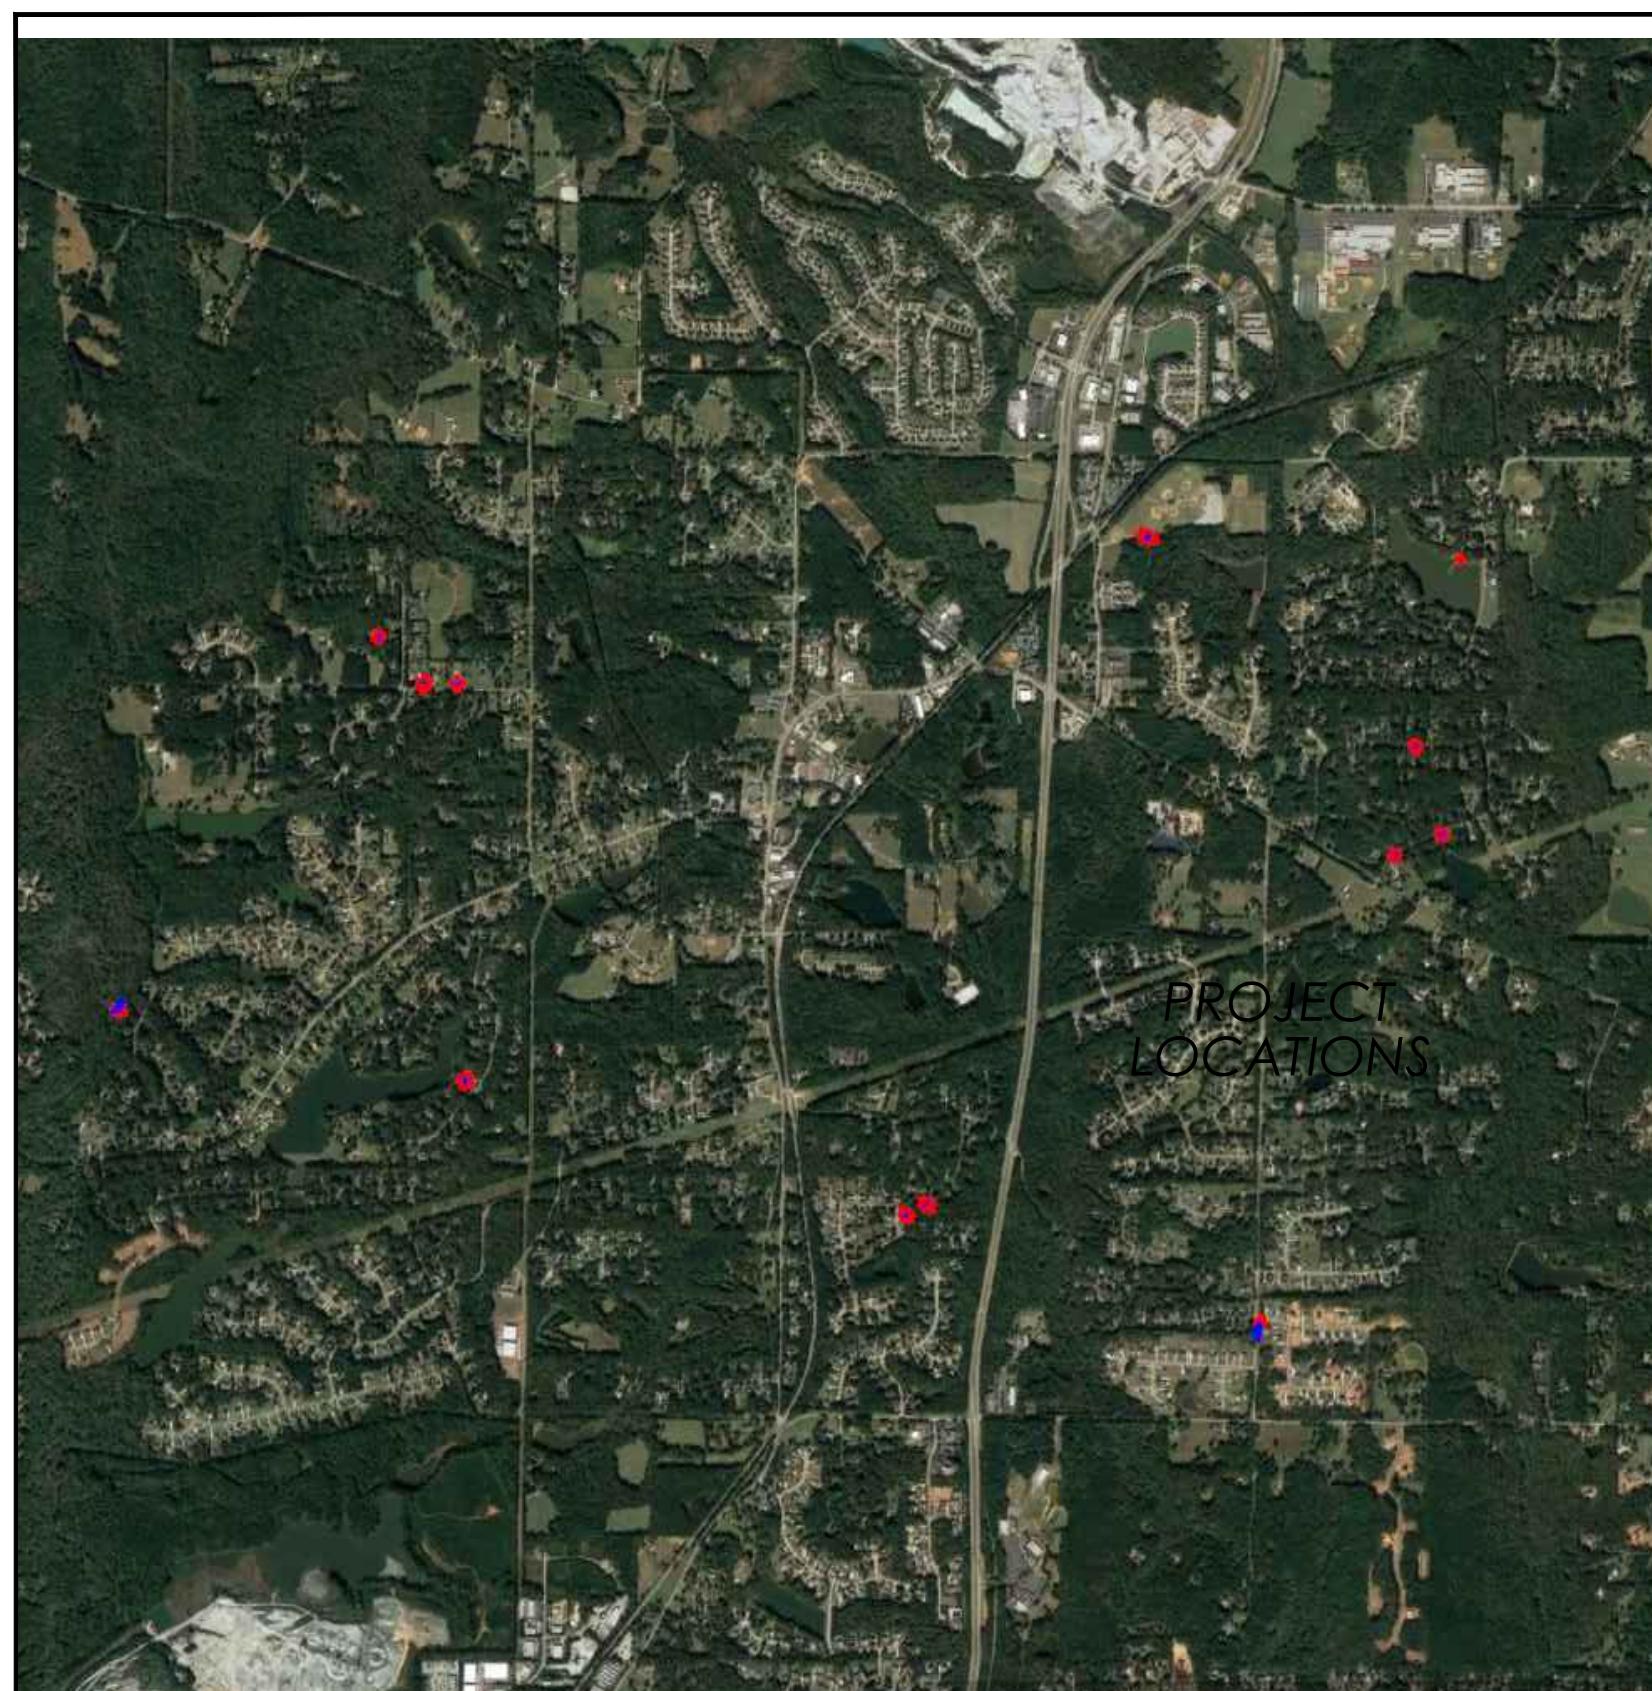

LOCATION MAP
FAYETTE COUNTY

FLOOD STATEMENT:
I HAVE THIS DATE EXAMINED THE NATIONAL FLOOD INSURANCE PROGRAM FLOOD INSURANCE RATE MAP (FIRM) AND FOUND THAT BY GRAPHIC PLOTTING ONLY, A PORTION OF THE REFERENCE PARCEL IS LOCATED IN AN AREA HAVING SPECIAL FLOOD HAZARDS.
MAP ID: 1311C0077E EFFECTIVE DATE: 09/26/2008 ZONE: AE .

AUTHORIZED BY: TOWN OF TYRONE, GEORGIA

950 Senoia Road
Tyrone, Georgia 30290
P: 770-487-4038

Eric Dial - Mayor
Gloria Furr - Council Member (Mayor Pro Tem)
Billy Campbell - Council Member
Linda Howard - Council Member
Melissa Hill - Council Member

24 Hour Erosion Control Contact:

NAME: Scott Langford
ADDRESS: 950 Senoia Road
Tyrone, GA 30290
PHONE: (770)-487-4038


CONSTRUCTION SCHEDULE (PER PROJECT)

| DAY | 1 | 2 | 3 | 4 | 5 | 6 | 7 | 8 | 9 | 10 |
|------------------------------------------------------|---|---|---|---|---|---|---|---|---|----|
| STAKE LIMITS OF DISTURBANCES AND INSTALL INITIAL BMP | | | | | | | | | | |
| REMOVE EXISTING ROADWAY AND CULVERT PIPES | | | | | | | | | | |
| INSTALL NEW CULVERT AND HEADWALLS | | | | | | | | | | |
| REBUILD ROADWAY AND INSTALL FINAL BMP | | | | | | | | | | |
| FINAL PAVEMENT | | | | | | | | | | |

DRAWING INDEX

| SHEET NO. | DESCRIPTION |
|-----------|-------------------------------|
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| 5-7 | ANTHONY DRIVE (2) |
| 8-10 | BROOKS DRIVE (1) |
| 11-13 | BROOKS DRIVE (2) |
| 14-16 | CASTLE LAKE DRIVE |
| 17-19 | HANDLEY PARK |
| 20-22 | JULIE ROAD |
| 23-25 | LAURELWOOD (1) |
| 26-28 | LAURELWOOD (2) |
| 29-31 | PENDLETON LAKE |
| 32-34 | RIDGE ROAD |
| 35-37 | STRAND HILL ROAD |
| 38-40 | TAYLOR RIDGE |
| 41 | EROSION CONTROL DETAILS |
| 42-43 | CONSTRUCTION DETAILS |


Mallett Consulting, Inc.
101 Devant St., Suite 804, FAYETTEVILLE, GEORGIA 30214
PHONE: 770-719-3333 FAX: 770-719-3377

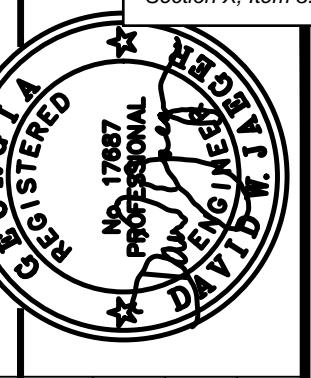

Section X, Item 3.

*PROPOSED REPLACEMENT OF
CROSS DRAINS AT
440,455 & 465 ANTHONY DRIVE
TYRONE, GEORGIA 30290*

RESERVED FOR CLERK OF COURT

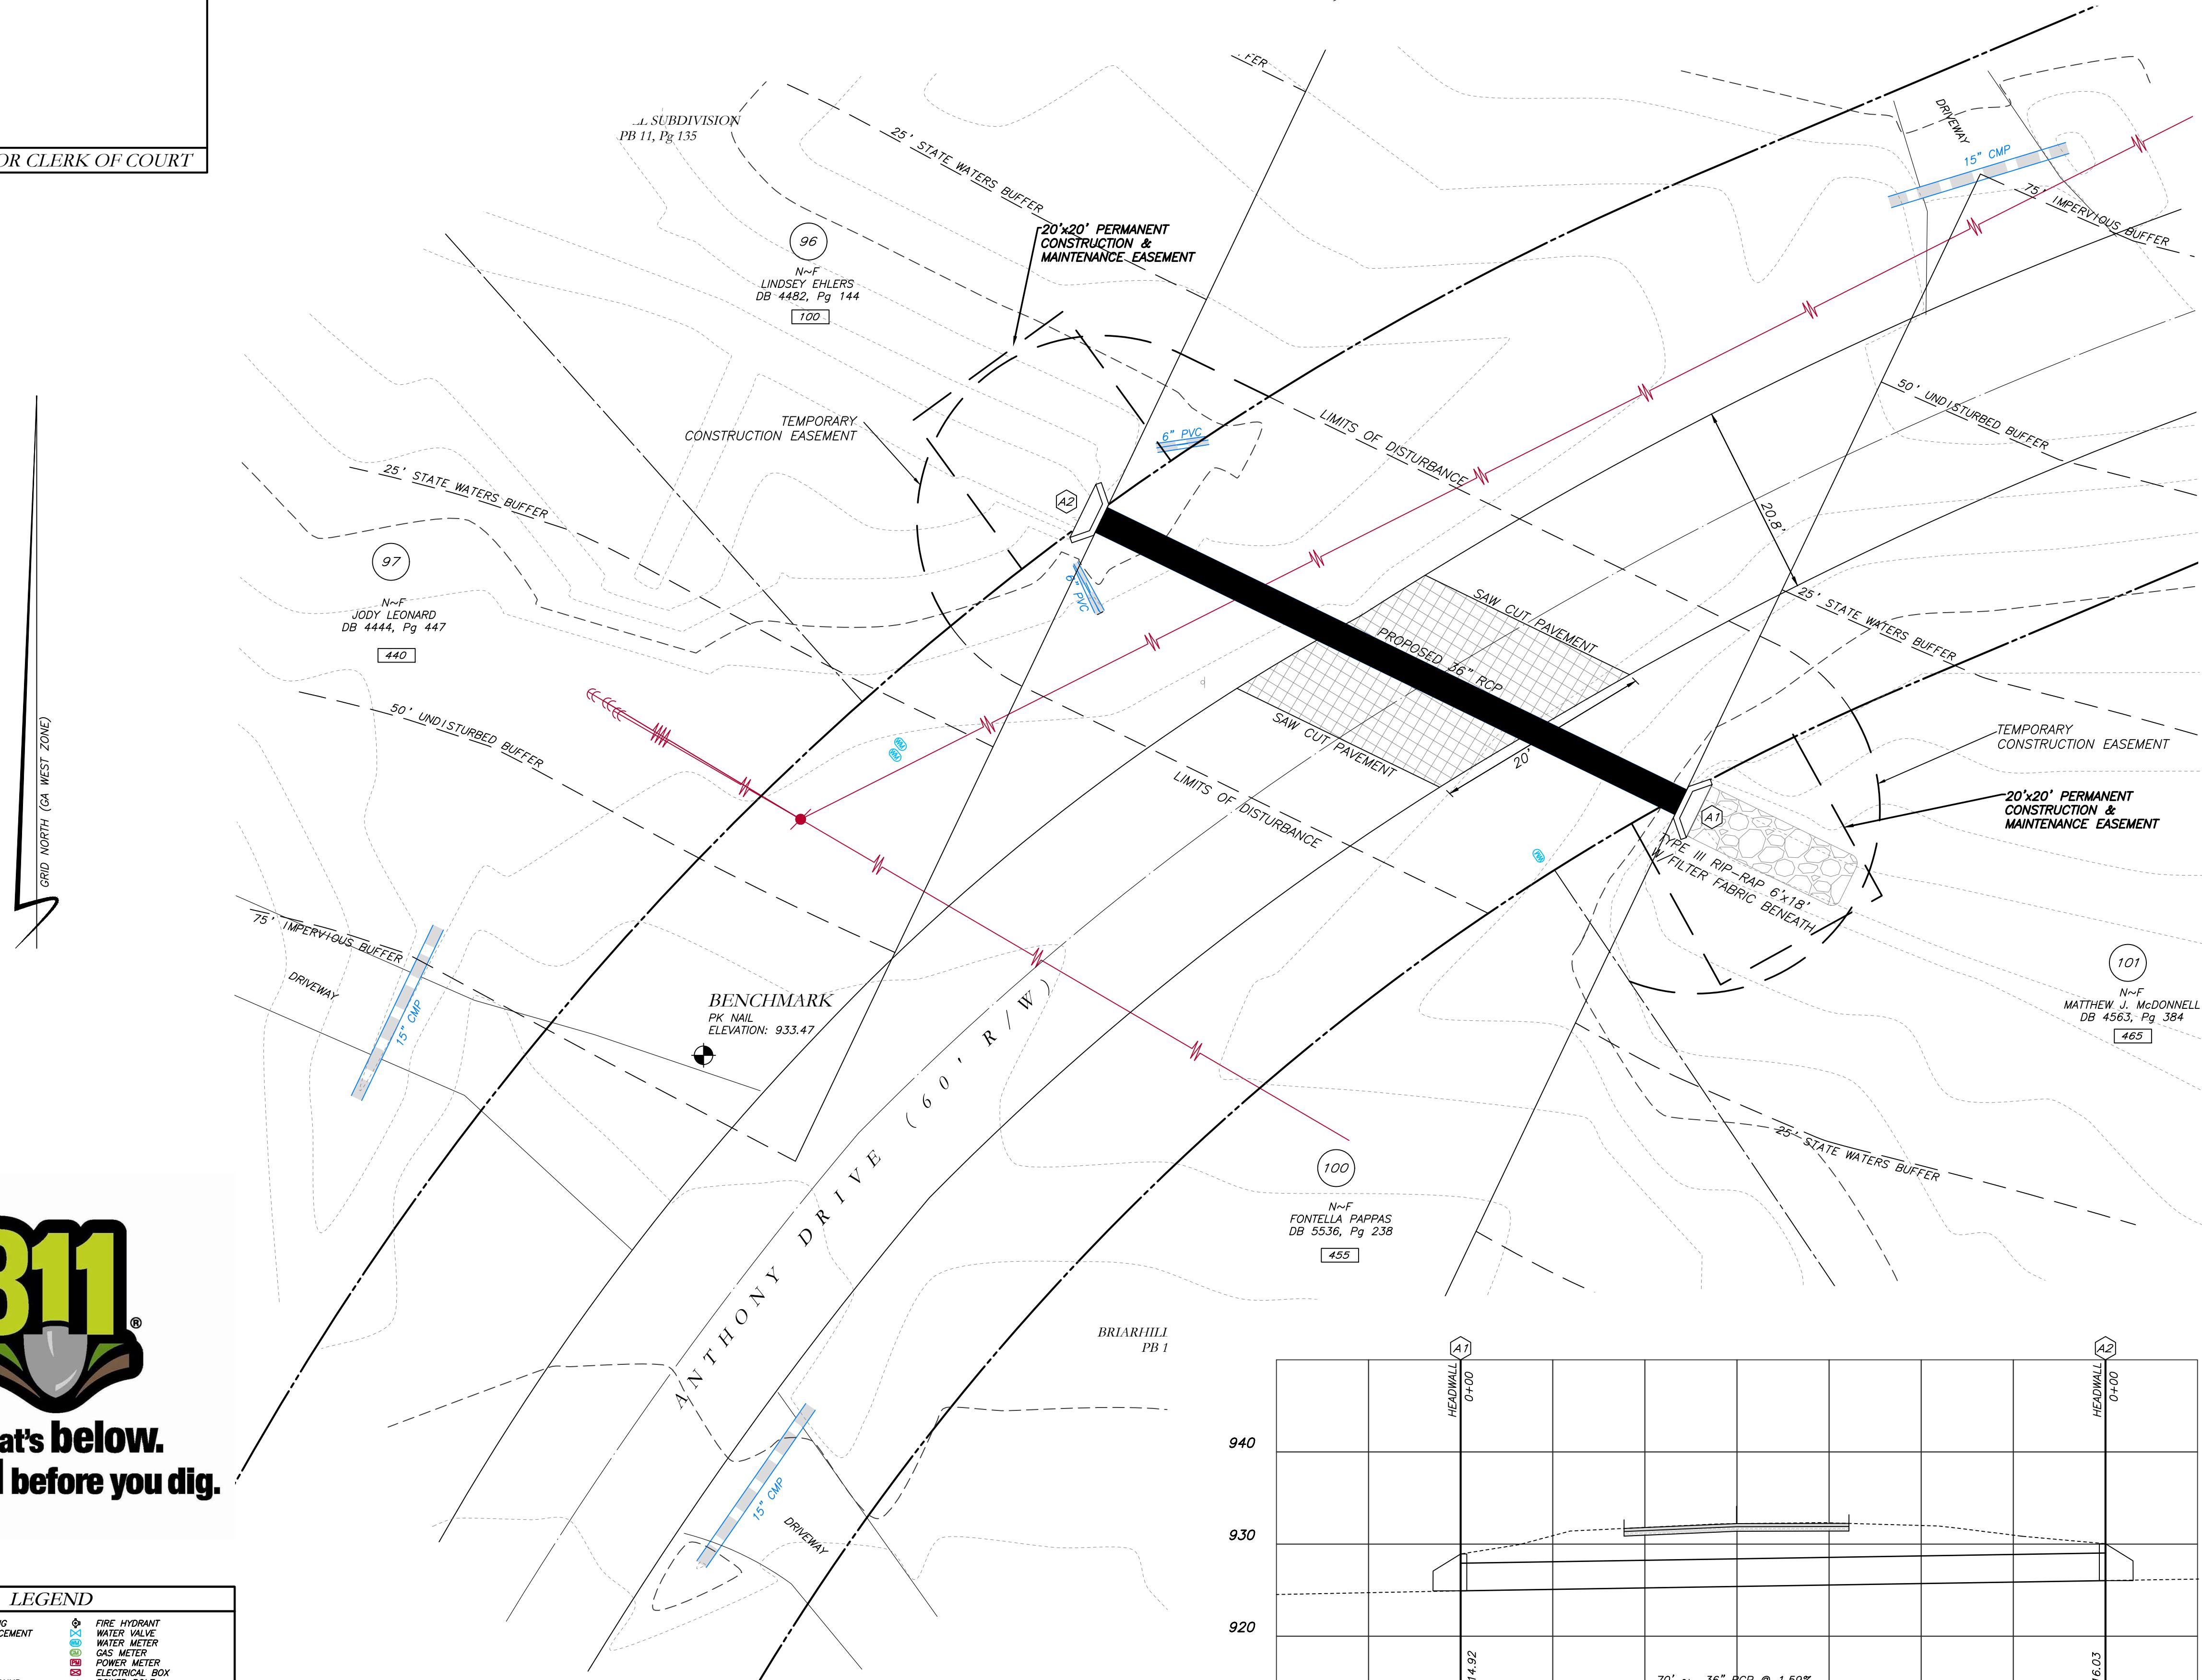


The logo consists of the large, bold, yellow numbers "811" with a black outline. A registered trademark symbol (®) is positioned to the right of the "1". Below the numbers is a stylized illustration of a shovel, angled downwards, with a grey blade and green and brown handles. The entire graphic is set against a white background.

**Know what's below.
Call before you dig.**

LEGEND

| LEGEND | |
|--------|--------------------------|
| POB | POINT OF BEGINNING |
| POC | POINT OF COMMENCEMENT |
| RBS | REBAR SET |
| RBF | REBAR FOUND |
| MNF | MAG NAIL FOUND |
| MNS | MAG NAIL SET |
| CTF | CRIMP TOP PIPE FOUND |
| OTF | OPEN TOP PIPE FOUND |
| CMF | CONCRETE MONUMENT FOUND |
| DI | DROP INLET |
| CI | CATCH INLET |
| YI | YARD INLET |
| OCS | OUTLET CONTROL STRUCTURE |
| JB | JUNCTION BOX |
| SWCB | SINGLE WING CATCH BASIN |
| DWCB | DOUBLE WING CATCH BASIN |
| HW | HEADWALL |
| FES | FLARED END SECTION |
| CMP | CORRUGATED METAL PIPE |
| RCP | REINFORCED CONCRETE PIPE |
| SS | SANITARY SEWER |
| F.M.E. | FORCE MAIN EASEMENT |
| S.S.E. | SANITARY SEWER EASEMENT |
| D.E. | DRAINAGE EASEMENT |
| W.E. | WATER EASEMENT |
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NOTES:

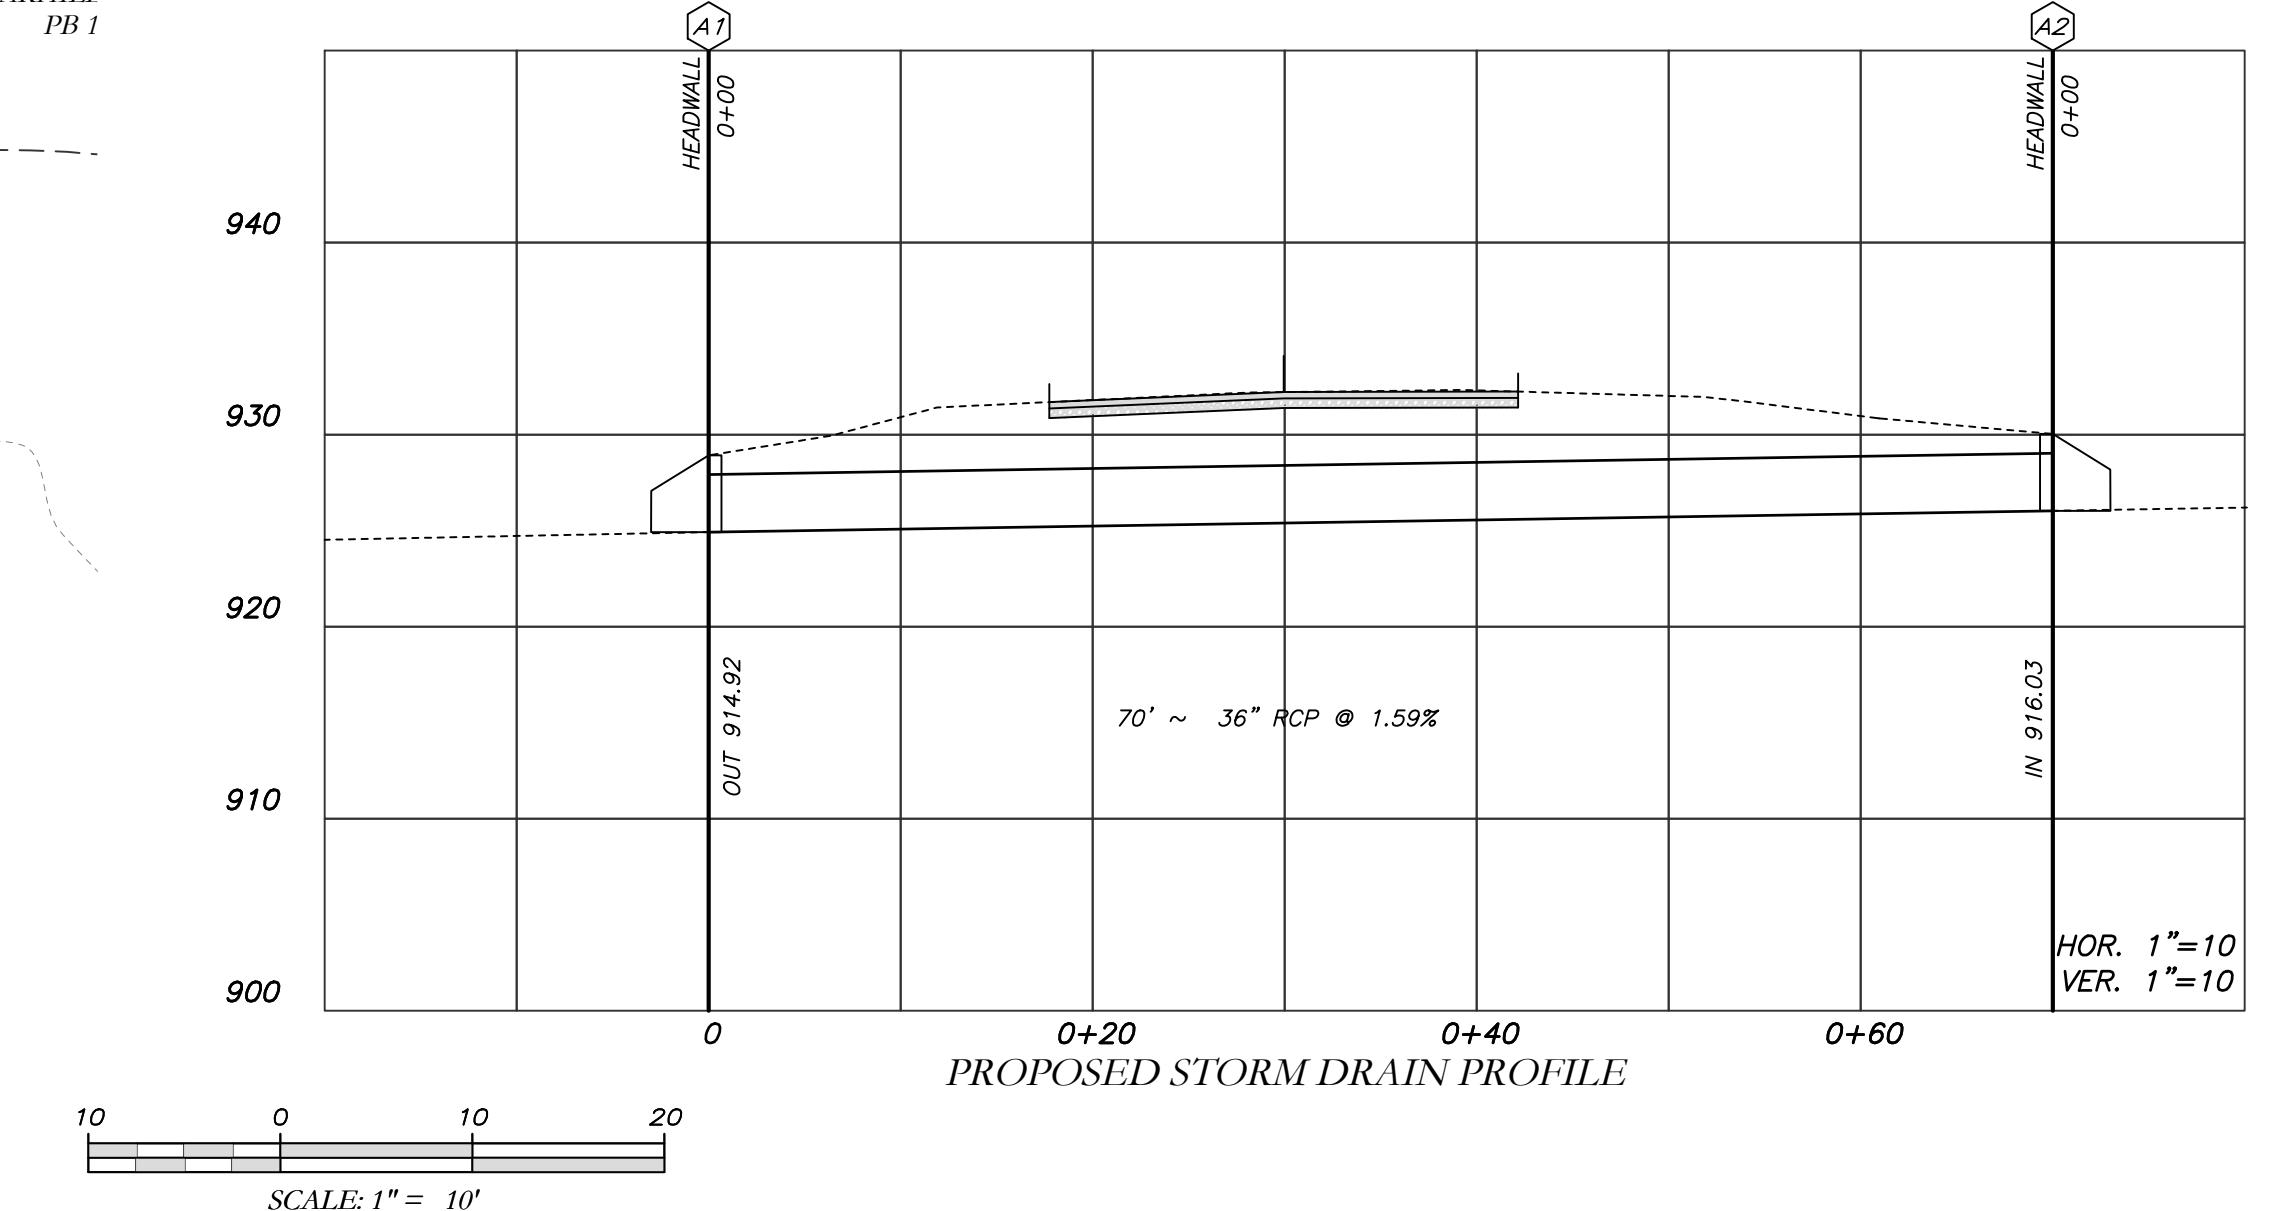- CONTRACTOR WILL BE RESPONSIBLE FOR LOCATING AND PROTECTING EXISTING UTILITIES.

EXISTING PAVEMENT SHALL BE SAW CUT AT LIMITS OF DEMOLITION ACTIVITIES. LOCATION OF SAW CUTS SHALL BE APPROVED IN ADVANCE BY THE TOWN ENGINEER.

CONTRACTOR TO STOCKPILE EXISTING RIP-RAP AND REUSE WHEN PRACTICAL.

ALL DEMOLITION MATERIALS, WASTE SOILS AND SEDIMENT SHALL BE HAULED AWAY AND DISPOSED OF OFFSITE AT A SUITABLE LOCATION, SELECTED BY THE CONTRACTOR. THIS SHALL BE DONE AT NO ADDITIONAL CHARGE.

TEMPORARY TRAFFIC CONTROL STRIPING, SIGNAGE AND DEVICES ARE REQUIRED DURING TRANSITION FROM EXISTING CONDITION TO COMPLETION OF PROJECT. PROVIDE CERTIFIED TRAFFIC CONTROL FLAGMEN DURING TEMPORARY LANE CLOSURES. BOTH LANES SHALL BE OPEN WHEN FLAGMEN ARE NOT PRESENT AND SHALL HAVE AN ALL WEATHER DRIVING SURFACE.


PAVEMENT WITHIN SAW CUT LINES TO BE REMOVED AND REPLACED.

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804 FAYETTEVILLE, GEORGIA 30214
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FAX: 770-719-3377

Anthony Drive (1) Proposed Conditions

**EROSION CONTROL PLAN FOR
CROSS DRAINS AT
440, 455 & 465 ANTHONY DRIVE
TYRONE, GEORGIA 30290**

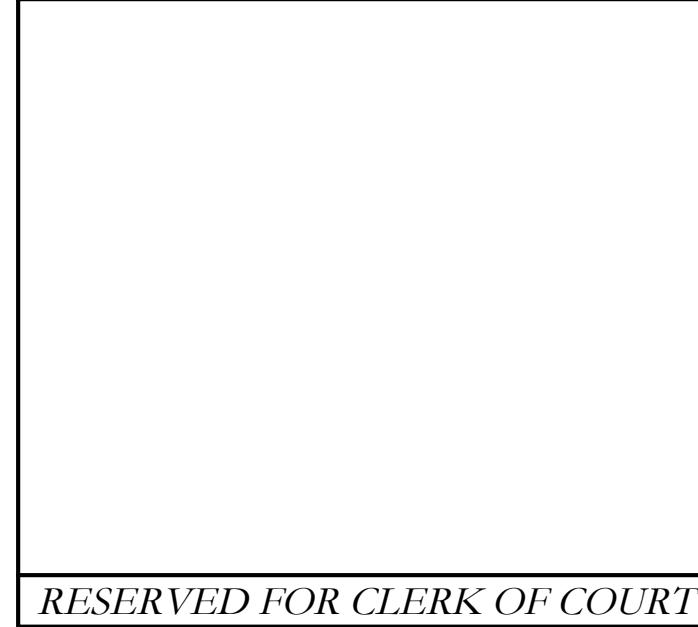

CPD NORTH (GA. WEST ZONE)





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| OTP | OPEN TOP PIPE FOUND |
| CMP | CORRUGATED METAL PIPE FOUND |
| DI | DROP INLET |
| CI | CATCH INLET |
| YAC | YARD AREA |
| OCS | OUTLET CONTROL STRUCTURE |
| JB | JUNCTION BOX |
| DWCB | DOUBLE WING CATCH BASIN |
| DWCB | DOUBLE WING CATCH BASIN |
| HW | HEADWALL |
| TEG | TEGEL AND SECTION |
| CMP | CORRUGATED METAL PIPE |
| RCP | REINFORCED CONCRETE PIPE |
| SS | SEWER SEAM |
| F.M.E. | FORCE MAIN EASEMENT |
| D.E. | DRIVEWAY EASEMENT |
| W.E. | WATER EASEMENT |
| G.T. | GREASE TRAP |
| FENCE | FENCE |
| BOL | BOLARD |
| S.P.E. | SPOT ELEVATION |
| FIRE HYDRANT | ● |
| WATER VALVE | ○ |
| POWER LADDER | △ |
| GAS METER | ◎ |
| POWER METER | □ |
| OVERHEAD BOX | ■ |
| POWER POLE | ▲ |
| OVERHEAD UTILITIES | ◆ |
| ROOF DRAIN | ○ |
| DROP INLET | ● |
| WATER VALVE | ○ |
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*LIMITED SURVEY OF
STORM DRAIN REPLACEMENT
470, 480, 495, 505 ANTHONY ROAD
TYRONE, GEORGIA 30290*

RESERVED FOR CLERK OF COURT




SURVEYOR'S CERTIFICATION

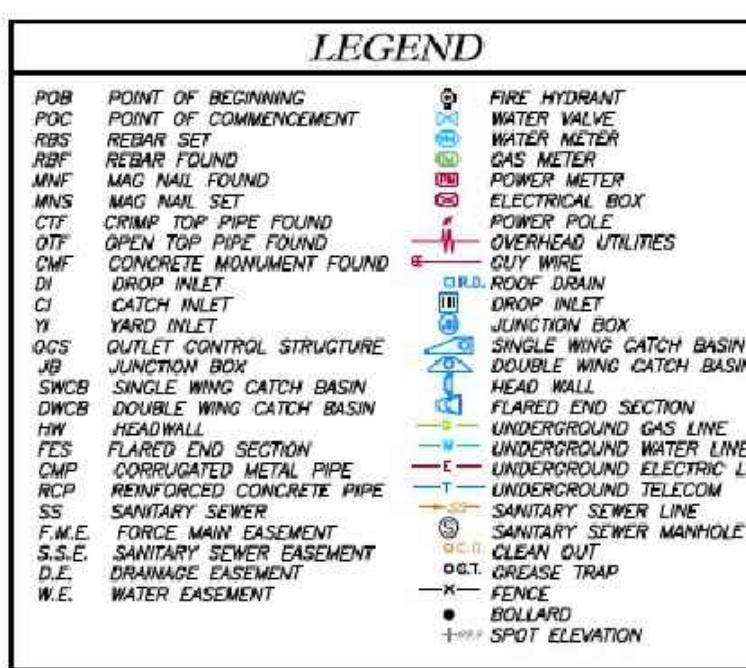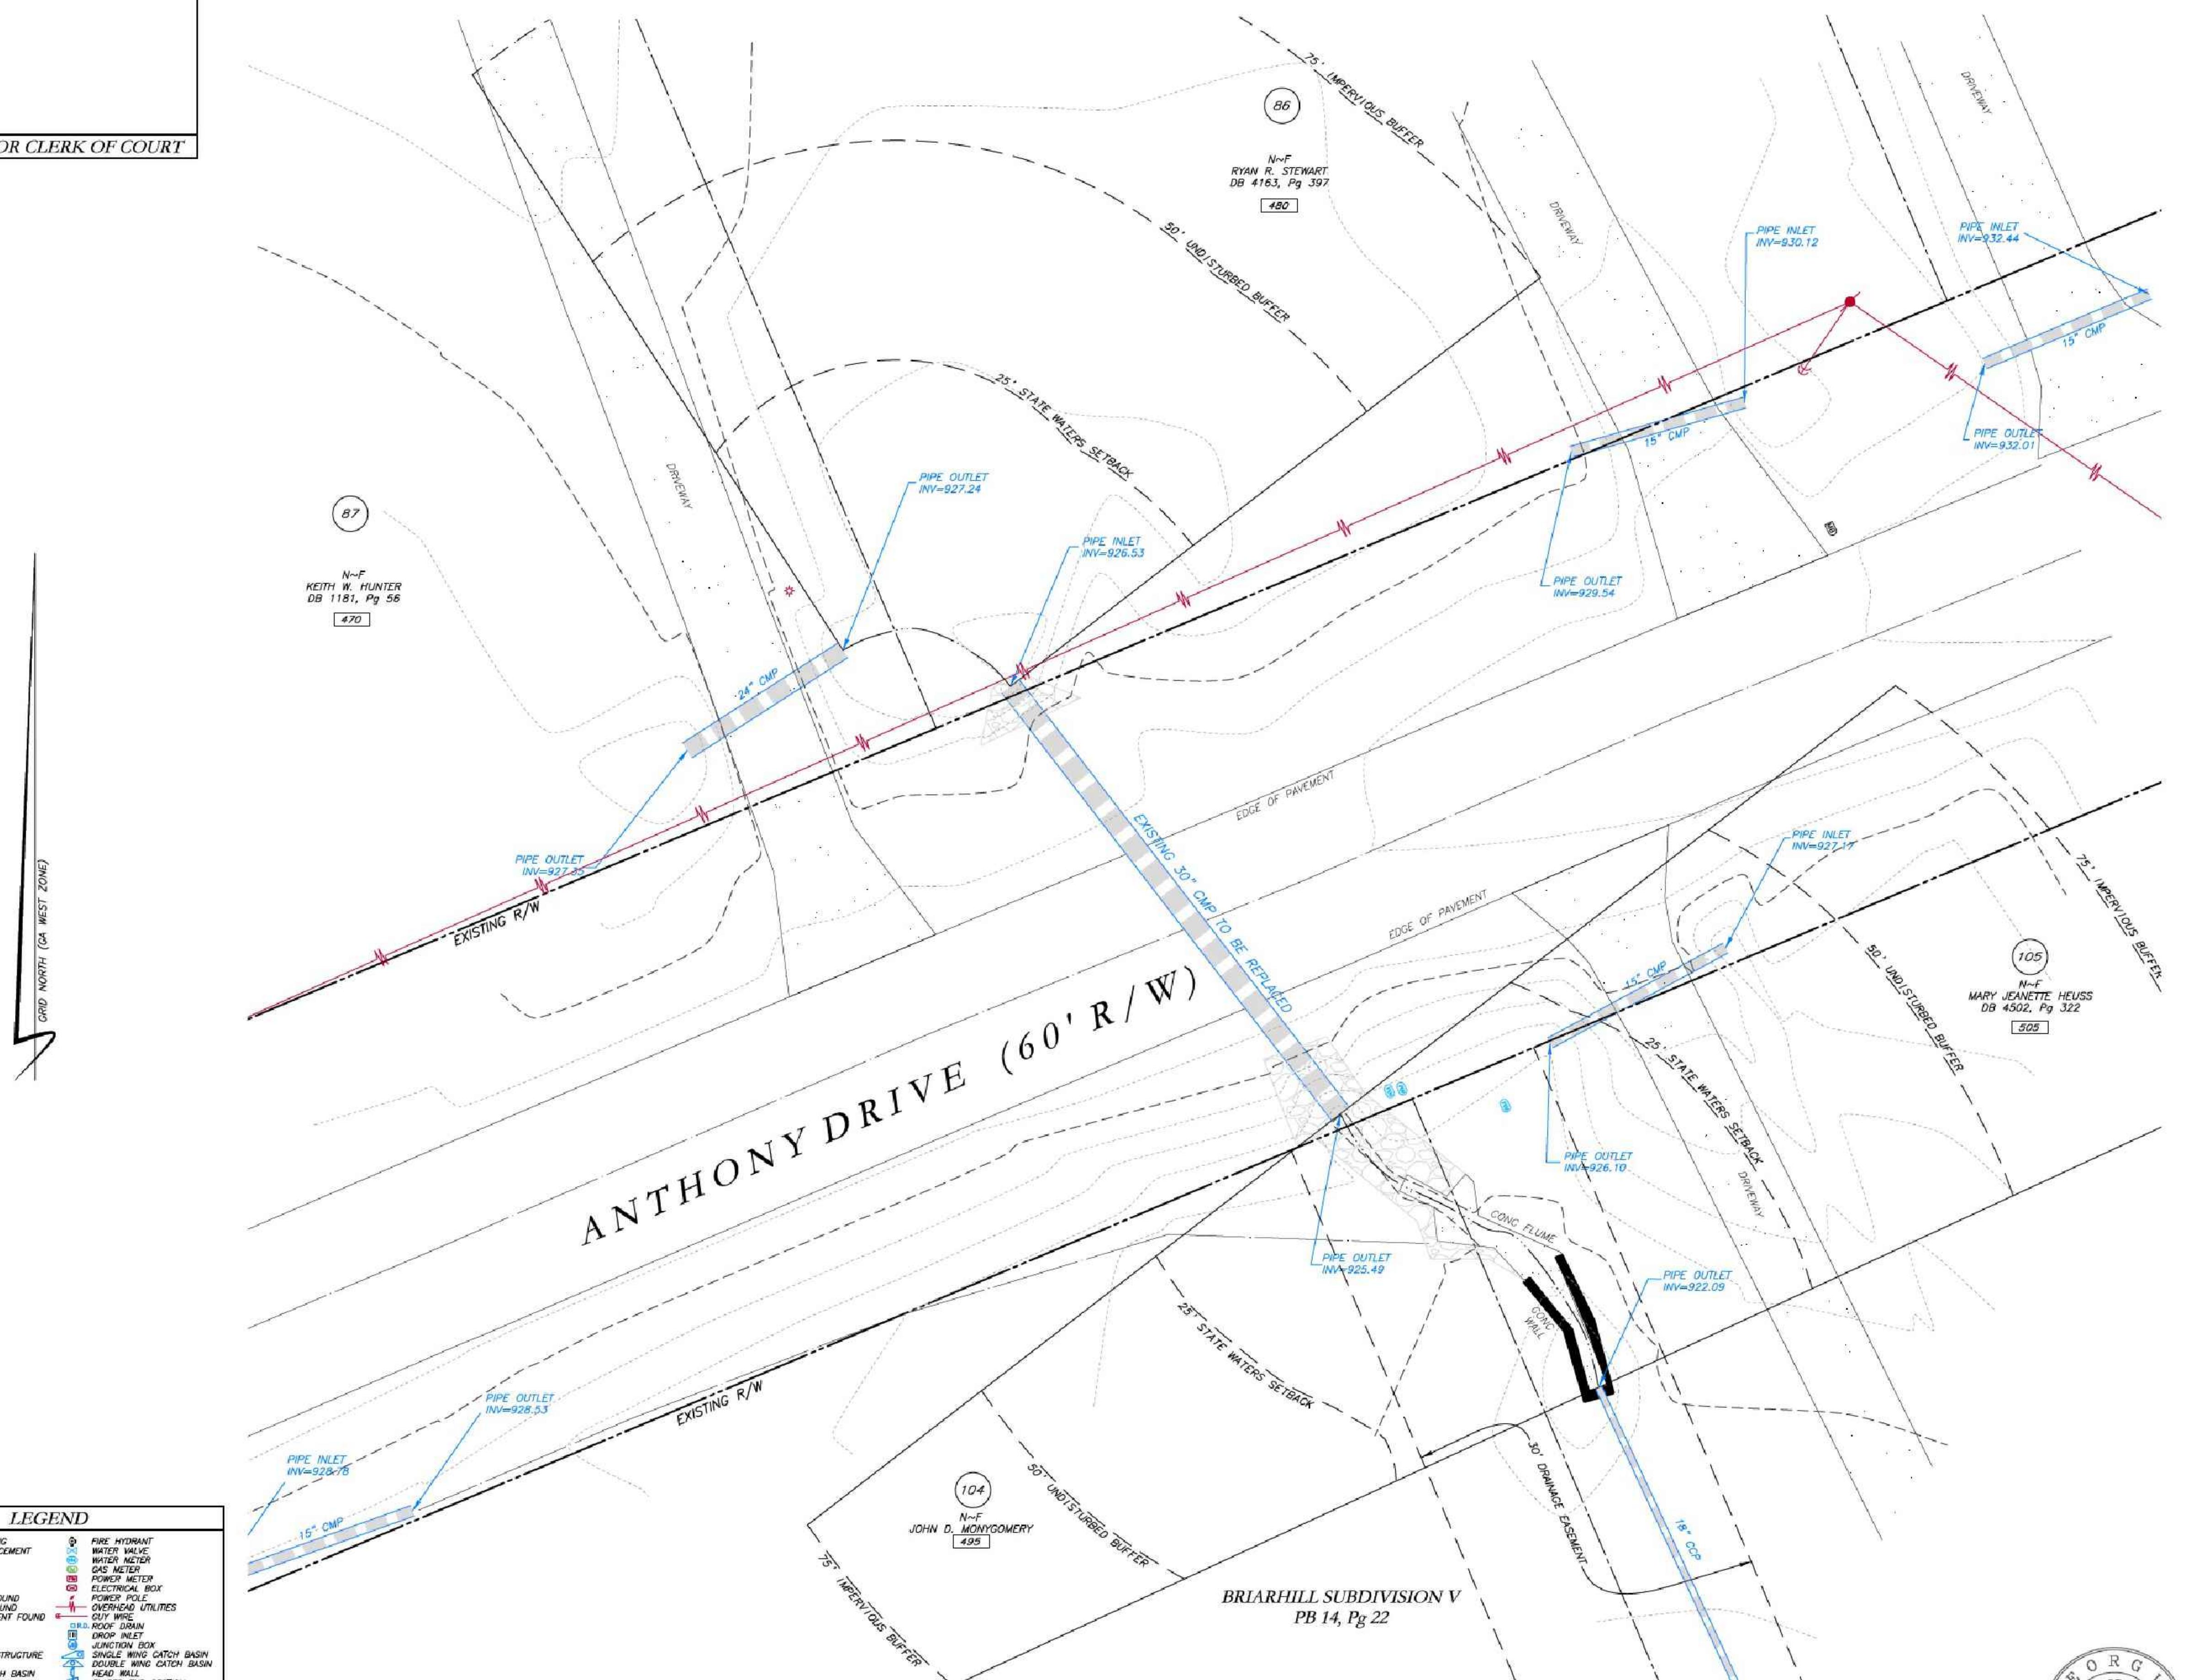IS PLAT IS A RETRACEMENT OF AN EXISTING PARCEL OR
PARCELS OF LAND AND DOES NOT SUBDIVIDE OR CREATE A
NEW PARCEL OR MAKE ANY CHANGES TO ANY REAL
PROPERTY BOUNDARIES. THE RECORDING INFORMATION OF THE
DOCUMENTS, MAPS, PLATS, OR OTHER INSTRUMENTS WHICH
STATE THAT PARCEL OR PARCELS ARE STATED HERE ON.
CORDATION OF THIS PLAT DOES NOT IMPLY APPROVAL OF
MY LOCAL JURISDICTION, AVAILABILITY OF PERMITS,
COMPLIANCE WITH LOCAL REGULATIONS OR REQUIREMENTS, OR
AVAILABILITY FOR ANY USE OR PURPOSE OF THE LAND.
FURTHERMORE, THE UNDERSIGNED LAND SURVEYOR CERTIFIES
THAT THIS PLAT COMPLIES WITH THE MINIMUM TECHNICAL
STANDARDS FOR PROPERTY SURVEYS IN GEORGIA AS SET
FORTH IN THE RULES AND REGULATIONS OF THE GEORGIA OF
THE BOARD OF REGISTRATION FOR PROFESSIONAL ENGINEERS
AND LAND SURVEYORS AS SET FORTH IN O.C.G.A. SECTION

-6-17.

JOSEPH T. BAKER, LS
GEORGIA LICENSE #2674
12/27/21
DATE

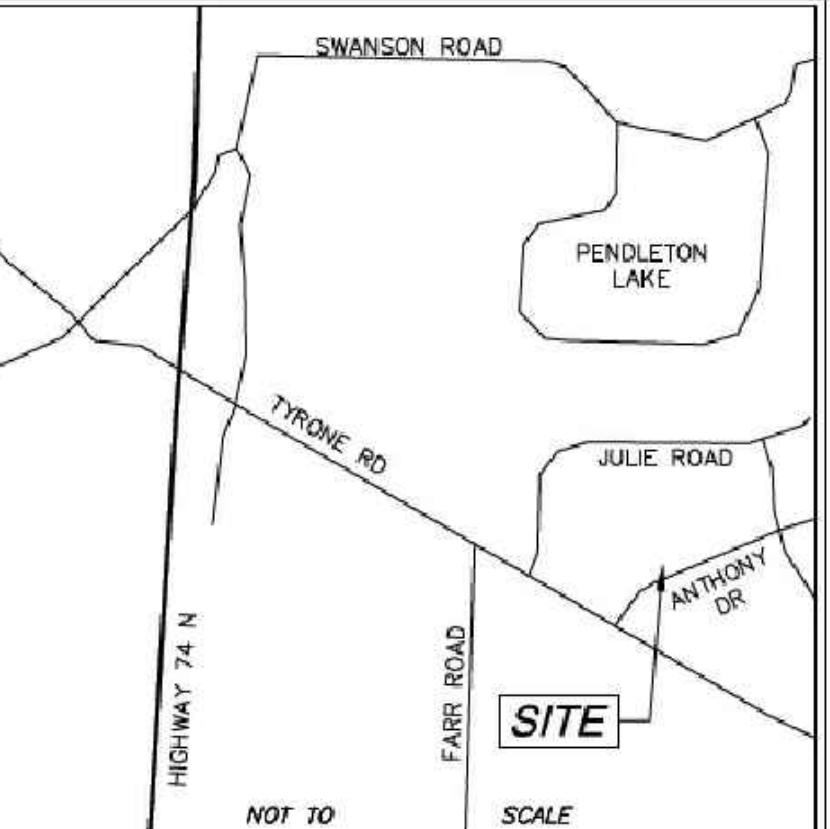

CINITY MAP

SURVEY NOTES

THIS PLAT WAS PREPARED FOR THE EXCLUSIVE USE OF THE
PERSON, PERSONS, OR ENTITY NAMED HEREON. THIS PLAT DOES
NOT EXTEND TO ANY UNNAMED PERSON, PERSONS OR ENTITY
WITHOUT EXPRESS WRITTEN CERTIFICATION BY THE SURVEYOR
KNOWING SAID PERSON, PERSONS, OR ENTITY.

NORTH ARROW AND BEARINGS ARE BASED ON GEORGIA STATE
LINE COORDINATES (NAD83), US FOOT. USING GLOBAL POSITIONAL
SYSTEM AND OBTAINED BY RTK OBSERVATIONS ON OCTOBER 20,
2012 USING THE TRIMBLE VRS SYSTEM. ALL DISTANCES SHOWN ARE
HORIZONTAL GROUND MEASUREMENTS EXPRESSED IN SURVEY FEET
ATUMS:
HORIZONTAL: GRID NORTH, NAD83
VERTICAL: NAVD88
EQUID: GEOD18 (CONUS)

CONTOURS AND SPOT ELEVATIONS SHOWN HEREON ARE BASED ON
U.S.G.S. DATUM (NAVD88). THE SITE BENCHMARKS ARE AS
SHOWN HEREON.

WATER MAIN, STORM SEWER, SANITARY SEWER AND FRANCHISE
PROPERTY STRUCTURES HAVE BEEN FIELD LOCATED WHERE VISIBLE.
NOTE: THE SURVEYOR MAKES NO GUARANTEES THAT THE
UNDERGROUND UTILITIES SHOWN COMPRIZE ALL SUCH UTILITIES IN
THE AREA, EITHER IN-SERVICE OR ABANDONED.

HERE WAS NO EVIDENCE OF RECENT CONSTRUCTION ON THE
PROPERTY OBSERVED IN THE PROCESS OF CONDUCTING THE
WORK

NO FIELD DELINEATED WETLANDS WERE OBSERVED IN THE
PROCESS OF CONDUCTING THE FIELDWORK.

EQUIPMENT USED FOR MEASUREMENT:
 1. TRIMBLE R10/SB ROBOTIC TOTAL STATION
 2. TRIMBLE R10/SB ROBOTIC TOTAL STATION

STATE COUNTY & LOCAL BUFFERS AND SETBACKS MIGHT EXIST

STATE, COUNTY, & LOCAL BOUNDRIES AND SETBACKS MIGHT EXIST
THE SUBJECT PROPERTY THAT ARE NOT SHOWN HEREON.

ATWELL
855.850.4200 www.atwell-group.com
1800 PARKWAY PLACE, SUITE 700
MARIETTA, GA

LOCATED IN
TOWN OF TYRONE

STORM DRAIN REPLACEMENT

EXISTING CONDITIONS

70, 480, 495, 505 ANTHONY ROAD
TYRONE, GEORGIA 30290


DATE 12/30/2022

12/30/2022

REVISIONS

| | |
|--------------|-----|
| DWG. JCB | CH. |
| P.M. JTB | |
| CODE TP | |
| NOB 22006046 | |
| SHEET NO. | |

**PROPOSED REPLACEMENT OF
CROSS DRAIN AT
480, 495 & 505 ANTHONY ROAD
TYRONE, GEORGIA 30290**


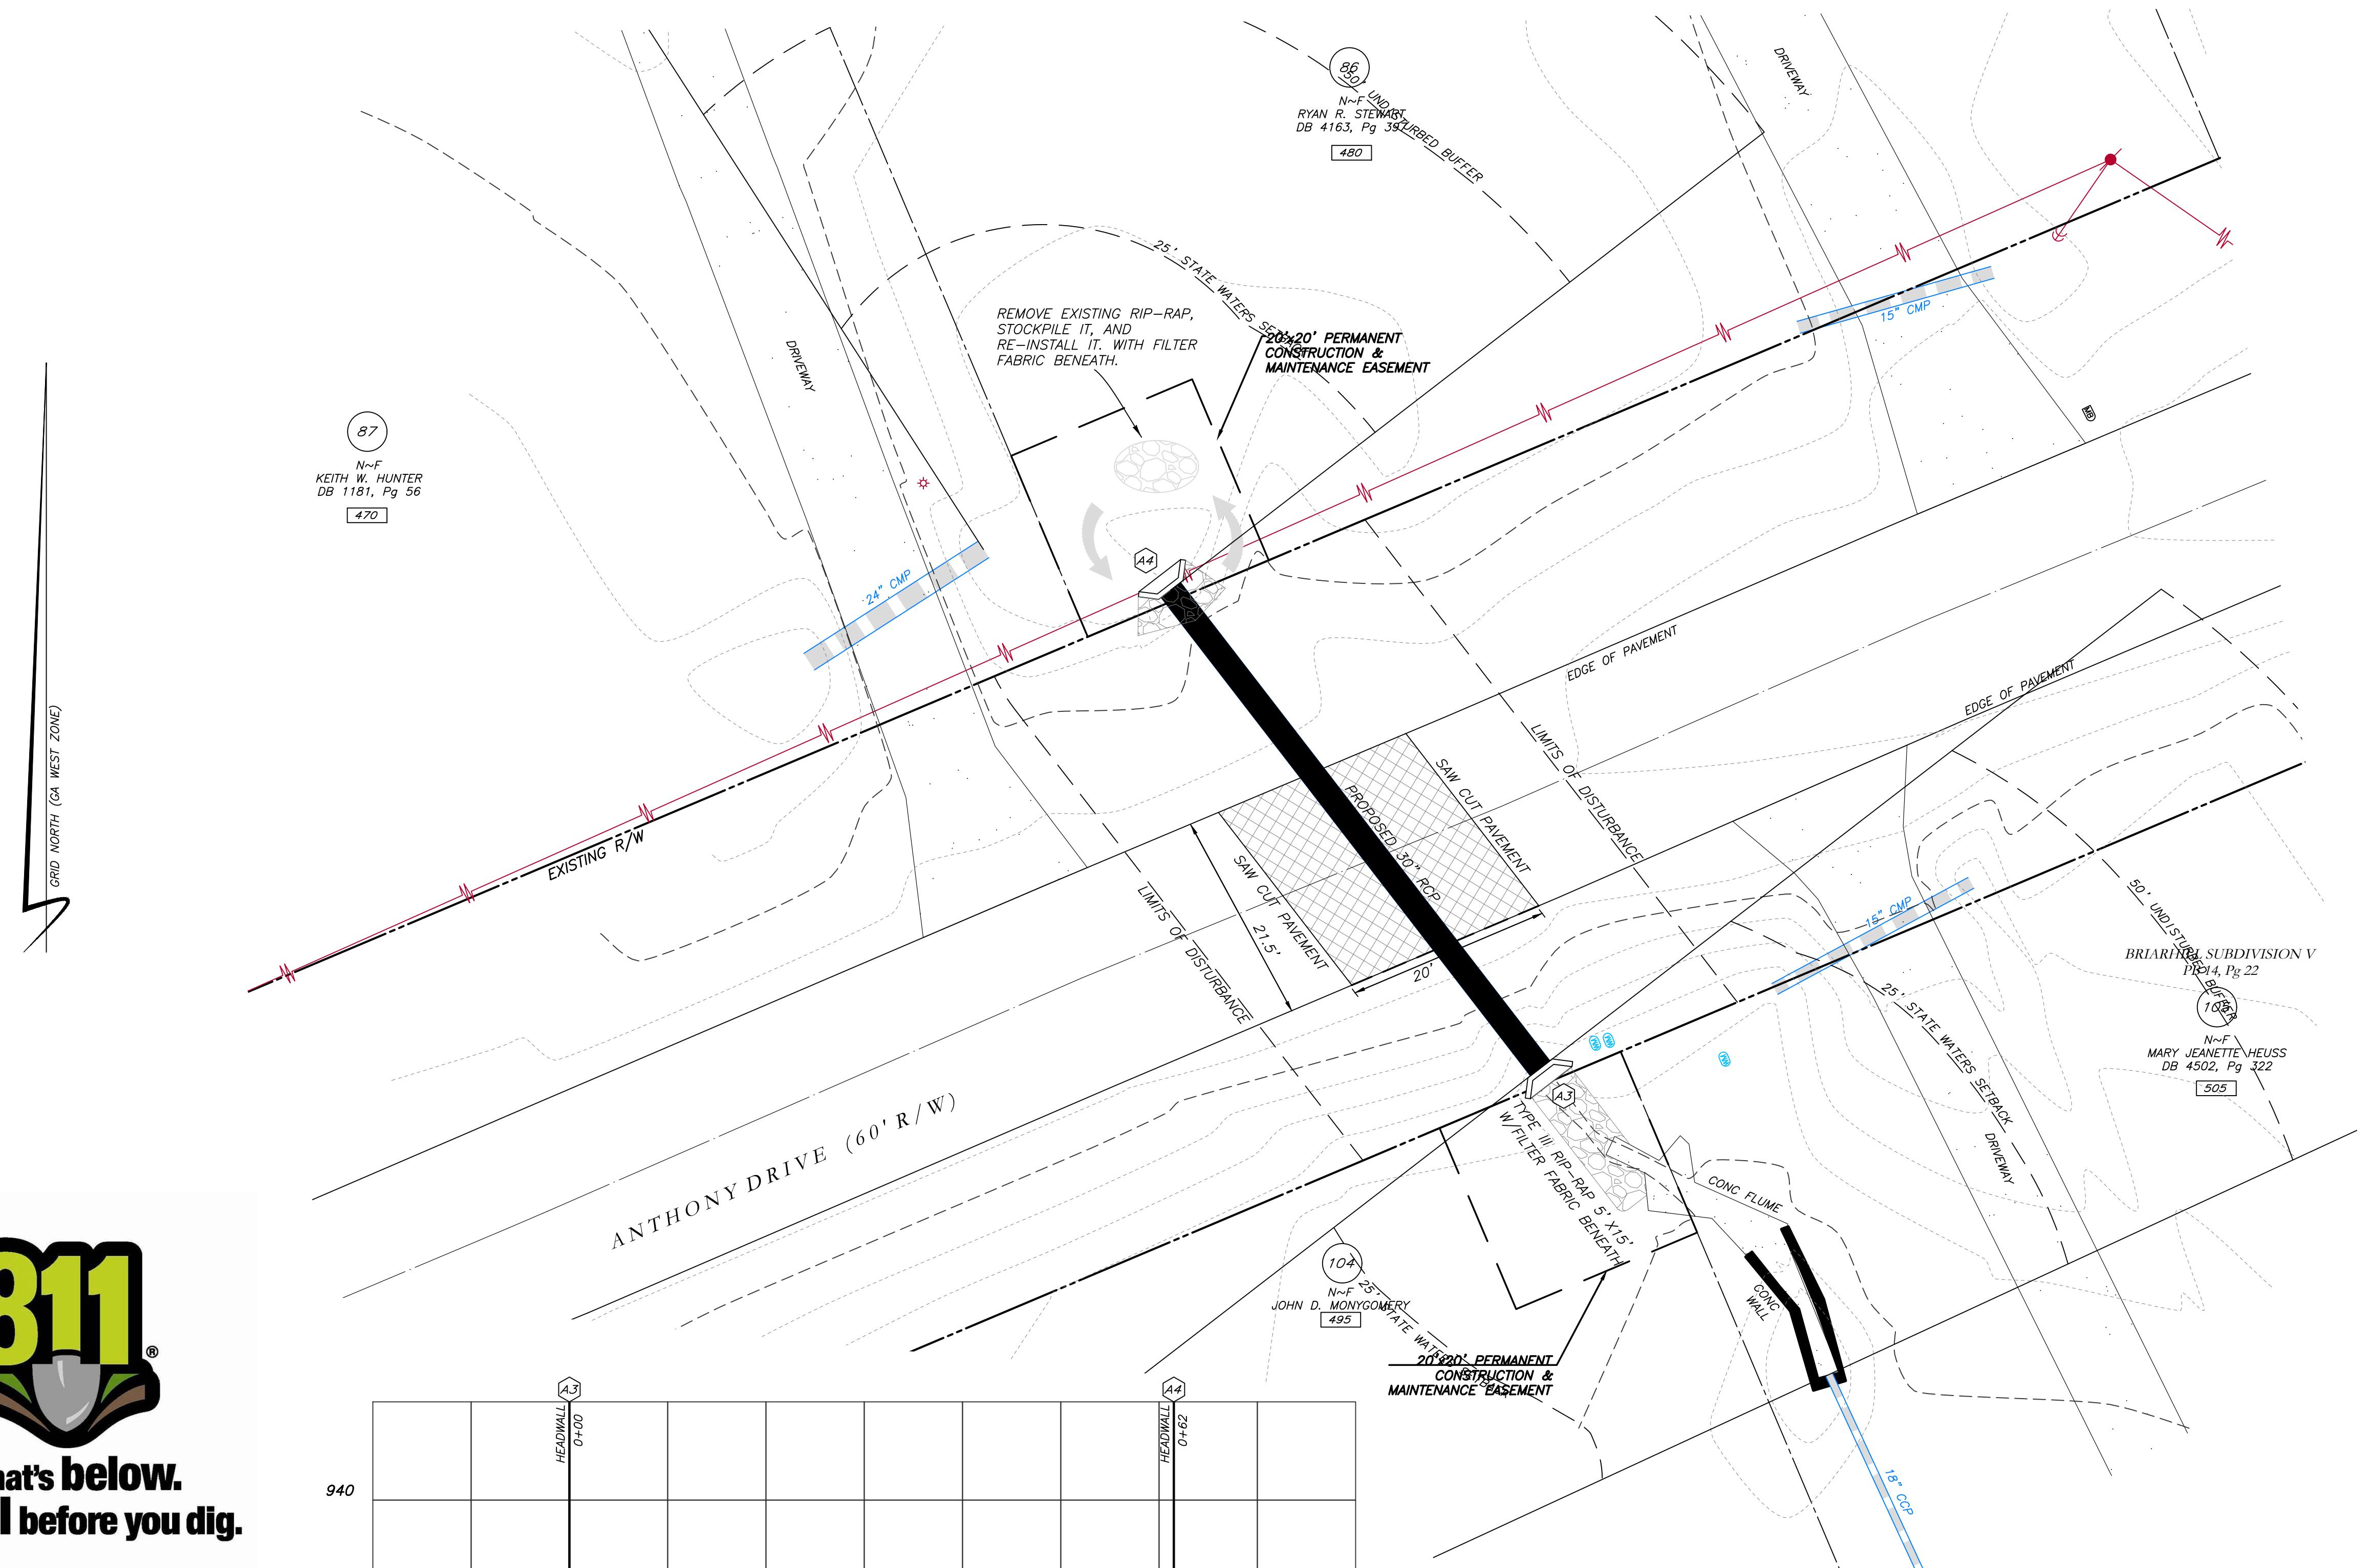


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| G.T. | GREASE TRAP |
| FENCE | FENCE |
| BOL | BOL |
| SPOT ELEVATION | SPOT ELEVATION |
| FIRE HYDRANT | |
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| ROOF DRAIN | |
| DROP INLET | |
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| SINGLE WING CATCH BASIN | |
| DOUBLE WING CATCH BASIN | |
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| UNDERGROUND GAS LINE | |
| UNDERGROUND WATER LINE | |
| UNDERGROUND ELECTRIC LINE | |
| TELECOM | |
| SANITARY SEWER | |
| SEWER MANHOLE | |

PROPOSED STORM DRAIN PROFILE

SCALE: 1" = 10'
10 0 10 20

VICINITY MAP
NOT TO SCALE
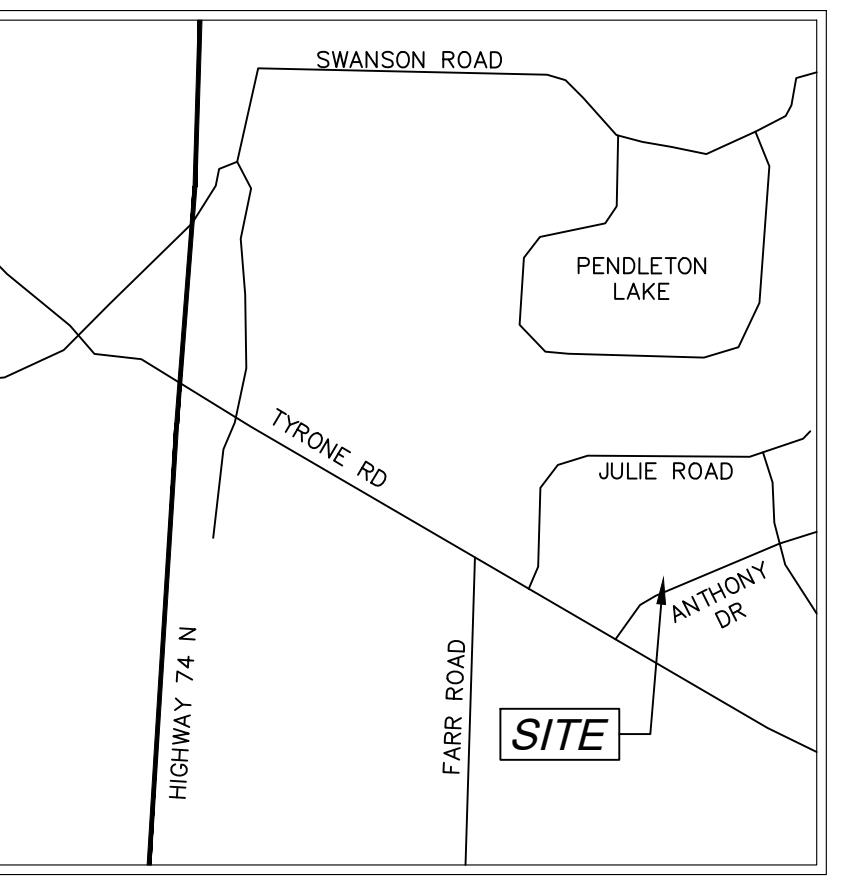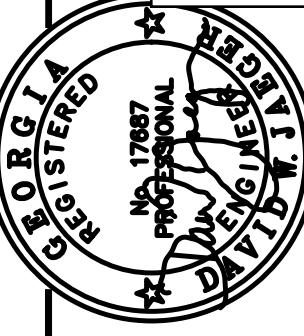
| PROJECT NUMBER PW-20 | |
|----------------------|----------|
| DESIGN | SCALE |
| DRAWN | MCI |
| DATE | 01/16/23 |
| CHECK | DWJ |
| FILE NO. | 2101-16 |
| APPROVED | DWJ |
| SHEET NO. | |


| REV. NO. | DATE | DESCRIPTION | BY AP/PD |
|----------|------|-------------|----------|
| | | | |

**Cross Drain Replacement
for Town of Tyrone, Georgia
Anthony Drive (2)
Proposed Conditions**

Mallett Consulting, Inc.
101 Devant St., Suite 804, Fayetteville, Georgia 30214
PHONE: 770-719-3333 FAX: 770-719-3377


- NOTES:**
- CONTRACTOR WILL BE RESPONSIBLE FOR LOCATING AND PROTECTING EXISTING UTILITIES.
 - EXISTING PAVEMENT SHALL BE SAW CUT AT LIMITS OF DEMOLITION ACTIVITIES. LOCATION OF SAW CUTS SHALL BE APPROVED IN ADVANCE BY THE TOWN ENGINEER.
 - CONTRACTOR TO STOCKPILE EXISTING RIP-RAP AND REUSE WHEN PRACTICAL.
 - ALL DEMOLITION MATERIALS, WASTE SOILS AND SEDIMENT SHALL BE HAULED AWAY AND DISPOSED OF OFFSITE AT A SUITABLE LOCATION, SELECTED BY THE CONTRACTOR. THIS SHALL BE DONE AT NO ADDITIONAL CHARGE.
 - TEMPORARY TRAFFIC CONTROL STRIPING, SIGNAGE AND DEVICES ARE REQUIRED DURING TRANSITION FROM EXISTING CONDITION TO COMPLETION OF PROJECT. PROVIDE CERTIFIED TRAFFIC CONTROL FLAGMEN DURING TEMPORARY LANE CLOSURES. BOTH LANES SHALL BE OPEN WHEN FLAGMEN ARE NOT PRESENT AND SHALL HAVE AN ALL WEATHER DRIVING SURFACE.
 - PAVEMENT WITHIN SAW CUT LINES TO BE REMOVED AND REPLACED.

**EROSION CONTROL PLAN FOR
CROSS DRAINS AT
480, 495 & 505 ANTHONY ROAD
TYRONE, GEORGIA 30290**

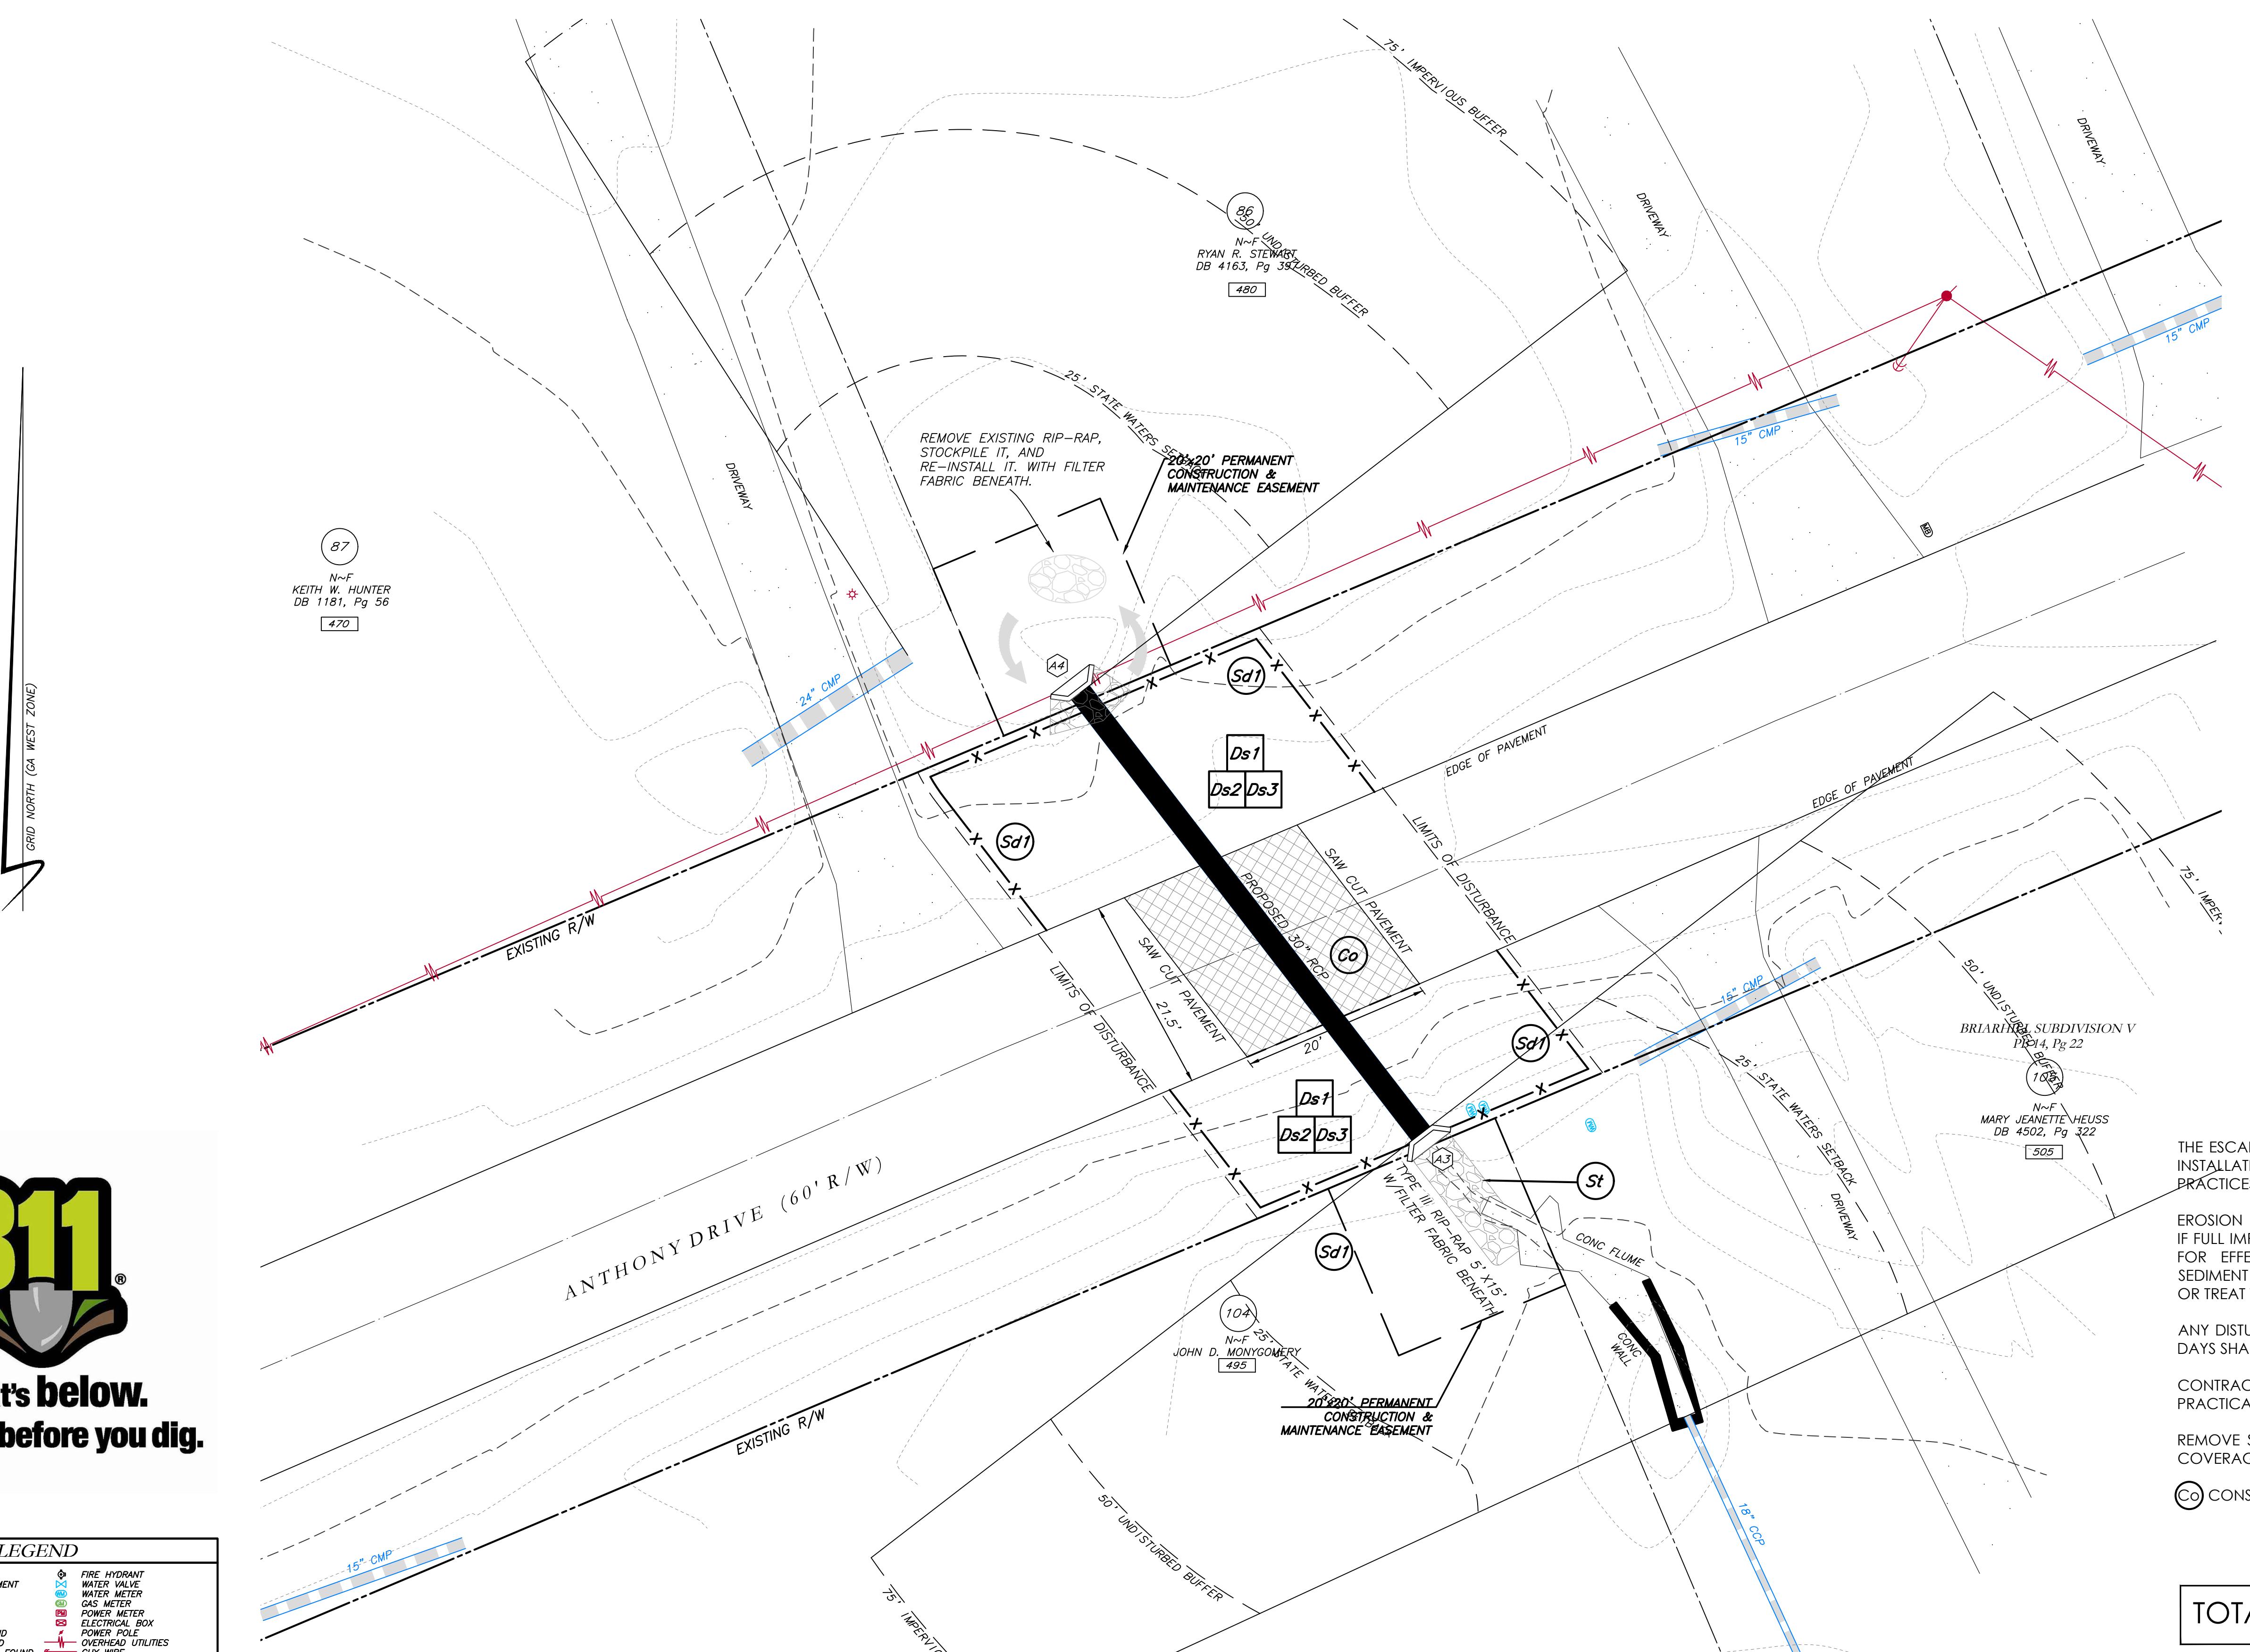



**Know what's below.
Call before you dig.**

| LEGEND | |
|--------|--------------------------|
| POB | POINT OF BEGINNING |
| POC | POINT OF COMMENCEMENT |
| RBS | REBAR FOUND |
| RRF | REBAR FOUND |
| MNF | MAG NAIL FOUND |
| MNS | MAG NAIL FOUND |
| CTP | CRIMP TOP PIPE FOUND |
| OTP | OPEN TOP PIPE FOUND |
| DIF | DRIP INLET FOUND |
| DI | DRIP INLET |
| CI | CATCH INLET |
| YAC | YARD AREA |
| OCS | OUTLET CONTROL STRUCTURE |
| JB | JUNCTION BOX |
| DWCB | DOUBLE WING CATCH BASIN |
| DWCB | DOUBLE WING CATCH BASIN |
| HW | HEADWALL |
| TE | TELECOM |
| CMP | CORRUGATED METAL PIPE |
| RCP | REINFORCED CONCRETE PIPE |
| SS | SANITARY SEWER |
| F.M.E. | FORCE MAIN EASEMENT |
| D.E. | DOWN EASEMENT |
| D.W.E. | DRAINAGE EASEMENT |
| W.E. | WATER EASEMENT |
| G.T. | GREASE TRAP |
| X | FENCE |
| • | BOLLARD |
| 0.00 | SPOT ELEVATION |

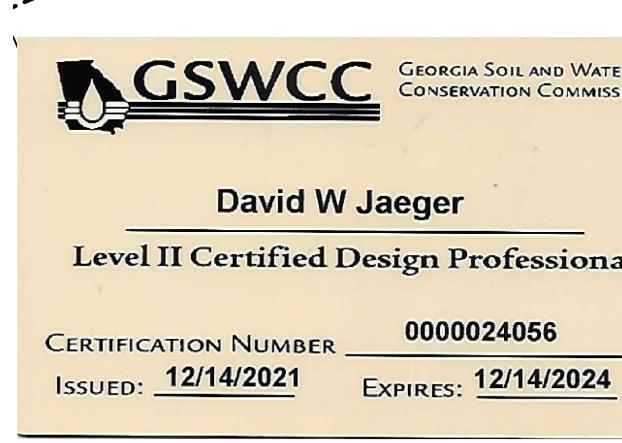

I CERTIFY AS THE PLAN DESIGNER THAT I HAVE VISITED THE SITE PRIOR TO THE DESIGN OF THE E&PC PLANS
David W Jaeger

SCALE: 1" = 10'

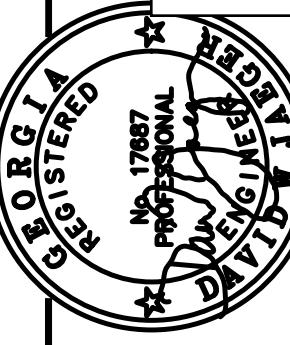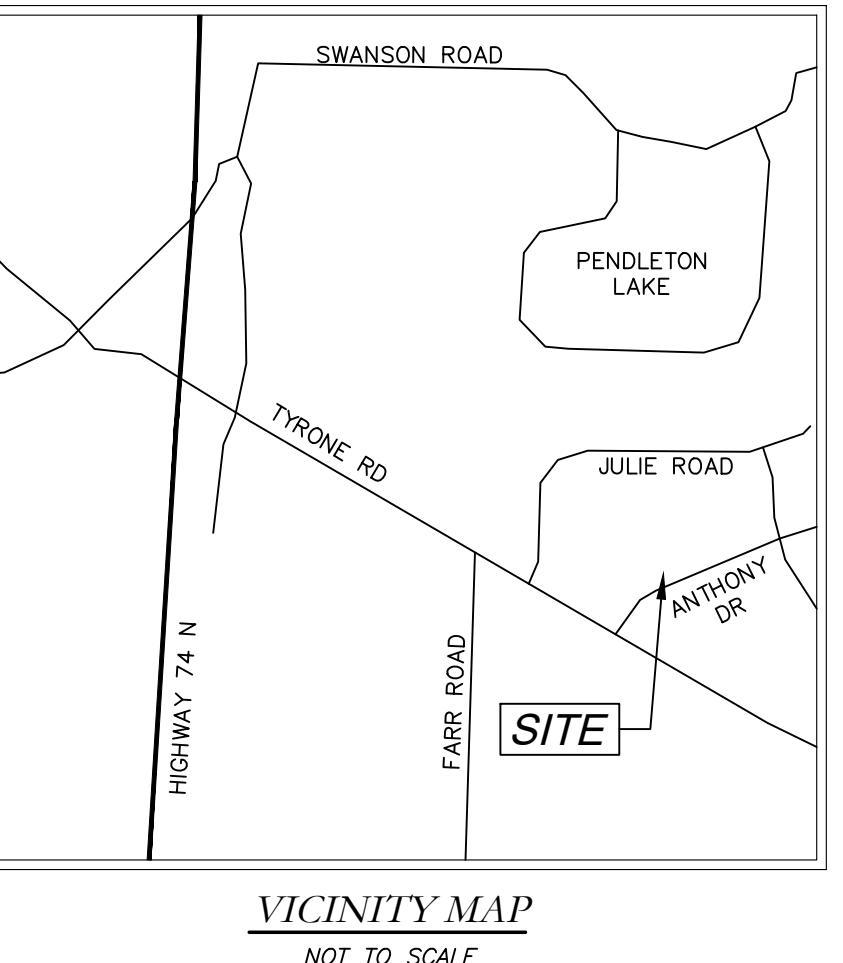

PROJECT NUMBER PW-20
DESIGN MCI SCALE
DRAWN ALG DATE 01/16/23
CHECK DWJ FILE NO. 21101-16
APPROVED DWJ SHEET NO.

REV. NO. DATE DESCRIPTION BY APPD
REVISION

**Cross Drain Replacement
for Town of Tyrone, Georgia
Anthony Drive (2)
Erosion Control Plan**

Mallett Consulting, Inc.
101 Devant St., Suite 804, Fayetteville, Georgia 30214
PHONE: 770-719-3333 FAX: 770-719-3377

THE ESCAPE OF SEDIMENT FROM THE SITE SHALL BE PREVENTED BY THE INSTALLATION OF EROSION AND SEDIMENT CONTROL MEASURES AND PRACTICES PRIOR TO LAND DISTURBING ACTIVITIES.

EROSION CONTROL MEASURES SHALL BE MAINTAINED AT ALL TIMES. IF FULL IMPLEMENTATION OF THE APPROVED PLAN DOES NOT PROVIDE FOR EFFECTIVE EROSION CONTROL, ADDITIONAL EROSION AND SEDIMENT CONTROL MEASURES SHALL BE IMPLEMENTED TO CONTROL OR TREAT THE SEDIMENT SOURCE.

ANY DISTURBED AREA LEFT EXPOSED FOR A PERIOD GREATER THAN 14 DAYS SHALL BE STABILIZED WITH MULCH OR TEMPORARY SEEDING.

CONTRACTOR TO STOCKPILE EXISTING RIP-RAP AND REUSE WHEN PRACTICAL.

REMOVE SC1 WHEN GRASS HAS BEEN ESTABLISHED TO AT LEAST 85% COVERAGE.

CONSTRUCTION EXIT TO BE MAINTAINED WITHIN SAW CUT LINES.

TOTAL DISTURBED ACRES = 0.09

24 Hour Erosion Control Contact:

NAME: Scott Langford
ADDRESS: 950 Senoia Road
Tyrone, GA 30290
PHONE: (770)-487-4038




Know what's below.


Call before you dig.
The locations of existing underground utilities are shown in this approximate map only for your information. It is the responsibility of the contractor to determine the exact location of all existing underground utilities before commencing work, and agrees to assume full responsibility for any damage and all damages which might be occasioned by the contractor's failure to do so. The contractor will preserve any and all underground utilities.

NOTICE:
CONSTRUCTION SITE SAFETY IS THE
CONTRACTOR'S RESPONSIBILITY. THE OWNER
AND THE ENGINEER SHALL BE
EXEMPT FROM LIABILITY FOR ANY
RESPONSIBILITY FOR SAFETY OF
THE WORK OR OF PERSONS ENGAGED
IN THE WORK, OF EQUIPMENT,
STRUCTURES, OR OF ANY OTHER
PERSONS.


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WITHOUT THE PRIOR WRITTEN
CONSENT OF ATWELL LLC

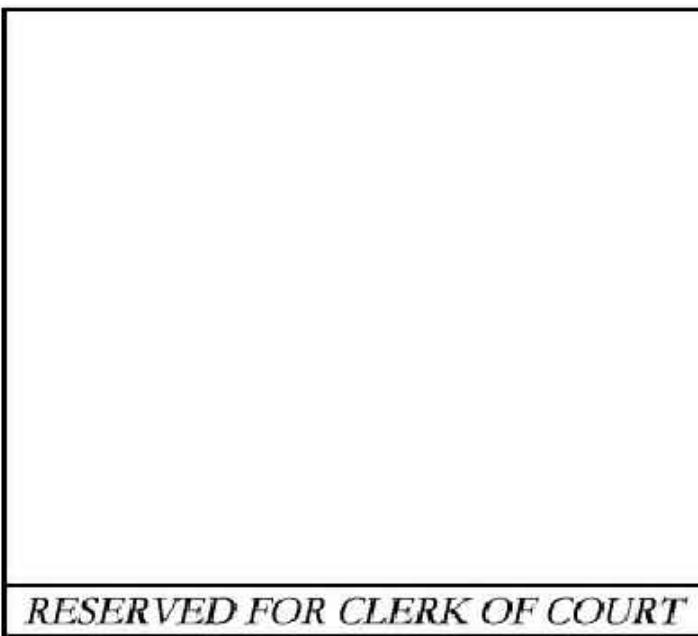

LIMITED SURVEY OF
STORM DRAIN REPLACEMENT
145 & 170 BROOKS DRIVE
TYRONE, GEORGIA 30290

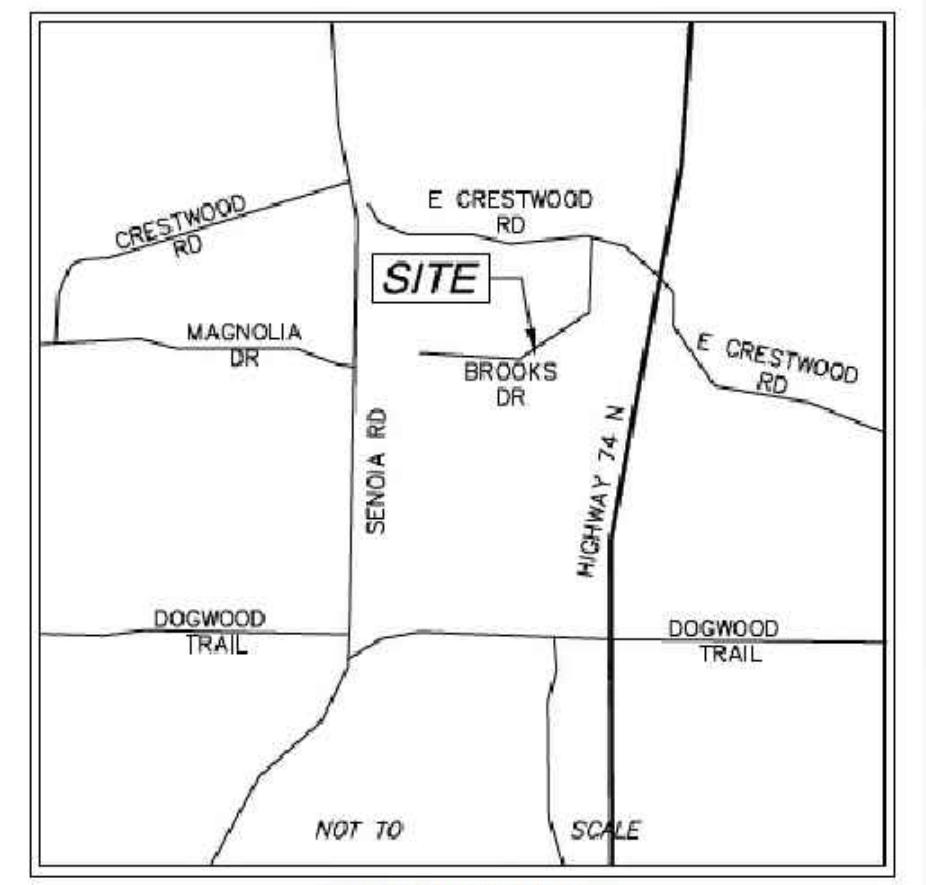

VICINITY MAP

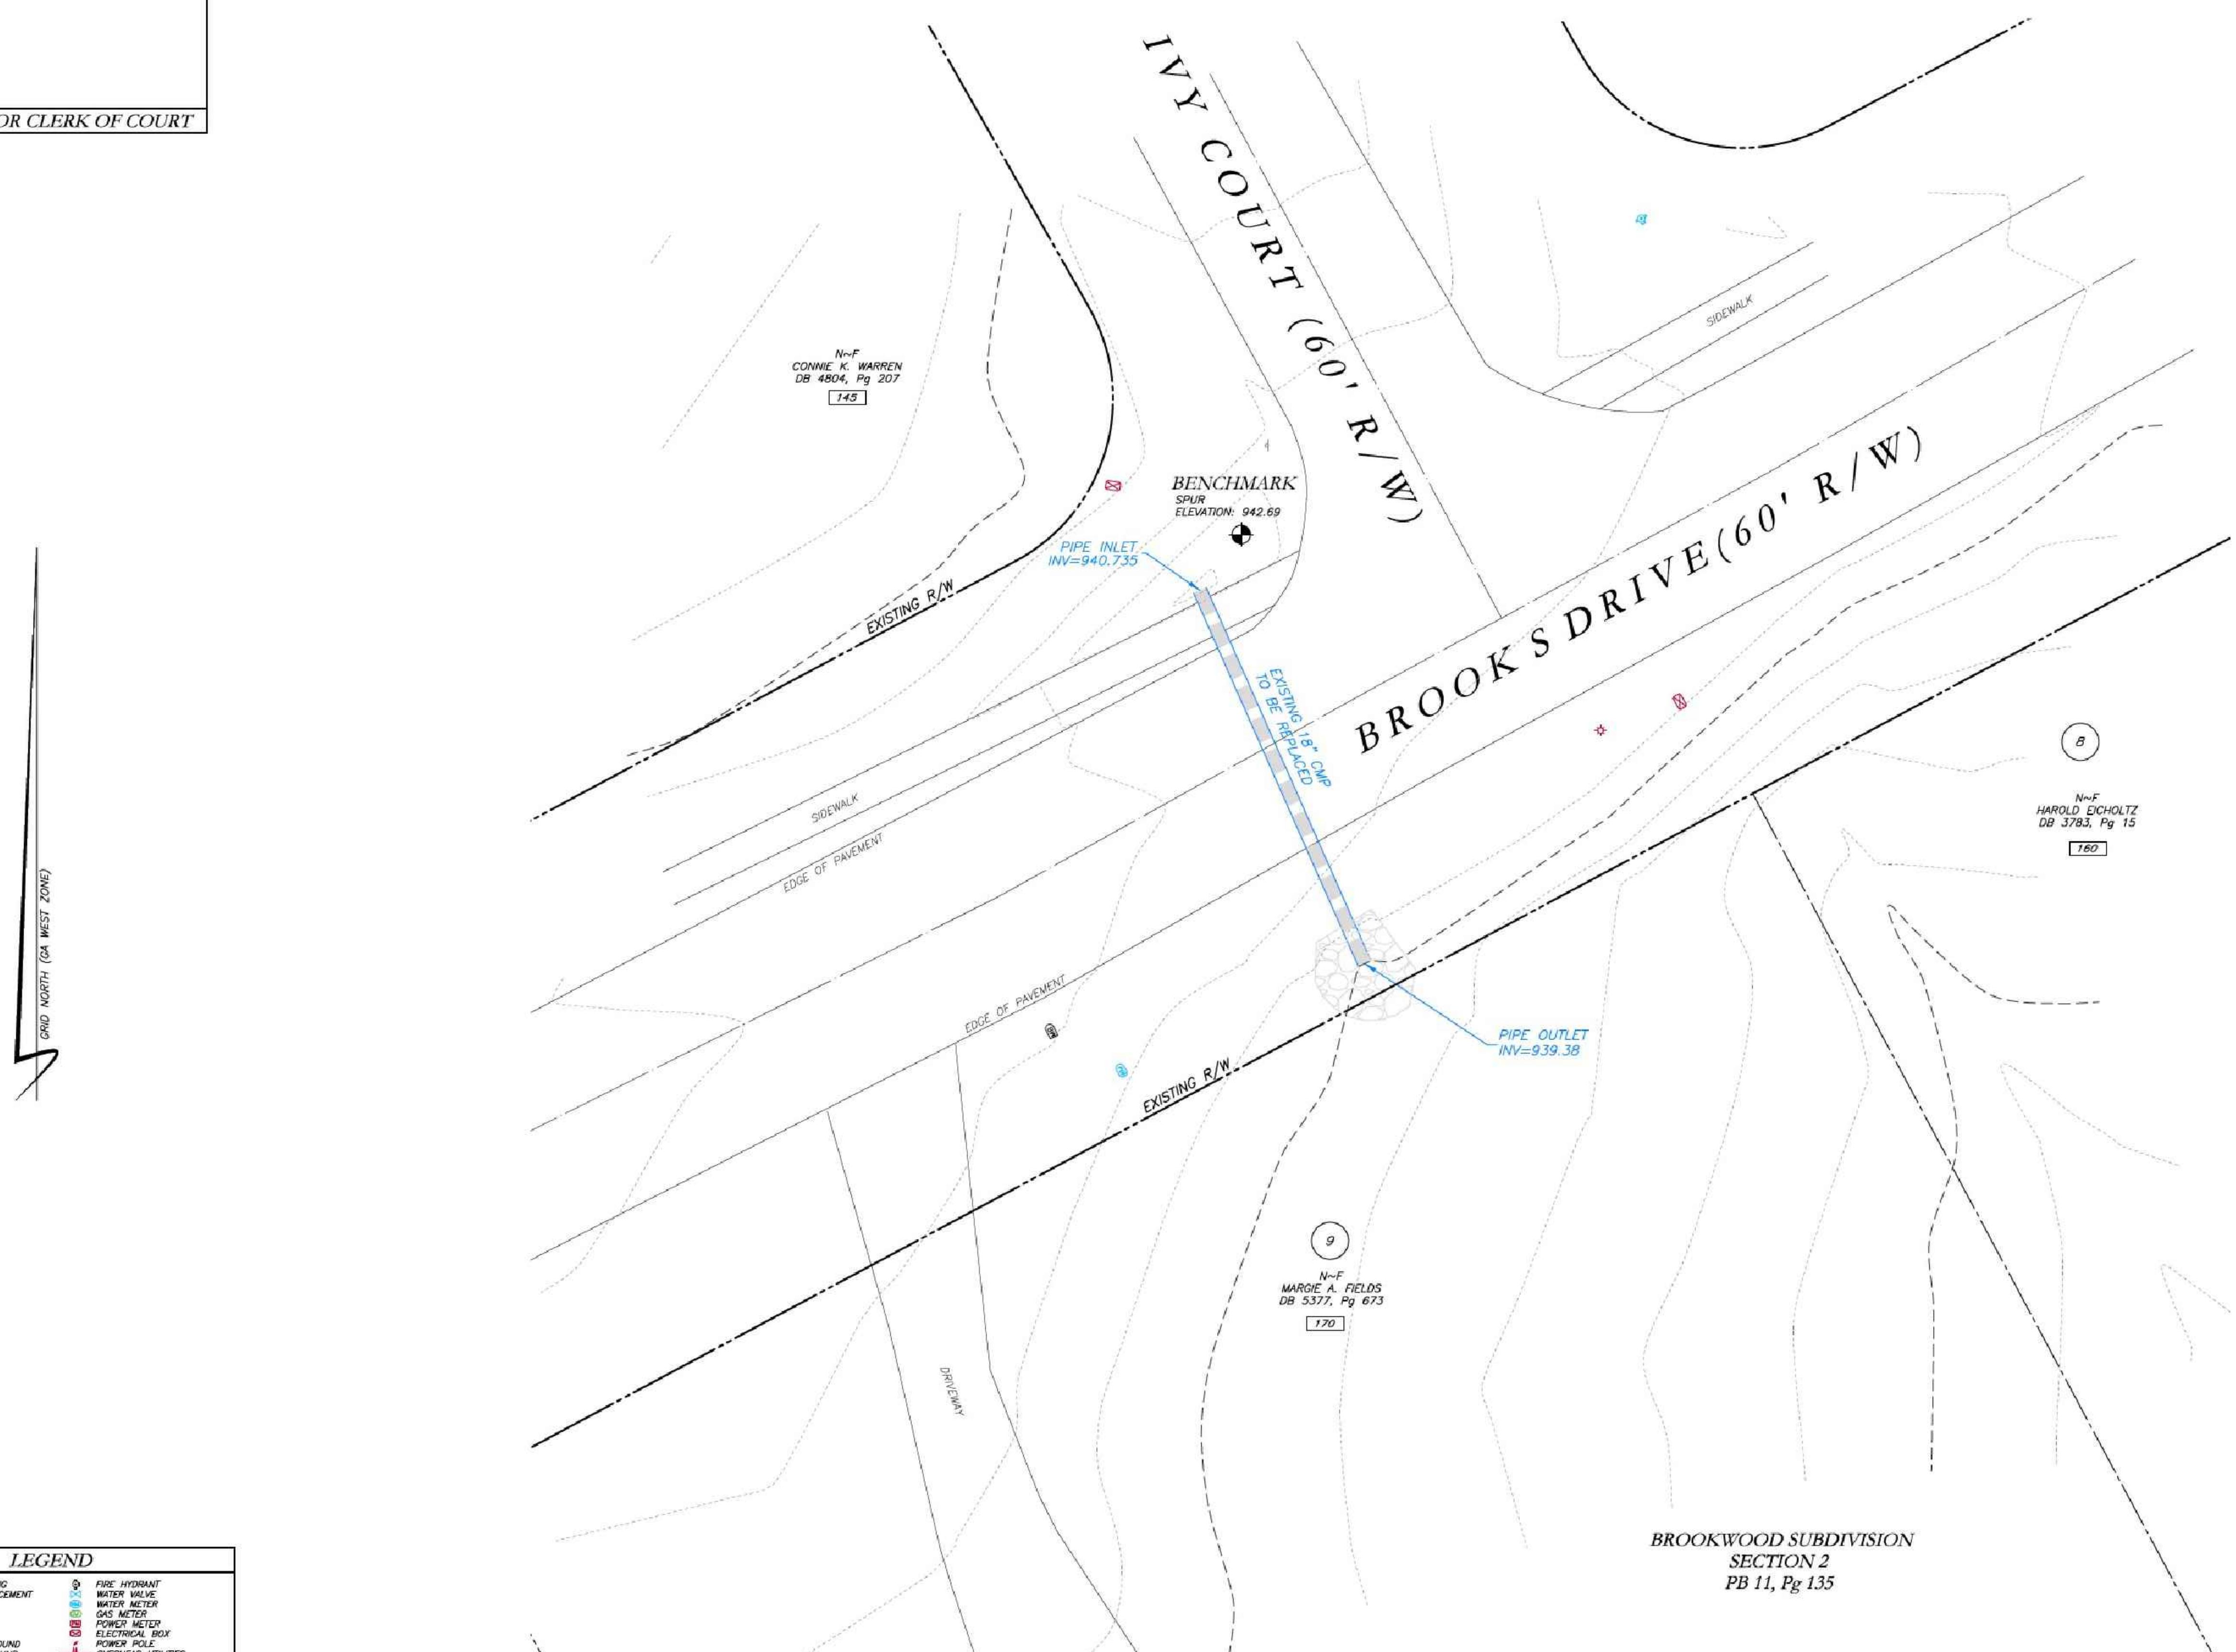

| LEGEND | |
|--------|---------------------------|
| POB | POINT OF BEGINNING |
| POC | POINT OF COMMENCEMENT |
| RRF | REVERSE READING |
| RRB | REVERSE READING |
| MNF | MAG NAIL FOUND |
| MAD | MAG ADAPTER FOUND |
| CTP | CIMP TOP PIPE FOUND |
| OTP | OPEN TOP PIPE FOUND |
| DTP | DEEP TOP PIPE FOUND |
| DI | DROP INLET |
| CI | CATCH INLET |
| WCS | WATER CONTROL STRUCTURE |
| OCS | OUTLET CONTROL STRUCTURE |
| JGB | JUNCTION BOX |
| DWCB | DOUBLE WING CATCH BASIN |
| DWCB | DOUBLE WING CATCH BASIN |
| HW | HEADWALL |
| TEF | THREADED END SECTION |
| CMP | CORRUGATED METAL PIPE |
| RCP | REINFORCED CONCRETE PIPE |
| SS | SANITARY SEWER |
| F.M.E. | FORCE MAIN EASEMENT |
| D.E. | DRIVEWAY EASEMENT |
| D.E. | DRAINAGE EASEMENT |
| W.E. | WATER EASEMENT |
| | |
| | FIRE HYDRANT |
| | WATER VALVE |
| | HEAT EXCHANGER |
| | GAS METER |
| | POWER METER |
| | OVERHEAD BOX |
| | POWER POLE |
| | OVERHEAD UTILITIES |
| | ROOF DRAIN |
| | DROP INLET |
| | SEWER BOX |
| | SINGLE WING CATCH BASIN |
| | DOUBLE WING CATCH BASIN |
| | HEADWALL |
| | FLARED END SECTION |
| | UNDERGROUND GAS LINE |
| | UNDERGROUND WATER LINE |
| | UNDERGROUND ELECTRIC LINE |
| | TELEPHONE TELCO LINE |
| | SANITARY SEWER MANHOLE |
| | SEWER MANHOLE |
| | GREASE TRAP |
| | FENCE |
| | BOLLARD |
| | SPOT ELEVATION |

10 0 10 20
SCALE: 1" = 10'

BROOKWOOD SUBDIVISION
SECTION 2
PB 11, Pg 135



SURVEYOR'S CERTIFICATION

This plat is a retrace of an existing parcel or parcels of land and does not subdivide or create a new parcel or make any changes to any real property boundaries. It is a record of the portion of the documents, maps, plans, or other instruments which created that parcel or parcels are stated here on. Recordation of this plat does not imply approval of any local jurisdiction, availability of permits, compliance with zoning, lot size, or requirements, or suitability for any use of parcels of land. Furthermore, the undersigned land surveyor certifies that this plat complies with the minimum technical standards for property surveys in Georgia as set forth in the rules and regulations of the Georgia Board of Registration for Professional Engineers and Land Surveyors as set forth in O.C.G.A. Section 15-6-177.

12/27/21
JOSEPH T. BAKER, LS
CODE: TP
JOB: 22006046
SHEET NO.
8 OF 43





| | |
|------------|-------------------------|
| LOCATED IN | TOWN OF TYRONE |
| | FAYETTE COUNTY, GEORGIA |

STORM DRAIN REPLACEMENT
EXISTING CONDITIONS
145 & 170 BROOKS DRIVE
TYRONE, GEORGIA 30290

DATE
12/30/2022

DWG. JCB CH. JTB
P.M. JTB
CODE: TP
JOB: 22006046
SHEET NO.
8 OF 43

PROPOSED REPLACEMENT OF
CROSS DRAINS AT
145, 160 & 170 BROOKS DR
TYRONE, GEORGIA 30290

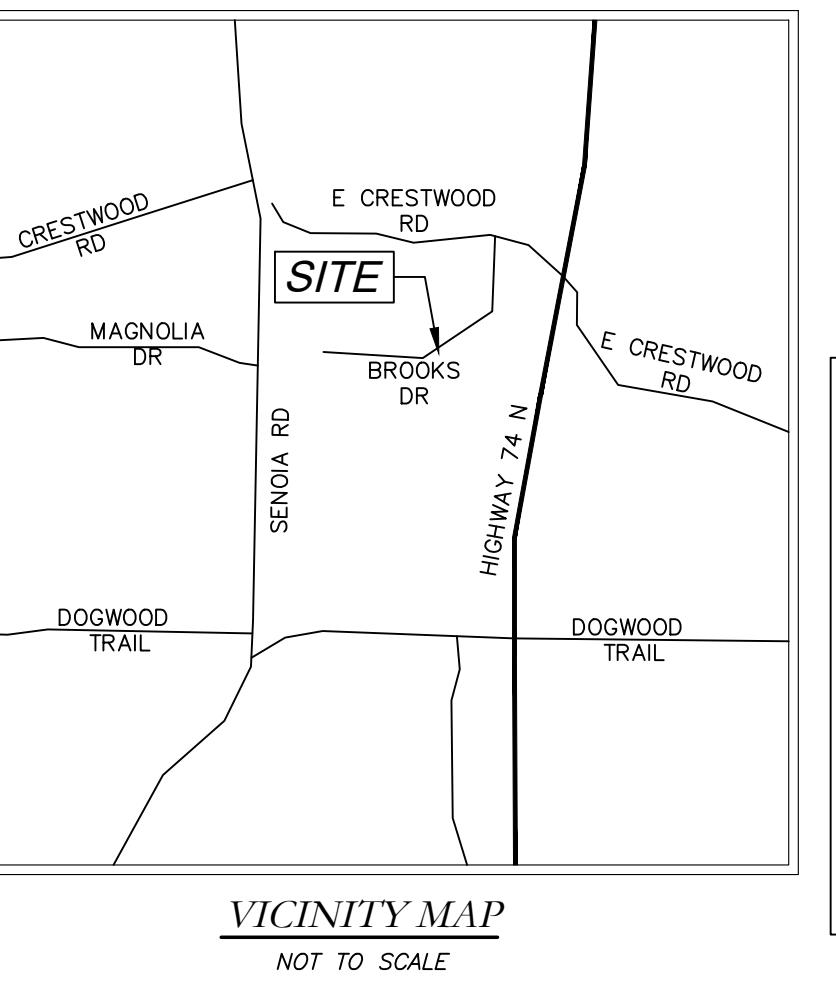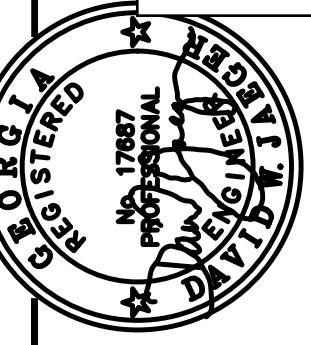

| PROJECT NUMBER PW-20 | |
|----------------------|---------------|
| DESIGN | SCALE |
| DRAWN | MCI |
| ALG | DATE 01/16/23 |
| CHECK | FILE NO. DWJ |
| APPROVED | SHEET NO. DWJ |
| BY APPD | |


| REV. NO. | DATE | DESCRIPTION | BY | APPD |
|----------|------|-------------|----|------|
| | | | | |

REVISION

NOT TO SCALE


Cross Drain Replacement
for Town of Tyrone, Georgia
Brooks Drive (1)
Proposed Conditions

Mallett Consulting, Inc.
101 Devant St., Suite 804, FAYETTEVILLE, GEORGIA 30214
PHONE: 770-719-3333 FAX: 770-719-3377

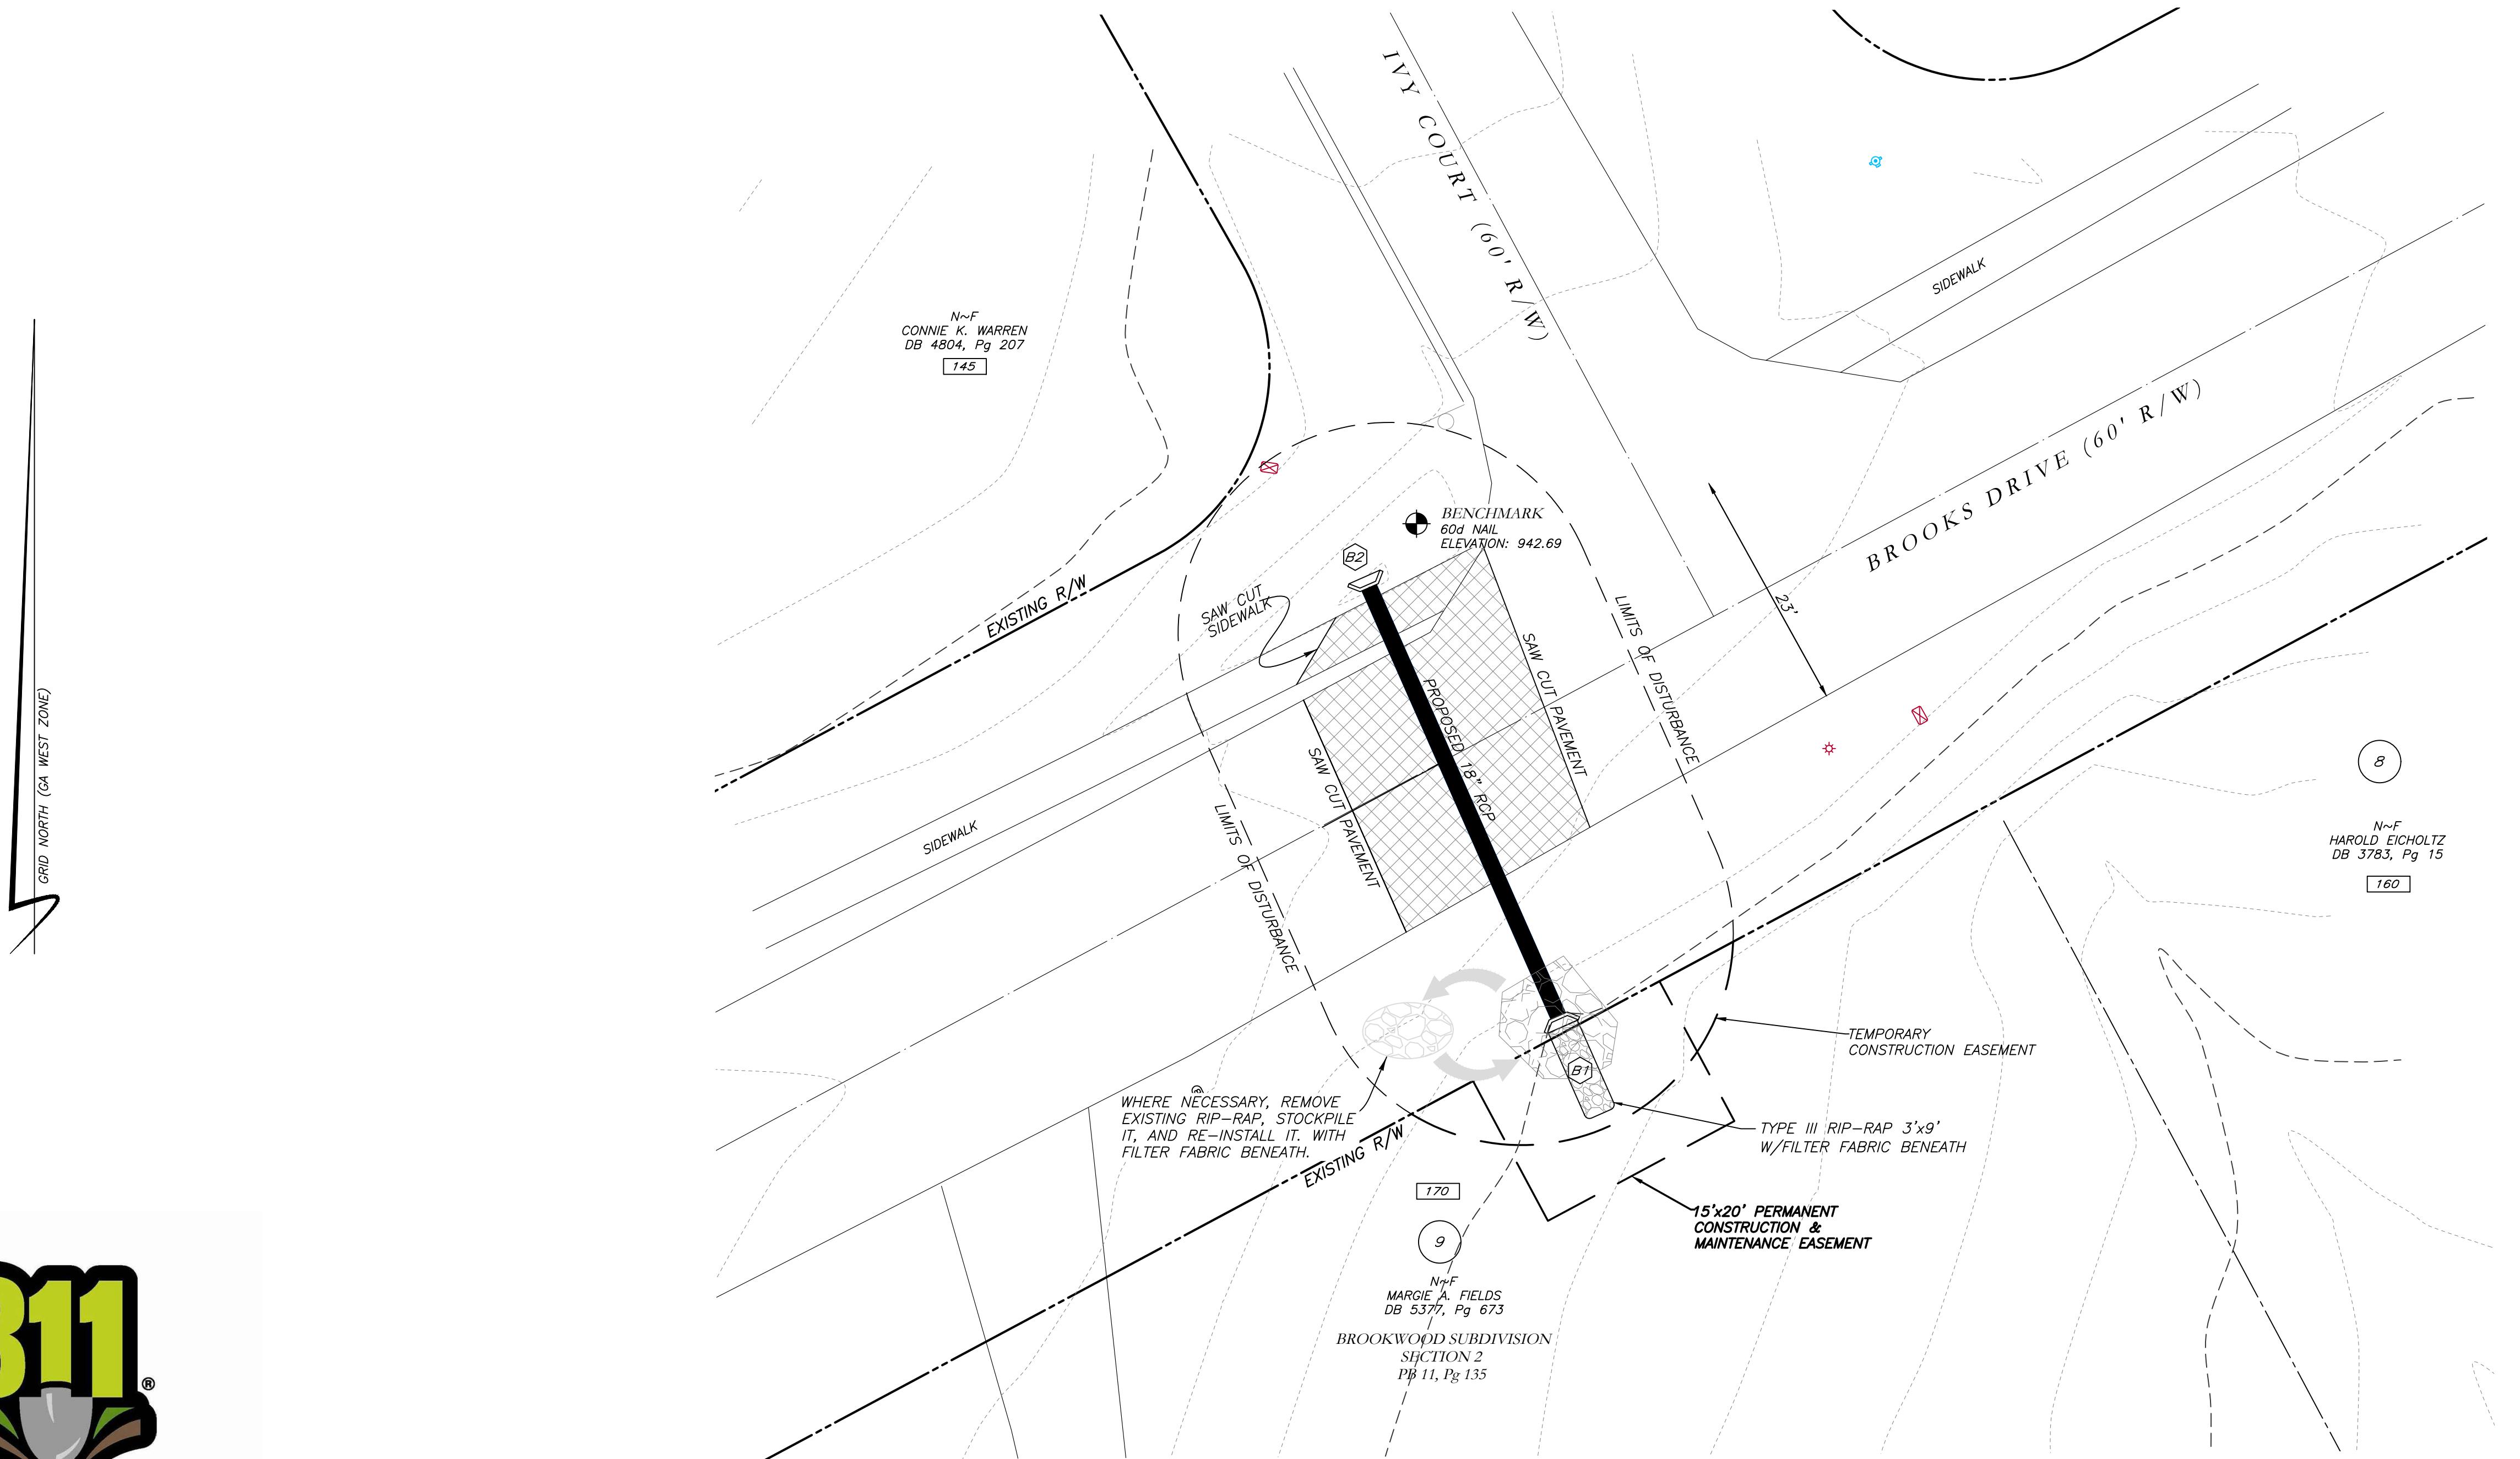

Know what's below.
Call before you dig.

| LEGEND | |
|----------------|--------------------------|
| POB | POINT OF BEGINNING |
| POC | POINT OF COMMENCEMENT |
| RBS | REBAR FOUND |
| RBF | REBAR FOUND |
| MNF | MAG NAIL FOUND |
| MNP | MAG NAIL FOUND |
| CTF | CRIMP TOP PIPE FOUND |
| OTP | OPEN TOP PIPE FOUND |
| DPF | DETERMINED PIPE FOUND |
| DI | DROP INLET |
| CI | CATCH INLET |
| YAC | YARD ACCESS |
| OCS | OUTLET CONTROL STRUCTURE |
| JB | JUNCTION BOX |
| DWCB | DOUBLE WING CATCH BASIN |
| DWCB | DOUBLE WING CATCH BASIN |
| HW | HEADWALL |
| TES | THICK END SECTION |
| CMP | CORRUGATED METAL PIPE |
| RCP | REINFORCED CONCRETE PIPE |
| SS | SEWER SLEEVE |
| F.M.E. | FORCE MAIN EASEMENT |
| D.E. | DRIVEWAY EASEMENT |
| W.E. | WATER EASEMENT |
| G.T. | GREASE TRAP |
| FENCE | FENCE |
| BOLLARD | BOLLARD |
| SPOT ELEVATION | SPOT ELEVATION |

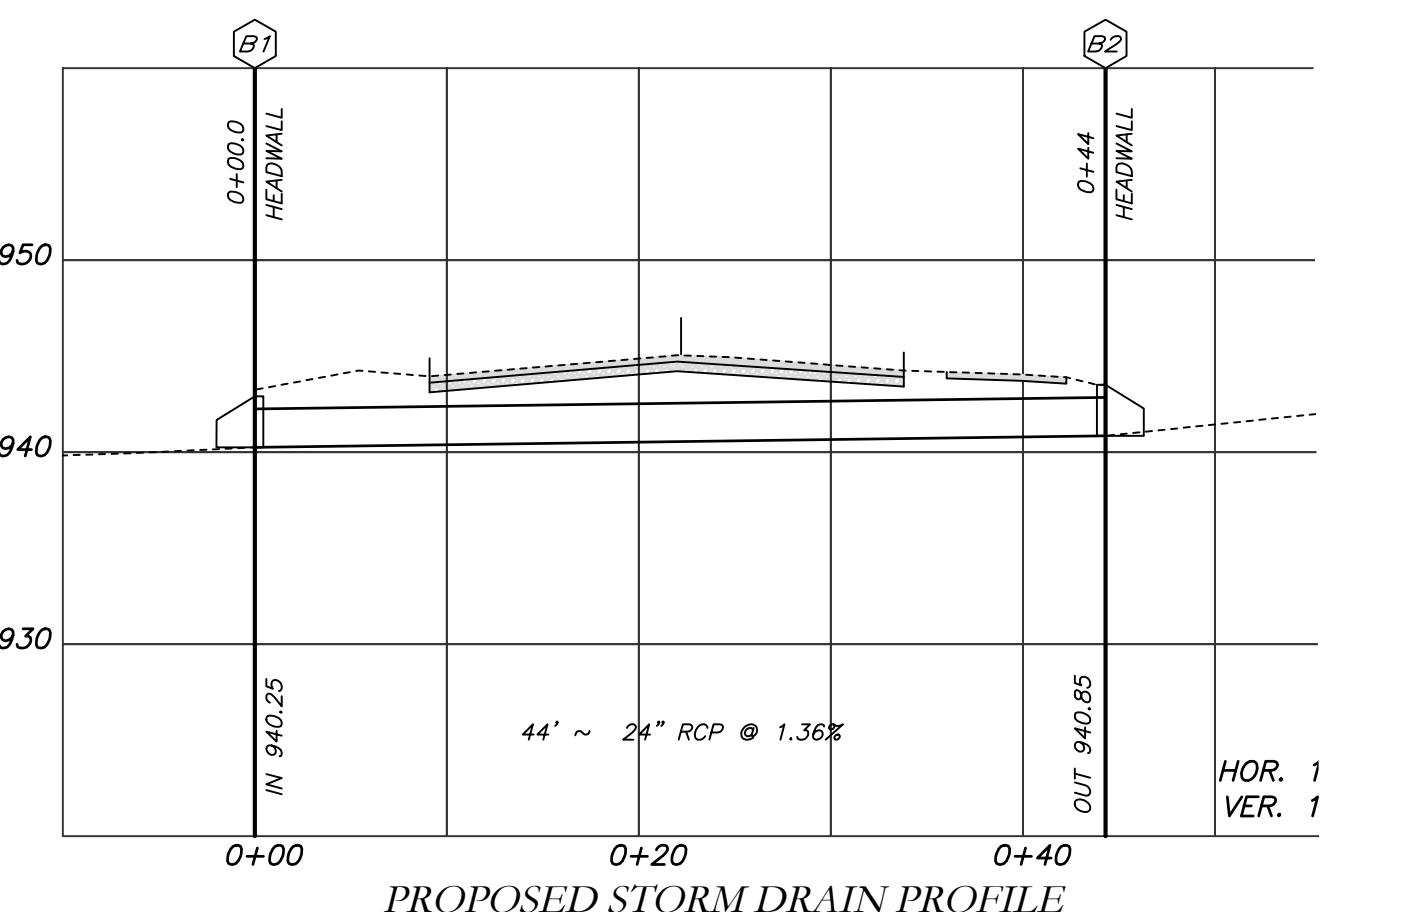


SCALE: 1" = 10'
HOR. 1
VER. 1

- NOTES:
- CONTRACTOR WILL BE RESPONSIBLE FOR LOCATING AND PROTECTING EXISTING UTILITIES.
 - EXISTING PAVEMENT SHALL BE SAW CUT AT LIMITS OF DEMOLITION ACTIVITIES. LOCATION OF SAW CUTS SHALL BE APPROVED IN ADVANCE BY THE TOWN ENGINEER.
 - CONTRACTOR TO STOCKPILE EXISTING RIP-RAP AND REUSE WHEN PRACTICAL.
 - ALL DEMOLITION MATERIALS, WASTE SOILS AND SEDIMENT SHALL BE HAULED AWAY AND DISPOSED OF OFFSITE AT A SUITABLE LOCATION, SELECTED BY THE CONTRACTOR. THIS SHALL BE DONE AT NO ADDITIONAL CHARGE.
 - TEMPORARY TRAFFIC CONTROL STRIPING, SIGNAGE AND DEVICES ARE REQUIRED DURING TRANSITION FROM EXISTING CONDITION TO COMPLETION OF PROJECT. PROVIDE CERTIFIED TRAFFIC CONTROL FLAGMEN DURING TEMPORARY LANE CLOSURES. BOTH LANES SHALL BE OPEN WHEN FLAGMEN ARE NOT PRESENT AND SHALL HAVE AN ALL WEATHER DRIVING SURFACE.
 - PAVEMENT WITHIN SAW CUT LINES TO BE REMOVED AND REPLACED.

SHEET NO.
9 of 43

**EROSION CONTROL PLAN FOR
CROSS DRAIN AT
145 & 170 BROOKS DRIVE
TYRONE, GEORGIA 30290**

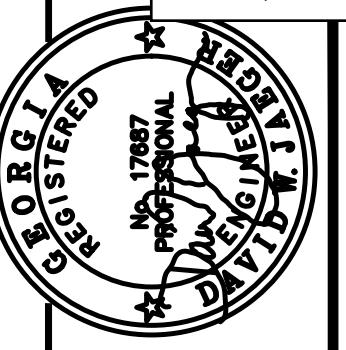

VICINITY MAP
NOT TO SCALE


| PROJECT NUMBER PW-20 | | | | | |
|----------------------|-------|----------|------|----------|-----------|
| DESIGN | SCALE | MCI | DATE | FILE NO. | SHEET NO. |
| DRAWN | AUG | 01/16/23 | DWJ | 21/01-16 | |
| CHECK | | | | | |
| APPROVED | APPD | | | | |

**Cross Drain Replacement
for Town of Tyrone, Georgia
Brooks Drive (1)
Erosion Control Plan**



**Know what's below.
Call before you dig.**

| LEGEND | |
|--------|---------------------------|
| POB | POINT OF BEGINNING |
| POC | POINT OF COMMENCEMENT |
| RBS | REBAR FOUND |
| RBF | REBAR FOUND |
| MNF | MAG NAIL FOUND |
| MNP | MAG NAIL FOUND |
| CTP | CRIMP TOP PIPE FOUND |
| OTP | OPEN TOP PIPE FOUND |
| CMF | CONCRETE MONUMENT FOUND |
| DI | DROP INLET |
| CI | CATCH INLET |
| YAC | YARD AREA |
| OCS | OUTLET CONTROL STRUCTURE |
| JB | JUNCTION BOX |
| DWCB | DOUBLE WING CATCH BASIN |
| DWCB | DOUBLE WING CATCH BASIN |
| HW | HEADWALL |
| TEC | TERMINAL END SECTION |
| CMP | CORRUGATED METAL PIPE |
| RCP | REINFORCED CONCRETE PIPE |
| SS | SEWER SLEEVE |
| F.M.E. | FORCE MAIN EASEMENT |
| D.E. | DRIVEWAY EASEMENT |
| D.E. | DRAINAGE EASEMENT |
| W.E. | WATER EASEMENT |
| G.H.T. | GREASE TRAP |
| X | FENCE |
| ● | BOLLARD |
| ○ | SPOT ELEVATION |
| ◆ | FIRE HYDRANT |
| ■ | WATER VALVE |
| ▲ | POWER CABLE |
| ● | GAS METER |
| ○ | POWER METER |
| □ | POWER BOX |
| ■ | POWER POLE |
| ◆ | OVERHEAD UTILITIES |
| ○ | ROOF DRAIN |
| △ | DROP INLET |
| ○ | DRIVEWAY |
| □ | MANHOLE |
| ○ | SINGLE WING CATCH BASIN |
| ○ | DOUBLE WING CATCH BASIN |
| ○ | MANHOLE |
| ○ | FLARED END SECTION |
| ○ | UNDERGROUND GAS LINE |
| ○ | UNDERGROUND WATER LINE |
| ○ | UNDERGROUND ELECTRIC LINE |
| ○ | TELECOM |
| ○ | SANITARY SEWER |
| ○ | SEWER MANHOLE |

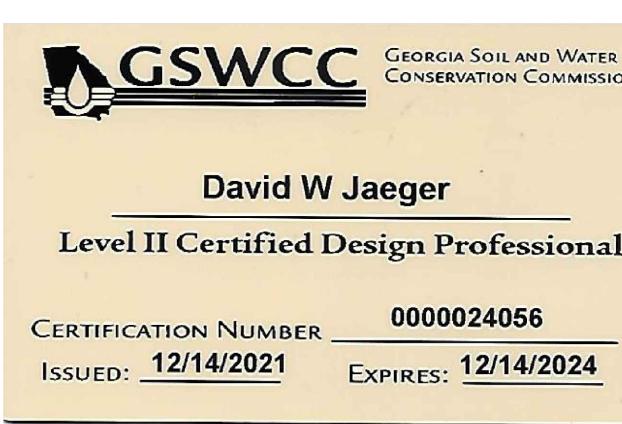

I CERTIFY AS THE PLAN DESIGNER THAT I HAVE VISITED
THE SITE PRIOR TO THE DESIGN OF THE ES&PC PLANS

David W Jaeger

10 0 10 20
SCALE: 1" = 10'

THE ESCAPE OF SEDIMENT FROM THE SITE SHALL BE PREVENTED BY THE
INSTALLATION OF EROSION AND SEDIMENT CONTROL MEASURES AND
PRACTICES PRIOR TO LAND DISTURBING ACTIVITIES.

EROSION CONTROL MEASURES SHALL BE MAINTAINED AT ALL TIMES.
IF FULL IMPLEMENTATION OF THE APPROVED PLAN DOES NOT PROVIDE
FOR EFFECTIVE EROSION CONTROL, ADDITIONAL EROSION AND
SEDIMENT CONTROL MEASURES SHALL BE IMPLEMENTED TO CONTROL
OR TREAT THE SEDIMENT SOURCE.

ANY DISTURBED AREA LEFT EXPOSED FOR A PERIOD GREATER THAN 14
DAYS SHALL BE STABILIZED WITH MULCH OR TEMPORARY SEEDING.

CONTRACTOR TO STOCKPILE EXISTING RIP-RAP AND REUSE WHEN
PRACTICAL.

REMOVE Sd1 WHEN GRASS HAS BEEN ESTABLISHED TO AT LEAST 85%
COVERAGE.

(C) CONSTRUCTION EXIT TO BE MAINTAINED WITHIN SAW CUT LINES.

TOTAL DISTurbed ACRES = 0.06

24 Hour Erosion Control Contact:

NAME: Scott Langford
ADDRESS: 950 Senoia Road
Tyrone, GA 30290
PHONE: (770)-487-4038




Know what's below.

Call before you dig.
THE LOCATIONS OF EXISTING UNDERGROUND UTILITIES ARE SHOWN IN THIS APPRAISAL MAP ONLY AS DETERMINED AND VERIFIED BY THE CONTRACTOR. THE CONTRACTOR IS NOT RESPONSIBLE FOR THE LOCATION OF ANY EXISTING UTILITIES WHICH MAY NOT BE SHOWN ON THIS MAP. THE CONTRACTOR SHALL DETERMINE THE EXACT LOCATION OF ALL EXISTING UTILITIES PRIOR TO COMMENCING WORK, AND AGREES TO SOLELY BE RESPONSIBLE FOR ANY AND ALL DAMAGES WHICH MIGHT BE OCCASIONED BY THE CONTRACTOR'S FAILURE TO LOCATE THESE UTILITIES AND PRESERVE ANY AND ALL UNDERGROUND UTILITIES.

NOTICE:
CONSTRUCTION SITE SAFETY IS THE CONTRACTOR'S RESPONSIBILITY. THE OWNER OR ENGINEER SHALL BE DULY NOTIFIED OF THE CONTRACTOR'S RESPONSIBILITY FOR SAFETY OF THE WORK OF CONSTRUCTION ENGAGED IN THE USE OF EXISTING UTILITIES, STRUCTURES, OR OF ANY OTHER PERSONS.

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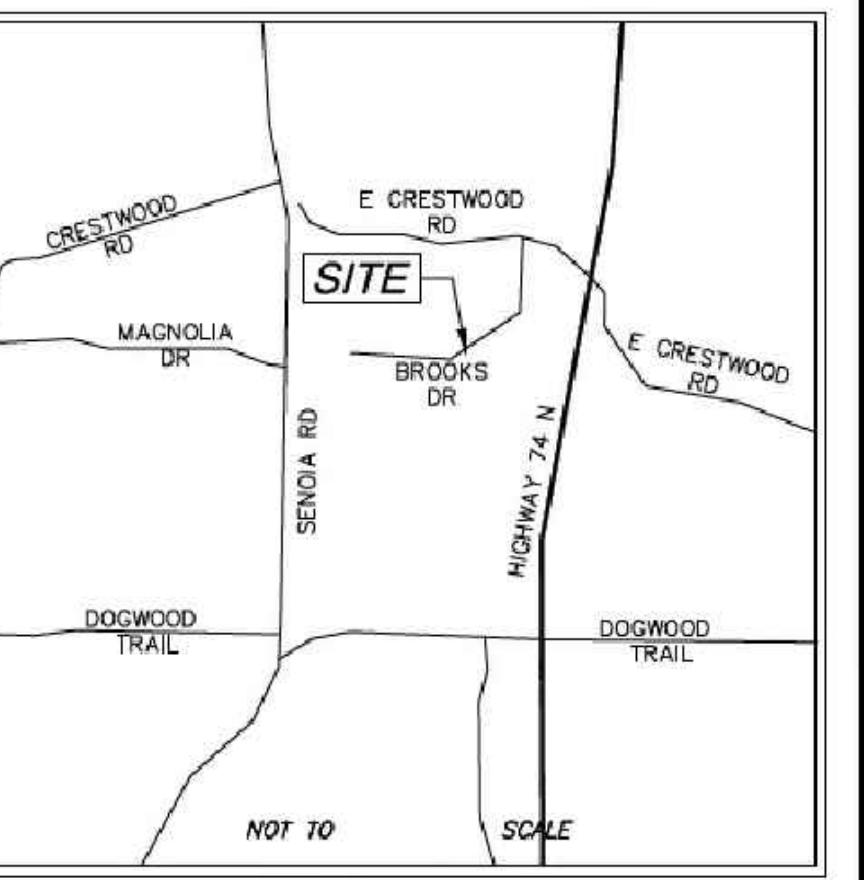
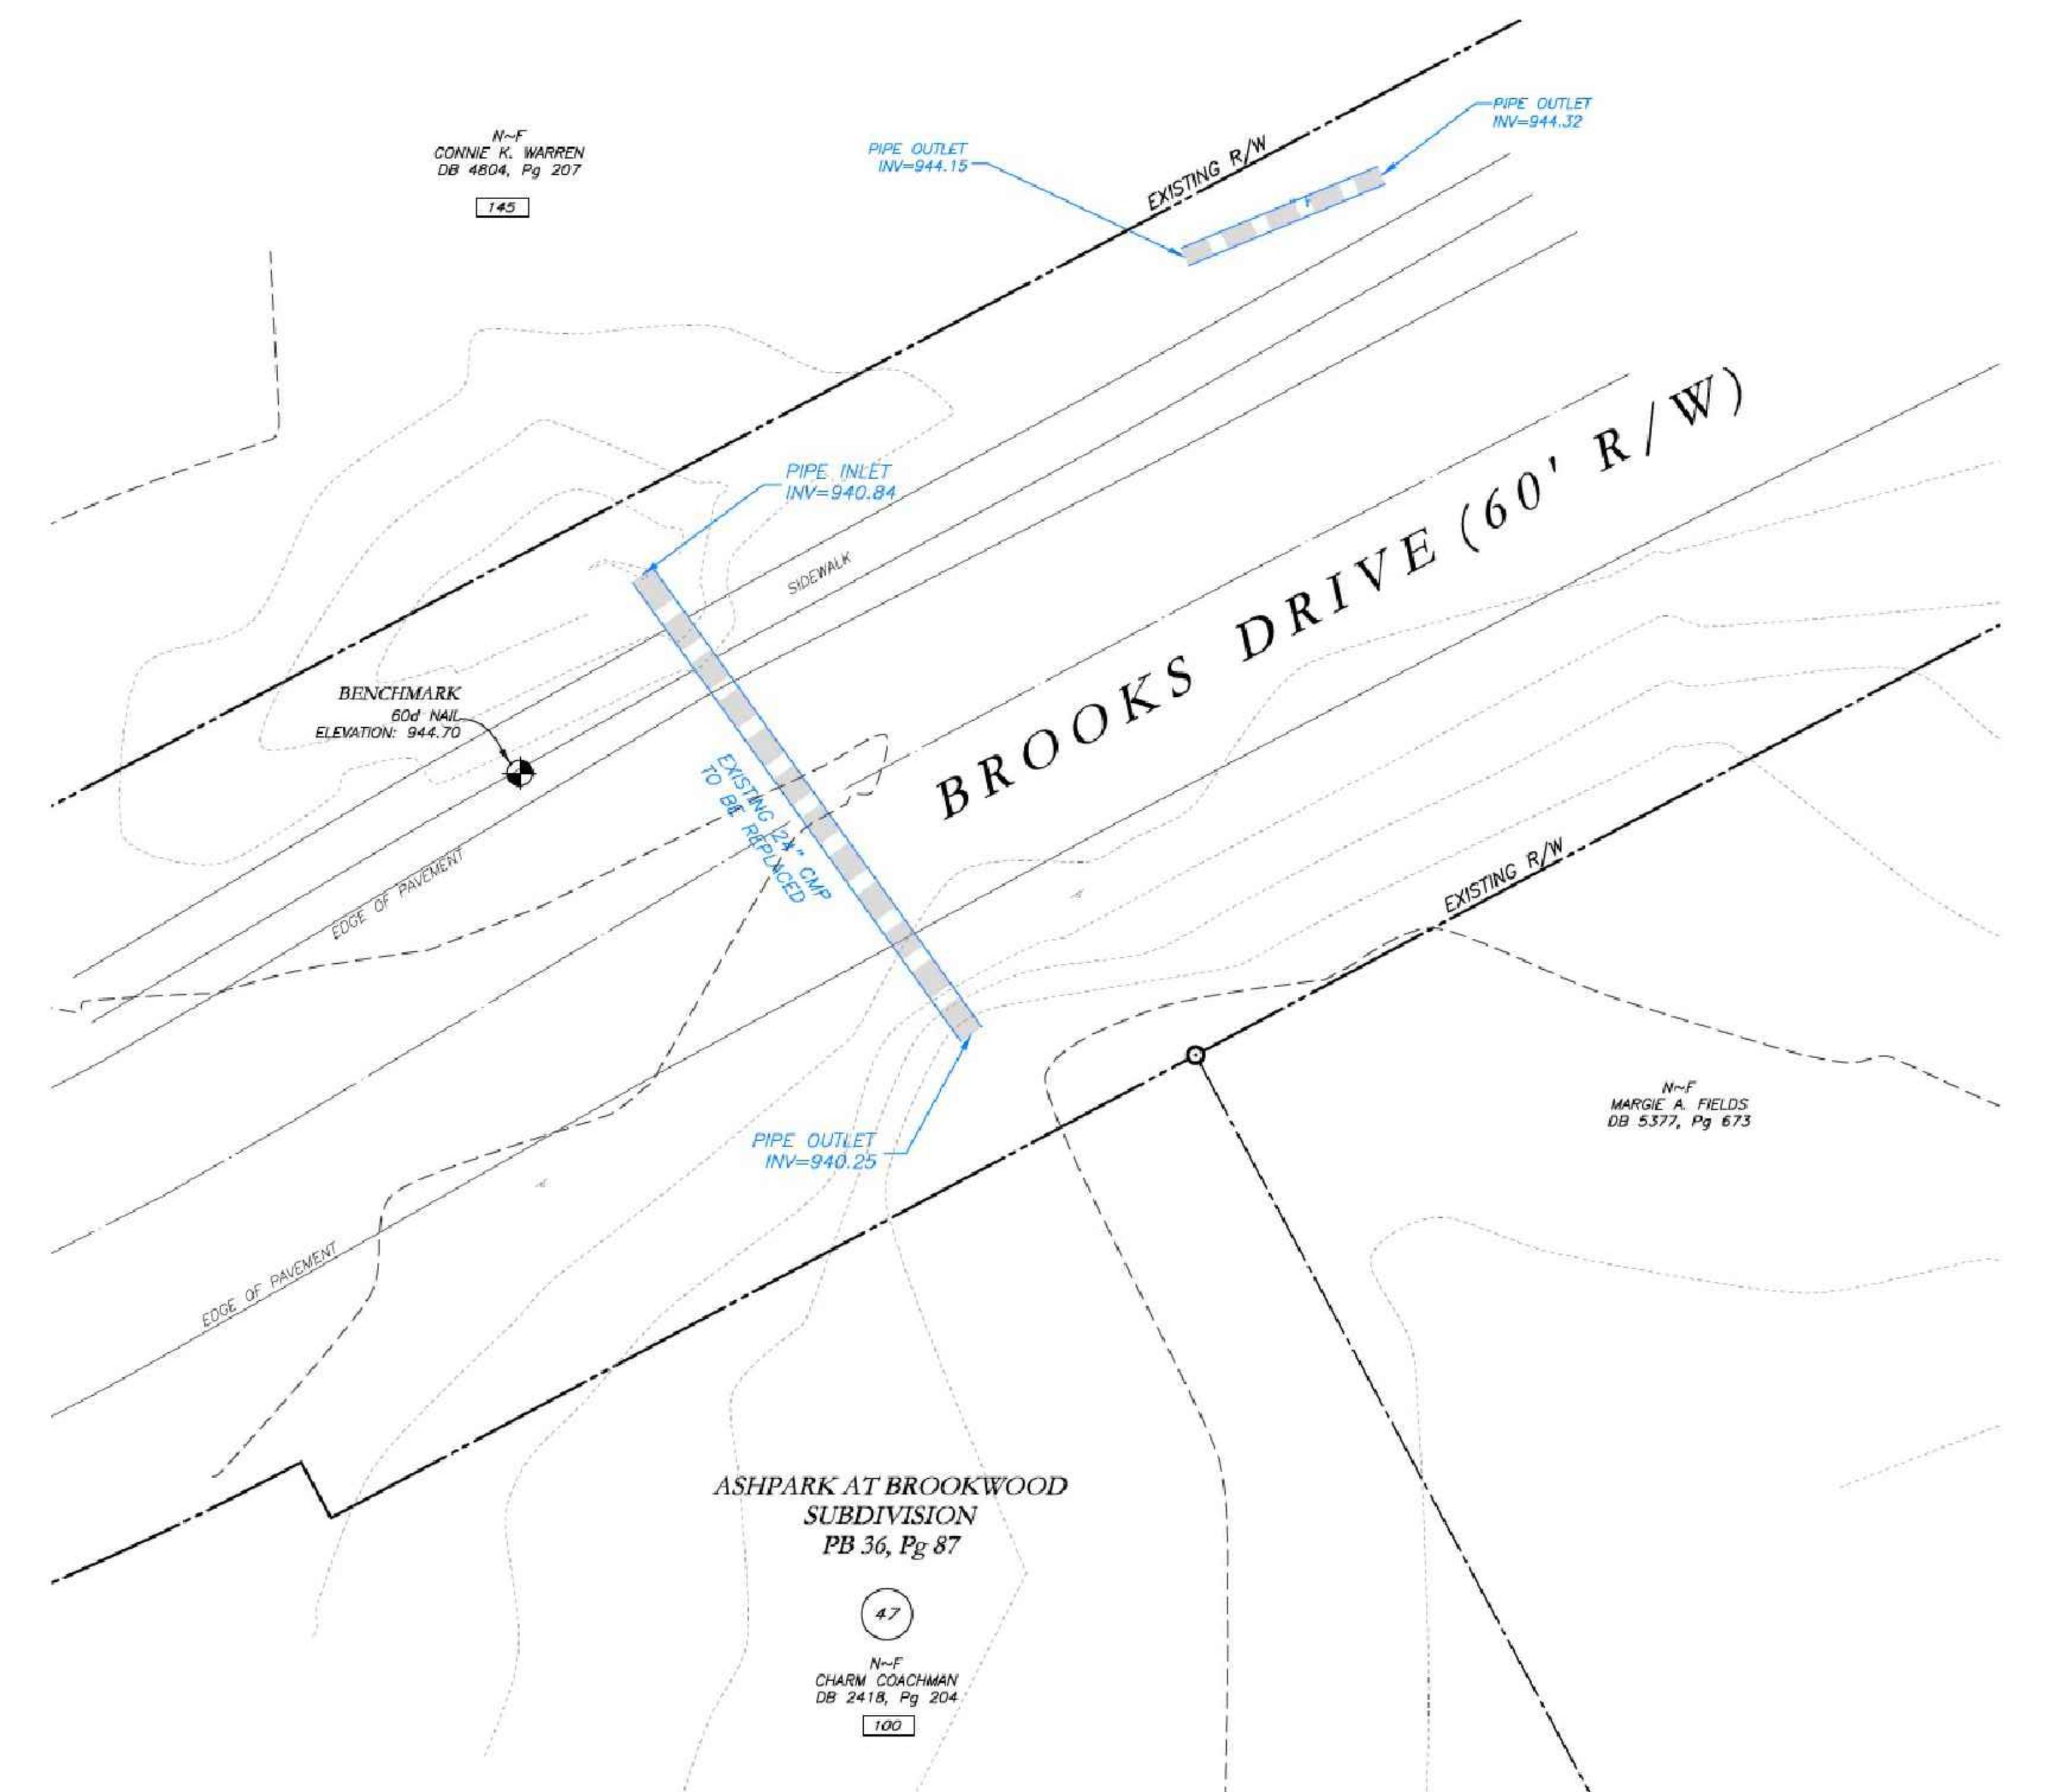


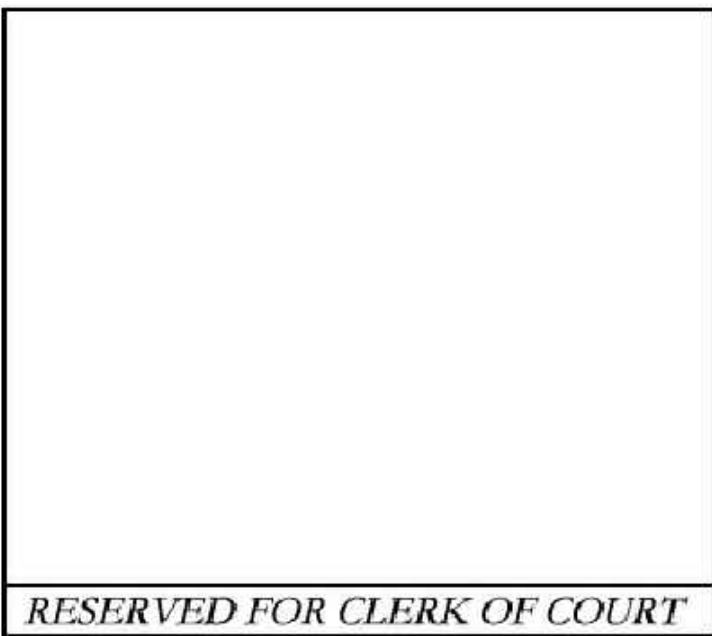LIMITED SURVEY OF STORM DRAIN REPLACEMENT 201, 145 BROOKS DR TYRONE, GEORGIA 30290

RESERVED FOR CLERK OF COURT

N-F
CONNIE K. WARREN
DB 4804, Pg 207

145

PIPE OUTLET
INV=944.15EXISTING R/W
PIPE OUTLET
INV=944.32

VICINITY MAP

SURVEY NOTES

1. THIS PLAT WAS PREPARED FOR THE EXCLUSIVE USE OF THE PERSON, PERSONS, OR ENTITY NAMED HEREON. THIS PLAT DOES NOT EXTEND TO ANY OTHER PERSON, PERSONS, OR ENTITY WITHIN THE EXPOSED WRITTEN CERTIFICATION BY THE SURVEYOR NAMING SAID PERSON, PERSONS, OR ENTITY.

2. NORTH ARROW AND BEARINGS ARE BASED ON GEORGIA STATE PLANE COORDINATES (NAVD88), US FOOT, USING GLOBAL POSITIONING SYSTEM (GPS) OBTRUSIVE SURVEYING ON OCTOBER 20, 2022 USING THE TRIMBLE VRS SYSTEM. ALL DISTANCES SHOWN ARE HORIZONTAL GROUND MEASUREMENTS EXPRESSED IN SURVEY FEET.

DATUMS:
HORIZONTAL: GRID NORTH, NAVD88
VERTICAL: NAVD88
GEOD: GEOD18 (CONUS)

3. CONTOURS AND SPOT ELEVATIONS SHOWN HEREON ARE BASED ON THE U.S.G.S. DATUM (NAVD88). THE SITE BENCHMARKS ARE AS SHOWN HEREON.

4. WATER MAIN, STORM SEWER, SANITARY SEWER, AND FRANCHISE UTILITY STRUCTURES HAVE BEEN LOCATED WHERE VISIBLE. NOTE: THE SURVEYOR MAKES NO GUARANTEES THAT THE UNDERGROUND UTILITIES SHOWN COMprise ALL SUCH UTILITIES IN THE AREA, EITHER IN-SERVICE OR ABANDONED.

5. THERE WAS NO EVIDENCE OF RECENT CONSTRUCTION ON THE SUBJECT PROPERTY OBSERVED IN THE PROCESS OF CONDUCTING THE FIELDWORK.

6. NO FIELD DELINEATED WETLANDS WERE OBSERVED IN THE PROCESS OF CONDUCTING THE FIELDWORK.

7. EQUIPMENT USED FOR MEASUREMENT:
ANGULAR: TRIMBLE R10/SB ROBOTIC TOTAL STATION
LINEAR: TRIMBLE R10/SB ROBOTIC TOTAL STATION
GPS: TRIMBLE R10 GPS RECEIVER

8. STATE, COUNTY, & LOCAL BUFFERS AND SETBACKS MIGHT EXIST ON THE SUBJECT PROPERTY THAT ARE NOT SHOWN HEREON.

9. THERE ARE NO STATE WATERS ON THIS SITE.

ATWELL
866.350.3200 www.atwell-group.com

1800 PARKWAY PLACE, SUITE 700
MARIETTA, GA
770.423.8007

LOCATED IN
TOWN OF TYRONE
FAYETTE COUNTY, GEORGIA

STORM DRAIN REPLACEMENT
EXISTING CONDITIONS
201, 145 BROOKS DR
TYRONE, GEORGIA 30290

DATE
12/30/2022

SURVEYOR'S CERTIFICATION

THIS PLAT IS A RETRACEMENT OF AN EXISTING PARCEL OR PARCELS OF LAND AND DOES NOT SUBDIVIDE OR CREATE A NEW PARCEL, OR MAKE ANY CHANGES TO ANY, REAR, FRONT, SIDE, END, OR CORNER OF THE PROPERTY. THE RECORDING OF THE DOCUMENTS, MAPS, PLATS, OR OTHER INSTRUMENTS WHICH CREATED THAT PARCEL OR PARCELS ARE STATED HEREON. RECORDING OF THIS PLAT DOES NOT IMPLY APPROVAL OF ANY LOCAL JURISDICTION, AVAILABILITY OF PERMITS, CONCURRENCE WITH LOCAL ZONING, OR REQUIREMENTS, OR SUITABILITY FOR ANY USE OF PURPOSE OF THE LAND. Furthermore, the undersigned land surveyor certifies that this plat complies with the minimum technical standards for property surveys in Georgia as set forth in the rules and regulations of the Georgia Board of Registration for Professional Engineers and Land Surveyors as set forth in O.C.G.A. Section 15-6-17.




JOSEPH T. BAKER, LS
CODE TP
JOB 22006046
SHEET NO.

DWG. JCB CH. JTB
P.M. JTB
CODE TP
JOB 22006046
SHEET NO.


| LEGEND | |
|--------|---------------------------|
| POB | POINT OF BEGINNING |
| POC | POINT OF COMMENCEMENT |
| POB | POINT OF BEGINNING |
| RRB | REBAR FOUND |
| MNF | MAG NAIL FOUND |
| MNF | MAG NAIL FOUND |
| CTP | CIMP TOP PIPE FOUND |
| OTP | OPEN TOP PIPE FOUND |
| DPF | DEEP PIPE FOUND |
| DI | DROP INLET |
| CI | CATCH INLET |
| YI | YARD INLET |
| OCS | OUTLET CONTROL STRUCTURE |
| JGB | JUNCTION BOX |
| DWCB | SINGLE WING CATCH BASIN |
| DWCB | DOUBLE WING CATCH BASIN |
| DWCB | DOUBLE WING CATCH BASIN |
| HW | HEADWALL |
| TEF | FLARED END SECTION |
| CMP | CORRUGATED METAL PIPE |
| RCP | REINFORCED CONCRETE PIPE |
| SS | SEWER SCAPE |
| F.M.E. | FORCE MAIN EASEMENT |
| S.E.E. | SEWER EASEMENT |
| D.E.E. | DRAINAGE EASEMENT |
| W.E. | WATER EASEMENT |
| G.H. | GROOVE HOLE |
| G.T. | GREASE TRAP |
| F. | FENCE |
| B. | BOULARD |
| S.E. | SPOT ELEVATION |
| | WATER VALVE |
| | HEAT EXCHANGER |
| | GAS METER |
| | POWER METER |
| | POWER POLE |
| | OVERHEAD UTILITIES |
| | ROOF DRAIN |
| | DROP INLET |
| | OUTLET BOX |
| | SINGLE WING CATCH BASIN |
| | DOUBLE WING CATCH BASIN |
| | HEADWALL |
| | FLARED END SECTION |
| | UNDERGROUND GAS LINE |
| | UNDERGROUND WATER LINE |
| | UNDERGROUND ELECTRIC LINE |
| | SANITARY SEWER LINE |
| | SANITARY SEWER MANHOLE |

10 0 10 20
SCALE: 1" = 10'

PROPOSED REPLACEMENT OF
CROSS DRAINS AT
100 & 201 BROOKS DR
TYRONE, GEORGIA 30290

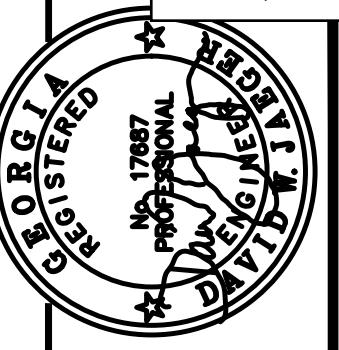


| PROJECT NUMBER PW-20 | DESIGN MCI | SCALE |
|----------------------|---------------|---------------|
| DRAWN ALG | DATE 01/16/23 | FILE NO. DWJ |
| CHECK DWJ | | SHEET NO. DWJ |
| APPROVED DWJ | BY APPD | |

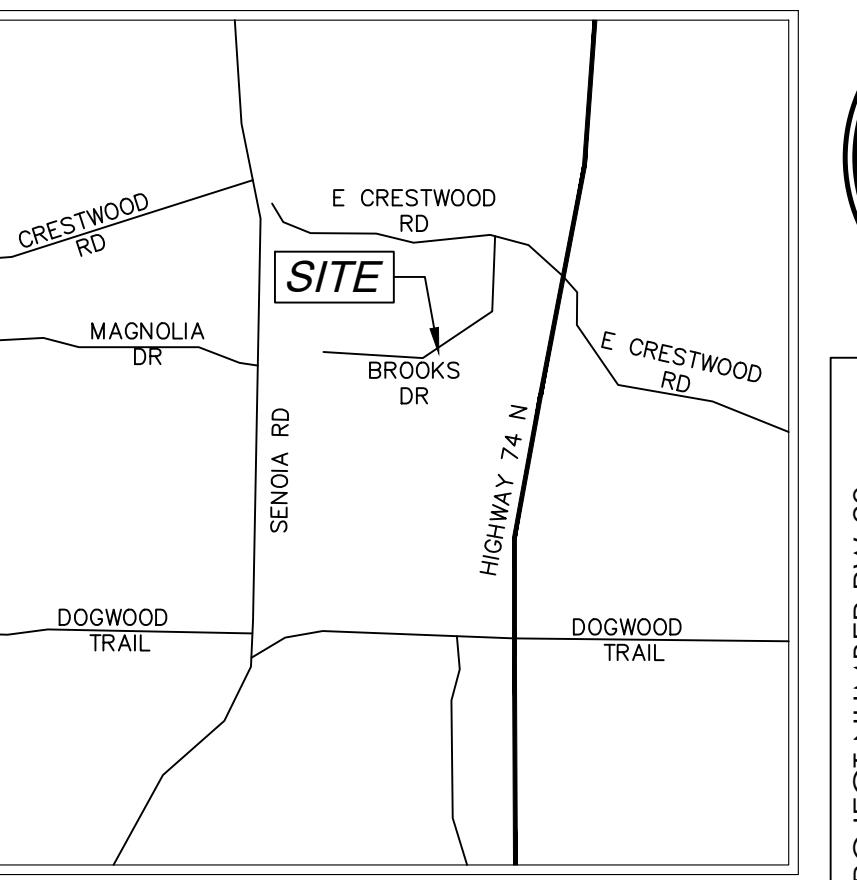

| Cross Drain Replacement | |
|-----------------------------------------|--|
| for Town of Tyrone, Georgia | |
| Brooks Drive (2) Proposed Conditions | |

Mallett Consulting, Inc.
101 Devant St., Suite 804, Fayetteville, Georgia 30214
PHONE: 770-719-3333 FAX: 770-719-3377

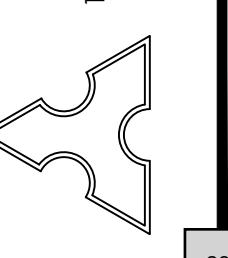


- NOTES:**
- CONTRACTOR WILL BE RESPONSIBLE FOR LOCATING AND PROTECTING EXISTING UTILITIES.
 - EXISTING PAVEMENT SHALL BE SAW CUT AT LIMITS OF DEMOLITION ACTIVITIES. LOCATION OF SAW CUTS SHALL BE APPROVED IN ADVANCE BY THE TOWN ENGINEER.
 - CONTRACTOR TO STOCKPILE EXISTING RIP-RAP AND REUSE WHEN PRACTICAL.
 - ALL DEMOLITION MATERIALS, WASTE SOILS AND SEDIMENT SHALL BE HAULED AWAY AND DISPOSED OF OFFSITE AT A SUITABLE LOCATION, SELECTED BY THE CONTRACTOR. THIS SHALL BE DONE AT NO ADDITIONAL CHARGE.
 - TEMPORARY TRAFFIC CONTROL STRIPING, SIGNAGE AND DEVICES ARE REQUIRED DURING TRANSITION FROM EXISTING CONDITION TO COMPLETION OF PROJECT. PROVIDE CERTIFIED TRAFFIC CONTROL FLAGMEN DURING TEMPORARY LANE CLOSURES. BOTH LANES SHALL BE OPEN WHEN FLAGMEN ARE NOT PRESENT AND SHALL HAVE AN ALL WEATHER DRIVING SURFACE.
 - PAVEMENT WITHIN SAW CUT LINES TO BE REMOVED AND REPLACED.




Know what's below.
Call before you dig.

| LEGEND | |
|----------------|---------------------------|
| POB | POINT OF BEGINNING |
| POC | POINT OF COMMENCEMENT |
| RBS | REBAR FOUND |
| RRF | REINFORCED REBAR |
| MNF | MAG NAIL FOUND |
| MNS | MAG NAIL FOUND |
| CTP | CRIMP TOP PIPE FOUND |
| OTP | OPEN TOP PIPE FOUND |
| DPF | DEFORMED PIPE FOUND |
| DI | DROP INLET |
| CI | CATCH INLET |
| YAC | YARD AREA |
| OCS | OUTLET CONTROL STRUCTURE |
| JB | JUNCTION BOX |
| DWCB | DOUBLE WING CATCH BASIN |
| DWCB | DOUBLE WING CATCH BASIN |
| HW | HEADWALL |
| TEC | TERMINAL END SECTION |
| CMP | CORRUGATED METAL PIPE |
| RCP | REINFORCED CONCRETE PIPE |
| SS | SEWER SEWER |
| F.M.E. | FORCE MAIN EASEMENT |
| S.E. | SEWER EASEMENT |
| D.E. | DRAINAGE EASEMENT |
| W.E. | WATER EASEMENT |
| G.H.T. | GAS LINE |
| U.G.T. | UNDERGROUND GAS LINE |
| U.E.L. | UNDERGROUND ELECTRIC LINE |
| U.T.C. | UNDERGROUND TELECOM |
| S.S. | SANITARY SEWER |
| S.W. | SANITARY SEWER MANHOLE |
| G.T. | GREASE TRAP |
| FENCE | FENCE |
| BOLLARD | BOLLARD |
| SPOT ELEVATION | SPOT ELEVATION |

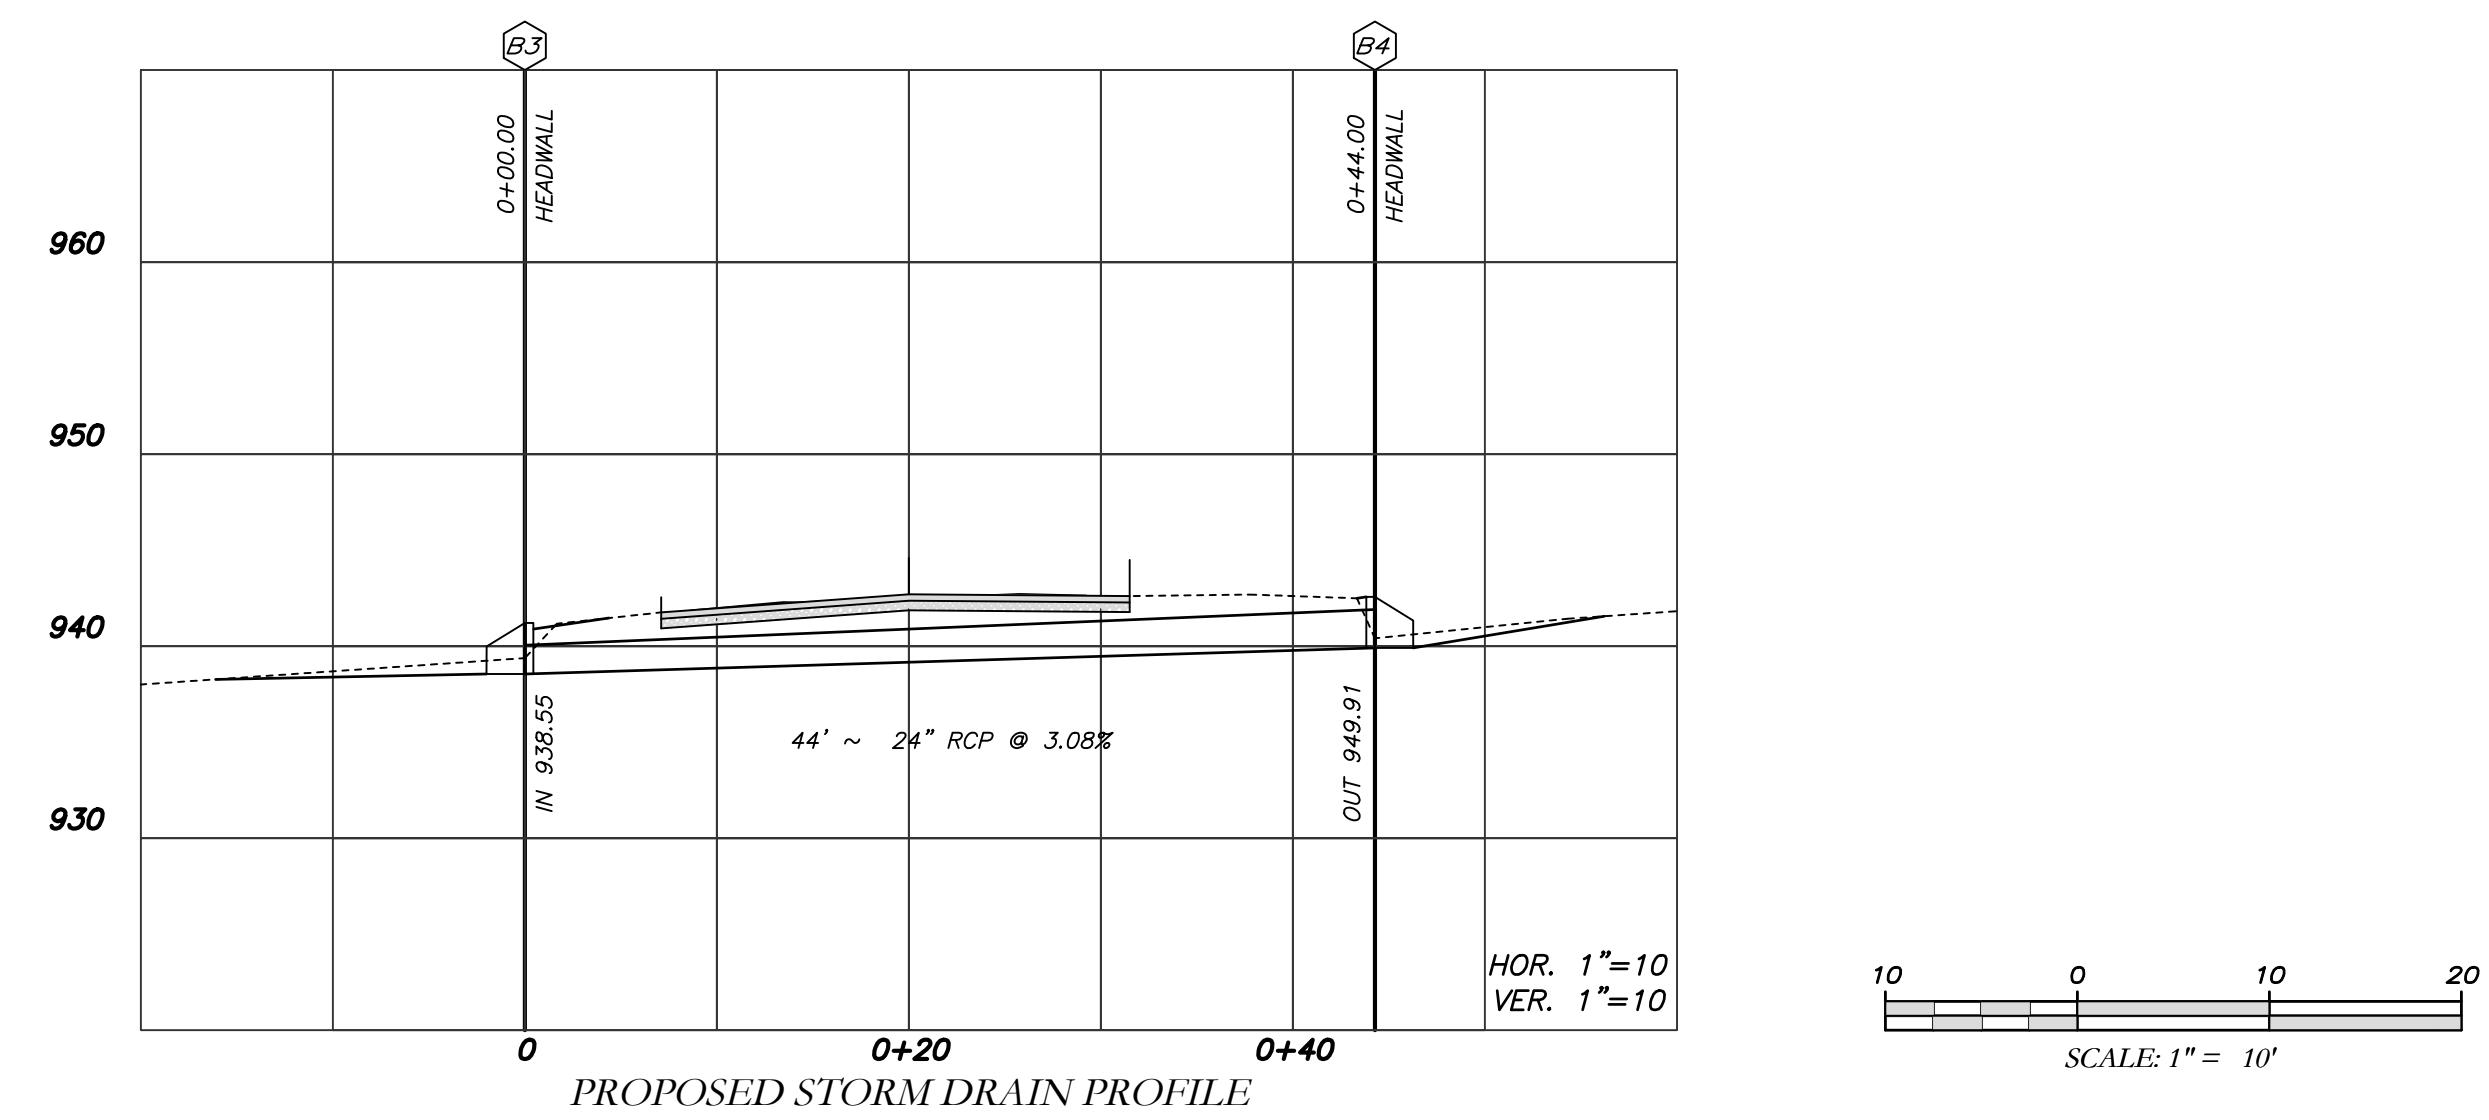


**EROSION CONTROL PLAN FOR
CROSS DRAINS AT
100 & 201 BROOKS DR
TYRONE, GEORGIA 30290**

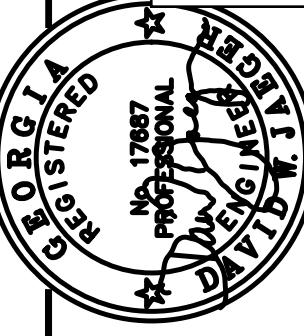

PROJECT NUMBER PW-20
SCALE
DESIGN MCI DATE 01/16/23
DRAWN ALG FILE NO. DWJ SHEET NO.
CHECK DWJ APPROVED DWJ BY APPD


REV. NO. DATE DESCRIPTION BY APPD
REV. NO. DATE DESCRIPTION BY APPD
REV. NO. DATE DESCRIPTION BY APPD

**Cross Drain Replacement
for Town of Tyrone, Georgia
Brooks Drive (2)
Erosion Control Plan**

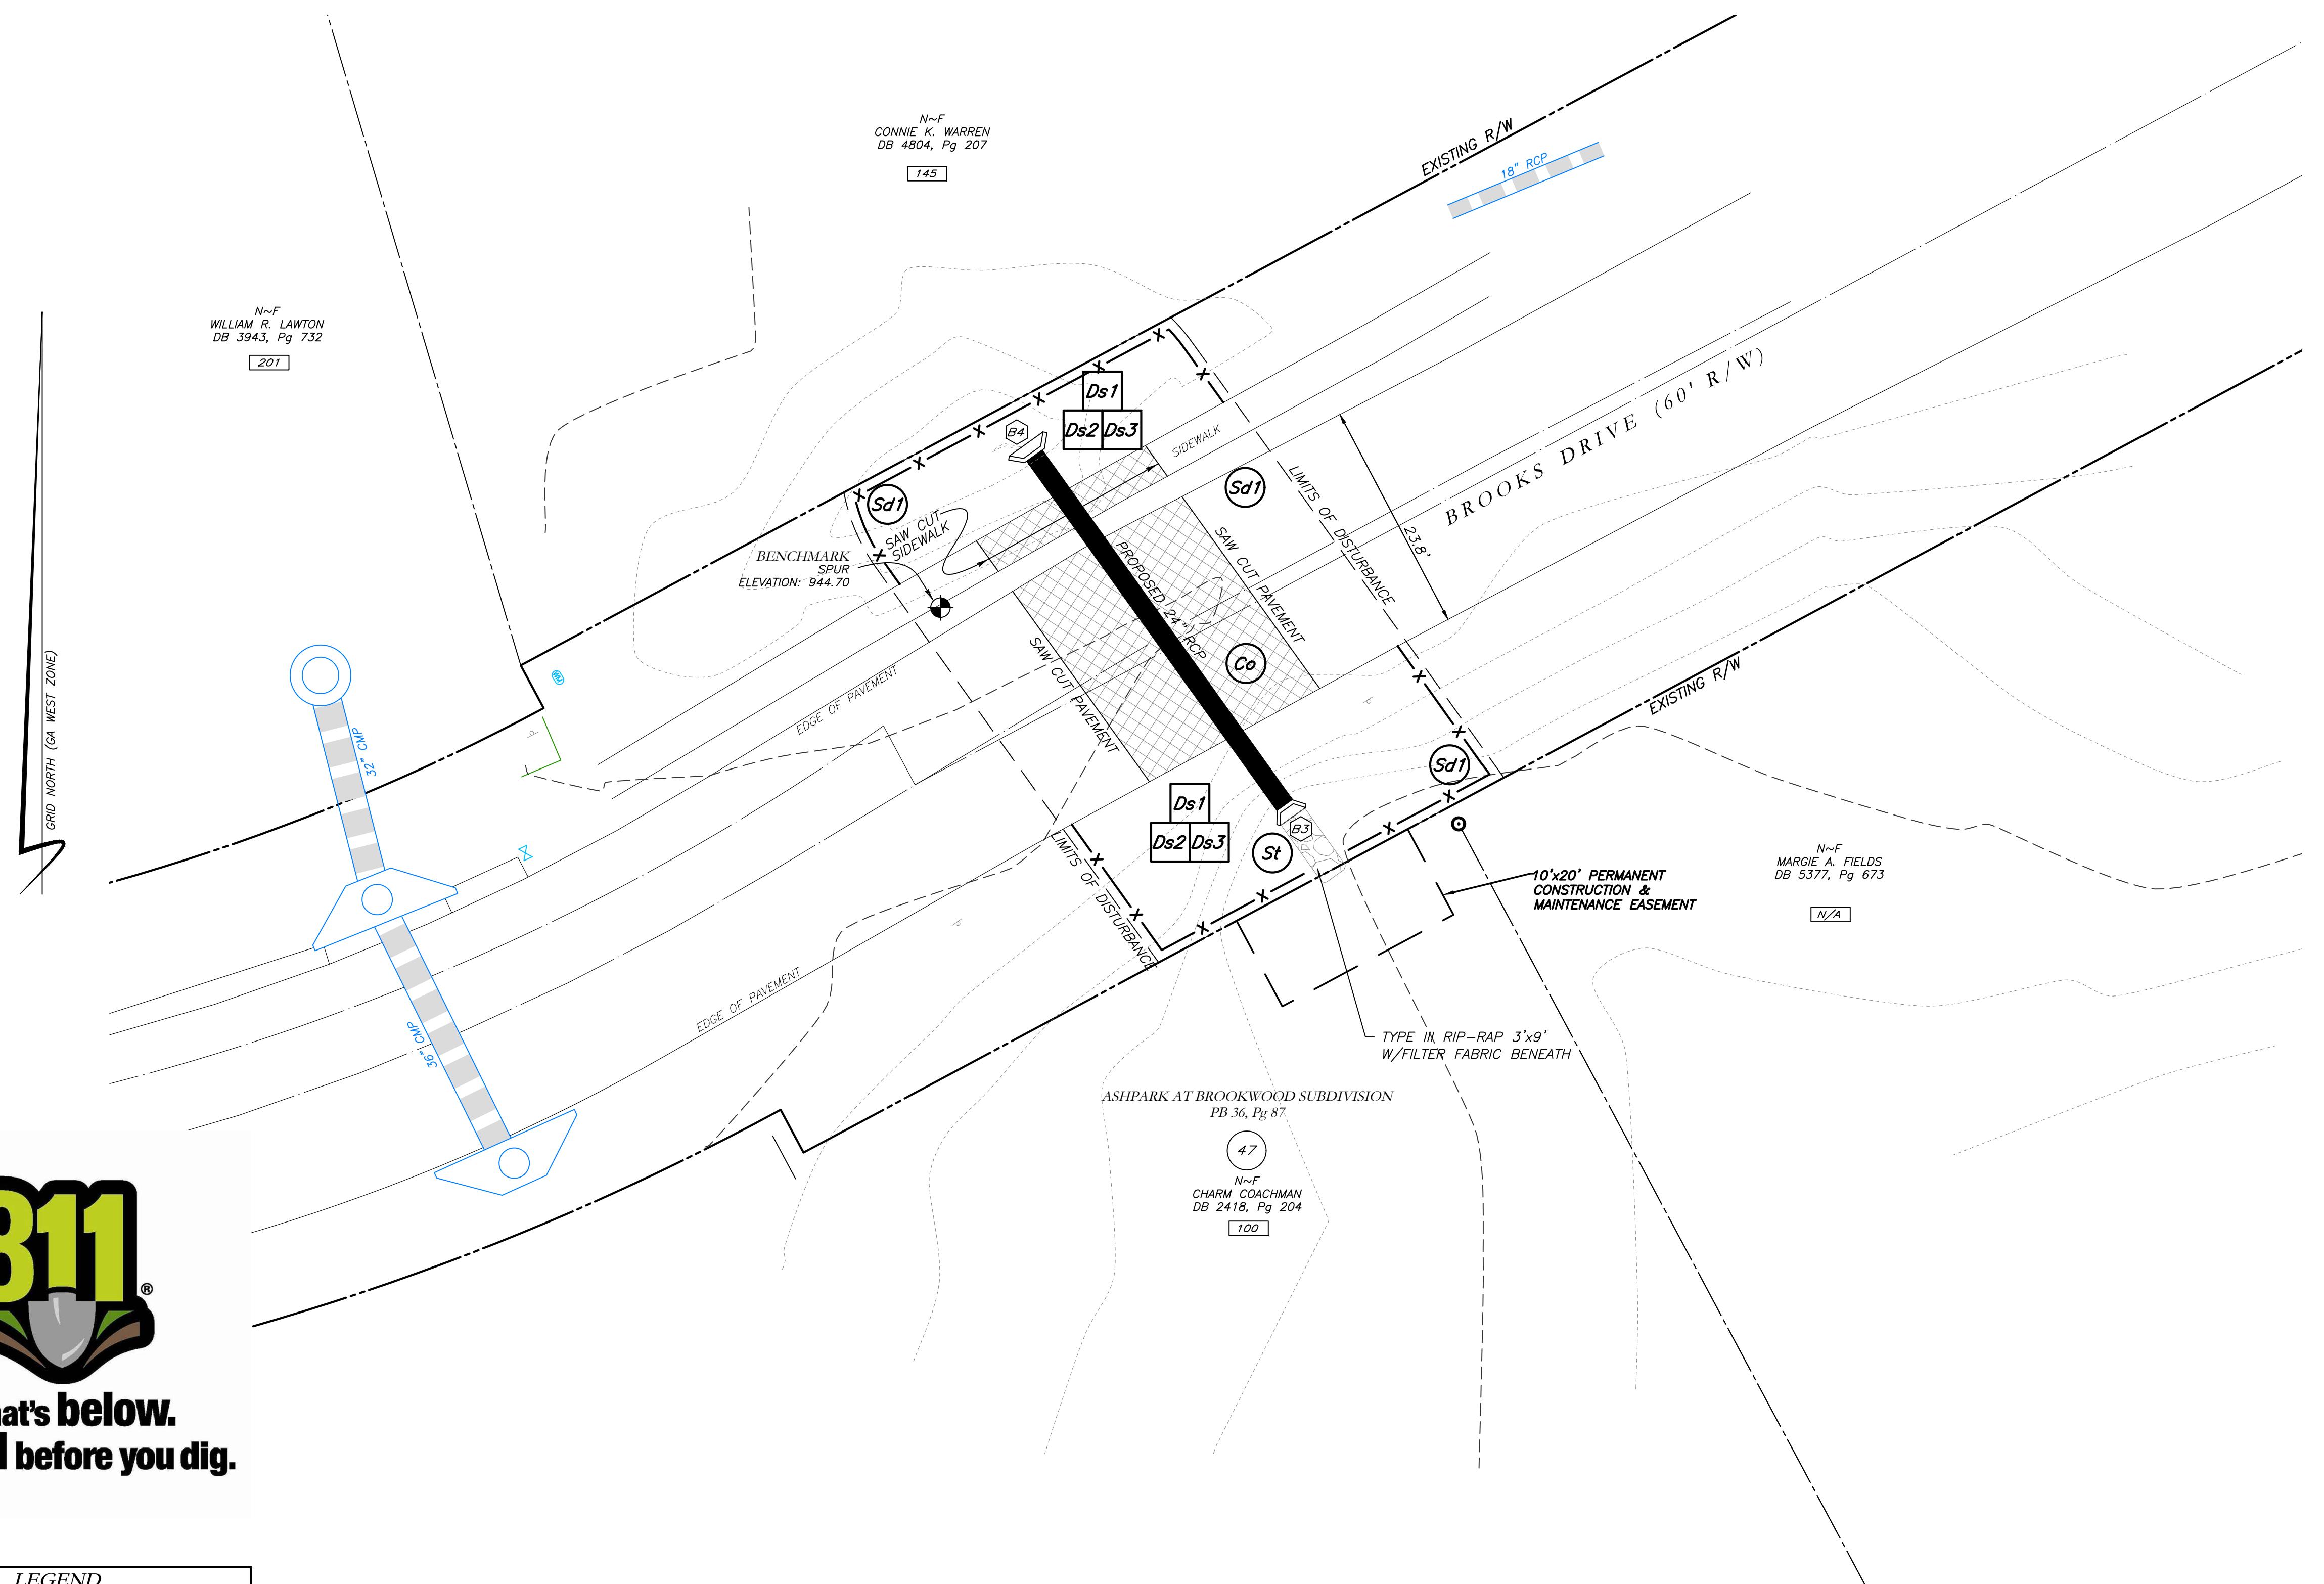

**Know what's below.
Call before you dig.**

| LEGEND | |
|---------------------------|--------------------------|
| POB | POINT OF BEGINNING |
| POC | POINT OF COMMENCEMENT |
| RBS | REBAR FOUND |
| RRF | REBAR FOUND |
| MNF | MAG NAIL FOUND |
| MNS | MAG NAIL FOUND |
| CTP | CRIMP TOP PIPE FOUND |
| OTP | OPEN TOP PIPE FOUND |
| DMP | DRILLED METAL PIPE FOUND |
| DI | DROP INLET |
| CI | CATCH INLET |
| YAC | YARD AREA |
| OCS | OUTLET CONTROL STRUCTURE |
| JB | JUNCTION BOX |
| DWCB | DOUBLE WING CATCH BASIN |
| DWCB | DOUBLE WING CATCH BASIN |
| HW | HEADWALL |
| TEC | TERMINAL END SECTION |
| CMP | CORRUGATED METAL PIPE |
| RCP | REINFORCED CONCRETE PIPE |
| SS | SANITARY SEWER |
| F.M.E. | FORCE MAIN EASEMENT |
| D.E. | DRIVEWAY EASEMENT |
| D.E. | DRAINAGE EASEMENT |
| W.E. | WATER EASEMENT |
| G.H.T. | GREASE TRAP |
| FENCE | FENCE |
| BOL | BOLLARD |
| S.P.E. | SPOT ELEVATION |
| FIRE HYDRANT | ◆ |
| WATER VALVE | ◆ |
| POWER LADDER | ◆ |
| GAS METER | ◆ |
| POWER METER | ◆ |
| POWER BOX | ◆ |
| POWER POLE | ◆ |
| OVERHEAD UTILITIES | ◆ |
| ROOF DRAIN | ◆ |
| DROP INLET | ◆ |
| MANHOLE | ◆ |
| SINGLE WING CATCH BASIN | ◆ |
| DOUBLE WING CATCH BASIN | ◆ |
| FLARED END SECTION | ◆ |
| UNDERGROUND GAS LINE | ◆ |
| UNDERGROUND WATER LINE | ◆ |
| UNDERGROUND ELECTRIC LINE | ◆ |
| TELECOM | ◆ |
| SANITARY SEWER | ◆ |
| SEWER MANHOLE | ◆ |
| G.O.T. | ◆ |

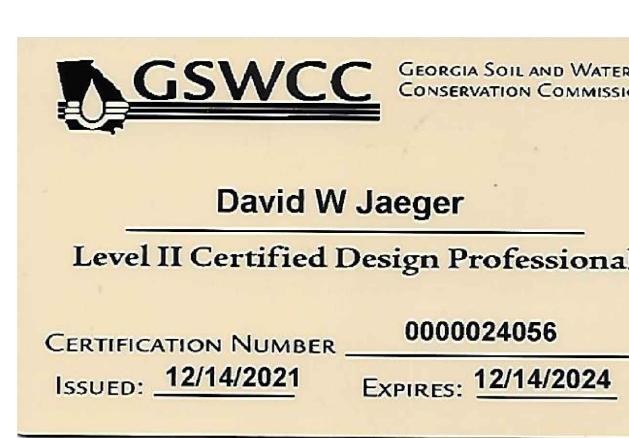

I CERTIFY AS THE PLAN DESIGNER THAT I HAVE VISITED THE SITE PRIOR TO THE DESIGN OF THE E&PC PLANS
David W Jaeger

10 0 10 20
SCALE: 1" = 10'

TOTAL DISTURBED ACRES = 0.06

24 Hour Erosion Control Contact:

NAME: Scott Langford
ADDRESS: 950 Senoia Road
Tyrone, GA 30290
PHONE: (770)-487-4038

Mallett Consulting, Inc.
101 Devant St., Suite 804, Fayetteville, Georgia 30214
PHONE: 770-719-3333
FAX: 770-719-3377

Know what's below.
Call before you dig.

The locations of existing underground utilities are shown in this approximate way only. They have not been independently verified by the contractor. It is the responsibility of the contractor to determine the exact location of all existing underground utilities before commencing work and agrees to indemnify the owner for any damage and all damages which might be occasioned by the contractor's failure to do so. The contractor will preserve any and all underground utilities.

NOTICE: CONSTRUCTION SITE SAFETY IS THE CONTRACTOR'S RESPONSIBILITY. THE OWNER OR THE ENGINEER SHALL BE EXEMPTED FROM ANY AND ALL RESPONSIBILITY FOR SAFETY OF THE WORK OF PERSONS ENGAGED IN THE WORK OF REMOVING, MODIFYING, PRESERVING ANY AND ALL UNDERGROUND UTILITIES.

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VICINITY MAP

SURVEY NOTES

1. THIS PLAT WAS PREPARED FOR THE EXCLUSIVE USE OF THE PERSON, PERSONS, OR ENTITY NAMED HEREON. THIS PLAT DOES NOT EXTEND TO UNNAMED PERSONS, PERSONS, OR ENTITY WITHOUT EXPRESS WRITTEN CERTIFICATION BY THE SURVEYOR NAMING SAID PERSON, PERSONS, OR ENTITY.

2. NORTH ARROW AND BEARINGS ARE BASED ON GEORGIA STATE PLANE COORDINATES (NAVD83), US FOOT, USING GLOBAL POSITIONING SYSTEM (GPS) BY TRIMBLE R10 GPS RECEIVER ON OCTOBER 20, 2022 USING THE TRIMBLE VRS SYSTEM. ALL DISTANCES SHOWN ARE HORIZONTAL GROUND MEASUREMENTS EXPRESSED IN SURVEY FEET.
DATUM:
HORIZONTAL: GRID NORTH, NAVD83
VERTICAL: NAVD88
GEODID: GEOFID18 (CONUS)

3. CONTOURS AND SPOT ELEVATIONS SHOWN HEREON ARE BASED ON THE U.S.G.S. DATUM (NAVD88). THE SITE BENCHMARKS ARE AS SHOWN HEREON.

4. WATER MAIN, STORM SEWER, SANITARY SEWER, AND FRANCHISE UTILITY STRUCTURES HAVE BEEN LOCATED WHERE VISIBLE. NOTE: THE SURVEYOR MAKES NO GUARANTEES THAT THE UNDERGROUND UTILITIES SHOWN COMprise ALL SUCH UTILITIES IN THE AREA, EITHER IN-SERVICE OR ABANDONED.

5. THERE WAS NO EVIDENCE OF RECENT CONSTRUCTION ON THE SUBJECT PROPERTY OBSERVED IN THE PROCESS OF CONDUCTING THE FIELDWORK.

6. NO FIELD DELINEATED WETLANDS WERE OBSERVED IN THE PROCESS OF CONDUCTING THE FIELDWORK.

7. EQUIPMENT USED FOR MEASUREMENT:
ANGULAR: TRIMBLE R10/SB ROBOTIC TOTAL STATION
LINEAR: TRIMBLE R10/SB ROBOTIC TOTAL STATION
GPS: TRIMBLE R10 GPS RECEIVER

8. STATE, COUNTY, & LOCAL BUFFERS AND SETBACKS MIGHT EXIST ON THE SUBJECT PROPERTY THAT ARE NOT SHOWN HEREON.

ATWELL
866.850.3200 www.atwell-group.com


1800 PARKWAY BLUFF, SUITE 700
MARIETTA, GA
770.473.8087

| | |
|------------|-------------------------|
| LOCATED IN | TOWN OF TYRONE |
| | FAYETTE COUNTY, GEORGIA |


STORM DRAIN REPLACEMENT

EXISTING CONDITIONS


DATE
12/30/2022
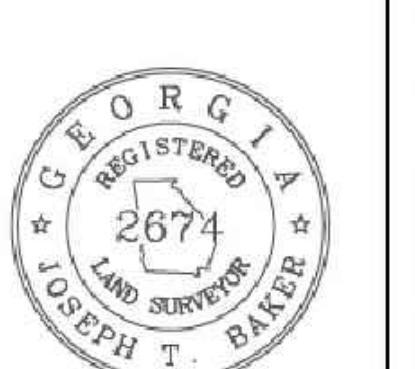
| | |
|------------------------------------------------------------------------------------------------------------------------------------------------------------------------------------------------------------------------------------------------------------------------------------------------------------------------------------------------------------------------------------------------------------------------------------------------------------------------------------------------------------------------------------------------------------------------------------------------------------------------------------------------------------------------------------------------------------------------------------------------------------------------------------------------------------------------------------------------------|--|
| SURVEYOR'S CERTIFICATION | |
| <p>This plat is a retrace of an existing parcel or parcels of land and does not subdivide or create a new parcel, or make any changes to any real property rights or interests. The recordation of the documents, maps, plats, or other instruments which created that parcel or parcels are stated here on. Recordation of this plat does not imply approval of any local jurisdiction, availability of permits, compliance with local regulations or requirements, or suitability for any use or purpose of the land. Furthermore, the undersigned land surveyor certifies that this plat complies with the minimum technical standards for property surveys in Georgia as set forth in the rules and regulations of the Georgia Board of Registration for Professional Engineers and Land Surveyors as set forth in O.C.G.A. Section 15-6-17.</p> | |
|  | |
| <p>JOSEPH T. BAKER, LS 12/27/21 CODE: TP JOB: 22006046 SHEET NO. 14 OF 43</p> | |

10 0 10 20
SCALE: 1" = 10'

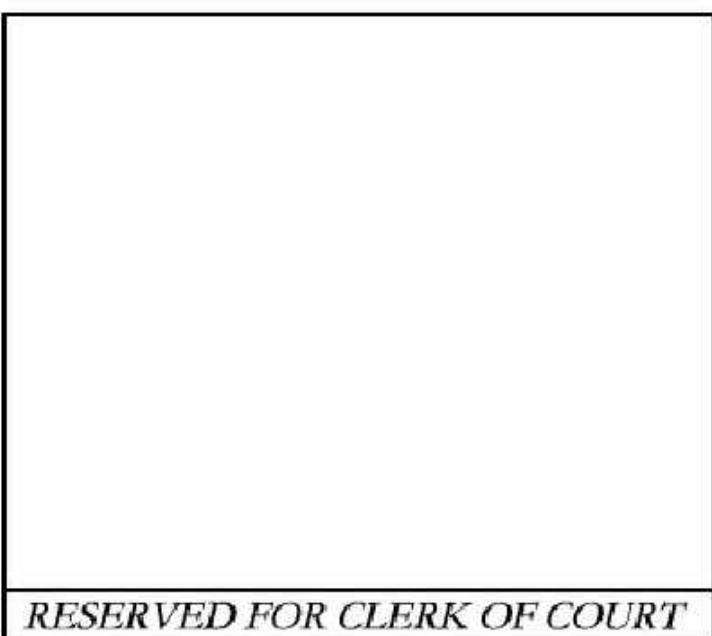



RESERVED FOR CLERK OF COURT

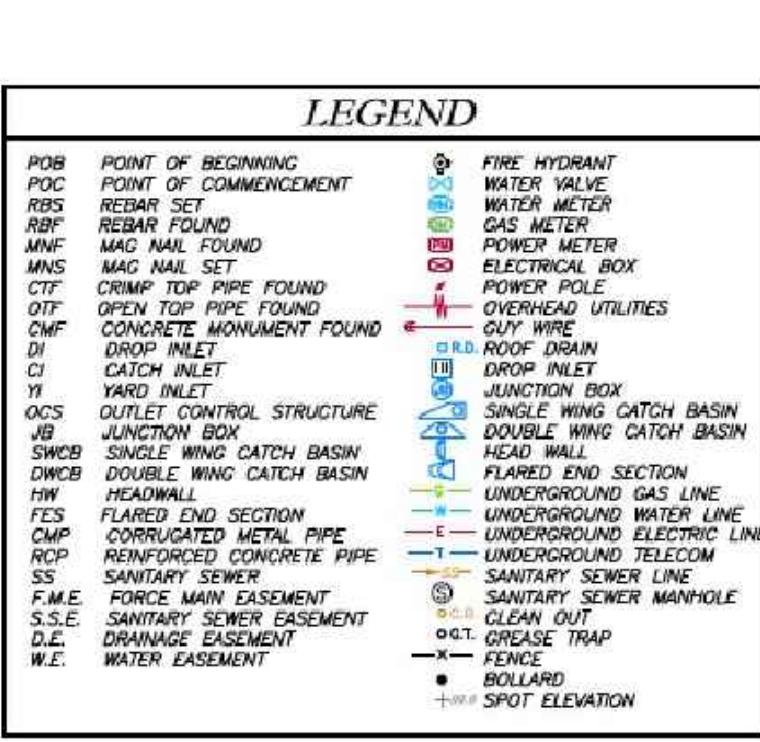

LEGEND

| | | |
|--------|--------------------------|---------------------------|
| POB | POINT OF BEGINNING | WATER VALVE |
| POC | POINT OF COMMENCEMENT | HEAVY DUTY FLOOR |
| RFB | REBAR FOUND | GAS METER |
| MNF | MAG NAIL FOUND | POWER METER |
| MNS | MAG NAIL FOUND | POWER POLE |
| CTE | CRIMP TOP PIPE FOUND | OVERHEAD UTILITIES |
| OTP | OPEN TOP PIPE FOUND | |
| DTP | DRILLED TOP PIPE FOUND | |
| DPF | DRILLED PIPE FOUND | |
| DI | DROP INLET | ROOF DRAIN |
| CI | CATCH INLET | DROP INLET |
| W | WATER | JOHNSON BOX |
| OCS | OUTLET CONTROL STRUCTURE | SINGLE WING CATCH BASIN |
| JG | JUNCTION BOX | DOUBLE WING CATCH BASIN |
| DWCB | DOUBLE WING CATCH BASIN | HUB |
| DWB | DOUBLE WING CATCH BASIN | FLARED END SECTION |
| HW | HEADWALL | UNDERGROUND GAS LINE |
| TE | TELEPHONE | UNDERGROUND POWER LINE |
| CMP | CORRUGATED METAL PIPE | UNDERGROUND ELECTRIC LINE |
| RCP | REINFORCED CONCRETE PIPE | TELEPHONE TELCO |
| SS | SEWER | SANITARY SEWER |
| F.M.E. | FORCE MAIN EASEMENT | SANITARY SEWER MANHOLE |
| D.E. | DRAINAGE EASEMENT | G.C.T. GATE |
| W.E. | WATER EASEMENT | FENCE |
| | | BOLLARD |
| | | SPOT ELEVATION |

**PROPOSED REPLACEMENT OF
CROSS DRAIN AT
2175, 2180, 2185 CASTLE LAKE DR
TYRONE, GEORGIA 30290**

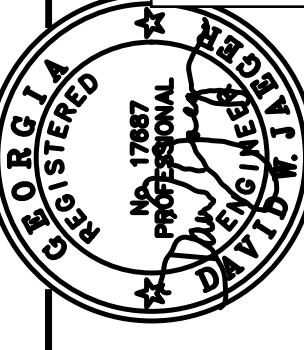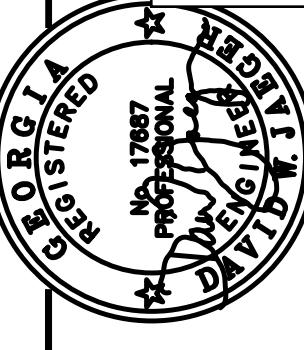



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|----------------------|----------|
| DESIGN | SCALE |
| DRAWN | MCI |
| DATE | 01/16/23 |
| CHECK | DWJ |
| FILE NO. | 21101-16 |
| APPROVED | DWJ |
| SHEET NO. | |

| Cross Drain Replacement | |
|-----------------------------|--|
| for Town of Tyrone, Georgia | |
| Castle Lake Drive (1) | |
| Proposed Conditions | |
| REV. NO. | |
| DATE | |
| DESCRIPTION | |
| BY APPD | |

| Cross Drain Replacement | |
|-----------------------------|--|
| for Town of Tyrone, Georgia | |
| Castle Lake Drive (1) | |
| Proposed Conditions | |
| REV. NO. | |
| DATE | |
| DESCRIPTION | |
| BY APPD | |




**Know what's below.
Call before you dig.**

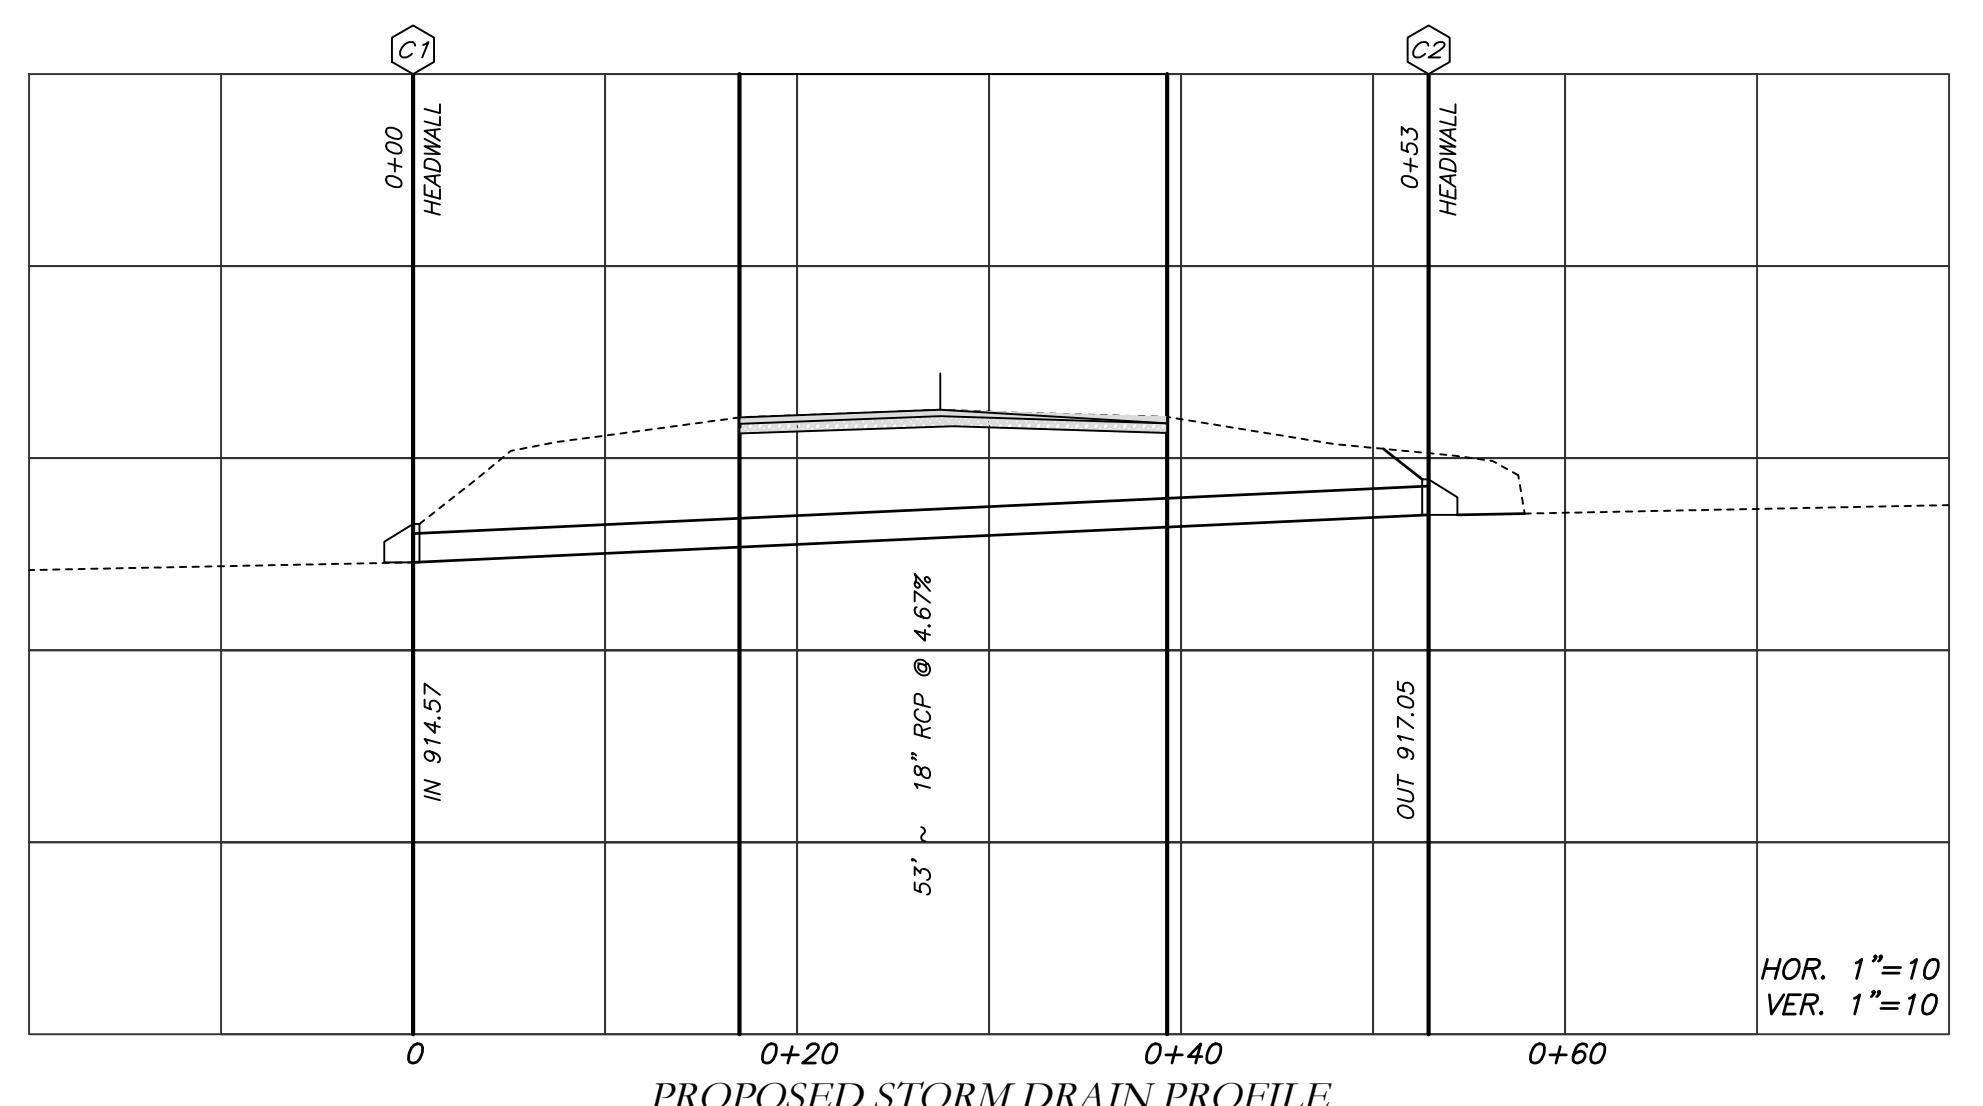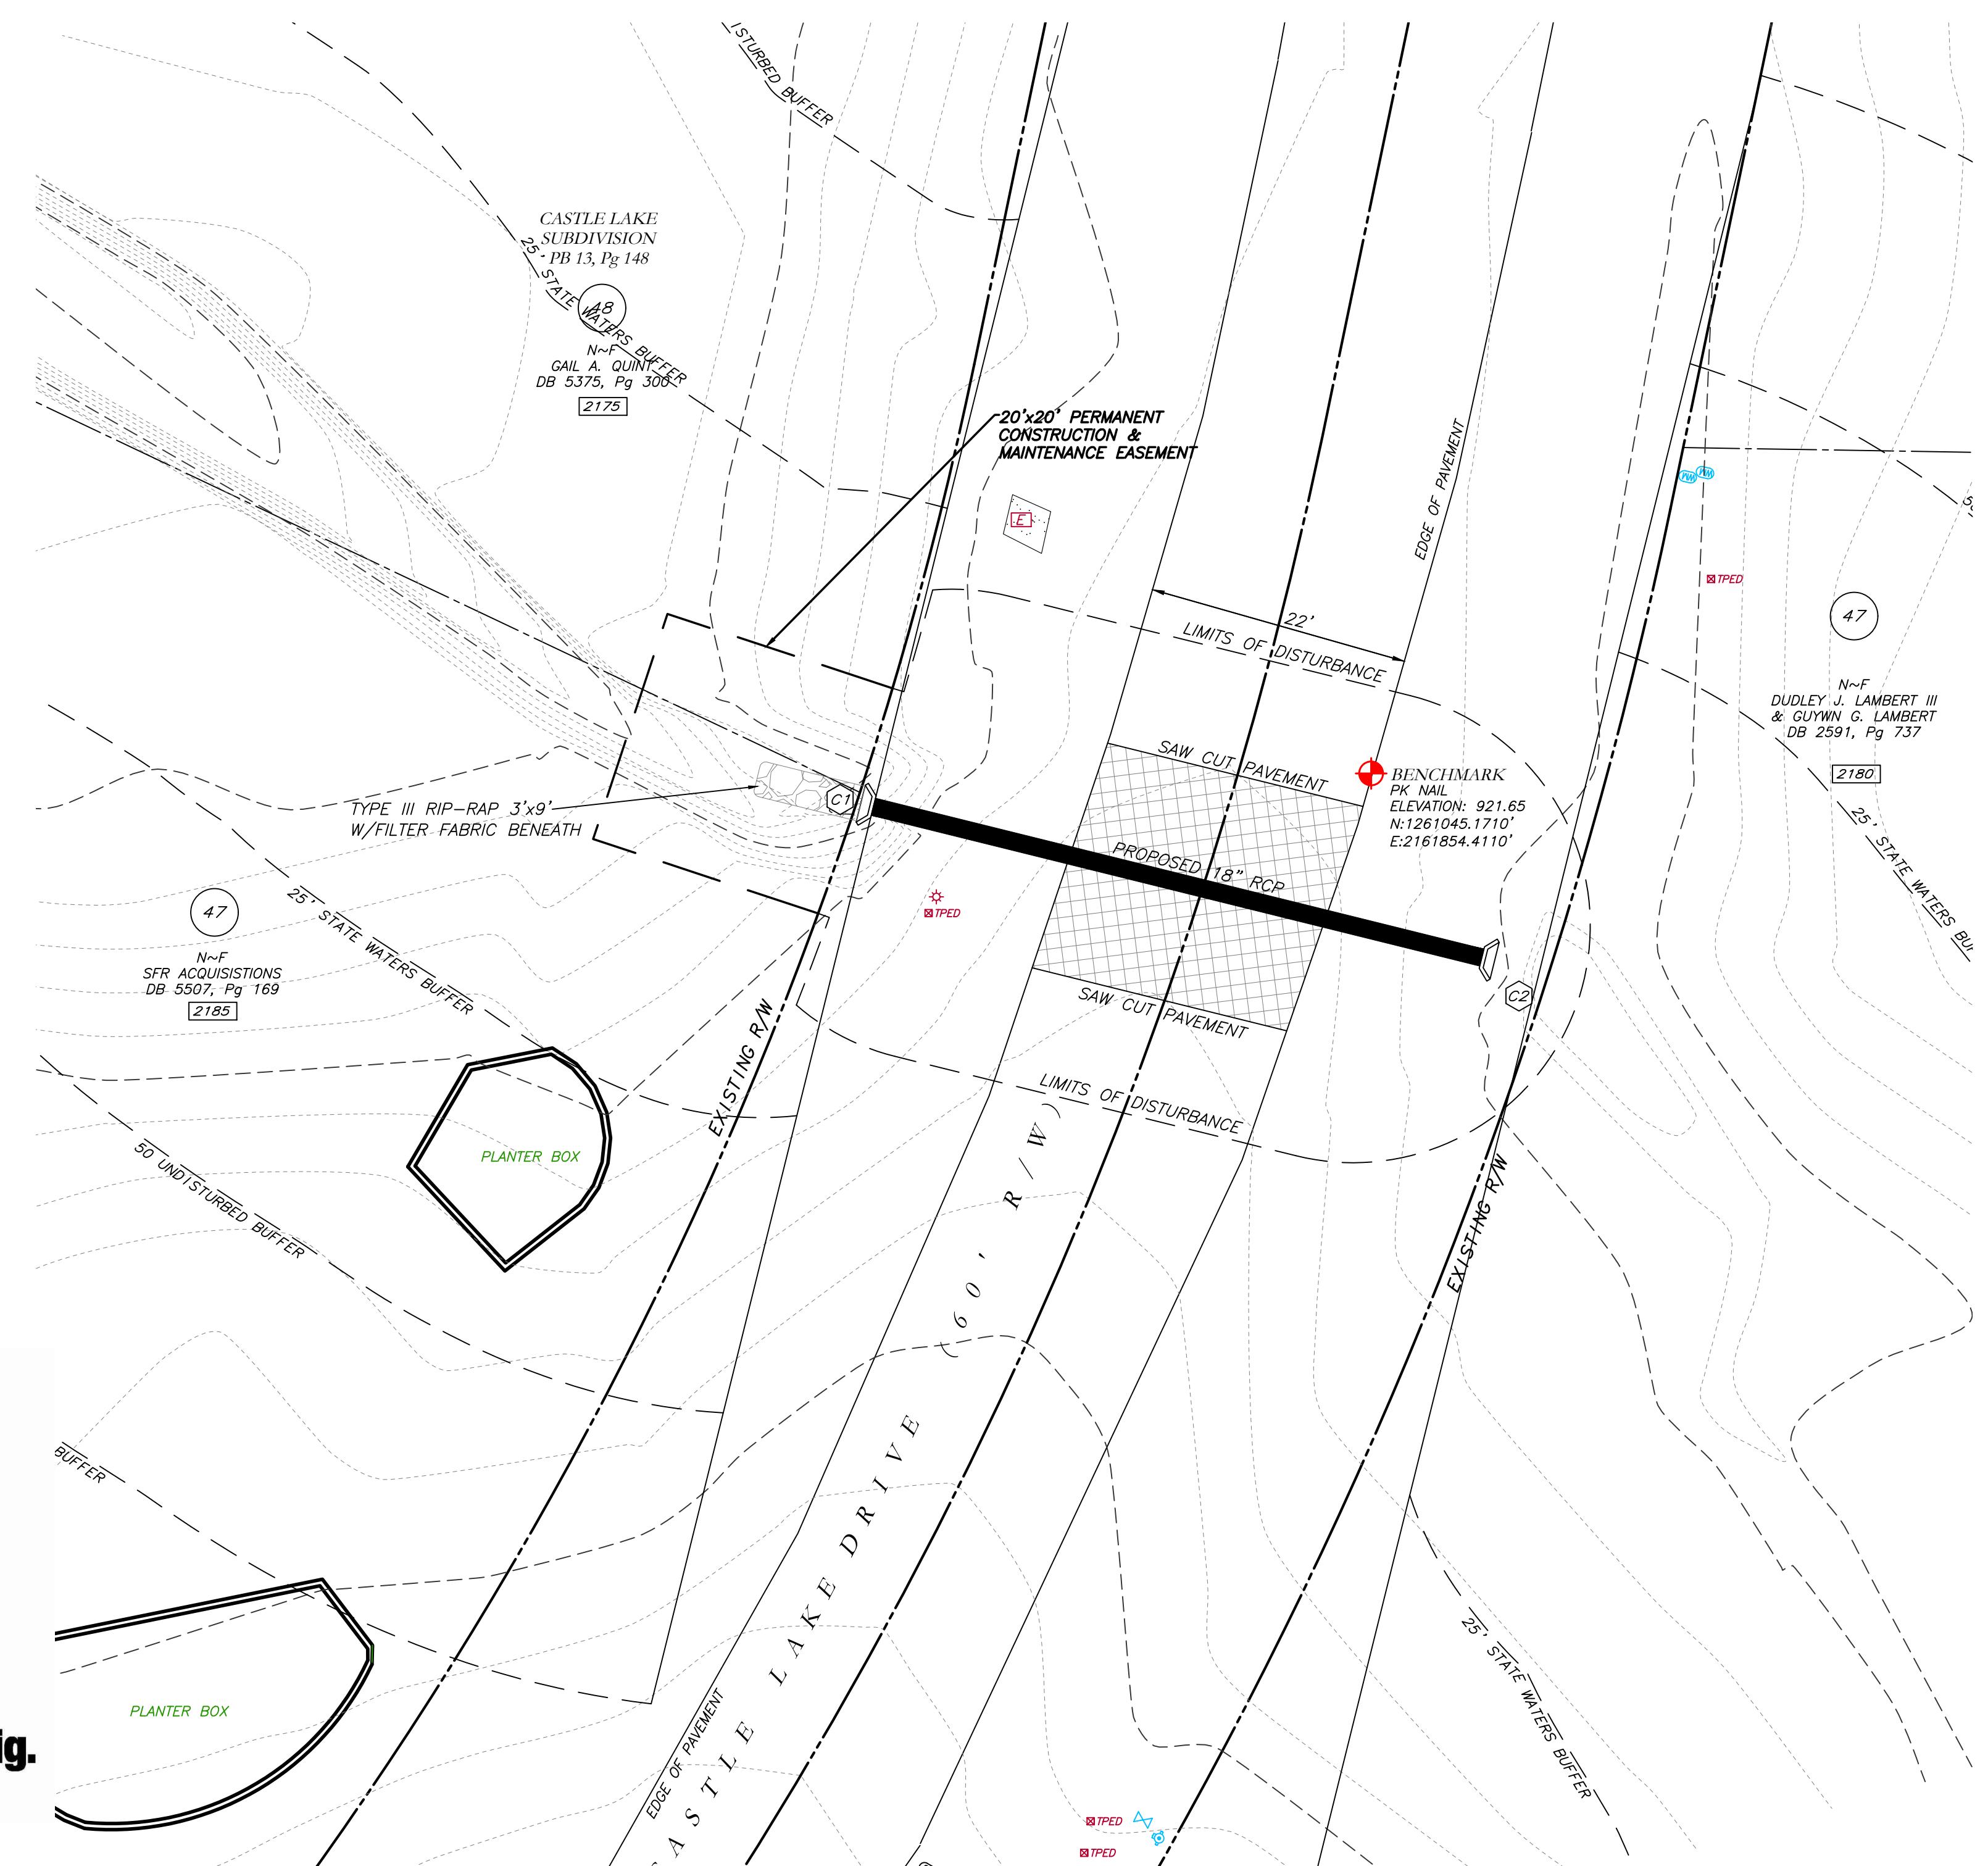

NOTES:

- CONTRACTOR WILL BE RESPONSIBLE FOR LOCATING AND PROTECTING EXISTING UTILITIES.
- EXISTING PAVEMENT SHALL BE SAW CUT AT LIMITS OF DEMOLITION ACTIVITIES. LOCATION OF SAW CUTS SHALL BE APPROVED IN ADVANCE BY THE TOWN ENGINEER.
- CONTRACTOR TO STOCKPILE EXISTING RIP-RAP AND REUSE WHEN PRACTICAL.
- ALL DEMOLITION MATERIALS, WASTE SOILS AND SEDIMENT SHALL BE HAULED AWAY AND DISPOSED OF OFFSITE AT A SUITABLE LOCATION, SELECTED BY THE CONTRACTOR. THIS SHALL BE DONE AT NO ADDITIONAL CHARGE.
- TEMPORARY TRAFFIC CONTROL STRIPING, SIGNAGE AND DEVICES ARE REQUIRED DURING TRANSITION FROM EXISTING CONDITION TO COMPLETION OF PROJECT. PROVIDE CERTIFIED TRAFFIC CONTROL FLAGMEN DURING TEMPORARY LANE CLOSURES. BOTH LANES SHALL BE OPEN WHEN FLAGMEN ARE NOT PRESENT AND SHALL HAVE AN ALL WEATHER DRIVING SURFACE.
- PAVEMENT WITHIN SAW CUT LINES TO BE REMOVED AND REPLACED.

| LEGEND | |
|---------------------------|---------------------------|
| POB | POINT OF BEGINNING |
| POC | POINT OF COMMENCEMENT |
| RBS | REBAR FOUND |
| RRF | REINFORCED CONCRETE PIPE |
| MNF | MAG NAIL FOUND |
| MNS | MAG NAIL FOUND |
| CTP | CRIMP TOP PIPE FOUND |
| OTP | OPEN TOP PIPE FOUND |
| DPF | DETERMINED POSITION FOUND |
| DI | DROP INLET |
| CI | CATCH INLET |
| YAC | YARD AREA |
| OCS | OUTLET CONTROL STRUCTURE |
| JB | JUNCTION BOX |
| DWCB | DOUBLE WING CATCH BASIN |
| DWCB | DOUBLE WING CATCH BASIN |
| HW | HEADWALL |
| TES | TRANSITION SECTION |
| CMP | CORRUGATED METAL PIPE |
| RCP | REINFORCED CONCRETE PIPE |
| SS | SEWER SEWER |
| F.M.E. | FORCE MAIN EASEMENT |
| D.E. | DRIVEWAY EASEMENT |
| D.W.E. | DRAINSAGE EASEMENT |
| W.E. | WATER EASEMENT |
| G.H.T. | GREASE TRAP |
| FENCE | FENCE |
| BOLLARD | BOLLARD |
| SPOT ELEVATION | SPOT ELEVATION |
| FIRE HYDRANT | |
| WATER VALVE | |
| POWER METER | |
| GAS METER | |
| POWER METER | |
| POWER POLE | |
| OVERHEAD UTILITIES | |
| ROOF DRAIN | |
| DROP INLET | |
| PLANER BOX | |
| SINGLE WING CATCH BASIN | |
| DOUBLE WING CATCH BASIN | |
| FLARED END SECTION | |
| UNDERGROUND GAS LINE | |
| UNDERGROUND WATER LINE | |
| UNDERGROUND ELECTRIC LINE | |
| TELECOM | |
| SANITARY SEWER | |
| SEWER MANHOLE | |

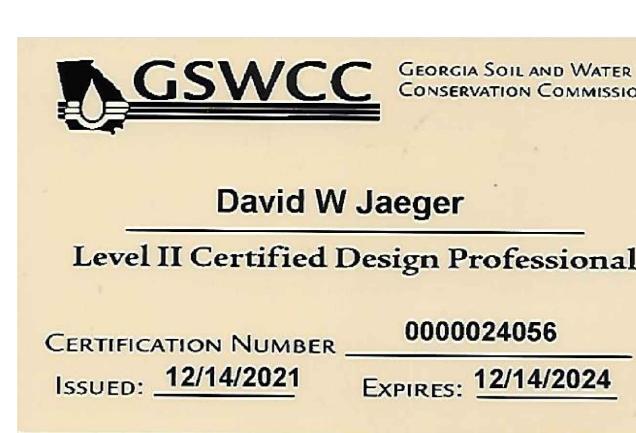


I CERTIFY AS THE PLAN DESIGNER THAT I HAVE VISITED THE SITE PRIOR TO THE DESIGN OF THE ES&PC PLANS

David W Jaeger

10 0 10 20
SCALE: 1" = 10'

**EROSION CONTROL PLAN FOR
CROSS DRAIN AT
2175, 2180, 2185 CASTLE LAKE DR
TYRONE, GEORGIA 30290**

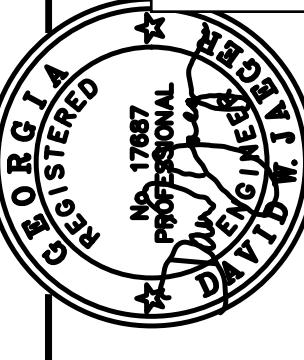


| PROJECT NUMBER PW-20 | |
|----------------------|---------------|
| DESIGN | SCALE |
| DRAWN | MCI |
| ALG | DATE 01/16/23 |
| CHECK | FILE NO. DWJ |
| APPROVED | SHEET NO. DWJ |
| APPD | |

| Cross Drain Replacement for Town of Tyrone, Georgia Castle Lake Drive Erosion Control Plan | | | |
|-----------------------------------------------------------------------------------------------------|------|-------------|----|
| REV. NO. | DATE | DESCRIPTION | BY |
| | | | |



**Know what's below.
Call before you dig.**

| LEGEND | |
|--------------------------|--------------------------|
| POB | POINT OF BEGINNING |
| POC | POINT OF COMMENCEMENT |
| RBS | REBAR FOUND |
| RRF | REBAR FOUND |
| MNF | MAG NAIL FOUND |
| MNS | MAG NAIL FOUND |
| CTP | CRIMP TOP PIPE FOUND |
| OTP | OPEN TOP PIPE FOUND |
| DPF | DETAILED PIPE FOUND |
| DI | DROP INLET |
| CI | CATCH INLET |
| YI | YARD INLET |
| OCS | OUTLET CONTROL STRUCTURE |
| JB | JUNCTION BOX |
| DWCB | DOUBLE WING CATCH BASIN |
| DWCB | DOUBLE WING CATCH BASIN |
| HW | HEADWALL |
| TEC | TELECOM SECTION |
| CMP | CORRUGATED METAL PIPE |
| RCP | REINFORCED CONCRETE PIPE |
| SS | SEWER SEWER |
| F.M.E. | FORCE MAIN EASEMENT |
| D.E. | DRIVEWAY EASEMENT |
| D.W.E. | DRAINAGE EASEMENT |
| W.E. | WATER EASEMENT |
| G.H.T. | GREASE TRAP |
| FENCE | FENCE |
| BOLLARD | BOLLARD |
| SPOT ELEVATION | SPOT ELEVATION |
| FIRE HYDRANT | |
| WATER VALVE | |
| POWER METER | |
| GAS METER | |
| POWER METER | |
| POWER POLE | |
| OVERHEAD UTILITIES | |
| ROOF DRAIN | |
| DROP INLET | |
| CATCH INLET | |
| YARD INLET | |
| OUTLET CONTROL STRUCTURE | |
| JUNCTION BOX | |
| DOUBLE WING CATCH BASIN | |
| DOUBLE WING CATCH BASIN | |
| HEADWALL | |
| TELECOM SECTION | |
| CORRUGATED METAL PIPE | |
| REINFORCED CONCRETE PIPE | |
| SEWER SEWER | |
| FORCE MAIN EASEMENT | |
| DRIVEWAY EASEMENT | |
| DRAINAGE EASEMENT | |
| WATER EASEMENT | |
| GREASE TRAP | |
| FENCE | |
| BOLLARD | |
| SPOT ELEVATION | |

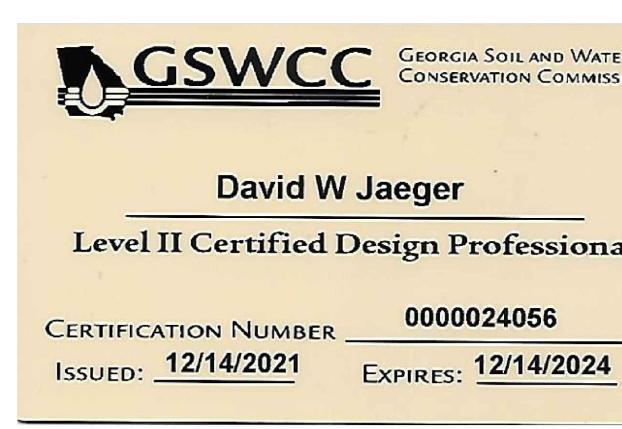

I CERTIFY AS THE PLAN DESIGNER THAT I HAVE VISITED THE SITE PRIOR TO THE DESIGN OF THE E&PC PLANS
David W Jaeger

10 0 10 20
SCALE: 1" = 10'

THE ESCAPE OF SEDIMENT FROM THE SITE SHALL BE PREVENTED BY THE INSTALLATION OF EROSION AND SEDIMENT CONTROL MEASURES AND PRACTICES PRIOR TO LAND DISTURBING ACTIVITIES.

EROSION CONTROL MEASURES SHALL BE MAINTAINED AT ALL TIMES. IF FULL IMPLEMENTATION OF THE APPROVED PLAN DOES NOT PROVIDE FOR EFFECTIVE EROSION CONTROL, ADDITIONAL EROSION AND SEDIMENT CONTROL MEASURES SHALL BE IMPLEMENTED TO CONTROL OR TREAT THE SEDIMENT SOURCE.

ANY DISTURBED AREA LEFT EXPOSED FOR A PERIOD GREATER THAN 14 DAYS SHALL BE STABILIZED WITH MULCH OR TEMPORARY SEEDING.

CONTRACTOR TO STOCKPILE EXISTING RIP-RAP AND REUSE WHEN POSSIBLE.


REMOVE Sd1 WHEN GRASS HAS BEEN ESTABLISHED TO AT LEAST 85% COVERAGE.

(C) CONSTRUCTION EXIT TO BE MAINTAINED WITHIN SAW CUT LINES.

TOTAL DISTURBED ACRES = 0.06

24 Hour Erosion Control Contact:

NAME: Scott Langford
ADDRESS: 950 Senoia Road
Tyrone, GA 30290
PHONE: (770)-487-4038

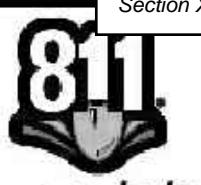

Know what's below.
Call before you dig.

THE LOCATIONS OF EXISTING UNDERGROUND UTILITIES ARE SHOWN IN AN APPROXIMATE WAY ONLY AND HAVE NOT BEEN INDEPENDENTLY VERIFIED BY THE OWNER OR ITS REPRESENTATIVE. THE CONTRACTOR SHALL DETERMINE THE EXACT LOCATION OF ALL EXISTING UTILITIES BEFORE COMMENCING WORK, AND AGREES TO BE FULLY RESPONSIBLE FOR ANY AND ALL DAMAGES WHICH MIGHT BE OCCASIONED BY THE CONTRACTOR'S FAILURE TO EXACTLY LOCATE AND PRESERVE ANY AND ALL UNDERGROUND UTILITIES.


NOTICE:
CONSTRUCTION SITE SAFETY IS THE
SOLE RESPONSIBILITY OF THE
CONTRACTOR; NEITHER THE OWNER
NOR THE ENGINEER SHALL BE
EXPECTED TO ASSUME ANY
RESPONSIBILITY FOR SAFETY OF
THE WORK, OF PERSONS ENGAGED
IN THE WORK, OF ANY NEARBY
STRUCTURES, OR OF ANY OTHER
PERSONS.

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CONSENT OF ATWELL LLC

com

*LIMITED SURVEY OF
STORM DRAIN REPLACEMENT
HANDLEY PARK
TYRONE, GEORGIA 30290*

RESERVED FOR CLERK OF COURT

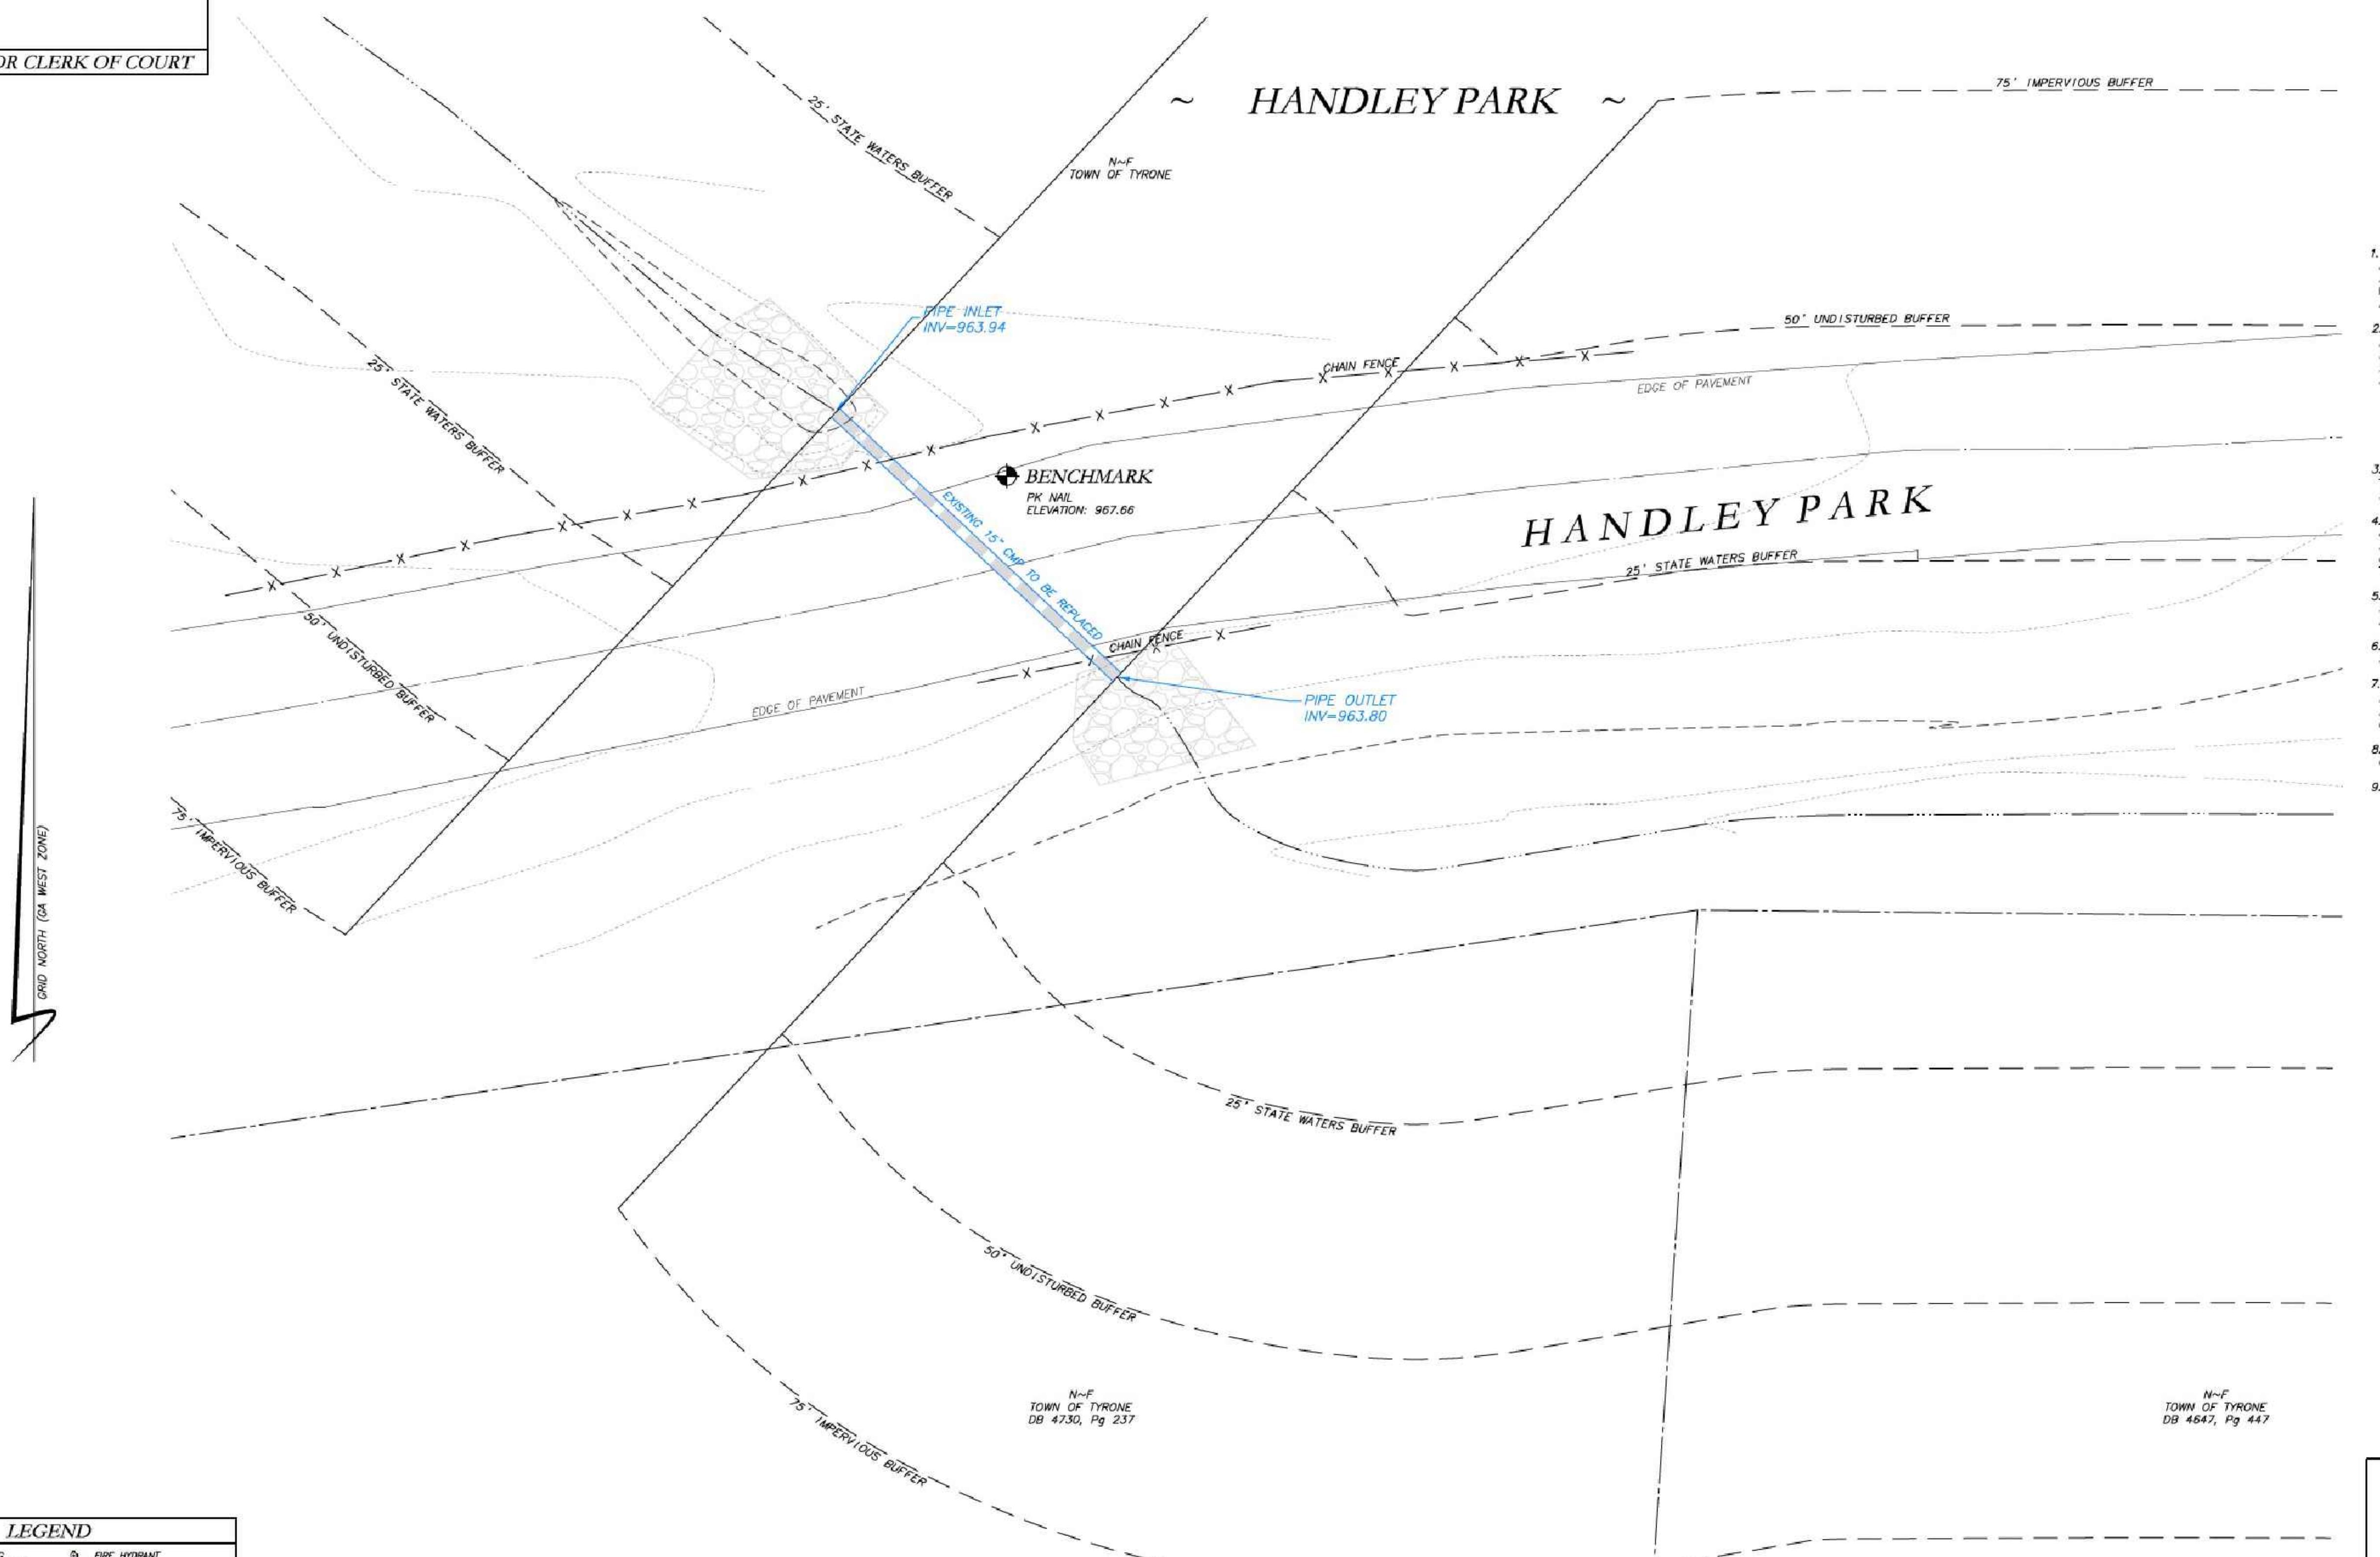

A hand-drawn map showing the location of a site relative to several roads. The map includes Highway 74 N, Palmetto Rd, Senoia Rd, Swanson Rd, Handley Park, Tyrone Rd, and a site marked with a box.

The map shows a network of roads. Highway 74 N runs vertically down the center. Palmetto Rd runs diagonally from top-left to bottom-right, intersecting Highway 74 N. Senoia Rd is a curved road on the left side. Swanson Rd is a straight road on the right side, intersecting Highway 74 N. Handley Park is a rectangular area bounded by Highway 74 N, Swanson Rd, and a road to its left. Tyrone Rd is a diagonal road running from the bottom-left towards the center. A box labeled "SITE" is located near the intersection of Highway 74 N and Tyrone Rd. An arrow points from the word "HANDLEY" to the "SITE" box. The words "NOT TO SCALE" are written at the bottom left, and "SCALE" is written at the bottom right.

VEY NOTES

- THIS PLAT WAS PREPARED FOR THE EXCLUSIVE USE OF THE PERSON, PERSONS, OR ENTITY NAMED HEREON. THIS PLAT DOES NOT EXTEND TO ANY UNNAMED PERSON, PERSONS OR ENTITY WITHOUT EXPRESS WRITTEN CERTIFICATION BY THE SURVEYOR NAMED PERSON, PERSONS, OR ENTITY.

NORTH ARROW AND BEARINGS ARE BASED ON GEORGIA STATE COORDINATES (NAD83), US FOOT, USING GLOBAL POSITIONING SYSTEM AND OBTAINED BY RTK OBSERVATIONS ON OCTOBER 20, 2011, USING THE TRIMBLE VRS SYSTEM. ALL DISTANCES SHOWN ARE HORIZONTAL GROUND MEASUREMENTS EXPRESSED IN SURVEY FEET.

DATUMS:

HORIZONTAL: GRID NORTH, NAD83.

VERTICAL: NAVD88

GEODESIC: GEOD18 (CONUS)

CONTours AND SPOT ELEVATIONS SHOWN HEREON ARE BASED ON U.S.G.S. DATUM (NAVD88). THE SITE BENCHMARKS ARE AS SHOWN HEREON.

NO WATER MAIN, STORM SEWER, SANITARY SEWER AND FRANCHISE UTILITY STRUCTURES HAVE BEEN FIELD LOCATED WHERE VISIBLE. THE SURVEYOR MAKES NO GUARANTEES THAT THE UNDERGROUND UTILITIES SHOWN COMprise ALL SUCH UTILITIES IN THE AREA, EITHER IN-SERVICE OR ABANDONED.

NO EVIDENCE OF RECENT CONSTRUCTION ON THE SUBJECT PROPERTY OBSERVED IN THE PROCESS OF CONDUCTING THE FIELDWORK.

NO FIELD DELINEATED WETLANDS WERE OBSERVED IN THE PROCESS OF CONDUCTING THE FIELDWORK.

| EQUIPMENT | USED | FOR | MEASUREMENT: |
|--------------------------|--------|---------|---------------|
| BAR: TRIMBLE R10/S8 | R10/S8 | ROBOTIC | TOTAL STATION |
| BAR: TRIMBLE R10/S8 | R10/S8 | ROBOTIC | TOTAL STATION |
| TRIMBLE R10 GPS RECEIVER | | | |

STATE, COUNTY, & LOCAL BUFFERS AND SETBACKS MIGHT EXIST ON THE SUBJECT PROPERTY THAT ARE NOT SHOWN HEREON.

NO STATE WATERS ON THIS SITE.

ATWELL
866.850.4200 www.atwell-group.com
1800 PARKWAY PLACE, SUITE 700
MARIETTA, GA
770.423.0807

LOCATED IN
TOWN OF TYRONE
FAYETTE COUNTY, GEORGIA

STORM DRAIN REPLACEMENT
EXISTING CONDITIONS
HANDLEY PARK
TYRONE, GEORGIA 30290

DATE

SURVEYOR'S CERTIFICATION


PLAT IS A RETRACEMENT OF AN EXISTING PARCEL OR
PARCELS OF LAND AND DOES NOT SUBDIVIDE OR CREATE A
PARCEL OR MAKE ANY CHANGES TO ANY REAL
PROPERTY BOUNDARIES. THE RECORDING INFORMATION OF THE
DOCUMENTS, MAPS, PLATS, OR OTHER INSTRUMENTS WHICH
STATE THAT PARCEL OR PARCELS ARE STATED HERE ON.
ORDINATION OF THIS PLAT DOES NOT IMPLY APPROVAL OF
LOCAL JURISDICTION, AVAILABILITY OF PERMITS,
COMPLIANCE WITH LOCAL REGULATIONS OR REQUIREMENTS, OR
ABILITY FOR ANY USE OR PURPOSE OF THE LAND.
THERMORE, THE UNDERSIGNED LAND SURVEYOR CERTIFIES
THAT THIS PLAT COMPLIES WITH THE MINIMUM TECHNICAL
STANDARDS FOR PROPERTY SURVEYS IN GEORGIA AS SET
FORTH IN THE RULES AND REGULATIONS OF THE GEORGIA
BOARD OF REGISTRATION FOR PROFESSIONAL ENGINEERS
LAND SURVEYORS AS SET FORTH IN O.C.G.A. SECTION
43-17

A circular Georgia Land Surveyor registration stamp. The outer ring contains the words "GEORGIA" at the top and "BAKER" at the bottom. The inner circle contains "REGISTERED" at the top and "LAND SURVEYOR" at the bottom. In the center is a five-pointed star containing the number "2674".


12/27/21
SEPH T. BAKER, LS
ORGIA LICENSE #2674
DATE

LEGEND

| | | | |
|--------|--------------------------|--|---------------------------|
| POB | POINT OF BEGINNING | | FIRE HYDRANT |
| POC | POINT OF COMMENCEMENT | | WATER VALVE |
| RBS | REBAR SET | | WATER METER |
| RRF | REBAR FOUND | | GAS METER |
| MNF | MAG NAIL FOUND | | POWER METER |
| MNS | MAG NAIL SET | | ELECTRICAL BOX |
| CTP | CRIMP TOP PIPE FOUND | | POWER POLE |
| OTF | OPEN TOP PIPE FOUND | | OVERHEAD UTILITIES |
| CMF | CONCRETE MONUMENT FOUND | | GUY WIRE |
| DI | DROP INLET | | ROOF DRAIN |
| CI | CATCH INLET | | DROP INLET |
| YI | YARD INLET | | JUNCTION BOX |
| OCS | OUTLET CONTROL STRUCTURE | | SINGLE WING CATCH BASIN |
| JB | JUNCTION BOX | | DOUBLE WING CATCH BASIN |
| SWCB | SINGLE WING CATCH BASIN | | HEAD WALL |
| DWCB | DOUBLE WING CATCH BASIN | | FLARED END SECTION |
| HW | HEADWALL | | UNDERGROUND GAS LINE |
| FES | FLARED END SECTION | | UNDERGROUND WATER LINE |
| CMP | CORRUGATED METAL PIPE | | UNDERGROUND ELECTRIC LINE |
| RCP | REINFORCED CONCRETE PIPE | | UNDERGROUND TELECOM |
| SS | SANITARY SEWER | | SANITARY SEWER LINE |
| F.M.E. | FORCE MAIN EASEMENT | | SANITARY SEWER MANHOLE |
| S.S.E. | SANITARY SEWER EASEMENT | | CLEAN OUT |
| D.E. | DRAINAGE EASEMENT | | GREASE TRAP |
| W.E. | WATER EASEMENT | | FENCE |
| | | | BOLLARD |
| | | | SPOT ELEVATION |

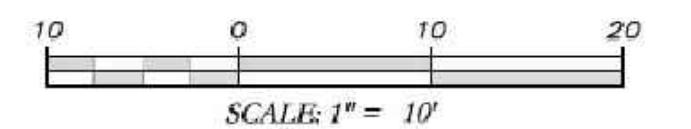


PROPOSED REPLACEMENT OF
CROSS DRAIN
AT HANDLEY PARK
TYRONE, GEORGIA 30290

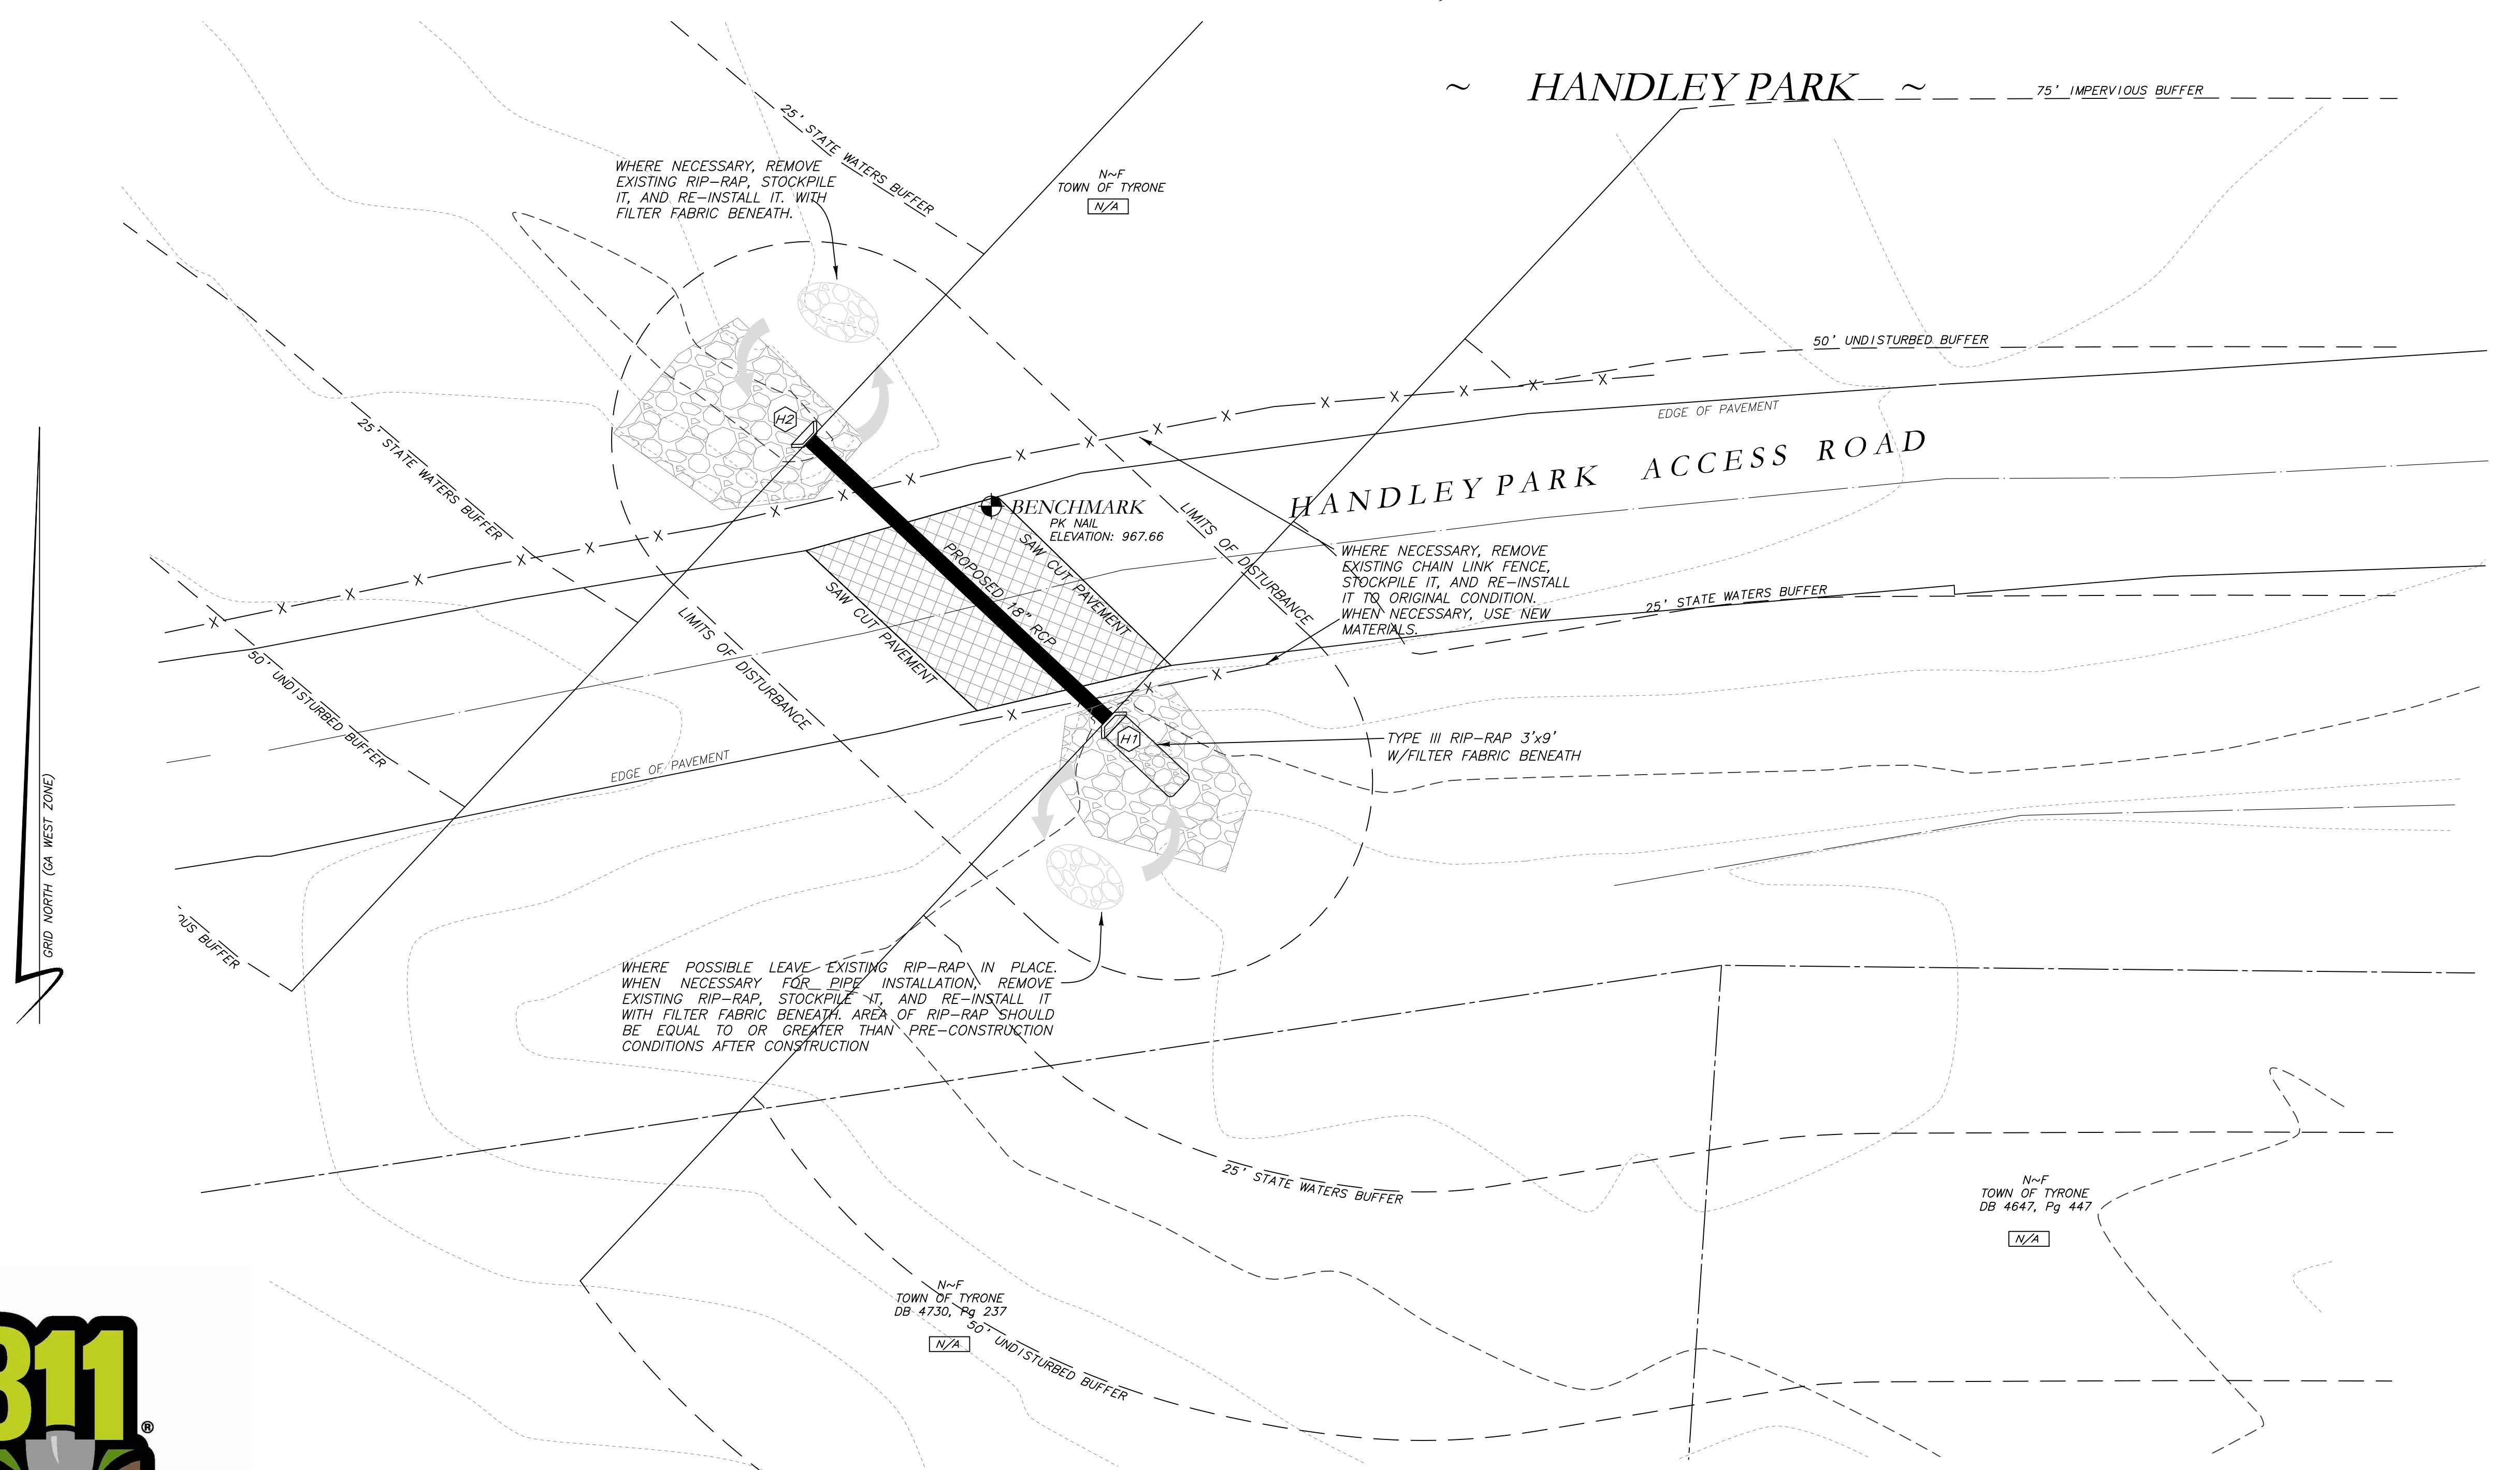


**Know what's below.
Call before you dig.**

| LEGEND | |
|---------|---------------------------|
| POB | POINT OF BEGINNING |
| POC | POINT OF COMMENCEMENT |
| RBS | REBAR FOUND |
| RBF | REBAR FOUND |
| MNF | MAG NAIL FOUND |
| MNS | MAG NAIL FOUND |
| CTP | CRIMP TOP PIPE FOUND |
| OTP | OPEN TOP PIPE FOUND |
| DTP | OPEN TOP PIPE FOUND |
| DPF | DETERMINED POSITION FOUND |
| DI | DROP INLET |
| CI | CATCH INLET |
| YAC | YARD AREA |
| OCS | OUTLET CONTROL STRUCTURE |
| JB | JUNCTION BOX |
| DWCB | DOUBLE WING CATCH BASIN |
| DWCB | DOUBLE WING CATCH BASIN |
| HW | HEADWALL |
| FES | FLARED END SECTION |
| CMP | CORRUGATED METAL PIPE |
| RCP | REINFORCED CONCRETE PIPE |
| SS | SANITARY SEWER |
| F.M.E. | FORCE MAIN EASEMENT |
| S.E.E. | SANITARY EASEMENT |
| D.E.E. | DRAINAGE EASEMENT |
| W.E. | WATER EASEMENT |
| G.T. | GREASE TRAP |
| -X- | FENCE |
| ● | BOLLARD |
| 100-000 | SPOT ELEVATION |

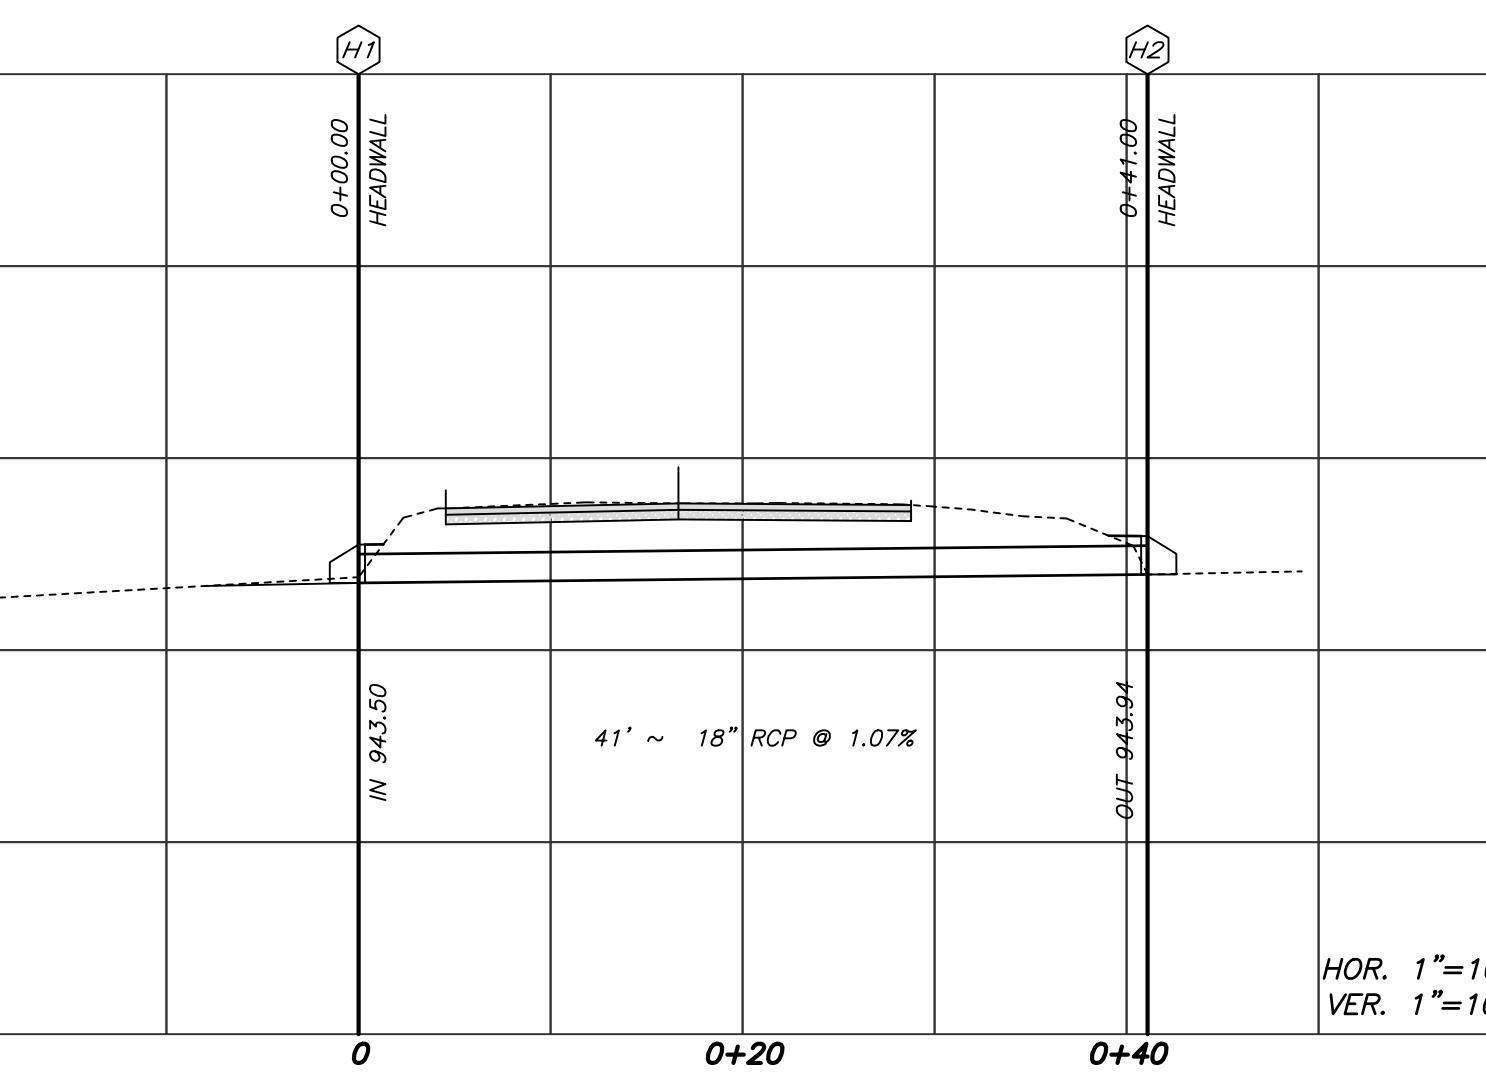

PROPOSED STORM DRAIN PROFILE

10 0 10 20
SCALE: 1" = 10'
10 0 10 20
SCALE: 1" = 10'

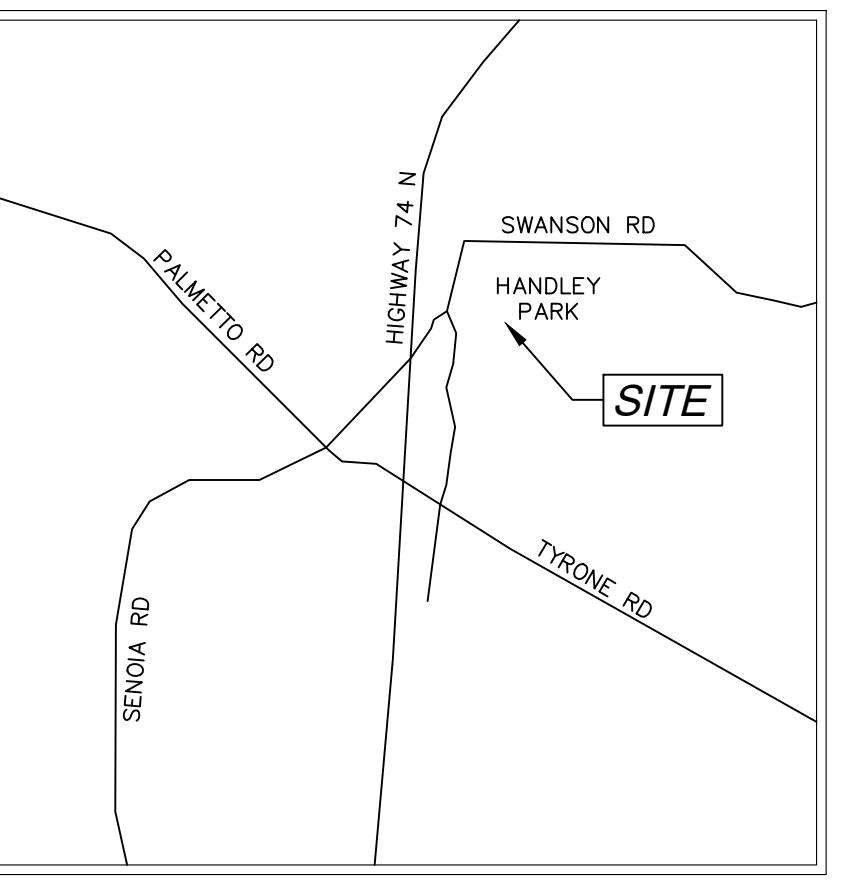


VICINITY MAP
NOT TO SCALE

| | |
|----------------------|----------|
| PROJECT NUMBER PW-20 | |
| DESIGN | SCALE |
| DRAWN | MCI |
| DATE | 01/16/23 |
| CHECK | DWJ |
| FILE NO. | 2101-16 |
| APPROVED | DWJ |
| SHEET NO. | |

| | | | |
|----------|------|-------------|----------|
| REV. NO. | DATE | DESCRIPTION | BY AP/PD |
|----------|------|-------------|----------|




Cross Drain Replacement
for Town of Tyrone, Georgia
Handley Park
Proposed Conditions

Mallett Consulting, Inc.
101 Devant St., Suite 804, Fayetteville, Georgia 30214
PHONE: 770-719-3333
FAX: 770-719-3377

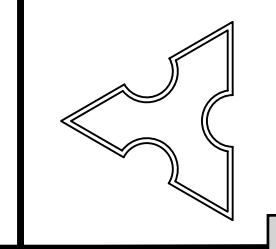

- NOTES:
1. CONTRACTOR WILL BE RESPONSIBLE FOR LOCATING AND PROTECTING EXISTING UTILITIES.
 2. EXISTING PAVEMENT SHALL BE SAW CUT AT LIMITS OF DEMOLITION ACTIVITIES. LOCATION OF SAW CUTS SHALL BE APPROVED IN ADVANCE BY THE TOWN ENGINEER.
 3. CONTRACTOR TO STOCKPILE EXISTING RIP-RAP AND REUSE WHEN PRACTICAL.
 4. ALL DEMOLITION MATERIALS, WASTE SOILS AND SEDIMENT SHALL BE HAULED AWAY AND DISPOSED OF OFFSITE AT A SUITABLE LOCATION, SELECTED BY THE CONTRACTOR. THIS SHALL BE DONE AT NO ADDITIONAL CHARGE.
 5. TEMPORARY TRAFFIC CONTROL STRIPING, SIGNAGE AND DEVICES ARE REQUIRED DURING TRANSITION FROM EXISTING CONDITION TO COMPLETION OF PROJECT. PROVIDE CERTIFIED TRAFFIC CONTROL FLAGMEN DURING TEMPORARY LANE CLOSURES. BOTH LANES SHALL BE OPEN WHEN FLAGMEN ARE NOT PRESENT AND SHALL HAVE AN ALL WEATHER DRIVING SURFACE.
 6. PAVEMENT WITHIN SAW CUT LINES TO BE REMOVED AND REPLACED.

**EROSION CONTROL PLAN FOR
CROSS DRAIN
AT HANDLEY PARK
TYRONE, GEORGIA 30290**

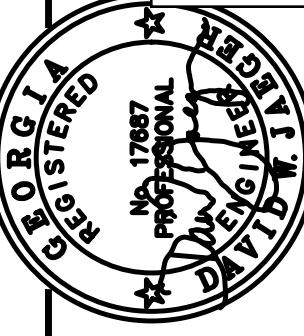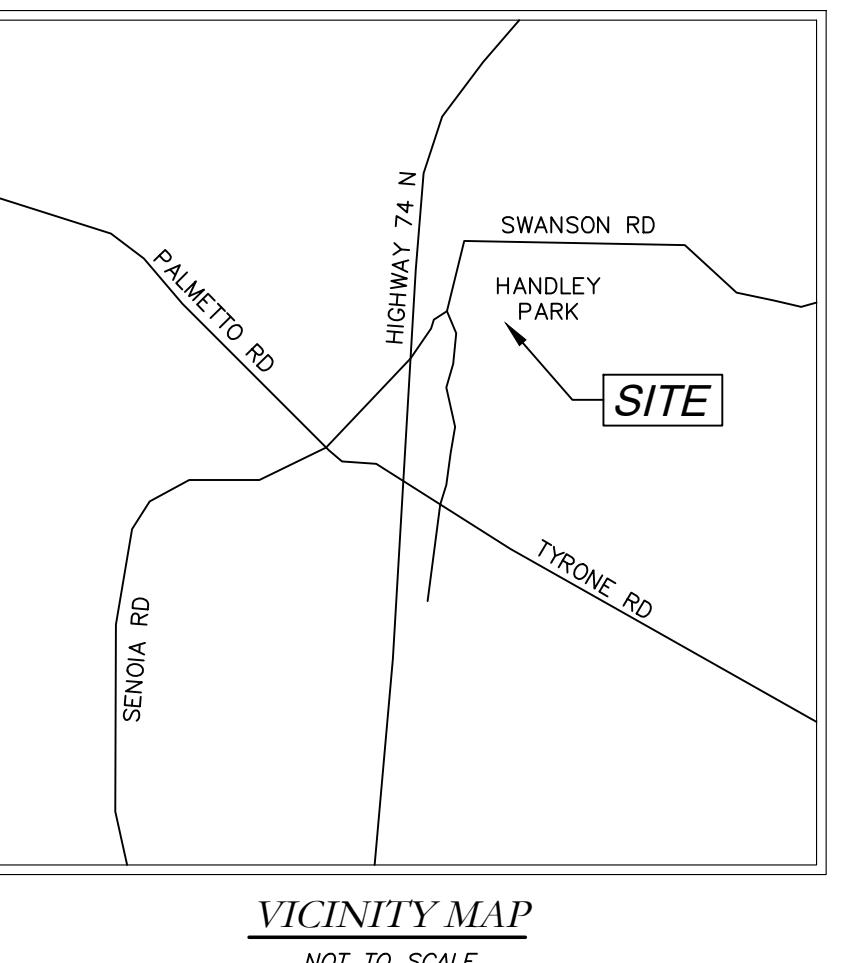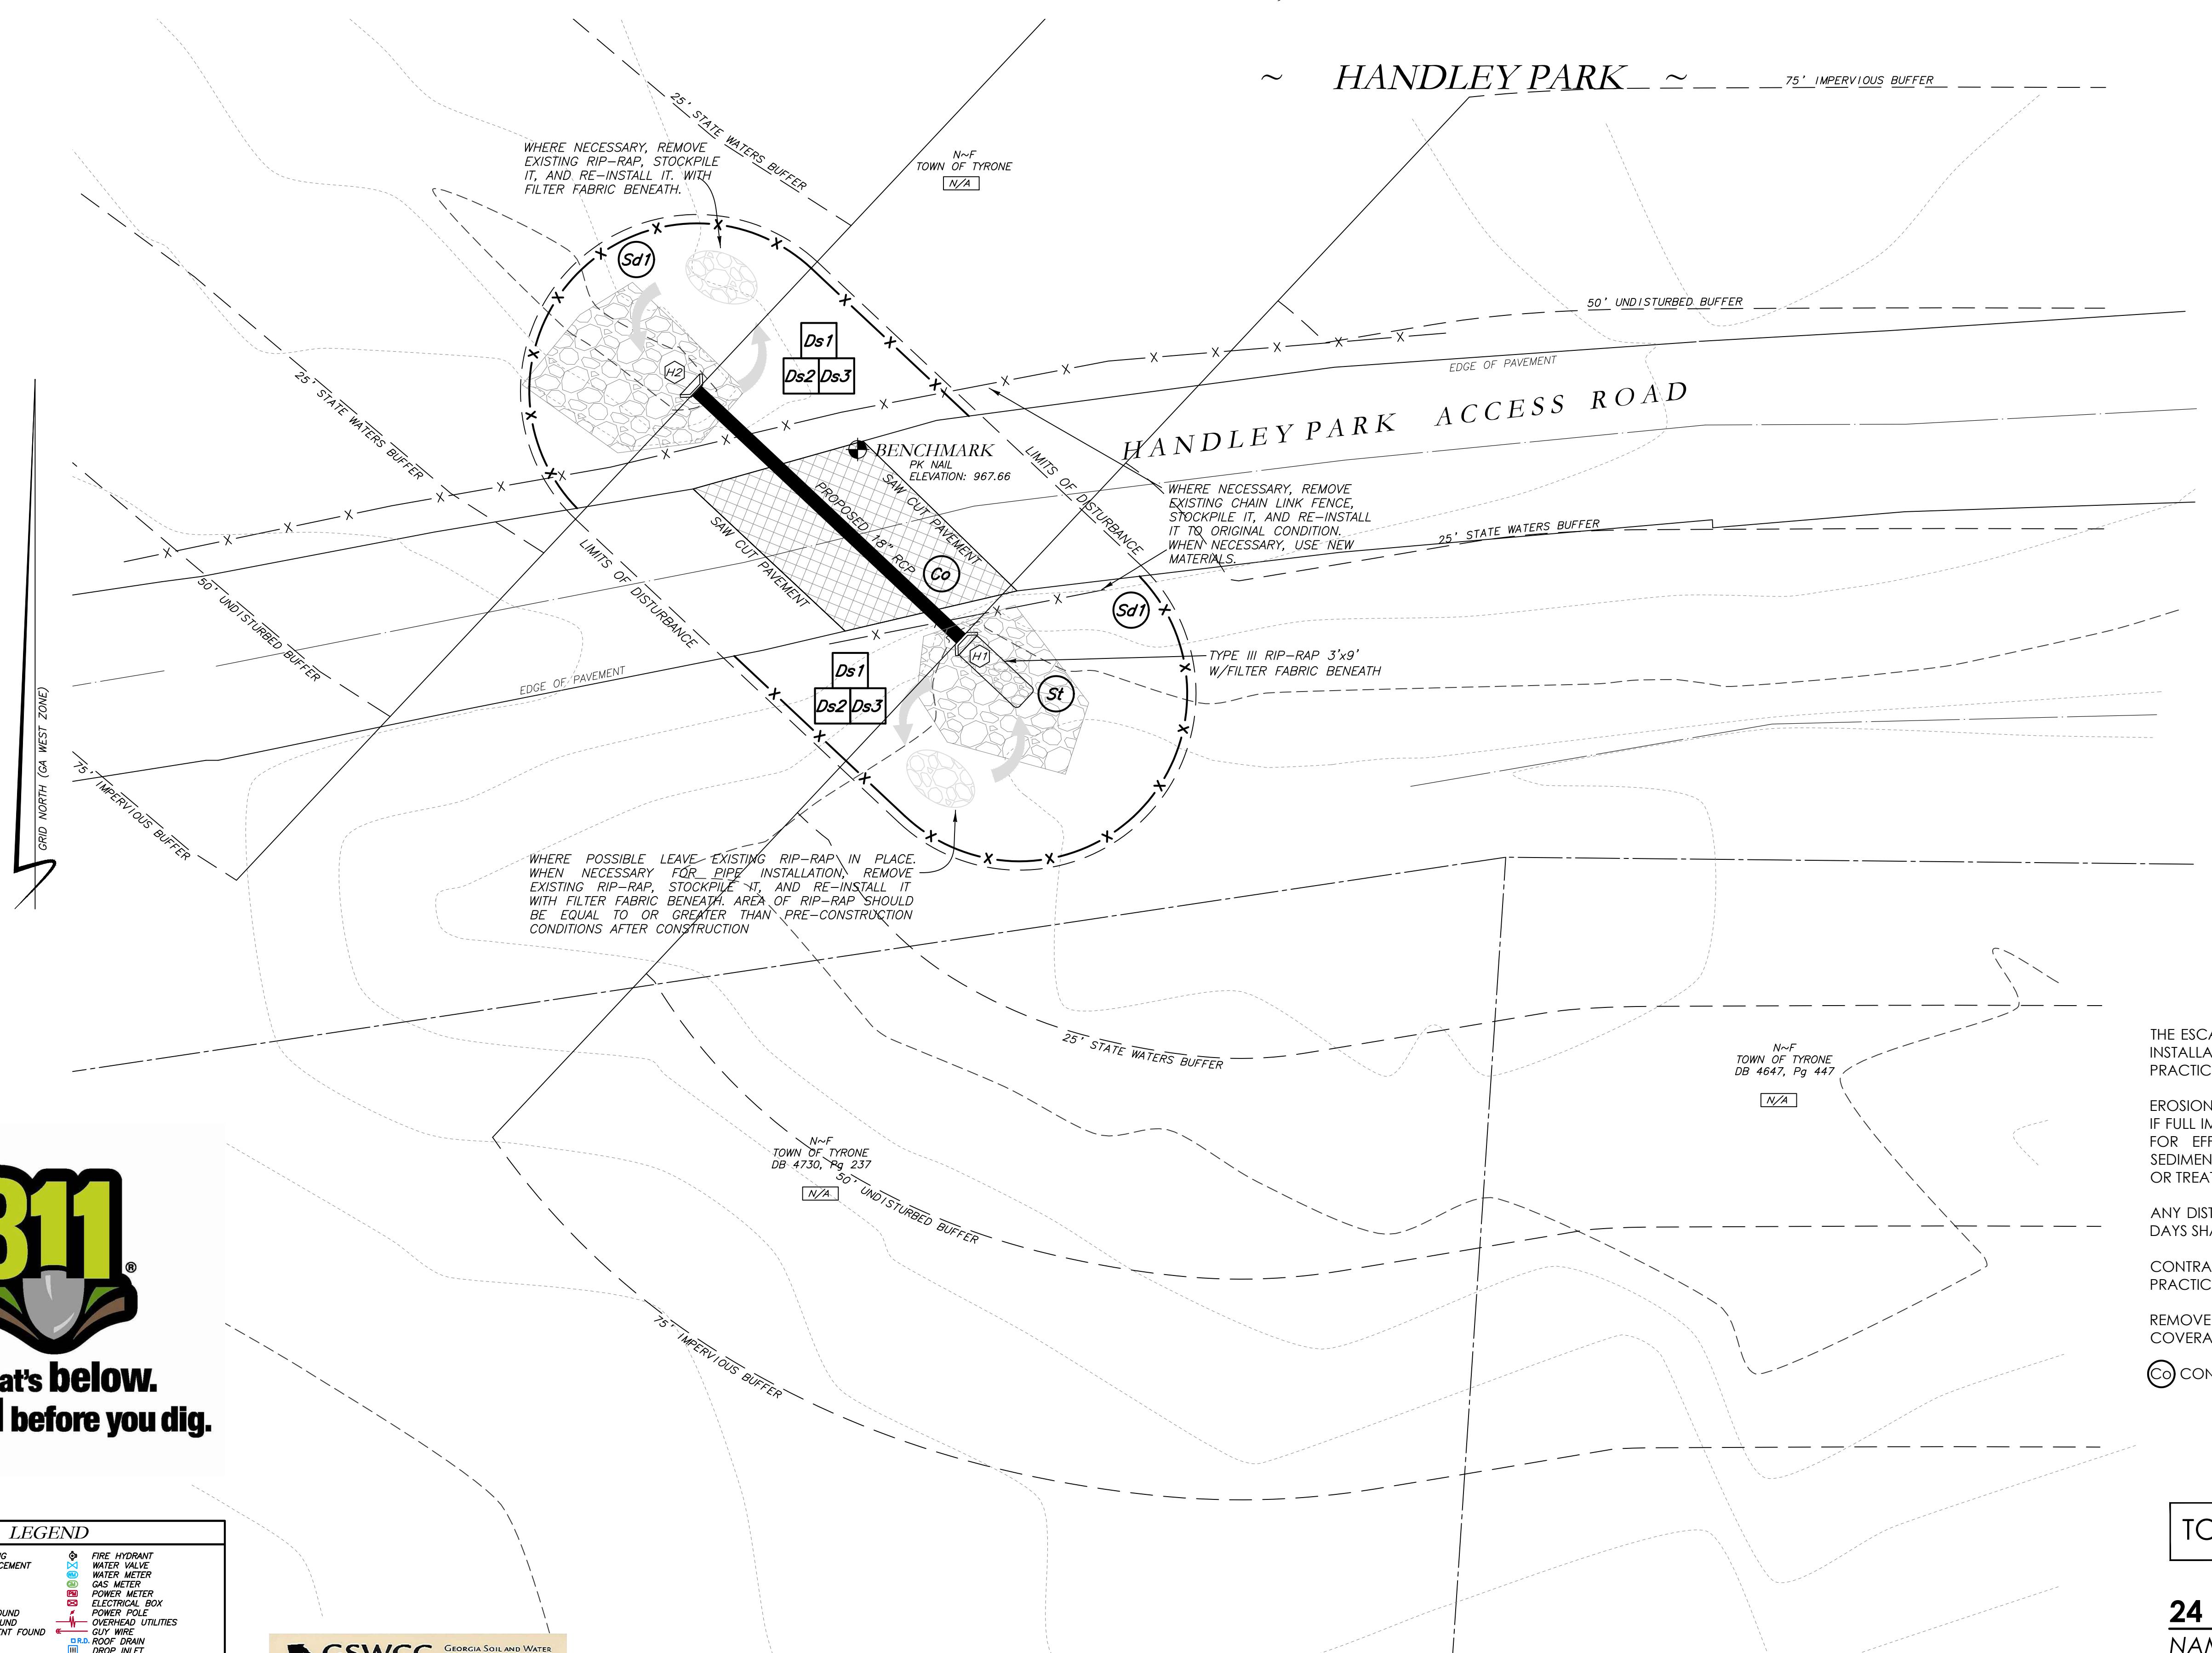

| PROJECT NUMBER PW-20 | | | | | |
|----------------------|-----|-------|----------|-----|-----------|
| DESIGN | MCI | SCALE | DRAWN | ALG | DATE |
| | | | 01/16/23 | | FILE NO. |
| | | | CHECK | DWJ | 12/14/21 |
| | | | APPROVED | DWJ | SHEET NO. |

| REV. NO. | DATE | DESCRIPTION | BY AP/PD |
|----------|------|-------------|----------|
| | | | |

REVISIONS

NOTES

DRAWN BY

CHECKED BY

APPROVED BY

SHEET NO.

DWJ

12/14/21

DWJ

12/14



Know what's below.



Call before you dig.

The locations of existing underground utilities are shown in this approximate map only where they are needed independently verified by the contractor. The contractor shall determine the exact location of all existing underground utilities commencing work, and agrees to indemnify the owner from any and all damages which might be occasioned by the contractor's failure to do so. The contractor shall preserve any and all underground utilities.

NOTICE:
CONSTRUCTION SITE SAFETY IS THE RESPONSIBILITY OF THE CONTRACTOR. WHETHER THE OWNER OR THE ENGINEER SHALL BE LIABLE FOR ANY INJURY OR DAMAGE TO PERSONS OR PROPERTY OR TO THE WORK OF CONSTRUCTION ENGAGED IN THE WORK OF REMOVING EXISTING STRUCTURES OR OF ANY OTHER PERSONS.

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LIMITED SURVEY OF STORM DRAIN REPLACEMENT 220, 215, 225 & 230 JULIE ROAD TYRONE, GEORGIA 30290

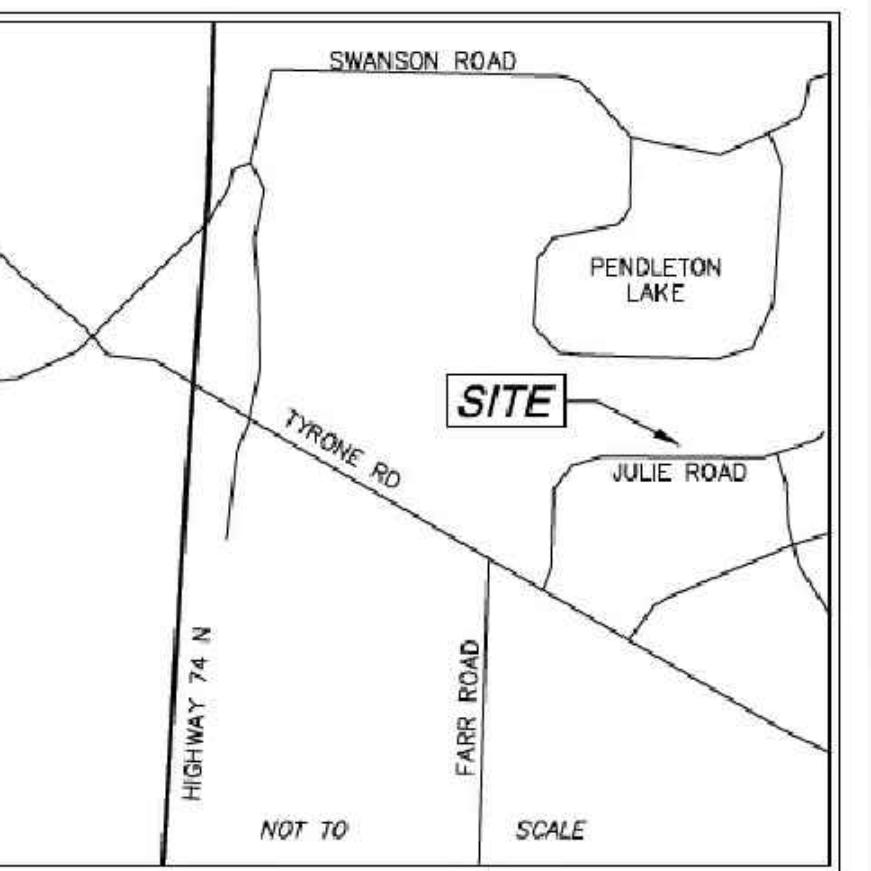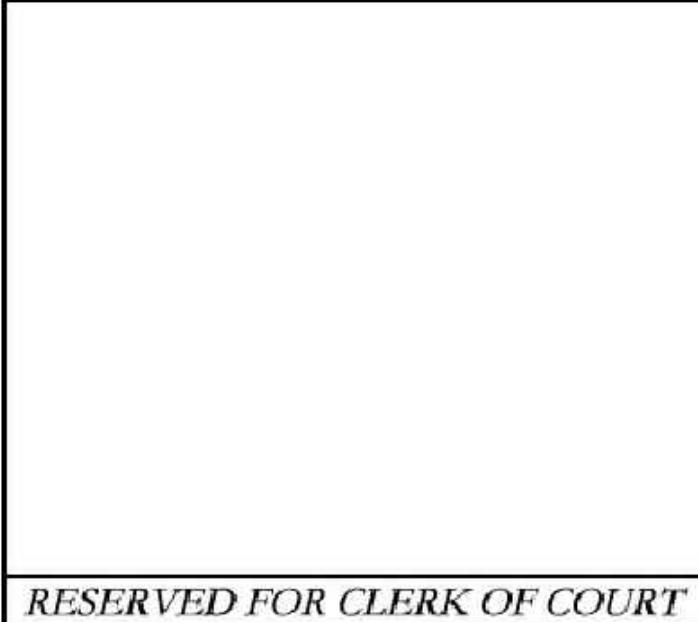

VICINITY MAP

SURVEY NOTES

1. THIS PLAT WAS PREPARED FOR THE EXCLUSIVE USE OF THE PERSON, PERSONS, OR ENTITY NAMED HEREON. THIS PLAT DOES NOT EXTEND TO ANY OTHER PERSON, PERSONS, OR ENTITY WITHIN THE EXPOSED WRITTEN CERTIFICATION BY THE SURVEYOR NAMING SAID PERSON, PERSONS, OR ENTITY.

2. NORTH ARROW AND BEARINGS ARE BASED ON GEORGIA STATE PLAT COORDINATES (NAVD88), US FOOT, USING GLOBAL POSITIONING SYSTEM (GPS) OBSTACLES BY THE SURVEYOR ON OCTOBER 20, 2022 USING THE TRIMBLE VRS SYSTEM. ALL DISTANCES SHOWN ARE HORIZONTAL GROUND MEASUREMENTS EXPRESSED IN SURVEY FEET.
DATUM:
HORIZONTAL: GRID NORTH, NAVD88
VERTICAL: NAVD88
GEOD: GEOD18 (CONUS)

3. CONTOURS AND SPOT ELEVATIONS SHOWN HEREON ARE BASED ON THE U.S.G.S. DATUM (NAVD88). THE SITE BENCHMARKS ARE AS SHOWN HEREON.

4. WATER MAIN, STORM SEWER, SANITARY SEWER, AND FRANCHISE UTILITY STRUCTURES HAVE BEEN FIELD LOCATED WHERE VISIBLE. NOTE: THE SURVEYOR MAKES NO GUARANTEES THAT THE UNDERGROUND UTILITIES SHOWN COMprise ALL SUCH UTILITIES IN THE AREA, EITHER IN-SERVICE OR ABANDONED.


5. THERE WAS NO EVIDENCE OF RECENT CONSTRUCTION ON THE SUBJECT PROPERTY OBSERVED IN THE PROCESS OF CONDUCTING THE FIELDWORK.

6. NO FIELD DELINEATED WETLANDS WERE OBSERVED IN THE PROCESS OF CONDUCTING THE FIELDWORK.

7. EQUIPMENT USED FOR MEASUREMENT:
ANGULAR: TRIMBLE R10/SB ROBOTIC TOTAL STATION
LINEAR: TRIMBLE R10/SB ROBOTIC TOTAL STATION
GPS: TRIMBLE R10 GPS RECEIVER

8. STATE, COUNTY, & LOCAL BUFFERS AND SETBACKS MIGHT EXIST ON THE SUBJECT PROPERTY THAT ARE NOT SHOWN HEREON.

9. THERE ARE NO STATE WATERS ON THIS SITE.

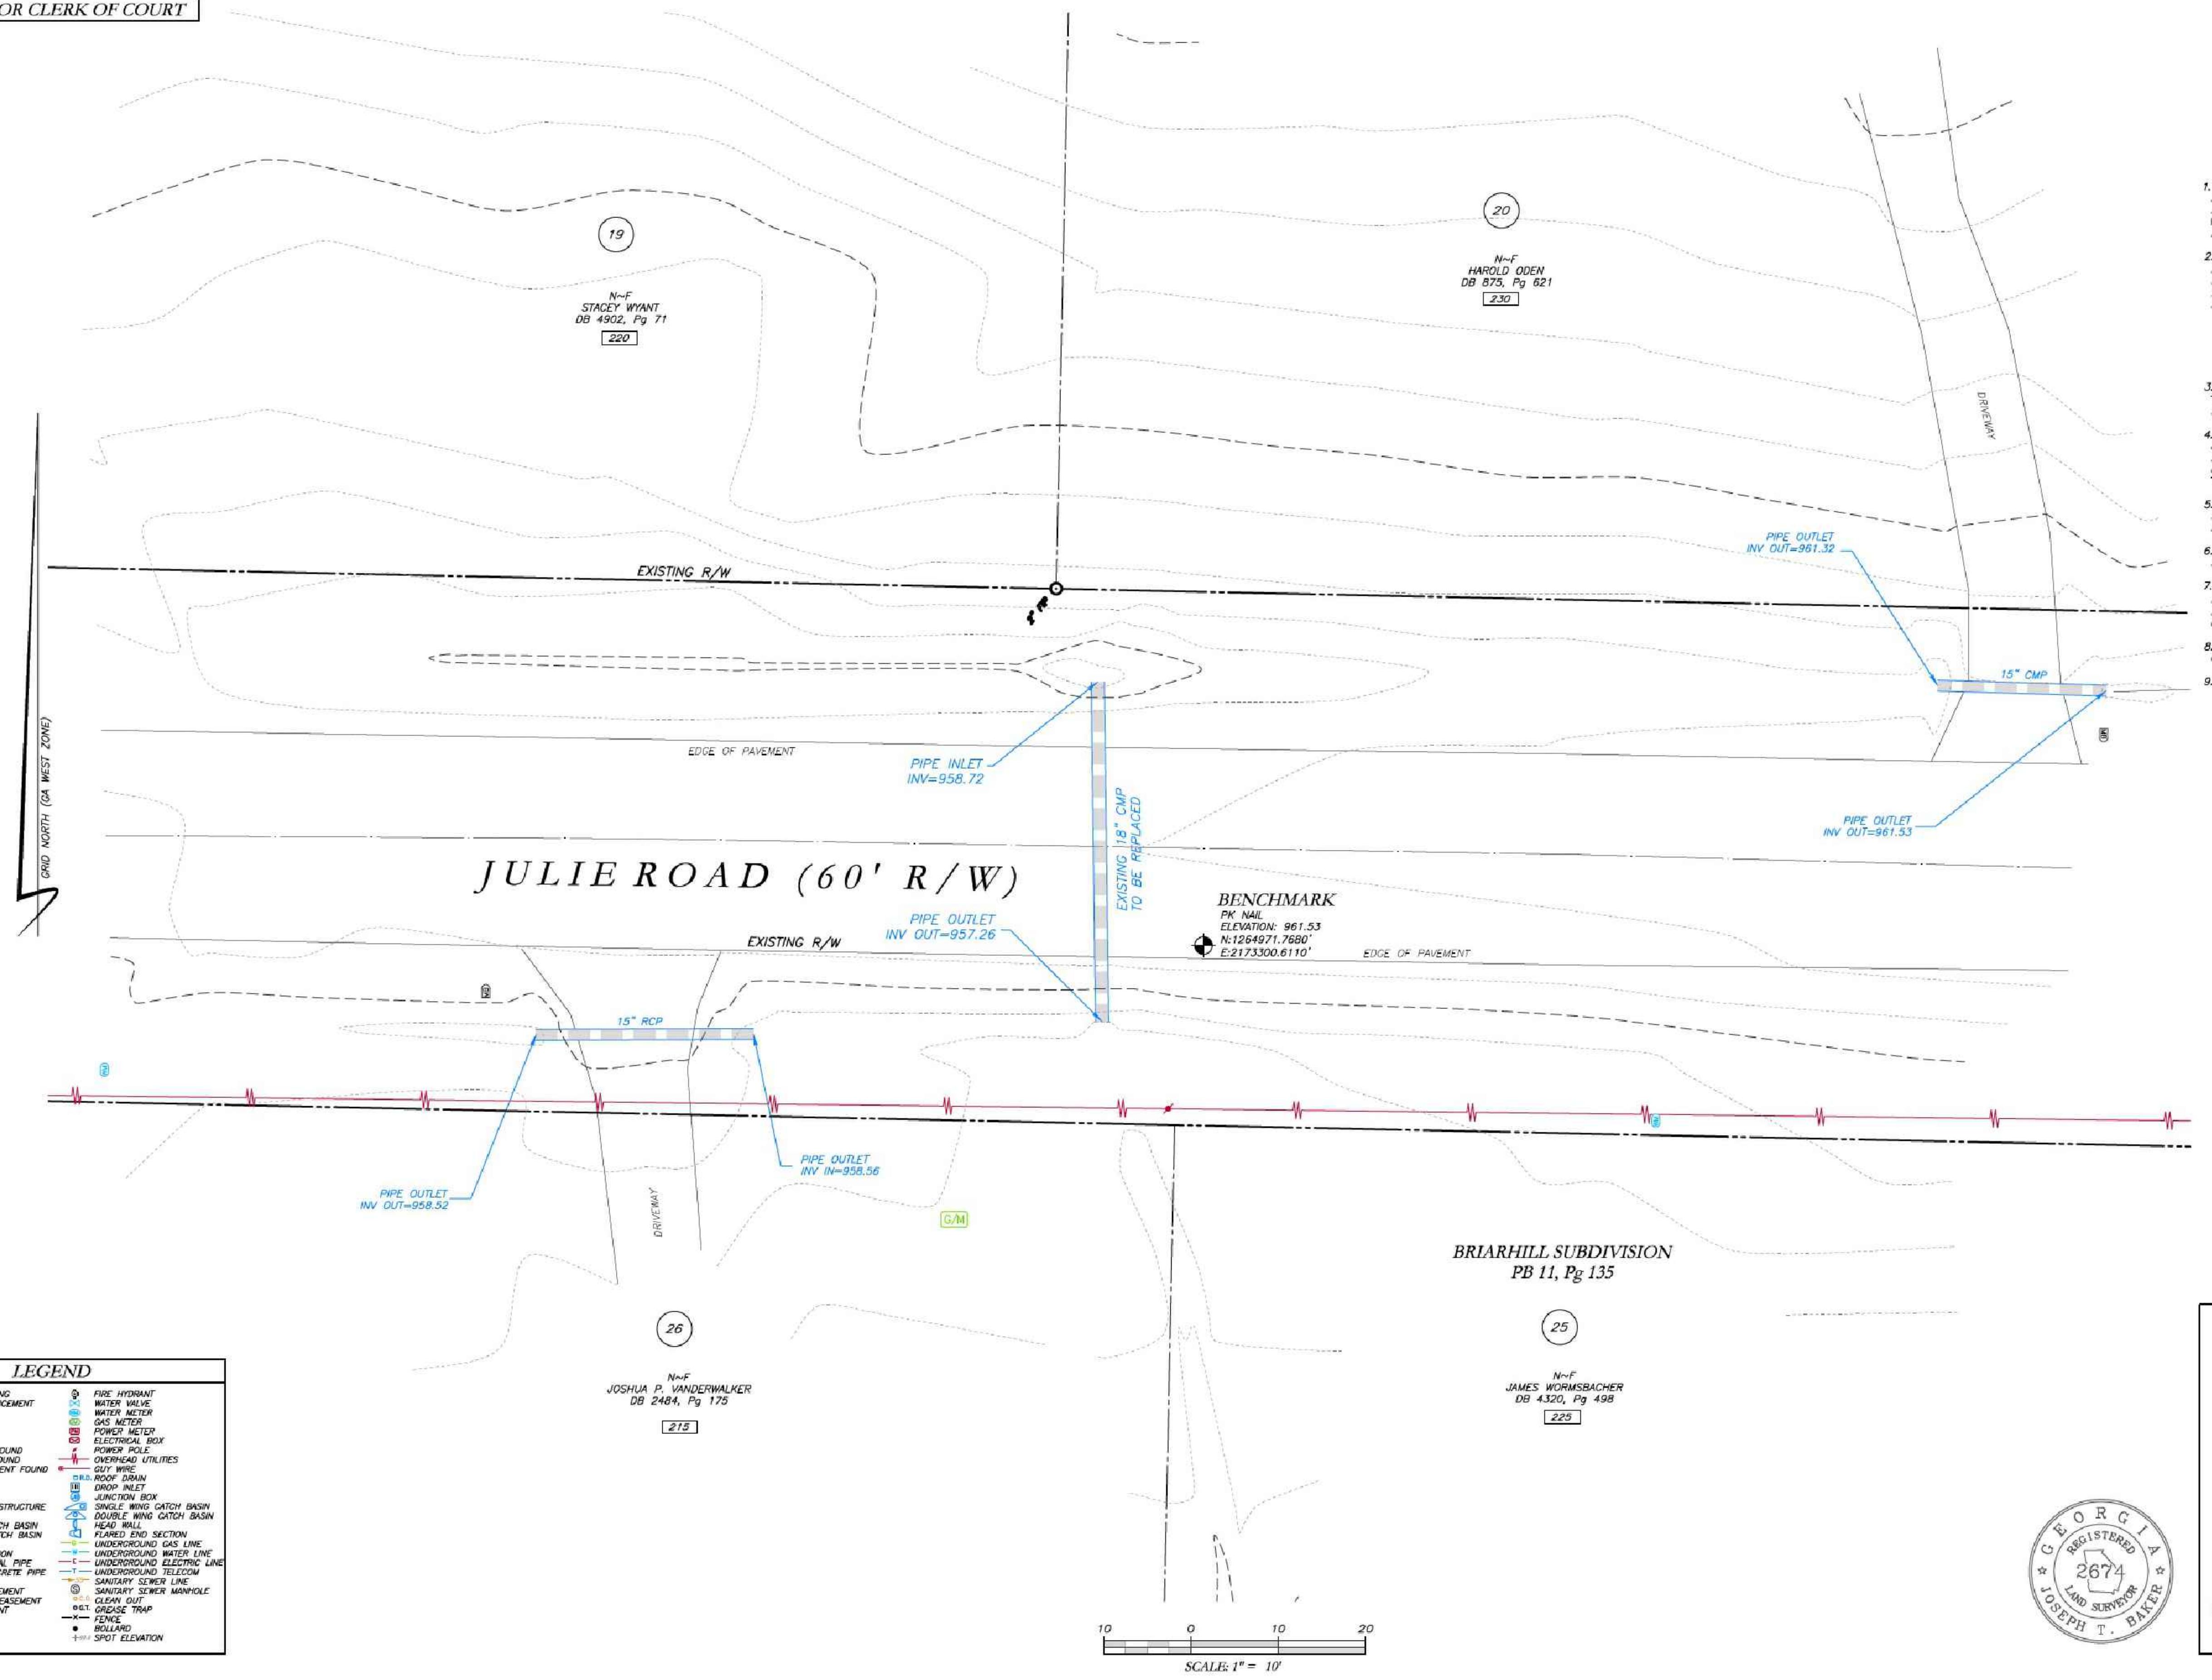BRIARHILL SUBDIVISION
PB 11, Pg 135

| LEGEND | |
|---------------------------|---------------------------|
| POB | POINT OF BEGINNING |
| POC | POINT OF COMMENCEMENT |
| RFB | REVERSE BARING FOUND |
| MNF | MAG NAIL FOUND |
| MAN | MANHOLE |
| CTF | CMP TOP PIPE FOUND |
| OTF | OPEN TOP PIPE FOUND |
| DMP | DEMAND PIPE FOUND |
| DI | DROP INLET |
| CI | CATCH INLET |
| Y | Y-HOSE |
| OCS | OUTLET CONTROL STRUCTURE |
| JG | JUNCTION BOX |
| DWCB | DOUBLE WING CATCH BASIN |
| DWCB | DOUBLE WING CATCH BASIN |
| HW | HEADWALL |
| TEF | TEFLON END SECTION |
| CMP | CORRUGATED METAL PIPE |
| RCP | REINFORCED CONCRETE PIPE |
| SS | SANITARY SEWER |
| F.M.E. | FORCE MAIN EASEMENT |
| D.E. | DRIVEWAY EASEMENT |
| W.E. | WATER EASEMENT |
| G.C.T. | GREASE TRAP |
| FENCE | FENCE |
| BOLLARD | BOLLARD |
| SPOT ELEVATION | SPOT ELEVATION |
| WATER VALVE | WATER VALVE |
| HIGH GAS METER | HIGH GAS METER |
| POWER METER | POWER METER |
| OVERHEAD POLE | OVERHEAD POLE |
| ROOF DRAIN | ROOF DRAIN |
| SINGLE WING CATCH BASIN | SINGLE WING CATCH BASIN |
| DOUBLE WING CATCH BASIN | DOUBLE WING CATCH BASIN |
| FLARED END SECTION | FLARED END SECTION |
| UNDERGROUND GAS LINE | UNDERGROUND GAS LINE |
| UNDERGROUND POWER LINE | UNDERGROUND POWER LINE |
| UNDERGROUND ELECTRIC LINE | UNDERGROUND ELECTRIC LINE |
| SANITARY SEWER LINE | SANITARY SEWER LINE |
| SANITARY SEWER MANHOLE | SANITARY SEWER MANHOLE |

SCALE: 1" = 10'

N-F
JOSHUA P. VANDERWALKER
DB 2484, Pg 175

N-F
JAMES WORMSBACHER
DB 4320, Pg 498



SURVEYOR'S CERTIFICATION

THIS PLAT IS A RETRACEMENT OF AN EXISTING PARCEL OR PARCELS OF LAND AND DOES NOT SUBDIVIDE OR CREATE A NEW PARCEL, OR MAKE ANY CHANGES TO ANY REALED PARCELS OR BOUNDARIES. THE RECORDING OF THIS PLAT OR THE DOCUMENTS, MAPS, PLATS, OR OTHER INSTRUMENTS WHICH CREATED THAT PARCEL OR PARCELS ARE STATED HEREON. RECORDATION OF THIS PLAT DOES NOT IMPLY APPROVAL OF ANY LOCAL JURISDICTION, AVAILABILITY OF PERMITS, CONCURRENCE WITH LOCAL ZONING OR REQUIREMENTS, OR SUITABILITY FOR ANY USE OF PURPOSE OF THE LAND. FURTHERMORE, THE UNDERSIGNED LAND SURVEYOR CERTIFIES THAT THIS PLAT COMPLIES WITH THE MINIMUM TECHNICAL STANDARDS FOR PROPERTY SURVEYS IN GEORGIA AS SET FORTH IN THE RULES AND REGULATIONS OF THE GEORGIA BOARD OF REGISTRATION FOR PROFESSIONAL ENGINEERS AND LAND SURVEYORS AS SET FORTH IN O.C.G.A. SECTION 15-6-17.

JOSEPH T. BAKER, LS
CODE TP
JOB 22006046
SHEET NO. 1
DATE 12/27/21





ATWELL
866.350.2000 www.atwell-group.com
1800 PARKWAY PLACE, SUITE 700
MARIETTA, GA 30067
T 770.473.8007

STORM DRAIN REPLACEMENT
EXISTING CONDITIONS
220, 215, 225 & 230 JULIE ROAD
TYRONE, GEORGIA 30290
DATE 12/30/2022

REVISIONS
DWG. JCB CH. JTB
P.M. JTB
CODE TP
JOB 22006046
SHEET NO. 1
DATE 12/27/21
JOSEPH T. BAKER, LS
CODE TP
JOB 22006046
SHEET NO. 1
DATE 12/27/21

PROPOSED REPLACEMENT OF
CROSS DRAINS AT
215, 220, 225 & 230 JULIE ROAD
TYRONE, GEORGIA 30290

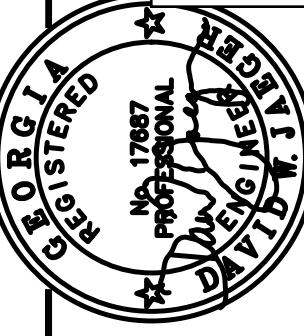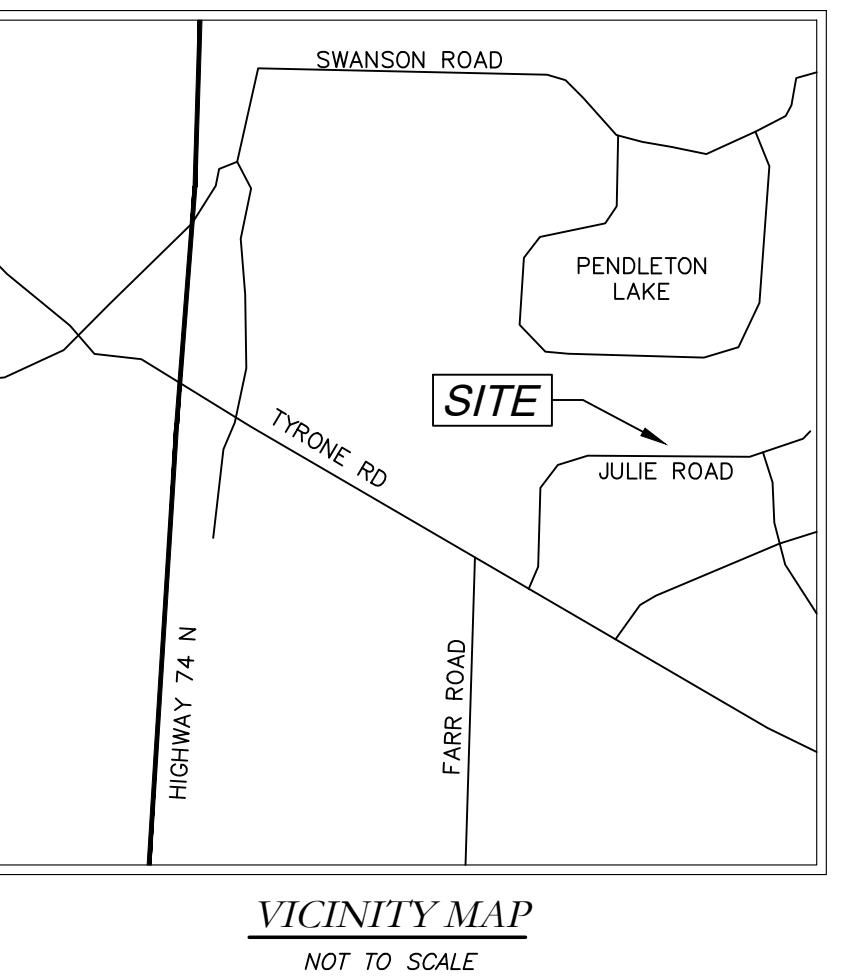

PROJECT NUMBER PW-20
SCALE
DESIGN MCI DATE 01/16/23
DRAWN ALG FILE NO. 2101-16
CHECK DWJ SHEET NO.
APPROVED DWJ


Cross Drain Replacement
for Town of Tyrone, Georgia
Julie Road
Proposed Conditions

Mallett Consulting, Inc.
101 Devant St., Suite 804, Fayetteville, Georgia 30214
PHONE: 770-719-3333 FAX: 770-719-3377



Know what's below.
Call before you dig.


| LEGEND | |
|--------|-----------------------------|
| POB | POINT OF BEGINNING |
| POC | POINT OF COMMENCEMENT |
| RBS | REBAR FOUND |
| RRF | REBAR FOUND |
| MNF | MAG NAIL FOUND |
| MNS | MAG NAIL FOUND |
| CTP | CRIMP TOP PIPE FOUND |
| OTP | OPEN TOP PIPE FOUND |
| DMP | DEMONSTRATED CONCRETE FOUND |
| DI | DROP INLET |
| CI | CATCH INLET |
| YAC | YARD AREA |
| OCS | OUTLET CONTROL STRUCTURE |
| JB | JUNCTION BOX |
| SWCB | SINGLE WING CATCH BASIN |
| DWCB | DOUBLE WING CATCH BASIN |
| HW | HEADWALL |
| TEC | TELECOM |
| CMP | CORRUGATED METAL PIPE |
| RCP | REINFORCED CONCRETE PIPE |
| SS | SEWER SEWER |
| F.M.E. | FORCE MAIN EASEMENT |
| S.E. | SEWER EASEMENT |
| D.E. | DRAINAGE EASEMENT |
| W.E. | WATER EASEMENT |
| G.H.T. | GREASE TRAP |
| X | FENCE |
| • | BOLLARD |
| 5'-0" | SPOT ELEVATION |

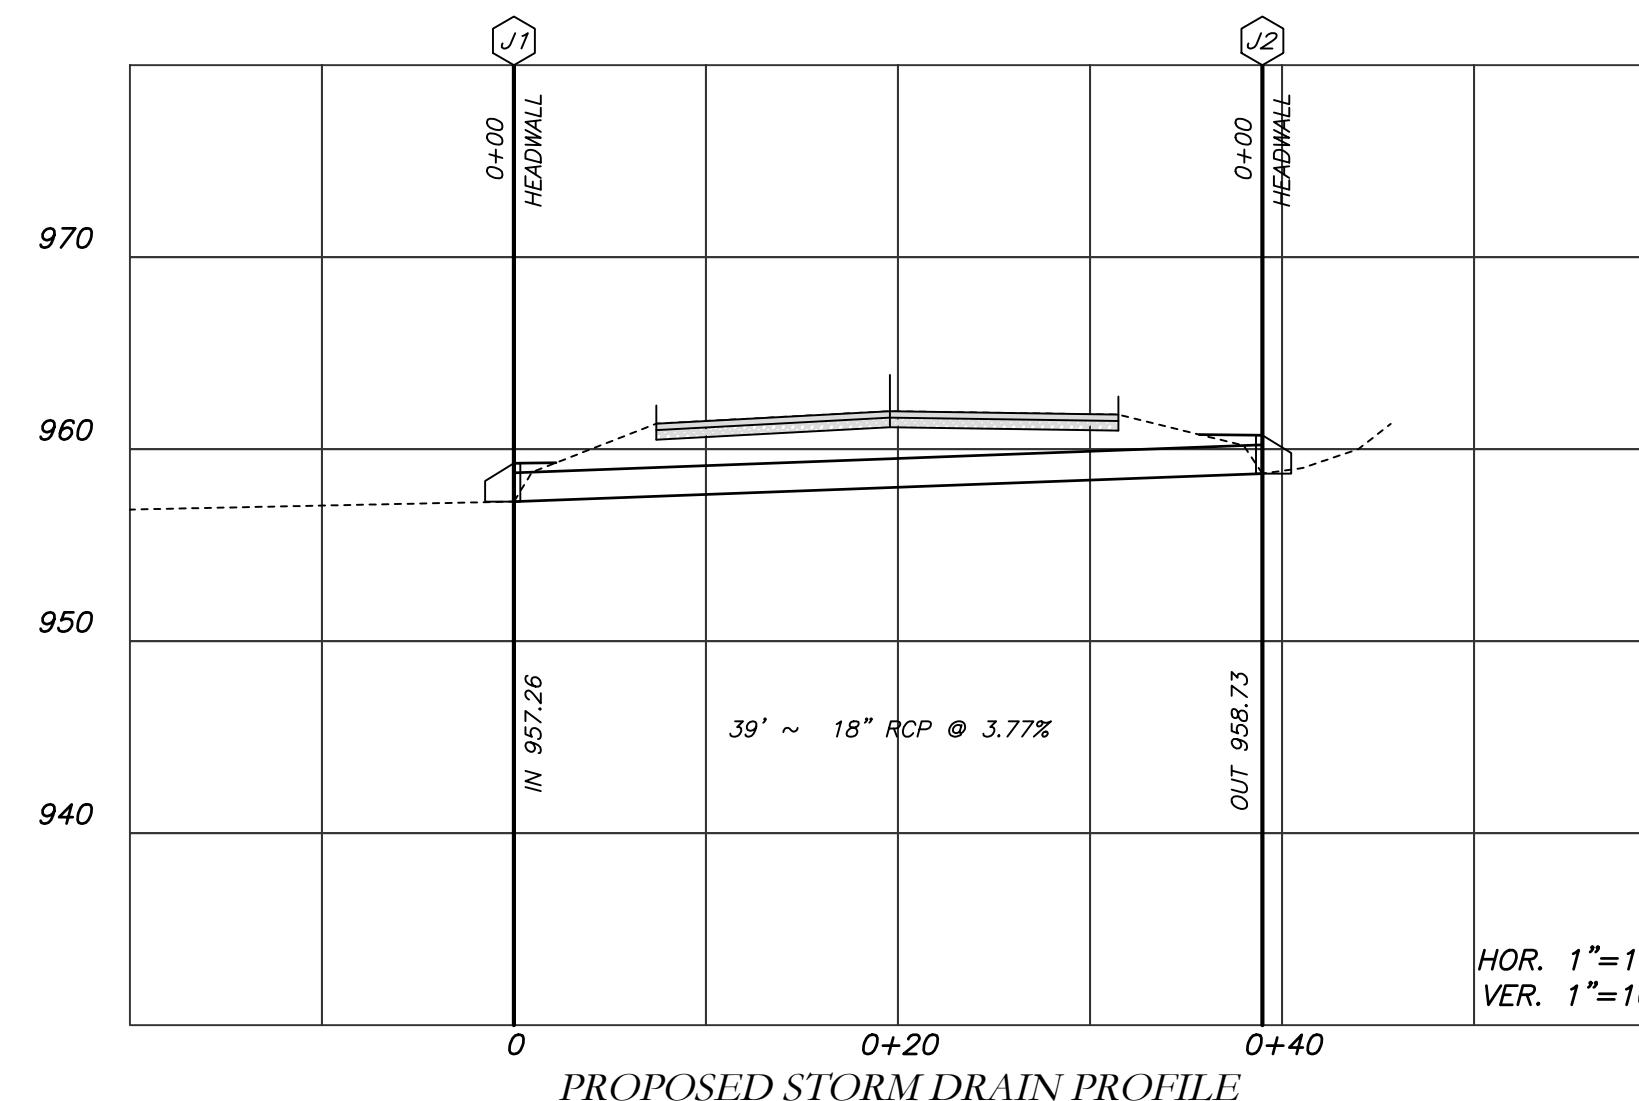

10 0 10 20
SCALE: 1" = 10'
VER. 1" = 10'

NOTES:

- CONTRACTOR WILL BE RESPONSIBLE FOR LOCATING AND PROTECTING EXISTING UTILITIES.
- EXISTING PAVEMENT SHALL BE SAW CUT AT LIMITS OF DEMOLITION ACTIVITIES. LOCATION OF SAW CUTS SHALL BE APPROVED IN ADVANCE BY THE TOWN ENGINEER.
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- ALL DEMOLITION MATERIALS, WASTE SOILS AND SEDIMENT SHALL BE HAULED AWAY AND DISPOSED OF OFFSITE AT A SUITABLE LOCATION, SELECTED BY THE CONTRACTOR. THIS SHALL BE DONE AT NO ADDITIONAL CHARGE.
- TEMPORARY TRAFFIC CONTROL STRIPING, SIGNAGE AND DEVICES ARE REQUIRED DURING TRANSITION FROM EXISTING CONDITION TO COMPLETION OF PROJECT. PROVIDE CERTIFIED TRAFFIC CONTROL FLAGMEN DURING TEMPORARY LANE CLOSURES. BOTH LANES SHALL BE OPEN WHEN FLAGMEN ARE NOT PRESENT AND SHALL HAVE AN ALL WEATHER DRIVING SURFACE.
- PAVEMENT WITHIN SAW CUT LINES TO BE REMOVED AND REPLACED.

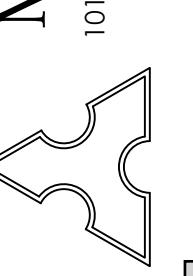

101 DEVANT ST., SUITE 804, FAYETTEVILLE, GEORGIA 30214
PHONE: 770-719-3333 FAX: 770-719-3377

101 DEVANT ST., SUITE 804, FAYETTEVILLE, GEORGIA 30214
PHONE: 770-719-3333 FAX: 770-719-3377




Know what's below.

Call before you dig.
THE LOCATIONS OF EXISTING UNDERGROUND UTILITIES ARE SHOWN IN APPROXIMATE FORM ONLY AND ARE NOT USED INDEPENDENTLY VERIFIED BY THE CONTRACTOR. THE CONTRACTOR SHALL DETERMINE THE EXACT LOCATION OF ALL EXISTING UTILITIES PRIOR TO COMMENCING WORK, AND AGREES TO SOLELY BE RESPONSIBLE FOR ANY AND ALL DAMAGES WHICH MIGHT BE OCCASIONED BY THE CONTRACTOR'S FAILURE TO DETERMINE AND PRESERVE ANY AND ALL UNDERGROUND UTILITIES.

NOTICE:
CONSTRUCTION SITE SAFETY IS THE SOLE RESPONSIBILITY OF THE CONTRACTOR. WHETHER THE OWNER NOR THE ENGINEER SHALL BE LIABLE FOR ANY AND ALL RESPONSIBILITY FOR SAFETY OF THE WORK OF PERSONS ENGAGED IN THE CONSTRUCTION OF ANY STRUCTURES, OR OF ANY OTHER PERSONS.

COPIRIGHT © 2023 ATWELL LLC NO PART OF THIS DRAWING MAY BE REPRODUCED WITHOUT THE PRIOR WRITTEN CONSENT OF ATWELL LLC.

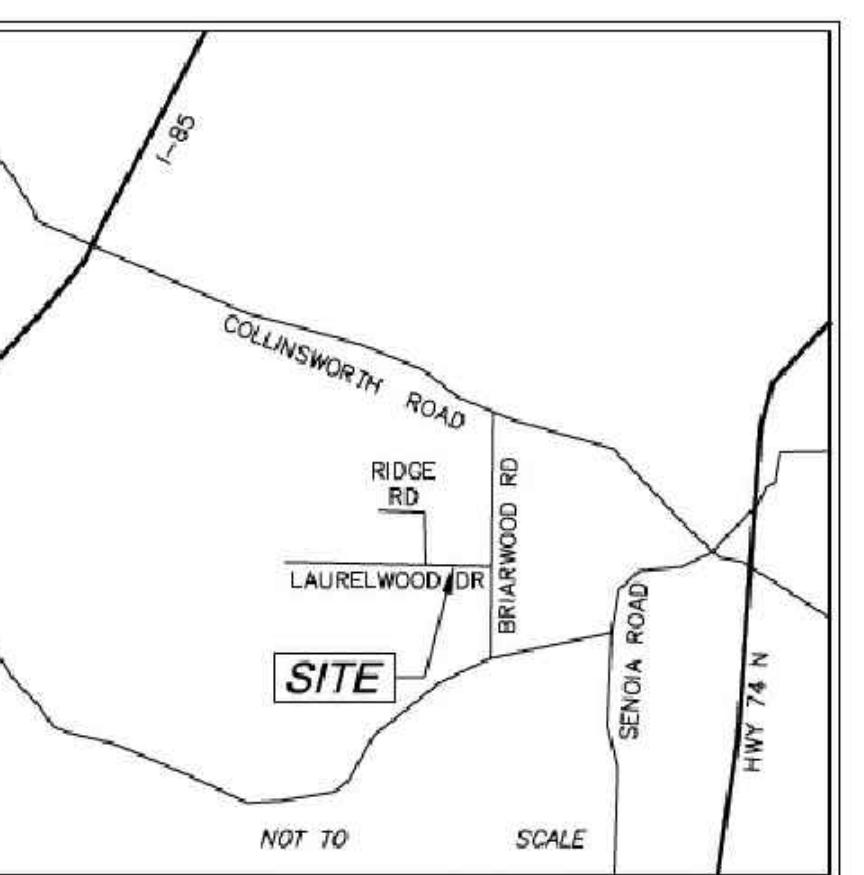

VICINITY MAP

SURVEY NOTES

1. THIS PLAT WAS PREPARED FOR THE EXCLUSIVE USE OF THE PERSON, PERSONS, OR ENTITY NAMED HEREON. THIS PLAT DOES NOT EXTEND TO ANY OTHER PERSON, PERSONS, OR ENTITY WITHIN. AN EXPRESS WRITTEN CERTIFICATION BY THE SURVEYOR NAMING SAID PERSON, PERSONS, OR ENTITY.

2. NORTH ARROW AND BEARINGS ARE BASED ON GEORGIA STATE PLAT COORDINATES (NAVD88), US FOOT, USING GLOBAL POSITIONING SYSTEM (GPS) OBSTACLES REMOVED ON OCTOBER 20, 2022 USING THE TRIMBLE VRS SYSTEM. ALL DISTANCES SHOWN ARE HORIZONTAL GROUND MEASUREMENTS EXPRESSED IN SURVEY FEET.
DATUMS:
HORIZONTAL: GRID NORTH, NAVD88
VERTICAL: NAVD88
GEODID: GEOD18 (CONUS)

3. CONTOURS AND SPOT ELEVATIONS SHOWN HEREON ARE BASED ON THE U.S.G.S. DATUM (NAVD88). THE SITE BENCHMARKS ARE AS SHOWN HEREON.

4. WATER MAIN, STORM SEWER, SANITARY SEWER, AND FRANCHISE UTILITY STRUCTURES HAVE BEEN FIELD LOCATED WHERE VISIBLE. NOTE: THE SURVEYOR MAKES NO GUARANTEES THAT THE UNDERGROUND UTILITIES SHOWN COMprise ALL SUCH UTILITIES IN THE AREA, EITHER IN-SERVICE OR ABANDONED.

5. THERE WAS NO EVIDENCE OF RECENT CONSTRUCTION ON THE SUBJECT PROPERTY OBSERVED IN THE PROCESS OF CONDUCTING THE FIELDWORK.

6. NO FIELD DELINEATED WETLANDS WERE OBSERVED IN THE PROCESS OF CONDUCTING THE FIELDWORK.

7. EQUIPMENT USED FOR MEASUREMENT:
ANGULAR: TRIMBLE R10/SB ROBOTIC TOTAL STATION
LINEAR: TRIMBLE R10/58 ROBOTIC TOTAL STATION
GPS: TRIMBLE R10 GPS RECEIVER

8. STATE, COUNTY, & LOCAL BUFFERS AND SETBACKS MIGHT EXIST ON THE SUBJECT PROPERTY THAT ARE NOT SHOWN HEREON.

9. THERE ARE NO STATE WATERS ON THIS SITE.

ATWELL
866.350.2000 www.atwell-group.com
1800 PARKWAY PLACE, SUITE 700
MARIETTA, GA 30067



LOCATED IN
TOWN OF TYRONE
FAYETTE COUNTY, GEORGIA

STORM DRAIN REPLACEMENT
EXISTING CONDITIONS
340, 345, 350 & 355
LAURELWOOD DRIVE
TYRONE, GEORGIA 30290

DATE
12/30/2022


SURVEYOR'S CERTIFICATION

THIS PLAT IS A RETRACEMENT OF AN EXISTING PARCEL OR PARCELS OF LAND AND DOES NOT SUBDIVIDE OR CREATE A NEW PARCEL, OR MAKE ANY CHANGES TO ANY REALED PARCELS OR BOUNDARIES. THE RECORDING OF THIS PLAT OR THE DOCUMENTS, MAPS, PLATS, OR OTHER INSTRUMENTS WHICH CREATED THAT PARCEL OR PARCELS ARE STATED HEREON. RECORDATION OF THIS PLAT DOES NOT IMPLY APPROVAL OF ANY LOCAL JURISDICTION, AVAILABILITY OF PERMITS, CONCURRENCE WITH LOCAL ZONING, OR REQUIREMENTS, OR SUITABILITY FOR ANY USE OF PURPOSE OF THE LAND. FURTHERMORE, THE UNDERSIGNED LAND SURVEYOR CERTIFIES THAT THIS PLAT COMPLIES WITH THE MINIMUM TECHNICAL STANDARDS FOR PROPERTY SURVEYS IN GEORGIA AS SET FORTH IN THE RULES AND REGULATIONS OF THE GEORGIA BOARD OF REGISTRATION FOR PROFESSIONAL ENGINEERS AND LAND SURVEYORS AS SET FORTH IN O.C.G.A. SECTION 15-6-17.



JOSEPH T. BAKER, LS
GEORGIA LICENSE #2674

DWG. JCB CH. JTB
P.M. JTB
CODE TP
JOB 22006046
SHEET NO.
23 OF 43

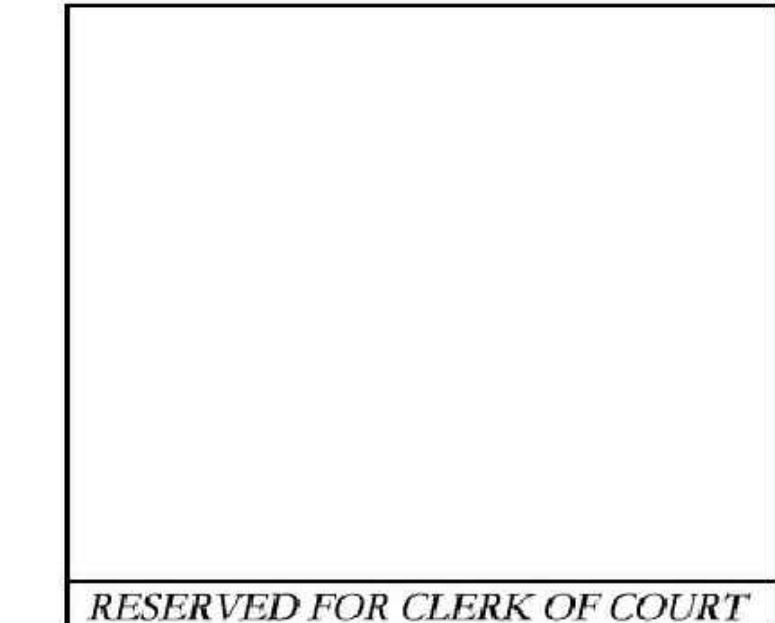



RESERVED FOR CLERK OF COURT



| LEGEND | |
|---------------------------|-----------------------------|
| POB | POINT OF BEGINNING |
| POC | POINT OF COMMENCEMENT |
| RFB | REVERSE BEND FOUND |
| MNF | MAG NAIL FOUND |
| MAD | MAG ADAPTER FOUND |
| CTP | Crimp Top Pipe Found |
| OTP | Open Top Pipe Found |
| CMF | Corrugated Metal Pipe Found |
| DI | Drop Inlet |
| CI | Catch Inlet |
| YB | Yoke Box |
| OCS | Outlet Control Structure |
| JGB | Junction Box |
| DWCB | Single Wing Catch Basin |
| DWCB | Double Wing Catch Basin |
| HW | Heading |
| TEF | Threaded End Section |
| CMP | Corrugated Metal Pipe |
| RCP | Reinforced Concrete Pipe |
| SS | Sanitary Sewer |
| F.M.E. | Force Main Easement |
| S.D.E. | Storm Drainage Easement |
| W.E. | Water Easement |
| G.C.T. | Grease Trap |
| FENCE | Fence |
| BOLLARD | Bollard |
| SPOT ELEVATION | Spot Elevation |
| FIRE HYDRANT | Fire Hydrant |
| WATER VALVE | Water Valve |
| HEAT EXCHANGER | Heat Exchanger |
| GAS METER | Gas Meter |
| POWER METER | Power Meter |
| POWER POLE | Power Pole |
| OVERHEAD UTILITIES | Overhead Utilities |
| ROOF DRAIN | Roof Drain |
| DROP INLET | Drop Inlet |
| YOLE BOX | Yoke Box |
| SINGLE WING CATCH BASIN | Single Wing Catch Basin |
| DOUBLE WING CATCH BASIN | Double Wing Catch Basin |
| FLARED END SECTION | Flared End Section |
| UNDERGROUND GAS LINE | Underground Gas Line |
| UNDERGROUND WATER LINE | Underground Water Line |
| UNDERGROUND ELECTRIC LINE | Underground Electric Line |
| SANITARY SEWER LINE | Sanitary Sewer Line |
| SANITARY SEWER MANHOLE | Sanitary Sewer Manhole |

SCALE: 1" = 10'

**PROPOSED REPLACEMENT OF
CROSS DRAIN AT
340 & 355 LAURELWOOD DR
TYRONE, GEORGIA 30290**

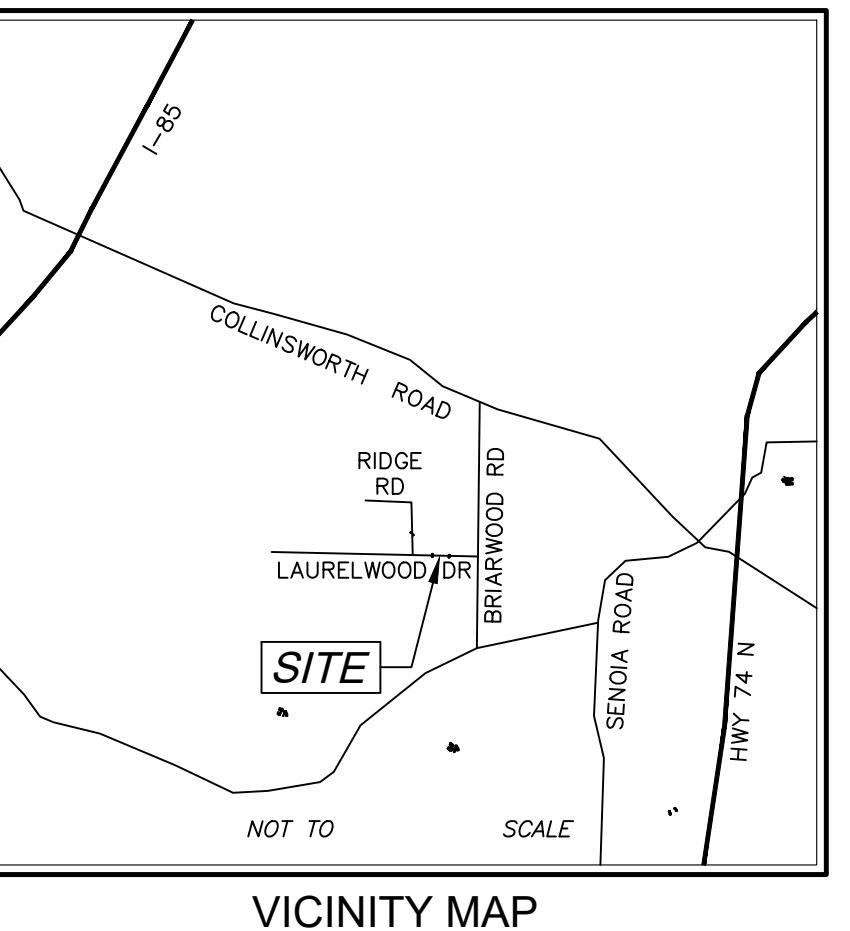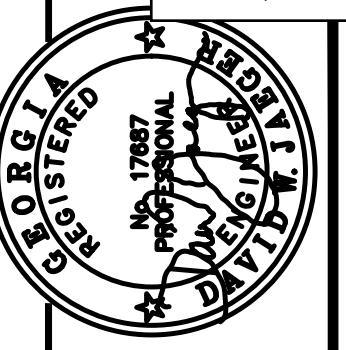


VICINITY MAP

| PROJECT NUMBER PW-20 | DESIGN | SCALE |
|----------------------|--------|-----------|
| DRAWN | MCI | DATE |
| | | 01/16/23 |
| CHECK | DWJ | FILE NO. |
| | | 21/01-16 |
| APPROVED | DWJ | SHEET NO. |

| REV. NO. | DATE | DESCRIPTION | BY AP/PD |
|----------|------|-------------|----------|
| | | | |


| Cross Drain Replacement for Town of Tyrone, Georgia | |
|--------------------------------------------------------|--|
| Laurelwood Drive (1) Proposed Conditions | |

Mallett Consulting, Inc.
101 Devant St., Suite 804, Fayetteville, Georgia 30214
PHONE: 770-719-3333 FAX: 770-719-3377


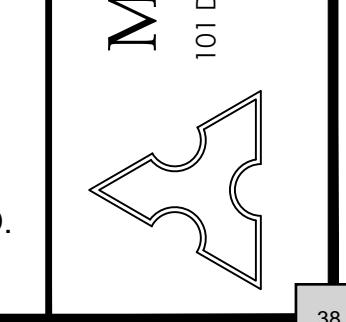


NOTES:

- CONTRACTOR WILL BE RESPONSIBLE FOR LOCATING AND PROTECTING EXISTING UTILITIES.
- EXISTING PAVEMENT SHALL BE SAW CUT AT LIMITS OF DEMOLITION ACTIVITIES. LOCATION OF SAW CUTS SHALL BE APPROVED IN ADVANCE BY THE TOWN ENGINEER.
- CONTRACTOR TO STOCKPILE EXISTING RIP-RAP AND REUSE WHEN PRACTICAL.
- ALL DEMOLITION MATERIALS, WASTE SOILS AND SEDIMENT SHALL BE HAULED AWAY AND DISPOSED OF OFFSITE AT A SUITABLE LOCATION, SELECTED BY THE CONTRACTOR. THIS SHALL BE DONE AT NO ADDITIONAL CHARGE.
- TEMPORARY TRAFFIC CONTROL STRIPING, SIGNAGE AND DEVICES ARE REQUIRED DURING TRANSITION FROM EXISTING CONDITION TO COMPLETION OF PROJECT. PROVIDE CERTIFIED TRAFFIC CONTROL FLAGMEN DURING TEMPORARY LANE CLOSURES. BOTH LANES SHALL BE OPEN WHEN FLAGMEN ARE NOT PRESENT AND SHALL HAVE AN ALL WEATHER DRIVING SURFACE.
- PAVEMENT WITHIN SAW CUT LINES TO BE REMOVED AND REPLACED.

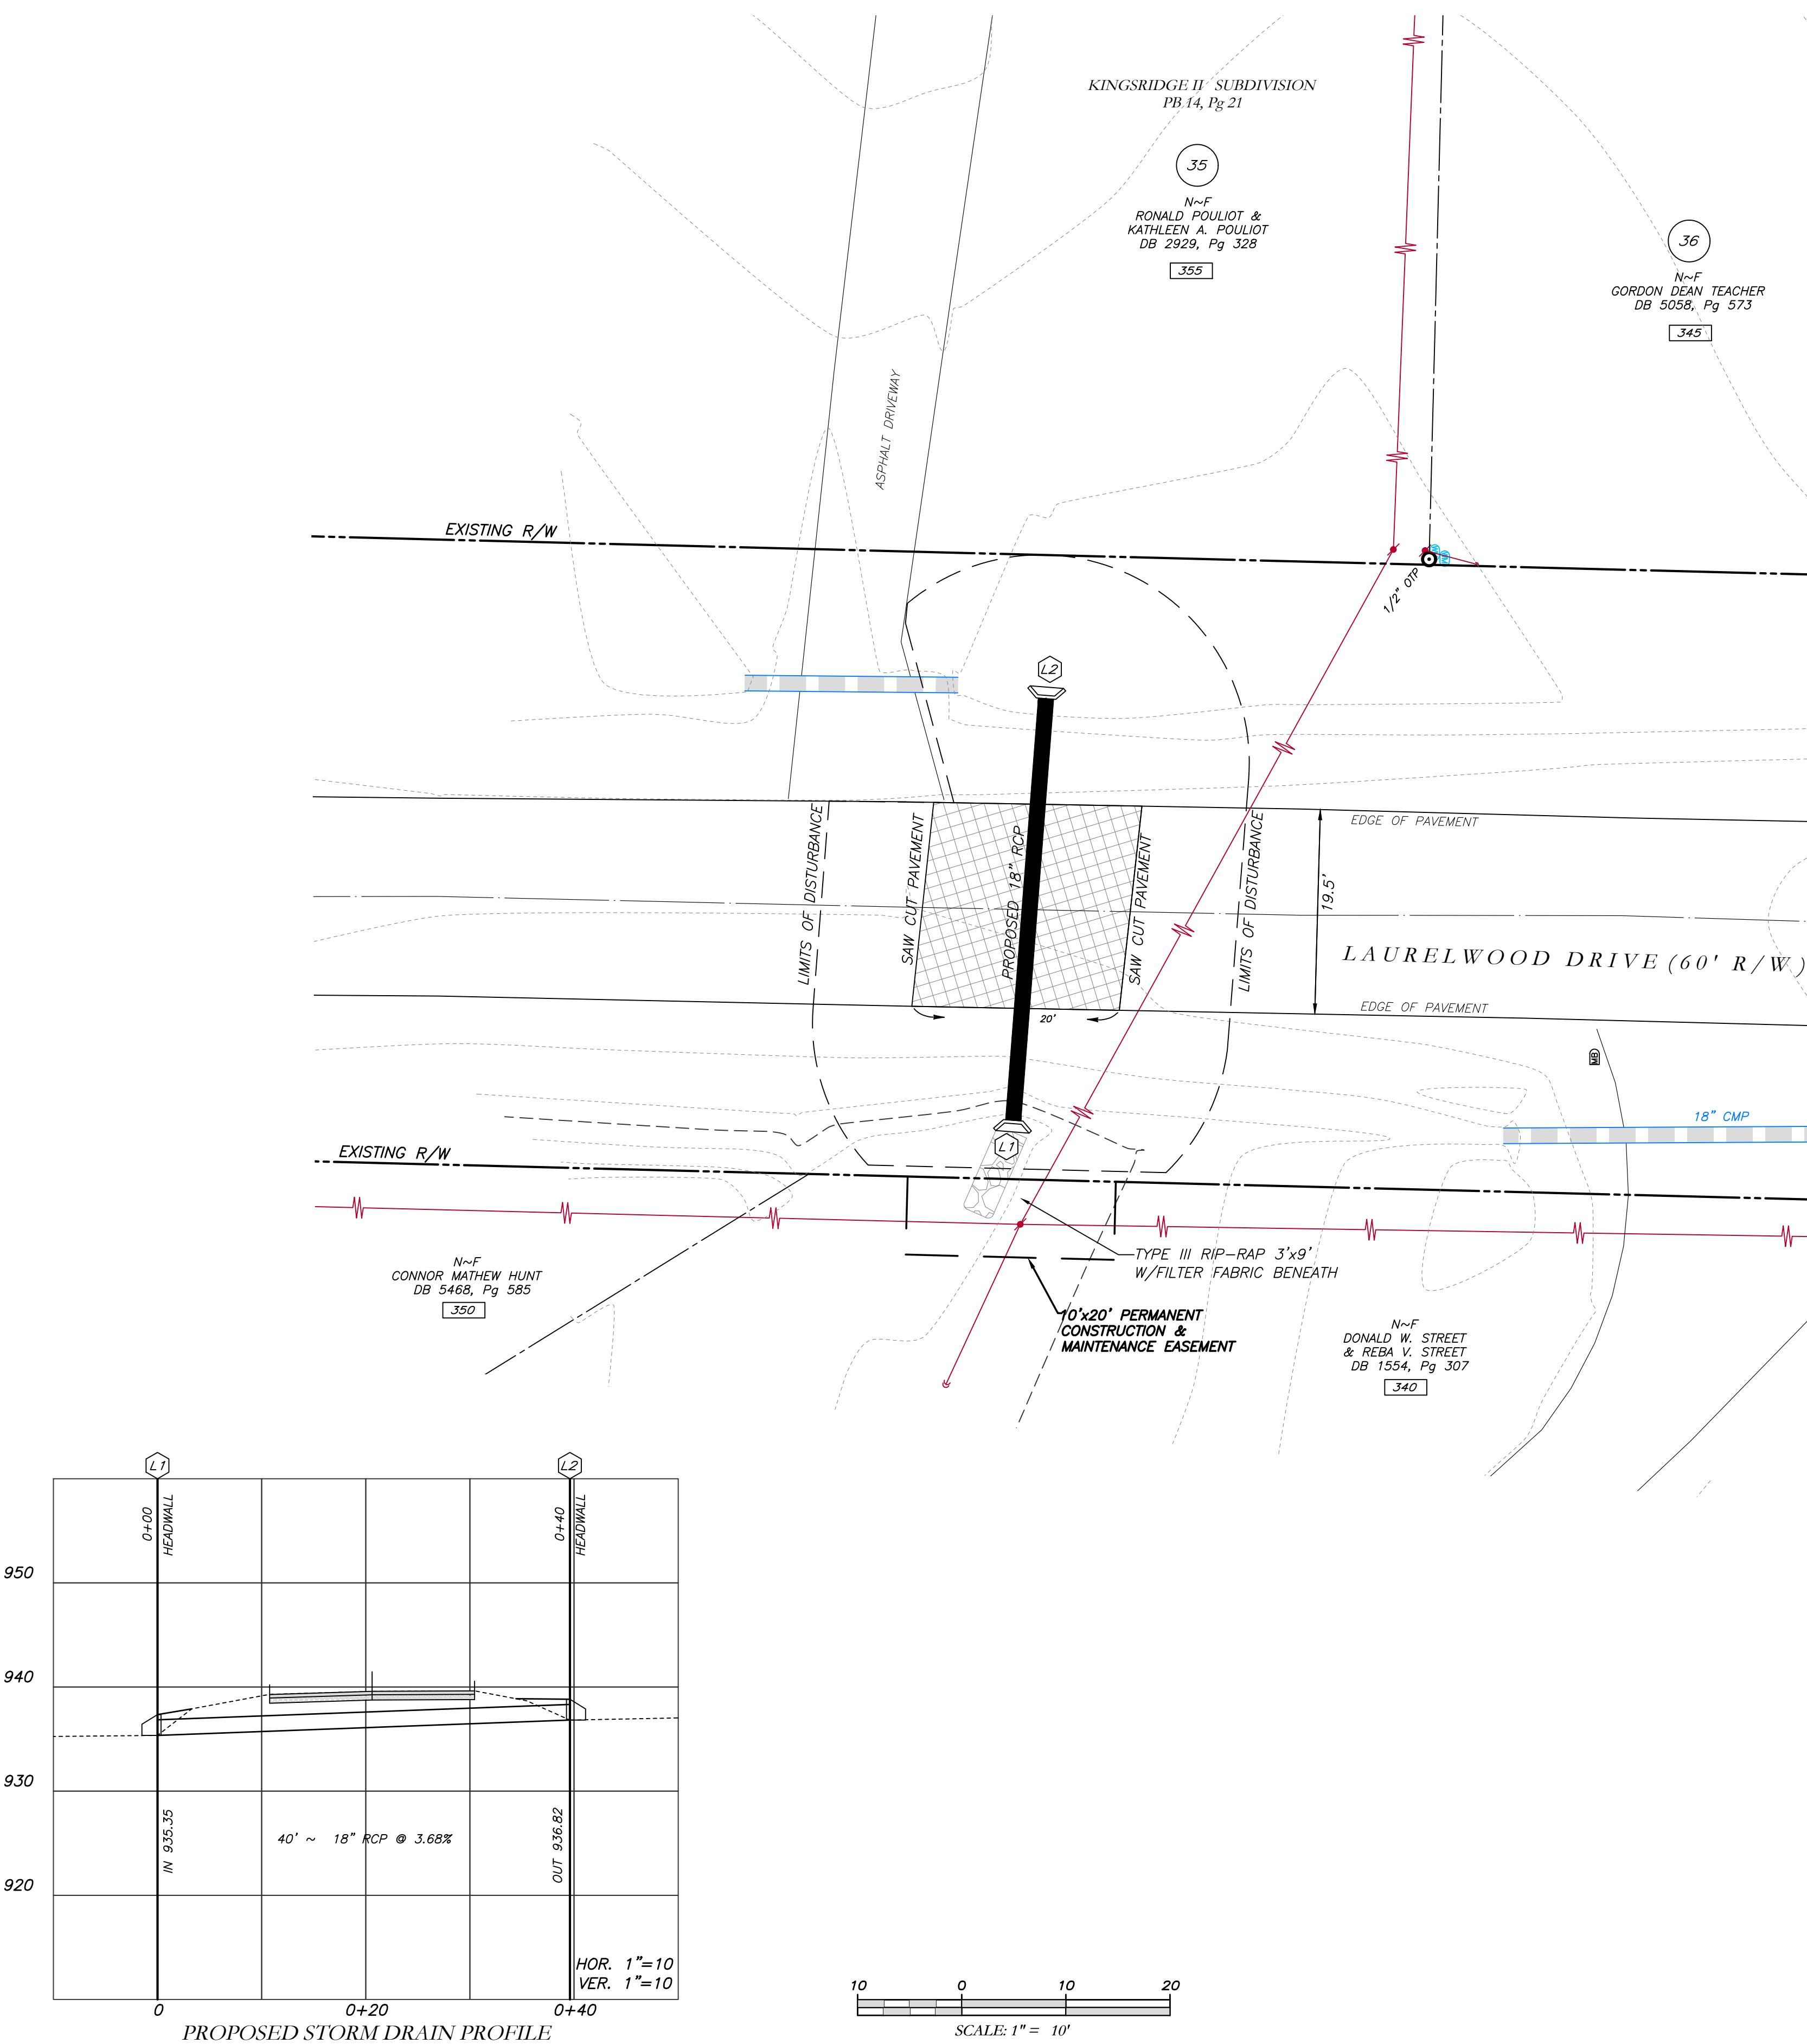SHEET NO.
24 OF 43

**EROSION CONTROL PLAN FOR
CROSS DRAIN AT
340 & 355 LAURELWOOD DR
TYRONE, GEORGIA 30290**

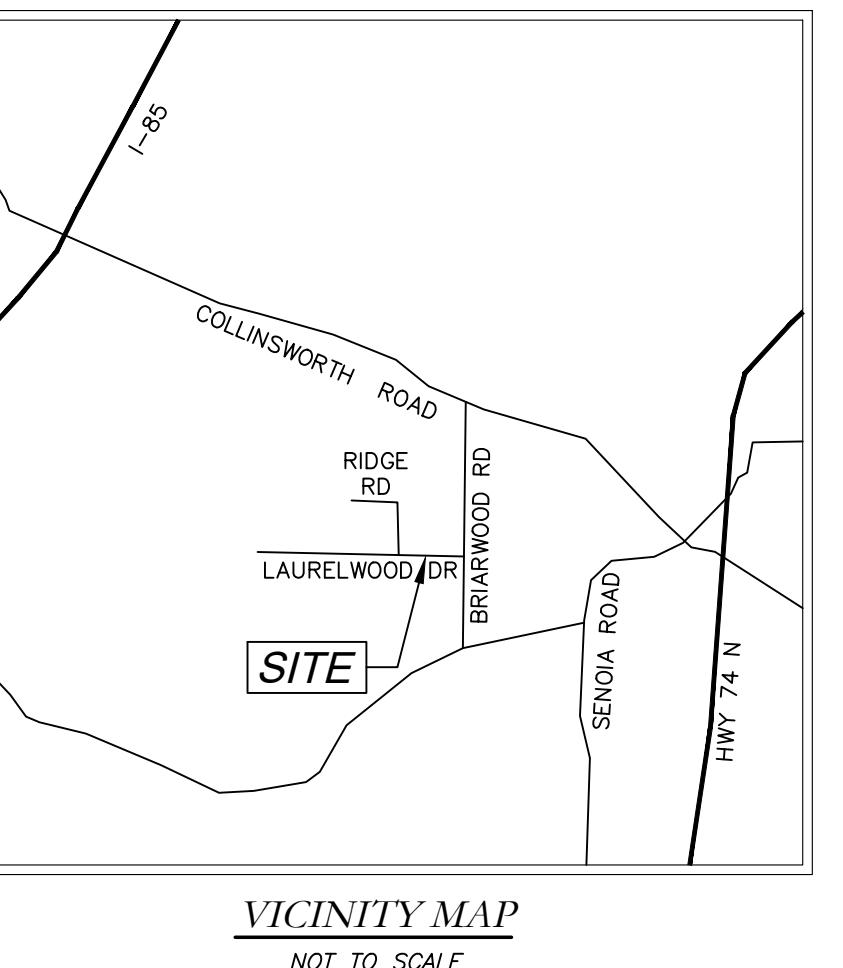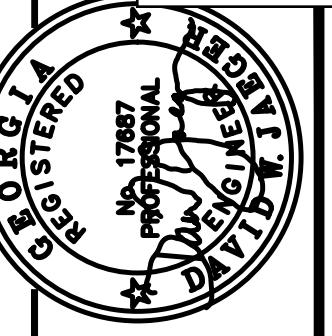


VICINITY MAP
NOT TO SCALE

| PROJECT NUMBER PW-20 | |
|----------------------|----------|
| DESIGN | SCALE |
| DRAWN | MCI |
| DATE | 01/16/23 |
| CHECK | DWJ |
| FILE NO. | 210116 |
| APPROVED | DWJ |
| SHEET NO. | |


| REV. NO. | DATE | DESCRIPTION | BY AP/PD |
|----------|------|-------------|----------|
| | | | |

| Cross Drain Replacement for Town of Tyrone, Georgia | |
|--------------------------------------------------------|--|
| Laurelwood Drive (1) Erosion Control Plan | |

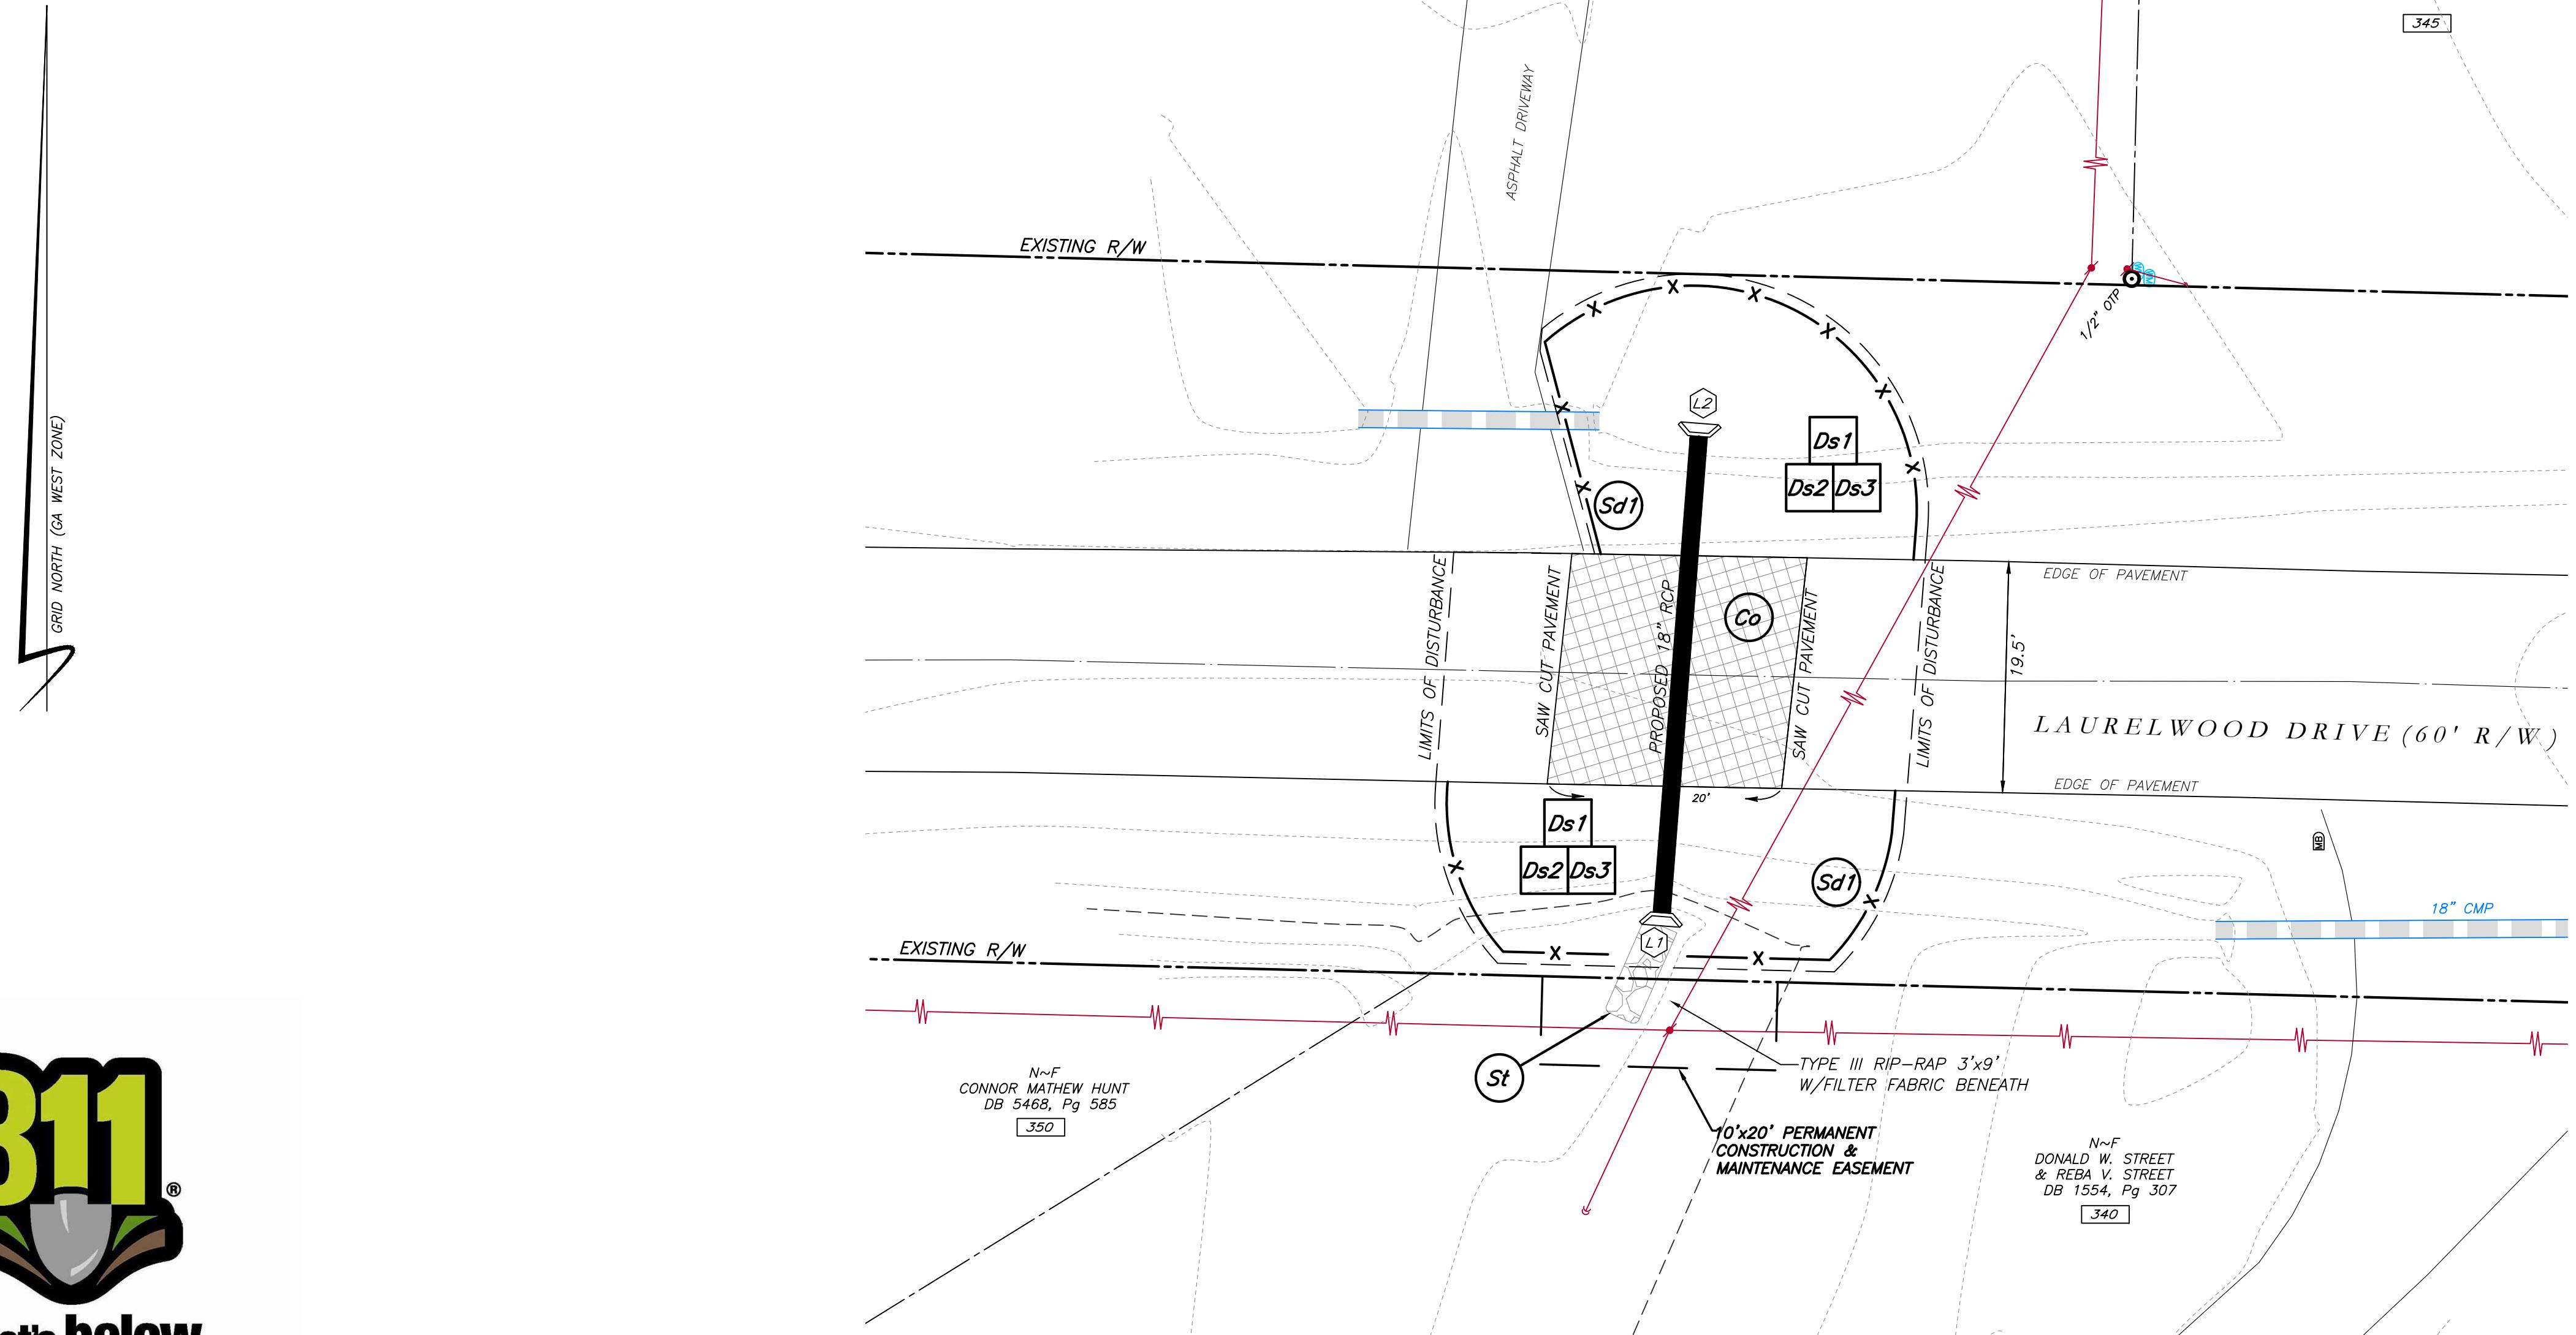

**Know what's below.
Call before you dig.**

| LEGEND | |
|-----------|-----------------------------|
| POB | POINT OF BEGINNING |
| POC | POINT OF COMMENCEMENT |
| RBS | REBAR FOUND |
| RBF | REBAR FOUND |
| MNF | MAG NAIL FOUND |
| MNS | MAG NAIL FOUND |
| CTF | CRIMP TOP PIPE FOUND |
| OTF | OPEN TOP PIPE FOUND |
| CMP | CORRUGATED METAL PIPE FOUND |
| DMF | DETERMINED CONCRETE FOUND |
| DI | DROP INLET |
| CI | CATCH INLET |
| YI | YARD INLET |
| OCS | OUTLET CONTROL STRUCTURE |
| JB | JUNCTION BOX |
| DWCB | DOUBLE WING CATCH BASIN |
| DWCB | DOUBLE WING CATCH BASIN |
| HW | HEADWALL |
| TEC | TELECOM |
| CMP | CORRUGATED METAL PIPE |
| RCP | REINFORCED CONCRETE PIPE |
| SS | SEWER |
| F.M.E. | FORCE MAIN EASEMENT |
| D.E. | DRIVEWAY EASEMENT |
| D.E.E. | DRAINAGE EASEMENT |
| W.E. | WATER EASEMENT |
| G.H.T. | GREASE TRAP |
| X | FENCE |
| • | BOLLARD |
| ± 0.00 ft | SPOT ELEVATION |

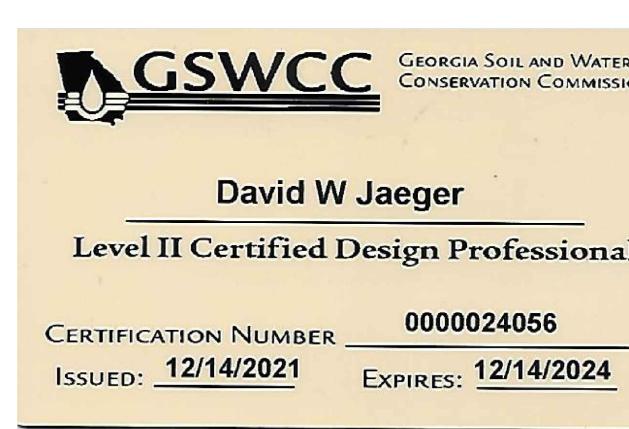

I CERTIFY AS THE PLAN DESIGNER THAT I HAVE VISITED THE SITE PRIOR TO THE DESIGN OF THE ES&PC PLANS

David W Jaeger

10 0 10 20
SCALE: 1" = 10'

TOTAL DISTURBED ACRES = 0.07

24 Hour Erosion Control Contact:

NAME: Scott Langford
ADDRESS: 950 Senoia Road
Tyrone, GA 30290
PHONE: (770)-487-4038

Mallett Consulting, Inc.
101 Devant St., Suite 804, Fayetteville, Georgia 30214
PHONE: 770-719-3373
FAX: 770-719-3377




Know what's below.


Call before you dig.
THE LOCATIONS OF EXISTING
UNDERGROUND UTILITIES ARE
SHOWN IN THIS APPRAISAL MAP
ONLY AS DETERMINED AND
INDEPENDENTLY VERIFIED BY THE
CONTRACTOR'S SURVEYOR.
THE CONTRACTOR SHALL DETERMINE
THE EXACT LOCATION OF ALL
EXISTING UTILITIES PRIOR TO
COMMENCING WORK, AND AGREES TO
SO DO IN A MANNER THAT WILL
NOT DAMAGE ANY OF THE UTILITIES
AND ALL DAMAGES WHICH MIGHT BE
OCURRED BY THE CONTRACTOR'S
FAILURE TO DO SO SHALL BE BORN
BY THE CONTRACTOR AND NOT BY
THE OWNER OR BY ANY OTHER
PERSONS.

NOTICE:
CONSTRUCTION SITE SAFETY IS THE
RESPONSIBILITY OF THE CONTRACTOR. WHETHER THE OWNER
OR THE ENGINEER SHALL BE
CERTIFIED AS TO THE SAFETY
RESPONSIBILITY FOR SAFETY OF
THE WORK OF CONSTRUCTION ENGAGED
IN THE FIELD, OF EXISTING UTILITIES
STRUCTURES, OR OF ANY OTHER
PERSONS.


Copyright © 2023 ATWELL LLC NO
RESPONSES WILL BE MADE WITHOUT THE PRIOR WRITTEN
CONSENT OF ATWELL LLC

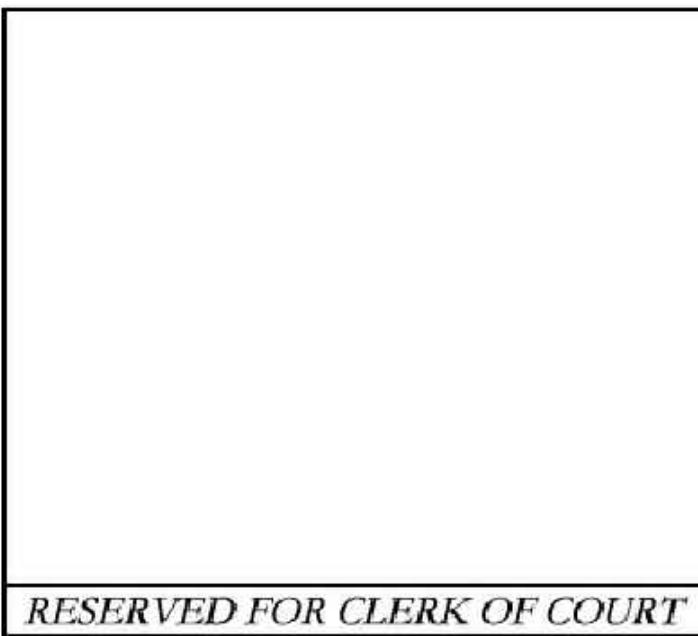

LIMITED SURVEY OF STORM DRAIN RE PLACEMENT 300 & 315 LAURELWOOD DRIVE TYRONE, GEORGIA 30290

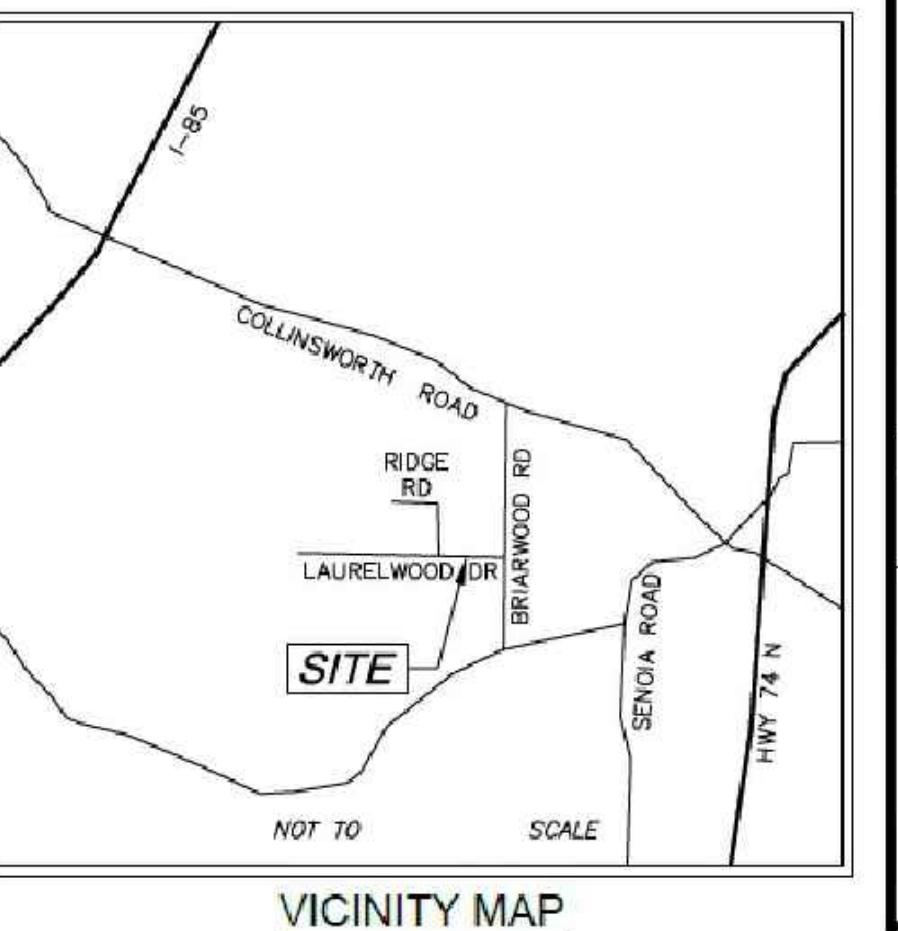

VICINITY MAP

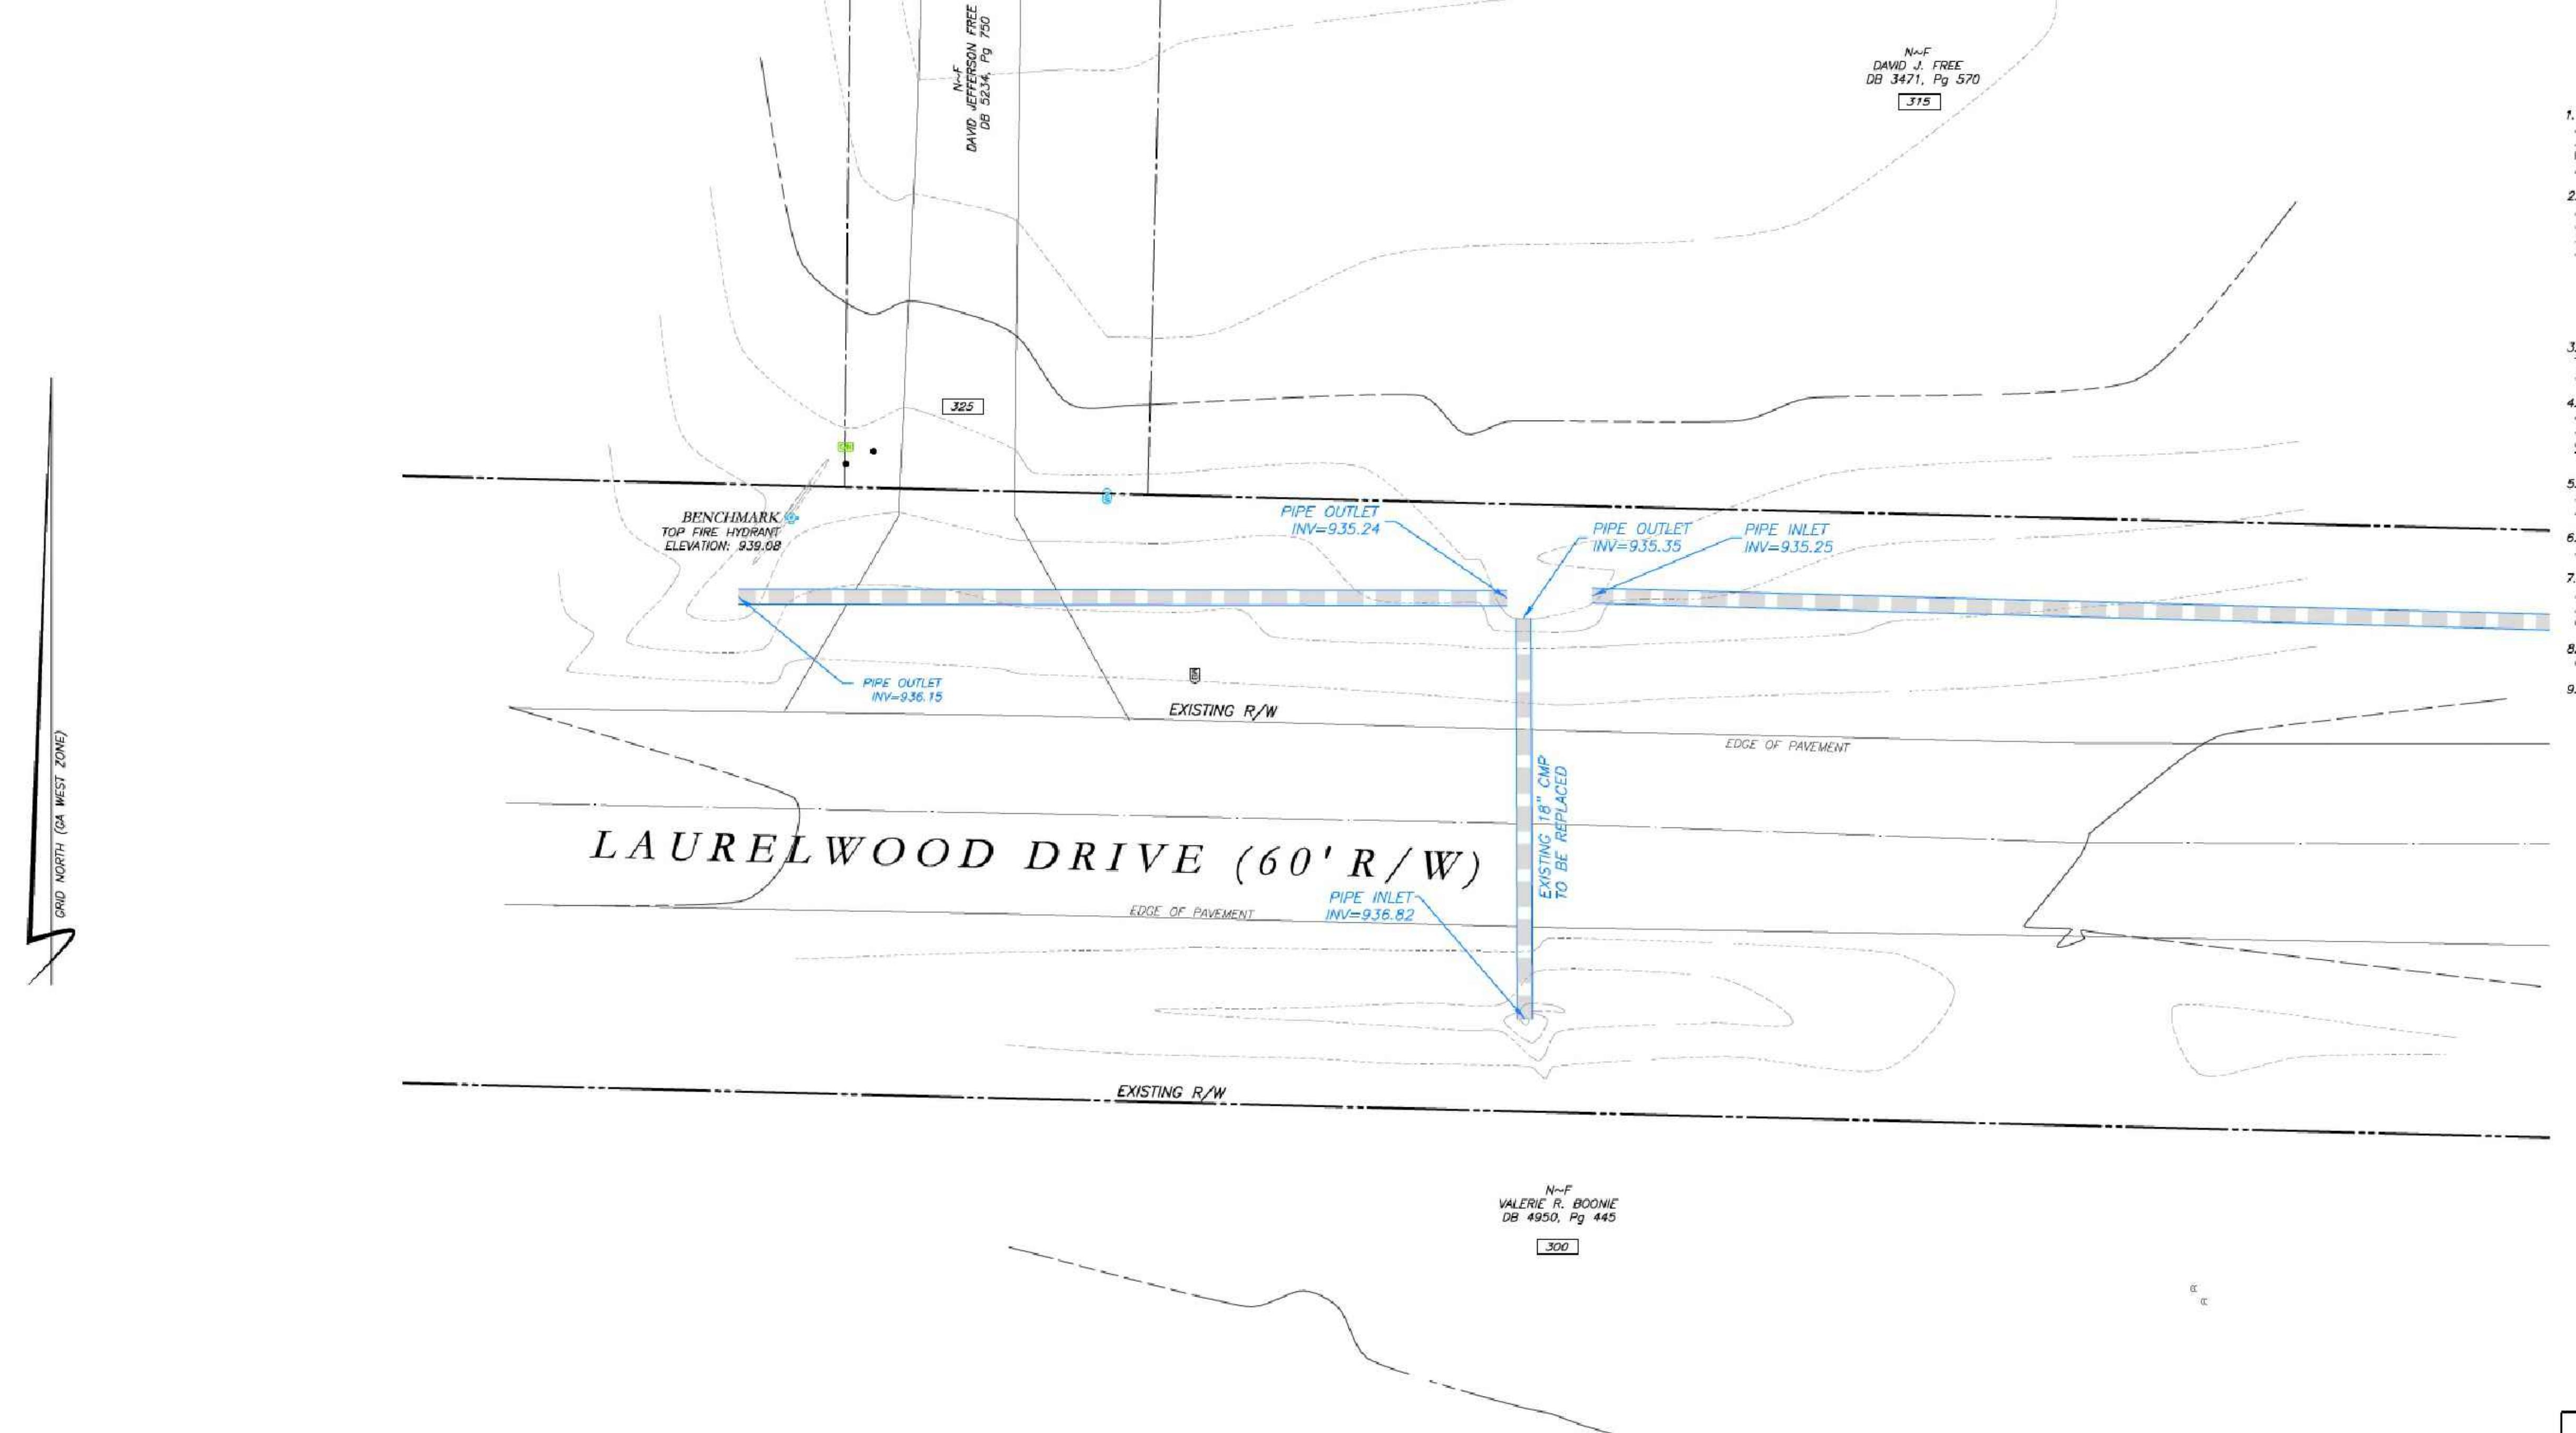

SURVEY NOTES

1. THIS PLAT WAS PREPARED FOR THE EXCLUSIVE USE OF THE PERSON, PERSONS, OR ENTITY NAMED HEREON. THIS PLAT DOES NOT EXTEND TO ANY OTHER PERSON, PERSONS, OR ENTITY WITH THE EXCEPT EXPRESS WRITTEN CERTIFICATION BY THE SURVEYOR NAMING SAID PERSON, PERSONS, OR ENTITY.
2. NORTH ARROW AND BEARINGS ARE BASED ON GEORGIA STATE PLAT COORDINATES (NAVD88), US FOOT, USING GLOBAL POSITIONING SYSTEM (GPS) OBTRUSION BY THE SURVEYOR ON OCTOBER 20, 2022 USING THE TRIMBLE VRS SYSTEM. ALL DISTANCES SHOWN ARE HORIZONTAL GROUND MEASUREMENTS EXPRESSED IN SURVEY FEET.
3. DATUMS:
HORIZONTAL: GRID NORTH, NAVD88
VERTICAL: NAVD88
GEOD: GEOD18 (CONUS)
4. CONTOURS AND SPOT ELEVATIONS SHOWN HEREON ARE BASED ON THE U.S.G.S. DATUM (NAVD88). THE SITE BENCHMARKS ARE AS SHOWN HEREON.
5. THERE WAS NO EVIDENCE OF RECENT CONSTRUCTION ON THE SUBJECT PROPERTY OBSERVED IN THE PROCESS OF CONDUCTING THE FIELDWORK.
6. NO FIELD DELINEATED WETLANDS WERE OBSERVED IN THE PROCESS OF CONDUCTING THE FIELDWORK.
7. EQUIPMENT USED FOR MEASUREMENT:
ANGULAR: TRIMBLE R10/SB ROBOTIC TOTAL STATION
LINEAR: TRIMBLE R10/SB ROBOTIC TOTAL STATION
GPS: TRIMBLE R10 GPS RECEIVER
8. STATE, COUNTY, & LOCAL BUFFERS AND SETBACKS MIGHT EXIST ON THE SUBJECT PROPERTY THAT ARE NOT SHOWN HEREON.
9. THERE ARE NO STATE WATERS ON THIS SITE.



866.350.2000 www.atwell-group.com

1800 PARKWAY PLACE, SUITE 700

MARIETTA, GA
770.423.8607

| | |
|---------------------|-------------------------|
| LOCATED IN | TOWN OF TYRONE |
| EXISTING CONDITIONS | FAYETTE COUNTY, GEORGIA |

| | |
|---------------------|-----------------------------------------------------|
| DATE | 12/30/2022 |
| EXISTING CONDITIONS | 300 & 315 LAURELWOOD DRIVE TYRONE, GEORGIA 30290 |

LEGEND

| | | | |
|----------------|--------------------------|---|-------------------------|
| POB | POINT OF BEGINNING | X | WATER VALVE |
| POC | POINT OF COMMENCEMENT | X | HIGH VOLTAGE |
| RBF | REBAR FOUND | X | GAS METER |
| MNF | MAG HAIL FOUND | X | POWER METER |
| MAN | MANHOLE FOUND | X | POWER SOURCE |
| CTP | CRIMP TOP PIPE FOUND | X | OVERHEAD POLE |
| OTP | OPEN TOP PIPE FOUND | X | OVERHEAD UTILITIES |
| DTP | DROPPED TOP PIPE FOUND | X | POWER POLE |
| DI | DROOP INLET | X | ROOF DRAIN |
| CI | CATCH INLET | X | DROP INLET |
| W | WATER VALVE | X | SEWER |
| OCS | OUTLET CONTROL STRUCTURE | X | SINGLE WING CATCH BASIN |
| JB | JUNCTION BOX | X | DOUBLE WING CATCH BASIN |
| DWCB | DOUBLE WING CATCH BASIN | X | HEADING |
| DWCB | DOUBLE WING CATCH BASIN | X | FLARED END SECTION |
| HW | HEADING | X | UNDERGROUND GAS LINE |
| TEF | TEE END SECTION | X | UNDERGROUND POWER LINE |
| CMF | CORRUGATED METAL PIPE | X | UNDERGROUND TELECOM |
| RCF | REINFORCED CONCRETE PIPE | X | SANITARY SEWER LINE |
| SS | SANITARY SEWER | X | SANITARY SEWER MANHOLE |
| F.M.E. | FORCE MAIN EASEMENT | X | SEWER |
| D.E.E. | DRAINAGE EASEMENT | X | SEWER |
| W.E. | WATER EASEMENT | X | SEWER |
| G.T. | GREASE TRAP | X | SEWER |
| FENCE | FENCE | X | SEWER |
| BOULARD | BOULARD | X | SEWER |
| SPOT ELEVATION | SPOT ELEVATION | X | SEWER |

SCALE: 1" = 10'





JOSEPH T. BAKER, LS
CODE: TP
JOB: 22006046
SHEET NO.
26 OF 43

SURVEYOR'S CERTIFICATION

THIS PLAT IS A RETRACEMENT OF AN EXISTING PARCEL OR PARCELS OF LAND AND DOES NOT SUBDIVIDE OR CREATE A NEW PARCEL, OR MAKE ANY CHANGES TO ANY REALED PARCELS OR BOUNDARIES. THE RECORDING OF THIS PLAT OR THE DOCUMENTS, MAPS, PLATS, OR OTHER INSTRUMENTS WHICH CREATED THAT PARCEL OR PARCELS ARE STATED HEREON. RECORDING OF THIS PLAT DOES NOT IMPLY APPROVAL OF ANY LOCAL JURISDICTION, AVAILABILITY OF PERMITS, COMPLIANCE WITH LOCAL ZONING OR REQUIREMENTS, OR SUITABILITY FOR ANY USE OF PURPOSE OF THE LAND. FURTHERMORE, THE UNDERSIGNED LAND SURVEYOR CERTIFIES THAT THIS PLAT COMPLIES WITH THE MINIMUM TECHNICAL STANDARDS FOR PROPERTY SURVEYS IN GEORGIA AS SET FORTH IN THE RULES AND REGULATIONS OF THE GEORGIA BOARD OF REGISTRATION FOR PROFESSIONAL ENGINEERS AND LAND SURVEYORS AS SET FORTH IN O.C.G.A. SECTION 15-6-17.

12/27/21
P.M. JTB
CODE: TP
JOB: 22006046
SHEET NO.
26 OF 43

PROPOSED REPLACEMENT OF
CROSS DRAINS AT
315, 300 LAURELWOOD DR
TYRONE, GEORGIA 30290

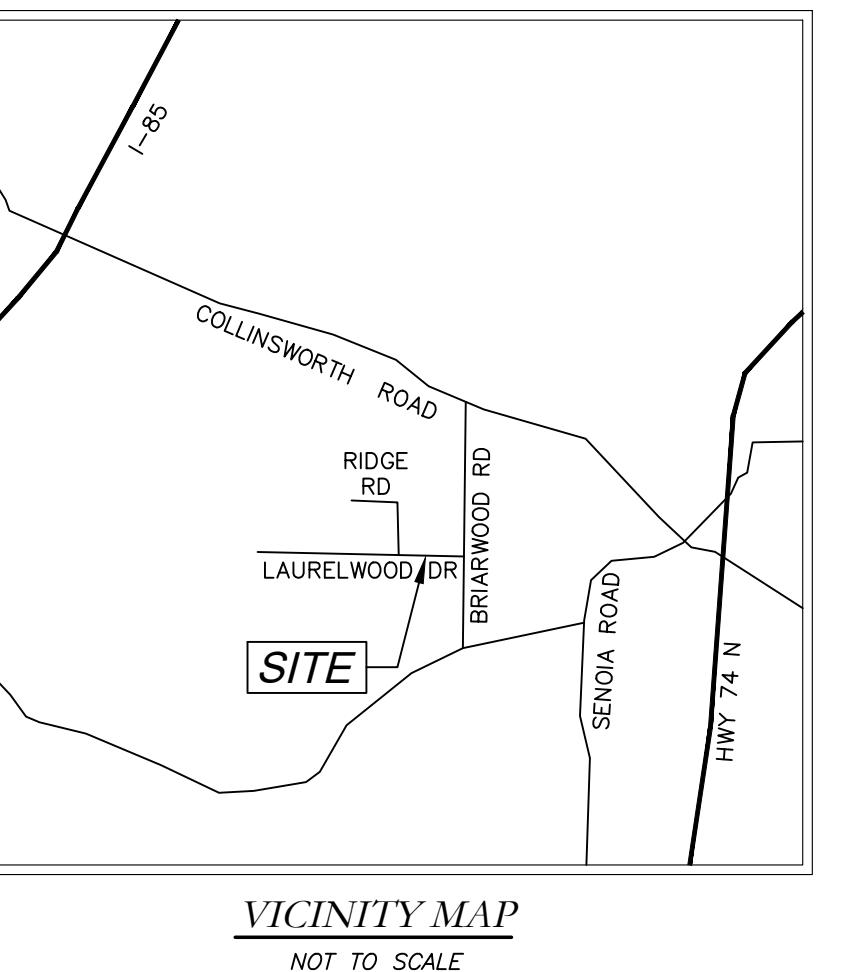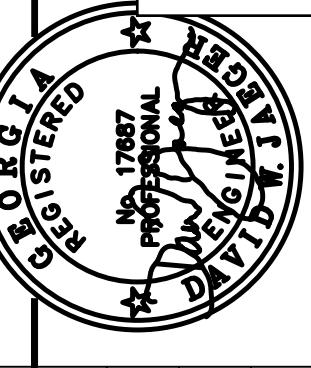

VICINITY MAP
NOT TO SCALE

| PROJECT NUMBER PW-20 | DESIGN | SCALE |
|----------------------|--------|-----------|
| | | |
| MCI | DATE | FILE NO. |
| DRAWN | ALG | 01/16/23 |
| CHECK | DWJ | 21/01-16 |
| APPROVED | APPD | SHEET NO. |


Cross Drain Replacement
for Town of Tyrone, Georgia
Laurelwood Drive (2)
Proposed Conditions

Mallett Consulting, Inc.
101 Devant St., Suite 804, Fayetteville, Georgia 30214
PHONE: 770-719-3373 FAX: 770-719-3377



Know what's below.
Call before you dig.



| LEGEND | |
|---------|--------------------------|
| POB | POINT OF BEGINNING |
| POC | POINT OF COMMENCEMENT |
| RBS | REBAR FOUND |
| RBF | REBAR FOUND |
| MNF | MAG NAIL FOUND |
| MNS | MAG NAIL FOUND |
| CTP | CRIMP TOP PIPE FOUND |
| OTP | OPEN TOP PIPE FOUND |
| DPF | DEFORMED PIPE FOUND |
| DI | DROP INLET |
| CI | CATCH INLET |
| YAC | YARD AREA |
| OCS | OUTLET CONTROL STRUCTURE |
| JB | JUNCTION BOX |
| DWCB | DOUBLE WING CATCH BASIN |
| DWCB | DOUBLE WING CATCH BASIN |
| HW | HEADWALL |
| TEC | TEMPERATURE SECTION |
| CMP | CORRUGATED METAL PIPE |
| RCP | REINFORCED CONCRETE PIPE |
| SS | SEWER SLEEVE |
| F.M.E. | FORCE MAIN EASEMENT |
| D.E. | DRIVEWAY EASEMENT |
| W.E. | WATER EASEMENT |
| G.T. | GREASE TRAP |
| X | FENCE |
| ● | BOLLARD |
| 5.99 ft | SPOT ELEVATION |

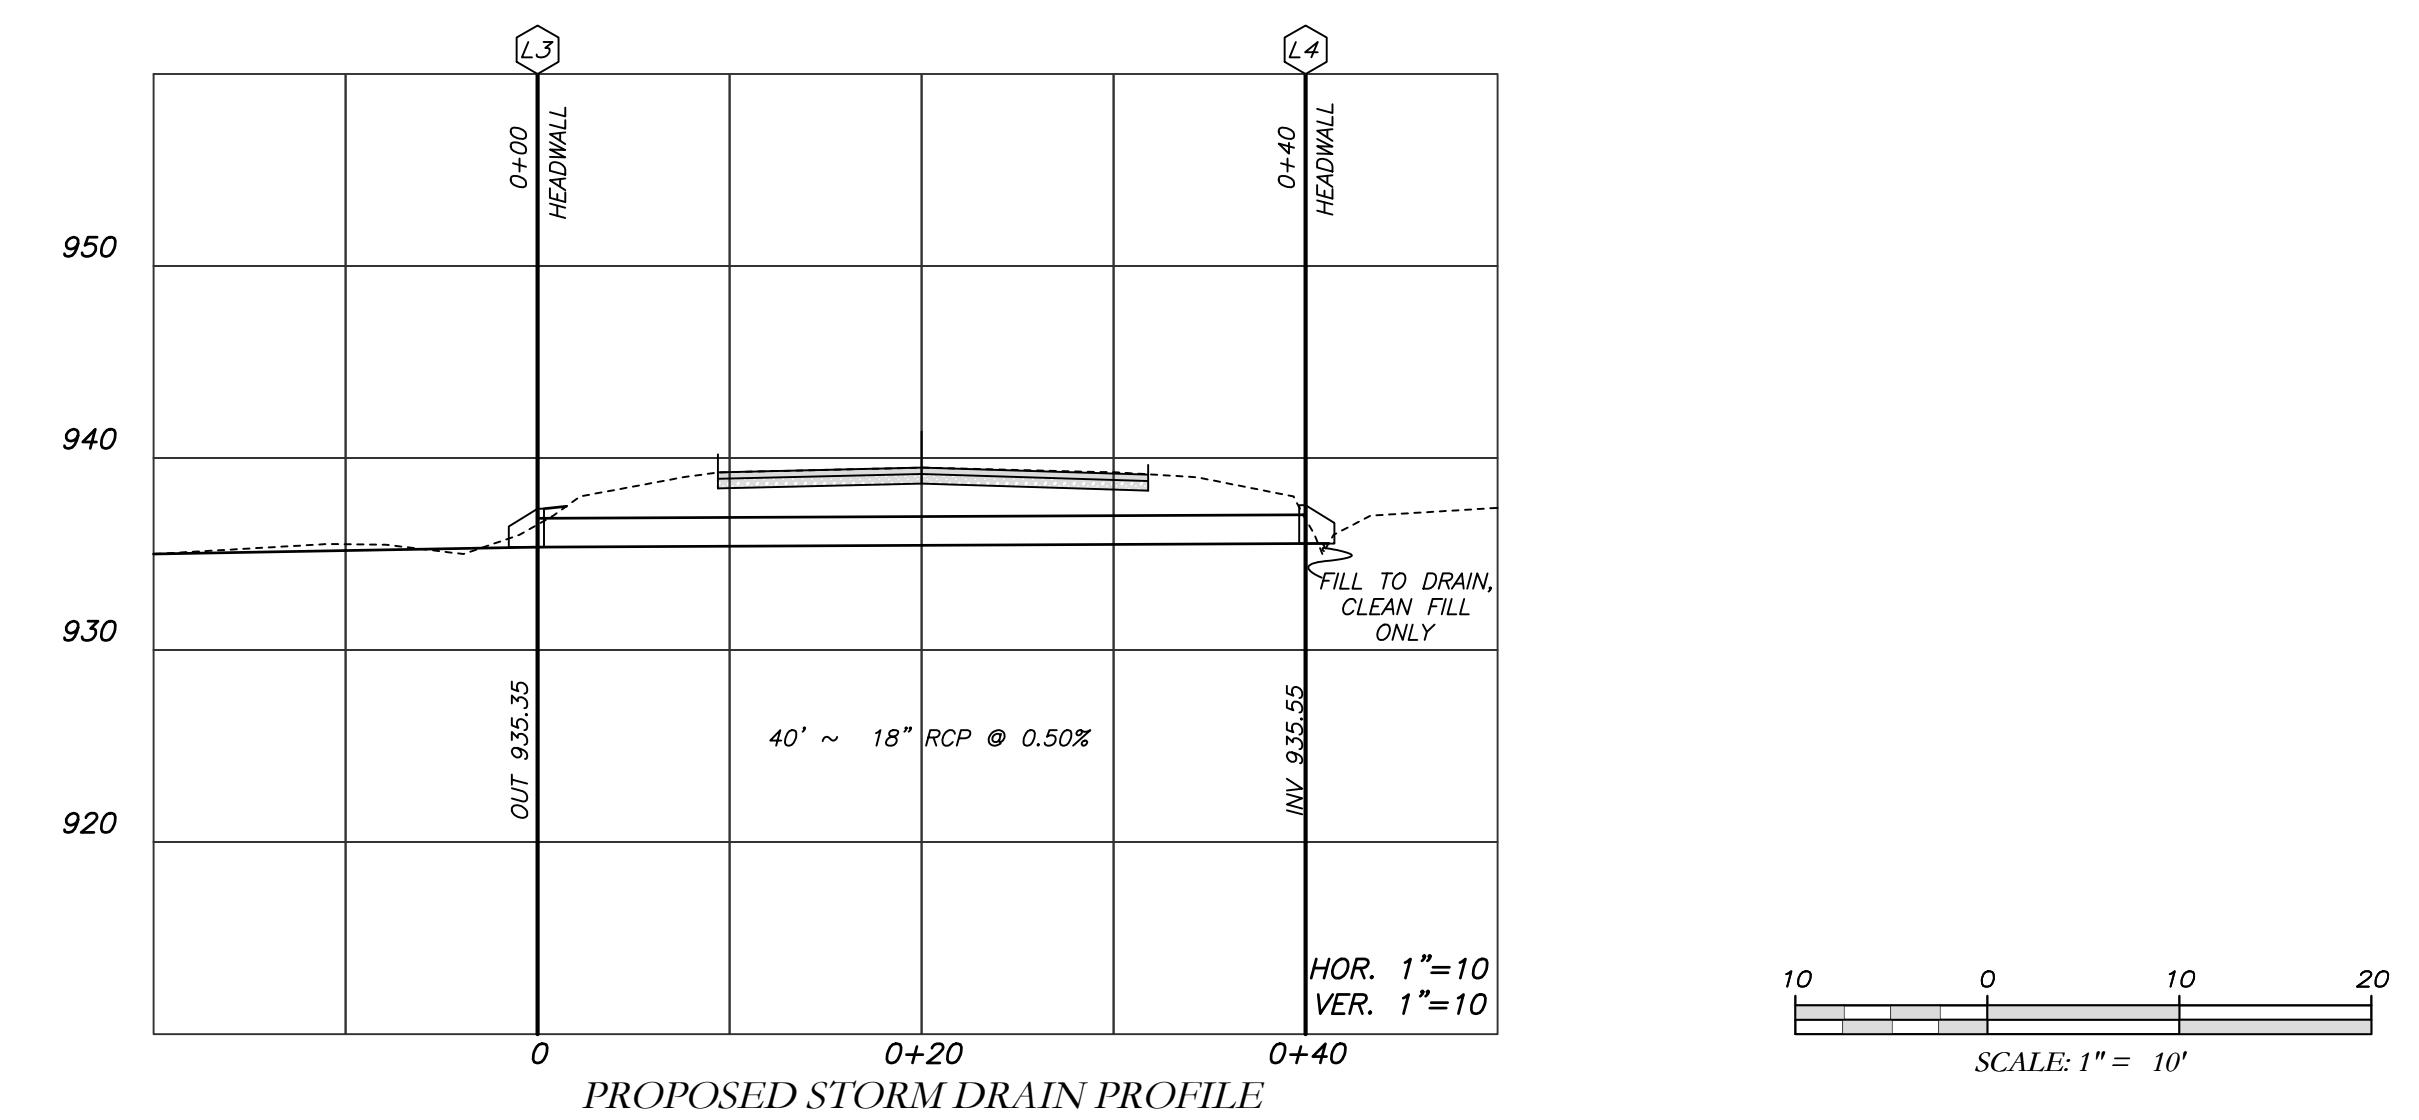

NOTES:

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- EXISTING PAVEMENT SHALL BE SAW CUT AT LIMITS OF DEMOLITION ACTIVITIES. LOCATION OF SAW CUTS SHALL BE APPROVED IN ADVANCE BY THE TOWN ENGINEER.
- CONTRACTOR TO STOCKPILE EXISTING RIP-RAP AND REUSE WHEN PRACTICAL.
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- PAVEMENT WITHIN SAW CUT LINES TO BE REMOVED AND REPLACED.

**EROSION CONTROL PLAN FOR
CROSS DRAIN AT
300 & 325 LAURELWOOD DR
TYRONE, GEORGIA 30290**

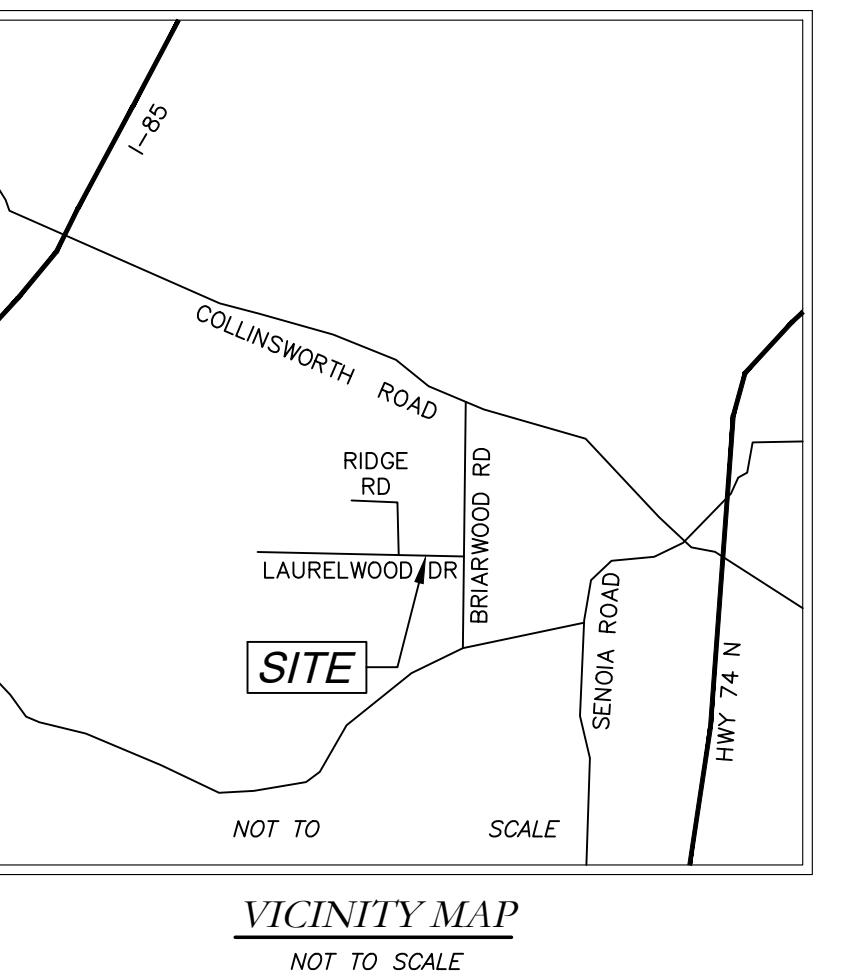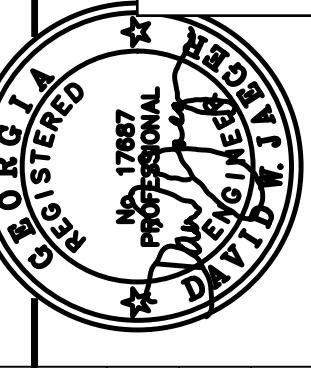

| PROJECT NUMBER PW-20 | | |
|----------------------|-------|------------------|
| DESIGN | SCALE | |
| DRAWN | MCI | DATE 01/16/23 |
| CHECK | DWJ | FILE NO. 2101-16 |
| APPROVED | DWJ | SHEET NO. |

| REV. NO. | DATE | DESCRIPTION | BY APPD |
|----------|------|-------------|---------|
| | | | |


| Cross Drain Replacement for Town of Tyrone, Georgia | |
|--------------------------------------------------------|--|
| Laurelwood Drive (2) Erosion Control Plan | |

Mallett Consulting, Inc.
101 DEVANT ST., SUITE 804 FAYETTEVILLE, GEORGIA 30214
PHONE: (770) 719-3333 FAX: (770) 719-3377



**Know what's below.
Call before you dig.**

| LEGEND | |
|---------------------------|---------------------------|
| POB | POINT OF BEGINNING |
| POC | POINT OF COMMENCEMENT |
| RBS | REBAR FOUND |
| RRF | REBAR FOUND |
| MNF | MAG NAIL FOUND |
| MNS | MAG NAIL FOUND |
| CTP | CRIMP TOP PIPE FOUND |
| OTP | OPEN TOP PIPE FOUND |
| DPF | DETERMINED POSITION FOUND |
| DI | DROP INLET |
| CI | CATCH INLET |
| YAC | YARD AREA |
| OCS | OUTLET CONTROL STRUCTURE |
| JB | JUNCTION BOX |
| DWCB | DOUBLE WING CATCH BASIN |
| DWCB | DOUBLE WING CATCH BASIN |
| HW | HEADWALL |
| FES | FLARED END SECTION |
| CMP | CORRUGATED METAL PIPE |
| RCP | REINFORCED CONCRETE PIPE |
| SS | SEWER SLEEVE |
| F.M.E. | FORCE MAIN EASEMENT |
| D.E. | DRAINAGE EASEMENT |
| W.E. | WATER EASEMENT |
| G.T. | GREASE TRAP |
| FENCE | FENCE |
| BOLLARD | BOLLARD |
| SPOT ELEVATION | SPOT ELEVATION |
| FIRE HYDRANT | |
| WATER VALVE | |
| POWER LAYER | |
| GAS METER | |
| POWER METER | |
| TELECOM BOX | |
| POWER POLE | |
| OVERHEAD UTILITIES | |
| ROOF DRAIN | |
| DROP INLET | |
| YARD AREA | |
| SINGLE WING CATCH BASIN | |
| DOUBLE WING CATCH BASIN | |
| FLARED END SECTION | |
| UNDERGROUND GAS LINE | |
| UNDERGROUND WATER LINE | |
| UNDERGROUND ELECTRIC LINE | |
| TELECOM | |
| SANITARY SEWER | |
| SEWER MANHOLE | |

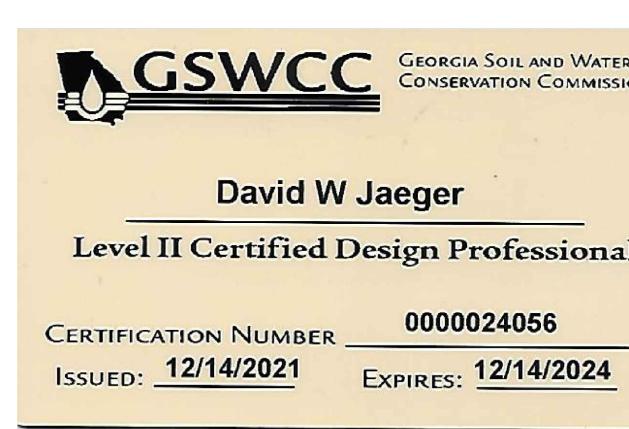

I CERTIFY AS THE PLAN DESIGNER THAT I HAVE VISITED THE SITE PRIOR TO THE DESIGN OF THE ES&PC PLANS
David W Jaeger

10 0 10 20
SCALE: 1" = 10'

THE ESCAPE OF SEDIMENT FROM THE SITE SHALL BE PREVENTED BY THE INSTALLATION OF EROSION AND SEDIMENT CONTROL MEASURES AND PRACTICES PRIOR TO LAND DISTURBING ACTIVITIES.

EROSION CONTROL MEASURES SHALL BE MAINTAINED AT ALL TIMES. IF FULL IMPLEMENTATION OF THE APPROVED PLAN DOES NOT PROVIDE FOR EFFECTIVE EROSION CONTROL, ADDITIONAL EROSION AND SEDIMENT CONTROL MEASURES SHALL BE IMPLEMENTED TO CONTROL OR TREAT THE SEDIMENT SOURCE.

ANY DISTURBED AREA LEFT EXPOSED FOR A PERIOD GREATER THAN 14 DAYS SHALL BE STABILIZED WITH MULCH OR TEMPORARY SEEDING.

CONTRACTOR TO STOCKPILE EXISTING RIP-RAP AND REUSE WHEN PRACTICAL.

REMOVE Sd1 WHEN GRASS HAS BEEN ESTABLISHED TO AT LEAST 85% COVERAGE.

(C) CONSTRUCTION EXIT TO BE MAINTAINED WITHIN SAW CUT LINES.

TOTAL DISTURBED ACRES = 0.05

24 Hour Erosion Control Contact:

NAME: Scott Langford
ADDRESS: 950 Senoia Road
Tyrone, GA 30290
PHONE: (770)-487-4038




Know what's below.

Call before you dig.

The locations of existing underground utilities are shown in this map. They may only be located where they need to be. The contractor shall determine the exact location of all existing underground utility lines prior to commencing work, and agrees to assume responsibility for any damage to such lines and all damages which might be occasioned by the contractor's failure to take reasonable steps to preserve any and all underground utilities.

NOTICE:
CONSTRUCTION SITE SAFETY IS THE
SOLE RESPONSIBILITY OF THE CONTRACTOR. NEITHER THE OWNER NOR THE ENGINEER SHALL BE
LIABLE FOR ANY INJURY OR DAMAGE
TO THE WORK OF CONTRACTORS ENGAGED
IN THE WORK, OR OF OTHER
STRUCTURES, OR OF ANY OTHER
PERSONS.

COPYRIGHT © 2003 ATWELL LLC NO
PART OF THIS DRAWING MAY BE
REPRODUCED IN WHOLE OR IN PART
WITHOUT THE PRIOR WRITTEN
CONSENT OF ATWELL LLC.

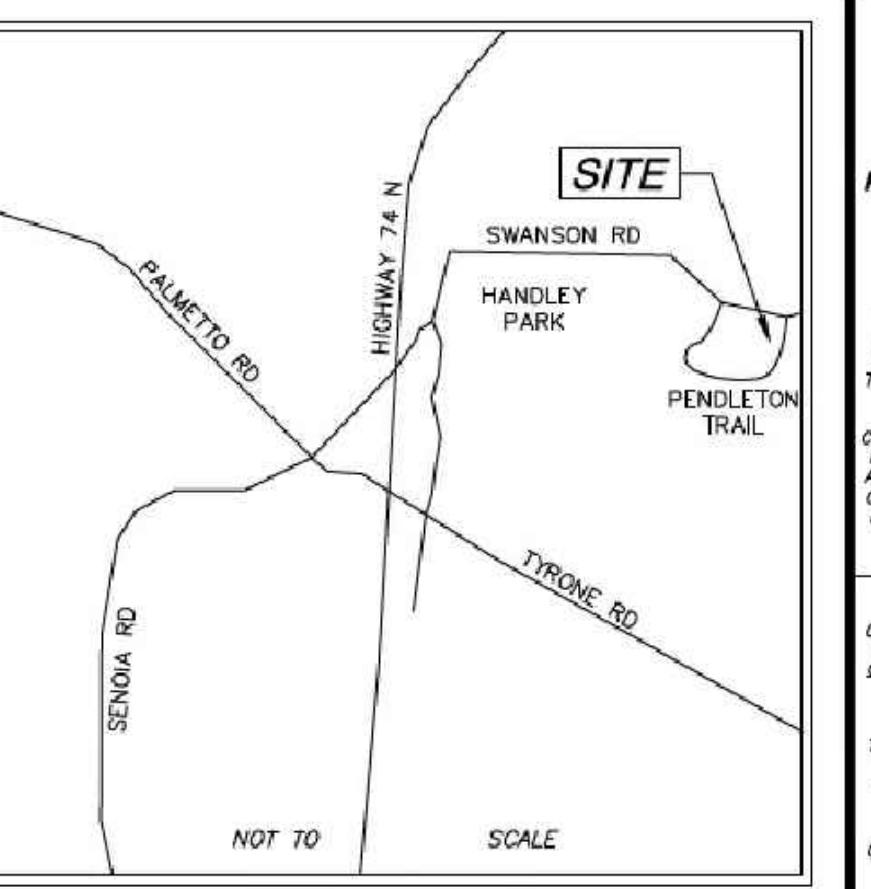

VICINITY MAP

SURVEY NOTES

1. THIS PLAT WAS PREPARED FOR THE EXCLUSIVE USE OF THE PERSON, PERSONS, OR ENTITY NAMED HEREON. THIS PLAT DOES NOT EXTEND TO ANY OTHER PERSON, PERSONS, OR ENTITY WITHOUT THE EXPRESS WRITTEN CERTIFICATION BY THE SURVEYOR NAMING SAID PERSON, PERSONS, OR ENTITY.
2. NORTH ARROW AND BEARINGS ARE BASED ON GEORGIA STATE PLANE COORDINATES (NAVD83), US FOOT, USING GLOBAL POSITIONING SYSTEM (GPS) DATA OBTAINED BY THE SURVEYOR ON OCTOBER 20, 2022 USING THE TRIMBLE VRS SYSTEM. ALL DISTANCES SHOWN ARE HORIZONTAL GROUND MEASUREMENTS EXPRESSED IN SURVEY FEET.
3. DATUMS:
HORIZONTAL: GRID NORTH, NAD83
VERTICAL: NAVD88
GEOD: GEOFID18 (CONUS)
4. CONTOURS AND SPOT ELEVATIONS SHOWN HEREON ARE BASED ON THE U.S.G.S. DATUM (NAVD88). THE SITE BENCHMARKS ARE AS SHOWN HEREON.
5. THERE WAS NO EVIDENCE OF RECENT CONSTRUCTION ON THE SUBJECT PROPERTY OBSERVED IN THE PROCESS OF CONDUCTING THE FIELDWORK.
6. NO FIELD DELINEATED WETLANDS WERE OBSERVED IN THE PROCESS OF CONDUCTING THE FIELDWORK.
7. EQUIPMENT USED FOR MEASUREMENT:
ANGULAR: TRIMBLE R10/SB ROBOTIC TOTAL STATION
LINEAR: TRIMBLE R10/SB ROBOTIC TOTAL STATION
GPS: TRIMBLE R10 GPS RECEIVER
8. STATE, COUNTY, & LOCAL BUFFERS AND SETBACKS MIGHT EXIST ON THE SUBJECT PROPERTY THAT ARE NOT SHOWN HEREON.



ATWELL
866.350.3200 www.atwell-group.com
1800 PARKWAY PLACE, SUITE 700
MARIETTA, GA
770.473.8607


| | |
|---------------------|----------------------------------------------|
| LOCATED IN | TOWN OF TYRONE |
| EXISTING CONDITIONS | 135 PENDLETON TRAIL TYRONE, GEORGIA 30290 |

| | |
|-------------------------|------------|
| STORM DRAIN REPLACEMENT | DATE |
| EXISTING CONDITIONS | 12/30/2022 |

REVISIONS


12/30/2022

| | |
|-------------------------------------------------------------------------------------------------------------------------------------------------------------------------------------------------------------------------------------------------------------------------------------------------------------------------------------------------------------------------------------------------------------------------------------------------------------------------------------------------------------------------------------------------------------------------------------------------------------------------------------------------------------------------------------------------------------------------------------------------------------------------------------------------------------------------------------------------------------------------------------------------------|--|
| SURVEYOR'S CERTIFICATION | |
| <p>This plat is a retrace of an existing parcel or parcels of land and does not subdivide or create a new parcel, or make any changes to any real property boundaries. It is the responsibility of the surveyor to verify the correctness of the information contained in the documents, maps, plats, or other instruments which created that parcel or parcels are stated hereon. Recording of this plat does not imply approval of any local jurisdiction, availability of permits, compliance with zoning regulations, or suitability for any use or purpose of land. Furthermore, the undersigned land surveyor certifies that this plat complies with the minimum technical standards for property surveys in Georgia as set forth in the rules and regulations of the Georgia Board of Registration for Professional Engineers and Land Surveyors as set forth in O.C.G.A. Section 15-6-17.</p> | |
| | |
| <p>JOSEPH T. BAKER, LS CODE TP GEORGIA LICENSE #2674 JOB 22006046 SHEET NO. 29 OF 43</p> | |

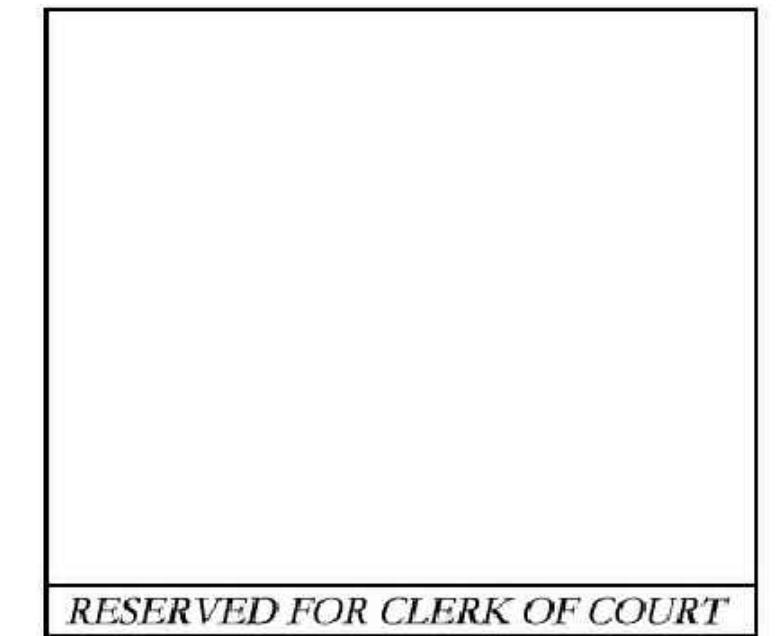

RESERVED FOR CLERK OF COURT

LIMITED SURVEY OF STORM DRAIN REPLACEMENT 135 PENDLETON TRAIL TYRONE, GEORGIA 30290

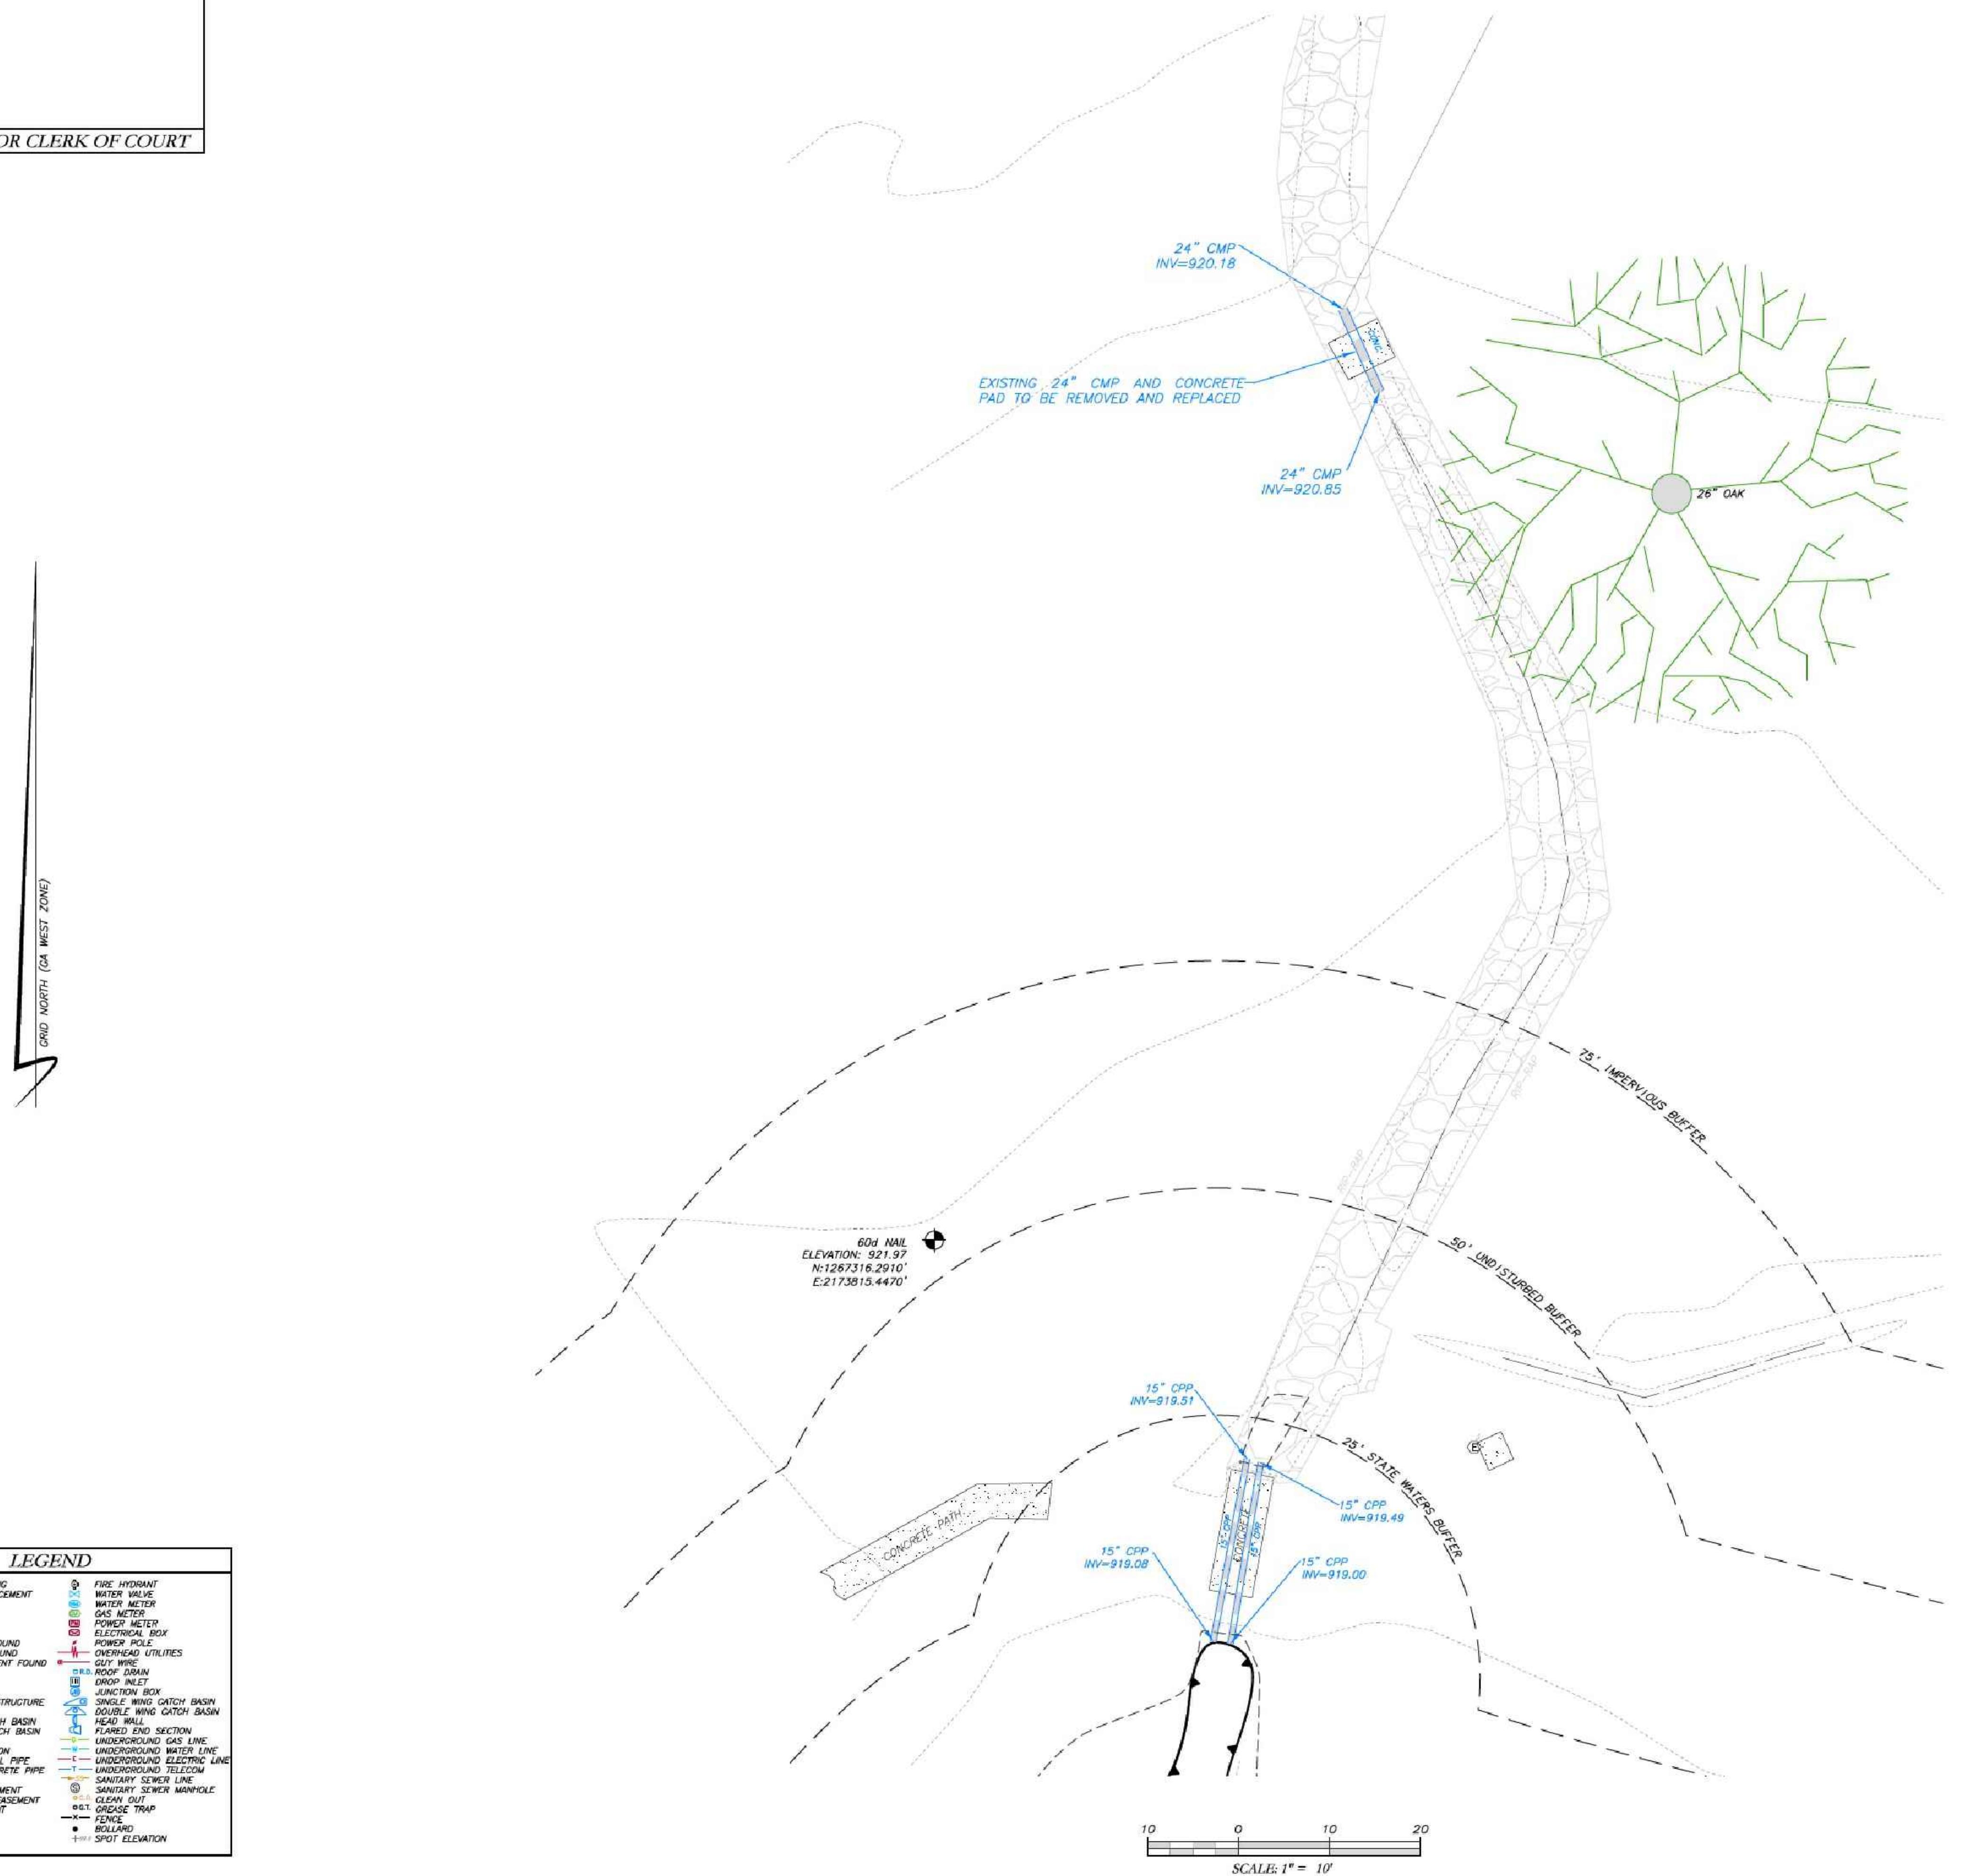

PROPOSED REPLACEMENT OF
STORM DRAIN AT
PENDLETON LAKE
TYRONE, GEORGIA 30290


GRD NORTH (Ga. West Zone)




**Know what's below.
Call before you dig.**

| LEGEND | |
|---------------------------|-------------------------------|
| POB | POINT OF BEGINNING |
| POC | POINT OF COMMENCEMENT |
| RBS | REBAR FOUND |
| RRF | REBAR FOUND |
| MNF | MAG NAIL FOUND |
| MNP | MAG NAIL FOUND |
| CTP | CRIMP TOP PIPE FOUND |
| OTP | OPEN TOP PIPE FOUND |
| DMP | DEMONSTRATED CONVENTION FOUND |
| DI | DROP INLET |
| CI | CATCH INLET |
| Y | YARD |
| OCS | OUTLET CONTROL STRUCTURE |
| JB | JUNCTION BOX |
| DWCB | DOUBLE WING CATCH BASIN |
| DWCB | DOUBLE WING CATCH BASIN |
| HW | HEADWALL |
| TEG | TEGEL END SECTION |
| CMP | CORRUGATED METAL PIPE |
| RCP | REINFORCED CONCRETE PIPE |
| SS | SANITARY SEWER |
| F.M.E. | FORCE MAIN EASEMENT |
| D.E. | DRAINAGE EASEMENT |
| W.E. | WATER EASEMENT |
| GHT | GATE |
| GT | GATE |
| FT | FLANGED END SECTION |
| UGL | UNDERGROUND GAS LINE |
| UEL | UNDERGROUND ELECTRIC LINE |
| UTL | UNDERGROUND TELECOM |
| SSM | SANITARY SEWER MANHOLE |
| FGT | GREASE TRAP |
| FENCE | FENCE |
| BOL | BOLLARD |
| SPE | SPOT ELEVATION |
| FIRE HYDRANT | FIRE HYDRANT |
| WATER VALVE | WATER VALVE |
| POWER CABLE | POWER CABLE |
| GAS METER | GAS METER |
| POWER METER | POWER METER |
| POWER POLE | POWER POLE |
| OVERHEAD UTILITIES | OVERHEAD UTILITIES |
| ROAD | ROAD |
| DROP INLET | DROP INLET |
| MANHOLE | MANHOLE |
| SINGLE WING CATCH BASIN | SINGLE WING CATCH BASIN |
| DOUBLE WING CATCH BASIN | DOUBLE WING CATCH BASIN |
| FLARED END SECTION | FLARED END SECTION |
| UNDERGROUND GAS LINE | UNDERGROUND GAS LINE |
| UNDERGROUND ELECTRIC LINE | UNDERGROUND ELECTRIC LINE |
| SANITARY SEWER | SANITARY SEWER |
| SANITARY SEWER MANHOLE | SANITARY SEWER MANHOLE |

| | |
|-------------------------------------------------------------------------------------------------------|---------------------------------------------------|
| GSWCC | Georgia Soil and Water Conservation Commission |
| David W Jaeger | |
| Level II Certified Design Professional | |
| I CERTIFY AS THE PLAN DESIGNER THAT I HAVE VISITED THE SITE PRIOR TO THE DESIGN OF THE ES&PC PLANS | |
| <i>[Signature]</i> | |
| CERTIFICATION NUMBER 0000024056 | |
| ISSUED: 12/14/2021 EXPIRES: 12/14/2024 | |

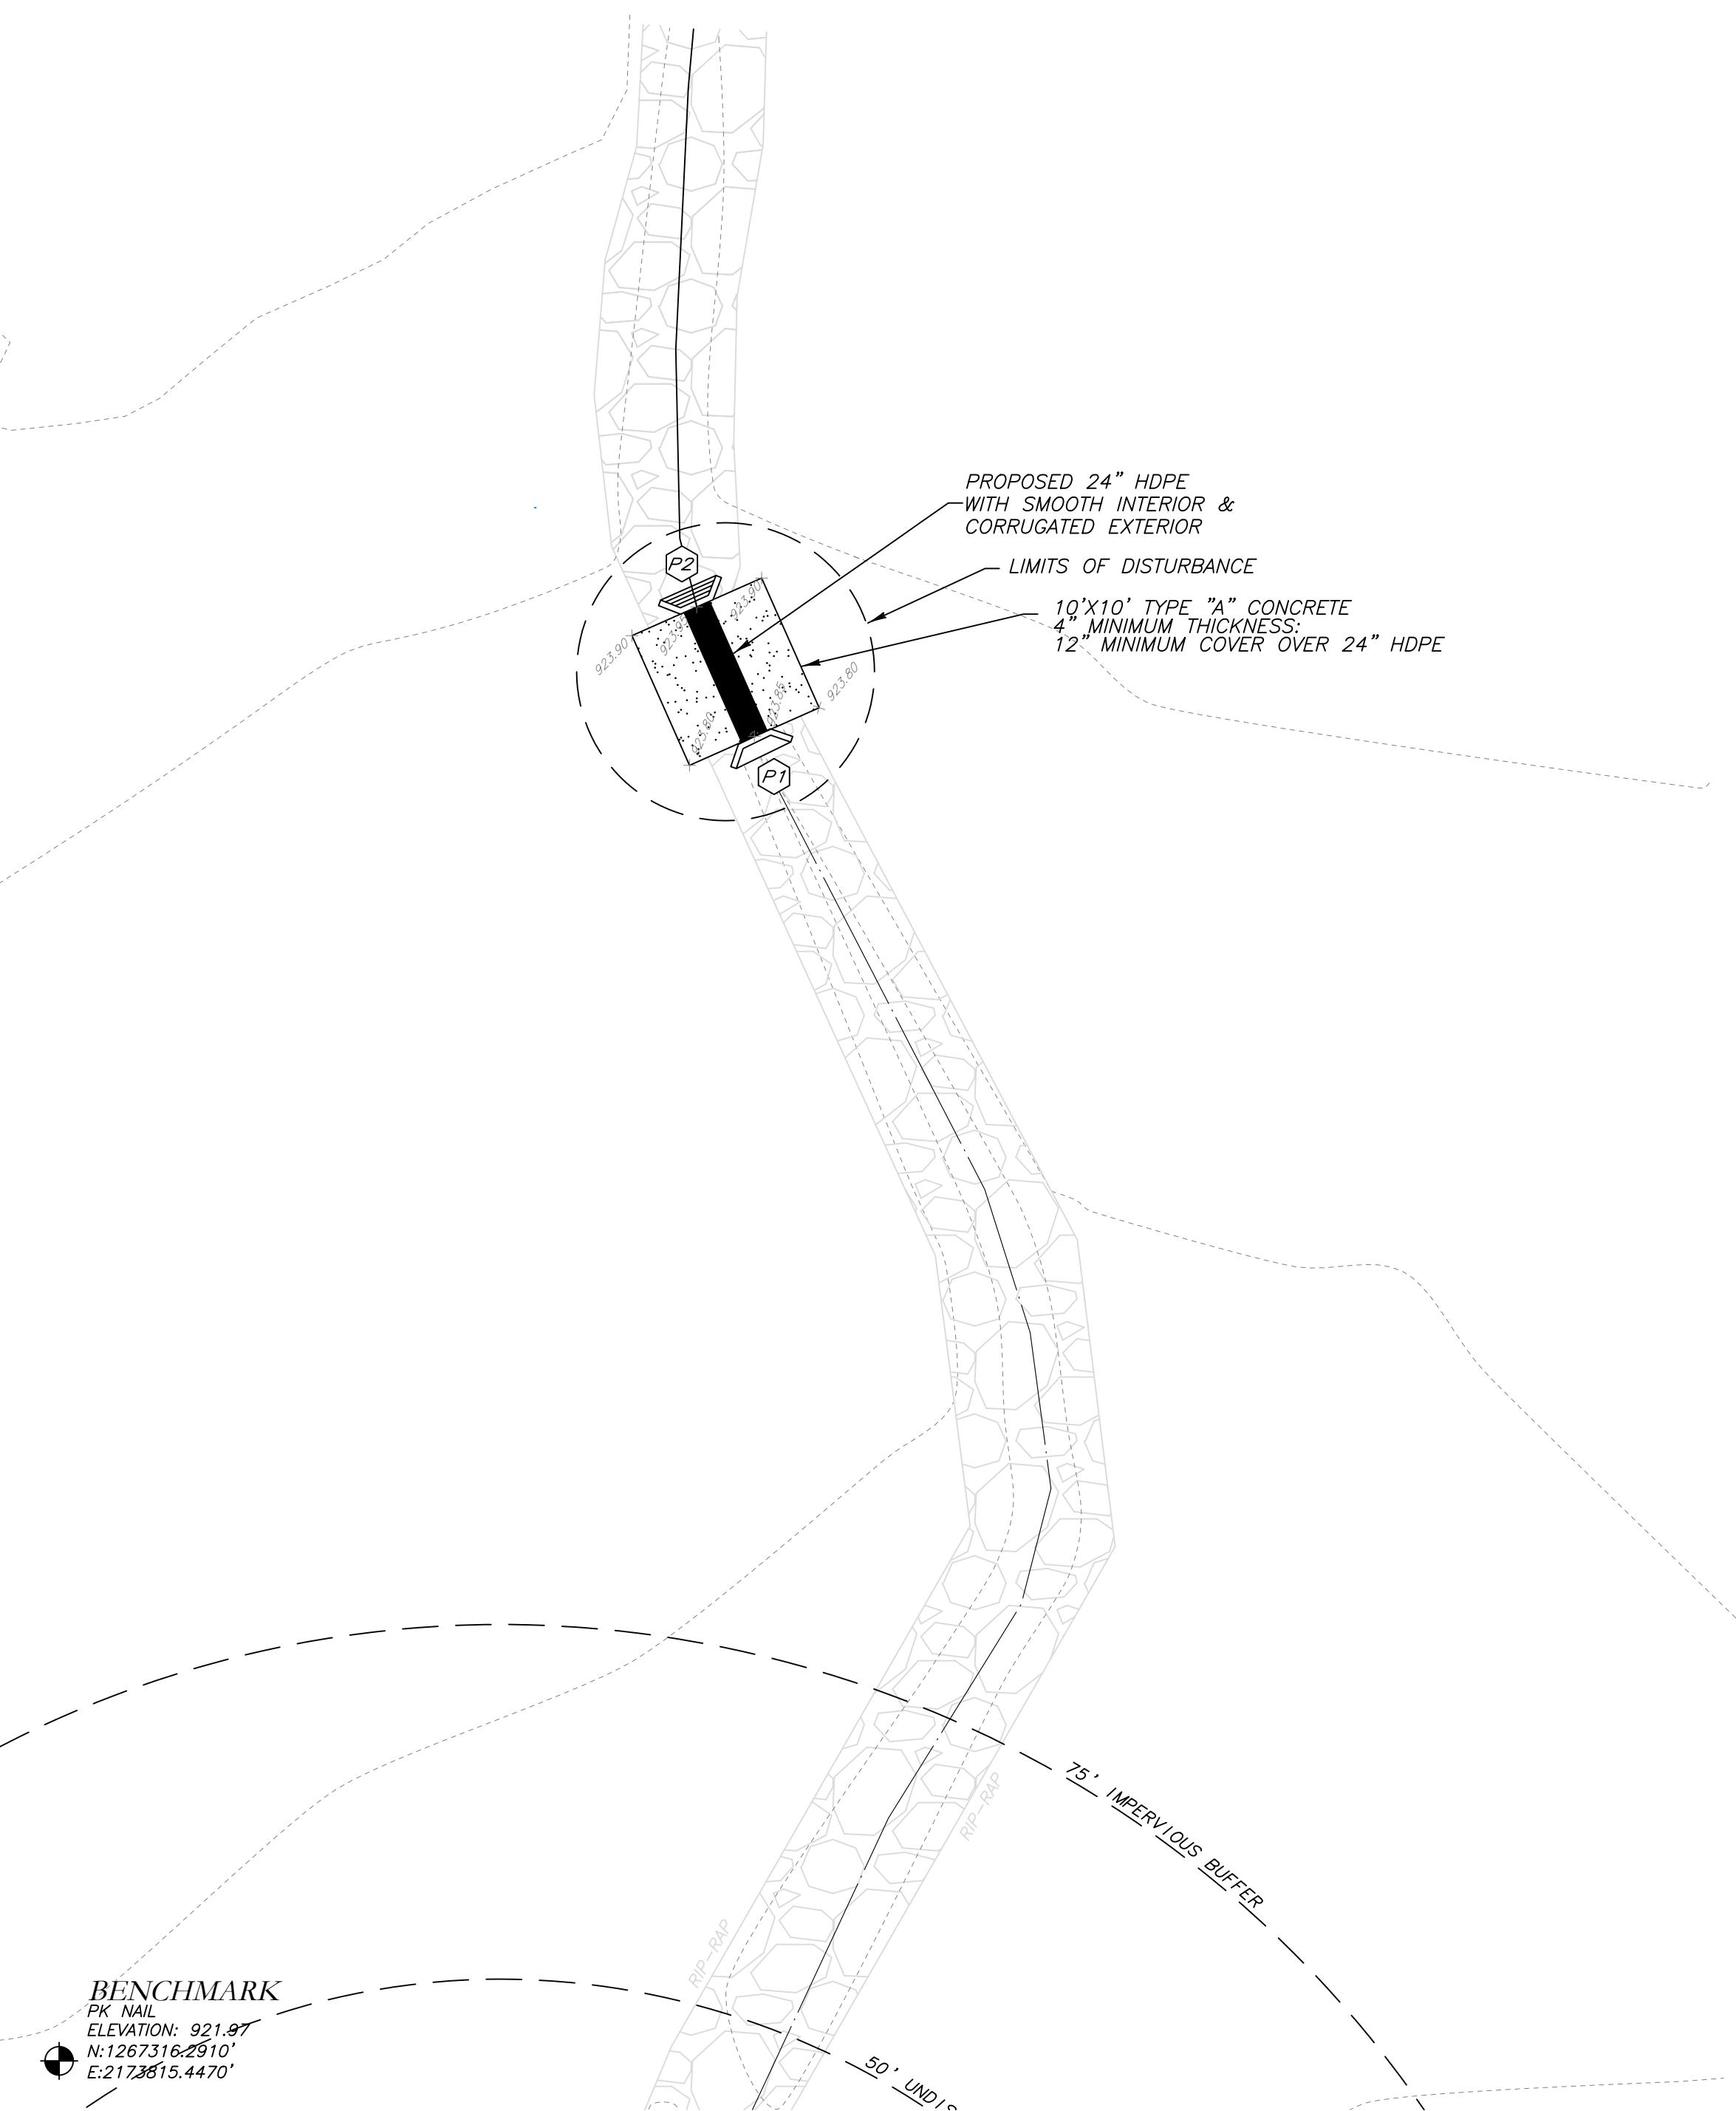

10 0 10 20
SCALE: 1" = 10'

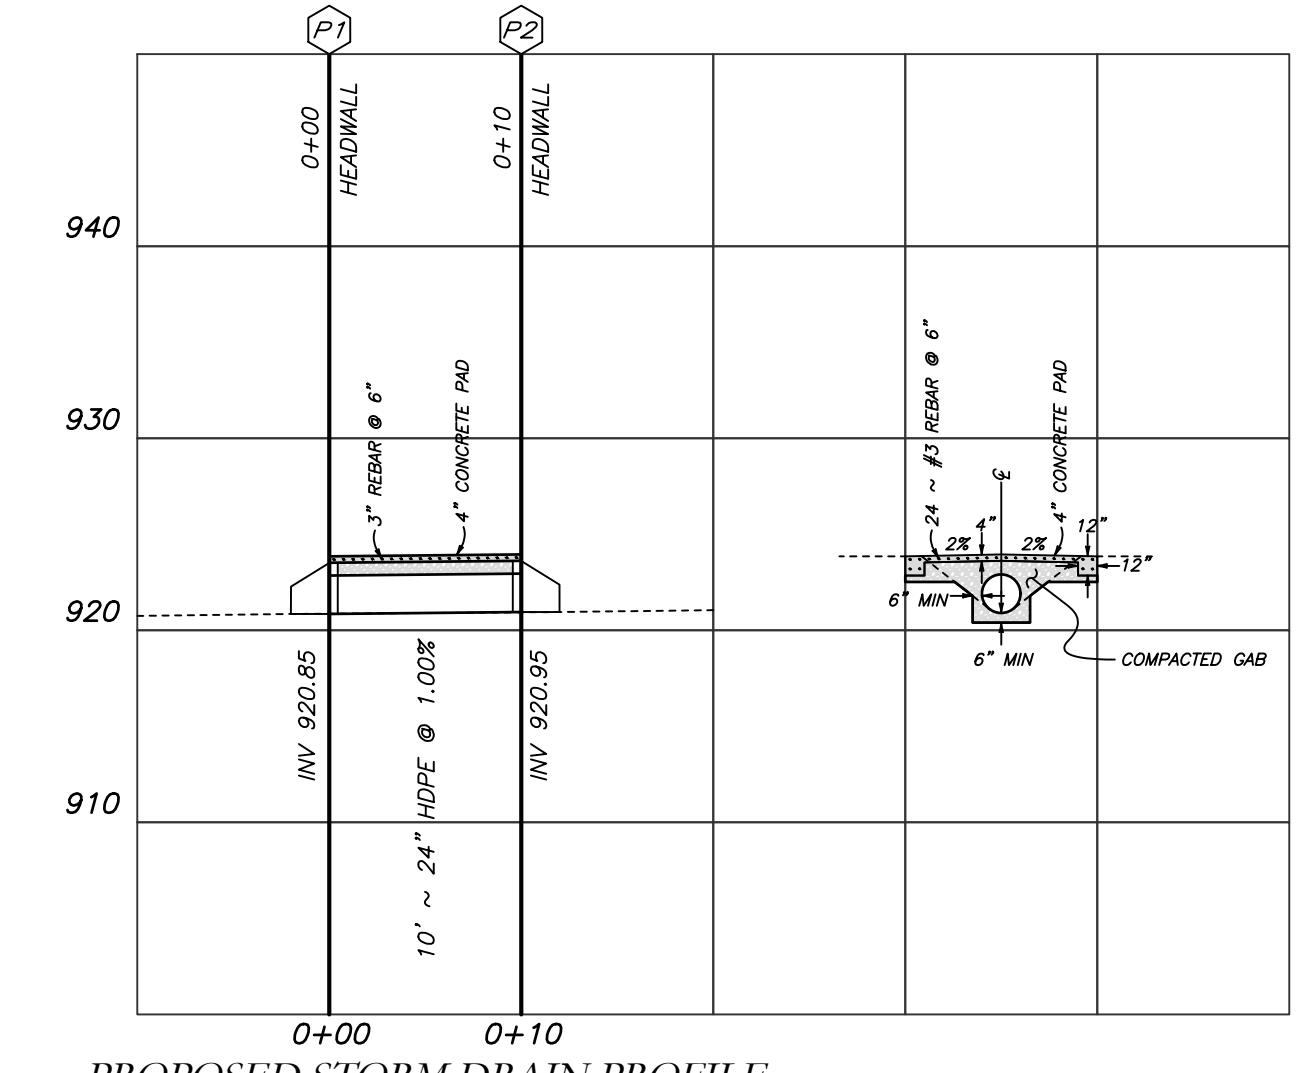

PROPOSED STORM DRAIN PROFILE

Cross Drain Replacement
for Town of Tyrone, Georgia
Pendleton Lake
Proposed Conditions


Mallett Consulting, Inc.
101 Devant St., Suite 804, Fayetteville, Georgia 30214
PHONE: 770-719-3333 FAX: 770-719-3377


SHEET NO.
30 OF 43

| PROJECT NUMBER PW-20 | | DESIGN | MCI | SCALE |
|----------------------|--|--------|-----|-------------------|
| DRAWN | | | | 01/16/23 |
| CHECK | | | | FILE NO. 21101-16 |
| APPROVED | | | | SHEET NO. |
| REV. NO. | | | | DWJ |

- NOTES:**
- CONTRACTOR WILL BE RESPONSIBLE FOR LOCATING AND PROTECTING EXISTING UTILITIES.
 - EXISTING PAVEMENT SHALL BE SAW CUT AT LIMITS OF DEMOLITION ACTIVITIES. LOCATION OF SAW CUTS SHALL BE APPROVED IN ADVANCE BY THE TOWN ENGINEER.
 - CONTRACTOR TO STOCKPILE EXISTING RIP-RAP AND REUSE WHEN PRACTICAL.
 - ALL DEMOLITION MATERIALS, WASTE SOILS AND SEDIMENT SHALL BE HAULED AWAY AND DISPOSED OF OFFSITE AT A SUITABLE LOCATION, SELECTED BY THE CONTRACTOR. THIS SHALL BE DONE AT NO ADDITIONAL CHARGE.
 - GRADED AGGREGATE BASE BELOW NEW SLAB SHALL BE COMPACTION WITH MECHANICAL VIBRATORY COMPACTOR EQUIPMENT AND INSPECTED BY DESIGN ENGINEER PRIOR TO PLACING CONCRETE FOR NEW SLAB.

Section X, Item 3.

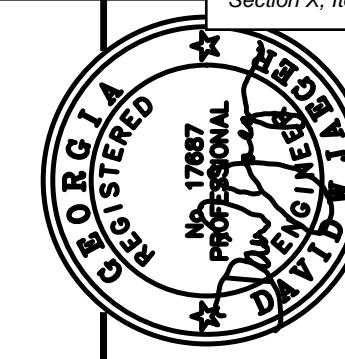

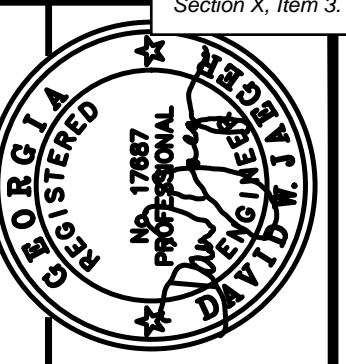


**EROSION CONTROL PLAN FOR
STORM DRAIN AT
PENDLETON LAKE
TYRONE, GEORGIA 30290**

| PROJECT NUMBER PW-20 | SCALE |
|----------------------|----------|
| DESIGN | MCI |
| DRAWN | ALG |
| DATE | 01/16/23 |
| CHECK | DWJ |
| FILE NO. | 21/01-16 |
| APPROVED | DWJ |
| SHEET NO. | |


| REV. NO. | DESCRIPTION | BY / APP'D | APPROVED | DWJ |
|----------|-------------|------------|----------|-----|
| | | | | |

**Cross Drain Replacement
for Town of Tyrone, Georgia
Pendleton Lake
Erosion Control Plan**

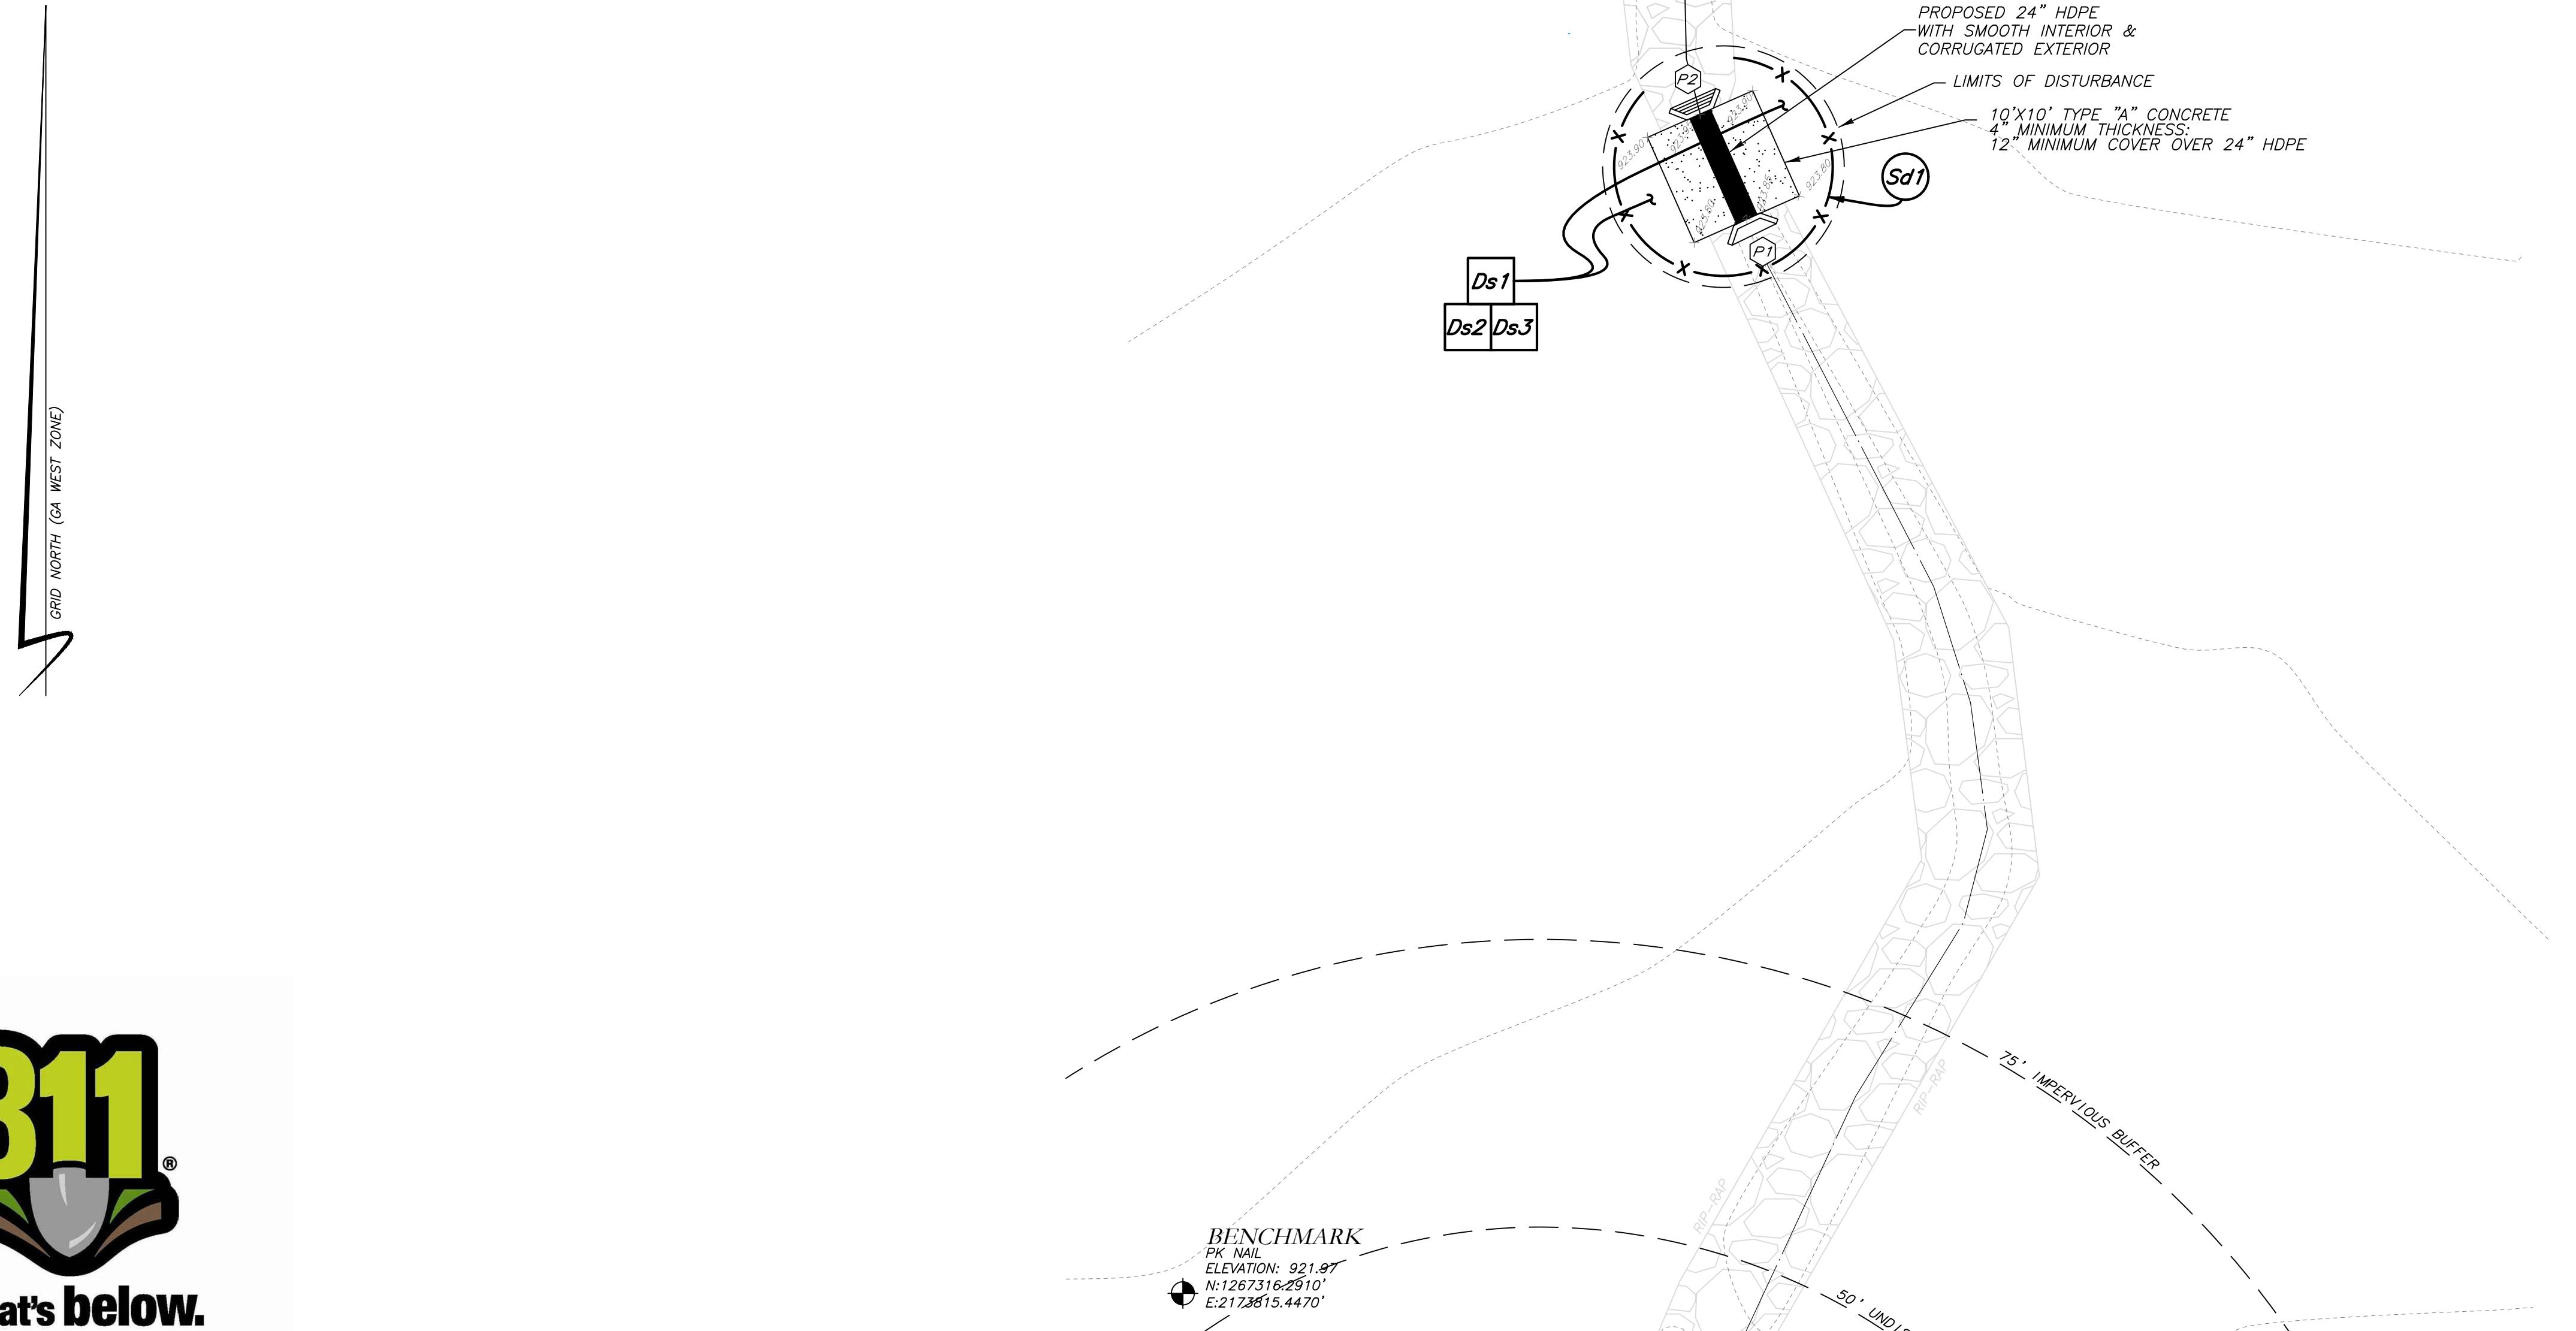

**Know what's below.
Call before you dig.**

| LEGEND | |
|---------------------------|--------------------------|
| POB | POINT OF BEGINNING |
| POC | POINT OF COMMENCEMENT |
| RBS | REBAR FOUND |
| RRF | REBAR FOUND |
| MNF | MAG NAIL FOUND |
| MNS | MAG NAIL FOUND |
| CTP | CRIMP TOP PIPE FOUND |
| OTP | OPEN TOP PIPE FOUND |
| CMF | CONCRETE MANIFOLD FOUND |
| DI | DROP INLET |
| CI | CATCH INLET |
| Y | Y-INLET |
| OCS | OUTLET CONTROL STRUCTURE |
| JB | JUNCTION BOX |
| DWCB | DOUBLE WING CATCH BASIN |
| DWCB | DOUBLE WING CATCH BASIN |
| HW | HEADWALL |
| FES | FLARED END SECTION |
| CMP | CORRUGATED METAL PIPE |
| RCP | REINFORCED CONCRETE PIPE |
| SS | SEWER SLEEVE |
| F.M.E. | FORCE MAIN EASEMENT |
| D.E. | DRAINAGE EASEMENT |
| W.E. | WATER EASEMENT |
| G.T. | GREASE TRAP |
| FENCE | FENCE |
| BOLLARD | BOLLARD |
| SPOT ELEVATION | SPOT ELEVATION |
| FIRE HYDRANT | |
| WATER VALVE | |
| POWER CABLE | |
| GAS METER | |
| POWER METER | |
| POWER BOX | |
| POWER POLE | |
| OVERHEAD UTILITIES | |
| ROOF DRAIN | |
| DROP INLET | |
| OUTLET BOX | |
| SINGLE WING CATCH BASIN | |
| DOUBLE WING CATCH BASIN | |
| FLARED END SECTION | |
| UNDERGROUND GAS LINE | |
| UNDERGROUND WATER LINE | |
| UNDERGROUND ELECTRIC LINE | |
| TELECOM | |
| SANITARY SEWER | |
| SEWER MANHOLE | |

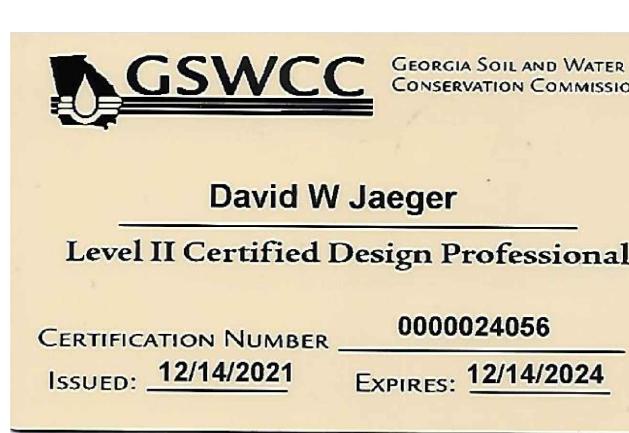

I CERTIFY AS THE PLAN DESIGNER THAT I HAVE VISITED THE SITE PRIOR TO THE DESIGN OF THE ES&PC PLANS

David W Jaeger

10 0 10 20
SCALE: 1" = 10'

THE ESCAPE OF SEDIMENT FROM THE SITE SHALL BE PREVENTED BY THE INSTALLATION OF EROSION AND SEDIMENT CONTROL MEASURES AND PRACTICES PRIOR TO LAND DISTURBING ACTIVITIES.

EROSION CONTROL MEASURES SHALL BE MAINTAINED AT ALL TIMES. IF FULL IMPLEMENTATION OF THE APPROVED PLAN DOES NOT PROVIDE FOR EFFECTIVE EROSION CONTROL, ADDITIONAL EROSION AND SEDIMENT CONTROL MEASURES SHALL BE IMPLEMENTED TO CONTROL OR TREAT THE SEDIMENT SOURCE.

ANY DISTURBED AREA LEFT EXPOSED FOR A PERIOD GREATER THAN 14 DAYS SHALL BE STABILIZED WITH MULCH OR TEMPORARY SEEDING.

CONTRACTOR TO STOCKPILE EXISTING RIP-RAP AND REUSE WHEN PRACTICAL.

REMOVE Sd1 WHEN GRASS HAS BEEN ESTABLISHED TO AT LEAST 85% COVERAGE.

(C) CONSTRUCTION EXIT TO BE MAINTAINED WITHIN SAW CUT LINES.

TOTAL DISTURBED ACRES = 0.01

24 Hour Erosion Control Contact:

NAME: Scott Langford
ADDRESS: 950 Senoia Road
Tyrone, GA 30290
PHONE: (770)-487-4038




Know what's below.
Call before you dig.

The locations of existing underground utilities are shown in an approximate way ONLY AND HAVE NOT BEEN INSPECTED BY THE CONTRACTOR OR ITS REPRESENTATIVE. THE CONTRACTOR SHALL DETERMINE THE EXACT LOCATIONS OF ALL EXISTING UTILITIES BEFORE CONDUCTING FIELDWORK. IT IS THE RESPONSIBILITY OF THE CONTRACTOR, WHETHER THE OWNER AND/OR LAND OWNER, TO ENSURE THAT THE CONTRACTOR LOCATES ALL EXISTING UTILITIES BEFORE CONDUCTING FIELDWORK. IT IS THE RESPONSIBILITY OF THE CONTRACTOR TO BE FULLY RESPONSIBLE FOR ANY AND ALL DAMAGES WHICH MIGHT BE CAUSED TO EXISTING UTILITIES DUE TO FAILURE TO EXACTLY LOCATE AND PROTECT THESE UTILITIES.

NOTICE:
CONSTRUCTION SITE SAFETY IS THE SOLE RESPONSIBILITY OF THE CONTRACTOR. WHETHER THE OWNER AND/OR LAND OWNER ARE EXPECTED TO ASSUME ANY RESPONSIBILITY FOR SAFETY OF THE WORKER, CONTRACTOR, OR OTHERS IN THE WORK OF ANY NEARBY STRUCTURES OR PROPERTY, OR ANY OTHER PERSONS.

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VICINITY MAP

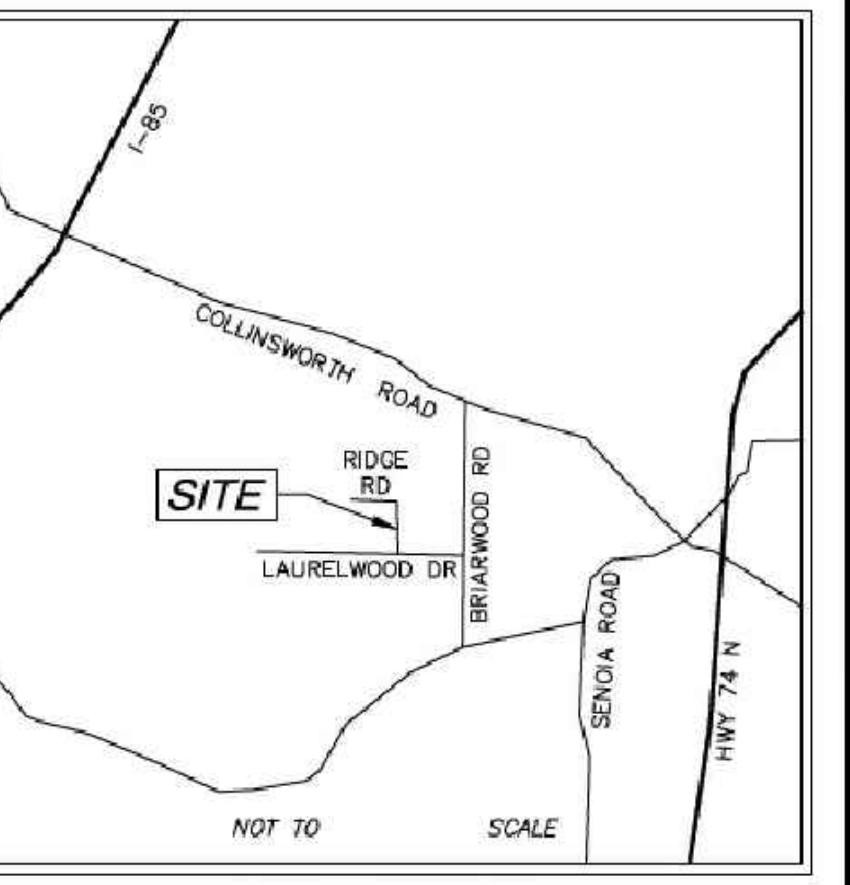SURVEY NOTES

1. THIS PLAT WAS PREPARED FOR THE EXCLUSIVE USE OF THE PERSON, PERSONS, OR ENTITY NAMED HEREON. THIS PLAT DOES NOT EXTEND TO ANY UNNAMED PERSON, PERSONS, OR ENTITY WITHOUT EXPRESS WRITTEN CERTIFICATION BY THE SURVEYOR NAMING SAID PERSON, PERSONS, OR ENTITY.

2. NORTH ARROW AND BEARINGS ARE BASED ON GEORGIA STATE PLANE COORDINATES (NAVD83), US FOOT, USING GLOBAL POSITIONING SYSTEM AND OBTAINED BY RTK OBSERVATIONS ON OCTOBER 20, 2022 USING THE TRIMBLE VRS SYSTEM. ALL DISTANCES SHOWN ARE HORIZONTAL GROUND MEASUREMENTS EXPRESSED IN SURVEY FEET DATUM: NAVD88
HORIZONTAL GRID NORTH, NAVD83
VERTICAL: NAVD88
GEOD: GEOFID18 (CONUS)

3. CONTOURS AND SPOT ELEVATIONS SHOWN HEREON ARE BASED ON THE U.S.G.S. DATUM (NAVD88). THE SITE BENCHMARKS ARE AS SHOWN HEREON.

4. WATER MAIN, STORM SEWER, SANITARY SEWER, AND FRANCHISE UTILITY STRUCTURES HAVE BEEN FOUND LOCATED WHERE VISIBLE. NOTE: THE SURVEYOR MAKES NO GUARANTEES THAT THE UNDERGROUND UTILITIES SHOWN COMprise ALL SUCH UTILITIES IN THE AREA, EITHER IN-SERVICE OR ABANDONED.

5. THERE WAS NO EVIDENCE OF RECENT CONSTRUCTION ON THE SUBJECT PROPERTY OBSERVED IN THE PROCESS OF CONDUCTING THE FIELDWORK.

6. NO FIELD DELINEATED WETLANDS WERE OBSERVED IN THE PROCESS OF CONDUCTING THE FIELDWORK.

7. EQUIPMENT USED FOR MEASUREMENT:
ANGULAR: TRIMBLE R10/58 ROBOTIC TOTAL STATION
LINEAR: TRIMBLE R10/58 ROBOTIC TOTAL STATION
GPS: TRIMBLE R10 GPS RECEIVER

8. STATE, COUNTY, & LOCAL BUFFERS AND SETBACKS MIGHT EXIST ON THE SUBJECT PROPERTY THAT ARE NOT SHOWN HEREON.

9. THERE ARE NO STATE WATERS ON THIS SITE.



ATWELL GROUP.com
866.850.4200 www.atwell-group.com
1800 PARKWAY PLACE, SUITE 700
MARIETTA, GA 30067-0607


STORM DRAIN REPLACEMENT
EXISTING CONDITIONS
LOCATED IN
TOWN OF TYRONE
FAYETTE COUNTY, GEORGIA

DATE
12/30/2022

100, 115, 120 & 125 RIDGE ROAD
TYRONE, GEORGIA 30290

| | |
|------------------------------------------------------------------------------------------------------------------------------------------------------------------------------------------------------------------------------------------------------------------------------------------------------------------------------------------------------------------------------------------------------------------------------------------------------------------------------------------------------------------------------------------------------------------------------------------------------------------------------------------------------------------------------------------------------------------------------------------------------------------------------------------------------------------------------------------|--|
| SURVEYOR'S CERTIFICATION | |
| <p>This plat is a reversioning of an existing parcel or parcels of land and does not subdivide or create a new parcel or make any changes to any real property boundaries. The recording information of the documents, maps, plats, or other instruments which created that parcel or parcels are stated here on record. This plat does not mean approval of any local jurisdiction, availability of permits, compliance with local regulations or requirements, or suitability for any use or purpose of the land. Furthermore, the undersigned land surveyor certifies that this plat complies with the technical standards for property surveys in Georgia as set forth in the rules and regulations of the Georgia Board of Registration for Professional Engineers and Land Surveyors as set forth in O.C.G.A. Section 15-6-17.</p> | |
| <p><i>[Signature]</i> 12/27/21 JOSEPH T. BAKER, LS JOSEPH T. BAKER REG. NO. #2674 STATE OF GEORGIA LAND SURVEYOR JOSEPH T. BAKER REVISIONS DWG. JCB CH. JTB P.M. JTB CODE TP JOB 22006046 SHEET NO. 1 OF 1 </p> | |

**LIMITED SURVEY OF
STORM DRAIN RE PLACEMENT
100, 115, 120 & 125 RIDGE ROAD
TYRONE, GEORGIA 30290**

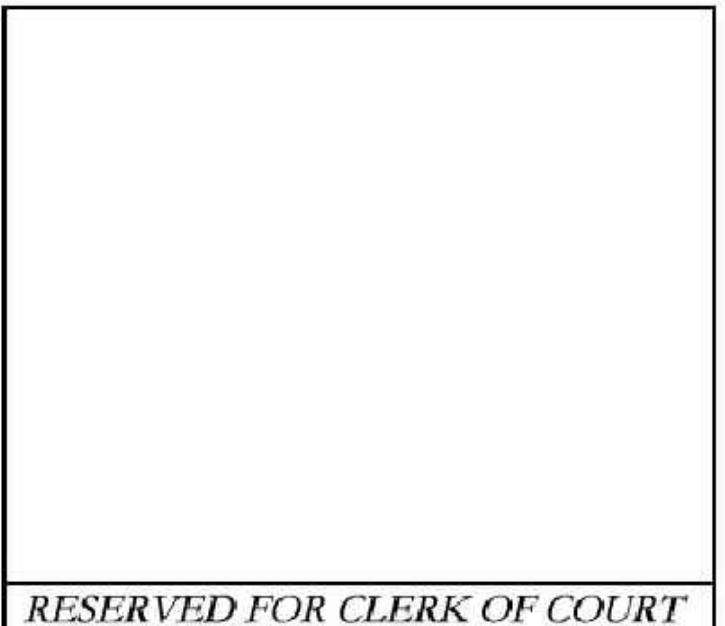


RESERVED FOR CLERK OF COURT

KINGSRIDGE
SUBDIVISION
PB 12, Pg 160

N=n
KENNETH S. BANNISTER &
JENNIFER A. BANNISTER
120

RIDGE ROAD (60' R/W)

SCALE: 1" = 10'

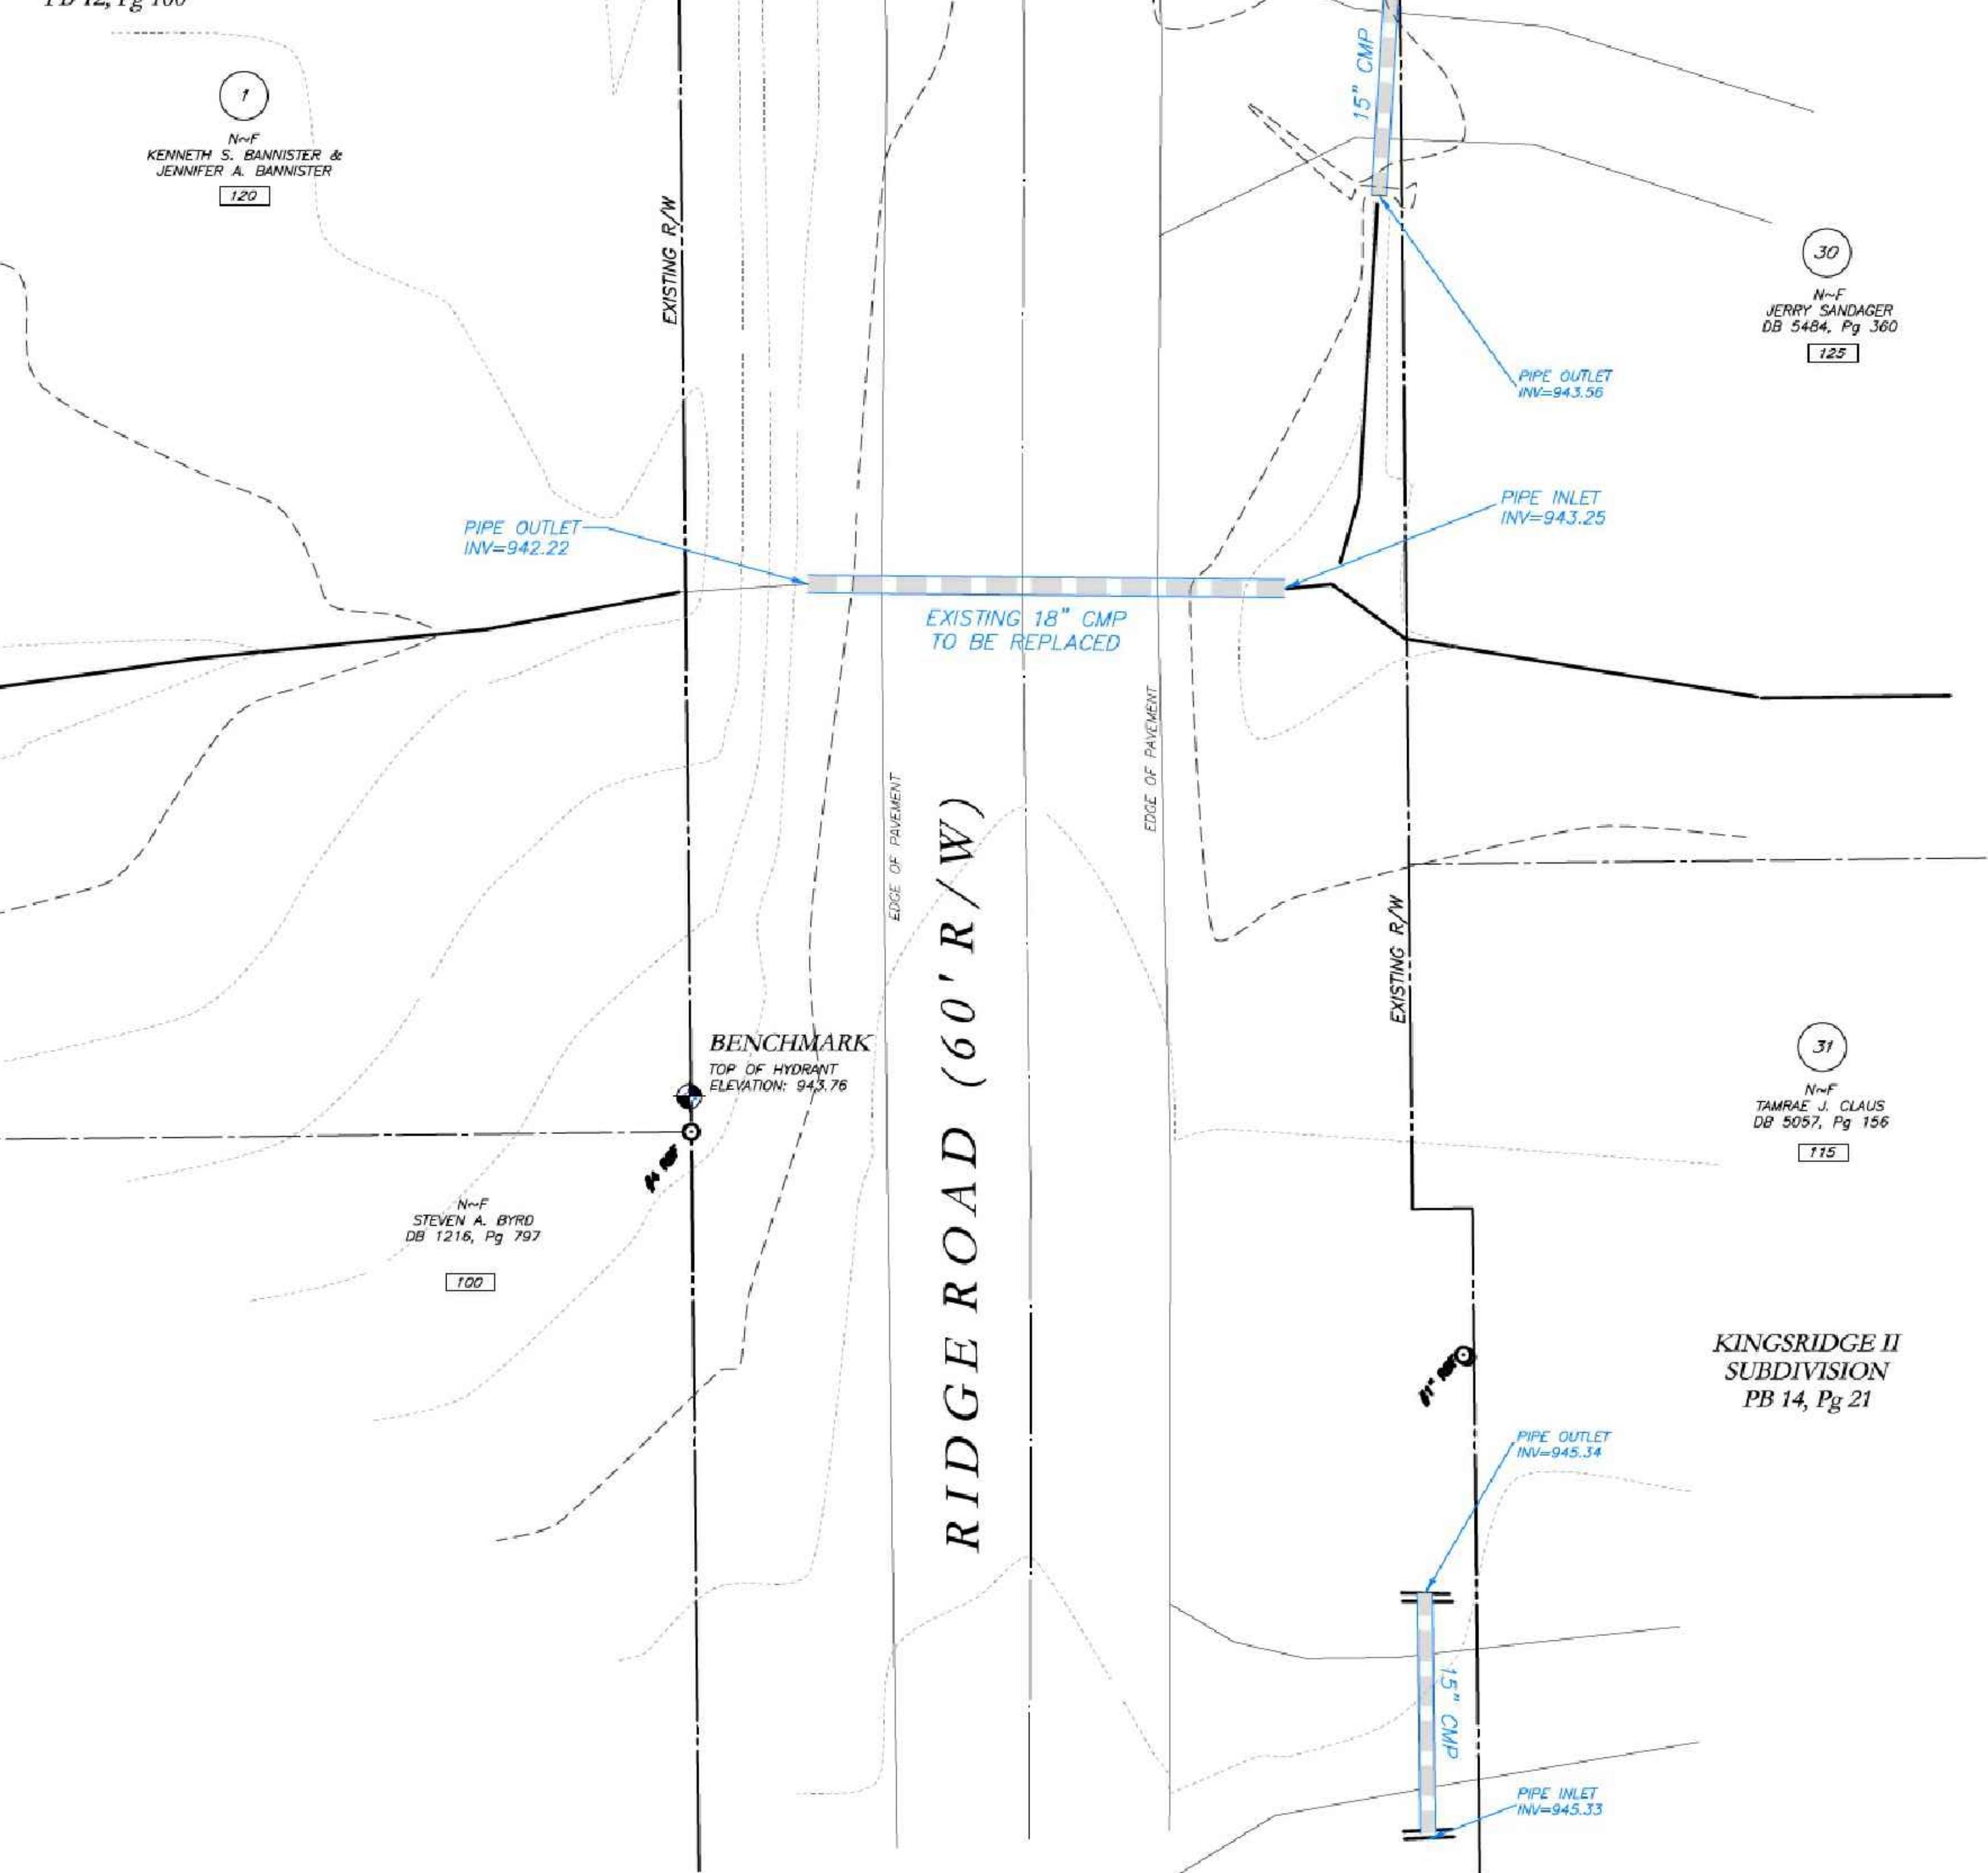

| LEGEND | |
|--------|--------------------------|
| POB | POINT OF BEGINNING |
| POC | POINT OF COMMENCEMENT |
| RBS | REBAR SET |
| RF | REBAR FOUND |
| M&F | MARSHAL & FOUNDRY |
| MNS | MAC MAIL SET |
| CTP | CROSS TOP PIPE FOUND |
| OTP | OPEN TOP PIPE FOUND |
| CMP | CONCRETE MONUMENT FOUND |
| DI | DRIP INLET |
| DI | DRIP INLET |
| WI | WATER INLET |
| YI | YARD INLET |
| OCS | OUTLET CIVIL STRUCTURE |
| JB | JACK BROWN BOX |
| SWCB | SINGLE WING CATCH BASIN |
| DWCB | DOUBLE WING CATCH BASIN |
| HW | HORNWELL SECTION |
| FES | FLARED END SECTION |
| CAP | CAP |
| RCP | REINFORCED CONCRETE PIPE |
| SS | SANITARY SEWER |
| SWE | SANITARY SEWER EASEMENT |
| SSE | SANITARY SEWER BASEMENT |
| DLE | DRAINAGE EASEMENT |
| WE | WATER EASEMENT |
| | PIPE HYDRANT |
| | WATER VALVE |
| | GAS METER |
| | ELECTRICAL BOX |
| | POWER POLE |
| | CHIMNEY UTILITIES |
| | GUY WIRE |
| | PIPE |
| | DROP INLET |
| | JUNCTION BOX |
| | OUTLET CIVIL STRUCTURE |
| | DOUBLE WING CATCH BASIN |
| | HEAD WALL CATCH BASIN |
| | HW SECTION |
| | UNDERGROUND WATER LINE |
| | UNDERGROUND TELECOM LINE |
| | SANITARY SEWER LINE |
| | SEWER MANHOLE |
| | CLEAN OUT |
| | SEWAGE TRAP |
| | BOLLARD |
| | SPOT ELEVATION |



JOSEPH T. BAKER, LS

JOSEPH T. BAKER

REG. NO. #2674

STATE OF GEORGIA

LAND SURVEYOR

JOSEPH T. BAKER

REVISIONS

DWG. JCB CH. JTB

P.M. JTB



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JOB 22006046


SHEET NO.

1 OF 1

PROPOSED REPLACEMENT OF
CROSS DRAIN AT
120 & 125 RIDGE ROAD
TYRONE, GEORGIA 30290

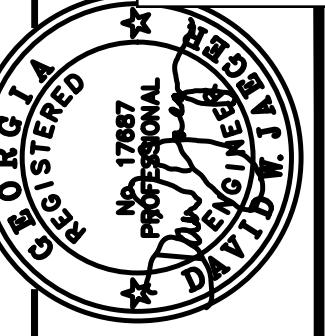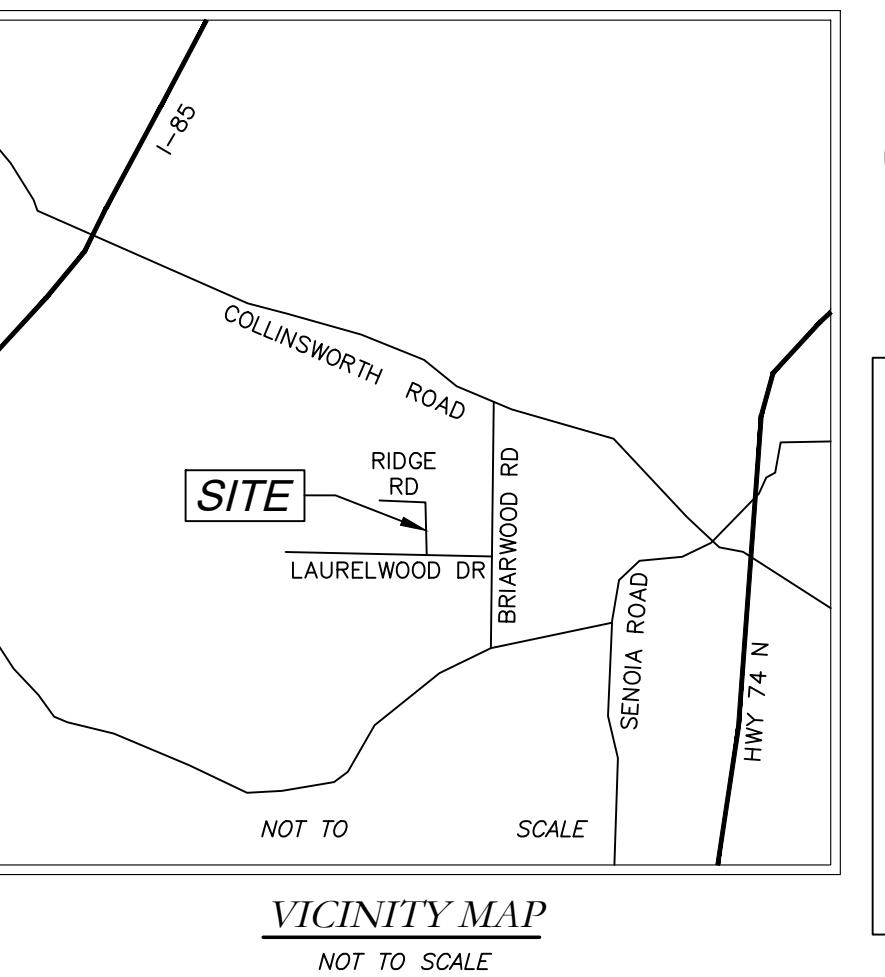


VICINITY MAP
NOT TO SCALE

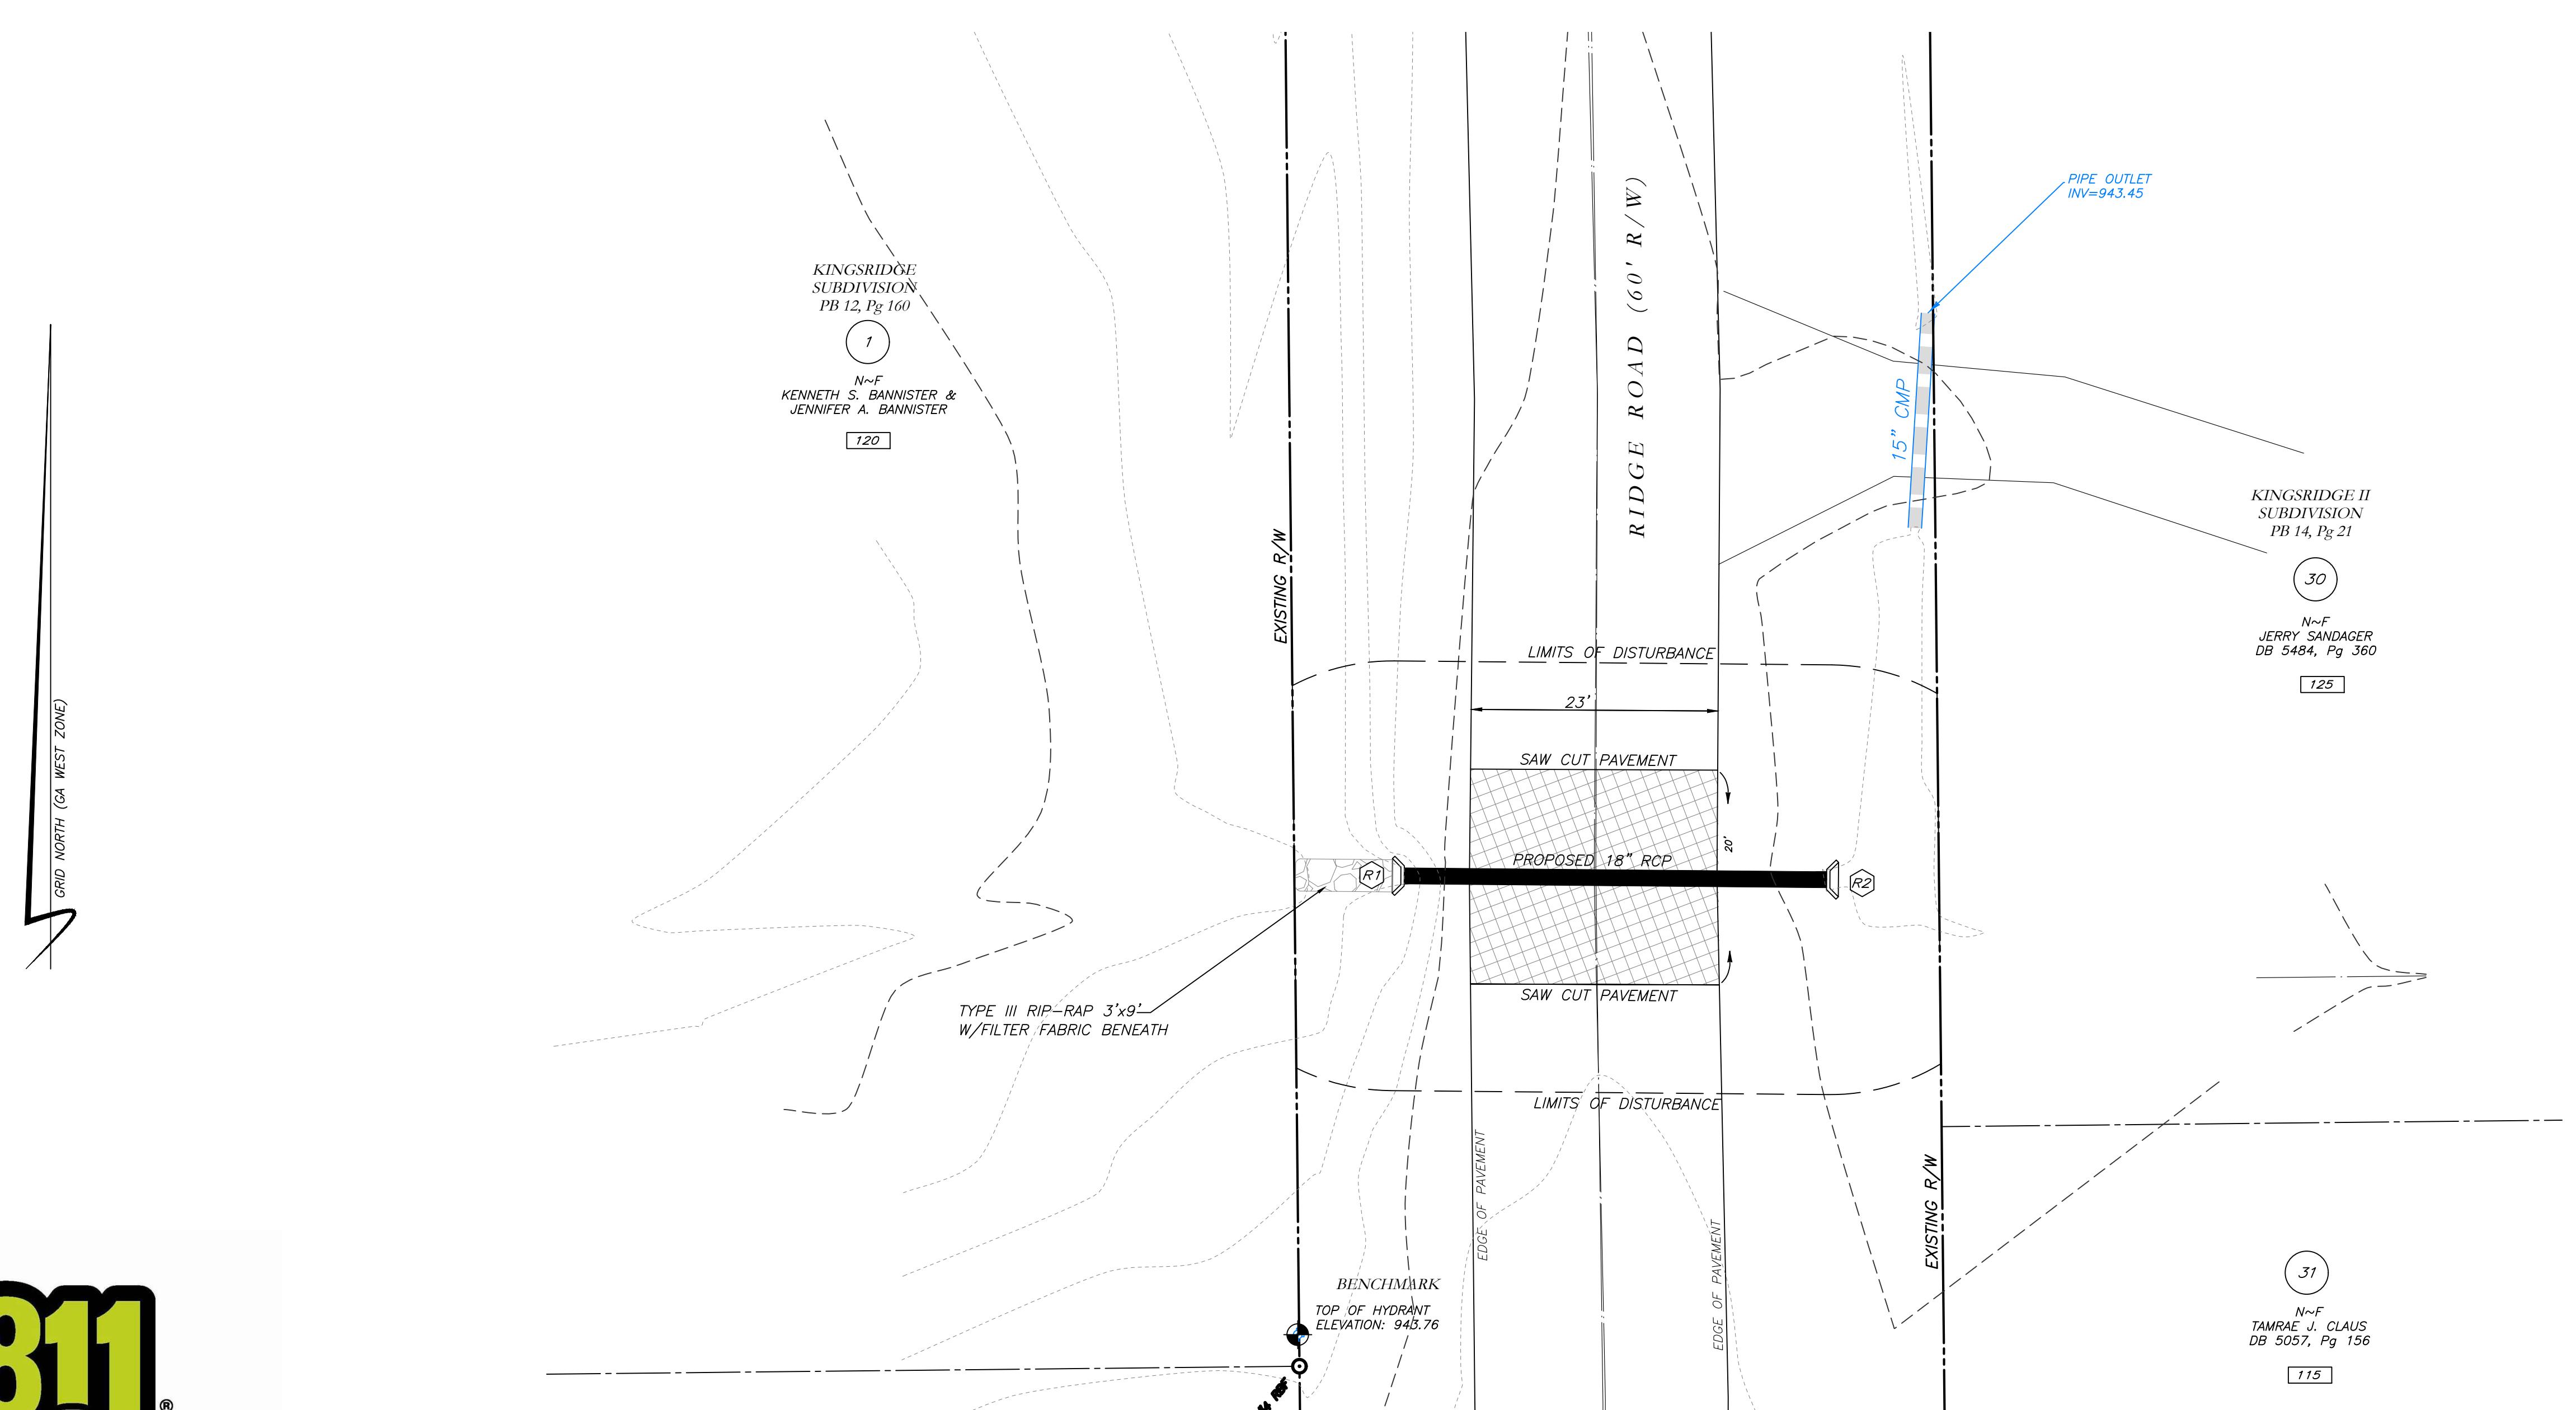

Know what's below.
Call before you dig.


| LEGEND | |
|--------|-----------------------------|
| POB | POINT OF BEGINNING |
| POC | POINT OF COMMENCEMENT |
| RBS | REBAR FOUND |
| RBF | REBAR FOUND |
| MNF | MAG NAIL FOUND |
| MNP | MAG NAIL FOUND |
| CTP | CRIMP TOP PIPE FOUND |
| OTP | OPEN TOP PIPE FOUND |
| CMP | CORRUGATED METAL PIPE FOUND |
| DI | DROP INLET |
| CI | CATCH INLET |
| YAC | YARD ACTIVITY |
| OCS | OUTLET CONTROL STRUCTURE |
| JB | JUNCTION BOX |
| SWCB | SINGLE WING CATCH BASIN |
| DWCB | DOUBLE WING CATCH BASIN |
| HW | HEADWALL |
| TEC | TEMPORARY END SECTION |
| CMP | CORRUGATED METAL PIPE |
| RCP | REINFORCED CONCRETE PIPE |
| SS | SEWER SLEEVE |
| F.M.E. | FORCE MAIN EASEMENT |
| S.E. | SEWER EASEMENT |
| D.E. | DRAINAGE EASEMENT |
| W.E. | WATER EASEMENT |
| G.H.T. | GREASE TRAP |
| X | FENCE |
| • | BOLLARD |
| 5'-0" | SPOT ELEVATION |
| ♦ | FIRE HYDRANT |
| ● | WATER VALVE |
| ○ | POWER METER |
| ◎ | GAS METER |
| ■ | POWER METER |
| □ | POWER POLE |
| ◆ | OVERHEAD UTILITIES |
| ○ | ROOF DRAIN |
| △ | DROP INLET |
| ○ | MANHOLE |
| ○ | SINGLE WING CATCH BASIN |
| ○ | DOUBLE WING CATCH BASIN |
| ○ | MANHOLE |
| ○ | FLARED END SECTION |
| ○ | UNDERGROUND GAS LINE |
| ○ | UNDERGROUND WATER LINE |
| — | UNDERGROUND ELECTRIC LINE |
| — | TELECOM |
| ○ | SANITARY SEWER |
| ○ | SEWER MANHOLE |

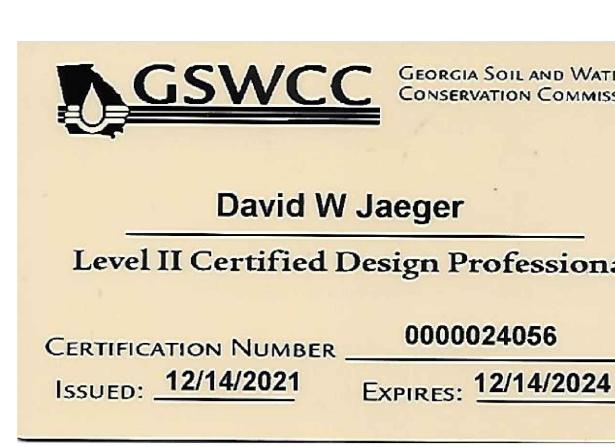

I CERTIFY AS THE PLAN DESIGNER THAT I HAVE VISITED THE SITE PRIOR TO THE DESIGN OF THE ES&PC PLANS

David W Jaeger

10 0 10 20
SCALE: 1" = 10'

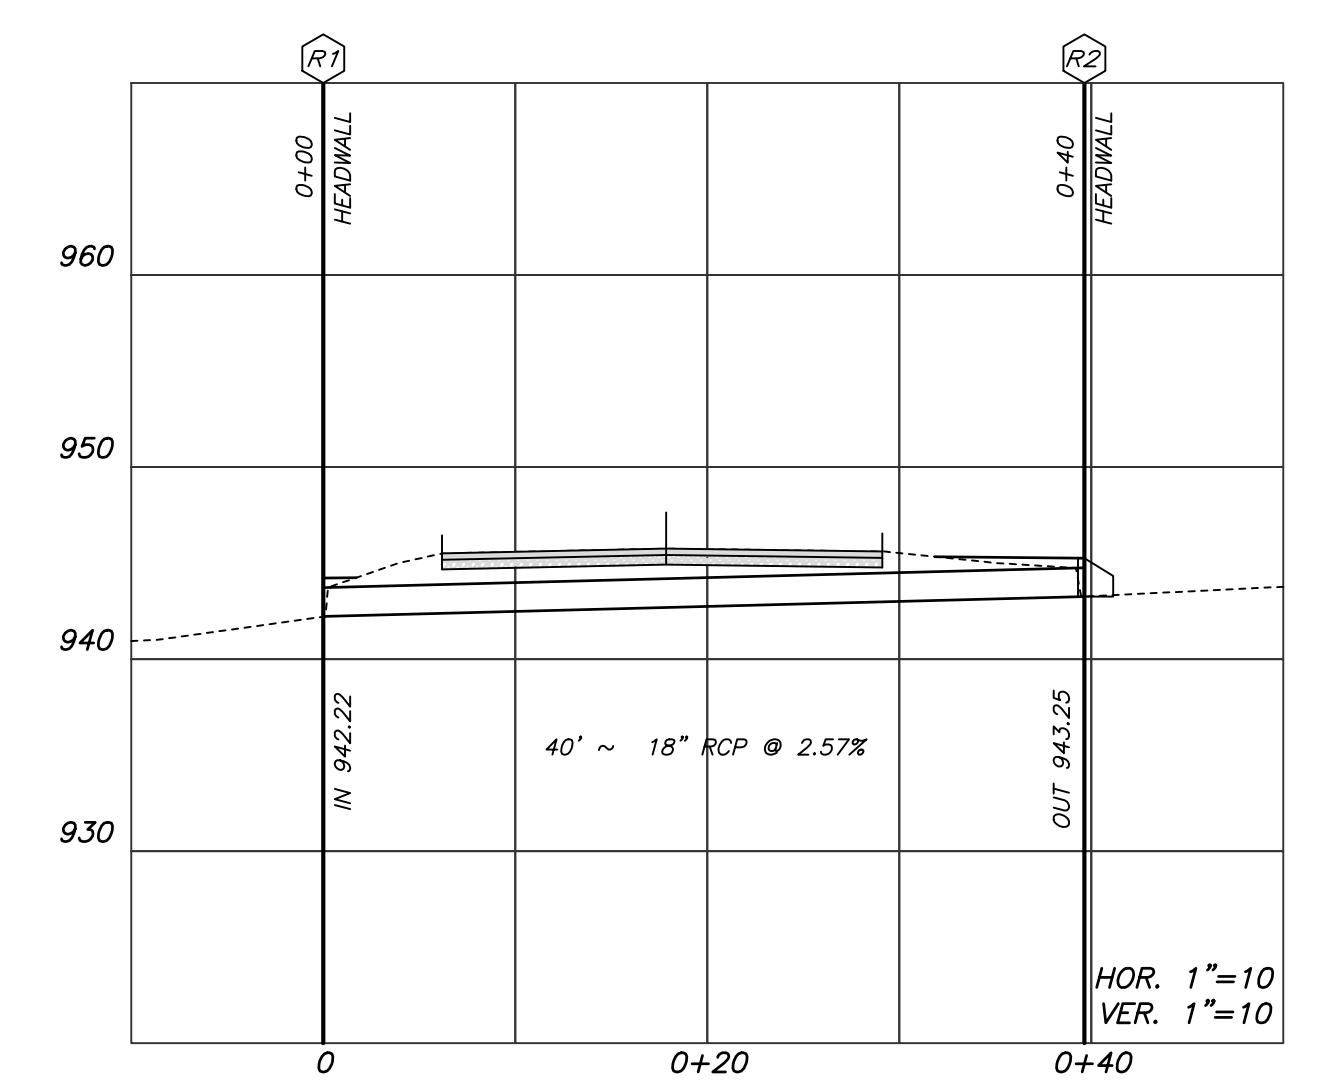

PROPOSED STORM DRAIN PROFILE



NOTES:

- CONTRACTOR WILL BE RESPONSIBLE FOR LOCATING AND PROTECTING EXISTING UTILITIES.
- EXISTING PAVEMENT SHALL BE SAW CUT AT LIMITS OF DEMOLITION ACTIVITIES. LOCATION OF SAW CUTS SHALL BE APPROVED IN ADVANCE BY THE TOWN ENGINEER.
- CONTRACTOR TO STOCKPILE EXISTING RIP-RAP AND REUSE WHEN PRACTICAL.
- ALL DEMOLITION MATERIALS, WASTE SOILS AND SEDIMENT SHALL BE HAULED AWAY AND DISPOSED OF OFFSITE AT A SUITABLE LOCATION, SELECTED BY THE CONTRACTOR. THIS SHALL BE DONE AT NO ADDITIONAL CHARGE.
- TEMPORARY TRAFFIC CONTROL STRIPING, SIGNAGE AND DEVICES ARE REQUIRED DURING TRANSITION FROM EXISTING CONDITION TO COMPLETION OF PROJECT. PROVIDE CERTIFIED TRAFFIC CONTROL FLAGMEN DURING TEMPORARY LANE CLOSURES. BOTH LANES SHALL BE OPEN WHEN FLAGMEN ARE NOT PRESENT AND SHALL HAVE AN ALL WEATHER DRIVING SURFACE.
- PAVEMENT WITHIN SAW CUT LINES TO BE REMOVED AND REPLACED.

Mallett Consulting, Inc.
101 Devant St., Suite 804, Fayetteville, Georgia 30214
PHONE: 770-719-3533 FAX: 770-719-3377

SHEET NO.
33 of 43


**EROSION CONTROL PLAN FOR
CROSS DRAIN AT
120 & 125 RIDGE RD
TYRONE, GEORGIA 30290**

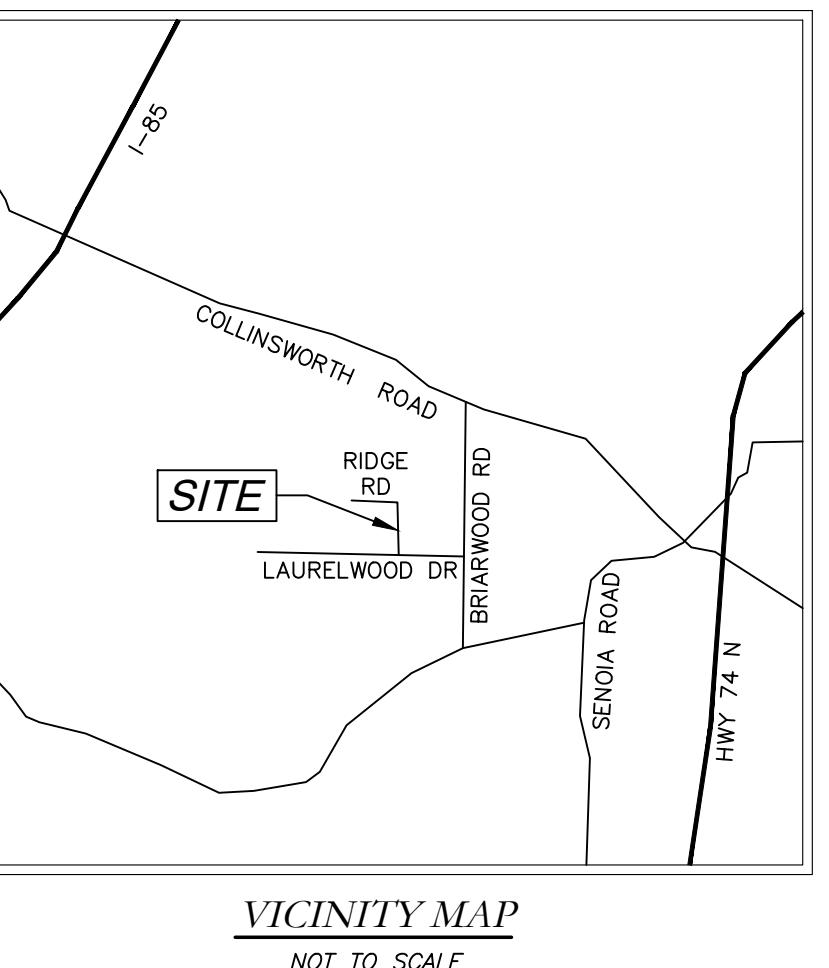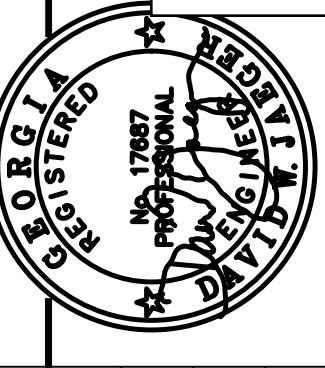

VICINITY MAP
NOT TO SCALE

| PROJECT NUMBER PW-20 | | | | | |
|----------------------|-----|-------|-------|-----|-----------|
| DESIGN | MCI | SCALE | DRAWN | ALG | DATE |
| | | | | | 01/16/23 |
| CHECK | | | | | FILE NO. |
| | | | | | DWJ |
| APPROVED | | | | | SHEET NO. |
| BY APPD | | | | | DWJ |

**Cross Drain Replacement
for Town of Tyrone, Georgia
Ridge Road
Erosion Control Plan**

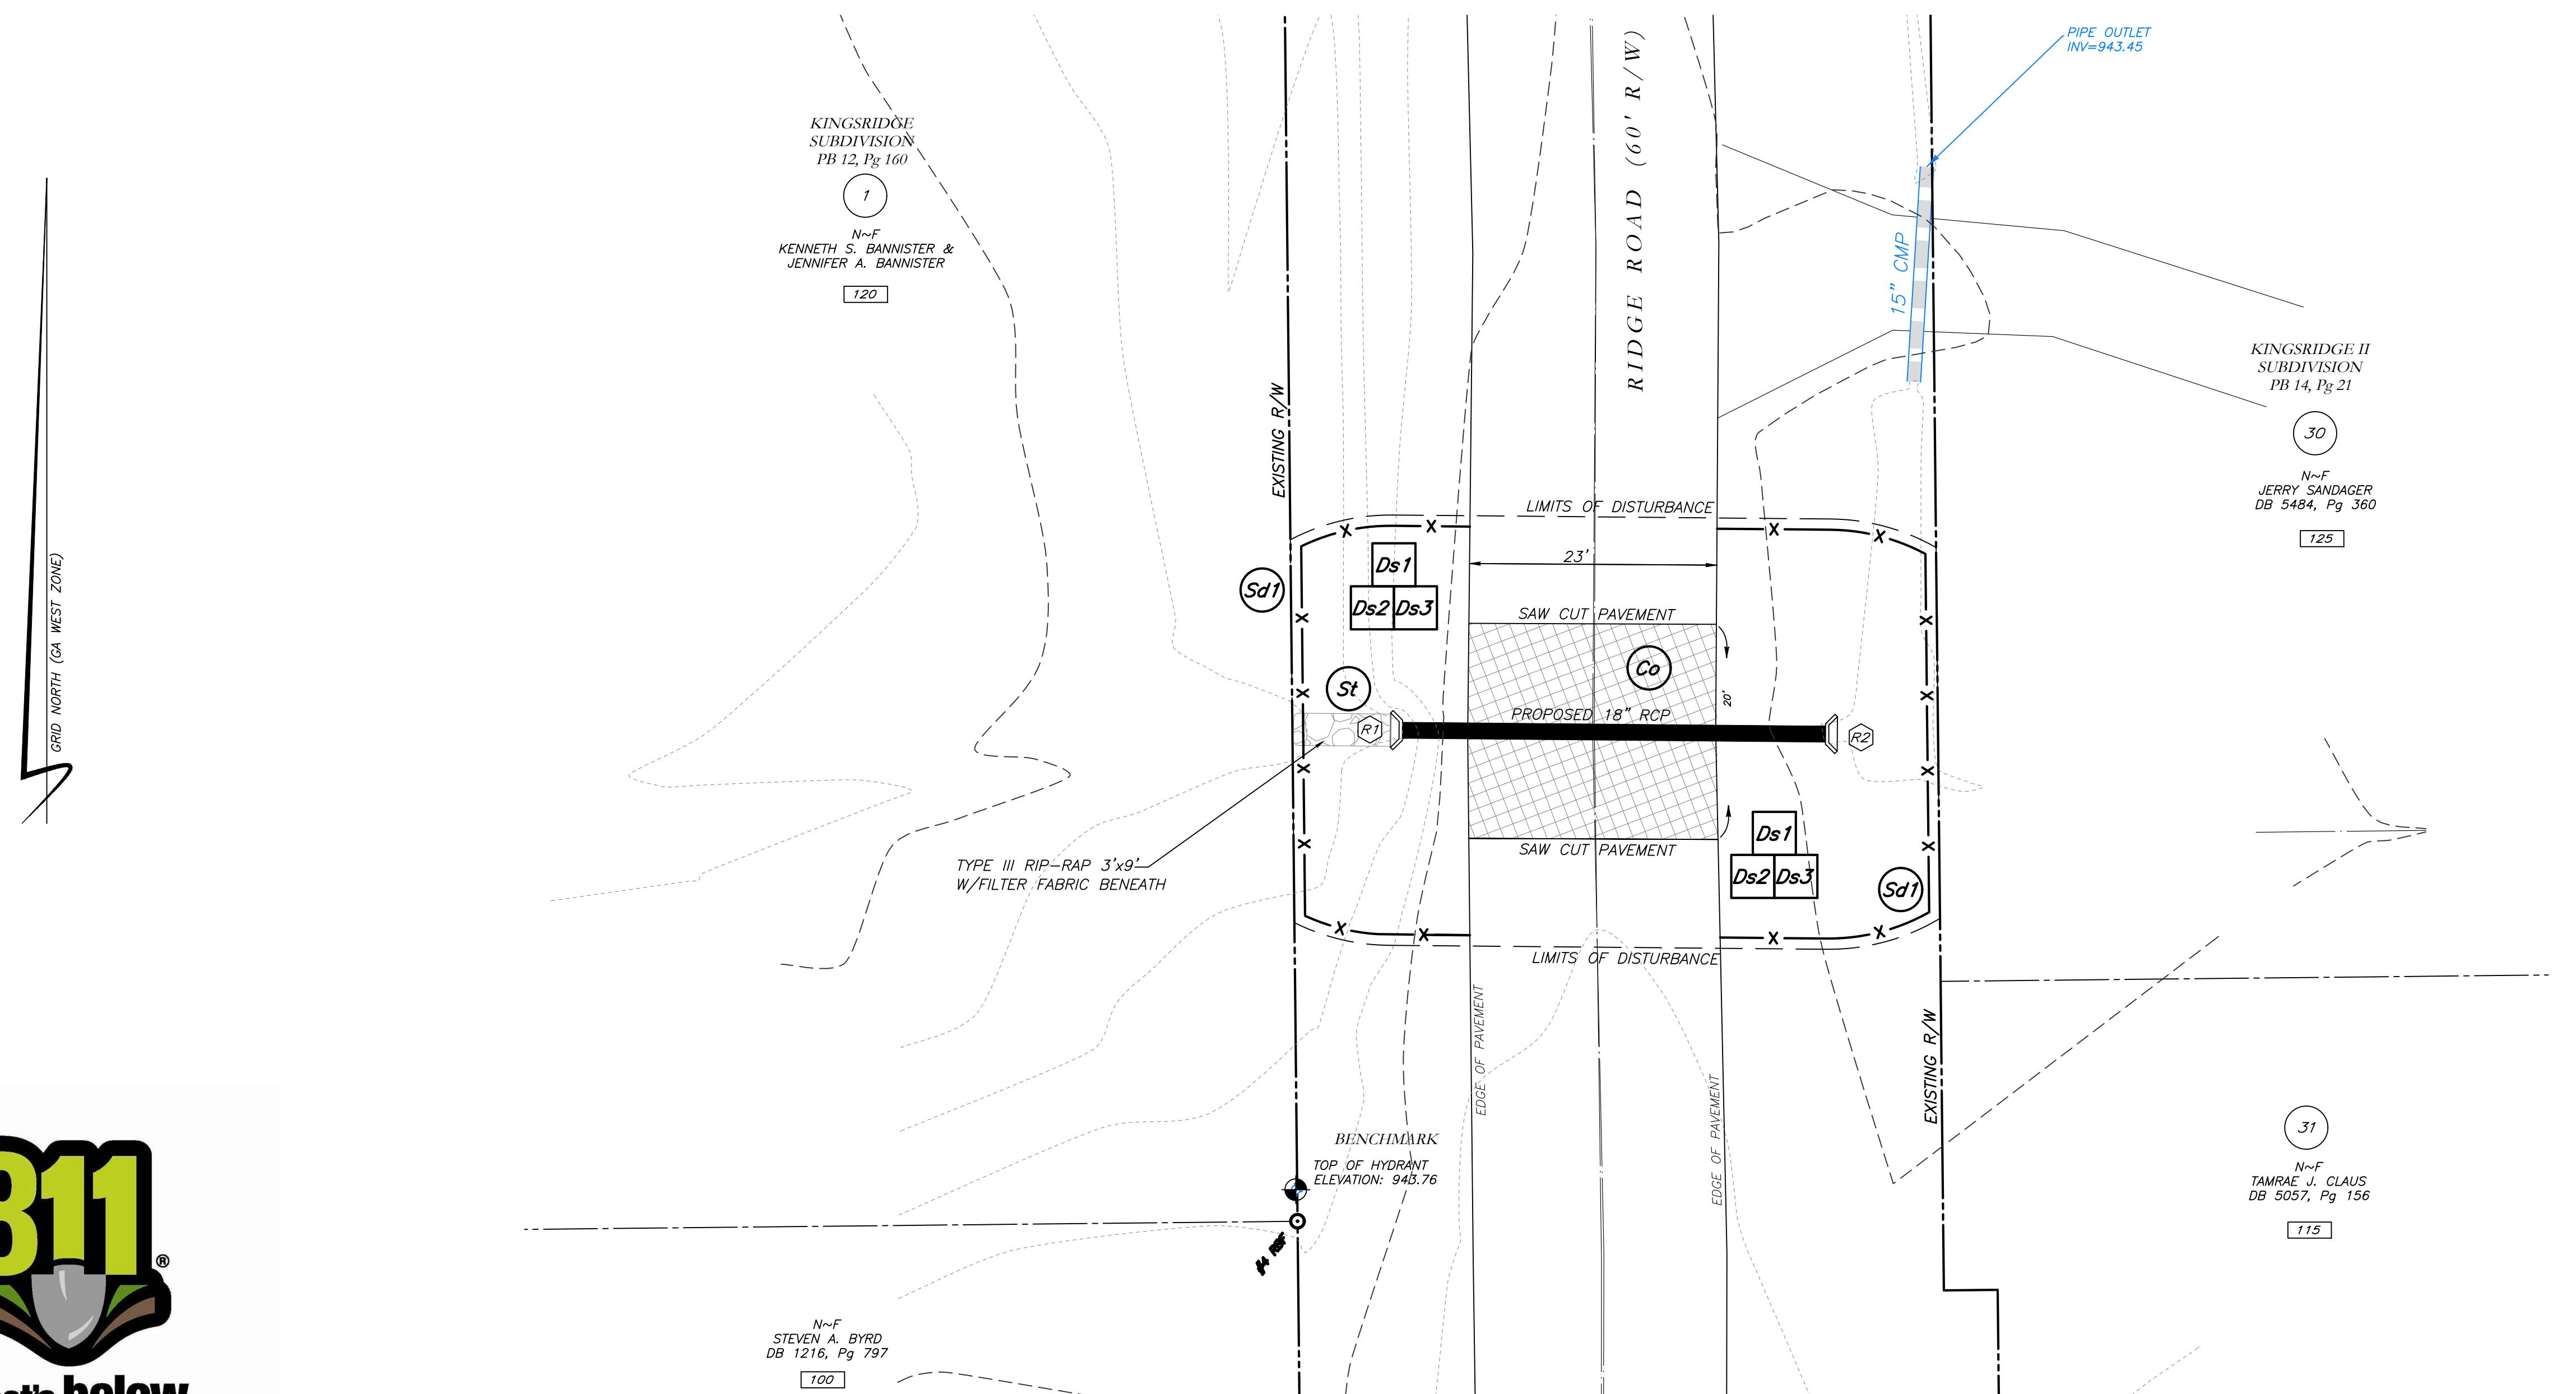

THE ESCAPE OF SEDIMENT FROM THE SITE SHALL BE PREVENTED BY THE INSTALLATION OF EROSION AND SEDIMENT CONTROL MEASURES AND PRACTICES PRIOR TO LAND DISTURBING ACTIVITIES.

EROSION CONTROL MEASURES SHALL BE MAINTAINED AT ALL TIMES. IF FULL IMPLEMENTATION OF THE APPROVED PLAN DOES NOT PROVIDE FOR EFFECTIVE EROSION CONTROL, ADDITIONAL EROSION AND SEDIMENT CONTROL MEASURES SHALL BE IMPLEMENTED TO CONTROL OR TREAT THE SEDIMENT SOURCE.

ANY DISTURBED AREA LEFT EXPOSED FOR A PERIOD GREATER THAN 14 DAYS SHALL BE STABILIZED WITH MULCH OR TEMPORARY SEEDING.


CONTRACTOR TO STOCKPILE EXISTING RIP-RAP AND REUSE WHEN PRACTICAL.

REMOVE SD1 WHEN GRASS HAS BEEN ESTABLISHED TO AT LEAST 85% COVERAGE.

(Co) CONSTRUCTION EXIT TO BE MAINTAINED WITHIN SAW CUT LINES.

TOTAL DISTurbed ACRES = 0.05

| LEGEND | |
|---------------------------|--------------------------|
| POB | POINT OF BEGINNING |
| POC | POINT OF COMMENCEMENT |
| RBS | REBAR FOUND |
| RBF | REBAR FOUND |
| MNF | MAG NAIL FOUND |
| MNS | MAG NAIL FOUND |
| CTP | CRIMP TOP PIPE FOUND |
| OTP | OPEN TOP PIPE FOUND |
| CMF | CONCRETE MANIFOLD FOUND |
| DI | DROP INLET |
| CI | CATCH INLET |
| YAC | YARD ACCESS |
| OCS | OUTLET CONTROL STRUCTURE |
| JB | JUNCTION BOX |
| DWCB | DOUBLE WING CATCH BASIN |
| DWCB | DOUBLE WING CATCH BASIN |
| HW | HEADWALL |
| TEC | TELECOM |
| CMP | CORRUGATED METAL PIPE |
| RCP | REINFORCED CONCRETE PIPE |
| SS | SEWER |
| F.M.E. | FORCE MAIN EASEMENT |
| D.E. | DRAINAGE EASEMENT |
| W.E. | WATER EASEMENT |
| G.T. | GREASE TRAP |
| FENCE | FENCE |
| BOLLARD | BOLLARD |
| SPOT ELEVATION | SPOT ELEVATION |
| FIRE HYDRANT | |
| WATER VALVE | |
| POWER METER | |
| GAS METER | |
| POWER METER | |
| POWER POLE | |
| OVERHEAD UTILITIES | |
| ROOF DRAIN | |
| DROP INLET | |
| YARD ACCESS | |
| SINGLE WING CATCH BASIN | |
| DOUBLE WING CATCH BASIN | |
| FLARED END SECTION | |
| UNDERGROUND GAS LINE | |
| UNDERGROUND WATER LINE | |
| UNDERGROUND ELECTRIC LINE | |
| TELECOM | |
| SANITARY SEWER | |
| SEWER | |
| SANITARY SEWER MANHOLE | |

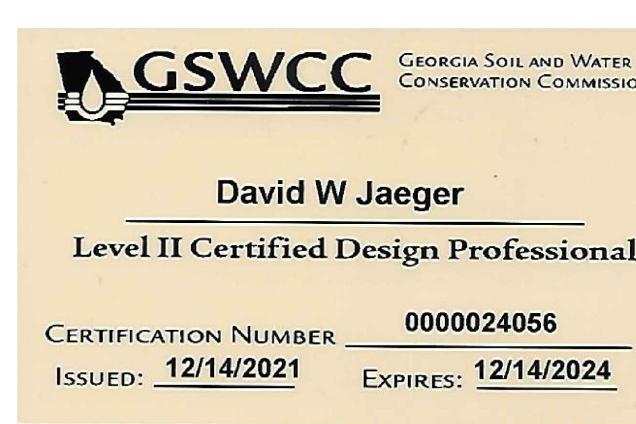

I CERTIFY AS THE PLAN DESIGNER THAT I HAVE VISITED THE SITE PRIOR TO THE DESIGN OF THE ES&PC PLANS
David W Jaeger
Level II Certified Design Professional

CERTIFICATION NUMBER 0000024056
ISSUED: 12/14/2021 EXPIRES: 12/14/2024

10 0 10 20
SCALE: 1" = 10'

24 Hour Erosion Control Contact:

NAME: Scott Langford
ADDRESS: 950 Senoia Road
Tyrone, GA 30290
PHONE: (770)-487-4038



Know what's below.

Call before you dig.

The locations of existing underground utilities are shown on this map. They may only and have not been indicated or may have been removed by the owner or their representative. The contractor shall determine the exact location of all existing utilities before commencing work and shall be fully responsible for any and all damages which might be occasioned by failure to exactly locate and preserve any and all underground utilities.

NOTICE: CONSTRUCTION SAFETY IS THE SOLE RESPONSIBILITY OF THE CONTRACTOR; NEITHER THE OWNER NOR THE SURVEYOR IS EXPECTED TO ASSUME ANY RESPONSIBILITY FOR SAFETY OF THE WORK, OR FOR ANY DAMAGE IN THE WORK, OF ANY NEARBY STRUCTURES, OR OF ANY OTHER PROPERTY.

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VICINITY MAP

SURVEY NOTES

1. THIS PLAT WAS PREPARED FOR THE EXCLUSIVE USE OF THE PERSON, PERSONS OR ENTITY NAMED HEREON. THIS PLAT DOES NOT EXTEND TO ANY UNNAMED PERSON, PERSONS OR ENTITY WITHOUT EXPRESS WRITTEN CERTIFICATION BY THE SURVEYOR NAMING SAID PERSON, PERSONS, OR ENTITY.

2. NORTH ARROW AND DEPARTURES ARE BASED ON GEORGIA STATE PLANE COORDINATES (NAD83). US FOOT, USING GLOBAL POSITIONING SYSTEM AND OBTAINED BY RTK OBSERVATIONS ON OCTOBER 20, 2022 USING THE TRIMBLE VRS SYSTEM. ALL DISTANCES SHOWN ARE HORIZONTAL GROUND MEASUREMENTS EXPRESSED IN SURVEY FEET.

DATUM:

HORIZONTAL: GRID NORTH, NAD83

VERTICAL: NAVD88

GEOD: GEOD18 (CONUS)

3. CONTOURS AND SPOT ELEVATIONS SHOWN HEREON ARE BASED ON THE U.S.G.S. DATUM (NAVD88). THE SITE BENCHMARKS ARE AS SHOWN HEREON.

4. WATER MAIN, STORM SEWER, SANITARY SEWER AND FRANCHISE UTILITY STRUCTURES HAVE BEEN FIELD LOCATED WHERE VISIBLE. NOTABLE FIELD LOCATIONS ARE GUARANTEED THAT THE UNDERGROUND UTILITIES SHOWN COMprise ALL SUCH UTILITIES IN THE AREA, EITHER IN-SERVICE OR ABANDONED.

5. THERE WAS NO EVIDENCE OF RECENT CONSTRUCTION ON THE SUBJECT PROPERTY OBSERVED IN THE PROCESS OF CONDUCTING THE FIELDWORK.

6. NO FIELD DELINEATED WETLANDS WERE OBSERVED IN THE PROCESS OF CONDUCTING THE FIELDWORK.

7. EQUIPMENT USED FOR MEASUREMENTS:

| | | | |
|----------|--------------------------|---------|---------------|
| ANGULAR: | TRIMBLE R10/SB | FOR | MEASUREMENTS: |
| LINEAR: | TRIMBLE R10/SB | ROBOTIC | TOTAL STATION |
| GPS: | TRIMBLE R10 GPS RECEIVER | ROBOTIC | TOTAL STATION |

8. STATE, COUNTY, & LOCAL BUFFERS AND SETBACKS MIGHT EXIST ON THE SUBJECT PROPERTY THAT ARE NOT SHOWN HEREON.

ATWELL

www.atwell-group.com

1800 PARKWAY PLACE, SUITE 700

MARIETTA, GA

270.223.0807

STORM DRAIN REPLACEMENT
EXISTING CONDITIONS
160, 165 & 170 STRANDHILL ROAD
TYRONE, GEORGIA 30290
TOWN OF TYRONE
FAYETTE COUNTY, GEORGIA

DATE
12/30/2022
REVISIONS

THIS PLAT IS A RETRACEMENT OF AN EXISTING PARCEL OR PARCELS OF LAND AND DOES NOT SUBDIVIDE OR CREATE A NEW PARCEL OR MAKE ANY CHANGES TO ANY REAL PROPERTY BOUNDARIES. THE RECORDING INFORMATION OF THE DOCUMENTS, MAPS, PLATS, OR OTHER INSTRUMENTS WHICH CREATED THAT PARCEL OR PARCELS ARE STATED HEREON. NO RECORDING INFORMATION IS PROVIDED. APPROVAL OF ANY LOCAL JURISDICTION, AVAILABILITY OF PERMITS, COMPLIANCE WITH LOCAL REGULATIONS OR REQUIREMENTS, OR SUITABILITY FOR ANY USE OR PURPOSE OF THE LAND. FURTHERMORE, THE UNDERSIGNED LAND SURVEYOR CERTIFIES THAT THE PLAT IS PREPARED IN ACCORDANCE WITH THE STANDARDS FOR PROPERTY SURVEYS IN GEORGIA AS SET FORTH IN THE RULES AND REGULATIONS OF THE GEORGIA BOARD OF REGISTRATION FOR PROFESSIONAL ENGINEERS AND LAND SURVEYORS AS SET FORTH IN O.C.G.A. SECTION 15-6-17.

DWG. JCB | CH. JTB
P.M. JTB
CODE TP
JOB 22006046
SHEET NO. 1 OF 1

1 OF 1

49

SURVEYOR'S CERTIFICATION

This plat is a retracement of an existing parcel or parcels of land and does not subdivide or create a new parcel or make any changes to any real property boundaries. The recording information of the documents, maps, plats, or other instruments which created that parcel or parcels are stated hereon. No recording information is provided. Approval of any local jurisdiction, availability of permits, compliance with local regulations or requirements, or suitability for any use or purpose of the land. Furthermore, the undersigned land surveyor certifies that the plat is prepared in accordance with the standards for property surveys in Georgia as set forth in the rules and regulations of the Georgia Board of Registration for Professional Engineers and Land Surveyors as set forth in O.C.G.A. Section 15-6-17.






JOSEPH T. BAKER, LS
12/27/21
DATE
GEORGIA LICENSE #2674
JOSEPH T. BAKER
12/27/21
DATE
GEORGIA LICENSE #2674


RESERVED FOR CLERK OF COURT

LIMITED SURVEY OF
STORM DRAIN REPLACEMENT
160, 165 & 170 STRANDHILL ROAD
TYRONE, GEORGIA 30290


SCALE: 1" = 10'

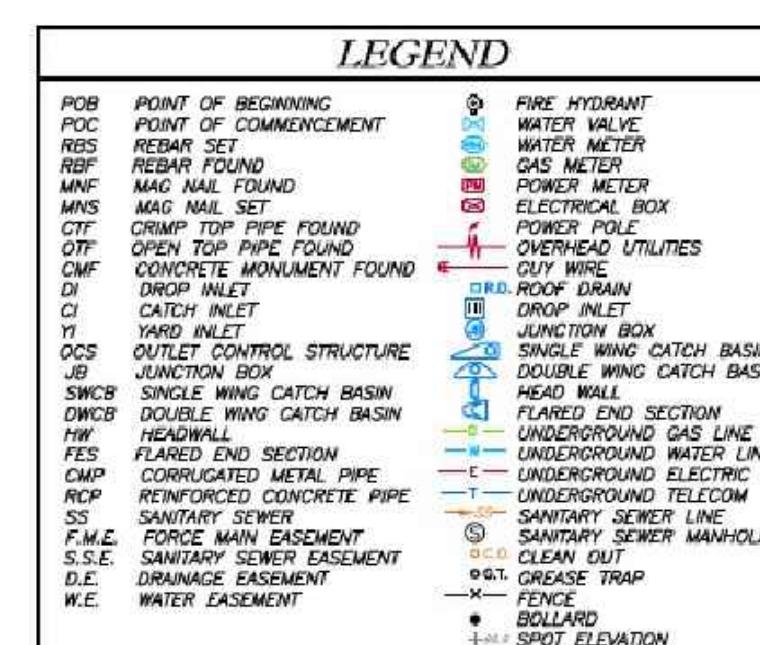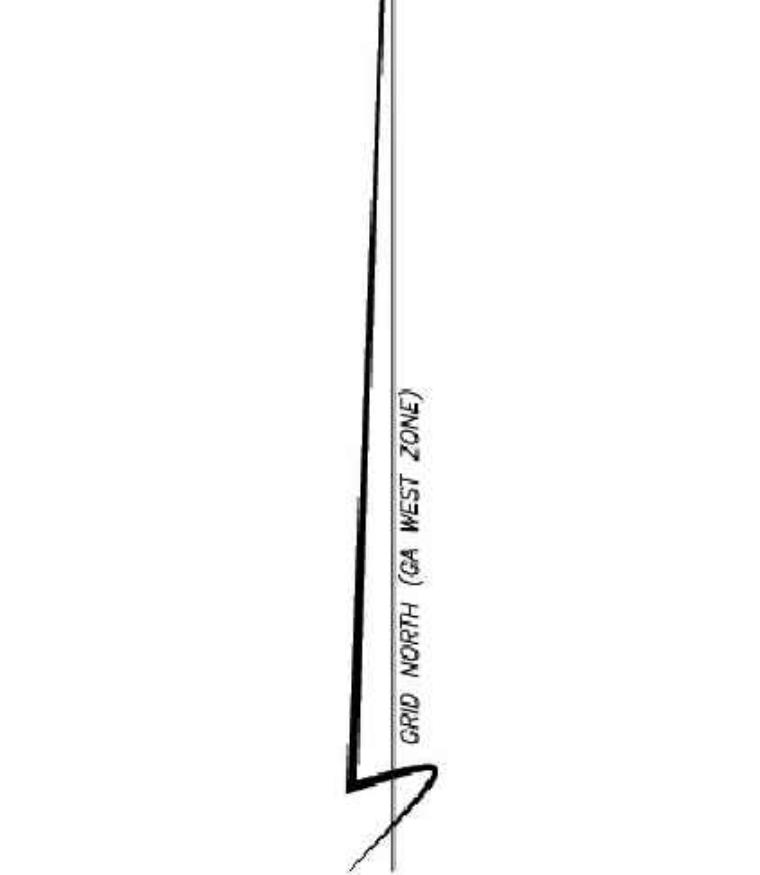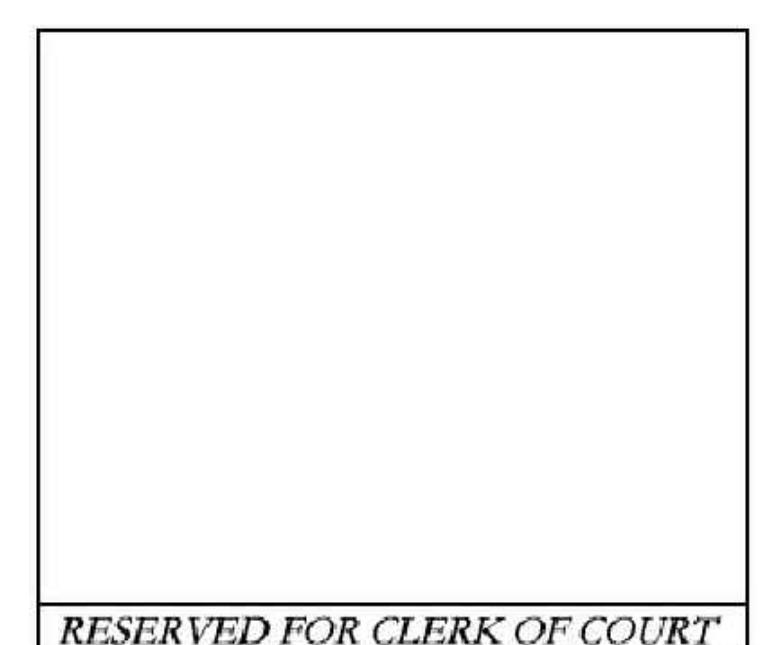

*PROPOSED REPLACEMENT OF
CROSS DRAIN AT
165, 170, & 160 STRANDHILL ROAD
TYRONE, GEORGIA 30290*

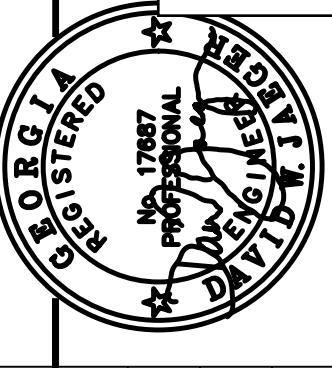


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CINITY MAP
NOT TO SCALE

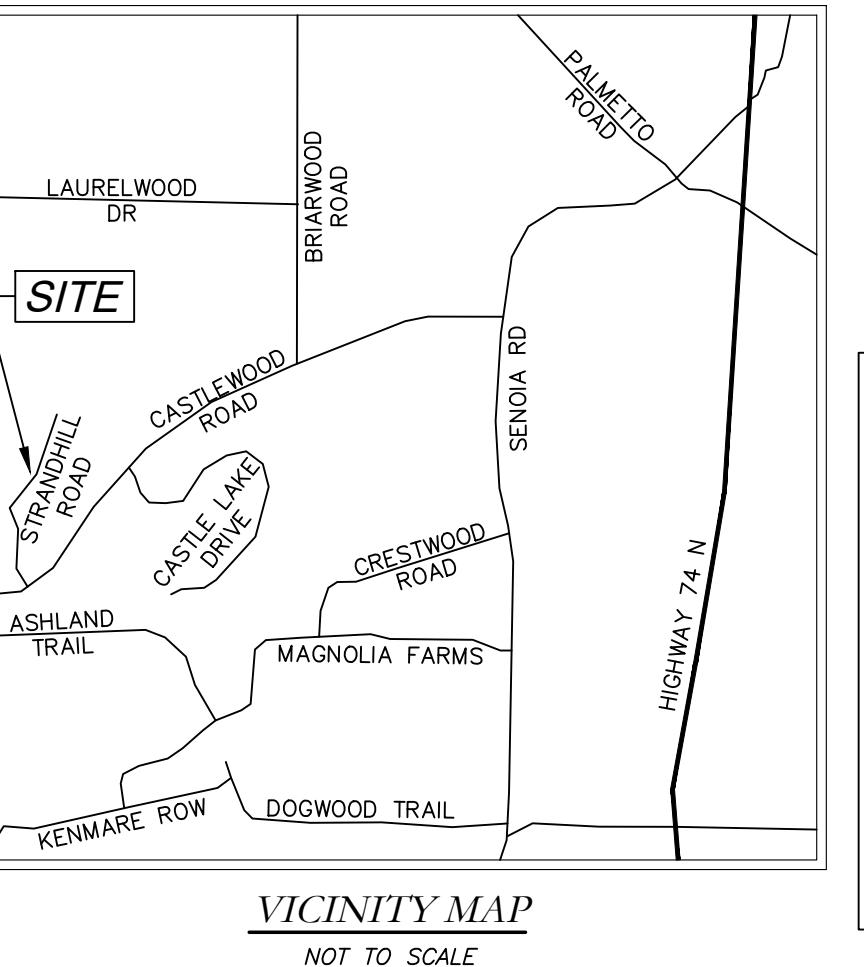
Mallett Consulting, Inc.
101 DEVANT ST., SUITE 804 FAYETTEVILLE, GEORGIA 30214

PHONE: 770-719-3333
FAX: 770-719-3377




**Know what's below.
Call before you dig.**
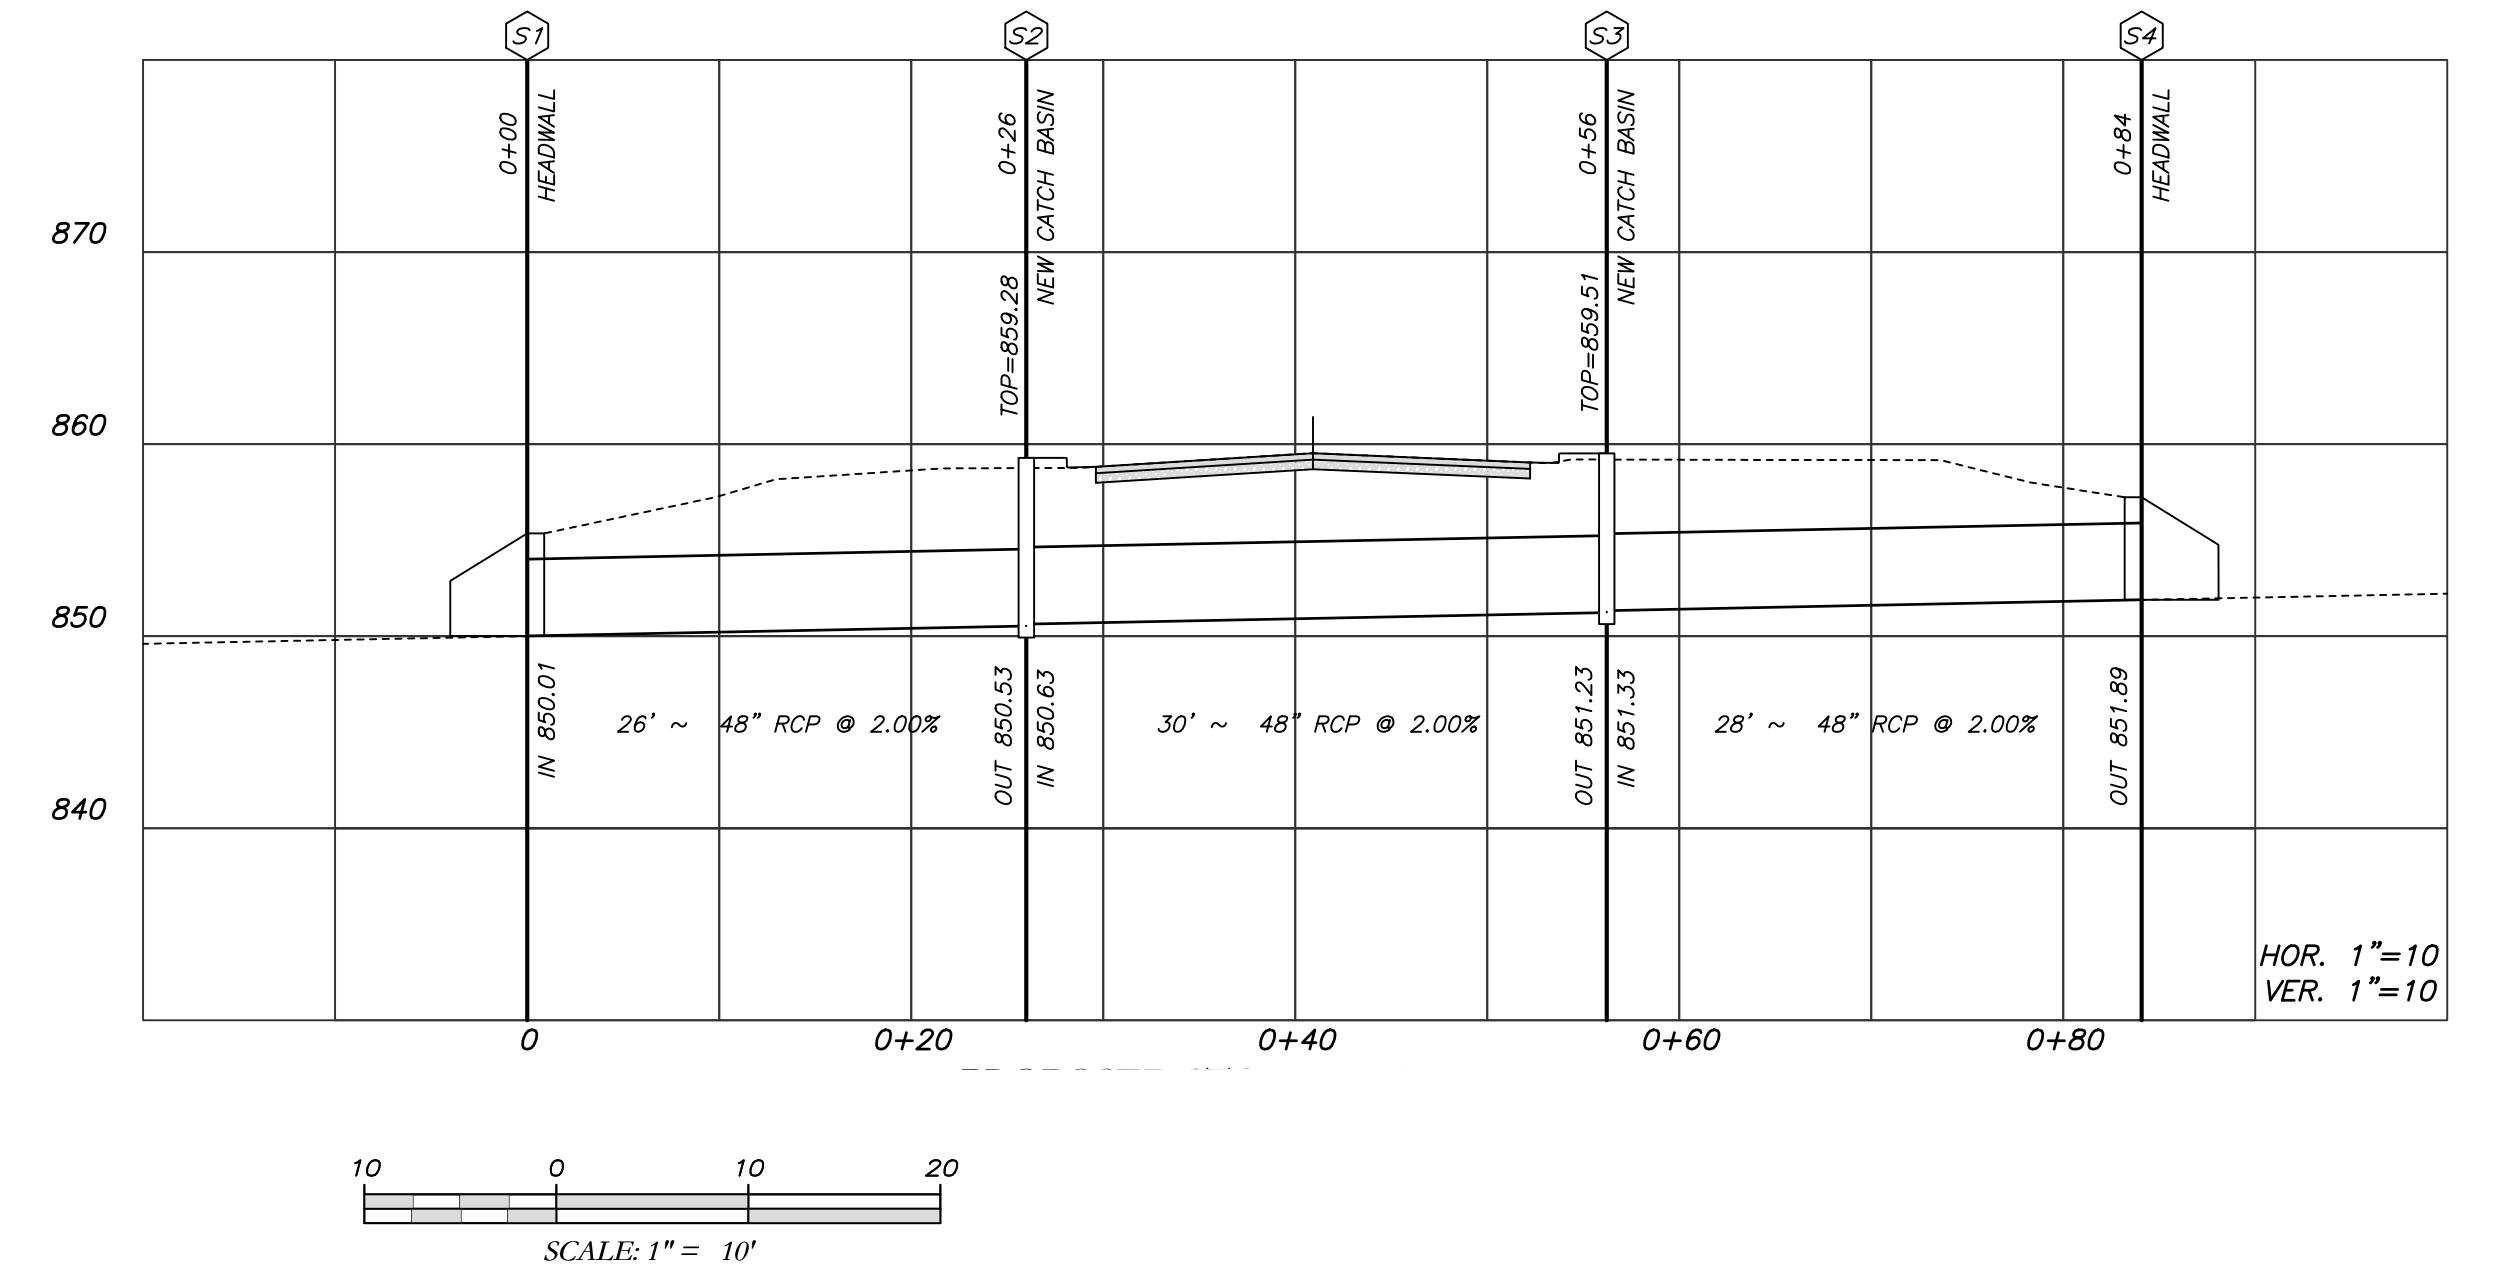
| LEGEND | |
|--------|---------------------------|
| POB | POINT OF BEGINNING |
| POC | POINT OF COMMENCEMENT |
| RBS | REBAR SET |
| RBF | REBAR FOUND |
| MNF | MAG NAIL FOUND |
| MNS | MAG NAIL SET |
| CTF | CRIMP TOP PIPE FOUND |
| OTF | OPEN TOP PIPE FOUND |
| CMF | CONCRETE MONUMENT FOUND |
| DI | DROP INLET |
| CI | CATCH INLET |
| YI | YARD INLET |
| OCS | OUTLET CONTROL STRUCTURE |
| JB | JUNCTION BOX |
| SWCB | SINGLE WING CATCH BASIN |
| DWCB | DOUBLE WING CATCH BASIN |
| HW | HEADWALL |
| FES | FLARED END SECTION |
| CMP | CORRUGATED METAL PIPE |
| RCP | REINFORCED CONCRETE PIPE |
| SS | SANITARY SEWER |
| F.M.E. | FORCE MAIN EASEMENT |
| S.S.E. | SANITARY SEWER EASEMENT |
| D.E. | DRAINAGE EASEMENT |
| W.E. | WATER EASEMENT |
| Φ | FIRE HYDRANT |
| WV | WATER VALVE |
| WM | WATER METER |
| GM | GAS METER |
| PM | POWER METER |
| EB | ELECTRICAL BOX |
| PP | POWER POLE |
| OU | OVERHEAD UTILITIES |
| GW | GUY WIRE |
| R.D. | ROOF DRAIN |
| DI | DROP INLET |
| JB | JUNCTION BOX |
| SWB | SINGLE WING CATCH BASIN |
| DWB | DOUBLE WING CATCH BASIN |
| H.W. | HEAD WALL |
| LES | FLARED END SECTION |
| UGGL | UNDERGROUND GAS LINE |
| UGWL | UNDERGROUND WATER LINE |
| UEEL | UNDERGROUND ELECTRIC LINE |
| UTCL | UNDERGROUND TELECOM |
| SSL | SANITARY SEWER LINE |
| SMH | SANITARY SEWER MANHOLE |
| CO | CLEAN OUT |
| G.T. | GREASE TRAP |
| F | FENCE |
| B | BOLLARD |
| SE | SPOT ELEVATION |

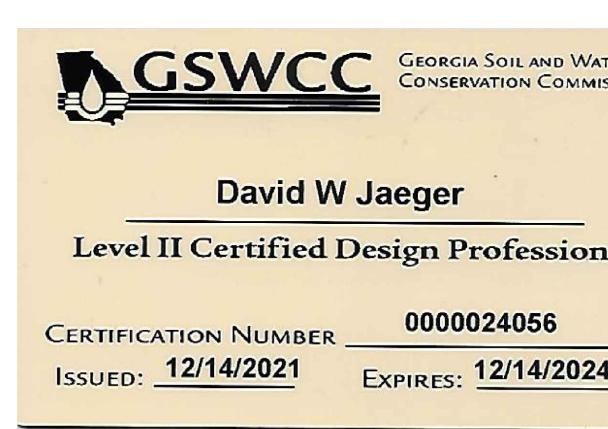

I CERTIFY AS THE PLAN DESIGNER THAT I HAVE VISITED THE SITE PRIOR TO THE DESIGN OF THE ES&PC PLANS

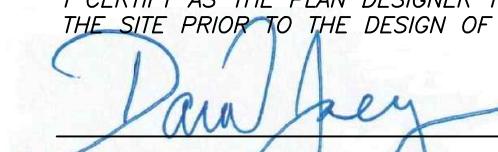
Dan J. Key

- ES:

CONTRACTOR WILL BE RESPONSIBLE FOR LOCATING AND PROTECTING EXISTING UTILITIES.

EXISTING PAVEMENT SHALL BE SAW CUT AT LIMITS OF DEMOLITION ACTIVITIES. LOCATION OF SAW CUTS SHALL BE APPROVED IN ADVANCE BY THE OWN ENGINEER.

CONTRACTOR TO STOCKPILE EXISTING RIP-RAP AND REUSE WHEN PRACTICAL.


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TEMPORARY TRAFFIC CONTROL STRIPING, SGAGE AND DEVICES ARE REQUIRED DURING ANSITION FROM EXISTING CONDITION TO OMPLETION OF PROJECT. PROVIDE CERTIFIED AFFIC CONTROL FLAGMEN DURING TEMPORARY NE CLOSURES. BOTH LANES SHALL BE OPEN HEN FLAGMEN ARE NOT PRESENT AND SHALL HAVE AN ALL WEATHER DRIVING SURFACE.


PAVEMENT WITHIN SAW CUT LINES TO BE EMMOVED AND REPLACED.

SHEET NO. 36 OF 43

*EROSION CONTROL PLAN FOR
CROSS DRAIN AT
160, 165, & 170 STRANDHILL ROAD
TYRONE, GEORGIA 30290*

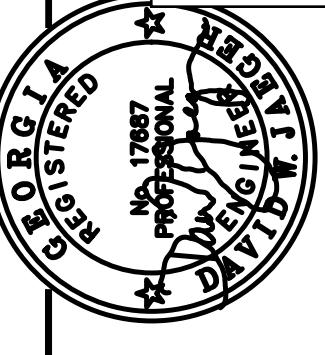

X, Item

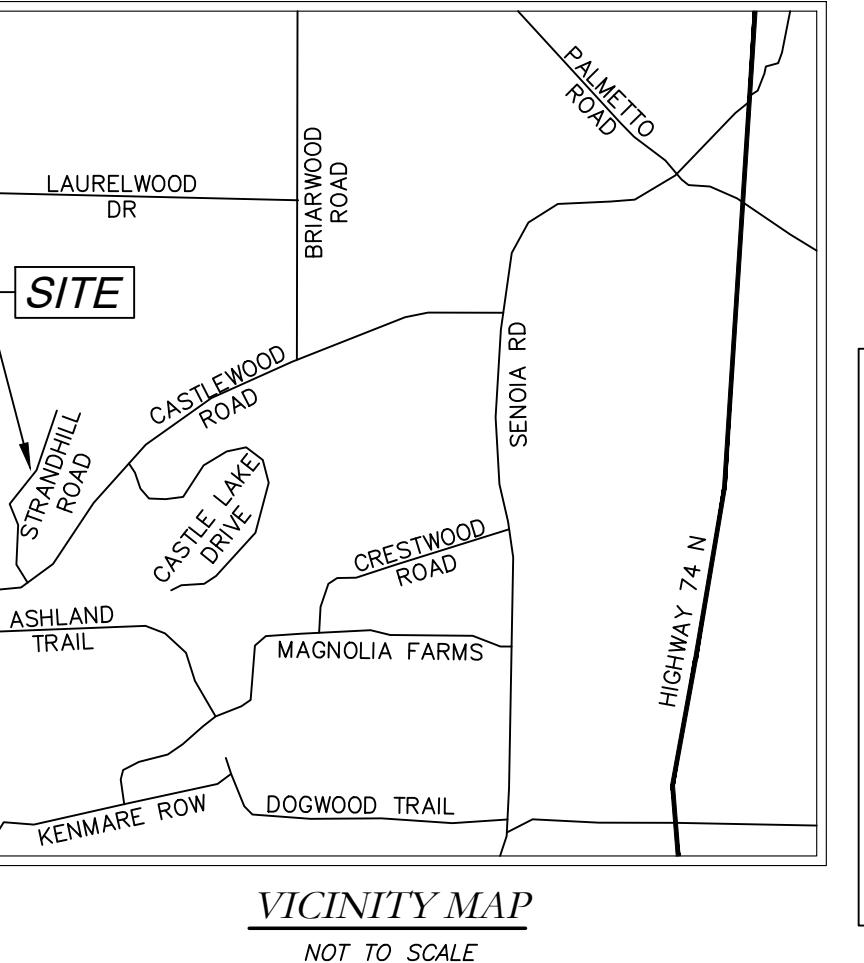

CINITY MAP
NOT TO SCALE

THE ESCAPE OF SEDIMENT FROM THE SITE SHALL BE PREVENTED BY THE INSTALLATION OF EROSION AND SEDIMENT CONTROL MEASURES AND PRACTICES PRIOR TO LAND DISTURBING ACTIVITIES.

EROSION CONTROL MEASURES SHALL BE MAINTAINED AT ALL TIMES. FULL IMPLEMENTATION OF THE APPROVED PLAN DOES NOT PROVIDE FOR EFFECTIVE EROSION CONTROL, ADDITIONAL EROSION AND SEDIMENT CONTROL MEASURES SHALL BE IMPLEMENTED TO CONTROL TREAT THE SEDIMENT SOURCE.

Y DISTURBED AREA LEFT EXPOSED FOR A PERIOD GREATER THAN 14 DAYS SHALL BE STABILIZED WITH MULCH OR TEMPORARY SEEDING

CONTRACTOR TO STOCKPILE EXISTING RIP-RAP AND REUSE WHEN PRACTICAL.

MOVE Sd1 WHEN GRASS HAS BEEN ESTABLISHED TO AT LEAST 85% COVERAGE

CONSTRUCTION EXIT TO BE MAINTAINED WITHIN SAW CUT LINES.

TOTAL DISTURBED ACRES = 0.11

24 Hour Erosion Control Contact:


NAME: Scott Langford
ADDRESS: 950 Senoia Road
Tyrone, GA 30290
PHONE: (770)-487-4038



**Know what's below.
Call before you dig.**

LEGEND

| LEGEND | |
|--------|------------------------------|
| POB | POINT OF BEGINNING |
| POC | POINT OF COMMENCEMENT |
| RBS | REBAR SET |
| RBF | REBAR FOUND |
| MNF | MAG NAIL FOUND |
| MNS | MAG NAIL SET |
| CTF | CRIMP TOP PIPE FOUND |
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| D.E. | DRAINAGE EASEMENT |
| W.E. | WATER EASEMENT |
| | Φ FIRE HYDRANT |
| | ↙ WATER VALVE |
| | WM WATER METER |
| | GM GAS METER |
| | PM POWER METER |
| | EB ELECTRICAL BOX |
| | PO POWER POLE |
| | ↔ OVERHEAD UTILITIES |
| | ↖ GUY WIRE |
| | RD ROOF DRAIN |
| | III DROP INLET |
| | JB JUNCTION BOX |
| | ↑↑ SINGLE WING CATCH BASIN |
| | ↑↑ DOUBLE WING CATCH BASIN |
| | ↑ HEAD WALL |
| | ↑ FLARED END SECTION |
| | —G UNDERGROUND GAS LINE |
| | —W UNDERGROUND WATER LINE |
| | —E UNDERGROUND ELECTRIC LINE |
| | —T UNDERGROUND TELECOM |
| | →—SS SANITARY SEWER LINE |
| | (S) SANITARY SEWER MANHOLE |
| | ○ C.O. CLEAN OUT |
| | ○ G.T. GREASE TRAP |
| | —X— FENCE |
| | ● BOLLARD |
| | + 99.9 SPOT ELEVATION |

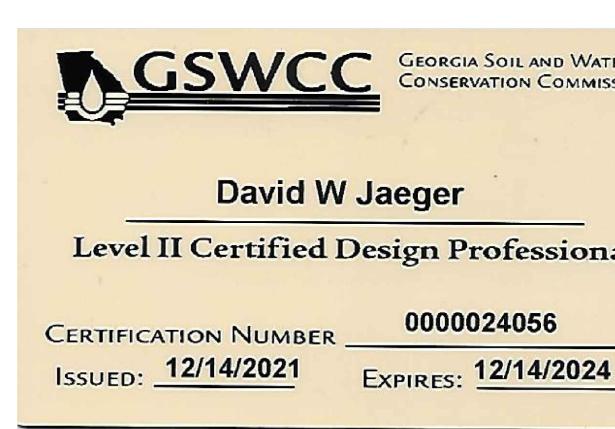

I CERTIFY AS THE PLAN DESIGNER THAT I HAVE VISITED
THE SITE PRIOR TO THE DESIGN OF THE ES&PC PLANS

Dana Jaey

SCALE: $1'' = 10'$



now what's below.
Call before you dig.

THE LOCATIONS OF EXISTING UNDERGROUND UTILITIES ARE SHOWN IN AN APPROXIMATE WAY ONLY AND HAVE NOT BEEN INDEPENDENTLY VERIFIED BY THE OWNER OR ITS REPRESENTATIVE. THE CONTRACTOR SHALL DETERMINE THE EXACT LOCATION OF ALL EXISTING UTILITIES BEFORE COMMENCING WORK, AND AGREES TO BE FULLY RESPONSIBLE FOR ANY AND ALL DAMAGES WHICH MIGHT BE OCCASIONED BY THE CONTRACTOR'S FAILURE TO EXACTLY LOCATE AND PRESERVE ANY AND ALL UNDERGROUND UTILITIES.

NOTICE:
CONSTRUCTION SITE SAFETY IS THE
SOLE RESPONSIBILITY OF THE
CONTRACTOR. NEITHER THE OWNER
NOR THE ENGINEER SHALL BE
EXPECTED TO ASSUME ANY
RESPONSIBILITY FOR SAFETY OF
THE WORK, OF PERSONS ENGAGED
IN THE WORK, OF ANY NEARBY
STRUCTURES, OR OF ANY OTHER
PERSONS.

©2023 ATWELL LLC NO
REPRODUCTION SHALL BE MADE
WITHOUT THE PRIOR WRITTEN
CONSENT OF ATWELL LLC

100.com


ATWEL
350.4200 www.atwell-group.com
1800 PARKWAY PLACE, SUITE 700
MARIETTA, GA
770.423.0807

866

LOCATED IN
TOWN OF TYRONE
FULTON COUNTY, GEORGIA

*LIMITED SURVEY OF
STORM DRAIN REPLACEMENT
'05 TAYLOR RIDGE COURT
TYRONE, GEORGIA 30290*

RESERVED FOR CLERK OF COURT

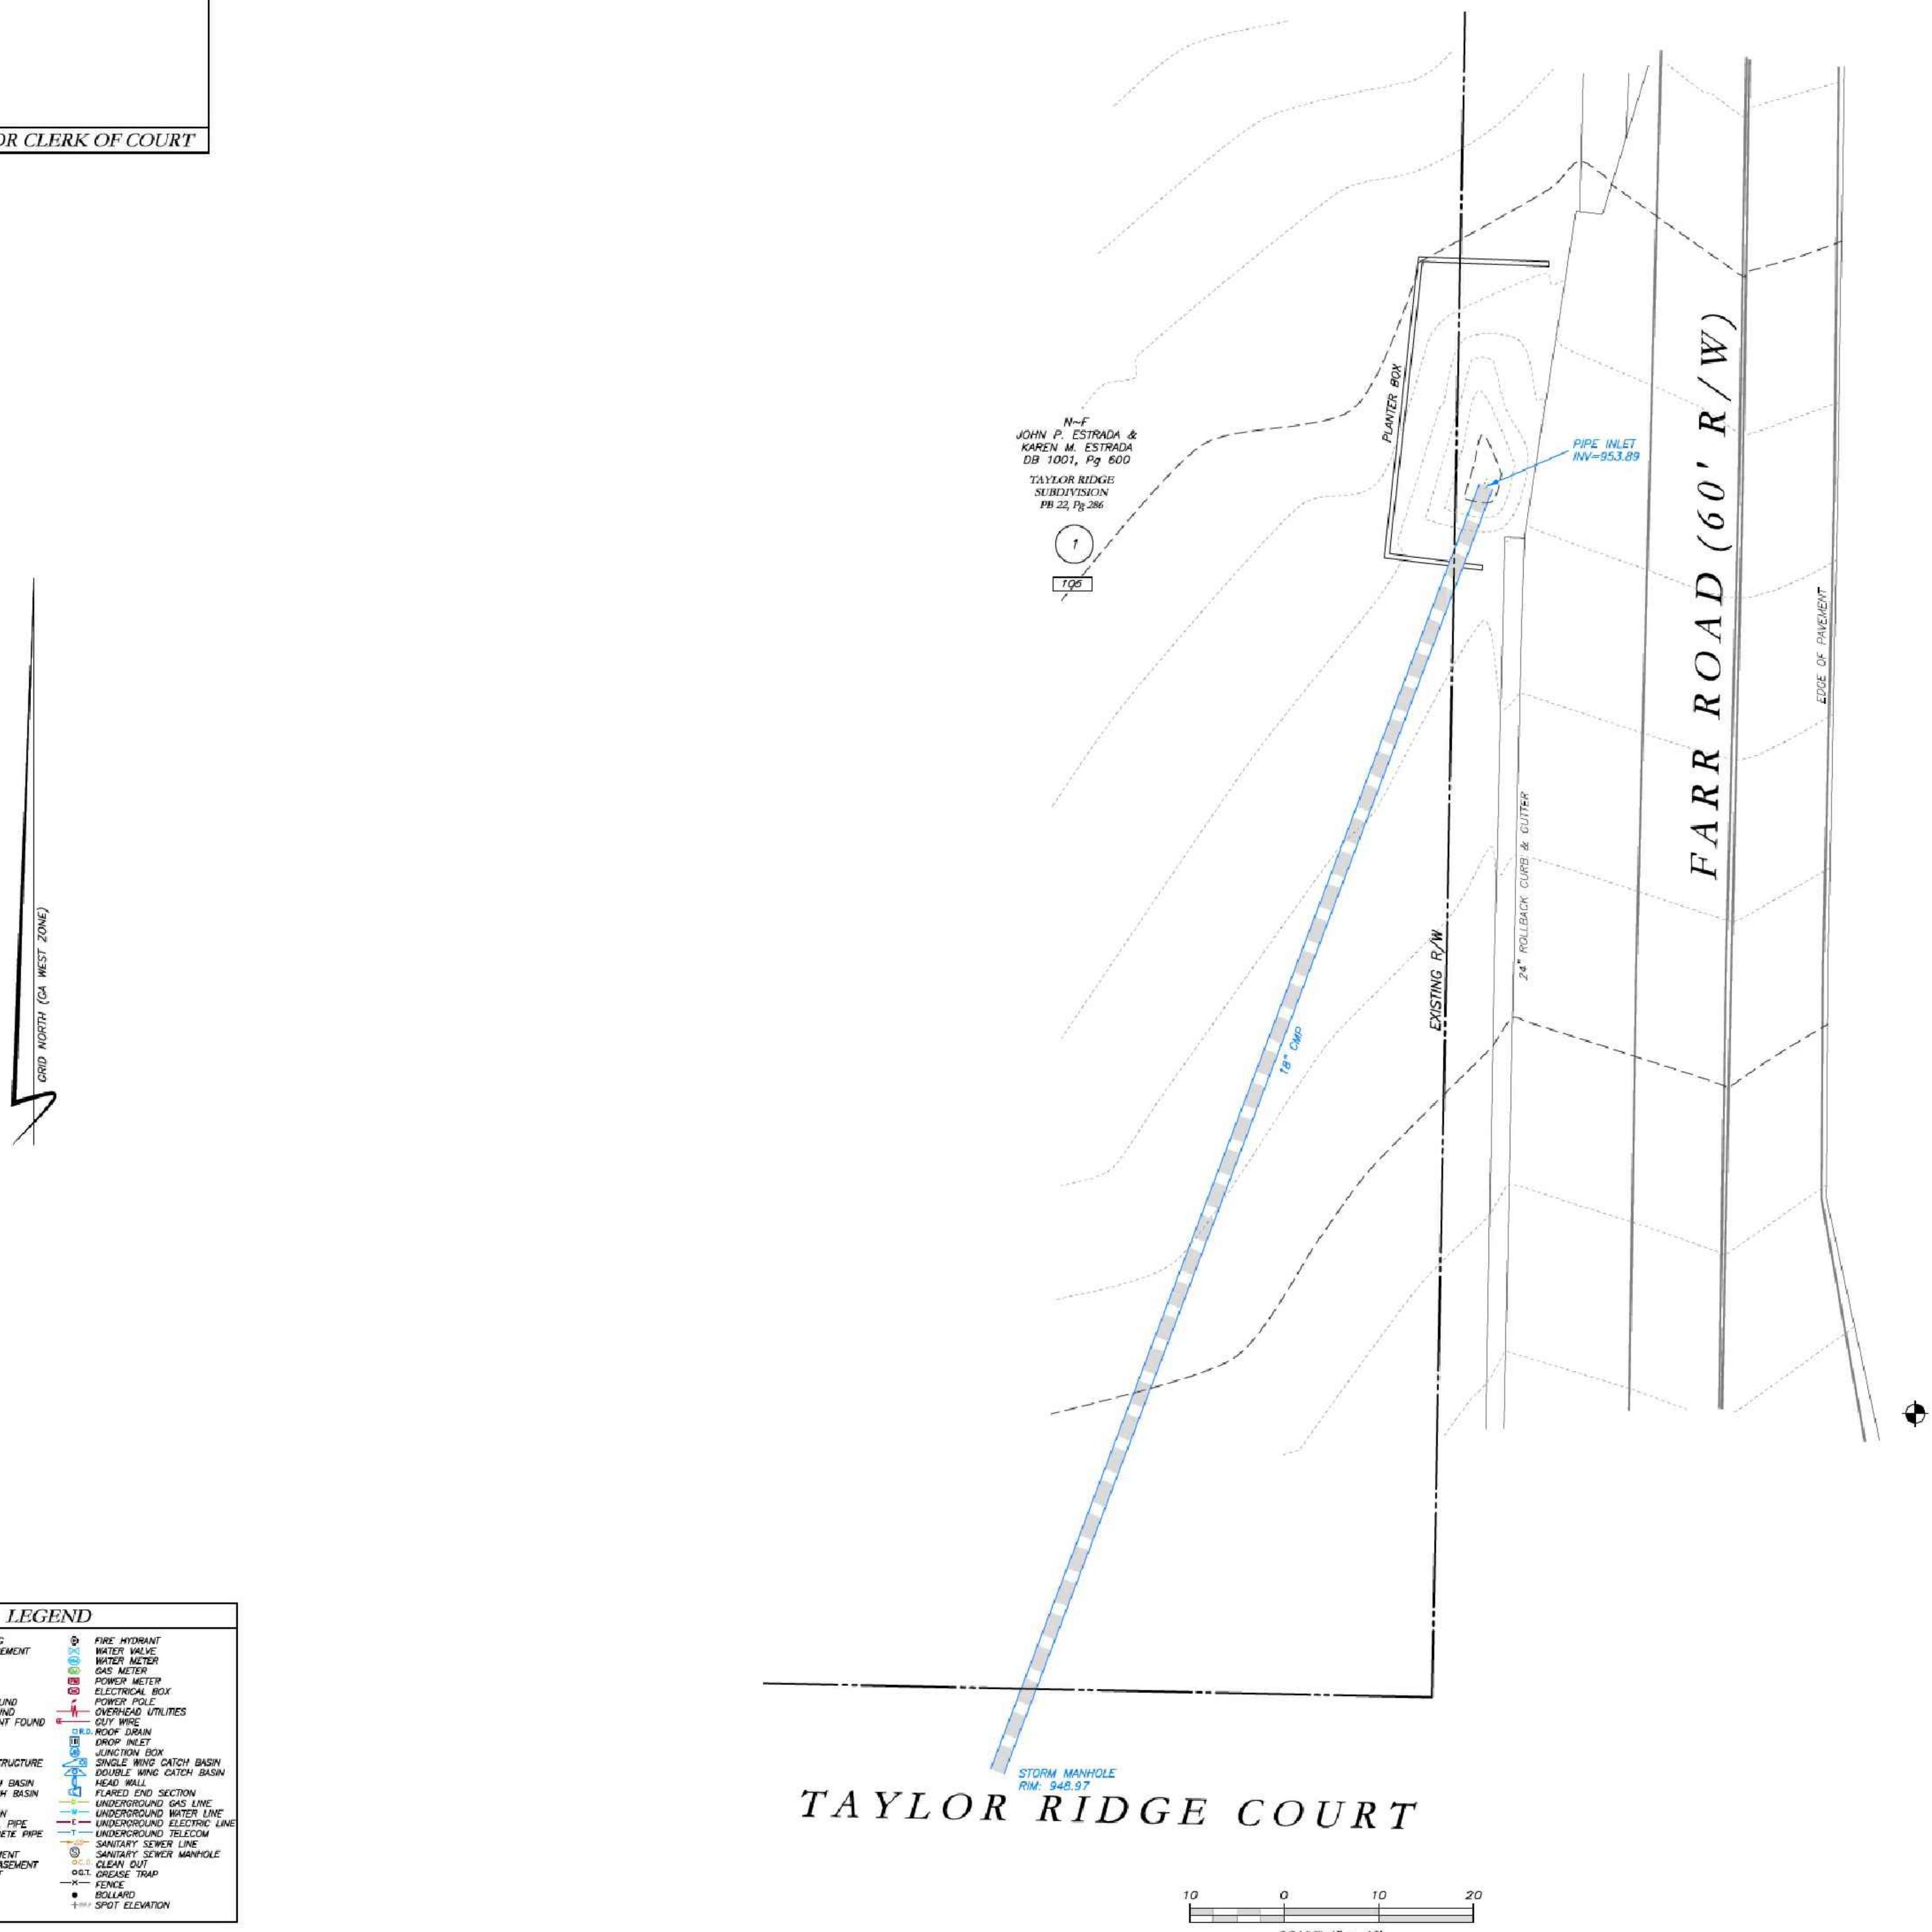



SURVEYOR'S CERTIFICATION

THIS PLAT IS A RETRACEMENT OF AN EXISTING PARCEL OR PARCELS OF LAND AND DOES NOT SUBDIVIDE OR CREATE A NEW PARCEL OR MAKE ANY CHANGES TO ANY REAL PROPERTY BOUNDARIES. THE RECORDING INFORMATION OF THE DOCUMENTS, MAPS, PLATS, OR OTHER INSTRUMENTS WHICH CREATED THAT PARCEL OR PARCELS ARE STATED HERE ON. RECORDATION OF THIS PLAT DOES NOT IMPLY APPROVAL OF ANY LOCAL JURISDICTION, AVAILABILITY OF PERMITS, COMPLIANCE WITH LOCAL REGULATIONS OR REQUIREMENTS, OR SUITABILITY FOR ANY USE OR PURPOSE OF THE LAND. FURTHERMORE, THE UNDERSIGNED LAND SURVEYOR CERTIFIES THAT THIS PLAT COMPLIES WITH THE MINIMUM TECHNICAL STANDARDS FOR PROPERTY SURVEYS IN GEORGIA AS SET FORTH IN THE RULES AND REGULATIONS OF THE GEORGIA OF THE BOARD OF REGISTRATION FOR PROFESSIONAL ENGINEERS AND LAND SURVEYORS AS SET FORTH IN 90-6-1, SECTION

A circular metal stamp used for registering land surveyors in Georgia. The outer ring contains the word "GEORGIA" at the top and "BAKER" at the bottom. The inner circle features the words "REGISTERED" at the top and "LAND SURVEYOR" at the bottom. In the center is a small map of Georgia with the number "2674" overlaid on it.


JOSEPH T. BAKER, LS

PROPOSED REPLACEMENT OF
CROSS DRAIN AT
TAYLOR RIDGE RD
TYRONE, GEORGIA 30290

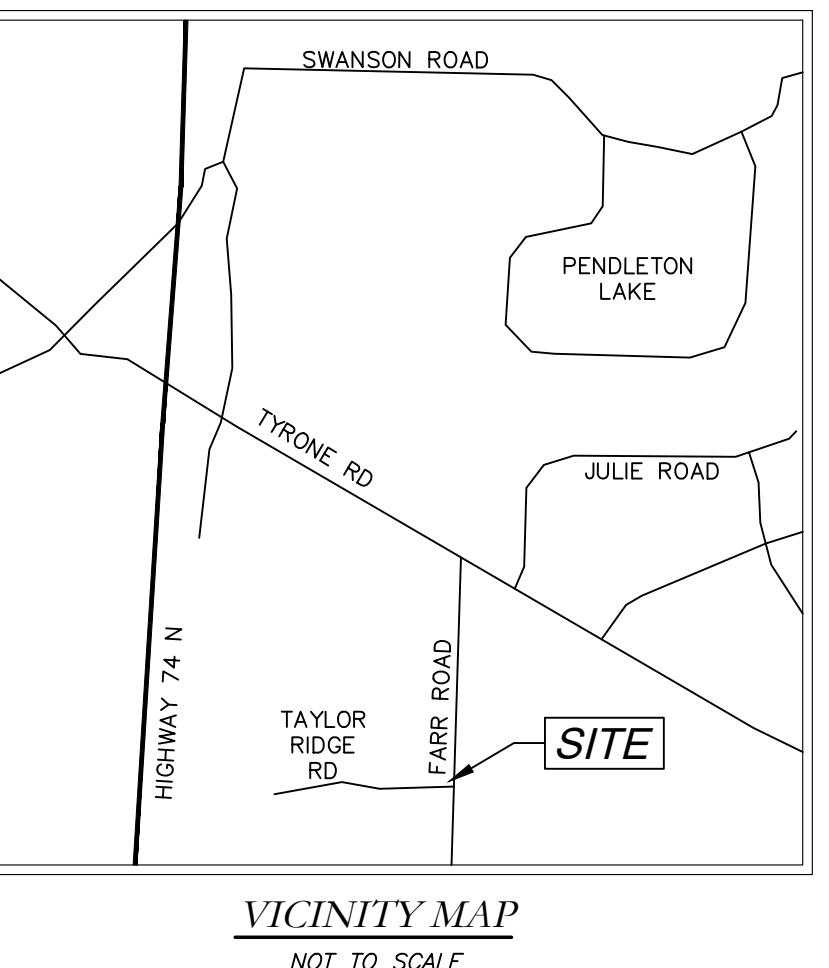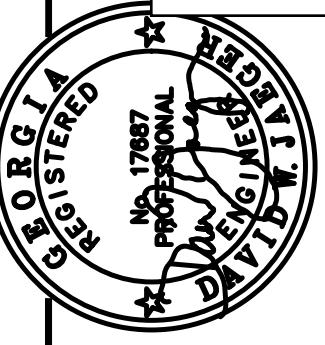

VICINITY MAP
NOT TO SCALE




| PROJECT NUMBER PW-20 | DESIGN | SCALE |
|----------------------|--------|-------|
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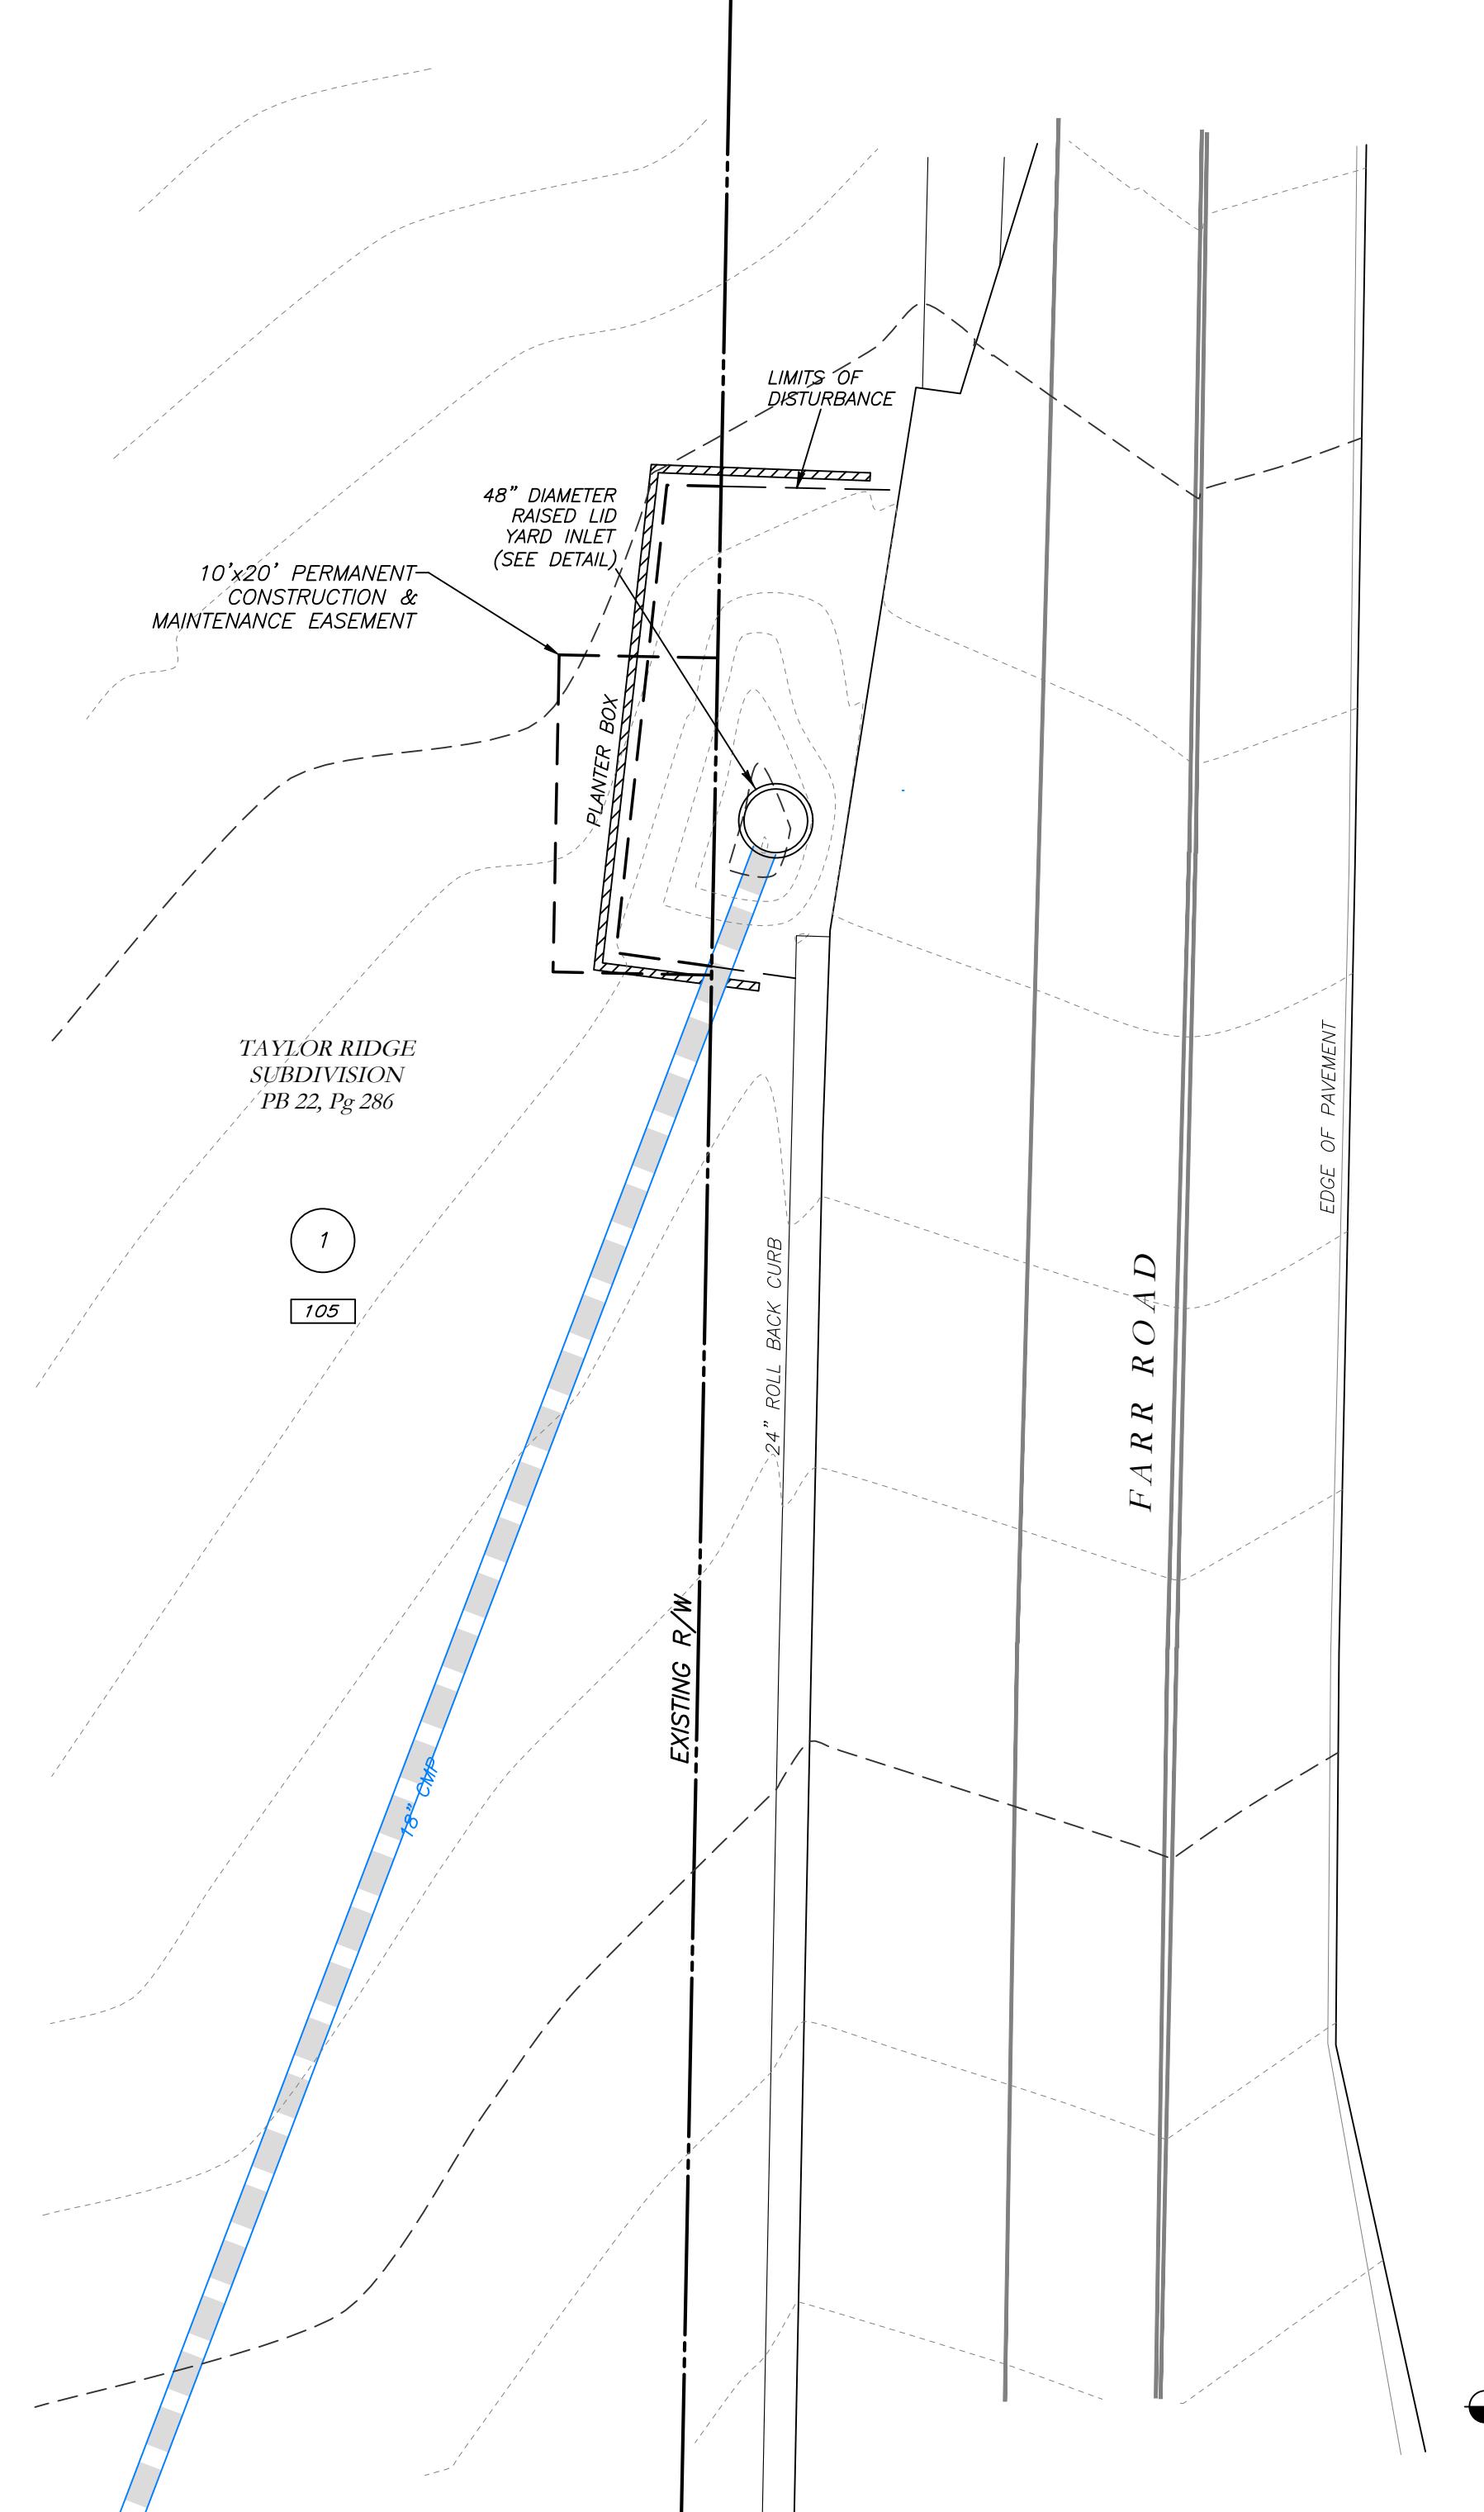
APPROVED DWJ SHEET NO. 1

| REV. NO. | DATE | DESCRIPTION | BY AP/PD |
|----------|------|-------------|----------|
| | | | |

DWJ SHEET NO. 1

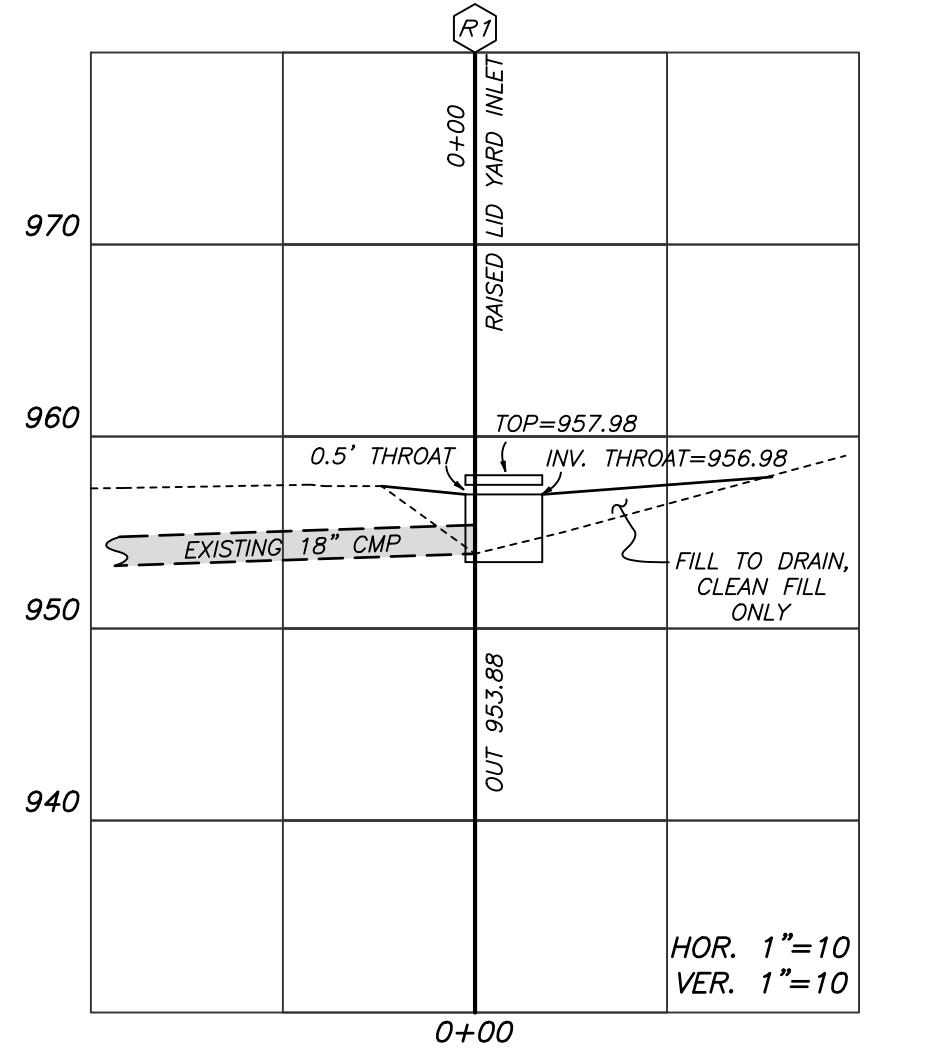

PROPOSED STORM DRAIN PROFILE



NOTES:

- CONTRACTOR WILL BE RESPONSIBLE FOR LOCATING AND PROTECTING EXISTING UTILITIES.
- EXISTING PAVEMENT SHALL BE SAW CUT AT LIMITS OF DEMOLITION ACTIVITIES. LOCATION OF SAW CUTS SHALL BE APPROVED IN ADVANCE BY THE TOWN ENGINEER.
- CONTRACTOR TO STOCKPILE EXISTING RIP-RAP AND REUSE WHEN PRACTICAL.
- ALL DEMOLITION MATERIALS, WASTE SOILS AND SEDIMENT SHALL BE HAULED AWAY AND DISPOSED OF OFFSITE AT A SUITABLE LOCATION, SELECTED BY THE CONTRACTOR. THIS SHALL BE DONE AT NO ADDITIONAL CHARGE.
- TEMPORARY TRAFFIC CONTROL STRIPING, SIGNAGE AND DEVICES ARE REQUIRED DURING TRANSITION FROM EXISTING CONDITION TO COMPLETION OF PROJECT. PROVIDE CERTIFIED TRAFFIC CONTROL FLAGMEN DURING TEMPORARY LANE CLOSURES. BOTH LANES SHALL BE OPEN WHEN FLAGMEN ARE NOT PRESENT AND SHALL HAVE AN ALL WEATHER DRIVING SURFACE.
- PAVEMENT WITHIN SAW CUT LINES TO BE REMOVED AND REPLACED.




Know what's below.
Call before you dig.

| LEGEND | |
|--------|--------------------------|
| POB | POINT OF BEGINNING |
| POC | POINT OF COMMENCEMENT |
| RBS | REBAR FOUND |
| RBF | REBAR FOUND |
| MNF | MAG NAIL FOUND |
| MNS | MAG NAIL FOUND |
| CTP | CRIMP TOP PIPE FOUND |
| OTP | OPEN TOP PIPE FOUND |
| DPF | DEFORMED PIPE FOUND |
| DI | DROP INLET |
| CI | CATCH INLET |
| YI | YARD INLET |
| OCS | OUTLET CONTROL STRUCTURE |
| JB | JUNCTION BOX |
| DWCB | DOUBLE WING CATCH BASIN |
| DWCB | DOUBLE WING CATCH BASIN |
| HW | HEADWALL |
| TE | TEMPORARY END SECTION |
| CMP | CORRUGATED METAL PIPE |
| RCP | REINFORCED CONCRETE PIPE |
| SS | SANITARY SEWER |
| F.M.E. | FORCE MAIN EASEMENT |
| D.E. | DRIVEWAY EASEMENT |
| D.W.E. | DRAINED WATER EASEMENT |
| W.E. | WATER EASEMENT |
| G.T. | GREASE TRAP |
| FENCE | FENCE |
| BOL | BOLLARD |
| S.P. | SPOT ELEVATION |


| | |
|----------------------------------------------------------------------------------------------------|---------------------------------------------------|
| GSWCC | Georgia Soil and Water Conservation Commission |
| David W Jaeger | Level II Certified Design Professional |
| I CERTIFY AS THE PLAN DESIGNER THAT I HAVE VISITED THE SITE PRIOR TO THE DESIGN OF THE ES&PC PLANS | |
| <i>Signature of David W Jaeger</i> | |
| CERTIFICATION NUMBER | 0000024056 |
| ISSUED: | 12/14/2021 |
| EXPIRES: | 12/14/2024 |

10 0 10 20
SCALE: 1" = 10'

Mallett Consulting, Inc.
101 Devant St., Suite 804, Fayetteville, Georgia 30214
PHONE: 770-719-3333
FAX: 770-719-3377

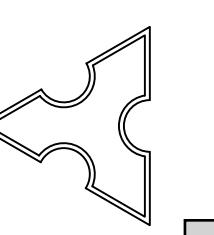

**EROSION CONTROL PLAN FOR
STORM DRAIN AT
TAYLOR RIDGE ROAD
TYRONE, GEORGIA 30290**

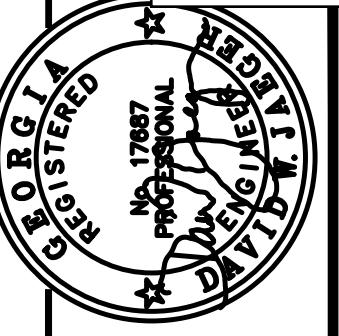

VICINITY MAP
NOT TO SCALE

| PROJECT NUMBER PW-20 | | DESIGN MCI | DRAWN ALG | DATE 01/16/23 | FILE NO. DWJ | SHEET NO. DWJ |
|----------------------|-------------|------------|-----------|---------------|--------------|---------------|
| REV. NO. | DESCRIPTION | | | | | |
| | | | | | | |


**Cross Drain Replacement
for Town of Tyrone, Georgia**

101 DEVANT ST., SUITE 804 FAYETTEVILLE, GEORGIA 30214
PHONE: 770-719-3333 FAX: 770-719-3377




**Know what's below.
Call before you dig.**

| LEGEND | |
|--------|--------------------------|
| POB | POINT OF BEGINNING |
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| RBS | REBAR FOUND |
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| SS | SANITARY SEWER |
| F.M.E. | FORCE MAIN EASEMENT |
| D.E. | DRAINAGE EASEMENT |
| W.E. | WATER EASEMENT |

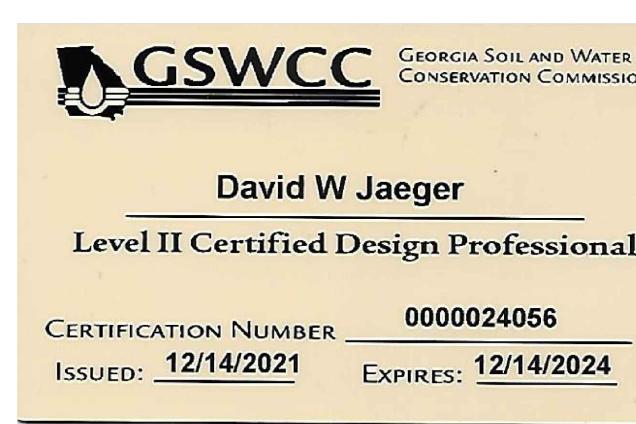

I CERTIFY AS THE PLAN DESIGNER THAT I HAVE VISITED
THE SITE PRIOR TO THE DESIGN OF THE ES&PC PLANS
David W Jaeger

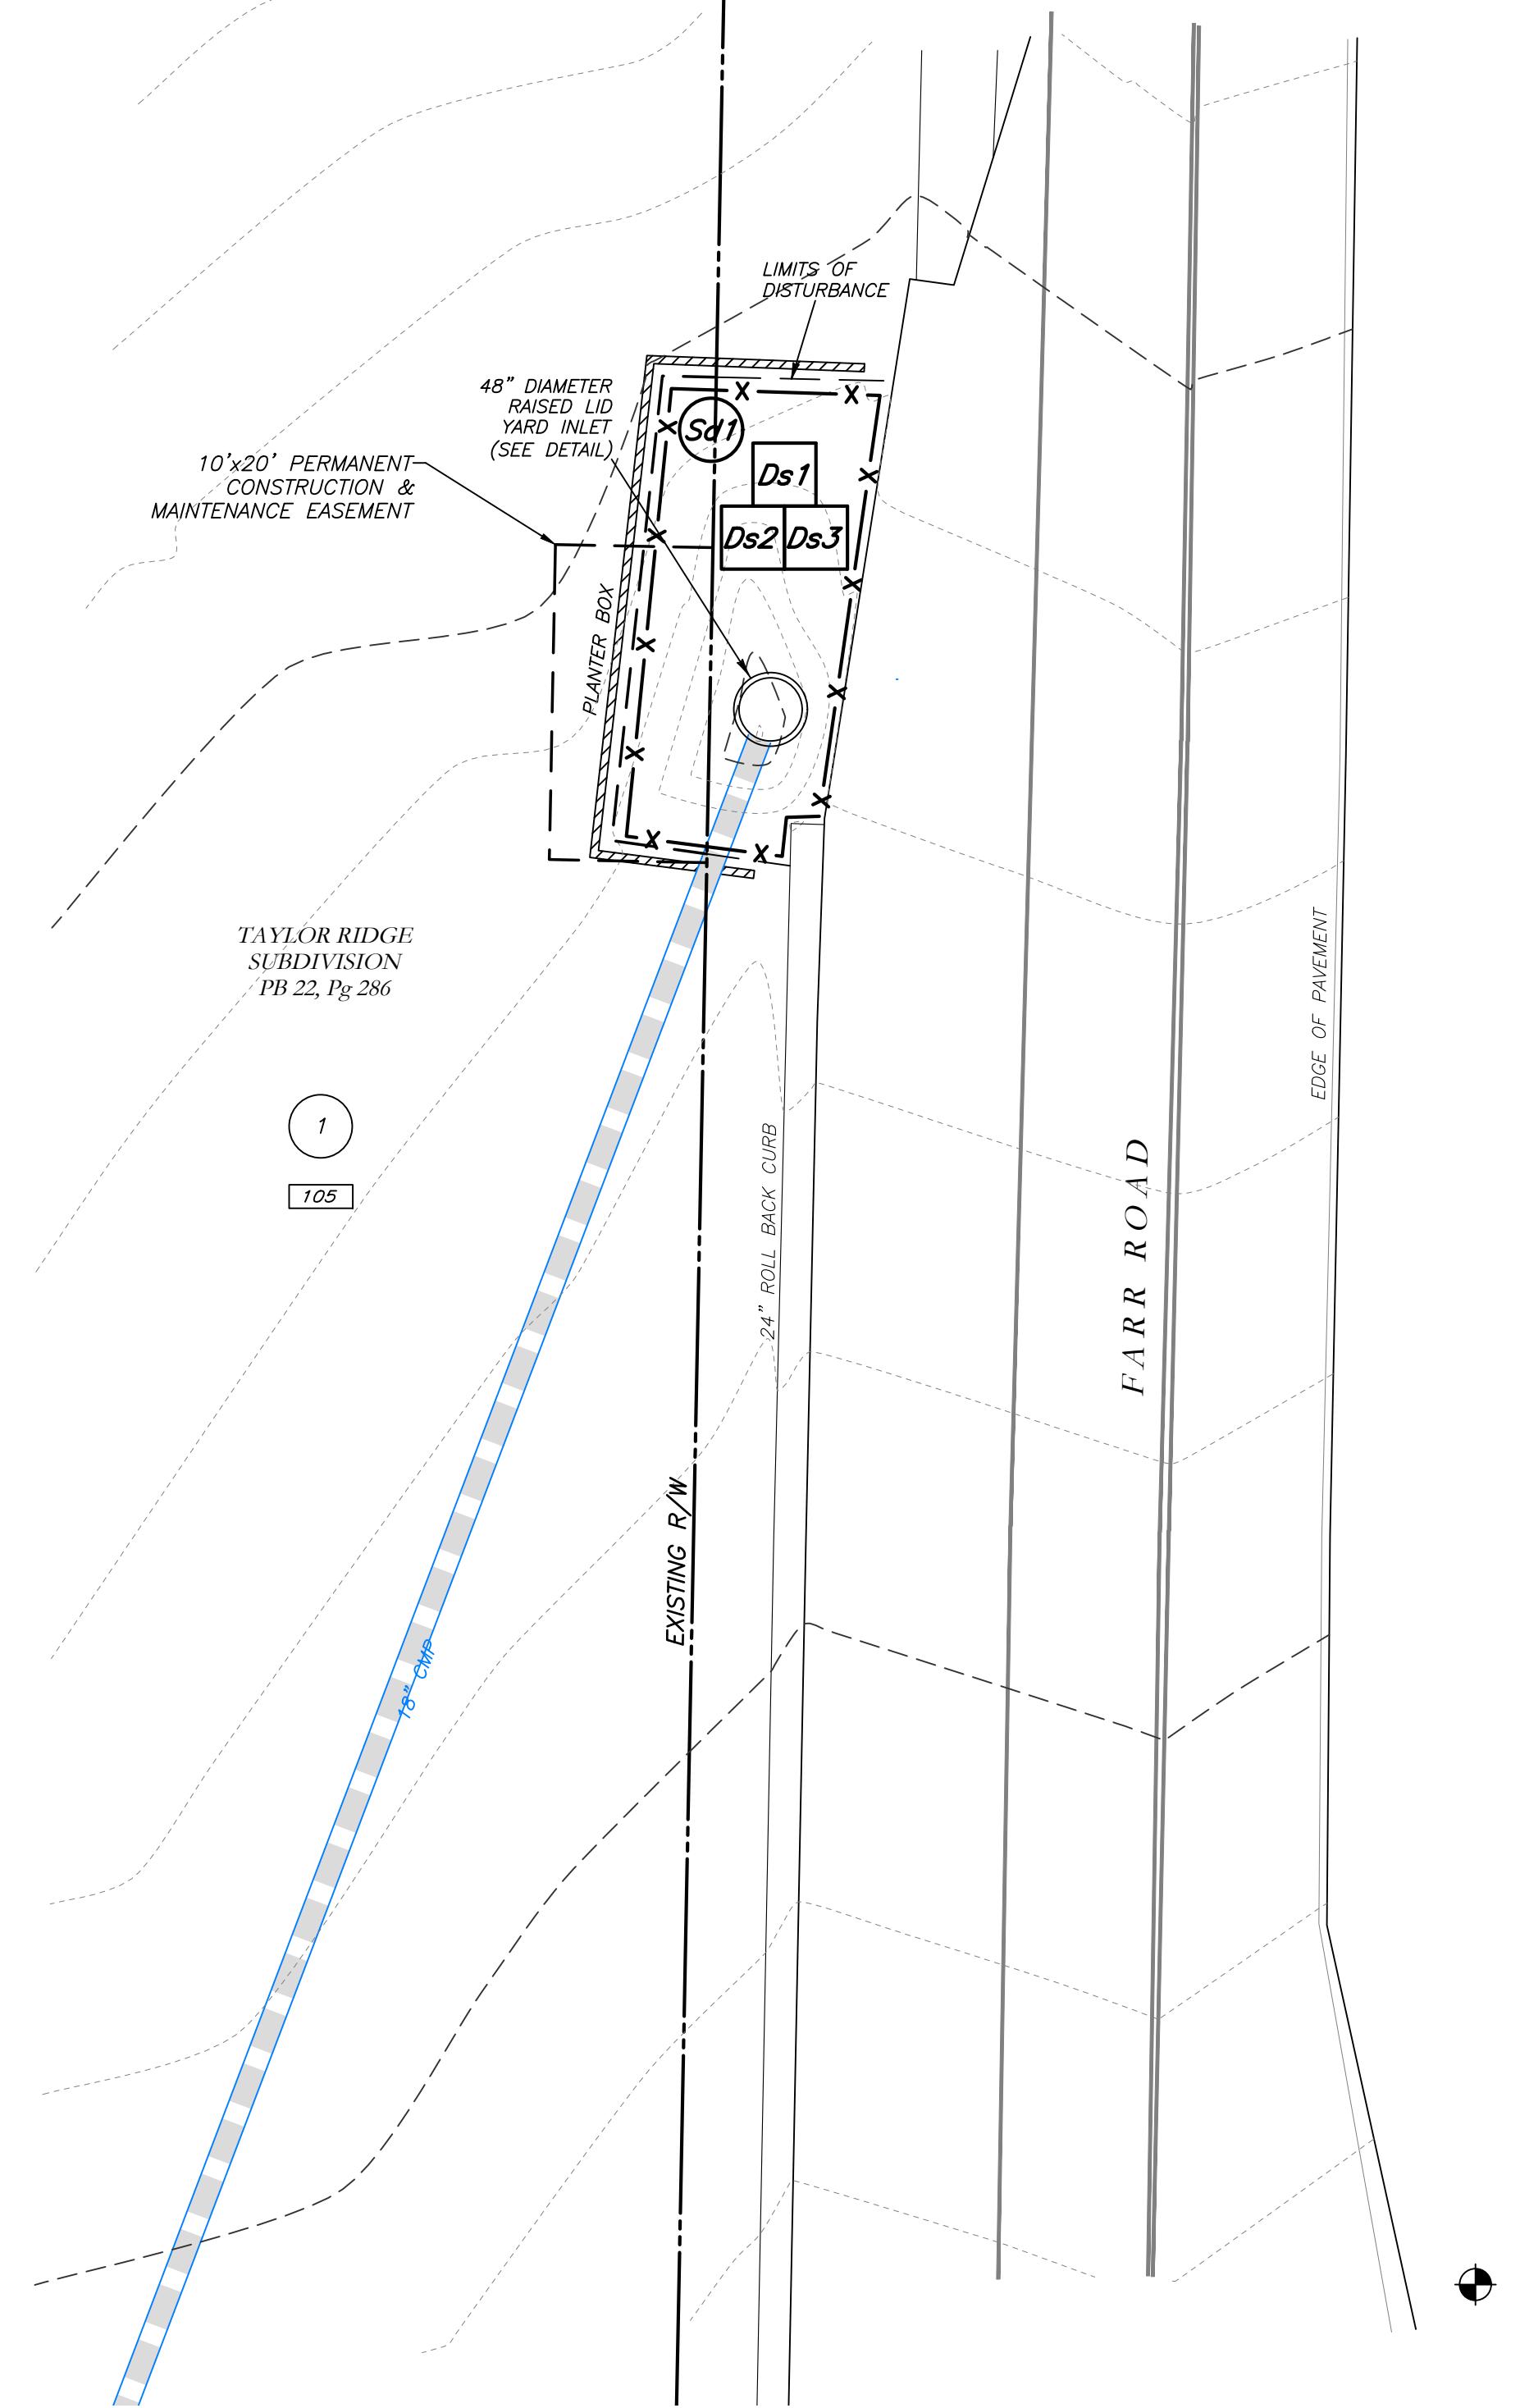

10 0 10 20
SCALE: 1" = 10'
S.99.P SPOT ELEVATION

THE ESCAPE OF SEDIMENT FROM THE SITE SHALL BE PREVENTED BY THE INSTALLATION OF EROSION AND SEDIMENT CONTROL MEASURES AND PRACTICES PRIOR TO LAND DISTURBING ACTIVITIES.

EROSION CONTROL MEASURES SHALL BE MAINTAINED AT ALL TIMES. IF FULL IMPLEMENTATION OF THE APPROVED PLAN DOES NOT PROVIDE FOR EFFECTIVE EROSION CONTROL, ADDITIONAL EROSION AND SEDIMENT CONTROL MEASURES SHALL BE IMPLEMENTED TO CONTROL OR TREAT THE SEDIMENT SOURCE.

ANY DISTURBED AREA LEFT EXPOSED FOR A PERIOD GREATER THAN 14 DAYS SHALL BE STABILIZED WITH MULCH OR TEMPORARY SEEDING.

CONTRACTOR TO STOCKPILE EXISTING RIP-RAP AND REUSE WHEN PRACTICAL.


REMOVE DS1 WHEN GRASS HAS BEEN ESTABLISHED TO AT LEAST 85% COVERAGE.


(C) CONSTRUCTION EXIT TO BE MAINTAINED WITHIN SAW CUT LINES.

TOTAL DISTURBED ACRES = N/A

24 Hour Erosion Control Contact:

NAME: Scott Langford
ADDRESS: 950 Senoia Road
Tyrone, GA 30290
PHONE: (770)-487-4038

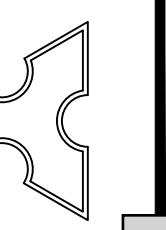

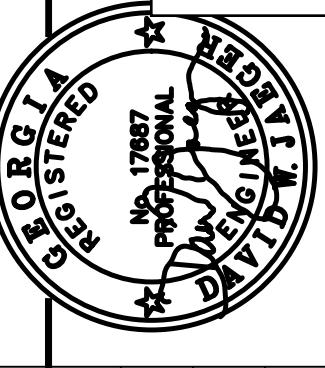

PROJECT NUMBER PW-20
SCALE
DESIGN MCI DATE 01/16/23
DRAWN ALG FILE NO. 21/01-16
SHEET NO. DWJ

Cross Drain Replacement for Town of Tyrone, Georgia

Erosion Control Details

Mallett Consulting, Inc.
101 DEVANT ST., SUITE 804 FAYETTEVILLE, GEORGIA 30214
PHONE: 770-719-3333 FAX: 770-719-3377

GEORGIA UNIFORM CODING SYSTEM

FOR SOIL EROSION AND SEDIMENT CONTROL PRACTICES GEORGIA SOIL AND WATER CONSERVATION COMMISSION

STRUCTURAL PRACTICES

| CODE | PRACTICE | DETAIL | MAP SYMBOL | DESCRIPTION |
|-------|----------------------------------|--------|------------|-----------------------------------------------------------------------------------------------------------------------------------------------------------------------------------------------------------|
| (Co) | CHECKDAM | | | A small temporary barrier or dam constructed across a stream or watercourse to control flow. |
| (Ch) | CHANNEL STABILIZATION | | | Improving, constructing or protecting channel banks. |
| (Co) | CONSTRUCTION EXIT | | | A crushed stone pad located at the construction site exit to provide a place for vehicles to turn around. |
| (Cr) | CONSTRUCTION ROAD STABILIZATION | | | A driveway constructed as part of a construction plan including access roads, rights-of-way, parking areas and one or more vehicle transportation routes. |
| (Dc) | STREAM CHANNEL | | | A temporary or permanent structure to convey water around a construction area while the permanent structure is being constructed. |
| (Di) | DIVERSION | | | An earth channel or dike located above, below or around a slope to divert runoff. This may be a temporary or permanent structure. |
| (Dm) | TEMPORARY DOWN-CHANNEL STRUCTURE | | | A flexible conduit of heavy-duty fabric or other material designed to safely conduct surface runoff down a slope. |
| (Dn) | PERMANENT DOWN-CHANNEL STRUCTURE | | | A paved chute, pipe, sectional conduit or similar material designed to safely conduct surface runoff down a slope. |
| (Fr) | FILTER RING | | | A temporary stone barrier constructed at storm drain inlets and outlet. |
| (Ga) | GABION | | | Rock fiber baskets which are hand-placed into position forming soil stabilizing structures. |
| (Gr) | GRADE STABILIZATION | | | Permanent structures installed to protect channels or waterways where otherwise the slope would be sufficient for the running water to erode the soil. |
| (Lv) | LEVEL SPREADER | | | A structure to convert concentrated flow of water into erosive sheet flow. This should be constructed only on undisturbed soils. |
| (Rd) | ROCK FILTER | | | A permanent or temporary stone filter dam installed across small streams or drainage areas. |
| (Re) | RETAINING WALL | | | A wall installed to stabilize cut and fill slopes where maximum permissible slopes are not attainable. Each situation will require special design. |
| (Rt) | RETRO FITTING | | | A device or structure placed in front of a permanent structure to serve as a temporary sediment filter. |
| (Sd) | SEDIMENT BARRIER | | | A barrier to prevent sediment from leaving the construction site. It may be sandbags, bales of straw, brush, logs and poles, gravel, or a silt fence. |
| (Sd) | SEDIMENT TRAP | | | An impounding device by excavating around the trap site. The resulting excavation will be filled and stabilized on completion of the project. |
| (Sd) | TEMPORARY SEDIMENT BASIN | | | A basin created by excavation or a dam across a stream or watercourse. The basin will temporarily store enough of the bulk of the sediment to drop out. |
| (Sd) | TEMPORARY SEDIMENT TRAP | | | A diversion device that directs a disturbed area so that sediment can settle out. The principle feature of a temporary sediment trap is that the temporary sediment basin is the back of a pipe or riser. |
| (Sk) | FLOATING FILTER OR SKIMMER | | | A floating device that releases/drains water from the surface of sediment ponds, traps, or berms at a controlled rate of flow. |
| (Sp) | SEEP BERM | | | Linear control device constructed as a diversion structure to reduce surface runoff infiltration and subsidence. |
| (Ss) | SLOPE STABILIZATION | | | A protective covering used to prevent erosion and maintain soil stability on steep slopes, shore lines, or embankments. |
| (Tac) | TACKIFERS AND BINDER | | | Substance used to anchor straw or hay mulch by causing the organic material to bind together. |



STRUCTURAL PRACTICES

| CODE | PRACTICE | DETAIL | MAP SYMBOL | DESCRIPTION |
|------|--------------------------------------------|--------|------------|-------------------------------------------------------------------------------------------------------------------------------------------------------------------------------------------------------------|
| (Sr) | TEMPORARY STREAM CROSSING | | | A temporary bridge or culvert-type structure protecting a stream or watercourse from damage by crossing construction equipment. |
| (St) | STORMSEWER OUTLET PROTECTION | | | A paved or short section of riprap channel at the outlet of a storm drain system preventing damage to the outlet or the channel. |
| (Su) | SURFACE ROUGHENING | | | A rough soil surface on a corner or slopes left in a roughened condition after grading. |
| (Tc) | TURBIDITY CURTAIN | | | A floating or staked barrier installed within the water (it may also be referred to as a floating boom, oil buster, or oil curtain). |
| (Tp) | TOPSOILING | | | A temporary or permanent soil stabilization technique involving stripping off the more fertile soils, storing them, and then applying them to the disturbed area after completion of construction activity. |
| (Tr) | TREE PROTECTION | | | To protect desirable trees from injury during construction activity. |
| (Wb) | MORTIFIED WATERSHED STORMWATER CONVERGENCE | | | Paved or vegetated outlets for diversion terraces, berms, dikes or similar structures. |



VEGETATIVE PRACTICES


| CODE | PRACTICE | DETAIL | MAP SYMBOL | DESCRIPTION |
|-------|------------------------------------------------------|--------|------------|----------------------------------------------------------------------------------------------------------------------------------------------------------------------------------|
| (Bf) | BUFFER ZONE | | | Strip of undisturbed original vegetation, enhanced or restored existing vegetation or the area immediately adjacent thereto extending an area of disturbance or bordering areas. |
| (Cs) | COASTAL DUNE STABILIZATION/VEGETATION | | | Planting vegetation on dunes that are denuded or destroyed. |
| (Ds1) | DISTURBED AREA STABILIZATION (ANTICIPATED ONLY) | | | Establishing temporary protection for disturbed areas where seedings may not have an opportunity to take hold to produce an erosion retarding cover. |
| (Ds2) | DISTURBED AREA STABILIZATION (WITH TEMP. PROTECTION) | | | Establishing a temporary vegetative cover such as grasses, legumes, or other growing seedlings on disturbed areas. |
| (Ds3) | DISTURBED AREA STABILIZATION (PERMANENT) | | | Establishing a permanent vegetative cover such as trees, shrubs, vines, grasses, or legumes on disturbed areas. |
| (Ds4) | DISTURBED AREA STABILIZATION (SOILSODS) | | | A permanent vegetative cover using sods on highly erodible or culturally eroded lands. |
| (Du) | DUST CONTROL ON CONSTRUCTION SITES | | | Controlling surface dust and movement of dust on construction site, roadways and similar sites. |
| (F-C) | FLUOGLANTS AND COAGULANTS | | | Substance formulated to assist in the solids/liquid separation of suspended particles. |
| (Sb) | STREAMBED STABILIZATION (WITH VEGETATION) | | | The use of readily available native plant materials to maintain and enhance streambanks, or to prevent, control or repair minor streambank erosion problems. |
| (Ss) | SLOPE STABILIZATION | | | A protective covering used to prevent erosion and maintain soil stability on steep slopes, shore lines, or embankments. |
| (Tac) | TACKIFERS AND BINDER | | | Substance used to anchor straw or hay mulch by causing the organic material to bind together. |

GoGWCC (Amended - 2013)

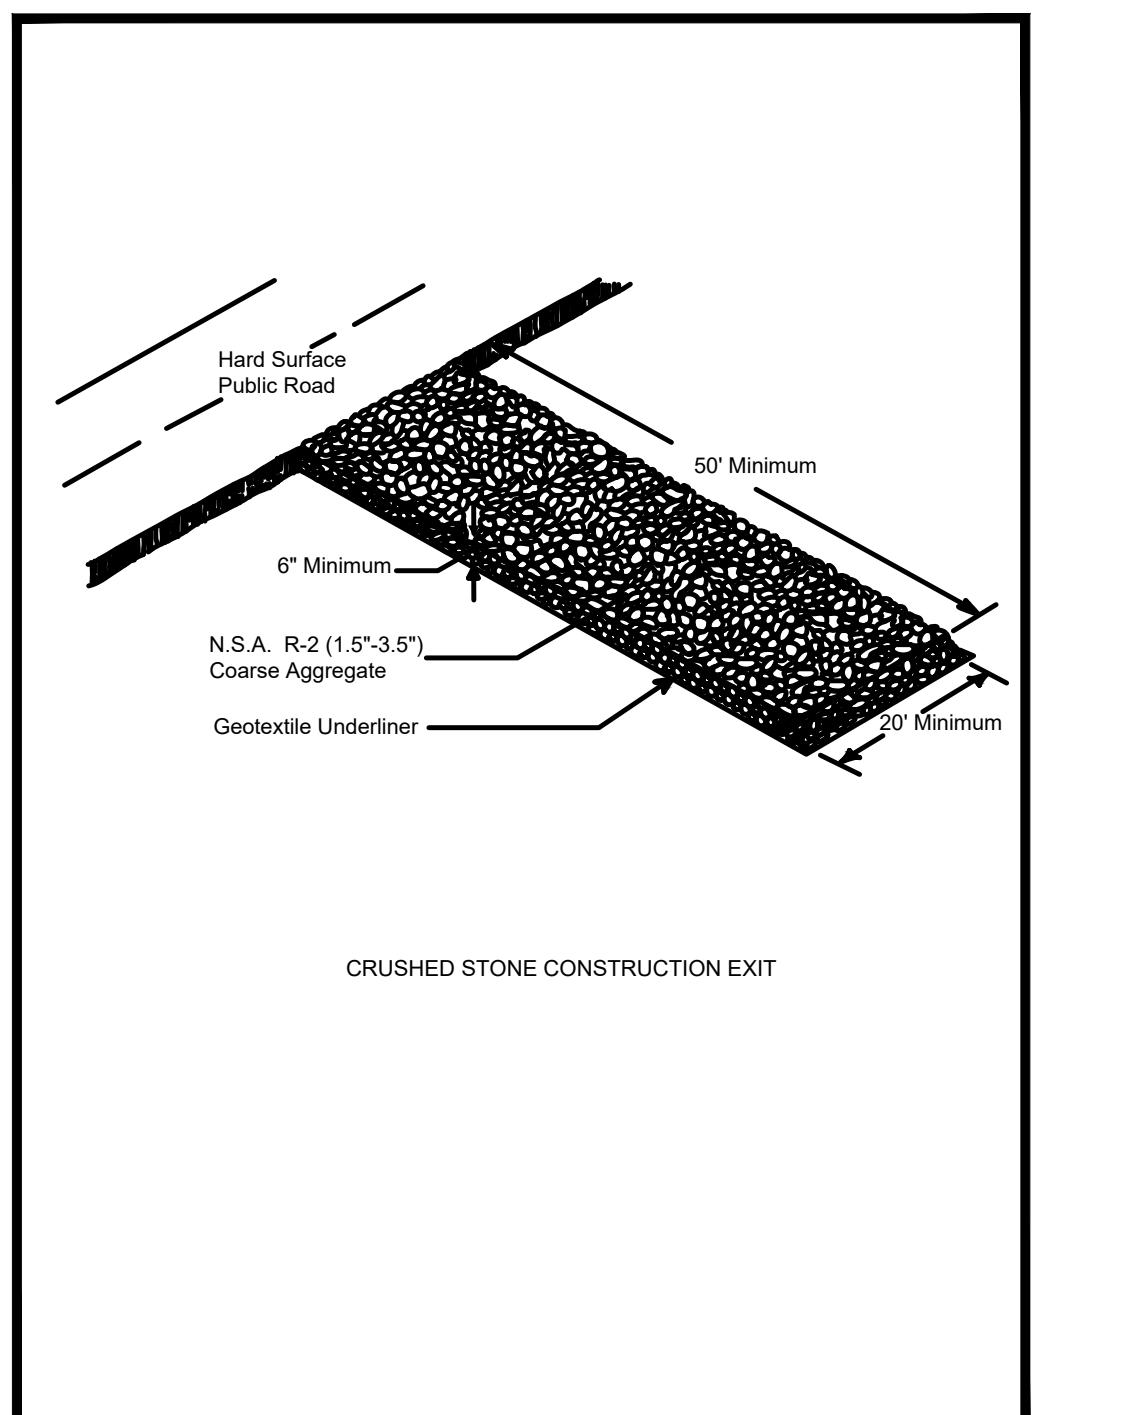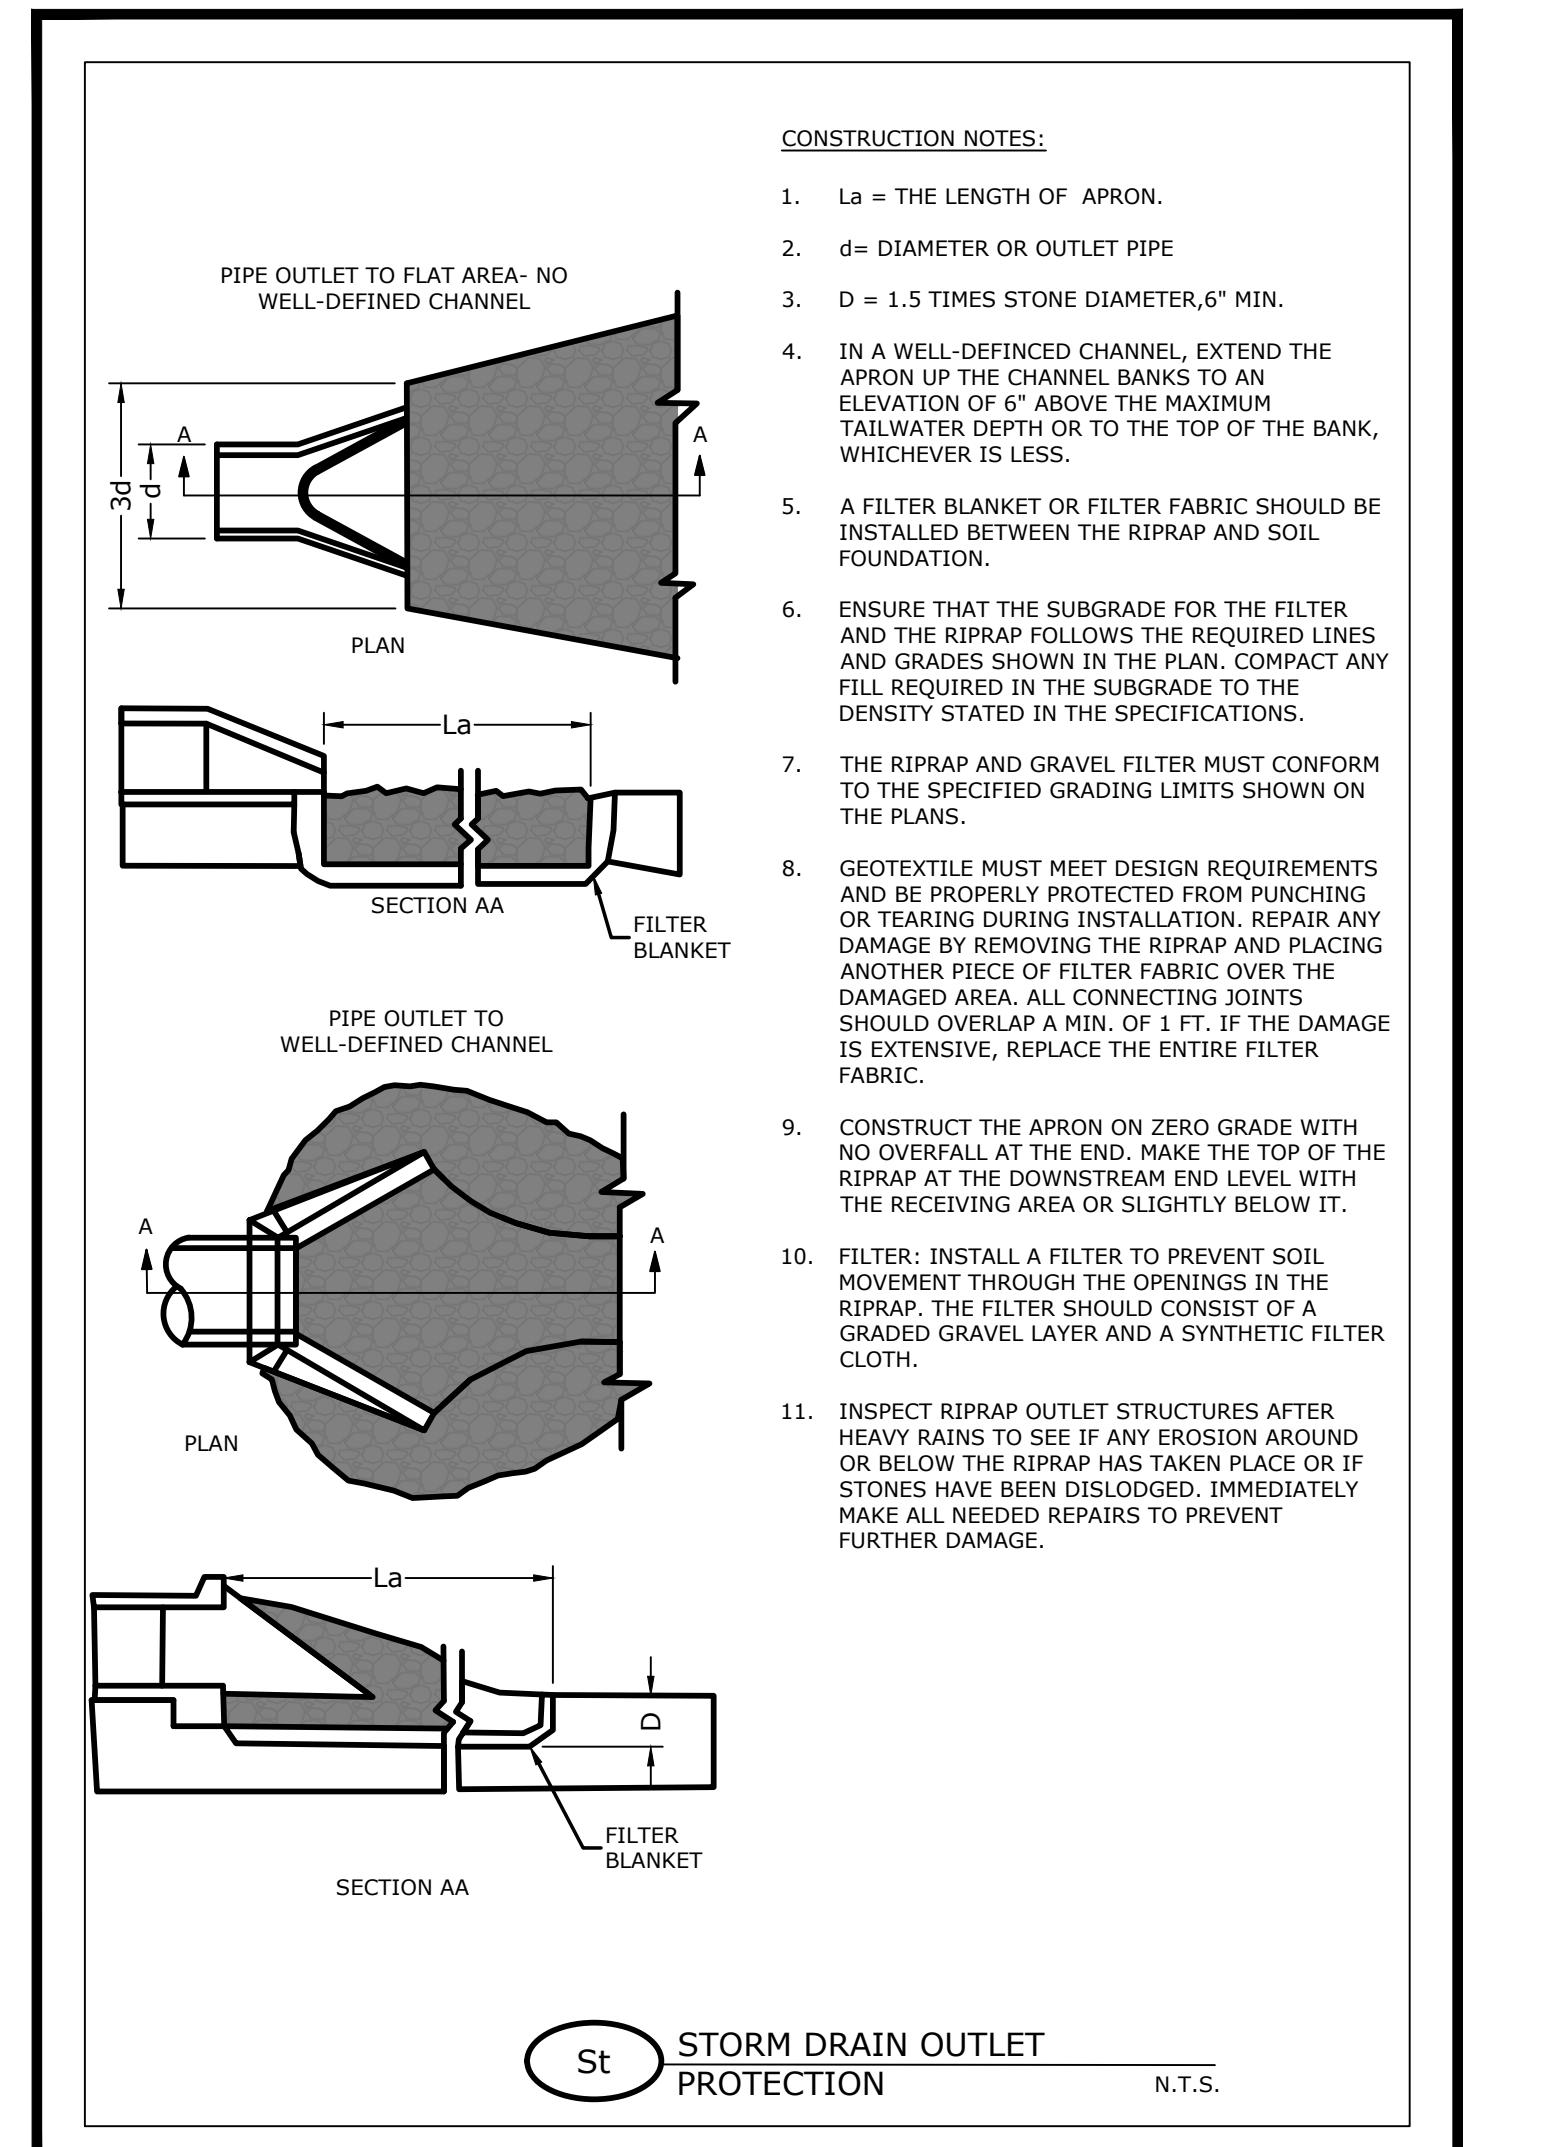

(Co) CONSTRUCTION EXIT
TO BE USED FOR CONSTRUCTION TRAFFIC AS DIRECTED BY THE ENGINEER

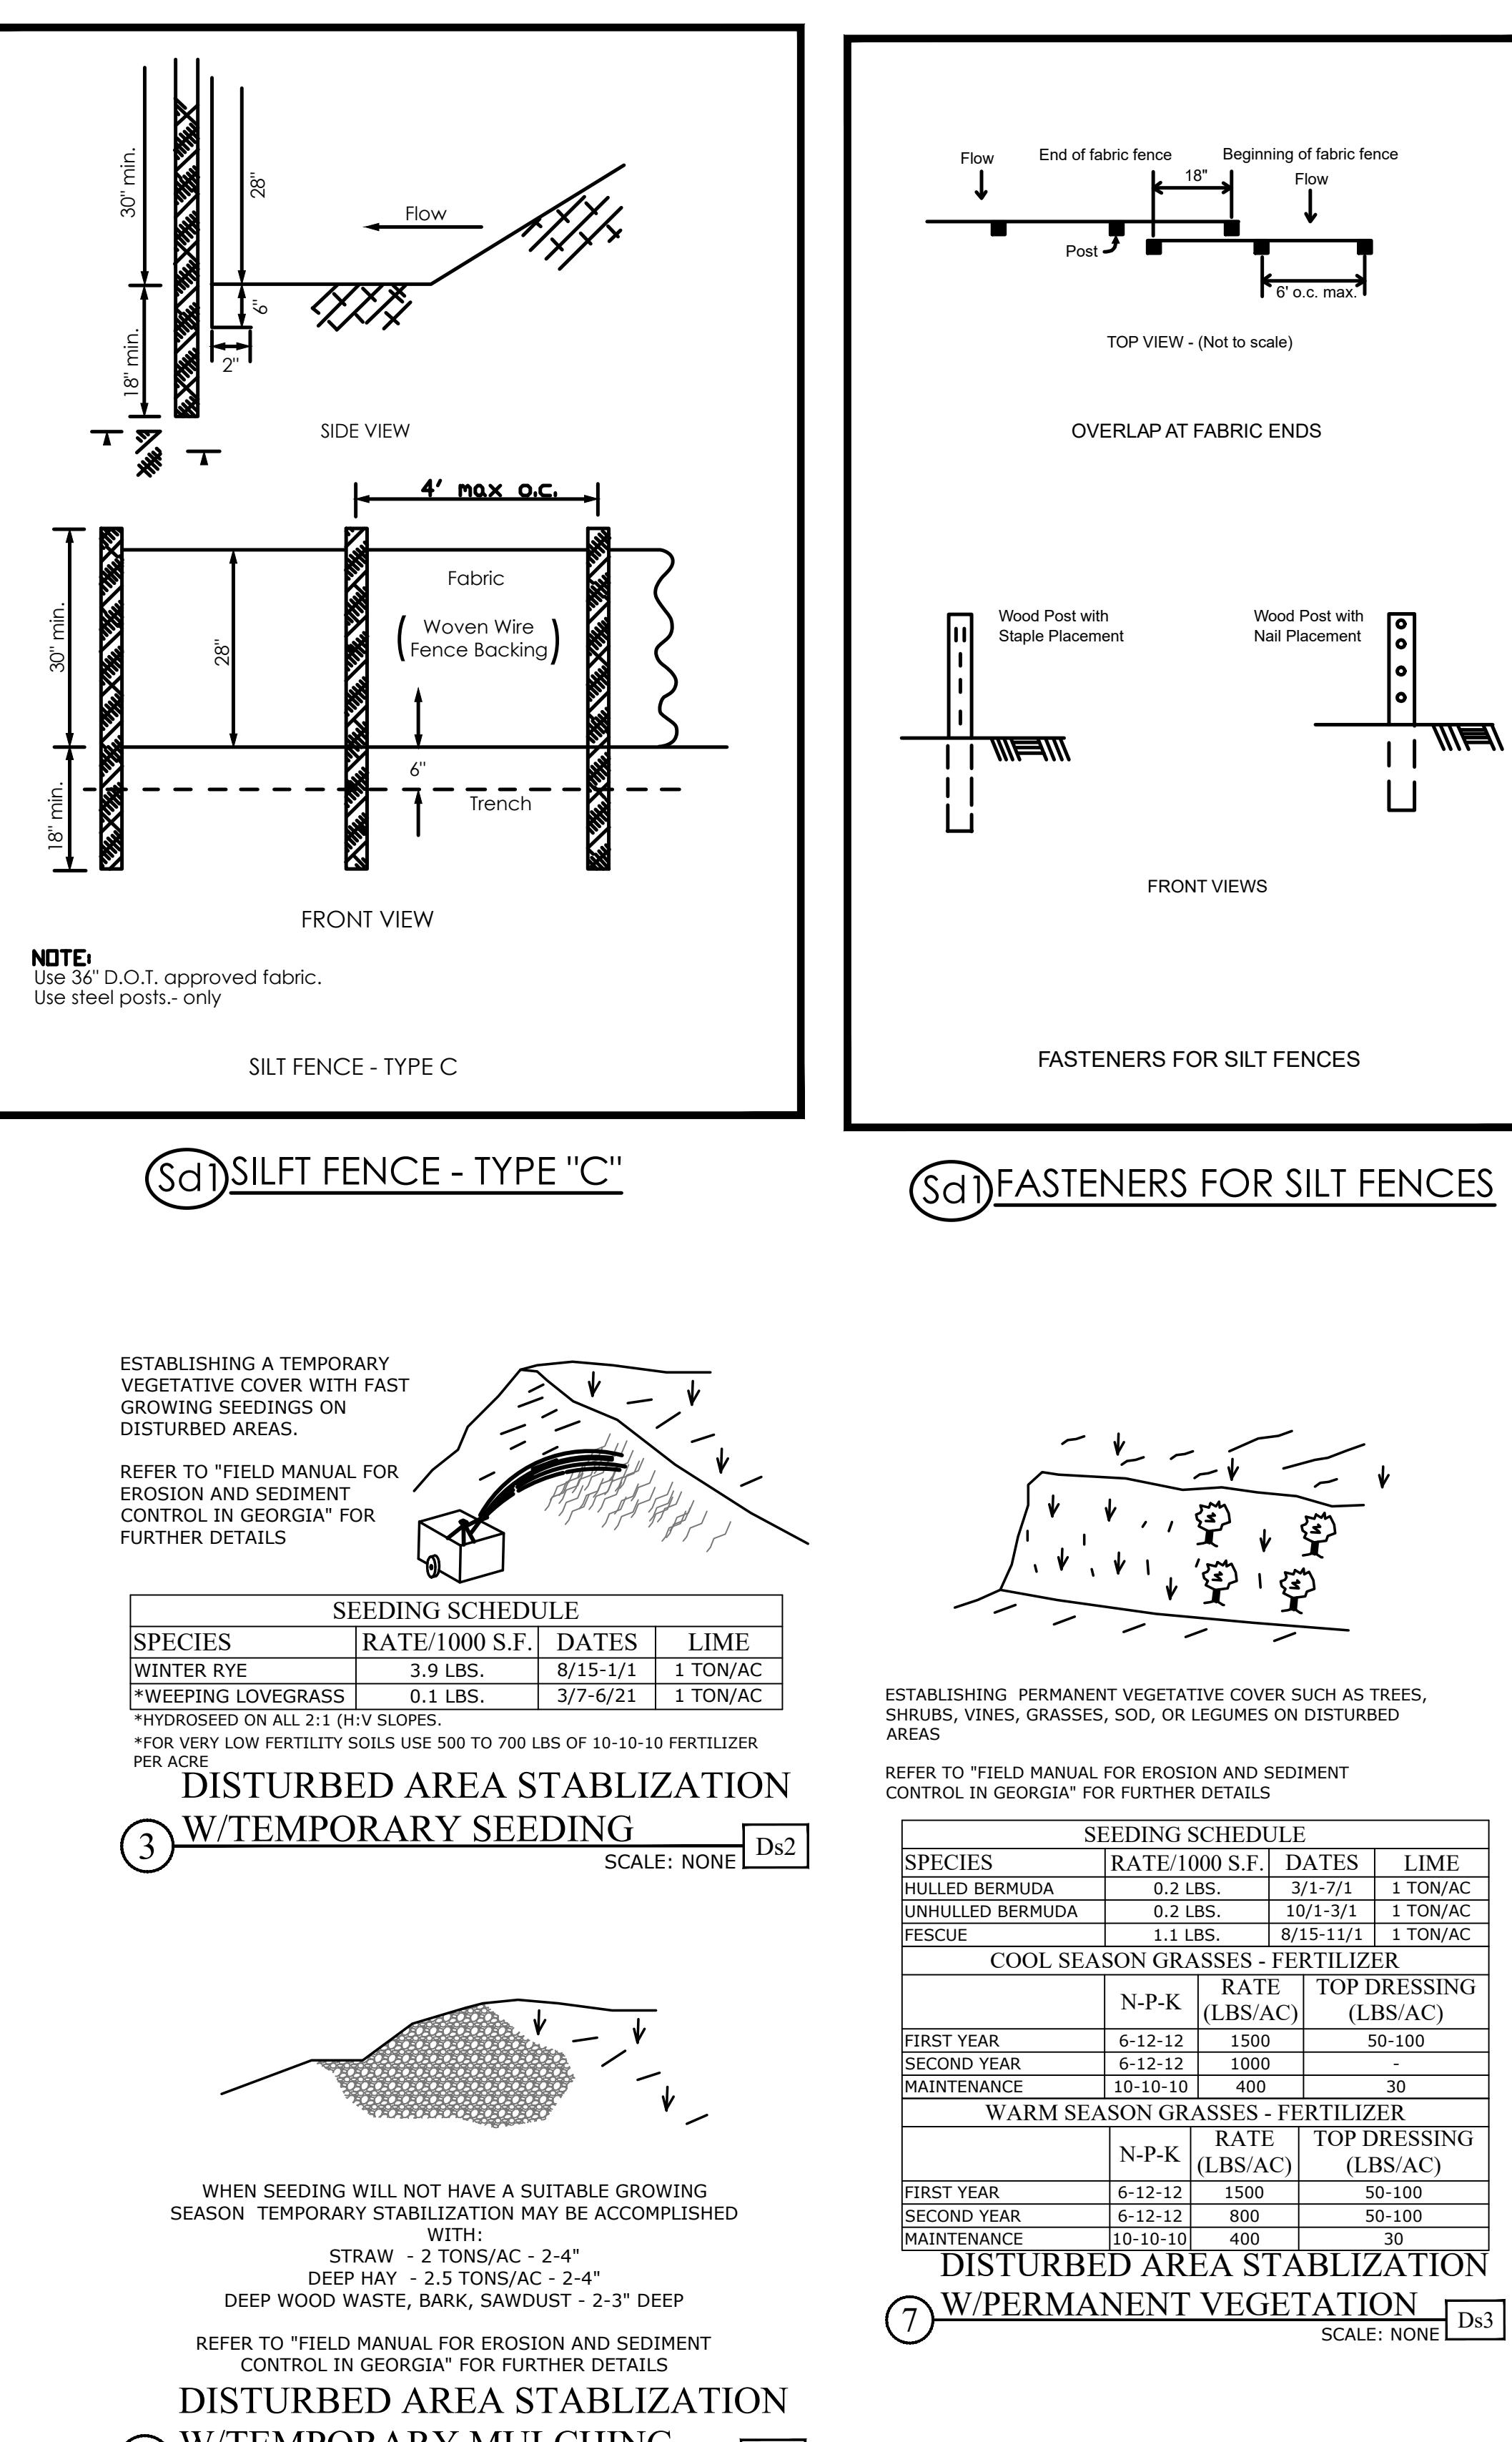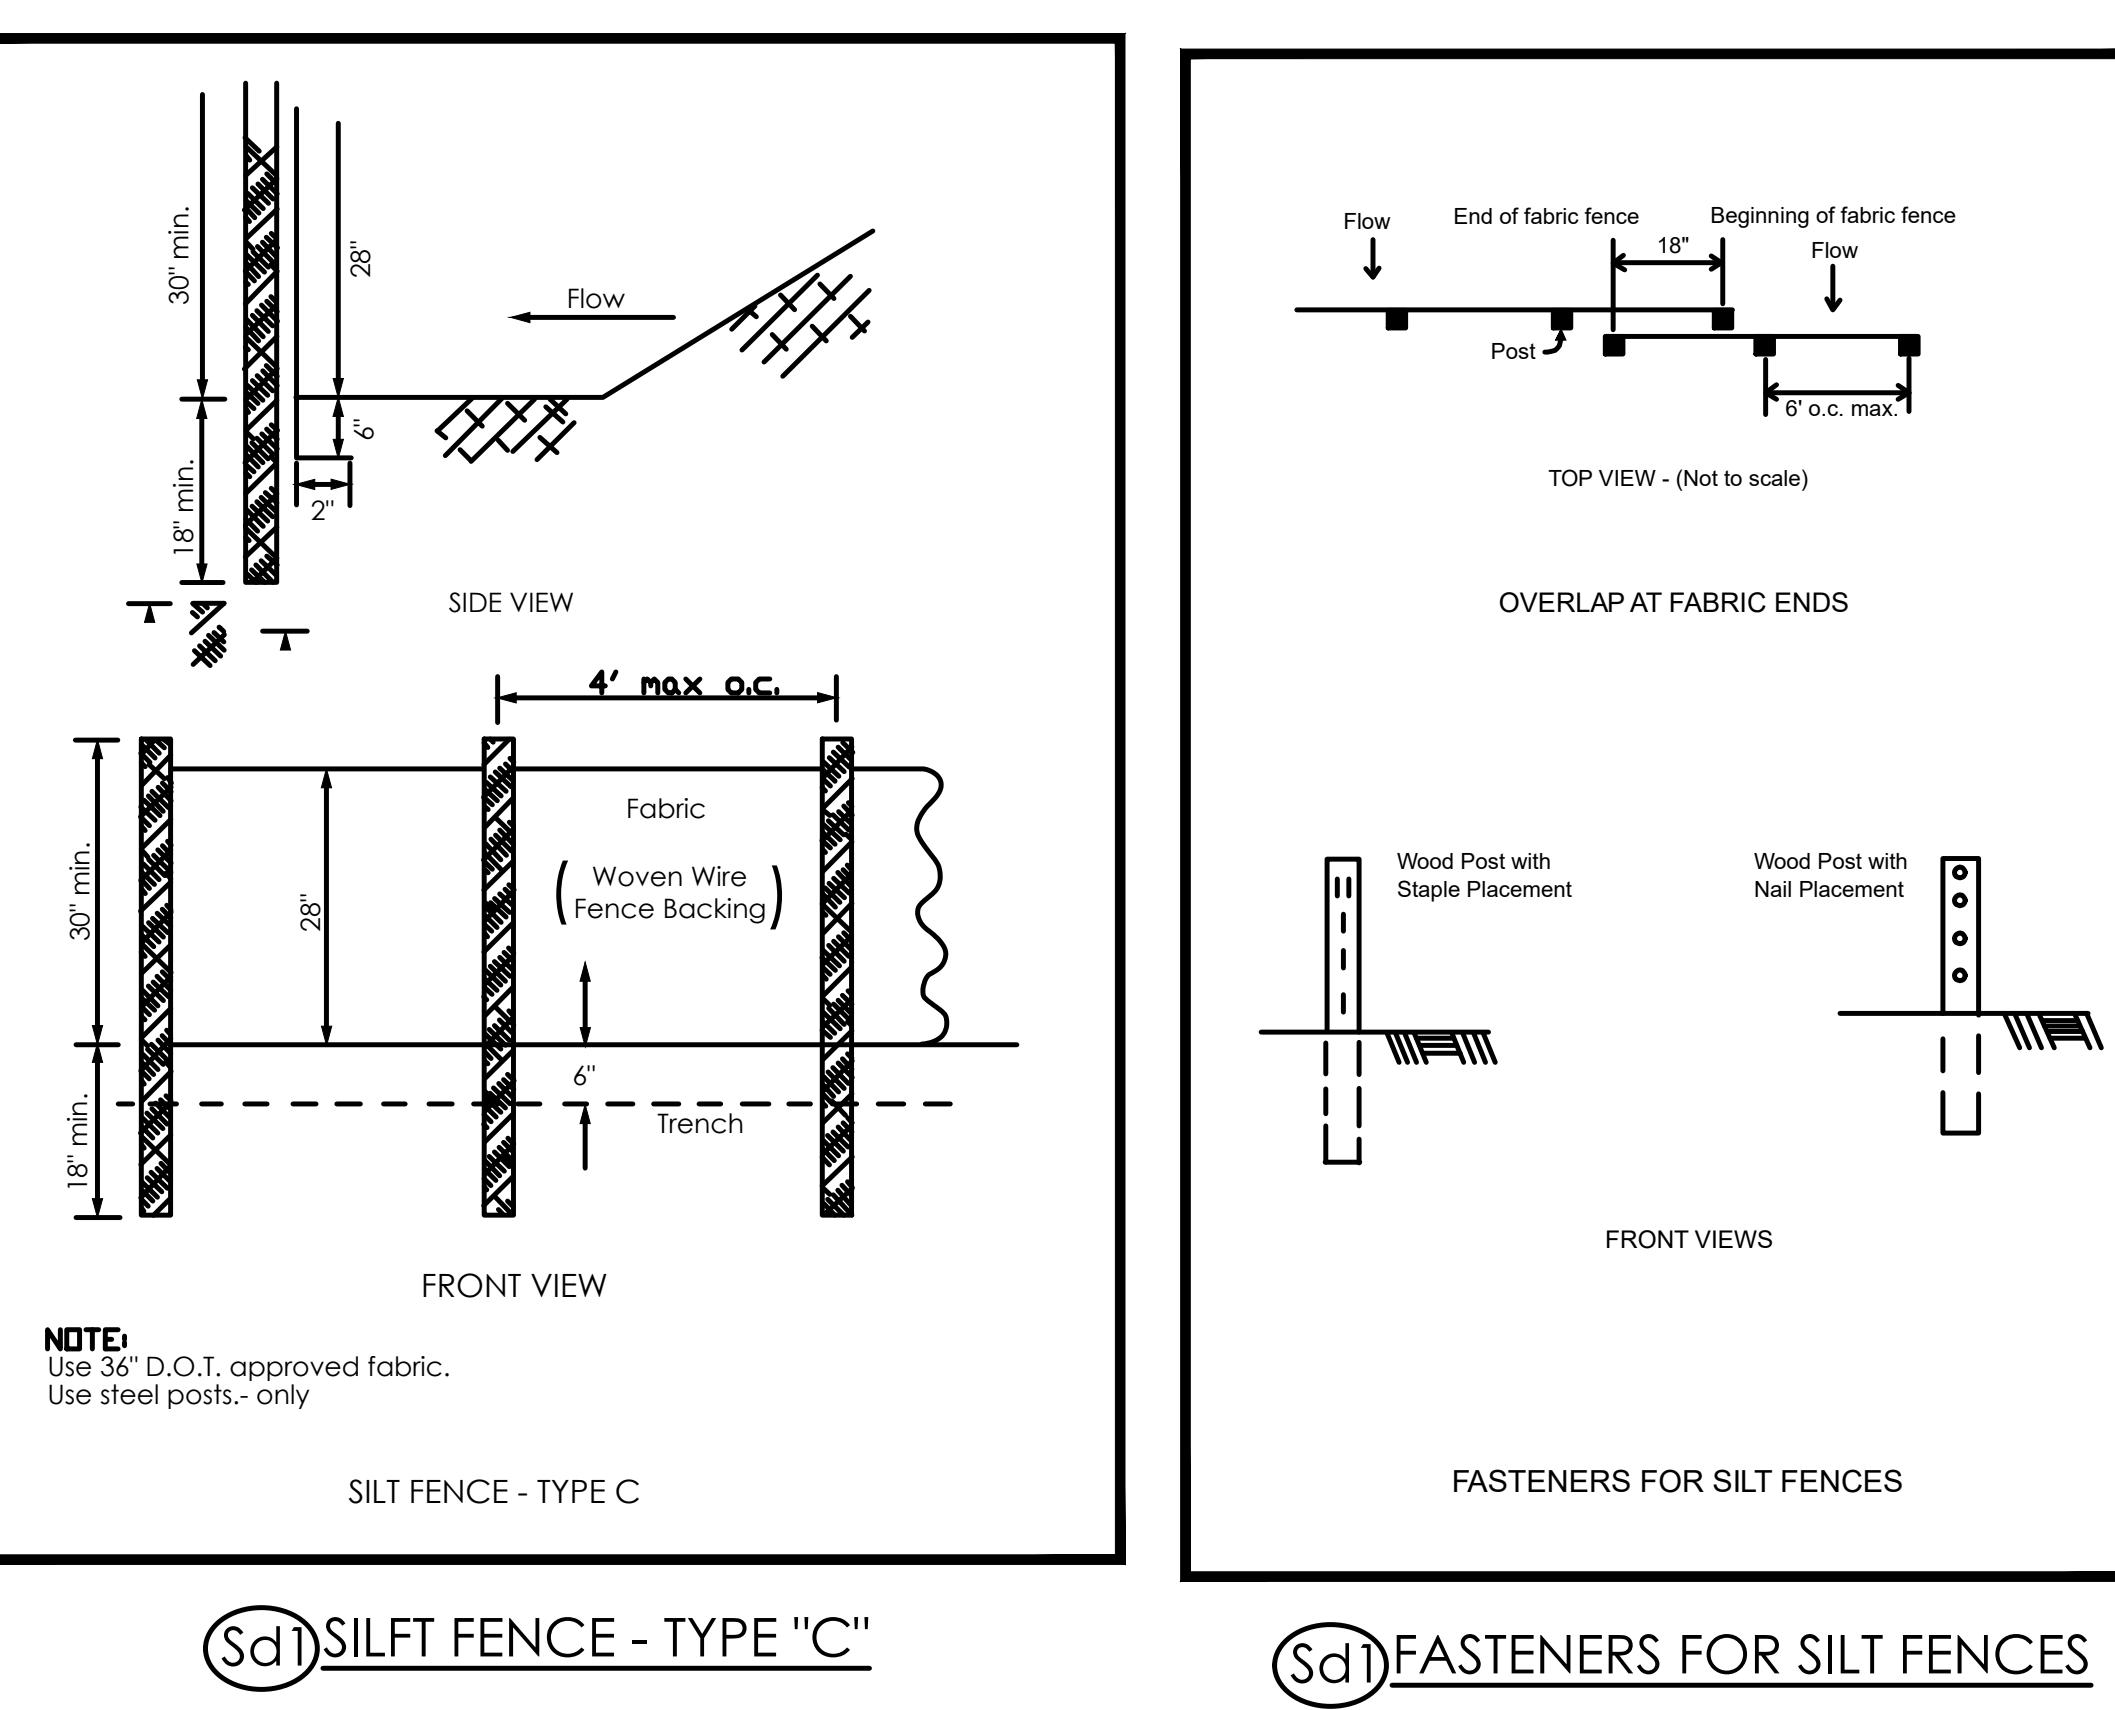

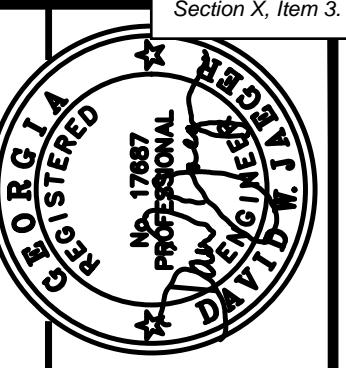



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| PROJECT NUMBER PW-20 | | SCALE | |
| DESIGN | MCI | DRAWN | ALG |
| CHECK | DWJ | FILE NO. | 01/16/23 |
| APPROVED | DWJ | SHEET NO. | 21/01-16 |
| REV. NO. | DATE | DESCRIPTION | BY APPD |

Mallett Consulting, Inc.
101 DEVANT ST., SUITE 804 FAYETTEVILLE, GEORGIA 30214
PHONE: 770-719-3333 FAX: 770-719-3377

Cross Drain Replacement for Town of Tyrone, Georgia


Construction Details

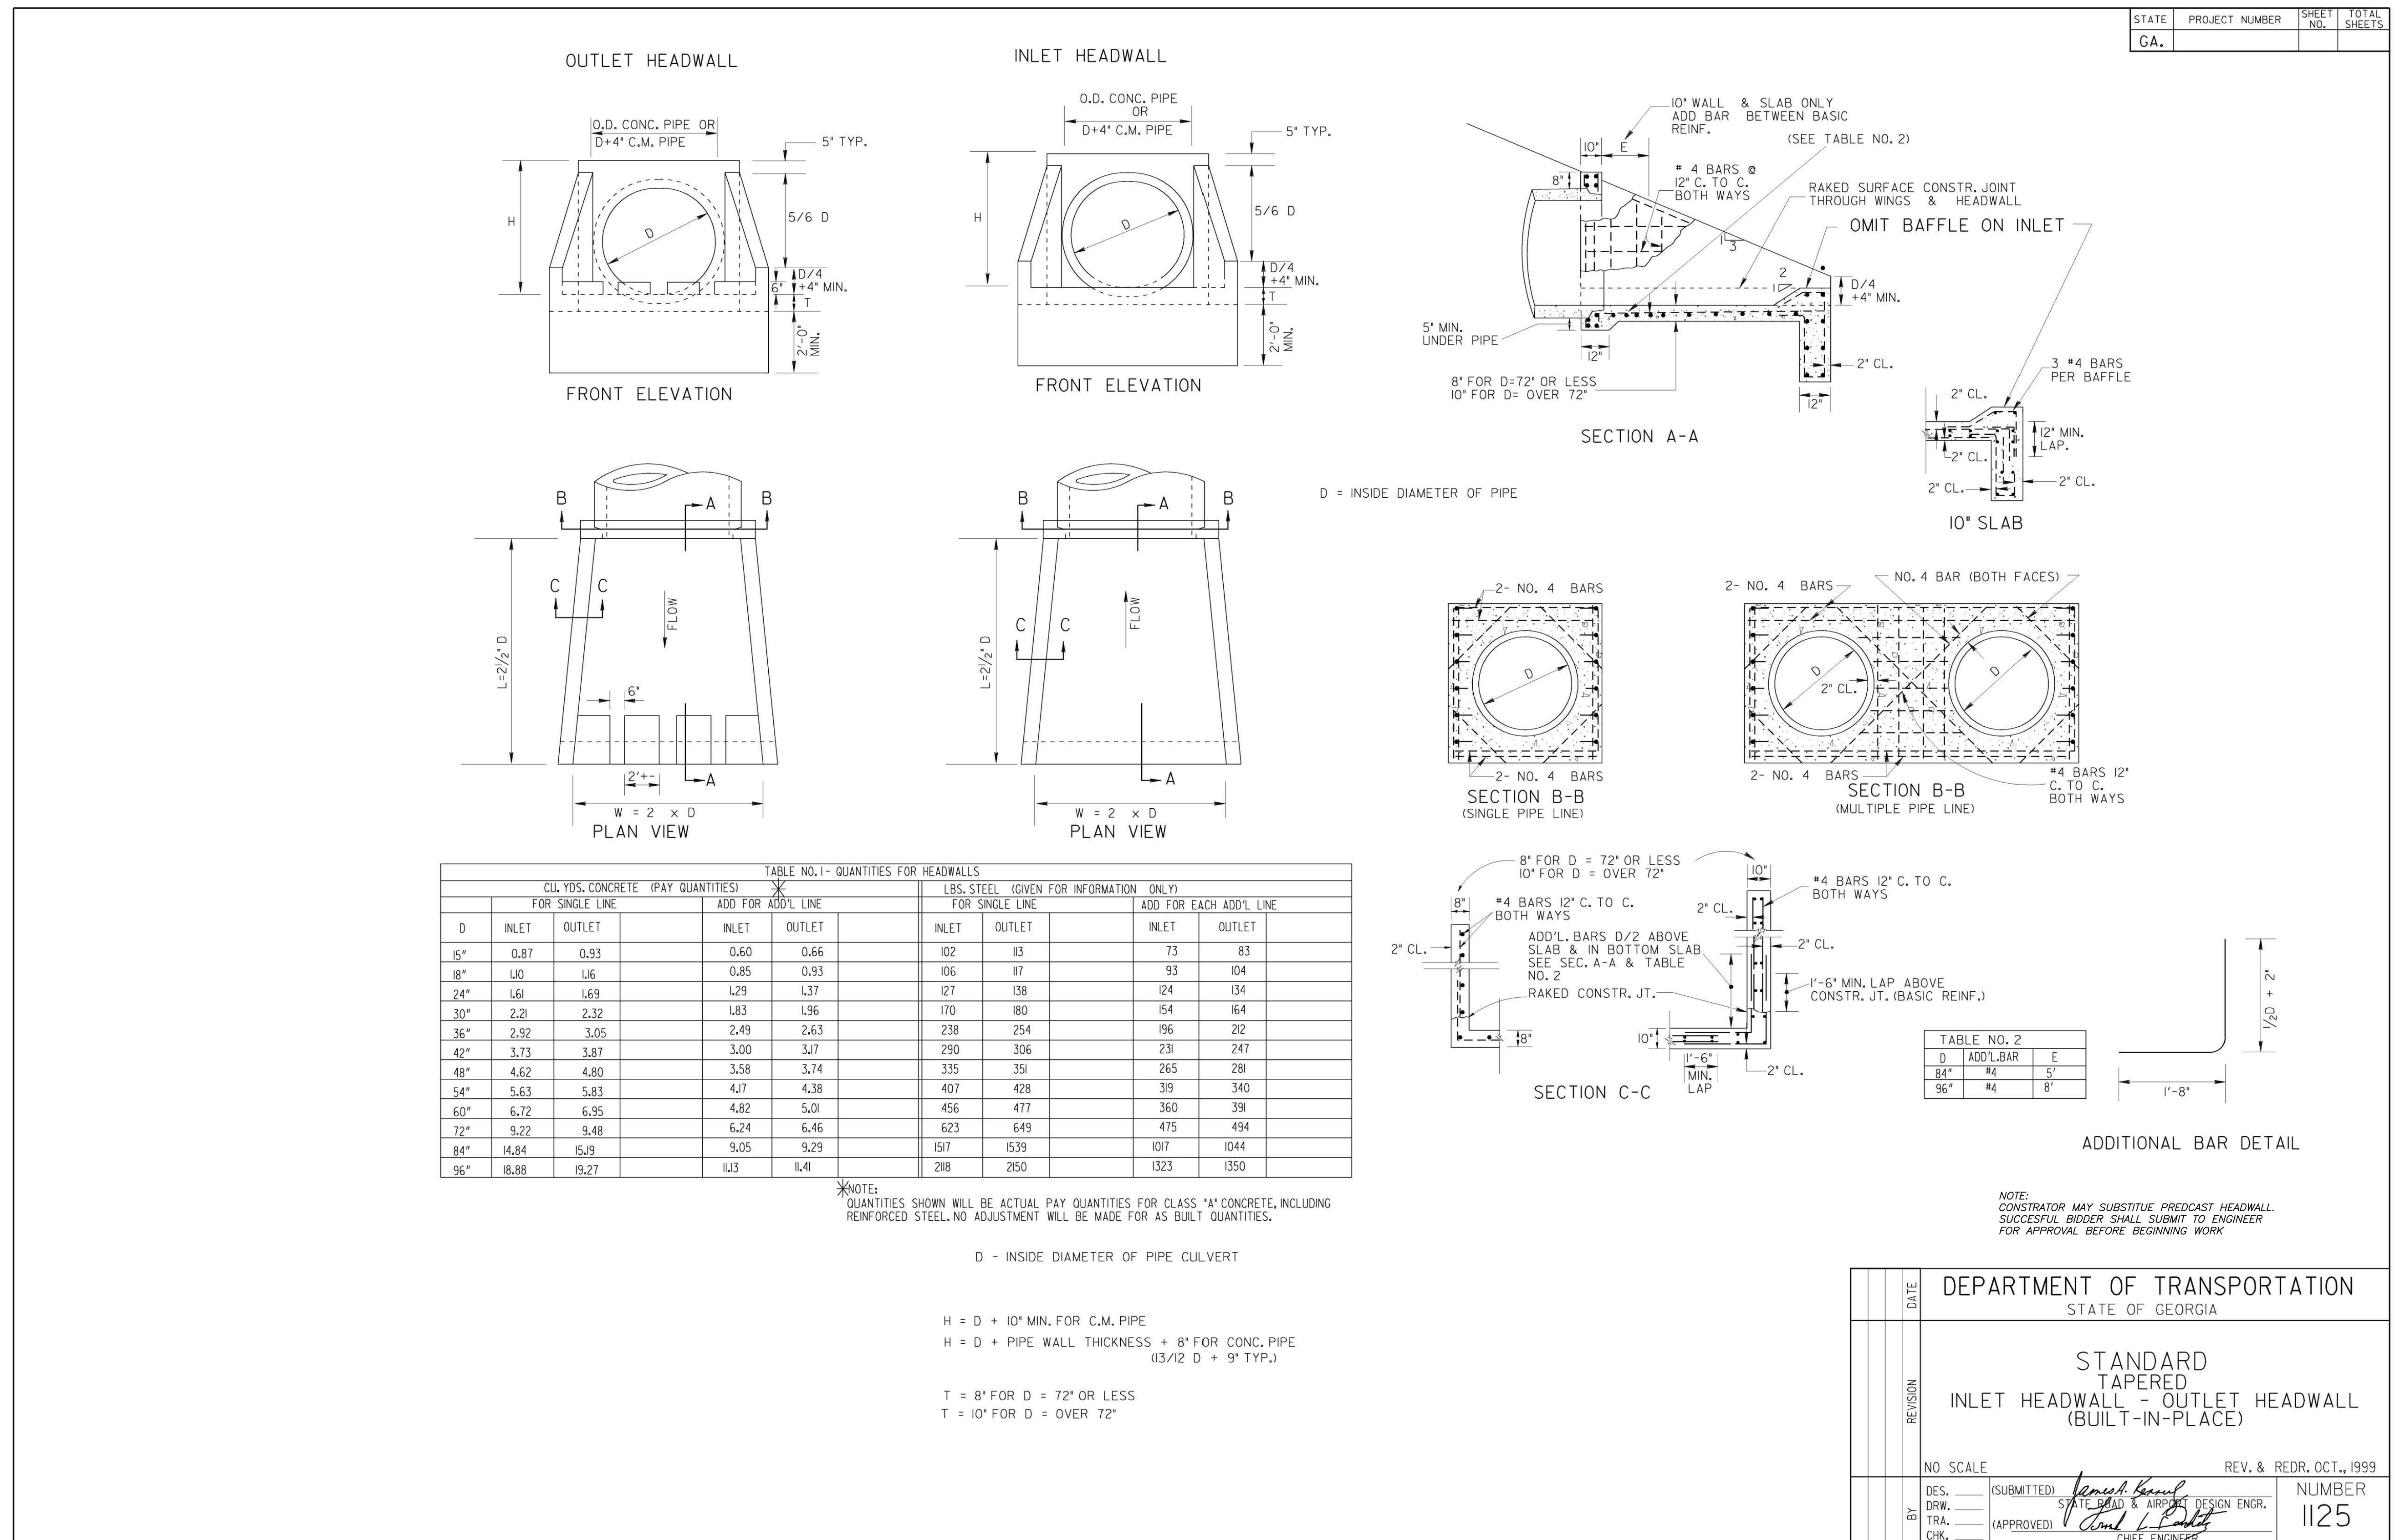

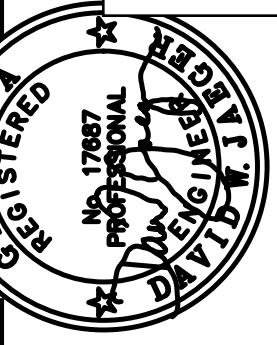


Cross Drain Replacement for Town of Tyrone, Georgia

Construction Details

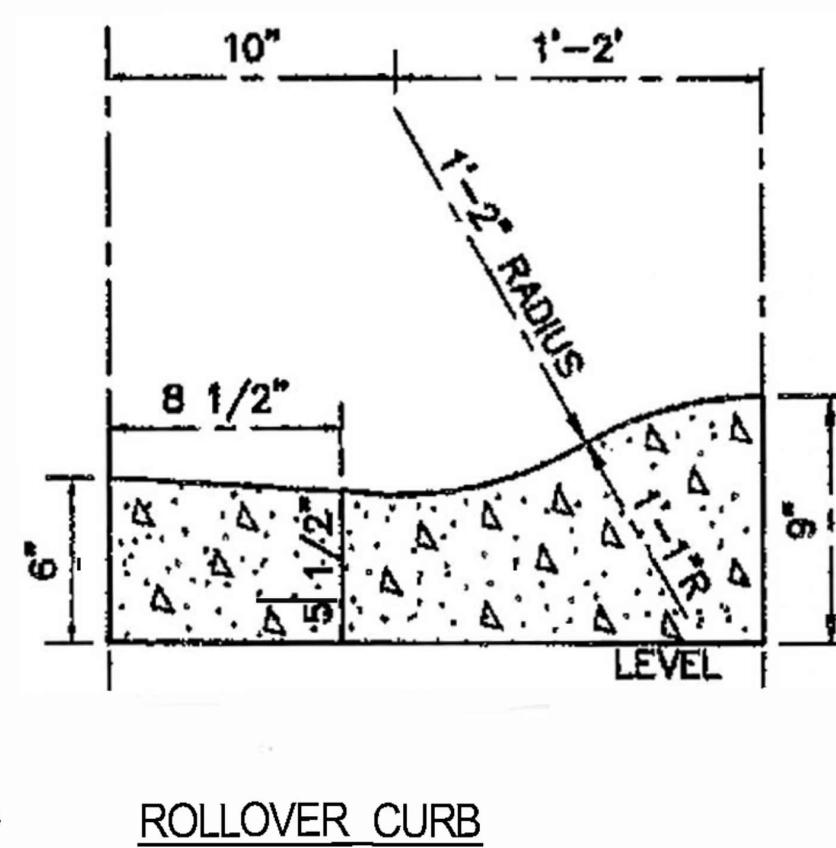

ROLLOVER CURB


DETAIL

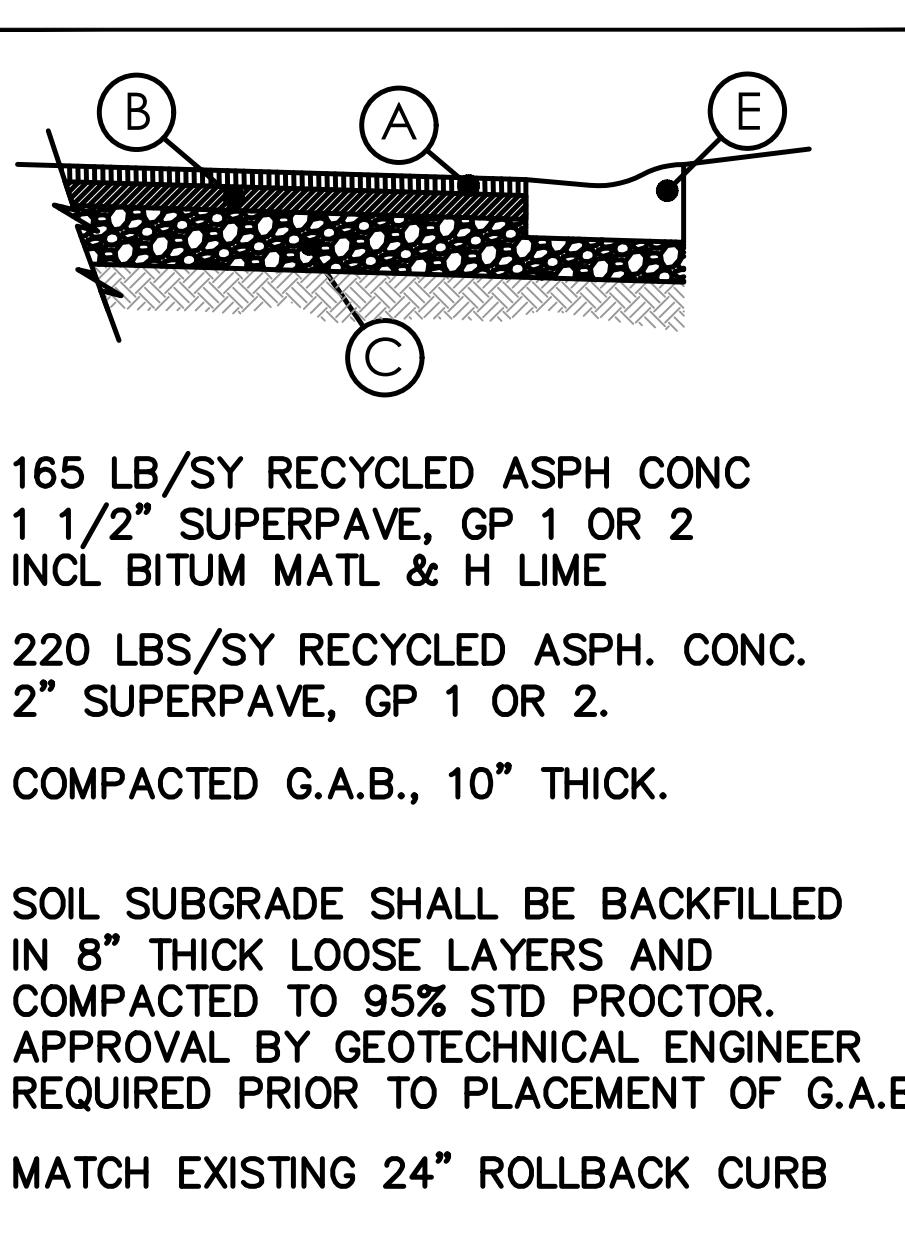

- (A) 165 LB/SY RECYCLED ASPH CONC 1 1/2" SUPERPAVE, GP 1 OR 2 INCL BITUM MATL & H LIME
- (B) 220 LBS/SY RECYCLED ASPH. CONC. 2" SUPERPAVE, GP 1 OR 2.
- (C) COMPACTED G.A.B., 10" THICK.
- (D) SOIL SUBGRADE SHALL BE BACKFILLED IN 8" THICK LOOSE LAYERS AND COMPACTED TO 95% STD PROCTOR. APPROVAL BY GEOTECHNICAL ENGINEER REQUIRED PRIOR TO PLACEMENT OF G.A.B.
- (E) MATCH EXISTING 24" ROLLCBACK CURB

PAVEMENT REPAIR DETAIL

N.T.S.

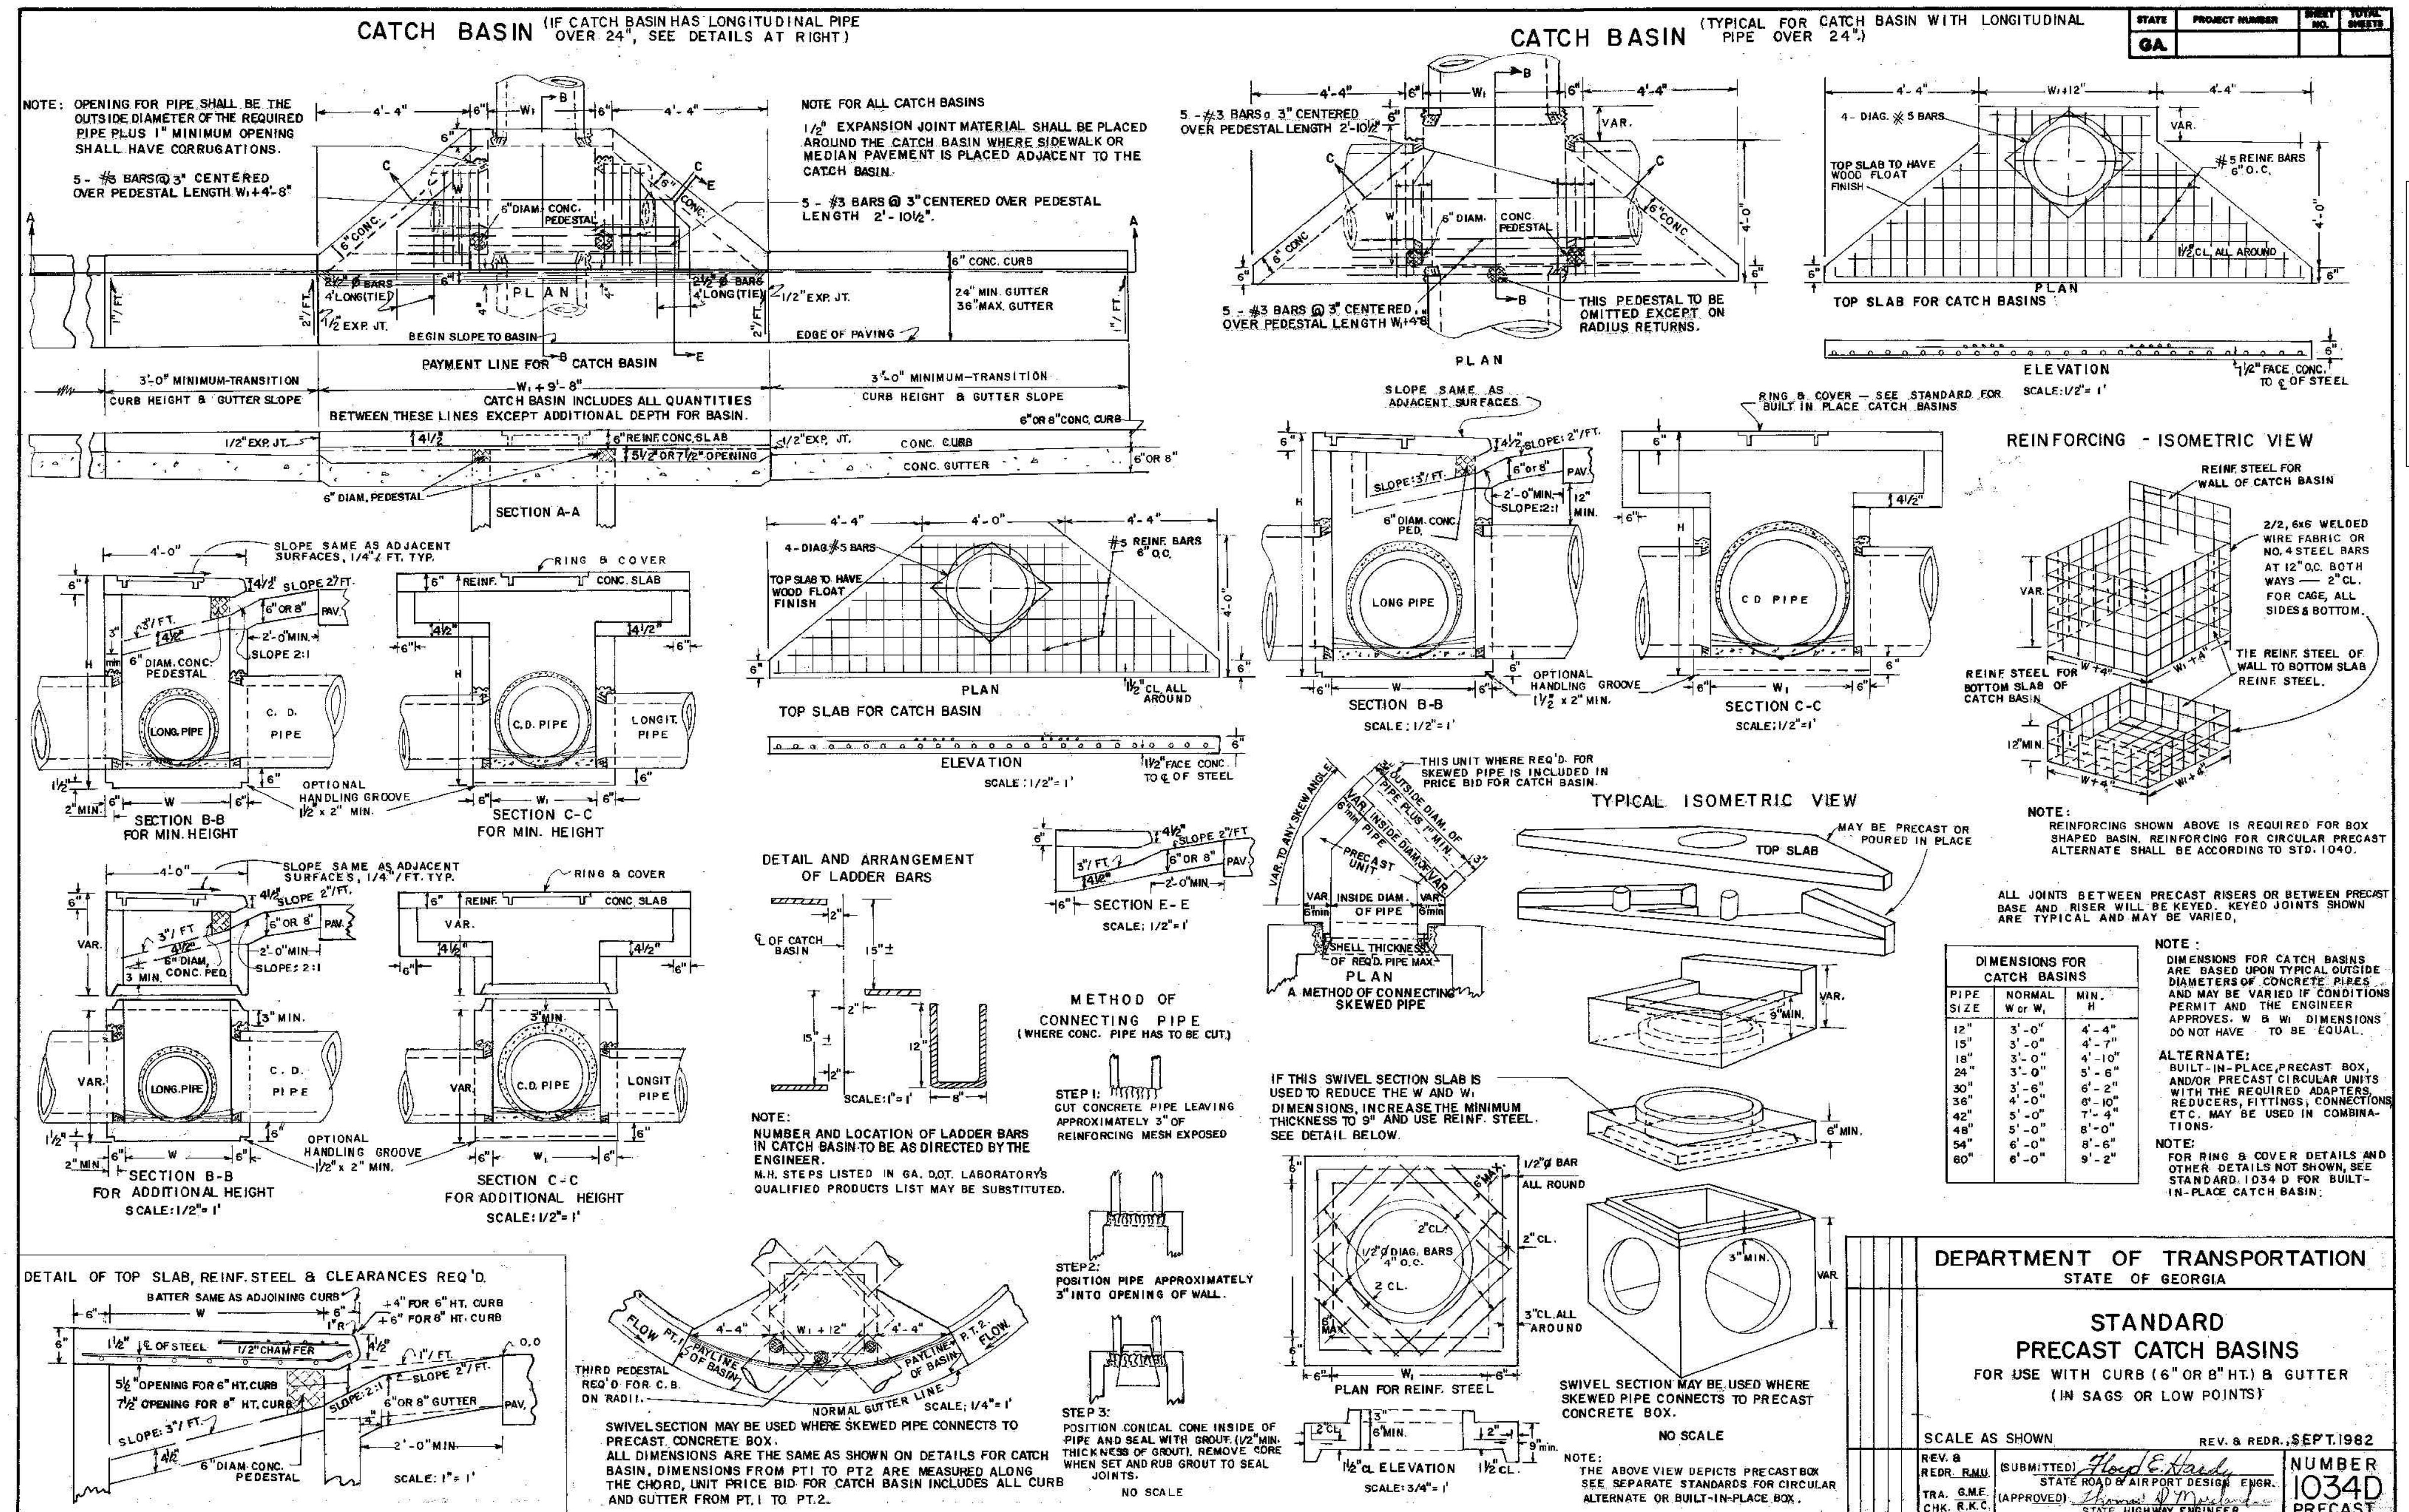



COUNCIL AGENDA ITEM COVER SHEET

Meeting Type: Council - Regular

Meeting Date: October 19, 2023

Agenda Item Type: Presentation

Staff Contact: April Spradlin and Randy Mundy

STAFF REPORT

AGENDA ITEM:

Purchase of Server and Associated Installation and Migration of Current Data

BACKGROUND:

See attached

FUNDING:

100-20-54-2001

STAFF RECOMMENDATION:

The purchase of a Server and Associated Installation and Migration of Current Data not to exceed the cost of \$41,000 formally allocated for the purchase of scanning court documents and LaseFische Database.

ATTACHMENTS:

Click or tap here to enter text.

PREVIOUS DISCUSSIONS:

The approval of scanning court documents and purchasing Laserfische searchable database.



October 19, 2023

To: Mayor and Council

CC:

From: April Spradlin, Clerk of Court and Randy Mundy, Chief of Police

Re: Purchase of Server, Installation, and Migration of Current Data

Mayor and Council approved the expense of \$41,000 for the intended purpose of the Municipal Court scanning court documents and purchasing LaseFische as a search database for those documents. However, the Municipal Court Clerk has determined that with the help of technology currently in place and the use of Courtware the expense of the requested \$41,000 from the Municipal Court is not needed. On March 29, 2023, our body worn camera vendor, Watchguard, informed us that our current body camera systems were at the end of useful life and would no longer be able to be serviced. As several of our cameras have become inoperative, we are forced to purchase new equipment. Mayor and Council approved the purchase of new equipment. However, and not previously disclosed, we were informed that the new equipment would not operate on our current PD server which is also near its end of life. Consequently, we are tasked with the purchase and installation of a significantly new and robust server to handle the requirements of our new body worn cameras. On September 19, 2023 a quote from VC3 was requested for the needed server. As of this request, despite several follow up request by email and phone, we have still not received that quote. Because of this delay, we have now also sought a quote from Dell under state contract.

Incorporated 1911

950 Senoia Road | Suite B | Tyrone, Georgia
30290 Phone: (770) 487-4038 | Fax: (770)
487-4529
www.tyrone.org



COUNCIL ITEM AGENDA REQUEST FORM

Department: Community Development/DDA

Meeting Date: 10/16/2023

Staff Contact: Phillip Trocquet

Agenda Section: New

Business

Staff Report:

Item Description:

Background/History:

The Town's ordinances per Sec. 109-84 require that any non-residential development within the SR-74 overlay obtain a Certificate of Appropriateness based on *"how the proposed development relates to the surrounding environment to ensure visual continuity and how the development will be approved, be in compliance with the SR-74 Quality Growth District special requirements."*

The SR-74 requirements have been included in this package.

The applicant, Mr. Steven Gulas, has submitted conceptual information on a proposed extended stay hotel for the property with a conceptual site plan and example images of other hotels for architectural reference.

Findings/Current Activity:

The property lies within the Commercial Corridor character area which encourages commercial development consistent with the Town's C-1, C-2, CMU, and O-I zoning classifications to maintain a high standard of architecture, landscaping, and sign controls that also accommodate pedestrian and traffic circulation throughout the developments

Although extended stay hotels are not considered by our ordinance, hotels are listed as a permitted use in both C-1 and C-2 zoning classifications. This property is zoned C-2. The submitted conceptual site plan appears to be generally consistent with the Town's zoning ordinance save an apparent buffer encroachment within the 75' buffer requirement, but will require a full, in-depth, site plan review by the Town's Technical Review Committee and Planning Commission.

Proximity to the neighborhood and relationship to the surrounding development is a major consideration for this development. The neighborhood does have a large, wooded buffer and the site plan reflects the maintenance of an additional buffer along the rear of the property, but does not reflect whether it is 75' as stipulated in the C-2 zoning district.

Pedestrian connectivity to the Publix Shopping center as well as the existing sidewalk network will be required. The conceptual/example structures provided show both buildings at 4 stories which does not meet the Town's height restrictions. The site plan reflects a 3-story hotel. The proposed images reflect one building that does not meet the Town's architectural requirements (prototype) and another depicted as all brick which could meet the Town's architectural requirements.


Staff Determination:

Any hotel or structure within the SR-74 overlay must adhere to the Town's architectural standards, which include 70% Class A materials on all sides. Structures should not surpass 3 stories or 35 feet in height. The conceptual site plan showcases a 3-story building, but the images do not align with the Town's height restrictions.

Staff concludes that a hotel could be appropriate if aligned with the comprehensive plan and zoning ordinance's intent which does not reference extended stay hotels. Approval of any certificate of appropriateness should consider meeting the architectural, size, and height criteria of our ordinance.


ARCHITECTURAL SITE PLAN

SCALE: 1" = 40'-0"

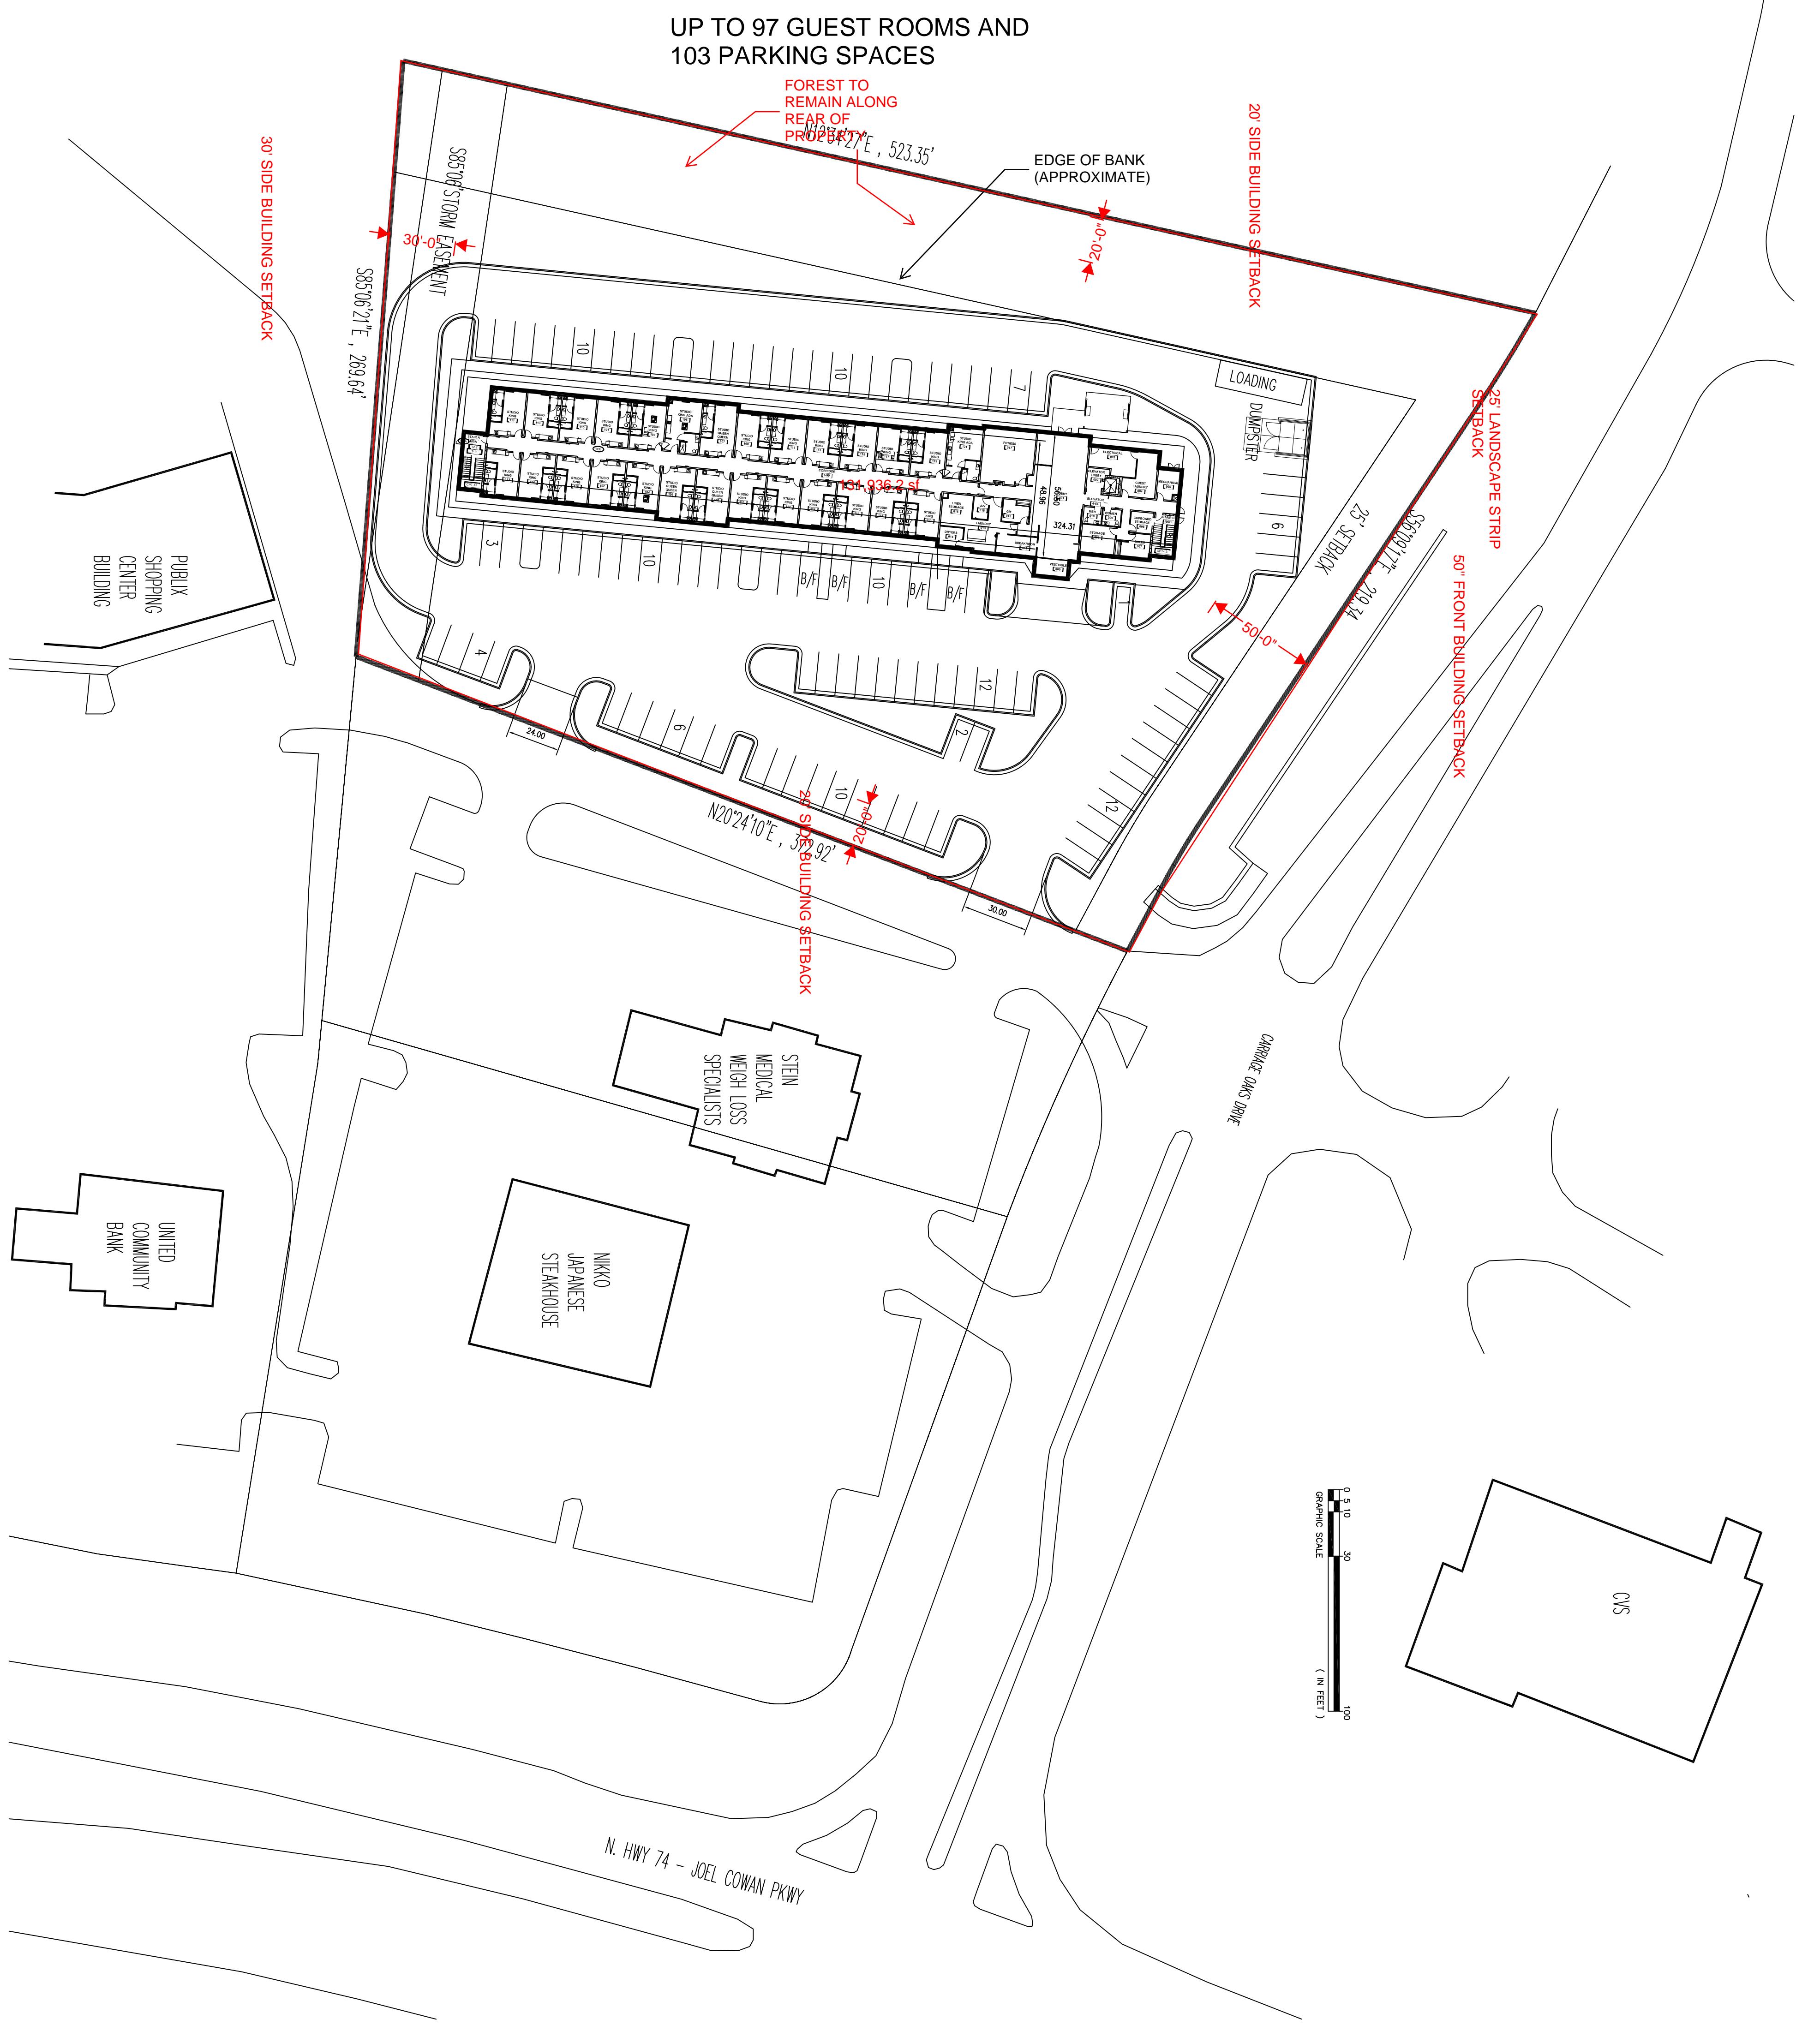

| <u>SITE ANALYSIS</u> | |
|----------------------|---|
| TOTAL SITE AREA | = |
| BUILDING FOOTPRINT | = |
| WALKS AND PAVING | = |
| GREEN SPACE | = |
| IMPERVIOUS AREA | = |
| RENTAL ROOMS | = |
| PARKING SPACES | = |

| PROPERTY INFO | |
|-------------------------------------------------------------------------------------------------------------------------------------------------------------------------------------|-----------------------------|
| <u>PROPERTY INFORMATION:</u> | |
| <ul style="list-style-type: none"> • INFORMATION TAKEN FROM QPUBLIC - FAYETTE COUNTY, GA • A PRELIMINARY SITE SKETCH PROVIDED, AND • OTHER SOURCES | |
| PARCEL NUMBER | 0726 051 |
| LOCATION ADDRESS | CARRIAGE OAKS DR |
| LEGAL DESCRIPTION | 3.01 ACRES CARRIAGE OAKS DR |
| PROPERTY CLASS | C3 - COMMERCIAL LOTS |
| SUBDIVISION | |
| TAX DISTRICT | 03 |
| ZONING | C C2 |
| ACRES | 3.01 |
| HOMESTEAD | N |

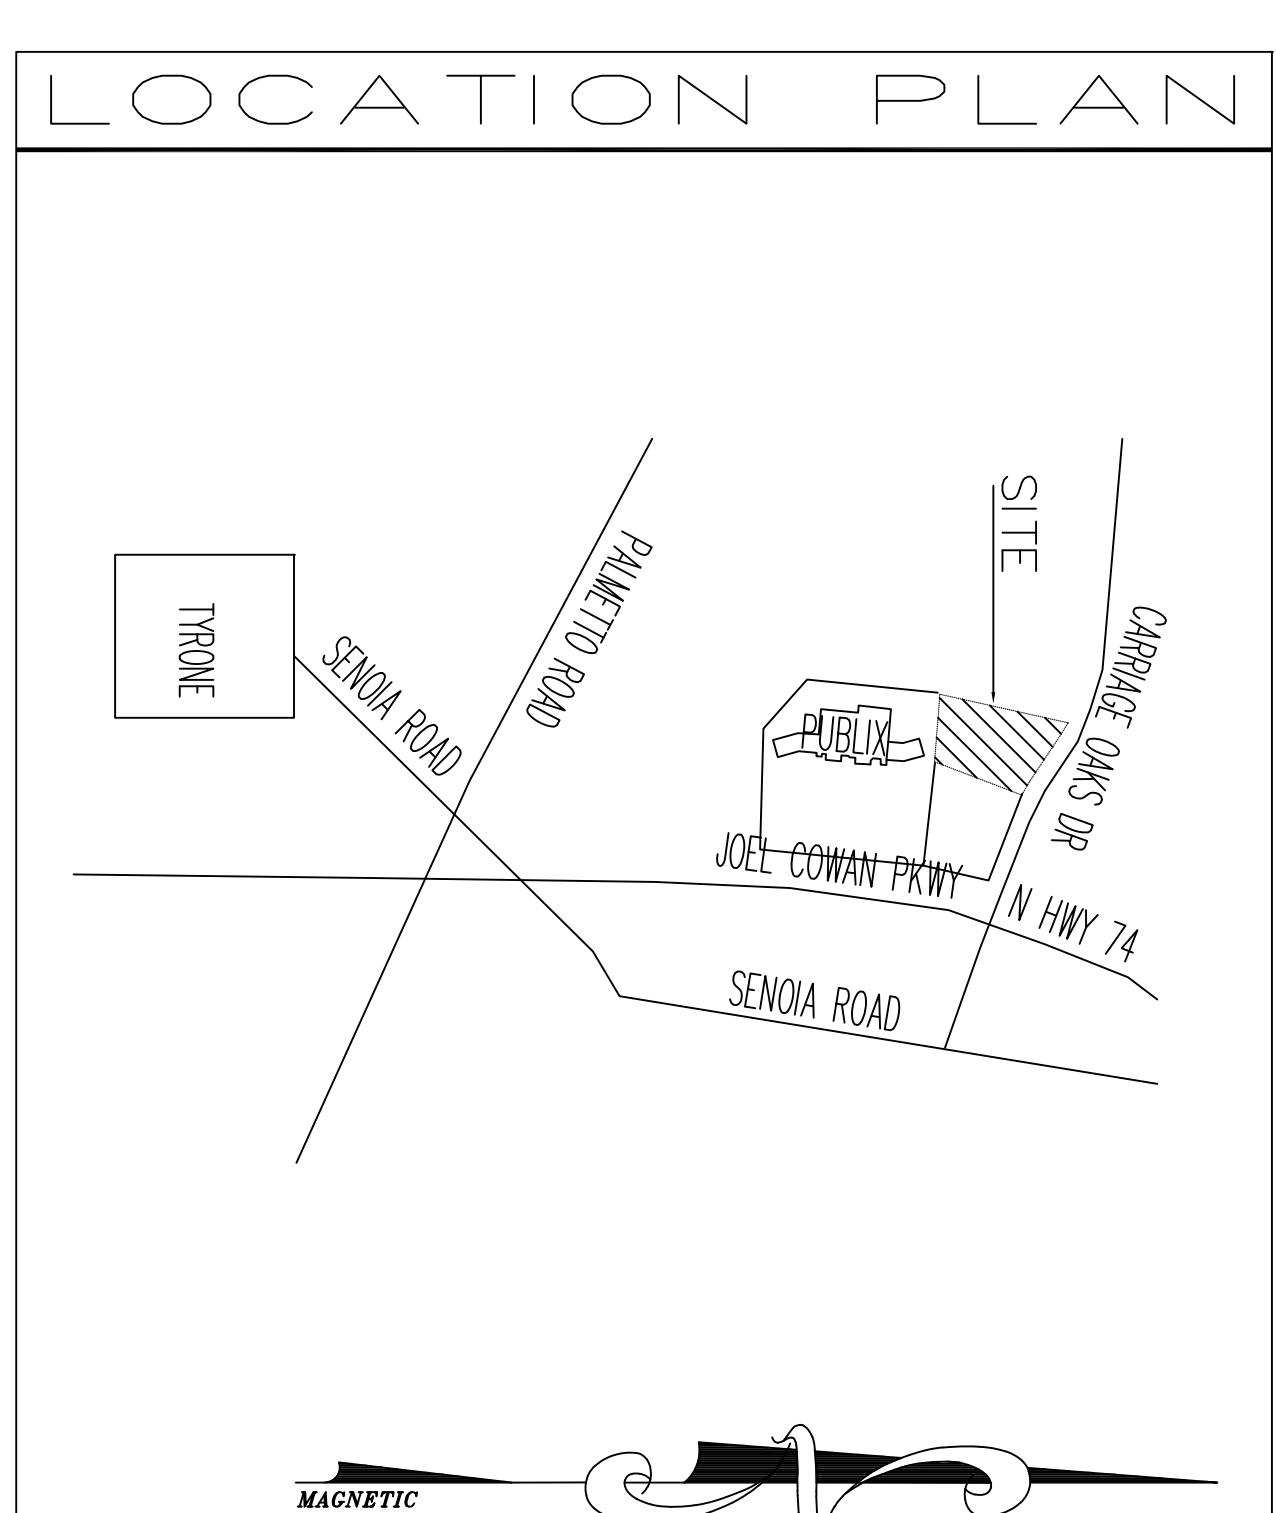


sheet:

ARCHITECTURAL SITE PLAN

A NEW HOTEL BUILDING:
Candlewood Suites

SOUTHHAMPTON TYRONE GEORGIA

PROJECT #2023.0217

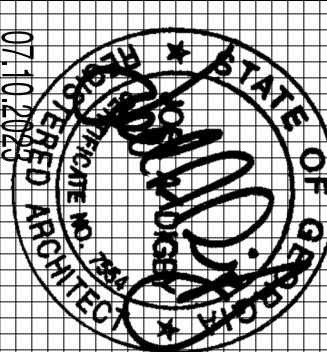



Candlewood Suites brick hotel, previous prototype

IHG does not have three story Candlewood Suites hotels with mostly brick and stone so they provided this four story hotel as best example of mostly brick veneer. Candlewood Suites hotel will have 80% brick/stone/glass to meet Highway 74 quality corridor standards.

Candlewood Newnan GA



CANDLEWOOD SUITES, SALT LAKE CITY, NEW PROTOTYPE

IHG's new Candlewood Suites prototype has not yet been built as a mostly brick or stone three story hotel. Candlewood Tyrone will be the first.









Site Plan Application & Checklist

PROJECT: CANDLEWOOD SUITES, IHG HOTEL (THREE STORY UP TO 97 ROOMS AND UP TO 103 PARKING SPACES)

APPLICANT: STEVEN GULAS OF MAP EQUITIES LLC AND KAMLESH PATEL

ADDRESS: 500 WEST LANIER AVE, STE 910, FAYETTEVILLE GA 30214

PHONE: 770-722-6789

EMAIL ADDRESS: GULASSTEVEN@GMAIL.COM

Item Checklist

One PDF copy of the Site Plan / Revised Plan (Signed and Sealed by Architect) ATTACHED 3 STORY CANDLEWOOD SUITES IHG HOTEL SITE PLAN

Digital copies of Recorded Warranty Deed of Subject Property/Properties OBTAINING DEED PRIOR TO SPLIT OFFS

Digital Copy of latest Approved and Recorded Plat for Subject Property (Legal description on warranty deed should match boundaries of recorded plat) ATTACHED SHOPPING CENTER PLAT (OUTPARCEL 3)

Property Owner Consent & Agent Authorization (Included in packet) ATTACHED

Letter of Intent PROPERTY IS UNDER CONTRACT FOR SALE TO KAMLESH PATEL AND MAP EQUITIES (STEVEN GULAS).

Development of Regional Impact N/A OUTPARCEL ORIGINAL CONCEPT DESIGN FOR THE SITE WAS RETAIL BUILDING WITH 90 PARKING SPACES; HOTEL WILL HAVE LESS TRIPS THAN A LARGE RETAIL BUILDING

One PDF copy of a Hydrology Report ATTACHED HYDROLOGY REPORT CALCULATING BASED ON THE SOUTHHAMPTON HYDROLOGY REPORT; APPLICANT ACKNOWLEDGES THE POND DOES NOT SATISFY WATER QUALITY REQUIREMENTS

Stormwater Plan THERE IS A STORM PIPE GOING THROUH SOUTH END OF PROPERTY WE WILL TIE INTO; STORMWATER SYSTEM WILL BE DESIGNED AFTER SITE PLAN APPROVAL WITH CIVIL DRAWINGS

Grading Plan (THE SITE'S SLOPE IS MODERATE AND THE LENGTH OF THE BUILDING IS RUN WITH THE CONTOURS. GRADING PLAN WILL BE DESIGNED AFTER SITE PLAN APPROVAL WITH CIVIL DRAWINGS?)

Inspection and Maintenance Agreement TOWN HAS SOUTHHAMPTON MAINTENANCE AGREEMENT ON FILE

Operation and Maintenance Plan TOWN HAS SOUTHHAMPTON MAINTENANCE AGREEMENT ON FILE

Stormwater Management Plan THERE IS A STORM PIPE GOING THROUH SOUTH END OF PROPERTY WE WILL TIE INTO; CAN WE DRAW STORM SYSTEM LATER WHEN WE DO CIVIL DRAWINGS?

SUBJECT PROPERTY

SITE ADDRESS: CARRIAGE OAKS DR., TYRONE, GA 30290

TRACT 2S: 3.0163 ACRES ±
TRACT 3S A: 1.6570 ACRES ±
TRACT 3S B: 1.1583 ACRES ±
OVERALL TRACT 3S (A & B): 2.8153 ACRES ±

ZONED: PUD

SURVEYOR'S ACKNOWLEDGEMENT

IT IS HEREBY CERTIFIED THAT THIS PLAT IS TRUE AND CORRECT AND WAS PREPARED FROM AN ACTUAL SURVEY OF THE PROPERTY MADE BY ME OR UNDER MY SUPERVISION; THAT ALL THE MONUMENTS SHOWN HEREON ACTUALLY EXIST OR ARE MARKED AS FUTURE* AND THEIR LOCATION, SIZE, TYPE, AND MATERIAL ARE CORRECTLY SHOWN; THIS PLAT CONFORMS TO ALL REQUIREMENTS OF GEORGIA PLAT ACT.

BY _____
REGISTERED GEORGIA PROFESSIONAL
LAND SURVEYOR NO. _____
DATE: _____

THIS PLAT COMPLIES WITH THE ZONING REGULATIONS, THE LAND DEVELOPMENT ORDINANCE AND ALL OTHER REGULATIONS GOVERNING THE LAND DEVELOPMENT FOR TYRONE.

TOWN ENGINEER DATE _____
MAYOR DATE _____
TOWN CLERK DATE _____

OWNER'S ACKNOWLEDGEMENT

I THE UNDERSIGNED OWNER OF THE PROPERTY SHOWN ON THIS PLAT HEREBY OFFER TO DEDICATE AND/OR RESERVE FOR PUBLIC USE THE RIGHTS-OF-WAY, EASEMENTS, AND OTHER GROUND SHOWN.

OWNER: _____ DATE: _____

N/F
JOHN WIELAND HOMES, INC

| LEGEND | |
|--------|--------------------------|
| PPB | POINT OF BEGINNING |
| IPS | IRON PIN SET |
| IFP | IRON PIN FOUND |
| CMP | CONCRETE MONUMENT FOUND |
| UP | UTILITY POLE |
| LP | LIGHT POLE |
| FP | FLAG POLE |
| SSMH | SANITARY SEWER MANHOLE |
| SDMH | SEWER DRAIN MANHOLE |
| INV | INVERTER |
| FH | PIPE HYDRANT |
| EP | EDGE OF PAVEMENT |
| TC | TOP OF CURB |
| BC | BOTTOM OF CURB |
| TOF | TOP OF WALL |
| BW | BOTTOM OF WALL |
| OUE | OUTDOOR UTILITY |
| UE | UNDERGROUND UTILITY |
| CMP | CORRODED METAL PIPE |
| RCP | REINFORCED CONCRETE PIPE |
| PVC | PIPE VICTORY CORDE PIPE |
| GW | GUY WIRE ANCHOR |
| TR | TRANSFORMER |
| JB | JUNCTION BOX |
| SWCB | STORM WATER CATCH BASIN |
| DWCB | DOUBLE MINE CATCH BASIN |
| CLF | CHAN LINK FENCE |
| WV | WATER VALVE |
| WW | WATER WHEEL |
| CO | SEWER CLEANOUT |
| GV | GAS VALVE |
| IRV | IRRIGATION VALVE |
| PSL | PIPER SIDE LINE |
| TSP | TRAFFIC SIGNAL BOX |
| TSF | TRAFFIC SIGNAL POLE |
| YI | YARD INLET |
| B.S.L. | BUILDING SETBACK LINE |
| S.S.E. | SANITARY SEWER EASEMENT |
| D.E. | Drainage Easement |
| —S— | SEWER LINE |
| —OU— | OVERHEAD UTILITIES |
| —AE— | APPROX. ELECTRIC LINE |
| —AG— | APPROX. GAS LINE |
| —ATL— | APPROX. TELEPHONE LINE |

GENERAL NOTES

THIS SURVEY WAS PREPARED WITHOUT BENEFIT OF A TITLE REPORT WHICH MAY REVEAL ADDITIONAL CONVEYANCES, EASEMENTS, OR RIGHTS-OF-WAY NOT SHOWN HEREON.

EQUIPMENT USED FOR ANGULAR & LINEAR MEASUREMENTS: LEICA TCR 1103 ROBOTIC


THE FIELD DATA UPON WHICH THIS SURVEY IS BASED HAS A CLOSURE PRECISION OF ONE FOOT IN 43,962+ FEET AND AN ANGULAR ERROR OF 3.0° PER ANGLE POINT AND WAS ADJUSTED USING LEAST SQUARES METHOD.

THE PLAT HAS BEEN CALCULATED FOR CLOSURE AND IS FOUND TO BE ACCURATE TO WITHIN ONE FOOT IN 100,000+ FEET.

BEARINGS SHOWN ON THIS SURVEY ARE FROM GRID NORTH. (GA 83 WEST ZONE)

NO PORTION OF THIS PROPERTY IS LOCATED IN A SPECIAL FLOOD AREA AS PER F.I.R.M. COMMUNITY PANEL NO. I-3113C0040 dated 03/18/1996.

THE UNDERGROUND UTILITIES SHOWN HAVE BEEN LOCATED FROM ABOVE GROUND FIELD SURVEY INFORMATION. THE SURVEYOR MAKES NO GUARANTEES THAT THE UNDERGROUND UTILITIES SHOWN COMPRISE ALL SUCH UTILITIES IN THE AREA, EITHER IN-SERVICE OR ABANDONED. THE SURVEYOR FURTHER DOES NOT WARRANT THAT THE UNDERGROUND UTILITIES SHOWN ARE IN THE EXACT LOCATION INDICATED ALTHOUGH THEY ARE LOCATED AS ACCURATELY AS POSSIBLE FROM INFORMATION AVAILABLE. THE SURVEYOR HAS NOT PHYSICALLY LOCATED THE UNDERGROUND UTILITIES.

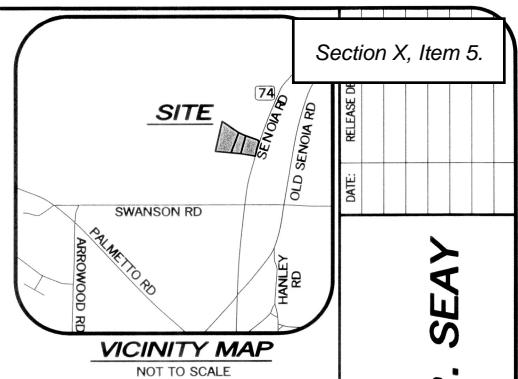

VICINITY MAP
NOT TO SCALE

Section X, Item 5.

A FINAL PLAT PREPARED FOR:


PHILLIP R. SEAY

POINT TO POINT
LAND SURVEYORS
810 Jackson Street
Locust Grove, Georgia 30248
(p) 678.565.4440 (f) 678.565.4497
(w) pointtopointsurvey.com



LAND LOT: 116
DISTRICT: 7TH
SECTION: N/A
CITY: TYRONE
COUNTY: FAYETTE
STATE: GEORGIA
DATE: 27 NOV., 2006
DRAWN BY: KJW
CHKD BY: C. INER
APPROVED BY: C. McCANN
JOB NO.: 2006.653
FILE #: 06-C-101
SHEET NUMBER:

1
69

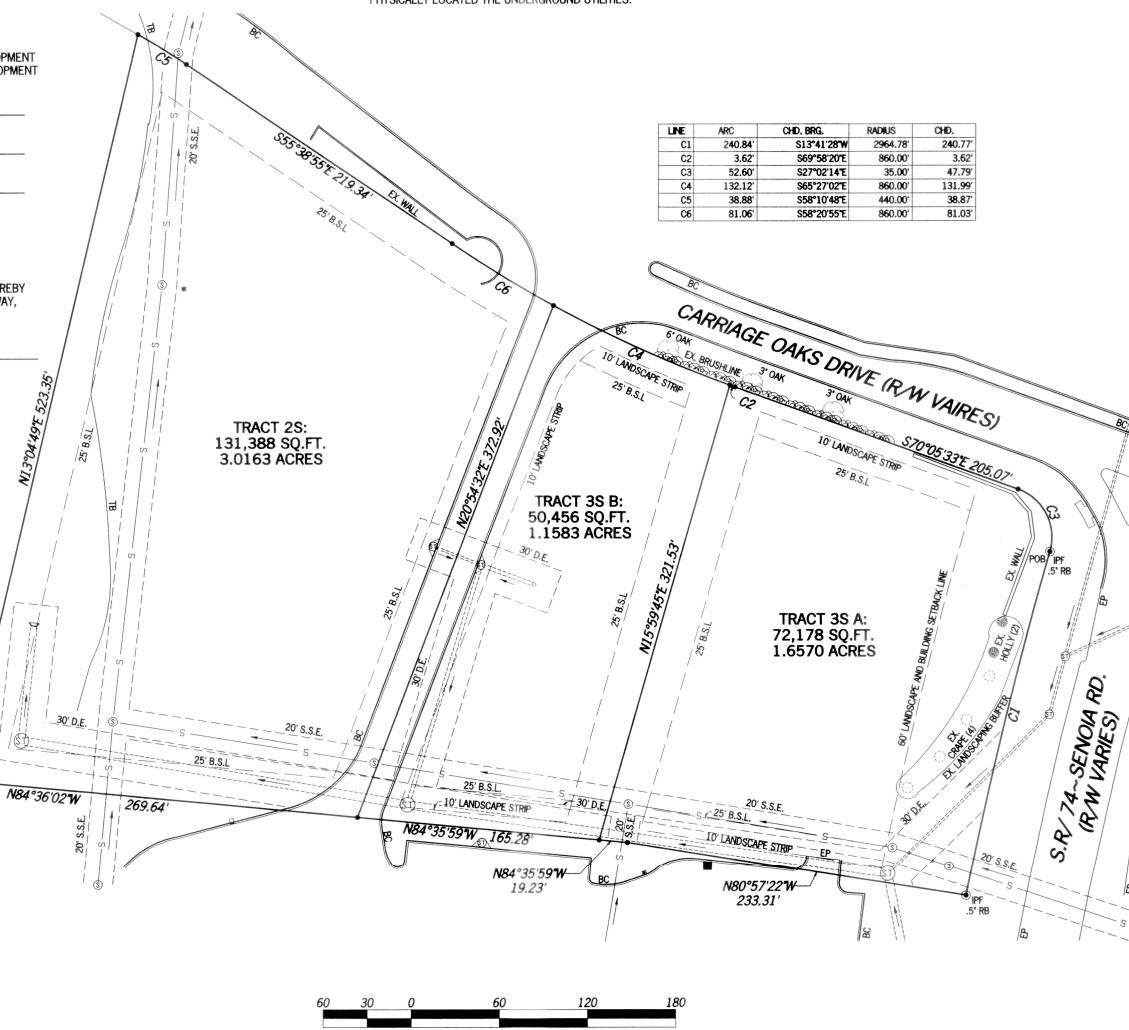

Hovey & Associates, Inc.

130 Howard Lane; Suite B
Fayetteville, Georgia 30214
Ph. # (770) 460-2200
Dghovey@bellsouth.net

Aug. 28, 2023

To: Mr. Steve Gulas

Re: IGH Candlewood extended stay hotel site
Town of Tyrone, Fayette County, Ga.

Mr. Gulas,

As requested, I have analyzed the Hydrological Study for the South Hampton Subdivision (dated July 17, 1998) for the purposes of determining if the site chosen for the potential Candlewood extended stay hotel does indeed meet the requirements for storm water detention as per the mentioned study. The site in question fall within the study basin B which has an overall drainage area considered of 78 acres. For the developed conditions of this basin, 15.4% is considered as residential with a developed runoff curve number of 72, 43.6 % is considered as commercial development with a developed curve number of 92, and 41.0% is considered as offsite areas with a runoff curve number of 61. The proposed Candlewood site falls within the commercial areas having a developed runoff curve number of 92. What constitutes a developed runoff curve number of 92 is that 85% of the site is considered as impervious areas and the remaining 15% is considered as landscaped/open space. The proposed Candlewood site - as depicted in your layout-falls well below the 85% impervious areas, therefore this site can be considered as still being fully detained for in the adjacent detention basin (pond 2 as per the study).

If you have questions concerning this matter please feel free to give me a call.

Sincerely,



David G. Hovey, P.E.
Hovey & Associates, Inc.

Town of Tyrone

PROPERTY OWNER CONSENT AND AGENT AUTHORIZATION FORM (Application requires authorization by ALL property owners of subject property)

Name(s) of All Property Owners of Record found on the latest recorded Warranty Deed for the subject property

Phillip R. Seay, Jr., as Executor of the Last Will and Testament of Phillip R. Seay, deceased

Please Print Names

Property Tax identification Number(s) of Subject Property: 0726051

(I am) (We are) the sole owner(s) of the above -referenced property. Subject property is located in the Land Lot(s) _____ of the _____ District, and (if applicable to more than one land district) Land Lot(s) of the _____ District, and said property consists of a total of acres (legal description corresponding to most recent recorded plat for the subject property is attached herewith).

(I)(We) hereby delegate authority to Kamlesh Patel and Steven Gulas act as (my) (our) Agent for this site plan. As Agent, they have the authority to agree to any and all conditions, which may be imposed by the Board.

(I)(We) certify that all of the information field with this application including written statements or showing made in any paper or plans submitted herewith are true and correct to the best of (my) (our) knowledge and belief. Further, (I) (We) understand that any knowingly false information given herein by me/us will result in the denial, revocation or administrative withdrawal of the application or permit. (I) (We) further acknowledge that additional information may be required by the Town of Tyrone to process this application.



-Executor

Signature of Property Owner 1



NADIA A WAGNER
NOTARY
EXPIRES
2/2/2025
COBB COUNTY
PUBLIC

Signature of Notary Public

145 Thomas Overby Dr., Sharpsburg GA 30277

Address

September 18, 2023

Date

Signature of Property Owner 2

Signature of Notary Public

Address

Date

Signature of Property Owner 3

Signature of Notary Public

Address

Date

Signature of Property Owner 4

Signature of Notary Public

Address

Date

Town of Tyrone

Requirements for Site Plan

- A. **UsesandStructures.** No property shall be used and no structures shall be constructed or modified unless it is shown that a proposed use or structure is in compliance with all Town regulations as verified by a Certificate of Zoning Compliance.
- B. **Building Permit.** Before issuing any type of building permit for the site, the Building Official must receive a Certification of Zoning Compliance approved by the Planning Director.
- C. **Site Plan Required.** Prior to the certification of zoning by the Planning Director, the Town must approve a site plan.
 - 1) No clearing, grubbing, or grading may be undertaken until a land disturbance permit has been approved by the Town and visible posted at the primary point of access to the property.
 - 2) No clear, grubbing, or grading involving the use of explosives may be undertaken until a special permit has been issued by the fire Marshal.
 - 3) No installation or removal of underground tanks for Class I, II, III flammable liquids shall be undertaken until the appropriate permits and inspections have been conducted by the Fire Marshal.
- D. **FilingofSite Plan.** The Site Plan shall be submitted in accordance with the schedule of established application deadlines and meeting dates, a copy of which is available in the office of the Planning Director. The Site Plan shall be submitted in accordance with the schedule of established application deadlines and meeting dates, a copy of which is included in this packet. The Site Plan shall be deemed filed when the complete packet is submitted and all fees are paid to the Planning Director. Applications should be submitted online through our online permitting system. Instructions can be found at www.tyronega.gov.
- E. **Site Plan Distribution.** All submissions must be completed online. The Planning Director will distribute the plans to the following offices for review.
 - 1. Town Engineer/Public Works Director
 - 2. Environmental Protection/Planning
 - 3. Environmental Health Office
 - 4. Fire Marshal
 - 5. Water Systems Manager
 - 6. Planning & Development Director
- F. **Site Plan Contents.** A site plan must be prepared by an engineer or architect who is registered by the state and shall include in addition to the certified property lines, all applicable information as required on the Site Plan review checklist, a copy of which is available at the office of the Planning Director.
- G. **DepartmentApproval.** Upon completion of site plan review by the required departments, each department will return its comments to the Planning Director, who will make the appropriate entries on the Site Plan Review Checklist and notify the applicant of approval, administrative conditions of approval, or additional requirements.
- H. **Fee.** A site plan review and compliance fee as specified in this code will be collected and a receipt provided at the time of issuance of the certificate of zoning compliance by the Planning Director and prior to the issuance of a building permit.
- I. **Otherplans required.** The building plans and sign plans are not required to be submitted with the Site Plan.
- J. **Verificationoflot.** In addition to an approved site plan, an applicant must provide verification that a plat of subdivision has been approved and recorded if required by the subdivision regulations.

- K. **Approval by Planning Director:** Upon approval of the site plan by all required departments, the Planning Director may approve the certificate of zoning compliance
- L. **Certification to Building official.** The certificate of zoning compliance will then be attached to the site plan review checklist and presented to the building official. The applicant will be notified the site plan has been approved.
- M. **Site Plan Changes.** Any deviation from an approved site plan must be shown on a revised site plan and approved by the town employee(s) having jurisdiction over the change. Changes shall be authorized in writing on the revised site plan by the appropriate town employee(s). A copy of the revised site plan will then be given to the building official for inclusion in the project file.
- N. **Fire Marshal approval.** The Fire Marshal shall approve all construction plans and submit to the building department. Prior to any building construction, the applicant must obtain a construction permit through the Bureau of Fire Prevention. This permit will not be in lieu of required permit through the Building Official.
- O. **Certificate of Occupancy.** In no case shall the Building Official issue a certificate of occupancy unless an as-built condition is reflected on an approved site plan.
- P. **Expiration of Certificate of Zoning Compliance.** If no application is made to obtain a building permit from the Building Official within twelve (12) months from said enactment date shall be deemed null and void.

Additional Items Needed for Land Disturbance Permit:

Copy of Erosion Control Card

Copy of Certified Receipt for Notice of Intent

Notice of Intent

Tree Survey and Inventory Plan (Checklist Included in packet)

Tree Protection Plan/ Tree Replacement (Checklist Included in packet)

Landscaping Plan (Checklist Included in packet)

Erosion, Sedimentation & Pollution Control Plan (Checklist Included in packet)

An Architect or Engineer who is registered by the State of Georgia must prepare the site plan and shall include all of the following information:

- { } 1. Name and location of the development.
- { } 2. Name, address, and telephone number of owner and applicant.
- { } 3. Name, address, telephone number and seal of person preparing plan.
- { } 4. Name, address and telephone number of the developer.
- { } 5. Zoning of adjoining property and adjoining property owners.
- { } 6. Vicinity map.
- { } 7. Date, scale, north arrow, and number
- { } 8. Locations and dimensions of all existing structures (principal and accessory).
- { } 9. The limits of a 100-year flood including elevations, and applicable watershed protection buffers and setbacks. A minimum of 1.0 acre or 50% of the minimum lot size of the zoning district, whichever is greater, must be out of the 100-year floodplain. The MFFE must be 3.0 feet above the 100-year elevation.
- { } 10. Show existing easements, burial grounds, railroad rights-of-way and the location, width and names of all existing or platted streets or other public ways within or immediately adjacent to the tract to be developed.
- { } 11. Zoning of property; rezoning conditions, if applicable, total acreage of site.
- { } 12. Locations and dimensions of all proposed structures (principal and accessory) and proposed use (s).
- { } 13. Right-of-way, pavement edges, center lines of roadways and all easements.
- { } 14. Minimum yards and setback specified in the Zoning Ordinance.
- { } 15. Distance between buildings
- { } 16. The location and size of any parcels of land proposed to be set aside for park or playground use, greenbelts or other public use, or for the exclusive use of property owners in the proposed property. Indicate areas to be landscaped.
- { } 17. Number of stores, square footage per unit size, numbers of units per unit size and total number of units.
- { } 18. If multi-family, square footage per unit size, number of units per unit size and total number of units.
- { } 19. Exit/Entrances, and internal circulation pattern including traffic lanes, fire lanes, acceleration/deceleration lanes and all dimensions.
- { } 20. The location of temporary stakes, if required by the Planning Commission and Town Staff.
- { } 21. Parking layout, including handicapped parking and landscaping. Indicate how number of space was determined. If the parking area has more than twelve spaces show landscaped islands
- { } 22. Required landscape areas, buffers, and screening.
- { } 23. Off-Street loading and screening.
- { } 24. Location of refuses collection area(s) and any onsite storage and /or service areas, and how such refuse and storage area will be screened.
- { } 25. Storm drainage systems (including detention) and hydrological report or documentation
- { } 26. Limits of construction.
- { } 27. Use of Building
- { } 28. Contour lines based on sea level datum. These shall be drawn at intervals of not more than two (2) feet. Contour lines shall be based on field surveys

- and basis for the topographic contour shown shall be specified.
- { } 29. Location of existing and proposed water, sanitary sewer lines and fire hydrants.
- { } 30. Outdoor lighting to include type of fixtures, intensity and locations.
- { } 31. Natural features within the proposed development, including drainage channels, bodies of water, wooded areas (tree lines) and other significant features. On all watercourses entering the tract the direction and acreage of the drainage are above the point of entry shall be noted, and the one hundred-year floodplain shall be outlined.
- { } 32. Show location of septic system / sewer system - including initial and replacement drain fields.
- { } 33. Elevations, if applicable
- { } 34. Right-of-way denotation.
- { } 35. The applicant shall submit information sufficient to permit an adequate evaluation of the development proposal in conformance with these and all other regulations and in conformance with the Town's comprehensive land use plan. Specifically, the applicant shall provide the areas in square feet and acres of the various components of the development, including streets, buildings and other property to be dedicated to the Town.

The Site Plan Should Also Reflect the Following Items:

All adjacent uses, approvals, developments, and zoning districts; all adjacent right of ways and easements; all buffers and requirements; access points; site circulation indication right of way widths, safe sight corners, curve radii; location, area and dimensions of structures or building envelopes; location and dimension of parking and loading spaces; locations and area of open space (i.e. lakes, golf courses, open fields); lot lines; out parcel boundaries; phase lines; easements including type and width; well fields; septic systems' family cemeteries and access; preserve areas locations and access; dimension and notes for all improvements and related requirements, location of all landscape material; and other existing natural or manmade features; and , any other information required by code or by conditions of approval.

Comments:

Reviewed by _____ Date _____

DEVELOPMENTS OF REGIONAL IMPACT (DRI)

Site Plan Applicant:

A. Please review the attached "Thresholds: Developments of Regional Impact" established by the State Department of Community Affairs (DCA) to determine if the proposed project meets or exceeds these thresholds. If the proposed project does not meet the established thresholds (is less than those listed) then skip to section C. below and complete.

B. If the project does meet or exceed the established thresholds for the type of development proposed, the applicant is responsible for completing the Atlanta Regional Commission (ARC) **"Developments of Regional Impact: Request for Review Form"** prior to submittal of the site plan application. You may contact ARC at (404)463-3311 to request the form. A copy of the completed form and documentation that the form has been submitted to ARC for review is required to be included with this application.

C. I have reviewed and understand the attached "Thresholds: Developments of Regional Impact".
 The proposed project related to this rezoning request DOES NOT meet or exceed the established DRI thresholds.

[] The proposed project related to this rezoning request DOES meet or exceed the established DRI thresholds and documentation regarding the required ARCs DRI Request for Review Form is attached.

Applicant

Date

THRESHOLDS: DEVELOPMENTS OF REGIONAL IMPACT

| TYPE OF DEVELOPMENT | ATLANTA REGION | METROPOLITAN AREAS | RURAL AREAS |
|--------------------------------------------------------------|---------------------------------------------------------------------------------------------------------------------------------|---------------------------------------------------------------------------------------------------------------------------------|---------------------------------------------------------------------------------------------------------------------------------|
| (1) OFFICE | > 500,000 net square feet | > 400,000 net square feet | > 250,000 net square feet |
| (2) COMMERCIAL, WHOLESALE & DISTRIBUTION | > 700,000 net square feet | > 560,000 net square feet | > 350,000 net square feet |
| (3) HOSPITALS | > 600 new beds | > 480 new beds | > 300 new beds |
| (4) HOUSING | > 500 new lots or units | > 400 new lots or units | > 250 new lots or units |
| (5) INDUSTRIAL | Park or single user > 500 acres, or employing more than 2,000 people, or using more than 100,000 gallons per day of water | > 500 acres, or employing more than 1,600 people, or using reserve capacity of other jurisdictions | > 500 acres, or employing more than 1,000 people, or using reserve capacity of other jurisdictions |
| (6) HOTELS | > 500 rooms | > 400 rooms | > 250 rooms |
| (7) MIXED USE | > 500,000 net square feet | Two or more land uses, common ownership, and > 40 acres | Two or more land uses, common ownership, and > 40 acres |
| (8) AIRPORTS | Any new airport, new runway, or runway extension | Any new airport, new runway, or runway extension | Any new airport with paved runway, or runway additions of more than 25% of existing runway length |
| (9) ATTRACTIONS OR RECREATIONAL | > 2,000 parking spaces or more than 7,500 permanent seats | > 1,600 parking spaces or more than 6,000 permanent seats | > 1,000 parking spaces or more than 3,750 permanent seats |
| (10) POST SECONDARY SCHOOLS | New school with capacity of more than 3,000 students, or expansion of this type school by at least 25% of capacity | New school with capacity of more than 2,400 students, or expansion of this type school by at least 20% of capacity | New school with capacity of more than 1,500 students, or expansion of school by 25% or more new full-time students |
| (11) WASTE DISPOSAL | New facility or expansion of use of an existing facility by 50% or more, intending to accept waste from another jurisdiction | New facility or expansion of use of an existing facility by 50% or more, intending to accept waste from another jurisdiction | New facility or expansion of use of an existing facility by 50% or more, intending to accept waste from another jurisdiction |
| (12) WASTEWATER FACILITIES, QUARRY, ASPHALT OR CEMENT PLANTS | New facility or expansion of use of existing facility by 50% or more, and located within one-half mile of a government boundary | New facility or expansion of use of existing facility by 50% or more, and located within one-half mile of a government boundary | New facility or expansion of use of existing facility by 50% or more, and located within one-half mile of a government boundary |
| (13) PETROLEUM STORAGE FACILITY | Petroleum storage > 50,000 barrels, if within 1,000 feet of any water supply, or storage > 200,000 barrels | Petroleum storage > 50,000 barrels, if within 1,000 feet of any water supply, or storage > 200,000 barrels | Petroleum storage > 50,000 barrels, if within 1,000 feet of any water supply, or storage > 200,000 barrels |

*(14) APPLICANT=S DEMAND ON INFRASTRUCTURE THRESHOLD
(To be used ONLY if a project DOES NOT fit into one of the above categories)*

| | | | |
|----------------------|--------------------------------------------------------------------------------------------------------------------|--------------------------------------------------------------------------------------------------------------------|--------------------------------------------------------------------------------------------------------------------|
| ELECTRICAL | Any increase in average electrical demand > 100 megawatts | Any increase in average electrical demand > 100 megawatts | Any increase in average electrical demand > 100 megawatts |
| NATURAL GAS | Any increase in demand for natural gas > 100,000 therms per day | Any increase in demand for natural gas > 100,000 therms per day | Any increase in demand for natural gas > 100,000 therms per day |
| WATER | Any increase in demand of > 100,000 gallons per day or will absorb the reserve capacity of another jurisdiction | Any increase in demand of > 100,000 gallons per day or will absorb the reserve capacity of another jurisdiction | Any increase in demand of > 100,000 gallons per day or will absorb the reserve capacity of another jurisdiction |
| WASTEWATER TREATMENT | Any increase in treatment of > 500,000 gallons per day or will absorb the reserve capacity of another jurisdiction | Any increase in treatment of > 400,000 gallons per day or will absorb the reserve capacity of another jurisdiction | Any increase in treatment of > 250,000 gallons per day or will absorb the reserve capacity of another jurisdiction |
| TRANSPORTATION | Any increase > 1500 peak hour vehicle trips per day | Any increase > 1200 peak hour vehicle trips per day | Any increase > 750 peak hour vehicle trips per day |