

#### GENERAL GOVERNMENT COMMITTEE MEETING AGENDA

#### Online via Zoom and In Person at Tumwater City Hall, Council Conference Room, 555 Israel Rd. SW, Tumwater, WA 98501

#### Wednesday, November 09, 2022 2:00 PM

- 1. Call to Order
- 2. Roll Call
- 3. Approval of Minutes: General Government Committee, September 14, 2022
- 4. Resolution No. R2022-013 Tumwater Cowlitz Trail (Chuck Denney)
- 5. 2022-25 Comprehensive Plan Periodic Update Process Work Program (Brad Medrud)
- 6. Contract Approval for an 8-Year Multifamily Tax Exemption for the 350 North Street Apartments (TUM-22-1338) (Brad Medrud)
- 7. Contract Approval for an 8-Year Multifamily Tax Exemption for the Craft District Apartments (TUM-22-1393) (Brad Medrud)
- 8. Additional Items
- 9. Adjourn

## **Meeting Information**

All committee members will be attending remotely. The public are welcome to attend in person, by telephone or online via Zoom.

## Watch Online

https://us02web.zoom.us/j/89088512664?pwd=NTA0cWpPVWN1OWc1OU9OVm5xVDZzQT09

#### Listen by Telephone

Call (253) 215-8782, listen for the prompts and enter the Webinar ID 890 8851 2664 and Passcode 075579.

#### **Public Comment**

The public may submit comments by sending an email to <u>council@ci.tumwater.wa.us</u>, no later than 9:00 a.m. the day of the meeting. Comments are submitted directly to the Committee members and will not be read individually into the record of the meeting.

#### **Post Meeting**

Audio of the meeting will be recorded and later available by request, please email <u>CityClerk@ci.tumwater.wa.us</u>

#### Accommodations

The City of Tumwater takes pride in ensuring that people with disabilities are able to take part in, and benefit from, the range of public programs, services, and activities offered by the City. To request an accommodation or alternate format of communication, please contact the City Clerk by calling (360) 252-5488 or email <u>CityClerk@ci.tumwater.wa.us</u>. For vision or hearing impaired services, please contact the Washington State Relay Services at 7-1-1 or 1-(800)-833-6384. To contact the City's ADA Coordinator directly, call (360) 754-4128 or email <u>ADACoordinator@ci.tumwater.wa.us</u>.

CONVENE:	2:00 p.m.
PRESENT:	Chair Michael Althauser and Councilmembers Joan Cathey and Leatta Dahlhoff.
	Staff: City Attorney Karen Kirkpatrick and Planning Manager Brad Medrud.

## APPROVAL OF MINUTES: JUNE 8, 2022 AND JULY 13, 2022:

## MOTION: Councilmember Cathey moved, seconded by Councilmember Dahlhoff, to approve the General Government Committee meeting minutes of June 8, 2022 and July 13, 2022 as published. A voice vote approved the motion unanimously.

ORDINANCE NO. O2022 Manager Medrud reported during 2020 and 2021, staff gathered 013, 2022 information on proposed minor Tumwater Municipal Code (TMC) DEVELOPMENT CODE HOUSEKEEPING AMENDMENTS: proposed amendments are intended as minor corrections to the City's development regulations. The Planning Commission reviewed the proposed amendments and issued a recommendation for the committee's consideration. TMC 18.60.025(A) establishes a process for development code housekeeping amendments that is similar to the one the City follows for annual Comprehensive Plan amendments.

The staff report includes a summary of the 15 amendments, code sections affected, and proposed amendment language. Staff is seeking a recommendation to forward the ordinance either to a Council worksession or to a regular Council meeting for the Council's consideration.

Councilmember Cathey asked whether the Planning Commission considered some suggestions offered by the committee during its preliminary review of the proposed amendments. Manager Medrud affirmed the Planning Commission considered the suggestions and included additional suggestions for several of the proposed amendments.

Manager Medrud reviewed the proposed change(s) for each amendment:

- **A. Accessory Dwelling Unit Entrances:** Amendment to TMC 18.42.010(D)(3) would change a requirement to an option.
- **B. Adult Family Homes/Residential Care Facilities:** Amendments would address consistency of adult family home and residential care facilities as permitted and conditional uses. The proposed amendment to TMC 18.53.020 would allow adult

family homes as a permitted use in the following zoning districts: GB, OS, RSR, SFL, SFM, MFM, MFH, MHP, CBC, BD, NC, MU, GC, CS, HC, and TC. The proposed amendment to TMC 18.53.030 would allow residential care facilities as a permitted use in the following zoning districts: GB, OS, RSR, SFL, SFM, MFM, MFH, MHP, CBC, BD, NC, MU, GC, CS, HC, and TC.

- C. Bicycle Storage: Clarifies bicycle storage requirements.
- **D. Capitol Boulevard Community Multifamily Parking Requirements:** Adjusts the 1.0 parking space per dwelling unit limit based on the number of bedrooms of multifamily dwelling units to relieve off-street parking impacts to adjacent neighborhoods.
- **E. Car Washes:** Adds "carwash" as an amendment to Title 17 Zoning definitions, instead of a specifically listed use.
- **F. Duplexes:** Amends the permitted uses in the Residential/Sensitive Resource, Single-Family Low Residential Density, and Single-Family Medium Residential Density zone districts. Councilmember Althauser had previously offered some clarifying language to ensure that duplexes would be allowed on individual lots that are currently in existence as well as in a new subdivision with limits on the percentage of lots housing a duplex.
- **G. Impound Yards:** Adds "impound yards" as a new use, which is not currently permitted in any zone districts in the City. The proposal adds the use as a conditional use to LI, HI, and ARI zone districts and adds minimal conditions through the conditional use process in TMC 18.56.180. Several inquiries have been received by staff conveying interest in locating the use in the City.

Councilmember Cathey questioned the intent of "minimal conditions through the conditional use process." Manager Medrud explained that the process for a conditional use is different from a permitted use by considering and evaluating potential additional impacts above the current process for permitted uses. The conditional use requires a hearing examiner public hearing to evaluate the proposed use against specific criteria. Councilmember Cathey said her concern surrounding the language is the use of "minimal" because it could be subject to misinterpretation. Manager Medrud said the option of including "minimal" could be revised by indicating that additional conditions through the conditional use process are beyond the basic conditions that are required. Additionally, "minimal" is not included in the proposed amendments or in the ordinance.

**H. Mixed Use Overlay (MUO):** Clarifies that MUO requires commercial uses along primary roadways rather than 20% 20%

of every building. Each parcel in the mixed-use overlay shall contain residential and commercial uses. The entire gross floor area of the first floor of building(s) facing existing or new public right-of-way frontage shall be dedicated to commercial uses with the exception of required building features serving the residential uses on the upper floors, such as a residential lobby, stairways, mechanical equipment, and elevators. A minimum of twenty percent of each building shall be residential. No less than eight thousand five hundred square feet of gross floor area of a building and no more than fifty thousand square feet of gross floor area of a building shall be dedicated to commercial uses.

- **I.** Nonconforming Signs: Addresses a conflict in the nonconforming signs requirements in TMC 18.44 *Signs*.
- J. Optometry Clinics: Addresses "optometry clinics," which do not fit in the existing "medical clinic" or "professional services" uses. Creates a new "optometry clinics" use with a new definition in TMC 18.04.150. Adds as a permitted use to the NC, CS, MU, CBC, GC, TC, LI, HC, BD, and ARI zone districts.
- K. Personal and Professional Services: For consistency and clarity, splits "personal and professional services" into "personal services" and "professional and services" and removes "personal and professional and services and sales" from the TMC 18.07.020 Table Commercial zone districts permitted and conditional uses Summary Tables of Uses. "Personal service" means a business which is neither the practice of a profession, nor dealing primarily with the sale of products as stock-in-trade on the premises. Product sales shall not occupy more than twenty-five percent of the gross floor area of the business. Such businesses include, but are not limited to, barber and beauty shops, tailoring, shoe repairing, photographic studios, tanning parlors, and pet grooming and obedience training.

Councilmember Dahlhoff questioned the purpose of prescribing the gross floor area allowed for uses, such as beauty salon as it could be perceived as a limiting option that might inadvertently exclude entrepreneurial businesses. Manager Medrud said it is likely the gross floor area of 25% could be an arbitrary figure; however, the intent is to ensure the floor space within the business is devoted primarily to the provision of the services listed as the primary use. As an example, a salon would be occupying the majority of the space with some space available for selling commercial salon products. Councilmember Dahlhoff explained that her concern is that the language is too prescriptive and could limit businesses from locating in the City. Councilmember Cathey noted that salon services can range from several types of services relative to the human body and

September 14, 2022 Page 4

suggested affording some flexibility for some professional businesses.

Councilmember Althauser noted that personal and professional services are essentially allowed in all zoning districts while retail sales uses are not allowed in all zoning districts. He asked whether the intent of the proposal is to promote some retail sales in conjunction with personal or professional services in Neighborhood Commercial zone districts as commercial retail is not allowed in that zone district. Manager Medrud offered to provide additional information on the source of the issue for additional discussion. The intent of the proposal was to ensure personal or professional services would not be focused primarily as a retail use but that the retail aspect of the use would be auxiliary to the primary personal or professional service. Councilmember Althauser recommended consideration of adding language that allows retail uses in Neighborhood Commercial zone districts.

- L. Residential Mechanical Equipment in Setbacks: Proposal allows "residential mechanical equipment" in the RSR, SFL, and SFM zone districts rear setbacks.
- **M. Public Building Signs:** Adds exemptions for the size and number of signs for public buildings and churches located in residential zone districts.

Councilmember Dahlhoff questioned the flexibility of the code to enable large signs for uses, such as churches that support City and community functions as well as serving as a church in the community. Manager Medrud said the issue is complicated, as it would likely entail examining some sort of wayfinding overlay provisions in the City. The challenge is adopting provisions in the code that would be applicable to all uses specific to the provision rather than addressing individual situations. Councilmember Dahlhoff cited the example of the church located off Israel Road that often supports community and City events. The issue is allowing a sign that can be viewed from the freeway. The church has forwarded some sign schematics to the City depicting examples of some larger signs for the church. She agreed to forward an email to staff from the church regarding the sign request.

Councilmember Althauser said the Commission's proposal included the addition of churches allowing a church one sign up to 15 feet in height measuring no more than 55 square feet within a residential zone. He is unsure whether he is supportive of the proposal because schools and public buildings have some modicum of public accountability for signs. Larger signs for

those uses can be justified because signs can generate public announcements while a 55 square-foot sign for a church with no public accountability or oversight mechanism is concerning. Discussion ensued on the City's permitting process for signs acknowledging that the City cannot control the content of a sign. An application for a proposed sign would be evaluated for the size and location and if the proposal adheres to the proposed amendment, the sign would be permitted. The proposed change enables larger signs for churches. Churches are currently limited to a height of six feet and smaller in proportion if located within a residential zone. The proposal was generated from the Planning Commission's discussion about community uses. Councilmember Althauser said he would prefer to remove churches from the proposal with consideration for increasing square footage of signs. Discussion ensued regarding the expansion of uses in churches today, especially churches located in residential areas. Many churches are used as a community center, a respite center, a food bank distribution point, and sites of community gardens. Councilmembers Dahlhoff and Cathey preferred to retain churches within the proposed amendment. Councilmember Dahlhoff recommended staff provide some visual representations of different sizes of signs.

N. Residential Storage Sheds – Gravel Access: Adds an exemption for storage sheds smaller than five hundred square feet in the Green Belt (GB), Open Space (OS), Residential/Sensitive Resource (RSR), Single-Family Low Density Residential (SFL), or Single-Family Medium Density Residential (SFM) zone districts from driveway surface requirements.

Manager Medrud confirmed the committee's request to defer the amendments to a Council worksession to review the personal and professional services retail square footage limitation, consideration of expanding retail uses within the Neighborhood Commercial zone district, and review the size and height for the proposed sign amendments.

**Subdivision Dedication Code Language Update:** Updates the subdivision dedication code language in TMC 17.24.030(D)(2) to change "men" to "persons."

MOTION:Councilmember Cathey moved, seconded by Councilmember<br/>Dahlhoff, to recommend approval of the 13 proposed amendments<br/>as reviewed for the Council's consideration with the two identified<br/>amendments deferred for additional Council review and discussion.<br/>A voice vote approved the motion unanimously.

ORDINANCE NO. O2022-015, OTHER HOUSEKEEPING AMENDMENTS: Manager Medrud reported the other housekeeping amendments do not follow the TMC 18.60.025(A) process, but are considered concurrently with the final docket of development code amendments in Ordinance No. O2022-013. The Planning Commission reviewed the proposed amendments, held a public hearing, and forwarded a recommendation to the General Government Committee.

Two of the three amendments include Hearing Examiner Staff Reports– Schedule and Traffic Study Requirements. One amendment is a proposed change for consideration.

The hearing examiner has asked that the date when staff reports have to be available be changed from the current five working days prior to the public hearing to seven days. The change would amend TMC 2.58.110 *Distribution of information.* 

The second amendment would update criteria for when a traffic impact analysis is required. Traffic studies would be required for any development generating 50 or more vehicle trips during peak hours on adjacent streets or intersections regardless of peak direction. Additionally, any development generating 10 or more vehicle or truck trips on any Interstate 5 interchanges must provide trip distribution diagrams from a qualified transportation professional regardless if a full traffic study is required.

Additionally, the Commission included another recommendation arising from discussions on the sidewalk amendments. The issue was responsibility of temporary sidewalk obstructions. The Commission considered a proposal but elected not to include it in the ordinance. The City's Transportation Manager briefed the Commission on all issues and addressed the Commission's questions. The Commission recommended that the Council consider a public engagement and a voluntary support program to address any community issues prior to considering any amendments to Title 12 on sidewalks.

Staff recommends not including the amendments pertaining to sidewalks within the ordinance and include a recommendation to the City Council to consider a public engagement process.

Chair Althauser questioned whether the current code requires property owners to remove snow or other obstructions on a sidewalk adjacent to the property. Manager Medrud explained that prior to some amendments in 2011, the code included explicit provisions requiring property owners to address sidewalk obstructions. At some point, those provisions were removed from the code resulting in some uncertainties with respect to sidewalk maintenance of vegetation and obstructions.

City Attorney Kirkpatrick noted that under current law, abutting
property owners are responsible for sidewalk conditions. In those
situations where snow removal becomes an issue and continued for a
period, the matter would be a code enforcement action; however, she is
not aware of any situation that involved code enforcement action for the
condition of a sidewalk. The City has also established a small fund to
assist some neighborhoods with street tree issues because of root
conflicts with sidewalks. The City has the resources to provide
assistance in those types of situations.

Manager Medrud responded to a question on when traffic studies are required. The proposal changes the language when a traffic study is required. Currently, a traffic study is required if the development generates 50 or more vehicle trips in the peak direction during the peak hour on adjacent streets or interchanges. The proposal eliminates language addressing "peak direction" because traffic is generated in all directions in today's environment. A traffic study is required for all zoning districts based on the traffic the new development would generate.

- MOTION: Councilmember Dahlhoff moved, seconded by Councilmember Cathey, to recommend the Planning Commission's recommendation on Ordinance No. O2022-015, Other Housekeeping Amendments and consider a public engagement process for sidewalk amendments to the Council for review during a worksession. A voice vote approved the motion unanimously.
- ADJOURNMENT: With there being no further business, Chair Althauser adjourned the meeting at 3:12 p.m.

Prepared by Valerie L. Gow, Recording Secretary/President Puget Sound Meeting Services, psmsoly@earthlink.net

TO:	General Government Committee
FROM:	Chuck Denney, Parks and Recreation Director
DATE:	November 9, 2022
SUBJECT:	Resolution No. R2022-013 – Tumwater Cowlitz Trail

#### 1) <u>Recommended Action</u>:

The Tumwater Historical Commission is requesting that Resolution No. R2022-013 be forwarded to the City Council with a recommendation for adoption.

#### 2) Background:

The National Parks Service has established that the end of the Oregon Trail is believed to be in Oregon City, OR. Based on extensive research, the trail actually extends in many directions, one of which terminates at Tumwater Falls in the Brewery Park. The intent of this resolution is to begin a process seeking recognition for the importance of the trail to our region and Tumwater specifically. A National Historic Trail designation as the end of the Cowlitz Trail section of the Oregon Trail in Tumwater would have many benefits. The outcome of such a designation would result in National Parks logos posted along the I-5 corridor directing travelers to the Oregon Trail auto route to the Brewery Park, as well as to other historic sites in Tumwater, such as the Bush homestead.

#### 3) Policy Support:

Tumwater of the future will be people-oriented and highly livable, with a strong economy, dynamic places, vibrant neighborhoods, a healthy natural environment, diverse and engaged residents, and living connection to its history.

Seek opportunities to market Tumwater.

#### 4) <u>Alternatives</u>:

- Recommend City Council Adoption of Resolution No. R2022-013
- Send back to Historical Commission with recommendations for changes

#### 5) Fiscal Notes:

The fiscal impacts to the City are minimal.

#### 6) <u>Attachments</u>:

A. Resolution No. R2022-013 - Tumwater Cowlitz Trail

#### **RESOLUTION NO. R2022-013**

**A RESOLUTION** of the City Council of the City of Tumwater, Washington, in support of adding the Cowlitz Trail segment of the Oregon Trail, which terminated in Tumwater, to the National Historic Trails System.

WHEREAS, the Bush-Simmons party was the founding element of American colonization of the Puget Sound basin in 1845 in a settlement known initially as New Market and subsequently Tumwater in what eventually became the state of Washington; and

WHEREAS, the Bush-Simmons party had reached the lower Columbia River Valley in 1844 as part of a larger train of transcontinental emigrants who traversed the overland route to the Oregon Country from the Missouri Valley; and

WHEREAS, the Bush-Simmons party was prompted into taking the difficult route to Puget Sound Country from the vicinity of Fort Vancouver, known as the Cowlitz Trail and never previously tried by overland emigrants, because George Bush, an African-American, was discouraged from settling amongst other pioneers in the Willamette Valley because of his African heritage; and

WHEREAS, the main trunk of what is commonly known as The Oregon Trail, from Independence, Missouri, to Oregon City, Oregon, was recognized by Congress for incorporation within the system of National Historic Trails, in 1978; and

**WHEREAS**, the National Historical Trails is an administrative unit of the National Park Service with the Department of the Interior; and

WHEREAS, in 2020 the Department of the Interior/National Park Service issued the "Revised Feasibility and Suitability Study for Additional Routes of the Oregon, Mormon Pioneer, California, and Pony Express National Historic Trails"; and

**WHEREAS**, the Cowlitz Trail segment ending in Tumwater, traversed by the Bush-Simmons party, is among those considered in this study for addition to the National Historic Trails system in the category as an "alternate route"; and

WHEREAS, it is appropriate to recognize and stipulate that few segments of the pre-Civil War historic trail to the Oregon Country are more worthy of addition to the National Historic Trails system, not in the least respect because of the requirements of racial justice, than the Cowlitz Trail to Tumwater; and

Resolution No. R2022-013 – Page 1 of 2

**WHEREAS**, the addition of the Cowlitz Trail segment ending in Tumwater would be a western complement to the Selma Montgomery National Historic Trail, established in 1996.

# NOW, THEREFORE, BE IT RESOLVED BY THE CITY COUNCIL OF THE CITY OF TUMWATER, WASHINGTON AS FOLLOWS:

<u>Section 1</u>. <u>Declaration in Support</u>. The City Council of the City of Tumwater supports adding the Tumwater section of the Cowlitz Trail segment of the Oregon Trail to the system of National Historic Trails. The City Council urges the Thurston County Legislative Delegation to introduce a comparable resolution for adoption by the Washington State Legislature that can then, in turn, be forwarded to the State of Washington Congressional Delegation in furtherance of adding the Cowlitz Trail segment of the Oregon Trail to the system of National Historic Trails.

<u>Section 2</u>. <u>Ratification</u>. Any act consistent with the authority and prior to the effective date of this Resolution is hereby ratified and affirmed.

<u>Section 3</u>. <u>Severability</u>. The provisions of this Resolution are declared separate and severable. The invalidity of any clause, sentence, paragraph, subdivision, section, or portion of this Resolution or the invalidity of the application thereof to any person or circumstance, shall not affect the validity of the remainder of the Resolution, or the validity of its application to other persons or circumstances.

<u>Section 4</u>. <u>Effective Date</u>. This Resolution shall become effective immediately upon adoption and signature as provided by law.

**RESOLVED** this \_\_\_\_\_ day of \_\_\_\_\_, 20\_\_\_\_.

CITY OF TUMWATER

Debbie Sullivan, Mayor

ATTEST:

Melody Valiant, City Clerk

APPROVED AS TO FORM:

Karen Kirkpatrick, City Attorney

Resolution No. R2022-013 – Page 2 of 2

TO:	General Government Committee
FROM:	Brad Medrud, Planning Manager
DATE:	November 9, 2022
SUBJECT:	2022-25 Comprehensive Plan Periodic Update Process Work Program

#### 1) <u>Recommended Action</u>:

This is a discussion item about the 2022-25 Comprehensive Plan periodic update process work program. Review the attached memorandum and be prepared to discuss.

#### 2) Background:

On a ten-year cycle, the City is required to conduct a Growth Management Act periodic update of its Comprehensive Plan and related development regulations. For the current cycle, the City is required to complete work on the periodic update by June 30, 2025. Work on the periodic update started this fall.

At the direction of the City Administrator, the Comprehensive Plan document that will come out of the periodic update process will be shorter, leaner, and more user friendly. The updated Comprehensive Plan will consist of shorter individual Elements and Plans with appendices that contain the required technical information. At the end of the process, there will also be a brief Comprehensive Plan goal and policy guide for use by staff and policymakers.

The updated Comprehensive Plan will address diversity, equity, and inclusion throughout the Plan and incorporate climate mitigation, adaptation, and sustainability goals and actions in all the individual Elements and Plans.

For most of the Elements and Plans that make up the Comprehensive Plan, the data used is now more than 6 years old with the notable exception of the Parks, Recreation, and Open Space Plan where the data is more than 14 years out of date. This means that the current Comprehensive Plan does not reflect the increases in City population, the growth of City through annexations, and the transformation of semi-rural areas to urban development. Most importantly, it does not reflect the current needs of City residents.

The intent of our meeting on Wednesday, November 9, 2022, is to start the discussion with the City Council about the work program to complete the periodic update, the schedule for the periodic update, and the stakeholders in the process. Staff has met with all affected departments and the Planning Commission to discuss the work program.

#### 3) <u>Policy Support</u>:

Goal LPP-1: Provide sufficient and efficient services to Tumwater and the Urban Growth Area.

Goal LU-1: Ensure the Land Use Element is implementable and coordinated with all applicable City plans and the plans of other jurisdictions in the Thurston region.

- 4) <u>Alternatives</u>:
  - A. None.

#### 5) Fiscal Notes:

This is primarily an internally funded work program task. A Washington State Department of Commerce grant funding to support the periodic update of \$125,000 will be available July 1, 2023.

- 6) <u>Attachments</u>:
  - A. 2022-25 Comprehensive Plan Periodic Update Process Work Program Memorandum

#### Attachment A



City Hall 555 Israel Road SW Tumwater, WA 98501-6515 Phone: 360-754-5855 Fax: 360-754-4138

## Memorandum

Date:	November 9, 2022
То:	General Government Committee
From:	Brad Medrud, Planning Manager
Subject:	2022-25 Comprehensive Plan Periodic Update Process Work Program

## I. Issue

On a ten-year cycle, the City is required to conduct a Growth Management Act periodic update of its Comprehensive Plan and related development regulations. For the current cycle, the City is required to complete work on the periodic update by June 30, 2025. Work on the periodic update started this fall.

At the direction of the City Administrator, <u>the Comprehensive Plan document that will come</u> <u>out of the periodic update process will be shorter, leaner, and more user friendly</u>. The updated Comprehensive Plan will consist of shorter individual Elements and Plans with appendices that contain the required technical information. At the end of the process, there will also be a brief Comprehensive Plan goal and policy guide for use by staff and policymakers.

The updated Comprehensive Plan will address diversity, equity, and inclusion throughout the Plan and incorporate climate mitigation, adaptation, and sustainability goals and actions in all the individual Elements and Plans.

For most of the Elements and Plans that make up the Comprehensive Plan, the data used is now more than 6 years old with the notable exception of the Parks, Recreation, and Open Space Plan where the data is more than 14 years out of date. This means that the current Comprehensive Plan does not reflect the increases in City population, the growth of City through annexations, and the transformation of semi-rural areas to urban development. Most importantly, it does not reflect the current needs of City residents.

The intent of our meeting on Wednesday, November 9, 2022, is to start the discussion with the City Council about the work program to complete the periodic update, the schedule for the periodic update, and the stakeholders in the process. The periodic update will require staff resources across multiple City departments and consultant assistance. Final approval of the periodic update work program is expected to happen on the same schedule as the 2023 Long Range Work Program in January 2023.

#### Contents

I.	Issue	. 1
II.	City Priorities	. 2
III.	Community Engagement	. 2
IV.	Process and Schedule	. 6
V.	Resources Needed	. 9
VI.	Guidance	11
VII.	Appendix A – Council Priorities with Lead Department	12
VIII.	Appendix B – Detailed Schedule and Work Program	14
IX.	Appendix C – Stakeholders	35

## II. City Priorities

The periodic update is related to a number of City Council strategic priorities. See Appendix A *Council Priorities with Lead Department* for more details.

## III. Community Engagement

The objective of the community engagement process is to establish how the City will engage the public and stakeholders throughout the Comprehensive Plan update. Staff will use a range of public participation strategies to encourage and facilitate community involvement in the periodic update process.

The community engagement process will be flexible and may be changed to take advantage of events and opportunities that may arise. The process will employ multiple tools and platforms to inform and involve the community and internal and external stakeholders in the periodic update. Staff will work with the City's Communications Team to prepare a Public Engagement Plan that will guide this process.

## A. 2016 Periodic Update Community Outreach Effort

There were ten goals for the City's 2016 periodic update community outreach. Updated goals will be established for the 2025 periodic update.

- 1. Provide information to help public understanding of issues.
- 2. Seek early and continuous involvement from people who care about the Plan and the community.
- 3. Offer opportunities for people to provide feedback to staff, and appointed and elected officials.

- 4. Make the process accessible and engaging for everyone.
- 5. Make community-driven planning the priority for this Plan.
- 6. Highlight projects implemented since the last Comprehensive Plan update.
- 7. Use a flexible, phased approach.
- 8. Integrate and consolidate goals from all Elements of this Plan and resource Plans.
- 9. Develop a citizen's guide to the Comprehensive Plan that summarizes the most important parts of the Plan in an easy to read and understand format.
- 10. Rely on multiple communication media to share information.

#### B. Community Engagement Plan

A Community Engagement Plan will be created for the periodic update that will incorporate the timeline for community engagement below and include the following:

- 1. Take the work program to Planning Commission, General Government Committee, and City Council in the Fall 2022 and Winter 2023 for discussion and approval.
- 2. Follow the public participation and intergovernmental coordination procedures contained in Section 1.8.2 of the Land Use Element throughout periodic update process.
- 3. Coordinate with the Communications Team on the Public Engagement Plan in the Winter 2023. The Public Engagement Plan is expected to include a number of ways to engage the community and could include a community survey, open workshops, and a bus tour of the City to see "How is it going?"
- 4. Facilitate review and discussion of the Comprehensive Plan Elements and Plans by the Parks & Recreation Commission, the Planning Commission review, the General Government Committee, the Public Works Committee, and the City Council throughout the periodic update process
- 5. Hold a Planning Commission hearing on the updated Comprehensive Plan Elements and Plans.
- 6. Support City Council adoption of an ordinance to complete the periodic update process by June 30, 2025.

#### C. Stakeholders

For an initial list of proposed stakeholders in the periodic update process, see Appendix C *Stakeholders*.

#### D. Media

Media that is expected to be used in the periodic update process:

- 1. Social Media
- 2. Utility Inserts
- 3. Interested Parties e-mail listserv for periodic update
- 4. E-Newsletter
- 5. Webpage
- 6. Public Survey
- 7. Policy Talks with various community groups
- 8. Articles
- 9. Citizen's Guide

#### E. <u>Timeline for Community Engagement</u>

#### 1. Phase I – Start Community Engagement

#### Fall 2022 – Summer 2023

In Phase I, staff will begin to review the visions, goals, and policies in the existing Comprehensive Plan and prepare gap analyses of all the Comprehensive Plan Elements and Plans. The community and stakeholders will be introduced to the periodic update process through a series of communications and asked to prioritize the Comprehensive Plan's vision, goals, and policies through a variety of media outreach methods, including surveys, utility inserts, open houses, informal meetings, presentations, and social media. See the Media section below for more detail on potential ways that information on the periodic update will be shared.

2. Phase II – Plan Development

#### Summer 2023 – Spring 2024

In Phase II, feedback gathered through the community engagement process will be incorporated into the draft Comprehensive Plan Elements and Plans. Staff will present the draft language to city advisory boards and commissions as well as focus groups comprised of subject-area experts for review and response.

In addition to continuing to employ the strategies started in Phase I, Phase II will include consultation with the Historic Preservation Commission, Parks & Recreation

> Commission, Planning Commission, General Government Committee, Public Works Committee, and City Council that will continue throughout the periodic update process. These groups, as well as external and internal stakeholders, will review and provide feedback on the draft Comprehensive Plan Elements and Plans. Feedback gathered through the community engagement process will also be shared with these groups.

> Focus groups of technical experts will review those Comprehensive Plan Elements and Plans that are not represented through the City's boards or commissions. The focus groups will review and provide input into relevant draft Comprehensive Plan Elements and Plans. Feedback gathered through the community engagement process will also be shared with these groups.

#### 3. Phase III – Legislative Process

Summer 2024 – June 30, 2025

#### a. <u>Draft Plan</u>

The City will complete draft versions of the Comprehensive Plan Elements and Plans during Phase III. Several public open house meetings will provide an opportunity to see the draft Plan prior to the Joint Council - Planning Commission public hearing. Relevant city advisory boards and commissions will develop recommendations that will be forwarded to the Planning Commission. All the focus group members will have an opportunity to review the work, as well.

The process will culminate in the adoption of a new Comprehensive Plan by the Growth Management Act deadline of June 30, 2025.

#### b. Open Houses

In addition to continuing to employ the strategies started in Phases I and II, Phase III will include Open Houses to present the draft updated Comprehensive Plan to the public prior to the start of the legislative process. Staff will provide an overview of the periodic update, draft goals, policies, and actions, and next steps in the process. Information about open house dates and other key meeting dates will be widely distributed through media identified in the Community Engagement Plan.

#### c. Commission Worksessions and Public Hearing

The Planning Commission will hold a number of worksessions to discuss the Comprehensive Plan Elements and Plans. The Parks & Recreation Commission will hold similar worksessions on some form of minor update to the Parks, Recreation, and Open

Space Plan as part of the periodic update. Opportunities for a joint worksessions will be considered.

The Planning Commission will then conduct a public hearing to gather public comment on the draft Comprehensive Plan before developing findings of fact, conclusions, and recommendations that will be forwarded to City Council.

Public notice of the public hearing will be published in accordance with State law and the Tumwater Municipal Code at least 30 days prior to the date of the hearing. In addition to the required noticing procedures, notice will also be provided through means identified in the Engagement Plan.

## d. City Council Adoption Process

The City Council's General Government Committee and Public Works Committee will periodically review and discuss the updates to the Comprehensive Plan Elements and Plans. All meeting dates and materials will be posted on the city's website and notice will be provided through means identified in the Engagement Plan.

The City Council will hold a number of worksessions to discuss the Plan's Comprehensive Plan Elements and Plans. The City Council will consider the recommendation forwarded by the Planning Commission. In addition to the required noticing procedures, notice of City Council meeting will also be provided through means identified in the Engagement Plan.

## **IV.** Process and Schedule

For more details on the proposed periodic update process and schedule, see Appendix B – *Detailed Schedule and Work Program*.

A. Comprehensive Plan Periodic Update

- 1. <u>Phase I Start Community Engagement</u> Fall 2022 Summer 2023
  - <u>Develop Work Program</u> October through December 2022 Determine general outline of resources needed for the periodic update, its schedule, and stakeholders
    - 1) Planning Commission Briefing October 25, 2022
    - General Government Committee Briefing on Scope and Format November 9, 2022
    - 3) Meeting with Mayor and City Administrator November 22, 2022

- 4) Joint 2023 Long Range Planning Work Program Discussion City Council and Planning Commission December 13, 2022
- 5) Complete work program and schedule for the periodic update January 2023
- b. <u>Develop Community Engagement Plan</u> Winter 2023 See Section III Community Engagement above.
- c. Gap Analysis of Current Comprehensive Plan Goals and Policies Winter 2023
- d. <u>Start Community Engagement Process</u> Winter 2023 through June 30, 2025 *See Section III Community Engagement above for more details.*
- <u>Consultant Selection and Contracting</u> Develop and issue request for proposals for consultant and consultant selection and contracting – Spring and Summer 2023
- f. <u>Data Gathering</u> Staff and consultants gather data and start review of the Elements, Plans, and maps Spring and Summer 2023
- g. <u>Regional Review Coordination</u> Coordinate review of the Comprehensive Plan Elements and Plans with other jurisdictions – Starts Spring 2023
- h. <u>Initial Comprehensive Plan Element and Plan Review Meetings</u> Winter to Summer 2023
  - 1) Community Stakeholders For a complete list of stakeholders in the periodic update process, see Appendix C Stakeholders.
  - 2) Parks & Recreation Commission
  - 3) Planning Commission
  - 4) General Government Committee
  - 5) Public Works Committee
  - 6) City Council
- 2. <u>Phase II Plan Development</u> Summer 2023 Spring 2024
  - a. <u>Periodic Update Start</u> Staff and consultants start updates to draft Comprehensive Plan Elements, Plans, and maps – Summer and Fall 2023
  - Individual Comprehensive Plan Element and Plan Discussions and Worksessions Fall 2023 – Spring 2024

- 1) Community Stakeholders For a complete list of stakeholders in the periodic update process, see Appendix C Stakeholders.
- 2) Parks & Recreation Commission
- 3) Planning Commission
- 4) Public Works Committee
- 5) General Government Committee
- 6) City Council
- c. <u>Complete Draft of Periodic Update</u> Staff and consultants complete draft of the Comprehensive Plan Elements, Plans, and maps Spring 2024
- 3. Phase III Legislative Process Summer 2024 June 30, 2025
  - a. SEPA and Commerce Review Summer 2024
  - b. Public Adoption Meetings Summer and Fall 2024 and Winter 2025
    - 1) Parks and Recreation Commission
    - 2) Planning Commission
    - 3) Public Works Committee
    - 4) General Government Committee
    - 5) City Council
  - c. Submit Notice of Adoption to Commerce Spring 2025

#### B. Capital Facilities Plan Update – 2023

- 1. <u>Preliminary Docket Process</u> Winter 2023 *Expected to also include the Old Highway 99 Corridor Study*
- 2. <u>Develop Capital Facilities Plan</u> Spring and Summer 2023
- 3. SEPA and Commerce Review Summer 2023
- 4. <u>Final Docket Process</u> Fall 2023 *Expected to also include the Old Highway 99 Corridor Study*

#### C. Capital Facilities Plan Update – 2025

- 1. Preliminary Docket Process Winter 2025
- 2. Develop Capital Facilities Plan Spring and Summer 2025
- 3. SEPA and Commerce Review Summer 2025
- 4. Final Docket Process Fall 2025

#### D. Development Code Periodic Update Process - 2024/2025

- <u>Gap Analysis of Current Development Code Regulations (Titles 16, 17, and 18)</u> Summer and Fall 2024 – Will also include review of Chapter 3.50 TMC Impact Fees and Chapter 3.52 Tumwater Park Impact Fees
- 2. Draft Ordinance Staff and consultants complete draft ordinance Winter 2025
- 3. SEPA and Commerce Review Winter 2025
- 4. Public Adoption Meetings Winter 2025 and Spring 2025
  - a. Planning Commission
  - b. Public Works Committee
  - c. General Government Committee
  - d. City Council
- 5. Submit Notice of Adoption to Commerce June 30, 2025

## V. Resources Needed

For more details on the resources needed for the periodic update, see Appendix B – *Detailed Schedule and Work Program*.

#### A. Staff

The periodic update is expected to require the following staff resources:

- 1. <u>Community Development Department</u>
  - a. <u>Planning</u> The periodic update process is expected to require 70% of one FTE in 2023 and 2024.
  - b. <u>Economic Development</u> The minor periodic update of the goals and strategies in the Economic Development Plan and coordination with the Economic Development Manager and a consultant to update the data workbook is expected to require 5% of one FTE in 2023 and 2024.

- 2. Executive Department
  - a. <u>Executive</u> – The periodic update will require staff time from the Executive Team to support the periodic update.
  - b. <u>Communications Team</u> The periodic update will require staff time from the Communications Team to support the actions identified in the Public Engagement Plan.
- 3. Transportation & Engineering Department
  - a. <u>Transportation</u> The major periodic update of the Transportation Plan will require staff time from the Transportation & Engineering Department Director and Transportation Manager and coordination with a consultant.
  - b. <u>GIS Team</u> The periodic update will require staff time from the GIS Team to support the periodic update.
- <u>Water Resources & Sustainability Department</u> The major periodic update of the Lands for Public Purposes Element and Conservation Element will require staff time from the Water Resources & Sustainability Department Director and from the Water Resources & Sustainability staff including the Sustainability Coordinator.
- 5. <u>Parks & Recreation Department</u> The major periodic update of the Parks, Recreation, and Open Space Plan would require staff time from the Parks & Recreation Department Director and from the Parks & Recreation staff and coordination with a consultant has been identified, but that work is not funded as part of this periodic update process. Some form of minor update to the Parks, Recreation, and Open Space Plan will occur as part of the periodic update and the major periodic update of the Parks, Recreation, and Open Space Plan will occur later.

## B. Consultants

The periodic update is expected to require the following consultant resources for the following:

- <u>Economic Development Plan</u> Minor update of Plan that was updated last in 2019.
- 2. <u>Transportation Plan</u> Major update of Plan that was updated last in 2016.

Item 5.

2022-25 Comprehensive Plan Periodic Update Process Work Program November 9, 2022 Page 11

## C. Funding

State funding for the periodic update will be available starting July 1, 2023. The City is expecting State funding to be \$125,000 with the rest of the funding coming from general fund or other grant opportunities.

#### VI. Guidance

The State Department of Commerce has provided guidance specific to the periodic update on their Periodic Update webpage (https://www.commerce.wa.gov/serving-communities/growthmanagement/periodic-update/).

In addition, the Puget Sound Regional Council is conducting a series of workshops on a variety of topics related to the periodic update (www.psrc.org/our-work/passport-2044comprehensive-plan-workshop-series)

Additional guidance includes:

- 1. State Department of Commerce, Growth Management Division, www.commerce.wa.gov/serving-communities/growth-management/growthmanagement-topics
- Municipal Research Services Center, Comprehensive Planning, https://mrsc.org/getdoc/d7964de5-4821-4c4d-8284-488ec30f8605/Comprehensive-Planning.aspx
- Transportation Efficient Communities, www.transportationefficient.org/
- Active Community Environment Toolkit
- 5. The Washington State Plan for Healthy Communities
- 6. Transportation Efficient Communities
- 7. The Washington State Plan for Healthy Communities
- 8. Active Community Environment Toolkit
- 9. Protect Puget Sound Watersheds
- 10. Building Cities in the Rain
- 11. Ecology Stormwater Manuals
- 12. Puget Sound Partnership Action Agenda
- 13. Best Available Science: see WAC 365-195-900 through -925

## VII. Appendix A – Council Priorities with Lead Department

The Strategic Priorities and Goals that are most relevant to the periodic update process are shown below.

- A. Build a Community Recognized for Quality, Compassion and Humanity
  - Support and Advance Intergenerational Housing Opportunities Community Development
  - Update the Affordable Housing and Houselessness Action Plan Community Development
  - Explore Alternative Building Materials for Housing (Cargo containers, Composite, 3D Printing) Community Development
  - Support Housing Stability Policies/Programs Community Development / Non-Departmental
  - Adopt and Implement Tenant Protections Community Development
  - Streamline Permitting for Housing Projects Community Development
  - Implement MPD Tumwater Metropolitan Park District (TMPD) / General Government Capital Facilities Plan (GGCFP)
  - Plan and Site Community Center TMPD / GGCFP
- B. Be a Leader in Environmental Sustainability
  - Recruit Green Employers and Jobs Community Development
  - Streamline Permitting for Green Projects Community Development
  - Require New City Buildings be All Electric GGCFP
  - Continue to Update and Advance the Climate Action Plan Community Development /Water Resources & Sustainability / Parks and Recreation Facilities / Equipment Rental and Reserve (ERR)
  - Implement Urban Forestry Plan Community Development
  - Include Environmental Protections in City projects GGCFP and Transportation Capital Facilities Plan (TCFP)
  - Complete and Implement Habitat Conservation Plan Community Development
  - Continue Septic to Sewer Conversion Sewer Utility
  - Ensure Ample Water Supply Water Utility
  - Remove Obstructions to Fish Passage Storm Utility

- C. Create and Maintain a Transportation System Safe for All Modes of Travel
  - Implement Capitol Boulevard Plan TCFP / Streets / Executive
  - Bike and Pedestrian System Transportation Benefit District (TBD) / TCFP / Streets / GGCFP
  - Implement Sidewalk Plan TBD / TCFP / Streets
  - Update Transportation Impact Fee System TCFP
- E. Pursue Targeted Community Development Opportunities
  - Implement the City's Economic Development Plan Community Development / Executive
  - Seek Opportunities to Enhance City's Revenue Base Consistent with other City Objectives – Community Development / Executive
  - Continue to Build the Craft Beverage Legacy Community Development / Executive
  - Find a Permanent Home for Farmer's Market Community Development
- F. Refine and Sustain a Great Organization
  - Construct the O & M Facility Transportation and Engineering / CFPs

## VIII. Appendix B – Detailed Schedule and Work Program

The City must take action to review and update its Comprehensive Plan and development regulations by June 30, 2025. The State Growth Management Act requires that any required revisions be made to ensure the Comprehensive Plan and development regulations comply with State mandates. The City last completed a periodic update to its Comprehensive Plan and Development Regulations in 2016. The Parks, Recreation, and Open Space Plan was last substantially updated in 2008 with minor updates in 2016.

The City's annual long range planning work programs for the next three years will incorporate the process to review and update the Comprehensive Plan and development regulations. Because the periodic update will involve review of all Comprehensive Plan Elements and Plans, the City will not accept annual Comprehensive Plan Amendment private applications until the Periodic Update is complete. Instead, those seeking private Comprehensive Plan amendments will be invited to participate in the periodic update process.

From 2023 to 2025, the City will consider the changes to the Comprehensive Plan and development regulations outlined below. The majority of changes are general in nature unless otherwise noted, such as to meet a new statutory requirement or to incorporate planning projects that were completed since the last periodic update and are not yet fully integrated into the Comprehensive Plan. These include the Tumwater Housing Action Plan (2021), Thurston Climate Mitigation Plan (2021), and the Urban Forestry Management Plan (2021). Staff reviewed and considered the Growth Management Act periodic update checklists provided by the State Department of Commerce and State Department of Ecology during the development of this work program.

## Comprehensive Plan Document – General

Staff Lead:	Brad Medrud, Planning Manager, Community Development
Other Departments:	As noted in the individual plans and elements below
Consultant:	As noted in the individual plans and elements below
Update Timeline:	<u>Phase I – Start Community Engagement</u> – Fall 2022 – Summer 2023
	<u>Phase II – Plan Development</u> – Summer 2023 – Spring 2024
	<u>Phase III – Legislative Process</u> – Summer 2024 – June 30, 2025
Previous Update:	2016, with amendments approved annually

- Create a new format for the Comprehensive Plan that will be shorter, leaner, and more user friendly. The updated Comprehensive Plan will consist of shorter individual Elements and Plans with appendices that contain the required technical information.
- Create a new Community Engagement Plan for the periodic update process.
- Create a new Comprehensive Plan Goal and Policy Guide for use by staff and policymakers.
- Create a new Community Guide to the Comprehensive Plan as the current version is from 2016.
- Create a new Glossary for the Comprehensive Plan as the current version is from 2016.
- The County-Wide Planning Policies (2015) are not expected to be revised for the 2025 periodic update.
- Ensure that the updated Comprehensive Plan is internally consistent.
- Ensure that all the Comprehensive Plan Elements and Plans are consistent with County-Wide Planning policies, the Growth Management Act, coordinated with the Plans of adjacent jurisdictions, individual Comprehensive Plan Elements and Plans, and the future land use map.
- Update all maps that are a part of the Comprehensive Plan, including the City-Wide Land Use Map and all maps in the individual Comprehensive Plan Elements and Plans. Current versions are from 2016 with some maps updated through the annual amendment cycle since that time. This will require staff from the Department of Transportation & Engineering GIS Team to complete.
- Update all the appendices in the Comprehensive Plan, current versions are from 2016 with the Neighborhood Appendix updated through the annual amendment cycle since that time.
- Ensure that the updated Comprehensive Plan addresses diversity, equity, and inclusion throughout the Plan and incorporates climate mitigation and adaptation and sustainability goals and actions in all the individual Comprehensive Plan Elements and Plans.
- Review entire Plan to address the use of terms such as "neighborhood character," stability, and similar terms in support of the Tumwater Housing Action Plan as part of Planning Commission's 2022 Comprehensive Plan amendment cycle recommendations.
- Provide for a mutually agreeable Memorandum of Agreement between the City and tribes about collaboration and participation in the planning process unless otherwise agreed at the end of a mediation period.

• Provide for consideration for preserving property rights. The City must evaluate proposed regulatory or administrative actions to assure that such actions do not result in an unconstitutional taking of private property.

#### Land Use Element

Staff Lead:	Brad Medrud, Planning Manager, Community Development
Other Departments:	Parks & Recreation, Transportation & Engineering, GIS Team, and Water Resources & Sustainability
Consultant:	Not expected to be needed
Update Timeline:	<u>Phase I – Start Community Engagement</u> – Fall 2022 – Summer 2023
	<u>Phase II – Plan Development</u> – Summer 2023 – Spring 2024
	<u>Phase III – Legislative Process</u> – Summer 2024 – June 30, 2025
Previous Update:	2016, amended annually with the last amendments in 2022

- Update vision statement from Strategic Plan.
- Update City strategic priorities.
- Revise planning period from 2015 2035 to 2025 2045.
- Update discussion of Growth Management Act goals.
- Add references to the updated Shoreline Master Program (2019) and Economic Development Plan (2019) and the new Tumwater Housing Action Plan (2021), Thurston Climate Mitigation Plan (2021), and Urban Forestry Management Plan (2021), which were adopted by the City since the 2016 periodic update.
- Simplify, reduce, and update land use goals, policies, and actions.
- Update Tumwater Community Profile from Thurston Regional Planning Council.
- Update and use a consistent 20-year population projection for the City and its urban growth area throughout the Plan, which should be consistent with Thurston County's sub-county allocation of that forecast and housing needs.
- Update estimates of population densities and building intensities based on future land uses and housing needs.
- Update City land use patterns and distribution information.

- Update City-Wide Future Land Use Map.
- Buildable Lands Updates:
  - o Update existing land use and existing residential density charts.
  - Update commercial/industrial vacant land supply analysis.
  - o Update net buildable industrial land table.
  - Update total dwelling units buildout table.
- Update Neighborhood Appendix to incorporate current information describing existing development patterns.
- Remove transfer of development rights requirement for maximum densities in residential land use designations in coordination with the County.
- Update policies, land use designations, and zoning to discourage the siting of incompatible uses adjacent to the Olympia Regional Airport. The Plan and associated regulations must be filed with the State Department of Transportation for review.
- If forest or agricultural lands of long-term commercial significance are designated inside City, update the program authorizing transfer or purchase of development rights in coordination with the County.
- Incorporate provisions of the updated 2023 Hazard Mitigation Plan as appropriate.
- At the City Council's direction on March 1, 2022, the periodic update will include a review of the Littlerock Subarea Plan area and revisions to mixed use land designation citywide.
- Coordinate with Thurston County on new 2021-2022 legislation regarding urban growth area size, patterns of development, suitability, and infrastructure.
- Consider utilizing urban planning approaches that promote physical activity.
- Include a policy or procedure to reassess the Land Use Element if probable funding falls short of meeting existing needs.
- Review land use designations and zone districts for schools.
- Review the "neighborhood center" concept.
- Look more closely at 79th and Old Highway 99 as the area is currently designated Light Industrial but the informal Warehouse District functions as a General Commercial and Light Industrial land use designation hybrid in name, but not Comprehensive Plan designation.

- Look at 88th and Old Highway 99 as a neighborhood center, as it has General Commercial and Mixed use land use designations.
- Update to address the potential effects of the Habitat Conservation Plan on land capacity in the City.
- Update other sections of the Land Use Element as appropriate.

#### **Housing Element**

Staff Lead:	Brad Medrud, Planning Manager, Community Development
Other Departments:	GIS Team
Consultant:	Not expected to be needed
Update Timeline:	<u>Phase I – Start Community Engagement</u> – Fall 2022 – Summer 2023
	<u>Phase II – Plan Development</u> – Summer 2023 – Spring 2024
	<u>Phase III – Legislative Process</u> – Summer 2024 – June 30, 2025
Previous Update:	2016, with the last amendments in 2021

- Revise planning period from 2015 2035 to 2025 2045.
- Update and use a consistent 20-year population projection for the City and its urban growth area throughout the Plan, which should be consistent with Thurston County's sub-county allocation of that forecast and housing needs.
- Update estimates of population densities and building intensities based on future land uses and housing needs.
- Update discussion of Growth Management Act goals.
- Add references to the new Tumwater Housing Action Plan (2021) and Thurston Climate Mitigation Plan (2021), which were adopted by the City since the 2016 periodic update.
- Simplify, reduce, and update housing goals, policies, and actions.
- Update housing patterns, trends, and projections to 2055.
- Update goals, policies, and actions for the preservation, improvement, and development of housing.
- Within an urban growth area boundary, revise to consider the location of duplexes, triplexes, and townhomes.

- Revise to consider of housing locations in relation to employment locations and the role of accessory dwelling units.
- Revise inventory and analysis of existing and projected housing needs over the planning period, by income band, consistent with the jurisdiction's share of housing need, as provided by the State Department of Commerce.
- Revise to include adequate provisions for existing and projected housing needs for all economic segments of the community.
- Revise identification of capacity of land for housing including, but not limited to, government-assisted housing, housing for moderate, low, very low, and extremely low-income households, manufactured housing, multifamily housing, group homes, foster care facilities, emergency housing, emergency shelters, permanent supportive housing.
- Identify local policies and regulations that result in racially disparate impacts, displacement, and exclusion in housing, including zoning that may have a discriminatory effect, disinvestment, and infrastructure availability.
- Establish policies and regulations to address and begin to undo racially disparate impacts, displacement, and exclusion in housing caused by local policies, Plans, and actions.
- Identify areas that may be at higher risk of displacement from market forces that occur with changes to zoning development regulations and capital investments.
- Establish anti-displacement policies, with consideration given to the preservation of historical and cultural communities as well as investments in low, very low, extremely low, and moderate-income housing; equitable development initiatives; inclusionary zoning; community planning requirements; tenant protections; land disposition policies; and consideration of land that may be used for affordable housing.
- Update information on federal, State, and local financing programs.
- Update housing services provided by public and private service agencies.
- Update information on housing needs gap.
- Consider policies to support rental and residential inspections programs.
- Update regulatory barrier assessment, citywide housing needs, and existing and future housing needs to year 2045.
- Incorporate provisions of the updated 2023 Hazard Mitigation Plan as appropriate.
- Address Regional Housing Council and Five-Year Thurston County Homeless Plan
- Update other sections of the Housing Element as appropriate.

#### **Transportation Plan**

Staff Lead:	Brandon Hicks, Transportation & Engineering Director and Mary Heather Ames, Transportation Manager
Other Departments:	Community Development and GIS Team
Consultant:	Will be needed for work on Transportation Plan and impact fee updates
Update Timeline:	Phase I – Start Community Engagement – Fall 2022 – Summer 2023
	<u>Phase II – Plan Development</u> – Summer 2023 – Spring 2024
	<u>Phase III – Legislative Process</u> – Summer 2024 – June 30, 2025
Previous Update:	2016

- Revise planning period from 2015 2035 to 2025 2045.
- Update and use a consistent 20-year population projection for the City and its urban growth area throughout the Plan, which should be consistent with Thurston County's sub-county allocation of that forecast and housing needs.
- Update discussion of Growth Management Act goals as needed.
- Add references to the updated Economic Development Plan (2019) and the new Tumwater Housing Action Plan (2021) and Thurston Climate Mitigation Plan (2021), which were adopted by the City since the 2016 periodic update.
- Simplify, reduce, and update transportation goals, policies, and actions.
- Update existing conditions and operations currently dated 2016.
- Update planned improvements and future operations to 2045.
- Update transportation improvement program.
- Update financial analysis.
- Update traffic impact fees.
- Update land use assumptions used in estimating travel.
- Update estimated traffic impacts to state-owned transportation facilities resulting from land use assumptions to assist the department of transportation in monitoring the

performance of State facilities, to plan improvements for the facilities, and to assess the impact of land-use decisions on state-owned transportation facilities.

- Update facilities and services needs, including:
  - An inventory of air, water, and ground transportation facilities and services, including transit alignments and general aviation airport facilities, to define existing capital facilities and travel levels as a basis for future planning. This inventory must include state-owned transportation facilities within the city or county's jurisdictional boundaries.
  - Level of service standards for all locally owned arterials and transit routes to serve as a gauge to judge performance of the system. These standards should be regionally coordinated.
  - For state-owned transportation facilities, include the level of service standards for highways to gauge the performance of the system.
  - Specific actions and requirements for bringing into compliance locally owned transportation facilities or services that are below an established level of service standard.
  - Forecasts of traffic for at least ten years based on the adopted Land Use Element to provide information on the location, timing, and capacity needs of future growth.
  - Identification of State and local system needs to meet current and future demands.
     Identified needs on state-owned transportation facilities must be consistent with the statewide multimodal transportation plan.
- Update financial analysis, including:
  - An analysis of funding capability to judge needs against probable funding resources.
  - A multiyear financing plan based on the needs identified in the Comprehensive Plan, the appropriate parts of which shall serve as the basis for the six-year street, road, or transit program required for cities and for public transportation systems. The multiyear financing plan should be coordinated with the ten-year investment program developed by the office of financial management.
  - If probable funding falls short of meeting identified needs, a discussion of how additional funding will be raised, or how land use assumptions will be reassessed to ensure that level of service standards will be met.
- The Transportation Plan, the six-year Capital Facilities Plans for cities and for public transportation systems, and the ten-year investment program for the State, must be consistent.

- Provide a projection of State and local system needs to meet current and future demand.
- Provide a pedestrian and bicycle component to include collaborative efforts to identify and designate planned improvements for pedestrian and bicycle facilities and corridors that address and encourage enhanced community access and promote healthy lifestyles. Consider urban planning approaches that increase physical activity.
- Describe any existing and planned transportation demand management strategies, such as high occupancy vehicle lanes or subsidy programs, parking policies, etc.
- Provide an analysis of future funding capability to judge needs against probable funding resources.
- Provide a multi-year financing plan based on needs identified in the Comprehensive Plan, the appropriate parts of which serve as the basis for the six-year street, road or transit program.
- If probable funding falls short of meeting identified needs, provide a discussion of how additional funds will be raised, or how land use assumptions will be reassessed to ensure that level of service standards will be met.
- Describe intergovernmental coordination efforts, including an assessment of the impacts of the Transportation Plan, land use assumptions on the transportation systems of adjacent jurisdictions, and how the Plan is consistent with the regional transportation plan.
- Identify lands useful for public purposes such as utility corridors, transportation corridors, landfills, sewage treatment facilities, stormwater management facilities, recreation, schools, and other public uses.
- Identify open space corridors within and between urban growth areas, including lands useful for trails.
- Update as needed the process or criteria for identifying and siting essential public facilities in coordination with the periodic update of the Lands for Public Purposes Element.
- Update information on intergovernmental coordination efforts, including an assessment of the impacts of the Transportation Plan and land use assumptions on the transportation systems of adjacent jurisdictions.
- Update demand-management strategies.
- Update information on pedestrian and bicycle component to include collaborative efforts to identify and designate planned improvements for pedestrian and bicycle

facilities and corridors that address and encourage enhanced community access and promote healthy lifestyles.

- Incorporate provisions of the updated 2023 Hazard Mitigation Plan as appropriate.
- Revisions to allow for some form of Intercity turnarounds on Littlerock and Highway 99 to allow for future transit service.
- Update to include work done on the Thurston Thrives walkability work, Intercity transit work, and the Old Highway 99 Corridor Study.
- Update other sections of the Transportation Plan as appropriate.

### Park, Recreation, and Open Space Plan – Major Update Postponed Until After the Periodic Update – A Partial Update is being considered as part of the Periodic Update

Staff Lead:	Chuck Denney, Parks and Recreation Director
Other Departments:	Community Development and GIS Team
Consultant:	Will be needed for work on impact fee updates
Update Timeline:	<u>Phase I – Start Community Engagement</u> – Fall 2022 – Summer 2023
	<u>Phase II – Plan Development</u> – Summer 2023 – Spring 2024
	<u>Phase III – Legislative Process</u> – Summer 2024 – June 30, 2025
Previous Update:	The last complete update was in 2008, with a partial update in 2016 with no new data collection

- Revise planning period from 2015 2035 to 2025 2045.
- Update and use a consistent 20-year population projection for the City and its urban growth area throughout the Plan, which should be consistent with Thurston County's sub-county allocation of that forecast and housing needs.
- Update discussion of Growth Management Act goals as needed.
- Add references to the updated Shoreline Master Program (2019) and the new Thurston Climate Mitigation Plan (2021) and Urban Forestry Management Plan (2021), which were adopted by the City since the 2016 periodic update.
- Simplify, reduce, and update Parks, Recreation, and Open Space Plan goals, policies, and actions.
- Update to financing strategies including use of impact fees.

• Update other sections of the Parks, Recreation, and Open Space Plan as appropriate.

#### **Capital Facilities Plan**

Staff Leads:	Chuck Denney, Parks & Recreation Director
	Brandon Hicks, Transportation & Engineering Director
	Mary Heather Ames, Transportation Manager
	Dan Smith, Water Resources & Sustainability Director
	Brad Medrud, Planning Manager, Community Development
Other Departments:	Yes, Community Development, Parks & Recreation, Transportation & Engineering, Water Resources & Sustainability
Consultant:	Not expected to be needed
Update Timeline:	2023 and 2025
Previous Update:	2021, with updates every two years

- Update general government, transportation, parks and recreation, water, sanitary sewer, and stormwater construction projects for the next six years.
- Prepare an inventory of existing capital facilities owned by public entities, showing the locations and capacities of the capital facilities.
- Prepare a forecast of the future needs for such capital facilities.
- Show the proposed locations and capacities of expanded or new capital facilities.
- Prepare a six-year Capital Facilities Plan that will finance such capital facilities within projected funding capacities and clearly identifies sources of public money for such purposes.
- Include a requirement to reassess the Land Use Element if probable funding falls short of meeting existing needs and to ensure that the Land Use Element, Capital Facilities Plan, and financing plan within the Capital Facilities Plan are coordinated and consistent.
- Include park and recreation facilities in the Capital Facilities Plan.
- Update policies or procedures to ensure capital budget decisions are in conformity with the Comprehensive Plan.
- Update the inventory of existing capital facilities owned by public entities.

- Update the forecast of needed capital facilities based on projected population and adopted levels of service over the planning period.
- Update the proposed locations and capacities of expanded or new capital facilities. Infrastructure investments should consider equity and plan for any potential displacement impacts.
- If impact fees are collected, identify the public facilities on which money is to be spent.
- Update other sections of the Capital Facilities Plan as appropriate.

#### **Conservation Plan**

Staff Lead:	Brad Medrud, Planning Manager, Community Development Department
Other Departments:	Water Resources & Sustainability and GIS Team
Consultant:	Not expected to be needed
Update Timeline:	<u>Phase I – Start Community Engagement</u> – Fall 2022 – Summer 2023
	<u>Phase II – Plan Development</u> – Summer 2023 – Spring 2024
	<u>Phase III – Legislative Process</u> – Summer 2024 – June 30, 2025
Previous Update:	2016, with the last amendments in 2021

- Revise planning period from 2015 2035 to 2025 2045.
- Update and use a consistent 20-year population projection for the City and its urban growth area throughout the Plan, which should be consistent with Thurston County's sub-county allocation of that forecast and housing needs.
- Update discussion of Growth Management Act goals as needed.
- Add references to the updated Shoreline Master Program (2019) and the new Thurston Climate Mitigation Plan (2021) and Urban Forestry Management Plan (2021), which were adopted by the City since the 2016 periodic update.
- Simplify, reduce, and update conservation goals, policies, and actions.
- Update to address City's intent to develop a Habitat Conservation Plan for the effective management of affected listed species and prairie eco-systems across private and public lands in the City.

- Update policies to designate and protect critical areas including wetlands, fish and wildlife habitat protection areas, frequently flooded areas, critical aquifer recharge areas, and geologically hazardous areas. In developing these policies, the city must have included the best available science to protect the functions and values of critical areas, and give "special consideration" to conservation or protection measures necessary to preserve or enhance anadromous fisheries.
- If forest or agricultural lands of long-term commercial significance are designated inside City, update the program authorizing transfer or purchase of development rights in coordination with the County.
- Review updating greenhouse gas emission targets in the Conservation Element to address HB 2311 as part of Planning Commission's 2022 Comprehensive Plan amendment cycle recommendations.
- Update other sections of the Conservation Element as appropriate.

### **Economic Development Plan**

Staff Lead:	Austin Ramirez, Economic Development Manager, Community Development
Other Departments:	Executive
Consultant:	Needed only for the data workbook update
Update Timeline:	<u>Phase I – Start Community Engagement</u> – Fall 2022 – Summer 2023
	<u>Phase II – Plan Development</u> – Summer 2023 – Spring 2024
	<u>Phase III – Legislative Process</u> – Summer 2024 – June 30, 2025
Previous Update:	2019

- Revise planning period from 2015 2035 to 2025 2045.
- Update and use a consistent 20-year population projection for the City and its urban growth area throughout the Plan, which should be consistent with Thurston County's sub-county allocation of that forecast and housing needs.
- Update discussion of Growth Management Act goals as needed.
- Add references to the new Tumwater Housing Action Plan (2021) and Thurston Climate Mitigation Plan (2021), which were adopted by the City since the 2016 periodic update.
- Simplify, reduce, and update Economic Development Plan goals, policies, and actions.

- Update the data workbook for the Plan.
- Update other sections of the Economic Development Plan as appropriate.

#### Lands for Public Purposes / Essential Public Facilities Plan

Staff Lead:	Brad Medrud, Planning Manager, Community Development
Other Departments:	Water Resources & Sustainability and GIS Team
Consultant:	Not expected to be needed
Update Timeline:	<u>Phase I – Start Community Engagement</u> – Fall 2022 – Summer 2023
	<u>Phase II – Plan Development</u> – Summer 2023 – Spring 2024
	<u>Phase III – Legislative Process</u> – Summer 2024 – June 30, 2025
Previous Update:	2016, with the last amendments in 2019

- Revise planning period from 2015 2035 to 2025 2045.
- Update and use a consistent 20-year population projection for the City and its urban growth area throughout the Plan, which should be consistent with Thurston County's sub-county allocation of that forecast and housing needs.
- Update discussion of Growth Management Act goals as needed.
- Add references to the new Thurston Climate Mitigation Plan (2021), which was adopted by the City since the 2016 periodic update.
- Simplify, reduce, and update lands for public purposes goals, policies, and actions.
- Update inventory and projected needs for public buildings, facilities and services over the 20-year planning period.
- Use the updated City and urban growth area 20-Year population forecasts.
- Update provisions for protection of the quality and quantity of groundwater used for public water supplies.
- Update chart of zone districts that allow essential public facilities.
- Update the process or criteria for identifying and siting essential public facilities including the reentry and rehabilitation facilities as defined in State law.
- Update to include regional transit authority facilities in the list of essential public facilities.

- Update to allow an expansion of the area in the City that would allow for essential public facilities such as inpatient facilities including substance abuse facilities as part of Planning Commission's 2022 Comprehensive Plan amendment cycle recommendations. These essential public facilities uses include, but not limited to, intensive inpatient facilities; long-term residential drug treatment facilities; recovery house facilities.
- Update the identification of lands useful for public purposes such as utility corridors, transportation corridors, landfills, sewage treatment facilities, storm water management facilities, recreation, schools, and other public uses.
- Where applicable, update the review of drainage, flooding, and stormwater run-off in the area and nearby jurisdictions and provide guidance for corrective actions to mitigate or cleanse those discharges that pollute waters of the State.
- Incorporate provisions of the updated 2023 Hazard Mitigation Plan as appropriate.
- Address Organics Management Facility Siting (ESSHB 1799 (2022)).
- Update other sections of the Lands for Public Purposes Element as appropriate.

### Shoreline Master Program

Staff Lead:	Brad Medrud, Planning Manager, Community Development
Other Departments:	Not needed
Consultant:	Not needed
Update Timeline:	Not applicable
Previous Update:	Ecology approval in 2019

#### **Revisions and Actions**

• Shoreline Master Program is current with State law, no revisions are required as part of periodic update.

#### **Utilities Element**

Staff Lead:	Brad Medrud, Planning Manager, Community Development
Other Departments:	Not expected to be needed
Consultant:	Not expected to be needed
Update Timeline:	Phase I – Start Community Engagement – Fall 2022 – Summer 2023

Item 5.

ltem 5.

2022-25 Comprehensive Plan Periodic Update Process Work Program November 9, 2022

Page 29

Phase II – Plan Development – Summer 2023 – Spring 2024

Phase III – Legislative Process – Summer 2024 – June 30, 2025

Previous Update: 2016

#### **Revisions and Actions**

- Revise planning period from 2015 2035 to 2025 2045.
- Update and use a consistent 20-year population projection for the City and its urban growth area throughout the Plan, which should be consistent with Thurston County's sub-county allocation of that forecast and housing needs.
- Update discussion of Growth Management Act goals as needed.
- Simplify, reduce, and update utilities goals, policies, and actions.
- Update general location, proposed location and capacity of all existing and proposed gas, electric, cable television, and telecommunications to year 2045.
- Update wireless telecommunication facilities information as needed.
- Update overall utility policies as appropriate.
- Update the general location, proposed location, and capacity of all existing and proposed utilities.
- Incorporate provisions of the updated 2023 Hazard Mitigation Plan as appropriate.
- Update other sections of the Utilities Element as appropriate.

#### Subarea Plans

Staff Lead:	Brad Medrud, Planning Manager, Community Development
Other Departments:	Transportation & Engineering and GIS Team
Consultant:	Not expected to be needed
Update Timeline:	<u>Phase I – Start Community Engagement</u> – Fall 2022 – Summer 2023
	<u>Phase II – Plan Development</u> – Summer 2023 – Spring 2024
	<u>Phase III – Legislative Process</u> – Summer 2024 – June 30, 2025
Previous Update:	2016, with minor amendments approved annually
Revisions and Actions	

- Update and use a consistent 20-year population projection for the City and its urban growth area throughout the Plan, which should be consistent with Thurston County's sub-county allocation of that forecast and housing needs.
- Add references to the updated Shoreline Master Program (2019) and Economic Development Plan (2019) and the new Tumwater Housing Action Plan (2021), Thurston Climate Mitigation Plan (2021), and Urban Forestry Management Plan (2021), which were adopted by the City since the 2016 periodic update.
- Revise and update Littlerock Road Subarea Plan to address land use changes since adoption.
- Revised and update Town Center Plan to address land use changes since adoption.
- Revise and update Brewery District and Capitol Boulevard Corridor Plan as needed.

#### <u>Joint Plan</u>

Staff Lead:	Brad Medrud, Planning Manager, Community Development
Other Departments:	Not expected to be needed
Consultant:	Not expected to be needed
Update Timeline:	Not applicable
Previous Update:	2021

- Thurston County Board of Commissioners approved the Joint Plan update at the end of November 2021.
- Update Chapters 4 through 8 to reference and incorporate updates to the following Elements as applicable to the unincorporated urban growth area:
  - Chapter 4 Lands for Public Purposes
  - Chapter 5 Utilities
  - Chapter 6 Housing
  - Chapter 7 Parks, Recreation, and Open Space
  - Chapter 8 Economic Development
  - Chapter 9 Transportation
  - Chapter 10 Public Facilities and Services

• Update other information as appropriate.

#### **Development Regulations – City**

Staff Lead:	Brad Medrud, Planning Manager, Community Development
Other Departments:	Not expected to be needed
Consultant:	Not expected to be needed
Update Timeline:	Summer 2024 – June 30, 2025
Previous Update:	Regulations are updated continually on an annual basis. The amendments listed below are needed to address changes in State law that have not been addressing by other regulatory amendments, with the exception of the first item which is needed for consistency with related amendments to the Comprehensive Plan.

- Concurrency and Transportation Demand Management
  - Update as needed to address State law.
- Critical Areas
  - Address updates required in the State Department of Ecology's Critical Areas Checklist.
- Cultural Resources
  - Update regulations as needed to address procedures to identify, preserve, and/or monitor historical or archaeological resources according to State law.
- Energy, Sustainability, and Design
  - Add development regulations needed to implement Comprehensive Plan policies such as energy, sustainability, or design.
- Essential Public Facilities
  - Update the process or criteria for identifying and siting essential public facilities including the reentry and rehabilitation facilities as defined in State law.
  - Update to include regional transit authority facilities in the list of essential public facilities.
  - Update to allow an expansion of the area in the City that would allow for essential public facilities such as inpatient facilities including substance abuse facilities as part

of Planning Commission's 2022 Comprehensive Plan amendment cycle recommendations. These essential public facilities uses include, but not limited to, intensive inpatient facilities; long-term residential drug treatment facilities; recovery house facilities.

Housing

Item 5.

- Update as needed to address State law.
- Impact Fees
  - Ensure that impact fees are applied consistent with State law.
  - Ensure that the City's collection of impact fees follows and maintains a system for the deferred collection of impact fees for single-family detached and attached residential construction required by State law.
  - Ensure that the State law's limitations on impact fees for early learning facilities are followed.
  - Ensure that the State law exemptions of impact fees for low-income and emergency housing development are followed and definitions are updated.
- Land Division
  - Update subdivision regulations to address adequacy of public facilities according to State law.
  - Update vesting for preliminary subdivision approvals according to State law.
- Land Use
  - Update zoning to discourage the siting of incompatible uses adjacent to the Olympia Regional Airport. Regulations must be filed with the State Department of Transportation for review.
  - Review Mixed Use zone district locations and standards.
  - Remove the transfer of development rights requirement for maximum density in residential zone districts in coordination with the County.
  - Review limitations on the amount of parking the City can require for low-income, senior, disabled, and market-rate housing units located near high-quality transit service.
  - Update as needed to address the requirement that family day care providers are allowed in all residential dwellings located in areas zoned for residential or commercial. Update definition as needed according to State law.

- Update as needed to address the requirements for accessory dwelling units as needed according to State law.
- Update as needed to address the requirements for allowing for affordable housing as needed according to State law.
- Update as needed to address limitations on regulating outdoor encampments, safe parking efforts, indoor overnight shelters, and temporary small houses on property owned or controlled by a religious organization.
- Update as needed to address that electric vehicle infrastructure adjacent to Interstate 5 and other criteria must be allowed as a use in all areas except those zoned for residential, resource use, or critical areas.
- Multifamily Tax Exemption
  - Add 20-year option.
  - Increase required affordable housing component.
- Parks Concurrency
  - The transportation concurrency requirement includes specific language that prohibits development when level of service standards for transportation facilities cannot be met. Note: Concurrency is required for transportation, but may also be applied to park facilities, etc.
- Plan and Regulation Amendments
  - Update as needed to address State law.
- Project Review Procedures
  - Update as needed to address State law.
- Transportation Concurrency
  - Update regulations to address the transportation concurrency requirement that prohibits development when level of service standards for transportation facilities cannot be met.
  - Update regulations to address measures to bring into compliance locally owned transportation facilities or services that are below the levels of service established in the Comprehensive Plan. Levels of service can be established for automobiles, pedestrians, and bicycles.
  - Ensure that highways of statewide significance are exempt from the concurrency ordinance.

- Ensure that traffic demand management requirements are consistent with the Comprehensive Plan. Examples may include requiring new development to be oriented towards transit streets, pedestrian-oriented site and building design, and requiring bicycle and pedestrian connections to street and trail networks. State law recommends adopting methodologies that analyze the transportation system from a comprehensive, multimodal perspective.
- Ensure if required by state law, a commute trip reduction ordinance to achieve reductions in the proportion of single-occupant vehicle commute trips has been adopted. The ordinance should be consistent with Comprehensive Plan policies for commute trip reduction and Department of Transportation rules.

#### **Development Regulations – County Title 22 – Tumwater Urban Growth Area**

Staff Lead:	Brad Medrud, Planning Manager, Community Development
Other Departments:	Not expected to be needed
Consultant:	Not expected to be needed
Update Timeline:	Dependent on Thurston County Update Schedule
Previous Update:	None. Thurston County Code Title 22 has not been substantially updated since adoption in 1995.

#### **Revisions and Actions**

• Prepare amendments to update Thurston County Code Title 22 following Section 11.1.6 Zoning and Development Regulations Planned Actions and Section 11.1.7 Recommended Amendments to Thurston County Code in the updated Joint Plan (2021).

# IX. Appendix C – Stakeholders

The following is the start of an initial list of internal and external stakeholders for the periodic update process. The list will updated throughout the periodic update process.

### **Internal Stakeholders**

- 1. Mayor
- 2. Councils, Commissions, and Boards
  - a. City Council
  - b. General Government Committee
  - c. Public Works Committee
  - d. Historic Preservation Commission
  - e. Parks & Recreation Commission
  - f. Planning Commission
  - g. Tree Board
- 3. Departments
  - a. Communications
  - b. Community Development
  - c. Executive
  - d. Parks and Recreation
  - e. Transportation & Engineering
  - f. Water Resources & Sustainability

#### **External Stakeholders**

#### **Community Members**

- 1. Civic Groups
- 2. Employees
- 3. Neighborhood and Homeowner's Associations
- 4. Parent-Teacher Associations

- 5. Residents
- 6. Seniors
- 7. Students

#### **Other Governments**

- 1. Chehalis Tribal Nation
- 2. City of Olympia
- 3. Intercity Transit
- 4. LOTT Cleanwater Alliance
- 5. Nisqually Tribal Nation
- 6. Olympia School District
- 7. Port of Olympia
- 8. South Puget Sound Community College
- 9. Squaxin Tribal Nation
- 10. State Department of Commerce
- 11. State Department of Corrections\*
- 12. State Department of Ecology
- 13. State Department of Health\*
- 14. State Department of Fish and Wildlife
- 15. State Department of Labor and Industries\*
- 16. State Department of Natural Resources
- 17. State Department of Revenue\*
- 18. State Department of Transportation
- 19. State Parks and Recreation Commission<sup>\*</sup>
- 20. Thurston County Planning and Development Services

<sup>\*</sup> State agencies located in the City.

- 21. Thurston County Public Health Department, Thurston Thrives Environment and Climate Action Team
- 22. Tumwater School District
- 23. Thurston County Conservation District
- 24. Thurston Regional Planning Council
- 25. Timberland Regional Library
- 26. Washington State University Thurston County Extension Office
- 27. Thurston County Public Health

#### **Business / Development**

- 1. Employers
- 2. Kaufman Construction & Development, Inc.
- 3. Olympia Master Builders
- 4. Port Blakely
- 5. Puget Sound Energy
- 6. Thurston Chamber of Commerce
- 7. Tumwater Chamber of Commerce
- 8. Thurston County Realtors Association
- 9. Thurston Economic Development Council
- 10. Vine Street Investors / TransAmerica

#### **Other Non-Profits**

- 1. Black Hills Audubon Society
- 2. Restoring the Earth Connection
- 3. Thurston Climate Action Team

#### Social Service Agencies

- 1. Behavior Health Resources
- 2. Boys and Girls Club of Thurston County

- 3. Thurston Mason Lewis Area Agency on Aging
- 4. Together!
- 5. United Way of Thurston County

#### Individual Community Members

- 1. Eric Campbell
- 2. Gay Gorden
- 3. Nancy Partlow
- 4. Jorjana Pedersen
- 5. Laurie Schaetzel-Hill

The following is a list of organizations that are or work with or advocate for frontline community members that we have identified in the community for future outreach, but have not developed relationships or contacts with the following:

- 1. Cielo
- 2. Hispanics Roundtable
- 3. Parents Organizing for Welfare and Economic Rights
- 4. Black Alliance of Thurston County
- 5. Egyhop
- 6. Soup Co-Op
- 7. Sidewalk
- 8. Standing Up for Racial Justice Olympia
- 9. Interfaith Works
- 10. YWCA
- 11. Northwest Immigrant Rights Program
- 12. Center for Independence
- 13. Civil Survival

Item 6.

- TO: General Government Committee
- FROM: Brad Medrud, Planning Manager
- DATE: November 9, 2022
- SUBJECT: Contract Approval for an 8-Year Multifamily Tax Exemption for the 350 North Street Apartments (TUM-22-1338)

#### 1) <u>Recommended Action</u>:

Staff recommends that the General Government Committee review the application materials, be prepared to ask staff questions, and schedule the application for City Council consideration on December 6, 2022.

#### 2) Background:

In 2017, the City Council adopted the Multifamily Housing Tax Exemption program to stimulate desired housing development within key areas of the City, such as the Brewery District and Capitol Boulevard Corridor. In 2019, the City Council approved expanding the 12-Year Multifamily Housing Tax Exemption program to the Town Center and Littlerock Subarea to encourage the development of permanent affordable housing as part of its 2019 Housing Affordability Work Plans. The program includes both an 8-year exemption for providing multifamily housing in the designated areas and a 12-year exemption for development providing a minimum of 20% of units designated for low or moderate-income households.

The City has received an application for the 8-year exemption program for the 24-unit 350 North Street Apartment complex in the Brewery District Subarea (TUM-22-1338).

#### 3) <u>Policy Support</u>:

Comprehensive Plan Housing Element Action H-3.3.3: Establish a multi-family tax exemption program that gives financial incentive for developers to create multi-family structures in target areas and to set aside a percentage of units as low-income housing.

4) <u>Alternatives</u>:

None.

#### 5) <u>Fiscal Notes</u>:

The application is for an 8-year Multifamily Housing Tax Exemption.

#### 6) <u>Attachments</u>:

- A. Staff Report
- B. 350 North Street Apartments (TUM-22-1338) MFTE Tax Agreement

- C. 350 North Street Apartments (TUM-22-1338) Exhibits A Application and Exhibit B Building Plans
- D. 350 North Street Apartments (TUM-22-1338) Exhibit C Berschauer Group Letter

### Attachment A



City Hall 555 Israel Road SW Tumwater, WA 98501-6515 Phone: 360-754-5855 Fax: 360-754-4138

# **Staff Report**

Date:	November 9, 2022
To:	General Government Committee
From:	Brad Medrud
Subject:	Contract Approval for an Eight-Year Multifamily Tax Exemption for the 350 North Street Apartments (TUM-22-1338)

In 2017, the City Council adopted the Multifamily Housing Tax Exemption program to stimulate desired housing development within key areas of the City, such as the Brewery District and Capitol Boulevard Corridor.

The Multifamily Housing Tax Exemption program includes both an eight-year exemption for providing multifamily housing in the designated areas and a twelve-year exemption for development providing a minimum of 20% of units designated for low or moderate-income households.

In 2019, the City Council approved expanding the Twelve-Year Multifamily Housing Tax Exemption program to the Town Center and Littlerock Subarea to encourage the development of permanent affordable housing as part of its 2019 Housing Affordability Work Plan.

The City has received an application for the eight-year exemption program for a 24unit multifamily development in the Brewery District Subarea (TUM-22-1338).

This memorandum discusses the requirements for this Multifamily Tax Exemption Program application for the 350 North Street Apartments in the Brewery District Subarea.

The discussion points and the pertinent sections of TMC 3.30 *Multifamily Housing Tax Exemptions* are laid out below.

# Target Area and Length of Exemption

The 350 North Street Apartments are in the Brewery District Subarea.

The project will follow the eight-year MFTE requirements below.

3.30.040 Tax exemptions for multifamily housing in residential target areas authorized.

A. Duration of Exemption. The value of improvements qualifying under Chapter 84.14 RCW and this chapter will be exempt from ad valorem property taxation, as follows:

1. For eight successive years beginning January 1 of the year immediately following the calendar year of issuance of the certificate. The eight-year duration of exemption applies only for projects in the Area 1 – Capitol Boulevard Corridor and Area 2 – Brewery District residential target areas; or

2. For twelve successive years beginning January 1 of the year immediately following the calendar year of issuance of the certificate, if the property otherwise qualifies for the exemption under Chapter 84.14 RCW and meets the conditions in this subsection. For the property to qualify for the twelve-year exemption under this subsection, the applicant must commit to renting or selling at least twenty percent of the multifamily housing units as affordable housing units to low- and moderate-income households, and the property must satisfy that commitment and any additional affordability and income eligibility conditions adopted by the city. In the case of projects intended exclusively for owner occupancy, the minimum requirement of this subsection may be satisfied solely through housing affordable to moderate-income households.

B. Limits on Exemption. The exemption does not apply to the value of land or to the value of improvements not qualifying under this chapter, nor does the exemption apply to increases in assessed valuation of land and nonqualifying improvements. In the case of rehabilitation of existing buildings, the exemption does not include the value of improvements constructed prior to submission of the completed application required under this chapter. This chapter does not apply to increases in assessed valuation made by the assessor on nonqualifying portions of building and value of land nor to increases made by lawful order of a county board of equalization, the Department of Revenue, or a county, to a class of property throughout the county or specific area of the county to achieve the uniformity of assessment or appraisal required by law.

# **Project Eligibility**

The project meets the following requirements:

- 1. Location in the Brewery District Subarea Confirmed.
- 2. Tenant Displacement Prohibited Confirmed.
- 3. Size –The project has 24 dwelling units.
- 4. **Proposed Completion Date** The project will need to be completed within three years of application for the MFTE.

5. **Contract with City Approved by City Council** – The applicant must enter into a contract with city approved by City Council. See the attached.

#### 3.30.050 Project eligibility.

A proposed project must meet the following requirements for consideration for a property tax exemption:

A. Location. The project must be located within a residential target area as designated in TMC 3.30.030.

B. Tenant Displacement Prohibited. The project must not displace existing residential tenants of structures that are proposed for redevelopment. Existing dwelling units proposed for rehabilitation must have been unoccupied for a minimum of twelve months prior to submission of an application and must have one or more violations of the International Property Maintenance Code of the city of Tumwater. Applications for new construction cannot be submitted for vacant property upon which an occupied residential rental structure previously stood, unless a minimum of twelve months has elapsed from the time of most recent occupancy.

C. Size. The project must include at least four units of multifamily housing within a residential structure or as part of an urban development. A minimum of four new units must be constructed or at least four additional multifamily units must be added to existing occupied multifamily housing. Existing multifamily housing that has been vacant for twelve months or more does not have to provide additional units so long as the project provides at least four units of new, converted, or rehabilitated multifamily housing.

D. Proposed Completion Date. New construction multifamily housing and rehabilitation improvements must be completed within three years from the date of approval of the application.

E. Compliance with Guidelines and Standards. The project must be designed to comply with the city's comprehensive plan, building, housing, and zoning codes, and any other applicable regulations in effect at the time the application is approved. The project must also comply with any other standards and guidelines adopted by the city council for the residential target area in which the project will be developed.

F. At least fifty percent of the space in a new, converted, or rehabilitated multiple unit must be for permanent residential housing. In the case of existing occupied multifamily development, the multifamily housing must also provide for a minimum of four additional multifamily units. Existing multifamily vacant housing that has been vacant for twelve months or more does not have to provide additional units.

57

G. The applicant must enter into a contract with city approved by city council under which the applicant agrees to the implementation of the development on terms and conditions satisfactory to the city council.

# **Application Procedure**

Prior to April 1 of any year, the applicant must submit a complete application that includes the following:

- 1. A **completed city of application form** setting forth the grounds for the exemption. Applicant has provided a completed form. See Attachment C, Exhibit A.
- 2. **Preliminary floor and site plans of the proposed project**. Applicant has provided floor and site plans. See Attachment C, Exhibit B.
- 3. A statement acknowledging the potential tax liability when the project ceases to be eligible under this chapter. Applicant has provided. See Attachment D, Exhibit C.
- 4. Verification by oath or affirmation of the information submitted Applicant has provided this. See Attachment C, Exhibits B and C, and Attachment D, Exhibit C.

# 3.30.060 Application procedure.

A property owner who wishes to propose a project for a tax exemption shall complete the following procedures:

A. Prior to April 1 of any year, file with the director the required application along with the required fees as established by resolution of the city council.

B. A complete application shall include:

1. A completed city of Tumwater application form setting forth the grounds for the exemption;

2. Preliminary floor and site plans of the proposed project;

3. A statement acknowledging the potential tax liability when the project ceases to be eligible under this chapter; and

4. Verification by oath or affirmation of the information submitted.

[...]

### **Application Review**

Within 90 days of submittal of a complete application, the Community Development Director determined the project meets the approval criteria.

### 3.30.070 Application review and issuance of conditional certificate.

A decision to approve or deny an application shall be made within ninety calendar days of receipt of a complete application.

A. Approval. The director may approve the application if he/she finds that:

1. A minimum of four new units are being constructed or in the case of occupied rehabilitation or conversion a minimum of four additional multifamily units are being developed;

2. If applicable, the proposed multi-unit housing project meets the affordable housing requirements as described in RCW 84.14.020;

3. The proposed project is or will be, at the time of completion, in conformance with all local plans and regulations that apply at the time the application is approved;

4. The owner has complied with all standards and guidelines adopted by the city under this chapter; and

5. The site is located in a residential targeted area of an urban center that has been designated by the city council in accordance with procedures and guidelines of this chapter.

B. Before application approval the applicant shall enter into a contract with the city, approved by the city council, regarding the terms and conditions of the project. After city council approval of the contract, and director approval of the application, the director shall issue a conditional certificate of acceptance of tax exemption. The conditional certificate expires three years from the date of approval unless an extension is granted as provided in this chapter.

C. Denial. The director shall state in writing the reasons for denial and shall send notice to the applicant at the applicant's last known address within ten calendar days of the denial. An applicant may appeal a denial to the city council within thirty days after receipt of the denial. The appeal before the governing authority must be based upon the record made before the administrative official with the burden of proof on the applicant to show that there was no substantial evidence to support the administrative official's decision. The decision of the governing body in denying or approving the application is final.

# **Application for Final Certificate**

Once the conditions of the contract are met and at the time of temporary or permanent certificate of occupancy, the applicant will need to file an application for

final certificate following the process below. The Community Development Director has thirty days to review the application.

# 3.30.090 Application for final certificate.

Upon completion of the improvements agreed upon in the contract between the applicant and the city and upon issuance of a temporary or permanent certificate of occupancy, the applicant must file with the director the following:

A. A statement of expenditures made with respect to each multifamily housing unit and the total expenditures made with respect to the entire property;

B. A description of the completed work and a statement of qualification for the exemption;

C. If applicable, a statement that the project meets the affordable housing requirements as described in RCW 84.14.020; and

D. A statement that the work was completed within the required three-year period or any authorized extension.

Within thirty calendar days of receipt of all materials required for a final certificate, the director shall determine whether the specific improvements, and the affordability of the units, satisfy the requirements of the contract, application, and this chapter.

# **Issuing Final Certificate**

Once the Community Development Director has determined the project has meet the conditions of the contract, the director will issue the final certificate.

# 3.30.100 Issuance of final certificate.

If the director determines that the project has been completed in accordance with this chapter and the contract between the applicant and the city has been completed within the authorized time period, the city shall, within ten calendar days of the expiration of the thirty-day review period provided in TMC 3.30.090, file a final certificate of tax exemption with the Thurston County assessor.

A. Denial and Appeal. The director shall notify the applicant in writing that a final certificate will not be filed if the director determines that:

1. The improvements were not completed within the authorized time period;

2. The improvements were not completed in accordance with the application or contract between the applicant and the city; or

3. The owner's property is otherwise not qualified under this chapter.

Within fourteen calendar days of receipt of the director's denial of a final certificate, the applicant may file an appeal with the city's hearing examiner, as provided in TMC Chapter 2.58.

# MULTIFAMILY HOUSING LIMITED PROPERTY TAX EXEMPTION AGREEMENT 8-YEAR (<u>X</u>) 12-YEAR (\_\_\_)

**THIS AGREEMENT** is entered into this \_\_\_\_\_ day of \_\_\_\_\_ 20\_\_\_\_ by and between <u>PSDC INVESTMENT LLC</u>, hereafter referred to as "Applicant" and the City of Tumwater, Washington, a municipal corporation hereinafter referred to as the "City".

### WITNESSETH:

WHEREAS, the City has an interest in encouraging new construction or rehabilitation of multifamily housing in Residential Target Areas in order to reduce development pressure on single-family residential neighborhoods, to increase and improve affordable housing opportunities, and to encourage development densities supportive of economic development and transit use; and

**WHEREAS**, the City has, pursuant to the authority granted to it by Chapter 84.14 RCW, designated various Residential Target Areas for the provision of a limited property tax exemption for new multifamily residential housing; and

**WHEREAS**, the City has, through Tumwater Municipal Code (TMC) 3.30, enacted a program whereby property owners may qualify for a final certificate of tax exemption which certifies to the Thurston County Assessor that the Applicant is eligible to receive a limited property tax exemption; and

WHEREAS, Applicant is interested in receiving a limited property tax exemption for constructing <u>24 units</u> of new multifamily housing in the <u>Brewery District</u> <u>Subarea</u>; and

WHEREAS, the Applicant is requesting an X eight (8) or a \_\_\_\_\_\_ twelve (12) year limited property tax exemption. (For the property to qualify for the twelve-year exemption, the Applicant commits to renting or selling at least twenty percent (20%) of the multifamily housing units constructed on the Site as housing units affordable for low or moderate-income households as defined by Section 3.30.015 TMC, and the property must satisfy that commitment and any additional affordability and income eligibility conditions adopted by the City. In the case of projects intended exclusively for owner occupancy, the minimum requirement of this subsection may be satisfied solely through housing affordable to moderateincome households as defined by Section 3.30.015 TMC.); and

**WHEREAS**, Applicant has submitted to the City preliminary site plans and floor plans for new multifamily residential housing to be constructed on property situated approximately at <u>350 North Street SE</u> and described more specifically as follows:

PSDC INVESTMENT LLC's 350 North Street SE Apartments (TUM-22-1338)

County Assessor's Parcel Number: 09250057000

Legal Description: <u>Section 26 Township 18 Range 2W Donation Land Claim</u> <u>CROSBY DLC BLA211474 Tract A Document 4912595</u>

Street Address: <u>350 North Street SE</u>

Herein referred to as the "Site", and

**WHEREAS**, the following exhibits, plans and forms are attached to this Agreement and incorporated herein by this reference:

- A. PSDC INVESTMENT LLC's 350 North Street SE Apartments Application
- B. Building Plans
- C. <u>PSDC INVESTMENT LLC's 350 North Street SE Apartments Written</u> <u>Statement 8-Year Property Tax Exemption</u>

; and

**WHEREAS**, the City has determined that the improvements will, if completed and operated as proposed, satisfy the requirements for a final certificate of tax exemption; and

WHEREAS, the Tumwater Municipal Code requires an applicant for a limited property tax exemption to enter into an agreement, in which the applicant agrees to implement the proposed project on terms satisfactory to the Tumwater City Council so as to maintain the improvements' eligibility for the limited property tax exemption;

Multifamily Housing 8-year or 12-year Limited Property Tax Exemption Agreement - Page 2 of 10

**NOW, THEREFORE**, in exchange for the City's consideration of Applicant's request for a final certificate of tax exemption, Applicant and the City mutually agree as follows:

- 1. Each of the recitals set forth above are by this reference fully incorporated into this Agreement.
- 2. The City agrees to issue Applicant a conditional certificate of acceptance of tax exemption.
- 3. Applicant shall construct on the Site multifamily residential housing substantially as described in the most recent site plans, floor plans, and elevations on file with the City as of the date of City approval of this Agreement. In no event shall such construction provide fewer than four new multifamily permanent residential units nor shall it provide fewer than half of its total residential units as permanent housing.
- 4. The Applicant further agrees that execution of this Agreement by the Mayor, or issuance of a conditional certificate by the City pursuant to TMC 3.30.070, in no way constitutes approval of proposed improvements on the Site or obligates the City to approve proposed improvements.
- 5. Applicant shall complete construction of the agreed upon improvements within three (3) years from the date the City issues the conditional certificate of acceptance of tax exemption or within any extension thereof granted by the City.
- 6. Applicant shall, upon completion of the improvements and upon issuance by the City of a temporary or permanent certificate of occupancy, file with the City the following:
  - A. A statement of expenditures made with respect to each multifamily housing unit and the total expenditures made with respect to the entire property;
  - B. A description of the completed work and a statement of qualifications for the exemption;
  - C. A statement that the work was completed within the required threeyear period or any authorized extension; and

Multifamily Housing 8-year or 12-year Limited Property Tax Exemption Agreement - Page 3 of 10

- D. If applicable, a statement that the project meets the affordable housing requirements as described in TMC Chapter 3.30.
- 7. Upon Applicant's successful completion of the improvements in accordance with the terms of this Agreement, Applicant's filing of the materials described in Paragraph 6 above and payment of all fees, and upon the City's approval of a final certificate of tax exemption, the City shall file the final certificate with the Thurston County Assessor and provide a copy to the Applicant. The Applicant shall cause this Agreement to be recorded in the real property records of Thurston County, Washington. The Applicant shall pay all fees and charges incurred in connection with such recording and shall provide the City with a copy of the recorded document.
- 8. Applicant shall, within thirty (30) days following the first anniversary of the City's filing of the final certificate of tax exemption and each year thereafter for a period of <u>X</u> eight (8) years or <u>twelve (12)</u> years, file a notarized declaration with the City indicating the following:
  - A. A statement of occupancy and vacancy of the multifamily units during the previous year;
  - B. A certification that the Site continues to be in compliance with this Agreement and TMC Chapter 3.30 and, if applicable, that the Site has been in compliance with the affordable housing requirements as described in RCW 84.14.020 since the date of the approved certificate;
  - C. A description of any subsequent improvements or changes to the Site;
  - D. The total monthly rent by unit;
  - E. The income of each renter household at the time of initial occupancy; and
  - F. Any additional information requested by the city in regards to the units receiving a tax exemption.
- 9. City staff may also conduct on-site verification of the declaration referenced in Section 8 above.
- 10. Failure to submit the annual declaration in Section 8 above shall result in a review of the exemption per TMC 3.30.120.

Multifamily Housing 8-year or 12-year Limited Property Tax Exemption Agreement - Page 4 of 10

- 11. If, during the term of any final certificate of tax exemption, Applicant converts to another use any of the new multifamily residential housing units constructed under this Agreement, Applicant shall notify the Thurston County Assessor and the City within sixty (60) days of such change in use. The City may, in its sole discretion, revoke and cancel the final Certificate of tax exemption effective on the date of Applicant's conversion of any of the multifamily residential housing units to another use. The Applicant hereby covenants and agrees not to sell, transfer, or otherwise dispose of the project or any portion thereof without first providing a written statement executed by the purchaser that the purchaser understands the Applicant's duties and obligations under this Agreement and will enter into an agreement with the City for the continuation of those obligations. Such notice must be received by the City at least ten (10) working days prior to the close of escrow.
- 12. Applicant shall notify the City promptly of any transfer of Applicant's ownership interest in the Site or in the improvements made to the Site under this Agreement.
- 13. In addition to any other powers reserved to the City by law, the City may, in its sole discretion, cancel the final certificate of tax exemption should Applicant, its successors and assigns, fail to comply with any of the terms and conditions of this Agreement or for any other reason no longer qualifies for an exemption.
- 14. Notice and Appeal. Upon determining that a tax exemption is to be canceled, the City will notify the Applicant by mail, return receipt requested, of the determination to cancel the exemption. Pursuant to TMC 3.30.120, the Applicant may appeal the determination to the City hearing examiner within thirty (30) days by filing a notice of appeal with the city clerk, which notice must specify the factual and legal basis on which the determination of cancellation is alleged to be erroneous. The hearing examiner will affirm, modify, or repeal the decision of cancellation of exemption based on the evidence received. An aggrieved party may appeal the decision of the hearing examiner to the Thurston County superior court.
- 15. If the exemption is canceled for non-compliance, the Applicant acknowledges that state law requires that an additional real property tax is to be imposed in the amount of: (1) the difference between the tax paid and the tax that would have been paid if it had included the value of the non-qualifying improvements, dated back to the date that the improvements became non-

Multifamily Housing 8-year or 12-year Limited Property Tax Exemption Agreement - Page 5 of 10

qualifying; (2) a penalty of twenty percent (20%) of the difference calculated under subsection (1) of this paragraph; and (3) interest at the statutory rate on delinquent property taxes and penalties, calculated from the date the tax would have been due without penalty if the improvements had been assessed without regard to the exemptions provided by Chapter 84.14 RCW and Chapter 3.30 TMC. The Applicant acknowledges that, pursuant to RCW 84.14.110, any additional tax owed, together with interest and penalty, become a lien on that portion of the property on which the improvements are constructed and attach at the time the portion of the Site is removed from multifamily use or the amenities no longer meet applicable requirements, and that the lien has priority to and must be fully paid and satisfied before a recognizance, mortgage, judgment, debt, obligation, or responsibility to or with which the Site may become charged or liable. The Applicant further acknowledges that RCW 84.14.110 provides that any such lien may be foreclosed in the manner provided by law for foreclosure of liens for delinquent real property taxes. An additional tax unpaid on its due date is delinquent. From the date of delinquency until paid, interest must be charged at the same rate applied by law to delinquent ad valorem property taxes.

- 16. No modifications of the Agreement shall be made unless mutually agreed upon by the parties in writing.
- 17. The provisions, covenants, and conditions contained in this Agreement are binding upon the parties hereto and their legal heirs, representatives, successors, assigns, and subsidiaries.
- 18. This Agreement shall be governed by and construed in accordance with the laws of the State of Washington. Venue for any action arising out of this Agreement shall be in Thurston County superior court.
- 19. In the event that any term or clause of this Agreement conflicts with applicable law, such conflict shall not affect other terms of this Agreement that can be given effect without the conflicting terms or clause, and to this end, the terms of the Agreement are declared to be severable. However, if applicable and if the severable term prevents the City from receiving the benefits of having affordable housing as set forth in Chapter 84.14 RCW and Chapter 3.30 TMC, then this Agreement shall be deemed terminated, or may be terminated, as soon as possible in compliance with any applicable law.
- 20. The Applicant shall exercise reasonable diligence to comply with the requirements of this Agreement and shall correct any such noncompliance

Multifamily Housing 8-year or 12-year Limited Property Tax Exemption Agreement - Page 6 of 10

within sixty (60) calendar days after such noncompliance is first discovered by the Applicant or would have been discovered by the exercise of reasonable diligence, or within 60 calendar days after the Applicant receives notice of such noncompliance from the City, whichever is earliest; provided however, that such period for correction may be extended in writing by the City if the Applicant is exercising due diligence to correct the noncompliance. If such noncompliance remains uncured after such period, then the Applicant shall be in default and the City may deny or cancel the tax exemption pursuant to TMC 3.30 or take such other action at law or equity as may appear necessary or desirable to enforce the obligations, covenants, conditions and agreements of the Applicant under this Agreement.

21. A. The Applicant shall maintain complete and accurate records pertaining to the affordable housing units and shall, during regular business hours, permit any duly authorized representative of the City, to inspect the books and records of the Applicant pertaining to the affordable housing units, including the annual declaration, and if applicable, income documentation of households residing in affordable housing at the Site. The Applicant's failure to maintain such records or failure to allow inspection by the City or any duly authorized representative shall constitute a material default hereunder. The Applicant shall retain all records pertaining to the affordable housing units for at least six (6) years.

B. The City and the Applicant hereby recognize and agree that the representations and covenants set forth herein may be relied upon by City and the Applicant. In performing its duties and obligations hereunder, the City may rely upon statements and declarations of the Applicant, and upon audits of the books and records of the Applicant pertaining to occupancy of the affordable housing units.

- 22. Notwithstanding anything in this Agreement to the contrary, the Applicant shall submit all documentation required by this Agreement on the forms designated by the City, which may be modified by the City from time to time. Applicant.
- 23. The Applicant shall not discriminate on the basis of race, creed, religion, color, sex, sexual orientation, age, national origin, marital status, or presence of any mental or physical handicap as set forth in RCW 49.60.030, as now existing and as may be amended, or on the basis of source of income as set forth in RCW 59.18.255, as now existing and as may be amended, in the lease, use, or occupancy of the affordable housing units or in connection with

Multifamily Housing 8-year or 12-year Limited Property Tax Exemption Agreement - Page 7 of 10

the employment or application for employment of persons for the operation and management of the Site.

24. A. The City and Applicant hereby declare their understanding and intent that the covenants, conditions and restrictions set forth herein directly benefit the land (i) by enhancing and increasing the enjoyment and use of the Site by certain eligible households, and (ii) by furthering the public purposes of providing housing for low-income and moderate-income households as defined in TMC 3.30.015.

B. The City and the Applicant hereby declare that the covenants and conditions contained herein shall bind and the benefits shall inure to, respectively, the Applicant and all subsequent owners of the Site or any interest therein, and the City. Each and every contract, deed or other instrument hereafter executed conveying the Site or any portion thereof or interest therein shall contain an express provision making such conveyance subject to the covenants and conditions of this Agreement, provided however, that any such contract, deed or other instrument shall conclusively be held to have been executed, delivered and accepted subject to such covenants and conditions, regardless of whether or not such covenants and conditions are set forth or incorporated by reference in such contract, deed or other instrument.

- 25. The Applicant shall defend, indemnify, and hold the City, its officers, officials, employees, volunteers and its designee and any other party authorized hereunder to enforce the terms of this Agreement, harmless from any and all claims, injuries, damages, losses, or suits, including attorney fees, arising out of or resulting from this Agreement. This provision shall survive termination or expiration of this Agreement.
- 26. The provisions of this Agreement and of the documents to be executed and delivered in connection herewith are and will be for the benefit of the Applicant and the City only and, are not for the benefit of any third party (including, without limitation, any tenants or tenant organizations), and accordingly, no third party shall have the right to enforce the provisions of this Agreement or of the documents to be executed and delivered in connection herewith.

Multifamily Housing 8-year or 12-year Limited Property Tax Exemption Agreement - Page 8 of 10

IN WITNESS WHEREOF, the parties hereto have executed this Agreement as of the day and year first above written.

<u>City</u>: City of Tumwater 555 Israel Road SW Tumwater, WA 98501 <u>Applicant:</u> <u>PSDC INVESTMENT LLC</u> <u>3922 Country Club Dr. NW</u> <u>Olympia, WA 98502</u>

Debbie Sullivan, Mayor

Signature Name Printed: <u>Pat Berschauer</u> Title: <u>Principal</u>

Approved as to form:

Karen Kirkpatrick, City Attorney

State of Washington County of \_\_\_\_\_\_ This record was acknowledged before me on (date) by (name(s) of individuals) as (type of authority, such as officer or trustee) of (name of party on behalf of whom record was executed).

> (Signature) Notary Public in and for the State of Washington. My appointment expires \_\_\_\_\_\_. Date:\_\_\_\_\_\_.

State of Washington County of Thurston

I certify that I know or have satisfactory evidence that Debbie Sullivan is the person who appeared before me, and said person acknowledged that she signed this instrument, on oath stated that she was authorized to execute the instrument and acknowledged it as the Mayor of the City of Tumwater to be the free and voluntary act of such party for the uses and purposes mentioned in the instrument.

Multifamily Housing 8-year or 12-year Limited Property Tax Exemption Agreement - Page 9 of 10

Dated:\_\_\_\_\_

(Signature) Notary Public in and for the State of Washington. My appointment expires \_\_\_\_\_.

Multifamily Housing 8-year or 12-year Limited Property Tax Exemption Agreement - Page 10 of 10

CITY OF TUMWATER	CITY OF TUMWATER 555 ISRAEL RD. SW, TUMWATER, WA 98501 (360) 754-4180 Email: <u>cdd@ci.tumwater.wa.us</u> TAX EXEMPTION ON MULTI-FAMILY UNITS WITHIN A DESIGNATED RESIDENTIAL TARGET AREA APPLICATION	TUM -22- 1338           Kerri RCVD BY	DATE STAMP 09-07-2022
<b>8 YEAR TAX CREDIT</b> OR <b>12 YEAR TAX CREDIT</b>			
LEGAL OWNER: PSDC INVESTMENT LLC			
		patbers@msn.com	
Nana		//	
Mailing Address Phone: ()			
PROJECT INFORMATION			
PROPERTY ADDRESS: 350 North Street SE Tumwater WA PARCEL #: 09250057000			
LEGAL DESCRIPTION: Section 26 Township 18 Range 2W Donation Land Claim CROSBY DLC BLA211474TW TR A Document 4912595			
INTEREST IN PROPERTY:       Fee Simple       Contract Purchase       Other         NEW CONSTRUCTION:       Yes       No       REHABILITATION OF EXISTING UNITS:       Voc       No			
NEW CONSTRUCTION: $\blacksquare$ Yes $\Box$ No REHABILITATION OF EXISTING UNITS: $\Box$ Yes $\Box$ No NUMBER OF UNITS: NEW: 24 EXISTING EMPTY: EXISTING OCCUPIED:			
NUMBER OF UNITS FOR WHICH THIS EXEMPTION IS BEING APPLIED FOR: 24			
(Must be 4 or more)			
PERCENTAGE OF SPACE FOR PERMANENT RESIDENTIAL HOUSING: 100%			
** IF EXISTING UNITS ARE VACANT, DATE LAST OCCUPIED: * * AFFIDAVIT OF VACANCY MUST BE ATTACHED***			
DESCRIBE BUILDING USE AND SQUARE FEET INTENDED FOR EACH USE: New Multifamily project			
24 units, located in the Brewery District, 26,136 sf, and intended use will be for apartment rental investment.			
PROJECTED COST OF CONSTRUCTION / REHABILITATION: \$7,569,300			
PROPERTY ACQUISITION COST			
SOURCE OF COST ESTIMATE: CBRE appraisal 5.10.2022, and Berschauer Group Inc estimate			
EXPECTED DATE TO START PROJECT: 4.1.2022 PROPOSED COMPLETION DATE: July 2023			
RESIDENTIAL TARGET AREAS			
8 or 12 Year Tax Credit: 🗆 Capitol Boulevard Corridor 🛛 🗧 Brewery District			

12 Year Tax Credit only 🛛 Tumwater Town Center

□ Littlerock Road Subarea

Item 6.

## IF APPLYING FOR A 12-YEAR CREDIT, PLEASE ATTACH A STATEMENT ADDRESSING THE FOLLOWING QUESTIONS:

- 1. Total number of units being proposed
- 2. Estimated rent per unit

Item 6.

- 3. Number of units rented to low or moderate income households (or other households)
- 4. Estimated income of those households
- 5. Method for insuring program compliance over the period of the exemption

#### A COMPLETE APPLICATION SHALL INCLUDE:

1. A completed City of Tumwater application setting forth the grounds for the exemption;

2. Preliminary floor and site plans of proposed project;

3. A statement acknowledging the potential tax liability when the project ceases to be eligible under this chapter;

4. Verification by oath or affirmation of the information submitted.

For rehabilitation projects, the applicant shall also submit an affidavit that existing dwelling units have been unoccupied for a period of twelve months prior to filing the application and shall secure from the city verification of property noncompliance with the city's applicable building or housing codes.


Before application approval, the applicant shall enter into a contract with the City, approved by the City Council, regarding the terms and conditions of the project. After City Council approval of the contract, and Director of Community Development approval of the application, the Director shall issue a conditional Certificate of Acceptance of Tax Exemption. The Conditional Certificate expires three years from the date of approval unless an extension is granted as provided in this chapter."

(FO)	R CITY USE)			
Building is in a Multi-Family Tax Exemption Target Areas				
$\Box$ Building is not in compliance with the City's	Minimum Ho	using Code		
□ Required Preliminary Plans are attached:	🗆 Plans	🗆 Site Plan	Floor Plan	
$\Box$ \$100 application fee received				


I certify under penalty of perjury that the information furnished by me is true and correct to the best of my knowledge, and further, that I am the owner of this property or am authorized by the owner to perform the work for which this permit application is made. I further agree to hold harmless, the City of Tumwater as to any claim (including costs, expenses, and attorney fees incurred in investigation and defense of such claim), which may be made by any person, including the undersigned, and filed against the City of Tumwater, to the extent such claim arises out of the reliance of the City, including its officers and employees, upon the accuracy of the information supplied to the City as part of this application.

June	9-7-2022	
Signature of Owner	Date	
Pat Berschauer, PSDC Investment LLC	*	
Print Name		
Vant	9-7-2022	
Signature of Applicant/Agent	Date	
Pat Berschauer, Applicant		
Print Name		




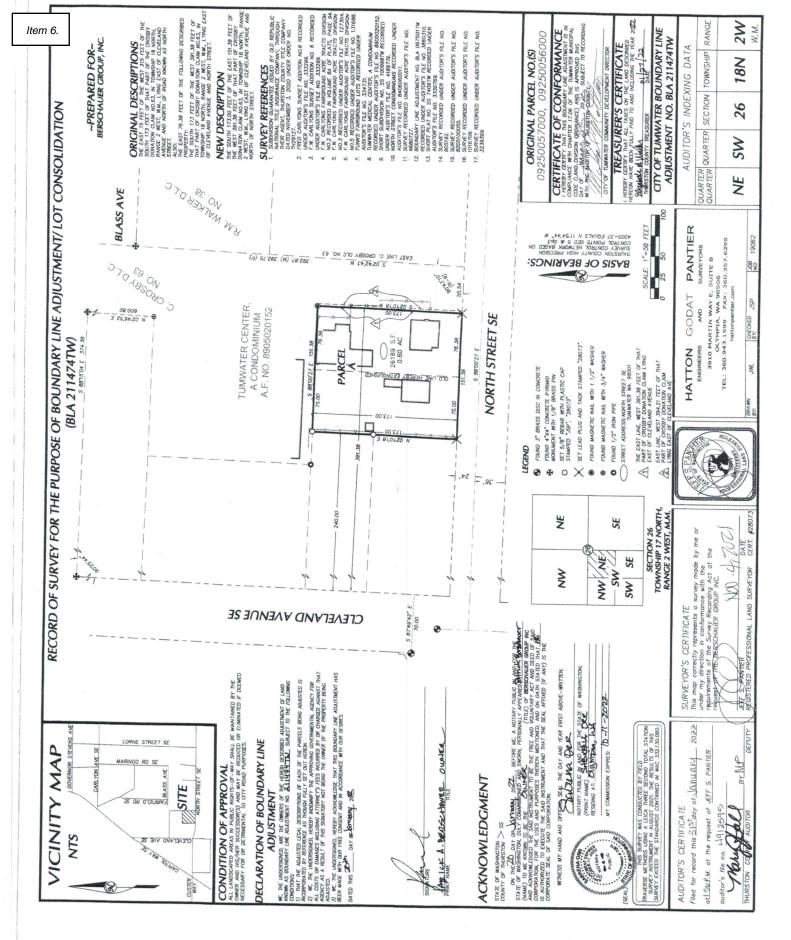



SbS10107#179

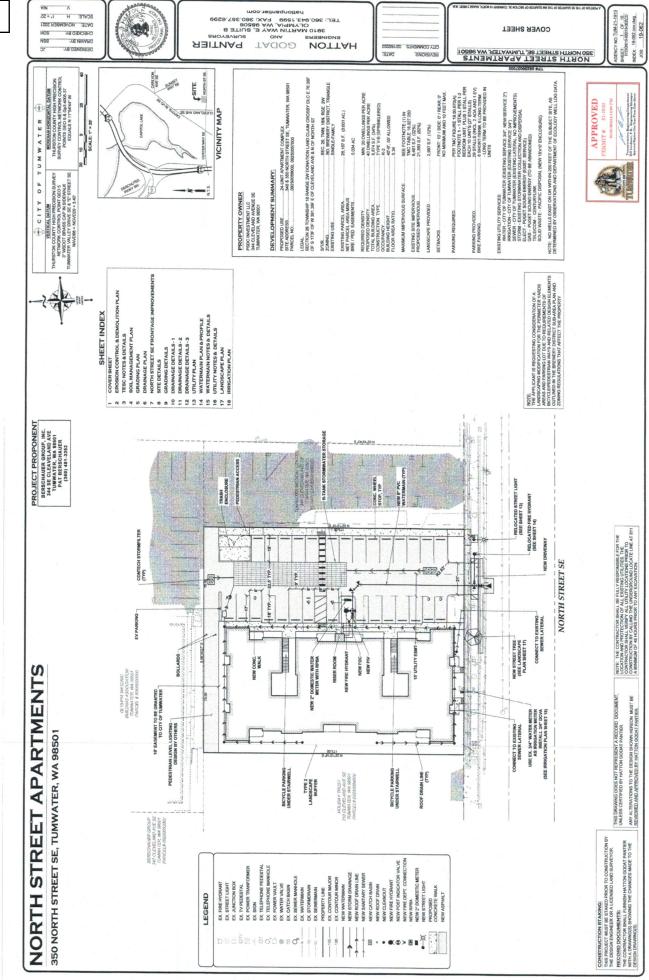

#### Item 6.

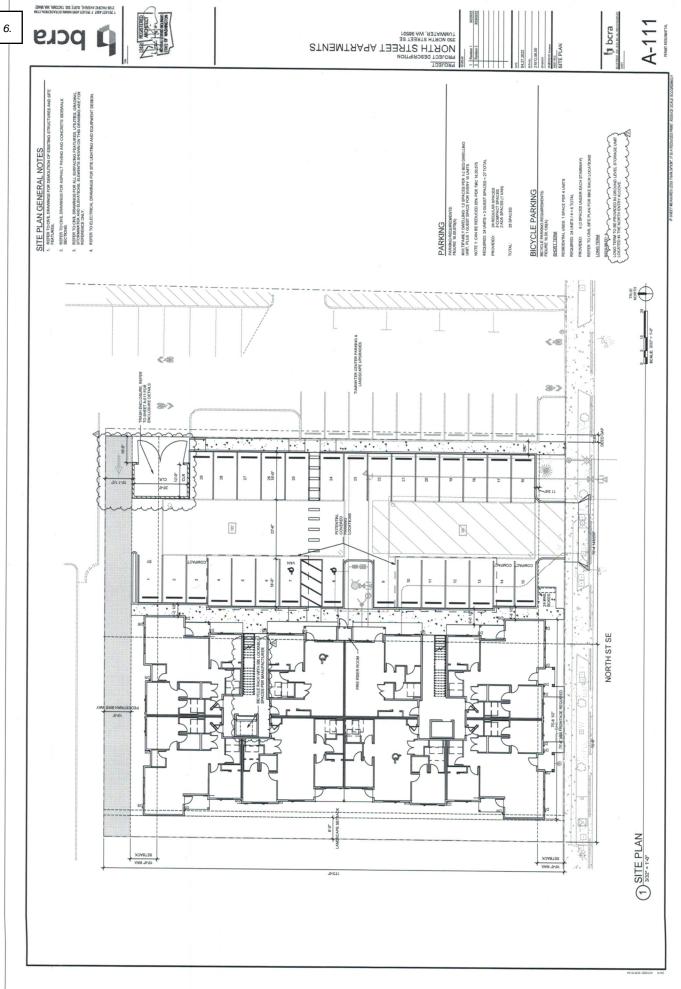

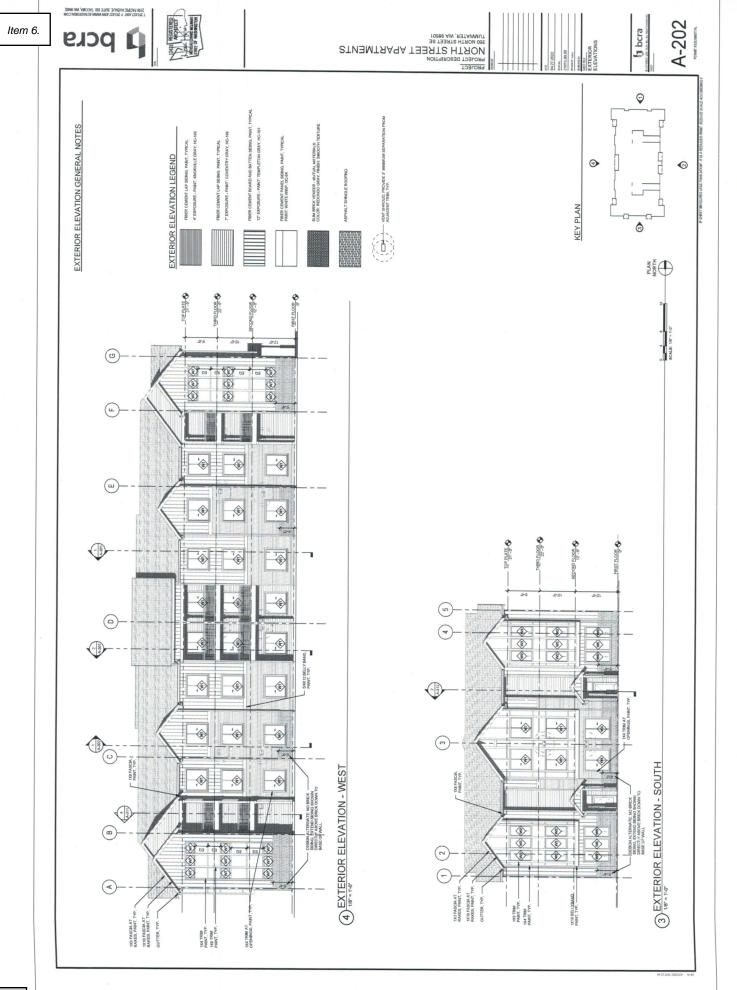

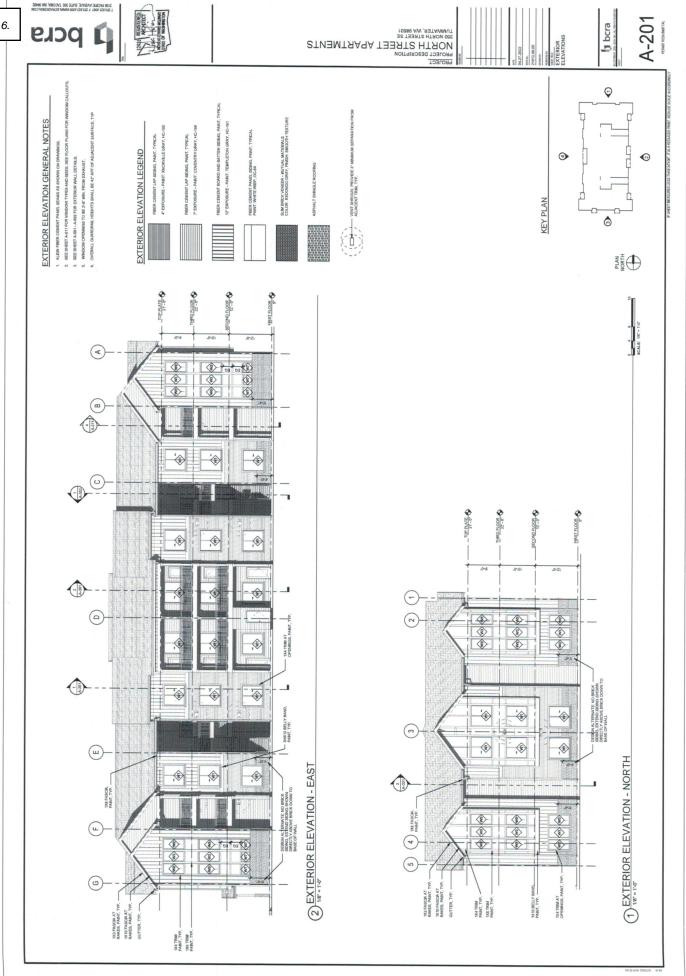

79

ltem 6.

CITY OF TUMWATER 555 ISRAEL ROAD SW TUMWATER, WA 98501 PH: (360) 754-4180 FAX: (360) 754-4126 E-Mail: permits@ci.tumwater.wa.us

#### PERMIT



 PERMIT NUMBER:
 TUM-22-0073

 APPLIED:
 12/10/2021

 ISSUED:
 5/24/2022

 EXPIRES:
 11/20/2022

 VALUATION:
 \$2,400,000.00

 MASTER PERMIT:
 TUM-21-1910

PROJECT:	NORTH STREET APARTMENTS
Project Address:	350 NORTH ST SE
Assessor's Parcel No:	09250057000
Permit Type:	MULTIFAMILY BUILDING PERMIT
Permit Description:	CONSTRUCTION OF A 3-STORY 24-UNIT APARTMENT BUILDING

OWNER	CONTRACTOR	LENDER	
PSDC INVESTMENT, LLC 3922 COUNTRY CLUB DR NW Olympia WA 98502 (360) 481-3252	BERSCHAUER GROUP, INC. NOT PROVIDED 344 CLEVELAND AVE SE SUITE C TUMWATER WA 98501-3342 (360) 539-7252		
CUSTOMER NUMBER: 00001766	Lic #: BERSCGI8	94P1 Exp Date: 10/27/2023	
FEES			
BLDG PLAN CHECK R2014-025	\$10,649.96	BUILDING PERMIT R2014-025	\$16,384.55
ENERGY PLAN CHECK MUL FAM	\$187.00	PASS THRU STATE FEE	\$52.50
PLUMBING PLAN REVIEW	\$2,763.15	PLUMBING PERMIT FEE	\$4,251.00
MECHANICAL PLAN REV R2010-18	\$2,522.00 MECHANICAL PERMIT FEE 2022		\$3,880.00
CDC FEE 2022	\$97,830.07	WATER METER-1ST 2022	\$25,375.08
SEWER CONNECTION 2022	\$42,274.42	PARK IMPACT FEE	\$57,914.88
TUMWATER SCHOOL IMPACT 2021	\$28,344.00	TRAN IMPACT FEE 2021	\$46,686.17
		Total Permit Fees	\$339,114.78

NOTICE: Separate electrical permits are required from the Department of Labor & Industries. This permit becomes null and void if work or construction authorized is not commenced within 180 days, or if construction or work is suspended or abandoned for a period of 180 days at any time after work is commenced. I hereby certify that I have read and examined this application and know the same to be true and correct. All provisions of laws and ordinances governing this type of work will be complied with whether specified herein or not. The granting of a permit does not presume to give authority to violate or cancel the provisions of any other state or local law regulating construction or the performance of construction. For information on contractor registration laws go to https://fortress.wa.gov.

ISSUED BY

APPLICANT OR OWNER'S SIGNATURE

Attachment D

Exhibit C



September 12, 2022

City of Tumwater Attention: Brad Medrud, Planning Manager

Re: Project: 350 North Street Apartments TMC 3.30 Tax Exemption Application

Brad,

Attached is our complete application for 350 North Street Apartments per Chapter 3.30 Multifamily Housing Tax Exemptions.

We also want to acknowledge per the application form the following:

- 1. The potential future tax liability when the project ceases to be eligible under this chapter
- 2. Our affidavit of vacancy of our existing (3) tenants was completed on March 31, 2022.
- 3. We affirm by oath that all our information submitted be true and accurate to the best of our knowledge.

If you have any questions regarding our application, please don't hesitate to call.

Sincerely,

Patrick Berschauer Applicant for PSDC Investment LLC 360.481.3252

Item 7.

- TO: General Government Committee
- FROM: Brad Medrud, Planning Manager
- DATE: November 9, 2022
- SUBJECT: Contract Approval for an 8-Year Multifamily Tax Exemption for the Craft District Apartments (TUM-22-1393)

#### 1) <u>Recommended Action</u>:

Staff recommends that the General Government Committee review the application materials, be prepared to ask staff questions, and schedule the application for City Council consideration on December 6, 2022.

#### 2) Background:

In 2017, the City Council adopted the Multifamily Housing Tax Exemption program to stimulate desired housing development within key areas of the City, such as the Brewery District and Capitol Boulevard Corridor. In 2019, the City Council approved expanding the 12-Year Multifamily Housing Tax Exemption program to the Town Center and Littlerock Subarea to encourage the development of permanent affordable housing as part of its 2019 Housing Affordability Work Plans. The program includes both an 8-year exemption for providing multifamily housing in the designated areas and a 12-year exemption for development providing a minimum of 20% of units designated for low or moderate-income households.

The City has received an application for the 8-year exemption program for a 95-unit apartment complex in the Brewery District Subarea (TUM-22-1393).

#### 3) <u>Policy Support</u>:

Comprehensive Plan Housing Element Action H-3.3.3: Establish a multi-family tax exemption program that gives financial incentive for developers to create multi-family structures in target areas and to set aside a percentage of units as low-income housing.

4) <u>Alternatives</u>:

None.

#### 5) <u>Fiscal Notes</u>:

The application is for an 8-year Multifamily Housing Tax Exemption.

#### 6) <u>Attachments</u>:

- A. Staff Report
- B. Craft District Apartments (TUM-22-1393) MFTE Tax Agreement

- C. Craft District Apartments (TUM-22-1393) Exhibit A Application
- D. Craft District Apartments (TUM-22-1393) Exhibit B Building Plans
- E. Craft District Apartments (TUM-22-1393) Exhibit C Exemption Request Letter F. Craft District Apartments (TUM-22-1393) Exhibit D Supplemental Questions

#### Attachment A



City Hall 555 Israel Road SW Tumwater, WA 98501-6515 Phone: 360-754-5855 Fax: 360-754-4138

### **Staff Report**

Date:	November 9, 2022
To:	General Government Committee
From:	Brad Medrud
Subject:	Contract Approval for an Eight-Year Multifamily Tax Exemption for the Craft District Apartments (TUM-22-1393)

In 2017, the City Council adopted the Multifamily Housing Tax Exemption program to stimulate desired housing development within key areas of the City, such as the Brewery District and Capitol Boulevard Corridor.

The Multifamily Housing Tax Exemption program includes both an eight-year exemption for providing multifamily housing in the designated areas and a twelve-year exemption for development providing a minimum of 20% of units designated for low or moderate-income households.

In 2019, the City Council approved expanding the Twelve-Year Multifamily Housing Tax Exemption program to the Town Center and Littlerock Subarea to encourage the development of permanent affordable housing as part of its 2019 Housing Affordability Work Plan.

The City has received an application for the eight-year exemption program for the Craft District Apartments multifamily development in the Brewery District Subarea (TUM-22-1393).

This memorandum discusses the requirements for this Multifamily Tax Exemption Program application for the 95-unit Craft District Apartments in the Brewery District Subarea.

The discussion points and the pertinent sections of TMC 3.30 *Multifamily Housing Tax Exemptions* are laid out below.

#### Target Area and Length of Exemption

The Craft District Apartments are in the Brewery District Subarea.

The project will follow the eight-year MFTE requirements below.

3.30.040 Tax exemptions for multifamily housing in residential target areas authorized.

A. Duration of Exemption. The value of improvements qualifying under Chapter 84.14 RCW and this chapter will be exempt from ad valorem property taxation, as follows:

1. For eight successive years beginning January 1 of the year immediately following the calendar year of issuance of the certificate. The eight-year duration of exemption applies only for projects in the Area 1 – Capitol Boulevard Corridor and Area 2 – Brewery District residential target areas; or

2. For twelve successive years beginning January 1 of the year immediately following the calendar year of issuance of the certificate, if the property otherwise qualifies for the exemption under Chapter 84.14 RCW and meets the conditions in this subsection. For the property to qualify for the twelve-year exemption under this subsection, the applicant must commit to renting or selling at least twenty percent of the multifamily housing units as affordable housing units to low- and moderate-income households, and the property must satisfy that commitment and any additional affordability and income eligibility conditions adopted by the city. In the case of projects intended exclusively for owner occupancy, the minimum requirement of this subsection may be satisfied solely through housing affordable to moderate-income households.

B. Limits on Exemption. The exemption does not apply to the value of land or to the value of improvements not qualifying under this chapter, nor does the exemption apply to increases in assessed valuation of land and nonqualifying improvements. In the case of rehabilitation of existing buildings, the exemption does not include the value of improvements constructed prior to submission of the completed application required under this chapter. This chapter does not apply to increases in assessed valuation made by the assessor on nonqualifying portions of building and value of land nor to increases made by lawful order of a county board of equalization, the Department of Revenue, or a county, to a class of property throughout the county or specific area of the county to achieve the uniformity of assessment or appraisal required by law.

#### **Project Eligibility**

The project meets the following requirements:

- 1. Location in the Brewery District Subarea Confirmed.
- 2. Tenant Displacement Prohibited Confirmed.
- 3. Size –The project has 95 dwelling units.
- 4. **Proposed Completion Date** The project will need to be completed within three years of application for the MFTE.

5. **Contract with City Approved by City Council** – The applicant must enter into a contract with city approved by City Council. See the attached.

#### 3.30.050 Project eligibility.

A proposed project must meet the following requirements for consideration for a property tax exemption:

A. Location. The project must be located within a residential target area as designated in TMC 3.30.030.

B. Tenant Displacement Prohibited. The project must not displace existing residential tenants of structures that are proposed for redevelopment. Existing dwelling units proposed for rehabilitation must have been unoccupied for a minimum of twelve months prior to submission of an application and must have one or more violations of the International Property Maintenance Code of the city of Tumwater. Applications for new construction cannot be submitted for vacant property upon which an occupied residential rental structure previously stood, unless a minimum of twelve months has elapsed from the time of most recent occupancy.

C. Size. The project must include at least four units of multifamily housing within a residential structure or as part of an urban development. A minimum of four new units must be constructed or at least four additional multifamily units must be added to existing occupied multifamily housing. Existing multifamily housing that has been vacant for twelve months or more does not have to provide additional units so long as the project provides at least four units of new, converted, or rehabilitated multifamily housing.

D. Proposed Completion Date. New construction multifamily housing and rehabilitation improvements must be completed within three years from the date of approval of the application.

E. Compliance with Guidelines and Standards. The project must be designed to comply with the city's comprehensive plan, building, housing, and zoning codes, and any other applicable regulations in effect at the time the application is approved. The project must also comply with any other standards and guidelines adopted by the city council for the residential target area in which the project will be developed.

F. At least fifty percent of the space in a new, converted, or rehabilitated multiple unit must be for permanent residential housing. In the case of existing occupied multifamily development, the multifamily housing must also provide for a minimum of four additional multifamily units. Existing multifamily vacant housing that has been vacant for twelve months or more does not have to provide additional units. Multifamily Tax Exemption – Craft District Apartments Staff Report November 9, 2022

G. The applicant must enter into a contract with city approved by city council under which the applicant agrees to the implementation of the development on terms and conditions satisfactory to the city council.

#### **Application Procedure**

Prior to April 1 of any year, the applicant must submit a complete application that includes the following:

- 1. A **completed city of application form** setting forth the grounds for the exemption. Applicant has provided a completed form. See Attachment C, Exhibit A, and Attachment F, Exhibit D.
- 2. **Preliminary floor and site plans of the proposed project**. Applicant has provided floor and site plans. See Attachment D, Exhibit B.
- 3. A statement acknowledging the potential tax liability when the project ceases to be eligible under this chapter. Applicant has provided. See Attachment E, Exhibit C, and Attachment F, Exhibit D.
- 4. **Verification by oath or affirmation of the information submitted** Applicant has provided this. See Attachment C, Exhibit A, and Attachment F, Exhibit D.

#### 3.30.060 Application procedure.

A property owner who wishes to propose a project for a tax exemption shall complete the following procedures:

A. Prior to April 1 of any year, file with the director the required application along with the required fees as established by resolution of the city council.

B. A complete application shall include:

1. A completed city of Tumwater application form setting forth the grounds for the exemption;

2. Preliminary floor and site plans of the proposed project;

3. A statement acknowledging the potential tax liability when the project ceases to be eligible under this chapter; and

4. Verification by oath or affirmation of the information submitted.

[...]

Multifamily Tax Exemption – Craft District Apartments Staff Report November 9, 2022

#### **Application Review**

Within 90 days of submittal of a complete application, the Community Development Director determined the project meets the approval criteria.

#### 3.30.070 Application review and issuance of conditional certificate.

A decision to approve or deny an application shall be made within ninety calendar days of receipt of a complete application.

A. Approval. The director may approve the application if he/she finds that:

1. A minimum of four new units are being constructed or in the case of occupied rehabilitation or conversion a minimum of four additional multifamily units are being developed;

2. If applicable, the proposed multi-unit housing project meets the affordable housing requirements as described in RCW 84.14.020;

3. The proposed project is or will be, at the time of completion, in conformance with all local plans and regulations that apply at the time the application is approved;

4. The owner has complied with all standards and guidelines adopted by the city under this chapter; and

5. The site is located in a residential targeted area of an urban center that has been designated by the city council in accordance with procedures and guidelines of this chapter.

B. Before application approval the applicant shall enter into a contract with the city, approved by the city council, regarding the terms and conditions of the project. After city council approval of the contract, and director approval of the application, the director shall issue a conditional certificate of acceptance of tax exemption. The conditional certificate expires three years from the date of approval unless an extension is granted as provided in this chapter.

C. Denial. The director shall state in writing the reasons for denial and shall send notice to the applicant at the applicant's last known address within ten calendar days of the denial. An applicant may appeal a denial to the city council within thirty days after receipt of the denial. The appeal before the governing authority must be based upon the record made before the administrative official with the burden of proof on the applicant to show that there was no substantial evidence to support the administrative official's decision. The decision of the governing body in denying or approving the application is final.

#### Application for Final Certificate

Once the conditions of the contract are met and at the time of temporary or permanent certificate of occupancy, the applicant will need to file an application for

final certificate following the process below. The Community Development Director has thirty days to review the application.

### 3.30.090 Application for final certificate.

Upon completion of the improvements agreed upon in the contract between the applicant and the city and upon issuance of a temporary or permanent certificate of occupancy, the applicant must file with the director the following:

A. A statement of expenditures made with respect to each multifamily housing unit and the total expenditures made with respect to the entire property;

B. A description of the completed work and a statement of qualification for the exemption;

C. If applicable, a statement that the project meets the affordable housing requirements as described in RCW 84.14.020; and

D. A statement that the work was completed within the required three-year period or any authorized extension.

Within thirty calendar days of receipt of all materials required for a final certificate, the director shall determine whether the specific improvements, and the affordability of the units, satisfy the requirements of the contract, application, and this chapter.

### **Issuing Final Certificate**

Once the Community Development Director has determined the project has meet the conditions of the contract, the director will issue the final certificate.

### 3.30.100 Issuance of final certificate.

If the director determines that the project has been completed in accordance with this chapter and the contract between the applicant and the city has been completed within the authorized time period, the city shall, within ten calendar days of the expiration of the thirty-day review period provided in TMC 3.30.090, file a final certificate of tax exemption with the Thurston County assessor.

A. Denial and Appeal. The director shall notify the applicant in writing that a final certificate will not be filed if the director determines that:

1. The improvements were not completed within the authorized time period;

2. The improvements were not completed in accordance with the application or contract between the applicant and the city; or

3. The owner's property is otherwise not qualified under this chapter.

Within fourteen calendar days of receipt of the director's denial of a final certificate, the applicant may file an appeal with the city's hearing examiner, as provided in TMC Chapter 2.58.

#### MULTIFAMILY HOUSING LIMITED PROPERTY TAX EXEMPTION AGREEMENT 8-YEAR (<u>X</u>) 12-YEAR (\_\_\_)

**THIS AGREEMENT** is entered into this \_\_\_\_\_ day of \_\_\_\_\_, 20\_\_\_\_ by and between <u>Craft District II, LLC</u>, hereafter referred to as "Applicant" and the City of Tumwater, Washington, a municipal corporation hereinafter referred to as the "City".

#### WITNESSETH:

WHEREAS, the City has an interest in encouraging new construction or rehabilitation of multifamily housing in Residential Target Areas in order to reduce development pressure on single-family residential neighborhoods, to increase and improve affordable housing opportunities, and to encourage development densities supportive of economic development and transit use; and

**WHEREAS**, the City has, pursuant to the authority granted to it by Chapter 84.14 RCW, designated various Residential Target Areas for the provision of a limited property tax exemption for new multifamily residential housing; and

**WHEREAS**, the City has, through Tumwater Municipal Code (TMC) 3.30, enacted a program whereby property owners may qualify for a final certificate of tax exemption which certifies to the Thurston County Assessor that the Applicant is eligible to receive a limited property tax exemption; and

WHEREAS, Applicant is interested in receiving a limited property tax exemption for constructing <u>95 units</u> of new multifamily housing in the <u>Brewery District</u> <u>Subarea</u>; and

WHEREAS, the Applicant is requesting an X eight (8) or a \_\_\_\_\_\_ twelve (12) year limited property tax exemption. (For the property to qualify for the twelve-year exemption, the Applicant commits to renting or selling at least twenty percent (20%) of the multifamily housing units constructed on the Site as housing units affordable for low or moderate-income households as defined by Section 3.30.015 TMC, and the property must satisfy that commitment and any additional affordability and income eligibility conditions adopted by the City. In the case of projects intended exclusively for owner occupancy, the minimum requirement of this subsection may be satisfied solely through housing affordable to moderateincome households as defined by Section 3.30.015 TMC.); and

**WHEREAS**, Applicant has submitted to the City preliminary site plans and floor plans for new multifamily residential housing to be constructed on property situated approximately at <u>4300 Capitol Boulevard SE</u> and described more specifically as follows:

Craft District II, LLC's Craft District Apartments (TUM-22-1393)

County Assessor's Parcel Number: <u>33870000400</u>

Legal Description: <u>Section 26 Township 18 Range 2W Quarter SW, NW</u> <u>Donation Land Claim BELLATORRE BSP NO 12-0034TW LT 4 Document</u> <u>4250623</u>

Street Address: <u>4300 Capitol Boulevard SE</u>

Herein referred to as the "Site", and

**WHEREAS**, the following exhibits, plans and forms are attached to this Agreement and incorporated herein by this reference:

- A. Craft District II, LLC's Craft District Apartments Application
- B. Building Plans
- C. <u>Craft District II, LLC's Craft District Apartments Written Statement 8-</u> <u>Year Property Tax Exemption</u>
- D. <u>Craft District II, LLC's Craft District Apartments Application –</u> <u>Supplemental Questions</u>

; and

**WHEREAS**, the City has determined that the improvements will, if completed and operated as proposed, satisfy the requirements for a final certificate of tax exemption; and

**WHEREAS**, the Tumwater Municipal Code requires an applicant for a limited property tax exemption to enter into an agreement, in which the applicant agrees to

Multifamily Housing 8-year or 12-year Limited Property Tax Exemption Agreement - Page 2 of 11

implement the proposed project on terms satisfactory to the Tumwater City Council so as to maintain the improvements' eligibility for the limited property tax exemption;

**NOW, THEREFORE**, in exchange for the City's consideration of Applicant's request for a final certificate of tax exemption, Applicant and the City mutually agree as follows:

- 1. Each of the recitals set forth above are by this reference fully incorporated into this Agreement.
- 2. The City agrees to issue Applicant a conditional certificate of acceptance of tax exemption.
- 3. Applicant shall construct on the Site multifamily residential housing substantially as described in the most recent site plans, floor plans, and elevations on file with the City as of the date of City approval of this Agreement. In no event shall such construction provide fewer than four new multifamily permanent residential units nor shall it provide fewer than half of its total residential units as permanent housing.
- 4. The Applicant further agrees that execution of this Agreement by the Mayor, or issuance of a conditional certificate by the City pursuant to TMC 3.30.070, in no way constitutes approval of proposed improvements on the Site or obligates the City to approve proposed improvements.
- 5. Applicant shall complete construction of the agreed upon improvements within three (3) years from the date the City issues the conditional certificate of acceptance of tax exemption or within any extension thereof granted by the City.
- 6. Applicant shall, upon completion of the improvements and upon issuance by the City of a temporary or permanent certificate of occupancy, file with the City the following:
  - A. A statement of expenditures made with respect to each multifamily housing unit and the total expenditures made with respect to the entire property;
  - B. A description of the completed work and a statement of qualifications for the exemption;

Multifamily Housing 8-year or 12-year Limited Property Tax Exemption Agreement - Page 3 of 11

- C. A statement that the work was completed within the required threeyear period or any authorized extension; and
- D. If applicable, a statement that the project meets the affordable housing requirements as described in TMC Chapter 3.30.
- 7. Upon Applicant's successful completion of the improvements in accordance with the terms of this Agreement, Applicant's filing of the materials described in Paragraph 6 above and payment of all fees, and upon the City's approval of a final certificate of tax exemption, the City shall file the final certificate with the Thurston County Assessor and provide a copy to the Applicant. The Applicant shall cause this Agreement to be recorded in the real property records of Thurston County, Washington. The Applicant shall pay all fees and charges incurred in connection with such recording and shall provide the City with a copy of the recorded document.
- 8. Applicant shall, within thirty (30) days following the first anniversary of the City's filing of the final certificate of tax exemption and each year thereafter for a period of <u>X</u> eight (8) years or <u>twelve (12)</u> years, file a notarized declaration with the City indicating the following:
  - A. A statement of occupancy and vacancy of the multifamily units during the previous year;
  - B. A certification that the Site continues to be in compliance with this Agreement and TMC Chapter 3.30 and, if applicable, that the Site has been in compliance with the affordable housing requirements as described in RCW 84.14.020 since the date of the approved certificate;
  - C. A description of any subsequent improvements or changes to the Site;
  - D. The total monthly rent by unit;
  - E. The income of each renter household at the time of initial occupancy; and
  - F. Any additional information requested by the city in regards to the units receiving a tax exemption.

Multifamily Housing 8-year or 12-year Limited Property Tax Exemption Agreement - Page 4 of 11

- 9. City staff may also conduct on-site verification of the declaration referenced in Section 8 above.
- 10. Failure to submit the annual declaration in Section 8 above shall result in a review of the exemption per TMC 3.30.120.
- 11. If, during the term of any final certificate of tax exemption, Applicant converts to another use any of the new multifamily residential housing units constructed under this Agreement, Applicant shall notify the Thurston County Assessor and the City within sixty (60) days of such change in use. The City may, in its sole discretion, revoke and cancel the final Certificate of tax exemption effective on the date of Applicant's conversion of any of the multifamily residential housing units to another use. The Applicant hereby covenants and agrees not to sell, transfer, or otherwise dispose of the project or any portion thereof without first providing a written statement executed by the purchaser that the purchaser understands the Applicant's duties and obligations under this Agreement and will enter into an agreement with the City for the continuation of those obligations. Such notice must be received by the City at least ten (10) working days prior to the close of escrow.
- 12. Applicant shall notify the City promptly of any transfer of Applicant's ownership interest in the Site or in the improvements made to the Site under this Agreement.
- 13. In addition to any other powers reserved to the City by law, the City may, in its sole discretion, cancel the final certificate of tax exemption should Applicant, its successors and assigns, fail to comply with any of the terms and conditions of this Agreement or for any other reason no longer qualifies for an exemption.
- 14. Notice and Appeal. Upon determining that a tax exemption is to be canceled, the City will notify the Applicant by mail, return receipt requested, of the determination to cancel the exemption. Pursuant to TMC 3.30.120, the Applicant may appeal the determination to the City hearing examiner within thirty (30) days by filing a notice of appeal with the city clerk, which notice must specify the factual and legal basis on which the determination of cancellation is alleged to be erroneous. The hearing examiner will affirm, modify, or repeal the decision of cancellation of exemption based on the evidence received. An aggrieved party may appeal the decision of the hearing examiner to the Thurston County superior court.

Multifamily Housing 8-year or 12-year Limited Property Tax Exemption Agreement - Page 5 of 11

- 15. If the exemption is canceled for non-compliance, the Applicant acknowledges that state law requires that an additional real property tax is to be imposed in the amount of: (1) the difference between the tax paid and the tax that would have been paid if it had included the value of the non-qualifying improvements, dated back to the date that the improvements became nonqualifying; (2) a penalty of twenty percent (20%) of the difference calculated under subsection (1) of this paragraph; and (3) interest at the statutory rate on delinquent property taxes and penalties, calculated from the date the tax would have been due without penalty if the improvements had been assessed without regard to the exemptions provided by Chapter 84.14 RCW and Chapter 3.30 TMC. The Applicant acknowledges that, pursuant to RCW 84.14.110, any additional tax owed, together with interest and penalty, become a lien on that portion of the property on which the improvements are constructed and attach at the time the portion of the Site is removed from multifamily use or the amenities no longer meet applicable requirements, and that the lien has priority to and must be fully paid and satisfied before a recognizance, mortgage, judgment, debt, obligation, or responsibility to or with which the Site may become charged or liable. The Applicant further acknowledges that RCW 84.14.110 provides that any such lien may be foreclosed in the manner provided by law for foreclosure of liens for delinquent real property taxes. An additional tax unpaid on its due date is delinquent. From the date of delinquency until paid, interest must be charged at the same rate applied by law to delinquent ad valorem property taxes.
- 16. No modifications of the Agreement shall be made unless mutually agreed upon by the parties in writing.
- 17. The provisions, covenants, and conditions contained in this Agreement are binding upon the parties hereto and their legal heirs, representatives, successors, assigns, and subsidiaries.
- 18. This Agreement shall be governed by and construed in accordance with the laws of the State of Washington. Venue for any action arising out of this Agreement shall be in Thurston County superior court.
- 19. In the event that any term or clause of this Agreement conflicts with applicable law, such conflict shall not affect other terms of this Agreement that can be given effect without the conflicting terms or clause, and to this end, the terms of the Agreement are declared to be severable. However, if applicable and if the severable term prevents the City from receiving the benefits of having affordable housing as set forth in Chapter 84.14 RCW and

Multifamily Housing 8-year or 12-year Limited Property Tax Exemption Agreement - Page 6 of 11

Chapter 3.30 TMC, then this Agreement shall be deemed terminated, or may be terminated, as soon as possible in compliance with any applicable law.

- 20. The Applicant shall exercise reasonable diligence to comply with the requirements of this Agreement and shall correct any such noncompliance within sixty (60) calendar days after such noncompliance is first discovered by the Applicant or would have been discovered by the exercise of reasonable diligence, or within 60 calendar days after the Applicant receives notice of such noncompliance from the City, whichever is earliest; provided however, that such period for correction may be extended in writing by the City if the Applicant is exercising due diligence to correct the noncompliance. If such noncompliance remains uncured after such period, then the Applicant shall be in default and the City may deny or cancel the tax exemption pursuant to TMC 3.30 or take such other action at law or equity as may appear necessary or desirable to enforce the obligations, covenants, conditions and agreements of the Applicant under this Agreement.
- 21. A. The Applicant shall maintain complete and accurate records pertaining to the affordable housing units and shall, during regular business hours, permit any duly authorized representative of the City, to inspect the books and records of the Applicant pertaining to the affordable housing units, including the annual declaration, and if applicable, income documentation of households residing in affordable housing at the Site. The Applicant's failure to maintain such records or failure to allow inspection by the City or any duly authorized representative shall constitute a material default hereunder. The Applicant shall retain all records pertaining to the affordable housing units for at least six (6) years.
  - B. The City and the Applicant hereby recognize and agree that the representations and covenants set forth herein may be relied upon by City and the Applicant. In performing its duties and obligations hereunder, the City may rely upon statements and declarations of the Applicant, and upon audits of the books and records of the Applicant pertaining to occupancy of the affordable housing units.
- 22. Notwithstanding anything in this Agreement to the contrary, the Applicant shall submit all documentation required by this Agreement on the forms designated by the City, which may be modified by the City from time to time. Applicant.

Multifamily Housing 8-year or 12-year Limited Property Tax Exemption Agreement - Page 7 of 11

- 23. The Applicant shall not discriminate on the basis of race, creed, religion, color, sex, sexual orientation, age, national origin, marital status, or presence of any mental or physical handicap as set forth in RCW 49.60.030, as now existing and as may be amended, or on the basis of source of income as set forth in RCW 59.18.255, as now existing and as may be amended, in the lease, use, or occupancy of the affordable housing units or in connection with the employment or application for employment of persons for the operation and management of the Site.
- 24. A. The City and Applicant hereby declare their understanding and intent that the covenants, conditions and restrictions set forth herein directly benefit the land (i) by enhancing and increasing the enjoyment and use of the Site by certain eligible households, and (ii) by furthering the public purposes of providing housing for low-income and moderate-income households as defined in TMC 3.30.015.
  - B. The City and the Applicant hereby declare that the covenants and conditions contained herein shall bind and the benefits shall inure to, respectively, the Applicant and all subsequent owners of the Site or any interest therein, and the City. Each and every contract, deed or other instrument hereafter executed conveying the Site or any portion thereof or interest therein shall contain an express provision making such conveyance subject to the covenants and conditions of this Agreement, provided however, that any such contract, deed or other instrument shall conclusively be held to have been executed, delivered and accepted subject to such covenants and conditions, regardless of whether or not such covenants and conditions are set forth or incorporated by reference in such contract, deed or other instrument.
- 25. The Applicant shall defend, indemnify, and hold the City, its officers, officials, employees, volunteers and its designee and any other party authorized hereunder to enforce the terms of this Agreement, harmless from any and all claims, injuries, damages, losses, or suits, including attorney fees, arising out of or resulting from this Agreement. This provision shall survive termination or expiration of this Agreement.
- 26. The provisions of this Agreement and of the documents to be executed and delivered in connection herewith are and will be for the benefit of the Applicant and the City only and, are not for the benefit of any third party (including, without limitation, any tenants or tenant organizations), and accordingly, no third party shall have the right to enforce the provisions of

Multifamily Housing 8-year or 12-year Limited Property Tax Exemption Agreement - Page 8 of 11

this Agreement or of the documents to be executed and delivered in connection herewith.

Multifamily Housing 8-year or 12-year Limited Property Tax Exemption Agreement - Page 9 of 11

IN WITNESS WHEREOF, the parties hereto have executed this Agreement as of the day and year first above written.

<u>City</u>: City of Tumwater 555 Israel Road SW Tumwater, WA 98501 <u>Applicant</u>: <u>Craft District II, LLC</u> <u>2840 Black Lake Blvd SW #C</u> <u>Tumwater, WA 98512</u>

Debbie Sullivan, Mayor

Signature Name Printed: <u>John Peters</u> Title: <u>Principal</u>

Approved as to form:

Karen Kirkpatrick, City Attorney

State of Washington County of \_\_\_\_\_\_ This record was acknowledged before me on <u>(date)</u> by <u>(name(s) of individuals)</u> as <u>(type of authority, such as officer or trustee)</u> of <u>(name of party on behalf of whom</u> record was executed).

> (Signature) Notary Public in and for the State of Washington. My appointment expires \_\_\_\_\_\_. Date:\_\_\_\_\_\_.

State of Washington County of Thurston

I certify that I know or have satisfactory evidence that Debbie Sullivan is the person who appeared before me, and said person acknowledged that she signed this instrument, on oath stated that she was authorized to execute the instrument and acknowledged it as the Mayor of the City of Tumwater to be the free and voluntary act of such party for the uses and purposes mentioned in the instrument.

Multifamily Housing 8-year or 12-year Limited Property Tax Exemption Agreement - Page 10 of 11

Dated:\_\_\_\_\_

(Signature) Notary Public in and for the State of Washington. My appointment expires \_\_\_\_\_.

Multifamily Housing 8-year or 12-year Limited Property Tax Exemption Agreement - Page 11 of 11

Attachment C

Page 1 of 2

Exhibit "A"

Y-AFRA	CITY OF TUMWATER	TUM 22-	DATE STAMP		
( THE	555 ISRAEL RD. SW, TUMWATER, WA 98501 (360) 754-4180	1393			
Carlottered.	Email: <u>cdd@ci.tumwater.wa.us</u> TAX EXEMPTION ON MULTI-FAMILY UNITS	17 .	09-23-2022		
TUNIN	WITHIN A DESIGNATED RESIDENTIAL TARGET AREA	$\frac{\text{Kerri}}{\text{RCVD BY}}$	the second second		
	APPLICATION	RUVDBY			
	<b>8 YEAR TAX CREDIT</b> OR <b>1</b> 2	2 YEAR TAX CRE	EDIT		
LEGAL OWNER: Craft District II, LLC Email: rdp.peters@gmail.co					
Mailing Address 284	0 Black Lake Blvd SW # C, Tumwater 9851	2 Phone: (360)	790-8570		
APPLICANT: Craft	District II, LLC		ers@gmail.com		
Mailing Address	0 Black Lake Blvd SW #C, Tumwater 9851	2 Phone: (360) 7	790-8570		
AGENT: John Pete	ers	<sub>Email:</sub> rdp.pet	ers@gmail.com		
Mailing Address 284	0 Black Lake Blvd SW # C, Tumwater 9851	2 Phone: ( <u>360</u> ) 7	790-8570		
	<b>PROJECT INFORMATION</b>	seen name			
PROPERTY ADDI	RESS: 4300 Capitol Blvd SE, Tum 98501 PAR	RCEL #: 338700	00400		
	TION: Legal:Section 26 Township 18 Range				
	and ClaimBELLATORRE BSP NO 12-0034T				
INTEREST IN PRO	OPERTY: 🗧 Fee Simple 🗆 Contract Purchase	e 🗆 Other			
NEW CONSTRUCT	TION: 🗎 Yes 🗆 No REHABILITATION OF EX	ISTING UNITS:	🗆 Yes 🖪 No		
	TS: NEW: 95 EXISTING EMPTY: N/A				
NUMBER OF UNI	TS FOR WHICH THIS EXEMPTION IS BEING AI	PPLIED FOR: $\frac{95}{M}$	ust be 4 or more)		
PERCENTAGE OI	F SPACE FOR PERMANENT RESIDENTIAL HO				
	NITS ARE VACANT, DATE LAST OCCUPIED: N	/A			
		F VACANCY MUST BE			
DESCRIBE BUILT	DING USE AND SQUARE FEET INTENDED FOR 24 units(ea bldg. 22,058 sf), 1 w/ 23 units(bl	EACH USE: $\frac{10}{100}$			
	T OF CONSTRUCTION / REHABILITATION:		100 /0 modaling.		
	JISITION COST $\frac{718,000.00}{2}$	,,			
	T ESTIMATE: General Contractor				
		· · · · · · · · · · · · · · · · · · ·	11/2024		
EXPECTED DATE	TO START PROJECT: 11/2022 PROPOSED	COMPLETION I	DATE: 17/2024		
	RESIDENTIAL TARGET AREAS	5			
8 or 12 Year Tax	Credit: 🛢 Capitol Boulevard Corridor 🛛 🛛	Brewery District	;		
12 Year Tax Cre	dit only 🗆 Tumwater Town Center 🔹 🗆 I	Littlerock Road S	Subarea		

### Craft District II, LLC, John Peters

Signature of Owner

Signature of Applicant/Agent John Peters

Print Name

## IF APPLYING FOR A 12-YEAR CREDIT, PLEASE ATTACH A STATEMENT ADDRESSING THE FOLLOWING QUESTIONS:

- 1. Total number of units being proposed
- 2. Estimated rent per unit
- 3. Number of units rented to low or moderate income households (or other households)
- 4. Estimated income of those households
- 5. Method for insuring program compliance over the period of the exemption

#### A COMPLETE APPLICATION SHALL INCLUDE:

1. A completed City of Tumwater application setting forth the grounds for the exemption;

2. Preliminary floor and site plans of proposed project;

3. A statement acknowledging the potential tax liability when the project ceases to be eligible under this chapter;

4. Verification by oath or affirmation of the information submitted.

For rehabilitation projects, the applicant shall also submit an affidavit that existing dwelling units have been unoccupied for a period of twelve months prior to filing the application and shall secure from the city verification of property noncompliance with the city's applicable building or housing codes.

Before application approval, the applicant shall enter into a contract with the City, approved by the City Council, regarding the terms and conditions of the project. After City Council approval of the contract, and Director of Community Development approval of the application, the Director shall issue a conditional Certificate of Acceptance of Tax Exemption. The Conditional Certificate expires three years from the date of approval unless an extension is granted as provided in this chapter."

(FOR CITY USE)
Building is in a Multi-Family Tax Exemption Target Areas
Building is not in compliance with the City's Minimum Housing Code
🗆 Required Preliminary Plans are attached: 🗆 Plans 🗆 Site Plan 🗆 Floor Plan
□ \$100 application fee received

I certify under penalty of perjury that the information furnished by me is true and correct to the best of my knowledge, and further, that I am the owner of this property or am authorized by the owner to perform the work for which this permit application is made. I further agree to hold harmless, the City of Tumwater as to any claim (including costs, expenses, and attorney fees incurred in investigation and defense of such claim), which may be made by any person, including the undersigned, and filed against the City of Tumwater, to the extent such claim arises out of the reliance of the City, including its officers and employees, upon the accuracy of the information supplied to the City as part of this application.

9/16/22

Date

9/16/22

Date

# CRAFT DISTRICT II APARTMENTS 05.06.2022 PERMIT SET



## PROJECT TEAM CONTACT INFORMATION BY DISCIPLINE

### **OWNER / CLIENT**

CRAFT DISTRICT II, LLC NAME: ADDRESS: 2840 BLACK LACK BLVD SW #C TUMWATER, WA 98512 PHONE: (360) 790-8570 PRIMARY CONTACT: JOHN PETERS rdp.peters@gmail.com

ARCHITECT NAME:

ADDRESS:

PHONE:

FERGUSON ARCHITECTURE, PS 1916 JEFFERSON AVE. TACOMA, WA 98402 (253) 248-6060 PRIMARY CONTACT: MEGAN JOHNSON mjohnson@fergusonarch.com SECONDARY: BEN FERGUSON, AIA, PRINCIPAL-IN CHARGE bferguson@fergusonarch.com

MECHANICAL EMERALD AIRE

5108 D STREET, NW AUBURN, WA 98001 (253) 872-5665 PRIMARY CONTACT: GRANT MIDDLETON

NAME: ADDRESS:

PHONE:

CIVIL

LDC, INC 1411 STATE AVE NE, SUITE 200 OLYMPIA, WA 98506 (360) 878-0678 PRIMARY CONTACT: TYRELL BRADLEY, PE tbradley@ldccorp.com

ROBISON ENGINEERING, INC

В

\_\_\_\_\_

Item 7.

GENERAL CONTRACTOR BELOTTI + MCHUGH DESIGN AND CONSTRUCTION NAME: SERVICES (BMDC) ADDRESS: 2600 W COMMODORE WAY, SUITE 2 SEATTLE, WA 98199 PHONE: (206) 458-0570 PRIMARY CONTACT: TODD MCHUGH todd@belottimchugh.com SECONDARY: TIM KAIREZ tim@belottimchugh.com

### LANDSCAPE

NAME: SCJ ALLIANCE ADDRESS: 8730 TALLON LANE NE, SUITE 200 LACEY, WA 98516 PHONE: (360) 352-1465 x195 PRIMARY CONTACT: ANGIE VOS angie.vos@scjalliance.com

1

NAME: ADDRESS:

PHONE:

grantm@emeraldaire.com

#### ELECTRICAL NAME:

ADDRESS: 19401 40TH AVE W, SUITE 302 LYNNWOOD, WA 98036 (206) 364-3343 x123 PHONE: PRIMARY CONTACT: IAN ANDERSON ianderson@robisonengineering.com

	STRUCTURAL	
	NAME:	PIERUCCIONI E&C, LLC
	ADDRESS:	3128 N BENNETT STREET TACOMA, WA 98407
	PHONE:	(206) 949-7866
	PRIMARY CONTACT	CHON PIERUCCIONI, PE
		cpieru@hotmail.com
	PLUMBING	
	NAME:	ROBISON ENGINEERING, INC
	ADDRESS:	19401 40TH AVE W, SUITE 302 LYNNWOOD, WA 98036
	PHONE:	(206) 364-3343
	PRIMARY CONTACT	FUNSHO KUFILE
7		fkufile@robisonengineering.com

## SHEET INDICES BY DISCIPLINE DELIVERABLE RECORD

	SHEET IN	NDEX - 00 GEN	IERAL					SHEET IND	IEX - 05 STRU	ICTURAL			
SHEET	5 <b>_</b> _ 1	50% DD	100% DD	PERMIT	PERMIT REV.1	CD SET	SHEET		50% DD	100%	PERMIT	PERMIT REV.1	CD SET
NUMBER	SHEET NAME	08.27.2021	10.15.2021	05.06.2022	MO.DA.YEAR	MO.DA.YEAR	NUMBER	SHEET NAME	08.27.2021	10.15.21	05.06.2022	MO.DA.YEAR	MO.DA.YEA
000 001	COVER PAGE PROJECT INFORMATION	•	•	•			S-300 S-301	DETAILS DETAILS	•	•	•		
001	CODE SUMMARY	•	•	•			S-302	DETAILS	•	•	•		
003	CODE SUMMARY	•	•	•									
	SHEET	INDEX - 01 C	IVIL				SHEET	SHEET INL	DEX - 06 MECH 50% DD	100% DD	PERMIT	PERMIT REV.1	CD SET
SHEET		50% DD	100% DD	PERMIT	PERMIT REV.1		NUMBER	SHEET NAME	08.27.2021	10.15.2021	05.06.2022	MO.DA.YEAR	MO.DA.YEA
NUMBER S-01	SHEET NAME COVER SHEET	08.27.2021	10.15.2021	05.06.2022	MO.DA.YEAR	MO.DA.YEAR		HVAC TITLE SHEET HVAC EQUIPMENT SCHEDULES			•		
-01	TESC PLAN			•				HVAC PLAN BLDGS A & C - LEVEL 1			•		
2-02	TESC PLAN			•				HVAC PLAN BLDGS A & C - LEVEL 2			•		
2-03	TESC NOTES AND DETAILS			•			M-112	HVAC PLAN BLDGS A & C - LEVEL 3			•		
R-01	GRADING PLAN			•				HVAC PLAN BLDGS B & D - LEVEL 1			•		
R-02 R-03	GRADING PLAN WALL PROFILES			•				HVAC PLAN BLDGS B & D - LEVEL 2 HVAC PLAN BLDGS B & D - LEVEL 3			•		
)-01	STORM DRAINAGE PLAN			•				HVAC PLAN BLDGS B & D - LEVEL S HVAC DETAILS			•		
)-02	STORM DRAINAGE PLAN			•									
D-03	STORM PROFILES			•				SHEET IN	DEX - 07 PLU	MBING			
)-04	STORM PROFILES			•			SHEET		50% DD	100% DD	PERMIT F	PERMIT REV.1	CD SET
)-05 )-06	STORM DRAINAGE NOTES AND DETAILS STORM DRAINAGE NOTES AND DETAILS			•			NUMBER	SHEET NAME	08.27.2021			MO.DA.YEAR	MO.DA.YEAR
P-01	SITE PLAN			•			PA0.00	LEGEND, GENERAL NOTES, AND DRAWING INDEX			•		
P-02	SITE PLAN			•			PA0.01	PLUMBING NOTES			•		
P-03	SITE PLAN NOTES AND DETAILS			•			PA0.02 PA0.03	PLUMBING FIXTURE AND DRAIN SCHEDULES PLUMBING EQUIPMENT SCHEDULES			•		
9-04	SITE PLAN NOTES AND DETAILS			•			PA0.04	PANEL SCHEDULES BLD A			•		
S-01 S-02	SEWER PLAN SEWER NOTES AND DETAILS			•			PA2.00	UNDERSLAB OVERALL PLUMBING PLAN			•		
A-01	WATER PLAN			•				LEVEL 1 - ROOF WASTE & VENT PLUMBING PLAN			•		
4-02	WATER NOTES AND DETAILS			•				LEVEL 1 - 3 SUPPLY PLAN			•		
4-03	WATER NOTES AND DETAILS			•			PA4.00-4.02 PA5.00	TYPICAL WASTE & VENT RISER DIAGRAM TYPICAL SUPPLY RISER DIAGRAM			•		
							PA6.00	ENLARGED DIAGRAM			•		
	SHEET INI	DEX - 02 LAND	ISCAPE				PA7.00-7.01				•		
SHEET		50% DD	100% DD	PERMIT	PERMIT REV.1		PB0.00	LEGEND, GENERAL NOTES, AND DRAWING INDEX			•		
NUMBER	SHEET NAME	08.27.2021	10.15.2021	05.06.2022	MO.DA.YEAR	MO.DA.YEAR	PB0.01	PLUMBING NOTES			•		
-01 -02	LANDSCAPE PLAN LANDSCAPE PLAN			•			PB0.02 PB0.03	PLUMBING FIXTURE AND DRAIN SCHEDULES PLUMBING EQUIPMENT SCHEDULES			•		
-03	PLANT LIST & SPECS			•			PB2.00	UNDERSLAB OVERALL PLUMBING PLAN			•		
-04	LANDSCAPE DETAILS			•			PB2.01-2.04	LEVEL 1 - ROOF WASTE & VENT PLUMBING PLAN			•		
-05	IRRIGATION PLAN			•				LEVEL 1 - 3 SUPPLY PLAN			•		
-06	IRRIGATION PLAN			•							•		
-07 -08	IRRIGATION SCHEDULES AND DETAILS IRRIGATION DETAILS AND NOTES			•			PB5.00 PB6.00	TYPICAL SUPPLY RISER DIAGRAM ENLARGED DIAGRAM			•		
							PB7.00-7.01				•		
	SHEET INDE	EX - 04 ARCHIT	FECTURE				PC0.00	LEGEND, GENERAL NOTES, AND DRAWING INDEX			•		
SHEET		50% DD	100% DD	PERMIT	PERMIT REV.1	CD SET	PC0.01	PLUMBING NOTES			•		
NUMBER	SHEET NAME	08.27.2021	10.15.2021	05.06.2022	MO.DA.YEAR		PC0.02 PC0.03	PLUMBING FIXTURE AND DRAIN SCHEDULES PLUMBING EQUIPMENT SCHEDULES			•		
000	CODE PLANS & ELEVATIONS	•	•	•			PC2.00	UNDERSLAB OVERALL PLUMBING PLAN			•		
005 010	ACCESSIBILITY & CODE DETAILS ASSEMBLIES - BASIC & FINISH WALL TYPES	•	•	•			PC2.01-2.04	LEVEL 1 - ROOF WASTE & VENT PLUMBING PLAN			•		
011	ASSEMBLIES - FLOOR, ROOF, & CEILING TYPES	•	•	•				LEVEL 1 - 3 SUPPLY PLAN			•		
100	ARCHITECTURAL SITE PLAN	•	•	•			PC4.00-4.02 PC5.00	TYPICAL WASTE & VENT RISER DIAGRAM TYPICAL SUPPLY RISER DIAGRAM			•		
105	ENLARGED SITE VIEWS	•	•	•			PC6.00	ENLARGED DIAGRAM			•		
110	FLOOR PLAN BLDG A & C - LEVEL 1	•	•	•			PC7.00-7.01				•		
·111 ·112	FLOOR PLAN BLDG A & C - LEVEL 2 FLOOR PLAN BLDG A & C - LEVEL 3	•	•	•			PD0.00	LEGEND, GENERAL NOTES, AND DRAWING INDEX			•		
113	FLOOR PLAN BLDG A & C - ROOF	•	•	•			PD0.01 PD0.02	PLUMBING NOTES			•		
120	FLOOR PLAN BLDG B & D - LEVEL 1		•	•			PD0.02 PD0.03	PLUMBING FIXTURE AND DRAIN SCHEDULES PLUMBING EQUIPMENT SCHEDULES			•		
121	FLOOR PLAN BLDG B & D - LEVEL 2		•	•			PD2.00	UNDERSLAB OVERALL PLUMBING PLAN			•		
122 122	FLOOR PLAN BLDG B & D - LEVEL 3		•	•			PD2.01-2.04	LEVEL 1 - ROOF WASTE & VENT PLUMBING PLAN			•		
123 130	FLOOR PLAN BLDG B & D - ROOF SLAB EDGE PLAN - TYP BLDG A, B, C, D	•	•	•				LEVEL 1 - 3 SUPPLY PLAN			•		
200	EXTERIOR ELEVATIONS - BLDG A & C	•	•	•				TYPICAL WASTE & VENT RISER DIAGRAM TYPICAL SUPPLY RISER DIAGRAM			•		
201	EXTERIOR ELEVATIONS - BLDG A & C UNIT ENTRY		•	•			PD5.00 PD6.00	ENLARGED DIAGRAM			•		
220	EXTERIOR ELEVATIONS - BLDG B & D		•	•			PD7.00-7.01				•		
221 300	EXTERIOR ELEVATIONS - BLDG B & D UNIT ENTRY BUILDING SECTIONS - TYP	•	•	•									
	WALL SECTIONS - TYP	•	•	•				SHEET INI	DEX - 08 ELEC	CTRICAL			
310	ENLARGED PLANS & ELEVATIONS - LEASING		_	•			SHEET		50% DD	100% DD	PERMIT	PERMIT REV.1	CD SET
		•	•				NUMBER	SHEET NAME	08.27.2021	10.15.2021	05.06.2022	MO.DA.YEAR	MO.DA.YEA
400 410	UNIT PLANS & ELEVATIONS - 0x1A	•	•	•		1					•		
400 410 411	UNIT PLANS & ELEVATIONS - 0x1A UNIT PLANS & ELEVATIONS - 0x1A - TYPE A	•	•	•			E0.000				-		
400 410 411 412	UNIT PLANS & ELEVATIONS - 0x1A UNIT PLANS & ELEVATIONS - 0x1A - TYPE A UNIT PLANS & ELEVATIONS - 0x1B	• • •	•	• • •			E0.20	SITE PLAN - LIGHTING			•		
400 410 411 412 414	UNIT PLANS & ELEVATIONS - 0x1A UNIT PLANS & ELEVATIONS - 0x1A - TYPE A	• • •	• • •	• • • •			E0.20 E0.21				• •		
400 410 411 412 414 415	UNIT PLANS & ELEVATIONS - 0x1A UNIT PLANS & ELEVATIONS - 0x1A - TYPE A UNIT PLANS & ELEVATIONS - 0x1B UNIT PLANS & ELEVATIONS - 1x1A	• • •	• • •	• • • •			E0.20 E0.21	SITE PLAN - LIGHTING SITE PLAN - PHOTOMETRIC			• • •		
00 10 11 12 14 15 16 18	UNIT PLANS & ELEVATIONS - 0x1A UNIT PLANS & ELEVATIONS - 0x1A - TYPE A UNIT PLANS & ELEVATIONS - 0x1B UNIT PLANS & ELEVATIONS - 1x1A UNIT PLANS & ELEVATIONS - 1x1A - TYPE A UNIT PLANS & ELEVATIONS - 1x1B UNIT PLANS & ELEVATIONS - 1x1C	• • • • •	• • •	• • • • •			E0.20 E0.21 E1.00-1.01 E2.50 E4.00	SITE PLAN - LIGHTING SITE PLAN - PHOTOMETRIC SITE PLAN - POWER LIGHTING NOTES & LUMINAIRE SCHEDULE UNIT LUMINAIRE & DEVICE SCHEDULE			• • •		
400 410 411 412 414 415 416 418 420	UNIT PLANS & ELEVATIONS - 0x1A UNIT PLANS & ELEVATIONS - 0x1A - TYPE A UNIT PLANS & ELEVATIONS - 0x1B UNIT PLANS & ELEVATIONS - 1x1A UNIT PLANS & ELEVATIONS - 1x1A - TYPE A UNIT PLANS & ELEVATIONS - 1x1B UNIT PLANS & ELEVATIONS - 1x1C UNIT PLANS & ELEVATIONS - 1x1D	• • • • • •	• • • • • • •	• • • • •			E0.20 E0.21 E1.00-1.01 E2.50 E4.00 E4.01-4.03	SITE PLAN - LIGHTING SITE PLAN - PHOTOMETRIC SITE PLAN - POWER LIGHTING NOTES & LUMINAIRE SCHEDULE UNIT LUMINAIRE & DEVICE SCHEDULE UNIT PLANS			• • • • •		
400 410 411 412 414 415 416 418 420 422	UNIT PLANS & ELEVATIONS - 0x1A UNIT PLANS & ELEVATIONS - 0x1A - TYPE A UNIT PLANS & ELEVATIONS - 0x1B UNIT PLANS & ELEVATIONS - 1x1A UNIT PLANS & ELEVATIONS - 1x1A - TYPE A UNIT PLANS & ELEVATIONS - 1x1B UNIT PLANS & ELEVATIONS - 1x1C UNIT PLANS & ELEVATIONS - 1x1D UNIT PLANS & ELEVATIONS - 2x1	• • • • •	• • • • •	• • • • • • •			E0.20 E0.21 E1.00-1.01 E2.50 E4.00 E4.01-4.03 EA0.01	SITE PLAN - LIGHTING SITE PLAN - PHOTOMETRIC SITE PLAN - POWER LIGHTING NOTES & LUMINAIRE SCHEDULE UNIT LUMINAIRE & DEVICE SCHEDULE UNIT PLANS ONE LINE DIAGRAM BLD A			• • • • • •		
400 410 411 412 414 415 416 418 420 422 423	UNIT PLANS & ELEVATIONS - 0x1A UNIT PLANS & ELEVATIONS - 0x1A - TYPE A UNIT PLANS & ELEVATIONS - 0x1B UNIT PLANS & ELEVATIONS - 1x1A UNIT PLANS & ELEVATIONS - 1x1A - TYPE A UNIT PLANS & ELEVATIONS - 1x1B UNIT PLANS & ELEVATIONS - 1x1C UNIT PLANS & ELEVATIONS - 1x1D	• • E0.20 E0.21 E1.00-1.01 E2.50 E4.00 E4.01-4.03 EA0.01	SITE PLAN - LIGHTING SITE PLAN - PHOTOMETRIC SITE PLAN - POWER LIGHTING NOTES & LUMINAIRE SCHEDULE UNIT LUMINAIRE & DEVICE SCHEDULE UNIT PLANS			• • • • •		
400 410 411 412 414 415 416 418 420 422 423 424	UNIT PLANS & ELEVATIONS - 0x1A UNIT PLANS & ELEVATIONS - 0x1A - TYPE A UNIT PLANS & ELEVATIONS - 0x1B UNIT PLANS & ELEVATIONS - 1x1A UNIT PLANS & ELEVATIONS - 1x1A - TYPE A UNIT PLANS & ELEVATIONS - 1x1B UNIT PLANS & ELEVATIONS - 1x1C UNIT PLANS & ELEVATIONS - 1x1D UNIT PLANS & ELEVATIONS - 2x1 UNIT PLANS & ELEVATIONS - 2x1 - TYPE A	• • E0.20 E0.21 E1.00-1.01 E2.50 E4.00 E4.01-4.03 EA0.01 EA0.02-0.04	SITE PLAN - LIGHTING SITE PLAN - PHOTOMETRIC SITE PLAN - POWER LIGHTING NOTES & LUMINAIRE SCHEDULE UNIT LUMINAIRE & DEVICE SCHEDULE UNIT PLANS ONE LINE DIAGRAM BLD A PANEL SCHEDULES BLD A			• • • • • •		
400 410 411 412 414 415 416 416 418 420 422 423 424 426 428	UNIT PLANS & ELEVATIONS - 0x1A UNIT PLANS & ELEVATIONS - 0x1A - TYPE A UNIT PLANS & ELEVATIONS - 0x1B UNIT PLANS & ELEVATIONS - 1x1A UNIT PLANS & ELEVATIONS - 1x1A - TYPE A UNIT PLANS & ELEVATIONS - 1x1B UNIT PLANS & ELEVATIONS - 1x1D UNIT PLANS & ELEVATIONS - 1x1D UNIT PLANS & ELEVATIONS - 2x1 UNIT PLANS & ELEVATIONS - 2x1 - TYPE A UNIT PLANS & ELEVATIONS - 2x2A UNIT PLANS & ELEVATIONS - 2x2A	• • E0.20 E0.21 E1.00-1.01 E2.50 E4.00 E4.01-4.03 EA0.01 EA0.02-0.04 EA0.05 EA0.06 EA2.01-2.03	SITE PLAN - LIGHTING SITE PLAN - PHOTOMETRIC SITE PLAN - POWER LIGHTING NOTES & LUMINAIRE SCHEDULE UNIT LUMINAIRE & DEVICE SCHEDULE UNIT PLANS ONE LINE DIAGRAM BLD A PANEL SCHEDULES BLD A FAULT CURRENT SCHEDULES BLD A VOLTAGE DROP SCHEDULE BLD A LIGHTING PLAN - LEVELS 1 - 3			• • • • • • • •		
400 410 411 412 414 415 416 418 420 422 423 424 426 428 430	UNIT PLANS & ELEVATIONS - 0x1A UNIT PLANS & ELEVATIONS - 0x1A - TYPE A UNIT PLANS & ELEVATIONS - 0x1B UNIT PLANS & ELEVATIONS - 1x1A UNIT PLANS & ELEVATIONS - 1x1A - TYPE A UNIT PLANS & ELEVATIONS - 1x1B UNIT PLANS & ELEVATIONS - 1x1C UNIT PLANS & ELEVATIONS - 1x1D UNIT PLANS & ELEVATIONS - 2x1 UNIT PLANS & ELEVATIONS - 2x2A UNIT PLANS & ELEVATIONS - 2x2A UNIT PLANS & ELEVATIONS - 2x2B UNIT PLANS & ELEVATIONS - 2x2C UNIT PLANS & ELEVATIONS - 2x2D		• • • • • • • • • • • • • • • • • • • •				E0.20 E0.21 E1.00-1.01 E2.50 E4.00 E4.01-4.03 EA0.01 EA0.02-0.04 EA0.05 EA0.06 EA2.01-2.03 EA3.00-3.03	SITE PLAN - LIGHTING SITE PLAN - PHOTOMETRIC SITE PLAN - POWER LIGHTING NOTES & LUMINAIRE SCHEDULE UNIT LUMINAIRE & DEVICE SCHEDULE UNIT PLANS ONE LINE DIAGRAM BLD A PANEL SCHEDULES BLD A FAULT CURRENT SCHEDULES BLD A VOLTAGE DROP SCHEDULE BLD A LIGHTING PLAN - LEVELS 1 - 3 POWER PLAN - LEVELS 1 - ROOF					
400 410 411 412 414 415 416 418 420 422 423 424 426 428 430 500	UNIT PLANS & ELEVATIONS - 0x1A UNIT PLANS & ELEVATIONS - 0x1A - TYPE A UNIT PLANS & ELEVATIONS - 0x1B UNIT PLANS & ELEVATIONS - 1x1A UNIT PLANS & ELEVATIONS - 1x1A - TYPE A UNIT PLANS & ELEVATIONS - 1x1B UNIT PLANS & ELEVATIONS - 1x1C UNIT PLANS & ELEVATIONS - 1x1D UNIT PLANS & ELEVATIONS - 2x1 UNIT PLANS & ELEVATIONS - 2x1 - TYPE A UNIT PLANS & ELEVATIONS - 2x2A UNIT PLANS & ELEVATIONS - 2x2B UNIT PLANS & ELEVATIONS - 2x2C UNIT PLANS & ELEVATIONS - 2x2D EXTERIOR DETAILS	• • E0.20 E0.21 E1.00-1.01 E2.50 E4.00 E4.01-4.03 EA0.01 EA0.02-0.04 EA0.05 EA0.06 EA2.01-2.03 EA3.00-3.03 EB0.01	SITE PLAN - LIGHTING SITE PLAN - PHOTOMETRIC SITE PLAN - POWER LIGHTING NOTES & LUMINAIRE SCHEDULE UNIT LUMINAIRE & DEVICE SCHEDULE UNIT PLANS ONE LINE DIAGRAM BLD A PANEL SCHEDULES BLD A FAULT CURRENT SCHEDULES BLD A VOLTAGE DROP SCHEDULE BLD A LIGHTING PLAN - LEVELS 1 - 3 POWER PLAN - LEVELS 1 - ROOF ONE LINE DIAGRAM BLD B			• • • • • • • • • • • • • • • • • • • •		
400 410 411 412 414 415 416 416 418 420 422 423 424 428 428 430 500	UNIT PLANS & ELEVATIONS - 0x1A UNIT PLANS & ELEVATIONS - 0x1A - TYPE A UNIT PLANS & ELEVATIONS - 0x1B UNIT PLANS & ELEVATIONS - 1x1A UNIT PLANS & ELEVATIONS - 1x1A - TYPE A UNIT PLANS & ELEVATIONS - 1x1B UNIT PLANS & ELEVATIONS - 1x1C UNIT PLANS & ELEVATIONS - 1x1D UNIT PLANS & ELEVATIONS - 2x1 UNIT PLANS & ELEVATIONS - 2x2A UNIT PLANS & ELEVATIONS - 2x2A UNIT PLANS & ELEVATIONS - 2x2B UNIT PLANS & ELEVATIONS - 2x2C UNIT PLANS & ELEVATIONS - 2x2D	• • E0.20 E0.21 E1.00-1.01 E2.50 E4.00 E4.01-4.03 EA0.01 EA0.02-0.04 EA0.05 EA0.06 EA2.01-2.03 EA3.00-3.03 EB0.01	SITE PLAN - LIGHTING SITE PLAN - PHOTOMETRIC SITE PLAN - POWER LIGHTING NOTES & LUMINAIRE SCHEDULE UNIT LUMINAIRE & DEVICE SCHEDULE UNIT PLANS ONE LINE DIAGRAM BLD A PANEL SCHEDULES BLD A FAULT CURRENT SCHEDULES BLD A VOLTAGE DROP SCHEDULE BLD A LIGHTING PLAN - LEVELS 1 - 3 POWER PLAN - LEVELS 1 - ROOF			• • • • • • • • • • • • • • • • • • •		
400 410 411 412 414 415 416 418 420 422 423 424 426 428 430 500 501 550	UNIT PLANS & ELEVATIONS - 0x1A UNIT PLANS & ELEVATIONS - 0x1A - TYPE A UNIT PLANS & ELEVATIONS - 0x1B UNIT PLANS & ELEVATIONS - 1x1A UNIT PLANS & ELEVATIONS - 1x1A - TYPE A UNIT PLANS & ELEVATIONS - 1x1B UNIT PLANS & ELEVATIONS - 1x1C UNIT PLANS & ELEVATIONS - 1x1D UNIT PLANS & ELEVATIONS - 1x1D UNIT PLANS & ELEVATIONS - 2x1 UNIT PLANS & ELEVATIONS - 2x2A UNIT PLANS & ELEVATIONS - 2x2A UNIT PLANS & ELEVATIONS - 2x2B UNIT PLANS & ELEVATIONS - 2x2C UNIT PLANS & ELEVATIONS - 2x2D EXTERIOR DETAILS	• • E0.20 E0.21 E1.00-1.01 E2.50 E4.00 E4.01-4.03 EA0.01 EA0.02-0.04 EA0.05 EA0.06 EA2.01-2.03 EA3.00-3.03 EB0.01 EB0.02-0.04	SITE PLAN - LIGHTING SITE PLAN - PHOTOMETRIC SITE PLAN - POWER LIGHTING NOTES & LUMINAIRE SCHEDULE UNIT LUMINAIRE & DEVICE SCHEDULE UNIT PLANS ONE LINE DIAGRAM BLD A PANEL SCHEDULES BLD A FAULT CURRENT SCHEDULES BLD A VOLTAGE DROP SCHEDULE BLD A LIGHTING PLAN - LEVELS 1 - 3 POWER PLAN - LEVELS 1 - ROOF ONE LINE DIAGRAM BLD B PANEL SCHEDULES BLD B					
400 410 411 412 414 415 416 418 420 422 423 424 426 428 430 500 501 550 500 500 700	UNIT PLANS & ELEVATIONS - 0x1A UNIT PLANS & ELEVATIONS - 0x1A - TYPE A UNIT PLANS & ELEVATIONS - 0x1B UNIT PLANS & ELEVATIONS - 1x1A UNIT PLANS & ELEVATIONS - 1x1A - TYPE A UNIT PLANS & ELEVATIONS - 1x1A - TYPE A UNIT PLANS & ELEVATIONS - 1x1C UNIT PLANS & ELEVATIONS - 1x1D UNIT PLANS & ELEVATIONS - 1x1D UNIT PLANS & ELEVATIONS - 2x1 UNIT PLANS & ELEVATIONS - 2x2A UNIT PLANS & ELEVATIONS - 2x2B UNIT PLANS & ELEVATIONS - 2x2D EXTERIOR DETAILS EXTERIOR DETAILS - TYP UNIT ENTRY INTERIOR DETAILS OPENING TYPES AND SCHEDULE STAIRS - PLANS & RCPS	• • E0.20 E0.21 E1.00-1.01 E2.50 E4.00 E4.01-4.03 EA0.01 EA0.02-0.04 EA0.05 EA0.06 EA2.01-2.03 EB0.01 EB0.02-0.04 EB0.05 EB0.06 EB2.01-2.03	SITE PLAN - LIGHTING SITE PLAN - PHOTOMETRIC SITE PLAN - POWER LIGHTING NOTES & LUMINAIRE SCHEDULE UNIT LUMINAIRE & DEVICE SCHEDULE UNIT PLANS ONE LINE DIAGRAM BLD A PANEL SCHEDULES BLD A FAULT CURRENT SCHEDULES BLD A VOLTAGE DROP SCHEDULE BLD A LIGHTING PLAN - LEVELS 1 - 3 POWER PLAN - LEVELS 1 - ROOF ONE LINE DIAGRAM BLD B PANEL SCHEDULES BLD B FAULT CURRENT SCHEDULES BLD B VOLTAGE DROP SCHEDULE BLD B VOLTAGE DROP SCHEDULE BLD B					
400 410 411 412 414 415 416 418 420 422 423 424 428 423 424 428 430 500 501 550 600 700	UNIT PLANS & ELEVATIONS - 0x1A UNIT PLANS & ELEVATIONS - 0x1A - TYPE A UNIT PLANS & ELEVATIONS - 0x1B UNIT PLANS & ELEVATIONS - 1x1A UNIT PLANS & ELEVATIONS - 1x1A - TYPE A UNIT PLANS & ELEVATIONS - 1x1B UNIT PLANS & ELEVATIONS - 1x1C UNIT PLANS & ELEVATIONS - 1x1D UNIT PLANS & ELEVATIONS - 2x1 UNIT PLANS & ELEVATIONS - 2x1 - TYPE A UNIT PLANS & ELEVATIONS - 2x2A UNIT PLANS & ELEVATIONS - 2x2A UNIT PLANS & ELEVATIONS - 2x2B UNIT PLANS & ELEVATIONS - 2x2D EXTERIOR DETAILS EXTERIOR DETAILS OPENING TYPES AND SCHEDULE	• • E0.20 E0.21 E1.00-1.01 E2.50 E4.00 E4.01-4.03 EA0.01 EA0.02-0.04 EA0.05 EA0.06 EA2.01-2.03 EB0.01 EB0.05 EB0.06 EB2.01-2.03 EB3.00-3.03	SITE PLAN - LIGHTING SITE PLAN - PHOTOMETRIC SITE PLAN - POWER LIGHTING NOTES & LUMINAIRE SCHEDULE UNIT LUMINAIRE & DEVICE SCHEDULE UNIT PLANS ONE LINE DIAGRAM BLD A PANEL SCHEDULES BLD A FAULT CURRENT SCHEDULES BLD A VOLTAGE DROP SCHEDULE BLD A LIGHTING PLAN - LEVELS 1 - 3 POWER PLAN - LEVELS 1 - ROOF ONE LINE DIAGRAM BLD B PANEL SCHEDULES BLD B FAULT CURRENT SCHEDULES BLD B VOLTAGE DROP SCHEDULE BLD B LIGHTING PLAN - LEVELS 1 - 3					
400 410 411 412 414 415 416 418 420 422 423 424 428 423 424 428 430 500 501 550 600 700	UNIT PLANS & ELEVATIONS - 0x1A UNIT PLANS & ELEVATIONS - 0x1A - TYPE A UNIT PLANS & ELEVATIONS - 0x1B UNIT PLANS & ELEVATIONS - 1x1A UNIT PLANS & ELEVATIONS - 1x1A - TYPE A UNIT PLANS & ELEVATIONS - 1x1A - TYPE A UNIT PLANS & ELEVATIONS - 1x1D UNIT PLANS & ELEVATIONS - 1x1D UNIT PLANS & ELEVATIONS - 1x1D UNIT PLANS & ELEVATIONS - 2x1 UNIT PLANS & ELEVATIONS - 2x1 - TYPE A UNIT PLANS & ELEVATIONS - 2x2A UNIT PLANS & ELEVATIONS - 2x2B UNIT PLANS & ELEVATIONS - 2x2D EXTERIOR DETAILS EXTERIOR DETAILS OPENING TYPES AND SCHEDULE STAIRS - PLANS & RCPS STAIRS - SECTIONS & DETAILS						E0.20 E0.21 E1.00-1.01 E2.50 E4.00 E4.01-4.03 EA0.01 EA0.02-0.04 EA0.05 EA0.06 EA2.01-2.03 EB0.01 EB0.05 EB0.06 EB2.01-2.03 EB3.00-3.03 EC0.01	SITE PLAN - LIGHTING SITE PLAN - PHOTOMETRIC SITE PLAN - POWER LIGHTING NOTES & LUMINAIRE SCHEDULE UNIT LUMINAIRE & DEVICE SCHEDULE UNIT PLANS ONE LINE DIAGRAM BLD A PANEL SCHEDULES BLD A FAULT CURRENT SCHEDULES BLD A VOLTAGE DROP SCHEDULE BLD A LIGHTING PLAN - LEVELS 1 - 3 POWER PLAN - LEVELS 1 - ROOF ONE LINE DIAGRAM BLD B PANEL SCHEDULES BLD B FAULT CURRENT SCHEDULES BLD B VOLTAGE DROP SCHEDULE BLD B LIGHTING PLAN - LEVELS 1 - 3 POWER PLAN - LEVELS 1 - 3					
400 410 411 412 414 415 416 418 420 422 423 424 426 428 430 500 501 550 500 700 700	UNIT PLANS & ELEVATIONS - 0x1A UNIT PLANS & ELEVATIONS - 0x1A - TYPE A UNIT PLANS & ELEVATIONS - 0x1B UNIT PLANS & ELEVATIONS - 1x1A UNIT PLANS & ELEVATIONS - 1x1A - TYPE A UNIT PLANS & ELEVATIONS - 1x1A - TYPE A UNIT PLANS & ELEVATIONS - 1x1D UNIT PLANS & ELEVATIONS - 1x1D UNIT PLANS & ELEVATIONS - 1x1D UNIT PLANS & ELEVATIONS - 2x1 UNIT PLANS & ELEVATIONS - 2x1 - TYPE A UNIT PLANS & ELEVATIONS - 2x2A UNIT PLANS & ELEVATIONS - 2x2B UNIT PLANS & ELEVATIONS - 2x2D EXTERIOR DETAILS EXTERIOR DETAILS OPENING TYPES AND SCHEDULE STAIRS - PLANS & RCPS STAIRS - SECTIONS & DETAILS	• • • • • • • • • • • • • • • • • • •					E0.20 E0.21 E1.00-1.01 E2.50 E4.00 E4.01-4.03 EA0.01 EA0.02-0.04 EA0.05 EA0.06 EA2.01-2.03 EB0.01 EB0.05 EB0.06 EB2.01-2.03 EB3.00-3.03 EC0.01	SITE PLAN - LIGHTING SITE PLAN - PHOTOMETRIC SITE PLAN - POWER LIGHTING NOTES & LUMINAIRE SCHEDULE UNIT LUMINAIRE & DEVICE SCHEDULE UNIT PLANS ONE LINE DIAGRAM BLD A PANEL SCHEDULES BLD A FAULT CURRENT SCHEDULES BLD A VOLTAGE DROP SCHEDULE BLD A LIGHTING PLAN - LEVELS 1 - 3 POWER PLAN - LEVELS 1 - ROOF ONE LINE DIAGRAM BLD B PANEL SCHEDULES BLD B FAULT CURRENT SCHEDULES BLD B VOLTAGE DROP SCHEDULE BLD B LIGHTING PLAN - LEVELS 1 - 3					
400 410 411 412 414 415 416 418 420 422 423 424 428 423 424 428 430 500 501 550 500 700 700 700 701	UNIT PLANS & ELEVATIONS - 0x1A UNIT PLANS & ELEVATIONS - 0x1A - TYPE A UNIT PLANS & ELEVATIONS - 0x1B UNIT PLANS & ELEVATIONS - 1x1A UNIT PLANS & ELEVATIONS - 1x1A - TYPE A UNIT PLANS & ELEVATIONS - 1x1B UNIT PLANS & ELEVATIONS - 1x1D UNIT PLANS & ELEVATIONS - 1x1D UNIT PLANS & ELEVATIONS - 2x1 UNIT PLANS & ELEVATIONS - 2x2A UNIT PLANS & ELEVATIONS - 2x2B UNIT PLANS & ELEVATIONS - 2x2D EXTERIOR DETAILS EXTERIOR DETAILS OPENING TYPES AND SCHEDULE STAIRS - PLANS & RCPS STAIRS - SECTIONS & DETAILS	50% DD	100%	• • • • • • • • • • • • • • • • • • •	PERMIT REV.1		E0.20 E0.21 E1.00-1.01 E2.50 E4.00 E4.01-4.03 E4.01-4.03 EA0.01 EA0.05 EA0.06 EA2.01-2.03 EA3.00-3.03 EB0.01 EB0.05 EB0.06 EB2.01-2.03 EB3.00-3.03 EC0.01 EC0.02-0.04	SITE PLAN - LIGHTING SITE PLAN - PHOTOMETRIC SITE PLAN - POWER LIGHTING NOTES & LUMINAIRE SCHEDULE UNIT LUMINAIRE & DEVICE SCHEDULE UNIT PLANS ONE LINE DIAGRAM BLD A PANEL SCHEDULES BLD A FAULT CURRENT SCHEDULES BLD A VOLTAGE DROP SCHEDULE BLD A LIGHTING PLAN - LEVELS 1 - 3 POWER PLAN - LEVELS 1 - ROOF ONE LINE DIAGRAM BLD B PANEL SCHEDULES BLD B FAULT CURRENT SCHEDULES BLD B VOLTAGE DROP SCHEDULE BLD B LIGHTING PLAN - LEVELS 1 - 3 POWER PLAN - LEVELS 1 - 3 POWER PLAN - LEVELS 1 - 3					
400 410 411 412 414 415 416 418 420 422 423 424 426 428 430 500 501 550 600 700 701 SHEET NUMBER	UNIT PLANS & ELEVATIONS - 0x1A UNIT PLANS & ELEVATIONS - 0x1A - TYPE A UNIT PLANS & ELEVATIONS - 0x1B UNIT PLANS & ELEVATIONS - 1x1A UNIT PLANS & ELEVATIONS - 1x1A - TYPE A UNIT PLANS & ELEVATIONS - 1x1B UNIT PLANS & ELEVATIONS - 1x1C UNIT PLANS & ELEVATIONS - 1x1D UNIT PLANS & ELEVATIONS - 2x1 UNIT PLANS & ELEVATIONS - 2x1 - TYPE A UNIT PLANS & ELEVATIONS - 2x2A UNIT PLANS & ELEVATIONS - 2x2B UNIT PLANS & ELEVATIONS - 2x2D EXTERIOR DETAILS EXTERIOR DETAILS OPENING TYPES AND SCHEDULE STAIRS - PLANS & RCPS STAIRS - SECTIONS & DETAILS SHEET NAME			• • • • • • • • • • • • • • • • • • •			E0.20 E0.21 E1.00-1.01 E2.50 E4.00 E4.01-4.03 EA0.01 EA0.02-0.04 EA0.05 EA0.06 EA2.01-2.03 EB0.01 EB0.02-0.04 EB0.05 EB0.06 EB2.01-2.03 EB3.00-3.03 EC0.01 EC0.02-0.04 EC0.05 EC0.06	SITE PLAN - LIGHTING SITE PLAN - PHOTOMETRIC SITE PLAN - POWER LIGHTING NOTES & LUMINAIRE SCHEDULE UNIT LUMINAIRE & DEVICE SCHEDULE UNIT PLANS ONE LINE DIAGRAM BLD A PANEL SCHEDULES BLD A FAULT CURRENT SCHEDULES BLD A VOLTAGE DROP SCHEDULE BLD A LIGHTING PLAN - LEVELS 1 - 3 POWER PLAN - LEVELS 1 - ROOF ONE LINE DIAGRAM BLD B PANEL SCHEDULES BLD B FAULT CURRENT SCHEDULES BLD B VOLTAGE DROP SCHEDULE BLD B UIGHTING PLAN - LEVELS 1 - 3 POWER PLAN - LEVELS 1 - 3 POWER PLAN - LEVELS 1 - 3 POWER PLAN - LEVELS 1 - 13 POWER PLAN - LEVELS 1 - 3 POWER PLAN - LEVELS 1 - 3 POWER PLAN - LEVELS 1 - 20 CONE LINE DIAGRAM BLD C PANEL SCHEDULES BLD C FAULT CURRENT SCHEDULES BLD C					
400 410 411 412 414 415 416 418 420 422 423 424 426 428 420 500 501 550 500 501 550 500 700 700 700 701 SHEET NUMBER 100	UNIT PLANS & ELEVATIONS - 0x1A UNIT PLANS & ELEVATIONS - 0x1A - TYPE A UNIT PLANS & ELEVATIONS - 0x1B UNIT PLANS & ELEVATIONS - 1x1A UNIT PLANS & ELEVATIONS - 1x1A - TYPE A UNIT PLANS & ELEVATIONS - 1x1D UNIT PLANS & ELEVATIONS - 1x1D UNIT PLANS & ELEVATIONS - 1x1D UNIT PLANS & ELEVATIONS - 2x1 UNIT PLANS & ELEVATIONS - 2x1 - TYPE A UNIT PLANS & ELEVATIONS - 2x2B UNIT PLANS & ELEVATIONS - 2x2D EXTERIOR DETAILS EXTERIOR DETAILS OPENING TYPES AND SCHEDULE STAIRS - PLANS & RCPS STAIRS - SECTIONS & DETAILS SHEET NAME STRUCTURAL NOTES	50% DD	100%				E0.20 E0.21 E1.00-1.01 E2.50 E4.00 E4.01-4.03 EA0.02-0.04 EA0.05 EA0.06 EA2.01-2.03 EB0.01 EB0.05 EB0.06 EB2.01-2.03 EB3.00-3.03 EC0.01 EC0.05 EC0.06 EC2.01-2.03 EC3.00-3.03	SITE PLAN - LIGHTING SITE PLAN - PHOTOMETRIC SITE PLAN - POWER LIGHTING NOTES & LUMINAIRE SCHEDULE UNIT LUMINAIRE & DEVICE SCHEDULE UNIT PLANS ONE LINE DIAGRAM BLD A PANEL SCHEDULES BLD A FAULT CURRENT SCHEDULES BLD A VOLTAGE DROP SCHEDULE BLD A LIGHTING PLAN - LEVELS 1 - 3 POWER PLAN - LEVELS 1 - ROOF ONE LINE DIAGRAM BLD B PANEL SCHEDULES BLD B FAULT CURRENT SCHEDULES BLD B VOLTAGE DROP SCHEDULE BLD B LIGHTING PLAN - LEVELS 1 - 3 POWER PLAN - LEVELS 1 - 3 POWER PLAN - LEVELS 1 - ROOF ONE LINE DIAGRAM BLD C PANEL SCHEDULES BLD C FAULT CURRENT SCHEDULES BLD C ILGHTING PLAN - LEVELS 1 - 3 POWER PLAN - LEVELS 1 - 3					
400 410 411 412 414 415 416 418 420 422 423 424 426 428 430 500 501 550 600 700 700 701 SHEET NUMBER 100 210	UNIT PLANS & ELEVATIONS - 0x1A UNIT PLANS & ELEVATIONS - 0x1A - TYPE A UNIT PLANS & ELEVATIONS - 0x1B UNIT PLANS & ELEVATIONS - 1x1A UNIT PLANS & ELEVATIONS - 1x1A - TYPE A UNIT PLANS & ELEVATIONS - 1x1B UNIT PLANS & ELEVATIONS - 1x1C UNIT PLANS & ELEVATIONS - 1x1D UNIT PLANS & ELEVATIONS - 2x1 UNIT PLANS & ELEVATIONS - 2x1 - TYPE A UNIT PLANS & ELEVATIONS - 2x2A UNIT PLANS & ELEVATIONS - 2x2B UNIT PLANS & ELEVATIONS - 2x2D EXTERIOR DETAILS EXTERIOR DETAILS OPENING TYPES AND SCHEDULE STAIRS - PLANS & RCPS STAIRS - SECTIONS & DETAILS SHEET NAME	50% DD	100%				E0.20 E0.21 E1.00-1.01 E2.50 E4.00 E4.01-4.03 E4.01-4.03 EA0.05 EA0.06 EA2.01-2.03 EA3.00-3.03 EB0.01 EB0.05 EB0.06 EB2.01-2.03 EB3.00-3.03 EC0.01 EC0.05 EC0.06 EC2.01-2.03 EC3.00-3.03 EC3.00-3.03 EC3.00-3.03	SITE PLAN - LIGHTING SITE PLAN - PHOTOMETRIC SITE PLAN - POWER LIGHTING NOTES & LUMINAIRE SCHEDULE UNIT LUMINAIRE & DEVICE SCHEDULE UNIT PLANS ONE LINE DIAGRAM BLD A PANEL SCHEDULES BLD A FAULT CURRENT SCHEDULES BLD A VOLTAGE DROP SCHEDULE BLD A LIGHTING PLAN - LEVELS 1 - 3 POWER PLAN - LEVELS 1 - ROOF ONE LINE DIAGRAM BLD B PANEL SCHEDULES BLD B FAULT CURRENT SCHEDULES BLD B VOLTAGE DROP SCHEDULE BLD B LIGHTING PLAN - LEVELS 1 - 3 POWER PLAN - LEVELS 1 - 3 POWER PLAN - LEVELS 1 - ROOF ONE LINE DIAGRAM BLD C PANEL SCHEDULES BLD C FAULT CURRENT SCHEDULES BLD C VOLTAGE DROP SCHEDULE BLD C LIGHTING PLAN - LEVELS 1 - 3 POWER PLAN - LEVELS 1 - 800F					
400 410 411 412 414 415 416 418 420 422 423 424 426 428 430 500 501 550 600 700 700 700 701 SHEET NUMBER 100 210 211 212	UNIT PLANS & ELEVATIONS - 0x1A UNIT PLANS & ELEVATIONS - 0x1A - TYPE A UNIT PLANS & ELEVATIONS - 0x1B UNIT PLANS & ELEVATIONS - 1x1A UNIT PLANS & ELEVATIONS - 1x1A - TYPE A UNIT PLANS & ELEVATIONS - 1x1B UNIT PLANS & ELEVATIONS - 1x1D UNIT PLANS & ELEVATIONS - 1x1D UNIT PLANS & ELEVATIONS - 2x1 UNIT PLANS & ELEVATIONS - 2x1 - TYPE A UNIT PLANS & ELEVATIONS - 2x2B UNIT PLANS & ELEVATIONS - 2x2C UNIT PLANS & ELEVATIONS - 2x2D EXTERIOR DETAILS EXTERIOR DETAILS OPENING TYPES AND SCHEDULE STAIRS - PLANS & RCPS STAIRS - SECTIONS & DETAILS SHEET NAME STRUCTURAL NOTES FOUNDATION	50% DD	100%				E0.20 E0.21 E1.00-1.01 E2.50 E4.00 E4.01-4.03 EA0.02-0.04 EA0.05 EA0.06 EA2.01-2.03 EB0.01 EB0.05 EB0.06 EB2.01-2.03 EB3.00-3.03 EC0.01 EC0.05 EC0.06 EC2.01-2.03 EC0.06 EC2.01-2.03 EC0.01 EC0.05 EC0.06 EC2.01-2.03 EC0.01 EC0.02-0.04	SITE PLAN - LIGHTING SITE PLAN - PHOTOMETRIC SITE PLAN - POWER LIGHTING NOTES & LUMINAIRE SCHEDULE UNIT LUMINAIRE & DEVICE SCHEDULE UNIT PLANS ONE LINE DIAGRAM BLD A PANEL SCHEDULES BLD A FAULT CURRENT SCHEDULES BLD A VOLTAGE DROP SCHEDULE BLD A LIGHTING PLAN - LEVELS 1 - 3 POWER PLAN - LEVELS 1 - ROOF ONE LINE DIAGRAM BLD B PANEL SCHEDULES BLD B FAULT CURRENT SCHEDULES BLD B VOLTAGE DROP SCHEDULE BLD B LIGHTING PLAN - LEVELS 1 - 3 POWER PLAN - LEVELS 1 - 1 ONE LINE DIAGRAM BLD C PANEL SCHEDULES BLD C FAULT CURRENT SCHEDULES BLD C VOLTAGE DROP SCHEDULE BLD C LIGHTING PLAN - LEVELS 1 - 3 POWER PLAN - LEVELS 1 - 1 PANEL SCHEDULES BLD C					
NUMBER -100 -210 -211 -212 -213	UNIT PLANS & ELEVATIONS - 0x1A UNIT PLANS & ELEVATIONS - 0x1A - TYPE A UNIT PLANS & ELEVATIONS - 0x1B UNIT PLANS & ELEVATIONS - 1x1A UNIT PLANS & ELEVATIONS - 1x1A - TYPE A UNIT PLANS & ELEVATIONS - 1x1B UNIT PLANS & ELEVATIONS - 1x1C UNIT PLANS & ELEVATIONS - 1x1D UNIT PLANS & ELEVATIONS - 2x1 UNIT PLANS & ELEVATIONS - 2x2A UNIT PLANS & ELEVATIONS - 2x2A UNIT PLANS & ELEVATIONS - 2x2D UNIT PLANS & ELEVATIONS - 2x2D EXTERIOR DETAILS EXTERIOR DETAILS OPENING TYPES AND SCHEDULE STAIRS - PLANS & RCPS STAIRS - SECTIONS & DETAILS SHEET NAME STRUCTURAL NOTES FOUNDATION FRAMING PLAN FRAMING PLAN	50% DD	100%				E0.20 E0.21 E1.00-1.01 E2.50 E4.00 E4.01-4.03 E4.01-4.03 EA0.05 EA0.06 EA2.01-2.03 EA3.00-3.03 EB0.01 EB0.05 EB0.06 EB2.01-2.03 EB3.00-3.03 EC0.01 EC0.05 EC0.06 EC2.01-2.03 EC3.00-3.03 EC3.00-3.03 EC3.00-3.03	SITE PLAN - LIGHTING SITE PLAN - PHOTOMETRIC SITE PLAN - POWER LIGHTING NOTES & LUMINAIRE SCHEDULE UNIT LUMINAIRE & DEVICE SCHEDULE UNIT PLANS ONE LINE DIAGRAM BLD A PANEL SCHEDULES BLD A FAULT CURRENT SCHEDULES BLD A VOLTAGE DROP SCHEDULE BLD A LIGHTING PLAN - LEVELS 1 - 3 POWER PLAN - LEVELS 1 - ROOF ONE LINE DIAGRAM BLD B PANEL SCHEDULES BLD B FAULT CURRENT SCHEDULES BLD B VOLTAGE DROP SCHEDULE BLD B LIGHTING PLAN - LEVELS 1 - 3 POWER PLAN - LEVELS 1 - 3 POWER PLAN - LEVELS 1 - 1 POWER PLAN - LEVELS 1 - 800F ONE LINE DIAGRAM BLD C PANEL SCHEDULES BLD C FAULT CURRENT SCHEDULES BLD C VOLTAGE DROP SCHEDULE BLD C LIGHTING PLAN - LEVELS 1 - 3 POWER PLAN - LEVELS 1 - 13					
400 410 411 412 414 415 416 416 418 420 422 423 424 426 428 424 426 428 420 500 501 550 600 700 701 550 600 700 701 550 600 700 701 550 600 700 701 550 600 700 701 211 212	UNIT PLANS & ELEVATIONS - 0x1A UNIT PLANS & ELEVATIONS - 0x1A - TYPE A UNIT PLANS & ELEVATIONS - 0x1B UNIT PLANS & ELEVATIONS - 1x1A UNIT PLANS & ELEVATIONS - 1x1A - TYPE A UNIT PLANS & ELEVATIONS - 1x1B UNIT PLANS & ELEVATIONS - 1x1D UNIT PLANS & ELEVATIONS - 1x1D UNIT PLANS & ELEVATIONS - 2x1 UNIT PLANS & ELEVATIONS - 2x1 - TYPE A UNIT PLANS & ELEVATIONS - 2x2A UNIT PLANS & ELEVATIONS - 2x2B UNIT PLANS & ELEVATIONS - 2x2D EXTERIOR DETAILS EXTERIOR DETAILS OPENING TYPES AND SCHEDULE STAIRS - PLANS & RCPS STAIRS - SECTIONS & DETAILS SHEET NAME STRUCTURAL NOTES FOUNDATION FRAMING PLAN	50% DD	100%				E0.20 E0.21 E1.00-1.01 E2.50 E4.00 E4.01-4.03 E4.01-4.03 EA0.01 EA0.02-0.04 EA0.05 EA0.06 EA2.01-2.03 EB0.01 EB0.02-0.04 EB0.05 EB0.06 EB2.01-2.03 EC0.01 EC0.05 EC0.06 EC2.01-2.03 EC0.01 EC0.04 ED0.02-0.04 ED0.05 ED0.06	SITE PLAN - LIGHTING SITE PLAN - PHOTOMETRIC SITE PLAN - POWER LIGHTING NOTES & LUMINAIRE SCHEDULE UNIT LUMINAIRE & DEVICE SCHEDULE UNIT PLANS ONE LINE DIAGRAM BLD A PANEL SCHEDULES BLD A FAULT CURRENT SCHEDULES BLD A VOLTAGE DROP SCHEDULE BLD A LIGHTING PLAN - LEVELS 1 - 3 POWER PLAN - LEVELS 1 - ROOF ONE LINE DIAGRAM BLD B PANEL SCHEDULES BLD B FAULT CURRENT SCHEDULES BLD B VOLTAGE DROP SCHEDULE BLD B LIGHTING PLAN - LEVELS 1 - 3 POWER PLAN - LEVELS 1 - ROOF ONE LINE DIAGRAM BLD C PANEL SCHEDULES BLD C FAULT CURRENT SCHEDULES BLD C VOLTAGE DROP SCHEDULE BLD C LIGHTING PLAN - LEVELS 1 - 3 POWER PLAN - LEVELS 1 - 80OF					

4

Attach,emt D	
--------------	--





DARTMENTS BLVD SE **TRIC** 312, 4408 CRAFT

MARK R		SION	DA	ΑTE
PROJECT NO: PRINCIPAL-IN-CHARGE PROJECT ARCHITECT: DRAWN BY:		050-01-	21 bf mj hl	
PROJECT STATUS: PFRMIT SFT				
05.06.2022				
0	et title: VER PAGE	Ξ		

SHEET NO.

G-000

# **CRAFT DISTRICT II APARTMENTS** 05.06.2022 PERMIT SET


## VICINITY MAP



## LOCATION MAP



ltem 7.

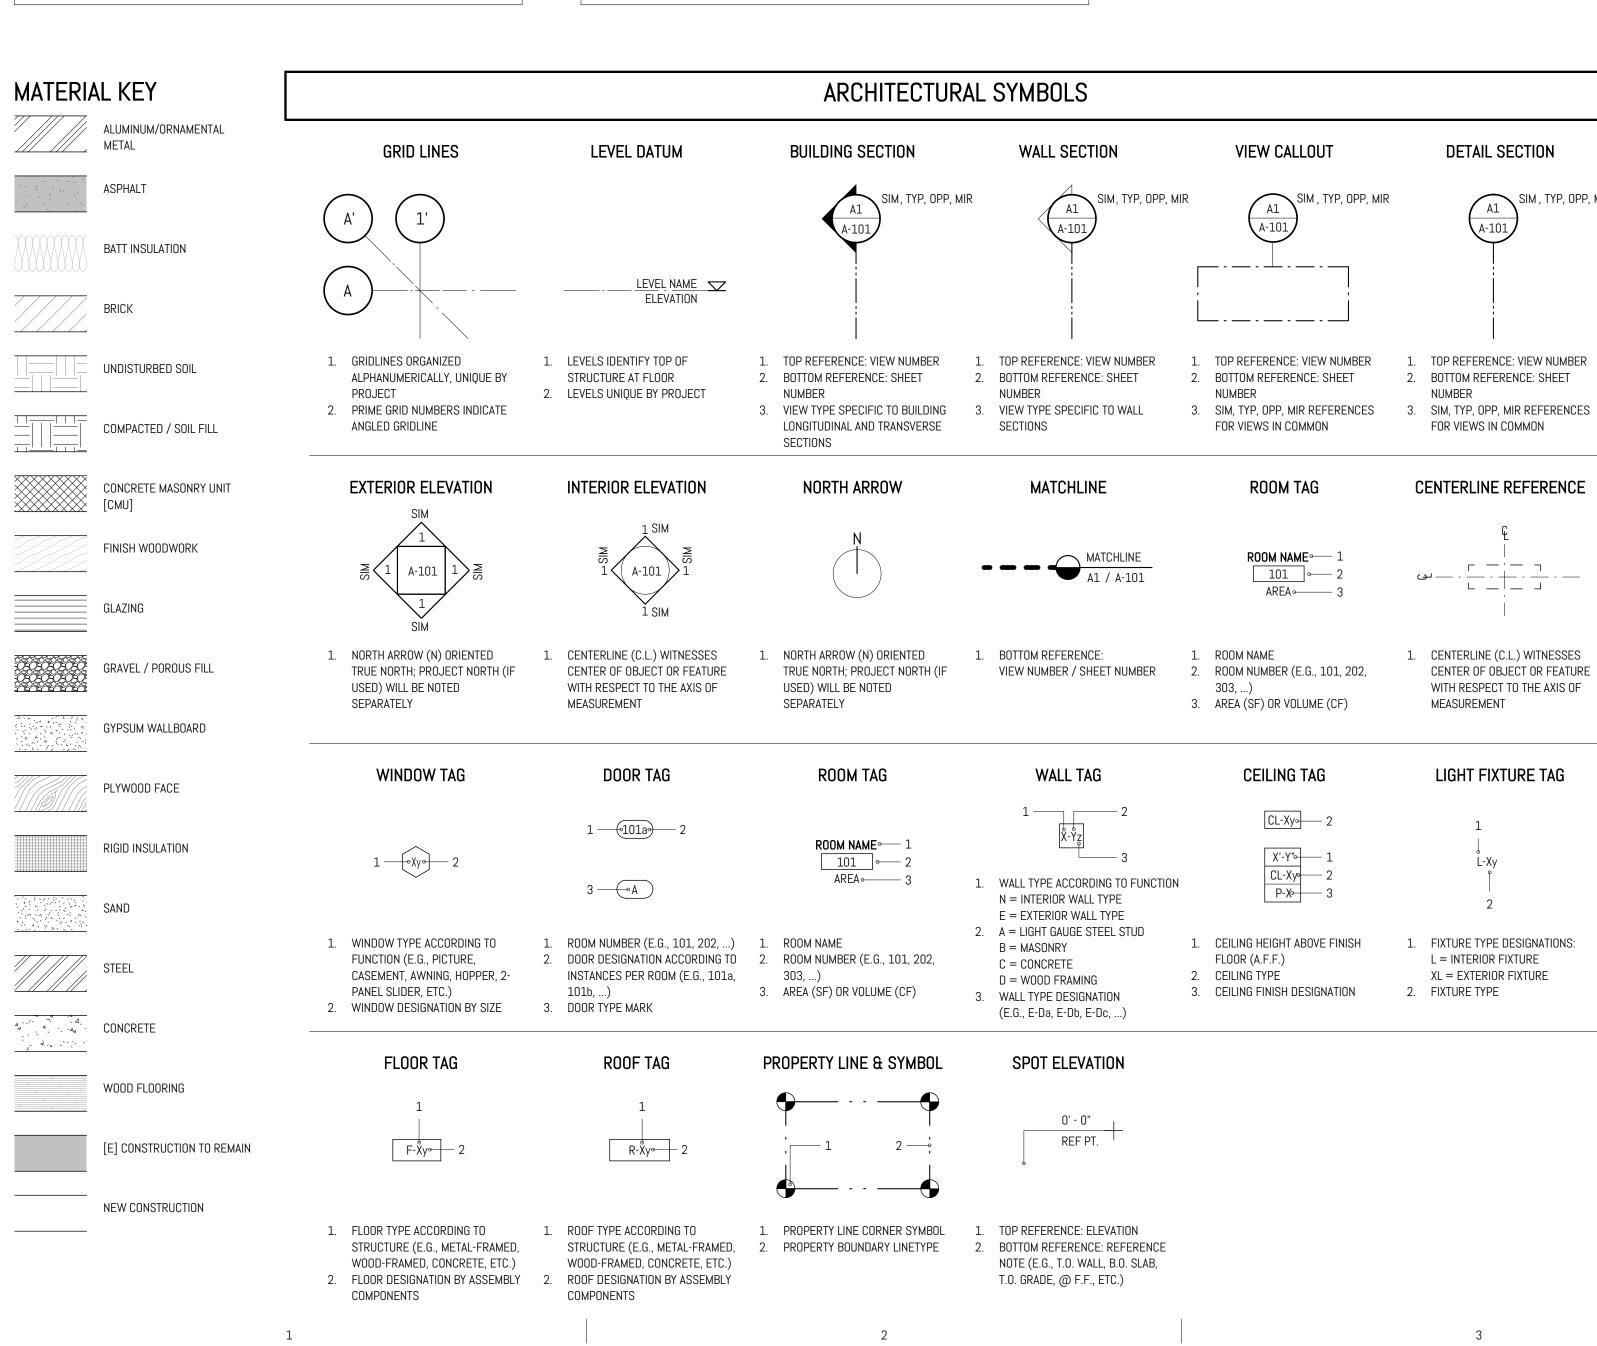


## SHEET SERIES REFERENCES

REFER TO: G-000 SERIES FOR ADDITIONAL GENERAL NOTES A-000 SERIES FOR CODE COMPLIANCE NOTES AND DETAILS A-000 SERIES FOR WALL, FLOOR, CEILING, AND ROOF TYPES

- A-100 SERIES FOR ARCHITECTURAL SITE PLAN & SITE ELEMENTS
- A-110 SERIES FOR OVERALL FLOOR PLANS A-130 SERIES FOR SLAB EDGE PLANS
- A-200 SERIES FOR EXTERIOR ELEVATIONS
- A-300 SERIES FOR BUILDING & WALL SECTIONS A-400 SERIES FOR TYPICAL UNITS PLANS, RCPS, & INTERIOR ELEVATIONS
- A-500 SERIES FOR EXTERIOR & INTERIOR DETAILS
- A-600 SERIES FOR OPENING TYPES & SCHEDULE A-700 SERIES FOR STAIR PLANS, RCPS, SECTIONS, & DETAILS

1. CEILING HEIGHT ABOVE FINISH 3. CEILING FINISH DESIGNATION

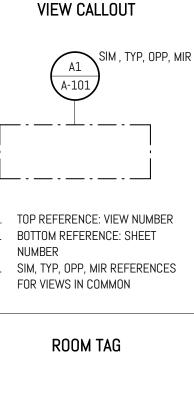

**ROOM NAME** - 1

2. ROOM NUMBER (E.G., 101, 202,

CEILING TAG

CL-Xy₀ \_\_\_\_ 2

X'-Y"→ 1

CL-Xy 2

FLOOR (A.F.F.)


2. CEILING TYPE

3. AREA (SF) OR VOLUME (CF)

1. ROOM NAME


303, ...)

101 - 2 AREA⊶ 3 DETAIL SECTION

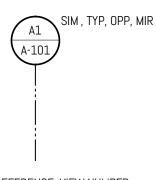


- 2. BOTTOM REFERENCE: SHEET
- NUMBER FOR VIEWS IN COMMON

**CENTERLINE REFERENCE** 

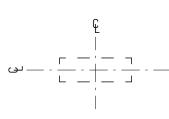

1. CENTERLINE (C.L.) WITNESSES CENTER OF OBJECT OR FEATURE WITH RESPECT TO THE AXIS OF MEASUREMENT

### LIGHT FIXTURE TAG

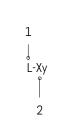

- FIXTURE TYPE DESIGNATIONS: L = INTERIOR FIXTURE
- XL = EXTERIOR FIXTURE2. FIXTURE TYPE

- 1. THE CONTRACTOR SHALL BE SOLELY AND COMPLETELY RESPONSIBLE FOR CONDITIONS ON THE JOB SI SAFETY OF PERSONS, PROPERTY, AND FOR NECESSARY INDEPENDENT ENGINEERING REVIEWS OF THE AND FOR COMPLIANCE WITH O.S.H.A. SAFETY STANDARDS. ARCHITECTS AND THEIR CONSULTANTS' JOI OBSERVATIONS ARE NOT INTENDED TO INCLUDE REVIEW OF THE ADEQUACY OF THE CONTRACTOR'S SA
- 2. EACH CONTRACTOR SHALL FAMILIARIZE THEMSELVES WITH SPECIFIED PRODUCTS RELATING TO THEIR WORK. THEY ARE TO SUBMIT WRITTEN OBJECTIONS PRIOR TO BIDDING, IF THE CONTRACTOR HAS AN OBJECTION TO ANY PRODUCT AND/OR DISCREPANCIES BETWEEN DRAWINGS AND SPECIFICATIONS.
- 3. THE GENERAL CONTRACTOR SHALL VERIFY EXISTING CONDITIONS IN THE FIELD. THE ARCHITECT SHALL BE NOTIFIED IMMEDIATELY OF ANY DISCREPANCIES BETWEEN ACTUAL FIELD CONDITIONS AND CONSTRUCTION DOCUMENTS. WORK THAT COULD BE EFFECTED BY THE DISCREPANCY SHALL BE HELD UNTIL SUCH DISCREPANCIES ARE RESOLVED.
- 4. SEPARATE PERMITS, WHEN REQUIRED AND / OR ARE DESIGN / BUILD , SHALL BE OBTAINED BY THE CONTRACTOR FOR MECHANICAL, ELECTRICAL AND FIRE ALARM. DESCRIPTIVE, DETAILED DESIGN AND SUPPLEMENTAL DOCUMENTS SHALL BE PROVIDED FOR REVIEW BY THE AUTHORITY HAVING JURISDICTION AND BY THE OWNER / ARCHITECT FOR APPROVAL PRIOR TO ANY WORK BEING PERFORMED.
- 5. SPECIAL INSPECTIONS WHERE REQUIRED BY THE SCOPE OF WORK SHALL BE PERFORMED BY AN APPROVED INSPECTION SERVICE APPROVED BY THE AUTHORITY HAVING JURISDICTION OR BUILDING OFFICIAL AND SHALL BE HIRED BY THE BUILDING OWNER.

TUMWATER MUNICIPAL CODE

### PROJECT SCOPE SUMMARY

THIS PROJECT PROPOSES (4) 3-STORY TYPE V-B APARTMENTS (R-2) FOR A TOTAL OF 95 DWELLING UNITS AND 1 LEASING OFFICE. 119 OFF-STREET, SURFACE PARKING STALLS WILL BE PROVIDED, AND (3) TRASH ENCLOSURES WILL BE PROVIDED.

### **PROJECT INFORMATION**

PROJECT ADDRESSES 4302, 4312, 4408, & 4422 CAPITOL BLVD SE TUMWATER, WA 98501 PARCEL NUMBER[S] 33870000400 BD (BREWERY DISTRICT - DESCHUTES) ZONING PROPERTY SIZE [SF / ACRES] 151,088 SF [3.48 ACRES] STRUCTURE SIZE [SF] BUILDING A 21,974 SF BUILDING B 22,058 SF BUILDING C 22,058 SF BUILDING D 22,058 SF TOTAL 88,148 SF NATURAL GAS SOURCE PUGET SOUND ENERGY [PSE] CITY OF TUMWATER PUBLIC UTILITY SEWER DISTRICT WATER DISTRICT CITY OF TUMWATER PUBLIC UTILITY POWER SOURCE PUGET SOUND ENERGY [PSE] LEGAL DESCRIPTION SECTION 26 TOWNSHIP 18 RANGE 2W QUARTER 406.3

### AIR BARRIER TESTING

PROVIDE AIR BARRIER TESTING ACCORDING TO WSEC C402.5.1.2. TESTING SHALL BE PERFORMED PER ASTM C779 WITH A TARGET LEAKAGE RATE OF 5 CHANGES PER HOUR AT 0.2 IN. WG (50 Pa). SUBMIT TESTING REPORTS TO JURISDICTION AND OWNER, AND COMPLY WITH CORRECTIVE MEASURES AND/OR RETESTING IF REQUIRED PER WSEC C402.5.1.2.

SW, NW DONATION LAND CLAIN BELLATORRE

BSP N0 12-0034TW LT 4 DOCUMENT 4250623

### **ABBREVIATIONS**

VIA	FIONS
А А А А А А А А А А А А А А	NCHOR BOLT SPHALT CONCRETE PAVEMENT COUSTIC TILE REA DRAIN DJACENT DJUSTABLE COUSTICAL DIFFUSION PANEL BOVE FINISH FLOOR GGREGATE LUMINUM LTERNATE PPROXIMATE (LY) BUSE RESISTANT RCHITECT (URAL) SPHALT TREATED BASE COUSTICAL WALL PANEL
E E E E E	NTUMINOUS RLINDS NUILDING NEAM SOTTOM OF NOTTOM RUILT UP ROOFING
	ABINET ACTCH BASIN ONTROL JOINT ENTER LINE HAIN LINK FENCE EILING LEAR (ANCE) LEAR (ANCE) LEAN OUT COUTINUOUS/CONTINUATION CONTRACTOR CONTROL PANEL CONTRACTOR CONTROL PANEL ERAMIC TILE COUNTER SINK CUSTODIAN COLD WATER
	DEEP/DRYER 10UBLE 19EMOLITION 1JAMETER 10IMENSION 10ISPENSER 10WN 100R 10WNSPOUT 19ETAIL 19SHWASHER 19RAWING 1RAWER
	XISTING AST ACH XIT DEVICE XHAUST FAN XT. INSUL FINISH SYSTEM XPANSION JOINT LECTRIC(AL) LEVATION/ELEVATOR INTRY MAT LECTRO MAGNETIC CLOSER LECTRO MAGNETIC HOLDER

ELECTRICAL PANEL EQUAL EQUIPMENT EPOXY RESIN ELASTOMERIC SHEET ROOFING EXPOSED/EXPANSION EXTERIOR
FIRE ALARM FIBER CEMENT BOARD FIBER CEMENT SIDING FLOOR DRAIN FOUNDATION FIRE EXTINGUISHER FIRE EXTINGUISHER CABINET FINSH FLOOR FINSH GRADE FIRE ALARM GRAPHIC PANEL FIRE ALARM GRAPHIC PANEL FIRE HYDRANT FINISH(ED) FLASH(ING) FLOOR FACE OF CONCRETE FACE OF FINISH FACE OF FINISH FACE OF FINISH FACE OF FINISH FACE OF CONCRETE FACE OF CONCRETE FACE OF FINISH FACE OF MASONRY FACE OF STUD FALL RESTRAINT FIBER REINFORCED CEMENT PANE FIBER REINFORCED CEMENT PANE FIBER REINFORCED CEMENT PANE FIBER REINFORCED PANEL FIRE RESISTANT TRAINING FIRE STOP(PING) FOOT, FEET FOOTING FURRING
GAUGE GALVANIZED GRAB BAR GENERAL CONTRACT (OR) GLASS, GLAZING GYPSUM SHEATHING GRAVEL GYPSUM WALL BOARD
HOSE BIB HANDICAP HEADER HARDWARE HOLLOW METAL HOLLOW METAL CASING HORIZONTAL HANDRAIL HEIGHT HEATING VENTILATION & AIR CONDITIONING HOT WATER HOT WATER HEATER/TANK
INSIDE DIAMETER INSULATED GLASS INCLUDE (ED, ING) INSULATE (D) (ION) INTERIOR IMPACT RESISTANT INTER-STEEL STRUCTURES INC. MODULAR FRAME BUILDING SYSTE

#### JOIST KNOCK OUT KNEE SPACE

REINF

REOD

6. WORK DONE SHALL BE IN CONFORMANCE WITH THE APPROVED PLANS AND PROJECT SPECIFICATIONS. THE

8. WHEN CONSTRUCTION DETAILS ARE NOT SHOWN OR NOTED FOR ANY PART OF THE WORK, DETAILS SHALL BE THE

SAME AS FOR OTHER SIMILAR WORK. IF OUESTIONS CAN NOT BE RESOLVED IN THIS MANNER, CONTACT THE

9. WORK AND MATERIALS SHALL BE PLACED / INSTALLED IN FULL ACCORDANCE WITH THE LATEST EDITION OF THE

INTERNATIONAL BUILDING CODE IN AFFECT WITHIN THE JURISDICTION WORK IN PERFORMED AND ALL OTHER

CONSTRUED TO PERMIT WORK WHICH IS NOT IN CONFORMANCE WITH ANY CODE OR REGULATION IN AFFECT.

10. PROTECTIVE MEASURES SHALL BE TAKEN BY THE CONTRACTOR TO PROTECT ADJACENT PROPERTY THROUGHOUT

11. THE CONTRACTOR SHALL COMPLY WITH CURRENT APPLICABLE LOCAL ORDINANCES FOR UTILITY SERVICES.

APPLICABLE STATE OR LOCAL LAWS AND REGULATIONS AS ARE APPLICABLE. NOTHING IN THESE DRAWINGS SHALL BE

APPROVED, PERMITTED, STAMPED PLANS ARE TO REMAIN ON SITE AT ALL TIMES.

7. DO NOT SCALE DRAWINGS; DIMENSIONS GOVERN.

ARCHITECT PRIOR TO PROCEEDING.

### PROJECT **GENERAL NOTES**

ITE, INCLUDING THE	
ESE CONDITIONS,	
3 SITE	
AFETY MEASURES.	

### PROJECT DATA & SUMMARY OF SCOPE **GENERAL NOTES**

CONSTRUCTION.

### **REGULATING CODES**

2018 INTERNATIONAL BUILDING CODE (IBC) 2018 INTERNATIONAL MECHANICAL CODE (IMC) 2018 UNIFORM PLUMBING CODE (UPC) 2018 INTERNATIONAL FIRE CODE (IFC) 2018 WASHINGTON STATE ENERGY CODE (WSEC) 2015 VENTILATION & INDOOR AIR QUALITY CODE (VIAQ) 2009 ICC/ANSI 117.1 (ACCESSIBILITY) 2018 WASHINGTON STATE AMENDMENTS REVISED CODE OF WASHINGTON [RCW]

### ENERGY REQUIREMENTS

WSEC CLOSEOUT DOCUMENTATION

PROVIDE CLOSEOUT DOCUMENTATION, INLCUDING APPLICABLE CALCULATIONS, WSEC ENVELOPE COMPLIANCE REPORTS, AND FENESTRATION NRFC RATING CERTIFICATES PER WSEC C103.6.3.

WSEC RESIDENTIAL ENERGY EFFICIENCY CREDITS

CREDITS REQUIRED CREDITS PROPOSED			4.5 5.5
<b>TABLE</b> 406.2	<b>Option</b> 2	DESCRIPTION INITIAL HEATING SYSTEM USING A HEAT PUMP THAT MEETS FEDERAL STANDARDS FOR EQUIP LISTED IN TABLE C403.3.2[1]C OR C403.3.2[2]	CREDIT [R-2] 1.0
406.3	*REFEF 3.6	TO MECHANICAL FOR DOCUMENTATION DUCT-LESS SPLIT SYSTEM HEAT PUMP WITH NO ELECT RESISTANCE HEATING IN PRIMARY LIVING AREA. DUCTLESS HEAT PUMP SIZED FOR ENTIRE DWELLING UNIT [<1,500 SF EACH], [MIN HSPF 10]	3.0
406.3	*REFEF 7.1	R TO MECHANICAL FOR DOCUMENTATION NEW AND INSTALLED RESIDENTIAL APPLIANCES ARE ENERGY STAR RATED: REFRIGERATOR, DISH WASHER, WASHING MACHINE, DRYER	1.5

LAVATORY LINEAR FOOT (FEET) LAMINATED GLASS LEFT HAND LOCAL IMPROVEMENT DISTRICT LINDLEUM LIGHT LUXURY VINYL TILE
MODIFIED ASPHALT ROOFING MATERIAL MAXIMUM MACHINE BOLT MECHANICAL MANUFACTURE(R) MANHOLE MINIMUM MIRROR MISCELLANEOUS METAL MICROWAVE
NORTH NOT APPLICABLE NOT IN CONTRACT NUMBER NOMINAL NOT TO SCALE
ON CENTER OUTSIDE DIAMETER OWNER FURNISHED/ CONTRACTOR INSTALLED OVERFLOW DRAIN OVER HANG
PARALLEL PARTITION PRECAST PERFORATE (D) PERPENDICULAR PHASE/PANIC HARDWARE PROPERTY LINE PLASTIC LAMINATE PLASTIC LAMINATE PLASTER PLYWOOD PANEL PANEL POWER PANEL PAIR PRESSURE TREATED POUNDS PER SQUARE FOOT POUNDS PER SQUARE FOOT POUNDS PER SQUARE INCH PAINT PAPER TOWEL DISPENSER PAPER TOWEL
DISPENSER/RECEPTACLE POLYVINYL CHLORIDE (PLASTIC
RADIUS RISER RUBBERIZED ASPHALT
UNDERLAYMENT RUBBER BASE ROOF DRAIN RESILIENT FLOORING FOR REFERENCE ONLY/REFRIG REINFORCE (D) PEOLIDEED

REOUIRE

//REFRIGERATOR

LAMINATE (D)

## DEFERRED SUBMITTALS

THE GENERAL CONTRACTOR (GC) SHALL BE RESPONSIBLE FOR VERIFYING EXISTING FIELD CONDITIONS AND COORDINATING DEFERRED SUBMITTALS. THE GC'S SUBCONTRACTOR(S) SHALL BE RESPONSIBLE FOR VERIFYING COMPLIANCE WITH LOCAL AUTHORITIES AND CURRENT CODES. REGULATIONS AND REQUIREMENTS

DOCUMENTS FOR DEFERRED SUBMITTALS ITEMS SHALL BE SUBMITTED TO THE REGISTERED DESIGN PROFESSIONAL IN RESPONSIBLE CHARGE WHO SHALL REVIEW THEM AND FORWARD THEM TO THE BUILDING OFFICIAL WITH A NOTATION INDICATING THAT THE DEFERRED SUBMITTAL DOCUMENT HAVE BEEN REVIEWED AND FOUND TO BE IN GENERAL CONFORMANCE TO THE DESIGN OF THE BUILDING. THE DEFERRED SUBMITTAL ITEMS SHALL NOT BE INSTALLED UNTIL THE DEFERRED SUBMITTAL DOCUMENTS HAVE BEEN APPROVED BY THE BUILDING OFFICIAL.

•	STOREFRONT SYSTEMS	•
•	ROOF TRUSSES	•
٠	FIRE ALARM	

FIRE SPRINKLER GUARDRAILS

### SEPARATE PERMITS

THE FIRE SPRINKLER AND FIRE ALARM WORK FOR THE PROJECT SHALL BE PERFORMED AS DESIGN-BUILD. THE GC SHALL SUBMIT WITH THE BID A PROPOSED DRAWING THAT COORDINATES WITH THE ARCHITECTURAL DRAWINGS AND COMPLIES WITH APPLICABLE CODES, REGULATIONS AND REQUIREMENTS.

THE GC'S SUBCONTRACTOR WILL BE RESPONSIBLE FOR APPLYING FOR AND SECURING NECESSARY PERMITS.

### SPECIAL INSPECTIONS

SPECIAL INSPECTIONS ARE NOTATED IN STRUCTURAL GENERAL NOTES PROVIDED AT PERMIT SUBMITTAL.

- STRUCTURAL STEEL STRUCTURAL CONCRETE
- STRUCTURAL WOOD FRAMING

RIGHT HAND ROOM ROUGH OPENING RIGHT OF WAY RIGHT
SINK SOUTH SEALER/HARDENER SPECIAL COATING SCHEDULE (D) SEAT COVER DISPENSER SOAP DISPENSER SECTION SQUARE FOOT (FEET) SAFETY GLAZING SHOWER SHEET SIMILAR (CONDITIONS VARY) SLOPE SIMULATED STONE COUNTERI SANITARY NAPKIN DISPOSAL U SPECIFIED/SPECIFICATIONS SQUARE STAINLESS STEEL STAIN STAIN & LACQUER STAIN STANDARD STELL STORAGE STRUCTURAL SUSPEND (ED)
TREAD TILE TONGUE & GROOVE TEMPERED GLASS THICK TOP OF TOWEL DISPENSER TOILET TISSUE DISPENSER TYPICAL
UNLESS NOTED OTHERWISE
VARIES VAPOR BARRIER VENEER VERTICAL VERIFY IN FIELD

VENEER
VERTICAL
VERIFY IN FIELD
VENEER PLASTER
VAPOR RETARDER
VENDOR - SANITARY NA
WEST, WIDE, WASHER
WITH
WITHOUT
WALK OFF MAT
WHITE BOARD
WOOD
WASHER/DRYER
WOOD BASE
WOOD FLOOR
WIRE GLASS
WINDOW
WATER RESISTANT
WINDOW TREATMENT
YARD





 $\geq$  $\geq$  $\infty$ 

MARK	REVIS	SION	DATE	Ξ
PROJ	IECT NO:	050-01-2	21	
PRIN	CIPAL-IN-CHARGE	:	BF	
PROJ	IECT ARCHITECT:		MJ	
DRAV	VN BY:		HL	
PROJ	IECT STATUS:			
PE	RMIT SET			
05	.06.2022			

SHEET TITLE:

**PROJECT INFORMATION** 

SHEET NO.

G-001

ltem 7.

## 2018 IBC CHAPTER 3 USE AND OCCUPANCY CLASSIFICATION

CLASSIFICATION

### PROPOSED SPACES BY USE AND OCCUPANCY CLASS

USE RESIDENTIAL APARTMENTS: R-2 RETAIL / LEASING OFFICE:

APPLIED CASES BUILDINGS A, B, C, & D BUILDING A

\*REFER TO CODE PLANS, A-000, FOR USE AND OCCUPANCY IDENTIFICATION BY SPACE, AS WELL AS ASSOCIATED AREA, OCCUPANT LOAD, AND MEANS OF EGRESS.

## 2018 IBC CHAPTER 4 SPECIAL DETAILED REQUIREMENTS BASED ON USE AND OCCUPANCY

### SECTION 420 - GROUPS I-1, R-1, R-2, R-3 AND R-4

420.2 - SEPARATION WALLS

WALLS SEPARATING DWELLING UNITS IN THE SAME BUILDING, WALLS SEPARATING SLEEPING UNITS IN THE SAME BUILDING AND WALLS SEPARATING DWELLING OR SLEEPING UNITS FROM OTHER OCCUPANCIES CONTIGUOUS TO THEM IN THE SAME BUILDING SHALL BE CONSTRUCTED AS FIRE PARTITIONS IN ACCORDANCE WITH SECTION 708.

#### 420.3 - HORIZONTAL SEPARATION

FLOOR ASSEMBLIES SEPARATING DWELLING UNITS IN THE SAME BUILDINGS, FLOOR ASSEMBLIES SEPARATING SLEEPING UNITS IN THE SAME BUILDING AND FLOOR ASSEMBLIES SEPARATING DWELLING OR SLEEPING UNITS FROM OTHER OCCUPANCIES CONTIGUOUS TO THEM IN THE SAME BUILDING SHALL BE CONSTRUCTED AS HORIZONTAL ASSEMBLIES IN ACCORDANCE WITH SECTION 711.

#### [F] 420.5 - AUTOMATIC SPRINKLER

GROUP R OCCUPANCIES SHALL BE EQUIPPED THROUGHOUT WITH AN AUTOMATIC SPRINKLER SYSTEM IN ACCORDANCE WITH SECTION 903.2.8. QUICK RESPONSE OR RESIDENTIAL AUTOMATIC SPRINKLERS SHALL BE INSTALLED IN ACCORDANCE WITH SECTION 903.3.2.

APPLIED CASE(S) - THROUGHOUT PROJECT (SUBJECT TO EXCEPTIONS AND LIMITATIONS DESCRIBED IN SECTION 708) REFER TO CODE PLANS, A-000, FOR REQUIRED LOCATIONS AND ASSEMBLY TYPES FOR REQUIRED FIRE RATINGS AND UL ASSEMBLIES.

APPLIED CASE(S) - THROUGHOUT PROJECT (SUBJECT TO EXCEPTIONS AND LIMITATIONS DESCRIBED IN SECTION 711) REFER TO CODE PLANS AND SECTIONS, A-000, FOR REQUIRED LOCATIONS AND ASSEMBLY TYPES FOR REQUIRED FIRE RATINGS AND UL ASSEMBLIES.

APPLIED CASE(S) - THROUGHOUT PROJECT (SUBJECT TO EXCEPTIONS AND LIMITATIONS DESCRIBED IN SECTION 903) REFER TO CODE SUMMARY OF APPLICABLE SECTIONS FROM CHAPTER 903 FOR SYSTEM TYPE AND REQUIRED LOCATIONS.

SE

SE

SE

SF

### 2018 IBC CHAPTER 5 & TMC CHAPTER 18 GENERAL BUILDING HEIGHTS AND AREAS

#### SECTION 504 - HEIGHT IN FEET

USE CODE

106

	TABLE 504.3 - ALLOW	ABLE BUILDING HEI	GHT IN FEET ABO	OVE GRADE PLAN	١E
		AUTOMATIC	TYPE OF CO	NSTRUCTION	
	OCCUPANCY CLASSIFICATION	SPRINKER PER 903.3.1.2	TYF	PE V	
			А	В	
	R	S13R	60 FT	*60 FT	

\*BUILDING HEIGHT MAX. SUBJECT TO AND SUPERSEDED BY LOCAL LAND

#### TUMWATER MUNCIPAL CODE CHAPTER 18

#### TABLE 18.27.050 - DEVELOPMENT STANDARDS

	DISTRICT	PROVIDED	
	DESCHUTES BREWERY DISTRICT ZONE		
MAXIMUM BUILDING HEIGHT	55'-0"	44'-5"	
MAXIMUM LOT COVERAGE	**	**	
MINIMUM STREET-FACING SETBACK	5' FACING CAPITOL BLVD SE NO MIN FOR OTHER STREETS	12'-6" FACING CAPITOL BLVD SE N/A FOR OTHER STREETS	
MAXIMUM STREET-FACING SETBACK	NO MAX FACING CAPITOL BLVD SE 15' MAX FOR OTHER STREETS	N/A FACING CAPITOL BLVD SE 8'-4" MAX FOR TUMWATER VALLEY DR	
MINIMUM SIDE & REAR SETBACKS	NO MINIMUM	NO MINIMUM	
MINIMUM STREET-FACING BUILDING FRONTAGE	50% AT ALL STREETS	<i>90% FACING CAPITOL BLVD SE 32% AT TUMWATER VALLEY DR***</i>	
MINIMUM RESIDENTIAL NET DENSITY*	20 DU/ACRE	35.7 DU/ACRE	

\*\* MAXIMUM OBTAINABLE LOT COVERAGE SUBJECT TO ON-SITE PARKING REQUIREMENTS, MINIMUM LANDSCAPING REQUIREMENTS, MINIMUM SETBACK REQUIREMENTS, AND ON-SITE STORMWATER MANAGEMENT REQUIREMENTS. \*\*\*APPROVED WITH VARIANCE SUBMITTED UNDER SITE PLAN REVIEW PROCESS

TABLE 504.4 - ALLOWABLE STORIES ABOVE GRADE PLANE				
OCCUPANCY CLASSIFICATION	AUTOMATIC SPRINKER PER	TYPE OF COI	NSTRUCTION	
		TYP	ΡΕV	
	903.3.1.2	А	В	
R-2	S13R	4	3	

APPLIED CASE(S) - BLDGS A, B, C, & D

GREATEST BUILDING HEIGHT PROVIDED = **44' - 5" < 55' - 0" OK** GREATEST NUMBER OF BUILDING STORIES PROVIDED = 3 < 3 OK

Image: Section Section 2010; 1: 2020 2: 20200 2: 2020 2: 2020 2: 2020 2: 2020 2: 2020 2: 2020	
Model (Marcolling)	
Model (Marcolling)	
Link         (m)         (m) <th(m)< th=""> <th(m)< td="" th<=""><td>LS SHALL COM</td></th(m)<></th(m)<>	LS SHALL COM
HICL 2002PHY       [B + - 7/2019/29 + 7/2019 + 7/2019 - 7/2019   1/2019 + 7/2019   1/2019	
LECE 1         PC - 45000 P - (1000 P - (1000 P - (1000 P - (1000 P - 1000 P -	EGREE OF OPE PROTECTION
	UNPROTEC
EXCUS         EXCUS (V = 2, V = -50, V = 2, V	UNPROTEC
	UNPROTEC
4 - 4000 Million (1) 	ONSPRINKLERE UNPROTEC ONSPRINKLERE
A - HULLWORD REACK (ST)       A - HULWWORD REACK (ST) </td <td>UNPROTEC</td>	UNPROTEC
Image: Section 60.3.3 - MOUNT OF INCREASE         Section 60.3.3 - MOUNT OF INCREASE           IEDUCTION 65.3 - Large 7.76 - 2.02, *1/07.20, *0/07.2	ONSPRINKLERE UNPROTEC ONSPRINKLERE
Building and a standard window (b)         - (f) (f)         Section 708 - FIRE PARITIE         SECTION 708 - FIRE PARITIE           UBJAND (b)         - (f) (f)         - (f) <td></td>	
NUM	
BUDB         4 = (276 / 422 · 0.23) * (20 / 20 - 0.2         128 + 68 - 128 + 68 - 212         128 + 27 - 273         IPP - 2011000           BUDD         4 = (276 / 422 · 0.23) * (20 / 30) - 0.2         138 + 68 - 128 + 68 - 422         128 + 72 - 773         IPP - 2011000           BUDD         4 = (276 / 422 · 0.23) * (20 / 30) - 0.30         138 + 58 + 138 + 68 - 412         138 + 58 - 138 - 54 - 45         SECTION 723 - SHAFT ENCL           Find DD         Find DD         58 + 138 + 58 - 138 - 58 - 412         138 + 58 + 138 - 54 - 45         SECTION 723 - SHAFT ENCL           Find DD         Find DD <td>INS</td>	INS
RUGE         + # (2007.432) + 0.23 * (207.20) + 0.24         1.29 + 69 + 1.29 + 69 + 1.29 + 207           RUGE         + # (2007.432) + 0.23 * (207.20) + 0.58         1.29 + 69 + 1.29 + 69 + 1.29 + 34           # = AGE_METTER OFT PRIMATE (X)         1.29 + 69 + 1.29 + 69 + 1.29 + 34         SECTION 7.13 - SHAFT ENCLU 7.2 + DRAWED BETEMENTER OFT PRIMATE (X)           # = CALLACTED WOHN OF DELC WAR 20 OFT /* = RUMENTE COTTENDING THE CLEW XX 20 OFT /* = RUMENTE COTTENDING THE CLEW XX 20 OFT /* = RUMENTE CLEW XX 20 OFTEX STATUS         APPLIED CASE(S) - RUBS A. B, C, D & E         ALDWARE (HK)         PROPOSED (HK)           DETION 508 - MIXED USE AND DOCCUPANCY TABLE SOR 4 - REQUIRED SEMANTION OF DOCUMANCES (HOURS)         APPLIED CASE(S) - RUBS A. B, C, D & E         ALDWARE (HK)         PROPOSED (HK)           DETION 508 - MIXED USE AND DOCCUPANCY TABLE SOR 4 - REQUIRED SEMANTION OF DOCUMANCES (HOURS)         APPLIED CASE(S) - RUBS A. B, C, D & E         ALDWARE (HK)         PROPOSED (HK)           DETION 501 - GENERAL READED TO TO ALL MARK MULL COTTEND ELEMENTS (MOUNTS)         THE RED THE RED TO ALL THE RED TO TO ALL MARK MULL COTTEND COTTEND 501 - GENERAL         APPLIED CASE(S) - RUDS A. B, C, A D           BUILDING ELEMENT TO THE ALL MARK MULL COTTEND MULL SECTION CLASSIFICATION MULL SECTION SECTION CLASSIFICATION MULL SECTION SECTION CLASSIFICATION MULL	
4	
APPENDATION NUMBER 011, PARKING PUBLIC WAY > 20 FT       71.3 - CONSTRUCTION         P = DRUMERS 01 - PROMISE 011, PARKING PUBLIC WAY > 20 FT       71.3 - FREADED WITH SETTIC PUBLIC WAY OR UPEN STALE (FT)         TOTION 506 - MIXED USE AND OCCUPANCY       71.3 - FREADED WITH SETTIC PUBLIC WAY OR UPEN STALE (FT)       71.3 - FREADED WITH SETTIC PUBLIC WAY OR UPEN STALE (FT)         TOTION 506 - MIXED USE AND OCCUPANCY       MUTCANTIC STANDORS (HOURS)       71.3 - FREADED WITH SETIC PUBLIC WAY OR UPEN STALE (FT)         U       9.2       YES       NU       90.3.1.2         U       9.2       YES       NU       90.0.3.1.2         U       9.2       YES       NU       90.0.4.1.1.1.1.1.1.1.1.1.1.1.1.1.1.1.1.1.	
MULTIMING SHRINGHT PTR 3033.12       MULTIMING SHRINGHT PTR 30333.12       MULTIMING SHRINGHT PTR 303333.12       MULTIMING SHRINGHT PTR 30333.12 <td>N 707 OR HORIZ H. <b>RATINGS</b> HAVE A FIRE-RI NECTING FOUR</td>	N 707 OR HORIZ H. <b>RATINGS</b> HAVE A FIRE-RI NECTING FOUR
Image:	
THAT REQUIRED BY THE BUILDING         DIAL E GOL - FIRE-RESISTANCE RATING REQUIREMENTS FOR BUILDING         DIAL E GOL - FIRE-RESISTANCE RATING REQUIREMENTS FOR BUILDING         DIAL E GOL - FIRE-RESISTANCE RATING REQUIREMENTS FOR BUILDING         DIAL E GOL - FIRE-RESISTANCE RATING REQUIREMENTS FOR BUILDING         DIAL ELEMENTS         DIAL E GOL - FIRE-RESISTANCE RATING REQUIREMENTS FOR BUILDING         DIAL ELEMENTS         DIAL ELEMENTS         PRIME RESISTANCE RATING REQUIREMENTS FOR BUILDING         ELEMENTS (MURE) STUTCTION AUGUSTRUCTION TO BE ADJUSTED BY SECTIONS         DIAL ELEMENTS TO PED ALLS STUTCTION TO BE ADJUSTED BY SECTIONS         PRIME RESISTANCE RATING REQUIREMENTS FOR BUILDING         PRIME RESISTANCE RATING REQUIREMENTS FOR BUILDING ELEMENTS IN V B (NON RATED CONSTRUCTION         NFPA 13R AUTOMATIC SPRINKLER SYSTEM COMPLIANT         SECTION 903 - AUTOMATIC         AUTOMATIC SPRINKLER SYSTEM COMPLIANT	<b>E RATING</b> NG OF HORIZON
TYPES OF CONSTRUCTION         CTION 601 - GENERAL         APPLIED CASE(S) - BLOGS A, B, C, A D         BUILDING ELEMENT         BUILDING ELEMENT         TYPE VB         PRIMARY STRUCTURAL FRAME; BEARING WALLS - EXTERIOR / INTERDIR, NONBEARING WALLS - EXTERIOR / MENDERS, RODO CONSTRUCTION AND ASSOCIATED SECONDARY MEMBERS, RODO CONSTRUCTION AND ADJOINTED SECONDARY MEMBERS, RODO CONSTRUCTION AND ADJOINTED SECONDARY MEMBERS, RODO CONSTRUCTION CLASSIFICATION       *0 HR         *SEE NOTE 1. INDER APPLIED CASE(S) FOR APPLICABILITY OF AND ADJOINTMENTS TO REQUIREMENTS FOR EXTERIOR WALLS BASED ON FIRE SEPARATION DISTANCE       *0 HR         *SEE NOTE 1. INDER APPLIED CASE(S) FOR APPLICABILITY OF AND ADJOINTMENTS TO REQUIREMENTS FOR EXTERIOR WALLS BASED ON FIRE SEPARATION DISTANCE FATING REQUIREMENTS FOR EXTERIOR WALLS BASED ON FIRE SEPARATION DISTANCE       APPLIED CASE(S) - BLOGS A, B, C, A D         WILED CASE(S) - FIRE-RESISTANCE RATING REQUIREMENTS FOR EXTERIOR WALLS BASED ON FIRE SEPARATION DISTANCE	
CTION 601 - GENERAL         Table 601 - FIRE-RESISTANCE RATING REQUIREMENTS FOR BUILDING ELEMENTS (HOURS)         BUILDING ELEMENT         BUILDING ELEMENT         PRIMARY STRUCTURAL FRAME; BERNOWALLS S CHERING XILLS OR PARTITIONS - SUFFERIOR / INTERIOR; NONBEARING WALLS OR PARTITIONS - SUFFERIOR / INTERIOR; INTERIOR; NONBEARING WALLS OR PARTITIONS - SUFFERIOR / INTERIOR; NEED ON STRUCTION AND ASSOCIATED SECONDARY MEMBERS CTION 602 - CONSTRUCTION CLASSIFICATION       NFPA 13R AUTOMATIC SPRINKLER SYSTEM COMPLIANT         SECTION 602 - CONSTRUCTION CLASSIFICATION       SECTION 903 - AUTOMATIC IF] 903.31.2 - NFPA 1 AUTOMATIC SPRINKLER INCLLIDING FOUNS STORM FEET IN HEIGHT ABOVE I INSTALLED THROUGHOU SOCIATED SECTION 602 - CONSTRUCTION CLASSIFICATION       SECTION 903 - AUTOMATIC IF] 903.31.2 - NFPA 1 AUTOMATIC SPRINKLER INCLLIDING FOUNS STORM FEET IN HEIGHT ABOVE I INSTALLED THROUGHOU SOCIATED SECTION 903 - RESISTANCE RATING REQUIREMENTS FOR EXTERIOR WHERE FIRE SEPARATION DISTANCE       APPLIED CASE(S) - BLOGS A, B, C, & D WHERE FIRE SEPARATION DISTANCE       903.31.2.1 - BALCOME SPRINKLER STATUS FOR EXTERIOR WHERE FIRE SEPARATION DISTANCE       903.31.2.1 - BALCOME SPRINKLER STATUS FOR EXTERIOR	
TABLE 601 - FIRE-RESISTANCE RATING REQUIREMENTS FOR BUILDING         BUILDING ELEMENT       TYPE Y-B         BUILDING ELEMENT       TYPE Y-B         PRIMARY STRUCTURAL FRAME; BEARING WALLS - EXTERIOR / INTERIOR; NONBERNIS WALLS 0R       BUILDING FLEMENT         PRIMARY STRUCTURAL FRAME; BEARING WALLS - EXTERIOR / INTERIOR; NONBERNIS WALLS 0R       *0 HR         SSOCIATED SECONDARY       *0 HR         SSOCIATED SECONDARY       *0 HR         SSOCIATED SECONDARY       *0 HR         ADJUSTMENTS TO REQUIRED FRE-RESISTANCE RATING REQUIREMENTS FOR EXTERIOR MULLS BASED ON FIRE-RESISTANCE RATING REQUIREMENTS FOR EXTERIOR       NFPA 13R AUTOMATIC SPRINKLER SYSTEM COMPLIANT         TABLE 602 - FIRE-RESISTANCE RATING REQUIREMENTS FOR EXTERIOR WALLS BASED ON FIRE SECONDARY       APPLIED CASE(S) - BLOGS A, B, C, & D         WHERE FIRE SEPARATION DISTANCE       APPLIED CASE(S) - BLOGS A, B, C, & D         WHERE FIRE SEPARATION DISTANCE       SPRINKLER PRITEERION	
PARTITIONS - EXTERIOR / INTERIOR; FLOOR CONSTRUCTION AND ASSOCIATED SECONDARY MEMBERS; ROOF CONSTRUCTION AND ASSOCIATED SECONDARYMEMBERS       *0 HR       NFPA 13R AUTOMATIC SPRINKLER SYSTEM COMPLIANT         **0 HR       *0 HR       *0 HR       SECTION 903 - AUTOMATIC         **0 HR       *0 HR       SECTION 903 - AUTOMATIC         ASSOCIATED SECONDARY MEMBERS       *0 HR       SECTION 903 - AUTOMATIC         **SEE NOTE 1. UNDER APPLIED CASE(S) FOR APPLICABILITY OF AND ADJUSTMENTS TO REQUIRED FIRE-RESISTANCE RATINGS       If 903.3.1.2 - NFPA 1         CTION 602 - CONSTRUCTION CLASSIFICATION       AUTOMATIC SPRINKLER INCLUDING FOUR STORIC FEET IN HEIGHT ABOVE O INSTALLED THROUGHOU       903.3.1.2.1 - BALCONE SPRINKLER PROTECTION DISTANCE         TABLE 602 - FIRE-RESISTANCE RATING REQUIREMENTS FOR EXTERIOR WALLS BASED ON FIRE SEPARATION DISTANCE       APPLIED CASE(S) - BLDGS A, B, C, & D WHERE FIRE SEPARATION DISTANCE BETWEEN UNIT EXTERIOR WALLS IS LESS THAN 10' - 0",       SPRINKLER PROTECTION	
*SEE NOTE 1. UNDER APPLIED CASE(S) FOR APPLICABILITY OF AND       [F] 903.3.1.2 - NFPA 1         ADJUSTMENTS TO REQUIRED FIRE-RESISTANCE RATINGS       AUTOMATIC SPRINKLER         CTION 602 - CONSTRUCTION CLASSIFICATION       FEET IN HEIGHT ABOVE ON INSTALLED THROUGHOUT         TABLE 602 - FIRE-RESISTANCE RATING REQUIREMENTS FOR EXTERIOR       APPLIED CASE(S) - BLDGS A, B, C, & D       903.3.1.2.1 - BALCONIE         WHERE FIRE SEPARATION DISTANCE       WHERE FIRE SEPARATION DISTANCE BETWEEN UNIT EXTERIOR WALLS IS LESS THAN 10' - 0",       SPRINKLER PROTECTION	SPRINKLEI
TABLE 602 - FIRE-RESISTANCE RATING REQUIREMENTS FOR EXTERIORAPPLIED CASE(S) - BLDGS A, B, C, & D903.3.1.2.1 - BALCONIEWALLS BASED ON FIRE SEPARATION DISTANCEWHERE FIRE SEPARATION DISTANCE BETWEEN UNIT EXTERIOR WALLS IS LESS THAN 10' - 0",SPRINKLER PROTECTION	SYSTEMS IN GRO S IN HEIGHT IN RADE PLANE SH
WALLS BASED ON FIRE SEPARATION DISTANCE       WHERE FIRE SEPARATION DISTANCE BETWEEN UNIT EXTERIOR WALLS IS LESS THAN 10' - 0",       SPRINKLER PROTECTION	
	IOR PATIOS OF I
DISTANCE (FT) CONSTRUCTION GROUPS R-2 NFPA 13R AUTOMATIC SPRINKLER SYSTEM COMPLIANT THERE IS A ROOF OR DE	
X < 5         ALL         1 HR           5 < X < 10	
10 < X < 30     V-B     0 HR       Y > 20     All     0 HR	NSE AND RESI
X > 30     ALL     0 HR       UICK-RESPONSE OR RE	SIDENTIAL AUTO
2018 IBC CHAPTER 7	
SI DWELLING L OCCUPANCIES	NITS AND SLEEF
CTION 705 - EXTERIOR WALLS SECTION 906 - FIRE EXTIN	JUISHERS

705.3 - BUILDINGS ON THE SAME LOT

EXCEPTION 1

TWO OR MORE BUILDINGS ON THE SAME LOT SHALL BE EITHER REGULATED AS SEPARATE BUILDINGS OR SHALL BE CONSIDERED AS PORTIONS OF ONE BUILDING IF THE AGGREGATE AREA OF SUCH BUILDINGS IS WITHIN THE LIMITS SPECIFIED IN CHAPTER 5 FOR A SINGLE BUILDING.

#### 705.5 - FIRE-RESISTANCE RATINGS

EXTERIOR WALLS SHALL BE FIRE-RESISTANCE RATED IN ACCORDANCE WITH TABLES 601 AND 602 AND THIS SECTION. THE REQUIRED FIRE-RESISTANCE RATING OF EXTERIOR WALLS WITH A FIRE SEPARATION DISTANCE OF GREATER THAN 10 FEET SHALL BE RATED FOR EXPOSURE TO FIRE FROM THE INSIDE. THE REQUIRED FIRE-RESISTANCE RATING OF EXTERIOR WALLS WITH A FIRE SEPARATION DISTANCE OF LESS THAN OR EQUAL TO 10 FEET SHALL BE RATED FOR EXPOSURE TO FIRE FROM BOTH SIDES.

APPLIED CASE(S) - BLDGS A, B, C, & D

FIRE-RESISTANCE RATING PROVIDED FOR FIRE BARRIERS WHERE FIRE SEPARATION DISTANCE BETWEEN BUILDINGS IS LESS THAN 10' - 0", REFER TO SHEET A-000 FOR LOCATIONS OF IMAGINARY LOT LINES AND DISTANCES BETWEEN BUILDINGS.

#### APPLIED CASE(S) - BLDGS A, B, C, & D

FIRE-RESISTANCE RATING PROVIDED FOR FIRE BARRIERS WHERE FIRE SEPARATION DISTANCE BETWEEN BUILDINGS IS > 10' - 0" TYPICAL AT ALL BLDGS  $1 \text{ HR} \ge 1 \text{ HR}$ FIRE-RESISTANCE RATING PROVIDED FOR FIRE BARRIERS WHERE FIRE SEPARATION DISTANCE BETWEEN BUILDINGS OR TO NEAREST IMAGINARY LOT LINE IS < 10' - 0", AS AT WALLS ABUTTING EXTERIOR EXIT STAIRWAYS TYPICAL AT ALL BLDGS =  $1 \text{ HR} \ge 1 \text{ HR}$ 

SECTION 907 - FIRE ALARM AND DETECTION SYSTEMS 907.2.9 - GROUP R-2

AS REQUIRED BY OCCUPANCY.

APPLICABLE OCCUPANCIES: B, R-2

FIRE ALARM SYSTEMS AND SMOKE ALARMS SHALL BE INSTALLED IN

GROUP R-2 OCCUPANCIES AS REQUIRED IN SECTIONS 907.2.9.1 THROUGH 907.2.9.3.

### 2018 IBC CHAPTER 7 FIRE AND SMOKE PROTECTION FEATURES

BELOW:

APPLIED CASE(S) - BLDGS A, B, C, & D

AND OPENING CALCULATIONS.

THE WORST CASE FIRE SEPARATION DISTANCE (FSDwc) PROVIDED, AS MEASURED FROM

FSD<sub>wc</sub> = 20' - 0" BETWEEN EACH BLDG; 0.5(FSD<sub>wc</sub>) = IMAGINARY LOT LINE = *10' - 0"* 

ALL OTHER CASES APPLICABLE ARE ALLOWED AREA OF NO LIMIT PER TABLE 705.8

REFER TO CODE ELEVATIONS SHEET A-000 FOR ADDITIONAL INFORMATION.

FROM FACE OF BUILDING(S) TO INTERIOR LOT LINE, CENTERLINE OF STREET (PUBLIC RIGHT OF WAY), OR IMAGINARY LINE BETWEEN TWO BUILDINGS ON THE SAME LOT PROVIDED

REFER TO CALCULATIONS AND TABLE PROVIDED IN A-000 SERIES FOR EXTERIOR ELEVATIONS

### COMPLY WITH SECTIONS 705.8.1

#### TERIOR WALL OPENINGS BASED ON GREE OF OPENING PROTECTION

PENING ON	ALLOWABLE AREA	
ECTED, RED (UP, NS)	10%	
ECTED, RED (UP, NS)	15%	
ECTED, RED (UP, NS)	25%	
ECTED, RED (UP, NS)	45%	
ECTED, RED (UP, NS)	70%	
ECTED, RED (UP, NS)	NO LIMIT	
BI III NINGS NAT FALIIPPEN		

BUILDINGS NOT EQUIPPED PRINKLER SYSTEM IN ACCORDANCE

RESISTANCE RATING OF NOT LESS THAN

APPLIED CASE(S) - BLDGS A, B, C, & D FIRE-RESISTANCE RATING PROVIDED AT FIRE PARTITIONS WHERE DWELLING UNITS ARE SEPARATED AT WALLS SHARED BY TWO ADJOINING APARTMENT UNITS TYPICAL AT BLDGS A-D,

RUCTED AS FIRE BARRIERS IN HORIZONTAL ASSEMBLIES IN ACCORDANCE

RE-RESISTANCE RATING OF NOT LESS FOUR STORIES OR MORE, AND NOT ING LESS THAN FOUR STORIES.

IES

RIZONTAL ASSEMBLIES SHALL COMPLY 11.2.4.6 BUT SHALL BE NOT LESS THAN E OF CONSTRUCTION.

AND PROVIDED THAT AN AUTOMATIC SPRINKLER SYSTEM COMPLIANT WITH SECTION 903 = 1 HR

APPLIED CASE(S) - BLDGS A, B, C, & D FIRE BARRIERS PROVIDED AT AUTOMATIC SPRINKLER PLUMBING RISER CHASES, AS LOCATED AT EACH UNIT STACK. FIRE-RESISTANCE RATING OF FIRE BARRIERS ENCLOSING CHASES SPECIFIED BELOW.

GREATEST NUMBER OF BUILDING LEVELS CONNECTED BY SHAFT =  $3 \le 4$ FIRE-RESISTANCE RATING PROVIDED AT SHAFT FIRE BARRIERS = 1 HR

APPLIED CASE(S) - BLDGS A, B, C, & D CONSTRUCTION TYPE = V-BAUTOMATIC SPRINKLER SYSTEM = NFPA 13R FIRE-RESISTANCE RATING PROVIDED AT HORIZONTAL FLOOR ASSEMBLIES SEPARATING DWELLING UNITS = *1 HR* > 0.5 HR

## 2018 IBC CHAPTER 9 FIRE PROTECTION SYSTEMS

### KLER SYSTEMS

KLER SYSTEMS N GROUP R OCCUPANCIES UP TO AND T IN BUILDINGS NOT EXCEEDING 60 NE SHALL BE PERMITTED TO BE DANCE WITH NFPA 13R.

PROVIDED FOR EXTERIOR BALCONIES, S OF DWELLING UNITS AND SLEEPING TYPE V CONSTRUCTION, PROVIDED

RESIDENTIAL SPRINKLERS STEMS ARE REQUIRED BY THIS CODE, \_ AUTOMATIC SPRINKLERS SHALL BE IG AREAS IN ACCORDANCE WITH

SLEEPING UNITS IN GROUP R

906.1 - PORTABLE FIRE EXTINGUISHERS PORTABLE EXTINGUISHERS SHALL BE INSTALLED

APPLIED CASE(S) - BLDGS A, B, C, & D GREATEST BUILDING HEIGHT PROVIDED = 44' - 4" < 60' - 0" OK GREATEST NUMBER OF BUILDING STORIES PROVIDED =  $3 \le 3$  OK NFPA 13R AUTOMATIC SPRINKLER SYSTEM COMPLIANT

APPLIED CASE(S) - BLDGS A, B, C, & D GROUND-LEVEL PATIOS PROPOSED AT UNITS LOCATED AT LEVEL L-1 BALCONIES PROPOSED AT UNITS LOCATED AT LEVELS L-2 AND L-3

BALCONIES AND GROUND-LEVEL PATIOS SHALL HAVE UNDER-MOUNTED SPRINKLERS INSTALLED AS TYPICAL UNLESS NOTED OTHERWISE. AUTOMATIC SPRINKLER SYSTEM SHALL COMPLY WITH THE CODE REQUIREMENTS DESCRIBED IN SECTION 903

APPLIED CASE(S) - BLDGS A, B, C, & D (R-2) DWELLING UNITS PROPOSED

AUTOMATIC SPRINKLER SYSTEM SHALL BE FIT WITH QUICK-RESPONSE COMPONENTS ACCORDING TO 903.3.1 REQUIREMENTS IN APARTMENT UNITS

APPLIED CASE(S) - BLDGS A, B, C, & D PER EXCEPTION 2, R-2: ONE EXTINGUISHER RATED 1-A:10-B:C PER SHALL BE REQUIRED IN EACH DWELLING UNIT, ONE PROVIDED PER UNIT

B OCCUPANCIES TO BE OUTFITTED WITH FIRE EXTINGUISHERS PER 906

APPLIED CASE(S) - BLDGS A, B, C, & D MANUAL FIRE AND SMOKE ALARMS TO BE INSTALLED AT EACH R-2 APARTMENT UNIT

\*FIRE PROTECTION DEFERRED TO SUBMITTED UNDER SEPARATE PERMIT. FIRE PROTECTION CONTRACTOR SHALL COMPLY WITH ALL CODE REQUIREMENTS STIPULATED HEREIN AS WELL AS ADDITIONAL REQUIREMENTS AS STIPULATED BY 2018 IFC AND OTHER APPLICABLE CODES.



æ ω 

MARK	REVIS	SION	DATE
PROJ	JECT NO:	050-01-	21
PRIN	CIPAL-IN-CHARGE		BF
<u></u>		•	
PROJECT ARCHITECT:		MJ	
DRAV	VN BY:		<u>    HL    </u>

PROJECT STATUS: PERMIT SET 05.06.2022

SHEET TITLE: CODE SUMMARY

SHEET NO.

### SECTION 1004 - OCCUPANT LOAD

#### 1004.1 - DESIGN OCCUPANT LOAD MEANS OF EGRESS REQUIREMENTS SHALL BE BASED ON THE OCCUPANTS FOR WHOM MEANS OF EGRESS FACILITIES ARE PROVIDED.

#### TABLE 1004.1.2 - MAXIMUM FLOOR AREA ALLOWANCES PER OCCUPANT

FUNCTION OF SPACE	OCCUPANT LOAD FACTOR
BUSINESS AREAS	150 GROSS
RESIDENTIAL	200 GROSS
STORAGE	300 GROSS

### SECTION 1005 - MEANS OF EGRESS SIZING

#### 1005.3.1 - STAIRWAYS

THE CAPACITY, IN INCHES, OF MEANS OF EGRESS STAIRWAYS SHALL BE CALCULATED BY MULTIPLYING THE OCCUPANT LOAD SERVED BY SUCH STAIRWAYS BY A MEANS OF EGRESS CAPACITY FACTOR OF 0.3 INCH PER OCCUPANT. WHERE STAIRWAYS SERVE MORE THAN ONE STORY, ONLY THE OCCUPANT LOAD OF EACH STORY CONSIDERED INDIVIDUALLY SHALL BE USED IN CALCULATING THE REQUIRED CAPACITY OF THE STAIRWAYS SERVING THAT STORY.

EXCEPTIONS:

1. FOR OTHER THAN GROUP H AND I-2 OCCUPANCIES, THE CAPACITY, IN INCHES, OF MEANS OF EGRESS STAIRWAYS SHALL BE CALCULATED BY MULTIPLYING THE OCCUPANT LOAD SERVED BY SUCH STAIRWAYS BY A MEANS OF EGRESS CAPACITY FACTOR OF 0.2 INCH PER OCCUPANT IN BUILDINGS EQUIPPED THROUGHOUT WITH AN AUTOMATIC SPRINKLER SYSTEM INSTALLED IN ACCORDANCE WITH SECTION 903.3.1.2 AND AN EMERGENCY VOICE/ALARM COMMUNICATION SYSTEM IN ACCORDANCE WITH SECTION 907.5.2.2.

#### SECTION 1006 - NUMBER OF EXITS AND EXIT ACCESS DOORWAYS

1006.2.1 - EGRESS BASED ON OCCUPANT LOAD AND COMMON PATH OF EGRESS TRAVEL DISTANCE

EXCEPTION 1 IN GROUP R-2 OCCUPANCY, ONE MEANS OF EGRESS IS PERMITTED WITHIN AND FROM INDIVIDUAL DWELLING UNITS WITH A MAXIMUM OCCUPANT LOAD OF 20 WHERE THE DWELLING UNIT IS EQUIPPED THROUGHOUT WITH AN AUTOMATIC SPRINKLER SYSTEM IN ACCORDANCE WITH SECTION 903.3.1.2 AND THE COMMON PATH OF EGRESS TRAVEL DOES NOT EXCEED 125 FT.

#### SECTION 1008 - MEANS OF EGRESS ILLUMINATION

#### 1008.2 - ILLUMINATION LEVEL UNDER NORMAL POWER

TWO EXITS OR EXIT ACCESS DOORWAYS FROM ANY SPACE SHALL BE PROVIDED WHERE THE DESIGN OCCUPANT LOAD OR THE COMMON PATH OF EGRESS TRAVEL DISTANCE EXCEEDS THE VALUES LISTED IN TABLE 1006.2.1.

#### 1008.3 - EMERGENCY POWER FOR ILLUMINATION

IN EVENT OF A FULL POWER FAILURE IN ROOMS REQUIRING > 2 MEANS OF EGRESS, EMERGENCY ELECTRICAL SYSTEM SHALL AUTOMATICALLY ILLUMINATE AISLES, CORRIORS AND EXIT ACCESS STAIRWAYS AND RAMPS AND THE FOLLOWING AREAS FOR A MINIMUM OF 90-MINUTES MEETING ILLUMINATION MINIMUMS OF 0.1 FOOT CANDLE (FC) AND NOT LESS THAN 1FC AVERAGE ALONG THE PATH OF EGRESS AT FLOOR LEVEL:

- INTERIOR AND EXTERIOR EXIT STAIRWAYS AND RAMPS EXIT PASSAGEWAYS
- VESTIBULES AND AREAS ON THE LEVEL OF
- DISCHARGE USED FOR EXIT DISCHARGE IN
- ACCORDANCE WITH SECTION 1028.1
- EXTERIOR LANDINGS AS REQUIRED BY SECTION 1010.1.6 FOR EXIT DOORWAYS LEADING DIRECTLY TO EXIT DISCHARGE

#### **SECTION 1011 - STAIRWAYS**

1011.2 - WIDTH AND CAPACITY

THE REQUIRED CAPACITY OF STAIRWAYS SHALL BE DETERMINED AS SPECIFIED IN SECTION 1005.1, BUT THE MINIMUM WIDTH SHALL BE NOT LESS THAN 44 INCHES. SEE SECTION 1009.3 FOR ACCESSIBLE MEANS OF EGRESS STAIRWAYS.

#### EXCEPTIONS:

1. STAIRWAYS SERVING AN OCCUPANT LOAD OF LESS THAN 50 SHALL HAVE A WIDTH OF NOT LESS THAN **36 INCHES**.

#### SECTION 1017 - EXIT ACCESS TRAVEL DISTANCE

#### 1017.2 - LIMITATIONS

EXIT ACCESS TRAVEL DISTANCE SHALL NOT EXCEED THE VALUES GIVEN IN THE TABLE 1017.2:

### TABLE 1017.2 - EXIT ACCESS TRAVEL DISTANCE

OCCUPANCY	WITH SPRINKLER SYSTEM [FT]
RESIDENTIAL	250 FT*
BUSINESS	300 FT*

\*BUILDING EQUIPPED WITH AUTOMATIC SPRINKLER SYSTEM IN ACCORDANCE WITH 903.3.1.2

#### 1017.3.1 - EXIT ACCESS STAIRWAYS AND RAMPS

TRAVEL DISTANCE ON EXIT ACCESS STAIRWAYS SHALL BE INCLUDED IN THE EXIT ACCESS TRAVEL DISTANCE MEASUREMENT. THE MEASUREMENT ALONG STAIRWAYS SHALL BE MADE ON A PLANE PARALLEL AND TANGENT TO THE STAIR TREAD NOSINGS IN THE CENTER OF THE STAIR AND LANDINGS.

APPLIED CASE(S) - BLDGS A, B, C, & D

REFER TO A-000 SERIES - CODE PLANS FOR OCCUPANCY AND OCCUPANT LOAD BY SPACE, INCLUDING TRIBUTARY AND CUMULATIVE LOADS

### APPLIED CASE(S) - BLDGS A, B, C & D

THE FOLLOWING TABLE DOCUMENTS THE WORST CASE IN TERMS OF GREATEST 1 CUMULATIVE OCCUPANT LOAD TABULATED FOR EACH EXTERIOR EXIT STAIR TO DEMONSTRATE GREATEST NUMBER OF OCCUPANTS SERVED. DESPITE COMPLIANCE WITH 1005.3.1

	GREATEST NO. OF	REQUIRED WIDTH	STAIR WIDTH
	OCCS. SERVED	(OCC.*0.2")	PROVIDED
BLDG A-D:	17	3.4" (36" MIN. PER 1011.2)	48"

#### APPLIED CASE(S) - BLDGS A, B, C & D TABLE 1006 2.1 - SPACES WITH ONE EXIT OR EXIT ACCESS DOORWAY

TADLE 1000.2.1 SFA	LES WITH UNE EATT OR EAT	TAULISS DUURWAT
OCCUPANCY	MAX OCC LOAD OF SPACE	MAX COMMON PATH OF EGRESS TRAVEL DISTANCE (WITH SPRINKLER SYSTEM [FT])
BUSINESS	ALLOWABLE: 49	ALLOWABLE: 100 FT*
(BLDG A)	PROVIDED: 10	PROVIDED: 16'-10"
RESIDENTIAL (R-2)	ALLOWABLE: 20	ALLOWABLE: 125 FT*
(ALL BLDGS)	PROVIDED: 17	PROVIDED: 110'-4"

\*BUILDINGS EQUIPPED THROUGHOUT WITH AN AUTOMATIC SPRINKLER SYSTEM INSTALLED IN ACCORDANCE WITH 903.3.1.2, REFER TO SHEET A-000 SERIES FOR COMMON PATH OF EGRESS TRAVEL DISTANCES.

#### APPLIED CASE(S) - BLDGS A, B, C & D

LIGHTING PROVIDED FOR MEANS OF EGRESS ILLUMINATION: EXCEPT WHERE EXEMPT IN GROUPS R-2, MEANS OF EGRESS ILLUMINATION PROVIDED MINIMUM 1 FOOT CANDLE (fc) AT WALKING SURFACE IN COMPLIANCE WITH SECTION 1008.3

#### APPLIED CASE(S) - BLDGS A, B, C & D

LIGHTING PROVIDED IN EVENT OF POWER FAILURE: 1. DURATION OF EMERGENCY POWER PROVIDED, NOT LESS THAN 90-MINUTES IN COMPLIANCE WITH SECTION 1008.3.4

- 1008.3.5 ILLUMINATION MEETING THE MINIMUM 1fc AVERAGE , MEANS OF EGRESS 2. ILLUMINATION PROVIDED MINIMUM 1 FOOT CANDLE AT WALKING SURFACE IN 3
- COMPLIANCE WITH SECTION 1008.3 IN ROOMS AND SPACES REQUIRING > 2 MEANS OF EGRESS AND/OR AS REQUIRED BY SECTION 1008.3.3 EMERGENCY LIGHTS PROVIDING ILLUMINATION MINIMUM OF 0.1fc PROVIDED ALONG 4.
- PATH OF EGRESS AT FLOOR LEVEL. MAXIMUM-TO-MINIMUM ILLUMINATION UNIFORMITY RATIO OF 40:1 NOT EXCEEDED

## APPLIED CASE(S) - BLDGS A, B, C & D

TYPICAL BIDDER-DESIGNED EXTERIOR STAIR WIDTH PROVIDED = 48" > 36"

### APPLIED CASE(S) - BLDGS A, B, C & D

EXIT ACCESS TRAVEL DISTANCE MEASURED IN ACCORDANCE WITH 1017.3.1 FROM THE WORST-CASE RESIDENTIAL UNIT, EXTERIOR STAIR EXIT ACCESS PROVIDED = 110'-4"

#### 110' - 4" < 250' - 0" [ALL BUILDINGS]

REFER TO A-000 SERIES CODE PLANS FOR WORST-CASE DISTANCES PER BUILDING.

REF. A-000 - CODE PLAN SERIES FOR TYPICAL EXIT ACCESS STAIRWAY TRAVEL DISTANCE INFORMATION.

107

ACCESSIBILITY SECTION 1104 - ACCESSIBLE ROUTE 1104.1 - SITE ARRIVAL POINTS, 1104.2 - WITHIN A SITE AT LEAST ONE ACCESSIBLE ROUTE WITHIN THE SITE SHALL BE PROVIDED REF. A-000 CODE SITE PLAN FOR ACCESSIBLE ROUTES WITHIN THE PROJECT SITE FROM ACCESSIBLE PARKING AND SIDEWALKS TO THE ACCESSIBLE

2018 IBC CHAPTER 11

APPLIED CASE(S) - BLDGS A, B, C, & D

PROJECT PROPOSES 119 PARKING STALLS PER TABLE 1106.1.

(6) STALLS SHALL BE ACCESSIBLE (ONE PER TYPE A UNIT).

ONE SHALL BY A VAN ACCESSIBLE PARKING SPACE.

TOTAL RESIDENTIAL UNITS PROVIDED = 95 > 10

TYPE A UNIT LOCATIONS:

(6) TYPE A UNITS TO BE PROVIDED

REFER TO UNIT LOCATION KEY PLAN

(1) VAN ACCESSIBLE PARKING SPACE IS REQUIRED.

TOTAL TYPE A UNITS REQUIRED = 95 \* 0.05 = 5 UNITS

PER 1106.5, FOR EVERY SIX, OR FRACTION OF SIX ACCESSIBLE PARKING SPACES, AT LEAST

BUIDLING ENTRANCE SERVED, AT LEAST ONE ACCESSIBLE ROUTE SHALL CONNECT ACCESSIBLE BUILDINGS, ELEMENTS AND PARKING SPACES ON THE SAME SITE.

#### 1106 - PARKING AND PASSENGER LOADING FACILITIES WHERE PARKING IS PROVIDED. ACCESSIBLE PARKING SPACES SHALL BE PROVIDED IN COMPLIANCE WITH TABLE 1106.1


WHERE AT LEAST ONE PARKING SPACE IS PROVIDED FOR EACH DWELLING UNIT, AT LEAST ONE ACCESSIBLE PARKING SPACE SHALL BE PROVIDED FOR EACH TYPE A UNIT.

### 1107.6 - DWELLING UNITS AND SLEEPING UNITS

UNIT LOCATION KEY PLAN

IN GROUP R-2, OCCUPANCIES CONTAINING MORE THAN (10) DWELLING UNITS, 5% SHALL BE A "TYPE A" UNIT. TYPE A UNITS SHALL BE DISTRIBUTED AMONG THE VARIOUS CLASSES OF UNITS. ON SITES WITH MORE THAN (4) DWELLING UNITS, UNITS SHALL BE DESIGNATED AS A TYPE B UNIT.

WHERE ELEVATOR SERVICE IS NOT PROVIDED IN A STRUCTURE. ONLY THE DWELLING UNITS AND SLEEPING UNITS THAT ARE LOCATED ON STORIES INDICATED IN SECTIONS 1107.7.1.1 AND 1107.7.1.2 ARE REQUIRED TO BE TYPE A AND TYPE B UNITS, RESPECTIVELY.

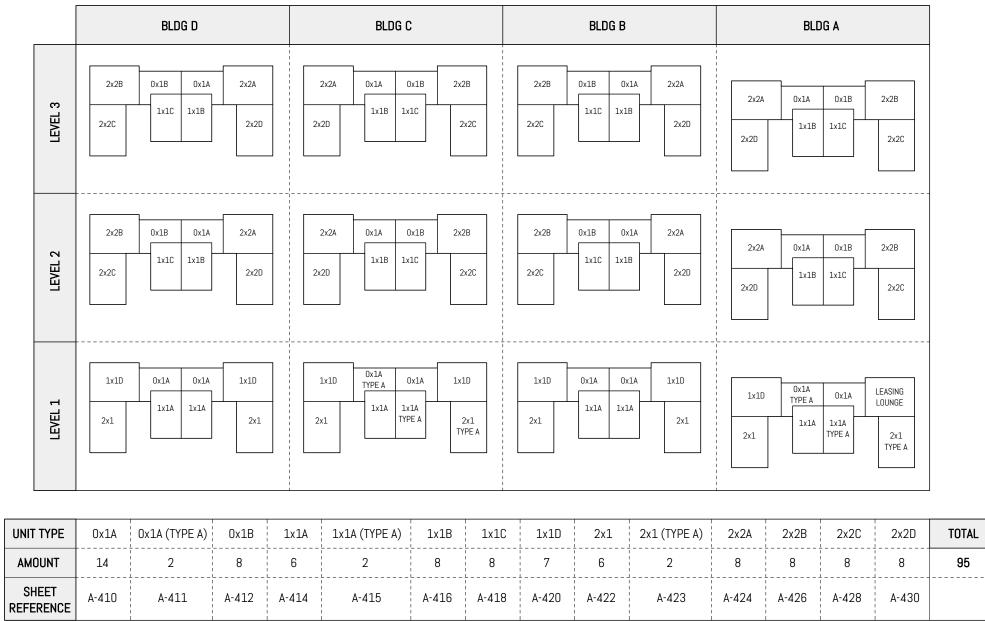

### 2018 IBC CHAPTER 12 INTERIOR ENVIRONMENT

### **SECTION 1202 - VENTILATION**

#### 1202.2 - ATTIC SPACES

BLOCK AND BRIDGING SHALL BE ARRANGED TO NOT INTERFERE WITH MOVEMENT OF AIR, AND A 1" AIR SPACE SHALL BE PROVIDED BETWEEN INSULATION AND ROOF SHEATHING. THE NET FREE VENTILATING AREA SHALL BE NOT LESS THAN 1/150 OF THE AREA OF THE SPACE VENTILATED. VENTILATORS SHALL BE INSTALLED IN ACCORDANCE WITH MANUFACTURER'S INSTALLATION INSTRUCTIONS.

EXCEPTION 1: NET CROSS VENTILATION AT ENCLOSED ATTICS AND RAFTER SPACES FORMED WHERE CEILINGS ARE APPLIED DIRECTLY TO THE UNDERSIDE OF ROOF FRAMING MEMBERS SHALL BE 1/300 PROVIDED:

A CLASS I OR II VAPOR RETARDER IS INSTALLED ON THE WARM 1. IN WINTER SIDE OF THE CEILING [SEE ASSEMBLIES A-011]. AT LEAST 40% AND NOT MORE THAN 50% OF THE REQUIRED

VENTING AREA IS PROVIDED IN THE UPPER PORTION OF THE ATTIC. UPPER VENTILATORS SHALL BE SPACED NOT MORE THAN 3'-0" BELOW THE RIDGE, MEASURED VERTICALLY, WITH THE BALANCE OF THE VENTILATION PROVIDED BY EAVE OR CORNICE VENTS.

#### APPLIED CASE(S) - BLDGS A, B, C & D

REFER TO A-110 SERIES ROOF PLANS FOR ATTIC VENTILATION PROVIDED. DESIGN LOADS 

DETERMINED USING CODE PRESCRIPTIVE 1:300 RATIO BETWEEN AREA OF SPACE VENTILATED AND				E VENTILATED AND
NET FREE	E VENTILATING AREA, TOTA <b>ROOF AREA</b>	ls provided in SF. <b>Required Area</b>	PROVIDED AREA	VENTILATION AT RIDGE $[40\% \le X \le 50\%]$
BLDG A:	9,485 SF	32 SF	33 SF	49%
BLDG B:	9,485 SF	32 SF	33 SF	49%
BLDG C:	9,485 SF	32 SF	33 SF	49%
BLDG D:	9,485 SF	32 SF	33 SF	49%

## SECTION 2902 - MINIMUM PLUMBING FACILITIES

PUBLIC (NON-RESIDENTIAL) PLUMBING FACILITIES ARE FAMILY / SINGLE USER TOILET FACILITIES. TABLE 2902.1 - MINIMUM NUMBER OF REQUIRED PLUMBING FIXTURES [LEASING OFFICE | BUILDING A]

SECTION 4 - [CE] COMMERCIA C402.4 - FENESTRATION	AL ENERGY E	EFFICIENCY	
TABLE C402.4 - BUILDING E U-FACTOR AND SHGC REQU		RATION MAXIM	
CLIMATE ZONE	5 AND M	ARINE 4	
U-factor for Class AW w with AAMA/CSA101/I. walls and site-built	S.2/A440, vertica	al curtain	
Fixed <sup>b</sup> U-factor	U-0	.38	
Operable <sup>c</sup> U-factor	U-0	.40	
Entran	Entrance doors <sup>d</sup>		
U-factor	U-0	.60	
U-factor for all oth	U-factor for all other vertical fenestration		
U-factor	U-0	.30	
SHGC for all vertical fen	SHGC for all vertical fenestration		
ORIENTATION <sup>e, f</sup>	SEW	N	
PF < 0.2	0.38	0.51	
$0.2 \le PF \le 0.5$	0.46	0.56	
PF ≥ 0.5	0.61	0.61	
Sk	ylights		
U-factor	U-0	.50	
SHGC	0.3	35	

## 2018 IBC CHAPTER 29 PLUMBING SYSTEMS

ALL CUMULATIVE SQUARE FOOTAGE AT OFFICES: 746 SF / 150 OLF = 5 OCCUPANTS PER 2902.2 EXCEPTION 5, SEPARATE FACILITIES ARE NOT REQUIRED. WATER CLOSET REQUIRED = 1, LAVATORY REQUIRED = 1

PER 2902.5.1, OCCUPANT LOADS UNDER 30 DO NOT REQUIRE DRINKING FOUNTAINS

### APPLIED CASE

1 PROVIDED WATER CLOSET / 1 PROVIDED LAVATORY NO DRINKING FOUNTAINS PROVIDED



## WASHINGTON STATE **ENERGY CODE**

VALUE METHOD

CLIMATE ZONE All Other Group R Roofs nsulation entirely R-38ci R-38ci above deck

OPAQUE THERMAL ENVELOPE INSULATION COMPONENT MINIMUM REQUIREMENTS, R-

5 AND MARINE 4

C402.1.3 - INSULATION COMPONENT R-VALUE

Metal buildings <sup>b</sup>	R-25 + R-11 LS	R-25 + R-11 LS
Attic and other	R-49	R=49
3	Valls, Above Grade	
Mass <sup>h</sup>	R-9.5 <sup>c</sup> ci	R-13.3ci
Mass transfer deck slab edge	R-5	R-5
Metal building	R-19ci or R-13 + R-13ci	R-19ci or R-13 + R-13ci
Steel framed	R-13 + R-10ci	R-19 + R-8.5ci
Wood framed and other	R-21 int or R-15 + R-5ci std	R-13 + R-7.5ci std or R-20 + R-3.8ci std or R-25 std
	Walls, Below Grade	
Below-grade wall <sup>d, h</sup>	Same as above grade	Same as above grade
	Floors	
Mass <sup>f</sup>	R-30ci	R-30ci
Joist/framing	R-30 <sup>e</sup>	R-30 <sup>e</sup>
s	lab-on-Grade Floors	
Unheated slabs	R-10 for 24" below	R-10 for 24" below
Heated slabs <sup>d</sup>	R-10 perimeter & under entire slab	R-10 perimeter & under entire slab
	Opaque Doors <sup>g</sup>	
Nonswinging	R-4.75	R-4.75


Z 1  $\infty$ 

MARK	REV	ISION	DATE
PRO	JECT NO:	050-01-	21
PRIN	CIPAL-IN-CHARGE	Ξ:	BF
PROJ	JECT ARCHITECT:		MJ
DRAV	WN BY:		HL
PRO	JECT STATUS:		
PE	RMIT SET	-	
በፍ	.06.2022	1	
00	.00.2022		
SHEE	et title:		

CODE SUMMARY

G-003

SHEET NO.

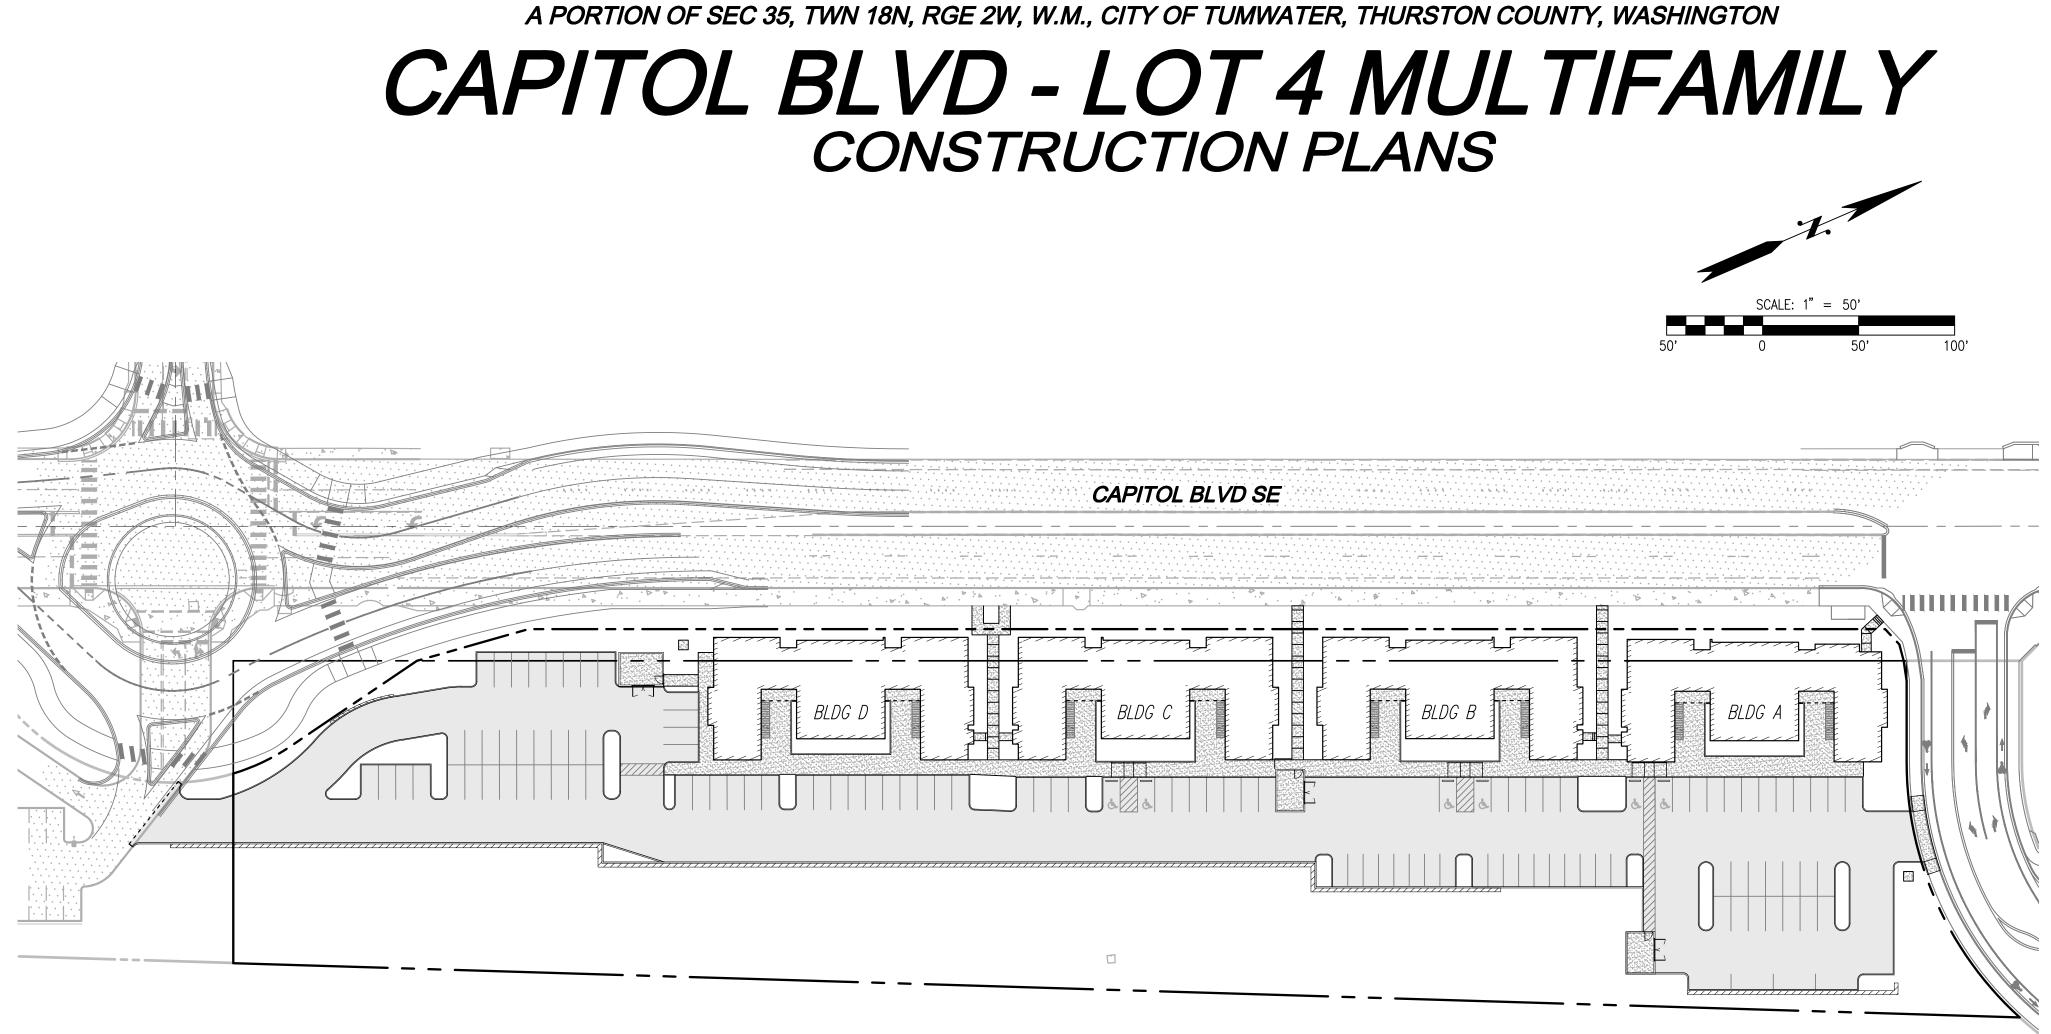

## I FGEND AND ABBREVIATIONS

<u>LEGEND</u>	<u>AND ABBREV</u>
	SYMBOLS
SYMBOL	DESCRIPTION
$\odot_{D}$	STORM MANHOLE
	STORM CATCH BASIN
$O_{s}$	SEWER MANHOLE
	FIRE HYDRANT
$\boxtimes \!$	WATER VALVE
	IRRIGATION BOX
-0 <u>-</u>	POWER POLE
(	GUY ANCHOR
×	STREET LIGHT
$\bigcirc$	DECIDUOUS TREE
PROPOSED W	VATER SYMBOLS
SYMBOL	DESCRIPTION
С	WATER CAP
	CONCRETE BLOCKING
M	BUTTERFLY VALVE
$\mathbf{r}$	11° BEND
چ ا	45° BEND
Å-I	90° BEND
×	22° BEND
, M	VALVE
<b>_</b>	HYDRANT ASSEMBLY
•	BLOW-OFF VALVE
•	REDUCER
*⊛_	AIR-VAC ASSEMBLY
	WATER METER
	WATER PIPE
PROPOSED S	EWER SYMBOLS
SYMBOL	DESCRIPTION
С	SEWER CAP
0	SEWER CLEANOUT
	SEWER MANHOLE
	SEWER PIPE

AE	BREVIATIONS
СВ	CATCH BASIN
¢	CENTERLINE
СМР	CORRUGATED METAL PIPE
CP	CONCRETE PIPE
EL	ELEVATION
EXIST.	EXISTING
f	FLOWLINE
IE	INVERT ELEVATION
LCPE	LINE CORRUGATED POLYETHYLENE
Æ	PROPERTY LINE
PP	POWER POLE
PVC	POLYVINYL CHLORIDE PIPE
R/W	RIGHT-OF-WAY
STA	STATION
SD	STORM DRAIN
SS	SANITARY SEWER
SSMH	SANITARY SEWER MANHOLE
SWPE	SOLID WALL POLYETHYLENE PIPE
TYP	TYPICAL
TBR	TO BE REMOVED
	D STORM SYMBOLS
SYMBOL	DESCRIPTION
	TYPE 1 CATCH BASIN, GRATED LIE
	TYPE 1 CATCH BASIN, SOLID LID
	TYPE 2 CATCH BASIN, GRATED LIE
	TYPE 2 CATCH BASIN, SOLID LID
	BEEHIVE MANHOLE COVER
	SQUARE YARD DRAIN
•	ROUND YARD DRAIN
0	STORM CLEAN OUT

STORM PIPE

TABLE OF CONTENTS		
1	<u>CS-01</u>	COVER SHEE
2	ER-01	TESC PLAN
3	ER-02	TESC PLAN
4	ER-03	TESC NOTES
5	SP-01	SITE PLAN
6	SP-02	SITE PLAN
7	SP-03	SITE PLAN NO
8	SP-04	SITE PLAN NO
9	GR-01	GRADING PL
10	GR-02	GRADING PL
11	GR-03	WALL PROFIL
12	SD-01	STORM DRAI
13	SD-02	STORM DRAI
14	SD-03	STORM PROP
15	SD-04	STORM PROP
16	SD-05	STORM DRAI
17	SD-06	STORM DRAI
18	SS-01	SEWER PLAN
19	SS-02	SEWER NOTE
20	WA-01	WATER PLAN
21	WA-02	WATER NOTE
22	WA-03	WATER NOTE

ltem 7.

ET

SAND DETAILS

IOTES AND DETAILS IOTES AND DETAILS .AN AN LES INAGE PLAN NINAGE PLAN OFILES FILES INAGE NOTES AND DETAILS INAGE NOTES AND DETAILS ES AND DETAILS ES AND DETAILS TES AND DETAILS

### **PROJECT INFORMATION**

#### TAX PARCELS: SITE ADDRESS:

SITE AREA: CURRENT ZONING: PROPOSED LAND USE: PROPOSED BUILDING #1 AREA: PROPOSED BUILDING #2 AREA: PROPOSED BUILDING #3 AREA: PROPOSED BUILDING #4 AREA: FLOOR AREA RATIO: BUILDING HEIGHT PROPOSED IBC CONSTRUCTION TYPE: OPEN SPACE: (OUTSIDE WETLAND BUFFER) OPEN SPACE: (WITHIN WETLAND BUFFER) TOTAL OPEN SPACE: DENSITY REQUIRED: DENSITY PROVIDED: PARKING SPACES PROVIDED: WATER: SEWER: POWER: GAS: TELEPHONE: CABLE: SCHOOL DISTRICT: FIRE DISTRICT: PERCENT OF SITE IMPERVIOUS:

4200 CAPITOL BOULEVARD SE TUMWATER, WA 98501 151,121 SF 3.47 AC BREWERY DISTRICT (BD) MULTIFAMILY APARTMENTS ±6,564 SF ±6,564 SF ±6,564 SF ±6,430 SF SEE ARCHITECTURAL PLANS SEE ARCHITECTURAL PLANS TYPE II-B NON COMBUSTIBLE 17,601 SF (0.40 ACRES) 3,507 SF (0.08 ACRES)

33870000400

49,127 SF (1.13 ACRES) 20 DWELLING UNITS PER AC 96 TOTAL UNITS / 2.42 AC = 39.7 UNITS PER AC 119

CITY OF TUMWATER CITY OF TUMWATER PSE PSE COMCAST COMCAST TUMWATER SCHOOL DISTRICT

TUMWATER PAVED AREAS: 44% (67,075 SF) BUILDING AREAS: 17% (26,256 SF) TOTAL: 61%



OWNER: CRAFT DISTRICT, LLC 2840 BLACK LAKE BLVD SE #C TUMWATER, WA 98512 CONTACT: JOHN PETERS PHONE: (360) 760-8570

#### ARCHITECT: FERGUSON ARCHITECTURE 1916 JEFFERSON AVE TACOMA, WA 98402 CONTACT: BEN FERGUSON, AIA

PHONE: (253) 248–6060 GEOTECH: INSIGHT GEOLOGIC, INC. 1015 4TH AVE E OLYMPIA, WASHINGTON 98506 CONTACT: WILLIAM E. HALBERT, LHG, LEG

PHONE: (360) 754–2128 FAX: (360) 754–9299 EMAIL: billh@insightgeologic.com

### EARTHWORK QUANTITIES

CUT: FILL: NET: DISTURBED AREA:

9,000 CY 9,600 CY 600 CY FILL 139,500 SF (3.20 ACRES)

### UTILITY NOTE

THE CONTRACTOR SHALL VERIFY THE LOCATION OF ALL EXISTING UTILITIES PRIOR TO ANY CONSTRUCTION. AGENCIES INVOLVED SHALL BE NOTIFIED WITHIN A REASONABLE TIME PRIOR TO THE START OF CONSTRUCTION.


### DISCLAIMER

TOPOGRAPHIC SURVEY INFORMATION CONTAINED ON THESE PLANS HAS BEEN PROVIDED BY MTN2COAST, LLC. LDC, INC (LAND DEVELOPMENT CONSULTANTS, INC.) ASSUMES NO LIABILITY AS TO THE ACCURACY AND COMPLETENESS OF THIS DATA. ANY DISCREPANCIES FOUND BETWEEN WHAT IS SHOWN ON THE PLANS AND WHAT IS NOTED IN THE FIELD SHOULD BE BROUGHT IMMEDIATELY TO THE ATTENTION OF THE ENGINEER.

CIVIL ENGINEER:

LDC, INC. 1411 STATE AVE NE, STE 200 OLYMPIA, WA 98506 CONTACT: TYRELL E. BRADLEY, PE PHONE: (425) 806–1869 FAX: (425) 482–2893 EMAIL: tbradley@ldccorp.com

SURVEYOR: MTN 2 COAST, LLC 2320 MOTTMAN RD SW, SUITE 106 TUMWATER, WA 98512 CONTACT: SETH E. PRIGGE, PLS PHONE: (360) 688–1949

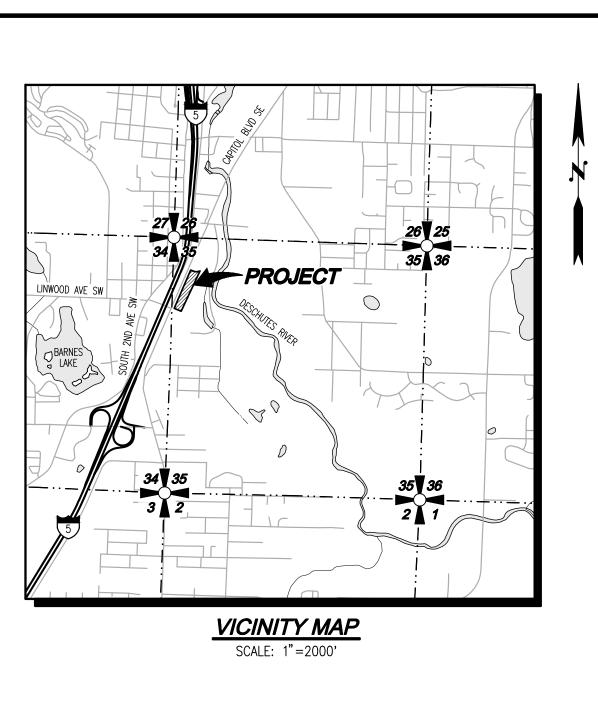

### SURVEY INFORMATION

### HORIZONTAL DATUM

WASHINGTON STATE PLANE COORDINATES. SOUTH ZONE. NAD 83/1991 BASED ON TIES TO THURSTON COUNTY CONTROL POINT GP34005-4T VERTICAL DATUM

NGVD 29 BASED ON TIES TO THURSTON COUNTY CONTROL POINT GP34005-4T ELEVATION=98.15

V 2× U DISTRICT AD AN NULTIF/ ROVER S CRAFT 4 U JOB NUMBER: C221

DRAWING NAME: C22174C-CS-DESIGNER: DRAFTING BY: DATE: 05/13/ SCALE: AS NOTE JURISDICTION: TUMWATE **CS-01** 

SHEET **1** OF **22** 





mon man Call 2 Business Days Before You Dig 811 or 1-800-424-5555

FOR THE CITY OF TUMWATER

Date: CITY ENGINEER

EXPIRES ONE YEAR FROM ACCEPTANCE DATE

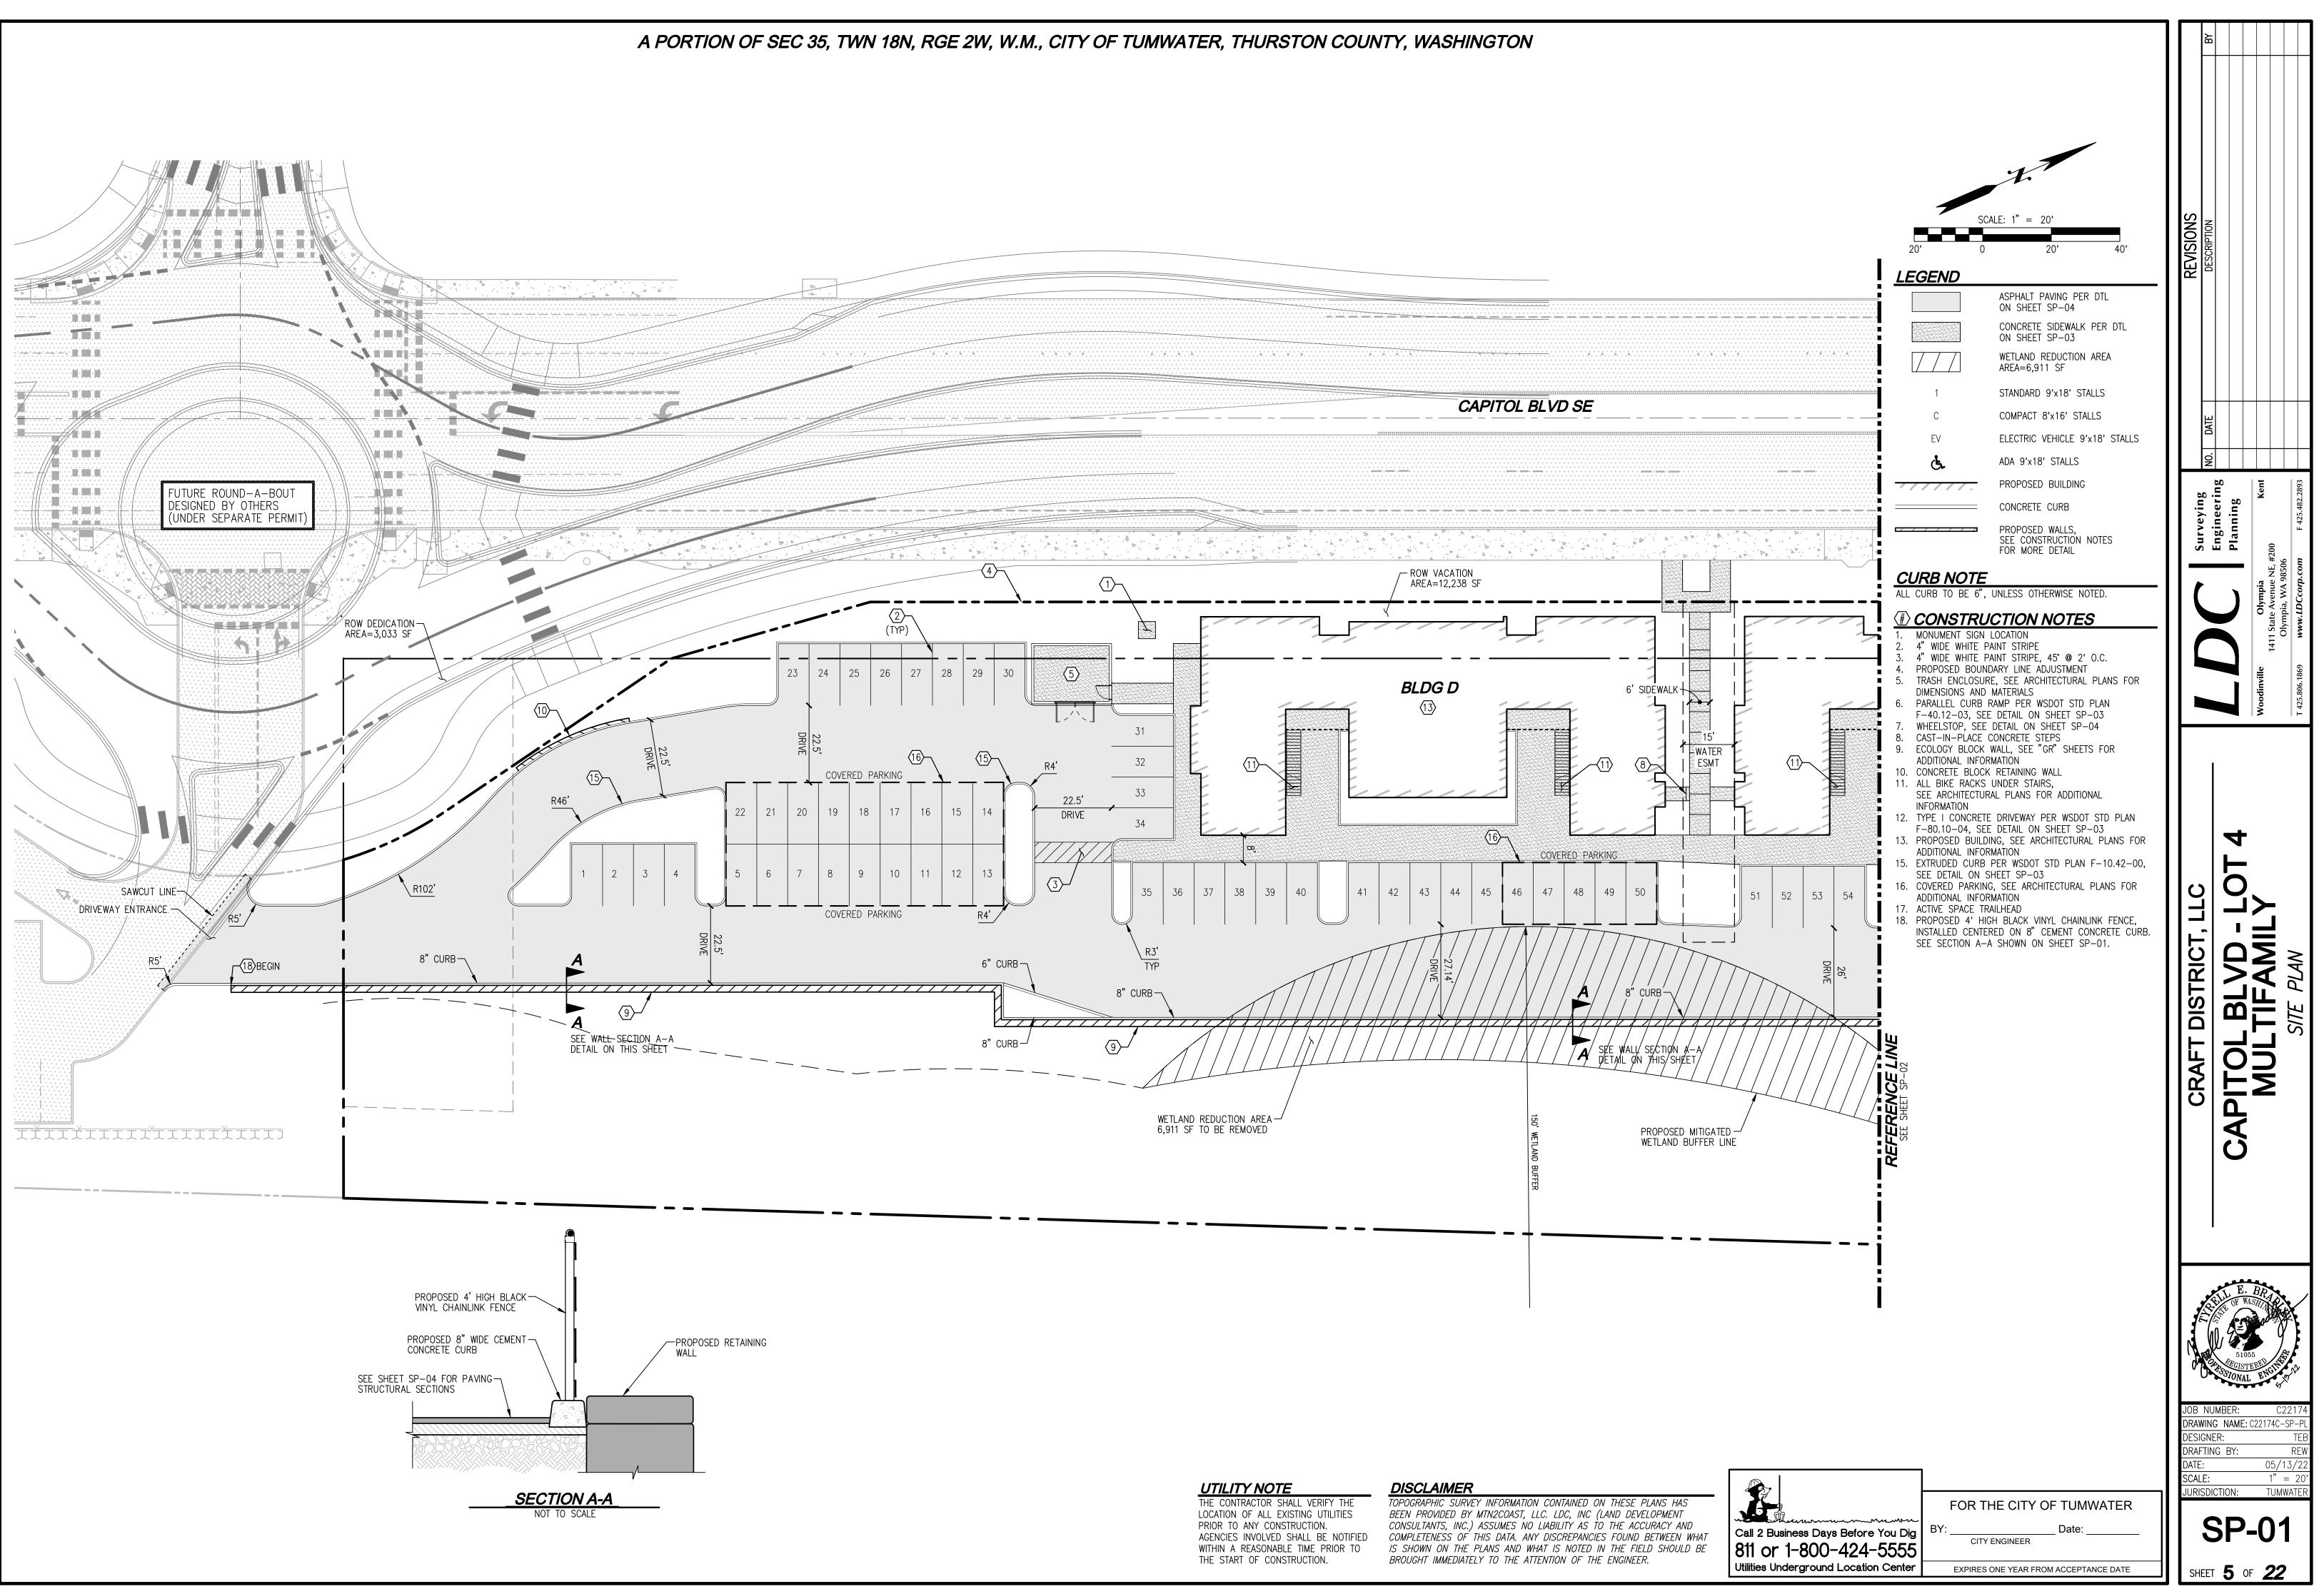

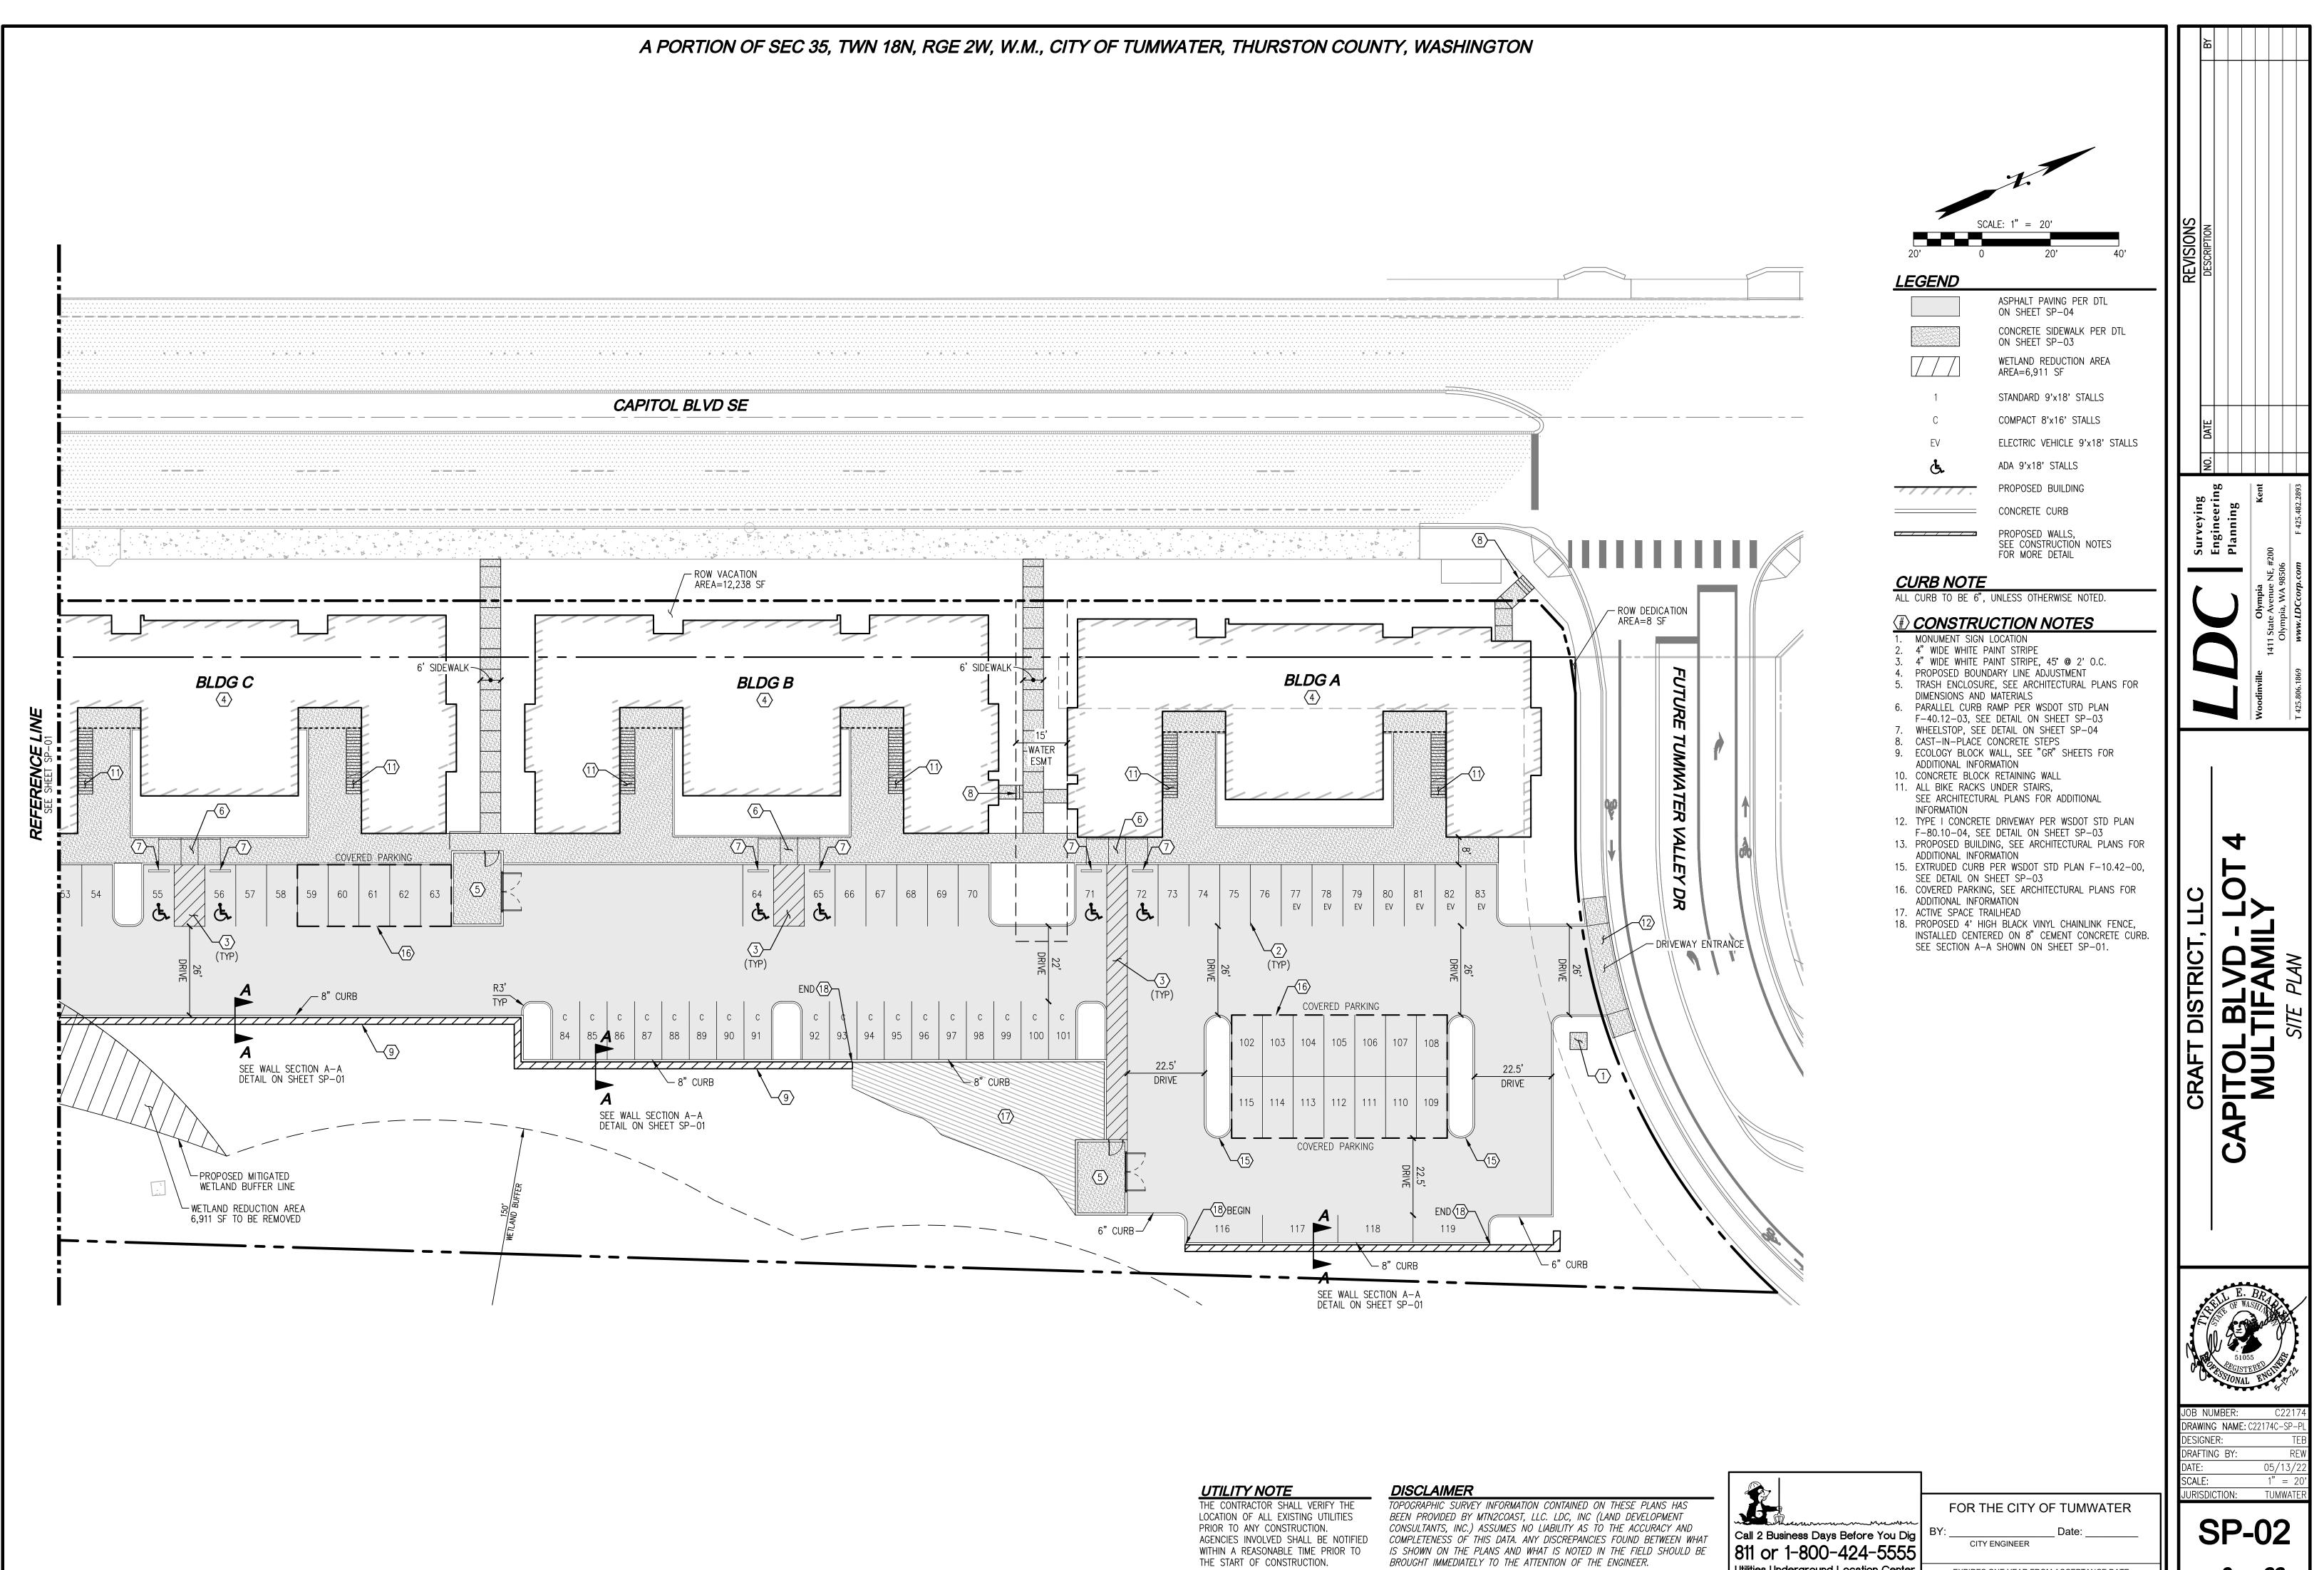

IS SHOWN ON THE PLANS AND WHAT IS NOTED IN THE FIELD SHOULD BE BROUGHT IMMEDIATELY TO THE ATTENTION OF THE ENGINEER.


Utilities Underground Location Center


EXPIRES ONE YEAR FROM ACCEPTANCE DATE


SHEET **6** OF **22** 






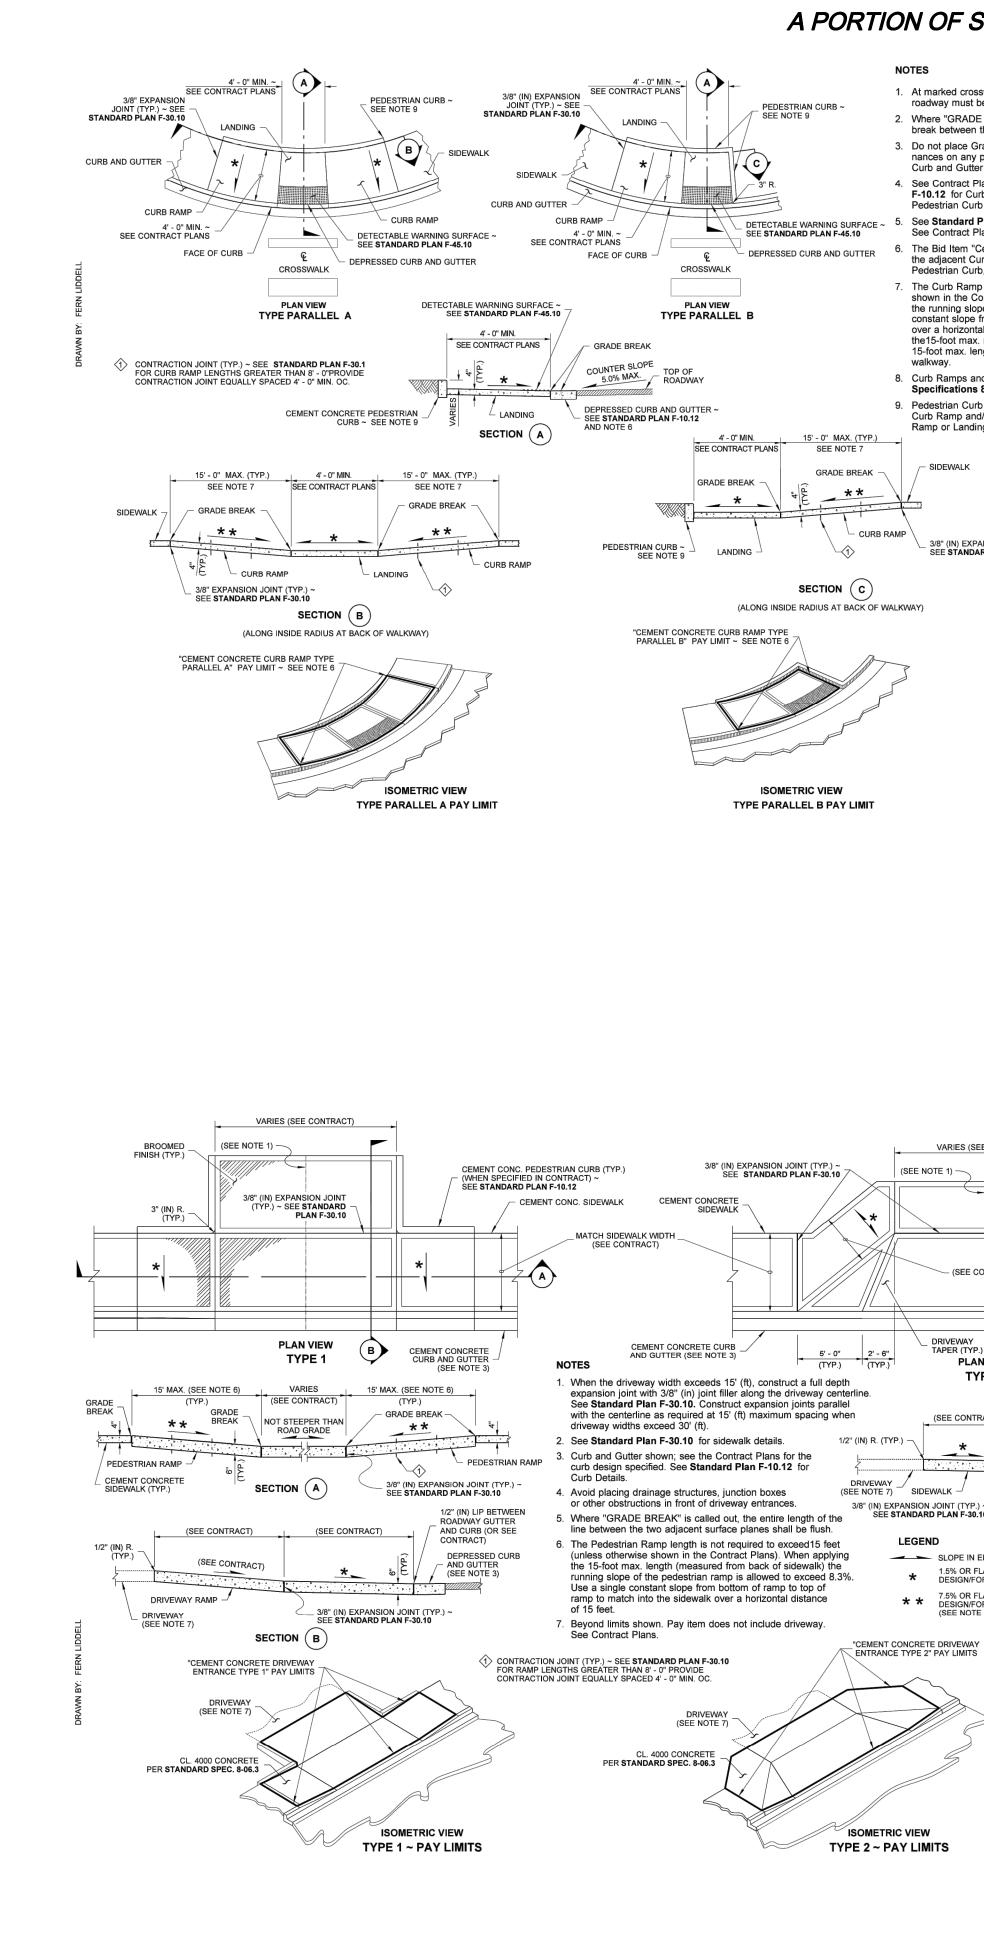

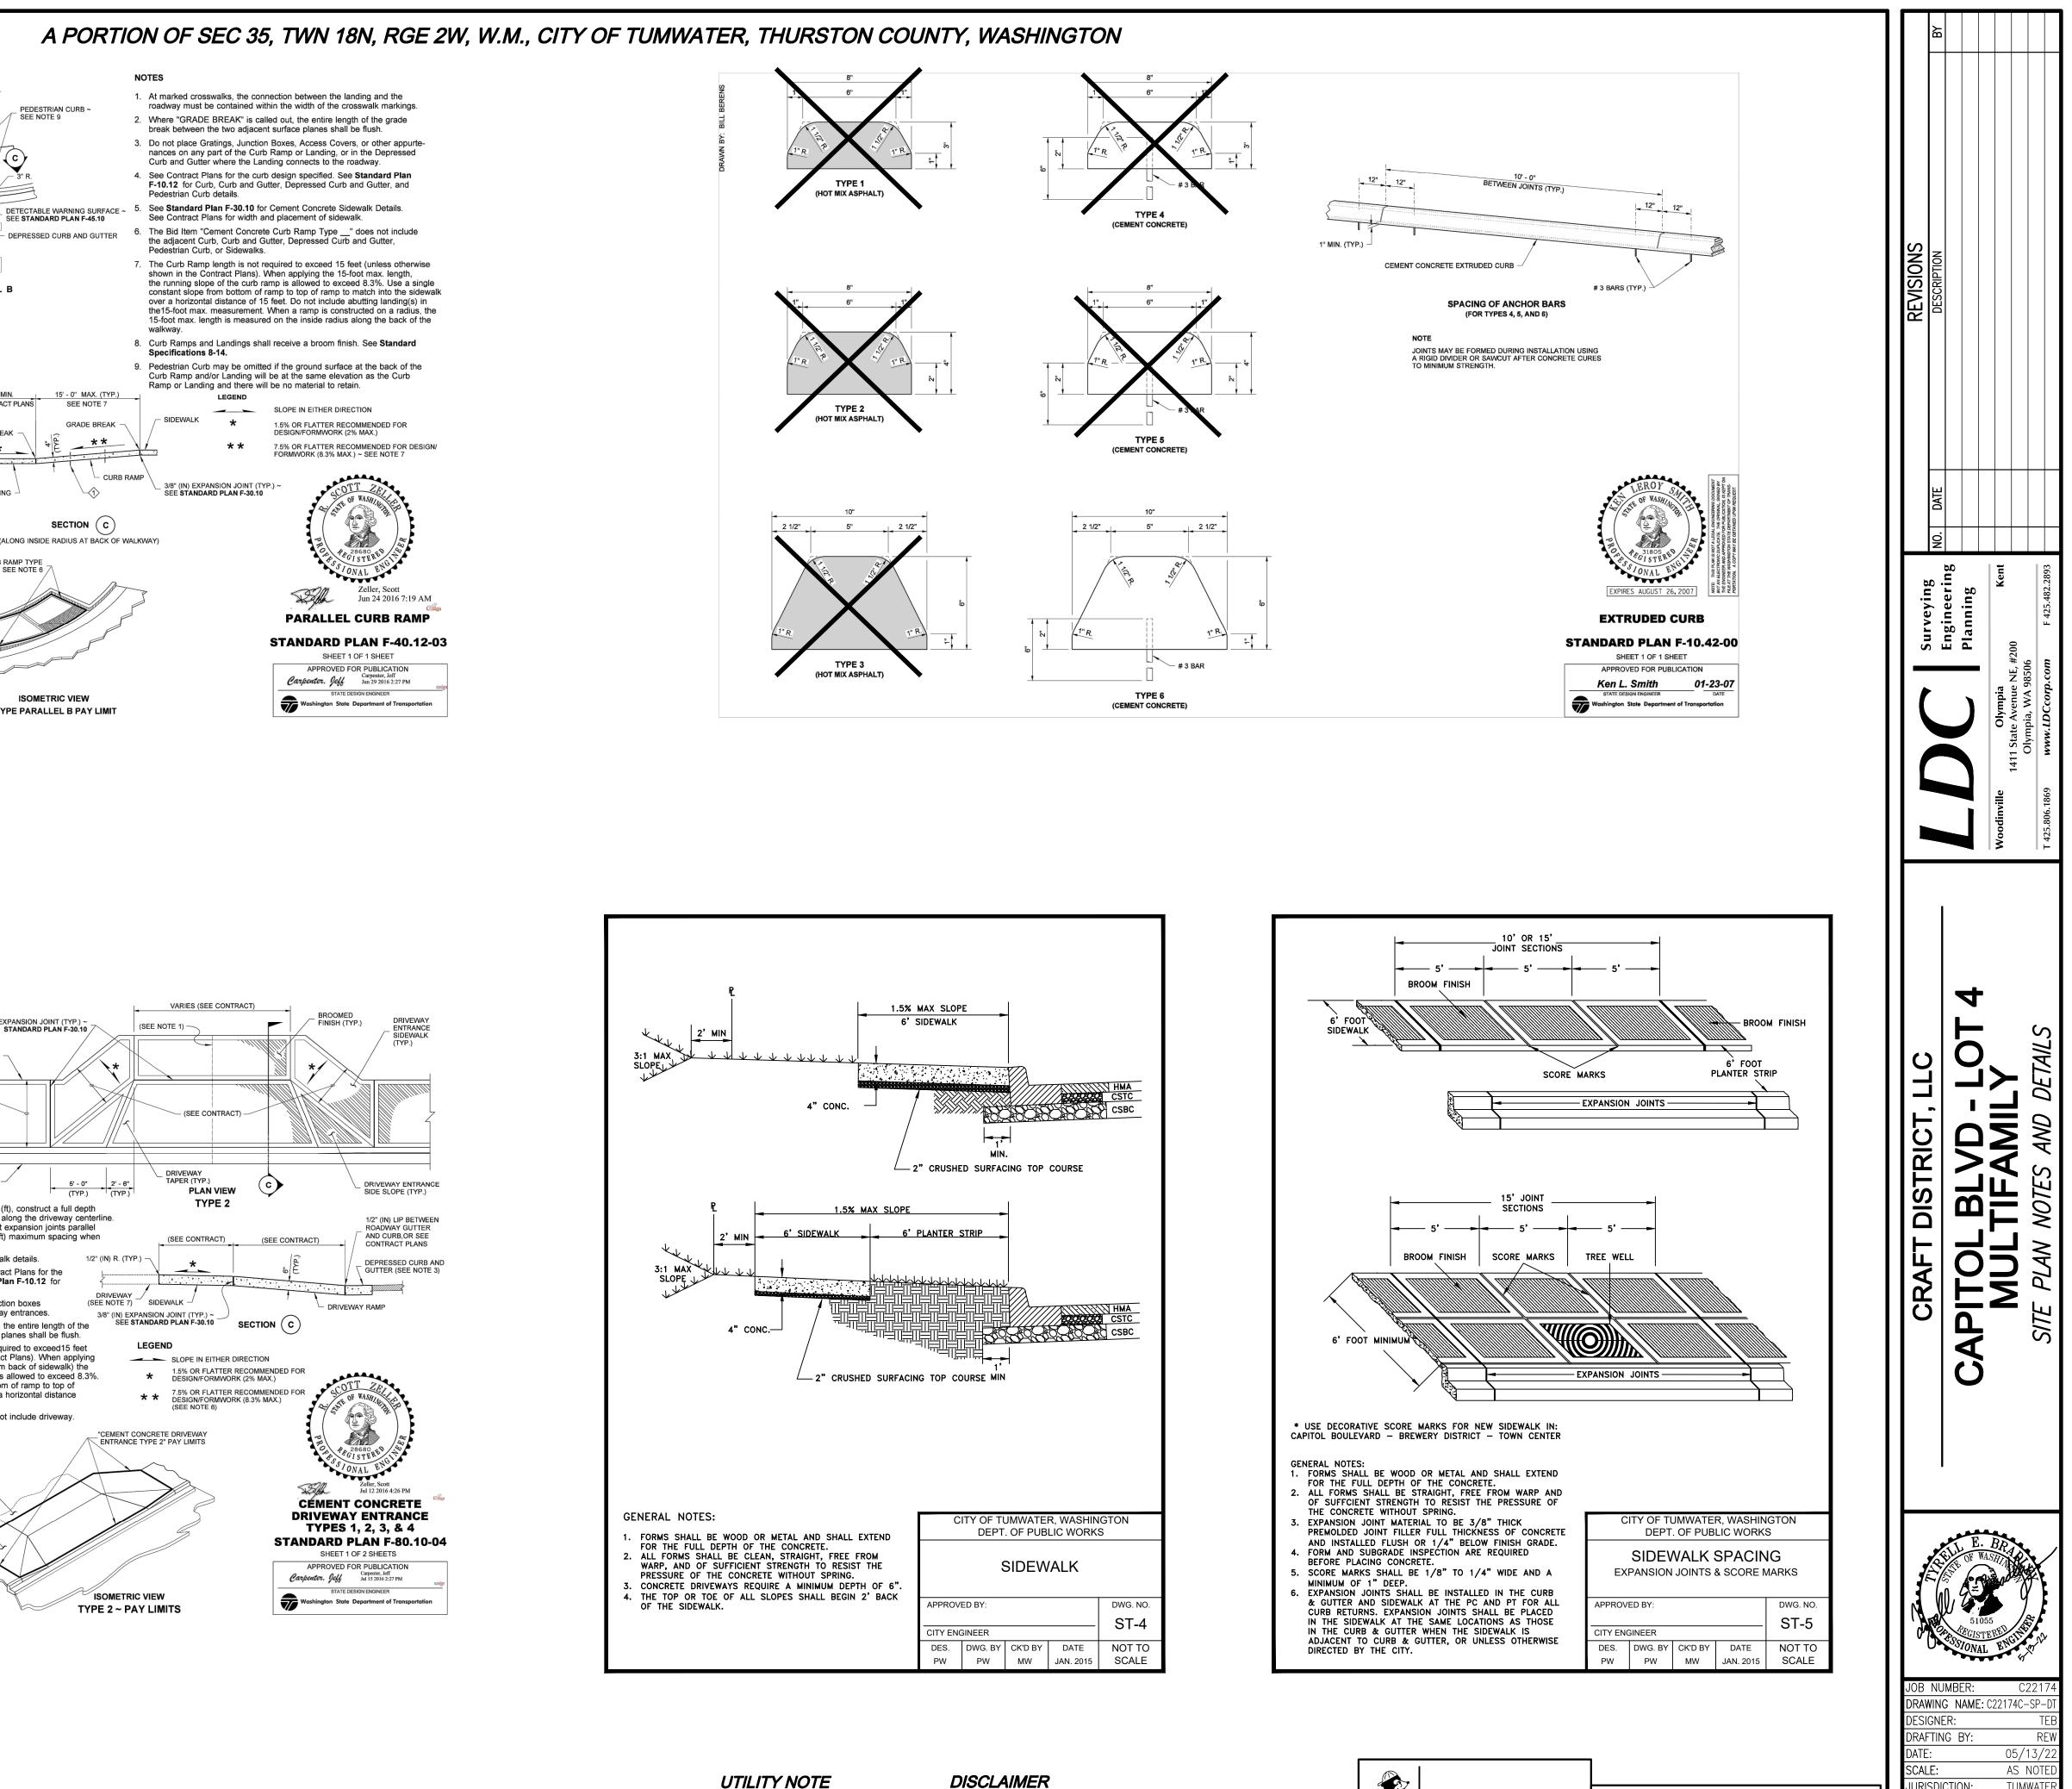

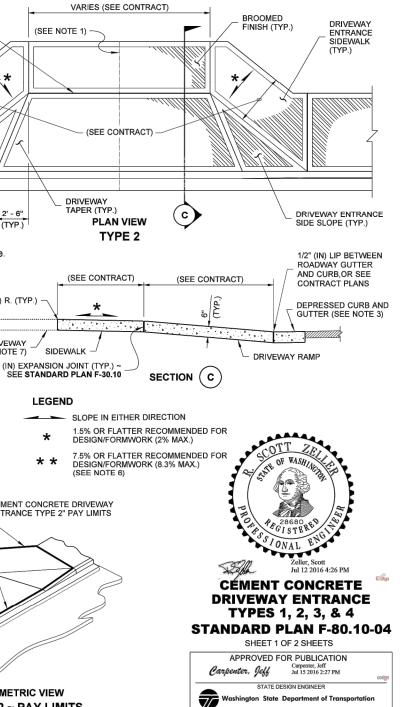

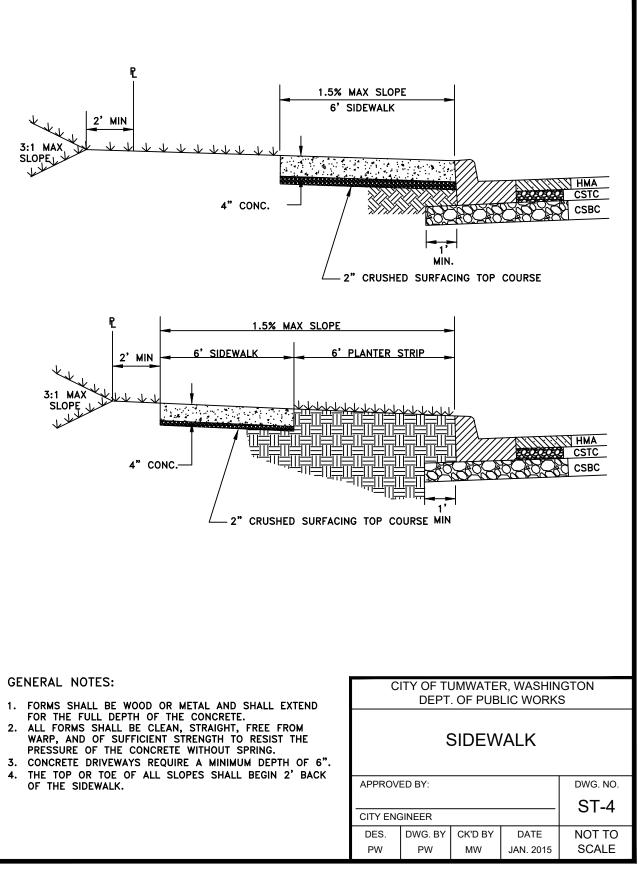

### UTILITY NOTE


THE CONTRACTOR SHALL VERIFY THE LOCATION OF ALL EXISTING UTILITIES PRIOR TO ANY CONSTRUCTION. AGENCIES INVOLVED SHALL BE NOTIFIED WITHIN A REASONABLE TIME PRIOR TO THE START OF CONSTRUCTION.


### **DISCLAIMER**

TOPOGRAPHIC SURVEY INFORMATION CONTAINED ON THESE BEEN PROVIDED BY MTN2COAST, LLC. LDC, INC (LAND DE CONSULTANTS, INC.) ASSUMES NO LIABILITY AS TO THE A COMPLETENESS OF THIS DATA. ANY DISCREPANCIES FOUND IS SHOWN ON THE PLANS AND WHAT IS NOTED IN THE F BROUGHT IMMEDIATELY TO THE ATTENTION OF THE ENGINE

E PLANS HAS EVELOPMENT			CITY OF TUMWATER
ICCURACY AND ID BETWEEN WHAT FIELD SHOULD BE EER.	Call 2 Business Days Before You Dig 811 or 1-800-424-5555	BY:	Date: INEER
	Utilities Underground Location Center	EXPIRES ONE	YEAR FROM ACCEPTANCE DATE


JURISDICTION: TUMWATE **SP-03** SHEET 7 OF 22

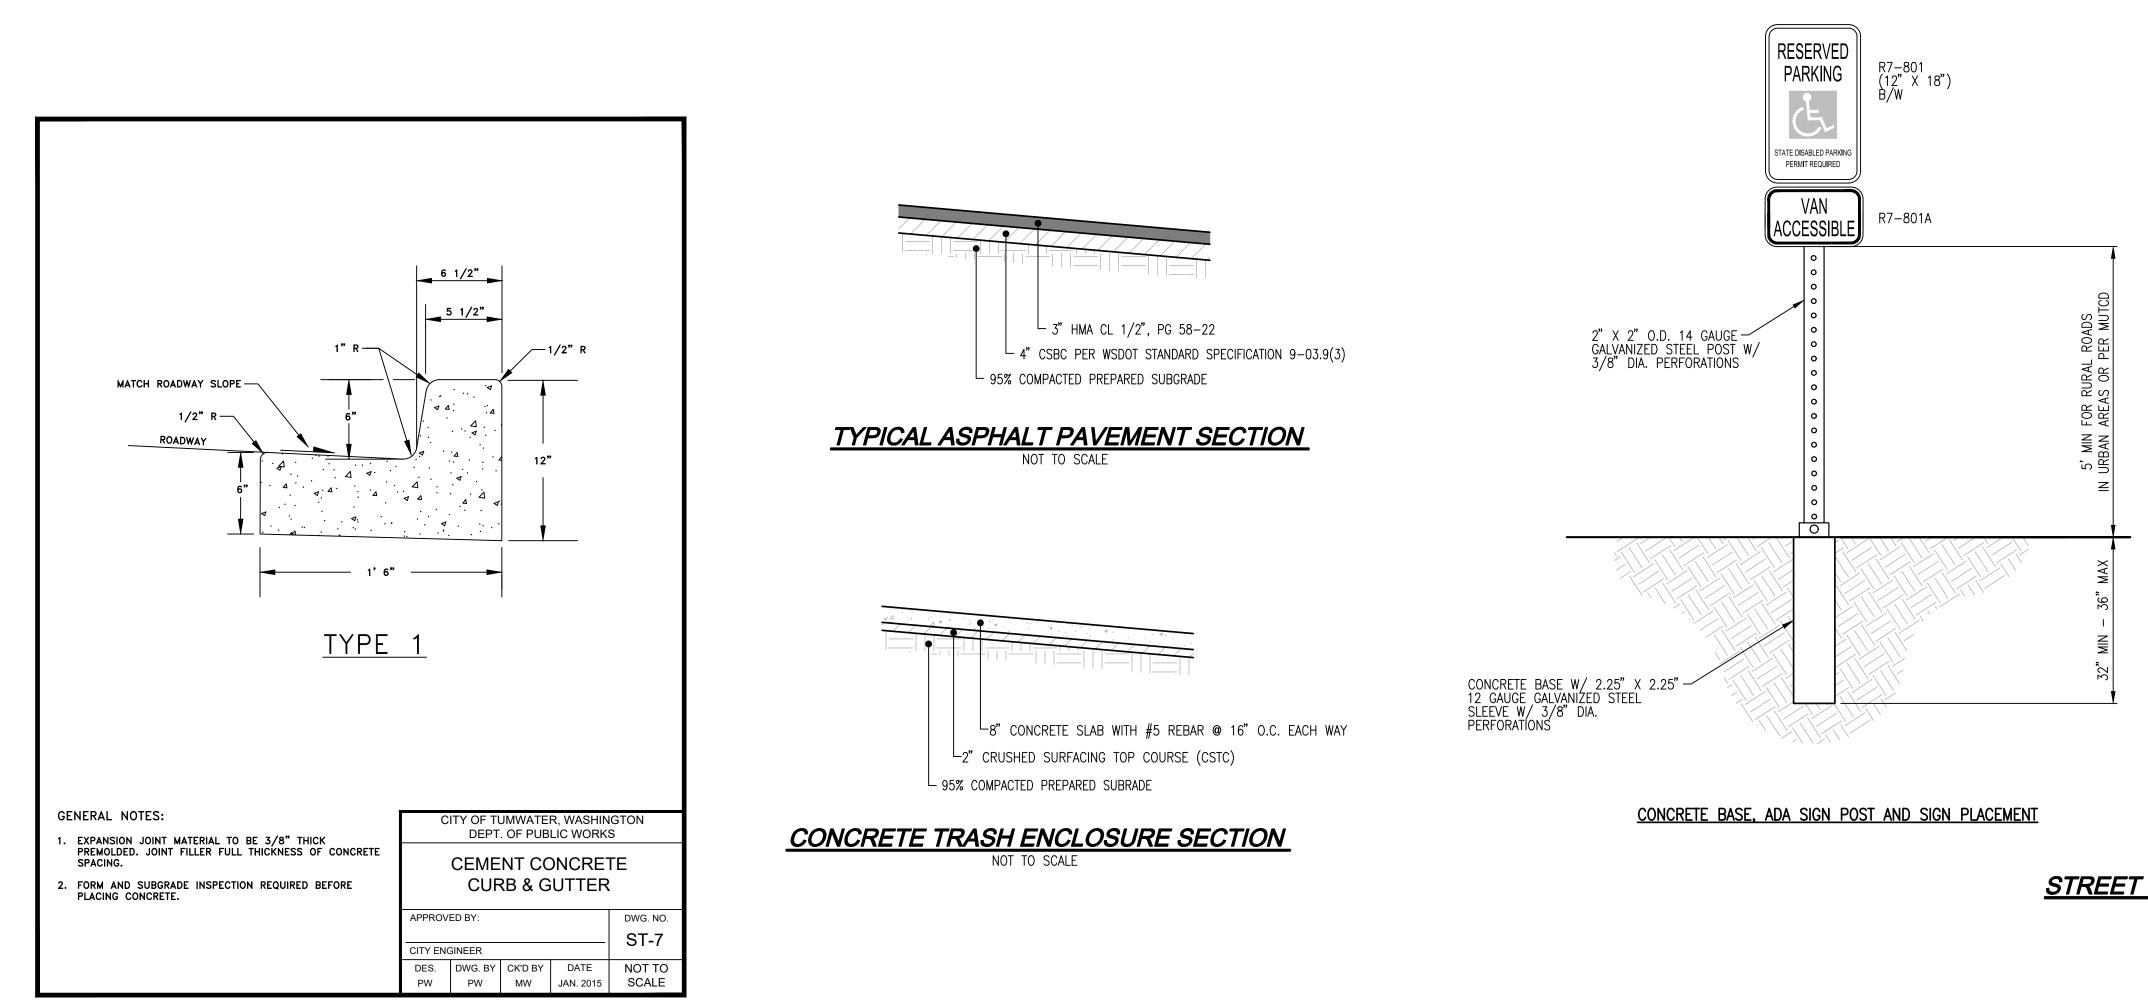

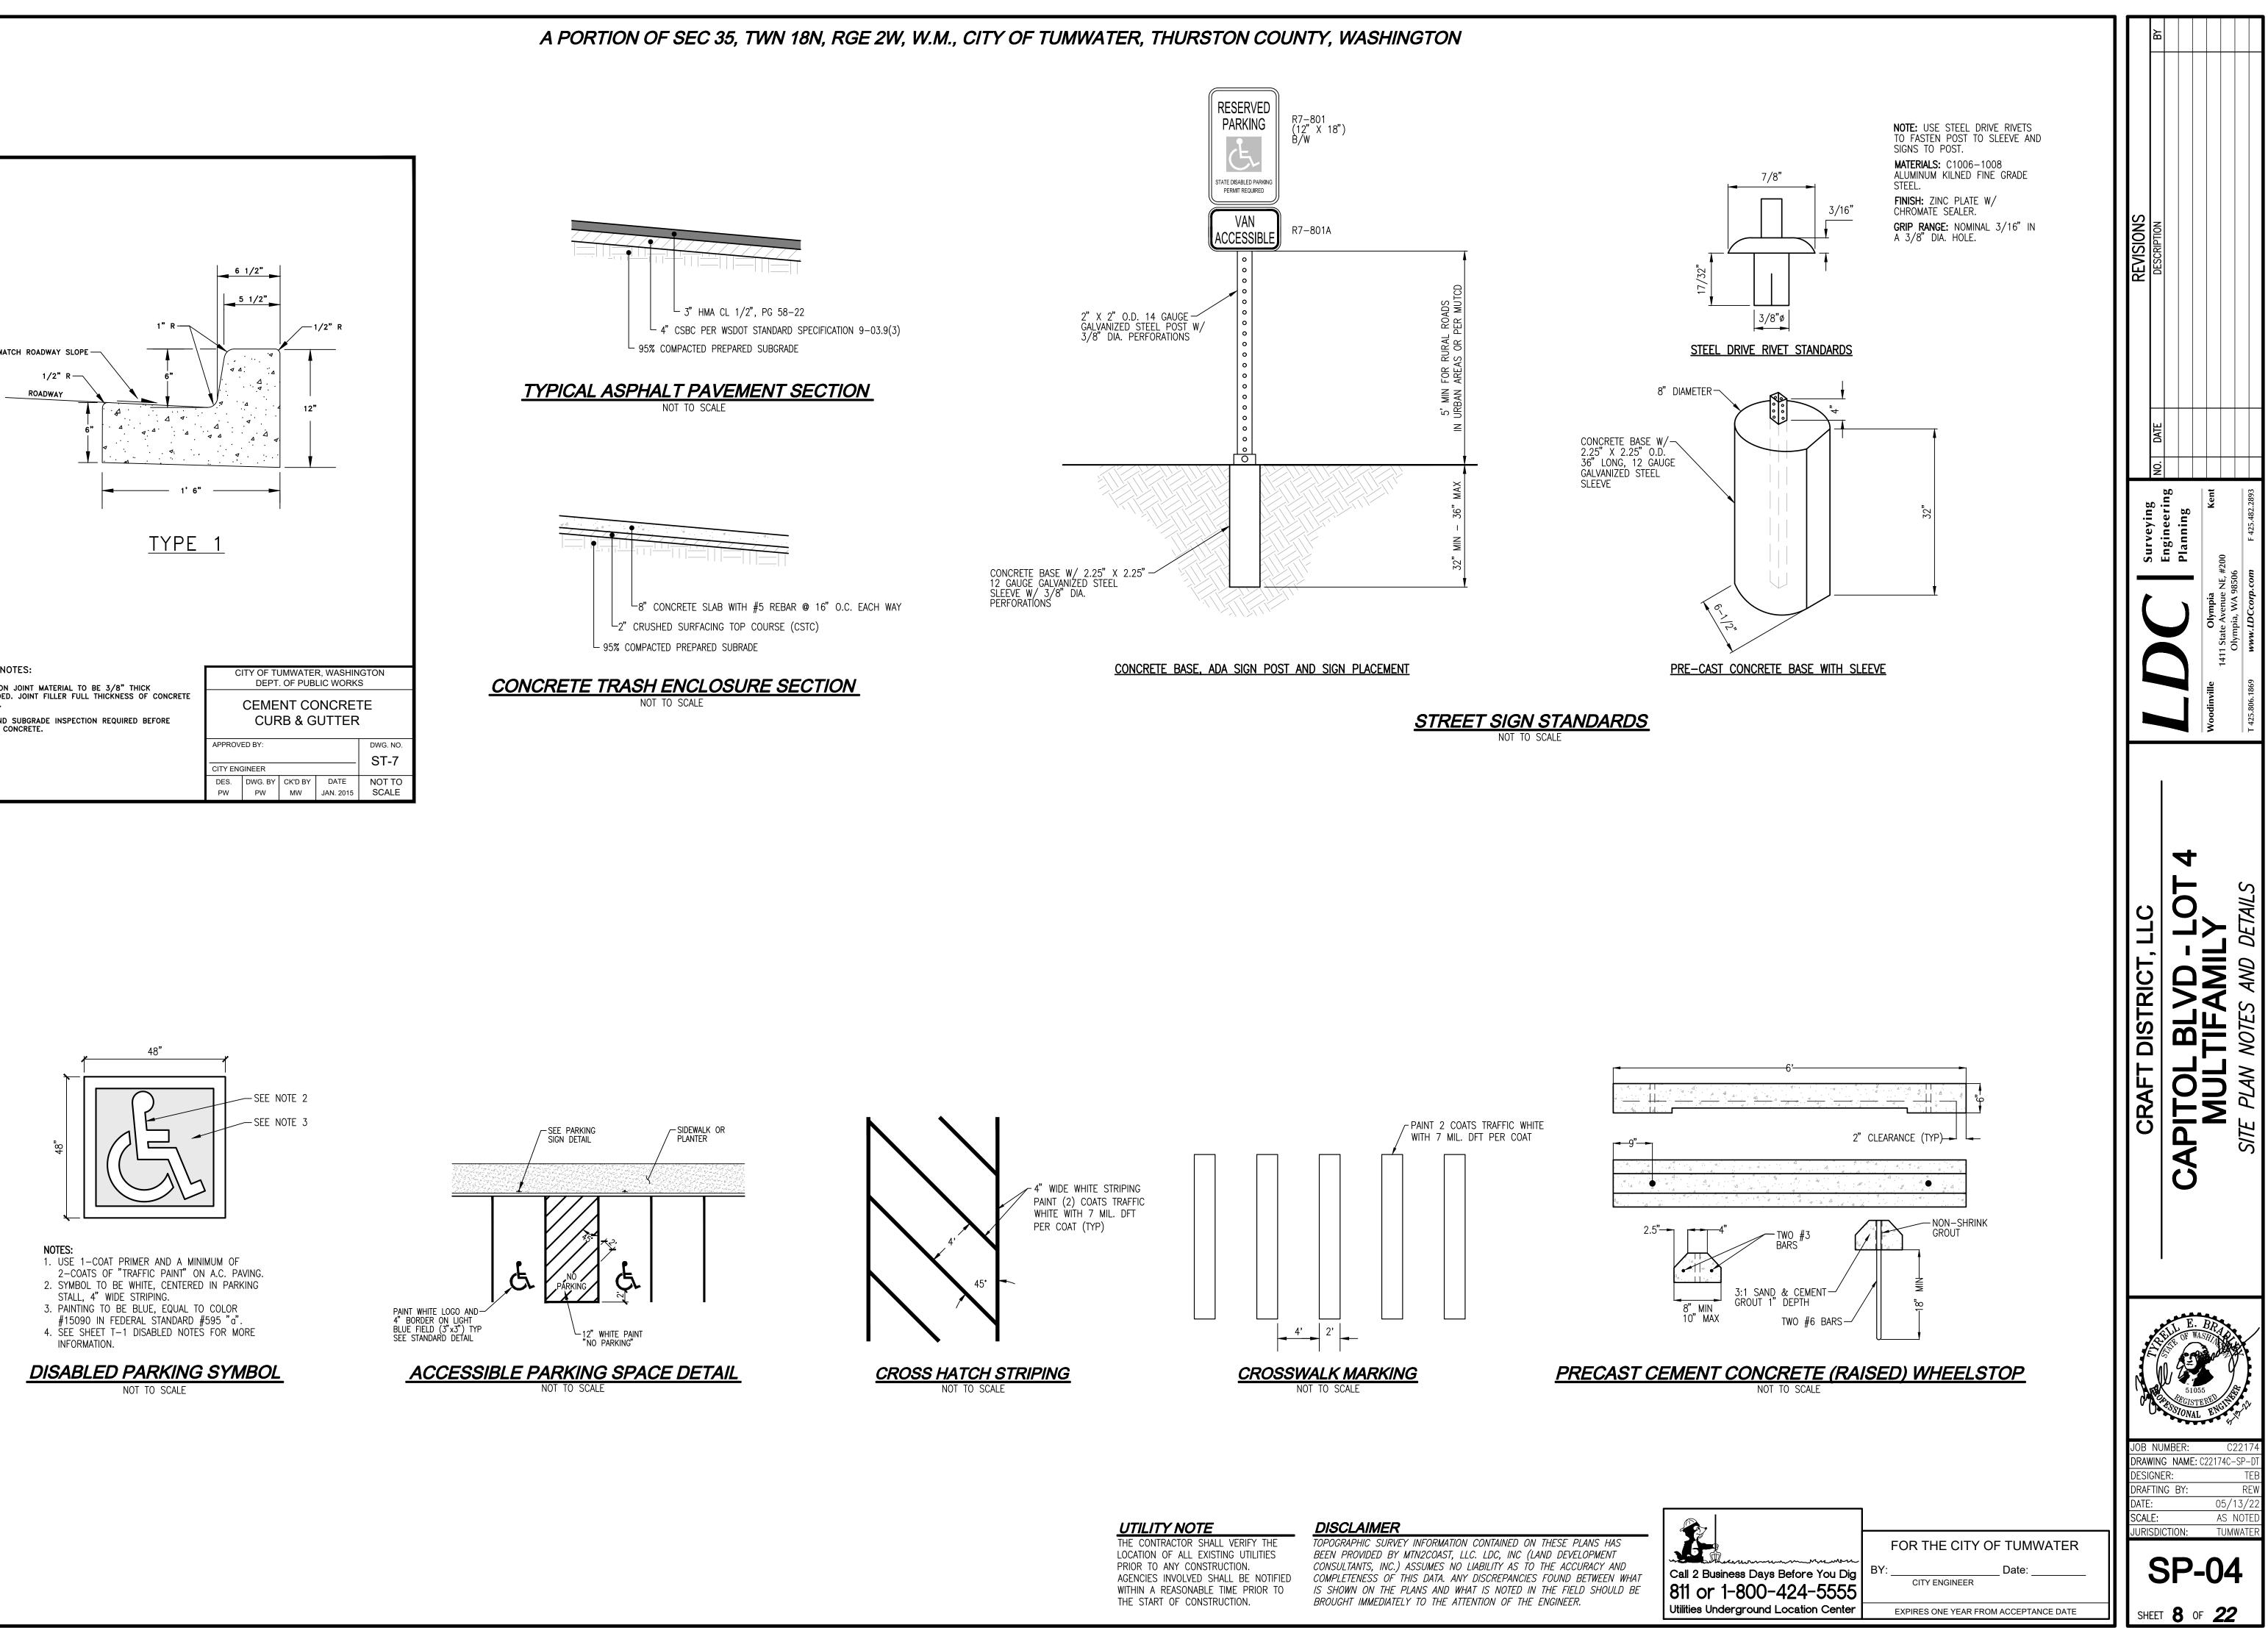




ltem 7.

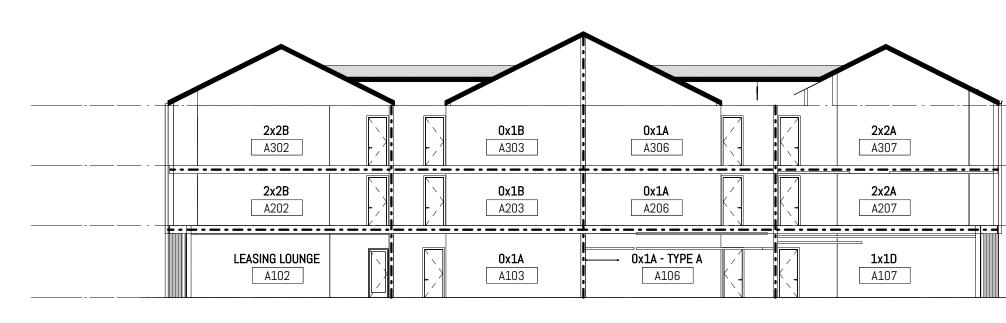


D1 CODE SECTION - FIRE RATED ASSEMBLIES, TYPICAL - BUILDINGS A, B, C, D SCALE: 1/16" = 1'-0" @ FULL SCALE

1

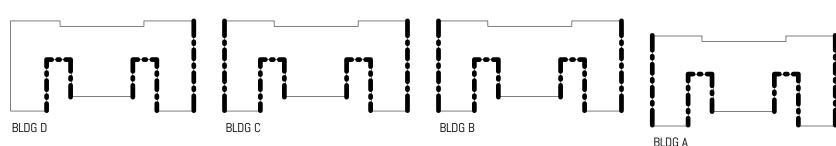

1

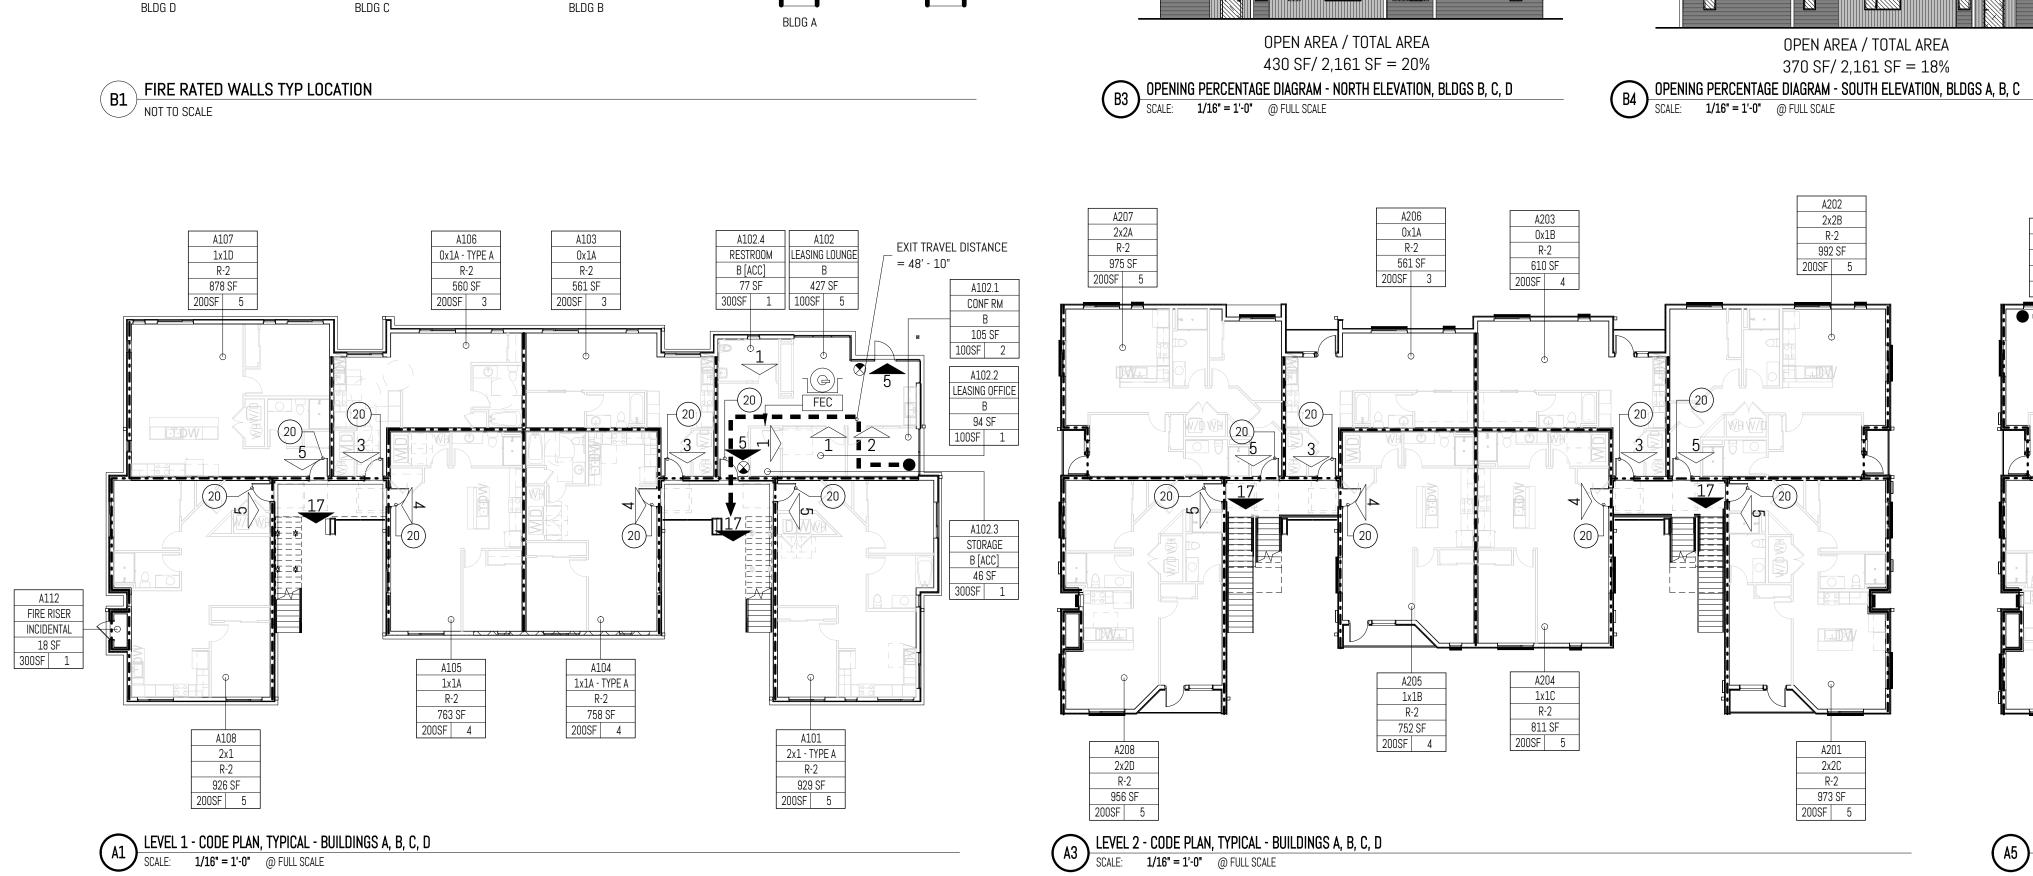

2

113

ltem 7.

С

DOIEDING / ELEVATION					001
BLDGS A, B, C / SOUTH ELEVATION	20' - 0"	45%	16%	1 HR	
BLDGS B, C, D / NORTH ELEVATION	20' - 0"	45%	16%	1 HR	

CODE COMPLIANCE - FIRE SEPARATION DISTANCE AND OPENING AREA					
BUILDING / ELEVATION	SEPARATION DISTANCE [FT]	ALLOWABLE AREA [%, SF]	AREA PROPOSED [%, SF]	FIRE RATING [HR]	COMPLIES
BLDGS A, B, C / SOUTH ELEVATION	20' - 0"	45%	16%	1 HR	ОК
BLDGS B, C, D / NORTH ELEVATION	20' - 0"	45%	16%	1 HR	OK

γZ SF Y ⊶

B •-----X SF⊶

BLDG A - L-4 - T.O. WALL 32' - 0"		EMERGENCY EXIT SIGNAGE SOLID FILL SHOWS ARROW DIRECTION
BLDG A - L-3 - T.O. FLOOR 22' - 0"	(45)	DOOR TAG - FIRE RESISTANCE RATING (MINUTES)
BLDG A - L-2 - T.O <u>. FLOOR</u> 12' - 0"	FEX	FIRE EXTINGUISHER
BLDG A - L-1 - T.O. SLAB O' - O"	FEC	FIRE EXTINGUISHER CABINET
	100 ⊶ ROOM⊶	ROOM NUMBER

3

# CODE COMPLIANCE **GRAPHIC LEGEND**

X	CUMULATIVE OCCUPANT LOAD	1HR
X	OCCUPANT LOAD BY ROOM	PARK H V
•0.0" °	X" MIN. REQ'D	V EV
	- MINIMUM REQUIRED CLEAR DOOR WIDTH	С
	- CLEAR DOOR WIDTH PROVIDED	OTHE STAN
	BEGINNING OF PATH	
	EGRESS TRAVEL DISTANCE TO BUILDING EXTERIOR	1
	BEGINNING OF PATH	2
-	- • - • -	-

4

R RATED ASSEMBLY RKING STALL DESIGNATIONS HANDICAP HANDICAP VAN ELECTRIC VEHICLE CHARGING STATION COMPACT [8'-0" X 17'-0"] HERWISE, PROVIDE STALL PER AHJ ANDARD [9'-0" X 18'-0"] EXIT TRAVEL DISTANCE IN DWELLING

UNIT TO ENTRY DOOR EXIT TRAVEL DISTANCE FROM THIRD STORY ENTRY DOOR TO EXIT DISCHARGE -SEE B5/A-000 FOR MEASUREMENT

COMMON PATH OF TRAVEL

R-2 975 SF 200SF 5

A308

2x2D

R-2 956 SF

4

3

AREA NOT IN SCOPE (N.I.C)

- OCCUPANCY TYPE

– AREA SQUARE FOOTAGE

- NUMBER OF OCCUPANTS - OCCUPANT LOAD FACTOR


(3) TOTAL EXIT TRAVEL DISTANCE

CODE COMPLIANCE **GENERAL NOTES** 


1. DO NOT SCALE THE DRAWINGS.


- 2. THE CONTRACTOR SHALL ENSURE COMPLIANCE WITH CHAPTER 33 OF THE INTERNATIONAL FIRE CODE FOR ALL CONSTRUCTION ACTIVITIES. ADEQUATE FIRE APPARATUS ACCESS SHALL BE PROVIDED TO THE BUILDING AND SITE AT ALL TIMES DURING CONSTRUCTION.
- 3. DOORS LOCATED IN CORRIDOR PARTITIONS SHALL BE INSTALLED TO RESIST THE PASSAGE OF SMOKE, UNLESS NOTED OTHERWISE.
- 4. EMERGENCY LIGHTING SHALL BE PROVIDED ALONG EGRESS PATHS AT MINIMUM 1 FC (FOOTCANDLE) CONTINUOUSLY PER IBC 1025.5.
- 5. PARTITION TYPES AND FIRE RESISTIVE RATINGS INDICATED ON A WALL ARE TO BE CONTINUOUS FOR THE LENGTH AND HEIGHT OF THAT PARTITION.
- 6. PER ICC 177.1 SECTION 809.5, PROVIDE HARD-WIRED DOORBELL AT ALL UNIT ENTRIES.



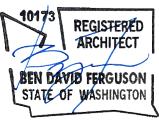


CODE COMPLIANCE - EXIT ACCESS TRAVEL DISTANCE						
BUILDING / LOCATION	EGRESS DISTANCE CALCULATION FROM EXIT TYPICAL ACCESS STAIRWAYS TO EXIT					
	MAXIMUM DISTANCE UNIT TO ENTRYENTRY TO EXIT DISCHARGETOTAL EXIT DISTANCECOMPLIE①②③					
BLDG TYP	55' - 3"	55' - 1"	110' - 4" < 125'	ОК		

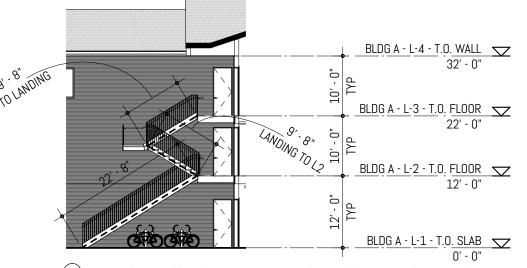

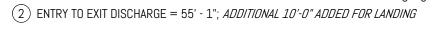

B5 CODE STAIR SECTION - TYP EGRESS SCALE: 1/16" = 1'-0" @ FULL SCALE

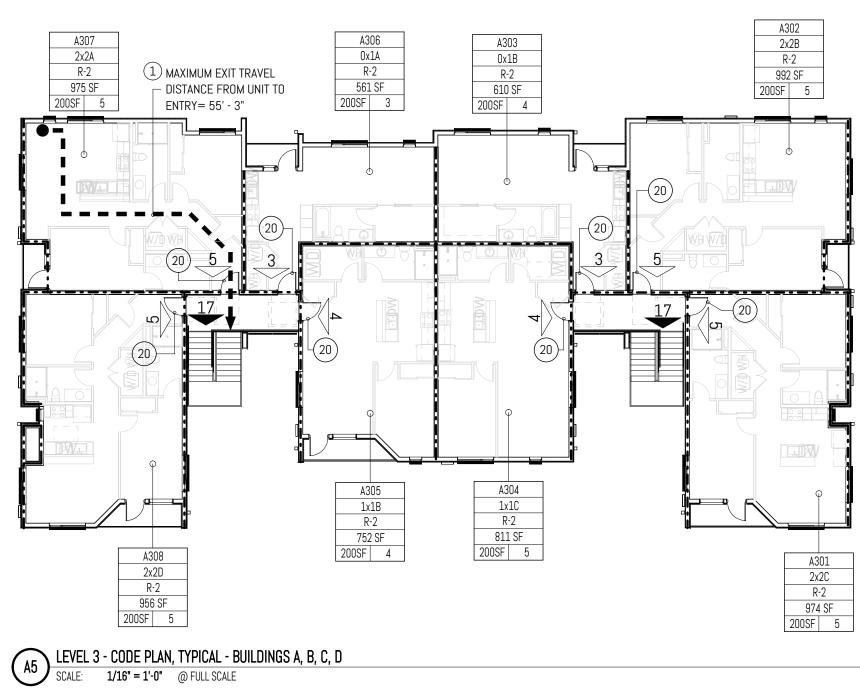

→z PROJECT NORTH TRUE NORTH




_				
	MARK	REVISION	l	DATE
	PRIN PROJ	ECT NO: OS CIPAL-IN-CHARGE: IECT ARCHITECT: VN BY:	50-01-	21  MJ 
A	PE	ECT STATUS: RMIT SET .06.2022		
	CO	et title: DE PLANS & EVATIONS	Ì	







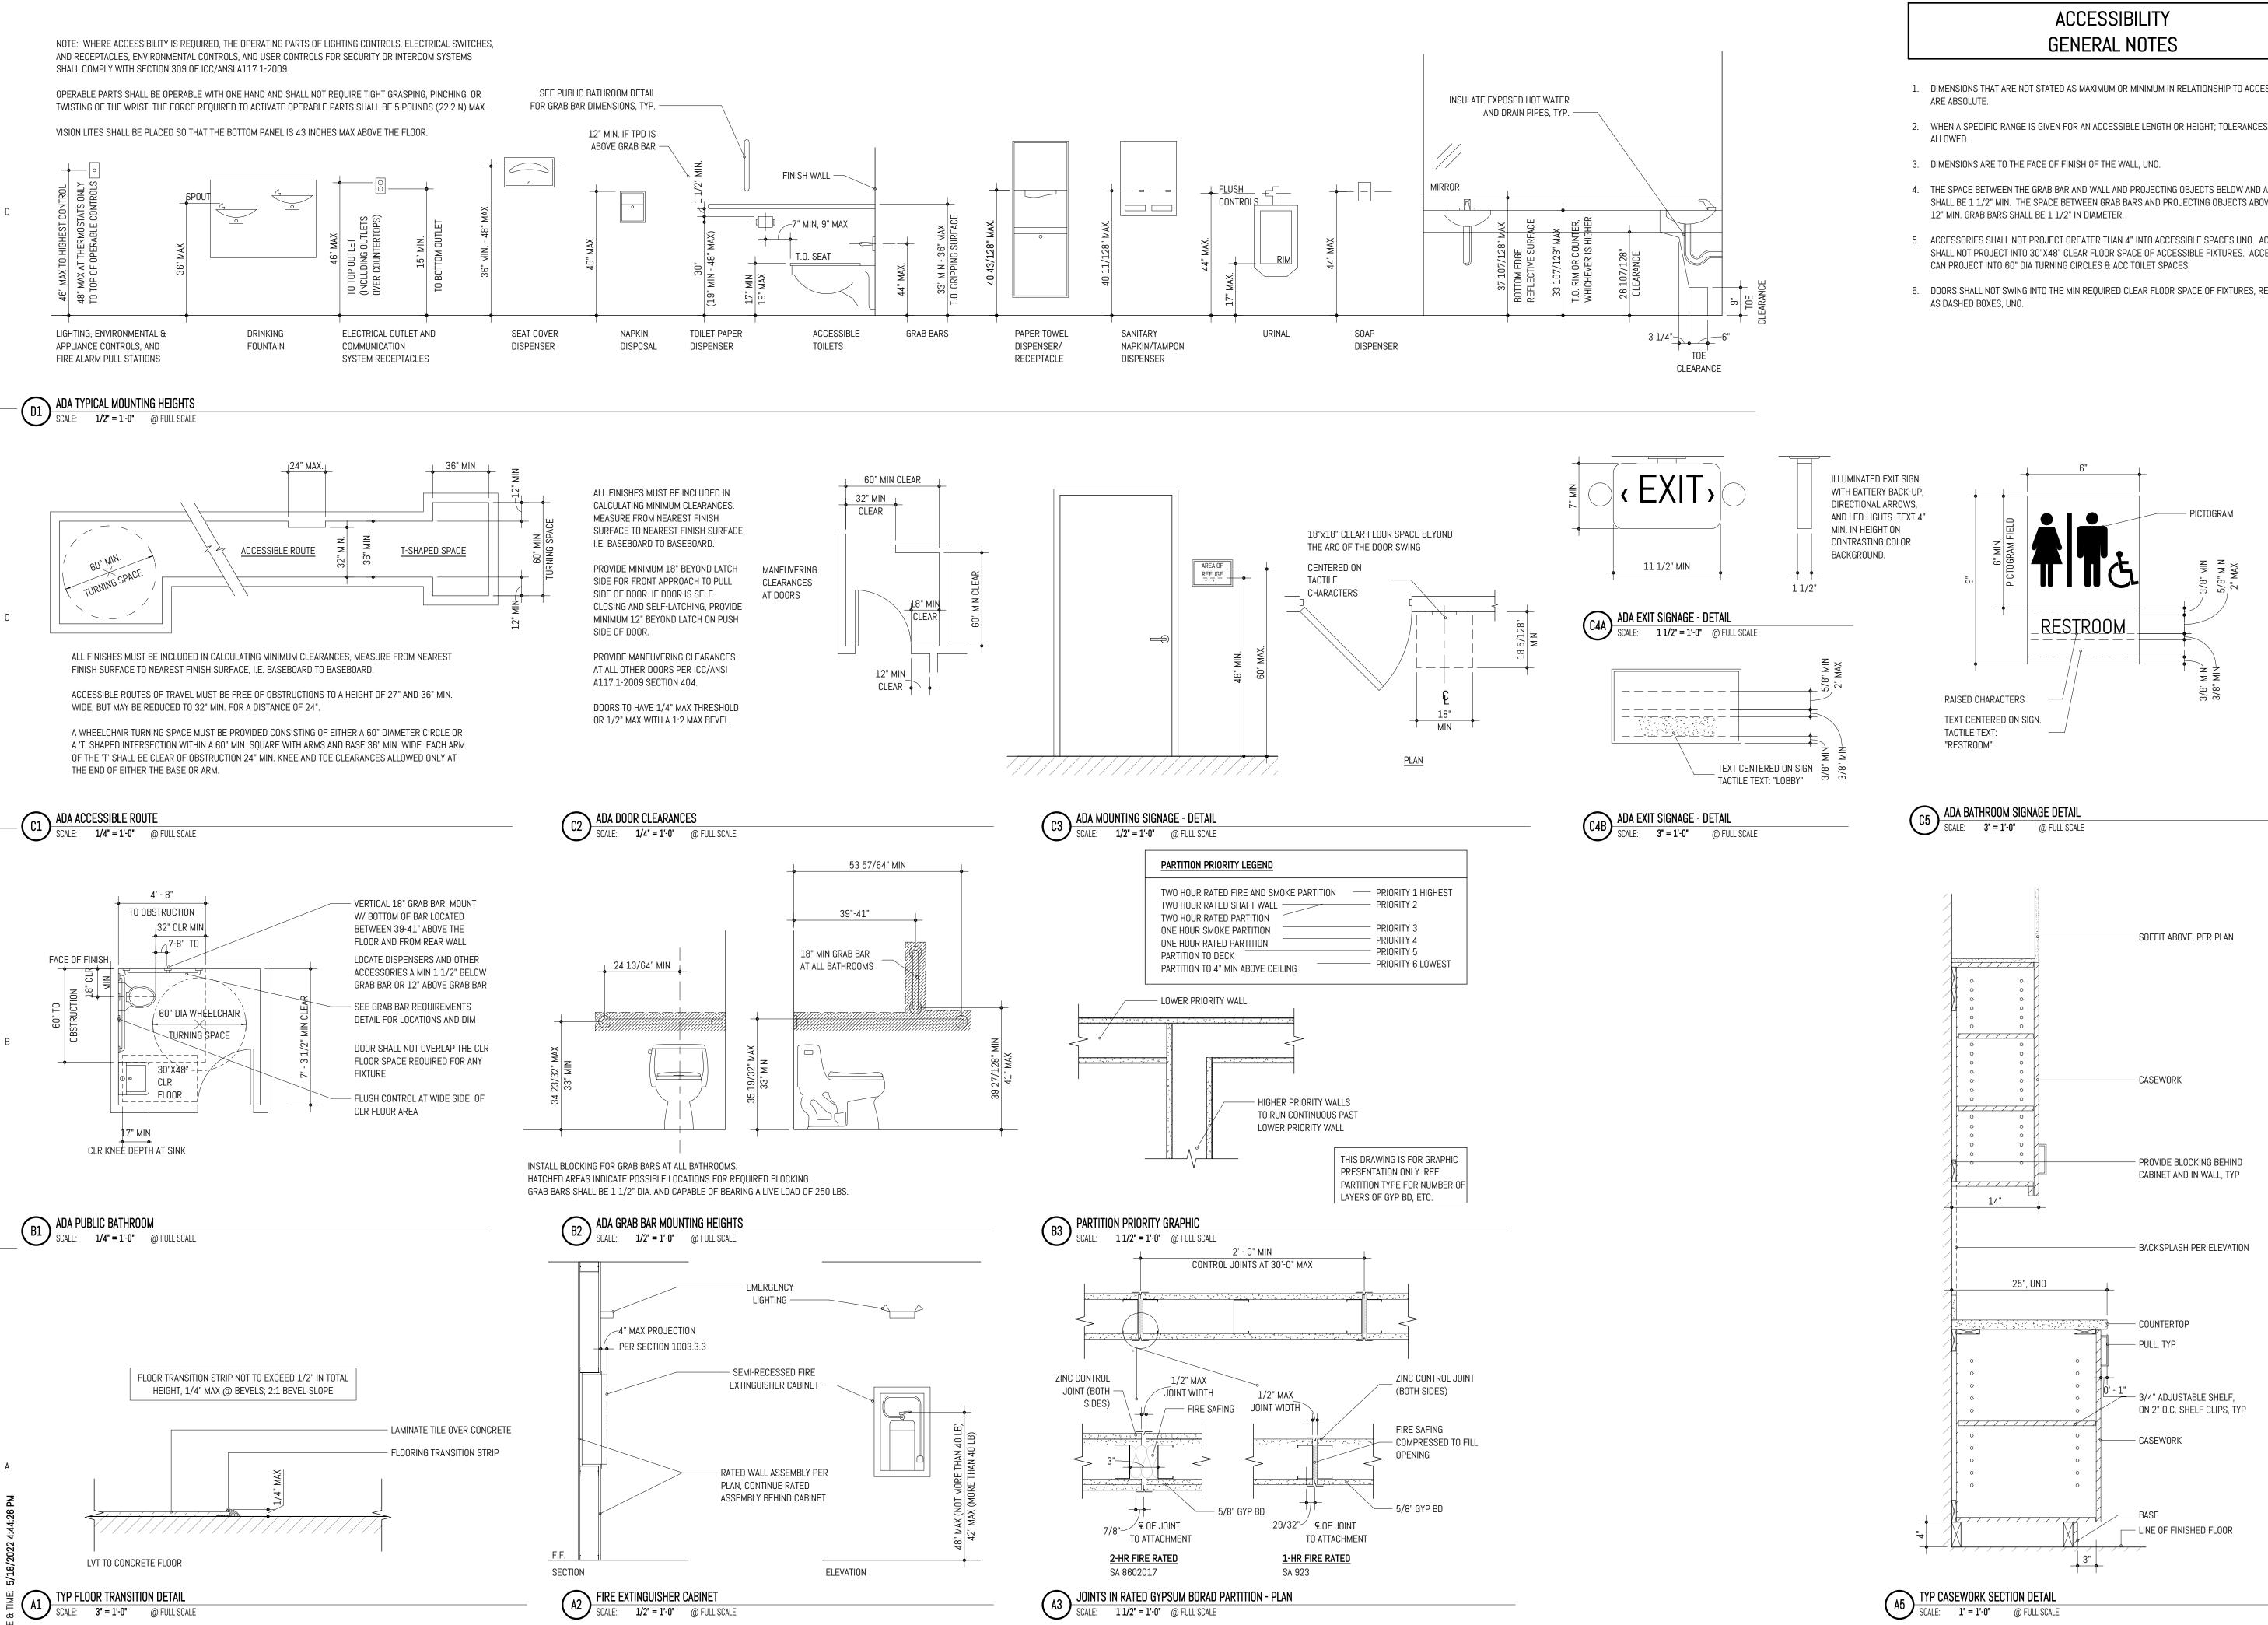

1

114


ltem 7.

1

- 1. DIMENSIONS THAT ARE NOT STATED AS MAXIMUM OR MINIMUM IN RELATIONSHIP TO ACCESSIBILITY
- 2. WHEN A SPECIFIC RANGE IS GIVEN FOR AN ACCESSIBLE LENGTH OR HEIGHT; TOLERANCES ARE NOT
- 4. THE SPACE BETWEEN THE GRAB BAR AND WALL AND PROJECTING OBJECTS BELOW AND AT ENDS SHALL BE 1 1/2" MIN. THE SPACE BETWEEN GRAB BARS AND PROJECTING OBJECTS ABOVE SHALL BE
- 5. ACCESSORIES SHALL NOT PROJECT GREATER THAN 4" INTO ACCESSIBLE SPACES UNO. ACCESSORIES SHALL NOT PROJECT INTO 30"X48" CLEAR FLOOR SPACE OF ACCESSIBLE FIXTURES. ACCESSORIES
- 6. DOORS SHALL NOT SWING INTO THE MIN REQUIRED CLEAR FLOOR SPACE OF FIXTURES, REPRESENTED





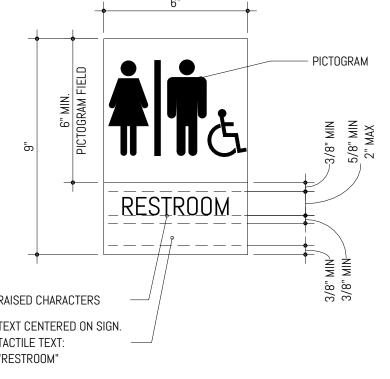


IMEN 8, & ATE Ъ RIC 1302, 43 CRAF

MARK	REVISION	DAT	Έ
PROJECT N	10: 050-C	)1-21	
PRINCIPAL-	IN-CHARGE:	BF	
PROJECT A	RCHITECT:	MJ	
DRAWN BY	:	HL	
PROJECT S	STATUS		
PERM			
05.06	.2022		
SHEET TITL			
ACCES	SSIBILITY & (	CODE	
DETAI	10		
DLIAI	LJ		
SHEET NO			
SHEET NU.			

A-005

4

### ASSEMBLY TYPES **EXTERIOR FINISH WALLS**

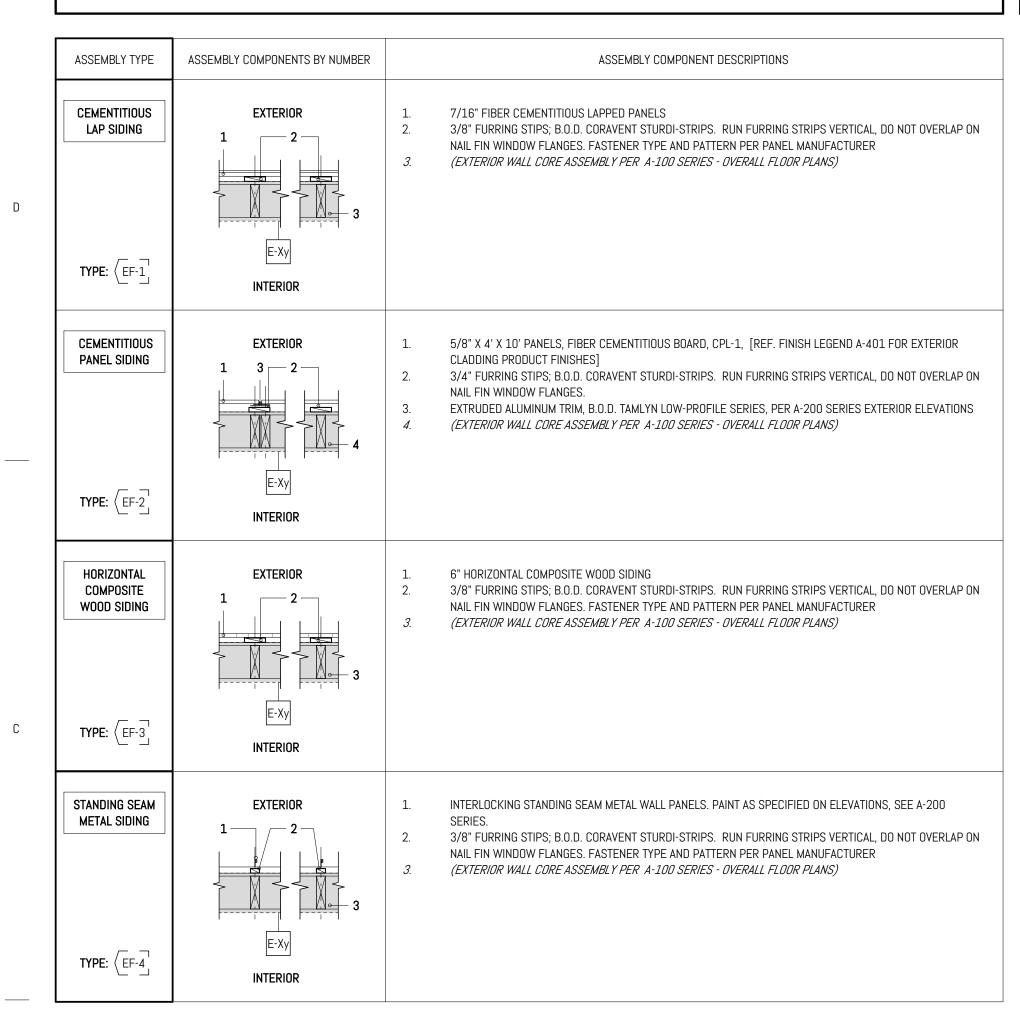

ASSEMBLY COMPONENTS BY NUMBER THERI ASSEMBLY TYPE ASSEMBLY COMPONENT DESCRIPTIONS REQUIRI VALUE PE RATED EXTERIOR EXTERIOR (EXTERIOR WALL FINISH TYPE PER A-100 SERIES - OVERALL FLOOR PLANS) CHAP SHEAR WALL HOUSEWRAP (PRIMARY W.R.B.), INSTALLATION PER MANUFACTURER; B.O.D. 'DUPONT - TYVEK 3060B' OR EQUAL 1 2 (EF-Xy) 3 4 5/8" CD-X OR OSB SHEATHING [REF. STRUCTURAL FOR SHEAR WALL SHEATHING REQUIREMENTS] 5/8" EXTERIOR GYPSUM SHEATHING, INSTALLATION PER MANUFACTURER; B.O.D. 'GEORGIA-PACIFIC -DENSGLASS FIREGUARD SHEATHING'; TO BE INSTALLED OUTBOUND OF ENGINEERED WOOD SHEATHING MINERAL WOOL INSULATION, THERMAL PERFORMANCE @ R-25. MIN.; 'ROCKWOOL - SAFEnSOUND R-30' REQ'D DUE TO COMPRESSIVE VALUE PROVID (1) PRESSURE TREATED 2X8 SILL PLATE AND SILL GASKET @ FOUNDATION AND LEVEL 1, U.N.O. GIVEN 2X8 WOOD STUDS [REF. STRUCTURAL FOR SHEAR WALL FRAMING REQUIREMENTS] 5/8" TYPE 'X' GWB, LEVEL 4 FINISH, TYP; [REF. UNIT PLANS AND FINISH LEGEND FOR FINISH TYPE] 678 TYPE: E-1 INTERIOR REQUIRE VALUE PE EXTERIOR SHEAR EXTERIOR (EXTERIOR WALL FINISH TYPE PER A-100 SERIES - OVERALL FLOOR PLANS) CHAF WALL HOUSEWRAP (PRIMARY W.R.B.), INSTALLATION PER MANUFACTURER; B.O.D. 'DUPONT - TYVEK 3060B' OR EQUAL 1 2 (EF-Xy 5/8" CD-X OR OSB SHEATHING [REF. STRUCTURAL FOR SHEAR WALL SHEATHING REQUIREMENTS] FIBERGLASS INSULATION, THERMAL PERFORMANCE @ R-25. MIN.; B.O.D. 'OWENS CORNING PINK FIBERGLAS INSULATION' (1) PRESSURE TREATED 2X8 SILL PLATE AND SILL GASKET @ FOUNDATION AND LEVEL 1, U.N.O. PROVID 2X8 WOOD STUDS [REF. STRUCTURAL FOR SHEAR WALL FRAMING REQUIREMENTS] GIVEN 5/8" TYPE 'X' GWB, LEVEL 4 FINISH, TYP. [REF. UNIT PLANS AND FINISH LEGEND FOR FINISH TYPE] 67 TYPE: E-2 INTERIOR

ASSEMBLY TYPES - EXTERIOR CORE WALLS

ltem 7.

### **BUILDING ASSEMBLIES UL LISTING DESCRIPTIONS - WALL TYPES**

### PRESCRIPTIVE 721.15-1.13 1-HOUR - EXTERIOR WALL ASSEMBLY

1. GYPSUM BOARD — 5/8 IN. THICK, WITH SQUARE OR TAPERED EDGES, APPLIED VERTICALLY OR HORIZONTALLY WITH VERTICAL JOINTS CENTERED OVER STUDS. HORIZONTAL JOINTS NEED NOT BE BACKED BY FRAMING. FASTENED TO STUDS AND PLATES WITH 2-1/4 IN. LONG TYPE S DRYWALL SCREWS SPACED 12 IN. OC. WITH LAST SCREW 1 IN. FROM EDGE OF BOARD. VERTICAL JOINTS STAGGERED 48" ON OPPOSITE SIDES. CGC INC — TYPES AR, C, IP-AR, IP-X1, IP-X2, IPC-AR, SCX, ULIX, ULX, WRC, WRX

2. WOOD STUDS — NOM 2 X 6 IN. SPACED 16 IN. WITH DOUBLE TOP PLATE AND SINGLE BOTTOM PLATE.

3. GYPSUM BOARD — 5/8 IN. THICK, WITH SQUARE OR TAPERED EDGES, APPLIED VERTICALLY OR HORIZONTALLY WITH VERTICAL JOINTS CENTERED OVER STUDS. HORIZONTAL JOINTS NEED NOT BE BACKED BY FRAMING. FASTENED TO STUDS AND PLATES WITH 2-1/4 IN. LONG TYPE S DRYWALL SCREWS SPACED 7 IN. OC. WITH LAST SCREW 1 IN. FROM EDGE OF BOARD. VERTICAL JOINTS STAGGERED 48" ON OPPOSITE SIDES. CGC INC — TYPES AR, C, IP-AR, IP-X1, IP-X2, IPC-AR, SCX, ULIX, ULX, WRC, WRX

5. JOINTS — WHEN TAPERED EDGE GYPSUM BOARD IS USED. JOINTS COVERED WITH JOINT COMPOUND AND PAPER TAPE. AS AN ALTERNATE, GYPSUM VENEER PLASTER MAY BE APPLIED TO THE ENTIRE SURFACE OF CLASSIFIED VENEER BASEBOARD WITH JOINTS REINFORCED WITH PAPER TAPE. WHEN SQUARE-EDGE GYPSUM BOARD IS USED, TREATMENT OF JOINTS IS OPTIONAL.

4. BATTS AND BLANKETS — 5.5 IN. THICK (R-19 MIN) MINERAL FIBER BATT INSULATION IN STUD SPACE.

### UL U311 - 1-HOUR - INTERIOR PARTY WALL ASSEMBLY

1. GYPSUM BOARD — 5/8 IN. THICK, WITH SQUARE OR TAPERED EDGES, APPLIED VERTICALLY OR HORIZONTALLY WITH VERTICAL JOINTS CENTERED OVER STUDS. HORIZONTAL JOINTS NEED NOT BE BACKED BY FRAMING. FASTENED TO STUDS AND PLATES WITH 1-1/4 IN. LONG TYPE S DRYWALL SCREWS SPACED 12 IN. OC. WITH LAST SCREW 1 IN. FROM EDGE OF BOARD. VERTICAL JOINTS STAGGERED 48" ON OPPOSITE SIDES. CGC INC — TYPES AR, C, IP-AR, IP-X1, IP-X2, IPC-AR, SCX, ULIX, ULX, WRC, WRX

2. WOOD STUDS — NOM 2 X 4 IN. SPACED 16 IN. OR 24 IN. OC.

3. RESILIENT CHANNELS — 24 IN. O.C.ATTACHED AT. RIGHT ANGLES TO ONE SIDE OF WOOD STUDS WITH 1-1/4 IN. LONG TYPE S DRYWALL SCREWS SPACED 12 IN. OC.

4. GYPSUM BOARD — 5/8 IN. THICK, WITH SOUARE OR TAPERED EDGES, APPLIED VERTICALLY OR HORIZONTALLY WITH VERTICAL JOINTS CENTERED OVER STUDS, APPLIED PARALLEL TO CHANNELS. FASTENED TO STUDS AND PLATES WITH 1 IN. LONG TYPE S DRYWALL SCREWS SPACED 12 IN. OC , WITH LAST SCREW 1 IN. FROM EDGE OF BOARD. END JOINTS BACKBLOCKED WITH RESILIENT CHANNELS. 54 IN. WIDTHS APPLIED HORIZONTALLY. CGC INC — TYPES AR, C, IP-AR, IP-X1, IP-X2, IPC-AR, SCX, ULIX, ULX, WRC, WRX

5. JOINTS — WHEN TAPERED EDGE GYPSUM BOARD IS USED, JOINTS COVERED WITH JOINT COMPOUND AND PAPER TAPE. AS AN ALTERNATE, GYPSUM VENEER PLASTER MAY BE APPLIED TO THE ENTIRE SURFACE OF CLASSIFIED VENEER BASEBOARD WITH JOINTS REINFORCED WITH PAPER TAPE. WHEN SQUARE-EDGE GYPSUM BOARD IS USED, TREATMENT OF JOINTS IS OPTIONAL.

4. BATTS AND BLANKETS — MIN 3 IN. THICK MINERAL FIBER BATT INSULATION, 2.0 OR 2.3 PCF IN STUD SPACE.


### **BUILDING ASSEMBLIES** ACOUSTIC NOTES


### ACOUSTIC NOTES BY NUMBER

- INTERIOR PARTITIONS ENCLOSING BATHROOMS AND BEDROOMS IN UNITS TO RECEIVE ACOUSTICAL BATT INSULATION UNLESS NOTED OTHERWISE. JOINTS ON WALLS WITH MULTIPLE LAYERS OF GYPSUM WALL BOARD TO BE STAGGER
- AT INTERIOR BASIC WALLS, CAULK ALONG BOTH SIDES OF THE PERIMETER OF WALL SILICONE MASTIC.
- AVOID BACK-TO-BACK OUTLETS. CAULK OPENINGS IN ELECTRICAL BOXES.
- WHERE A DOUBLE ROW OF STUDS IS SPECIFIED, MAKE NO CONNECTIONS BETWEEN
- UNLESS NOTED OTHERWISE IN FIRE RESISTANCE RATING SPECIFICATIONS OR STRUC USE ACOUSTICAL SEALANT AT HEAD AND BASE CONDITIONS OF SOUND RETARDANT F PROVIDE FIBERGLASS ACOUSTICAL BATT AT INTERIOR PARTITION WALLS ADJACENT 1

### WALL TYPE MARKS & CONFIGURATIONS

BATHROOMS, TYPICAL.

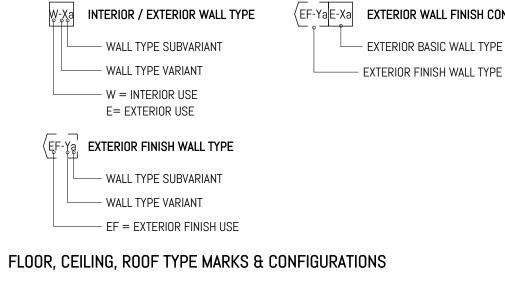

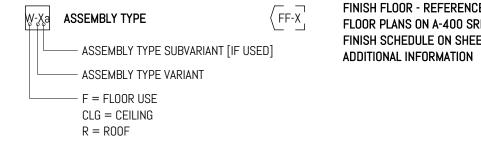

ASSEMBLY TYPES - INTERIOR WALLS	
ASSEMBLY COMPONENT DESCRIPTIONS	

ASSEMBLY COMPONENTS BY NUMBER	ASSEMBLY COMPONENT DESCRIPTIONS	THERMAL RATING	ACOUSTIC RATING	FIRE-RESISTANCE RATING
INTERIOR	1. 5/8" TYPE 'X' GWB, LEVEL 4 FINISH, TYP. [REF. UNIT PLANS AND FINISH LEGEND FOR FINISH TYPE]	REQUIRED MINIMUM R- VALUE PER 2018 WSEC	REQUIRED MINIMUM STC RATING PER 2018 IBC	REQUIRED MINIMUM FIRE - RESISTANCE RATING PER
1 2 3 1 2 3 4 5 6 INTERIOR	<ol> <li>[WHERE REQUIRED PER STRUCTURAL] CD-X OR OSB SHEATHING [REF. STRUCTURAL FOR SHEAR WALL SHEATHING REQUIREMENTS]</li> <li>3-1/2" FIBERGLASS ACOUSTICAL BATT INSULATION; B.O.D. 'OWENS CORNING - QUIETZONE ECOTOUCH PINK ACOUSTIC SOUNDPROOFING UNFACED BATT' OR EQUAL [WHERE OCCURS, REFER TO ACOUSTIC NOTES BY NUMBER, THIS SHEET]</li> <li>(1) PRESSURE TREATED 2X SILL PLATE AND SILL GASKET @ FOUNDATION AND LEVEL 1, U.N.O.</li> <li>2X4 WOOD STUDS [REF. STRUCTURAL FOR FRAMING REQUIREMENTS]</li> <li>5/8" TYPE 'X' GWB, LEVEL 4 FINISH, TYP. [REF. UNIT PLANS AND FINISH LEGEND FOR FINISH TYPE]</li> </ol>	N/A	N/A ESTIMATED STC RATING IN GIVEN ASSEMBLY: 34 - 39	2018 IBC CHAPTER 6: N/A
INTERIOR 1 2 3 1 2 3 4 5 6 INTERIOR	<ol> <li>5/8" TYPE 'X' GWB, LEVEL 4 FINISH, TYP. [REF. UNIT PLANS AND FINISH LEGEND FOR FINISH TYPE]</li> <li>[WHERE REQUIRED PER STRUCTURAL] CD-X OR OSB SHEATHING [REF. STRUCTURAL FOR SHEAR WALL SHEATHING REQUIREMENTS]</li> <li>5-1/2" FIBERGLASS ACOUSTICAL BATT INSULATION; B.O.D. 'OWENS CORNING - QUIETZONE ECOTOUCH PINK ACOUSTIC SOUNDPROOFING UNFACED BATT' OR EQUAL [WHERE OCCURS, REFER TO ACOUSTIC NOTES BY NUMBER, THIS SHEET]</li> <li>(1) PRESSURE TREATED 2X SILL PLATE AND SILL GASKET @ FOUNDATION AND LEVEL 1, U.N.O.</li> <li>2X6 WOOD STUDS [REF. STRUCTURAL FOR FRAMING REQUIREMENTS]</li> <li>5/8" TYPE 'X' GWB, LEVEL 4 FINISH, TYP. [REF. UNIT PLANS AND FINISH LEGEND FOR FINISH TYPE]</li> </ol>	REQUIRED MINIMUM R- VALUE PER 2018 WSEC CHAPTER 4, § R402: N/A	REQUIRED MINIMUM STC RATING PER 2018 IBC CHAPTER 12, § 1206: N/A ESTIMATED STC RATING IN GIVEN ASSEMBLY: 34 - 39	REQUIRED MINIMUM FIRE - RESISTANCE RATING PER 2018 IBC CHAPTER 6: N/A
INTERIOR 1 2 3 1 2 3 5 4 ABUTTING WALL / VOID	<ol> <li>5/8" TYPE 'X' GWB, LEVEL 4 FINISH, TYP. [REF. UNIT PLANS AND FINISH LEGEND FOR FINISH TYPE]</li> <li>5-1/2" FIBERGLASS ACOUSTICAL BATT INSULATION; B.O.D. 'OWENS CORNING - QUIETZONE ECOTOUCH PINK ACOUSTIC SOUNDPROOFING UNFACED BATT' OR EQUAL [WHERE OCCURS, REFER TO ACOUSTIC NOTES BY NUMBER, THIS SHEET]</li> <li>(1) PRESSURE TREATED 2X SILL PLATE AND SILL GASKET @ FOUNDATION AND LEVEL 1, U.N.O.</li> <li>2X6 WOOD STUDS [REF. STRUCTURAL FOR FRAMING REQUIREMENTS]</li> <li>ROUTE SERVICE THROUGH CENTER OF FRAMING PER STRUCTURAL, WHERE OCCURS</li> </ol>	REQUIRED MINIMUM R- VALUE PER 2018 WSEC CHAPTER 4, § R402: N/A	REQUIRED MINIMUM STC RATING PER 2018 IBC CHAPTER 12, § 1206: N/A	REQUIRED MINIMUM FIRE - RESISTANCE RATING PER 2018 IBC CHAPTER 6: N/A
	4. 2X4 WOOD STUDS [REF. STRUCTURAL FOR FRAMING REQUIREMENTS]			
	<ol> <li>5/8" TYPE 'X' GWB, LEVEL 4 FINISH, TYP. [REF. UNIT PLANS AND FINISH LEGEND FOR FINISH TYPE]</li> <li>CD-X OR OSB SHEATHING [REF. STRUCTURAL FOR SHEAR WALL SHEATHING REQUIREMENTS]</li> <li>FIBERGLASS ACOUSTICAL BATT INSULATION; B.O.D. 'OWENS CORNING - QUIETZONE ECOTOUCH PINK ACOUSTIC SOUNDPROOFING UNFACED BATT' OR EQUAL</li> </ol>	REQUIRED MINIMUM R- VALUE PER 2018 WSEC CHAPTER 4, § R402:	REQUIRED MINIMUM STC RATING PER 2018 IBC CHAPTER 12, § 1206:	REQUIRED MINIMUM FIRE - RESISTANCE RATING PER 2018 IBC CHAPTER 6:
	<ol> <li>(1) PRESSURE TREATED 2X SILL PLATE AND SILL GASKET @ FOUNDATION AND LEVEL 1, U.N.O.</li> <li>2X6 WOOD STUDS; FIRE SEPARATION ELEMENTS INCLUDING, BUT NOT LIMITED TO, BLOCKING, FIRESAFING, SEALING, AND GWB FIRESTOPS TO OCCUR PER A-300 SERIES - BUILDING AND WALL SECTIONS</li> <li>2 X 1/2" HAT CHANNEL ON 1-1/4" ISOLATION CLIPS: BOD PAC-INTL RSIC-1</li> </ol>	N/A	50 STC RATING IN GIVEN ASSEMBLY:	1 HOUR UL U311
	INTERIOR 1 2 3 4 5 6 INTERIOR 1 2 3 4 5 7 5 4 ABUTTING WALL / VOID	INTERIOR       1       5/8* TYPE X* GWB, LEVEL 4 FINISH, TYP. [REF. UNIT PLANS AND FINISH LEBEND FOR FINISH TYPE]         Image: Constraint of Equipment of the Constraint of the Standard Constraints (IEEE STRUCTURAL FOR SHEAR WALL SHAFTING (IEEE) COLORS, REFERENT ACULIST. CONSTRAIL COLORS, REFERENT ACULIST. CONSTRAIL COLORS, REFERENT ACULIST. CONSTRAIL COLORS, REFERENT ACULST. CONSTRAIL CONSTR	INTERIOR         1         SAT TYPE Y DWR, LEVEL 4 FINISH, TYP, [REF. LINIT FLANS AND FINISH LEDEND FOR FINISH TYPE]         RECURED MINIMUR ? WLUE FREE ZOBE WSEE CHAPTER 4, 5 & AD 2           1         2.3         3.2         7.2         FIDERALS ADDURTON NS]         RECURED AND THE SERVICIDIAL (CITY OR DRS SHEAT HING [REF. STRUCTURAL FOR SHEAR WALL SHEAT HING REQUIREMENTS]         RECURED AND THE SHEAT THIS ULATION & D.D. OWENS CORNING - OUTCZONE COTODICI PINK ADDUSTIC SOLUMPROTING UNK-ACE DATT OR EQUAL (WHERE DECORS, REFER TO ACDUSTIC NOTES BY NUMBER INS SHEET]         N/A           1         2.3         5.07 TYPE Y DWR, LEVEL 4 FINISH, TYP [REF. UNIT FLANS AND FINISH LEGEND FOR FINISH TYPE]         REQUIRED MINIMUR ? N/A           1         2.0         5.07 TYPE Y DWR, LEVEL 4 FINISH, TYP [REF. UNIT FLANS AND FINISH LEGEND FOR FINISH TYPE]         REQUIRED MINIMUR ? N/A           1         5.07 TYPE Y DWR, LEVEL 4 FINISH, TYP [REF. UNIT FLANS AND FINISH LEGEND FOR FINISH TYPE]         REQUIRED MINIMUR ? N/A           1         5.07 TYPE Y DWR, LEVEL 4 FINISH, TYP [REF. UNIT FLANS AND FINISH LEGEND FOR FINISH TYPE]         REQUIRED MINIMUR ? N/A           1         5.07 TYPE Y DWR, LEVEL 4 FINISH, TYP [REF. UNIT FLANS AND FINISH LEGEND FOR FINISH TYPE]         REQUIRED MINIMUR ? N/A           1         5.07 TYPE Y DWR, LEVEL 4 FINISH, TYP [REF. UNIT FLANS AND FINISH LEGEND FOR FINISH TYPE]         REQUIRED MINIMUR ? N/A           2         5.17 FIRERALSS ADDUSTICAL REF TINDULATION AD LEVEL 1, U.N.O.         REQUIRED MINIMER ADDUSTICAL REF REF TO ADUSTI	INTERDR         1         Soft TYPE X: DWALENTLATING TYPE (BTT UNIT PLANS AND TIMELITEDING TOR FINST TYPE) TYPE X: DWALE REQUIRED THE X STRUCTURAL (DIX IR COSS STRUCTURAL TOR

RMAL RATING	ACOUSTIC RATING	FIRE-RESISTANCE RATING
RED MINIMUM R- PER 2018 WSEC APTER R402:	REQUIRED MINIMUM STC RATING PER 2018 IBC CHAPTER 12, § 1206:	REQUIRED MINIMUM FIRE - RESISTANCE RATING PER 2018 IBC CHAPTER 6:
R-25	N/A	1 HOUR
DED R-VALUE IN EN ASSEMBLY:	ESTIMATED STC RATING IN GIVEN ASSEMBLY:	
R-25	34 - 46	
RED MINIMUM R- PER 2018 WSEC APTER R402:	REQUIRED MINIMUM STC RATING PER 2018 IBC CHAPTER 12, § 1206:	REQUIRED MINIMUM FIRE - RESISTANCE RATING PER 2018 IBC CHAPTER 6:
R-25	N/A	N/A
DED R-VALUE IN EN ASSEMBLY:	ESTIMATED STC RATING IN GIVEN ASSEMBLY:	
R-25	34 - 46	

# **BUILDING ASSEMBLIES**

# **GENERAL NOTES**

EXTERIOR CLADDING FINISH ALIGNMENT AND ORIENTATION PER A-200 SERIES - BUILDING ELEVATIONS;

REFER TO CODE PLANS FOR LOCATION AND EXTENT OF RATED ASSEMBLIES.

/E FIBERGLASS
RED. WITH NON-HARDENING
I FRAMING ROWS CTURAL DRAWINGS. PARTITIONS. TO BEDROOMS AND
INISH CONFIGURATION

EXTERIOR WALL FINISH TYPES PER EXTERIOR FINISH LEGEND, A-200 SERIES FRAMING MEMBERS AND INTERIOR GYPSUM WALL BOARD SHEATHING AT RATED PARTITIONS TO EXTEND TO 3 ROOF SHEATHING - REFER TO A-300 SERIES - WALL SECTIONS FOR MORE INFORMATION. LAYERS OF GWB THAT EXTEND TO THE UNDERSIDE OF ROOF SHEATHING ABOVE TO BE SEALED AIRTIGHT WITH APPROVED FIRE SEALANT DEFER TO STRUCTURAL DRAWINGS AND SPECIFICATIONS FOR FRAMING MEMBER TYPES, SIZES, SPACING, 4. FASTENING, AND ANCHORAGE. FRAMING MEMBERS IN ARCHITECTURAL INTERIOR AND EXTERIOR BASIC WALL ASSEMBLIES SHOWN FOR REFERENCE ONLY. FIRE SEPARATION ELEMENTS INCLUDING, BUT NOT LIMITED TO, BLOCKING, FIRESAFING, SEALING, AND GWB FIRESTOPS TO OCCUR PER A-300 SERIES - BUILDING AND WALL SECTIONS; INSTALLATION TO MEET STANDARDS SET FORTH BY 2018 IBC & IFC. WHEN INSTALLED VERTICALLY, GWB TO BE TYPE 'X'; WHEN INSTALLED HORIZONTALLY, GWB TO BE TYPE 'C', UNLESS NOTED OTHERWISE.

DRYWALL TO BE INSTALLED LEVEL 4 FINISH, UNLESS NOTED OTHERWISE USE MOISTURE-RESISTANT GWB AT RESTROOMS AND WITHIN 48" OF PLUMBING FIXTURES OUTSIDE OF RESTROOMS.

REFER TO ENLARGED PLANS AND INTERIOR ELEVATIONS FOR FINISHES.

**GENERAL NOTES BY NUMBER** 

1.

8.

9





FINISH FLOOR - REFERENCE ENLARGED FLOOR PLANS ON A-400 SRIES AND FINISH SCHEDULE ON SHEET A-401 FOR

 $\infty$ 

PROJECT NO:	050-01-21
PRINCIPAL-IN-CHARGE	E: BF
PROJECT ARCHITECT:	MJ
DRAWN BY:	HL

REVISION

DATE

PROJECT STATUS: PERMIT SET 05.06.2022

MARK

SHEET TITLE: ASSEMBLIES - BASIC & FINISH WALL TYPES

SHEET NO.

BUILDING ASSEMBLIES UL LISTING DESCRIPTIONS - FLOOR, ROOF & CEILING TYPES

### UL L570 - 1-HOUR - INTERIOR FLOOR ASSEMBLY

ltem 7.

**1. FLOORING SYSTEM** — THE FLOORING SYSTEM SHALL CONSIST OF THE FOLLOWING (SYSTEM NO. 15): SUBFLOORING — 1-1/2 IN. THICK T & G LAMINATED COMPOSITE PLYWOOD SUB-FLOOR PANELS TO BE PERPENDICULAR TO THE TRUSSES WITH END JOINTS STAGGERED 4 FT. END JOINTS CENTERED OVER TOP CHORD OF TRUSSES. SUBFLOOR PANELS SECURED TO TRUSSES WITH CONSTRUCTION ADHESIVE AND #8 BY 3 IN. WOOD SCREWS SPACED 12 IN. OC IN THE FIELD AND 6 IN. OC AT THE END JOINTS. SOUND ABSORPTION PANEL — RSP INDUSTRIES INC OR EQUAL

2. SUBFLOORING — 3/4 IN. WOOD STRUCTURAL PANEL. 3. STRUCTURAL WOOD MEMBERS — MIN 9-1/2 IN. DEEP "I" SHAPED WOOD JOISTS SPACED AT A MAX OF

24 IN. OC. (WHERE BATTS AND BLANKETS USED). JOISTS SHALL CONFORM TO ICC-ES ESR-1153 REPORT. **3. INSULATION** — GLASS FIBER BATT INSULATION, SECURED TO THE SUBFLOORING WITH STAPLES, OR TO THE WOOD JOISTS WITH 0.090 IN. DIAM GALV STEEL WIRES, OR DRAPED OVER THE RESILIENT CHANNEL/GYPSUM PANEL CEILING MEMBRANE. ANY THICKNESS OF GLASS FIBER INSULATION BEARING THE UL CLASSIFICATION MARKING AS TO SURFACE BURNING CHARACTERISTICS AND/OR FIRE RESISTANCE.

4. RESILIENT CHANNEL — 1/2 IN. 25 GA RESILIENT CHANNEL SPACED 24 IN. OC. SECURED TO EACH TRUSS WITH 1-1/4 IN. LONG TYPE S SCREWS.

5. GYPSUM BOARD — TWO LAYERS OF 5/8 IN. THICK BY 4 FT WIDE GYPSUM PANELS, INSTALLED PERPENDICULAR TO RESILIENT CHANNELS (ITEM 4). THE BASE LAYER OF PANELS SCREW-ATTACHED TO THE RESILIENT CHANNELS WITH 1 IN. LONG TYPE S SCREWS SPACED 8 IN. OC AT THE BUTT JOINTS AND 16 IN. OC IN THE FIELD OF THE PANEL. THE FACE LAYER SCREW-ATTACHED TO THE RESILIENT CHANNELS WITH 1-5/8 IN. TYPE S SCREWS SPACED 8 IN. OC AND 1-1/2 IN. TYPE G SCREWS SPACED 8 IN. OC AT THE BUTT JOINTS LOCATED MID-SPAN BETWEEN RESILIENT CHANNELS.

6. FINISHING SYSTEM — FIBER TAPE EMBEDDED IN COMPOUND OVER JOINTS AND EXPOSED NAIL HEADS, COVERED WITH COMPOUND WITH EDGES OF COMPOUND FEATHERED OUT. AS AN ALTERNATE, NOM 3/32 IN. THICK GYPSUM VENEER PLASTER MAY BE APPLIED TO THE ENTIRE SURFACE OF CLASSIFIED VENEER BASEBOARD. JOINTS REINFORCED.

### UL L501 - 1-HOUR - EXTERIOR FLOOR ASSEMBLY

**1. FLOORING SYSTEMS** — THE FLOORING SYSTEM SHALL CONSIST OF THE FOLLOWING (SYSTEM NO. 2): SUBFLOORING — MIN 15/32 IN. THICK WOOD STRUCTURAL PANELS, MIN GRADE "C-D" OR "SHEATHING". FACE GRAIN OF PLYWOOD OR STRENGTH AXIS OF PANELS TO BE PERPENDICULAR TO THE JOISTS WITH JOINTS STAGGERED.

VAPOR BARRIER --- (OPTIONAL) --- NOM 0.030 IN. THICK COMMERCIAL ASPHALT SATURATED FELT. FLOOR MAT MATERIALS — (OPTIONAL) — FLOOR MAT MATERIAL LOOSE LAID OVER THE SUBFLOOR. REFER TO MANUFACTURER'S INSTRUCTIONS REGARDING THE MINIMUM THICKNESS OF FLOOR TOPPING OVER EACH FLOOR MAT MATERIAL.

FINISH FLOORING — FLOOR TOPPING MIXTURE — MIN 3/4 HAVING A MIN COMPRESSIVE STRENGTH OF 1800 PSI. REFER TO MANUFACTURER'S INSTRUCTIONS ACCOMPANYING THE MATERIAL FOR SPECIFIC MIX DESIGN.

**5. GYPSUM BOARD** — (FINISH RATING — 30 MINUTES UNLESS OTHERWISE NOTED) — NOM 5/8 IN. THICK, 48 IN. WIDE GYPSUM BOARD, INSTALLED WITH LONG DIMENSION PERPENDICULAR TO JOISTS. GYPSUM BOARD SECURED WITH 1-7/8 IN. LONG, 6D CEMENT COATED NAILS SPACED 6 IN. OC. **6. FINISHING SYSTEM** — VINYL, DRY OR PREMIXED JOINT COMPOUND, APPLIED IN TWO COATS TO JOINTS AND SCREW-HEADS. NOM 2 IN. WIDE PAPER TAPE EMBEDDED IN FIRST LAYER OF COMPOUND OVER ALL JOINTS. AS AN ALTERNATE, NOM 3/32 IN. THICK VENEER PLASTER MAY BE APPLIED TO THE ENTIRE SURFACE OF GYPSUM BOARD.

ASSEMBLY TYPES - BASIC FLOORS					ASSEMBLY TYPES - ROOF FINISHES - EXTERIOR							
ASSEM	IBLY TYPE	ASSEMBLY COMPONENTS BY NUMBER	ASSEMBLY COMPONENT DESCRIPTIONS	THERMAL RATING	ACOUSTIC RATING	FIRE-RESISTANCE RATING	ASSEMBLY TYPE	ASSEMBLY COMPONENTS BY NUMBER	ASSEMBLY COMPONENT DESCRIPTIONS	THERMAL RATING	ACOUSTIC RATING	FIRE-RESISTANCE RATING
SEPA	RIOR UNIT ARATION 2 / CEILING	$ \begin{array}{c} \text{INTERIOR} \\  \overline{FF} \cdot \overline{X} \\ 1 2 3 4 5 \\ \end{array} $	<ul> <li>(WHERE OCCURS, FLOOR FINISH TYPE PER A-100 SERIES - OVERALL FLOOR PLANS)</li> <li>1. 1" LIGHTWEIGHT GYPSUM UNDERLAYMENT; B.O.D. "UNITED STATES GYPSUM - LEVELROCK BRAND 2500 SERIES'</li> <li>2. 1/4" MIN. ACOUSTIC MAT; B.O.D. 'UNITED STATES GYPSUM - LEVELROCK SOUND MAT' OR EQUAL</li> <li>3. 3/4" TONGUE-AND-GROOVE PLYWOOD SUBLOOR [REF. STRUCTURAL FOR FASTENING PATTERN]</li> </ul>	REQUIRED MINIMUM R- VALUE PER 2018 WSEC CHAPTER R402: N/A		REQUIRED MINIMUM FIRE - RESISTANCE RATING PER 2018 IBC CHAPTER 6: 1 HOUR	COMPOSITION SHINGLE ROOF		<ul> <li>(REF. A-300 SERIES - BUILDING / WALL SECTIONS AND STRUCTURAL SET FOR TRUSS INFORMATION)</li> <li>1. ASHALT COMPOSITION ROOFING SHINGLES, [REF. FINISH LEGEND A-400 FOR EXTERIOR CLADDING PRODUCT FINISHES]</li> <li>2. ASPHALT-SATURATED FELT UNDERLAYMENT; INSTALLATION PER MANUFACTURER</li> </ul>	REQUIRED MINIMUM R- VALUE PER 2018 WSEC CHAPTER R402: R-49	REQUIRED MINIMUM STC RATING PER 2018 IBC CHAPTER 12, § 1206: N/A	REQUIRED MINIMUM FIRE - RESISTANCE RATING PER 2018 IBC CHAPTER 6: N/A
_			<ol> <li>11-7/8" ENGINEERED I-JOISTS [REF. STRUCTURAL FOR SPACING, CHORD WIDTH, AND FASTENING REQ.]</li> <li>FIBERGLASS BATT INSULATION W/ SOUND BARRIER, THERMAL PERFORMANCE @ R-19. MIN.; B.O.D. 'OWENS CORNING - PROPINK' FIBERGLASS BATT</li> <li>SINGLE-PART SOUND ISOLATING CLIPS TO ATTACH FLOOR FRAMING MEMBERS TO HAT CHANNELS, SPACING PER STRUCTURAL; B.O.D. 'GREEN GLUE - NOISEPROOFING CLIP SYSTEM' OR EQUAL; FASTENING PER MANUFACTURER</li> <li>7/8" 22 GA. HAT CHANNELS TO RUN PERPENDICULAR TO FLOOR FRAMING MEMBERS; HAT CHANNELS TO ATTACH TO SOUND ISOLATING CLIPS, SPACING OF CHANNELS TO MATCH CLIP SPACING; B.O.D. 'GREEN GLUE -</li> </ol>	PROVIDED R-VALUE IN GIVEN ASSEMBLY: <b>R-19</b>	PROVIDED STC RATING IN GIVEN ASSEMBLY: 62 PER RAL-0T03-05/06	PROVIDED R-VALUE IN GIVEN ASSEMBLY: <b>1 HOUR</b> PER UL L570			<ol> <li>MM MIN. SELF-ADHERED WEATHERPROOFING UNDERLAYMENT; B.O.D. 'GCP APPLIED TECHNOLOGIES - GRACE ICE &amp; WATER SHIELD;' INSTALLATION PER MANUFACTURER</li> <li>1/2" APA RATED SHEATHING [REF. STRUCTURAL FOR FASTENING REQUIREMENTS]</li> <li>[TRUSS, BY OTHERS, SHOWN FOR REFERENCE]</li> <li>1" MIN. AIR GAP</li> <li>19" FIBERGLASS HIGH-DENSITY BATT INSULATION, THERMAL PERFORMANCE @ R-49 MIN.; B.O.D. 'OWENS CORNING - ECOTOUCH PINK FIBERGLAS INSULATION WITH PUREFIBER'. DENSE-PACKED AGAINST FIBER OR</li> </ol>	PROVIDED R-VALUE IN GIVEN ASSEMBLY: <b>R-49</b>		
TYPE:	: F-1	6 7 8 INTERIOR	NOISEPROOFING CLIP SYSTEM' 8. (2) 5/8" TYPE 'C' GWB, LEVEL 4 FINISH, TYP.; REF. UNIT PLANS AND FINISH LEGEND FOR FINISH TYPE				TYPE: R-1	INTERIOR	<ul> <li>CARDBOARD BAFFLES BETWEEN TRUSSES.</li> <li>CLASS I OR II VAPOR RETARDER; B.O.D. 'STEGO WRAP' CLASS A VAPOR BARRIER (10 MIL)</li> <li>5/8" TYPE 'X' GWB, LEVEL 4 FINISH, TYP.; REF. UNIT PLANS AND FINISH LEGEND FOR FINISH TYPE</li> </ul>			
	RIOR STAIR NDING	EXTERIOR 1 2 5 3	<ol> <li>1" LIGHTWEIGHT CONCRETE TOPPING; [REF. STRUCTURAL FOR MAX. ALLOWABLE WEIGHT AND CONCRETE TYPE]</li> <li>6 MIL POLYETHYLENE VAPOR RETARDER LINING BENEATH CONCRETE TOPPING</li> <li>1/2" APA RATED SHEATHING [REF. STRUCTURAL FOR FASTENING REQUIREMENTS]</li> </ol>	REQUIRED MINIMUM R- VALUE PER 2018 WSEC CHAPTER R402: N/A	REQUIRED MINIMUM STC RATING PER 2018 IBC CHAPTER 12, § 1206: N/A	REQUIRED MINIMUM FIRE - RESISTANCE RATING PER 2018 IBC CHAPTER 6: N/A	ASSEMBLY TYPE	ASSEMBLY COMPONENTS BY NUMBER	ASSEMBLY TYPES - BASIC CEILING - INTERIOR ASSEMBLY COMPONENT DESCRIPTIONS	THERMAL RATING	ACOUSTIC RATING	FIRE-RESISTANCE RATING
			<ol> <li>(1) 5/8" EXTERIOR GYPSUM SHEATHING; B.O.D. 'GEORGIA-PACIFIC - DENSGLASS FIREGUARD SHEATHING'</li> <li>2x12 JOIST [REF. STRUCTURAL FOR SPACING AND FASTENING REQUIREMENTS FOR FLOOR FRAMING MEMBERS]</li> <li>1" X 2" P.T. WOOD FURRING TO RUN PERPENDICULAR TO FLOOR FRAMING MEMBERS [REF. STRUCTURAL FOR SPACING, FASTENING]</li> <li>CEMENTITIOUS SOFFIT PANEL [REF. FINISH SCHEDULE]</li> </ol>				GWB CEILING	CEILING CAVITY / CHASE 3	<ol> <li>5/8" TYPE 'C' GWB, LEVEL 4 FINISH, TYP.; REF. UNIT PLANS AND FINISH LEGEND FOR FINISH TYPE</li> <li>FIBERGLASS ACOUSTICAL BATT INSULATION; B.O.D. 'OWENS CORNING - QUIETZONE ECOTOUCH PINK ACOUSTIC SOUNDPROOFING UNFACED BATT' OR EQUAL</li> <li>2X BLOCKING AS REQUIRED</li> </ol>	REQUIRED MINIMUM R- VALUE PER 2018 WSEC CHAPTER R402: N/A	REQUIRED MINIMUM STC RATING PER 2018 IBC CHAPTER 12, § 1206: N/A	REQUIRED MINIMUM FIRE - RESISTANCE RATING PER 2018 IBC CHAPTER 6: N/A
EXTER	: F-2 Rior Unit LCony	EXTERIOR	(WHERE OCCURS, FLOOR FINISH TYPE PER A-100 AND A-310 SERIES ) 1. 60 MIL VINYL DECK MEMBRANE; B.O.D. 'DURADECK ' ULTRA VINYL MEMBRANE, COLOR: GRAY 2. 1/2" APA RATED SHEATHING [REF. STRUCTURAL FOR FASTENING REQUIREMENTS]	REQUIRED MINIMUM R- VALUE PER 2018 WSEC CHAPTER R402:		REQUIRED MINIMUM FIRE - RESISTANCE RATING PER 2018 IBC CHAPTER 6:	TYPE: CLG-1					
-			<ol> <li>2x12 CANTED WOOD JOIST SLOPED TOWARDS EXTERIOR AT 1/4" PER 12" [REF. STRUCTURAL]</li> <li>[WHEN ABOVE CONDITIONED SPACE] PROVIDE R-30 BATT INSULATION IN CAVITY. PROVIDE NON-RATED SOFFIT BELOW RATED ASSEMBLY AND PROVIDE R-19 BATT INSULATION AT SOFFIT.</li> <li>1x WOOD BLOCKING[ALTERNATE DIRECTION FROM JOIST, REF. STRUCTURAL FOR FRAMING REQUIREMENTS]</li> <li>(2) LAYERS 5/8" TYPE 'C' GYPSUM SHEATHING [REF. FINISH SCHEDULE]</li> <li>CEMENTITIOUS SOFFIT PANEL, CPL-2, [REF. FINISH SCHEDULE]</li> </ol>	N/A PROVIDED R-VALUE IN GIVEN ASSEMBLY:	N/A	1 HOUR WHERE CONDITION SPACE IS BELOW BALCONY PROVIDED R-VALUE IN GIVEN ASSEMBLY:						
TYPE:	: F-3	3 4 5 6 7 INTERIOR		R-49* *AT BALCONIES DIRECTLY OVER CONDITION SPACE AT L2		1 HOUR PER IBC 721						
	ON-GRADE LOOR	INTERIOR / ABOVE GRADE	<ul> <li>(WHERE OCCURS, FLOOR FINISH TYPE PER A-100 SERIES - OVERALL FLOOR PLANS)</li> <li>4" REINFORCED CONCRETE FLOOR SLAB [REF. STRUCTURAL FOR STEEL REINFORCEMENT SPACING, COVERAGE, # DIA. AND TYPE, AND OTHER REQUIREMENTS]</li> <li>6-MIL CONTINUOUS POLYETHYLENE VAPOR RETARDER; B.O.D. 'SIMPLESOLUTIONS - MOISTUREBLOC 6-MIL FILM VAPOR BARRIER UNDERLAYMENT' OR EQUAL</li> </ul>	REQUIRED MINIMUM R- VALUE PER 2018 WSEC CHAPTER R402: R-10	REQUIRED MINIMUM STC RATING PER 2018 IBC CHAPTER 12, § 1206: N/A	REQUIRED MINIMUM FIRE - RESISTANCE RATING PER 2018 IBC CHAPTER 6: N/A						
			<ol> <li>2" RIGID INSULATION WITHIN 24" OF PERIMETER, THERMAL PERFORMANCE @ R-5/IN MIN.; B.O.D. 'OWENS CORNING - EXTRUDED POLYSTYRENE [XPS]' OR EQUAL</li> <li>4-6" BASE COURSE CRUSH ROCK SUBGRADE, NO FINES</li> <li>COMPACTED SOIL [REF. CIVIL AND STRUCTURAL FOR APPLICABLE COMPACTION REQUIREMENTS]</li> </ol>	PROVIDED R-VALUE IN GIVEN ASSEMBLY: <b>R-10</b>								
	:: F-4	4 3 5 EXTERIOR / BELOW GRADE										

### UL P522 - 1-HOUR - CEILING & ROOF ASSEMBLY

**1. ROOFING SYSTEM** — ANY UL CLASS A, B OR C ROOFING SYSTEM (TGFU) OR PREPARED ROOF COVERING (TFWZ) ACCEPTABLE FOR USE OVER NOM 15/32 IN. THICK WOOD STRUCTURAL PANELS, MIN. GRADE "C-D" OR "SHEATHING". NOM 15/32 IN. THICK WOOD STRUCTURAL PANELS SECURED TO TRUSSES WITH NO. 6D RINGED SHANK NAILS SPACED 12 IN. OC ALONG EACH TRUSS. STAPLES HAVING EQUAL OR GREATER WITHDRAWAL AND LATERAL RESISTANCE STRENGTH MAY BE SUBSTITUTED FOR THE 6D NAILS. CONSTRUCTION ADHESIVE MAY BE USED WITH EITHER THE NAILS OR STAPLES. 2. TRUSSES — PITCHED OR PARALLEL CHORD WOOD TRUSSES, SPACED A MAX OF 24 IN. OC, FABRICATED FROM NOM 2 BY 4 LUMBER, WITH LUMBER ORIENTED VERTICALLY OR HORIZONTALLY. TRUSS MEMBERS SECURED TOGETHER WITH MIN. 0.0356 IN. THICK GALV STEEL PLATES. PLATES HAVE 5/16 IN. LONG TEETH PROJECTING PERPENDICULAR TO THE PLANE OF THE PLATE. THE TEETH ARE IN PAIRS FACING EACH OTHER (MADE BY THE SAME PUNCH), FORMING A SPLIT TOOTH TYPE PLATE. EACH TOOTH HAS A CHISEL POINT ON ITS OUTSIDE EDGE. THESE POINTS ARE DIAGONALLY OPPOSITE EACH OTHER FOR EACH PAIR. THE TOP HALF OF EACH TOOTH HAS A TWIST FOR STIFFNESS. THE PAIRS ARE REPEATED ON APPROXIMATELY 7/8 IN. CENTERS WITH FOUR ROWS OF TEETH PER INCH OF PLATE WIDTH. WHERE THE TRUSS INTERSECTS WITH THE INTERIOR FACE OF THE EXTERIOR WALLS, THE MIN TRUSS DEPTH SHALL BE 5-1/4 IN. WITH A MIN ROOF SLOPE OF 3/12 AND A MIN. AREA IN THE PLANE

OF THE TRUSS OF 21 SQ/FT. **3B. FOAMED PLASTIC** — SPRAY FOAM INSULATION APPLIED DIRECTLY TO THE UNDERSIDE OF THE UNDERSIDE OF THE ROOFING SYSTEM (ITEM 1). SPRAY FOAM INSULATION INSTALLED TO A MAXIMUM THICKNESS OF 10 IN. AT A NOMINAL 0.5 LB/FT3 DENSITY, WHILE MAINTAINING A MINIMUM 8-1/2 IN. CLEARANCE BETWEEN THE SPRAY FOAM INSULATION AND THE GYPSUM BOARD (ITEM 7). WHEN SPRAY FOAM INSULATION IS USED, RESILIENT CHANNELS (ITEM 6) SHALL BE INSTALLED MAXIMUM 12 IN. OC, WITH CHANNELS ADJACENT TO BUTT JOINTS OF GYPSUM BOARD (ITEM 7) INSTALLED AT 6 IN. OC TO ALLOW FOR MAXIMUM 3 IN. SPACING OFF ENDS OF THE GYPSUM BOARD JOINTS. GYPSUM BOARD (ITEM 7) TO BE INSTALLED USING 1-1/4 IN. LONG TYPE S SCREWS, SPACED MAXIMUM 8 IN. OC, AND BUTTED END JOINTS SHALL BE STAGGERED MIN. 2 FT WITHIN THE ASSEMBLY, AND OCCUR MIDWAY BETWEEN THE CONTINUOUS FURRING CHANNELS.

4. AIR DUCT — ANY UL CLASS 0 OR CLASS 1 FLEXIBLE AIR DUCT INSTALLED IN ACCORDANCE WITH THE INSTRUCTIONS PROVIDED BY THE DAMPER MANUFACTURER.

5. CEILING DAMPER — MAX NOM AREA, 324 SQ IN. MAX SQUARE SIZE, 18 IN. BY 18 IN. RECTANGULAR SIZES NOT TO EXCEED 324 SQ IN. WITH A MAX WIDTH OF 18 IN. MAX DAMPER HEIGHT IS 14 IN. INSTALLED IN ACCORDANCE WITH MANUFACTURERS INSTALLATION INSTRUCTIONS PROVIDED WITH THE DAMPER. MAX DAMPER OPENINGS NOT TO EXCEED 162 SQ IN. PER 100 SQ FT OF CEILING AREA.

6. FURRING CHANNELS — RESILIENT CHANNELS FORMED OF 25 MSG THICK GALV STEEL. INSTALLED PERPENDICULAR TO THE TRUSSES (ITEM 2), SPACED A MAX OF 16 IN. OC WHEN NO INSULATION (ITEM 3 OR 3A) IS FITTED IN THE CONCEALED SPACED, OR A MAX OF 12 IN. OC WHEN INSULATION (ITEM 3 OR 3A) IS FITTED IN THE CONCEALED SPACE, DRAPED OVER THE RESILIENT CHANNEL/GYPSUM BOARD CEILING MEMBRANE, OR WHEN INSULATION (ITEM 3B, 3D OR 3E) IS APPLIED TO THE UNDERSIDE OF THE ROOFING SYSTEM (ITEM 1). TWO COURSES OF RESILIENT CHANNEL POSITIONED 6 IN. OC AT WALLBOARD BUTT-JOINTS (3) IN. FROM EACH END OF WALLBOARD). CHANNELS ORIENTED OPPOSITE AT WALLBOARD BUTT-JOINTS. CHANNEL SPLICES OVERLAPPED 4 IN. BENEATH WOOD TRUSSES. CHANNELS SECURED TO EACH TRUSS WITH 1-1/4 IN. LONG TYPE S SCREWS. 7. GYPSUM BOARD — ONE LAYER OF NOM 5/8 IN. THICK BY 48 IN. WIDE BOARDS, INSTALLED WITH LONG DIMENSION PARALLEL TO TRUSSES. ATTACHED TO THE RESILIENT CHANNELS USING 1 IN. LONG TYPE S BUGLE-HEAD SCREWS. (ITEM 3B, 3D OR 3E) IS


INSTALLED IN THE CONCEALED SPACE, SPRAY-APPLIED TO THE UNDERSIDE OF THE ROOFING SYSTEM (ITEM 1), SCREWS ARE SPACED A MAX OF 8 IN. OC ALONG RESILIENT CHANNELS, FASTENERS ARE INCREASED IN LENGTH TO 1-1/4 IN, AND GYPSUM BOARD BUTT JOINTS SHALL BE STAGGERED MIN. 2 FT WITHIN THE ASSEMBLY, AND OCCUR BETWEEN THE MAIN FURRING CHANNELS.


### **BUILDING ASSEMBLIES** ACOUSTIC NOTES


### ACOUSTIC NOTES BY NUMBER

- INTERIOR PARTITIONS ENCLOSING BATHROOMS AND BEDROOMS IN UNITS TO RECEIVE ACOUSTICAL BATT INSULATION UNLESS NOTED OTHERWISE.
- JOINTS ON WALLS WITH MULTIPLE LAYERS OF GYPSUM WALL BOARD TO BE STAGGERE AT INTERIOR BASIC WALLS, CAULK ALONG BOTH SIDES OF THE PERIMETER OF WALL W
- SILICONE MASTIC.
- AVOID BACK-TO-BACK OUTLETS. CAULK OPENINGS IN ELECTRICAL BOXES.
- WHERE A DOUBLE ROW OF STUDS IS SPECIFIED, MAKE NO CONNECTIONS BETWEEN F
- UNLESS NOTED OTHERWISE IN FIRE RESISTANCE RATING SPECIFICATIONS OR STRUCT USE ACOUSTICAL SEALANT AT HEAD AND BASE CONDITIONS OF SOUND RETARDANT PA PROVIDE FIBERGLASS ACOUSTICAL BATT AT INTERIOR PARTITION WALLS ADJACENT TO BATHROOMS, TYPICAL.

### WALL TYPE MARKS & CONFIGURATIONS

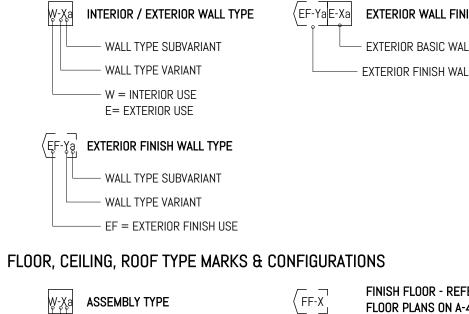

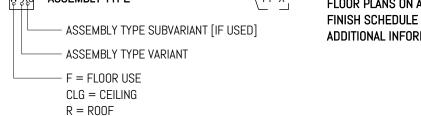

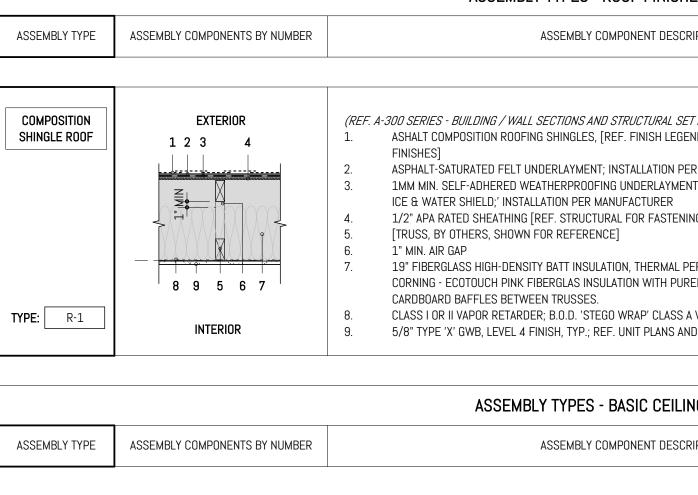

# **BUILDING ASSEMBLIES**

	GEN	IERAL NOTES BY NUMBER
FIBERGLASS	1.	REFER TO CODE PLANS FOR LOCATION AND EXTENT OF RATED ASSEMBLIES.
	2.	EXTERIOR CLADDING FINISH ALIGNMENT AND ORIENTATION PER A-200 SERIES - BUILDING ELEVATIONS;
D.		EXTERIOR WALL FINISH TYPES PER EXTERIOR FINISH LEGEND, A-200 SERIES
ITH NON-HARDENING	3.	FRAMING MEMBERS AND INTERIOR GYPSUM WALL BOARD SHEATHING AT RATED PARTITIONS TO EXTEND TO
		ROOF SHEATHING - REFER TO A-300 SERIES - WALL SECTIONS FOR MORE INFORMATION. LAYERS OF GWB
		THAT EXTEND TO THE UNDERSIDE OF ROOF SHEATHING ABOVE TO BE SEALED AIRTIGHT WITH APPROVED FIRE
RAMING ROWS		SEALANT.
URAL DRAWINGS.	4.	DEFER TO STRUCTURAL DRAWINGS AND SPECIFICATIONS FOR FRAMING MEMBER TYPES, SIZES, SPACING,
RTITIONS.		FASTENING, AND ANCHORAGE. FRAMING MEMBERS IN ARCHITECTURAL INTERIOR AND EXTERIOR BASIC WALL
BEDROOMS AND		ASSEMBLIES SHOWN FOR REFERENCE ONLY.
	5.	FIRE SEPARATION ELEMENTS INCLUDING, BUT NOT LIMITED TO, BLOCKING, FIRESAFING, SEALING, AND GWB
		FIRESTOPS TO OCCUR PER A-300 SERIES - BUILDING AND WALL SECTIONS; INSTALLATION TO MEET
		STANDARDS SET FORTH BY 2018 IBC & IFC.
	6.	WHEN INSTALLED VERTICALLY, GWB TO BE TYPE 'X'; WHEN INSTALLED HORIZONTALLY, GWB TO BE TYPE 'C',
SH CONFIGURATION		UNLESS NOTED OTHERWISE.
	7.	DRYWALL TO BE INSTALLED LEVEL 4 FINISH, UNLESS NOTED OTHERWISE
L TYPE	8.	USE MOISTURE-RESISTANT GWB AT RESTROOMS AND WITHIN 48" OF PLUMBING FIXTURES OUTSIDE OF
L TYPE		RESTROOMS.
	9.	REFER TO ENLARGED PLANS AND INTERIOR ELEVATIONS FOR FINISHES.

FERENCE ENLARGED
-400 SRIES AND
ON SHEET A-401 FOR
MATION






	MARK	REVISION		DATE
-	PRIN PROJ	JECT NO: CIPAL-IN-CHA JECT ARCHITI VN BY:		21 BF MJ HL
A	PE	RMIT S 06.202	ET	
	AS		IES - FLOOF CEILING TYF	•

SHEET NO.

A-011

# **GENERAL NOTES**

CRAF

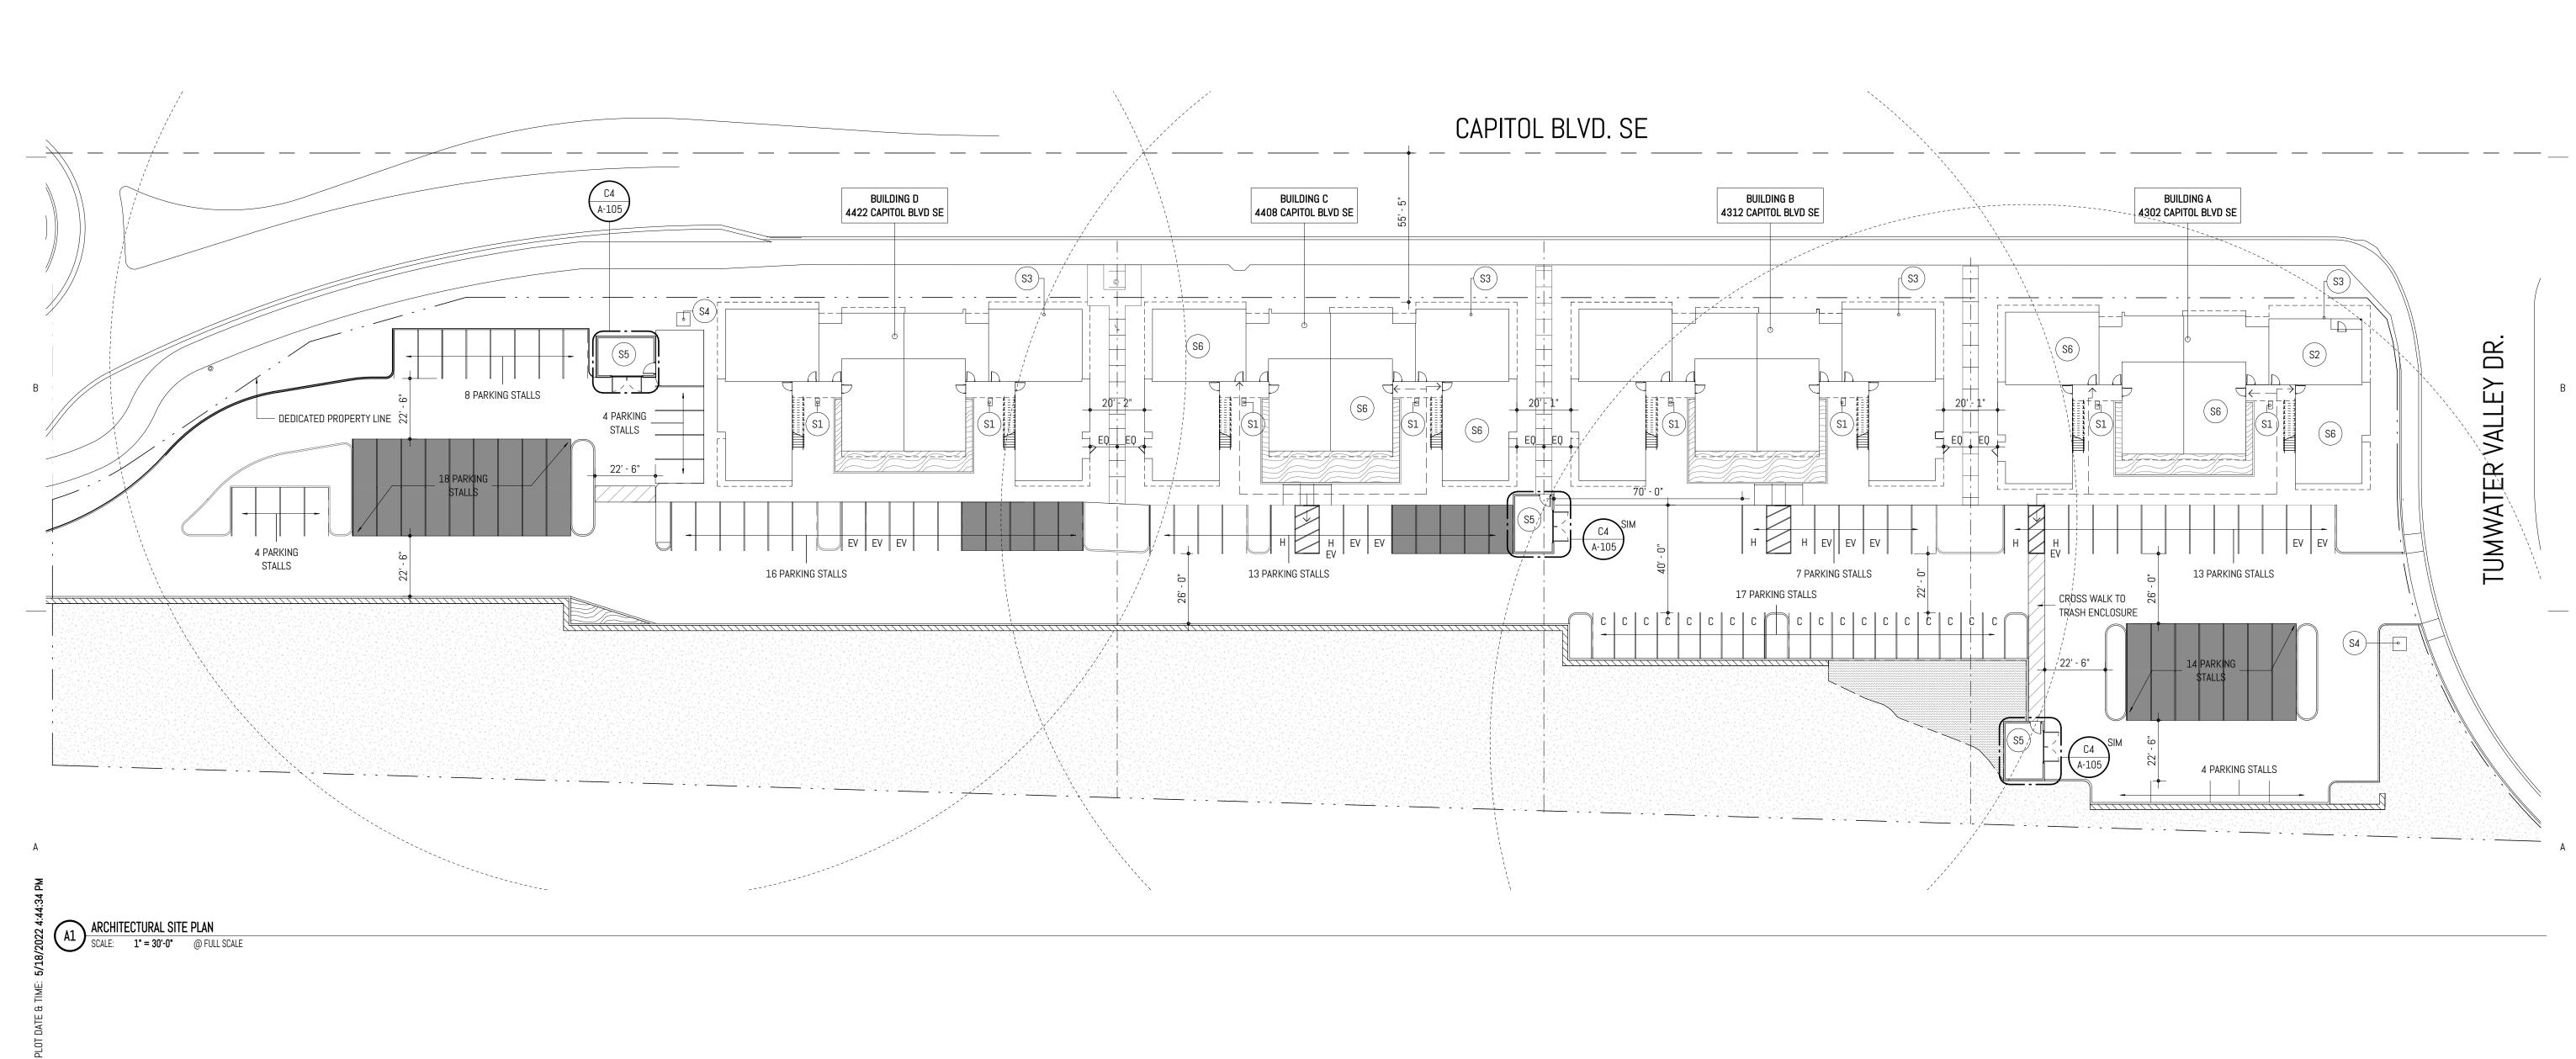


С

Item 7.

117

1

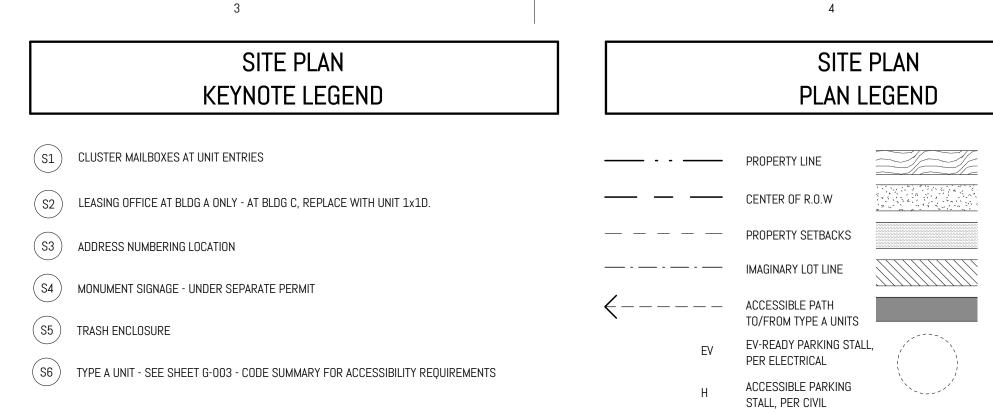

COMPACT PARKING STALL, PER CIVIL

С

### ARCHITECTURAL SITE GENERAL NOTES

	GENERAL NUTES
	GENERAL NOTES BY NUMBER
OSCAPED AREA	1. REFERENCE CIVIL DRAWINGS FOR ALL SITE CONSTRUCTION INFORMATION, INCLUDING BUT NOT
ISTURBED STEEP SLOPE	LIMITED TO THE FOLLOWING: -SITE GEOMETRY AND DIMENSIONAL CONTROL, INCLUDING FINISH ELEVATIONS
/E SPACE TRAILHEAD	-SITE UTILITIES -SITE GRADING AND DRAINAGE -ASPHALT/CONCRETE PAVING DETAILS
INING WALL, PER CIVIL	-PAVING MARKERS -CONCRETE SIDEWALK, CURB, AND GUTTER DETAILS
ERED PARKING STALLS	-PARKING BUMPERS -TRAFFIC SIGNAGE
H ENCLOSURE	-PAVING STRIPING AND CURB MARKINGS -TYPICAL HANDICAP SIGNAGE/SPACES
/EL DISTANCE IUS - 200' MAXIMUM	<ol> <li>RE: ELECTRICAL DRAWINGS FOR SITE INFORMATION INCLUDING, BUT NOT LIMITED TO THE FOLLOWING:</li> </ol>
	-SITE LIGHT STANDARD LOCATIONS AND SIZES
	-ELECTRICAL SLEEVING LOCATIONS AND SIZES
	-TELEPHONE AND CABLE TV PULL BOX LOCATIONS
	-ELECTRICAL MANHOLE LOCATIONS AND DETAILS -PULL BOX LOCATIONS AND SIZES FOR VARIOUS SITE LIGHTING ELEMENTS
	-POLL BOX LOCATIONS AND SIZES FOR VARIOUS SITE LIGHTING ELEMENTS -EXTERIOR BUILDING ILLUMINATION AND UTILITY COORDINATION
	3. THE CONTRACTOR SHALL MAINTAIN ACCESS FOR EMERGENCY ENTRANCES AND SHALL NOT
	BLOCK ACCESS TO DRIVES. SITE WORK AND STAGING THAT AFFECT THE AREAS ADJACENT TO
	ACCESSIBLE ENTRIES TO OTHER NEIGHBORING BUILDINGS WILL REQUIRE A WRITTEN
	COORDINATION PLAN SUBMITTED TO AND APPROVED BY THE OWNER.
	4. DO NOT SCALE THE DRAWINGS.
	5. THE CONTRACTOR SHALL ENSURE COMPLIANCE WITH CHAPTER 33 OF THE INTERNATIONAL FIRE CODE FOR ALL CONSTRUCTION ACTIVITIES. ADEQUATE FIRE APPARATUS ACCESS SHALL BE
	PROVIDED TO THE BUILDING AND SITE AT ALL TIMES DURING CONSTRUCTION.
	<ol> <li>EMERGENCY LIGHTING SHALL BE PROVIDED ALONG EGRESS PATHS AT MINIMUM 1 FC (FOOTCANDLE) CONTINUOUSLY PER IBC 1025.5.</li> </ol>
	7. REFERENCE LANDSCAPE DRAWINGS FOR LANDSCAPE DESIGN.
	<ol> <li>8. APPROVED 12" MINUMUM ADDRESS NUMBERING TO BE PROVIDED ON EACH BUILDING. THE</li> </ol>
	ADDRESS NUMBERING SHALL BE HIGH CONTRAST TO THE CLADDING MATERIAL THEY ARE
	ATTACHED T. BUILDING SHALL BE ADDRESSED AS FOLLOWS:
	BUILDING A: 4302 CAPITOL BLVD SE, TUMWATER WA 98501
	BUILDING B: 4312 CAPITOL BLVD SE, TUMWATER WA 98501
	BUILDING C: 4408 CAPITOL BLVD SE, TUMWATER WA 98501
	BUILDING D: 4422 CAPITOL BLVD SE, TUMWATER WA 98501
	С

ARCHITECT DAVID FERGUSON TE OF WASHINGTON




DATE	REVISION		
21	050-01-2		
	000 01 /	PROJ	
BF	CHARGE:	PRIN	
MJ	HITECT:	PROJ	
HL		DRAV	

PROJECT STATUS: PERMIT SET 05.06.2022

SHEET TITLE: ARCHITECTURAL SITE PLAN

SHEET NO.

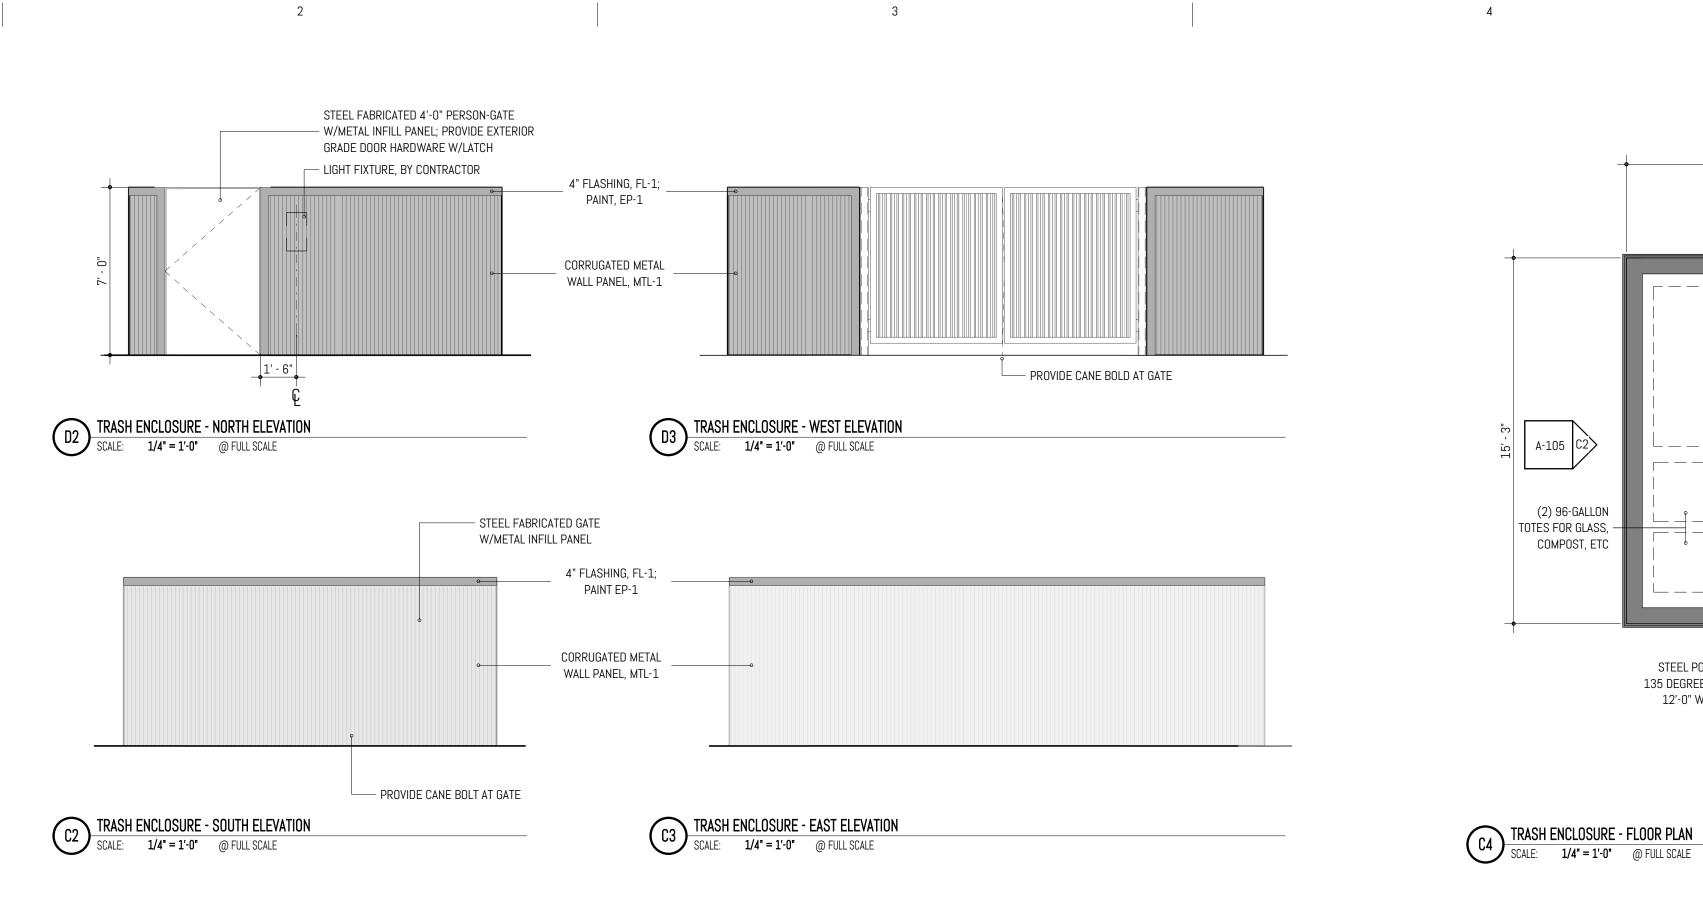

118

ltem 7.

П


С

1

2

3

4

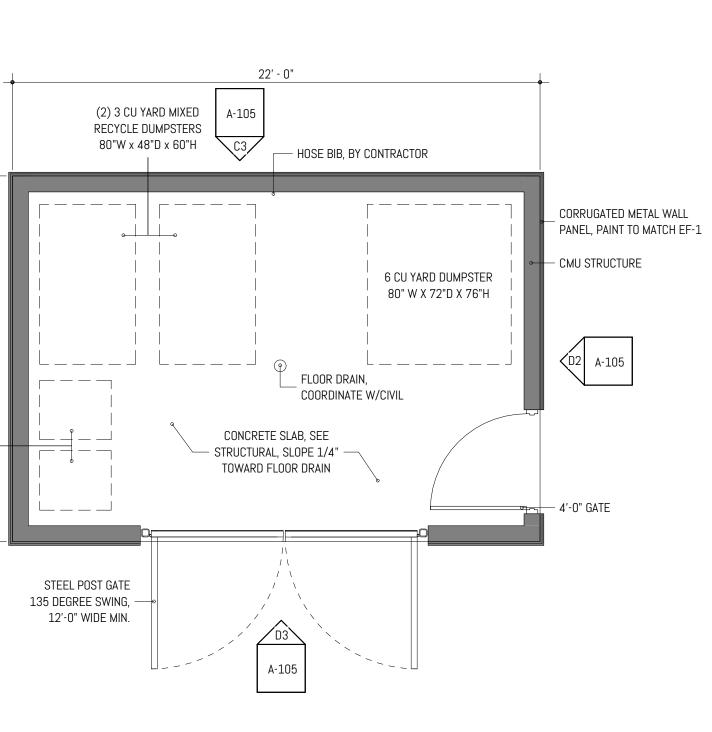

5


10 n **Y**<sup>I</sup> 10173 REGISTERED ARCHITECT BEN DAVID FERGUSON STATE OF WASHINGTON

# $\mathcal{O}$ APITOL BLVD SE **Д** 18, в. 4. /АТЕР, 4302, 4 CRAFT

	MARK	REVISION		DATE
	PRO	JECT NO:	050-01-	21
	PRIN	CIPAL-IN-CHARGE	:	BF_
	PRO	JECT ARCHITECT:		MJ
	DRAV	WN BY:		HL
	PRO	JECT STATUS:		
1	PE	RMIT SET		
	05	.06.2022		
	EN	LARGED S		72

SHEET NO.

5

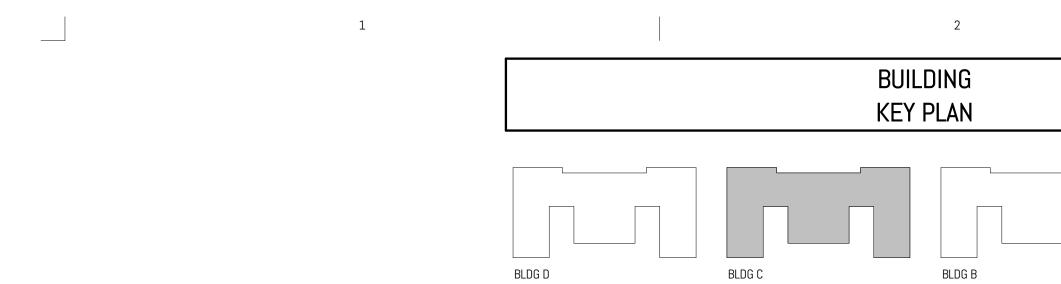

С


1

A.g 3' - 10" 4' - 0" W-1 A-200 A1 (EF-1 E-1 | (EF-4 E-1 (EF-1 E-1

A2 FLOOR PLAN - BUILDING A & C - LEVEL 1 SCALE: 1/8" = 1'-0" @ FULL SCALE

(EF-1 E-1)

119

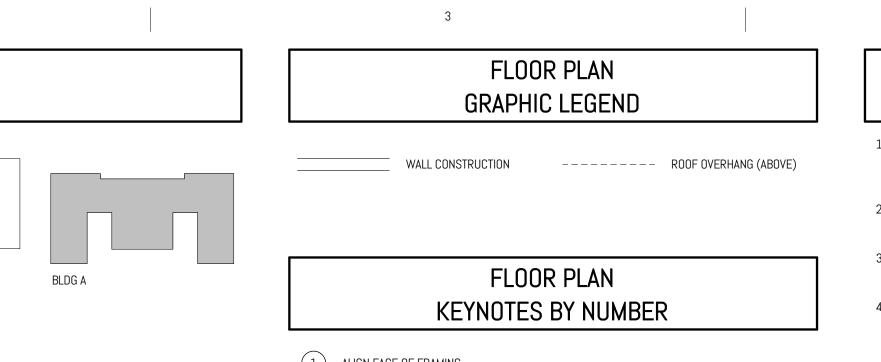

1 ALIGN FACE OF FRAMING

(2) GRID X.d FRAMING TO CENTERLINE OF STUD

1. GRIDLINES RUNNING EAST-WEST ARE INDICATED NUMERICALLY, GRIDLINES RUNNING NORTH-SOUTH ARE INDICATED ALPHABETICALLY. EACH GRIDLINE HAS A PREFIX THAT CORRESPONDS TO THE BUILDING LOCATION, REFER TO LEGEND ON THIS SHEET.

2. GRIDLINES ARE LOCATED AT FACE OF CONCRETE STEM WALLS AND FACE OF STUD FRAMING, EXCEPT AT GRID X.d WHERE GRIDLINE IS AT THE STUD CENTERLINE.


4

3. STUDS SHALL BE OFFSET AND ADDITIONAL LAYERS OF GYPSUM BOARD SHALL BE PROVIDED AS REQUIRED TO PROVIDE FACE ALIGNMENT OF GYPSUM BOARD.

4. PROVIDE MINIMUM 1'-0" CLEAR FLOOR SPACE AT THE PUSH SIDE OF EVERY DOOR WITH A CLOSER. PROVIDE MINIMUM 1'-6" CLEAR AT THE PULL SIDE OF EVERY DOOR, UNLESS SPECIFICALLY DIMENSIONED, NOTED OR SHOWN OTHERWISE.

5. WALL TYPES SHALL BE CONSTRUCTED AS BELOW. STRUCTURAL REQUIREMENTS PER STRUCTURAL SERIES TAKE PRECEDENT. OWNER SHALL BE NOTIFIED OF ANY DISCREPENCIES PRIOR TO INSTALLATION. CONTRACTOR TO REFER TO SHEET A-000 - CODE PLANS & ELEVATIONS TO CONFIRM FIRE RATING OF WALLS. REFER TO SHEET SERIES A-400 - UNIT FLOOR PLANS, FOR WALL TYPES WITHIN UNITS.

6. FRAMED WALL DIMENSIONS INDICATED FROM FACE OF STUD, UNO.

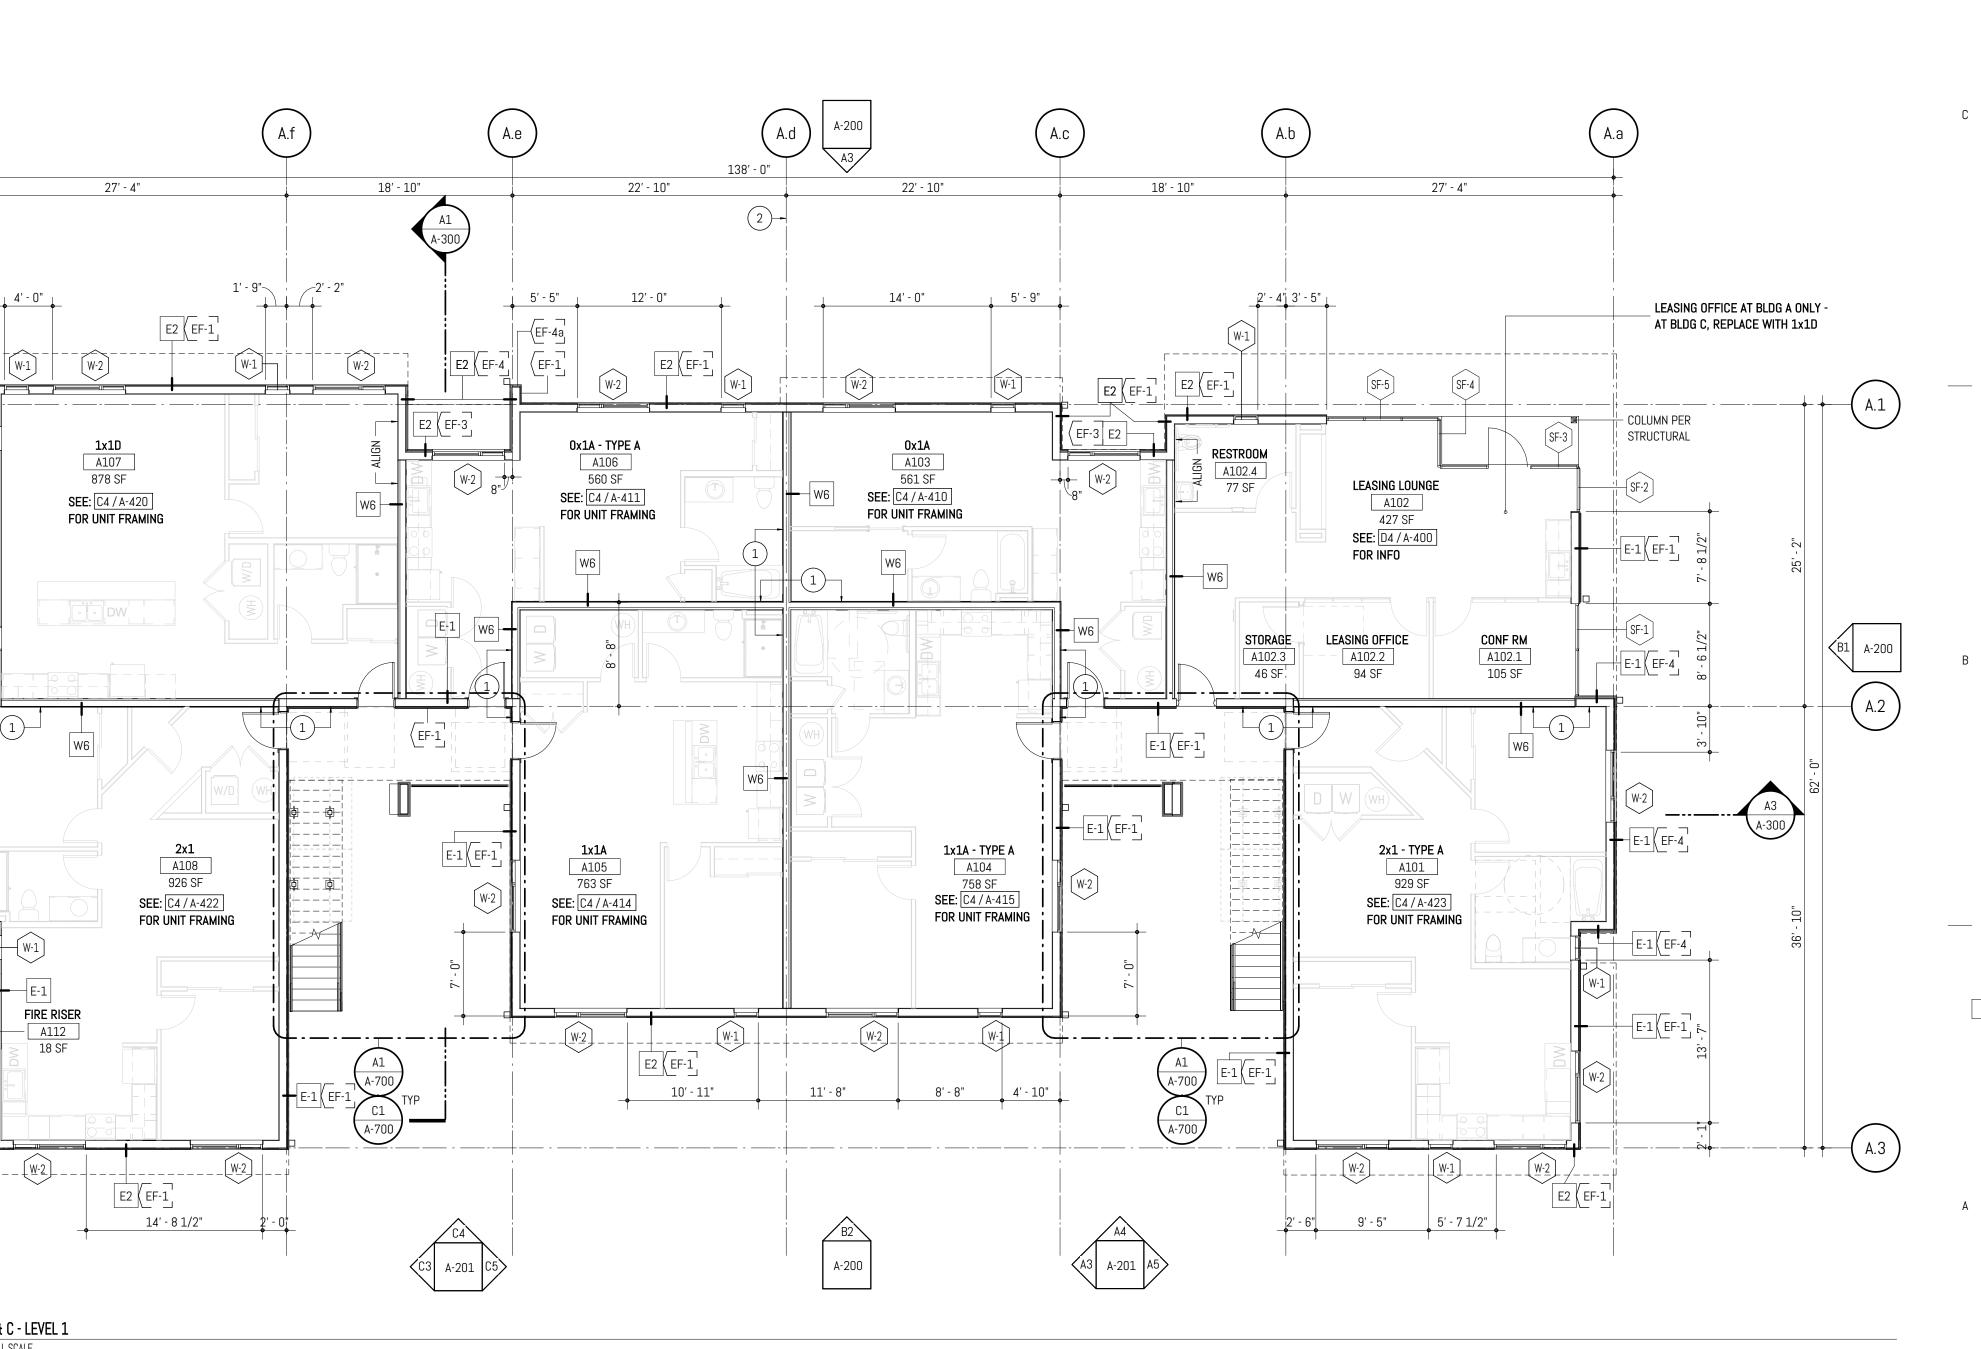

4

# FLOOR PLAN **GENERAL NOTES**

7. FRAMING SHALL BE FURRED OUT, OR ADDITIONAL LAYERS OF GYPSUM BOARD SHALL BE INSTALLED AS REQUIRED TO ALIGN WITH ADJACENT FACE OF FINISH.

8. DOORS ADJACENT TO FRAMED WALLS SHALL BE 4" FROM NEAREST FACE OF STUD UNO.

9. REFER TO A-400, TYPICAL UNIT PLAN SERIES, FOR INTERIOR MINIMUM CLEAR DIMENSIONS. GENERAL CONTRACTOR SHALL REPORT DISCREPNCIES TO OWNER OR ARCHITECT IF FRAMING AND INTERIOR CLEAR DIMENSIONS ARE FOUND TO CONFLICT.

10. STOREFRONT SYSTEMS ARE DIMENSIONED TO JAMBS, REFER TO A-600 FOR ADDITIONAL INFORMATION.





S


MARK	R	EVISION	DATE
			Ditte
PRO	JECT NO:	050-01-	21
PRIN	CIPAL-IN-CHA	RGE:	BF
PRO	IECT ARCHITE	CT:	MJ
DRAV	VN BY:		HL
PROJ	IECT STATUS:		
PE	rmit Si	ET	
05	.06.202	22	
SHEE	ET TITLE:		
FL	OOR PL	AN BLDG A	ት ር -

FLUUR PLAN DLUU A C C LEVEL 1

SHEET NO.

→z

PROJECT NORTH TRUE NORTH

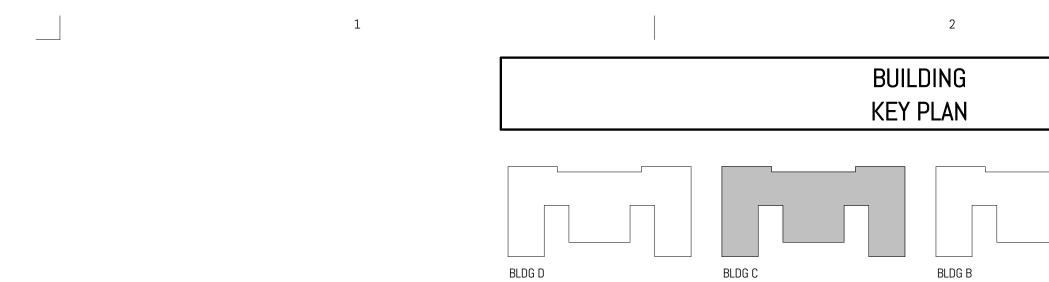

С

R


1

A.g (EF-4) W-4 A-200 A1 (EF-4 EF-4

(EF-4 – EF-4

A2 FLOOR PLAN - BUILDING A & C - LEVEL 2 SCALE: 1/8" = 1'-0" @ FULL SCALE

120

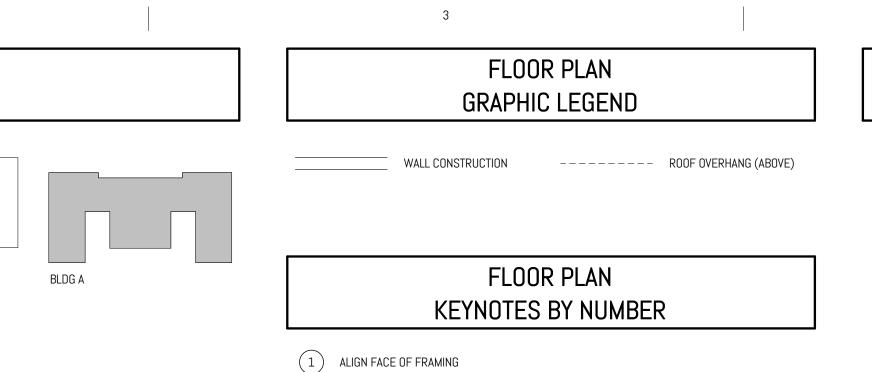


- (2) GRID X.d FRAMING TO CENTERLINE OF STUD

3

1. GRIDLINES RUNNING EAST-WEST ARE INDICATED NUMERICALLY, GRIDLINES RUNNING NORTH-SOUTH ARE INDICATED ALPHABETICALLY. EACH GRIDLINE HAS A PREFIX THAT CORRESPONDS TO THE BUILDING LOCATION, REFER TO LEGEND ON THIS SHEET.

4

- 2. GRIDLINES ARE LOCATED AT FACE OF CONCRETE STEM WALLS AND FACE OF STUD FRAMING, EXCEPT AT GRID X.d WHERE GRIDLINE IS AT THE STUD CENTERLINE.
- 3. STUDS SHALL BE OFFSET AND ADDITIONAL LAYERS OF GYPSUM BOARD SHALL BE PROVIDED AS REQUIRED TO PROVIDE FACE ALIGNMENT OF GYPSUM BOARD.
- 4. PROVIDE MINIMUM 1'-0" CLEAR FLOOR SPACE AT THE PUSH SIDE OF EVERY DOOR WITH A CLOSER. PROVIDE MINIMUM 1'-6" CLEAR AT THE PULL SIDE OF EVERY DOOR, UNLESS SPECIFICALLY DIMENSIONED, NOTED OR SHOWN OTHERWISE.
- 5. WALL TYPES SHALL BE CONSTRUCTED AS BELOW. STRUCTURAL REQUIREMENTS PER STRUCTURAL SERIES TAKE PRECEDENT. OWNER SHALL BE NOTIFIED OF ANY DISCREPENCIES PRIOR TO INSTALLATION. CONTRACTOR TO REFER TO SHEET A-000 - CODE PLANS & ELEVATIONS TO CONFIRM FIRE RATING OF WALLS. REFER TO SHEET SERIES A-400 - UNIT FLOOR PLANS, FOR WALL TYPES WITHIN UNITS.
- 6. FRAMED WALL DIMENSIONS INDICATED FROM FACE OF STUD, UNO.

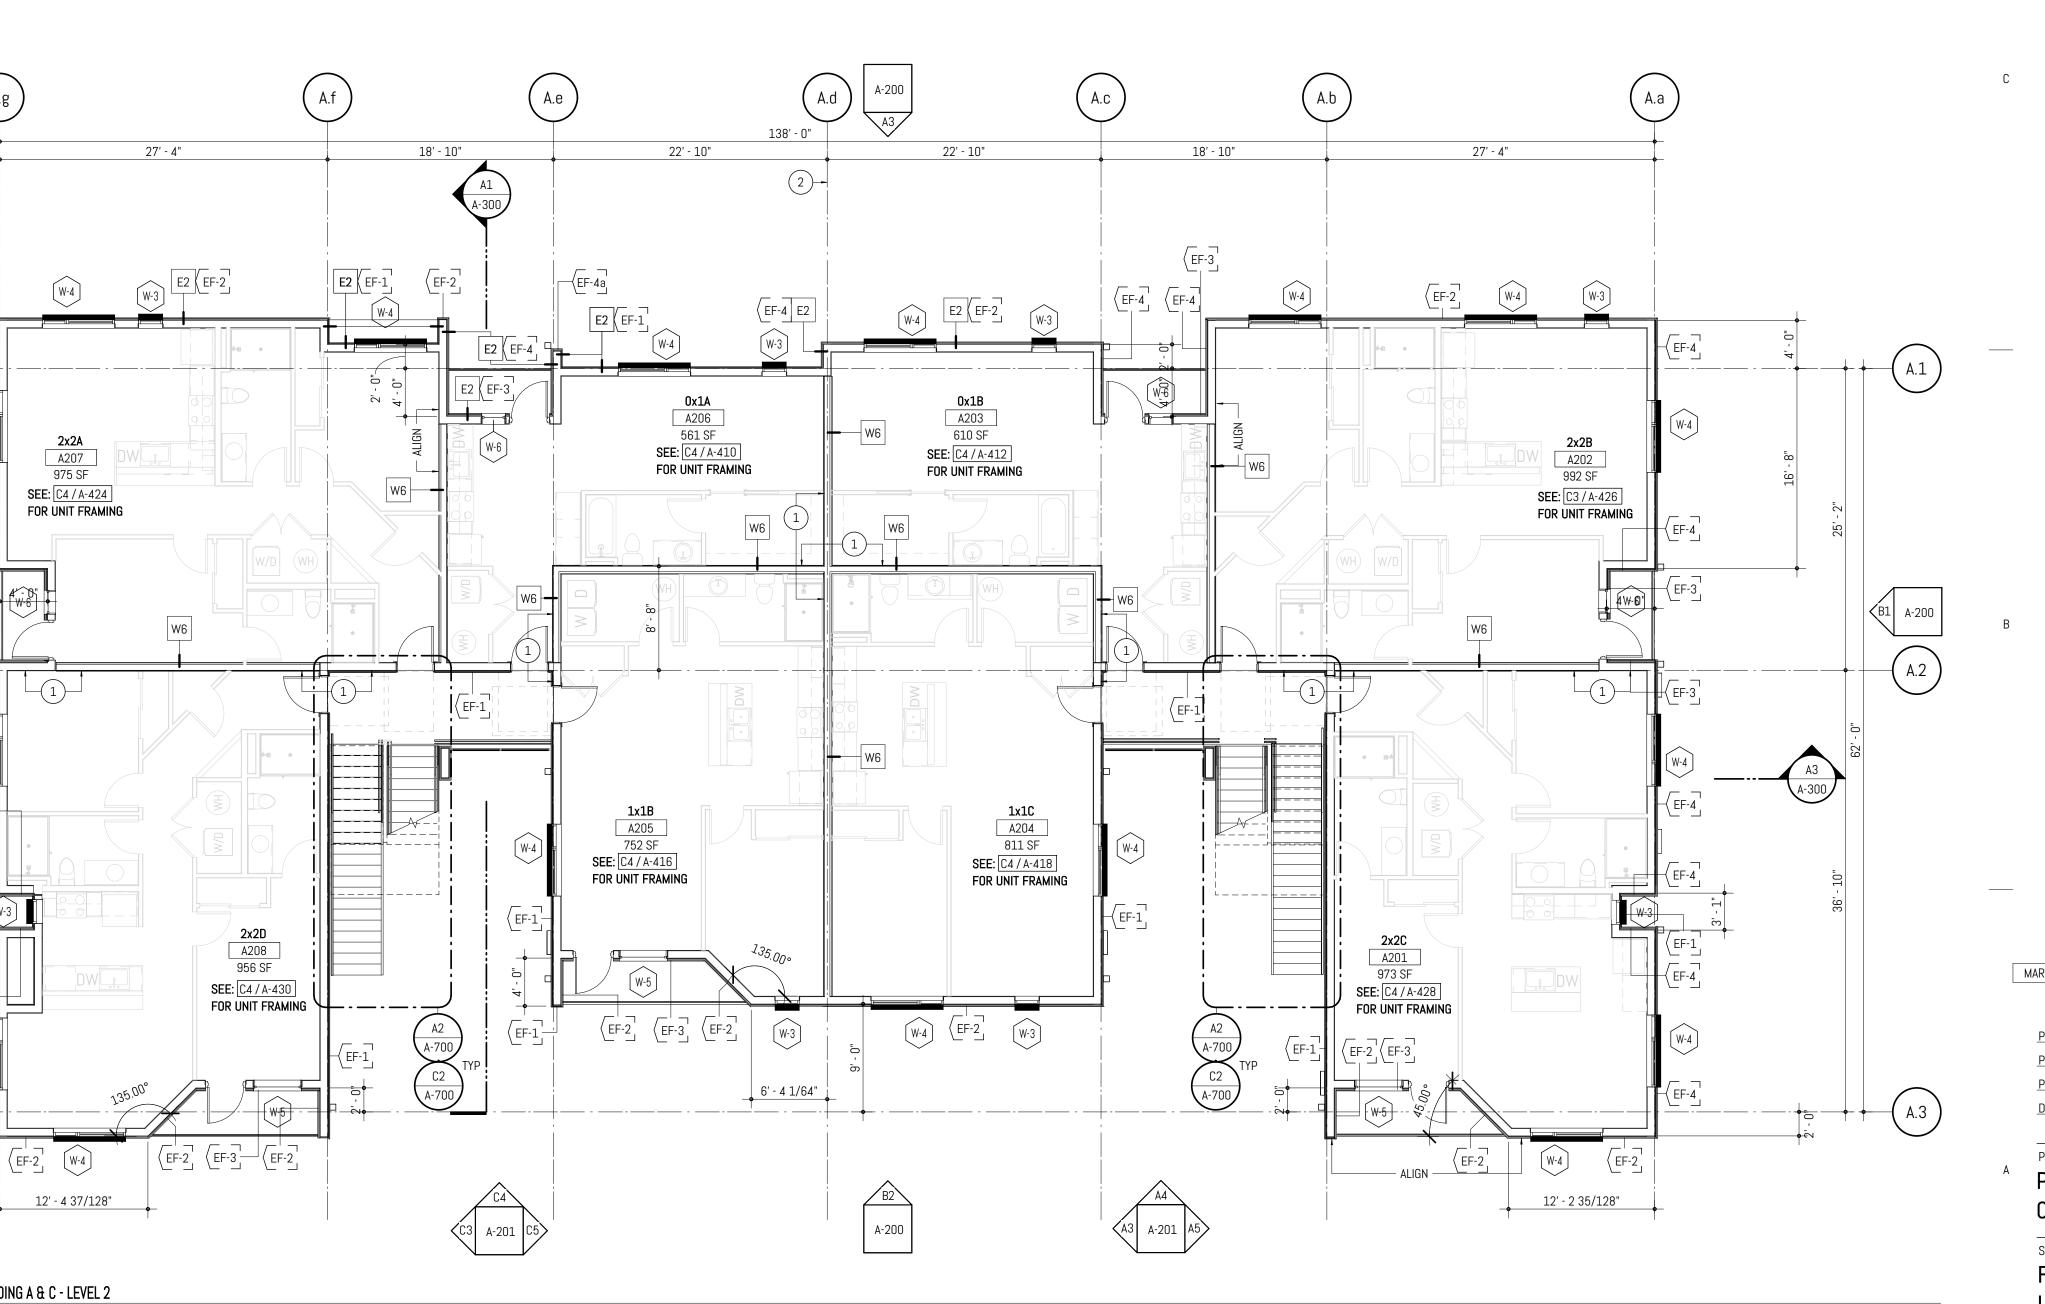

4

# FLOOR PLAN **GENERAL NOTES**


7. FRAMING SHALL BE FURRED OUT, OR ADDITIONAL LAYERS OF GYPSUM BOARD SHALL BE INSTALLED AS REQUIRED TO ALIGN WITH ADJACENT FACE OF FINISH.

8. DOORS ADJACENT TO FRAMED WALLS SHALL BE 4" FROM NEAREST FACE OF STUD UNO.

9. REFER TO A-400, TYPICAL UNIT PLAN SERIES, FOR INTERIOR MINIMUM CLEAR DIMENSIONS. GENERAL CONTRACTOR SHALL REPORT DISCREPNCIES TO OWNER OR ARCHITECT IF FRAMING AND INTERIOR CLEAR DIMENSIONS ARE FOUND TO CONFLICT.

10. STOREFRONT SYSTEMS ARE DIMENSIONED TO JAMBS, REFER TO A-600 FOR ADDITIONAL INFORMATION.



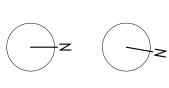




MARK	REVIS	SION	DATE
DDU	JECT NO:	050-01-2	21
PRUL	IEGT NU.	000 01	
PRIN	CIPAL-IN-CHARGE	•	BF
PROJ	IECT ARCHITECT:		MJ
DRAV	VN BY:		HL
PROJ	IECT STATUS:		


PERMIT SET 05.06.2022 SHEET TITLE:

FLOOR PLAN BLDG A & C -LEVEL 2

SHEET NO.

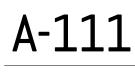

PROJECT NORTH TRUE NORTH

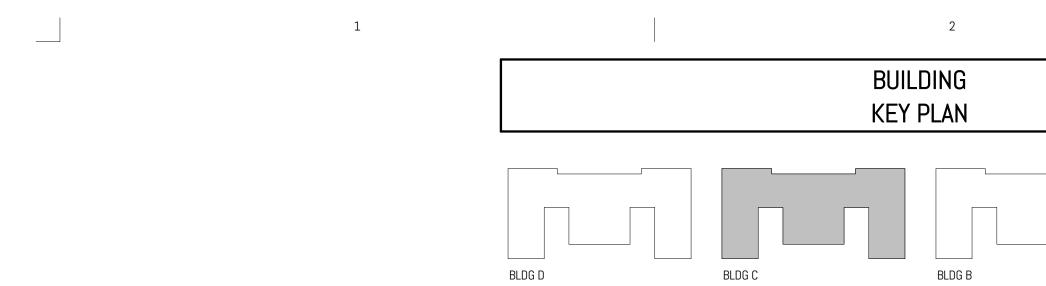

С

R


1

A-200 A1 3' - 1"

A2 FLOOR PLAN - BUILDING A & C - LEVEL 3 SCALE: 1/8" = 1'-0" @ FULL SCALE

A.g

W-4

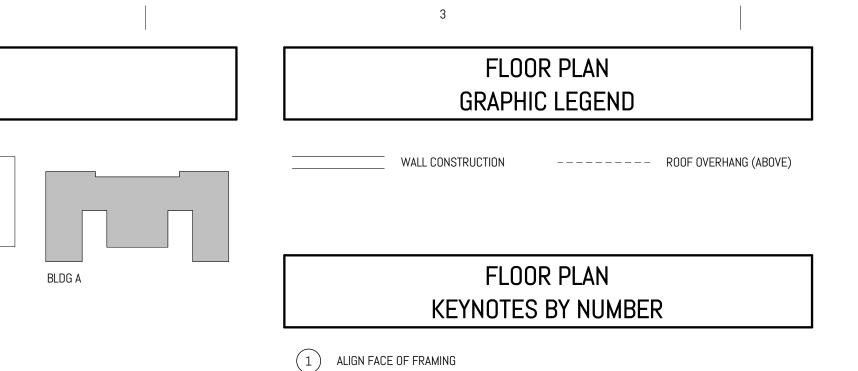


- (2) GRID X.d FRAMING TO CENTERLINE OF STUD

3

1. GRIDLINES RUNNING EAST-WEST ARE INDICATED NUMERICALLY, GRIDLINES RUNNING NORTH-SOUTH ARE INDICATED ALPHABETICALLY. EACH GRIDLINE HAS A PREFIX THAT CORRESPONDS TO THE BUILDING LOCATION, REFER TO LEGEND ON THIS SHEET.

4

- 2. GRIDLINES ARE LOCATED AT FACE OF CONCRETE STEM WALLS AND FACE OF STUD FRAMING, EXCEPT AT GRID X.d WHERE GRIDLINE IS AT THE STUD CENTERLINE.
- 3. STUDS SHALL BE OFFSET AND ADDITIONAL LAYERS OF GYPSUM BOARD SHALL BE PROVIDED AS REQUIRED TO PROVIDE FACE ALIGNMENT OF GYPSUM BOARD.
- 4. PROVIDE MINIMUM 1'-0" CLEAR FLOOR SPACE AT THE PUSH SIDE OF EVERY DOOR WITH A CLOSER. PROVIDE MINIMUM 1'-6" CLEAR AT THE PULL SIDE OF EVERY DOOR, UNLESS SPECIFICALLY DIMENSIONED, NOTED OR SHOWN OTHERWISE.
- 5. WALL TYPES SHALL BE CONSTRUCTED AS BELOW. STRUCTURAL REQUIREMENTS PER STRUCTURAL SERIES TAKE PRECEDENT. OWNER SHALL BE NOTIFIED OF ANY DISCREPENCIES PRIOR TO INSTALLATION. CONTRACTOR TO REFER TO SHEET A-000 - CODE PLANS & ELEVATIONS TO CONFIRM FIRE RATING OF WALLS. REFER TO SHEET SERIES A-400 - UNIT FLOOR PLANS, FOR WALL TYPES WITHIN UNITS.
- 6. FRAMED WALL DIMENSIONS INDICATED FROM FACE OF STUD, UNO.

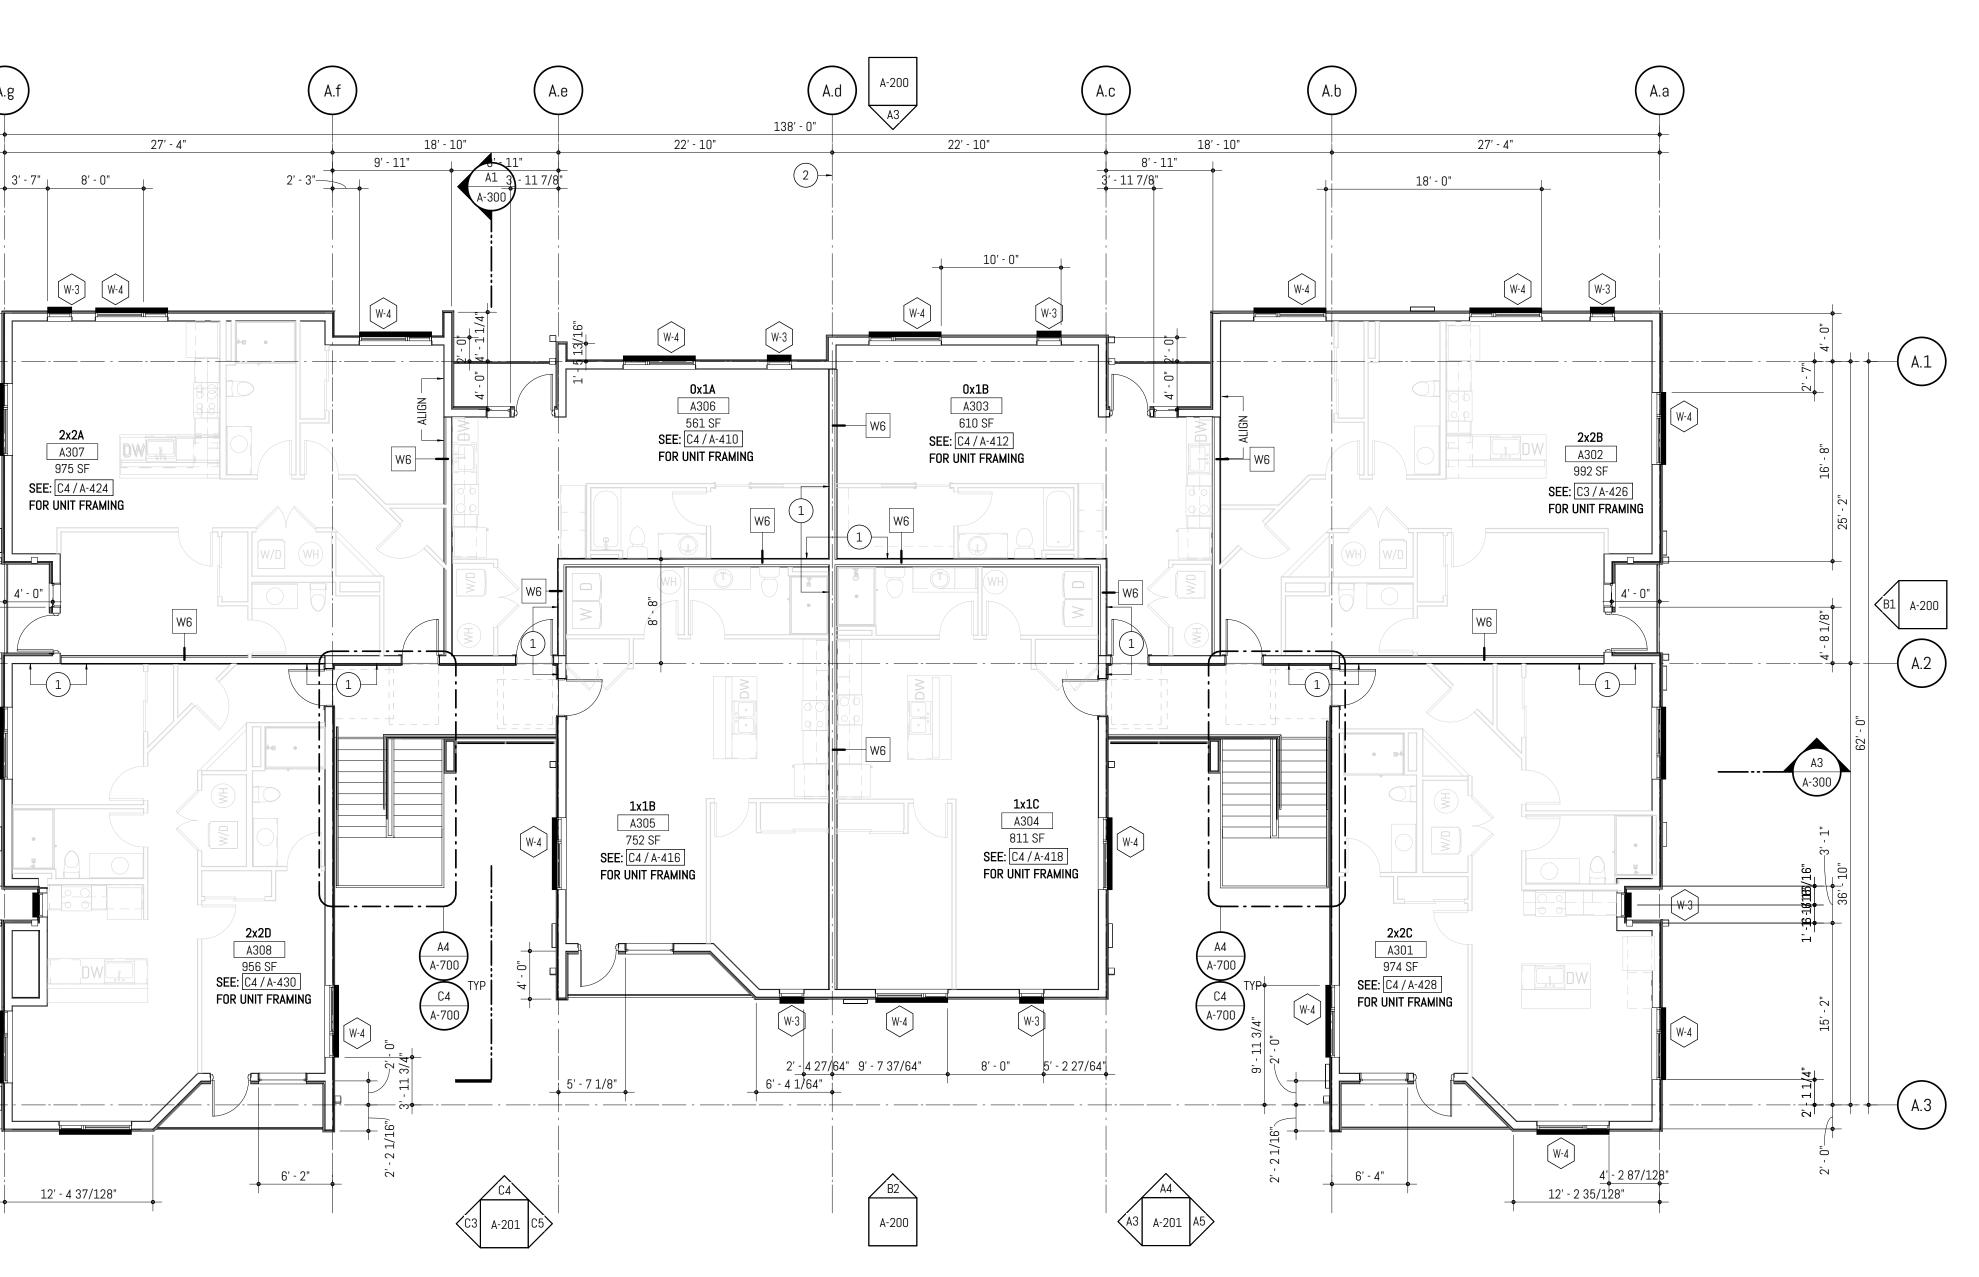

4

# FLOOR PLAN **GENERAL NOTES**

7. FRAMING SHALL BE FURRED OUT, OR ADDITIONAL LAYERS OF GYPSUM BOARD SHALL BE INSTALLED AS REQUIRED TO ALIGN WITH ADJACENT FACE OF FINISH.

8. DOORS ADJACENT TO FRAMED WALLS SHALL BE 4" FROM NEAREST FACE OF STUD UNO. 9. REFER TO A-400, TYPICAL UNIT PLAN SERIES, FOR INTERIOR MINIMUM CLEAR DIMENSIONS. GENERAL CONTRACTOR SHALL REPORT DISCREPNCIES TO OWNER OR ARCHITECT IF FRAMING AND INTERIOR CLEAR DIMENSIONS ARE FOUND TO CONFLICT.

10. STOREFRONT SYSTEMS ARE DIMENSIONED TO JAMBS, REFER TO A-600 FOR ADDITIONAL INFORMATION.



[MEN] 8, 8 ATE CRAFT DISTRIC 4302, 4312, 4408, TUMWA<sup>T</sup>

S

MARK	REVISION		DATE
		050.01	01
PROJ	JECT NO:	050-01-	
PRINCIPAL-IN-CHARGE:			BF
PROJECT ARCHITECT:		MJ	
DRAWN BY:		HL	
PROJECT STATUS:			
PERMIT SET			
05	.06.2022		
0	et title: OOR PLAN	I BLDG A	& C -

LEVEL 3 SHEET NO.

A-112



→z

ltem 7.

П

С

R

1

A2 FLOOR PLAN - BUILDING A & C - ROOF SCALE: 1/8" = 1'-0" @ FULL SCALE

A-000 A-200 A1

1

BLDG D


A.g


GUTTER -

DS ·

\_\_\_\_\_ DS —

DS –

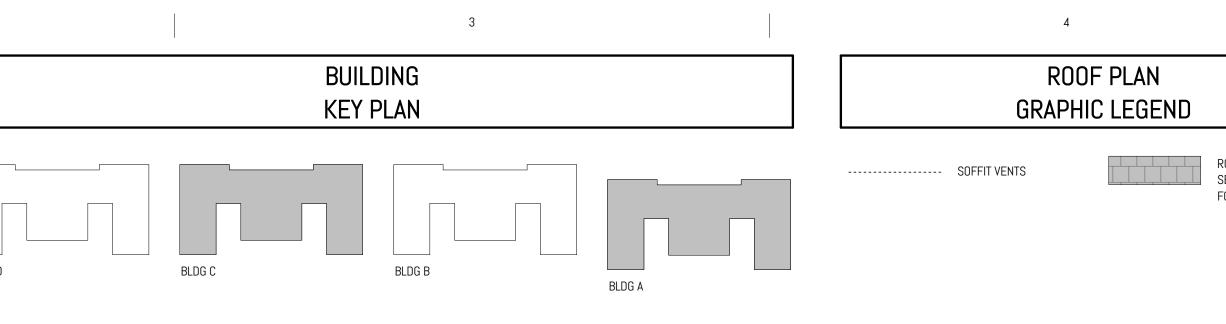

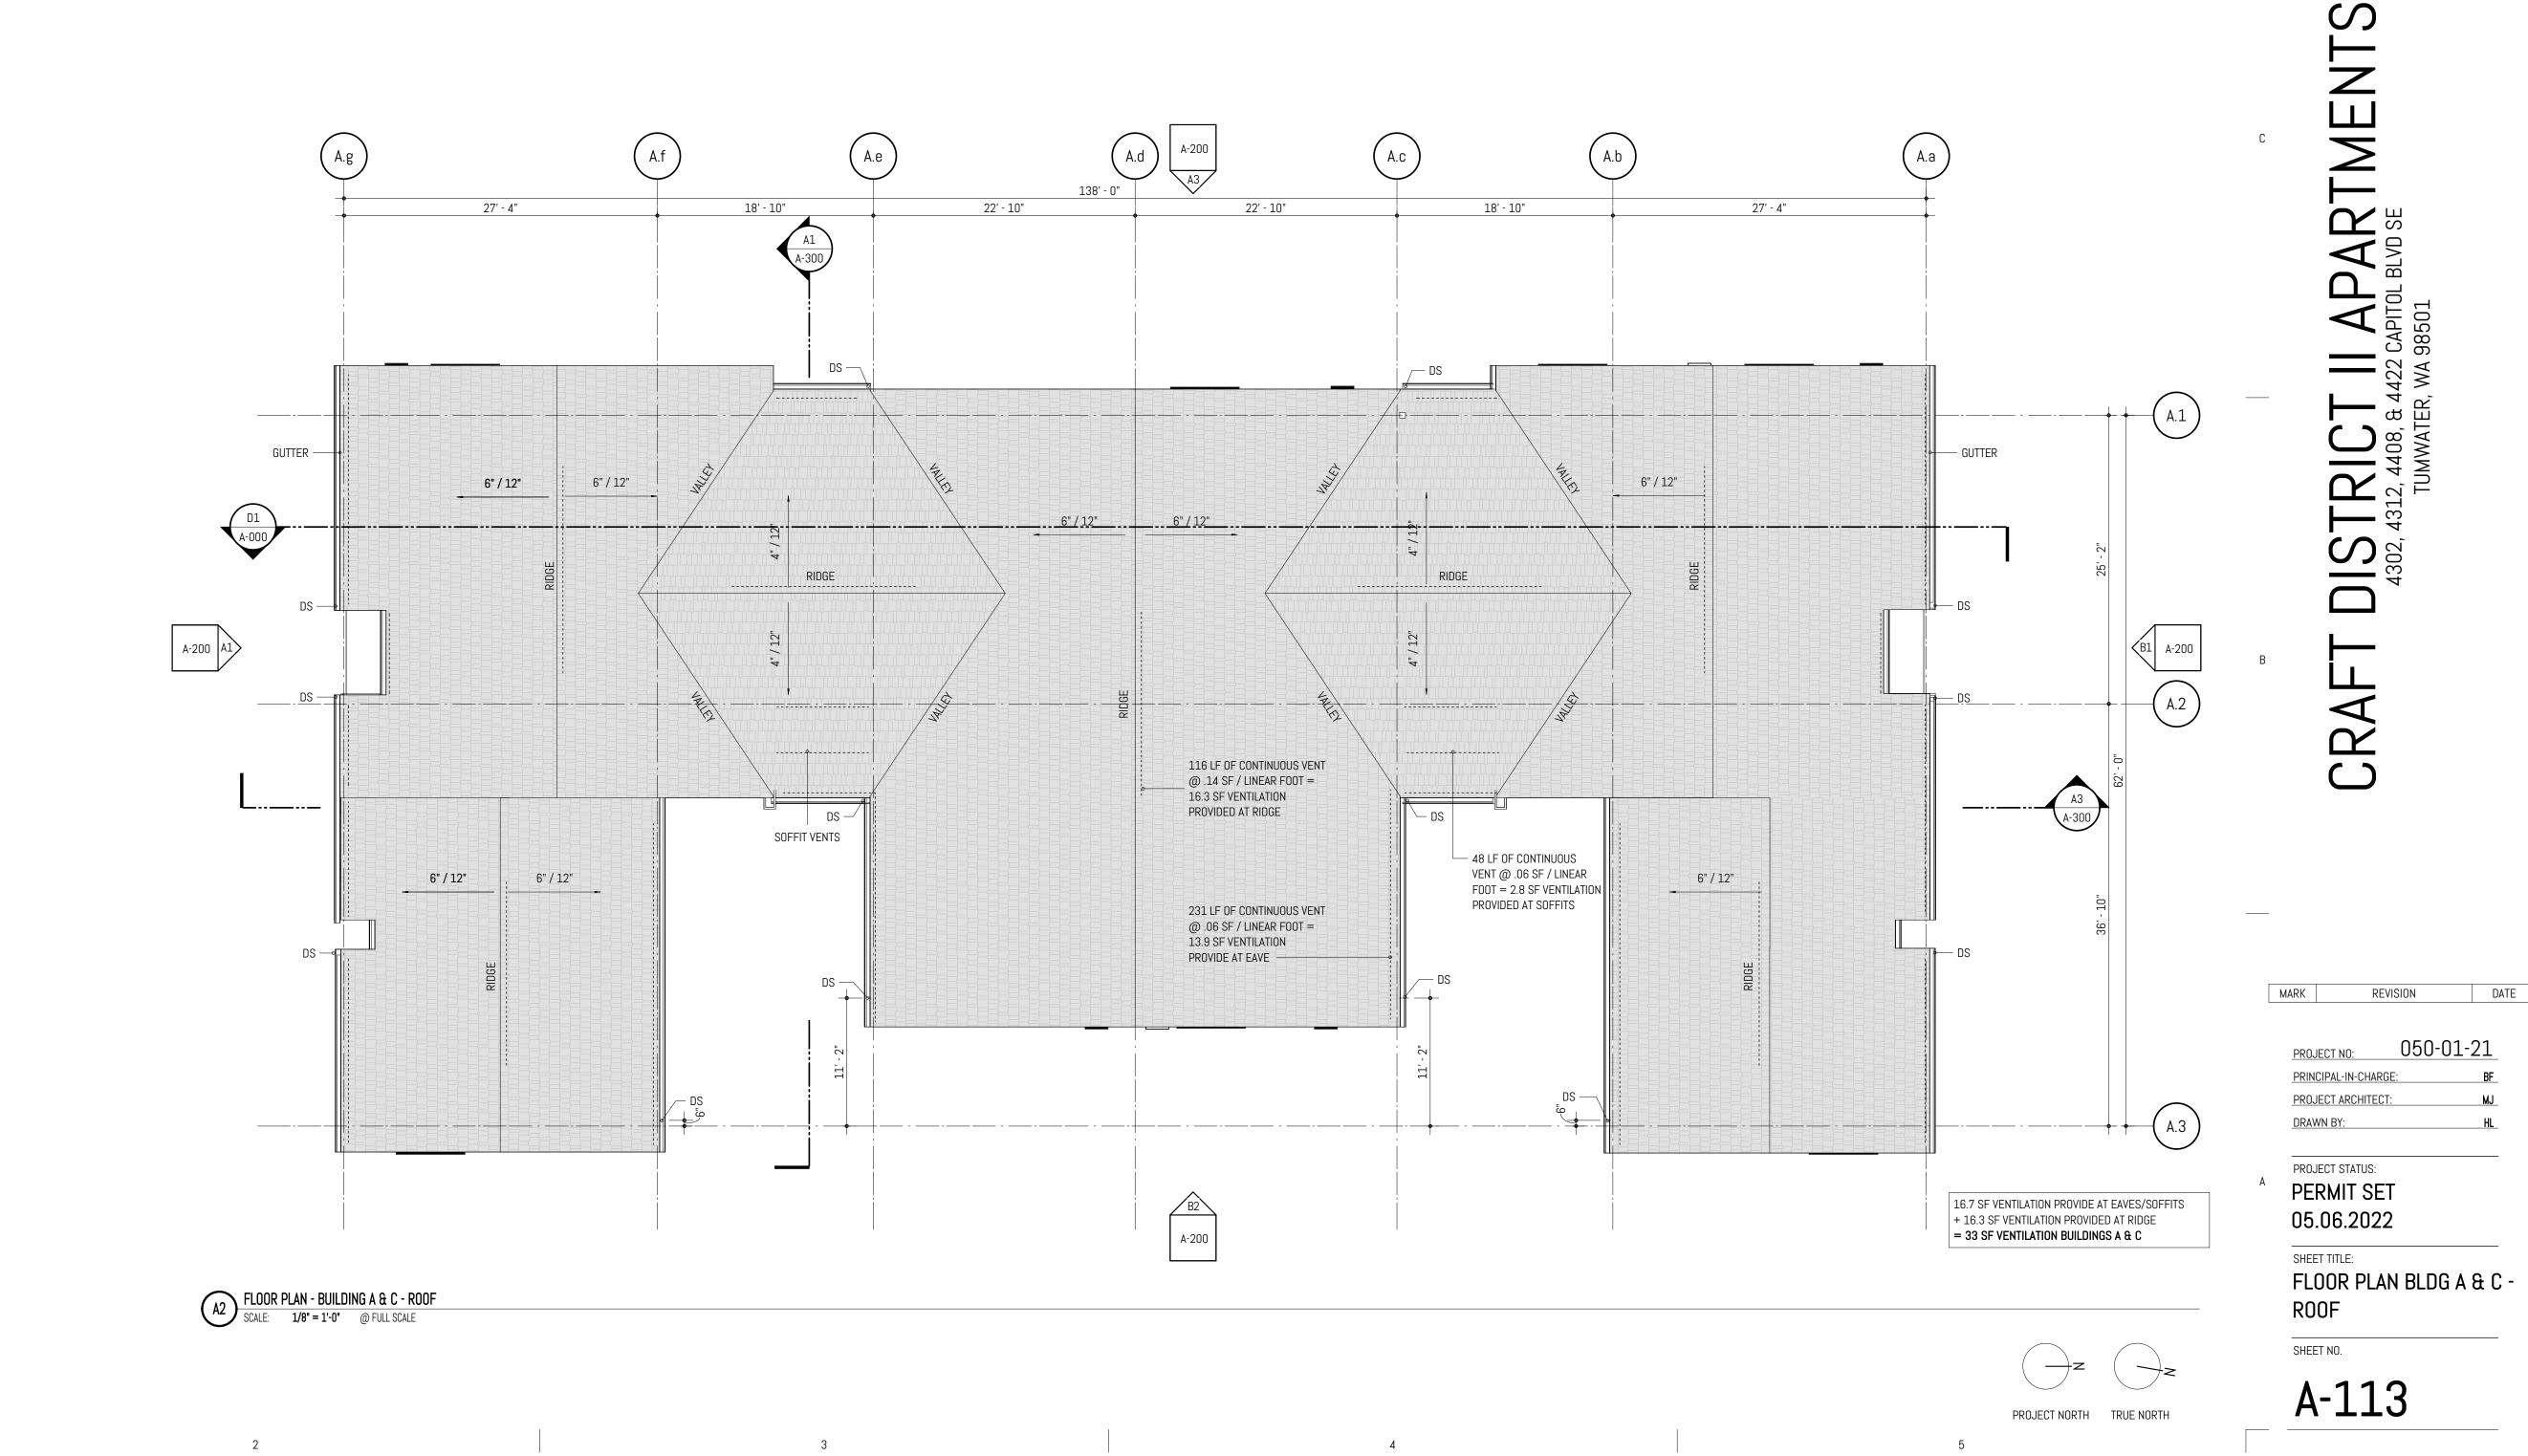

- R00F-1, SEE A-401 - FINISH LEGEND FOR ADDITIONAL INFORMATION
- ROOF PLAN **GENERAL NOTES**


5

- 1. GRIDLINES RUNNING EAST-WEST ARE INDICATED NUMERICALLY, GRIDLINES RUNNING NORTH-SOUTH ARE INDICATED ALPHABETICALLY. EACH GRIDLINE HAS A PREFIX THAT CORRESPONDS TO THE BUILDING LOCATION, REFER TO LEGEND ON THIS SHEET. 2. GRIDLINES ARE LOCATED AT FACE OF CONCRETE WALLS, CENTER OF COLUMNS, FACE OF STUD FRAMING, U.N.O.
- FOR LOCATIONS OF PIPING, CURBS, VENTS, DUCTS, FANS AND OTHER ITEMS ON THE ROOF SURFACE, REFER TO MECHANICAL, PLUMBING AND ELECTRICAL DRAWINGS. FOR ROOF DRAIN SIZING, REFER TO PLUMBING DRAWINGS.
- 3. PAINT EXPOSED ROOF-MOUNTED EQUIPMENT, PIPING, ETC. EXCEPT THOSE ITEMS WHICH ARE ALUMINUM OR STAINLESS STEEL. COLOR AS SELECTED BY ARCHITECT.

5

4. ROOF FLASHING TO BE ACCORDING TO MANUFACTURER'S RECOMMENDATIONS.



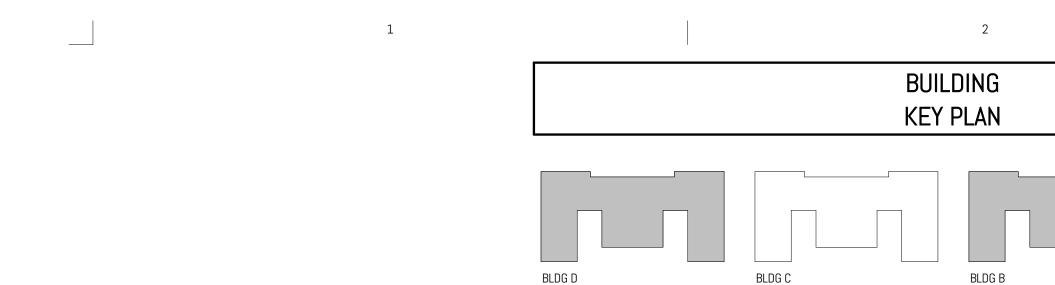

С

1

A-220 A1

A2 FLOOR PLAN - BUILDING B & D - LEVEL 1 SCALE: 1/8" = 1'-0" @ FULL SCALE


B.g

['W-1

W-2

W-1

W-2

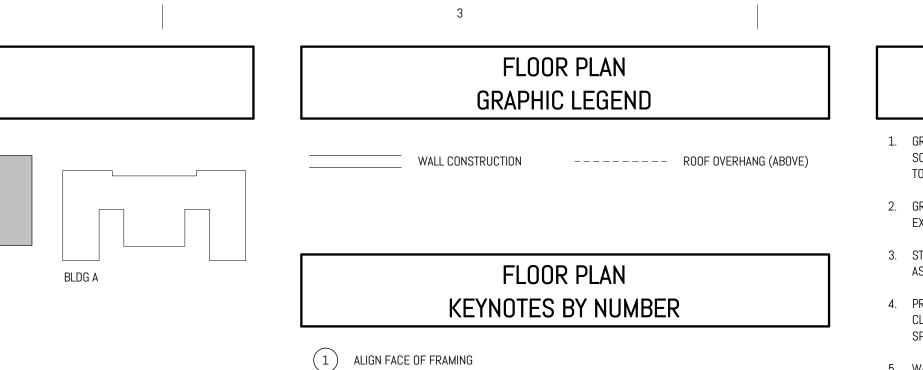


(2) GRID X.d FRAMING TO CENTERLINE OF STUD

3

1. GRIDLINES RUNNING EAST-WEST ARE INDICATED NUMERICALLY, GRIDLINES RUNNING NORTH-SOUTH ARE INDICATED ALPHABETICALLY. EACH GRIDLINE HAS A PREFIX THAT CORRESPONDS TO THE BUILDING LOCATION, REFER TO LEGEND ON THIS SHEET.

4

- 2. GRIDLINES ARE LOCATED AT FACE OF CONCRETE STEM WALLS AND FACE OF STUD FRAMING, EXCEPT AT GRID X.d WHERE GRIDLINE IS AT THE STUD CENTERLINE.
- 3. STUDS SHALL BE OFFSET AND ADDITIONAL LAYERS OF GYPSUM BOARD SHALL BE PROVIDED AS REQUIRED TO PROVIDE FACE ALIGNMENT OF GYPSUM BOARD.
- 4. PROVIDE MINIMUM 1'-0" CLEAR FLOOR SPACE AT THE PUSH SIDE OF EVERY DOOR WITH A CLOSER. PROVIDE MINIMUM 1'-6" CLEAR AT THE PULL SIDE OF EVERY DOOR, UNLESS SPECIFICALLY DIMENSIONED, NOTED OR SHOWN OTHERWISE.
- 5. WALL TYPES SHALL BE CONSTRUCTED AS BELOW. STRUCTURAL REQUIREMENTS PER STRUCTURAL SERIES TAKE PRECEDENT. OWNER SHALL BE NOTIFIED OF ANY DISCREPENCIES PRIOR TO INSTALLATION. CONTRACTOR TO REFER TO SHEET A-000 - CODE PLANS & ELEVATIONS TO CONFIRM FIRE RATING OF WALLS. REFER TO SHEET SERIES A-400 - UNIT FLOOR PLANS, FOR WALL TYPES WITHIN UNITS.
- 6. FRAMED WALL DIMENSIONS INDICATED FROM FACE OF STUD, UNO.

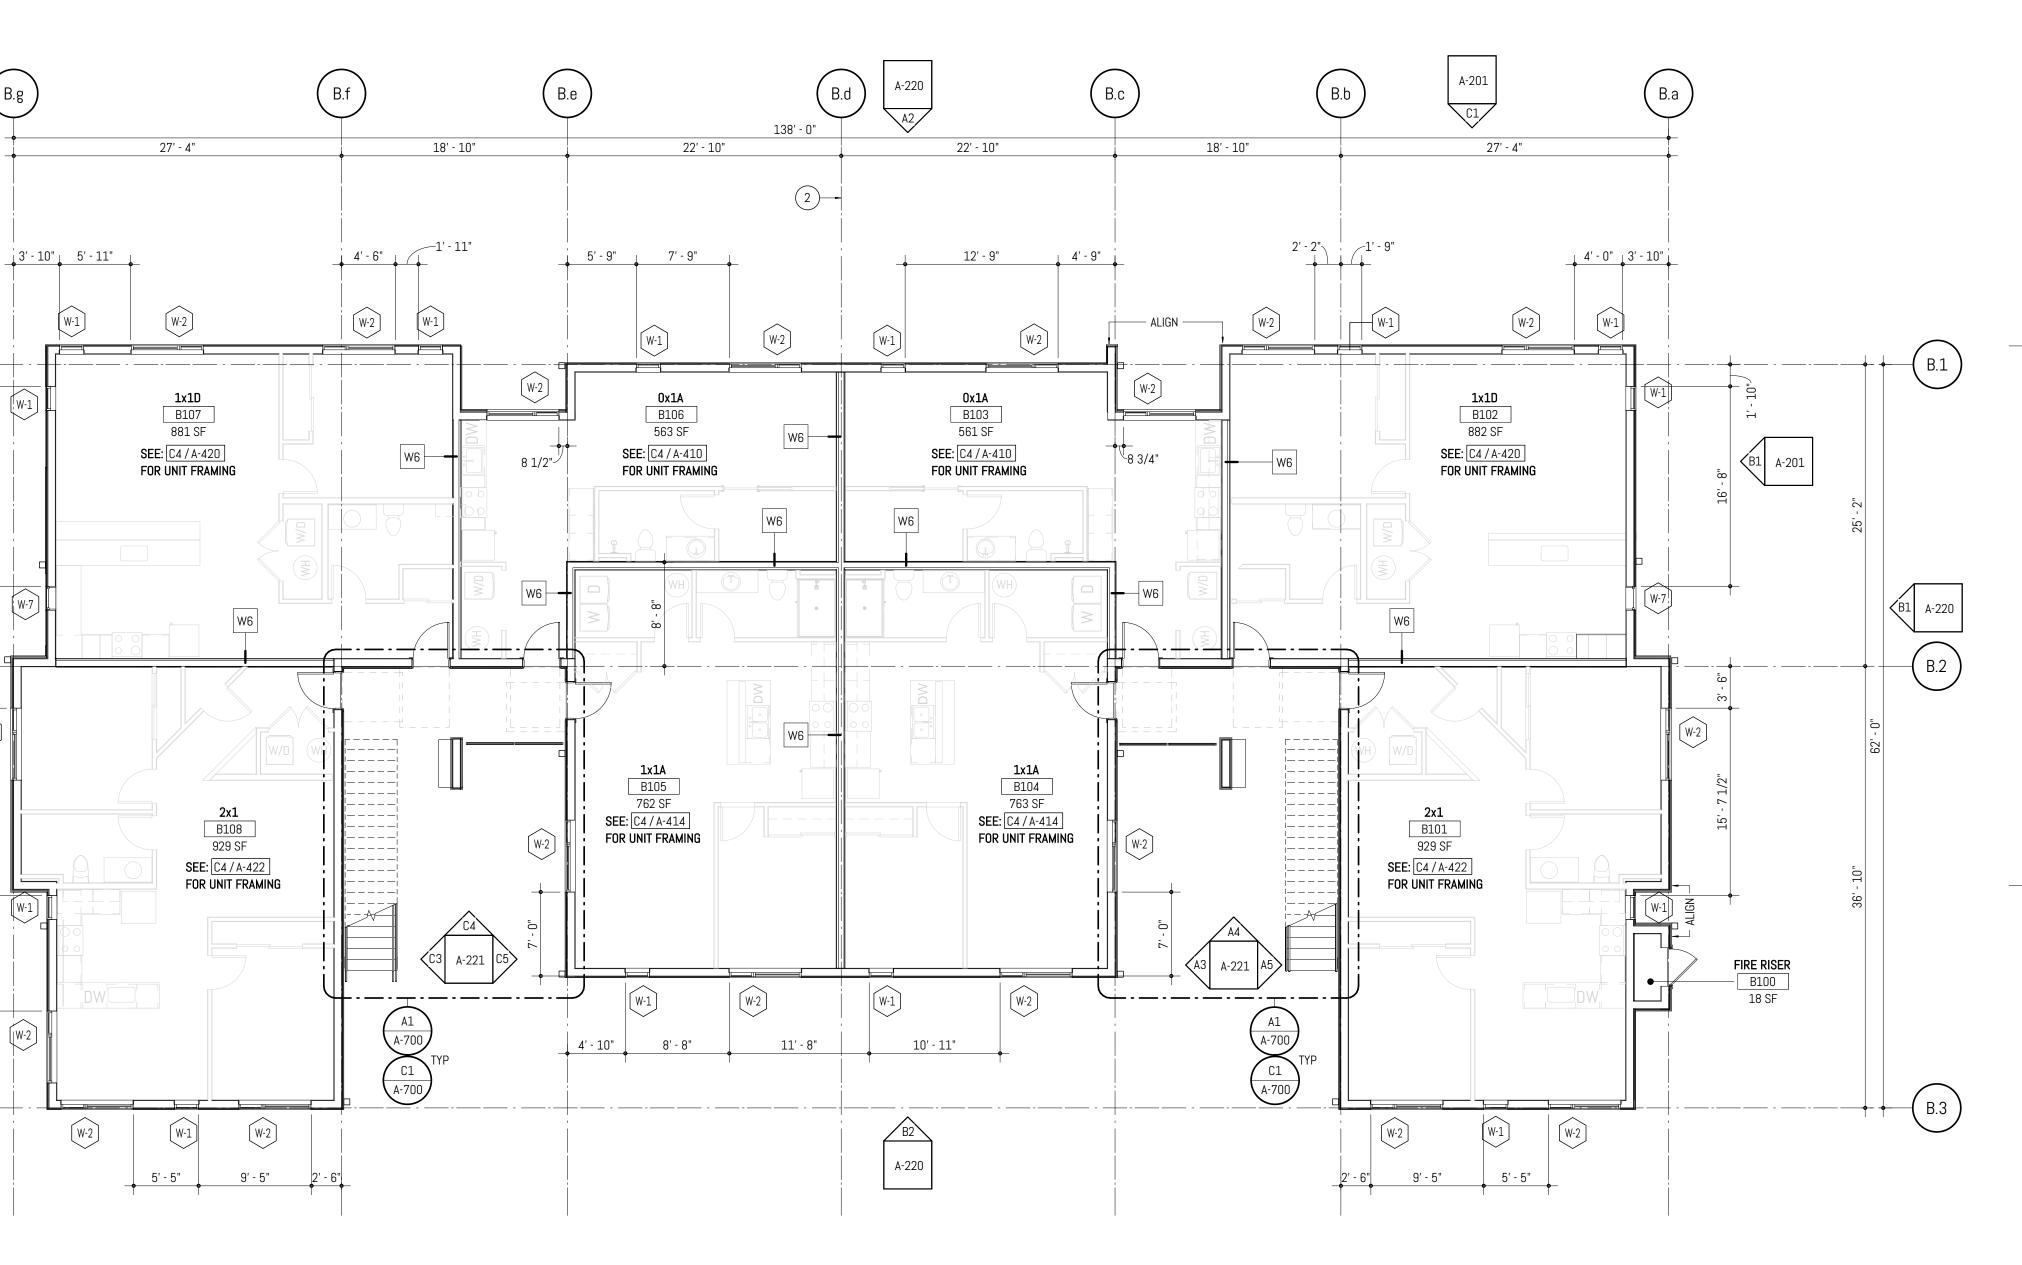

4

# FLOOR PLAN **GENERAL NOTES**

7. FRAMING SHALL BE FURRED OUT, OR ADDITIONAL LAYERS OF GYPSUM BOARD SHALL BE INSTALLED AS REQUIRED TO ALIGN WITH ADJACENT FACE OF FINISH.

8. DOORS ADJACENT TO FRAMED WALLS SHALL BE 4" FROM NEAREST FACE OF STUD UNO.

9. REFER TO A-400, TYPICAL UNIT PLAN SERIES, FOR INTERIOR MINIMUM CLEAR DIMENSIONS. GENERAL CONTRACTOR SHALL REPORT DISCREPNCIES TO OWNER OR ARCHITECT IF FRAMING AND INTERIOR CLEAR DIMENSIONS ARE FOUND TO CONFLICT.

10. STOREFRONT SYSTEMS ARE DIMENSIONED TO JAMBS, REFER TO A-600 FOR ADDITIONAL INFORMATION.





 $\mathcal{O}$ 

TMEN 8, 8 ATE DISTRIC 4302, 4312, 440 TUMW. CRAFT


MARK	Ā	REVISION	DATE
PRO	IECT NO:	050-01	-21
PRIN	CIPAL-IN-CHA	RGE:	BF
PROJECT ARCHITECT:			MJ
DRAV	VN BY:		MJ
PRO	IECT STATUS:		
ΡE	RMIT S	ET	
05	.06.202	22	


FLOOR PLAN BLDG B & D -LEVEL 1

SHEET NO.

→z

PROJECT NORTH TRUE NORTH

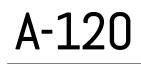

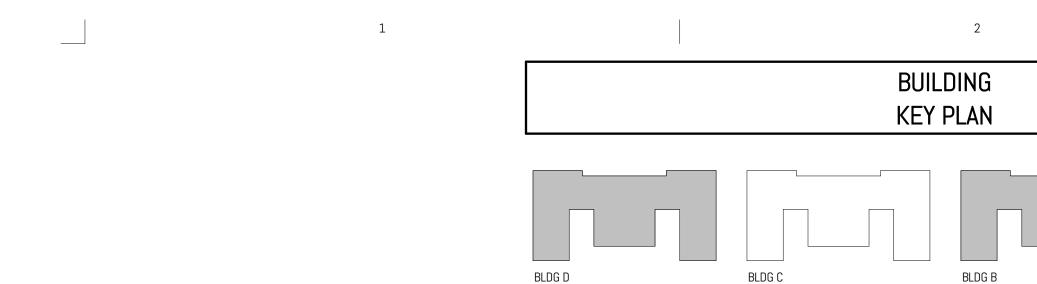


Item 7.

С


1

A2 FLOOR PLAN - BUILDING B & D - LEVEL 2 SCALE: 1/8" = 1'-0" @ FULL SCALE

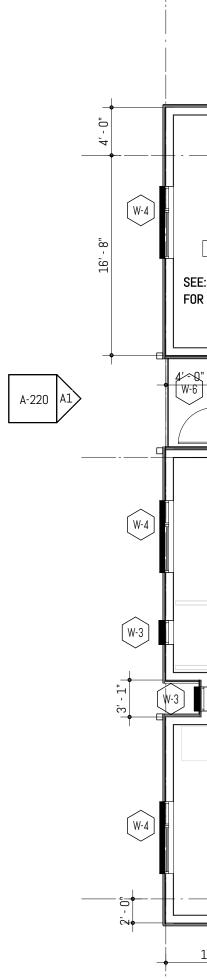

B.g

124

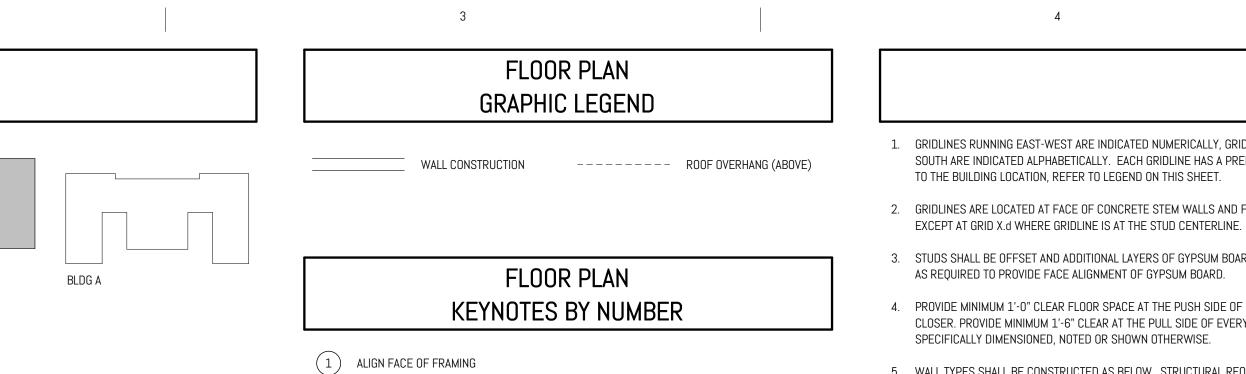


(2) GRID X.d FRAMING TO CENTERLINE OF STUD

3

5. WALL TYPES SHALL BE CONSTRUCTED AS BELOW. STRUCTURAL REQUIREMENTS PER STRUCTURAL SERIES TAKE PRECEDENT. OWNER SHALL BE NOTIFIED OF ANY DISCREPENCIES PRIOR TO INSTALLATION. CONTRACTOR TO REFER TO SHEET A-000 - CODE PLANS & ELEVATIONS TO CONFIRM FIRE RATING OF WALLS. REFER TO SHEET SERIES A-400 - UNIT FLOOR PLANS, FOR WALL TYPES WITHIN UNITS.

6. FRAMED WALL DIMENSIONS INDICATED FROM FACE OF STUD, UNO.

4

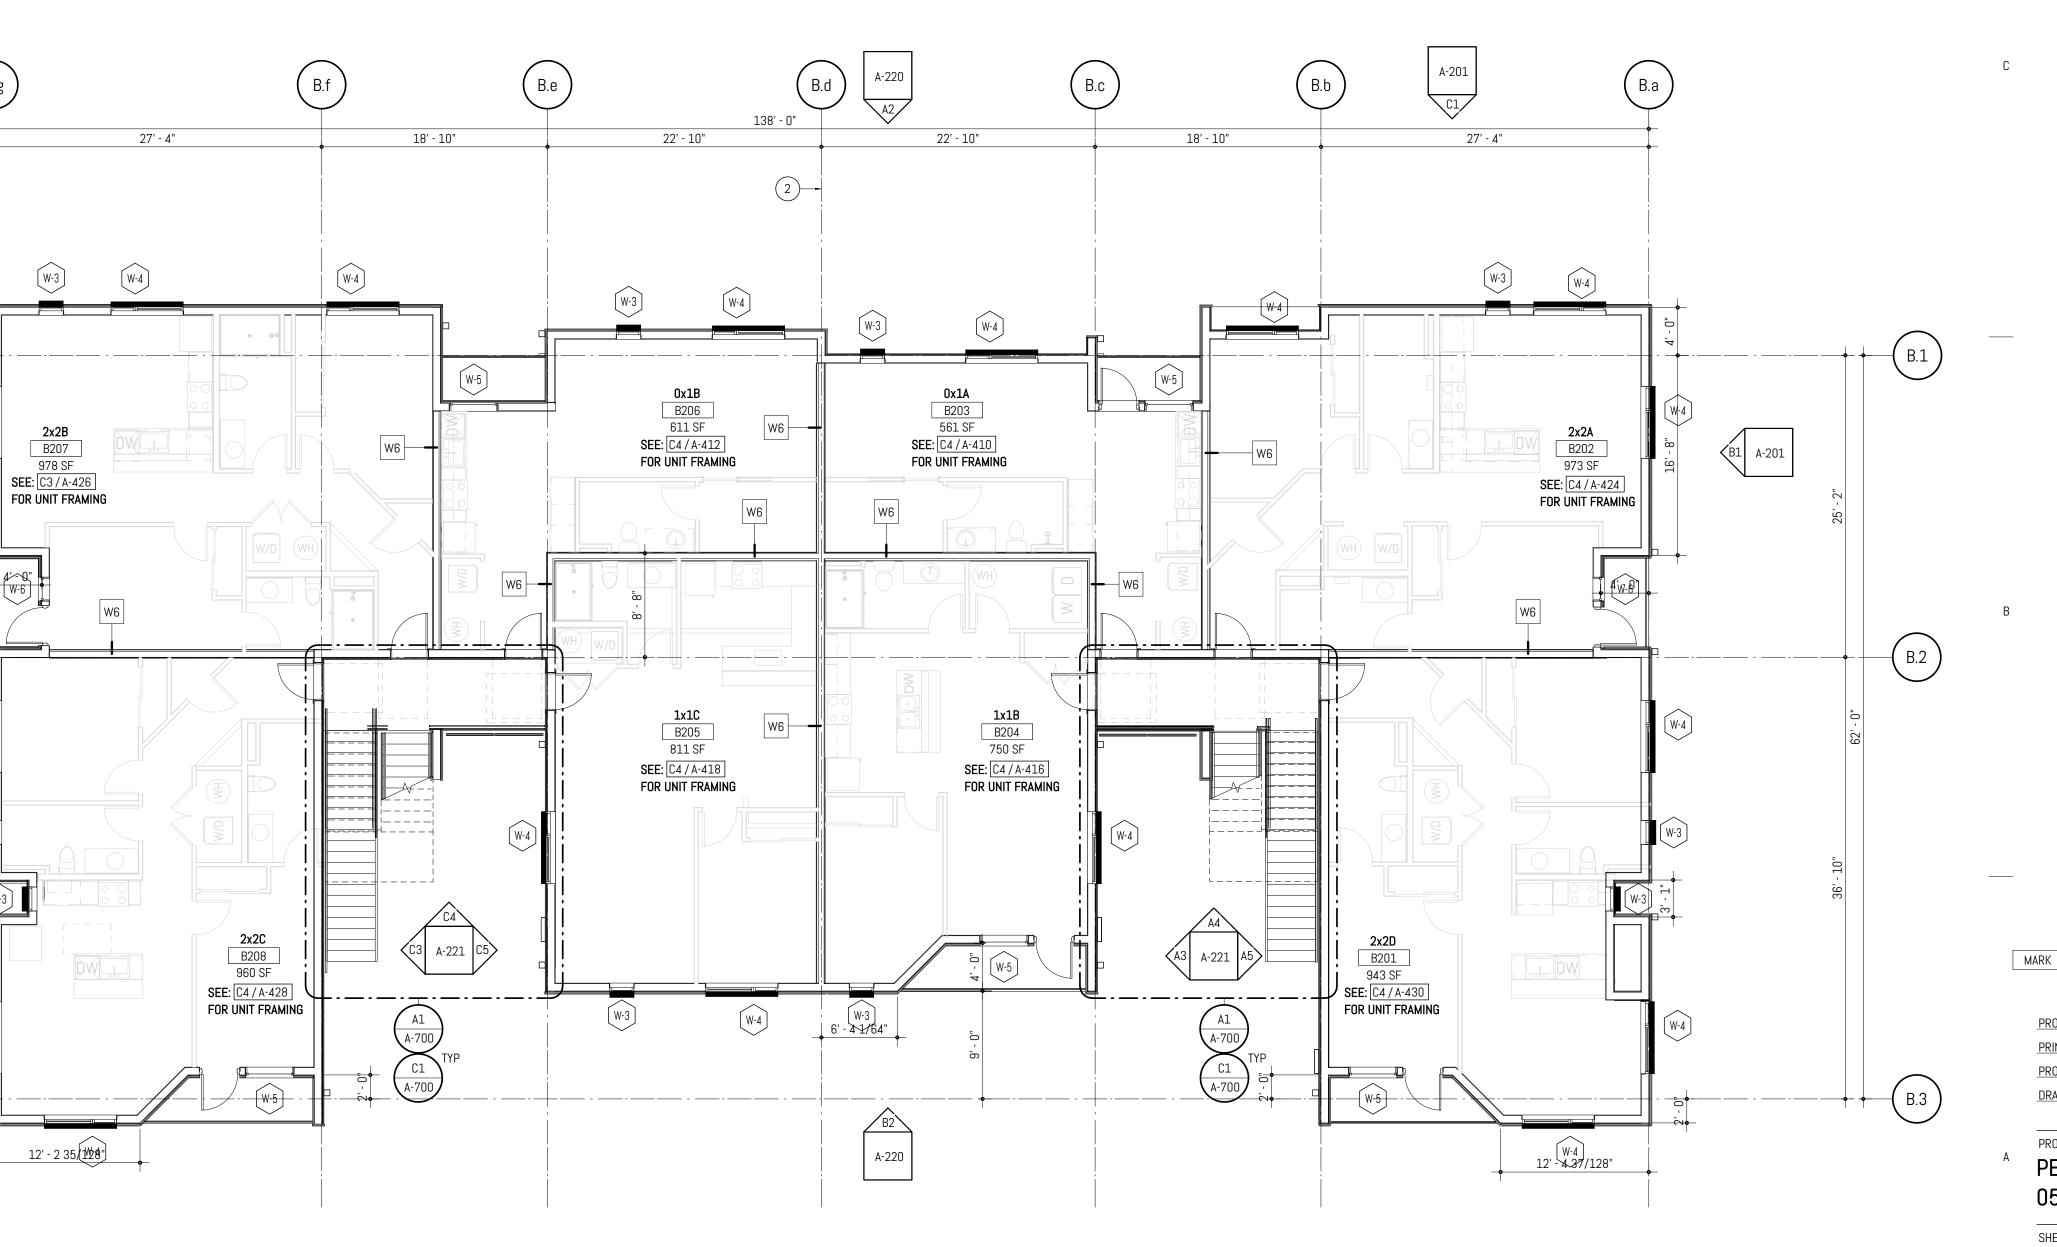

4

# FLOOR PLAN **GENERAL NOTES**

1. GRIDLINES RUNNING EAST-WEST ARE INDICATED NUMERICALLY, GRIDLINES RUNNING NORTH-SOUTH ARE INDICATED ALPHABETICALLY. EACH GRIDLINE HAS A PREFIX THAT CORRESPONDS

2. GRIDLINES ARE LOCATED AT FACE OF CONCRETE STEM WALLS AND FACE OF STUD FRAMING,

3. STUDS SHALL BE OFFSET AND ADDITIONAL LAYERS OF GYPSUM BOARD SHALL BE PROVIDED

4. PROVIDE MINIMUM 1'-0" CLEAR FLOOR SPACE AT THE PUSH SIDE OF EVERY DOOR WITH A CLOSER. PROVIDE MINIMUM 1'-6" CLEAR AT THE PULL SIDE OF EVERY DOOR, UNLESS

7. FRAMING SHALL BE FURRED OUT, OR ADDITIONAL LAYERS OF GYPSUM BOARD SHALL BE INSTALLED AS REQUIRED TO ALIGN WITH ADJACENT FACE OF FINISH.

8. DOORS ADJACENT TO FRAMED WALLS SHALL BE 4" FROM NEAREST FACE OF STUD UNO. 9. REFER TO A-400, TYPICAL UNIT PLAN SERIES, FOR INTERIOR MINIMUM CLEAR DIMENSIONS.

GENERAL CONTRACTOR SHALL REPORT DISCREPNCIES TO OWNER OR ARCHITECT IF FRAMING AND INTERIOR CLEAR DIMENSIONS ARE FOUND TO CONFLICT.

10. STOREFRONT SYSTEMS ARE DIMENSIONED TO JAMBS, REFER TO A-600 FOR ADDITIONAL INFORMATION.





 $\mathcal{O}$ 

TMEN

ATE 8

DISTRIC 4302, 4312, 4408 TUMW/

CRAFT REVISION 050-01-21 PROJECT NO:


PRINCIPAL-IN-CHARGE: PROJECT ARCHITECT: DRAWN BY: PROJECT STATUS:

DATE

PERMIT SET 05.06.2022

SHEET TITLE: FLOOR PLAN BLDG B & D -LEVEL 2


SHEET NO.

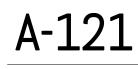

→z

PROJECT NORTH TRUE NORTH

 $\rightarrow$ z

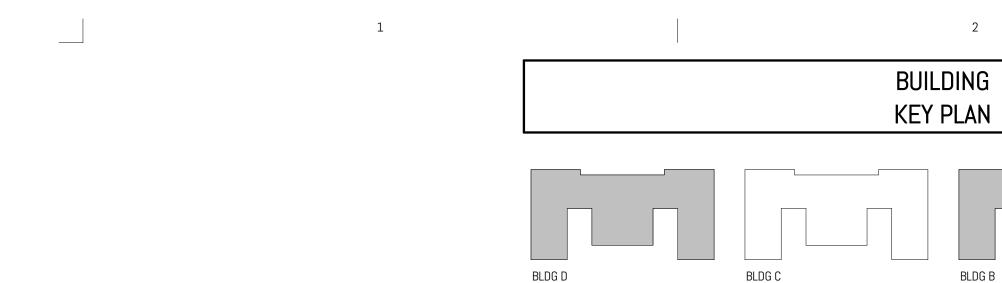

Item 7.


С

R


1

A-220 A1

A2 FLOOR PLAN - BUILDING B & D - LEVEL 3 SCALE: 1/8" = 1'-0" @ FULL SCALE

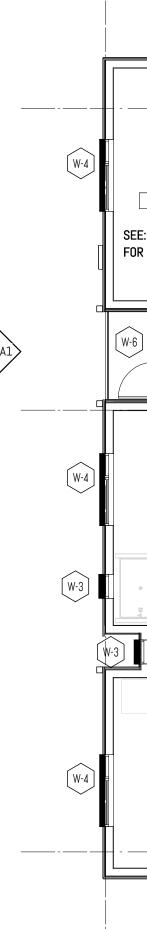

B.g

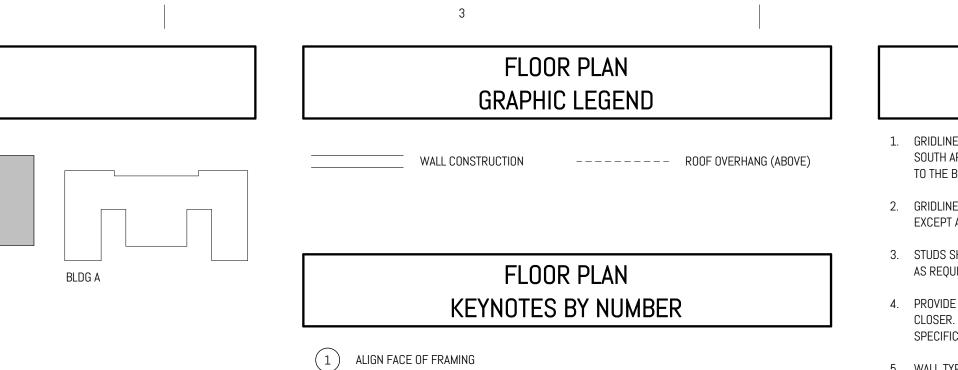


(2) GRID X.d FRAMING TO CENTERLINE OF STUD

3

1. GRIDLINES RUNNING EAST-WEST ARE INDICATED NUMERICALLY, GRIDLINES RUNNING NORTH-SOUTH ARE INDICATED ALPHABETICALLY. EACH GRIDLINE HAS A PREFIX THAT CORRESPONDS TO THE BUILDING LOCATION, REFER TO LEGEND ON THIS SHEET.

4

- 2. GRIDLINES ARE LOCATED AT FACE OF CONCRETE STEM WALLS AND FACE OF STUD FRAMING, EXCEPT AT GRID X.d WHERE GRIDLINE IS AT THE STUD CENTERLINE.
- 3. STUDS SHALL BE OFFSET AND ADDITIONAL LAYERS OF GYPSUM BOARD SHALL BE PROVIDED AS REQUIRED TO PROVIDE FACE ALIGNMENT OF GYPSUM BOARD.
- 4. PROVIDE MINIMUM 1'-0" CLEAR FLOOR SPACE AT THE PUSH SIDE OF EVERY DOOR WITH A CLOSER. PROVIDE MINIMUM 1'-6" CLEAR AT THE PULL SIDE OF EVERY DOOR, UNLESS SPECIFICALLY DIMENSIONED, NOTED OR SHOWN OTHERWISE.
- 5. WALL TYPES SHALL BE CONSTRUCTED AS BELOW. STRUCTURAL REQUIREMENTS PER STRUCTURAL SERIES TAKE PRECEDENT. OWNER SHALL BE NOTIFIED OF ANY DISCREPENCIES PRIOR TO INSTALLATION. CONTRACTOR TO REFER TO SHEET A-000 - CODE PLANS & ELEVATIONS TO CONFIRM FIRE RATING OF WALLS. REFER TO SHEET SERIES A-400 - UNIT FLOOR PLANS, FOR WALL TYPES WITHIN UNITS.
- 6. FRAMED WALL DIMENSIONS INDICATED FROM FACE OF STUD, UNO.

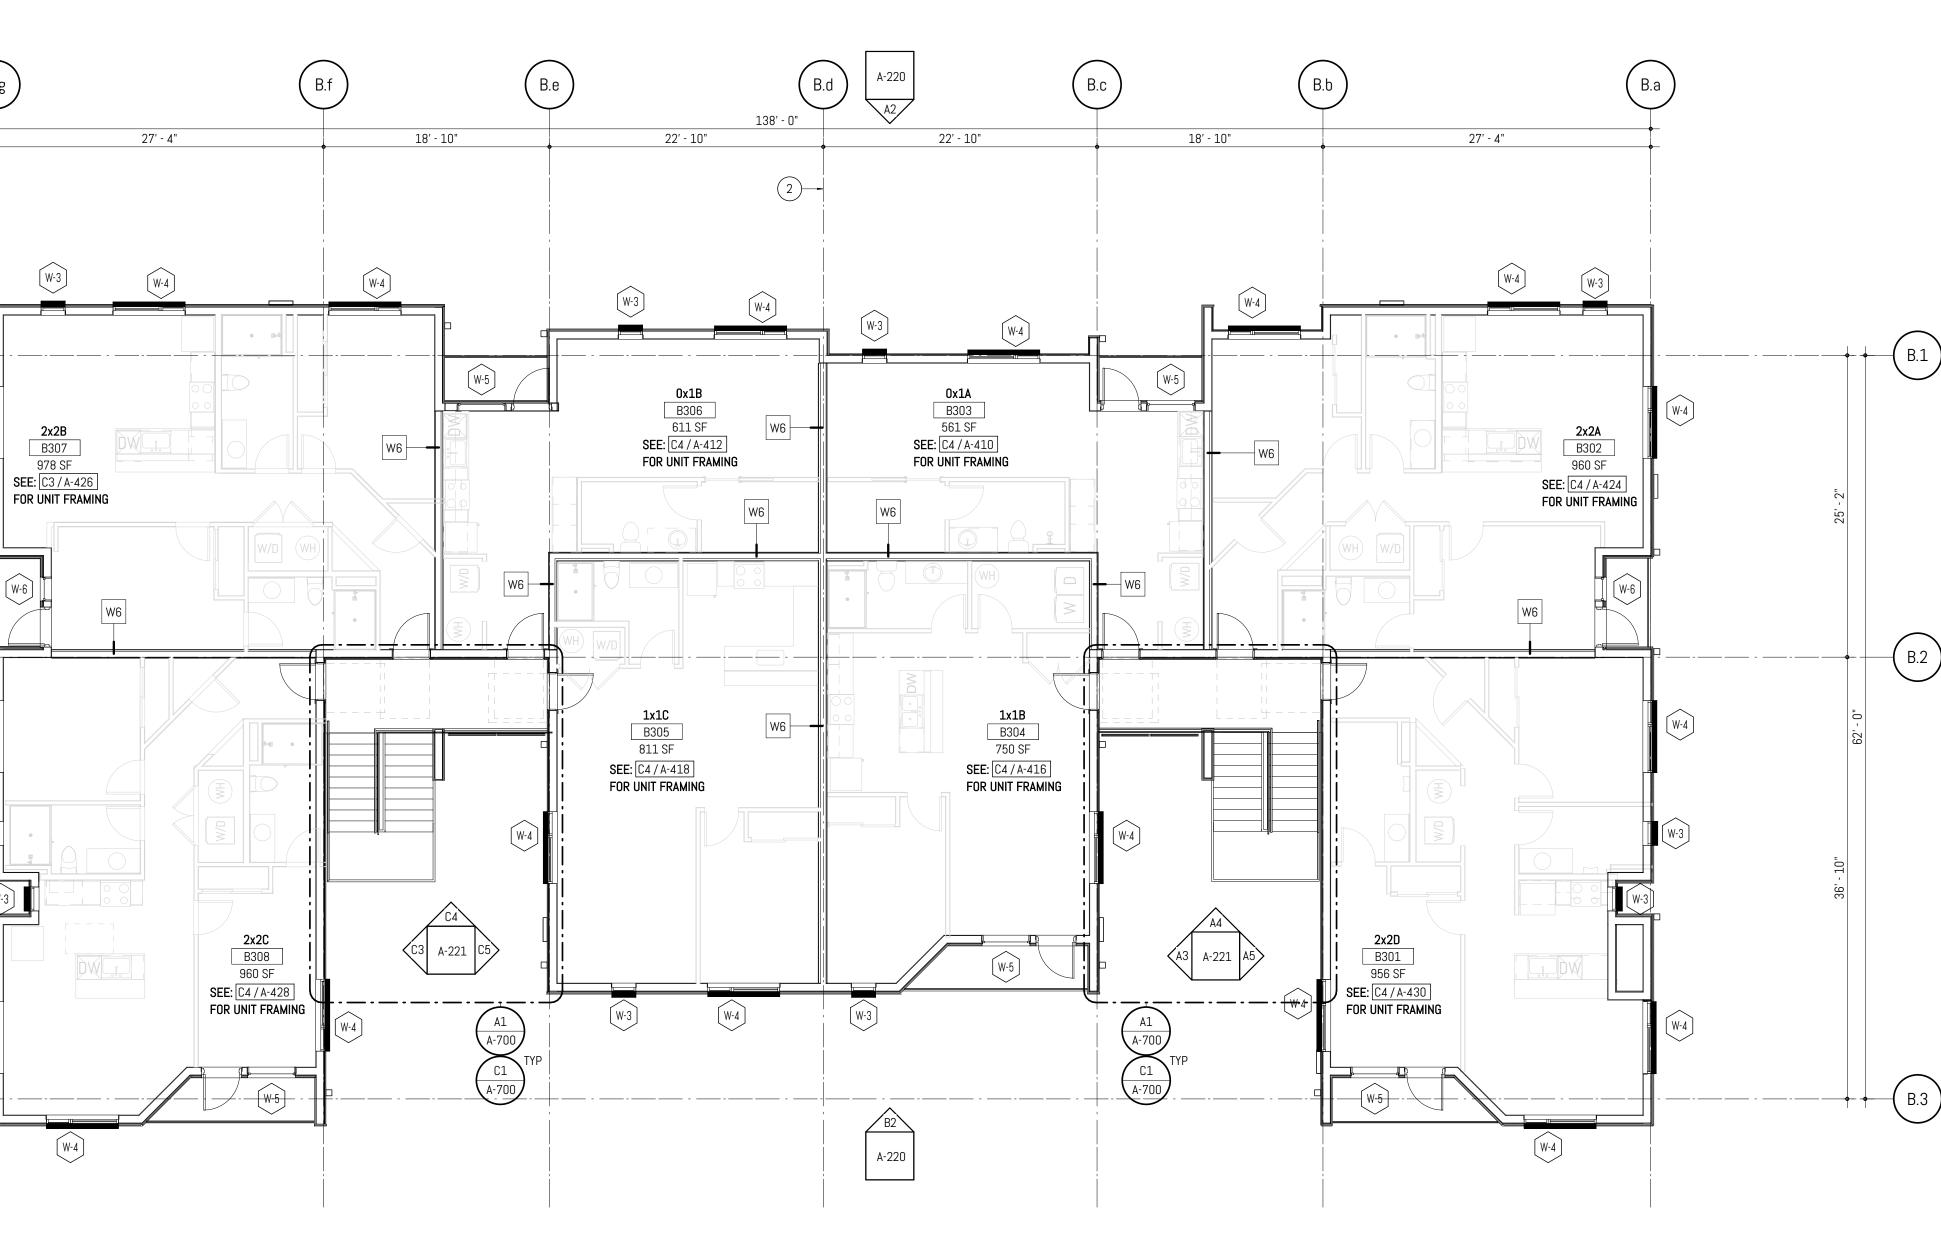

4

# FLOOR PLAN **GENERAL NOTES**

7. FRAMING SHALL BE FURRED OUT, OR ADDITIONAL LAYERS OF GYPSUM BOARD SHALL BE INSTALLED AS REQUIRED TO ALIGN WITH ADJACENT FACE OF FINISH.

8. DOORS ADJACENT TO FRAMED WALLS SHALL BE 4" FROM NEAREST FACE OF STUD UNO. 9. REFER TO A-400, TYPICAL UNIT PLAN SERIES, FOR INTERIOR MINIMUM CLEAR DIMENSIONS. GENERAL CONTRACTOR SHALL REPORT DISCREPNCIES TO OWNER OR ARCHITECT IF FRAMING AND INTERIOR CLEAR DIMENSIONS ARE FOUND TO CONFLICT.

10. STOREFRONT SYSTEMS ARE DIMENSIONED TO JAMBS, REFER TO A-600 FOR ADDITIONAL INFORMATION.






-(B.2)

	MARK		REVISION	DATE
	PRIN	IECT NO: CIPAL-IN-CH/ IECT ARCHIT VN BY:		21 BF MJ
A	PE	RMIT S	ET	

SHEET TITLE: FLOOR PLAN BLDG B & D -LEVEL 3

SHEET NO.

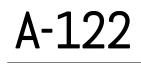

→z

 $\rightarrow$ z

ltem 7.

С

В

\_\_\_\_\_

1

\_\_\_\_\_DS —

A-220 A1

DS —


A2 FLOOR PLAN - BUILDING B & D - ROOF SCALE: 1/8" = 1'-0" @ FULL SCALE


1

B.g


GUTTER -

DS

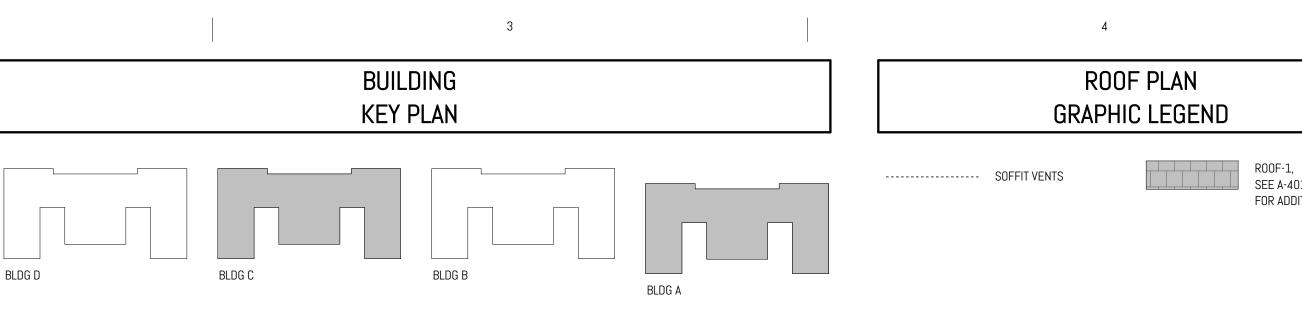

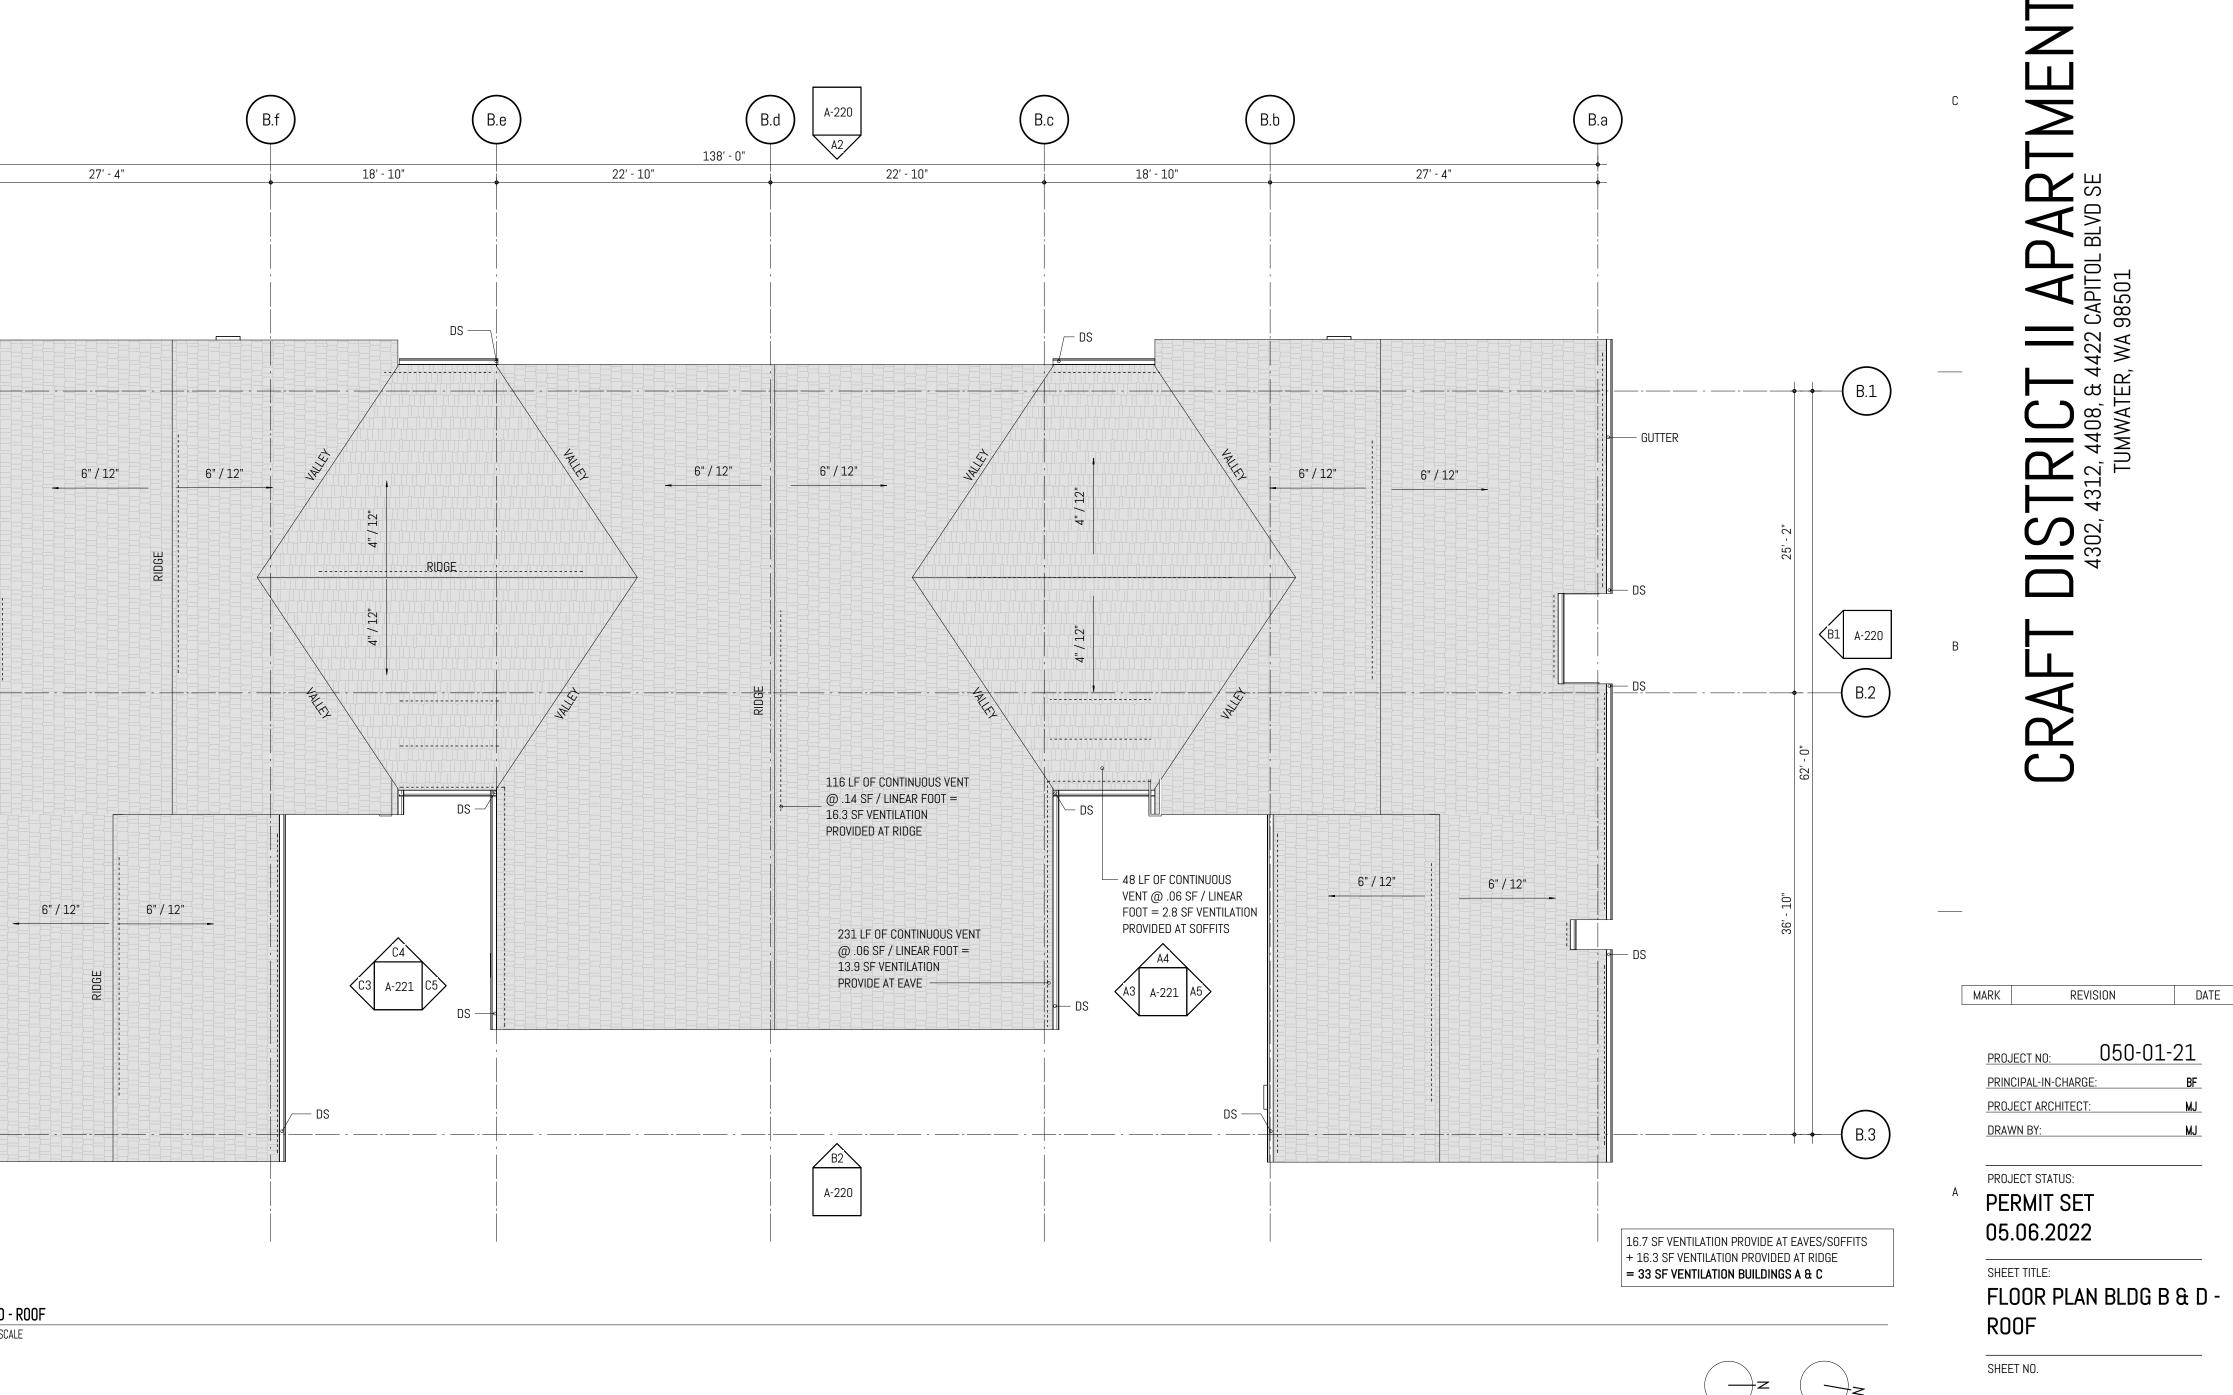

2 3

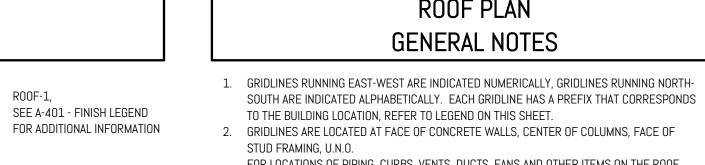

# ROOF PLAN **GENERAL NOTES**

5

- 2. GRIDLINES ARE LOCATED AT FACE OF CONCRETE WALLS, CENTER OF COLUMNS, FACE OF FOR LOCATIONS OF PIPING, CURBS, VENTS, DUCTS, FANS AND OTHER ITEMS ON THE ROOF SURFACE, REFER TO MECHANICAL, PLUMBING AND ELECTRICAL DRAWINGS. FOR ROOF DRAIN
- SIZING, REFER TO PLUMBING DRAWINGS. 3. PAINT EXPOSED ROOF-MOUNTED EQUIPMENT, PIPING, ETC. EXCEPT THOSE ITEMS WHICH ARE
- ALUMINUM OR STAINLESS STEEL. COLOR AS SELECTED BY ARCHITECT. 4. ROOF FLASHING TO BE ACCORDING TO MANUFACTURER'S RECOMMENDATIONS.



 $\mathcal{O}$ 


5









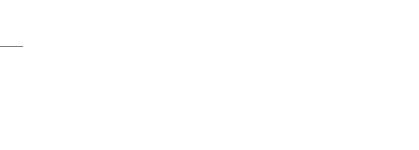









· · · · ·


A1 SLAB EDGE & DOWNSPOUT DETAIL SCALE: 3/4" = 1'-0" @ FULL SCALE









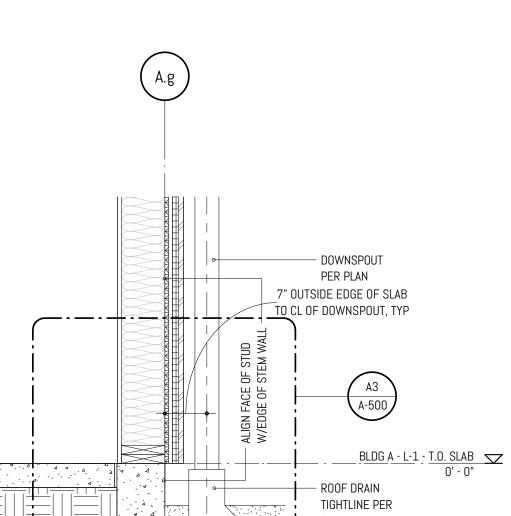


<del>╷╧╸╸</del>┿┿╢<mark>╸╧╧┥┥┽╧╸┽</mark>┿┿╢<mark>╸╧╧┥┥┿╧╸╸</mark>┿┿

1

FOR STRUCTURAL DETAIL COORDINATION, SEE 1/S-300


— | | | — – | | | — – | | | — + | | | — – | | | — – | |

CIVIL

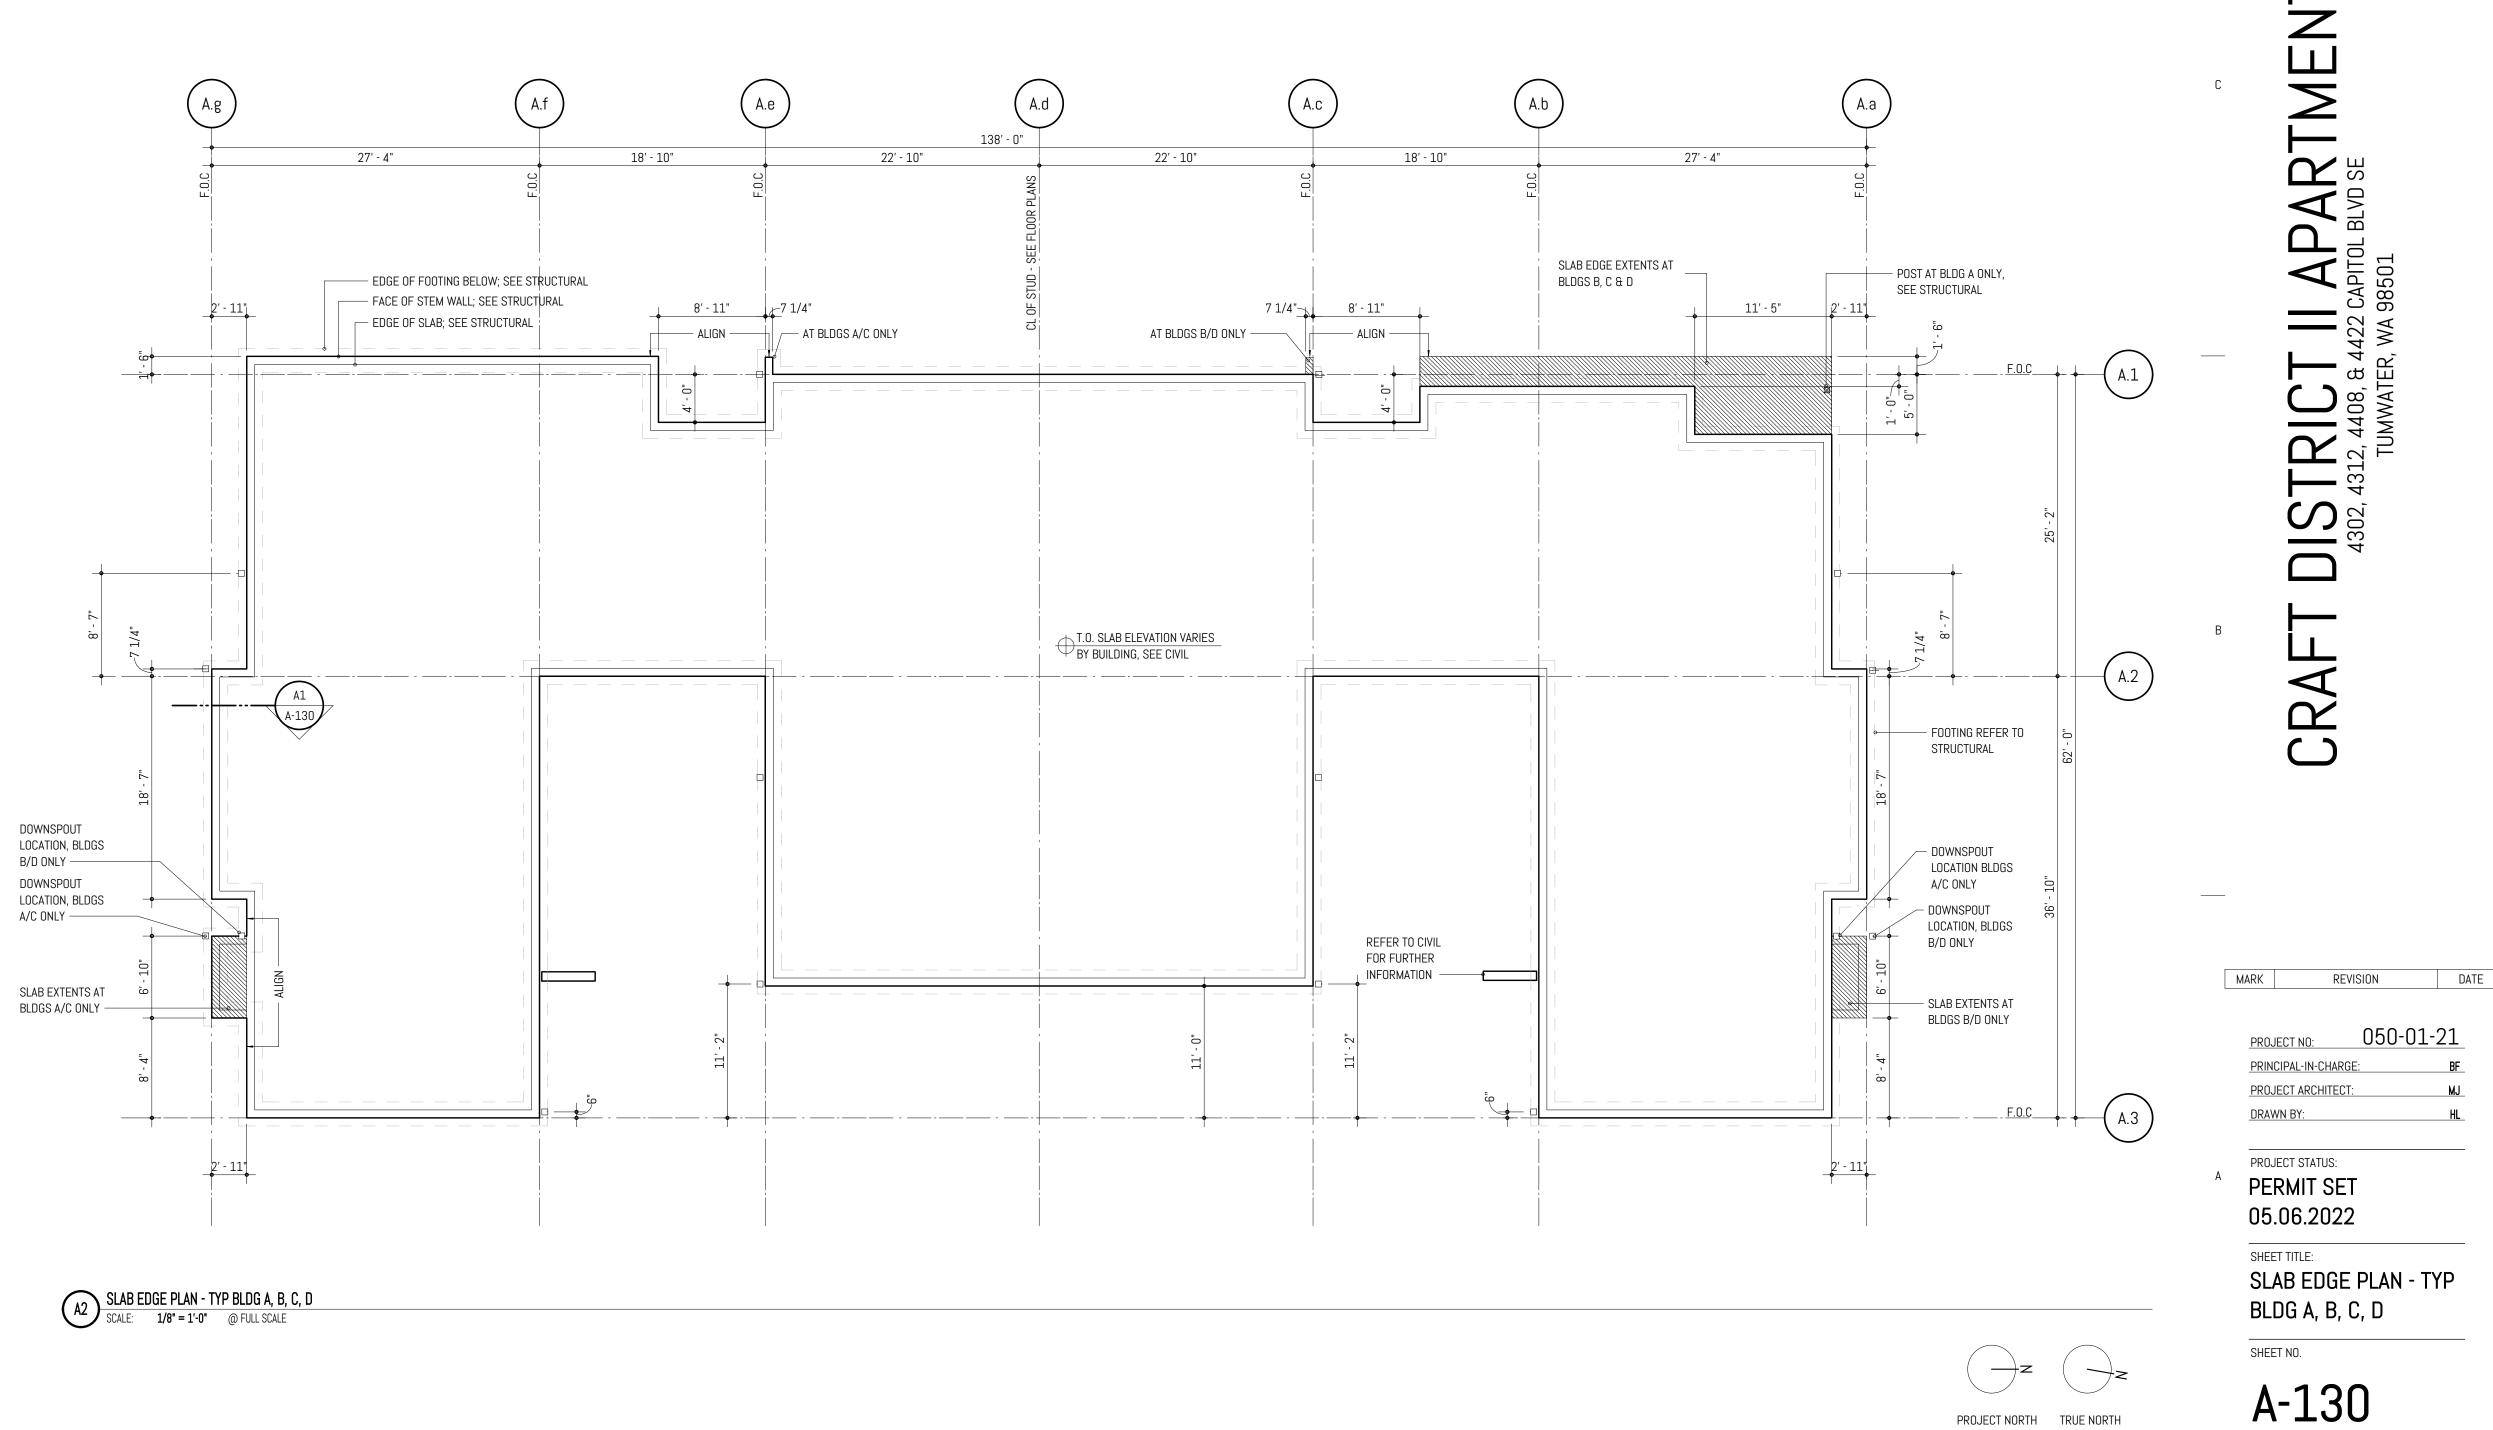


4



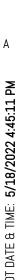

127

2

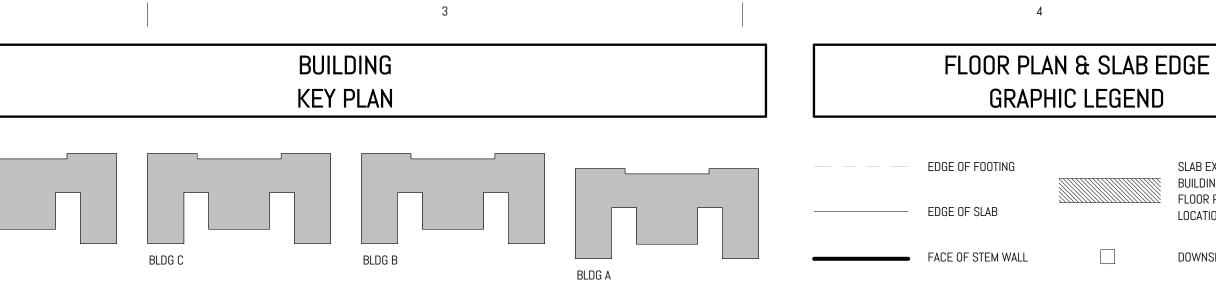

3

### SLAB EXTENT CHANGES BETWEEN BUILDINGS - REFER TO NOTES ON FLOOR PLAN FOR BUILDING LOCATION AND EXTENTS

DOWNSPOUTS

### FLOOR PLAN & SLAB EDGE **GENERAL NOTES**

5

1. THE CONTRACTOR SHALL COMPARE THIS SLAB EDGE PLAN WITH STRUCTURAL DRAWINGS. THE CONTRACTOR SHALL REPORT ANY OMISSIONS OR INCONSISTENCIES TO THE ARCHITECT. 2. DIMENSIONS INDICATED FROM SLAB EDGE U.N.O.

3. STRUCTURAL COLUMNS TO CENTER ON GRIDLINES U.N.O.; REFER TO STRUCTURAL DRAWINGS FOR COLUMN TYPES.

- 4. OPENINGS AT DESIGN-BUILD EGRESS STAIRS TO BE VERIFIED BY THE MANUFACTURER.
- 5. EMBED PLATES NOT SHOWN IN SLAB EDGE A-130 SERIES. STRUCTURAL SHEET SET TO SPECIFY EMBED SIZING UNLESS NOTED OTHERWISE IN ARCHITECTURAL SHEET SET.

PROJECT NORTH TRUE NORTH



S

П







Item 7.

С

ECTION	

4



# S IMEN. WA В, & 4. АТЕР, DISTRIC 4302, 4312, 4406 TUMW/ CRAFT

PROJECT NO:	050-01-21
PRINCIPAL-IN-CHARG	iE: BF
PROJECT ARCHITECT	: MJ
DRAWN BY:	HL

REVISION

DATE

### PROJECT STATUS: PERMIT SET 05.06.2022

MARK

SHEET TITLE: EXTERIOR ELEVATIONS BLDG A & C

SHEET NO.







1

R




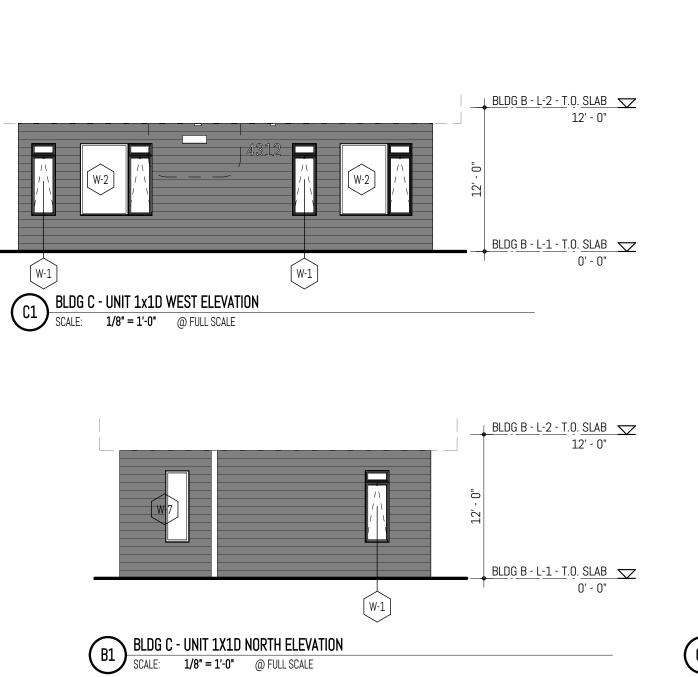


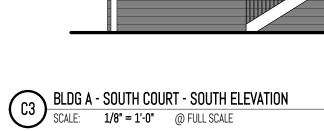

GT-1 -DS-1 -


WIRE MESH SCREEN - SEE \_ SHEET A-550 FOR DETAILS

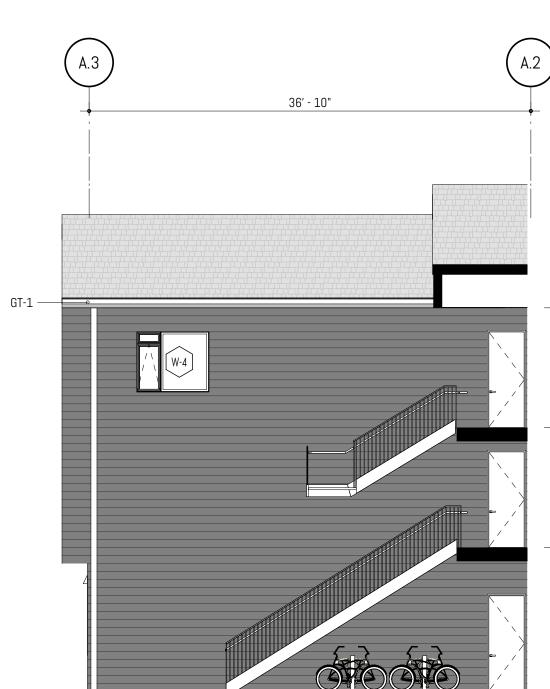

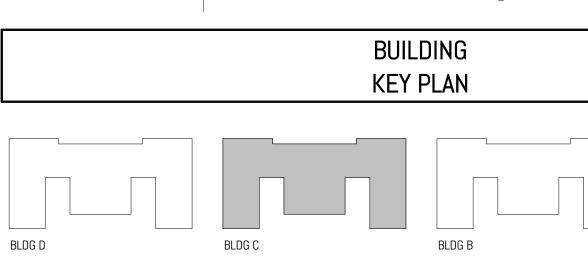



ltem 7. 

129

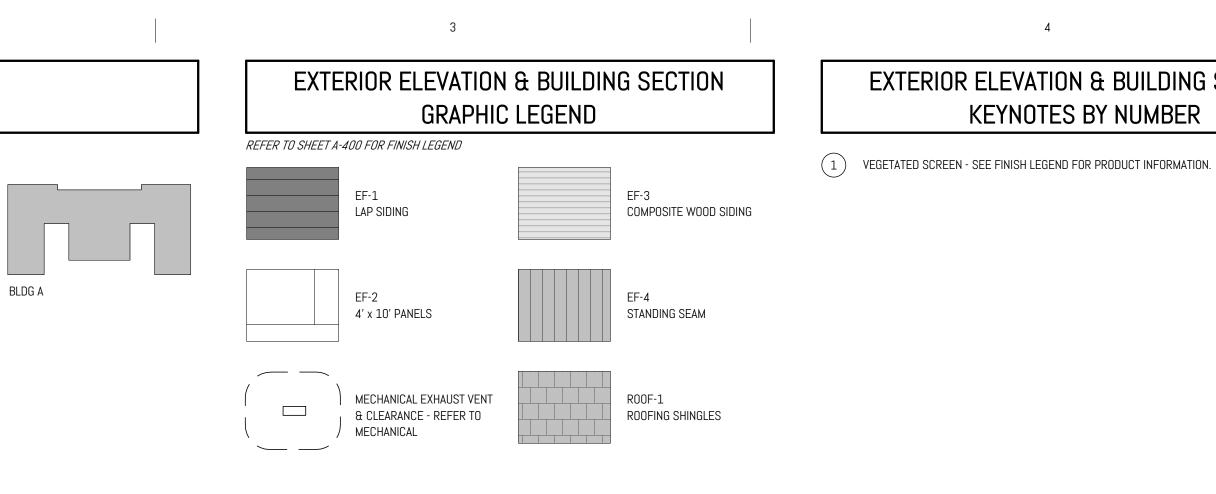

	BLDG <u>A - L-4 - T.O. WALL</u> 32' - 0"
10' - 0"	
	BLDG A - L-3 - T.O. FLOOR 22' - 0"
10' - 0" 37' - 0"	BLDG A - L-2 - T.O. FLOOR 12' - 0"
12' - 0"	12' - 0"
12	BLDG A - L-1 - T.O. SLAB 0' - 0"

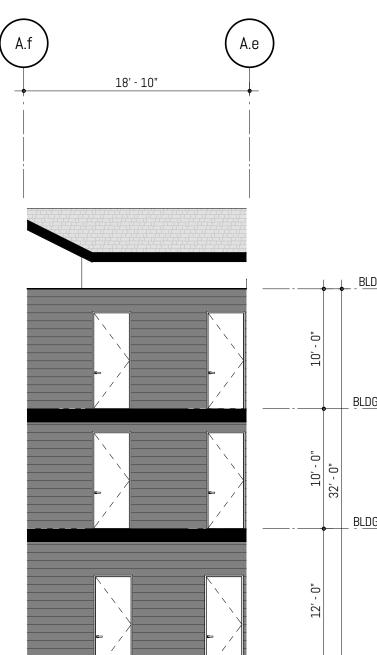


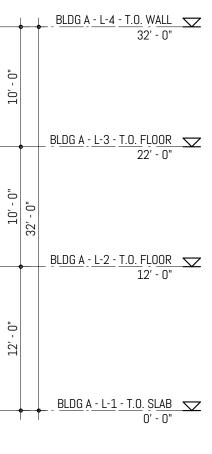


C4 BLDG A - SOUTH COURT - WEST ELEVATION SCALE: 1/8" = 1'-0" @ FULL SCALE


	BLDG A - L-4 - T.O. WALL 32' - 0"
10' - 0"	BLDG A - L-3 - T.O. FLOOR
10' - 0" 32' - 0"	22' - 0" <u>BLDG A - L-2 - T.O. FLOOR</u>
12' - 0"	BLDG A - L-1 - T.O. SLAB
 <b> · _ · </b>	0' - 0"



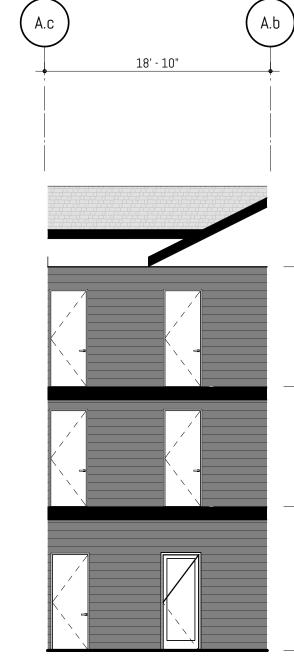

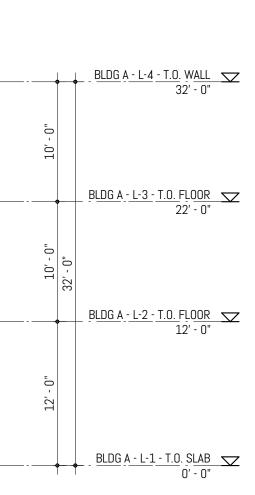

4

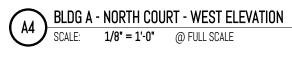

ì	SECTION	
-		

### EXTERIOR ELEVATION & BUILDING SECTION **GENERAL NOTES**

F

ш

2

REGISTERED ARCHITECT

BEN DAVID FERGUSON

STATE OF WASHINGTON

 $\geq$ 

 $\leq$ 

8, & ATE

DISTRIC 4302, 4312, 4408 TUMWA

CRAFT

REVISION

PROJECT NO: 050-01-21

EXTERIOR ELEVATIONS -

BLDG A & C UNIT ENTRY

PRINCIPAL-IN-CHARGE: PROJECT ARCHITECT:

DRAWN BY:

PROJECT STATUS: PERMIT SET


05.06.2022

SHEET TITLE:


DATE

< n -

- 1. EXTERIOR WALL FINISH PANELS DIMENSIONED ACCORDING TO MANUFACTURER-PROVIDED NOMINAL SIZES; INSTALLER TO ADJUST PANEL LAYOUT AS NEEDED TO ACCOMMODATE HORIZONTAL AND VERTICAL JOINTS.
- 2. EXISTING WALL-HOSTED UTILITY / SERVICE CONNECTIONS TO BE LOCATED AND IDENTIFIED BEFORE COMMENCEMENT OF CONSTRUCTION. UTILITY / SERVICE CONNECTIONS NOT SHOWN IN ARCHITECTURAL DRAWINGS TO BE DOCUMENTED AND REPORTED TO ARCHITECT IN ADVANCE OF WALL FRAMING AND / OR SIDING INSTALLATION.
- 3. SIDING INSTALLER TO MOCK-UP JOINTS, TRANSITIONS, FASTENER TYPE AND PATTERN, AND APPLIED FINISHES (INCLUDING PAINT AND STAIN) FOR OWNER AND ARCHITECT APPROVAL BEFORE INSTALLATION.
- 4. SEE SHEET A-200 FOR TYPICAL EXTERIOR ELEVATION NOTE, U.N.O.
- 5. MATERIAL FINISHES HAVE BEEN ABBREVIATED PER THE FINISH LEGEND SEE SHEET A-401 FOR ADDITIONAL INFORMATION. 6. FOR TYPICAL BUILDING ELEVATION DIMENSIONS, CALLOUTS, & ANNOTATIONS, SEE SHEET A-200. 7. SEE A-100 SERIES - OVERALL FLOOR PLANS FOR EXTERIOR DOOR TAGS & A-400 SERIES - ENLARGED
- FLOOR PLANS FOR INTERIOR DOOR TAGS. 8. APPROVED 12" MINUMUM ADDRESS NUMBERING TO BE PROVIDED ON EACH BUILDING. THE ADDRESS
- NUMBERING SHALL BE HIGH CONTRAST TO THE CLADDING MATERIAL THEY ARE ATTACHED T. BUILDING SHALL BE ADDRESSED AS FOLLOWS:
  - BUILDING A: 4302 CAPITOL BLVD SE, TUMWATER WA 98501 BUILDING B: 4312 CAPITOL BLVD SE, TUMWATER WA 98501
  - BUILDING C: 4408 CAPITOL BLVD SE, TUMWATER WA 98501

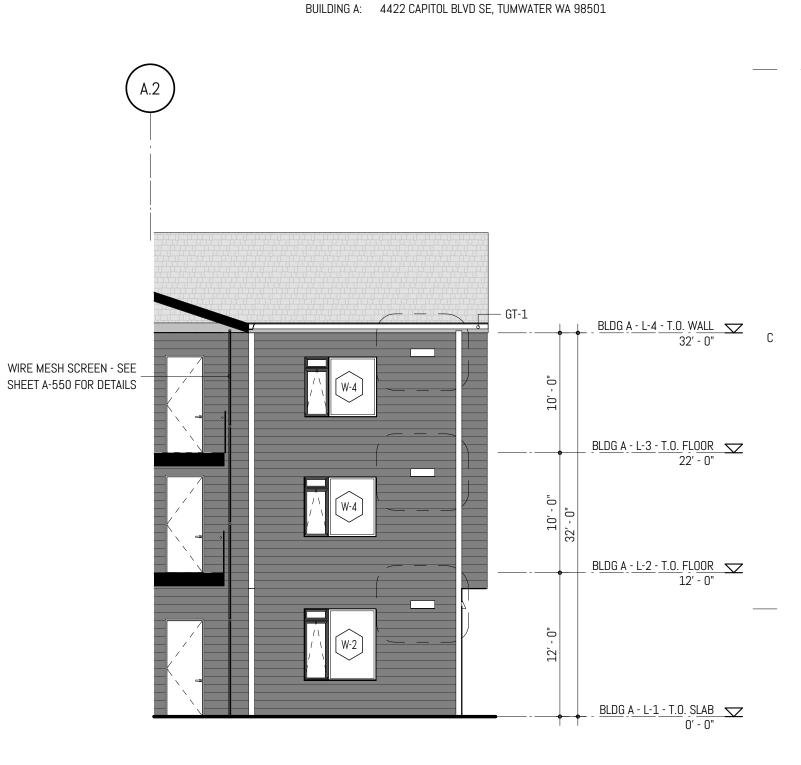



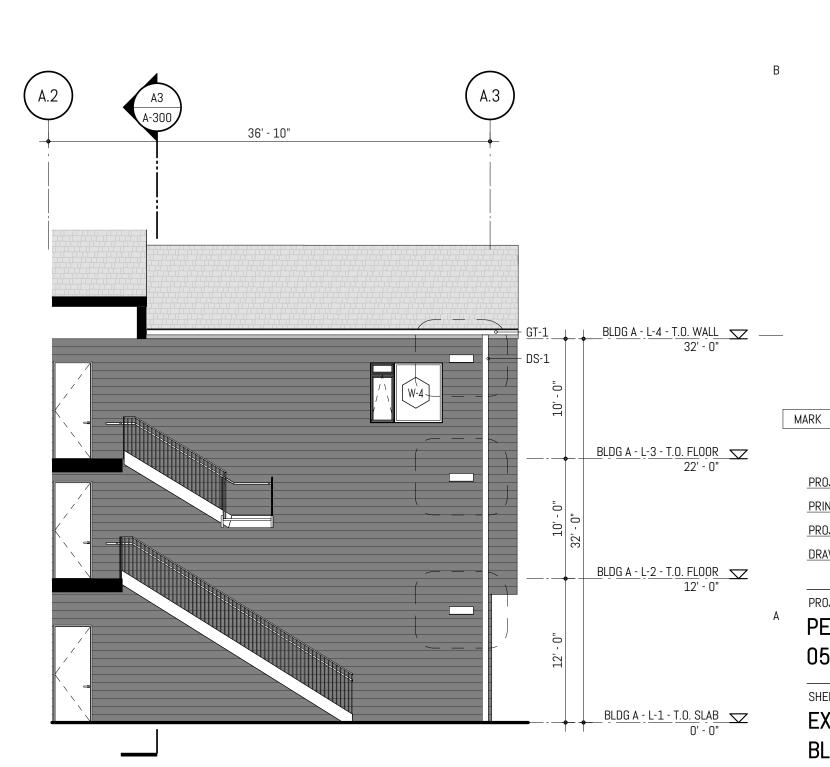









B1 BLDG B - NORTH ELEVATION SCALE: 1/8" = 1'-0" @ FULL SCALE



A1 BLDG B - SOUTH ELEVATION SCALE: 1/8" = 1'-0" @ FULL SCALE

1

ltem 7.




4

050-01-21
E: BF
MJ
FD

DATE

EXTERIOR ELEVATIONS BLDG B & D

SHEET NO.

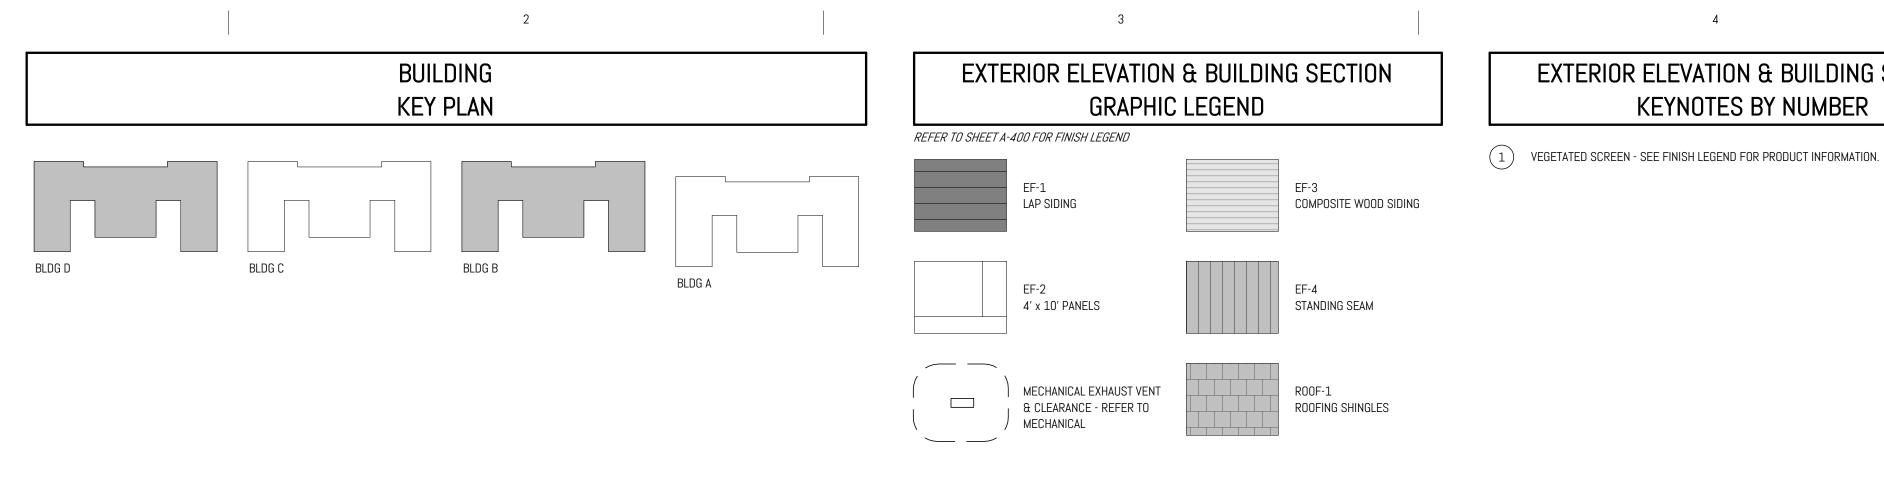


# С


1


B.3 DS-1 -


C3 BLDG B - SOUTH COURT - SOUTH ELEVATION SCALE: 1/8" = 1'-0" @ FULL SCALE

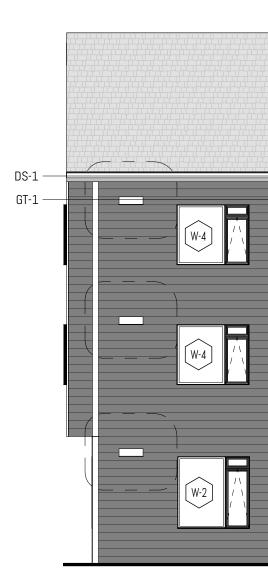


A3 BLDG B - NORTH COURT - SOUTH ELEVATION SCALE: 1/8" = 1'-0" @ FULL SCALE

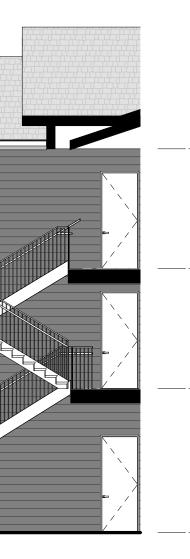


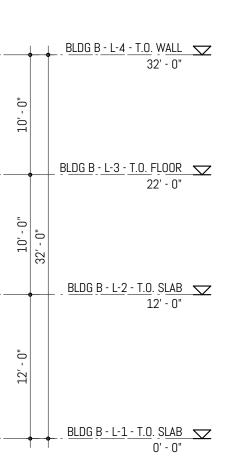


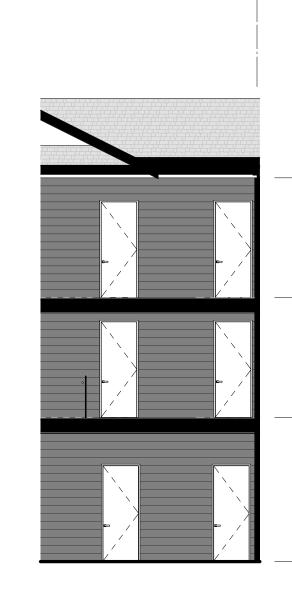


B.e

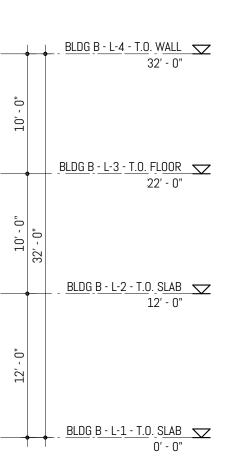


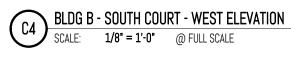

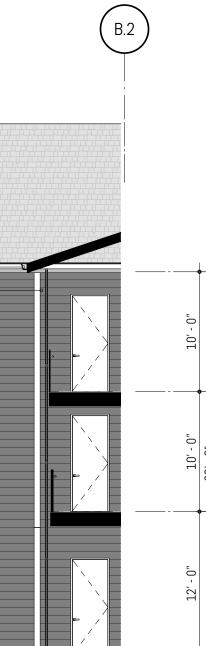

		BLDG B - L-4 - T.O. WALL
		_ <u>BLDG B - L-3 - T.O. FLOOR</u>
TO0T	32' - 0"	22' - 0"
	, ,	<u>BLDG B - L-2 - T.O. SLAB</u> 12' - 0"
TT		
	•	► - BLDG <u>B - L-1 - T.O. SLAB</u> 0' - 0"

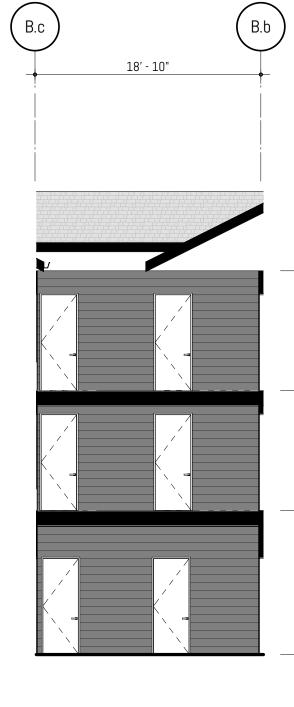

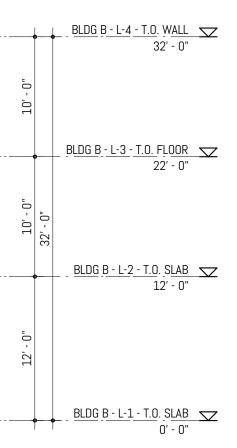


4


A4 BLDG B - NORTH COURT - WEST ELEVATION SCALE: 1/8" = 1'-0" @ FULL SCALE

ì	SECTION	
1	SECTION	


# EXTERIOR ELEVATION & BUILDING SECTION **GENERAL NOTES**

- 1. EXTERIOR WALL FINISH PANELS DIMENSIONED ACCORDING TO MANUFACTURER-PROVIDED NOMINAL SIZES; INSTALLER TO ADJUST PANEL LAYOUT AS NEEDED TO ACCOMMODATE HORIZONTAL AND VERTICAL JOINTS.
- 2. EXISTING WALL-HOSTED UTILITY / SERVICE CONNECTIONS TO BE LOCATED AND IDENTIFIED BEFORE COMMENCEMENT OF CONSTRUCTION. UTILITY / SERVICE CONNECTIONS NOT SHOWN IN ARCHITECTURAL DRAWINGS TO BE DOCUMENTED AND REPORTED TO ARCHITECT IN ADVANCE OF WALL FRAMING AND / OR SIDING INSTALLATION.
- 3. SIDING INSTALLER TO MOCK-UP JOINTS, TRANSITIONS, FASTENER TYPE AND PATTERN, AND APPLIED FINISHES (INCLUDING PAINT AND STAIN) FOR OWNER AND ARCHITECT APPROVAL BEFORE INSTALLATION.
- 4. SEE SHEET A-200 FOR TYPICAL EXTERIOR ELEVATION NOTE, U.N.O.
- 5. MATERIAL FINISHES HAVE BEEN ABBREVIATED PER THE FINISH LEGEND SEE SHEET A-401 FOR ADDITIONAL INFORMATION. 6. FOR TYPICAL BUILDING ELEVATION DIMENSIONS, CALLOUTS, & ANNOTATIONS, SEE SHEET A-200. 7. SEE A-100 SERIES - OVERALL FLOOR PLANS FOR EXTERIOR DOOR TAGS & A-400 SERIES - ENLARGED
- FLOOR PLANS FOR INTERIOR DOOR TAGS. 8. APPROVED 12" MINUMUM ADDRESS NUMBERING TO BE PROVIDED ON EACH BUILDING. THE ADDRESS
- NUMBERING SHALL BE HIGH CONTRAST TO THE CLADDING MATERIAL THEY ARE ATTACHED T. BUILDING SHALL BE ADDRESSED AS FOLLOWS:
  - BUILDING A: 4302 CAPITOL BLVD SE, TUMWATER WA 98501 BUILDING B: 4312 CAPITOL BLVD SE, TUMWATER WA 98501 BUILDING C: 4408 CAPITOL BLVD SE, TUMWATER WA 98501
  - BUILDING A: 4422 CAPITOL BLVD SE, TUMWATER WA 98501

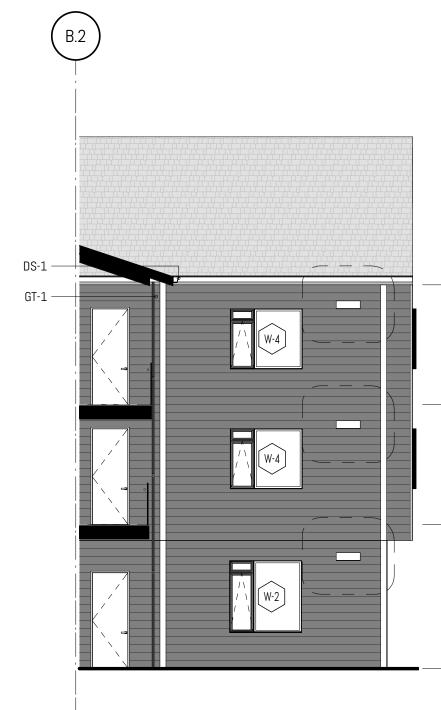

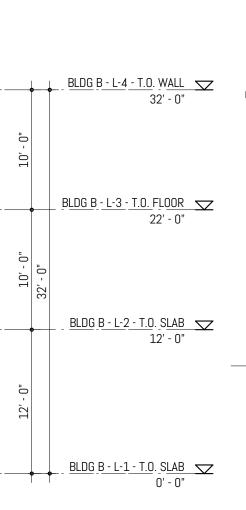

C5 BLDG B - SOUTH COURT - NORTH ELEVATION SCALE: 1/8" = 1'-0" @ FULL SCALE

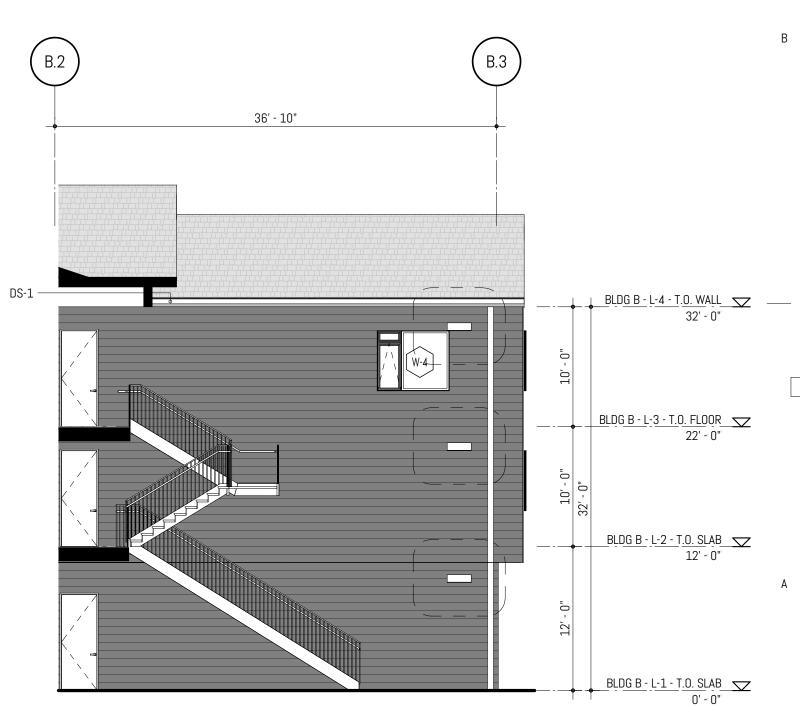

5

A5 BLDG B - NORTH COURT - NORTH ELEVATION SCALE: 1/8" = 1'-0" @ FULL SCALE

BLDG B - L-3 - T.O. FLOOR 22' - 0" BLDG B - L-2 - T.O. SLAB 12' - 0" BLDG B - L-1 - T.O. SLAB 0' - 0"



Z | 8, & ATE DISTRIC 4302, 4312, 4406 TUMW

MARK REVISION		DATE	
PROJ	ECT NO:	050-01-2	21
PRINCIPAL-IN-CHARGE:		BF	
PROJECT ARCHITECT:			MJ
DRAWN BY:		FD	

PROJECT STATUS: PERMIT SET 05.06.2022

CRAFT

SHEET TITLE: EXTERIOR ELEVATIONS -BLDG B & D UNIT ENTRY

A-221

ltem 7. 

С

В ( A.3

\_\_\_\_\_

ONO

36' - 10"

( A.2 62' - 0"

( A.1 )

2

25' - 2" A3 A-300 **0x1A** 561 SF

**0x1A** 561 SF 0x1A - TYPE A 560 SF

A1 BLDG A - E-W SECTION SCALE: 1/8" = 1'-0" @ FULL SCALE

1

132


# EXTERIOR ELEVATION & BUILDING SECTION **GRAPHIC LEGEND**

EF-1 HARDIE LAP SIDING	EF-3 CEDAR PLANK SIDING
EF-2 HARDIE PANELS	EF-4 STANDING SEAM
	ROOF-1 ROOFING SHINGLES

# **EXTERIOR ELEVATION & BUILDING** KEYNOTES BY NUMBER

4

(1) VEGETATED SCREEN - SEE FINISH LEGEND FOR PRODUCT INFORMATION.

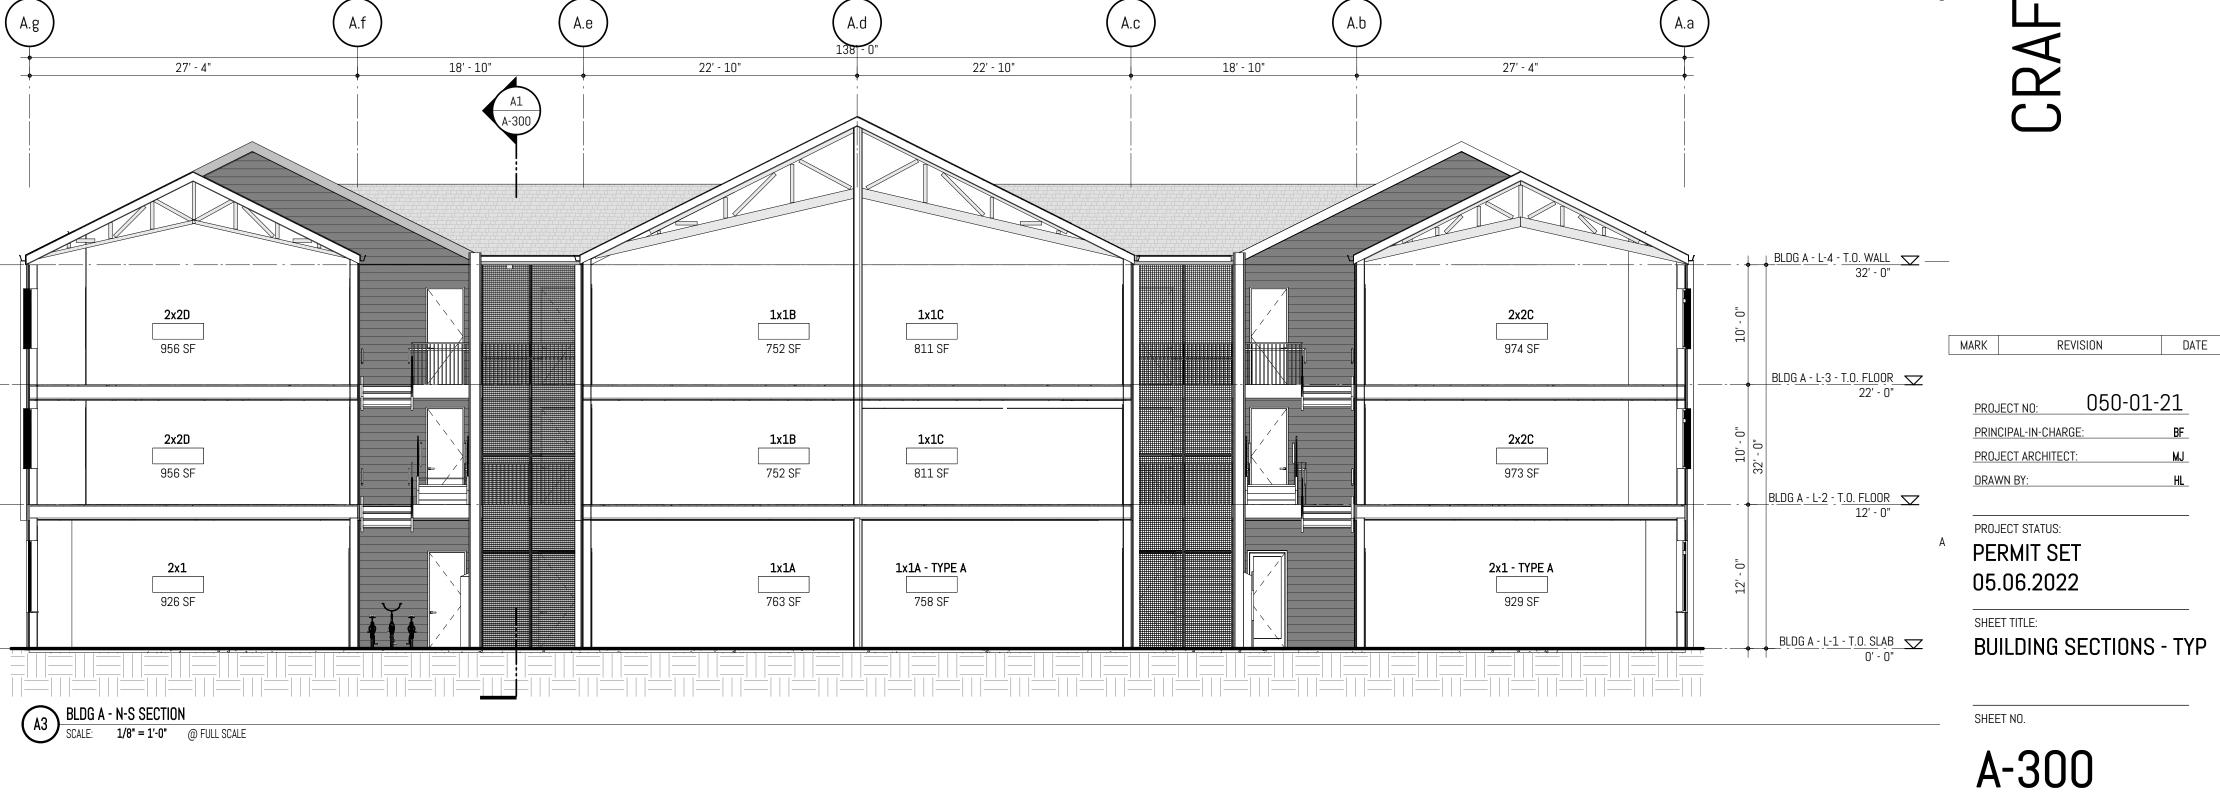

4

### EXTERIOR ELEVATION & BUILDING SECTION **GENERAL NOTES**

- 1. EXTERIOR WALL FINISH PANELS DIMENSIONED ACCORDING TO MANUFACTURER-PROVIDED NOMINAL SIZES; INSTALLER TO ADJUST PANEL LAYOUT AS NEEDED TO ACCOMMODATE HORIZONTAL AND VERTICAL JOINTS.
- 2. EXISTING WALL-HOSTED UTILITY / SERVICE CONNECTIONS TO BE LOCATED AND IDENTIFIED BEFORE COMMENCEMENT OF CONSTRUCTION. UTILITY / SERVICE CONNECTIONS NOT SHOWN IN ARCHITECTURAL DRAWINGS TO BE DOCUMENTED AND REPORTED TO ARCHITECT IN ADVANCE OF WALL FRAMING AND / OR SIDING INSTALLATION.
- 3. SIDING INSTALLER TO MOCK-UP JOINTS, TRANSITIONS, FASTENER TYPE AND PATTERN, AND APPLIED FINISHES (INCLUDING PAINT AND STAIN) FOR OWNER AND ARCHITECT APPROVAL BEFORE INSTALLATION.
- 4. SEE SHEET A-200 FOR TYPICAL EXTERIOR ELEVATION NOTE, U.N.O.
- 5. MATERIAL FINISHES HAVE BEEN ABBREVIATED PER THE FINISH LEGEND SEE SHEET A-401 FOR ADDITIONAL INFORMATION.
- 6. FOR TYPICAL BUILDING ELEVATION DIMENSIONS, CALLOUTS, & ANNOTATIONS, SEE SHEET A-200.
- 7. SEE A-100 SERIES OVERALL FLOOR PLANS FOR EXTERIOR DOOR TAGS & A-400 SERIES ENLARGED FLOOR PLANS FOR INTERIOR DOOR TAGS.




П



Item 7.

С

R

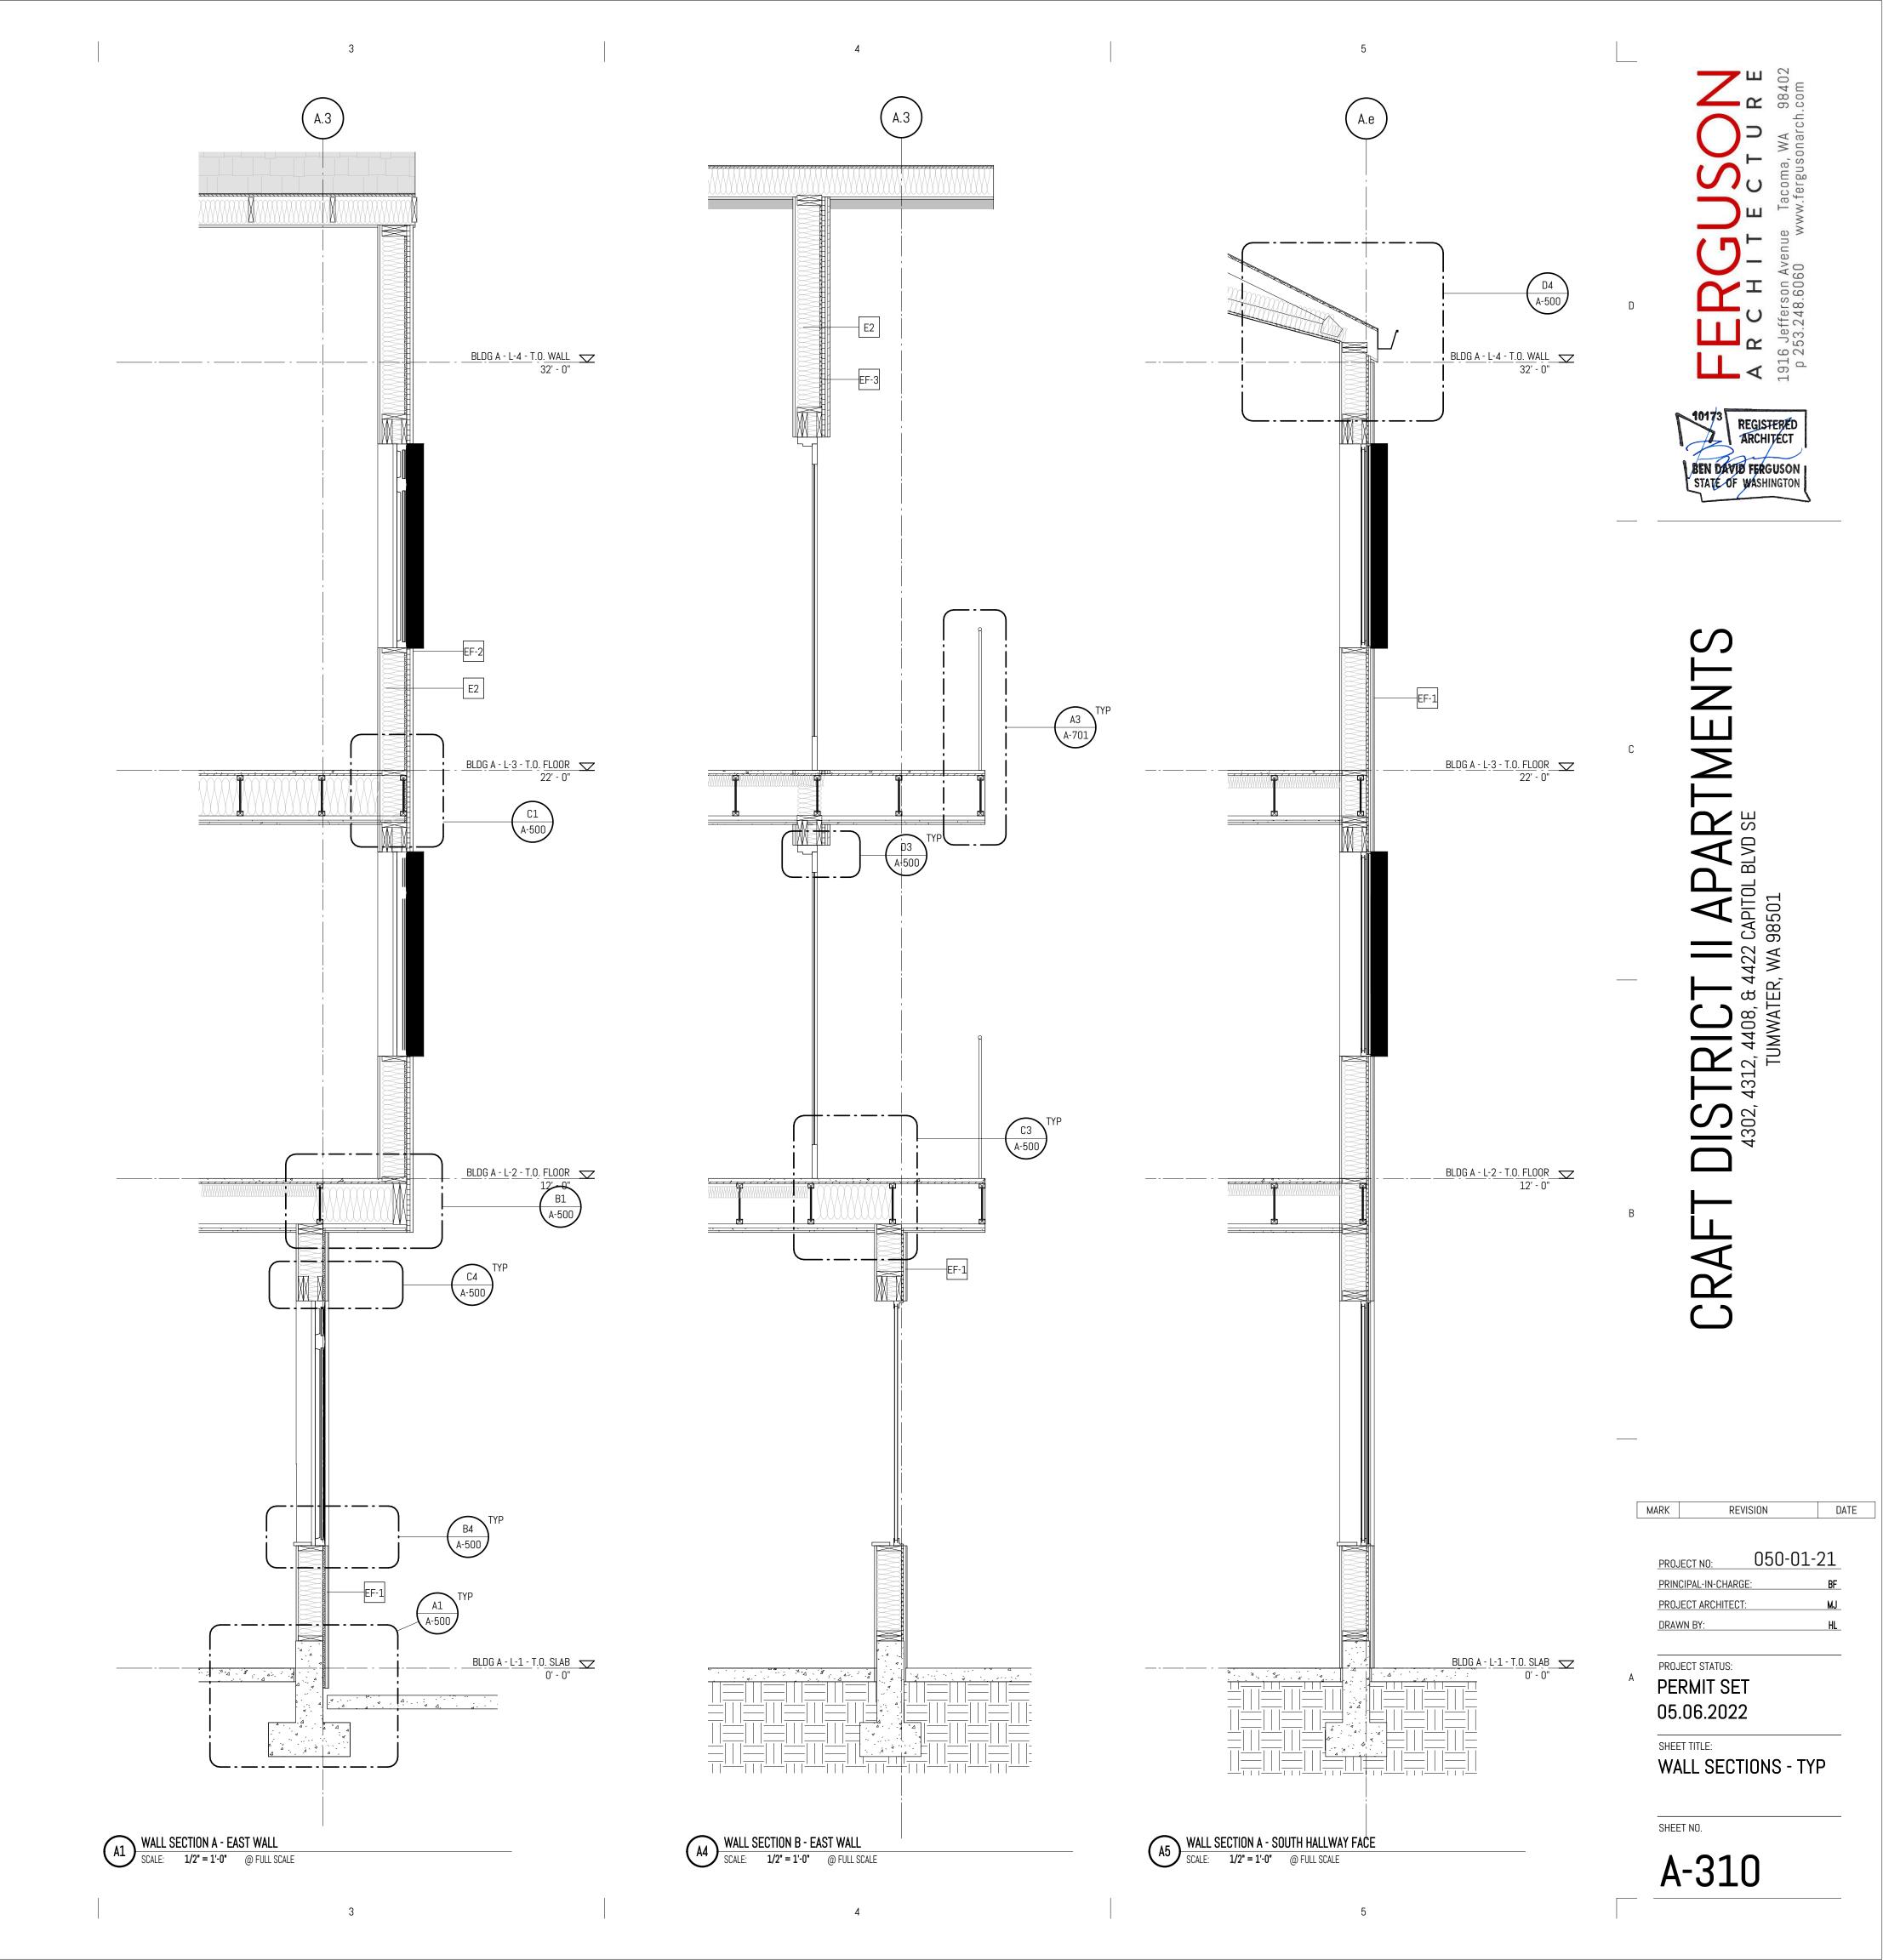



Item 7. 


1


2


C2 ELEVATION - LEASING LOUNGE RESTROOM 1 SCALE: 1/4" = 1'-0" @ FULL SCALE

·F·

42"

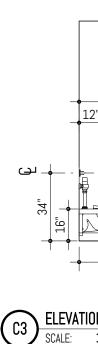

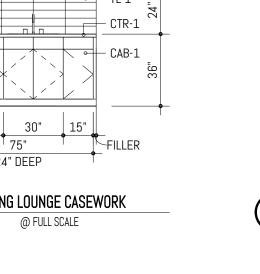

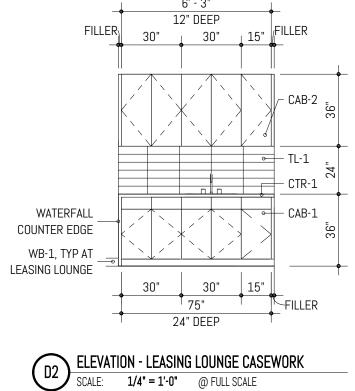


TL-3 -

MIRROR -




1




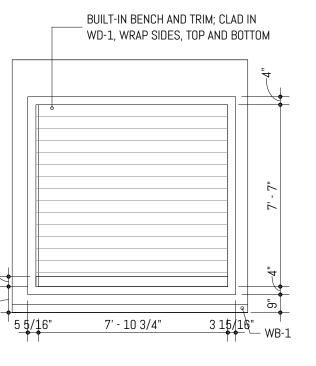




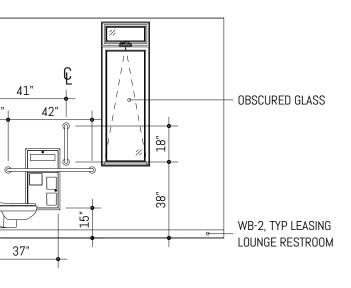


C3 ELEVATION - LEASING LOUNGE RESTROOM 2 SCALE: 1/4" = 1'-0" @ FULL SCALE

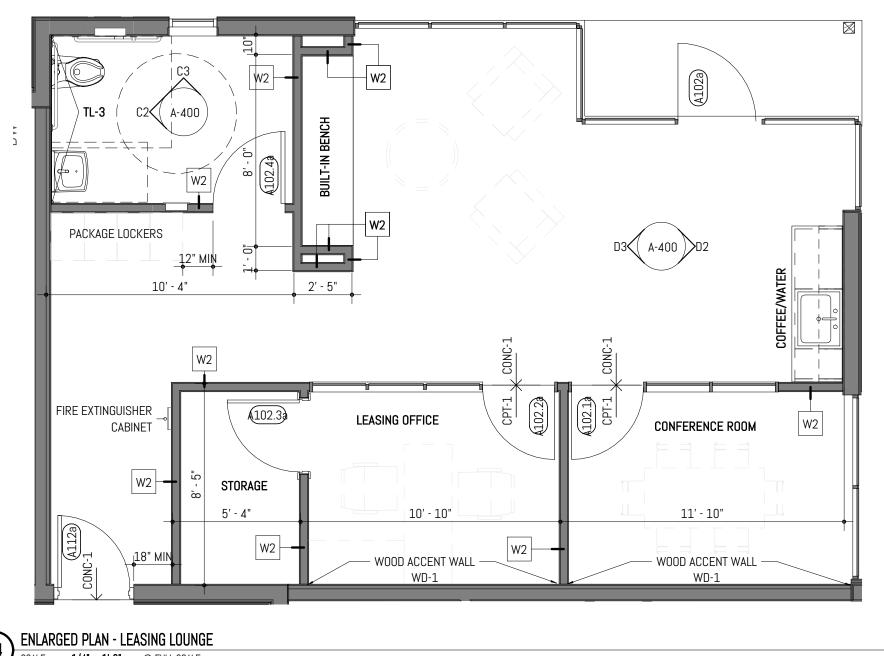

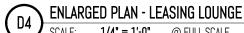

3

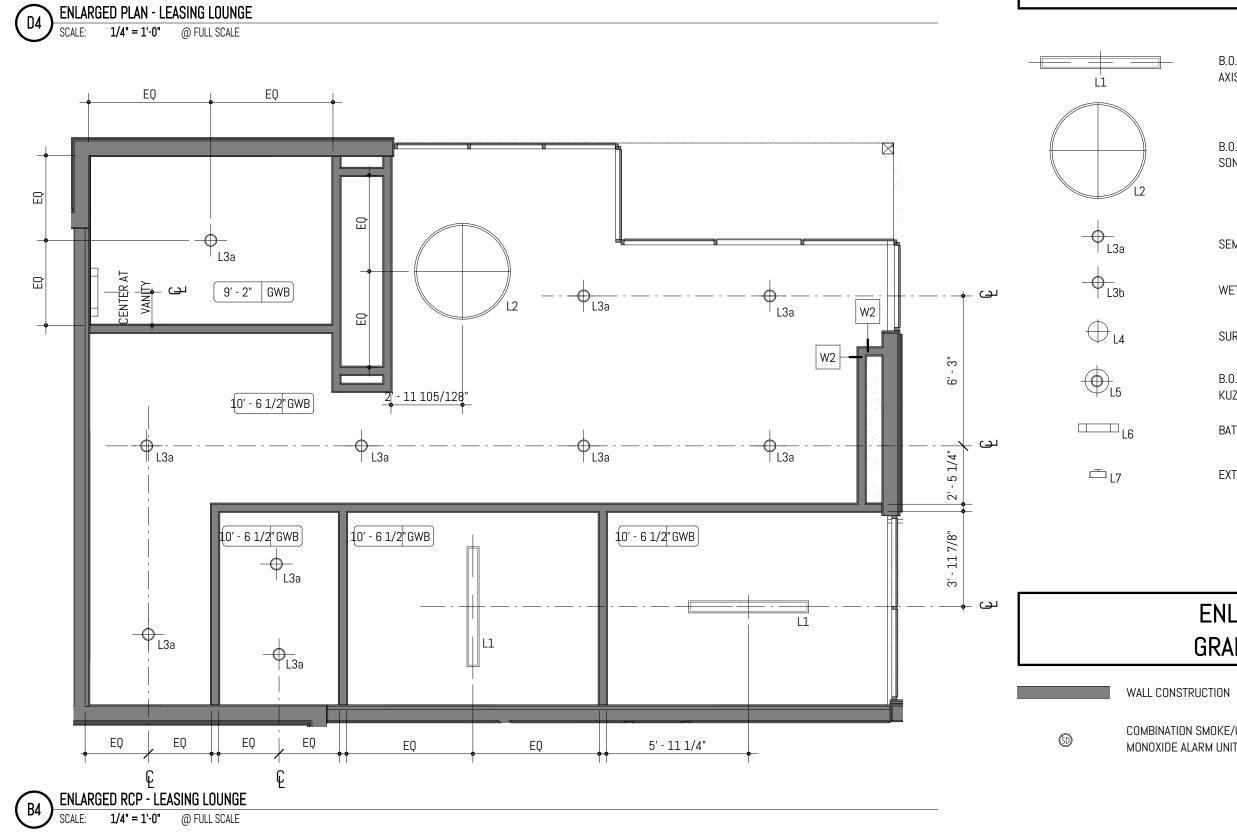

4

				FIN	NSH LEGEND
DESIGNATION	TYPE	MANUFACTURER	PRODUCT NAME/NUMBER	COLOR NAME/NUMBER	FINISH
CAB-1	CASEWORK	LANZ OR EQ.			P-LAM 1
CAB-2	CASEWORK	LANZ OR EQ.			P-LAM 2
CAB-3	CASEWORK	LANZ OR EQ.			P-LAM 3
CONC-1	CONCRETE				LIGHT GRIND, POLISH AND SEAL
CPT-1	CARPET	EF CONTRACT	LANDLINE	LND57 SWITCHBOARD	
CTR-1 (OPT 1)	COUNTERTOP	MSI STONE	Q™	FOSSIL GRAY	POLISHED
CTR-1 (OPT 2)	COUNTERTOP	PENTAL QUARTZ	SORANO POLISHED	BQ8730P	POLISHED
DS-1	DOWNSPOUT			EP-1	PRE-FINISHED MTL
EF-1	CEMENTITIOUS LAP SIDING	JAMESHARDIE	HARDIEPLANK LAP—SMOOTH		
EF-2	CEMENTITIOUS PANEL SIDING	JAMESHARDIE	REVEAL		
EF-3	COMPOSITE WOOD SIDING				
EF-4	STANDING SEAM	AEP SPAN	SELECT SEAM NARROW BATTEN		
GT-1	GUTTER			EP-1	PRE-FINISHED MTL
LVT-1	VINYL FLOORING	EF CONTRACT	FACET	EFCFC-001 STRAW	
P-1	PAINT	SHERWIN WILLIAMS	SW 7005	PURE WHITE	EGGSHELL
P-LAM 1	LAMINATE	WILSONART	TRACELESS	CHARCOAL VELVET 15504-31	TRACELESS FINISH
P-LAM 2	LAMINATE	FORMICA		BEIGE ELM 5794-NG	NATURAL GRAIN FINISH
P-LAM 3	LAMINATE	FORMICA		SARUM GREY 2770-58	MATTE
RF-1	RESILIENT FLOORING	FORBO	MARMOLEUM FRESCO	VOLCANIC ASH / 3872	
RL-1	ALUMINUM GUARDRAIL SYSTEM				POWDER COAT
ROOF-1	COMPOSITION ROOF SHINGLE	GAF	TIMBERLINE NS	ARCTIC WHITE	
TL-1 (OPT 1)	TILE	THOMPSON TILE & STONE	CALACATTA	VINTAGE WHITE	HONED
TL-1 (OPT 2)	TILE	MSI STONE	GRAY GLOSSY SUBWAY TILE	GRAY	GLOSSY
TL-3	TILE	MSI STONE	WHITE SUBWAY TILE	WHITE	GLOSSY
WB-1	WALL BASE		PAINTED MDF	PER ELEVATIONS	SEMIGLOSS
WB-2	WALL BASE	ROPPE	CONTOURS - SIMPLICITY #00	123 CHARCOAL	
WD-1	WOOD PLANKS	TBD	CEDAR PLANKS		STAIN TBD
WN-1	VINYL WINDOW			BLACK (EXT) / WHITE (INT)	VINYL
WT-1	WINDOW TREATMENT	HUNTER DOUGLAS OR EQ.	ROLLER SHADES	WHITE	

### ENLARGED PLAN **GENERAL NOTES**

5

- 1. PROVIDE MINIMUM 1'-0" CLEAR FLOOR SPACE AT THE PUSH SIDE OF EVERY DOOR WITH A CLOSER. PROVIDE MINIMUM 1'-6" CLEAR AT THE PULL SIDE OF EVERY DOOR, UNLESS SPECIFICALLY DIMENSIONED, NOTED OR SHOWN OTHERWISE. 2. APPLIANCES CFCI U.N.O.
- 3. CASEWORK LOCATIONS DIMENSIONED FROM FACE OF FINISHED WALL TO FACE OF CASEWORK FINISH U.N.O.
- 4. CONTINUE FLOOR FINISH UNDER APPLIANCES AND CABINETS REQUIRING ACCESSIBLE PULL-IN CLEARANCE AND AT REMOVABLE CABINETRY.
- 5. WALL OUTLETS, FIXTURE COVERINGS, AND PANELS TO MATCH ADJ. WALL FINISH TYP. 6. MOUNT CLOSET RODS AT 48" MAX AFF TO THE TOP IN TYPE A UNITS.
- 7. UNIT ENTRY DOORS TO BE 8'-0" TALL.
- 8. FURNITURE SHOWN FOR REFERENCE ONLY. 9. TYP AT UNITS, FLOORING TO BE LVT, WITH RESILIENT FLOORING AT BATHROOMS, U.N.O.
- 10. TILE BACKSPLASH TYP ALL KITCHENS, REFER TO FINISH SCHEDULE
- 11. COUNTERTOP CTR-1 TO BE USED AT ALL KITCHENS AND BATHROOMS, REFER TO FINISH SCHEDULE 12. P-LAM CABINETS AT ALL UNIT KITCHENS AND BATHROOMS
- 13. UNITS TO RECEIVE 1X4" PAINTED MDF WALL BASE U.N.O., PAINT TO MATCH WALLS, SEMIGLOSS SHEEN 14. SPRING-LOADED BLINDS AT ALL EXTERIOR WINDOWS, TYP ALL UNITS
- 15. WATERFALL EDGES AT KITCHEN PENINSULA & KITCHEN ISLAND ENDS U.N.O.
- 16. LEVEL 1: TYP CEILING HEIGHT TO BE 9'-8"
- LEVEL 2: TYP CEILING HEIGHT TO BE 8'-8"
- LEVEL 3: TYP CEILING HEIGHTS VARY DUE TO SCISSOR TRUSS 17. AT PROPOSED LOCATIONS FOR EXHAUST DUCTING, PROVIDE FRAMED GYP CEILING 8" FROM RATED ASSEMBLY
- 18. UNIT WALLS AND CEILINGS TO BE PAINTED P-1 U.N.O.; EGGSHELL SHEEN AT WALLS, FLAT AT CEILINGS 19. SIX (6) ASSORTED GROUND FLOOR UNITS TO BE TYPE A, WHICH SHALL INCLUDE ACCESSIBLE RESTROOMS AND KITCHENS.
- 20. FOR TYP ADA FIXTURE AND ACCESSORY MOUNTING HEIGHTS, REFER TO SHEET A-005 ACCESSIBILITY & CODE DETAILS.

# ENLARGED PLAN LIGHTING LEGEND

B.O.D. FIXTURE: BEAM 2 PENDANT

AXISLIGHTING; 5FT, BLACK FINISH

- B.O.D. FIXTURE: LIGHT GUIDE RING 9-LIGHT CHANDELIER SONNEMAN LIGHTING; 48.25" DIA, SATIN BLACK/APRICOT FINISH SEMI-RECESSED CAN LIGHT
- WET-RATED RECESSED CAN LIGHT
- SURFACE MOUNTED CEILING LIGHT

B.O.D. FIXTURE: HELENA MINI PENDANT; KUZCO LIGHTING; 7.87" DIAMETER, GRAPHITE/COPPER FINISH

BATHROOM VANITY SCONCE

EXTERIOR WALL SCONCE

### ENLARGED PLAN **GRAPHIC LEGEND**

REMARKS

CABINET PULLS - RICHELIEU CONTEMPORARY METAL PULL - 5632 BRUSHED NICKEL 5 1/32" CABINET PULLS - RICHELIEU CONTEMPORARY METAL PULL - 5632 BRUSHED NICKEL 5 1/32"

CABINET PULLS - RICHELIEU CONTEMPORARY METAL PULL - 5632 BRUSHED NICKEL 5 1/32"

FURNITURE

PROPOSED EXHAUST DUCTING

# REGISTERED BEN DAVID FERGUSON STATE OF WASHINGTON $\mathcal{O}$ TMEN 01 422 WA **Д** 18, & 4. АТЕР, **TRIC** 312, 4408

F

ш

CRAFT	

**DIST** 4302, 43

MARK	REV	ISION	DA
PRO	JECT NO:	050-01-	21_
PRIN	CIPAL-IN-CHARG	E:	BF
PRO	JECT ARCHITECT	:	MJ
	WN BY:		MJ

PROJECT STATUS: PERMIT SET 05.06.2022

\_\_\_\_\_

SHEET TITLE:

ENLARGED PLANS & **ELEVATIONS - LEASING** 

SHEET NO.



COMBINATION SMOKE/CARBON MONOXIDE ALARM UNIT

3% OPENNESS EXTERIOR WINDOWS THROUGHOUT - NFPA 101 (CLASS A RATING); NFPA 701; IBC 803. 1.1 (CLASS A RATING)

6" CLASS A FIRE RATING

3"×12" SCHLUTER TRIM AT EXPOSED TILE EDGES, TYP.

SIZE

12' 2 CM

3/4"

4"

4'×8'

4" 7"×48"

2"

4"×16" 4"×16"


1"×4" 4"

SEE SCHED

24-GAUGE STEEL

INTERIOR (THROUGHOUT)



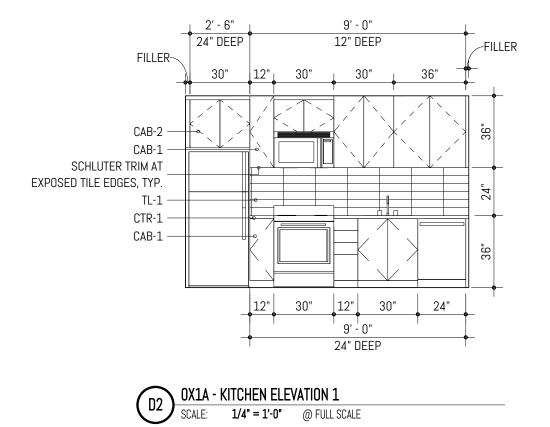

-

1


С

В


1


135

Item 7.

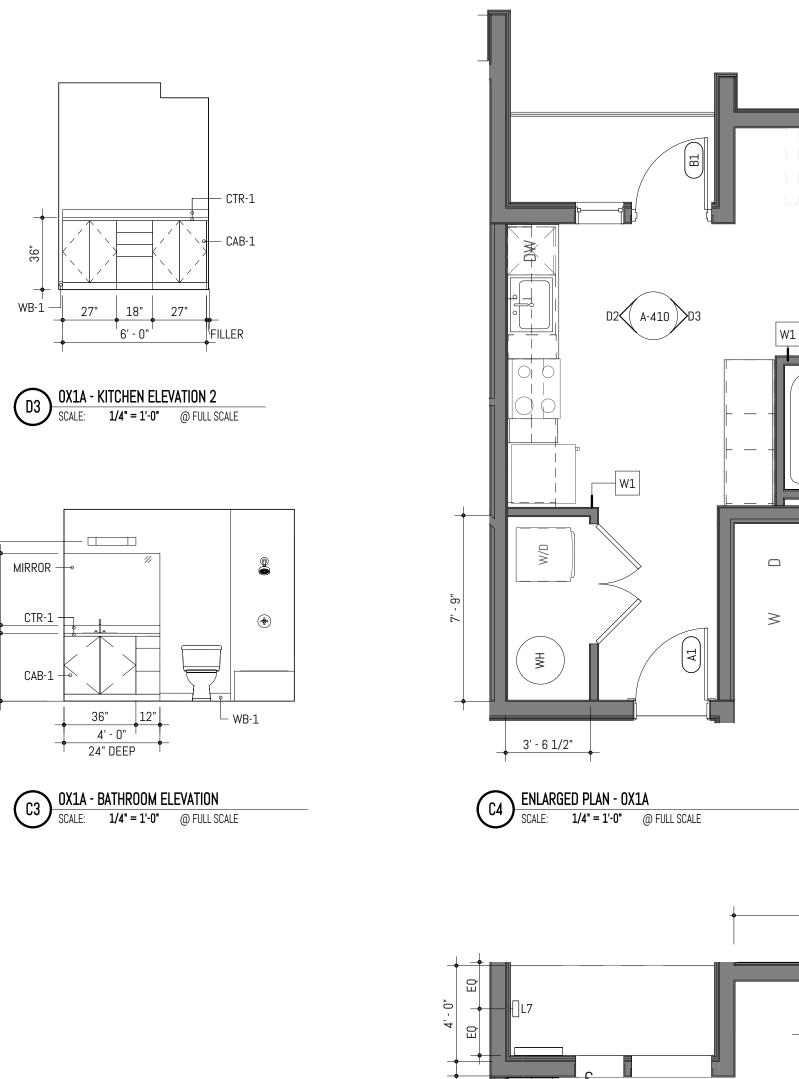

3

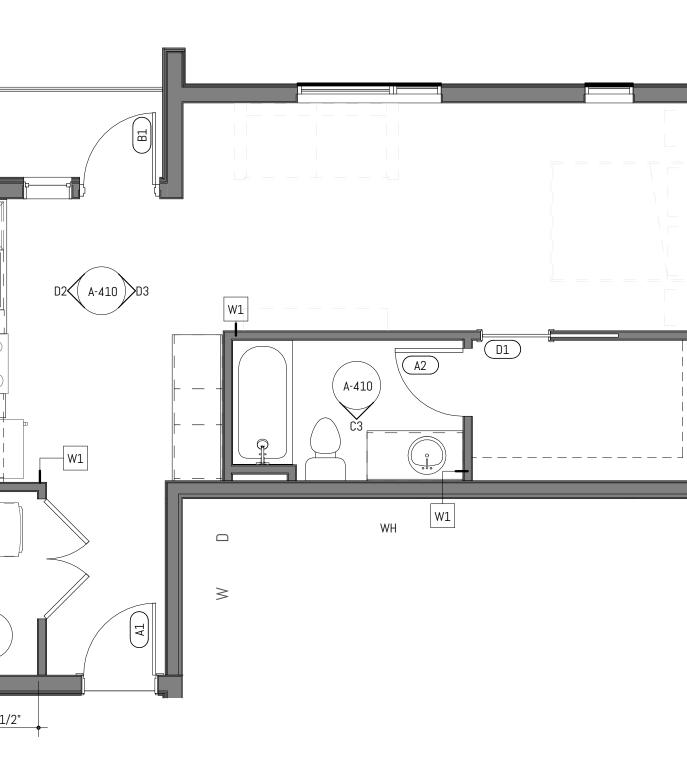

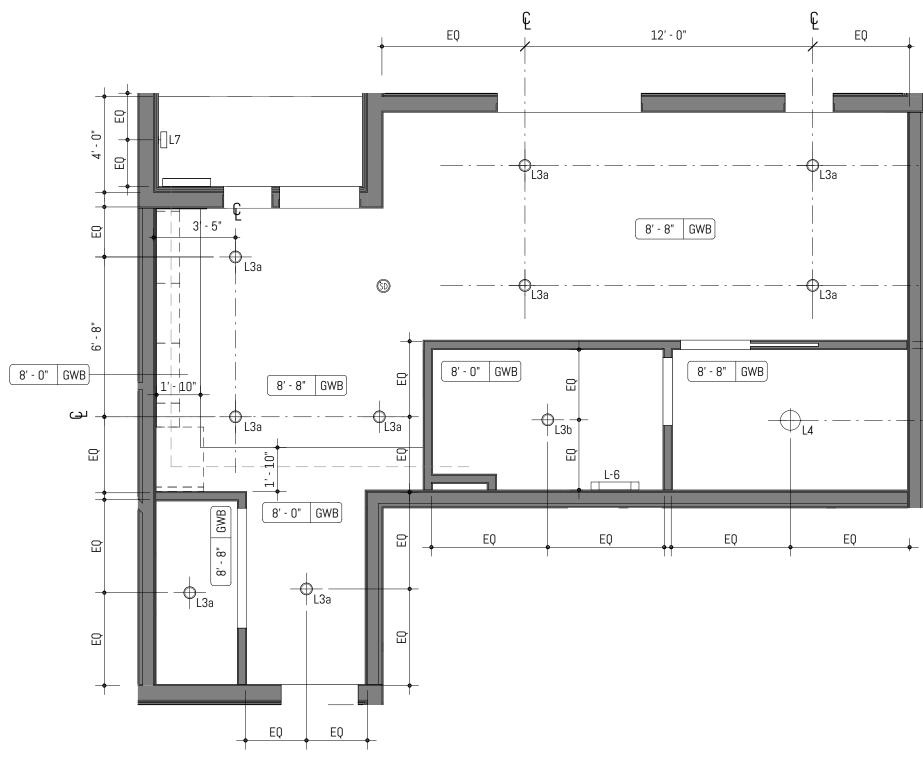

B4 ENLARGED RCP - 0X1A SCALE: 1/4" = 1'-0" @ FULL SCALE


3

### ENLARGED PLAN **GENERAL NOTES**

5

- 1. PROVIDE MINIMUM 1'-0" CLEAR FLOOR SPACE AT THE PUSH SIDE OF EVERY DOOR WITH A CLOSER. PROVIDE MINIMUM 1'-6" CLEAR AT THE PULL SIDE OF EVERY DOOR, UNLESS SPECIFICALLY DIMENSIONED, NOTED OR SHOWN OTHERWISE.
- 2. APPLIANCES CFCI U.N.O. 3. CASEWORK LOCATIONS DIMENSIONED FROM FACE OF FINISHED WALL TO FACE OF CASEWORK FINISH U.N.O.
- 4. CONTINUE FLOOR FINISH UNDER APPLIANCES AND CABINETS REQUIRING ACCESSIBLE PULL-IN CLEARANCE AND AT REMOVABLE CABINETRY.
- 5. WALL OUTLETS, FIXTURE COVERINGS, AND PANELS TO MATCH ADJ. WALL FINISH TYP.
- 6. MOUNT CLOSET RODS AT 48" MAX AFF TO THE TOP IN TYPE A UNITS. 7. UNIT ENTRY DOORS TO BE 8'-0" TALL.
- 8. FURNITURE SHOWN FOR REFERENCE ONLY.
- 9. TYP AT UNITS, FLOORING TO BE LVT, WITH RESILIENT FLOORING AT BATHROOMS, U.N.O. 10. TILE BACKSPLASH TYP ALL KITCHENS, REFER TO FINISH SCHEDULE
- 11. COUNTERTOP CTR-1 TO BE USED AT ALL KITCHENS AND BATHROOMS, REFER TO FINISH SCHEDULE
- 12. P-LAM CABINETS AT ALL UNIT KITCHENS AND BATHROOMS 13. UNITS TO RECEIVE 1X4" PAINTED MDF WALL BASE U.N.O., PAINT TO MATCH WALLS, SEMIGLOSS SHEEN
- 14. SPRING-LOADED BLINDS AT ALL EXTERIOR WINDOWS, TYP ALL UNITS
- 15. WATERFALL EDGES AT KITCHEN PENINSULA & KITCHEN ISLAND ENDS U.N.O. 16. LEVEL 1: TYP CEILING HEIGHT TO BE 9'-8"
- LEVEL 2: TYP CEILING HEIGHT TO BE 8'-8"
- LEVEL 3: TYP CEILING HEIGHTS VARY DUE TO SCISSOR TRUSS 17. AT PROPOSED LOCATIONS FOR EXHAUST DUCTING, PROVIDE FRAMED GYP CEILING 8" FROM RATED ASSEMBLY
- 18. UNIT WALLS AND CEILINGS TO BE PAINTED P-1 U.N.O.; EGGSHELL SHEEN AT WALLS, FLAT AT CEILINGS 19. SIX (6) ASSORTED GROUND FLOOR UNITS TO BE TYPE A, WHICH SHALL INCLUDE ACCESSIBLE RESTROOMS AND KITCHENS.
- 20. FOR TYP ADA FIXTURE AND ACCESSORY MOUNTING HEIGHTS, REFER TO SHEET A-005 ACCESSIBILITY & CODE DETAILS.

### ENLARGED PLAN LIGHTING LEGEND

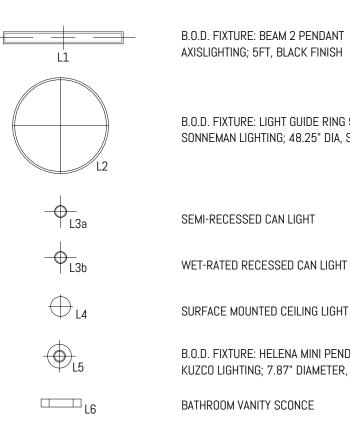

<sup>⊥</sup>L7

GD

- B.O.D. FIXTURE: LIGHT GUIDE RING 9-LIGHT CHANDELIER SONNEMAN LIGHTING; 48.25" DIA, SATIN BLACK/APRICOT FINISH
- SEMI-RECESSED CAN LIGHT
- WET-RATED RECESSED CAN LIGHT
- SURFACE MOUNTED CEILING LIGHT

B.O.D. FIXTURE: HELENA MINI PENDANT; KUZCO LIGHTING; 7.87" DIAMETER, GRAPHITE/COPPER FINISH

BATHROOM VANITY SCONCE

EXTERIOR WALL SCONCE

4

\_\_\_\_ ப

### ENLARGED PLAN **GRAPHIC LEGEND**

5

WALL CONSTRUCTION

MONOXIDE ALARM UNIT

COMBINATION SMOKE/CARBON

FURNITURE

PROPOSED EXHAUST DUCTING








	MARK	REVIS	SION	DATE
			050.04	0.4
	PROJ	JECT NO:	050-01-	21
	PRIN	CIPAL-IN-CHARGE		BF
	PROJ	JECT ARCHITECT:		MJ
	DRAV	WN BY:		MJ
	PROJ	JECT STATUS:		
7	PE	RMIT SET		
	05	.06.2022		
	SHEE	ET TITLE:		

UNIT PLANS & ELEVATIONS - 0x1A







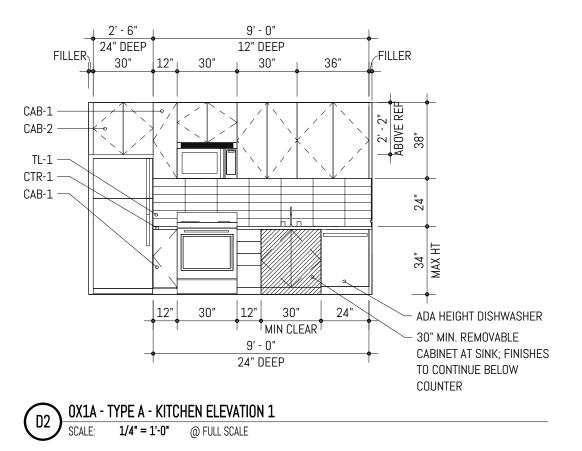

ltem 7. 


С

В


1

136


2

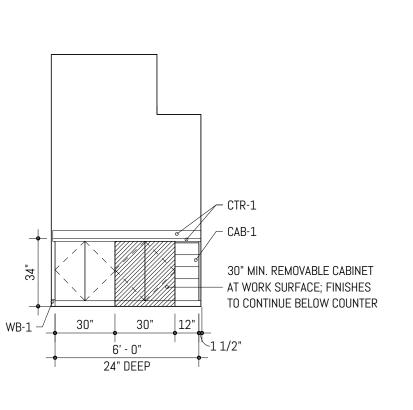



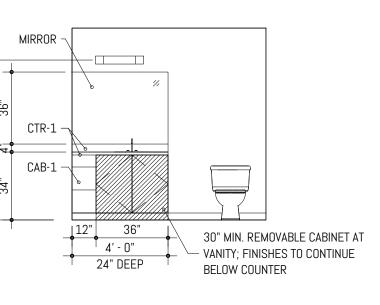


C3 OX1A - TYPE A - BATHROOM ELEVATION SCALE: 1/4" = 1'-0" @ FULL SCALE

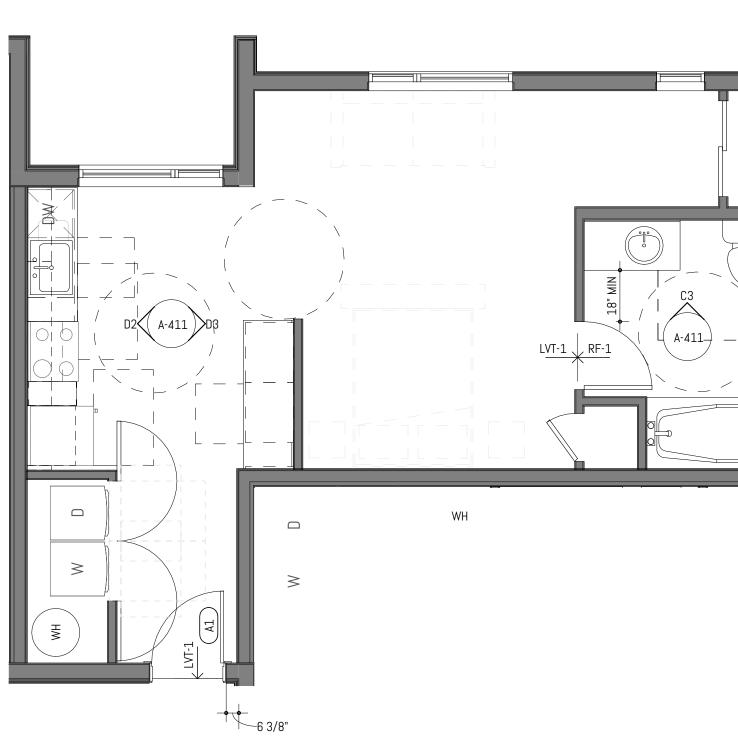

C4 ENLARGED PLAN - OX1A - TYPE A SCALE: 1/4" = 1'-0" @ FULL SCALE

3


3

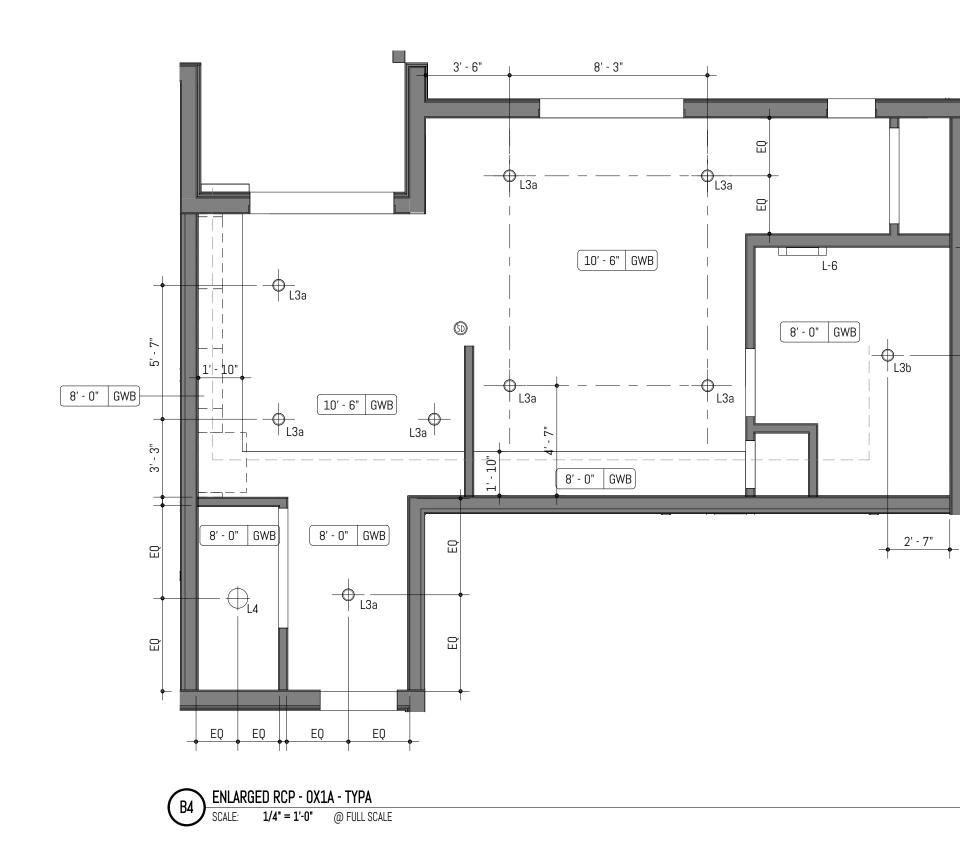

### ENLARGED PLAN **GENERAL NOTES**

- 1. PROVIDE MINIMUM 1'-0" CLEAR FLOOR SPACE AT THE PUSH SIDE OF EVERY DOOR WITH A CLOSER. PROVIDE MINIMUM 1'-6" CLEAR AT THE PULL SIDE OF EVERY DOOR, UNLESS SPECIFICALLY DIMENSIONED, NOTED OR SHOWN OTHERWISE.
- 2. APPLIANCES CFCI U.N.O. 3. CASEWORK LOCATIONS DIMENSIONED FROM FACE OF FINISHED WALL TO FACE OF CASEWORK FINISH U.N.O.
- 4. CONTINUE FLOOR FINISH UNDER APPLIANCES AND CABINETS REQUIRING ACCESSIBLE PULL-IN CLEARANCE AND AT REMOVABLE CABINETRY.
- 5. WALL OUTLETS, FIXTURE COVERINGS, AND PANELS TO MATCH ADJ. WALL FINISH TYP. 6. MOUNT CLOSET RODS AT 48" MAX AFF TO THE TOP IN TYPE A UNITS.
- 7. UNIT ENTRY DOORS TO BE 8'-0" TALL.
- 8. FURNITURE SHOWN FOR REFERENCE ONLY.
- 9. TYP AT UNITS, FLOORING TO BE LVT, WITH RESILIENT FLOORING AT BATHROOMS, U.N.O. 10. TILE BACKSPLASH TYP ALL KITCHENS, REFER TO FINISH SCHEDULE
- 11. COUNTERTOP CTR-1 TO BE USED AT ALL KITCHENS AND BATHROOMS, REFER TO FINISH SCHEDULE
- 12. P-LAM CABINETS AT ALL UNIT KITCHENS AND BATHROOMS 13. UNITS TO RECEIVE 1X4" PAINTED MDF WALL BASE U.N.O., PAINT TO MATCH WALLS, SEMIGLOSS SHEEN
- 14. SPRING-LOADED BLINDS AT ALL EXTERIOR WINDOWS, TYP ALL UNITS
- 15. WATERFALL EDGES AT KITCHEN PENINSULA & KITCHEN ISLAND ENDS U.N.O.
- 16. LEVEL 1: TYP CEILING HEIGHT TO BE 9'-8" LEVEL 2: TYP CEILING HEIGHT TO BE 8'-8"
- LEVEL 3: TYP CEILING HEIGHTS VARY DUE TO SCISSOR TRUSS
- 17. AT PROPOSED LOCATIONS FOR EXHAUST DUCTING, PROVIDE FRAMED GYP CEILING 8" FROM RATED ASSEMBLY
- 18. UNIT WALLS AND CEILINGS TO BE PAINTED P-1 U.N.O.; EGGSHELL SHEEN AT WALLS, FLAT AT CEILINGS 19. SIX (6) ASSORTED GROUND FLOOR UNITS TO BE TYPE A, WHICH SHALL INCLUDE ACCESSIBLE RESTROOMS AND KITCHENS.
- 20. FOR TYP ADA FIXTURE AND ACCESSORY MOUNTING HEIGHTS, REFER TO SHEET A-005 ACCESSIBILITY & CODE DETAILS.

### ENLARGED PLAN LIGHTING LEGEND

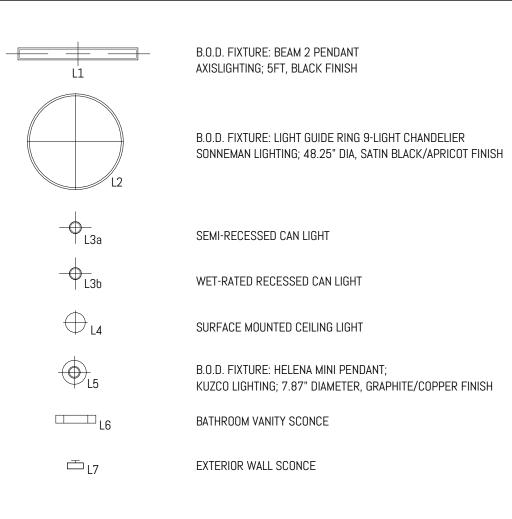



4

### ENLARGED PLAN **GRAPHIC LEGEND**

5

WALL CONSTRUCTION

MONOXIDE ALARM UNIT


SD

COMBINATION SMOKE/CARBON

FURNITURE

PROPOSED EXHAUST DUCTING



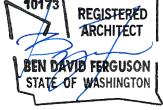



	MARK	REVI	SION	DATE
	PR0.	JECT NO:	050-01-	21
	PRIN	CIPAL-IN-CHARGE	·.	BF
	PROJ	IECT ARCHITECT:		MJ
	DRAV	VN BY:		AM
A	PE	RMIT SET		

05.06.2022

SHEET TITLE: UNIT PLANS & ELEVATIONS - Ox1A - TYPE A

SHEET NO.

ltem 7. 

С

В

1


1

2

**FILLER**~ 30" 24" 30" 12" 30" 12" 9′ - 0<sup>″</sup> 24" DEEP D2 OX1B - KITCHEN ELEVATION 1 SCALE: 1/4" = 1'-0" @ FULL SCALE


2' - 6" 24" DEEP - CAB-1 — CAB-2 – TL-1 — CTR-1 - CAB-1

2

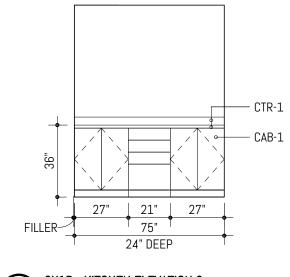




- MIRROR CTR-1 CAB-1 12" 36" 4' - 0" 24" DEEP FILLER

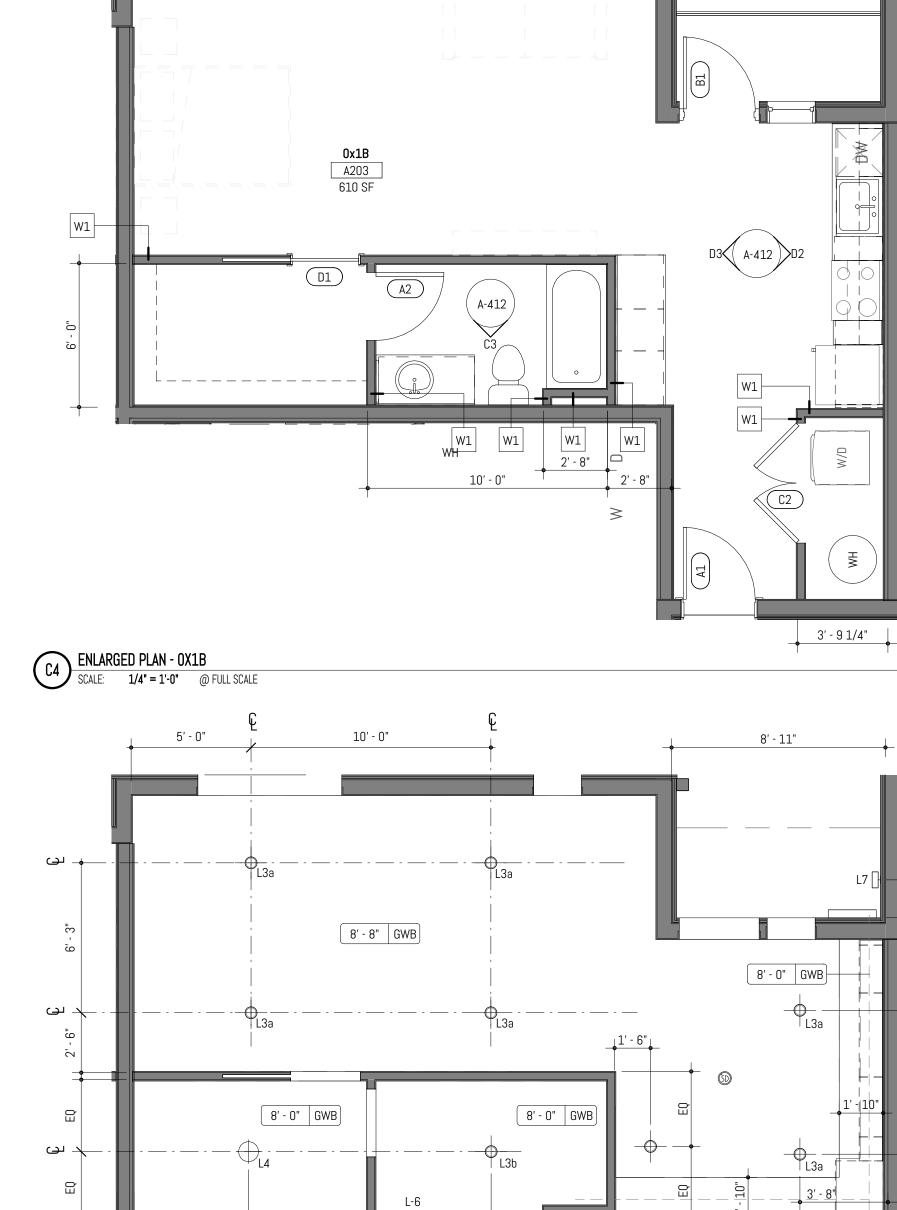

C3 OX1B - BATHROOM ELEVATION SCALE: 1/4" = 1'-0" @ FULL SCALE

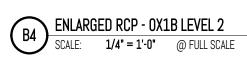

3

EQ

\_**\_** 

EQ

EO

EQ

8' - 0" GWB

4

EQ EQ EQ EQ


3

### ENLARGED PLAN **GENERAL NOTES**

5

- 1. PROVIDE MINIMUM 1'-0" CLEAR FLOOR SPACE AT THE PUSH SIDE OF EVERY DOOR WITH A CLOSER. PROVIDE MINIMUM 1'-6" CLEAR AT THE PULL SIDE OF EVERY DOOR, UNLESS SPECIFICALLY DIMENSIONED, NOTED OR SHOWN OTHERWISE.
- 2. APPLIANCES CFCI U.N.O. 3. CASEWORK LOCATIONS DIMENSIONED FROM FACE OF FINISHED WALL TO FACE OF CASEWORK FINISH
- U.N.O. 4. CONTINUE FLOOR FINISH UNDER APPLIANCES AND CABINETS REQUIRING ACCESSIBLE PULL-IN CLEARANCE AND AT REMOVABLE CABINETRY.
- 5. WALL OUTLETS, FIXTURE COVERINGS, AND PANELS TO MATCH ADJ. WALL FINISH TYP.
- 6. MOUNT CLOSET RODS AT 48" MAX AFF TO THE TOP IN TYPE A UNITS.
- 7. UNIT ENTRY DOORS TO BE 8'-0" TALL. 8. FURNITURE SHOWN FOR REFERENCE ONLY.
- 9. TYP AT UNITS, FLOORING TO BE LVT, WITH RESILIENT FLOORING AT BATHROOMS, U.N.O.
- 10. TILE BACKSPLASH TYP ALL KITCHENS, REFER TO FINISH SCHEDULE
- 11. COUNTERTOP CTR-1 TO BE USED AT ALL KITCHENS AND BATHROOMS, REFER TO FINISH SCHEDULE 12. P-LAM CABINETS AT ALL UNIT KITCHENS AND BATHROOMS
- 13. UNITS TO RECEIVE 1X4" PAINTED MDF WALL BASE U.N.O., PAINT TO MATCH WALLS, SEMIGLOSS SHEEN
- 14. SPRING-LOADED BLINDS AT ALL EXTERIOR WINDOWS, TYP ALL UNITS 15. WATERFALL EDGES AT KITCHEN PENINSULA & KITCHEN ISLAND ENDS U.N.O.
- 16. LEVEL 1: TYP CEILING HEIGHT TO BE 9'-8"
- LEVEL 2: TYP CEILING HEIGHT TO BE 8'-8"
- LEVEL 3: TYP CEILING HEIGHTS VARY DUE TO SCISSOR TRUSS 17. AT PROPOSED LOCATIONS FOR EXHAUST DUCTING, PROVIDE FRAMED GYP CEILING 8" FROM RATED ASSEMBLY
- 18. UNIT WALLS AND CEILINGS TO BE PAINTED P-1 U.N.O.; EGGSHELL SHEEN AT WALLS, FLAT AT CEILINGS 19. SIX (6) ASSORTED GROUND FLOOR UNITS TO BE TYPE A, WHICH SHALL INCLUDE ACCESSIBLE RESTROOMS AND KITCHENS.
- 20. FOR TYP ADA FIXTURE AND ACCESSORY MOUNTING HEIGHTS, REFER TO SHEET A-005 ACCESSIBILITY & CODE DETAILS.

### ENLARGED PLAN LIGHTING LEGEND

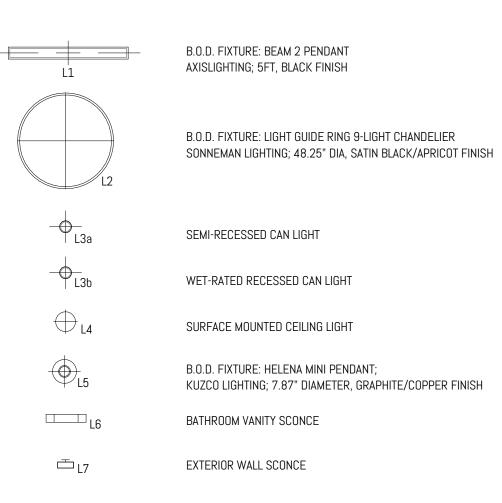







ENLARGED PLAN
GRAPHIC LEGEN

5

WALL CONSTRUCTION

(SD)


— ப

-O L3a

COMBINATION SMOKE/CARBON MONOXIDE ALARM UNIT

FURNITURE

PROPOSED EXHAUST DUCTING

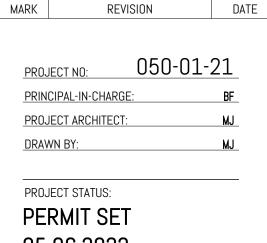

05.06.2022

SHEET TITLE: UNIT PLANS & ELEVATIONS - 0x1B



R

1

2


С


ltem 7. 

1


10' - 3' 12" DEEP 21" 30" 36" 🕺 CTR-1 CAB-1

D2 1X1A - KITCHEN ELEVATION 1 SCALE: 1/4" = 1'-0" @ FULL SCALE

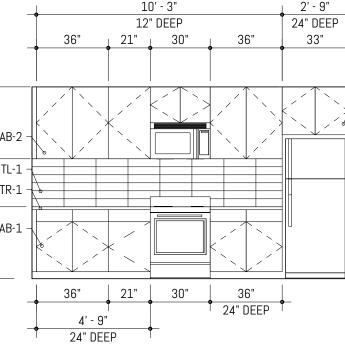


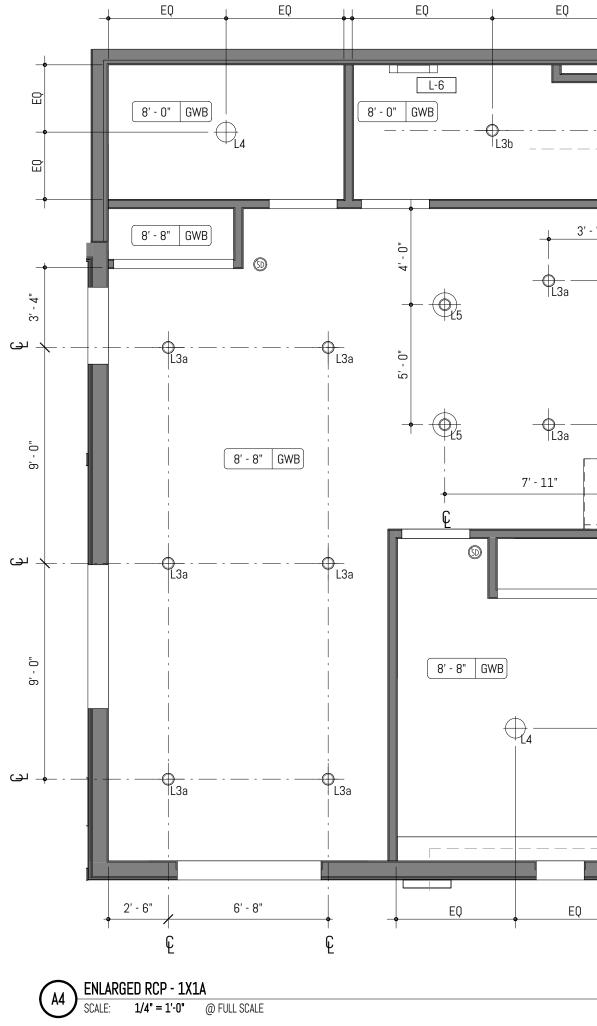



4

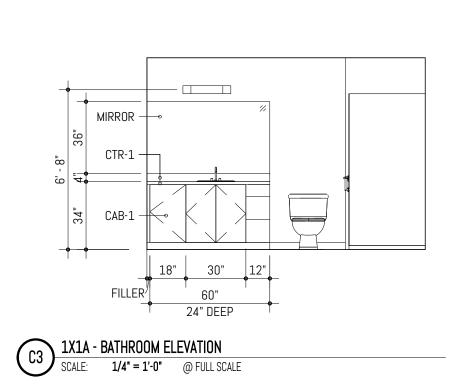


3

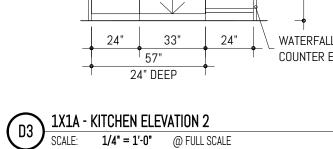

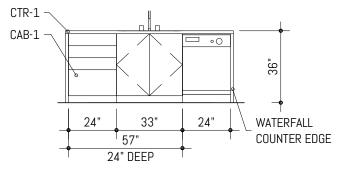

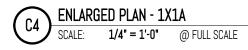

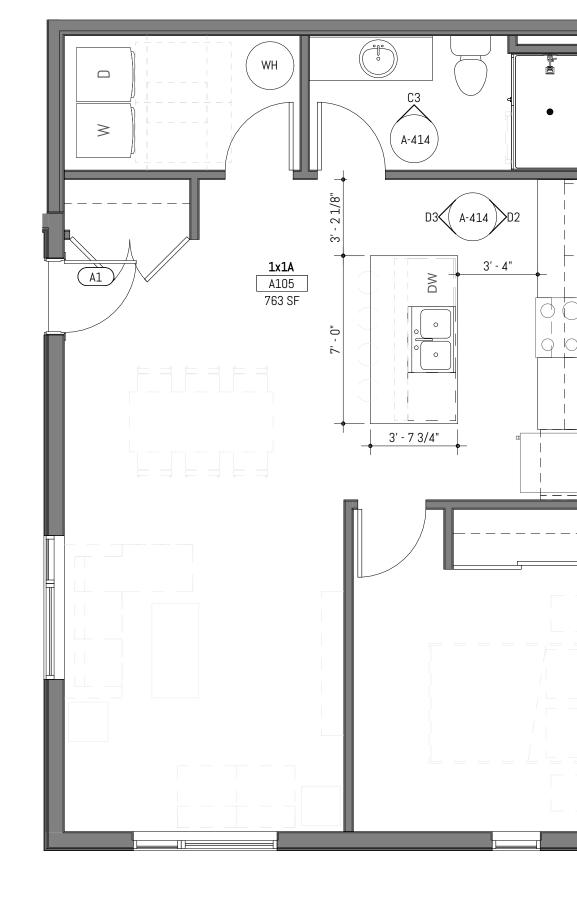






5


- 1. PROVIDE MINIMUM 1'-0" CLEAR FLOOR SPACE AT THE PUSH SIDE OF EVERY DOOR WITH A CLOSER. PROVIDE MINIMUM 1'-6" CLEAR AT THE PULL SIDE OF EVERY DOOR, UNLESS SPECIFICALLY DIMENSIONED, NOTED OR SHOWN OTHERWISE. 2. APPLIANCES CFCI U.N.O.
- 3. CASEWORK LOCATIONS DIMENSIONED FROM FACE OF FINISHED WALL TO FACE OF CASEWORK FINISH U.N.O.
- 4. CONTINUE FLOOR FINISH UNDER APPLIANCES AND CABINETS REQUIRING ACCESSIBLE PULL-IN CLEARANCE AND AT REMOVABLE CABINETRY.
- 5. WALL OUTLETS, FIXTURE COVERINGS, AND PANELS TO MATCH ADJ. WALL FINISH TYP. 6. MOUNT CLOSET RODS AT 48" MAX AFF TO THE TOP IN TYPE A UNITS.
- 7. UNIT ENTRY DOORS TO BE 8'-0" TALL.
- 8. FURNITURE SHOWN FOR REFERENCE ONLY.
- 9. TYP AT UNITS, FLOORING TO BE LVT, WITH RESILIENT FLOORING AT BATHROOMS, U.N.O. 10. TILE BACKSPLASH TYP ALL KITCHENS, REFER TO FINISH SCHEDULE
- 11. COUNTERTOP CTR-1 TO BE USED AT ALL KITCHENS AND BATHROOMS, REFER TO FINISH SCHEDULE
- 12. P-LAM CABINETS AT ALL UNIT KITCHENS AND BATHROOMS 13. UNITS TO RECEIVE 1X4" PAINTED MDF WALL BASE U.N.O., PAINT TO MATCH WALLS, SEMIGLOSS SHEEN
- 14. SPRING-LOADED BLINDS AT ALL EXTERIOR WINDOWS, TYP ALL UNITS
- 15. WATERFALL EDGES AT KITCHEN PENINSULA & KITCHEN ISLAND ENDS U.N.O. 16. LEVEL 1: TYP CEILING HEIGHT TO BE 9'-8"
- LEVEL 2: TYP CEILING HEIGHT TO BE 8'-8"
- LEVEL 3: TYP CEILING HEIGHTS VARY DUE TO SCISSOR TRUSS
- 17. AT PROPOSED LOCATIONS FOR EXHAUST DUCTING, PROVIDE FRAMED GYP CEILING 8" FROM RATED ASSEMBLY
- 18. UNIT WALLS AND CEILINGS TO BE PAINTED P-1 U.N.O.; EGGSHELL SHEEN AT WALLS, FLAT AT CEILINGS 19. SIX (6) ASSORTED GROUND FLOOR UNITS TO BE TYPE A, WHICH SHALL INCLUDE ACCESSIBLE RESTROOMS AND KITCHENS.
- 20. FOR TYP ADA FIXTURE AND ACCESSORY MOUNTING HEIGHTS, REFER TO SHEET A-005 ACCESSIBILITY & CODE DETAILS.

### ENLARGED PLAN LIGHTING LEGEND

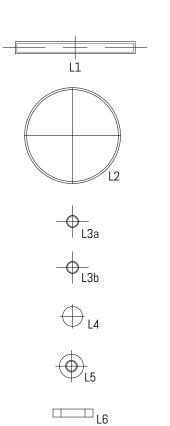

<sup>⊥</sup>L7

(SD)

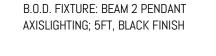

B.O.D. FIXTURE: LIGHT GUIDE RING 9-LIGHT CHANDELIER SONNEMAN LIGHTING; 48.25" DIA, SATIN BLACK/APRICOT FINISH

- SEMI-RECESSED CAN LIGHT
- WET-RATED RECESSED CAN LIGHT
- SURFACE MOUNTED CEILING LIGHT

B.O.D. FIXTURE: HELENA MINI PENDANT; KUZCO LIGHTING; 7.87" DIAMETER, GRAPHITE/COPPER FINISH

BATHROOM VANITY SCONCE

EXTERIOR WALL SCONCE

– 8' - 0" GWB 8' - 0" GWB

### ENLARGED PLAN **GRAPHIC LEGEND**

5

WALL CONSTRUCTION

COMBINATION SMOKE/CARBON MONOXIDE ALARM UNIT

FURNITURE

PROPOSED EXHAUST DUCTING








IARK	REVI	SIUN	DATE
			01
<u>PROJ</u>	JECT NO:	050-01-	
PRIN	CIPAL-IN-CHARGE		BF
PRO	JECT ARCHITECT:		MJ
DRAV	WN BY:		MJ
PRO	JECT STATUS:		
	RMIT SET		
05	.06.2022		
SHEE	ET TITLE:		
	IT PLANS	ନ FI FV∆	TIONS

UNIT PLANS  $\alpha$  ELEVATIONS - 1x1A

SHEET NO.



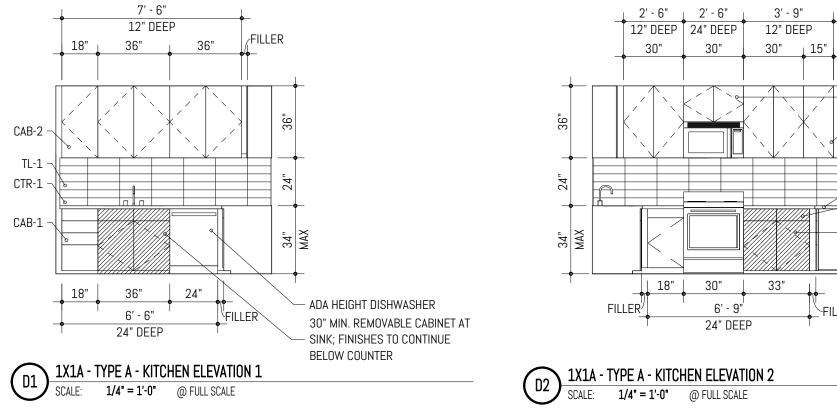

С

В

1

6' - 9" 24" DEEP

D2 1X1A - TYPE A - KITCHEN ELEVATION 2 SCALE: 1/4" = 1'-0" @ FULL SCALE




30" MIN. REMOVABLE CABINET AT

- VANITY; FINISHES TO CONTINUE

BELOW COUNTER


FILLER




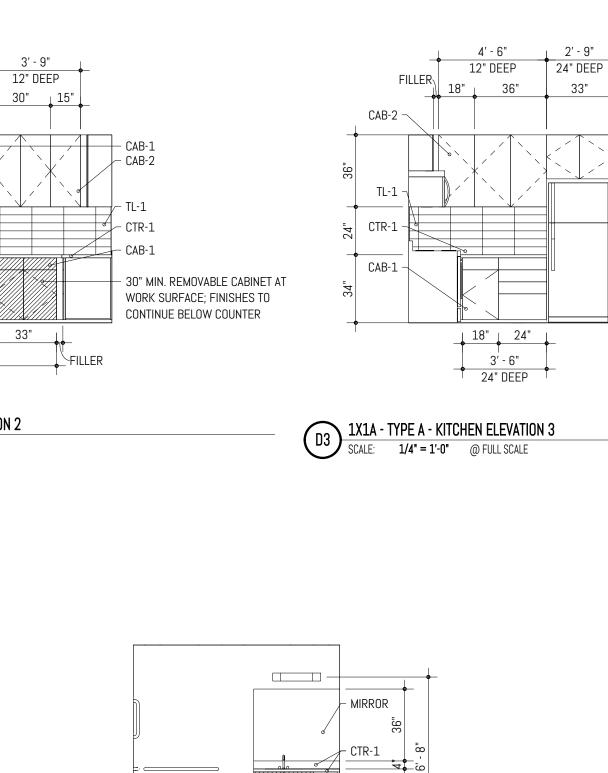


CAB-1

30" 12"

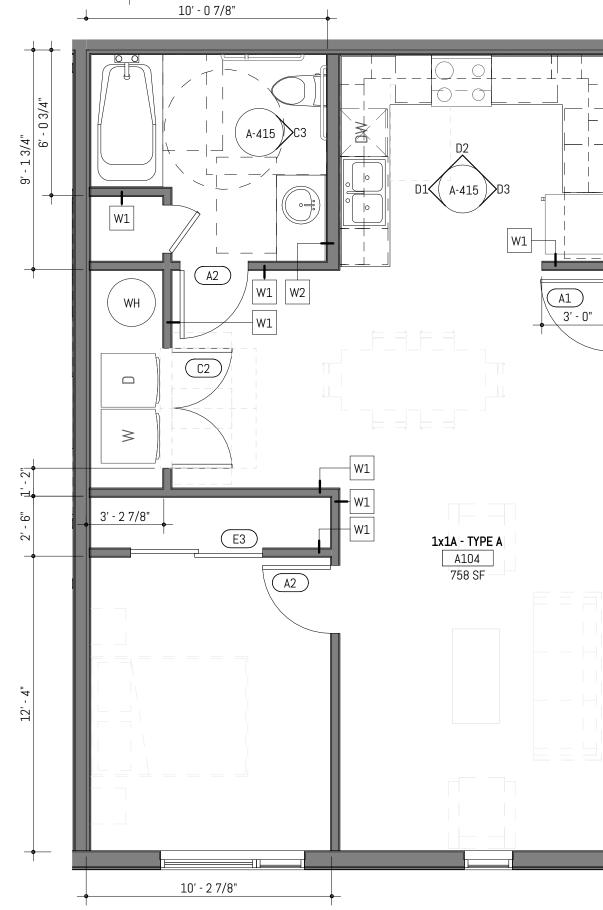

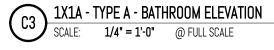


C4 ENLARGED PLAN - 1X1A - TYPE A SCALE: 1/4" = 1'-0" @ FULL SCALE

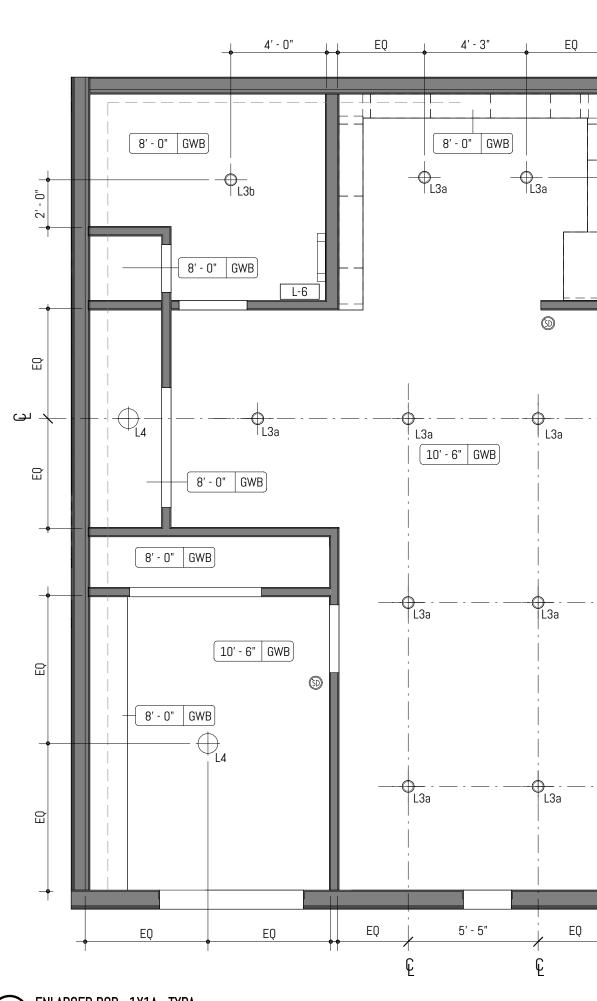


4

A4 ENLARGED RCP - 1X1A - TYPA SCALE: 1/4" = 1'-0" @ FULL SCALE

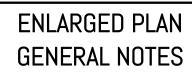

- 1. PROVIDE MINIMUM 1'-0" CLEAR FLOOR SPACE AT THE PUSH SIDE OF EVERY DOOR WITH A CLOSER. PROVIDE MINIMUM 1'-6" CLEAR AT THE PULL SIDE OF EVERY DOOR, UNLESS SPECIFICALLY DIMENSIONED, NOTED OR SHOWN OTHERWISE. 2. APPLIANCES CFCI U.N.O.
- 3. CASEWORK LOCATIONS DIMENSIONED FROM FACE OF FINISHED WALL TO FACE OF CASEWORK FINISH U.N.O.
- 4. CONTINUE FLOOR FINISH UNDER APPLIANCES AND CABINETS REQUIRING ACCESSIBLE PULL-IN CLEARANCE AND AT REMOVABLE CABINETRY.
- 5. WALL OUTLETS, FIXTURE COVERINGS, AND PANELS TO MATCH ADJ. WALL FINISH TYP. 6. MOUNT CLOSET RODS AT 48" MAX AFF TO THE TOP IN TYPE A UNITS.
- 7. UNIT ENTRY DOORS TO BE 8'-0" TALL.
- 8. FURNITURE SHOWN FOR REFERENCE ONLY.
- 9. TYP AT UNITS, FLOORING TO BE LVT, WITH RESILIENT FLOORING AT BATHROOMS, U.N.O. 10. TILE BACKSPLASH TYP ALL KITCHENS, REFER TO FINISH SCHEDULE
- 11. COUNTERTOP CTR-1 TO BE USED AT ALL KITCHENS AND BATHROOMS, REFER TO FINISH SCHEDULE
- 12. P-LAM CABINETS AT ALL UNIT KITCHENS AND BATHROOMS 13. UNITS TO RECEIVE 1X4" PAINTED MDF WALL BASE U.N.O., PAINT TO MATCH WALLS, SEMIGLOSS SHEEN
- 14. SPRING-LOADED BLINDS AT ALL EXTERIOR WINDOWS, TYP ALL UNITS 15. WATERFALL EDGES AT KITCHEN PENINSULA & KITCHEN ISLAND ENDS U.N.O.
- 16. LEVEL 1: TYP CEILING HEIGHT TO BE 9'-8"
- LEVEL 2: TYP CEILING HEIGHT TO BE 8'-8"
- LEVEL 3: TYP CEILING HEIGHTS VARY DUE TO SCISSOR TRUSS 17. AT PROPOSED LOCATIONS FOR EXHAUST DUCTING, PROVIDE FRAMED GYP CEILING 8" FROM RATED ASSEMBLY
- 18. UNIT WALLS AND CEILINGS TO BE PAINTED P-1 U.N.O.; EGGSHELL SHEEN AT WALLS, FLAT AT CEILINGS 19. SIX (6) ASSORTED GROUND FLOOR UNITS TO BE TYPE A, WHICH SHALL INCLUDE ACCESSIBLE RESTROOMS AND KITCHENS.
- 20. FOR TYP ADA FIXTURE AND ACCESSORY MOUNTING HEIGHTS, REFER TO SHEET A-005 ACCESSIBILITY & CODE DETAILS.

## ENLARGED PLAN LIGHTING LEGEND

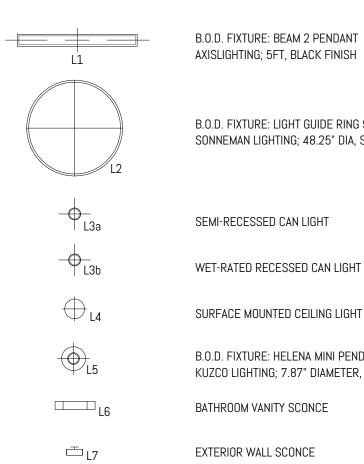

WALL CONSTRUCTION

(SD)

— ப

ىچى 📥 ـ

COMBINATION SMOKE/CARBON

MONOXIDE ALARM UNIT

AXISLIGHTING; 5FT, BLACK FINISH

B.O.D. FIXTURE: LIGHT GUIDE RING 9-LIGHT CHANDELIER SONNEMAN LIGHTING; 48.25" DIA, SATIN BLACK/APRICOT FINISH

- SEMI-RECESSED CAN LIGHT
- WET-RATED RECESSED CAN LIGHT
- SURFACE MOUNTED CEILING LIGHT
- B.O.D. FIXTURE: HELENA MINI PENDANT; KUZCO LIGHTING; 7.87" DIAMETER, GRAPHITE/COPPER FINISH
- BATHROOM VANITY SCONCE
- EXTERIOR WALL SCONCE







ENLARGED PLAN
GRAPHIC LEGEND

5

\_\_\_\_

FURNITURE

PROPOSED EXHAUST DUCTING

> MARK DATE REVISION 050-01-21 PROJECT NO: PRINCIPAL-IN-CHARGE: PROJECT ARCHITECT: DRAWN BY: PROJECT STATUS: PERMIT SET 05.06.2022

SHEET TITLE: UNIT PLANS & ELEVATIONS - 1x1A - TYPE A

SHEET NO.

В


С


1


2

1


D2 IX1B - KITCHEN ELEVATION SCALE: 1/4" = 1'-0" @ FULL SCALE

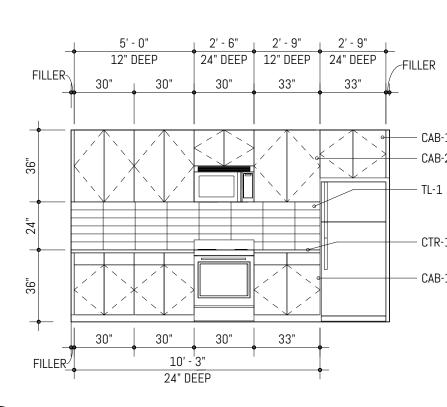


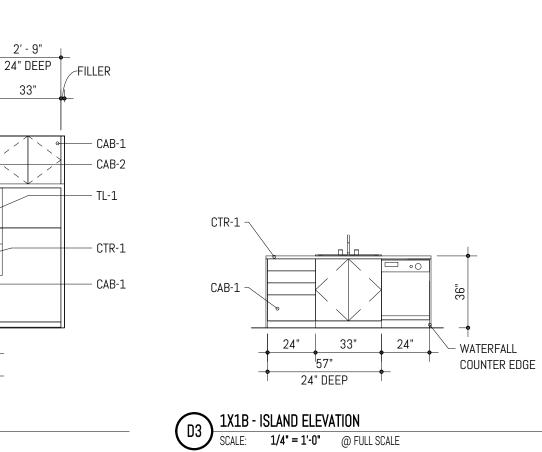

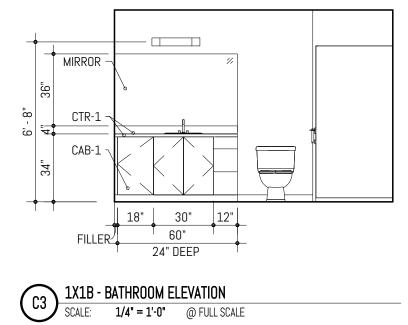

3

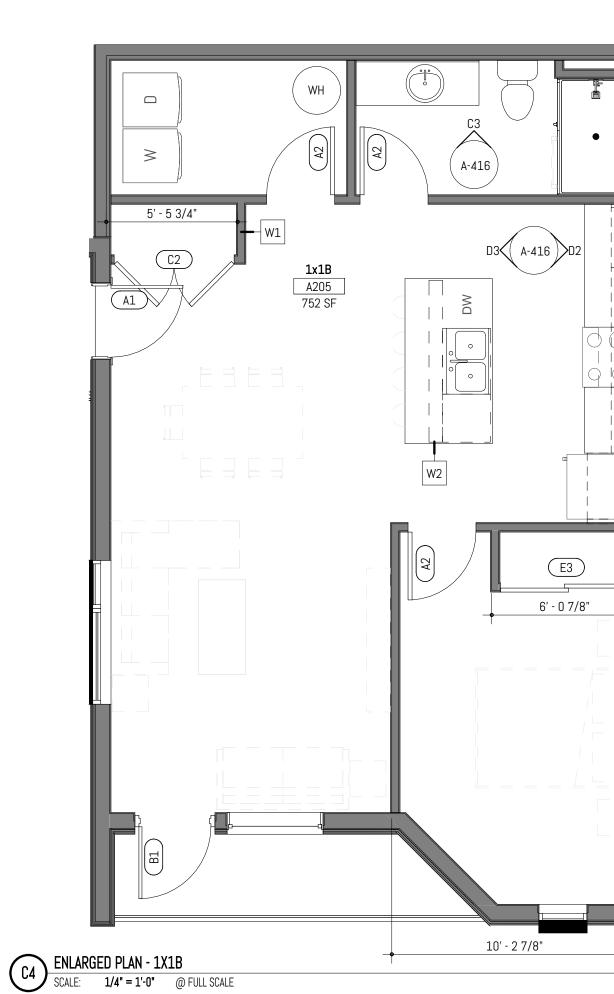

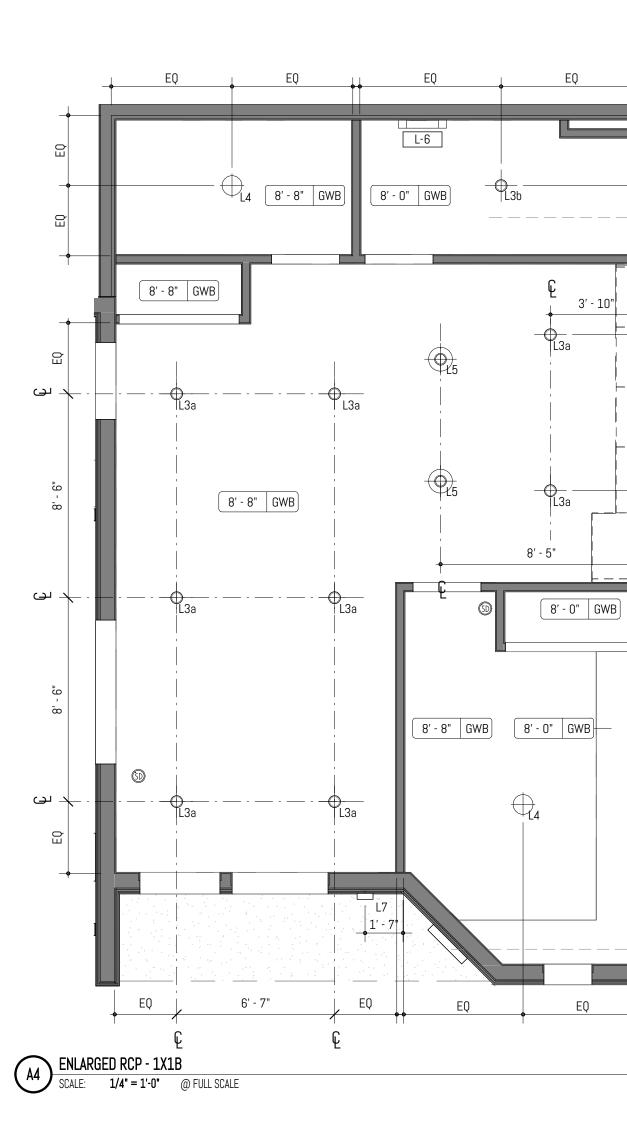

4




- 1. PROVIDE MINIMUM 1'-0" CLEAR FLOOR SPACE AT THE PUSH SIDE OF EVERY DOOR WITH A CLOSER. PROVIDE MINIMUM 1'-6" CLEAR AT THE PULL SIDE OF EVERY DOOR, UNLESS SPECIFICALLY DIMENSIONED, NOTED OR SHOWN OTHERWISE.
- 2. APPLIANCES CFCI U.N.O. 3. CASEWORK LOCATIONS DIMENSIONED FROM FACE OF FINISHED WALL TO FACE OF CASEWORK FINISH U.N.O.
- 4. CONTINUE FLOOR FINISH UNDER APPLIANCES AND CABINETS REQUIRING ACCESSIBLE PULL-IN CLEARANCE AND AT REMOVABLE CABINETRY.
- 5. WALL OUTLETS, FIXTURE COVERINGS, AND PANELS TO MATCH ADJ. WALL FINISH TYP. 6. MOUNT CLOSET RODS AT 48" MAX AFF TO THE TOP IN TYPE A UNITS.
- 7. UNIT ENTRY DOORS TO BE 8'-0" TALL.
- 8. FURNITURE SHOWN FOR REFERENCE ONLY.
- 9. TYP AT UNITS, FLOORING TO BE LVT, WITH RESILIENT FLOORING AT BATHROOMS, U.N.O.
- 10. TILE BACKSPLASH TYP ALL KITCHENS, REFER TO FINISH SCHEDULE 11. COUNTERTOP CTR-1 TO BE USED AT ALL KITCHENS AND BATHROOMS, REFER TO FINISH SCHEDULE
- 12. P-LAM CABINETS AT ALL UNIT KITCHENS AND BATHROOMS 13. UNITS TO RECEIVE 1X4" PAINTED MDF WALL BASE U.N.O., PAINT TO MATCH WALLS, SEMIGLOSS SHEEN
- 14. SPRING-LOADED BLINDS AT ALL EXTERIOR WINDOWS, TYP ALL UNITS
- 15. WATERFALL EDGES AT KITCHEN PENINSULA & KITCHEN ISLAND ENDS U.N.O. 16. LEVEL 1: TYP CEILING HEIGHT TO BE 9'-8"
- LEVEL 2: TYP CEILING HEIGHT TO BE 8'-8"
- LEVEL 3: TYP CEILING HEIGHTS VARY DUE TO SCISSOR TRUSS
- 17. AT PROPOSED LOCATIONS FOR EXHAUST DUCTING, PROVIDE FRAMED GYP CEILING 8" FROM RATED ASSEMBLY 18. UNIT WALLS AND CEILINGS TO BE PAINTED P-1 U.N.O.; EGGSHELL SHEEN AT WALLS, FLAT AT CEILINGS
- 19. SIX (6) ASSORTED GROUND FLOOR UNITS TO BE TYPE A, WHICH SHALL INCLUDE ACCESSIBLE RESTROOMS AND KITCHENS.
- 20. FOR TYP ADA FIXTURE AND ACCESSORY MOUNTING HEIGHTS, REFER TO SHEET A-005 ACCESSIBILITY & CODE DETAILS.

# ENLARGED PLAN LIGHTING LEGEND

B.O.D. FIXTURE: BEAM 2 PENDANT

AXISLIGHTING; 5FT, BLACK FINISH

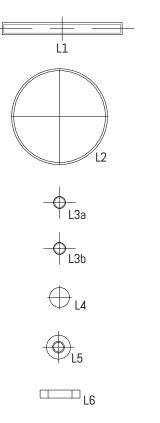

⊡ L7

(SD)

- B.O.D. FIXTURE: LIGHT GUIDE RING 9-LIGHT CHANDELIER SONNEMAN LIGHTING; 48.25" DIA, SATIN BLACK/APRICOT FINISH
- SEMI-RECESSED CAN LIGHT
- WET-RATED RECESSED CAN LIGHT
- SURFACE MOUNTED CEILING LIGHT
- B.O.D. FIXTURE: HELENA MINI PENDANT; KUZCO LIGHTING; 7.87" DIAMETER, GRAPHITE/COPPER FINISH
- BATHROOM VANITY SCONCE
- EXTERIOR WALL SCONCE







ENLARGED PLAN
GRAPHIC LEGENI
WALL CONSTRUCTION

5

COMBINATION SMOKE/CARBON MONOXIDE ALARM UNIT

FURNITURE

PROPOSED EXHAUST DUCTING

- 8' - 0" GWB

PROJECT NO:	050-01-21
PRINCIPAL-IN-CHARGE	
PROJECT ARCHITECT:	M
DRAWN BY:	M
PROJECT STATUS:	
PROJECT STATUS: PERMIT SET	


REVISION

DATE

00.00.2022

MARK

SHEET TITLE: UNIT PLANS & ELEVATIONS - 1x1B

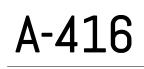

Item 7.


С


1

1


2

10' - 3" 24" DEEP D2 1X1C - KITCHEN ELEVATION SCALE: 1/4" = 1'-0" @ FULL SCALE

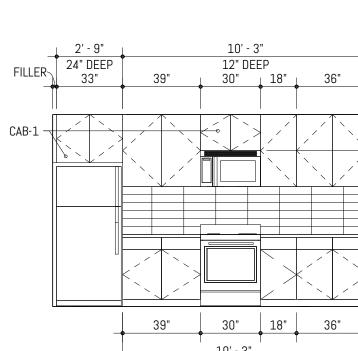


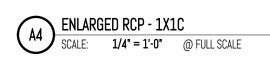



3

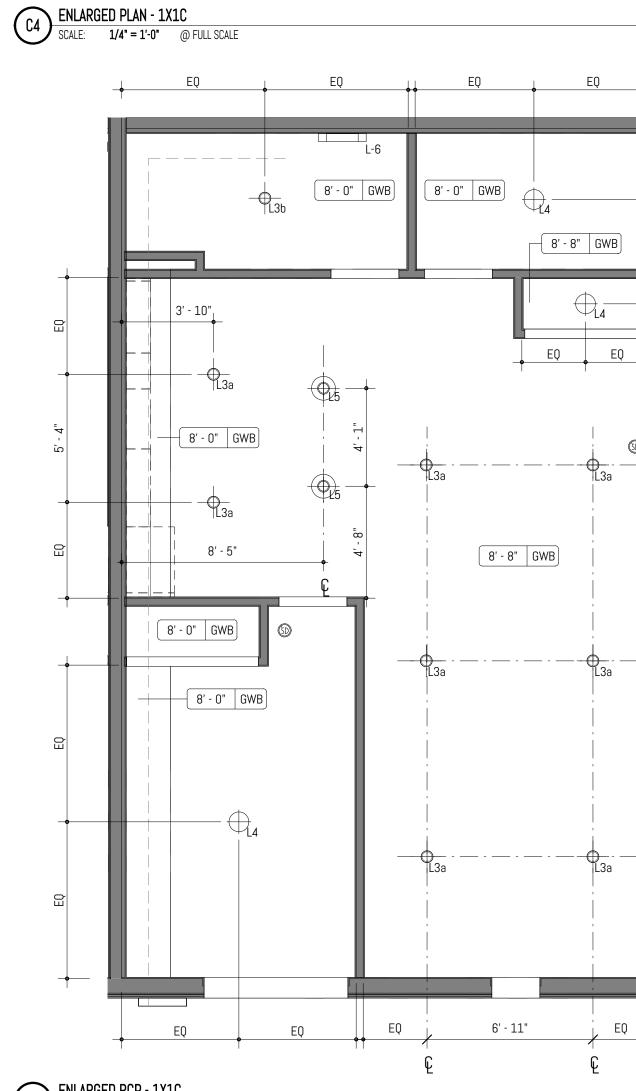

4

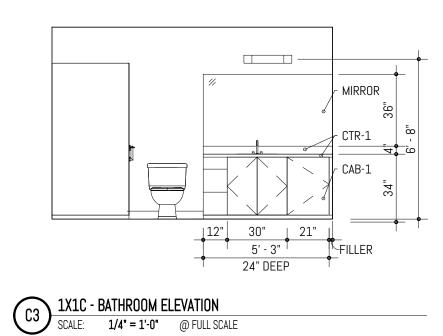

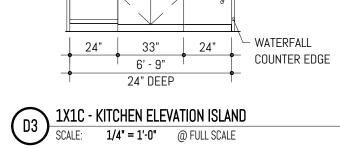

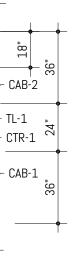

-FILLER



/- CTR-1

CAB-1

<u>11' - 1 3/</u>8" 3' - 4 7/8" A-418 ) -1 W1 (A2) (A2) W1 |W1⊢ ( A-418 ) 1x1C A204 811 SF E3 W1

-----W1

6' - 0 7/8"


10' - 0 7/8"

W1

### ENLARGED PLAN **GENERAL NOTES**

- 1. PROVIDE MINIMUM 1'-0" CLEAR FLOOR SPACE AT THE PUSH SIDE OF EVERY DOOR WITH A CLOSER. PROVIDE MINIMUM 1'-6" CLEAR AT THE PULL SIDE OF EVERY DOOR, UNLESS SPECIFICALLY DIMENSIONED, NOTED OR SHOWN OTHERWISE. 2. APPLIANCES CFCI U.N.O.
- 3. CASEWORK LOCATIONS DIMENSIONED FROM FACE OF FINISHED WALL TO FACE OF CASEWORK FINISH U.N.O.
- 4. CONTINUE FLOOR FINISH UNDER APPLIANCES AND CABINETS REQUIRING ACCESSIBLE PULL-IN CLEARANCE AND AT REMOVABLE CABINETRY.
- 5. WALL OUTLETS, FIXTURE COVERINGS, AND PANELS TO MATCH ADJ. WALL FINISH TYP. 6. MOUNT CLOSET RODS AT 48" MAX AFF TO THE TOP IN TYPE A UNITS.
- 7. UNIT ENTRY DOORS TO BE 8'-0" TALL.
- 8. FURNITURE SHOWN FOR REFERENCE ONLY. 9. TYP AT UNITS, FLOORING TO BE LVT, WITH RESILIENT FLOORING AT BATHROOMS, U.N.O.
- 10. TILE BACKSPLASH TYP ALL KITCHENS, REFER TO FINISH SCHEDULE
- 11. COUNTERTOP CTR-1 TO BE USED AT ALL KITCHENS AND BATHROOMS, REFER TO FINISH SCHEDULE
- 12. P-LAM CABINETS AT ALL UNIT KITCHENS AND BATHROOMS 13. UNITS TO RECEIVE 1X4" PAINTED MDF WALL BASE U.N.O., PAINT TO MATCH WALLS, SEMIGLOSS SHEEN
- 14. SPRING-LOADED BLINDS AT ALL EXTERIOR WINDOWS, TYP ALL UNITS 15. WATERFALL EDGES AT KITCHEN PENINSULA & KITCHEN ISLAND ENDS U.N.O.
- 16. LEVEL 1: TYP CEILING HEIGHT TO BE 9'-8"
- LEVEL 2: TYP CEILING HEIGHT TO BE 8'-8"
- LEVEL 3: TYP CEILING HEIGHTS VARY DUE TO SCISSOR TRUSS 17. AT PROPOSED LOCATIONS FOR EXHAUST DUCTING, PROVIDE FRAMED GYP CEILING 8" FROM RATED ASSEMBLY
- 18. UNIT WALLS AND CEILINGS TO BE PAINTED P-1 U.N.O.; EGGSHELL SHEEN AT WALLS, FLAT AT CEILINGS 19. SIX (6) ASSORTED GROUND FLOOR UNITS TO BE TYPE A, WHICH SHALL INCLUDE ACCESSIBLE RESTROOMS AND KITCHENS.
- 20. FOR TYP ADA FIXTURE AND ACCESSORY MOUNTING HEIGHTS, REFER TO SHEET A-005 ACCESSIBILITY & CODE DETAILS.

# ENLARGED PLAN LIGHTING LEGEND

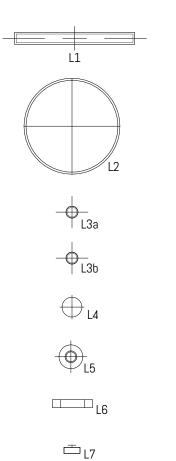

### B.O.D. FIXTURE: BEAM 2 PENDANT AXISLIGHTING; 5FT, BLACK FINISH

B.O.D. FIXTURE: LIGHT GUIDE RING 9-LIGHT CHANDELIER SONNEMAN LIGHTING; 48.25" DIA, SATIN BLACK/APRICOT FINISH

- SEMI-RECESSED CAN LIGHT
- WET-RATED RECESSED CAN LIGHT
- SURFACE MOUNTED CEILING LIGHT
- B.O.D. FIXTURE: HELENA MINI PENDANT; KUZCO LIGHTING; 7.87" DIAMETER, GRAPHITE/COPPER FINISH
- BATHROOM VANITY SCONCE
- EXTERIOR WALL SCONCE

D

D.

ىدى \_

ىن ب\_\_ \_

ى \_\_\_\_ ب

### ENLARGED PLAN **GRAPHIC LEGEND**

5

WALL CONSTRUCTION

COMBINATION SMOKE/CARBON MONOXIDE ALARM UNIT

FURNITURE

PROPOSED EXHAUST DUCTING







[	MARK	REVIS	SION	DATE
	PROJ	JECT NO:	050-01-	21
	PRIN	CIPAL-IN-CHARGE	:	BF
	PROJ	IECT ARCHITECT:		MJ
	DRAV	VN BY:		MJ
	PROJ	IECT STATUS:		
4	PE	RMIT SET		
	05	.06.2022		
	SHEE	ET TITLE:		
	UN	<b>IT PLANS</b>	& ELEVA	TIONS
	- 1	x1C		






1


С


В


Item 7.

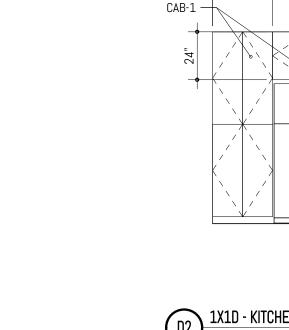

1

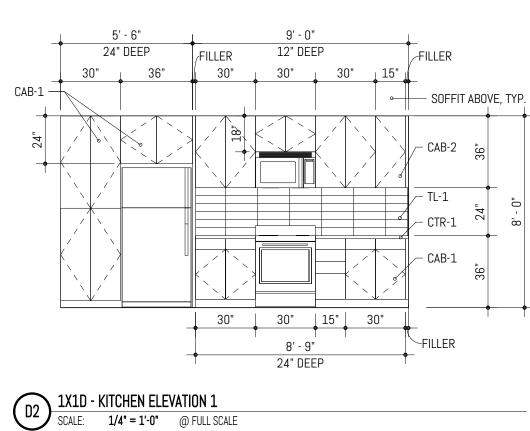

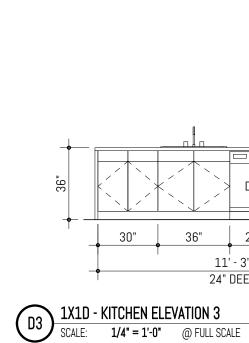

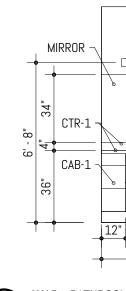

C3 1X1D - BATHROOM ELEVATION 1 SCALE: 1/4" = 1'-0" @ FULL SCALE

2







1x1D A107 878 SF

DW

W2

W2

A-420

E1

4' - 8 7/8"

\_**\_**\_ 11' - 0"<sup>'</sup>


E


( A2 )

HN

(C2)


4

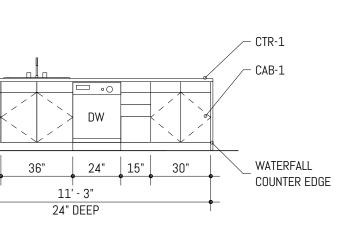

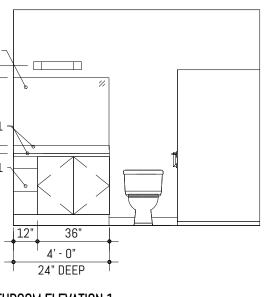



C4 ENLARGED PLAN - 1X1D SCALE: 1/4" = 1'-0" @ FULL SCALE

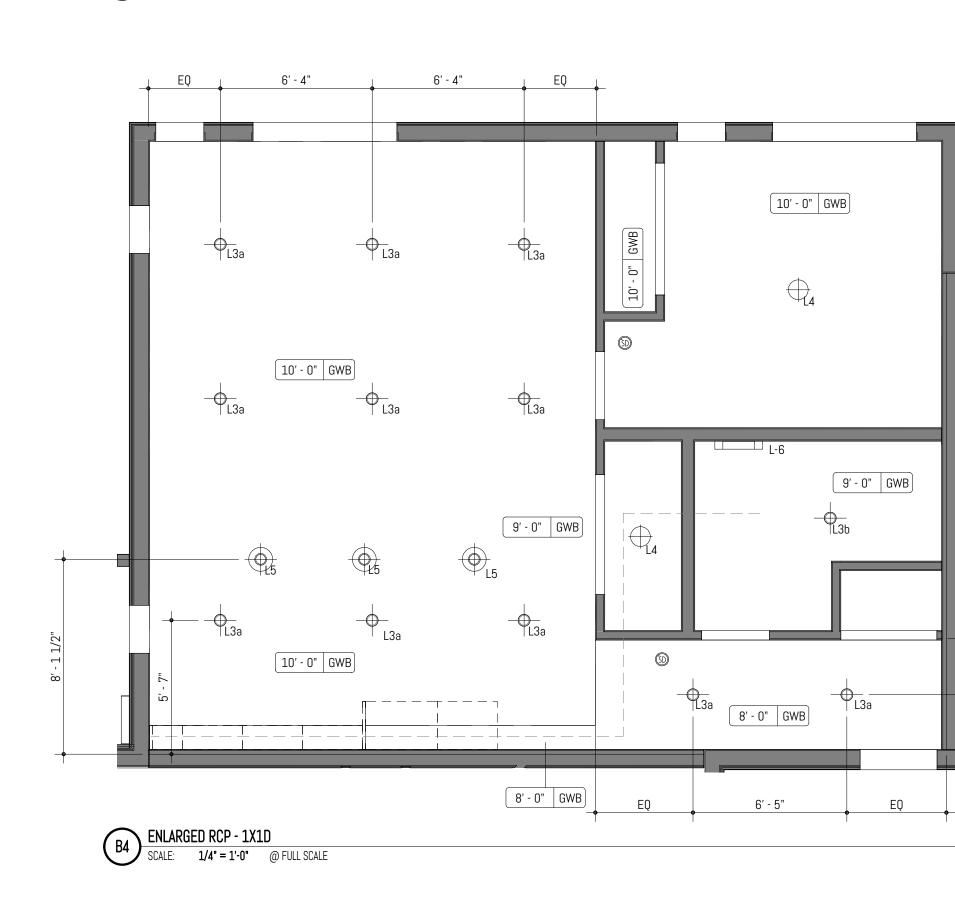

3

4

### ENLARGED PLAN **GENERAL NOTES**


5

- 1. PROVIDE MINIMUM 1'-0" CLEAR FLOOR SPACE AT THE PUSH SIDE OF EVERY DOOR WITH A CLOSER. PROVIDE MINIMUM 1'-6" CLEAR AT THE PULL SIDE OF EVERY DOOR, UNLESS SPECIFICALLY DIMENSIONED, NOTED OR SHOWN OTHERWISE.
- 2. APPLIANCES CFCI U.N.O. 3. CASEWORK LOCATIONS DIMENSIONED FROM FACE OF FINISHED WALL TO FACE OF CASEWORK FINISH U.N.O.
- 4. CONTINUE FLOOR FINISH UNDER APPLIANCES AND CABINETS REQUIRING ACCESSIBLE PULL-IN CLEARANCE AND AT REMOVABLE CABINETRY.
- 5. WALL OUTLETS, FIXTURE COVERINGS, AND PANELS TO MATCH ADJ. WALL FINISH TYP. 6. MOUNT CLOSET RODS AT 48" MAX AFF TO THE TOP IN TYPE A UNITS.
- 7. UNIT ENTRY DOORS TO BE 8'-0" TALL.
- 8. FURNITURE SHOWN FOR REFERENCE ONLY.
- 9. TYP AT UNITS, FLOORING TO BE LVT, WITH RESILIENT FLOORING AT BATHROOMS, U.N.O. 10. TILE BACKSPLASH TYP ALL KITCHENS, REFER TO FINISH SCHEDULE
- 11. COUNTERTOP CTR-1 TO BE USED AT ALL KITCHENS AND BATHROOMS, REFER TO FINISH SCHEDULE
- 12. P-LAM CABINETS AT ALL UNIT KITCHENS AND BATHROOMS 13. UNITS TO RECEIVE 1X4" PAINTED MDF WALL BASE U.N.O., PAINT TO MATCH WALLS, SEMIGLOSS SHEEN
- 14. SPRING-LOADED BLINDS AT ALL EXTERIOR WINDOWS, TYP ALL UNITS 15. WATERFALL EDGES AT KITCHEN PENINSULA & KITCHEN ISLAND ENDS U.N.O.
- 16. LEVEL 1: TYP CEILING HEIGHT TO BE 9'-8"
- LEVEL 2: TYP CEILING HEIGHT TO BE 8'-8"
- LEVEL 3: TYP CEILING HEIGHTS VARY DUE TO SCISSOR TRUSS 17. AT PROPOSED LOCATIONS FOR EXHAUST DUCTING, PROVIDE FRAMED GYP CEILING 8" FROM RATED ASSEMBLY
- 18. UNIT WALLS AND CEILINGS TO BE PAINTED P-1 U.N.O.; EGGSHELL SHEEN AT WALLS, FLAT AT CEILINGS 19. SIX (6) ASSORTED GROUND FLOOR UNITS TO BE TYPE A, WHICH SHALL INCLUDE ACCESSIBLE RESTROOMS AND KITCHENS.
- 20. FOR TYP ADA FIXTURE AND ACCESSORY MOUNTING HEIGHTS, REFER TO SHEET A-005 ACCESSIBILITY & CODE DETAILS.

### ENLARGED PLAN LIGHTING LEGEND

B.O.D. FIXTURE: BEAM 2 PENDANT

AXISLIGHTING; 5FT, BLACK FINISH

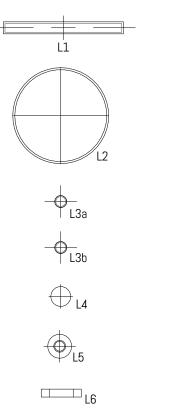

<sup>⊥</sup>L7

SD

SEMI-RECESSED CAN LIGHT WET-RATED RECESSED CAN LIGHT

B.O.D. FIXTURE: LIGHT GUIDE RING 9-LIGHT CHANDELIER

SONNEMAN LIGHTING; 48.25" DIA, SATIN BLACK/APRICOT FINISH

SURFACE MOUNTED CEILING LIGHT

B.O.D. FIXTURE: HELENA MINI PENDANT; KUZCO LIGHTING; 7.87" DIAMETER, GRAPHITE/COPPER FINISH

BATHROOM VANITY SCONCE

EXTERIOR WALL SCONCE

9' - 0" GWB

### ENLARGED PLAN **GRAPHIC LEGEND**

5

WALL CONSTRUCTION

COMBINATION SMOKE/CARBON MONOXIDE ALARM UNIT

FURNITURE

PROPOSED EXHAUST DUCTING








	MARK	REVISION		DATE	
	PROJ	JECT NO:	050-01-	21	
	PRINCIPAL-IN-CHARGE:		:	BF	
	PROJECT ARCHITECT:			MJ	
	DRAV	WN BY:		MJ	
	PROJ	JECT STATUS:			
١	PE	RMIT SET			
	05	.06.2022			
	00	.00.2022			
	SHEE	ET TITLE:			

UNIT PLANS & ELEVATIONS - 1x1D



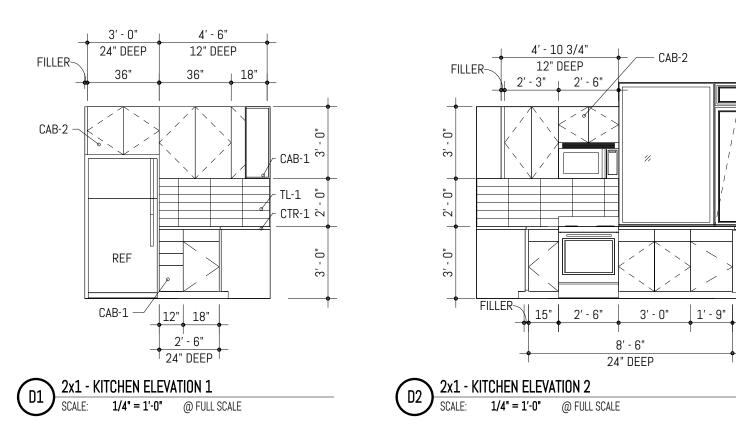




С

В

ltem 7.


143


1

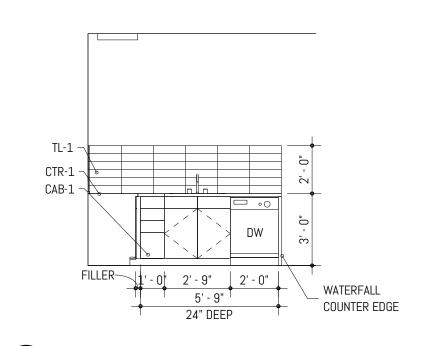


3

D3 2x1 - KITCHEN ELEVATION 3 SCALE: 1/4" = 1'-0" @ FULL SCALE

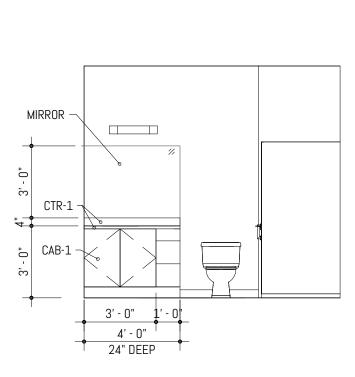

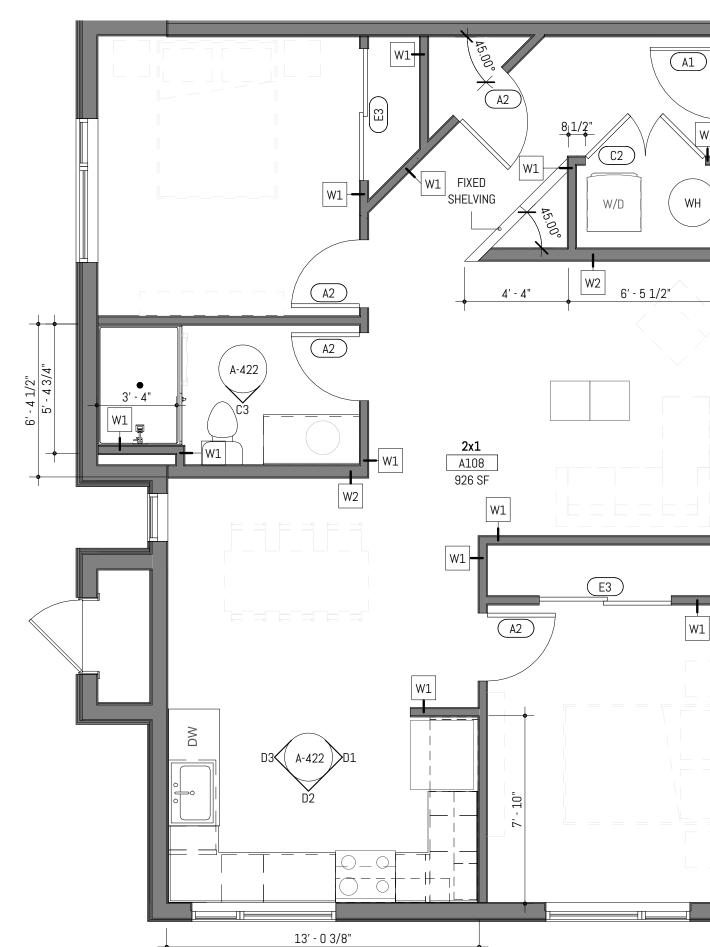

C4 ENLARGED PLAN - 2X1 SCALE: 1/4" = 1'-0" @ FULL SCALE

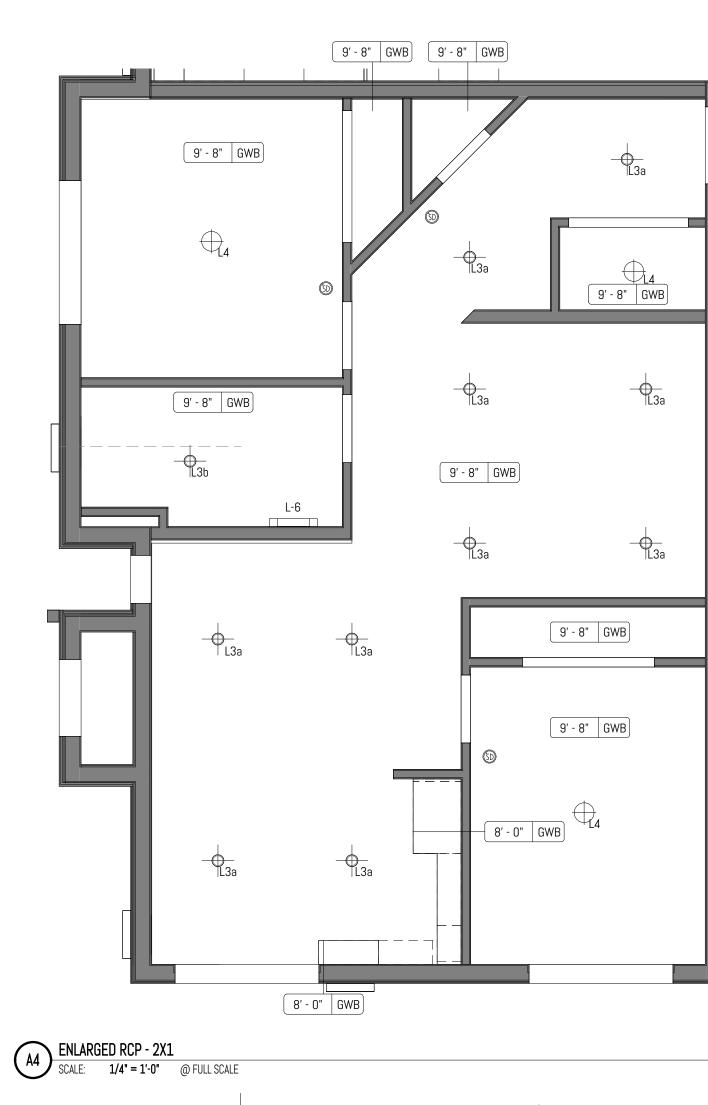


C3 2x1 - BATHROOM ELEVATION SCALE: 1/4" = 1'-0" @ FULL SCALE

8' - 6"

24" DEEP

3

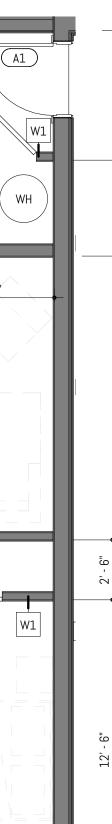


# ENLARGED PLAN **GENERAL NOTES**

5

- 1. PROVIDE MINIMUM 1'-0" CLEAR FLOOR SPACE AT THE PUSH SIDE OF EVERY DOOR WITH A CLOSER. PROVIDE MINIMUM 1'-6" CLEAR AT THE PULL SIDE OF EVERY DOOR, UNLESS SPECIFICALLY DIMENSIONED, NOTED OR SHOWN OTHERWISE.
- 2. APPLIANCES CFCI U.N.O. 3. CASEWORK LOCATIONS DIMENSIONED FROM FACE OF FINISHED WALL TO FACE OF CASEWORK FINISH U.N.O.
- 4. CONTINUE FLOOR FINISH UNDER APPLIANCES AND CABINETS REQUIRING ACCESSIBLE PULL-IN CLEARANCE AND AT REMOVABLE CABINETRY.
- 5. WALL OUTLETS, FIXTURE COVERINGS, AND PANELS TO MATCH ADJ. WALL FINISH TYP. 6. MOUNT CLOSET RODS AT 48" MAX AFF TO THE TOP IN TYPE A UNITS.
- 7. UNIT ENTRY DOORS TO BE 8'-0" TALL.
- 8. FURNITURE SHOWN FOR REFERENCE ONLY. 9. TYP AT UNITS, FLOORING TO BE LVT, WITH RESILIENT FLOORING AT BATHROOMS, U.N.O.
- 10. TILE BACKSPLASH TYP ALL KITCHENS, REFER TO FINISH SCHEDULE
- 11. COUNTERTOP CTR-1 TO BE USED AT ALL KITCHENS AND BATHROOMS, REFER TO FINISH SCHEDULE 12. P-LAM CABINETS AT ALL UNIT KITCHENS AND BATHROOMS
- 13. UNITS TO RECEIVE 1X4" PAINTED MDF WALL BASE U.N.O., PAINT TO MATCH WALLS, SEMIGLOSS SHEEN 14. SPRING-LOADED BLINDS AT ALL EXTERIOR WINDOWS, TYP ALL UNITS
- 15. WATERFALL EDGES AT KITCHEN PENINSULA & KITCHEN ISLAND ENDS U.N.O.
- 16. LEVEL 1: TYP CEILING HEIGHT TO BE 9'-8"
- LEVEL 2: TYP CEILING HEIGHT TO BE 8'-8" LEVEL 3: TYP CEILING HEIGHTS VARY DUE TO SCISSOR TRUSS
- 17. AT PROPOSED LOCATIONS FOR EXHAUST DUCTING, PROVIDE FRAMED GYP CEILING 8" FROM RATED ASSEMBLY
- 18. UNIT WALLS AND CEILINGS TO BE PAINTED P-1 U.N.O.; EGGSHELL SHEEN AT WALLS, FLAT AT CEILINGS 19. SIX (6) ASSORTED GROUND FLOOR UNITS TO BE TYPE A, WHICH SHALL INCLUDE ACCESSIBLE RESTROOMS AND KITCHENS.
- 20. FOR TYP ADA FIXTURE AND ACCESSORY MOUNTING HEIGHTS, REFER TO SHEET A-005 ACCESSIBILITY & CODE DETAILS.

# ENLARGED PLAN LIGHTING LEGEND

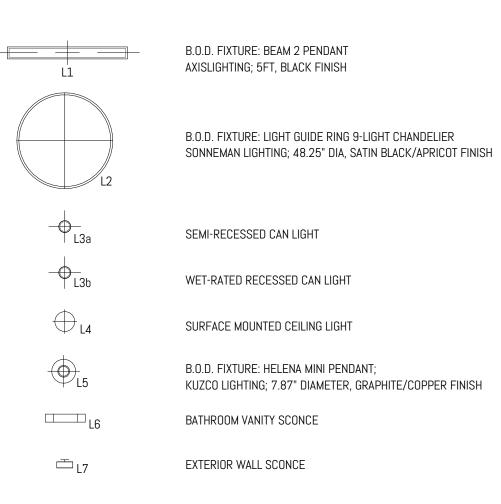

# F **М**о ш • n · 2





ENLARGED PLAN
GRAPHIC LEGEND

5

WALL CONSTRUCTION

D

COMBINATION SMOKE/CARBON MONOXIDE ALARM UNIT

FURNITURE

PROPOSED EXHAUST DUCTING

> 050-01-21 PROJECT NO: PRINCIPAL-IN-CHARGE: PROJECT ARCHITECT: DRAWN BY: PROJECT STATUS:

REVISION


DATE

PERMIT SET 05.06.2022

MARK

SHEET TITLE: UNIT PLANS & ELEVATIONS - 2x1

A-422

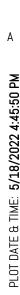

С

В



1

D1 2X1 - TYPE A - KITCHEN ELEVATION 1 SCALE: 1/4" = 1'-0" @ FULL SCALE

ADA HEIGHT DISHWASHER —

30" MIN. REMOVABLE CABINET

AT SINK; FINISHES TO CONTINUE -----

BELOW COUNTER

1

TL-1 -

CTR-1 -


CAB-1 -

24"


33"


24" DEEP


ltem 7. 

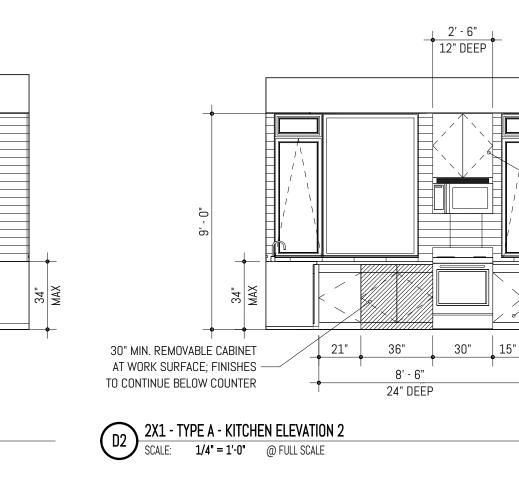



2

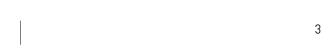


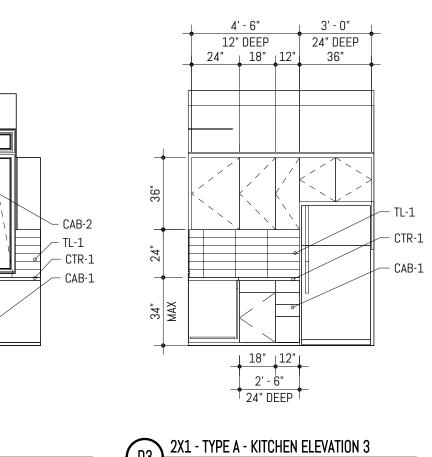

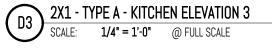

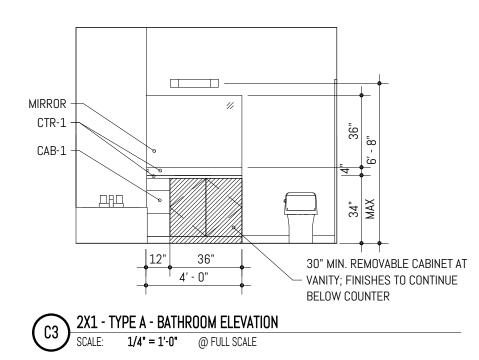


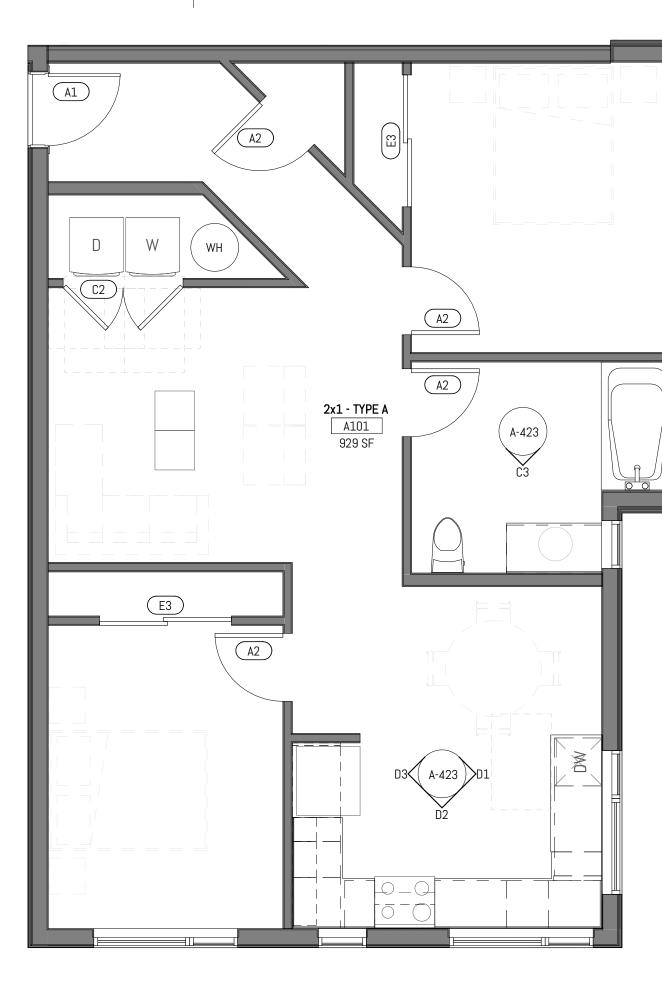

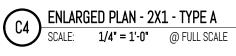

A4 ENLARGED RCP - 2X1 - TYPE A SCALE: 1/4" = 1'-0" @ FULL SCALE


3

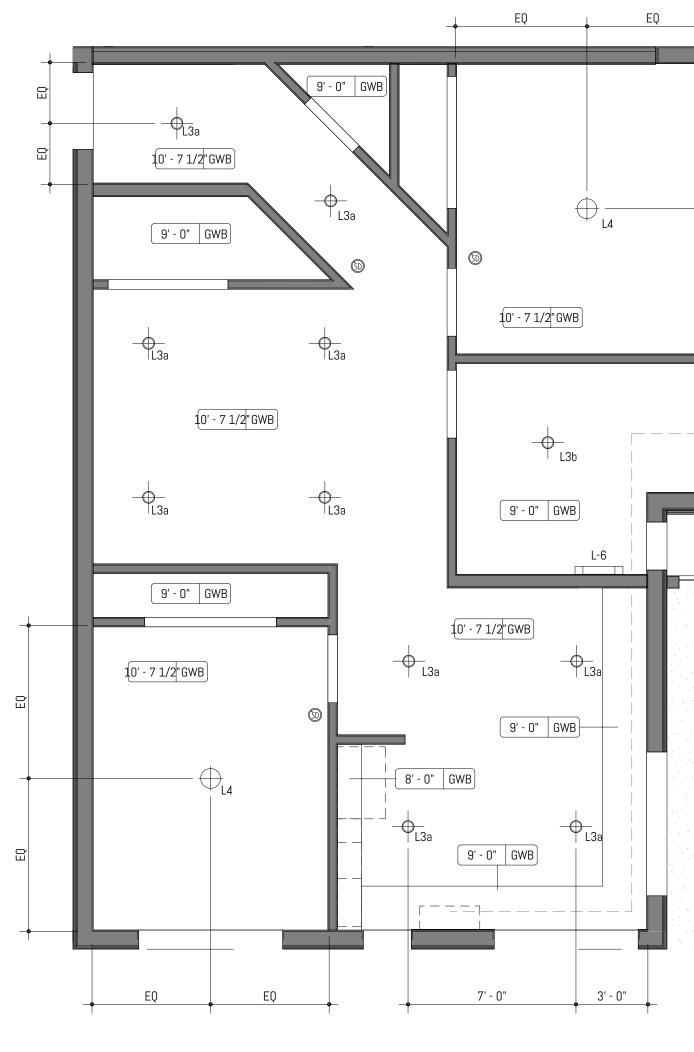

### ENLARGED PLAN **GENERAL NOTES**

- 1. PROVIDE MINIMUM 1'-0" CLEAR FLOOR SPACE AT THE PUSH SIDE OF EVERY DOOR WITH A CLOSER. PROVIDE MINIMUM 1'-6" CLEAR AT THE PULL SIDE OF EVERY DOOR, UNLESS SPECIFICALLY DIMENSIONED, NOTED OR SHOWN OTHERWISE. 2. APPLIANCES CFCI U.N.O.
- 3. CASEWORK LOCATIONS DIMENSIONED FROM FACE OF FINISHED WALL TO FACE OF CASEWORK FINISH U.N.O.
- 4. CONTINUE FLOOR FINISH UNDER APPLIANCES AND CABINETS REQUIRING ACCESSIBLE PULL-IN CLEARANCE AND AT REMOVABLE CABINETRY. 5. WALL OUTLETS, FIXTURE COVERINGS, AND PANELS TO MATCH ADJ. WALL FINISH TYP.
- 6. MOUNT CLOSET RODS AT 48" MAX AFF TO THE TOP IN TYPE A UNITS.
- 7. UNIT ENTRY DOORS TO BE 8'-0" TALL.
- 8. FURNITURE SHOWN FOR REFERENCE ONLY. 9. TYP AT UNITS, FLOORING TO BE LVT, WITH RESILIENT FLOORING AT BATHROOMS, U.N.O.
- 10. TILE BACKSPLASH TYP ALL KITCHENS, REFER TO FINISH SCHEDULE
- 11. COUNTERTOP CTR-1 TO BE USED AT ALL KITCHENS AND BATHROOMS, REFER TO FINISH SCHEDULE
- 12. P-LAM CABINETS AT ALL UNIT KITCHENS AND BATHROOMS 13. UNITS TO RECEIVE 1X4" PAINTED MDF WALL BASE U.N.O., PAINT TO MATCH WALLS, SEMIGLOSS SHEEN
- 14. SPRING-LOADED BLINDS AT ALL EXTERIOR WINDOWS, TYP ALL UNITS 15. WATERFALL EDGES AT KITCHEN PENINSULA & KITCHEN ISLAND ENDS U.N.O.
- 16. LEVEL 1: TYP CEILING HEIGHT TO BE 9'-8"
- LEVEL 2: TYP CEILING HEIGHT TO BE 8'-8"
- LEVEL 3: TYP CEILING HEIGHTS VARY DUE TO SCISSOR TRUSS 17. AT PROPOSED LOCATIONS FOR EXHAUST DUCTING, PROVIDE FRAMED GYP CEILING 8" FROM RATED ASSEMBLY
- 18. UNIT WALLS AND CEILINGS TO BE PAINTED P-1 U.N.O.; EGGSHELL SHEEN AT WALLS, FLAT AT CEILINGS 19. SIX (6) ASSORTED GROUND FLOOR UNITS TO BE TYPE A, WHICH SHALL INCLUDE ACCESSIBLE RESTROOMS AND KITCHENS.
- 20. FOR TYP ADA FIXTURE AND ACCESSORY MOUNTING HEIGHTS, REFER TO SHEET A-005 ACCESSIBILITY & CODE DETAILS.

# ENLARGED PLAN LIGHTING LEGEND

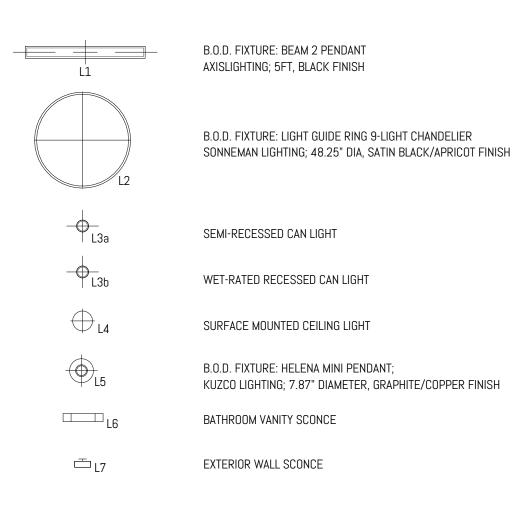

# TMENT $\mathbf{X}$ 01 422 WA ■ 18, & 4 /ATER, DISTRIC 4302, 4312, 4408

CRAF

 $\mathcal{O}$ 

F

ш

2

REGISTERED

BEN DAVID FERGUSON STATE OF WASHINGTON

С U

### ENLARGED PLAN **GRAPHIC LEGEND**

5

\_\_\_\_

WALL CONSTRUCTION

SD

COMBINATION SMOKE/CARBON

MONOXIDE ALARM UNIT

FURNITURE

PROPOSED EXHAUST DUCTING

> 050-01-21 PROJECT NO: PRINCIPAL-IN-CHARGE: PROJECT ARCHITECT: DRAWN BY:

REVISION


DATE

PROJECT STATUS: PERMIT SET 05.06.2022


MARK

SHEET TITLE: UNIT PLANS & ELEVATIONS - 2x1 - TYPE A



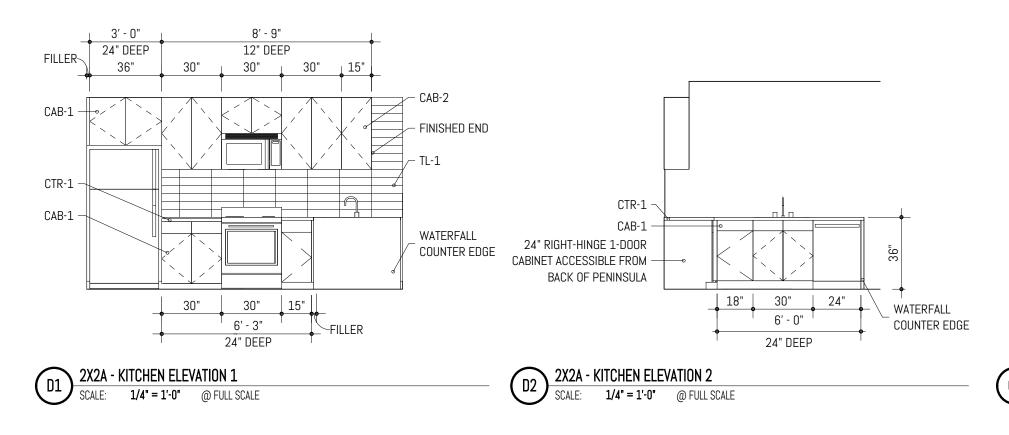

1

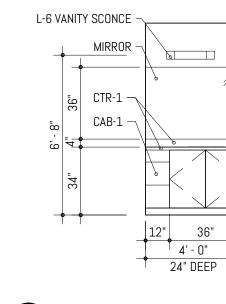



145


1

Item 7.

D

С

В

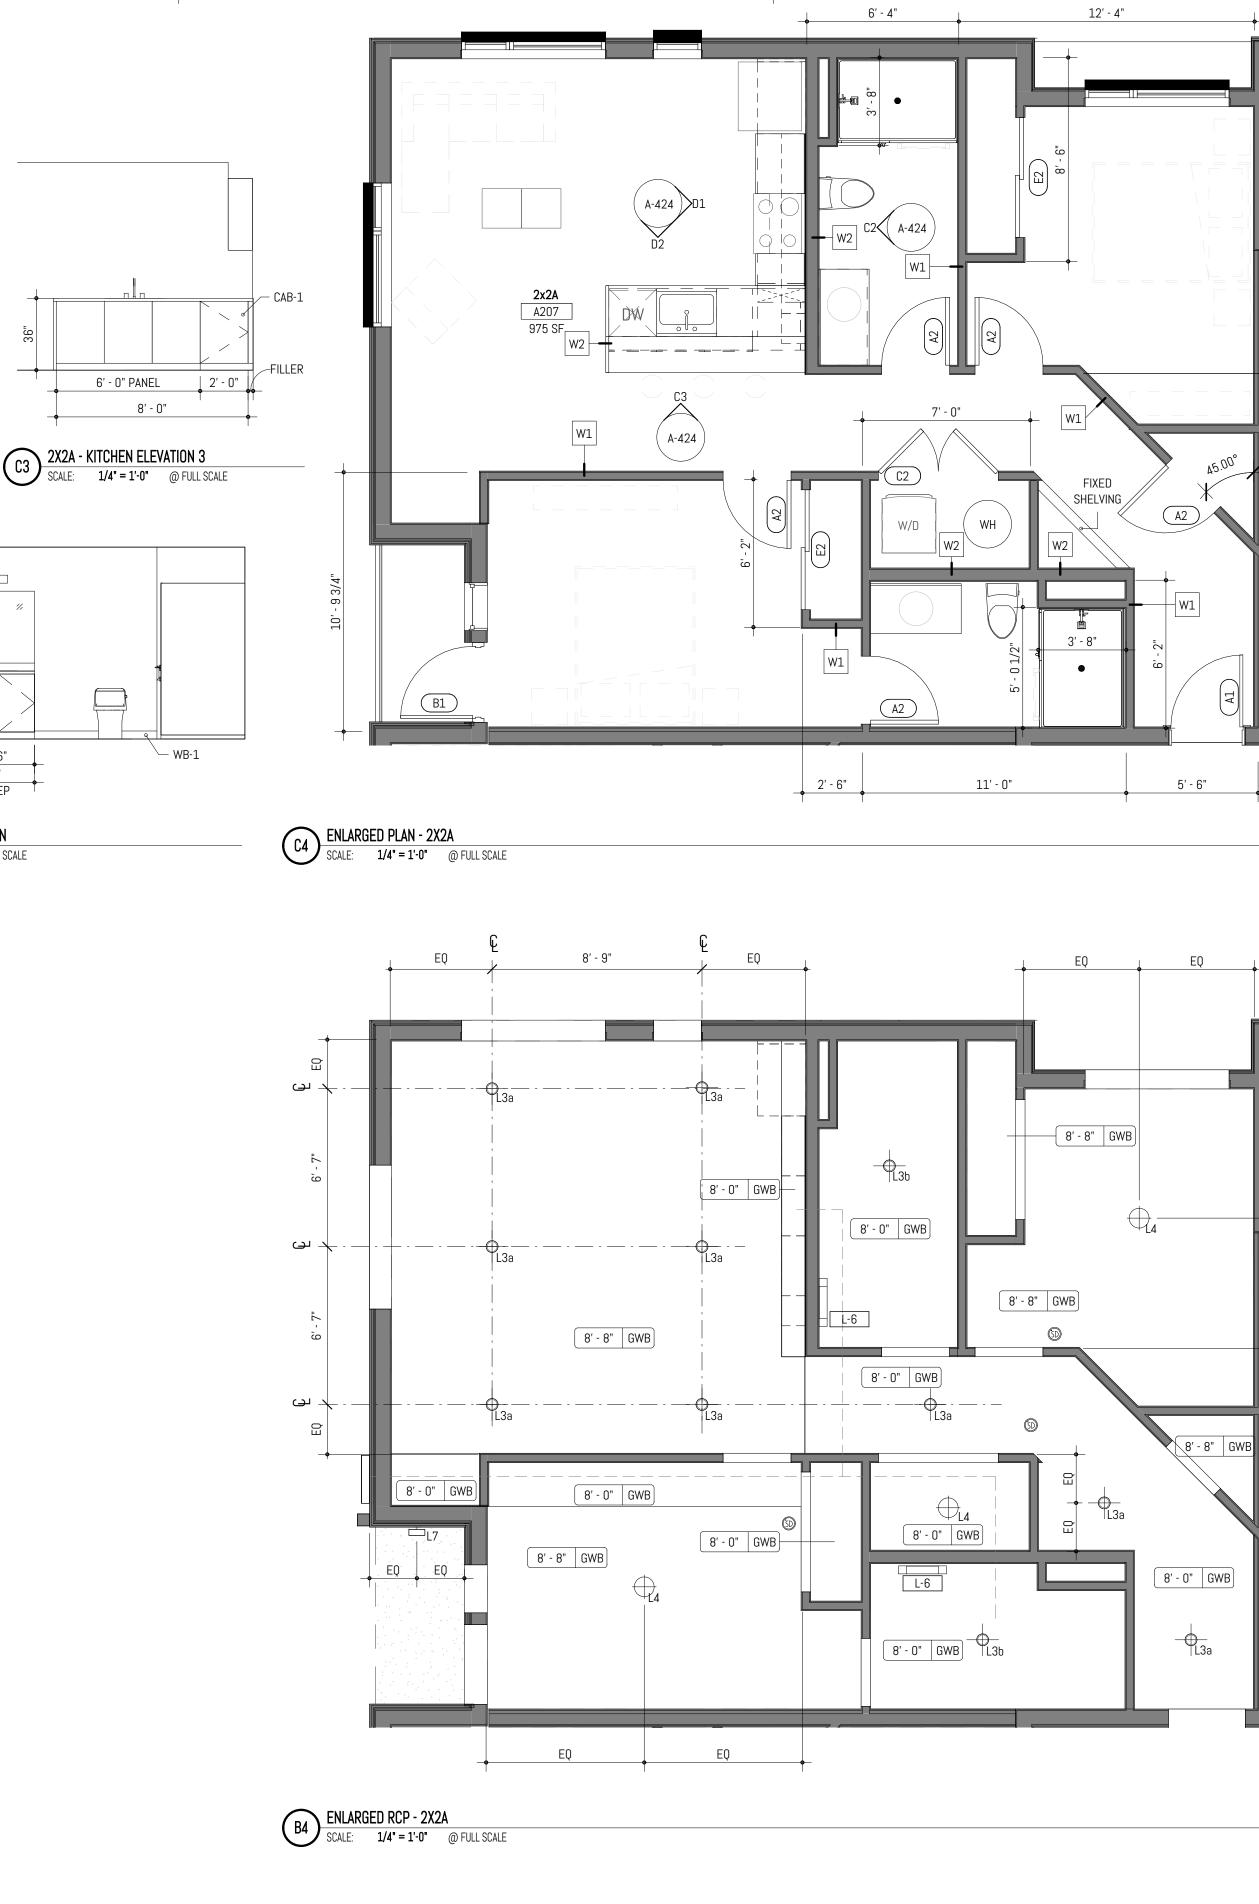

3

# ENLARGED PLAN **GENERAL NOTES**

5

- 1. PROVIDE MINIMUM 1'-0" CLEAR FLOOR SPACE AT THE PUSH SIDE OF EVERY DOOR WITH A CLOSER. PROVIDE MINIMUM 1'-6" CLEAR AT THE PULL SIDE OF EVERY DOOR, UNLESS SPECIFICALLY DIMENSIONED, NOTED OR SHOWN OTHERWISE.
- 2. APPLIANCES CFCI U.N.O. 3. CASEWORK LOCATIONS DIMENSIONED FROM FACE OF FINISHED WALL TO FACE OF CASEWORK FINISH U.N.O.
- 4. CONTINUE FLOOR FINISH UNDER APPLIANCES AND CABINETS REQUIRING ACCESSIBLE PULL-IN CLEARANCE AND AT REMOVABLE CABINETRY.
- 5. WALL OUTLETS, FIXTURE COVERINGS, AND PANELS TO MATCH ADJ. WALL FINISH TYP.
- 6. MOUNT CLOSET RODS AT 48" MAX AFF TO THE TOP IN TYPE A UNITS. 7. UNIT ENTRY DOORS TO BE 8'-0" TALL.

4

4

- 8. FURNITURE SHOWN FOR REFERENCE ONLY.
- 9. TYP AT UNITS, FLOORING TO BE LVT, WITH RESILIENT FLOORING AT BATHROOMS, U.N.O. 10. TILE BACKSPLASH TYP ALL KITCHENS, REFER TO FINISH SCHEDULE
- 11. COUNTERTOP CTR-1 TO BE USED AT ALL KITCHENS AND BATHROOMS, REFER TO FINISH SCHEDULE
- 12. P-LAM CABINETS AT ALL UNIT KITCHENS AND BATHROOMS 13. UNITS TO RECEIVE 1X4" PAINTED MDF WALL BASE U.N.O., PAINT TO MATCH WALLS, SEMIGLOSS SHEEN
- 14. SPRING-LOADED BLINDS AT ALL EXTERIOR WINDOWS, TYP ALL UNITS 15. WATERFALL EDGES AT KITCHEN PENINSULA & KITCHEN ISLAND ENDS U.N.O.
- 16. LEVEL 1: TYP CEILING HEIGHT TO BE 9'-8"
- LEVEL 2: TYP CEILING HEIGHT TO BE 8'-8"
- LEVEL 3: TYP CEILING HEIGHTS VARY DUE TO SCISSOR TRUSS 17. AT PROPOSED LOCATIONS FOR EXHAUST DUCTING, PROVIDE FRAMED GYP CEILING 8" FROM RATED ASSEMBLY
- 18. UNIT WALLS AND CEILINGS TO BE PAINTED P-1 U.N.O.; EGGSHELL SHEEN AT WALLS, FLAT AT CEILINGS 19. SIX (6) ASSORTED GROUND FLOOR UNITS TO BE TYPE A, WHICH SHALL INCLUDE ACCESSIBLE RESTROOMS AND KITCHENS.
- 20. FOR TYP ADA FIXTURE AND ACCESSORY MOUNTING HEIGHTS, REFER TO SHEET A-005 ACCESSIBILITY & CODE DETAILS.

# ENLARGED PLAN LIGHTING LEGEND



WALL CONSTRUCTION

MONOXIDE ALARM UNIT

(SD)

COMBINATION SMOKE/CARBON

# AXISLIGHTING; 5FT, BLACK FINISH B.O.D. FIXTURE: LIGHT GUIDE RING 9-LIGHT CHANDELIER SONNEMAN LIGHTING; 48.25" DIA, SATIN BLACK/APRICOT FINISH SEMI-RECESSED CAN LIGHT WET-RATED RECESSED CAN LIGHT SURFACE MOUNTED CEILING LIGHT B.O.D. FIXTURE: HELENA MINI PENDANT; KUZCO LIGHTING; 7.87" DIAMETER, GRAPHITE/COPPER FINISH

BATHROOM VANITY SCONCE

EXTERIOR WALL SCONCE

5

ENLARGED PLAN **GRAPHIC LEGEND** 

FURNITURE

PROPOSED EXHAUST DUCTING







MARK REVIS		SIUN	DATE
PROJ	JECT NO:	050-01-	21
PRIN	CIPAL-IN-CHARGE	:	BF
PROJ	IECT ARCHITECT:		MJ
DRAV	VN BY:		MJ
PROJ	IECT STATUS:		
PERMIT SET			
05	.06.2022		

SHEET TITLE: UNIT PLANS & ELEVATIONS - 2x2A

SHEET NO.

A-424

ltem 7. 

С


В

1


1

2

C2 2X2B - BATHROOM ELEVATION SCALE: 1/4" = 1'-0" @ FULL SCALE

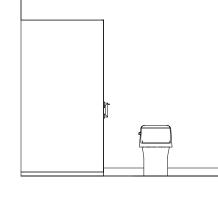


CAB-1 –⁄

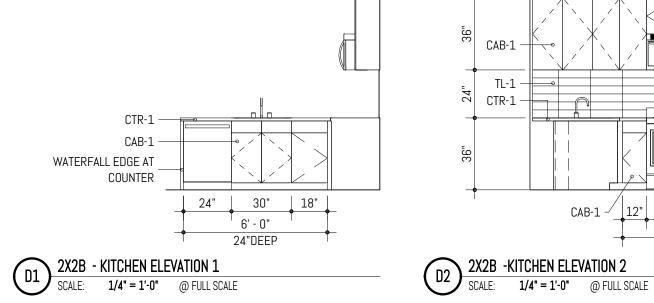


9' - 9" 12" DEEP

27" 30"

30"

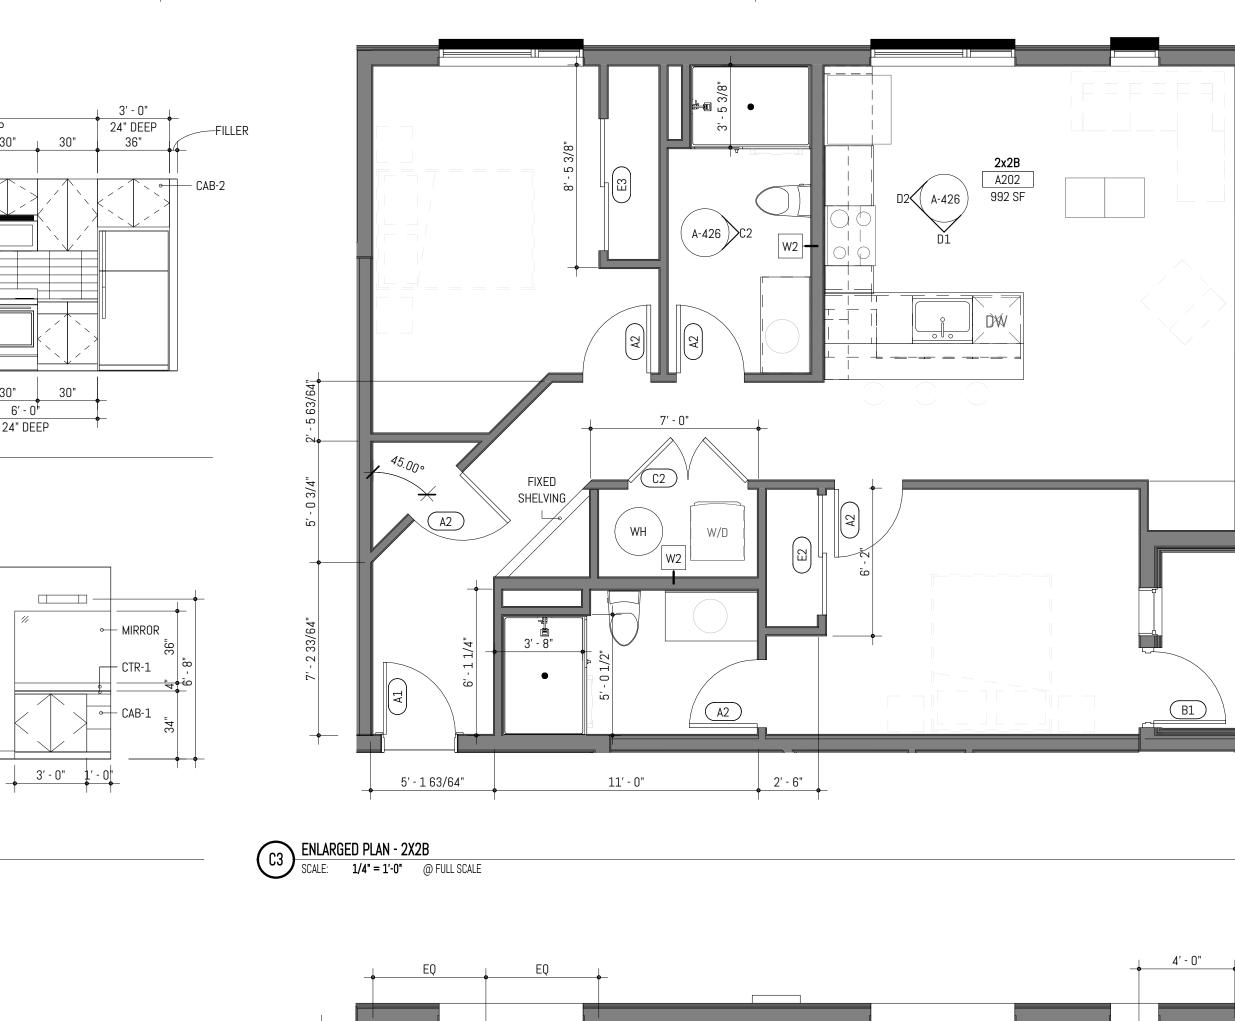

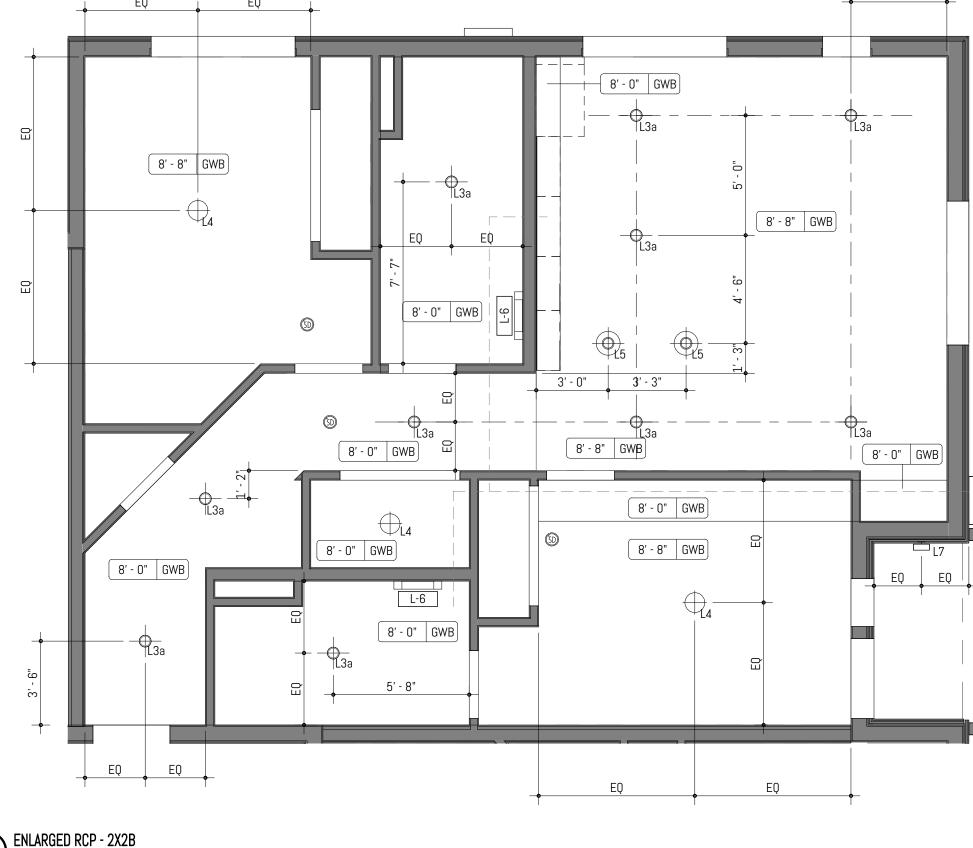

4

B3 ENLARGED RCP - 2X2B SCALE: 1/4" = 1'-0" @ FULL SCALE


3

## ENLARGED PLAN **GENERAL NOTES**

5

- 1. PROVIDE MINIMUM 1'-0" CLEAR FLOOR SPACE AT THE PUSH SIDE OF EVERY DOOR WITH A CLOSER. PROVIDE MINIMUM 1'-6" CLEAR AT THE PULL SIDE OF EVERY DOOR, UNLESS SPECIFICALLY DIMENSIONED, NOTED OR SHOWN OTHERWISE. 2. APPLIANCES CFCI U.N.O.
- 3. CASEWORK LOCATIONS DIMENSIONED FROM FACE OF FINISHED WALL TO FACE OF CASEWORK FINISH U.N.O.
- 4. CONTINUE FLOOR FINISH UNDER APPLIANCES AND CABINETS REQUIRING ACCESSIBLE PULL-IN CLEARANCE AND AT REMOVABLE CABINETRY.
- 5. WALL OUTLETS, FIXTURE COVERINGS, AND PANELS TO MATCH ADJ. WALL FINISH TYP. 6. MOUNT CLOSET RODS AT 48" MAX AFF TO THE TOP IN TYPE A UNITS.
- 7. UNIT ENTRY DOORS TO BE 8'-0" TALL.
- 8. FURNITURE SHOWN FOR REFERENCE ONLY. 9. TYP AT UNITS, FLOORING TO BE LVT, WITH RESILIENT FLOORING AT BATHROOMS, U.N.O.
- 10. TILE BACKSPLASH TYP ALL KITCHENS, REFER TO FINISH SCHEDULE
- 11. COUNTERTOP CTR-1 TO BE USED AT ALL KITCHENS AND BATHROOMS, REFER TO FINISH SCHEDULE 12. P-LAM CABINETS AT ALL UNIT KITCHENS AND BATHROOMS
- 13. UNITS TO RECEIVE 1X4" PAINTED MDF WALL BASE U.N.O., PAINT TO MATCH WALLS, SEMIGLOSS SHEEN
- 14. SPRING-LOADED BLINDS AT ALL EXTERIOR WINDOWS, TYP ALL UNITS 15. WATERFALL EDGES AT KITCHEN PENINSULA & KITCHEN ISLAND ENDS U.N.O.
- 16. LEVEL 1: TYP CEILING HEIGHT TO BE 9'-8"
- LEVEL 2: TYP CEILING HEIGHT TO BE 8'-8"
- LEVEL 3: TYP CEILING HEIGHTS VARY DUE TO SCISSOR TRUSS 17. AT PROPOSED LOCATIONS FOR EXHAUST DUCTING, PROVIDE FRAMED GYP CEILING 8" FROM RATED ASSEMBLY
- 18. UNIT WALLS AND CEILINGS TO BE PAINTED P-1 U.N.O.; EGGSHELL SHEEN AT WALLS, FLAT AT CEILINGS 19. SIX (6) ASSORTED GROUND FLOOR UNITS TO BE TYPE A, WHICH SHALL INCLUDE ACCESSIBLE RESTROOMS AND KITCHENS.
- 20. FOR TYP ADA FIXTURE AND ACCESSORY MOUNTING HEIGHTS, REFER TO SHEET A-005 ACCESSIBILITY & CODE DETAILS.

# ENLARGED PLAN LIGHTING LEGEND

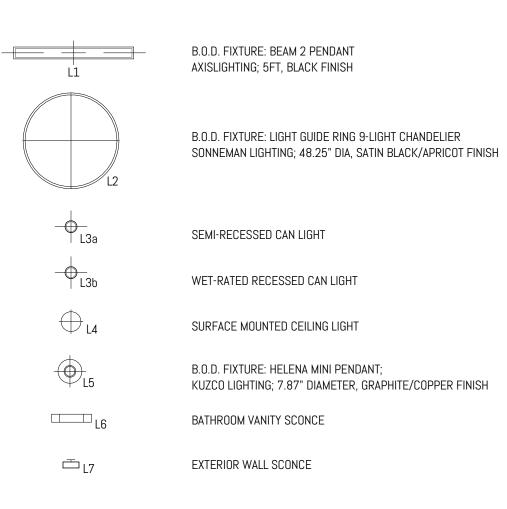

# S S ш -YI 2





# ENLARGED PLAN **GRAPHIC LEGEND**

5

WALL CONSTRUCTION

MONOXIDE ALARM UNIT

D

COMBINATION SMOKE/CARBON

FURNITURE

PROPOSED EXHAUST DUCTING

> 050-01-21 PROJECT NO: PRINCIPAL-IN-CHARGE: PROJECT ARCHITECT: DRAWN BY: PROJECT STATUS:

REVISION

DATE


PERMIT SET 05.06.2022

MARK


SHEET TITLE: UNIT PLANS & ELEVATIONS - 2x2B


SHEET NO.

A-426

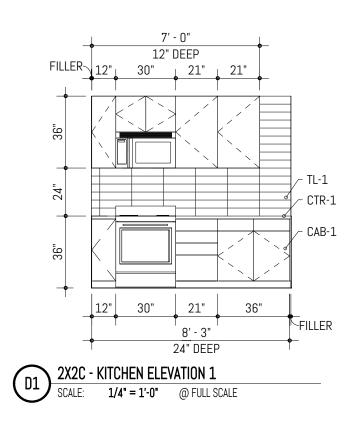

1

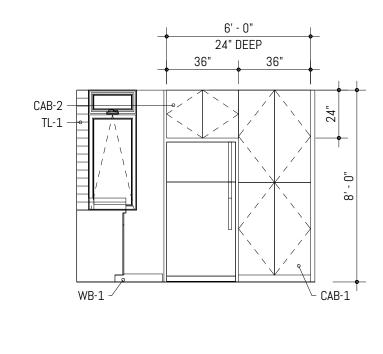

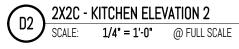


147

1

С


R

ltem 7.

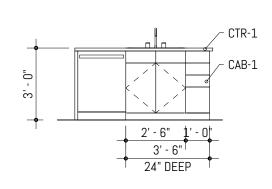


3



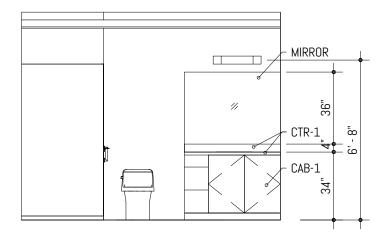

C3 2X2C - BATHROOM ELEVATION SCALE: 1/4" = 1'-0" @ FULL SCALE

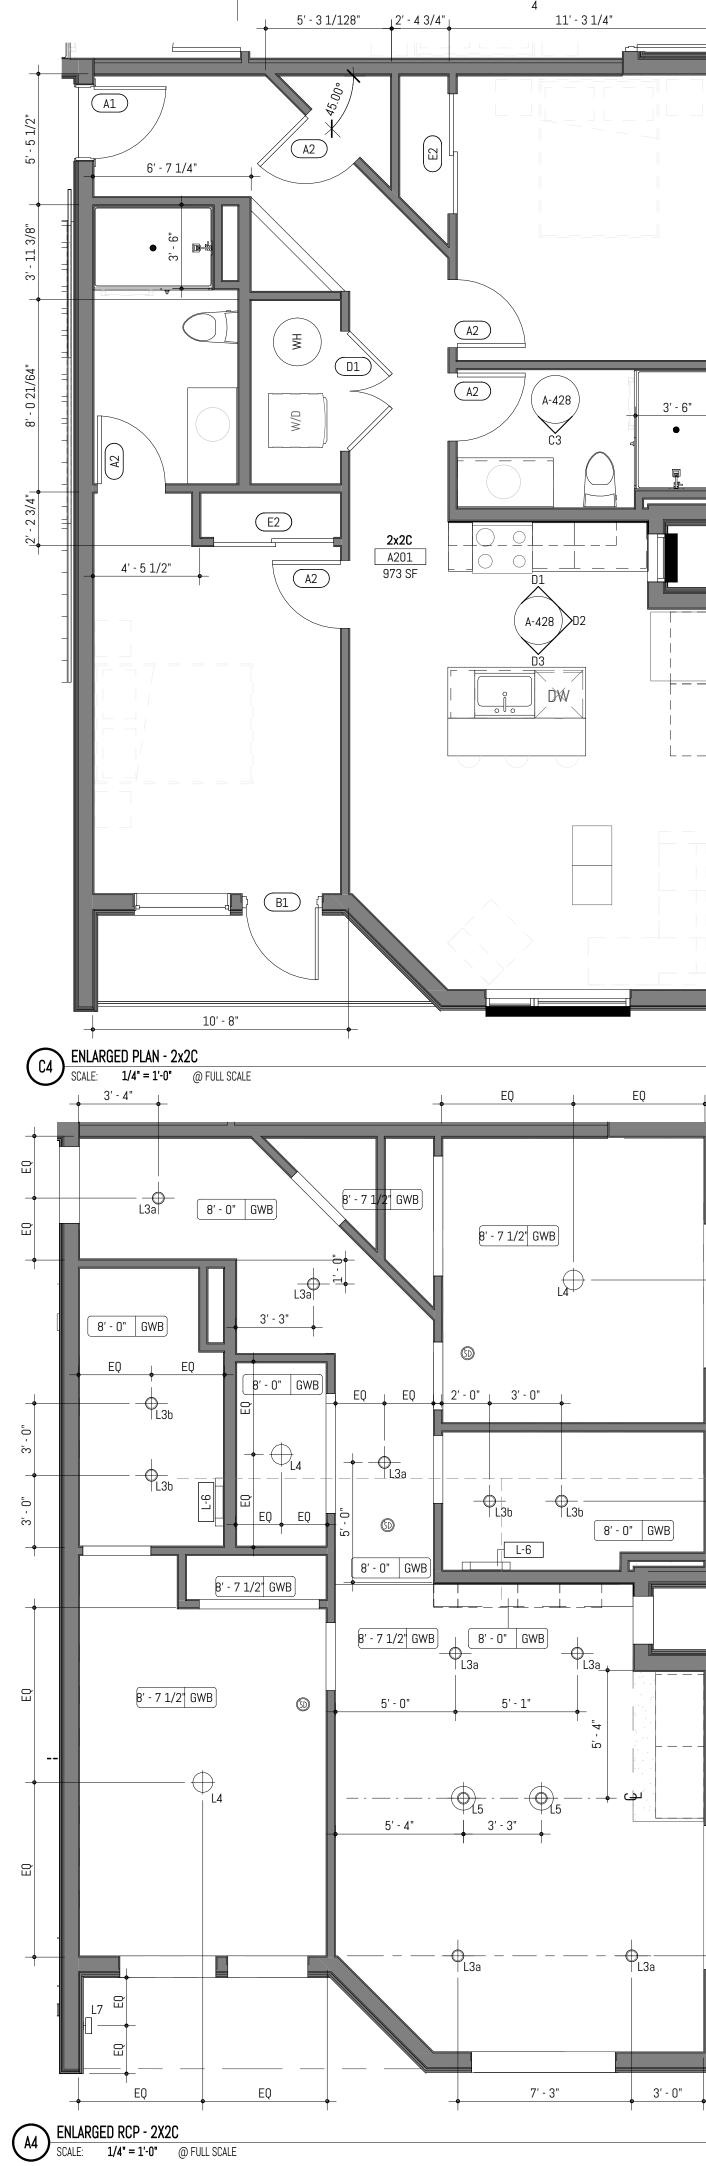


3



5

- 1. PROVIDE MINIMUM 1'-0" CLEAR FLOOR SPACE AT THE PUSH SIDE OF EVERY DOOR WITH A CLOSER. PROVIDE MINIMUM 1'-6" CLEAR AT THE PULL SIDE OF EVERY DOOR, UNLESS SPECIFICALLY DIMENSIONED, NOTED OR SHOWN OTHERWISE. 2. APPLIANCES CFCI U.N.O.
- 3. CASEWORK LOCATIONS DIMENSIONED FROM FACE OF FINISHED WALL TO FACE OF CASEWORK FINISH U.N.O.
- 4. CONTINUE FLOOR FINISH UNDER APPLIANCES AND CABINETS REQUIRING ACCESSIBLE PULL-IN
- CLEARANCE AND AT REMOVABLE CABINETRY.
- 5. WALL OUTLETS, FIXTURE COVERINGS, AND PANELS TO MATCH ADJ. WALL FINISH TYP. 6. MOUNT CLOSET RODS AT 48" MAX AFF TO THE TOP IN TYPE A UNITS.
- 7. UNIT ENTRY DOORS TO BE 8'-0" TALL.
- 8. FURNITURE SHOWN FOR REFERENCE ONLY.
- 9. TYP AT UNITS, FLOORING TO BE LVT, WITH RESILIENT FLOORING AT BATHROOMS, U.N.O. 10. TILE BACKSPLASH TYP ALL KITCHENS, REFER TO FINISH SCHEDULE
- 11. COUNTERTOP CTR-1 TO BE USED AT ALL KITCHENS AND BATHROOMS, REFER TO FINISH SCHEDULE
- 12. P-LAM CABINETS AT ALL UNIT KITCHENS AND BATHROOMS 13. UNITS TO RECEIVE 1X4" PAINTED MDF WALL BASE U.N.O., PAINT TO MATCH WALLS, SEMIGLOSS SHEEN
- 14. SPRING-LOADED BLINDS AT ALL EXTERIOR WINDOWS, TYP ALL UNITS 15. WATERFALL EDGES AT KITCHEN PENINSULA & KITCHEN ISLAND ENDS U.N.O.
- 16. LEVEL 1: TYP CEILING HEIGHT TO BE 9'-8"
- LEVEL 2: TYP CEILING HEIGHT TO BE 8'-8" LEVEL 3: TYP CEILING HEIGHTS VARY DUE TO SCISSOR TRUSS
- 17. AT PROPOSED LOCATIONS FOR EXHAUST DUCTING, PROVIDE FRAMED GYP CEILING 8" FROM RATED ASSEMBLY
- 18. UNIT WALLS AND CEILINGS TO BE PAINTED P-1 U.N.O.; EGGSHELL SHEEN AT WALLS, FLAT AT CEILINGS 19. SIX (6) ASSORTED GROUND FLOOR UNITS TO BE TYPE A, WHICH SHALL INCLUDE ACCESSIBLE RESTROOMS AND KITCHENS.
- 20. FOR TYP ADA FIXTURE AND ACCESSORY MOUNTING HEIGHTS, REFER TO SHEET A-005 ACCESSIBILITY & CODE DETAILS.

# ENLARGED PLAN LIGHTING LEGEND

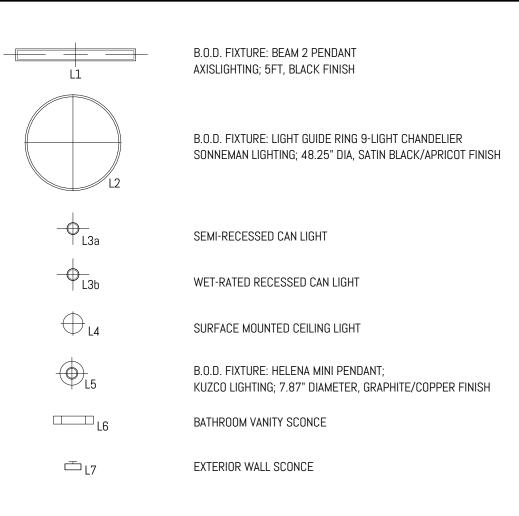







ENLARGED PLAN
GRAPHIC I EGENI

GRAPHIC LEGE	ND

5

COMBINATION SMOKE/CARBON MONOXIDE ALARM UNIT

WALL CONSTRUCTION

PROPOSED EXHAUST DUCTING

FURNITURE

050-01-21 PROJECT NO: PRINCIPAL-IN-CHARGE: PROJECT ARCHITECT: Designer DRAWN BY: Author PROJECT STATUS:

REVISION

DATE

PERMIT SET 05.06.2022

MARK

SHEET TITLE: UNIT PLANS & ELEVATIONS - 2x2C

SHEET NO.

A-428

Δ

В

1


2


С

1


Item 7.


D2 2X2D - KITCHEN ELEVATION 1 SCALE: 1/4" = 1'-0" @ FULL SCALE

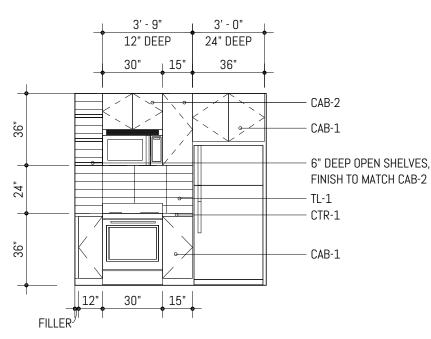

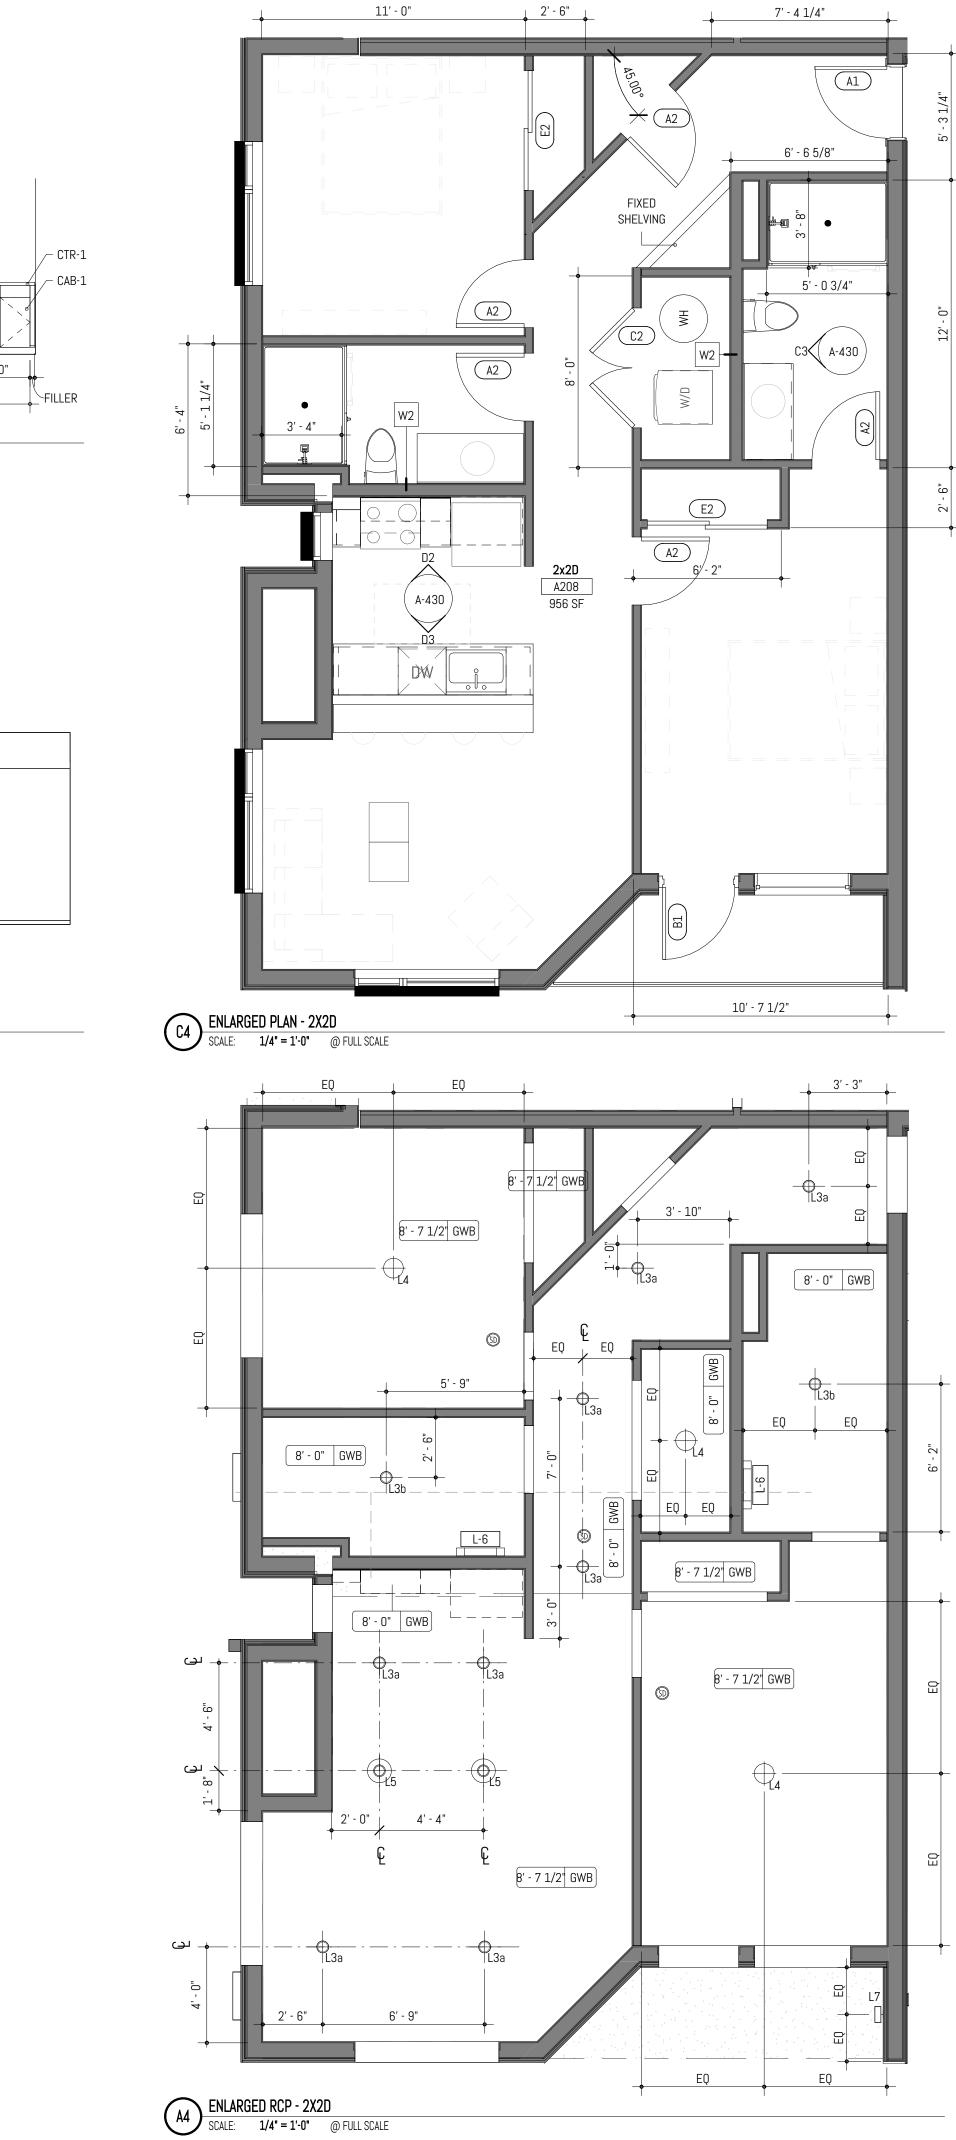

Δ

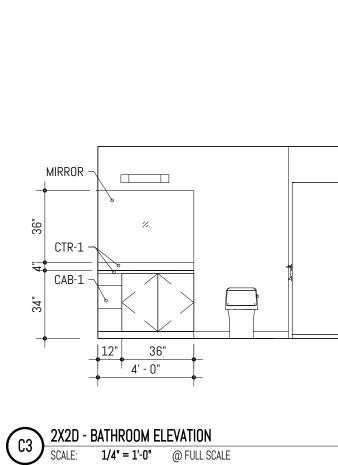

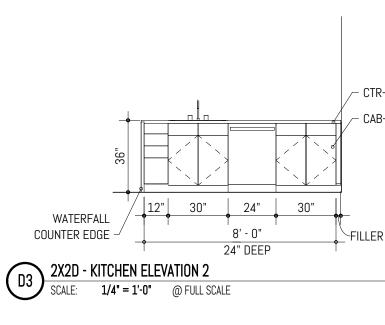

3

Exhibit "B"

# ENLARGED PLAN **GENERAL NOTES**

- 1. PROVIDE MINIMUM 1'-0" CLEAR FLOOR SPACE AT THE PUSH SIDE OF EVERY DOOR WITH A CLOSER. PROVIDE MINIMUM 1'-6" CLEAR AT THE PULL SIDE OF EVERY DOOR, UNLESS SPECIFICALLY DIMENSIONED, NOTED OR SHOWN OTHERWISE.
- 2. APPLIANCES CFCI U.N.O. 3. CASEWORK LOCATIONS DIMENSIONED FROM FACE OF FINISHED WALL TO FACE OF CASEWORK FINISH U.N.O.
- 4. CONTINUE FLOOR FINISH UNDER APPLIANCES AND CABINETS REQUIRING ACCESSIBLE PULL-IN CLEARANCE AND AT REMOVABLE CABINETRY.
- 5. WALL OUTLETS, FIXTURE COVERINGS, AND PANELS TO MATCH ADJ. WALL FINISH TYP. 6. MOUNT CLOSET RODS AT 48" MAX AFF TO THE TOP IN TYPE A UNITS.
- 7. UNIT ENTRY DOORS TO BE 8'-0" TALL.
- 8. FURNITURE SHOWN FOR REFERENCE ONLY. 9. TYP AT UNITS, FLOORING TO BE LVT, WITH RESILIENT FLOORING AT BATHROOMS, U.N.O.
- 10. TILE BACKSPLASH TYP ALL KITCHENS, REFER TO FINISH SCHEDULE
- 11. COUNTERTOP CTR-1 TO BE USED AT ALL KITCHENS AND BATHROOMS, REFER TO FINISH SCHEDULE
- 12. P-LAM CABINETS AT ALL UNIT KITCHENS AND BATHROOMS 13. UNITS TO RECEIVE 1X4" PAINTED MDF WALL BASE U.N.O., PAINT TO MATCH WALLS, SEMIGLOSS SHEEN
- 14. SPRING-LOADED BLINDS AT ALL EXTERIOR WINDOWS, TYP ALL UNITS 15. WATERFALL EDGES AT KITCHEN PENINSULA & KITCHEN ISLAND ENDS U.N.O.
- 16. LEVEL 1: TYP CEILING HEIGHT TO BE 9'-8"
- LEVEL 2: TYP CEILING HEIGHT TO BE 8'-8"
- LEVEL 3: TYP CEILING HEIGHTS VARY DUE TO SCISSOR TRUSS 17. AT PROPOSED LOCATIONS FOR EXHAUST DUCTING, PROVIDE FRAMED GYP CEILING 8" FROM RATED ASSEMBLY
- 18. UNIT WALLS AND CEILINGS TO BE PAINTED P-1 U.N.O.; EGGSHELL SHEEN AT WALLS, FLAT AT CEILINGS 19. SIX (6) ASSORTED GROUND FLOOR UNITS TO BE TYPE A, WHICH SHALL INCLUDE ACCESSIBLE RESTROOMS AND KITCHENS.
- 20. FOR TYP ADA FIXTURE AND ACCESSORY MOUNTING HEIGHTS, REFER TO SHEET A-005 ACCESSIBILITY & CODE DETAILS.

# ENLARGED PLAN LIGHTING LEGEND



AXISLIGHTING; 5FT, BLACK FINISH B.O.D. FIXTURE: LIGHT GUIDE RING 9-LIGHT CHANDELIER SONNEMAN LIGHTING; 48.25" DIA, SATIN BLACK/APRICOT FINISH SEMI-RECESSED CAN LIGHT WET-RATED RECESSED CAN LIGHT SURFACE MOUNTED CEILING LIGHT

B.O.D. FIXTURE: HELENA MINI PENDANT; KUZCO LIGHTING; 7.87" DIAMETER, GRAPHITE/COPPER FINISH

BATHROOM VANITY SCONCE

EXTERIOR WALL SCONCE







ENLARGED PLAN
GRAPHIC LEGEND

FURNITURE

MARK DATE REVISION 050-01-21 PROJECT NO: PRINCIPAL-IN-CHARGE: PROJECT ARCHITECT: DRAWN BY: PROJECT STATUS: PERMIT SET 05.06.2022 SHEET TITLE:

UNIT PLANS & ELEVATIONS - 2x2D

SHEET NO.

A-430

5


WALL CONSTRUCTION

COMBINATION SMOKE/CARBON MONOXIDE ALARM UNIT

(SD)

\_\_\_\_

PROPOSED EXHAUST DUCTING

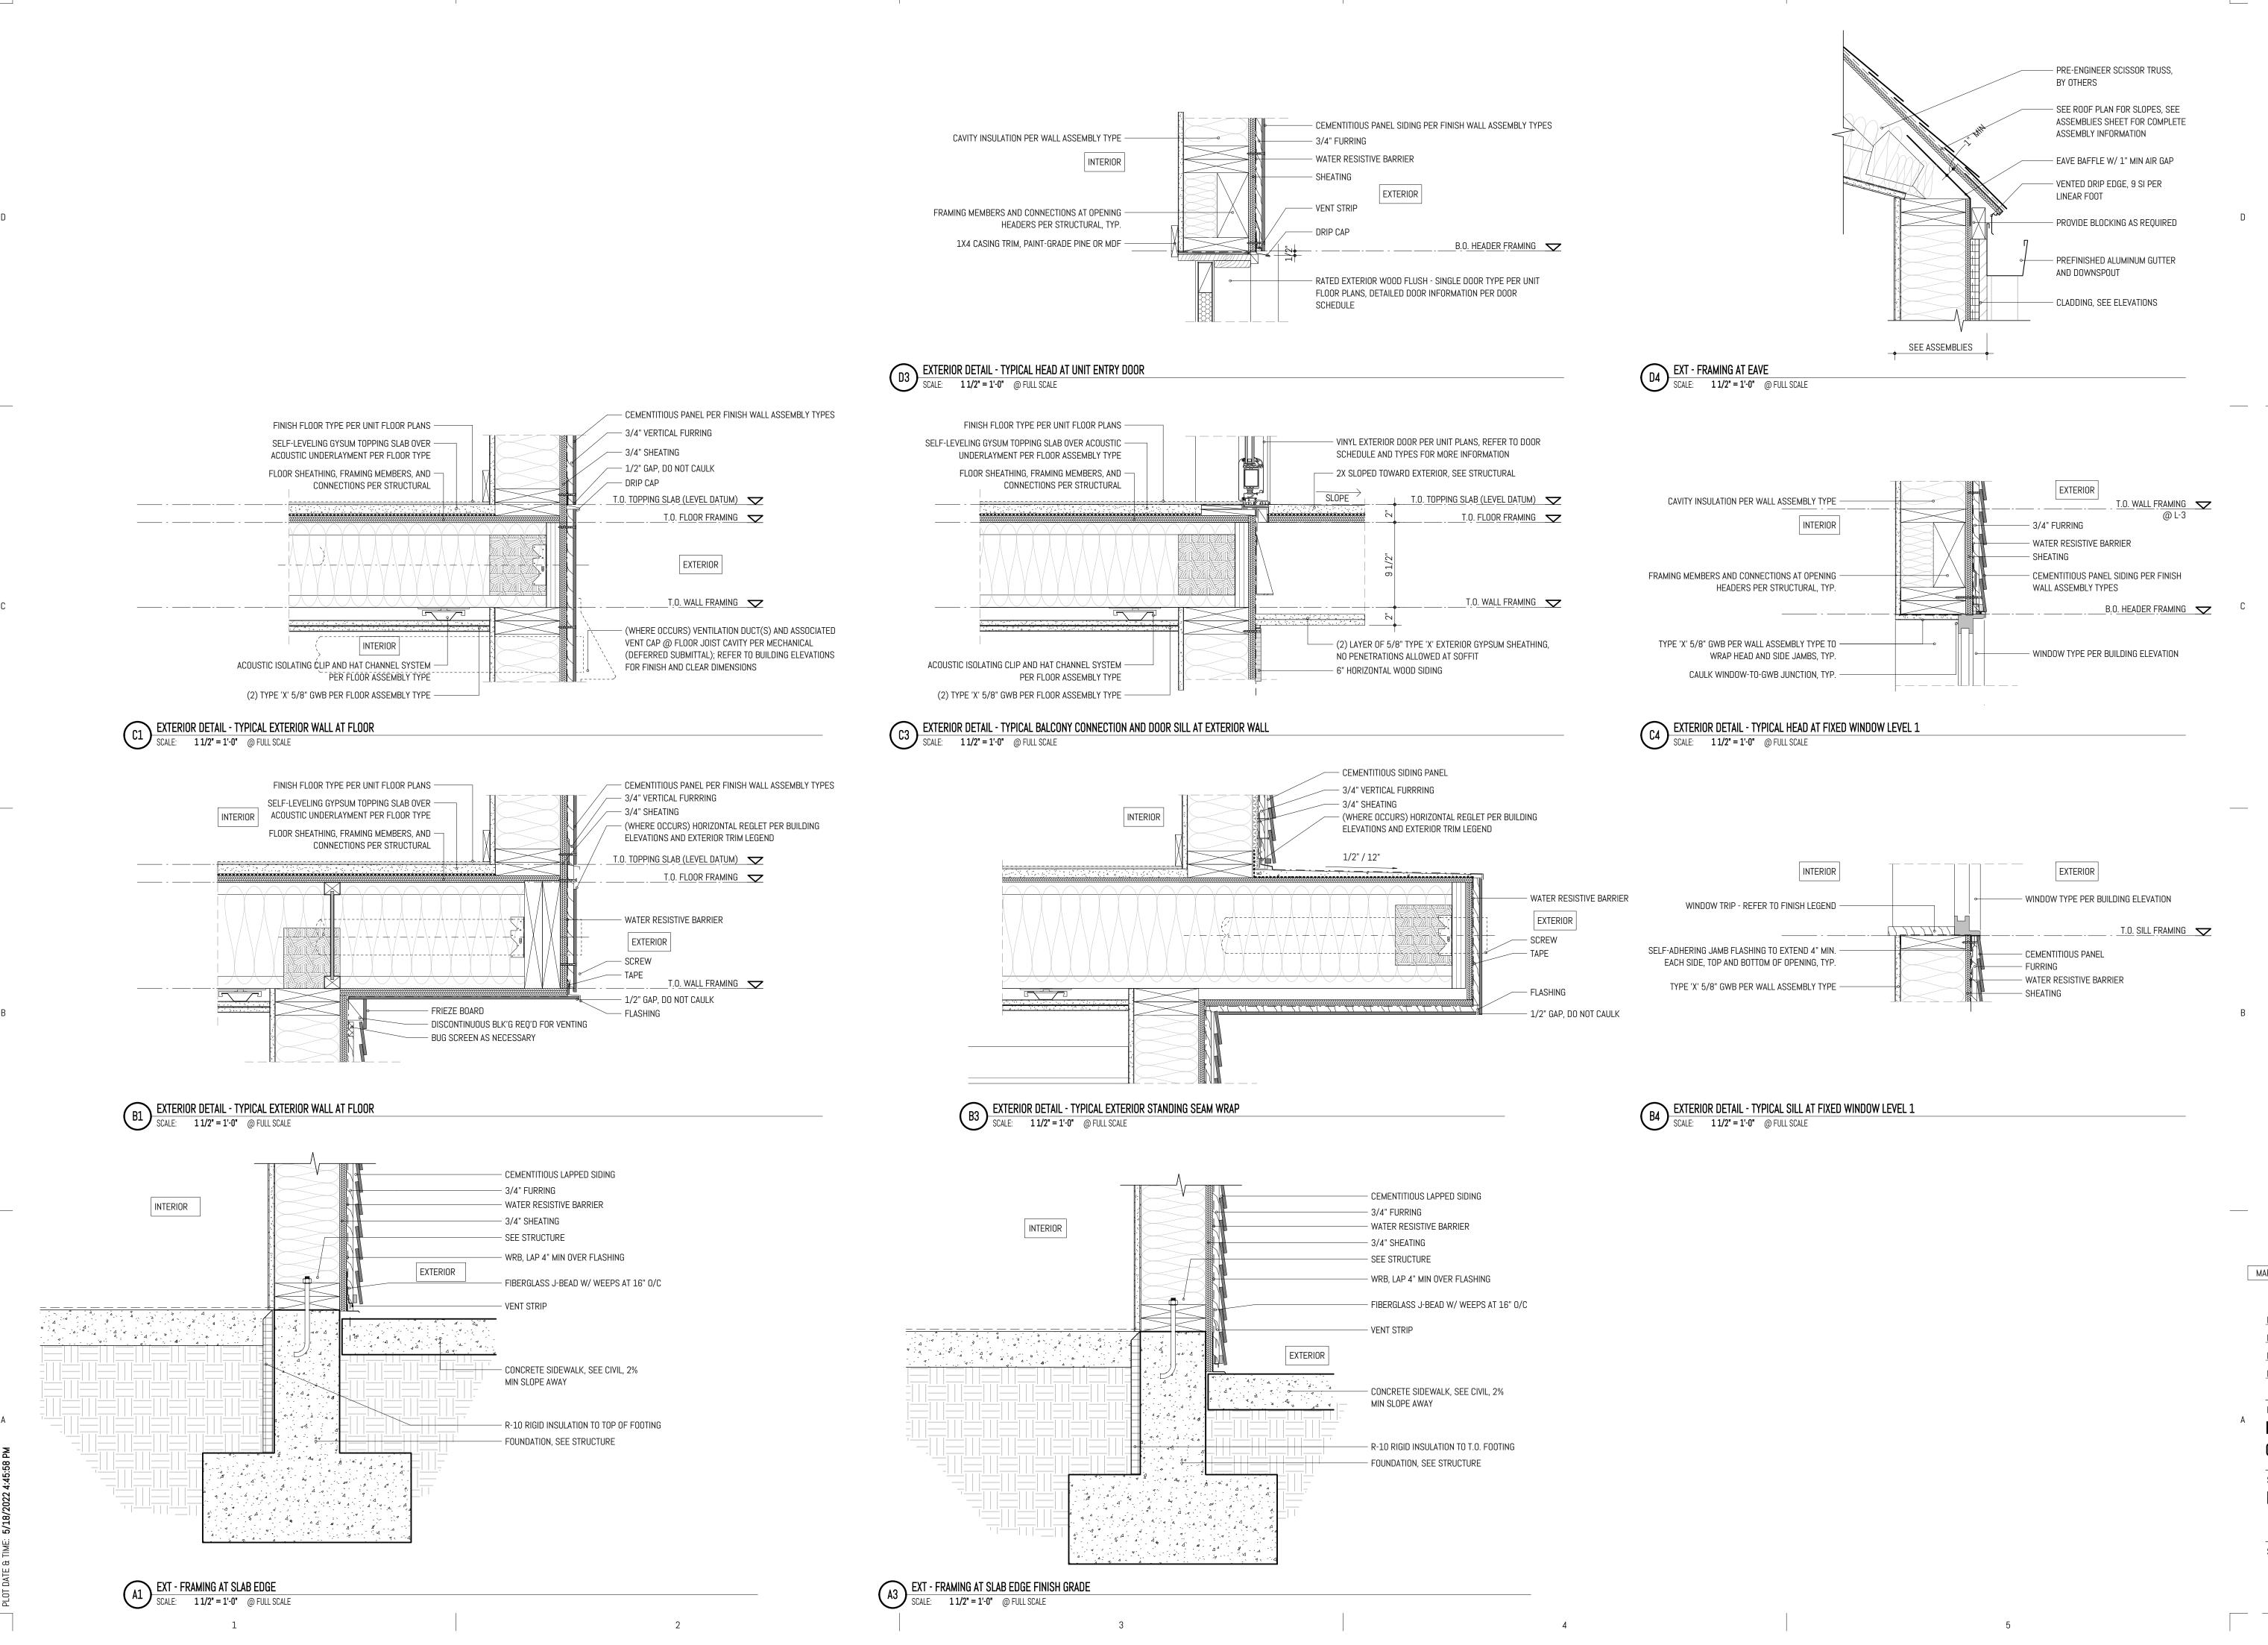

3

Item 7.

1

DATE MARK REVISION 050-01-21 PROJECT NO: PRINCIPAL-IN-CHARGE: PROJECT ARCHITECT: DRAWN BY: PROJECT STATUS: PERMIT SET

05.06.2022

SHEET TITLE: EXTERIOR DETAILS

SHEET NO.


A-500




∞ <u> </u>≺

**DIST** 4302, 431

CRAFT

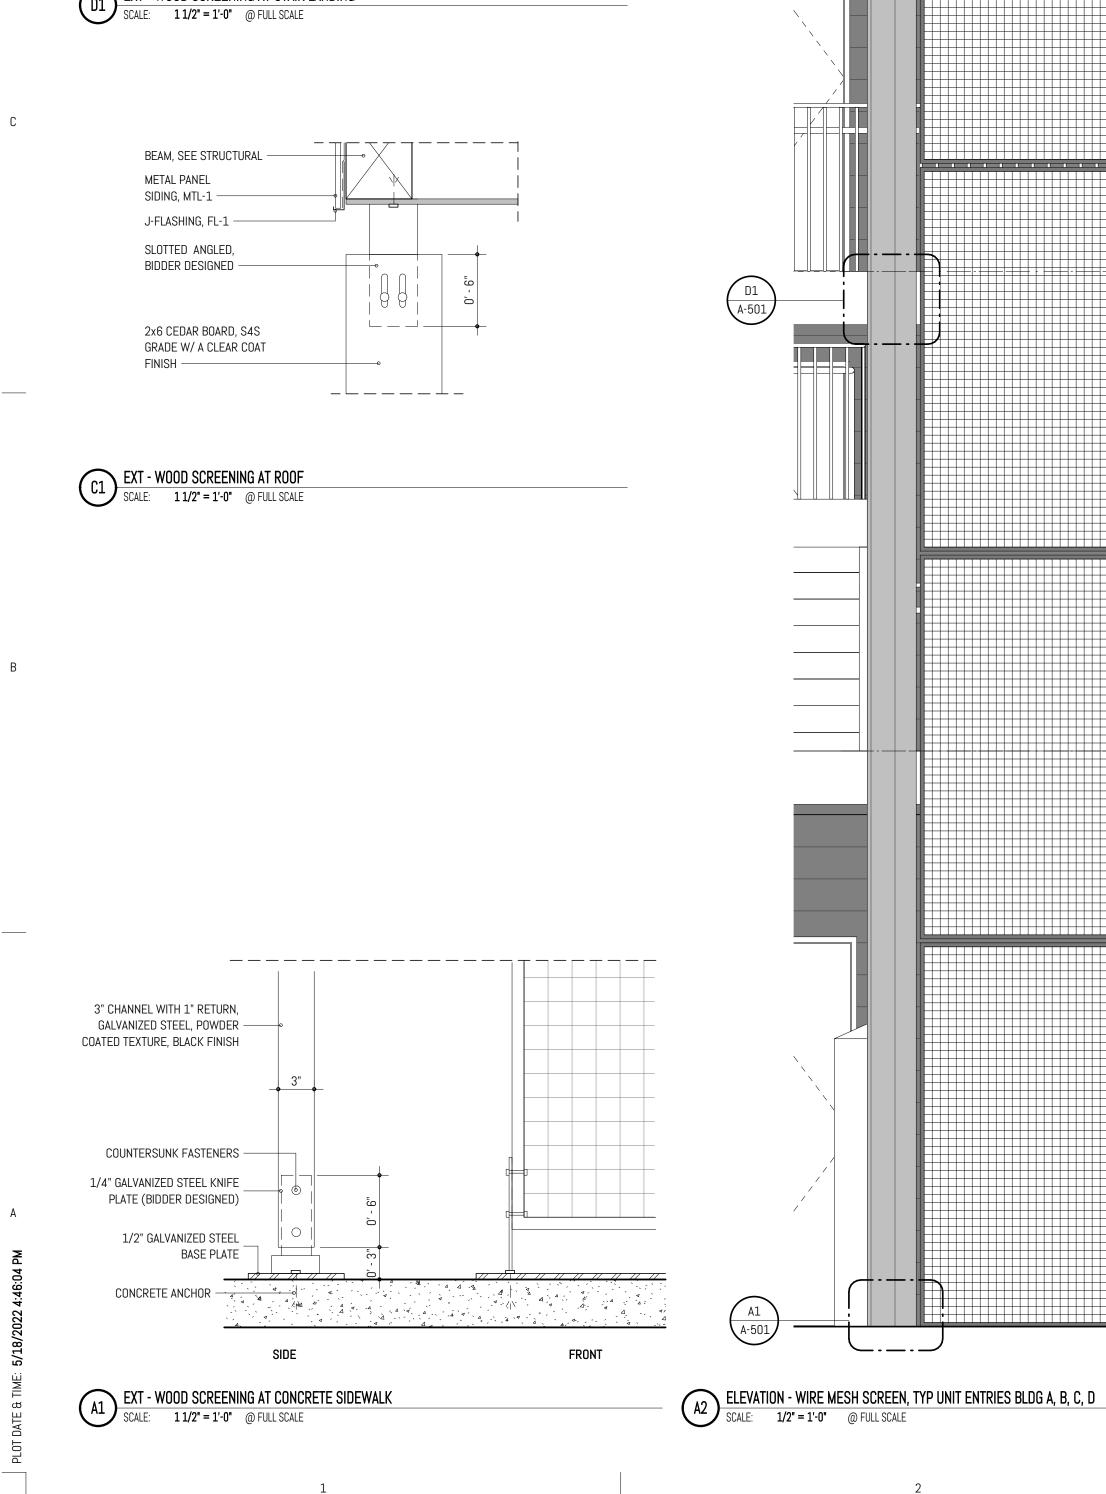

D1 EXT - WOOD SCREENING AT STAIR LANDING SCALE: 1 1/2" = 1'-0" @ FULL SCALE

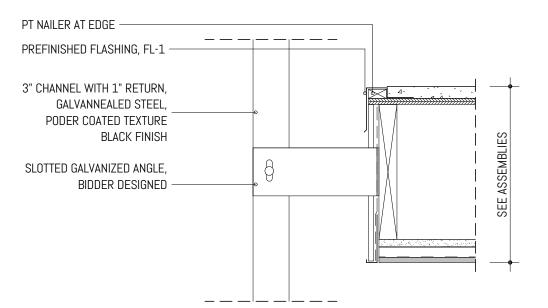


1

D


Item 7.

2

A-501

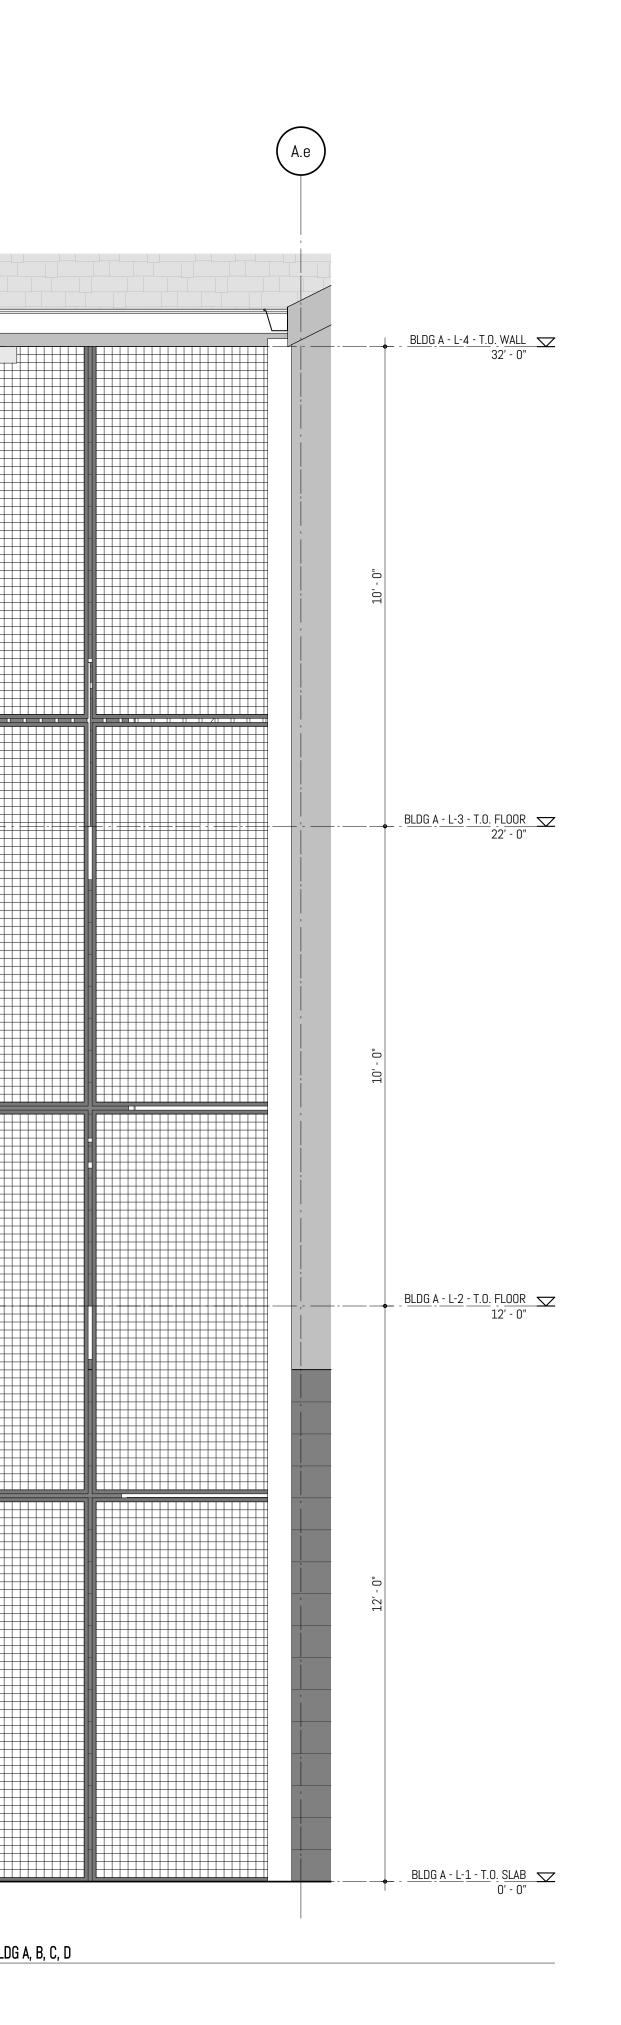

3

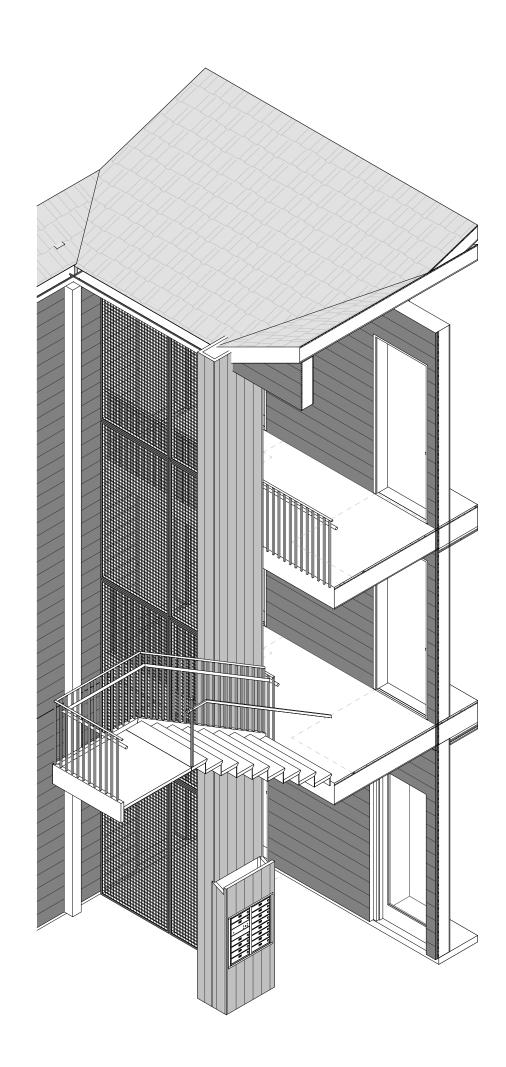

4




WIRE MESH SCREEN

0


A3 TENANT MAILBOX - FLOOR PLAN SCALE: 11/2" = 1'-0" @ FULL SCALE

MAILBOX ———


4

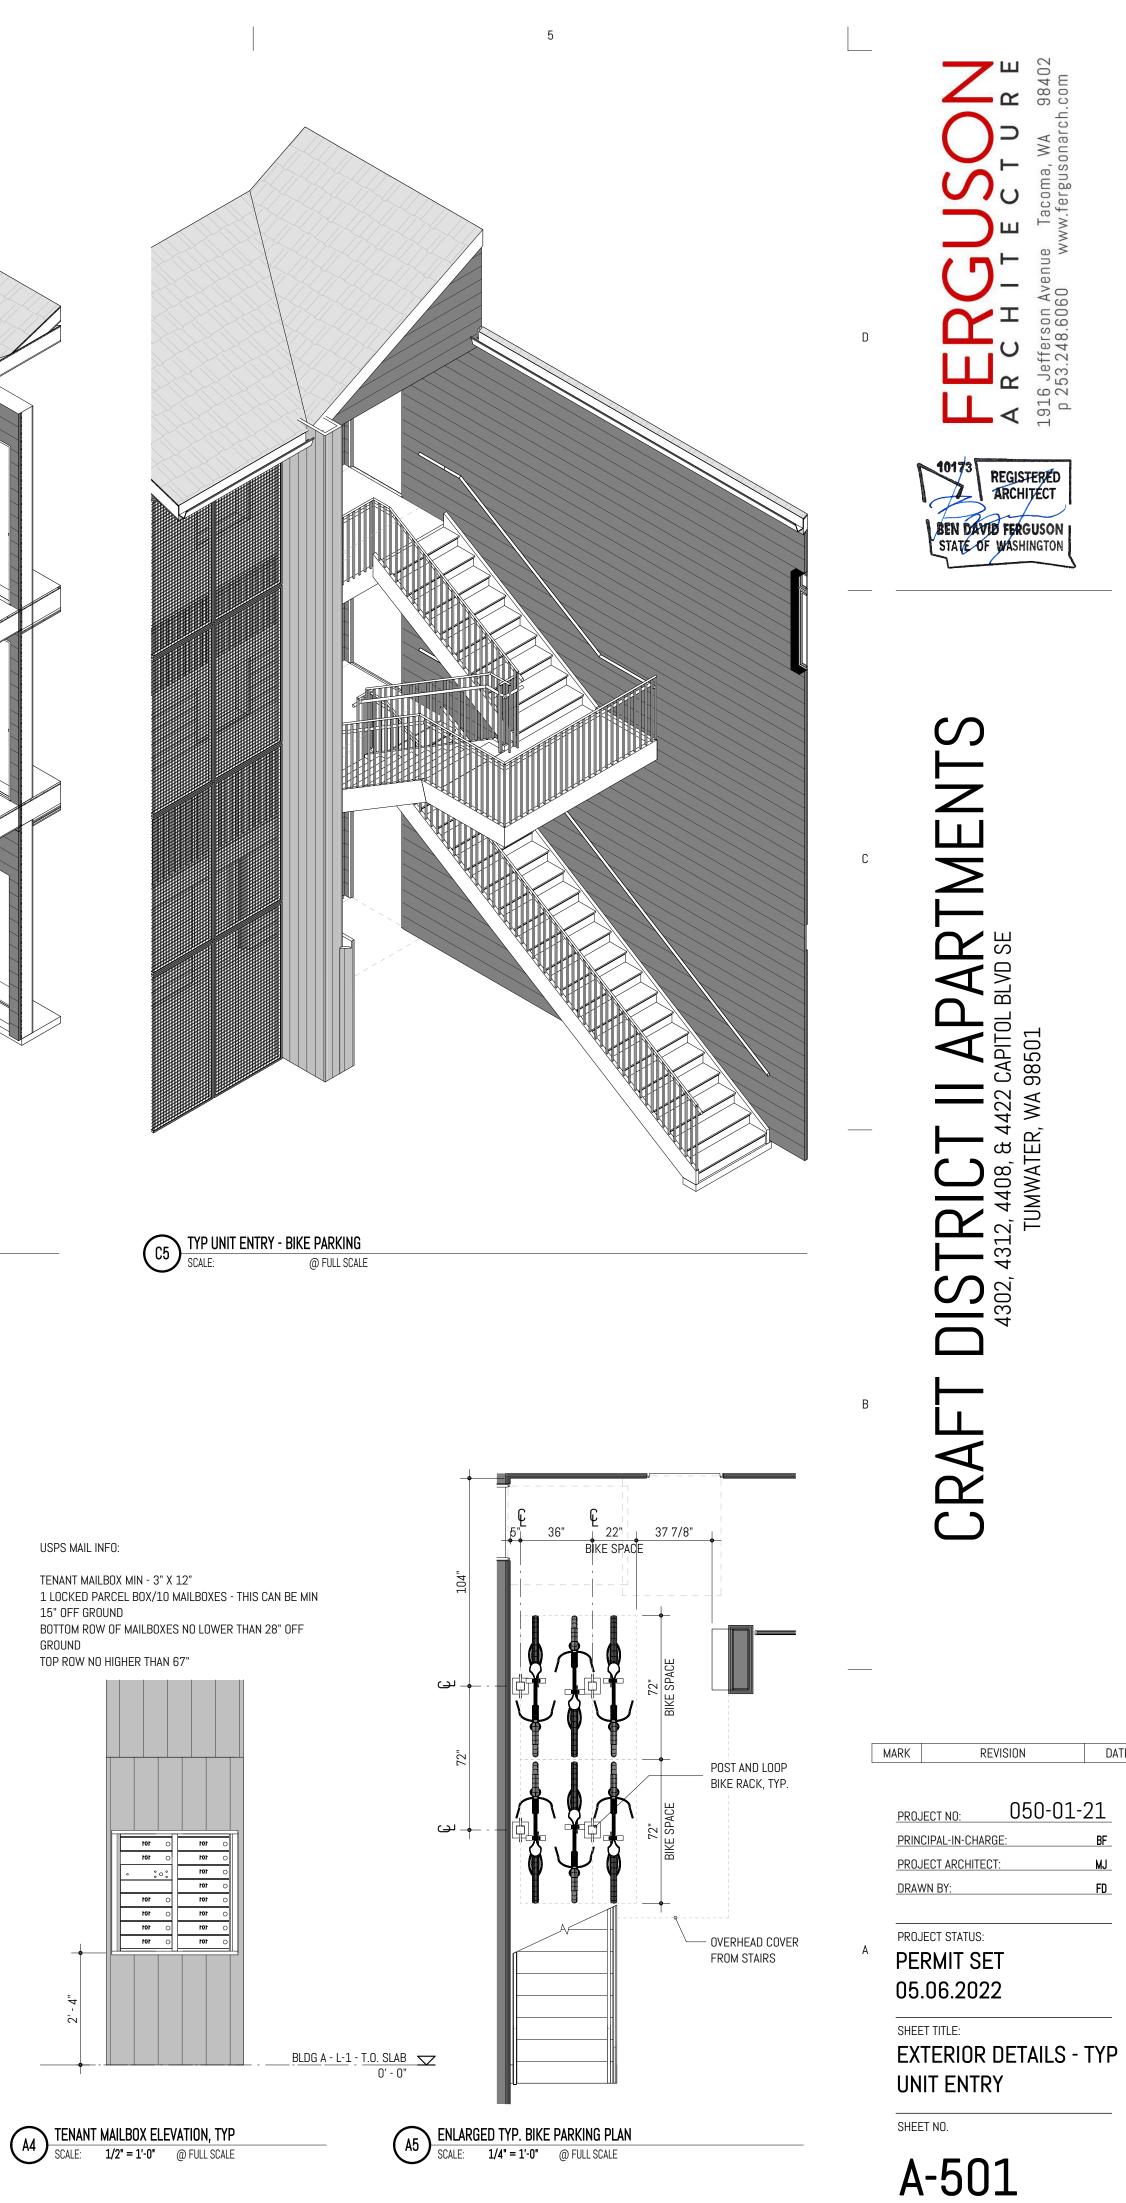


DATE

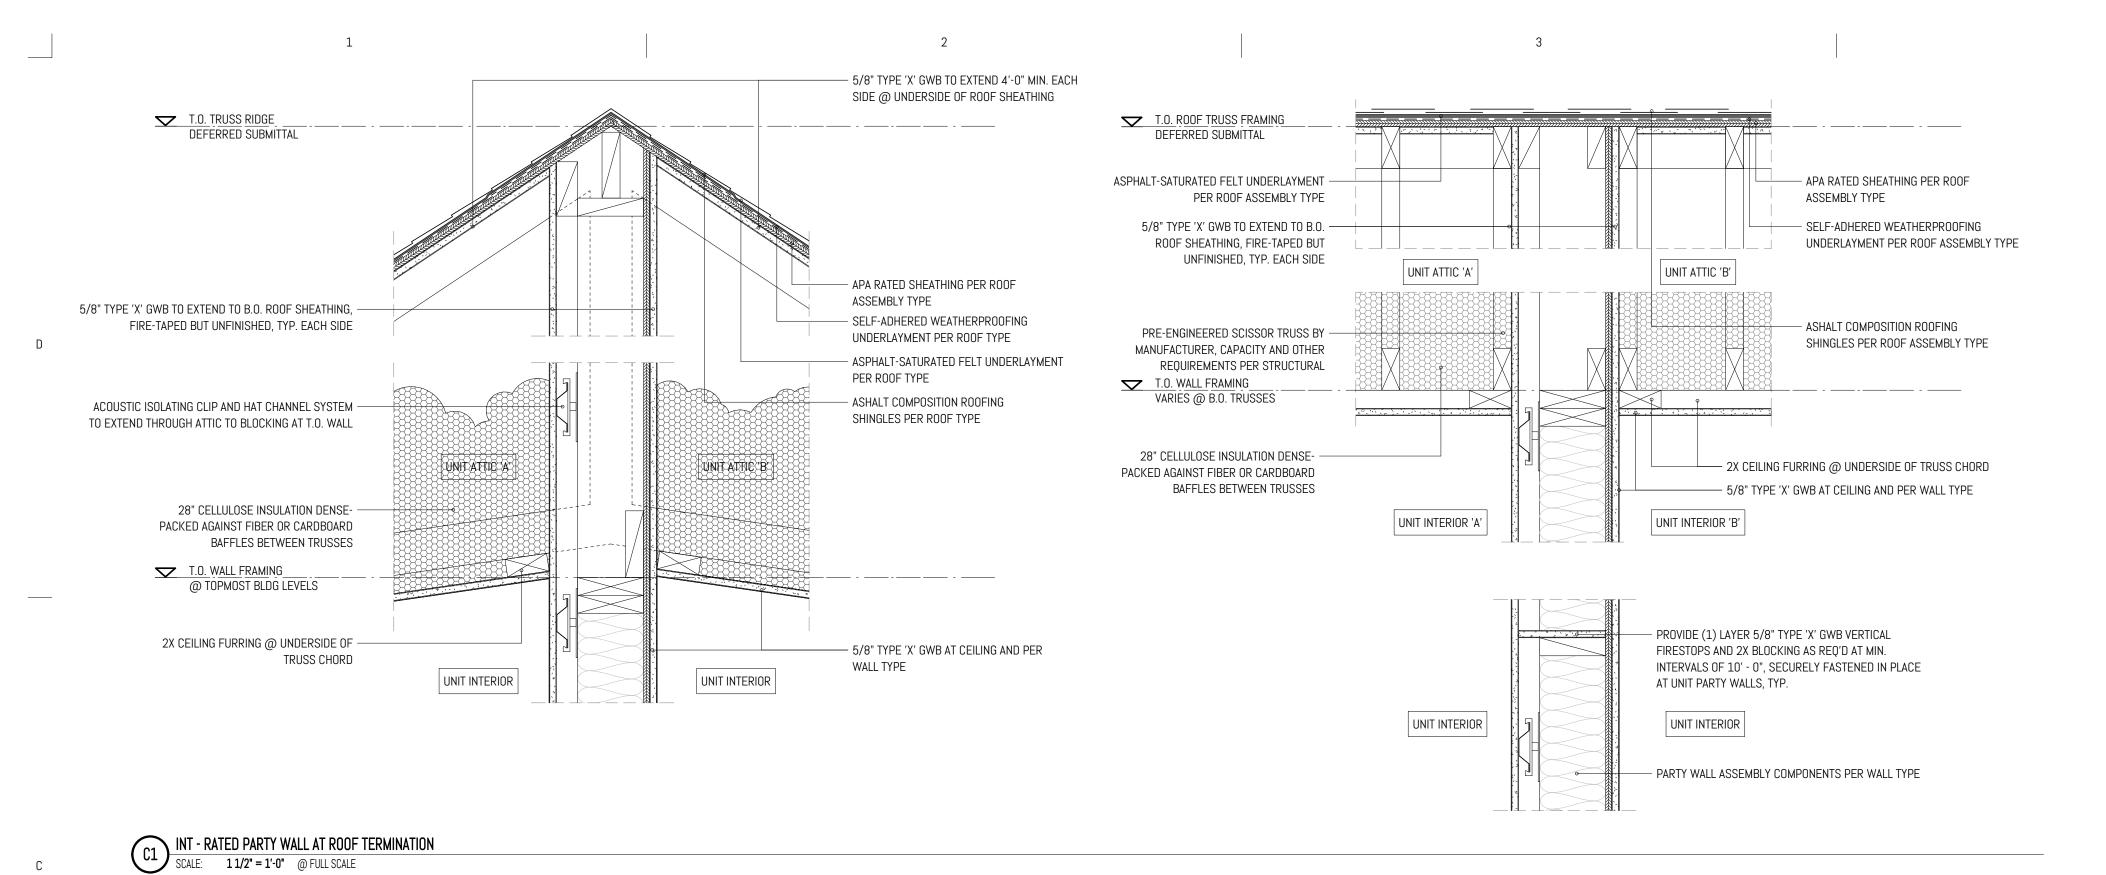

B1 INT - NON-BEARING WALL AT 1HR FLOOR SCALE: 11/2" = 1'-0" @ FULL SCALE

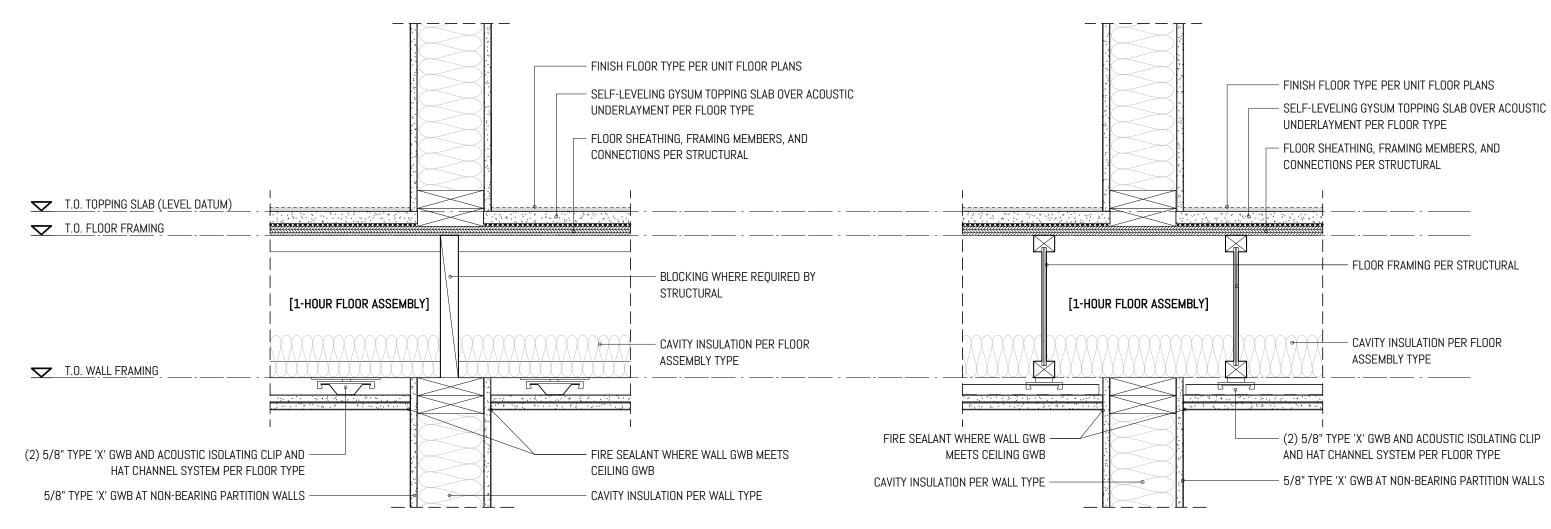

### INTERIOR DETAIL - TYP. INTERIOR NON-BEARING WALL AT PERPENDICULAR FLOOR FRAMING

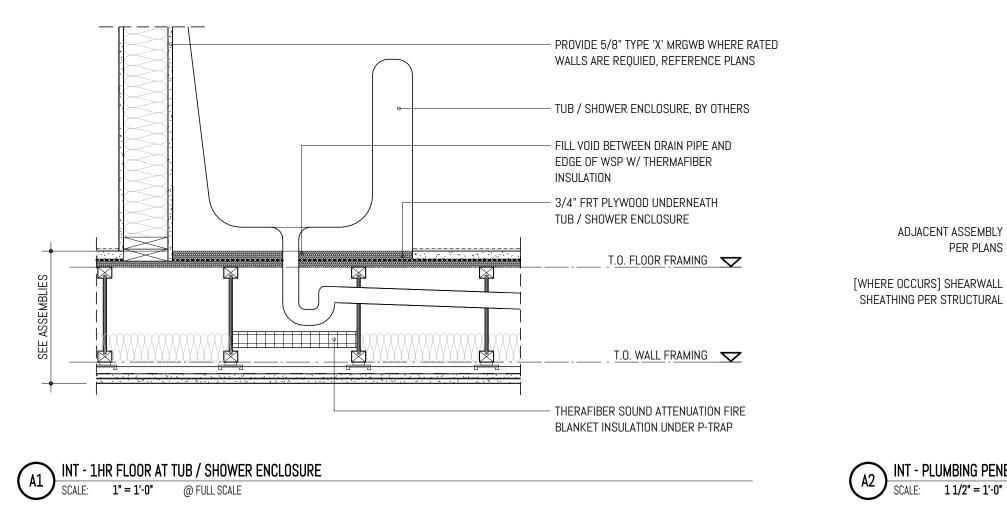


ltem 7.

- SELF-LEVELING GYSUM TOPPING SLAB OVER ACOUSTIC - FLOOR SHEATHING, FRAMING MEMBERS, AND

- FLOOR FRAMING PER STRUCTURAL

- (2) 5/8" TYPE 'X' GWB AND ACOUSTIC ISOLATING CLIP AND HAT CHANNEL SYSTEM PER FLOOR TYPE

INTERIOR DETAIL - TYP. INTERIOR NON-BEARING WALL AT PARALLEL FLOOR FRAMING

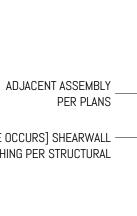



TUB/SHOWER VALVE AND SPOUT PENETRATIONS SHALL BE PROTECTED PER UL FIRESTOP.

# A2 INT - PLUMBING PENETRATION AT 1HR WALL, TYP SCALE: 11/2" = 1'-0" © FUEL COME

A3 INT - PARTY WALL AT 1HR FLOOR SCALE: 11/2" = 1'-0" @ FULL SCALE

FINISH FLOOR TYPE PER UNIT FLOOR PLANS -

T.O. TOPPING SLAB (LEVEL DATUM)

SELF-LEVELING GYSUM TOPPING SLAB OVER

ACOUSTIC UNDERLAYMENT PER FLOOR TYPE

FLOOR SHEATHING, FRAMING MEMBERS, AND

CONTINUOUS BEAD OFFIRE SEALANT, TYP.

WHERE VERTICAL GWB MEETS RATED

HORIZONTAL ASSEMBLY

CONNECTIONS PER STRUCTURAL

T.O. FLOOR FRAMING


T.O. WALL FRAMING

UNIT INTERIOR

[1-HOUR FLOOR ASSEMBLY]


UNIT INTERIOR

3

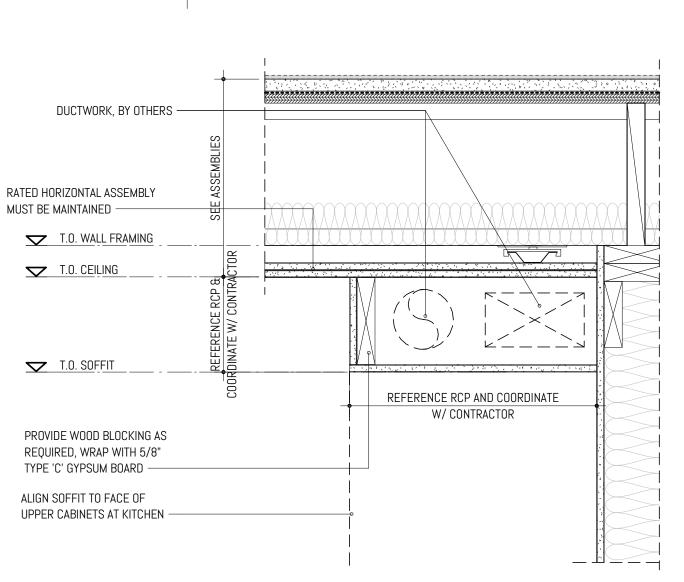


### NINT - SOFFIT AT MECH DUCTWORK SCALE: 11/2" = 1'-0" @ FULL SCALE

D5

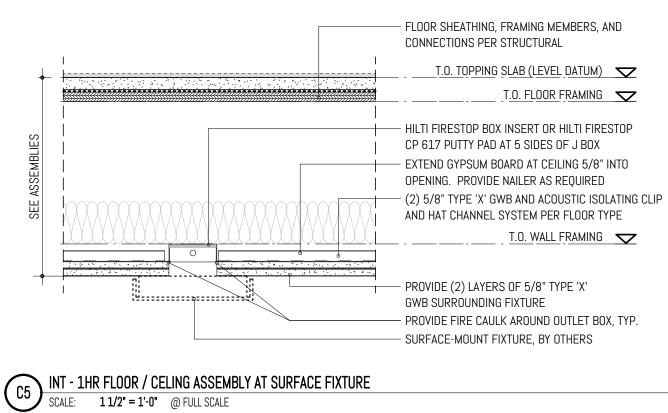

# B5 INT - 1HR FLOOR / CELING ASSEMBLY AT FIXTURE SCALE: 11/2" = 1'-0" @ FULL SCALE

SCALE: 11/2" = 1'-0" @ FULL SCALE

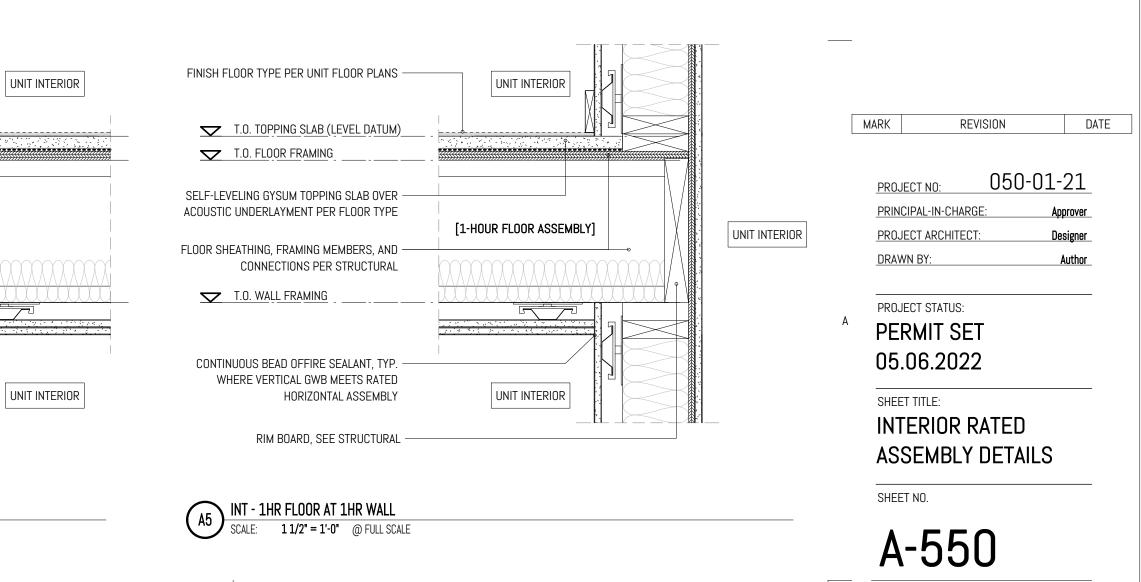

REGISTERED ARCHITECT BEN DAVID FERGUSON STATE OF WASHINGTON

IMEN

8, & ATE ф

4302, 433

CRAF

PROVIDE (2) LAYERS OF 5/8" TYPE 'X' GWB SURROUNDING FIXTURE - FLOOR SHEATHING, FRAMING MEMBERS, AND CONNECTIONS PER STRUCTURAL T.O. TOPPING SLAB (LEVEL DATUM) 🔽 T.O. FLOOR FRAMING 🔽 – FAN / FIXTURE, BY OTHERS — EXHAUST, BY OTHERS

T.O. FLOOR FRAMING 🔽

T.O. WALL FRAMING 🔽

- EXTEND GYPSUM BOARD AT CEILING 5/8" INTO OPENING. PROVIDE NAILER AS REQUIRED T.O. WALL FRAMING 🔽

- (2) 5/8" TYPE 'X' GWB AND ACOUSTIC ISOLATING CLIP AND HAT CHANNEL SYSTEM PER FLOOR TYPE - PROVIDE FIRE CAULK AROUND FIXTURE, TYP.

				CO	MMON D	OOR SCH	IEDULE			
MARK	DOOR						FRAME			
MARK	TYPE	MATERIAL	FINISH	THICKNESS	WIDTH	HEIGHT	TYPE	MATERIAL	FINISH	HARDWARE
A102.1a	С	НМ	P-1	0' - 1 1/2"	3' - 0"	7' - 0"	В	НМ	P-1	04
A102.2a	С	HM	P-1	0' - 1 1/2"	3' - 0"	7' - 0"	В	НМ	P-1	04
A102.3a	A	HM	P-1	0' - 1 1/2"	3' - 2 1/2"	6' - 8"	В	НМ	P-1	05
A102.4a	A	НМ	P-1	0' - 2"	3' - 0"	6' - 8"	В	НМ	P-1	05
1100	0			0/ 1 1 /0"	01 01	0/ 11 1/4				00

A102a C ESF-1 FF 0'-11/2" 3'-6" 8'-111/4" ESF-1 ESF-1 FF 03

A112a A HM EP-1 0'-13/8" 3'-21/2" 8'-0" B HM EP-1 01

### DOOR ASSEMBLY & INSTALLATION - GENERAL NOTES


1

1. ALL EXTERIOR DOORWAYS TO BE SEALED, CAULKED, GASKETED, AND/OR

WEATHERSTRIPPED TO PREVENT AIR LEAKAGE AND MOISTURE FILTRATION.

2. ALL GLAZING IN INTERIOR DOORS TO HAVE LAMINATED INSULATED SAFETY GLAZING. 3. ALL DOOR GLAZING AND/OR RELITE GLAZING WITHIN 12" OF A DOOR OPENING AND 18"

OF FLOOR TO BE SAFETY RATED.

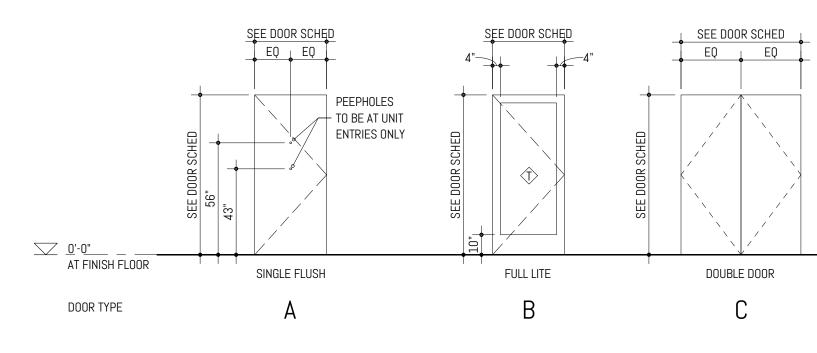


С


В

П

ltem 7. 

1

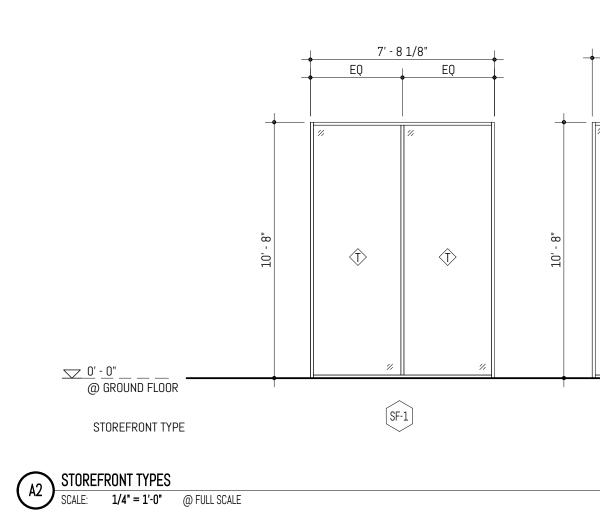

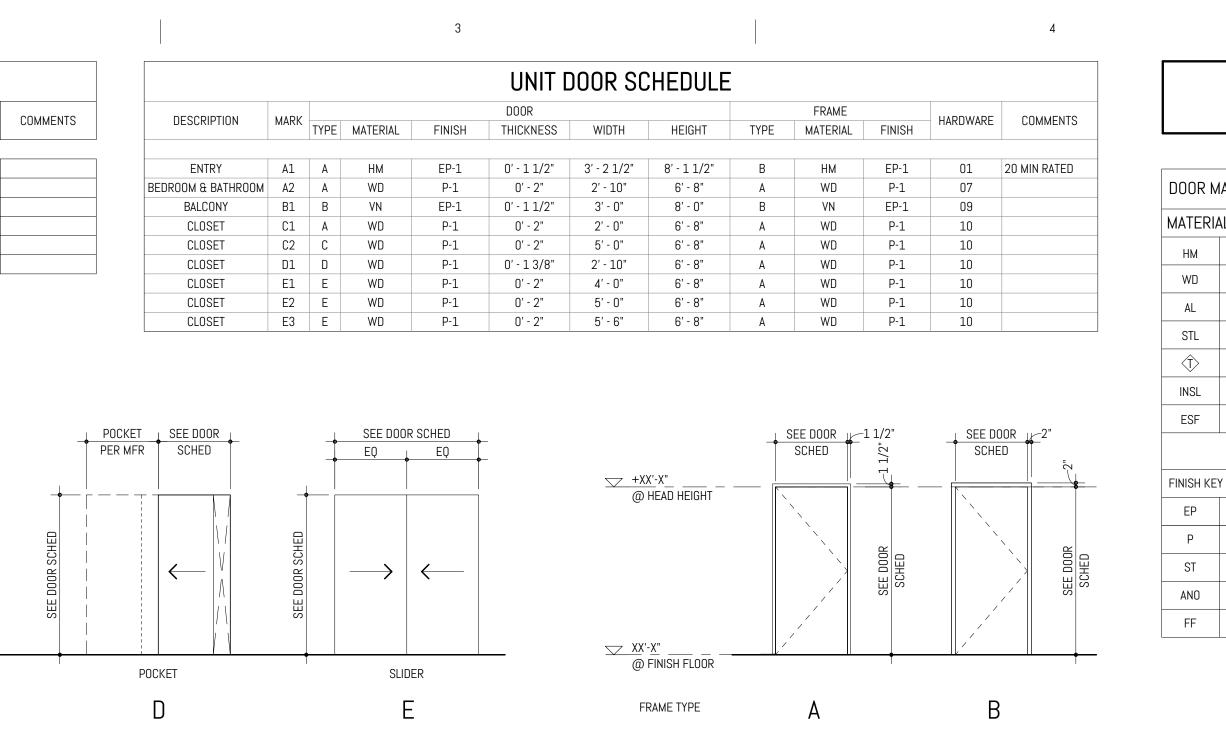

WINDOW SCHEDULE						
TYPE	MATERIAL	WIDTH	HEIGHT	SILL HEIGHT	COMMENTS	
			•			
W-1	WN-1	2' - 0"	6' - 0"	3' - 0"		
W-2	WN-1	6' - 0"	6' - 0"	3' - 0"		
W-3	WN-1	2' - 0"	5' - 0"	3' - 0"		
W-4	WN-1	6' - 0"	5' - 0"	3' - 0"		
W-5	WN-1	4' - 0"	5' - 0"	3' - 0"		
W-6	WN-1	2' - 0"	5' - 0"	3' - 0"		
W-7	WN-1	2' - 0"	6' - 0"	3' - 0"		


3

WINDOW ASSEMBLY & INSTALLATION - GENERAL NOTES


1. GENERAL CONTRACTOR TO FIELD VERIFY (E) ROUGH OPENINGS AND CONFIRM WITH


ARCHITECT BEFORE PURCHASE AND INSTALL OF (N) WINDOWS. 2. ALL EXTERIOR WINDOW OPENINGS TO BE SEALED, CAULKED, GASKETED, AND/OR

WEATHERSTRIPPED TO PREVENT AIR LEAKAGE AND MOISTURE FILTRATION.

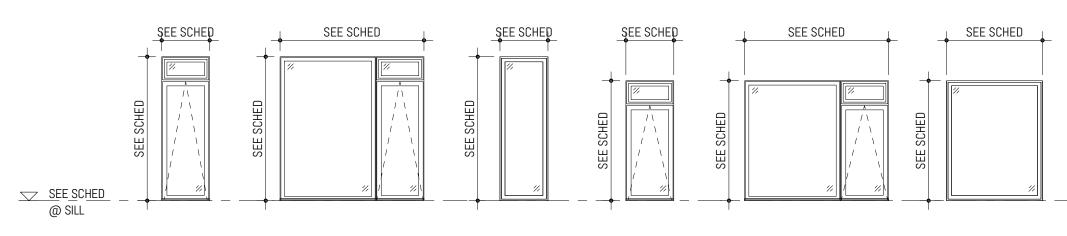

\_\_\_\_\_0'-0" \_\_\_\_\_ @ FINISH FLOOR

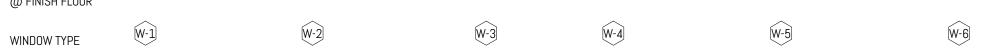

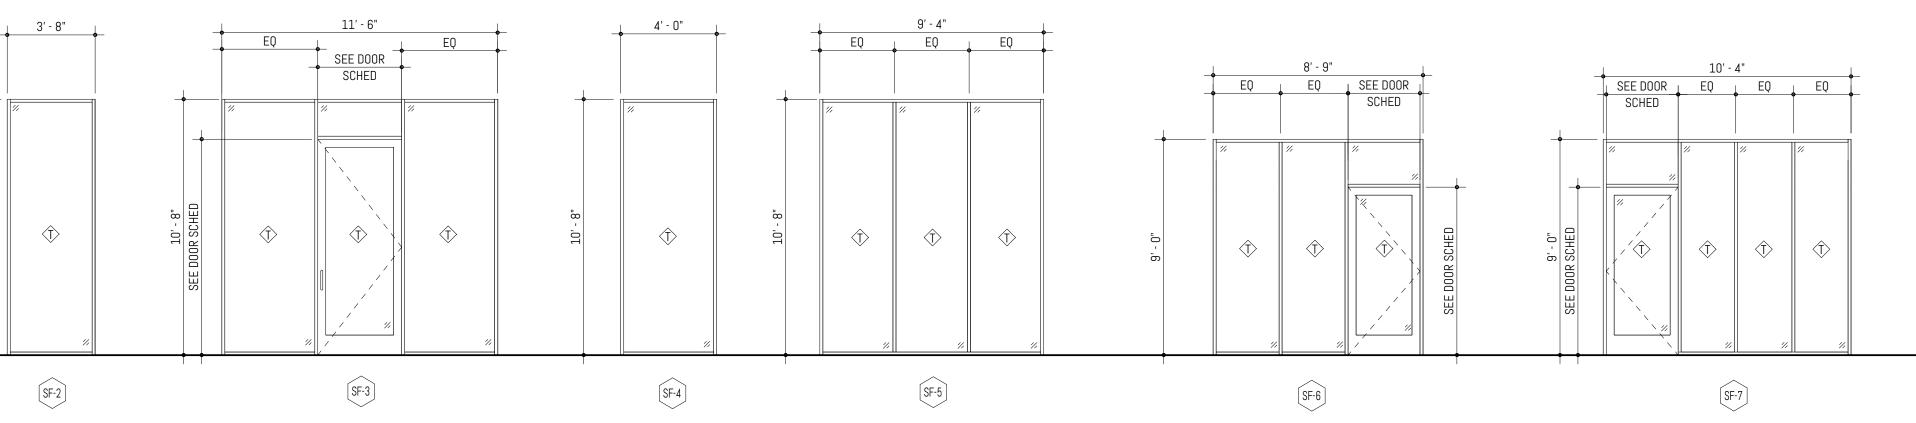

4

# **OPENING TYPES GENERAL NOTES**

## DOOR MATERIAL & FINISH LEGEND

RIA	AL KEY
	HOLLOW METAL
	WOOD
	ALUMINUM
	STEEL
	TEMPERED GLASS
-	INSULATED
	STOREFRONT (EXTERIOR)

PAINT (EXTERIOR)	
PAINT (INTERIOR)	
STAIN	
ANODIZED	
FACTORY FINISH	

MATERIAL FINISHES HAVE BEEN ABBREVIATED PER THE FINISH LEGEND - SEE SHEET A-400 FOR ADDITIONAL INFORMATION.

5

- FOR WINDOW DIMENSIONS, REFER TO SCHEDULES. DIMENSIONS NOTED INSTRUCT DESIGN INTENT. MEASUREMENTS TO BE V.I.F.
- 3. FIT BACKERROD AND SEALANT TO MEET TOLERANCE AT WINDOW FRAMES, MINIMUM 3/8" -MAXIMUM 1" AT EACH INSTANCE.
- 4. ALL UNIT DOORS TO BE PAINTED SOLID CORE DOORS. UNIT DOOR FRAMES TO BE TYPE 'A' D PROFILE AND MDF, PAINTED PER OPENING SCHEDULE.
- 5. BALCONY DOORS WILL BE VINYL DOORS WITH A FACTORY FINISH.
- 6. DOOR HARDWARE TO STAIN STAINLESS STEEL, US32D, UNO.
- 7. REFER TO CODE SUMMARY SHEET SERIES, G-000, FOR ENERGY PERFORMANCE REQUIREMENTS.

## OPENING TYPES

A	EXTERIOR WINDOW / GLAZING
1	INTERIOR WINDOW / GLAZING

LV-1 EXTERIOR LOUVER LV-A INTERIOR LOUVER


	98402 com
	98. .cor
<b>O</b> <sup>-</sup>	e Tacoma, WA 98. www.fergusonarch.con
	la, usc
	Tacoma, WA w.fergusonar
	Ta.ww/
	Avenue 30 w
<b>U</b> -	Ave S0
	50n 606
	efferson A 3.248.606
∢	1916 p 2
10173 REGIST	FERED



DOOR HARDWARE GROUPS							
MARK GENERAL LOCATION COMPONENTS QTY. COMMENTS							
<u>GROUP <b>01</b></u> 45 MIN RATING	UNIT ENTRY	4 1/2" BUTTS ENTRY LOCKSET WALL STOP SILENCER CLOSER	4 1 1 1 1				
<u>GROUP <b>02</b></u>	LOBBY ENTRY	4 1/2" BUTTS ENTRY LOCKSET ASTRAGAL	8 1 1	REMOVABLE			
<u>GROUP <b>03</b></u>	LOBBY ENTRY	4 1/2" BUTTS ENTRY LOCKSET ASTRAGAL CLOSER	8 1 1 1	REMOVABLE			
<u>GROUP</u> 04	OFFICE / CONFERENCE	4 1/2" BUTTS PRIVACY LOCKSET WALL STOP	4 1 1				
<u>GROUP</u> 05	JANITOR / STORAGE	4 1/2" BUTTS STORAGE ROOM LOCKSET WALL STOP KICKPLATE	3 1 1 1				
<u>GROUP</u> 06	RESTROOMS / PASS-THRU	4 1/2" BUTTS PRIVACY LOCKSET WALL STOP SILENCER KICK PLATE	3 1 1 1 1				
<u>GROUP <b>07</b></u>	BEDROOMS / BATHROOMS	4 1/2" BUTTS PRIVACY LOCKSET WALL STOP	3 1 1				
<u>GROUP</u> 08	STORAGE	4 1/2" BUTTS PASSAGE SET	3				
<u>GROUP <b>09</b></u>	BALCONY	4 1/2" BUTTS PRIVACY LOCKSET	4				
<u>GROUP</u> 10	CLOSET / BATHROOMS	BY CONTRACTOR	1				

5



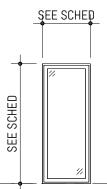




	MARK	MARK REVISION		DA	ΔTE
	PROJ	IECT NO:	050-01-	21	
	PRIN	CIPAL-IN-CHARGE:		BF	
	PROJ		MJ		
	DRAWN BY:				
A	PE	IECT STATUS: RMIT SET .06.2022			

SHEET TITLE: OPENING TYPES AND SCHEDULE

SHEET NO.

A-600

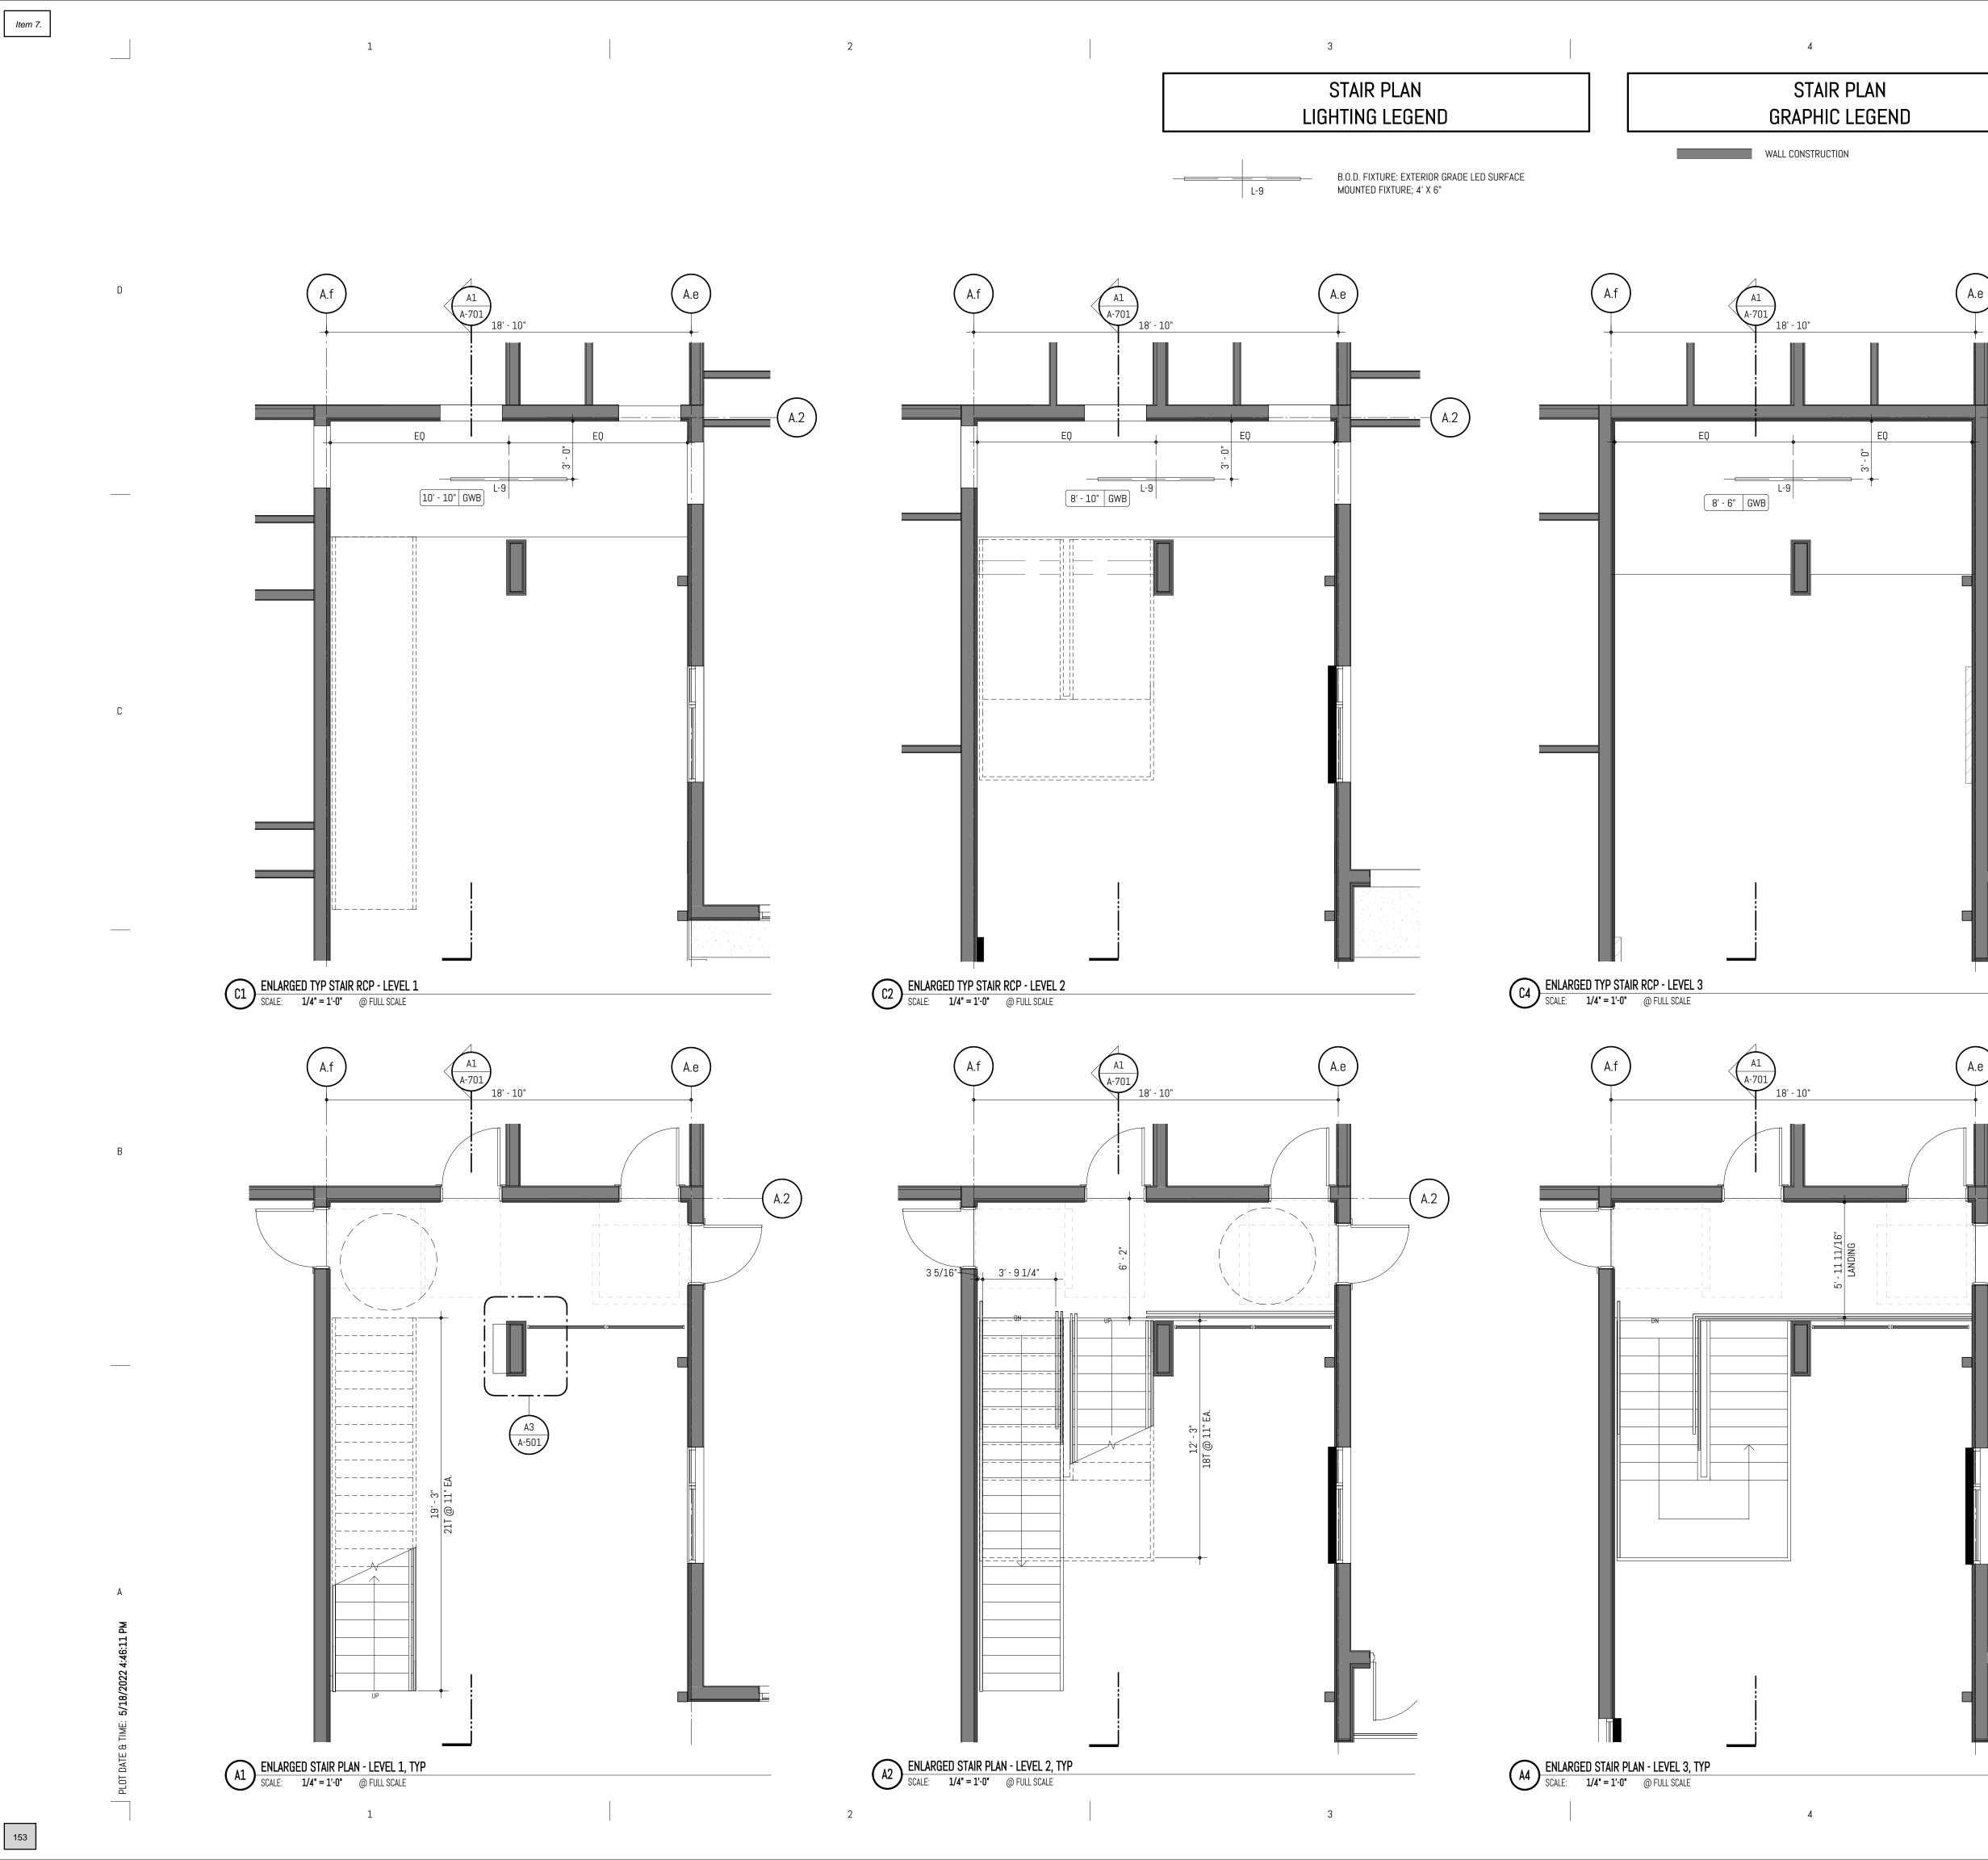




1. HANDRAILS SHALL COMPLY WITH WA. STATE AMENDMENTS TO 2018 IBC, SECTION 1014. WHERE GUARDRAILS ARE REQUIRED, THEY SHALL COMPLY WITH 2018 IBC, SECTION 1011. A. STAIRWAYS AND LANDINGS TO HAVE AT MINIMUM 44" CLEAR DIMENSION.

- B. A PROJECTION GREATER THAN 4" INTO THE STAIR WIDTH IS NOT ALLOWED UNLESS IT IS GREATER THAN 80" ABOVE THE EDGE OF THE NOSINGS, INCLUDING ONE TREAD DEPTH BEYOND THE BOTTOM RISER. THIS MINIMUM HEAD ROOM CLEARANCE SHALL BE MAINTAINED ABOVE LANDINGS. C. A 4" SPHERE SHALL NOT PASS THROUGH ANY OPENING WITHIN A GUARD. A GUARD EXTENDS FROM TOP OF STRINGER, OR CLOSURE PLATE, TO THE TOP OF GUARDRAIL.
- 2. RAIL HEIGHTS ARE PLUMB TO NOSE OF TREADS, U.N.O.

A.2

A.2

- 3. AT STAIRS, GUARDRAIL PICKETS ARE 1/2" X 1/2" BAR, U.N.O. 4. VERTICAL GUARDRAILS TO BE EQUALLY SPACED BUT NO GREATER THAN 4'-0" O.C., DIMENSIONED TO
- CENTERLINE OF STEEL BALUSTER, MAX.
- 5. HINGE-SIDE DOOR PLACEMENT 4" FROM NEAREST WALL U.N.O. TYP.

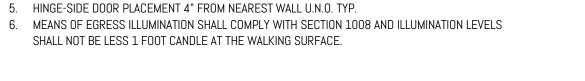







MARK		REVISION	DATE
		050.01	01
PRO	JECT NO:	050-01-	21
PRIN	<u>CIPAL-IN-C</u>	HARGE:	BF
PRO	JECT ARCH	ITECT:	MJ
DRA	WN BY:		HL
PRO	JECT STATI	JS:	
ΡE	RMIT	SET	
05	.06.20	122	
	.00.20	522	
SHE	et title:		
от			


STAIRS - PLANS & RCPS

SHEET NO.

A-700





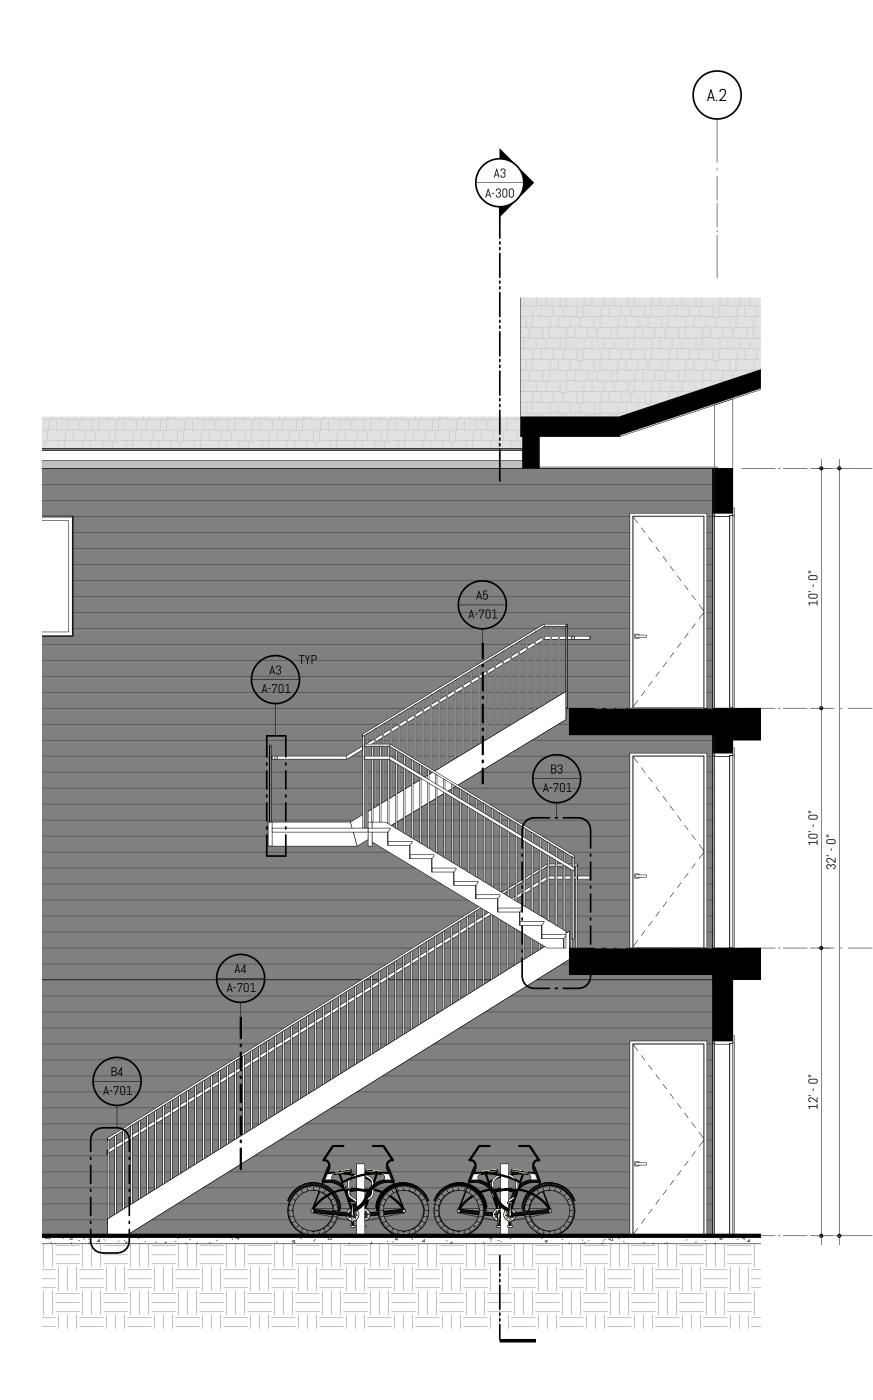

A1 STAIR SECTION - LONGITUDINAL SCALE: 1/4" = 1'-0" @ FULL SCALE

1


154


ltem 7.


П

С

1

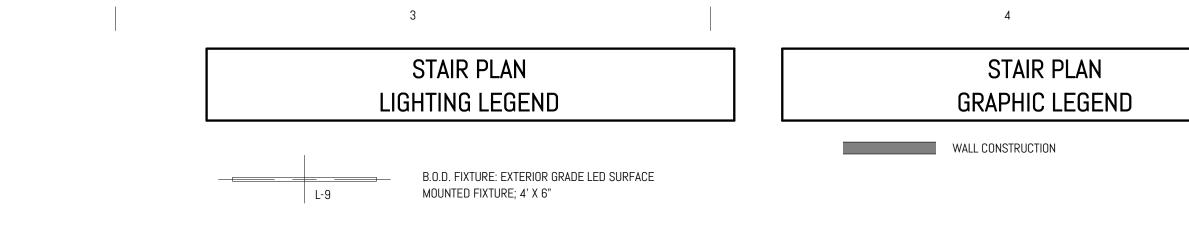

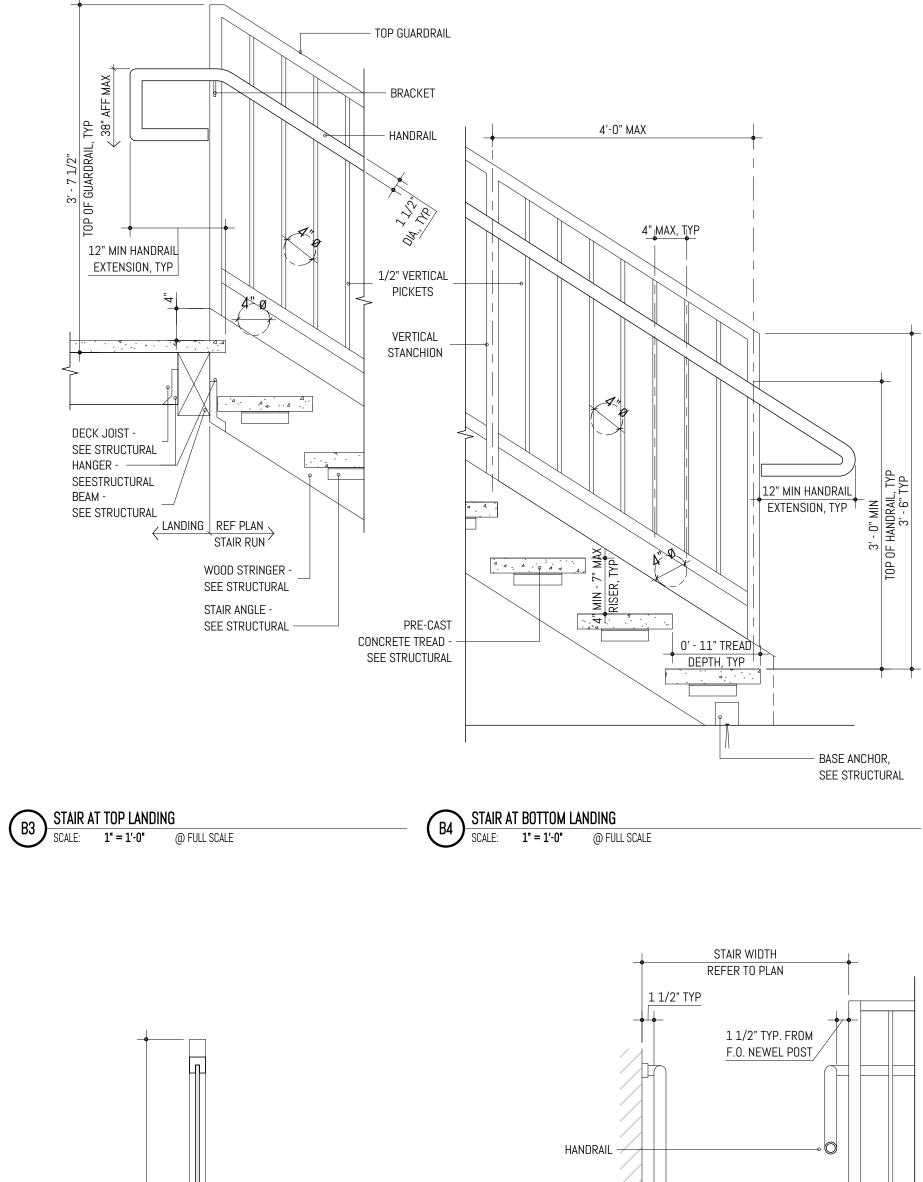

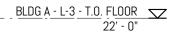


BLDG A - L-4 - T.O. WALL


32' - 0"

2




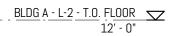



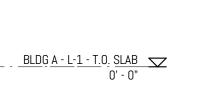

2

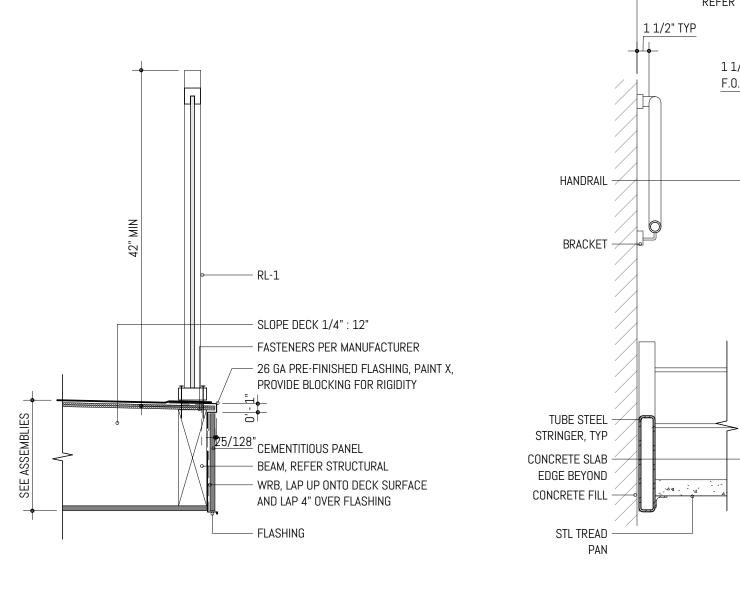

 GUARDRAIL DETAIL AT STAIR LANDING

 SCALE:
 1" = 1'-0"

 @ FULL SCALE


4


# STAIR PLAN & SECTION **GENERAL NOTES**


- 1. HANDRAILS SHALL COMPLY WITH WA. STATE AMENDMENTS TO 2018 IBC, SECTION 1014. WHERE GUARDRAILS ARE REQUIRED, THEY SHALL COMPLY WITH 2018 IBC, SECTION 1011. A. STAIRWAYS AND LANDINGS TO HAVE AT MINIMUM 44" CLEAR DIMENSION.
- B. A PROJECTION GREATER THAN 4" INTO THE STAIR WIDTH IS NOT ALLOWED UNLESS IT IS GREATER THAN 80" ABOVE THE EDGE OF THE NOSINGS, INCLUDING ONE TREAD DEPTH BEYOND THE BOTTOM RISER. THIS MINIMUM HEAD ROOM CLEARANCE SHALL BE MAINTAINED ABOVE LANDINGS. C. A 4" SPHERE SHALL NOT PASS THROUGH ANY OPENING WITHIN A GUARD. A GUARD EXTENDS
- FROM TOP OF STRINGER, OR CLOSURE PLATE, TO THE TOP OF GUARDRAIL. 2. RAIL HEIGHTS ARE PLUMB TO NOSE OF TREADS, U.N.O.
- 3. AT STAIRS, GUARDRAIL PICKETS ARE 1/2" X 1/2" BAR, U.N.O.
- 4. VERTICAL GUARDRAILS TO BE EQUALLY SPACED BUT NO GREATER THAN 4'-0" O.C., DIMENSIONED TO CENTERLINE OF STEEL BALUSTER, MAX.
- 5. HINGE-SIDE DOOR PLACEMENT 4" FROM NEAREST WALL U.N.O. TYP.
- 6. MEANS OF EGRESS ILLUMINATION SHALL COMPLY WITH SECTION 1008 AND ILLUMINATION LEVELS SHALL NOT BE LESS 1 FOOT CANDLE AT THE WALKING SURFACE.





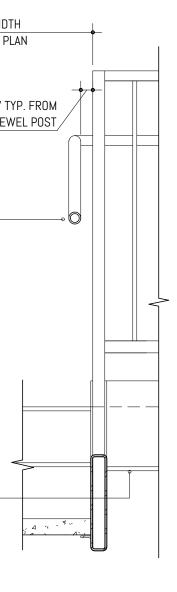

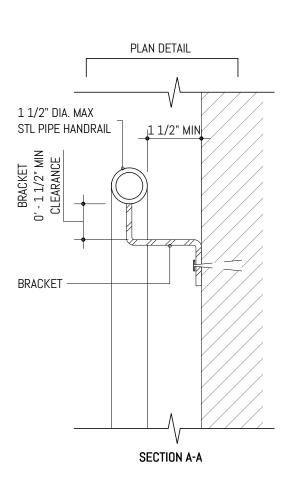

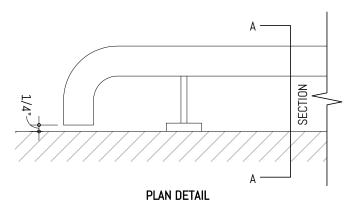

A5 STAIR HANDRAIL AT WALL SCALE: 3" = 1'-0" @ FULL SCALE



MARK	REVISION		DATE
PRO	JECT NO:	050-01-	21
PRIN	CIPAL-IN-CHARGE	:	BF
PROJ	JECT ARCHITECT:		MJ
DRAV	WN BY:		HL
PRO	JECT STATUS:		
PE	RMIT SET		
05	.06.2022		
0.121	ET TITLE:		
ST	AIRS - SE	CTIONS 8	t
DE	TAILS		
SHEE	et no.		



Exhibit "C"

4200 Capitol Blvd S Tumwater WA, 98501 360.790.8570 www.tumwatercraftdistrict.com



September 20, 2022

Tami Merriman City of Tumwater Public Works 555 Israel Rd SW Tumwater, WA 98501

Ms. Merriman,

This letter and enclosed attachments are intended to present grounds for the Multifamily Tax Exemption. Please advise if any additional information is needed for application review and issuance of a conditional certificate.

Craft District II, LLC is applying for the Multifamily Tax Exemption at 4300 Capitol Blvd SE, Tumwater WA, 98501. This property is within a residential target area, is proposed to include approximately 95 market rate permanent residential apartments, and will not displace any existing residential tenants. The project is proposed to begin construction in 2022 in compliance with City Guidelines and Standards.

Craft District II, LLC acknowledges the potential tax liability when the project ceases to be eligible for tax exemption in eight years.

The signature below shall be considered affirmation of all information within this letter and attached.

Thank you,

John Peters Managing Member Craft District II, LLC

Attached: City of Tumwater Application Preliminary Floor and Site Plans

#### Attachment F

ltem	7.

Contraction of the
CITY OF
TUMWATTER

	CITY OF TUMWATER	TUM	DATE STAMP
	555 ISRAEL RD. SW, TUMWATER, WA 98501	<u>-22-1393</u>	
	(360) 754-4180		
	Email: <u>cdd@ci.tumwater.wa.us</u>		
	TAX EXEMPTION ON MULTI-FAMILY UNITS		
	WITHIN A DESIGNATED RESIDENTIAL		
K	TARGET AREA		
	APPLICATION FOR A CONDITIONAL		
	CERTIFICATE		
	SUPPLEMENTAL QUESTIONS	RCVD BY	

#### **PROJECT INFORMATION**

PROPERTY ADDRESS: 4300 Capitol Blvd SE, Tumwater, WA 98501

PARCEL #: <u>3387000400</u> PROJECT NAME: <u>Deschutes Valley Apartments</u>

DESCRIPTION OF THE PROJECT, INCLUDING USES OF ALL PROPOSED BUILDING AND ON-

SITE AMENITIES: Green space & walking trail access.

#### COMPLETE THE FOLLOWING TABLE:

PROPOSED DWELLING UNITS	STUDIO	1-BR	2-BR	3-BR+	TOTAL UNITS
NUMBER OF INCOME-RESTRICTED UNITS	N/A				N/A
NUMBER OF MARKET-RATE UNITS	24	31	40		95
AVERAGE MONTHLY RENT (INCOME- RESTRICTED)	N/A				N/A
AVERAGE MONTHLY RENT (MARKET- RATE)	\$1,600.00	\$1,900.00	\$2,320.00	N/A	95
AVERAGE UNIT SIZE (SF)	577	619	961		
DEVELOPMENT COST PER UNIT	\$90,000.00	\$116,000.00	\$156,00.00		
NUMBER OF UNITS VACANT FOR 12 MONTHS OR MORE*	0				
NUMBER OF UNITS THAT ARE CURRENTLY OCCUPIED*	0				
	1			1	1

\* COMPLETE IF APPLICANT WILL REHABILITATE EXISTING UNITS

TOTAL SITE AREA: <u>3.47acre's</u> **PROPOSED DENSITY**: <u>27 units per acre</u>

#### STATEMENT OF POTENTIAL TAX LIABILITY

AS OWNER OF THE LAND DESCRIBED IN THIS APPLICATION, I HEREBY INDICATE BY MY SIGNATURE THAT I AM AWARE OF THE ADDITIONAL TAX LIABILITY IF AND WHEN THE PROPERTY CEASES TO BE ELIGIBLE FOR EXEMPTION. I AM AWARE THAT THE TAX EXEMPTION MUST BE CANCELLED IF THE PROPERTY IS CONVERTED FROM MULTIFAMILY TO ANOTHER USE. I AM AWARE THAT IF I DECIDE TO CONVERT THE MULTIFAMILY HOUSING TO ANOTHER USE OR INTEND TO DISCONTINUE COMPLIANCE WITH THE AFFORDABLE HOUSING REQUIREMENTS, I MUST NOTIFY THE CITY COMMUNITY DEVELOPMENT DEPARTMENT AND THE COUNTY ASSESSOR WITHIN 60 DAYS OF THE CHANGE IN USE OR INTENDED DISCONTINUANCE.

OWNER SIGNATURE:	hh P.t.
DATE: 9/30/22	

#### **AFFIRMATION**

AS TAXPAYER(S) OF THE LAND DESCRIBED IN THIS APPLICATION, I HEREBY INDICATE BY MY SIGNATURE THAT I AM AWARE THAT THE EXEMPTION DOES NOT BEGIN UNTIL AFTER THE PROJECT IS COMPLETE AND I HAVE APPLIED FOR A FINAL CERTIFICATE OF EXEMPTION. I DECLARE UNDER PENALTY OF PERJURY UNDER THE LAWS OF THE STATE OF WASHINGTON THAT THIS APPLICATION AND ANY ACCOMPANYING DOCUMENTS HAVE BEEN EXAMINED BY ME AND THAT THEY ARE TRUE, CORRECT, AND COMPLETE TO THE BEST OF MY KNOWLEDGE.

OWNER SIGNATURE: _		Jul Pitr
DATE:	9/30/22	0

#### SUMMARY OF PROCESS STEPS

- 1. **Pre-application meeting:** A meeting with staff to discuss the process and criteria is recommended prior to application.
- 2. **Application:** Complete the attached application and submit the applicable materials listed on the form along with the required filing fee. The application must be submitted prior to applying for a building permit.

#### 3. Review process:

- a. The Community Development Department reviews the application and within 90 days determines whether it is consistent with the program criteria.
- b. If the proposal is found to be consistent, the Community Development Department Director may certify the project as eligible for the tax exemption. The applicant shall then enter into a contract with the City regarding the terms and conditions of the project.
- c. Upon approval of the contract by Community Development Department Director, the Director issues a Conditional Certificate of Tax Exemption. The Conditional Certificate expires three years from the date of approval unless an extension is granted.
- d. If the Community Development Department Director denies the eligibility for tax exemption, the applicant may file an appeal within 30 days of receipt of notice. The City Council decides the appeal.
- 4. **Application for final certificate:** Upon completion of the improvements agreed upon in the contract between the applicant and the City and upon issuance of a temporary or permanent certificate of occupancy, the applicant may request a Final Certificate of Tax Exemption. The applicant must file with the Community Development Department the following:
  - a. A statement of expenditures made with respect to each multifamily housing unit and the total expenditures made with respect to the entire property.
  - b. A description of the completed work with evidence of final City inspection of all work completed and a statement of qualification for the exemption.
  - c. A statement that the work was completed within the required three-year period or any authorized extension.

157

- d. If applicable, a statement that the project meets the affordability requirements.
- e. Other requirements, if applicable
- f. Within 30 days of receipt of all materials required for the Final Certificate, the Community Development Department Director determines whether the project has been completed in accordance with the contract.

#### 5. Issuance of final certificate.

- a. If approved, the Community Development Department Director files a Final Certificate of Exemption with the county assessor.
- b. If denied, within fourteen calendar days of receipt of the director's denial of a final certificate, the applicant may file an appeal with the City's hearing examiner, as provided in TMC Chapter 2.58.
- 6. Annual compliance review. Within thirty calendar days after the first anniversary of the date of filing the final certificate of tax exemption and each year thereafter for the tax exemption period, the property owner shall file a notarized declaration with the director indicating the following:
  - a. A statement of occupancy and vacancy of the multifamily units during the previous year;
  - b. A certification that the property continues to be in compliance with the contract with the City and this chapter and, if applicable, that the property has been in compliance with the affordable housing requirements as described in RCW 84.14.020 since the date of the approved certificate;
  - c. A description of any subsequent improvements or changes to the property; and
  - d. Any additional information requested by the City in regards to the units receiving a tax exemption.
  - e. City staff may also conduct on-site verification of the declaration.
  - f. Failure to submit the annual declaration shall result in a review of the exemption per TMC 3.30.120.