

# AGENDA FOR PLANNING COMMISSION MEETING NOTICE

A Planning Commission meeting will be held on Thursday, August 31, 2023 at <u>5:30 PM</u> in the Council Chambers at City Hall, 819 Superior Avenue, Tomah, WI.

## Join Zoom Meeting

https://us06web.zoom.us/j/2708608080?pwd=ZTZ0cmlLVEFEb1dzVDNwdi91UHFYQT09

Meeting ID: 270 860 8080

Passcode: 206751

One tap mobile +13126266799,,2708608080#,,,,\*206751# US (Chicago)

#### **ROLL CALL**

### APPROVAL OF MEETING MINUTES

A. July 2023 Meeting Minutes

#### **PUBLIC HEARING**

- 1. <u>Public Hearing, Section 52-116(10)</u>, to consider the Conditional Use Permit of Michael Clark (Tomah Area Powersport) to operate a UTV, ATV, Motorcycle, PWC, sales and services store at 605 Fair St.
- 2. Discussion and recommendation related to the request from Michael Clark (Tomah Area Powersport) to obtain a Conditional Use Permit to operate a UTV, ATV, Motorcycle, PWC, sales and service store at 605 Fair St.

#### **PUBLIC HEARING**

- 1. <u>Public Hearing, Section 52-256, to consider the request from Alexandra Matthews & David Deprey to rezone the property located at 1201 Kilbourn Ave from B-Business District to R2-One-and-Two Family Residential District.</u>
- 2. Discussion and recommendation related to the request from Alexandra Matthews & David Deprey to rezone the property located at 1201 Kilbourn Ave from B-Business District to R2-One-and-Two-Family Residential District

#### **CERTIFICATE OF APPROPRIATENESS**

1. Review/Approval of Certificate of Appropriateness for 1408 Superior Ave

### **SITE PLAN REVIEWS**

1. Review/Approval of Site Plan for 1408 Superior Ave

#### **CERTIFIED SURVEY MAP**

 Review/Approval of, Certified Survey Map (CSM) for Thomas E. Clay Revocable Living Trust, Description: Vol. 7 Certified Survey Maps, Page 50, Document No. 390765 and located in the SW1/4-SW1/4 and SE1/4-SW1/4, Section 34, T18N-R1W, City of Tomah, Monroe County, Wisconsin

## **ADJOURNMENT**

**NOTICE**: It is possible that a quorum of members of other governmental bodies of the municipality may be in attendance at the above-stated meeting to gather information. No action will be taken by any governmental body at the above-stated meeting other than the governmental body specifically referred to above in this notice. Please note that, upon reasonable notice, efforts will be made to accommodate the needs of disabled individuals through appropriate aids and services. For additional information or to request this service, contact Becki Weyer, City Clerk, at 819 Superior Avenue, Tomah, WI 54660.

# MINUTES FOR PLANNING COMMISSION

A Planning Commission was held on **Thursday, July 27, 2023 at <u>5:30 PM</u>** in the Council Chambers at City Hall, 819 Superior Avenue, Tomah, WI.

Tina Thompson called the meeting to order at 5:33 PM

# **ROLL CALL**

Present: Travis Scholze, Eric Prise, Brian Rice and Tina Thompson. Also present: Shane Rolff. Absent: Bryan Meyer, John Glynn, and Mike Murray.

# **APPROVAL OF MEETING MINUTES**

Motion by Scholze, second by Prise to approve the meeting minutes for June 2023. All ayes. Motion carried.

## **DISCUSSION ITEMS**

1. Certificate of Appropriateness: 1000 Superior Ave

Brief discussion on the certificate of appropriateness for 1000 Superior Ave.

Motion made by Scholze, second by Prise to approve the certificate of appropriateness. All ayes. Motion carried.

2. Ordinance 18-129 Amendment

Lengthy discussion on if the city wants to get rid of shipping containers on properties all together or limit the number of days they are allowed on site. Rolff will bring back an ordinance amendment at a later date.

## **ADJOURNMENT**

Motion made by Prise, second by Scholze to adjourn at 5:55 PM.

# CITY OF TOMAH PLAN COMMISSION STAFF COMMITTEE PREPARATION REPORT

# **August 31st, 2023**

**Agenda Item:** Request from Michael Clark (Tomah Area Powersport) to operate a UTV, ATV, Motorcycle, PWC, sales and service store at 605 Fair St. The location is located in the M-1 Limited Industrial District.

**Summary and background information:** Applicant wishes to operate a UTV, ATV, Motorcycle, PWC, sales and service store in an Industrial Zoned District. Retail sales stores in the M-1 Limited Industrial District require the issuance of a Conditional Use Permit pursuant to following Zoning District regulations.

# Sec. 52-35.

#### B business district.

*Permitted uses.* The following uses are permitted in the B district: appliance dealers; art and school supply stores; automotive parts sales stores; automobile sales lots and show room lots; and other uses similar to or customarily incidental to any of the above uses.

### M-1 Limited Industrial District

(3) Conditional uses. Airports and airstrips, governmental and cultural, large animal hospital, disposal area, manufacture or use of certain toxic or hazardous chemicals or material, outside storage area and all business uses permitted or conditional in the B district

Recommendation: Based on review of the application I recommend approval of the conditional use permit for the sales and service of at the above stated location.

Shane Rolff	8/10/23
Zoning Administrator	Date

# M-1 — Limited Industrial District

# Lot Requirements

- Min. area = 20,000 sq. ft.
- Min. frontage = 100 ft.
- Max. building height = 45
- Max. lot coverage = 50%

# **Setbacks**

Principal structure setbacks:

> Front = 25 ft. Side = 15 ft.

Rear = 20 ft.

Accessory structure setbacks:


> Side = 10 ft. Rear = 10 ft.

# **Permitted Uses**

- Manufacture, fabrication, packing, packaging and assembly of products from furs, glass, leather, metals, paper, plaster, plastics, textiles and wood
- Recycling areas (not to include salvage yards) provided any crushing and storage is inside a building or semi-trailer unit
- Manufacture, fabrication, processing and packaging of confections, cosmetics, toiletries, electrical appliances, electronic devices, instruments, jewelry and pharmaceuticals
- Food processing, except cabbage, fish and fish products, meat and meat products and pea vining
- Tobacco processing
- Mini-storage facilities

# **Conditional Uses**

- Airports and airstrips
- Governmental and cultural uses
- Large animal hospital
- Disposal areas
- Manufacture or use of certain toxic or hazardous chemicals or materials
- Outside storage areas
- All business uses permitted or conditional in the B District

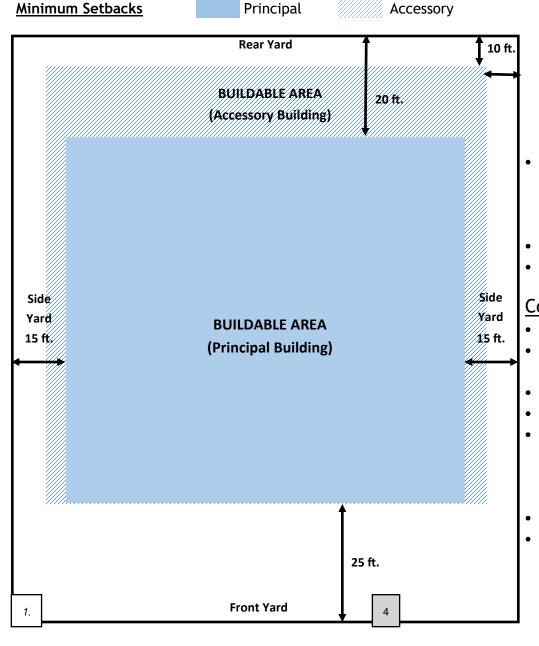

# City of Tomah CONDITIONAL USE APPLICATION

<u>APPLICANT</u>
Applicant Name: Michael Clark DBA Tomah Area Powersport  Address of Conditional Use Request: 605 Fair St Tomah
Address of Conditional Use Request: 605 Fair St Tomah
Owner of Site: Mike Clark / DBA Clark Powersport Group
1) Legal Description: 2 buildings (existing) and property lines associated with regal boundaries of 605 Fair St. Tomah-
(2) Present Zoning Classification:
(3) Description of Existing Use Including Structures if any: Sales / Service powerspoorts
(4) Describe Reason for Requesting a Conditional Use Permit: Per recomendated City of Tomoh Zoning -
<u>ATTACHMENTS</u>
(1) Plat Plan Drawn to Scale Existing - No changes
(2) Names and Addresses of All Owners of Properties within 200 Feet of subject property.(City shall provide)
(3) Fee Receipt in the Amount of \$125.00 from the City Treasurer
CERTIFICATION
I hereby certify that all the above statements and attachments submitted hereto are true and correct to the best of my knowledge and belief.
JAN 215 E. Mudison St. 180000, WT 7-17-23
Applicant Signature Address of Applicant Date

# CITY OF TOMAH PLAN COMMISSION STAFF COMMITTEE PREPARATION REPORT

# **August 31st, 2023**

**Agenda Item:** Request from Alexandra Matthews & David Deprey to rezone the property located at 1201 Kilbourn Ave. from B-Business District to R2-One- and Two-Family Residential District.

**Summary and background information:** Applicants wish to rezone the property located at 1201 Kilbourn Ave. from B-Business District to R2-One and Two Family Residential. The property currently has a single-family residence and is considered a legal nonconforming use. The rezone would bring the property into compliance with the City of Tomah zoning ordinances and is consistent with the City of Tomah Future Land Use Map.

Sec. 52-34. - Residential districts.

# (b) R-2 one- and two-family residential district.

- (1) Established. The R-2 district is established to delineate certain areas of land, both developed and undeveloped, with peculiar characteristics, such as presently existing one- and two-unit dwellings, proximity to commercial development or proximity to major streets and because of a probable continued demand for such dwelling accommodations which are well-designed, pleasant places in which to live.
- (2) *Principal uses.* One- and two-family dwellings and all uses permitted in the R-1 district.

#### Suitable Zoning Districts:

Areas identified as Downtown Mixed Use are regulated by the City of Tomah Zoning Code. Generally acceptable zoning districts within DMU areas include: Business (B), Multi-Family Residential (R-3), and Zero Lot Line Residential (R-6). In addition, those properties between McLean Ave and the alley running parallel to Superior Ave., and between Kilbourn Ave. and the alley running parallel to Superior Ave., may be zoned for One- and Two-Family Residential (R-2).

Red	commend	lati	on:	В	ased on re	view	of th	e app	olica	ation I re	commend appro	oval of
the	rezoning	as	it i	S	consistent	with	the	City	of	Tomah	Comprehensive	Plan
Futi	ure Land I	Jse	ma	p.								

Shane Rolff	8/9/23	
Zoning Administrator	Date	

# APPLICANT

Applicant Name: ALEXANDRA MATTHEWS & DAVID DEPRE AVENUE DAVID y MATTHEMS KILBOURN Owner of Site: ALEXANDR A Address of Rezone Request: 1201

# DESCRIPTION OF THE SUBJECT SITE

- (1) Legal Description:
- District Business 8 (2) Present Zoning Classification: \_
- Formily Residentia - One + Two Proposed Zoning Classification: RA (3)
- Description of Existing Use Including Structures if any: RSICLUMPAL SAMMA A AMM I GAL match 10 Describe Reason for Proposed Change in Zoning: 4 (5)


# ATTACHMENTS

- (1) Plat Plan Drawn to Scale
- Names and Addresses of All Owners of Properties within 200 Feet of Area to be changed.(City will provide)  $\overline{0}$
- (3) Fee Receipt in the Amount of \$125.00 from the City Treasurer

# CERTIFICATION

I hereby certify that all the above statements and attachments submitted hereto are true and correct to the best of my knowledge and belief.

Applicant Signature Address of Applicant

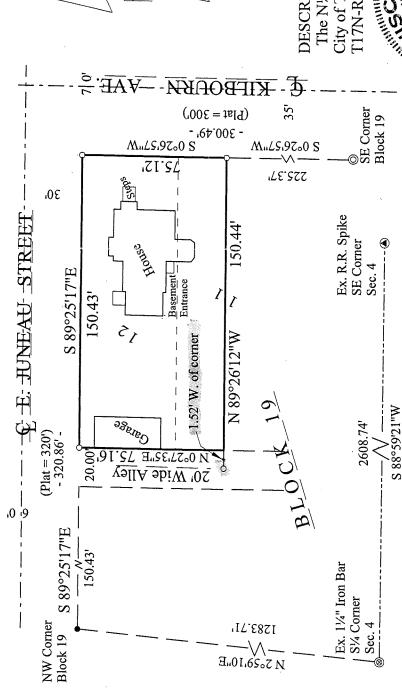

The south line of the SE¼, Sec. 4 is ASSUMED to bear S88°59'21"W

SCALE:  $l_{s}'' = 100'$ 


= Set 3/4"x18" Rd. Iron Bar weighing 1.50 lbs./lin.ft.

= Existing Drill hole in concrete

= Existing 11/4" Iron Pipe

DESCRIPTION

The N¼ of Lot 11 and Lot 12, Block 19, Original Plat, City of Tomah, being located in the SW¼-SE¼, Section 4, T17N-R1W, City of Tomah, Monroe County, Wisconsin.

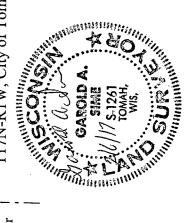

that the within map is a true and correct representation of the exterior boundaries of the

of Alexandra Matthews, I have surveyed and mapped the property shown hereon and

I, Garold A. Sime, do hereby certify that by the order and under the direction

SURVEYOR'S CERTIFICATE

land surveyed and that I have fully complied with the provisions of Chapter AE - 7 of

the Wisconsin Adminstrative Code to the best of my knowledge and belief.

GAROLD A. SIME, PROFESSIONAL LAND SURVEYOR S-1261

H. A. SIME & ASSOCIATES P. O. BOX 50 TOMAH, WISCONSIN 54660

Field Survey: 11-16-16 Map dated: 2-6-17

Sand a sin



# PLAT OF SURVEY

Located in the N¼ of Lot 11 and Lot 12, Block 19, Original Plat, City of Tomah, being part of the SW¼-SE¼, Section 4, T17N-R1W, City of Tomah, Monroe County, Wisconsin.

File No. 5446

# **Certificate of Appropriateness**

# **City of Tomah:** Building/Site Improvement Review **Application for Certificate of Appropriateness**

Address of Property:  1408 Superior Ave								
Property Owner Name:								
Troy Gilson & Jay La	arson							
Property Owner Address (if different fro								
1130 Charles Dr	Tomah	WI						
Street	Municipality	State						
Property Owner Phone Number: (Home	e/Mobile):							
608-343-3443								
Have you reviewed the Downtown Tom	ah Design Standards (if applicable)?							
Yes No Not Applicable								
Have you reviewed the City's Historic Pr	reservation Ordinance (if applicable)?							
Yes No Not Applicable								
Yes No	oric district, or contain a historic structure?							
Scope of project to include: (Please che	ck appropriate items.)							
New Construction	Siding	Signage						
Building Addition	Landscaping / Fencing	Exterior Lighting						
Façade Restoration	Parking / Rear Access	Other:						
Awning/Canopy/Shutters Doors, Windows, & Entrances								
Roofing Exterior Painting								
Briefly explain the proposed work: (Atta	ch extra sheets if necessary.)							
Briefly explain the proposed work: (Atta								

# **Certificate of Appropriateness**

# **City of Tomah:** Building/Site Improvement Review **Application for Certificate of Appropriateness**

Please	submit	the	following	information:
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- One historical (if available) and one modern photograph of building
- Eight (8) copies of plans of proposed work, including color and/or material samples if appropriate.
- A completed downtown design standards checklist

Estimated total cost/budget for proposed project:

\$375,000

Do you have any questions or concerns?

I understand the criteria for this application, approval and reviews by the Plan Commission and/or Historic Preservation Commission (check with Zoning Administrator if unknown whom will review), and agree to be subject to the Downtown Design Standards and/or Historic Preservation Ordinance (if applicable) for the above described work in accordance with City ordinances.

Signed: S/Troy Gilson

Property Owner / Applicant

Date: 08/14/2023

FOR OFFICE USE ONLY

Received By:

Date of Meeting:

Approved or Denied?:

Conditions of Approval

or Reasons for Denial:

Page 2 of 2

Instructions  If a section of these standar apply to the proposed project standards for a facade renomination entire section can be skipped.	ect (e.g. vation p	parkir project	t) the	In addition to this checklist, a site plan shall be submitted, including (as applicable):				
"does not apply" box NA. If any part of a section does apply, please fill out the entire section with checks for completed standards and cross outs for any that do not apply.  DA  A  Left The Section Can be skipped by checking the "does not apply".  The Section Can be skipped by checking the "does not apply".  A  Left The Section Can be skipped by checking the "does not apply" by the children in the skipped by checking the "does not apply" by the children in the skipped by checking the "does not apply" by the children in the section does apply, please fill out the entire section with checks for completed standards and cross outs for any that do not apply.			ire ords pply.	☐ Trash and recycling containers ☐ Pedestrian pathways ☐ Parking and circulation ☐ Landscaping ☐ Stormwater management features ☐ Lighting				
			AGI	E DESIGN				
Sign Type Usage Standards	₩ N/A			All signs conform to the sign design and maintenance requirements in the City's Zoning Ordinance, -AND- have applied/acquired sign permit.				
N/A Comments (office use only):	V N∕A			<ol> <li>All signs conform to the sign design and maintenance requirements in the City's Zoning Ordinance, -AND- have applied/acquired sign permit</li> <li>The project does not include following sign types: roof-mounted, pole, external neon cabinet/canister, billboard, -AND- there is no canopy in the public right-of-way.</li> <li>All ground signs, if any, utilize monument-style design.</li> <li>Ground signs do not extend higher than the mean</li> </ol>				
	N/A			3. All ground signs, if any, utilize monument-style design.				
	N/A			4. Ground signs do not extend higher than the mean street grade following the restriction shown below.  **Downtown Core** Only: 5 feet**  **Transitional Area** Only: 8 feet**				
	V N/A			5. Signage on awnings, marquees and canopies is > 75% of the front valance, flat profile, and/or roof AND - no signage is placed on the side of the structure.				
	VN/A			6. LED changeable messaging sign incorporated in monument sign does not comprise > 30% of the sign area, inclusive of the base area.				
				7. Signage is > 25% of each storefront display window/door area, excluding product display.				

1.

43

	Applicant	Staff / ZA	PC	
Sign Materials, Colors & Lettering Standards	□ N/A			Sign substrate is either MDO, Aluminum, or Aluminate. Acrylic material, if used, simulates metal or wood.
N/A	□ N/A		Ш	The sign style, color and materials complement the character of the building and other signage.
Comments (office use only):				3. Highly reflective material is not used.
	N/A N/A			4. The color tones between the sign's lettering/ symbols and background have sufficient contrast to make the sign clearly legible.
	□ N/A			5. The main lettering and predominant background does not use fluorescent colors.
		SIT	ΈI	DESIGN
Street Relationship Standards  N/A				symbols and background have sufficient contrast to make the sign clearly legible.  5. The main lettering and predominant background does not use fluorescent colors.  1. Downtown Core Only, primary structures will be built no more than 3-FT from the front property line, except a portion of the building may be set back per the following limitations:  The space provides an outdoor seating area, a hardscape plaza, or similar accessible pedestrian space, AND  25%, or minimum of 10-FT, of the building width is
Comments (office use only):	V N/A			The space provides an outdoor seating area, a hardscape plaza, or similar accessible pedestrian space, AND  25%, or minimum of 10-FT, of the building width is built to the restricted setback, -AND-  Maximum setback of 10-FT.
	N/A			Transitional Area Only, primary structures will be built within 25-FT of the front property line.
	N/A			3. There is at least one functional building entrance provided on the facade facing the (most prominent) street.

1.

		Applicant	Staff / ZA	PC	
	Exterior building and parking light fixtures are either semi- or full-cutoff -AND- not directed to the sky (excluding ground lights directed at building)	□ N/A			Exterior Lighting Standards
	2. Light trespass does not exceed 1.0 footcandles at the property line adjacent to park/residential use.	□ N/A			N/A Comments (office use only):
list	3. Parking/security poles are no taller than the building height restrictions in the underlying zoning district, or 35-FT, whichever is less. If abutting residential, the poles are no taller than 25-FT.	N/A			
heck	4. Exterior light fixtures are designed to complement the character/style of the building.	N/A			
rds C	5. Spec sheets for each light fixture are submitted.	□ N/A			
Design Standards Checklist	<ol> <li>Parking (5+ vehicles) are paved and include concrete curbs along all parking/drive areas (excluding gaps to allow stormwater flow to basins).</li> </ol>	N/A			Parking Areas Standards
gn Si	2. There is no off-street parking in front of building.	□ N/A			N/A Comments (office use only):
) esi	3. <b>Downtown Area Only,</b> side yard parking is no more than 66-FT wide.	□ N/A			
	4. <i>Transitional Area Only,</i> side yard parking is no more than 140-FT wide.	N/A			
	5. Walkways are provided connecting the building entrances to the public sidewalk. If the walkway crosses parking areas or a drive aisle they are clearly marked by striping or material change.	N/A			
	6. Parking stalls & drive aisles are separated from the public ROW & adjacent properties by a planted landscape buffer (at least 5 feet wide).	N/A			
	7. Parking rows of more than 15 parking spaces are interrupted by a landscape island/median.	□ N/A			
	8. Parking lots adjacent to residential properties have a semi-opaque buffer (min. of 4 feet in height).	N/A			

	Applicant	Staff / ZA	PC		
Storage & Service Areas	✓ N/A			1. Screening is compatible with the building architecture, as well as other site features.	
Standards N/A	V N/A			2. Street-level/rooftop mechanical equipment are not visible from the street or municipal parking lot.	
Comments (office use only):	V N/A			3. Dumpsters are fully screened, including dumpster gate, to not be visible from a public street, unless it has been determined that the screening impedes functionality/service.	
	V N/A			4. Service boxes are located away from the pedestrian zone (e.g., side/rear yard).	Desi
	VN/A			5. Permanent loading docks / staging areas are not in the front yard -AND- if visible from the street or facing residential property it is screened with landscaping and/or wall ≥ 6-FT in height and integrated with the overall site and building design.	Design Standards Checklist
	✓ N/A			6. There is no outdoor storage of products, materials, or equipment in the front yard (excluding short-term display items or items available for purchase).	ards C
Landscaping Standards N/A	N/A			1. All landscaping will be completed within 12 months of the issuance of an occupancy permit or final inspection, in accordance to the approved landscaping plan.	hecklist
Comments (office use only):	N/A			2. Parking lots (5+ vehicles) include 5 points worth of landscaping per parking space (based on landscaping point system shown on page 19) placed on the parking lot or within 10-FT of said lot.	
	□N/A			3. <i>Transitional Area Only</i> , development includes 10 points worth of planting per 1,000 SF of enclosed ground floor area (based on landscaping point system shown on page 19) placed along the base of the building, around storage areas and/or along street frontages.	
	✓ N/A			4. Plantings and low fences located between parking areas and the public sidewalk do not (and naturally will not) obscure vision 3-8 feet above the ground.	

Staff **BUILDING DESIGN** 1. If a new building, it is at least 18-FT tall from grade Scale, Articulation & to top of the parapet or midpoint of a pitch roof. N/A **Roofline Standard** 2. Any floor over three is set back from the N/A remainder of the facade. N/A Comments (office use only): 3. If a new building, vertical proportions on the **Design Standards Checklist** street facade is established (e.g., windows, doors, structural expression, etc.). N/A 4. Any building with a total width equal to or greater than its height utilizes one or more of the following techniques: Expression of structural bay, Variation in material, -AND/OR-✓ N/A Variation in the building plane. 5a. If a new buildings, a discernible base, middle and top is created using details or changes in materials. N/A 5b. A discernible base is at least 2-FT in height, but may include the entire first floor. N/A 6. Any secondary facade facing a public street (corner building) incorporates design qualities similar to the primary facade. N/A 7. Downtown Core Only, new buildings utilize a horizontal expression line that project at least 2 inches, articulating the transition between first and second floors. ✓ N/A 8. Street-facing facades over 100 feet in length have at least 25% of the facade vary in height, with such difference being 4-FT or more. N/A 9. **Downtown Core Only,** a flat or mansard roof system is used, unless a pitched roof system is deemed appropriate to the site and building style. ✓ N/A

47

# City of Tomah, WI

# Design Standards Checklist

	Applicant	Staff / ZA	PC	
Scale, Articulation & Roofline Standards (cont.) Comments (office use only):	N/A			10. <i>Transitional Area Only,</i> there is a positive visual termination at the top of the building, using either a pitched roof with gable(s) or parapet facing the street, mansard roof, or a flat roof with a defined cornice.
	N/A			11. The roof has a slope no less than 5:12.
	N/A N/A			12. An accurately-measure elevation of each exposed building facade, including roofline, is submitted. The elevations include for reference purposes any adjacent buildings, including the roof profile, window configuration, and any other important architectural features.
Projections Standards	N/A			Signage on projections meet the requirements under Signage Design section (P.11-13).
N/A Comments (office use only):	✓ N/A			2. Projections, excluding awnings, do NOT extend more than 5-FT beyond the property line. Awnings do NOT extend closer than 3 ft. from the street curb.
	V N/A			3. Canopies and marquees do not use wood or shingle components.
	✓ N/A			4. Canopies and marquees are a minimum of 10-FT above sidewalk grade.
	V N/A			5. Awnings are not made of shiny materials or have a shiny finish.
	V N/A			6. Awnings/Canopies are at least 3 feet in depth and at least 8 feet above the sidewal
	N/A			7. The building has no glowing awnings (backlit, light shows through the material).
	N/A			8. <b>Downtown Core Only,</b> awnings are mounted below the horizontal expression line that defines the ground floor.

		Applicant	Staff / ZA	PC	
	1. Ground-level facades facing the public street are comprised of at least 25% clear glass (up to 10 feet above street grade), excluding Superior Avenue facades in the <i>Downtown Core</i> (see Standard #2).	□ N/A			Window, Door & Garage Standards
	2. <b>Downtown Core Only,</b> ground-level facades facing Superior Avenue are comprised of at least 35% clear glass (up to 10 feet above the street grade).	□ N/A			Comments (office use only)
list	3. New buildings with upper stories have windows on all street-facing facades.	□ N/A			
heck	4. <b>Downtown Core Only,</b> there are NO garage doors facing Superior Avenue.	□ N/A			
ards C	5. <i>Transitional Area Only,</i> NO new garage doors are facing Superior Avenue, unless it is only providing pedestrian access to the building's interior space.	N/A			
Design Standards Checklist	<ul> <li>6. Where allowed, new vehicle-access garage doors facing a public street use one or more of the following techniques to mitigate their impact on the street frontage:</li> <li>Set back the garage bays from the primary facade a minimum of 4-FT,</li> <li>Set back every third garage door a minimum of 2-FT from the remaining garage door bays, and/or</li> <li>Screening garage doors from the street.</li> </ul>	□ N/A			
	7. Diagram(s) illustrating the percentage of transparent glass on each street-facing facade is submitted.	N/A			

	Applicant	Staff / ZA	PC		
Colors & Materials Standards	N/A			There are NO day-glo or fluorescent colors used on the building.	
N/A Comments (office use only):	N/A			2. There are NO bright colors used as the primary facade color.	
	N/A			3. Gravel aggregate materials, rough sawn wood, vinyl siding, manufactured stone veneer and polished stone are NOT being used on any facade.	
	N/A			<ul> <li>4. Downtown Core Only, metal panel/siding systems and other panelized products are:         <ul> <li>NOT visible from Superior Avenue (including corner facades), -AND-</li> <li>Does NOT cover more than 25% on all other facades (excluding Superior Avenue).</li> </ul> </li> </ul>	Design Standards Checklist
	N/A			5. <i>Transitional Area Only,</i> metal panel/siding systems and other panelized products do NOT cover more than:  25% of facades facing Superior Avenue -AND-  50% of all other facades.	ndards Che
	N/A			6. EIFS, metal panel/siding systems and other panelized products are NOT used at the base of the building (from 0-3 feet above street grade).	CKIIST
	□ N/A			7. A picture and a sample of each exterior material -AND- a facade illustration indicating colors/ materials is submitted.	

SUPER GRAPHIC DESIGN **Super Graphics** 1. The super graphic does NOT include lettering or imagery that could be construed as a commercial **Standards** message (i.e., advertising business conducted, N/A ∏ ✓ ✓ N/A services rendered or goods produced/sold). Comments (office use only): 2. The super graphic shall meet the following design requirements: **Design Standards Checklist** a. Harmonizes with the structure(s) on the parcel on which it is to be painted; b. Is suitable and appropriate to the district; c. Is well-designed and pleasing in appearance; d. Does not constitute a nuisance to the occupants of adjacent or contiguous property (as determined by the Zoning Administrator or the reviewing entity); -AND-. ✓ N/A e. Does not constitute a traffic and safety hazard (i.e. it is not distracting, or is not considered indecent or otherwise offensive to public morals). 3. Super graphics is NOT on the Superior Avenue Facade. N/A 4. NO part of the super graphic exceeds the height of the structure to which it is tiled, painted or fixed, -AND- does NOT extend more than six inches from ✓ N/A the plane of the wall. 5. Super graphic is NOT placed over windows, doors or vents. ✓ N/A 6. A graffiti resistent, clear sealer or suitable varnish/ topcoat will be applied to finish the mural. ✓ N/A 7. Super graphic will NOT consist of, or contain, electrical components, mechanical components or changing images. Static illumination turned off and back on not more than once a day is excluded from ✓ N/A this standard.

51

City of Tomah, WI

# Design Standards Checklist

# Checklist

PC

# **RESTORATION & PRESERVATION**

Restoration Standards	V N/A		could damage existing painted brick or stone, such as sandblasting.
N/A Comments (office use only):	V N/A		<ol><li>If necessary, surface cleaning will use the gentlest means possible. A surface cleaning test was conducted to determine the most appropriate cleaning method.</li></ol>
	₩N/A		<ol> <li>New mortar matches the original brick and mortar joint profile, including width and depth,</li> <li>AND- mortar duplicates the original in color, texture and strength.</li> </ol>
	₩ N/A		4. Existing historic base panels are not planned to be filled in with concrete block, unless it matches the primary facade material. Brick, if used to infill a historic base panel, will match the building as closely as possible in size, color, and texture.
	✓ N/A		5. Masonry on historic structures will NOT be painted, or stuccoed, if it has not been painted historically.
	□ N/A		6. Existing entry openings on historic structures are retained, where feasible. If additional entry openings are needed (i.e., for deliveries) they will be placed at regular intervals and should be of similar proportions as the original entry.
	₩ N/A		7. Existing window openings on facades facing a public street are retained.
	₩N/A		8. Original or historic features, including columns, bulkheads, transoms and moldings, are retained, if possible.
	₩ N/A		<ol> <li>Inappropriate past additions to buildings should be considered for removal, including siding, signs, wood filler in window openings, stucco, or exterior siding materials</li> </ol>

52

		Applicant	Staff / ZA	PC	
	1. Outdoor food service areas is permitted under Chapter 32 of the City's Ordinances.	□ N/A			Outdoor Food Service & Vending Unit
	2. Outdoor food service is on private property and selling similar products already available in the store, or is approved based on merits of the business plan.	□ N/A			N/A Comments (office use only):
list	3. Ancillary structures of a permanent nature (e.g., storage facilities, restrooms, seating pavilion) comply with all applicable building standards in this handbook & applicable City/County/State requirements.	VN/A			
heck	4. All outdoor food service areas open to the public meet ADA requirements.	✓ N/A			
rds C	5. No usage of floors coverings (e.g, artificial turf, paint & carpet).	V N/A			
anda	6. Building entrances have a direct clear path unimpeded (min. of 5 feet) for ingress & egress.	□ N/A			
Design Standards Checklist	7. If used, dumpsters and carts are screened from view from Superior Avenue through landscaping and/or fencing/walls.	□ N/A			
esi	8. Trash receptacles are provided for customers.	☑ N/A			
D	9. Lighting meet Lighting Standards in this Handbook. If used, string lights are commercial-grade & affixed to supports or building through typical construction means (no temporary method).	N/A N/A			
	10. Outdoor display & storage areas are screened from view from adjacent to a residential property by a minimum of 6-ft solid fence or wall.	VN/A			
	11. No sales from RVs and tent, unless conditionally approved for a special event.	□ N/A			
		E <sub>I</sub> N/A			

	Applicant	Staff / ZA	PC		
Outdoor Food Service & Vending Unit (cont.) Standards	VN/A			12. Dining furniture are commercial grade & are primarily constructed of finished-grade wood, metal or composite material. No use of lightweight materials, unstained/unpainted pressure-treated wood, and/or primarily plastic.	
Comments (office use only):	N/A			13. Vending unit is located on a paved pad & adheres to the setback requirements of the underlying zoning district.	
	□ N/A			14. If multiple (vending unit) pads are proposed, they are a minimum of 10 feet apart.	Des
	V N/A			15. Vending unit use of plastic materials, concrete block, fabric & other loose materials are not use as base materials.	ign St
					Design Standards Checklist

# **B** — Business District

# Lot Requirements\*

- Min. area = 3,000 sq. ft.
- Min. frontage = 20 ft.
- Max. building height = 45 ft.
- Max. lot coverage = 95%

# **Setbacks**

- Principal and accessory structure setbacks:
  - Front = none Side = none Rear = 10 ft.

# \*Lot Requirements for <a href="Shopping Centers">Shopping Centers</a>:

- Min. area = 4 acres
- Min. frontage = 300 ft.
- Max. height = 35 ft.
- Setbacks:

Front = 100 ft. Rear = 40 ft. Side = 40 ft.

# Minimum Setbacks

Principal

# Rear Yard 10 ft. **Side Yard BUILDABLE AREA** Side Yard **Front Yard** 1. 55

### **Permitted Uses**

- Appliance dealers/sales
- Art and school supply stores
- Automotive parts sales
- Automobile sales
- Antique shops
- Bakeries (retail)
- Barbershops/salons
- Banks/financial institutions
- Candy/ice cream shops
- Caterers
- Clothing/dry goods stores
- Clubs
- Cocktail lounges
- Drugstores/pharmacies
- Department stores
- Electrical supply stores (retail)
- Food stores/supermarkets
- Funeral homes
- Hotels/inns
- Insurance agencies
- Jewelry stores
- Lumber yards
- Liquor stores
- Medical facilities/clinics
- Ministorage facilities
- Music stores
- Markets (fruit and vegetable)
- Newsstands
- Opticians/optical supply stores
- Offices
- Paint/wallpaper stores
- Shoe stores
- Taverns
- Tourist information/hospitality centers
- Upholsterers
- Variety stores
- Veterinary clinics (small animal)
- Other uses incidental to the above

#### **Conditional Uses**

- Governmental and cultural uses
- Transportation uses
- Drive-in theaters
- Drive-in restaurants
- Motels
- Drive-in banks
- Recreational uses
- Vehicle repair and sales
- Recycling areas (not including salvage yards or can crushing), provided they are more than 500' from residential
- R-1, R-2, R-3 dwellings
  - Light fabrication if incidental to a permitted land use

# M&M video building site plan review cover letter

To Tomah building review

From Troy Gilson and Jay Larsen M & M Video

New 30 x 100 office warehouse

Parcel # 286-01806-001408 Superior st. is currently a vacant 50 x 150 lot in between 2 residential rental properties. .17 acres

M & M video is proposing to build a 30 x 40 and a 30x60 for a total of 100' split-level single-story office building/warehouse. The building is being constructed by the local high school shop class.

There is a complete set of plans that have been submitted with the application. The plans were drawn up by Eskay Architecture Onalaska WI. The footprint of the building and interior layout will all stay the same as the plans. What changes is the building will be constructed post frame. The windows and doors on Superior st will be resized and relocated to conform to the transition area requirements and the ordinance.

The owners would like to get approval to proceed with the foundation and excavating so we can be ready in Mid-September for the high school class to start construction. We can work through the final details of the exact windows and plan revisions in the next couple of weeks. If anything is needed to get this project moving. We would ask for conditional approval to proceed with the foundation while we work out all the minute details of colors, windows and any other concerns that arise.

Thomas Willan Ironman Buildings will be acting as the project manager. <a href="mailto:tom@ironmanbuildings.com">tom@ironmanbuildings.com</a> 608-438-3103

Dated this 14th day of August 2023
RESPECTFULLY SUBMITTED:

/s/ Troy Gilson



## SITE PLAN REVIEW APPLICATION

(This review does not include utilities and storm water)

# The following checklist will ensure the timely processing of your site plan review request: Site Plan Review Checklist:

➤ Include all items applicable and requested on the checklist

If incomplete, no further processing of the application will occur until the deficiencies are corrected. All development must meet the requirements of the City of Tomah and any other applicable local, state, or federal ordinances.

<b>Description of Proposed Develo</b>	pment:				
construct a new office and warehous	se for M & M video				
If you have	any questions, please contact the Zoning Dep	partment at 608-374-7429.			
Property Address:		Parcel Number:			
1408 Superior st	28	66-01806-0000			
Applicants	Mailing Address.	City State 7in.			
Applicant: Troy Gilson	Mailing Address: 1130 Charles Dr	City, State, Zip: Tomah WI 54660			
Phone Number:	Email:	✓ Primary Contact			
608-343-3443	tgilson@gmail.com				
Business: Owner/Contact:	Mailing Address:	City, State, Zip:			
Jay Larson	2105 HOLLISTER AVE	Tomah WI 54660			
Phone Number:	Email:	☐ Primary Contact			
	jaylarsen12@gmail.com				
Property Owner:	Mailing Address:	City, State, Zip:			
M & M Video	2105 HOLLISTER AVE	Tomah WI 54660			
Phone Number:	Email:	Primary Contact			
There wanted					
The undersigned hereby makes of	application at the location stated herein. The u	indersigned agrees that all work shall be done in			
accordance with the requirements		th all other applicable City Ordinances and the law			
	and regulations of the State of Wisc				
Signature of Applicant: S/Troy Gilson		Date: 08/14/2023			
Signature of Property Owner:		Date:			
S/Troy Gilson		08/14/2023			
C. 110 J C.110011		00, 1, 1, 2020			
OFFICE USE ONLY:	Date Received:	Application Received by:			
Zoning District:					



Site Plan review is required for all development including new construction, movement, reconstruction, conversion or structurally alterations to structures pertaining to triplexes, multi-family housing, commercial, industrial, and public projects. The submittal of the proposed project must include the following information to be considered a complete application for Site Plan Review. Check appropriate boxes to indicate completion of the corresponding requirement.

# Please provide the following with the site plan application submittal: 24" x 36" electronic version of entire plan set.

- 1. Completed Site Plan Review Application form with completed and signed checklist.

  Attached
- 2. A cover letter is required describing the request for the Site Plan Review. The letter shall include a general (description of the proposed project). Describe the proposed phasing of all buildings and site improvements. Also, describe any land divisions that need to occur.

  Attached
- 3. Site Plan. New development will require a professionally drawn site plan to be submitted, drawn to an engineered scale, and include the following items:
  - A. Name, address, and phone number for the owner, developer, and general contractor/designer.
  - B. Legal description of the site or copy of plat/certified survey map.
  - C. Survey completed on the property.
  - D. The location and dimensions of all site property lines and existing/proposed structures. (Existing structures legal conforming status?)
  - E. Show North Arrow, scale of drawing, Bench Mark location and elevation to NGS (if required).
  - F. Label all building front, rear, and side yard setbacks of the new development to adjacent property lines.
  - G. Lot dimensions, frontage, area in conformance.
  - H. Building height.
  - I. Show the location and label widths of all existing and proposed public rights-of-way and public/private easements adjacent to and within the site.
  - J. Identify existing and proposed street improvements including streets, alleys, curbs, sidewalks, and trails. Identify connections to existing/proposed sidewalks and trails.
  - K. Show existing and proposed driveways (ingress/egress), parking spaces (ADA), loading spaces, interior parking islands, sidewalks, and handicap ramp widths. Indicate the direction of travel for one-way drives and inside radii for all curves. Note dimensions of driveways and parking spaces and list total number of parking spaces required and provided. Provide cross-section drawings of proposed curbs and sidewalks.
  - L. Location and type of outside lighting.
  - M. Screening of dumpsters
  - N. Outside storage of materials or equipment

APPLICANT: Site Plan Review Data Checklist	Submitted	N/A
Cover/Title Page:		
Name and address of applicant and property owner	<b>V</b>	
Address and common description of property and complete legal description	V	
Dimensions of land and total acreage	V	
Description of proposed project or use, type of building or structures, and name of proposed	~	
development, if applicable		
Name and address of firm or individual who prepared the site plan	~	
Site and Zoning Data:		
Show North arrow, scaled drawing, Bench Mark location and elevation to NGS (if required)	<b>'</b>	
Existing lot lines, building lines, structures, parking areas, and other improvements on the		
site and within 100 feet of the site		
Proposed lot lines, lot dimensions, property lines setback dimensions, structures, and other improvements to the site	<b>✓</b>	
Label all building front, rear, and side yard setbacks of new development to adjacent		
property lines		
All existing and proposed easements	V	
Lot coverage, lot dimensions, frontage, area in conformance	V	
Finished graded surface (shall be dust free)	V	
Natural Features:		
Wetlands Floodplain		
Access and Circulation:		
Dimensions, curve radii, and centerlines of existing and proposed access points, roads, and		
road rights-of-way or access easements		
Location of proposed roads, driveways (ingress/egress), sidewalks, handicap ramp widths,		
and interior parking islands		
Calculations for required number of parking and loading spaces, location, and layout (ADA	<b>V</b>	
compliant)		
Dimensions of parking spaces, islands, circulation aisles, and loading zones	<b>V</b>	
Identify existing and proposed street improvements including streets, alleys, curbs, sidewalks, and trails	<b>✓</b>	
Building, Structure, and Miscellaneous Site Information:	<u>I</u>	
Location, height, and outside dimensions of all buildings and structures	<b>V</b>	
Building floor plans and total floor area	<u> </u>	
Details on accessory structures and any screening	V	
Location of exterior lighting (site and building lighting)	<u> </u>	
Lighting details: Sec. 52-208(3) Exposed sources of light shall be shielded so as not to be		
visible outside their premises.		
Screens and buffers: Sec. 52-207: Required buffer strips in industrial districts and property	_	
zoned business (North of Jefferson, East of Grain Ave, South of View St, West of Hugh Dickie		
Dr, and other similar areas) abuts a residential district.		
Location of trash receptacle(s) and transformer pad(s) and method of screening	<b>V</b>	
Location of outdoor storage materials/equipment	V	

# **M&M VIDEO AMUSEMENTS**

# New 3,000 S.F. Office and Warehouse Facility

1408 SUPERIOR AVE **TOMAH, WI 54660** 

# **Graphic Symbols**

Room Name

Room Number Section Number Sheet Number Elevation Number Sheet Number Detail Number Sheet Number

Door Number Window Type

TOP OF... Vertical Working Point Elevation

# Material Symbols

Concrete Block Face Brick

Structural Steel Batt Insulation Rigid Insulation

Rough Lumber Finish Wood

Ceramic Tile Gyp. Board

Plaster or Stucco

# Typical Abbreviations List

i ypica	ii Appreviations Li	St	
A.F.F. A.T. ADJ. ACP AT AWP ALT. ALUM.	ABOVE FINISHED FLOOR ACOUSTICAL TILE ADJUSTABLE ACOUSTIC CEILING PANEL ACOUSTIC CEILING TILE ACOUSTIC WALL PANEL ALTERNATE ALTMINUM	MBD MAS. M.O. MAX. MECH. MTL. MIN.	MARKER BOARD MASONRY MASONRY OPENING MAXIMUM MECHANICAL MITIAL MINIMUM
0	AT	N.I.C. N.T.S.	NOT IN CONTRACT NOT TO SCALE
BRG. BIT. BLK'G. BR. BLDG.	BEARING BITUMINOUS BLOCKING BRICK BUILDING	O.C. O.D. OH.	ON CENTER OUTSIDE DIAMETER OVERHEAD
CAB. CPT. CLG. CT. COL. CONC. C.B. CMU	CABINET CARPET CEILING CERAMIC TILE COLUMN CONCRETE CONCRETE CONCRETE CONCRETE MASONRY UNIT	P. PLAS. P. LAM. PL. PLBG. PLYWD. PCT. P/C P/C TERR.	PAINT PLASTER PLASTIC LAMINATE PLATE PLUMBING PLYWOOD PORCELAIN CERAMIC TILE PRECAST PRECAST TERRAZZO
CONT. CONTR. C.J. COORD.	CONTINUOUS — CONTINUED CONTRACTOR CONTROL JOINT COORDINATE	PREFAB. PREFIN. P.T.	PREFABRICATED PREFINISHED PRESSURE TREATED
DIA. DRS. D.S.	DIAMETER DOORS DOWN SPOUT	Q.T. REINF.	PUARRY TILE REINFORCING OR REINFORC
E.W.C. ELECT. EL. ELEV. E.P.	ELECTRIC WATER CHILLIER ELECTRICAL ELEVATION ELEVATOR EPOXY PAINT	REQ'D. R. R.D. RFG. RM.	REQUIRED RISERS ROOF DRAIN ROOFING ROOM
EQUIP. EXIST. E.P.S. EXP. EXT. E.I.F.S.	EQUIPMENT EXISTING EXPANDED POLYSTYRENE EXPOSED EXTERIOR EXTERIOR EXTERIOR INSULATION FINISH SYSTEM	SCHED. S. SIM. SV S.C. S.SURF.	SCHEDULE SEALED SIMILAR SHEET VINYL SOLID CORE SOLID SURFACE SPECIFICATION

EXISTING EXPANDED POLYSTYRENE EXPOSED SEALED SEALED
SIMILAR
SHEET VINYL
SOLID CORE
SOLID SURFACE
SPECIFICATION EXTERIOR EXTERIOR INSULATION FINISH SYSTEM FIELD VERIFY SPORT SURFACES FIRE EXTINGUISHER STAIN STAINLESS STEEL STRUCTURE OR STRUCTURAL FLOOR DRAIN FOOTING FOUNDATION TACKBOARD
TACK SURFACE
TEMPERED
TERRAZZO TILE
TONGUE & GROOVE
TOP OF
TOILET PARTITION

HEATING & VENTILATION HOLLOW CORE HOLLOW METAL HOLD OPEN ARM HORIZONTAL UNFIN.

VERTICALLY
VINYL COMPOSITION WEST SALEM
VINYL WALL COVERING
VINYL BASE WELDED WIRE FABRIC

UNFINISHED

VAPOR BARRIER

M&M VIDEO AMUSEMENTS 1408 SUPERIOR AVE. TOMAH, WI 54660







Site Vicinity Map

#### PROJECT DESCRIPTION

THIS PROJECT CONSISTS OF A 3,000 SQ. FT. SINGLE STORY BUILDING THIS BUILDING WILL BE USED AS A BUSINESS OFFICE AND WAREHOUSE FACILITY.

THE CONSTRUCTION CONSISTS OF A SLAB ON GRADE FLOOR THROUGHOUT WITH AN INTEGRAL PERIMETER GRADE BEAM FOUNDATION SYSTEM. THE FRAMING IS 2x WOOD FRAMED WALLS 2' O.C. STUDS. THE ROOF FRAMING IS AN ENGINEERED WOOD TRUSS ROOF SYSTEM SET @ 2'-0".

THE EXTERIOR FINISH IS LP SMARTSIDE LAP SIDING ROOFING IS ASPHALT SHINGLES.

#### CODE DATA

GOVERNING CODES

STATE OF WISCONSIN- CITY OF TOMAH - MONROE COUNTY

APPLICABLE CODES: ALL WORK UNDER THIS CONTRACT SHALL COMPLY WITH THE PROVISIONS OF THE SPECIFICATION AND DRAWINGS, AND SHALL SATISTY ALL APPLICABLE CODES, ORDINANCES AND REGULATIONS OF ALL COVERNING BODIES INVOLVED. APPLICABLE CODES INCLUDE BUT ARE NOT LIMITED TO THE FOLLOWING ADDPIED CODES:

2015 IBC WITH 2018 WISCONSIN AMENDMENTS (SPS 362) 2015 IMC WITH 2018 WISCONSIN AMENDMENTS (SPS 364) 2017 WISCONSIN ELECTRIC CODE (SPS 316) 2018 WISCONSIN PLUMBING CODE (SPS 381-387) 2015 IECC WITH 2018 WISCONSIN AMENDMENTS (SPS 362) 2015 NFPA 101 LIFE SAFETY CODE ACCESSIBILITY: 2009 ANSI 117.1 (IBC CHP 11)

#### I. BUILDING INFORMATION:

- A. BUILDING DESIGNATION; M&M VIDEO AMUSEMENTS OFFICE - WAREHOUSE BUILDING
- B. BUILDING LOCATION:

#### II. BUILDING CLASSIFICATIONS

- A. DCCUPANCY GROUP:
- B. BUILDING AREA: BUSINESS B = 1,200 S.F. MODERATE-HAZARD STORAGE S-1 = 1,800 SINGLE LEVEL 3,000 TOTAL S.F.

TAB. 506.2 ALLOWABLE AREA S1- STORAGE, NO SPRINKLER, CONSTR. TYPE VB = 9,000 S.F. SECT. 508.3 NONSEPARATED OCCUPANCIES

#### C. CONSTRUCTION TYPE; -SECTION 602.2 - TYPE V-B

D. SPRINKLER SYSTEMS -SECTION 902.9 - NO SPRINKLER SYSTEM REQUIRED S1 FIRE AREA DOES NOT EXCEED 12,000 S.F. NO STORAGE OF COMMERCIAL VEHICLES (GWW =>26,000 LBS.)

NUMBERS BASED ON TABLE 1004.1.2 -BUSINESS AREA = 100 S.F. PER OCCUPANT GROSS WAREHOUSE SPACES = 500 S.F. PER OCCUPANT GROSS 1,800 / 500 = 3 OCCUPANTS

## SHEET INDEX

### **GENERAL**

STEVEN S

ONALASKA.

T1.0 Title Sheet / Code Data / Plan Index A0.1 Architectural Site Plan

#### **ARCHITECTURAL**

A1.0 Floor Plan / Wall types

A1.1 Reflected Ceiling Plan A1.2 Restroom Plans & Details

A1.3 Door, Window, & Finish Schedules

A2.0 Exterior Elevations

A3.0 Building Sections

A3.1 Building Sections A3.2 Wall Sections

A3.3 Wall Sections

#### **STRUCTURAL**

S.01 Structural Specifications

S1.0 Foundation Plan S1.1 Foundation Details

S2.0 Roof Framing Plan

S2.1 Framing & Truss Details

3,000 S.F. OFFICE / WAREHOUSE

DATE / SET - TYPE 03/05/23 PERMIT SET

DRAWN BY:

REVISIONS


SHEET TITLE

TITLE SHEET

REVISIONS

SHEET TITLE

ARCHITECTURAL SITE PLAN

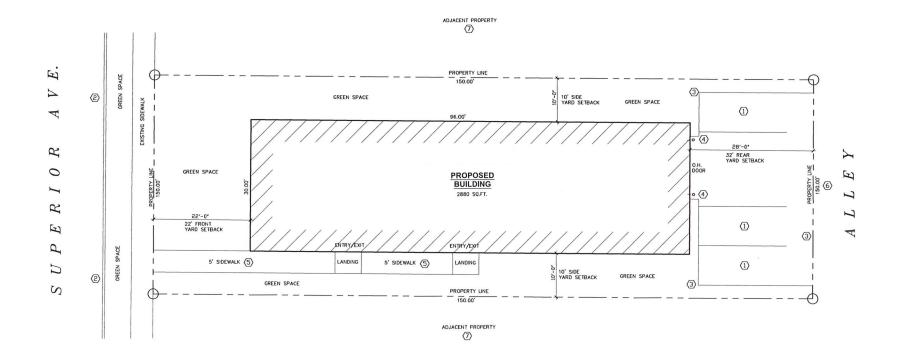

POST FABRIC. FLOW EXISTING GRADE

EROSION CONTROL FENCING TO BE INSTALLED ARDUND PERIMETER OF SITE, DO NOT REMOVE UNTIL AFTER FINAL GRADING


# $2^{\frac{\text{SILT FENCE DETAIL}}{\text{NTS}}}$

# SITE PLAN GENERAL NOTES

- 1. OBSERVE ALL STATE AND LOCAL CODES AND ORDINANCES
- VERIFY ALL EXISTING SITE CONDITIONS. ALL INFORMATION AND DIMENSIONS SHOWN ARE TO BE VERIFIED BY A CERTIFIED SURVEY.
- 3. PROVIDE POSITIVE STORM WATER DRAINAGE AWAY FROM BUILDING TO DESIGNATED AREA, REFER TO CIVIL DESIGN PLANS
  4. PROVIDE EROSION CONTROL FENCING AROUND LOT PERIMETERS. DO NOT REMOVE UNTIL FINAL GRADING IS COMPLETED, REFER TO CIVIL PLANS


# KEYNOTES $\bigcirc$

- (1) (3) 9' x 20' STANDARD PARKING SPACES
- (2) EXISTING STREET PARKING
- (3) EDGE OF NEW SURFACE PAYING/ASPHALT AREA
- 4 6" DIA CONCRETE FILLED STEEL BOLLARDS (SAFETY YELLOW)
- 5 NEW 5'-0" WIDE CONCRETE WALK.
- VERIFY ACCESS DRIVE AND PARKING LOT LOCATION, COORDINATE WITH ALLEY AND EXISTING CONDITIONS.
- (7) ADJOINING PROPERTY "DO NOT DISTURB" FIELD VERIFY LOCATION.

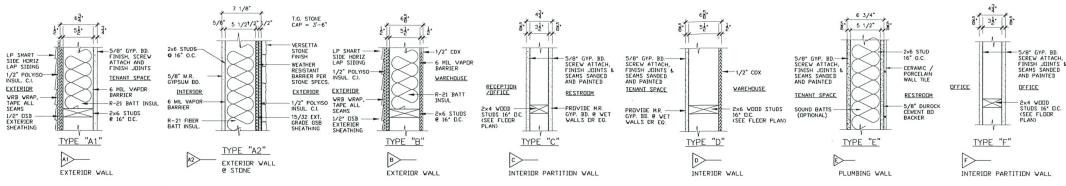

GENERAL CONSTRUCTION NOTES

- 8. 100 DENOTES DOOR TYPE. SEE DOOR SCHEDULE SHEET A1.4

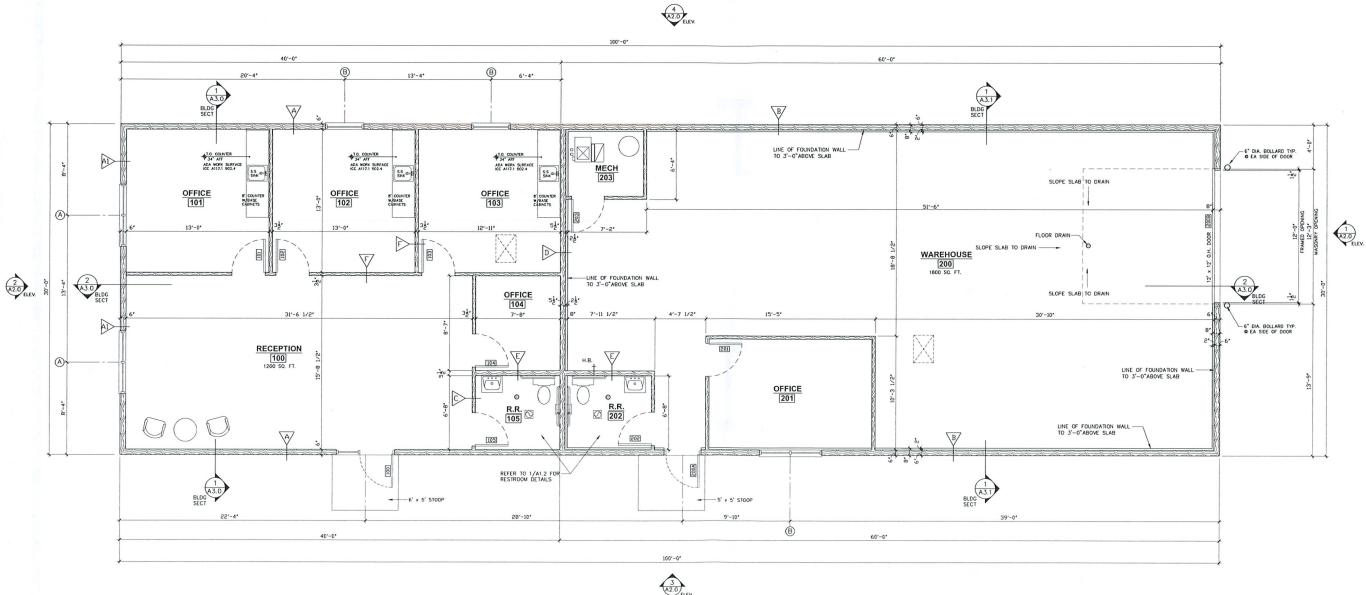

 $2^{\frac{\text{WALL TYPES}}{\text{NTS}}}$ 

FLOOR PLAN 1/4"=1'-0"

62

3,000 S.F. OFFICE / WAREHOUSE DATE / SET - TYPE 03/05/23 PERMIT SET DRAWN BY: REVISIONS NO. | DATE

FINAL SELECTIONS OF COLORS / MATERIALS / FINISHES TO BE APPROVED BY OWNER.

ATTIC VENTILATION - NET FREE AREA NOT LESS THAN 1/300 OF VENTILATION AREA.

A1.0

SHEET NO.

SHEET TITLE FLOOR PLAN

03/05/23 PERMIT SET

DRAWN BY:

NO. | DATE

SHEET TITLE

REFLECTED **CEILING PLAN** 

SHEET NO.

A1.1

LIFE SAFETY LEGEND SYMBOL ILLUMINATED EXIT SIGNAGE e<del>≥®∑</del>p EMERGENCY LIGHT EXIT COMBO W/90 MIN BACKUP PATH OF EGRESS - TRAVEL DISTANCE FE FIRE EXTINGUISHER - SEMI RECESSED CABINET FIRE EXTINGUISHER - WALL MOUNTED EMERGENCY LIGHT W/90 MINUTE BATTERY BACKUP D<sub>EM</sub> EXTERIOR EMERGENCY LIGHT W/90 MINUTE BATTERY

ELECTRICAL LIGHTING IS DESIGN/BUILD, REFER TO ELECTRICAL DRAWING FOR COMPLETE LIGHTING INFORMATION AND COORDINATION OF CEILING LAYOUT.

COORDINATE EXTERIOR BUILDING LIGHTING WITH CIVIL PLANS

EMERGENCY EXIT LIGHTING —
PROVIDE AVER. MIN. OF 1 FOOT
CANDLE ALONG PATH OF EGRESS
TRAVEL COORDINATE WITH
ELECTRICAL DESIGNER/CONTRACTOR

VERIFY FIRE EXTINGUISHER REQUIREMENTS WITH LOCAL AUTHORITIES.

- 3 EXTERIOR SURFACE/WALL MOUNTED FIXTURE
- 4' LED CEILING MOUNTED STRIP LIGHT, COORDINATE SPACING W/ELECTRICAL
- 5 EXIT/ EMERGENCY LIGHT COMBO FIXTURE


EMERGENCY EXIT LIGHTING TO BE TIED IN WITH OVERALL GENERAL LIGHTING.

### **KEYED NOTES**

- 1 EXHAUST FAN, VENT TO OUTSIDE
- 2 EXTERIOR EMERGENCY LIGHTING


- 6 2' × 2' LED FLAT PANEL CEILING MOUNTED LIGHT FIXTURE, COORDINATE QUANTITY AND SPACING W/ELECTRICAL

- GENERAL ROOM LIGHTING IS SURFACE MOUNTED COORDINATE FIXTURE TYPE AND LAYOUT WITH ELECTRICAL DESIGNER. TO BE APPROVED BY OWNER.
- MECHANICAL/ELECTRICAL CONTRACTOR TO BE RESPONSIBLE FOR ALL COORDINATION AND ARRANGEMENTS REGARDING INSTALLATION OF GRILLES, DIFFUSERS, LIGHT FIXTURES ETC. INTO THE CEILING.
- 3. PROVIDE POSITIVE ATTACHMENT TO STRUCTURE FOR ALL CEILING SUPPORTED FIXTURES.
- 4. SMOKE DETECTORS, FIRE ALARM, EMERGENCY EXIT LIGHTING, EXIT LIGHTS AND ANY OTHER SERVICES REQUIRED BY THE LOCAL BUILDING CODE OR ANY OTHER APPLICABLE CODES AND BYLAWS SET FORTH BY LOCAL AUTHORITIES MUST BE INSTALLED.
- PAINT GRILLES AND DIFFUSERS TO MATCH ADJACENT FINISHES.
- 6. OWNER TO APPROVE ALL LIGHTING FIXTURES.

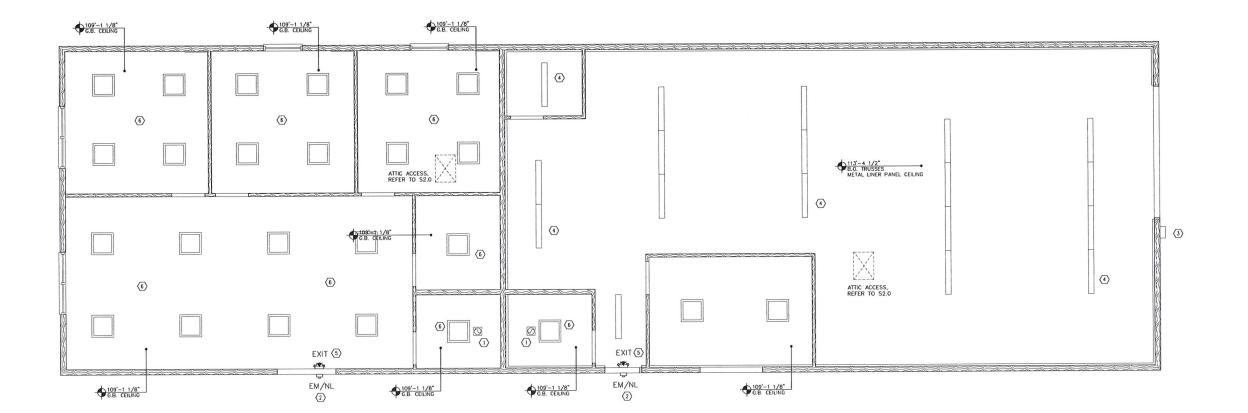



1 REFLECTION 1/4"=1'-0" REFLECTED CEILING PLAN

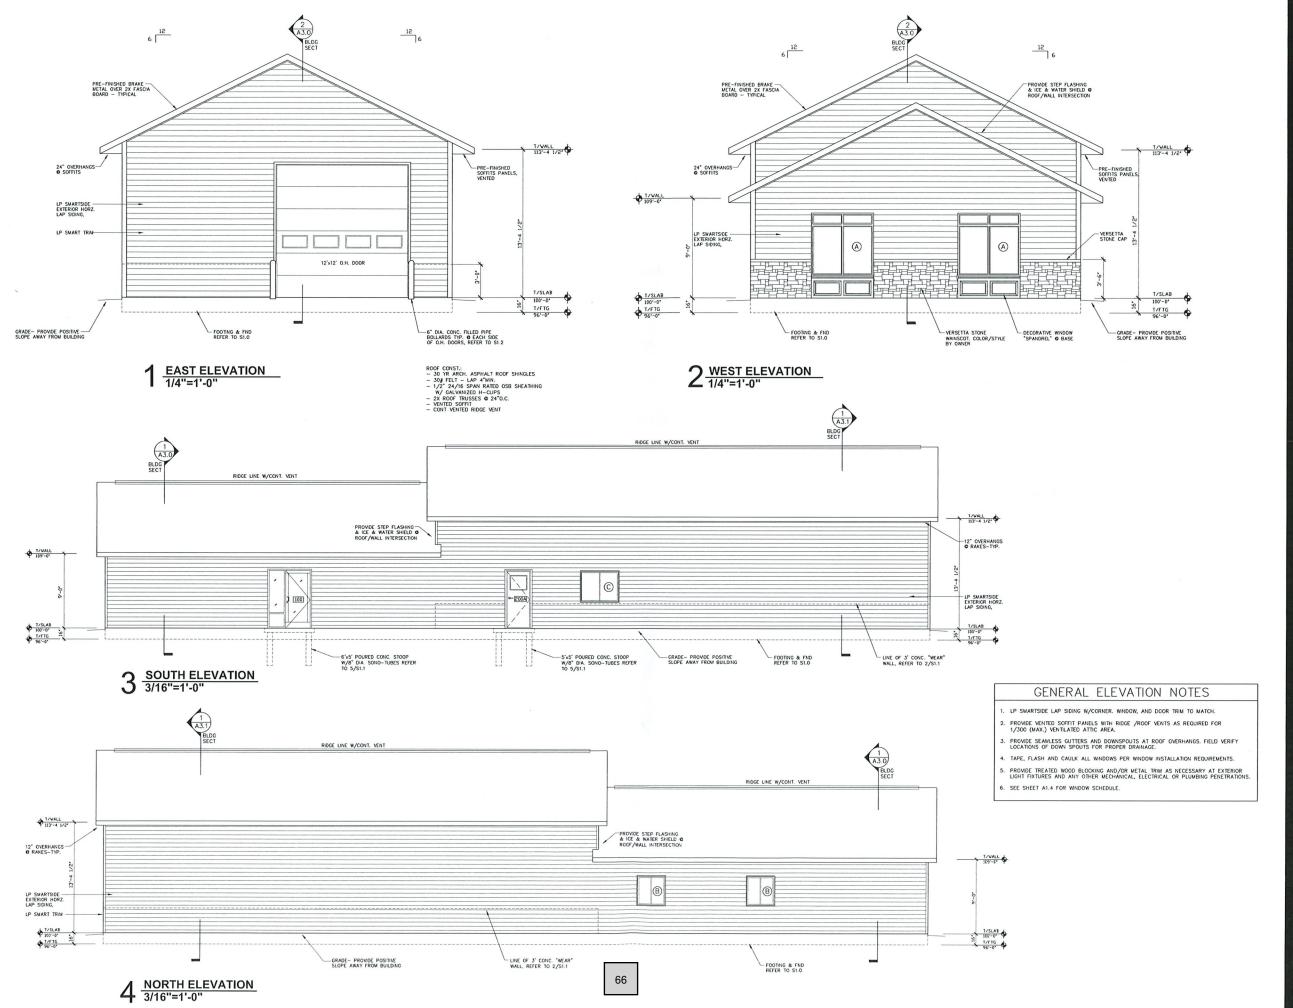

Skay

rchitecture

Onalaska, WI 54650 Ph: 66

Email: eskayarchitect@gm

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3,000 S.F. OFFICE / WAREHOUSE

PROJECT LOCATION:
1408 SUPERIOR AVE.
TOMAH, WI 54660 DATE / SET - TYPE

03/05/23 PERMIT SET

DRAWN BY:


REVISIONS


NO. | DATE SHEET TITLE

**ELEVATIONS** 

SHEET NO.

A2.0

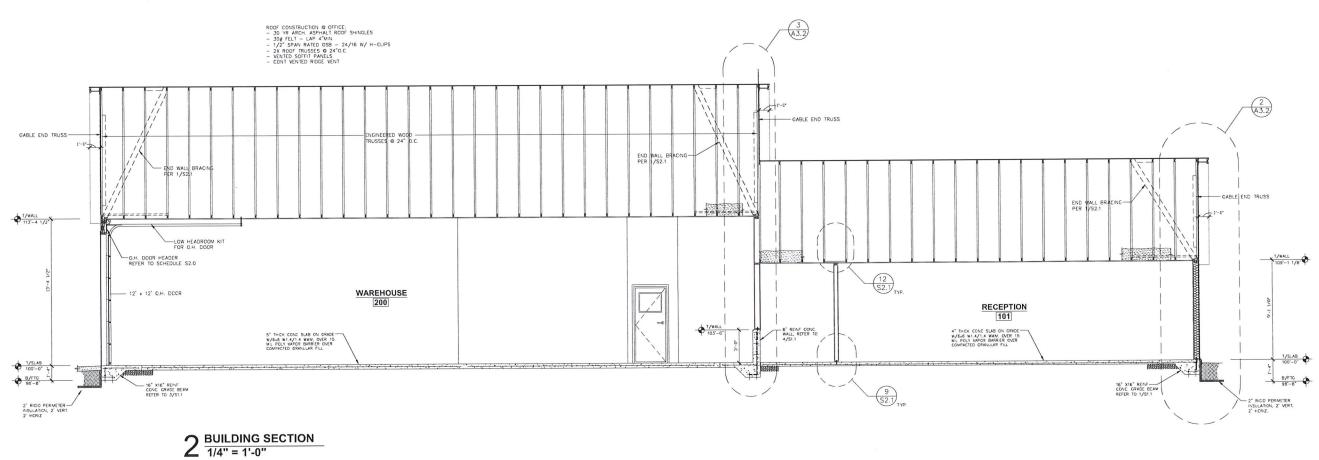

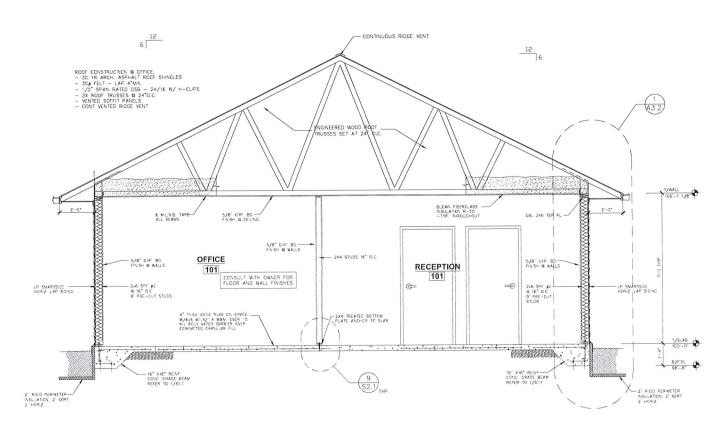

3,000 S.F. OFFICE / WAREHOUSE

3,000 PROJECT

DATE / SET - TYPE 03/05/23 PERMIT SET

DRAWN BY:

REVISIONS

NO. DATE

SHEET TITLE

BUILDING SECTIONS

SHEET NO.

A3.0

BUILDING SECTION
3/8" = 1'-0"

67

3,000 S.F. OFFICE / WAREHOUSE DATE / SET - TYPE 03/05/23 PERMIT SET DRAWN BY: REVISIONS


SHEET NO.


SHEET TITLE

A3.1


**BUILDING SECTIONS** 

BUILDING SECTION
1/2" = 1'-0"

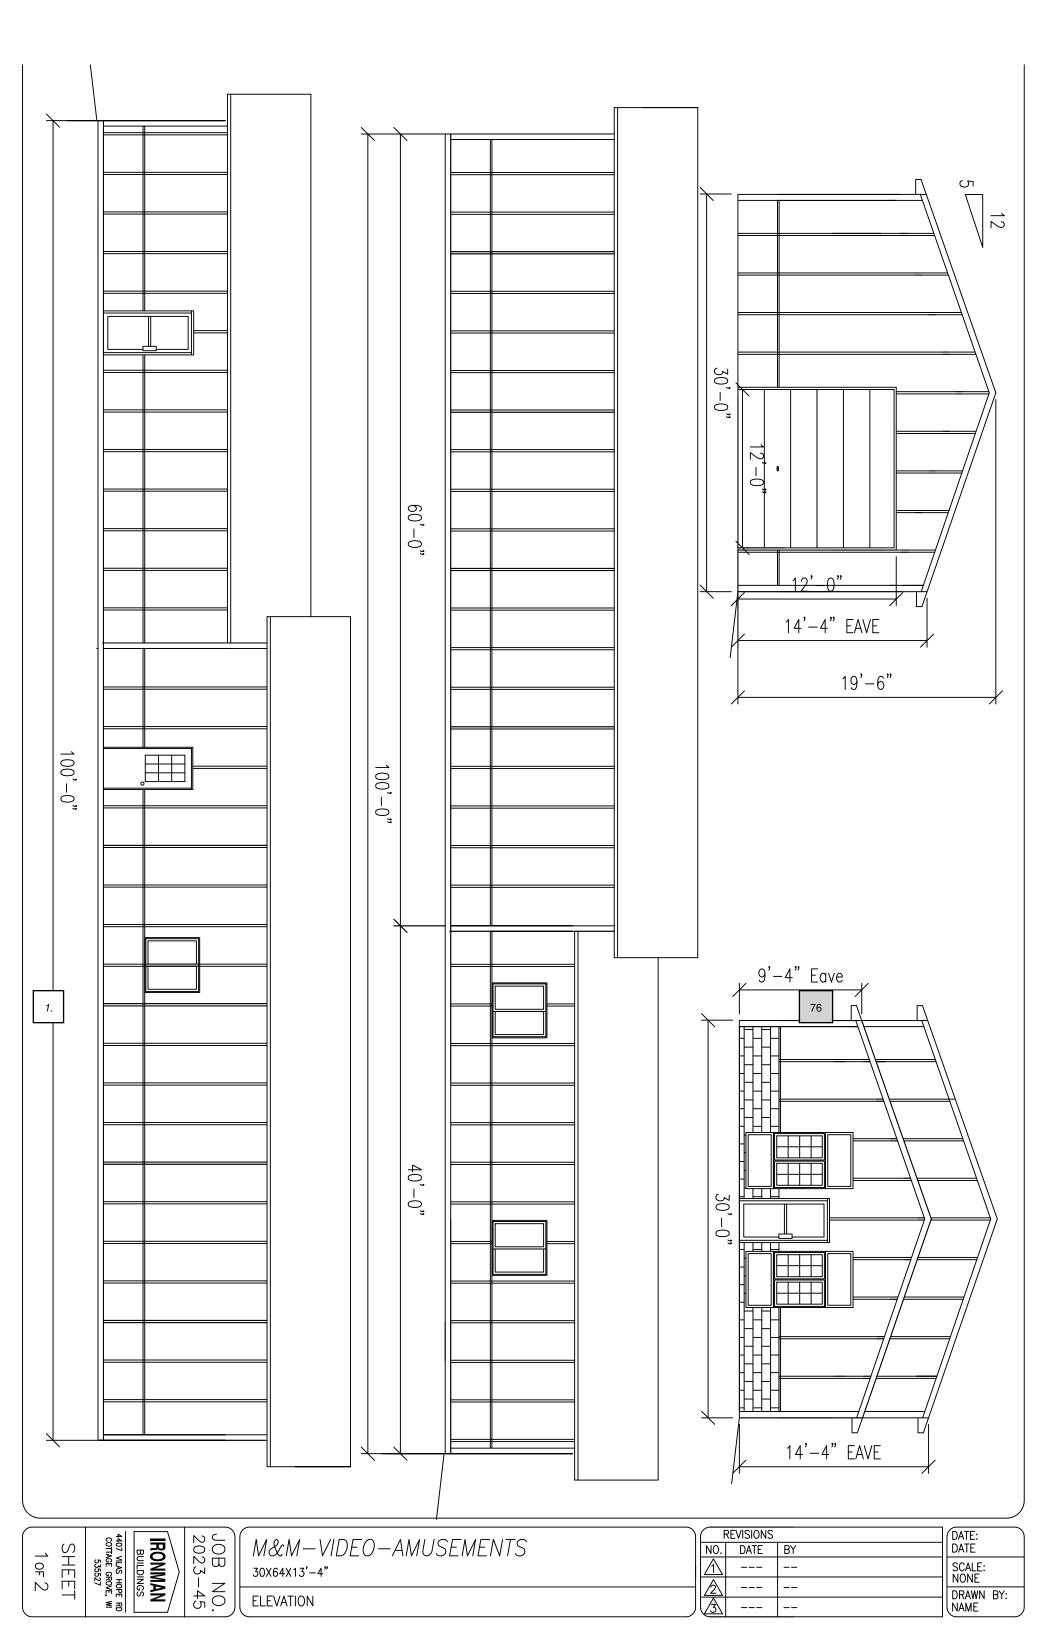

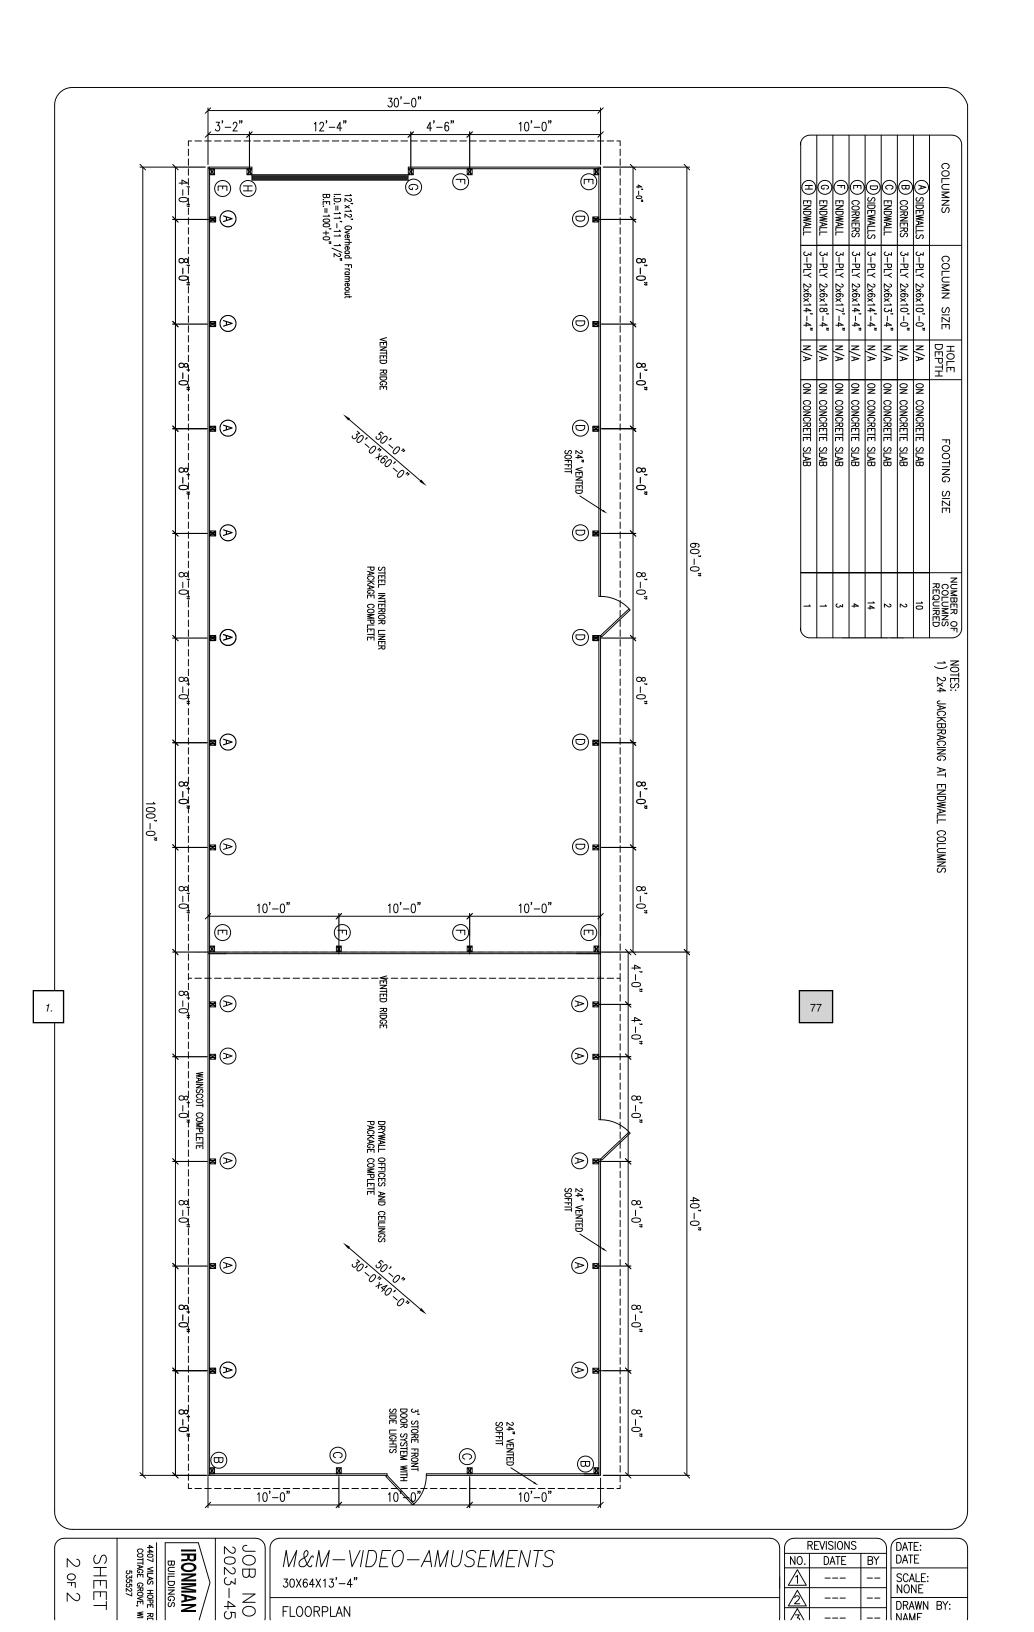

# Nova brik 4

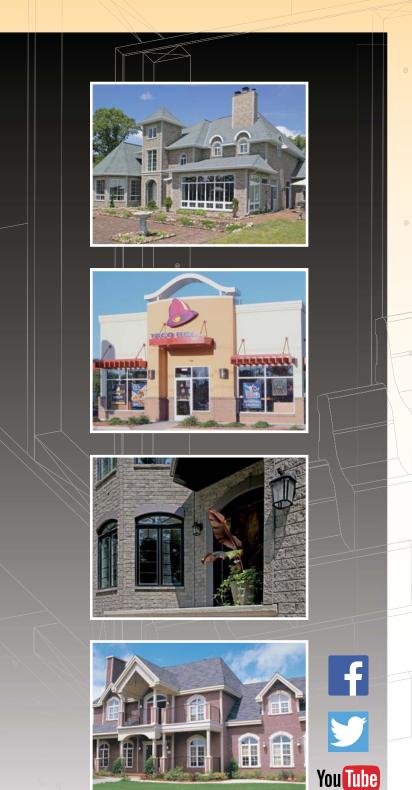



NOVABRIK YOUR PROJECT!
REMODEL YOUR HOME NOW!

# CHANGE THE LOOK OF YOUR HOME!

FROM VINYL SIDING TO MASONRY

**NOVABRIK, THE TRENDY SOLUTION** 



21'000

Do like this satisfied customer:

Mr Don Sargent Simpsonville, SC

In a blink of an eye he changed his vinyl siding into a great masonry home and added \$ 36'000 value



Project: Transform a vinyl house into a BRICK HOUSE and this with no mortar and brick ledge.

Mr Sargent invested \$ 15'000 by replacing vinyl with NOVABRIK:

Value of Mr Sargent house (with vinyl siding): \$ 199'000
Value of Mr Sargent house with NOVABRIK: \$ 235'000
Cost of the project: \$ 15'000

Return of the Investment: 79





# Follow the TREN D

# Prefer NOVABRIK




















# Details for ALL PROJECTS









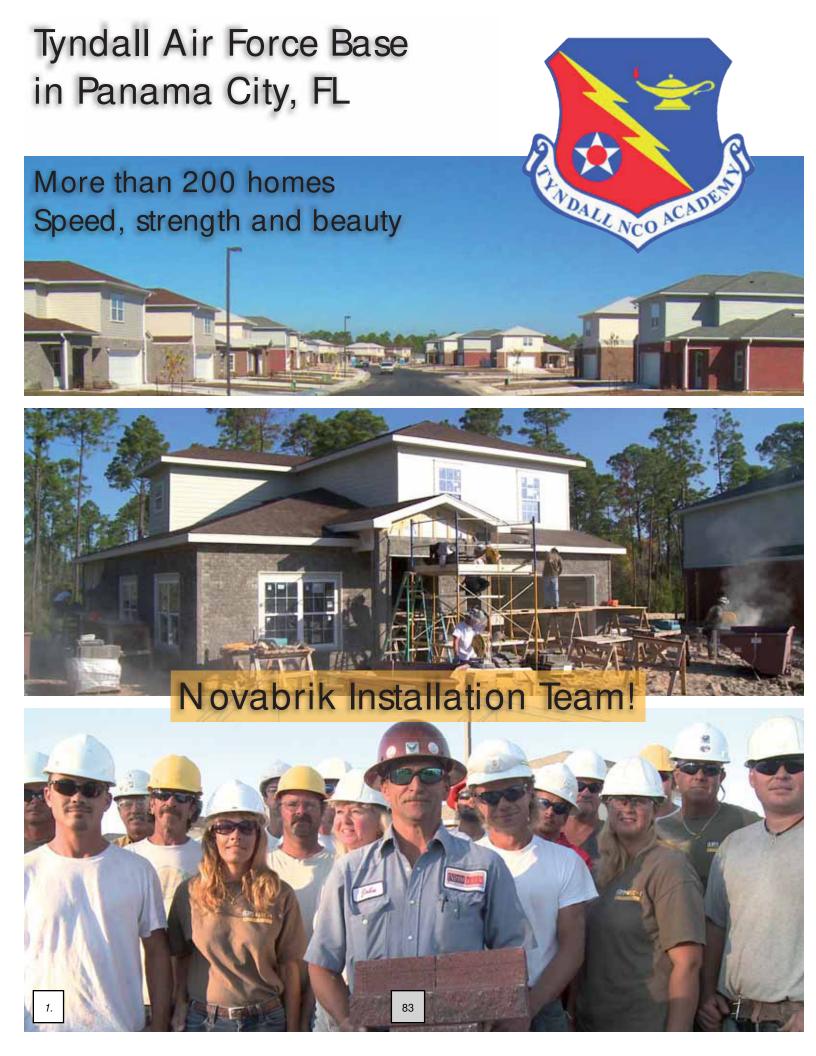



- EASY INSTAIL
- NINE COLORS
- SPHT OR SMOOTH TEXTURE
- 50 YEARS GUARANTEE
- FREE TAKE OFF










#### CAN BE INSTALLED ON VARIOUS TYPES OF STRUCTURES

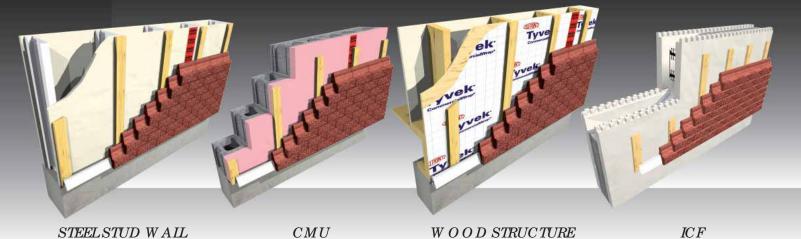

Nova brik 40

nova brik com


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K (2745)


### **MASTERRIB®**



Your Roof. For Life! On Time and Complete!™

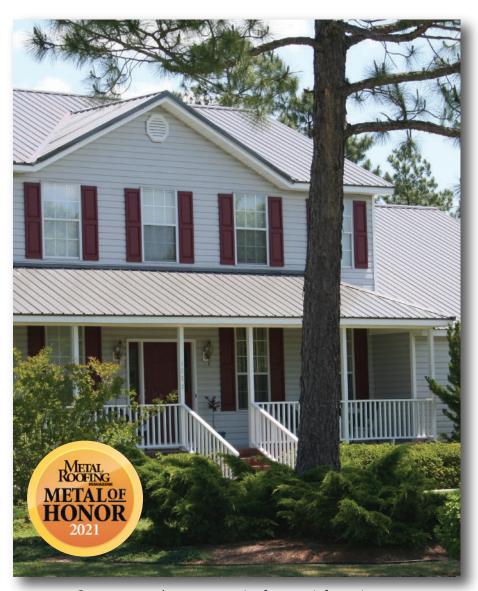

Contact your sales representative for more information.

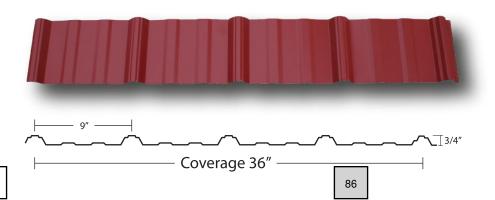

#### **Description**

An industry leader in strength and durability, this popular and versatile panel features classic looks and is used in a wide range of applications including residential, commercial, and post-frame installations. MasterRib was designed with extra-wide ribs to increase strength and ease in handling and installation. In addition, the oversized anti-siphoning channel on the underlap rib provides superior water shedding capacity in the presence of extreme wind and rain loads.

#### **Specifications**

- Exposed fastener panel for roof and wall applications
- 3:12 minimum recommended roof pitch
- Suitable for solid deck or open framing

#### **Substrates and Coatings**

- 29 and 26 gauge high strength steel
- Anti-corrosion AZ50 Galvalume coating for painted and AZ55 for unpainted steel.
- 45 Year and Lifetime Siliconized Modified Polyester Paint System

#### **Finish Options**

- 20 Paint Colors
- Energy Star Certified Color Available
- Unpainted Galvalume
- Unpainted Galvanized

#### **Approvals and Certifications**

- Metal Construction Association Certified
- Miami-Dade Approved for Wind Uplift
- Florida Building Code Approved
- Energy Star Certified
- Texas Department of Insurance Approved
- Highest UL Ratings for Wind Uplift, Fire and Impact Resistance
- No Coastal Set Back





#### **CERTIFICATIONS & TESTING**

- UL 790 Fire Resistance Class A
- UL 2218 Impact Resistance Class A
- UL 580 Class 90 Wind Uplift Construction #584 Texas Department of Insurance Approval #116
  - Metal Construction Association (MCA) Certified
  - Miami Dade County NOA Compliant

#### ALLOWABLE UNIFORM LOADS PER SQUARE FOOT

Maximum purlin spacing for roof 2' on center and maximum girt spacing for sidewall 3' on center. Place fasteners in the pan of panel for best results. (Three spans or more)


	LIVE LOAD (lb/ft²)							WIND LOAD (lb/ft²)							
SPAN (INCHES)	18"	24"	30"	36"	48"	54"	18"	24"	30"	36"	48"	54"			
29 Gauge	199	112	71	49	28	22	211	118	76	52	29	23			
26 Gauge	268	150	96	67	37	29	276	155	99	69	38	30			

#### **NOTES:**

- 1. Theoretical allowable loads are based on section properties and allowables calculated in accordance with 2001 AISI Specifications.
- 2. Theoretical allowable loads are based on three or more uniform spans.
- 3. For roof panels, deduct self weight for actual 'live load' capacity of the panel.
- 4. These loads are for panel strength. Frames, purlins, decks and fasteners must be designed to resist all loads imposed on the panel.
- 5. Check local building codes if panel testing is required.

#### RECOMMENDED FASTENING PATTERN FOR 1-1/2" SCREWS

#### PANEL OVERLAP

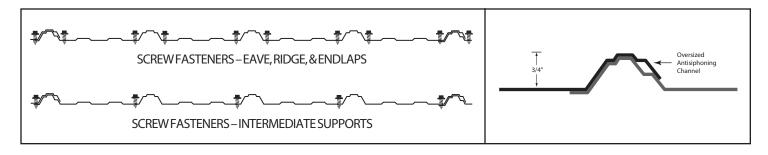

#### STORAGE

If the panels are not to be used immediately, store inside in a well ventilated and dry location. Condensation or other moisture can form between the sheets during storage, causing white rust or water stains, which detract from the appearance of the product, and may effect the product's useful life. Trapped moisture between sheets of painted metal can cause white rust to form underneath the paint. This can cause the paint to flake off of the panel immediately or several years later. To prevent white rust and staining, the following precautions should be taken:

- 1. Break the shipping bands on the metal and wipe the sheets dry.
- 2. Store metal on end or on an incline of at least 8" with support bands underneath to prevent sagging.
- 3. Fan sheets slightly at the bottom to allow for air circulation.
- 4. Keep the sheets off of the ground with an insulator such as wood.

Any outdoor storage is at the customer's own risk. If outdoor storage cannot be avoided, protect the metal using a canvas cover or waterproof paper. Never cover the metal with plastic as this will cause condensation to form.

#### $\mathsf{BFFQ}$ RE BEGINNING INSTALLATION OF THIS PROPUCT, READ OUR INSTALLATION INSTRUCTIONS.

For more information, call (888) MTL-ROOF or vis website at www.unioncorrugating.com \*\*



On Time and Complete!™

### • SMP Paint System

- 29 & 26 Gauge Galvalume® Steel Substrate
- 45-Year Industry Leading, Written Warranty on Painted Products with No Coastal Set Back

**Residential/Post Frame Color Chart** 



#### **Non-Painted**





Denotes Energy Star™ certified high reflectance color which can reduce cooling costs.



Union utilizes the most advanced Siliconized Modified Polyester paint system in the industry, based on Akzo Nobel's Ceram-A-Star 1050 technology.


**Note:** Colors shown have been matched as accurately as possible to actual finish. For exact color match, please request a metal color sample. Availability of colors and materials is subject to change. Most panels are available in bare galvanized or bare galvalume.


† TSR = Total Solar Reflectance. An Energy Star™ certified color must meet the following TSR requirements: 25% initial, 15% after 3 years of exposure testing.


‡ Premium color. To ensure proper color mateh and or metallic colors should be placed so that they come from the same batch.

88

TSR= 55%

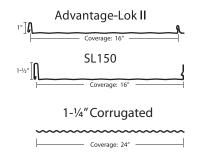

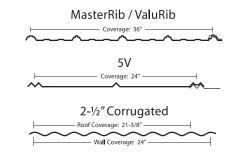

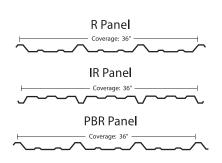

		Arctic III.	Barn B.	) 100 100 100 100 100 100 100 100 100 10	Burging	Molin	Charce Slate	Clay (Grey		Conn	Everar Metallic	איניפון	lvoru		Light C.	Scone	Patrice Green	ur Red	Rousis	Sahs.	White	Acylicos
PANEL	GAUGE	Arct	Barn	Black	Burg	Bur				3/3	EVer			Ligh	Ligh	Mari	Patr		Political	2/45	Whit	
Advantage Lok II	26	•	•	•	•	•	•		•	•	•	•			•	•	•	•	•	•		•
SL150	26	•	•	•	•	•	•		•	•	•	•			•	•	•	•	•	•		•
MasterRib	29	•	•	•	•	•	•	•	•		•	•	•	•	•		•	•	•	•	•	•
MasterRib	26	•	•	•	•	•	•		•	•	•	•	•		•	•	•	•	•	•	•	•
§ValuRib	29	•																				
5V	29		•								•										•	•
5V	26	•				•					•	•				•	•			•		•
1-1/4" Corrugated	29																					•
2-1/2" Corrugated	29		•								•										•	•
2-1/2" Corrugated	26	•				•					•	•				•	•			•		•
R Panel	26	•	•		•	•	•		•		•	•	•		•	•	•	•	•	•	•	•
IR Panel	26	•	•		•	•	•		•	•	•	•	•		•	•	•	•	•	•	•	•
PBR Panel	26		•			•	•		•		•			•	•			•		•	•	•

\*ValuRib is only offered in Arctic White at the following locations: Yukon, Janesville, Dayton and Scranton. Please see a Union Sales Representative for additional information.

§ValuRib colors are not Energy Star certified. Copper is a metallic paint with higher cost than SMP.

#### PERFORMANCE DATA

I EII GIMMAICE DATA											
COLOR	INITIAL SOLAR REFLECTANCE	3YR.TOTAL SOLAR REFLECTANCE	INITIAL THERMAL EMITTANCE	SOLAR REFLECTANCE INDEX							
Arctic White	0.65	0.63	0.87	78							
Barn Red	0.32	0.32	0.87	33							
Black	0.25	0.25	0.85	24							
Burgundy	0.25	0.25	0.87	24							
Burnished Slate	0.31	0.32	0.88	32							
Charcoal Gray	0.30	0.31	0.88	31							
Clay	0.33	0.32	0.87	35							
Cocoa Brown	0.28	0.29	0.89	29							
Copper Metallic	0.46	0.46	0.86	52							
Evergreen	0.26	0.26	0.88	26							
Gallery Blue	0.25	0.25	0.87	24							
lvory	0.60	0.58	0.87	71							
Light Brown	0.35	0.36	0.88	38							
Light Stone	0.52	0.51	0.87	60							
Marine Green	0.30	0.30	0.87	31							
Patriot Red	0.35	0.36	0.88	38							
Pearl Gray	0.37	0.35	0.87	40							
Royal Bue	0.30	0.31	0.87	31							
Sahara Tan	0.36	0.36	0.87	39							
White	0.56	0.46	0.87	66							
<b>Acrylic Coated Galvalume</b>	0.67	0.55	0.14	56							

## **ENERGY STAR Requirements** Initial Solar Reflectivity Steep Slope Roofs (>2:12)≥0.25

ow Slope Roofs (<2:12)≥0.65
Year Solar Reflectivity
teep Slope Roofs (>2:12)=0.15
Low Slope Roofs (<2:12)=0.50

### LEED 2.2 Requirements Solar Reflectance Index (SRI)

Steep Slope Roofs =  $\geq$ 29 Low Slope Roofs =  $\geq$ 78

#### **Plant Locations:**

## Corporate Headquarters\*\* 701 S. King St. Fayetteville, NC 28301

Fayetteville, NC 2830 888-685-7663

**Morrison, TN\*\*** 7747 Manchester Hwy. Morrison, TN 37357 931-668-4393

**Tifton, GA** 3365 US Hwy 41 S. Tifton, GA 31794 800-962-9131

**Orange, VA** 12435 James Madison Hwy. Orange, VA 22690 800-762-6785

**Ocala, FL\*\*** 490 Oak Rd. Ocala, FL 34472 800-331-3584

#### Vicksburg, MS

1463 Interplex Circle Ceres Industrial Complex Vicksburg, MS 39183 888-661-0577

#### **Dayton, OH** 625 N. Third St. Tipp City, OH 45371 877-615-9812

**Oklahoma City, OK\*** 600 N. Sara Rd. Ste B Yukon, OK 73099 866-373-5286

# Scranton, PA\* 100 Keystone Industrial Park Road Suite 2B Dunmore, PA 18512

Janesville, WI\*
3920 Kennedy Rd.
Janesville, WI 5354

866-695-6455

Janesville, WI 53545 608-563-3226