

### **CITY PLAN COMMISSION AGENDA**

### March 11, 2025 at 4:00 PM

City Hall, 3rd Floor - Council Chambers, 828 Center Avenue, Sheboygan, WI

Persons with disabilities who need accommodations to attend this meeting should contact the Department of City Development, (920) 459-3377. Persons other than commission, committee, and board members who wish to participate remotely shall provide notice to the City Development Department at 920-459-3377 at least 24 hours before the meeting so that the person may be provided a remote link for that purpose.

### **OPENING OF MEETING**

- 1. Roll Call
- 2. Pledge of Allegiance
- Identify potential conflict of interest

### **MINUTES**

4. Approval of the Plan Commission minutes from February 25, 2025.

### **PUBLIC HEARINGS**

5. Public hearing regarding application for Conditional Use with exceptions by Peggi Thiesenhusen to occupy a dwelling unit in the commercial building located at 834 N. Water Street.

### ITEMS FOR DISCUSSION AND POSSIBLE ACTION

- 6. Application for Conditional Use with exceptions by Peggi Thiesenhusen to occupy a dwelling unit in the commercial building located at 834 N. Water Street.
- 7. Application for site plan review by Abacus Architects to construct a metal pole building at Vollrath Co., Inc. located at 1236 N 18th Street.

### **NEXT MEETING**

8. March 25, 2025

### **ADJOURN**

9. Motion to Adjourn

In compliance with Wisconsin's Open Meetings Law, this agenda was posted in the following locations more than 24 hours prior to the time of the meeting:

City Hall • Mead Public Library
Sheboygan County Administration Building • City's website

### **CITY OF SHEBOYGAN**

### **CITY PLAN COMMISSION MINUTES**

### Tuesday, February 25, 2025

MEMBERS PRESENT: Mayor Ryan Sorenson, Marilyn Montemayor, Kevin Jump, Jerry Jones and Alderperson John

Belanger

**EXCUSED:** Kimberly Meller and Braden Schmidt

STAFF/OFFICIALS PRESENT: Associate Planner Ellise Rose and Building Inspection Specialist Linnae Wierus

### **OPENING OF MEETING**

1. Roll Call

Mayor Ryan Sorenson called the meeting to order.

2. Pledge of Allegiance

The Pledge of Allegiance is recited.

Identify potential conflict of interest

No committee member had a conflict of interest.

### **MINUTES**

4. Approval of the Plan Commission minutes from February 11, 2025.

MOTION TO APPROVE THE MINUTES OF THE PREVIOUS MEETING HELD ON FEBRUARY 11, 2025. Motion made by Alderperson John Belanger, seconded by Marilyn Montemayor Voting yea: Mayor Ryan Sorenson, Marilyn Montemayor, Kevin Jump, Jerry Jones and Alderperson John Belanger

Motion carried.

### **PUBLIC HEARINGS**

5. Public hearing regarding application for conditional use with exceptions by Old World Creamery to construct a building addition located at 1606 Erie Avenue.

MOTION TO CLOSE THE PUBLIC HEARINGS.

Motion made by Alderperson John Belanger, seconded by Jerry Jones Voting yea: Mayor Ryan Sorenson, Marilyn Montemayor, Kevin Jump, Jerry Jones and Alderperson John Belanger

Motion carried.

### ITEMS FOR DISCUSSION AND POSSIBLE ACTION

Item 4.

Application for conditional use with exceptions by Old World Creamery to construct a building additionated at 1606 Erie Avenue.

### MOTION TO APPROVE WITH THE FOLLOWING CONDITIONS.

Motion made by Alderperson John Belanger, seconded by Jerry Jones

Voting yea: Mayor Ryan Sorenson, Marilyn Montemayor, Kevin Jump, Jerry Jones and Alderperson John Belanger

- Prior to operation/occupancy, the applicant shall obtain all licenses and occupancy permits as well
  as meet all required codes including but not limited to building, plumbing, electrical, HVAC, fire,
  water, sewer, health, food, State of Wisconsin, hazardous materials, etc. An occupancy permit will
  be granted only at such time as the applicant has met all requirements.
- 2. Applicant shall obtain all necessary permits for the construction, the storage and the handling of hazardous chemicals and/or fuels (applicant shall be in contact with building inspection, fire department, etc.).
- 3. The facility will meet all zoning requirements including but not limited to noise, smells, vibration, hazardous materials, etc.
- 4. Submittal/approval of a proposed storm drainage plan prior to building permit issuance.
- 5. Submittal and approval of a landscape plan prior to building permit issuance. Landscaping shall be installed prior to issuance of an occupancy permit.
- 6. If using dumpsters, the dumpster(s) shall be screened/enclosed and constructed of like materials and colors of the facility.
- 7. Outdoor storage of materials, products or equipment shall be prohibited.
- 8. All new lighting shall be installed per Section 105-932 of the City of Sheboygan Zoning Ordinance. There shall be no spillover light onto adjacent properties or the streets.
- 9. Applicant shall obtain the necessary sign permits prior to installation.
- 10. All areas used for parking/maneuvering of vehicles shall be paved.
- 11. All areas that are not required to be paved shall be landscaped with grass and/or approved landscaping.
- 12. Any new ingress/egress driveway openings and any drives to be closed or modified shall be improved to standard City specifications.
- 13. Any work within City of Sheboygan Public rights-of-way shall be discussed with the City Engineering Department and constructed to standard City specifications (including, but not limited to, new and old ingress/egress driveway openings, curb, gutter, sidewalk, pavement, utilities, street trees, etc.).
- 14. Absolutely no portion of the new building and/or site improvements shall cross the property line (buildings, parking, retaining walls, signs, landscaping, etc.).
- 15. It will be the applicant's responsibility to work with all private and public utilities in order to provide easements and/or relocate utilities as necessary.
- 16. Applicant will provide adequate public access along all streets and sidewalks and will take all appropriate actions to minimize the time period that adjacent properties and streets/sidewalks are impacted by the development (utilities, streets, etc.).
- 17. All Semi-trucks shall use designated truck routes in the City of Sheboygan.
- 18. Prior to building permit issuance, the City of Sheboygan Architectural Review Board shall review/approve the proposed building design.
- 19. If there are any amendments to the approved use and/or site plan, the applicant will be required to submit a new site plan and/or conditional use application reflecting those amendments

### Exceptions granted:

- To have a setback of 21.9' on St. Clair Avenue
- To have a setback of 10' on N 17<sup>th</sup> Street

Item 4.

 From the locational landscaping requirements. Landscape Plan still required and required poi must be met.

Motion carried.

 Application for Site Plan Review by Elite Builds to construct a cold storage building located at 3502 Behrens Parkway

MOTION TO APPROVE WITH THE FOLLOWING CONDITIONS.

Motion made by Alderperson John Belanger, seconded by Jerry Jones

Voting yea: Mayor Ryan Sorenson, Marilyn Montemayor, Kevin Jump, Jerry Jones and Alderperson John Belanger

- 1. Prior to building permit issuance, the applicant shall obtain all licenses/permits as well as meet all required codes including but not limited to building, plumbing, electrical, HVAC, fire, health, water, sewer, health, storm drainage, State of Wisconsin DNR, etc. (Applicant shall be in contact with building inspection, fire, police, etc.). An occupancy permit will be granted only at such time as the applicant has met all requirements.
- 2. Applicant shall obtain all necessary permits for the construction, the storage and the handling of hazardous chemicals and/or fuels (applicant shall be in contact with building inspection, fire/police departments, etc.).
- 3. Applicant shall meet all zoning requirements including but not limited to noise, vibration, hazardous materials, etc.
- 4. Submittal/approval of a proposed storm drainage plan prior to building permit issuance.
- 5. All new lighting shall be installed per Section 105-932 of the City of Sheboygan Zoning Ordinance. There shall be no spillover light onto adjacent properties or the streets.
- 6. Applicant shall obtain any necessary sign permits prior to installation.
- 7. If there are any amendments to the approved use and/or site plan, the applicant will be required to submit a new site plan and/or conditional use application reflecting those amendments.

Motion carried.

### **NEXT MEETING**

8. March 11, 2025

The next meeting is scheduled to be held on March 11, 2025.

### **ADJOURN**

Motion to Adjourn

MOTION TO ADJOURN AT 4:03 PM.

Motion made by Alderperson John Belanger, seconded by Kevin Jump

Voting yea: Mayor Ryan Sorenson, Marilyn Montemayor, Kevin Jump, Jerry Jones and Alderperson John Belanger

Motion carried.

### CITY OF SHEBOYGAN

### REQUEST FOR CITY PLAN COMMISSION CONSIDERATION

**ITEM DESCRIPTION:** Application for Conditional Use with exceptions by Peggi Thiesenhusen to occupy a dwelling unit in the commercial building located at 834 N. Water Street. NC zone

REPORT PREPARED BY: Ellise Rose, Associate Planner

**REPORT DATE:** March 5, 2025 **MEETING DATE:** March 11, 2025

FISCAL SUMMARY: STATUTORY REFERENCE:

Budget Line Item: N/A Wisconsin N/A

Budget Summary: N/A Statutes:

Budgeted Expenditure: N/A Municipal Code: N/A

Budgeted Revenue: N/A

### **BACKGROUND / ANALYSIS:**

Peggi Thiesenhusen is proposing to construct a new dwelling unit in the commercial building located at 834 N. Water Street. The applicant states the following about the project:

- We are looking to renew the residential CUP permit granted for this space in February, 2023 as it has expired.
- We are the owners of the building since October, 2002.
- There will be two residents who are the owners of the property.
- This historic building (Verifine Dairy) has been in existence since 1945, and we have owned it since October, 2002.
- No new interior or exterior work is planned for the property or the landscaping surrounding the property.
- The property is fully compatible with our neighbors, the Garton Toy Factory Apartment building, another historical property renovated for residential purposes in 1998 as part of Sheboygan's North Water Street Redevelopment Plan.
- We partnered with the City of Sheboygan in 2002 to purchase and renovate this property, which was in a blighted condition at the time, receiving a HUD redevelopment grant for \$75,000 and providing an easement to the City for the construction of a connecting piece of the public bike trail which currently curves eastward at the north end of our property and dead ends on North Water St. The idea was to allow the path to run through the lower level of the property and join with the bike trail the City constructed behind Garton Toy Factory Apartments, but currently dead ends on the south end of property. Unfortunately, the project was never initiated and ultimately, the City released their easement rights to the property.
- We have never received complaints regarding our use of the property. In fact, we often
  receive compliments on our gardens, front planters and care of the property as a whole
  from our neighbors and tourists/people using the bike path and park area.

- We are respectfully requesting a renewal of the residential CUP permit granted for the lower level of our property February 14, 2023. We are mindful there may be needs identified by Building Inspection to be addressed and are happy to work with them to do so.
- As a resident and business owner in the City we have taken to heart our commitment to improving our property, our neighborhood, and promoting economic positivity.
- It is our hope to remain a positive partner with the City and County as we work to transition through the sale of our property to the next generation of dreamers, investors and caretakers of this truly unique building.

### **STAFF COMMENTS:**

The owner previously obtained a Conditional Use Permit in February of 2023 for a residential space in this building. A full occupancy permit was never obtained. As such, the Conditional Use Permit expired in February of 2024. The current owners or any potential future owners will be required to obtain the required approvals, permits and inspections prior to receiving an occupancy permit to occupy the residential space. One of the permits that will be required is a Floodplain Permit as the structure is located within the floodplain. The applicant is aware of this requirement.

The applicant will need to work with the building inspection department regarding the conversion of the lower level into a residential dwelling. Occupancy shall be granted only at such time as all permits and codes have been met.

The current owners are in the processes of selling the property. Any future owners of the property may need to obtain additional permits including, but not limited to, conditional use, occupancy, building, plumbing, electrical, HVAC, fire, DNR, floodplain, etc. for any future uses of the property. Additionally, if the current owners do not obtain an occupancy permit, or any other required permits, before the sale of the property, the new owners will be required to obtain the permits before the conditional use permit expires.

### **ACTION REQUESTED:**

Staff recommends approval of the conditional use permit subject to the following conditions:

- Prior to occupancy permit issuance, the applicant shall obtain all licenses/permits as well as meet all required codes including but not limited to building, plumbing, electrical, HVAC, fire, DNR, floodplain, etc. A floodplain permit must be obtained before an occupancy permit will be granted. An occupancy permit will be granted only at such time as the applicant has met all requirements.
- 2. No person shall be permitted to reside in the building prior to an occupancy permit being obtained.
- 3. Outdoor storage of materials, products or equipment shall be prohibited.
- 4. All lighting shall be installed per Section 105-932 of the City of Sheboygan Zoning Ordinance. There shall be no spillover light onto adjacent properties or the streets.
- 5. It will be the applicant's responsibility to work with all private and public utilities in order to provide easements and/or relocate utilities as necessary.

- 6. Absolutely no portion of the building and/or site improvements shall cross the property lines including but not limited to buildings, balconies, decks, foundations, walls, gutters, eaves, roof, parking, fencing/retaining walls, signs, landscaping, etc.
- 7. Any work within City of Sheboygan Public rights-of-way shall be discussed with the City Engineering Department and constructed to standard City specifications (including, but not limited to, driveway openings, curb, gutter, sidewalk, pavement, utilities, street trees, etc.).
- 8. If there are to be any exterior renovations to the facility, the applicant will be required to obtain Architectural Review Board approval prior to receiving a building permit for such renovation. The colors and materials are to complement/match the existing building.
- 9. If applicant leases space to additional tenants, the tenants shall obtain all necessary land use and building approvals/permits prior to occupancy (future uses and/or phases may require conditional use permits, building/mechanical permits, occupancy permits, etc.).
- 10. If there are any amendments to the site plan, the applicant will be required to submit a new conditional use application reflecting those amendments.

### **ATTACHMENTS:**

Conditional Use Permit Application and required attachments.

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### CITY OF SHEBOYGAN

# APPLICATION FOR CONDITIONAL USE

Fee:	\$250.00	
Revi	ew Date:	
Zoniı	ng:	

Read all instructions before completing. If additional space is needed, attach additional pages.

SECTION 1: Applicant/ Permittee Infor	mation	图5000000000		Hardwood	
Applicant Name (Ind., Org. or Entity)	Authorized Representative		Title		
Blue Moon Studio Inc.	Peggi Thiesenhusen		Owner/Secretary		
Mailing Address	City		State		ZIP Code
834 North Water Street	Sheboygan		WI		53081
Email Address		Phone Number (inc	d. area cod	de)	e e
peggi.bluemoonstudio@mac.com		920-803-8482			
SECTION 2: Landowner Information (c	omplete these fields	s when project site o	wner is di	fferent th	an applicant)
Applicant Name (Ind., Org. or Entity)	Contact Person		Title		
Mailing Address	City		State		ZIP Code
Email Address	<del>                                     </del>	Phone Number (inc	cl. area coo	de)	ster.
SECTION 3: Project or Site Location					
Project Address/Description			Parcel No	).	
834 N. Water Street Sheboyan, WI 530	081				
SECTION 4: Proposed Conditional Use					
Name of Proposed/Existing Business:	Blue Moon Studio	Inc.			
Existing Zoning:	NC				
Present Use of Parcel:	Business				
Proposed Use of Parcel:	Business/Residenti	ial			
Present Use of Adjacent Properties:					
SECTION 5: Certification and Permission	on				
Certification: I hereby certify that I am	the owner or author	rized representative	of the owr	ner of the	property which is
the subject of this Permit Application.	I certify that the info	rmation contained in	n this form	and attac	chments is true and
accurate. I certify that the project will I					
with any or all of the provisions of the	permit may result in	permit revocation a	nd a fine a	nd/or for	eiture under the
provisions of applicable laws.					
Permission: I hereby give the City permission to enter and inspect the property at reasonable times, to evaluate this					
notice and application, and to determine compliance with any resulting permit coverage.					
Name of Owner/Authorized Represent	ative (please print)	Title		Phone N	umber
Peggi Thiesenhusen	<u> </u>	Owner/Secretary		920-803-	-8482
Signature of Applicant  WC WIND	usou		Date Sign	ned - 4- 2	025

Complete application is to be filed with the Department of City Development, 828 Center Avenue, Suite 208. To be placed on the agenda of the City Plan Commission, application must be filed three weeks prior to date of meeting — check with City Development on application submittal deadline date. Applications will not be processed if all required attachments and filing fee of \$250 (payable to the City of Sheboygan) are not submitted along with a complete and legible application. Application filing fee is non-refundable.

### CONDITIONAL USE WRITTEN EXPLANANTION REQUIREMENTS

- A. Name of project/development Blue Moon Studio Residential Apartment, Lower-Level
- B. Summary of the Conditional Use and general operation of proposed use:
  - Description of existing use Residential Apartment Unit on lower level of property
  - Description of proposed use (indoor, outdoor, etc.), why was this site selected? We are looking to renew the Residential CUP permit granted for this space in February, 2023 as it has expired. We are the owners of the building since October, 2002.
  - All services, products, etc. to be provided N/A
  - Projected number of residents, employees, and/or daily customers: 2 residents Owners of the property
  - Proposed number of dwelling units, floor area, landscape area, and parking area expressed in square feet and acreage to the nearest one-hundredth of an acre N/A
  - Description of proposed building and all new site improvements (square footage of new and existing structure(s), traffic, ingress/egress, parking, sidewalk, retaining walls, storm drainage, landscaping, lighting, dumpster enclosure, screening of mechanicals, etc.) N/A
  - A written description of the proposed general orientation, design, arrangement, texture, material and color of the building or structure and how it is compatible with the development and redevelopment in and around the area: This historic building (Verifine Dairy) has been in existence since 1945, and we have owned it since October, 2002; no new interior or exterior work is planned for the property or the landscaping surrounding the property. That said, the property is fully compatible with our neighbors, the Garton Toy Factory Apartment building, another historical property renovated for residential purposes in 1998 as part of the City of Sheboygan's North Water Street Redevelopment Plan. We partnered with the City of Sheboygan in 2002 to purchase and renovate this property, which was in a blighted condition at the time, receiving a HUD redevelopment grant for \$75,000 and providing an easement to the City for the construction of a connecting piece of the public bike trail which currently curves eastward at the north end of our property and dead ends on North Water Street. The idea was to allow the path to run through the lower level of the property and join with the bike trail the City constructed behind the Garton Toy Factory Apartments, but currently dead ends on the south end of our property. Unfortunately, for whatever reason, the project was never initiated and ultimately, the City released their easement rights to the property.
  - An explanation of any interior and/or exterior renovations: None planned
  - Is access appropriate and is their sufficient customers/resident off-street parking? Yes
  - Proposed signage: None
  - Project timeline and estimated value of project: Immediate and none
  - Compatibility of the proposed use and design with adjacent and other properties in the area:
     Fully compatible no changes planned for current use or design of the property; please see above response regarding compatibility with the development and redevelopment in the area.
  - How will you ensure that the business will not become a nuisance to adjacent properties (i.e. parking, noise, smells, hours of operations, etc. We have never received complaints regarding our use of the property. In fact, we often receive compliments on our gardens, front planters and care of the property as a whole from our neighbors and tourists/people using the bike path and park area. Additionally, a number of years ago we installed a pet poo station used by all the surrounding apartment pet owners, which we maintain at our expense and empty weekly to ensure a clean park area for the local schools to use for their student's physical education classes and families to use all summer long for picnics, sports, the splash pad etc... We also

Water Street. We have received numerous thanks over the years for helping to keep the neighborhood clean, safe and waste free, including from the office and maintenance staff at the Garton Toy Factory. Finally, though the area in front of our property, which is used as a turnabout for all Garton apartment dwellers, their guests and all mail and deliveries, is a City street, we have paid for 22 years to plow and salt it, sweep it clean of sharp or potentially dangerous debris, and ensure any safety issues are called into the City for immediate assessment as the City has not provided care for it as long as we have owned the property.

- Other information that would be considered pertinent by the Plan Commission: We are respectfully requesting a renewal of the residential CUP permit granted for the lower level of our property February 14, 2023. We are mindful there may be needs identified by Building Inspection to be addressed and are happy to work with them to do so.
- C. If applicable, please describe any exceptions/variances that are required for this project (i.e. setbacks, parking, landscaping, etc.) None
- D. Written justification for the proposed conditional use, indicating reasons why the applicant believes the proposed conditional use is appropriate:
  - a) How is the proposed conditional use (independent of its location) in harmony with the purposes, goals, objectives, policies and standards of the City of Sheboygan Comprehensive Master Plan? Please see the above responses regarding partnering with the City for the specific purpose of enabling their public bike trail, as well as all ways in which we have improved the property and therefore, the neighborhood since purchasing in 2002. As a resident and business owner in the City we have taken to heart our commitment to improving our property, our neighborhood and promoting economic positivity. Over the decades we have employed 100+ individuals, utilized local retailers for everything from prop, set and food items and printing and advertising needs, to construction and maintenance needs and materials. We have promoted tourism of the City and County, introducing our out of town and out of state clients and stylists to the many amazing restaurants, art, shopping and event venues and accommodations throughout the City and surrounding towns. We believe Sheboygan County is remarkable given its size, with its unique and culturally diverse offerings such as the JMKAC and the Levitt Concert Series sponsored on the Green each summer, the summer Farmer's Market in Fountain Park, the venues of Uptown Sheboygan on 8th Street, South Pier and the Marina development and world class golf and boat racing, Bookworm Gardens and so much more. Sheboygan County is home to many national and international manufacturing companies, many of which we have been proud to work for and partner with over these many years, frequently donating our services and time for special projects, community events and fundraisers. It is our hope to remain a positive partner with the City and County as we work to transition through the sale of our property to the next generation of dreamers, investors and caretakers of this truly unique building.
  - b) Does the conditional use, in its proposed location, result in any substantial or undue adverse impact on nearby property the character of the neighborhood, environment, traffic, parking, public improvements, public property or rights-of-way? None

- c) How does the proposed conditional use maintain the desired consistency of land uses relation to the setting within which the property is located? Please see above responses
- d) Is the proposed conditional use located in an area that will be adequately served by utilities, or services provided by public agencies? Yes If not, please explain.

### CONDITIONAL USE APPLICATION SUBMITTAL REQUIREMENTS

### For a home occupation

- 1. A Site Plan including: Please see attached Feasibility Study submitted by the Fitzgerald's in February, 2023 plus the ALTA survey of the property from August, 2022. Please note on the Feasibility study page 2 we have removed the words 'bedroom suite' and 'living suite' from the original submitted and approved version, as we will not be undertaking any construction to alter the space as it currently exists.
- The overall property
- The existing location of building(s) on the property
- The parking spaces location on the property
- 2. A Floor Plan including:
  - □ The dwelling floor plan showing where the business will take place in the dwelling unit.
  - All information necessary to understand the proposal

### For all other Conditional Use Permits

- 1. A certified survey map showing existing property boundaries and improvements.
- 2. A map providing the following information:
  - □ The map and all its parts shall be clearly reproducible with a photocopier at a size of 11" X 17" and map scale not less than 1' = 600' with lot dimensions of the subject property provided and a graphic scale and north arrow.
  - All lands for which the conditional use is proposed.
  - All other lands within 100 feet of the boundaries of the subject property.
  - The current zoning of the subject property and its environs (200 feet),
- A site plan (conforming to the requirements of Section 15.908(3) of the subject property as proposed for development):
  - □ Submit TWO (2) hardcopies of the site plan and ONE (1) 11" X 17" reduction of the site plan.
  - Submit digital plans and drawings of the project by email, flash drive, etc.
  - □ Title block that provides all contact information for the petitioner and/or owner, if different
  - □ Full name and contact information of petitioner's engineers/surveyors/architects, or other design professionals used in the plan preparation
  - ☐ The date of the original plan and latest date of revision to the plan
  - A north arrow and graphic scale. Said scale is not to be smaller than one inch equals 100 feet
  - All property lines & existing/proposed right-of-way lines with bearings & dimensions clearly labeled
  - Existing/proposed easement lines and dimensions with an explanation of ownership and purpose.
  - All required building setback lines
  - Existing and proposed buildings, structures and paved areas, including building entrances, walks, drives, decks, patios, fences, utility poles, drainage facilities and walls.
  - Location and dimension of all curb cuts and throat widths of all access points onto public streets or allevs.
  - □ The location and dimension of all on-site parking including a summary of the number of parking stalls provided versus the requirements of the ordinance
  - □ The location and dimension of all loading and service areas on subject property
  - The location of all outdoor storage areas and the design of all screening devices
  - Location of all outdoor storage and refuse disposal areas and the design and materials used for construction and operation

# **FEASABILITY STUDY**

**FITZGERALD** 






PROJECT ADDRESS 834 NORTH WATER ST. SHEROYGAN, WI


PROJECT INFORMATION


# SHEET LIST


### SYMBOLS LEGEND SHEET NUMBERING SECTION REFERENCE COLUMN GRID DESIGNATORS PARTITION TYPE SYMBOL DETAIL REFERENCE DETAIL NUMBERING LINE TYPE IDENTIFICATION WALL IDENTIFICATION DETAIL - View Name DESCRIBES THE DETAIL **ELEVATION REFERENCE** ELEVATION SYMBOLS ROOM IDENTIFICATION INTERIOR FINISH TAGS

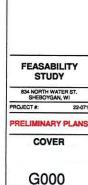

DESCRIPTION

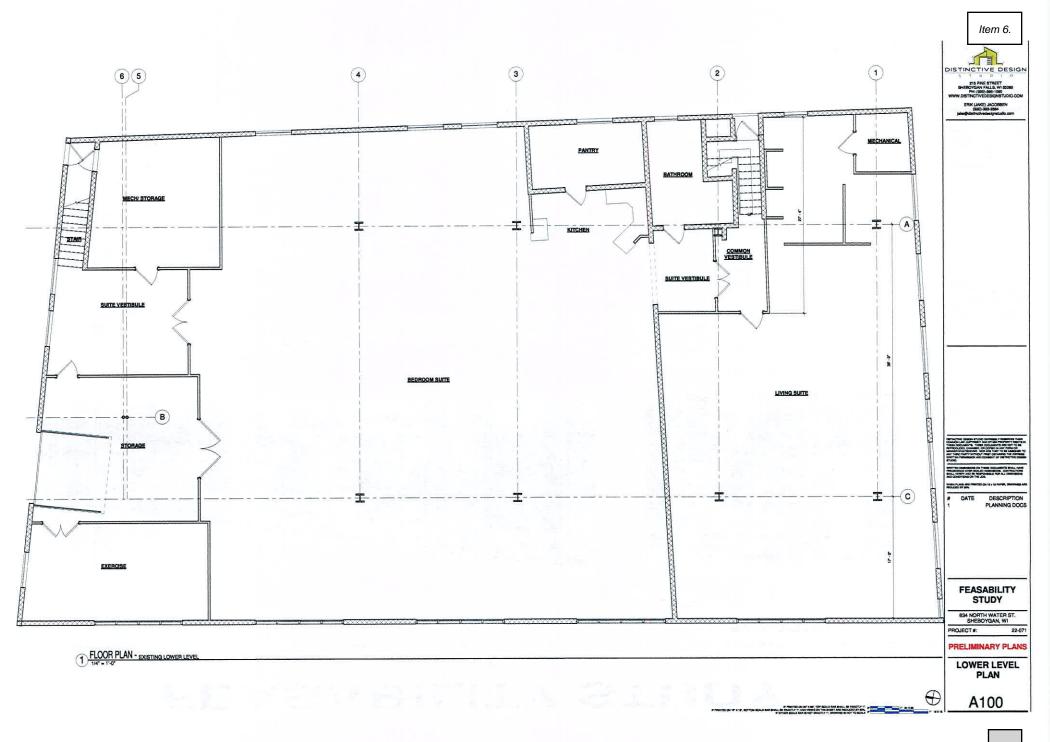

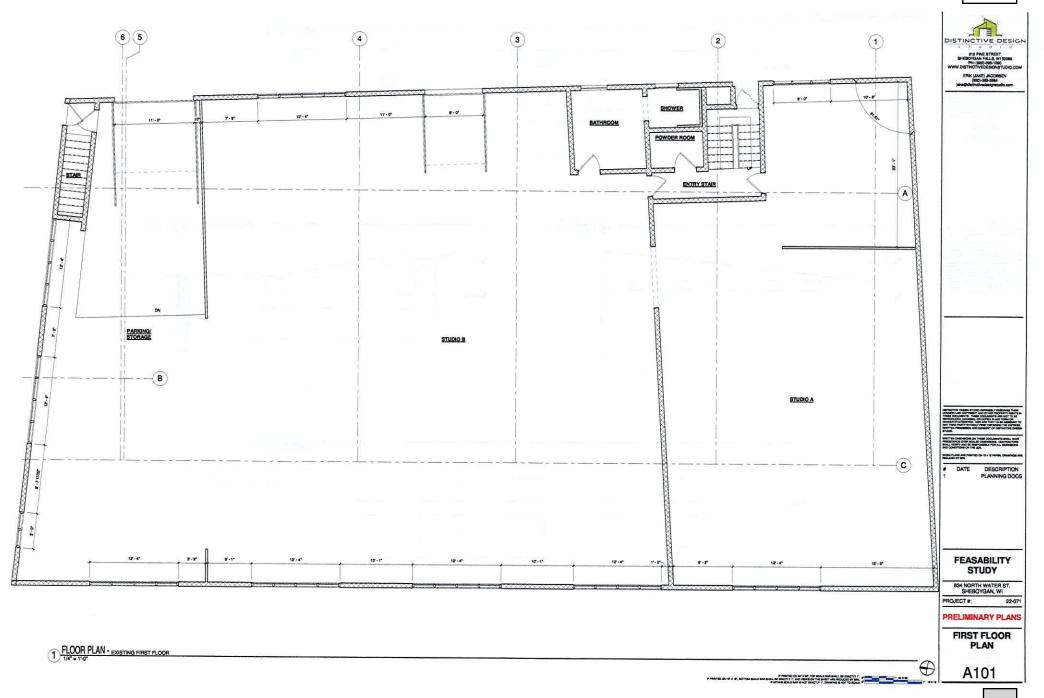

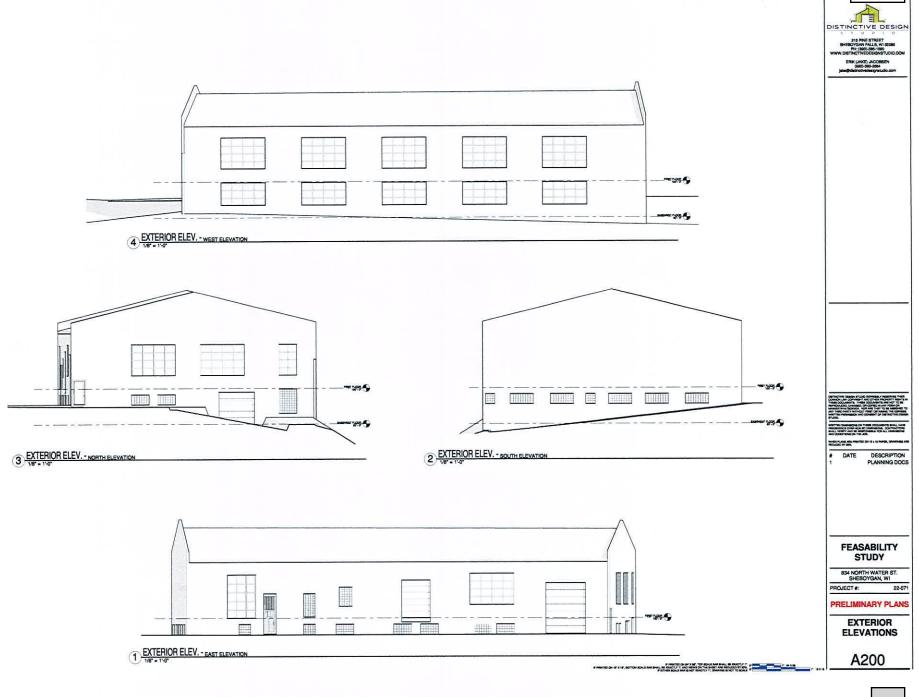

### CITY OF SHEBOYGAN

### REQUEST FOR CITY PLAN COMMISSION CONSIDERATION

**ITEM DESCRIPTION:** Application for site plan review by Abacus Architects to construct a metal pole building at Vollrath Co., Inc. located at 1236 N 18<sup>th</sup> Street. SI Zone.

REPORT PREPARED BY: Ellise Rose, Associate Planner

**REPORT DATE:** March 5, 2025 **MEETING DATE:** March 11, 2025

FISCAL SUMMARY: STATUTORY REFERENCE:

Budget Line Item: N/A Wisconsin N/A

Budget Summary: N/A Statutes:

Budgeted Expenditure: N/A Municipal Code: N/A

Budgeted Revenue: N/A

### **BACKGROUND / ANALYSIS:**

Abacus Architects is proposing to construct a metal pole building at Vollrath Co., Inc. located at 1236 N 18th Street. The applicant states the following:

- The Vollrath Co., Inc., founded in 1874 has been providing high quality, commercial cooking and serving equipment that provides efficiency and ease of use in the demanding environment of commercial kitchens and foodservice operations.
- Vollrath offers OEM Solutions, Wholesale Food Service Products, and advanced cleaning products.
- Vollrath serves both U.S. and International Markets.
- The Vollrath Co., Inc. Will be constructing a new Metal Pole Building (approx. 40' x 60') on their property to accommodate storage needs for equipment.
- This is required as they prepare for new and improve existing building areas to accommodate future growth.
- The structure will be located in the vicinity of the existing Production area on the North end of the site approx. a few hundred feet from Superior Avenue to the North.
- The structure itself is a Pre-Engineered Metal Pole Building.
- This type of Architectural Design will match existing buildings on the Vollrath Campus and surrounding buildings such as S.E.A.S. on the Northeast corner of 18<sup>th</sup> and Superior Avenue.
- Materials Colors will be similar to man other buildings on The Vollrath Campus so that new building blends in with Architectural character of surrounding building on property and those adjoining.
- Project start will be as soon as possible relative to City of Sheboygan Plan Commission, Architectural Review Board and Building Inspection Approvals.
- The Pole Building is required to facilitate growth at The Vollrath Company.

- It is the first piece in a Long-Range Master Planning to not only improve current operations, but to efficiently and methodically build for the next generation.
- The structure will not require additional parking, revised loading and/or service areas, Site Lighting, Signage or new lighting-illumination.

### **STAFF COMMENTS:**

It appears the applicant is designing the new pole building to be compatible with the Vollrath Co. building and other accessory buildings located at the site in terms of materials, colors, etc.

### **ACTION REQUESTED:**

Staff recommends approval of the conditional use permit and exceptions subject to the following conditions:

- Prior to building permit issuance, the applicant shall obtain all licenses/permits as well as meet all required codes including but not limited to building, plumbing, electrical, HVAC, fire, hazardous materials, health, storm drainage, etc.
- 2. Submittal/approval of a proposed storm drainage plan prior to building permit issuance.
- 3. Submittal and approval of a landscape plan prior to building permit issuance.
- 4. Outdoor storage of materials, products or equipment shall be prohibited.
- 5. All new lighting shall be installed per Section 105-932 of the City of Sheboygan Zoning Ordinance.
- 6. All areas used for parking/maneuvering of vehicles shall be paved.
- 7. All areas that are not required to be paved shall be landscaped with grass and/or approved landscaping.
- 8. The addition will meet all zoning requirements including but not limited to noise, vibration, hazardous materials, etc.
- Applicant is responsible for working with all private and public utilities in order to adequately service this development proposal (applicant will need to provide the necessary easements and/or relocate utilities as necessary).
- 10. Applicant shall obtain the required demolition permit for building to be removed.
- 11. If there are any amendments to the approved site plan, the applicant will be required to submit a new site plan review application reflecting those amendments.

### **ATTACHMENTS:**

Site Plan Review Application and Attachments

1tam	7
item	7.



### **CITY OF SHEBOYGAN**

# SPECIAL USE AND SITE PLAN REVIEW APPLICATION

Fee: \$100	
Review Date:	

Read all instructions before completing. If additional space is needed, attach additional pages.

<b>SECTION 1: Applicant/ Permittee Infor</b>	mation			
Name (Ind., Org. or Entity)	Authorized Representative		Title	
KURT MAMS-ABACUS	KURT DAVIS		Arehinect	
Mailing Address	City		State	ZIP Code
11354 MICHIGAN AVE.	SHEBOYUA	N	Wl	53081
Email Address		Phone Number (inc	cl. area code)	
KDANSE ABACUS A RCHITECUS.		920-207-2		
SECTION 2: Landowner Information (co	omplete these fields	when project site of	wner is different th	an applicant)
Name (Ind., Org. or Entity)	Contact Person		Title	
Vourant co., Le	GARY SAUE	XR.	MACHINES (	DIRECTOR
Mailing Address	City		State	ZIP Code
1236 NORTH 18th P.U. 611	City SHEBOY6A	N	WI	ZIP Code 53081
Email Address	_	Phone Number (inc	l. area code)	
GARYSAVIALE VOLIZATILE	D. COM	920 - 459	- 5205	
SECTION 3: Architect Information				
Name				
KURT PAUS				
Mailing Address	City		State	Zip
1135A MICHIGAN AVE.	SHEBOY4	AN	WI	Zip 53081
Email Address		Phone Number (inc	d. area code)	
KOAUSC ABACUS ARCHITE	CTS. NUT	920 - 207	-4829	·
SECTION 4: Contractor Information				
Name			•	
TBD				
Mailing Address	City		State	Zip
				'
Email Address		Phone Number (inc	l. area code)	
		•	,	
SECTION 5: Certification and Permissio	n			****
Certification: I hereby certify that I am t		ized representative	of the owner of the	property which is
the subject of this Site Plan Review App				
are true and accurate. I certify that the				
comply with any or all of the provisions of the permit may result in permit revocation and a fine and/or forfeiture				
under the provisions of applicable laws.				
Permission: I hereby give the City permission to enter and inspect the property at reasonable times, to evaluate this				
notice and application, and to determine compliance with any resulting permit coverage.				
Name of Owner/Authorized Representa		Title	Phone N	umber
KURT DAYS	the same to the sa	ARCHITECT		7-4829
Signature of Applicant Date Signed				
W. 1/_			2-17-	25
			<i> </i>	· · · · · · · · · · · · · · · · ·

Complete application is to be filed with the Department of City Development, 828 Center Avenue, Suite 208. To be placed on the agenda of the City Plan Commission, application must be filed three weeks prior to date of meeting — check with City Development on application submittal deadline date. Applications will not be processed if all required attachments and filing fee of \$100 (payable to the City of Sheboygan) are not submitted along with a complete and legible application. Application filing fee is non-refundable.

· ·	/to 7
SECTION 6: Description of the Subject Site/Proposed Project	Item 7.
Parcel No. 59281214074 Zoning Classification SUBURGAW - SUBUSTR	IAL
Name of Proposed/Existing Business: VOLLRANA CO., INC.	
Address of Property Affected: 1236 NH 18th ST. SHEBOYLAW, WI 53081	
New Building: Remodeling: Remodeling:	
SECTION 7: Brief Description of Type of Structure	
VOLERATH CO., FINC. IS CONSTRUCTING A NEW QU'X60' METAL POLE PUILDING ON EXISTING PARCELTO BE USED FOR STORAGE IN PLACE OF AREDA (BUILDING) TO BE REMOVED AS PART OF A MASTER PLAN FOR NEW BUILDING STRUCTURE(S)	
The state of the s	
METAL POLE POUDDING ON EXISTING PARCEL TO ISE	ŀ
USED FOR STORAGE IN PLACE OF ARETA CISULDING)	
TO BE REMOVED AS PART OF A MASNER PLAN	
FOR NION BUILDING STRUCTURE(S)	
porce production of the state o	
SECTION 8: Description of EXISTING Operation or Use	
N/A	
	1
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SECTION 9: Description of the PROPOSED Operation or Use	
Section 3. Description of the PROPOSED Operation of Ose	
STORAGE	
	Ī
	1

### SPECIAL USE AND SITE PLAN USE APPLICATION SUBMITTAL REQUIREMENTS

- A. Name of project/development.
- B. Summary of general operation and proposed use:
  - Description of existing use
  - Description of proposed use (indoor, outdoor, etc.), why was this site selected?
  - All services, products, etc. to be provided
  - Projected number of residents, employees, and/or daily customers
  - Proposed number of dwelling units, floor area, landscape area, and parking area expressed in square feet and acreage to the nearest one-hundredth of an acre
  - Description of proposed building and all new site improvements (square footage of new and existing structure(s), traffic, ingress/egress, parking, sidewalk, retaining walls, storm drainage, landscaping, lighting, dumpster enclosure, screening of mechanicals, etc.)
  - A written description of the proposed general orientation, design, arrangement, texture, material and color of the building or structure and how it is compatible with the development and redevelopment in and around the area
  - An explanation of any interior and/or exterior renovations
  - Is access appropriate and is their sufficient customers/resident off-street parking?
  - Proposed signage
  - Project timeline and estimated value of project
  - Compatibility of the proposed use and design with adjacent and other properties in the area.
  - How will you insure that the business will not become a nuisance to adjacent properties (i.e. parking, noise, smells, hours of operations, etc.
  - Other information that would be considered pertinent by the Plan Commission.



Submit TWO (2) copies of a property site plan drawing, which includes:

- A certified survey map showing existing property boundaries and improvements
- A map providing the following information:
  - $\circ$  The map and all its parts shall be clearly reproducible with a photocopier at a size of 11" X 17" and map scale not less than 1' = 600' with lot dimensions of the subject property provided and a graphic scale and north arrow
  - o All lands for which the conditional use is proposed
  - All other lands within 100 feet of the boundaries of the subject property
  - o The current zoning of the subject property and its environs (200 feet)
- A site plan (conforming to the requirements of Section 15.908(3) of the subject property as proposed for development):
  - Submit TWO (2) hardcopies of the site plan and ONE (1) 11" X 17" reduction of the site plan
  - Submit digital plans and drawings of the project by email, flash drive, etc.
  - o Title block that provides all contact information for the petitioner and/or owner, if different
  - Full name and contact information of petitioner's engineers/surveyors/architects, or other design professionals used in the plan preparation
  - The date of the original plan and latest date of revision to the plan
  - A north arrow and graphic scale. Said scale is not to be smaller than one inch equals 100 feet
  - All property lines & existing/proposed right-of-way lines with bearings & dimensions clearly labeled

Item 7.

- Existing /proposed easement lines and dimensions with an explanation of ownership and purpose
- All required building setback lines
- Existing and proposed buildings, structures and paved areas, including building entrances, walks, drives, decks, patios, fences, utility poles, drainage facilities and walls
- Location and dimension of all curb cuts and throat widths of all access points onto public streets or alleys
- The location and dimension of all on-site parking including a summary of the number of parking stalls provided versus the requirements of the ordinance
- o The location and dimension of all loading and service areas on subject property
- o The location of all outdoor storage areas and the design of all screening devices
- Location of all outdoor storage and refuse disposal areas and the design and materials used for construction and operation
- The location, type, height, size and lighting of all signage
- Location, height, design, illumination power and orientation of all exterior lighting on the property including a photometrics plan
- Location of all exterior mechanical equipment and utilities and elevations of proposed screening devices where applicable (i.e. visible from a public street or residential use or district). Mechanical equipment includes, but is not limited to; HVAC equipment, electrical transformers and boxes, exhaust flues, plumbing vents, gas regulators, generator
- o Location of all existing and proposed landscape areas, storm water areas, etc.

D. Building elevations and perspectives.

NOTE: A Traffic Impact Study (TIA) may be required with large development proposals.

### NOTE

### Initiation of Land Use or Development Activity

Absolutely no land use or development activity, including site clearing, grubbing, or grading shall occur on the subject property prior to the approval of the site plan by the City Plan Commission. Any such activity prior to such approval shall be a violation of law and shall be subject to all applicable enforcement mechanisms and penalties.

### Modification of an Approved Site Plan

Any and all unauthorized variations between development and/or land use activity on the subject property and the approved site plan is a violation of law. An approved site plan may be revised so as to clearly and completely depict any and all proposed modifications to a previously approved site plan by the City Plan Commission. Prior to the initiation of said modifications, the City Plan Commission must approve the revised plan.

### Office Use Only

### **ACTION BY CITY PLAN COMMISSION**

DATE OF MEET	ΓING:		
CONDITIONS	CONDITIONALLY APPROVED:		
			·
	,,,,,,,,,,,,,,,,,,,,,,,,,,,,,,,,,,,,,,		
<u> </u>			
SIGNATURE:		DATE:	
	Director or Representative	DAIL.	
	Department of City Development		

### **NOTES**

**Permit may be revoked** without notice if misrepresentation of any of the above information or attachments is found to exist.

Permit shall expire within six (6) months from date of approval unless substantial work has commenced.

**Permit is null and void** if issued in error. It is understood that any permit issued on this application will not grant any right or privilege to erect any structure or to use any permits for any purpose that is prohibited by the City Zoning Ordinance or any other state or local laws.

**Changes in the plans or specifications** submitted in the original application shall not be made without prior written approval of the City Plan Commission.

Check sidewalk grades from City Engineering Department with finished site grade.

### APPLICATION SUBMITTAL

### STEP 1: Initial Meeting with City Planning Office:

An initial meeting is to ensure that both the applicant and the city staff have a proper understanding of what is being requested and to explain the approvals necessary. An engineered drawing is not required for this meeting, but an accurate sketch and any applicable background information may be needed. Additional meetings can be arranged by calling the Department of City Development.

### STEP 2: Official Submission:

A special use permit and site plan application may be filed at the City of Sheboygan Planning and Development office located on the 2nd floor of City Hall or may be submitted electronically via email: Steve.Sokolowski@SheboyganWI.gov

If submitting electronically, please verify application has been accepted and will be placed on the next Plan Commission agenda.

Payment of the application fee must be received prior to the application filing deadline. Payment may be submitted via postal delivery, in person, or by phone using credit card.

Mailing Address: Department of City Development

828 Center Ave. Suite 208 Sheboygan, WI 53081

NOTE: Applications will not be accepted until complete. A complete application includes all items in the respective checklists above. Applications must be complete before they are scheduled for a meeting before the Plan Commission.

### PLAN COMMISSION MEETING

Meeting Date: The Plan Commission meets on the 2nd and 4th Tuesdays of the month at 4:00 p.m. in the Council Chambers of City Hall, 828 Center Ave. The project applicant or a representative must attend the Plan Commission meeting to present the request and answer questions regarding the proposal. Public comment will be invited at the Plan Commission meeting.

Project Review: The purpose of a special use permit and site plan is to assure compatibility between land uses. City staff analyzes a proposal and prepares a recommendation for the Plan Commission. The project analysis considers the location of the affected property, surrounding uses, and the operational details of a proposed use.

Plan Commission: The Plan Commission is charged with the authority to approve or deny a special use permit and site plan request. In the event an applicant wishes to contest the decision of the Plan Commission, the applicant may appeal the decision to the Sheboygan County Circuit Court.

Plan Commission meeting agendas and minutes may be viewed on the City's website: www.SheboyganWl.gov

FOR INFORMATION OR ASSISTANCE CONTACT THE ZONING MANAGER: (920) 459-3382

### RELATIONAL ARCHITECTURE



February 18th, 2025

City of Sheboygan 828 Center Avenue Sheboygan, WI 53081

### SITE PLAN REVIEW

The Vollrath Company, Inc. – Pole Building Sheboygan, WI

### THE VOLLRATH COMPANY

The Vollrath Co., Inc., founded in 1874 has been providing high quality, commercial cooking and serving equipment that provides efficiency and ease of use in the demanding environment of commercial kitchens and foodservice operations.

Vollrath offers OEM Solutions, Wholesale Food Service Products, and advanced cleaning products.

Vollrath serve both U.S. and International Markets.

### PROJECT DESCRIPTION

The Vollrath Co., Inc. will be constructing a new Metal Pole Building (approx. 40' x 60') on their property to accommodate storage needs for equipment. This is required as they prepare for new and improve existing building areas to accommodate future growth. The structure will be located in the vicinity of the existing Production area on the North end of the site approx. a few hundred feet from Superior Avenue to the North. Site plan and Survey are attached.

The structure itself is a Pre-Engineered Metal Pole Building (plans and elevations attached). This type of Architectural Design will match existing buildings on the Vollrath Campus and surrounding buildings such as S.E.A.S. on the Northeast corner of 18<sup>th</sup> and Superior Avenue. Materials – Colors will be similar to many other buildings on The Vollrath Campus so that new building blends in with Architectural character of surrounding building on property and those adjoining.

### SITE

The existing site is zoned Suburban Industrial. Please find attached to this submittal an overall Site Plan and Zoning classification of adjacent properties.

### PROJECT TIMELINE

Project Start will be as soon as possible relative to City of Sheboygan Plan Commission, Architectural Review Board and Building Inspection Approvals.



### **OTHER PROJECT INFORMATION**

The Pole Building is required to facilitate growth at The Vollrath Company. It is the first piece of Long-Range Master Planning to not only improve current operations, but to efficiently and methodically build for the next generation.

The structure will not require additional parking, revised loading and/ or service areas, Site Lighting, Signage or new lighting-illumination.

Please call me directly if you have any questions that I can answer before the Plan Commission Meeting.

Sincerely,

Kurt Davis, Vice President Abacus Architects, Inc.



1/15/2025 CHAPPA, TYLER Doc ID: 21183220250115125039

### Cleary/Owner Project Proposal - Material Only

## Roof Finish and Accessories for Building 1

### **Exterior Finishes**

Roof: Premium Steel Panel

- Lifetime Film Integrity Warranty, 35 Year Fade and Chalk Warranty, and G-90 Galvanizing Up to 1.0 ounce of Zinc

### Ventilation

Roof

Ridge Cap(s):

62' 0" of Standard Ridge Cap. Marco LP2 Weather-Tite Ridge Vent "Low Profile" (Add ventilation to ridge).

### Accessories

Roof

Condensation Control for Building 1: None

Weathervane: Cleary weathervane not included with building

# **Elevations for Building 1**

South Side Wall 1 on Building 1

Note: These colors are as close to the actual colors as permitted by printing. Actual metal samples must be reviewed with your Sales Specialist. Colors vary depending upon position and angles.

### **Exterior Finishes**

Side Wall 1 on Building 1

Siding: Premium Steel Panel

- Lifetime Film Integrity Warranty, 35 Year Fade and Chalk Warranty, and G-90 Galvanizing Up to 1.0 ounce of Zinc Protection.

House Wrap: None

Wainscot: None

Eave Filler Strips: None

C-110 v12/10







1/15/2025 CHAPPA, TYLER Doc ID: 21183220250115125039

### Cleary/Owner Project Proposal - Material Only

Treated Plank Filler Strips: None

### Ventilation

Side Wall 1 on Building 1

Overhang: 12" Aluminum soffit (Sidewall) with vented soffit

Bird Screening for the interior to prevent birds from nesting in overhang.

### Accessories

Side Wall 1 on Building 1


None

### Interior Finishes / Insulation

Side Wall 1 on Building 1

Condensation Control: None

Insulation: None

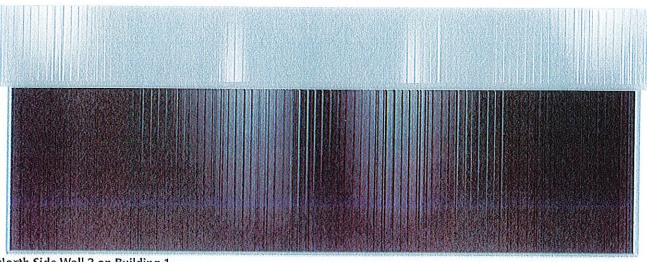

### North Side Wall 2 on Building 1

Note: These colors are as close to the actual colors as permitted by printing. Actual metal samples must be reviewed with your Sales Specialist. Colors vary depending upon position and angles.

### **Exterior Finishes**

Side Wall 2 on Building 1

Siding: Premium Steel Panel

- Lifetime Film Integrity Warranty, 35 Year Fade and Chalk Warranty, and G-90 Galvanizing Up to 1.0 ounce of Zinc Protection.

House Wrap: None

Wainscot: None

Eave Filler Strips: None

Treated Plank Filler Strips: None

### Ventilation

Side Wall 2 on Building 1

Overhang: 12" Aluminum soffit (Sidewall) with vented soffit

Bird Screening for the interior to prevent birds from nesting in overhang.

### Accessories

C-110 v12/10

built with pride before the ( is applied \*






1/15/2025 CHAPPA, TYLER Doc ID: 21183220250115125039

### Cleary/Owner Project Proposal - Material Only

Side Wall 2 on Building 1 None

### Interior Finishes / Insulation

Side Wall 2 on Building 1 Condensation Control: None Insulation: None

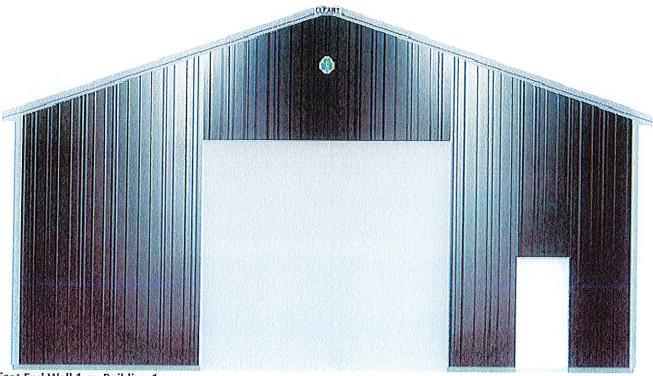

East End Wall 1 on Building 1

Note: These colors are as close to the actual colors as permitted by printing. Actual metal samples must be reviewed with your Sales Specialist. Colors vary depending upon position and angles.

### **Exterior Finishes**

End Wall 1 on Building 1

Siding: Premium Steel Panel

- Lifetime Film Integrity Warranty, 35 Year Fade and Chalk Warranty, and G-90 Galvanizing Up to 1.0 ounce of Zinc Protection.

House Wrap: None

Wainscot: None

Gable Filler Strips: Gable filler strips not included.

Treated Plank Filler Strips: None


### Ventilation

End Wall 1 on Building 1

Overhang: 12" Aluminum soffit (Endwall) with vented soffit

C-110 v12/10

built with pride before the (ii) is applied \*

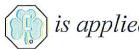



1/15/2025 CHAPPA, TYLER Doc ID: 21183220250115125039

### Cleary/Owner Project Proposal - Material Only

### Accessories

End Wall 1 on Building 1

Overhead Frame Out(s):

16' 0" Width x 14' 0" Height

Headroom Available: 1' 10"

Additional Header material required: Overhead Frame Out with 13" to 20" of Required Headroom without Liner

Distance from left edge of wall to left edge: 12' 0 1/4"

Distance from 100'+0" mark to bottom of the overhead frame out plus: 4"

Inside edge of overhead frame out to be trimmed with door edge.

OVERHEAD DOOR NOT INCLUDED UNLESS OTHERWISE NOTED IN WRITING IN THE ADDITIONAL BUILDING COMPONENTS OR CLOPAY BUILDING PRODUCTS SECTION.

### Walk Door(s):

Standard, Steel Jamb 3 1/2" 3'-0"x6'-8"

Distance from left edge of wall to left edge: 32' 7"

Distance from 100'+0" mark to bottom of door plus: 4"

Anchor: ANCHOR KIT (WOOD)

Closer: No Closer

Dead Bolt: Key/Latch Door Chain: No Chain

**Embossment: No Embossment** 

Frame: 2x6

Hinge: 4" 304 STAINLESS STEEL FIXED PIN

Jamb: 3 1/2" Jamb

Kick Plate: No Kick Plate

Latch Guard: No Latch Guard

Latch: None

Lockset: Knob/Knob

Panic Hardware: No Panic Hardware

Skin: Blank

Swing: Right Hand Swing In Single Door

Window: None

Keyed Alike. Group 1

### Interior Finishes / Insulation

End Wall 1 on Building 1


Condensation Control: None

Insulation: None



1/15/2025 CHAPPA, TYLER Doc ID: 21183220250115125039

### Cleary/Owner Project Proposal - Material Only

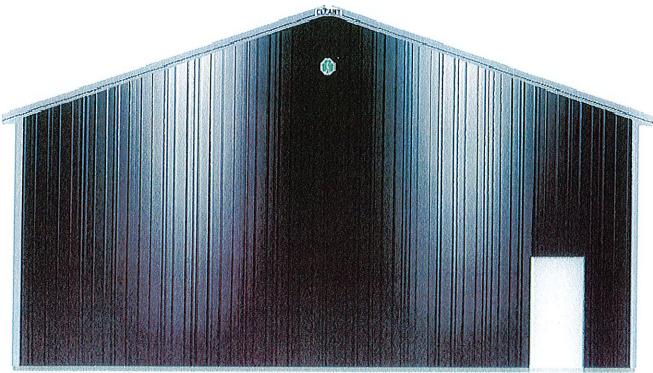

### West End Wall 2 on Building 1

Note: These colors are as close to the actual colors as permitted by printing. Actual metal samples must be reviewed with your Sales Specialist. Colors vary depending upon position and angles.

### **Exterior Finishes**

End Wall 2 on Building 1

Siding: Premium Steel Panel

- Lifetime Film Integrity Warranty, 35 Year Fade and Chalk Warranty, and G-90 Galvanizing Up to 1.0 ounce of Zinc Protection.

House Wrap: None

Wainscot: None

Gable Filler Strips: Gable filler strips not included.

Treated Plank Filler Strips: None

### Ventilation

End Wall 2 on Building 1

Overhang: 12" Aluminum soffit (Endwall) with vented soffit

### Accessories

End Wall 2 on Building 1

Walk Door(s):

Standard, Steel Jamb 3 1/2" 3'-0"x6'-8"

Distance from left edge of wall to left edge: 33' 6"

Distance from 100'+0" mark to bottom of door plus: 4"

Anchor: ANCHOR KIT (WOOD)

C-110 v12/10



1/15/2025 CHAPPA, TYLER Doc ID: 21183220250115125039

### Cleary/Owner Project Proposal - Material Only

Closer: No Closer Dead Bolt: Key/Latch Door Chain: No Chain

**Embossment: No Embossment** 

Frame: 2x6

Hinge: 4" 304 STAINLESS STEEL FIXED PIN

Jamb: 3 1/2" Jamb Kick Plate: No Kick Plate Latch Guard: No Latch Guard

Latch: None

Lockset: Knob/Knob

Panic Hardware: No Panic Hardware

Skin: Blank

Swing: Right Hand Swing In Single Door

Window: None Keyed Alike. Group 1

### Interior Finishes / Insulation


End Wall 2 on Building 1 Condensation Control: None

Insulation: None



1/15/2025 CHAPPA, TYLER Doc ID: 21183220250115125039

### Cleary/Owner Project Proposal - Material Only

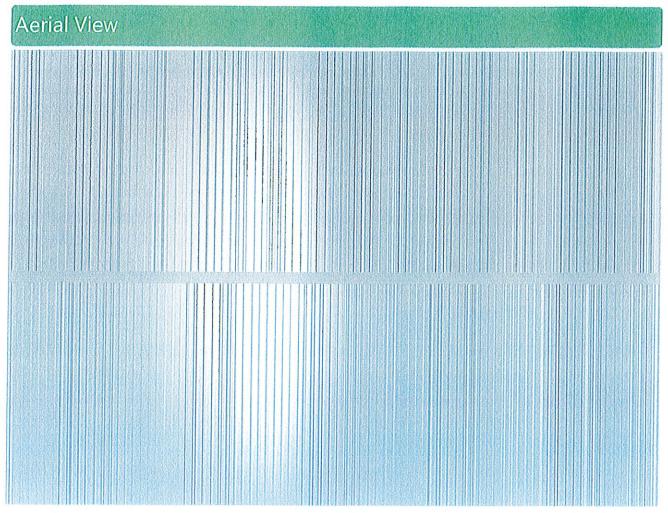

Note: These colors are as close to the actual colors as permitted by printing. Actual metal samples must be reviewed with your Sales Specialist. Colors vary depending upon position and angles.



1/15/2025 CHAPPA, TYLER Doc ID: 21183220250115125039

Cleary/Owner Project Proposal - Material Only

### **Project Colors**

### **Building** - Exterior

### Siding

Premium Steel Panel: Umber Corner Trim: Light Gray Bottom Trim: Light Gray

### Roof

Premium Steel Panel: Light Gray

### Trim

Gable: Light Gray Eave/Fascia: Light Gray Ridge Cap: Light Gray

Trim Color Unless Otherwise Specified: Light Gray

### **Overhangs**

Soffit: Light Gray

WallToSoffitTrim: Light Gray CeilingEnclosureTrim: Light Gray

### **Overhead Frameout**

J-Trim: Light Gray InsideTrim: Light Gray

### Walk Doors

Standard Blocked 3068: Brilliant

J-Trim: Light Gray

All applicable Wall Steel, Roof Steel, Walk Door, and Trim colors have been reviewed using steel color chips.

### Purchaser Initials

Purchaser and BSS to meet at a later date to confirm colors with color chips. This will be documented with a change order.

Purchaser Initials



## **GENERAL NOTES AND SPECIFICATIONS**

- 1. The materials and labor shown on these plans that are provided by Cleary Building Corp. are limited to those materials and labor as defined by the Cleary Building Corp. contract. Additional materials or accessories that are not being provided by Cleary Building Corp. may be shown on plans for context or building code compliance.
- 2. This building is designed in accordance with the following codes and specifications as applicable:

2018 Wisconsin Administrative Code chs. SPS 361-366 2015 International Building Code (IBC) as amended by SPS 362 2015 International Energy Conservation Code (IECC) as amended by SPS 363 2015 International Existing Building Code (IEBC) as amended by SPS 365 2015 National Design Specification for Wood Construction (NDS)

Use Group(s) Classification:

Building Use:

Type of Construction:

Building Area:

2400 Sq. Ft.

Building Design Loads: Snow Design Data:

Ground Snow Load (Pg): — 47 PSF
Snow Exposure Factor (Ce): 1 37 PSF Leeward 20.39 PSF Leeward surcharge 8.1 Ft. Width of surcharge

Wind Design Data: Design Internal Pressure Coefficient: ± 0.18

Earthquake Design Data:


Basic Seismic Force Resisting System:————————————————————————Building Frame System/Light Frame Walls Sheathed with Wood Structural Panels or Steel Sheets Design Base Shear:—— Seismic Response Coefficient (Cs)————— 0.012 Analysis Procedure Used: ———— Equivalent Lateral Force Procedure Seismic Design Category:— Mapped Spectral Response Accelerations (Ss): 6.6%q Spectral Response Coefficients (Sps):——— Seismic Importance Factor (I<sub>F</sub>)

- 3. All lumber, unless noted otherwise, shall be S4S #2 SPF or better. All lumber embedded in the ground shall be treated with Chromated Copper Arsenate to a retention level of .60 lbs. per cubic foot. AWPA U1, UC4B.
- 4. All nails are to be threaded hardened steel unless otherwise noted.


- 5. Grading should be such that the surface water is drained away from the foundation. Minimum grade would be six inches of vertical drop per ten feet of horizontal away from the foundation (5%).
- 6. Fill used for concrete floor slab sub grade, if present, shall be reasonably graded granular material. Fill used in columns holes shall be the excavated soil unless noted otherwise. All fill shall be free from debris, stones over 4"\$\psi\$ and frozen material.
- Electrical work, heating, ventilating, air conditioning, plumbing, and site draining is not a part of this drawing and shall be installed as per applicable codes.
- 8. This design is based on a building site with sand, silty sand, clayey sand, silty gravel, clayey gravel soil. As per the IBC building code and Referenced Standard ASAE 486.1, an assumed soil bearing design value of 1500 psf with increases for depth and width has been used in this design. If information is discovered before or during construction contrary to this, the building designer should be contacted.


This building, as depicted, must be constructed 10 feet or more from any and all lot lines and 20 feet or more from any other buildings on the same lot. See IBC code and/or the local building official for exceptions.

This document, as presented and sealed, is not intended to be, nor should i be construed as such, a complete building design. It is intended to represent just the building itself. It should also be noted that the designer is unaware of any subsoil investigation reports. Footings have been sized on assumed values as per note 8.0 under General Specifications and Notes. The designer excludes determination that the assumed soil conditions are present at the site. If a concrete floor will be installed, the design of the concrete floor is not part of these plans, nor is it intended to be. If shown, the concrete floor is only depicted to show its location with respect to related components of the building. The client or general contractor is encouraged to contract with other professional engineers or architects for the design of the concrete floor and its subgrade.

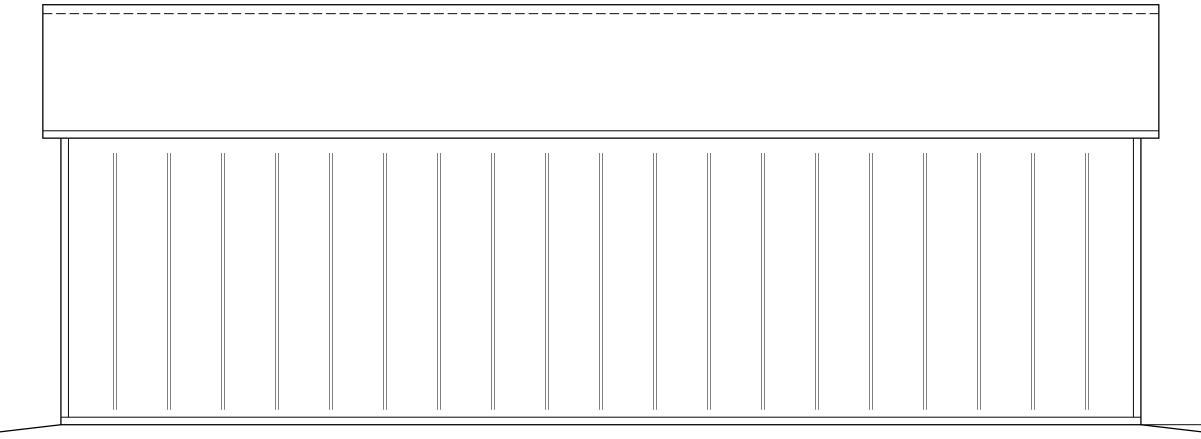


# **SOUTH ELEVATION**

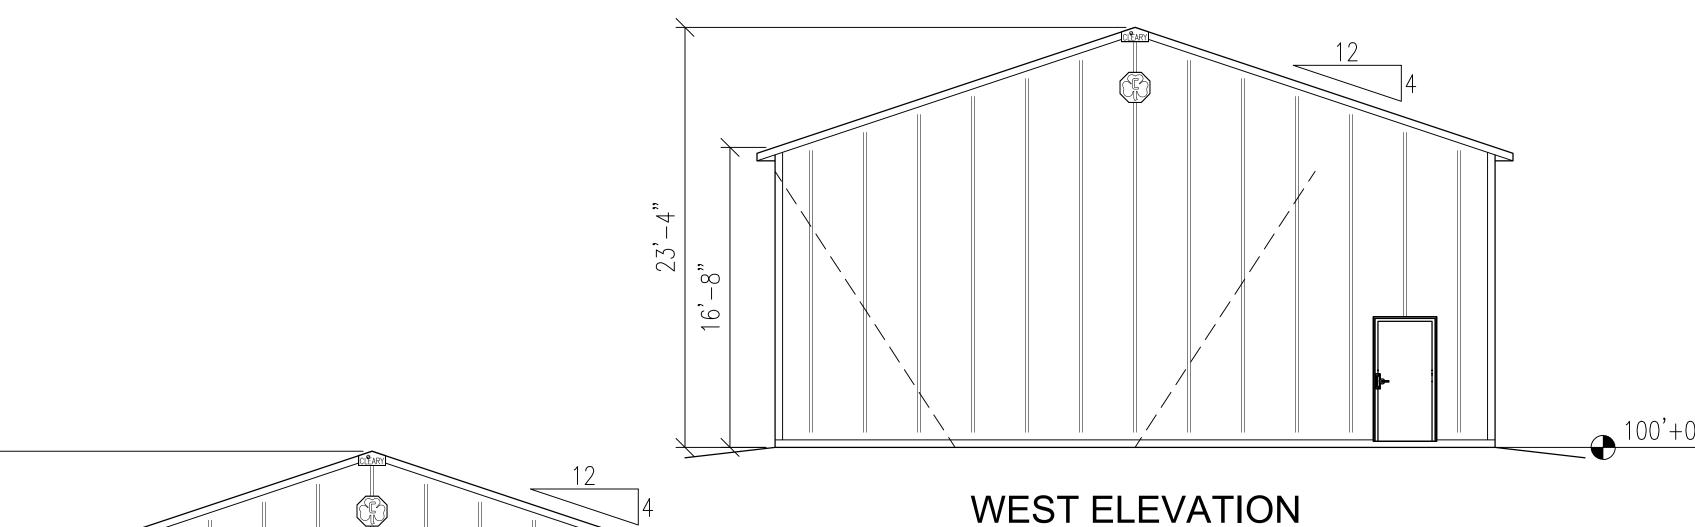

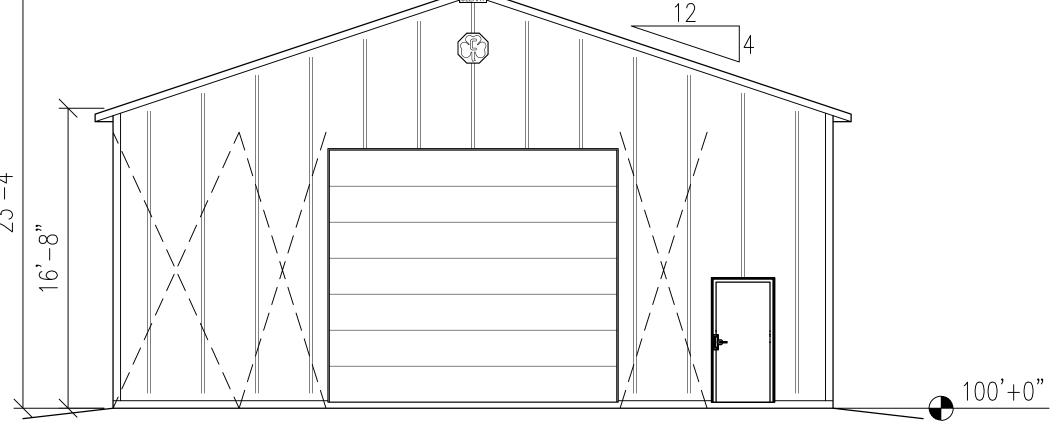

# EAST ELEVATION

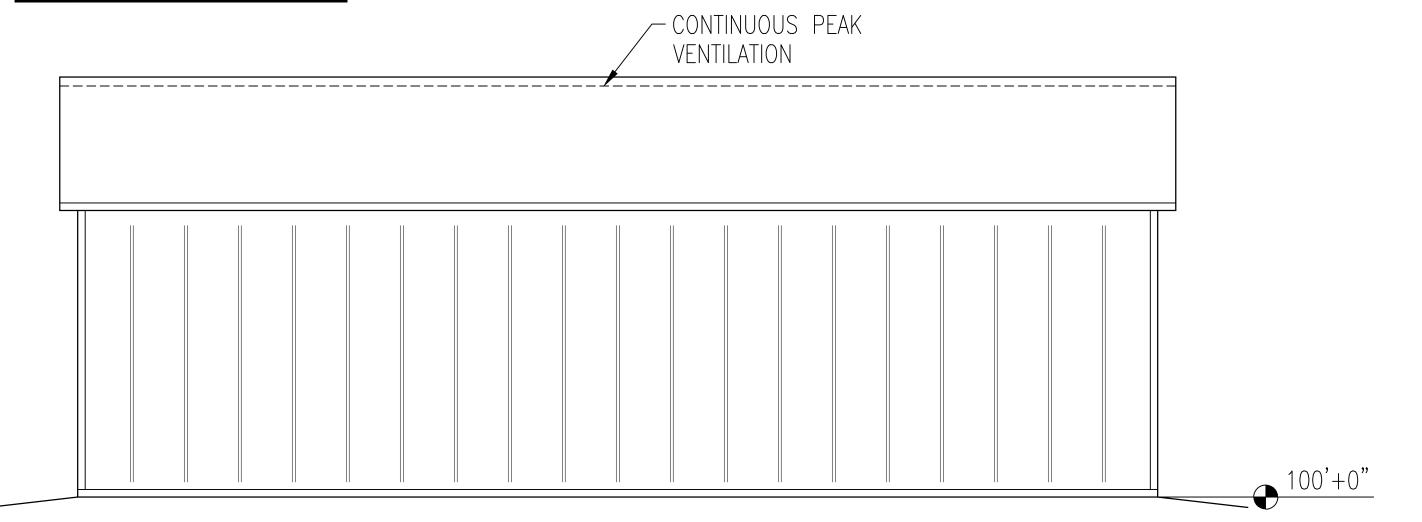

NORTH ELEVATION



190 PAOLI STREET / P.O. BOX 930220 VERONA, WI 53593 / (800) 373-5550

DRAWN BY: JENKINS

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**DATE DRAWN:** 02/10/25

PLAN REVISIONS:

NUMBER 3 4

TYLER

PROJECT NUMBER: 2025100424

SHEET NUMBER: 110

WHEN PRINTED ON 24"x36" PAPER SCALE IS 3/16"=1'-0"



PM	FOOTING
12:19	COLUMN ANCHOR DETAIL
/10/2025	
Date Printed: 2/10/2025 12:19 PM	= ANCHOR COLUMNS WITH (2) 2x6x8" TREATE BLOCKS ATTACHED TO COLUMN WITH (3) 20d NAILS PER EACH BLOCK FOR UPLI NOTE: COLUMN SETS ON TOP OF FOOTING — CHECK COLUMN CHART FOR EXACT FOOTING SIZE REQUIREMENTS
	(2) 2x6x8" TREATED BLOCKS

60# BAGS OF-SACKCRETE

= ANCHOR COLUMNS WITH (2) 2x6x8" TREATED BLOCKS ATTACHED TO COLUMN WITH (3) 20d NAILS PER EACH BLOCK FOR UPLIFT NOTE: COLUMN SETS ON TOP OF FOOTING — CHECK COLUMN CHART FOR EXACT FOOTING SIZE REQUIREMENTS
(2) 2x6x8" TREATED BLOCKS

5'-6"

5'-6"

75 TOTAL BAGS OF SACKCRETE

THE FOOTING PAD IS THE AGCO MOLDED COMPOSITE CIRCULAR FOOTING PAD (SEE ESR-2147)

> ANCHORAGE NOT SHOWN FOR CLARITY

> > 24"

= ANCHOR COLUMNS WITH

= ANCHOR COLUMNS WITH

FOOTING PAD DETAIL

(6) 60# BAGS OF SACKCRETE AND (1) #4x12" REBAR FOR UPLIFT

(3) 60# BAGS OF SACKCRETE AND (1) #4x12" REBAR FOR UPLIFT NOTE: COLUMN SETS ON TOP OF

EXACT FOOTING SIZE REQUIREMENTS

FOOTING - CHECK COLUMN CHART FOR

—(1) #4x12" REBAR

FP-24

**FOOTING** 

PAD

REQUIRED FOR COLUMN ANCHORAGE

18"ø

3-PLY 2x6x26'-0"

3-PLY 2x6x28'-8"

FLAT SIDE — OF FOOTING PAD DOWN

(F) ENDWALL

G ENDWALL


**COLUMN ANCHOR DETAIL** 

NUMBER OF BUILDING ACCESSORY SCHEDULE HOLE DEPTH HOLE COLUMN SIZE COLUMNS **FOOTING SIZE** COLUMNS DIAMETER ITEM B.E./T.E. ROUGH OPENING & ACCESSORY FEATURES REQUIRED B.E. =100' 4" 2 1 | SOLID WALK DOOR | 3' 0"x6' 8" R.O. 3' 4 3/8"x6' 9 3/4", STANDARD, BRILLIANT, LEV./LEV. (A) CORNER 3-PLY 2x6x22'-0" 18"ø 4"x14"ø PRECAST CONCRETE FOOTING 5'-6" LOCKSET, LATCH GUARD, KEYED ALIKE, CLOSER, H.CAP THRESHOLD (B) SIDEWALL 5'-6" AGCO FP-24 FOOTING PAD (SEE NOTE/DETAIL) 4-PLY 2x6x22'-0" 10 24**"**ø 2 OVERHEAD DOOR 16' 0"x14' 0" B.E. =100' 4" I.D. =15' 11 1/2", 13-20" HEADROOM OPTION WITHOUT LINER, 2-PLY 2x6x9'-2" © VERT. BRACE VERTICAL BRACE B.E.=14' 1 1/2" TRIM INSIDE EDGE, DOOR NOT BY CLEARY (D) ENDWALL 3-PLY 2x6x24'-4" 5'-6" 4"x14"Ø PRECAST CONCRETE FOOTING 5'-6" (E) ENDWALL 3-PLY 2x6x25'-4" 4"x14"ø PRECAST CONCRETE FOOTING

4"x14"ø PRECAST CONCRETE FOOTING

4"x14"ø PRECAST CONCRETE FOOTING

- 1. FIELD VERIFY ALL DOOR AND WINDOW ROUGH OPENING SIZES PRIOR TO INSTALLING FRAME-OUTS
- 2. ENDWALL COLUMNS ARE 3-PLY TO THE BUILDING EAVE HEIGHT AND 1-PLY FROM THERE TO THE ROOF PLANE
- 3. 2x6 STANDARD DIAGONAL CORNER BRACING AT ALL CORNERS (UNLESS OTHERWISE NOTED)
- 4. END WALL 1 ON BUILDING 1 (EAST) INSTALL STANDARD 15" SHAMROCK
- 5. END WALL 2 ON BUILDING 1 (WEST) INSTALL STANDARD 15" SHAMROCK

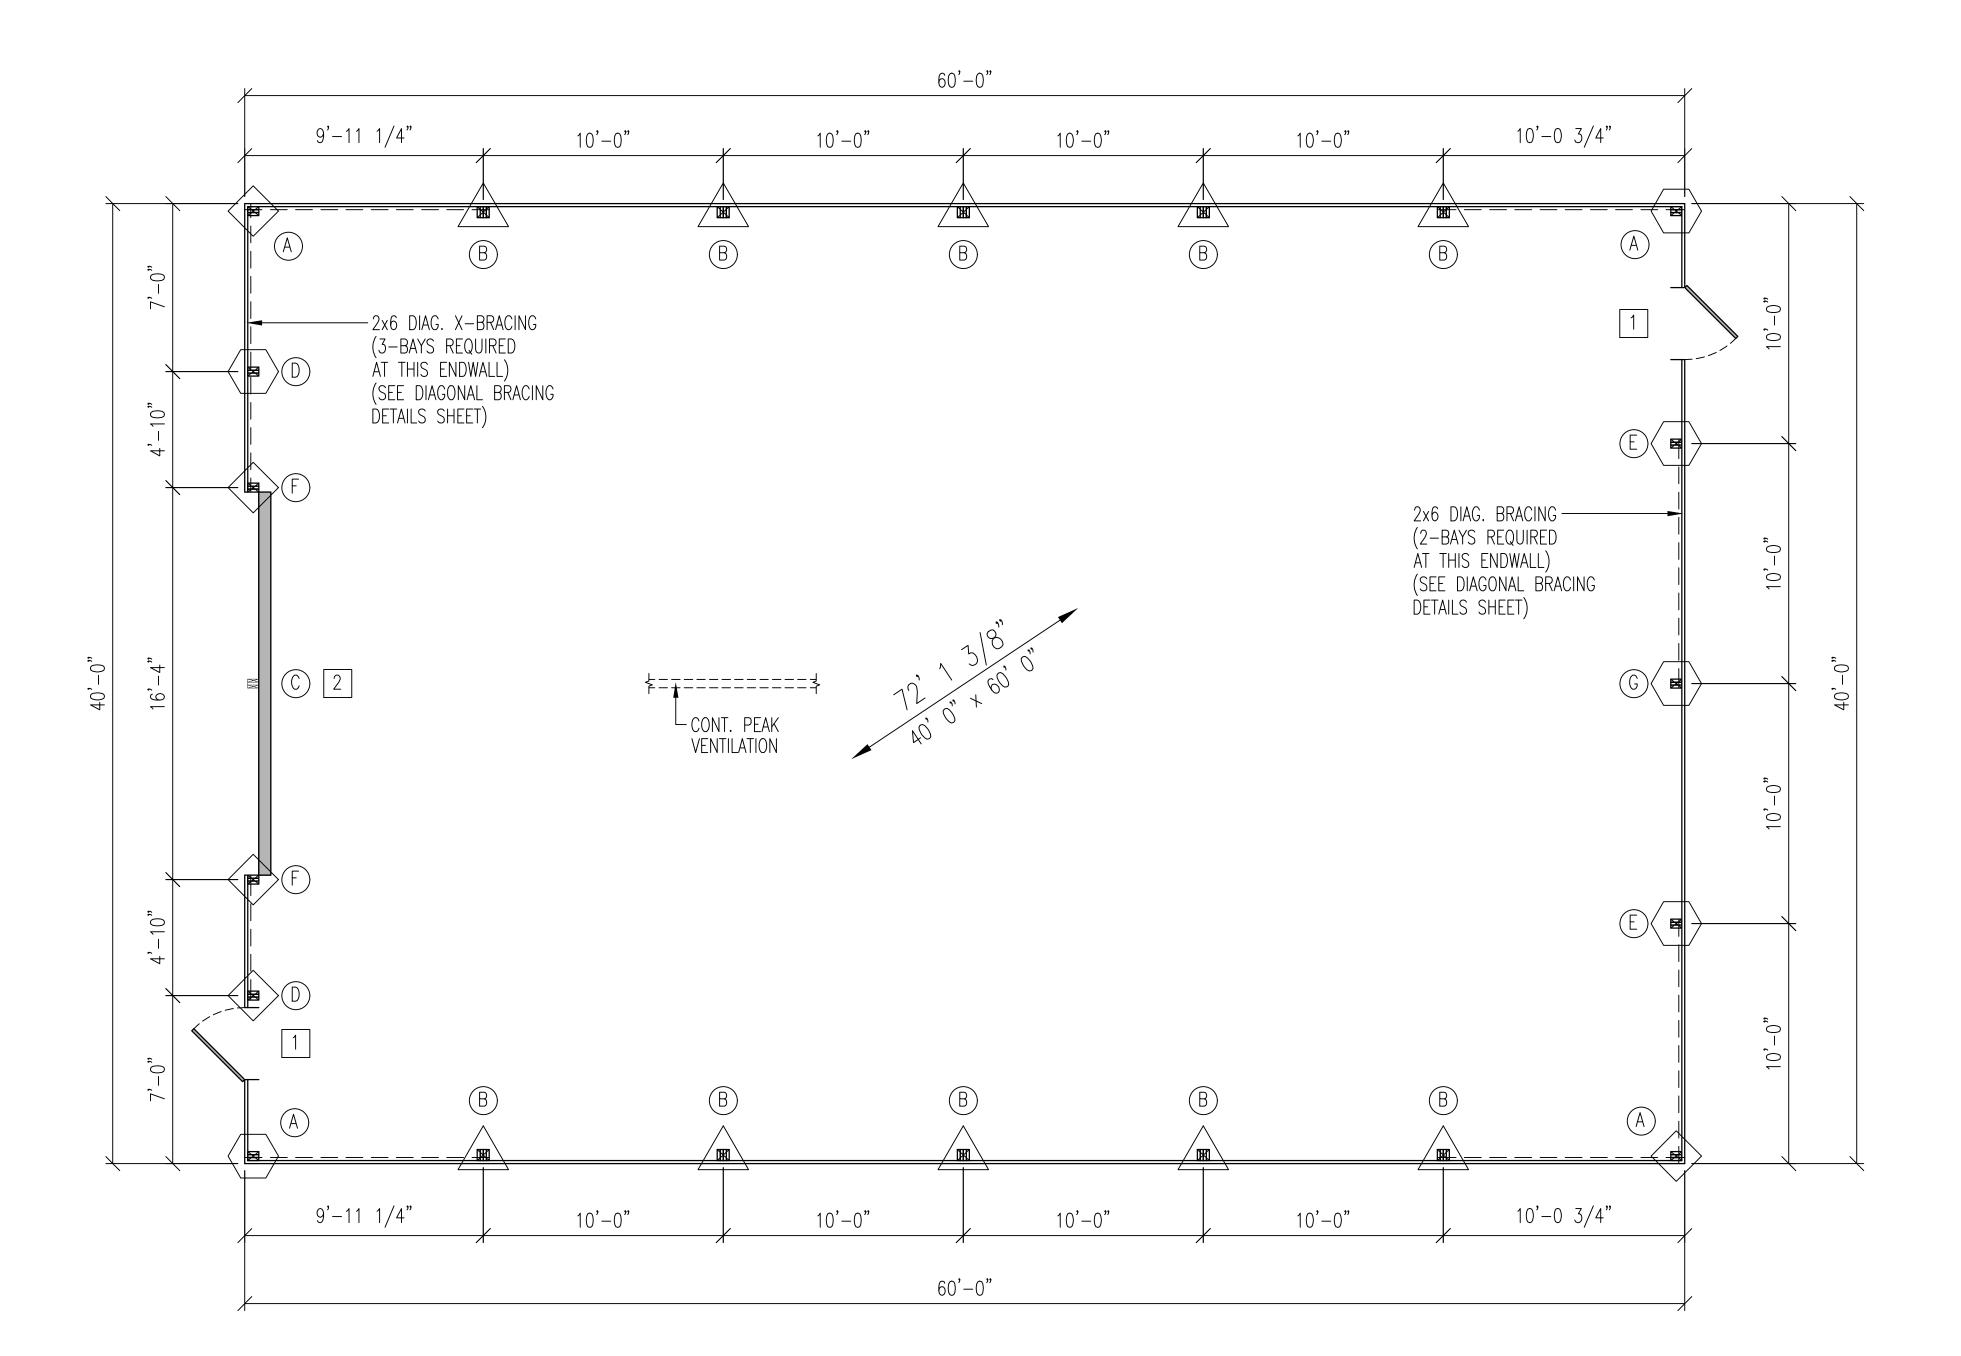



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**DATE DRAWN:** 02/10/25

PLAN REVISIONS:

PLAN KLVISIONS.			
NUMBER	DATE	BY	
1			
2			
3			
4			

83 (SHEBOYGAN)

SHEET NAME: FLOOR PLAN

世

PROJECT NUMBER: 2025100424 SHEET NUMBER:

120

WHEN PRINTED ON 24"x36" PAPER SCALE IS 1/4"=1'-0"



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IORTH

**DATE DRAWN:** 02/10/25

PLAN REVISIONS:			
IUMBER	DATE	BY	
1			
2			
3			
4			

FRAMING

TYLEF

PROJECT NUMBER: 2025100424

SHEET NUMBER: 125

WHEN PRINTED ON 24"x36" PAPER SCALE IS 1/4"=1'-0"




TRUSS INFORMATION SCREW PLACEMENT HOLE DESCRIPTION NONE TB39-9SEW4WO-H12HEEL125W PURLINS NAILED NONE TA39-9PLSC37STNO100C4TRUSS125W PURLINS NAILED NONE TA39-9PLSC37STN0100C4TRUSS125W PURLINS NAILED NONE PURLINS NAILED TA39-9PLSC37STNO100C4TRUSS125W NONE TA39-9PLSC37STN0100C4TRUSS125W PURLINS NAILED NONE TA39-9PLSC37STN0100C4TRUSS125W PURLINS NAILED NONE TB39-9SEW4WO-H12HEEL125W PURLINS NAILED

- 1. 2x6 JACKBRACING AT ENDWALL COLUMNS (NOT NEEDED AT FULL LENGTH COLUMNS) ├─ = LOCATION ON THIS SHEET FOR JACKBRACING (SEE DETAIL THIS SHEET)
- 2. 2x4 PURLIN BLOCKING AT ENDWALL TRUSSES
- 3. (>>>) = BAYS WITH 2x4 ROOFLINE X-BRACING (SEE DETAIL THIS SHEET)


ATTACH ALL PURLINS TO TRUSS WITH 1) 60d NAIL AND TOE-NAIL WITH ) 10d NAIL, ALSO ATTACH ROOF

- 4-PLY 2x6 SIDEWALL COLUMN - INTERMEDIATE CLEARSPAN TRUSS - 4-PLY 2x6 SIDEWALL COLUMN — SIDEWALL GIRTS

TYPICAL TRUSS PLACEMENT DETAIL

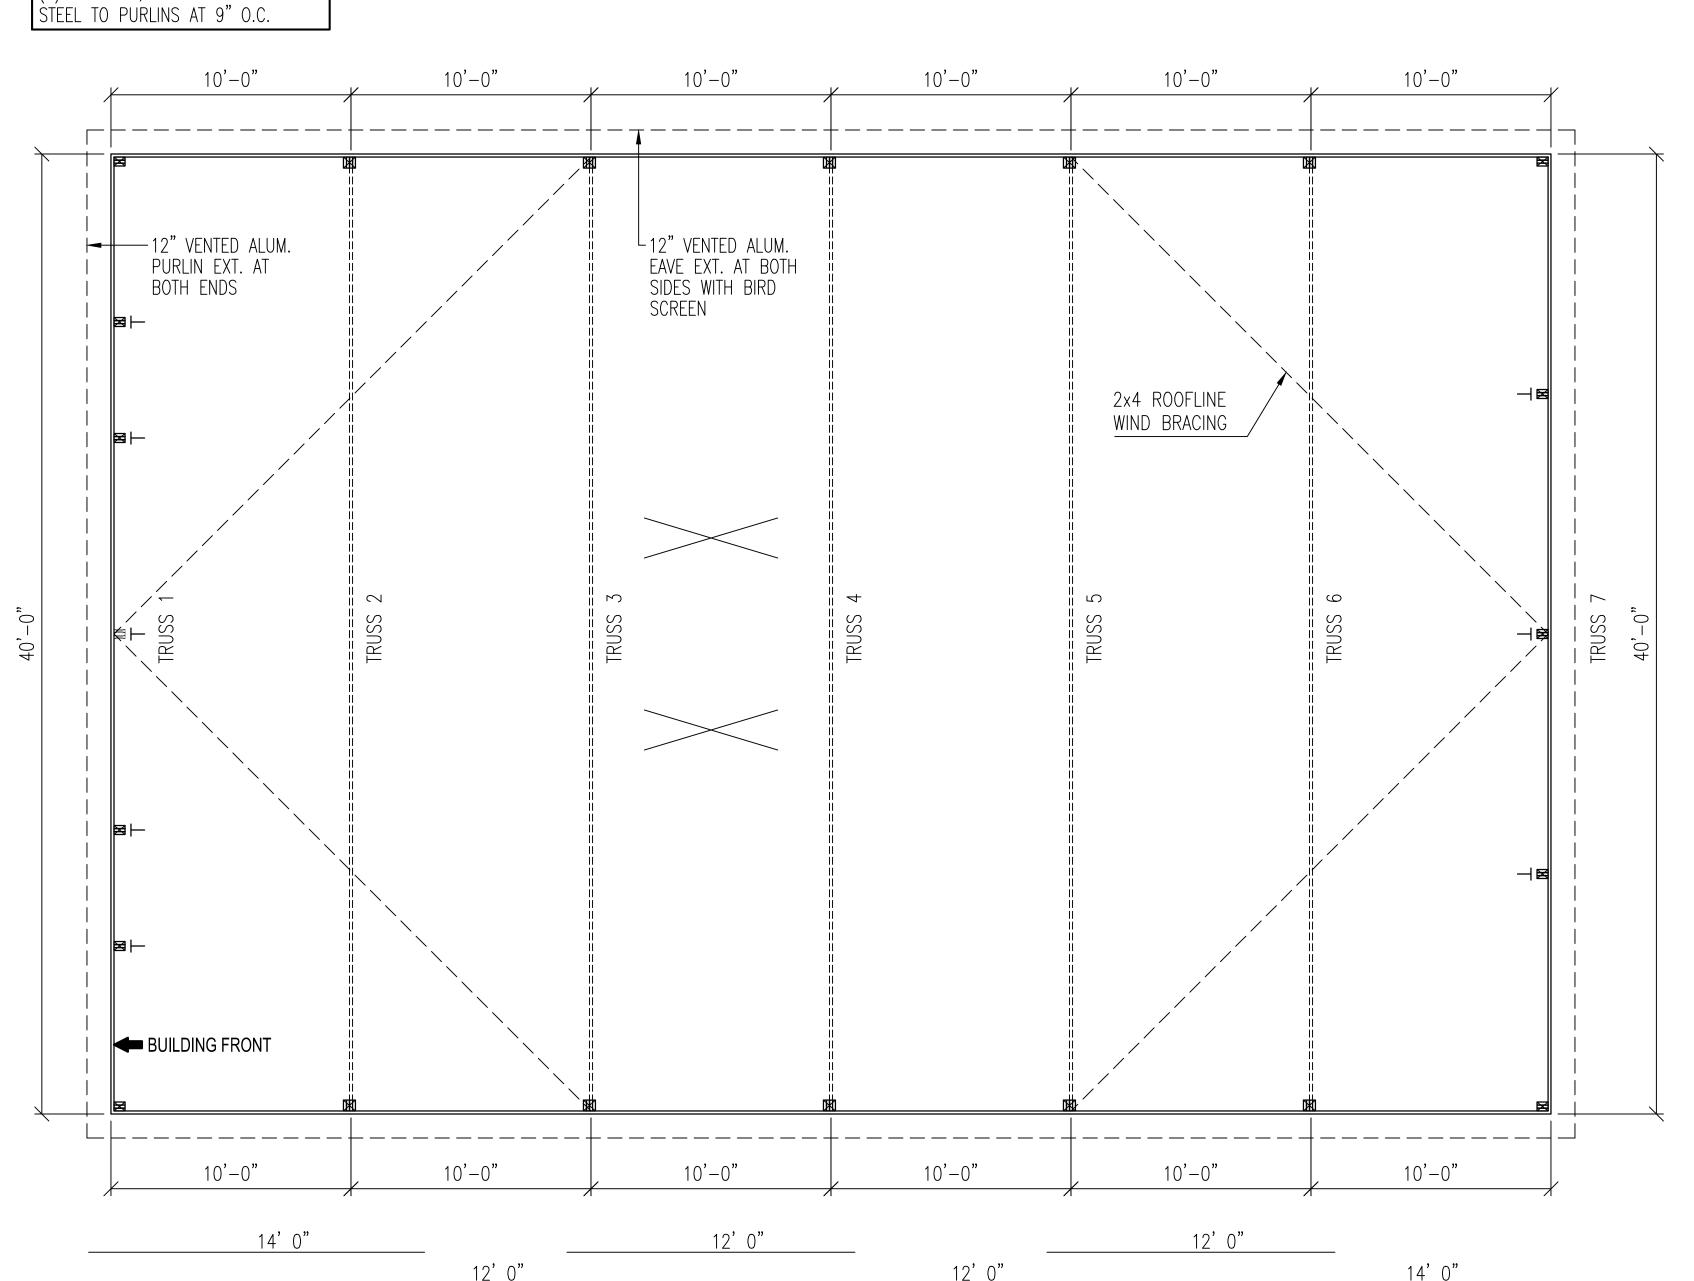




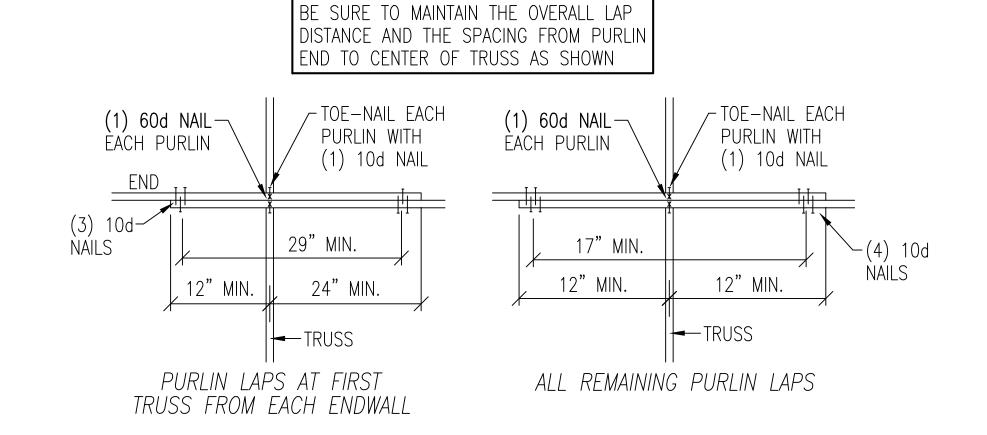


CONT. PURLIN DESIGN


CONSTRUCTION FOREMAN NOTE:

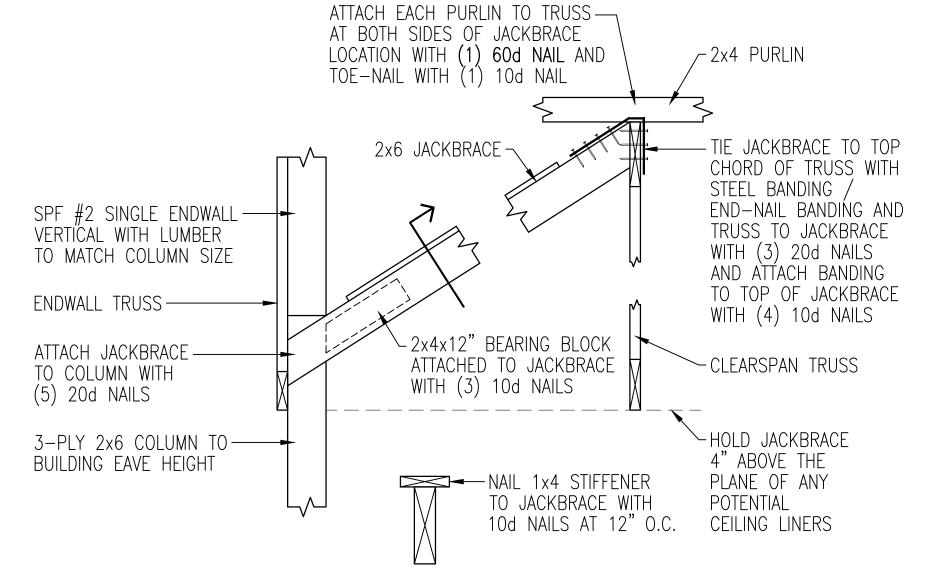



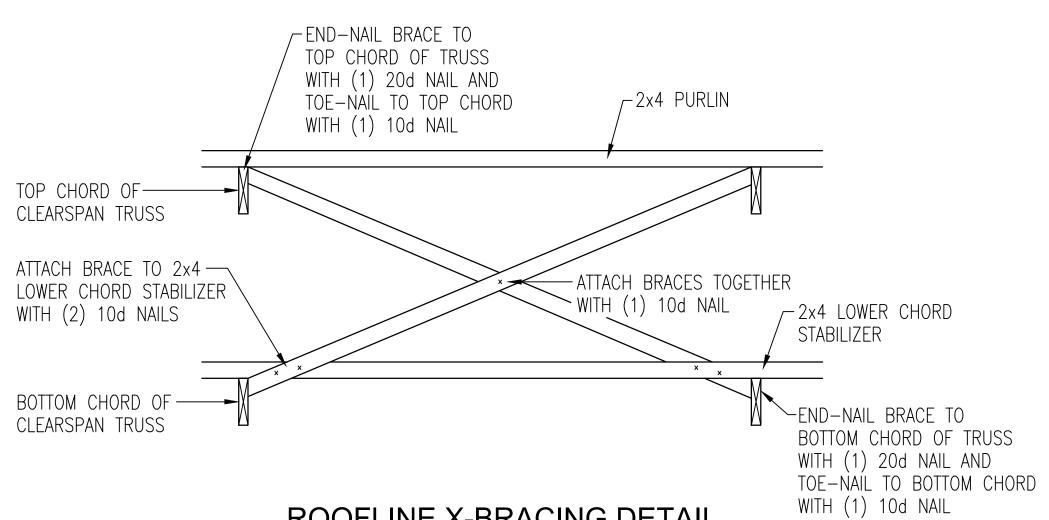

ROOFLINE X-BRACING DETAIL X—BRACING IS ATTACHED TO LOWER CHORD STABILIZER

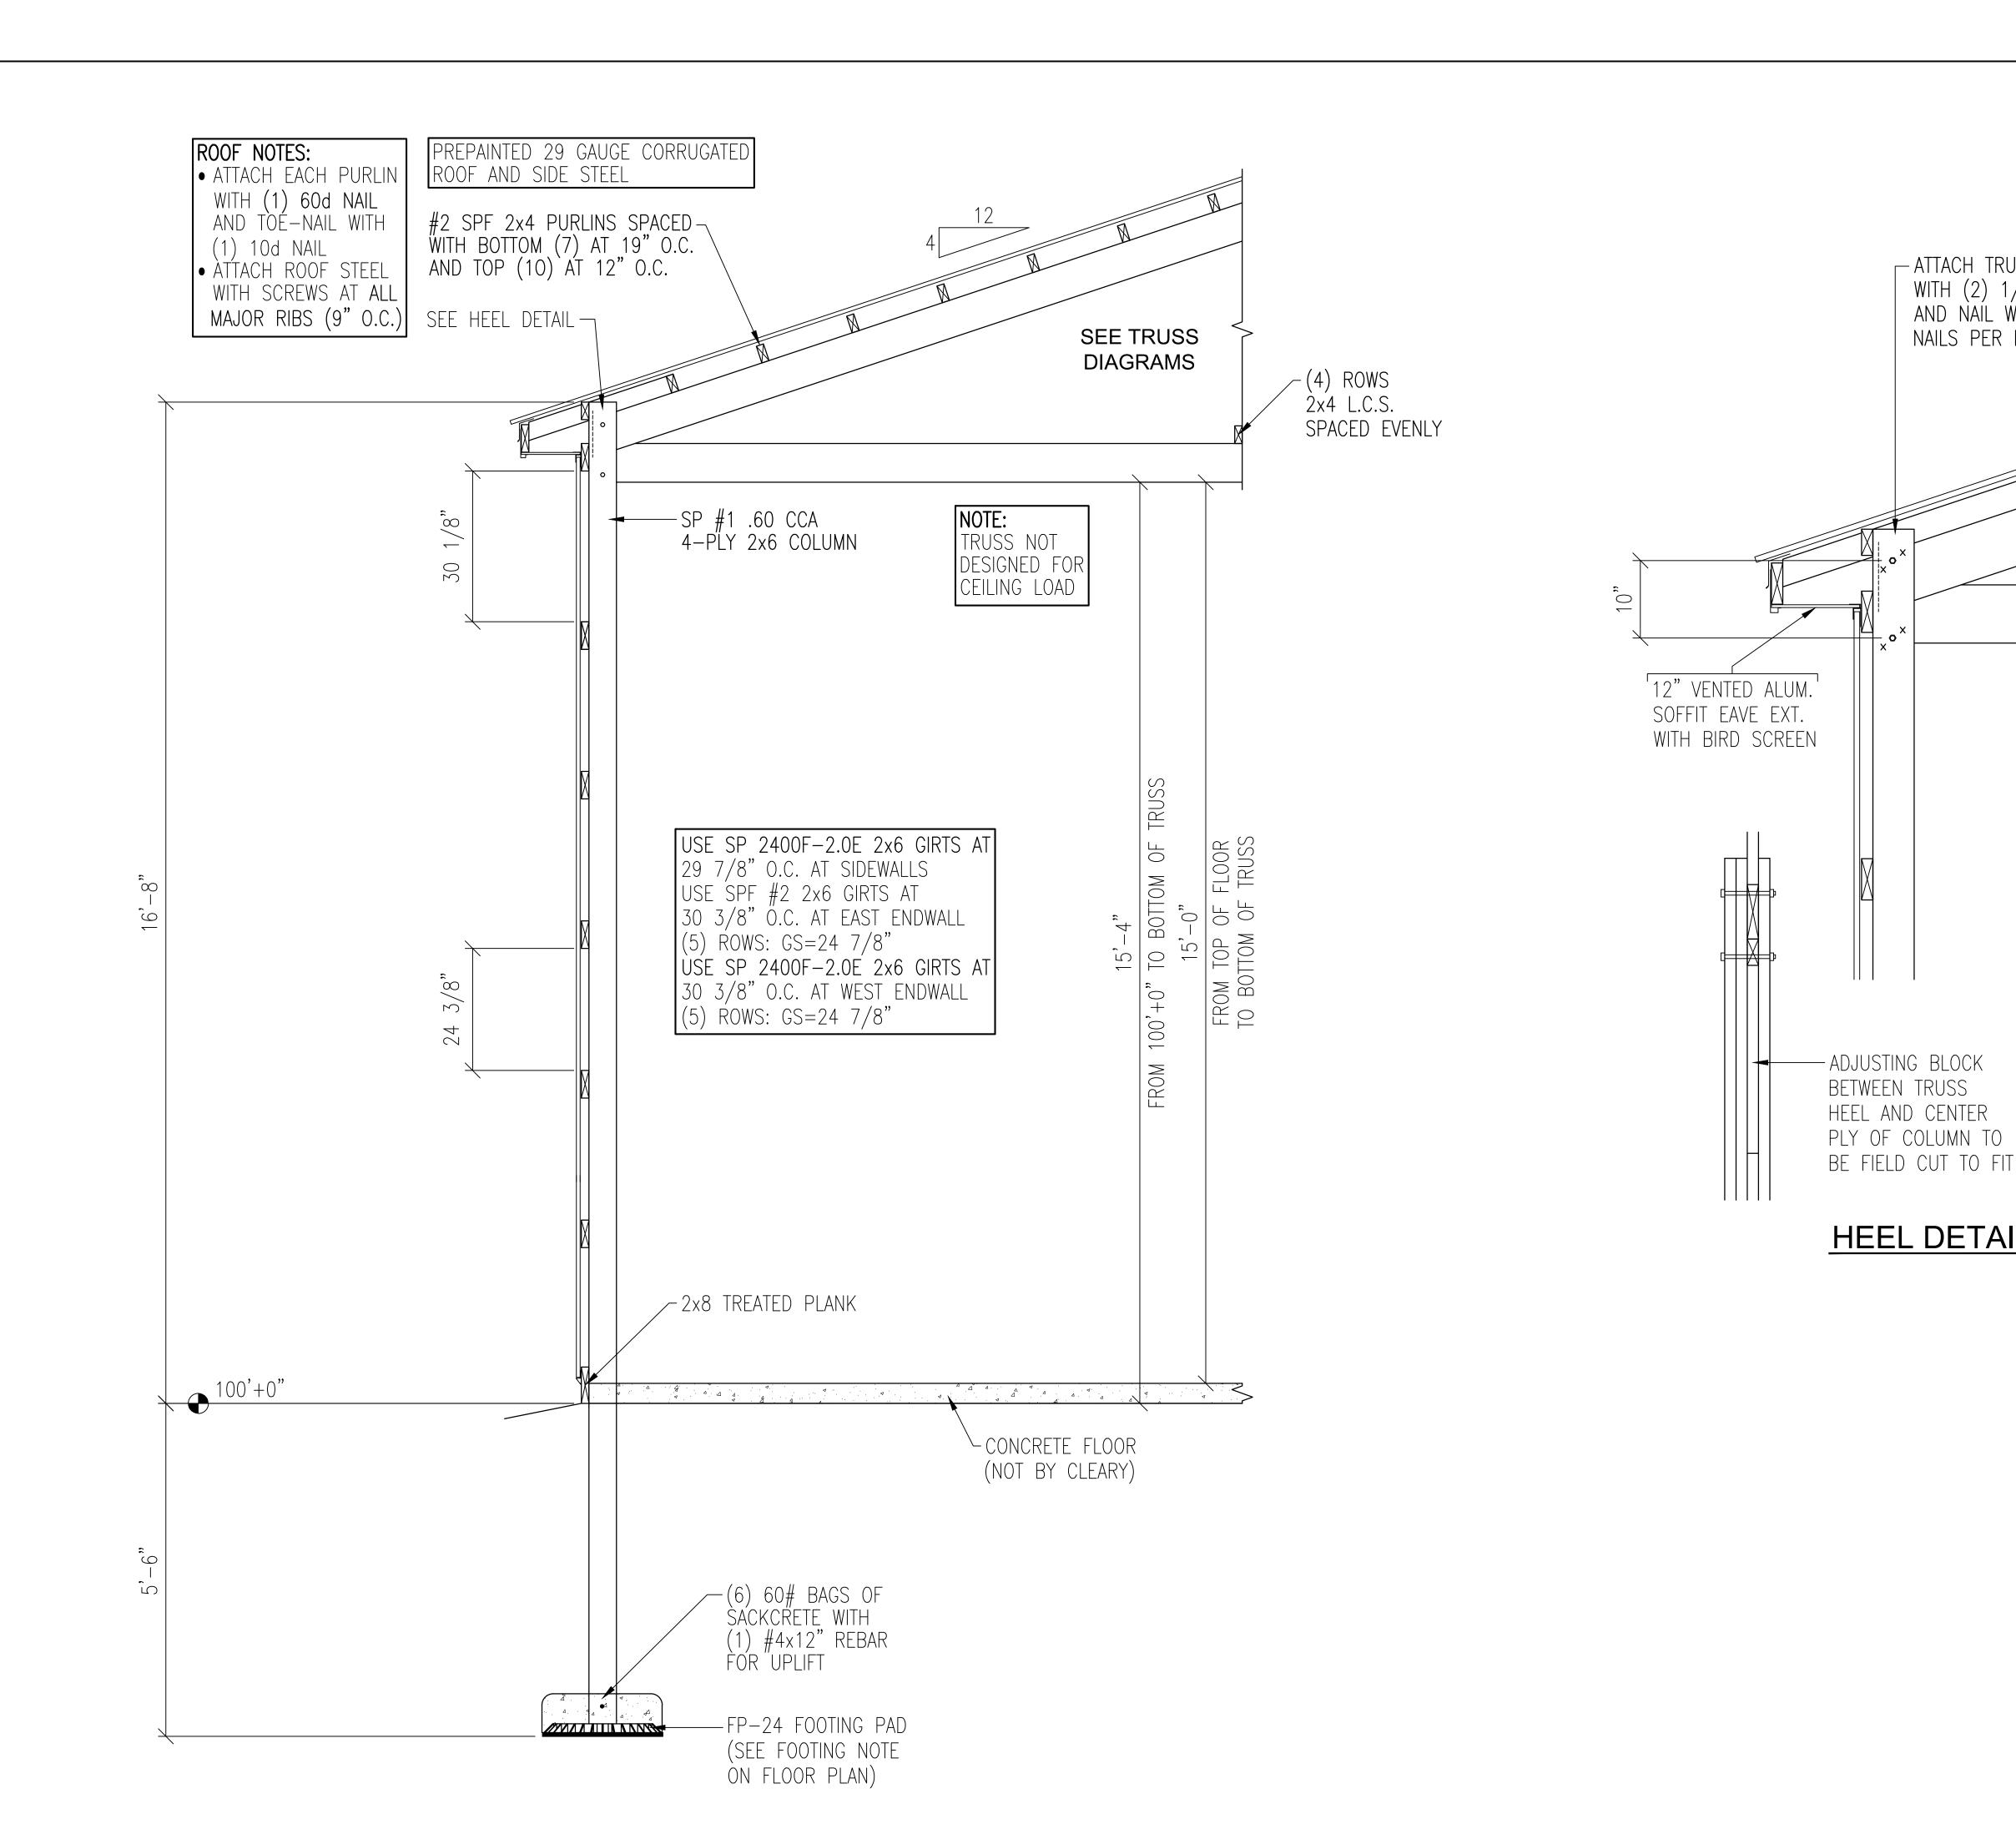

nerd\1CAD FILES\2025\2025 Printed: 2/10/2025 12:19 PM

**BUILDING CORP.** 

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**DRAWN BY:** JENKINS

- ATTACH TRUSS TO COLUMN

WITH (2) 1/2"øx7" BOLTS AND NAIL WITH (2) 20d NAILS PER BOLT

**HEEL DETAIL** 

**DATE DRAWN:** 02/10/25

PLAN REVISIONS:

NUMBER DATE

3 4

53083 (SHEBOYGAN)

PROJECT NUMBER:

LER

2025100424 SHEET NUMBER:

130

WHEN PRINTED ON 24"x36" PAPER SCALE IS 3/4"=1'-0"



# BRACE TO GIRT CONNECTION DETAIL

ATTACH 2x4 BEARING BLOCK

COLUMN WITH (5) 20d NAILS

- ATTACH BOTTOM CHORD OF

ENDWALL TRUSS TO BUILDING

COLUMN WITH (5) 20d NAILS

BRACE WITH (11) 10d NAILS


(BEARING BLOCK BEARS ON


BOTTOM CHORD OF TRUSS)

OR TRUSS VERTICAL TO


— 2x6x24" BEARING BLOCK

ATTACHED TO DIAGONAL

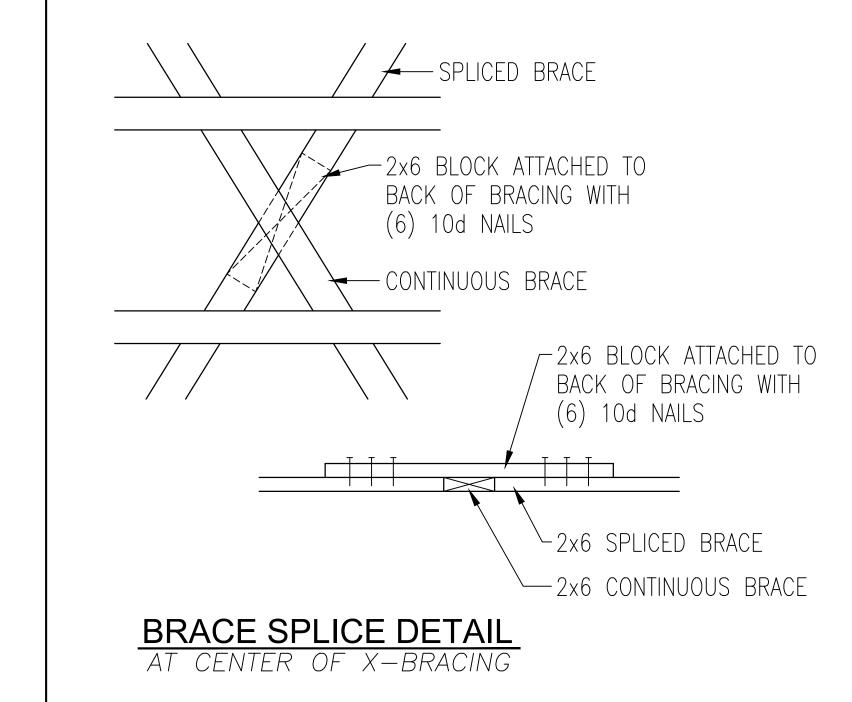

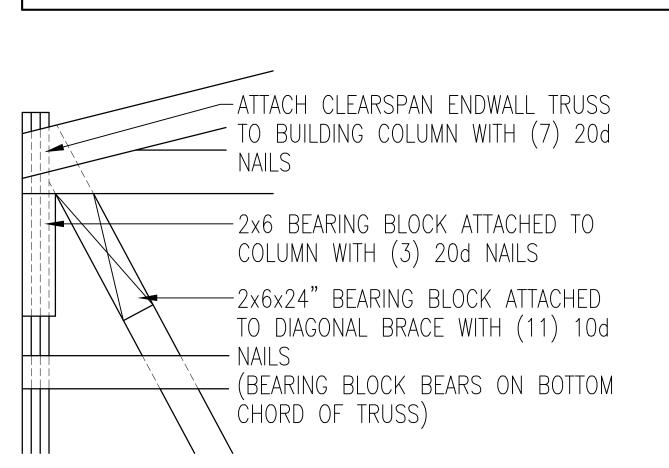

# BRACE CONNECTION DETAIL AT TOP OF BRACE AT CORNER COLUMN

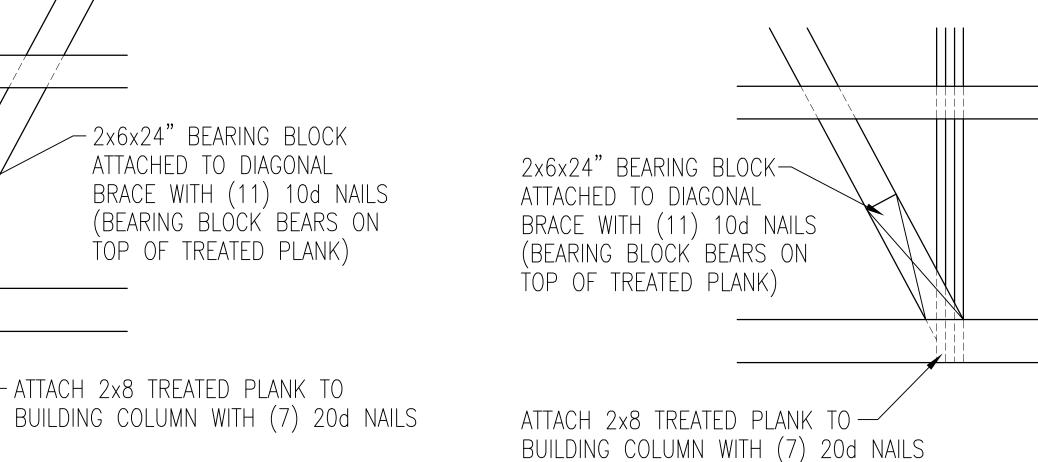

## BRACE CONNECTION DETAIL AT BOTTOM OF BRACE AT ENDWALL COLUMN


**BRACE CONNECTION DETAIL** 

AT TOP OF BRACE AT ENDWALL COLUMN


# **BRACE CONNECTION DETAIL** AT BOTTOM OF BRACE AT ENDWALL COLUMN

# ENDWALL DIAGONAL BRACING DETAIL


AT WEST ENDWALL

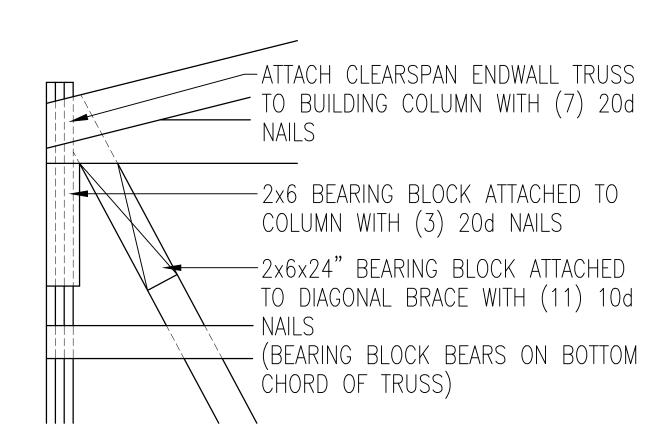


## BRACE CONNECTION DETAIL AT TOP OF BRACE AT CORNER COLUMN

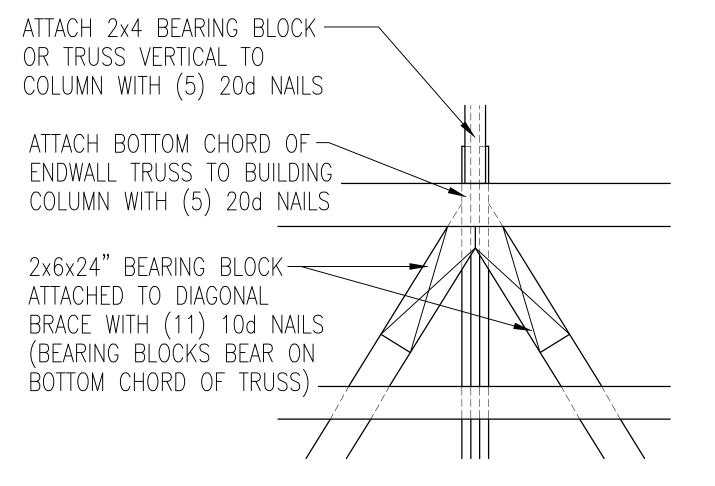


## **BRACE CONNECTION DETAIL** AT TOP OF BRACE AT ENDWALL COLUMN

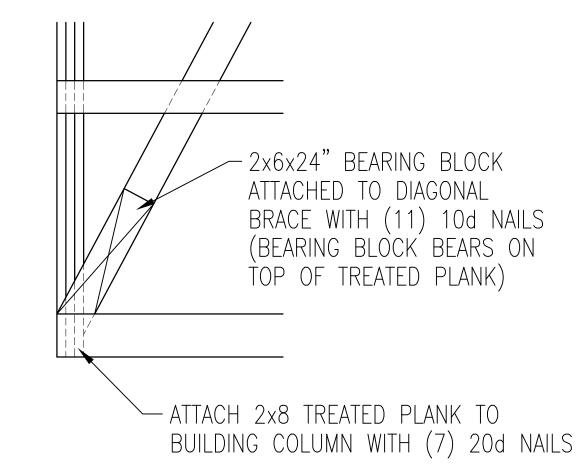

**BRACE CONNECTION DETAIL** AT BOTTOM OF BRACE AT ENDWALL COLUMN

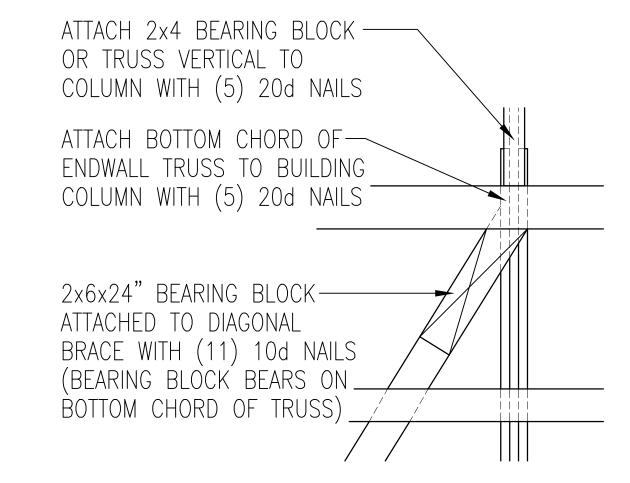


**BRACE CONNECTION DETAIL** AT TOP OF BRACE AT ENDWALL COLUMN

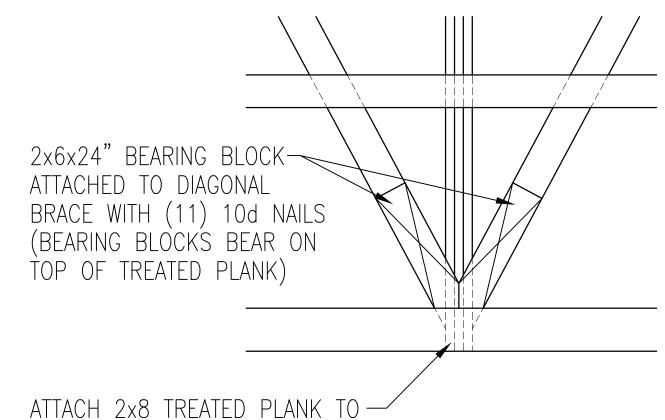

BUILDING COLUMN WITH (7) 20d NAILS

## **BRACE CONNECTION DETAIL** AT BOTTOM OF BRACE AT ENDWALL COLUMN

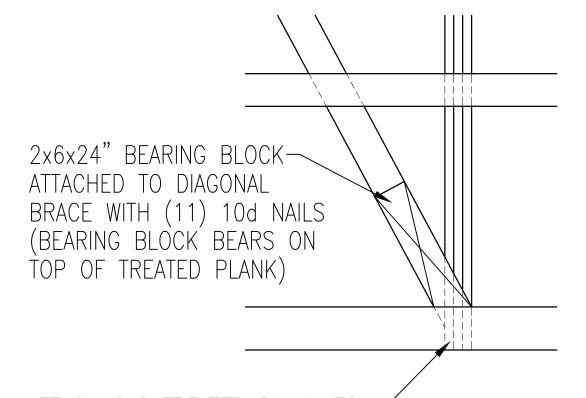

ATTACH 2x8 TREATED PLANK TO — BUILDING COLUMN WITH (7) 20d NAILS

# **BRACE CONNECTION DETAIL**

AT BOTTOM OF BRACE AT ENDWALL COLUMN

# ENDWALL DIAGONAL X-BRACING DETAIL

AT EAST ENDWALL



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PLAN REVISIONS: NUMBER DATE

PROJECT NUMBER:

2025100424

SHEET NUMBER: 140


PAPER SCALE IS N.T.S.



# ROOF AND SIDE STEEL ATTACHMENT DETAIL

NOTE: PAN NAILS MAY BE SUBSTITUTED FOR PANEL

END FASTENERS WHEN CONCEALED BY FLASHING

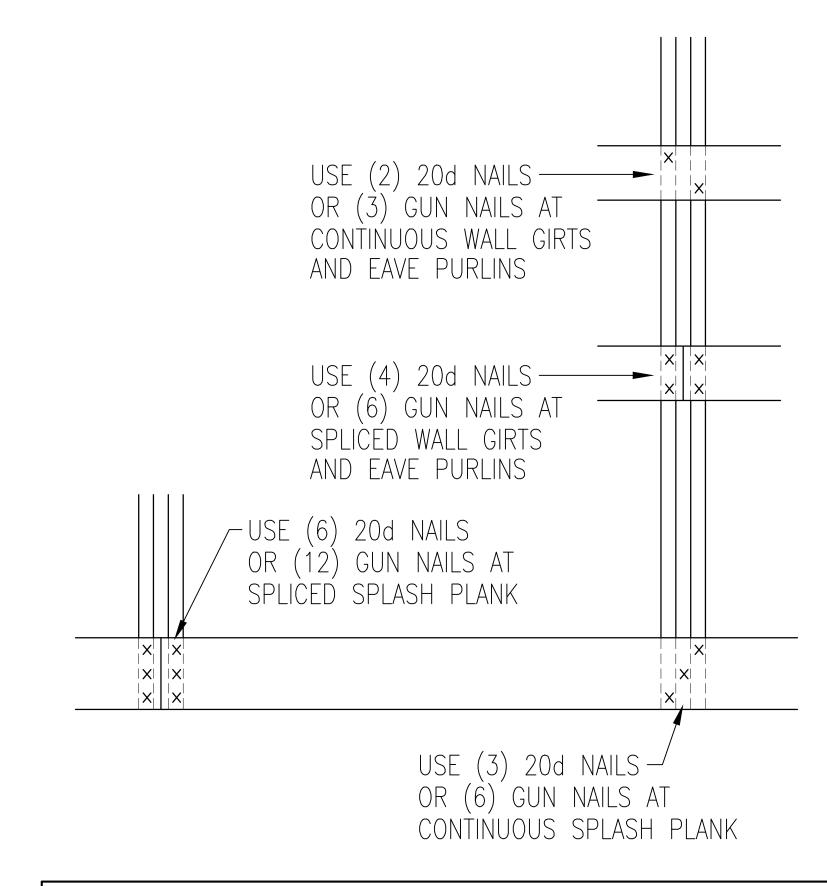


ENDWALL TRUSS -

NOTE: 20d NAILS TO BE RING SHANK HOT DIPPED GALVANIZED GUN NAIL ALTERNATE =  $0.131 \times 3 \times 1/2 \text{ RS-TLN}$ 

NOTE: SPLASH PLANK AT BRACING LOCATIONS REQUIRE ADDITIONAL FASTENERS (SEE BRACING DETAIL SHEET)

# STANDARD WALL FRAMING NAILING

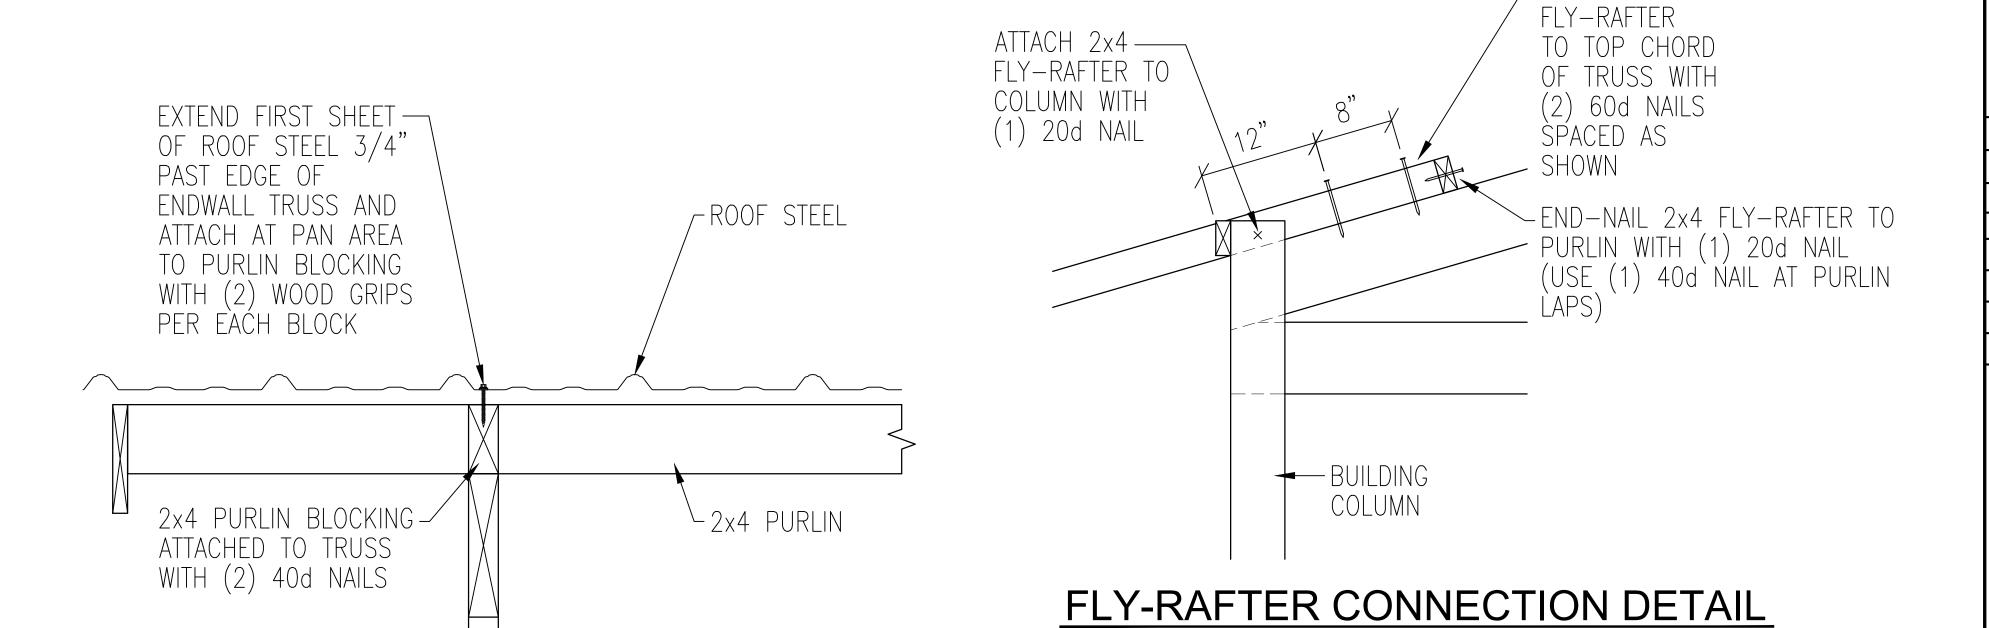

GABLE DETAIL WITH PURLIN EXTENSION ~ ATTACH TOP CHORD OF ENDWALL TRUSS TO COLUMN WITH (4) 20d NAILS ATTACH TRUSS— TO COLUMN WITH (7) 20d NAILS 2x4 BEARING BLOCK (SCRAP) OR TRUSS VERTICAL ATTACHED TO COLUMN WITH (8) 20d NAILS -SPF #2 SINGLE ATTACH BOTTOM — ENDWALL VERTICAL CHORD OF ENDWALL ATTACH SP #1-TRUSS TO COLUMN 2x6x12" BEARING WITH (5) 20d NAILS BLOCK TO  $|\times|$ COLUMN WITH (3) 20d NAILS

STRUCTURAL ENDWALL TRUSS CONNECTION DETAILS

3-PLY COLUMN-

AT BOTH ENDWALLS



- ATTACH 2x4

→ 3-PLY COLUMN

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**DATE DRAWN:** 02/10/25

PLAN REVISIONS:

NUMBER

2

3 4

ACTION

PROJECT NUMBER:

2025100424 SHEET NUMBER:

150

PAPER SCALE IS N.T.S.



SEQN: 136600

FROM: AJY

COMN | Ply: 1

≡SS0919(B2)

37.00

4.00

0.00

1.00

Des Ld: 42.00

NCBCLL: 0.00

Soffit: 2.00

Spacing: 120.0 "

Loading

member design.

enclosed wall buildings.

Load Duration: 1.15

Top chord: 2x10 SP 2400f-2.0E;

Bot chord: 2x8 SP 2400f-2.0E;

BCLL:

BCDL:

Wind Std: ASCE 7-10

Speed: 125 mph

Enclosure: Closed

Risk Category: II

EXP: C Kzt: NA

C&C Dist a: 3.97 ft

Loc. from endwall: Any

Wind Duration: 1.60

TCDL: 2.4 psf

BCDL: 0.6 psf

Webs: 2x4 SP #2; W3,W4,W5,W6 2x6 SP 2400f-2.0E;

Slope reduction based on Unobstructed Slippery Surface.

Wind loads based on MWFRS with additional C&C

Lt Wedge: 2x4 SP #2;Rt Wedge: 2x4 SP #2;

Truss designed for unbalanced snow loads.

See Cleary Building Corp. drawing for bearing

attachment and bottom chord bracing details.

This designs applies to both open wall and

In lieu of structural panels or rigid ceiling

use purlins to brace TC @ 24" OC.

Mean Height: 20.00 ft

MWFRS Parallel Dist: 0 to h/2

GCpi: 0.18

Qty: 1

4 12

Job Number: 2025100424

Truss Label: TA39-9PLSC37STNO10OC4truss125W

19'10"8

5'10"

Snow Criteria (Pg,Pf in PSF) | Defl/CSI Criteria

Pf: 39.5

Building Code:

TPI Std: 2014

Rep Fac: No

Plate Type(s):

18SS, WAVE, HS

IBC 2015

Lu: 21.0 Cs: 0.94

Snow Duration: 1.15

FT/RT/PT:20(20)/10(10)/4(0)

Pg: 47.0 Ct: 1.2 CAT: II PP Deflection in loc L/defl L/#

VERT(LL): 0.815 M 580 240

HORZ(LL): 0.282 I

HORZ(TL): 0.322 I

Max TC CSI: 0.896

Max BC CSI: 0.964

Max Web CSI: 0.888

VIEW Ver: 21.01.01.0429.14

Creep Factor: 2.0

VERT(CL): 0.930 M 508 240 P 8393 /-

\*\*WARNING\*\* READ AND FOLLOW ALL NOTES ON THIS DRAWING!

\*\*IMPORTANT\*\* FURNISH THIS DRAWING TO ALL CONTRACTORS INCLUDING THE INSTALLERS

Trusses require extreme care in fabricating, handling, installing and bracing. Refer to and follow the latest edition of BCSI (Building Component Safety Information, by TPI and SBCA) for safety practices prior to performing these functions. Installers shall provide temporary bracing per BCSI. Unless noted otherwise, top chord shall have properly attached structural sheathing and bottom chord shall have a properly attached rigid ceiling. Locations shown for permanent lateral restraint of webs shall have continuous lateral restraint (CLR), installed with diagonal bracing installed on the CLR per BCSI sections B3, B7, or B10, as applicable. Apply plates to each face of truss and position as shown above and on the Joint Details, unless noted otherwise. Refer to drawings 160A-Z for standard plate positions. Refer to job's General Notes page for additional information.

Alpine, a division of ITW Building Components Group Inc. shall not be responsible for any deviation from this drawing, any failure to build the truss in conformance with ANSI/TPI 1, or for handling, shipping, installation and bracing of trusses. A seal on this drawing or cover page listing this drawing, indicates acceptance of professional engineering responsibility solely for the design shown. The suitability and use of this drawing for any structure is the responsibility of the Building Designer per ANSI/TPI 1 Sec. 2.

For more information see these web sites: Albine: albineitw com: TPI: tpinst org: SBCA: sbcacomponents com: ICC: iccsafe org: AWC: awc org. For more information see these web sites: Alpine: alpineitw.com; TPI: tpinst.org; SBCA: sbcacomponents.com; ICC: iccsafe.org; AWC: awc.org

WI COA #2902-011



Cust: R 7054 JRef: 1Y7a70540001 T2887

≡ SS0919(B2)

/1135 /2817 /527

4689 - 2347

2395 - 4655

1629 - 1197

1305 - 1729

/1135 /2817 /-

Loc R+ /R- /Rh /Rw /U /RL

Members not listed have forces less than 375#

Chords Tens.Comp. Chords Tens. Comp.

<sup>⊔</sup> B - C 10715-17579 F - G 10758 - 17426

C - D 10758- 17426 G - H 10716 - 17579

D - E 9354-14729 H - I 11111 - 18818

Chords Tens.Comp. Chords Tens.Comp.

A-O 17377 -9917 L-K 15334 -8478

O-N 15334 -8472 K-J 15334 -8478

N-M 15334 - 8472 J-I 17377 - 9911

Webs Tens.Comp. Webs Tens. Comp.

L-F

J - H

Maximum Web Forces Per Ply (lbs)

1629 - 1197

4689 - 2347

1305 - 1729 E - L

2395 - 4655 F - J

Maximum Bot Chord Forces Per Ply (lbs)

Maximum Top Chord Forces Per Ply (lbs)

Wind reactions based on MWFRS

P Brg Wid = 5.5 Min Req = ---

Q Brg Wid = 5.5 Min Req = ---

Bearings P & Q are a rigid surface.


A - B 11110- 18818 E - F

M - L 12044 - 6326

DrwNo: 037.25.1022.03087

5'5"2 1'0"10

Q 8393 /-

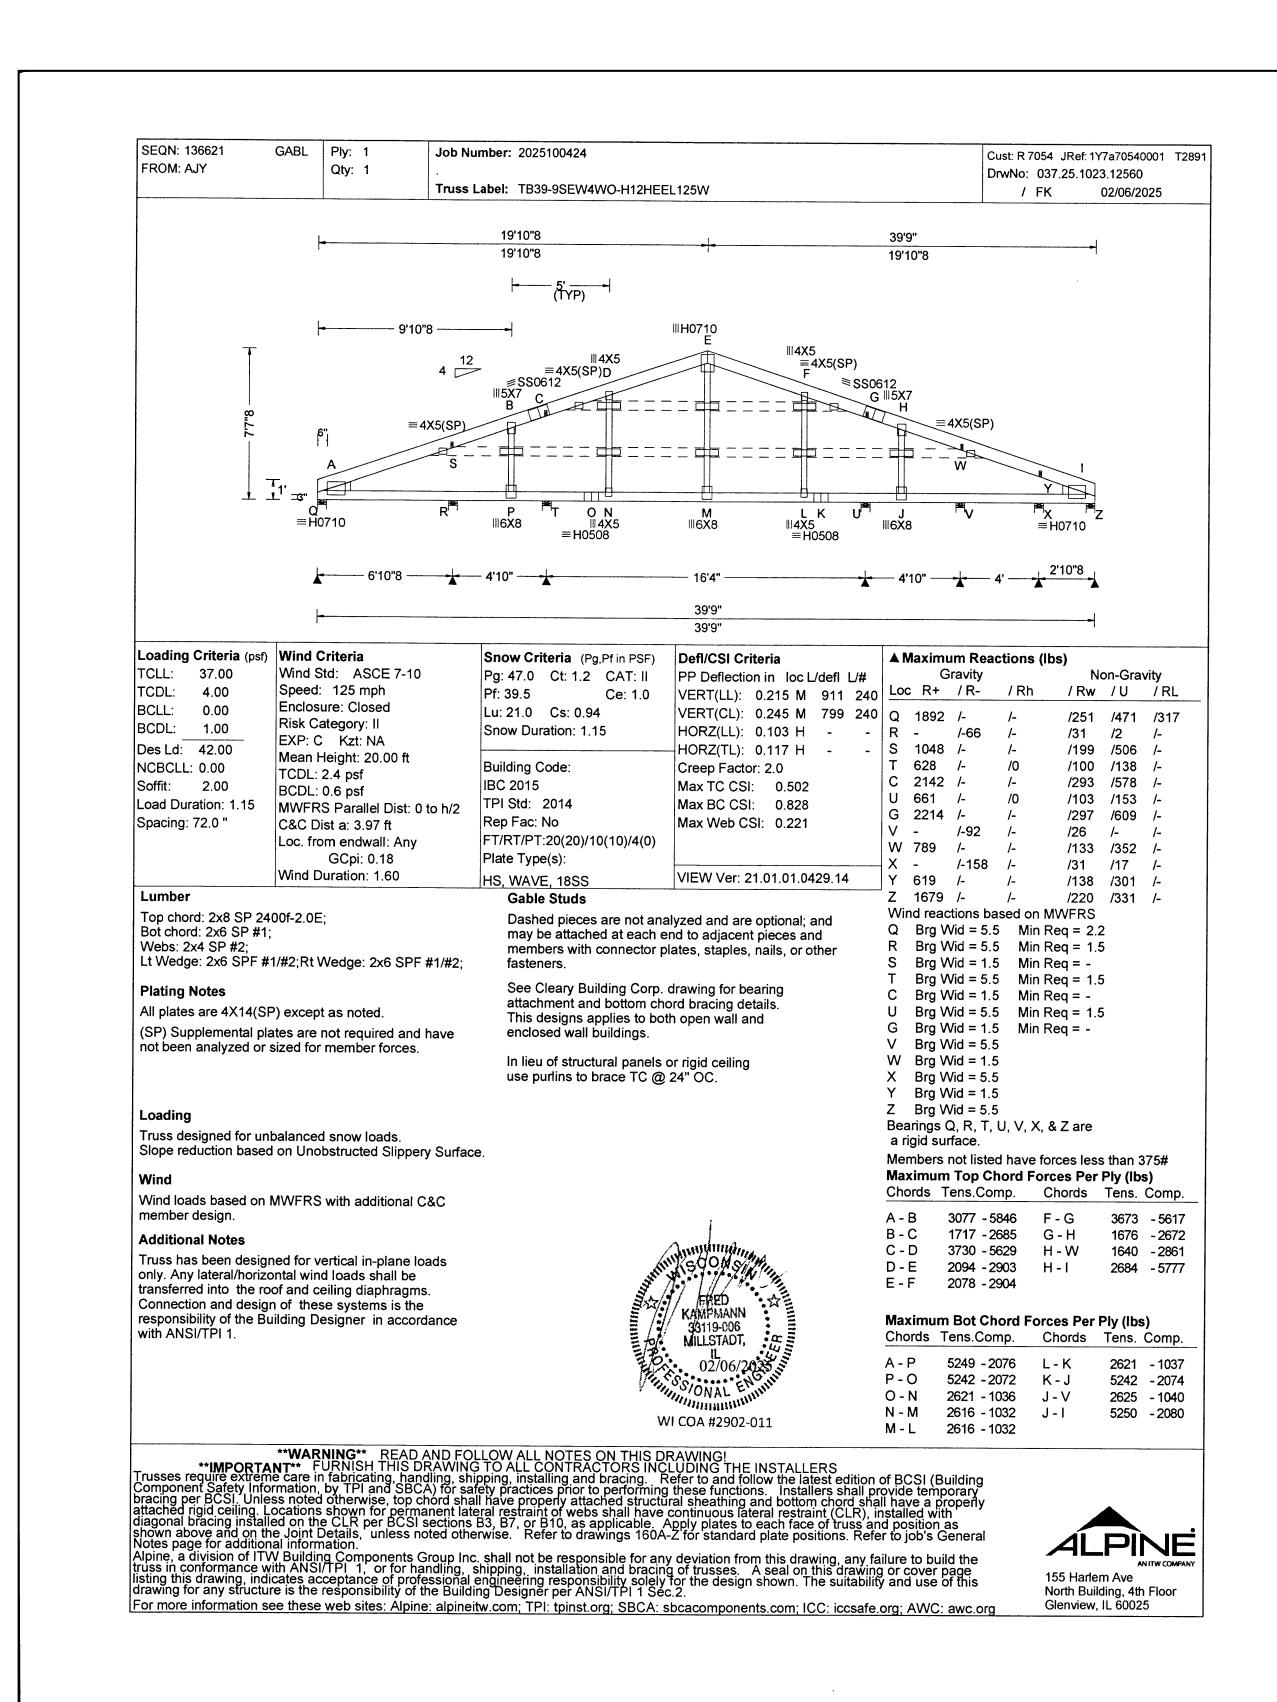

## TRUSS CHECK (CHECK BOX AND INITIAL)

X TRUSS SIZE

X ROOF PITCH

X BAY SPACING NJJ

X SLC / RLC

NJJ

X DESIGN LOADS NJJ

X OVERHANGS NJJ

LLCAN	
BUILDING CORP.	

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**DRAWN BY:** JENKINS

**DATE DRAWN:** 02/10/25

PLAN REVISIONS:

NUMBER 4

2

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16' × PROJECT SITE ADD 1236 N 18TH S SHEBOYGAN, N BUILDING SIZE: 40' 0" x 60' 0" SHEET NAME: TRUSS DIAGRA 0


ROJECT NAME CHAPPA PROJECT NUMBER: 2025100424


SHEET NUMBER:


160

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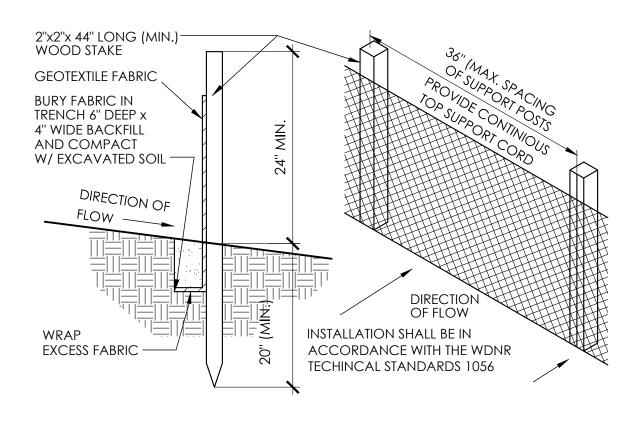
Itom 7

- 2\Construction Documents\S.3 Site\202

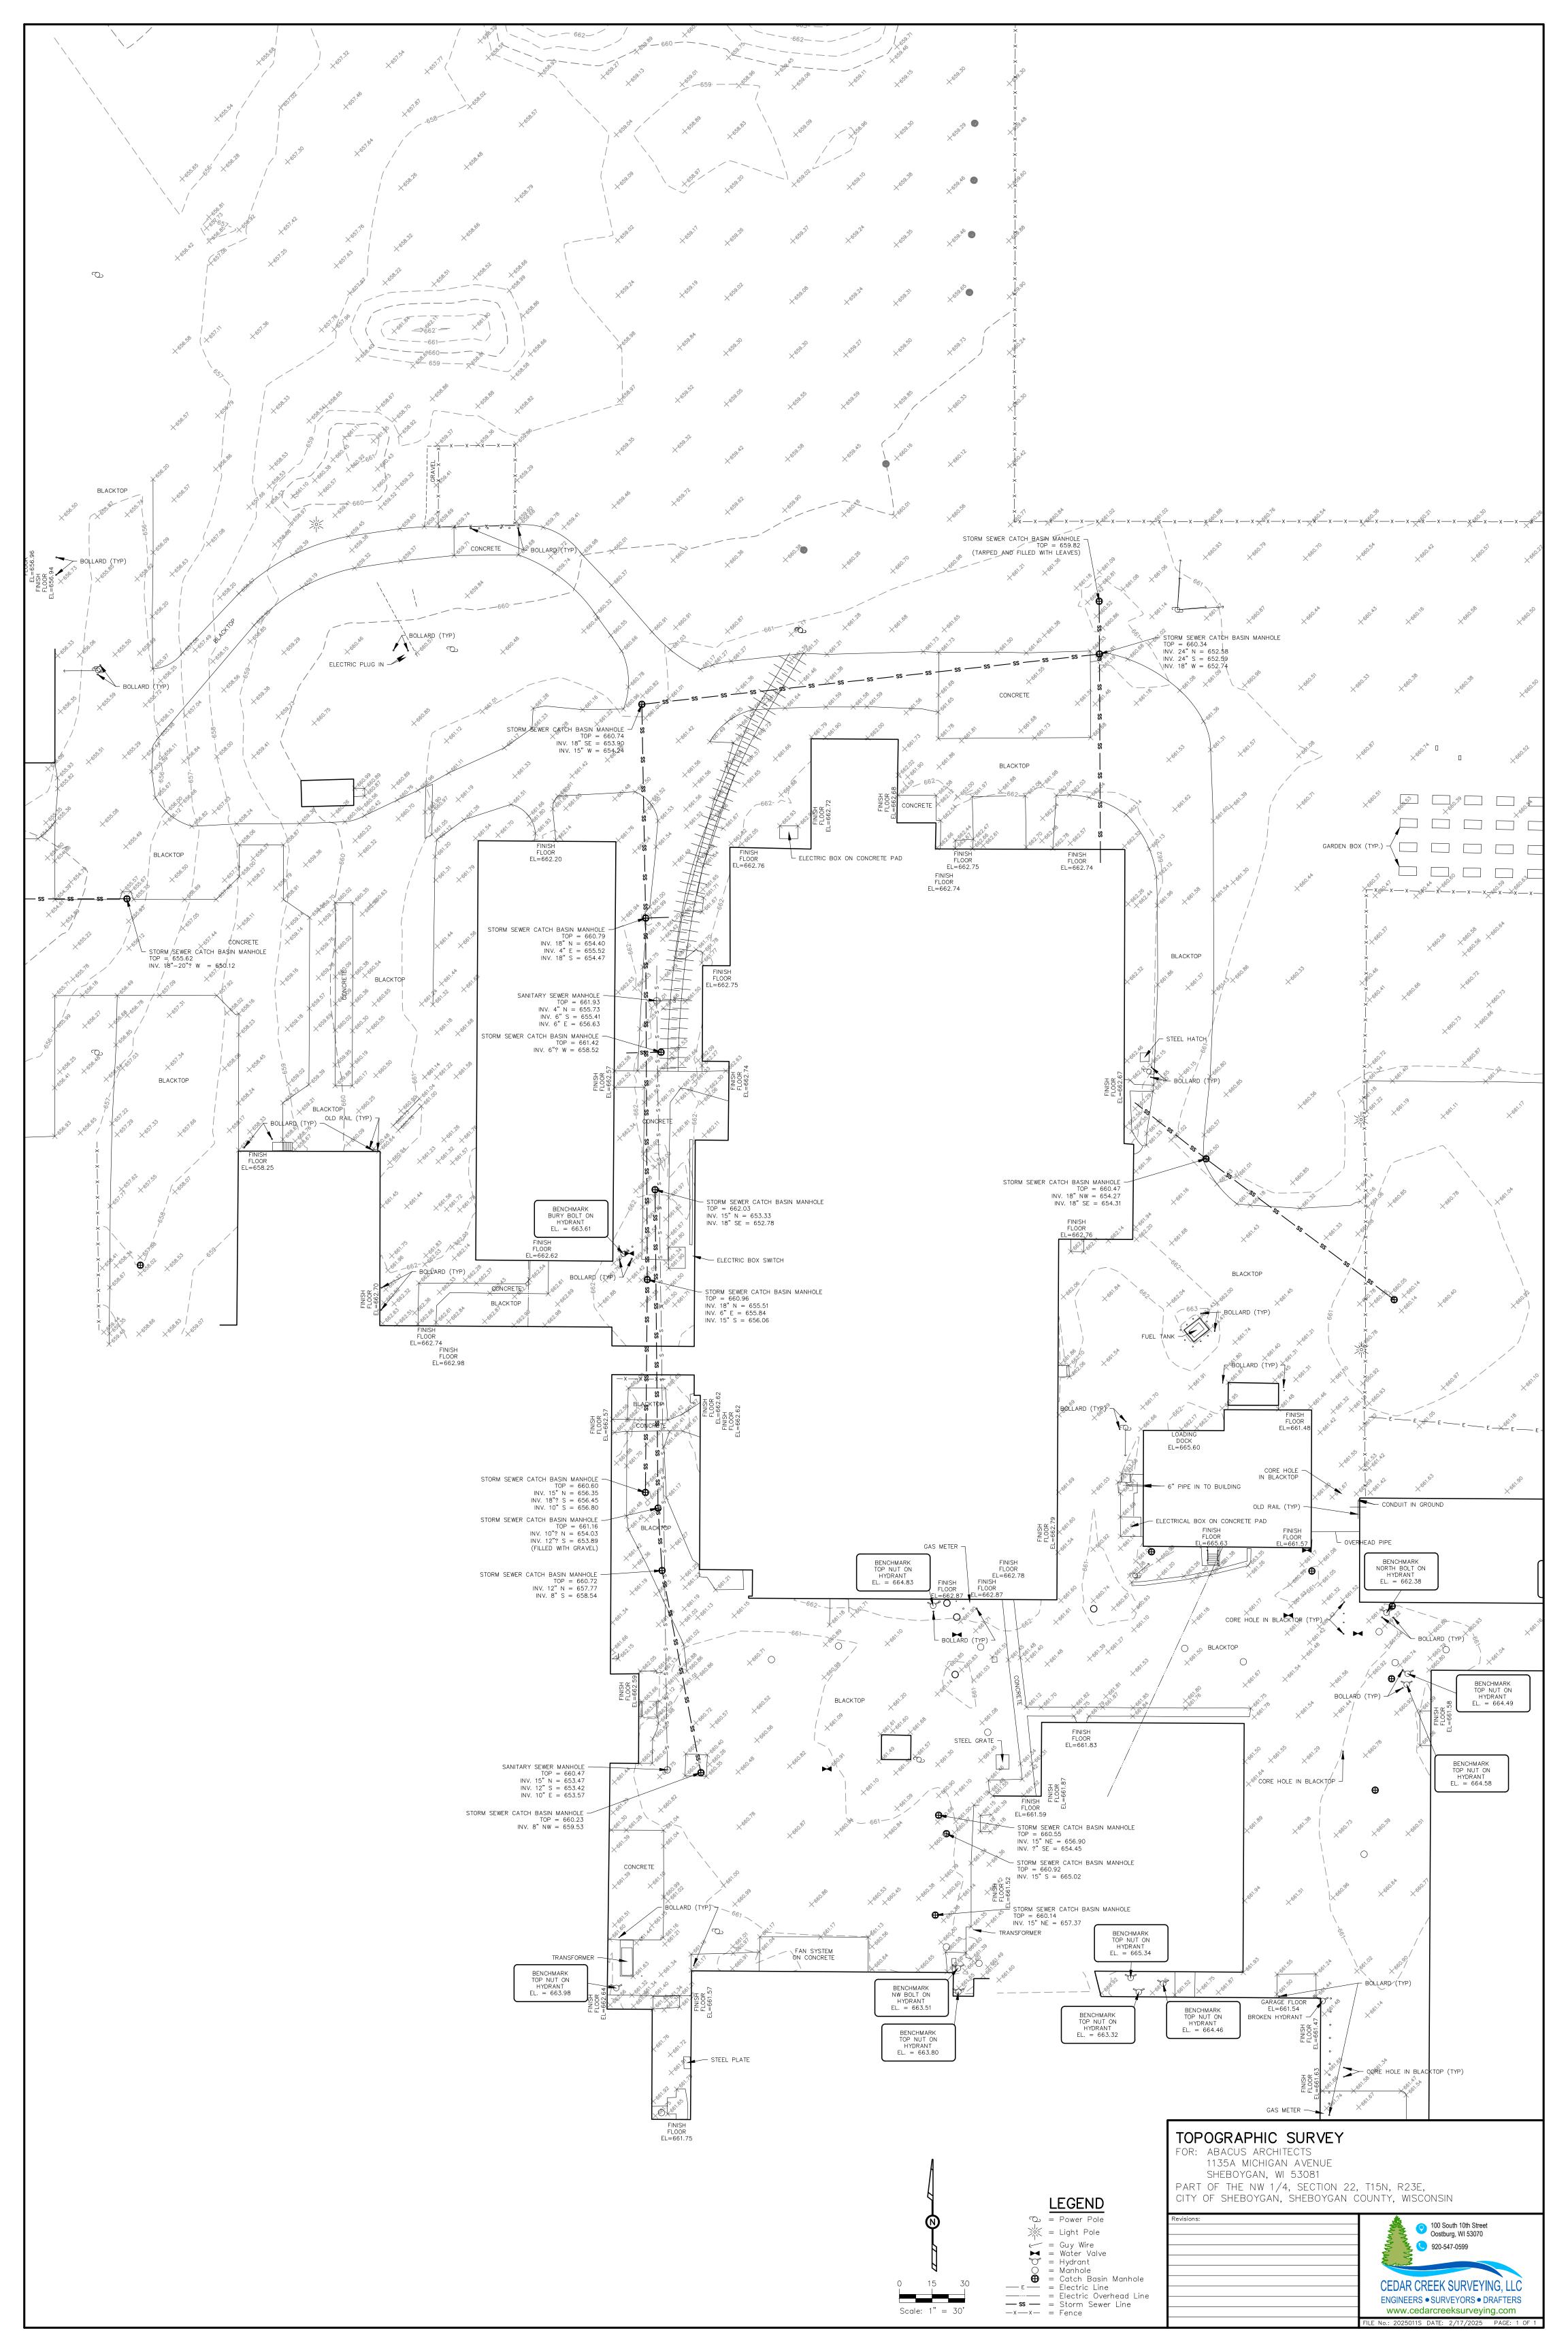
/, Pole Building, Sub Station, Bldg 8, Building 19 Toilet Remodel\Phase - 2

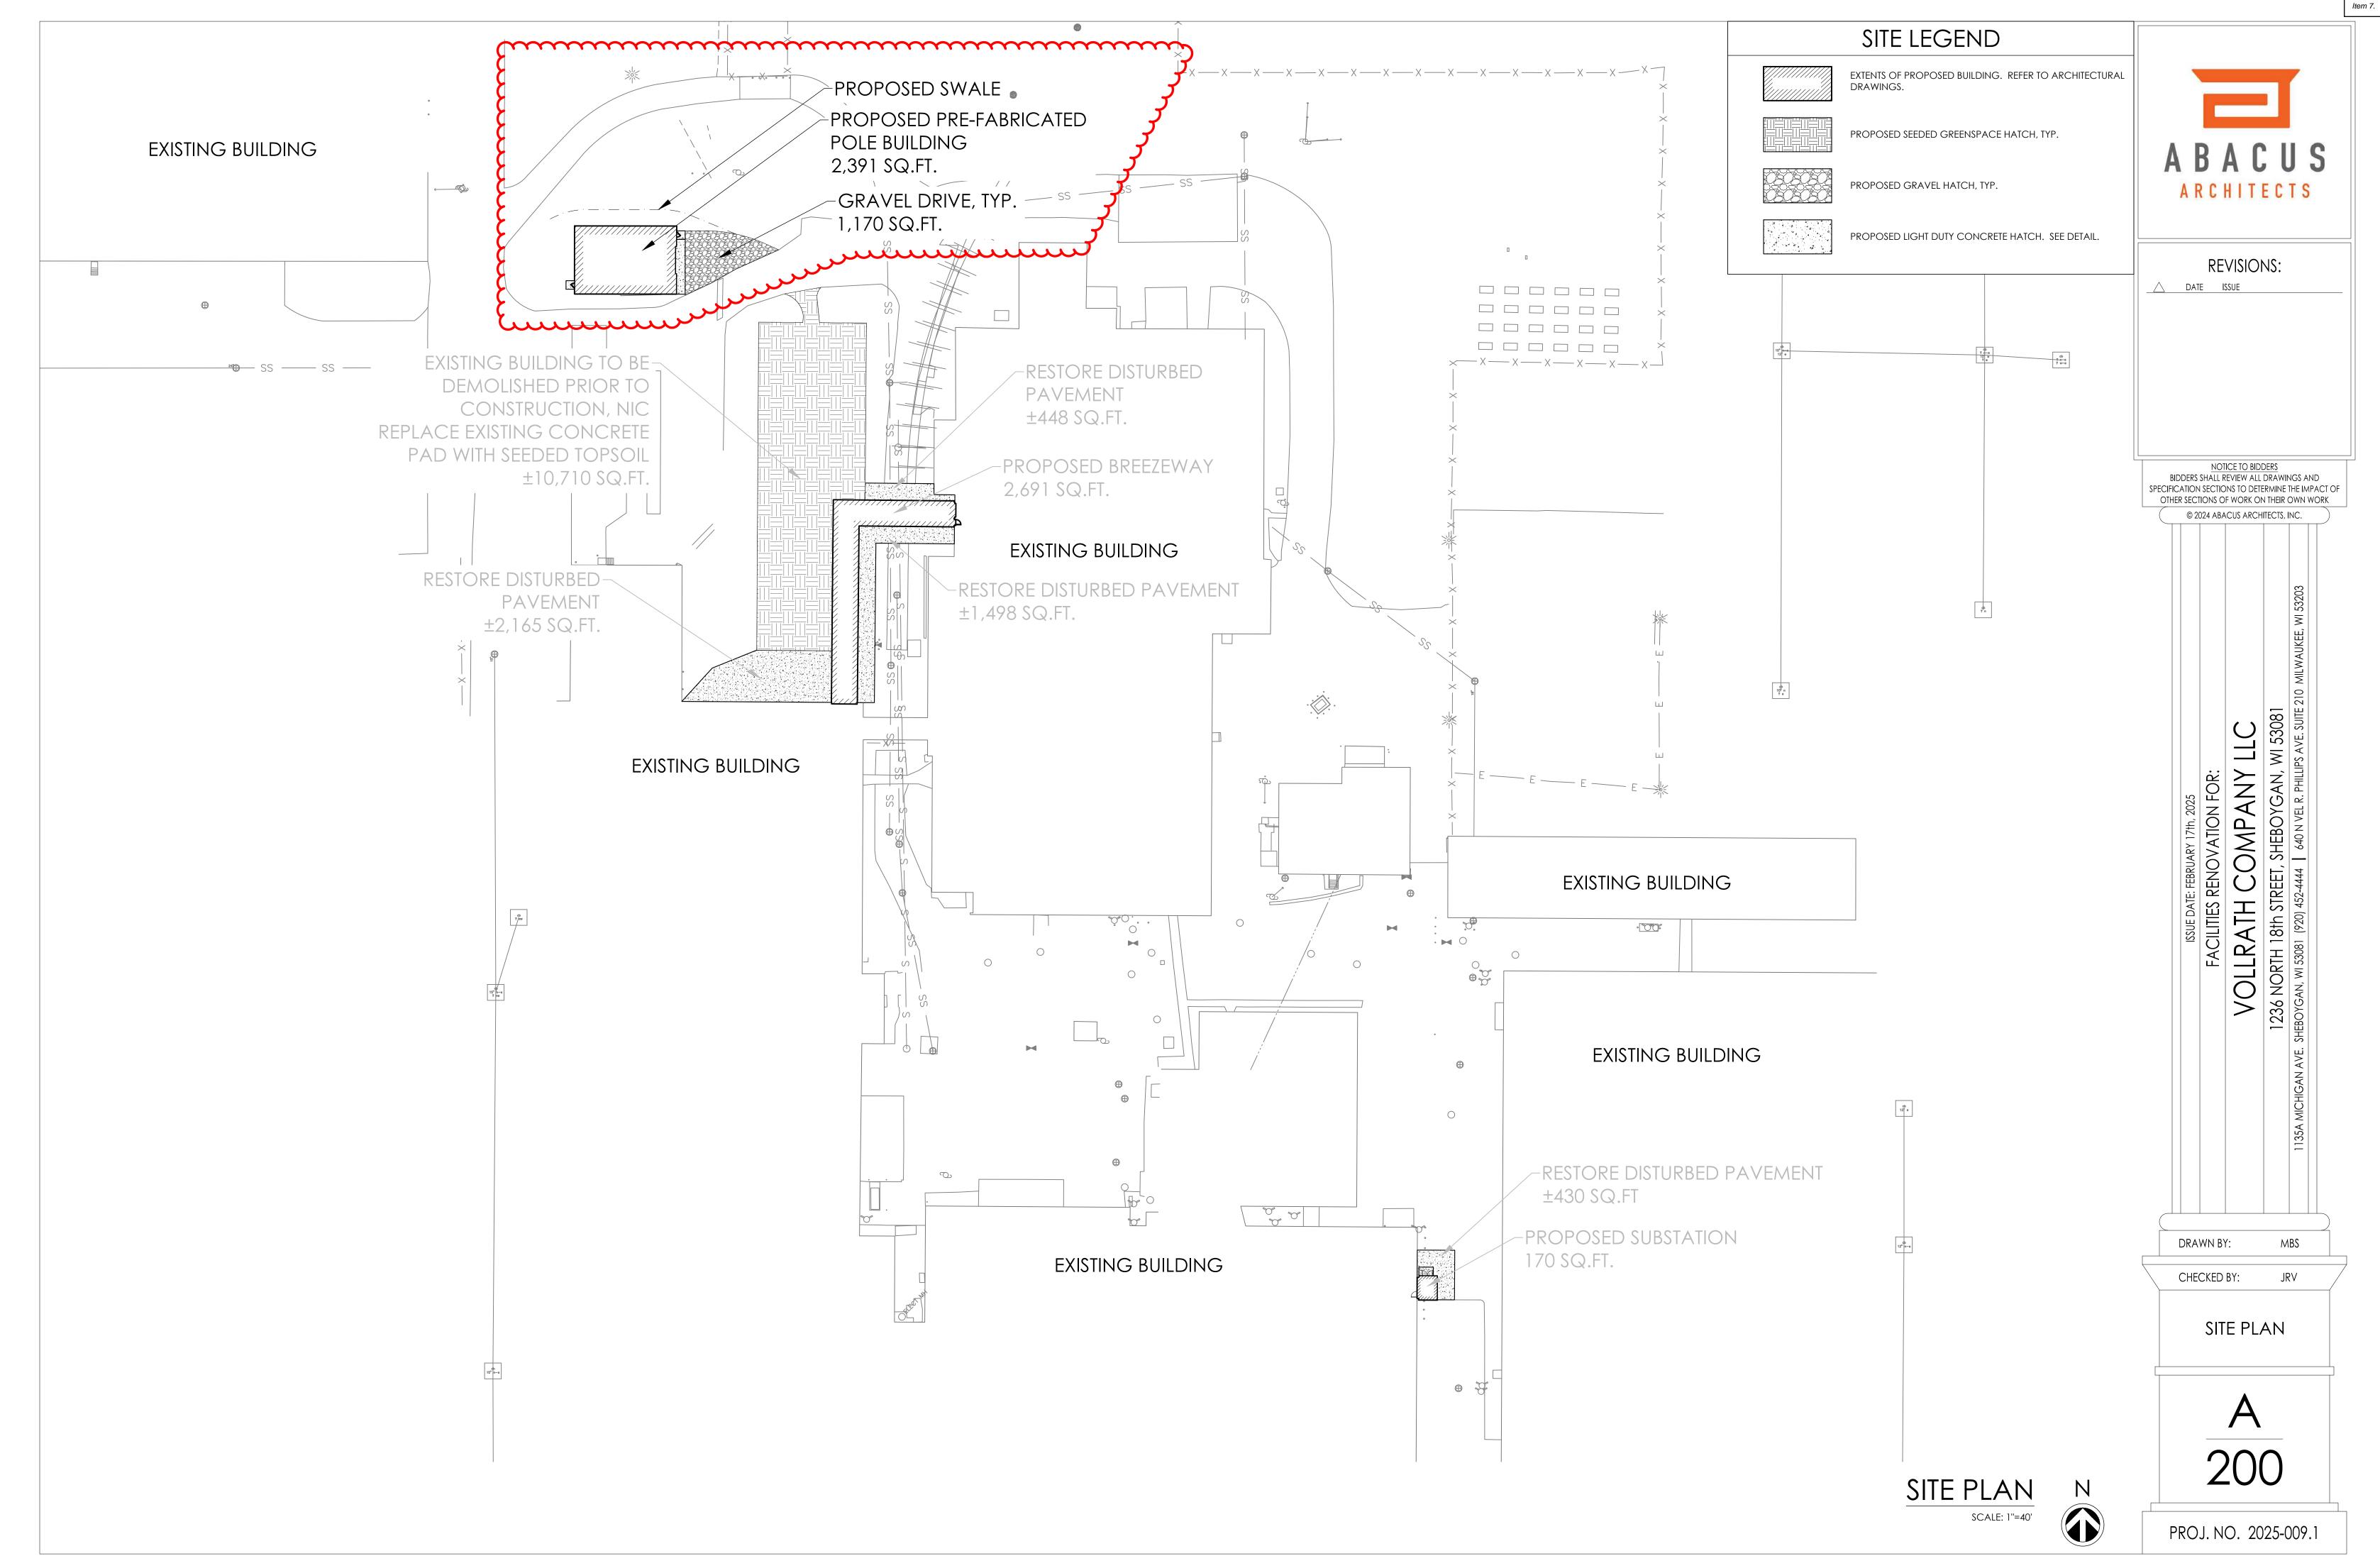4" CONCRETE WITH FIBER MESH
REINFORCEMENT (LIGHT DUTY)
8" CONCRETE WITH FIBER MESH
REINFORCEMENT (HEAVY DUTY)
6" COMPACTED AGGREGATE
BASE COURSE (LIGHT DUTY)
8" COMPACTED AGGREGATE
BASE COURSE (HEAVY DUTY)
EXISTING SUBGRADE (COMPACTED
PRIOR TO PLACING BASE COURSE)
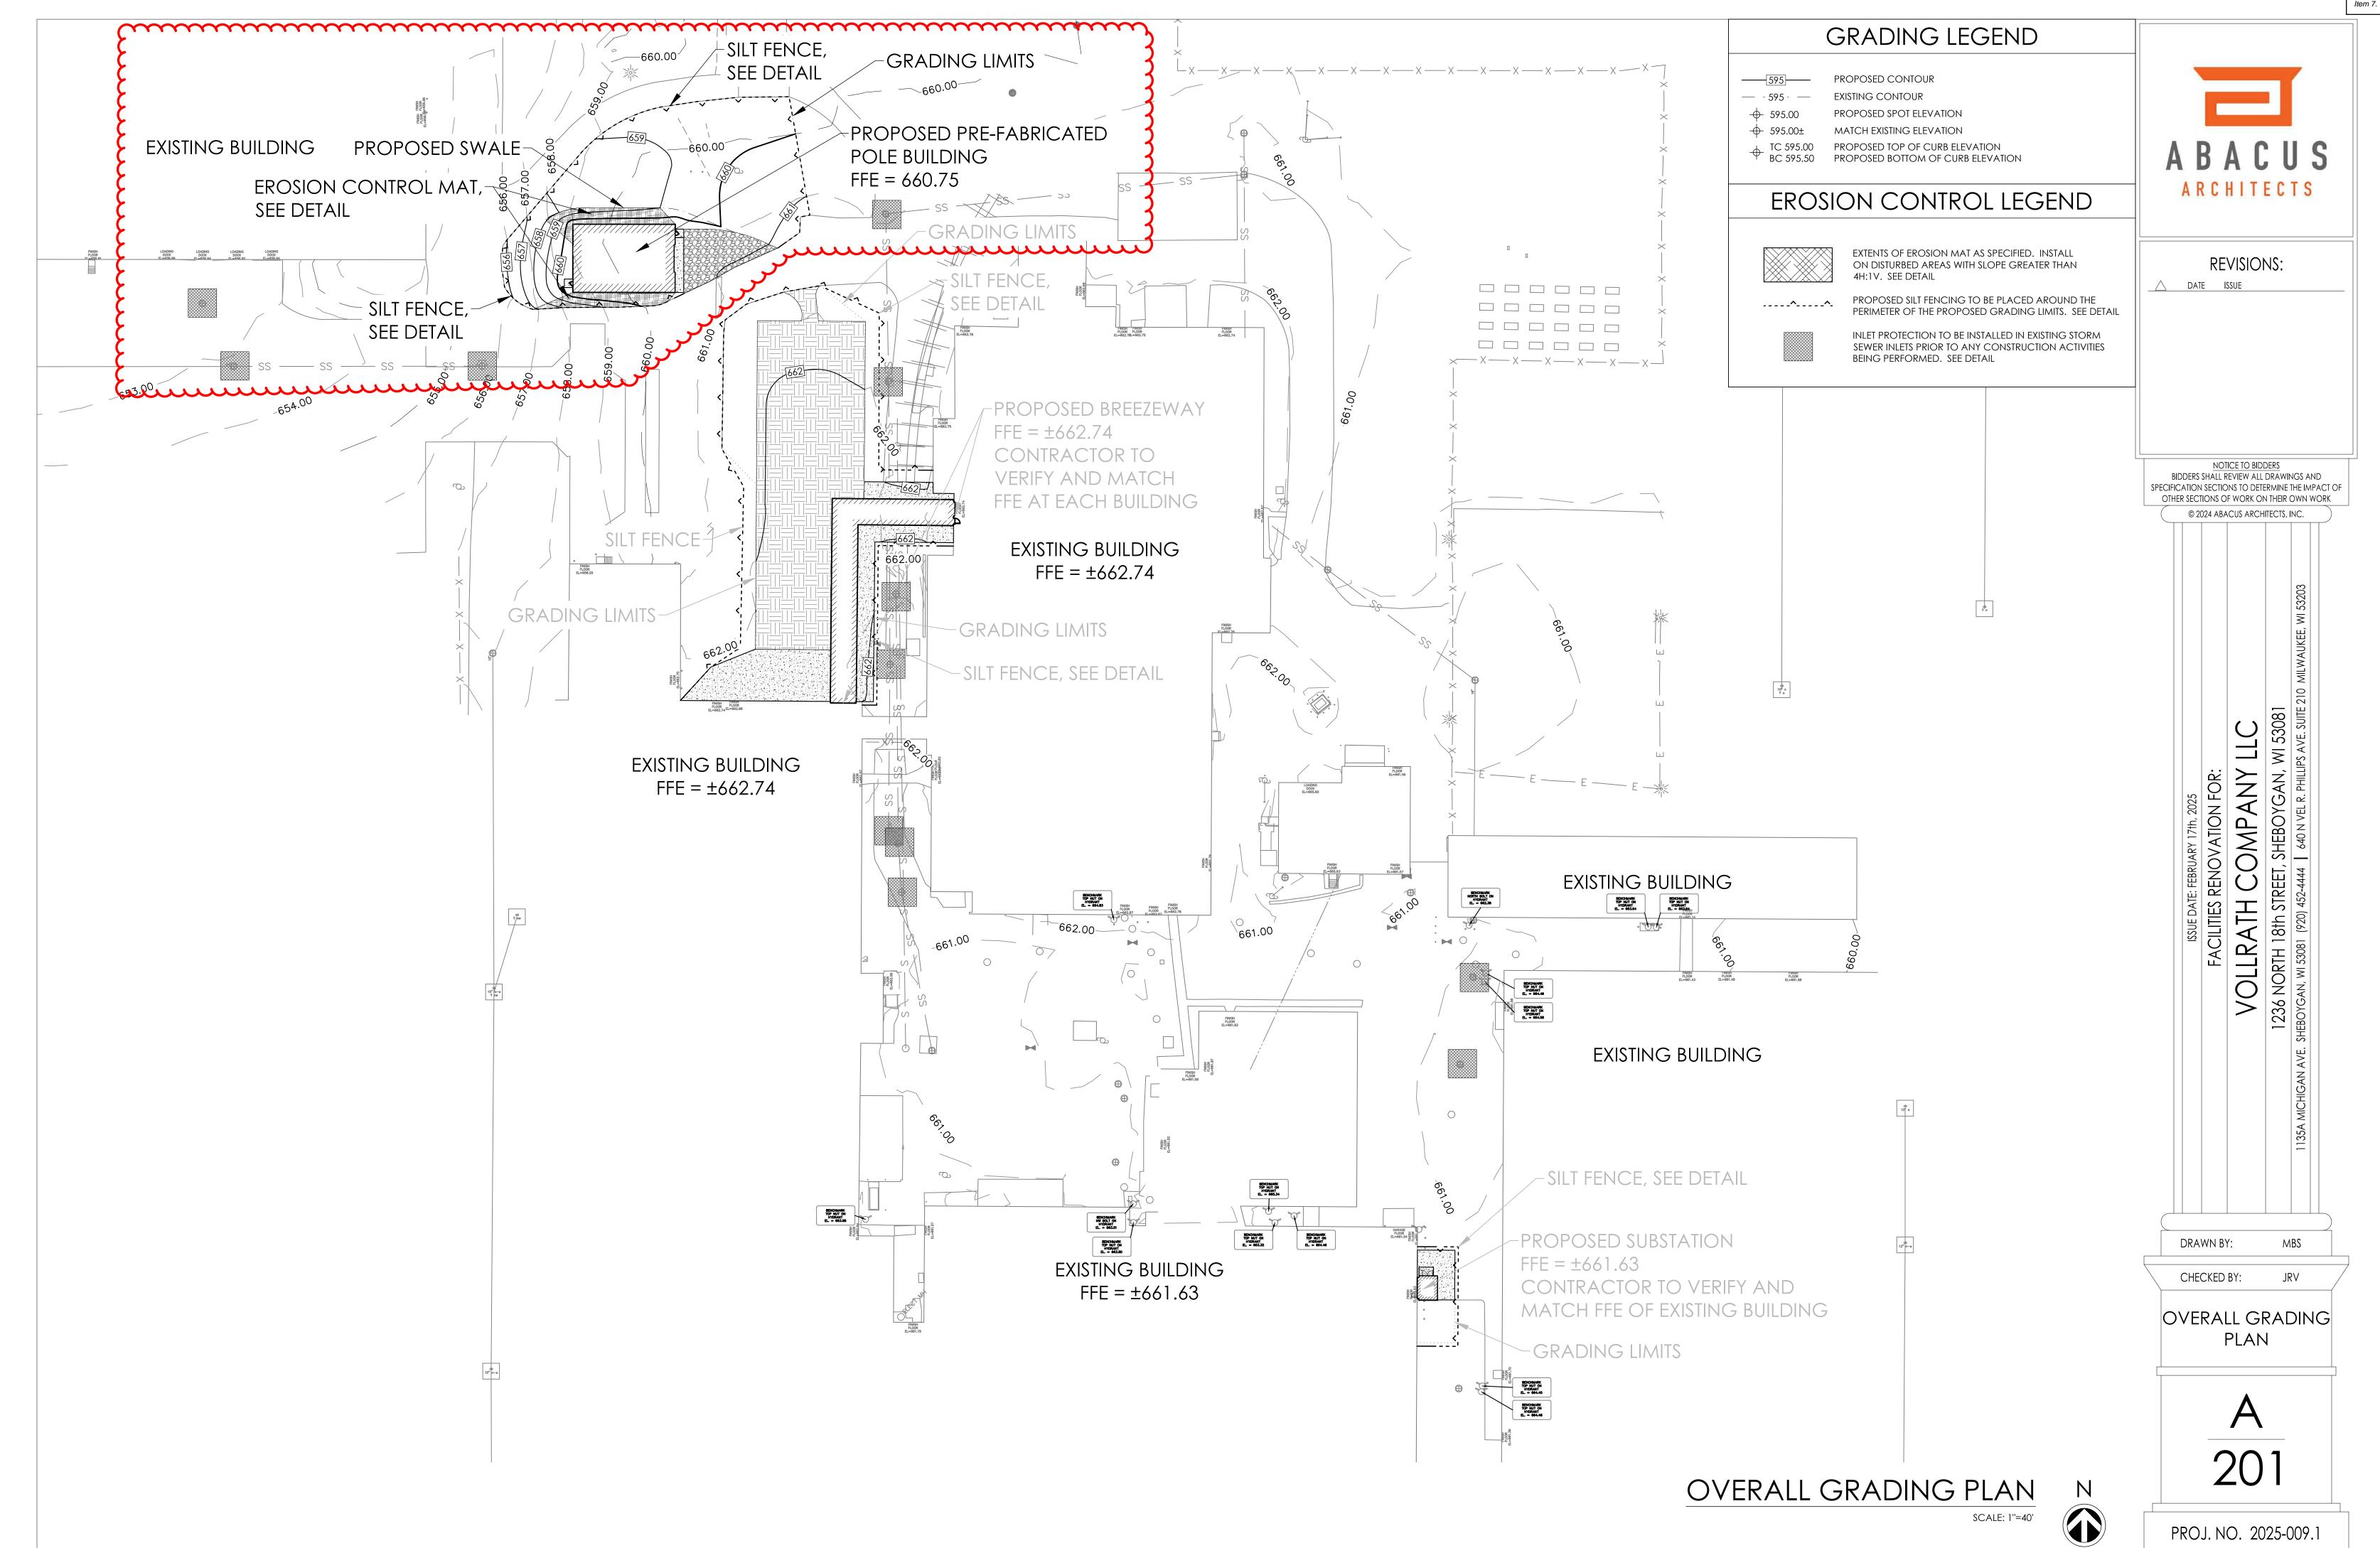
# CONCRETE PAVEMENT CROSS SECTION



SILT FENCE SECTION & DETAIL

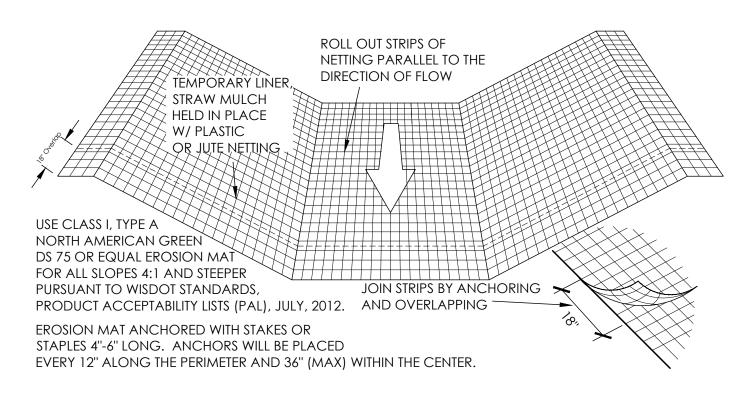

EROSION MATTING DETAIL (FOR SIDE SLOPES ONLY - NOT FOR CHANNELIZED FLOW)

FABRIC SHALL BE REPLACED AT THE ENGINEERS DISCRETION.

WHEN REMOVING OR MAINTAINING INLET PROTECTION, CARE SHALL BE TAKEN SO THAT THE SEDIMENT TRAPPED ON THE GEOTEXTILE FABRIC DOES NOT FALL INTO THE INLET, ANY MATERIAL FALLING INTO THE INLET SHALL BE REMOVED IMMEDIATELY.

ATTACH GEOTEXTILE FABRIC, TYPE FF TO THE TOP OF STAKES AND CROSS BRACING OF STAKES BRACINGS


BRACINGS

BRACINGS

WITH SEDIMENT, WATER WITH SEDIMENT, WATER WITH SEDIMENT, WATER WATER WITH SEDIMENT, TYPE FF TO THE TOP OF STAKES AND CROSS BRACING OF STAKES AND CROSS BRACING OF STAKES AND CROSS BRACINGS BRACINGS OF STAKES AND CROSS BRACING OF STAK

INLET PROTECTION, TYPE 'A'

INSTALLATION PURSUANT TO WDNR TECHNICAL STANDARD 1060

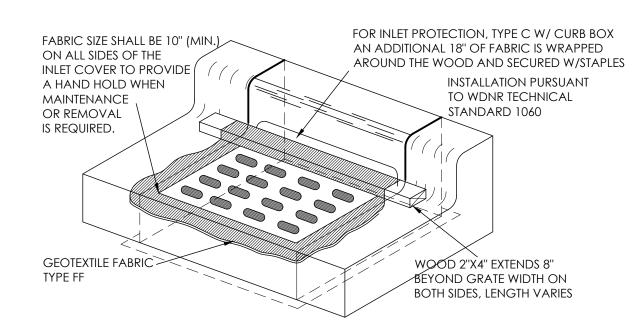

# INLET PROTECTION, TYPE 'C'

TRIM EXCESS FABRIC IN THE FLOW LINE TO WITHIN 3" OF THE GRATE.

THE CONTRACTOR SHALL DEMONSTRATE A METHOD OF MAINTENANCE, USING A SEWN FLAP, HAND HOLDS OR OTHER METHOD TO PREVENT ACCUMULATED SEDIMENT FROM ENTERING THE INLET.

TYPE 'C' INLET PROTECTION TO BE IMPLEMENTED UPON CONSTRUCTION OF CURB AND GUTTER. PRIOR TO CURB AND GUTTER CONSTRUCTION, TYPE 'A' INLET PROTECTION SHALL BE PROVIDED.



REVISIONS:

NOTICE TO BIDDERS

BIDDERS SHALL REVIEW ALL DRAWINGS AND
SPECIFICATION SECTIONS TO DETERMINE THE IMPACT OF
OTHER SECTIONS OF WORK ON THEIR OWN WORK

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FACILITIES RENOVATION FOR:

LLRATH COMPANY LLC

DRTH 18th Street, Sheboygan, WI 53081

WI 53081 (920) 452-4444 | 640 n vel R. Phillips ave, suite 210 milwauke

DRAWN BY: MBS

CHECKED BY:

CIVIL DETAILS

A 203

PROJ. NO. 2025-009.1

CIVIL DETAILS

