

# **CITY PLAN COMMISSION AGENDA**

### September 09, 2025 at 4:00 PM

City Hall, 3rd Floor - Council Chambers, 828 Center Avenue, Sheboygan, WI

Persons with disabilities who need accommodations to attend this meeting should contact the Department of City Development, (920) 459-3377. Persons other than commission, committee, and board members who wish to participate remotely shall provide notice to the City Development Department at 920-459-3377 at least 24 hours before the meeting so that the person may be provided a remote link for that purpose.

### **OPENING OF MEETING**

- 1. Roll Call
- Pledge of Allegiance
- Identify potential conflict of interest

### **MINUTES**

4. Approval of the Plan Commission minutes from August 26, 2025

### **PUBLIC HEARINGS**

- 5. Public hearing regarding application for Conditional Use with exceptions by Olufemi Tomori to operate an indoor family entertainment center located at 2927 N 15th St.
- 6. Public hearing regarding application for Conditional Use with exceptions by Legacy Architecture, Inc. to create commercial indoor lodging located at 632 N 8th Street, Unit 2.
- 7. Public hearing regarding application for Conditional Use with exceptions by NORR, LLC to construct Crash Champions located at parcel # 59281431139.
- 8. Public hearing regarding application for Conditional Use with exceptions by Adam Hertel to construct a Valvoline Instant Oil Change located at parcel # 59281431139.

### ITEMS FOR DISCUSSION AND POSSIBLE ACTION

- 9. Application for Conditional Use with exceptions by Olufemi Tomori to operate PowerPlay Arena located at 2927 N 15th Street.
- 10. Application for Conditional Use with exceptions by Legacy Architecture, Inc. to create commercial indoor lodging located at 632 N 8th St, Unit 2.
- <u>11.</u> Application for Conditional Use with exceptions by NORR, LLC to construct Crash Champions located at parcel # 59281431139.
- 12. Architectural review of the construction of Crash Champions located at parcel 59281431139.

- 13. Application for Conditional Use with exceptions by Adam Hertel to construct a Valvoline Instant Oil Change located at parcel # 59281431139.
- <u>14.</u> Architectural review of the construction of a Valvoline Instant Oil Change located at parcel 59281431139.
- 15. Application for Special Use Permit by Paul Mertens to operate God Connection located at 818 Erie Ave.

### **NEXT MEETING**

16. September 23, 2025

### **ADJOURN**

17. Motion to Adjourn

In compliance with Wisconsin's Open Meetings Law, this agenda was posted in the following locations more than 24 hours prior to the time of the meeting:

City Hall • Mead Public Library
Sheboygan County Administration Building • City's website

### **CITY OF SHEBOYGAN**

### **CITY PLAN COMMISSION MINUTES**

### Tuesday, August 26, 2025

**MEMBERS PRESENT:** Mayor Ryan Sorenson, Kevin Jump, Kimberly Meller, Alderperson Michael Close, Braden Schmidt, Joe Clarke and Jerry Jones

STAFF/OFFICIALS PRESENT: Zoning Administrator Ellise Rose and Administrator Coordinator Linnae Wierus

### **OPENING OF MEETING**

1. Roll Call

Mayor Sorenson called the meeting to order.

2. Pledge of Allegiance

The Pledge of Allegiance is recited.

Identify potential conflict of interest

No conflicts were identified.

### **MINUTES**

4. Approval of the Plan Commission minutes from August 12, 2025.

MOTION TO APPROVED THE MINUTES OF THE PREVIOUS MEETING HELD ON August 12, 2025. Motion made by Jerry Jones, seconded by Braden Schmidt Voting yea: Mayor Ryan Sorenson, Kevin Jump, Kimberly Meller, Alderperson Michael Close, Braden Schmidt, Joe Clarke and Jerry Jones

Motion carried.

### **PUBLIC HEARINGS**

5. Public hearing regarding application for Conditional Use with exceptions by Geoff Lefeber to operate Hit Machine Baseball located at 2737 N 21st Street.

Agenda item tabled.

6. Public hearing regarding application for Conditional Use with exceptions by John Johnston to construct a building addition at Johnston's Bakery Frozen Dough Plant located at 3320 Weeden Creek Road.

No public comment.

MOTION TO CLOSE THE PUBLIC HEARING

Motion made by Jerry Jones, seconded by Kimberly Meller

Voting yea: Mayor Ryan Sorenson, Kevin Jump, Kimberly Meller, Alderperson Michael Close, Braden Schmidt, Joe Clarke and Jerry Jones

Motion carried.

### ITEMS FOR DISCUSSION AND POSSIBLE ACTION

 Application for Conditional Use with exceptions by Geoff Lefeber to operate Hit Machine Baseball located at 2737 N 21st Street.

Agenda item tabled.

8. Application for Conditional Use with exceptions by John Johnston to construct a building addition at Johnston's Bakery Frozen Dough Plant located at 3320 Weeden Creek Road.

### MOTION TO APPROVE WITH THE FOLLOWING CONDITIONS

Motion made by Jerry Jones, seconded by Kimberly Meller

Voting yea: Mayor Ryan Sorenson, Kevin Jump, Kimberly Meller, Alderperson Michael Close, Braden Schmidt, Joe Clarke and Jerry Jones

- 1. Prior to operation/occupancy, the applicant shall obtain all licenses and occupancy permits as well as meet all required codes including but not limited to building, plumbing, electrical, HVAC, fire, health, food, alcohol, etc. An occupancy permit will be granted only at such time as the applicant has met all requirements.
- 2. Applicant shall meet all zoning requirements including but not limited to noise, vibration, hazardous materials, etc.
- 3. Outdoor storage of materials, products or equipment shall be prohibited.
- 4. All new lighting shall be installed per Section 105-932 of the City of Sheboygan Zoning Ordinance. There shall be no spillover light onto adjacent properties or the streets.
- 5. If there are any amendments to the approved use and/or site plan, the applicant will be required to submit a new site plan and/or conditional use application reflecting those amendments.

Motion carried.

9. Architectural review of a building addition at Johnston's Bakery Frozen Dough facility located at 3320 Weeden Creek Road.

### MOTION TO CLOSE THE PUBLIC HEARING

Motion made by Joe Clarke, seconded by Jerry Jones

Voting yea: Mayor Ryan Sorenson, Kevin Jump, Kimberly Meller, Alderperson Michael Close, Braden Schmidt, Joe Clarke and Jerry Jones

Motion carried.

10. Specific Implementation Plan by Sheboygan Visual Artists to operate an artist's gallery located at 534 S Pier Drive.

### MOTION TO APPROVE WITH THE FOLLOWING CONDITIONS

Motion made by Braden Schmidt, seconded by Kimberly Meller

Voting yea: Mayor Ryan Sorenson, Kevin Jump, Kimberly Meller, Alderperson Michael Close, Braden Schmidt, Joe Clarke and Jerry Jones

- 1. Outdoor storage of materials, products or equipment shall be prohibited.
- 2. All areas used for parking/maneuvering of vehicles shall be paved.
- 3. All new lighting shall be installed per Section 105-932 of the City of Sheboygan Zoning Ordinance (site lighting, building lighting, signage, etc.). There shall be no spillover light onto adjacent properties or the streets

Item 4.

- 4. All areas that are not required to be paved shall be landscaped with grass and/or approlandscaping.
- 5. Applicant is responsible for working with all private and public utilities in order to adequately service this development.
- 6. If there are any amendments to the approved SIP the applicant will have to submit an amended SIP for review that accurately reflects any and all proposed changes.

Motion carried.

### **NEXT MEETING**

11. September 9, 2025

The next scheduled meeting is on September 9, 2025.

### **ADJOURN**

12. Motion to Adjourn

**MOTION TO ADJOURN AT 4:13 PM** 

Motion made by Jerry Jones, seconded by Kimberly Meller Voting yea: Mayor Ryan Sorenson, Kevin Jump, Kimberly Meller, Alderperson Michael Close, Braden Schmidt, Joe Clarke and Jerry Jones

Motion carried.

### CITY OF SHEBOYGAN

### REQUEST FOR CITY PLAN COMMISSION CONSIDERATION

**ITEM DESCRIPTION:** Application for Conditional Use with exceptions by Olufemi Tomori to operate PowerPlay Arena located at 2927 N 15th Street. UC Zone.

**REPORT PREPARED BY:** Ellise Rose, Zoning Administrator

**REPORT DATE:** September 2, 2025 **MEETING DATE:** September 9, 2025

FISCAL SUMMARY: STATUTORY REFERENCE:

Budget Line Item: N/A Wisconsin N/A

Budget Summary: N/A Statutes:

Budgeted Expenditure: N/A Municipal Code: N/A

Budgeted Revenue: N/A

### **BACKGROUND / ANALYSIS:**

Olufemi Tomori is proposing to operate PowerPlay Arena located at 2927 N 15<sup>th</sup> Street. The applicant states the following:

- This application is submitted for a Conditional Use Permit on behalf of PowerPlay Arena
   Powered by Inflatable Parties, LLC, a new family entertainment center we are planning to establish at 2927 N 15<sup>th</sup> Street, Sheboygan, WI.
- The space is currently a vacant commercial/retail unit with basic office, restroom, and storage areas.
- Our vision is to create a safe, engaging, and modern entertainment hub for the Sheboygan community, featuring virtual reality (VR) gaming stations, racing simulators, and interactive experiences, with plans to expand to additional attractions such as indoor laser tag and family activity zones in the future.
- The site was chosen for its size, open layout, visability, and location near neighborhoods, schools, and retail.
- PowerPlay Arena will serve as a family-friendly recreational space that encourages healthy social interaction, active play, and technology-driven experiences.
- Our facility will provide:
  - Community benefits: A positive, safe environment for youth, families, and adults to gather and enjoy entertainment locally, reducing the need to travel outside Sheboygan for similar experiences.
  - Economic impact: Creation of local jobs, attraction of visitors to the area, and increased activity for neighboring businesses.
  - Youth engagement: Offering unique gaming and simulator experiences that promote teamwork, creativity, and problem-solving, giving teens and young adults a constructive outlet.

Item 9.

- Flexible space: Party and group packages for birthdays, school outings, church
  groups, and team-building events, expanding Sheboygan's entertainment and eventhosting options.
- The proposed location at 2927 N 15<sup>th</sup> Street is ideally suited for this use. The open floor plan and existing amenities (bathrooms, storage, parking availability) make it wellpositioned to house our attractions with minimal structural changes.
- Our design will include safety features, ADA accessibility, and proper supervision protocols to ensure compliance with city requirements.
- There will be 4-6 part-time staff plus owner/operator and an estimated 30-50 daily visitors on weekdays and 60-100 on weekends.
- Hours from 12-8pm on weekdays and 10-8pm on weekends.
- As a locally owned business, already operating Inflatable Parties LLC in Sheboygan County, we are committed to community values, safety, and providing fun, affordable entertainment for families.
- PowerPlay Arena represents the next step in growing a business rooted in Sheboygan and designed to five back to the community.
- We believe PowerPlay Arena will be a valuable addition to Sheboygan, supporting the city's goals of growth, recreation, and community engagement.

### **STAFF COMMENTS:**

No formal sign package has been submitted. Applicant shall work with staff with regards to constructing a well-designed sign package for the site. Staff may bring the proposed signage design back to the Plan Commission if there are any concerns.

### **ACTION REQUESTED:**

Staff recommends approval of the conditional use permit and exceptions subject to the following conditions:

- 1. Prior to operation/occupancy, the applicant shall obtain all licenses and occupancy permits as well as meet all required codes including but not limited to building, plumbing, electrical, HVAC, fire, health, food, alcohol, etc. An occupancy permit will be granted only at such time as the applicant has met all requirements.
- 2. If using dumpsters, the dumpster(s) shall be screened/enclosed and constructed of like materials and colors of the facility.
- 3. Outdoor storage of materials, products or equipment shall be prohibited.
- 4. All new lighting shall be installed per Section 105-932 of the City of Sheboygan Zoning Ordinance. There shall be no spillover light onto adjacent properties or the streets.
- 5. Applicant shall obtain the necessary sign permits prior to installation. Applicant shall work with staff with regards to constructing a well-designed signage for the site that utilizes colors and materials similar to the building. Staff may bring the proposed signage design back to the Plan Commission for review/approval.
- 6. If there are to be any renovation to the exterior of the facility, the applicant will be required to obtain Architectural Review approval prior to receiving a building permit for such renovation.
- 7. If there are any amendments to the approved use and/or site plan, the applicant will be required to submit a new site plan and/or conditional use application reflecting those amendments.

# **ATTACHMENTS:**

Item 9.

Conditional Use Permit Application and Attachments

	_
Item	9.



### **CITY OF SHEBOYGAN**

# APPLICATION FOR CONDITIONAL USE

Fee: \$250.00	
Review Date:	
Zoning:	

Read all instructions before completing. If additional space is needed, attach additional pages.

SECTION 1: Applicant/ Permittee Info	mation				
Applicant Name (Ind., Org. or Entity) Inflatable Parties LLC(DBA:PowerPlay Arena)	Authorized Repres Olufemi Tomori		Title Owner		
Mailing Address 2003 Carmen Ave	City Sheboygan		State WI		ZIP Code 53081
Email Address inflatablepartiesllc@outlook.com		Phone Number (in 608-572-1304		•	
SECTION 2: Landowner Information (c	omplete these fields	when project site c	wner is di	ifferent tha	n applicant)
Applicant Name (Ind., Org. or Entity) FHCC LLC	Contact Person Carlee Beier		Title	y Manager	
Mailing Address 8575 W Forest Home Ave #160	City Greenfield		State WI		ZIP Code 53228
Email Address carlee@eccommercial.net		Phone Number (inc 414-235-4262	l. area co	de)	
SECTION 3: Project or Site Location					
Project Address/Description 2927 N. 15th Street, Sheboygan, WI - Proposed VR gaming, Racing simulator, and Family entertainment center 59281719341					
SECTION 4: Proposed Conditional Use					
Name of Proposed/Existing Business:	PowerPlay Arena- pov	ver by Inflatable Parties	LLC		
Existing Zoning:	Urban Commercial				
Present Use of Parcel:	Vacant commercial/ret	tail space			
Proposed Use of Parcel:	Indoor VR gaming, racing simulator, and family enetertainment center			or	
Present Use of Adjacent Properties:	Retail, grocery, and mix commercial				
SECTION 5: Certification and Permissic	on .	WELFELD FOR THE			
Certification: I hereby certify that I am					
the subject of this Permit Application. I	certify that the info	rmation contained ir	this form	and attach	ments is true and
accurate. I certify that the project will k	e in compliance witl	h all permit condition	ns. I under	stand that	failure to comply
with any or all of the provisions of the p	permit may result in	permit revocation a	nd a fine a	nd/or forfe	iture under the
provisions of applicable laws.					
Permission: I hereby give the City perm	ission to enter and i	nspect the property	at reasona	able times,	to evaluate this
notice and application, and to determin			coverage.		
Name of Owner/Authorized Representa Carlee Beier	ative (please print)	Title Property Manage		Phone Nui 414-235-	4262
Signature of Applicant	erer		Date Sign	<sup>ned</sup> 8/15	/2025

Complete application is to be filed with the Department of City Development, 828 Center Avenue, Suite 208. To be placed on the agenda of the City Plan Commission, application must be filed three weeks prior to date of meeting — check with City Development on application submittal deadline date. Applications will not be processed if all required attachments and filing fee of \$250 (payable to the City of Sheboygan) are not submitted along with a complete and legible application. Application filing fee is non-refundable.

Olufemi Tomori PowerPlay Arena – Powered by Inflatable Parties LLC 2003 Carmen Ave Sheboygan, WI 53081 [Date]

City of Sheboygan Planning & Development Department 828 Center Avenue, Suite 208 Sheboygan, WI 53081

Re: Conditional Use Permit Application for PowerPlay Arena

Dear Planning Commission,

I am submitting this application for a Conditional Use Permit (CUP) on behalf of PowerPlay Arena — Powered by Inflatable Parties LLC, a new family entertainment center we are planning to establish at 2927 N 15th Street, Sheboygan, WI. Our vision is to create a safe, engaging, and modern entertainment hub for the Sheboygan community, featuring virtual reality (VR) gaming stations, racing simulators, and interactive experiences, with plans to expand to additional attractions such as indoor laser tag and family activity zones in the future.

PowerPlay Arena will serve as a family-friendly recreational space that encourages healthy social interaction, active play, and technology-driven experiences. Our facility will provide:

- Community benefits: A positive, safe environment for youth, families, and adults to gather and enjoy entertainment locally, reducing the need to travel outside Sheboygan for similar experiences.
- Economic impact: Creation of local jobs, attraction of visitors to the area, and increased activity for neighboring businesses.
- Youth engagement: Offering unique gaming and simulator experiences that promote teamwork, creativity, and problem-solving, giving teens and young adults a constructive outlet.
- Flexible space: Party and group packages for birthdays, school outings, church groups, and team-building events, expanding Sheboygan's entertainment and event-hosting options.

The proposed location at 2927 N 15th Street is ideally suited for this use. The open floor plan and existing amenities (bathrooms, storage, parking availability) make it well-positioned to house our attractions with minimal structural changes. Our design will include safety features, ADA accessibility, and proper supervision protocols to ensure compliance with city requirements.

As a locally owned business, already operating Inflatable Parties LLC in Sheboygan County, we are committed to community values, safety, and providing fun, affordable entertainment for families. PowerPlay Arena represents the next step in growing a business rooted in Sheboygan and designed to give back to the community.

We respectfully request the Planning Commission's approval of our CUP application. We believe PowerPlay Arena will be a valuable addition to Sheboygan, supporting the city's goals of growth, recreation, and community engagement.

Thank you for your time and consideration. I look forward to the opportunity to present our project in more detail and answer any questions you may have.

Sincerely, Olufemi Tomori Owner, Inflatable Parties LLC
PowerPlay Arena – Powered by Inflatable Parties LLC
Phone: [Your Phone]
Email: inflatablepartiesllc@outlook.com

# PowerPlay Arena — Powered by Inflatable Parties LLC

### **Conditional Use Written Explanation**

### A. Name of Project/Development

PowerPlay Arena — Powered by Inflatable Parties LLC

### **B. Summary of Conditional Use and General Operation**

**Description of existing use:** The space is currently a vacant commercial/retail unit with basic office, restroom, and storage areas.

**Description of proposed use and why site was selected:** PowerPlay Arena will be an indoor family entertainment center featuring virtual reality (VR) gaming booths, racing simulator rigs, console gaming stations, and eventually a Flash Pad interactive play system. The site was chosen for its size (~4,200 sq. ft.), open layout, visibility, and location near neighborhoods, schools, and retail.

**Services/products provided:** VR gameplay (10 headsets, individual booths and free roam), 2 motion racing simulators, console lounge stations, party room rentals, and future Flash Pad system.

**Projected employees/customers:** 4–6 part-time staff plus owner/operator. Estimated 30–50 daily visitors on weekdays, 60–100 on weekends.

**Square footage/parking:** 4,200 sq. ft. interior. No dwelling units. Parking provided through shared commercial lot (~50+ spaces).

**Building improvements:** Interior layout with booths, simulators, seating, reception desk. Exterior changes limited to signage. Lighting upgraded with LED accent lights. Refuse handled through existing facilities.

**Design compatibility:** Family-friendly, modern finishes (murals, LED lights). Consistent with neighboring tenants.

**Renovations:** Interior cosmetic improvements (paint, lighting, electrical line runs, floor touch-ups). No structural changes.

Access & parking: Existing entrances and parking sufficient.

**Signage:** Wall-mounted sign per city code, optional window graphics.

**Timeline & value:** Build-out in 2–3 months after approval. Total investment ~\$100,000.

**Compatibility with adjacent properties:** Compatible with retail/service neighbors. No outdoor noise, smoke, or odors.

**Noise/hours:** Hours 12–8 pm weekdays, 10–8 pm weekends. Indoor-only sound, no external disturbance.

### C. Exceptions/Variances Required

None requested. Parking, landscaping, and setbacks sufficient.

### D. Written Justification

- a) The project supports the City's Master Plan goals for family recreation, commercial revitalization, and adaptive reuse of vacant space.
- **b)** No undue adverse impact. Indoor-only use, low traffic, existing parking. Consistent with commercial uses. Complements dining, retail, and services.
- d) Served by municipal utilities, ADA restrooms, and 200-amp electrical. No special services required.

Exhibits: Sample booth mockups and Flash Pad screenshots to be attached.

# **NA**Pfefferle

# FOR LEASE Retail Space in Northgate Shopping Center



# 2821, 2825 & 2927 N. 15th Street, Sheboygan, WI

# **Property Features**

Retail space in a ±72,000 SF neighborhood shopping center anchored by Piggly Wiggly—the only grocery store serving Sheboygan's north side. Located near North High School and situated along one of the few major arterial roads in the area, this high-visibility center offers excellent access, ample parking, and mature landscaping that enhances curb appeal. Inline and end cap spaces are available at Northgate Shopping Center. Room for auxiliary features (outside eating areas and/or playgrounds). Motivated Landlord.

LEASE RATE	\$9.00/SF NNN
CAM	\$2.96/SF
SPACE AVAILABLE	2,500 SF, 4,000 SF, 8,000 SF
ZONING	URBAN COMMERCIAL DISTRICT

### For more information:

Dane Checolinski

920.344.8732 • danec@naipfefferle.com

NO WARRANTY OR REPRESENTATION, EXPRESS OR IMPLIED, IS MADE AS TO THE ACCURACY OF THE INFORMATION CONTAINED HEREIN, AND THE SAME IS SUBMITTED SUBJECT TO ERRORS, OMISSIONS, CHANGE OF PRICE, RENTAL OR OTHER CONDITIONS, PRIOR SALE, LEASE OR FINANCING, OR WITHDRAWAL WITHOUT NOTICE, AND OF ANY SPECIAL LISTING CONDITIONS IMPOSED BY OUR PRINCIPALS NO WARRANTIES OR REPRESENTATIONS ARE MADE AS TO THE CONDITION OF THE PROPERTY OR ANY HAZARDS CONTAINED THEREIN ARE ANY TO BE IMPLIED.

3414 Mill Road Sheboygan, WI 920.783.6330 naipfefferle.com

# For Lease

# MalPfefferle

2821, 2825 & 2927 N. 15th Street Sheboygan, WI

2927 N. 15th Street (4,000 SF)
















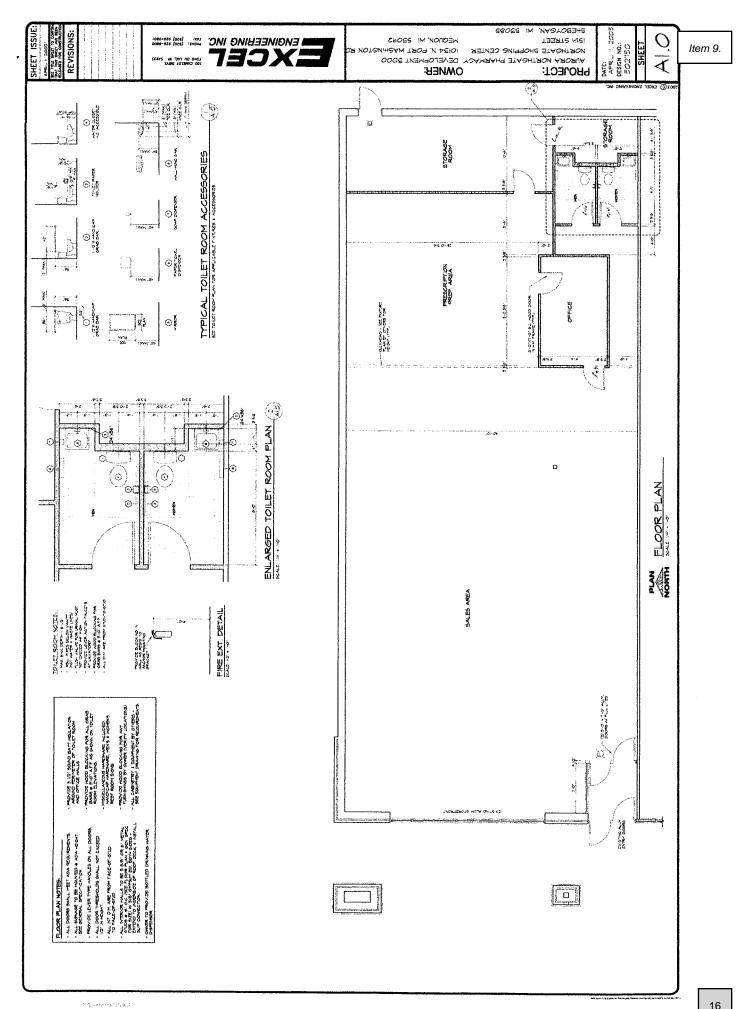

### CITY OF SHEBOYGAN

### REQUEST FOR CITY PLAN COMMISSION CONSIDERATION

**ITEM DESCRIPTION:** Application for Conditional Use with exceptions by Legacy Architecture, Inc. to create commercial indoor lodging located at 632 N 8<sup>th</sup> St, Unit 2. CC Zone.

**REPORT PREPARED BY:** Ellise Rose, Zoning Administrator

**REPORT DATE:** September 3, 2025 **MEETING DATE:** September 9, 2025

FISCAL SUMMARY: STATUTORY REFERENCE:

Budget Line Item: N/A Wisconsin N/A

Budget Summary: N/A Statutes:

Budgeted Expenditure: N/A Municipal Code: N/A

Budgeted Revenue: N/A

### **BACKGROUND / ANALYSIS:**

Legacy Architecture, Inc. is proposing to create commercial indoor lodging located at 632 N 8<sup>th</sup> Street, Unit 2. The applicant states the following:

- Currently the first floor of the building is a retail space, the second floor is a vacant office space, and the third floor is a residential space owned by a local business.
- The second floor, sold to the same business that purchased the third floor, is to be converted into a 4-unit lodging space, as this location has easy access to downtown and its amenities.
- Services include lodging for 1-4 guests. There will be no employees while guests are staying.
- There will be 4 lodging units, 2,965 square feet, with no landscaping or parking on the property.
- There will be an interior remodel of the first-floor elevator lobby and the second floor. No changes to site or exterior of the building.
- Interior remodel of second floor to create 4 units, matching the interior design of the third floor. Remodel of first floor elevator lobby to create storage for guests, also matching the interior design of the second and third floors.
- Existing entrances remain unchanged, and there is reserved parking for the property in the parking lot to the south.

1

- There will be no signage.
- Project timeline estimated from September 2025 to March 2026. Estimated value is unknown.
- This conditional use matches the increased residential presence in downtown Sheboygan.

17

Item 10.

- The second floor will only house 4 guests, who will use the reserved parking spaces the lot to the south. The proposed design includes proper sound attenuation in the walls, floor, and ceiling.
- The lodging use for the second floor allows a local business to use the second and third floors for customers, suppliers, and other invited guests. This use will be consistent with the increased residential presence in Harbor Centre Sheboygan, bringing people to the area who are likely to visit local venues such as restaurants and shops.

### **STAFF COMMENTS:**

The applicant will need to work with the building inspection department regarding the conversion of the 3rd floor space into an apartment. Occupancy shall be granted only at such time as all permits and codes have been met.

If operating as a short-term rental, the applicant will be required to file the proper room tax paperwork with the City of Sheboygan.

### **ACTION REQUESTED:**

Staff recommends approval of the conditional use permit and exceptions subject to the following conditions:

- 1. Prior to operation/occupancy, the applicant shall obtain all licenses and occupancy permits as well as meet all required codes including but not limited to building, plumbing, electrical, HVAC, fire, health, food, alcohol, etc. An occupancy permit will be granted only at such time as the applicant has met all requirements.
- 2. If using dumpsters, dumpster(s) shall be screened/enclosed and constructed of like materials and colors of the facility.
- 3. Outdoor storage of materials, products or equipment shall be prohibited.
- 4. All new lighting shall be installed per Section 105-932 of the City of Sheboygan Zoning Ordinance. There shall be no spillover light onto adjacent properties or the streets.
- 5. Absolutely no portion of the new building and/or site improvements shall cross the property lines including but not limited to buildings, balconies, decks, foundations, walls, gutters, eaves, roof, parking, fencing/retaining walls, signs, landscaping, etc.
- 6. If there are to be any exterior renovations to the facility, the applicant will be required to obtain Architectural Review approval prior to receiving a building permit for such renovation. The colors and materials are to complement/match the existing building.
- 7. If applicant leases space to additional tenants, the tenants shall obtain all necessary land use and building approvals/permits prior to occupancy (future uses and/or phases may require conditional use permits, building/mechanical permits, occupancy permits, etc.).
- 8. If operating as a short-term rental, the applicant will be required to file the proper room tax paperwork with the City of Sheboygan
- 9. If there are any amendments to the approved use and/or site plan, the applicant will be required to submit a new site plan and/or conditional use application reflecting those amendments.

### **ATTACHMENTS:**

Conditional Use Permit Application and Attachments

3



### **CITY OF SHEBOYGAN**


# APPLICATION FOR CONDITIONAL USE

Fee:	\$250.00	
Revie	ew Date:	
Zonir	ng:	

Read all instructions before completing. If additional space is needed, attach additional pages.

SECTION 1: Applicant/ Permittee Infor	mation				
Applicant Name (Ind., Org. or Entity) Legacy Architecture, Inc.	Authorized Repres Jennifer L. Lehrk		Title Presider	nt	
Mailing Address 605 Erie Avenue, Suite 101	City Sheboygan		State WI		ZIP Code 53081
Email Address jlehrke@legacy-architecture.com		Phone Number (ind (920) 783-6303	cl. area cod	de)	
SECTION 2: Landowner Information (co	omplete these fields	when project site o	wner is di	fferent th	an applicant)
Applicant Name (Ind., Org. or Entity) Eighth Street Condominium Owners in Common	Contact Person Paul Weaver		Title		
Mailing Address 508 New York Avenue	City Sheboygan		State WI		ZIP Code 53081-4126
Email Address paulw@project4services.com		Phone Number (ind (414) 731-0795	cl. area cod	de)	
SECTION 3: Project or Site Location					<b>机带放射性性</b> 抗炎的
Project Address/Description 632 N 8th Street, Unit 2, Sheboygan,		Parcel No 5928110			
<b>SECTION 4: Proposed Conditional Use</b>					
Name of Proposed/Existing Business:	Proposed: American Orthodontics/ Existing: Big Brothers Big Sisters WI Shoreline				oreline
Existing Zoning:	CC Central Commercial District				
Present Use of Parcel:	Indoor Sales or Service, Office, Commercial Indoor Lodging				
Proposed Use of Parcel:	Indoor Sales or Service, Commercial Indoor Lodging				
Present Use of Adjacent Properties:		sonal or Professional Serv	vices		
SECTION 5: Certification and Permission	on the same of				<b>以此为</b> 为4.00000000000000000000000000000000000
Certification: I hereby certify that I am the subject of this Permit Application. I accurate. I certify that the project will be with any or all of the provisions of the provisions of applicable laws.	certify that the info be in compliance wit	rmation contained ir h all permit conditio	n this form ns. I under	and attac stand that	hments is true and t failure to comply
<b>Permission:</b> I hereby give the City perm notice and application, and to determin				able times	, to evaluate this
Name of Owner/Authorized Representa Jennifer Lehrke		Title President		Phone N (920) 78	umber 83-6303
Signature of Applicant  Signature of Applicant  Signature of Applicant  Signature of Applicant	he		Date Sign	ned 25	

Complete application is to be filed with the Department of City Development, 828 Center Avenue, Suite 208. To be placed on the agenda of the City Plan Commission, application must be filed three weeks prior to date of meeting – check with City Development on application submittal deadline date. Applications will not be processed if all required attachments and filing fee of \$250 (payable to the City of Sheboygan) are not submitted along with a complete and legible application. Application filing fee is non-refundable.

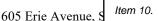

(920) 783-6303

Sheboygan, Wisconsin 53081

info@legacy-architecture.com www.legacy-architecture.com



August 15, 2025

City of Sheboygan Application for Conditional Use

### CONDITIONAL USE WRITTEN EXPLANATION

- A. Name of project/development

  Commercial Remodel for American Orthodontics
- B. Summary of the Conditional Use and general operation of proposed use:
  - Description of existing use

The first floor of the building is a retail space, the second floor is a vacant office space, and the third floor is a residential space owned by a local business.

- Description of proposed use (indoor, outdoor, etc.), why was this site selected?

  The second floor, sold to the same business that purchased the third floor, is to be converted into a 4-unit lodging space, as this location has easy access to downtown and its amenities.
- All services, products, etc. to be provided **Lodging for guests.**
- Projected number of residents, employees, and/or daily customers
- 1-4 guests, no employees while guests are staying.
- Proposed number of dwelling units, floor area, landscape area, and parking area expressed in square feet and acreage to the nearest one-hundredth of an acre
- 4 lodging units, 2,965 square feet, no landscaping or parking on property
- Description of proposed building and all new site improvements (square footage of new and existing structure(s), traffic, ingress/egress, parking, sidewalk, retaining walls, storm drainage, landscaping, lighting, dumpster enclosure, screening of mechanicals, etc.)

Interior remodel of first floor elevator lobby and second floor. No changes to site.

• A written description of the proposed general orientation, design, arrangement, texture, material and color of the building or structure and how it is compatible with the development and redevelopment in and around the area

No changes to exterior of building.

- An explanation of any interior and/or exterior renovations
- Remodel of second floor to create 4 units, matching the interior design of the third floor. Remodel of first floor elevator lobby to create storage for guests, also matching the interior design of the second and third floors.
- Is access appropriate and is there sufficient customers/resident off-street parking? Existing entrances remain unchanged, and there is reserved parking for the property in the parking lot to the south.
- Proposed signage

None

• Project timeline and estimated value of project

### Project timeline estimated from September 2025 to March 2026. Estimated value is unknown.

- Compatibility of the proposed use and design with adjacent and other properties in the area. This conditional use matches the increased residential presence in downtown Sheboygan.
- How will you ensure that the business will not become a nuisance to adjacent properties (i.e. parking, noise, smells, hours of operations, etc.)

The second floor will only house 4 guests, who will use the reserved parking spaces in the lot to the south. The proposed design includes proper sound attenuation in the walls, floor, and ceiling.

- Other information that would be considered pertinent by the Plan Commission.
- C. If applicable, please describe any exceptions/variances that are required for this project (i.e. setbacks, parking, landscaping, etc.)

None

- D. Written justification for the proposed conditional use, indicating reasons why the applicant believes the proposed conditional use is appropriate:
  - a. How is the proposed conditional use (independent of its location) in harmony with the purposes, goals, objectives, policies and standards of the City of Sheboygan Comprehensive Master Plan?

    The lodging use for the second floor allows a local business to use the second and third floors for customers, suppliers, and other invited guests. This use will be consistent with the increased residential presence in Harbor Centre Sheboygan, bringing people to the area who are likely to visit local venues such as restaurants and shops.
  - b. Does the conditional use, in its proposed location, result in any substantial or undue adverse impact on nearby property, the character of the neighborhood, environment, traffic, parking, public improvements, public property or rights-of-way?

No, the second-floor unit has dedicated off street parking in the lot to the south.


- **c.** How does the proposed conditional use maintain the desired consistency of land uses in relation to the setting within which the property is located?
  - The proposed use for the second floor matches that of the third floor, and commercial indoor lodging is permitted as a conditional use in the Central Commercial (CC) Zone.
- d. Is the proposed conditional use located in an area that will be adequately served by utilities, or services provided by public agencies? If not, please explain.
   Yes

### CONDITIONAL USE APPLICATION SUBMITTAL


- 1. Survey maps included
- 2. Zoning map included
- 3. Site plan included
  - No easement
  - No setbacks required (Sec 105-476 (b))
  - No curb cuts on property
  - No loading/service area
  - No outdoor storage area
  - No signage
  - No exterior lighting
  - No additional mechanical equipment on site
- 4. Building photos included

### **EIGHTH STREET CONDOMINIUM** Part of Lots 1 and 2, Block 151, Original Plat of Sheboygan, Located in the NE 1/4 of the SW 1/4, Section 23, T15N, R23E, Sheboygan County, Wisconsin. SURVEYORS CERTIFICATE 1, Bengamin J. Reenders, Registered Land Surveyor number 5-3114, do hereby certify that thave surveyed the following described property and that this survey is an accurate representation of the exterior boundary lines and the location of the proposed building and NEW YORK AVENUE CONCRETE ROAD COHC. QURB improvements on the property. Part of Lot 1 and Lot 2, Block 151 of the Original Plat of the City of Sheboygan, Sheboygan County, Wisconsin; and further described as follows: Commencing and point of beginning being CONCRETE WALK at the chiseled X of the NE corner of Block 151; thence the following bearings and distances; 500°00'00°E 55.5' along the east line of Block 151 and being the west right of way \$89'59'38'E 120.24' line of North 8th Street; N89"59'38"W 110.24' to a point on the public alley: N00"00"06"W 32.00" along the east line of said public alley; N89"59'38"W 10.00" along the north line of said public alley; N00"00"06"W 23.50" to a point on the south right of way line of New York Avenue; \$89°59'38"E 120.24" along the north line of Lots 1 and 2 of Block 151 and solid south right of way line of New York Avenue to the point of beginning and containing 6,673 I further certify that this plat is a correct representation of "Eighth Street Condominium" as proposed at the date hereof, and the identification and location of each UNIT Ind the common elements can be determined from the plat. The undersigned surveyor makes no certification as to the accuracy of the floor plans of the condominium building and units contained in the plat and the approximate deministrians and floor area thereof. STREET BLACK TO BTH PARE That I have fully complied with provisions of Section 236,34 of the Wisconein Statutes and the subdivision regulation of the City of Shebbygan in surveying, dividing and mapping the same. NORTH Bayouns J. Rundez Dond Doe 2000 day of September , 2019 N89'59'38'W 110,24' ZAX. **GLACK FOR** 0 SURY 30% 10 BLACK TOP Oceanur Avenue, Sulle 1 Oceanurg, WI 53070 IN WIDE PUBLIC ALLEY 18" MOE PUBLIC ALLEY O - Iron Pipe Found NOTE: \* BÉARINGS ARE BASED ON THE EAST LINE OF BLOCK 151 AS BEING ASSUMED 10 BEAR SOCOTOOPE. \* ANY AREA NOT DESIGNATED AS LIMITED COMMON ELEMENT OR CONDO BUILDING AREA IS COMMON FLEMENT. @ = Catch Basin Manhole 🚉 = Street Light CEDAR CREEK SURVEYING, LLC - Building Overheng www.cedarcreeksurveying.com -x--- # Wood Fence THIS INSTRUMENT WAS DRAFTED BY PETER RONDE OF CEDAR CREEK SURVEYING, LLC



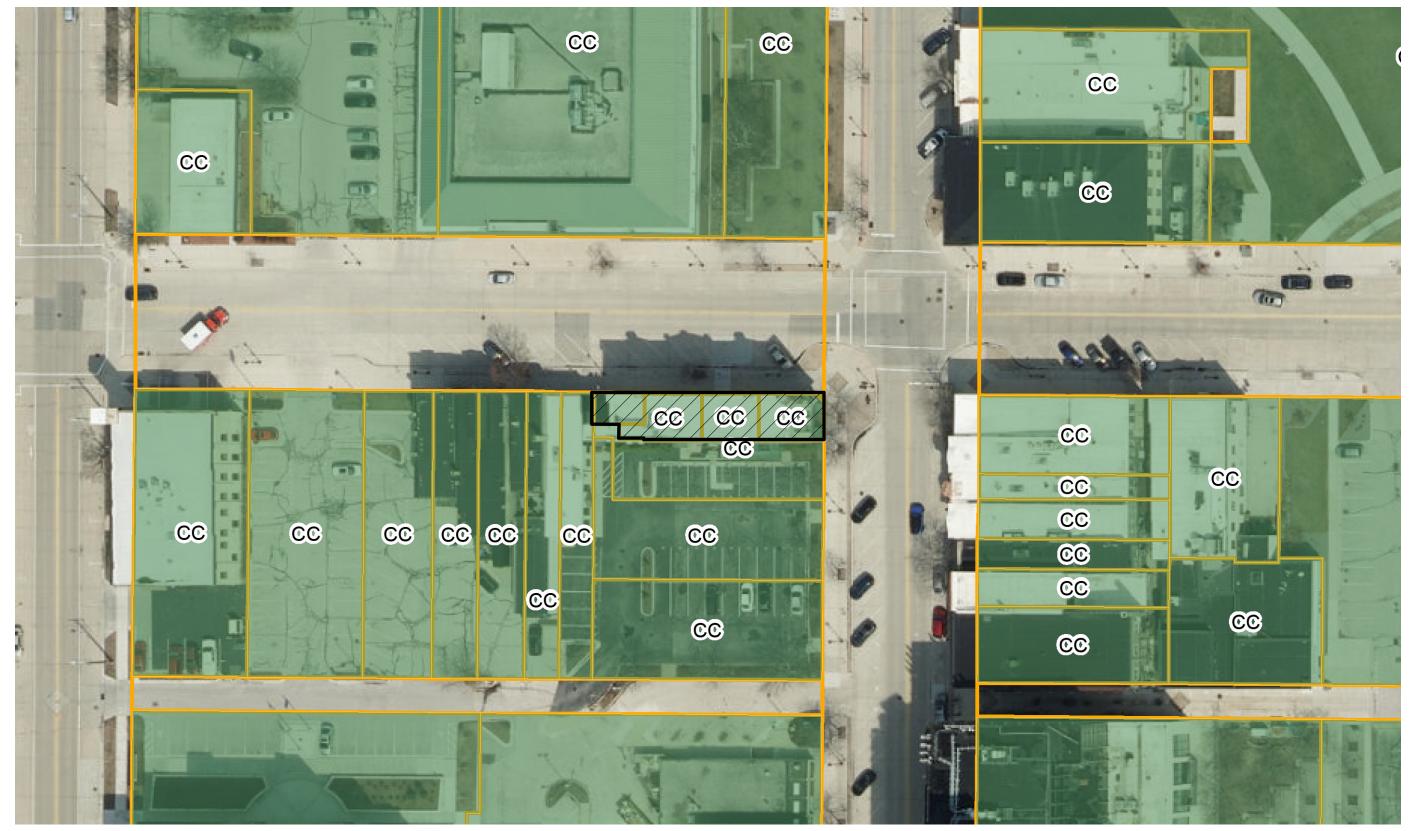



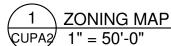




### FOR PERMITTING



COMMERCIAL REMODEL FOR: AMERICAN ORTHODONTICS 632 N 8TH STREET UNIT 2 SHEBOYGAN, WI 53081 PROJECT NUMBER
24.091

DATE
07/18/2025

SHEET NUMBER
CUPA
24

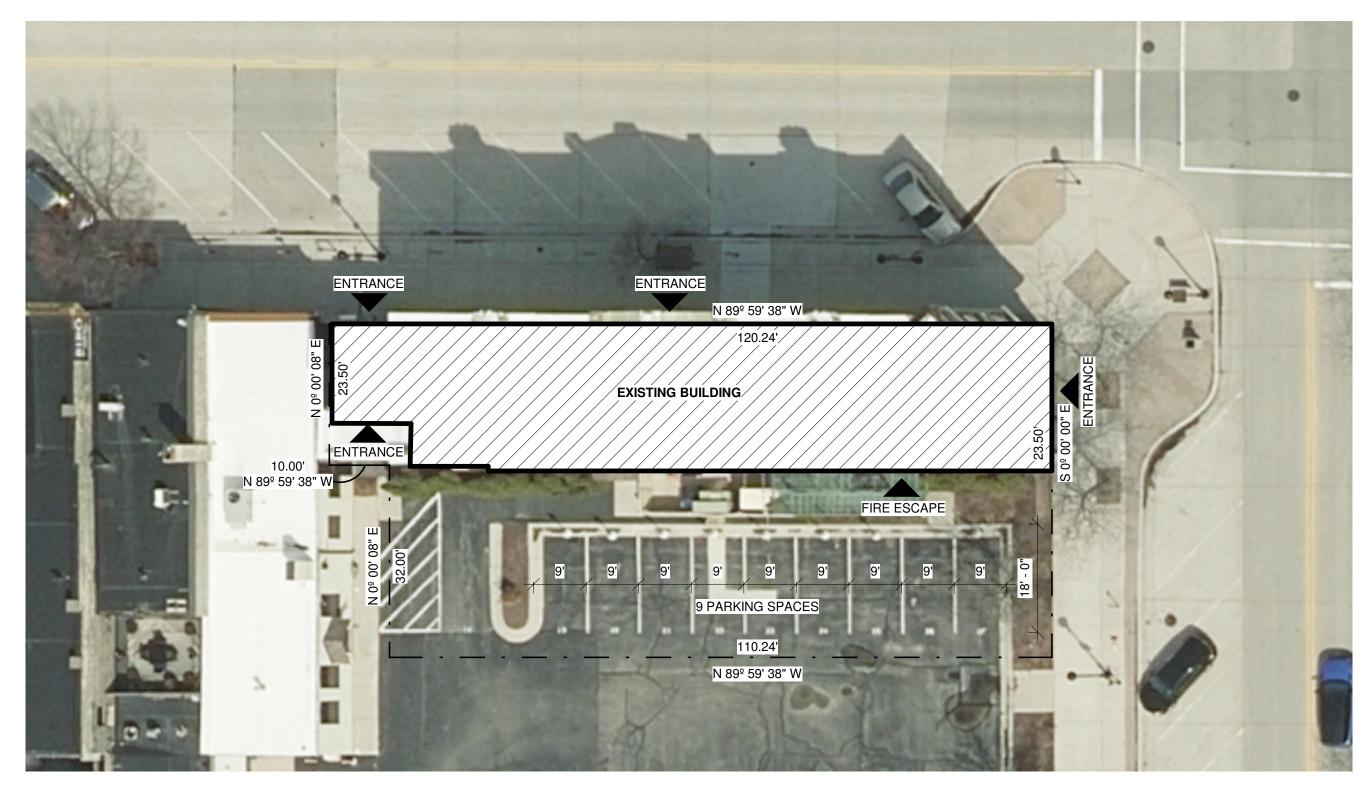







# FOR PERMITTING



COMMERCIAL REMODEL FOR: AMERICAN ORTHODONTICS 632 N 8TH STREET UNIT 2 SHEBOYGAN, WI 53081 PROJECT NUMBER
24.091

DATE
07/18/2025


SHEET NUMBER
CUPA
25

	DRAWING INDEX		
SHEET NO.	SHEET NAME	REVISION	REVISION DATE
GENERAL		,	
G0.01	PROJECT INFORMATION, DRAWING INDEX, AREA MAP		
G0.02	USE & OCCUPANCY CODE REVIEW		
G0.03	EGRESS & FIRE PROTECTION CODE REVIEW		
G0.04	GENERAL ACCESSIBILITY DETAILS		
G0.05	GENERAL ACCESSIBILITY DETAILS		
G0.06	ACCESSIBILITY CODE REVIEW		
ARCHITECTU	IRAL REMOVAL	·	
AR1.01	SELECTIVE REMOVAL PLANS		
ARCHITECTU	IRAL	,	
A1.01	FLOOR PLANS		
A1.02	REFLECTED CEILING PLANS		
A3.01	BUILDING SECTION		
A4.01	INTERIOR ELEVATIONS		
A4.02	INTERIOR ELEVATIONS		
A5.01	DETAILS		
A6.01	DOOR AND WINDOW SCHEDULE & DETAILS		
INTERIORS			
I1.01	FLOORING PLANS & ROOM FINISH SCHEDULE		
l1.02	FURNITURE & APPLIANCE PLANS & SCHEDULE		
ELECTRICAL			
E1.01	POWER PLANS		
E1.02	LIGHTING PLANS		

# COMMERCIAL REMODEL FOR: **AMERICAN ORTHODONTICS**


632 N 8TH STREET UNIT 2 SHEBOYGAN, WI 53081



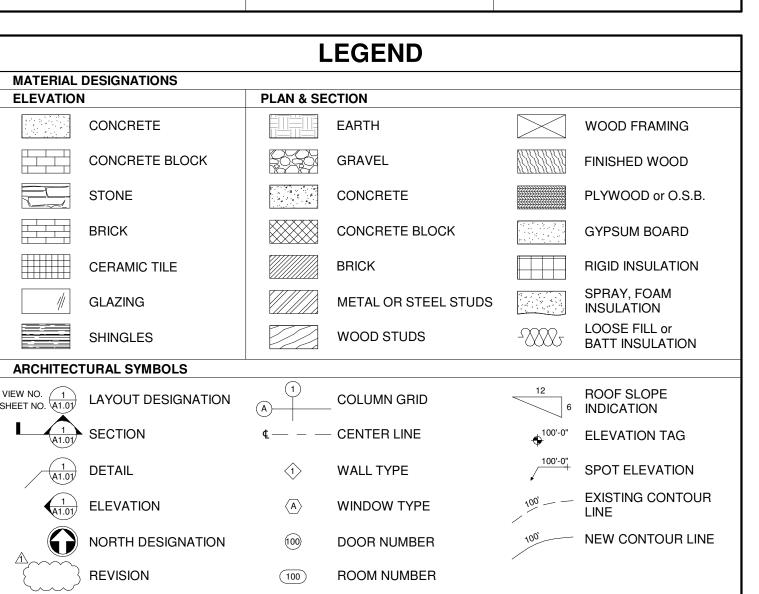





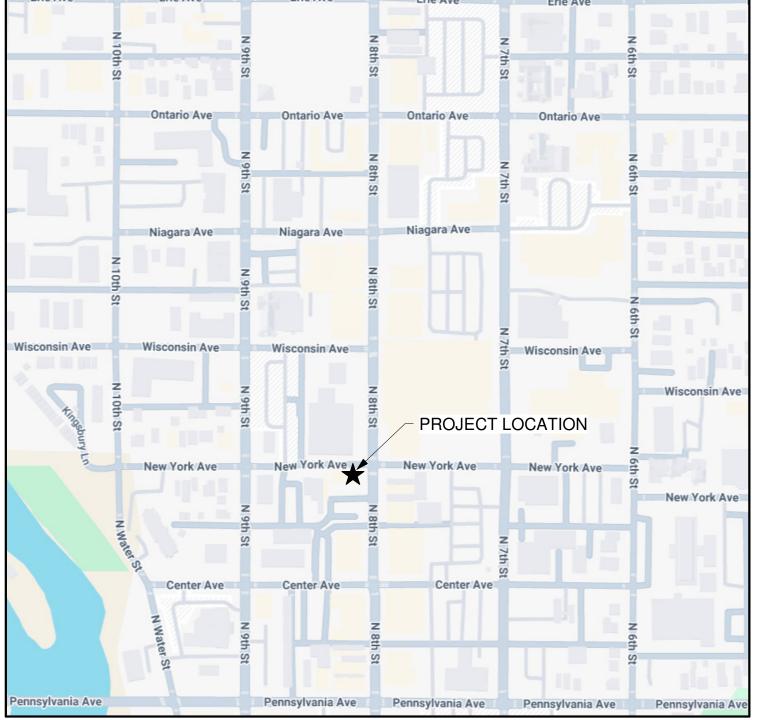

1 AREA MAP G0.01 N.T.S.

# **GENERAL PROJECT NOTES**

ALTHOUGH EVERY EFFORT HAS BEEN MADE IN PREPARING THESE PLANS AND CHECKING THEM FOR ACCURACY, THE CONTRACTOR MUST CHECK ALL DETAILS AND DIMENSIONS AND BE RESPONSIBLE FOR THE ACTUALLY EXISTING. ALL CONTRACTORS SHALL SATISFY THEMSELVES AS TO ALL EXISTING JOB CONDITIONS PRIOR TO CONSTRUCTION AND VERIFY ALL DIMENSIONS AT THE SITE. THE EXACT LOCATION OF ALL UTILITIES MUST BE FIELD VERIFIED BY THE CONTRACTOR PRIOR TO BEGINNING ANY CONSTRUCTION.

	<b>PROJECT</b>	INFORMATION	
CODES	IBC 2015, IEBC 201	5, ICC A117.1-2009, WI SPS 361-366	
OCCUPANCY TYPES	R-1		
CONSTRUCTION CLASS	TYPE IIIB		
NUMBER OF STORIES	3		
SPRINKLERED	YES		
TOTAL PROJECT AREA	FIRST FLOOR	565 SF	
(INCLUDING EXTERIOR WALLS)	SECOND FLOOR	2,400 SF	
		2,965 SF	

# Z. WENDT **CHECKED BY** J. LEHRKE DATE **JING**

07/18/2025

AL REMODEL F DRTHODONTIC TREET UNIT 2 V, WI 53081

CIAI N OI H STI

COMMERCAN AMERICAN 632 N 8TH 3 SHEBOYGA

PROJECT NUMBER

24.091

**DRAWN BY** 

SHEET TITLE **PROJECT** INFORMATION, DRAWING INDEX,

AREA MAP SHEET NUMBER

USE & OCCL	JPANCY	CLASSIFICATION	ON (IBC 302)
COMMON AREAS		GROUP R-1 - RESIDENTIAL	GROUP S-1 - STORAGE

OCCUPANT LC	AD (IBC 1004)		
GROUP	AREA	FACTOR	OCCUPANT LOAD
FIRST FLOOR	'		
GROUP S-1 - ACCESSORY STORAGE AREAS	139 SF	300 GROSS	0.46
COMMON AREAS	329 SF	100 GROSS	3.29
	468 SF		3.75
SECOND FLOOR			
R-1 - RESIDENTIAL	1,843 SF	200 GROSS	9.22
COMMON AREAS	180 SF	100 GROSS	1.80
	2,023 SF		11.02
TOTAL	2,491 SF		14.77

MIN. NUMBI	ER R	EQU	IIRE	D PL	_UMI	BING	G FI)	(TU	RES	•		<u> </u>
		,	WATERC	LOSETS	6		LAVAT	ORIES		DRIN FOUN	I	
OCCUPANCY CLASSIFICATION	OCCUPANT LOAD	MALE FACTOR	# MALE REQ'D	FEMALE FACTOR	# FEMALE REQ'D	MALE FACTOR	# MALE REQ'D	FEMALE FACTOR	# FEMALE REQ'D	FACTOR	# REQ'D	SERVICE SINKS
FIRST FLOOR	0.40	100	0.00	100	0.00	100	0.00	100	0.00	1 000	0.00	4
S-1 - STORAGE COMMON AREAS	0.46 3.29	100 25	0.00	100 25	0.00	100	0.00	100	0.00	1,000	0.00	1
SECOND FLOOR	0.20	25	0.07		0.07		0.04		0.04	100	0.00	
R-1 - HOTEL	9.22											1
COMMON AREA	1.80	25	0.04	25	0.04	40	0.02	40	0.02	100	0.02	1
TOTAL REQUIRED	14.77		0.10		0.10		0.07		0.07		0.05	
TOTAL PROVIDED			1*		1*		1*		1*		1*	1


# PLUMBING FIXTURES (SPS 362.2902)

- (1) MINIMUM NUMBER OF FIXTURES (A) EXCEPTIONS THESE ARE DEPARTMENT EXCEPTIONS TO THE REQUIREMENTS IN IBC SECTION 2902.1:

  1. WHERE MORE THAN ONE WATER CLOSET IS REQUIRED FOR MALES, URINALS MAY BE SUBSTITUTED FOR UP TO 50 PERCENT OF THE REQUIRED NUMBER OF WATER CLOSETS, EXCEPT THAT URINALS MAY BE SUBSTITUTED FOR UP TO 67 PERCENT OF THE REQUIRED NUMBER OF WATER CLOSETS IN GROUP A AND E
- OCCUPANCIES.


  2. WHERE DRINKING FOUNTAINS ARE REQUIRED, OTHER REASONABLE ALTERNATIVES ARE ACCEPTABLE, AS APPROVED BY THE DEPARTMENT.

(2) (B) - THIS IS A DEPARTMENT EXCEPTION TO THE REQUIREMENTS IN IBC SECTION 2902.2: SEPARATE FACILITIES MAY NOT BE REQUIRED IN ALL OCCUPANCIES WHEN THE NUMBER OF FIXTURES IS PROVIDED AS REQUIRED UNDER IBC TABLE 2902.1 IN INDIVIDUAL USER TOILET ROOMS.

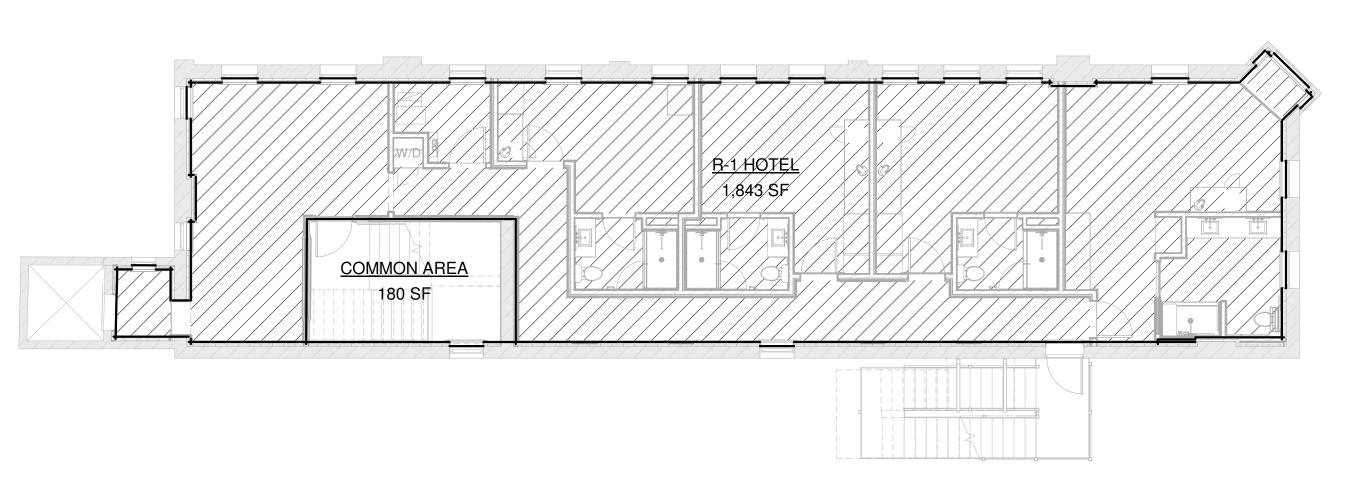





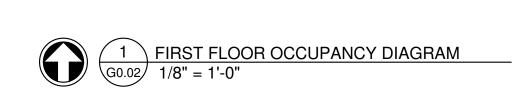

# COMMERCIAL REMODEL FOR: AMERICAN ORTHODONTICS 632 N 8TH STREET UNIT 2 SHEBOYGAN, WI 53081 PROJECT NUMBER 24.091 **DRAWN BY** Z. WENDT CHECKED BY J. LEHRKE DATE **FOR PERMITTING** 07/18/2025 SHEET TITLE

USE & OCCUPANCY CODE REVIEW

SHEET NUMBER

NEW 1-HR FIRE RESISTANCE RATED FLOOR/CEILING SYSTEM

EXISTING OR NEW 1/2-HR

FIRE-RESISTANCE RATED

FLOOR/CEILING SYSTEM

 SEE PLANS FOR SPECIFIC LOCATIONS OF NEW RATED WALL, FLOOR/CEILING, AND ROOF/CEILING ASSEMBLIES • FLOOR/CEILING OR ROOF/CEILING ASSEMBLIES ON THE FIRE-RESISTANCE RATING DIAGRAMS ARE SHOWN AS REFLECTED CEILING DIAGRAMS

1-HR. RATED HORIZONTAL ASSEMBLY TYP., IBC 420.3 - 1/2-HR. RATED FIRE PARTITION, TYP. SLEEPING UNIT SEPARATION WALLS, IBC 420.2 E.A.T.D. 52'-0" TWO-WAY -COMMUNICATION DEVICE DEAD END 33'-0 - 1-HR. RATED FIRE BARRIER STAIRWELL







# **GROUP R-1 (IBC 420)**

• WALLS SEPARATING DWELLING UNITS IN THE SAME BUILDING, WALLS SEPARATING SLEEPING UNITS IN THE SAME BUILDING, AND WALLS SEPARATING DWELLING OR SLEEPING UNITS FROM OTHER OCCUPANCIES CONTIGUOUS TO THEM IN THE SAME BUILDING SHALL BE CONSTRUCTED AS FIRE PARTITIONS IN ACCORDANCE

<u>420.3 HORIZONTAL SEPARATION</u>
• FLOOR ASSEMBLIES SEPARATING DWELLING UNITS IN THE SAME BUILDING, FLOOR ASSEMBLIES SEPARATING SLEEPING UNITS IN THE SAME BUILDING, AND FLOOR ASSEMBLIES SEPARATING DWELLING OR SLEEPING UNITS FROM OTHER OCCUPANCIES CONTIGUOUS TO THEM IN THE SAME BUILDING SHALL BE CONSTRUCTED AS HORIZONTAL ASSEMBLIES IN ACCORDANCE WITH SECTION 711

ACCORDANCE WITH SECTION 907.2.8.

• GROUP R OCCUPANCIES SHALL BE EQUIPPED THROUGHOUT WITH AN AUTOMATIC SPRINKLER SYSTEM IN ACCORDANCE WITH SECTION 903.2.8. QUICK-RESPONSE OR RESIDENTIAL AUTOMATIC SPRINKLERS SHALL BE INSTALLED IN ACCORDANCE WITH

# SECTION 903.2.2.

420.6 FIRE ALARM SYSTEMS AND SMOKE ALARMS FIRE ALARM SYSTEMS AND SMOKE ALARMS SHALL BE PROVIDED IN GROUP R-1 OCCUPANCIES IN

# **FIRE PARTITIONS (IBC 708)**

708.3 FIRE-RESISTANCE RATING
• FIRE PARTITIONS SHALL HAVE A FIRE-RESISTANCE RATING OF NOT LESS THAN 1 HOUR. • EXCEPTIONS:

1. CORRIDOR WALLS PERMITTED TO HAVE A 1/2-HOUR FIRE-RESISTANCE RATING BY TABLE 1020.1 2. DWELLING UNIT AND SLEEPING UNIT SEPARATIONS IN BUILDINGS OF TYPE IIB, IIIB, AND VB CONSTRUCTION SHALL HAVE FIRE-RESISTANCE RATINGS OF NOT LESS THAN 1/2 HOUR IN BUILDINGS EQUIPPED THROUGHOUT WITH AN AUTOMATIC SPRINKLER SYSTEM IN ACCORDANCE WITH SECTION 903.3.1.1

• FIRE PARTITIONS SHALL EXTEND FROM THE TOP OF THE FOUNDATION OR FLOOR/CEILING ASSEMBLY BELOW TO THE UNDERSIDE OF THE FLOOR OR ROOF SHEATHING, SLAB OR DECK ABOVE OR TO THE FIRE-RESISTANCE-RATED FLOOR/CEILING OR ROOF/CEILING ASSEMBLY ABOVE, AND SHALL BE SECURELY

• THE SUPPORTING CONSTRUCTION SHALL BE PROTECTED TO AFFORD THE REQUIRED FIRE-RESISTANCE RATING OF THE WALL SUPPORTED, EXCEPT FOR WALLS SEPARATING TENANT SPACES IN COVERED AND OPEN MALL BUILDINGS, WALLS SEPARATING DWELLING UNITS, WALLS SEPARATING SLEEPING UNITS, AND CORRIDOR WALLS, IN BUILDINGS OF TYPE IIB, IIB, AND VB CONSTRUCTION.

# **HORIZONTAL ASSEMBLIES (IBC 711)**

 ASSEMBLIES SHALL BE CONTINUOUS WITHOUT VERTICAL OPENINGS, EXCEPT AS PERMITTED BY THIS SECTION AND SECTION 712.

• THE SUPPORTING CONSTRUCTION SHALL BE PROTECTED TO AFFORD THE REQUIRED FIRE-RESISTANCE RATING OF THE HORIZONTAL ASSEMBLY SUPPORTED

 WHERE THE HORIZONTAL ASSEMBLY SEPARATES A SINGLE OCCUPANCY INTO DIFFERENT FIRE AREAS, THE ASSEMBLY SHALL HAVE A FIRE-RESISTANCE RATING OF NOT LESS THAN THAT REQUIRED BY SECTION 707.3.10

# **AUTOMATIC SPRINKLER SYSTEMS (IBC 903)** 903.2.8 GROUP R

• AN AUTOMATIC SPRINKLER SYSTEM INSTALLED IN ACCORDANCE WITH SECTION 903.3 SHALL BE PROVIDED THROUGHOUT ALL BUILDINGS WITH A GROUP R FIRE AREA.

# 903.3.2 QUICK-RESPONSE AND RESIDENTIAL SPRINKLERS • QUICK-RESPONSE OR RESIDENTIAL AUTOMATIC SPRINKLERS SHALL BE INSTALLED IN ALL OF THE FOLLOWING

AREAS IN ACCORDANCE WITH SECTION 903.3.1 AND THEIR LISTINGS: 1. THROUGHOUT ALL SPACES WITHIN A SMOKE COMPARTMENT CONTAINING CARE RECIPIENT SLEEPING UNITS IN GROUP I-2 IN ACCORDANCE WITH THIS CODE.

2. THROUGHOUT ALL SPACES WITHIN A SMOKE COMPARTMENT CONTAINING TREATMENT ROOMS IN

AMBULATORY CARE FACILITIES.

### DWELLING UNITS AND SLEEPING UNITS IN GROUP I-1 AND R OCCUPANCIES. 4. LIGHT-HAZARD OCCUPANCIES AS DEFINED IN NFPA 13.

# FIRE ALARM & DETECTION SYSTEMS (IBC 907.2)

• AN APPROVED FIRE ALARM SYSTEM INSTALLED IN ACCORDANCE WITH THE PROVISIONS OF THIS CODE AND NFPA 72 SHALL BE PROVIDED IN ACCORDANCE WITH SECTIONS 907.2.1 THROUGH 907.2.23 AND PROVIDE OCCUPANT NOTIFICATION IN ACCORDANCE WITH SECTION 907.5, UNLESS OTHER REQUIREMENTS ARE PROVIDED BY ANOTHER SECTION OF THIS CODE.

 NOT FEWER THAN ONE MANUAL FIRE ALARM BOX SHALL BE PROVIDED IN AN APPROVED LOCATION TO INITIATE A FIRE ALARM SIGNAL FOR FIRE ALARM SYSTEMS EMPLOYING AUTOMATIC FIRE DETECTORS OR WATERFLOW DETECTION DEVICES. WHERE OTHER SECTIONS OF THIS CODE ALLOW ELIMINATION OF FIRE ALARM BOXES DUE TO SPRINKLERS, A SINGLE FIRE ALARM BOX SHALL BE INSTALLED

# SINGLE- & MULTIPLE-STATION SMOKE ALARMS (IBC 907.2.11)

 LISTED SINGLE- AND MULTIPLE-STATION SMOKE ALARMS COMPLYING WITH UL 217 SHALL BE INSTALLED IN ACCORDANCE WITH SECTIONS 907.2.11.1 THROUGH 907.2.11.6 AND NFPA 72.

GROUP R-1 (SECTION 907.2.11.1)

• SINGLE- OR MULTIPLE-STATION SMOKE ALARMS SHALL BE INSTALLED IN ALL OF THE FOLLOWING LOCATIONS IN GROUP R-1:

- 1. IN SLEEPING AREAS.
- 2. IN EVERY ROOM IN THE PATH OF THE MEANS OF EGRESS FROM THE SLEEPING AREA TO THE DOOR LEADING FROM THE SLEEPING UNIT. 3. IN EACH STORY WITHIN THE SLEEPING UNIT, INCLUDING BASEMENTS. FOR SLEEPING UNITS WITH SPLIT
- LEVELS AND WITHOUT AN INTERVENING DOOR BETWEEN THE ADJACENT LEVELS. A SMOKE ALARM INSTALLED ON THE UPPER LEVEL SHALL SUFFICE FOR THE ADJACENT LOWER LEVEL PROVIDED THAT THE LOWER LEVEL IS LESS THAN ONE FULL STORY BELOW THE UPPER LEVEL.

• SMOKE ALARMS SHALL BE INSTALLED NOT LESS THAN 3 FEET HORIZONTALLY FROM THE DOOR OR OPENING OF A BATHROOM THAT CONTAINS A BATHTUB OR SHOWER UNLESS THIS WOULD PREVENT PLACEMENT OF A SMOKE ALARM REQUIRED BY SECTION 907.2.11.1 OR 907.2.11.2.

• WHERE MORE THAN ONE SMOKE ALARM IS REQUIRED TO BE INSTALLED WITH IN AN INDIVIDUAL DWELLING UNIT OR SLEEPING UNIT IN GROUP R OR I-1 OCCUPANCIES. THE SMOKE ALARMS SHALL BE INTERCONNECTED IN SUCH A MANNER THAT THE ACTIVATION OF ONE ALARM WILL ACTIVATE ALL OF THE ALARMS IN THE INDIVIDUAL UNIT. PHYSICAL INTERCONNECTION OF SMOKE ALARMS SHALL NOT BE REQUIRED WHERE LISTED WIRELESS ALARMS ARE INSTALLED AND ALL ALARMS SOUND UPON ACTIVATION OF ONE ALARM. THE ALARM SHALL BE CLEARLY AUDIBLE IN ALL THE BEDROOMS OVER BACKGROUND NOISE LEVELS WITH ALL

INTERVENING DOORS CLOSED.

• IN NEW CONSTRUCTION, REQUIRED SMOKE ALARMS SHALL RECEIVE THEIR PRIMARY POWER FORM THE BUILDING WIRING WHERE SUCH WIRING IS SERVED FROM A COMMERCIAL SOURCE AND SHALL BE EQUIPPED WITH A BATTERY BACKUP. SMOKE ALARMS SHALL EMIT A SIGNAL WHEN THE BATTERIES ARE LOW. WIRING SHALL BE PERMANENT AND WITHOUT A DISCONNECTING SWITCH OTHER THAN AS REQUIRED FOR

# OVERCURRENT PROTECTION.

• SMOKE DETECTORS LISTED IN ACCORDANCE WITH UL 268 AND PROVIDED AS PART OF THE BUILDING FIRE ALARM SYSTEM SHALL BE AN ACCEPTABLE ALTERNATIVE TO SINGLE- AND MULTIPLE-STATION SMOKE ALARMS

- AND SHALL COMPLY WITH THE FOLLOWING: 1. THE FIRE ALARM SYSTEM SHALL COMPLY WITH ALL APPLICABLE REQUIREMENTS IN SECTION 907. 2. ACTIVATION OF A SMOKE DETECTOR IN A DWELLING UNIT OR SLEEPING UNIT SHALL INITIATE ALARM NOTIFICATION IN THE DWELLING UNIT OR SLEEPING UNIT IN ACCORDANCE WITH SECTION 907.5.2.
- 3. ACTIVATION OF A SMOKE DETECTOR IN A DWELLING UNIT OR SLEEPING UNIT SHALL NOT ACTIVATE ALARM NOTIFICATION APPLIANCES OUTSIDE OF THE DWELLING UNIT OR SLEEPING UNIT. PROVIDED THAT A SUPERVISORY SIGNAL IS GENERATED AND MONITORED IN ACCORDANCE WITH SECTION 907.6.6.

# **VISIBLE ALARMS (IBC 907.5.2.3)**

VISIBLE ALARM NOTIFICATION APPLIANCES SHALL BE PROVIDED IN PUBLIC USE AREAS AND COMMON USE

AREAS. GROUP I-1 AND R-1 DWELLING UNITS OR SLEEPING UNITS IN ACCORDANCE WITH TABLE 907.5.2.3.2 SHALL BE PROVIDED WITH A VISIBLE ALARM NOTIFICATION APPLIANCE, ACTIVATED BY BOTH THE IN-ROOM SMOKE ALARM AND THE BUILDING FIRE ALARM SYSTEM. (NONE REQUIRED)

# TWO WAY COMMUNICATION (IBC 1009.8)

LOCATION. TWO WAY COMMUNICATION DEVICE SHALE BE PROVIDED AT THE ELEVATOR LANDING SERVING EACH ELEVATOR OR BANK OF ELEVATORS ON EACH ACCESSIBLE FLOOR THAT IS ONE OR MORE STORIES ABOVE OR BELOW THE LEVEL OF EXIT DISCHARGE.

SYSTEM REQUIREMENTS. TWO-WAY COMMUNICATION SYSTEMS SHALL PROVIDE COMMUNICATION BETWEEN EACH REQUIRED LOCATION AND THE FIRE COMMAND CENTER OR A CENTRAL CONTROL POINT LOCATION APPROVED BY THE FIRE DEPARTMENT. WHERE THE CENTRAL CONTROL POINT IS NOT A CONSTANTLY ATTENDED LOCATION, A TWO-WAY COMMUNICATION SYSTEM SHALL HAVE A TIMED AUTOMATIC TELEPHONE DIAL-OUT CAPABILITY TO A MONITORING LOCATION OR 9-1-1. THE TWO-WAY COMMUNICATION SYSTEM SHALL

INCLUDE BOTH AUDIBLE AND VISIBLE SIGNALS. DIRECTIONS. DIRECTIONS FOR THE USE OF THE TWO-WAY COMMUNICATION SYSTEM, INSTRUCTIONS FOR SUMMONING ASSISTANCE VIA THE TWO-WAY COMMUNICATION SYSTEM AND WRITTEN IDENTIFICATION OF THE LOCATION SHALL BE POSTED ADJACENT TO THE TWO-WAY COMMUNICATION SYSTEM. SIGNAGE SHALL COMPLY WITH THE ICC A117.1 REQUIREMENTS FOR VISUAL CHARACTERS

# **EXIT SIGNS (IBC 1013)**

EXITS AND EXIT ACCESS DOORS SHALL BE MARKED BY AN APPROVED EXIT SIGN READILY VISIBLE FROM ANY DIRECTION OF EGRESS TRAVEL. THE PATH OF EGRESS TRAVEL TO EXITS AND WITHIN EXITS SHALL BE MARKED BY READILY VISIBLE EXIT SIGNS TO CLEARLY INDICATE THE DIRECTION OF EGRESS TRAVEL IN CASES WHERE THE EXIT OR THE PATH OF EGRESS TRAVEL IS NOT IMMEDIATELY VISIBLE TO OCCUPANTS. INTERVENING MEANS OF EGRESS DOORS WITHIN EXITS SHALL BE MARKED BY EXIT SIGNS. EXIT SIGN PLACEMENT SHALL BE SUCH THAT NO POINT IN AN EXIT ACCESS CORRIDOR OR EXIT PASSAGEWAY IS MORE THAN 100' OR THE LISTED VIEWING DISTANCE FOR THE SIGN, WHICHEVER IS LESS, FROM THE NEAREST VISIBLE EXIT SIGN.

I. EXIT SIGNS ARE NOT REQUIRED IN ROOMS OR AREAS THAT REQUIRE ONLY ONE EXIT OR EXIT ACCESS 2. MAIN EXTERIOR EXIT DOORS THAT ARE OBVIOUSLY AND CLEARLY IDENTIFIABLE AS EXITS NEED NOT HAVE EXIT SIGNS WHERE APPROVED BY THE BUILDING OFFICIAL

# **EXIT ACCESS TRAVEL DISTANCE (IBC 1017.2)**

OCCUPANCY CLASSIFICATION WITH SPRINKLER SYSTEM **ACTUAL** GROUP R 250 FEET 52' - 0"

# **CORRIDORS (IBC 1020)**

THE REQUIRED CAPACITY OF CORRIDORS SHALL BE DETERMINED AS SPECIFIED IN SECTION 1005.1, BUT THE MINIMUM WIDTH SHALL BE NOT LESS THAN THAT SPECIFIED IN TABLE 1020.2. (MIN. 36")

# THE MINIMUM WIDTH OR REQUIRED CAPACITY OF CORRIDORS SHALL BE UNOBSTRUCTED.

EXCEPTION: ENCROACHMENTS COMPLYING WITH SECTION 1005.7.

### WHERE MORE THAN ONE EXIT OR EXIT ACCESS DOORWAY IS REQUIRED, THE EXIT ACCESS SHALL BE ARRANGED SUCH THAT THERE ARE NO DEAD ENDS IN CORRIDORS MORE THAN 20 FEET IN LENGTH.

2. IN OCCUPANCIES IN GROUPS B, E, F, I-1, M, R-1, R-2, R-4, S, AND U, WHERE THE BUILDING IS EQUIPPED THROUGHOUT WITH AN AUTOMATIC SPRINKLER SYSTEM IN ACCORDANCE WITH SECTION 903.3.1.1, THE LENGTH OF THE DEAD-END CORRIDORS SHALL NOT EXCEED 50 FEET

# **SOUND TRANSMISSION (IBC 1207)**

1207.1 SCOPE
• THIS SECTION SHALL APPLY TO COMMON INTERIOR WALLS, PARTITIONS, AND FLOOR/CEILING ASSEMBLIES BETWEEN ADJACENT DWELLING UNITS AND SLEEPING UNITS OR BETWEEN DWELLING UNITS AND SLEEPING UNITS AND ADJACENT PUBLIC AREAS SUCH AS HALLS, CORRIDORS, OR SERVICE AREAS.

 WALLS, PARTITIONS, AND FLOOR/CEILING ASSEMBLIES SEPARATING DWELLING UNITS AND SLEEPING UNITS FROM EACH OTHER OR FROM PUBLIC OR SERVICE AREAS SHALL HAVE A SOUND TRANSMISSION CLASS OF NOT LESS THAN 50, OR NOT LESS THAN 45 IF FIELD TESTED, FOR AIR-BORNE NOISE WHEN TESTED IN ACCORDANCE WITH ASTM E90. PENETRATIONS AND OPENINGS IN CONSTRUCTION ASSEMBLIES FOR PIPING: ELECTRICAL DEVICES; RECESSED CABINETS; BATHTUBS; SOFFITS; OR HEATING, VENTILATING, OR EXHAUST DUCTS SHALL BE SEALED, LINED, INSULATED, OR OTHERWISE TREATED TO MAINTAIN THE REQUIRED RATINGS THIS REQUIREMENT SHALL NOT APPLY TO ENTRANCE DOORS; HOWEVER, SUCH DOORS SHALL BE TIGHT FITTING TO THE FRAME AND SILL.

FLOOR/CEILING ASSEMBLIES BETWEEN DWELLING UNITS AND SLEEPING UNITS OR BETWEEN A DWELLING UNIT OR SLEEPING UNIT AND A PUBLIC OR SERVICE AREA WITHIN THE STRUCTURE SHALL HAVE AN IMPACT INSULATION CLASS RATING OF NOT LESS THAN 50, OR NOT LESS THAN 45 IF FIELD TESTED, WHEN TESTED IN ACCORDANCE WITH ASTM E492.

# **TOILET & BATHING ROOMS (IBC 1210)**

TOILET, BATHING, AND SHOWER ROOM FLOOR FINISH MATERIALS SHALL HAVE A SMOOTH, HARD, NONABSORBENT SURFACE. THE INTERSECTIONS OF SUCH FLOORS WITH WALLS SHALL HAVE A SMOOTH, HARD, NONABSORBENT VERTICAL BASE THAT EXTENDS UPWARD ONTO THE WALLS NOT LESS THAN 4".

 WALLS AND PARTITIONS WITHIN 2' OF SERVICE SINKS, URINALS, AND WATER CLOSETS SHALL HAVE A SMOOTH HARD, NONABSORBENT SURFACE, TO A HEIGHT OF NOT LESS THAN 4' A.F.F., AND EXCEPT FOR STRUCTURAL ELEMENTS, THE MATERIALS USED IN SUCH WALLS SHALL BE OF A TYPE THAT IS NOT ADVERSELY AFFECTED

ACCESSORIES SUCH AS GRAB BARS, TOWEL BARS, PAPER DISPENSERS, AND SOAP DISHES, PROVIDED ON OR WITHIN WALLS, SHALL BE INSTALLED AND SEALED TO PROTECT STRUCTURAL ELEMENTS FROM MOISTURE.

# **MEANS OF EGRESS (IEBC 805)**

805.3.1.1 SINGLE-EXIT BUILDINGS · ONLY ONE EXIT IS REQUIRED FROM BUILDINGS AND SPACES OF THE FOLLOWING OCCUPANCIES: 1. IN GROUP A AND S OCCUPANCIES, A SINGLE EXIT IS PERMITTED IN THE STORY AT THE LEVEL OF EXIT DISCHARGE WHEN THE OCCUPANT LOAD OF THE STORY DOES NOT EXCEED 50 AND THE EXIT ACCESS TRAVEL DISTANCE DOES NOT EXCEED 75 FEET.

# 805.4.1.1 OCCUPANT LOAD AND TRAVEL DISTANCE

• IN ANY WORK AREA, ALL ROOMS AND SPACES HAVING AN OCCUPANT LOAD GREATER THAN 50 OR IN WHICH THE TRAVEL DISTANCE TO AN EXIT EXCEEDS 75 FEET SHALL HAVE A MINIMUM OF TWO EGRESS DOORWAYS.


1. STORAGE ROOMS HAVING A MAXIMUM OCCUPANT LOAD OF 10.

# 2. WHERE THE WORK AREA IS SERVED BY A SINGLE EXIT IN ACCORDANCE WITH SECTION 805.3.1.1.

805.9.1 MINIMIM REQUIREMENT (HANDRAILS) · EVERY REQUIRED EXIT STAIRWAY THAT IS PART OF THE MEANS OF EGRESS FOR ANY WORK AREA AND THAT HAS THREE OR MORE RISERS AND IS NOT PROVIDED WITH AT LEAST ONE HANDRAIL, OR IN WHICH THE EXISTING HANDRAILS ARE JUDGED TO BE IN DANGER OF COLLAPSING, SHALL BE PROVIDED WITH HANDRAILS FOR THE FULL LENGTH OF THE STAIRWAY ON AT LEAST ONE SIDE. ALL EXIT STAIRWAYS WITH A REQUIRED EGRESS OF MORE THAN 66 INCHES SHALL HAVE HANDRAILS ON BOTH SIDES.

# **STAIRWAY RAILINGS (IEBC 1203.9)**

EXISTING HANDRAILS AND GUARDS AT ALL STAIRWAYS SHALL BE PERMITTED TO REMAIN, PROVIDED THEY ARE NOT STUCTURALLY DANGEROUS.

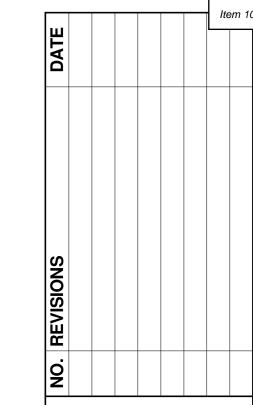



IL () EMODEL I ODONTIC ET UNIT 2 53081 RTH() CIAL N OI H STI SOMMERCIAN MERICAN OF N STH (

PROJECT NUMBER

0 6 6 0 S

24.091 **DRAWN BY** 

Z. WENDT

**CHECKED BY** J. LEHRKE

DATE 07/18/2025

SHEET TITLE


**E** 

 $\mathbf{C}$ 

OR

**EGRESS & FIRE** PROTECTION CODE REVIEW


**SHEET NUMBER** 

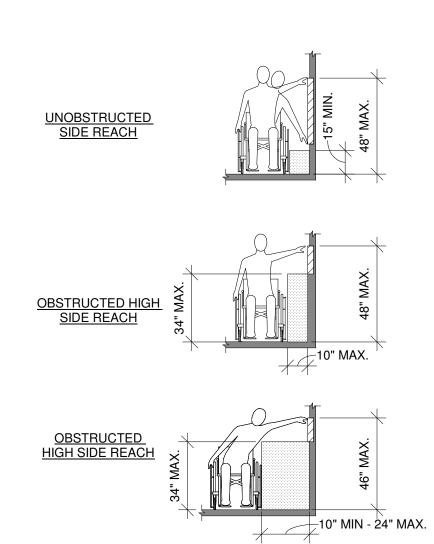

• WHERE A CLEAR FLOOR OR GROUND SPACE ALLOWS A PARALLEL APPROACH TO AN ELEMENT AND THE SIDE REACH IS UNOBSTRUCTED, THE HIGH SIDE REACH SHALL BE 48" MAX. AND THE LOW SIDE REACH SHALL BE 15" MIN. ABOVE THE FINISH FLOOR OR GROUND. • WHERE A CLEAR FLOOR OR GROUND SPACE ALLOWS A PARALLEL APPROACH TO AN ELEMENT AND THE HIGH SIDE REACH IS OVER AN OBSTRUCTION, THE HEIGHT OF THE OBSTRUCTION SHALL BE 34" MAX. AND THE DEPTH OF THE OBSTRUCTION SHALL BE 24" MAX. THE HIGH SIDE REACH SHALL BE 48" MAX. FOR A REACH DEPTH OF 10" MAX. WHERE THE REACH RANGE EXCEEDS 10", THE HIGH SIDE

REACH SHALL BE 46" MAX. FOR A REACH DEPTH OF 24" MAX.

8 TYP. ACCESSIBLE SIDE REACH DETAIL G0.04 1/4" = 1'-0"

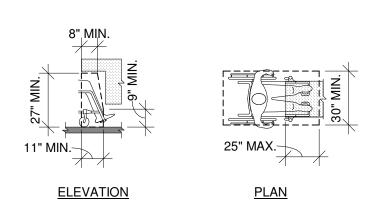


• SPACE UNDER AN ELEMENT BETWEEN 9" AND 27" ABOVE THE FINISH FLOOR SHALL BE CONSIDERED KNEE CLEARANCE. • KNEE CLEARANCE SHALL EXTEND 25" MAX. UNDER AN ELEMENT AT 9" ABOVE THE FINISH FLOOR OR GROUND. • WHERE KNEE CLEARANCE IS REQUIRED UNDER AN ELEMENT AS PART OF A CLEAR FLOOR SPACE, THE KNEE CLEARANCE SHALL BE 11" DEEP MIN. AT 9" ABOVE THE FLOOR OR GROUND AND 8" DEEP MIN. AT 27" ABOVE THE FINISH FLOOR OR GROUND. • BETWEEN 9" AND 27" ABOVE THE FINISH FLOOR OR GROUND, THE KNEE CLEARANCE SHALL BE PERMITTED TO REDUCE AT A RATE OF 1" IN DEPTH FOR EVERY 6" IN HEIGHT.

√ 3 \ TYP. ACCESSIBLE TOE CLEARANCE DETAIL

SHALL EXTEND 17" MIN. UNDER THE ELEMENT.

• TOE CLEARANCE SHALL BE 30" WIDE MINIMUM.

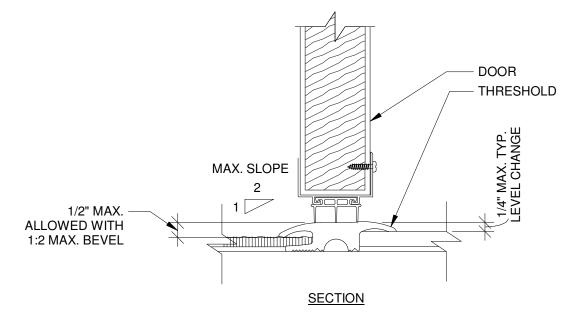

15 TYP. ACCESSIBLE DOOR THRESHOLD DETAIL

G0.04 1/4" = 1'-0"

FORWARD REACH

OBSTRUCTED HIGH FORWARD REACH


OBSTRUCTED HIGH FORWARD REACH

G0.04 1/4" = 1'-0"

6" MAX.

**ELEVATION** 

BE CONSIDERED TOE CLEARANCE.

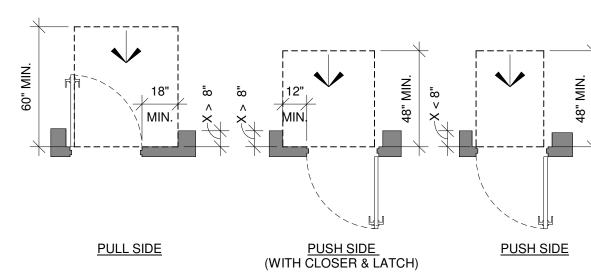

20" MIN. - 25" MAX.

NOTES:

• WHERE A FORWARD REACH IS UNOBSTRUCTED, THE HIGH

FORWARD REACH SHALL BE 48" MAX. AND THE LOW FORWARD

REACH SHALL BE 15" MIN. ABOVE THE FINISH FLOOR OR GROUND.

• WHERE A HIGH FORWARD REACH IS OVER AN OBSTRUCTION, THE

FOR A DISTANCE NOT LESS THAN THE REQUIRED REACH DEPTH

OVER THE OBSTRUCTION. THE HIGH FORWARD REACH SHALL BE

REACH DEPTH EXCEEDS 20", THE HIGH FORWARD REACH SHALL

CLEAR FLOOR SPACE SHALL EXTEND BENEATH THE ELEMENT

48" MAX. WHERE THE REACH DEPTH IS 20" MAX. WHERE THE

17" MIN. - 25" MAX.-

• SPACE UNDER AN ELEMENT BETWEEN THE FINISH FLOOR OR

GROUND AND 9" ABOVE THE FINISH FLOOR OR GROUND SHALL

• TOE CLEARANCE SHALL EXTEND 25" MAX. UNDER AN ELEMENT.

• WHERE TOE CLEARANCE IS REQUIRED AT AN ELEMENT AS


PART OF THE CLEAR FLOOR SPACE, THE TOE CLEARANCE

<u>PLAN</u>

BE 44" MAX. AND THE REACH DEPTH SHALL BE 25" MAX.


√ 7 \ TYP. ACCESSIBLE FORWARD REACH DETAIL

TYP. MANEUVERING CLEARANCE AT RECESSED ACCESSIBLE 13 DOORS/GATES DETAIL

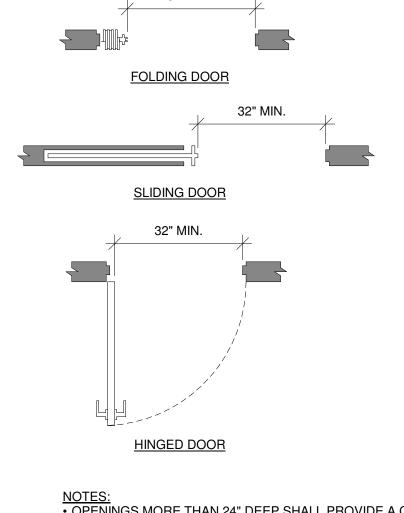


NOTES:
OPENINGS MORE THAN 24" DEEP SHALL PROVIDE A CLEAR OPENING OF 36" MINIMUM. • THERE SHALL BE NO PROJECTIONS INTO THE REQUIRED CLEAR OPENING WIDTH LOWER THAN 34" ABOVE THE FINISH FLOOR OR GROUND. PROJECTIONS INTO THE CLEAR OPENING WIDTH BETWEEN 34" AND 80" ABOVE THE FINISH FLOOR OR GROUND SHALL NOT EXCEED 4".

12 TYP. CLEAR OPENING AT ACCESSIBLE DOOR/GATE DETAIL G0.04 1/2" = 1'-0"

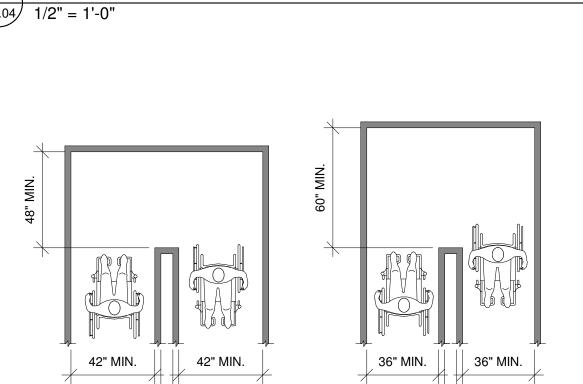


TYP. ACCESSIBLE ROUTE CLEAR WIDTH AT TURN 10 (AROUND OBSTRUCTION) AND SLOPE DETAIL

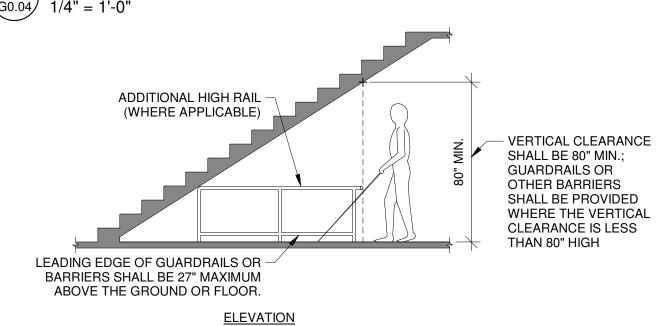

X < 48"

NOTE:
• WHERE RAILING IS USED AS A BARRIER, IT IS RECOMMENDED TO PROVIDE ONE DETECTABLE RAIL BELOW A MAXIMUM OF 27" AFF, BUT PREFERABLY AT A LOW HEIGHT (AT 6" AFF) WITH AN ADDITIONAL RAIL HIGHER (AT 34" AFF).


✓ 6 \ TYP. ACCESSIBLE VERTICAL CLEARANCE DETAIL G0.04 1/4" = 1'-0"

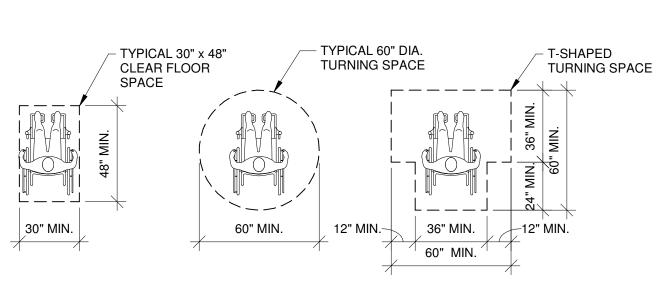

NOTES:

• THE FLOOR OR GROUND SURFACE WITHIN THE REQUIRED MANEUVERING CLEARANCES OR CLEAR FLOOR SPACE SHALL SLOPE NO MORE THAN 1:48 (2%) AND CHANGES IN LEVEL WITHIN THIS AREA ARE NOT PERMITTED.

 $^{\prime}$  2  $^{\setminus}$  TYP. ACCESSIBLE CLEAR FLOOR AND TURNING SPACE

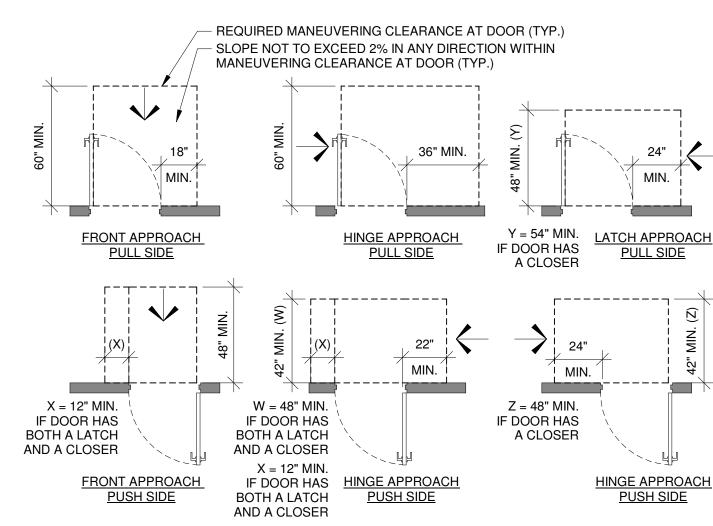


NOTES:

1. MANEUVERING CLEARANCES FOR FORWARD APPROACH SHALL BE PROVIDED WHEN ANY OBSTRUCTION WITHIN 18" OF THE LATCH SIDE OF A DOORWAY PROJECTS MORE THAN 8" BEYOND THE FACE OF THE DOOR, MEASURED PERPENDICULAR TO THE FACE OF THE DOOR OR GATE. REFER TO TYP. ACCESSIBLE MANEUVERING CLEARANCE AT RECESSED DOORS DETAIL. 2. THE FLOOR OR GROUND SURFACE WITHIN THE REQUIRED MANEUVERING CLEARANCES SHALL SLOPE NO MORE THAN 1:48 (2%) AND CHANGES IN LEVEL WITHIN THIS AREA ARE NOT

TYP. REQUIRED DOOR MANEUVERING CLEARANCES AT ACCESSIBLE DOOR/GATES


G0.04 1/4" = 1'-0"

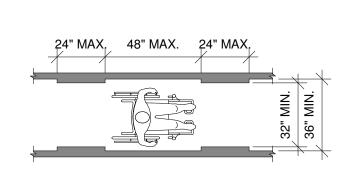

• THE CLEAR WIDTH OF AN ACCESSIBLE ROUTE SHALL BE 36" MIN.: THE CLEAR WIDTH MAY BE REDUCED TO 32" MIN. FOR A LENGTH OF 24" MAX. PROVIDED THAT THE REDUCED WIDTH SEGMENTS THAT ARE 48" LONG MIN. AND 36" WIDE MIN. • THE RUNNING SLOPE OF WALKING SURFACES SHALL NOT BE STEEPER THAN 1:20 (5%). • THE CROSS SLOPE OF WALKING SURFACES SHALL NOT BE


ACCESSIBLE ROUTE CLEAR WIDTH AND SLOPE DETAIL G0.04

STEEPER THAN 1:48 (2%).

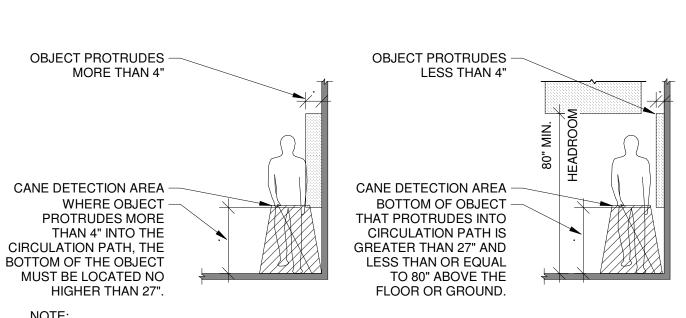

NOTE:
• PROTRUDING OBJECTS SHALL NOT REDUCE THE CLEAR WIDTH FOR ACCESSIBLE ROUTES

5 TYP. ACCESSIBLE PROTRUDING OBJECTS DETAIL

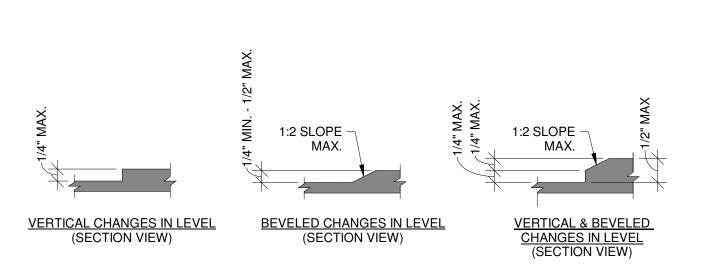

NOTES:

• CHANGES IN LEVEL OF 1/4" MAX. SHALL BE PERMITTED TO BE VERTICAL. • CHANGES IN LEVEL OF 1/4" IN HEIGHT AND NOT MORE THAN 1/2" MAX. IN HEIGHT SHALL BE BEVELED WITH A SLOPE NOT STEEPER THAN 1:2 (50%). • CHANGES IN LEVEL GREATER THAN 1/2" SHALL BE COMPLY WITH RAMP REQUIREMENTS

<u>\ TYP. VERTICAL LEVEL CHANGE ON ACCESSIBLE ROUTE DETAIL</u> G0.04 1/4" = 1'-0"



Item 10.

PROJECT NUMBER 24.091 DRAWN BY Z. WENDT **CHECKED BY** J. LEHRKE DATE **PERMITTING** 07/18/2025

SHEET TITLE **GENERAL ACCESSIBILITY** DETAILS

SHEET NUMBER

OR

4 \ TYP. ACCESSIBLE KNEE CLEARANCE DETAIL G0.04 1/4" = 1'-0"

G0.04 1/4" = 1'-0"

• WHERE TURNING SPACE IS REQUIRED, THE CIRCLE OR THE T-SHAPED SPACE MAY BE USED.


G0.04 1/4" = 1'-0"


NOTES:


• ALL MOUNTING HEIGHTS ARE TYPICAL UNLESS NOTED OTHERWISE • CONFIRM ALL MOUNTING HEIGHTS WITH LOCAL CODE REQUIREMENTS. • VERIFY MOUNTING HEIGHT FOR WALL MOUNTED SMOKE DETECTORS WITH LOCAL CODES.

8 TYP. ACCESSIBLE ELECTRICAL DEVICE MOUNTING G0.05 1/4" = 1'-0"

6 ADA DINING AND WORK SURFACES DETAIL

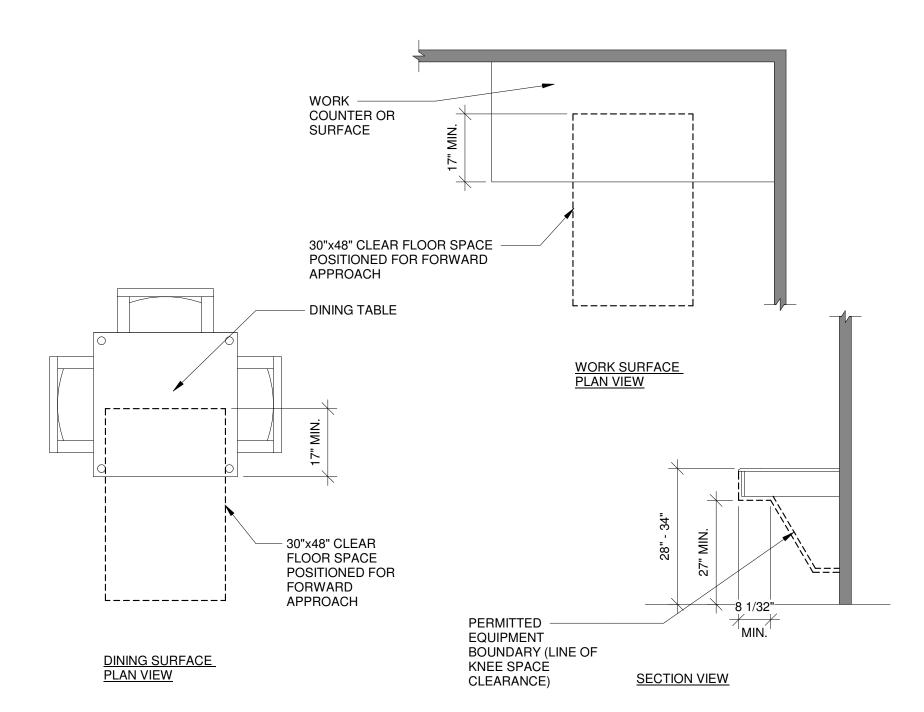

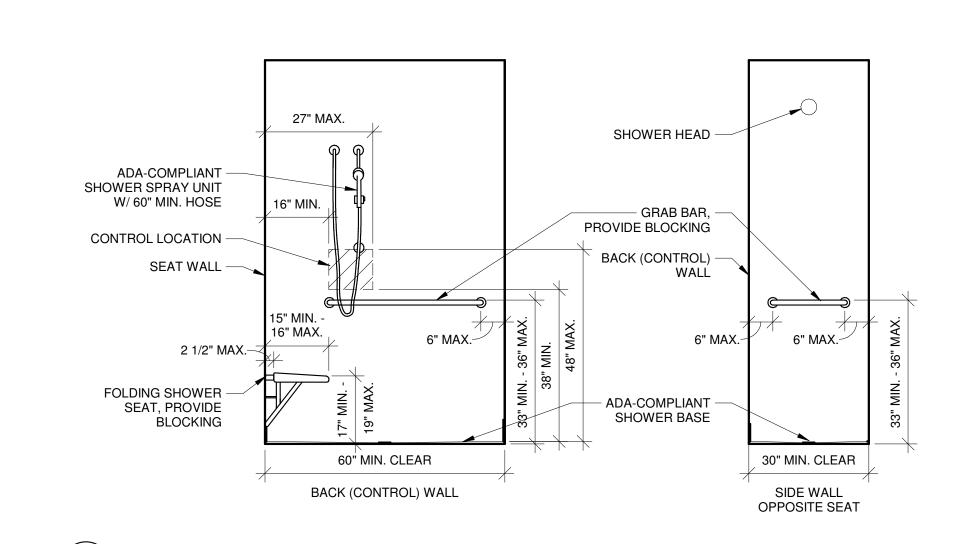


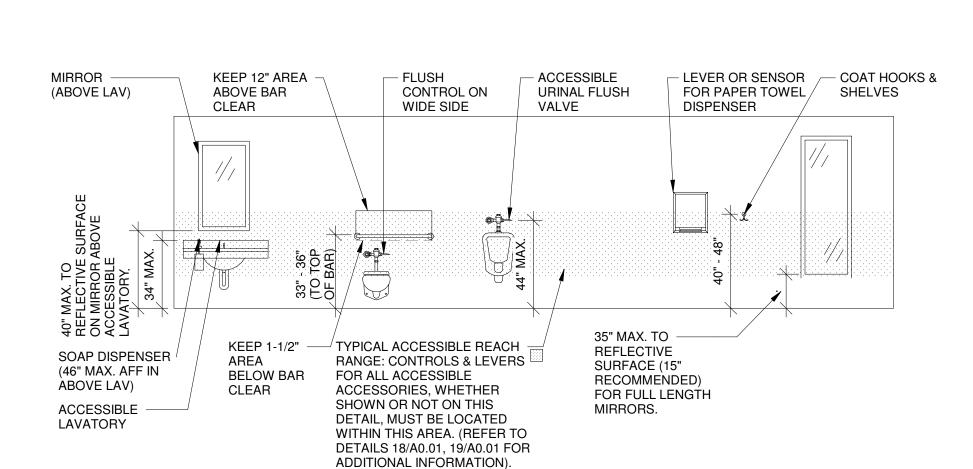

1. THE CLEAR FLOOR SPACE AT ACCESSORIES SHALL BE 30" MIN. BY 48" MIN. 2. UNLESS OTHERWISE SPECIFIED, THE CLEAR FLOOR SPACE MAY BE POSITIONED FOR EITHER FORWARD OR PARALLEL


- APPROACH TO AN ELEMENT. 3. OPERABLE PARTS SHALL BE OPERABLE WITH ONE HAND AND SHALL NOT REQUIRE TIGHT GRASPING, PINCHING, OR TWISTING OF THE WRIST. THE FORCE REQUIRED TO ACTIVATE OPERABLE PARTS SHALL BE 5 POUNDS MAX. 4. REFER TO 18/A0.01, 19/A0.01 FOR DETAILED INFORMATION REGARDING FORWARD AND SIDE REACH REQUIREMENTS
- 5. TOILET AND BATHING ROOM ACCESSORIES MUST BE LOCATED OR SELECTED SO THEY ARE NOT PROTRUDING OBJECTS INTO THE CIRCULATION SPACE. REFER TO DETAILS 16/A0.01, 17/A0.01 FOR ADDITIONAL INFORMATION.
- ADA TOILET AND BATHING ROOM ACCESSIBLE ACCESSORY

MOUNTING HEIGHTS G0.05 1/4" = 1'-0"

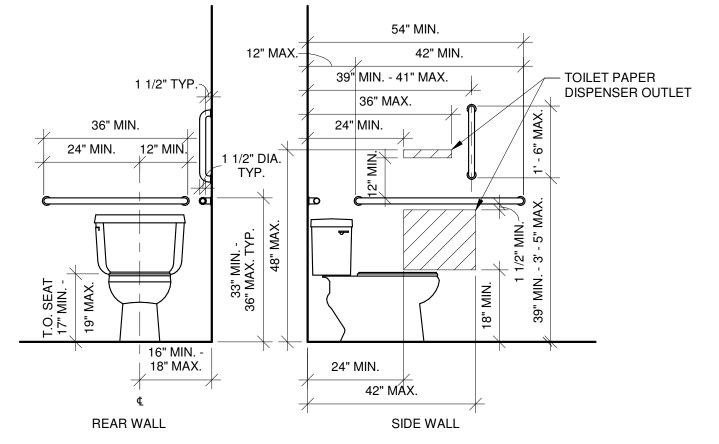

2 TYP. ADA TOILET ELEVATIONS G0.05 1/2" = 1'-0"


5 \ TYP. ADA ROLL-IN SHOWER ELEVATIONS

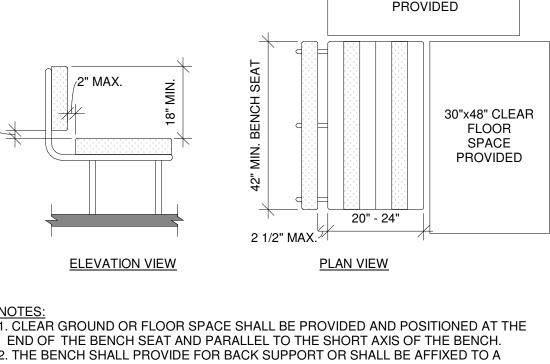

30"x48" CLEAR FLOOR SPACE


1. CLEAR GROUND OR FLOOR SPACE SHALL BE PROVIDED AND POSITIONED AT THE END OF THE BENCH SEAT AND PARALLEL TO THE SHORT AXIS OF THE BENCH. 2. THE BENCH SHALL PROVIDE FOR BACK SUPPORT OR SHALL BE AFFIXED TO A WALL. BACK SUPPORT SHALL BE 42" LONG MINIMUM AND SHALL EXTEND FROM A POINT 2" MAX. FROM THE REAR EDGE OF THE SEAT MEASURED HORIZONTALLY. 3. ALLOWABLE STRESSES SHALL NOT BE EXCEEDED FOR MATERIALS USED WHEN A VERTICAL OR HORIZONTAL FORCE OF 250 POUNDS IS APPLIED AT ANY POINT ON THE SEAT, FASTENER, MOUNTING DEVICE, OR SUPPORTING STRUCTURE. 4. WHERE INSTALLED IN WET LOCATIONS, THE SURFACE OF THE SEAT SHALL BE SLIP RESISTANT AND SHALL NOT ACCUMULATE WATER.

TYP. ACCESSIBLE BENCH DETAIL G0.05 1/2" = 1'-0"

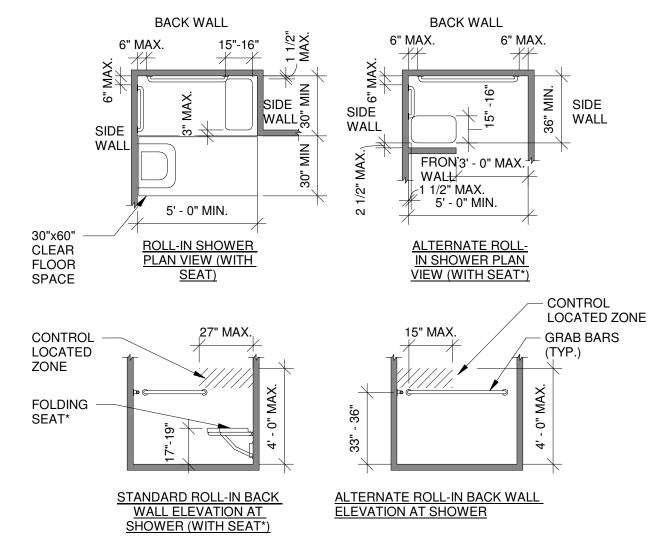

\* FOLDING SEATS ARE REQUIRED IN ROLL-IN TYPE SHOWERS IN TRANSIENT LODGING GUEST ROOMS WITH MOBILITY FEATURES

ADA GUESTROOM ROLL-IN SHOWER WITH SEAT COMPARTMENT G0.05 1/4" = 1'-0"

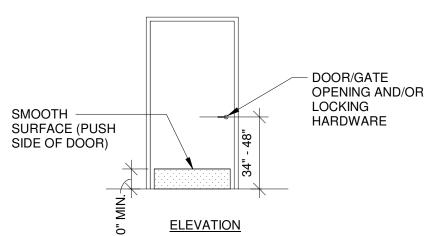

• HANDLES, PULLS, LATCHES, LOCKS, AND OTHER OPERABLE PARTS ON ACCESSIBLE DOORS SHALL HAVE A SHAPE THAT IS EASY TO GRIP WITH ONE HAND AND DOES NOT REQUIRE TIGHT GRASPING, PINCHING OR TWISTING OF THE WRIST TO OPERATE. SUCH HARDWARE SHALL BE 34" MIN. AND 48" MAX. ABOVE THE FLOOR OR GROUND. WHERE SLIDING DOORS ARE IN THE FULLY OPEN POSITION, OPERATING HARDWARE SHALL BE EXPOSED AND USABLE FROM BOTH

• DOOR CLOSERS SHALL BE ADJUSTED SO THAT FROM AN OPEN POSITION OF 90°, THE TIME REQUIRED TO MOVE THE DOOR TO AN OPEN POSITION OF 12° SHALL BE 5 SECONDS MIN. • DOOR SPRING HINGES SHALL BE ADJUSTED SO THAT FROM THE OPEN POSITION OF 70°, THE DOOR SHALL MOVE TO THE CLOSED POSITION IN 1.5 SECONDS MIN., MEASURED UNDER

AMBIENT CONDITIONS. • FIRE DOORS SHALL HAVE THE MIN. OPENING FORCE ALLOWED BY THE APPROPRIATE ADMINISTRATIVE AUTHORITY. THE MAX. FORCE FOR PUSHING OPEN OR PULLING OPEN DOORS OTHER THAN FIRE DOORS SHALL BE AS FOLLOWS:

1. INTERIOR HINGED DOOR 5.0 POUNDS 2. SLIDING OR FOLDING DOOR 5.0 POUNDS

THESE FORCES DO NOT APPLY TO THE FORCE REQUIRED TO RETRACT LATCH BOLTS OR DISENGAGE OTHER DEVICES THAT HOLD THE DOOR IN A CLOSED POSITION. • DOOR SURFACES WITHIN 10" OF THE FLOOR OR GROUND MEASURED VERTICALLY SHALL BE A SMOOTH SURFACE ON THE PUSH SIDE EXTENDING THE FULL WIDTH OF THE DOOR. PARTS CREATING HORIZONTAL OR VERTICAL JOINTS IN SUCH SURFACE SHALL BE WITHIN 1/16" OF THE SAME PLANE AS THE OTHER. CAVITIES CREATED BY ADDED KICK PLATES SHALL BE CAPPED.

ADA DOOR AND GATE HARDWARE DETAIL G0.05 1/4" = 1'-0"

**PERMITTIN** OR

**SHEET NUMBER** 

**ACCESSIBILITY** DETAILS

00

CIA

REMODEL FOR STHODONTICS SEET UNIT 2 WI 53081

COMMERICAL AMERICAL 632 N 8TH SHEBOYG

PROJECT NUMBER

24.091

DRAWN BY

Z. WENDT

**CHECKED BY** 

J. LEHRKE

DATE

07/18/2025

SHEET TITLE

**GENERAL** 

# **ACCESSIBILITY (IEBC 705)**

# **705.1.1 ENTRANCES**

• WHERE AN ALTERATION INCLUDES ALTERATIONS TO AN ENTRANCE, AND THE FACILITY HAS AN ACCESSIBLE ENTRANCE ON AN ACCESSIBLE ROUTE, THE ALTERED ENTRANCE IS NOT REQUIRED TO BE ACCESSIBLE UNLESS REQUIRED BY SECTION 705.2. SIGNS COMPLYING WITH SECTION 1111 OF THE INTERNATIONAL BUILDING CODE SHAL BE PROVIDED.

• WHERE STEEPER SLOPES THAN ALLOWED BY SECTION 1012.2 OF THE INTERNATIONAL BUILDING CODE ARE NECESSITATED BY SPACE LIMITATIONS, THE SLOPE OF RAMPS IN OR PROVIDING ACCESS TO EXISTING FACILITIES SHALL COMPLY WITH TABLE 705.1.4.

• THE MAXIMUM HEIGHT OF THRESHOLDS AT DOORWAYS SHALL BE 3/4". SUCH THRESHOLDS SHALL HAVE

BEVELED EDGES ON EACH SIDE.

FACILITY OR PORTION OF A FACILITY.

• AN ALTERATION OF AN EXISTING ELEMENT, SPACE, OR AREA OF A FACILITY SHALL NOT IMPOSE A REQUIREMENT FOR GREATER ACCESSIBILITY THAN THAT WHICH WOULD BE REQUIRED FOR NEW

# **RAMPS (IEBC 705.1.4)**

CONSTRUCTION. ALTERATIONS SHALL NOT REDUCE OR HAVE THE EFFECT OF REDUCING ACCESSIBILITY OF A

[	
SLOPE	MAXIMUM RISE
STEEPER THAN 1:10 BUT NOT STEEPER THAN 1:8	3"
STEEPER THAN 1:12 BUT NOT STEEPER THAN 1:10	6"

# **TURNING SPACE (ICC A117.1 304)**

• THE TURNING SPACE SHALL BE A CIRCULAR SPACE WITH A 60" MIN. DIAMETER. THE TURNING SPACE SHALL BE PERMITTED TO INCLUDE KNEE AND TOE CLEARANCE. UNLESS OTHERWISE SPECIFIED, DOORS SHALL BE PERMITTED TO SWING INTO TURNING SPACES.

# **CLEAR FLOOR SPACE (ICC A117.1 305)**

 THE CLEAR FLOOR SPACE SHALL BE 48" MIN. IN LENGTH AND 30" MIN. IN WIDTH. • UNLESS OTHERWISE SPECIFIED, CLEAR FLOOR SPACE SHALL BE PERMITTED TO INCLUDE KNEE AND TOE CLEARANCE.

# **KNEE & TOE CLEARANCE (ICC A117.1 306)**

• SPACE BENEATH AN ELEMENT BETWEEN THE FLOOR AND 9" A.F.F. SHALL BE CONSIDERED TOE CLEARANCE. • TOE CLEARANCE SHALL BE PERMITTED TO EXTEND 25" MAX. UNDER AN ELEMENT. • WHERE TOE CLEARANCE IS REQUIRED AT AN ELEMENT AS PART OF A CLEAR FLOOR SPACE. THE TOE CLEARANCE SHALL EXTEND 17" MIN. BENEATH THE ELEMENT.

• SPACE BENEATH AN ELEMENT BETWEEN 9" AND 27" A.F.F. SHALL BE CONSIDERED KNEE CLEARANCE. KNEE CLEARANCE SHALL BE PERMITTED TO EXTEND 25" MAX. UNDER AN ELEMENT AT 9" A.F.F. • WHERE KNEE CLEARANCE IS REQUIRED BENEATH AN ELEMENT AS PART OF A CLEAR FLOOR SPACE, THE KNEE CLEARANCE SHALL BE 11" MIN. IN DEPTH AT 9" A.F.F., AND 8" MIN. IN DEPTH AT 27" A.F.F. • BETWEEN 9" AND 27" A.F.F., THE KNEE CLEARANCE SHALL BE PERMITTED TO BE REDUCED AT A RATE OF 1" IN DEPTH FOR EACH 6" IN HEIGHT. KNEE CLEARANCE SHALL BE 30" MIN. IN WIDTH.

# **REACH RANGES (ICC A117.1 308)**

· WHERE A FORWARD REACH IS UNOBSTRUCTED, THE HIGH FORWARD REACH SHALL BE 48" MAX. A.F.F. AND THE LOW FORWARD REACH SHALL BE 15" MIN. A.F.F. · WHERE A HIGH FORWARD REACH IS OVER AN OBSTRUCTION. THE CLEAR FLOOR SPACE SHALL EXTEND BENEATH THE ELEMENT FOR A DISTANCE NOT LESS THAN THE REQUIRED REACH DEPTH OVER THE OBSTRUCTION. THE HIGH FORWARD REACH SHALL BE 48" MAX. A.F.F. WHERE THE REACH DEPTH IS 20" MAX. WHERE THE REACH DEPTH EXCEEDS 20". THE HIGH FORWARD REACH SHALL BE 44" MAX. A.F.F. AND THE REACH DEPTH SHALL BE 25" MAX.

 WHERE A CLEAR FLOOR SPACE ALLOWS FOR A PARALLEL APPROACH AND THE EDGE OF THE CLEAR FLOOR SPACE IS 10" MAX. FROM THE ELEMENT, THE HIGH SIDE REACH SHALL BE 48" MAX. A.F.F. AND THE LOW SIDE REACH SHALL BE 15" MIN. A.F.F.

• WHERE A CLEAR FLOOR SPACE ALLOWS FOR A PARALLEL APPROACH AND THE HIGH REACH IS OVER AN OBSTRUCTION, THE HEIGHT OF THE OBSTRUCTION SHALL BE 34" MAX. A.F.F. AND THE DEPTH SHALL BE 24" MAX. THE HIGH SIDE REACH SHALL BE 48" MAX. A.F.F. FOR A REACH DEPTH OF 10" MAX. WHERE THE REACH DEPTH EXCEEDS 10", THE HIGH SIDE REACH SHALL BE 46" MAX A.F.F. FOR A REACH DEPTH OF 24" MAX. (EXCEPTION: AT WASHING MACHINES AND CLOTHES DRYERS, THE HEIGHT OF THE OBSTRUCTION SHALL BE 36"

# **OPERABLE PARTS (ICC A117.1 309)**

• A CLEAR FLOOR SPACE SHALL BE PROVIDED.

• TOE CLEARANCE SHALL BE 30" MIN. IN WIDTH.

OPERABLE PARTS SHALL BE WITHIN REACH RANGES.

 OPERABLE PARTS SHALL BE OPERABLE WITH ONE HAND AND SHALL NOT REQUIRE TIGHT GRASPING, PINCHING, OR TWISTING OF THE WRIST. THE FORCE REQUIRED TO ACTIVE OPERABLE PARTS SHALL BE 5.0 LBS MAX.

# **RAMPS (ICC A117.1 405)**

• RAMPS ALONG ACCESSIBLE ROUTES SHALL COMPLY WITH SECTION 405.

• RAMP RUNS SHALL HAVE A RUNNING SLOPE GREATER THAN 1:20 AND NOT STEEPER THAN 1:12. • EXCEPTION: IN EXISTING BUILDINGS OR FACILITIES, RAMPS SHALL BE PERMITTED TO HAVE SLOPES STEEPER THAN 1:12 COMPLYING WITH TABLE 405.2 WHERE SUCH SLOPES ARE NECESSARY DUE TO SPACE LIMITATIONS.

• CROSS SLOPE OF RAMP RUNS SHALL NOT BE STEEPER THAN 1:48. • FLOOR SURFACES OF RAMP RUNS SHALL COMPLY WITH SECTION 302.

• THE CLEAR WIDTH OF A RAMP RUN SHALL BE 36" MINIMUM. HANDRAILS AND HAND-RAIL SUPPORTS THAT ARE PROVIDED ON THE RAMP RUN SHALL NOT PROJECT INTO THE REQUIRED CLEAR WIDTH OF THE RAMP RUN. • THE RISE FOR ANY RAMP RUN SHALL BE 30" MAXIMUM.

• RAMPS SHALL HAVE LANDINGS AT THE BOTTOM AND TOP OF EACH RAMP RUN. LANDINGS SHALL COMPLY WITH

1. LANDINGS SHALL HAVE A SLOPE NOT STEEPER THAN 1:48 AND SHALL COMPLY WITH SECTION 302.

2. CLEAR WIDTH OF LANDINGS SHALL BE AT LEAST AS WIDE AS THE WIDEST RAMP RUN LEADING TO THE

3. LANDINGS SHALL HAVE A CLEAR LENGTH OF 60" MINIMUM.

WITH SECTION 505. (ACTUAL RISE 5-3/4")

4. CHANGE IN DIRECTION. RAMPS THAT CHANGE DIRECTION AT RAMP LANDINGS SHALL BE SIZED TO PROVIDE A TURNING SPACE COMPLYING WITH SECTION 304.3.

5. DOORWAYS. WHERE DOORWAYS ARE ADJACENT TO A RAMP LANDING, MANEUVERING CLEARANCES REQUIRED BY SECTIONS 404.2.3 AND 404.3.2 SHALL BE PERMITTED TO OVERLAP THE LANDING AREA. HANDRAILS. RAMP RUNS WITH A RISE GREATER THAN 6 INCHES (150 MM) SHALL HAVE HANDRAILS COMPLYING

# WASHING MACHINES & CLOTHES DRYERS (ICC A117.1 611)

• ACCESSIBLE OPERABLE PARTS REQUIREMENTS APPLY, SEE ACCESSIBLE REACH & OPERABLE PARTS NOTES. ACCESSIBLE REACH RANGE REQUIREMENTS APPLY, SEE ACCESSIBLE REACH & OPERABLE PARTS NOTES.

**ACCESSIBLE WASHING MACHINES & CLOTHES DRYERS** • A CLEAR FLOOR SPACE 30" MIN. IN WIDTH & 48" MIN. IN DEPTH POSITIONED FOR PARALLEL APPROACH SHALL BE PROVIDED. FOR TOP-LOADING MACHINES, THE CLEAR FLOOR SPACE SHALL BE CENTERED ON THE APPLIANCE, FOR FRONT-LOADING MACHINES, THE CENTERLINE OF THE CLEAR FLOOR SPACE SHALL BE

OFFSET 24" MAX. FROM THE CENTERLINE OF THE DOOR OPENING. • TOP-LOADING MACHINES SHALL HAVE THE DOOR TO THE LAUNDRY COMPARTMENT 36" MAX. A.F.F. • FRONT-LOADING MACHINES SHALL HAVE THE BOTTOM OF THE OPENING TO THE LAUNDRY COMPARTMENT 15" MIN. & 36" MAX. A.F.F.

# **BENCHES (ICC A117.1 903)**

# **BUILT-IN BENCHES**

BENCHES SHALL HAVE SEATS 42" MIN. IN LENGTH & 20" MIN. & 24" MAX. IN DEPTH. THE BENCH SHALL PROVIDE FOR BACK SUPPORT OR SHALL BE AFFIXED TO A WALL. BACK SUPPORT SHALL EXTEND FROM A POINT 2" MAX. ABOVE THE SEAT SURFACE TO A POINT 18" MIN. ABOVE THE SEAT SURFACE. BACK SUPPORT SHALL BE 2-1/2" MAX. FROM THE REAR EDGE OF THE SEAT MEASURED HORIZONTALLY. THE TOP OF THE BENCH SEAT SHALL BE 17" MIN. & 19" MAX. A.F.F. MEASURED TO THE TOP OF THE SEAT. WHERE PROVIDED IN WET LOCATIONS, THE SURFACE OF THE SEAT SHALL BE SLIP RESISTANT AND SHALL NOT ACCUMULATE WATER.

# **ACCESSIBLE DWELLING UNIT NOTES (ICC A117.1 1002)**

• THE PRIMARY ENTRANCE DOOR TO THE UNIT AND ALL OTHER DOORWAYS INTENDED FOR USER PASSAGE SHALL COMPLY WITH ICC A117.1-2009 SECTION 1003.5 FOR MANEUVERING CLEARANCES. THRESHOLDS. CLEAR WIDTH, HARDWARE, CLOSING SPEEDS, ETC.

ALL ROOMS SERVED BY AN ACCESSIBLE ROUTE SHALL PROVIDE A TURNING SPACE THAT IS EITHER A CIRCULAR SPACE WITH A 60" MIN. DIAMETER OR A T-SHAPED SPACE WITHIN A 60" MIN. SQUARE WITH ARMS AND BASE 36" MIN. IN WIDTH, EACH ARM CLEAR OF OBSTRUCTIONS 12" MIN. IN EACH DIRECTION, AND THE BASE CLEAR OF OBSTRUCTIONS 24" MIN. THE ROUND TURNING SPACE SHALL BE PERMITTED TO INCLUDE KNEE AND TOE CLEARANCE; THE T-SHAPED TURNING SPACE SHALL BE PERMITTED TO INCLUDE KNEE AND TOE CLEARANCE ONLY AT THE END OF EITHER THE BASE OR ONE ARM. DOORS SHALL BE PERMITTED TO SWING INTO TURNING SPACES U.O.N. (EXCEPTIONS: A TURNING SPACE IS NOT REQUIRED WITHIN TOILET ROOMS AND BATHROOMS NOT REQUIRED TO BE ACCESSIBLE OR WITHIN CLOSETS OR PANTRIES THAT ARE 48" MAX. IN

· ACCESSIBLE OPERABLE PARTS REQUIREMENTS APPLY, SEE ACCESSIBLE REACH & OPERABLE PARTS NOTES.

ACCESSIBLE REACH RANGE REQUIREMENTS APPLY, SEE ACCESSIBLE REACH & OPERABLE PARTS NOTES. CARPET OR CARPET TILE SHALL COMPLY WITH ICC A117.1-2009 SECTION 302.2.

### ACCESSIBLE TOILET & SHOWER/BATHING FACILITIES

AT LEAST ONE TOILET AND SHOWER/BATHING FACILITY SHALL COMPLY WITH THE FOLLOWING REQUIREMENTS. THE ACCESSIBLE TOILET AND SHOWER/BATHING FIXTURES SHALL BE IN A SINGLE TOILET/BATHING AREA SUCH THAT TRAVEL BETWEEN FIXTURES FOES NOT REQUIRE TRAVEL THROUGH OTHER PARTS OF THE UNIT:

• DOORS SHALL NOT SWING INTO THE CLEAR FLOOR SPACE OR CLEARANCE FOR ANY FIXTURE, EXCEPT WHERE A CLEAR FLOOR SPACE 30" MIN. IN WIDTH AND 48" MIN. IN DEPTH. EXCLUDING KNEE & TOE

CLEARANCES UNDER ELEMENTS, IS PROVIDED WITHIN THE ROOM BEYOND THE ARC OF THE DOOR SWING. WHERE MIRRORS ARE LOCATED ABOVE LAVATORIES. A MIRROR SHALL BE LOCATED OVER THE ACCESSIBLE LAVATORY AND SHALL BE MOUNTED WITH THE BOTTOM EDGE OF THE REFLECTIVE SURFACE 40" MAX. A.F.F.

CCESSIBLE COAT HOOKS & SHELVES

• COAT HOOKS SHALL BE MOUNTED WITHIN ONE OR MORE ACCESSIBLE REACH RANGE ABOVE.

• SHELVES SHALL BE MOUNTED AT 40" MIN. AND 48" MAX. A.F.F.

<u>VANITY COUNTERTOPS</u>
• IF VANITY COUNTERTOP SPACE IS PROVIDED IN DWELLING OR SLEEPING UNITS NOT REQUIRED TO BE ACCESSIBLE UNITS WITHIN THE SAME FACILITY, EQUIVALENT VANITY COUNTERTOP SPACE IN TERMS OF SIZE AND PROXIMITY TO THE LAVATORY SHALL ALSO BE PROVIDED IN ACCESSIBLE UNITS.

• CENTERLINE OF WATER CLOSETS SHALL BE 16" MIN. AND 18" MAX. FROM THE SIDEWALL

CLEARANCE AROUND WATER CLOSETS SHALL BE 60" MIN. IN WIDTH MEASURED PERPENDICULAR FROM THE SIDE WALL OR PARTITION AND 56" MIN. IN DEPTH MEASURED PERPENDICULAR FROM THE REAR WALL.

• THE TOP OF WATER CLOSET SEATS SHALL BE 17" MIN. AND 19" MAX. A.F.F. WATER CLOSET SEATS SHALL NOT RETURN AUTOMATICALLY TO A LIFTED POSITION.

• FLUSH CONTROLS SHALL BE LOCATED ON THE OPEN SIDE OF THE WATER CLOSET. • A HORIZONTAL SIDE WALL GRAB BAR SHALL BE 42" MIN. IN LENGTH AND LOCATED 12" MAX. FROM THE REAR

WALL AND EXTEND 54" MIN. FROM THE REAR WALL. • A VERTICAL SIDEWALL GRAB BAR SHALL BE 18" MIN. IN LENGTH AND MOUNTED WITH THE BOTTOM OF THE BAR LOCATED 39" MIN. AND 41" MAX. A.F.F. AND CENTERLINE OF BAR LOCATED 39" MIN. AND 41" MAX. FROM

• A HORIZONTAL REAR WALL GRAB BAR SHALL BE 36" LONG MIN. AND EXTEND FROM THE CENTERLINE OF THE WATER CLOSET 12" MIN. ON THE SIDE CLOSEST TO THE WALL AND 24" ON THE TRANSFER SIDE.

ACCESSIBLE TOILET PAPER DISPENSERS • WHERE THE TOILET PAPER DISPENSER IS LOCATED ABOVE THE GRAB BAR, THE OUTLET SHALL BE LOCATED

WITHIN 24" MIN. AND 36" MAX. FROM THE REAR WALL. • WHERE THE TOILET PAPER DISPENSER IS LOCATED BELOW THE GRAB BAR, THE OUTLET SHALL BE LOCATED WITHIN 24" MIN. AND 42" MAX. FROM THE REAR WALL.

THE OUTLET SHALL BE LOCATED 18" MIN. AND 48" MAX. A.F.F. • THERE SHALL BE A CLEARANCE OF 1-1/2" MIN. BELOW AND 12" MIN. ABOVE GRAB BARS.

CCESSIBLE LAVATORIES & SINKS

• A CLEAR FLOOR SPACE 30" MIN. IN WIDTH AND 48" MIN. IN DEPTH POSITIONED FOR A FORWARD APPROACH

KNEE CLEARANCE SHALL BE 30" MIN. IN WIDTH, 27" MIN. A.F.F., 8" MIN. IN DEPTH AT 27" A.F.F., AND 11" MIN. IN DEPTH AT 9" A.F.F. BETWEEN 9" AND 27" A.F.F., THE KNEE CLEARANCE MAY REDUCE AT A RATE OF 1" IN DEPTH FOR EACH 6" IN HEIGHT. THE DIP OF THE OVERFLOW SHALL NOT BE CONSIDERED IN DETERMINING KNEE CLEARANCES. TOE CLEARANCE SHALL BE 9" A.F.F., 30" MIN. IN DEPTH, AND 17" MIN. AND 25" MAX. IN

• THE FRONT OF LAVATORIES AND SINKS SHALL BE 34" MAX. A.F.F., MEASURED TO THE HIGHER OF THE

FIXTURE RIM OR COUNTER SURFACE. · WATER SUPPLY AND DRAIN PIPES UNDER SINKS SHALL BE INSULATED OR OTHERWISE CONFIGURED TO PROTECT AGAINST CONTACT. THERE WILL BE NO SHARP OR ABRASIVE SURFACES UNDER SINKS. TANDARD ROLL-IN-TYPE ACCESSIBLE SHOWER COMPARTMENTS

• STANDARD ROLL-IN-TYPE SHOWER COMPARTMENTS SHALL HAVE A CLEAR INSIDE DIMENSION OF 60" MIN. IN

WIDTH AND 30" MIN. IN DEPTH, MEASURED AT THE CENTER POINT OF OPPOSING SIDES.

 AN ENTRY 60" MIN. IN WIDTH SHALL BE PROVIDED. • A CLEARANCE OF 60" MIN. IN LENGTH ADJACENT TO THE 60" MIN. WIDTH AND 30" MIN. DEPTH SHALL BE PROVIDED ADJACENT TO THE 60" MIN. WIDTH OF THE OPEN FACE OF THE SHOWER COMPARTMENT.

(EXCEPTION - AN ACCESSIBLE LAVATORY SHALL BE PERMITTED AT THE END OF THE CLEARANCE OPPOSITE THE SEAT.) A HORIZONTAL GRAB BAR SHALL BE PROVIDED ON THE BACK WALL BEGINNING AT THE EDGE OF THE SEAT.

THE GRAB BAR SHALL NOT BE PROVIDED ABOVE THE SEAT. THE BACK WALL GRAB BAR SHALL EXTEND THE LENGTH OF THE WALL BUT SHALL NOT BE REQUIRED TO EXCEED 48" IN LENGTH. WHERE A SIDE WALL IS PROVIDED OPPOSITE THE SEAT WITHIN 72" OF THE SEAT WALL, A HORIZONTAL GRAB BAR SHALL BE PROVIDED ON THE SIDE WALL OPPOSITE THE SEAT AND SHALL EXTEND THE LENGTH OF THE WALL BUT SHALL NOT BE REQUIRED TO EXCEED 30" IN LENGTH. HORIZONTAL GRAB BARS SHALL BE 6" MAX. FROM THE ADJACENT WALL

THE CONTROLS AND HAND SHOWER SHALL BE LOCATED ON THE BACK WALL ABOVE THE GRAB BAR, 48" MAX. A.F.F. AND 16" MIN. AND 27" MAX. FROM THE END WALL BEHIND THE SEAT. · A HAND SHOWER WITH A HOSE 59" MIN. IN LENGTH. THAT CAN BE USED BOTH AS A FIXED SHOWER HEAD AND AS A HAND SHOWER SHALL BE PROVIDED. THE HAND SHOWER SHALL HAVE A CONTROL WITH A NON-

POSITIVE SHUT-OFF FEATURE. WHERE PROVIDED, AN ADJUSTABLE-HEIGHT HAND SHOWER MOUNTED ON A VERTICAL BAR SHALL BE INSTALLED SO AS TO NOT OBSTRUCT THE USE OF THE GRAB BARS.  $\cdot$  IN ROLL-IN-TYPE SHOWER COMPARTMENTS, THRESHOLDS SHALL BE 1/2" MAX. IN HEIGHT. VERTICAL

THRESHOLDS SHALL NOT BE GREATER THAN 1/4" MAX. BEVELED THRESHOLDS SHALL NOT BE STEEPER THAN 1/2" MAX. AND SHALL HAVE A SLOPE NOT STEEPER THAN 1:2 MAX. SHOWER COMPARTMENT ENCLOSURES SHALL NOT OBSTRUCT CONTROLS OR OBSTRUCT TRANSFER FROM

WHEELCHAIRS ONTO SHOWER SEATS. TANDARD ROLL-IN-TYPE ACCESSIBLE SHOWER COMPARTMENT SEATS • A FOLDING SEAT SHALL BE PROVIDED ON AN END WALL. (EXCEPTION - A FIXED SEAT MAY BE PROVIDED

WHERE THE SEAT DOES NOT OVERLAP THE REQUIRED MINIMUM CLEAR INSIDE DIMENSIONS.) • THE TOP OF SHOWER COMPARTMENT SEATS SHALL BE 17" MIN. AND 19" MAX. A.F.F. SEATS IN STANDARD ROLL-IN SHOWER COMPARTMENTS SHALL EXTEND FROM THE CONTROL WALL TO A

POINT WITHIN 3" MAX. OF THE COMPARTMENT ENTRY. • SEATS MAY BE RECTANGULAR OR L-SHAPED. THE REAR EDGE OF A RECTANGULAR SEAT SHALL BE 2-1/2" MAX. AND THE FRONT EDGE 15" MIN. AND 16" MAX.

FROM THE SEAT WALL. THE SIDE EDGE OF A RECTANGULAR SEAT IN A ROLL-IN SHOWER COMPARTMENT SHALL BE 1-1/2" MAX. FROM THE CONTROL WALL. THE REAR EDGE OF AN L-SHAPED SEAT SHALL BE 2-1/2" MAX. AND THE FRONT EDGE 15" MIN. AND 16" MAX. FROM THE MAIN SEAT WALL. THE REAR EDGE OF THE "L" PORTION OF THE SEAT SHALL BE 1-1/2" MAX. FROM

SHALL BE 22" MIN. AND 23" MAX. FROM THE MAIN SEAT WALL. ALLOWABLE STRESSES SHALL NOT BE EXCEEDED FOR MATERIALS USED WHERE A VERT. OR HORIZ. FORCE OF 250 LBS. IS APPLIED AT ANY POINT ON THE SEAT, FASTENER MOUNTING DEVICE, OR SUPPORTING STRUCTURE.

THE WALL AND THE FRONT EDGE SHALL BE 14" MIN. AND 15" MAX. FROM THE WALL. THE END OF THE "L"

FOR MATERIALS USED WHERE A VERTICAL OR HORIZONTAL FORCE OF 250 POUNDS.

· ALL GRAB BARS SHALL BE MEASURED TO THE TOP OF THE GRIPPING SURFACE U.O.N. • ALL GRAB BARS SHALL HAVE A CIRCULAR CROSS SECTION WITH A DIAMETER OF 1-1/4" MIN. AND 2" MAX. • SPACE BETWEEN THE WALL AND ALL GRAB BARS SHALL BE 1-1/2".

• SPACE BETWEEN GRAB BARS AND PROJECTING OBJECTS BELOW AND AT THE END OF THE GRAB BAR SHALL BE 1-1/2" MIN. SPACE BETWEEN GRAB BARS AND PROJECTING OBJECTS ABOVE THE GRAB BAR SHALL BE 12" MIN.

(EXCEPTION: THE SPACE BETWEEN THE GRAB BARS AND SHOWER CONTROLS, SHOWER FITTINGS, AND OTHER GRAB BARS ABOVE THE GRAB BAR MAY BE 1-1/2" MIN.)

· ALL HORIZONTAL GRAB BARS SHALL BE MOUNTED 33" MIN. AND 36" MAX. A.F.F. U.O.N. • GRAB BARS, AND ANY WALL OR OTHER SURFACES ADJACENT TO GRAB BARS, SHALL BE FREE OF SHARP OR ABRASIVE ELEMENTS. EDGES SHALL BE ROUNDED. GRAB BARS SHALL NOT ROTATE WITHIN THEIR FITTINGS. ALLOWABLE STRESSES SHALL NOT BE EXCEEDED

HORIZ. AND VERT. GRAB BARS MAY BE SEPARATE BARS, A SINGLE PIECE BAR, OR COMBINATION THEREOF.

 ACCESSIBLE OPERABLE PARTS REQUIREMENTS APPLY, SEE ACCESSIBLE REACH & OPERABLE PARTS NOTES. ACCESSIBLE REACH RANGE REQUIREMENTS APPLY, SEE ACCESSIBLE REACH & OPERABLE PARTS NOTES.

• WHERE STORAGE FACILITIES ARE PROVIDED, AT LEAST ONE OF EACH TYPE SHALL PROVIDE A CLEAR FLOOR SPACE 30" MIN. IN WIDTH AND 48" MIN. IN DEPTH AND COMPLY WITH ONE OF THE ACCESSIBLE REACH RANGES.

# 0 0 T () ONTIC ONTIC JUIT 2 **∑**0 ⊢ **∑**2 L REI BTH( TREE I, WI ( XAI STI Ğ ₹ ± Ġ

PROJECT NUMBER

24.091

**○ ♦ ७ ७** 

**DRAWN BY** Z. WENDT

**CHECKED BY** J. LEHRKE

DATE 07/18/2025

SHEET TITLE ACCESSIBILITY CODE

REVIEW


Ž

Ī

**Q** 

OR

**SHEET NUMBER** 

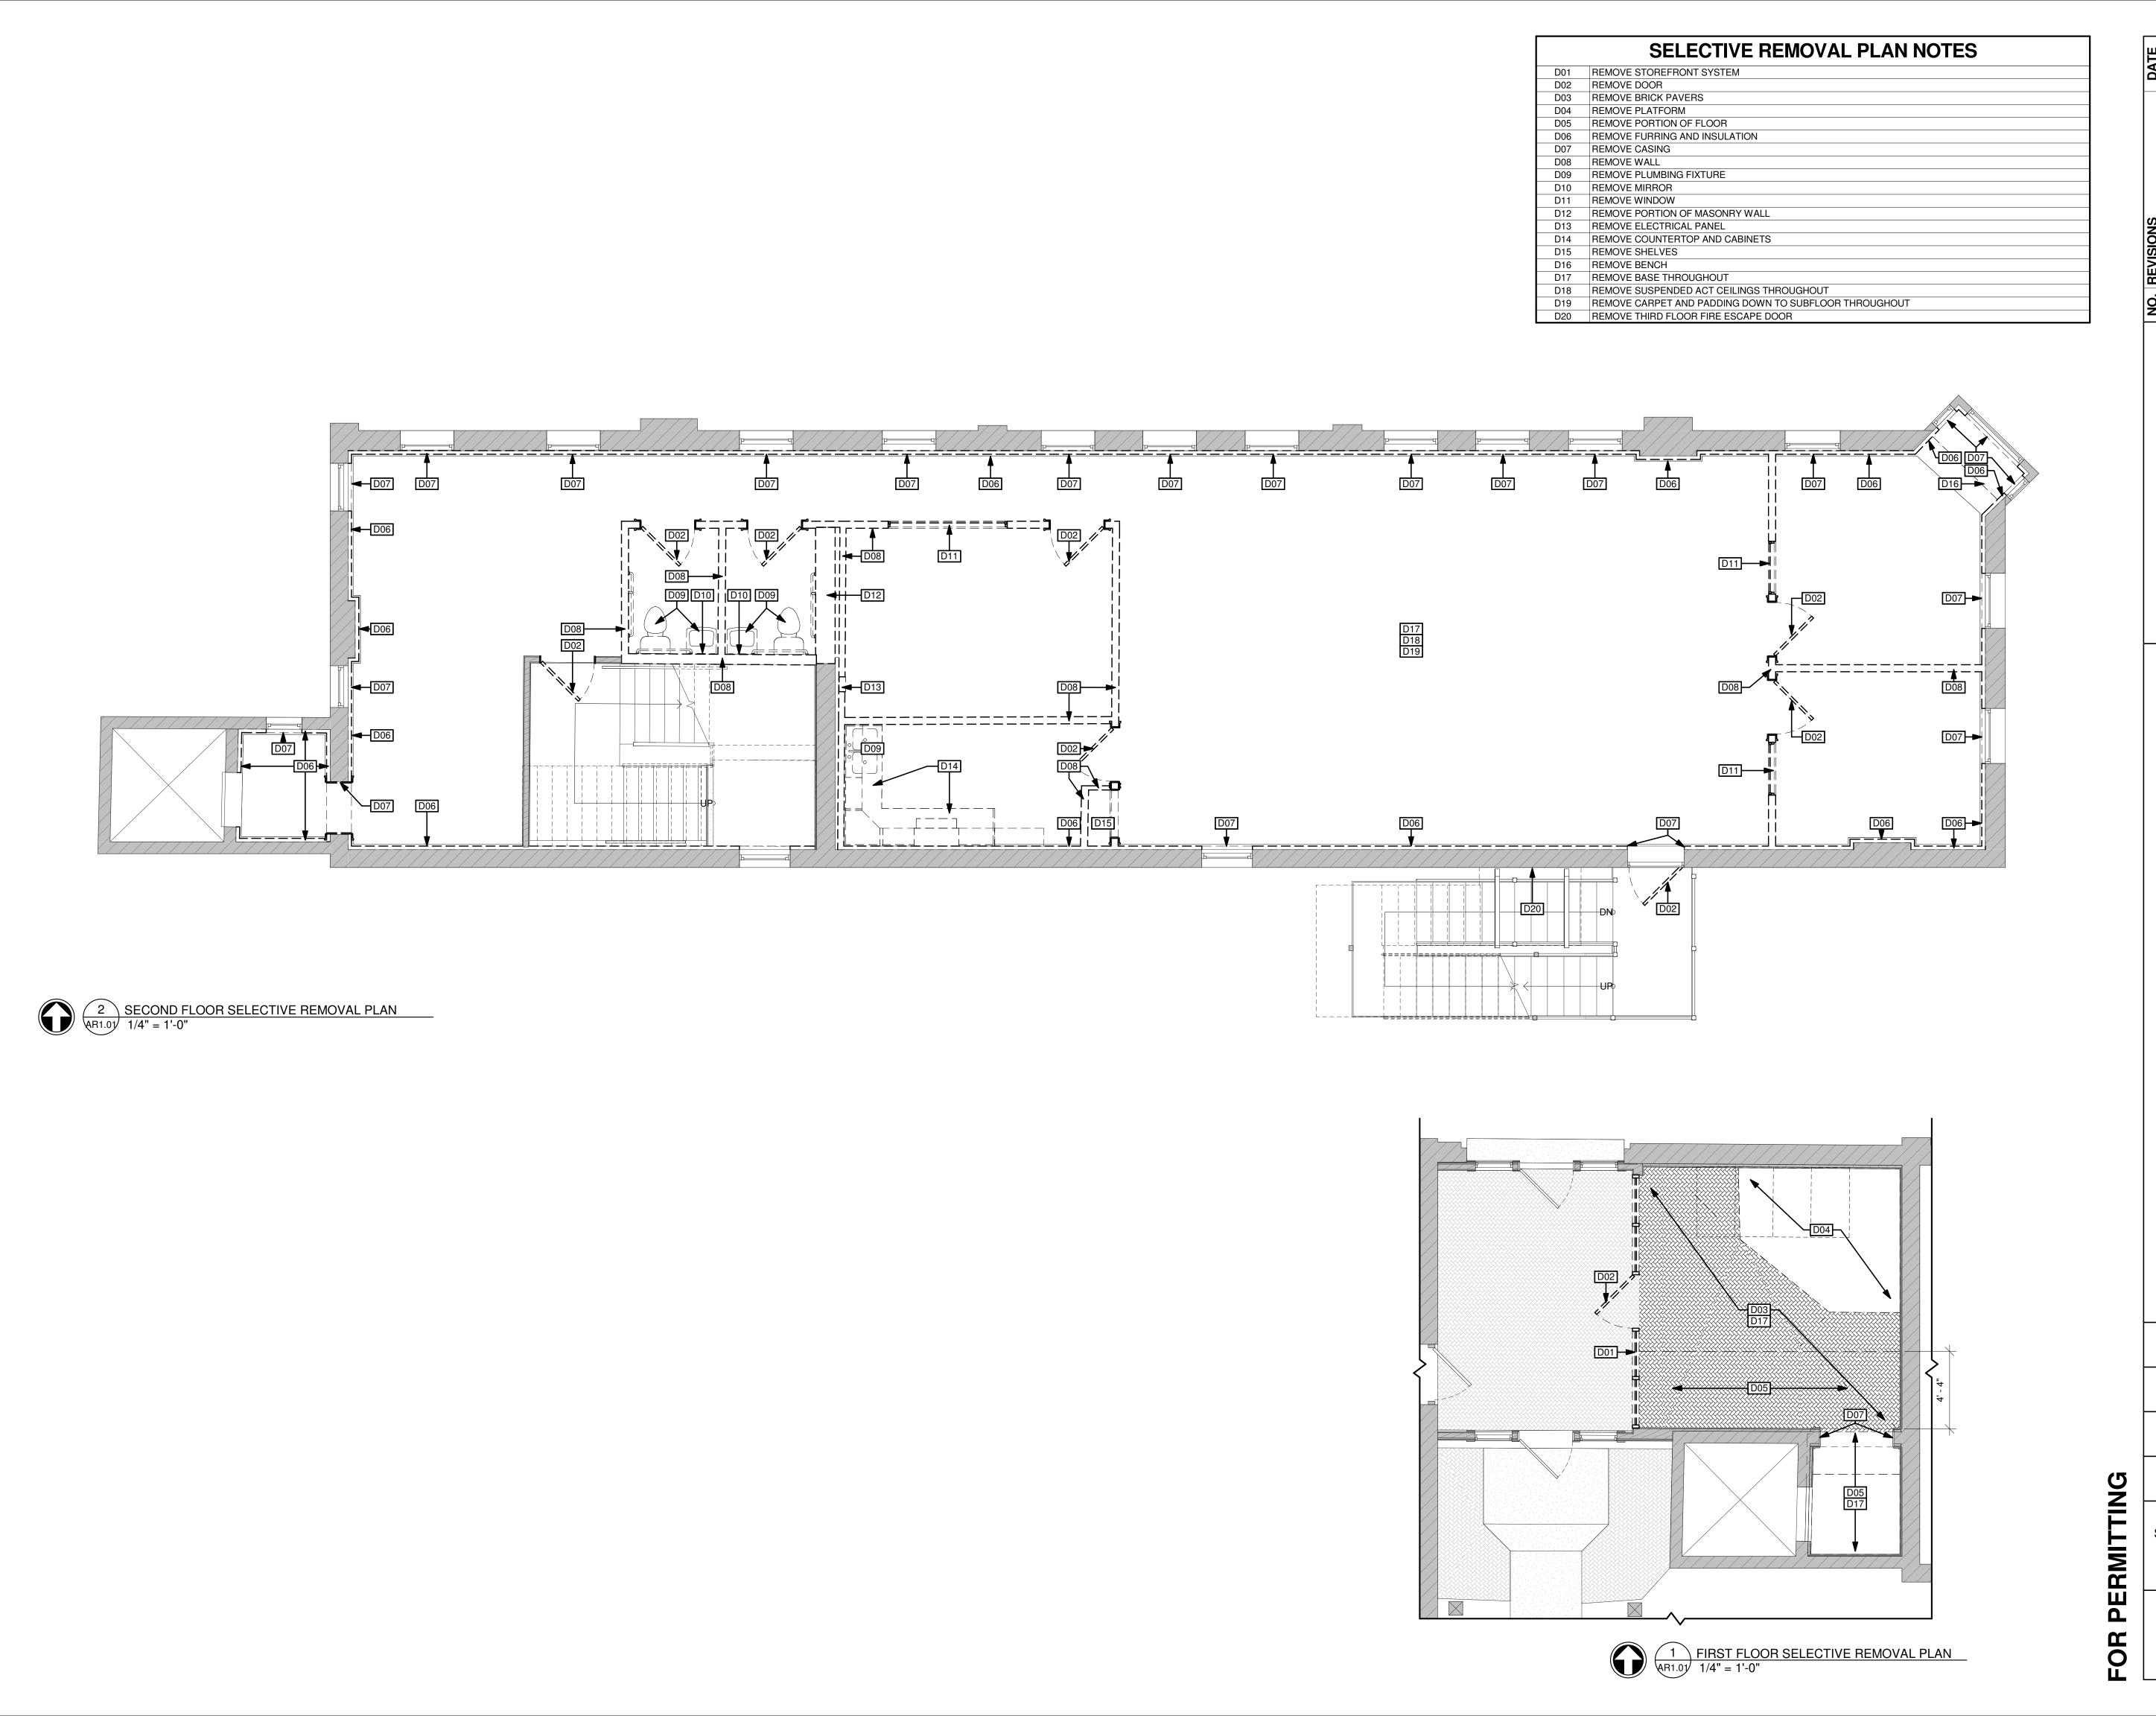

COMMERCIAL REMODEL FOR:
AMERICAN ORTHODONTICS
632 N 8TH STREET UNIT 2
SHEBOYGAN, WI 53081

PROJECT NUMBER 24.091


**DRAWN BY** Z. WENDT

CHECKED BY J. LEHRKE

DATE 07/18/2025

SHEET TITLE SELECTIVE REMOVAL PLANS


SHEET NUMBER **AR1.01** 

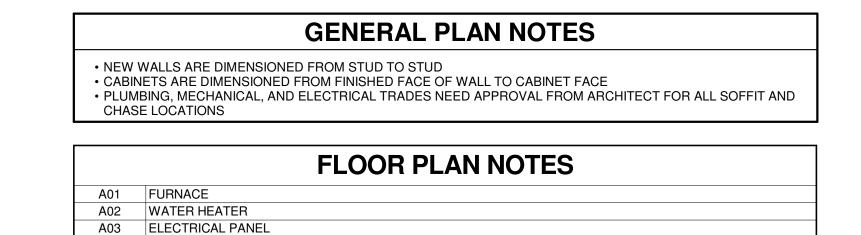



A04 WALL NICHE, SEE DETAIL

A06 REPLACE THIRD FLOOR FIRE ESCAPE DOOR W/ DOOR 301

A05 30" W. DESK

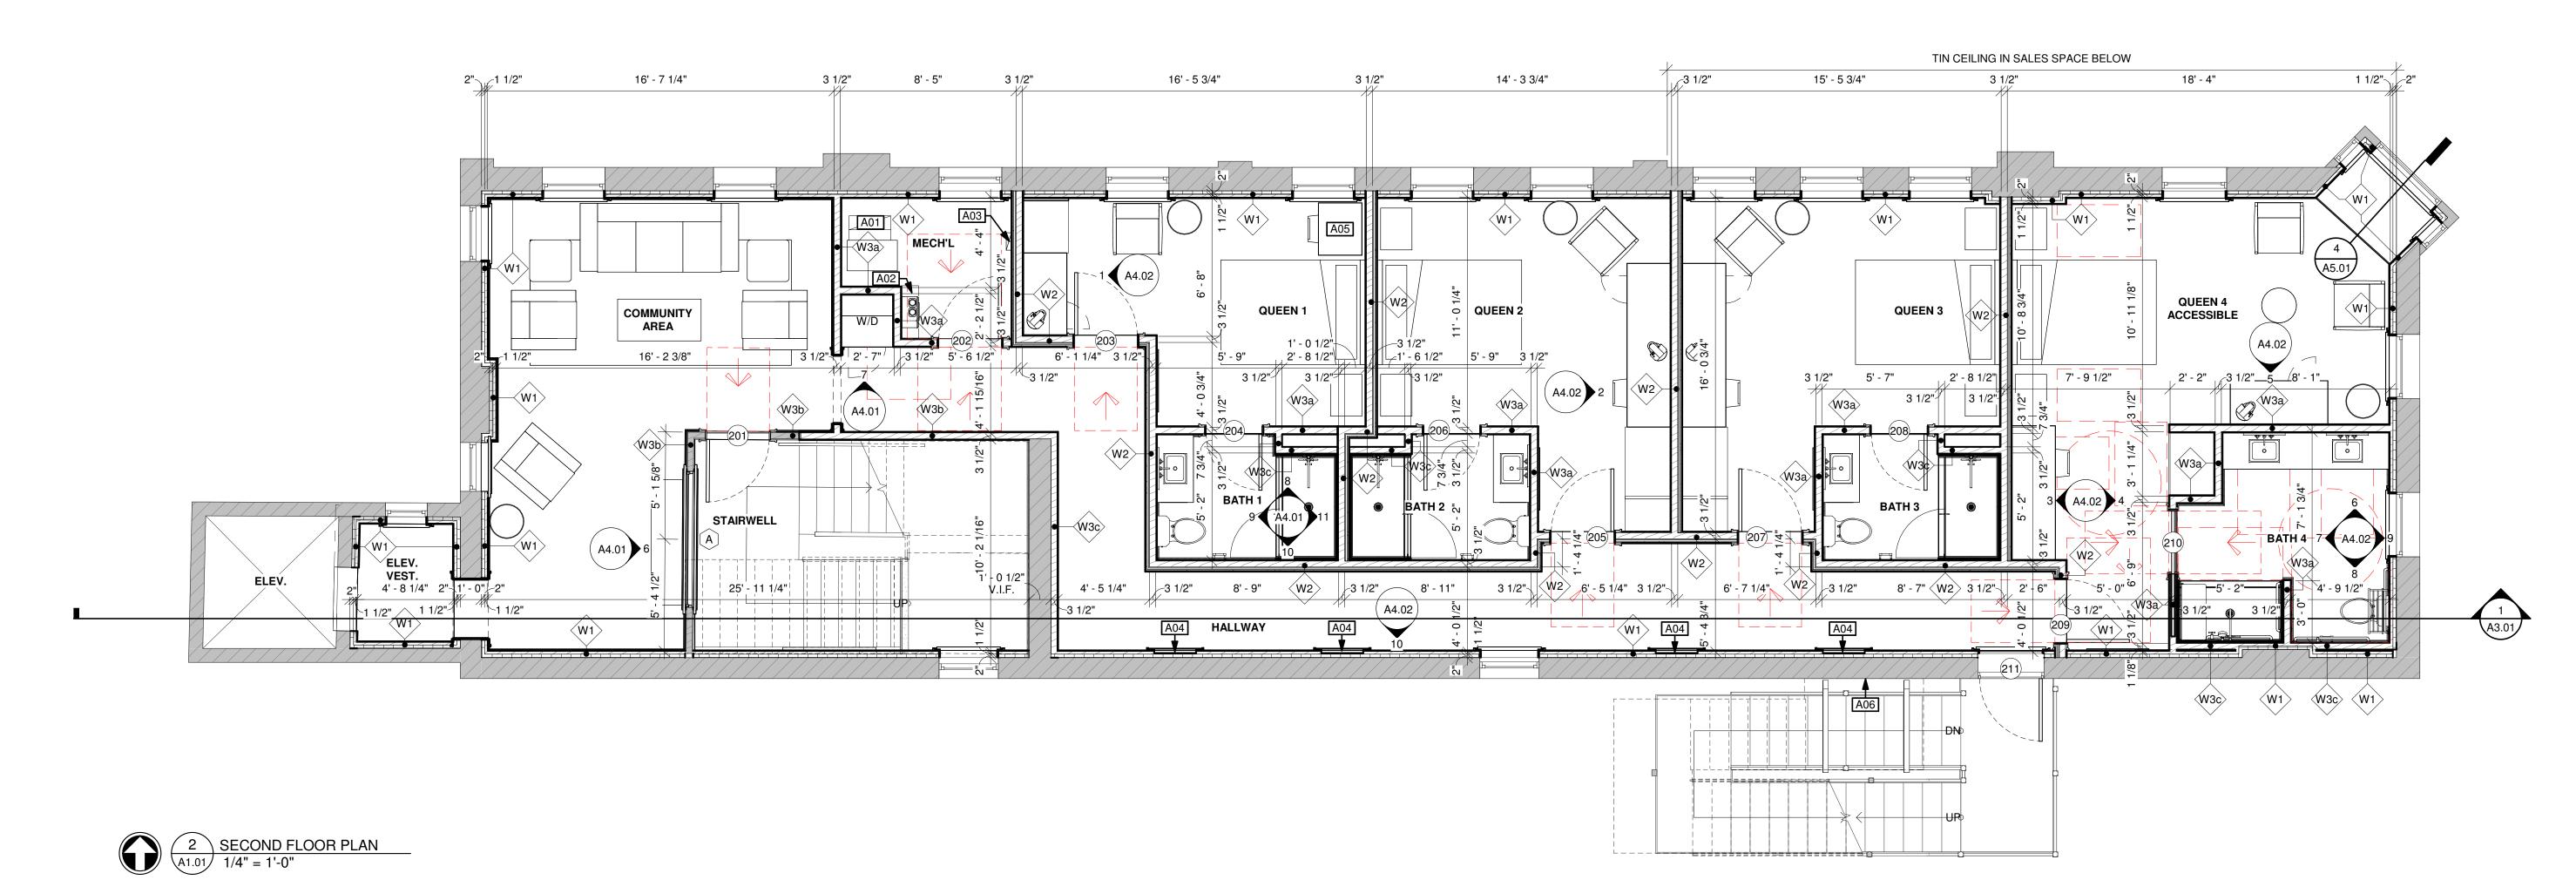

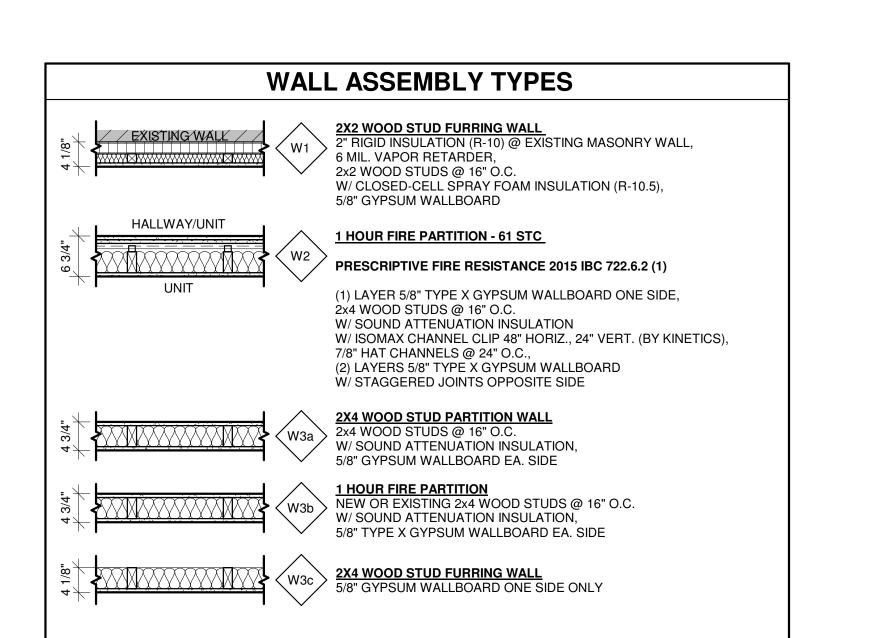

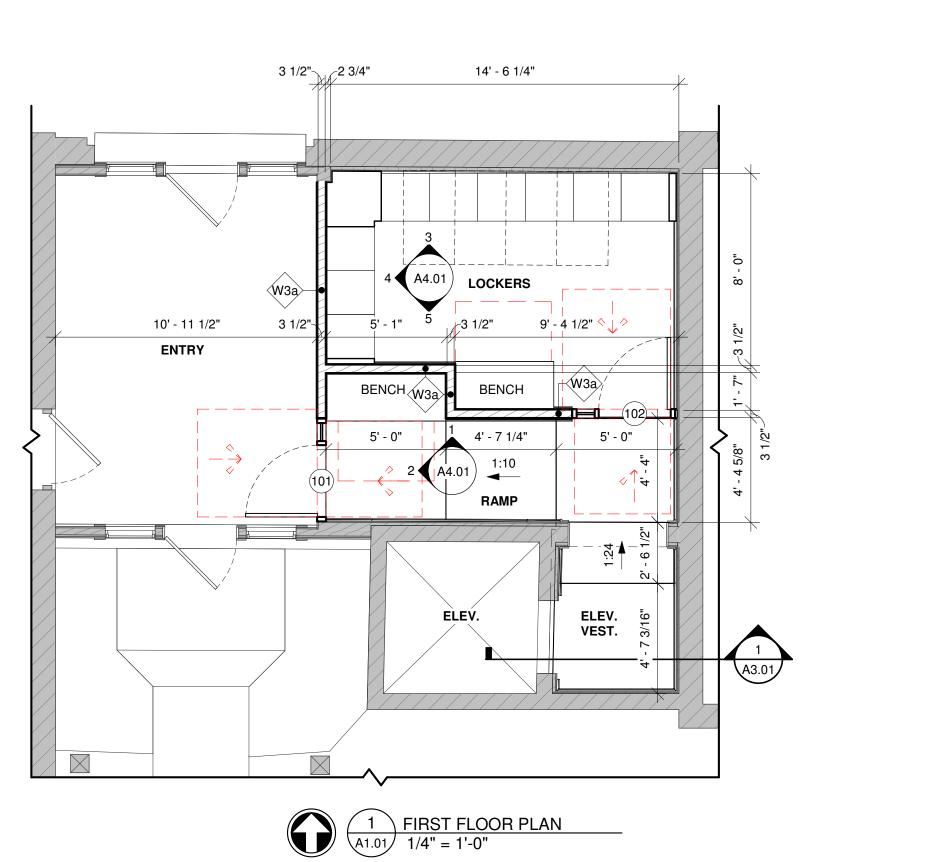

**PERMITTING** FOR

SHEET NUMBER

COMMERCIAL REMODEL FOR:
AMERICAN ORTHODONTICS
632 N 8TH STREET UNIT 2
SHEBOYGAN, WI 53081

**PROJECT NUMBER** 

24.091

**DRAWN BY** 

Z. WENDT

**CHECKED BY** J. LEHRKE

DATE

07/18/2025

SHEET TITLE FLOOR PLANS

# **GENERAL CEILING NOTES**

• PROVIDE APPROVED THROUGH-PENETRATION FIRESTOP SYSTEM AT ALL PENETRATIONS THROUGH FIRE-RESISTANCE-RATED HORIZONTAL ASSEMBLY AS REQUIRED BY 2015 IBC 714.4.1, INCLUDING BUT NOT LIMITED

TO LOCATIONS INDICATED ON PLANS

• LIGHTING DESIGN SHOULD BE CONSIDERED CONCEPTUAL IN NATURE. FINAL DESIGN SHALL BE THE RESPONSIBILITY OF THE ELECTRICAL DESIGN-BUILD SUBCONTRACTOR.

CEILING-MOUNTED LIGHT FIXTURES SHALL BE CENTERED IN ROOMS OR SPACES U.O.N.

COORDINATE LOCATIONS AND SIZES OF ALL NEW SOFFITS WITH PLUMBING, MECHANICAL, AND ELECTRICAL.

# **CEILING PLAN NOTES**


C01 18" X 36" RECESSED DRYWALL ACCESS DOOR WITH GYPSUM PANEL AND TAPE-IN FLANGE ABOVE. VERIFY LOCATION OF HVAC UNIT

• AT ACOUSTICAL TILE CEILINGS, CENTER ALL LIGHTING FIXTURES AND MECHANICAL VENTS IN INDIVIDUAL TILES.


C02 CEILING COFFER, SEE DETAIL, TYP.

SEE ROOM FINISH SCHEDULE FOR CEILING FINISHES

- C03 REMOVE EXISTING CAN AND PATCH CEILING
- C04 FERCHE F614 CROWN THROUGHOUT ROOM

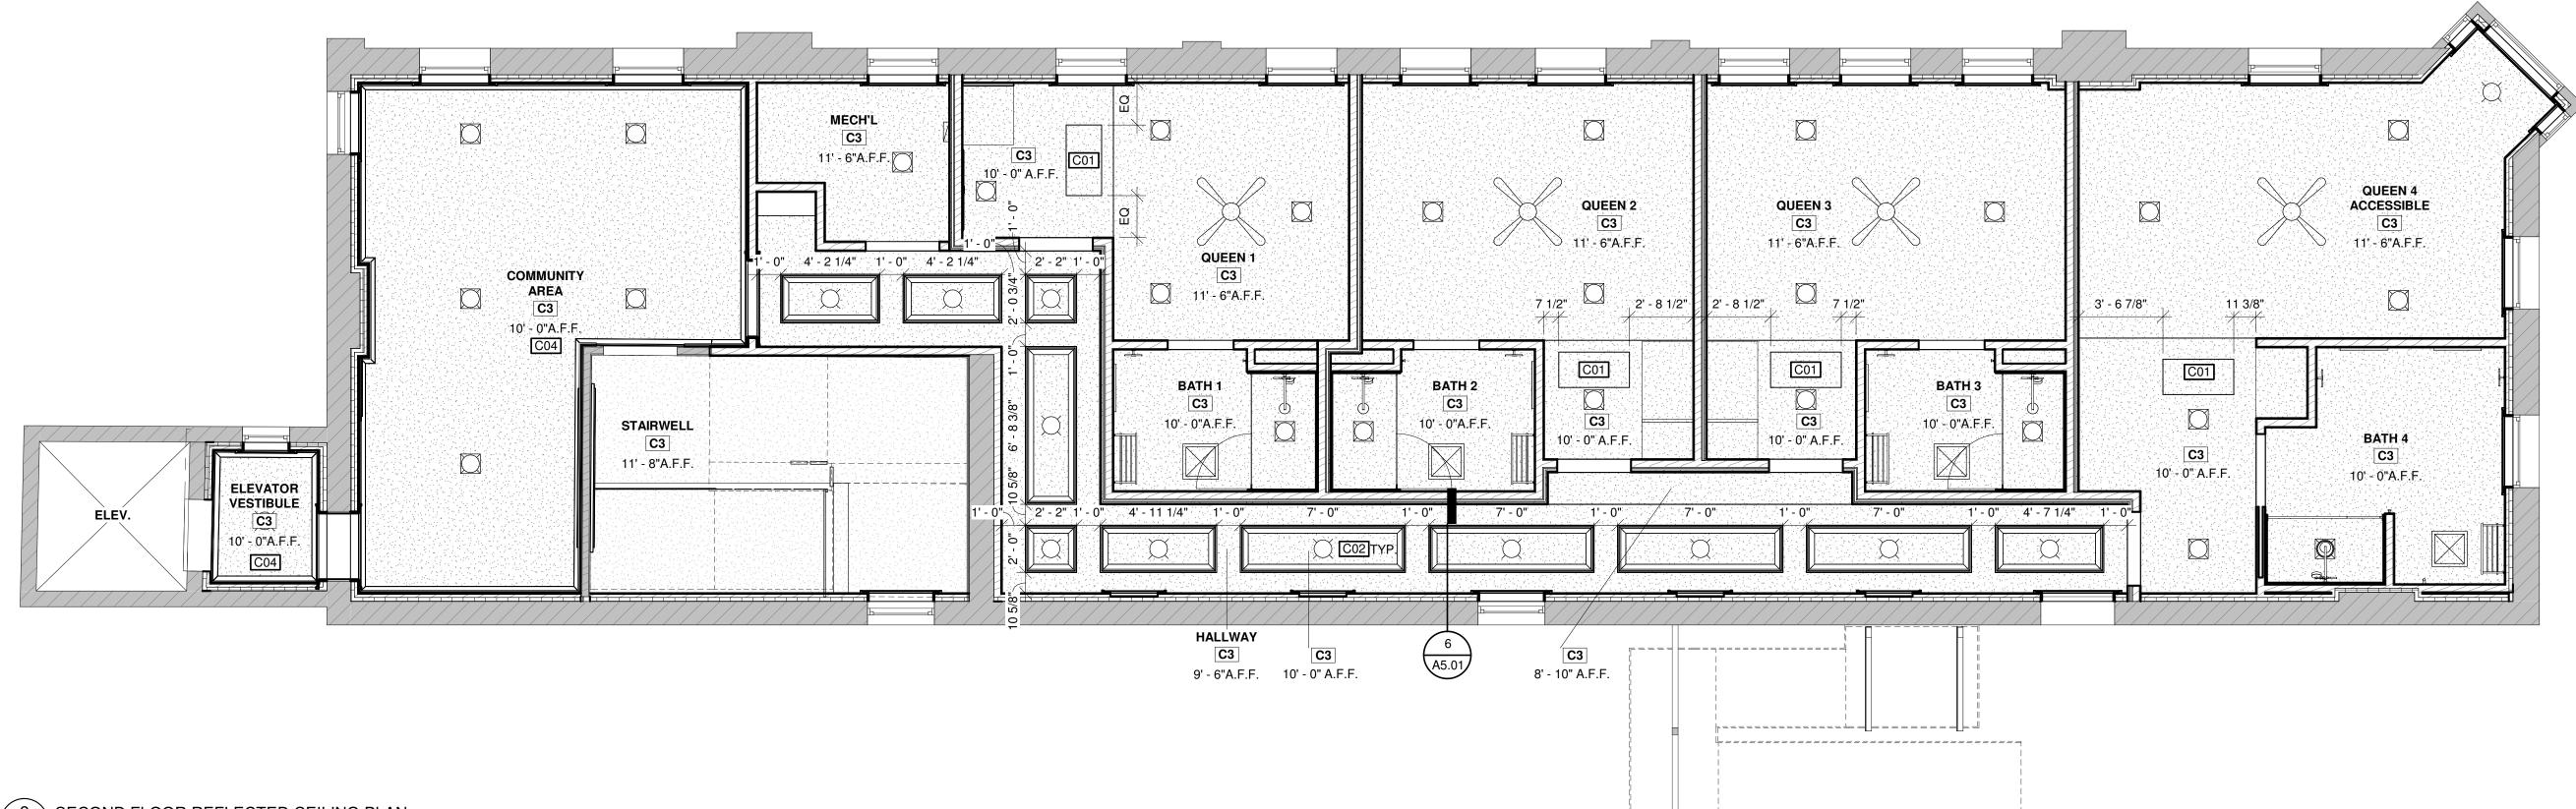



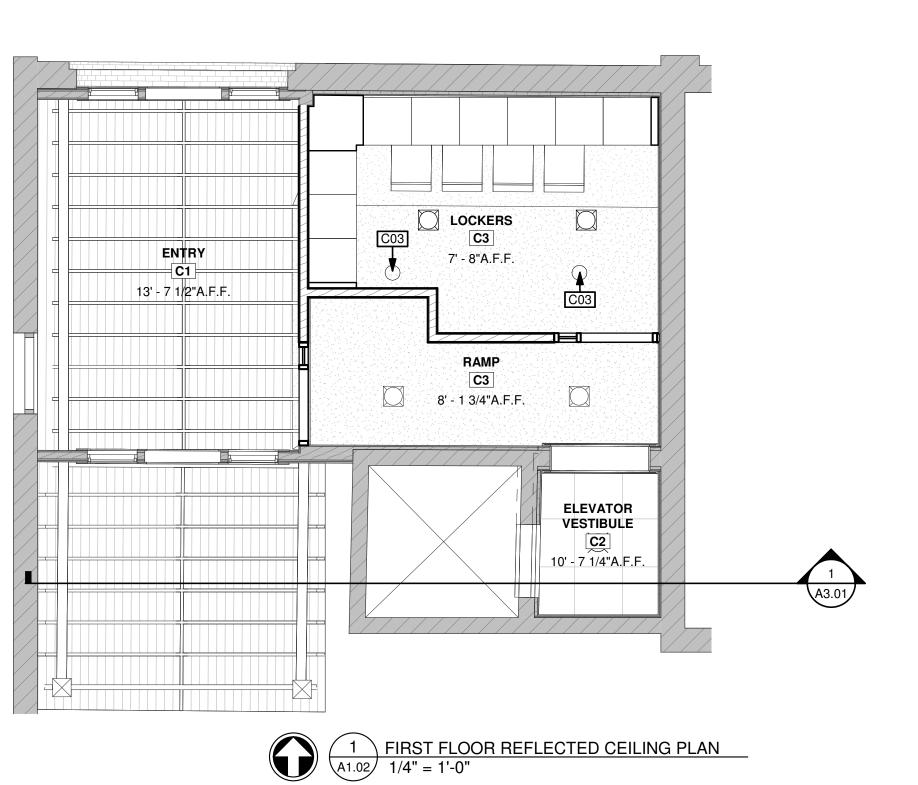

# **FOR PERMITTING**

REFLECTED CEILING PLANS

SHEET NUMBER

COMMERCIAL REMODEL FOR:
AMERICAN ORTHODONTICS
632 N 8TH STREET UNIT 2
SHEBOYGAN, WI 53081

PROJECT NUMBER 24.091


> **DRAWN BY** Z. WENDT

CHECKED BY J. LEHRKE

DATE

07/18/2025

SHEET TITLE

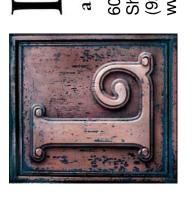

1 LONGITUDINAL SECTION THRU HALLWAY AND ELEVATOR SHAFT A3.01 3/16" = 1'-0"



COMMERCIAL REMODEL FOR:
AMERICAN ORTHODONTICS
632 N 8TH STREET UNIT 2
SHEBOYGAN, WI 53081 **PROJECT NUMBER** 

24.091 **DRAWN BY** Z. WENDT

**CHECKED BY** J. LEHRKE

DATE


07/18/2025

SHEET TITLE BUILDING SECTION


**PERMITTING** 


FOR

SHEET NUMBER

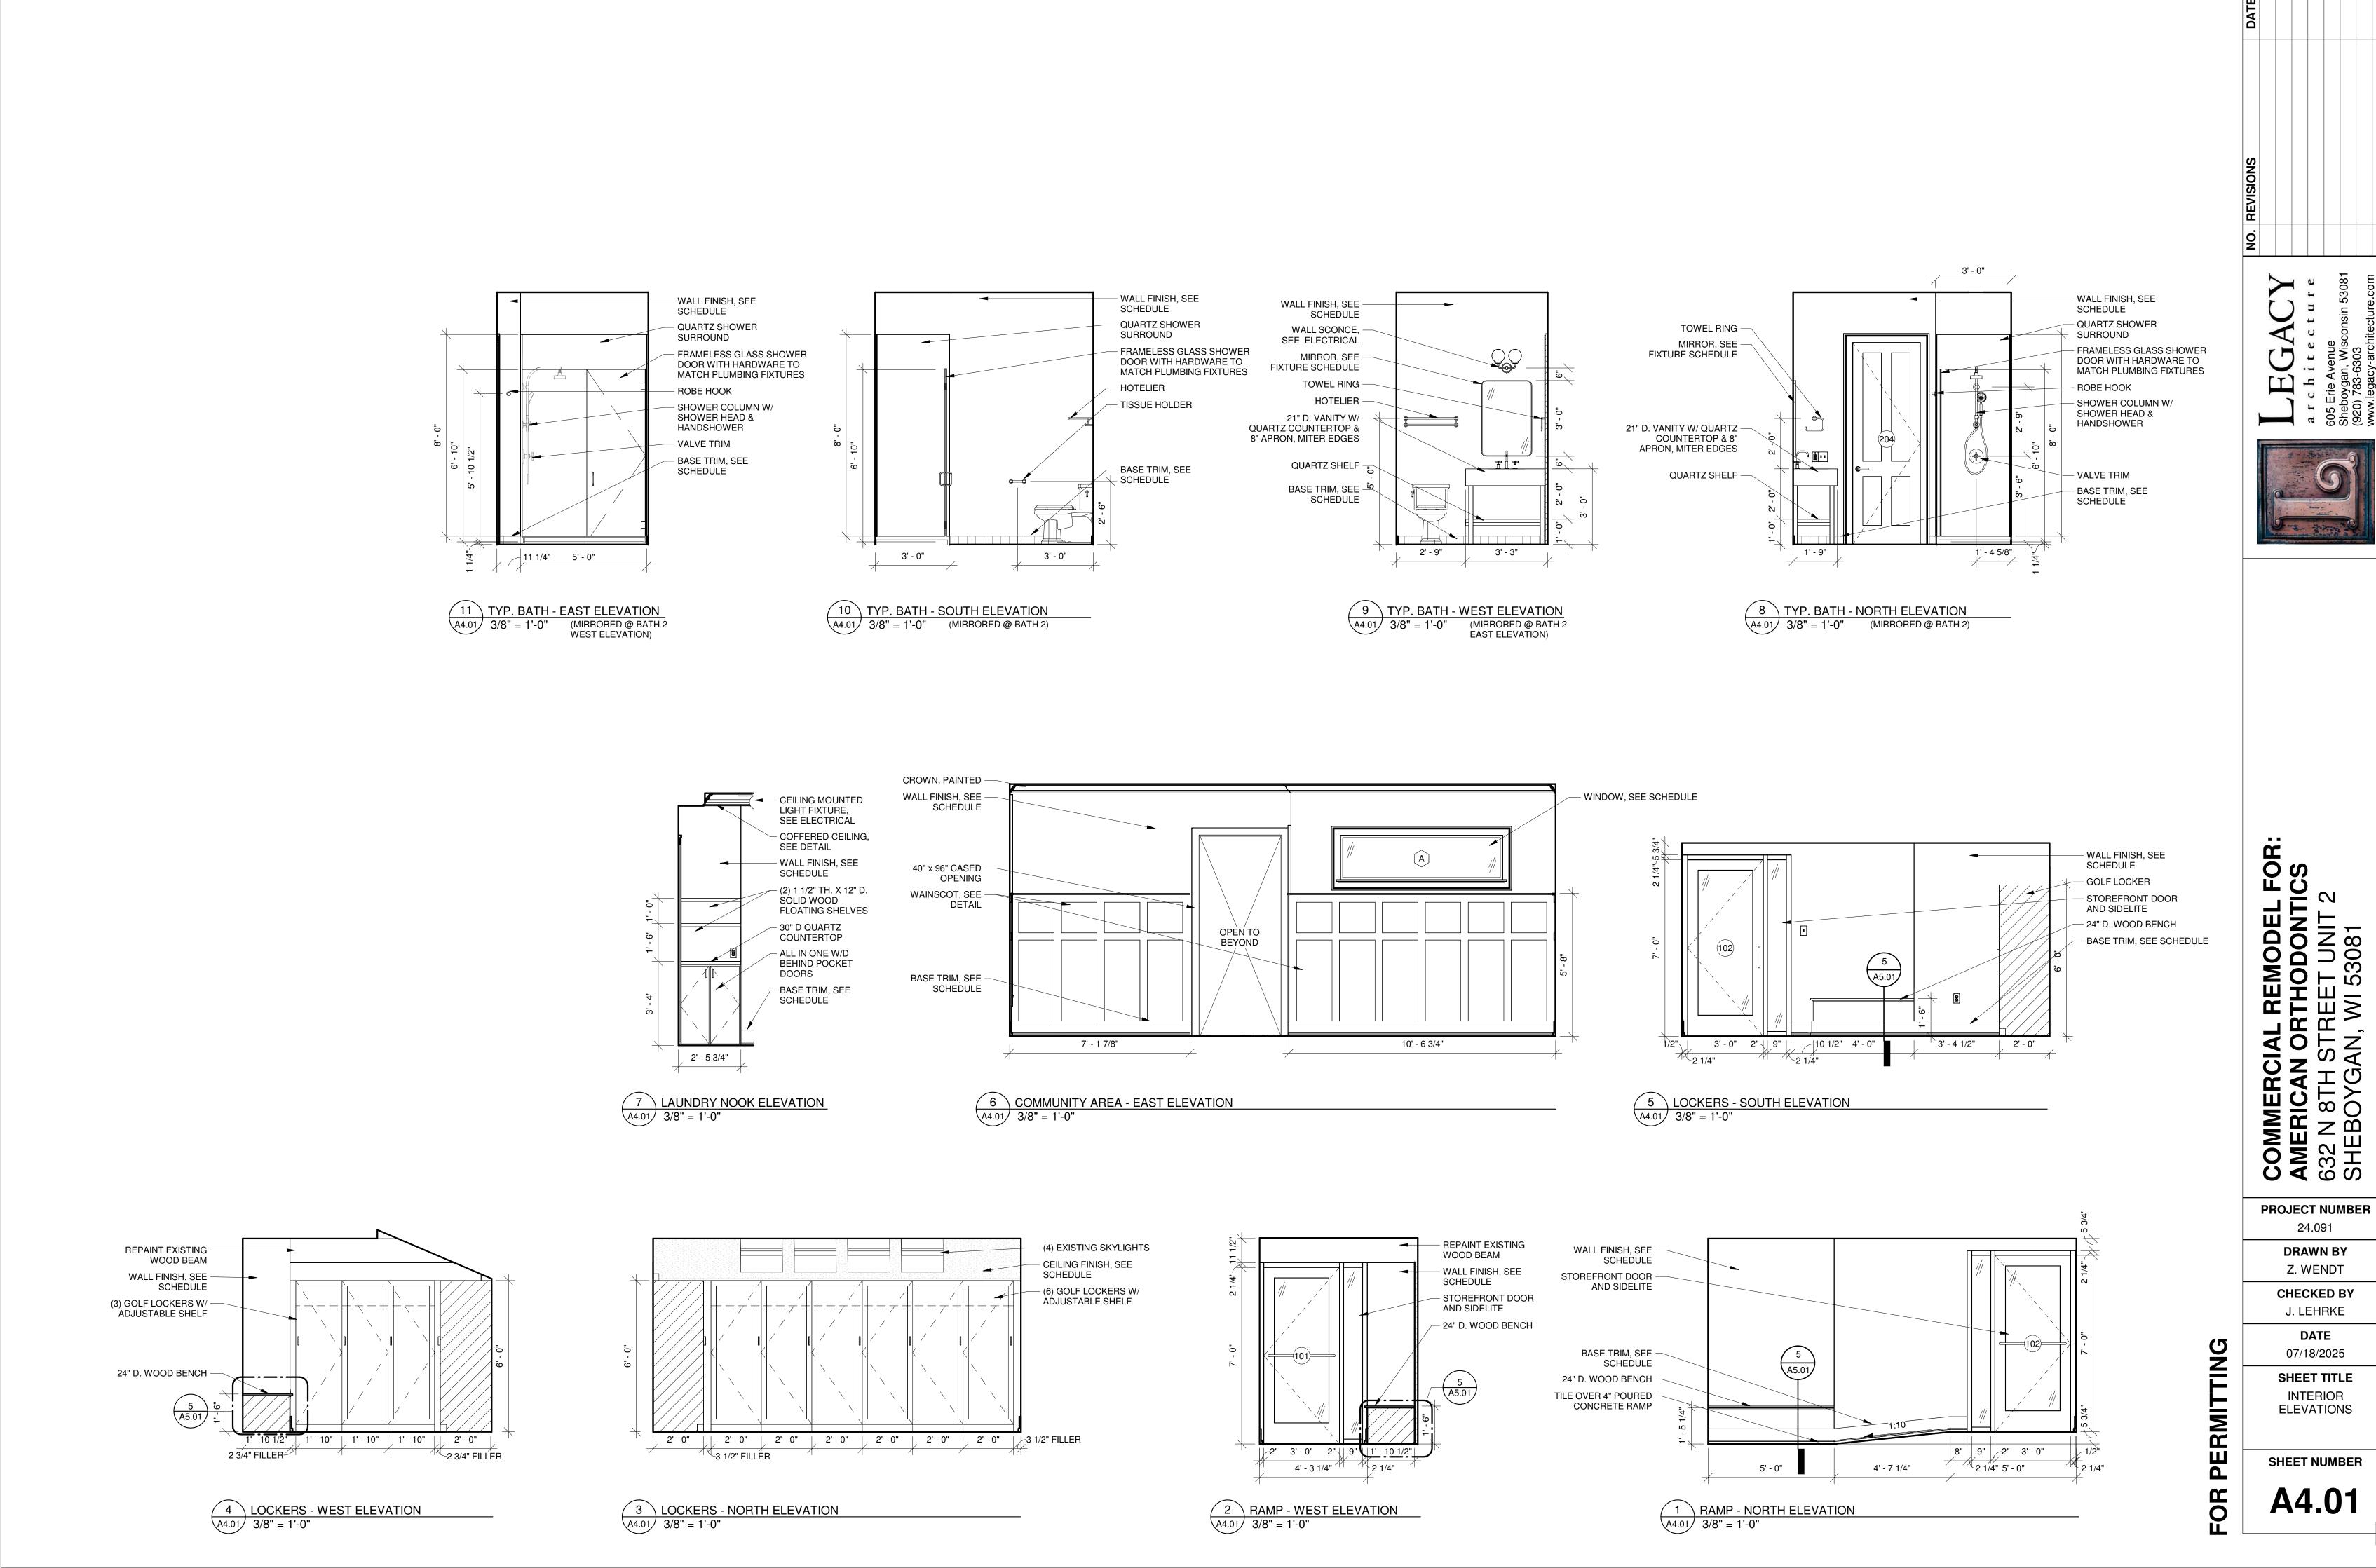

Item 10.

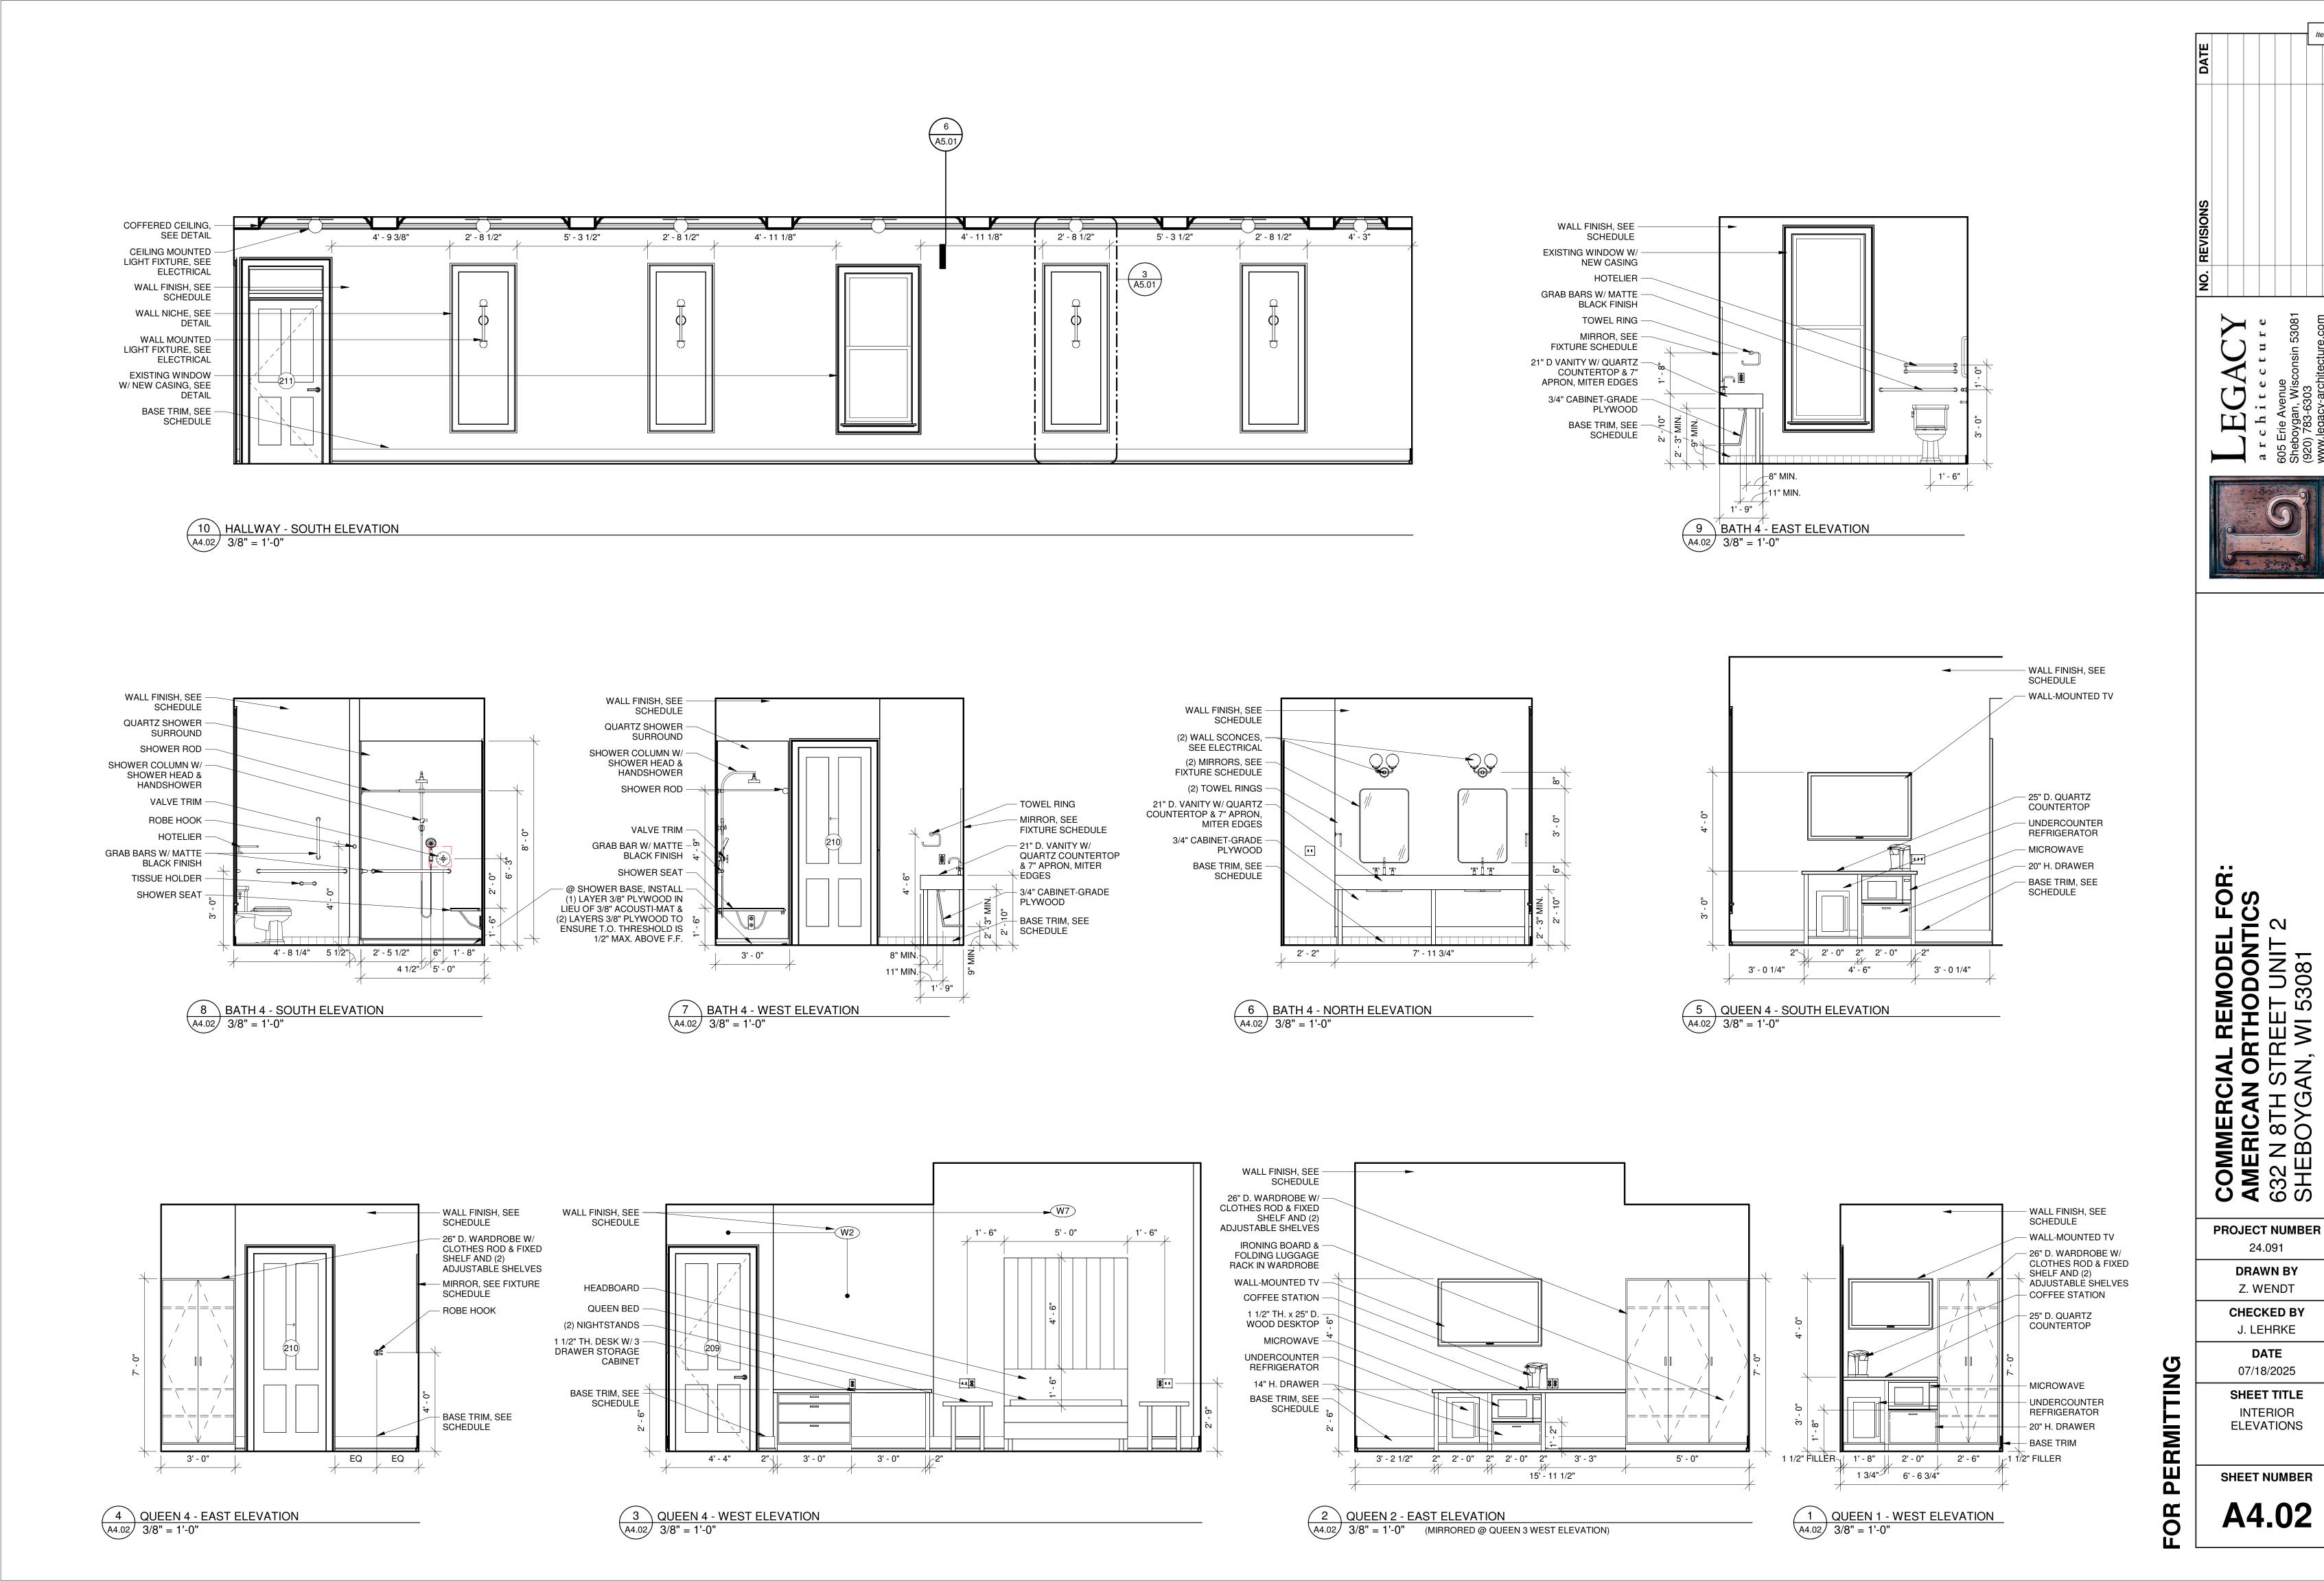

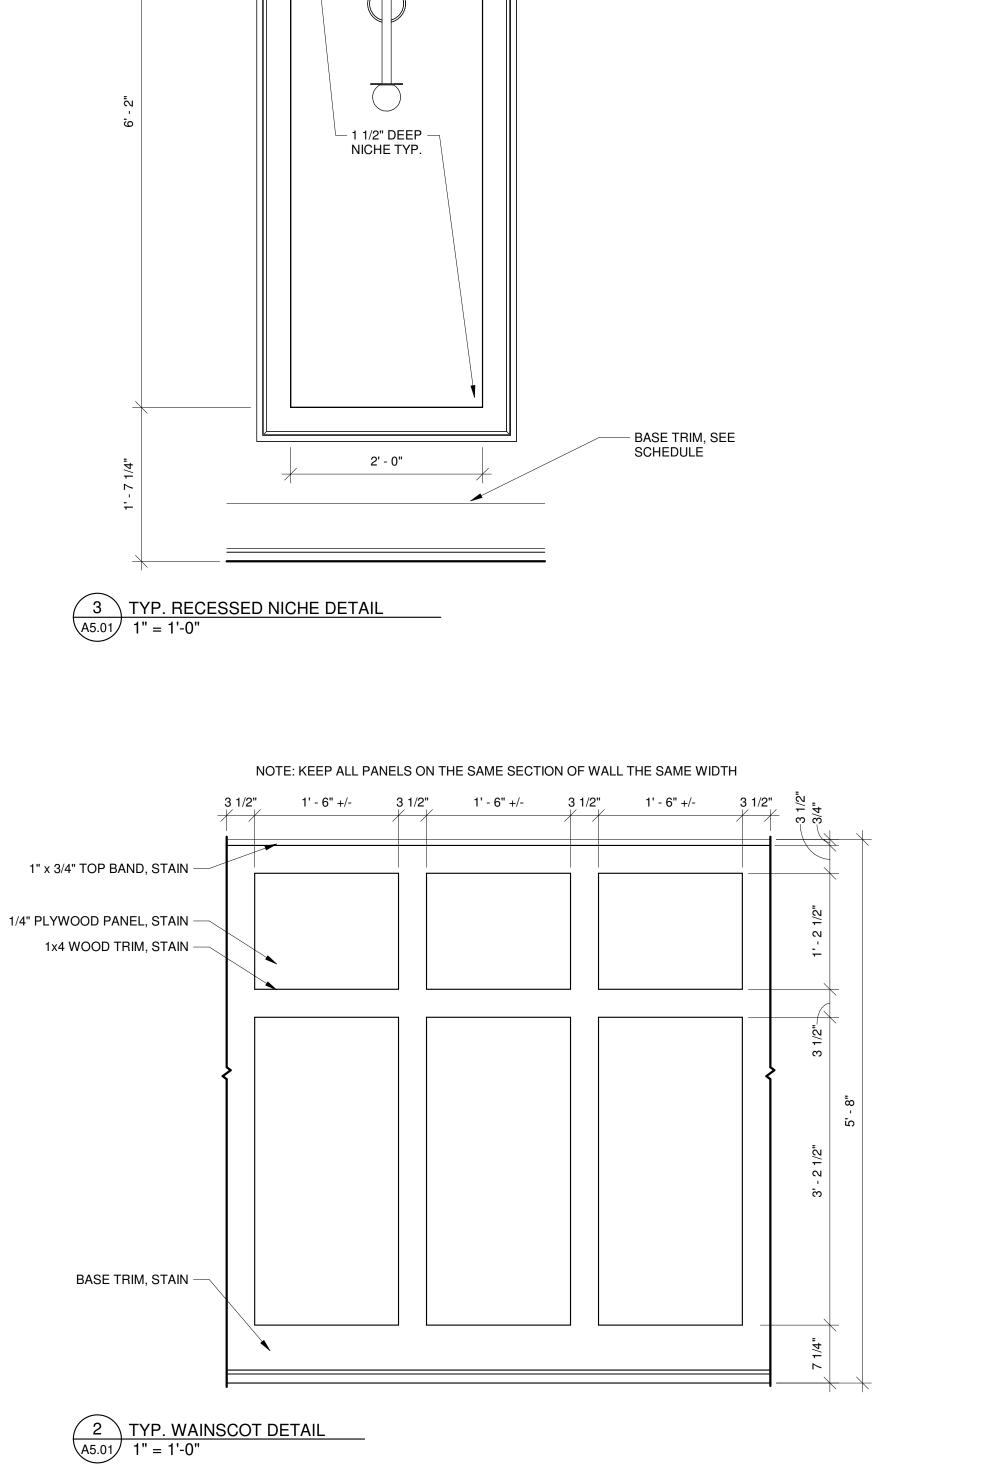


- COFFERED CEILING,

- CEILING MOUNTED LIGHT FIXTURE, SEE ELECTRICAL

- WALL FINISH, SEE SCHEDULE

SEE DETAIL

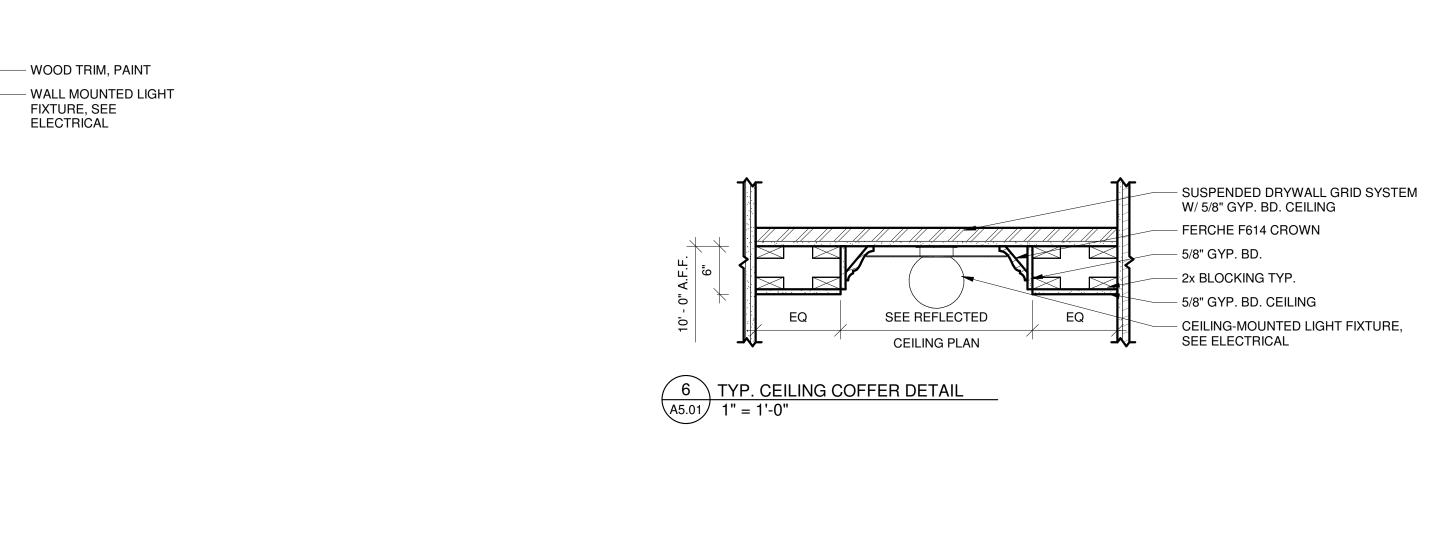


2' - 0"

1' - 7"

5 TYP. RAMP/LOCKER BENCH DETAIL A5.01 1" = 1'-0"

4 QUEEN 4 BENCH DETAIL A5.01 1" = 1'-0"

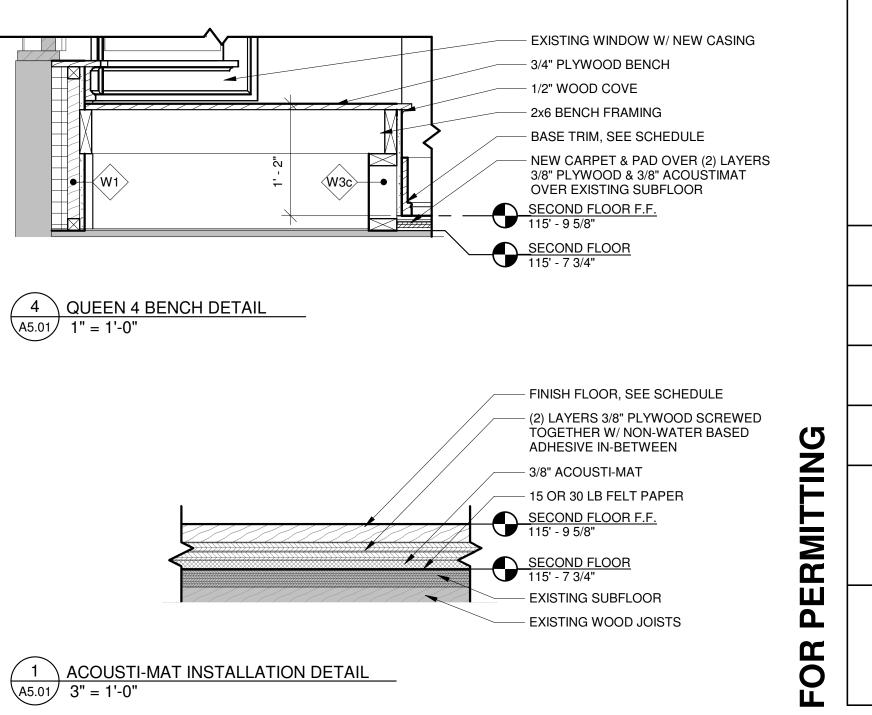

- 3/4" PLYWOOD BENCH

- 2x6 BENCH FRAMING

- 2x4 WOOD STUDS @ 16" O.C.

- BASE TRIM, SEE SCHEDULE FINISH FLOOR, SEE SCHEDULE

— 1/2" WOOD COVE

– 5/8" GYP. BD.

(5	
Ž	
$\geq$	
<u> </u>	
Ш	
~	


CHECKED BY J. LEHRKE  DATE  07/18/2025	
SHEET TITLE DETAILS	
SHEET NUMBER  A5.01	10/202E 2:4E:22 DM
<b>A0101</b>	_


COMMERCIAL REMODEL FOR:
AMERICAN ORTHODONTICS
632 N 8TH STREET UNIT 2
SHEBOYGAN, WI 53081

**PROJECT NUMBER** 24.091

> **DRAWN BY** Z. WENDT

Item 10.

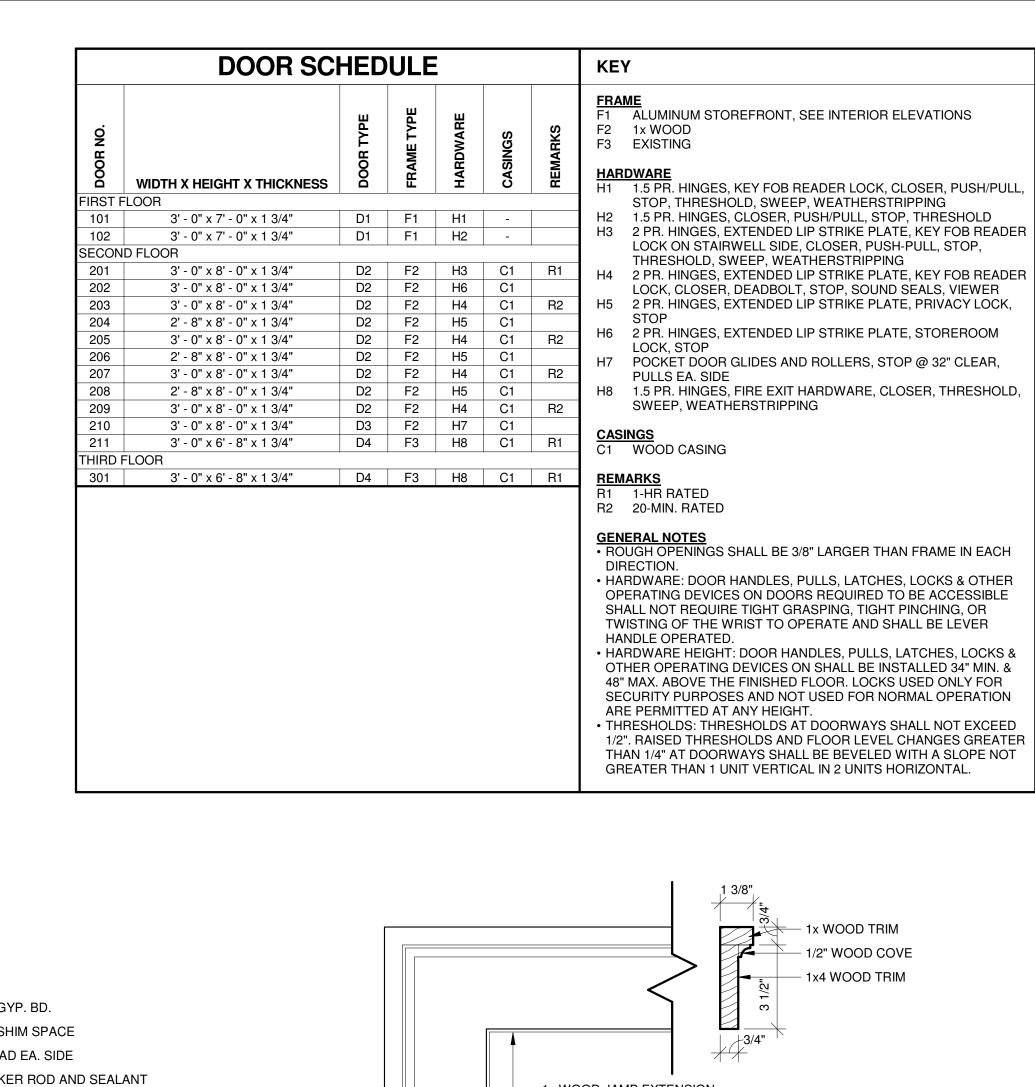

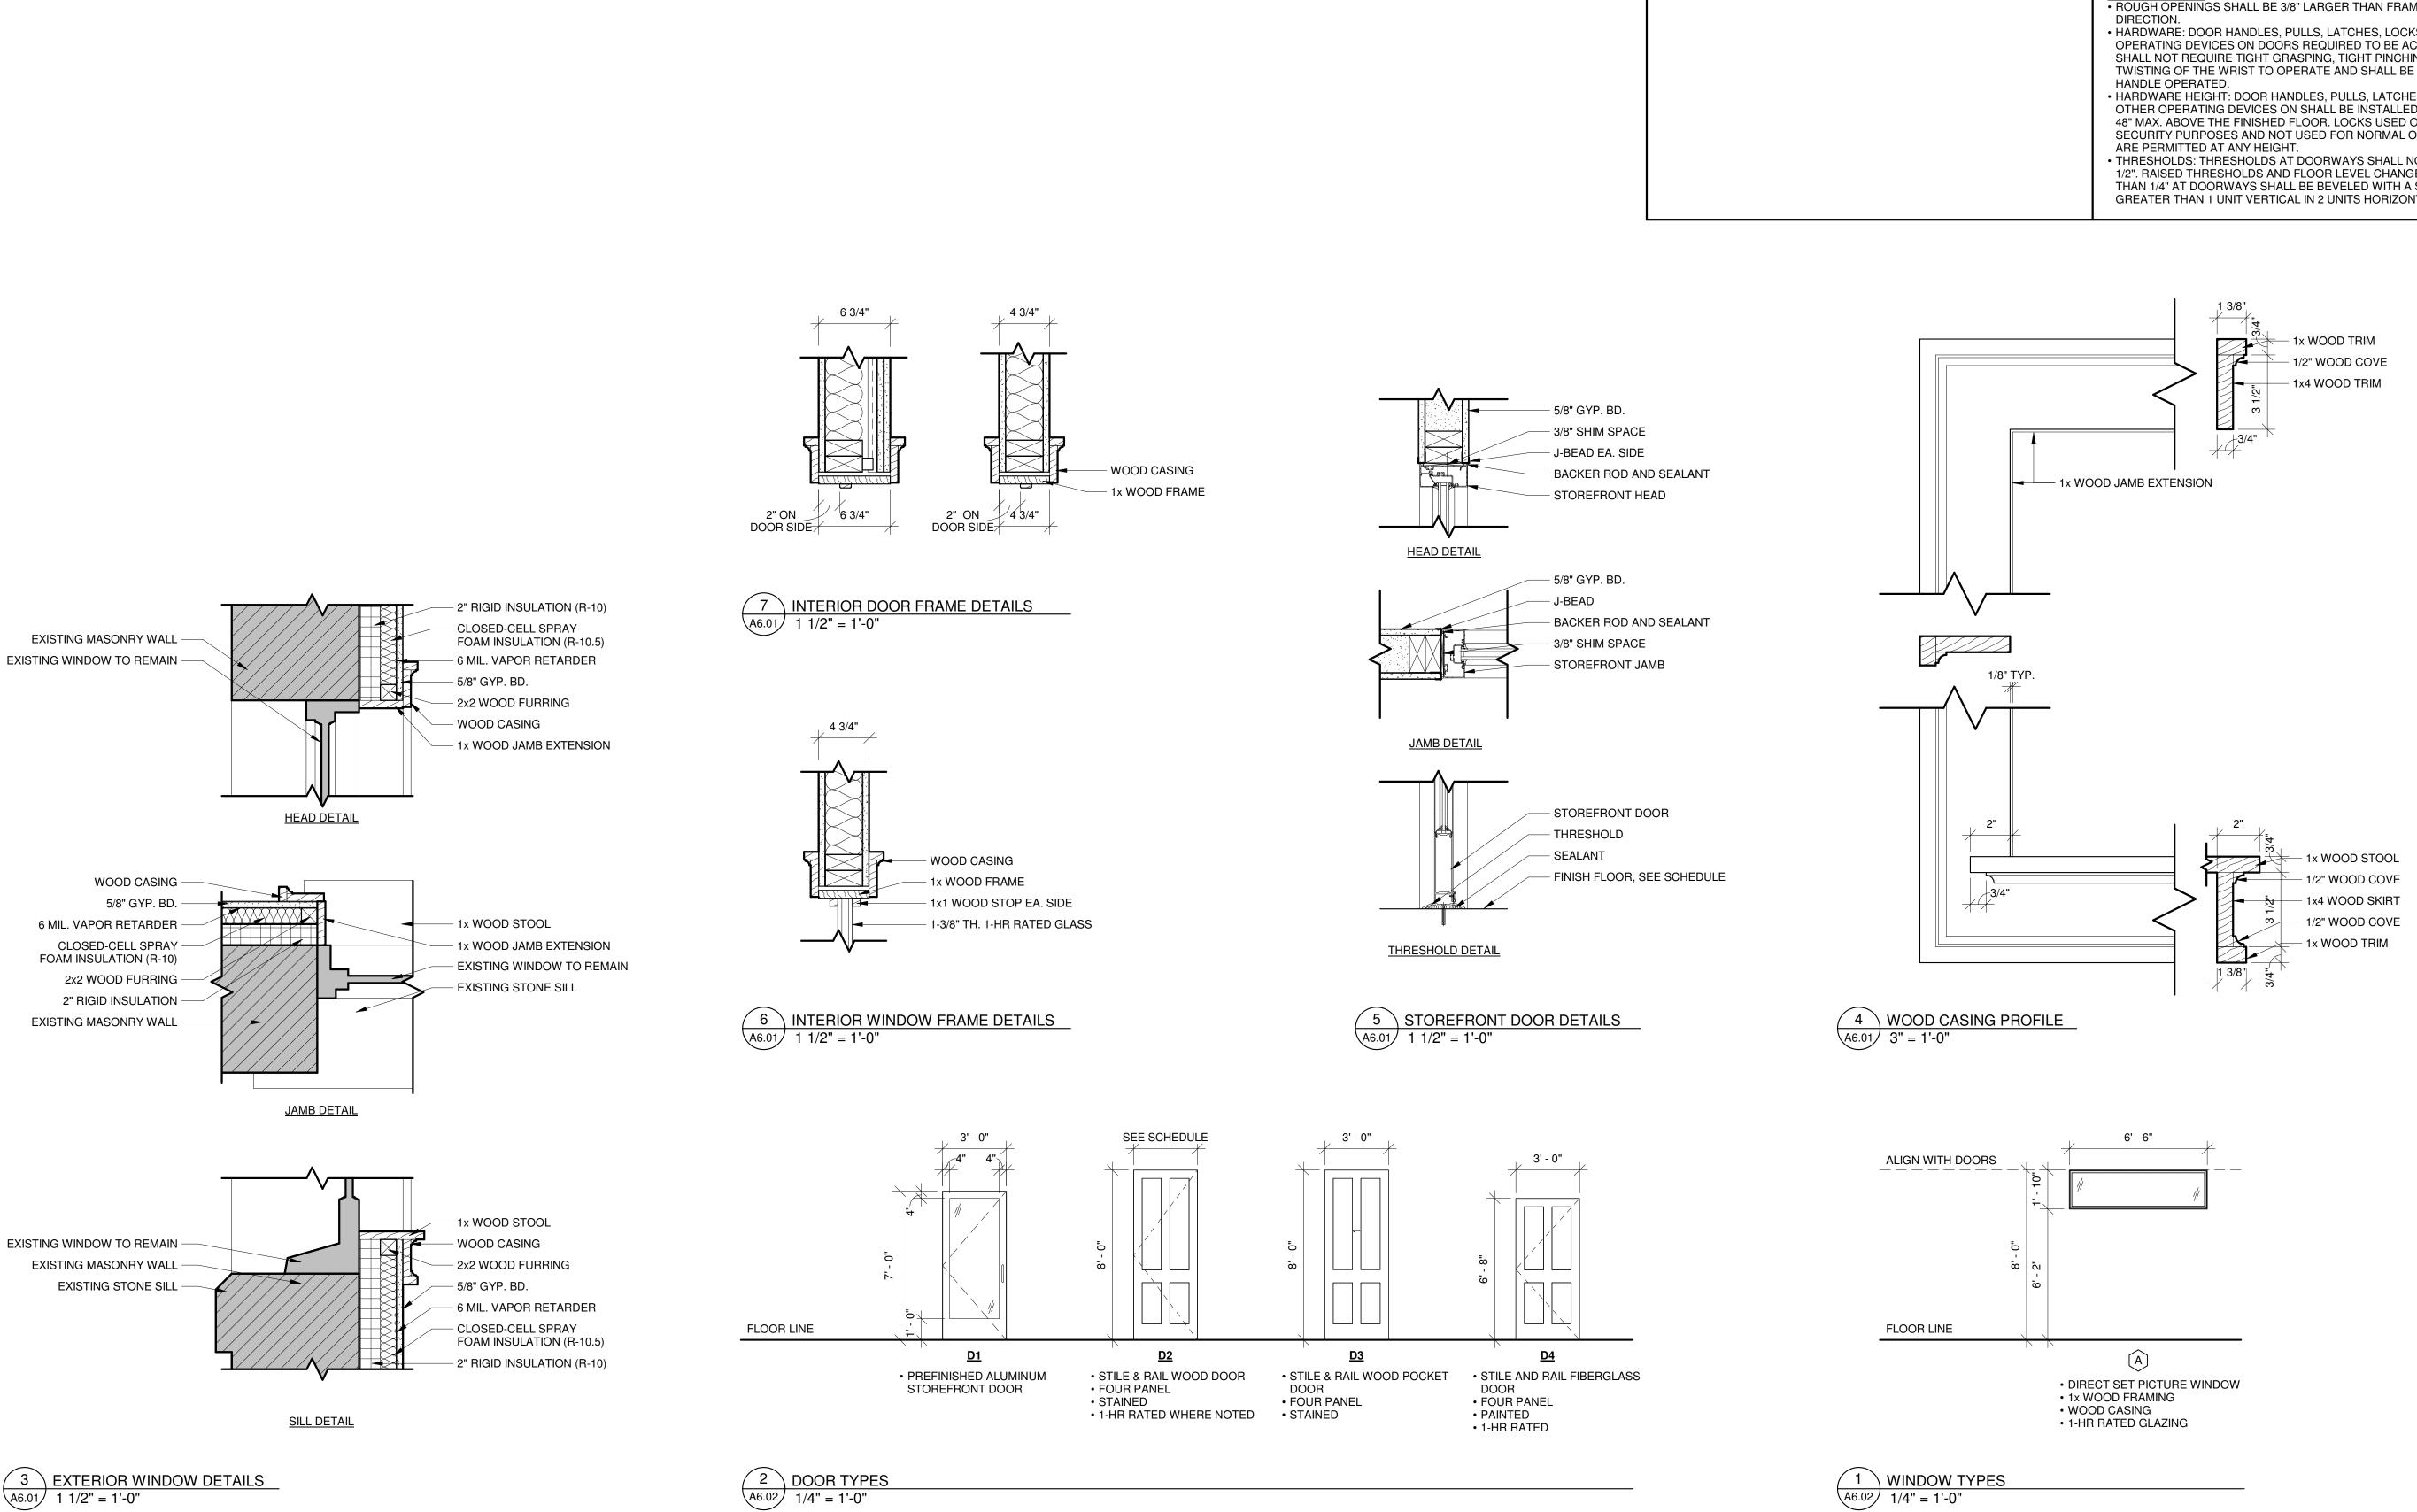

**PERMITTING** FOR

**SHEET NUMBER** 

COMMERCIAL REMODEL FOR AMERICAN ORTHODONTICS
632 N 8TH STREET UNIT 2
SHEBOYGAN, WI 53081

PROJECT NUMBER

24.091

**DRAWN BY** 

Z. WENDT

**CHECKED BY** 

J. LEHRKE

DATE

07/18/2025

SHEET TITLE

DOOR AND WINDOW


SCHEDULE & DETAILS


Item 10.

3 EXTERIOR WINDOW DETAILS
A6.01 1 1/2" = 1'-0"


MATERIAL SELECTIONS						
ENGINEERED HARDWOOD FLOOR DUCHATEAU, STRATA COLLECTION, FLINT	VINYL WALLCOVERING 1 JF FABRICS, ANTIQUITY COLLECTION, 5252, 99W7631					
CERAMIC TILE 1 THE TILE SHOP, HEX PORCELAIN WALL AND FLOOR TILE - 10 IN., BLACK, #680185	VINYL WALLCOVERING 2 JF FABRICS, ANTIQUITY COLLECTION, 5253, 65W7631					
& THE TILE SHOP, HEX PORCELAIN WALL AND FLOOR TILE - 10 IN., WHITE, #680184	VINYL WALLCOVERING 3 JF FABRICS, ANTIQUITY COLLECTION, 5253, 67W7631					
W/ ESPRESSO POLYMER GROUT  CERAMIC TILE 2	VINYL WALLCOVERING 4  JF FABRICS, ANTIQUITY COLLECTION, 5252, 67W7631					
THE TILE SHOP, OCTAGON MATTE WHITE W/ BLACK PORCELAIN MOSAIC, #615275 W/ MIDNIGHT BLACK POLYMER GROUT	VINYL WALLCOVERING 5 JF FABRICS, ANTIQUITY COLLECTION, 5252, 98W7631					
CARPET MASLAND, AMERICANA, EMERALD SEA, #9439-787	VINYL WALLCOVERING 6 OSBORNE & LITTLE, BIRD SONG, W6596-01					
PAINT COLOR SHERWIN-WILLIAMS, OYSTER WHITE, SW 7637	QUARTZ COUNTERTOP & SHOWER SURROUND  MSI SURFACES, CALACATTA LAZA, 2 CM, QSL-CALALAZA-2CM					

	F	ROC	)M F	INISH	I SCH	<b>IEDU</b>	LE					KEY
						WALLS			(	CEILING	Ŋ	FLOOR
ROOM NAME	AREA	FLOOR	BASE	ALL	NORTH	EAST	SOUTH	WEST	FINISH	НЕІСНТ	REMARKS	F1 EXISTING F2 ENGINEERED HARDWOOD FLOOR F3 CERAMIC TILE 1 F4 CERAMIC TILE 2
FIRST FLOOR			•	'	ļ.		1					F5 CARPET
ENTRY	162 SF	F1	-	-	W1	W2	W1	W1	C1	13' - 7 1/2"	R1	F6 LVT
RAMP	73 SF	F3	B1	-	W2	W1	W1	W2	C3	8' - 1 3/4"		
LOCKERS	134 SF	F3	B1	-	W1	W1	W2	W2	СЗ	7' - 8"		BASE
ELEVATOR VESTIBULE	35 SF	F3	B1	W1	-	-	-	-	C2	10' - 7 1/4"		B1 BASE PROFILE 1, PAINT B2 COVE TILE
SECOND FLOOR												B3 EXISTING
ELEVATOR VESTIBULE	26 SF	F3	B1	W2	-	-	-	-	C3	10' - 0"		DO EXIOTINO
COMMUNITY AREA	283 SF	F2	-	W2,W3	-	-	-	-	C3	10' - 0"		WALL WALL
STAIRWELL	162 SF	F1	B3	W0	-	=	-	-	C3	11' - 8"		W0 EXISTING
HALLWAY	290 SF	F2	B1	W2	-	-	-	-	C3	9' - 6"		W1 EXISTING, PAINT
MECH'L	48 SF	F6	-	W2	-	-	-	-	C3	11' - 6"		W2 GYP. BD., PAINT W3 WAINSCOT (SEE DETAIL)
QUEEN 1	151 SF	F5	B1	-	W2	W4	W2	W2	C3	11' - 6"		W4 VINYL WALLCOVERING 1
BATH 1	49 SF	F4	B2	-	W2	W2	W2	W8	C3	10' - 0"	R2	W5 VINYL WALLCOVERING 2
QUEEN 2	185 SF	F5	B1	-	W2	W2	W2	W5	C3	11' - 6"		W6 VINYL WALLCOVERING 3
BATH 2	49 SF	F4	B2	-	W2	W8	W2	W2	C3	10' - 0"	R2	W7 VINYL WALLCOVERING 4
QUEEN 3	198 SF	F5	B1	-	W2	W6	W2	W2	C3	11' - 6"		W8 VINYL WALLCOVERING 5 W9 VINYL WALLCOVERING 6
ВАТН 3	48 SF	F4	B2	-	W2	W2	W2	W8	C3	10' - 0"	R2	W9 VINYL WALLOUVERING 6
QUEEN 4 ACCESSIBLE	266 SF	F5	B1	-	W2	W2	W2	W2, W7	C3	11' - 6"		CEILING
BATH 4	93 SF	F4	B2	-	W8	W2	W2	W2	C3	10' - 0"	R2	(SEE REFLECTED CEILING PLANS)
												C1 EXISTING WOOD C2 EXISTING ACT CEILING C3 GYP. BD., PAINT  REMARKS R1 CEILING VAULTED, HEIGHT MEASURED TO PEARS R2 8' H. QUARTZ SHOWER SURROUND

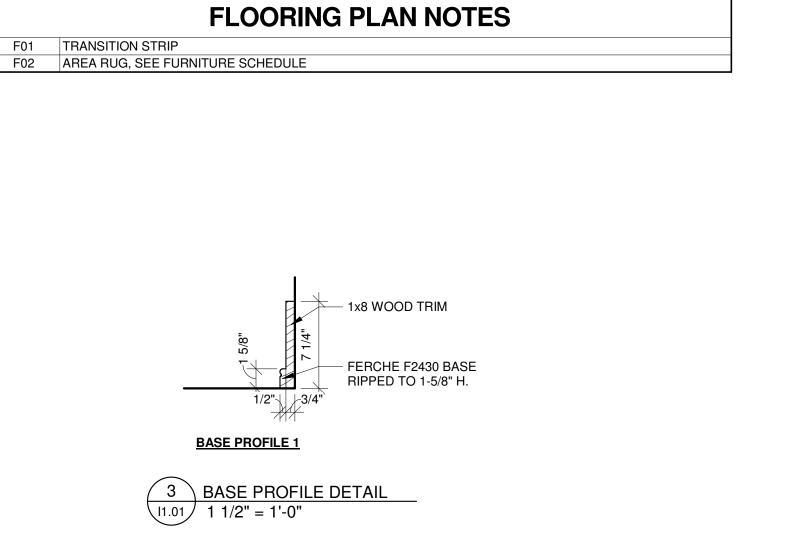

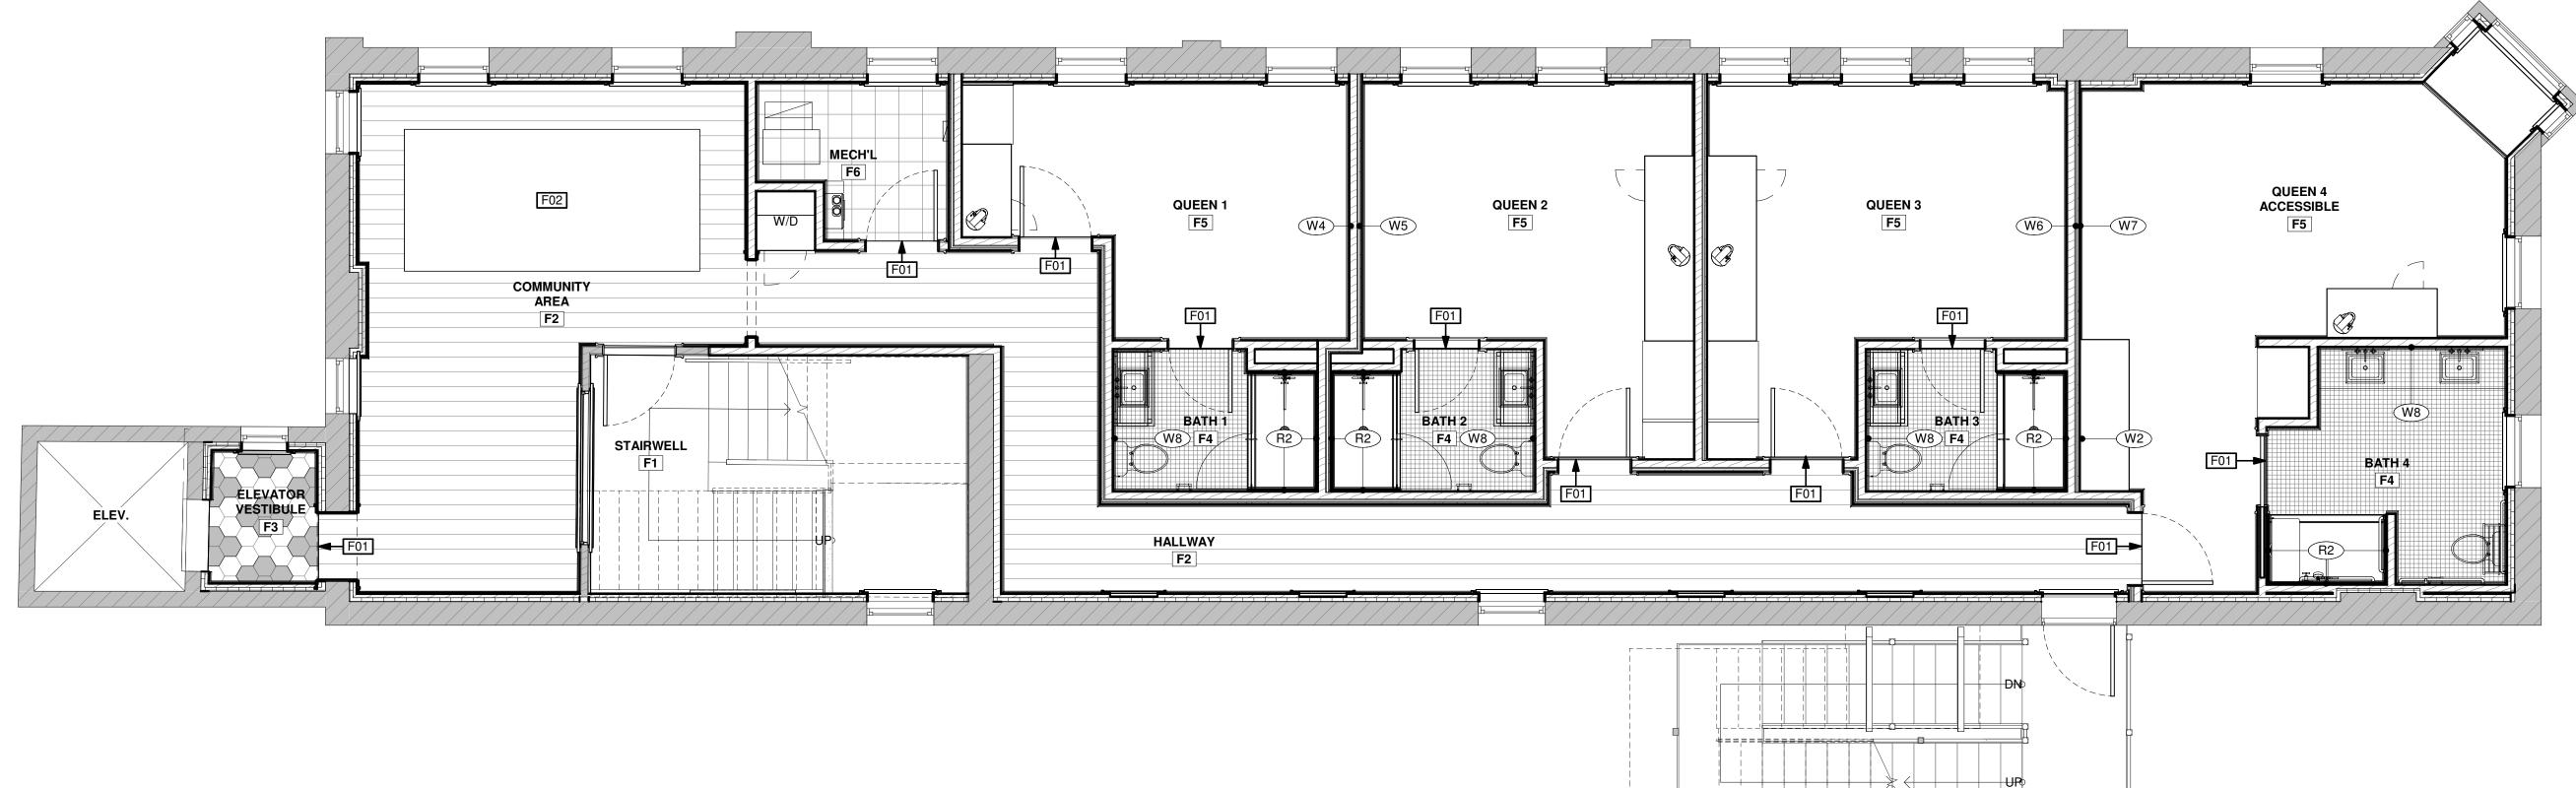



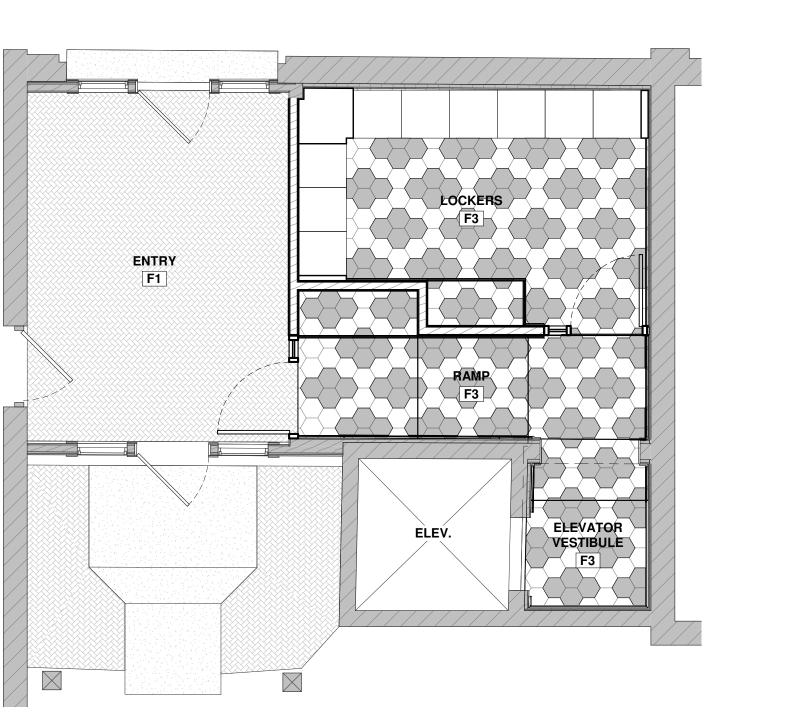

1 FIRST FLOOR FLOORING PLAN
1/4" = 1'-0"

FOR PERMITTING

SHEET NUMBER

COMMERCIAL REMODEL FOR:
AMERICAN ORTHODONTICS
632 N 8TH STREET UNIT 2
SHEBOYGAN, WI 53081

PROJECT NUMBER 24.091

**DRAWN BY**Z. WENDT

J. LEHRKE

DATE

07/18/2025

SHEET TITLE

FLOORING PLANS & ROOM FINISH SCHEDULE

Item 10.

				P	LUMBING FIXTURE SCH	HEDIII E			
KEY	ТҮРЕ	ITEM QTY.	MFGR.	MAKE	MODEL	PRODUCT#	FINISH	SIZE	NOTES
P01	TOILET	4	KOHLER	KATHRYN	ONE-PIECE COMPACT ELONGATED TOILET	K-3940-0	WHITE		
P02	TP HOLDER	4	KOHLER	PURIST	PIVOTING TOILET TISSUE HOLDER	K-14377-2MB	VIBRANT BRUSHED MODERNE BRASS		
P03	HOTELIER	4	KOHLER	PURIST	HOTELIER	K-14381-2MB	VIBRANT BRUSHED MODERNE BRASS		
P04	SINK	5	KOHLER	KATHRYN	UNDER-MOUNT BATHROOM SINK	K-2330-G-0	WHITE	19 3/4" X 15 5/8"	
P05	FAUCET	5	KOHLER	PURIST	SINK FAUCET WITH CROSS HANDLES	K-14406-3-2MB	VIBRANT BRUSHED MODERNE BRASS		
P06	MIRROR	5	KOHLER	ESSENTIAL	RECTANGLE MIRROR	K-31364-BGL	MODERNE BRUSHED GOLD	24" X 36"	
P07	TOWEL RING	5	KOHLER	PURIST	TOWEL RING	K-14441-2MB	VIBRANT BRUSHED MODERNE BRASS		
P08	SHOWER HEAD	4	KOHLER	PURIST	SINGLE FUNCTION SHOWERHEAD	K-965-AK	VIBRANT BRUSHED MODERNE BRASS		
P09	SHOWER COLUMN	4	KOHLER	HYDRORAIL	R ARCH SHOWER COLUMN	K-45211-2MB	VIBRANT BRUSHED MODERNE BRASS		
P10	HANDSHOWER	4	KOHLER	PURIST	FOUR-FUNCTION HANDSHOWER	K-22166-G-2MB	VIBRANT BRUSHED MODERNE BRASS		
P11	SHOWER HOSE	4	KOHLER	MASTERSHOWER	METAL SHOWER HOSE	K-9514-2MB	VIBRANT BRUSHED MODERNE BRASS	60"	
P12	VALVE TRIM	4	KOHLER	PURIST	VALVE TRIM WITH CROSS HANDLE	K-TS14423-3-2MB	VIBRANT BRUSHED MODERNE BRASS		
P13	HANDSHOWER HOLDER (ADA)	1	KOHLER	AWAKEN	ADJUSTABLE WALL HOLDER	K-98348-2MB	VIBRANT BRUSHED MODERNE BRASS		
P14	SHOWER ROD	1	KOHLER	ELATE	STRAIGHT SHOWER ROD	K-33810-2MB	VIBRANT BRUSHED MODERNE BRASS		
P15	SHOWER BASE	4	KOHLER	STONERIDGE	CENTER DRAIN ADA	K-44166-HW1	HONED WHITE	62" X 36"	
P16	SHOWER DOOR	3	-	-	-	-	-	78" H.	R1,R2
P17	ROBE HOOK	4	KOHLER	PURIST	ROBE HOOK	K-14443-2MB	VIBRANT BRUSHED MODERNE BRASS		

REMA	RKS
	5) ( 6

R1 BY GENERAL CONTRACTOR
R2 ALL HARDWARE TO MATCH DOOR OR PLUMBING FIXTURE HARDWARE

	FURNITURE & APPLIANCE SCHEDULE								
KEY	ТҮРЕ	QTY.	MANUFACTURER	MODEL	PRODUCT #	FINISH	FABRIC	SIZE	REMARKS
FN01	BED	4	-	-	-	-	-	QUEEN	R1
FN02A	HEADBOARD (QUEEN 1)	1	KNOLL TEXTILES	-	466798003 466931011	-	PLAIDTASTIC DAZZLE UTOPIA ATLANTIC	60" x 72"	R3
FN02B	HEADBOARD (QUEEN 2)	1	KNOLL TEXTILES	-	466798001 466931014	-	PLAIDTASTIC TECHNICOLOR UTOPIA APRICOT	60" x 72"	R3
FN02C	HEADBOARD (QUEEN 3)	1	KNOLL TEXTILES	-	466798005 466931010	-	PLAIDTASTIC CHILL UTOPIA WATER	60" x 72"	R3
FN02D	HEADBOARD (QUEEN 4)	1	KNOLL TEXTILES	-	466798002 466931009	-	PLAIDTASTIC SNAZZY UTOPIA SEASIDE	60" x 72"	R3
FN03	NIGHTSTAND	7	-	-	-	-	-	-	R1
FN04	SIDE CHAIR (BEDROOMS)	5	-	-	-	-	-	-	R1
FN05	SIDE TABLE	5	-	-	-	-	-	-	R1
FN06	DESK CHAIR	4	-	-	-	-	-	-	R1
FN07	MIRROR (BEDROOMS)	4	CB2	CLOONEY ANTIQUED RECTANGULAR WALL MIRROR	217262	BLACK IRON	-	36" x 48"	R2
FN08A	UC REFRIGERATOR (LH)	3	INNOVATIVE	40 LITER FRAMELESS GLASS DOOR	INN402CGDF	BLACK	-	22" H. x 15.9" W	-
FN08B	UC REFRIGERATOR (RH)	1	INNOVATIVE	40 LITER FRAMELESS GLASS DOOR	INN402CGDF	BLACK	-	22" H. x 15.9" W	-
FN09	MICROWAVE	4	-	-	-	-	-	24" W.	R1
FN10	COFFEE STATION	4	-	-	-	-	-	-	R1
FN11	ROBE HOOK	4	MOEN	ALIGN DOUBLE ROBE HOOK	YB0402BL	MATTE BLACK	-	-	-
FN12A	TV (55")	3	-	-	-	-	-	-	R1
FN12B	TV (43")	1	-	-	-	-	-	-	R1
FN13	OTTOMAN	1	-	-	-	-	-	20" DIA., 18" H.	R1
FN14	ALL-IN-ONE W/D	1	GE	24" WASHER/DRYER COMBO	GFQ14ESSNWW	WHITE	-	24" W.	R4
FN15	SOFA	1	-	-	-	-	-	-	R1
FN16	SIDE CHAIR (COMM. AREA)	3	-	-	-	-	-	-	R1
FN17	COFFEE TABLE (COMM. AREA)	1	-	-	-	-	-	24" x 48"	R1
FN18	END TABLE	2	-	-	-	-	-	-	R1
FN19	CONSOLE TABLE	1	-	-	-	-	-	-	R1
FN20	AREA RUG	1	-	-	-	-	-	150" x 72"	R1

REMARKS
R1 SELECTED BY OWNER R2 MOUNTED 48" A.F.F. TO BOTTOM

R3 BOTTOM FABRIC TO 18" ABOVE T.O. MATTRESS, UPPER FABRIC CHANNEL TUFTING TO TOP R4 INSTALL WITH 4" ADA RISER AND DRIP PAN - GAF14OSSNWW

FN03 FN04 FN05 FN03 FN04 FN06 FN04 FN18 FN09 FN12B FN08A FN10 FN08A FN08B FN13 FN04 FN12A FN09 FN10 FN01 FN02A FN01 FN01
FN02D FN16 FN16 FN17 FN14 FN07 FN11 P17 P07 P06 P12 P05 P11 P04 P10 P03 P09 P01 P08 P02 P15 P16 FN20 FN06 FN06 FN05 FN07

**FOR PERMITTING** 

FURNITURE & APPLIANCE PLANS & SCHEDULE

COMMERCIAL REMODEL FOR:
AMERICAN ORTHODONTICS
632 N 8TH STREET UNIT 2
SHEBOYGAN, WI 53081

PROJECT NUMBER 24.091

> **DRAWN BY** Z. WENDT

CHECKED BY J. LEHRKE

DATE

07/18/2025

SHEET TITLE


Item 10.


SHEET NUMBER


1 SECOND FLOOR FURNITURE PLAN
1/4" = 1'-0"

GENERAL ELECTRICAL NOTES

• ELECTRICAL PLANS SHOULD BE CONSIDERED CONCEPTUAL IN NATURE. FINAL DESIGN SHALL BE THE RESPONSIBILITY OF THE ELECTRICAL DESIGN-BUILD SUBCONTRACTOR.

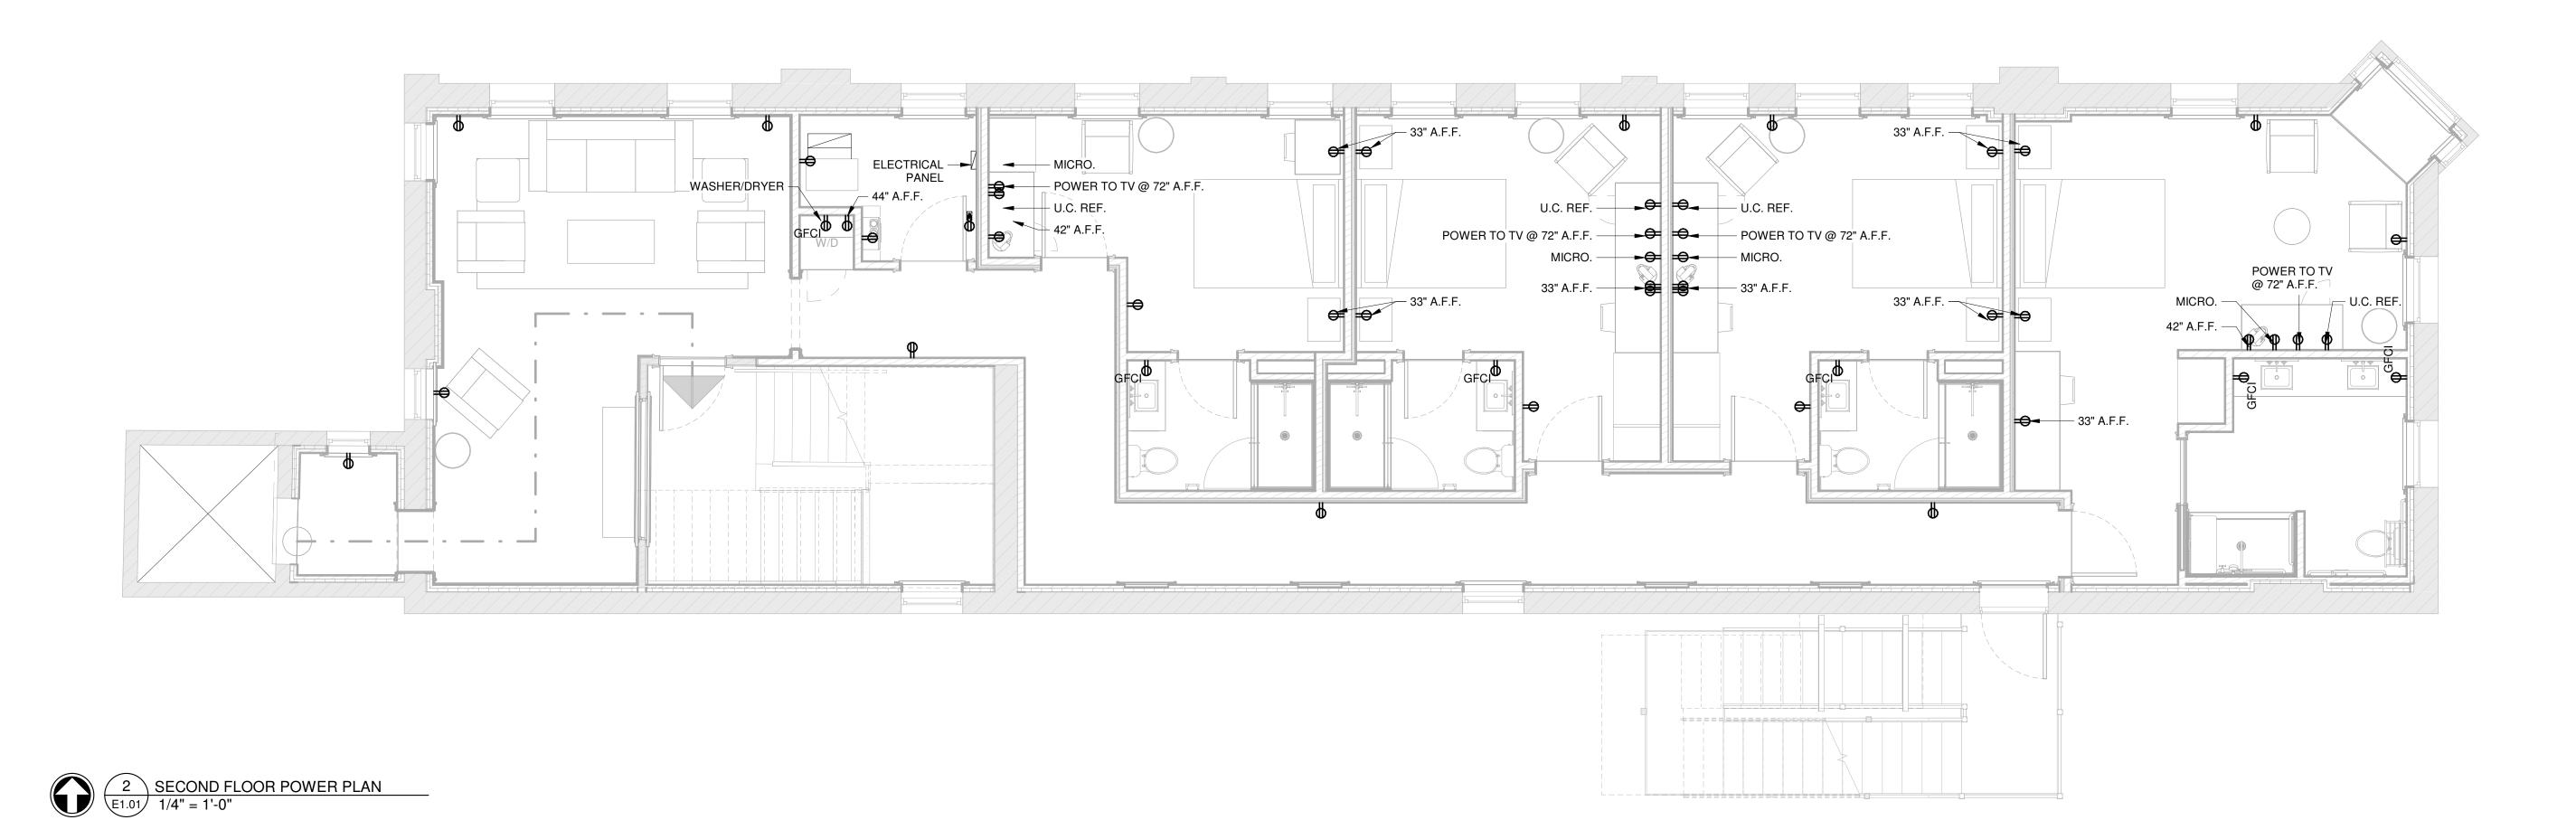

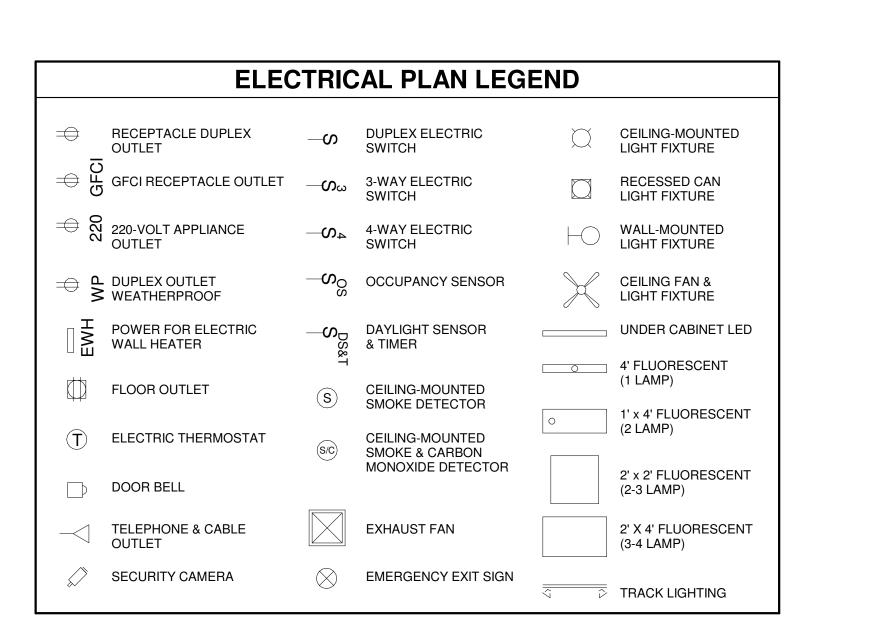

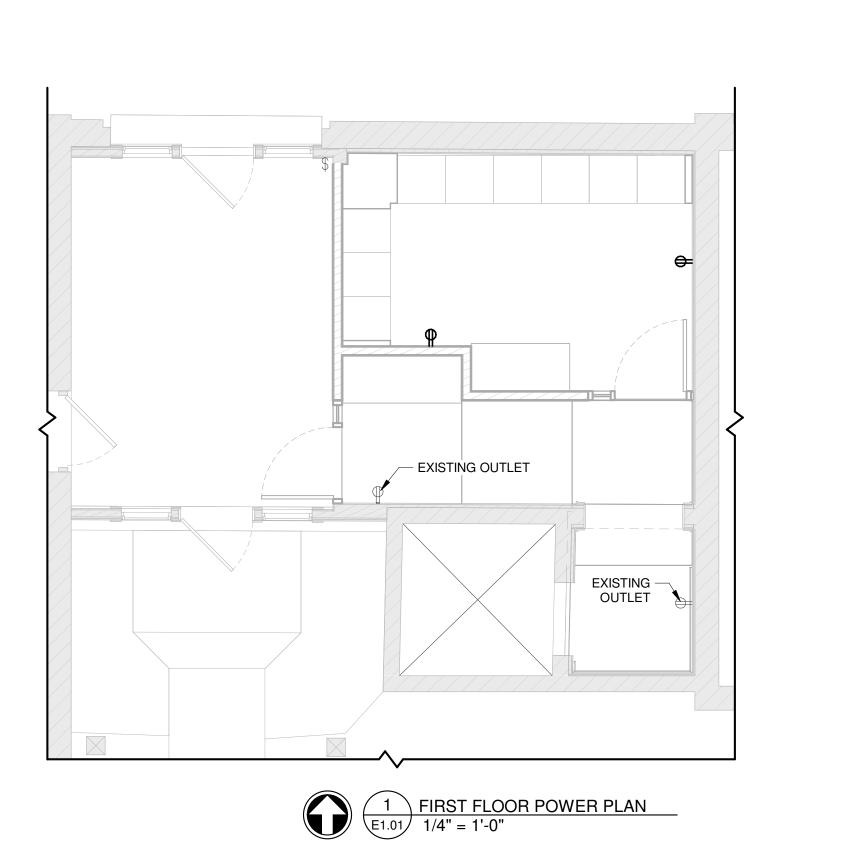

FOR PERMITTING

SHEET TITLE
POWER PLANS

SHEET NUMBER

E 1.01

COMMERCIAL REMODEL FOR:
AMERICAN ORTHODONTICS
632 N 8TH STREET UNIT 2
SHEBOYGAN, WI 53081

PROJECT NUMBER

24.091

**DRAWN BY** 

Z. WENDT

**CHECKED BY** 


J. LEHRKE


DATE


	LIGHTING FIXTURE SCHEDULE										
KEY	ТҮРЕ	QTY.	MANUFACTURER	MODEL	PRODUCT #	FINISH	BULBS PER FIXT.	WATT.	BASE	MOUNTING HEIGHT	REMARKS
1	RECESSED CAN	29	-	-	-	WHITE	0	10	-	VARIES	-
2	PENDANT	2	VISUAL COMFORT & CO.	PRECISION LARGE PENDANT	KW 5223AB-WG	ANTIQUE-BURNISHED BRASS	1	60	E26	VARIES	-
3	ENTRY SCONCE	2	VISUAL COMFORT & CO.	MCCARREN SINGLE SCONCE	RL 2551NB-WG	NATURAL BRASS	1	60	E26	7'-0"	-
1	HALLWAY LIGHT	11	VISUAL COMFORT & CO.	NODES LARGE FLUSH MOUNT	KF1021BBS	BURNISHED BRASS	1	3	G9 T4	10-0"	-
5	NICHE SCONCE	4	VISUAL COMFORT & CO.	NODES DOUBLE SCONCE	KWL1012BBS	BURNISHED BRASS	2	6	G9 T4	5'-10"	-
3	BEDROOM SCONCE	7	VISUAL COMFORT & CO.	NODES LARGE PIVOT SCONCE	KW1031BBS	BURNISHED BRASS	1	3	G9 T4	3'-6"	-
7	VANITY SCONCE	5	VISUAL COMFORT & CO.	BISTRO DOUBLE LIGHT CURVED SCONCE	S 2026HAB/BLK-WG	HAND-RUBBED ANTIQUE BRASS AND BLACK	2	80	E12	7'-0"	-
3	EXHAUST FAN & LIGHT	4	-	-	-	-	-	-	-	10'-0"	R1, R2
9	CEILING FAN	4	VISUAL COMFORT & CO.	MAVERICK 52" CEILING FAN	3MAVR52RZW	MATTE WHITE/MATTE WHITE	-	-	-	11'-6"	-
KEY											
REMARKS R1 SELECTED BY OWNER											

**GENERAL LIGHTING NOTES** 

LIGHTING PLANS SHOULD BE CONSIDERED CONCEPTUAL IN NATURE. FINAL DESIGN SHALL BE THE RESPONSIBILITY OF THE ELECTRICAL DESIGN-BUILD SUBCONTRACTOR.
 CEILING-MOUNTED LIGHT FIXTURES SHALL BE CENTERED IN ROOMS OR SPACES U.O.N.

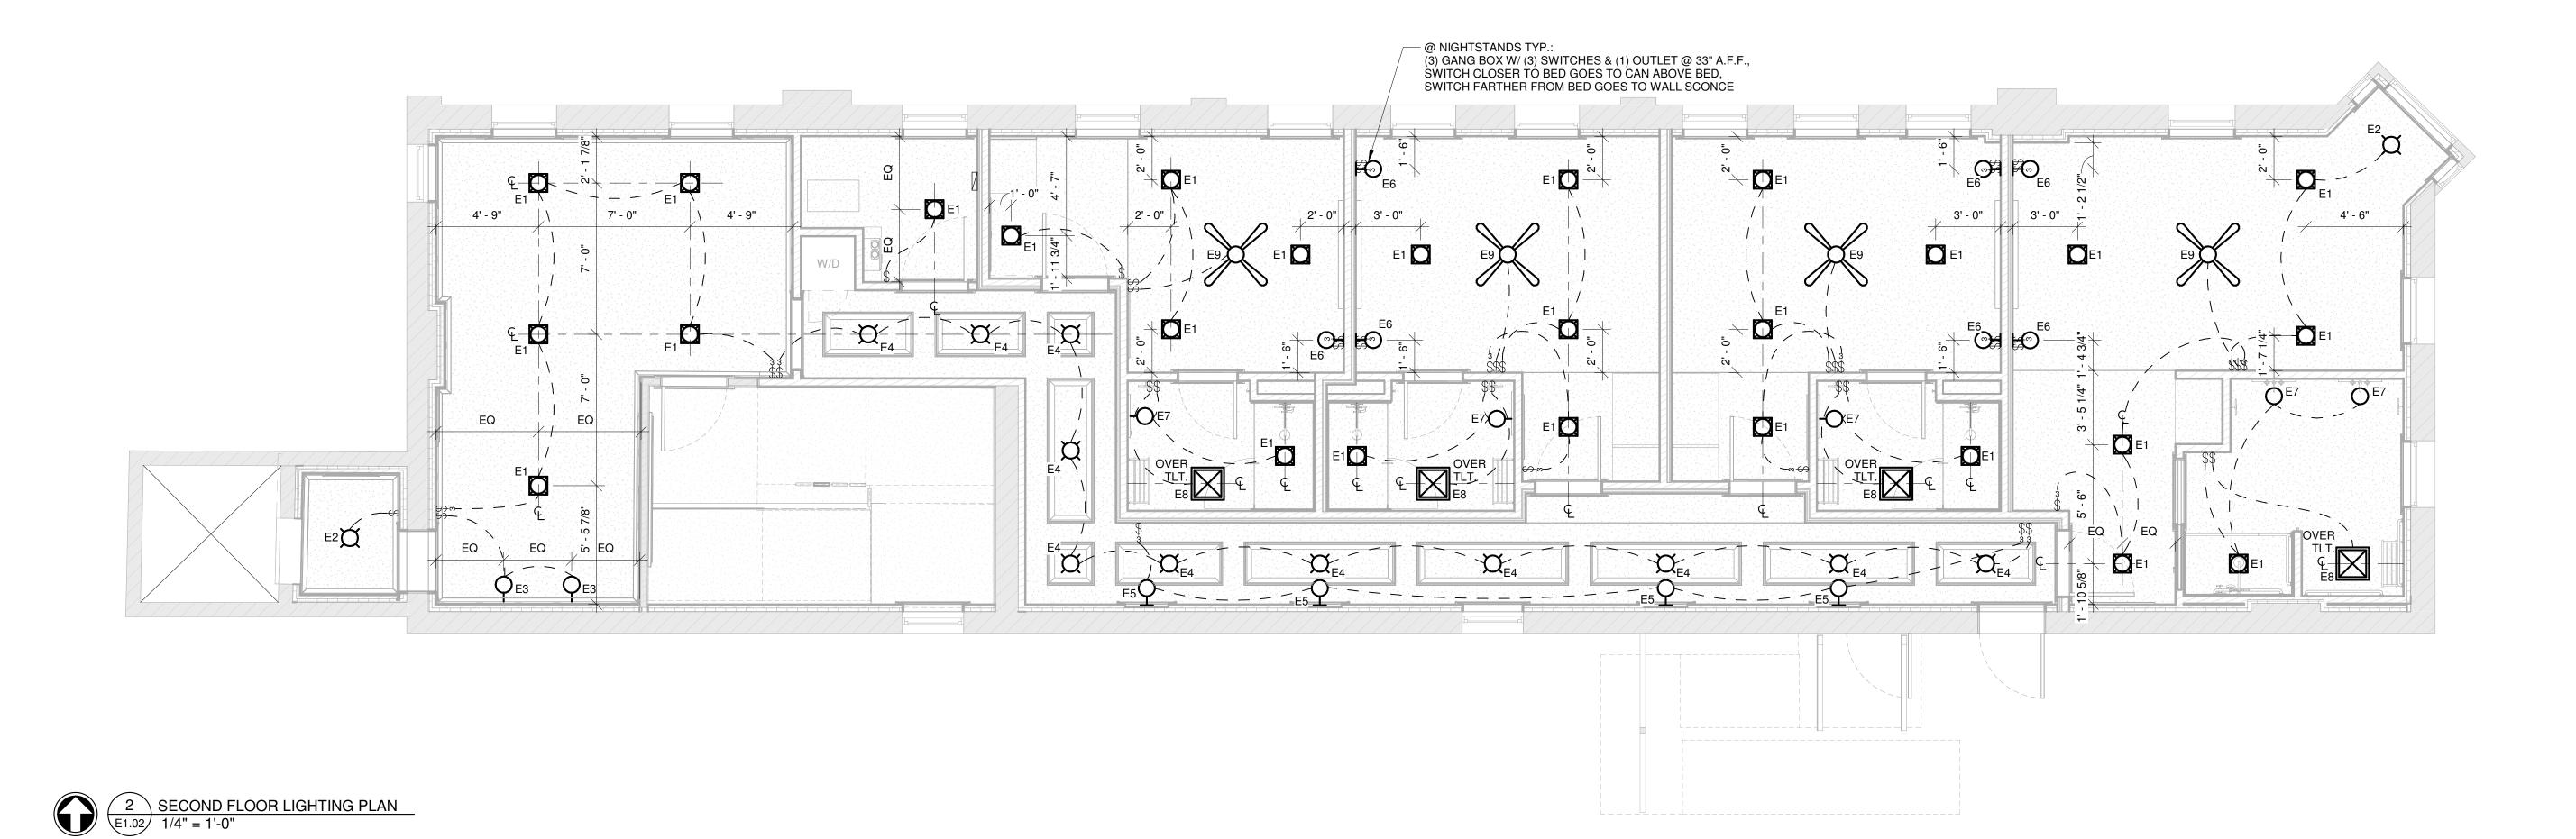

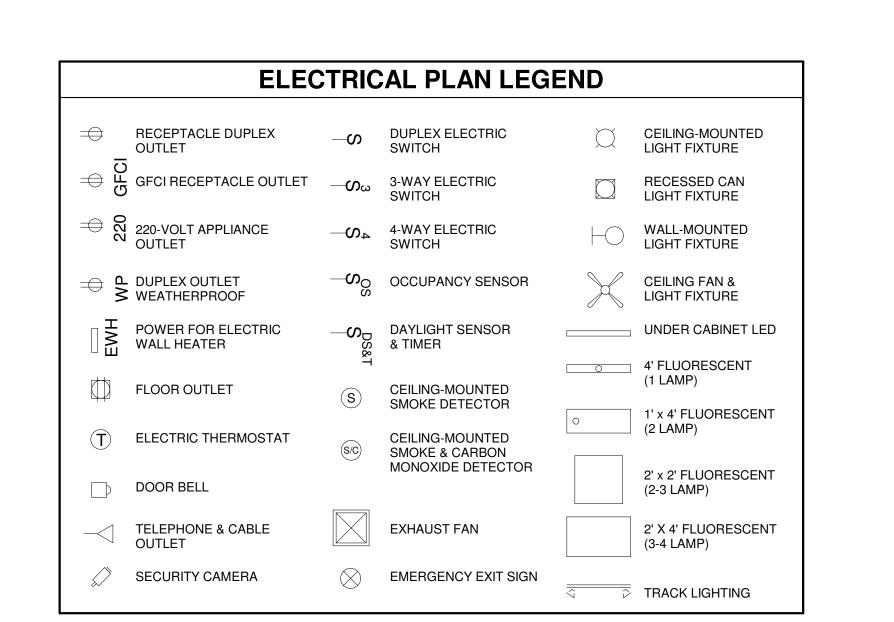

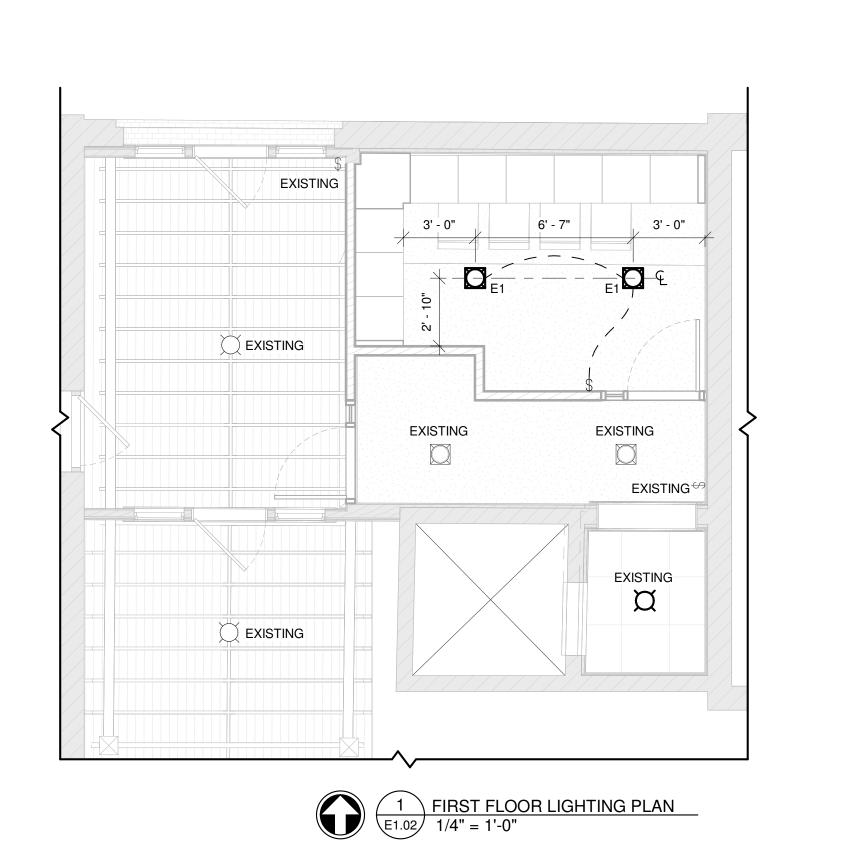

SHEET NUMBER

COMMERCIAL REMODEL FOR:
AMERICAN ORTHODONTICS
632 N 8TH STREET UNIT 2
SHEBOYGAN, WI 53081

PROJECT NUMBER 24.091

**DRAWN BY** 

Z. WENDT

**CHECKED BY** 

J. LEHRKE

DATE

07/18/2025

SHEET TITLE

LIGHTING PLANS

**FOR PERMITTING** 



## CITY OF SHEBOYGAN

## REQUEST FOR CITY PLAN COMMISSION CONSIDERATION

**ITEM DESCRIPTION:** Application for Conditional Use with exceptions by NORR, LLC to construct Crash Champions located at parcel # 59281431139. UC Zone.

**REPORT PREPARED BY:** Ellise Rose, Zoning Administrator

**REPORT DATE:** September 3, 2025 **MEETING DATE:** September 9, 2025

FISCAL SUMMARY: STATUTORY REFERENCE:

Budget Line Item: N/A Wisconsin N/A

Budget Summary: N/A Statutes:

Budgeted Expenditure: N/A Municipal Code: N/A

Budgeted Revenue: N/A

## **BACKGROUND / ANALYSIS:**

NORR, LLC is proposing to construct Crash Champions located at parcel # 59281431139. The applicant states the following:

- The existing parcel is a vacant lot.
- The project includes the construction of a new 15,000-square-foot Crash Champions facility on a previously undeveloped 2.95 -acre site. The building will feature a customer waiting area, offices, meeting rooms, and support spaces, with the majority of the facility dedicated to the repair shop.
- Customer parking will be located near the western entrance of the lot, adjacent to the front façade.
- The eastern portion of the site will be used as a vehicle staging area, enclosed by a privacy fence.
- Crash Champions is a national automotive collision repair company that provides comprehensive auto body repair services. The company primarily serves individuals and insurance partners by restoring vehicles after accidents, offering services such as: Collision repair, Dent and scratch removal, Paint refinishing, Frame straightening, Auto glass replacement, and Insurance claims assistance.
- The facility is proposed to be open from 8:00am to 5:00pm, Monday Friday and 9:00am - 12:00pm on Saturday.
- The facility with be staffed with 20 employees with a typical 15-20 customers per day.
- The project involves the construction of a new 15,000-square-foot Crash Champions facility. The building's front façade faces south and features a prominent raised entry clad in Alucobond composite metal panels. The remainder of the front façade is finished with face brick in a running bond pattern, using a black ironspot velour-textured brick for

1

45

Item 11.

added visual interest. A canopy extends over the main entrance to provide weather protection. The side and rear façades are finished with gray-painted ribbed metal panels.

- The site will include a total of 74 parking stalls, consisting of 22 customer spaces located near the front entrance and 52 vehicle staging spaces enclosed within a privacy fence at the NORR, LLC rear.
- Customer access is provided via a primary entrance off South Business Drive.
- Dumpsters will be housed within the fenced staging area to maintain a clean site appearance on the east side of the site.
- An accessible sidewalk will connect the customer parking area to the main entrance.
- Stormwater management will be handled through the use of an off-site regional retention pond located to the west of the property.
- The site layout includes clearly defined entry and exit points, facilitating smooth traffic flow for both customers and service vehicles. Internal circulation is designed to minimize congestion, with 22 customer parking spaces located near the front entrance for convenient access. At the rear of the site, a dedicated and privacy-fenced staging area accommodates up to 52 vehicles awaiting repair, ensuring efficient operations while maintaining a clean and organized appearance from the public view.
- A monument sign is being proposed near the front site entrance and a building mounted wall sign will be provided above the customer building entrance.
- The project is proposed to start in early January 2026 and completed by June 2026 with an estimated budget of \$6,500,000.
- A privacy screen fence will be installed to block public views of the staged, damaged vehicles. Photometrics study to be provided to ensure light pollution standards are met.

## **STAFF COMMENTS:**

The applicant shows conceptual signage but has not submitted a specific sign package for the site at this time. Applicant shall work with staff with regards to constructing a well-designed sign package for the site that utilizes colors and materials similar to the building. Staff may bring the proposed signage design back to the Plan Commission if there any concerns.

Applicant is requesting following exceptions:

Minimum paved surface setback: 5 feet – Applicant is requesting a 0 foot setback

Applicant is requesting a zero foot paved surface setback along the west side of the site in order to create a shared access with the rest of the development. This variance is required in order to create the new shared access driveway that customers from all facilities will use to enter and exit from these properties. The shared access reduces the number of potential traffic conflicts on S. Business Dr.

 Requesting a variance from the locational and bufferyard landscaping requirements -Applicant shall meet the four (4) locational landscaping requirements.

## **ACTION REQUESTED:**

Staff recommends approval of the conditional use permit and exceptions subject to the following conditions:

1. Prior to operation/occupancy, the applicant shall obtain all licenses and occupancy permits as well as meet all required codes including but not limited to building, plumbing,

Item 11.

electrical, HVAC, fire, health, state, federal, etc. An occupancy permit will be granted at such time as the applicant has met all requirements.

- 2. Applicant shall obtain all necessary permits for the construction, the storage and the handling of hazardous chemicals and/or fuels (applicant shall be in contact with building inspection, fire department, etc.).
- 3. The facility will meet all zoning requirements including but not limited to noise, smells, vibration, hazardous materials, etc. If any issues arise, this matter may be brought back to the Plan Commission for review.
- 4. If using dumpsters, dumpster(s) shall be screened/enclosed and constructed of like materials and colors of the facility. If using chain link fencing, the applicant shall install Privacy Decorative Slatting (PDS) material in order to effectively screen and enclose the dumpster.
- 5. The applicant may store outdoors vehicles waiting to be serviced in the screened and enclosed outdoor storage area (vehicles only) and this vehicular outdoor storage area shall be properly maintained in an orderly fashion at all times. If any issues arise concerning outdoor storage, this matter may be brought back to the Plan Commission for review.
- 6. All other outdoor storage of materials, products or equipment shall be prohibited.
- 7. Any fencing/retaining wall shall be installed per Section 105-945 of the City of Sheboygan Zoning Ordinance.
- 8. All new lighting shall be installed per Section 105-932 of the City of Sheboygan Zoning Ordinance. There shall be no spillover light onto adjacent properties or the streets.
- 9. Applicant shall obtain the necessary sign permits prior to installation. Applicant shall work with staff with regards to constructing a well-designed signage for the site that utilizes colors and materials similar to the building. Staff may bring the proposed signage design back to the Plan Commission for review/approval.
- 10. Applicant is responsible for working with all private and public utilities in order to adequately service this development proposal (applicant will need to provide the necessary easements and/or relocate utilities as necessary).
- 11. Any work within City of Sheboygan Public rights-of-way shall be discussed with the City Engineering Department and constructed to standard City specifications (including, but not limited to, new and old ingress/egress driveway openings, curb, gutter, sidewalk, pavement, utilities, street trees, etc.).
- 12. Absolutely no portion of the new building and/or site improvements shall cross the property lines including but not limited to buildings, balconies, decks, foundations, walls, gutters, eaves, roof, parking, fencing/retaining walls, signs, landscaping, etc.
- 13. All vehicles shall be located on the private property and shall not be located on any City streets, public rights-of-way, other private properties, etc. Vehicles may be parked/stored on paved surfaces (not gravel or landscaped areas).
- 14. If there are any amendments to the approved use and/or site plan, the applicant will be required to submit a new conditional use application reflecting those amendments.

## **ATTACHMENTS:**

Conditional Use Permit Application and Attachments

Item	11	
$H \rightarrow H H$	11	



## **CITY OF SHEBOYGAN**

## APPLICATION FOR CONDITIONAL USE

Fee:	\$250.00				
Review Date:					
Zonir	ng:				

Read all instructions before completing. If additional space is needed, attach additional pages.

<b>SECTION 1: Applicant/ Permittee Infor</b>	mation						
Applicant Name (Ind., Org. or Entity)	Authorized Repres	entative	Title				
NORR, LLC	Terri Douglas		Project M	anager			
Mailing Address	City		State				
150 West Jefferson Avenue	Detroit		MI		48226		
Email Address		Phone Number (inc	cl. area cod	de)			
terri,douglas@norr.com		3130324 3105					
SECTION 2: Landowner Information (co	<u>-</u>	s when project site o		fferent th	an applicant)		
Applicant Name (Ind., Org. or Entity)	Contact Person		Title				
St Nicholas Hospital of the Hospital Sisters of the 3rd Order of St Francis			Member				
Mailing Address	City		State		ZIP Code		
3100 Superior Ave	Sheboygan	T	WI		53081		
Email Address		Phone Number (inc 414-840-6667	cl. area cod	de)			
SECTION 3: Project or Site Location							
Project Address/Description							
S. Business Drive and Washington Avenue	(South 3107 S. Busine	ess Drive)					
<b>SECTION 4: Proposed Conditional Use</b>							
Name of Proposed/Existing Business:	Proposed: Crash Champions /	Existing: Vacant					
Existing Zoning:	(SC) Suburban Commercial D	District					
Present Use of Parcel:	Vacant						
Proposed Use of Parcel:	Collision Repair Service (In-Ve	Vehicle Service)					
Present Use of Adjacent Properties:	N: Vacant, E: Vacant, S: Resta	taurant (Culver's), W: Vacant					
<b>SECTION 5: Certification and Permission</b>	n						
<b>Certification:</b> I hereby certify that I am	the owner or author	rized representative	of the owr	ner of the	property which is		
the subject of this Permit Application. I	certify that the info	rmation contained ir	n this form	and attac	hments is true and		
accurate. I certify that the project will be	e in compliance wit	h all permit conditio	ns. I under	stand that	t failure to comply		
with any or all of the provisions of the	permit may result in	permit revocation a	nd a fine a	nd/or forf	eiture under the		
provisions of applicable laws.							
<b>Permission:</b> I hereby give the City nerm	<b>Permission:</b> I hereby give the City permission to enter and inspect the property at reasonable times, to evaluate this						
notice and application, and to determine				able tilles	, to evaluate this		
Name of Owner/Authorized Representa	•	Title Phone Number			umher		
Dean Kroll	active (piease print)	System VP Fa					
Signature of Applicant signed by:			Date Sign	ned <sub>8/5/20</sub>	25		
Dean Erol	L						
99DE1D14810B	44F						

Complete application is to be filed with the Department of City Development, 828 Center Avenue, Suite 208. To be placed on the agenda of the City Plan Commission, application must be filed three weeks prior to date of meeting – check with City Development on application submittal deadline date. Applications will not be processed if all required attachments and filing fee of \$250 (payable to the City of Sheboygan) are not submitted along with a complete and legible application. Application filing fee is non-refundable.



August 5, 2025

Crash Champions RT2025-0306

## City of Sheboygan - Conditional Use Permit

Please accept the following Conditional Use written explanation

- A. Name of Project: Crash Champions
- B. Summary
  - a. Description of existing use: The existing parcel is a vacant lot.
  - b. Description of proposed use (indoor, outdoor, etc.), why was this site selected? The project includes the construction of a new 15,000-square-foot Crash Champions facility on a previously undeveloped 2.95 -acre site. The building will feature a customer waiting area, offices, meeting rooms, and support spaces, with the majority of the facility dedicated to the repair shop. Customer parking will be located near the western entrance of the lot, adjacent to the front façade. The eastern portion of the site will be used as a vehicle staging area, enclosed by a privacy fence.
  - c. All services, products, etc. to be provided Crash Champions is a national automotive collision repair company that provides comprehensive auto body repair services. The company primarily serves individuals and insurance partners by restoring vehicles after accidents, offering services such as: Collision repair, Dent and scratch removal, Paint refinishing, Frame straightening, Auto glass replacement, and Insurance claims assistance.
  - d. Projected number of residents, employees, and/or daily customers
    The facility is proposed to be open from 8:00am to 5:00pm, Monday Friday and 9:00am12:00pm on Saturday. The facility with be staffed with 20 employees with a typical 15-20 customers per day.
  - e. Proposed number of dwelling units, floor area, landscape area, and parking area expressed in square feet and acreage to the nearest one-hundredth of an acre
    The project proposes a new 18,000-square-foot Crash Champions facility on a previously undeveloped 1.85-acre site.
  - f. Description of proposed building and all new site improvements (square footage of new and existing structure(s), traffic, ingress/egress, parking, sidewalk, retaining walls, storm drainage, landscaping, lighting, dumpster enclosure, screening of mechanicals, etc.)

    The project involves the construction of a new 15,000-square-foot Crash Champions facility. The building's front façade faces south and features a prominent raised entry clad in Alucobond composite metal panels. The remainder of the front façade is finished with face brick in a running bond pattern, using a black ironspot velour-textured brick for added visual interest. A canopy extends over the main entrance to provide weather protection. The side and rear façades are finished with gray-painted ribbed metal panels.

The site will include a total of 74 parking stalls, consisting of 22 customer spaces located near the front entrance and 52 vehicle staging spaces enclosed within a privacy fence at the

NORR, LLC

rear. Customer access is provided via a primary entrance off South Business Drive. Dumpsters will be housed within the fenced staging area to maintain a clean site appearance on the east side of the site. An accessible sidewalk will connect the customer parking area to the main entrance.

Stormwater management will be handled through the use of an off-site regional retention pond located to the west of the property.

- g. An explanation of any interior and/or exterior renovations Not applicable for this new building.
- h. Is access appropriate and is their sufficient customers/resident off-street parking? The site layout includes clearly defined entry and exit points, facilitating smooth traffic flow for both customers and service vehicles. Internal circulation is designed to minimize congestion, with 22 customer parking spaces located near the front entrance for convenient access. At the rear of the site, a dedicated and privacy-fenced staging area accommodates up to 52 vehicles awaiting repair, ensuring efficient operations while maintaining a clean and organized appearance from the public view.
- i. Proposed signage

A monument sign is being proposed near the front site entrance and a building mounted wall sign will be provided above the customer building entrance.

- j. Project timeline and estimated value of project
  The project is proposed to start in early January 2026 and completed by June 2026 with an
  estimated budget of \$6.500,000.
- k. Compatibility of the proposed use and design with adjacent and other properties in the area. The proposed use is compatible with surrounding land uses, which include a car wash and a vehicle repair facility.
- How will you insure that the business will not become a nuisance to adjacent properties (i.e. parking, noise, smells, hours of operations, etc.
   A privacy screen fence will be installed to block public views of the staged, damaged vehicles. Photometrics study to be provided to ensure light pollution standards are met.

### C. Variances

a. No variances or exceptions are being proposed for this project.

### D. Justification


- a. How is the proposed conditional use (independent of its location) in harmony with the purposes, goals, objectives, policies and standards of the City of Sheboygan Comprehensive Master Plan?
  - The proposed use supports the goals and policies of the City of Sheboygan Comprehensive Master Plan by contributing to economic development, promoting compatible land use, and enhancing neighborhood character. By providing a clean, well-organized automotive service facility, the development aligns with the city's objectives for orderly growth, improved site aesthetics, and efficient land utilization. The inclusion of screening and thoughtful site design also supports the plan's emphasis on maintaining visual quality and minimizing impacts on adjacent properties.
- b. Does the conditional use, in its proposed location, result in any substantial or undue adverse impact on nearby property the character of the neighborhood, environment, traffic, parking, public improvements, public property or rights-of-way?
  - The proposed development is compatible with neighboring uses, supported by the inclusion of a screening fence that conceals staged vehicles from public view. The building is strategically positioned on the site to allow for logical and convenient access from the main roadway. The site layout includes a clearly defined entry and exit point, facilitating smooth

- traffic flow for both customers and service vehicles. Internal circulation is designed to minimize congestion, with separate areas for customer parking near the front entrance and a dedicated, fenced staging area for vehicles awaiting repair at the rear of the site.
- How does the proposed conditional use maintain the desired consistency of land uses in relation to the setting within which the property is located? The proposed use is compatible with surrounding land uses, which include a car wash and a vehicle repair facility.
- d. Is the proposed conditional use located in an area that will be adequately served by utilities, or services provided by public agencies? If not, please explain. The proposed site is adequately served by existing utility infrastructure.


Sincerely,

Terri Douglas, Project Manager NORR LLC

51

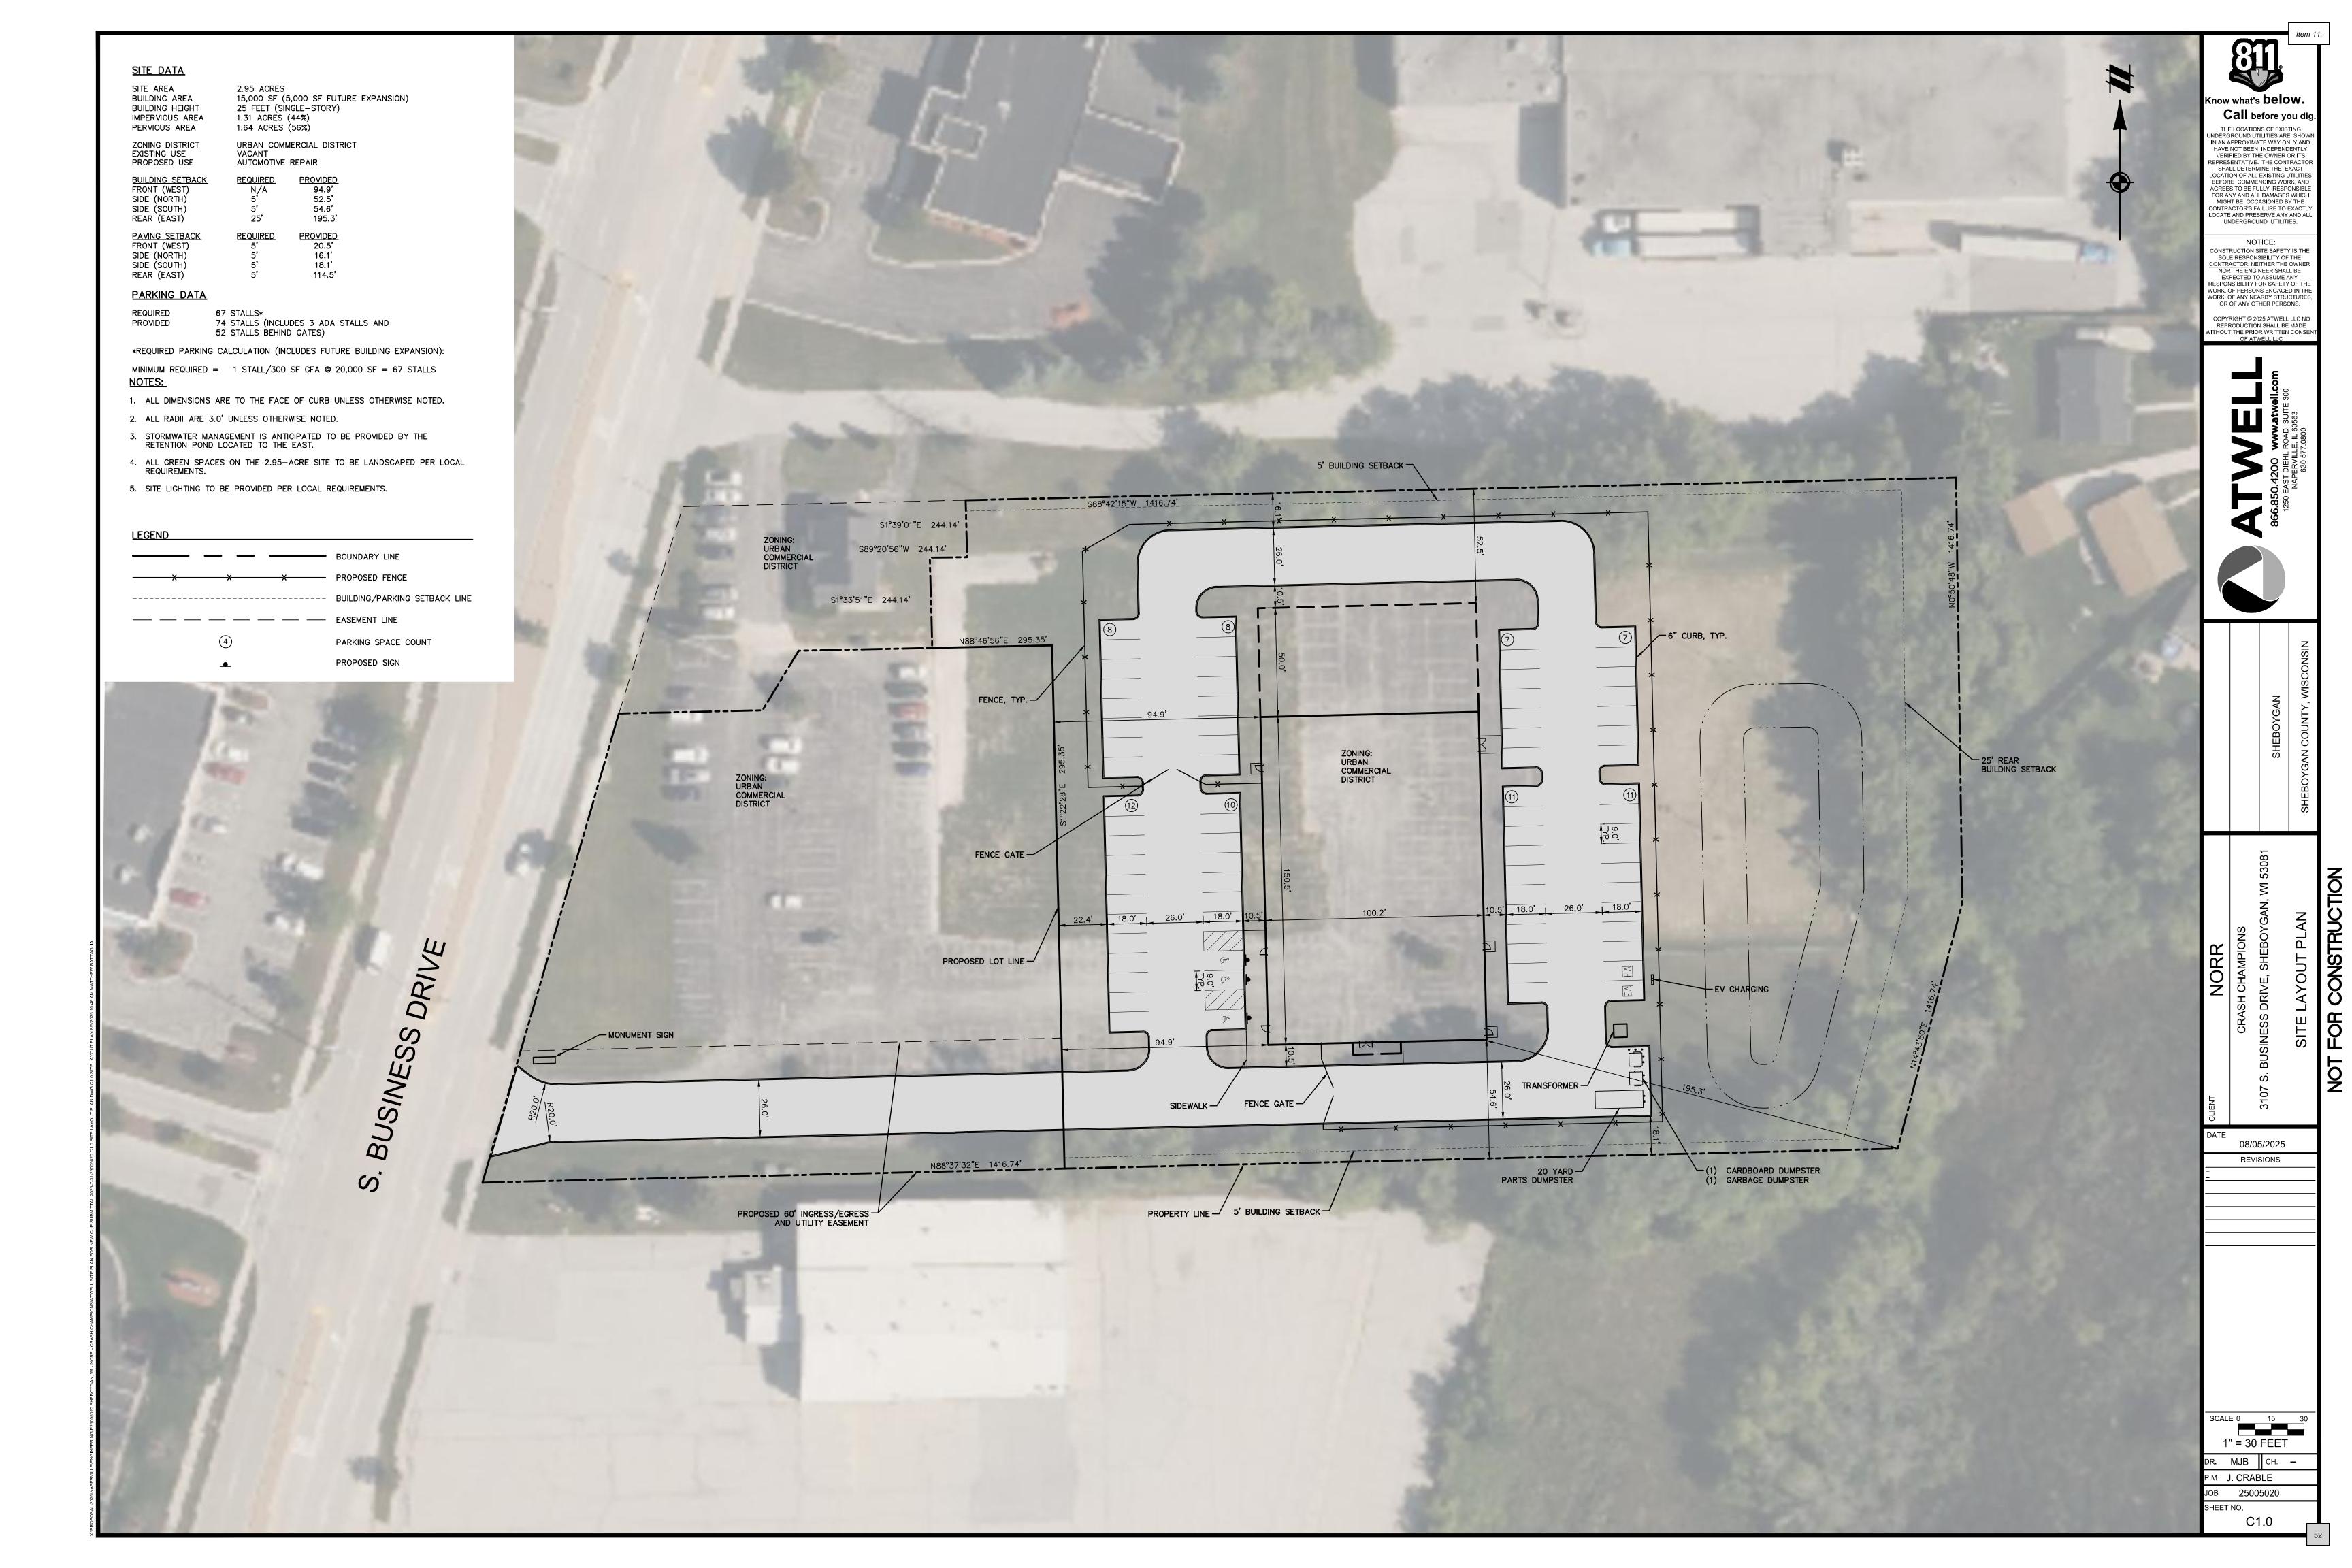



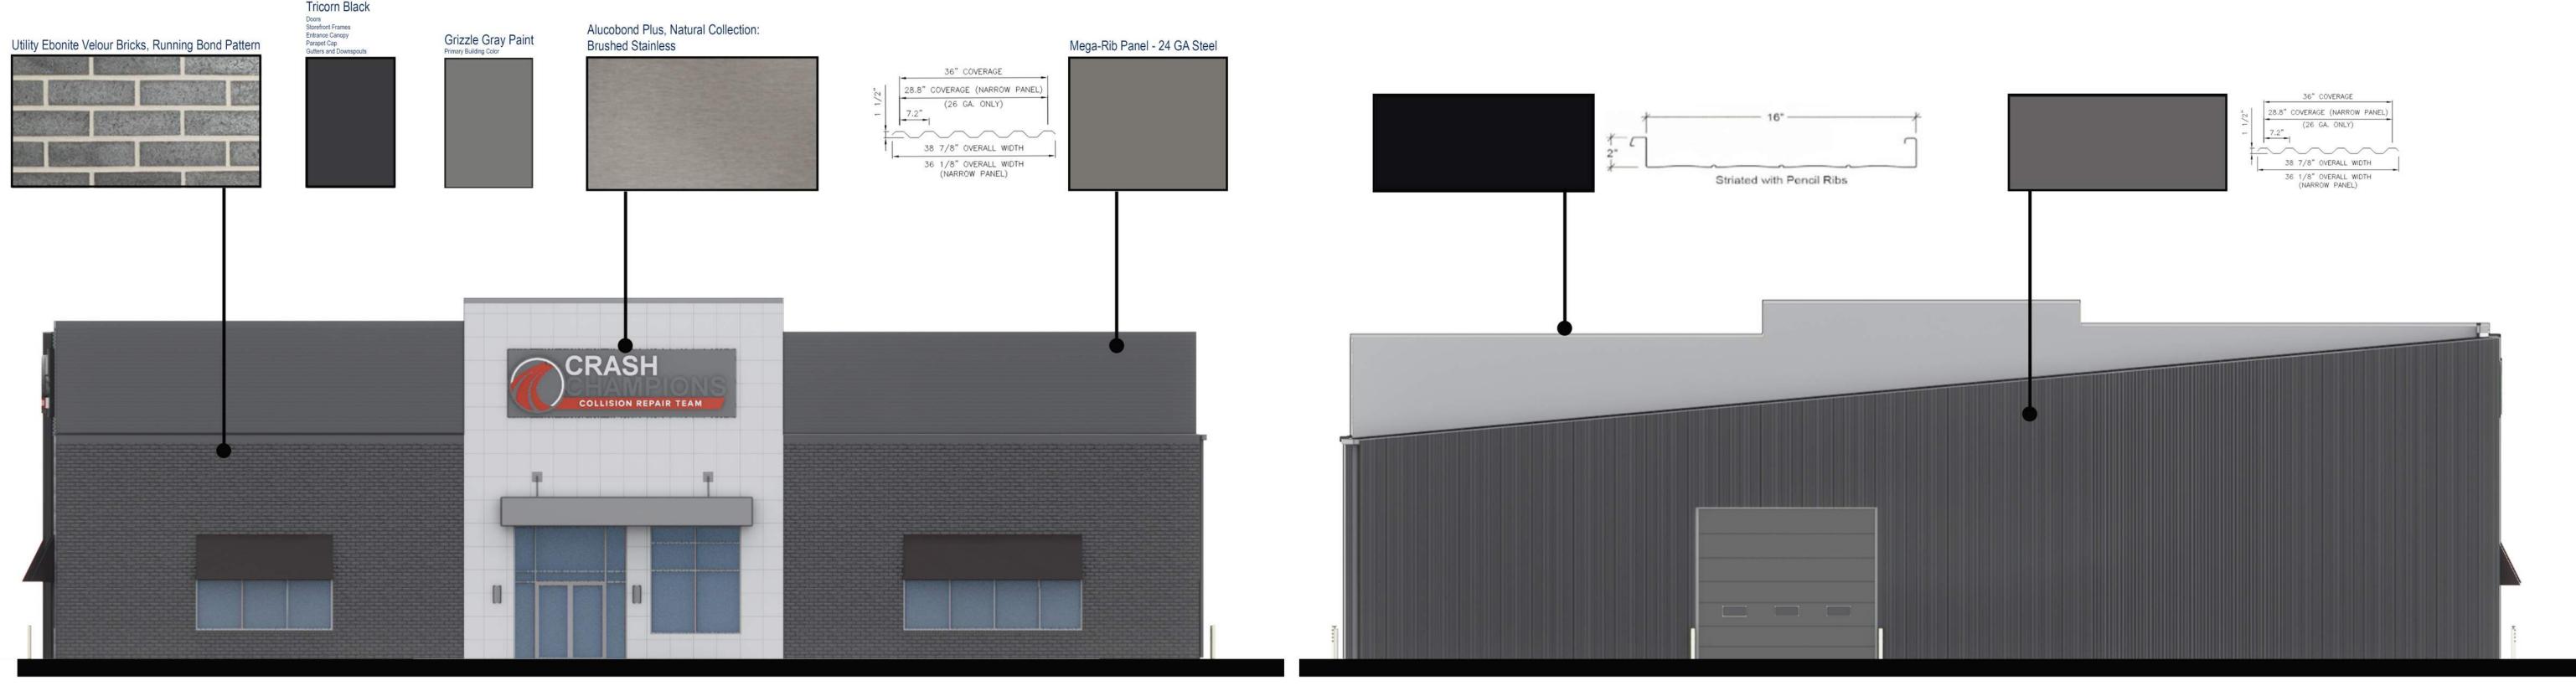

South Elevation

Scale: nts

North Elevation
Scale: nts



# West Elevation scale: nts




East Elevation
scale: nts









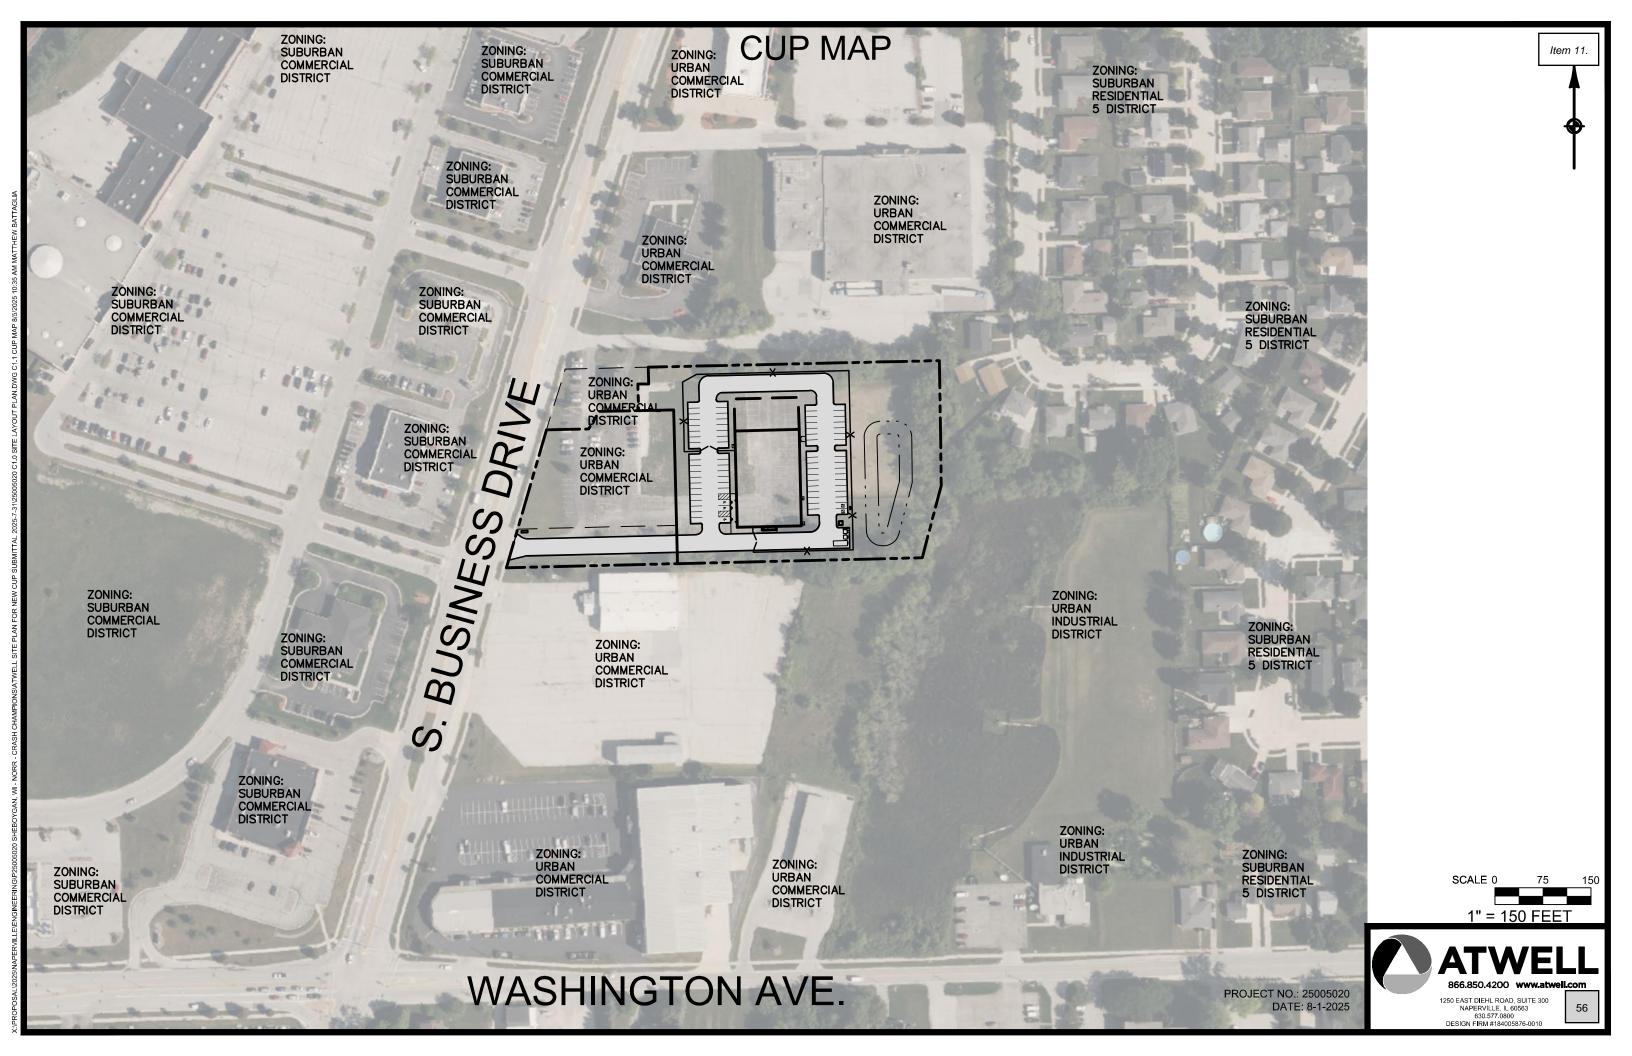

REVISIONS							
Rev #	DATE	BY:					
1	8/1/25	J.P.					

5.1 5.2 5.3 5.4 5.5 5.7 5.8 5.9 1.4 1.55.2 5.3 5.4 5.9 1.7 2.0 2.1 2.2 2.4 2.9 3.5 4.2 4.9 5.9 5.2 5.9 5.2 5.9 5.2 5.05.2 5.3 5.6 5.5 5.7 5.6 5.5 5.7 5.8 6.7 5.8 6.7 5.8 6.7 5.8 6.7 5.8 6.9 6.1 5.2 4.6 4.2 3.8 3.2 2.7 2.4 1.2 2.1 1.9 1.2 5.6 5.8 5.7 5.1 5.1 5.1 5.1 5.05.3 5.4 5.4 5.4 5.4 4.6 4.2 4.0 4.0 3.9 3.8 4.2 4.7 5.0 5.1 4.8 4.4 3.9 3.8 3.9 3.9 3.8 3.9 3.9 3.8 3.6 3.6 3.6 3.6 3.6 3.6 3.6 3.8 3.6 3.8 3.8 3.8 3.8 3.8 3.9 3.9 3.8 3.9 3.9 3.8 3.9 3.9 3.8 3.9 3.9 3.8 3.9 3.9 3.8 3.95.4 5.6 1.00.5 0.7 1.3 2.4 4 2 6.4 6.8 6.0 4.6 3.5 3.1 2.7 2.3 2.2 2.4 2.6 2.8 2.8 2.8 2.6 2.8 2.8 2.6 2.8 2. $0.7 / 1.1 \quad 1.8 \quad 3.6 \quad 5 \quad 5 \quad 8.8 \quad 7.2 \quad 4.9 \quad 3.5 \quad 2.9 \quad 2.3 \quad 1.9 \quad 1.7 \quad 1.8 \quad 1.8 \quad 1.9 \quad 1.8 \quad 1.7 \quad 1.7 \quad 1.8 \quad 2.1 \quad 2.6 \quad 3.1 \quad 4.0 \quad 5.5 \quad 6.7 \quad 6.8 \quad 3.3 \quad 3.0 \quad 1.6 \quad 0.9 \quad 5.6 \quad 5.4 \quad 5.3 \quad 5.2 \quad 5.1 \quad 5.1 \quad 5.1 \quad 5.1 \quad 5.0 \quad 5.$ 5.8 1.3 2 | .5 5.6 8 1.3 2 | .5 5.6 8 1.3 1.4 1.8 1.5 1.8 1. $0.8 \ 1.3 \ 2.3 \ 5.0 \ 7 \ 4.7 \ 3.2 \ 2.4 \ 1.8 \ 1.2 \ 0.9 \ 5.6 \ 0.4 \ 0.4 \ 0.5 \ 0.6 \ 0.8 \ 1.1 \ 1.6 \ 2.2 \ 2.8 \ 4.0 \ 5.6 \ 9.5 \ 3.0 \ 1.7 \ 1.0 \ 0.6 \ 0.3 \ 0.2 \ 0.1 \ 0.1 \ 0.1 \ 0.0 \$ 3 + 2.1 + 2.7 + 3.9 + 6.4 + 9.0 + 9.8 + 1 + 6.1 + 2.7 / 1.7 + 5.9 + 5.6 + 5.3 + 5.2 + 5.1 + 5.1 + 5.0.6 1.0 1.6 3.1 4.9 7.6 7.9 6.5 4.4 2.9 2.33 2.0 2.6 3.7 5.6 7.4 7.7 1.8 3.6 1.9 1.1 0.7 0.5 0.3 0.2 0.1 0.1 0.1 0.1 0.0 0.0 0.0 0.0 0.0 0.0 0.00.5 0.7 1.2 2.3 4 0 5.5 5.6 5.0 3.8 2.7 2.1 1 
 0.4
 0.6
 1
 0
 2.5
 4.7
 5.6
 1
 4.4
 3.6
 2.8
 2.2
 1.2
  $\frac{1.4}{1.9}$   $\frac{1.9}{2.4}$   $\frac{1}{3}$   $\frac{1}{3}$   $\frac{1}{4}$   $\frac{1}{5}$   $\frac{1}{4}$   $\frac{1}{5}$   $\frac{1}{4}$   $\frac{1}{5}$   $\frac{1}{5}$   $\frac{1}{4}$   $\frac{1}{5}$   $\frac{1}{5$  
 0.3
 0.5
 0.9
 2.5
 4.8
 5.5
 5.0
 4.4
 3.8
 3.3
 2.8
 2.2

 5.3
 5.5
 6.9
 2.2
 4.1
 4.7
 4.4
 4.1
 3.7
 3.4
 3.0
 2.5
 2.1 + 2.7 + 3.2 + 3.7 + 4.3 + 4.9 + 5.3 + 2 + 3.2 / 1.2 + 5.6 + 5.4 + 5.3 + 5.2 + 5.1 + 5.1 + 5.1 + 5.0 + $\begin{bmatrix} 2.4 \\ 2.9 \end{bmatrix}$   $\begin{bmatrix} 3.3 \\ 3.7 \end{bmatrix}$   $\begin{bmatrix} 4.1 \\ 4.4 \end{bmatrix}$   $\begin{bmatrix} 4.4 \\ 4.7 \end{bmatrix}$   $\begin{bmatrix} 4.6 \\ 2 \end{bmatrix}$   $\begin{bmatrix} 2.8 \\ 1.1 \\ 0.5 \end{bmatrix}$   $\begin{bmatrix} 5.3 \\ 0.2 \end{bmatrix}$   $\begin{bmatrix} 5.2 \\ 0.2 \end{bmatrix}$   $\begin{bmatrix} 5.1 \\ 0.1 \end{bmatrix}$   $\begin{bmatrix} 5.1 \\ 0.1 \end{bmatrix}$   $\begin{bmatrix} 5.0 \\ 0.0 \end{bmatrix}$  $0.3 \ 0.5 \ 0.9 \ 2.5 \ 4.6 \ 5.1 \ 4.7 \ 4.2 \ 3.7 \ 3.3 \ 2.9 \ 2.4$  
 0.4
 0.6
 1.0
 2.8
 5.3
 5.8
 5.2
 4.4
 3.7
 2.9
 2.4
 2.2 2.7 3.2 3.7 4.2 4.8 5.2 1.0 3.1 1.1 0.6 0.4 0.2 0.2 0.1 0.1 0.1 0.1 0.0 0.0 0.0 0.0 0.0 0.0 0.00.5 0.7 1.2 2.2 4.1 5.0 4.8 4.3 3.4 2.5 2.0 $0.6 \quad 0.9 \quad 1.5 \quad 2.8 \quad 4.8 \quad 6.8 \quad 7.0 \quad 5.7 \quad 3.9 \quad 2.7 \quad 2.1$  $3 + \frac{1.9}{2.5} + \frac{5.5}{3.6} + \frac{5.5}{5.5} + \frac{5.3}{1.7} + \frac{1}{3.3} + \frac{1.7}{3.3} + \frac{1.7}{3.0} + \frac{5.6}{5.4} + \frac{5.3}{5.3} + \frac{5.2}{5.1} + \frac{5.1}{5.1} + \frac{5.0}{5.0} + \frac{5.0}{5.0}$ 0.9/1.3 2.1 4.4 6 1 9.0 8.9 6.9 4.3 2.9 2.8 1.2 1.7 2.9 6.7 8 6 10.4 10.0 7.5 4.5 3.0 2.3 21.3 1.9 2.5 3.7 6.3 8.7 9.4 1.9 $\frac{1.6}{2.1}$   $\frac{1}{3}$  0  $\frac{1}{5}$  6  $\frac{1}{2}$   $\frac{1}{9.8}$   $\frac{1}{9}$  7  $\frac{1}{9}$  4  $\frac{1}{9}$   $\frac{1}{9}$  1.2 1.9 2.5 3.7 5.4 9.3 2 1.8 7.4 2.9 1.6 5.9 5.6 5.3 5/2 5.1 5/1 5.1 5,0 5.0 5.0 5.0 5.0 5.0 5.0 2.2 2.6 3.1 4.4 6.1 8.2 8.2 6.6 4.6 3.2 2.5 .2 1.9 2.5 3.7 6.1 8.4 5 0 6.4 4.9 2.3 1/3 5.8 5.5 5.3 /o.2 5.1 5.1 5.0 5.0 5.0 5.0 5.0 5.0 5.0 5.0 0.8 1.0 1.1 1.3 1.4 1.6 1.9 2.2 2.4 2.5 2.3 2.1 1.8 1.6 1.6 1.6 1.6 1.6 1.7 1.7 1.7 1.7 1.9 2.2 2.6 2.9 3.3 3|.6 4.3 5.7 6.5 6.2 5.6 4.4 ₹3.20 2.5 1 ₹8  $\begin{bmatrix} \mathbf{C} & 1.2 & 1.8 & 2.3 \end{bmatrix}$  3.4 5.1  $\begin{bmatrix} 1.6 & 5.8 & 5.2 \end{bmatrix}$  3.0  $\begin{bmatrix} 1.5 \\ 0.9 & 5.6 \end{bmatrix}$  5.9 5.6  $\begin{bmatrix} 5.4 & 5.3 \\ 5.2 & 5.1 \end{bmatrix}$  5.1 5.0 5.0 5.0 5.0 5.0 5.0 5.0 1.6 2.5 3.2 4.0 4.5 4.7 4.1 2.3 1/.2 | 5.6 5.4 | 5.3 5,2 5.1 5.1 5.1 5.0 5.0 5.0 5.0 5.0 5.0 5.0 0.6 \$\\displaysquaresqua 5.6 \$\\displaysquaresqua 0.6 0.9 0.6 0.9 0.6 0.95.6 5.9 4.3 5.0 5.8 5.1 5.2 4.0 4.9 4.7 5.2 5.8 4.5 5.4 5.2 4.0 4.5 5.4 5.2 5.4 6.3 5.2 4.0 4.5 5.4 6.3 5.2 4.0 4.5 5.4 6.3 5.2 4.0 4.5 5.4 6.3 5.2 5.4 6.3 5.2 6.35.6 5.8 1.2 1.6 5.2 1.6 5.2 1.9 1.7 1.9 1.7 1.9 1.7 1.9 1.9 1.7 1.9 1.9 1.7 1.9

 5.1
 5.1
 5.2
 5.2
 5.3
 5.3
 5.4
 5.4
 5.5
 5.6
 5.7
 5.8
 5.9
 5.2
 5.2
 5.4
 5.3
 5.2
 5.2
 5.1
 5.1
 5.1
 5.0
 5.0
 5.0</td

Luminaire Schedule

BASED ON THE INFORMATION PROVIDED, ALL DIMENSIONS AND LUMINAIRE LOCATIONS SHOWN REPRESENT RECOMMENDED POSITIONS. THE ENGINEER AND/OR ARCHITECT MUST DETERMINE APPLICABILITY OF THE LAYOUT TO EXISTING OR FUTURE FIELD CONDITIONS.

THIS LIGHTING PATTERN REPRESENTS ILLUMINATION LEVELS CALCULATED FROM LABORATORY DATA TAKEN UNDER CONTROLLED CONDITIONS UTILIZING CURRENT INDUSTRY STANDARD LAMP RATINGS IN ACCORDANCE WITH ILLUMINATING ENGINEERING SOCIETY APPROVED METHODS. ACTUAL PERFORMANCE OF ANY MANUFACTURER'S LUMINAIRE MAY VARY DUE TO VARIATION IN ELECTRICAL VOLTAGE, TOLERANCE IN LAMPS AND OTHER VARIABLE FIELD CONDITIONS.

Calculation Summary								
Label	Units	Avg	Max	Min	Avg/Min	Max/Min	PtSpcLr	PtSpcTb
ENTRANCE DRIVE	FC	4.55	8.2	1.8	2.53	4.56	10	10
PARKING	FC	5.00	10.4	2.0	2.50	5.20		
REAR & SIDES	Fc	4.42	10.4	1.3	3.40	8.00		

ILS17884 CRASH CHAMPIONS SHEBOYGAN, WI PM: KEN PLEASE EMAIL US FOR PRICING AT KBRONSTAD@WLSLIGHTING.COM								
ymbol	Qty	Label	Lum. Lumens	LLF	Description	Lum. Watts		
•	4	A	56842	0.950	WLS-SL2-A1-52K-LG-40-70-T4-SLW 30' MOUNTING HEIGHT	374		
• // ->>	3	В	58098	0.950	WLS-SL2-A1-52K-LG-40-70-T2-SLW 30' MOUNTING HEIGHT	374		
	3	С	4699	0.950	WLS-NV-W-T3-16L-7-40K-SLW 16' MOUNTING HEIGHT	37		



## **SPECIFICATIONS**

### POLE SHAFT

Pole shaft is electro-welded ASTM-A500 Grade C steel tubing with a minimum yield strength of 50,000 psi. On Tenon Mount steel poles, tenon is 2-3/8" O.D. high-strength pipe. Tenon is 4-3/4" in length. Straight poles are 4", 5", and 6" square.

Standard hand-hole location is 12" above pole base. Poles 22' and above have a 3" x 6" reinforced hand-hole. Shorter poles have a 2" x 4" non-reinforced hand-hole. BASE - Pole base is ASTM-A36 hot-rolled steel plate with a minimum yield strength of 36,000 psi. Two-piece square base cover is optional.

Poles are furnished with anchor bolts featuring zinc-plated double nuts and washers. Galvanized anchor bolts are optional. Anchor bolts conform to ASTM F 1554-07a Grade 55 with a minimum yield strength of 55,000 psi.

### **GROUND LUG**

Ground lug is standard.

### **DUPLEX RECEPTACLE**

Weatherproof duplex receptacle is optional.

### **GROUND FAULT CIRCUIT INTERRUPTER**

Self-testing ground fault circuit interrupter is optional.

Each pole is finished with DuraGrip®, WLS's baked-on polyester-powder finishing process which electrostatically applies and fuses a polyester powder to the pole. Provides an extremely smooth and uniform finish to withstand extreme weather changes without cracking or peeling, and features a five-year limited warranty. Optional DuraGrip® Plus features the added protection of a 3.0 to 5.0 mil thickness of polyesterpowder finish plus an inner coating, as well as a seven-year limited warranty.

## DETERMINING THE LUMINAIRE/POLE COMBINATION FOR YOUR APPLICATION:

- · Select luminaire from luminaire ordering information
- · Select bracket configuration if required
- Determine EPA value from luminaire/bracket EPA chart
- Select pole height
- Select MPH to match wind speed in the application area (See windspeed maps).
- · Confirm pole EPA equal to or exceeding value from note above
- Consult factory for special wind load requirements and banner brackets

SHIPPING WEIGHTS - SNTS Series	
4"(102mm) sq. 11 Ga. is approximately	7.50 lbs./ft.
4"(102mm) sq. 07 Ga. is approximately	10.00 lbs./ft.
5"(127mm) sq. 11 Ga. is approximately	9.00 lbs./ft.
5"(127mm) sq. 07 Ga. is approximately	12.50 lbs./ft.
6"(152mm) sq. 07 Ga. is approximately	15.40 lbs./ft.
Anchor Bolts (3/4" x 30")(19mm x 762mm)	15 lbs. (7kg)/set
Anchor Bolts (1" x 36")(25mm x 914mm)	30 lbs. (14kg)/set

## SQN -N= 2-3/8" (60mm) O.D. x 4-3/4" (121mm) Tenon 14'-39' (4.3m - 11.9m) Hand-hole 12" (305mm)Standard Optional Base Cover Projection Anchor Bolts **Foundation** By Other





SF – Single Flood ole Preparati





Made in the U.S.A. of the U.S. and imported parts. Meets Buy American requirments for ARRA.



1919 Windsor Place Fort Worth, TX 76110 800.622.8711

www.wlslighting.com

Project Name: .	
Data	
Location:	
Notes:	

Specifications subject to change without notice.

guide for patterns and fixture matches. 4SQB3 3"Reduced drilling pattern 5SQB3 3"Reduced drilling pattern 4SQB5 5"Traditional drilling pattern 4SQB5 5"Traditional drilling pattern 4SQB5 5"Traditional drilling pattern  SOTG 07 Ga. Steel 16 16' 18 18' D90° Double D90° Double D90° Double D90° Double D90° Double WHT White DGP DuraGrip° Plus LAB Less Anchor Bolts	SERIES	POLE SERIES	MATERIAL	HEIGHT <sup>2</sup>	MOUNTING CONFIGURATION	POLE FINISH	OPTIONS
ORDER:		guide for patterns and fixture matches.  45QB3 3" Reduced drilling pattern  55QB3 3" Reduced drilling pattern  45QB5 5"Traditional drilling pattern  65QB5 5"Traditional drilling pattern  65QB5 5"Traditional drilling pattern  45QB0  55QB0  65QB0  Tenon Mount See selection guide for teen and fixture/bracket matches.  45QN  55QN  65QN  No Mounting Holes Use with:  • BKA 4ISF & BKA 5ISF  • BKA X4ISF & BKA SISF  Internal Slip-fitter <sup>1</sup> 45QI		16 16' 18 18' 20 20' 22 22' 24 24' 26 26' 28 28' 30 30' 35 35'	D180° Double D90° Double DN90° Double T90° Triple TN120° Triple Q90° Quad QN90° Quad	BLK Black PLP Platinum Plus WHT White SVG Satin Verde Green GPT Graphite	DF <sup>3</sup> Double Flood DGP DuraGrip® Plus LAB Less Anchor Bolts OSXX <sup>4</sup> Pole preparation for PMOS
	WLS-SNTS						

Example: WLS-SNTS-4SQB3-S11G-20-T90-BRZ-GA

## **FOOTNOTES:**

- 1 See Area Lighting Brackets 3" Reduced Drill Pattern and Area Lighting Brackets - Bolt-on 5"Traditional Drlll Pattern spec sheets for Internal Slip-fitter brackets.
- 2 Pole heights will have +/- 1/2" tolerance.
- 3 See Flood Lighting Brackets section for choice of FBO brackets.
- 4 Order PMOS separately. Change "XX" to indicate height and side of pole location for pole preparation. EX: 0S18A indicates preparation is to be 18ft. up from pole base on side A. Optimal distance from ground to sensor is 20ft.
- 5 OSXX option required. Not for use with Metal Halide fixtures.

ACCESSOR ORDERING INFORMATION (Accessorie are field installed)	
Description	Order Number
4BC – 4" Square Base Cover	122559CLR
5BC – 5" Square Base Cover	122561CLR
6BC – 6" Square Base Cover	122563CLR
ER2 – Weatherproof Duplex Receptacle	122566CLR
GFI – Ground Fault Circuit Interrupter	122567CLR
MHP – Mounting Hole Plugs (3 plugs)-for use with 5" traditional drill pattern	132336
MHD – Mounting Hole Weatherproof Decal-for use with 3" reduced drill pattern	340120
Vibration Damper - 4" Square Pole (bolt-on mount only)	172539
Vibration Damper - 5" Square Pole (bolt-on mount only)	172538
Vibration Damper - 6" Square Pole (bolt-on mount only)	178361
PMOS120 - 120V Occupancy Sensor	518030CLR5
PMOS208/240 - 208, 240V Occupancy Sensor	534239CLR <sup>5</sup>
PMOS277 - 277V Occupancy Sensor	518029CLR <sup>5</sup>
PMOS480 - 480V Occupancy Sensor	534240CLR <sup>5</sup>




1919 Windsor Place Fort Worth, TX 76110 800.622.8711

www.wlslighting.com

Project Name:	
Date:	
Location:	
Notes:	

4" (102mm) square 10-1/8" (257mm) sq. 11" (279mm) bia. Bolt Circle	5" (127mm) square 10-1/8" (257mm) sq.	5" (127mm) square 10-1/8" (257mm) sq.	6" (152mm) square 12" (305mm) sq. 12" (305mm) Dia. Bolt Circle
В	С	D	J
Slotted	Slotted	Slotted	Slotted
8"-11" (203mm-279mm)	9″-11" (229mm-279mm)	9"-11" (229mm-279mm)	12" (305mm)
3/4" x 30"	3/4" x 30"	1" x 36"	1" x 36"
(19mm x 762mm)	(19mm x 762mm)	(25mm x 914mm)	(25mm x 914mm)
3-1/4"	3-1/4"	4"	4"
(83mm)	(83mm)	(102mm)	(102mm)
3-5/8"	4-3/4"	4-5/8"	5-5/8"
(92mm)	(121mm)	(117mm)	(143mm)
10-1/8" sq. x 3/4" thk.	10-1/8" sq. x 3/4" thk.	10-1/8" sq. x 1" thk.	12" sq. x 1-1/8" thk.
(257mm x 19mm)	(257mm x 19mm)	(257mm x 25mm)	(305mm x 29mm)
	10-1/8" (257mm) sq.  11" (279mm) Dia. Bolt Circle  B  Slotted 8"-11" (203mm-279mm)  3/4" x 30" (19mm x 762mm)  3-1/4" (83mm)  3-5/8" (92mm)  10-1/8" sq. x 3/4" thk.	10-1/8" (257mm) sq.  11" (279mm) Dia. Bolt Circle  Slotted 8"-11" (203mm-279mm)  3/4" x 30" (19mm x 762mm)  3-1/4" (83mm)  3-5/8" (92mm)  10-1/8" sq. x 3/4" thk.	10-1/8" (257mm) sq.  10-1/8" (257mm) sq.  11" (279mm) Dia. Bolt Circle  D  Slotted 8"-11" (203mm-279mm)  3/4" x 30" (19mm x 762mm)  3/4" x 30" (19mm x 762mm)  3-1/4" (83mm)  3-1/4" (83mm)  3-5/8" (92mm)  10-1/8" sq. x 3/4" thk.  10-1/8" sq. x 3/4" thk.

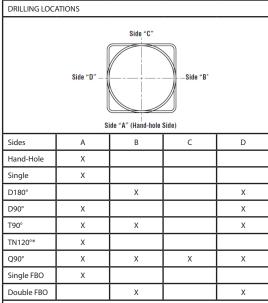

\*Other two locations will be 120° to the left and right of Side A. Note: Standard SF and DF pole preparations are located 3/4 of the height of the pole from the base, unless otherwise specified.



Project Name: _	
Date:	
Location:	
Notes:	

1919 Windsor Place Fort Worth, TX 76110

## **Use ONLY with "Wind Speed Map for ASCE7-05**

STEEL SQUA	RE POLES - A	SCE7-05						
POLE	90 MPH	100 MPH	110 MPH	120 MPH	130 MPH	140 MPH	150 MOH	Bolt Circle
4" 11GA 14'	18.7	14.5	11.5	9.1	17.3	5.9	4.6	В
4" 11GA 16'	15.1	11.5	8.9	6.9	5.4	4.1	3.1	В
4" 11GA 18'	12.2	9.1	6.8	5.1	3.7	2.7	1.8	В
4" 11GA 20'	9.5	6.9	4.9	3.4	2.2	1.3	0.5	В
4" 11GA 22'	9.6	7.0	4.7	3.0	1.5	0.5	0.0	В
4" 11GA 24'	7.7	5.3	3.4	1.8	0.4	0.0	0.0	В
4" 11GA 26'	5.7	3.3	1.9	0.6	0.0	0.0	0.0	В
4" 7GA 20'	14.8	11.2	8.4	6.4	4.8	3.5	2.4	В
4" 7GA 22'	14.9	11.0	8.2	6.0	4.4	3.0	1.9	В
4" 7GA 24'	12.4	8.8	6.3	4.4	2.9	1.7	0.8	В
4" 7GA 26'	10.1	6.9	4.6	2.9	1.6	0.5	0.0	В
5" 11GA 16'	29.4	23.0	18.2	14.6	11.8	9.6	7.8	С
5" 11GA 18'	24.2	19.7	14.5	11.4	9.0	7.1	5.5	С
5" 11GA 20'	20.0	14.9	11.5	8.8	6.6	49	3.6	С
5" 11GA 22'	20.8	15.5	11.7	8.7	6.4	4.6	3.2	С
5" 11GA 24'	17.2	12.8	9.3	6.6	4.5	3.0	1.6	С
5" 11GA 26'	14.8	10.2	7.1	4.7	2.8	1.4	0.2	С
5" 7GA 20'	30.5	23.7	18.6	14.7	11.7	9.3	7.4	D
5" 7GA 22'	41.2	32.0	25.4	20.3	16.2	13.2	10.5	D
5" 7GA 24'	36.0	27.9	21.8	17.1	13.5	10.7	8.4	D
5" 7GA 26'	32.0	23.8	18.3	14.1	10.9	8.3	6.2	D
5" 7GA 30'	24.1	17.5	13.0	9.4	6.7	4.5	2.8	D
6" 7GA 24'	51.0	39.7	31.3	24.9	19.9	16.0	12.8	J
6" 7GA 26'	44.5	34.2	26.7	20.9	16.4	12.9	10.0	J
6" 7GA 30'	34.3	25.8	19.4	14.6	10.8	7.9	5.4	J
6" 7GA 35'	24.8	17.8	12.5	8.5	5.4	2.9	0.9	J
6" 7GA 39'	18.6	12.4	7.8	4.4	1.6	0.0	0.0	J

All WLS Industries' poles are guaranteed to meet the EPA requirements listed. WLS Industries is not responsible if a pole order has a lower EPA rating than the indicated wind-loading zone where the pole will be located.

CAUTION: This guarantee does not apply if the pole/bracket/fixture combination is used to support any other items such as flags, pennants, or signs, which would add stress to the pole. WLS Industries cannot accept responsibility for harm or damage caused in these situations.



1919 Windsor Place Fort Worth, TX 76110 800.622.8711 Notes:

www.wlsl	ightin	ig.com
----------	--------	--------

Project Name:	
Date:	
Location:	

## **Use ONLY with "Wind Speed Map for ASCE7-10**

STEEL SQUARE POLES - ASCE7-10										
POLE	110 MPH	115 MPH	120 MPH	130 MPH	140 MPH	150 MPH	160 MPH	170 MPH	180 MPH	Bolt Circle
4" 11GA 14'	12.5	11.3	10.2	8.5	6.8	5.8	4.9	4.1	3.6	В
4" 11GA 16'	9.8	8.6	7.9	6.5	5.4	4.4	3.5	2.9	2.2	В
4" 11GA 18'	8.1	7.4	6.7	5.4	4.	3.4	2.8	2.2	1.7	В
4" 11GA 20'	7.1	6.3	5.6	4.4	3.4	2.7	2.1	1.6	1.1	В
4" 11GA 22'	9.9	8.8	7.9	6.3	5.1	4.0	3.1	2.5	2.0	В
4" 11GA 24'	8.6	7.5	6.8	5.3	4.2	3.3	2.5	1.9	1.3	В
4" 11GA 26'	6.8	6.1	5.5	4.2	3.2	2.3	1.6	1.0	0.6	В
4" 7GA 20'	10.7	9.7	8.7	7.0	5.7	4.6	3.8	3.1	2.5	В
4" 7GA 22'	11.3	10.2	9.1	7.3	5.8	4.7	3.5	2.7	2.1	В
4" 7GA 24'	9.8	8.9	7.8	6.0	47.5	3.5	2.8	2.1	1.6	В
4" 7GA 26'	7.9	7.1	6.1	4.7	3.6	2.8	1.9	1.2	0.7	В
5" 11GA 16'	18.1	16.4	14.8	12.3	10.3	8.7	7.3	6.3	5.3	С
5" 11GA 18'	15.7	14.2	12.8	10.5	8.7	7.3	6.1	5.1	4.3	С
5" 11GA 20'	13.5	12.3	11.1	9.0	7.4	6.0	4.8	3.8	3.1	С
5" 11GA 22'	15.8	14.3	12.6	10.2	8.3	6.5	5.4	4.2	3.5	С
5" 11GA 24'	13.8	12.5	1.8	8.6	6.7	5.2	3.9	3.0	2.1	С
5" 11GA 26'	11.3	10.3	8.9	6.9	5.3	4.0	3.0	2.2	1.5	С
5" 7GA 20'	20.7	18.8	17.0	14.0	11.7	9.8	7.9	7.0	5.9	D
5" 7GA 22'	25.8	23.3	21.0	17.5	14.6	12.3	10.4	8.8	7.5	D
5" 7GA 24'	23.3	21.0	19.0	15.6	12.9	10.7	9.0	7.5	6.3	D
5" 7GA 26'	20.0	18.0	16.2	13.2	10.7	8.9	7.3	6.0	4.8	D
5" 7GA 30'	16.4	14.6	13.0	10.3	7.9	6.5	5.2	4.0	3.1	D
6" 7GA 24'	35.0	30.8	28.5	23.7	19.6	16.7	14.0	11.8	10.2	J
6" 7GA 26'	29.2	26.2	23.47	19.3	15.9	13.2	11.0	8.69	7.5	J
6" 7GA 30'	23.6	21.2	19.0	15.2	12.3	9.9	8.0	6.4	5.0	J
6" 7GA 35'	17.6	15.2	13.6	10.7	8.2	6.2	4.6	3.2	2.1	J
6" 7GA 39'	13.9	11.9	10.4	7.7	5.5	3.8	2.4	1.2	0.2	J

All WLS Industries' poles are guaranteed to meet the EPA requirements listed. WLS Industries is not responsible if a pole order has a ower EPA rating than the indicated wind-loading zone where the pole will be located.

CAUTION: This guarantee does not apply if the pole/bracket/fixture combination is used to support any other items such as flags, pennants, or signs, which would add stress to the pole. WLS Industries cannot accept responsibility for harm or damage caused in these situations.




Project Name: \_\_\_\_\_ Date: \_ Location: \_\_

www.wlslighting.com

1919 Windsor Place Fort Worth, TX 76110

800.622.8711

Type:

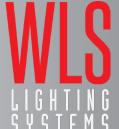

**DIMENSIONS** 

## SL2 SERIES LED AREA

## SPECIFICATIONS

### CONSTRUCTION

- Extruded Aluminum Body: Improves heat dissipation for longer life.
- Heavy-Duty Powder Coating: Bronze, white and black standard. Custom color options available 10.
- Unified Design: Same modern design as Site Lighter Wall Pack (SLW2) for unified aesthetics.
- EZ-Connect<sup>™</sup> Receptacle: The simplest and fastest way to add sensors and wireless controls at any time on the field. Twist and Lock system, no tools or wiring needed

### **ELECTRICA**

- Power Input: 120-277V or 347-480V, typical, depending on model.
- · Power Factor: 0.99 typical.
- Total Harmonic Distortion: <20%
- Surge Protection: Standard is 6kV for drivers. Additional surge protection (20kV/10kA) available as an option (SRG). Passed ANSI C136.2-2018 surge test for extreme level surge conditions (40 strikes at 20kV/10kA).
- Emergency Battery Backup: Optional (factory installed).
- EM10=10W output, EM10C=10W with cold start (-20°C),
- $\bullet$  EM16=16W output, EM16C=16W with cold start (-20°C),
- EM25=25W output.

### **OPERATION**

- Environment: IP65 rated for exterior applications.
- Ambient Range Operation: -40°C up to 55°C (-40°F up to 130°F), except XXL housing size which can withstand up to 50°C (122°F).

### **OPTICS**

- CCT: 2200K, 2700K, 3500K, 4000K and 5000K standard. Wildlife friendly lighting and other CCTs available upon request (extended lead time).
- CRI: >70 standard, other CRI available (extended lead time).
- Lenses: Polycarbonate lens with our proprietary HiOptiX™ technology, designed for superior uniformity and illumination
  efficiency by delivering the light precisely where it is needed. Optics available:
- - Type 2, Type 3, Type 4, Type 5.
- - Front Row: Automotive (AFR), Left (FRL), Right (FRR).
- - Flood: 35 degrees (F35), 60 degrees (F60).
- - Forward Throw Medium (TFTM).

### MOUNTING


 Mounting: Rapid Mount Bracket, Slip Fitter (Knuckle Adapter), Straight Arm, Trunnion (Yoke), and Wall Mount options available.

### WARRANTY

• 10 Year Performance Warranty: Fixture is guaranteed for 10 years, including lumen maintenance (L70), color temperature, and LED driver. "Defective" is considered if ten percent (10%) or more of the LEDs, per product, are non-operating LEDs, total lumen depreciation exceeds 30% (L70), or color temperature has shifted more than 500° Kelvin within the warranty period.

### **LISTINGS & CERTIFICATIONS**

- Intertek UL 1598.
- IP65.
- RoHS compliant.
- BAA/TAA Compliant.
- FCC CFR 47 Part 15.
- ANSI C136.2-2018 Extreme Surge Exposure Level

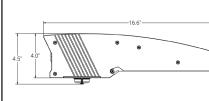

Dimensions						
Size	Length (in.)	Width (in.)	Height (in.)	Weigh (lb.)		
SM	16.6	10.50	4.0	15.1		
MD	16.6	13.50	4.0	19.2		
LG	16.6	20.00	4.0	27.23		
XL	16.6	26.42	4.0	41.2		
XXL	16.6	39.33	4.0	53.2		

1 1000000000	
Made in the IICA of the IIC and imported parts	Project Na

Φ

Φ

Meets Buy American requirements for ARRA.



6820 Corporation Pkwy Fort Worth, TX 76126 817.731.0020

www.wlslighting.com

Project Name:	
Date:	
Location:	
Notes:	

### 5 REV. 2/25

Specifications subject to change without notice.

## SL2 SERIES LED AREA

ORDERING INFORMATION SELECT APPROPRIATE CHOICE FROM EACH COLUMN TO FORMULATE ORDER CODE. Refer to example below.										
PRODUCT	COLOR TEMPERATURE	CRI	OPTIC	VOLTAGE	COLOR	MOUNTING	SENSORS	OPTIONS	DIMMING	ACCESSORIES
SL2-A1-08K-SM SL2-A1-12K-SM SL2-A1-15K-SM SL2-A1-18K-SM SL2-A1-21K-MD SL2-A1-24K-MD SL2-A1-30K-MD SL2-A1-32K-MD SL2-A1-38K-LG SL2-A1-46K-LG SL2-A1-52K-LG SL2-A1-52K-LG SL2-A1-62K-XL SL2-A1-71K-XL SL2-A1-105K-XXL	50K 5000K 40K 4000K 35K 3500K 30K 3000K 27K 2700K 22K 2200K	<b>70</b> 70+ CRI	T2 Type 2 T3 Type 3 T4 Type 4 T5 Type 5 F35 Flood 35 degrees F60 Flood 60 degrees AFR Automotive Front Row FRL Front Row Left FFRR Front Row Right TFTM Forward Throw Medium	LV 120-277V HV 347-480V	BRN Bronze BLK Black WHT White CUS Custom (Special Order)	RMB Rapid Mount Bracket SF Slip Fitter Bracket SA Straight Arm Bracket TM Trunnion Mount Bracket WM Wall Mount Box	EZ10 EZ-Connect™ Receptacle with Twist Lock system (standard) Sensors not included, Contact your Sales professional for available products	SRG Surge Protector (20kV/10kA) EM10 Emergency Battery Backup (10W) EM10C Emergency Battery Backup with Cold Start (10W/-20°C) EM16 Emergency Battery Backup (16W) EM25 Emergency Battery Backup (25W)	<b>10V</b> 0-10V	SL2-GSLR Glare Shield Left / Right. Field installed SL2-GSFB Glare Shield Front / Back. Field installed SL2-BLS Back Light Shield. Field installed.
ORDER:							•	•		•
WLS-SL2-A1-		70							10	

Example: WLS-SL2-A1-24K-MD-40K-70-T5-LV-BLK-SA-EZ10-SRG-10V-SLW



6820 Corporation Pkwy Fort Worth, TX 76126 817.731.0020

www.wlslighting.com

Project Name: .	
Date:	
Location:	
Notes:	

## **CITY OF SHEBOYGAN**

## REQUEST FOR ARCHITECTURAL REVIEW CONSIDERATION

**ITEM DESCRIPTION:** Architectural review of the construction of Crash Champions located at parcel 59281431139.

**REPORT PREPARED BY:** Ellise Rose, Zoning Administrator

**REPORT DATE:** September 3, 2025 **MEETING DATE:** September 9, 2025

FISCAL SUMMARY: STATUTORY REFERENCE:

Budget Line Item: N/A Wisconsin N/A

Budget Summary: N/A Statutes:

Budgeted Expenditure: N/A Municipal Code: N/A

Budgeted Revenue: N/A

## **BACKGROUND / ANALYSIS:**

NORR, LLC is proposing to construct a Crash Champions located at parcel 59281431139. The applicant states the following:

- The project proposes a new Crash Champions building of approximately 15,000 SF on a 2.95 Ac previously undeveloped lot.
- Crash Champions is a national automotive collision repair company that provides comprehensive auto body repair services. The company primarily serves individuals and insurance partners by restoring vehicles after accidents.
- The project features a front façade oriented to the south, highlighted by a prominent raised entry wrapped in Alucobond composite metal panels.
- The rest of the front façade is finished with face brick laid in a running bond pattern, using a black ironspot velour-textured brick for added visual interest.
- Black awnings will be added to window openings to soften the elevations and add an architectural element.
- A canopy extends over the main entrance to provide weather protection.
- The remaining façades are clad in gray-painted ribbed metal panels.

## **STAFF COMMENTS:**

None

## **ACTION REQUESTED:**

Motion to approve with possible amendments as determined by the Board.

1

65

## ATTACHMENTS:

Architectural Review Application and required attachments.

4
200
CI 1Cityof
Sheboygan
spirit on the lake

## **CITY OF SHEBOYGAN**

## ARCHITECTURAL REVIEW APPLICATION

	Item 12.
Fee:	
Review Date:	

Read all instructions before completing. If additional space is needed, attach additional pages.

SECTION 1: Applicant/ Permittee Infor	mation			
Name (Ind., Org. or Entity) NORR LLC	Authorized Repress Terri Douglas	entative	Title Project Mana	ger
Mailing Address 150 West Jefferson Avenue	City <b>Detroit</b>		State <b>MI</b>	ZIP Code <b>48226</b>
Email Address terri.douglas@norr.com		Phone Number (inc 313 324 3105	cl. area code)	
SECTION 2: Landowner Information (Co	omplete These Field	s When Proiect Site	Owner is Different	t than Applicant)
Name (Ind., Org. or Entity) St. Nicholas Hospital of the Hospital Sisters of 3rd Order of St. Francis	Contact Person	,	Title	
Mailing Address 3100 Superior Ave	<sup>City</sup> Sheboygan		State <b>WI</b>	ZIP Code <b>53081</b>
Email Address		Phone Number (inc	cl. area code)	
SECTION 3: Architect Information				
Name NORR LLC (Anthony Ricciut	i)			
Mailing Address 150 West Jefferson Avenue	<sup>City</sup> Detroit	1	State <b>MI</b>	<sup>Zip</sup> 48226
Email Address anthony.ricciuti@norr.com		Phone Number (inc 708-420-3036		
SECTION 4: Contractor Information				
Name TBD				
Mailing Address	City		State	Zip
Email Address		Phone Number (inc	cl. area code)	
SECTION 5: Certification and Permission	n			
Certification: I hereby certify that I am the subject of this Architectural Review attachments are true and accurate. I ce failure to comply with any or all of the profesture under the provisions of applie Permission: I hereby give the City permission and application, and to determine	the owner or author Application. I certify ertify that the project provisions of the per cable laws. hission to enter and in the compliance with a	y that the information to will be in compliand mit may result in pernspect the property any resulting permit	on contained in this ce with all condition ermit revocation and at reasonable time coverage.	form and ns. I understand that d a fine and/or es, to evaluate this
Name of Owner/Authorized Representa Dean Kroll		Title Systems VP F	acilities	Number
Signature of App Signed by: Dean Kroll Dean knoll			Date Signed 8/5/2025	
Complete application is to the fired with t	he Denartment of C	ity Develonment 82	8 Center Avenue S	uite 208 To be

Complete application is to be med with the Department of City Development, 828 Center Avenue, Suite 208. To be placed on the agenda of the Architectural Review Board, application must be filed three weeks prior to date of meeting – check with City Development on application submittal deadline date. Applications will not be processed if all required attachments and filing fee of \$100 (payable to the City of Sheboygan) are not submitted along with a complete and legible application. Application filing fee is non-refundable.

Item	12.
пспп	12.

<b>SECTION 6: Description of the Subject</b>	Site/Propose	ed Project			Item 12.
Project Address/Description	-		Parcel No.		
S. Business Drive and Washington Ave	`	·	l .	57	
		Crash Champions / Exist	<u> </u>	0407 O D :	D: \
		Drive and Washington Ave	enue (South of	3107 S. Business	Drive)
Zoning Classification:		ban Commercial District	Domondolino.	1	
New Building:  SECTION 7: Description of Proposed Pr	Addition:		Remodeling:		
		ions building of approx	vimataly 15 0	00 SE on a 2 (	)5 Ao
The project proposes a new Cra previously undeveloped lot. Cras	•	•	•		
that provides comprehensive au	-			•	ally
individuals and insurance partne	•	<u>-</u>		ily Serves	
individuals and insurance partite	is by iesic	oning vernoles after acc	Juents.		
SECTION 8: Description of EXISTING Ex	terior Design	n and Materials			
The existing project site is a vac-	ant lot.				
<b>31</b> ,					
SECTION 9: Description of the PROPOS	ED Exterior	Design and Materials			
The project features a front façad			•		-
wrapped in Alucobond composite					
brick laid in a running bond patter		•			
interest. A canopy extends over the		-	ner protection	i. The remaining	g
façades are clad in gray-painted i	ribbed met	al panels.			



August 5, 2025

Crash Champions RT2025-0306


City of Sheboygan - Architectural Review Project Narrative

The project proposes a new 15,000 square-foot Crash Champions facility on a previously undeveloped 2.95 -acre site. Crash Champions is a national automotive collision repair company that offers comprehensive auto body repair services. The company primarily serves individuals and insurance partners by restoring vehicles damaged in accidents.

The project features a front façade oriented to the south, highlighted by a prominent raised entry wrapped in Alucobond composite metal panels. The rest of the front façade is finished with face brick laid in a running bond pattern, using a black ironspot velour-textured brick for added visual interest. Black awnings will be added to window openings to soften the elevations and add an architectural element. A canopy extends over the main entrance to provide weather protection. The remaining façades are clad in gray-painted ribbed metal panels.

Sincerely,

Terri Douglas, Project Manager NORR LLC

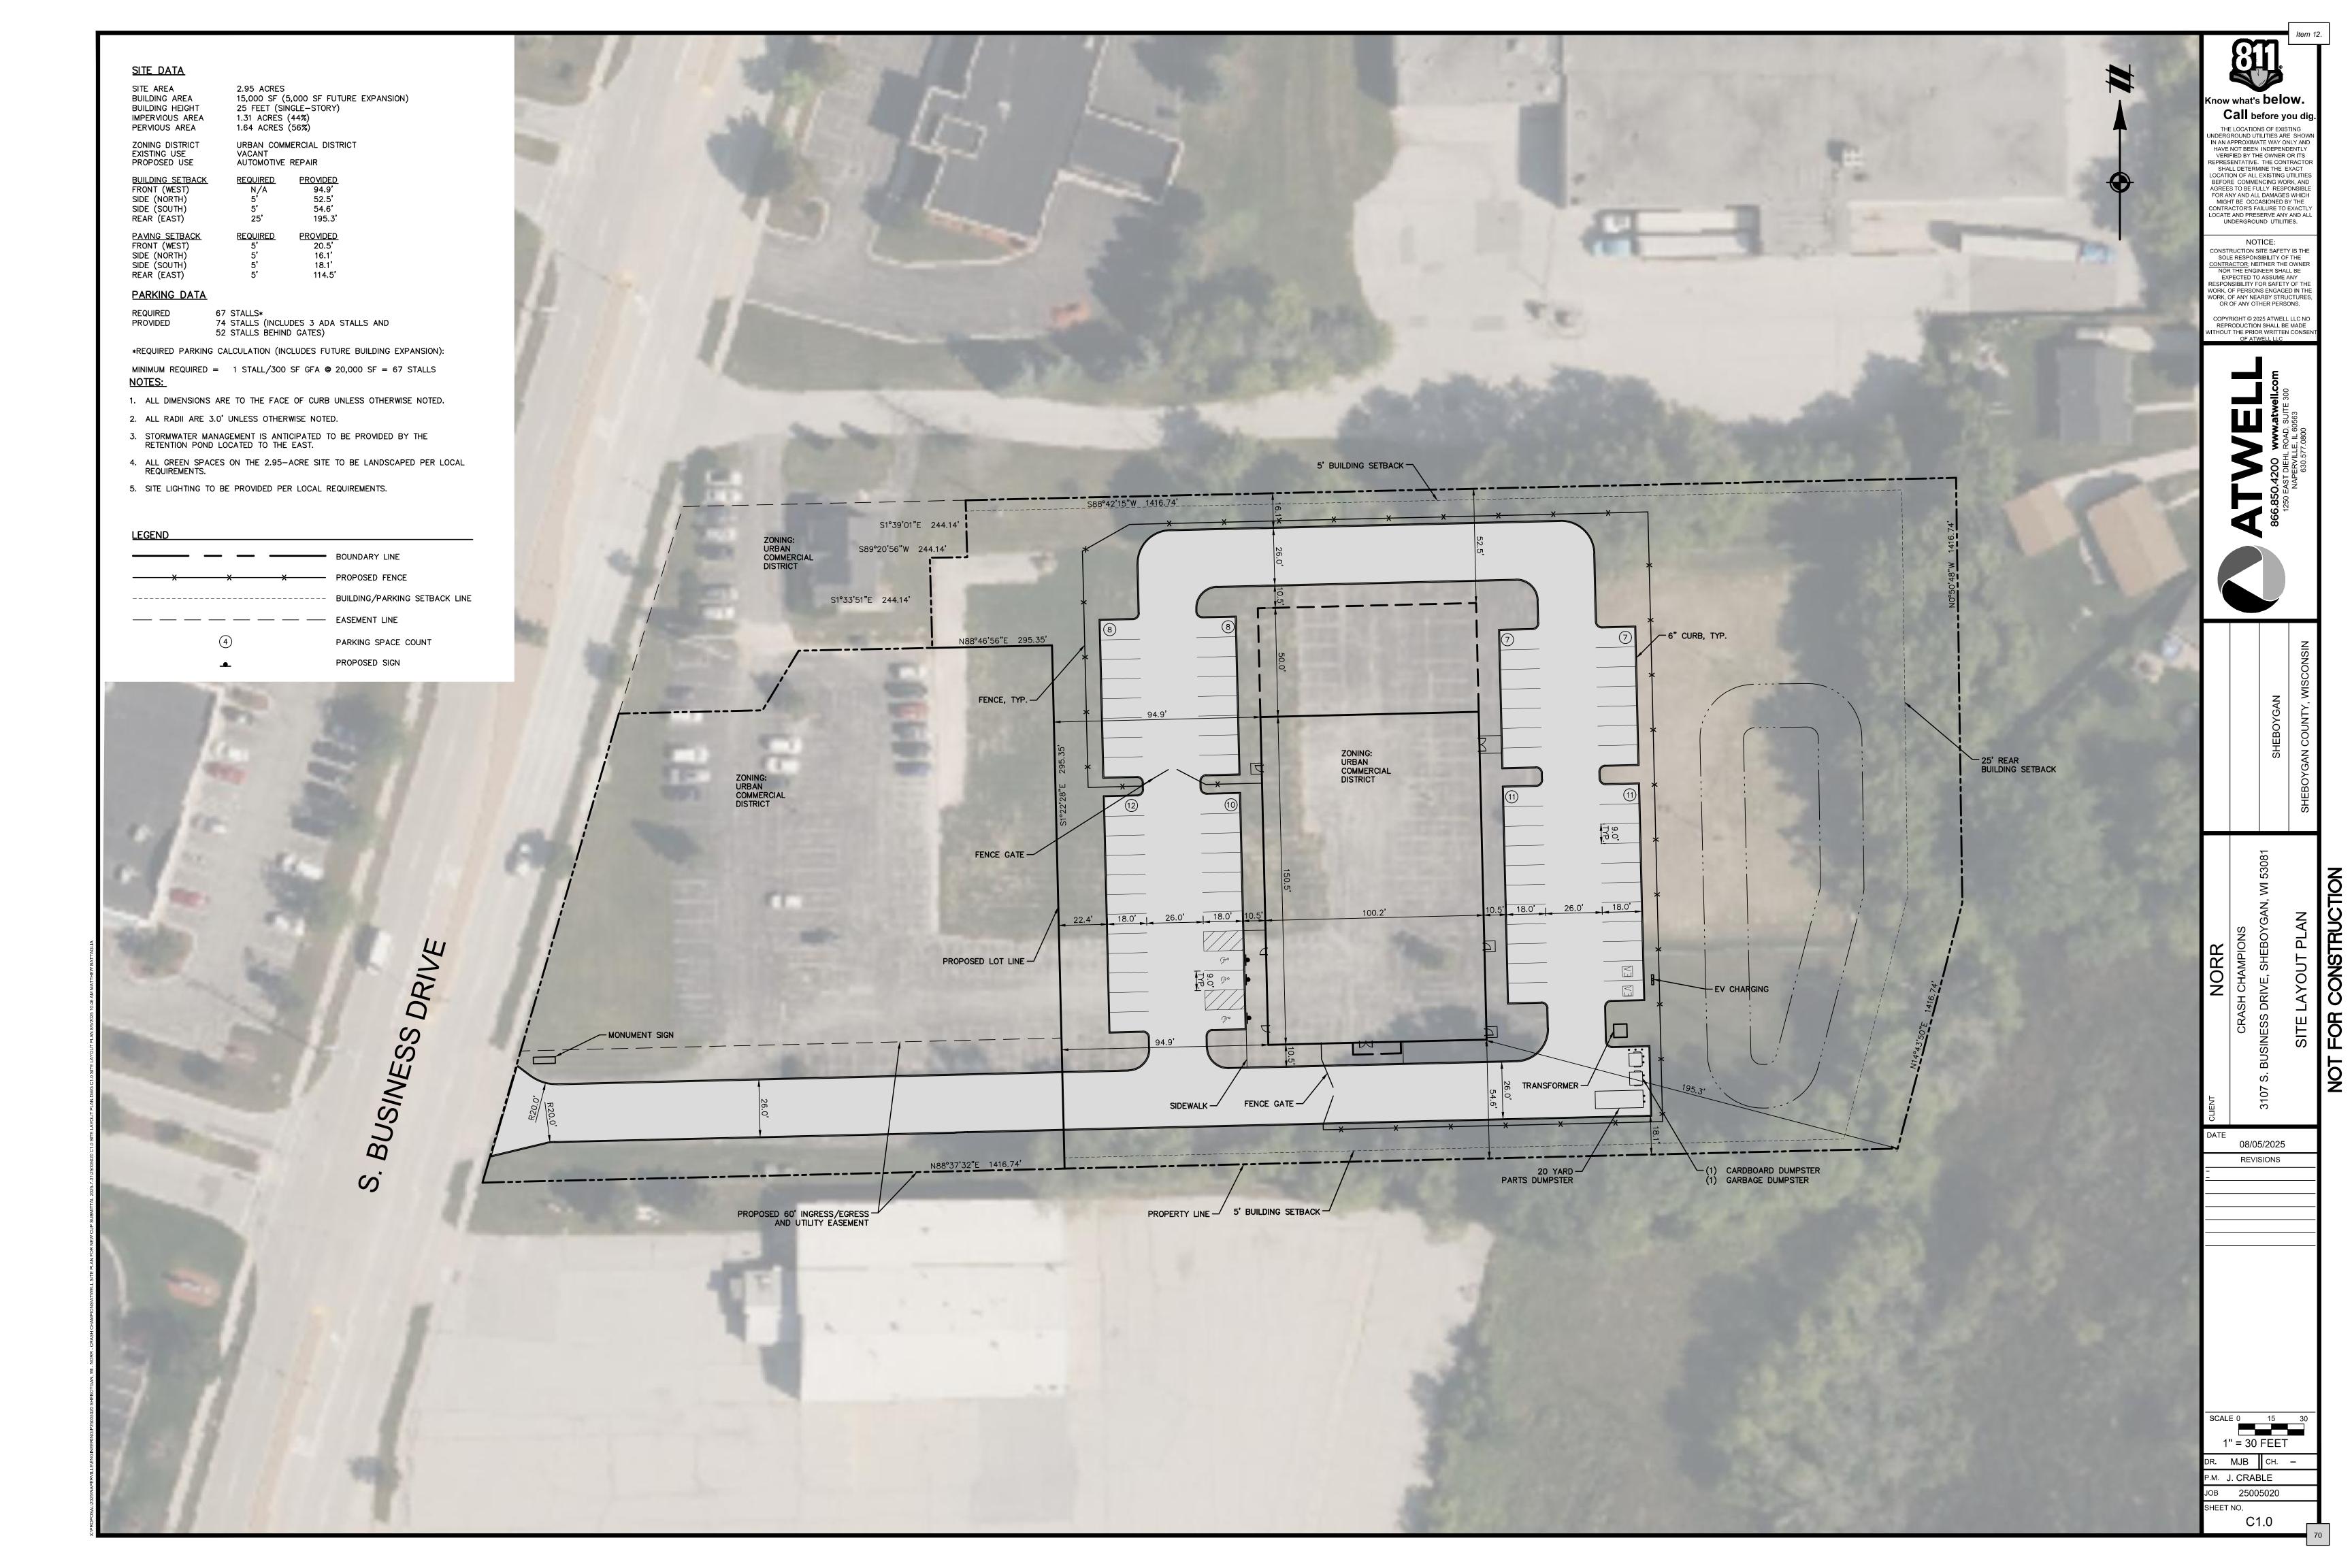










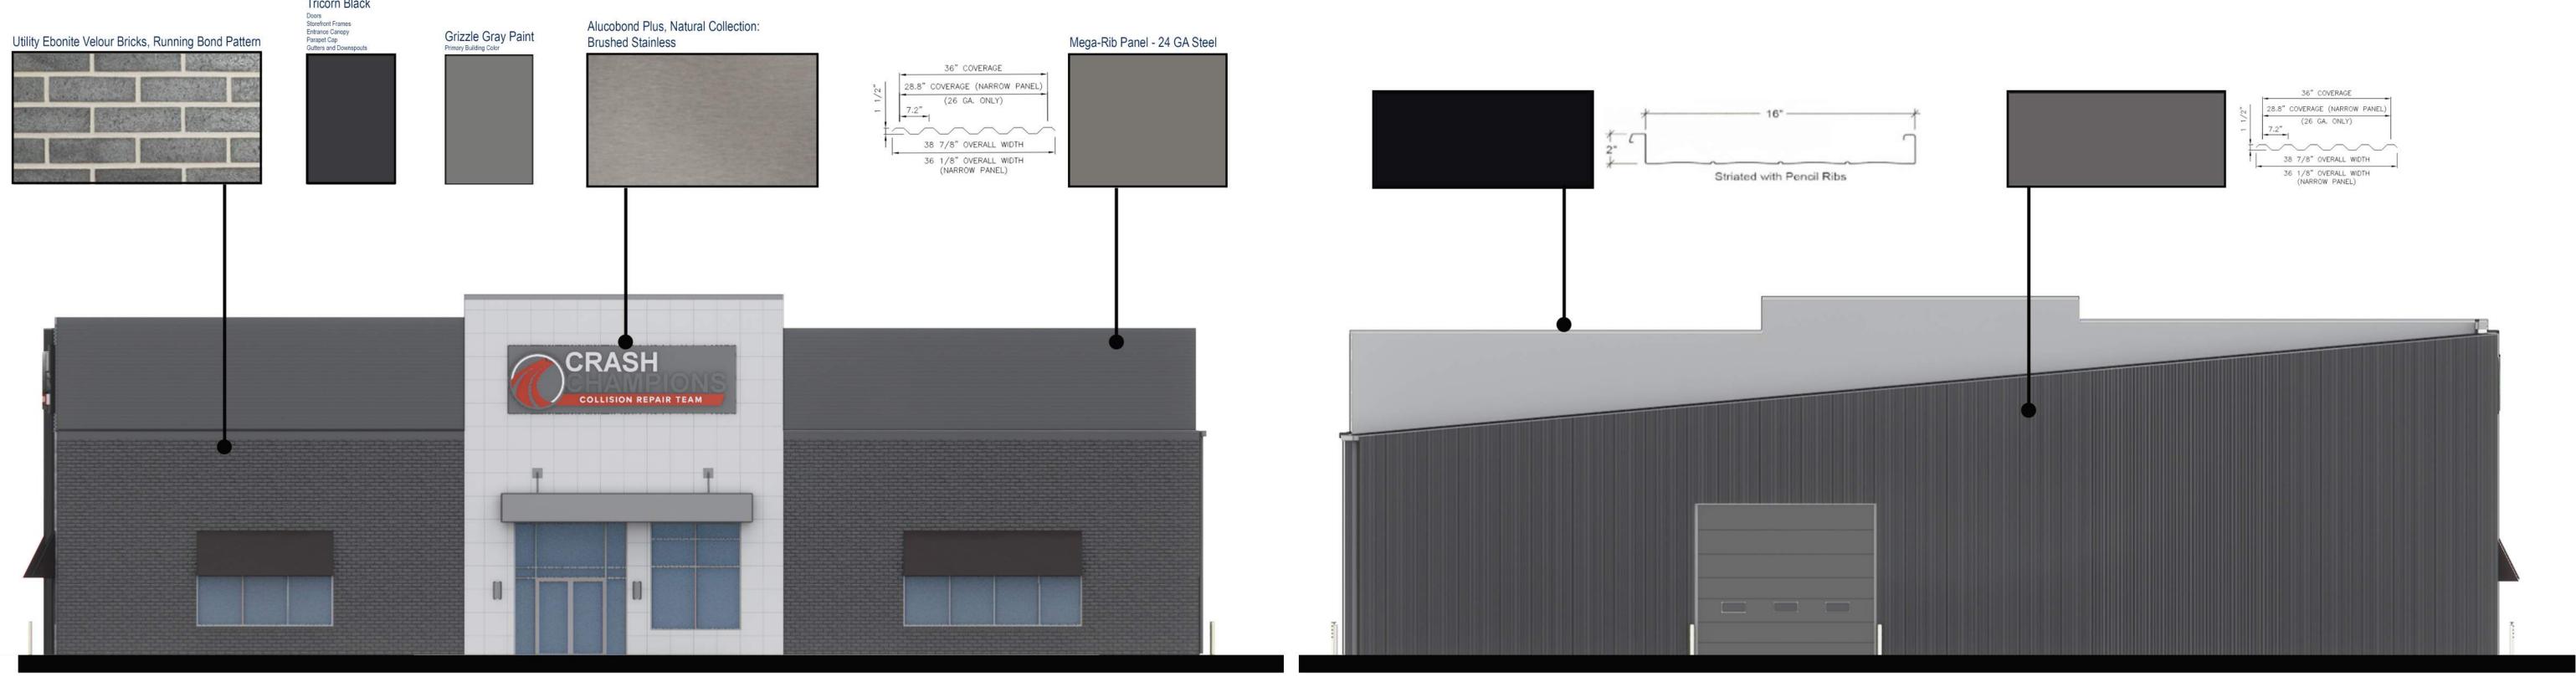

South Elevation

Scale: nts

North Elevation
Scale: nts



# West Elevation scale: nts



East Elevation
scale: nts

#### REQUEST FOR CITY PLAN COMMISSION CONSIDERATION

**ITEM DESCRIPTION:** Application for Conditional Use with exceptions by Adam Hertel to construct a Valvoline Instant Oil Change located at parcel # 59281431139. UC Zone.

**REPORT PREPARED BY:** Ellise Rose, Zoning Administrator

**REPORT DATE:** September 3, 2025 **MEETING DATE:** September 9, 2025

FISCAL SUMMARY: STATUTORY REFERENCE:

Budget Line Item: N/A Wisconsin N/A

Budget Summary: N/A Statutes:

Budgeted Expenditure: N/A Municipal Code: N/A

Budgeted Revenue: N/A

#### **BACKGROUND / ANALYSIS:**

Adam Hertel is proposing to construct a Valvoline Instant Oil Change located at parcel # 59281431139. The applicant states the following:

- Klees & Sulok Oil Company is a Valvoline Instant Oil Change franchisee. Our first store opened on January 27th, 2000 in West Bend, WI. Since that time, we have added four more locations. One additional location in West Bend, one location in Oconomowoc, Muskego and Grafton.
- As operators we strive to bring value to the communities that we serve by providing multiple services that prolongs the life of our customers' vehicles.
- The services we offer include full service oil change, radiator and air conditioning service, air filter replacement, along with other preventative maintenance services that are completed in approximately 15 minutes.
- Our unique drive through model involves customers staying in the comfort of their vehicle while services are completed.
- To date we have 50 employees and many live in the communities of where our stores are located. We anticipate hiring residents from Sheboygan to work at this potential location and serving the community with integrity, professionalism, and by adding beneficial preventative maintenance services.
- The proposed Valvoline Instant Oil Change project located at 3107 S. Business Drive is new construction on a site with an existing parking lot.
- The existing and surrounding properties are part of the commercial district.
- The new building will have a footprint of 1,666 square feet and with a main floor level and a basement level for oil changes.
- The building will be built of load bearing wood stud walls with brick veneer and EIFS for wall materials and sloped trusses with asphalt shingles for a roof.

1

- The store will have two maintenance bays with large glass overhead doors and a wal space with aluminum storefront windows.
- Other site features include paved parking areas, driveways, site lighting and landscaping.
- The new parking areas and driveways shall be paved with standard duty asphalt.
- Driveways will have curb and gutter and parking stalls will be appropriately marked with painted lines. Parking is maximized as much as allowed by the site with an effort to get as much parking as possible near the back of the site because very few customers park and enter the store. Parking includes customer and employee parking for the number of employees anticipated.
- The new store will require 5 technicians and at least one store manager to operate the store over the course of a year.
- On a daily basis the store will have 3 employees working from 8am 6pm for a total of 70 operation hours per week.
- Site lighting will be accomplished with a mix of traditional LED wall packs, which will be located at all exterior door locations.
- Landscaping will be a mix of trees and shrubs planted around the edge of the property and along the building as required.
- The site, including the road easement, is just over 1 acre and mostly impervious surface, therefore minimal stormwater management is required.

#### **STAFF COMMENTS:**

The applicant shows conceptual signage but has not submitted a specific sign package for the site at this time. Applicant shall work with staff with regards to constructing a well-designed sign package for the site that utilizes colors and materials similar to the building. Staff may bring the proposed signage design back to the Plan Commission if there any concerns.

Applicant is requesting following exceptions:

- Minimum paved surface setback: 5 feet Applicant is requesting a 0 foot setback
  - Applicant is requesting a zero foot paved surface setback along the east side of the site in order to create a shared access with the rest of the development. This variance is required in order to create the new shared access driveway that customers from all facilities will use to enter and exit from these properties. The shared access reduces the number of potential traffic conflicts on S. Business Dr.
- Requesting a variance from the locational and bufferyard landscaping requirements -Applicant shall meet the four (4) locational landscaping requirements.
- To have 8 parking spaces Minimum 33 parking spaces require.

#### **ACTION REQUESTED:**

Staff recommends approval of the conditional use permit and exceptions subject to the following conditions:

1. Prior to operation/occupancy, the applicant shall obtain all licenses and occupancy permits as well as meet all required codes including but not limited to building, plumbing,

Item 13.

electrical, HVAC, fire, health, state, federal, etc. An occupancy permit will be granted at such time as the applicant has met all requirements.

- 2. Applicant shall obtain all necessary permits for the construction, the storage and the handling of hazardous chemicals and/or fuels (applicant shall be in contact with building inspection, fire department, etc.).
- 3. The facility will meet all zoning requirements including but not limited to noise, smells, vibration, hazardous materials, etc. If any issues arise, this matter may be brought back to the Plan Commission for review.
- 4. If using dumpsters, dumpster(s) shall be screened/enclosed and constructed of like materials and colors of the facility. If using chain link fencing, the applicant shall install Privacy Decorative Slatting (PDS) material in order to effectively screen and enclose the dumpster.
- 5. All outdoor storage of materials, products or equipment shall be prohibited.
- 6. Any fencing/retaining wall shall be installed per Section 105-945 of the City of Sheboygan Zoning Ordinance.
- 7. All new lighting shall be installed per Section 105-932 of the City of Sheboygan Zoning Ordinance. There shall be no spillover light onto adjacent properties or the streets.
- 8. Applicant shall obtain the necessary sign permits prior to installation. Applicant shall work with staff with regards to constructing a well-designed signage for the site that utilizes colors and materials similar to the building. Staff may bring the proposed signage design back to the Plan Commission for review/approval.
- Applicant is responsible for working with all private and public utilities in order to adequately service this development proposal (applicant will need to provide the necessary easements and/or relocate utilities as necessary).
- 10. Any work within City of Sheboygan Public rights-of-way shall be discussed with the City Engineering Department and constructed to standard City specifications (including, but not limited to, new and old ingress/egress driveway openings, curb, gutter, sidewalk, pavement, utilities, street trees, etc.).
- 11. Absolutely no portion of the new building and/or site improvements shall cross the property lines including but not limited to buildings, balconies, decks, foundations, walls, gutters, eaves, roof, parking, fencing/retaining walls, signs, landscaping, etc.
- 12. All vehicles shall be located on the private property and shall not be located on any City streets, public rights-of-way, other private properties, etc. Vehicles may be parked/stored on paved surfaces (not gravel or landscaped areas).
- 13. If there are any amendments to the approved use and/or site plan, the applicant will be required to submit a new conditional use application reflecting those amendments.

#### **ATTACHMENTS:**

Conditional Use Permit Application and Attachments

11	- 40	
Iten	การ	



### APPLICATION FOR CONDITIONAL USE

Fee: \$250.00	
Review Date:	
Zoning:	

Read all instructions before completing. If additional space is needed, attach additional pages.

SECTION 1: Applicant/ Permittee Infor	mation				
Applicant Name (Ind., Org. or Entity) Adam Hertel	Authorized Representative		Title Architect		
Mailing Address 3350 S. River Road	City West Bend		State WI		ZIP Code 53095
		Phone Number (incl. area code) (262) 334-3811			
SECTION 2: Landowner Information (co	omplete these fields	when project site o	wner is dif	ferent th	an applicant)
Applicant Name (Ind., Org. or Entity) Dean Sulok	Contact Person		Title Owner		
Mailing Address 2795 E. Washington Street	City West Bend		State WI		ZIP Code 53095
Email Address sulokoilco@charter.net		Phone Number (inc	cl. area cod	e)	
SECTION 3: Project or Site Location					
Project Address/Description 3107 S. Business Drive		Parcel No. 59281431139			
<b>SECTION 4: Proposed Conditional Use</b>					
Name of Proposed/Existing Business:	Valvoline Instant	Oil Change			
Existing Zoning:	Urban Commerc	ial District			
Present Use of Parcel:	Vacant				
Proposed Use of Parcel:	Valvoline Instant				
Present Use of Adjacent Properties: South - Fast Food Restaurant, North - Car Rental & Adult Day Ca SECTION 5: Certification and Permission					& Adult Day Care
<b>Certification:</b> I hereby certify that I am the owner or authorized representative of the owner of the property which is the subject of this Permit Application. I certify that the information contained in this form and attachments is true and accurate. I certify that the project will be in compliance with all permit conditions. I understand that failure to comply with any or all of the provisions of the permit may result in permit revocation and a fine and/or forfeiture under the provisions of applicable laws.					
<b>Permission:</b> I hereby give the City perm notice and application, and to determine				ble times	, to evaluate this
Name of Owner/Authorized Represent Dean Sulok	ative (please print)	Title Owner		Phone Nu	umber
Signature of Applicant			Date Sign	ed / 9-	25

Complete application is to be filed with the Department of City Development, 828 Center Avenue, Suite 208. To be placed on the agenda of the City Plan Commission, application must be filed three weeks prior to date of meeting – check with City Development on application submittal deadline date. Applications will not be processed if all required attachments and filing fee of \$250 (payable to the City of Sheboygan) are not submitted along with a complete and legible application. Application filing fee is non-refundable.

August 21, 2025

City of Sheboygan 828 Center Avenue, Suite 300 Sheboygan, WI 53081

RE: Sheboygan Valvoline Conditional Use

Dear Plan Commission Members:

- A. Valvoline Instant Oil Change
- B. Klees & Sulok Oil Company is a Valvoline Instant Oil Change franchisee. Our first store opened on January 27<sup>th</sup>, 2000 in West Bend, WI. Since that time, we have added four more locations. One additional location in West Bend, one location in Oconomowoc, Muskego and Grafton. As operators we strive to bring value to the communities that we serve by providing multiple services that prolongs the life of our customers' vehicles. The services we offer include full service oil change, radiator and air conditioning service, air filter replacement, along with other preventative maintenance services that are completed in approximately 15 minutes. Our unique drive through model involves customers staying in the comfort of their vehicle while services are completed. To date we have 50 employees and many live in the communities of where our stores are located. We anticipate hiring residents from Sheboygan to work at this potential location and serving the community with integrity, professionalism, and by adding beneficial preventative maintenance services.

The proposed Valvoline Instant Oil Change project located at 3107 S. Business Drive is new construction on a site with an existing parking lot. The existing and surrounding properties are part of the commercial district. The new building will have a footprint of 1,666 square feet and with a main floor level and a basement level for oil changes. The building will be built of load bearing wood stud walls with brick veneer and EIFS for wall materials and sloped trusses with asphalt shingles for a roof. The store will have two maintenance bays with large glass overhead doors and a waiting space with aluminum storefront windows. Other site features include paved parking areas, driveways, site lighting and landscaping.

The new parking areas and driveways shall be paved with standard duty asphalt. Driveways will have curb and gutter and parking stalls will be appropriately marked with painted lines. Parking is maximized as much as allowed by the site with an effort to get as much parking as possible near the back of the site because very few customers park and enter the store. Parking includes customer and employee parking for the number of employees anticipated. The new store will require 5 technicians and at least one store manager to operate the store over the course of a year. On a daily basis the store will have 3 employees working from 8am – 6pm for a total of 70 operation hours per week.

Site lighting will be accomplished with a mix of traditional LED wall packs, which will be located at all exterior door locations. Landscaping will be a mix of trees and shrubs planted around the edge of the property and along the building as required. The site, including the road easement, is just over 1 acre and mostly impervious surface, therefore minimal stormwater management is required.

- C. We would be seeking two exceptions for this project. The first would be to have a paved driveway up to the property line. Due to the proposed driveway easement this would be necessary to access the development to the East of this proposed project. The second item would be to the number of parking stalls. As a vehicle based drive-thru service facility customers do not regularly parking their vehicles and enter the store.
- D. The proposed conditional use is in harmony with the purposes, goals, objectives, policies, and standards of the City of Sheboygan Comprehensive Master Plan. It aligns with the Plan's intent to encourage compatible development, support economic vitality, and promote efficient land use that enhances the community's overall character and livability.

  The proposed conditional use will not result in any substantial or undue adverse impacts on nearby property, the character of the neighborhood, the environment, traffic, parking, public improvements, public property, or rights-of-way. The project has been carefully designed to integrate with its surroundings in a manner that maintains neighborhood stability and supports safe and efficient traffic and parking patterns.

The proposed conditional use maintains consistency with surrounding land uses by complementing existing development patterns and reinforcing the intended character of the area. It provides an appropriate and beneficial use of the property within its setting, while ensuring compatibility with adjacent properties and the broader neighborhood context. The proposed conditional use is located in an area that is fully served by existing utilities and services provided by public agencies. No additional infrastructure extensions are necessary, and adequate capacity is available to support the proposed use without burdening public facilities or services.

# PROPOSED BUILDING:

# VALVOLINE INSTANT OIL CHANGE

3107 S. BUSINESS DRIVE CITY OF SHEBOYGAN, SHEBOYGAN COUNTY





Ctara



LOCATION MAP

SHEET INDEX

SHEET DESCRIPTION

PLAN COMMISSION SUBMITTAL

REVISIONS - 2

ARCHITECTURAL

A-100 PROPOSED SITE PLAN

A-101 LOWER LEVEL AND UPPER LEVEL PLANS

A-201 EXTERIOR ELEVATIONS

A-202 DUMPSTER ENCLOSURE AND SIGN DETAILS

#### PROJECT TEAM

OWNER CONTACT: Dean Sulok

Klees & Sulok Oil 2795 E. Washington Street West Bend, WI 53095 EMAIL: sulokoilco@charter.com

ARCHITECT:

Adam Hertel
American Architectural Group, Inc.
3350 South River Road
West Bend, WI 53095
PH: (262) 334-3811
EMAIL: adam@teamaag.net

\_\_\_\_


Document Date

Project Number

Sheet Title
TITLE SHEET AND
LOCATION MAP


Sheet Number


G-101\_

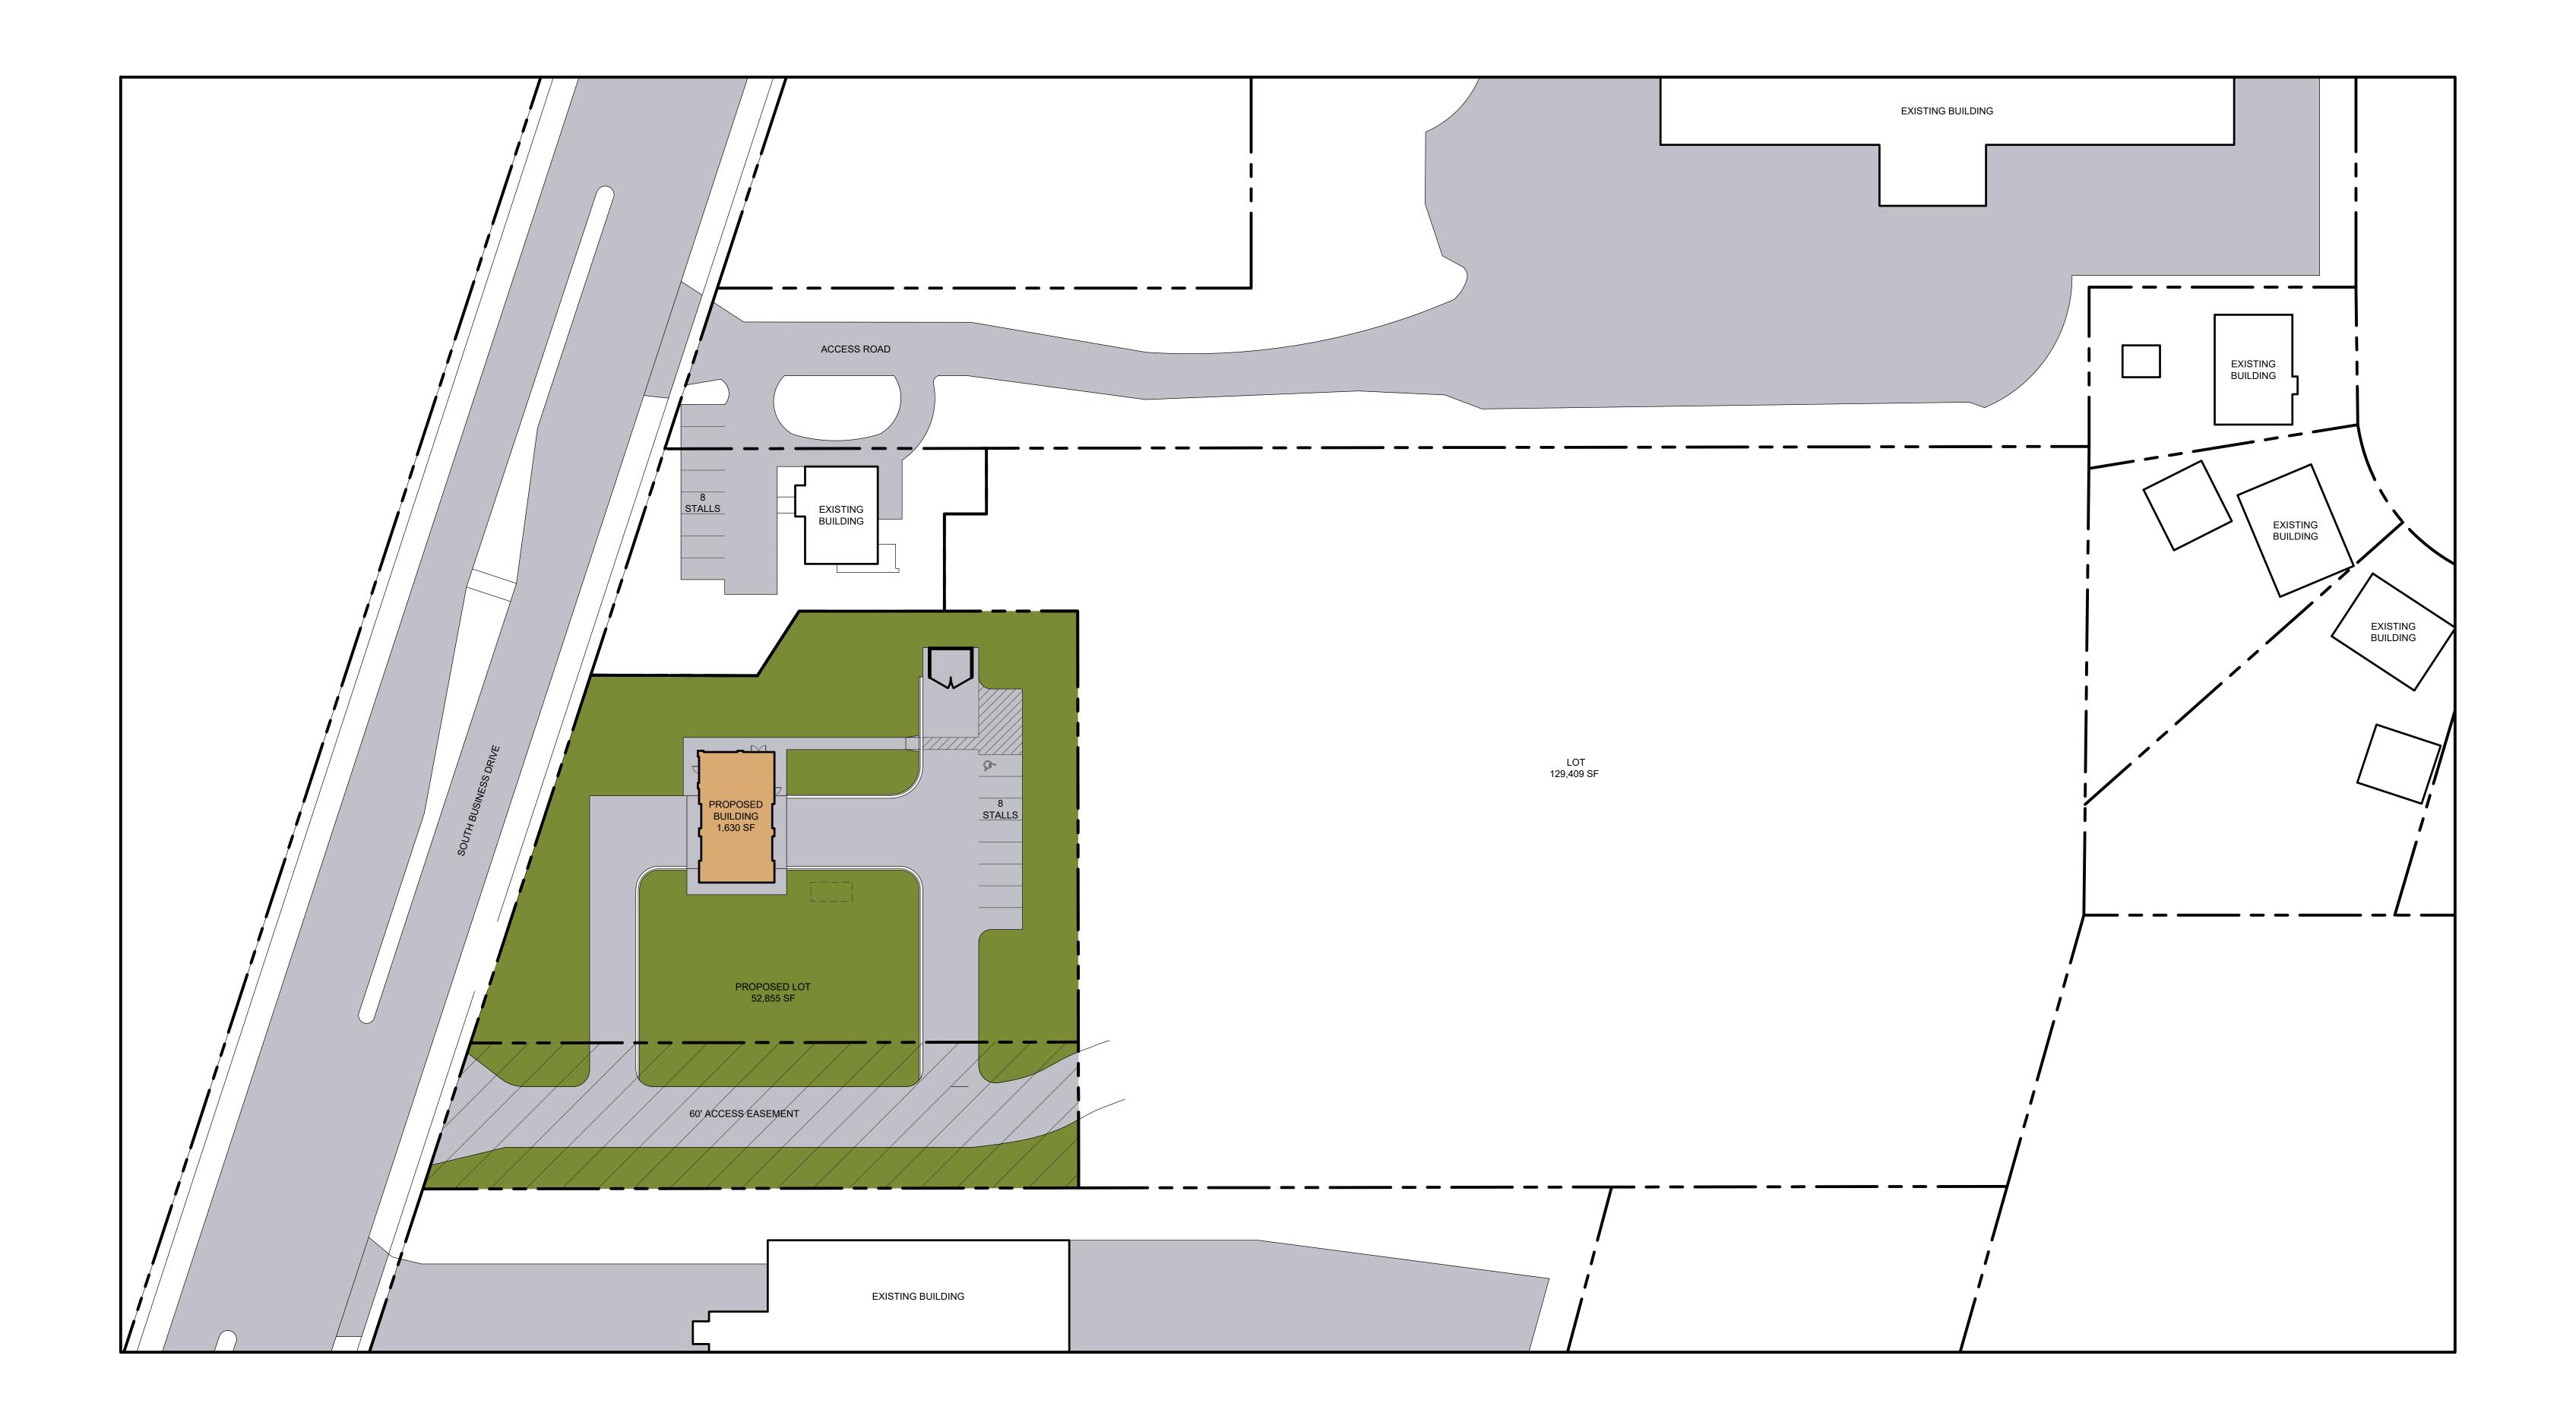






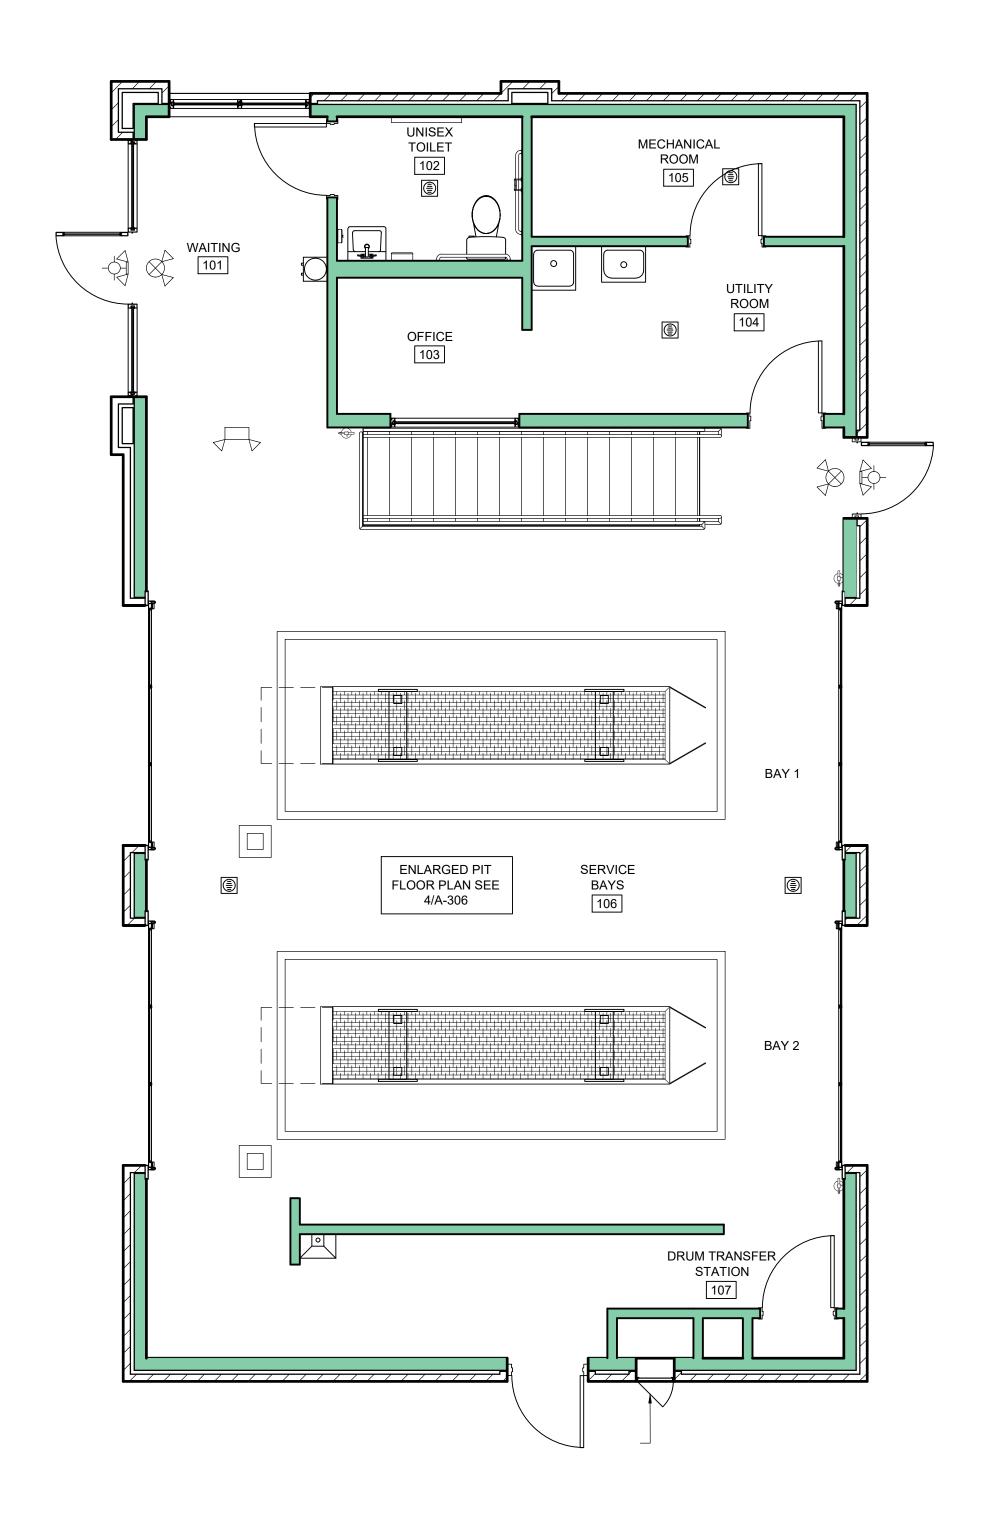

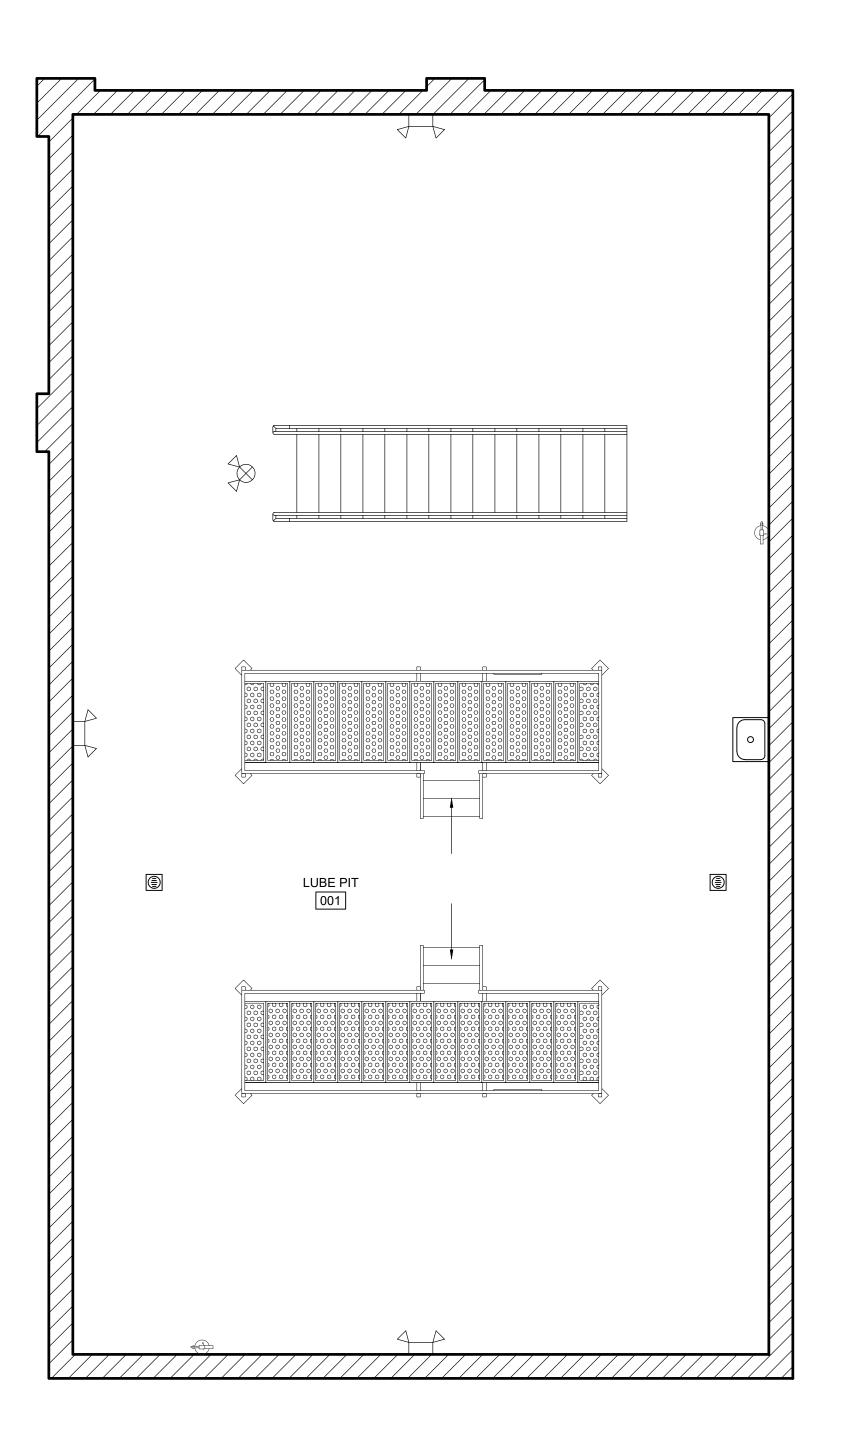

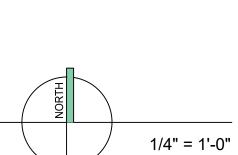

LOWER LEVEL PLAN



Document Date:


Project Number:

Sheet Title:
LOWER LEVEL AND
UPPER LEVEL PLANS

Sheet Number:

UPPER LEVEL PLAN

1/4" = 1'-0"

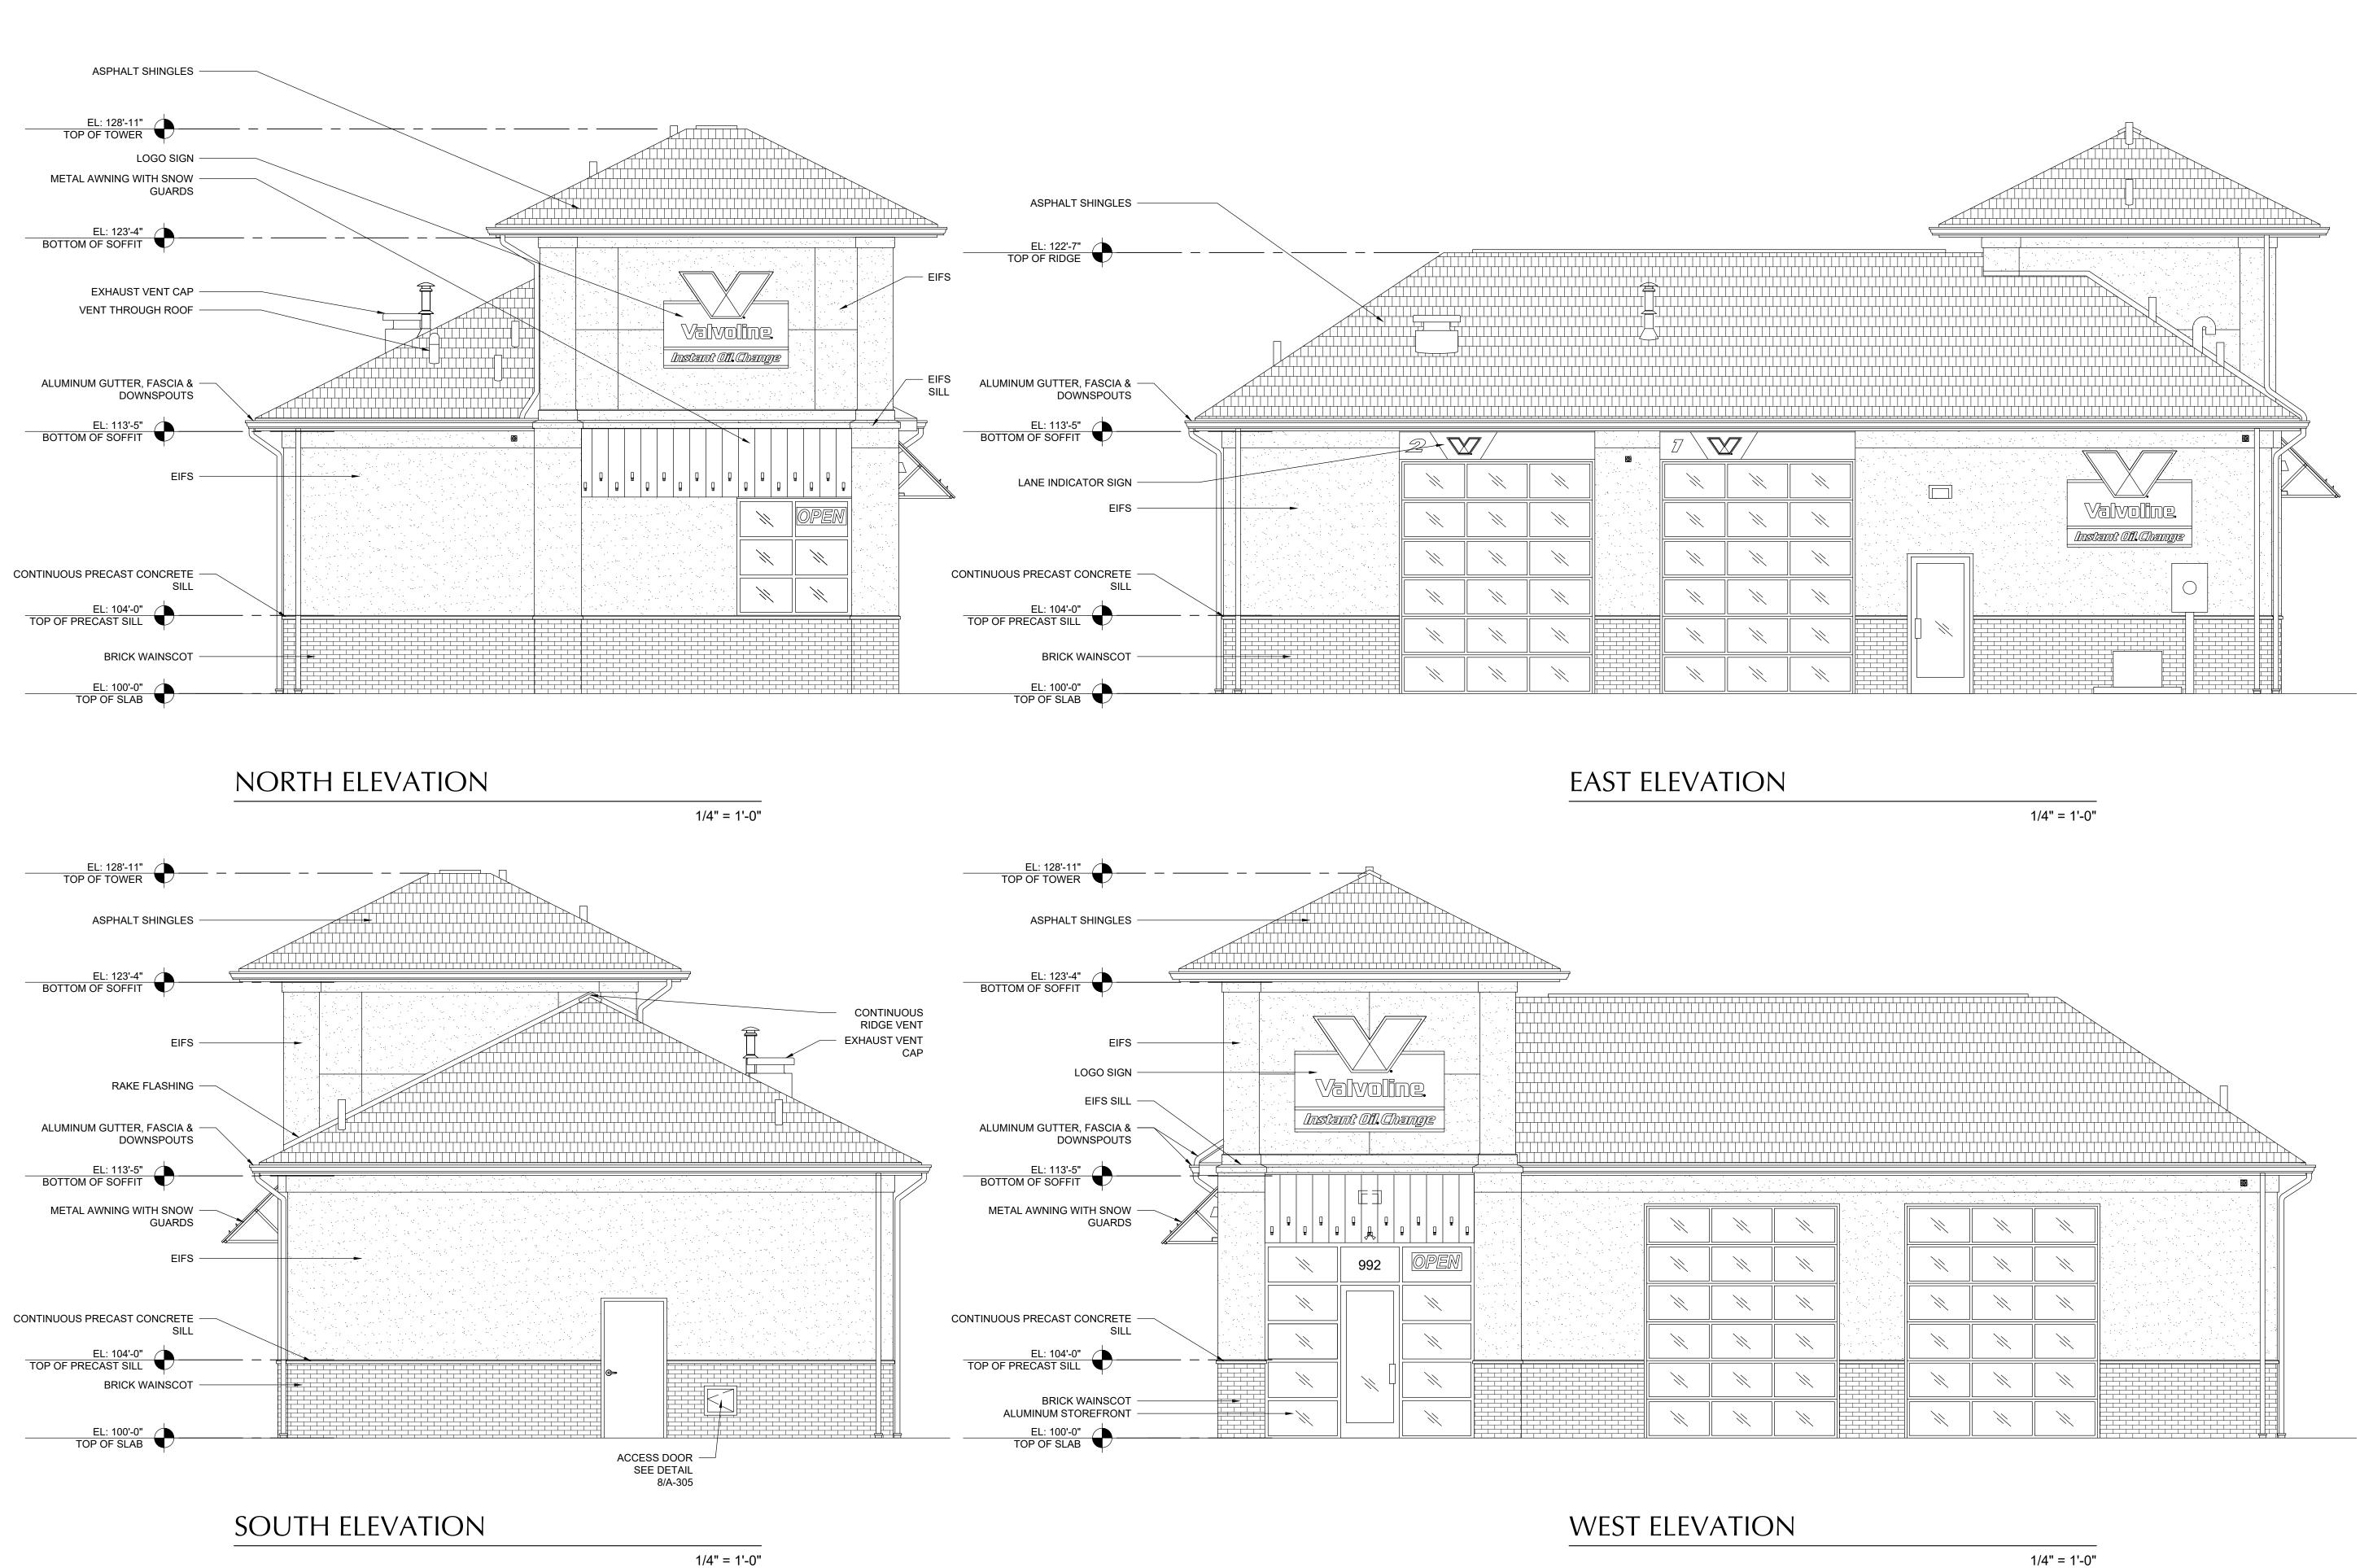



# ant Oil Change

PROPOSED BUILDING

Valvoline Instant (

SHEBOYGAN,

Issue:


Document Date:

Project Number:

Sheet Title: EXTERIOR ELEVATIONS


Sheet Number:

A-201

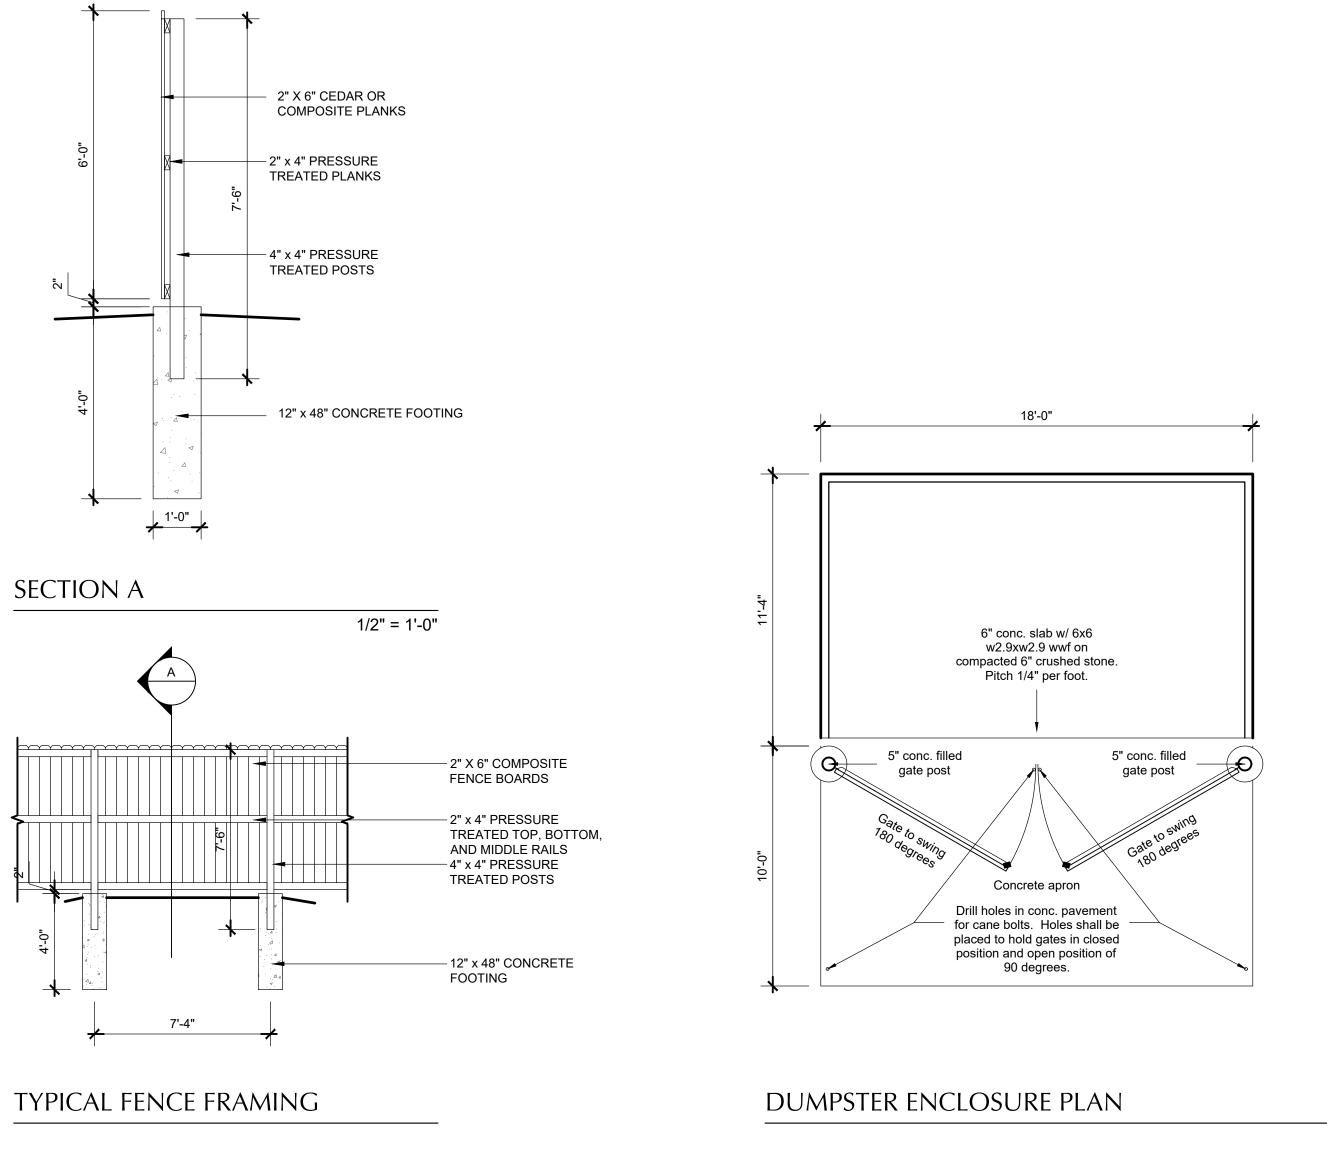

## DUMPSTER ENCLOSURE

1/4" = 1'-0"

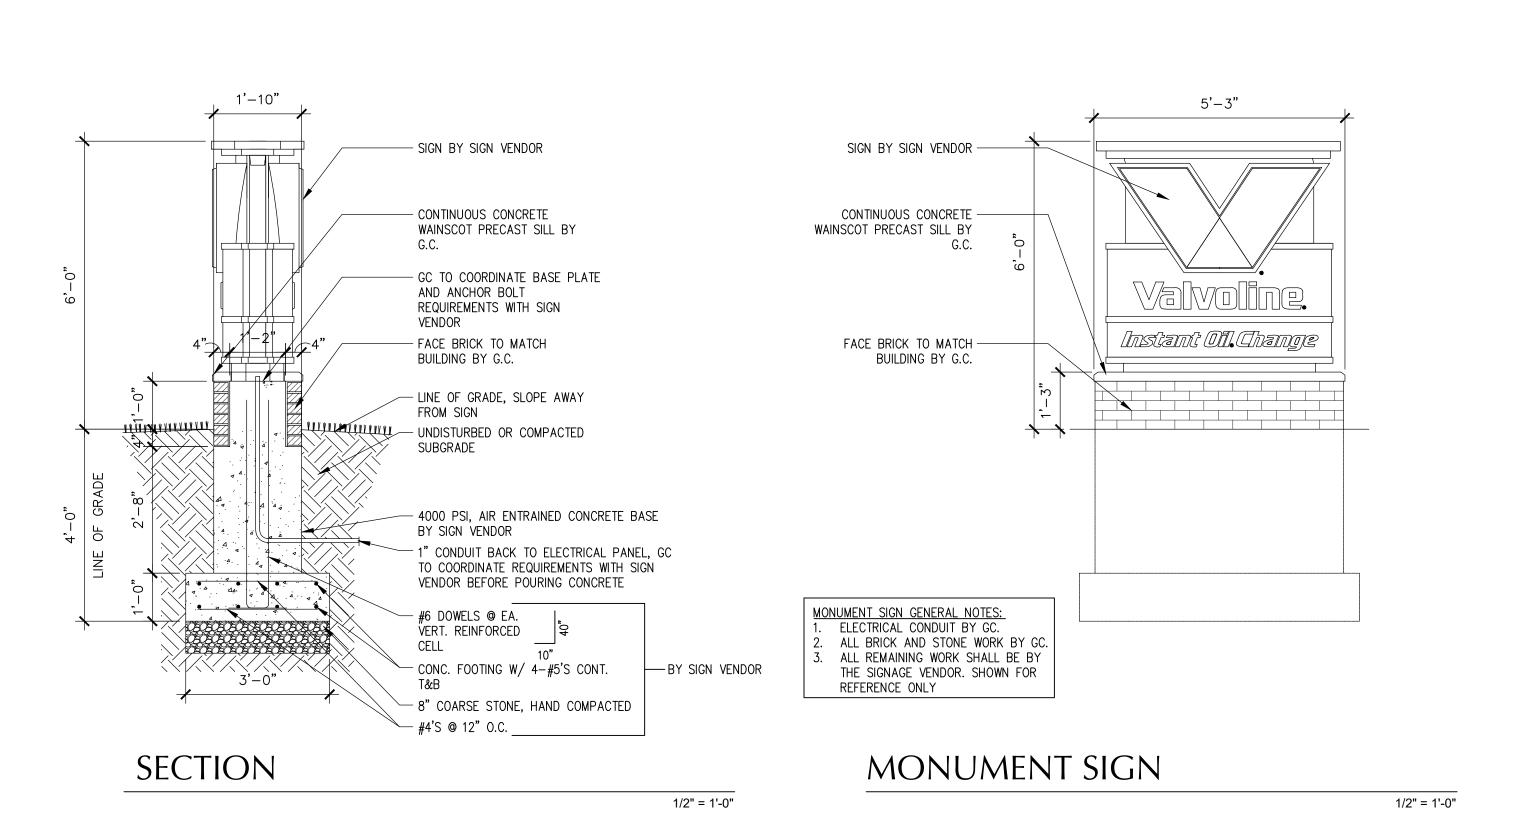



SH

SHEBOY

Document Date:

Issue:

Project Number:

Sheet Title: DUMPSTER ENCLOSURE AND SIGN DETAILS

Sheet Number:

#### REQUEST FOR ARCHITECTURAL REVIEW CONSIDERATION

**ITEM DESCRIPTION:** Architectural review of the construction of Valvoline Instant Oil Change located at parcel 59281431139.

**REPORT PREPARED BY:** Ellise Rose, Zoning Administrator

**REPORT DATE:** September 4, 2025 **MEETING DATE:** September 9, 2025

FISCAL SUMMARY: STATUTORY REFERENCE:

Budget Line Item: N/A Wisconsin N/A

Budget Summary: N/A Statutes:

Budgeted Expenditure: N/A Municipal Code: N/A

Budgeted Revenue: N/A

#### **BACKGROUND / ANALYSIS:**

Adam Hertel is proposing to construct a Valvoline Instant Oil Change located at parcel 59281431139. The applicant states the following:

- The proposed project is a Valvoline Instant Oil Change. The services offered include full service oil change, radiator and air conditioning service, air filter replacement, along with other preventative maintenance services that are completed in approximately 15 minutes.
- The drive through model involves customers staying in the comfort of their vehicle while services are completed.
- The new building will have a footprint of 1,666 square feet and with a main floor level and a basement level for oil changes.
- The building will be built of load bearing wood stud walls with brick veneer and EIFS for wall materials and sloped trusses with asphalt shingles for a roof.
- The store will have two maintenance bays with large glass overhead doors and a waiting space with aluminum storefront windows.
- Other site features include paved parking areas, driveways, site lighting and landscaping.

#### **STAFF COMMENTS:**

None

#### **ACTION REQUESTED:**

Motion to approve with possible amendments as determined by the Board.

#### ATTACHMENTS:

1

85

Item 14.

CITY OF SHEBOYGAN
ARCHITECTURAL REVIE

#### TURAL REVIEW **APPLICATION**

_		Item 14.
Fee:		 
Revie	w Date:	

Read all instructions before completing. If additional space is needed, attach additional pages.

SECTION 1: Applicant/ Permittee Infor	mation					
Name (Ind., Org. or Entity) American Architectural Group	Authorized Repres		Title Archited	ct		
Mailing Address 3350 S. River Road	City West Bend		State <b>W</b> I	ZIP Code <b>53095</b>		
Email Address adam@teamaag.net	Phone Number (inc 262-334-3811		•			
SECTION 2: Landowner Information (C	omplete These Field	s When Project Site	Owner is I	Different than Applicant)		
Name (Ind., Org. or Entity) Klees & Sulok Oil	Contact Person Dean Sulok		Title Owner	_		
Mailing Address 2795 E. Washington Street	City West Bend		State <b>W</b> I	ZIP Code <b>53095</b>		
Email Address sulokoilco@charter.net		Phone Number (inc	cl. area cod	le)		
SECTION 3: Architect Information						
Name Same as Section 1						
Mailing Address	City		State	Zip		
Email Address Phone Num		Phone Number (inc	er (incl. area code)			
<b>SECTION 4: Contractor Information</b>						
Name <b>NA</b>						
Mailing Address	City		State	Zip		
Email Address		Phone Number (inc	l. area cod	le)		
SECTION 5: Certification and Permission	n					
Certification: I hereby certify that I am	the owner or author	rized representative	of the own	er of the property which is		
the subject of this Architectural Review		•				
attachments are true and accurate. I ce	ertify that the project	t will be in compliand	ce with all o	conditions. I understand tha		
failure to comply with any or all of the	provisions of the per	mit may result in pe	rmit revoca	ation and a fine and/or		
forfeiture under the provisions of appli						
<b>Permission:</b> I hereby give the City perm				ble times, to evaluate this		
notice and application, and to determin		1	coverage.	Discount of the		
Name of Owner/Authorized Representa  Dean Sulok	ative (please print)	Title Owner		Phone Number		
Signature of Applicant			Date Sign	ed 19-25		
				1 0 3		

placed on the agenda of the Architectural Review Board, application must be filed three weeks prior to date of meeting – check with City Development on application submittal deadline date. Applications will not be processed if all required attachments and filing fee of \$100 (payable to the City of Sheboygan) are not submitted along with a complete and legible application. Application filing fee is non-refundable.

# PROPOSED BUILDING:

# VALVOLINE INSTANT OIL CHANGE

3107 S. BUSINESS DRIVE CITY OF SHEBOYGAN, SHEBOYGAN COUNTY





Stor

LOCATION MAP

SHEET INDEX

SHEET	DESCRIPTION		PLAN COMMISSION SUBMITTAL	REVISIONS - 1	REVISIONS - 2
		<u>,                                    </u>			
GENERAL					
G-101	TITLE SHEET AND LOCATION MAP		08 / 21 / 2025		
ARCHITECT					
A-100	PROPOSED SITE PLAN				
A-101	LOWER LEVEL AND UPPER LEVEL PLANS				
A-201	EXTERIOR ELEVATIONS				
A-202	DUMPSTER ENCLOSURE AND SIGN DETAILS				
				_	_

#### PROJECT TEAM

OWNER CONTACT: Dean Sulok

Klees & Sulok Oil 2795 E. Washington Street West Bend, WI 53095 EMAIL: sulokoilco@charter.com

ARCHITECT:

Adam Hertel
American Architectural Group, Inc.
3350 South River Road
West Bend, WI 53095
PH: (262) 334-3811
EMAIL: adam@teamaag.net

....


Document Date

Project Number

Sheet Title
TITLE SHEET AND
LOCATION MAP


Sheet Number


G-101\_

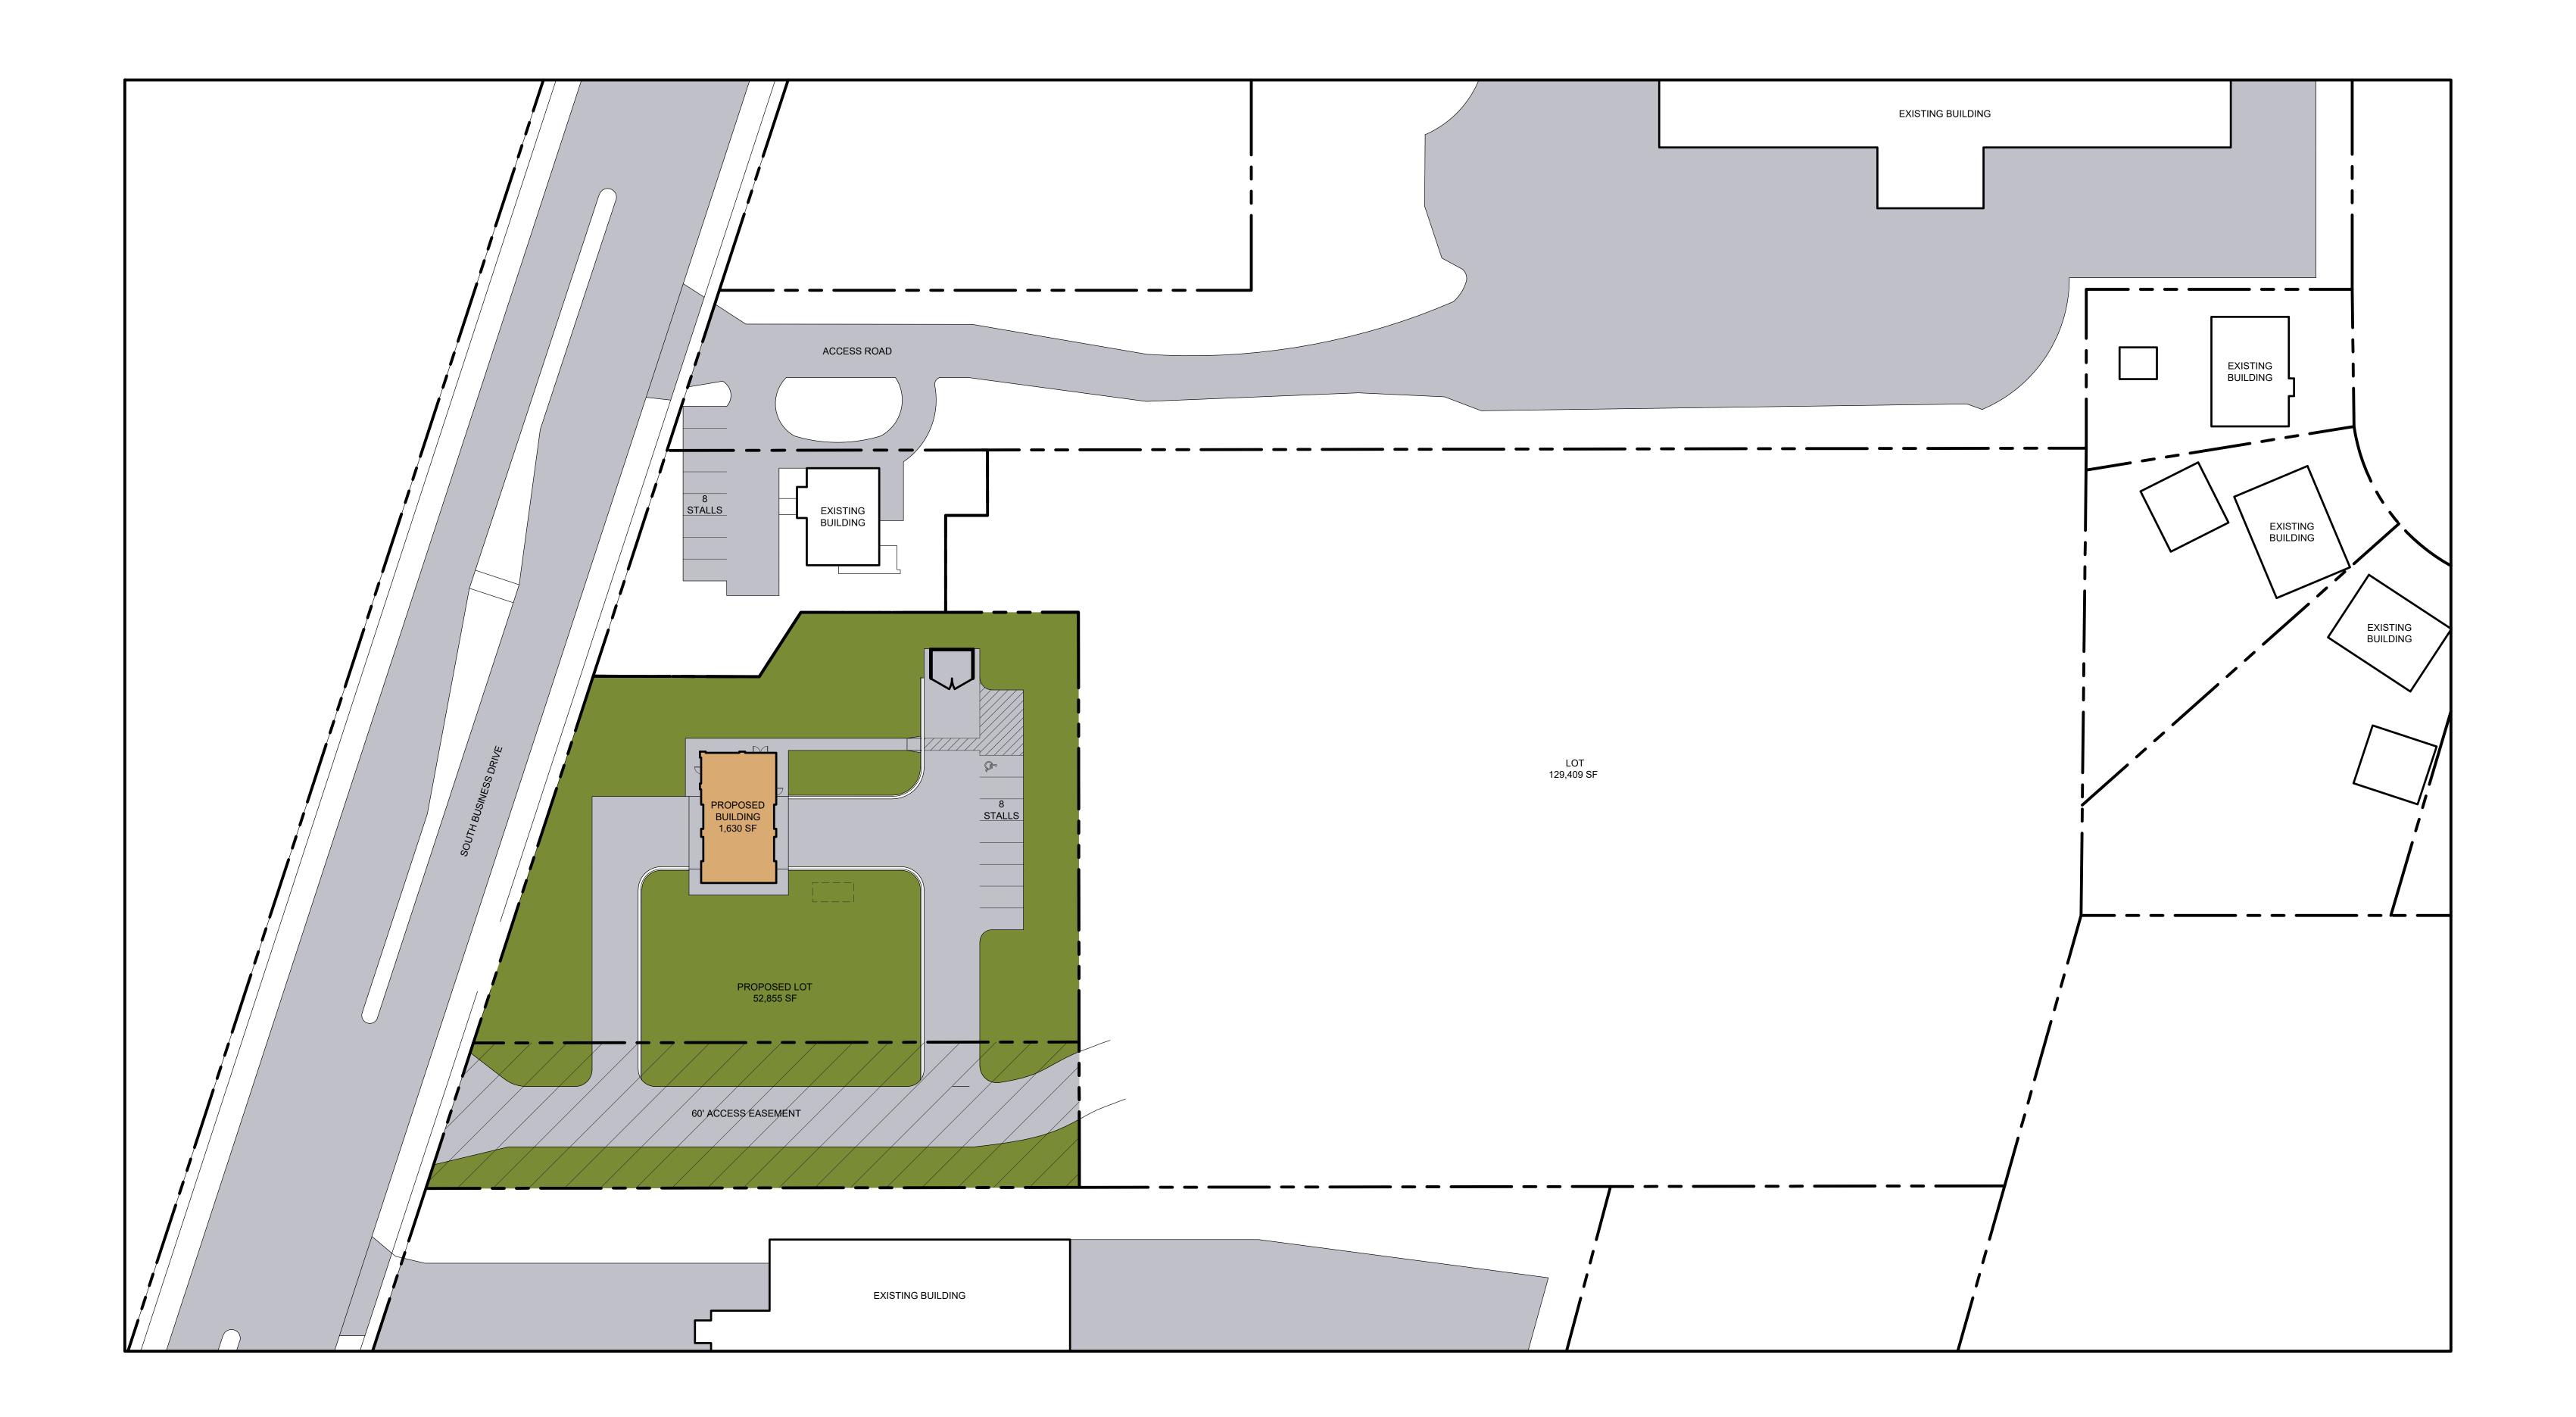






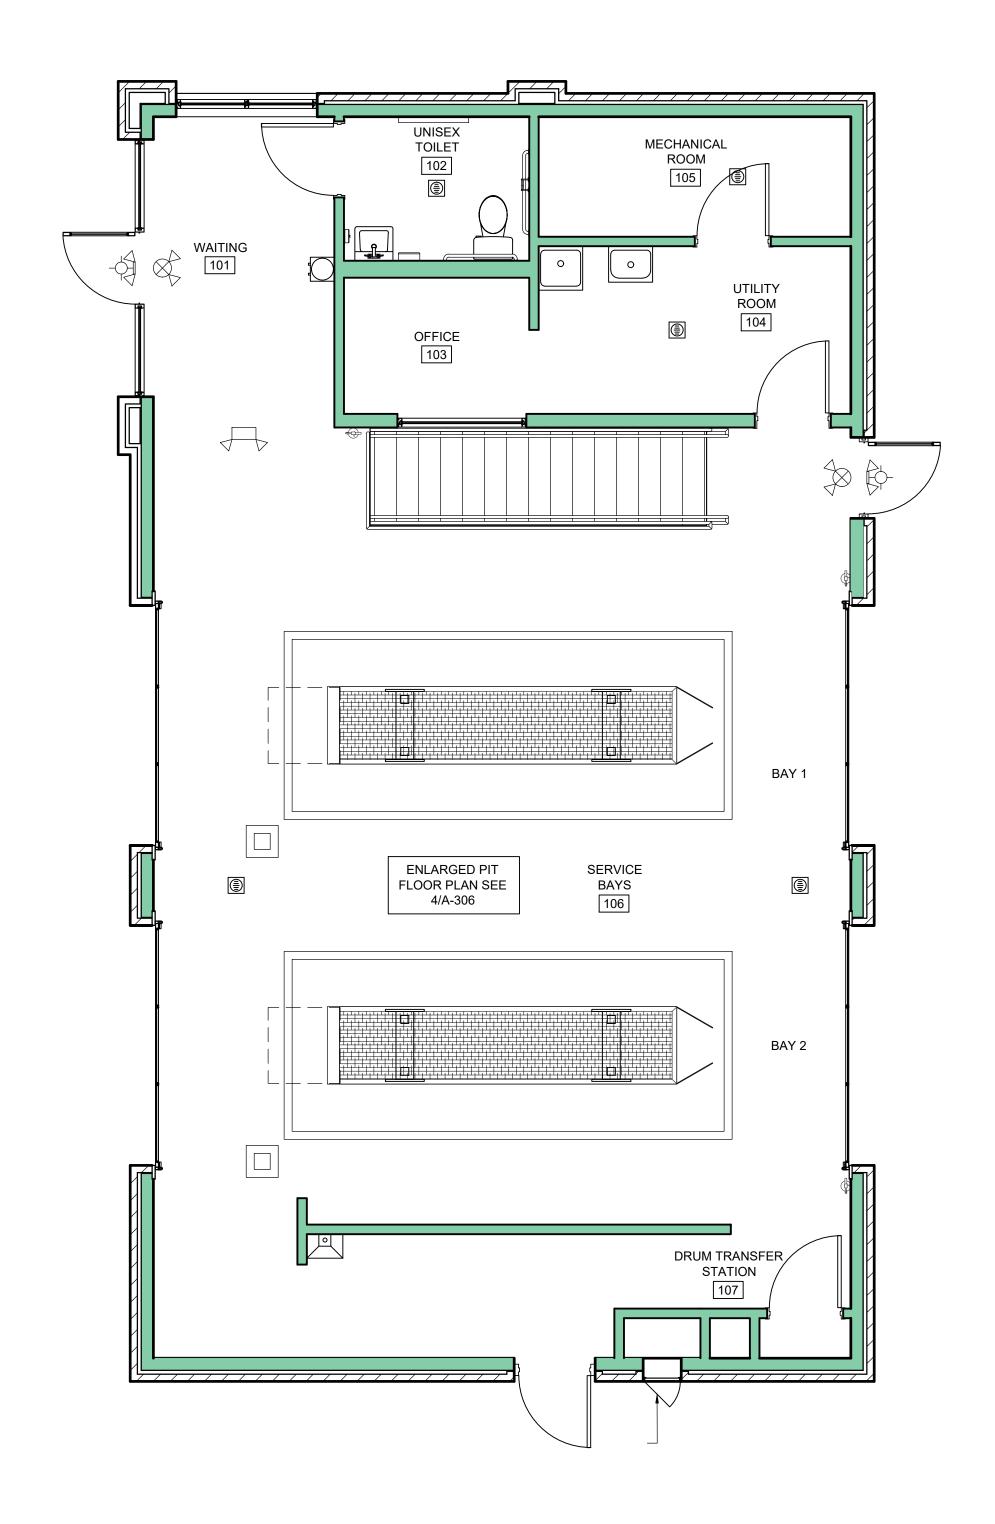

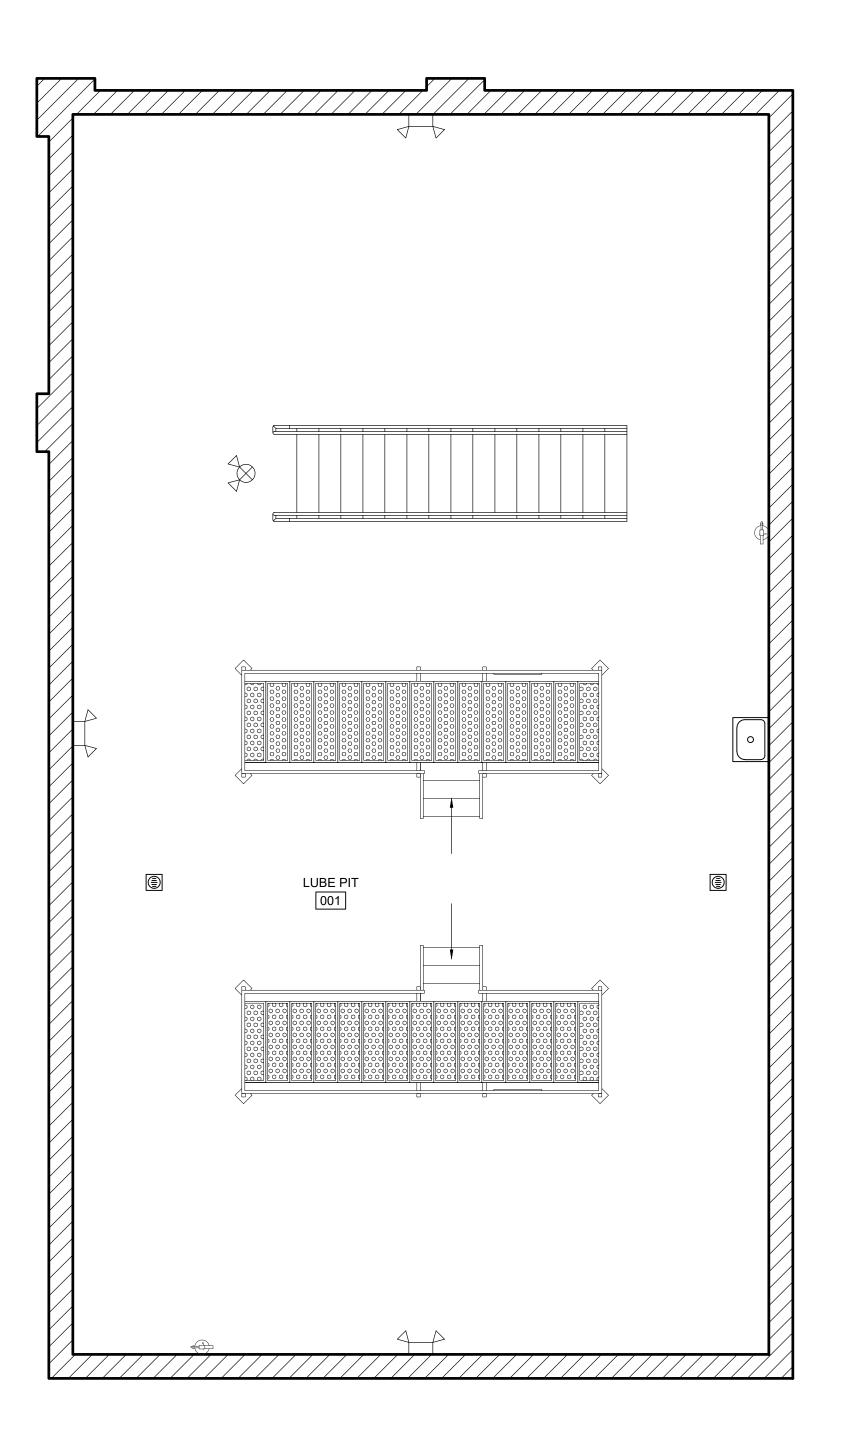

LOWER LEVEL PLAN

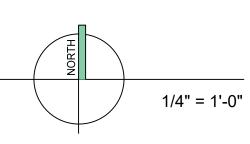



Valvoline Instant Oil Chai

Document Date:

Project Number:


Sheet Title:
LOWER LEVEL AND
UPPER LEVEL PLANS

Sheet Number:

A-101

UPPER LEVEL PLAN

1/4" = 1'-0"

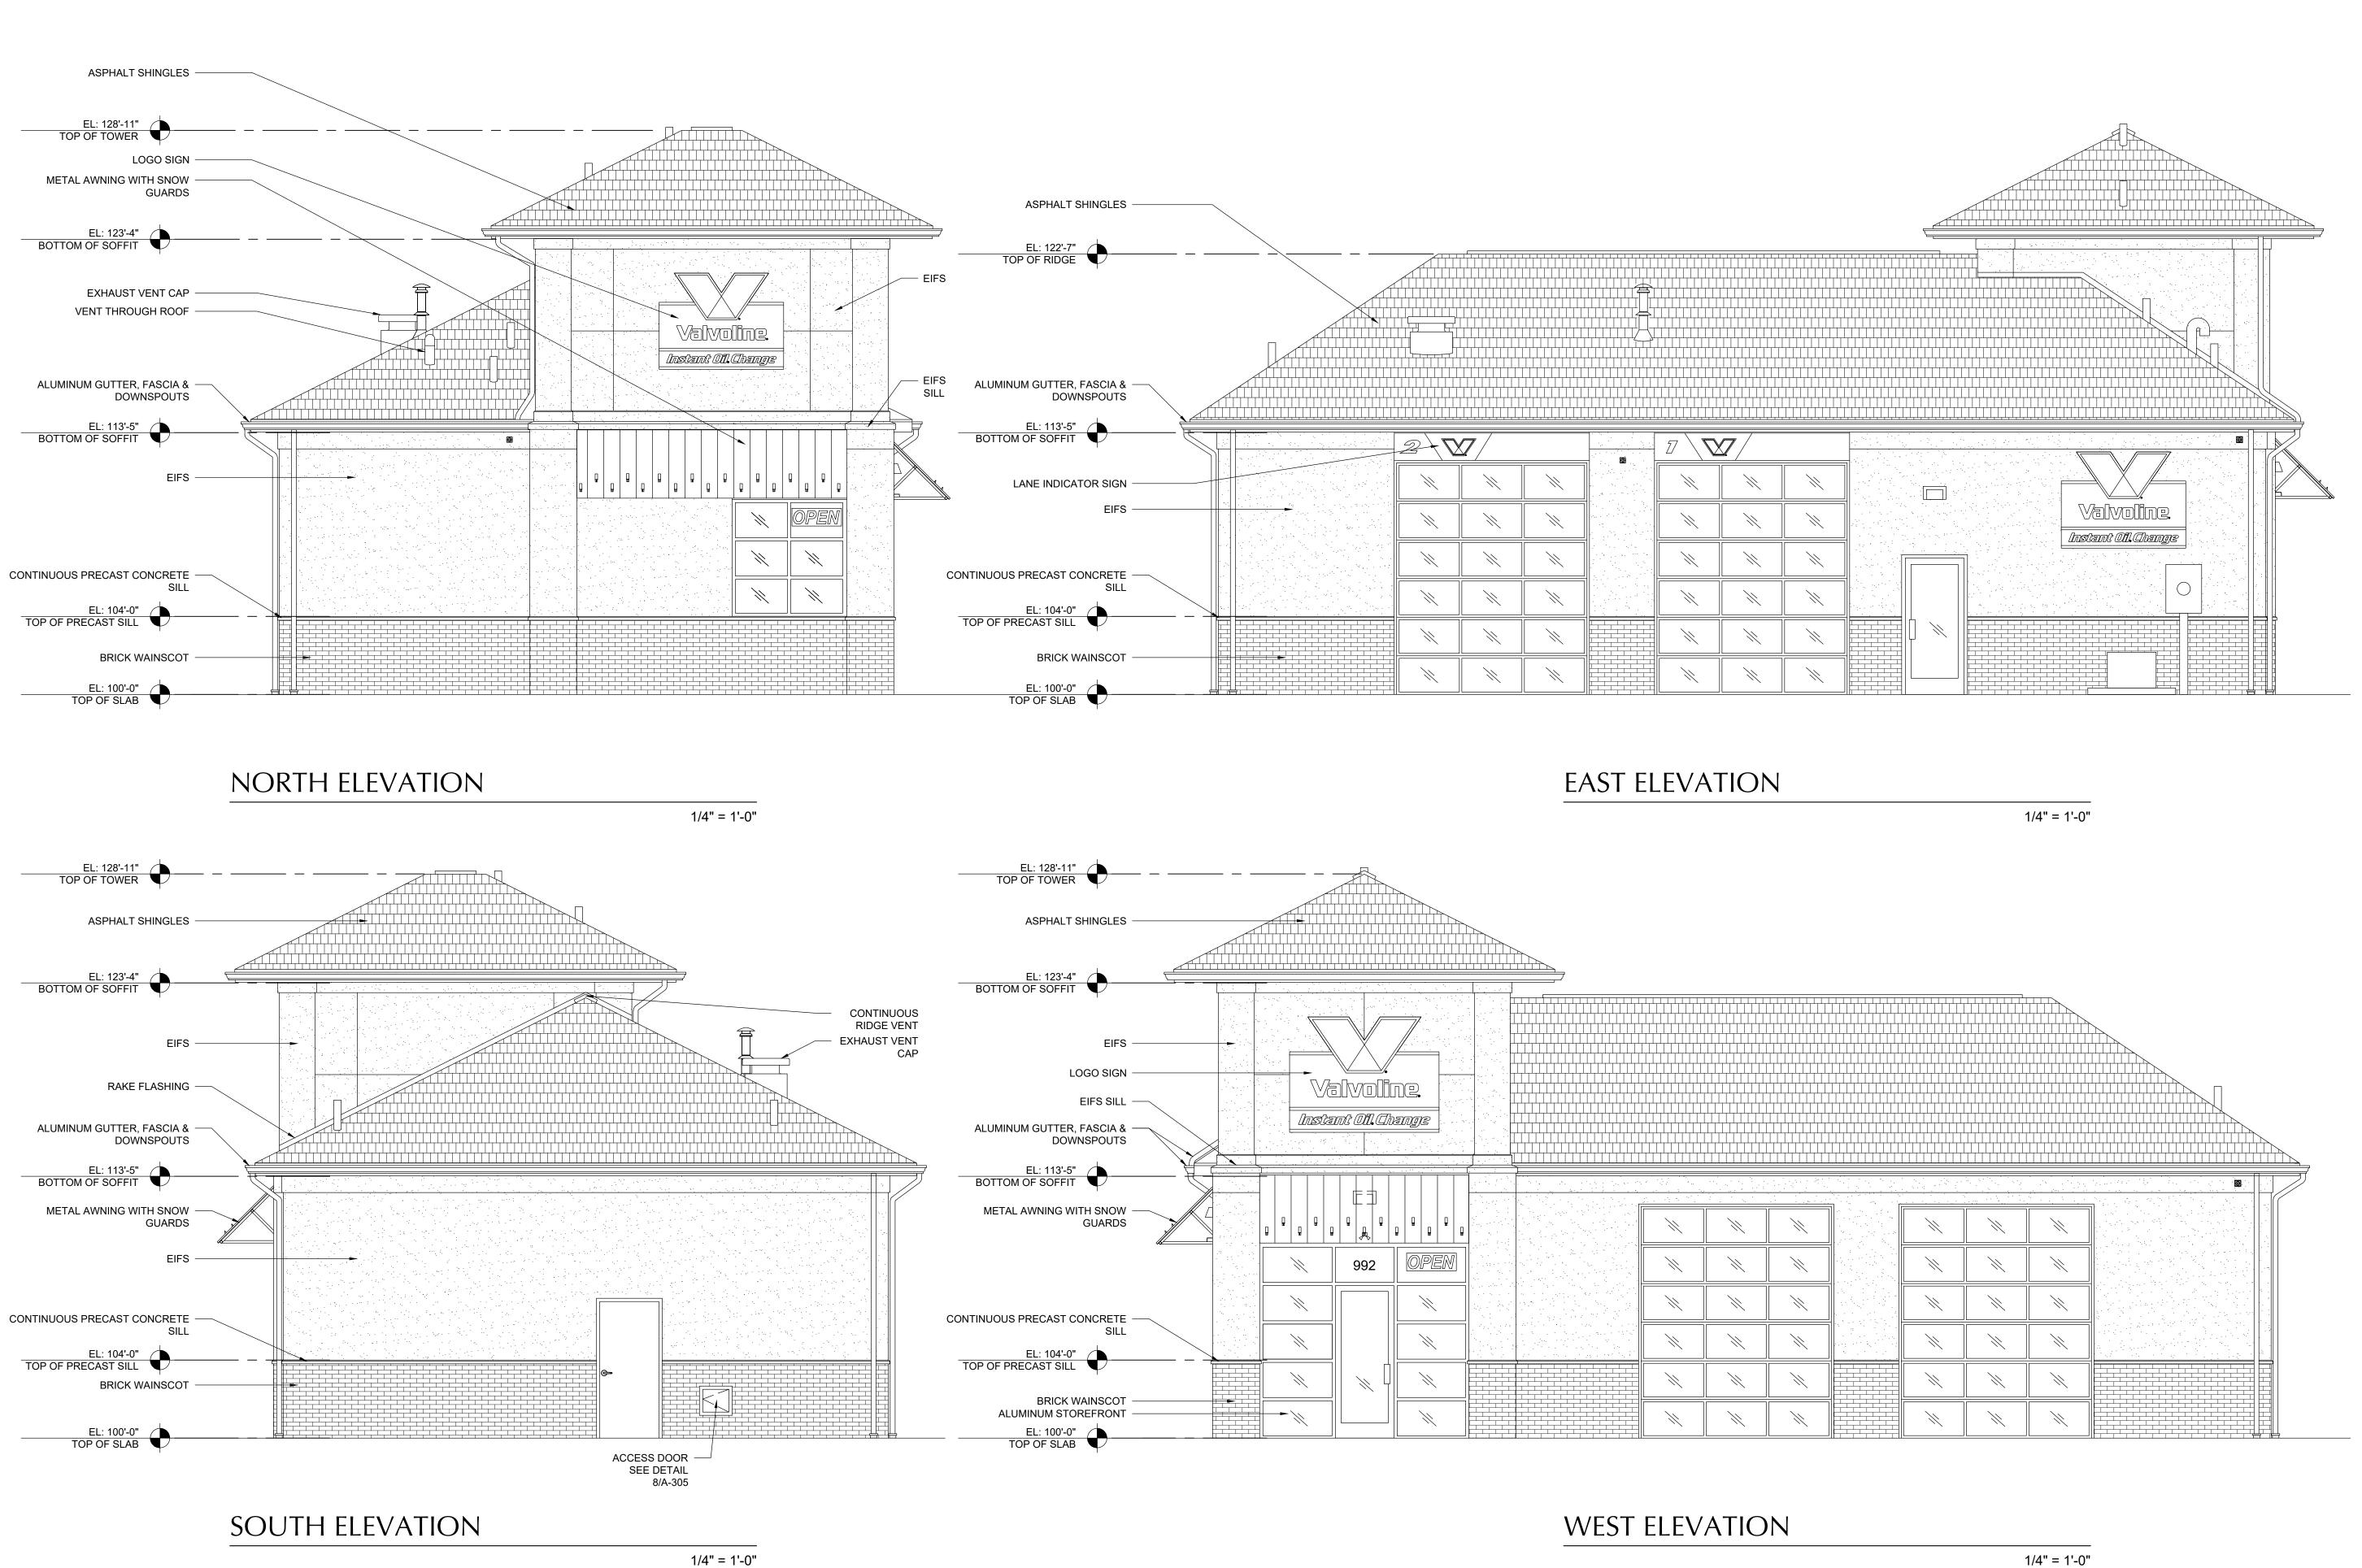



SHEBOYGAN,

PROPOSED


Issue:

Document Date:

Project Number:


Sheet Title: **EXTERIOR ELEVATIONS** 

Sheet Number:

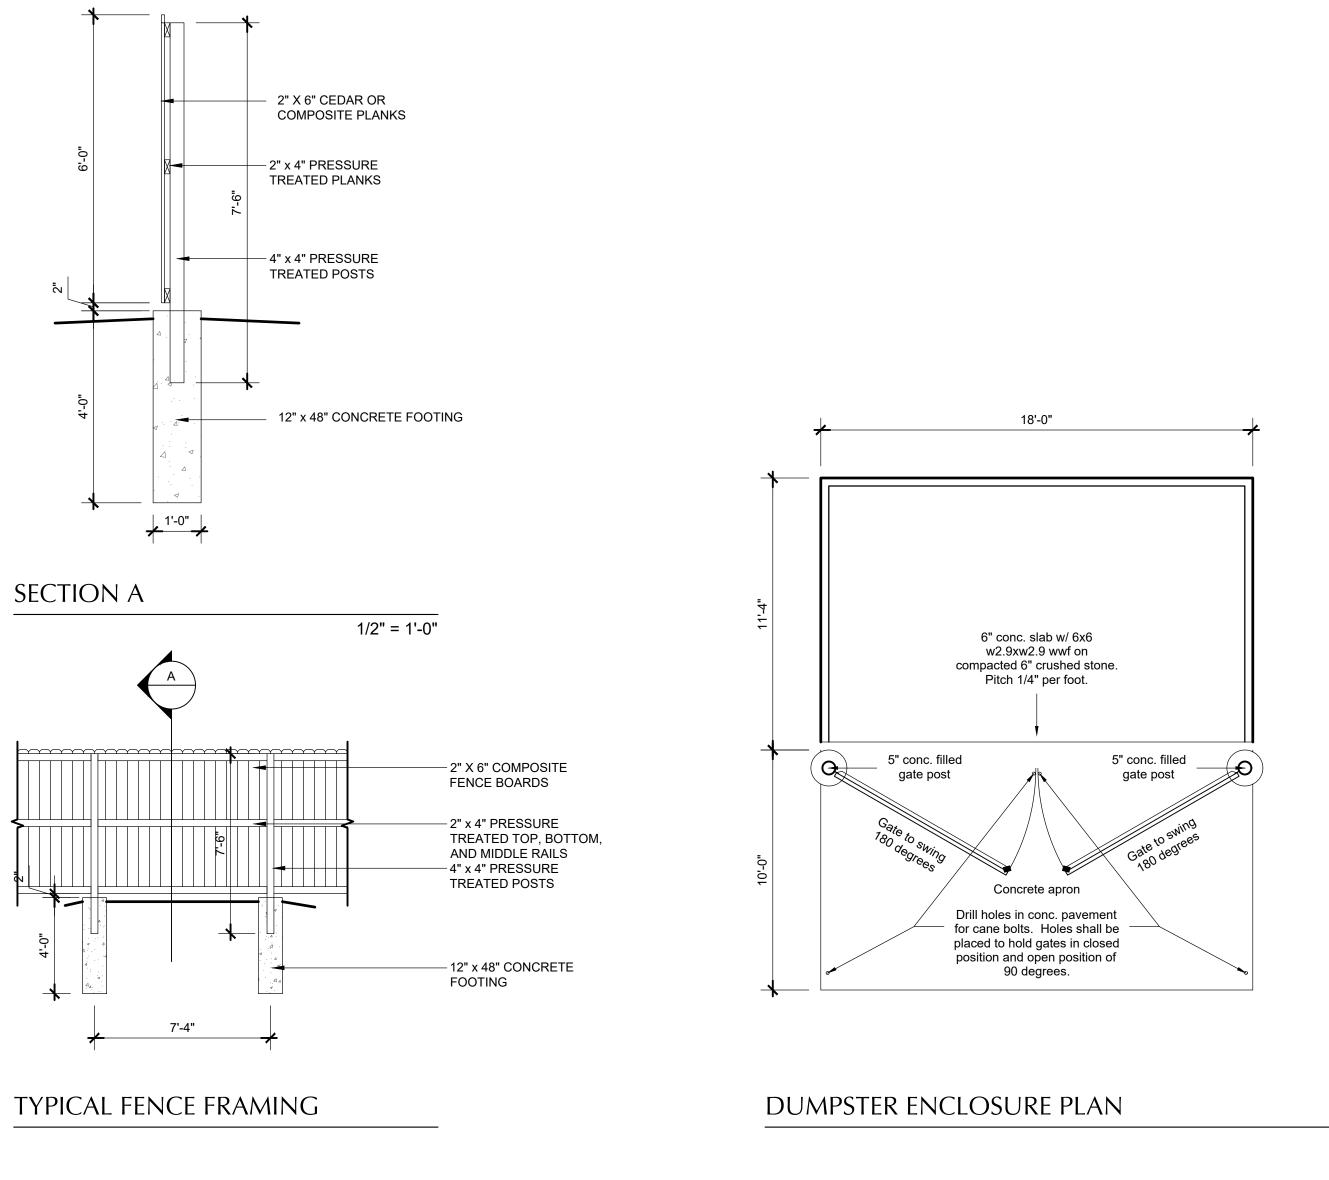

# DUMPSTER ENCLOSURE

1/4" = 1'-0"

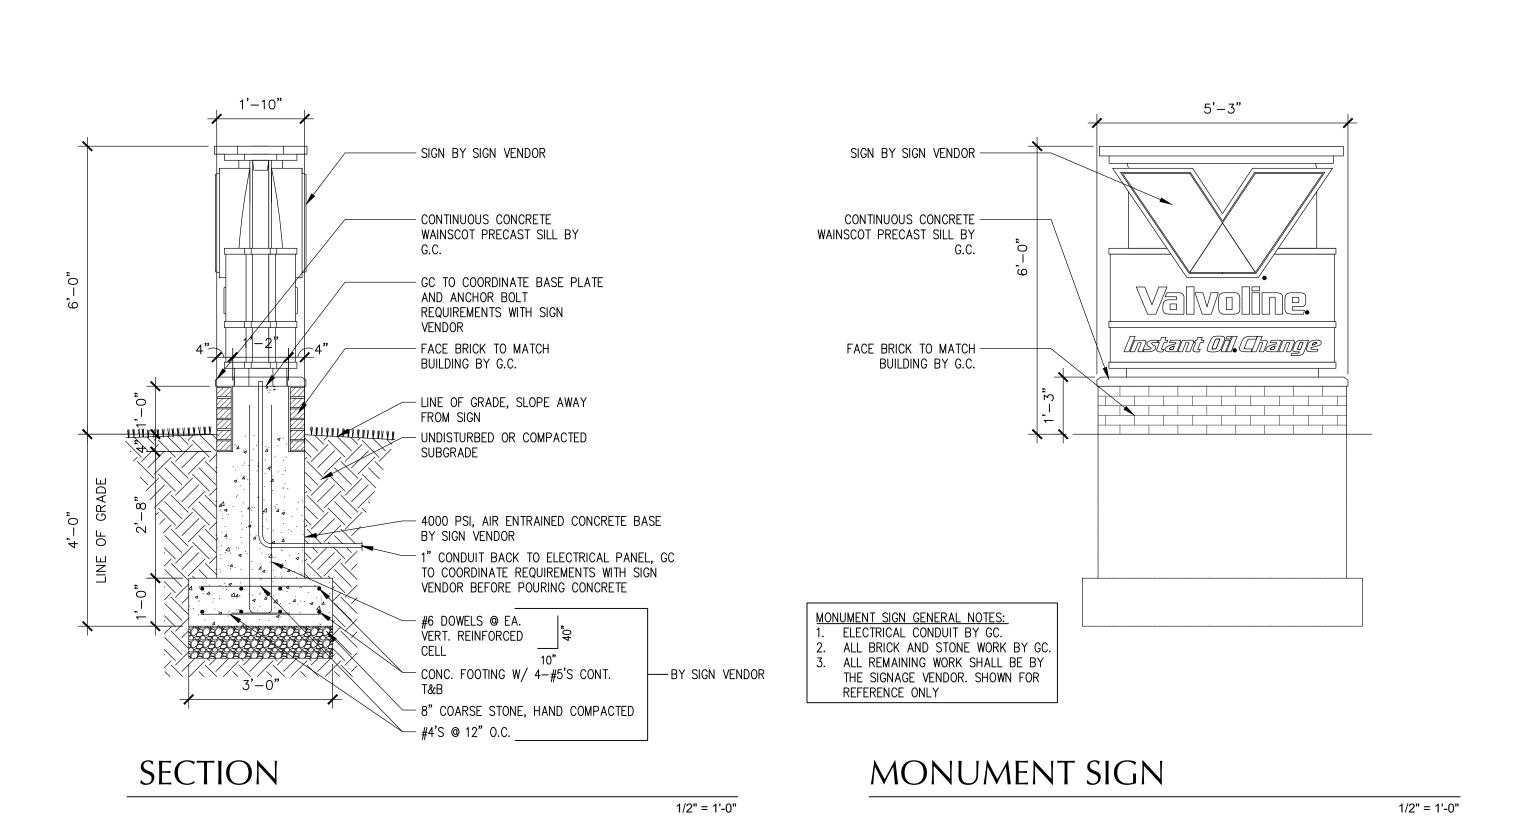



SH

SHEBOY

Issue:

Document Date:

Project Number:

Sheet Title: DUMPSTER ENCLOSURE AND SIGN DETAILS

Sheet Number:

#### REQUEST FOR CITY PLAN COMMISSION CONSIDERATION

**ITEM DESCRIPTION:** Application for Special Use Permit by Paul Mertens to operate God Connection located at 818 Erie Ave. CC Central Commercial Zone.

**REPORT PREPARED BY:** Ellise Rose, Zoning Administrator

**REPORT DATE:** September 2, 2025 **MEETING DATE:** September 9, 2025

#### **APPLICANT PROPOSAL:**

Paul Mertens is proposing to operate God Connection located at 818 Erie Ave. The applicant states the following:

- The structure is a retail storefront that is currently vacant
- The proposed use is a learning center open to the public for the study of Jesus Christ thru: movies, books, bible studies, lectures, and fellowship at no cost.

#### STAFF ANALYSIS:

The use is permitted as special use under the Central Commercial zoning district as indoor institutional. No exceptions are required for the project.

#### **ACTION REQUESTED:**

Staff recommends approval of the site plan subject to the following conditions:

- Prior to building permit issuance, the applicant shall obtain all licenses/permits as well as meet all required codes including but not limited to building, plumbing, electrical, HVAC, fire, water, sewer, storm drainage, health, State of Wisconsin, etc. An occupancy permit shall be granted only at such time as the applicant has met all requirements.
- 2. If dumpsters are used, dumpster(s) shall be screened/enclosed and constructed of like materials and colors of the facility. Applicant will provide plans that show the location of any dumpsters and will provide plans that show how the dumpster is to be screened and enclosed (design, materials, colors, location, etc.).
- 3. Outdoor storage of materials or equipment shall be prohibited.
- 4. All lighting shall be installed per Section 105-932 of the City of Sheboygan Zoning Ordinance. There shall be no spillover light onto adjacent properties or the streets.
- 5. Applicant shall work with staff with regards to appropriate signage. Only at such time as the sign package has been reviewed and approved may the applicant obtain sign

1

94

Item 15.

- permits to install the proposed signage. If staff has any concerns with proposed sign design, the matter may be brought back to the Plan Commission for their consideration.
- 6. If there are to be any remodel/renovations to the exterior of the facility, the applicant will be required to obtain Architectural Review approval prior to receiving a building permit for such remodel/renovation.
- 7. If there are any amendments to the approved special use permit and/or site plan, the applicant will be required to submit a new application reflecting those amendments.

#### **ATTACHMENTS:**

Site plan review application and attachments



## SPECIAL USE AND SITE PLAN REVIEW APPLICATION

Fee: \$100	Item 15.
Review Date:	
Zoning:	

Read all instructions before completing. If additional space is needed, attach additional pages.

SECTION 1: Applicant/ Permittee Infor	mation				
Name (Ind., Org. or Entity)	Authorized Repres	entative	Title		
GOD CONNECTION	PAUL R. A		0	WNED	P
Mailing Address	City		State		ZIP Code
14015.25TH ST	SHEBOX	FAN	WI		53031
Email Address		Phone Number (inc	cl. area cod	de)	,
PAULMERTENS@ ICLOU	DICOM	920-918	-055	4	
SECTION 2: Landowner Information (co	omplete these fields	when project site o	wner is di	fferent th	an applicant)
Name (Ind., Org. or Entity)	Contact Person		Title		
HM2 PROPERTY MANAGME	WT K	EVIN	MA	MAGE	ZIP Code
Mailing Address	City		State		ZIP Code
1313 MICHIGAN AVE	SHEBOY	6 AN	41		53081
Email Address		Phone Number (inc			_
		920-9	190-	2015	j .
SECTION 3: Architect Information		(1990年) · (1990年)			
Name A. /					
N/A					
Mailing Address	City		State		Zip
Email Address		Phone Number (inc	cl. area cod	de)	
SECTION 4: Contractor Information	<b>发出的</b> 。			1000	<b>发表是是一个人</b>
Name					
N/A					
Mailing Address	City		State		Zip
Email Address		Phone Number (inc	cl. area cod	de)	
		***			
<b>SECTION 5: Certification and Permission</b>	on				
Certification: I hereby certify that I am	the owner or author	rized representative	of the owr	ner of the	property which is
the subject of this Site Plan Review App	olication. I certify tha	it the information co	ntained in	this form	and attachments
are true and accurate. I certify that the					
comply with any or all of the provisions		-			
under the provisions of applicable laws					•
Permission: I hereby give the City perm		nspect the property	at reasona	able times	, to evaluate this
notice and application, and to determine					
Name of Owner/Authorized Represent		Title		Phone N	umber
A CONTRACTOR OF THE PARTY OF TH	and the same of th				consus appelle 1907
Signature of Applicant O	Access		Date Sign	ned a /	1
Taul R	Meston			8/2	10/2025
Complete application is to be filed with t	the Department of C	ity Development, 82	8 Center A	venue. Su	ite 208. To be

Complete application is to be filed with the Department of City Development, 828 Center Avenue, Suite 208. To be placed on the agenda of the City Plan Commission, application must be filed three weeks prior to date of meeting – check with City Development on application submittal deadline date. Applications will not be processed if all required attachments and filing fee of \$100 (payable to the City of Sheboygan) are not submitted along with a complete and legible application. Application filing fee is non-refundable.

SECTION 6: Description of the Subject Site/Proposed Project					Item 15.
Parcel No.		Zoning Classif	ication		
Name of Proposed/Existing Business:	600 CO	NNECTIO	W		
Address of Property Affected:	BIR ERIE	AUE S	SHEBOYL-AN		
New Building:	Addition:		Remodeling:		
SECTION 7: Brief Description of Type of	of Structure				

RETAIL STOREFRONT

#### **SECTION 8: Description of EXISTING Operation or Use**

VACAMT

#### **SECTION 9: Description of the PROPOSED Operation or Use**

A LEARNING CENTER OPEN TO THE PUBLIC FOR THE STUPY OF JESUS CHRIST THRU: MOVIES - BOOKS - BIBLE STUDIES -LECTURES - + FELLOWSHIP AT NO COST,

