

DEVELOPMENT REVIEW COMMITTEE

Tuesday, February 27, 2024, at 10:00 AM Council Chambers at City Hall Building and Online 110 S. Center Street, Santaquin, UT 84655

MEETINGS HELD IN PERSON & ONLINE

The public is invited to participate as outlined below:

- In Person The meeting will be held in the Council Chambers on the Main Floor in the City Hall Building
- YouTube Live Some public meetings will be shown live on the Santaquin City YouTube
 Channel, which can be found at https://bit.ly/2P7ICfQ
 or by searching for Santaquin City Channel on YouTube.

ADA NOTICE

If you are planning to attend this Public Meeting and due to a disability need assistance in understanding or participating in the meeting, please notify the City Office ten or more hours in advance and we will, within reason, provide what assistance may be required.

AGENDA

NEW BUSINESS

1. Scenic Ridge Estates Minor Change Review

A review of a minor change in the Scenic Ridge Estates subdivision located at approximately 430 S. 1200 E.

2. Apple Hollow at The Orchards B-1 & B-2 Final Plan

A final review of a 2-lot single-family and 8 townhome subdivision located at approximately 215 W, and 930 N.

3. Apple Hollow at The Orchards B-3 & B-4 Final Plan

A final review of a 7-lot single-family and 21 townhome subdivision located at approximately 130 W. and 930 N.

ADJOURNMENT

CERTIFICATE OF MAILING/POSTING


The undersigned duly appointed City Recorder for the municipality of Santaquin City hereby certifies that a copy of the foregoing Notice and Agenda may be found at www.santaquin.org, in three physical locations (Santaquin City Hall, Zions Bank, Santaquin Post Office), and on the State of Utah's Public Notice Website, https://www.utah.gov/pmn/index.html. A copy of the notice may also be requested by calling (801)754-1904.

BY: Amalie R Ottley City Recorder

SCENIC RIDGE ESTATES SUBDIVISION - PHASE 1

LOCATED IN THE:

17324 S.F

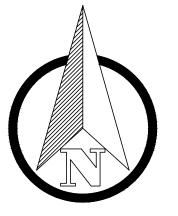

SOUTHWEST QUARTER OF SECTION 6, TOWNSHIP 10 SOUTH, RANGE 2 EAST SALT LAKE BASE AND MERIDIAN, SANTAQUIN CITY, UTAH COUNTY, UTAH

A 10.00 FOOT WIDE PUBLIC UTILITY EASEMENT (P.U.E) IS CREATED ALONG THE FRONT OF EACH LOT AND 5.00

2. THE SUBDIVISION BOUNDARY WAS ESTABLISHED FROM A COMPLETED RECORD OF SURVEY BY EPIC ENGINEERING, FILE NUMBER 22-003, AS FILED IN THE UTAH COUNTY SURVEYOR'S OFFICE.

GENERAL PLAT NOTES

FOOT ALONG THE REAR AND INTERIOR SIDE YARD, PER THIS PLAT. EACH LOT ALONG A STREET REQUIRES A

- ZONING: R-12 SETBACKS (BUILDABLE AREA) PER CODE 10.20.090: DETACHED SINGLE-FAMILY DEVELOPMENT STANDARDS: (SEE SHEET 2)
- FRONT YARD- FRONT SETBACKS TO THE LIVING AREA FROM ALL STREET FRONTING PROPERTY LINES: 30.0 SIDE YARD - 10.0 FEET (25.0 FEET STREET SIDE YARD) REAR YARD - 25.0 FEET. (SEE SHEET 2)

10.00 FOOT WIDE FRONT AND SIDE YARD PUBLIC UTILITY EASEMENT. (SEE SHEET 2)

- 5. AT THE TIME THAT THIS PLAT WAS PREPARED, THE PROPERTY OWNER WAS BYRON BASTIAN AND NEIL J. CRAIG, PER WARRANTY DEED, ENTRY NUMBER 35070:2021, AS RECORDED IN THE UTAH COUNTY RECORDER'S OFFICE, UTAH COUNTY PARCEL NUMBERS 32:040:0042, 32:040:0045 AND 32:040:0047.
- THIS PROPERTY IS LOCATED IN AN AGRICULTURAL COMMUNITY IN WHICH NORMAL AGRICULTURAL USES AND ACTIVITIES ARE COMMON AND PART OF THE IDENTITY OF SANTAQUIN CITY. IT CAN BE ANTICIPATED THAT SUCH AGRICULTURAL USES AND ACTIVITIES MAY NOW OR IN THE FUTURE BE CONDUCTED NEAR THIS PROPERTY PROPERTY OWNERS NEED TO UNDERSTAND AND ACKNOWLEDGE THAT THEY MAY EXPERIENCE ANNOYANCE OR INCONVENIENCE WHICH MAY RESULT FROM SUCH NORMAL AGRICULTURAL USES AND ACTIVITIES. ADDITIONALLY, PROPERTY OWNERS MUST REFRAIN FROM TRESPASSING ON PRIVATE PROPERTY WHICH CAN NEGATIVELY IMPACT THE INTEGRITY OF AGRICULTURAL LANDS AND BUSINESSES.

SUBDIVISION BOUNDARY DESCRIPTION

A PART OF THE SOUTHWEST QUARTER OF SECTION 6, TOWNSHIP 10 SOUTH, RANGE 2 EAST, SALT LAKE BASE AND MERIDIAN, SANTAQUIN CITY, UTAH COUNTY, UTAH: BEGINNING AT SOUTHEAST CORNER LOT 37 OAK SUMMIT PLAT 'B' (ENTRY #11320, UTAH COUNTY RECORDER'S OFFICE) 1276.33' FEET SOUTH 89°40'47" EAST ALONG SAID QUARTER SECTION LINE AND 130.24' NORTH 00°14'50" WEST FROM THE SOUTHWEST CORNER OF SAID SECTION 6; AND RUNNING THENCE ALONG THE EASTERLY AND SOUTHERLY LINES OF SAID OAK SUMMIT PLAT 'B' THE FOLLOWING SEVEN (3) COURSES: (1) NORTH 17°12'59" WEST 110.52 FEET TO THE SOUTHERLY LINE OF 430 SOUTH STREET; (2) NORTH 16°06'43" WEST 56.00 FEET TO THE NORTHERLY LINE OF 430 SOUTH STREET; AND (3) NORTH 16°06'53" WEST 108.36 FEET TO A POINT ON THE SOUTHERLY LINE OF LOT 51; OAK SUMMIT PLAT 'C' (ENTRY #11714, UTAH COUNTY RECORDER'S OFFICE); THENCE ALONG THE SOUTHERLY AND EASTERLY LINES OF SAID OAK SUMMIT PLAT 'C' THE FOLLOWING THREE (3) COURSES: (1) NORTH 76°45'02" EAST 119.79 FEET; (2) NORTH 78°17'52" EAST 248.65 FEET; (3) NORTH 15°14'13" WEST 324.61 FEET TO A POINT ON THE SOUTHERLY LINE OF LOT 73, OAK SUMMIT PLAT 'D' (ENTRY #11715, UTAH COUNTY RECORDER'S OFFICE); THENCE ALONG THE SOUTHERLY AND EASTERLY LINES OF SAID OAK SUMMIT PLAT 'D' AND THE EASTERLY AND SOUTHERLY LINE OF OAK SUMMIT PLAT 'E' (ENRTY #12871 UTAH COUNTY RECORD'S OFFICE) THE FOLLOWING EIGHT (8) COURSES: (1) NORTH 64°57'27" EAST 27.28 FEET; (2) NORTH 62°06'06" EAST 86.06 FEET TO THE WESTERLY LINE OF 1200 EAST STREET; (3) NORTH 57°05'35" EAST 57.06 FEET TO THE EASTERLY LINE OF 1200 EAST STREET; (4) NORTH 68°09'58" EAST 115.00 FEET; AND (5) NORTH 21°50'02" WEST 422.19 FEET TO THE SOUTHERLY LINE OF 270 SOUTH STREET TO THE BEGINNING OF A 1763.98 NONTANGENT CURVE TO THE RIGHT; (6) THENCE ALONG THE ARC 8.43 FEET (CENTRAL ANGLE EQUALS 0°26'26" CHORD BEARS NORTH 42°49'31" EAST 8.43 FEET); (7) NORTH 41°45'56" EAST 0.27 FEET TO THE BEGINNING OF A TANGENT CURVE; (8) NORTHEASTERLY ALONG THE ARC OF AN 18.00 FOOT RADIUS CURVE TO THE RIGHT A DISTANCE OF 24.55 FEET (CENTRAL ANGLE EQUALS 78°09'09" AND LONG CHORD BEARS NORTH 80°50'46" EAST 22.69 FEET) TO THE WESTERLY LINE OF OAK SUMMIT DRIVE AND A POINT OF TANGENCY; THENCE SOUTH 21°50'02" EAST 420.91 FEET; THENCE SOUTH 21°55'30" EAST 20.28 FEET TO THE BEGINNING OF TANGENT CURVE; THENCE SOUTHEASTERLY ALONG THE ARC OF AN 672.82 FOOT RADIUS CURVE TO THE RIGHT A DISTANCE OF 91.17 FEET (CENTRAL ANGLE EQUALS 07°45'49" AND LONG CHORD BEARS SOUTH 18°02'36" EAST 91.10 FEET); THENCE SOUTH 14°09'41" EAST 42.81 FEET; THENCE SOUTH 77°32'20" WEST 145.16 FEET; THENCE SOUTH 14°09'41" EAST 396.91 FEET; THENCE SOUTH 77°53'00" WEST 235.94 FEET TO THE BEGINNING OF A TANGET CURVE; THENCE SOUTHWESTERLY ALONG THE ARC OF AN 528.00 FOOT RADIUS CURVE TO THE RIGHT A DISTANCE OF 80.72 FEET (CENTRAL ANGLE EQUALS 08°45'33" AND LONG CHORD BEARS SOUTH 78°15'46" WEST 80.64 FEET); THENCE SOUTH 82°38'32" WEST 86.83 FEET TO THE BEGINNING OF A TANGENT CURVE; THENCE SOUTHEASTERLY ALONG THE ARC OF AN 472.00 FOOT RADIUS CURVE TO THE LEFT A DISTANCE OF 18.20 FEET (CENTRAL ANGLE EQUALS 02°12'34" AND LONG CHORD BEARS SOUTH 81°32'15" WEST 18.20 FEET); THENCE SOUTH 17°05'00" EAST 111.25 FEET;

			Curve Tal	DIE 	
Curve #	Length	Radius	Delta	Chord Direction	Chord Length
C1	8.43	1763.98	0°16'26"	N42°49'31"E	8.43
C2	24.55	18.00	78°09'09"	N80°50'46"E	22.69
C3	91.17	672.82	7°45'49"	S18°02'36"E	91.10
C4	80.72	528.00	8°45'33"	S78°15'46"W	80.64
C5	18.20	472.00	2°12'34"	S81°32'15"W	18.20
C6	53.92	472.00	6°32'41"	N77°09'37"E	53.89
C7	76.40	500.00	8°45'16"	N78°15'54"E	76.32
C8	64.04	528.00	6°56'56"	N77°21'45"E	5178.34
C9	6.63	472.00	0°48'18"	N82°14'23"E	5177.95
C10	65.53	472.00	7°57'15"	N77°51'37"E	5178.36
C11	76.44	500.00	8°45'33"	N78°15'46"E	76.36
C12	27.66	18.00	88°02'41"	N29°51'39"E	25.02
C13	63.21	472.00	7°40'21"	N17°59'52"W	63.16
C14	66.96	500.00	7°40'21"	N17°59'52"W	66.91
C15	70.71	528.00	7°40'21"	N17°59'52"W	70.65
C16	87.10	642.82	7°45'49"	N18°02'36"W	87.04
				N	76° 45' 02"E 119.79

Line Table

L1 | 56.00 | N16°06'43"W

L2 0.27 N41°45'56"E

Line # | Length | Direction

LOT: 2 12420 S.F. 0.29 AC. LOT:7 40807 S.F. LOT:4 12009 S.F. 0.28 AC. . 1143 E. 0.29 AC. 12029 S.F 0.28 AC. 250.23' S89° 40' 47"E 2672.54' MEAS. (BASIS OF BEARING) (S89° 40' 42"E 2672.420' REC.)

12084 S.F. 0.28 AC.

UTILITY APPROVAL

UTILITIES SHALL HAVE THE RIGHT TO INSTALL, MAINTAIN AND OPERATE | DOMINION ENERGY APPROVES THIS PLAT SOLELY FOR THEIR EQUIPMENT ABOVE AND BELOW GROUND AND ALL OTHER RELATED FACILITIES WITHIN THE PUBLIC UTILITY EASEMENTS IDENTIFIED ON THIS PLAT MAP AS MAY BE NECESSARY OR DESIRABLE IN PROVIDING UTILITY SERVICES WITHIN AND WITHOUT THE LOTS IDENTIFIED HEREIN, INCLUDING THE RIGHT O ACCESS TO SUCH FACILITIES AND THE RIGHT TO REQUIRE REMOVAL OF ANY OBSTRUCTIONS INCLUDING STRUCTURES, TREES, AND VEGETATION THAT MAY BE PLACED WITHIN THE PUE. THE UTILITY MAY REQUIRE THE LOT OWNER TO REMOVE ALL STRUCTURES WITHIN THE PUE AT THE OWNER'S EXPENSE, OR THE UTILITY MAY REMOVE SUCH STRUCTURES AT THE OWNER'S EXPENSE. AT NO TIME MAY ANY PERMANENT STRICTURES BE PLACED WITHIN THE PUE OR ANY OTHER OBSTRUCTIONS WHICH INTERFERES WITH THE USE OF THE PUE WITHOUT THE PRIOR WRITTEN APPROVAL OF THE UTILITIES WITH FACILITIES IN THE PUE.

ROCKY MOUNTAIN POWER: CETRACOM: CENTURY LINK:

DOMINION ENERGY

PER RECORD OF SURVEY

(ENTRY #07-4213)

THE PURPOSE OF CONFIRMING THAT THE PLAT CONTAINS PUBLIC UTILITY EASEMENTS. DOMINION ENERGY MAY REQUIRE OTHER EASEMENTS IN ORDER TO SERVE THIS DEVELOPMENT. THIS APPROVAL DOES NOT CONSTITUTE ACCEPTANCE, APPROVAL OR ACKNOWLEDGEMENT OF ANY TERMS CONTAINED IN THE PLAT, INCLUDING THOSE SET FORTH IN THE OWNERS DEDICATION AND THE NOTES AND DOES NOT CONSTITUTE A GUARANTEE OF PARTICULAR TERMS OF NATURAL GAS SERVICE. FOR FURTHER INFORMATION PLEASE CONTACT DOMINION ENERGY RIGHT OF WAY DEPARTMENT AT 1-800-366-8532. APPROVED THIS DAY OF

FOUND 3" UTAH COUNTY

BRASS CAP MONUMENT

S 1/4 COR SECTION 6,

T10S, R2E, SLB&M

FOUND 3" UTAH COUNTY

BRASS CAP MONUMENT

CENTER OF SECTION 6.

T10S, R2E, SLB&M

OWNER'S DEDICATION AND CONSENT TO RECORD

KNOWN ALL MEN BY THESE PRESENTS THAT WE THE UNDERSIGNED OWNERS OF THE TRACT OF LAND SHOWN AND DESCRIBED ON THIS SUBDIVISION PLAT, HAVE CAUSED THE SAME TO BE SUBDIVIDED INTO LOTS, STREETS AND EASEMENTS TO BE HEREAFTER KNOWN AS SCENIC RIDGE SUBDIVISION - PHASE 1. DO HEREBY DEDICATE FOR THE PERPETUAL USE OF THE PUBLIC ALL PARCELS OF LAND SHOWN ON THIS PLAT AS INTENDED FOR

AS WITNESS THEREOF, I HAVE HEREUNTO SET MY HAND THIS _____ DAY OF _____, 20__, A.D. BYRON BASTIAN - OWNER NEIL J. CRAIG - OWNER

ACKNOWLEDGMENT

THE FORGOING INSTRUMENT WAS ACKNOWLEDGED BEFORE ME THIS _ WHO REPRESENTED THAT (S)HE IS THE OWNER(S) OF THE ABOVE DESCRIBED PROPERTY AND HAVE THE AUTHORITY TO EXECUTE THIS INSTRUMENT.

SIGNATURE OF NOTARY PUBLIC PRINTED NAME OF NOTARY PUBLIC RESIDING IN_ STATE OF UTAH COUNTY OF _ MY COMMISSION EXPIRES: MY COMMISSION NUMBER: (NOTARY STAMP)

ACKNOWLEDGMENT

THE FORGOING INSTRUMENT WAS ACKNOWLEDGED BEFORE ME THIS ____ DAY OF , WHO REPRESENTED THAT (S)HE IS THE OWNER(S) OF THE ABOVE DESCRIBED PROPERTY AND HAVE THE AUTHORITY TO EXECUTE THIS INSTRUMENT.


SIGNATURE OF NOTARY PUBLIC PRINTED NAME OF NOTARY PUBLIC RESIDING IN_ STATE OF UTAH COUNTY OF MY COMMISSION EXPIRES: MY COMMISSION NUMBER:

(NOTARY STAMP)

SURVEYOR'S CERTIFICATE

I, TRAVIS R. GOWER, EMPLOYED BY RIMROCK ENGINEERING AND DEVELOPMENT, CONTACT NUMBER, 801-837-0633, HEREBY CERTIFY THAT I AM A PROFESSIONAL LAND SURVEYOR IN ACCORDANCE WITH TITLE 58, CHAPTER 22, PROFESSIONAL ENGINEERS AND PROFESSIONAL SURVEYORS LICENSING ACT AND THAT I HOLD CERTIFICATE NUMBER 6439364 AS PRESCRIBED BY THE LAWS OF THE STATE OF UTAH AND BY THE AUTHORITY OF THE OWNER(S), I HAVE REVIEWED A SURVEY OF THE TRACT OF LAND SHOWN ON THIS PLAT, IN OCTOBER 2021, IN ACCORDANCE WITH A RECORD OF SURVEY PREPARED BY EPIC ENGINEERING, FILE NUMBER 22-003, AS FILED IN THE UTAH COUNTY SURVEYOR'S OFFICE AND HAVE SUBDIVIDED SAID TRACT OF LAND INTO LOTS AND EASEMENTS, HEREAFTER TO BE KNOWN AS: SCENIC RIDGE ESTATES **SUBDIVISION - PHASE 1.**

TRAVIS R. GOWER P.L.S. 6439364

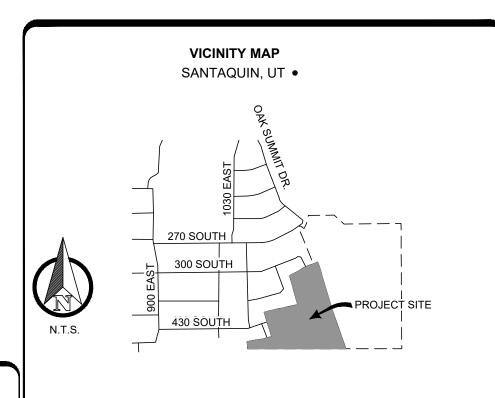

BASTIAN HOMES, LLC 1184 S. 1150 W. PAYSON, UTAH, 84651

LEGEND

SECTION LINE

PARCEL LINE

WIRE FENCE

BOUNDARY LINE


FOUND MONUMENT

CHAIN LINK FENCE

EDGE OF ASPHALT

PROPERTY OWNER/DEVELOPER

SECTION CORNER (FOUND) **SCENIC RIDGE ESTATES SUBDIVISION** PHASE 1 SW 1/4 OF SEC 6, T10S, R2E, SLB&M SANTAQUIN CITY, UTAH COUNTY, UTAH SET MONUMENT (AS NOTED)

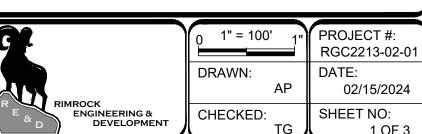

CONTAINS 190,973 SQ. FT. OR 4.38 ACRES, +/-

ACCEPTANCE BY LEGISLATIVE BODY THE CITY COUNCIL OF SANTAQUIN CITY, COUNTY OF UTAH, APPROVES THIS SUBDIVISION AND HEREBY ACCEPTS THE DEDICATION OF ALL STREETS, EASEMENTS AND OTHER PARCELS OF LAND INTENDED FOR PUBLIC PURPOSES FOR THE PERPETUAL USE OF THE PUBLIC THIS ____ DAY OF, _

APPROVED MAYOR OF SANTAQUIN ENGINEER (SEE SEAL) ATTEST - CLERK RECORDER (SEE SEAL)

THENCE SOUTH 75°54'45" WEST 107.51 FEET TO THE POINT OF BEGINNING.

CITY ENGINEER

1276.33'


FOUND 3" UTAH COUNTY

BRASS CAP MONUMENT

SW COR SECTION 6,


T10S, R2E, SLB&M


CLERK - RECORDER

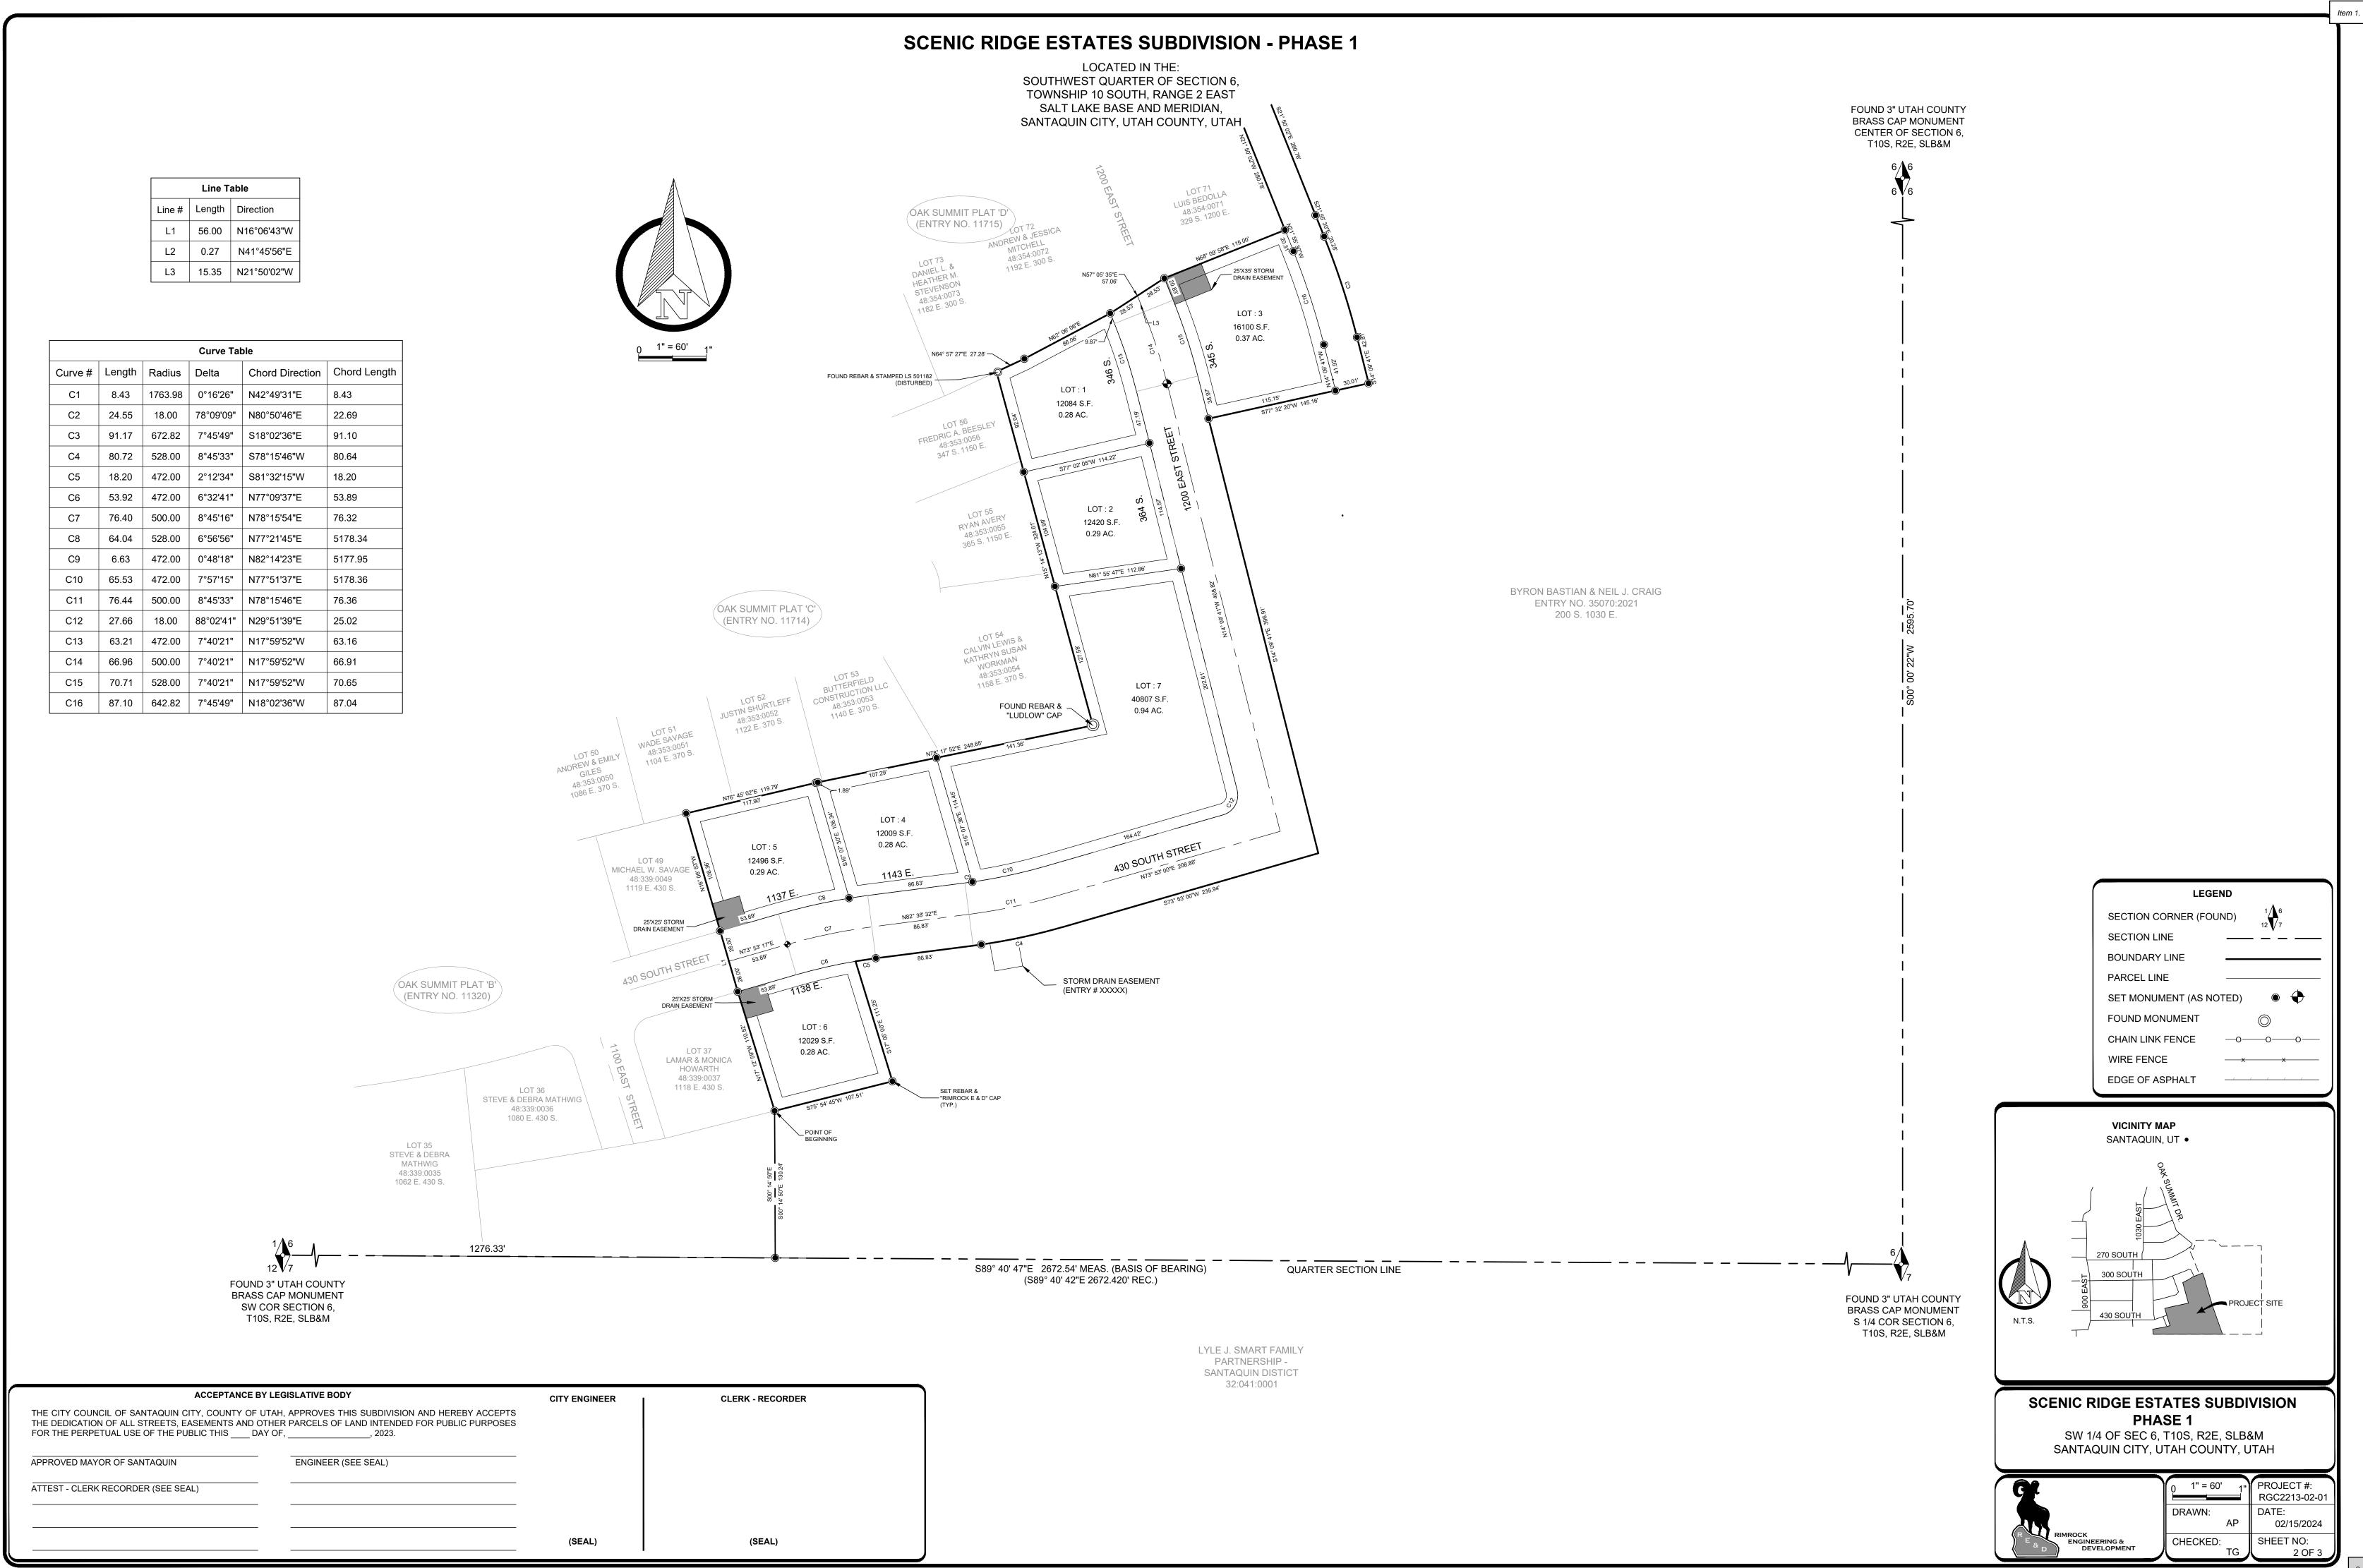

SCENIC RIDGE ESTATES SUBDIVISION - PHASE 1

LOCATED IN THE: SOUTHWEST QUARTER OF SECTION 6, TOWNSHIP 10 SOUTH, RANGE 2 EAST SALT LAKE BASE AND MERIDIAN, SANTAQUIN CITY, UTAH COUNTY, UTAH

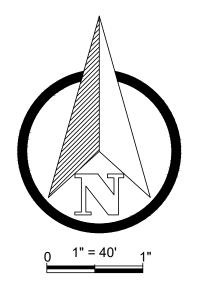

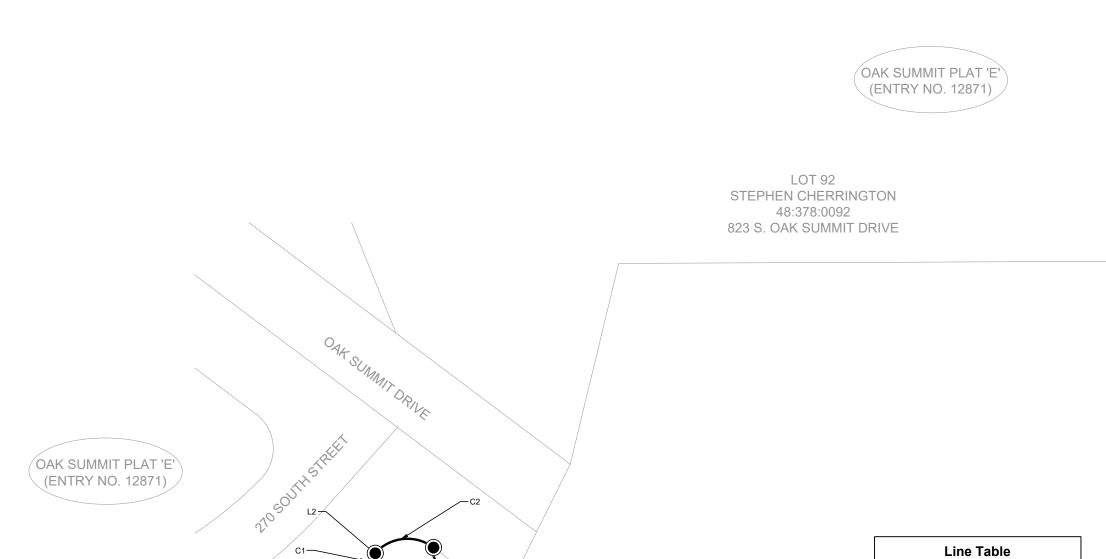

			Curve Tal	ole	
Curve #	Length	Radius	Delta	Chord Direction	Chord Length
C1	8.43	1763.98	0°16'26"	N42°49'31"E	8.43
C2	24.55	18.00	78°09'09"	N80°50'46"E	22.69

Line # Length Direction

L2 0.27 N41°45'56"E


BYRON BASTIAN & NEIL J. CRAIG ENTRY NO. 35070:2021 200 S. 1030 E.

OPEN SPACE 17324 S.F. 0.40 AC. LOT 68 LOT 69 GERALD L. BOWMAN 48:354:0069 JEFFREY R. VAN AUSDAL 48:354:0068 1197 E. 300 SOUTH 1209 E. 300 SOUTH LOT 70 LACEY & STEPHEN CROOK OAK SUMMIT PLAT 'D' 48:354:0070 (ENTRY NO. 11715) 309 S. 1200 EAST

> LOT 71 LUIS BEDOLLA 48:354:0071 329 S. 1200 E.

LOT 85 JAY TYLER HOOP 48:378:0085 1212 E. 270 SOUTH

SET REBAR & "RIMROCK E & D" CAP —

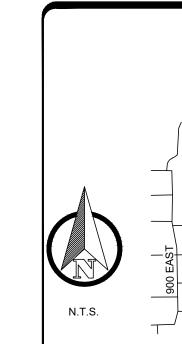

VICINITY MAP SANTAQUIN, UT • 300 SOUTH

LEGEND

SET MONUMENT (AS NOTED)

_0__0__

SECTION CORNER (FOUND)

SECTION LINE

PARCEL LINE

WIRE FENCE

BOUNDARY LINE

FOUND MONUMENT

CHAIN LINK FENCE

EDGE OF ASPHALT

SCENIC RIDGE ESTATES SUBDIVISION PHASE 1 SW 1/4 OF SEC 6, T10S, R2E, SLB&M

SANTAQUIN CITY, UTAH COUNTY, UTAH

G	0 1" = 40' 1"	PROJECT #: RGC2213-02-01
	DRAWN:	DATE: 02/15/2024
RIMROCK ENGINEERING & DEVELOPMENT	CHECKED: TG	SHEET NO: 3 OF 3

ACCEPTANCE BY LEG	GISLATIVE BODY	CITY ENGINEER	CLERK - RECORDER
THE CITY COUNCIL OF SANTAQUIN CITY, COUNTY OF UTAH, THE DEDICATION OF ALL STREETS, EASEMENTS AND OTHER FOR THE PERPETUAL USE OF THE PUBLIC THIS DAY OF	PARCELS OF LAND INTENDED FOR PUBLIC PURPOSES		
APPROVED MAYOR OF SANTAQUIN	ENGINEER (SEE SEAL)		
ATTEST - CLERK RECORDER (SEE SEAL)			
		(SEAL)	(SEAL)

APPLE HOLLOW @ THE ORCHARDS "B"

PHASE 1

SANTAQUIN, UTAH COUNTY, UTAH

PLAN SHEETS-

GENERAL


- 1. ALL WORK SHALL BE DONE IN ACCORDANCE WITH THE SPECIFICATIONS AND/OR REQUIREMENTS OF THE SANTAQUIN CITY PUBLIC WORKS DEPARTMENT.
- 2. A PRE CONSTRUCTION CONFERENCE WILL BE HELD A MINIMUM OF 3 WORKING DAYS PRIOR TO START OF WORK. ALL CONTRACTORS, SUBCONTRACTORS AND/OR UTILITY CONTRACTORS, SANTAQUIN CITY PUBLIC WORKS AND CITY'S ENGINEER SHOULD BE PRESENT.
- 3. ALL LOT DIMENSIONS, EASEMENTS AND CERTAIN OFF SITE EASEMENTS ARE TO BE TAKEN FROM THE PLAT OF THE ORCHARDS PLAT F-6 WITH THE COMPLETION OF ROW IMPROVEMENTS ASSOCIATED WITH
- 4. ALL CONSTRUCTION STAKES MUST BE REQUESTED A MINIMUM OF THREE (3) WORKING DAYS PRIOR TO PLANNED USE.
- 5. CERTAIN CONTROL POINTS WILL BE SET BY THE ENGINEER, OR HIS REPRESENTATIVE, WHICH ARE CRITICAL TO THE CONSTRUCTION STAKING OF THE PROJECT. THESE POINTS WILL BE DESIGNATED AT THE TIME THEY ARE SET AND THE CONTRACTOR SO NOTIFIED. DESTRUCTION OF THESE POINTS BY THE CONTRACTOR OR HIS SUBCONTRACTORS SHALL BE GROUNDS FOR CHARGING THE CONTRACTOR FOR REESTABLISHING SAID POINTS.
- 6. ALL RECOMMENDATIONS MADE IN A PERTINENT GEOTECHNICAL REPORT/STUDY SHALL BE FOLLOWED EXPLICITLY DURING CONSTRUCTION OF BUILDING AND SITE IMPROVEMENTS.
- 7. THE DEVELOPER AND THE GENERAL CONTRACTOR UNDERSTAND THAT IT IS HIS/HER RESPONSIBILITY TO ENSURE THAT ALL IMPROVEMENTS INSTALLED WITHIN THIS DEVELOPMENT ARE CONSTRUCTED IN FULL COMPLIANCE WITH ALL STATE AND SANTAQUIN CITY CODES, ORDINANCES AND STANDARDS. THESE PLANS ARE NOT ALL INCLUSIVE OF ALL MINIMUM CODES, ORDINANCES AND STANDARDS. THIS FACT DOES NOT RELIEVE THE DEVELOPER OR GENERAL CONTRACTOR FROM THE FULL COMPLIANCE WITH ALL MINIMUM STATE AND SANTAQUIN CITY CODES, ORDINANCES AND STANDARDS.
- 8. GARAGES ON THE TOWNHOMES WILL BE 24'X24' WITH A 20' OPENING


- 1. ALL ROADWAY CONSTRUCTION SHALL MEET THE MINIMUM REQUIREMENTS OF SANTAQUIN CITY'S TECHNICAL SPECIFICATIONS OR AS APPROVED IN THE PLANS HEREIN.
- 2. WHEN DISCREPANCIES OCCUR BETWEEN PLANS AND SPECIFICATIONS, THE CONTRACTOR SHALL IMMEDIATELY NOTIFY THE ENGINEER. UNTIMELY NOTIFICATION SHALL NEGATE ANY CONTRACTORS CLAIM FOR ADDITIONAL COMPENSATION.
- 3. ALL STORM DRAIN PIPES TO BE REINFORCED CONCRETE PIPE (RCP) CLASS III, HDPE STORM DRAIN PIPE, OR APPROVED EQUAL UNLESS OTHERWISE NOTED.
- 4. CONTRACTOR IS RESPONSIBLE TO ENSURE THAT ALL CLEANOUT/ACCESS LOCATIONS MEET SANTAQUIN IRRIGATION COMPANY SPECIFICATIONS AND ARE COMPLETED UNDER THE DIRECTION OF SANTAQUIN IRRIGATION COMPANY.
- 5. ALL IRRIGATION CORNERS (ANGLE POINTS) SHALL HAVE A PRE CAST REINFORCED CONCRETE MANHOLE, WITH A WATERTIGHT SOLID MANHOLE COVER.
- 6. ALL STORM DRAIN INLET BOXES TO MEET SANTAQUIN CITY STANDARD DRAWING SDI W/3' SEDIMENT

SEWER

- 1. ALL WORK SHALL BE DONE IN ACCORDANCE WITH THE LATEST SANTAQUIN CITY DESIGN STANDARDS & PUBLIC IMPROVEMENT SPECIFICATIONS DRAWINGS OF SANTAQUIN CITY.
- 2. FINAL APPROVAL AND ACCEPTANCE OF ALL SEWER CONSTRUCTION WILL BE BY SANTAQUIN CITY.
- 3. UPON THE COMPLETION OF WORK, THE CONTRACTOR SHALL SUBMIT 3 SETS OF AS-BUILT PLANS TO SANTAQUIN CITY & (1) SET TO NORTHERN ENGINEERING, INC.
- 4. HORIZONTAL AND VERTICAL SEPARATION OF CULINARY WATER AND SEWER SHALL BE IN COMPLIANCE WITH SANTAQUIN CITY STANDARDS.

- 1. THE WATER SYSTEM SHALL BE CONSTRUCTED TO CONFORM WITH THE STANDARDS SET FORTH IN THE "UTAH REGULATIONS FOR PUBLIC DRINKING WATER SYSTEMS", AND THE SANTAQUIN CITY PUBLIC WORKS DEPARTMENT STANDARD SPECIFICATIONS AND DRAWINGS.
- 2. CONTRACTOR SHALL NOTIFY NORTHERN ENGINEERING, INC. THREE (3) WORKING DAYS BEFORE INITIAL CONSTRUCTION BEGINS AND SHALL ALSO REQUEST SANTAQUIN CITY WATER DEPARTMENT INSPECTION OF WATER LINES AND APPURTENANCES TWENTY-FOUR (24) HOURS IN ADVANCE OF BACKFILLING.
- 3. CONTRACTOR TO FIELD VERIFY ALL VALVE BOX LID ELEVATIONS TO ASSURE THAT SAID LID ELEVATIONS MATCH FINAL STREET GRADE, AND ALL METER LID ELEVATIONS TO MATCH AN EXTENSION OF THE SIDEWALK GRADE.
- 4. UPON THE COMPLETION OF WORK, THE CONTRACTOR SHALL SUBMIT 3 SETS OF AS-BUILT PLANS TO SANTAQUIN CITY & (1) SET TO NORTHERN ENGINEERING, INC.
- 5. WATER VALVE LIDS ARE TO BE LABELED "WATER" FOR CULINARY VALVES.
- 6. HORIZONTAL AND VERTICAL SEPARATION OF CULINARY WATER AND SEWER SHALL BE IN COMPLIANCE WITH SANTAQUIN CITY STANDARDS.
- 7. WATERLINES TO BE BEDDED AS PER SANTAQUIN CITY DIVISION 3A SECTION 3A.04 SUB-SECTION E.
- 8. ALL CULINARY WATERLINES, REGARDLESS OF SIZE, SHALL BE C-900 PVC PIPE AS PER SANTAQUIN CITY

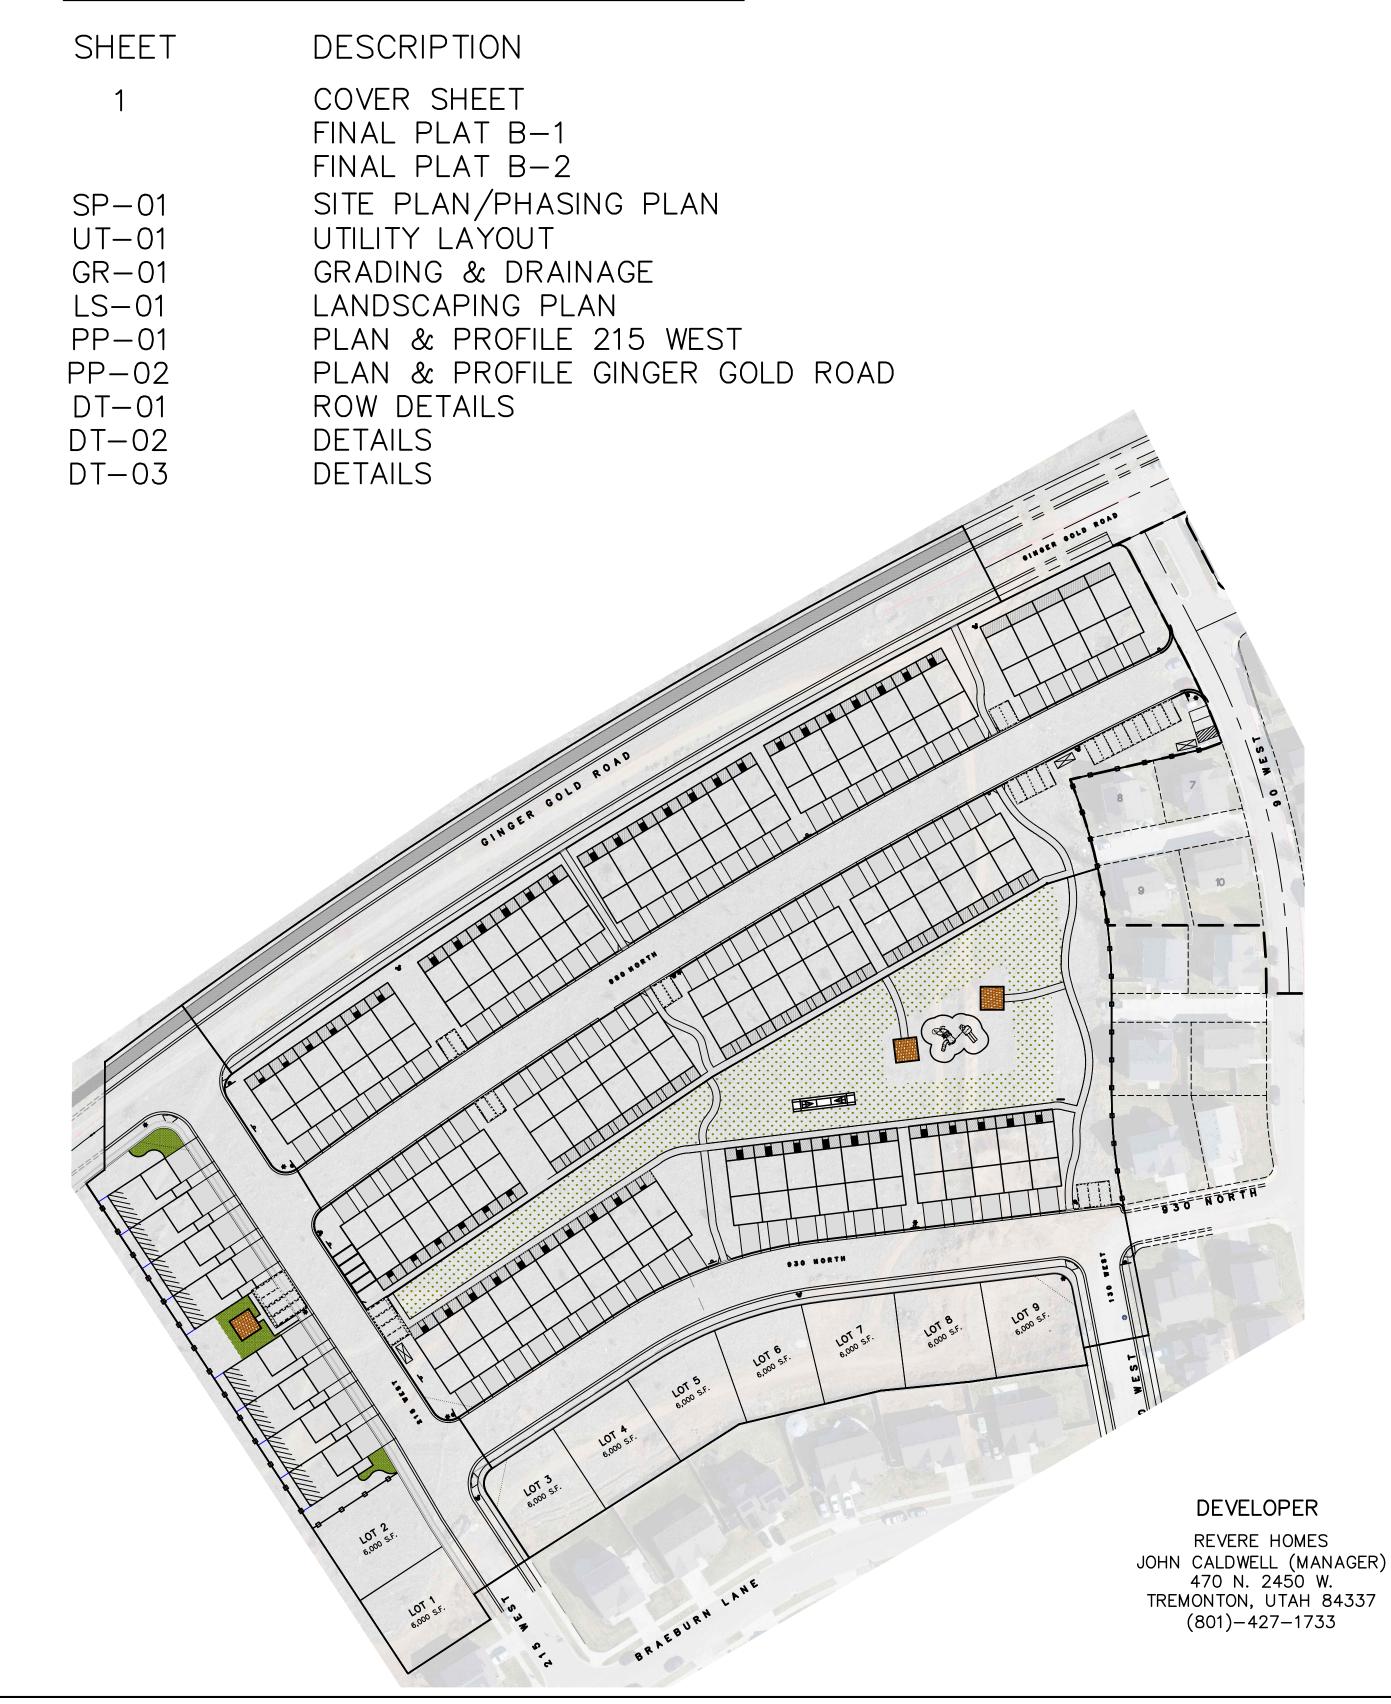

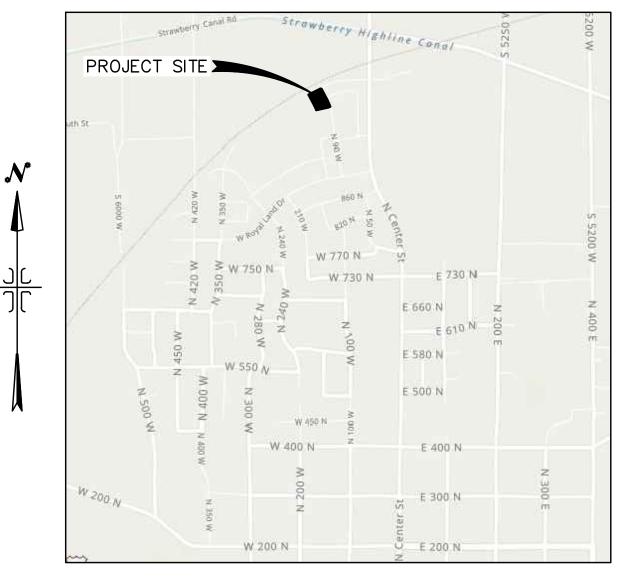

VICINITY MAP -NTS-

TABULATIONS

APPLE HOLLOW AT THE ORCHARDS B-PHASE 1 ZONE: R-10 PUD ZONE PLAT AREA: 1.73 ACRES # OF LOTS: 2 LOTS NUMBER OF TOWNHOMES: 8 UNITS LOT AREA: 0.28 ACRES TOWNHOMES AREA: 0.33 ACRES COMMON AREA: 0.36 ACRES

DENSITY: 5.78 UNITS/ACRE

0.03 ACRES

0.58 ACRES


	ACCEPTANCE	
SIGNATURE:	DEVELOPER	DATE
SIGNATURE:	CITY ENGINEER	DATE
SIGNATURE:	COMMUNITY DEV. DIRECTOR	DATE
SIGNATURE:	PUBLIC WORKS	DATE
SIGNATURE:	BUILDING DEPARTMENT	DATE
SIGNATURE:	POLICE DEPARTMENT	DATE
SIGNATURE:	FIRE DEPARTMENT	DATE

LIMITED COMMON AREA:


RIGHT-OF-WAY AREA:







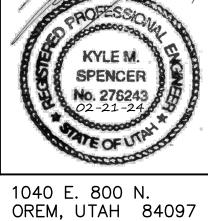


K:\3-20-031-00 Apple Hollow\CAD\Design\Apple Hollow CONCEPT 11 SHEET SET PHASE 1.dwg 2/21/2024 11:42 AM

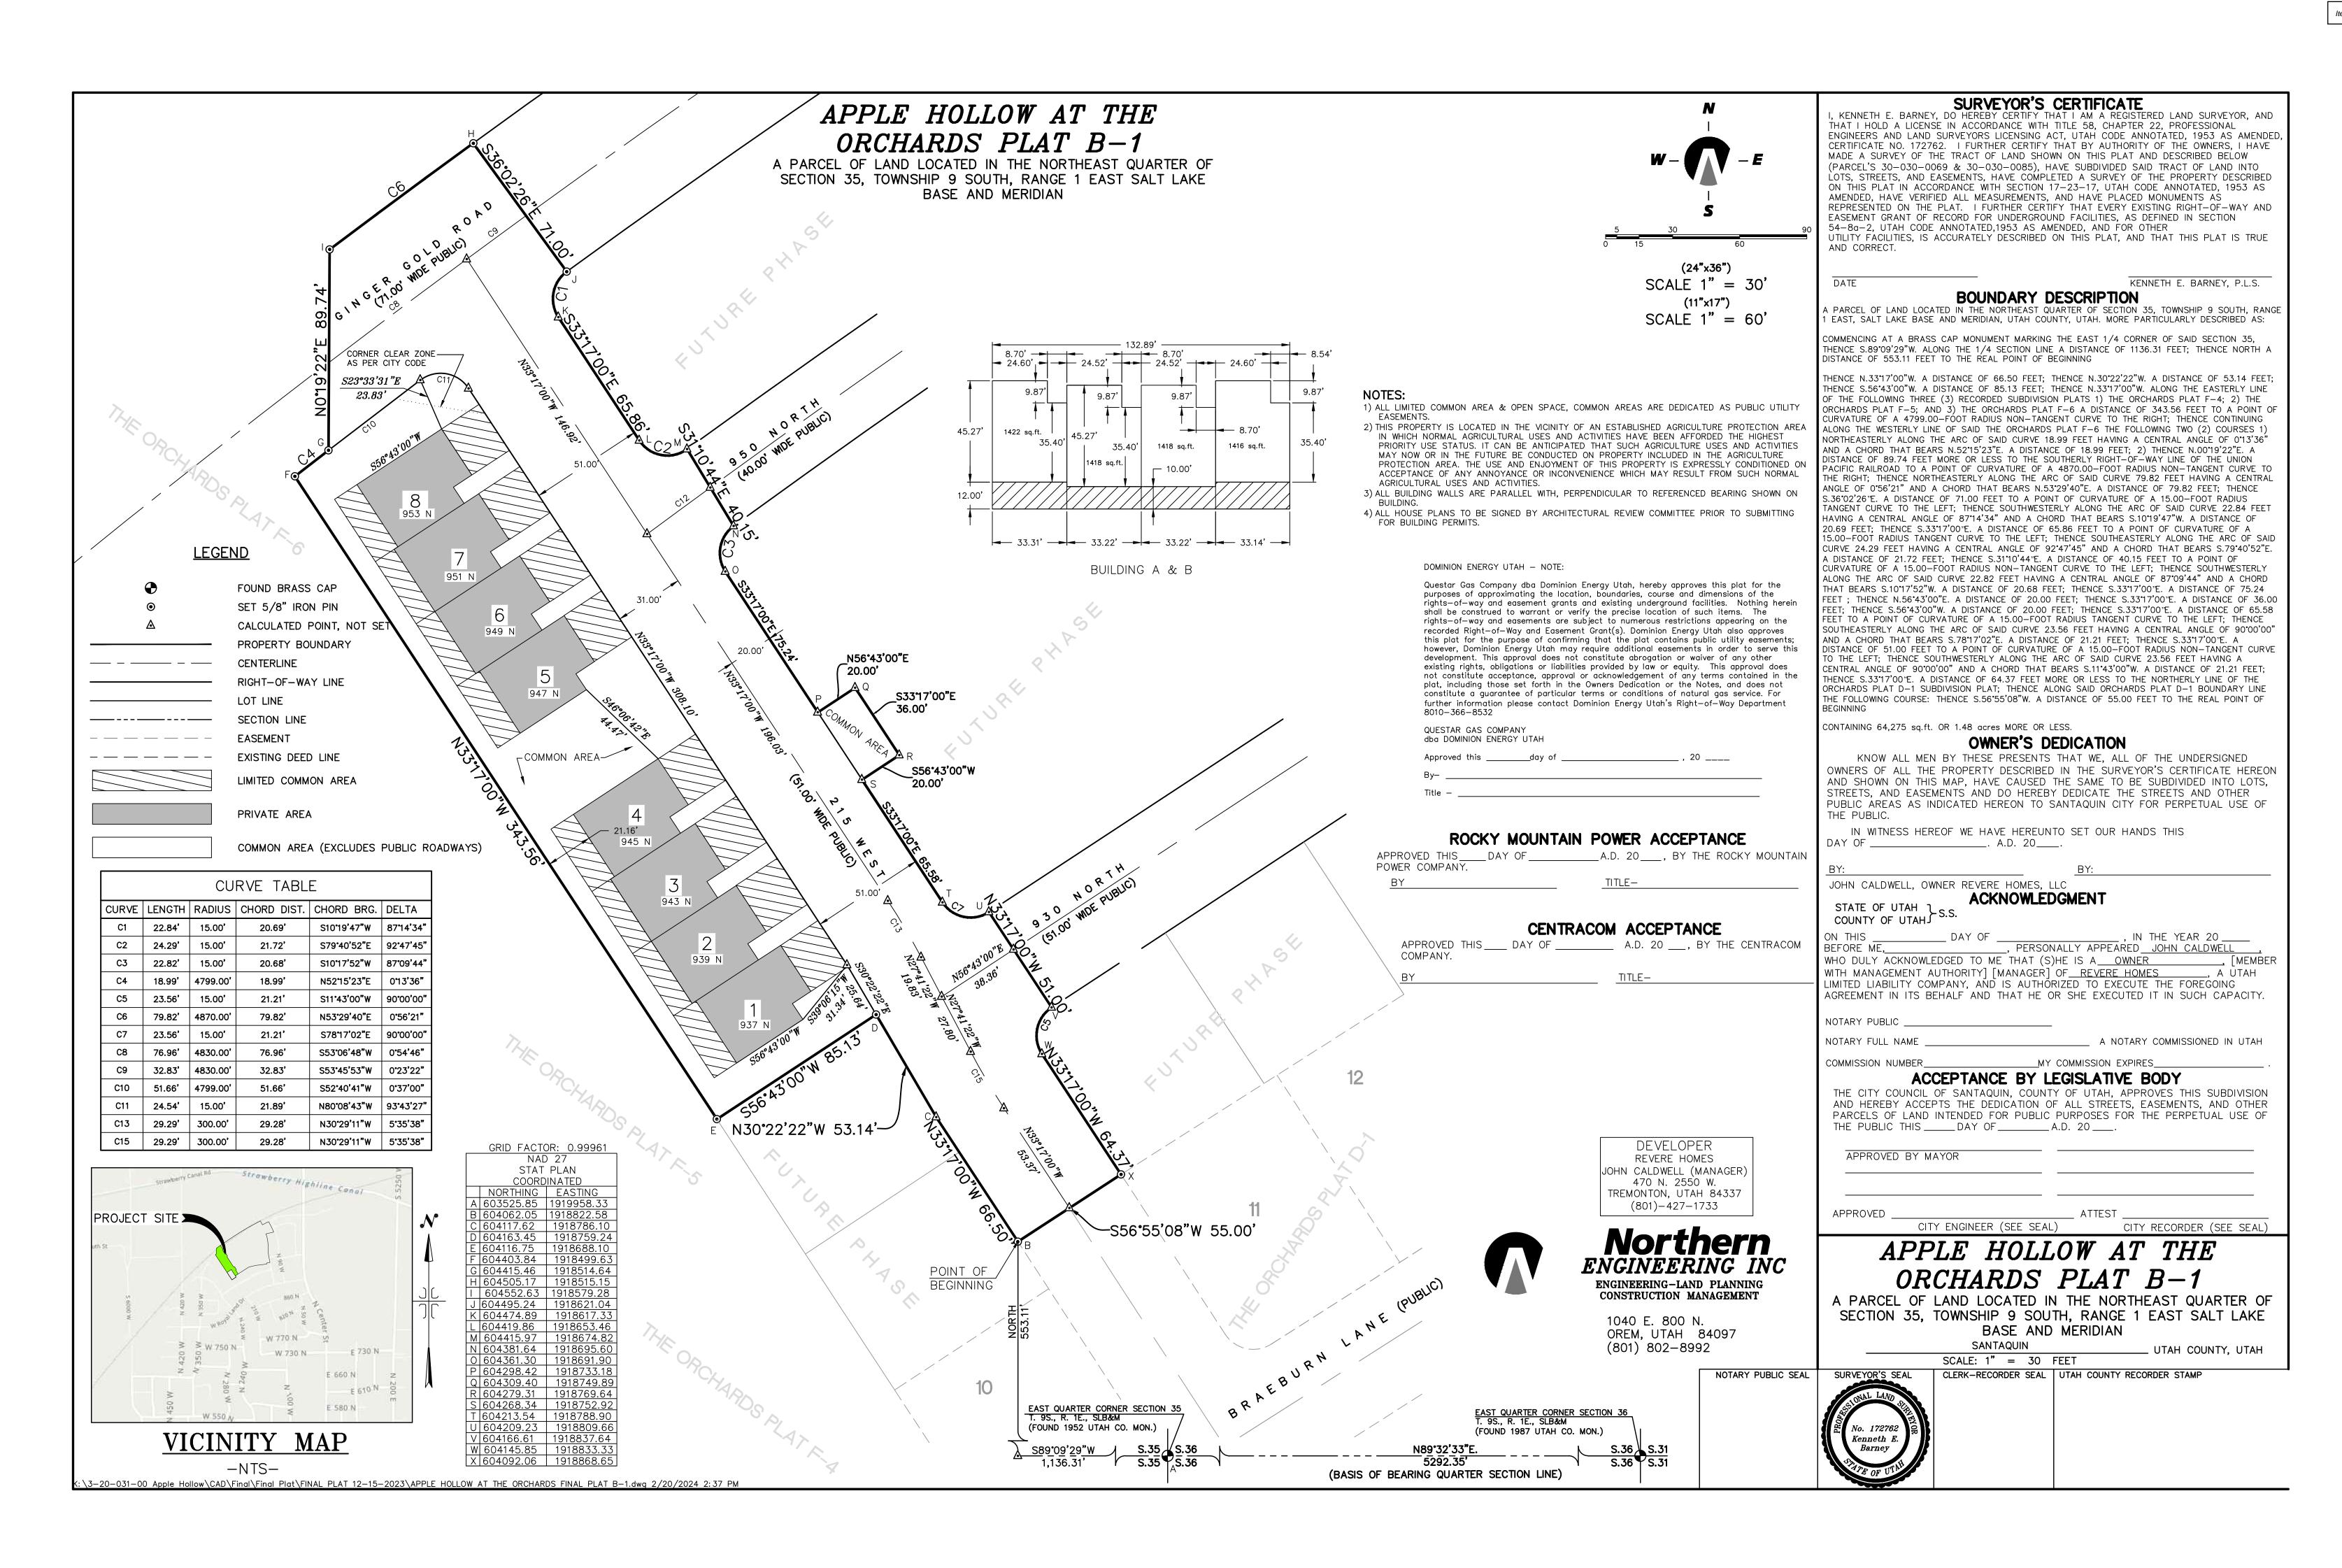


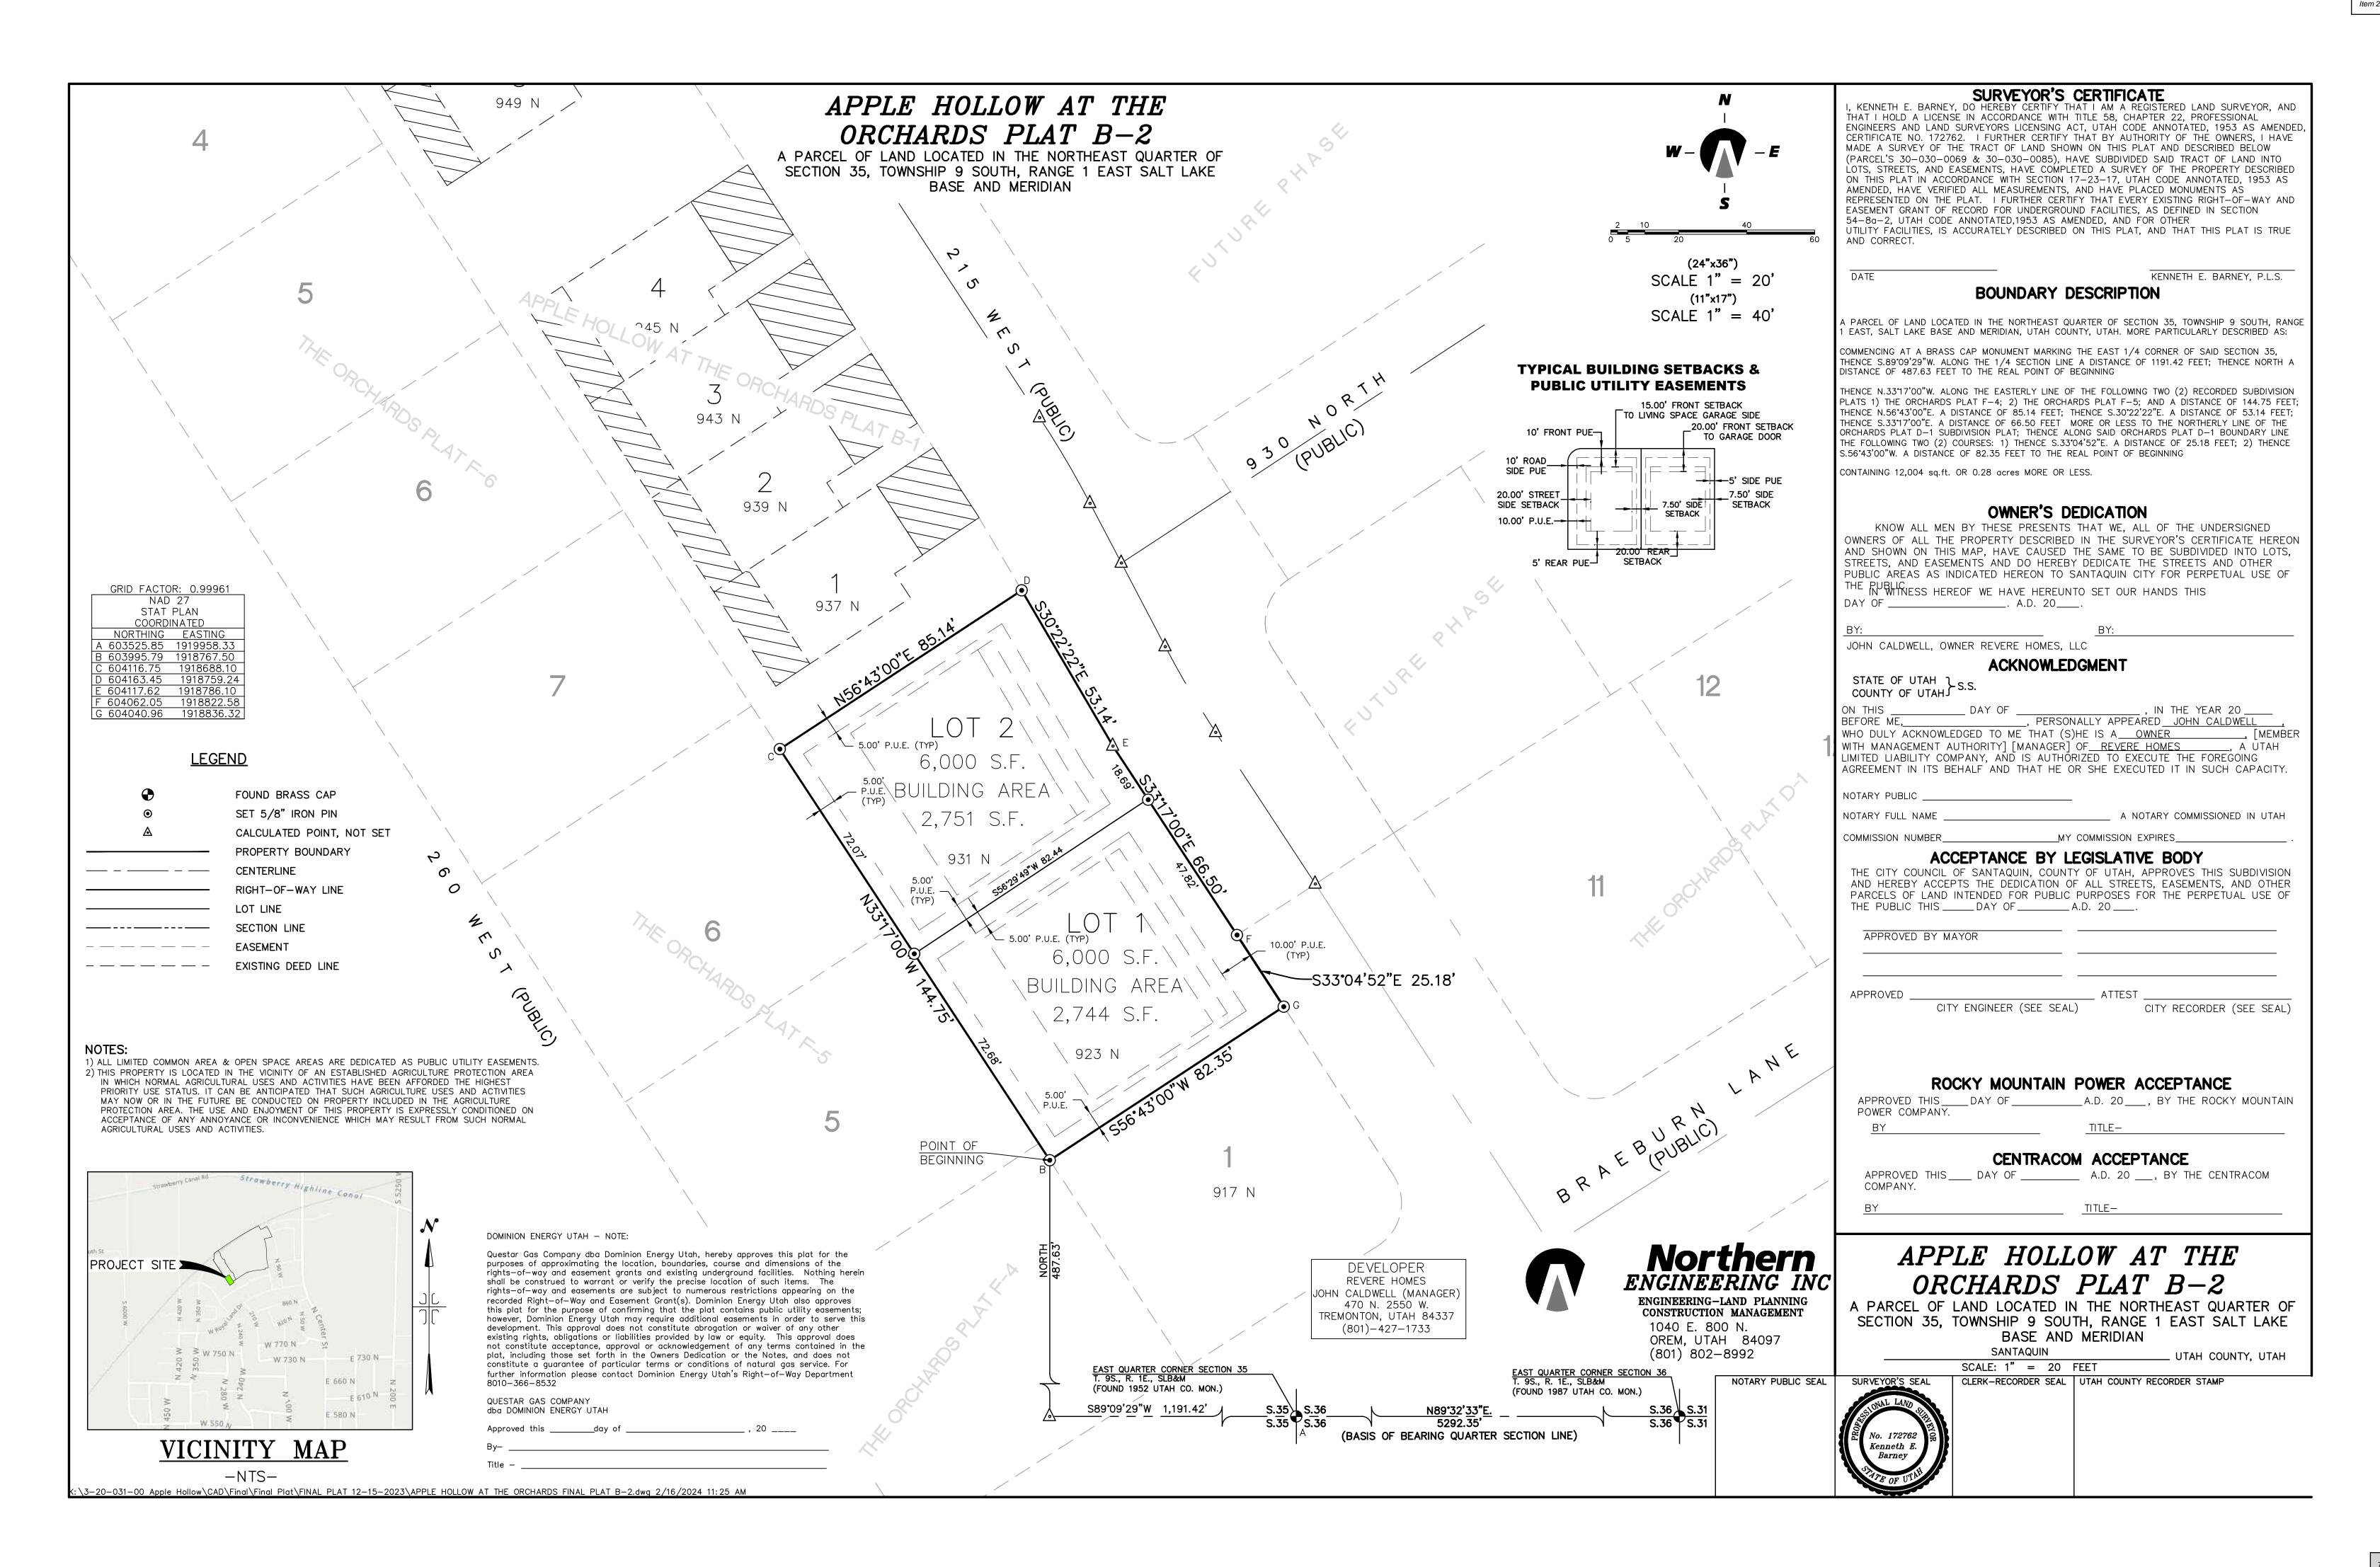

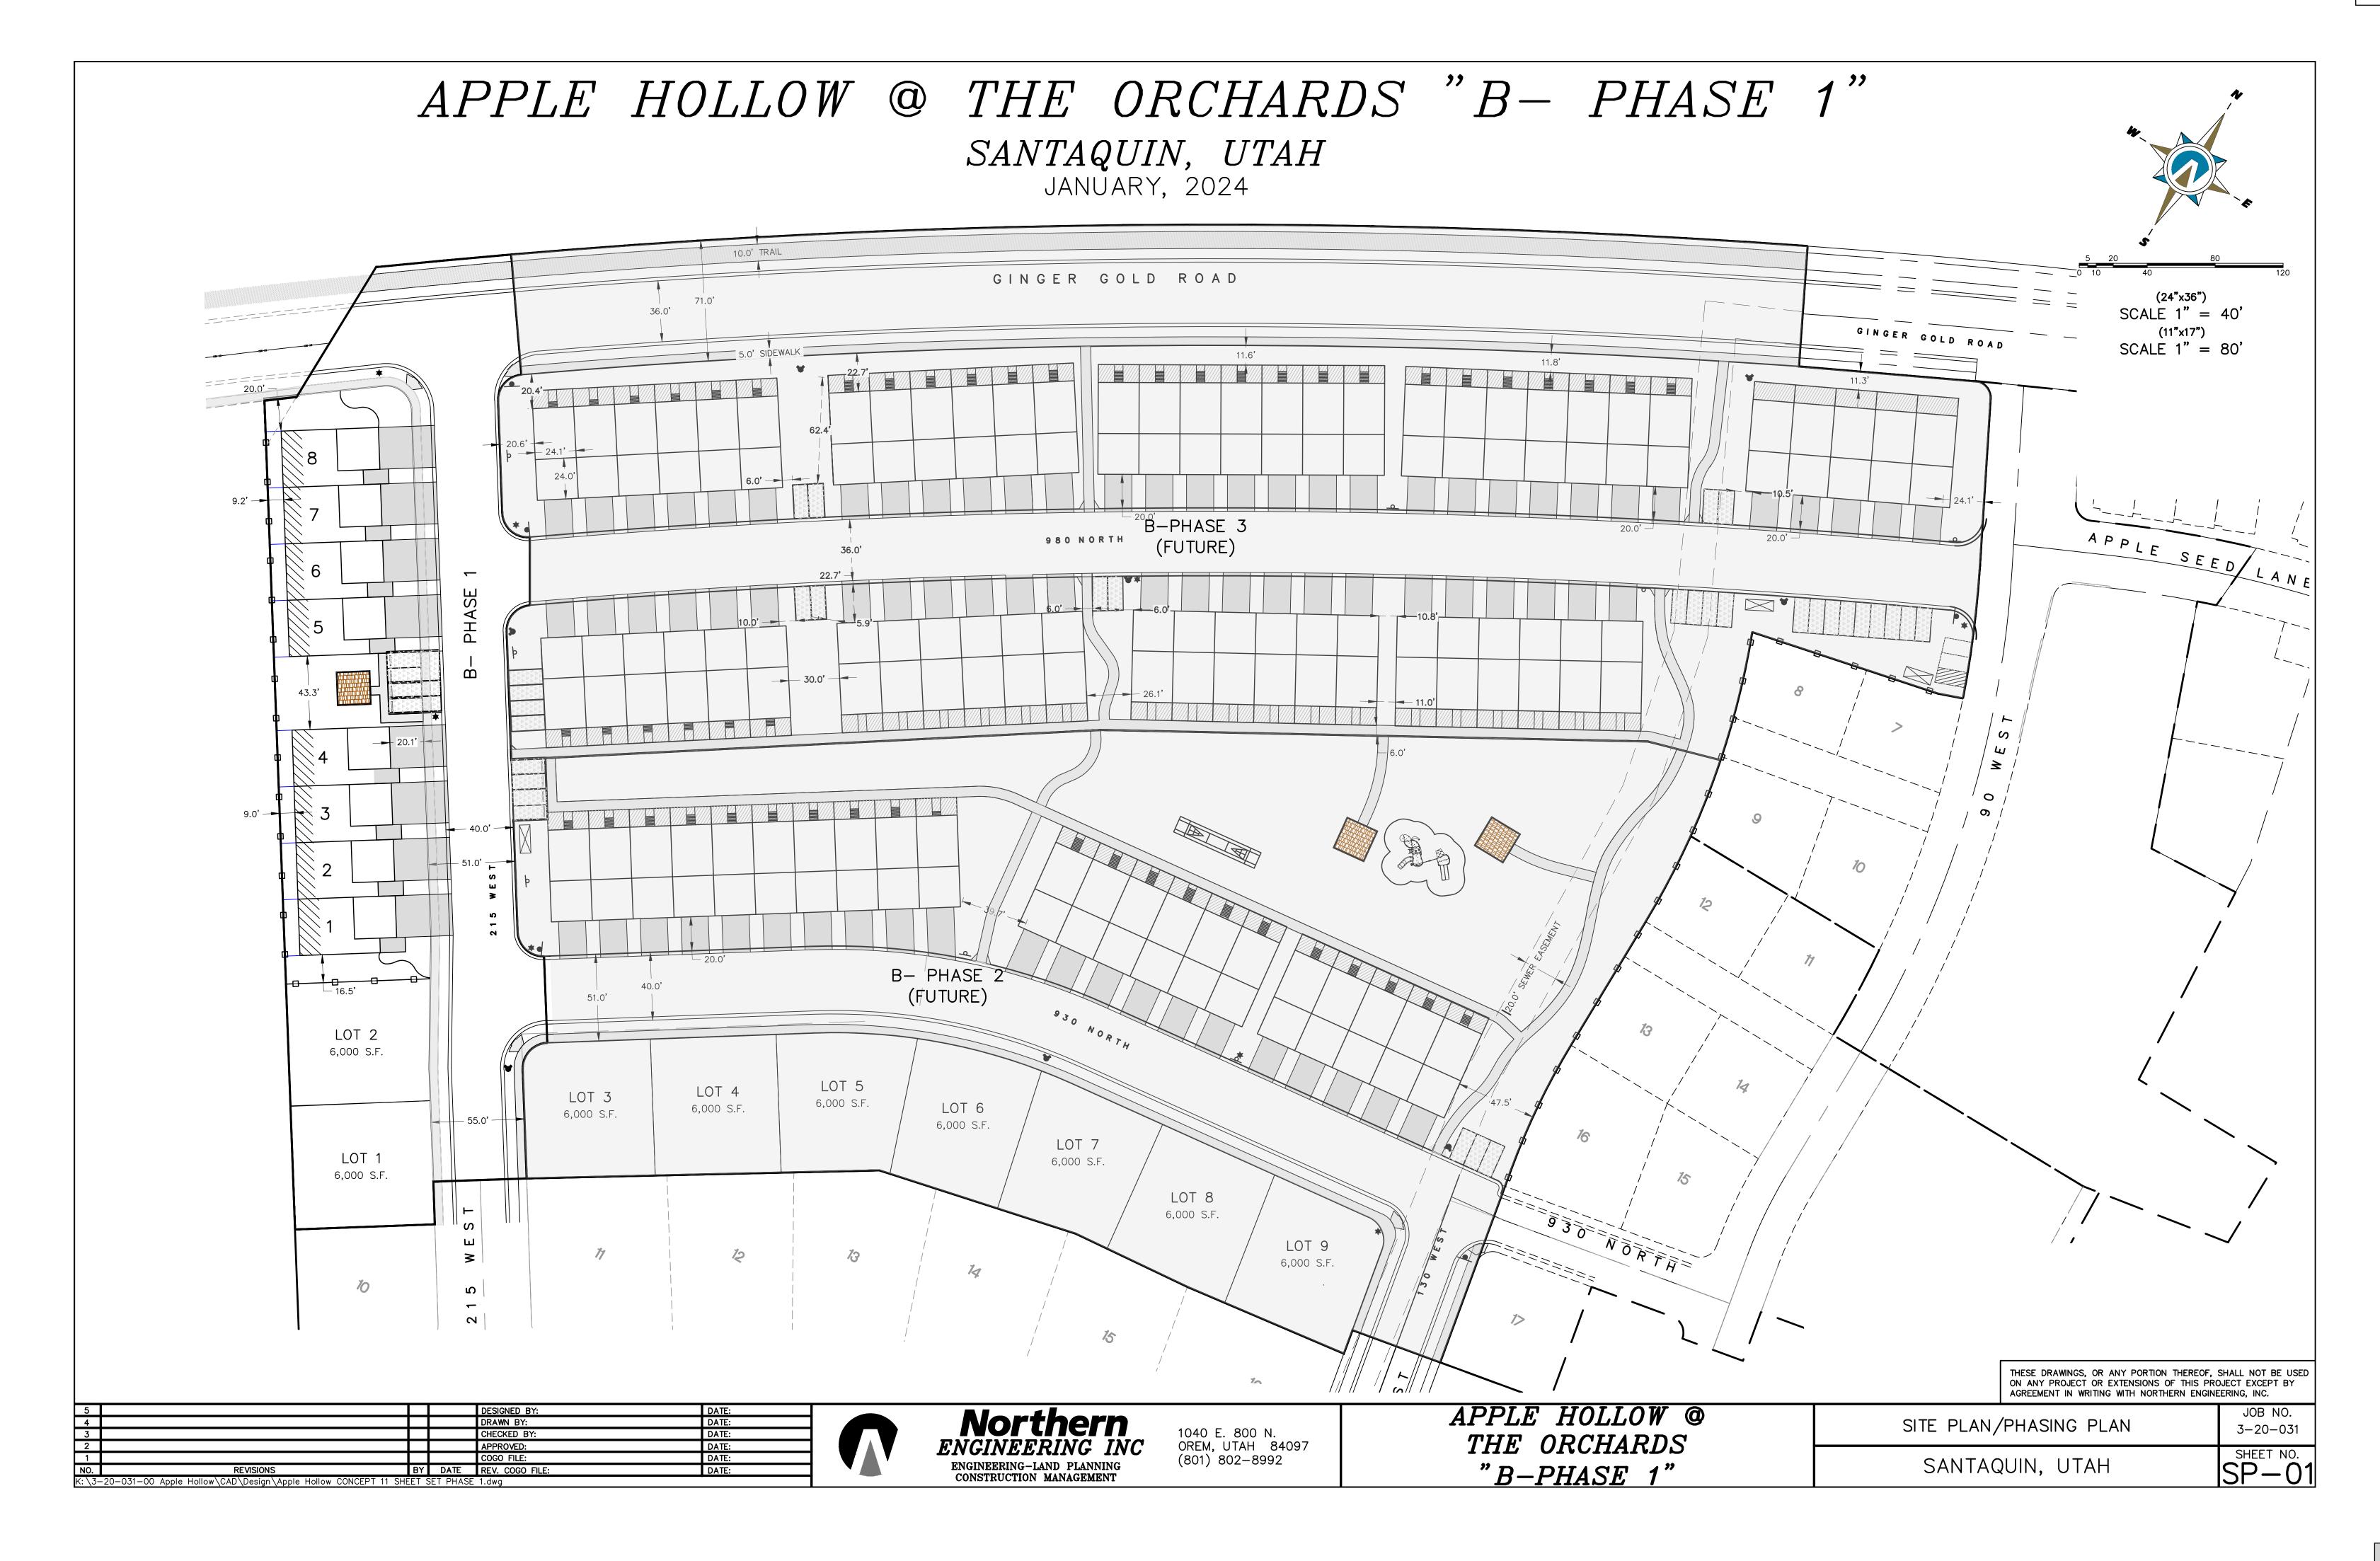

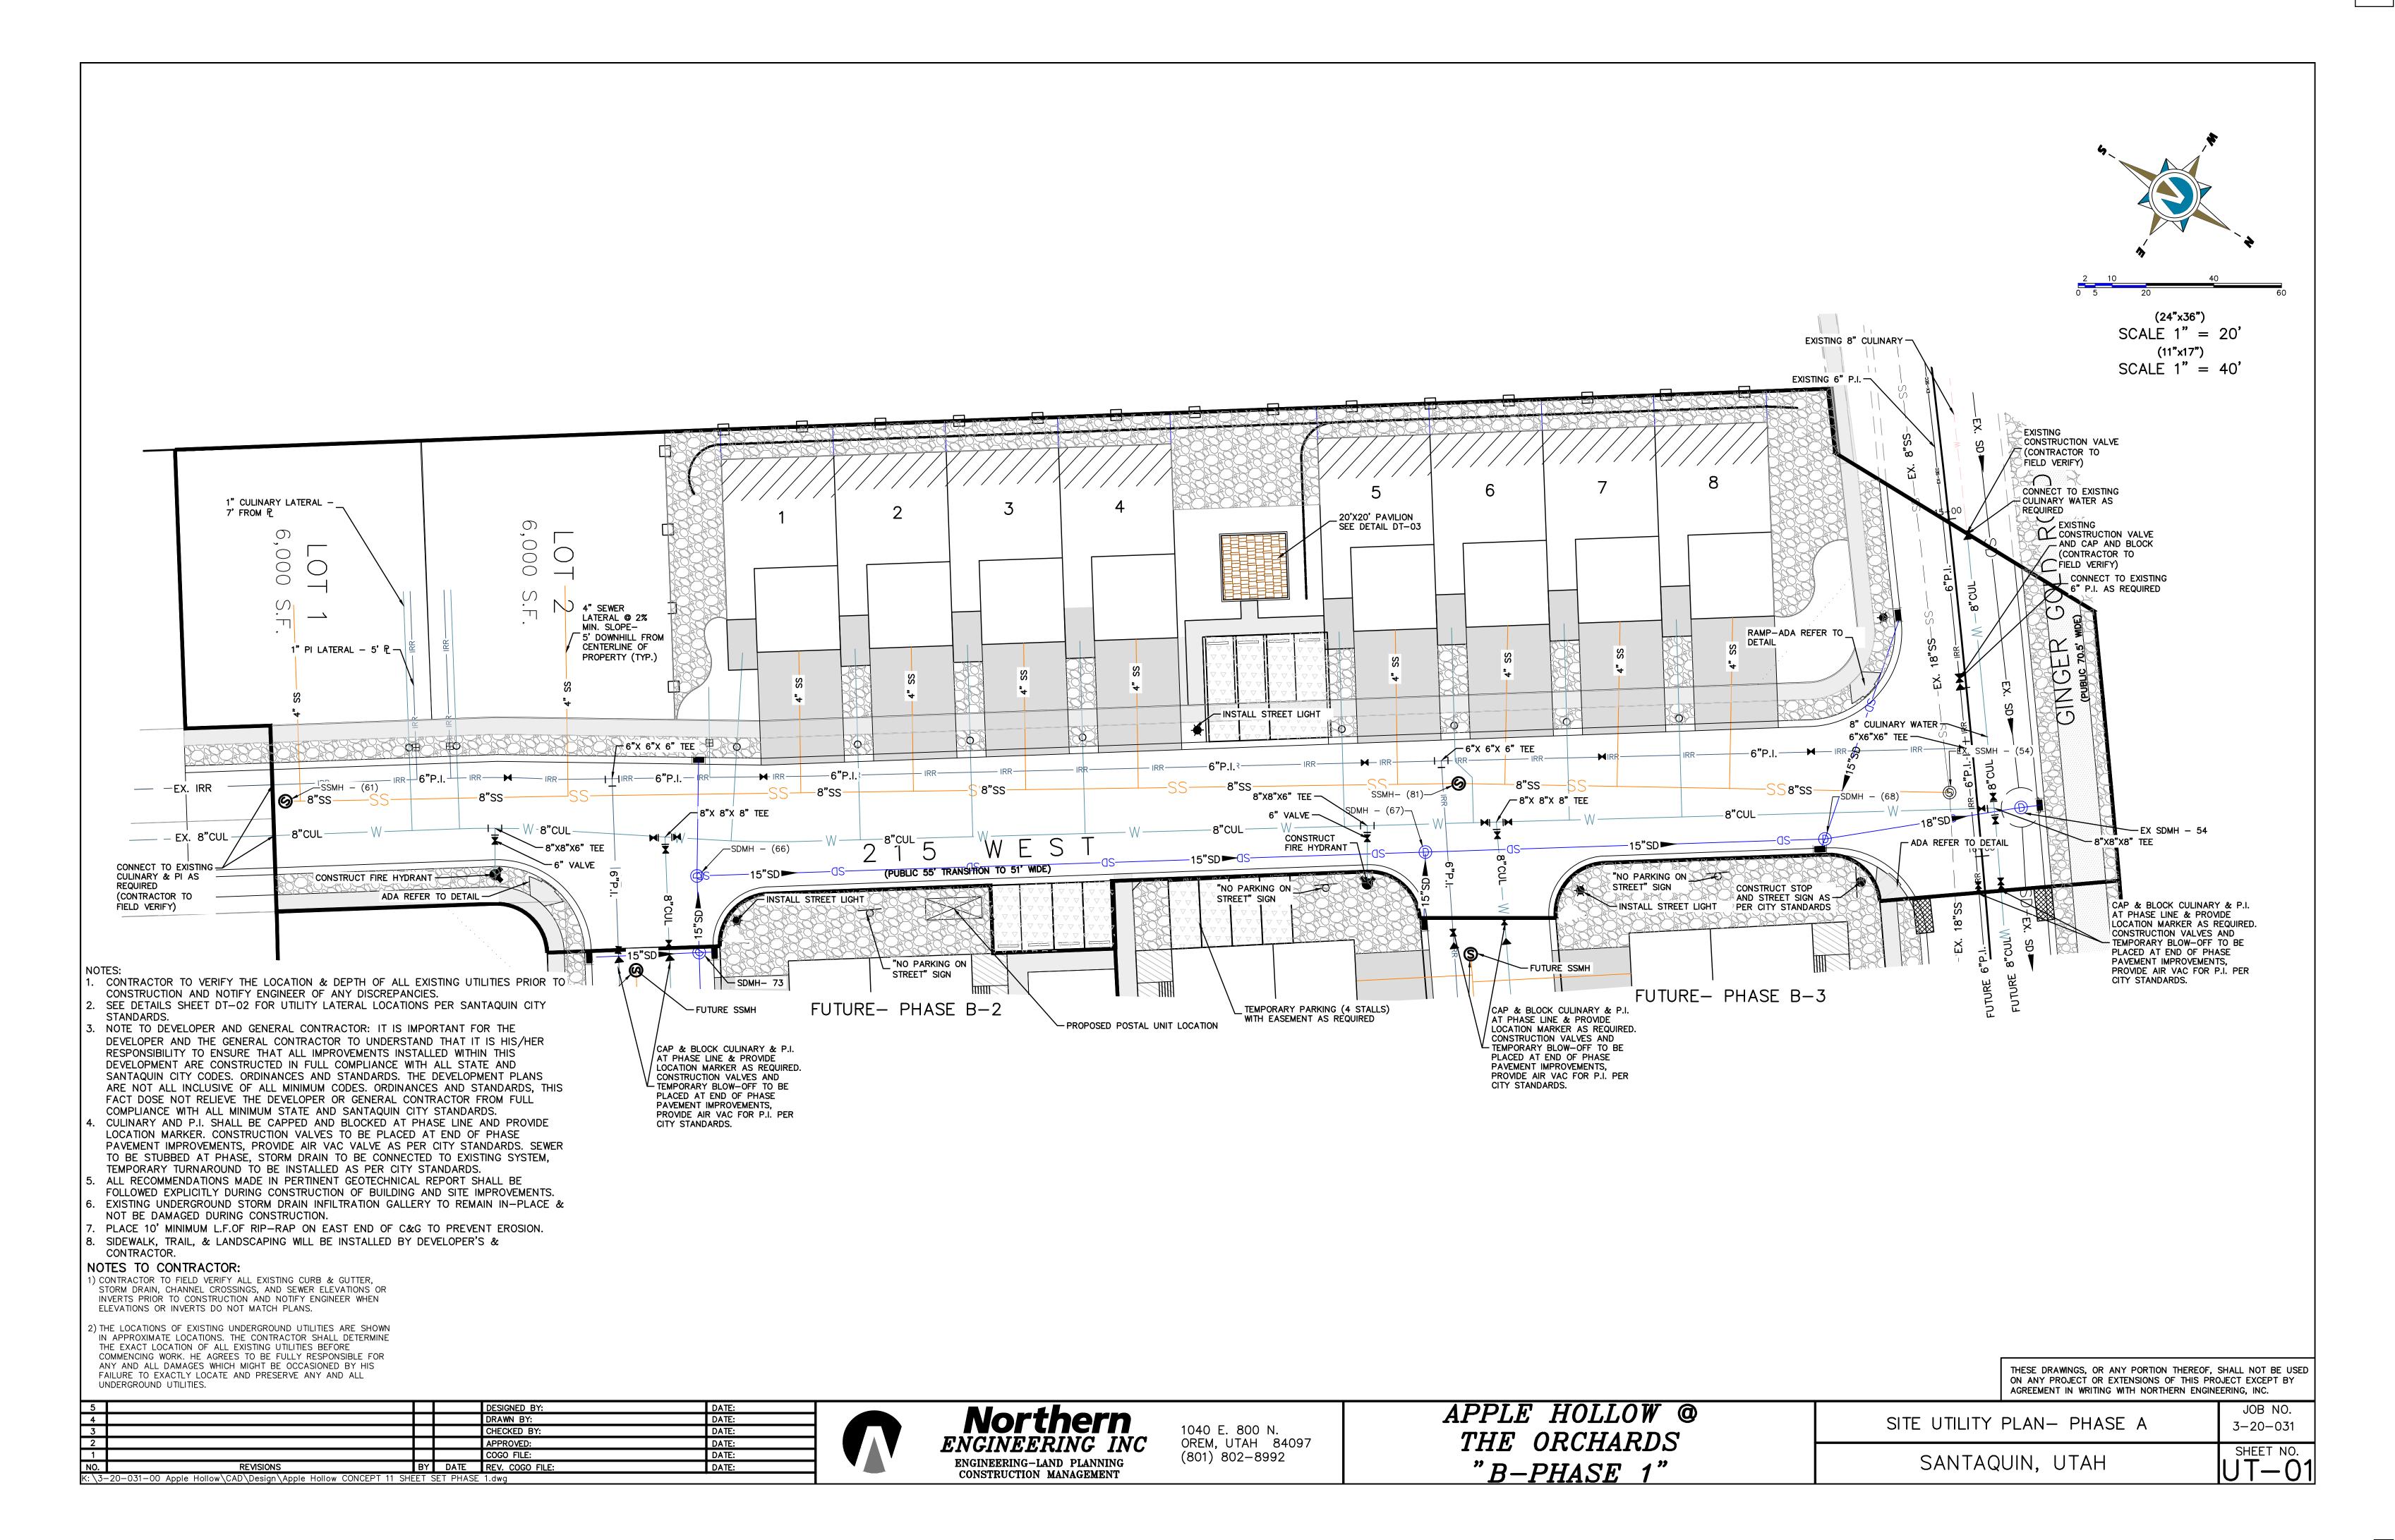

LANDSCAPING LEGEND:

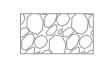

LANDSCAPE ROCK: TWO TO FOUR INCH (2" TO 4") DECORATIVE COBBLE ROCK. A SAMPLE OF THE PROPOSED MATERIAL MUST BE SUBMITTED TO AND APPROVED BY SANTAQUIN CITY PRIOR TO PLACING. COBBLE ROCK MULCH SHALL BR INSTALLED TO AN AVERAGE DEPTH OF FOUR INCHES (4") AND SHALL COMPLETELY COVER ALL PLANTER STRIP AREA. PRIOR TO INSTALLATION OF COBBLE ROCK, MULCH, A MIRAFI 600 (OR APPROVED EQUIVALENT) FABRIC MUST BE APPLIED TO THE PLANTER STRIP AREA.

21±

HELICTOTRICHON SEMPERVIRENS / BLUE OAT GRASS, 1-GAL.

28±

CALAMAGROSTIS X ACUTIFLORA FOERSTER / FEATHER REED GRASS,

5±

49±

EUONYMUS ALATUS COMPACTUS / COMPACT BURNING BUSH, 5-GAL.

RHAMNUS FRANGULA COLUMNARIS / ALDER BUCKTHORN, 5-GAL.



TILA AMERICAN REDMUND / REDMUND AMERICAN LINDEN, 2" - 2.5" CAL.

ACER FREEMAN / AUTUMN BLAZE MAPLE, 2" - 2.5" CAL.







PICEA PUNGENS / COLORADO "BLUE" SPRUCE,

NOTES:

- 1. STANDARD PLANTING PLAN FOR PLANTER AREAS ALONG GINGER GOLD ROAD. CONTRACTOR TO GET CITY APPROVAL PRIOR TO INSTALLATION.
- 2. ALL LANDSCAPING TO BE DONE ACCORDING TO SANTAQUIN CITY STANDARDS AND SPECIFICATIONS AND MEET THE CONDITIONS OF THE ARCHITECTURAL REVIEW COMMITTEE.
- 3. IRRIGATION TO BE DESIGNED BY OTHERS AND SUBMITTED TO CITY FOR APPROVAL BEFORE INSTALLATION.
- 4. GROUP TREES IN CLUSTERS AND VARIETY ALTERNATING BETWEEN GROUPS OF THREE.
- 5. TREES SHALL NOT BE PLANTED LESS THAN 5-FT FROM CURBS OR HARD SURFACE AREAS UNLESS A ROOT BARRIER IS INSTALLED NEXT TO HARDSCAPE SURFACE.
- 6. CONTRACTOR TO PLANT ALL TRESS AND SHRUBS ACCORDING TO SANTAQUIN CITY PLANTING STANDARDS.
- 7. ANY PROPOSED SUBSTITUTIONS OF PLAN SPECIES SHALL BE MADE WITH PLANTS OF EQUIVALENT OVERALL FORM, HEIGHT, BRANCHING HABIT, FLOWER, LEAF, COLOR, FRUIT AND CULTURE.
- 8. ALL TREES UP TO 2.5" CAL. SHALL BE DOUBLE STAKED AND ALL DECIDUOUS TREES GREATER THAN 2" CAL. AND ALL EVERGREEN TREES 6' AND TALLER SHALL BE TRIPLE STAKED OR GUYED.
- 9. NO PLANT MATERIAL SHALL BE PLANTED WITHIN 1-FT OF ANY WALK EDGE.
- 10. ALL PLANTING AREAS INCLUDING TREE AND SHRUB AREAS TO RECEIVE COMMERCIAL GRADE WEED BARRIER.
- 11. NO SOD GRASS IN PLANTER STRIP
- 12. 35% MAXIMUM SOD-GRASS ALLOWED IN FRONT OR SIDE YARD AS REQUIRED.
- 13. AIR CONDITIONING UNIT SCREENING IS REQUIRED.

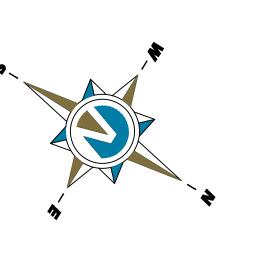

(24"x36") SCALE 1" = 20'(11"x17") SCALE 1" = 40'

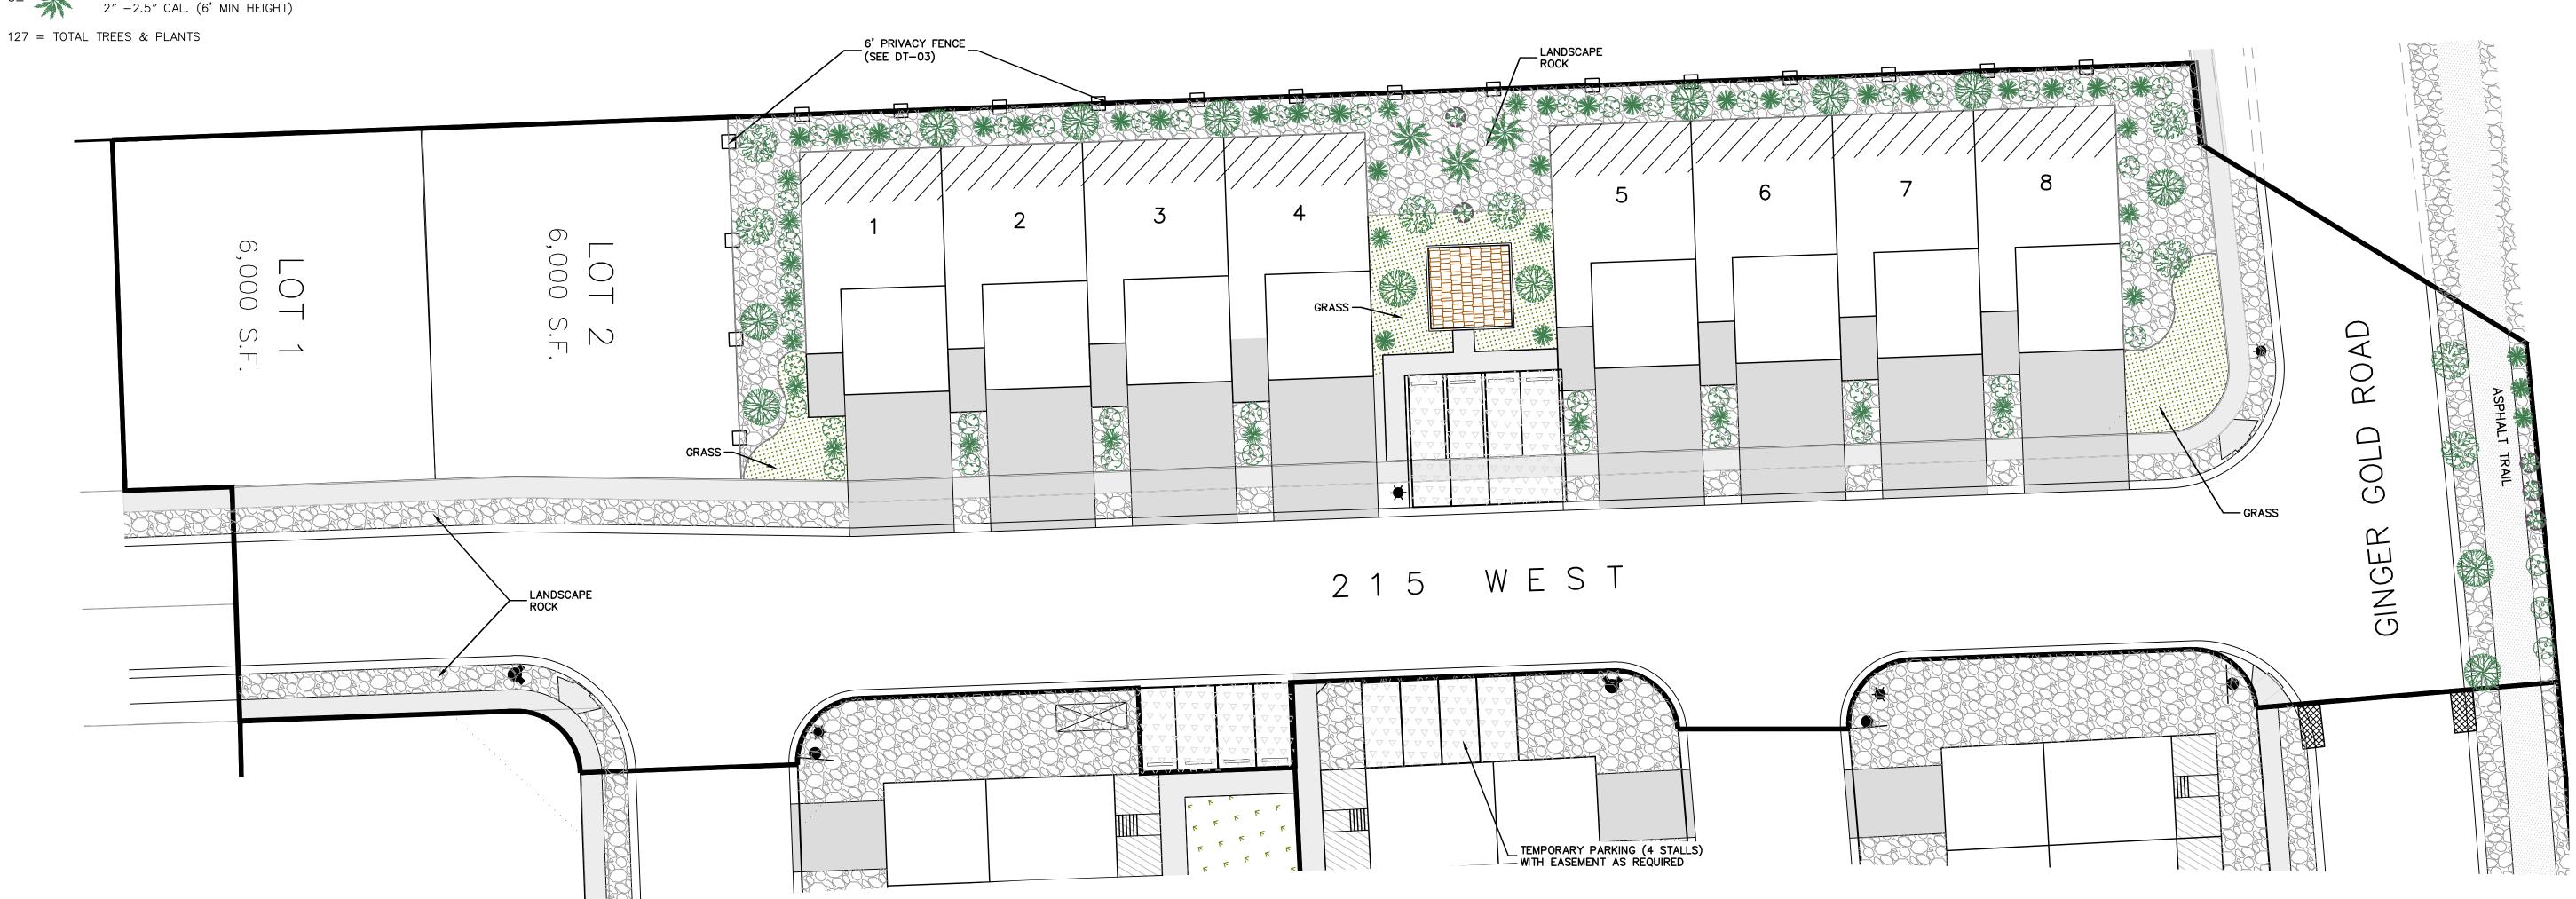

THESE DRAWINGS, OR ANY PORTION THEREOF, SHALL NOT BE USED ON ANY PROJECT OR EXTENSIONS OF THIS PROJECT EXCEPT BY

L						
[5				DESIGNED BY:	DATE:
	4				DRAWN BY:	DATE:
[3				CHECKED BY:	DATE:
	2				APPROVED:	DATE:
[1				COGO FILE:	DATE:
[NO.	REVISIONS	BY	DATE	REV. COGO FILE:	DATE:
	K: ∖3-	-20-031-00	ET S	SET PHASE	1.dwg	




ENGINEERING-LAND PLANNING CONSTRUCTION MANAGEMENT


APPLE	HOLLO)W @	
THE C	RCHAF	RDS	
"B-F	PHASE	1"	

	AGREEMENT IN WRITING WITH NORTHERN ENGINE	EERING, INC.
LANDS	CAPE PLAN	JOB NO. 3-20-031
SANTAG	UIN, UTAH	SHEET NO.

- 1. NOTE TO DEVELOPER AND GENERAL CONTRACTOR: IT IS IMPORTANT FOR THE DEVELOPER AND THE GENERAL CONTRACTOR TO UNDERSTAND THAT IT IS HIS/HER RESPONSIBILITY TO ENSURE THAT ALL IMPROVEMENTS INSTALLED WITHIN THIS DEVELOPMENT ARE CONSTRUCTED IN FULL COMPLIANCE WITH ALL STATE AND SANTAQUIN CITY CODES. ORDINANCES AND STANDARDS. THE DEVELOPMENT PLANS ARE NOT ALL INCLUSIVE OF ALL MINIMUM CODES. ORDINANCES AND STANDARDS, THIS FACT DOSE NOT RELIEVE THE DEVELOPER OR GENERAL CONTRACTOR FROM FULL COMPLIANCE WITH ALL MINIMUM STATE AND SANTAQUIN CITY STANDARDS.
- 2. ALL RECOMMENDATIONS MADE IN PERTINENT GEOTECHNICAL REPORT SHALL BE FOLLOWED EXPLICITLY DURING CONSTRUCTION OF BUILDING AND SITE IMPROVEMENTS.
- 3. INSTALL P.I. DRAIN TO CONNECT TO SDMH AS SHOWN AS PER CITY STANDARDS.
- 4. PLACE 10' MINIMUM L.F. OF RIP-RAP ON EAST END OF C&G TO PREVENT EROSION.

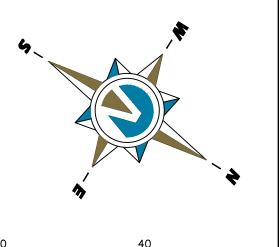

(24"x36") SCALE 1" = 20'(11"x17") SCALE 1" = 40

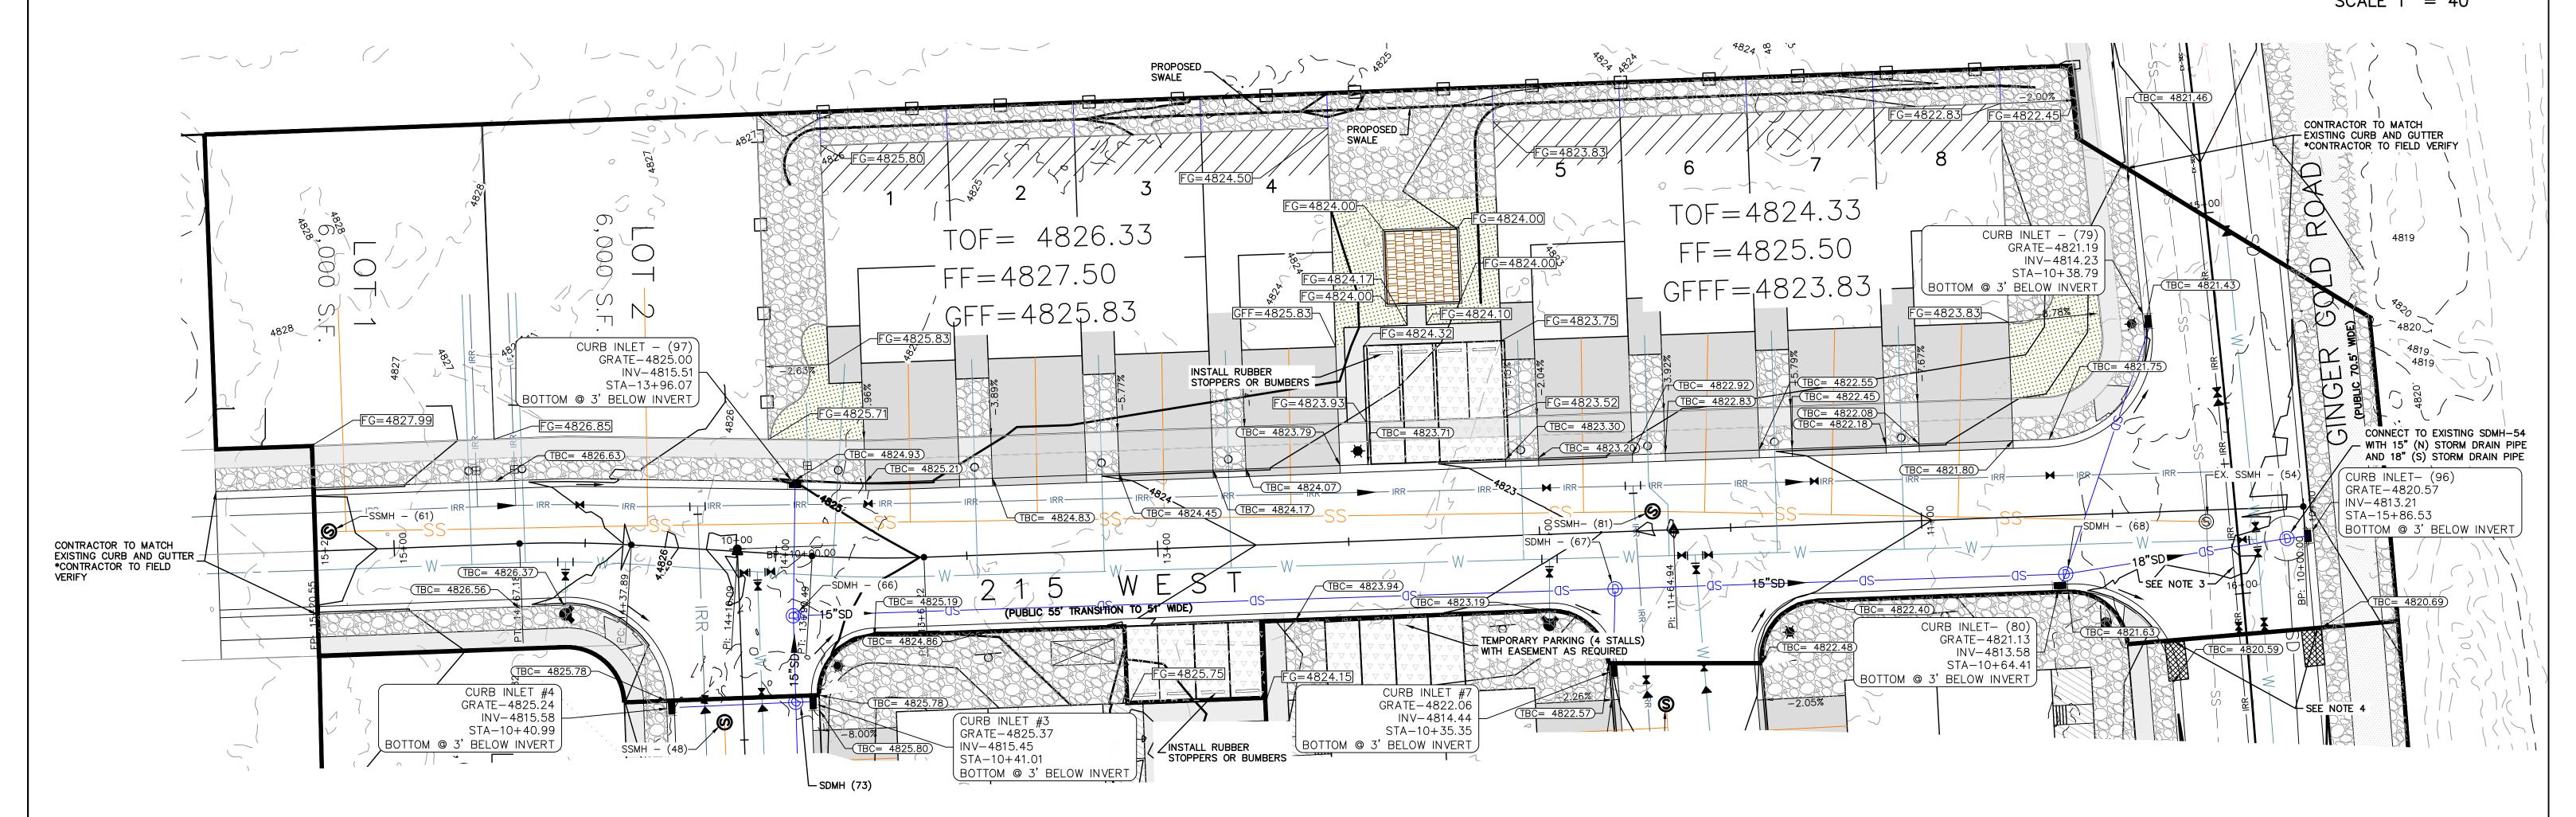

LEGEND:

TOF= TOP OF FOUNDATION FF=FINISHED FLOOR GFF=GARAGE FINISHED FLOOR BFF= BASEMENT FINISHED FLOOR

K:\3-20-031-00 Apple Hollow\CAD\Design\Apple Hollow CONCEPT 11 SHEET SET PHASE 1.dwg

NOTES TO CONTRACTOR:

- 1) CONTRACTOR TO FIELD VERIFY ALL EXISTING CURB & GUTTER, STORM DRAIN, CHANNEL CROSSINGS, AND SEWER ELEVATIONS OR INVERTS PRIOR TO CONSTRUCTION AND NOTIFY ENGINEER WHEN ELEVATIONS OR INVERTS DO NOT MATCH PLANS.
- 2) THE LOCATIONS OF EXISTING UNDERGROUND UTILITIES ARE SHOWN IN APPROXIMATE LOCATIONS. THE CONTRACTOR SHALL DETERMINE THE EXACT LOCATION OF ALL EXISTING UTILITIES BEFORE COMMENCING WORK. HE AGREES TO BE FULLY RESPONSIBLE FOR ANY AND ALL DAMAGES WHICH MIGHT BE OCCASIONED BY HIS FAILURE TO EXACTLY LOCATE AND PRESERVE ANY AND ALL UNDERGROUND UTILITIES.

NOTES: 1) 2% MAX GRADE FOR ALL ADA PARKING SPACES AND ACCESS AISLE.

THESE DRAWINGS, OR ANY PORTION THEREOF, SHALL NOT BE USED ON ANY PROJECT OR EXTENSIONS OF THIS PROJECT EXCEPT BY AGREEMENT IN WRITING WITH NORTHERN ENGINEERING, INC.


5				DESIGNED BY:	DATE:
4				DRAWN BY:	DATE:
3				CHECKED BY:	DATE:
2				APPROVED:	DATE:
1				COGO FILE:	DATE:
NO.	REVISIONS	BY	DATE	REV. COGO FILE:	DATF:



ENGINEERING-LAND PLANNING CONSTRUCTION MANAGEMENT

APPLE	HOLLO	W	@
THE	ORCHAI	RDS	5'
"B-	PHASE	1 "	

	AGREEMENT IN WRITING WITH NORTHERN ENGINE	ERING, INC.
ITE GRADING A	ND DRAINAGE PLAN	JOB 1 3-20-
SANTAQ	UIN, UTAH	SHEET GR-

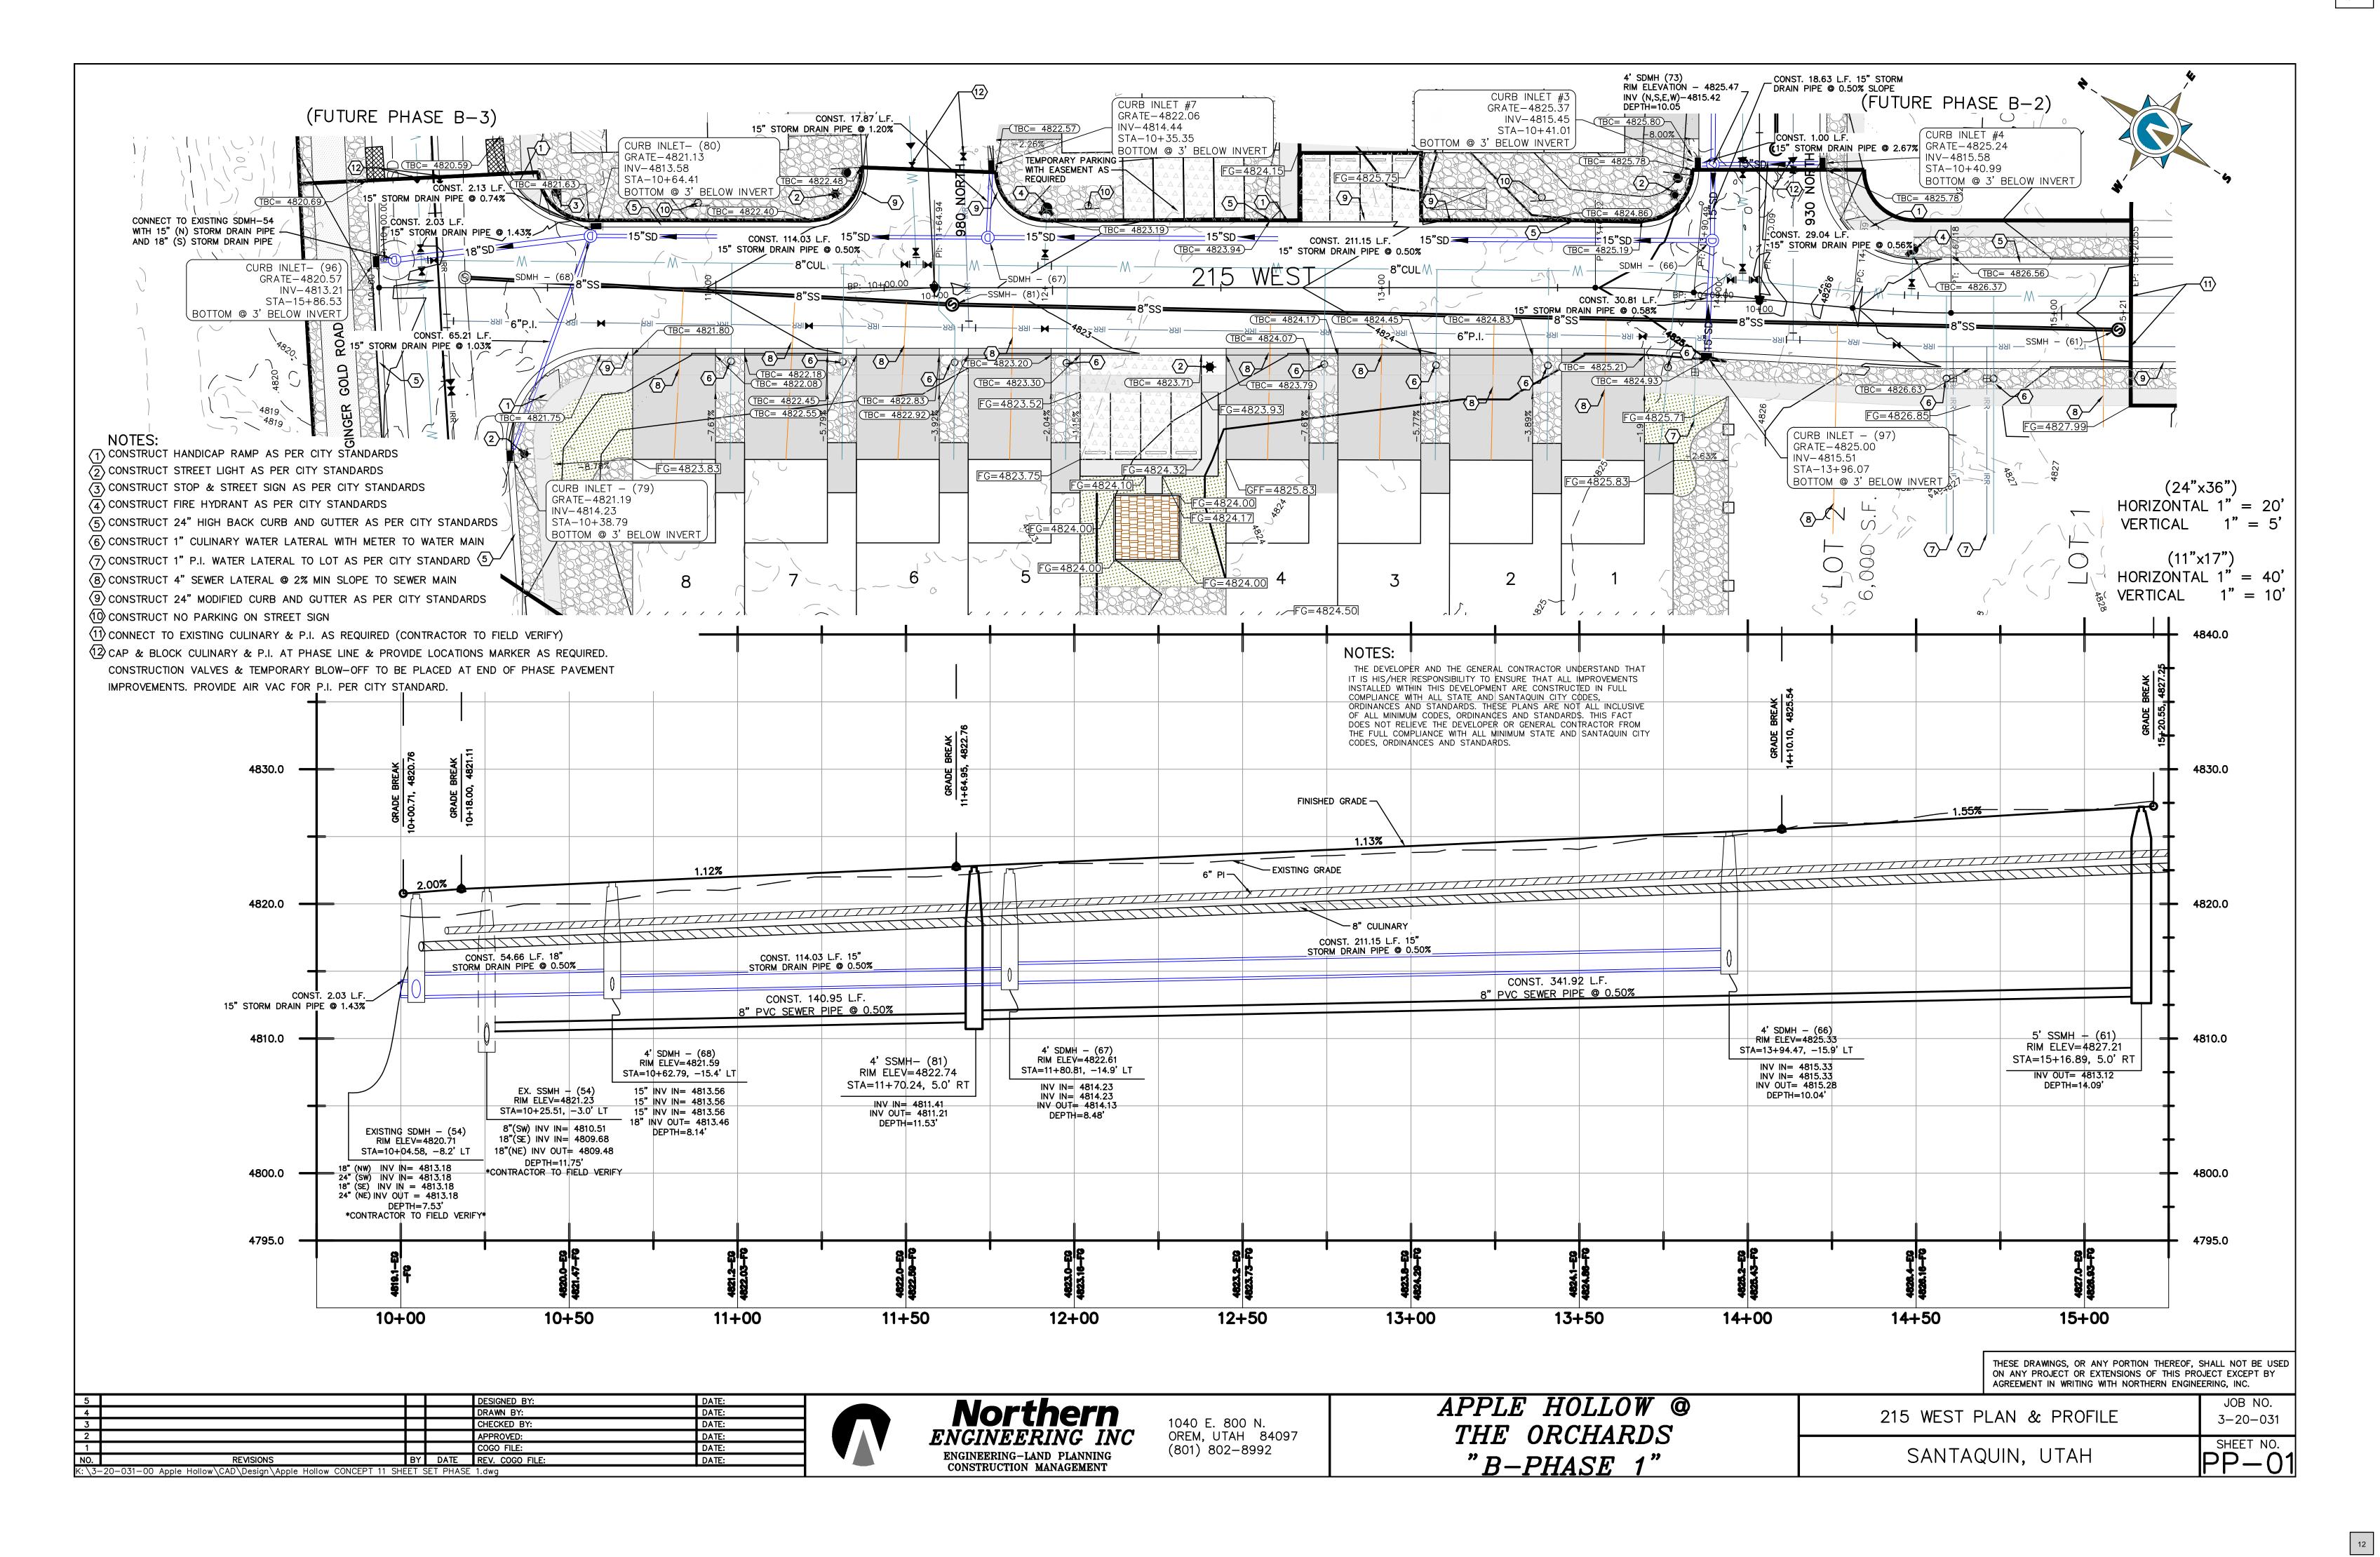

NOTES:

- (1) CONSTRUCT HANDICAP RAMP AS PER CITY STANDARDS
- (2) CONSTRUCT STREET LIGHT AS PER CITY STANDARDS
- (3) CONSTRUCT STOP & STREET SIGN AS PER CITY STANDARDS
- (4) CONSTRUCT FIRE HYDRANT AS PER CITY STANDARDS


THE DEVELOPER AND THE GENERAL CONTRACTOR UNDERSTAND THAT


DOES NOT RELIEVE THE DEVELOPER OR GENERAL CONTRACTOR FROM THE FULL COMPLIANCE WITH ALL MINIMUM STATE AND SANTAQUIN CITY CODES, ORDINANCES AND STANDARDS.

IT IS HIS/HER RESPONSIBILITY TO ENSURE THAT ALL IMPROVEMENTS

INSTALLED WITHIN THIS DEVELOPMENT ARE CONSTRUCTED IN FULL COMPLIANCE WITH ALL STATE AND SANTAQUIN CITY CODES, ORDINANCES AND STANDARDS. THESE PLANS ARE NOT ALL INCLUSIVE OF ALL MINIMUM CODES, ORDINANCES AND STANDARDS. THIS FACT


- (5) CONSTRUCT 24" HIGH BACK CURB AND GUTTER AS PER CITY STANDARDS
- 6 CONSTRUCT 1" CULINARY WATER LATERAL WITH METER TO WATER MAIN
- ONSTRUCT 1" P.I. WATER LATERAL TO LOT AS PER CITY STANDARD
- 8 CONSTRUCT 4" SEWER LATERAL @ 2% MIN SLOPE TO SEWER MAIN
- (9) CONSTRUCT 24" MODIFIED CURB AND GUTTER AS PER CITY STANDARDS

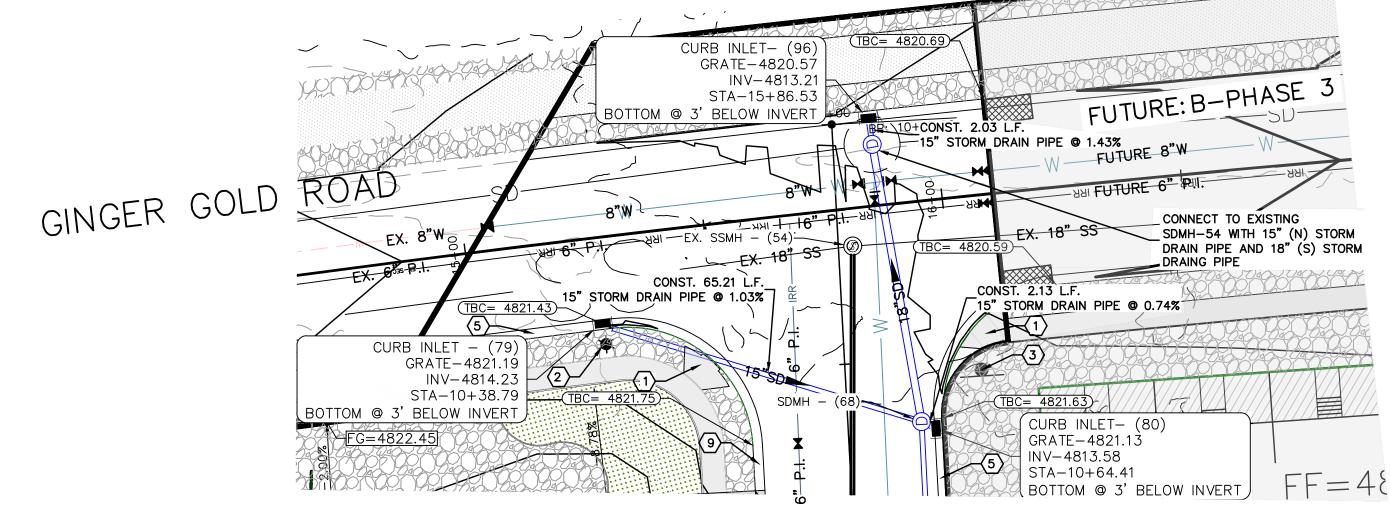

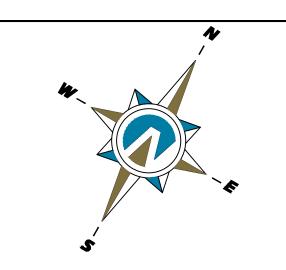


(24"x36") HORIZONTAL 1" = 20"VERTICAL 1" = 5'


(11"x17") HORIZONTAL 1" = 40"VERTICAL 1" = 10'

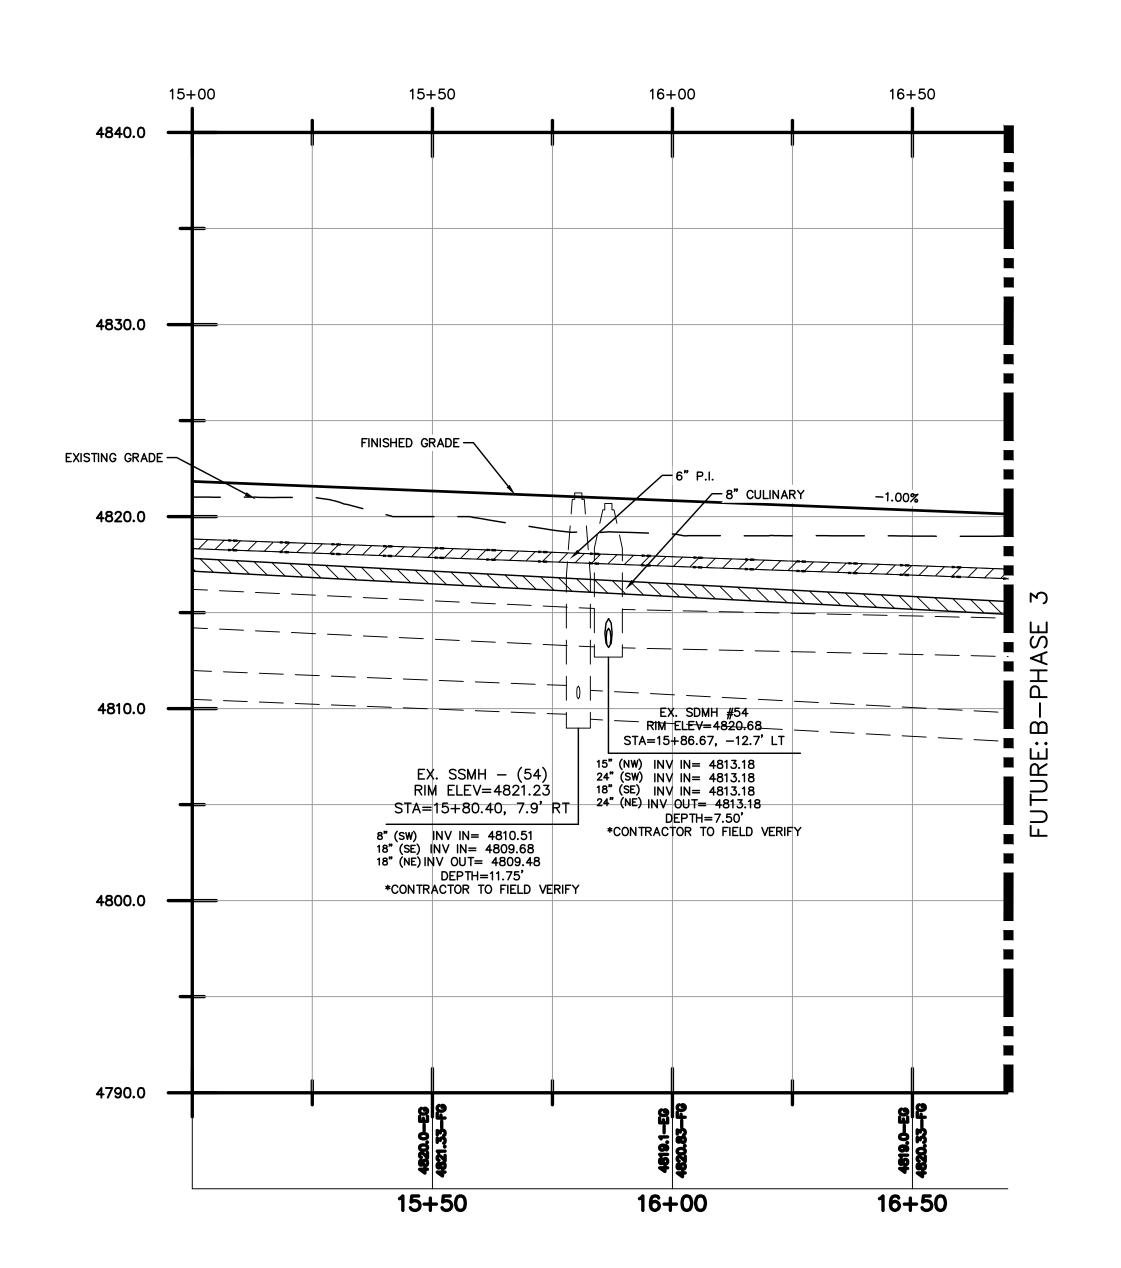



THESE DRAWINGS, OR ANY PORTION THEREOF, SHALL NOT BE USED ON ANY PROJECT OR EXTENSIONS OF THIS PROJECT EXCEPT BY AGREEMENT IN WRITING WITH NORTHERN ENGINEERING, INC.


5 DESIGNED BY: 4 DRAWN BY: 3 CHECKED BY: 4 APPROVED:	Northern ENGINEERING INC 1040 E. 800 N. OREM, UTAH 84097	APPLE HOLLOW @ THE ORCHARDS	STORM DRAIN PLAN & PROFILE	JOB NO. 3-20-031
APPROVED: 1	ENGINEERING INC ENGINEERING-LAND PLANNING CONSTRUCTION MANAGEMENT OREM, UTAH 84097 (801) 802-8992	"B-PHASE 1"	SANTAQUIN, UTAH	PP-02

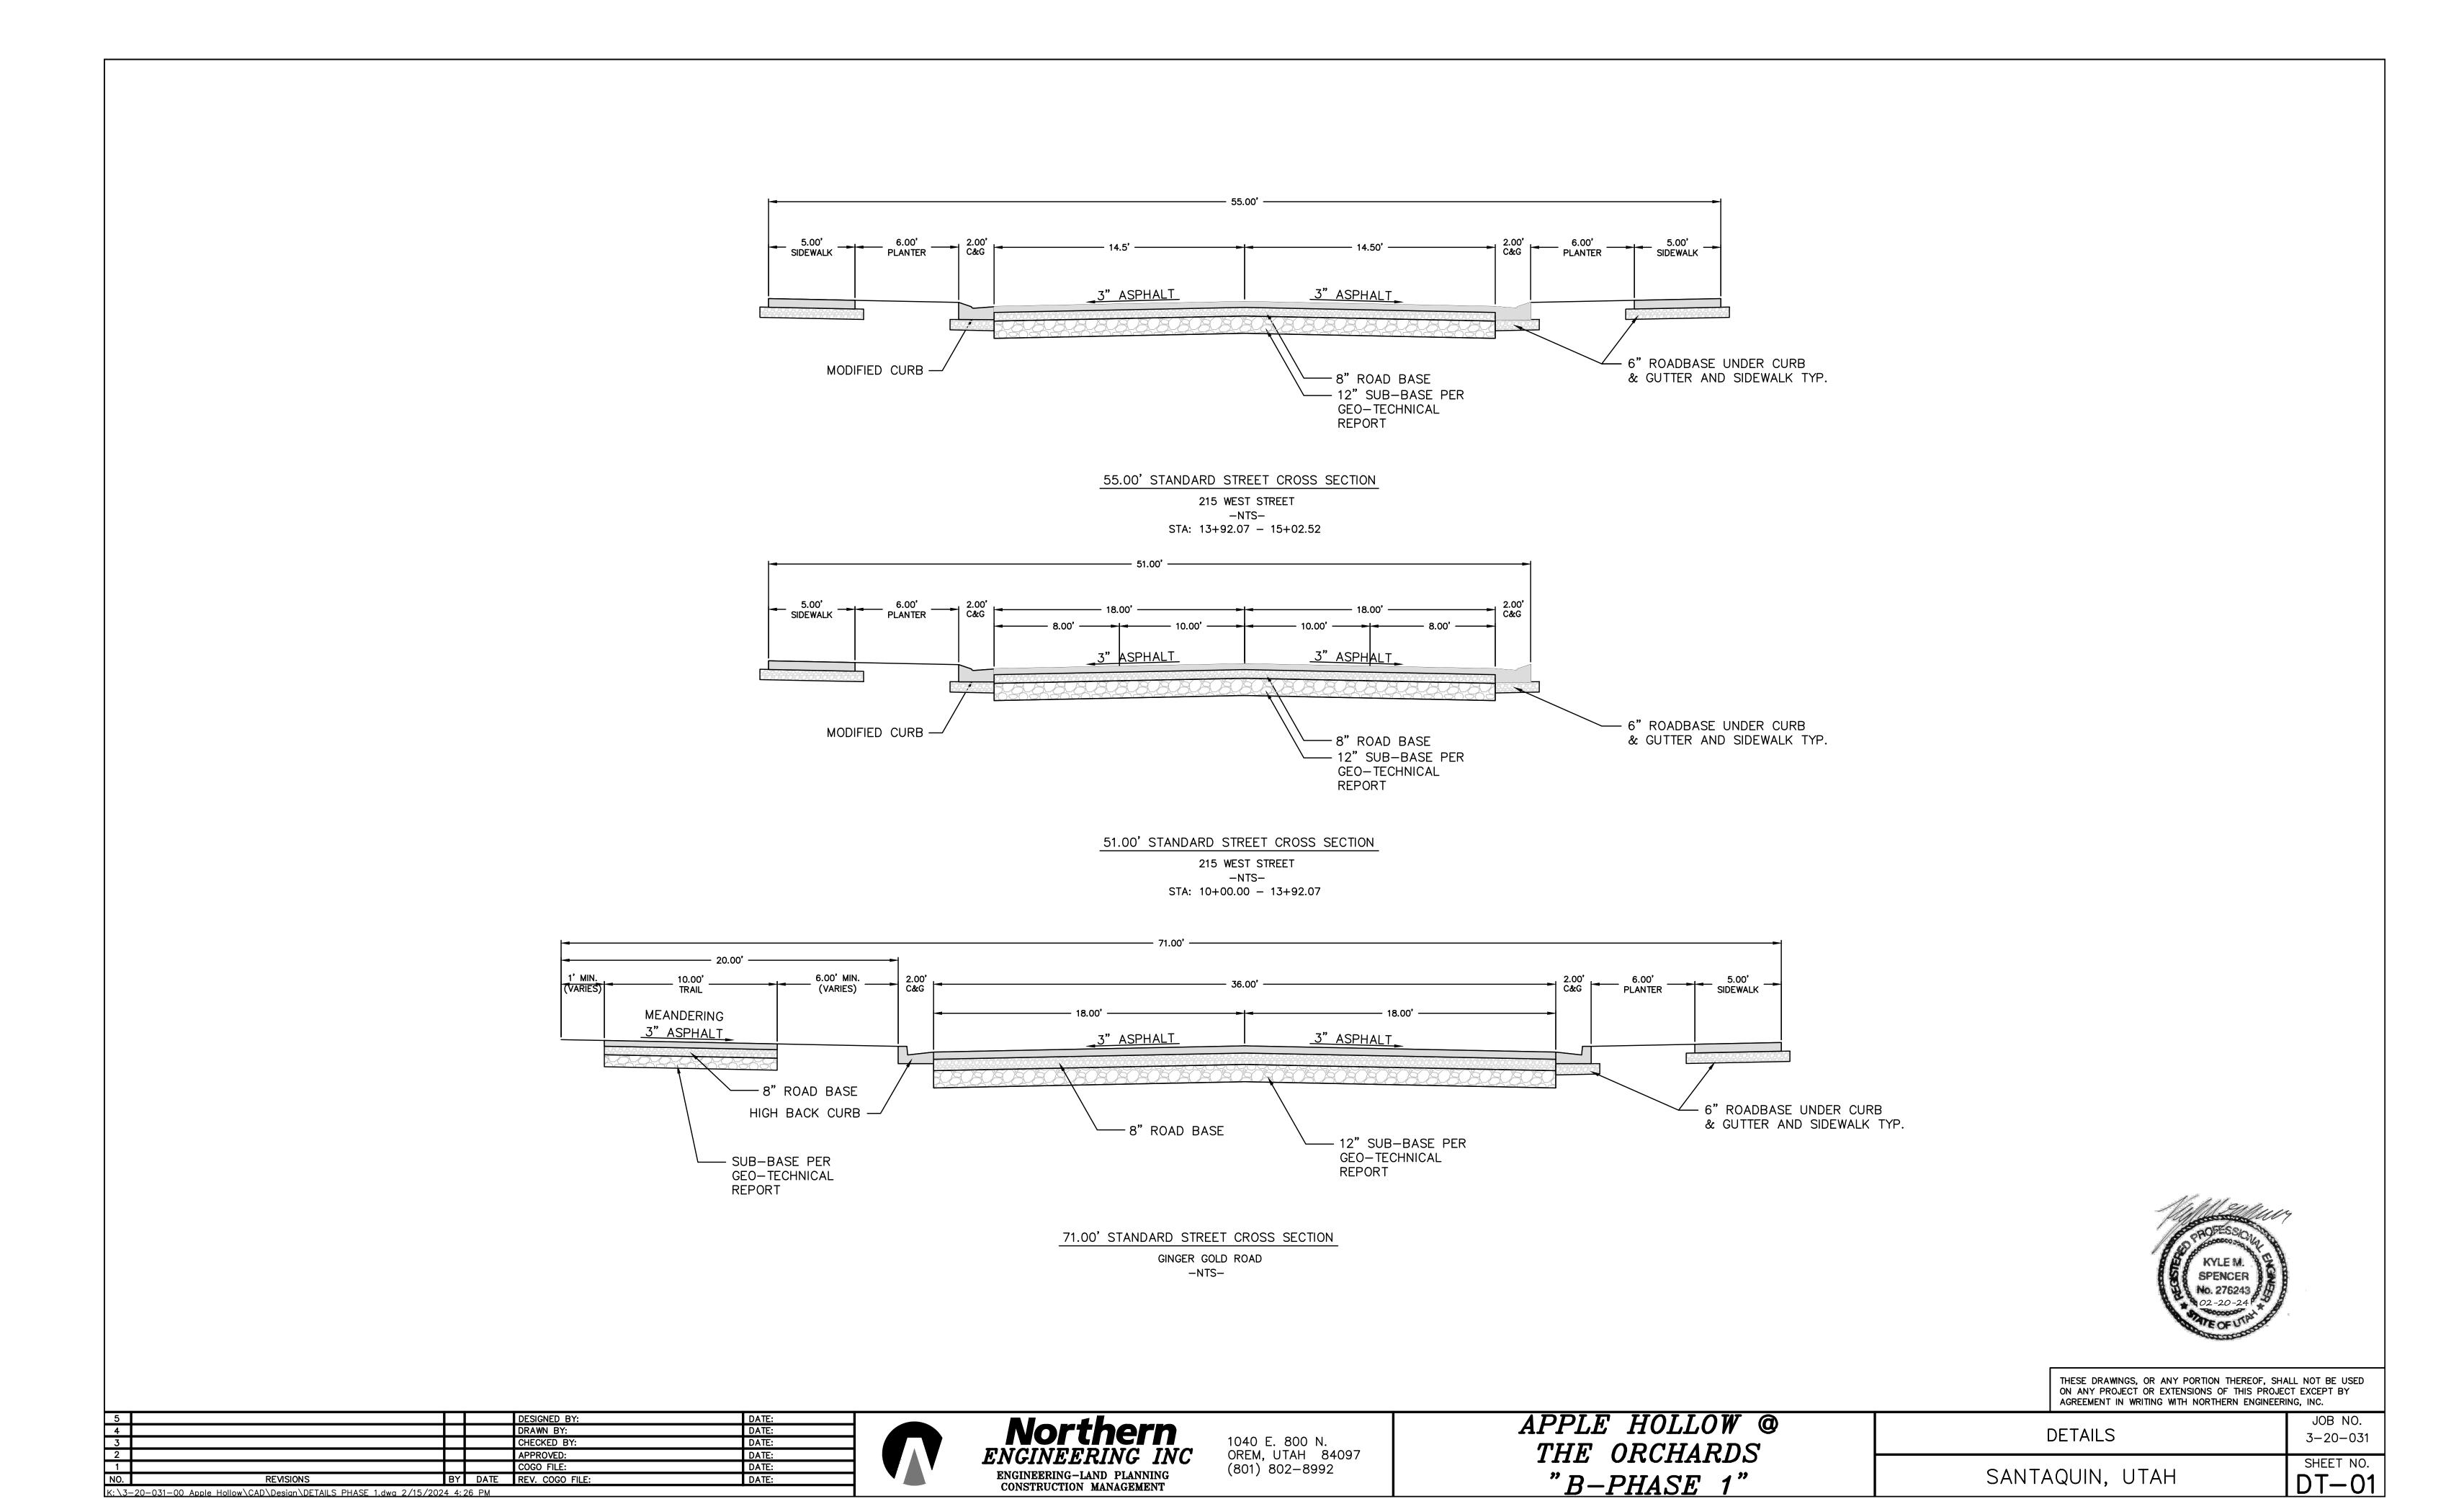


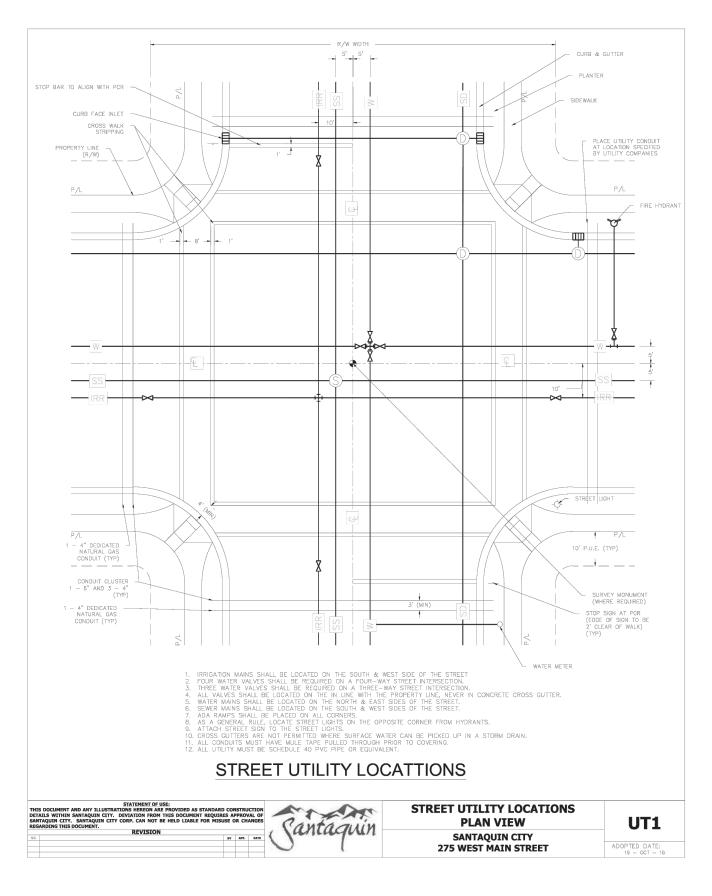


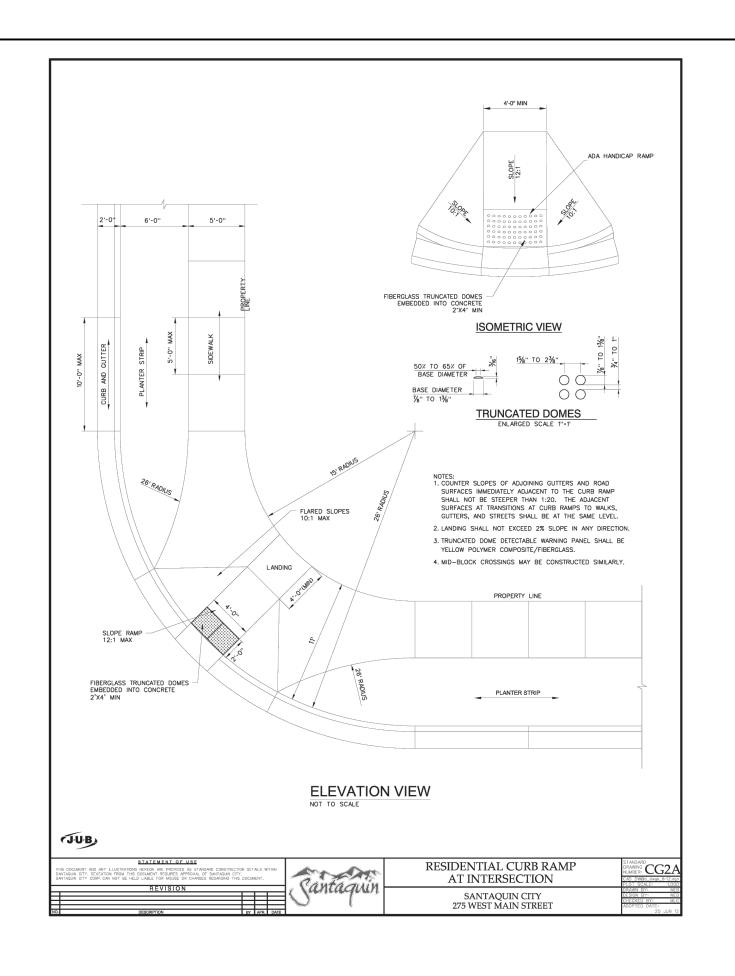


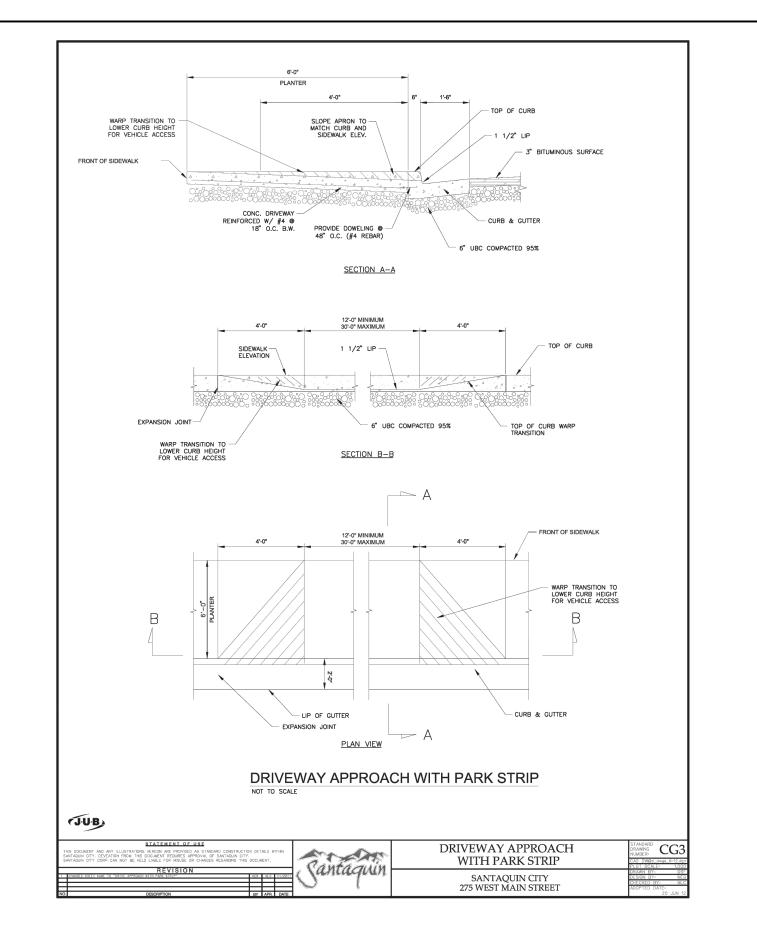


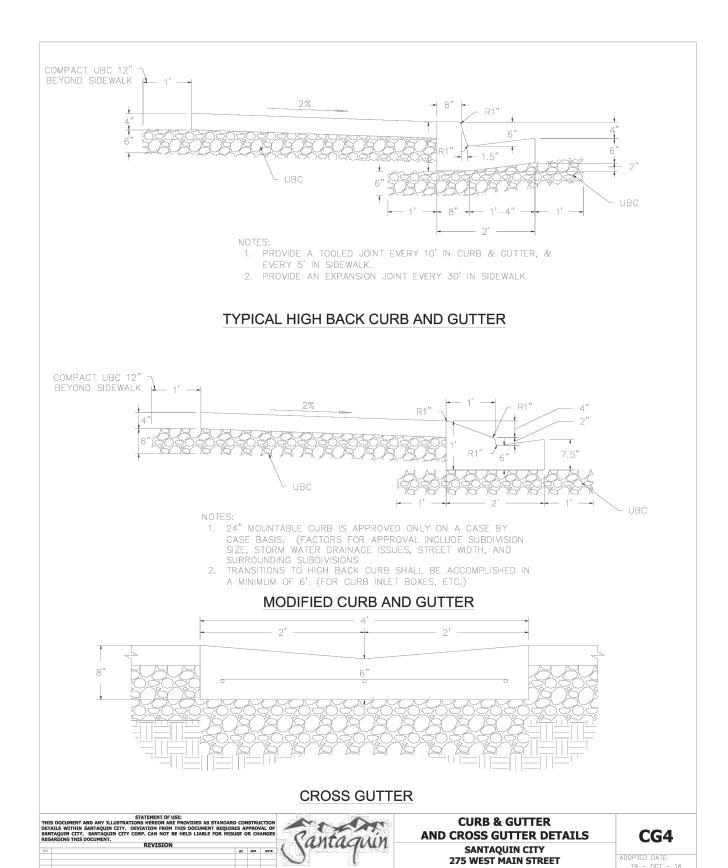


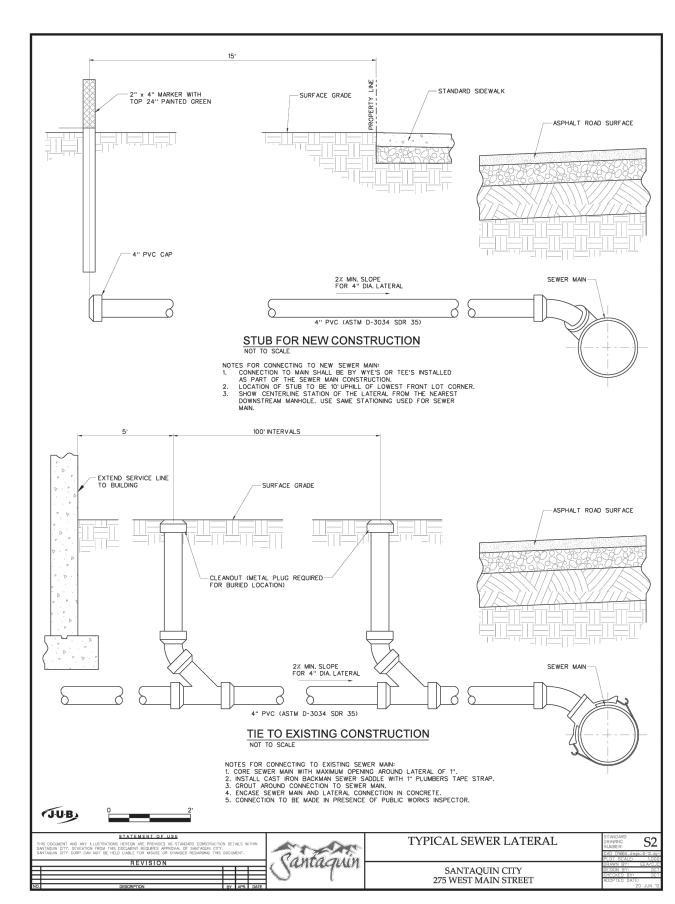

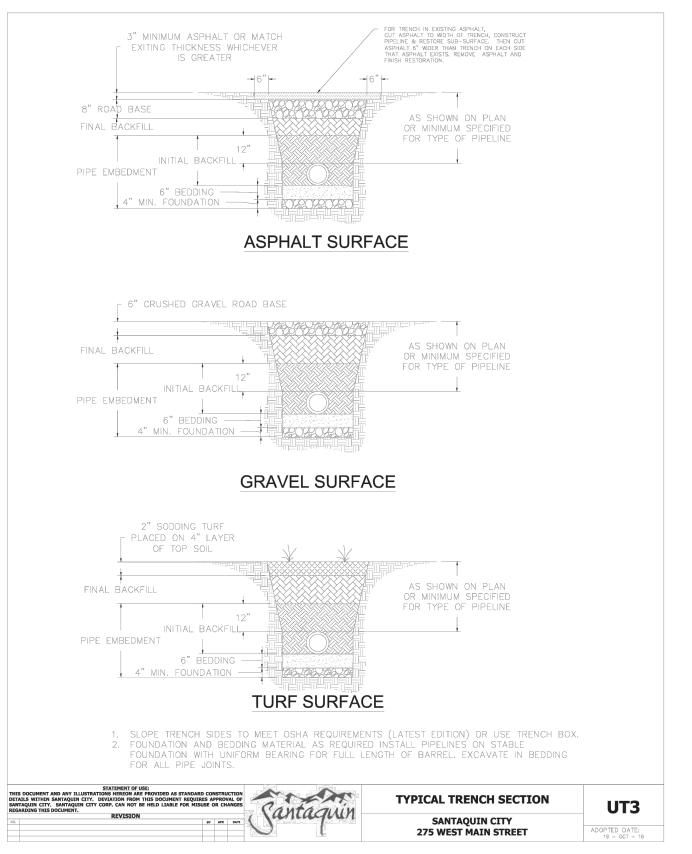

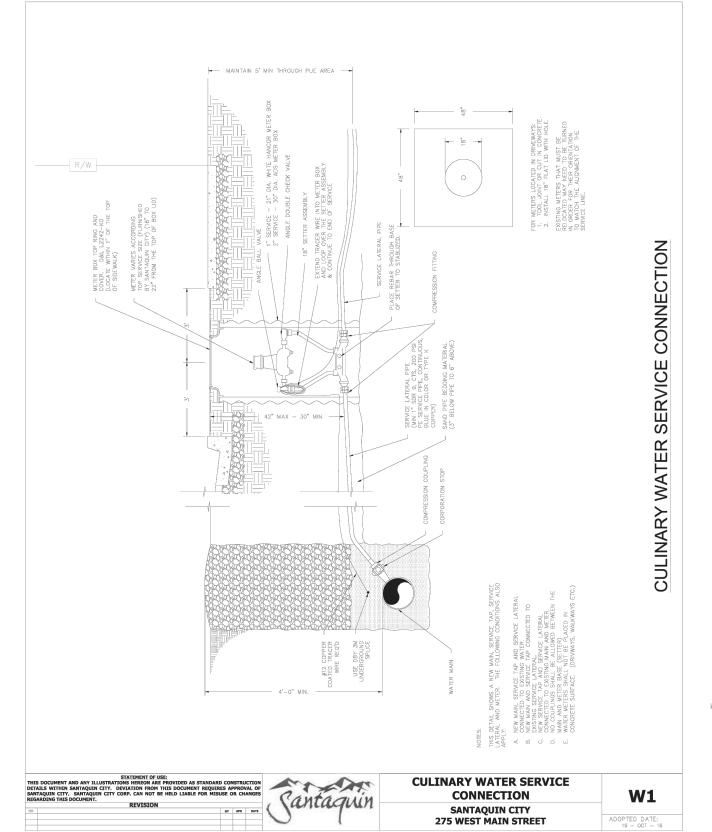

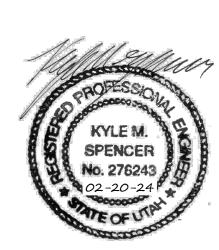

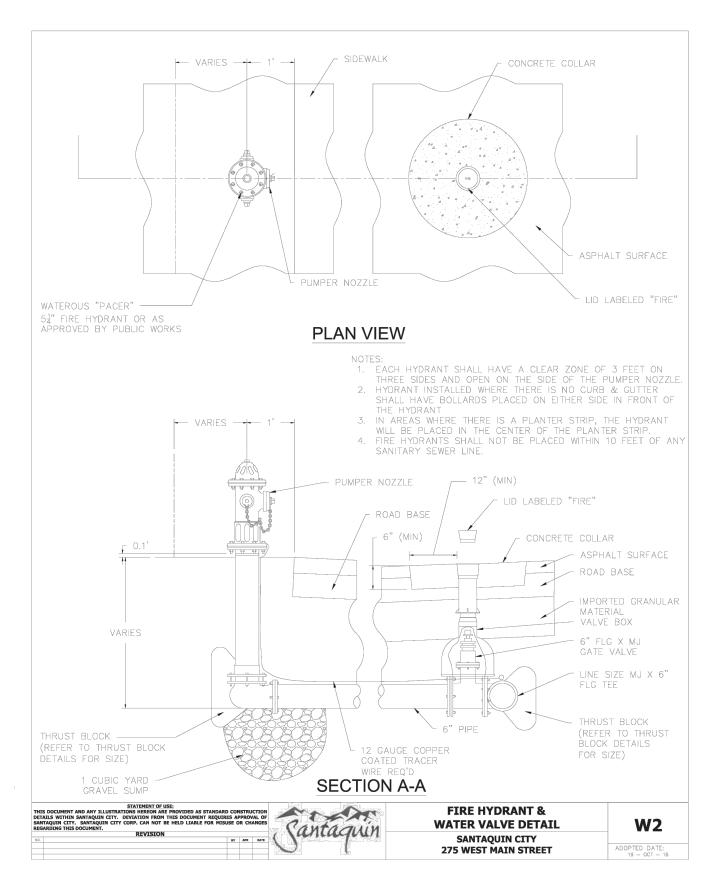


5				DESIGNED BY:	DATE:			
4				DRAWN BY:	DATE:			
3				CHECKED BY:	DATE:			
2				APPROVED:	DATE:			
1				COGO FILE:	DATE:			
NO.	REVISIONS	BY	DATE	REV. COGO FILE:	DATE:			
K: \3−2	K:\3-20-031-00 Apple Hollow\CAD\Design\DETAILS PHASE 1.dwg 2/15/2024 4:26 PM							





Northern ENGINEERING INC ENGINEERING-LAND PLANNING CONSTRUCTION MANAGEMENT


1040 E. 800 N. OREM, UTAH 84097 (801) 802-8992 APPLE HOLLOW @
THE ORCHARDS
"B-PHASE 1"

ON ANY PROJECT OR EXTENSIONS OF THIS PROJE	THESE DRAWINGS, OR ANY PORTION THEREOF, SHALL NOT BE USED ON ANY PROJECT OR EXTENSIONS OF THIS PROJECT EXCEPT BY AGREEMENT IN WRITING WITH NORTHERN ENGINEERING, INC.			
DETAILS	JOB NO. 3-20-031			
SANTAQUIN, UTAH	SHEET NO. DT-02			

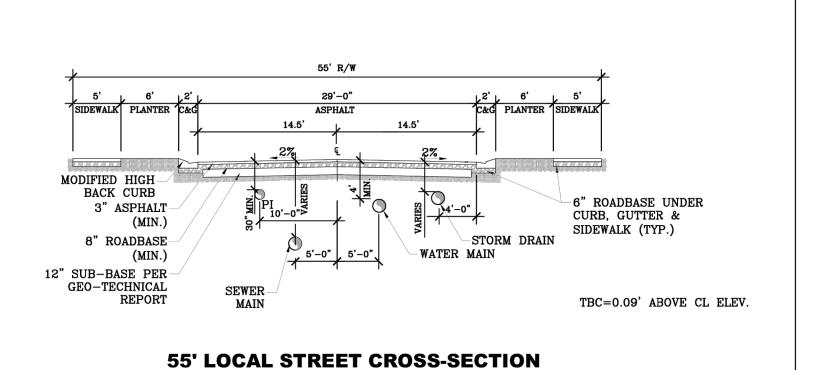

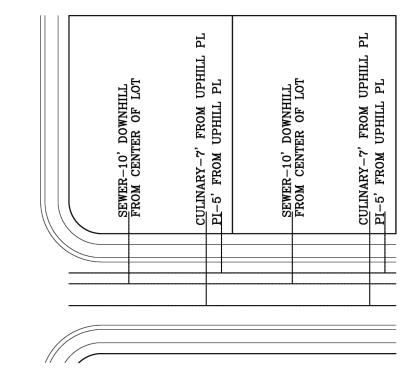

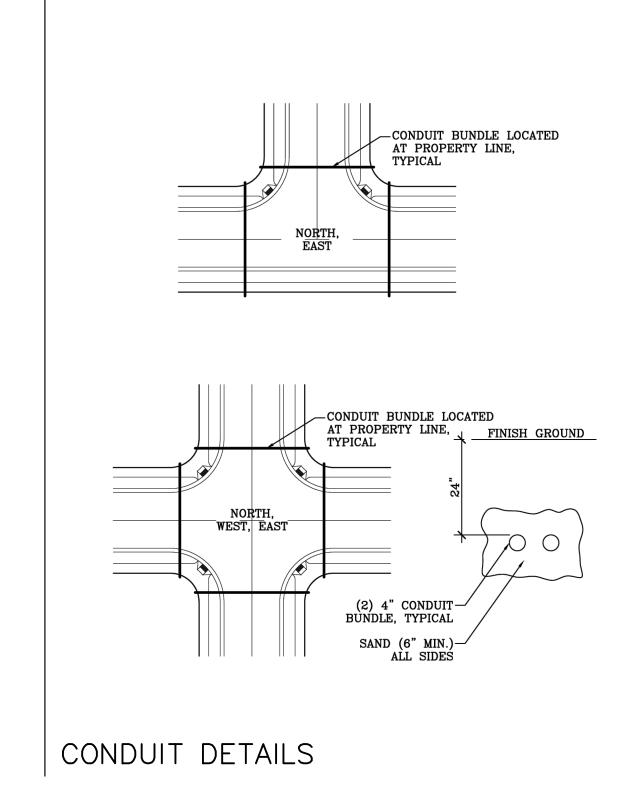


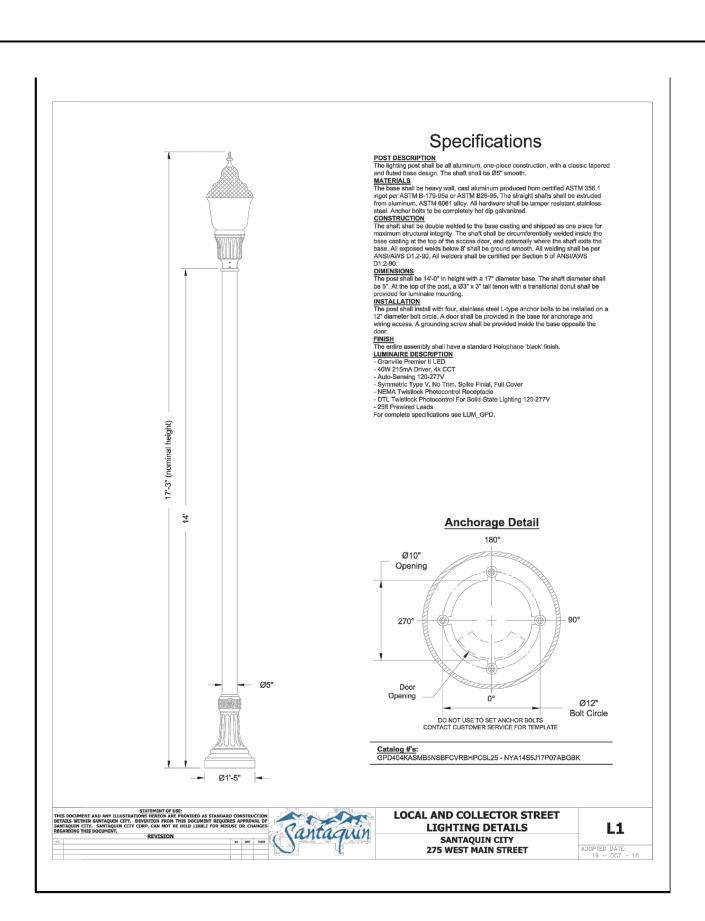

STREET CROSS-SECTIONS

LATERAL DETAIL



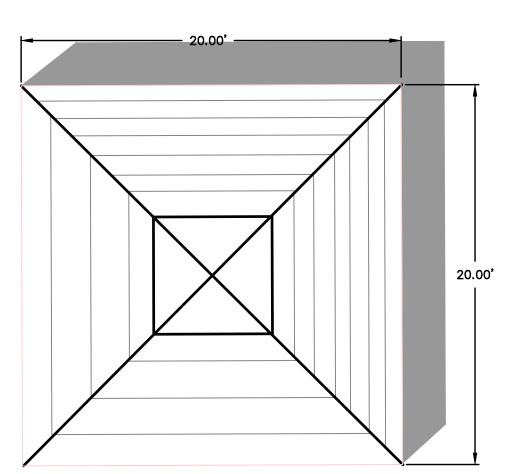


20'X20' PAVILION DETAIL
PROPOSED PAVILION OR EQUIVALENT
WITH 4 PICNIC TABLES OR EQUIVALENT
-NTS-

| Technical Information: Rhinorock fence Panel | Dimension of Panel | 105 kg | 230 bs | Weight per area | 21.5 kg/m² | 4.9 bs/f² | Tickness of Panel | 115 mm | 4.5° | EFS Foam Core thickness | 63-99mm | 2.5-3.75° | Tickness | 63-99mm | 2.5-3.75° | Tickness | 10.5 kg | 1.5 kg/m² | 1

TECHNICAL INFORMATION: RhinoRock Fence Panel						
Dimension of Panel	182 cm x 259 cm	72"x102"				
Weight of Panel	105 Kg	230 lbs				
Weight per area	21.5kg/m ²	4.9lbs/ft ²				
Thickness of Panel	115mm	4.5"				
EPS Foam Core thickness	63-95mm	2.5-3.75"				
Glass fiber reinforced concrete shell thickness	9mm	5/16"				
% glass fiber by volume	4-	4.50%				
Compressive Strength of proprietary concrete mix design	4x10 ⁷ N/m^2	5800 psi				
Ultimate tensile strength of glass fiber reinforced concrete	9.6x10 ⁶ - 1.4x10 ⁷ N/m ²	1400-2100 psi				
Wind load capacity of panel	225 km/h	140mph with 1.6 safety factor				
axial load capacity of panel	1644 kg/lineal meter	1100 lbs/lineal foot				
moisture absorption of EPS foam core by total immersion		<4%				
Combustibility of glass fiber reinforced concrete shell	Non-co	ombustible				
Freeze/thaw performance	200 freeze thaw c	ycles with no damage				
Derby, fungus, or mushroom attack	r	none				
Termite food source	r	none				

6' CLASSIC PRIVACY FENCE % x 11 % Panels & 1 ½ x 5 ½ Slotted Rails (68" Panel Height) Available Colors: White, Sandstone & Khaki

STREET LIGHT DETAIL

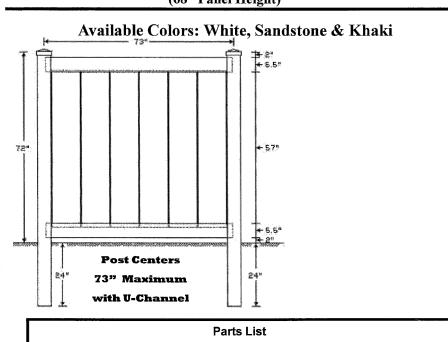


Parts List				
QTY	DESCRIPTION	LENGTH		
2	1 ½ x 5 ½ Slotted Rail	72"		
6	¾ x 11 ¼ T&G	60		
2	¾ U-Channel	60 7/8" - Optional		
6	#10 - Screw - (5/16" Hex Head)	¾" – for U-Channel		

Posts

5"x 5"- 8' .135 Wall 5" x 5" - 8' .150 Wall 24" Post Set (Check Local Code Requirements)

NOTE: 6' DECORATIVE MASONRY WALL STAINED & TREATED ON BOTH SIDES W/ANTI-GRAFFITI SEALANT

FENCE DETAIL
PROPOSED OR EQUIVALENT
-NTS-

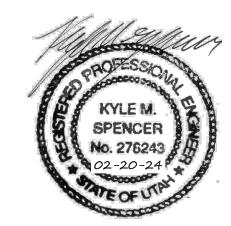

THESE DRAWINGS, OR ANY PORTION THEREOF, SHALL NOT BE USED ON ANY PROJECT OR EXTENSIONS OF THIS PROJECT EXCEPT BY AGREEMENT IN WRITING WITH NORTHERN ENGINEERING, INC.

5				DESIGNED BY:	DATE:		
4				DRAWN BY:	DATE:		
3				CHECKED BY:	DATE:		
2				APPROVED:	DATE:		
1				COGO FILE:	DATE:		
NO.	REVISIONS	BY	DATE	REV. COGO FILE:	DATE:		
K: \3-	K:\3-20-031-00 Apple Hollow\CAD\Design\DETAILS PHASE 1.dwg 2/15/2024 4:26 PM						



Northern ENGINEERING INC ENGINEERING-LAND PLANNING CONSTRUCTION MANAGEMENT

APPLE	HOLLO	W	@
THE	ORCHAI	RDS	5
"B-I	PHASE	1"	

DETAILS	JOB NO. 3-20-031
SANTAQUIN, UTAH	SHEET NO.

APPLE HOLLOW @ THE ORCHARDS "B-PHASE 2"

PHASE 2 SANTAQUIN, UTAH COUNTY, UTAH

GENERAL


- 1. ALL WORK SHALL BE DONE IN ACCORDANCE WITH THE SPECIFICATIONS AND/OR REQUIREMENTS OF THE SANTAQUIN CITY PUBLIC WORKS DEPARTMENT.
- 2. A PRE CONSTRUCTION CONFERENCE WILL BE HELD A MINIMUM OF 3 WORKING DAYS PRIOR TO START OF WORK. ALL CONTRACTORS, SUBCONTRACTORS AND/OR UTILITY CONTRACTORS, SANTAQUIN CITY PUBLIC WORKS AND CITY'S ENGINEER SHOULD BE PRESENT.
- 3. ALL LOT DIMENSIONS, EASEMENTS AND CERTAIN OFF SITE EASEMENTS ARE TO BE TAKEN FROM THE PLAT OF THE ORCHARDS PLAT F-6 WITH THE COMPLETION OF ROW IMPROVEMENTS ASSOCIATED WITH
- 4. ALL CONSTRUCTION STAKES MUST BE REQUESTED A MINIMUM OF THREE (3) WORKING DAYS PRIOR TO PLANNED USE.
- 5. CERTAIN CONTROL POINTS WILL BE SET BY THE ENGINEER, OR HIS REPRESENTATIVE, WHICH ARE CRITICAL TO THE CONSTRUCTION STAKING OF THE PROJECT. THESE POINTS WILL BE DESIGNATED AT THE TIME THEY ARE SET AND THE CONTRACTOR SO NOTIFIED. DESTRUCTION OF THESE POINTS BY THE CONTRACTOR OR HIS SUBCONTRACTORS SHALL BE GROUNDS FOR CHARGING THE CONTRACTOR FOR REESTABLISHING SAID POINTS.
- 6. ALL RECOMMENDATIONS MADE IN A PERTINENT GEOTECHNICAL REPORT/STUDY SHALL BE FOLLOWED EXPLICITLY DURING CONSTRUCTION OF BUILDING AND SITE IMPROVEMENTS.
- 7. THE DEVELOPER AND THE GENERAL CONTRACTOR UNDERSTAND THAT IT IS HIS/HER RESPONSIBILITY TO ENSURE THAT ALL IMPROVEMENTS INSTALLED WITHIN THIS DEVELOPMENT ARE CONSTRUCTED IN FULL COMPLIANCE WITH ALL STATE AND SANTAQUIN CITY CODES, ORDINANCES AND STANDARDS. THESE PLANS ARE NOT ALL INCLUSIVE OF ALL MINIMUM CODES, ORDINANCES AND STANDARDS. THIS FACT DOES NOT RELIEVE THE DEVELOPER OR GENERAL CONTRACTOR FROM THE FULL COMPLIANCE WITH ALL MINIMUM STATE AND SANTAQUIN CITY CODES, ORDINANCES AND STANDARDS.
- 8. GARAGES ON THE TOWNHOMES WILL BE 24'X24' WITH A 20' OPENING


- 1. ALL ROADWAY CONSTRUCTION SHALL MEET THE MINIMUM REQUIREMENTS OF SANTAQUIN CITY'S TECHNICAL SPECIFICATIONS OR AS APPROVED IN THE PLANS HEREIN.
- 2. WHEN DISCREPANCIES OCCUR BETWEEN PLANS AND SPECIFICATIONS, THE CONTRACTOR SHALL IMMEDIATELY NOTIFY THE ENGINEER. UNTIMELY NOTIFICATION SHALL NEGATE ANY CONTRACTORS CLAIM FOR ADDITIONAL COMPENSATION.
- 3. ALL STORM DRAIN PIPES TO BE REINFORCED CONCRETE PIPE (RCP) CLASS III, HDPE STORM DRAIN PIPE, OR APPROVED EQUAL UNLESS OTHERWISE NOTED.
- 4. CONTRACTOR IS RESPONSIBLE TO ENSURE THAT ALL CLEANOUT/ACCESS LOCATIONS MEET SANTAQUIN IRRIGATION COMPANY SPECIFICATIONS AND ARE COMPLETED UNDER THE DIRECTION OF SANTAQUIN IRRIGATION COMPANY.
- 5. ALL IRRIGATION CORNERS (ANGLE POINTS) SHALL HAVE A PRE CAST REINFORCED CONCRETE MANHOLE, WITH A WATERTIGHT SOLID MANHOLE COVER.
- 6. ALL STORM DRAIN INLET BOXES TO MEET SANTAQUIN CITY STANDARD DRAWING SDI W/3' SEDIMENT

SEWER

- 1. ALL WORK SHALL BE DONE IN ACCORDANCE WITH THE LATEST SANTAQUIN CITY DESIGN STANDARDS & PUBLIC IMPROVEMENT SPECIFICATIONS DRAWINGS OF SANTAQUIN CITY.
- 2. FINAL APPROVAL AND ACCEPTANCE OF ALL SEWER CONSTRUCTION WILL BE BY SANTAQUIN CITY.
- 3. UPON THE COMPLETION OF WORK, THE CONTRACTOR SHALL SUBMIT 3 SETS OF AS-BUILT PLANS TO SANTAQUIN CITY & (1) SET TO NORTHERN ENGINEERING, INC.
- 4. HORIZONTAL AND VERTICAL SEPARATION OF CULINARY WATER AND SEWER SHALL BE IN COMPLIANCE WITH SANTAQUIN CITY STANDARDS.

- 1. THE WATER SYSTEM SHALL BE CONSTRUCTED TO CONFORM WITH THE STANDARDS SET FORTH IN THE "UTAH REGULATIONS FOR PUBLIC DRINKING WATER SYSTEMS", AND THE SANTAQUIN CITY PUBLIC WORKS DEPARTMENT STANDARD SPECIFICATIONS AND DRAWINGS.
- 2. CONTRACTOR SHALL NOTIFY NORTHERN ENGINEERING, INC. THREE (3) WORKING DAYS BEFORE INITIAL CONSTRUCTION BEGINS AND SHALL ALSO REQUEST SANTAQUIN CITY WATER DEPARTMENT INSPECTION OF WATER LINES AND APPURTENANCES TWENTY-FOUR (24) HOURS IN ADVANCE OF BACKFILLING.
- 3. CONTRACTOR TO FIELD VERIFY ALL VALVE BOX LID ELEVATIONS TO ASSURE THAT SAID LID ELEVATIONS MATCH FINAL STREET GRADE, AND ALL METER LID ELEVATIONS TO MATCH AN EXTENSION OF THE SIDEWALK GRADE.
- 4. UPON THE COMPLETION OF WORK, THE CONTRACTOR SHALL SUBMIT 3 SETS OF AS-BUILT PLANS TO SANTAQUIN CITY & (1) SET TO NORTHERN ENGINEERING, INC.
- 5. WATER VALVE LIDS ARE TO BE LABELED "WATER" FOR CULINARY VALVES.
- 6. HORIZONTAL AND VERTICAL SEPARATION OF CULINARY WATER AND SEWER SHALL BE IN COMPLIANCE WITH SANTAQUIN CITY STANDARDS.
- 7. WATERLINES TO BE BEDDED AS PER SANTAQUIN CITY DIVISION 3A SECTION 3A.04 SUB-SECTION E.
- 8. ALL CULINARY WATERLINES, REGARDLESS OF SIZE, SHALL BE C-900 PVC PIPE AS PER SANTAQUIN CITY

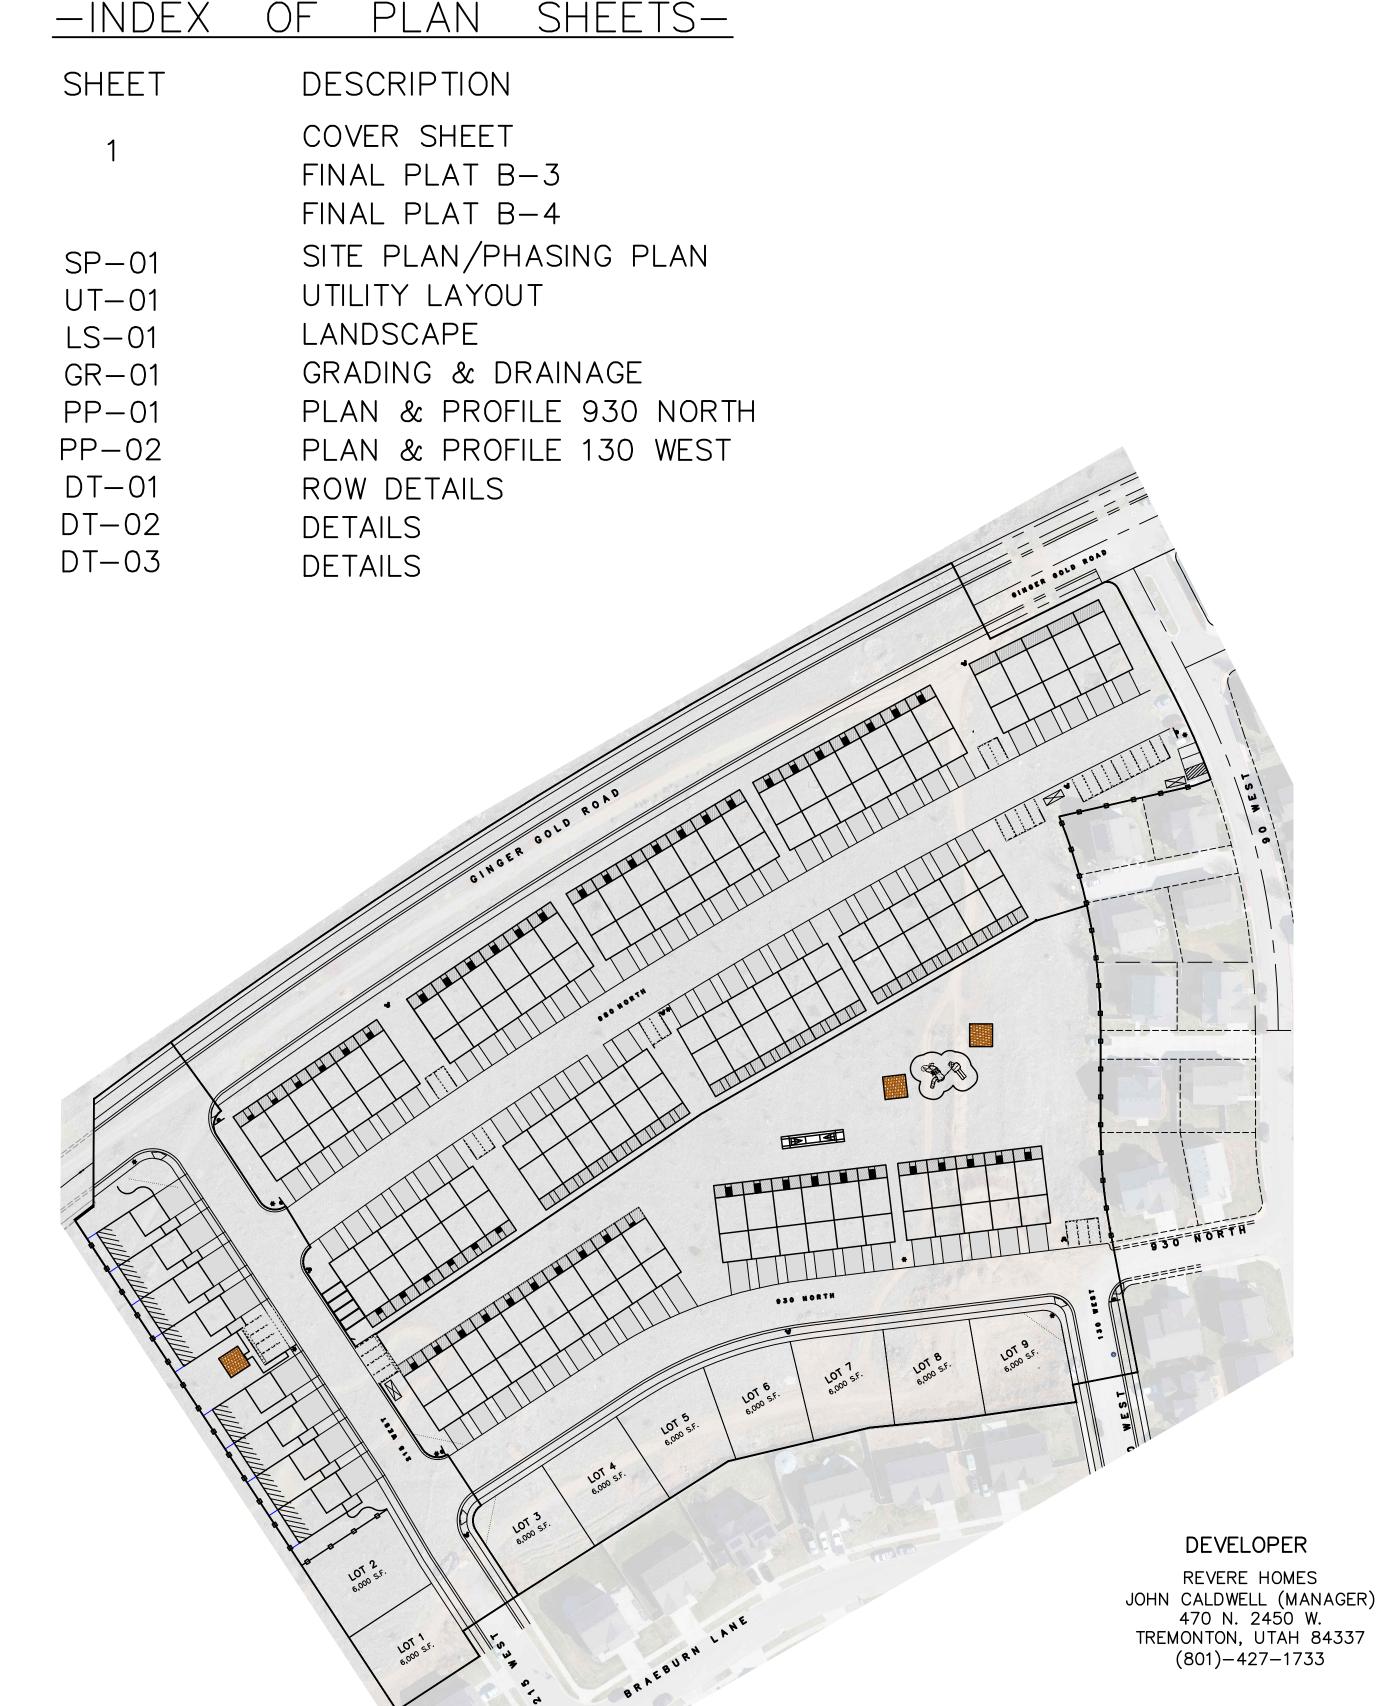

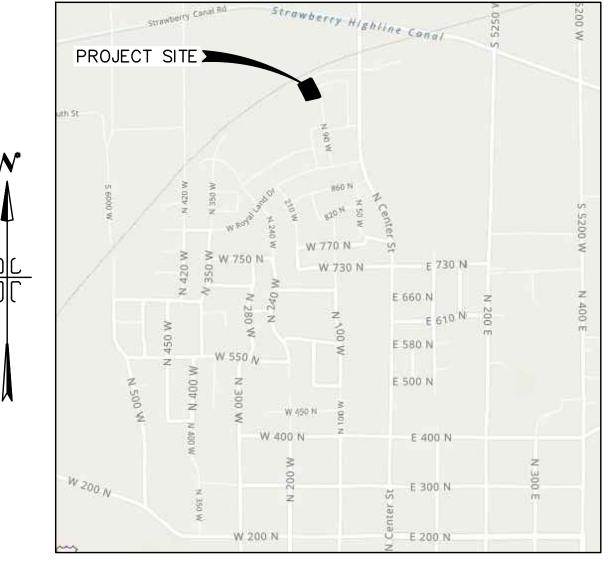


VICINITY MAP -NTS-

TABULATIONS

APPLE HOLLOW AT THE ORCHARDS B - PHASE 2 ZONE: R-10 PUD ZONE PLAT AREA: 4.27 ACRES # OF LOTS: 7 LOTS NUMBER OF TOWNHOMES: 21 UNITS LOT AREA: 0.96 ACRES TOWNHOME AREA: 0.75 ACRES 1.52 ACRES COMMON AREA: LIMITED COMMON AREA: 0.28 ACRES RIGHT-OF-WAY AREA: 0.76 ACRES DENSITY: 6.56 UNITS/ACRE


ACCEPTANCE				
SIGNATURE:	DEVELOPER	DATE		
SIGNATURE:	CITY ENGINEER	DATE		
SIGNATURE:	COMMUNITY DEV. DIRECTOR	DATE		
SIGNATURE:	PUBLIC WORKS	DATE		
SIGNATURE:	BUILDING DEPARTMENT	DATE		
SIGNATURE:	POLICE DEPARTMENT	DATE		
SIGNATURE:	FIRE DEPARTMENT	DATE		




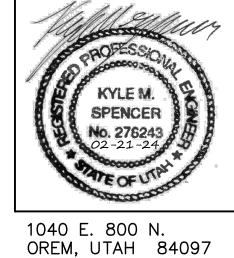



(801) 802-8992



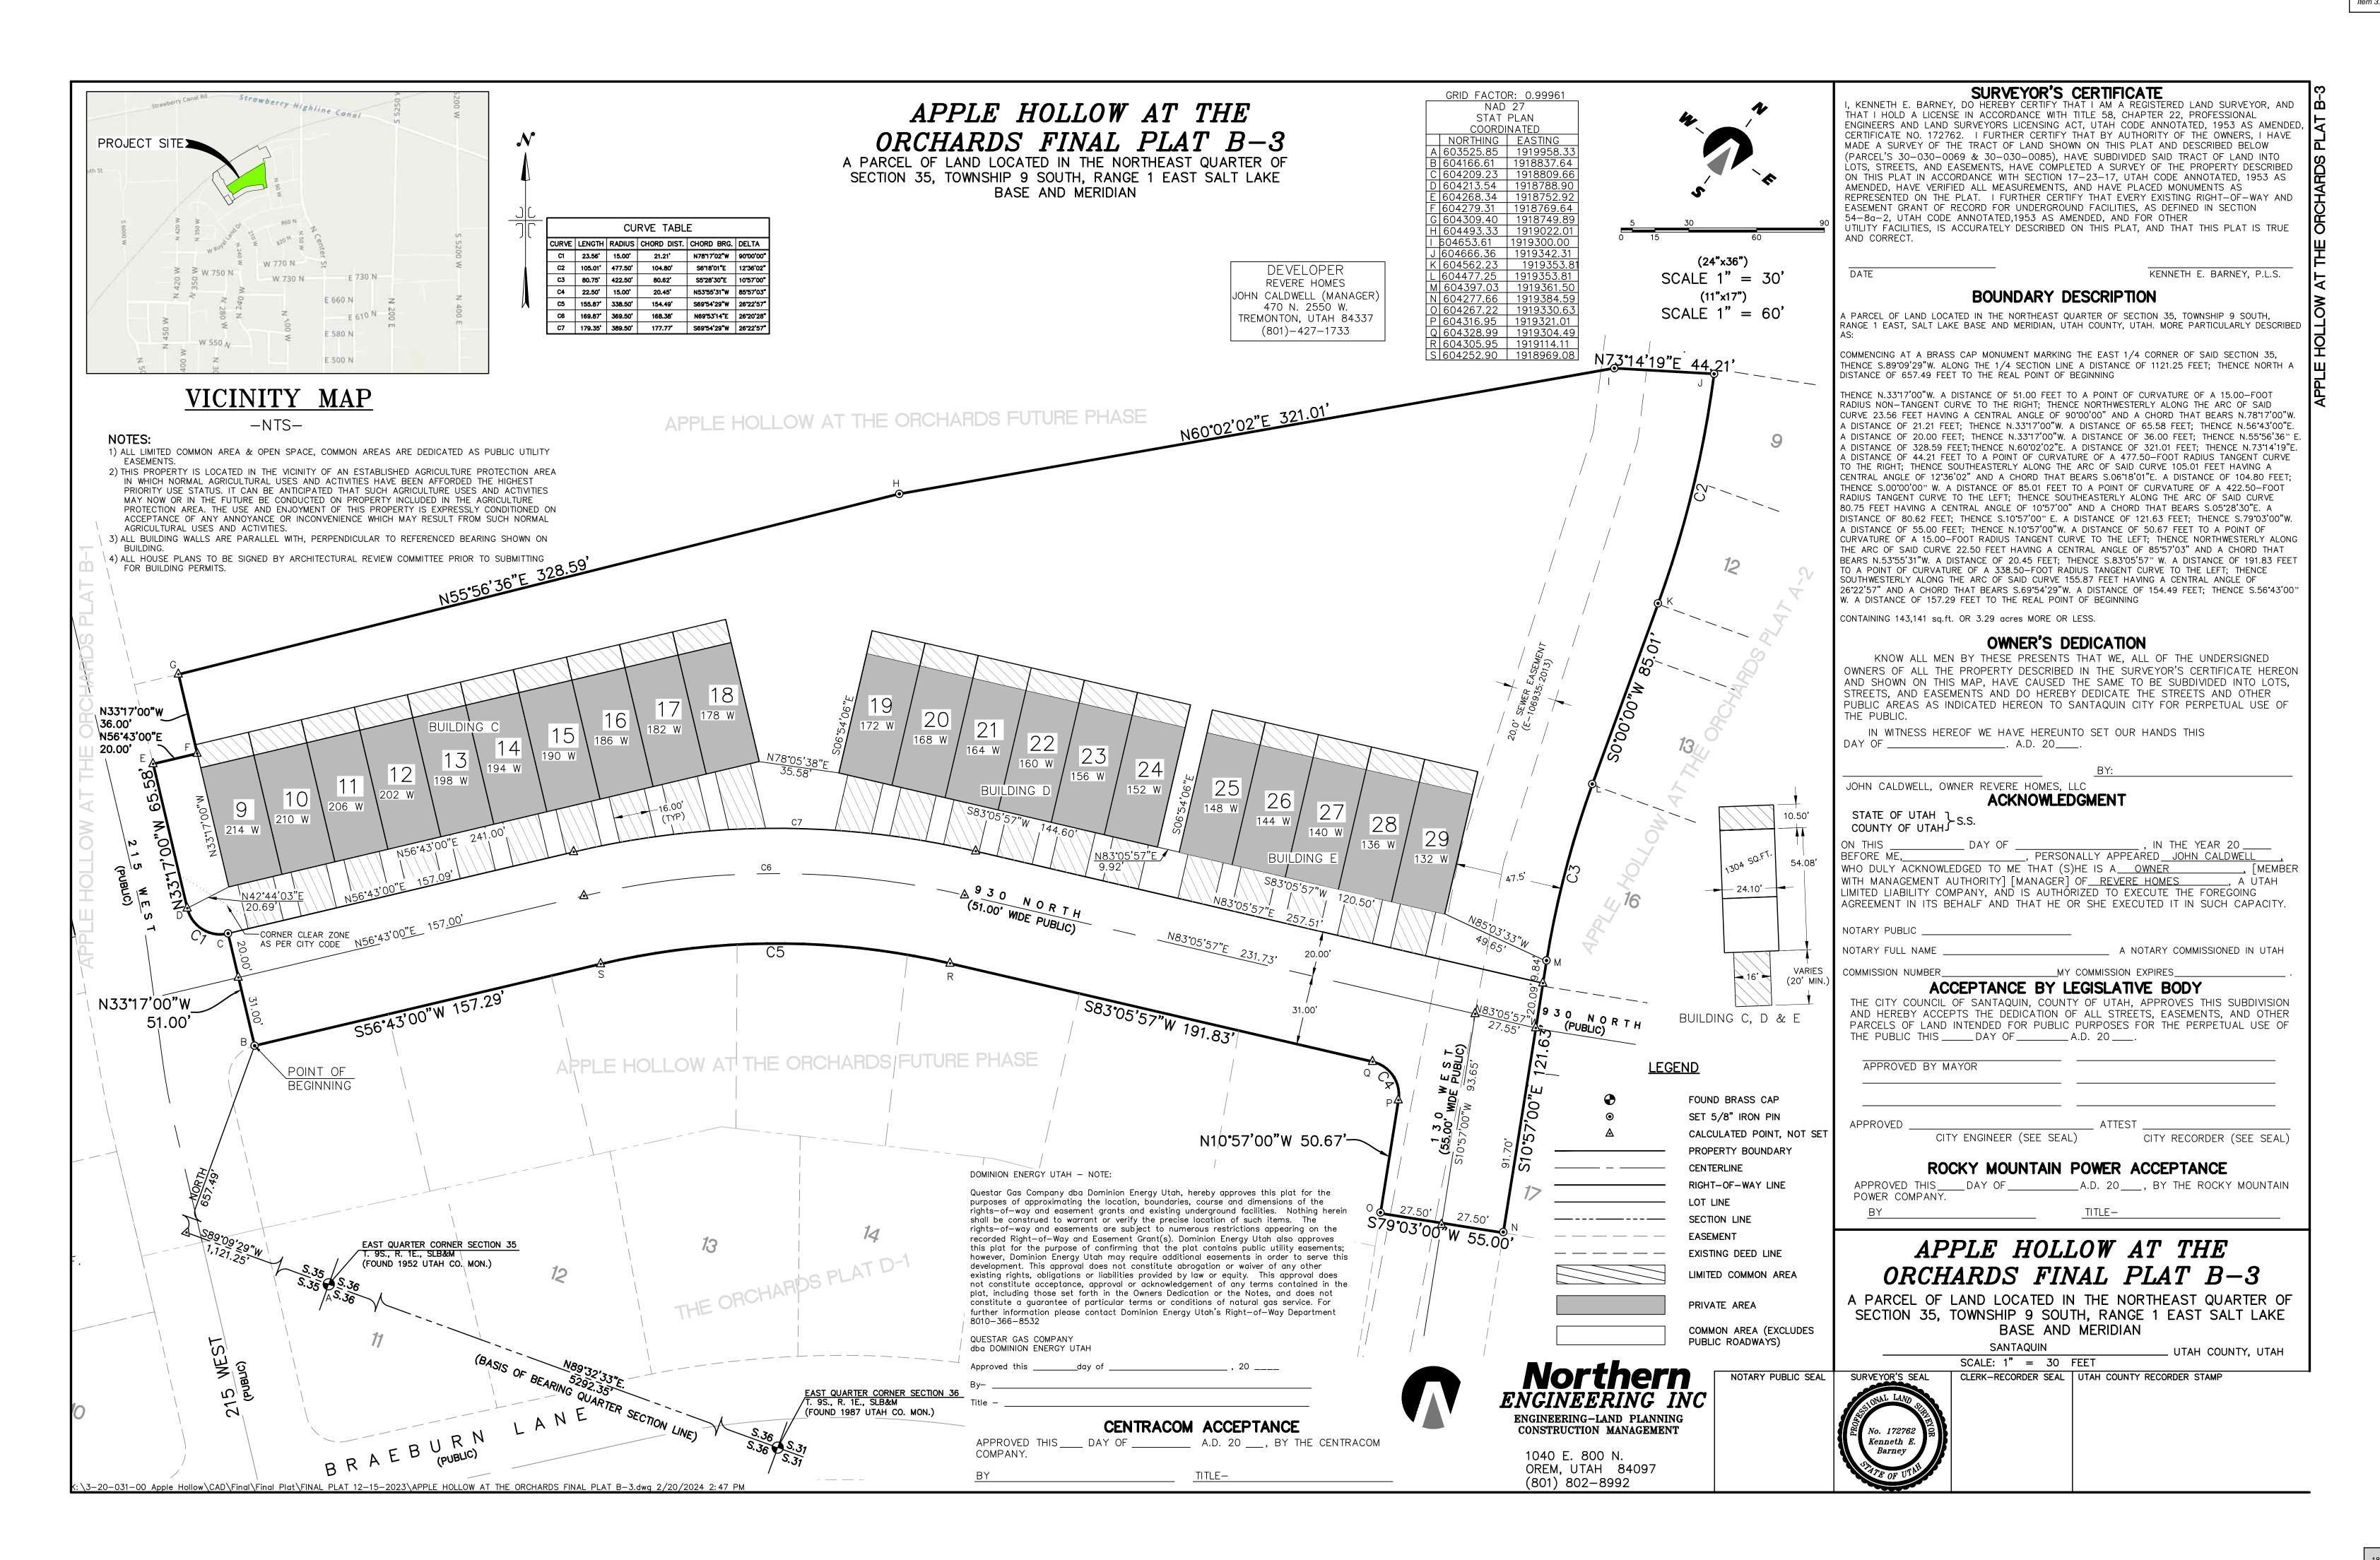


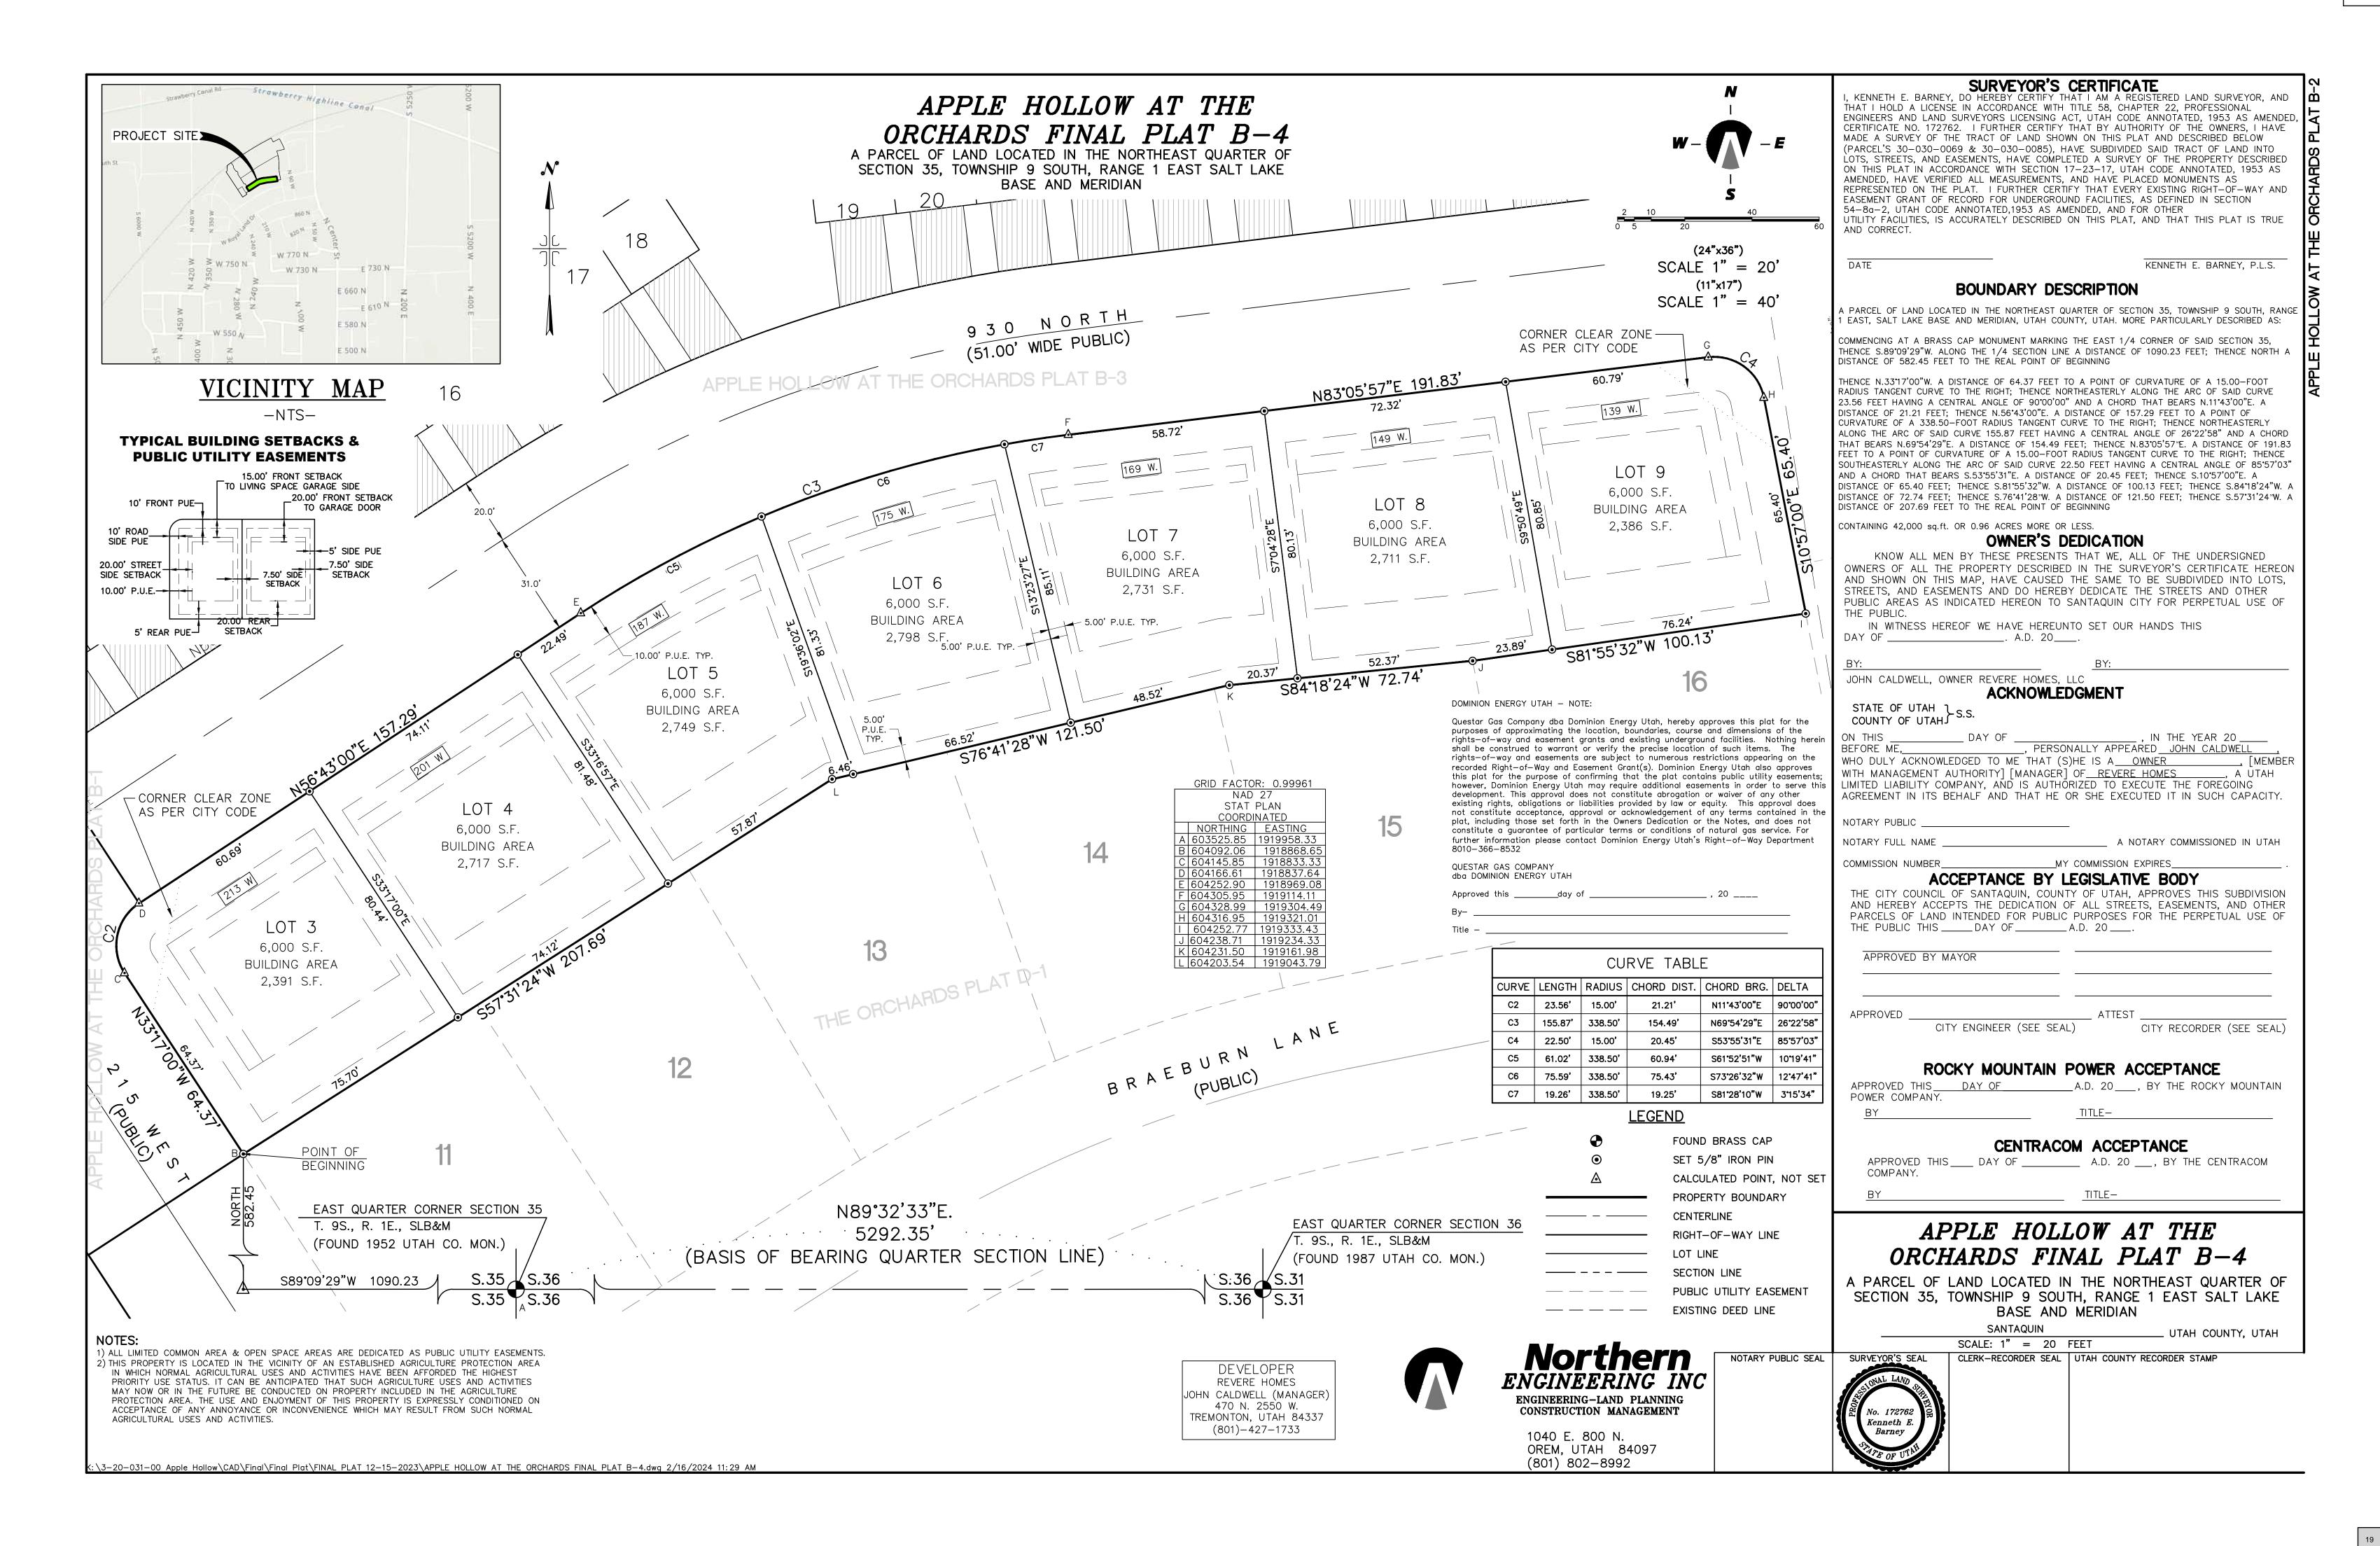

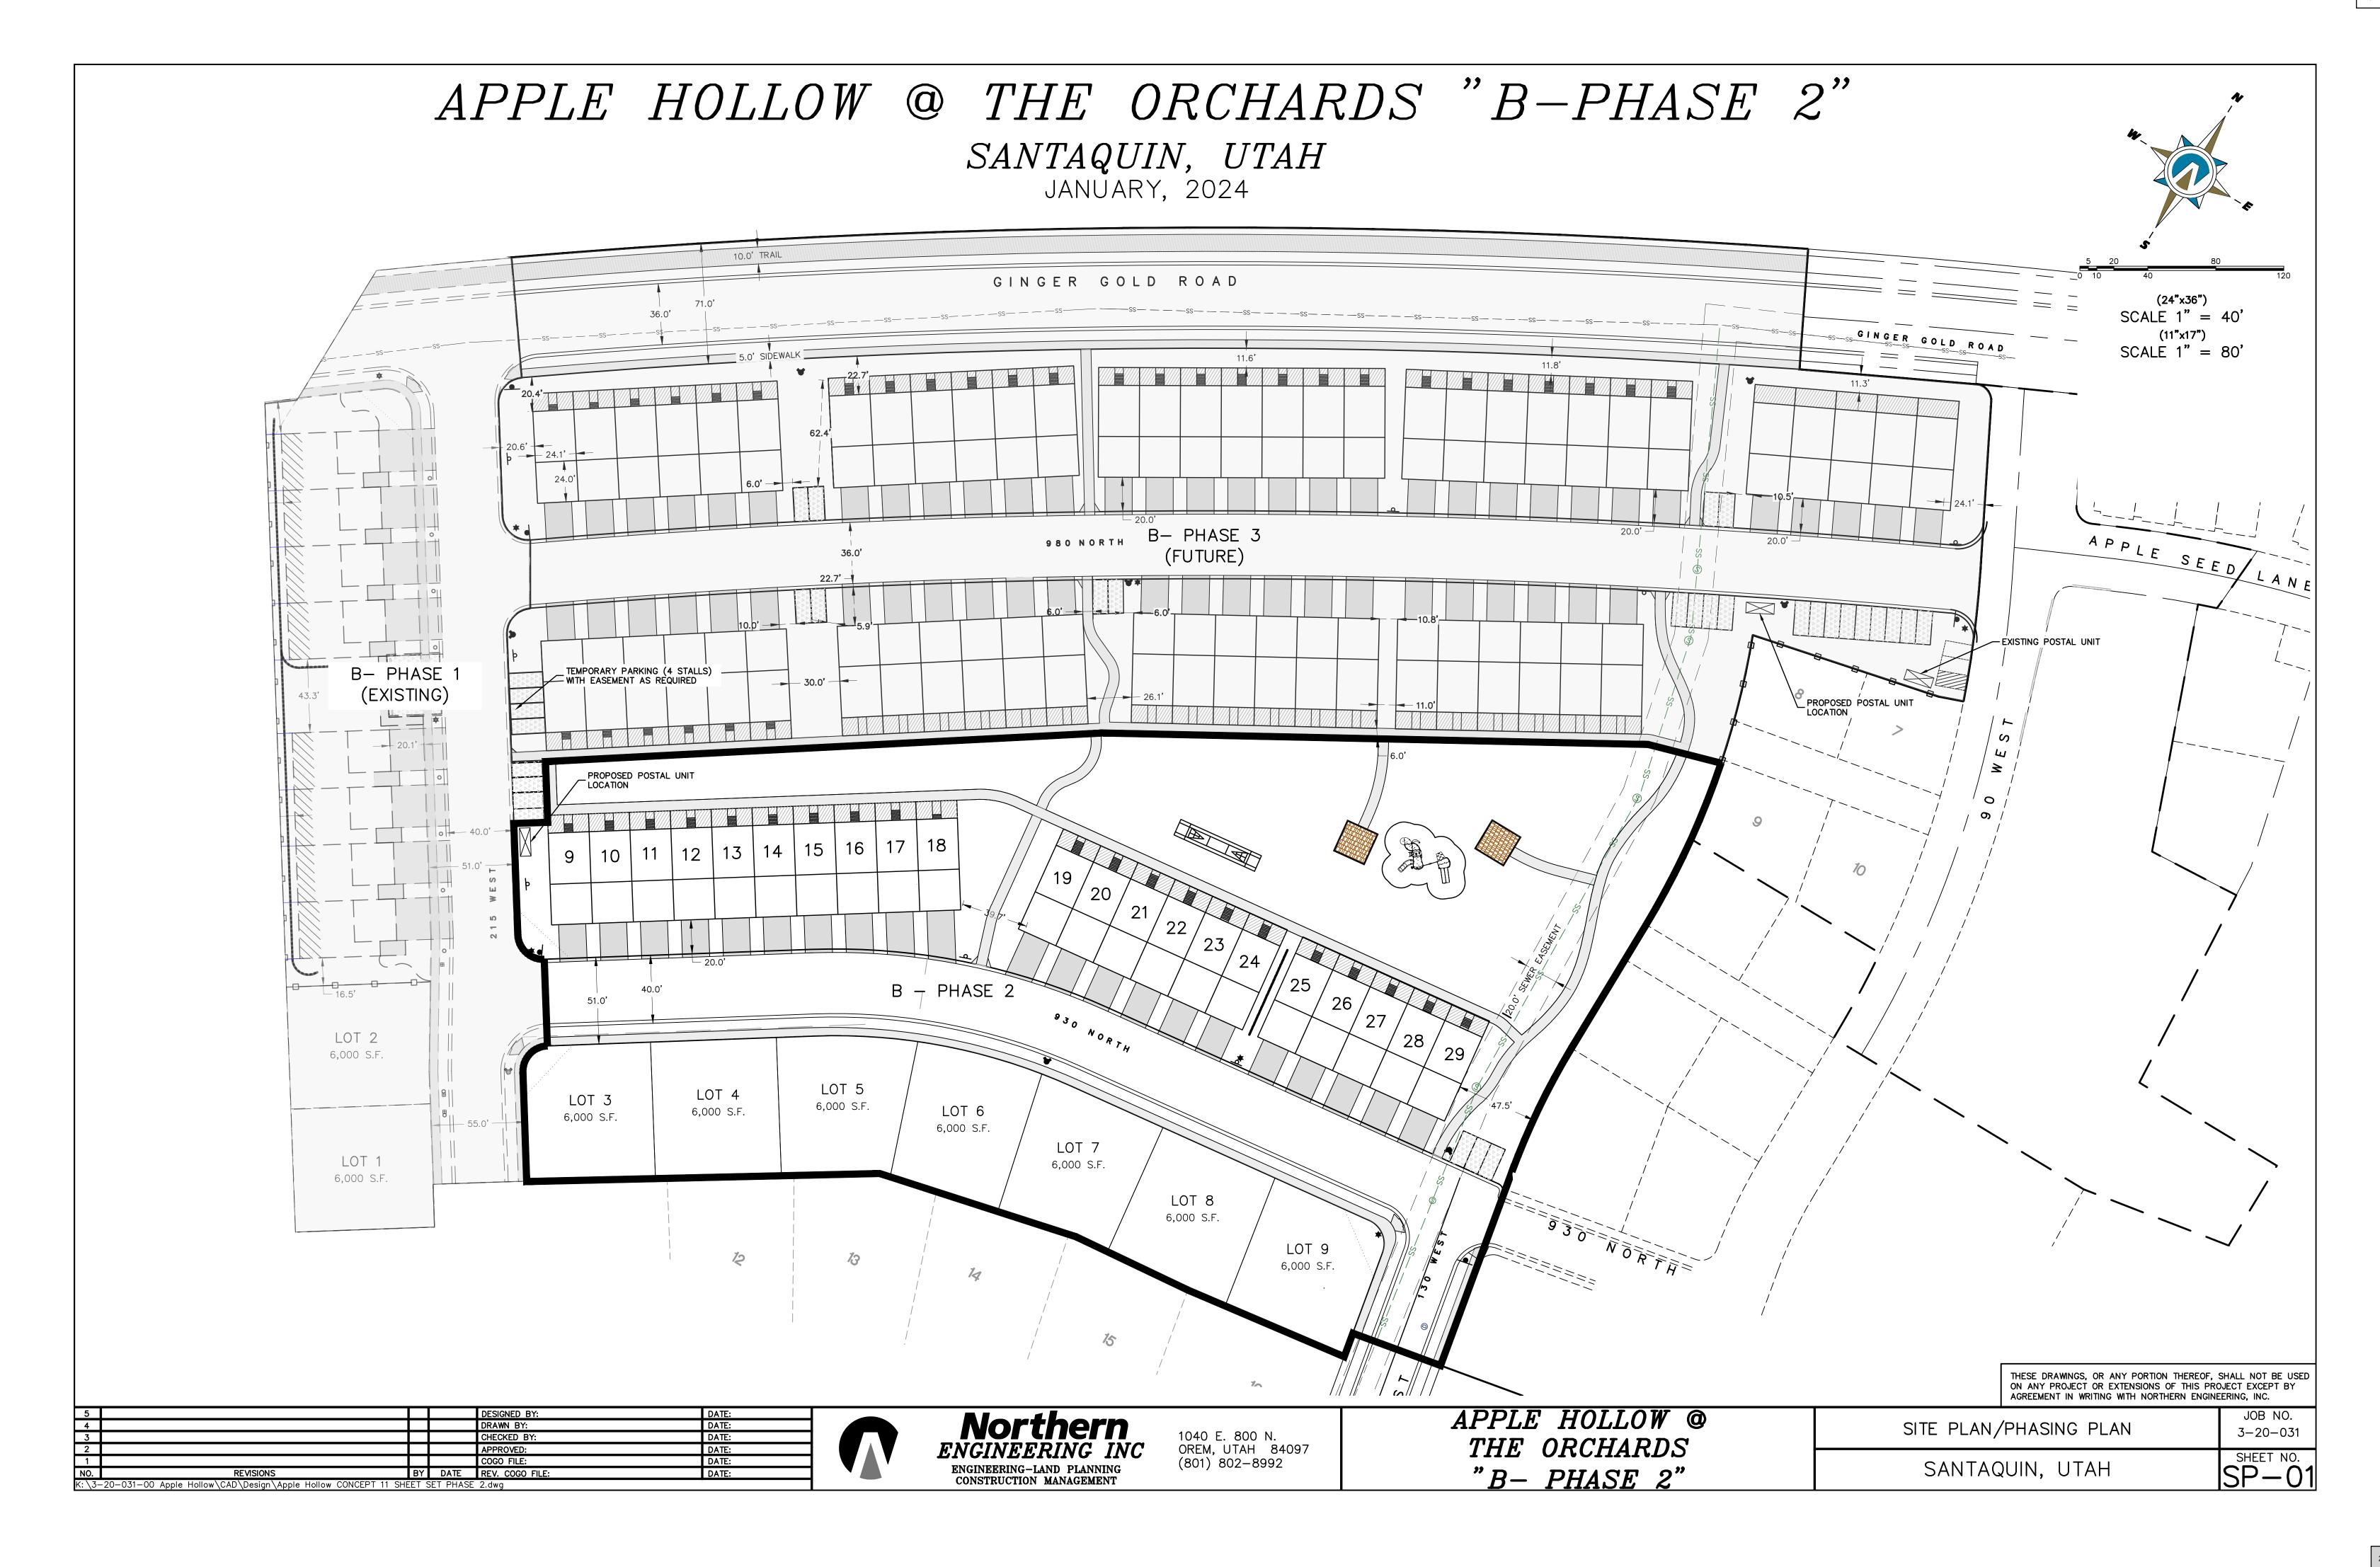

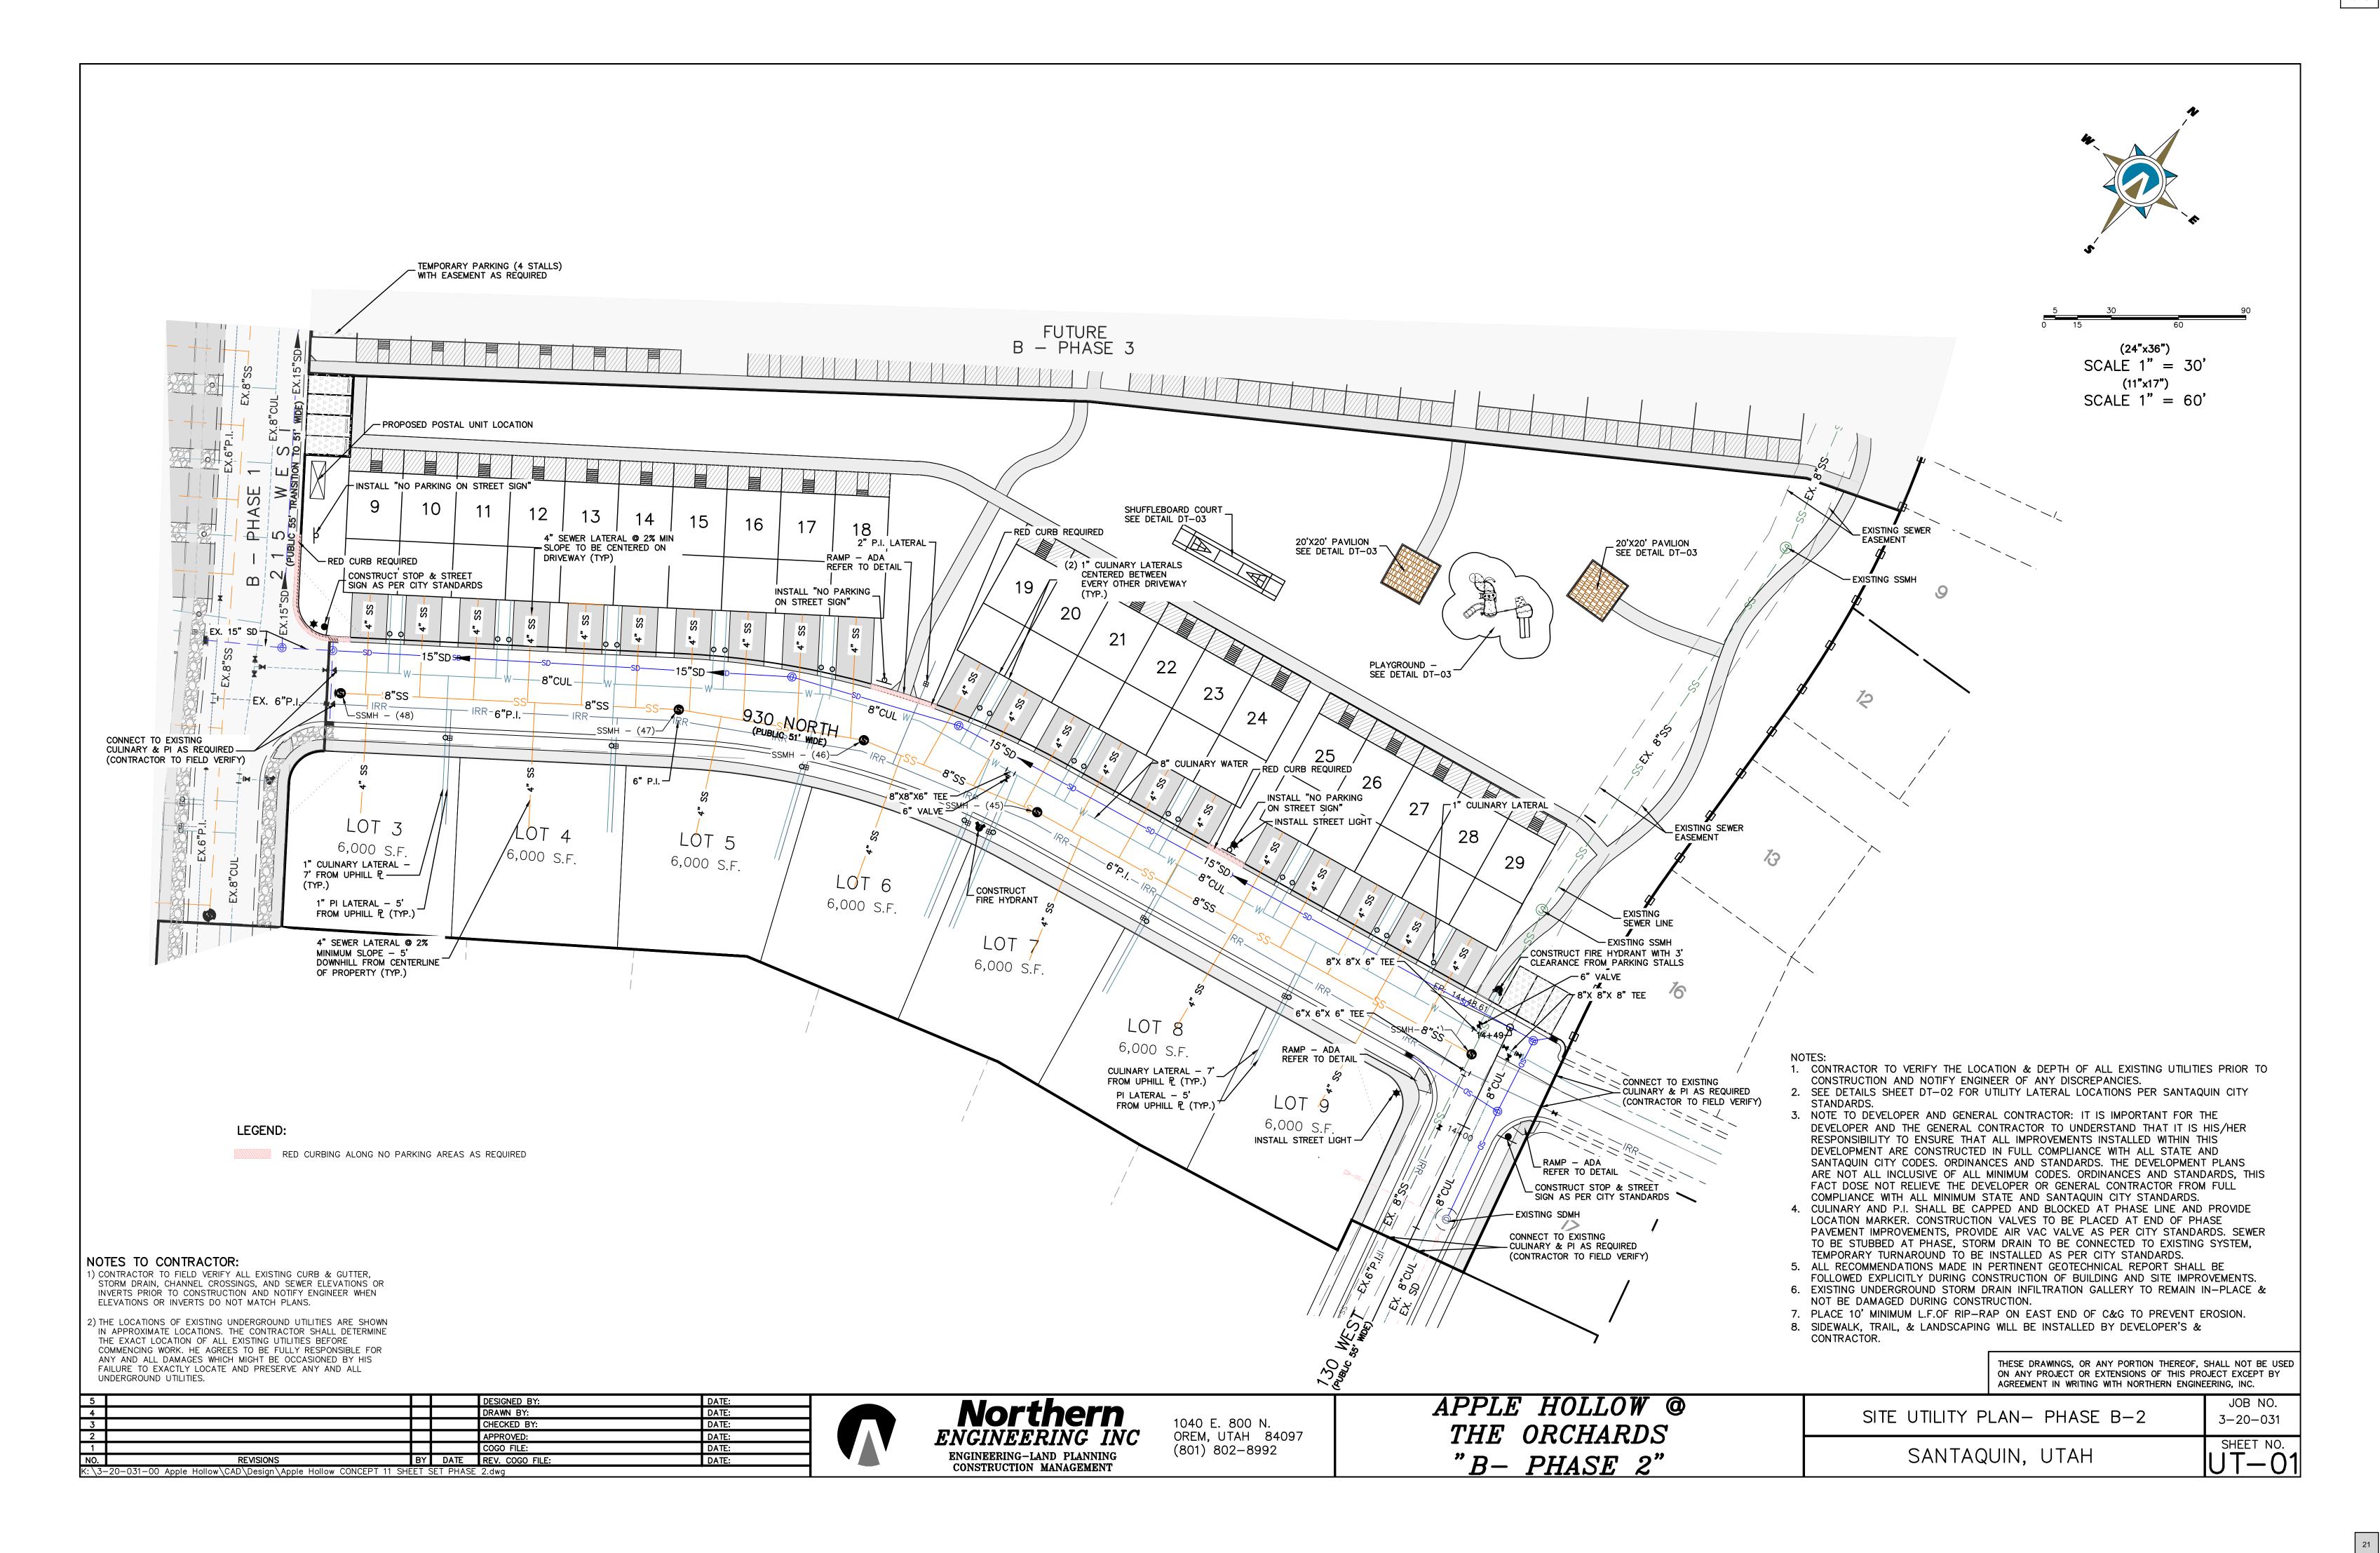

LANDSCAPING LEGEND:

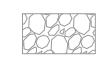

LANDSCAPE ROCK: TWO TO FOUR INCH (2" TO 4") DECORATIVE COBBLE ROCK. A SAMPLE OF THE PROPOSED MATERIAL MUST BE SUBMITTED TO AND APPROVED BY SANTAQUIN CITY PRIOR TO PLACING. COBBLE ROCK MULCH SHALL BR INSTALLED TO AN AVERAGE DEPTH OF FOUR INCHES (4") AND SHALL COMPLETELY COVER ALL PLANTER STRIP AREA. PRIOR TO INSTALLATION OF COBBLE ROCK, MULCH, A MIRAFI 600 (OR APPROVED EQUIVALENT) FABRIC MUST BE APPLIED TO THE PLANTER STRIP AREA.

40±

HELICTOTRICHON SEMPERVIRENS / BLUE OAT GRASS, 1-GAL.

14±

CALAMAGROSTIS X ACUTIFLORA FOERSTER / FEATHER REED GRASS,

64±

RHAMNUS FRANGULA COLUMNARIS / ALDER BUCKTHORN, 5-GAL.

EUONYMUS ALATUS COMPACTUS / COMPACT BURNING BUSH,

13±

TILA AMERICAN REDMUND / REDMUND AMERICAN LINDEN, 2" - 2.5" CAL.

ACER FREEMAN / AUTUMN BLAZE MAPLE, 2" - 2.5" CAL.

17±

2"-2.5" CAL. (6' MIN HEIGHT)

PICEA PUNGENS / COLORADO "BLUE" SPRUCE,

159 = TOTAL TREES AND PLANTS

NOTES:

THE DEVELOPER AND THE GENERAL CONTRACTOR UNDERSTAND THAT IT IS HIS/HER RESPONSIBILITY TO ENSURE THAT ALL IMPROVEMENTS INSTALLED WITHIN THIS DEVELOPMENT ARE CONSTRUCTED IN FULL COMPLIANCE WITH ALL STATE AND SANTAQUIN CITY CODES, ORDINANCES AND STANDARDS. THESE PLANS ARE NOT ALL INCLUSIVE OF ALL MINIMUM CODES, ORDINANCES AND STANDARDS. THIS FACT DOES NOT RELIEVE THE DEVELOPER OR GENERAL CONTRACTOR FROM THE FULL COMPLIANCE WITH ALL MINIMUM STATE AND SANTAQUIN CITY CODES, ORDINANCES AND STANDARDS.

NOTES:


NO PARKING ON -

STREE

WEST

STREET SIGN (TYP.)

- 1. ALL LANDSCAPING TO BE DONE ACCORDING TO SANTAQUIN CITY STANDARDS AND SPECIFICATIONS.
- 2. IRRIGATION TO BE DESIGNED BY OTHERS AND SUBMITTED TO CITY FOR APPROVAL BEFORE INSTALLATION AND MEET THE CONDITIONS OF THE ARCHITECTURAL REVIEW COMMITTEE.
- 3. GROUP TREES IN CLUSTERS AND VARIETY ALTERNATING BETWEEN GROUPS OF THREE.
- 4. TREES SHALL NOT BE PLANTED LESS THAN 5-FT FROM CURBS OR HARD SURFACE AREAS UNLESS A ROOT BARRIER IS INSTALLED NEXT TO HARDSCAPE SURFACE.
- 5. CONTRACTOR TO PLANT ALL TRESS AND SHRUBS ACCORDING TO SANTAQUIN CITY PLANTING STANDARDS.
- 6. ANY PROPOSED SUBSTITUTIONS OF PLAN SPECIES SHALL BE MADE WITH PLANTS OF EQUIVALENT OVERALL FORM, HEIGHT, BRANCHING HABIT, FLOWER, LEAF, COLOR, FRUIT AND CULTURE.
- 7. ALL TREES UP TO 2.5" CAL. SHALL BE DOUBLE STAKED AND ALL DECIDUOUS TREES GREATER THAN 2" CAL. AND ALL EVERGREEN TREES 6' AND TALLER SHALL BE TRIPLE STAKED OR GUYED.
- 8. NO PLANT MATERIAL SHALL BE PLANTED WITHIN 1-FT OF ANY WALK EDGE.
- 9. ALL PLANTING AREAS INCLUDING TREE AND SHRUB AREAS TO RECEIVE COMMERCIAL

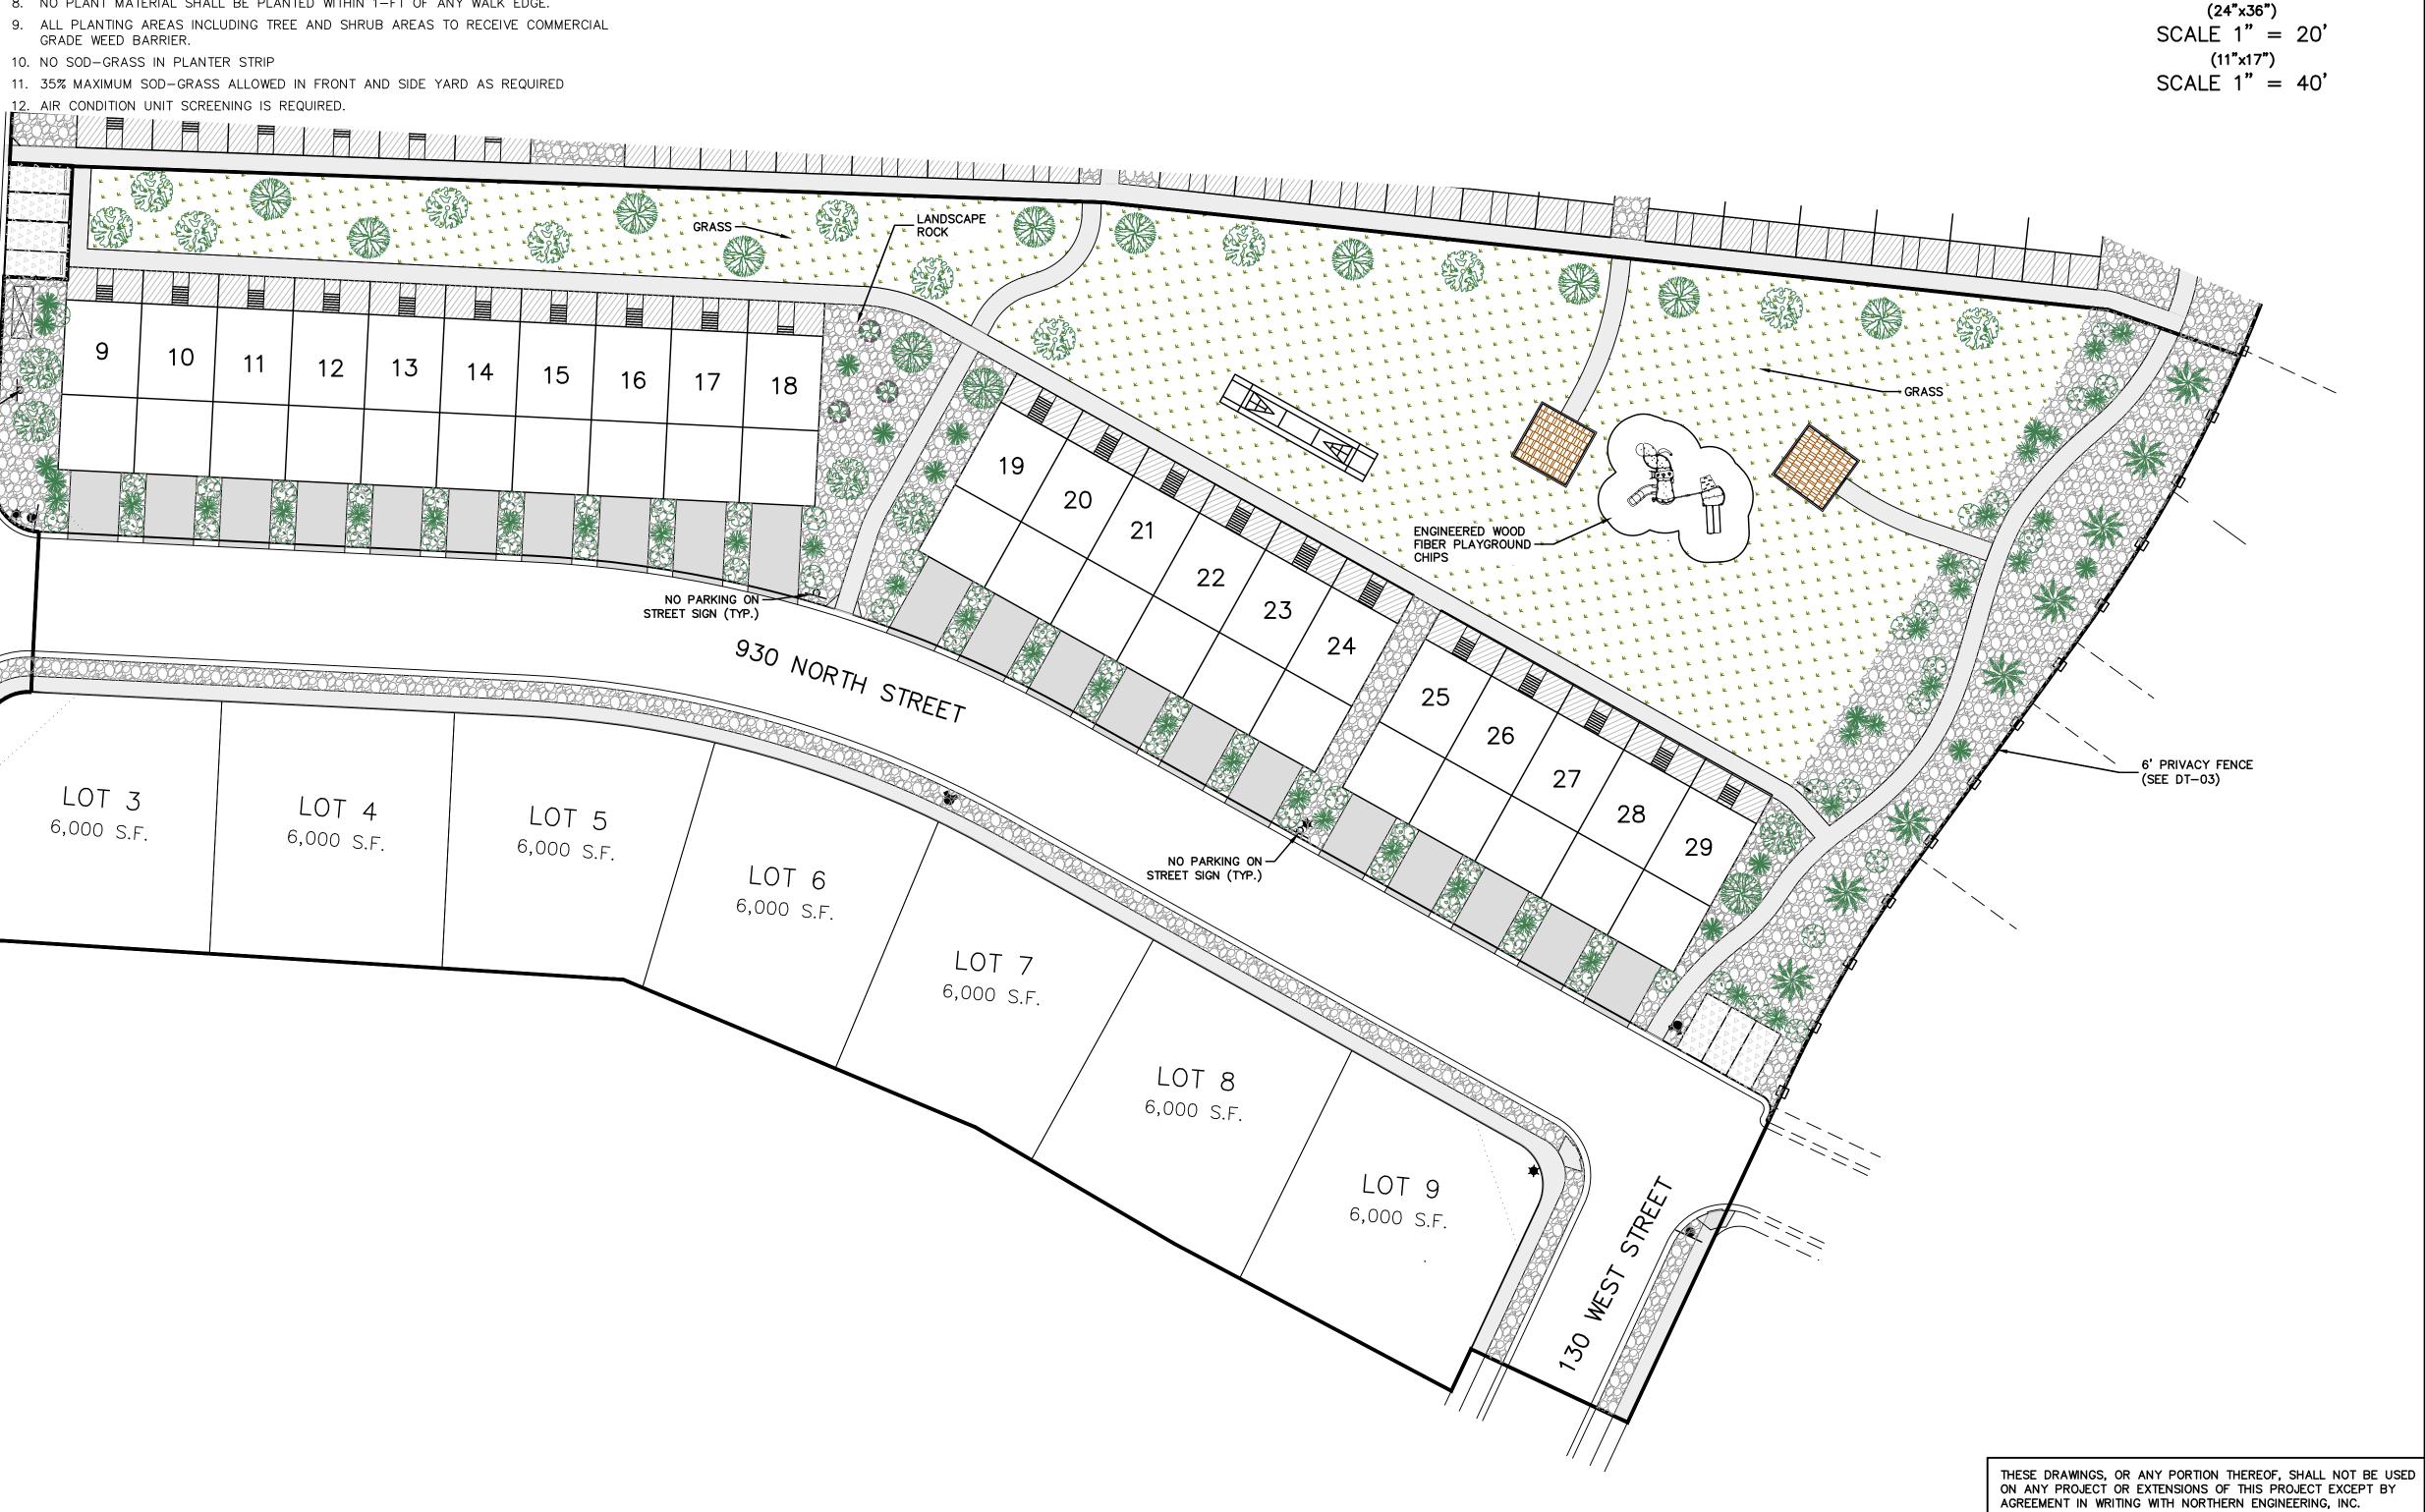

5				DESIGNED BY:	DATE:		
4				DRAWN BY:	DATE:		
3				CHECKED BY:	DATE:		
2				APPROVED:	DATE:		
1				COGO FILE:	DATE:		
NO.	REVISIONS	BY	DATE	REV. COGO FILE:	DATE:		
K:\3-20-031-00 Apple Hollow\CAD\Design\Apple Hollow CONCEPT 11 SHEET SET PHASE 2.dwg							




ENGINEERING-LAND PLANNING CONSTRUCTION MANAGEMENT


APPLE	HOLLOW @	
THE	ORCHARDS	
" <i>B</i> -	PHASE 2"	

LANDSCAPE PLAN	JOB NO. 3-20-031
SANTAQUIN, UTAH	SHEET NO.

1. NOTE TO DEVELOPER AND GENERAL CONTRACTOR: IT IS IMPORTANT FOR THE DEVELOPER AND THE GENERAL CONTRACTOR TO UNDERSTAND THAT IT IS HIS/HER RESPONSIBILITY TO ENSURE THAT ALL IMPROVEMENTS INSTALLED WITHIN THIS DEVELOPMENT ARE CONSTRUCTED IN FULL COMPLIANCE WITH ALL STATE AND SANTAQUIN CITY CODES. ORDINANCES AND STANDARDS. THE DEVELOPMENT PLANS ARE NOT ALL INCLUSIVE OF ALL MINIMUM CODES. ORDINANCES AND STANDARDS, THIS FACT DOSE NOT RELIEVE THE DEVELOPER OR GENERAL CONTRACTOR FROM FULL COMPLIANCE WITH ALL MINIMUM STATE AND SANTAQUIN CITY STANDARDS.

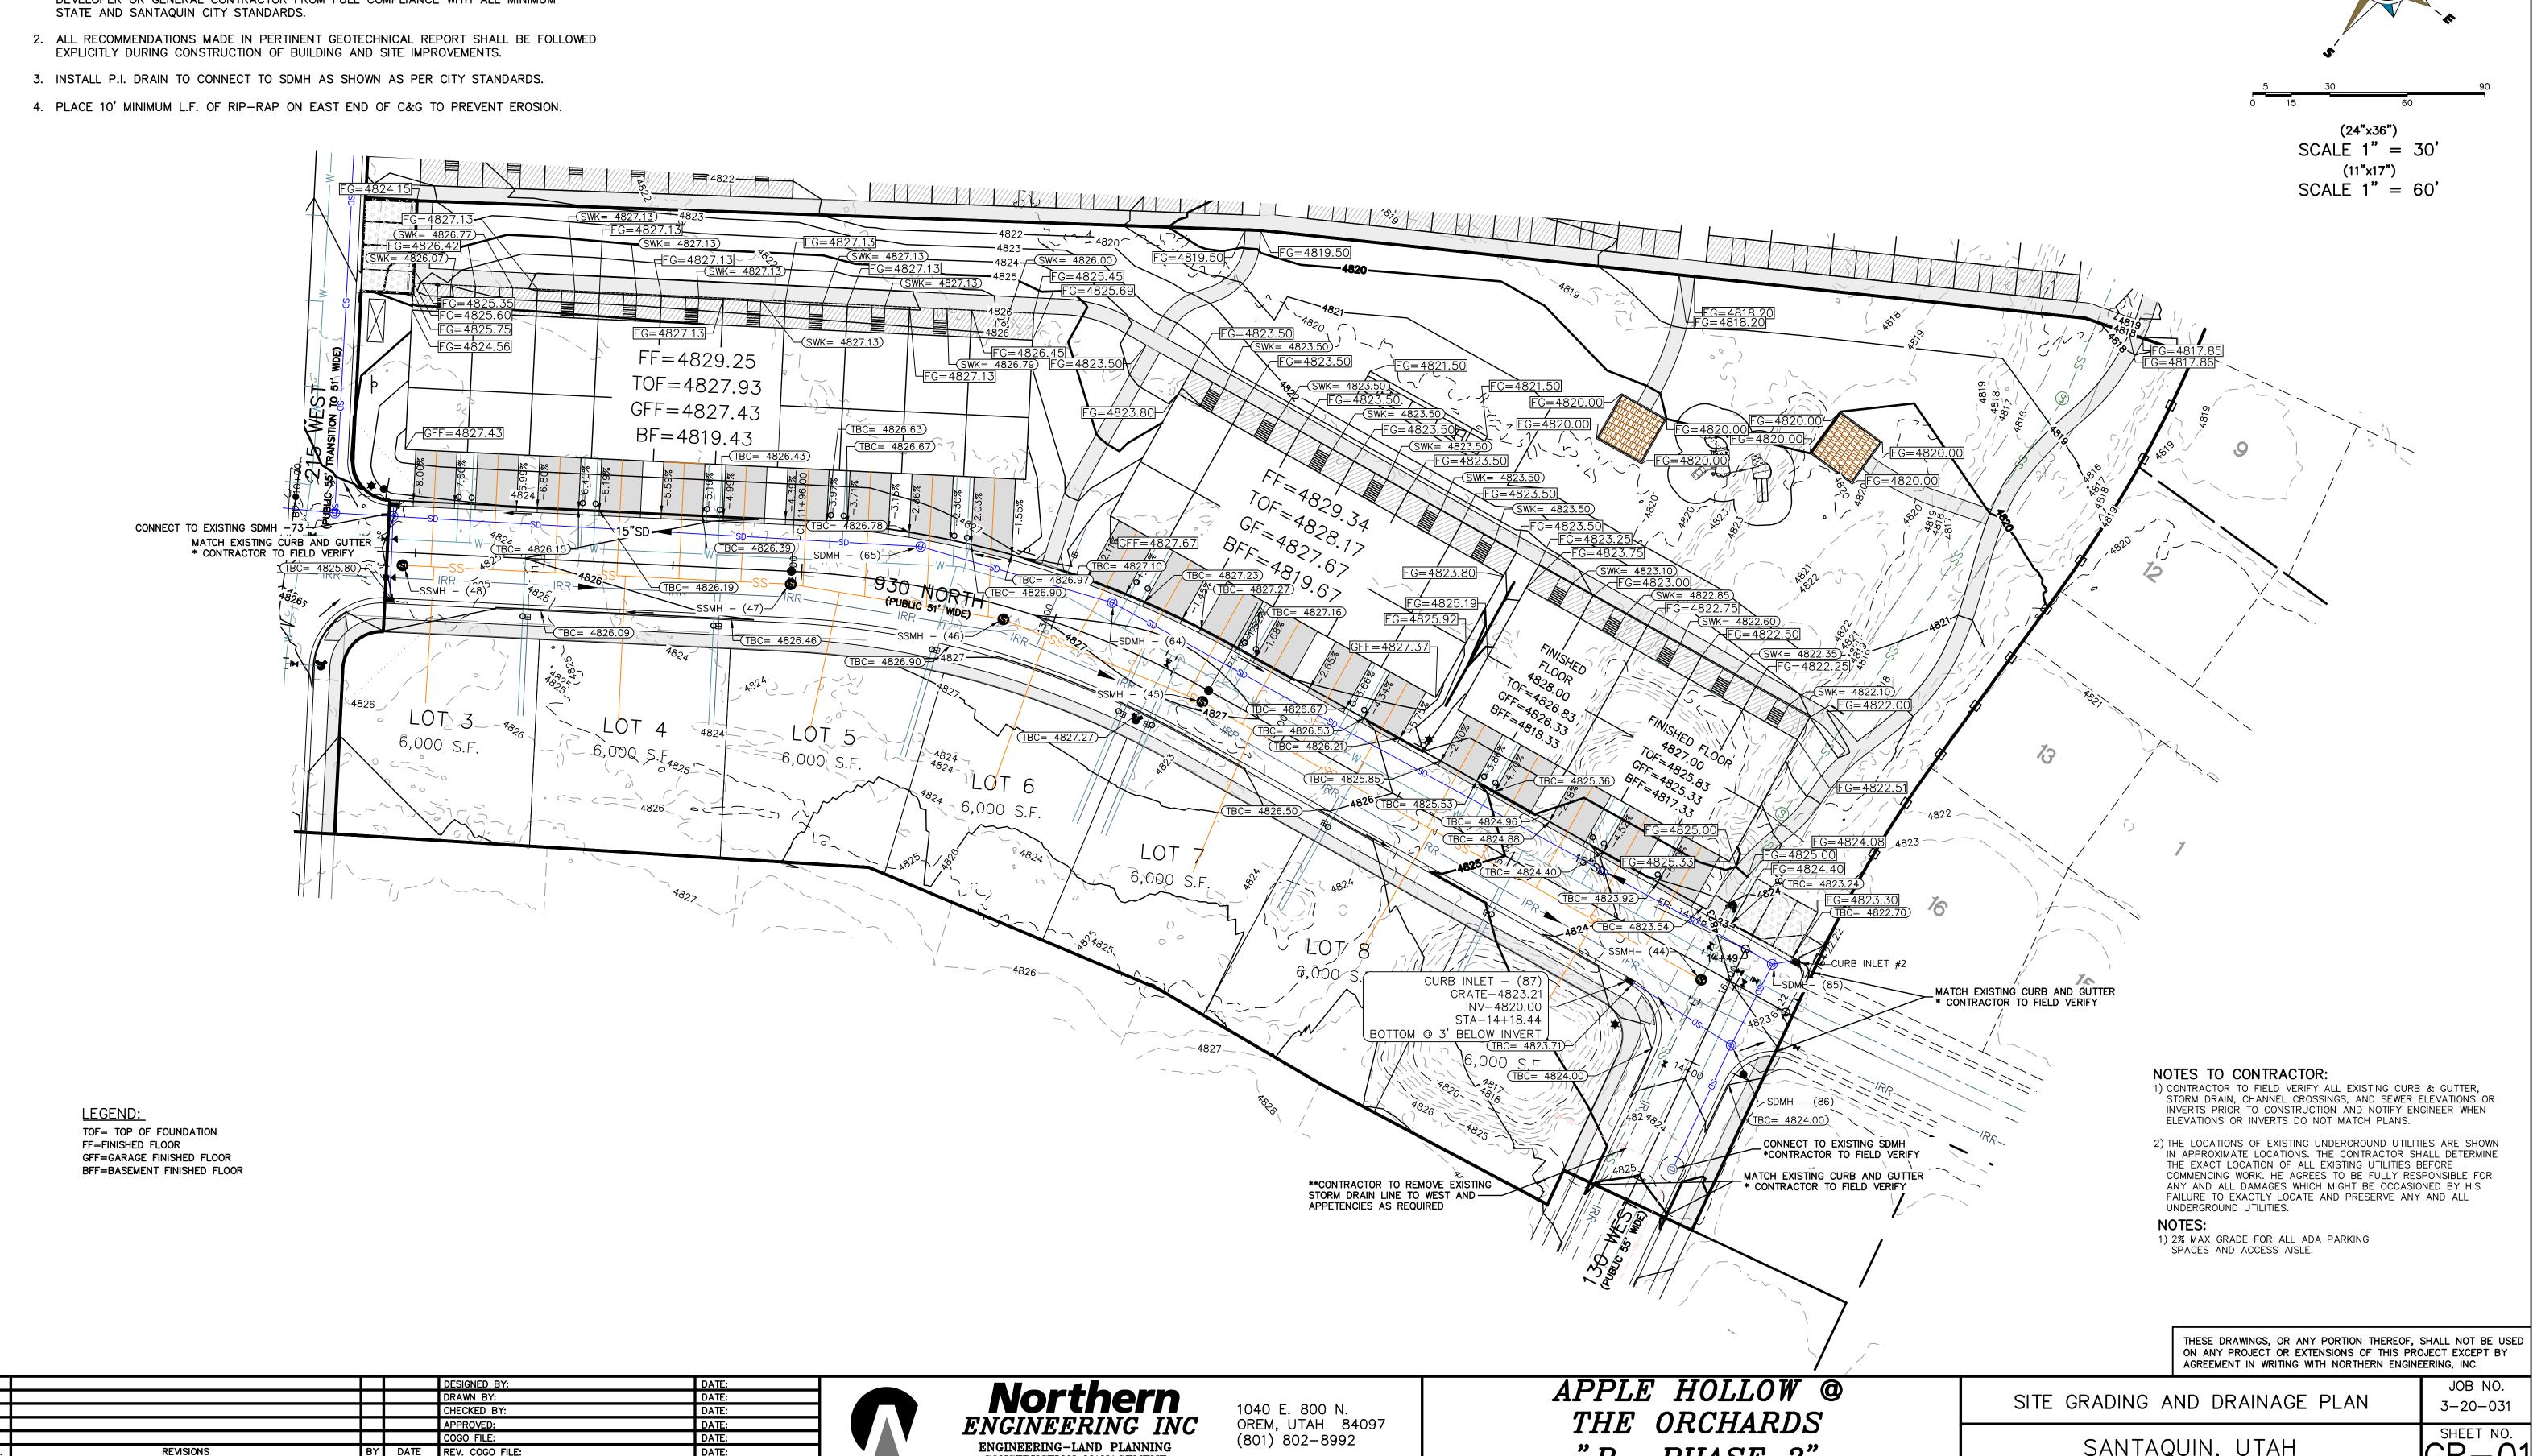


4				DRAWN BY:	DATE:		
3				CHECKED BY:	DATE:		
2				APPROVED:	DATE:		
1				COGO FILE:	DATE:		
NO.	REVISIONS	BY	DATE	REV. COGO FILE:	DATE:		
K: \3-	:\3-20-031-00 Apple Hollow\CAD\Design\Apple Hollow CONCEPT 11 SHEET SET PHASE 2.dwg						

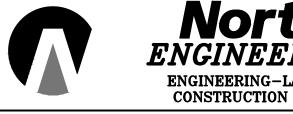

ENGINEERING-LAND PLANNING CONSTRUCTION MANAGEMENT

APPLE HOLLOW @
THE ORCHARDS
"B- PHASE 2"


SITE GRADING AND DRAINAGE PLAN	3-20-0 SHEET N
SANTAQUIN, UTAH	GR-

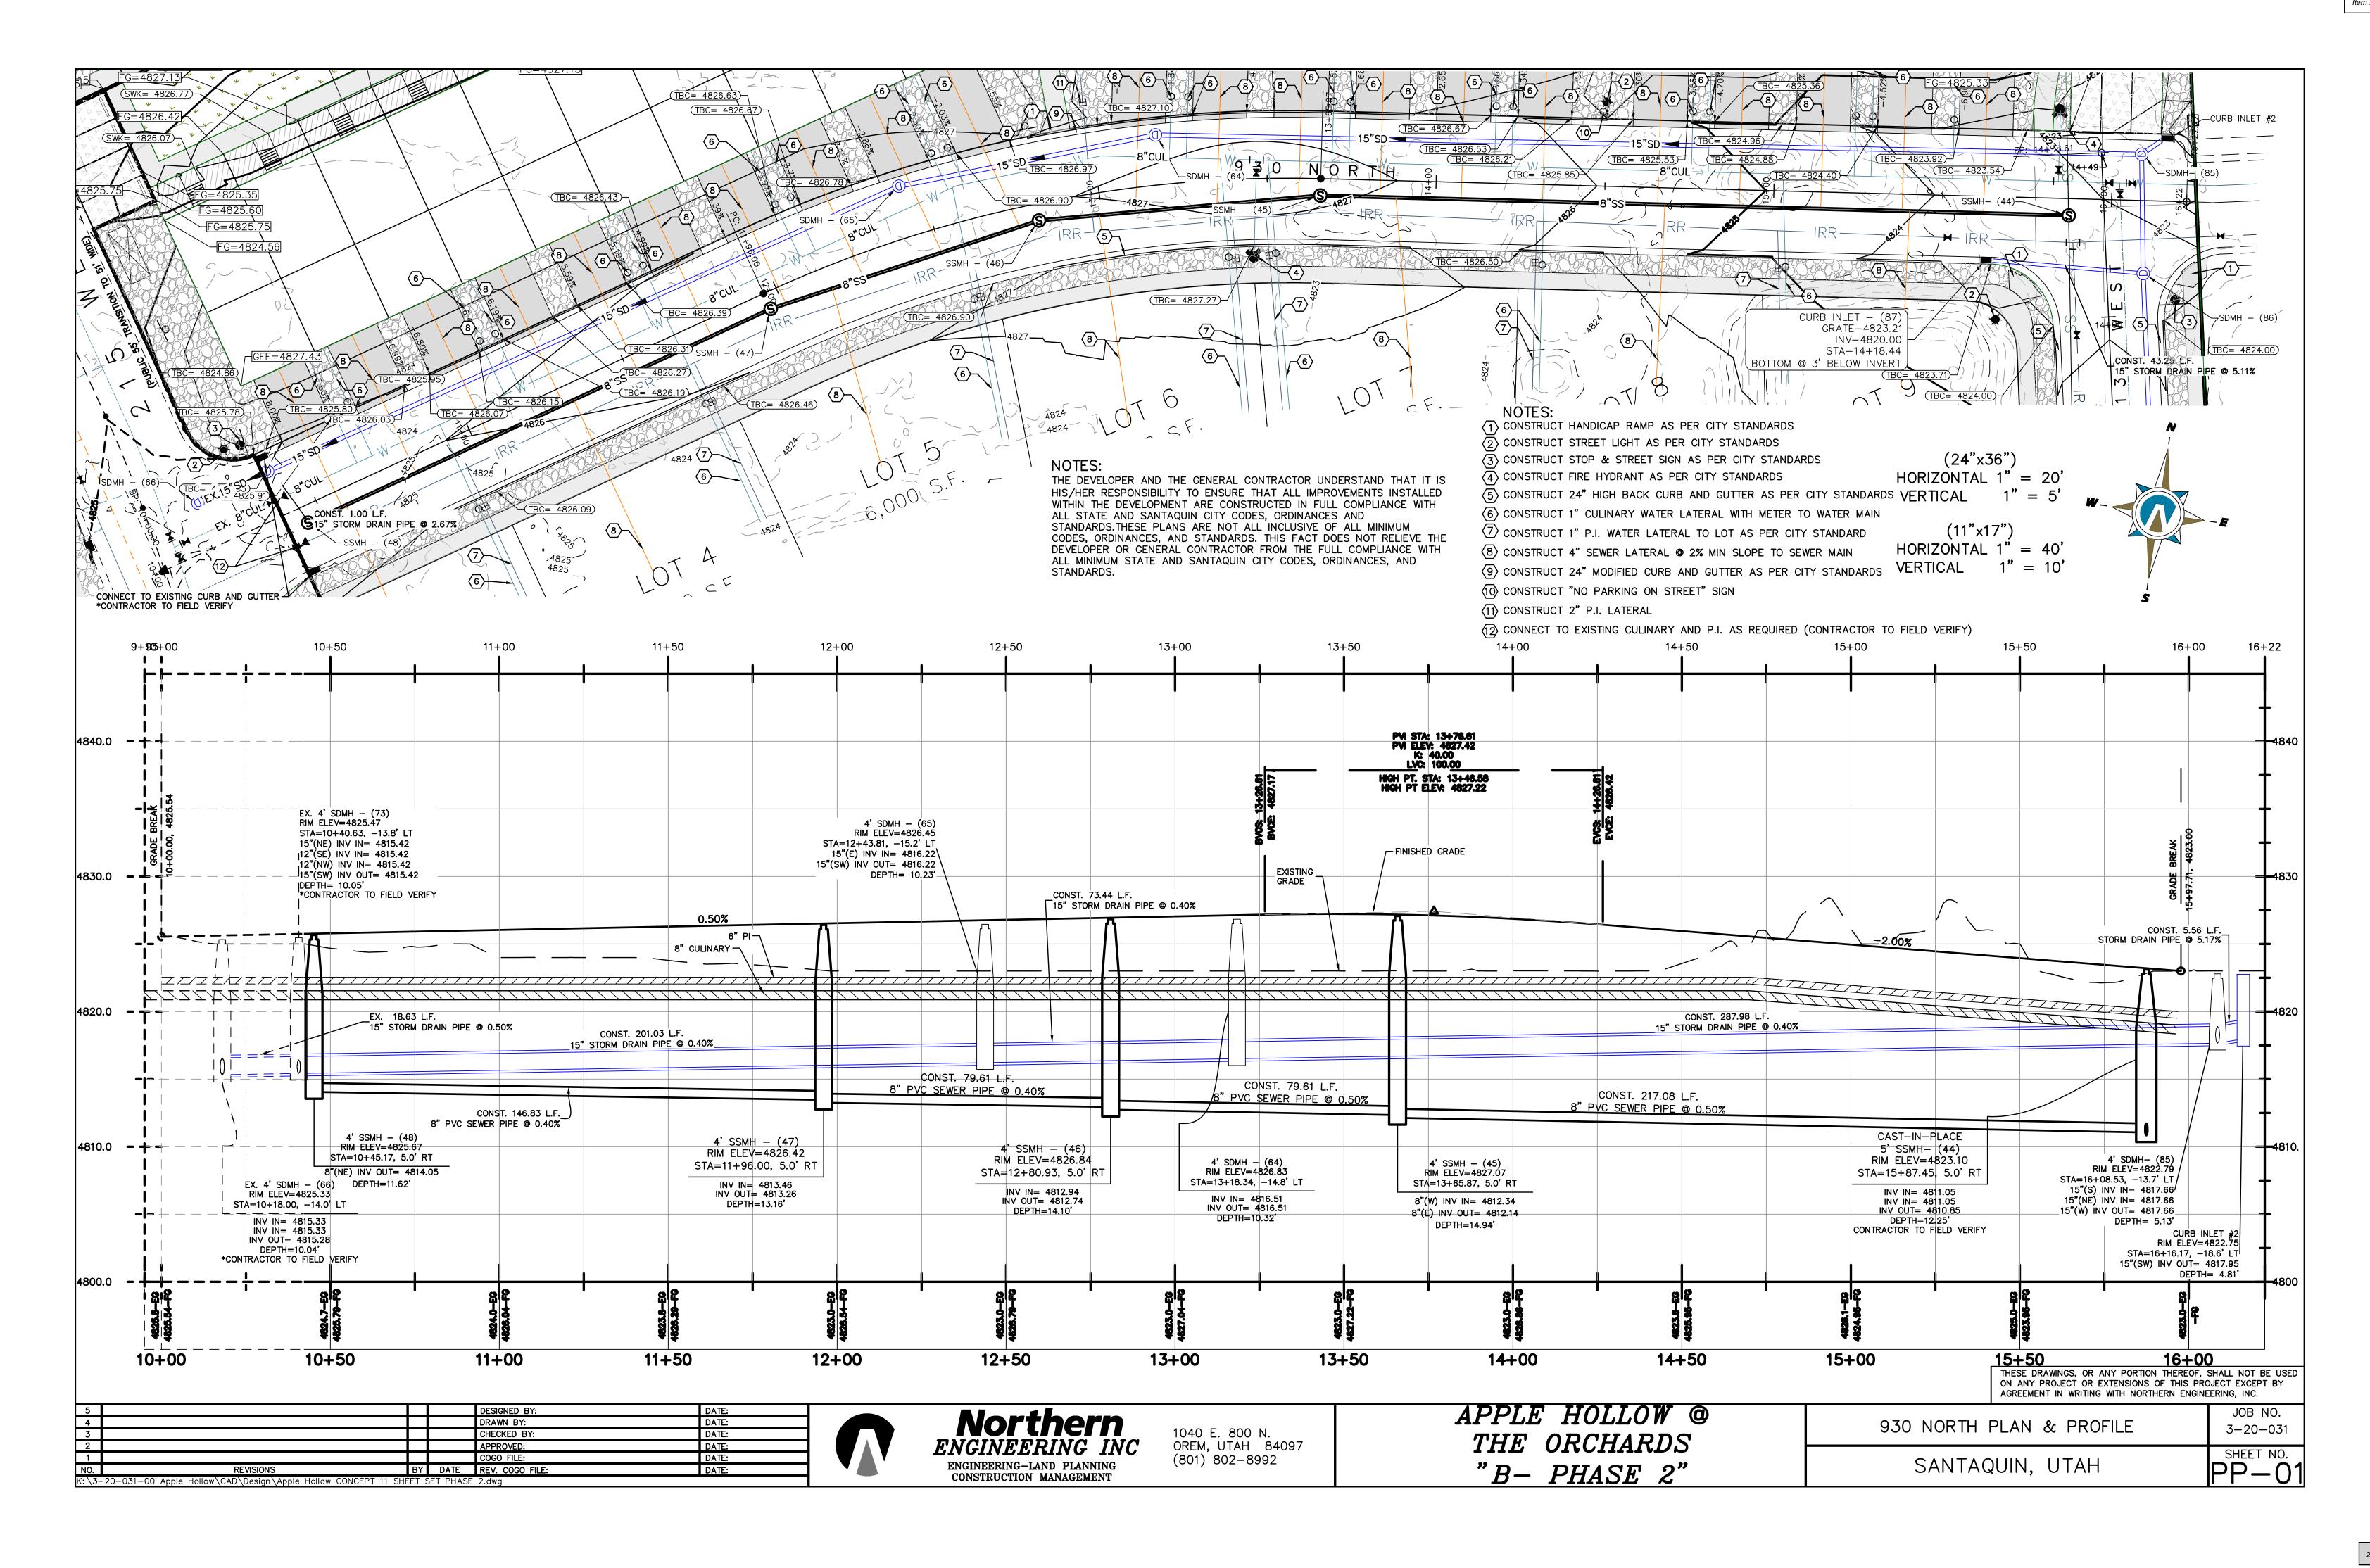


- (1) CONSTRUCT HANDICAP RAMP AS PER CITY STANDARDS
- 2 CONSTRUCT STREET LIGHT AS PER CITY STANDARDS
- $\overline{\overline{3}}$ CONSTRUCT STOP & STREET SIGN AS PER CITY STANDARDS
- (4) CONSTRUCT FIRE HYDRANT AS PER CITY STANDARDS
- (5) CONSTRUCT 24" HIGH BACK CURB AND GUTTER AS PER CITY STANDARDS
- (6) CONSTRUCT 1" CULINARY WATER LATERAL WITH METER TO WATER MAIN
- (7) CONSTRUCT 4" P.I. WATER LATERAL TO LOT AS PER CITY STANDARD
- 8 CONSTRUCT 4" SEWER LATERAL @ 2% MIN SLOPE TO SEWER MAIN
- (9) CONSTRUCT 24" MODIFIED CURB AND GUTTER AS PER CITY STANDARDS
 (10) CONNECT TO EXISTING CULINARY & P.I. AS REQUIRED (CONTRACTOR TO FIELD VERIFY)


NOTES:

THE DEVELOPER AND THE GENERAL CONTRACTOR UNDERSTAND THAT IT IS HIS/HER RESPONSIBILITY TO ENSURE THAT ALL IMPROVEMENTS INSTALLED WITHIN THE DEVELOPMENT ARE CONSTRUCTED IN FULL COMPLIANCE WITH ALL STATE AND SANTAQUIN CITY CODES, ORDINANCES AND STANDARDS. THESE PLANS ARE NOT ALL INCLUSIVE OF ALL MINIMUM CODES, ORDINANCES, AND STANDARDS. THIS FACT DOES NOT RELIEVE THE DEVELOPER OR GENERAL CONTRACTOR FROM THE FULL COMPLIANCE WITH ALL MINIMUM STATE AND SANTAQUIN CITY CODES, ORDINANCES, AND STANDARDS.

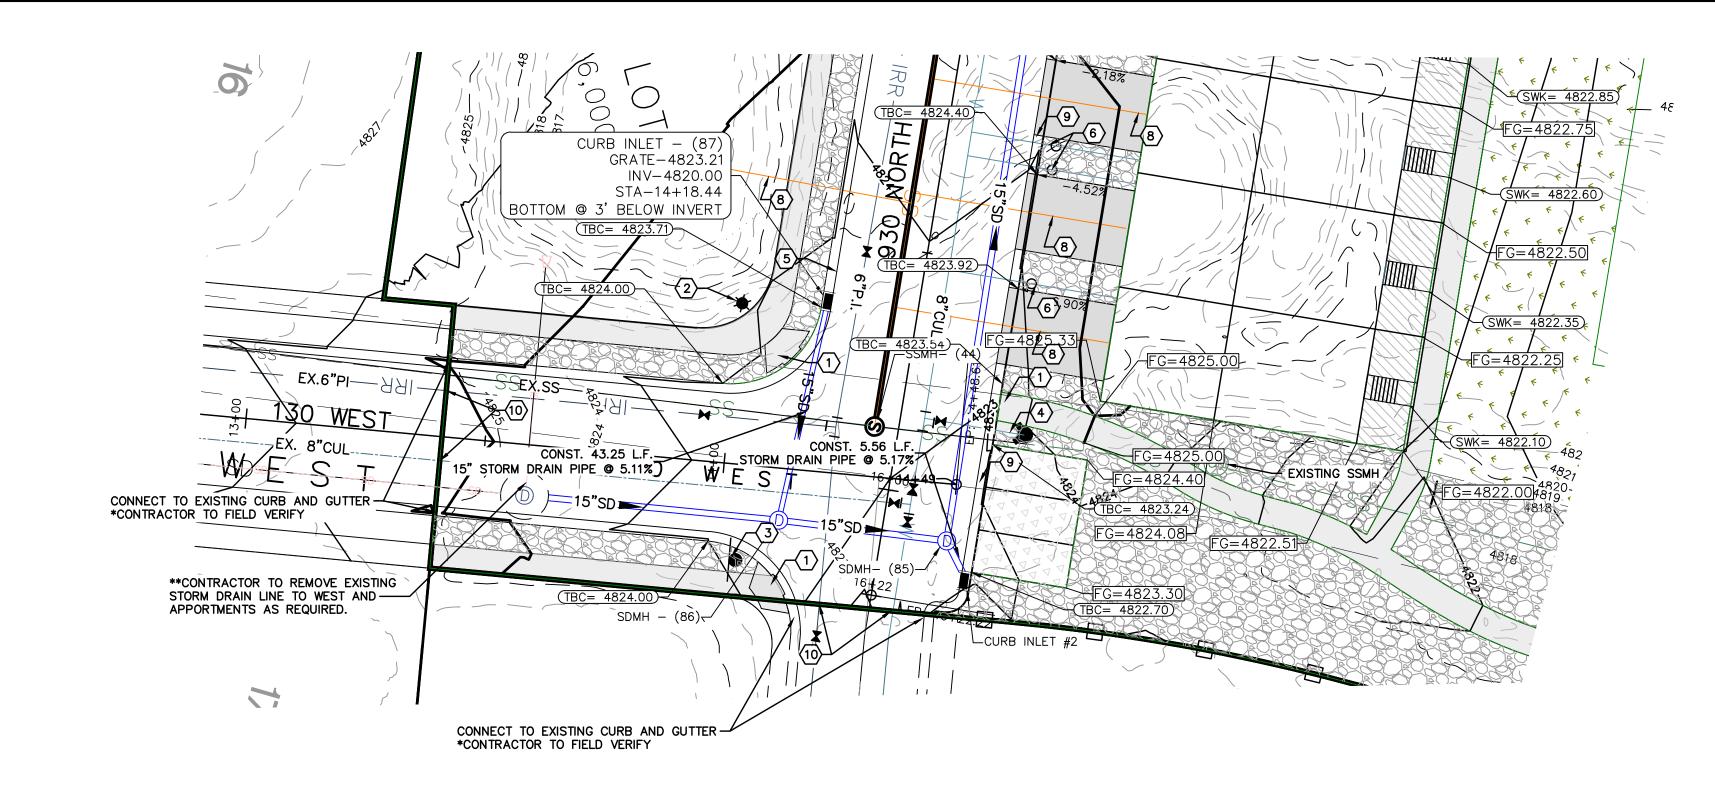

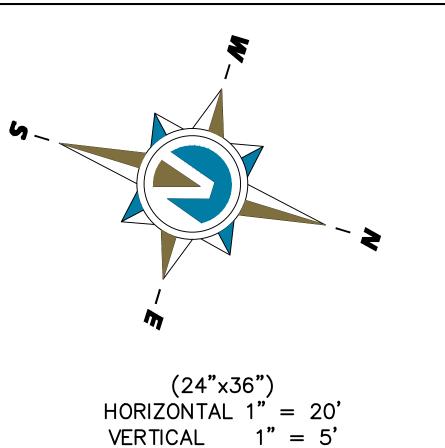

(11"x17")HORIZONTAL 1" = 40'
VERTICAL 1" = 10'

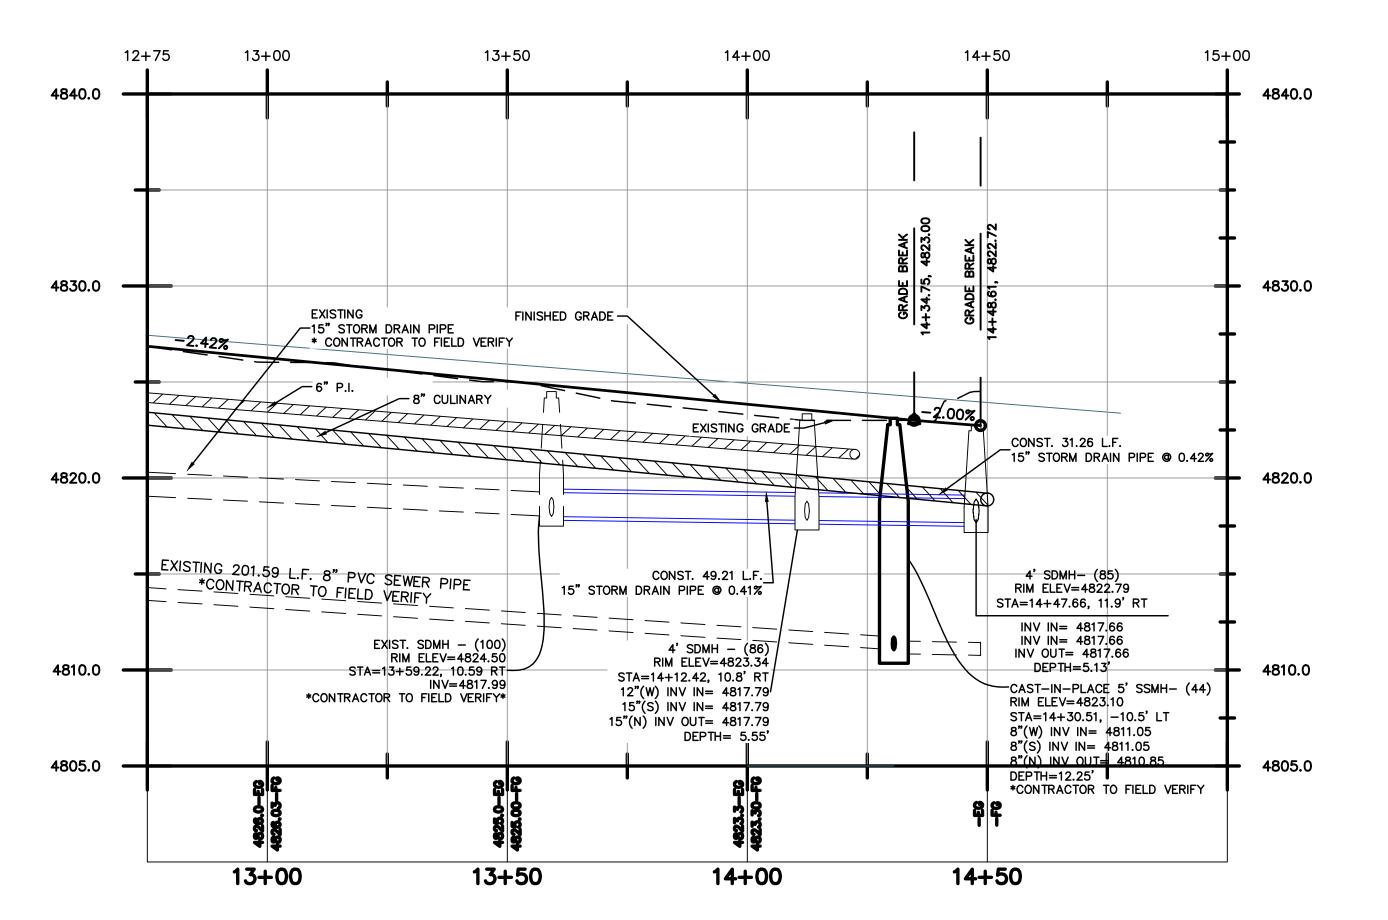

THESE DRAWINGS, OR ANY PORTION THEREOF, SHALL NOT BE USED ON ANY PROJECT OR EXTENSIONS OF THIS PROJECT EXCEPT BY AGREEMENT IN WRITING WITH NORTHERN ENGINEERING, INC.

5				DESIGNED BY:	DATE:
4				DRAWN BY:	DATE:
3				CHECKED BY:	DATE:
2				APPROVED:	DATE:
1				COGO FILE:	DATE:
NO.	REVISIONS	BY	DATE	REV. COGO FILE:	DATE:

K:\3-20-031-00 Apple Hollow\CAD\Design\Apple Hollow CONCEPT 11 SHEET SET PHASE 2.dwg

|--|

Northern
ENGINEERING INC
ENGINEERING-LAND PLANNING
CONSTRUCTION MANAGEMENT


1040 E. 800 N. OREM, UTAH 84097 (801) 802-8992

APPLE	HOLLO	W @	
THE	ORCHAR.	DS	
" R-	PHASE	2"	

130 WEST – PLAN & PROFILE

SANTAQUIN, UTAH


JOB NO. 3-20-031SHEET NO. P-02

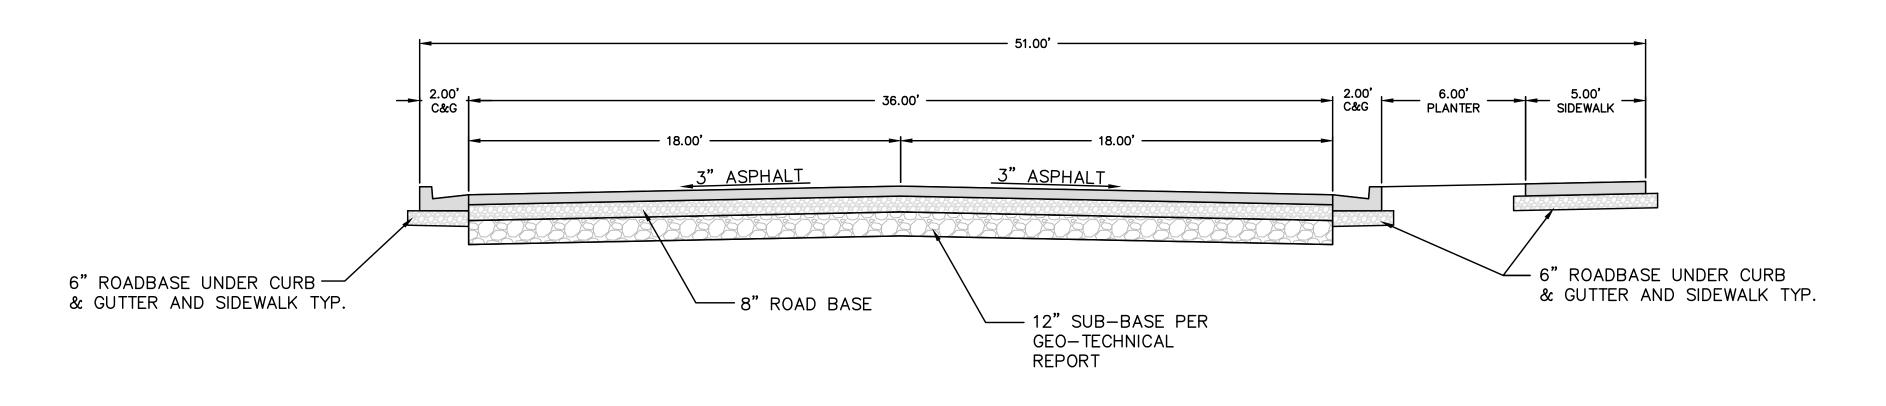

51.00' STANDARD STREET CROSS SECTION

930 NORTH


-NTS-

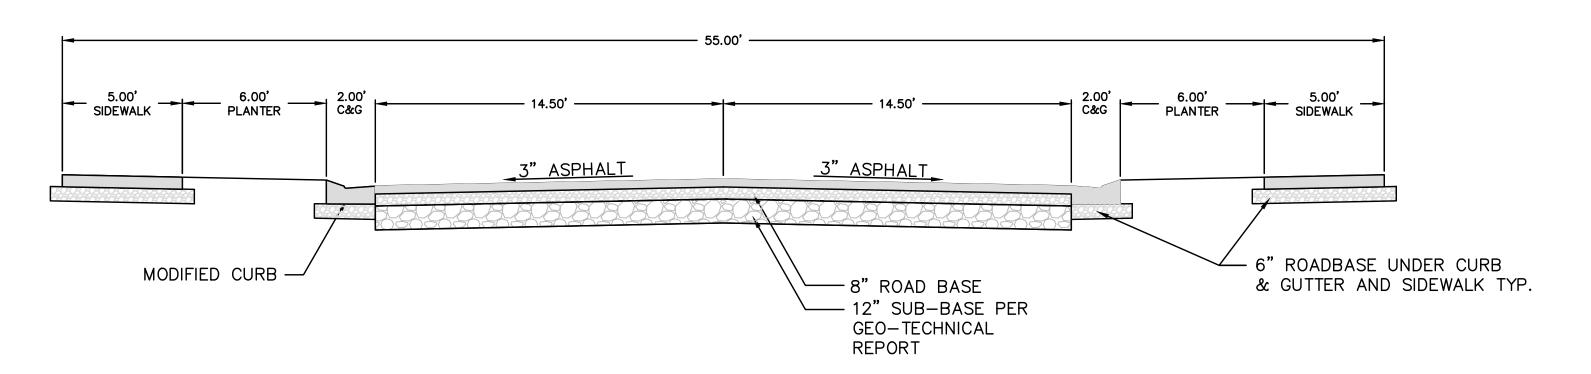

55.00' STANDARD STREET CROSS SECTION


130 WEST STREET


-NTS-

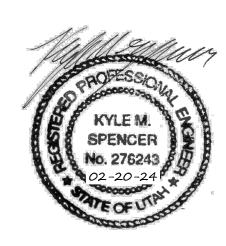



THESE DRAWINGS, OR ANY PORTION THEREOF, SHALL NOT BE USED ON ANY PROJECT OR EXTENSIONS OF THIS PROJECT EXCEPT BY AGREEMENT IN WRITING WITH NORTHERN ENGINEERING, INC.


Northern ENGINEERING INC ENGINEERING-LAND PLANNING CONSTRUCTION MANAGEMENT DATE:
DATE:
DATE: DESIGNED BY: DRAWN BY: APPLE HOLLOW @ DETAILS 1040 E. 800 N. OREM, UTAH 84097 (801) 802-8992 3-20-031 CHECKED BY: DATE: APPROVED: THE ORCHARDS "B-2" SHEET NO. COGO FILE: SANTAQUIN, UTAH DT-01 BY DATE REV. COGO FILE:

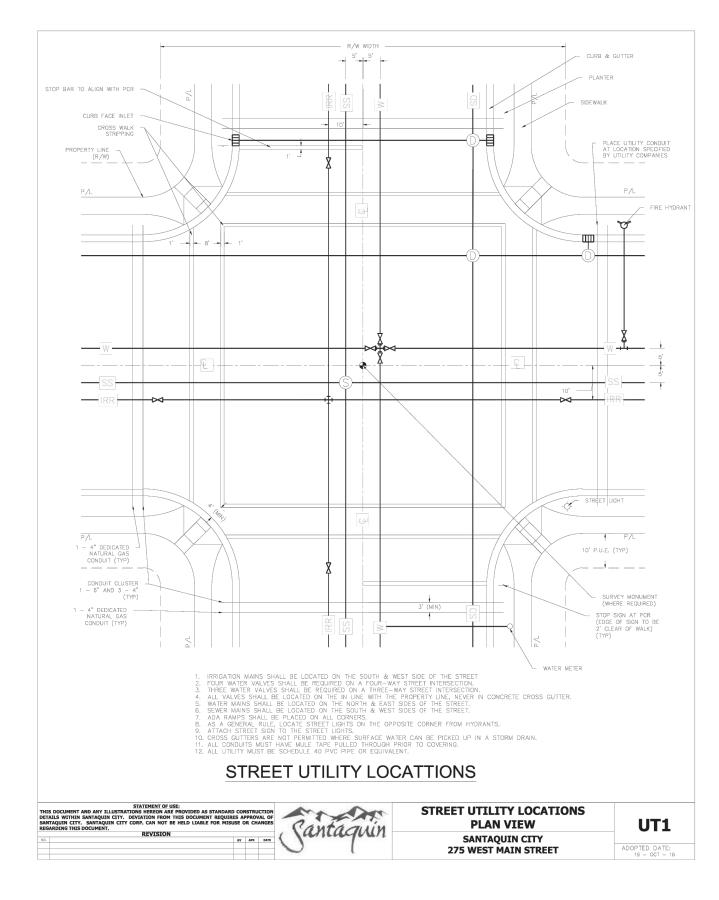


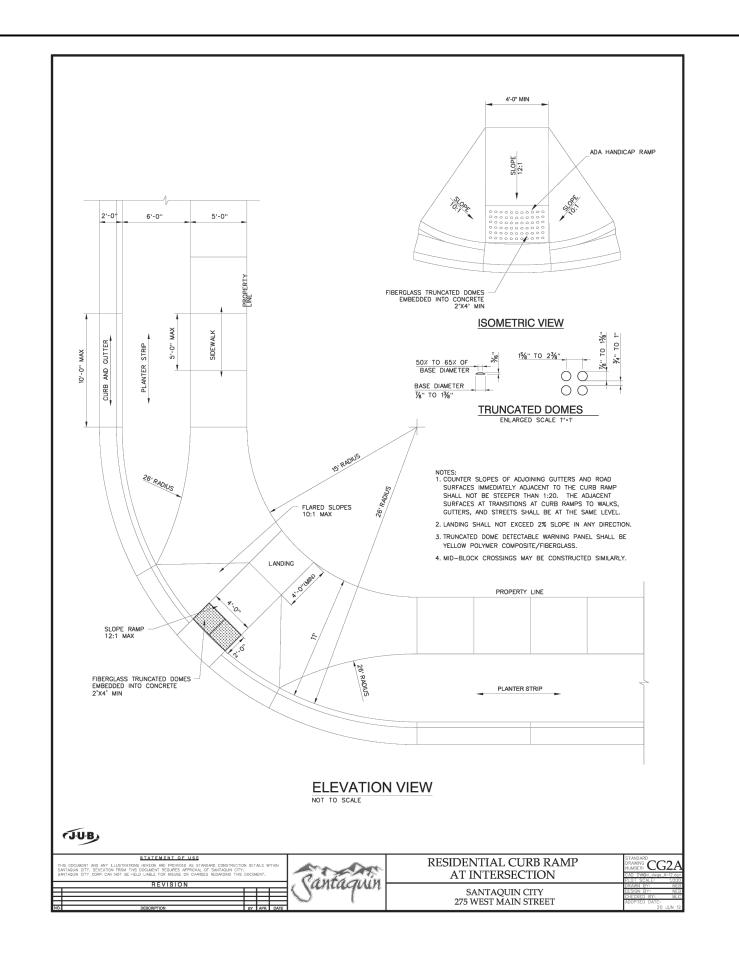


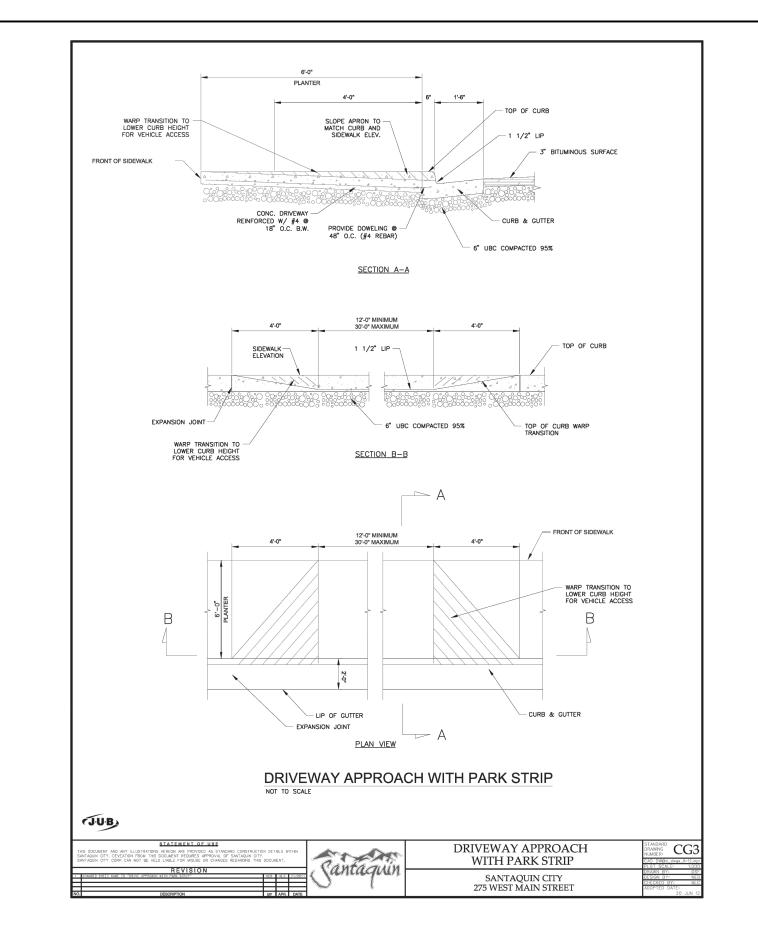


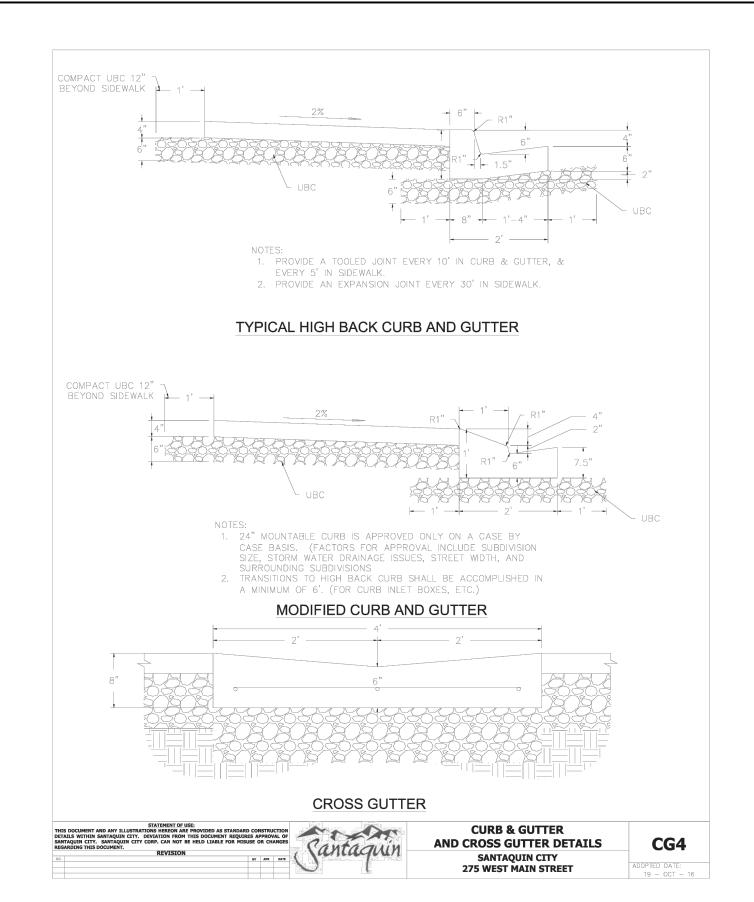


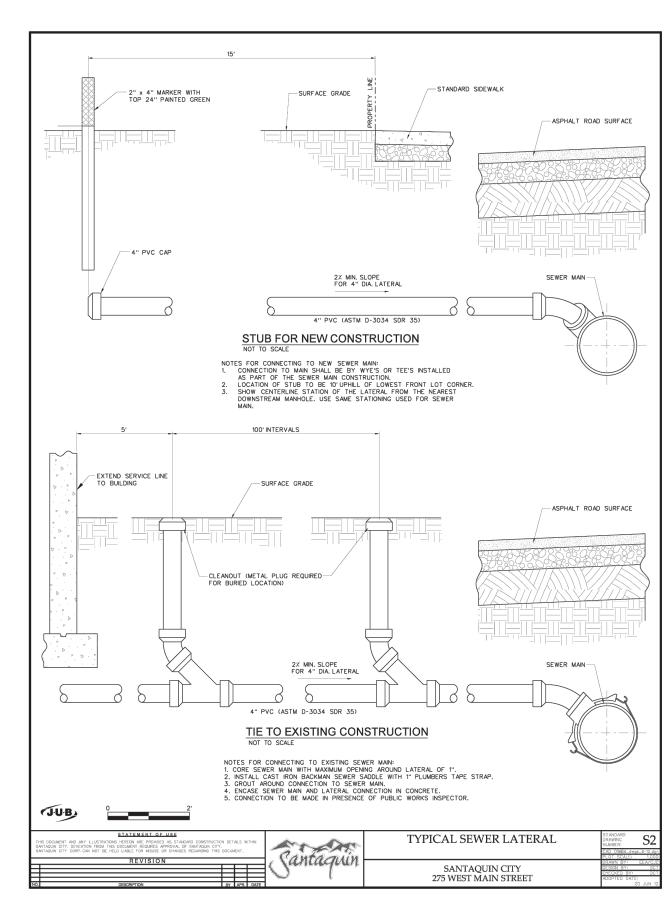

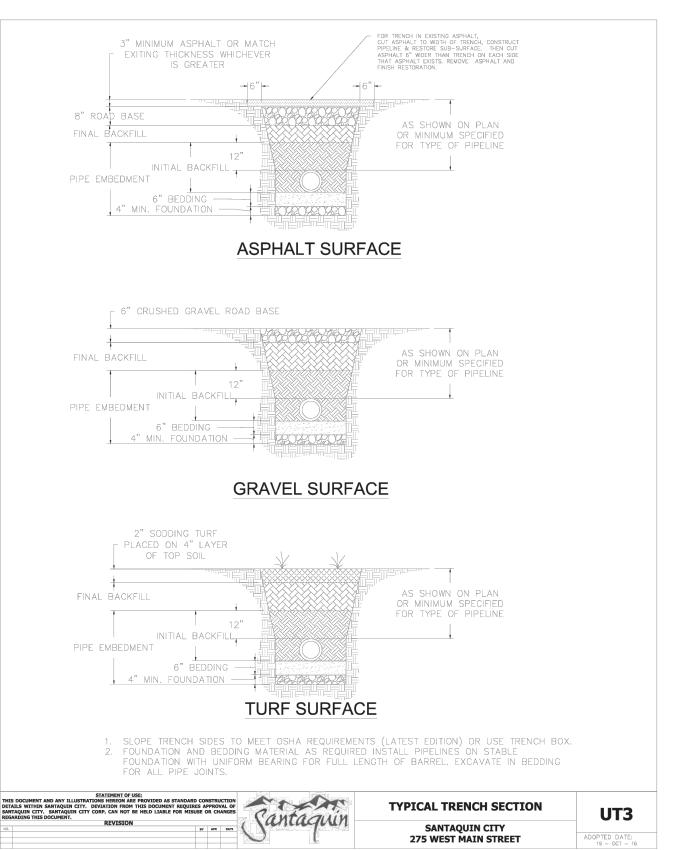

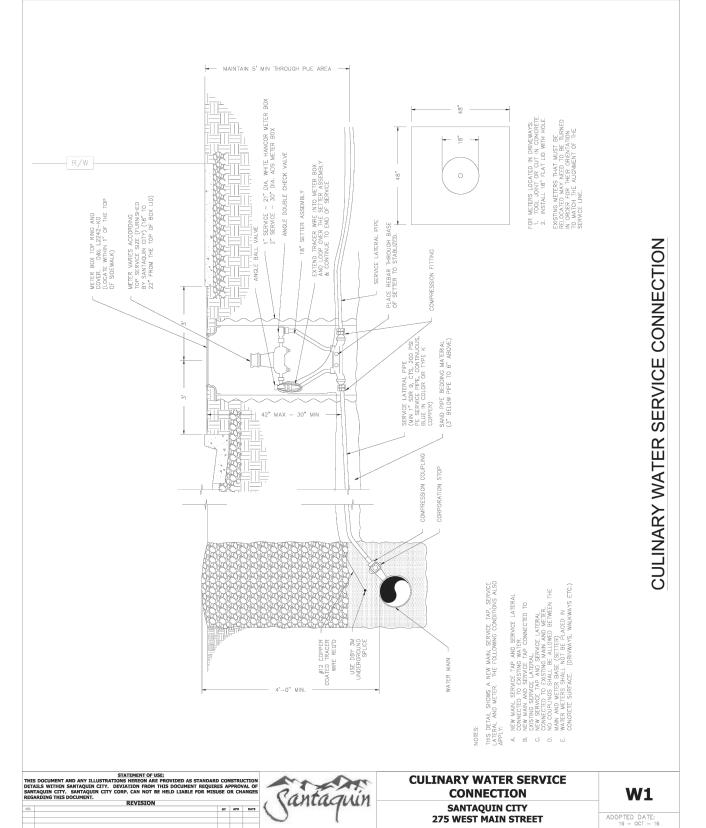

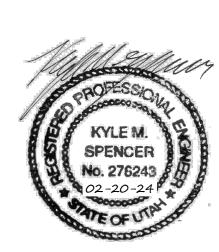

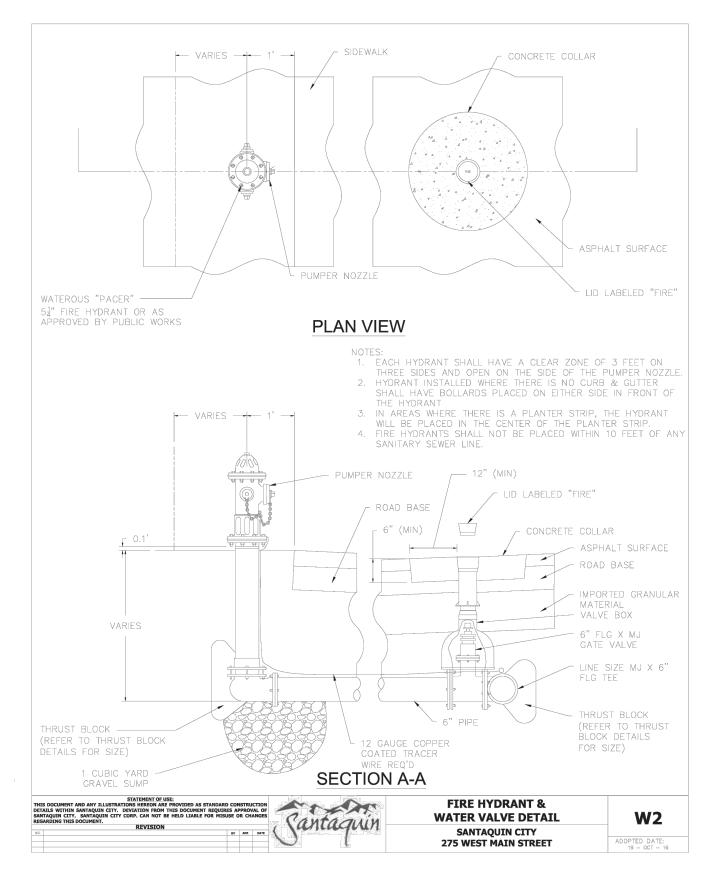

5				DESIGNED BY:	DATE:
4				DRAWN BY:	DATE:
3				CHECKED BY:	DATE:
2				APPROVED:	DATE:
1				COGO FILE:	DATE:
NO.	REVISIONS	BY	DATE	REV. COGO FILE:	DATE:
∠ ⋅\3.	K:\3-20-031-00 Apple Hollow\CAD\Design\DETAILS PHASE 2 dwg 2/16/2024 9:47 AM				



Northern ENGINEERING IN ENGINEERING-LAND PLANNING CONSTRUCTION MANAGEMENT

1040 E. 800 N. OREM, UTAH 84097 (801) 802-8992 APPLE HOLLOW @
THE ORCHARDS "B-2"

AGREEMENT IN WRITING WITH NORTHERN ENGINEER	aing, inc.
	JOB NO.
DETAILS	JOB NO. 3-20-031
SANTAQUIN, UTAH	SHEET NO. DT-02
	-

THESE DRAWINGS, OR ANY PORTION THEREOF, SHALL NOT BE USED ON ANY PROJECT OR EXTENSIONS OF THIS PROJECT EXCEPT BY

