



DEVELOPMENT REVIEW COMMITTEE

Tuesday, February 13, 2024, at 10:00 AM
Council Chambers at City Hall Building and Online
110 S. Center Street, Santaquin, UT 84655

MEETINGS HELD IN PERSON & ONLINE

The public is invited to participate as outlined below:

- **In Person** – The meeting will be held in the Council Chambers on the Main Floor in the City Hall Building
- **YouTube Live** – Some public meetings will be shown live on the Santaquin City YouTube Channel, which can be found at <https://bit.ly/2P7ICfQ> or by searching for Santaquin City Channel on YouTube.

ADA NOTICE

If you are planning to attend this Public Meeting and due to a disability need assistance in understanding or participating in the meeting, please notify the City Office ten or more hours in advance and we will, within reason, provide what assistance may be required.

AGENDA

NEW BUSINESS

1. Apple Hollow at The Orchards B-1 & B-2 Final Plan

A final review of a 2-lot and 8 townhome subdivision located at approximately 215 W. and 930 N.

2. Apple Hollow at The Orchards B-3 & B-4 Final Plan

A final review of a 7-lot and 21 townhome subdivision located at approximately 130 W. and 930 N.

3. Santaquin Research & Tech Center Phase 1 Site Plan Review

A site plan review of the Santaquin Research & Tech Center Phase 1 located at approximately 1972 S. Frontage Road.

4. Vincent Oaks (Deer Haven Estates) Preliminary Plan

A preliminary plan review of a 7-lot subdivision located at approximately 850 E. 450 S.

5. Sutherland Preliminary Plan

A preliminary review of a two-lot subdivision located at approximately 565 W. Lark Road.


MEETING MINUTES APPROVAL

6. January 23, 2024

ADJOURNMENT

CERTIFICATE OF MAILING/POSTING

The undersigned duly appointed City Recorder for the municipality of Santaquin City hereby certifies that a copy of the foregoing Notice and Agenda may be found at www.santaquin.org, in three physical locations (Santaquin City Hall, Zions Bank, Santaquin Post Office), and on the State of Utah's Public Notice Website, <https://www.utah.gov/pmn/index.html>. A copy of the notice may also be requested by calling (801)754-1904.

BY: 

Amalie R. Ottley, City Recorder

APPLE HOLLOW @ THE ORCHARDS "B"

PHASE 1 SANTAQUIN, UTAH COUNTY, UTAH -INDEX OF PLAN SHEETS-

GENERAL

- ALL WORK SHALL BE DONE IN ACCORDANCE WITH THE SPECIFICATIONS AND/OR REQUIREMENTS OF THE SANTAQUIN CITY PUBLIC WORKS DEPARTMENT.
- A PRE CONSTRUCTION CONFERENCE WILL BE HELD A MINIMUM OF 3 WORKING DAYS PRIOR TO START OF WORK. ALL CONTRACTORS, SUBCONTRACTORS AND/OR UTILITY CONTRACTORS, SANTAQUIN CITY PUBLIC WORKS AND CITY'S ENGINEER SHOULD BE PRESENT.
- ALL LOT DIMENSIONS, EASEMENTS AND CERTAIN OFF SITE EASEMENTS ARE TO BE TAKEN FROM THE PLAT OF THE ORCHARDS PLAT F-6 WITH THE COMPLETION OF ROW IMPROVEMENTS ASSOCIATED WITH ORCHARDS F-6.
- ALL CONSTRUCTION STAKES MUST BE REQUESTED A MINIMUM OF THREE (3) WORKING DAYS PRIOR TO PLANNED USE.
- CERTAIN CONTROL POINTS WILL BE SET BY THE ENGINEER, OR HIS REPRESENTATIVE, WHICH ARE CRITICAL TO THE CONSTRUCTION STAKING OF THE PROJECT. THESE POINTS WILL BE DESIGNATED AT THE TIME THEY ARE SET AND THE CONTRACTOR SO NOTIFIED. DESTRUCTION OF THESE POINTS BY THE CONTRACTOR OR HIS SUBCONTRACTORS SHALL BE GROUNDS FOR CHARGING THE CONTRACTOR FOR REESTABLISHING SAID POINTS.
- ALL RECOMMENDATIONS MADE IN A PERTINENT GEOTECHNICAL REPORT/STUDY SHALL BE FOLLOWED EXPLICITLY DURING CONSTRUCTION OF BUILDING AND SITE IMPROVEMENTS.
- THE DEVELOPER AND THE GENERAL CONTRACTOR UNDERSTAND THAT IT IS HIS/HER RESPONSIBILITY TO ENSURE THAT ALL IMPROVEMENTS INSTALLED WITHIN THIS DEVELOPMENT ARE CONSTRUCTED IN FULL COMPLIANCE WITH ALL STATE AND SANTAQUIN CITY CODES, ORDINANCES AND STANDARDS. THESE PLANS ARE NOT ALL INCLUSIVE OF ALL MINIMUM CODES, ORDINANCES AND STANDARDS. THIS FACT DOES NOT RELIEVE THE DEVELOPER OR GENERAL CONTRACTOR FROM THE FULL COMPLIANCE WITH ALL MINIMUM STATE AND SANTAQUIN CITY CODES, ORDINANCES AND STANDARDS.

ROADWAY/STORM DRAIN

- ALL ROADWAY CONSTRUCTION SHALL MEET THE MINIMUM REQUIREMENTS OF SANTAQUIN CITY'S TECHNICAL SPECIFICATIONS OR AS APPROVED IN THE PLANS HEREIN.
- WHEN DISCREPANCIES OCCUR BETWEEN PLANS AND SPECIFICATIONS, THE CONTRACTOR SHALL IMMEDIATELY NOTIFY THE ENGINEER. UNTIMELY NOTIFICATION SHALL NEGATE ANY CONTRACTORS CLAIM FOR ADDITIONAL COMPENSATION.
- ALL STORM DRAIN PIPES TO BE REINFORCED CONCRETE PIPE (RCP) CLASS III, HDPE STORM DRAIN PIPE, OR APPROVED EQUAL UNLESS OTHERWISE NOTED.
- CONTRACTOR IS RESPONSIBLE TO ENSURE THAT ALL CLEANOUT/ACCESS LOCATIONS MEET SANTAQUIN IRRIGATION COMPANY SPECIFICATIONS AND ARE COMPLETED UNDER THE DIRECTION OF SANTAQUIN IRRIGATION COMPANY.
- ALL IRRIGATION CORNERS (ANGLE POINTS) SHALL HAVE A PRE CAST - REINFORCED CONCRETE MANHOLE, WITH A WATERTIGHT SOLID MANHOLE COVER.
- ALL STORM DRAIN INLET BOXES TO MEET SANTAQUIN CITY STANDARD DRAWING SDI W/3' SEDIMENT TRAP.

SEWER

- ALL WORK SHALL BE DONE IN ACCORDANCE WITH THE LATEST SANTAQUIN CITY DESIGN STANDARDS & PUBLIC IMPROVEMENT SPECIFICATIONS DRAWINGS OF SANTAQUIN CITY.
- FINAL APPROVAL AND ACCEPTANCE OF ALL SEWER CONSTRUCTION WILL BE BY SANTAQUIN CITY.
- UPON THE COMPLETION OF WORK, THE CONTRACTOR SHALL SUBMIT 3 SETS OF AS-BUILT PLANS TO SANTAQUIN CITY & (1) SET TO NORTHERN ENGINEERING, INC.
- HORIZONTAL AND VERTICAL SEPARATION OF CULINARY WATER AND SEWER SHALL BE IN COMPLIANCE WITH SANTAQUIN CITY STANDARDS.

WATER

- THE WATER SYSTEM SHALL BE CONSTRUCTED TO CONFORM WITH THE STANDARDS SET FORTH IN THE "UTAH REGULATIONS FOR PUBLIC DRINKING WATER SYSTEMS", AND THE SANTAQUIN CITY PUBLIC WORKS DEPARTMENT STANDARD SPECIFICATIONS AND DRAWINGS.
- CONTRACTOR SHALL NOTIFY NORTHERN ENGINEERING, INC. THREE (3) WORKING DAYS BEFORE INITIAL CONSTRUCTION BEGINS AND SHALL ALSO REQUEST SANTAQUIN CITY WATER DEPARTMENT INSPECTION OF WATER LINES AND APPURTENANCES TWENTY-FOUR (24) HOURS IN ADVANCE OF BACKFILLING.
- CONTRACTOR TO FIELD VERIFY ALL VALVE BOX LID ELEVATIONS TO ASSURE THAT SAID LID ELEVATIONS MATCH FINAL STREET GRADE, AND ALL METER LID ELEVATIONS TO MATCH AN EXTENSION OF THE SIDEWALK GRADE.
- UPON THE COMPLETION OF WORK, THE CONTRACTOR SHALL SUBMIT 3 SETS OF AS-BUILT PLANS TO SANTAQUIN CITY & (1) SET TO NORTHERN ENGINEERING, INC.
- WATER VALVE LIDS ARE TO BE LABELED "WATER" FOR CULINARY VALVES.
- HORIZONTAL AND VERTICAL SEPARATION OF CULINARY WATER AND SEWER SHALL BE IN COMPLIANCE WITH SANTAQUIN CITY STANDARDS.
- WATERLINES TO BE BEDDED AS PER SANTAQUIN CITY DIVISION 3A SECTION 3A.04 SUB-SECTION E.
- ALL CULINARY WATERLINES, REGARDLESS OF SIZE, SHALL BE C-900 PVC PIPE AS PER SANTAQUIN CITY STANDARDS.

SHEET	DESCRIPTION
1	COVER SHEET FINAL PLAT B-1 FINAL PLAT B-2
SP-01	SITE PLAN/PHASING PLAN
UT-01	UTILITY LAYOUT
GR-01	GRADING & DRAINAGE
LS-01	LANDSCAPING PLAN
PP-01	PLAN & PROFILE 215 WEST
PP-02	PLAN & PROFILE GINGER GOLD ROAD
DT-01	ROW DETAILS
DT-02	DETAILS
DT-03	DETAILS



VICINITY MAP
-NTS-

TABULATIONS

APPLE HOLLOW AT THE ORCHARDS B-PHASE 1	
ZONE:	R-10 PUD ZONE
PLAT AREA:	1.73 ACRES
# OF LOTS:	2 LOTS
NUMBER OF TOWNHOMES:	8 UNITS
LOT AREA:	0.28 ACRES
TOWNHOMES AREA:	0.33 ACRES
COMMON AREA:	0.36 ACRES
LIMITED COMMON AREA:	0.03 ACRES
RIGHT-OF-WAY AREA:	0.58 ACRES
DENSITY:	5.78 UNITS/ACRE

ACCEPTANCE

SIGNATURE: _____ DATE _____
DEVELOPER

SIGNATURE: _____ DATE _____
CITY ENGINEER

SIGNATURE: _____ DATE _____
COMMUNITY DEV. DIRECTOR



SIGNATURE: _____ DATE _____
PUBLIC WORKS

SIGNATURE: _____ DATE _____
BUILDING DEPARTMENT

SIGNATURE: _____ DATE _____
POLICE DEPARTMENT

SIGNATURE: _____ DATE _____
FIRE DEPARTMENT

DEVELOPER
REVERE HOMES
JOHN CALDWELL (MANAGER)
470 N. 2450 W.
TREMONTON, UTAH 84337
(801)-427-1733

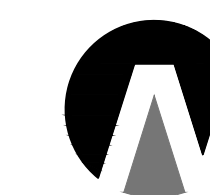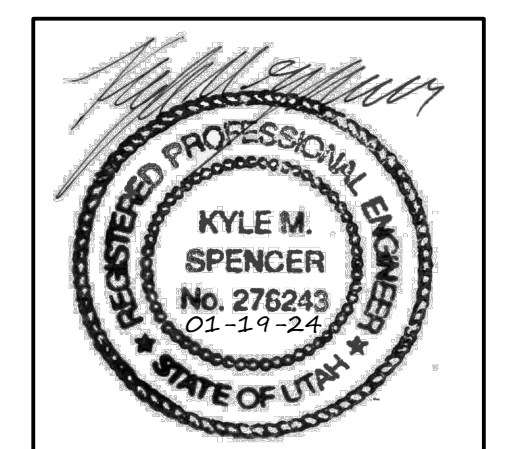


**Northern
ENGINEERING INC**
ENGINEERING-LAND PLANNING
CONSTRUCTION MANAGEMENT


1040 E. 800 N.
OREM, UTAH 84097
(801) 802-8992

APPLE HOLLOW AT THE ORCHARDS PLAT B-1

A PARCEL OF LAND LOCATED IN THE NORTHEAST QUARTER OF SECTION 35, TOWNSHIP 9 SOUTH, RANGE 1 EAST SALT LAKE BASE AND MERIDIAN

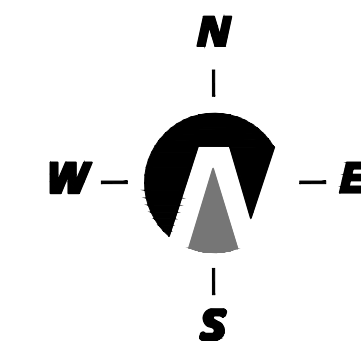

(24"x36")
SCALE 1" = 30'
(11"x17")
SCALE 1" = 60'

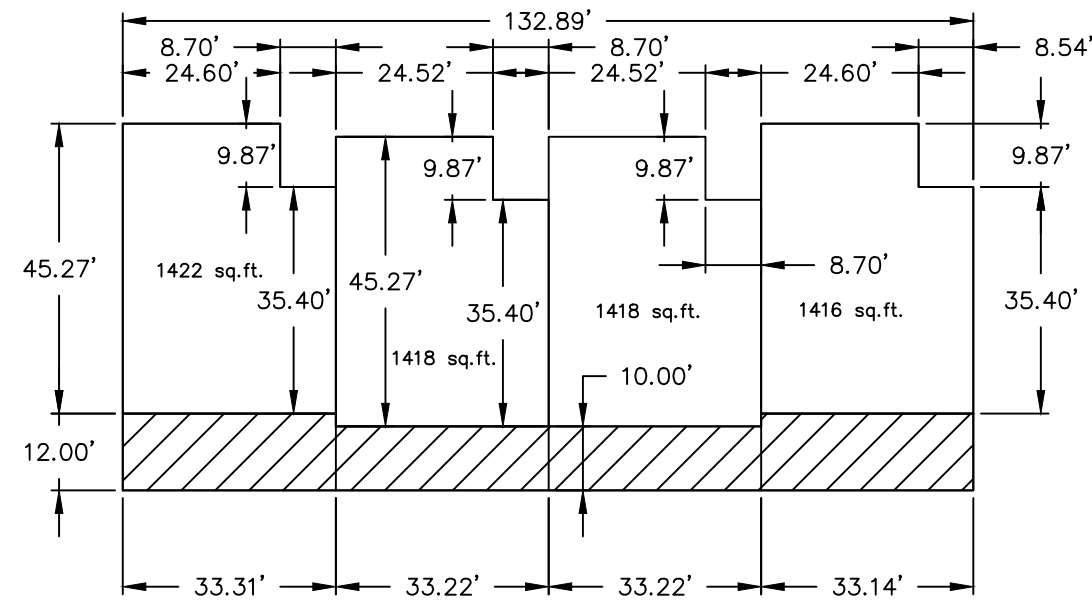

BUILDING A & B

NOTES:

- 1) ALL LIMITED COMMON AREA & OPEN SPACE, COMMON AREAS ARE DEDICATED AS PUBLIC UTILITY EASEMENTS.
- 2) THIS PROPERTY IS LOCATED IN THE VICINITY OF AN ESTABLISHED AGRICULTURE PROTECTION AREA IN WHICH NORMAL AGRICULTURAL USES AND ACTIVITIES HAVE BEEN AFFORDED THE HIGHEST PRIORITY USE STATUS. IT CAN BE ANTICIPATED THAT SUCH AGRICULTURE USES AND ACTIVITIES MAY NOW OR IN THE FUTURE BE CONDUCTED ON PROPERTY INCLUDED IN THE AGRICULTURE PROTECTION AREA. THE USE AND ENJOYMENT OF THIS PROPERTY IS EXPRESSLY CONDITIONED ON ACCEPTANCE OF ANY ANNOYANCE OR INCONVENIENCE WHICH MAY RESULT FROM SUCH NORMAL AGRICULTURAL USES AND ACTIVITIES.
- 3) ALL BUILDING WALLS ARE PARALLEL WITH, PERPENDICULAR TO REFERENCED BEARING SHOWN ON BUILDING.
- 4) ALL HOUSE PLANS TO BE SIGNED BY ARCHITECTURAL REVIEW COMMITTEE PRIOR TO SUBMITTING FOR BUILDING PERMITS.

DOMINION ENERGY UTAH - NOTE:

Questar Gas Company dba Dominion Energy Utah, hereby approves this plat for the purposes of approximating the location, boundaries, course and dimensions of the rights-of-way and easement grants and existing underground facilities. Nothing herein shall be construed to warrant or verify the precise location of such items. The rights-of-way and easements are subject to numerous restrictions appearing on the recorded Right-of-Way and Easement Grant(s). Dominion Energy Utah also approves this plat for the purpose of confirming that the plat contains public utility easements; however, Dominion Energy Utah may require additional easements in order to serve this development. This approval does not constitute abrogation or waiver of any other existing rights, obligations or liabilities provided by law or equity. This approval does not constitute acceptance, approval or acknowledgement of any terms contained in the plat, including those set forth in the Owners Dedication or the Notes, and does not constitute a guarantee of particular terms or conditions of natural gas service. For further information please contact Dominion Energy Utah's Right-of-Way Department 801-366-8532

QUESTAR GAS COMPANY
dba DOMINION ENERGY UTAH
Approved this _____ day of _____, 20____
By: _____
Title: _____

ROCKY MOUNTAIN POWER ACCEPTANCE

APPROVED THIS _____ DAY OF _____ A.D. 20____, BY THE ROCKY MOUNTAIN POWER COMPANY.
BY: _____ TITLE: _____

DEVELOPER
REVERE HOMES
JOHN CALDWELL (MANAGER)
470 N. 2550 W.
TREMONTON, UTAH 84037
(801)-427-1733

Northern ENGINEERING INC
ENGINEERING-LAND PLANNING
CONSTRUCTION MANAGEMENT

1040 E. 800 N.
OREM, UTAH 84097
(801) 802-8992

SURVEYOR'S CERTIFICATE

I, KENNETH E. BARNEY, DO HEREBY CERTIFY THAT I AM A REGISTERED LAND SURVEYOR, AND THAT I HOLD A LICENSE IN ACCORDANCE WITH TITLE 58, CHAPTER 22, PROFESSIONAL ENGINEERS AND LAND SURVEYORS LICENSING ACT, UTAH CODE ANNOTATED, 1953 AS AMENDED, CERTIFICATE NO. 172762. I FURTHER CERTIFY THAT BY AUTHORITY OF THE OWNERS, I HAVE MADE A SURVEY OF THE TRACT OF LAND SHOWN ON THIS PLAT AND DESCRIBED BELOW (PARCELS 1-15) AND SUBDIVISION PLATS 1) THE ORCHARDS PLAT F-4; 2) THE ORCHARDS PLAT F-5; 3) THE ORCHARDS PLAT F-6 A DISTANCE OF 343.56 FEET TO A POINT OF CURVATURE OF A 4799.00-FOOT RADIUS CURVE TO THE RIGHT; THENCE CONTINUING ALONG THE WESTERLY LINE OF SAID THE ORCHARDS PLAT F-6 THE FOLLOWING TWO (2) COURSES 1) NORTHEASTERLY ALONG THE ARC OF SAID CURVE 18.99 FEET HAVING A CENTRAL ANGLE OF 0°13'36" AND A CHORD THAT BEARS N.52°15'23"E. A DISTANCE OF 18.99 FEET; 2) THENCE N.00°19'22"E. A DISTANCE OF 89.74 FEET MORE OR LESS TO THE SOUTHERLY RIGHT-OF-WAY LINE OF THE UNION PACIFIC RAILROAD TO A POINT OF CURVATURE OF A 4870.00-FOOT RADIUS NON-TANGENT CURVE TO THE RIGHT; THENCE NORTHEASTERLY ALONG THE ARC OF SAID CURVE 79.82 FEET HAVING A CENTRAL ANGLE OF 0°56'21" AND A CHORD THAT BEARS N.53°29'40"E. A DISTANCE OF 79.82 FEET; THENCE S.36°02'26"E. A DISTANCE OF 71.00 FEET TO A POINT OF CURVATURE OF A 15.00-FOOT RADIUS TANGENT CURVE TO THE LEFT; THENCE SOUTHWESTERLY ALONG THE ARC OF SAID CURVE 22.84 FEET HAVING A CENTRAL ANGLE OF 87°14'34" AND A CHORD THAT BEARS S.10°19'47"W. A DISTANCE OF 20.69 FEET; THENCE S.33°17'00"E. A DISTANCE OF 65.86 FEET TO A POINT OF CURVATURE OF A 15.00-FOOT RADIUS NON-TANGENT CURVE TO THE LEFT; THENCE SOUTHEASTERLY ALONG THE ARC OF SAID CURVE 24.29 FEET HAVING A CENTRAL ANGLE OF 92°47'45" AND A CHORD THAT BEARS S.79°40'52"E. A DISTANCE OF 21.72 FEET; THENCE S.31°10'44"E. A DISTANCE OF 40.15 FEET TO A POINT OF CURVATURE OF A 15.00-FOOT RADIUS NON-TANGENT CURVE TO THE LEFT; THENCE SOUTHWESTERLY ALONG THE ARC OF SAID CURVE 22.82 FEET HAVING A CENTRAL ANGLE OF 87°09'44" AND A CHORD THAT BEARS S.10°17'52"W. A DISTANCE OF 20.68 FEET; THENCE S.33°17'00"E. A DISTANCE OF 176.82 FEET TO A POINT OF CURVATURE OF A 15.00-FOOT RADIUS TANGENT CURVE TO THE LEFT; THENCE SOUTHEASTERLY ALONG THE ARC OF SAID CURVE 23.56 FEET HAVING A CENTRAL ANGLE OF 90°00'00" AND A CHORD THAT BEARS S.78°17'02"E. A DISTANCE OF 21.21 FEET; THENCE S.33°17'00"E. A DISTANCE OF 51.00 FEET TO A POINT OF CURVATURE OF A 15.00-FOOT RADIUS NON-TANGENT CURVE TO THE LEFT; THENCE SOUTHWESTERLY ALONG THE ARC OF SAID CURVE 23.56 FEET HAVING A CENTRAL ANGLE OF 90°00'00" AND A CHORD THAT BEARS S.11°43'00"W. A DISTANCE OF 21.21 FEET; THENCE S.33°17'00"E. A DISTANCE OF 64.37 FEET MORE OR LESS TO THE NORTHERLY LINE OF THE ORCHARDS PLAT D-1 SUBDIVISION PLAT; THENCE ALONG SAID ORCHARDS PLAT D-1 BOUNDARY LINE THE FOLLOWING COURSE: THENCE S.56°55'08"W. A DISTANCE OF 55.00 FEET TO THE REAL POINT OF BEGINNING

BOUNDARY DESCRIPTION

A PARCEL OF LAND LOCATED IN THE NORTHEAST QUARTER OF SECTION 35, TOWNSHIP 9 SOUTH, RANGE 1 EAST, SALT LAKE BASE AND MERIDIAN, UTAH COUNTY, UTAH. MORE PARTICULARLY DESCRIBED AS:

COMMENCING AT A BRASS CAP MONUMENT MARKING THE EAST 1/4 CORNER OF SAID SECTION 35, THENCE S.89°09'29"W. ALONG THE 1/4 SECTION LINE A DISTANCE OF 1136.31 FEET; THENCE NORTH A DISTANCE OF 553.11 FEET TO THE REAL POINT OF BEGINNING

THENCE N.33°17'00"W. A DISTANCE OF 66.50 FEET; THENCE N.30°22'22"W. A DISTANCE OF 53.14 FEET; THENCE S.56°43'00"W. A DISTANCE OF 85.13 FEET; THENCE N.33°17'00"W. ALONG THE EASTERLY LINE OF THE FOLLOWING THREE (3) RECORDED SUBDIVISION PLATS 1) THE ORCHARDS PLAT F-4; 2) THE ORCHARDS PLAT F-5; AND 3) THE ORCHARDS PLAT F-6 A DISTANCE OF 343.56 FEET TO A POINT OF CURVATURE OF A 4799.00-FOOT RADIUS CURVE TO THE RIGHT; THENCE CONTINUING ALONG THE WESTERLY LINE OF SAID THE ORCHARDS PLAT F-6 THE FOLLOWING TWO (2) COURSES 1) NORTHEASTERLY ALONG THE ARC OF SAID CURVE 18.99 FEET HAVING A CENTRAL ANGLE OF 0°13'36" AND A CHORD THAT BEARS N.52°15'23"E. A DISTANCE OF 18.99 FEET; 2) THENCE N.00°19'22"E. A DISTANCE OF 89.74 FEET MORE OR LESS TO THE SOUTHERLY RIGHT-OF-WAY LINE OF THE UNION PACIFIC RAILROAD TO A POINT OF CURVATURE OF A 4870.00-FOOT RADIUS NON-TANGENT CURVE TO THE RIGHT; THENCE NORTHEASTERLY ALONG THE ARC OF SAID CURVE 79.82 FEET HAVING A CENTRAL ANGLE OF 0°56'21" AND A CHORD THAT BEARS N.53°29'40"E. A DISTANCE OF 79.82 FEET; THENCE S.36°02'26"E. A DISTANCE OF 71.00 FEET TO A POINT OF CURVATURE OF A 15.00-FOOT RADIUS TANGENT CURVE TO THE LEFT; THENCE SOUTHWESTERLY ALONG THE ARC OF SAID CURVE 22.84 FEET HAVING A CENTRAL ANGLE OF 87°14'34" AND A CHORD THAT BEARS S.10°19'47"W. A DISTANCE OF 20.69 FEET; THENCE S.33°17'00"E. A DISTANCE OF 65.86 FEET TO A POINT OF CURVATURE OF A 15.00-FOOT RADIUS NON-TANGENT CURVE TO THE LEFT; THENCE SOUTHEASTERLY ALONG THE ARC OF SAID CURVE 24.29 FEET HAVING A CENTRAL ANGLE OF 92°47'45" AND A CHORD THAT BEARS S.79°40'52"E. A DISTANCE OF 21.72 FEET; THENCE S.31°10'44"E. A DISTANCE OF 40.15 FEET TO A POINT OF CURVATURE OF A 15.00-FOOT RADIUS NON-TANGENT CURVE TO THE LEFT; THENCE SOUTHWESTERLY ALONG THE ARC OF SAID CURVE 22.82 FEET HAVING A CENTRAL ANGLE OF 87°09'44" AND A CHORD THAT BEARS S.10°17'52"W. A DISTANCE OF 20.68 FEET; THENCE S.33°17'00"E. A DISTANCE OF 176.82 FEET TO A POINT OF CURVATURE OF A 15.00-FOOT RADIUS TANGENT CURVE TO THE LEFT; THENCE SOUTHEASTERLY ALONG THE ARC OF SAID CURVE 23.56 FEET HAVING A CENTRAL ANGLE OF 90°00'00" AND A CHORD THAT BEARS S.78°17'02"E. A DISTANCE OF 21.21 FEET; THENCE S.33°17'00"E. A DISTANCE OF 51.00 FEET TO A POINT OF CURVATURE OF A 15.00-FOOT RADIUS NON-TANGENT CURVE TO THE LEFT; THENCE SOUTHWESTERLY ALONG THE ARC OF SAID CURVE 23.56 FEET HAVING A CENTRAL ANGLE OF 90°00'00" AND A CHORD THAT BEARS S.11°43'00"W. A DISTANCE OF 21.21 FEET; THENCE S.33°17'00"E. A DISTANCE OF 64.37 FEET MORE OR LESS TO THE NORTHERLY LINE OF THE ORCHARDS PLAT D-1 SUBDIVISION PLAT; THENCE ALONG SAID ORCHARDS PLAT D-1 BOUNDARY LINE THE FOLLOWING COURSE: THENCE S.56°55'08"W. A DISTANCE OF 55.00 FEET TO THE REAL POINT OF BEGINNING

CONTAINING 63,556 sq.ft. OR 1.46 acres MORE OR LESS.

OWNER'S DEDICATION

KNOW ALL MEN BY THESE PRESENTS THAT WE, ALL OF THE UNDERSIGNED OWNERS OF ALL THE PROPERTY DESCRIBED IN THE SURVEYOR'S CERTIFICATE HEREON AND SHOWN ON THIS MAP, HAVE CAUSED THE SAME TO BE SUBDIVIDED INTO LOTS, STREETS, AND EASEMENTS AND DO HEREBY DEDICATE THE STREETS AND OTHER PUBLIC AREAS AS INDICATED HEREON TO SANTAQUIN CITY FOR PERPETUAL USE OF THE PUBLIC.

IN WITNESS WHEREOF WE HAVE HERETO SET OUR HANDS THIS DAY OF _____ A.D. 20____.

BY: _____ JOHN CALDWELL, OWNER REVERE HOMES, LLC

ACKNOWLEDGMENT

STATE OF UTAH 1-S.S.
COUNTY OF UTAH J-S.S.

ON THIS _____ DAY OF _____, IN THE YEAR 20____, BEFORE ME, _____, PERSONALLY APPEARED JOHN CALDWELL, WHO DULY ACKNOWLEDGED TO ME THAT (S)HE IS AN OWNER _____, [MEMBER WITH MANAGEMENT AUTHORITY] [MANAGER] OF REVERE HOMES, _____, A UTAH LIMITED LIABILITY COMPANY, AND IS AUTHORIZED TO EXECUTE THE FOREGOING AGREEMENT IN ITS BEHALF AND THAT HE OR SHE EXECUTED IT IN SUCH CAPACITY.

NOTARY PUBLIC _____
NOTARY FULL NAME _____ A NOTARY COMMISSIONED IN UTAH
COMMISSION NUMBER _____ MY COMMISSION EXPIRES _____

ACCEPTANCE BY LEGISLATIVE BODY

THE CITY COUNCIL OF SANTAQUIN, COUNTY OF UTAH, APPROVES THIS SUBDIVISION AND HEREBY ACCEPTS THE DEDICATION OF ALL STREETS, EASEMENTS, AND OTHER PARCELS OF LAND INTENDED FOR PUBLIC PURPOSES FOR THE PERPETUAL USE OF THE PUBLIC THIS _____ DAY OF _____ A.D. 20____.

APPROVED BY MAYOR _____
APPROVED _____ ATTEST _____
CITY ENGINEER (SEE SEAL) CITY RECORDER (SEE SEAL)

APPLE HOLLOW AT THE ORCHARDS PLAT B-1

A PARCEL OF LAND LOCATED IN THE NORTHEAST QUARTER OF SECTION 35, TOWNSHIP 9 SOUTH, RANGE 1 EAST SALT LAKE BASE AND MERIDIAN
SANTAQUIN _____ UTAH COUNTY, UTAH
SCALE: 1" = 30 FEET

NOTARY PUBLIC SEAL SURVEYOR'S SEAL CLERK-RECORDER SEAL UTAH COUNTY RECORDER STAMP

LEGEND

- FOUND BRASS CAP
- SET 5/8" IRON PIN
- CALCULATED POINT, NOT SET
- PROPERTY BOUNDARY
- CENTERLINE
- RIGHT-OF-WAY LINE
- LOT LINE
- SECTION LINE
- EASEMENT
- EXISTING DEED LINE
- LIMITED COMMON AREA
- PRIVATE AREA
- COMMON AREA (EXCLUDES PUBLIC ROADWAYS)

CURVE TABLE

CURVE	LENGTH	RADIUS	CHORD DIST.	CHORD BRG.	DELTA
C1	22.84'	15.00'	20.69'	S10°19'47"W	87°14'34"
C2	24.29'	15.00'	21.72'	S79°40'52"E	92°47'45"
C3	22.82'	15.00'	20.68'	S10°17'52"W	87°09'44"
C4	18.99'	4799.00'	18.99'	N52°15'23"E	0°13'36"
C5	23.56'	15.00'	21.21'	S11°43'00"W	90°00'00"
C6	79.82'	4870.00'	79.82'	N53°29'40"E	0°56'21"
C7	23.56'	15.00'	21.21'	S78°17'02"E	90°00'00"
C8	76.96'	4830.00'	76.96'	S53°06'48"W	0°54'46"
C9	32.83'	4830.00'	32.83'	S53°45'53"W	0°23'22"
C10	51.66'	4799.00'	51.66'	S52°40'41"W	0°37'00"
C11	24.54'	15.00'	21.89'	N80°08'43"W	93°43'27"
C13	29.29'	300.00'	29.28'	N30°29'11"W	5°35'38"
C15	29.29'	300.00'	29.28'	N30°29'11"W	5°35'38"




GRID FACTOR: 0.99961
NAD 27
STAT PLAN
COORDINATED


NORTHING	EASTING
A 603525.85	1919958.33
B 604062.05	1918822.58
C 604117.62	1918786.10
D 604163.45	1918759.24
E 604116.75	1918688.10
F 604403.84	1918499.63
G 604415.46	1918514.64
H 604505.17	1918515.15
I 604552.63	1918579.28
J 604495.24	1918621.04
K 604474.89	1918617.33
L 604419.86	1918653.46
M 604415.97	1918674.82
N 604381.64	1918695.60
O 604361.30	1918691.90
P 604213.54	1918788.90
Q 604209.23	1918809.66
R 604166.61	1918837.64
S 604145.85	1918833.33
T 604092.06	1918868.65

APPLE HOLLOW AT THE ORCHARDS PLAT B-2

A PARCEL OF LAND LOCATED IN THE NORTHEAST QUARTER OF SECTION 35, TOWNSHIP 9 SOUTH, RANGE 1 EAST SALT LAKE BASE AND MERIDIAN

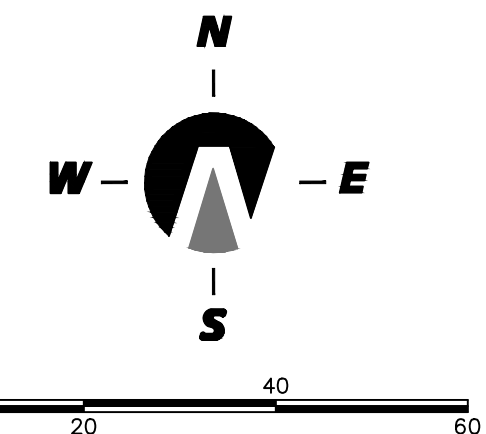

TYPICAL BUILDING SETBACKS & PUBLIC UTILITY EASEMENTS

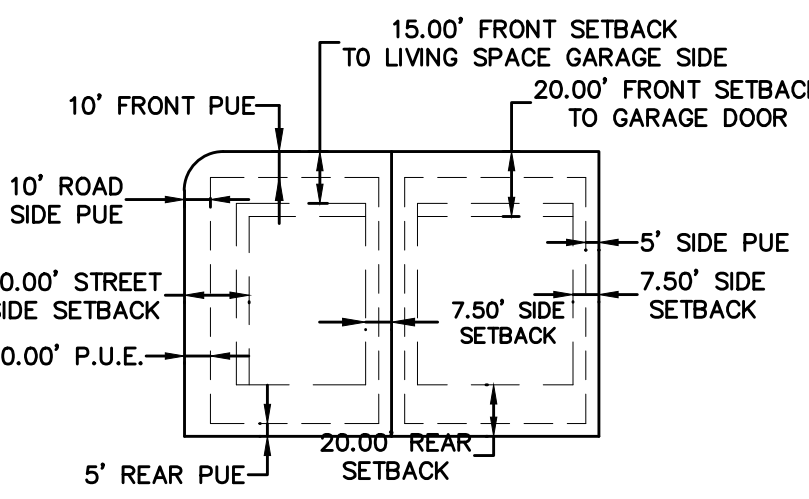

SURVEYOR'S CERTIFICATE

I, KENNETH E. BARNEY, DO HEREBY CERTIFY THAT I AM A REGISTERED LAND SURVEYOR, AND THAT I HOLD A LICENSE IN ACCORDANCE WITH TITLE 58, CHAPTER 22, PROFESSIONAL ENGINEERS AND LAND SURVEYORS LICENSING ACT, UTAH CODE ANNOTATED, 1953 AS AMENDED, CERTIFICATE NO. 172762. I FURTHER CERTIFY THAT BY AUTHORITY OF THE OWNERS, I HAVE MADE A SURVEY OF THE TRACT OF LAND SHOWN ON THIS PLAT AND DESCRIBED BELOW (PARCELS 30-030-00085 & 30-030-00085), HAVE SUBDIVIDED SAID TRACT OF LAND INTO LOTS, STREETS, AND EASEMENTS, HAVE COMPLETED A SURVEY OF THE PROPERTY DESCRIBED ON THIS PLAT IN ACCORDANCE WITH SECTION 17-23-17, UTAH CODE ANNOTATED, 1953 AS AMENDED, HAVE VERIFIED ALL MEASUREMENTS, AND HAVE PLACED MONUMENTS AS REPRESENTED ON THE PLAT. I FURTHER CERTIFY THAT EVERY EXISTING RIGHT-OF-WAY AND EASEMENT GRANT OF RECORD FOR UNDERGROUND FACILITIES, AS DEFINED IN SECTION 54-8a-2, UTAH CODE ANNOTATED, 1953 AS AMENDED, AND FOR OTHER UTILITY FACILITIES, IS ACCURATELY DESCRIBED ON THIS PLAT, AND THAT THIS PLAT IS TRUE AND CORRECT.

BOUNDARY DESCRIPTION

A PARCEL OF LAND LOCATED IN THE NORTHEAST QUARTER OF SECTION 35, TOWNSHIP 9 SOUTH, RANGE 1 EAST, SALT LAKE BASE AND MERIDIAN, UTAH COUNTY, UTAH, MORE PARTICULARLY DESCRIBED AS:

COMMENCING AT A BRASS CAP MONUMENT MARKING THE EAST 1/4 CORNER OF SAID SECTION 35, THENCE S.89°09'29"W ALONG THE 1/4 SECTION LINE A DISTANCE OF 1191.42 FEET; THENCE NORTH A DISTANCE OF 487.63 FEET TO THE REAL POINT OF BEGINNING

THENCE N.33°17'00"W ALONG THE EASTERLY LINE OF THE FOLLOWING TWO (2) RECORDED SUBDIVISION PLATS THE ORCHARDS PLAT F-4; 2) THE ORCHARDS PLAT F-5; AND A DISTANCE OF 144.75 FEET; THENCE N.56°43'00"E A DISTANCE OF 85.14 FEET; THENCE S.30°22'22"E A DISTANCE OF 53.14 FEET; THENCE S.33°17'00"E A DISTANCE OF 66.50 FEET MORE OR LESS TO THE NORTHERLY LINE OF THE ORCHARDS PLAT D-1 SUBDIVISION PLAT; THENCE ALONG SAID ORCHARDS PLAT D-1 BOUNDARY LINE THE FOLLOWING TWO (2) COURSES: 1) THENCE S.33°04'52"E A DISTANCE OF 25.18 FEET; 2) THENCE S.56°43'00"W A DISTANCE OF 82.35 FEET TO THE REAL POINT OF BEGINNING

CONTAINING 12,004 sq.ft. OR 0.28 acres MORE OR LESS.

OWNER'S DEDICATION

KNOW ALL MEN BY THESE PRESENTS THAT WE, ALL OF THE UNDERSIGNED OWNERS OF ALL THE PROPERTY DESCRIBED IN THE SURVEYOR'S CERTIFICATE HEREON AND SHOWN ON THIS MAP, HAVE CAUSED THE SAME TO BE SUBDIVIDED INTO LOTS, STREETS, AND EASEMENTS AND DO HEREBY DEDICATE THE STREETS AND OTHER PUBLIC AREAS AS INDICATED HEREON TO SANTAQUIN CITY FOR PERPETUAL USE OF THE PUBLIC. IN WITNESS WHEREOF WE HAVE HEREUNTO SET OUR HANDS THIS DAY OF _____, A.D. 20____.

BY: JOHN CALDWELL, OWNER REVERE HOMES, LLC

ACKNOWLEDGMENT

STATE OF UTAH } s.s.
COUNTY OF UTAH }
ON THIS _____ DAY OF _____, IN THE YEAR 20____, BEFORE ME, _____, PERSONALLY APPEARED JOHN CALDWELL, WHO DULY ACKNOWLEDGED TO ME THAT (S)HE IS A OWNER _____ [MEMBER WITH MANAGEMENT AUTHORITY] (MANAGER) OF REVERE HOMES _____ A UTAH LIMITED LIABILITY COMPANY, AND IS AUTHORIZED TO EXECUTE THE FOREGOING AGREEMENT IN ITS BEHALF AND THAT HE OR SHE EXECUTED IT IN SUCH CAPACITY.

NOTARY PUBLIC _____
NOTARY FULL NAME _____ A NOTARY COMMISSIONED IN UTAH
COMMISSION NUMBER _____ MY COMMISSION EXPIRES _____

ACCEPTANCE BY LEGISLATIVE BODY

THE CITY COUNCIL OF SANTAQUIN, COUNTY OF UTAH, APPROVES THIS SUBDIVISION AND HEREBY ACCEPTS THE DEDICATION OF ALL STREETS, EASEMENTS, AND OTHER PARCELS OF LAND INTENDED FOR PUBLIC PURPOSES FOR THE PERPETUAL USE OF THE PUBLIC THIS _____ DAY OF _____, A.D. 20____.

APPROVED BY MAYOR _____ ATTEST _____
CITY ENGINEER (SEE SEAL) CITY RECORDER (SEE SEAL)

ROCKY MOUNTAIN POWER ACCEPTANCE

APPROVED THIS _____ DAY OF _____, A.D. 20____, BY THE ROCKY MOUNTAIN POWER COMPANY.
BY _____ TITLE _____

APPLE HOLLOW AT THE ORCHARDS PLAT B-2

A PARCEL OF LAND LOCATED IN THE NORTHEAST QUARTER OF SECTION 35, TOWNSHIP 9 SOUTH, RANGE 1 EAST SALT LAKE BASE AND MERIDIAN
SANTAQUIN _____ UTAH COUNTY, UTAH
SCALE: 1" = 20 FEET

NOTARY PUBLIC SEAL SURVEYOR'S SEAL CLERK-RECORDER SEAL UTAH COUNTY RECORDER STAMP

GRID FACTOR: 0.99961

NAD 27 STAT PLAN COORDINATED	
NORTHING	EASTING
A 603525.85	1919958.33
B 603995.79	1918767.50
C 604416.75	1918688.10
D 604163.45	1918759.24
E 604117.62	1918786.10
F 604062.05	1918822.58
G 604040.96	1918836.32

- #### LEGEND
- FOUND BRASS CAP
 - SET 5/8" IRON PIN
 - CALCULATED POINT, NOT SET
 - PROPERTY BOUNDARY
 - CENTERLINE
 - RIGHT-OF-WAY LINE
 - LOT LINE
 - SECTION LINE
 - EASEMENT
 - EXISTING DEED LINE

NOTES:

1) ALL LIMITED COMMON AREA & OPEN SPACE AREAS ARE DEDICATED AS PUBLIC UTILITY EASEMENTS.
2) THIS PROPERTY IS LOCATED IN THE VICINITY OF AN ESTABLISHED AGRICULTURE PROTECTION AREA IN WHICH NORMAL AGRICULTURAL USES AND ACTIVITIES HAVE BEEN AFFORDED THE HIGHEST PRIORITY USE STATUS. IT CAN BE ANTICIPATED THAT SUCH AGRICULTURE USES AND ACTIVITIES MAY NOW OR IN THE FUTURE BE CONDUCTED ON PROPERTY INCLUDED IN THE AGRICULTURE PROTECTION AREA. THE USE AND ENJOYMENT OF THIS PROPERTY IS EXPRESSLY CONDITIONED ON ACCEPTANCE OF ANY ANNOYANCE OR INCONVENIENCE WHICH MAY RESULT FROM SUCH NORMAL AGRICULTURAL USES AND ACTIVITIES.




DOMINION ENERGY UTAH - NOTE:

Questar Gas Company dba Dominion Energy Utah, hereby approves this plat for the purposes of approximating the location, boundaries, course and dimensions of the rights-of-way and easement grants and existing underground facilities. Nothing herein shall be construed to warrant or verify the precise location of such items. The rights-of-way and easements are subject to numerous restrictions appearing on the recorded Right-of-Way and Easement Grant(s). Dominion Energy Utah also approves this plat for the purpose of confirming that the plat contains public utility easements; however, Dominion Energy Utah may require additional easements in order to serve this development. This approval does not constitute abrogation or waiver of any other existing rights, obligations or liabilities provided by law or equity. This approval does not constitute acceptance, approval or acknowledgement of any terms contained in the plat, including those set forth in the Owners Dedication or the Notes, and does not constitute a guarantee of particular terms or conditions of natural gas service. For further information please contact Dominion Energy Utah's Right-of-Way Department 8010-366-8532

QUESTAR GAS COMPANY
dba DOMINION ENERGY UTAH
Approved this _____ day of _____, 20____
By: _____
Title: _____

DEVELOPER
REVERE HOMES
JOHN CALDWELL (MANAGER)
470 N. 2550 W.
TREMONTON, UTAH 84337
(801)-427-1733

Northern ENGINEERING INC
ENGINEERING-LAND PLANNING
CONSTRUCTION MANAGEMENT
1040 E. 800 N.
OREM, UTAH 84097
(801) 802-8992

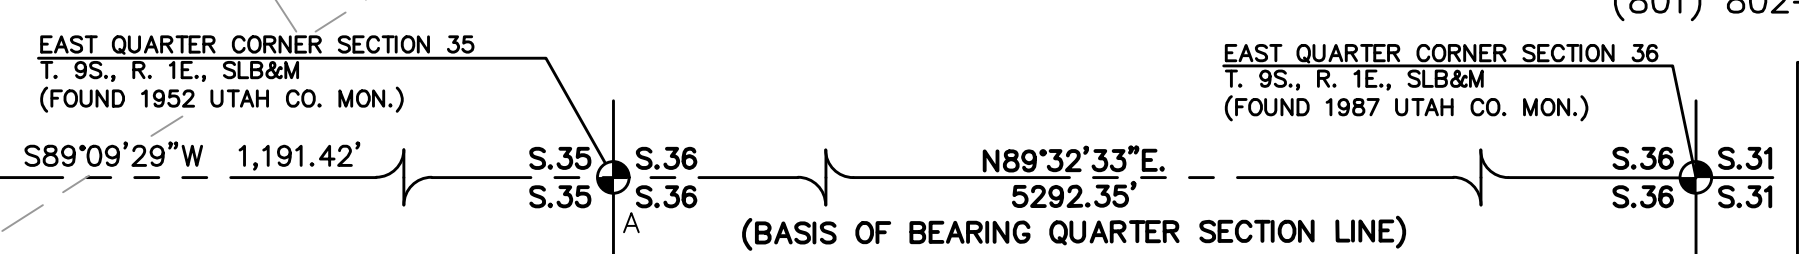

APPLE HOLLOW @ THE ORCHARDS "B-PHASE 1"

SANTAQUIN, UTAH

JANUARY, 2024



(24"x36")
 SCALE 1" = 40'
 (11"x17")
 SCALE 1" = 80'



THESE DRAWINGS, OR ANY PORTION THEREOF, SHALL NOT BE USED ON ANY PROJECT OR EXTENSIONS OF THIS PROJECT EXCEPT BY AGREEMENT IN WRITING WITH NORTHERN ENGINEERING, INC.

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4		DRAWN BY:	DATE:
3		CHECKED BY:	DATE:
2		APPROVED:	DATE:
1		COGO FILE:	DATE:
NO.	REVISIONS	BY	DATE
		REV. COGO FILE:	DATE:




Northern ENGINEERING INC
 ENGINEERING-LAND PLANNING
 CONSTRUCTION MANAGEMENT

1040 E. 800 N.
 OREM, UTAH 84097
 (801) 802-8992


APPLE HOLLOW @ THE ORCHARDS "B-PHASE 1"

SITE PLAN/PHASING PLAN	JOB NO. 3-20-031
SANTAQUIN, UTAH	SHEET NO. SP-01

K:\3-20-031-00 Apple Hollow\CAD\Design\Apple Hollow CONCEPT 11 SHEET SET PHASE 1.dwg

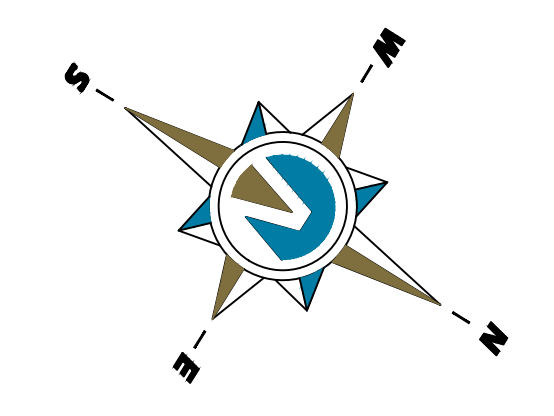

(24"x36")
SCALE 1" = 20'
(11"x17")
SCALE 1" = 40'

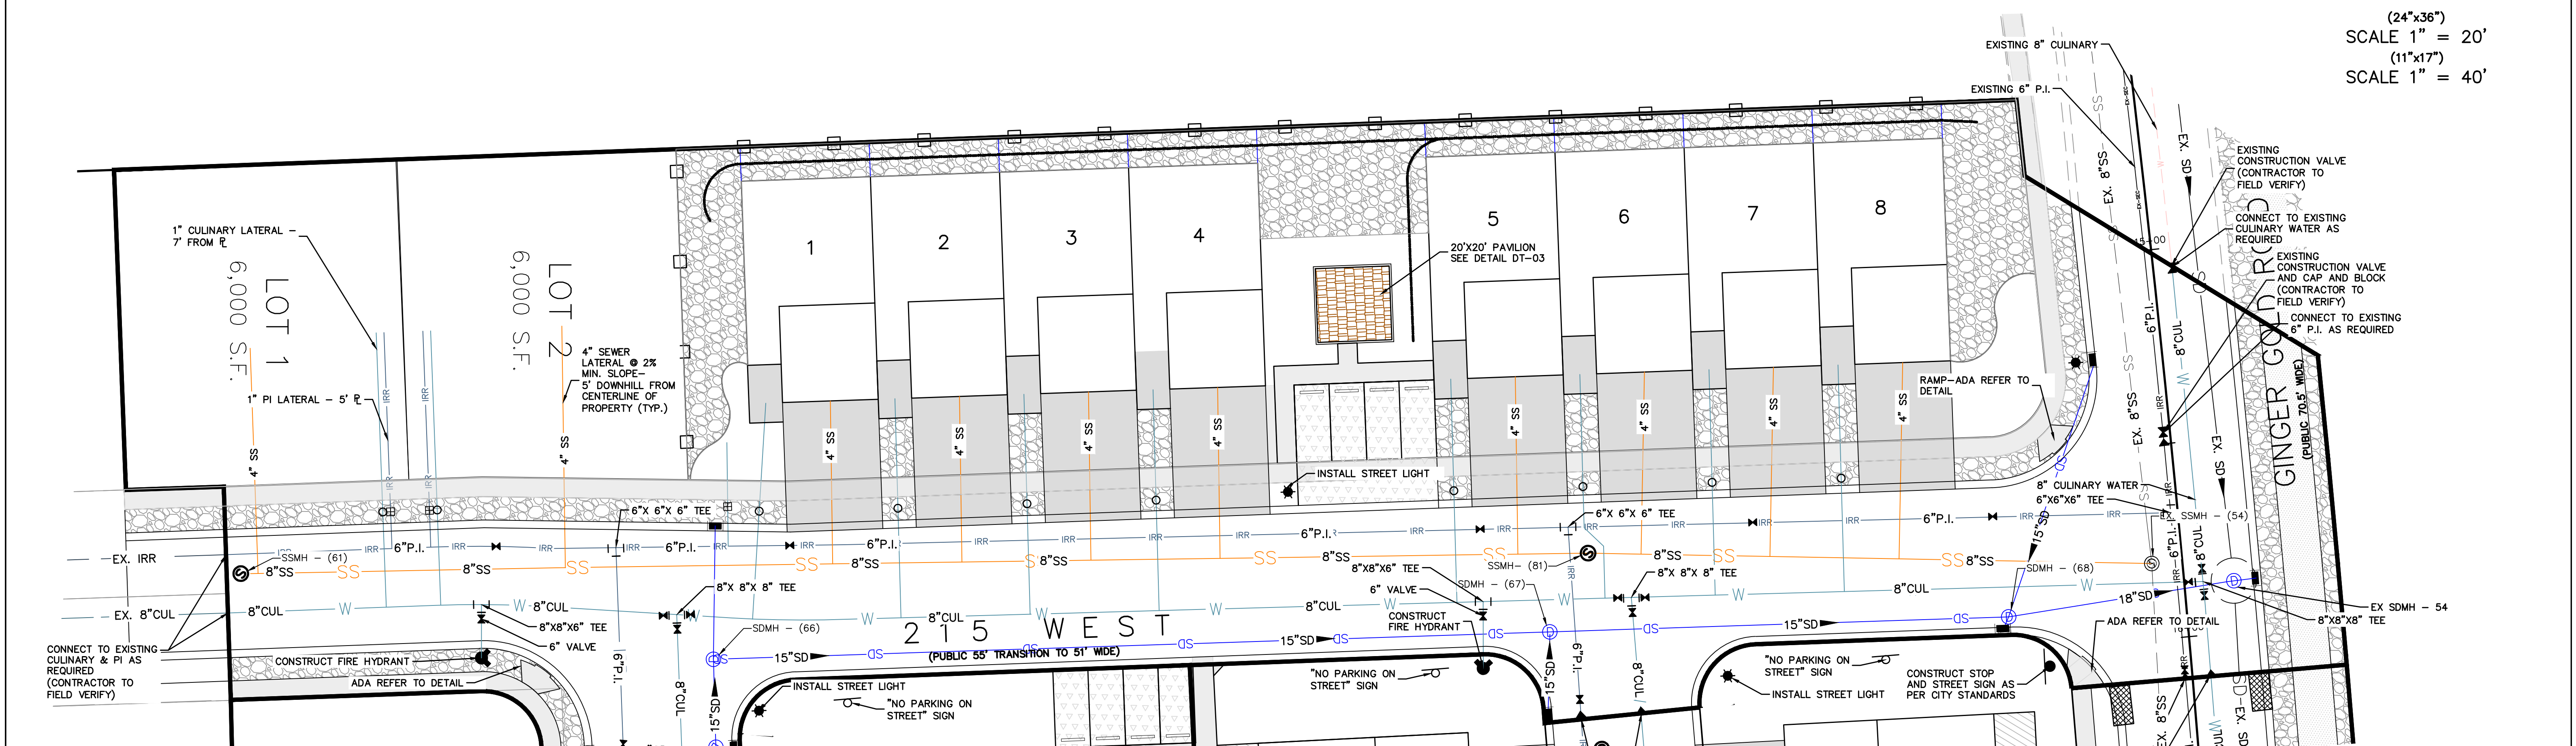

- NOTES:**
- CONTRACTOR TO VERIFY THE LOCATION & DEPTH OF ALL EXISTING UTILITIES PRIOR TO CONSTRUCTION AND NOTIFY ENGINEER OF ANY DISCREPANCIES.
 - SEE DETAILS SHEET DT-02 FOR UTILITY LATERAL LOCATIONS PER SANTAQUIN CITY STANDARDS.
 - NOTE TO DEVELOPER AND GENERAL CONTRACTOR: IT IS IMPORTANT FOR THE DEVELOPER AND THE GENERAL CONTRACTOR TO UNDERSTAND THAT IT IS HIS/HER RESPONSIBILITY TO ENSURE THAT ALL IMPROVEMENTS INSTALLED WITHIN THIS DEVELOPMENT ARE CONSTRUCTED IN FULL COMPLIANCE WITH ALL STATE AND SANTAQUIN CITY CODES, ORDINANCES AND STANDARDS. THE DEVELOPMENT PLANS ARE NOT ALL INCLUSIVE OF ALL MINIMUM CODES, ORDINANCES AND STANDARDS, THIS FACT DOES NOT RELIEVE THE DEVELOPER OR GENERAL CONTRACTOR FROM FULL COMPLIANCE WITH ALL MINIMUM STATE AND SANTAQUIN CITY STANDARDS.
 - CULINARY AND P.I. SHALL BE CAPPED AND BLOCKED AT PHASE LINE AND PROVIDE LOCATION MARKER. CONSTRUCTION VALVES TO BE PLACED AT END OF PHASE PAVEMENT IMPROVEMENTS, PROVIDE AIR VAC VALVE AS PER CITY STANDARDS. SEWER TO BE STUBBED AT PHASE, STORM DRAIN TO BE CONNECTED TO EXISTING SYSTEM, TEMPORARY TURNAROUND TO BE INSTALLED AS PER CITY STANDARDS.
 - ALL RECOMMENDATIONS MADE IN PERTINENT GEOTECHNICAL REPORT SHALL BE FOLLOWED EXPLICITLY DURING CONSTRUCTION OF BUILDING AND SITE IMPROVEMENTS.
 - EXISTING UNDERGROUND STORM DRAIN INFILTRATION GALLERY TO REMAIN IN-PLACE & NOT BE DAMAGED DURING CONSTRUCTION.
 - PLACE 10' MINIMUM L.F. OF RIP-RAP ON EAST END OF C&G TO PREVENT EROSION.
 - SIDEWALK, TRAIL, & LANDSCAPING WILL BE INSTALLED BY DEVELOPER'S & CONTRACTOR.

- NOTES TO CONTRACTOR:**
- CONTRACTOR TO FIELD VERIFY ALL EXISTING CURB & CUTTER, STORM DRAIN, CHANNEL CROSSINGS, AND SEWER ELEVATIONS OR INVERTS PRIOR TO CONSTRUCTION AND NOTIFY ENGINEER WHEN ELEVATIONS OR INVERTS DO NOT MATCH PLANS.
 - THE LOCATIONS OF EXISTING UNDERGROUND UTILITIES ARE SHOWN IN APPROXIMATE LOCATIONS. THE CONTRACTOR SHALL DETERMINE THE EXACT LOCATION OF ALL EXISTING UTILITIES BEFORE COMMENCING WORK. HE AGREES TO BE FULLY RESPONSIBLE FOR ANY AND ALL DAMAGES WHICH MIGHT BE OCCASIONED BY HIS FAILURE TO EXACTLY LOCATE AND PRESERVE ANY AND ALL UNDERGROUND UTILITIES.

CAP & BLOCK CULINARY & P.I. AT PHASE LINE & PROVIDE LOCATION MARKER AS REQUIRED. CONSTRUCTION VALVES TO BE PLACED AT END OF PHASE PAVEMENT IMPROVEMENTS. PROVIDE AIR VAC FOR P.I. PER CITY STANDARDS.

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K:\3-20-031-00 Apple Hollow\CAD\Design\Apple Hollow CONCEPT 11 SHEET SET PHASE 1.dwg			









Northern ENGINEERING INC
ENGINEERING—LAND PLANNING
CONSTRUCTION MANAGEMENT

1040 E. 800 N.
OREM, UTAH 84097
(801) 802-8992

APPLE HOLLOW @ THE ORCHARDS "B-PHASE 1"


SITE UTILITY PLAN— PHASE A	JOB NO. 3-20-031
SANTAQUIN, UTAH	SHEET NO. UT-01

LANDSCAPING LEGEND:

-  LANDSCAPE ROCK: TWO TO FOUR INCH (2" TO 4") DECORATIVE COBBLE ROCK. A SAMPLE OF THE PROPOSED MATERIAL MUST BE SUBMITTED TO AND APPROVED BY SANTAQUIN CITY PRIOR TO PLACING. COBBLE ROCK MULCH SHALL BE INSTALLED TO AN AVERAGE DEPTH OF FOUR INCHES (4") AND SHALL COMPLETELY COVER ALL PLANTER STRIP AREA. PRIOR TO INSTALLATION OF COBBLE ROCK, MULCH, A MIRAFI 600 (OR APPROVED EQUIVALENT) FABRIC MUST BE APPLIED TO THE PLANTER STRIP AREA.
-  HELICTOTRICHON SEMPERVIRENS / BLUE OAT GRASS, 1-GAL.
-  CALAMAGROSTIS X ACUTIFLORA FOERSTER / FEATHER REED GRASS, 1-GAL.
-  EUONYMUS ALATUS COMPACTUS / COMPACT BURNING BUSH, 5-GAL.
-  RHAMNUS FRANGULA COLUMNARIS / ALDER BUCKTHORN, 5-GAL.
-  TILA AMERICAN REDMUND / REDMUND AMERICAN LINDEN, 2" - 2.5" CAL.
-  ACER FREEMAN / AUTUMN BLAZE MAPLE, 2" - 2.5" CAL.
-  PICEA PUNGENS / COLORADO "BLUE" SPRUCE, 2" - 2.5" CAL. (6' MIN HEIGHT)

NOTES:

1. STANDARD PLANTING PLAN FOR PLANTER AREAS ALONG GINGER GOLD ROAD. CONTRACTOR TO GET CITY APPROVAL PRIOR TO INSTALLATION.
2. ALL LANDSCAPING TO BE DONE ACCORDING TO SANTAQUIN CITY STANDARDS AND SPECIFICATIONS.
3. IRRIGATION TO BE DESIGNED BY OTHERS AND SUBMITTED TO CITY FOR APPROVAL BEFORE INSTALLATION.
4. GROUP TREES IN CLUSTERS AND VARIETY ALTERNATING BETWEEN GROUPS OF THREE.
5. TREES SHALL NOT BE PLANTED LESS THAN 5-FT FROM CURBS OR HARD SURFACE AREAS UNLESS A ROOT BARRIER IS INSTALLED NEXT TO HARDSCAPE SURFACE.
6. CONTRACTOR TO PLANT ALL TREES AND SHRUBS ACCORDING TO SANTAQUIN CITY PLANTING STANDARDS.
7. ANY PROPOSED SUBSTITUTIONS OF PLAN SPECIES SHALL BE MADE WITH PLANTS OF EQUIVALENT OVERALL FORM, HEIGHT, BRANCHING HABIT, FLOWER, LEAF, COLOR, FRUIT AND CULTURE.
8. ALL TREES UP TO 2.5" CAL. SHALL BE DOUBLE STAKED AND ALL DECIDUOUS TREES GREATER THAN 2" CAL. AND ALL EVERGREEN TREES 6' AND TALLER SHALL BE TRIPLE STAKED OR GUYED.
9. NO PLANT MATERIAL SHALL BE PLANTED WITHIN 1-FT OF ANY WALK EDGE.
10. ALL PLANTING AREAS INCLUDING TREE AND SHRUB AREAS TO RECEIVE COMMERCIAL GRADE WEED BARRIER.
11. NO SOD GRASS IN PLANTER STRIP
12. 35% MAXIMUM SOD-GRASS ALLOWED IN FROM OR SIDE YARD AS REQUIRED.

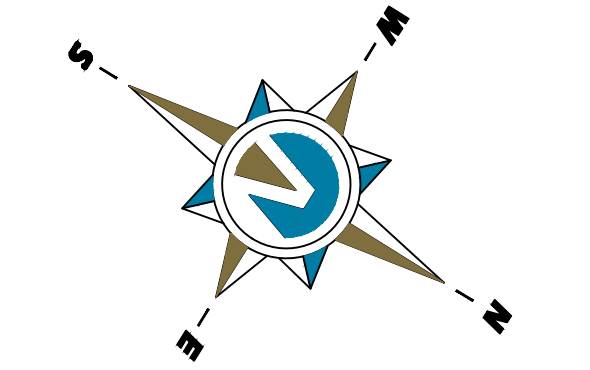

(24"x36")
SCALE 1" = 20'
(11"x17")
SCALE 1" = 40'



THESE DRAWINGS, OR ANY PORTION THEREOF, SHALL NOT BE USED ON ANY PROJECT OR EXTENSIONS OF THIS PROJECT EXCEPT BY AGREEMENT IN WRITING WITH NORTHERN ENGINEERING, INC.

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1		COGO FILE:	DATE:
NO.	REVISIONS	BY	DATE
K:\3-20-031-00 Apple Hollow\CAD\Design\Apple Hollow CONCEPT 11 SHEET SET PHASE 1.dwg		REV. COGO FILE:	DATE:

Northern ENGINEERING INC
ENGINEERING—LAND PLANNING
CONSTRUCTION MANAGEMENT



1040 E. 800 N.
OREM, UTAH 84097
(801) 802-8992

APPLE HOLLOW @ THE ORCHARDS
"B-PHASE 1"


LANDSCAPE PLAN	JOB NO. 3-20-031
SANTAQUIN, UTAH	SHEET NO. LS-01

NOTES:

- NOTE TO DEVELOPER AND GENERAL CONTRACTOR: IT IS IMPORTANT FOR THE DEVELOPER AND THE GENERAL CONTRACTOR TO UNDERSTAND THAT IT IS HIS/HER RESPONSIBILITY TO ENSURE THAT ALL IMPROVEMENTS INSTALLED WITHIN THIS DEVELOPMENT ARE CONSTRUCTED IN FULL COMPLIANCE WITH ALL STATE AND SANTAQUIN CITY CODES, ORDINANCES AND STANDARDS. THE DEVELOPMENT PLANS ARE NOT ALL INCLUSIVE OF ALL MINIMUM CODES, ORDINANCES AND STANDARDS, THIS FACT DOES NOT RELIEVE THE DEVELOPER OR GENERAL CONTRACTOR FROM FULL COMPLIANCE WITH ALL MINIMUM STATE AND SANTAQUIN CITY STANDARDS.
- ALL RECOMMENDATIONS MADE IN PERTINENT GEOTECHNICAL REPORT SHALL BE FOLLOWED EXPLICITLY DURING CONSTRUCTION OF BUILDING AND SITE IMPROVEMENTS.
- INSTALL P.I. DRAIN TO CONNECT TO SDMH AS SHOWN AS PER CITY STANDARDS.
- PLACE 10' MINIMUM L.F. OF RIP-RAP ON EAST END OF C&G TO PREVENT EROSION.

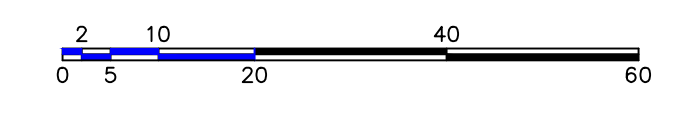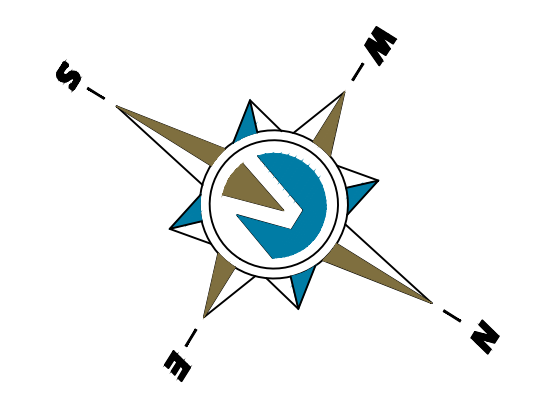

(24"x36")
 SCALE 1" = 20'
 (11"x17")
 SCALE 1" = 40'

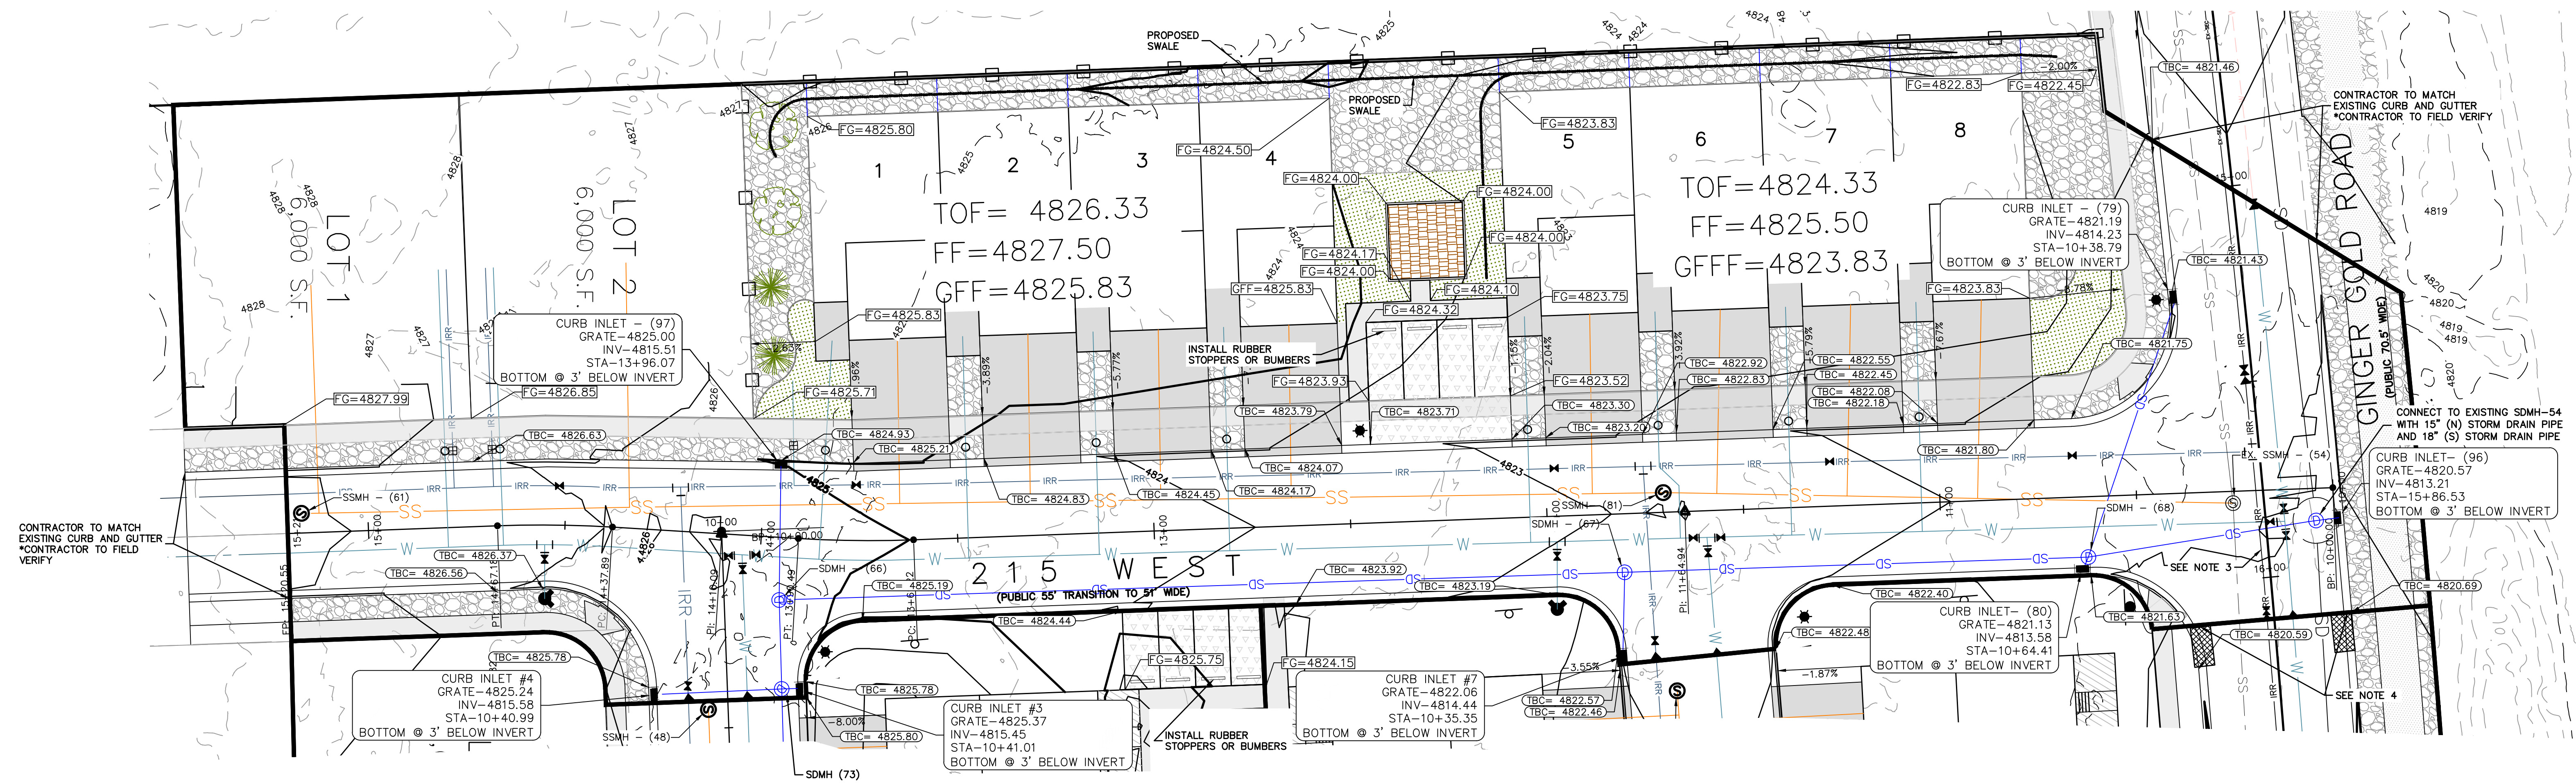

CONTRACTOR TO MATCH EXISTING CURB AND GUTTER
 *CONTRACTOR TO FIELD VERIFY

CONTRACTOR TO MATCH EXISTING CURB AND GUTTER
 *CONTRACTOR TO FIELD VERIFY

CONNECT TO EXISTING SDMH-54 WITH 15" (N) STORM DRAIN PIPE AND 18" (S) STORM DRAIN PIPE

NOTES TO CONTRACTOR:

- CONTRACTOR TO FIELD VERIFY ALL EXISTING CURB & GUTTER, STORM DRAIN, CHANNEL CROSSINGS, AND SEWER ELEVATIONS OR INVERTS PRIOR TO CONSTRUCTION AND NOTIFY ENGINEER WHEN ELEVATIONS OR INVERTS DO NOT MATCH PLANS.
- THE LOCATIONS OF EXISTING UNDERGROUND UTILITIES ARE SHOWN IN APPROXIMATE LOCATIONS. THE CONTRACTOR SHALL DETERMINE THE EXACT LOCATION OF ALL EXISTING UTILITIES BEFORE COMMENCING WORK. HE AGREES TO BE FULLY RESPONSIBLE FOR ANY AND ALL DAMAGES WHICH MIGHT BE OCCASIONED BY HIS FAILURE TO EXACTLY LOCATE AND PRESERVE ANY AND ALL UNDERGROUND UTILITIES.

NOTES:

- 2% MAX GRADE FOR ALL ADA PARKING SPACES AND ACCESS AISLE.

LEGEND:
 TOF= TOP OF FOUNDATION
 FF=FINISHED FLOOR
 GFF=GARAGE FINISHED FLOOR
 BFF= BASEMENT FINISHED FLOOR

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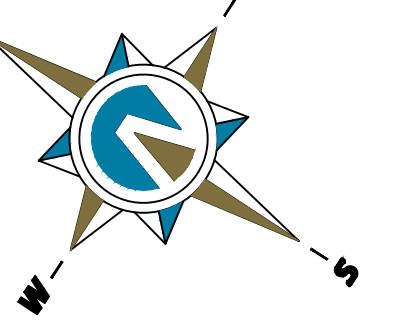
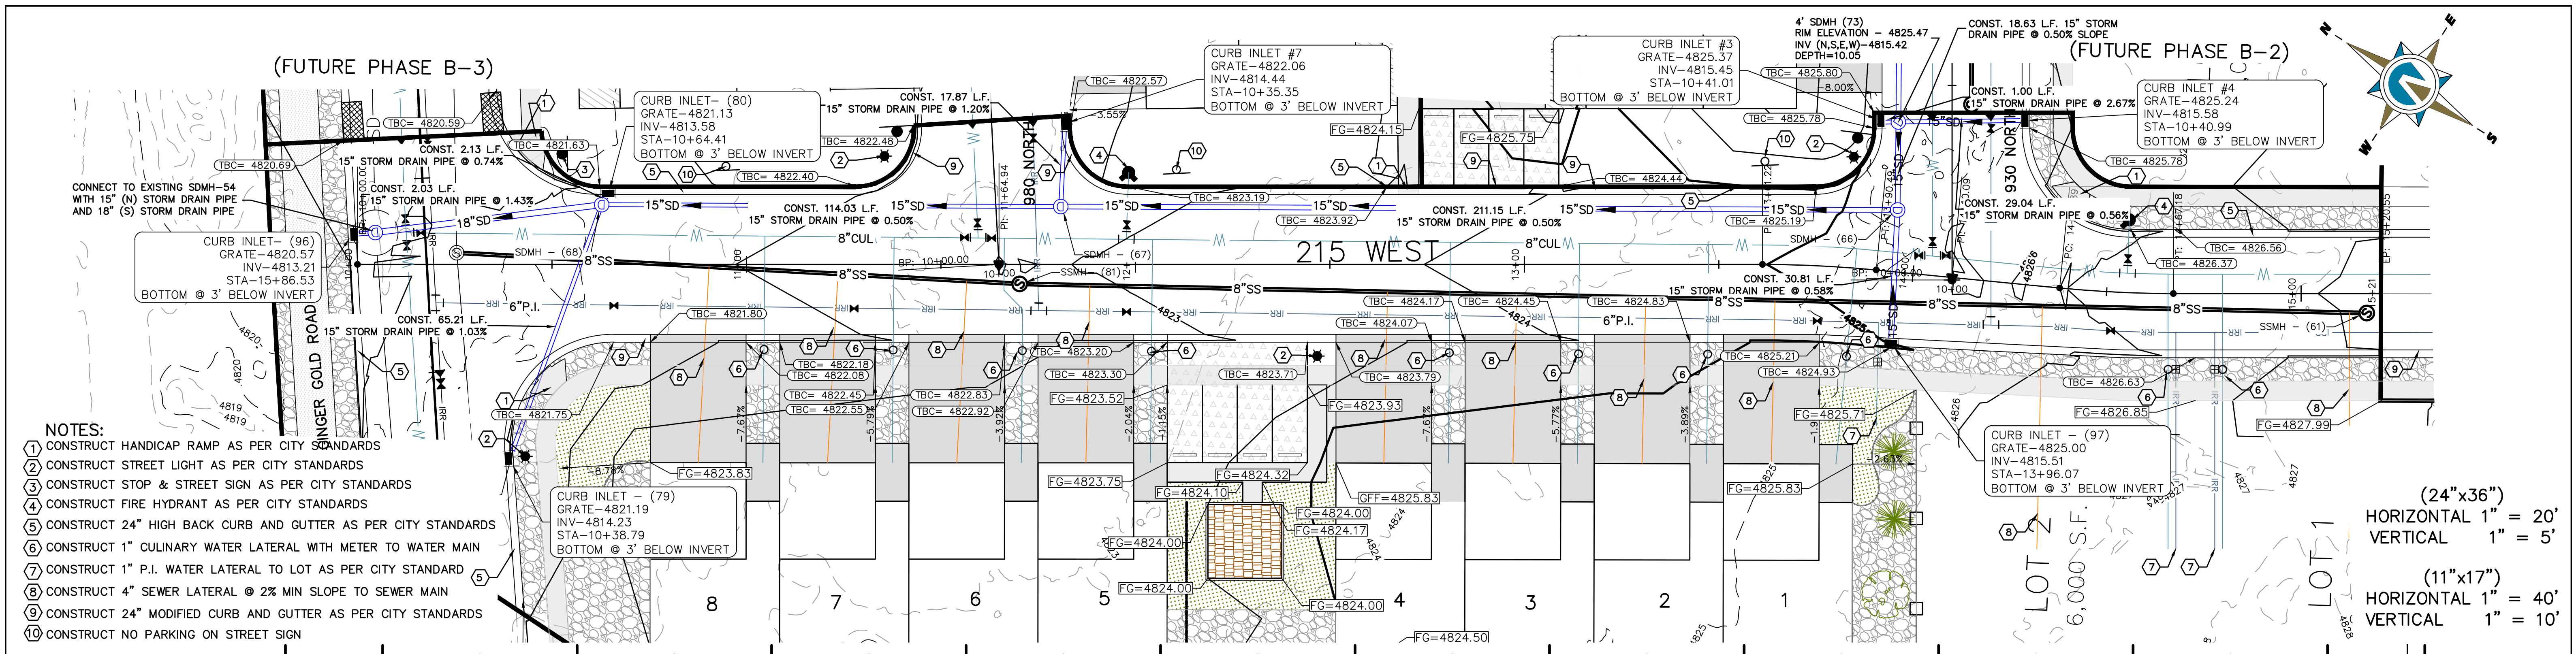
Northern ENGINEERING INC
 ENGINEERING-LAND PLANNING
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APPLE HOLLOW @ THE ORCHARDS "B-PHASE 1"


SITE GRADING AND DRAINAGE PLAN
 SANTAQUIN, UTAH

JOB NO. 3-20-031
 SHEET NO. GR-01



(24"x36")
HORIZONTAL 1" = 20'
VERTICAL 1" = 5'

(11"x17")
HORIZONTAL 1" = 40'
VERTICAL 1" = 10'

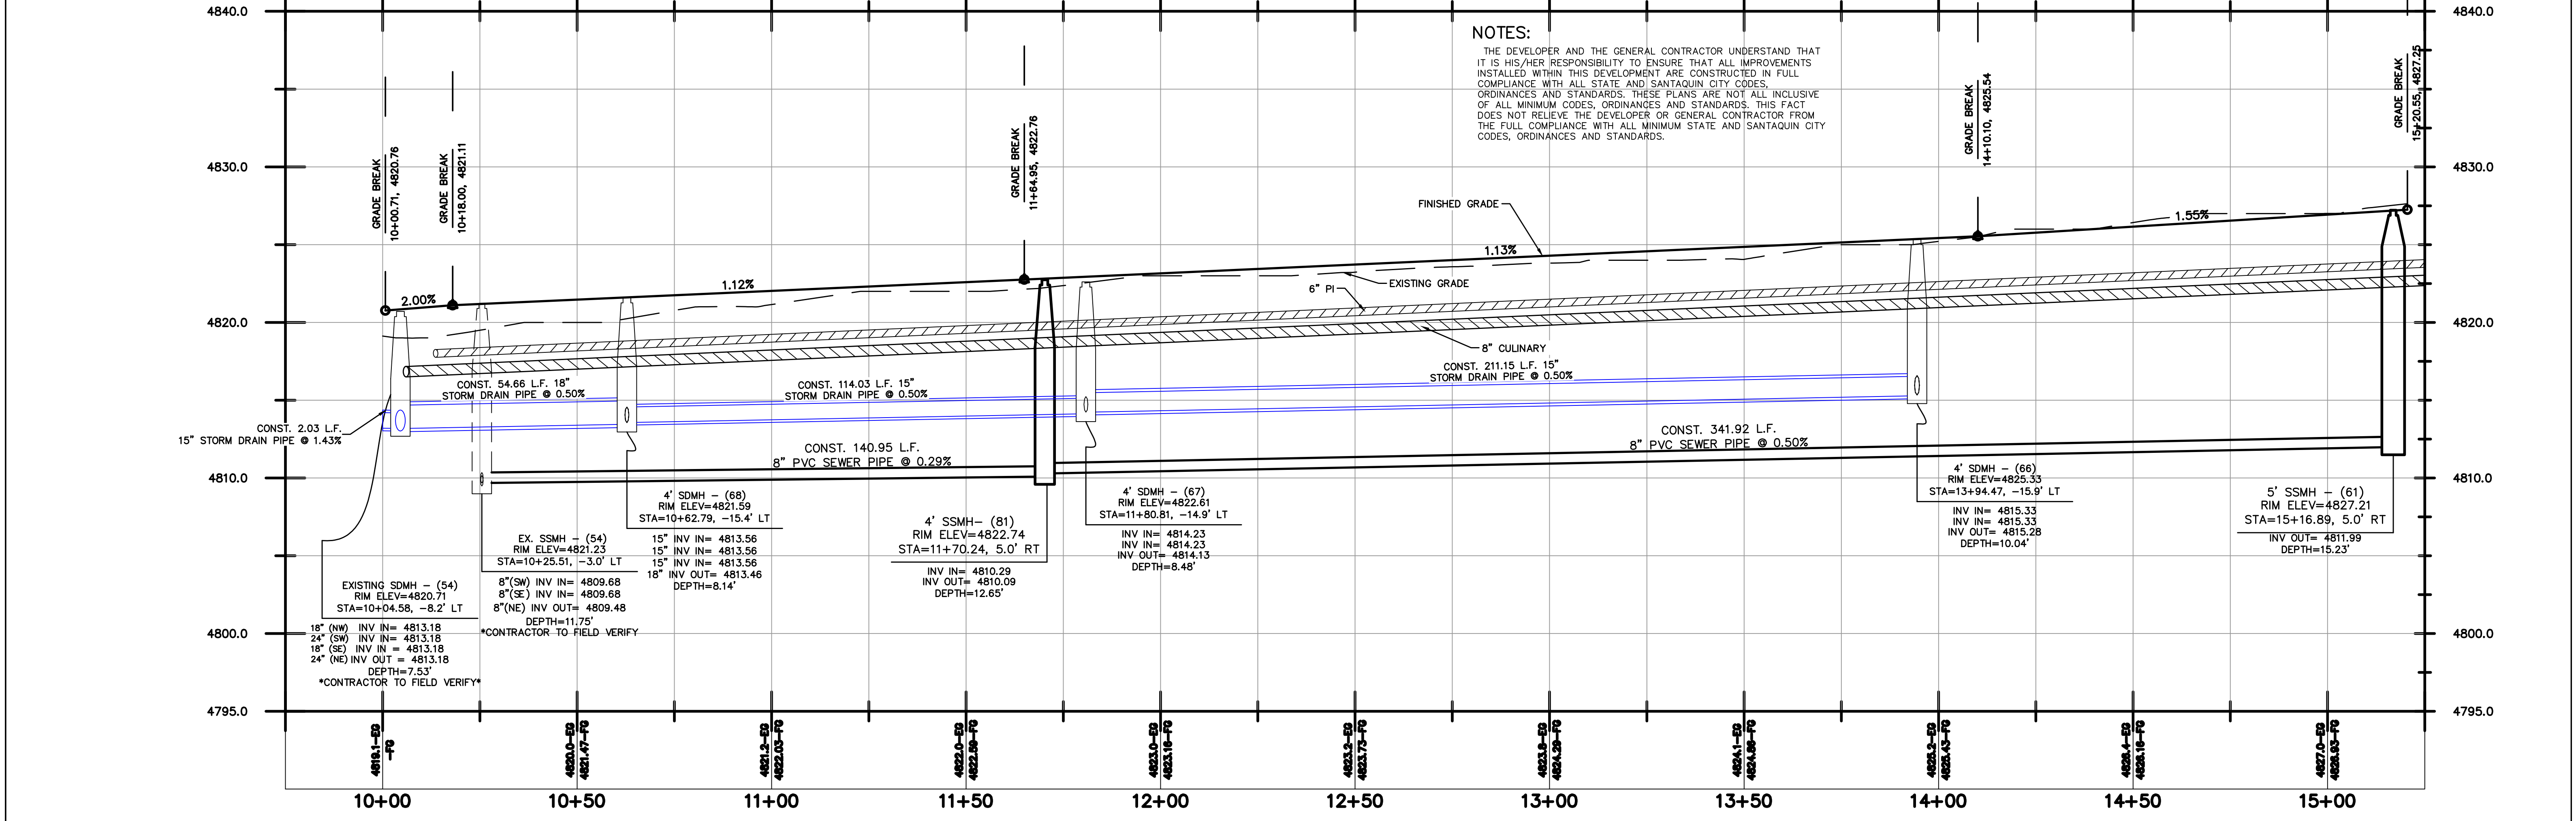

NO.	REVISIONS	BY	DATE	REV. COGO FILE	DATE
5					
4					
3					
2					
1					

DESIGNED BY:	DATE:
DRAWN BY:	DATE:
CHECKED BY:	DATE:
APPROVED:	DATE:
COGO FILE:	DATE:
BY:	DATE:
REV. COGO FILE:	DATE:

Northern ENGINEERING INC

ENGINEERING—LAND PLANNING
CONSTRUCTION MANAGEMENT

1040 E. 800 N.
OREM, UTAH 84097
(801) 802-8992

APPLE HOLLOW @ THE ORCHARDS "B-PHASE 1"

215 WEST PLAN & PROFILE

SANTAQUIN, UTAH

JOB NO. 3-20-031



SHEET NO. PP-01

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- NOTES:**
- 1 CONSTRUCT HANDICAP RAMP AS PER CITY STANDARDS
 - 2 CONSTRUCT STREET LIGHT AS PER CITY STANDARDS
 - 3 CONSTRUCT STOP & STREET SIGN AS PER CITY STANDARDS
 - 4 CONSTRUCT FIRE HYDRANT AS PER CITY STANDARDS
 - 5 CONSTRUCT 24" HIGH BACK CURB AND GUTTER AS PER CITY STANDARDS
 - 6 CONSTRUCT 1" CULINARY WATER LATERAL WITH METER TO WATER MAIN
 - 7 CONSTRUCT 1" P.I. WATER LATERAL TO LOT AS PER CITY STANDARD
 - 8 CONSTRUCT 4" SEWER LATERAL @ 2% MIN SLOPE TO SEWER MAIN
 - 9 CONSTRUCT 24" MODIFIED CURB AND GUTTER AS PER CITY STANDARDS


NOTES:

THE DEVELOPER AND THE GENERAL CONTRACTOR UNDERSTAND THAT IT IS HIS/HER RESPONSIBILITY TO ENSURE THAT ALL IMPROVEMENTS INSTALLED WITHIN THIS DEVELOPMENT ARE CONSTRUCTED IN FULL COMPLIANCE WITH ALL STATE AND SANTAQUIN CITY CODES, ORDINANCES AND STANDARDS. THESE PLANS ARE NOT ALL INCLUSIVE OF ALL MINIMUM CODES, ORDINANCES AND STANDARDS. THIS FACT DOES NOT RELIEVE THE DEVELOPER OR GENERAL CONTRACTOR FROM THE FULL COMPLIANCE WITH ALL MINIMUM STATE AND SANTAQUIN CITY CODES, ORDINANCES AND STANDARDS.

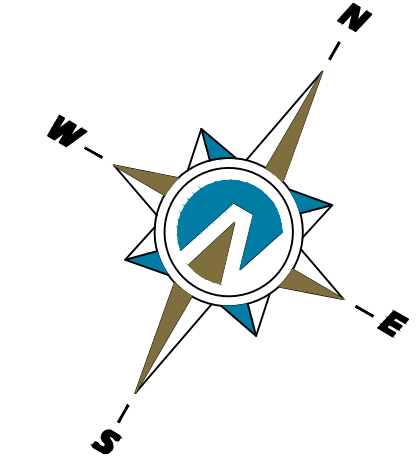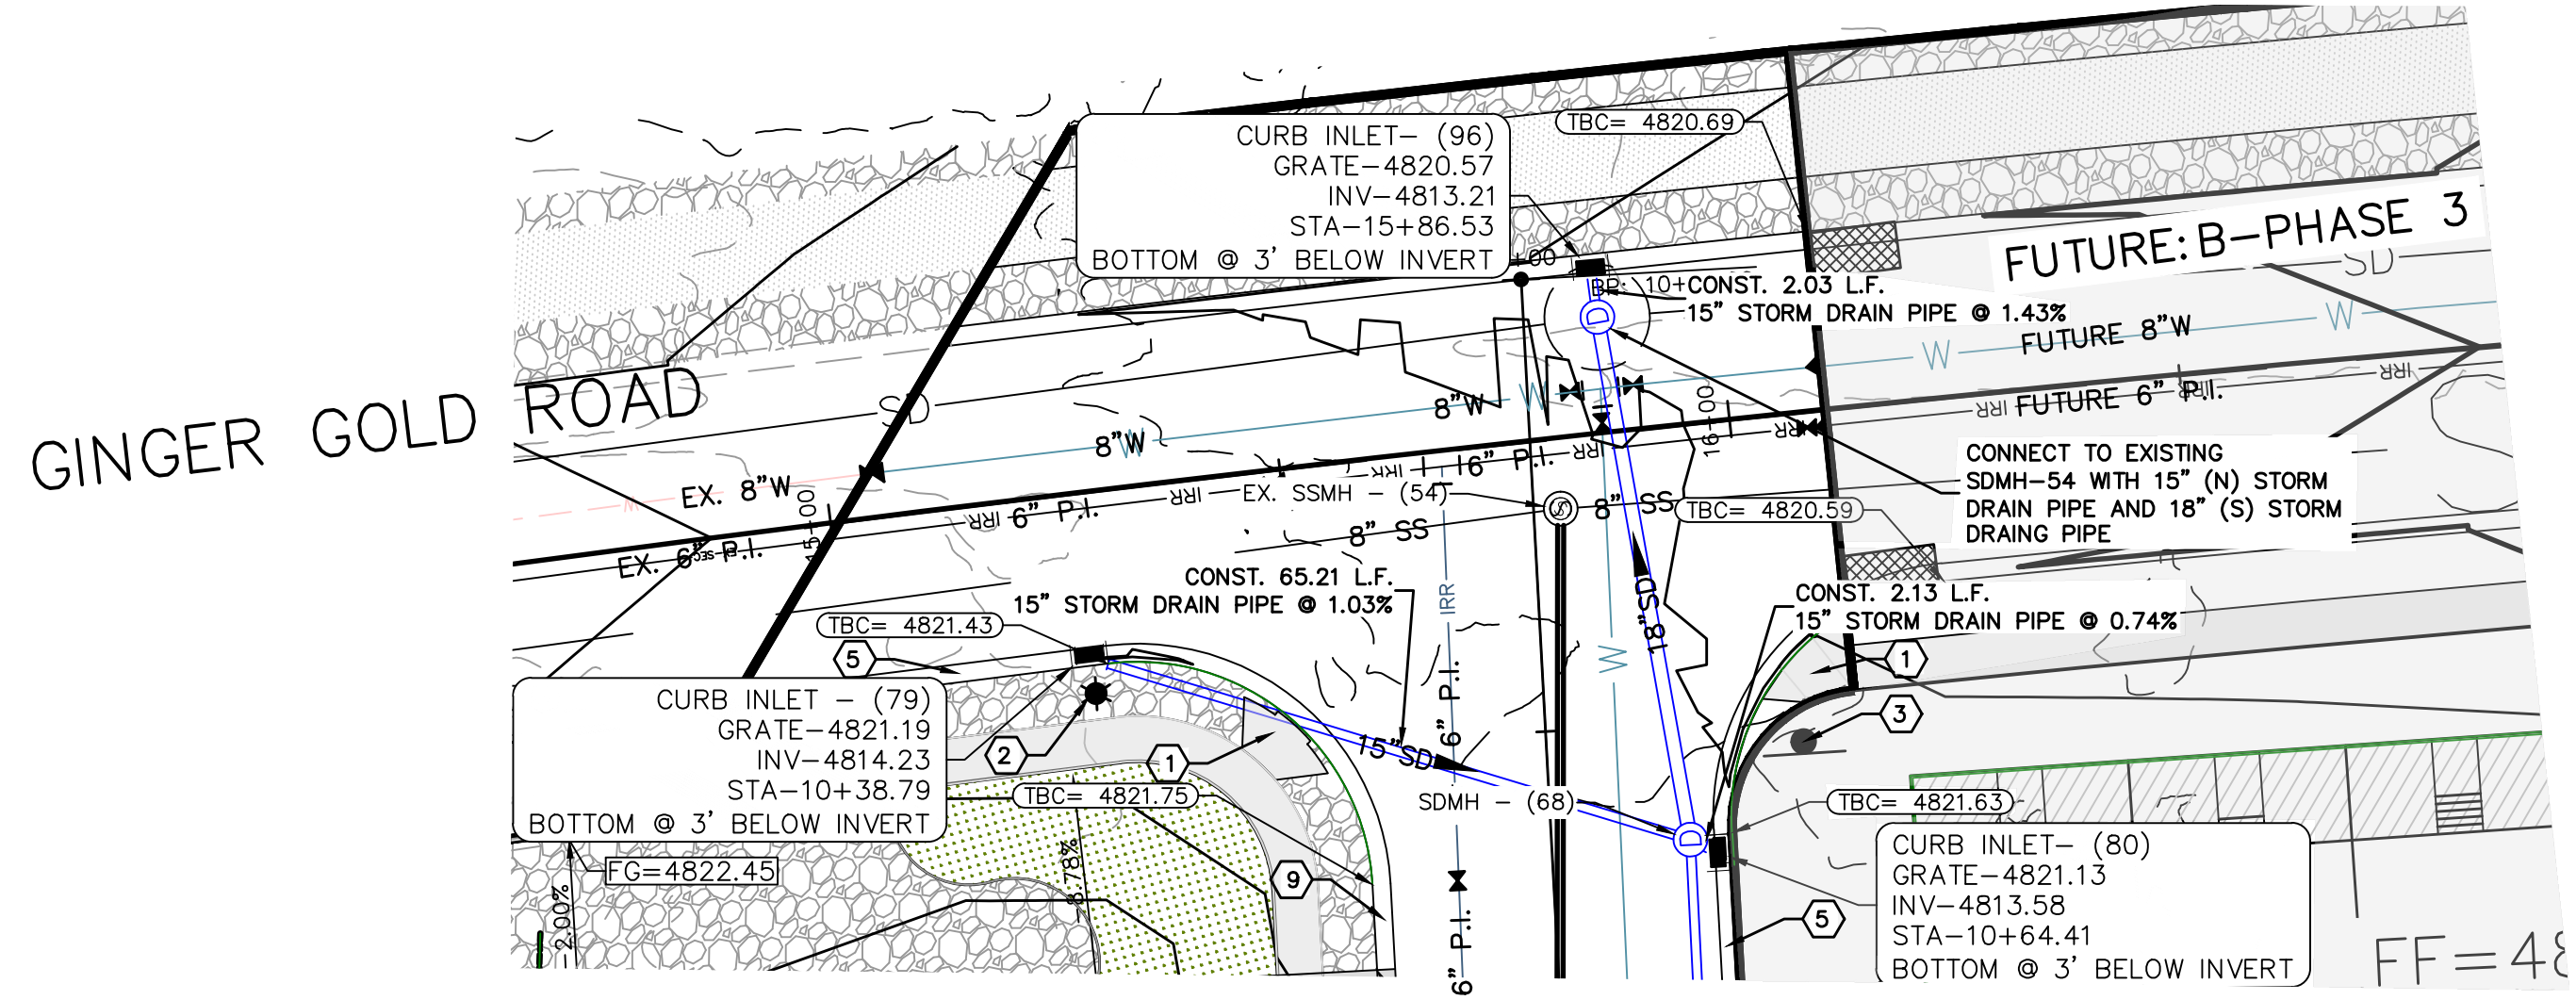

(24"x36")
 HORIZONTAL 1" = 20'
 VERTICAL 1" = 5'

(11"x17")
 HORIZONTAL 1" = 40'
 VERTICAL 1" = 10'

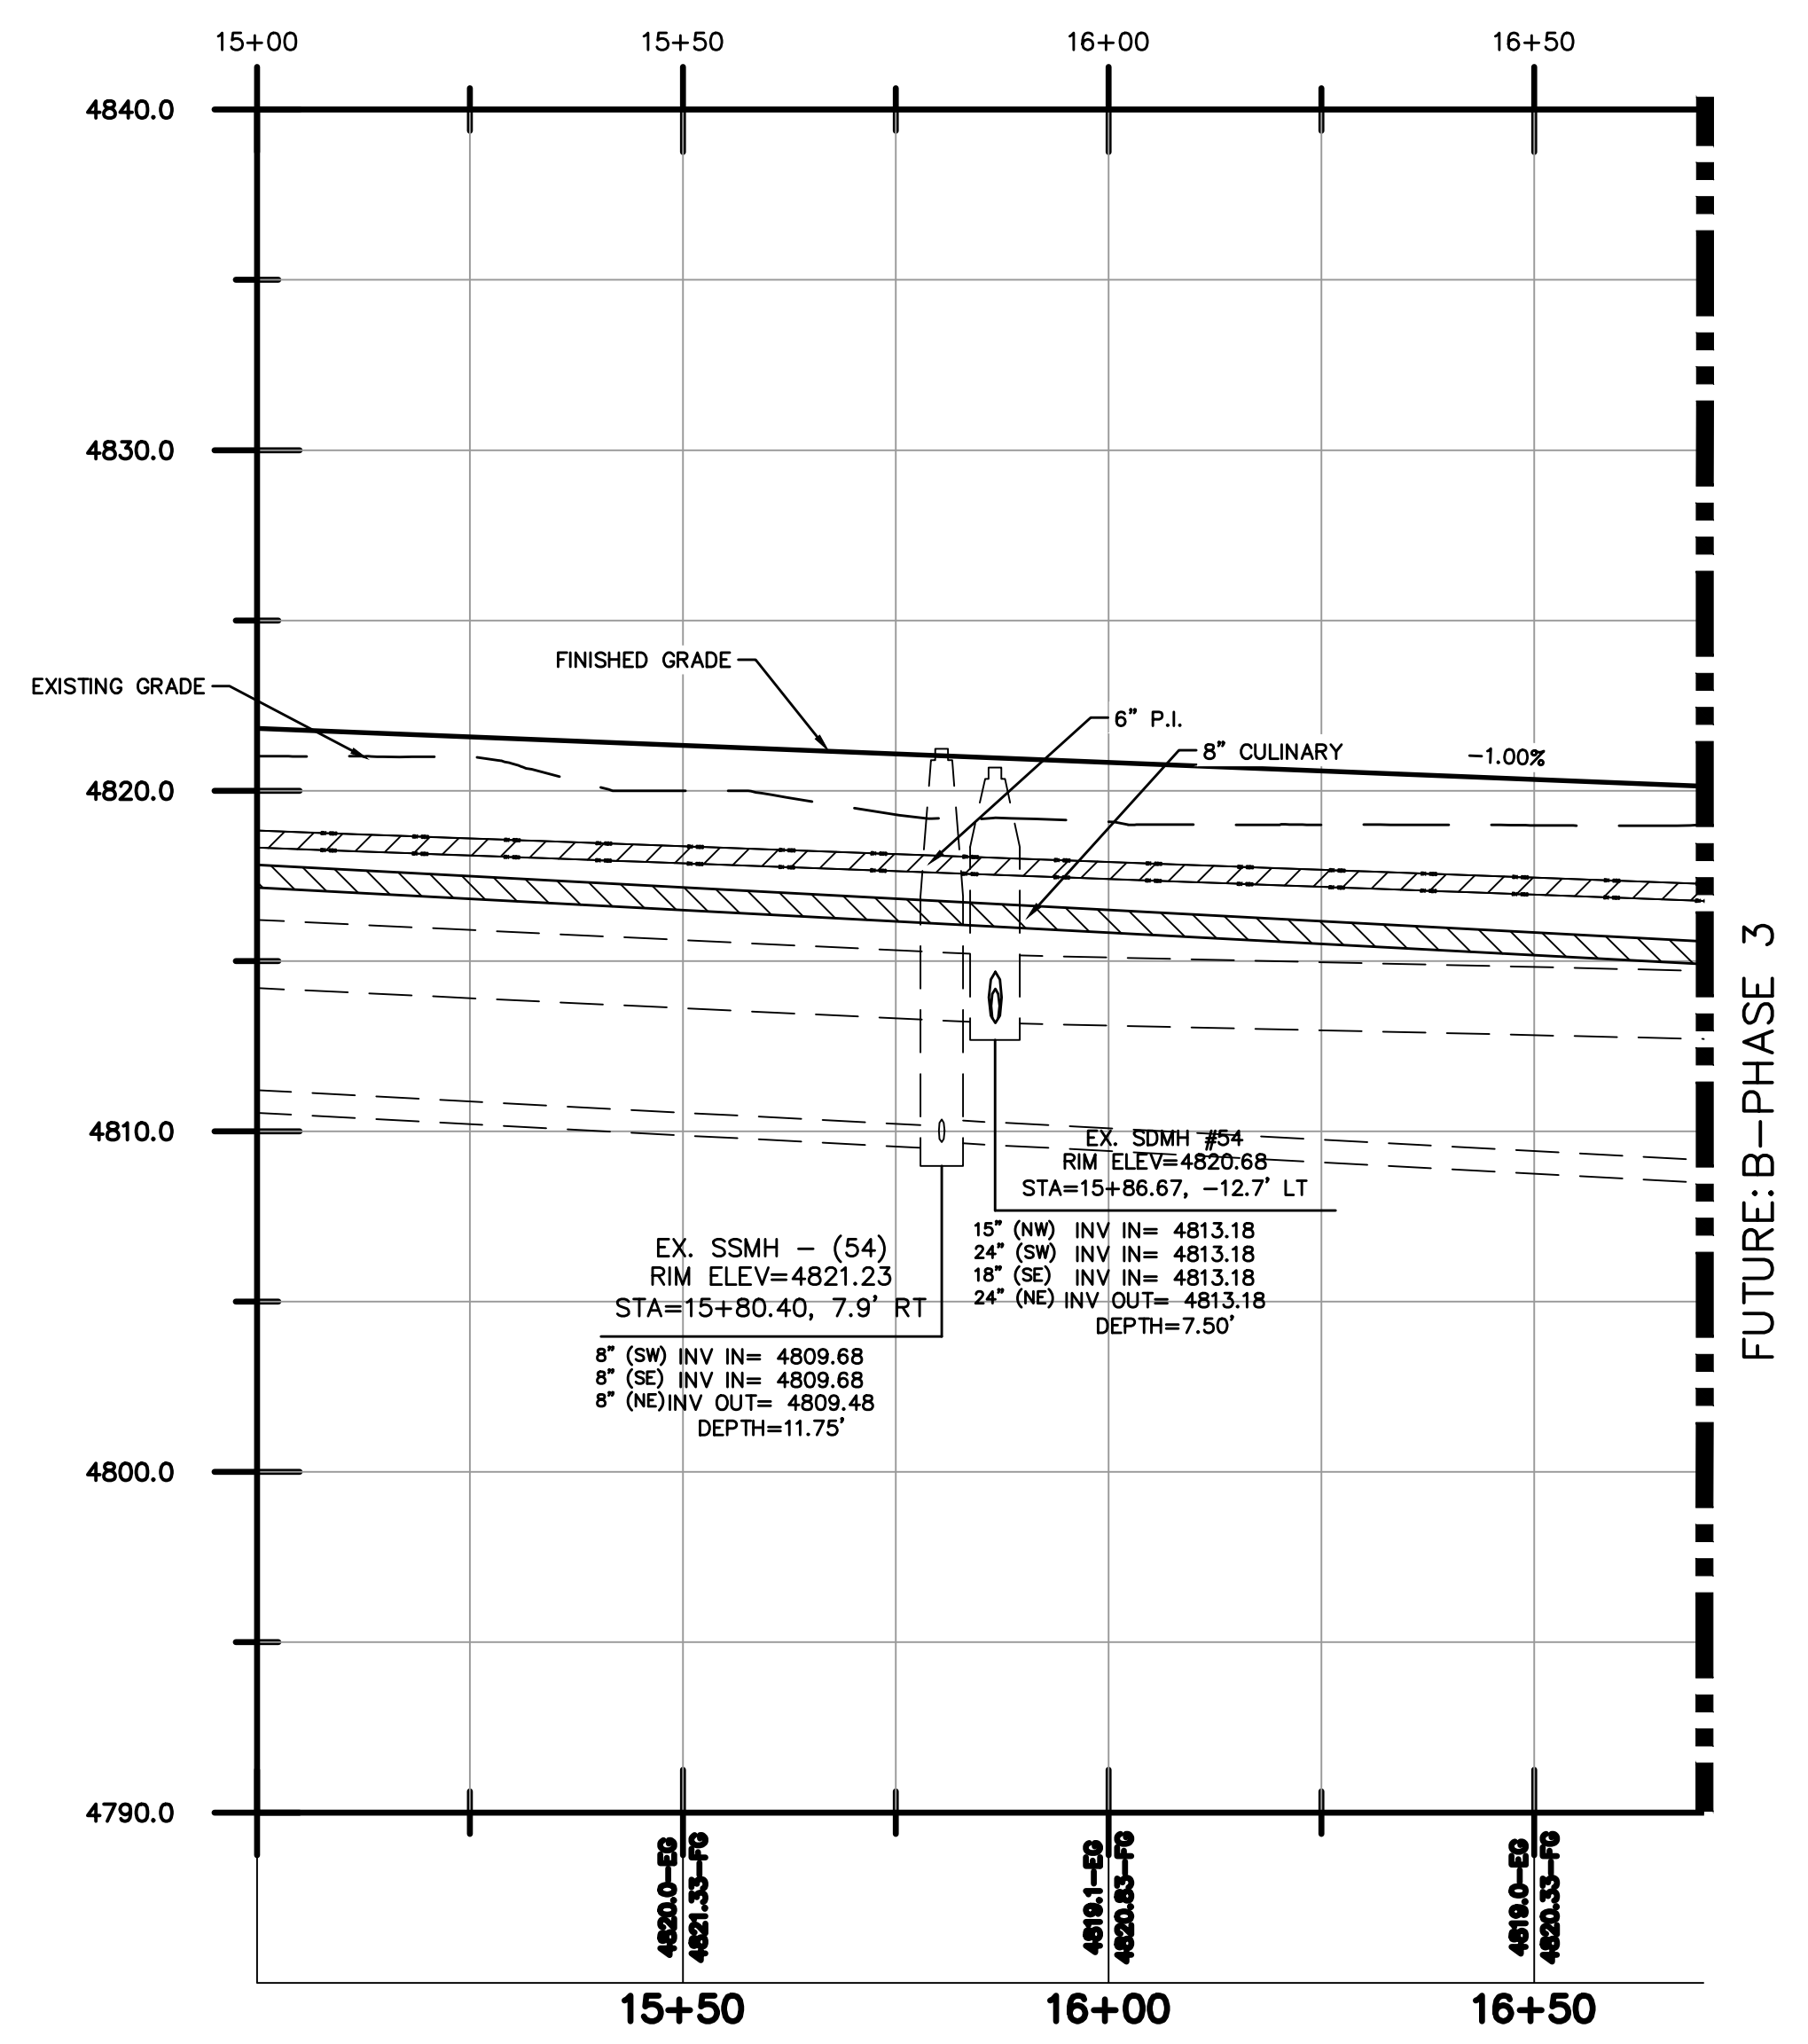

THESE DRAWINGS, OR ANY PORTION THEREOF, SHALL NOT BE USED ON ANY PROJECT OR EXTENSIONS OF THIS PROJECT EXCEPT BY AGREEMENT IN WRITING WITH NORTHERN ENGINEERING, INC.








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2		APPROVED:	DATE:
1		COGO FILE:	DATE:
NO.	REVISIONS	BY	DATE

Northern ENGINEERING INC
 ENGINEERING—LAND PLANNING
 CONSTRUCTION MANAGEMENT



1040 E. 800 N.
 OREM, UTAH 84097
 (801) 802-8992

APPLE HOLLOW @ THE ORCHARDS "B-PHASE 1"

STORM DRAIN PLAN & PROFILE	JOB NO. 3-20-031
SANTAQUIN, UTAH	SHEET NO. PP-02

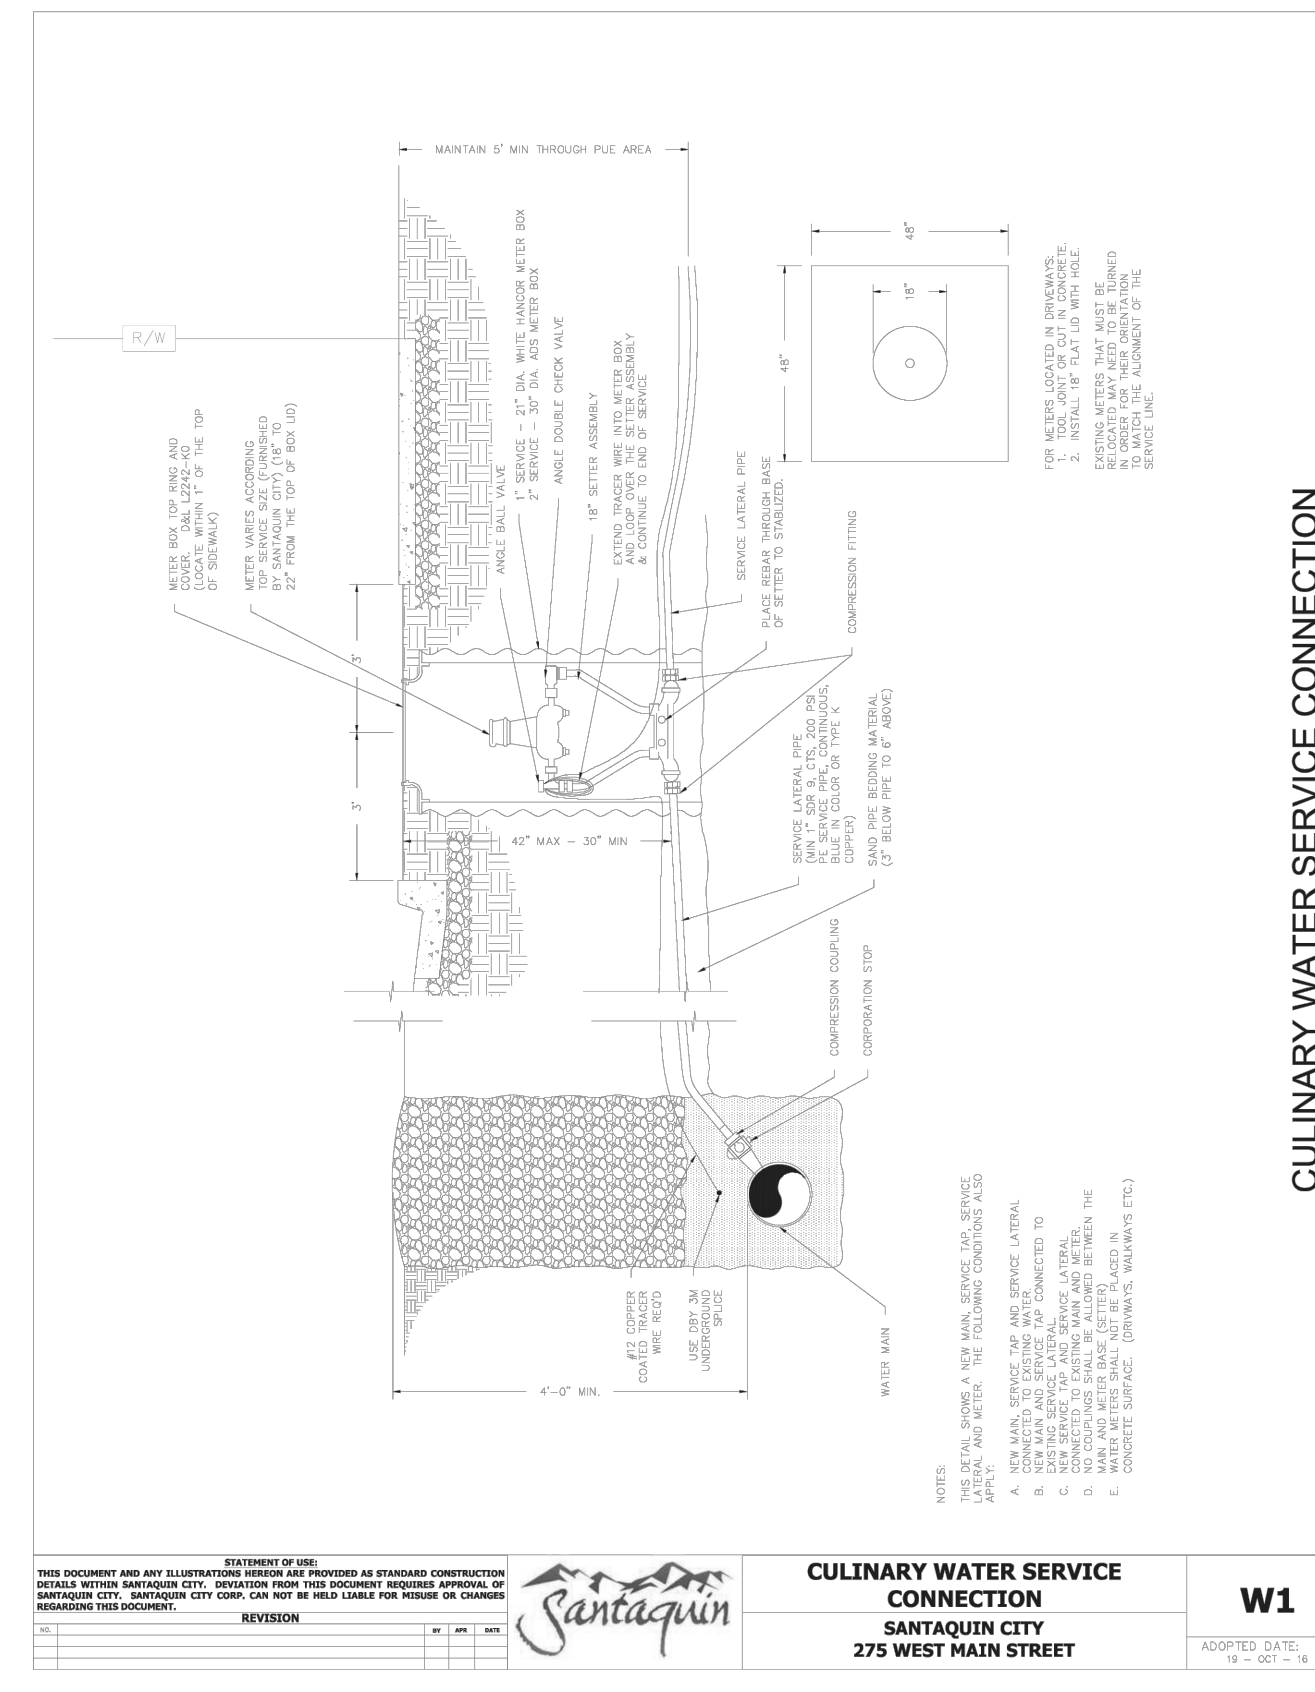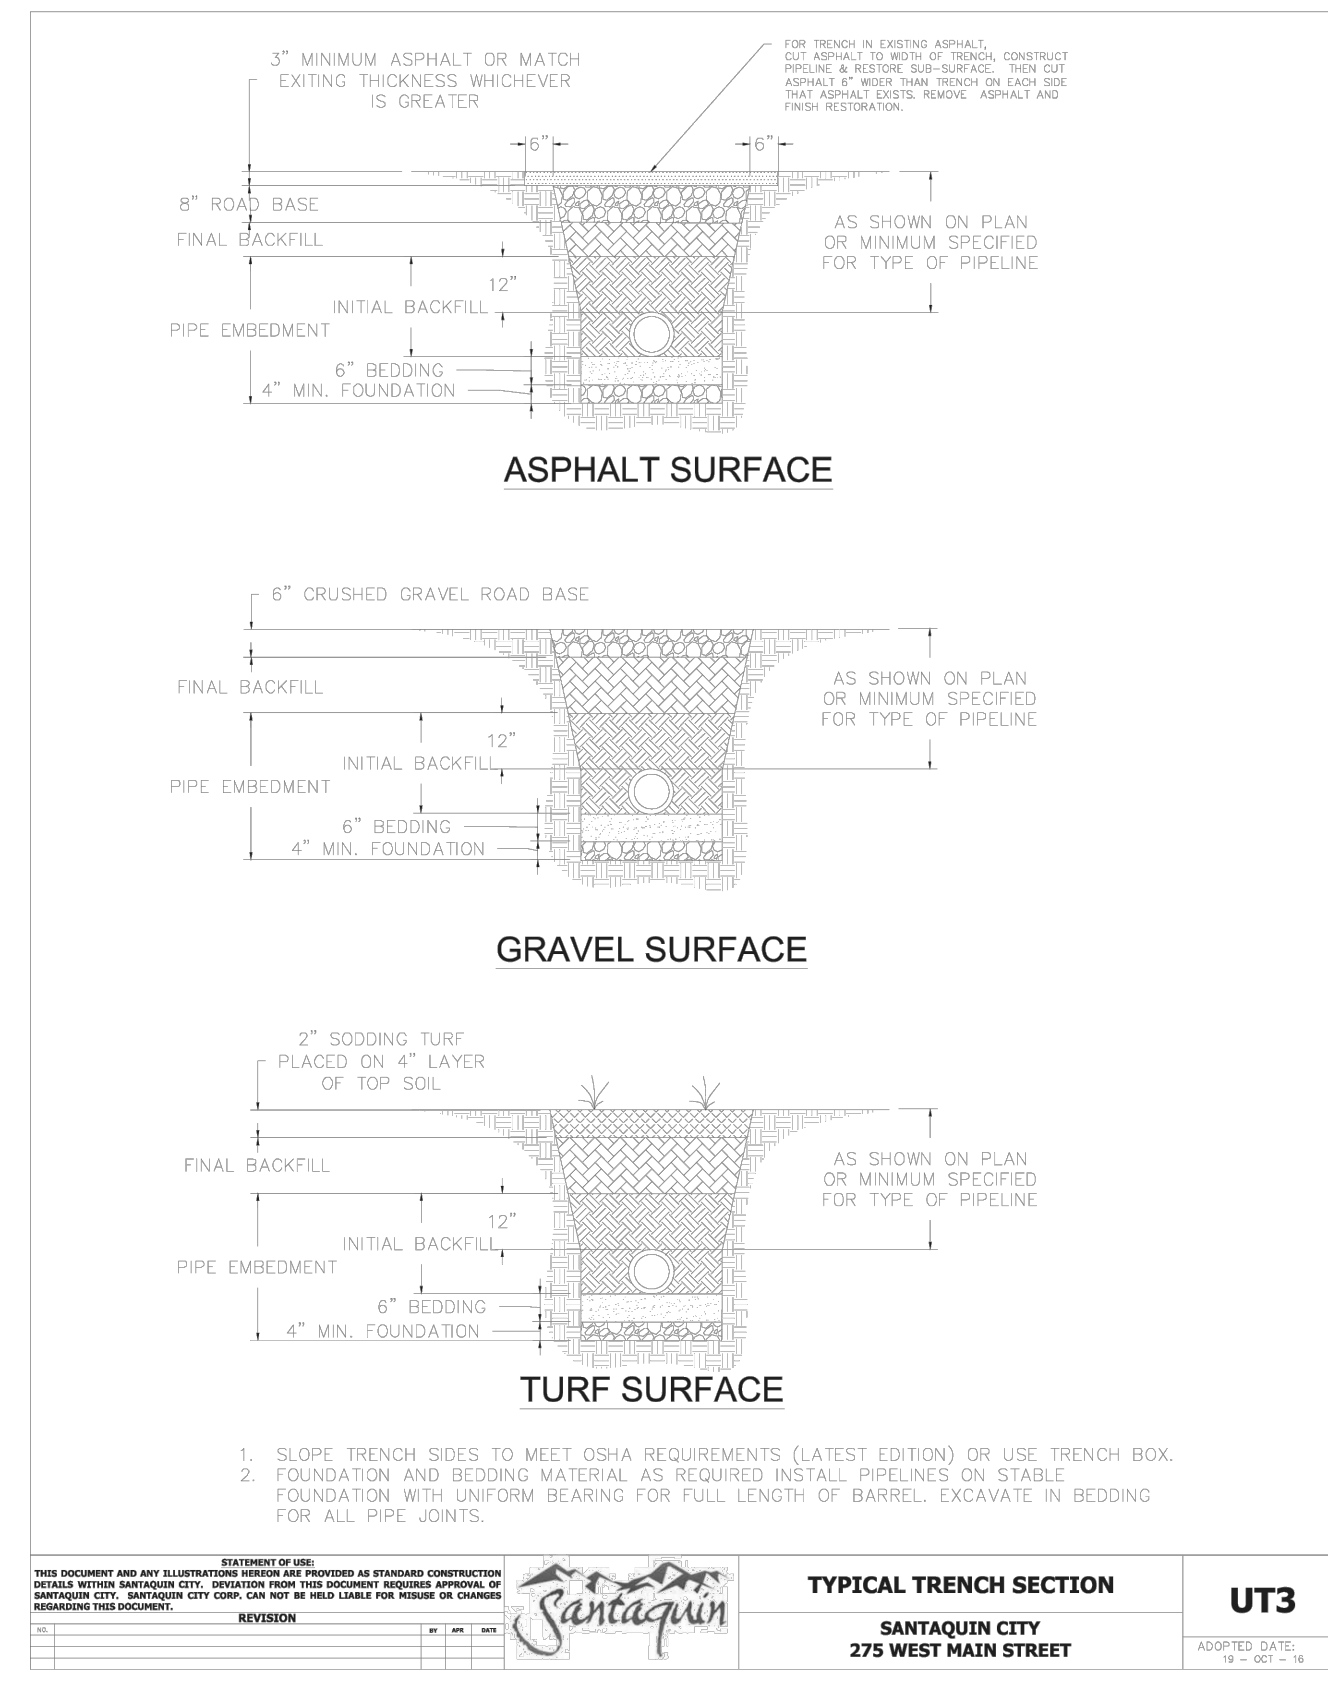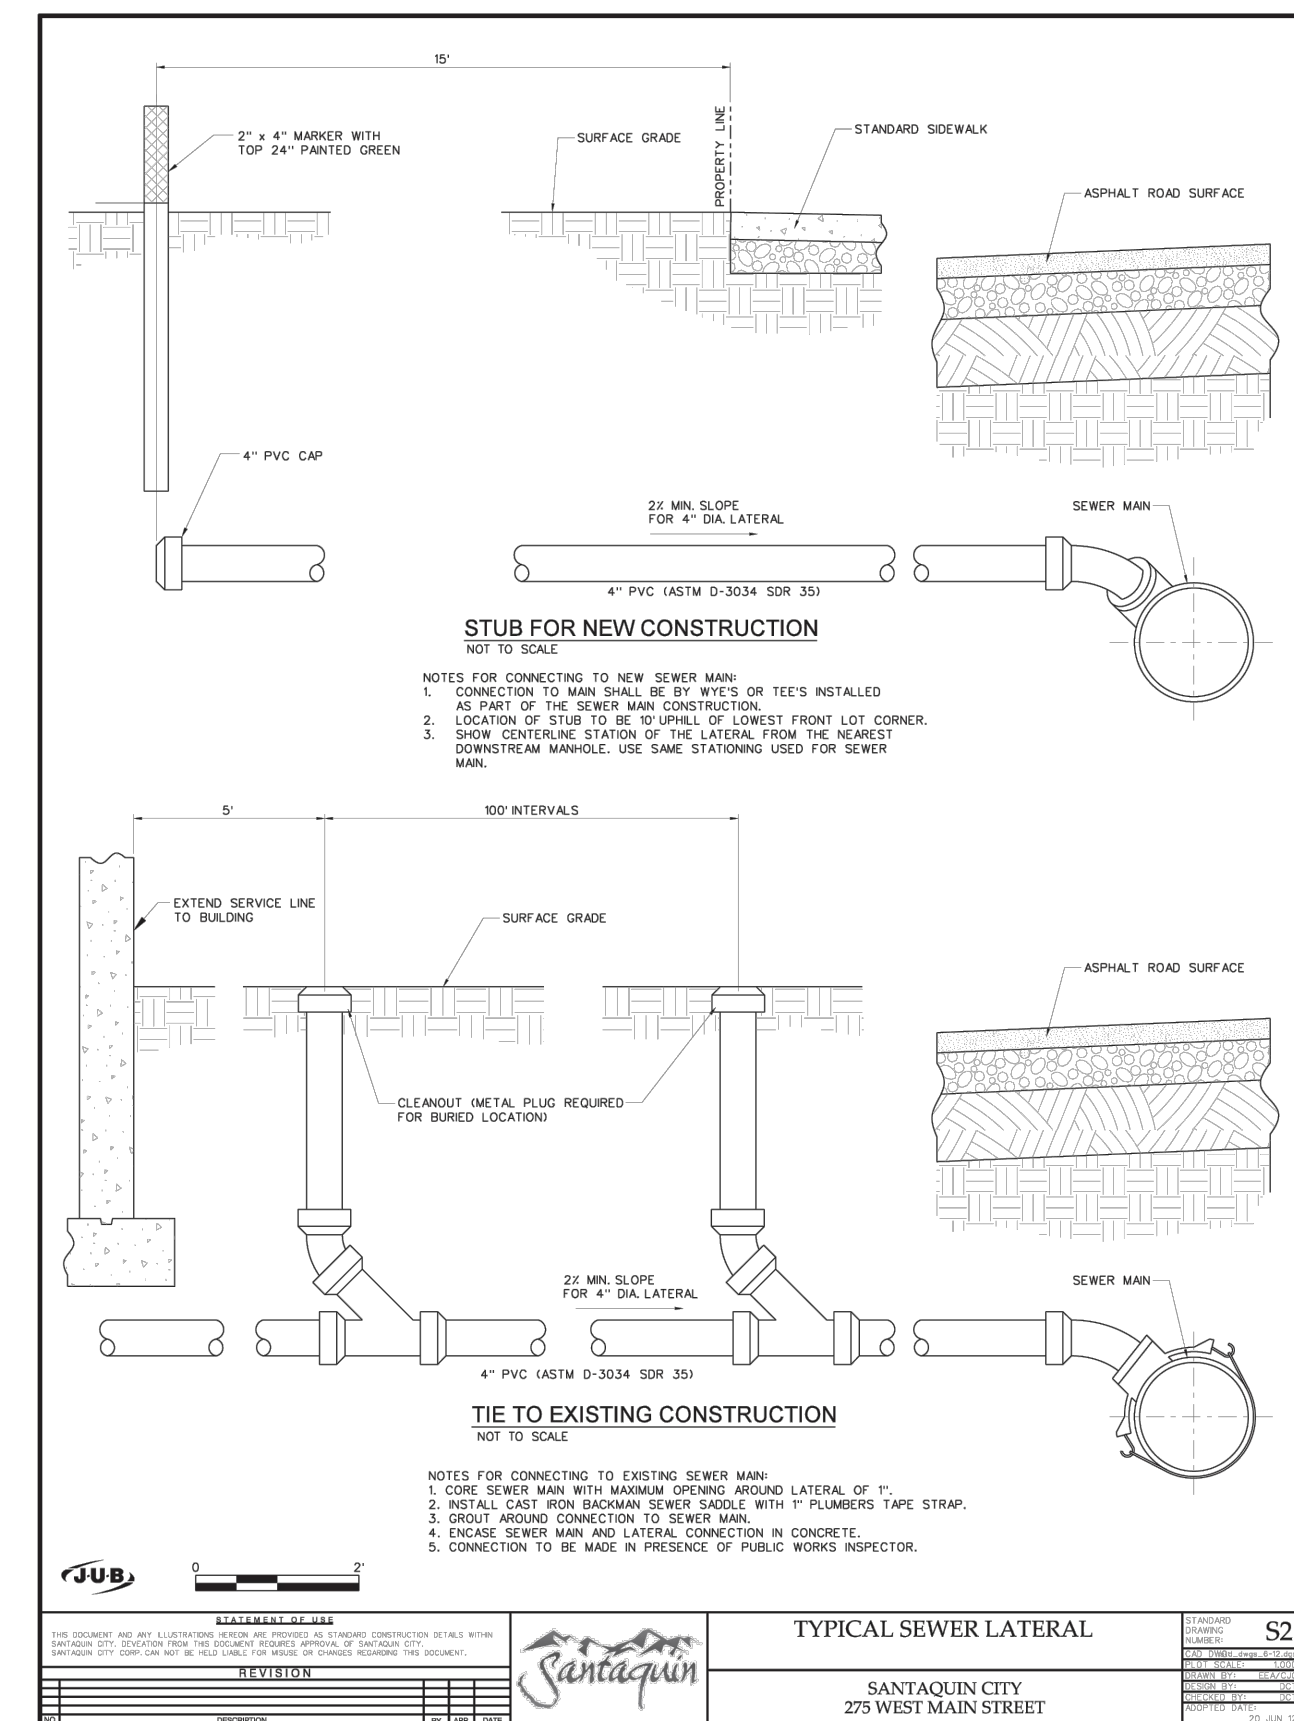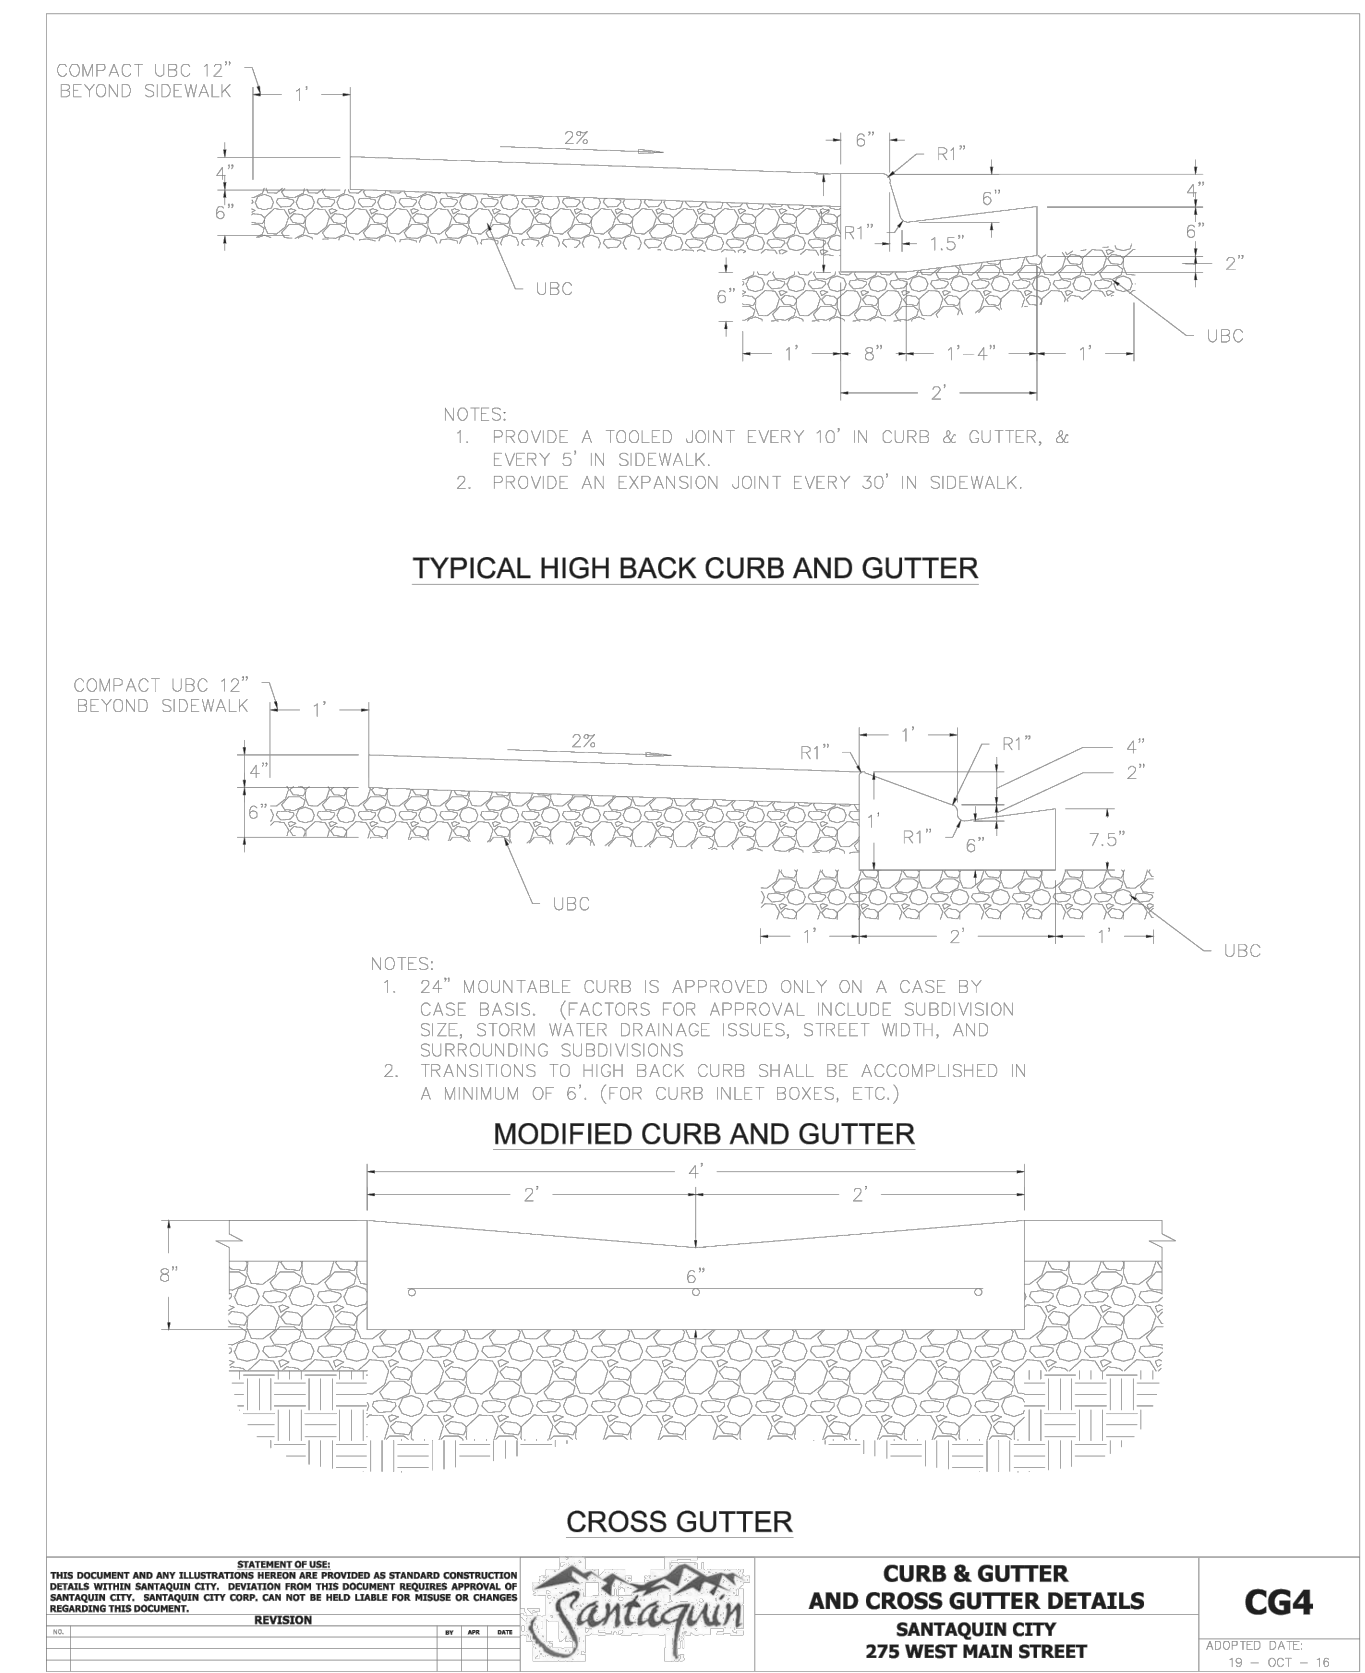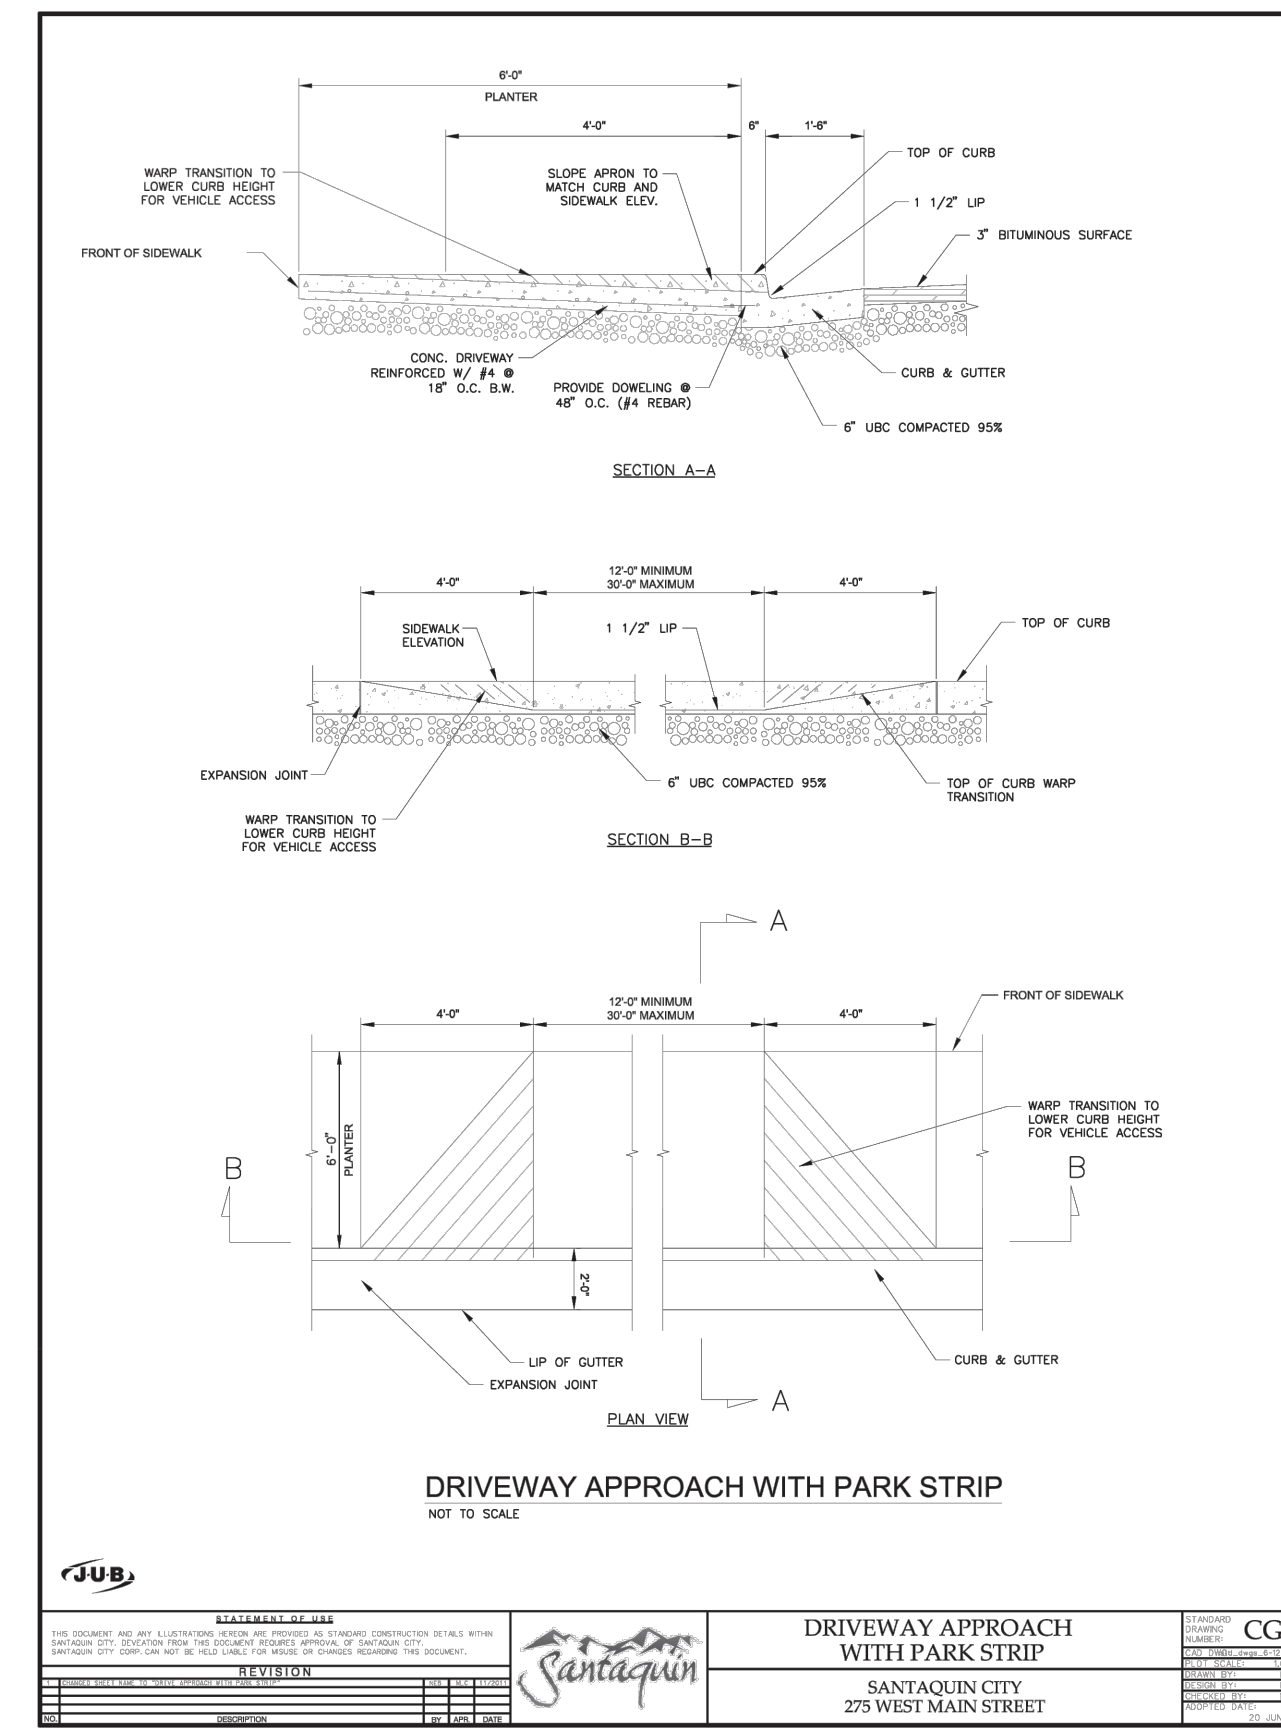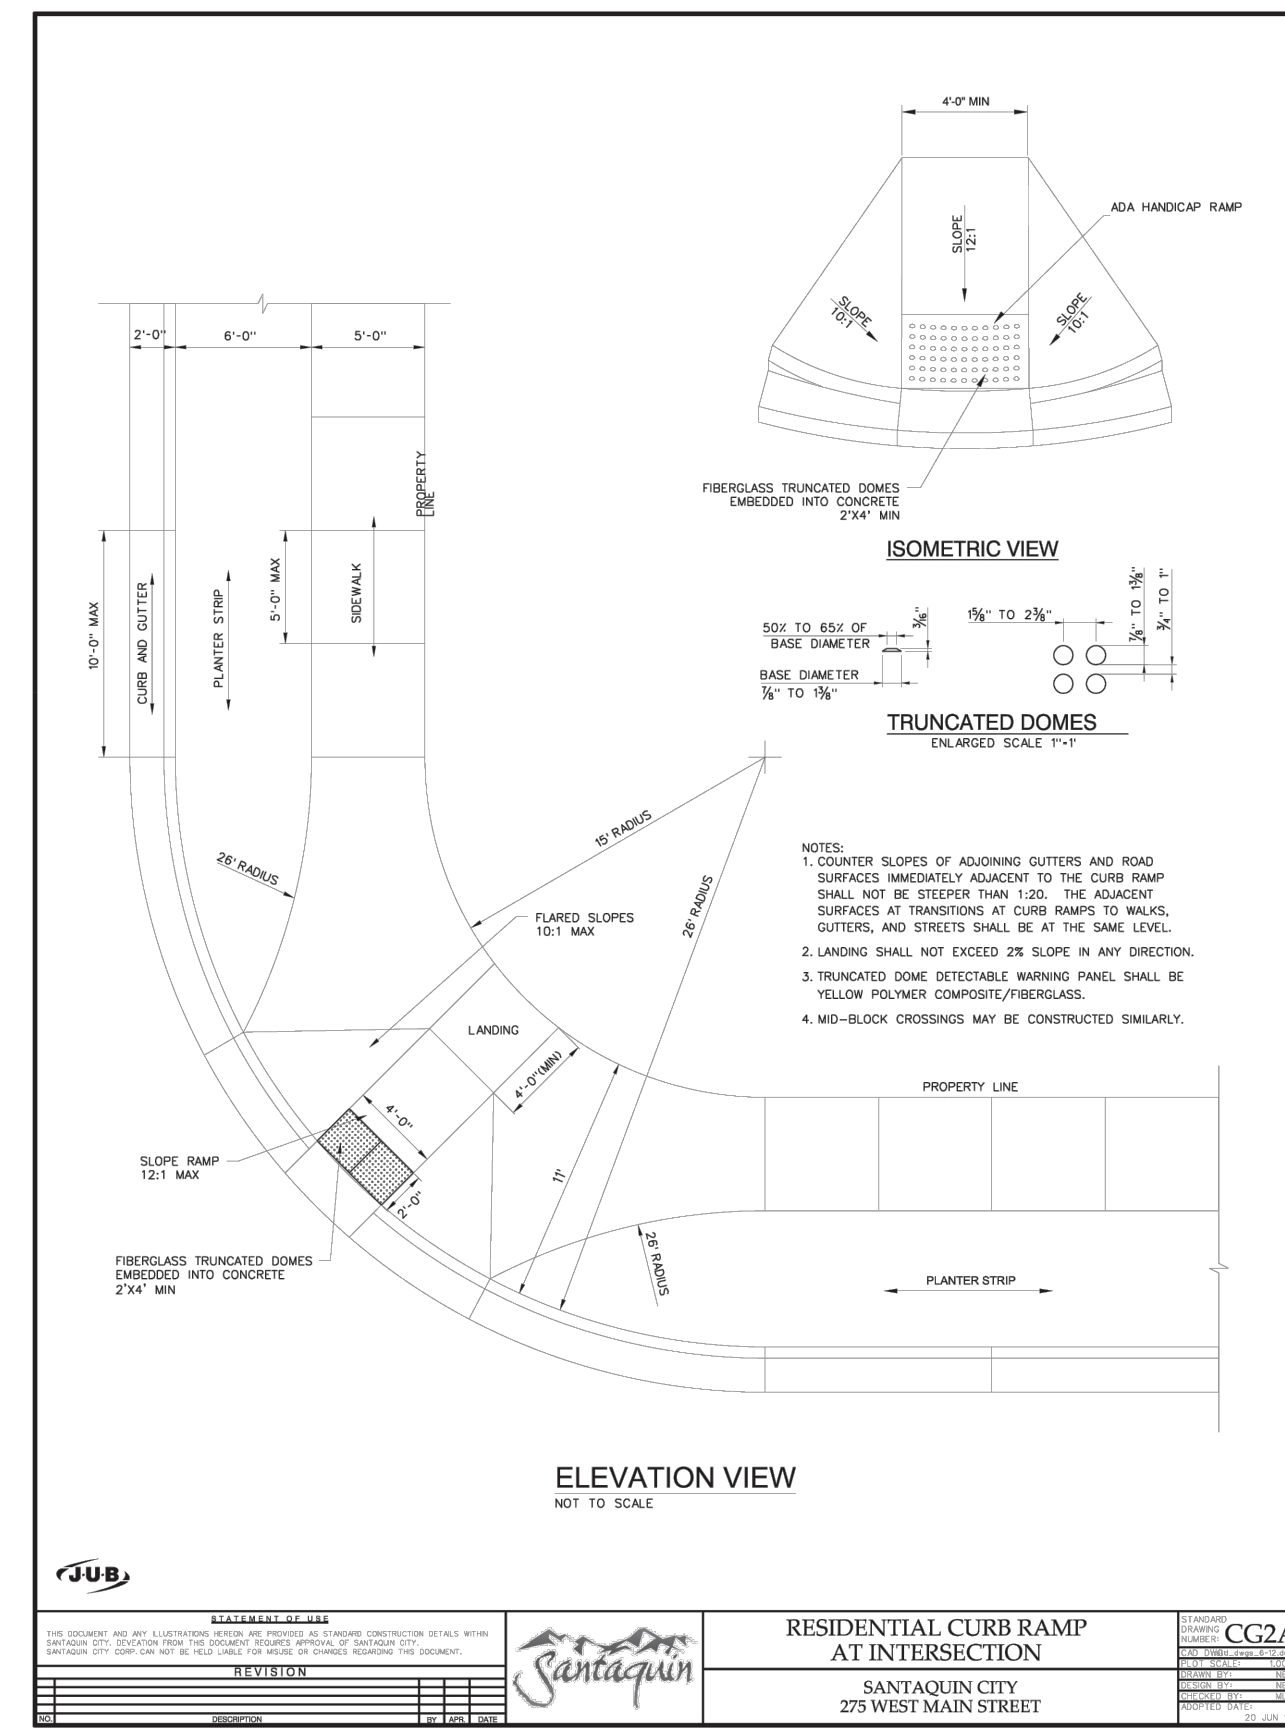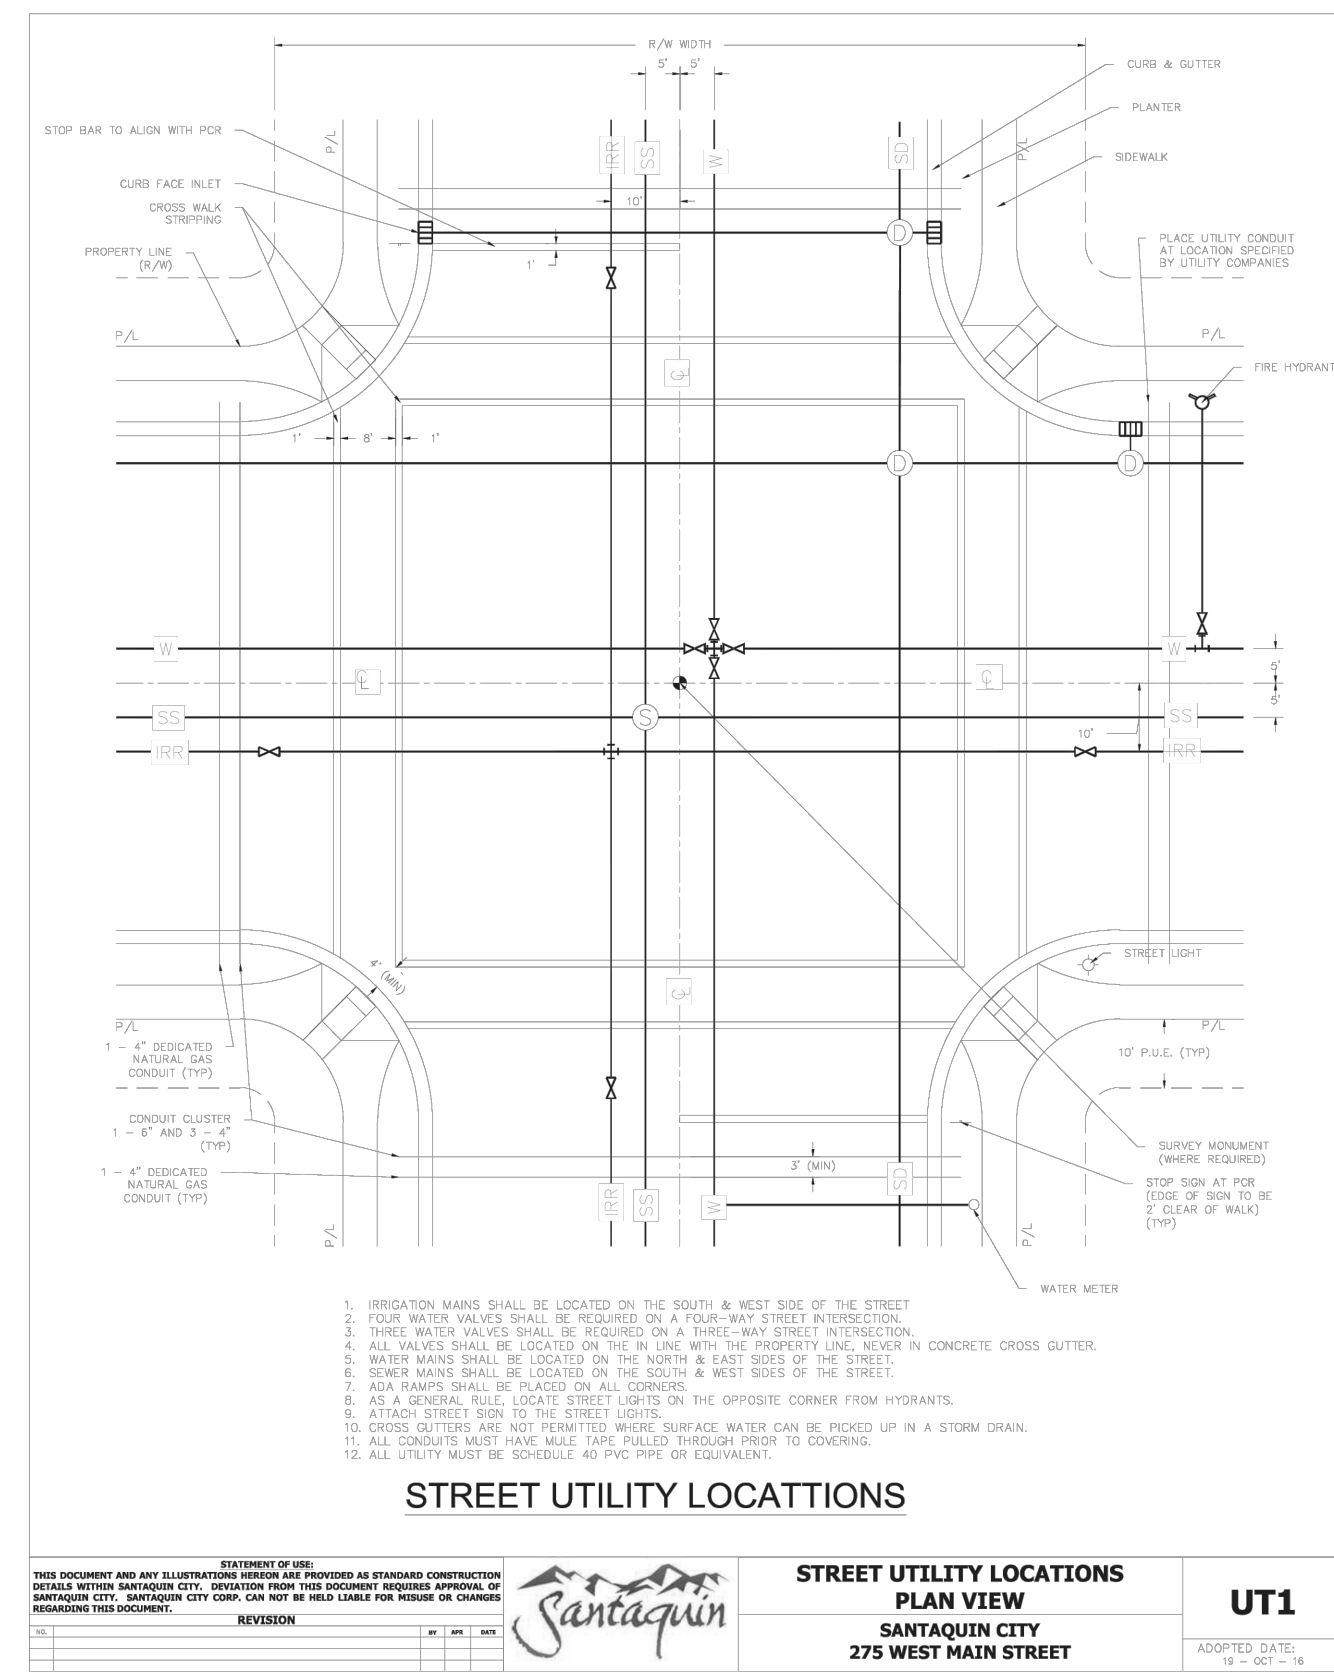

CULINARY WATER SERVICE CONNECTION

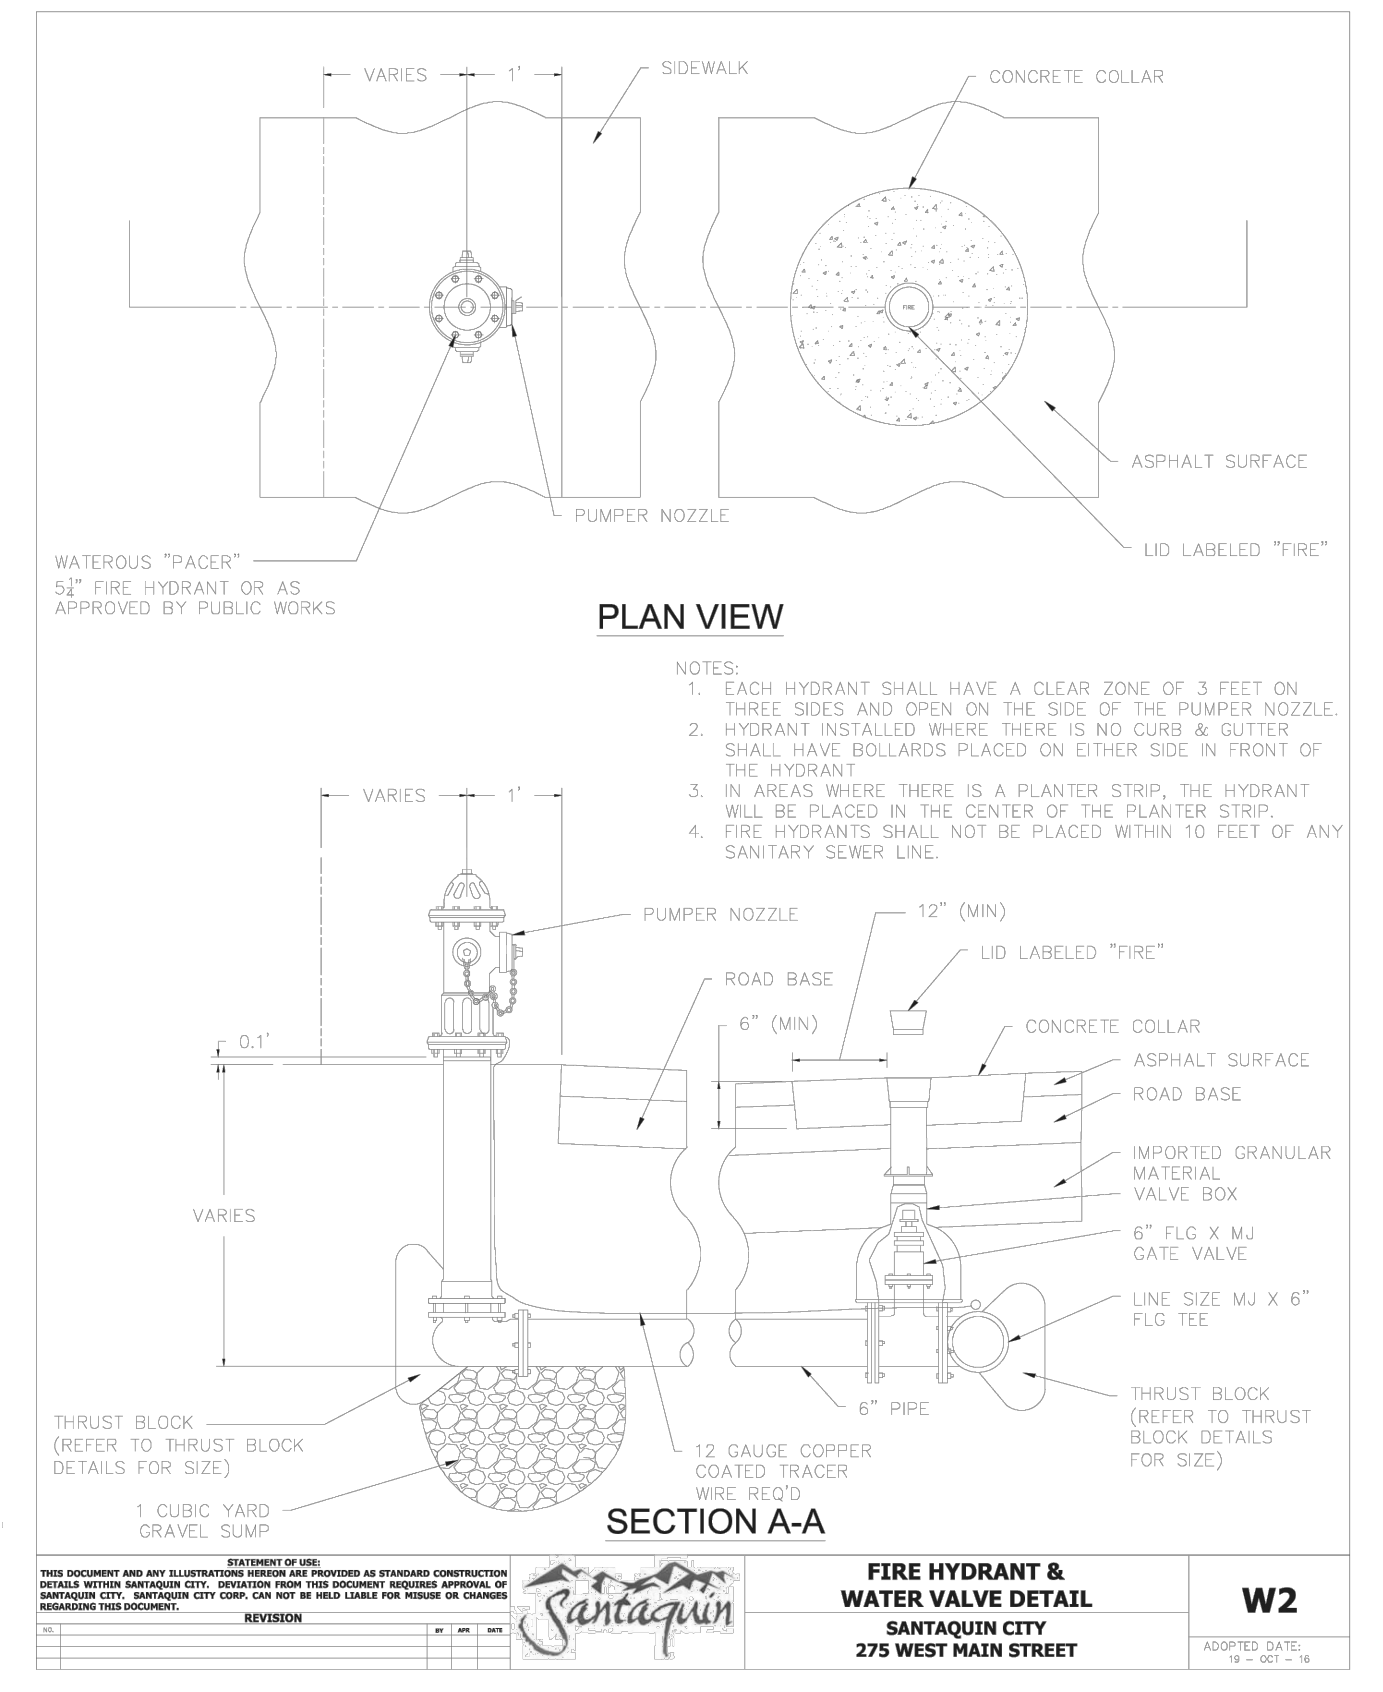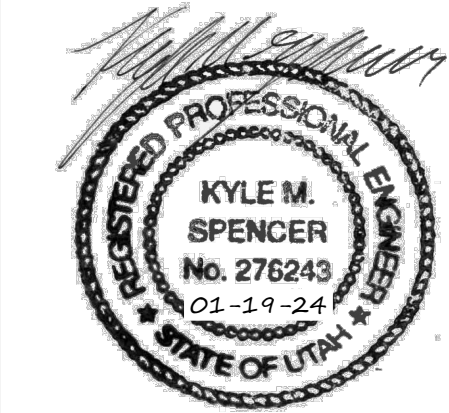

THESE DRAWINGS, OR ANY PORTION THEREOF, SHALL NOT BE USED ON ANY PROJECT OR EXTENSIONS OF THIS PROJECT EXCEPT BY AGREEMENT IN WRITING WITH NORTHERN ENGINEERING, INC.

5		DESIGNED BY:	DATE:
4		DRAWN BY:	DATE:
3		CHECKED BY:	DATE:
2		APPROVED:	DATE:
1		COGO FILE:	DATE:
NO.	REVISIONS	BY	DATE

NO. 13-20-031-00 Apple Hollow\CAD\Design\DETAILS PHASE 1.dwg 1/17/2024 4:37 PM


Northern ENGINEERING INC
ENGINEERING-LAND PLANNING CONSTRUCTION MANAGEMENT

1040 E. 800 N.
OREM, UTAH 84097
(801) 802-8992


APPLE HOLLOW @ THE ORCHARDS "B-PHASE 1"

DETAILS
SANTAQUIN, UTAH


JOB NO. 3-20-031
SHEET NO. DT-02

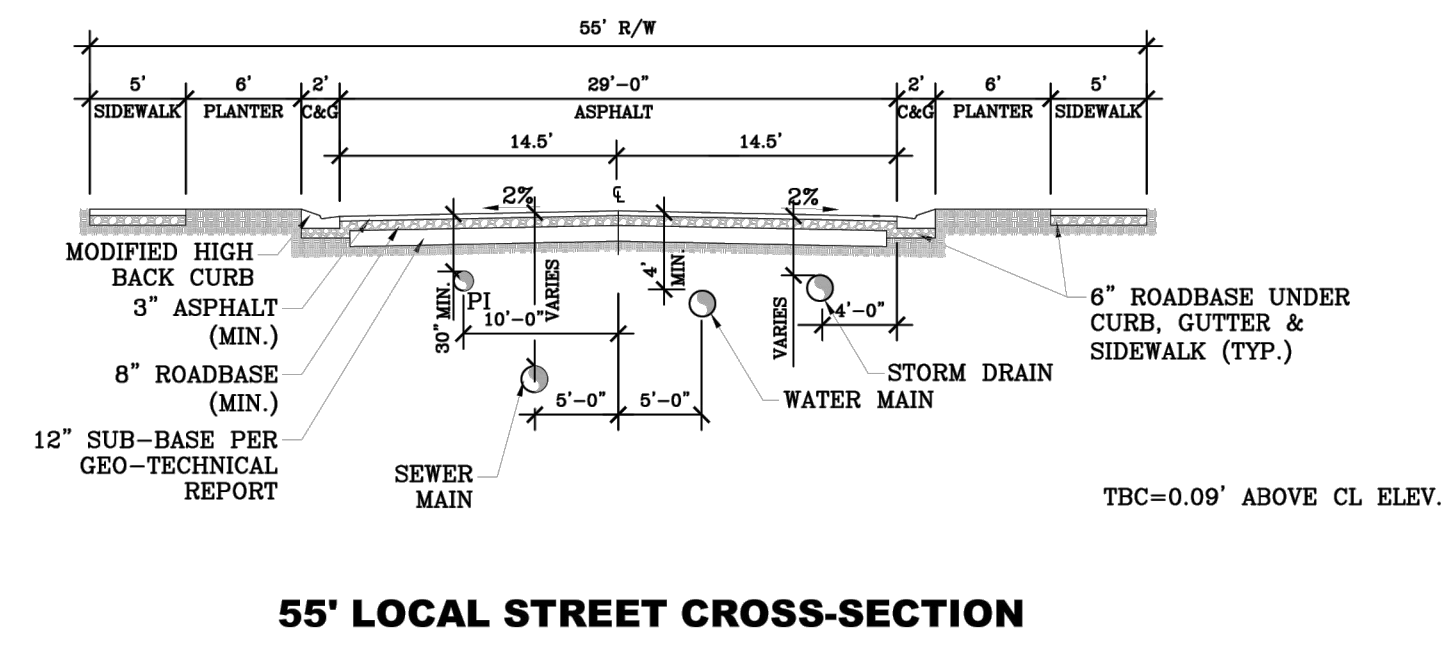


55' LOCAL STREET CROSS-SECTION

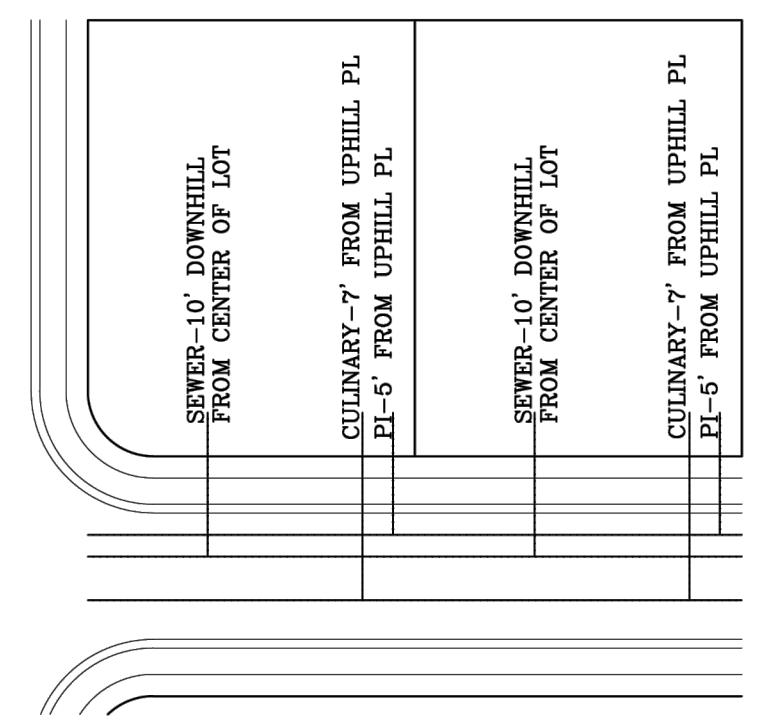

LATERAL DETAIL

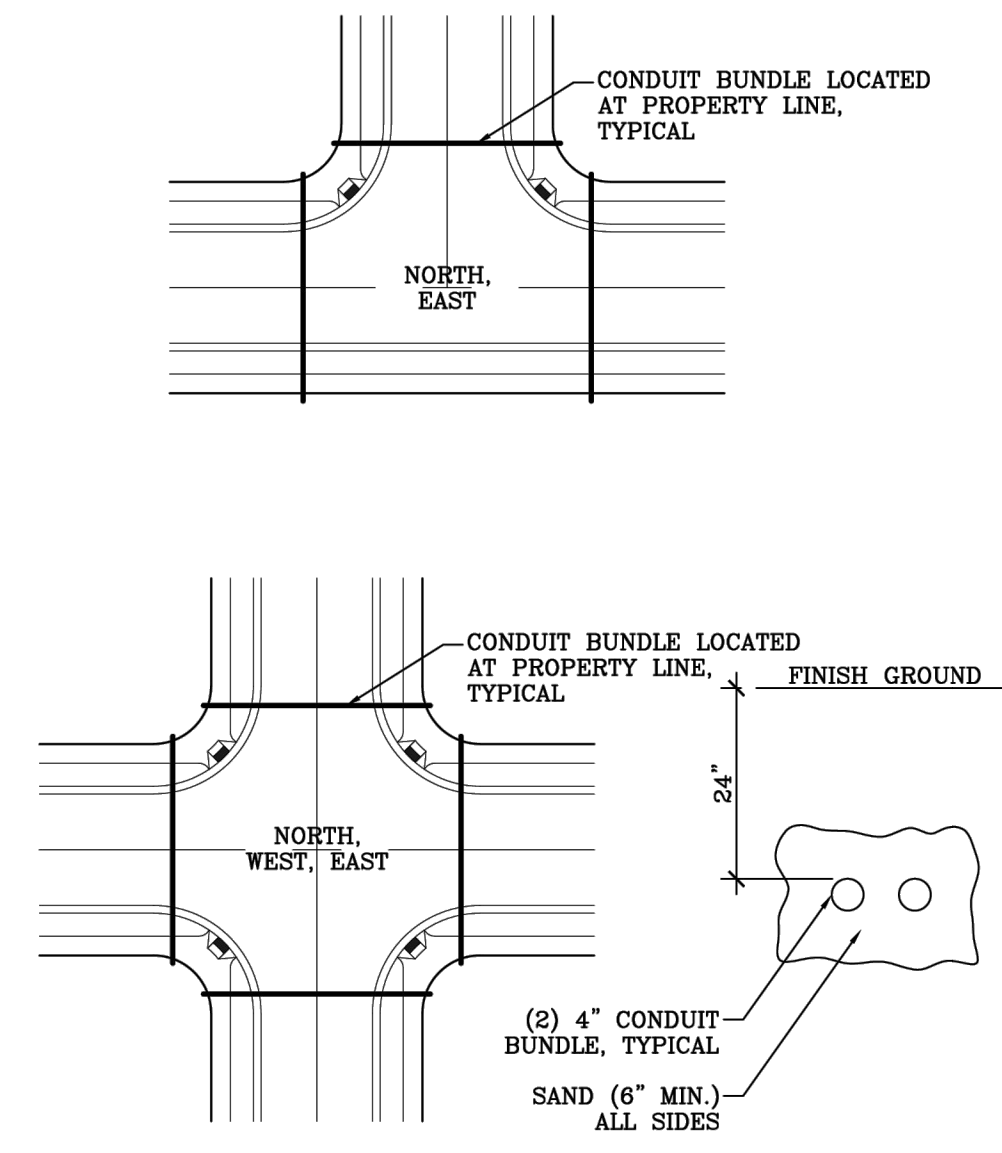

CONDUIT DETAILS

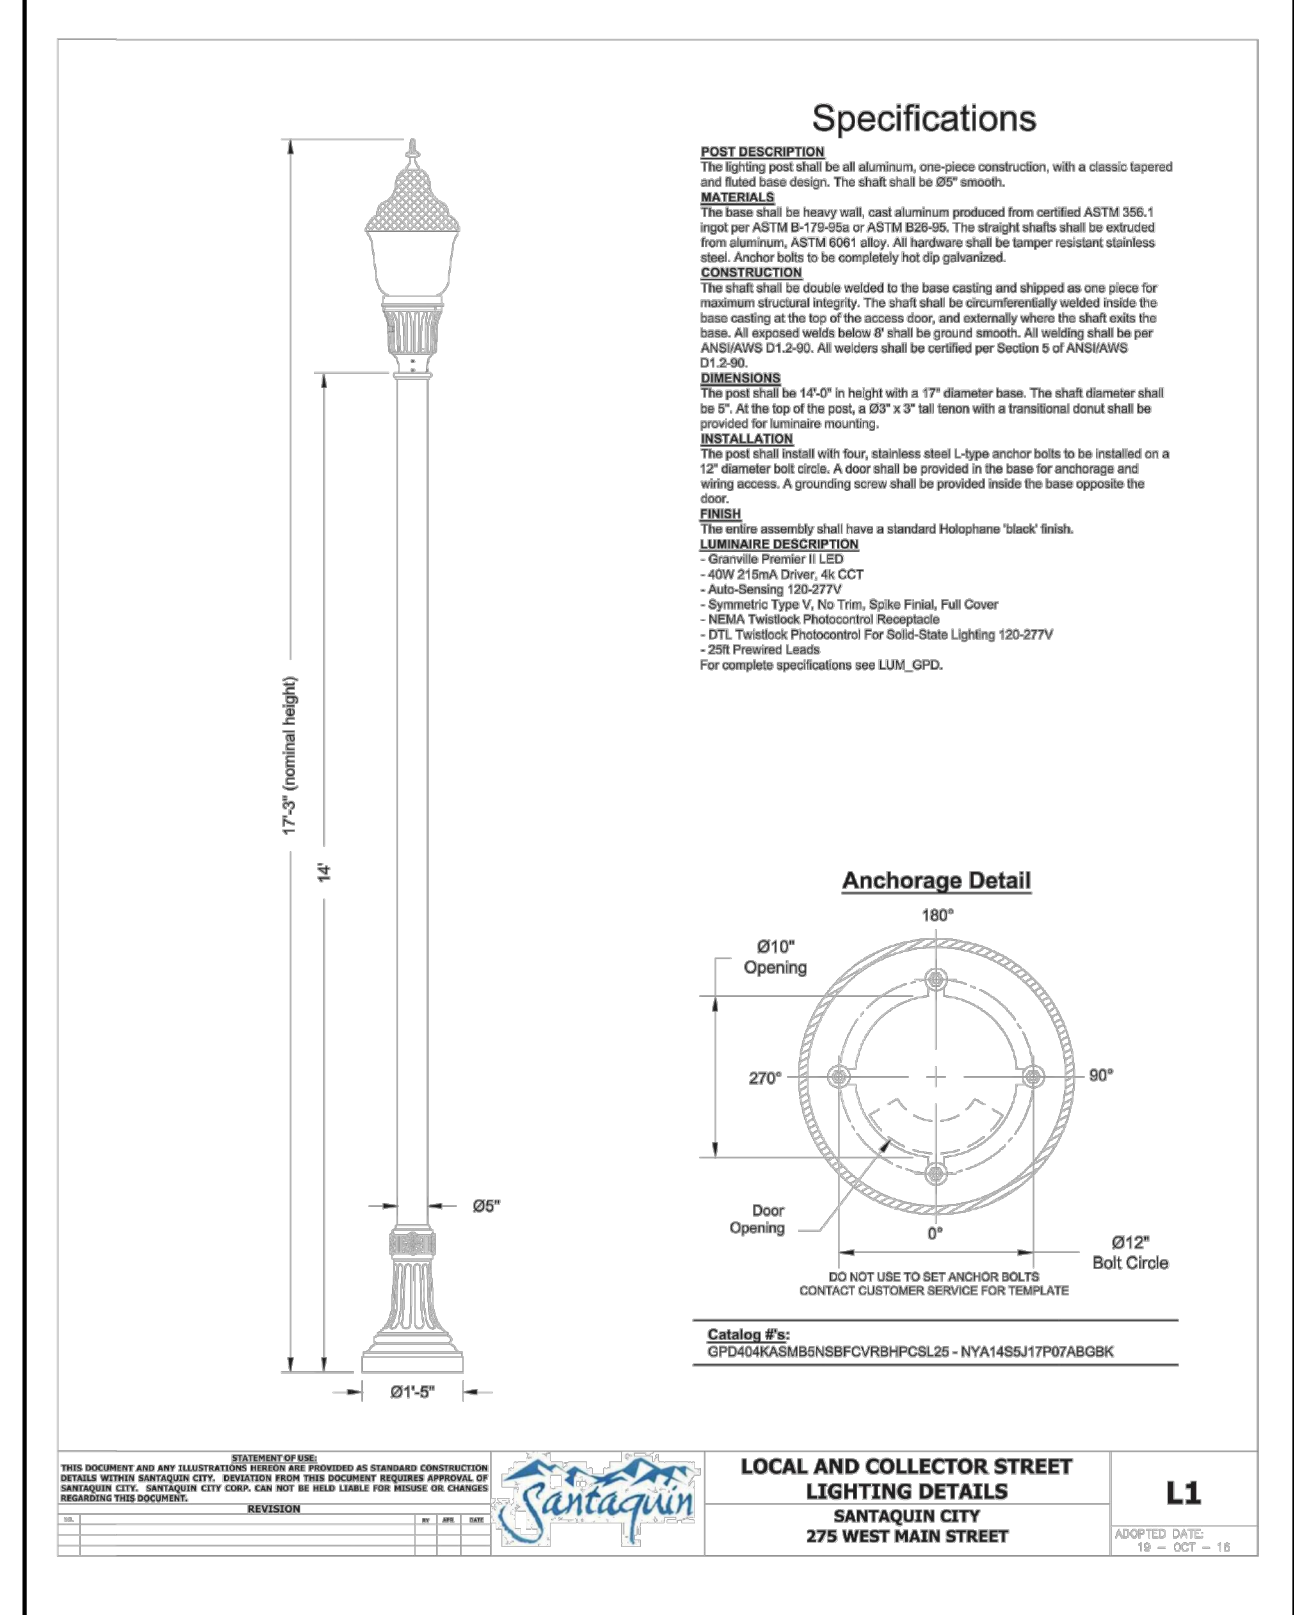


STREET LIGHT DETAIL

STREET CROSS-SECTIONS



20'X20' PAVILION DETAIL
PROPOSED PAVILION OR EQUIVALENT
WITH 4 PICNIC TABLES OR EQUIVALENT
-NTS-

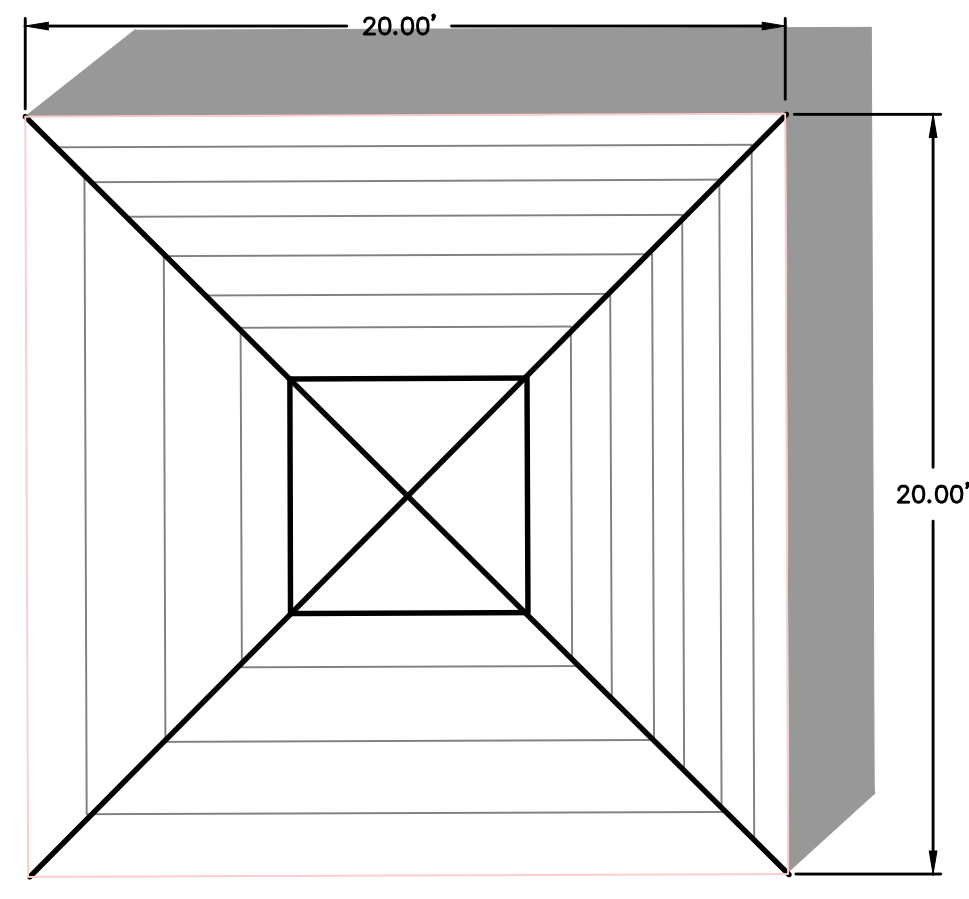

Rhinorock Fence Specifications

TECHNICAL INFORMATION: Rhinorock Fence Panel		
Dimension of Panel	182 cm x 350 cm	72"x102"
Weight of Panel	105 kg	230 lbs
Weight per area	21.5kg/m ²	4.9lbs/ft ²
Thickness of Panel	115mm	4.5"
EPS Foam Core Thickness	63-95mm	2.5-3.75"
Glass Fiber Reinforced concrete shell thickness	9mm	5/16"
% glass fiber by volume		4-4.50%
Compressive Strength of proprietary concrete mix design	4x10 ³ N/m ²	5800 psi
Ultimate tensile strength of glass fiber reinforced concrete	9.6x10 ³ - 1.4x10 ⁴ N/m ²	1400-2100 psi
Wind load capacity of panel	225 km/h	140mph with 1.6 safety factor
axial load capacity of panel	1644 kg/lineal meter	1100 lbs/lineal foot
moisture absorption of EPS foam core by total immersion		<4%
Combustibility of glass fiber reinforced concrete shell		Non-combustible
Freeze/thaw performance		200 freeze thaw cycles with no damage
Debris, fungus, or mushroom attack		none
Termite food source		none

6' CLASSIC PRIVACY FENCE
¾ x 1 ½ Panels & 1 ½ x 5 ½ Slotted Rails
(68" Panel Height)

Available Colors: White, Sandstone & Khaki

QTY	DESCRIPTION	LENGTH
2	1 ½ x 6 ½ Slotted Rail	72"
6	¾ x 1 ½ T&G	60
2	¾ U-Channel	60 7/8" - Optional
6	#10 - Screw - (5/16" Hex Head)	¾" - for U-Channel

Posts
5" x 5" - 8' .135 Wall 5" x 5" - 8' .150 Wall
24" Post Set (Check Local Code Requirements)

NOTE: 6' DECORATIVE MASONRY WALL STAINED & TREATED ON BOTH SIDES W/ANTI-GRAFFITI SEALANT

FENCE DETAIL
PROPOSED OR EQUIVALENT
-NTS-



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NO.	REVISIONS	BY	DATE	DESIGNED BY:	DATE:
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3					
2					
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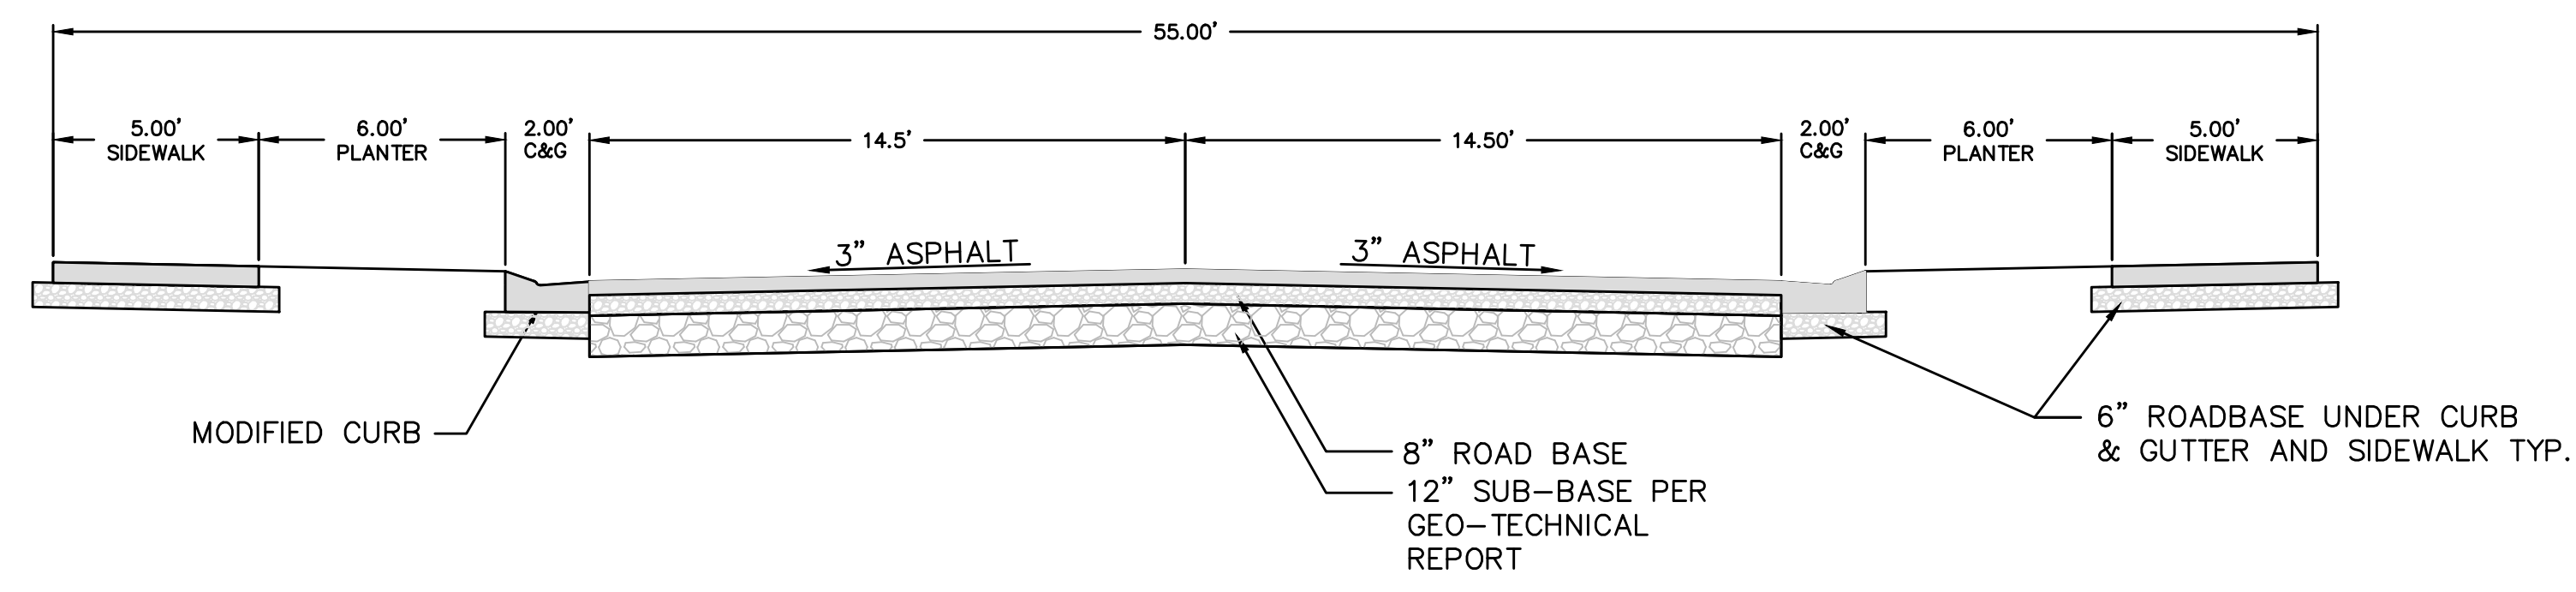
Northern ENGINEERING INC
ENGINEERING-LAND PLANNING CONSTRUCTION MANAGEMENT

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OREM, UTAH 84097
(801) 802-8992


APPLE HOLLOW @ THE ORCHARDS "B-PHASE 1"

DETAILS
SANTAQUIN, UTAH


JOB NO. 3-20-031
SHEET NO. DT-03




55.00' STANDARD STREET CROSS SECTION
 215 WEST STREET
 -NTS-
 STA: 13+92.07 - 15+02.52

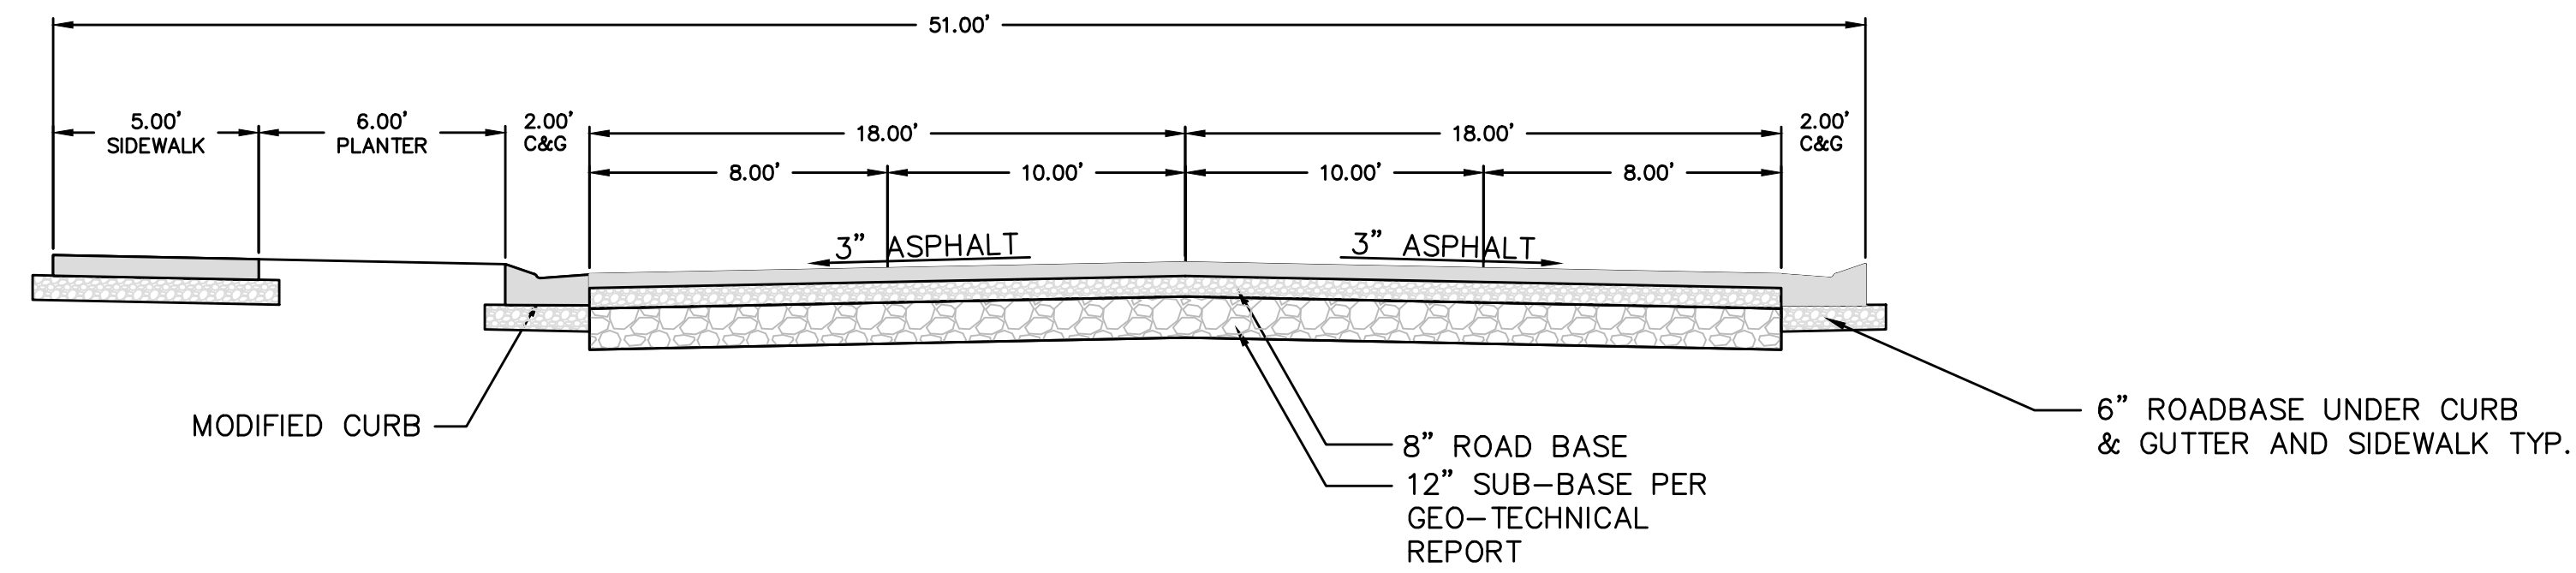

51.00' STANDARD STREET CROSS SECTION
 215 WEST STREET
 -NTS-
 STA: 10+00.00 - 13+92.07

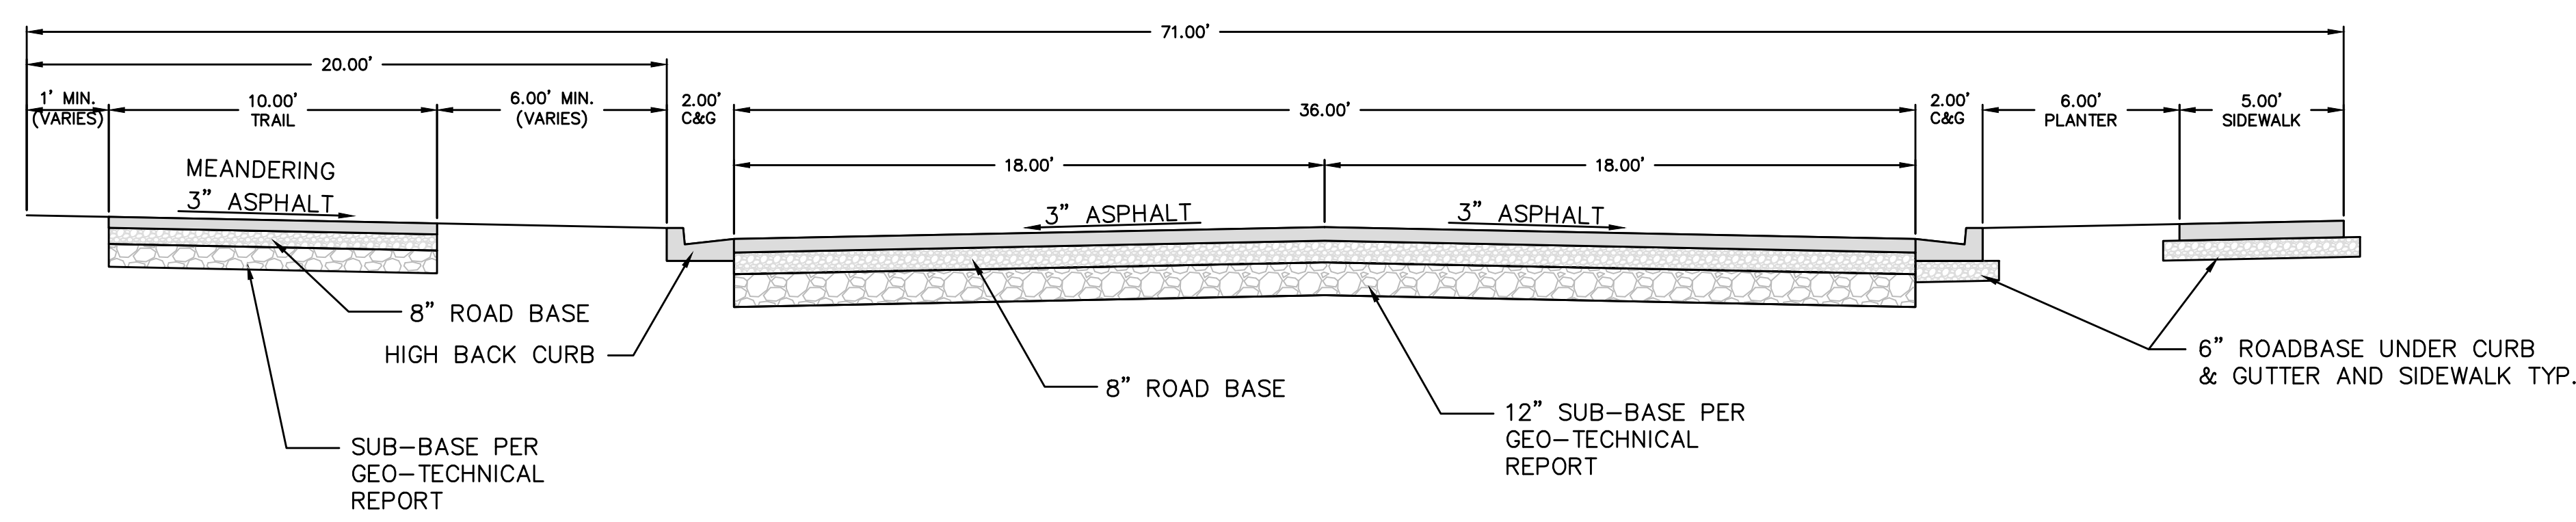

71.00' STANDARD STREET CROSS SECTION
 GINGER GOLD ROAD
 -NTS-

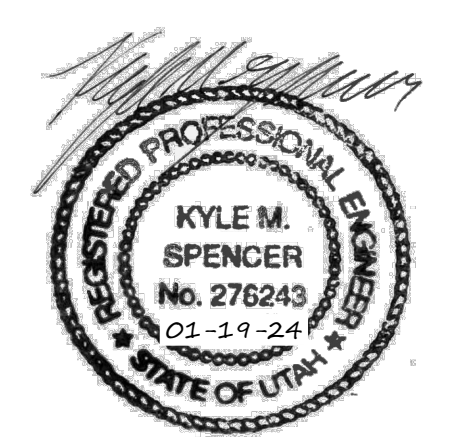

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3		CHECKED BY:	DATE:
2		APPROVED:	DATE:
1		COGO FILE:	DATE:
NO.	REVISIONS	BY	DATE
		REV. COGO FILE:	DATE:

Northern ENGINEERING INC
 ENGINEERING-LAND PLANNING
 CONSTRUCTION MANAGEMENT

1040 E. 800 N.
 OREM, UTAH 84097
 (801) 802-8992

**APPLE HOLLOW @
 THE ORCHARDS
 "B-PHASE 1"**

DETAILS	JOB NO. 3-20-031
SANTAQUIN, UTAH	SHEET NO. DT-01

APPLE HOLLOW @ THE ORCHARDS "B-PHASE 2"

PHASE 2 SANTAQUIN, UTAH COUNTY, UTAH -INDEX OF PLAN SHEETS-

GENERAL

- ALL WORK SHALL BE DONE IN ACCORDANCE WITH THE SPECIFICATIONS AND/OR REQUIREMENTS OF THE SANTAQUIN CITY PUBLIC WORKS DEPARTMENT.
- A PRE CONSTRUCTION CONFERENCE WILL BE HELD A MINIMUM OF 3 WORKING DAYS PRIOR TO START OF WORK. ALL CONTRACTORS, SUBCONTRACTORS AND/OR UTILITY CONTRACTORS, SANTAQUIN CITY PUBLIC WORKS AND CITY'S ENGINEER SHOULD BE PRESENT.
- ALL LOT DIMENSIONS, EASEMENTS AND CERTAIN OFF SITE EASEMENTS ARE TO BE TAKEN FROM THE PLAT OF THE ORCHARDS PLAT F-6 WITH THE COMPLETION OF ROW IMPROVEMENTS ASSOCIATED WITH ORCHARDS F-6.
- ALL CONSTRUCTION STAKES MUST BE REQUESTED A MINIMUM OF THREE (3) WORKING DAYS PRIOR TO PLANNED USE.
- CERTAIN CONTROL POINTS WILL BE SET BY THE ENGINEER, OR HIS REPRESENTATIVE, WHICH ARE CRITICAL TO THE CONSTRUCTION STAKING OF THE PROJECT. THESE POINTS WILL BE DESIGNATED AT THE TIME THEY ARE SET AND THE CONTRACTOR SO NOTIFIED. DESTRUCTION OF THESE POINTS BY THE CONTRACTOR OR HIS SUBCONTRACTORS SHALL BE GROUNDS FOR CHARGING THE CONTRACTOR FOR REESTABLISHING SAID POINTS.
- ALL RECOMMENDATIONS MADE IN A PERTINENT GEOTECHNICAL REPORT/STUDY SHALL BE FOLLOWED EXPLICITLY DURING CONSTRUCTION OF BUILDING AND SITE IMPROVEMENTS.
- THE DEVELOPER AND THE GENERAL CONTRACTOR UNDERSTAND THAT IT IS HIS/HER RESPONSIBILITY TO ENSURE THAT ALL IMPROVEMENTS INSTALLED WITHIN THIS DEVELOPMENT ARE CONSTRUCTED IN FULL COMPLIANCE WITH ALL STATE AND SANTAQUIN CITY CODES, ORDINANCES AND STANDARDS. THESE PLANS ARE NOT ALL INCLUSIVE OF ALL MINIMUM CODES, ORDINANCES AND STANDARDS. THIS FACT DOES NOT RELIEVE THE DEVELOPER OR GENERAL CONTRACTOR FROM THE FULL COMPLIANCE WITH ALL MINIMUM STATE AND SANTAQUIN CITY CODES, ORDINANCES AND STANDARDS.

ROADWAY/STORM DRAIN

- ALL ROADWAY CONSTRUCTION SHALL MEET THE MINIMUM REQUIREMENTS OF SANTAQUIN CITY'S TECHNICAL SPECIFICATIONS OR AS APPROVED IN THE PLANS HEREIN.
- WHEN DISCREPANCIES OCCUR BETWEEN PLANS AND SPECIFICATIONS, THE CONTRACTOR SHALL IMMEDIATELY NOTIFY THE ENGINEER. UNTIMELY NOTIFICATION SHALL NEGATE ANY CONTRACTORS CLAIM FOR ADDITIONAL COMPENSATION.
- ALL STORM DRAIN PIPES TO BE REINFORCED CONCRETE PIPE (RCP) CLASS III, HDPE STORM DRAIN PIPE, OR APPROVED EQUAL UNLESS OTHERWISE NOTED.
- CONTRACTOR IS RESPONSIBLE TO ENSURE THAT ALL CLEANOUT/ACCESS LOCATIONS MEET SANTAQUIN IRRIGATION COMPANY SPECIFICATIONS AND ARE COMPLETED UNDER THE DIRECTION OF SANTAQUIN IRRIGATION COMPANY.
- ALL IRRIGATION CORNERS (ANGLE POINTS) SHALL HAVE A PRE CAST - REINFORCED CONCRETE MANHOLE, WITH A WATERTIGHT SOLID MANHOLE COVER.
- ALL STORM DRAIN INLET BOXES TO MEET SANTAQUIN CITY STANDARD DRAWING SDI W/3' SEDIMENT TRAP.



SEWER

- ALL WORK SHALL BE DONE IN ACCORDANCE WITH THE LATEST SANTAQUIN CITY DESIGN STANDARDS & PUBLIC IMPROVEMENT SPECIFICATIONS DRAWINGS OF SANTAQUIN CITY.
- FINAL APPROVAL AND ACCEPTANCE OF ALL SEWER CONSTRUCTION WILL BE BY SANTAQUIN CITY.
- UPON THE COMPLETION OF WORK, THE CONTRACTOR SHALL SUBMIT 3 SETS OF AS-BUILT PLANS TO SANTAQUIN CITY & (1) SET TO NORTHERN ENGINEERING, INC.
- HORIZONTAL AND VERTICAL SEPARATION OF CULINARY WATER AND SEWER SHALL BE IN COMPLIANCE WITH SANTAQUIN CITY STANDARDS.

WATER

- THE WATER SYSTEM SHALL BE CONSTRUCTED TO CONFORM WITH THE STANDARDS SET FORTH IN THE "UTAH REGULATIONS FOR PUBLIC DRINKING WATER SYSTEMS", AND THE SANTAQUIN CITY PUBLIC WORKS DEPARTMENT STANDARD SPECIFICATIONS AND DRAWINGS.
- CONTRACTOR SHALL NOTIFY NORTHERN ENGINEERING, INC. THREE (3) WORKING DAYS BEFORE INITIAL CONSTRUCTION BEGINS AND SHALL ALSO REQUEST SANTAQUIN CITY WATER DEPARTMENT INSPECTION OF WATER LINES AND APPURTENANCES TWENTY-FOUR (24) HOURS IN ADVANCE OF BACKFILLING.
- CONTRACTOR TO FIELD VERIFY ALL VALVE BOX LID ELEVATIONS TO ASSURE THAT SAID LID ELEVATIONS MATCH FINAL STREET GRADE, AND ALL METER LID ELEVATIONS TO MATCH AN EXTENSION OF THE SIDEWALK GRADE.
- UPON THE COMPLETION OF WORK, THE CONTRACTOR SHALL SUBMIT 3 SETS OF AS-BUILT PLANS TO SANTAQUIN CITY & (1) SET TO NORTHERN ENGINEERING, INC.
- WATER VALVE LIDS ARE TO BE LABELED "WATER" FOR CULINARY VALVES.
- HORIZONTAL AND VERTICAL SEPARATION OF CULINARY WATER AND SEWER SHALL BE IN COMPLIANCE WITH SANTAQUIN CITY STANDARDS.
- WATERLINES TO BE BEDDED AS PER SANTAQUIN CITY DIVISION 3A SECTION 3A.04 SUB-SECTION E.
- ALL CULINARY WATERLINES, REGARDLESS OF SIZE, SHALL BE C-900 PVC PIPE AS PER SANTAQUIN CITY STANDARDS.

SHEET	DESCRIPTION
1	COVER SHEET FINAL PLAT B-3 FINAL PLAT B-4
SP-01	SITE PLAN/PHASING PLAN
UT-01	UTILITY LAYOUT
LS-01	LANDSCAPE
GR-01	GRADING & DRAINAGE
PP-01	PLAN & PROFILE 930 NORTH
PP-02	PLAN & PROFILE 130 WEST
DT-01	ROW DETAILS
DT-02	DETAILS
DT-03	DETAILS

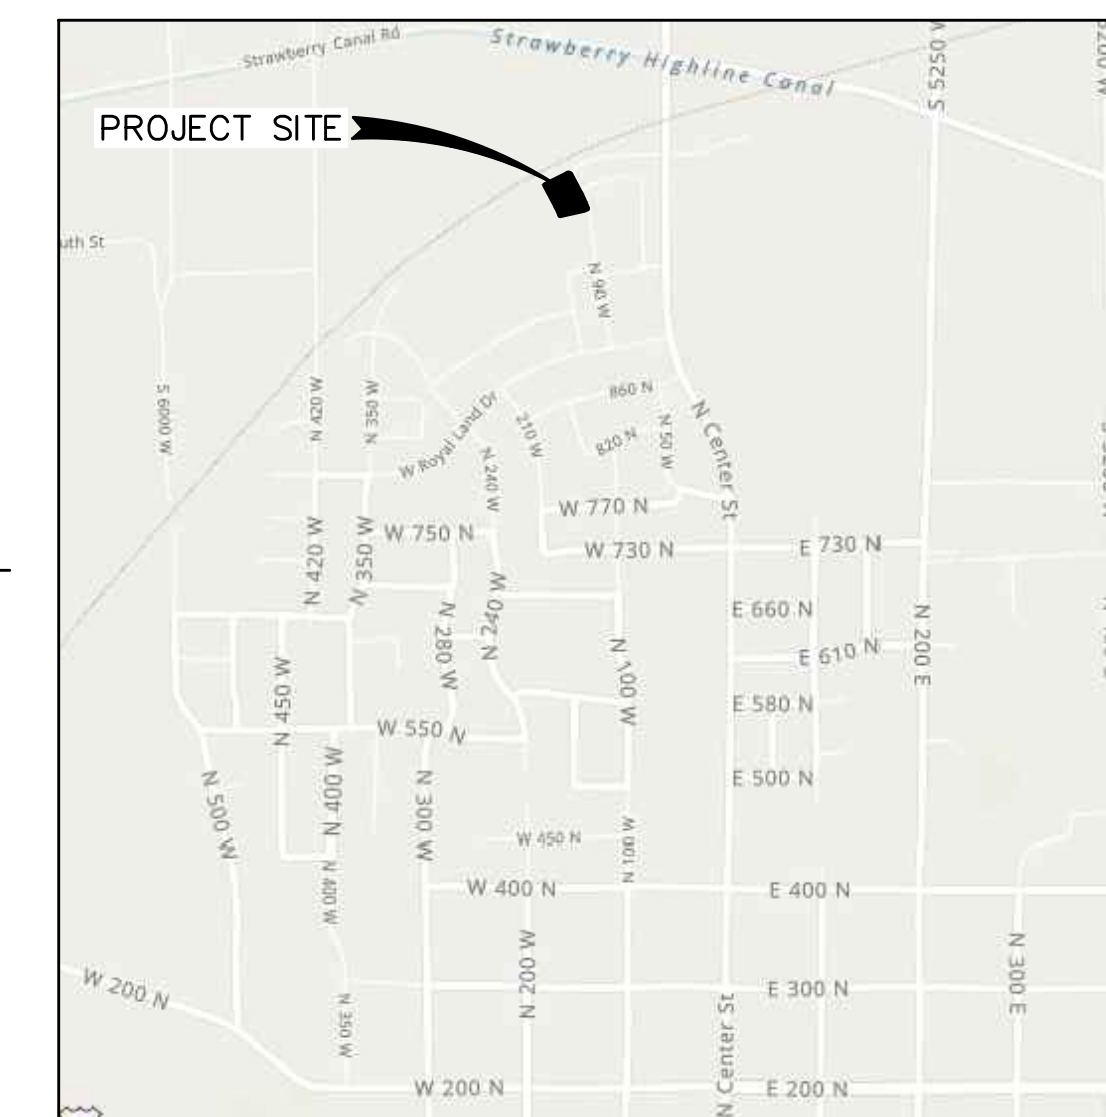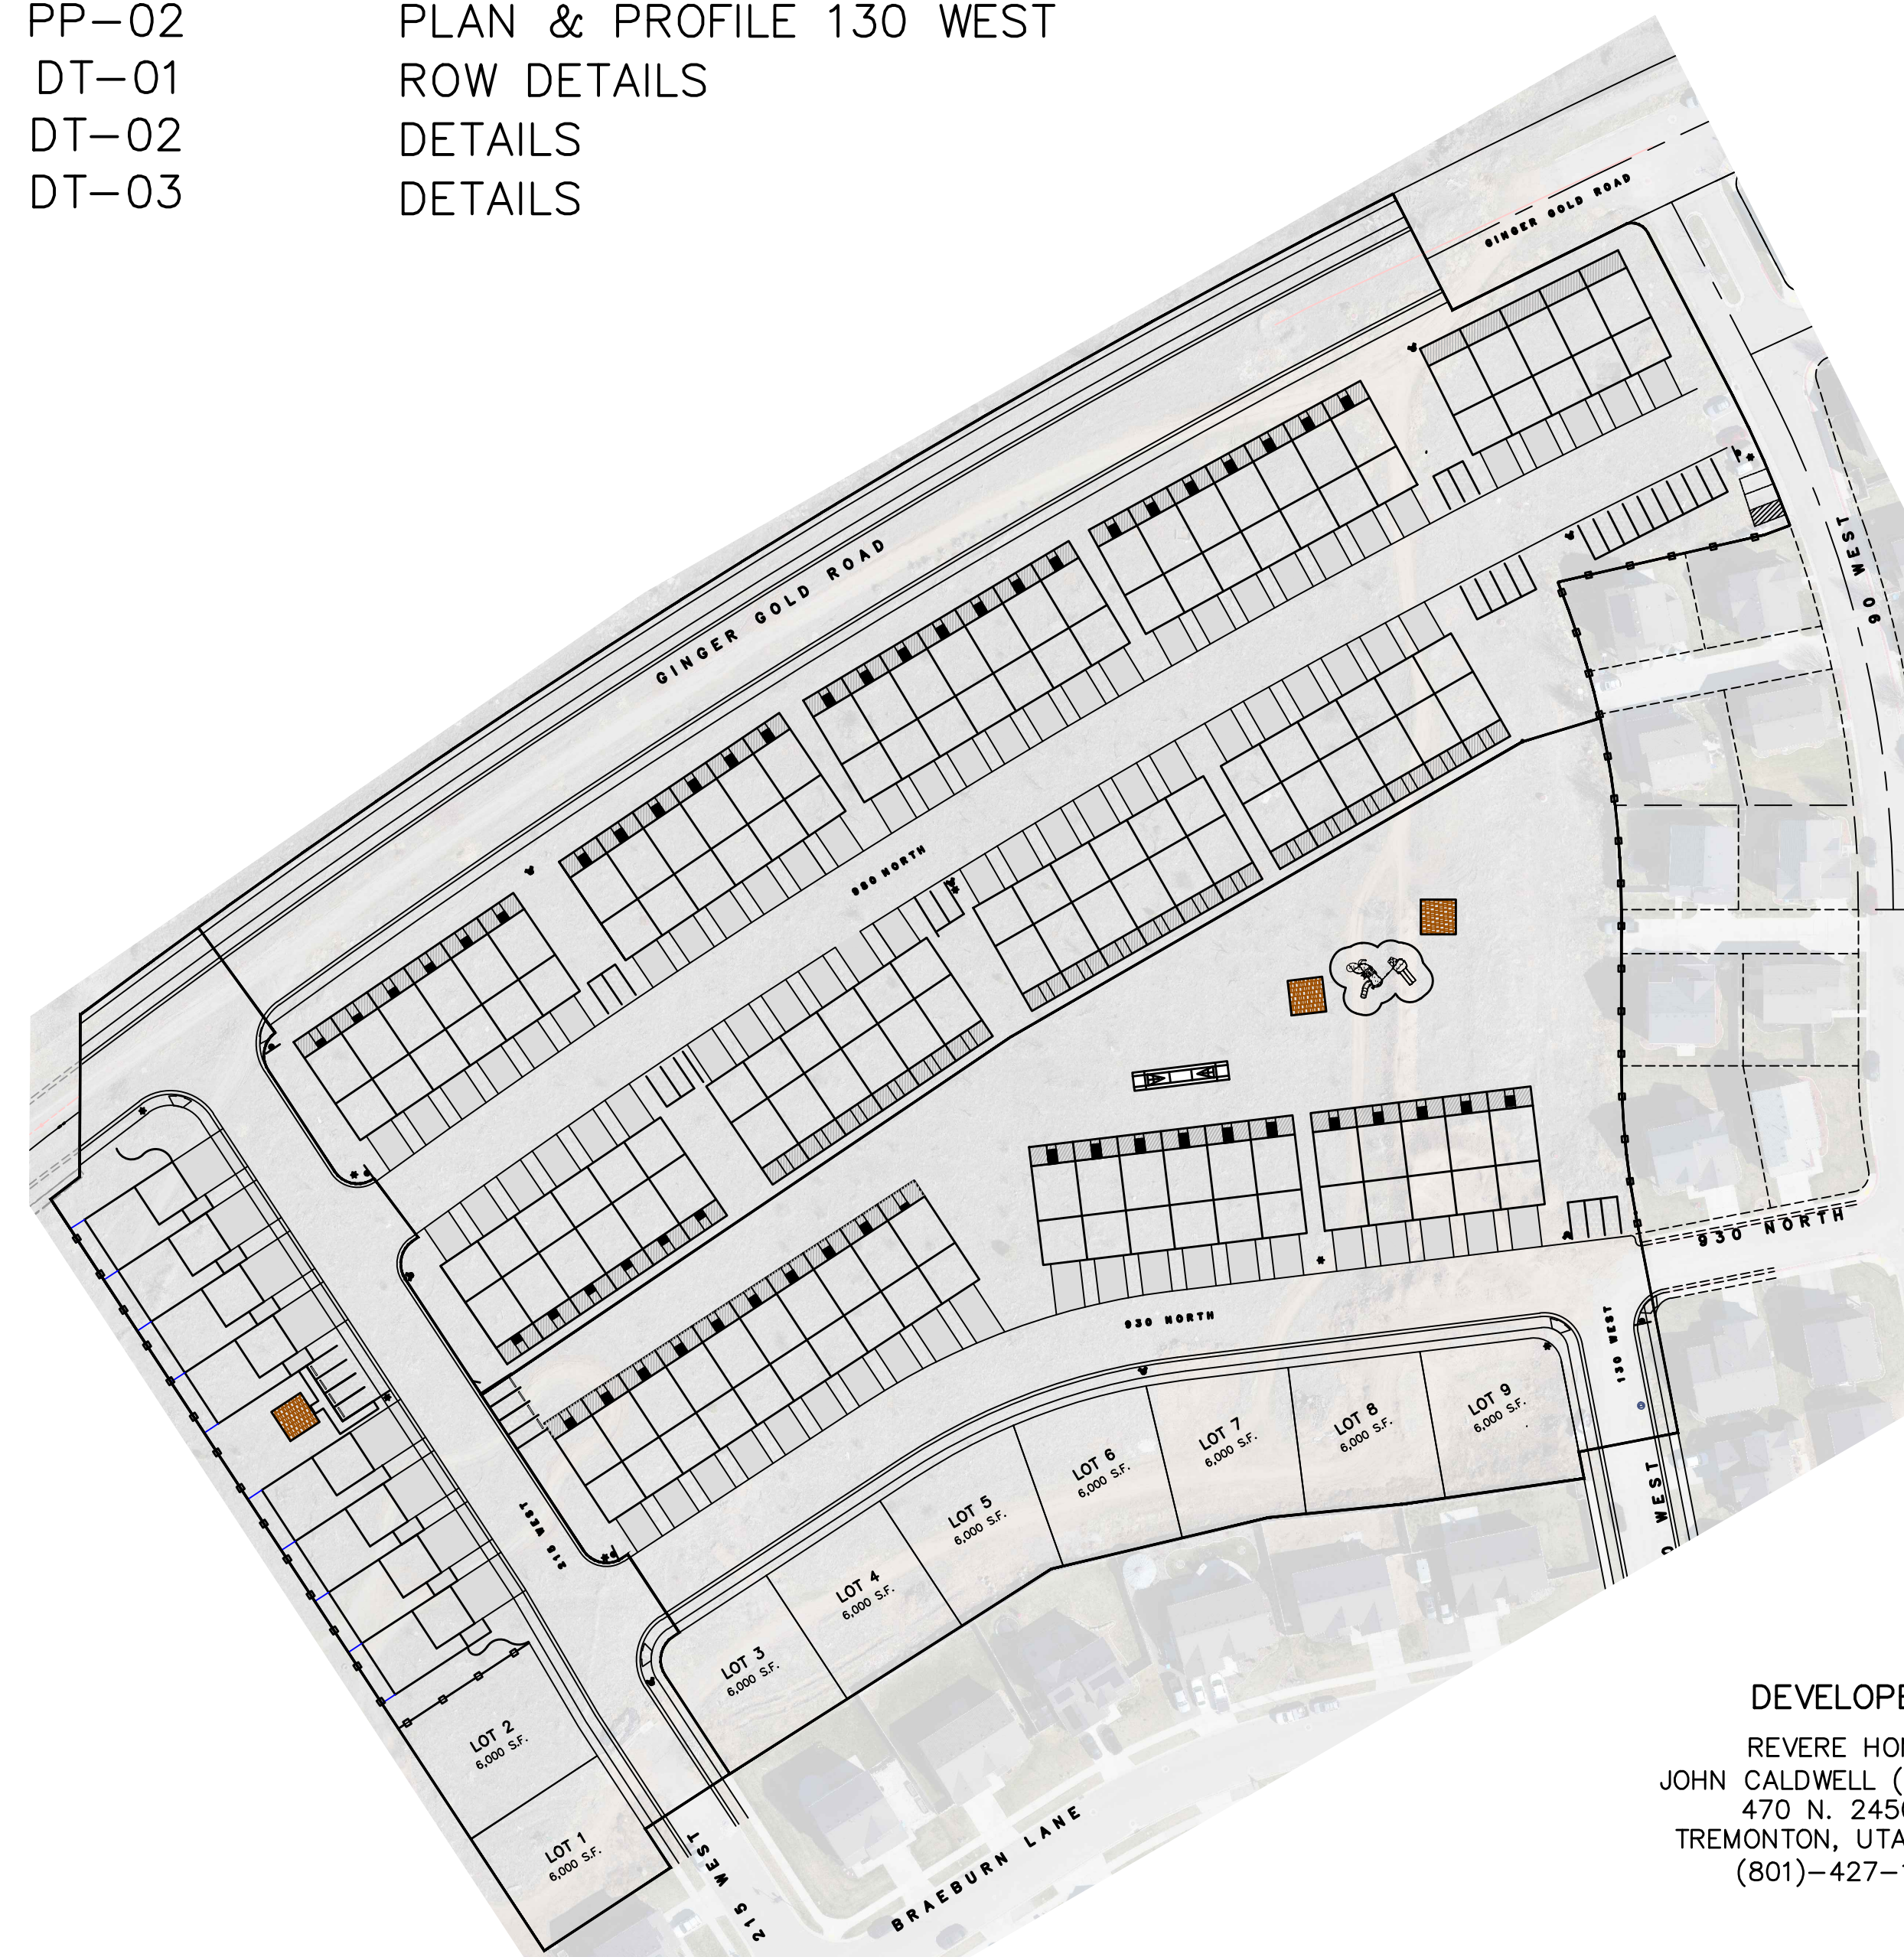

VICINITY MAP
-NTS-



TABULATIONS
APPLE HOLLOW AT THE ORCHARDS B - PHASE 2

ZONE:	R-10 PUD ZONE
PLAT AREA:	4.27 ACRES
# OF LOTS:	7 LOTS
NUMBER OF TOWNHOMES:	21 UNITS
LOT AREA:	0.96 ACRES
TOWNHOME AREA:	0.75 ACRES
COMMON AREA:	1.52 ACRES
LIMITED COMMON AREA:	0.28 ACRES
RIGHT-OF-WAY AREA:	0.76 ACRES
DENSITY:	6.56 UNITS/ACRE

ACCEPTANCE

SIGNATURE: DEVELOPER	DATE
SIGNATURE: CITY ENGINEER	DATE
SIGNATURE: COMMUNITY DEV. DIRECTOR	DATE
SIGNATURE: PUBLIC WORKS	DATE
SIGNATURE: BUILDING DEPARTMENT	DATE
SIGNATURE: POLICE DEPARTMENT	DATE
SIGNATURE: FIRE DEPARTMENT	DATE

DEVELOPER
REVERE HOMES
JOHN CALDWELL (MANAGER)
470 N. 2450 W.
TREMONTON, UTAH 84337
(801)-427-1733

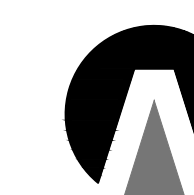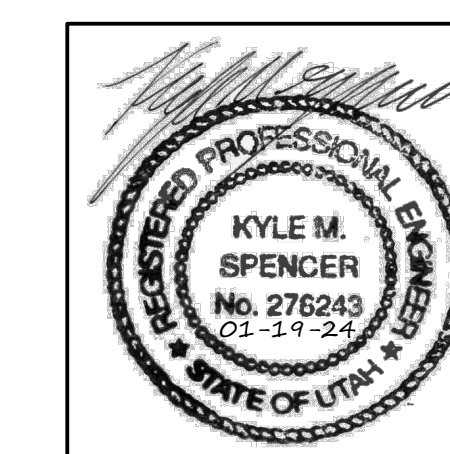

**Northern
ENGINEERING INC**
ENGINEERING-LAND PLANNING
CONSTRUCTION MANAGEMENT

1040 E. 800 N.
OREM, UTAH 84097
(801) 802-8992



VICINITY MAP

CURVE	LENGTH	RADIUS	CHORD DIST.	CHORD BRG.	DELTA
C1	23.56'	15.00'	21.31'	N78°17'02"W	90°00'00"
C2	105.01'	477.50'	104.80'	S81°8'01"E	123°02'
C3	80.75'	422.50'	80.82'	S52°28'30"E	105°00'
C4	22.50'	15.00'	20.45'	N53°55'31"W	85°57'03"
C5	155.87'	336.50'	154.49'	S69°54'29"W	28°22'28"
C6	169.87'	369.50'	168.38'	N69°53'14"E	28°22'28"
C7	176.35'	389.50'	177.77'	S69°54'29"W	28°22'28"

APPLE HOLLOW AT THE ORCHARDS FINAL PLAT B-3

A PARCEL OF LAND LOCATED IN THE NORTHEAST QUARTER OF SECTION 35, TOWNSHIP 9 SOUTH, RANGE 1 EAST SALT LAKE BASE AND MERIDIAN

DEVELOPER
REVERE HOMES
JOHN CALDWELL (MANAGER)
470 N. 2550 W.
TREMONTON, UTAH 84337
(801)-427-1733


GRID FACTOR: 0.99961

NAD 27 STAT PLAN COORDINATED	
NORTHING	EASTING
A	603525.85 1919958.33
B	604166.61 1918837.64
C	604209.23 1918809.66
D	604213.54 1918788.90
E	604298.20 1918733.32
F	604493.33 1919022.01
G	604653.61 1919300.00
H	604666.36 1919342.31
I	604562.23 1919353.81
J	604477.25 1919353.81
K	604397.03 1919361.50
L	604277.66 1919384.59
M	604267.22 1919330.63
N	604316.95 1919321.01
O	604328.99 1919304.49
P	604305.95 1919114.11
Q	604252.90 1918969.08



(24"x36")
SCALE 1" = 30'
(11"x17")
SCALE 1" = 60'

- NOTES:
- 1) ALL LIMITED COMMON AREA & OPEN SPACE, COMMON AREAS ARE DEDICATED AS PUBLIC UTILITY EASEMENTS
 - 2) THIS PROPERTY IS LOCATED IN THE VICINITY OF AN ESTABLISHED AGRICULTURE PROTECTION AREA IN WHICH NORMAL AGRICULTURAL USES AND ACTIVITIES HAVE BEEN AFFORDED THE HIGHEST PRIORITY USE STATUS. IT CAN BE ANTICIPATED THAT SUCH AGRICULTURE USES AND ACTIVITIES MAY NOW OR IN THE FUTURE BE CONDUCTED ON PROPERTY INCLUDED IN THE AGRICULTURE PROTECTION AREA. THE USE AND ENJOYMENT OF THIS PROPERTY IS EXPRESSLY CONDITIONED ON ACCEPTANCE OF ANY ANNOYANCE OR INCONVENIENCE WHICH MAY RESULT FROM SUCH NORMAL AGRICULTURAL USES AND ACTIVITIES.
 - 3) ALL BUILDING WALLS ARE PARALLEL WITH, PERPENDICULAR TO REFERENCED BEARING SHOWN ON BUILDING.
 - 4) ALL HOUSE PLANS TO BE SIGNED BY ARCHITECTURAL REVIEW COMMITTEE PRIOR TO SUBMITTING FOR BUILDING PERMITS.

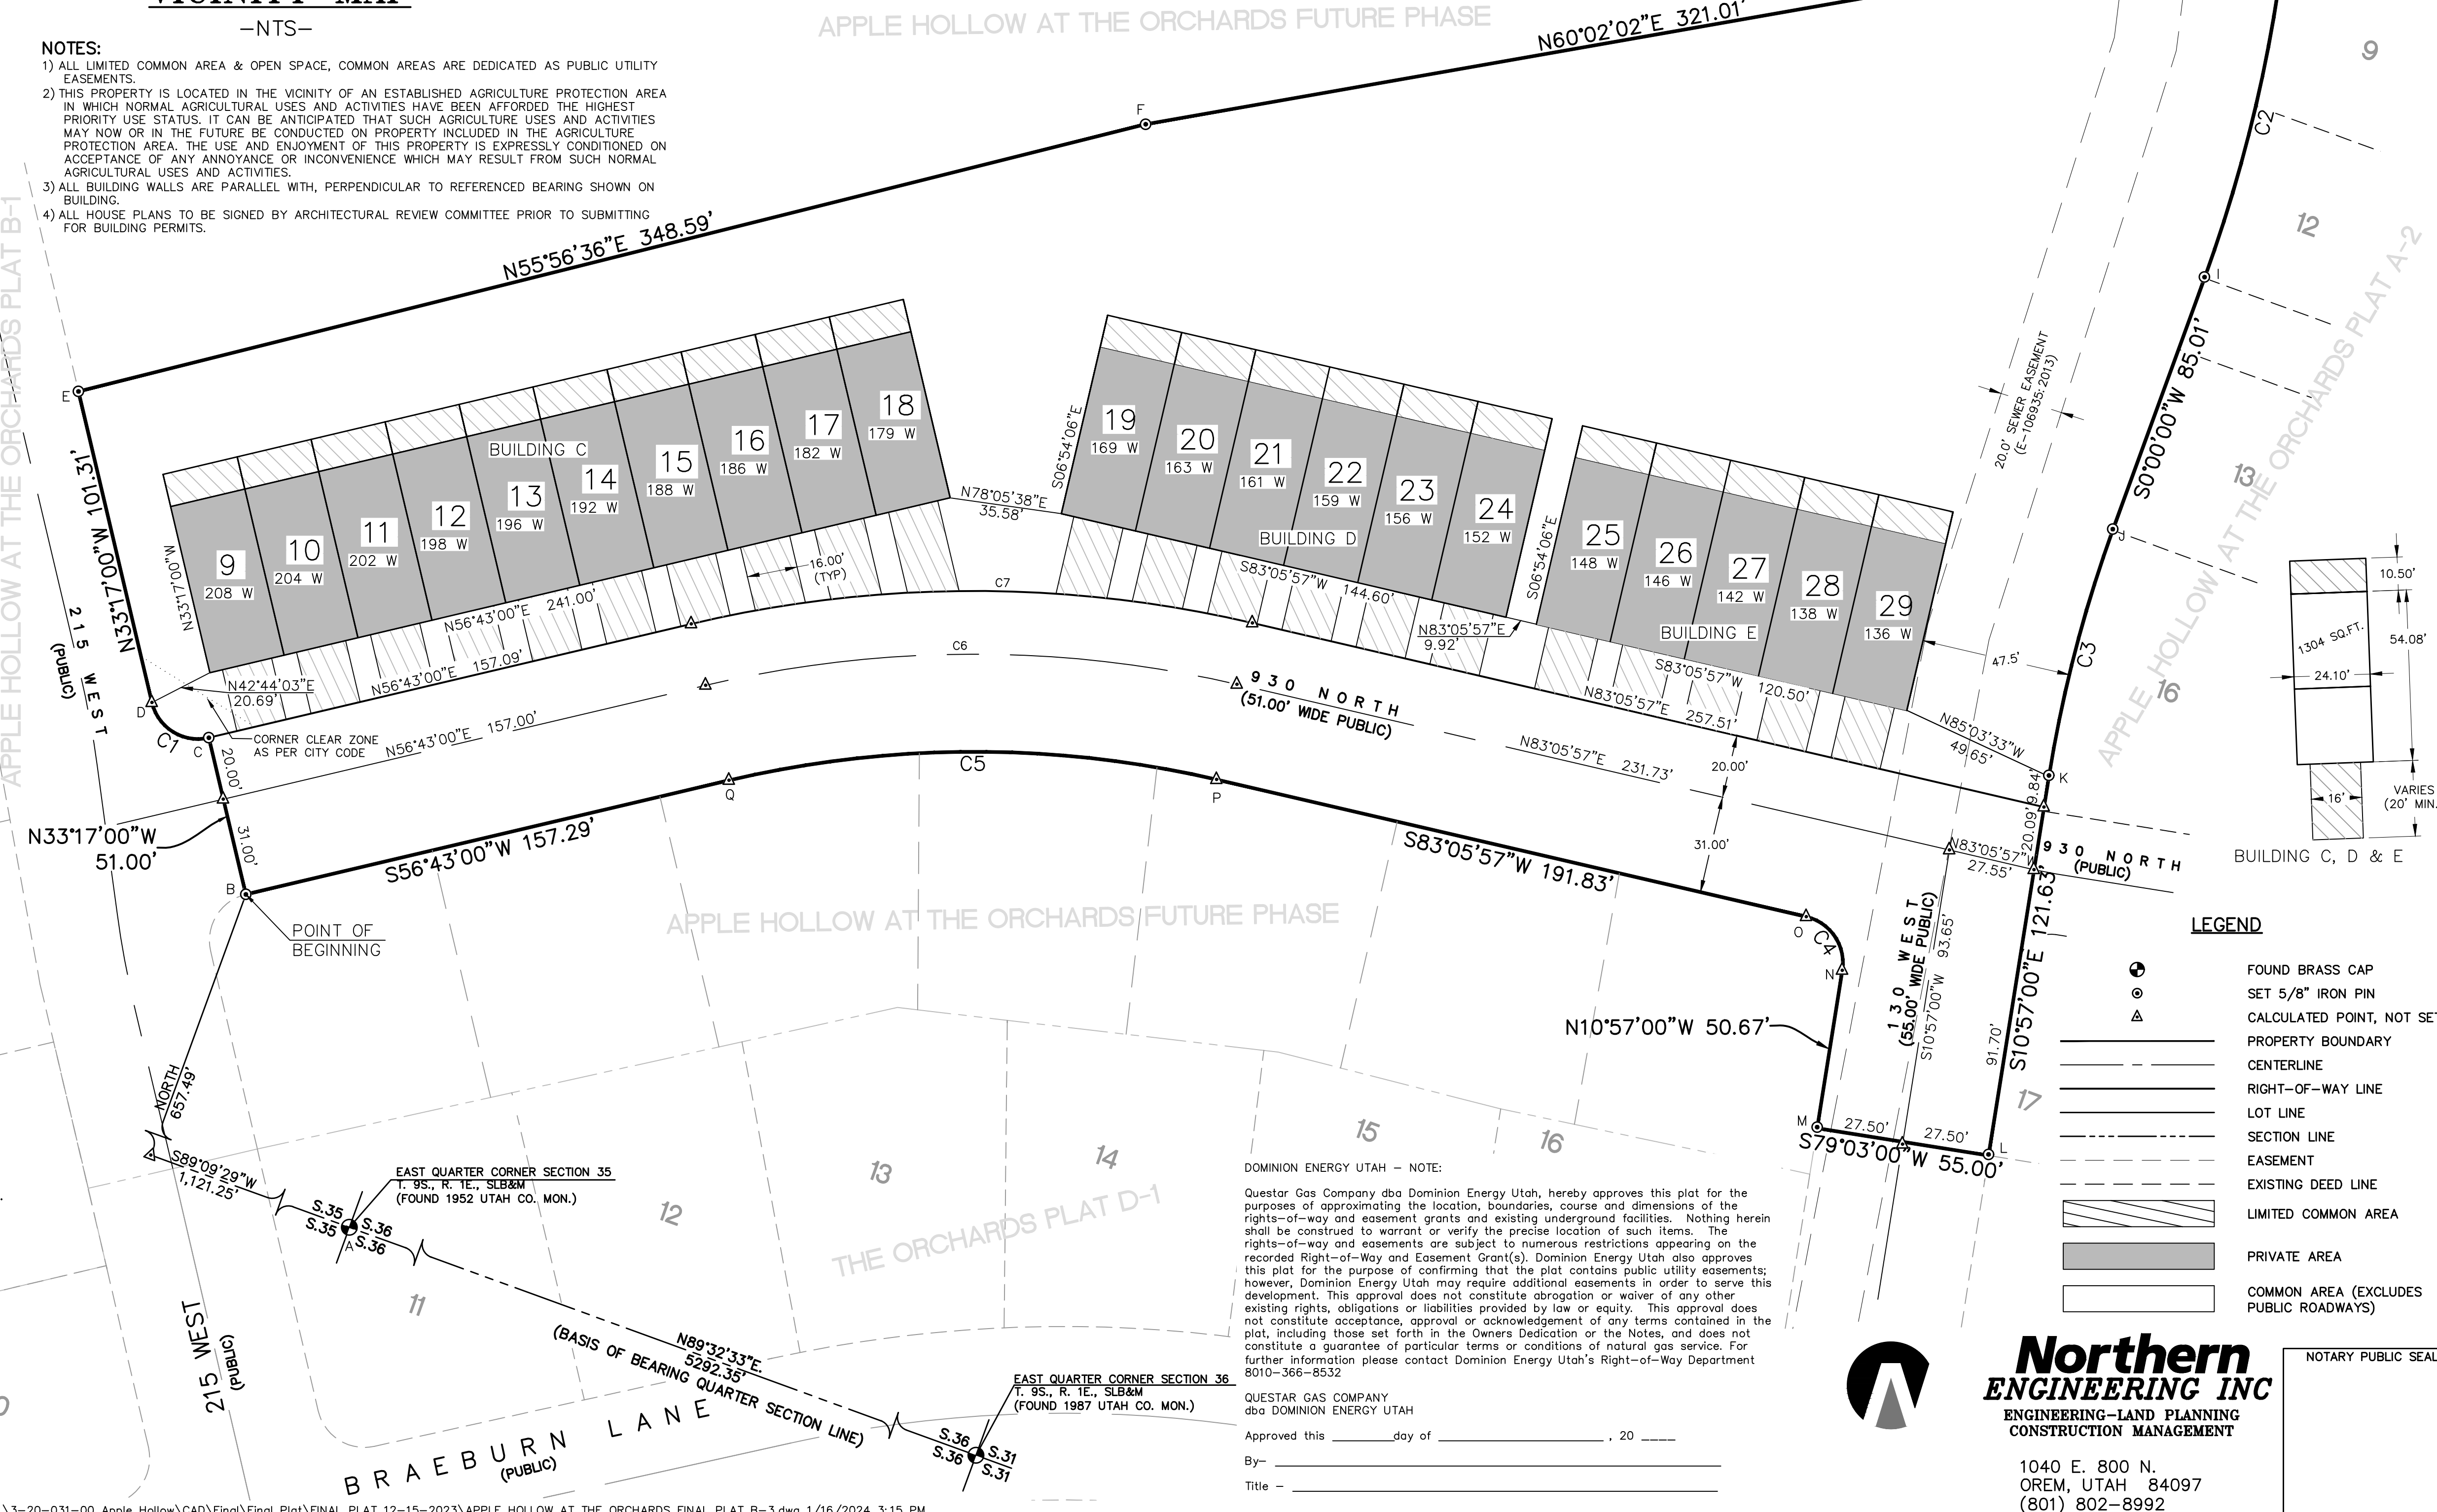

SURVEYOR'S CERTIFICATE

I, KENNETH E. BARNEY, DO HEREBY CERTIFY THAT I AM A REGISTERED LAND SURVEYOR, AND THAT I HOLD A LICENSE IN ACCORDANCE WITH TITLE 58, CHAPTER 22, PROFESSIONAL ENGINEERS AND LAND SURVEYORS LICENSING ACT, UTAH CODE ANNOTATED, 1953 AS AMENDED, CERTIFICATE NO. 172762. I FURTHER CERTIFY THAT BY AUTHORITY OF THE OWNERS, I HAVE MADE A SURVEY OF THE TRACT OF LAND SHOWN ON THIS PLAT AND DESCRIBED BELOW (PARCELS 30-030-0069 & 30-030-0085), HAVE SUBDIVIDED SAID TRACT OF LAND INTO LOTS, STREETS, AND EASEMENTS, HAVE COMPLETED A SURVEY OF THE PROPERTY DESCRIBED ON THIS PLAT IN ACCORDANCE WITH SECTION 17-23-17, UTAH CODE ANNOTATED, 1953 AS AMENDED, HAVE VERIFIED ALL MEASUREMENTS, AND HAVE PLACED MONUMENTS AS REPRESENTED ON THE PLAT. I FURTHER CERTIFY THAT EVERY EXISTING RIGHT-OF-WAY AND EASEMENT GRANT OF RECORD FOR UNDERGROUND FACILITIES, AS DEFINED IN SECTION 54-8a-2, UTAH CODE ANNOTATED, 1953 AS AMENDED, AND FOR OTHER UTILITY FACILITIES, IS ACCURATELY DESCRIBED ON THIS PLAT, AND THAT THIS PLAT IS TRUE AND CORRECT.

DATE _____ KENNETH E. BARNEY, P.L.S.

BOUNDARY DESCRIPTION

A PARCEL OF LAND LOCATED IN THE NORTHEAST QUARTER OF SECTION 35, TOWNSHIP 9 SOUTH, RANGE 1 EAST, SALT LAKE BASE AND MERIDIAN, UTAH COUNTY, UTAH. MORE PARTICULARLY DESCRIBED AS:

COMMENCING AT A BRASS CAP MONUMENT MARKING THE EAST 1/4 CORNER OF SAID SECTION 35, THENCE S.89°09'29"W. ALONG THE 1/4 SECTION LINE A DISTANCE OF 1121.25 FEET; THENCE NORTH A DISTANCE OF 657.49 FEET TO THE REAL POINT OF BEGINNING

THENCE N.33°17'00"W. A DISTANCE OF 51.00 FEET TO A POINT OF CURVATURE OF A 15.00-FOOT RADIUS NON-TANGENT CURVE TO THE LEFT; THENCE NORTHWESTERLY ALONG THE ARC OF SAID CURVE 23.56 FEET HAVING A CENTRAL ANGLE OF 90°00'00" AND A CHORD THAT BEARS N.78°17'00"W. A DISTANCE OF 21.31 FEET; THENCE N.33°17'00"W. A DISTANCE OF 101.31 FEET; THENCE N.55°56'36" E. A DISTANCE OF 348.59 FEET; THENCE N.60°02'02"E. A DISTANCE OF 321.01 FEET; THENCE N.73°14'19"E. A DISTANCE OF 44.21 FEET TO A POINT OF CURVATURE OF A 477.50-FOOT RADIUS TANGENT CURVE TO THE RIGHT; THENCE SOUTHEASTERLY ALONG THE ARC OF SAID CURVE 105.01 FEET HAVING A CENTRAL ANGLE OF 123°02'00" AND A CHORD THAT BEARS S.06°18'01"E. A DISTANCE OF 104.80 FEET; THENCE S.00°00'00" W. A DISTANCE OF 85.01 FEET TO A POINT OF CURVATURE OF A 422.50-FOOT RADIUS TANGENT CURVE TO THE LEFT; THENCE SOUTHEASTERLY ALONG THE ARC OF SAID CURVE 80.75 FEET HAVING A CENTRAL ANGLE OF 105°00'00" AND A CHORD THAT BEARS S.05°28'30"E. A DISTANCE OF 80.62 FEET; THENCE S.10°57'00" E. A DISTANCE OF 121.63 FEET; THENCE S.79°03'00"W. A DISTANCE OF 55.00 FEET; THENCE N.10°57'00"W. A DISTANCE OF 50.67 FEET TO A POINT OF CURVATURE OF A 15.00-FOOT RADIUS TANGENT CURVE TO THE LEFT; THENCE NORTHWESTERLY ALONG THE ARC OF SAID CURVE 22.50 FEET HAVING A CENTRAL ANGLE OF 85°57'03" AND A CHORD THAT BEARS N.53°55'31"W. A DISTANCE OF 20.45 FEET; THENCE S.83°05'57" W. A DISTANCE OF 191.83 FEET TO A POINT OF CURVATURE OF A 338.50-FOOT RADIUS TANGENT CURVE TO THE LEFT; THENCE SOUTHWESTERLY ALONG THE ARC OF SAID CURVE 155.87 FEET HAVING A CENTRAL ANGLE OF 26°22'28" AND A CHORD THAT BEARS S.69°54'29"W. A DISTANCE OF 154.49 FEET; THENCE S.56°43'00" W. A DISTANCE OF 157.29 FEET TO THE REAL POINT OF BEGINNING

CONTAINING 143,858 sq.ft. OR 3.30 acres MORE OR LESS.

OWNER'S DEDICATION

KNOW ALL MEN BY THESE PRESENTS THAT WE, ALL OF THE UNDERSIGNED OWNERS OF ALL THE PROPERTY DESCRIBED IN THE SURVEYOR'S CERTIFICATE HEREON AND SHOWN ON THIS MAP, HAVE CAUSED THE SAME TO BE SUBDIVIDED INTO LOTS, STREETS, AND EASEMENTS AND DO HEREBY DEDICATE THE STREETS AND OTHER PUBLIC AREAS AS INDICATED HEREON TO SANTAQUIN CITY FOR PERPETUAL USE OF THE PUBLIC.

IN WITNESS WHEREOF WE HAVE HEREUNTO SET OUR HANDS THIS DAY OF _____, A.D. 20____.

BY: _____

ACKNOWLEDGMENT

STATE OF UTAH } S.S.
COUNTY OF UTAH } S.S.

ON THIS _____ DAY OF _____, IN THE YEAR 20____, BEFORE ME, _____, PERSONALLY APPEARED JOHN CALDWELL, WHO DULY ACKNOWLEDGED TO ME THAT (S)HE IS A OWNER [MEMBER WITH MANAGEMENT AUTHORITY] [MANAGER] OF REVERE HOMES, A UTAH LIMITED LIABILITY COMPANY, AND IS AUTHORIZED TO EXECUTE THE FOREGOING AGREEMENT IN ITS BEHALF AND THAT HE OR SHE EXECUTED IT IN SUCH CAPACITY.

NOTARY PUBLIC _____
NOTARY FULL NAME _____ A NOTARY COMMISSIONED IN UTAH
COMMISSION NUMBER _____ MY COMMISSION EXPIRES _____

ACCEPTANCE BY LEGISLATIVE BODY

THE CITY COUNCIL OF SANTAQUIN, COUNTY OF UTAH, APPROVES THIS SUBDIVISION AND HEREBY ACCEPTS THE DEDICATION OF ALL STREETS, EASEMENTS, AND OTHER PARCELS OF LAND INTENDED FOR PUBLIC PURPOSES FOR THE PERPETUAL USE OF THE PUBLIC THIS _____ DAY OF _____, A.D. 20____.

APPROVED BY MAYOR _____
ATTEST _____
CITY ENGINEER (SEE SEAL) CITY RECORDER (SEE SEAL)

ROCKY MOUNTAIN POWER ACCEPTANCE

APPROVED THIS _____ DAY OF _____, A.D. 20____, BY THE ROCKY MOUNTAIN POWER COMPANY.
BY _____ TITLE _____

APPROVED THIS _____ DAY OF _____, A.D. 20____, BY THE ROCKY MOUNTAIN POWER COMPANY.
BY _____ TITLE _____

APPLE HOLLOW AT THE ORCHARDS FINAL PLAT B-3

A PARCEL OF LAND LOCATED IN THE NORTHEAST QUARTER OF SECTION 35, TOWNSHIP 9 SOUTH, RANGE 1 EAST SALT LAKE BASE AND MERIDIAN

SANTAQUIN UTAH COUNTY, UTAH

SCALE: 1" = 30 FEET

NOTARY PUBLIC SEAL _____

SURVEYOR'S SEAL
K E BARNEY
No. 172762
Kenneth E. Barney
STATE OF UTAH

CLERK-RECORDER SEAL _____

UTAH COUNTY RECORDER STAMP _____

DOMINION ENERGY UTAH - NOTE:

Questar Gas Company dba Dominion Energy Utah, hereby approves this plat for the purposes of approximating the location, boundaries, course and dimensions of the rights-of-way and easement grants and existing underground facilities. Nothing herein shall be construed to warrant or verify the precise location of such items. The rights-of-way and easements are subject to numerous restrictions appearing on the recorded Right-of-Way and Easement Grant(s). Dominion Energy Utah also approves this plat for the purpose of confirming that the plat contains public utility easements; however, Dominion Energy Utah may require additional easements in order to serve this development. This approval does not constitute abrogation or waiver of any other existing rights, obligations or liabilities provided by law or equity. This approval does not constitute acceptance, approval or acknowledgement of any terms contained in the plat, including those set forth in the Owners Dedication or the Notes, and does not constitute a guarantee of particular terms or conditions of natural gas service. For further information please contact Dominion Energy Utah's Right-of-Way Department 801-366-8532


QUESTAR GAS COMPANY dba DOMINION ENERGY UTAH
Approved this _____ day of _____, 20____
By: _____
Title _____

Northern ENGINEERING INC
ENGINEERING-LAND PLANNING
CONSTRUCTION MANAGEMENT


1040 E. 800 N.
OREM, UTAH 84097
(801) 802-8992



VICINITY MAP

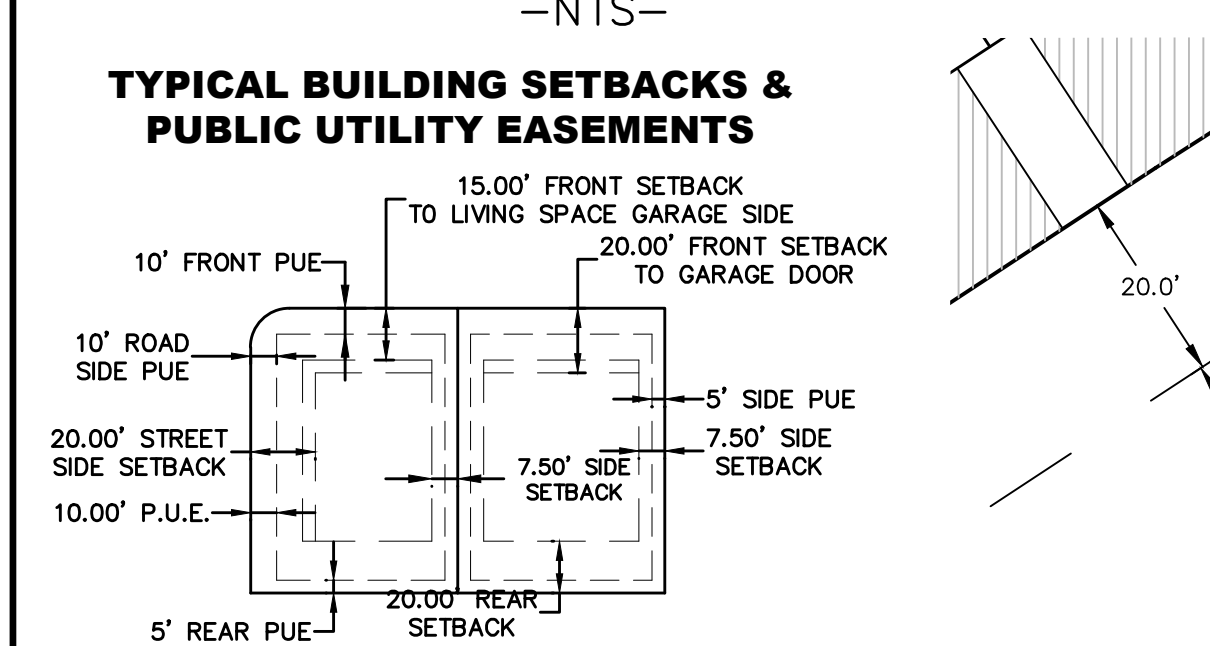

APPLE HOLLOW AT THE ORCHARDS FINAL PLAT B-4
 A PARCEL OF LAND LOCATED IN THE NORTHEAST QUARTER OF SECTION 35, TOWNSHIP 9 SOUTH, RANGE 1 EAST SALT LAKE BASE AND MERIDIAN

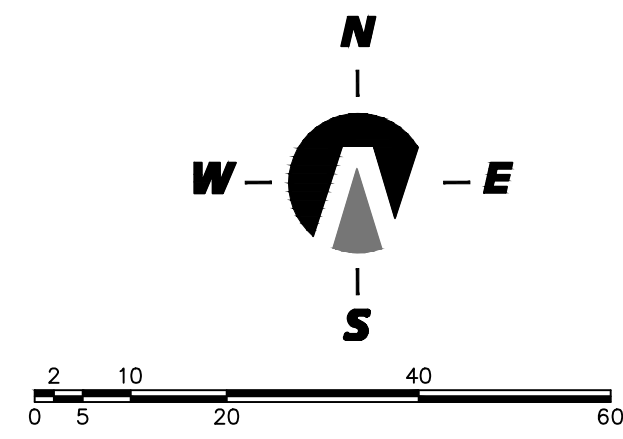

SURVEYOR'S CERTIFICATE
 I, KENNETH E. BARNEY, DO HEREBY CERTIFY THAT I AM A REGISTERED LAND SURVEYOR, AND THAT I HOLD A LICENSE IN ACCORDANCE WITH TITLE 58, CHAPTER 22, PROFESSIONAL ENGINEERS AND LAND SURVEYORS LICENSING ACT, UTAH CODE ANNOTATED, 1953 AS AMENDED, CERTIFICATE NO. 172762. I FURTHER CERTIFY THAT BY AUTHORITY OF THE OWNERS, I HAVE MADE A SURVEY OF THE TRACT OF LAND SHOWN ON THIS PLAT AND DESCRIBED BELOW (PARCELS 30-030-0069 & 30-030-0085), HAVE SUBDIVIDED SAID TRACT OF LAND INTO LOTS, STREETS, AND EASEMENTS, AND COMPLETED A SURVEY OF THE PROPERTY DESCRIBED ON THIS PLAT IN ACCORDANCE WITH SECTION 17-23-17, UTAH CODE ANNOTATED, 1953 AS AMENDED, HAVE VERIFIED ALL MEASUREMENTS, AND HAVE PLACED MONUMENTS AS REPRESENTED ON THE PLAT. I FURTHER CERTIFY THAT EVERY EXISTING RIGHT-OF-WAY AND EASEMENT GRANT OF RECORD FOR UNDERGROUND FACILITIES, AS DEFINED IN SECTION 54-8a-2, UTAH CODE ANNOTATED, 1953 AS AMENDED, AND FOR OTHER UTILITY FACILITIES, IS ACCURATELY DESCRIBED ON THIS PLAT, AND THAT THIS PLAT IS TRUE AND CORRECT.

DATE _____ KENNETH E. BARNEY, P.L.S.
BOUNDARY DESCRIPTION
 A PARCEL OF LAND LOCATED IN THE NORTHEAST QUARTER OF SECTION 35, TOWNSHIP 9 SOUTH, RANGE 1 EAST, SALT LAKE BASE AND MERIDIAN, UTAH COUNTY, UTAH. MORE PARTICULARLY DESCRIBED AS:

COMMENCING AT A BRASS CAP MONUMENT MARKING THE EAST 1/4 CORNER OF SAID SECTION 35, THENCE S.89°09'29"W ALONG THE 1/4 SECTION LINE A DISTANCE OF 1090.23 FEET; THENCE NORTH A DISTANCE OF 582.45 FEET TO THE REAL POINT OF BEGINNING
 THENCE N.33°17'00"W A DISTANCE OF 64.37 FEET TO A POINT OF CURVATURE OF A 15.00-FOOT RADIUS TANGENT CURVE TO THE RIGHT; THENCE NORTHEASTERLY ALONG THE ARC OF SAID CURVE 23.56 FEET HAVING A CENTRAL ANGLE OF 90°00'00" AND A CHORD THAT BEARS N.114°3'00"E. A DISTANCE OF 21.21 FEET; THENCE N.56°43'00"E A DISTANCE OF 157.29 FEET TO A POINT OF CURVATURE OF A 338.50-FOOT RADIUS TANGENT CURVE TO THE RIGHT; THENCE NORTHEASTERLY ALONG THE ARC OF SAID CURVE 155.87 FEET HAVING A CENTRAL ANGLE OF 26°22'58" AND A CHORD THAT BEARS N.69°54'29"E. A DISTANCE OF 154.49 FEET; THENCE N.83°05'57"E. A DISTANCE OF 191.83 FEET TO A POINT OF CURVATURE OF A 15.00-FOOT RADIUS TANGENT CURVE TO THE RIGHT; THENCE SOUTHEASTERLY ALONG THE ARC OF SAID CURVE 22.50 FEET HAVING A CENTRAL ANGLE OF 85°57'03" AND A CHORD THAT BEARS S.53°55'31"E. A DISTANCE OF 20.45 FEET; THENCE S.10°57'00"E. A DISTANCE OF 65.40 FEET; THENCE S.81°55'32"W A DISTANCE OF 100.13 FEET; THENCE S.84°18'24"W. A DISTANCE OF 72.74 FEET; THENCE S.76°41'28"W A DISTANCE OF 121.50 FEET; THENCE S.57°31'24"W A DISTANCE OF 207.69 FEET TO THE REAL POINT OF BEGINNING

CONTAINING 42,000 sq. ft. OR 0.96 ACRES MORE OR LESS.
OWNER'S DEDICATION
 KNOW ALL MEN BY THESE PRESENTS THAT WE, ALL OF THE UNDERSIGNED OWNERS OF ALL THE PROPERTY DESCRIBED IN THE SURVEYOR'S CERTIFICATE HEREON AND SHOWN ON THIS MAP, HAVE CAUSED THE SAME TO BE SUBDIVIDED INTO LOTS, STREETS, AND EASEMENTS AND DO HEREBY DEDICATE THE STREETS AND OTHER PUBLIC AREAS AS INDICATED HEREON TO SANTAQUIN CITY FOR PERPETUAL USE OF THE PUBLIC.
 IN WITNESS WHEREOF WE HAVE HERETO SET OUR HANDS THIS DAY OF _____ A.D. 20____.

BY: _____ BY: _____
 JOHN CALDWELL, OWNER REVERE HOMES, LLC

ACKNOWLEDGMENT
 STATE OF UTAH } s.s.
 COUNTY OF UTAH }
 ON THIS _____ DAY OF _____, IN THE YEAR 20____, BEFORE ME, _____, PERSONALLY APPEARED JOHN CALDWELL, WHO DULY ACKNOWLEDGED TO ME THAT (S)HE IS A _____ [MEMBER WITH MANAGEMENT AUTHORITY] [MANAGER] OF REVERE HOMES, A UTAH LIMITED LIABILITY COMPANY, AND IS AUTHORIZED TO EXECUTE THE FOREGOING AGREEMENT IN ITS BEHALF AND THAT HE OR SHE EXECUTED IT IN SUCH CAPACITY.

NOTARY PUBLIC _____
 NOTARY FULL NAME _____ A NOTARY COMMISSIONED IN UTAH
 COMMISSION NUMBER _____ MY COMMISSION EXPIRES _____



ACCEPTANCE BY LEGISLATIVE BODY
 THE CITY COUNCIL OF SANTAQUIN, COUNTY OF UTAH, APPROVES THIS SUBDIVISION AND HEREBY ACCEPTS THE DEDICATION OF ALL STREETS, EASEMENTS, AND OTHER PARCELS OF LAND INTENDED FOR PUBLIC PURPOSES FOR THE PERPETUAL USE OF THE PUBLIC THIS _____ DAY OF _____ A.D. 20____.

APPROVED BY MAYOR _____ ATTEST _____
 CITY ENGINEER (SEE SEAL) CITY RECORDER (SEE SEAL)

ROCKY MOUNTAIN POWER ACCEPTANCE
 APPROVED THIS _____ DAY OF _____ A.D. 20____, BY THE ROCKY MOUNTAIN POWER COMPANY.
 BY _____ TITLE _____

APPLE HOLLOW AT THE ORCHARDS FINAL PLAT B-4
 A PARCEL OF LAND LOCATED IN THE NORTHEAST QUARTER OF SECTION 35, TOWNSHIP 9 SOUTH, RANGE 1 EAST SALT LAKE BASE AND MERIDIAN
 SANTAQUIN UTAH COUNTY, UTAH
 SCALE: 1" = 20 FEET

NOTARY PUBLIC SEAL SURVEYOR'S SEAL CLERK-RECORDER SEAL UTAH COUNTY RECORDER STAMP

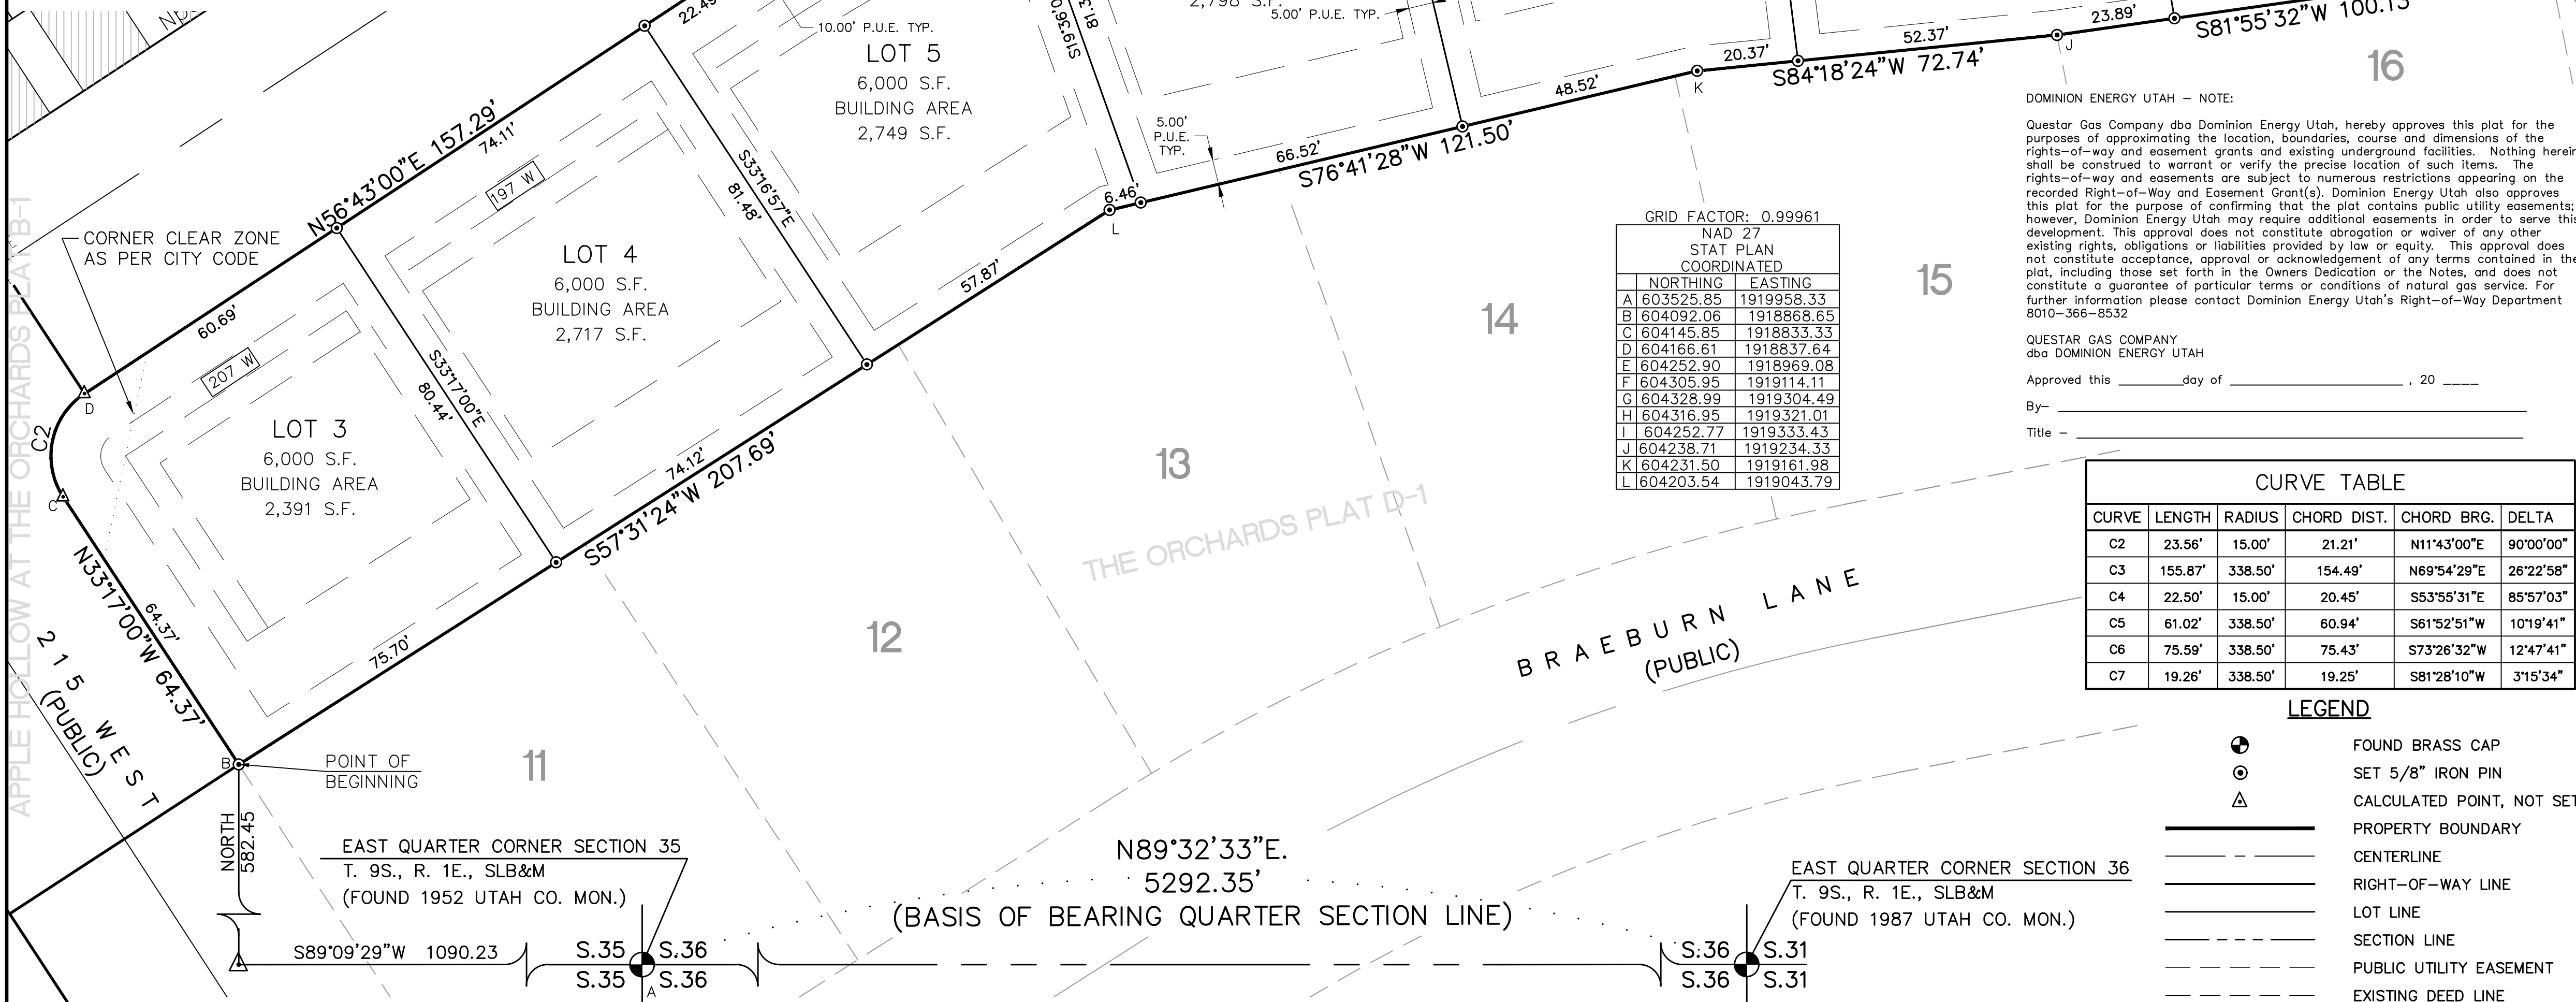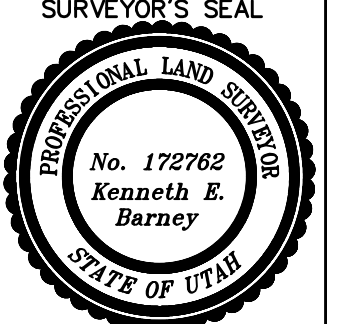

GRID FACTOR: 0.99961

NAD 27 STAT PLAN COORDINATED	
NORTHING	EASTING
A	603525.85 1919958.33
B	604092.06 1918868.65
C	604145.85 1918833.33
D	604166.61 1918837.64
E	604252.90 1918969.08
F	604305.95 1919114.11
G	604328.99 1919304.49
H	604316.95 1919321.01
I	604252.77 1919333.43
J	604238.71 1919234.33
K	604231.50 1919161.98
L	604203.54 1919043.79

DOMINION ENERGY UTAH - NOTE:
 Questar Gas Company dba Dominion Energy Utah, hereby approves this plat for the purposes of approximating the location, boundaries, course and dimensions of the rights-of-way and easement grants and existing underground facilities. Nothing herein shall be construed to warrant or verify the precise location of such items. The rights-of-way and easements are subject to numerous restrictions appearing on the recorded Right-of-Way and Easement Grant(s). Dominion Energy Utah also approves this plat for the purpose of confirming that the plat contains public utility easements; however, Dominion Energy Utah may require additional easements in order to serve this development. This approval does not constitute abrogation or waiver of any other existing rights, obligations or liabilities provided by law or equity. This approval does not constitute acceptance, approval or acknowledgement of any terms contained in the plat, including those set forth in the Owners Dedication or the Notes, and does not constitute a guarantee of particular terms or conditions of natural gas service. For further information please contact Dominion Energy Utah's Right-of-Way Department 8010-366-8532

QUESTAR GAS COMPANY
 dba DOMINION ENERGY UTAH
 Approved this _____ day of _____, 20____
 By: _____
 Title: _____


CURVE TABLE

CURVE	LENGTH	RADIUS	CHORD DIST.	CHORD BRG.	DELTA
C2	23.56'	15.00'	21.21'	N11°43'00"E	90°00'00"
C3	155.87'	338.50'	154.49'	N69°54'29"E	26°22'58"
C4	22.50'	15.00'	20.45'	S53°55'31"E	85°57'03"
C5	61.02'	338.50'	60.94'	S61°52'51"W	101°19'41"
C6	75.59'	338.50'	75.43'	S73°26'32"W	12°47'41"
C7	19.26'	338.50'	19.25'	S81°28'10"W	31°5'34"

- LEGEND**
- ⊙ FOUND BRASS CAP
 - ⊙ SET 5/8" IRON PIN
 - △ CALCULATED POINT, NOT SET
 - PROPERTY BOUNDARY
 - CENTERLINE
 - RIGHT-OF-WAY LINE
 - LOT LINE
 - SECTION LINE
 - PUBLIC UTILITY EASEMENT
 - EXISTING DEED LINE

NOTES:
 1) ALL LIMITED COMMON AREA & OPEN SPACE AREAS ARE DEDICATED AS PUBLIC UTILITY EASEMENTS.
 2) THIS PROPERTY IS LOCATED IN THE VICINITY OF AN ESTABLISHED AGRICULTURE PROTECTION AREA IN WHICH NORMAL AGRICULTURAL USES AND ACTIVITIES HAVE BEEN AFFORDED THE HIGHEST PRIORITY USE STATUS. IT CAN BE ANTICIPATED THAT SUCH AGRICULTURE USES AND ACTIVITIES MAY NOW OR IN THE FUTURE BE CONDUCTED ON PROPERTY INCLUDED IN THE AGRICULTURE PROTECTION AREA. THE USE AND ENJOYMENT OF THIS PROPERTY IS EXPRESSLY CONDITIONED ON ACCEPTANCE OF ANY ANNOYANCE OR INCONVENIENCE WHICH MAY RESULT FROM SUCH NORMAL AGRICULTURAL USES AND ACTIVITIES.

DEVELOPER
 REVERE HOMES
 JOHN CALDWELL (MANAGER)
 470 N. 2550 W.
 TREMONTON, UTAH 84337
 (801)-427-1733

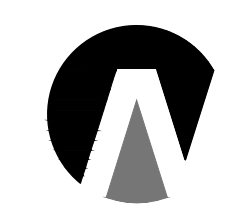


Northern ENGINEERING INC
 ENGINEERING-LAND PLANNING
 CONSTRUCTION MANAGEMENT
 1040 E. 800 N.
 OREM, UTAH 84097
 (801) 802-8992


APPLE HOLLOW @ THE ORCHARDS "B-PHASE 2"

SANTAQUIN, UTAH

JANUARY, 2024

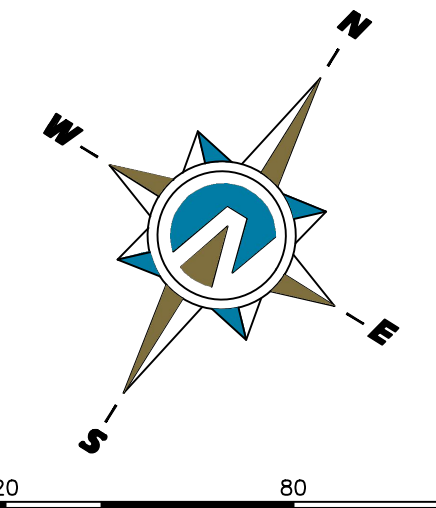

(24"x36")
SCALE 1" = 40'
(11"x17")
SCALE 1" = 80'

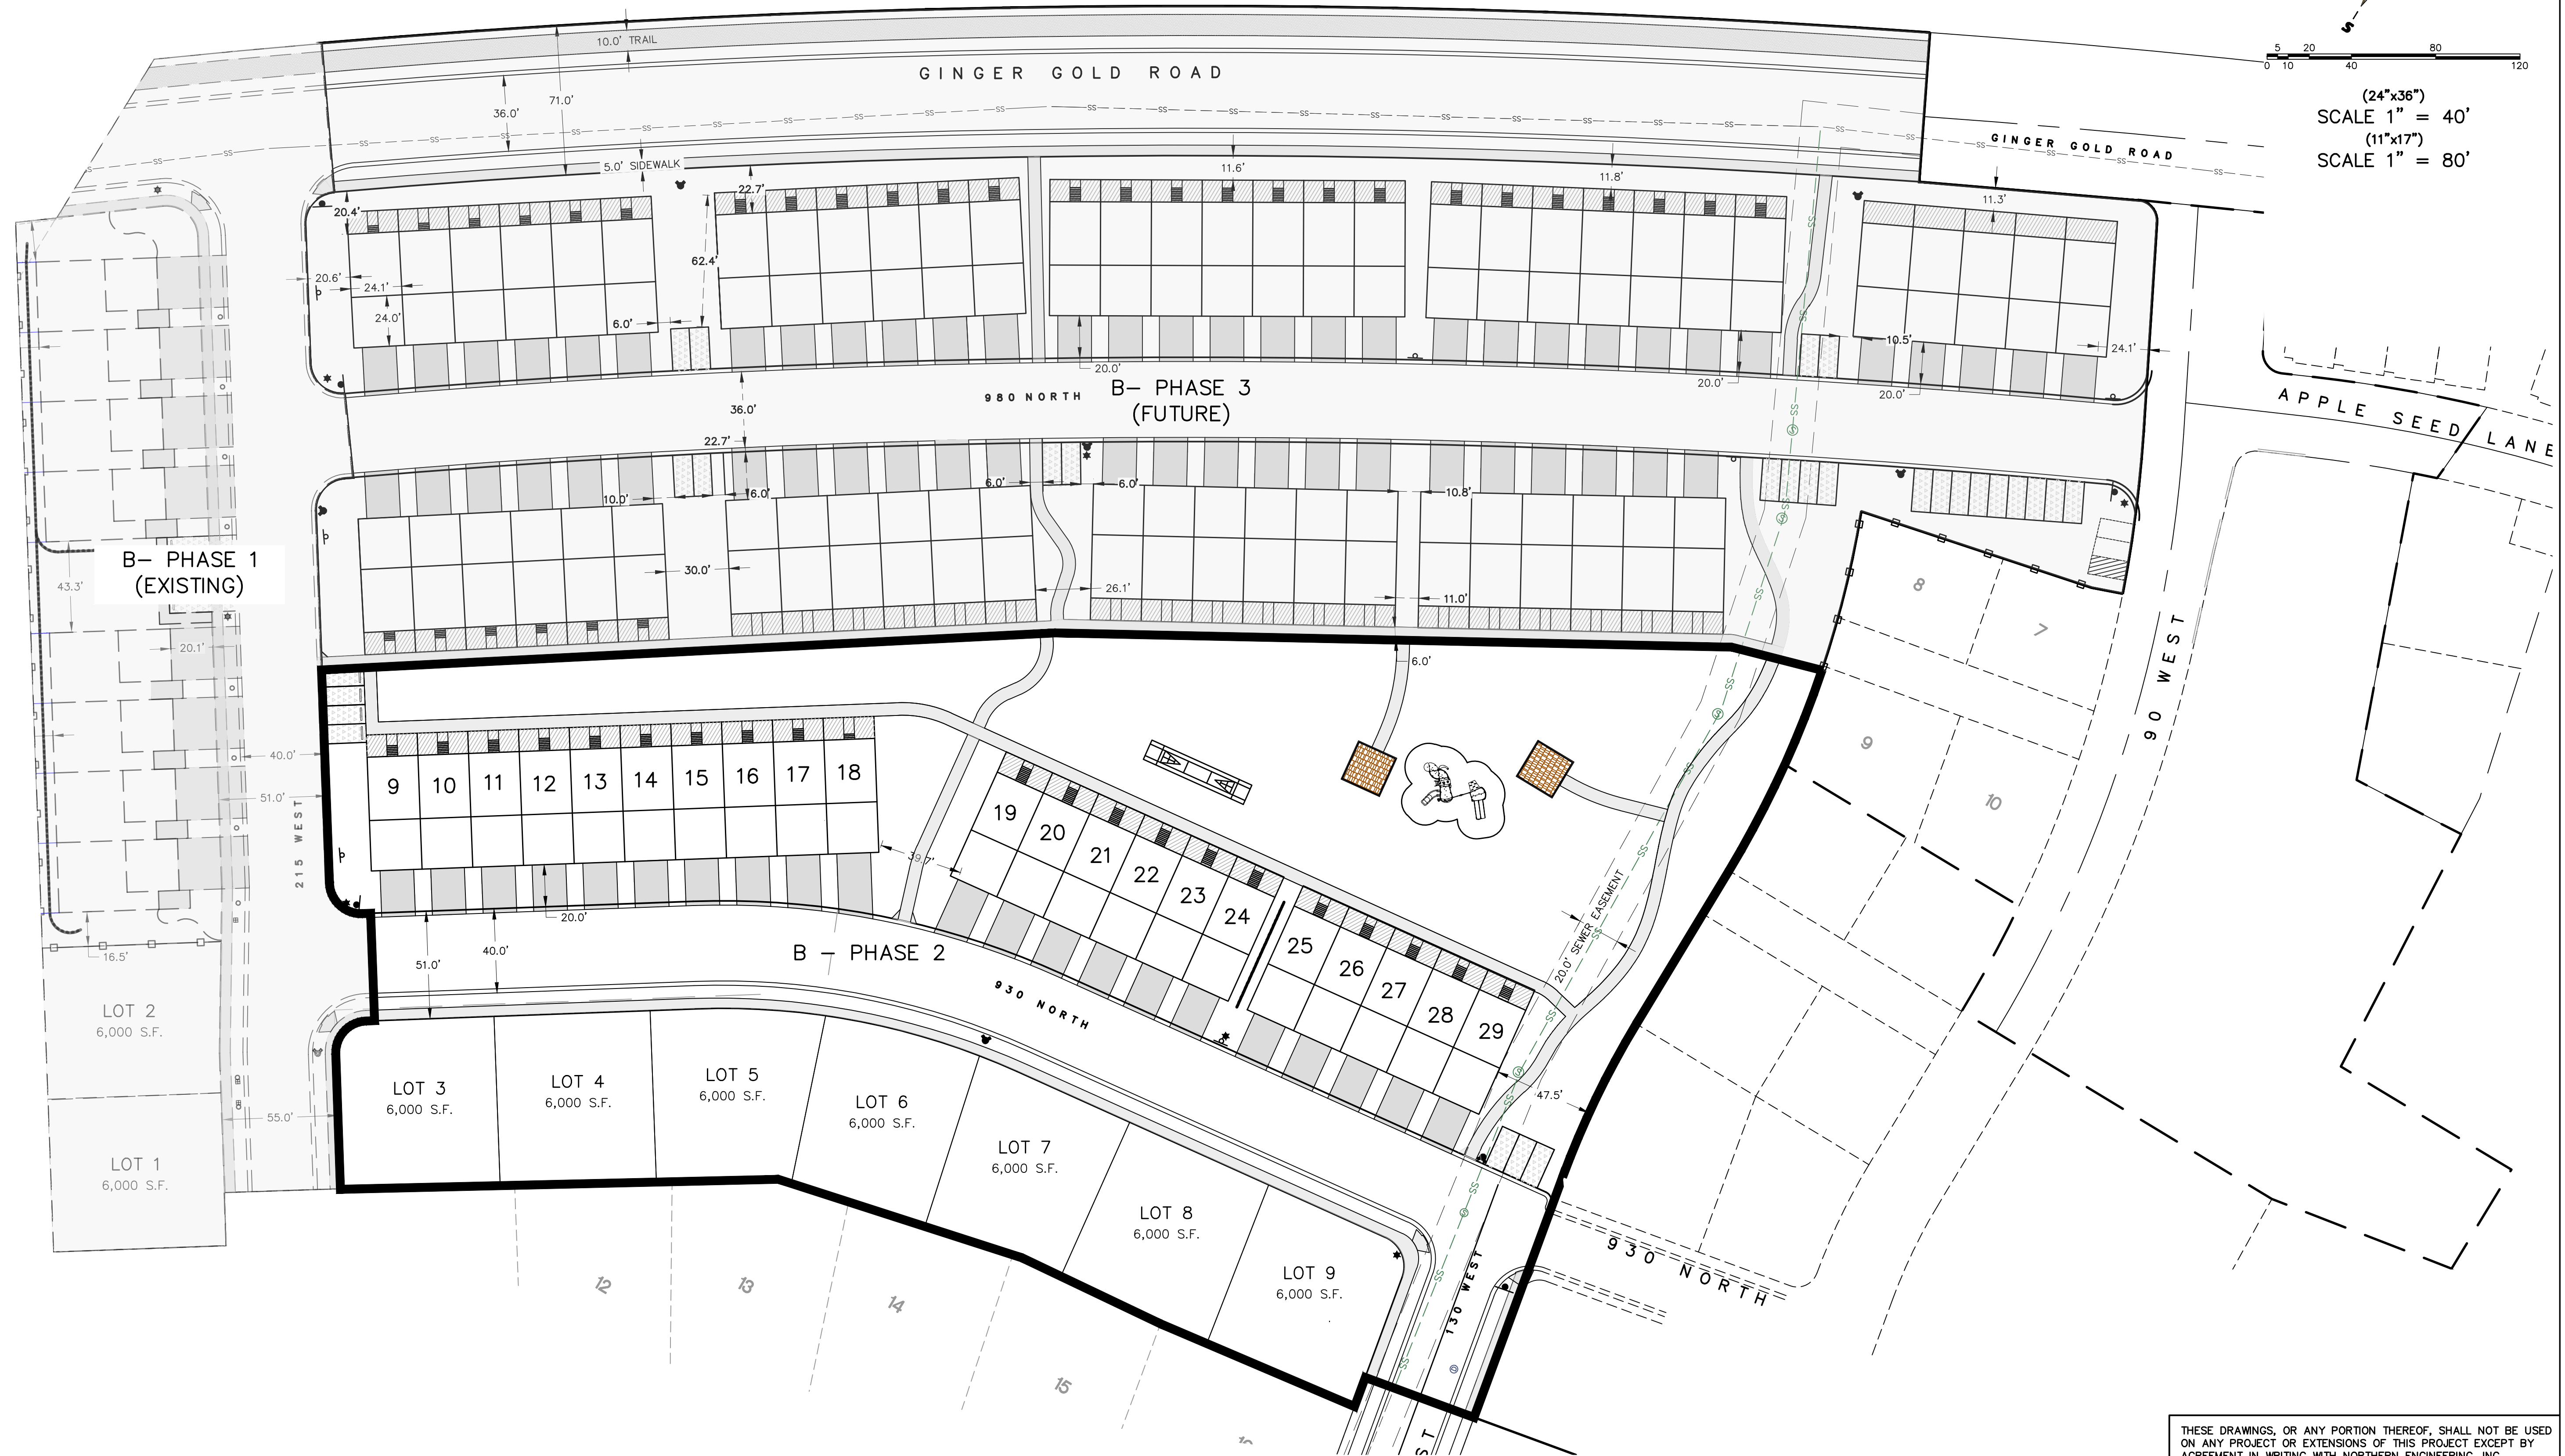

THESE DRAWINGS, OR ANY PORTION THEREOF, SHALL NOT BE USED ON ANY PROJECT OR EXTENSIONS OF THIS PROJECT EXCEPT BY AGREEMENT IN WRITING WITH NORTHERN ENGINEERING, INC.

5		DESIGNED BY:	DATE:
4		DRAWN BY:	DATE:
3		CHECKED BY:	DATE:
2		APPROVED:	DATE:
1		COGO FILE:	DATE:
NO.	REVISIONS	BY	DATE
		REV. COGO FILE:	DATE:




Northern ENGINEERING INC
ENGINEERING—LAND PLANNING
CONSTRUCTION MANAGEMENT

1040 E. 800 N.
OREM, UTAH 84097
(801) 802-8992


APPLE HOLLOW @ THE ORCHARDS "B-PHASE 2"

SITE PLAN/PHASING PLAN	JOB NO. 3-20-031
SANTAQUIN, UTAH	SHEET NO. SP-01

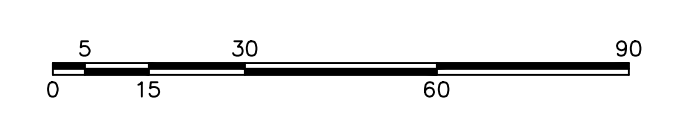

(24"x36")
SCALE 1" = 30'
(11"x17")
SCALE 1" = 60'

FUTURE
B - PHASE 3

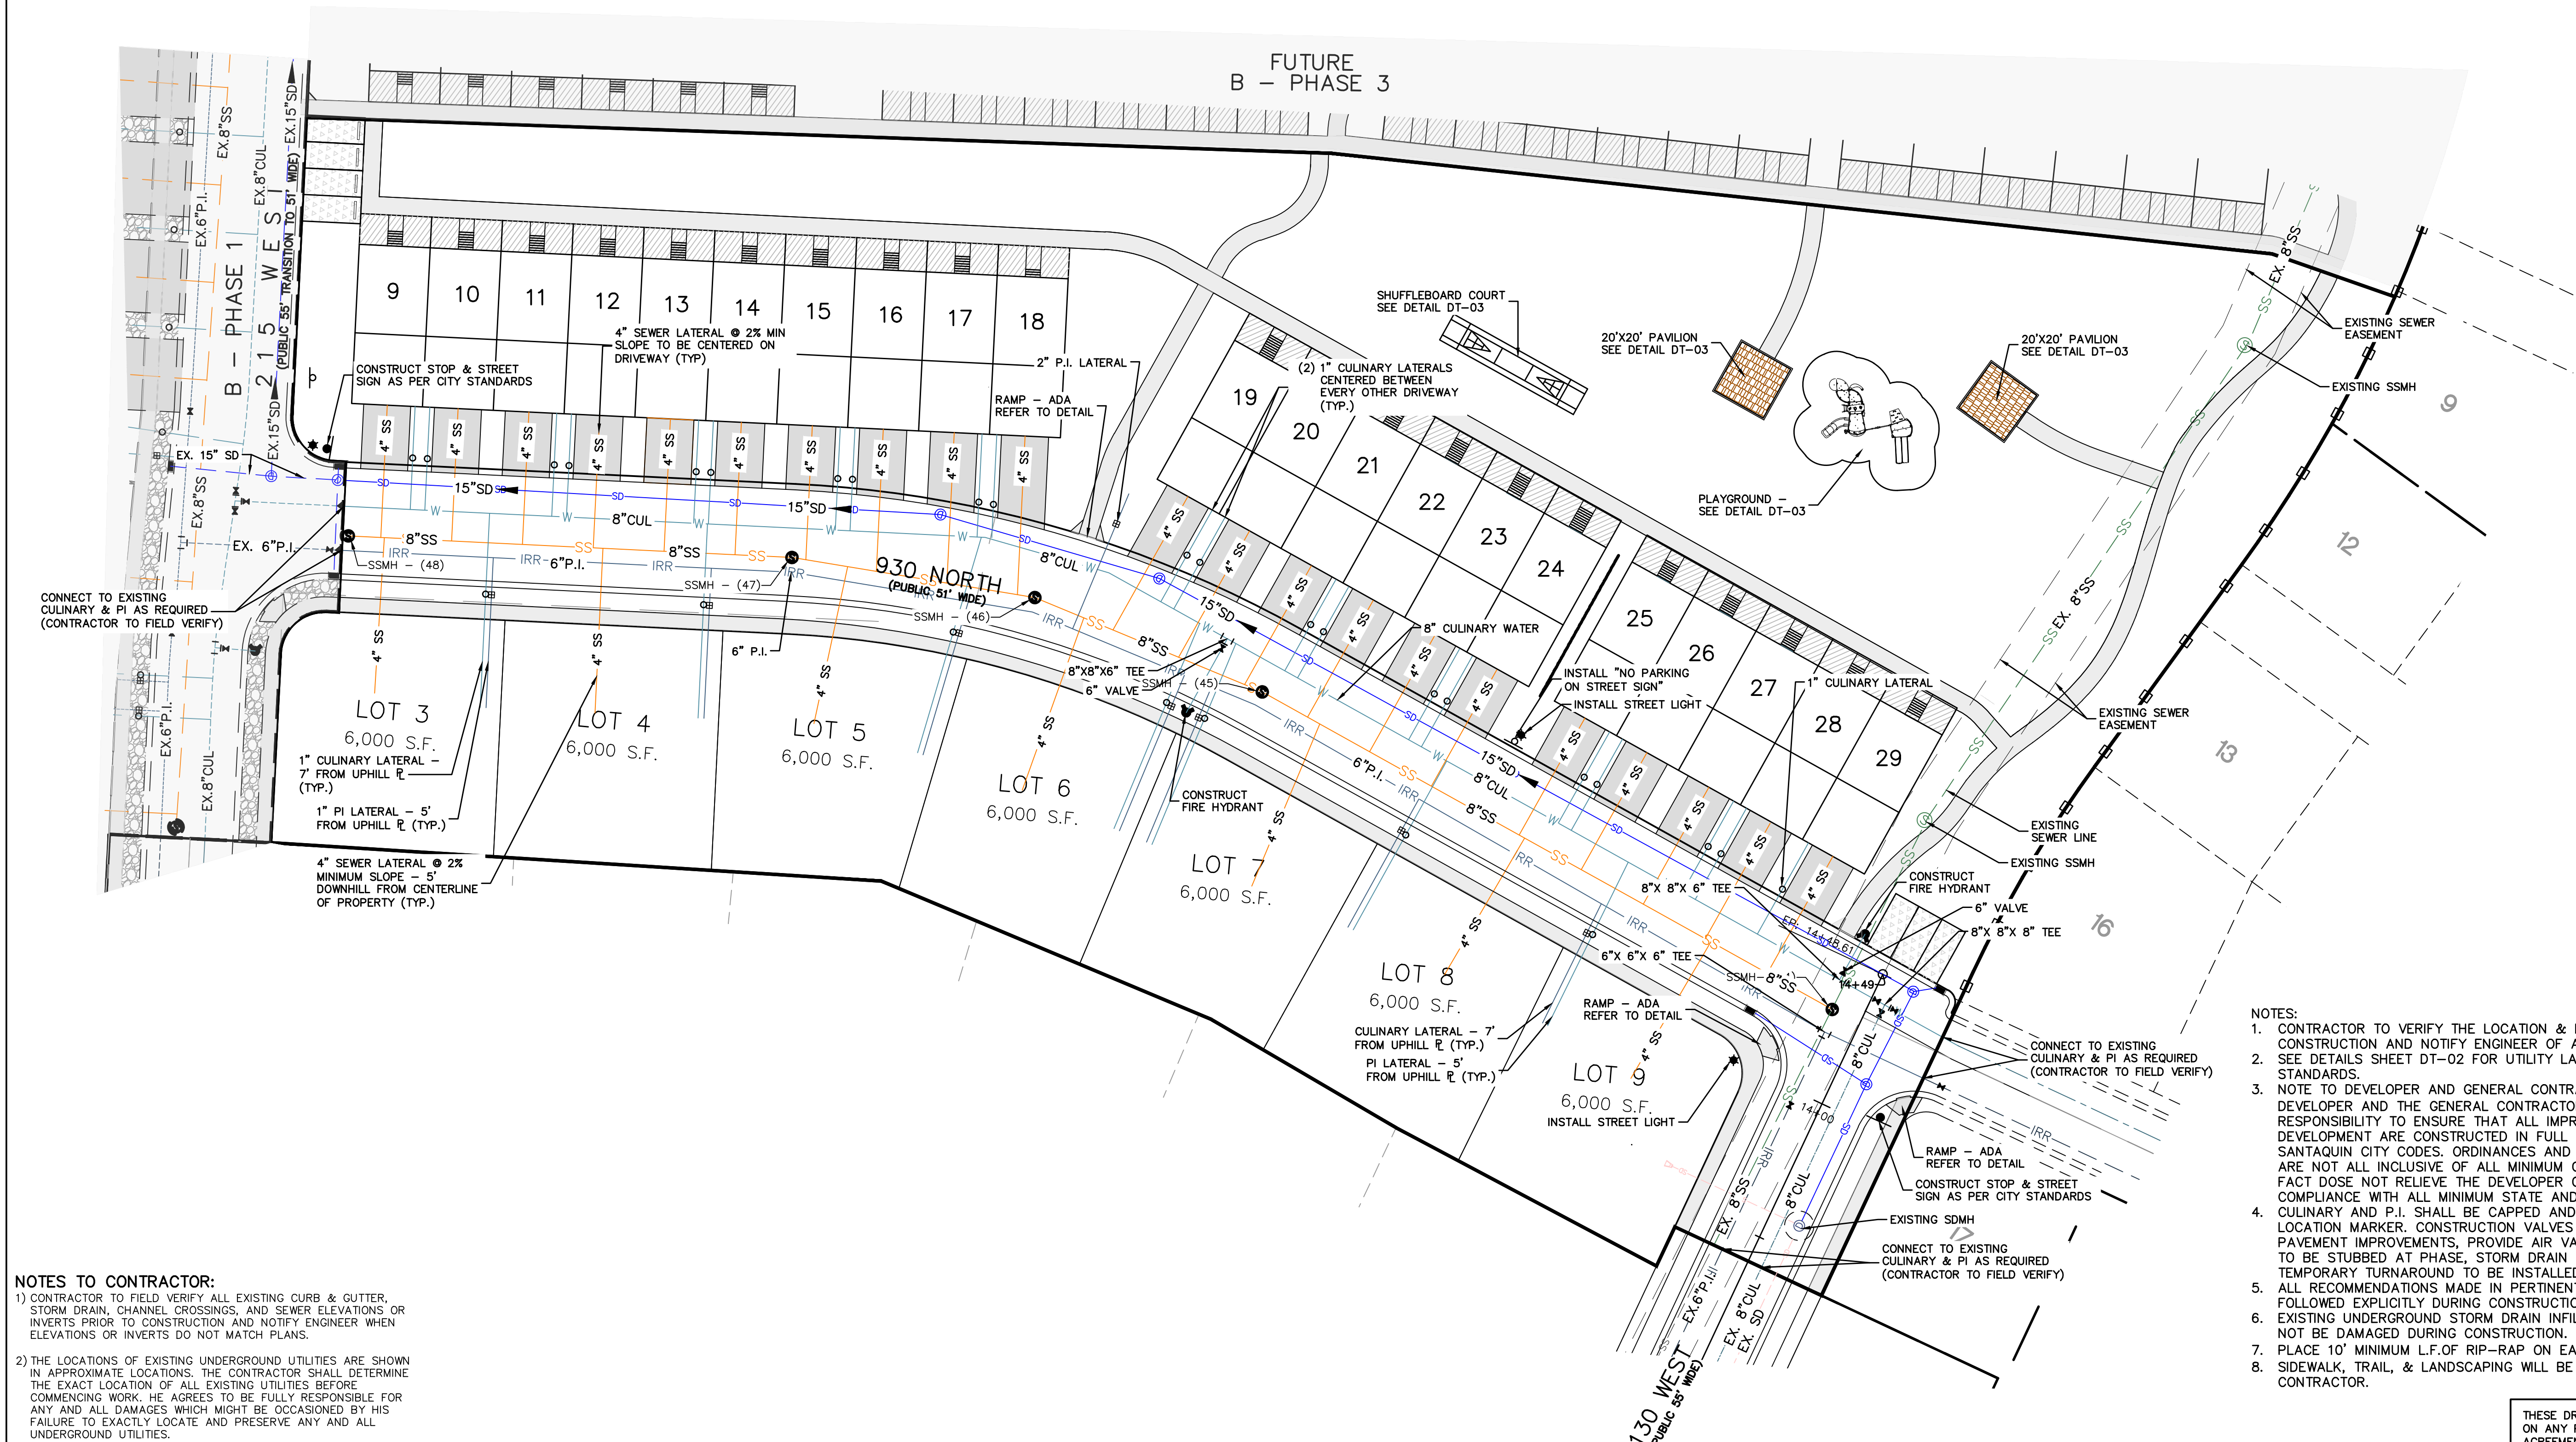

NOTES TO CONTRACTOR:
1) CONTRACTOR TO FIELD VERIFY ALL EXISTING CURB & CUTTER, STORM DRAIN, CHANNEL CROSSINGS, AND SEWER ELEVATIONS OR INVERTS PRIOR TO CONSTRUCTION AND NOTIFY ENGINEER WHEN ELEVATIONS OR INVERTS DO NOT MATCH PLANS.
2) THE LOCATIONS OF EXISTING UNDERGROUND UTILITIES ARE SHOWN IN APPROXIMATE LOCATIONS. THE CONTRACTOR SHALL DETERMINE THE EXACT LOCATION OF ALL EXISTING UTILITIES BEFORE COMMENCING WORK. HE AGREES TO BE FULLY RESPONSIBLE FOR ANY AND ALL DAMAGES WHICH MIGHT BE OCCASIONED BY HIS FAILURE TO EXACTLY LOCATE AND PRESERVE ANY AND ALL UNDERGROUND UTILITIES.

- NOTES:**
1. CONTRACTOR TO VERIFY THE LOCATION & DEPTH OF ALL EXISTING UTILITIES PRIOR TO CONSTRUCTION AND NOTIFY ENGINEER OF ANY DISCREPANCIES.
 2. SEE DETAILS SHEET DT-02 FOR UTILITY LATERAL LOCATIONS PER SANTAQUIN CITY STANDARDS.
 3. NOTE TO DEVELOPER AND GENERAL CONTRACTOR: IT IS IMPORTANT FOR THE DEVELOPER AND THE GENERAL CONTRACTOR TO UNDERSTAND THAT IT IS HIS/HER RESPONSIBILITY TO ENSURE THAT ALL IMPROVEMENTS INSTALLED WITHIN THIS DEVELOPMENT ARE CONSTRUCTED IN FULL COMPLIANCE WITH ALL STATE AND SANTAQUIN CITY CODES, ORDINANCES AND STANDARDS. THE DEVELOPMENT PLANS ARE NOT ALL INCLUSIVE OF ALL MINIMUM CODES, ORDINANCES AND STANDARDS. THIS FACT DOES NOT RELIEVE THE DEVELOPER OR GENERAL CONTRACTOR FROM FULL COMPLIANCE WITH ALL MINIMUM STATE AND SANTAQUIN CITY STANDARDS.
 4. CULINARY AND P.I. SHALL BE CAPPED AND BLOCKED AT PHASE LINE AND PROVIDE LOCATION MARKER. CONSTRUCTION VALVES TO BE PLACED AT END OF PHASE PAVEMENT IMPROVEMENTS, PROVIDE AIR VAC VALVE AS PER CITY STANDARDS. SEWER TO BE STUBBED AT PHASE, STORM DRAIN TO BE CONNECTED TO EXISTING SYSTEM, TEMPORARY TURNAROUND TO BE INSTALLED AS PER CITY STANDARDS.
 5. ALL RECOMMENDATIONS MADE IN PERTINENT GEOTECHNICAL REPORT SHALL BE FOLLOWED EXPLICITLY DURING CONSTRUCTION OF BUILDING AND SITE IMPROVEMENTS.
 6. EXISTING UNDERGROUND STORM DRAIN INFILTRATION GALLERY TO REMAIN IN-PLACE & NOT BE DAMAGED DURING CONSTRUCTION.
 7. PLACE 10' MINIMUM L.F. OF RIP-RAP ON EAST END OF C&G TO PREVENT EROSION.
 8. SIDEWALK, TRAIL, & LANDSCAPING WILL BE INSTALLED BY DEVELOPER'S & CONTRACTOR.

THESE DRAWINGS, OR ANY PORTION THEREOF, SHALL NOT BE USED ON ANY PROJECT OR EXTENSIONS OF THIS PROJECT EXCEPT BY AGREEMENT IN WRITING WITH NORTHERN ENGINEERING, INC.

NO.	REVISIONS	BY	DATE	REV. COGO FILE	DATE
5					
4					
3					
2					
1					

DESIGNED BY:	DATE:
DRAWN BY:	DATE:
CHECKED BY:	DATE:
APPROVED:	DATE:
COGO FILE:	DATE:


 **Northern ENGINEERING INC**
ENGINEERING—LAND PLANNING
CONSTRUCTION MANAGEMENT
1040 E. 800 N.
OREM, UTAH 84097
(801) 802-8992

**APPLE HOLLOW @
THE ORCHARDS
"B- PHASE 2"**

SITE UTILITY PLAN- PHASE B-2
SANTAQUIN, UTAH
JOB NO. 3-20-031
SHEET NO. **UT-01**

K:\3-20-031-00 Apple Hollow\CAD\Design\Apple Hollow CONCEPT 11 SHEET SET PHASE 2.dwg

LANDSCAPING LEGEND:


-  LANDSCAPE ROCK: TWO TO FOUR INCH (2" TO 4") DECORATIVE COBBLE ROCK. A SAMPLE OF THE PROPOSED MATERIAL MUST BE SUBMITTED TO AND APPROVED BY SANTAQUIN CITY PRIOR TO PLACING. COBBLE ROCK MULCH SHALL BE INSTALLED TO AN AVERAGE DEPTH OF FOUR INCHES (4") AND SHALL COMPLETELY COVER ALL PLANTER STRIP AREA. PRIOR TO INSTALLATION OF COBBLE ROCK, MULCH, A MIRAFL 600 (OR APPROVED EQUIVALENT) FABRIC MUST BE APPLIED TO THE PLANTER STRIP AREA.
-  HELICTOTRICHON SEMPERVIRENS / BLUE OAT GRASS, 1-GAL.
-  CALAMAGROSTIS X ACUTIFLORA FOERSTER / FEATHER REED GRASS, 1-GAL.
-  EUONYMUS ALATUS COMPACTUS / COMPACT BURNING BUSH, 5-GAL.
-  RHAMNUS FRANGULA COLUMNARIS / ALDER BUCKTHORN, 5-GAL.
-  TILA AMERICAN REDMUND / REDMUND AMERICAN LINDEN, 2" - 2.5" CAL.
-  ACER FREEMAN / AUTUMN BLAZE MAPLE, 2" - 2.5" CAL.
-  PICEA PUNGENS / COLORADO "BLUE" SPRUCE, 2" - 2.5" CAL. (6' MIN HEIGHT)

NOTES:

1. ALL LANDSCAPING TO BE DONE ACCORDING TO SANTAQUIN CITY STANDARDS AND SPECIFICATIONS.
2. IRRIGATION TO BE DESIGNED BY OTHERS AND SUBMITTED TO CITY FOR APPROVAL BEFORE INSTALLATION.
3. GROUP TREES IN CLUSTERS AND VARIETY ALTERNATING BETWEEN GROUPS OF THREE.
4. TREES SHALL NOT BE PLANTED LESS THAN 5-FT FROM CURBS OR HARD SURFACE AREAS UNLESS A ROOT BARRIER IS INSTALLED NEXT TO HARDSCAPE SURFACE.
5. CONTRACTOR TO PLANT ALL TREES AND SHRUBS ACCORDING TO SANTAQUIN CITY PLANTING STANDARDS.
6. ANY PROPOSED SUBSTITUTIONS OF PLAN SPECIES SHALL BE MADE WITH PLANTS OF EQUIVALENT OVERALL FORM, HEIGHT, BRANCHING HABIT, FLOWER, LEAF, COLOR, FRUIT AND CULTURE.
7. ALL TREES UP TO 2.5" CAL. SHALL BE DOUBLE STAKED AND ALL DECIDUOUS TREES GREATER THAN 2" CAL. AND ALL EVERGREEN TREES 6" AND TALLER SHALL BE TRIPLE STAKED OR GUYED.
8. NO PLANT MATERIAL SHALL BE PLANTED WITHIN 1-FT OF ANY WALK EDGE.
9. ALL PLANTING AREAS INCLUDING TREE AND SHRUB AREAS TO RECEIVE COMMERCIAL GRADE WEED BARRIER.
10. NO SOD-GRASS IN PLANTER STRIP
11. 35% MAXIMUM SOD-GRASS ALLOWED IN FRONT AND SIDE YARD AS REQUIRED

NOTES:

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Northern ENGINEERING INC
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1040 E. 800 N.
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 (801) 802-8992

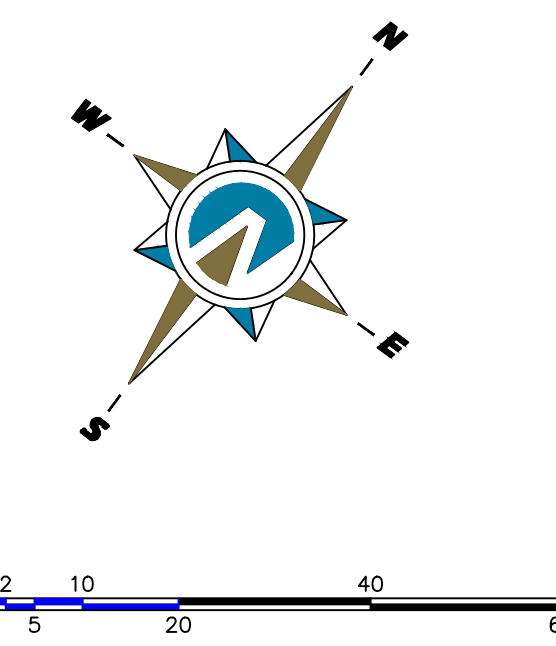
APPLE HOLLOW @ THE ORCHARDS "B- PHASE 2"

LANDSCAPE PLAN	JOB NO. 3-20-031
SANTAQUIN, UTAH	SHEET NO. LS-01


K:\3-20-031-00 Apple Hollow\CAD\Design\Apple Hollow CONCEPT 11 SHEET SET PHASE 2.dwg

NOTES:

- NOTE TO DEVELOPER AND GENERAL CONTRACTOR: IT IS IMPORTANT FOR THE DEVELOPER AND THE GENERAL CONTRACTOR TO UNDERSTAND THAT IT IS HIS/HER RESPONSIBILITY TO ENSURE THAT ALL IMPROVEMENTS INSTALLED WITHIN THIS DEVELOPMENT ARE CONSTRUCTED IN FULL COMPLIANCE WITH ALL STATE AND SANTAQUIN CITY CODES, ORDINANCES AND STANDARDS. THE DEVELOPMENT PLANS ARE NOT ALL INCLUSIVE OF ALL MINIMUM CODES, ORDINANCES AND STANDARDS, THIS FACT DOES NOT RELIEVE THE DEVELOPER OR GENERAL CONTRACTOR FROM FULL COMPLIANCE WITH ALL MINIMUM STATE AND SANTAQUIN CITY STANDARDS.
- ALL RECOMMENDATIONS MADE IN PERTINENT GEOTECHNICAL REPORT SHALL BE FOLLOWED EXPLICITLY DURING CONSTRUCTION OF BUILDING AND SITE IMPROVEMENTS.
- INSTALL P.I. DRAIN TO CONNECT TO SDMH AS SHOWN AS PER CITY STANDARDS.
- PLACE 10' MINIMUM L.F. OF RIP-RAP ON EAST END OF C&G TO PREVENT EROSION.

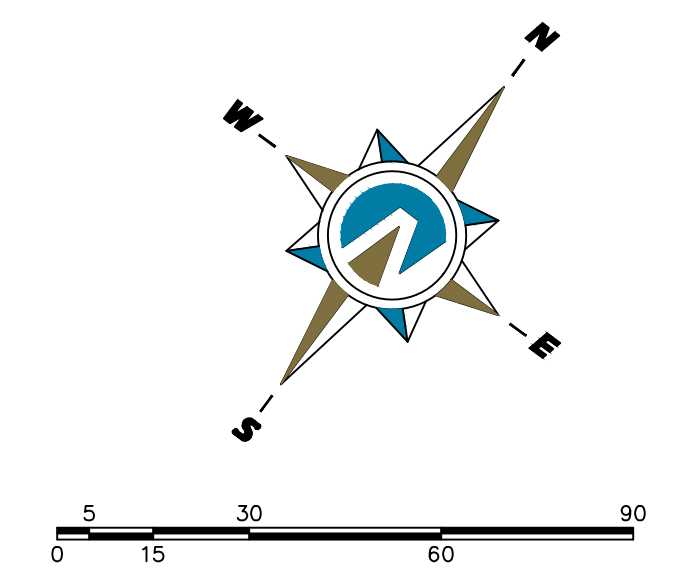

(24"x36")
 SCALE 1" = 30'
 (11"x17")
 SCALE 1" = 60'

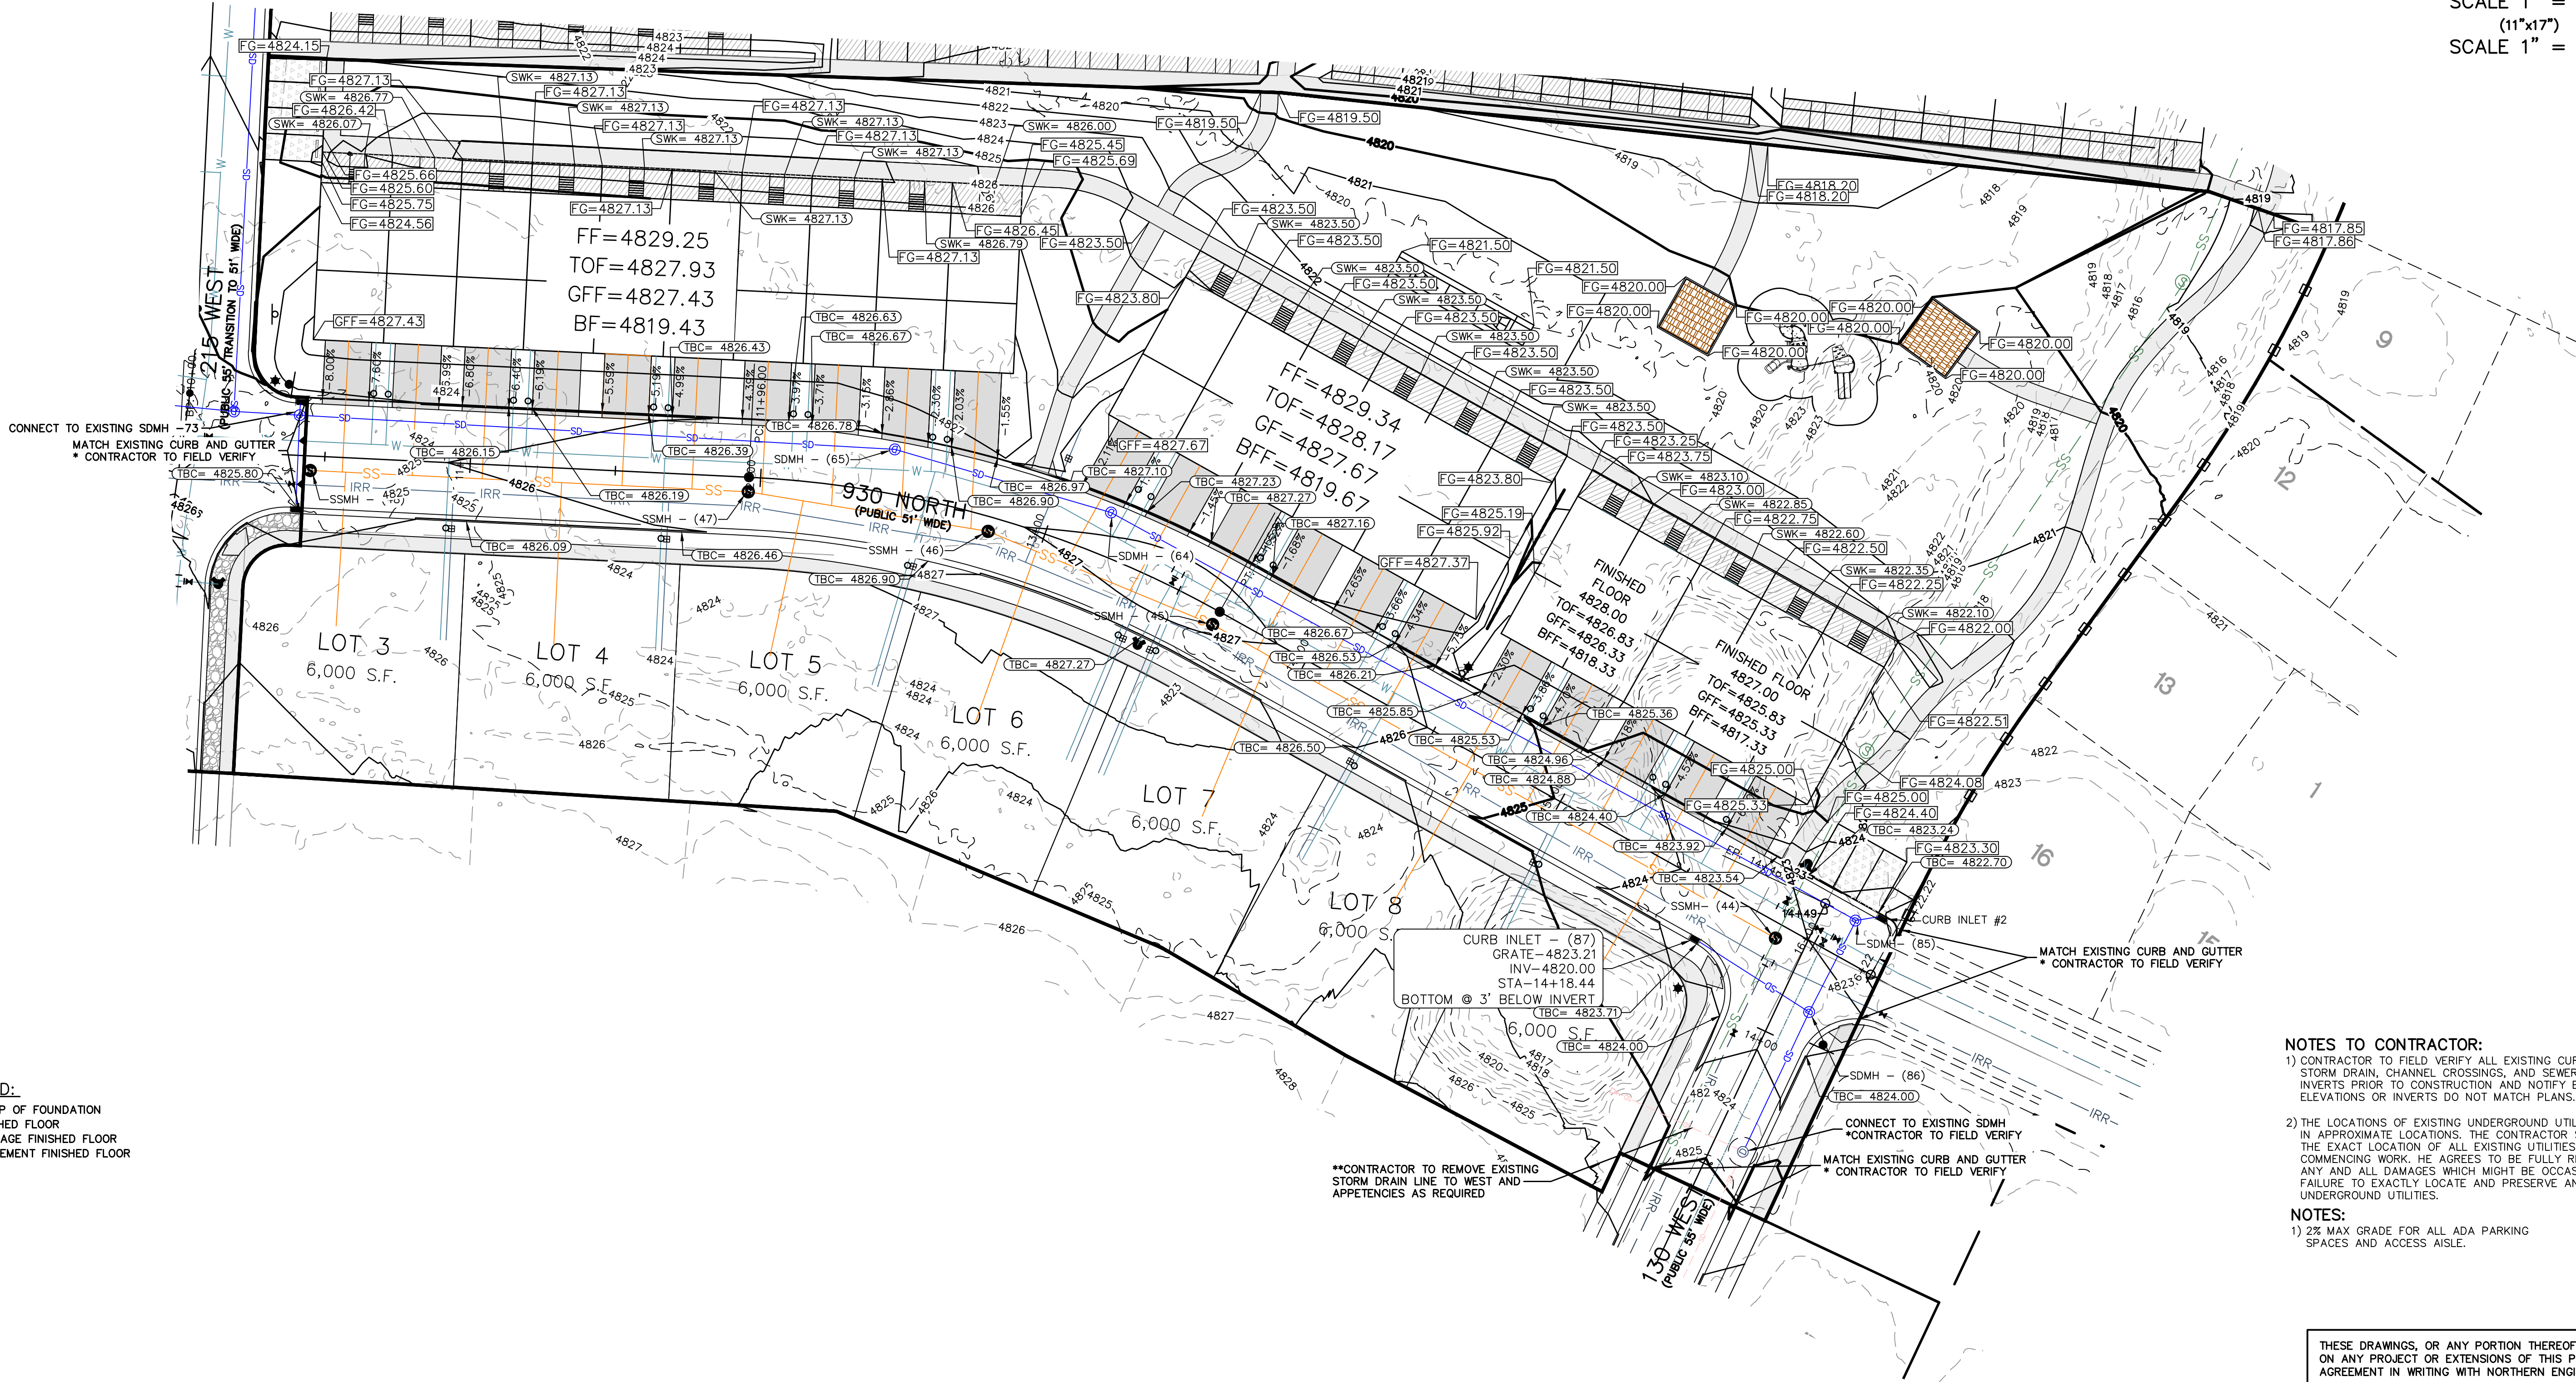

LEGEND:
 TOF= TOP OF FOUNDATION
 FF=FINISHED FLOOR
 GFF=GARAGE FINISHED FLOOR
 BFF=BASEMENT FINISHED FLOOR

- NOTES TO CONTRACTOR:**
- CONTRACTOR TO FIELD VERIFY ALL EXISTING CURB & GUTTER, STORM DRAIN, CHANNEL CROSSINGS, AND SEWER ELEVATIONS OR INVERTS PRIOR TO CONSTRUCTION AND NOTIFY ENGINEER WHEN ELEVATIONS OR INVERTS DO NOT MATCH PLANS.
 - THE LOCATIONS OF EXISTING UNDERGROUND UTILITIES ARE SHOWN IN APPROXIMATE LOCATIONS. THE CONTRACTOR SHALL DETERMINE THE EXACT LOCATION OF ALL EXISTING UTILITIES BEFORE COMMENCING WORK. HE AGREES TO BE FULLY RESPONSIBLE FOR ANY AND ALL DAMAGES WHICH MIGHT BE OCCASIONED BY HIS FAILURE TO EXACTLY LOCATE AND PRESERVE ANY AND ALL UNDERGROUND UTILITIES.
- NOTES:**
- 2% MAX GRADE FOR ALL ADA PARKING SPACES AND ACCESS AISLE.

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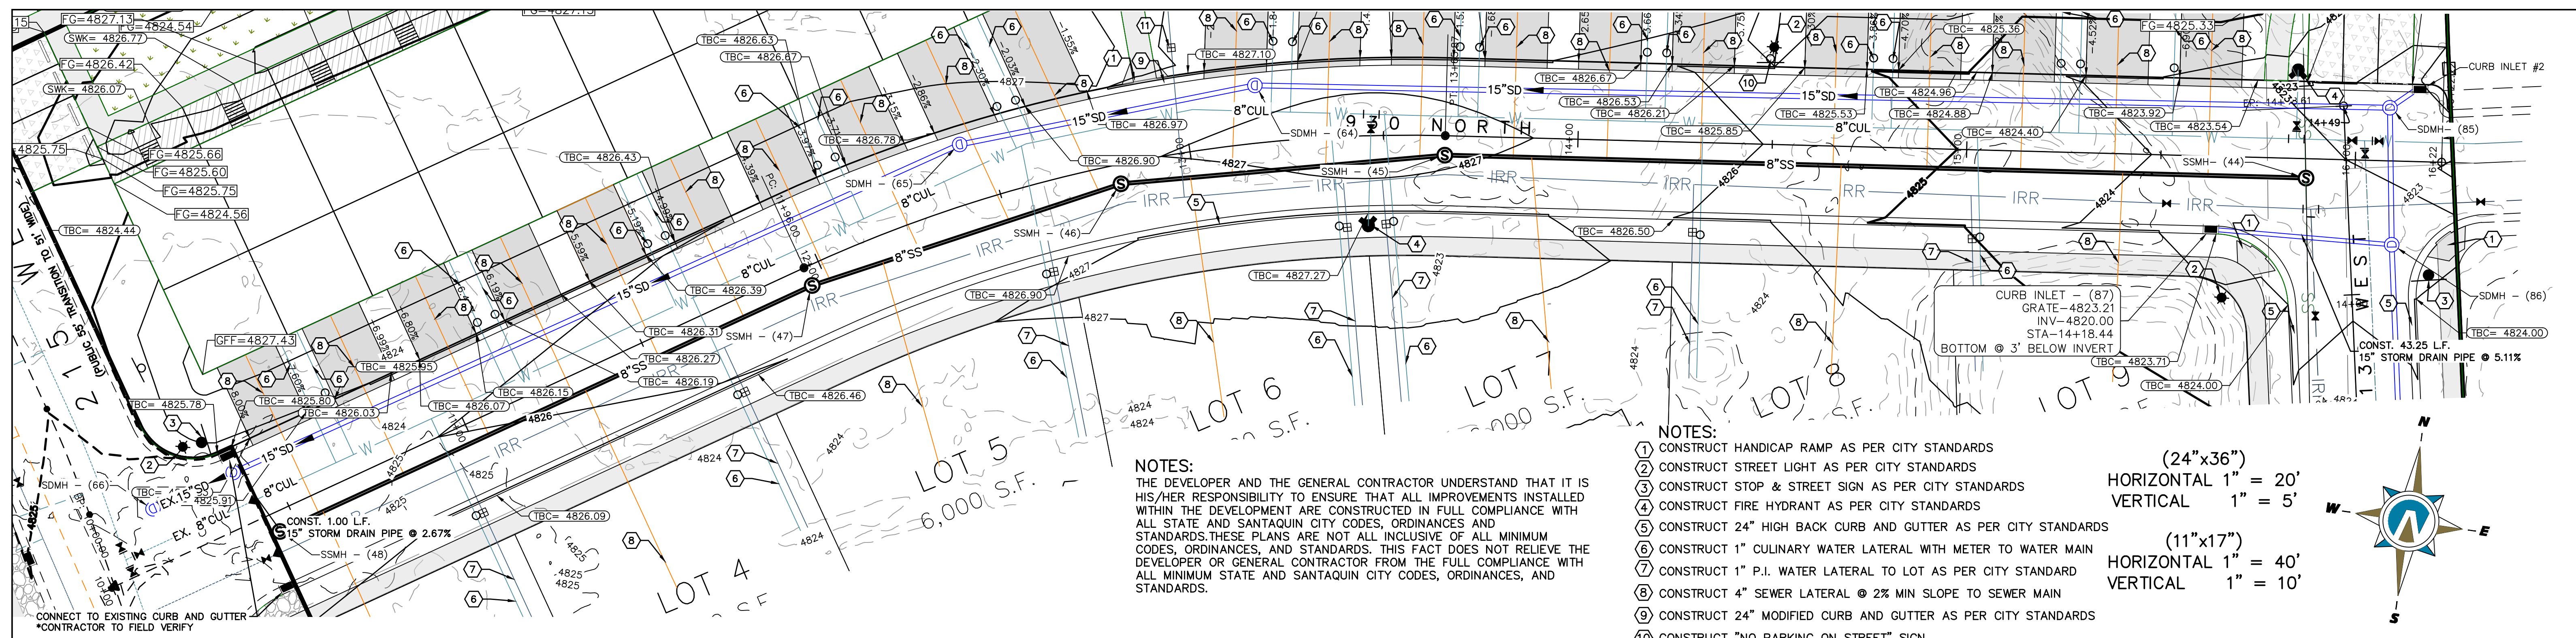
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 OREM, UTAH 84097
 (801) 802-8992

APPLE HOLLOW @ THE ORCHARDS "B- PHASE 2"

SITE GRADING AND DRAINAGE PLAN	JOB NO. 3-20-031
SANTAQUIN, UTAH	SHEET NO. GR-01





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- NOTES:**
- CONSTRUCT HANDICAP RAMP AS PER CITY STANDARDS
 - CONSTRUCT STREET LIGHT AS PER CITY STANDARDS
 - CONSTRUCT STOP & STREET SIGN AS PER CITY STANDARDS
 - CONSTRUCT FIRE HYDRANT AS PER CITY STANDARDS
 - CONSTRUCT 24" HIGH BACK CURB AND GUTTER AS PER CITY STANDARDS
 - CONSTRUCT 1" CULINARY WATER LATERAL WITH METER TO WATER MAIN
 - CONSTRUCT 1" P.I. WATER LATERAL TO LOT AS PER CITY STANDARD
 - CONSTRUCT 4" SEWER LATERAL @ 2% MIN SLOPE TO SEWER MAIN
 - CONSTRUCT 24" MODIFIED CURB AND GUTTER AS PER CITY STANDARDS
 - CONSTRUCT "NO PARKING ON STREET" SIGN

(24"x36")
 HORIZONTAL 1" = 20'
 VERTICAL 1" = 5'

(11"x17")
 HORIZONTAL 1" = 40'
 VERTICAL 1" = 10'

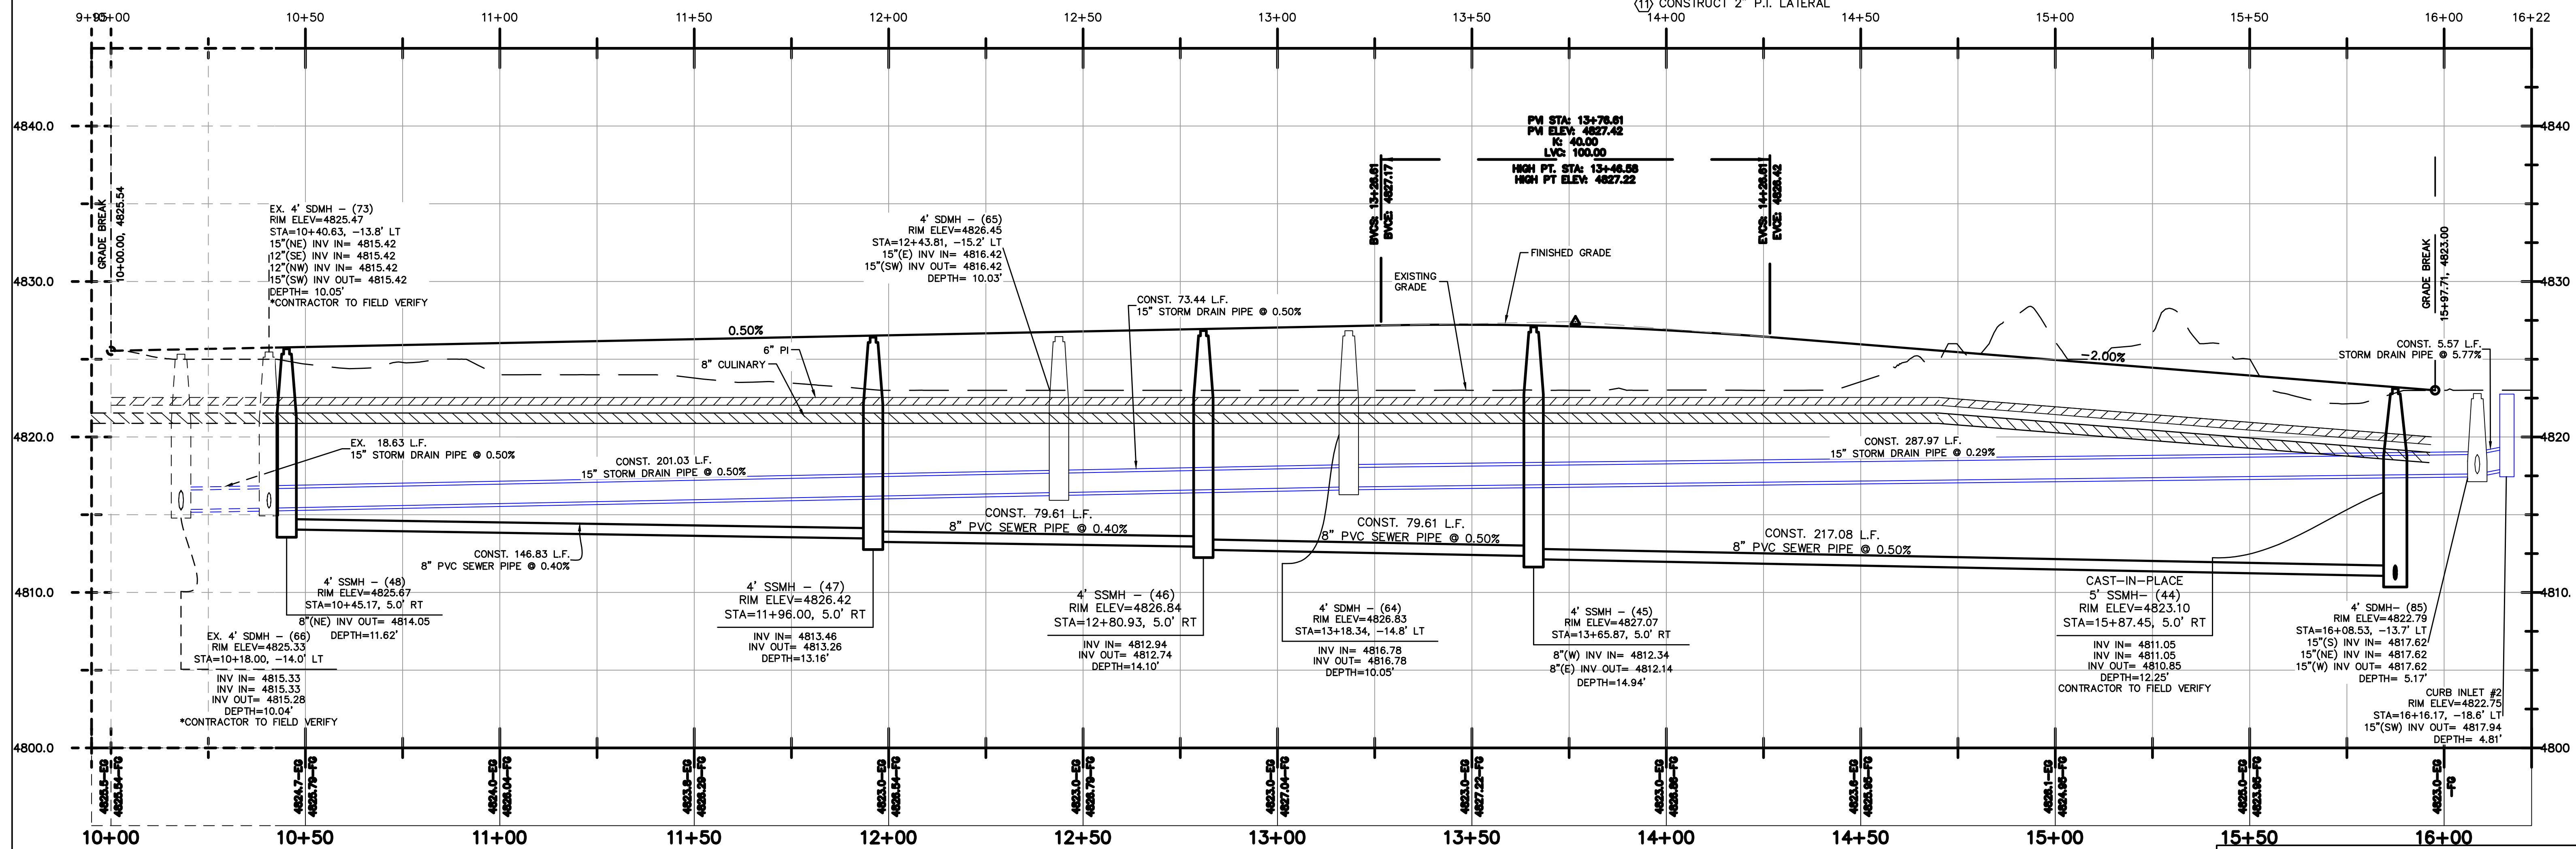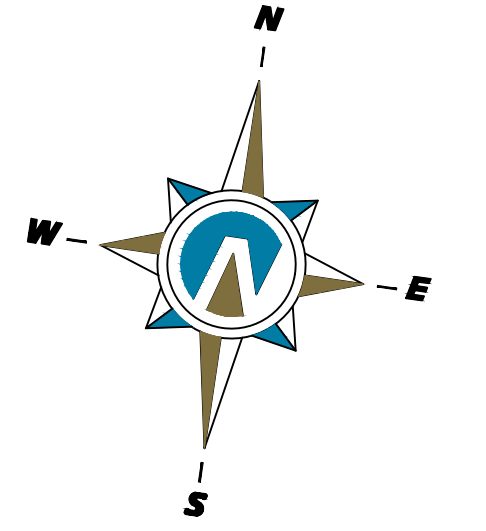

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APPLE HOLLOW @ THE ORCHARDS "B- PHASE 2"



930 NORTH PLAN & PROFILE
 SANTAQUIN, UTAH

JOB NO. 3-20-031
 SHEET NO. PP-01

K:\3-20-031-00 Apple Hollow\CAD\Design\Apple Hollow CONCEPT 11 SHEET SET PHASE 2.dwg


- NOTES:**
- ① CONSTRUCT HANDICAP RAMP AS PER CITY STANDARDS
 - ② CONSTRUCT STREET LIGHT AS PER CITY STANDARDS
 - ③ CONSTRUCT STOP & STREET SIGN AS PER CITY STANDARDS
 - ④ CONSTRUCT FIRE HYDRANT AS PER CITY STANDARDS
 - ⑤ CONSTRUCT 24" HIGH BACK CURB AND GUTTER AS PER CITY STANDARDS
 - ⑥ CONSTRUCT 1" CULINARY WATER LATERAL WITH METER TO WATER MAIN
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(24"x36")
 HORIZONTAL 1" = 20'
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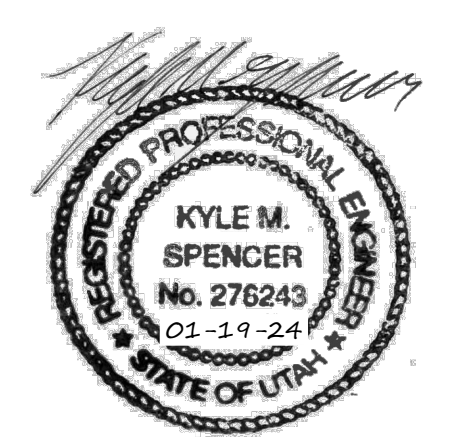
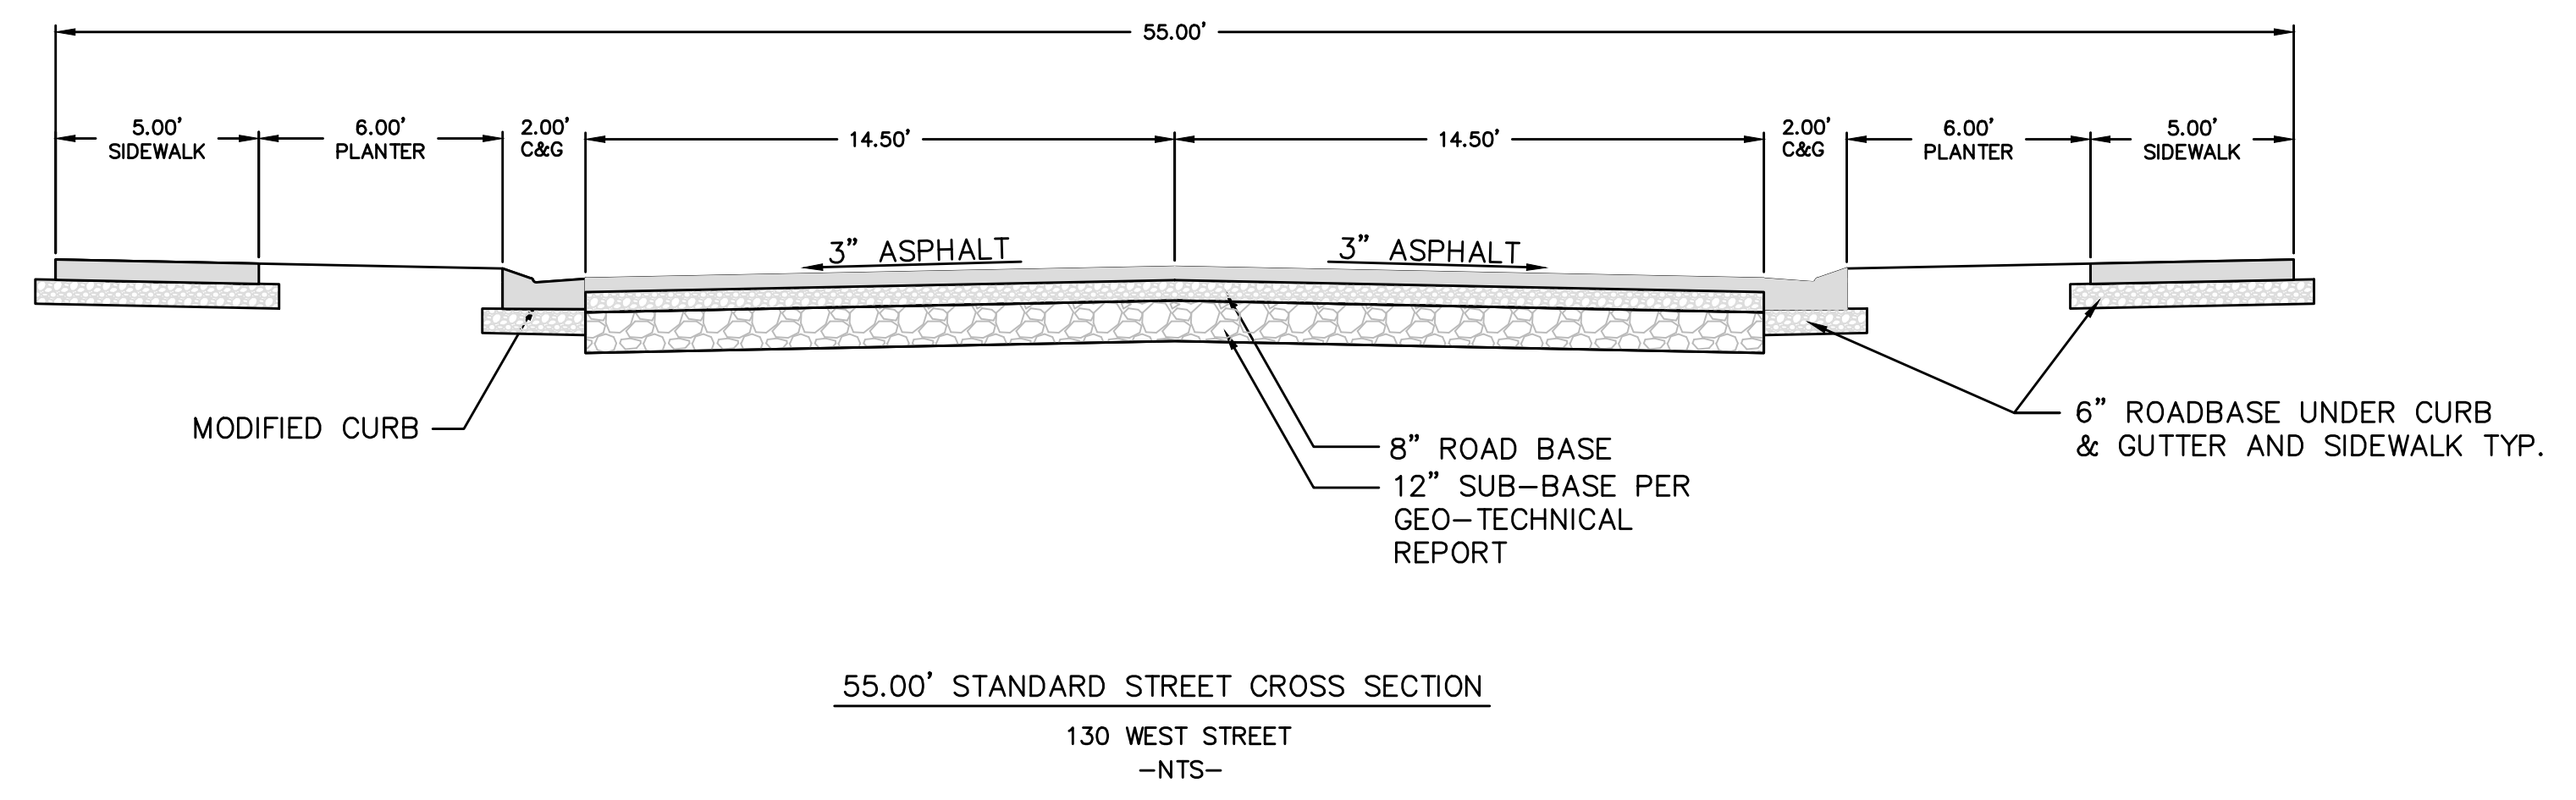
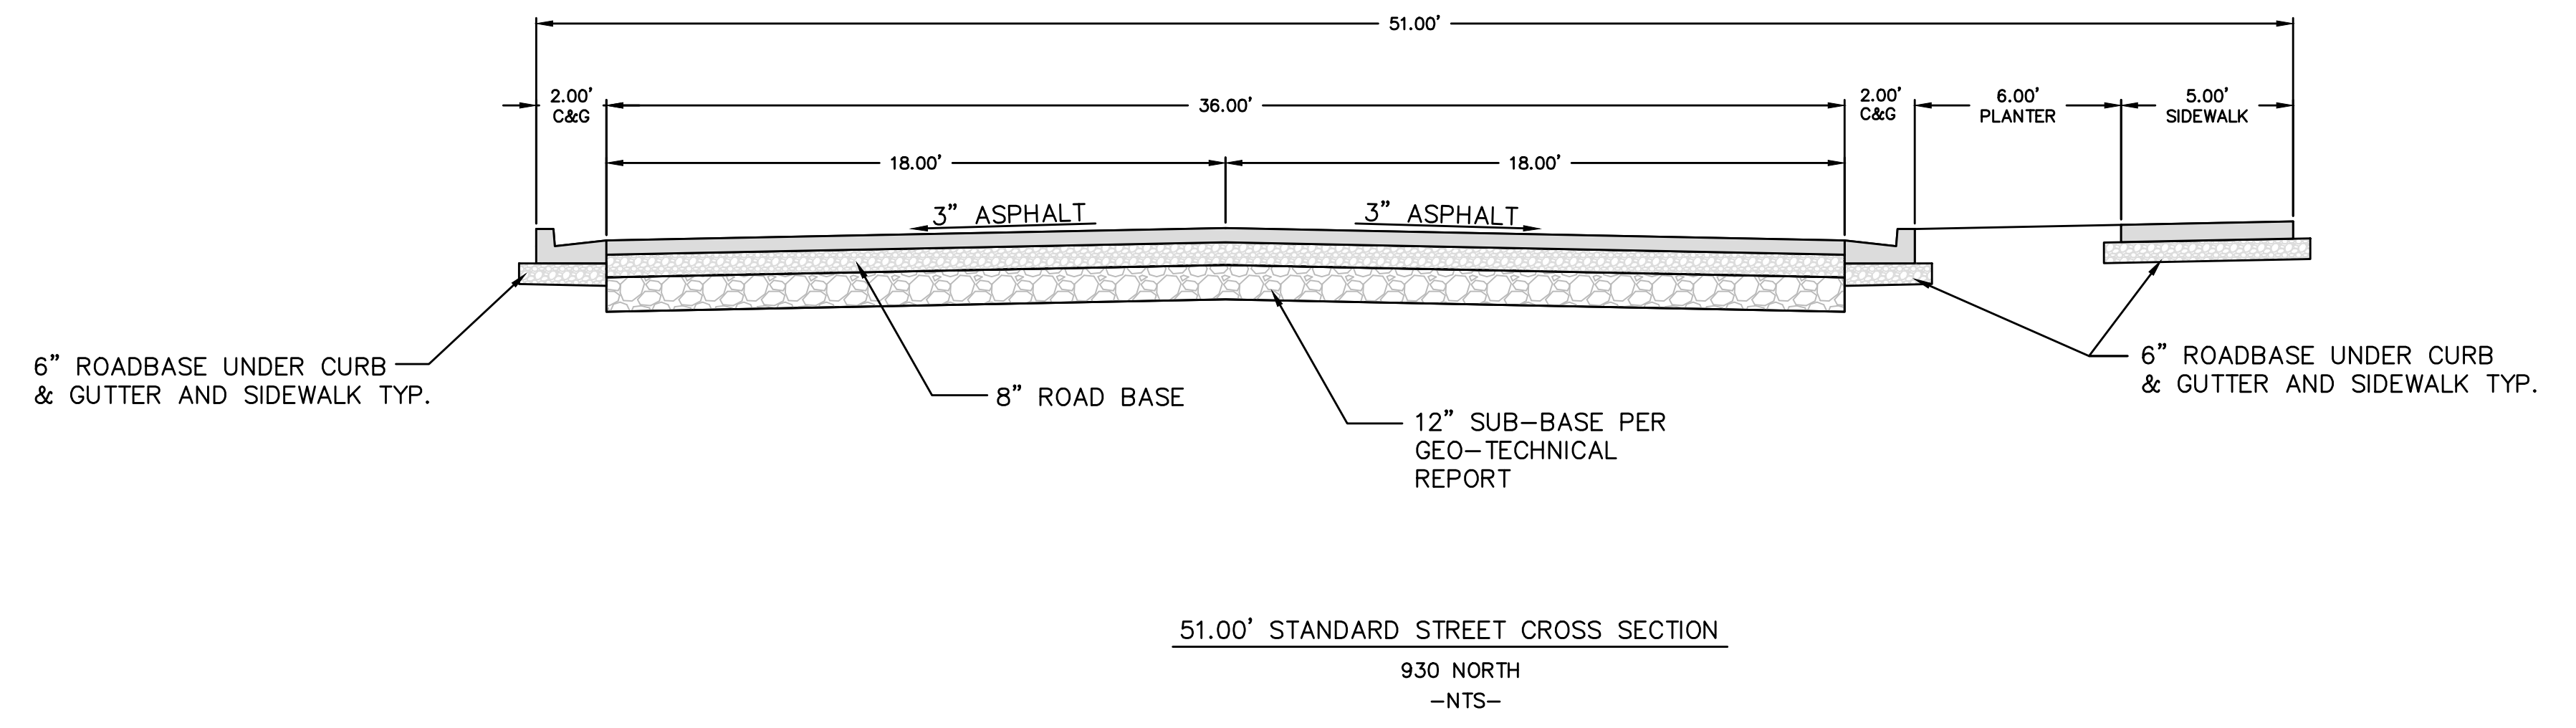
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APPLE HOLLOW @ THE ORCHARDS "B- PHASE 2"

130 WEST – PLAN & PROFILE
 SANTAQUIN, UTAH

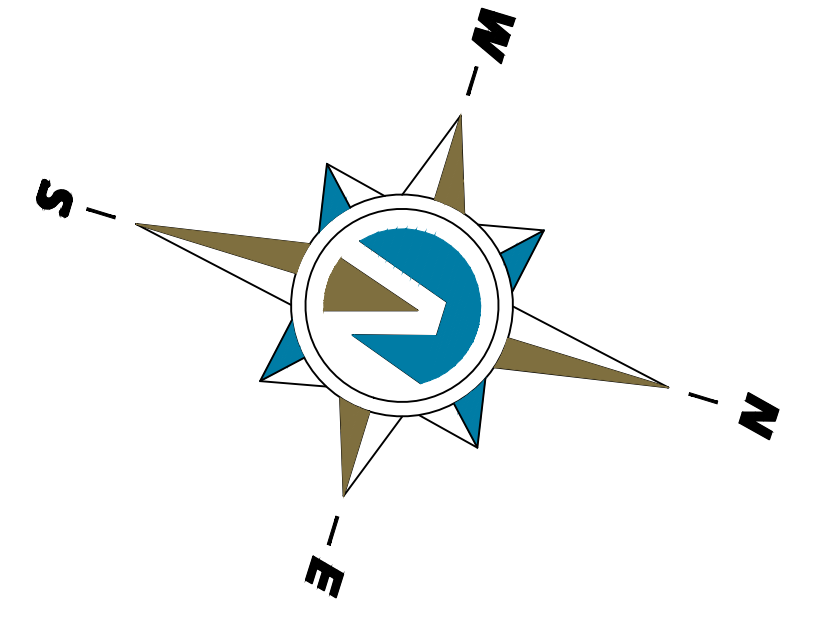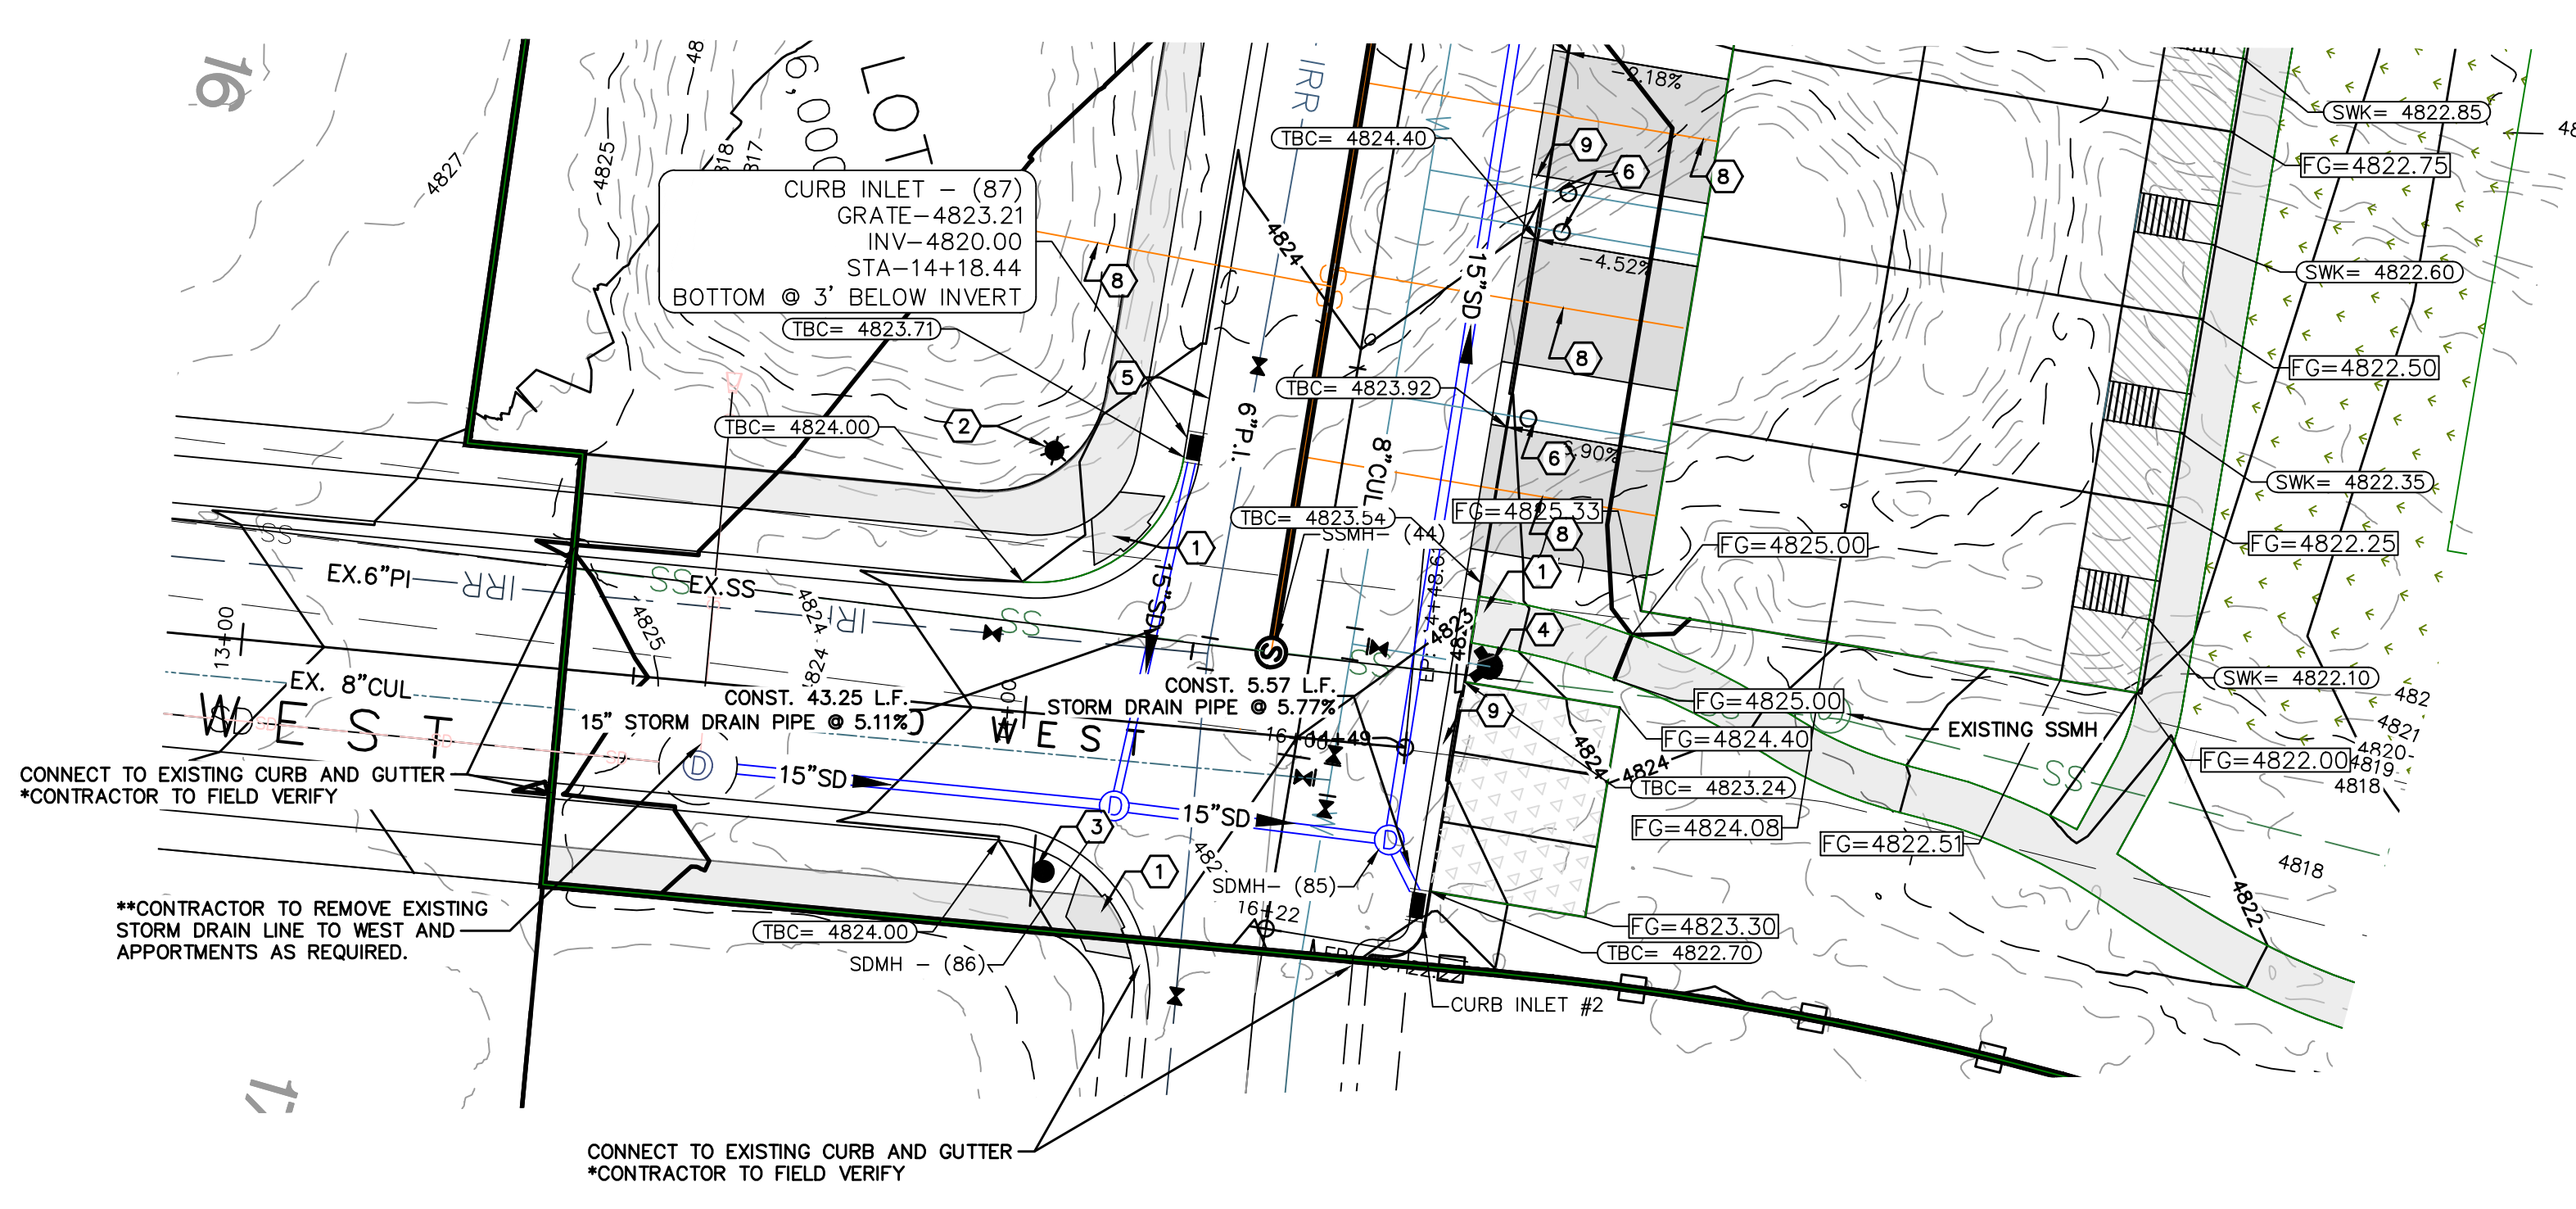JOB NO. 3-20-031
 SHEET NO. PP-02



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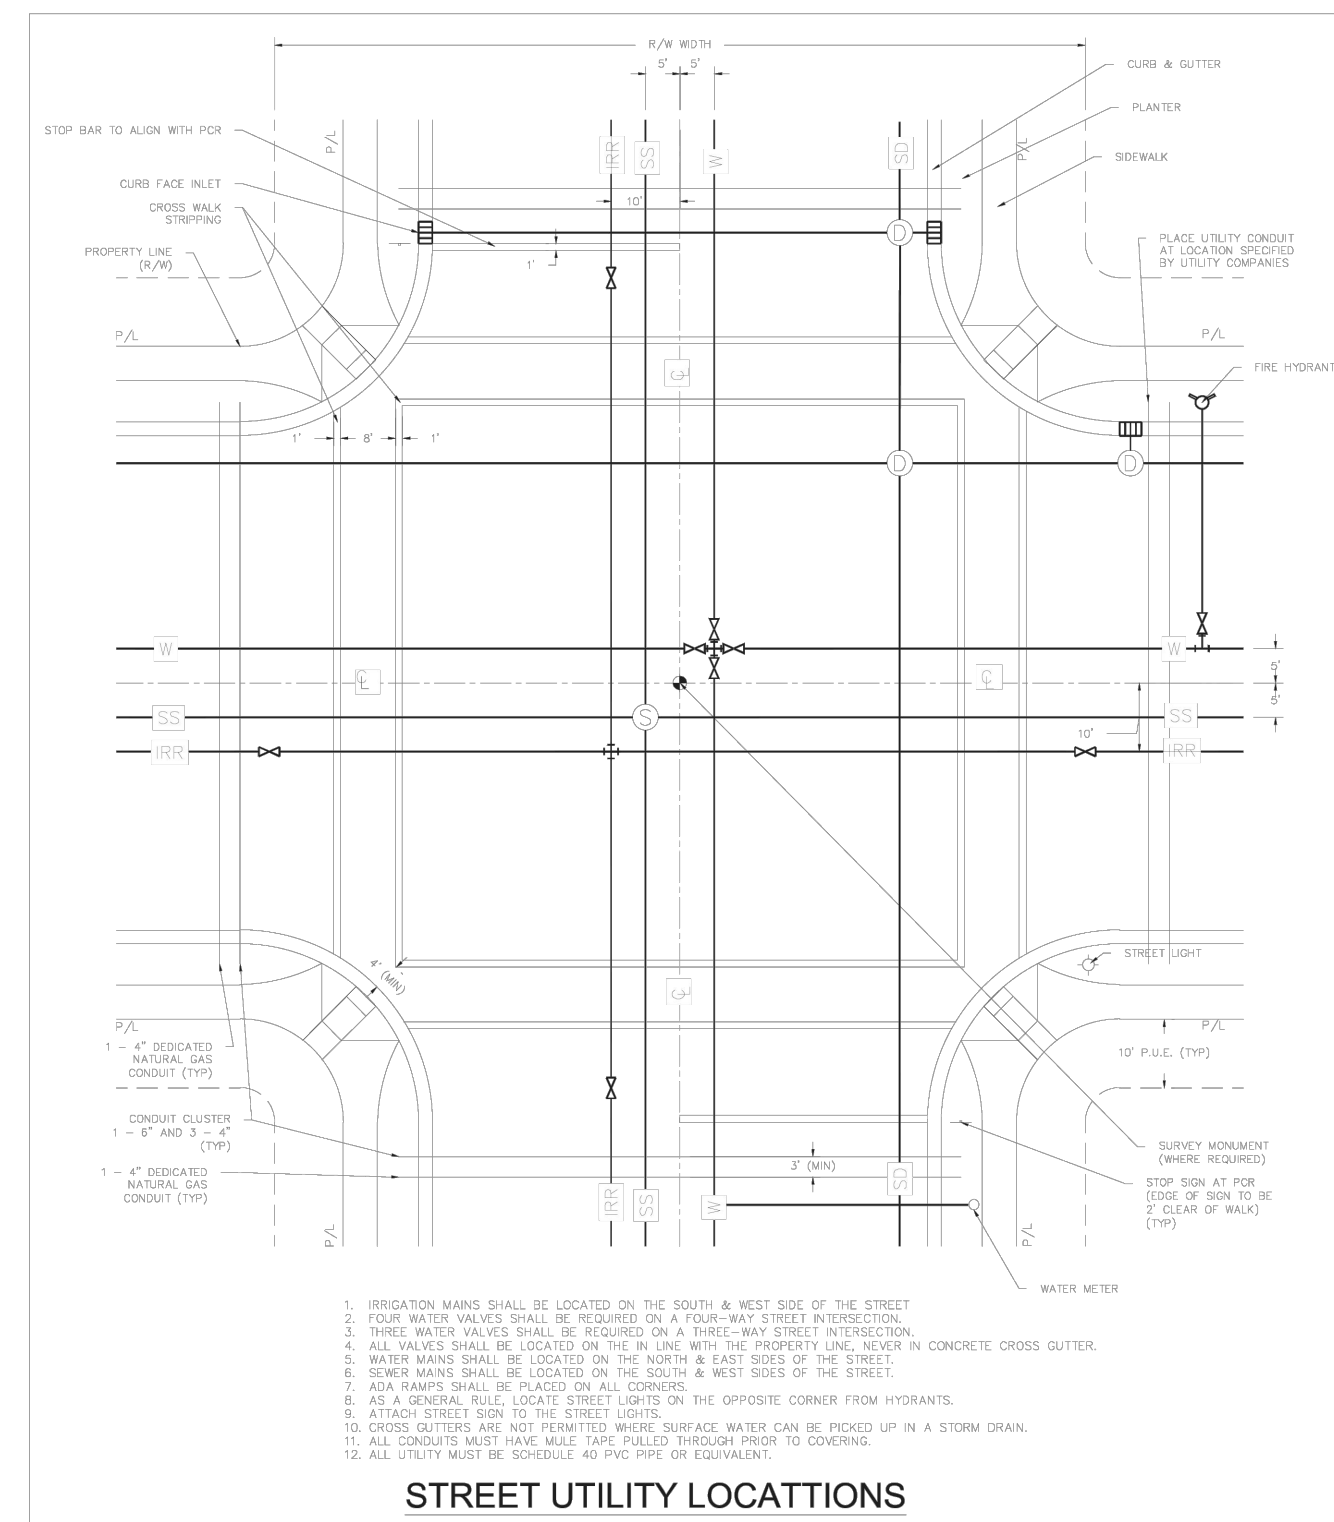
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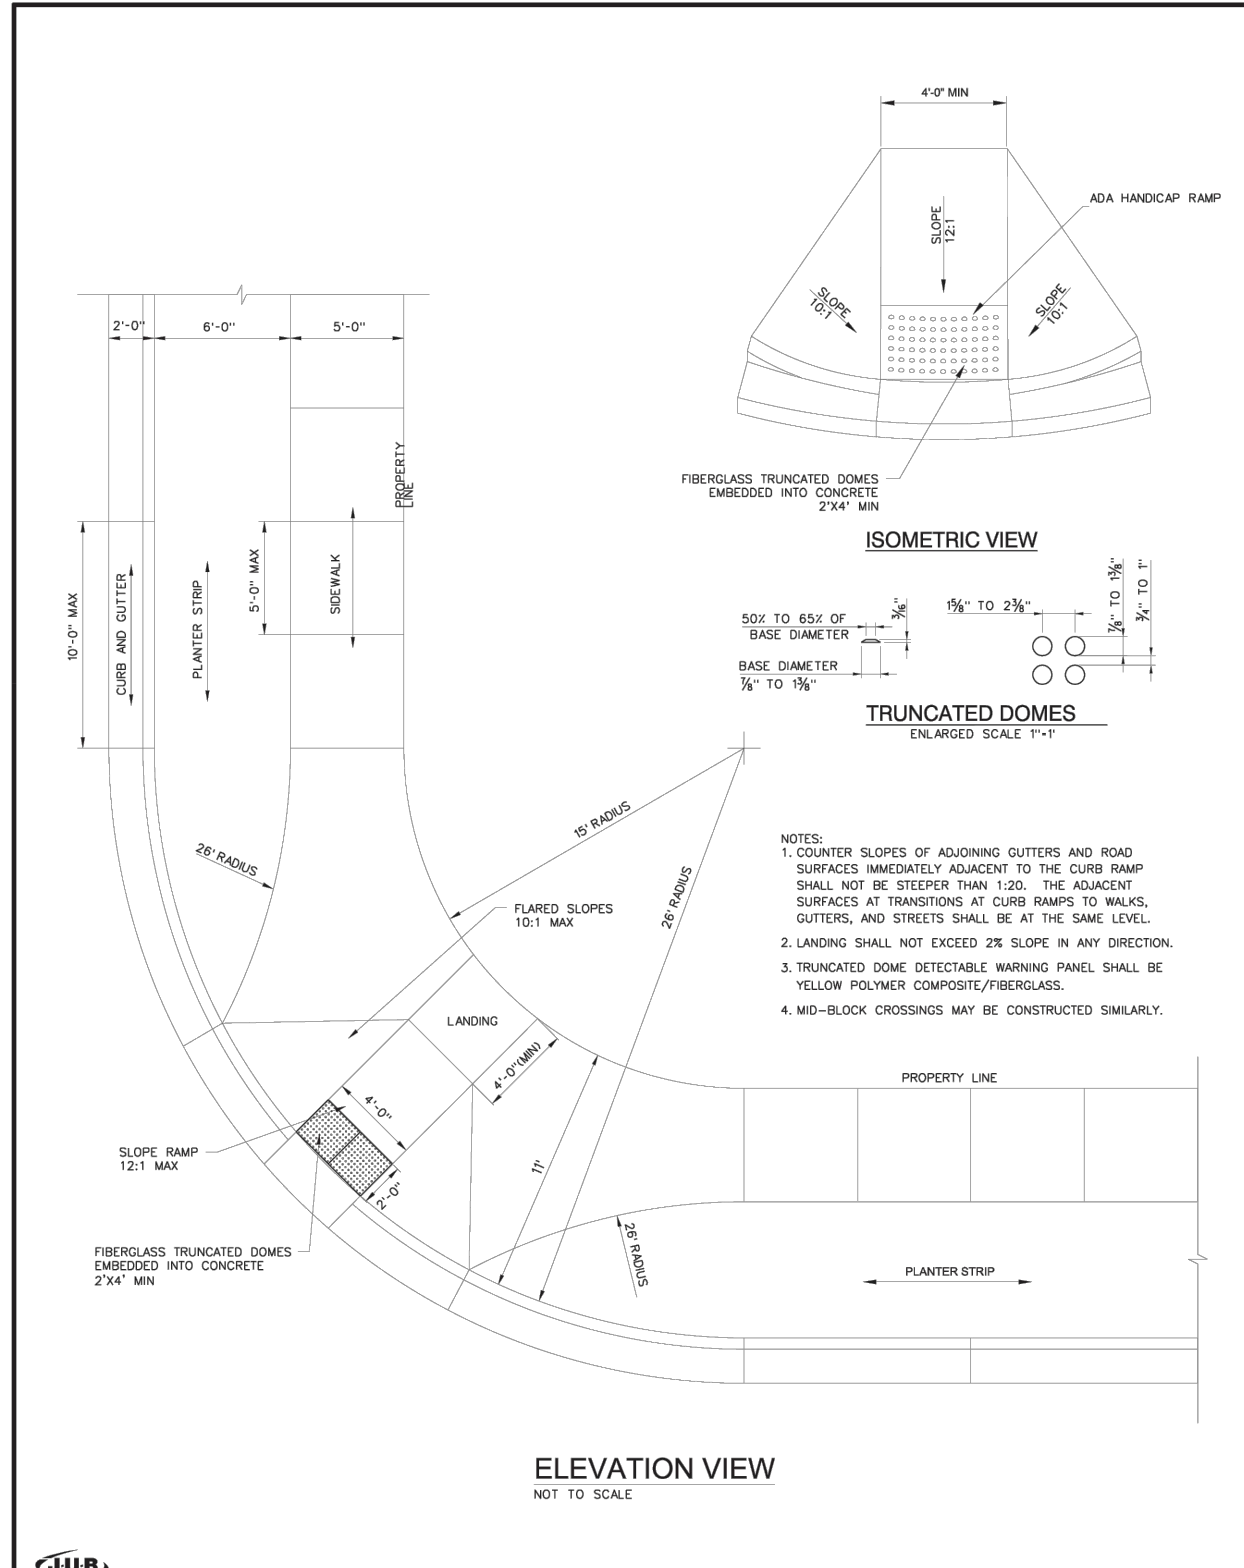
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**APPLE HOLLOW @
THE ORCHARDS "B-2"**

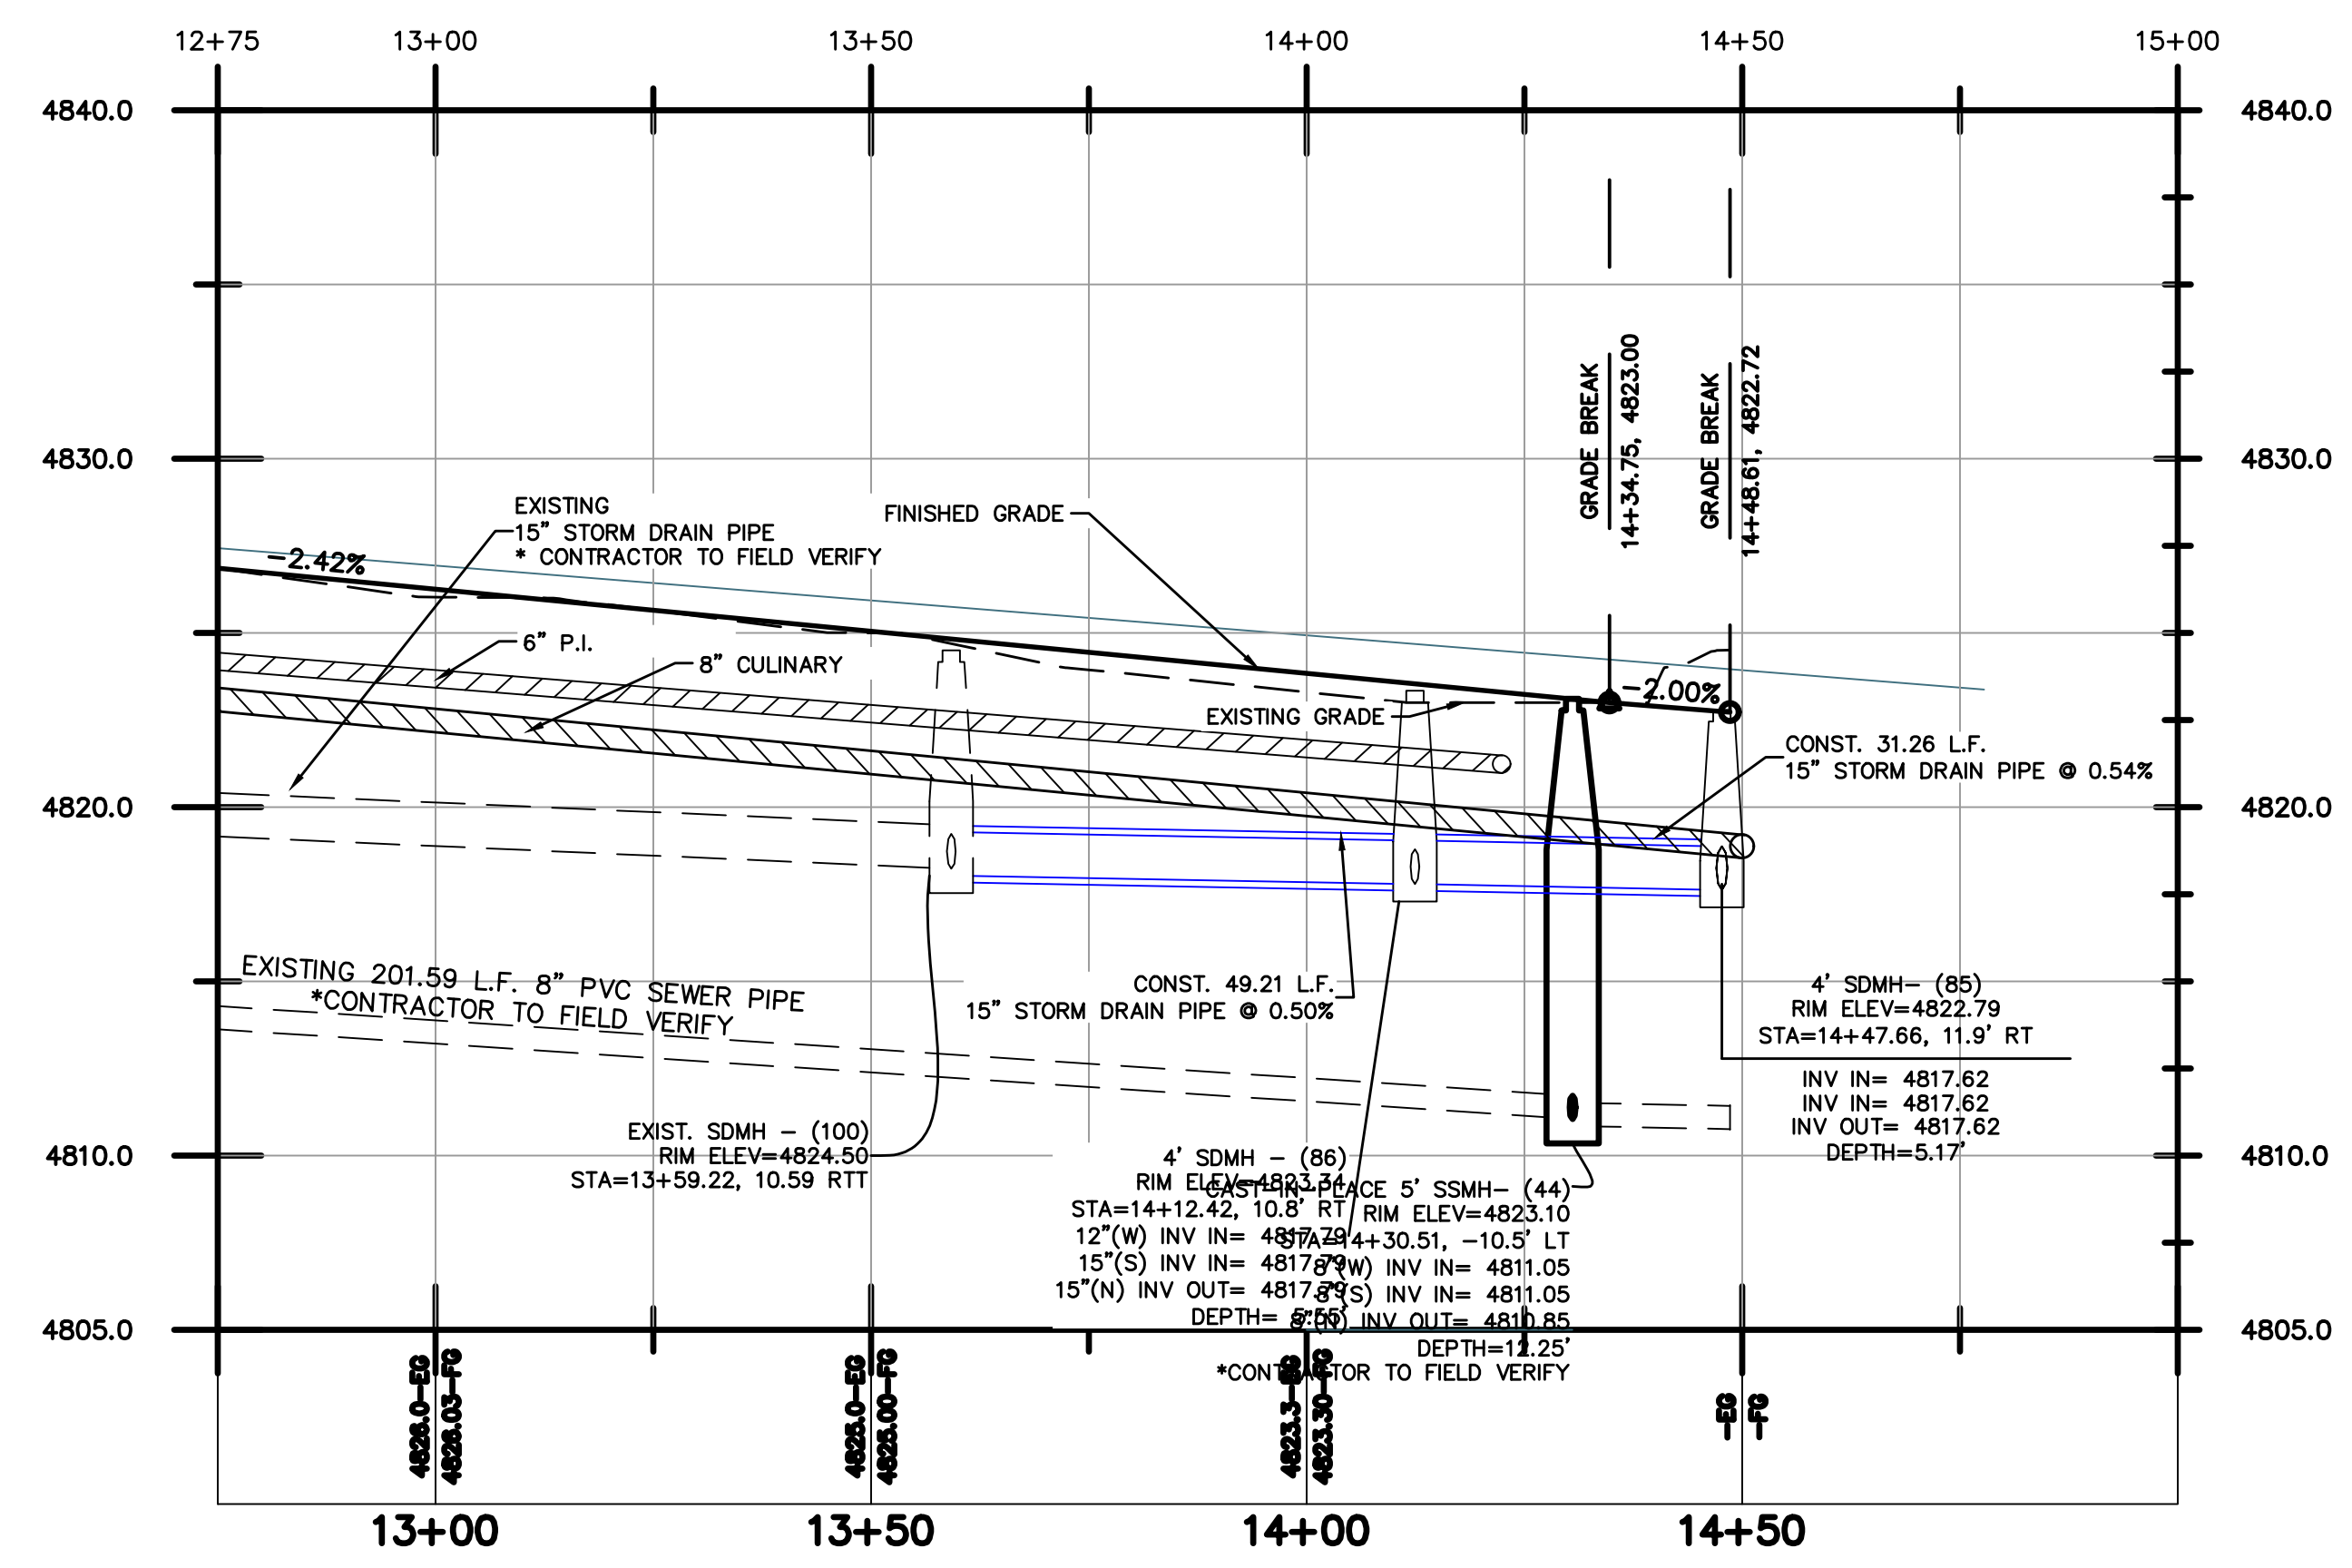
DETAILS	JOB NO. 3-20-031
SANTAQUIN, UTAH	SHEET NO. DT-01




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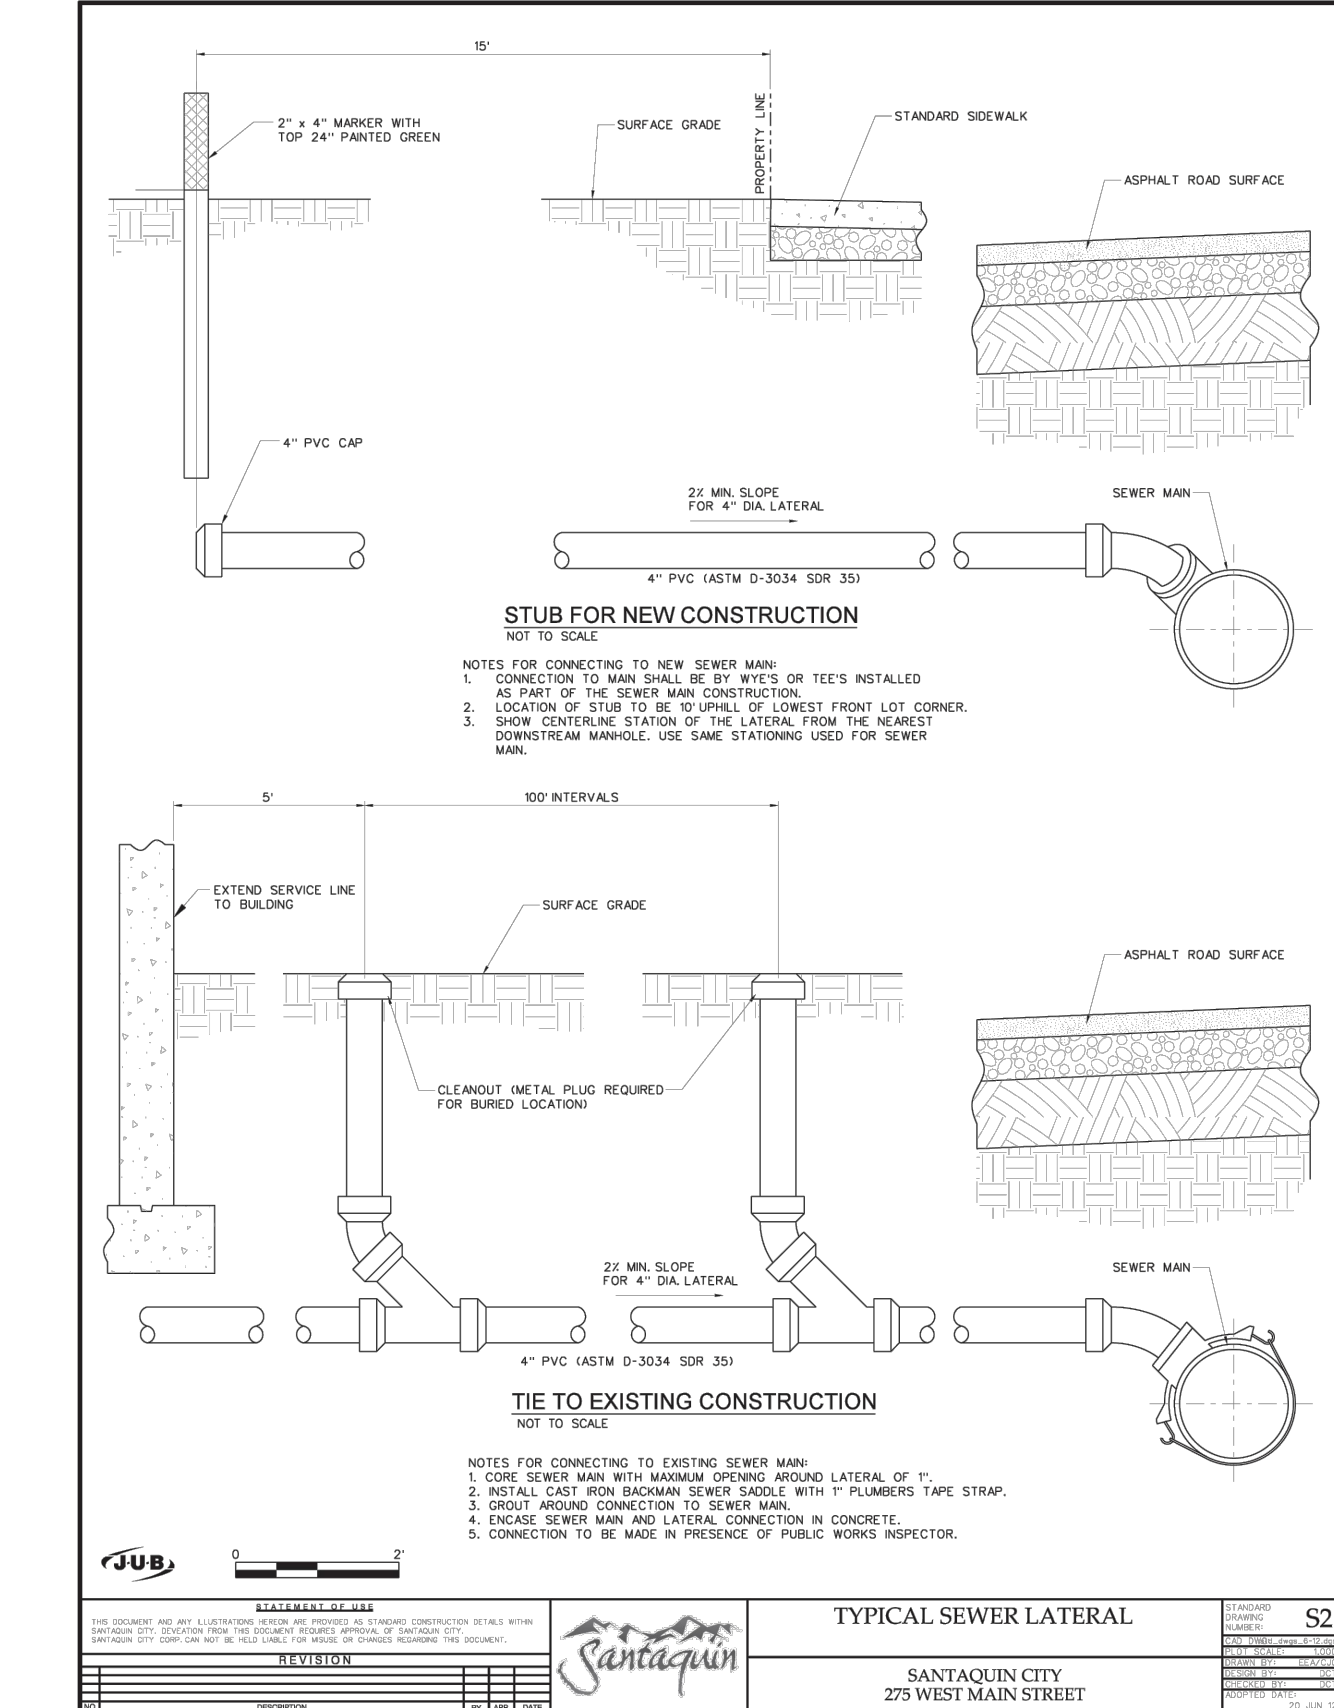
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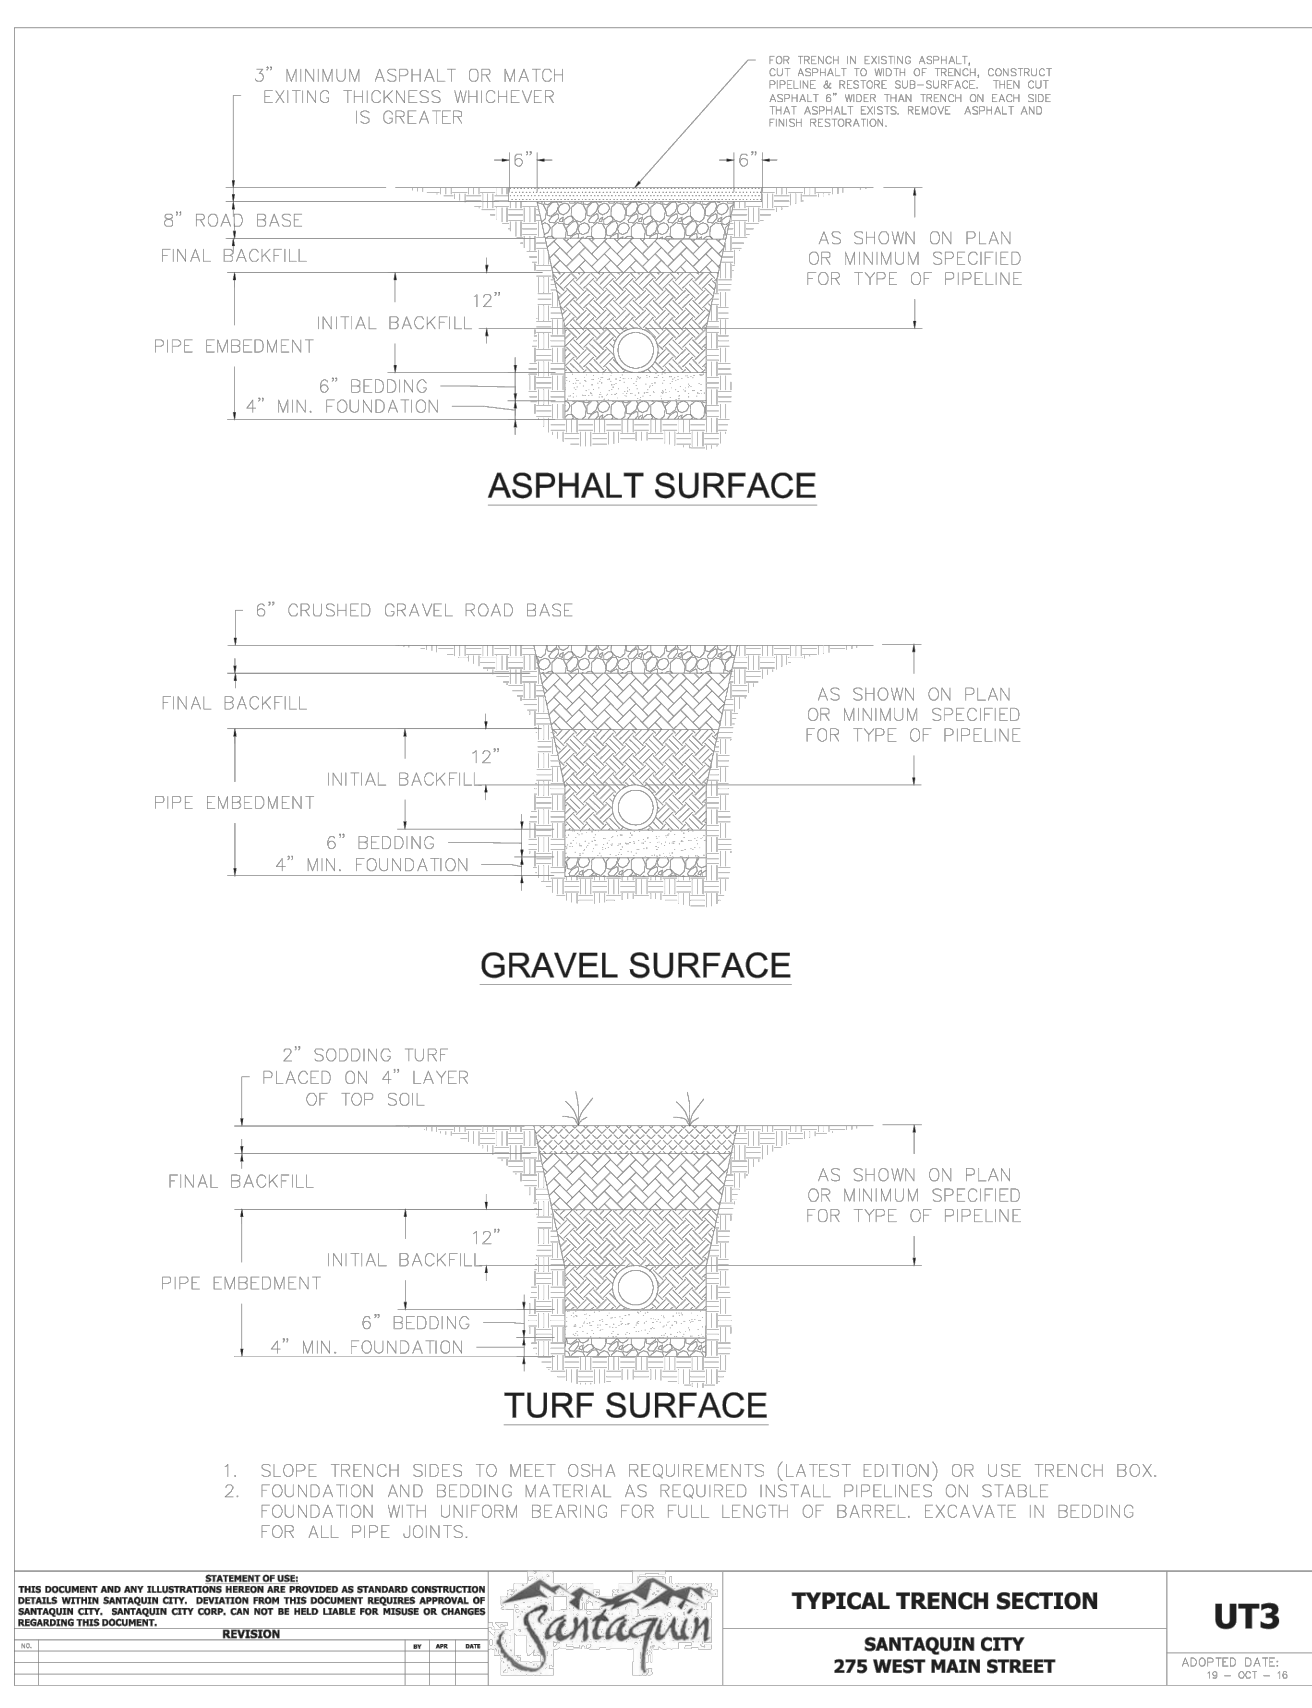
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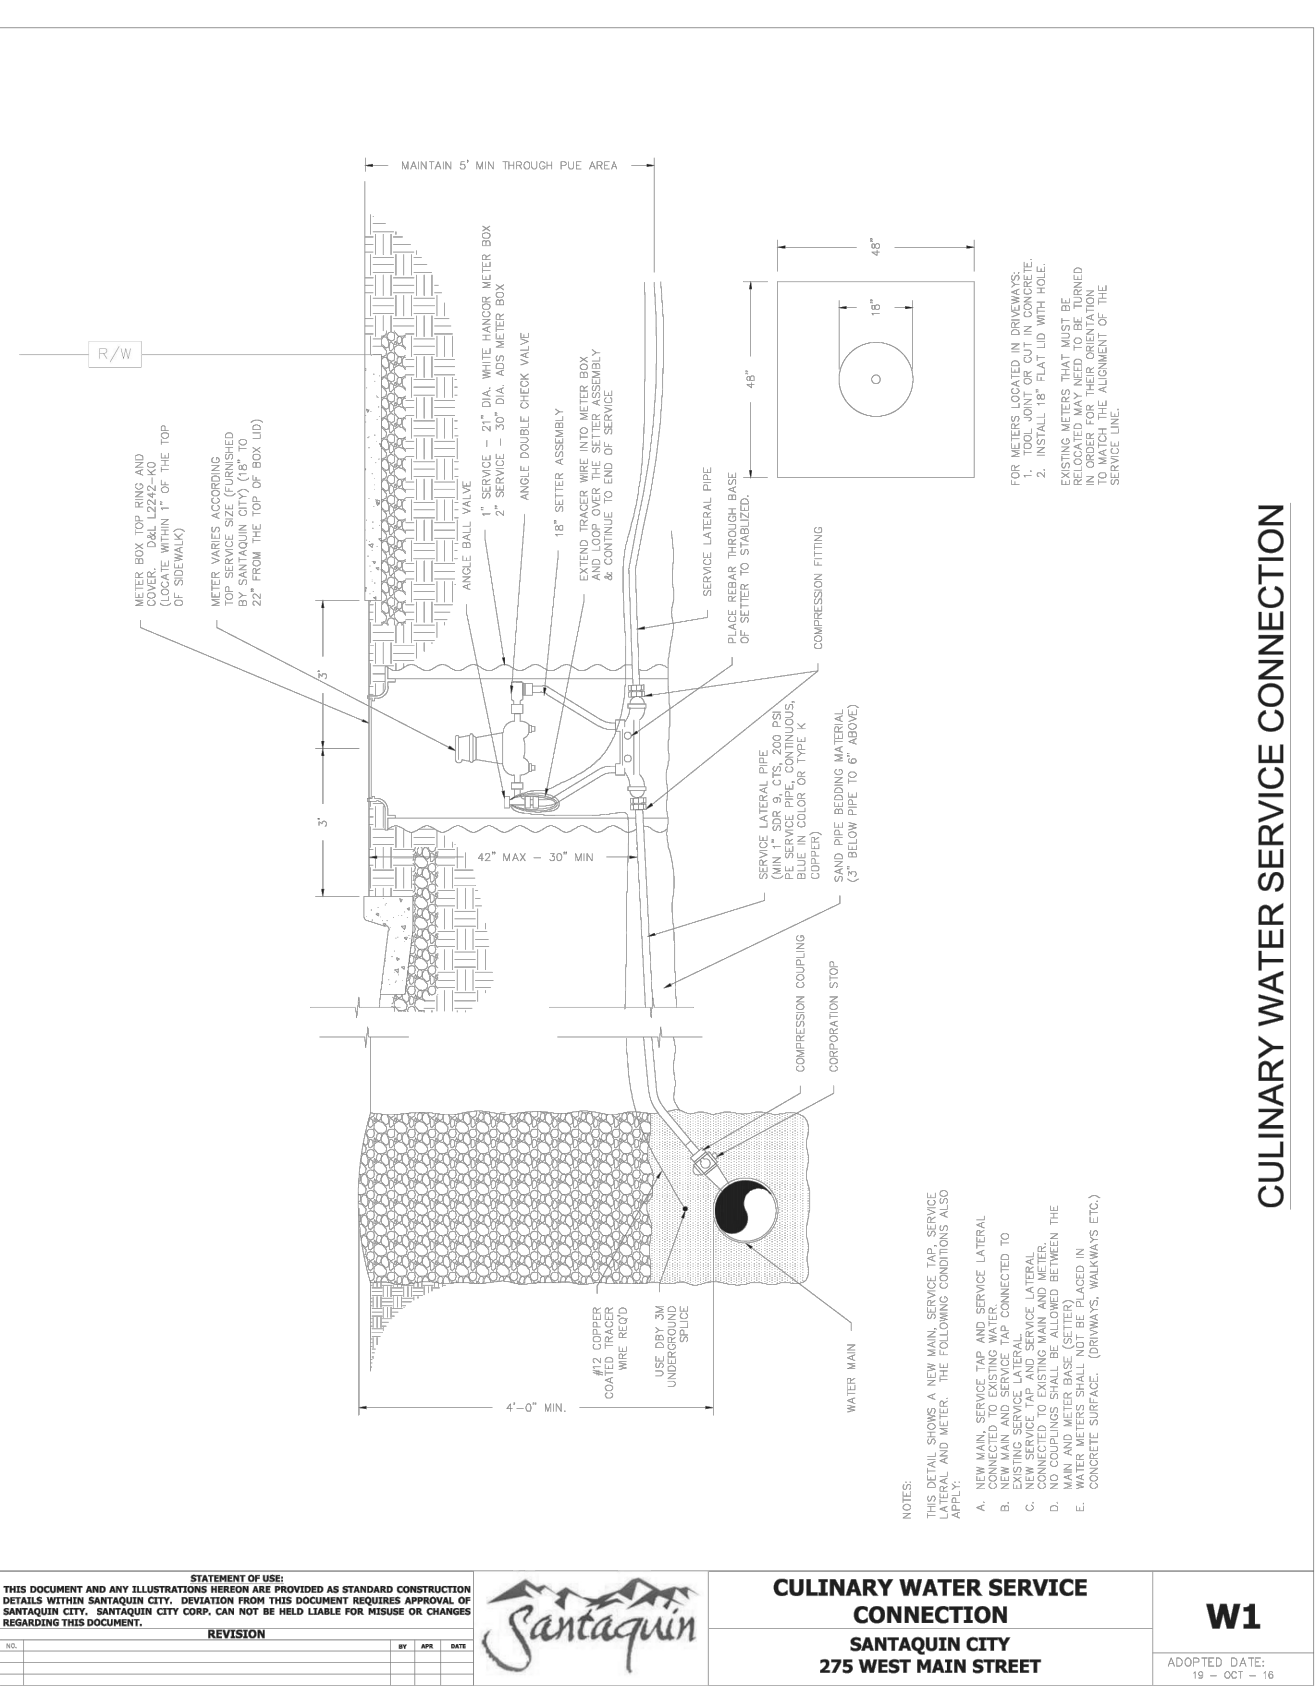
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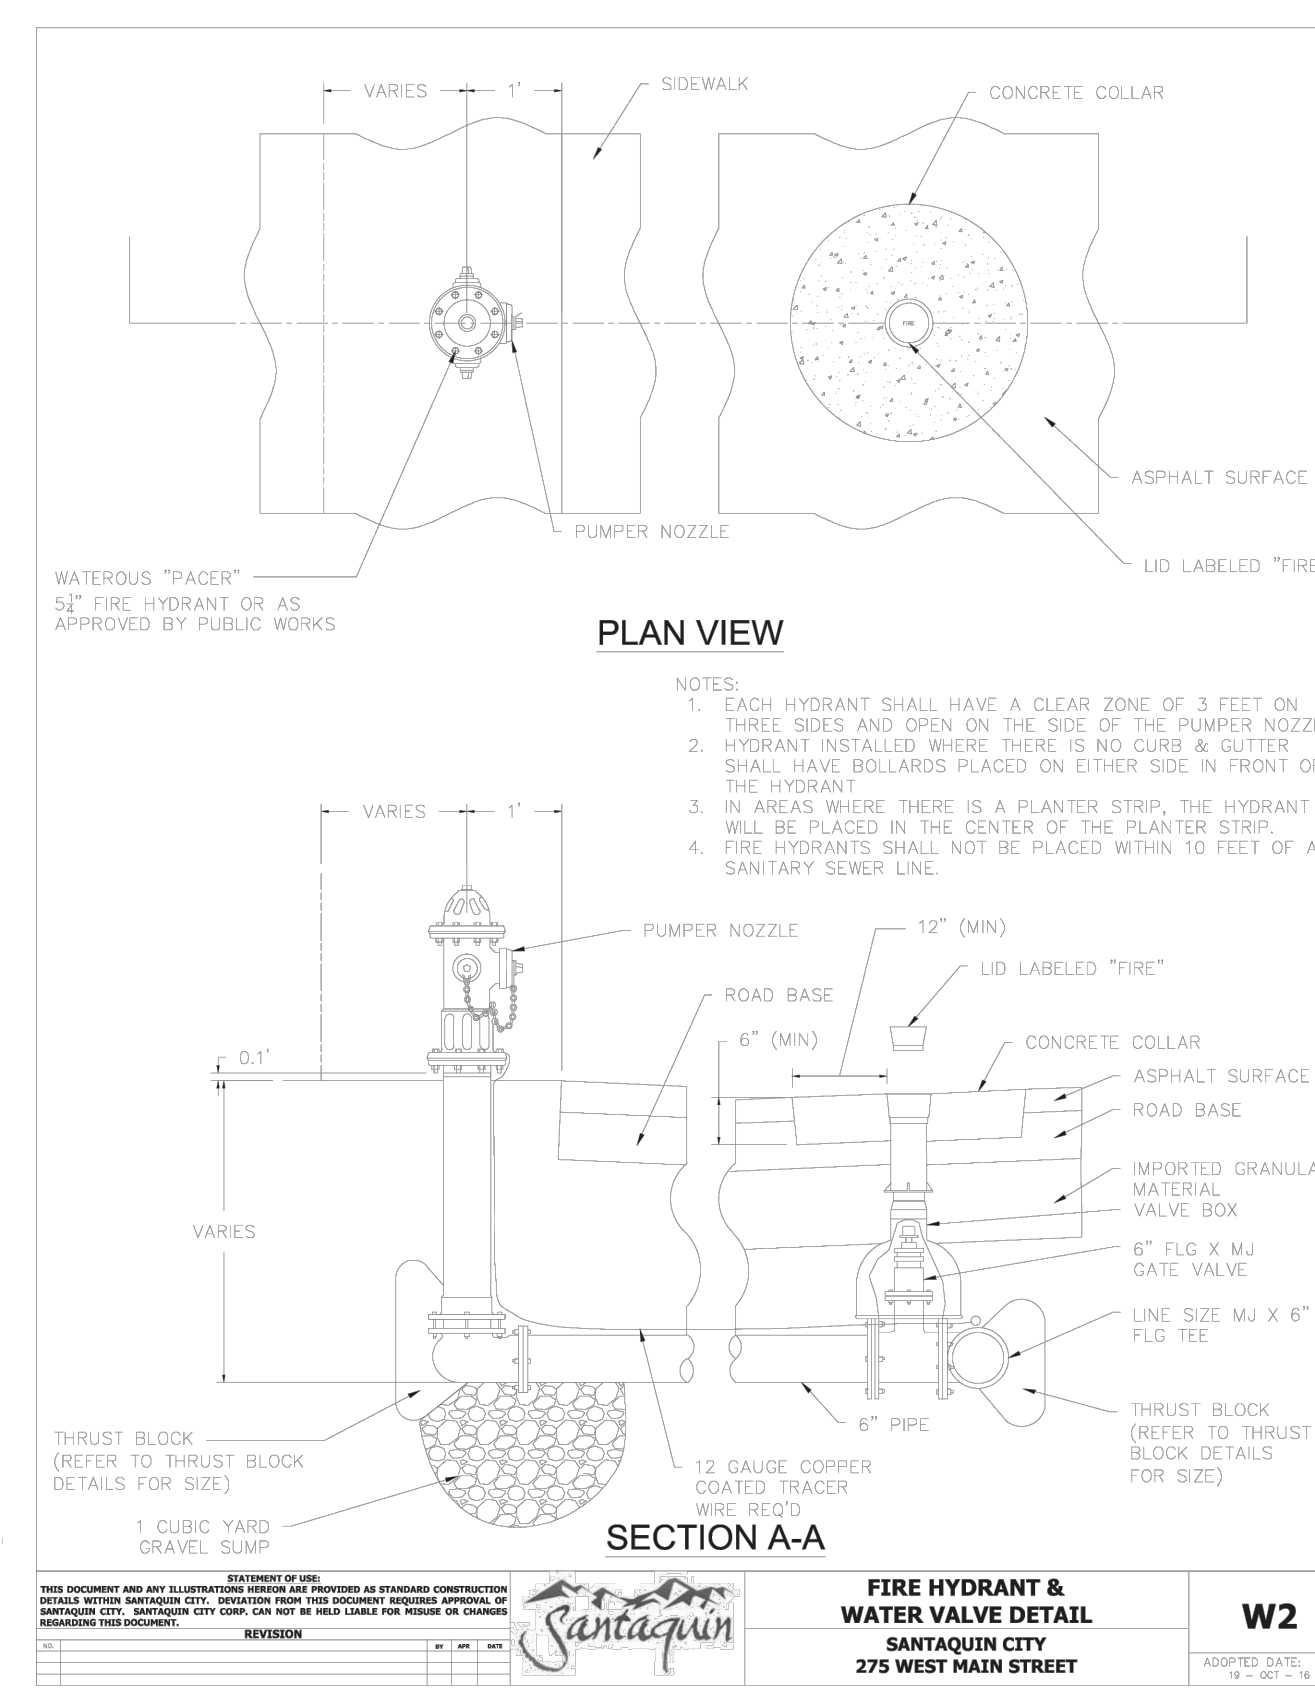
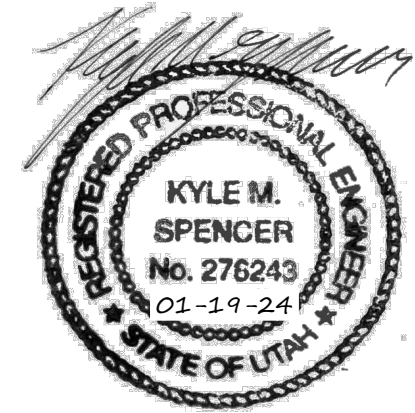
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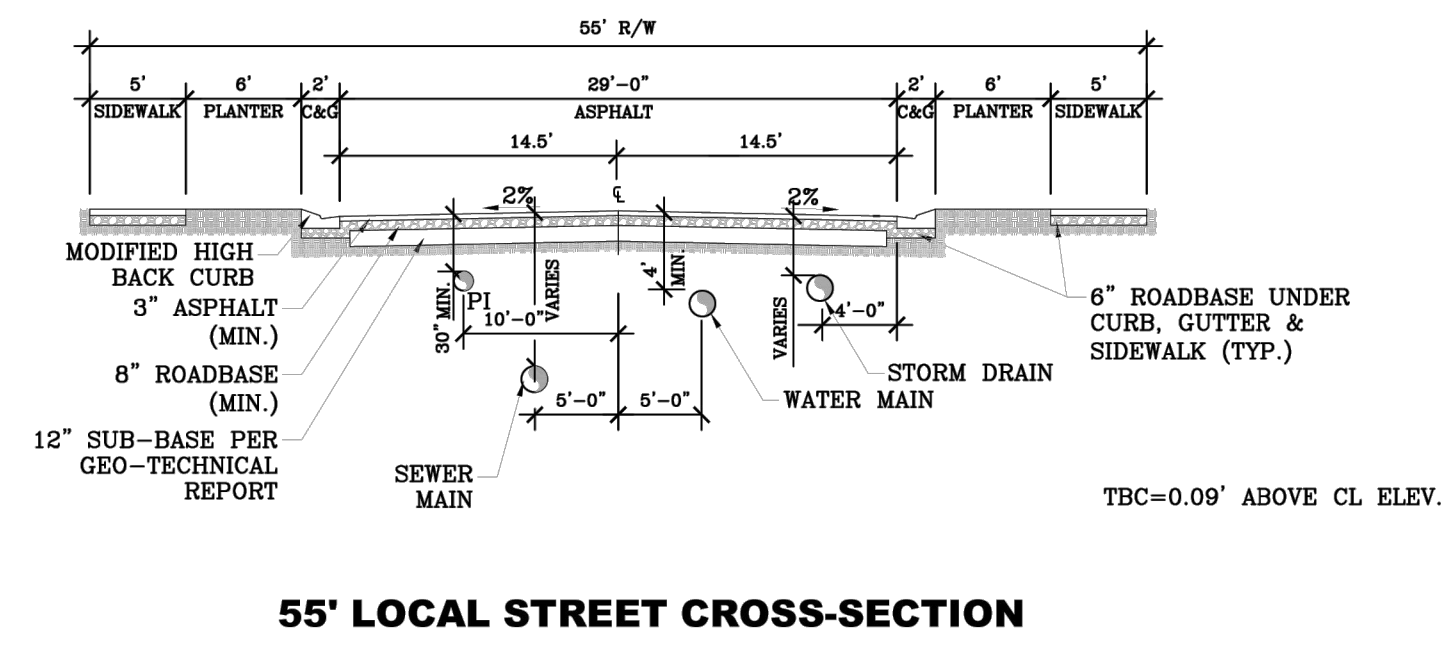
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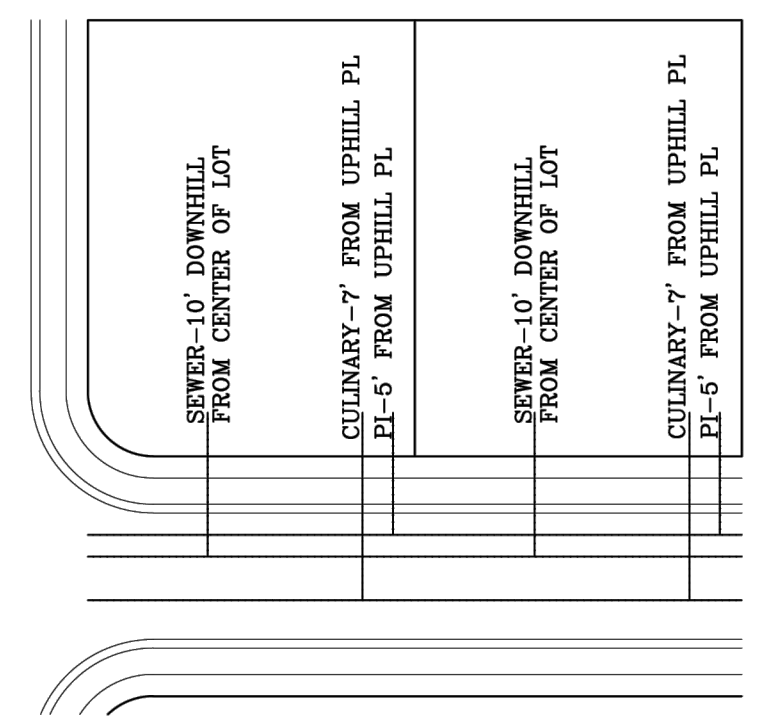
APPLE HOLLOW @ THE ORCHARDS "B-2"

DETAILS
SANTAQUIN, UTAH


JOB NO.
3-20-031
SHEET NO.
DT-02

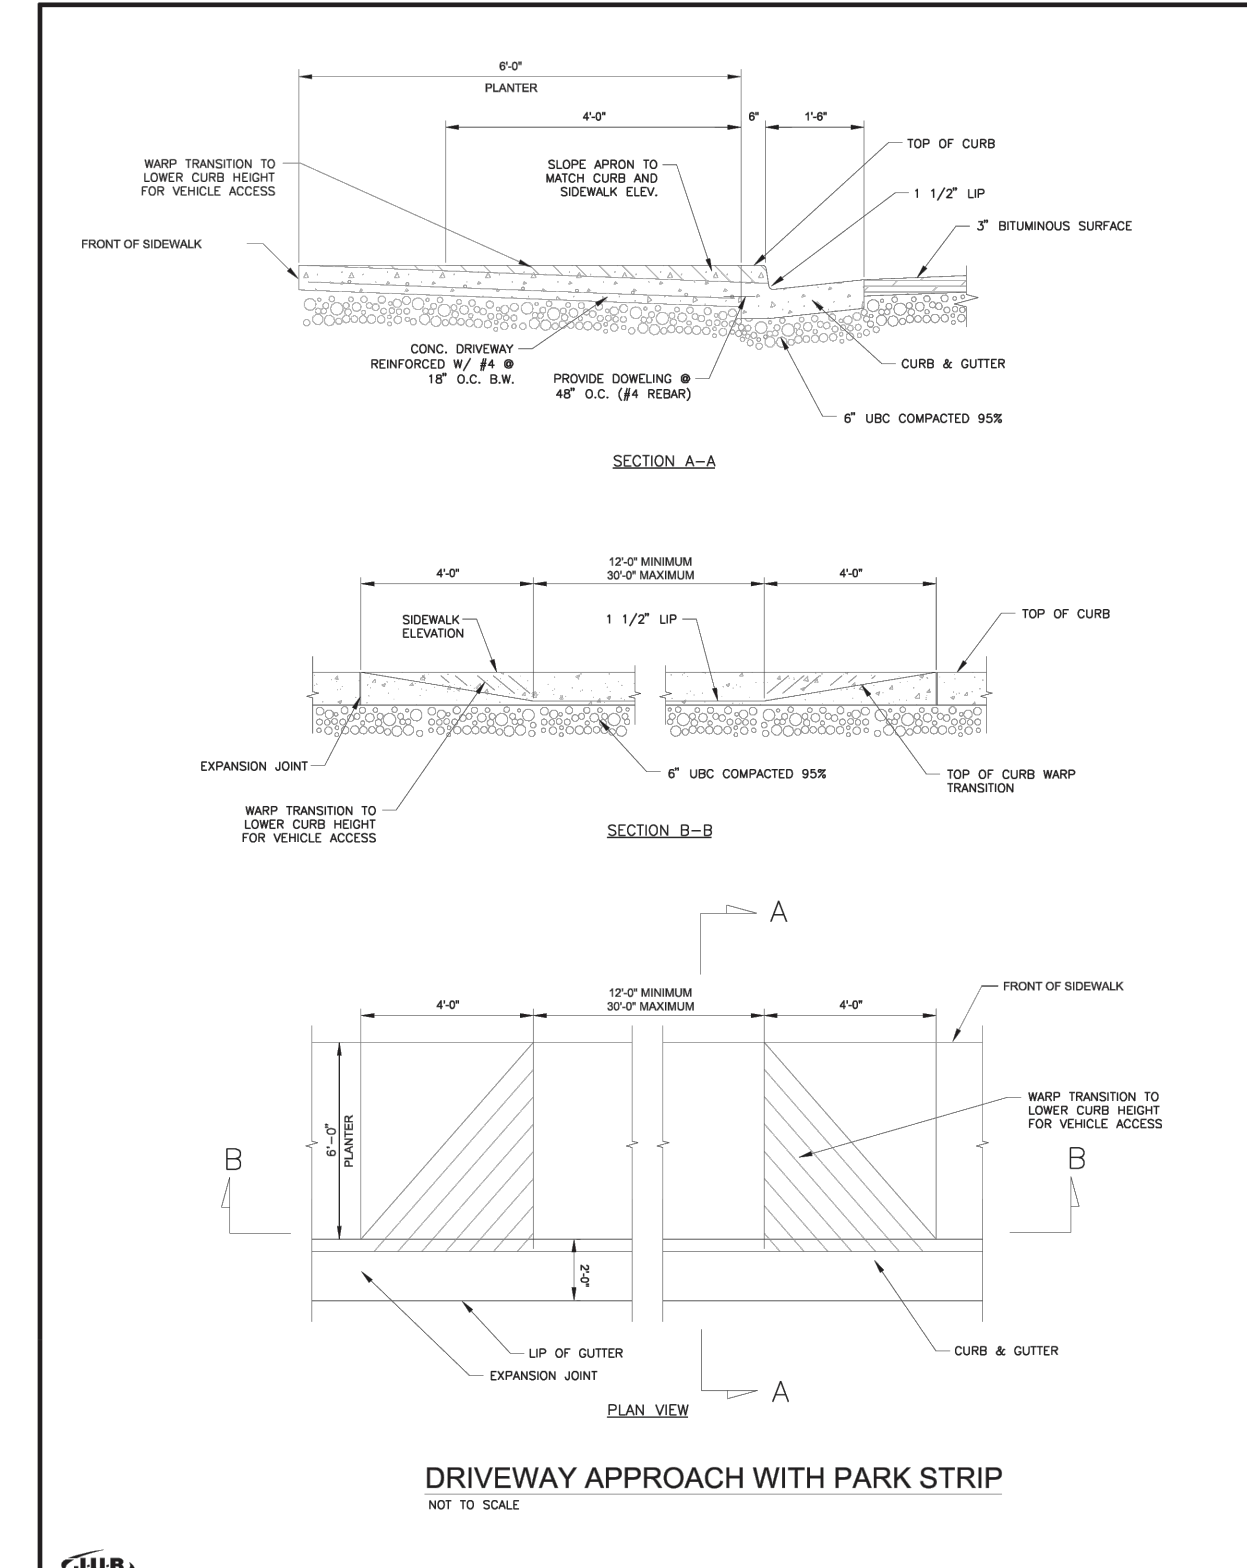


55' LOCAL STREET CROSS-SECTION

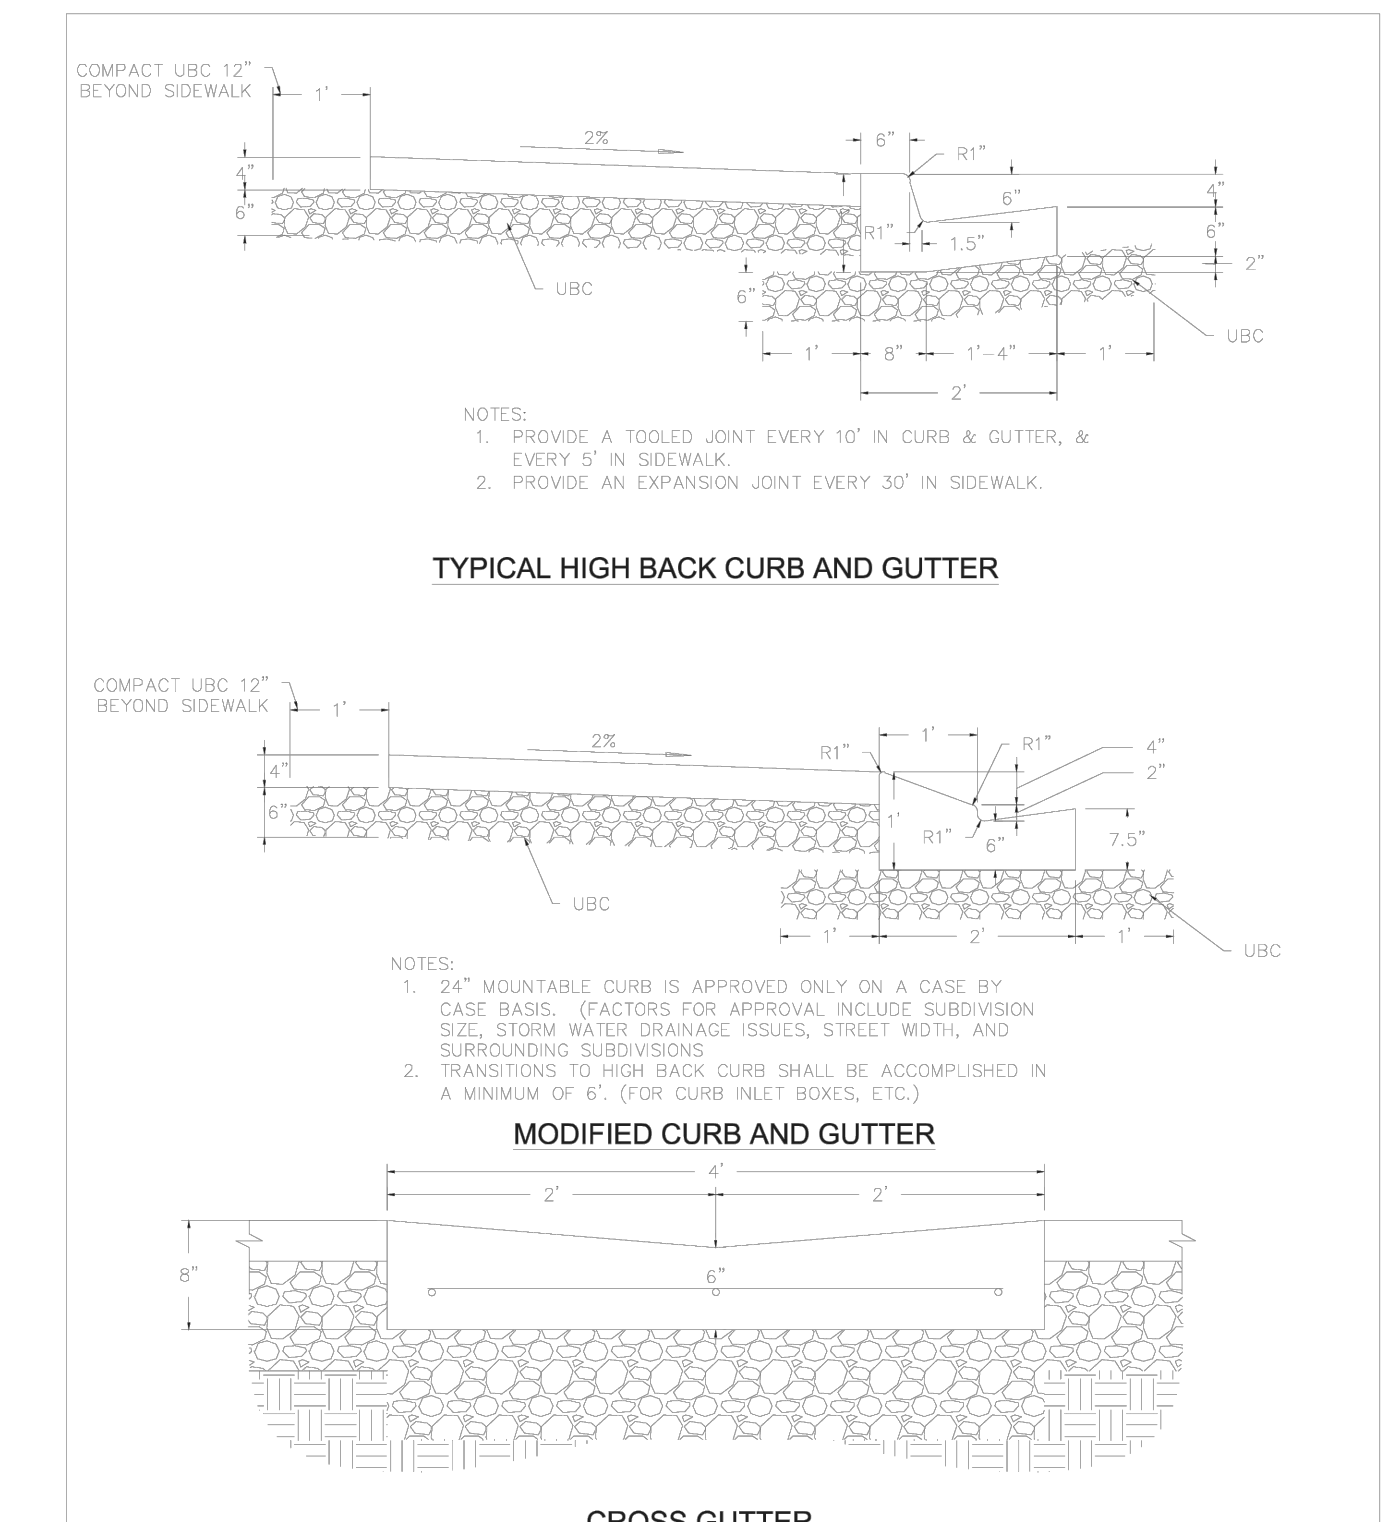

LATERAL DETAIL

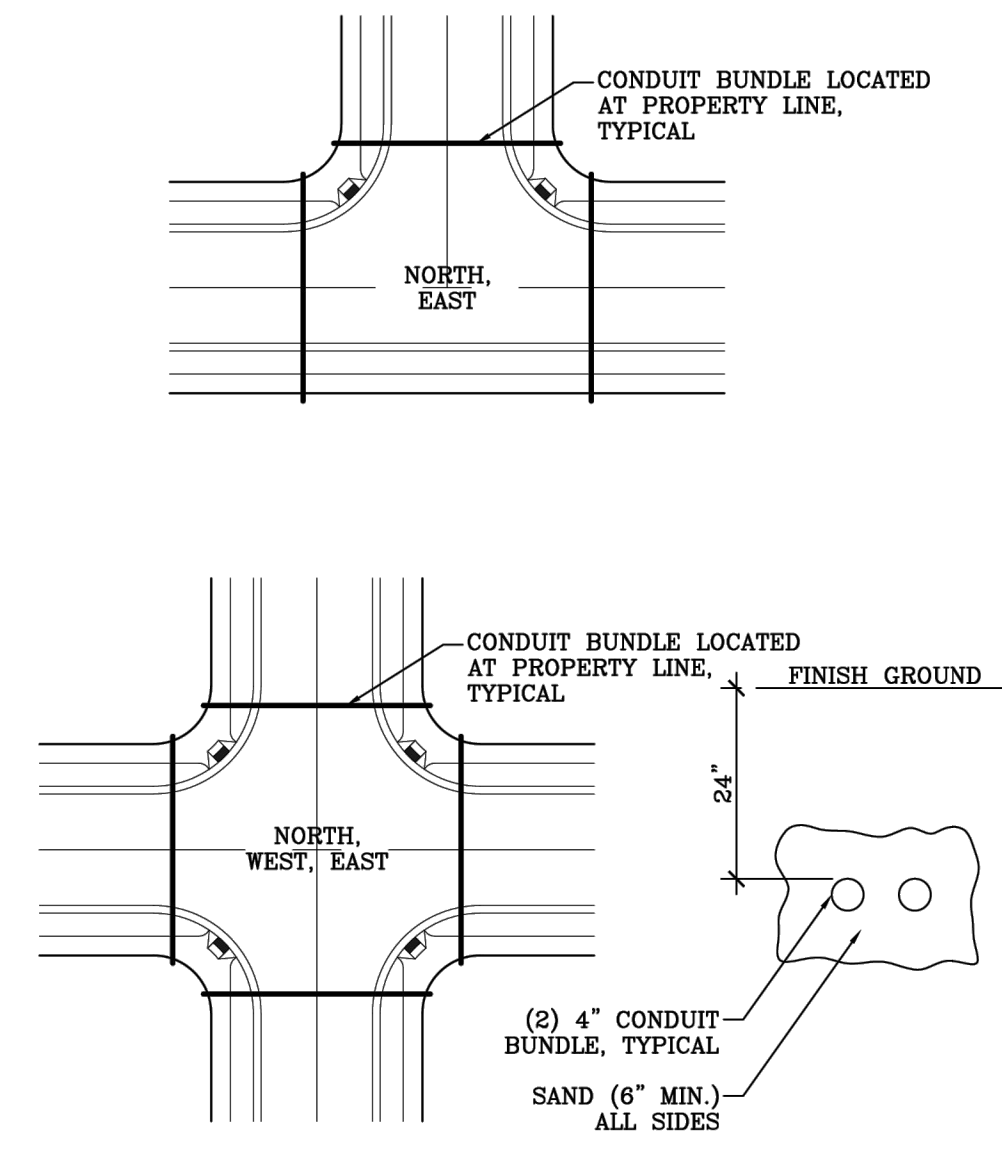

CONDUIT DETAILS

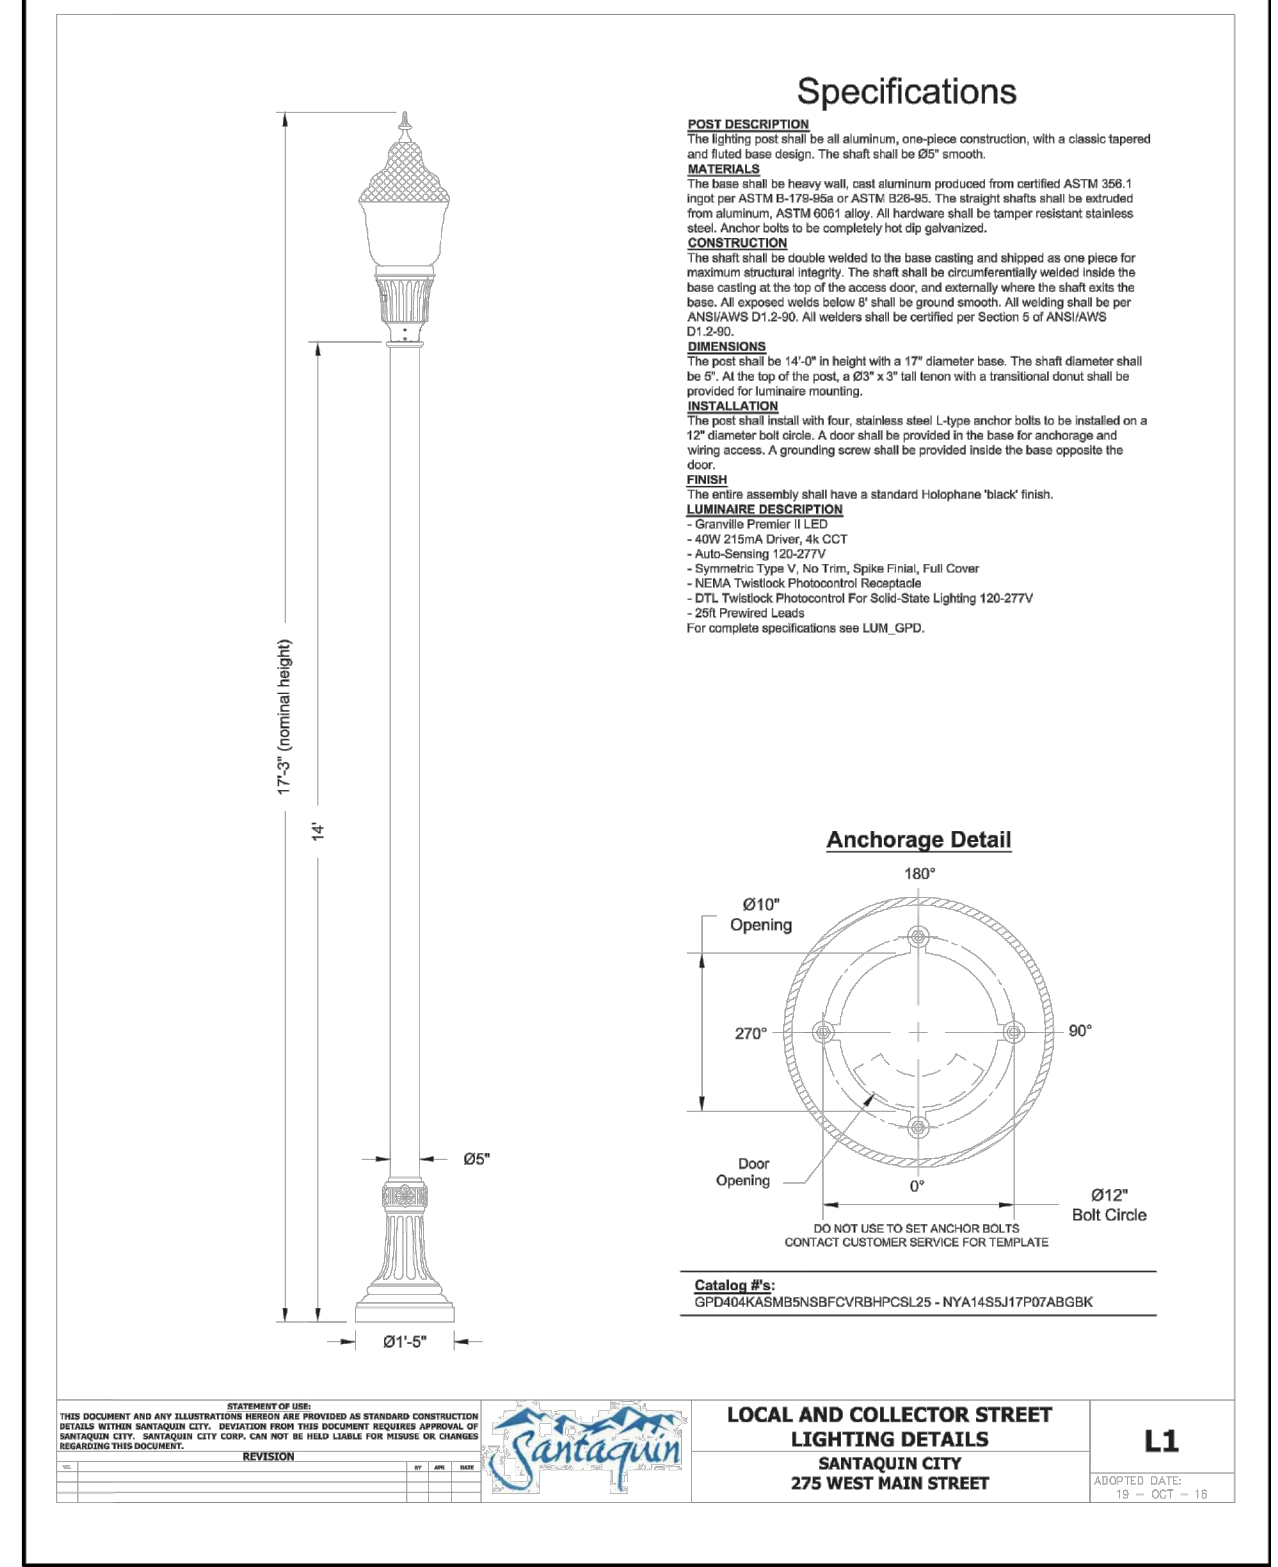


STREET LIGHT DETAIL

STREET CROSS-SECTIONS




20'X20' PAVILION DETAIL
PROPOSED PAVILION OR EQUIVALENT
WITH 4 PICNIC TABLES OR EQUIVALENT
-NTS-

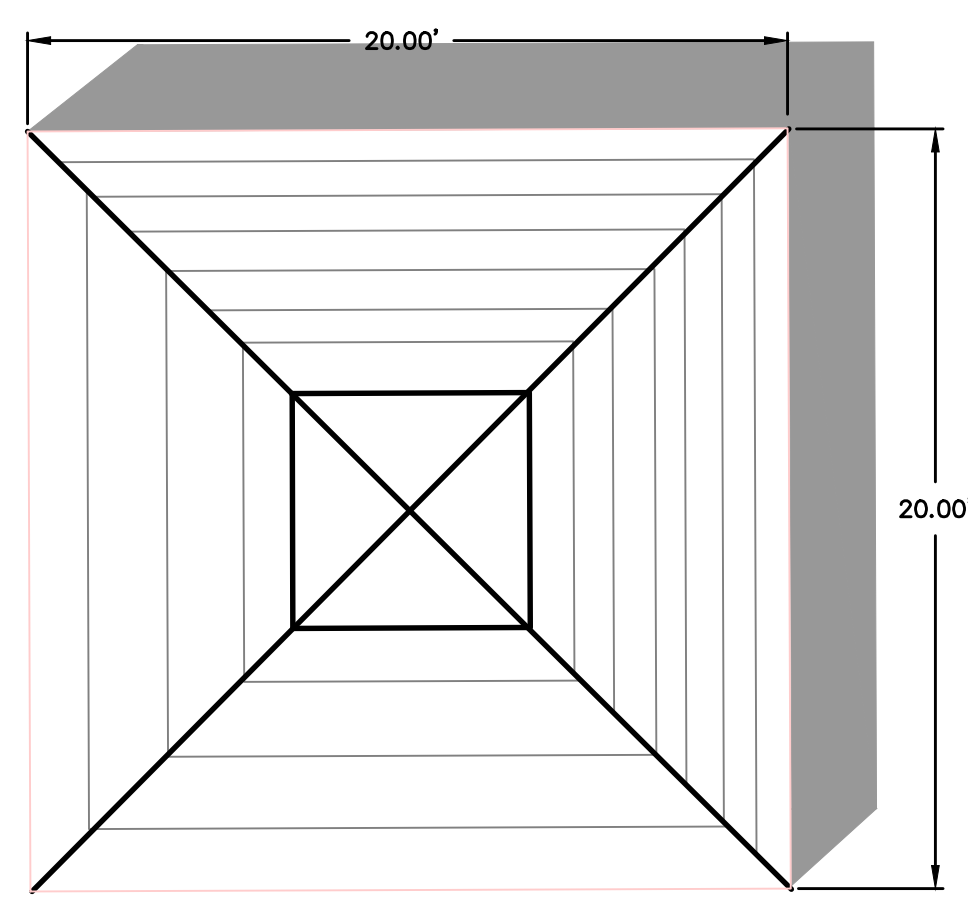


PLAYGROUND DETAIL
PROPOSED OR EQUIVALENT
-NTS-

RHINOROCK FENCE SPECIFICATIONS

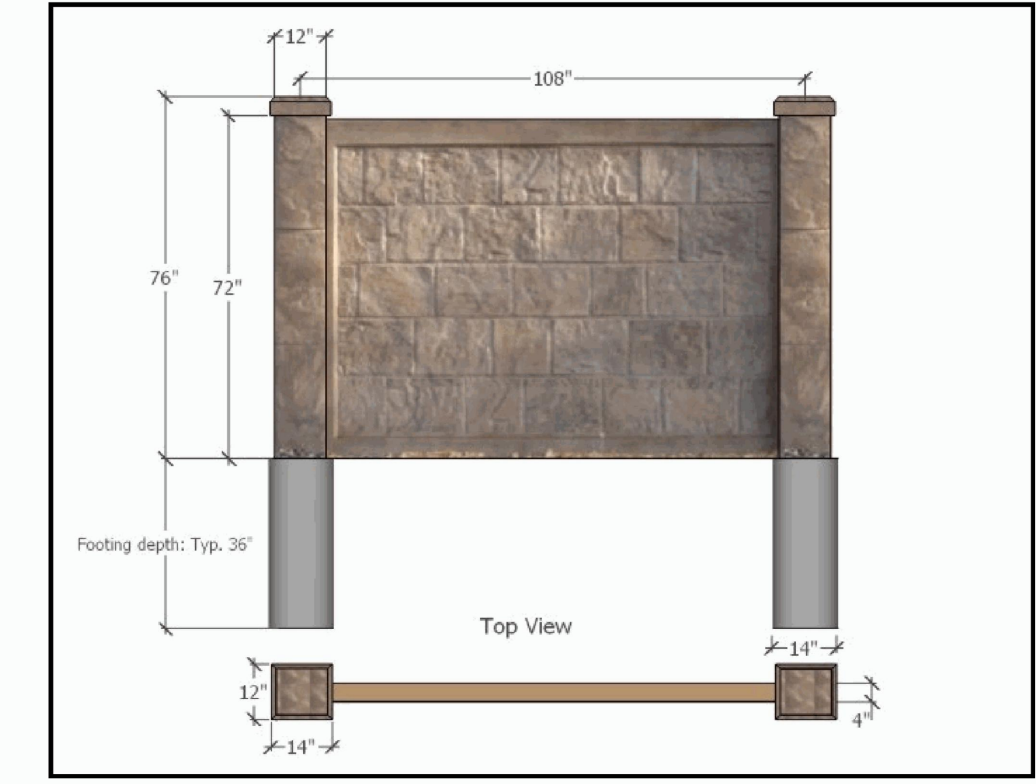

TECHNICAL INFORMATION: RhinoRock Fence Panel		
Dimension of Panel	182 cm x 259 cm	72"x102"
Weight of Panel	105 kg	230 lbs
Weight per area	21.5kg/m ²	4.9lbs/ft ²
Thickness of Panel	115mm	4.5"
EPS foam core thickness	63-95mm	2.5-3.75"
Glass fiber reinforced concrete shell thickness	9mm	5/16"
% glass fiber by volume		4-4.50%
Compressive Strength of proprietary concrete mix design	4x10 ³ N/m ²	5800 psi
Ultimate tensile strength of glass fiber reinforced concrete	9.6x10 ³ - 1.4x10 ⁴ N/m ²	1400-2100 psi
Wind load capacity of panel	225 km/h	140mph with 1.6 safety factor
axial load capacity of panel	1644 kg/lineal meter	1100 lbs/lineal foot
moisture absorption of EPS foam core by total immersion		<4%
Combustibility of glass fiber reinforced concrete shell		Non-combustible
freeze/thaw performance	200 freeze thaw cycles with no damage	
Delry, fungus, or moldroom attack		none
Termite food source		none


6' CLASSIC PRIVACY FENCE
3/4 x 1 1/4 Panels & 1 1/2 x 5 1/2 Slotted Rails
(68" Panel Height)

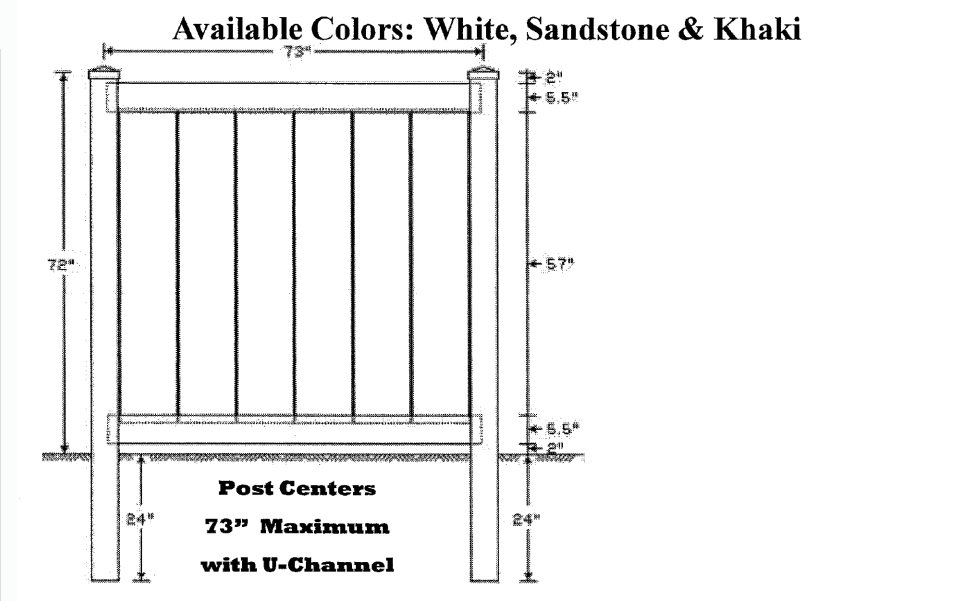


Parts List		
QTY	DESCRIPTION	LENGTH
2	1 1/2 x 5 1/2 Slotted Rail	72"
6	3/4 x 1 1/4 T&G	60
2	1/2 U-Channel	60 7/8" - Optional
6	#10 - Screw - (5/16" Hex Head)	3/2" - for U-Channel

Posts
5"x 5" - 8' .135 Wall 5" x 5" - 8' .150 Wall
24" Post Set (Check Local Code Requirements)

NOTE: 6' DECORATIVE MASONRY WALL STAINED & TREATED ON BOTH SIDES W/ANTI-GRAFFITI SEALANT

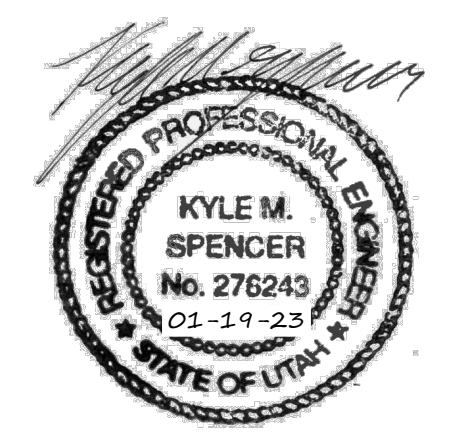

FENCE DETAIL
PROPOSED OR EQUIVALENT
-NTS-

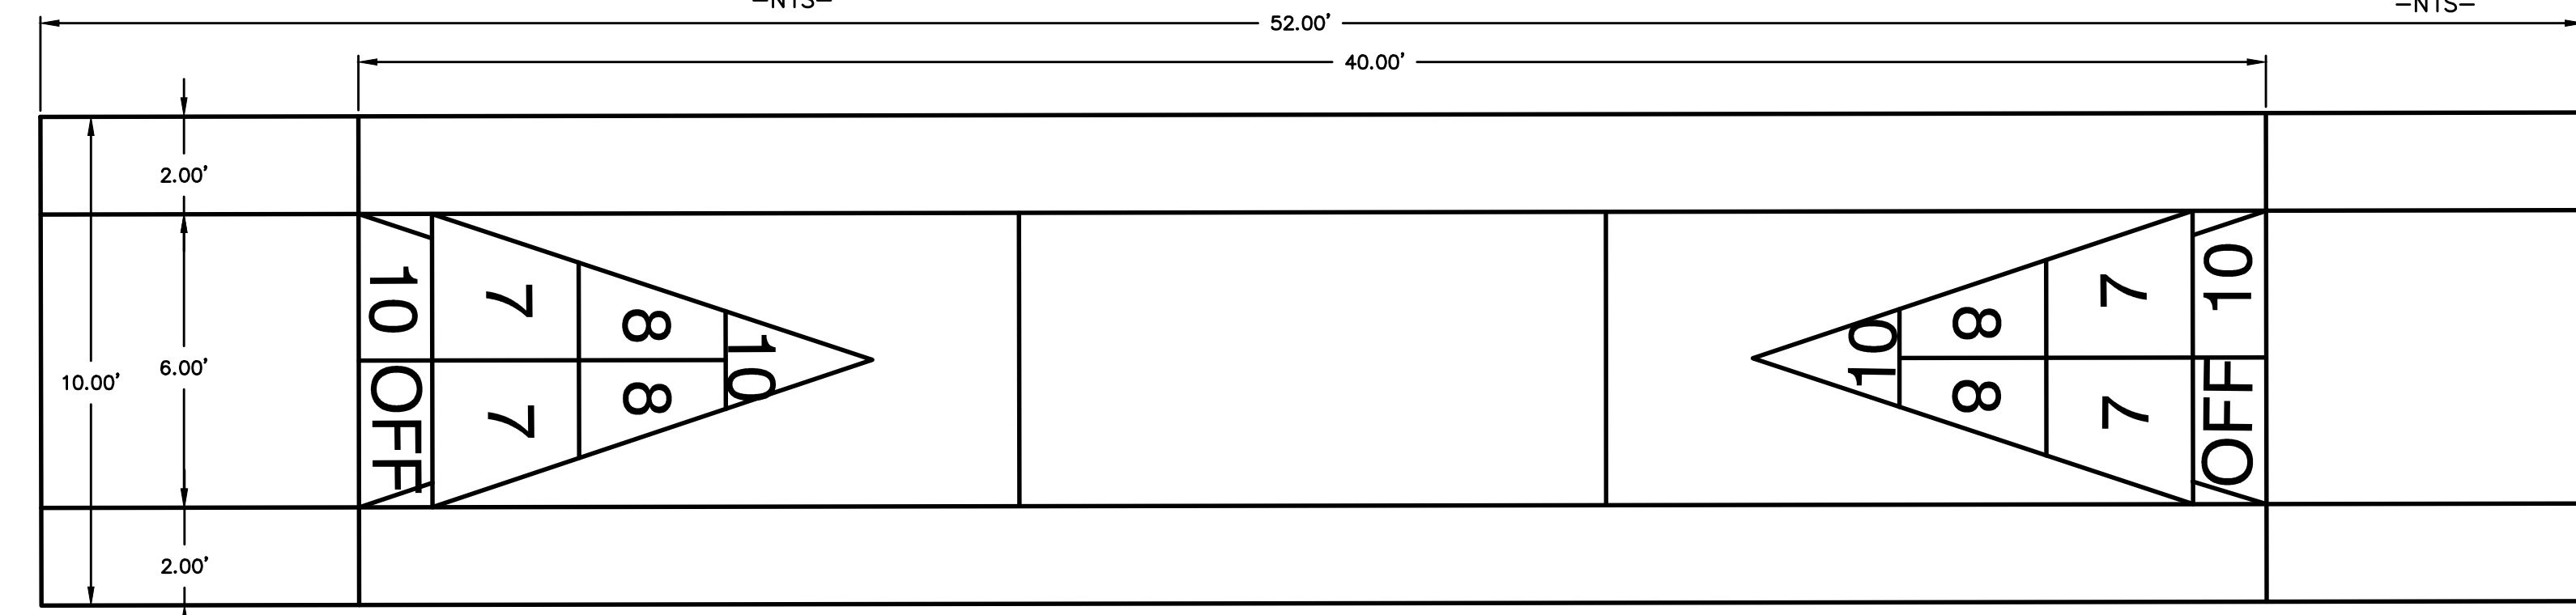

SHUFFLEBOARD DETAIL
PROPOSED OR EQUIVALENT
-NTS-

NO.	REVISIONS	BY	DATE	DESIGNED BY:	DATE:
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4					
3					
2					
1					

Northern ENGINEERING INC
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1040 E. 800 N. OREM, UTAH 84097 (801) 802-8992

APPLE HOLLOW @ THE ORCHARDS "B-PHASE 2"

DETAILS
SANTAQUIN, UTAH
JOB NO. 3-20-031
SHEET NO. DT-03

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SANTAQUIN RESEARCH & TECH CENTER - PHASE 1

SOUTH RIDGE FARMS ROAD
SANTAQUIN CITY, UTAH 84655


DECEMBER 15, 2023

NO.	REVISIONS	BY	DATE

CIVIL ENGINEERING + SURVEYING
10718 S BECKSTEAD LANE, SUITE 102
South Jordan, Utah - 801-949-6296
DESIGNER: SDT PROJECT ENGINEER: SDT

SANTAQUIN RESEARCH & TECH CENTER - PHASE 1
SOUTH RIDGE FARMS ROAD, SANTAQUIN UT, 84655
COVER SHEET

LEGEND	
---	PROPERTY LINE
---	EASEMENT LINE
-4240.0	PROPOSED GRADE CONTOURS
-4240.0	EXISTING GRADE CONTOURS
---	EXISTING CURB
---	PROPOSED CURB AND GUTTER
---	PROPOSED CURB WALL
---	REVERSE PAN CURB & GUTTER
---	EXISTING SEWER
SS	PROPOSED SEWER
---	EXISTING WATER
W	PROPOSED WATER
---	EXISTING FIRE LINE
F	PROPOSED FIRE LINE
---	EXISTING STORM DRAIN
SD	PROPOSED STORM DRAIN
---	PROPOSED ROOF DRAIN
---	EXISTING GAS
G	PROPOSED GAS
---	EXISTING OVERHEAD POWER
UGP	EXISTING UNDERGROUND POWER
---	PROPOSED UNDERGROUND POWER
---	EXISTING TELEPHONE LINE
T	PROPOSED TELEPHONE LINE
---	EXISTING FIBER OPTIC LINE
FO	PROPOSED FIBER OPTIC LINE
---	PROPOSED CONCRETE
---	PROPOSED ASPHALT
---	PROPOSED LANDSCAPING
---	EXISTING FIRE HYDRANT
---	PROPOSED FIRE HYDRANT
---	EXISTING STREET LIGHT
---	PROPOSED STREET LIGHT
---	PROPOSED PARKING LOT LIGHT
---	EXISTING WATER METER
---	EXISTING WATER VALVE
---	EXISTING GATE VALVE
---	EXISTING OVERHEAD POWER POLE
TBC	TOP BACK CONCRETE
FF	FINISHED FLOOR
HW	HIGH WATER
TOG	TOP OF GRATE
TOL	TOP OF LID
IE	INVERT ELEVATION
EX	EXISTING
NG	NATURAL GROUND
TA	TOP OF ASPHALT
TC	TOP OF CONCRETE
EC	EDGE OF CONCRETE
EA	EDGE OF ASPHALT
TOW	TOP OF WALL
TG	TOP OF GRAVEL
TL	TOP OF LANDSCAPING
TS	TOP OF SIDEWALK
PROP	PROPOSED
39.0	TBC CALLOUT UNLESS OTHERWISE DESIGNATED

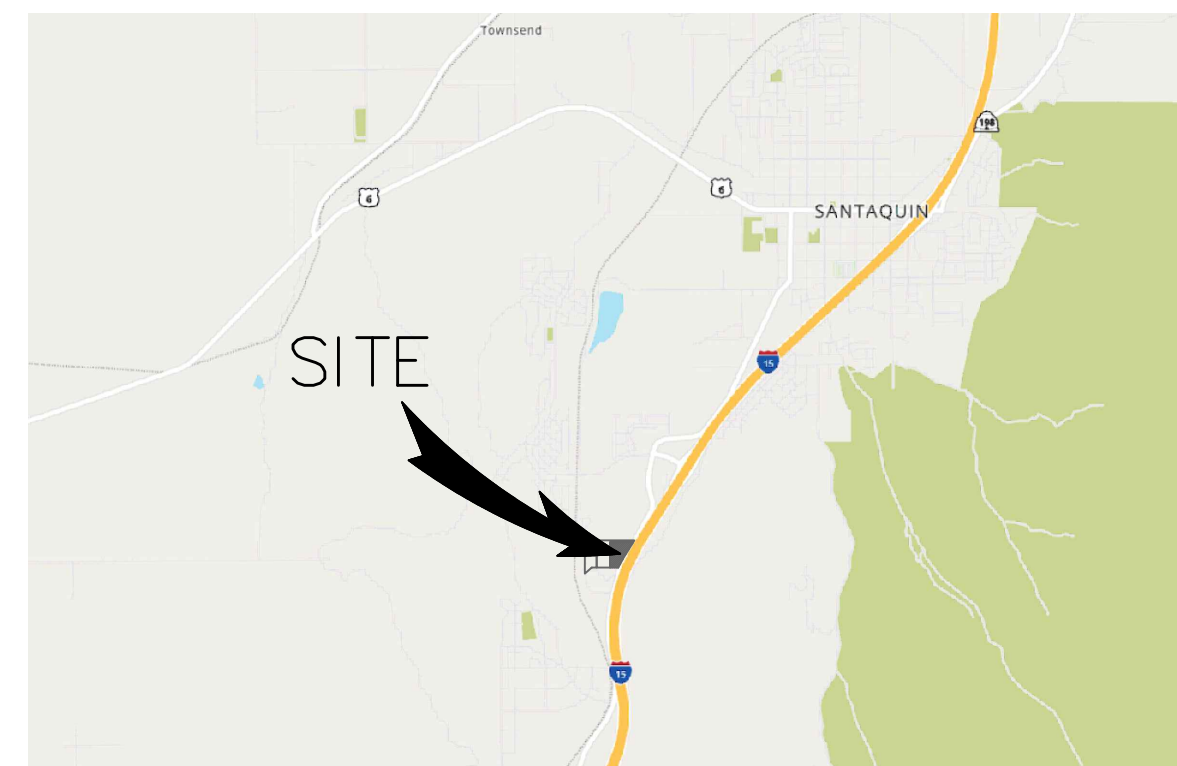

VICINITY MAP
NOT TO SCALE

SHEET INDEX

- CV COVER SHEET
- C1.0 SITE PLAN
- C2.0 OVERALL GRADING PLAN
- C2.1 GRADING PLAN
- C2.2 GRADING PLAN
- C2.3 GRADING PLAN
- C2.4 DRAINAGE PLAN
- C3.0 UTILITY PLAN
- C4.1 ROAD WIDENING PLAN & PROFILE (STA: 20+00 TO 26+50)
- C4.2 ROAD WIDENING PLAN & PROFILE (STA: 26+50 TO 33+00)
- C5.1 UTILITY PLAN & PROFILE (STA: 20+00 TO 26+00)
- C5.2 UTILITY PLAN & PROFILE (STA: 26+00 TO 32+00)
- C5.3 UTILITY PLAN & PROFILE (STA: 32+00 TO 36+00)
- C6.0 DETAIL SHEET
- C6.1 SANTAQUIN CITY DETAIL SHEET
- C7.0 EROSION CONTROL PLAN (SWPPP)
- C7.1 EROSION CONTROL DETAIL SHEET

PROJECT CONSTRUCTION NOTES:

1. CONTRACTOR TO NOTIFY BLUE STAKES PRIOR TO CONSTRUCTION, 1-800-662-4111.
2. CONTRACTOR TO VERIFY LOCATION OF ALL EXISTING UTILITIES PRIOR TO CONSTRUCTION.
3. SEE SOILS REPORT FOR PAVEMENT SECTION DETAILS, INSTALLATION SPECIFICATIONS AND ALL SITE EARTHWORK REQUIREMENTS.
4. ALL CONSTRUCTION SHALL CONFORM TO CITY STANDARDS AND SPECIFICATIONS. IF A CONFLICT BETWEEN THESE PLANS AND THE CITY STANDARDS AND SPECIFICATIONS OCCURS, THE CITY STANDARDS AND SPECIFICATIONS SHALL GOVERN.
5. ALL HANDICAP PARKING STALLS TO BE INSTALLED PER ADA STANDARDS. SLOPE ON ANY ADA STALL IS TO BE LESS THAN 2% IN ALL DIRECTIONS.
6. CONTRACTOR TO VERIFY PRIOR TO ANY CONSTRUCTION THAT THE BUILDING AND BUILDING LOCATION SHOWN ON CIVIL DRAWINGS MATCHES THE ARCHITECTURAL PLANS.
7. CONTRACTOR TO VERIFY, WITH ARCHITECT, THAT F.F. ELEVATION SHOWN ON CIVIL PLANS EQUALS THE ARCHITECTS 100.0' ELEVATION.
8. CONTRACTOR TO REPLACE IN KIND ANY AREAS THAT ARE DAMAGED DURING CONSTRUCTION.
9. INSTALL ALL SIDEWALKS PER CITY STANDARDS.
10. INSTALL ALL CONCRETE PAVEMENT JOINTS PER CITY STANDARDS.
11. ALL SEWER, WATER AND STORM DRAIN PIPES SHALL BE BACKFILLED WITH SELECT GRANULAR FILL PER CITY STANDARDS AND SPECIFICATIONS.
12. ALL CATCH BASINS AND MANHOLES TO BE INSTALLED PER CITY STANDARDS.
13. ALL STORM DRAIN PIPING TO BE CUT OFF FLUSH WITH INSIDE WALL OF DRAINAGE BOX. INSIDE WALL TO BE GROUTED SMOOTH WITH A NON-SHRINK GROUT.
14. FOR STORM DRAIN INLET BOXES AND MANHOLES THE I.E. IN AND I.E. OUT ELEVATIONS ARE THE SAME UNLESS OTHERWISE CALLED OUT ON THE PLANS.
15. ALL WATER LINES TO HAVE A MINIMUM 5' OF COVER WITH A MINIMUM VERTICAL CLEARANCE OF 1' OF COVER BETWEEN OTHER UTILITY LINES (1.5' VERTICAL SEPARATION WITH SEWER).
16. CONTRACTOR SHALL COORDINATE CONSTRUCTION AND INSTALLATION OF ELECTRICAL, TELEPHONE, NATURAL GAS AND CABLE TV SERVICES WITH THE RESPECTIVE UTILITY COMPANY.
17. THE EXISTENCE AND LOCATION OF ALL UNDERGROUND UTILITY PIPES, LINES OR STRUCTURES SHOWN ON THESE PLANS WERE OBTAINED AND SHOWN FROM SURVEYED INFORMATION AND EXISTING UTILITY LOCATIONS PROVIDED BY OTHERS. THERE IS NO GUARANTEE THAT ALL EXISTING UTILITY INFORMATION IS SHOWN ON THESE PLANS. CONTRACTOR IS RESPONSIBLE FOR CONTACTING BLUE STAKES AND FIELD VERIFYING THE LOCATION AND ELEVATION OF ALL EXISTING UTILITY PIPES, LINES AND STRUCTURES, PRIOR TO CONSTRUCTION.
18. ANY OFF SITE DAMAGE TO EXISTING ASPHALT, CURB & GUTTER, LANDSCAPING AND ALL UTILITIES TO BE REPLACED IN KIND.
19. ALL ACCESSIBLE ROUTES AND ACCESSIBLE MEANS OF EGRESS ROUTES, THE MAXIMUM SLOPE SHALL NOT EXCEED 5% AND THE CROSS SLOPE SHALL NOT EXCEED 2%. ALL EXTERIOR LANDINGS AT DOORS SHALL NOT EXCEED 2% SLOPE.

Include the following notes on the cover sheet.

-THE DEVELOPER AND THE GENERAL CONTRACTOR UNDERSTAND THAT IT IS HIS/HER RESPONSIBILITY TO ENSURE THAT ALL IMPROVEMENTS INSTALLED WITHIN THIS DEVELOPMENT ARE CONSTRUCTED IN FULL COMPLIANCE WITH ALL STATE AND SANTAQUIN CITY CODES, ORDINANCES AND STANDARDS. THESE PLANS ARE NOT ALL INCLUSIVE OF ALL MINIMUM CODES, ORDINANCES AND STANDARDS. THIS FACT DOES NOT RELIEVE THE DEVELOPER OR GENERAL CONTRACTOR FROM THE FULL COMPLIANCE WITH ALL MINIMUM STATE AND SANTAQUIN CITY CODES, ORDINANCES AND STANDARDS.

-ALL RECOMMENDATIONS MADE IN A PERTINENT GEOTECHNICAL REPORT/STUDY SHALL BE FOLLOWED EXPLICITLY DURING CONSTRUCTION OF BUILDINGS AND SITE IMPROVEMENTS.

Include the name, address and telephone number of the property owner. The Utah County Parcel map has the property owner as LG SQ1 LLC.

CIVIL ENGINEER:

CIVIL ENGINEERING + SURVEYING
10718 S BECKSTEAD LANE, SUITE 102
South Jordan, Utah - 801-949-6296

OWNER:

TAMARAK
TAMARAK DESIGN BUILD, LLC
PO BOX 970271
OREM, UT 84097
385.201.7848

ARCHITECT:


AE URBIA
909 W SOUTH JORDAN PARKWAY
SOUTH JORDAN, UTAH 84095
CONTACT PERSON: ANDREW BOLLSCHWEILER
PH: (801) 746-0456

CONTRACTOR

CAMPBELL CONSTRUCTION, INC.
905 N MAIN ST,
NORTH SALT LAKE, UT 84054



SHEET NO.	CV
PROJECT ID:	E23-143
DATE:	12/15/23
FILE NAME:	PRJ-SJ1
SCALE:	

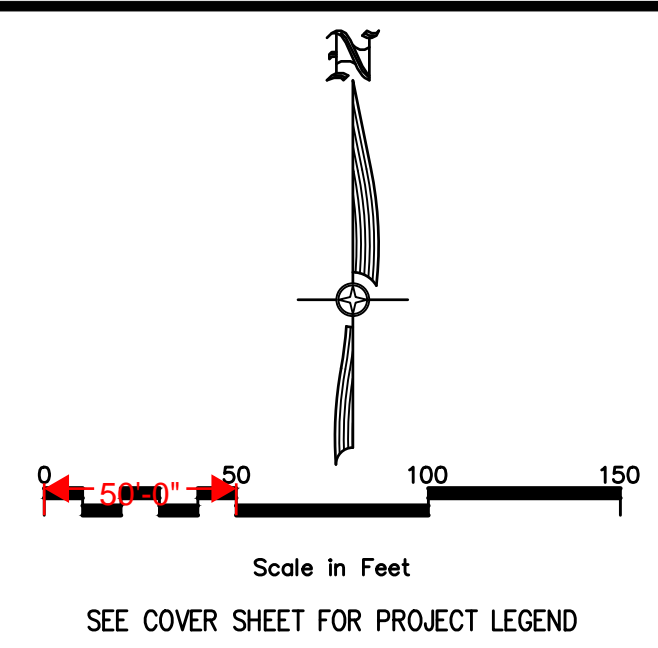

SHEET LEGEND

- PROPOSED LIGHT ASPHALT SEE DETAIL C2.0
- PROPOSED MEDIUM ASPHALT SEE DETAIL C2.0
- PROPOSED HEAVY ASPHALT SEE DETAIL C2.0
- PROPOSED CONCRETE SEE DETAIL C2.0
- PROPOSED ROUGH GRADE FUTURE ROADWAY

SITE PLAN NOTES:

- 1 PROPOSED 24" CURB & GUTTER. SEE DETAIL 1/C6.0.
- 2 PROPOSED 24" REVERSE PAN CURB AND GUTTER. SEE DETAIL 2/C6.0.
- 3 PROVIDE SMOOTH TRANSITION FROM CURB & GUTTER TO REV. PAN CURB & GUTTER.
- 4 ALL HANDICAP STALLS AND RAMPS TO BE INSTALLED PER SANTAQUIN CITY AND ADA STANDARDS AND SPECIFICATIONS. SEE DETAIL 9/C6.0.
- 5 ALL PARKING LOT STRIPING TO BE REFLECTIVE WHITE (TYP.) AND PER SANTAQUIN CITY STANDARDS.
- 6 PROPOSED TRASH ENCLOSURE TO BE LOCATED IN DOCK AREA. SEE ARCHITECTURAL DRAWINGS FOR DETAILS.
- 7 PROPOSED DOCK WALL. SEE ARCHITECTURAL DRAWINGS FOR DETAILS.
- 8 INSTALL 5' WIDE CONCRETE SIDEWALK PER CITY STANDARDS. SEE DETAIL CG5/C6.1.
- 9 PROPOSED 4' ROLL GUTTER. SEE DETAIL 3/C6.0.
- 10 FUTURE PHASE ACCESS ROAD. ROUGH GRADING ONLY AS PART OF PHASE 1.
- 11 PROPOSED JERSEY BARRIER OR APPROVED EQUAL.
- 12 ADA RAMPS ARE TO BE INSTALLED PER CITY AND ADA STANDARDS AND SPECIFICATIONS. SEE DETAIL 4/C6.0.
- 13 PROPOSED BIKE RACK. SEE DETAIL 6/C6.0.
- 14 ELECTRICAL EQUIPMENT (SEE MEP PLANS).
- 15 INSTALL STREET LIGHT POLE AS PER SANTAQUIN CITY STANDARD DETAIL L1 AND L2.
- 16 INSTALL DRIVE APPROACH AS PER SANTAQUIN CITY STANDARD CG3/C6.1

LOT 1 AREAS:


LOT	SQ. FT.	ACRES.
BUILDING FOOTPRINT	466,432	10.708
ASPHALT	116,255	2.365
LANDSCAPING	187,207	4.298
CONCRETE	59,945	1.376



NOTE:
 1. ALL AREA CALCULATIONS ARE APPROXIMATE AND CAN CHANGE DUE TO CONSTRUCTION TOLERANCES.

LOT 1 PARKING REQUIREMENTS:

	SQ. FT.	CITY REQ'T
OFFICE	10,000	50 (1/200)
WAREHOUSE	93,025	86 (1/1000)
TOTAL REQUIRED	143	136
TOTAL PROVIDED	0	129
ACCESSIBLE SPACES	6	(5 REQ'D 101 TO 150)
BICYCLE SPACES	18	


NOTE:
 1. ALL AREA CALCULATIONS ARE APPROXIMATE AND CAN CHANGE DUE TO CONSTRUCTION TOLERANCES.

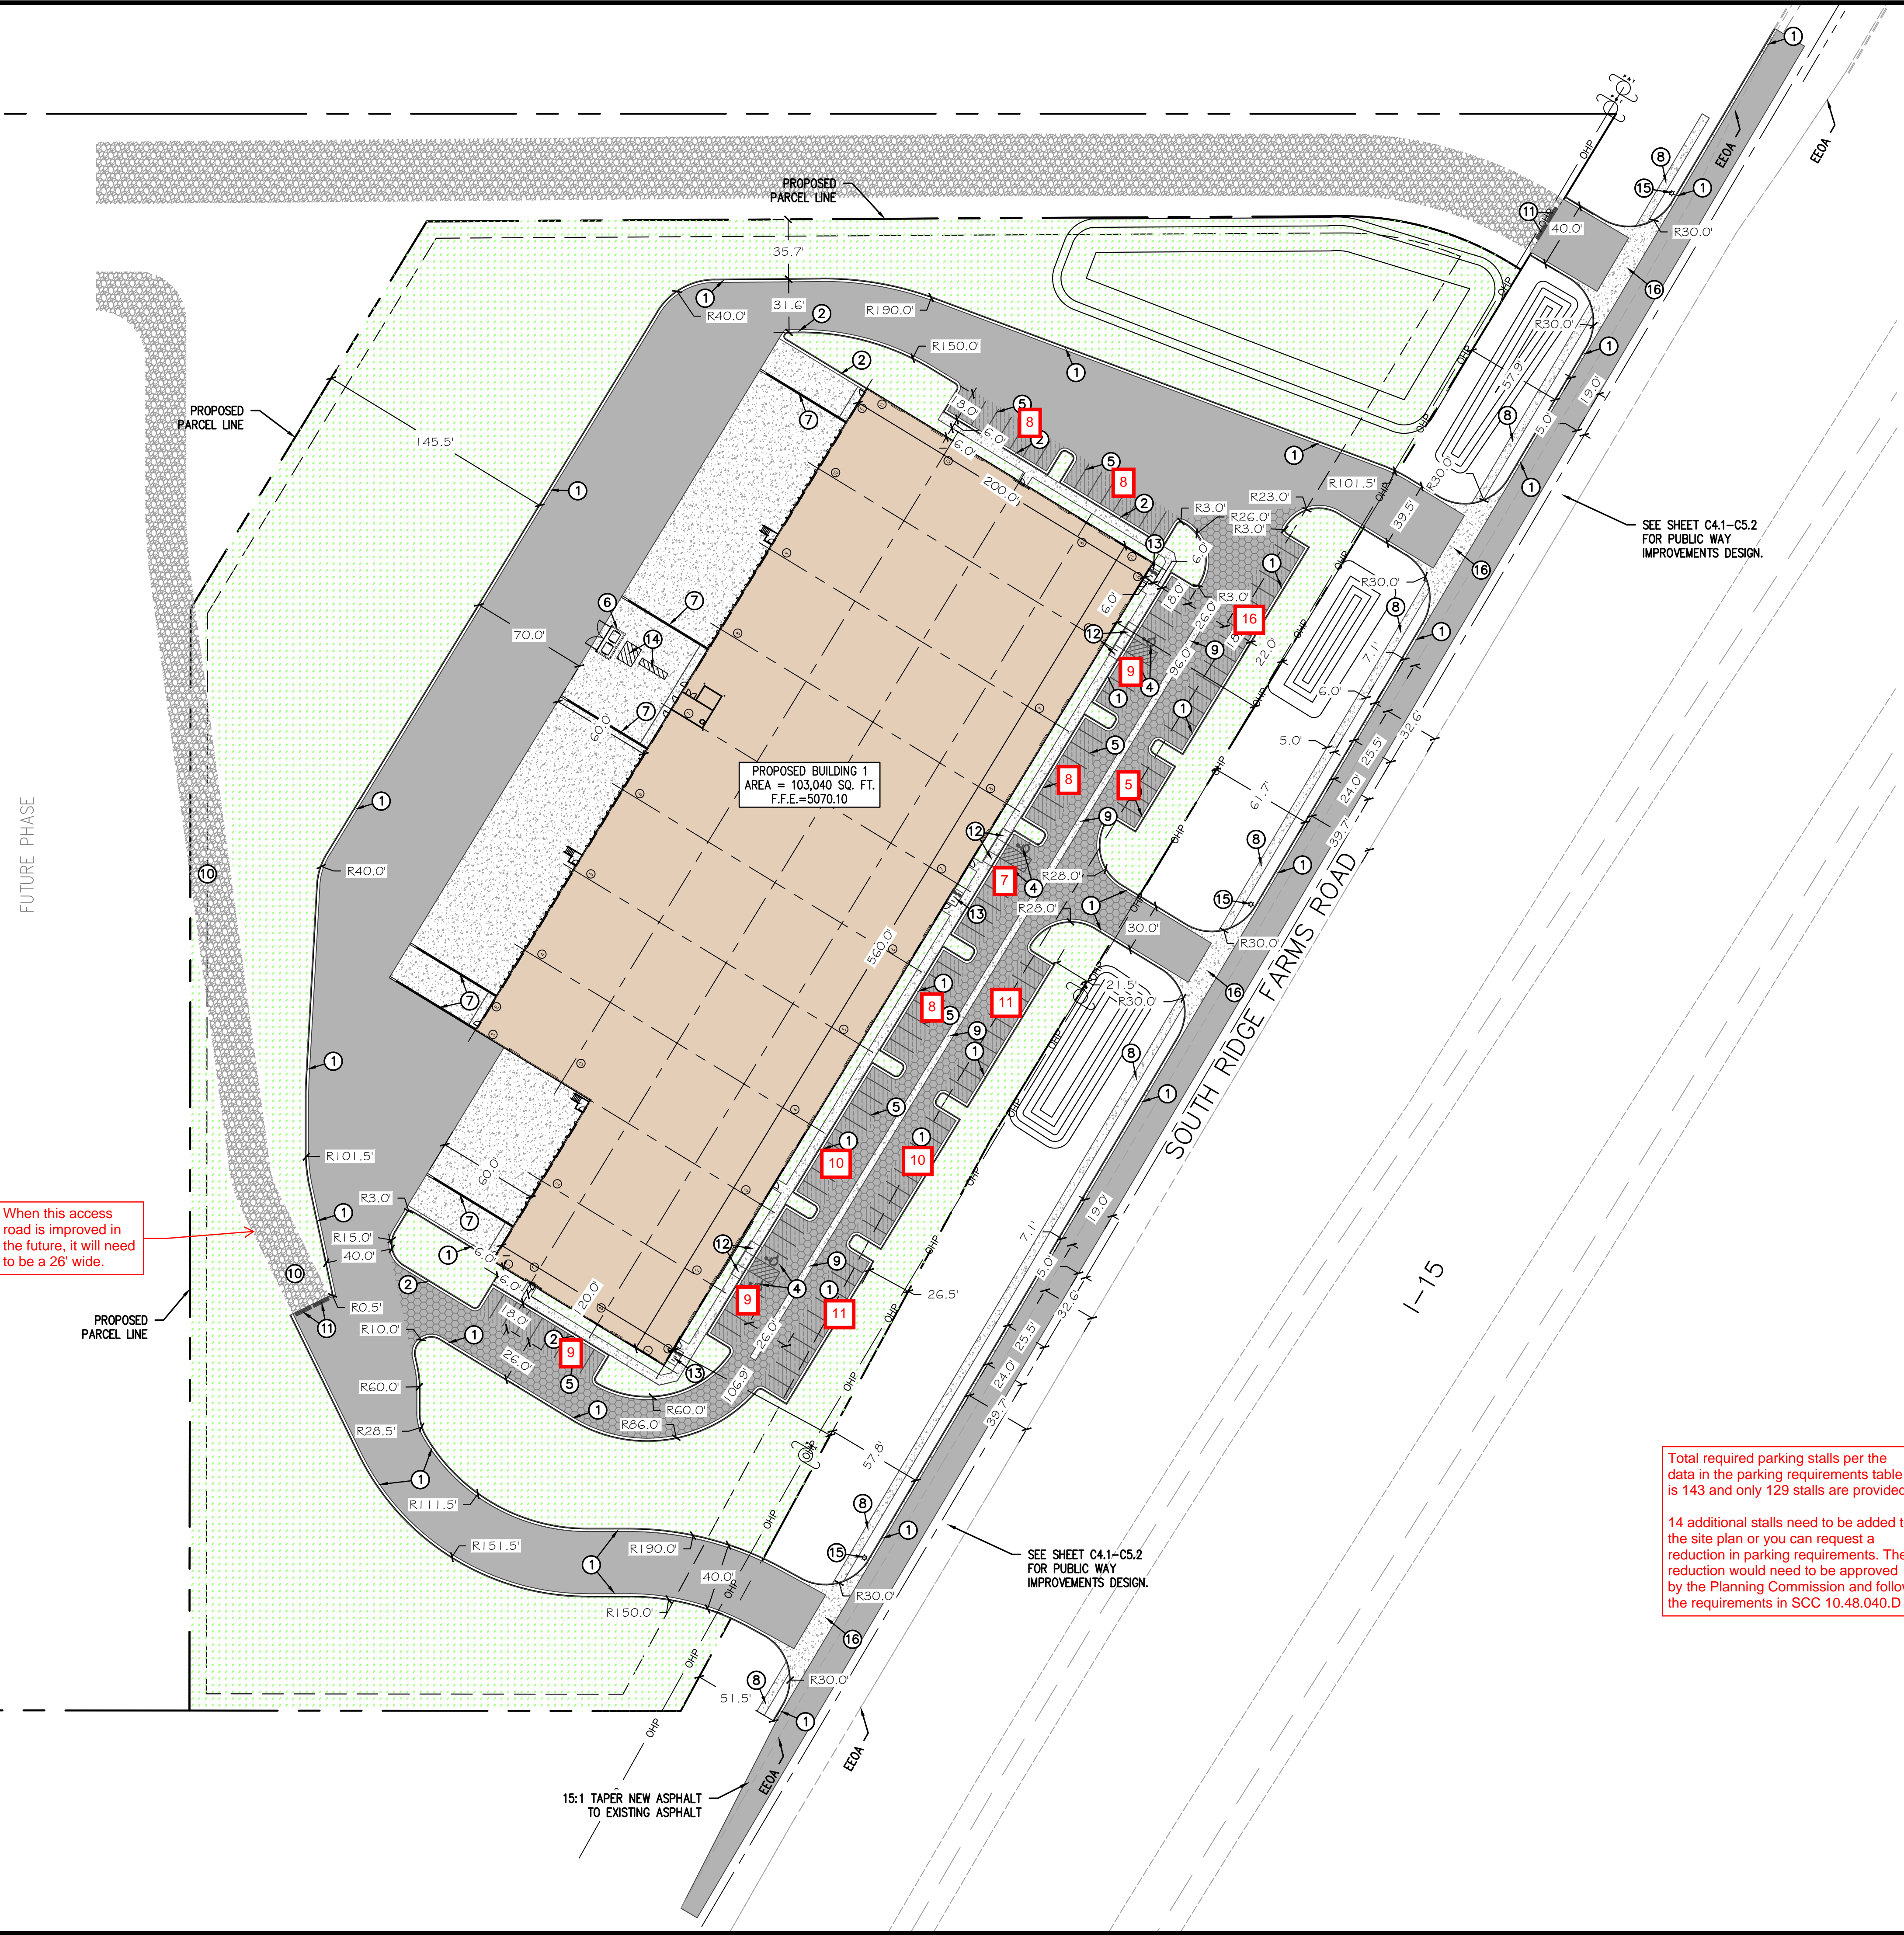

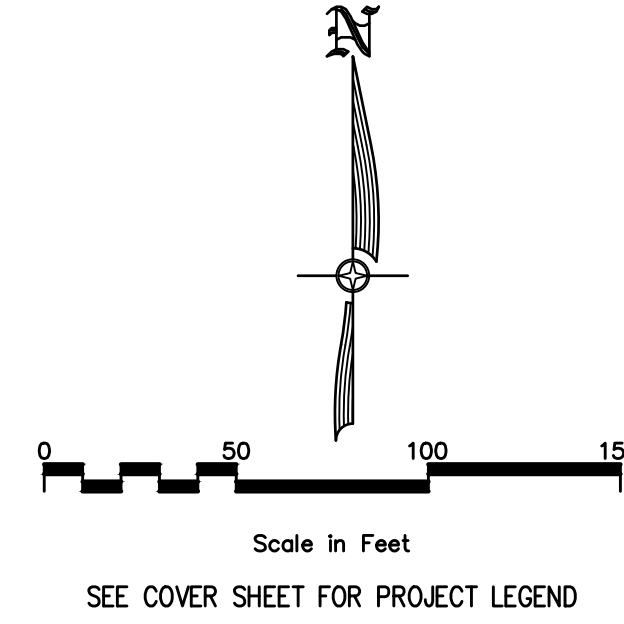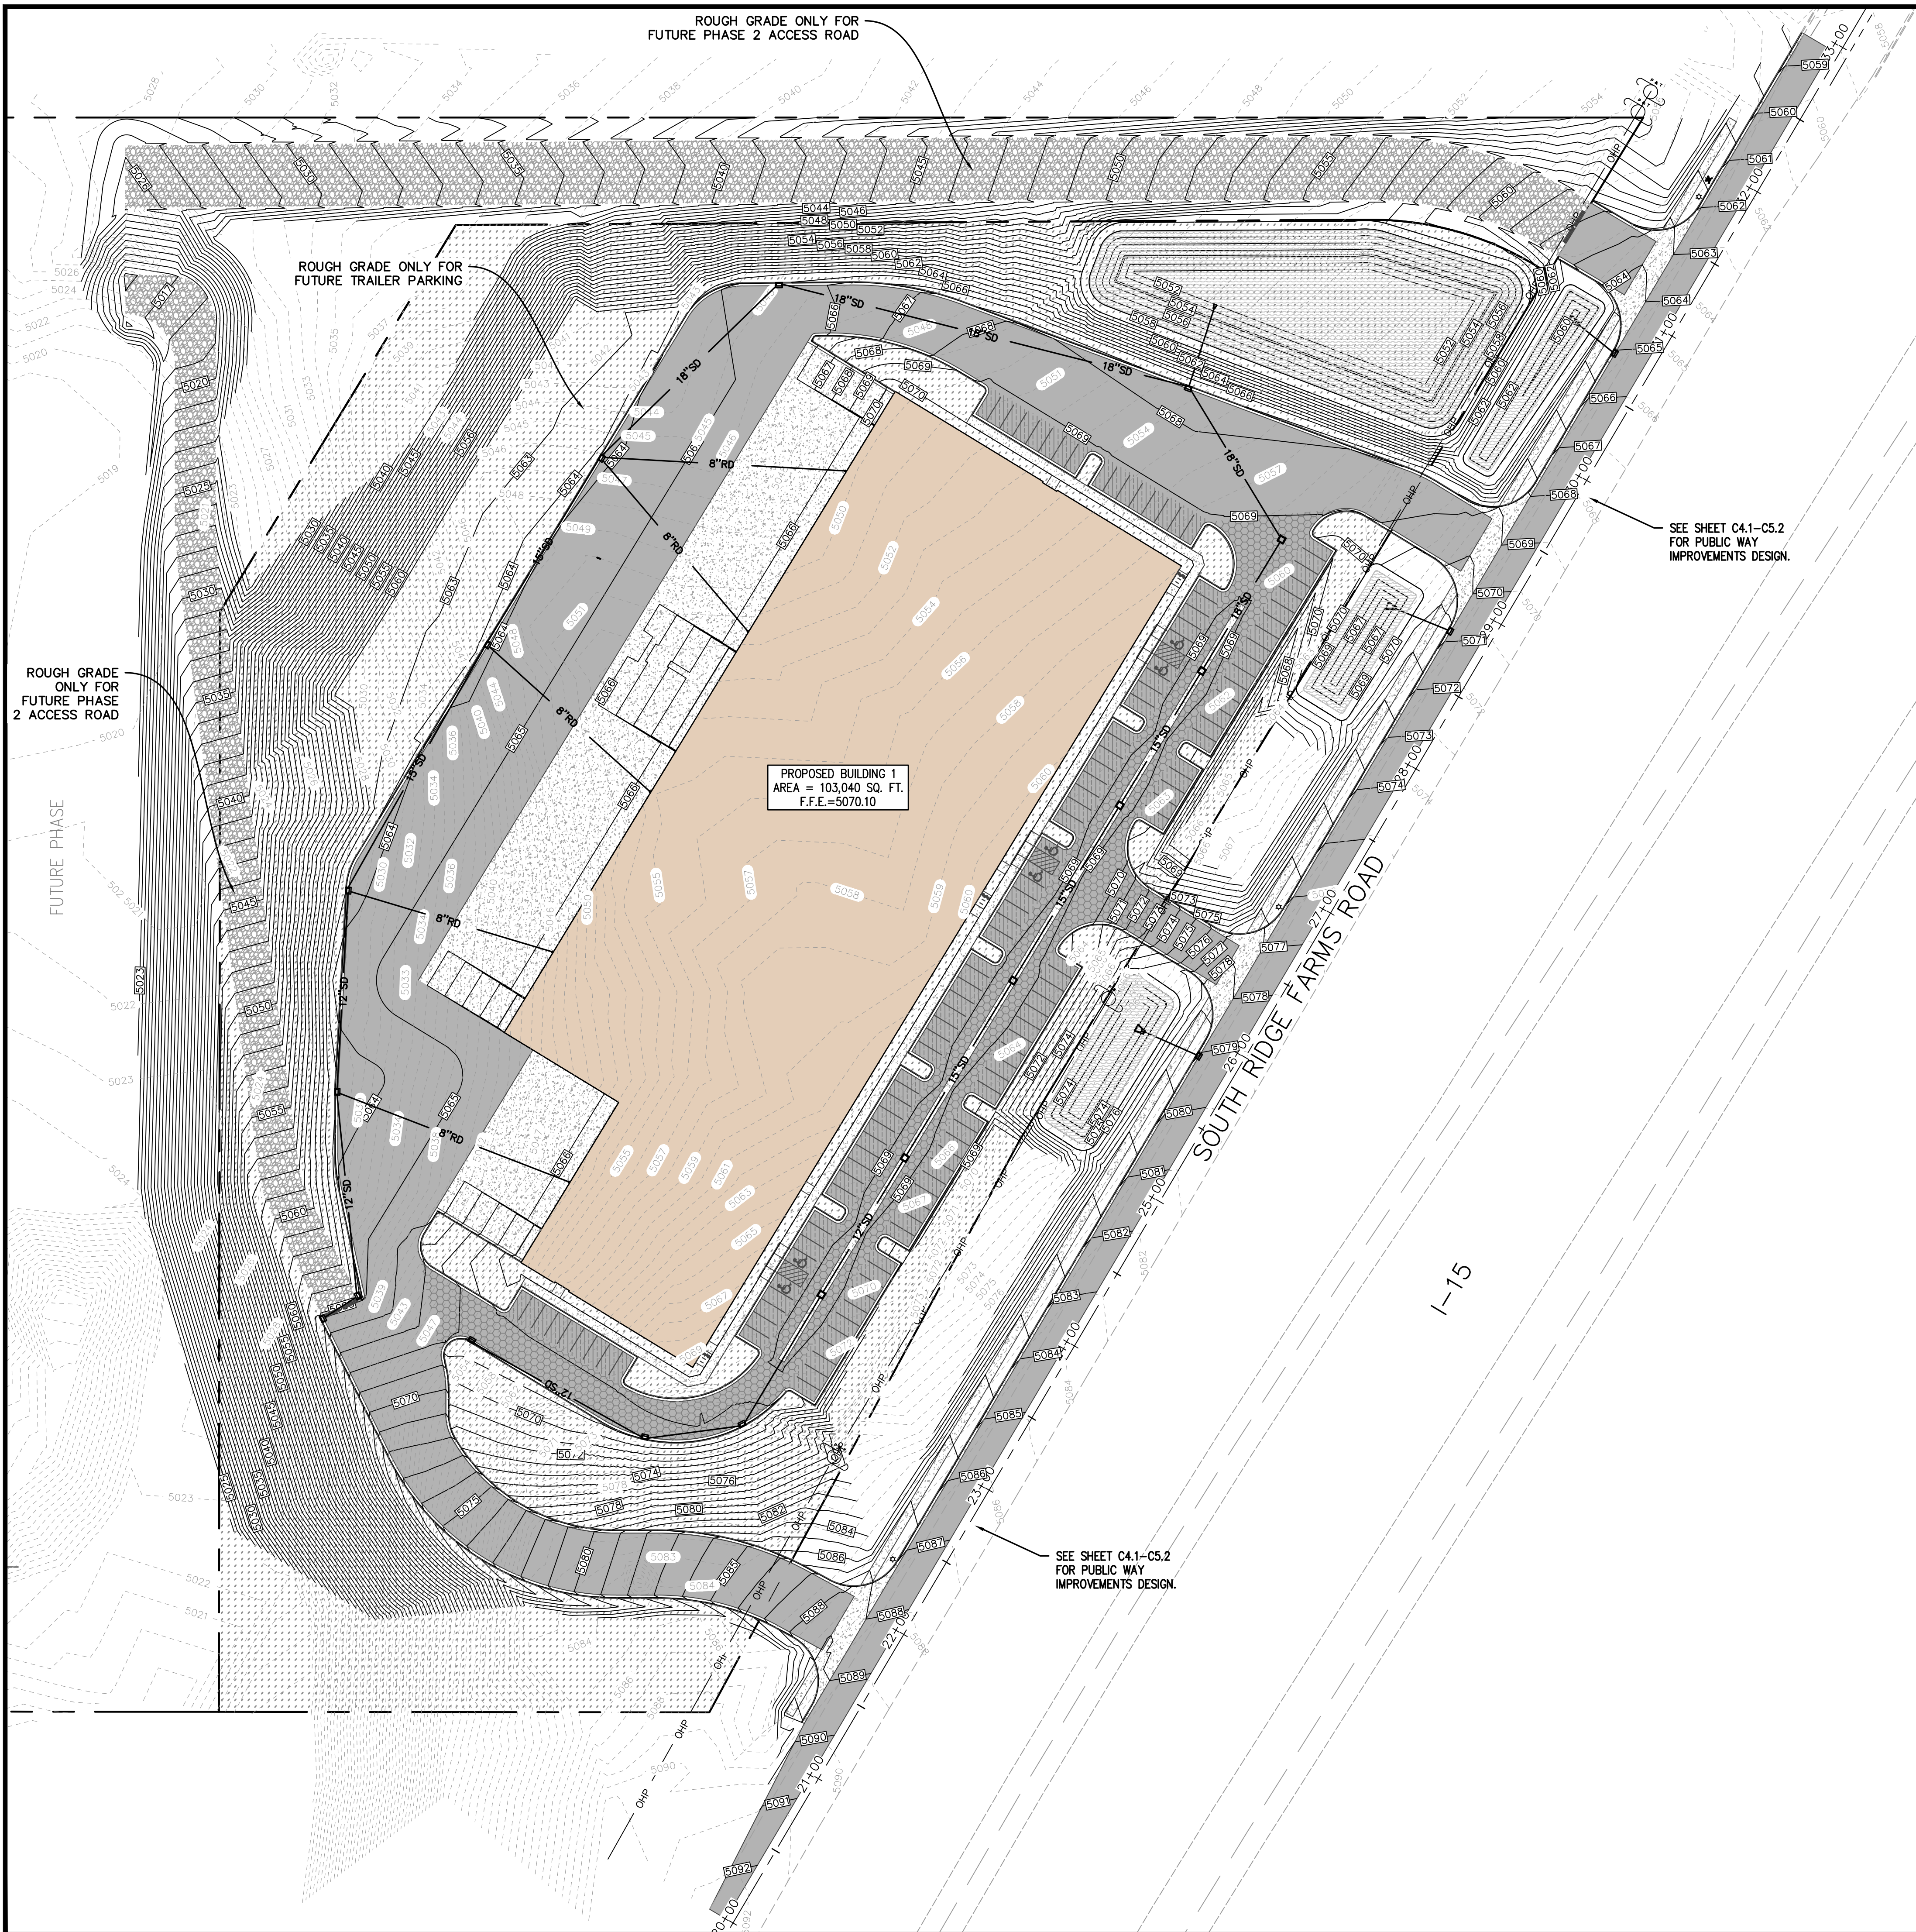


SHEET LEGEND

- PROPOSED LIGHT ASPHALT
SEE DETAIL BELOW
- PROPOSED MEDIUM ASPHALT
SEE DETAIL BELOW
- PROPOSED HEAVY ASPHALT
SEE DETAIL BELOW
- PROPOSED CONCRETE
SEE DETAIL BELOW
- PROPOSED ROUGH GRADE
FUTURE ROADWAY

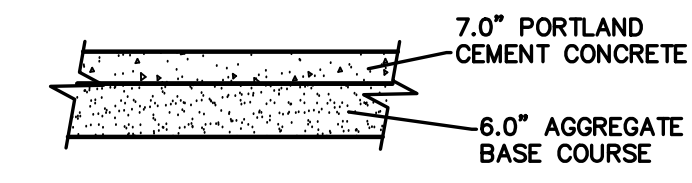


OVER PROPERLY PREPARED NATURAL SUBGRADE SOILS, AND/OR STRUCTURAL SITE GRADING FILL EXTENDING TO PROPERLY PREPARED NATURAL SUBGRADE SOILS.

DOCK CONCRETE PAVEMENT
N.T.S.

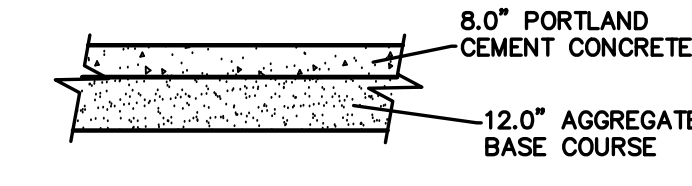


OVER PROPERLY PREPARED NATURAL SUBGRADE SOILS, AND/OR STRUCTURAL SITE GRADING FILL. DUMPSTER PADS SHOULD NOT BE CONSTRUCTED OVERLYING NON-ENGINEERED FILLS UNDER ANY CIRCUMSTANCES.

DUMPSTER PAD CONCRETE
N.T.S.

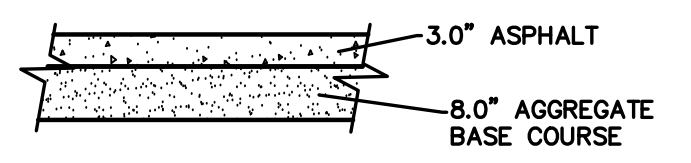


OVER PROPERLY PREPARED FILLS, NATURAL SUBGRADE SOILS, AND/OR STRUCTURAL SITE GRADING FILL EXTENDING TO PROPERLY PREPARED FILLS AND/OR NATURAL SUBGRADE SOILS.

LIGHT ASPHALT PAVEMENT
N.T.S.

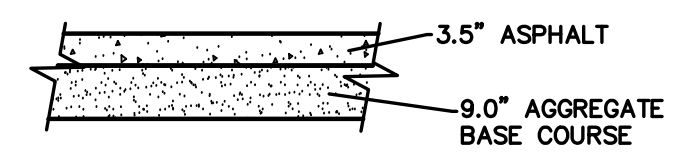

OVER PROPERLY PREPARED FILLS, NATURAL SUBGRADE SOILS, AND/OR STRUCTURAL SITE GRADING FILL EXTENDING TO PROPERLY PREPARED FILLS AND/OR NATURAL SUBGRADE SOILS.

MEDIUM ASPHALT PAVEMENT
N.T.S.

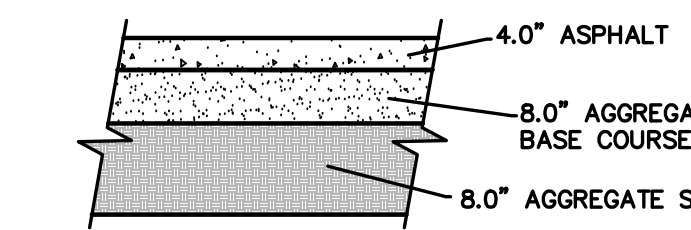

OVER PROPERLY PREPARED FILLS, NATURAL SUBGRADE SOILS, AND/OR STRUCTURAL SITE GRADING FILL EXTENDING TO PROPERLY PREPARED FILLS AND/OR NATURAL SUBGRADE SOILS.

HEAVY ASPHALT PAVEMENT
N.T.S.

PAVEMENT SECTIONS ARE PER THE DECEMBER 29, 2022 GEOTECHNICAL STUDY BY GSH (JOB NO 3523-010-22). CONTRACTOR TO INSTALL ALL PAVEMENT PER THE GEOTECH REPORT.

NO.	REVISIONS	BY	DATE




DESIGNER: SDT PROJECT ENGINEER: SDT

CIVIL ENGINEERING + SURVEYING
 10718 S BECKSTEAD LANE, SUITE 102
 South Jordan, Utah - 801-949-6296

SANTAQUIN RESEARCH & TECH CENTER - PHASE 1
 SOUTH RIDGE FARMS ROAD, SANTAQUIN UT, 84655
OVERALL GRADING PLAN

SHEET NO.	C2.0
PROJECT ID	E23-143
DATE	12/15/23
FILE NAME	PRJ-SJI
SCALE	1"=50'



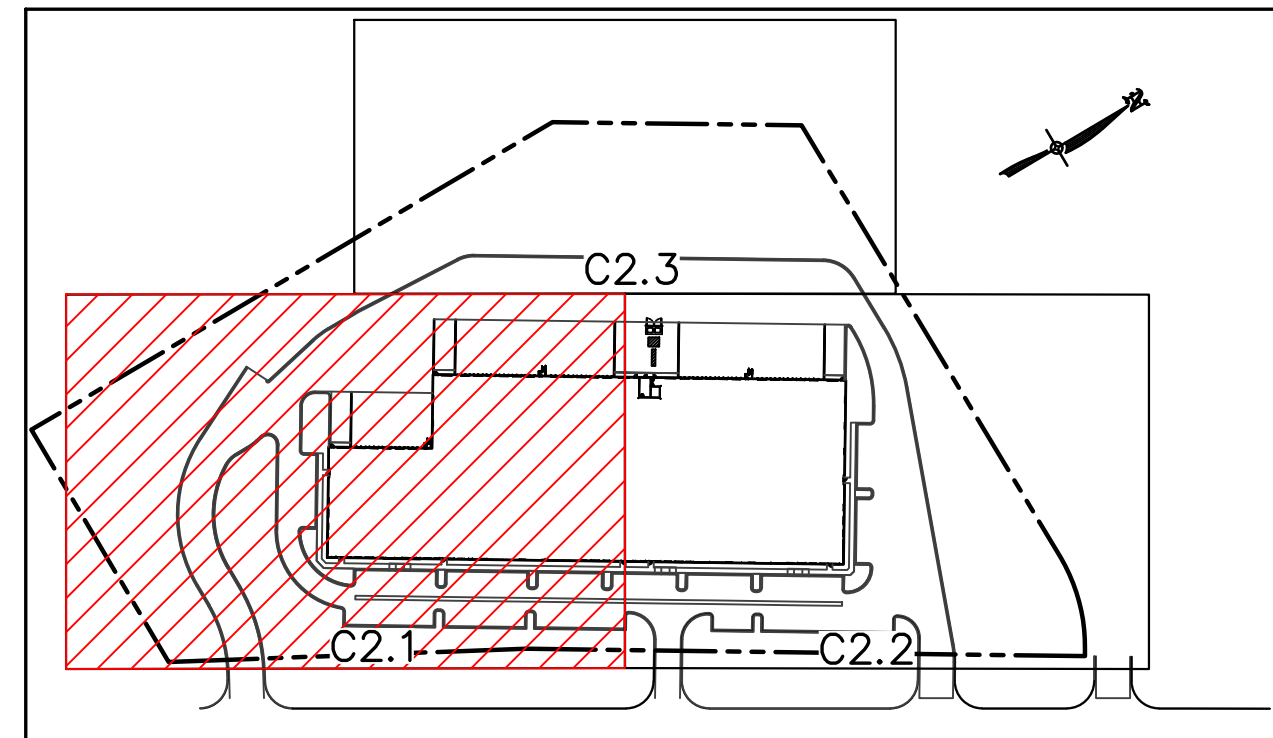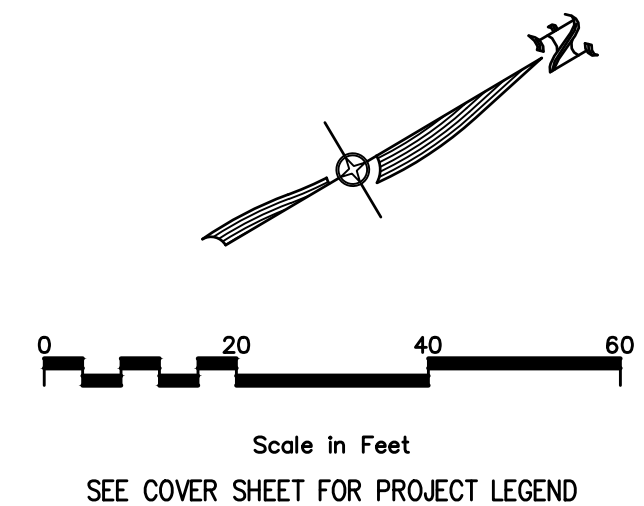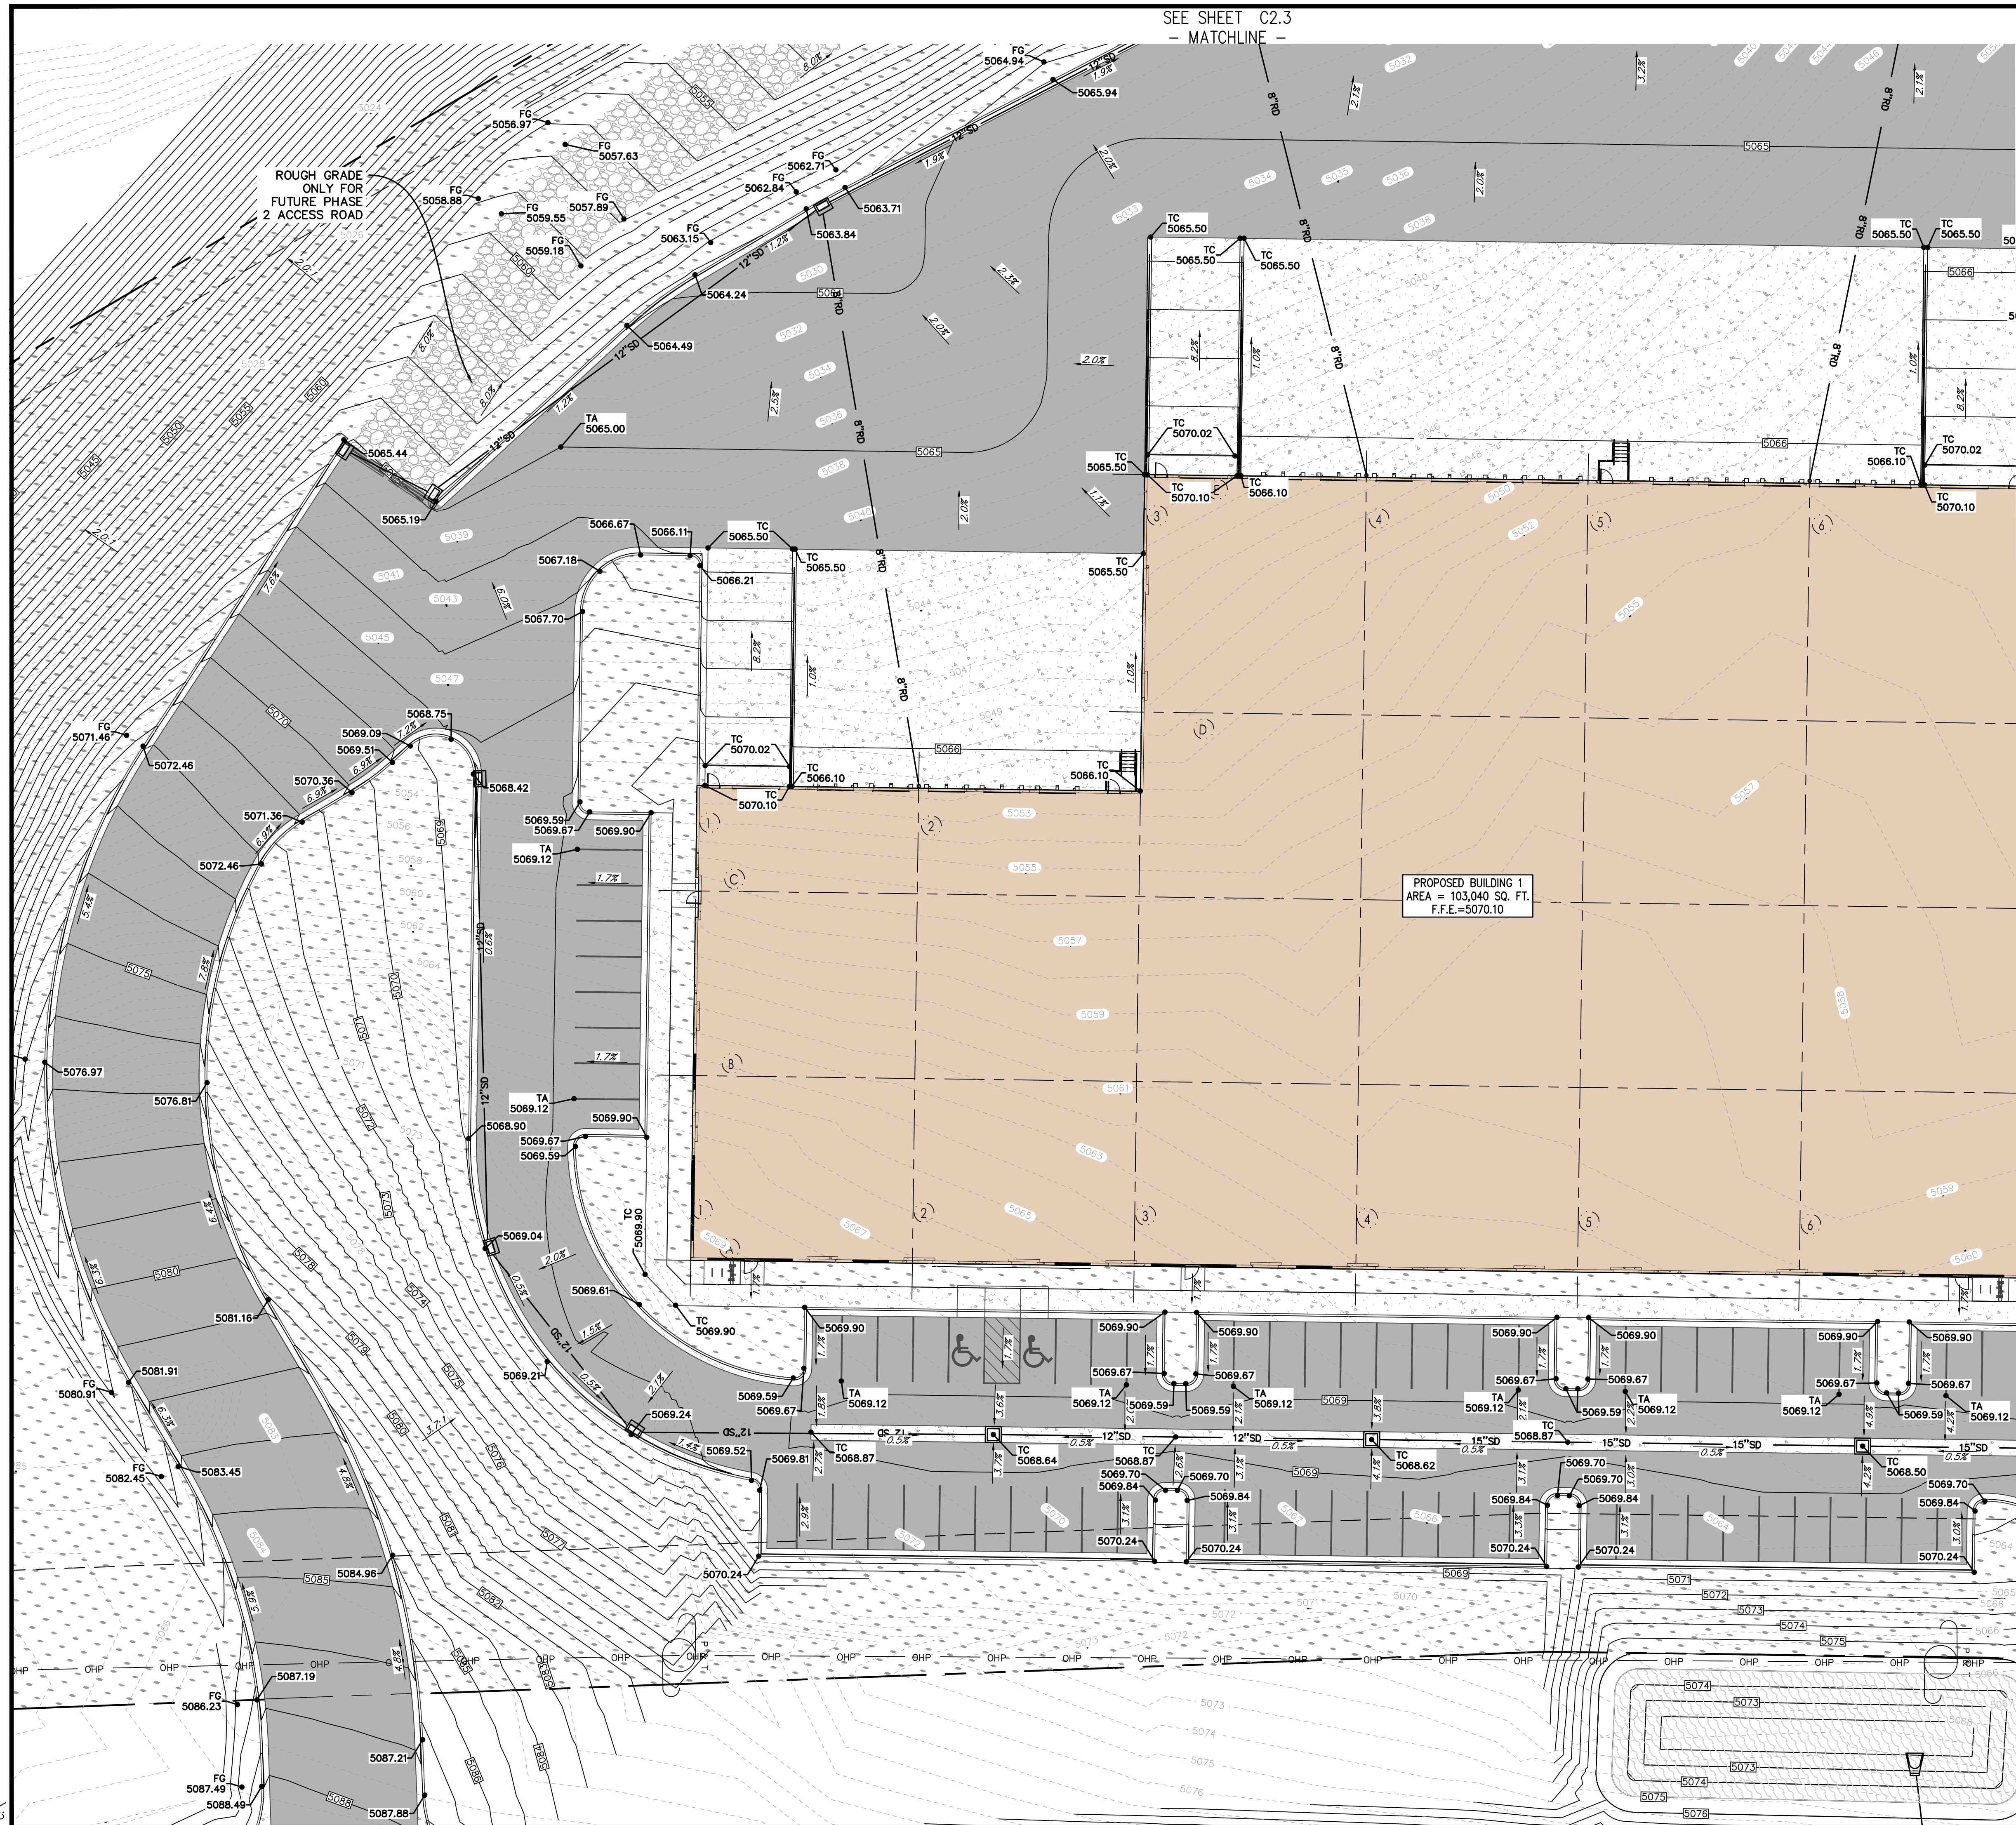

- MATCHLINE -
SEE SHEET C2.2

NO.	REVISIONS	BY	DATE

DESIGNER: SDT
PROJECT ENGINEER: SDT

CIVIL ENGINEERING + SURVEYING
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South Jordan, Utah - 801-949-6296

SANTAQUIN RESEARCH & TECH CENTER - PHASE 1
SOUTH RIDGE FARMS ROAD, SANTAQUIN UT, 84655



GRADING PLAN

SHEET NO. C2.1

PROJECT ID: E23-143
DATE: 12/15/23
FILE NAME: PRJ-SJT
SCALE: 1"=20'




SEE SHEET C2.3
- MATCHLINE -

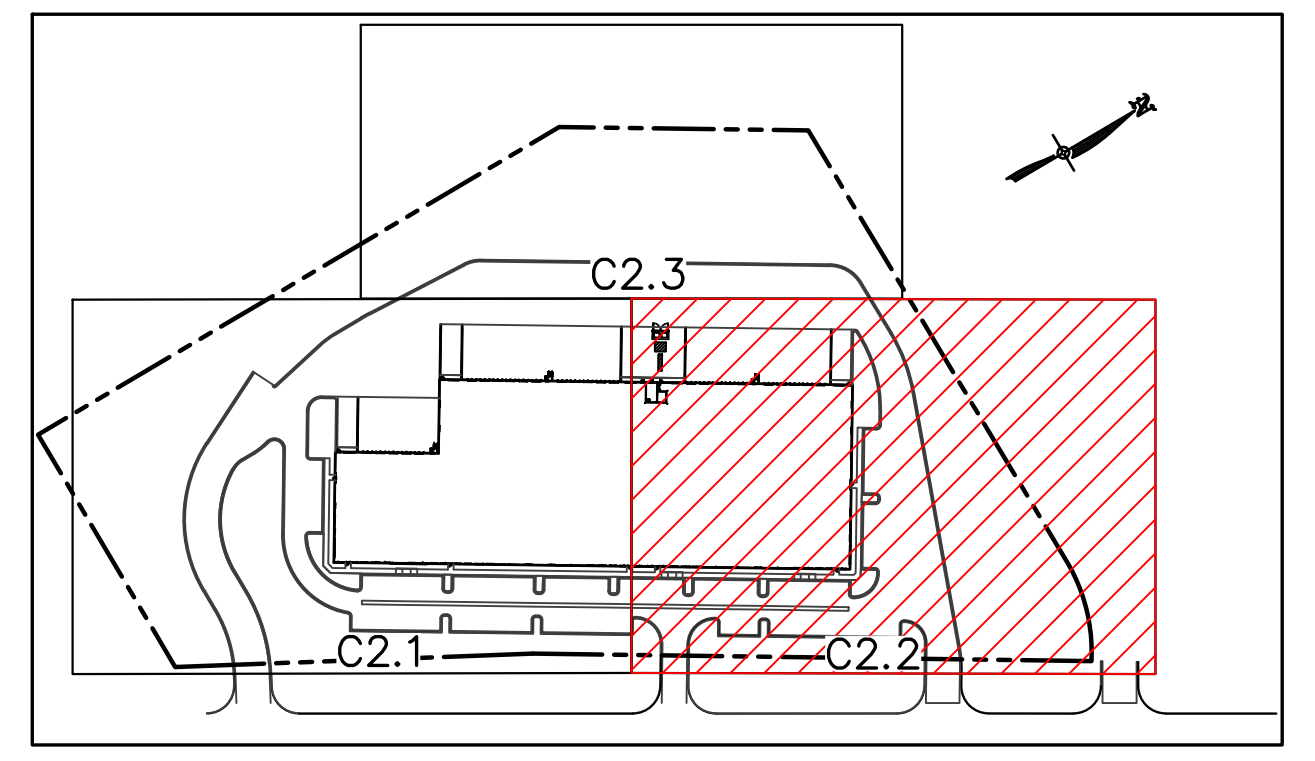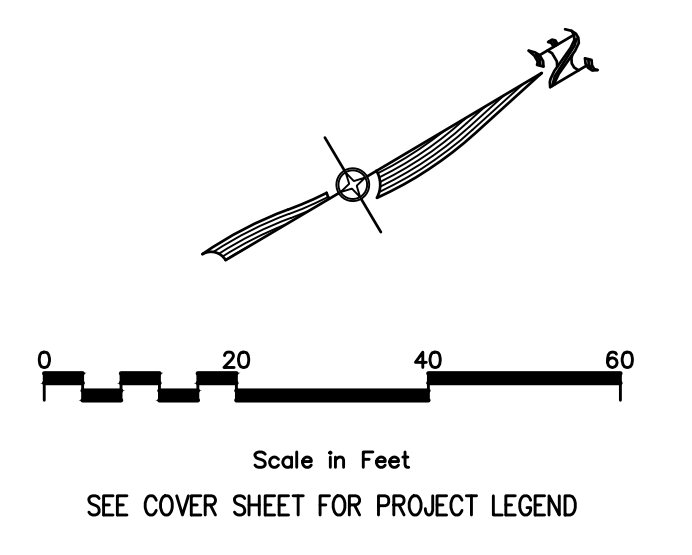

ROUGH GRADE
ONLY FOR
FUTURE PHASE
2 ACCESS ROAD

PROPOSED BUILDING 1
AREA = 103,040 SQ. FT.
F.F.E.=5070.10

SEE SHEET C2.1
- MATCHLINE -

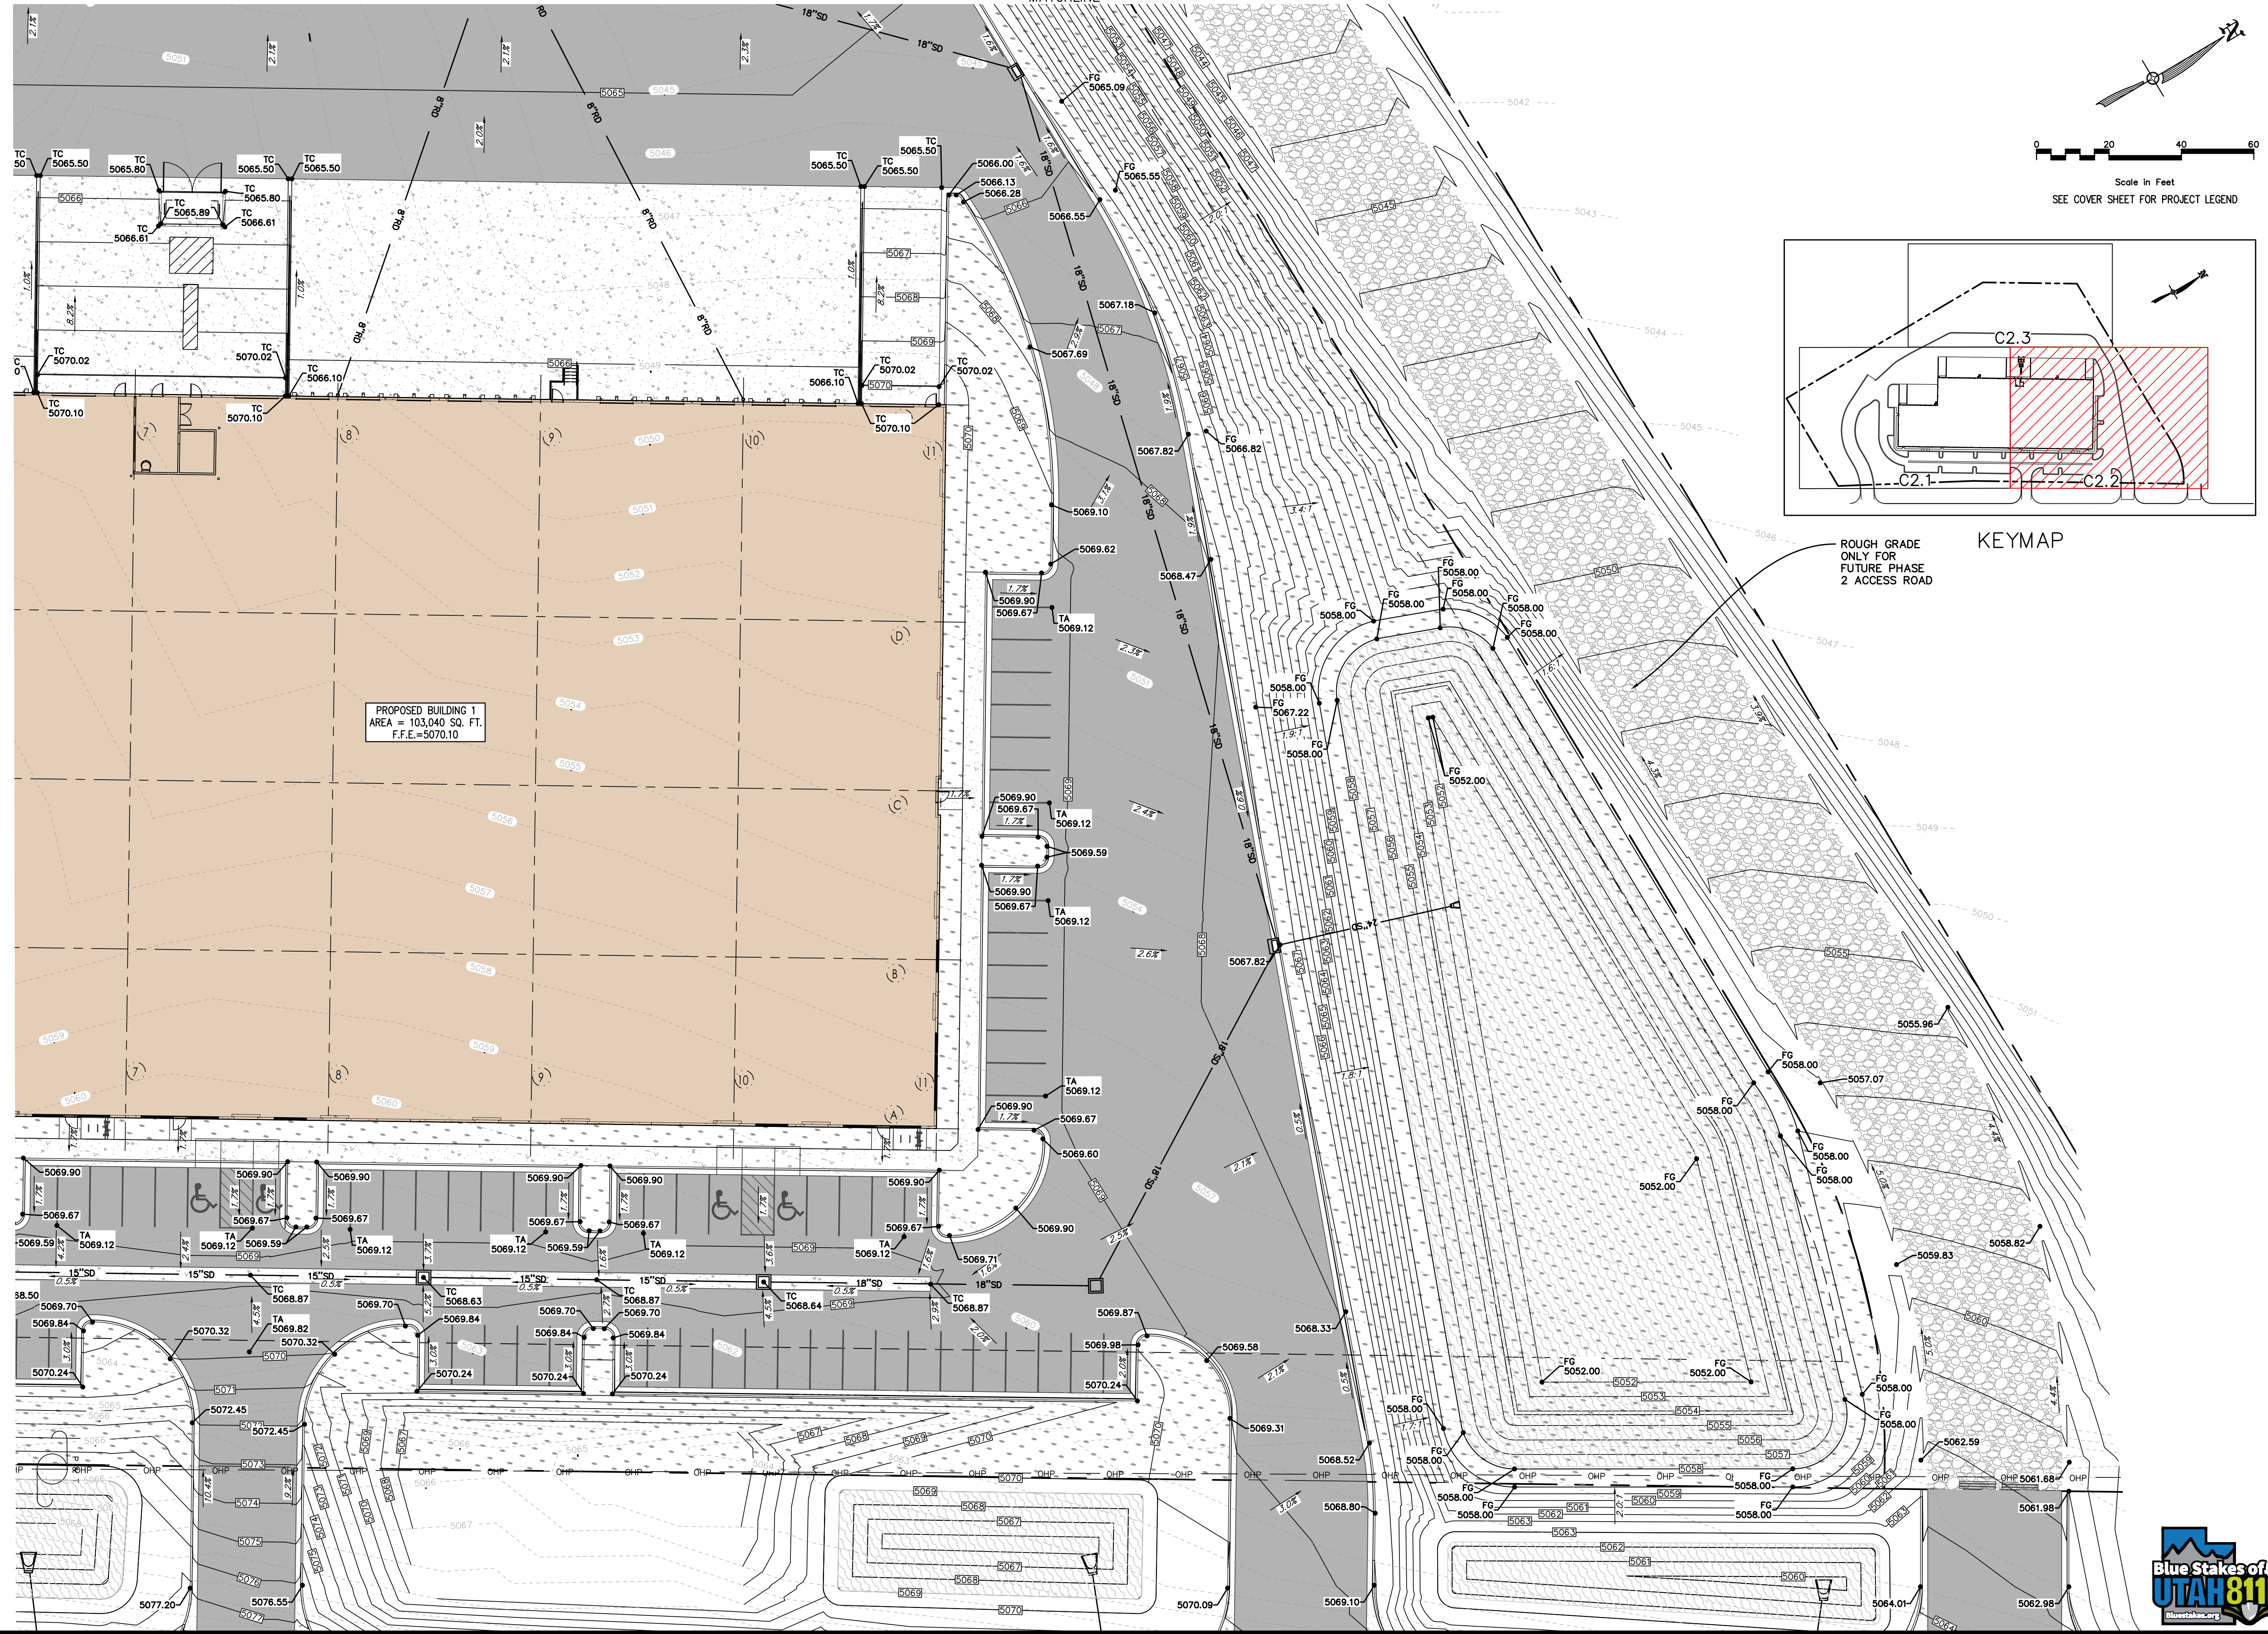

NO.	REVISIONS	BY	DATE




DESIGNER: SDT
PROJECT ENGINEER: SDT

CIVIL ENGINEERING + SURVEYING
10718 S BECKSTEAD LANE, SUITE 102
South Jordan, Utah - 801-594-6296

SANTAQUIN RESEARCH & TECH CENTER - PHASE 1
SOUTH RIDGE FARMS ROAD, SANTAQUIN UT, 84655

SHEET NO. **C2.2**
PROJECT ID: E23-143
DATE: 12/15/23
FILE NAME: PRJ-SJI
SCALE: 1"=20'



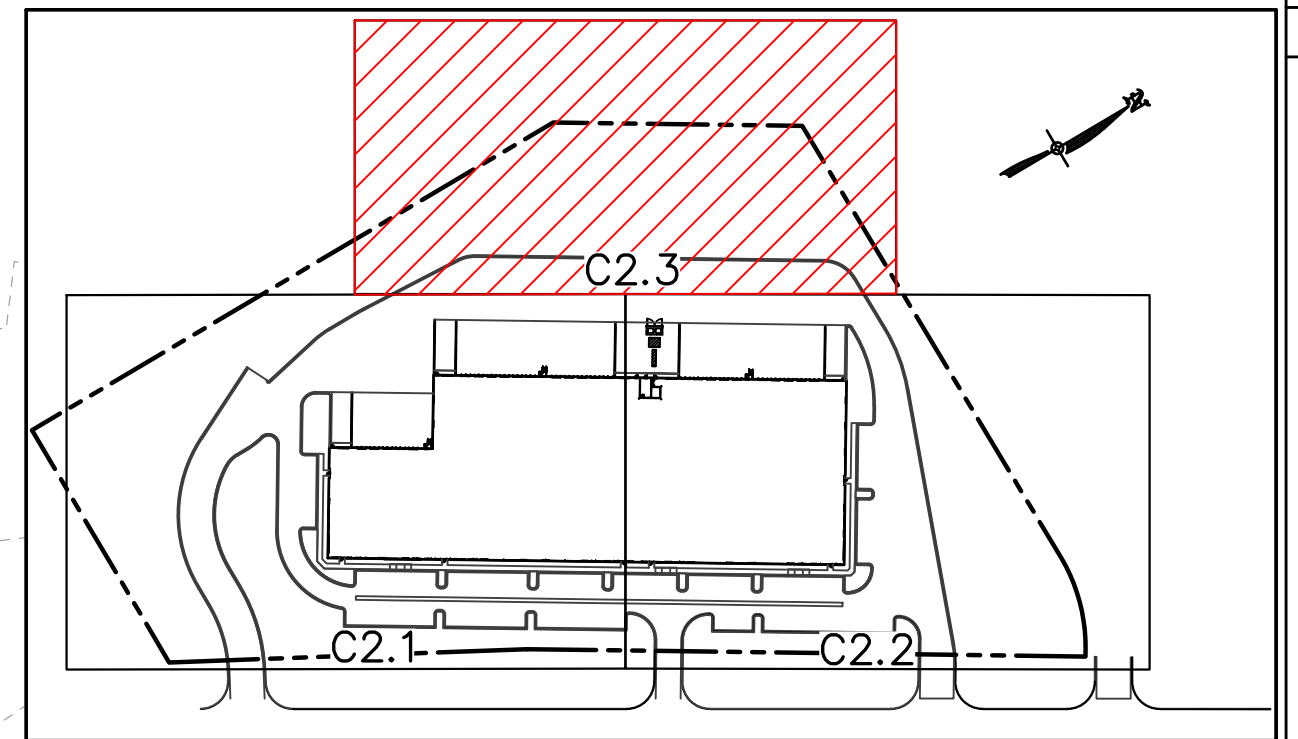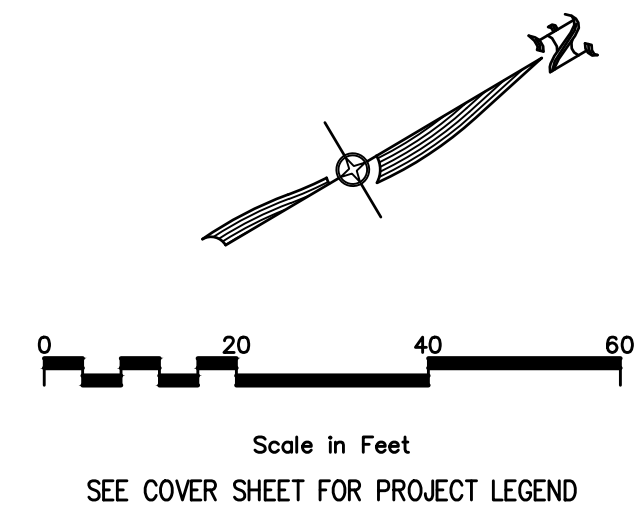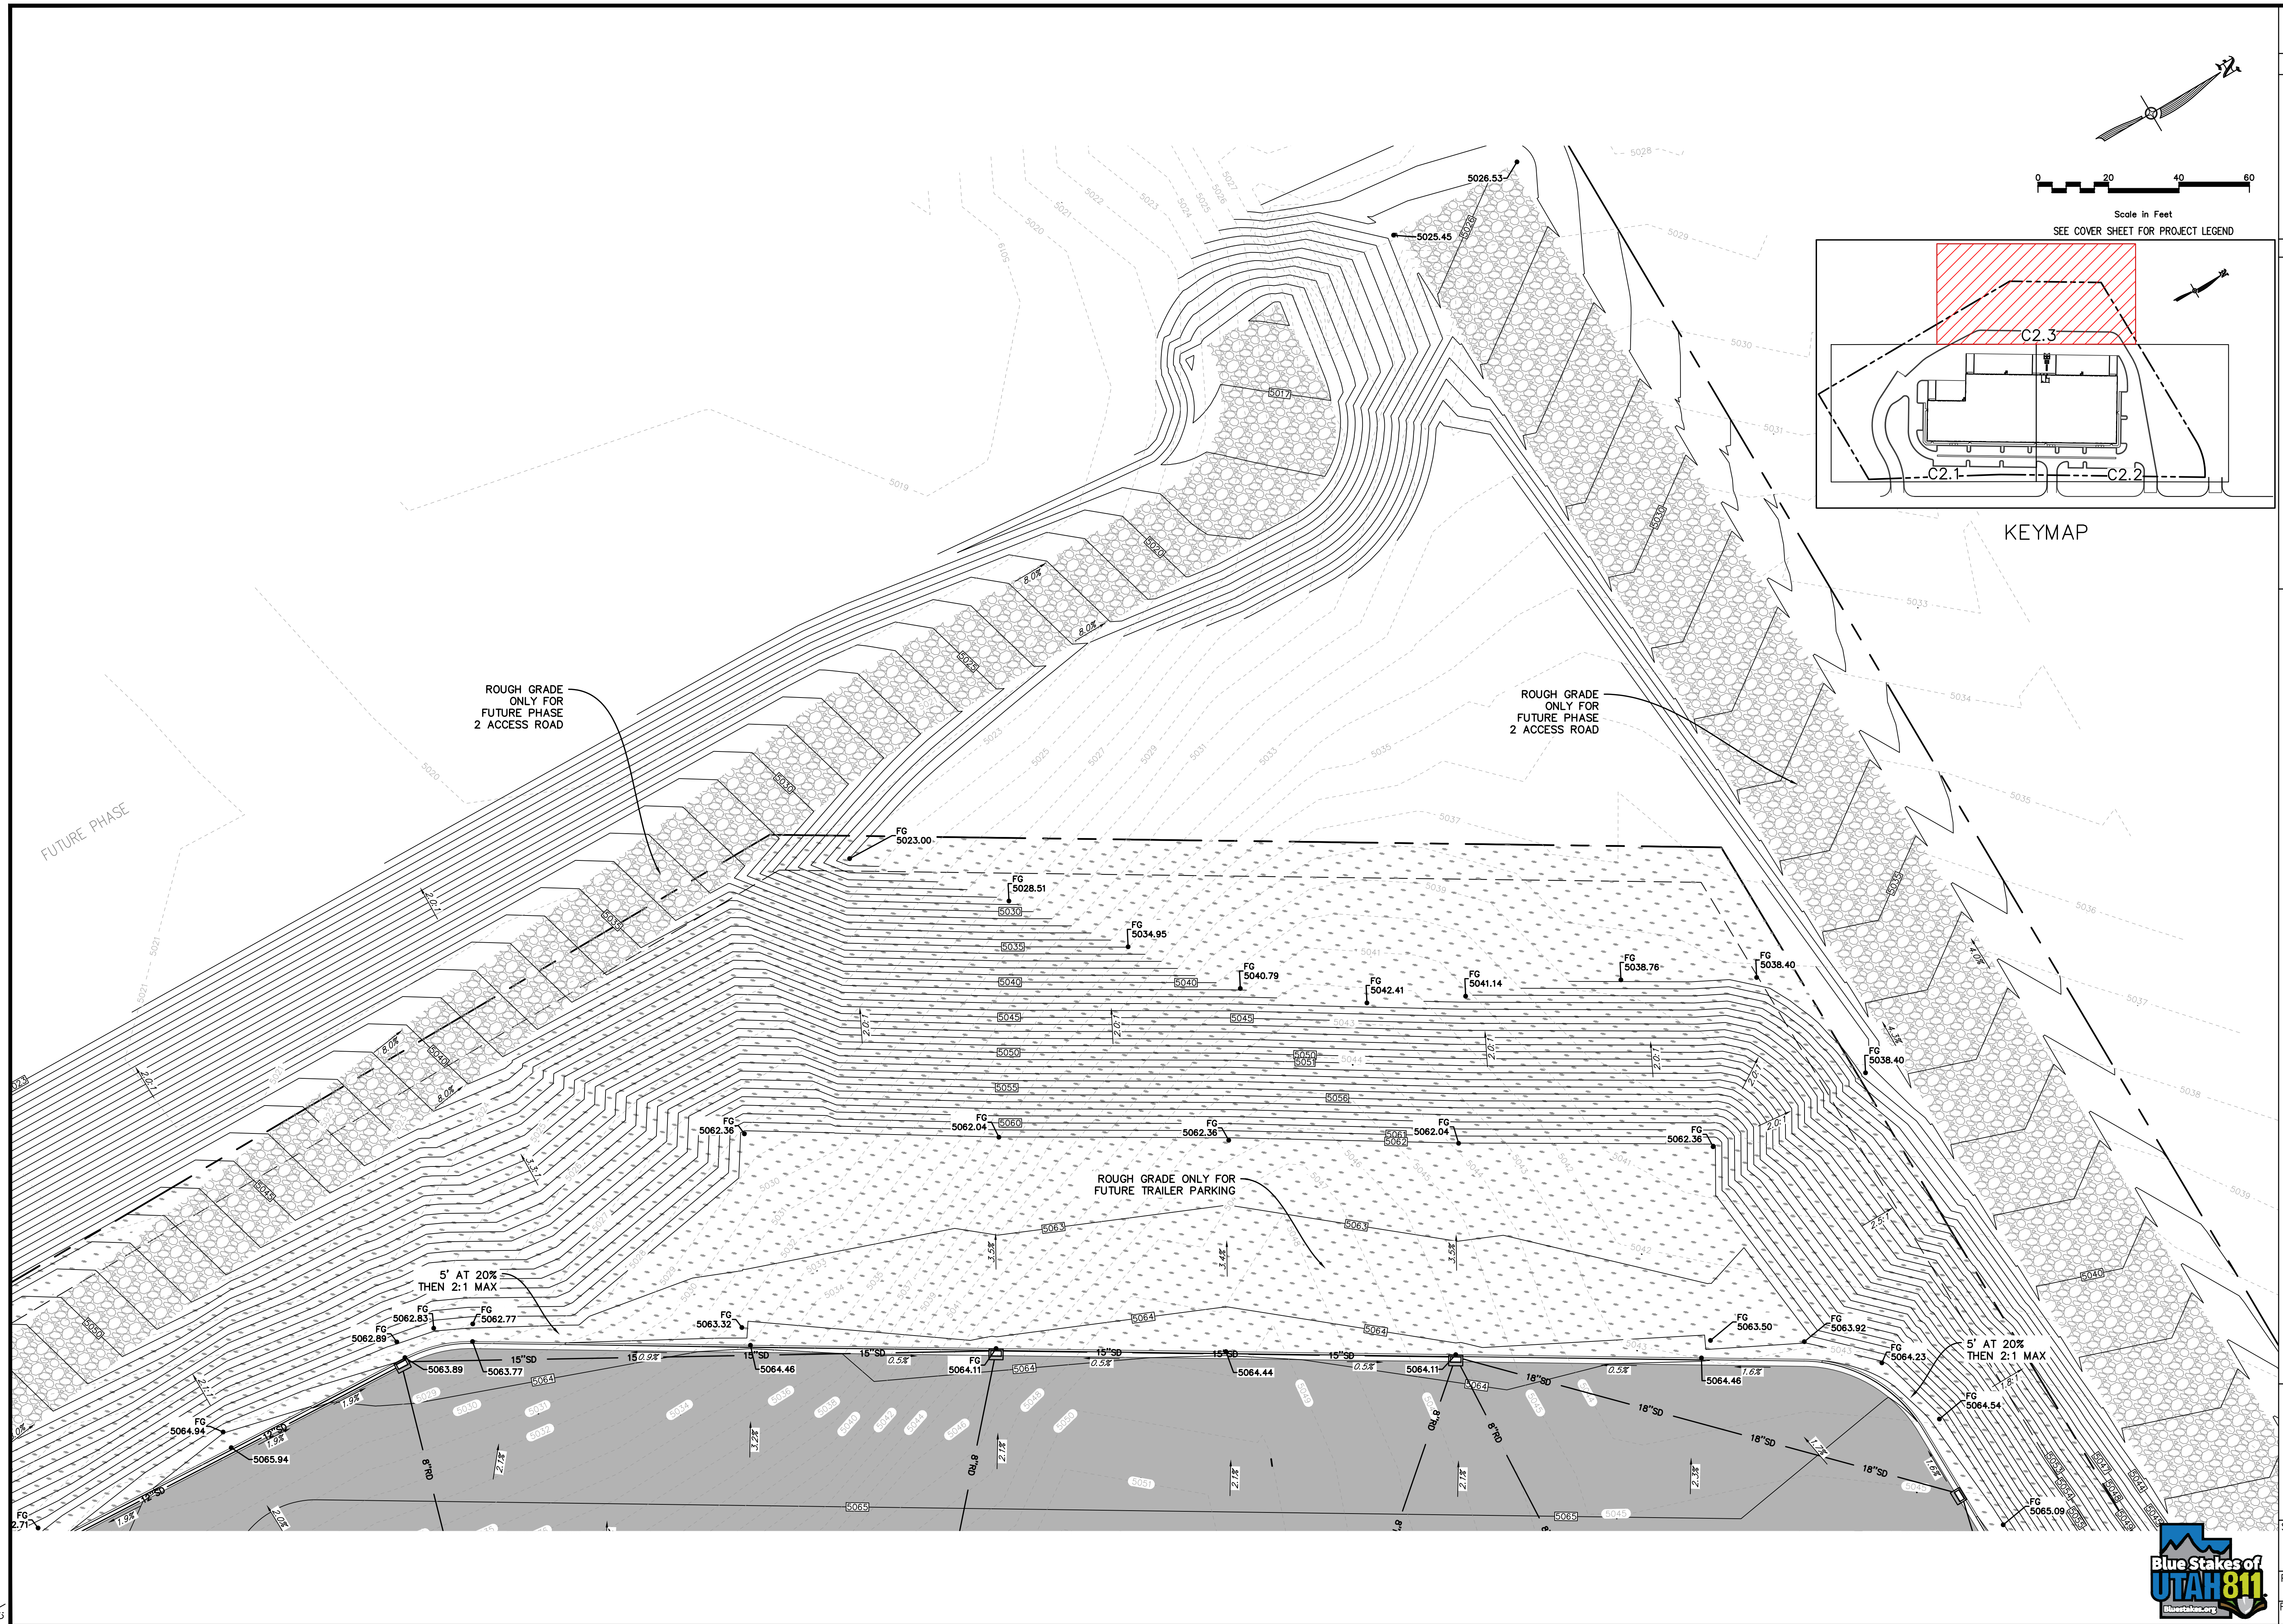

KEYMAP

NO.	REVISIONS	BY	DATE


CIVIL ENGINEERING + SURVEYING
 10718 S BECKSTEAD LANE, SUITE 102
 South Jordan, Utah - 801-594-6296

SANTAQUIN RESEARCH & TECH CENTER - PHASE 1
 SOUTH RIDGE FARMS ROAD, SANTAQUIN UT, 84655

GRADING PLAN

SHEET NO.	C2.3
PROJECT ID	E23-143
DATE	12/15/23
FILE NAME	PRJ-SJ1
SCALE	1"=20'



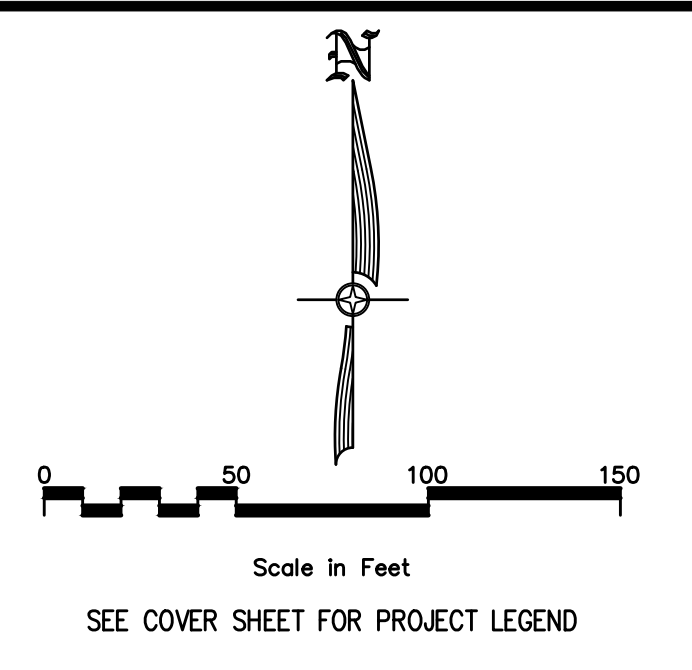

UTILITY PLAN NOTES:

- 1 INSTALL 2" POLY PIPE WITH BENDS. END WATER LINE 5' FROM BUILDING AND SEE MECHANICAL PLANS FOR CONTINUATION INTO BUILDING.
- 2 CONNECT PROPOSED 8" PVC C-900 FIRE LINE TO PROPOSED 8" PVC C-900 FIRE LINE LATERAL.
- 3 PROPOSED 8" PVC C-900 FIRE LINE.
- 4 INSTALL 8" 11.25" BEND W/THRUST BLOCK.
- 5 INSTALL 8" 22.5" BEND W/THRUST BLOCK.
- 6 INSTALL 8" 45" BEND W/THRUST BLOCK.
- 7 INSTALL 8"x8"x6" TEE W/6" GATE VALVE W/THRUST BLOCKS
- 8 INSTALL 8"x8"x8" TEE W/8" GATE VALVE W/THRUST BLOCKS
- 9 INSTALL WALL MOUNTED FDC PER SANTAQUIN STANDARDS.
- 10 END 8" PVC C-900 FIRE LINE 5' FROM BUILDING AND SEE FIRE SPRINKLER PLANS FOR CONTINUATION TO FIRE RISER.
- 11 INSTALL FIRE HYDRANT WITH VALVE PER SANTAQUIN SEE DETAIL C6.0.
- 12 FIRE HYDRANT INSTALLED AS PART OF ROAD IMPROVEMENT PLANS (SEE SHEETS C4.0-4.2 AND C5.1-C5.2 FOR DETAILS).
- 13 INSTALL KNOX BOX 3500 SERIES KEY BOX FOR FIRE DEPARTMENT ACCESS TO FIRE RISER ROOM.
- 14 CONNECT TO 6" SEWER STUB AND INSTALL 6" SEWER CLEANOUT WYE. TOL=5095.00, I.E.=5067.95.
- 15 INSTALL 84± OF 6" PVC SDR-35 SEWER PIPE, S=27.3%. END PIPE 5' FROM BUILDING (I.E.=5090.90) AND SEE PLUMBING PLANS FOR CONTINUATION INTO BUILDING.

NO.	REVISIONS	BY	DATE

DESIGNER: SDT PROJECT ENGINEER: SDT

CIVIL ENGINEERING + SURVEYING





10718 S BECKSTEAD LANE, SUITE 102
South Jordan, Utah - 801-949-6296

SANTAQUIN RESEARCH & TECH CENTER - PHASE 1
SOUTH RIDGE FARMS ROAD, SANTAQUIN UT, 84655

UTILITY PLAN




SHEET NO.	C3.0
PROJECT ID:	E23-143
DATE:	12/15/23
FILE NAME:	PRJ-SJI
SCALE:	1"=50'

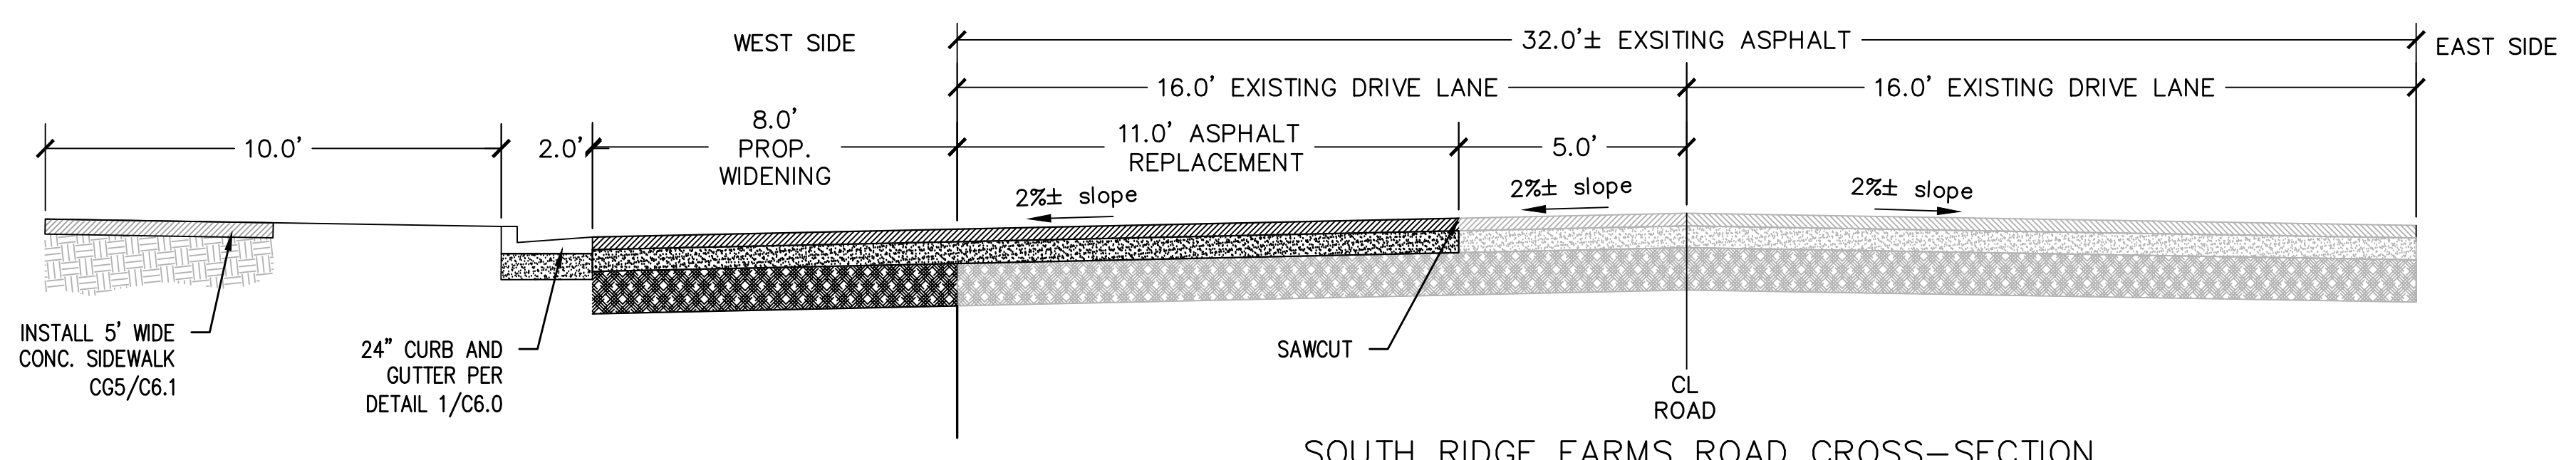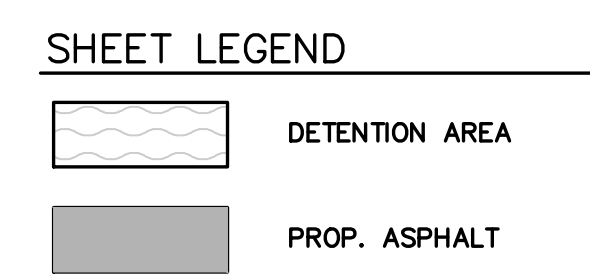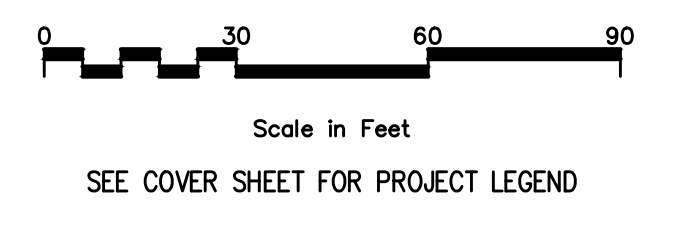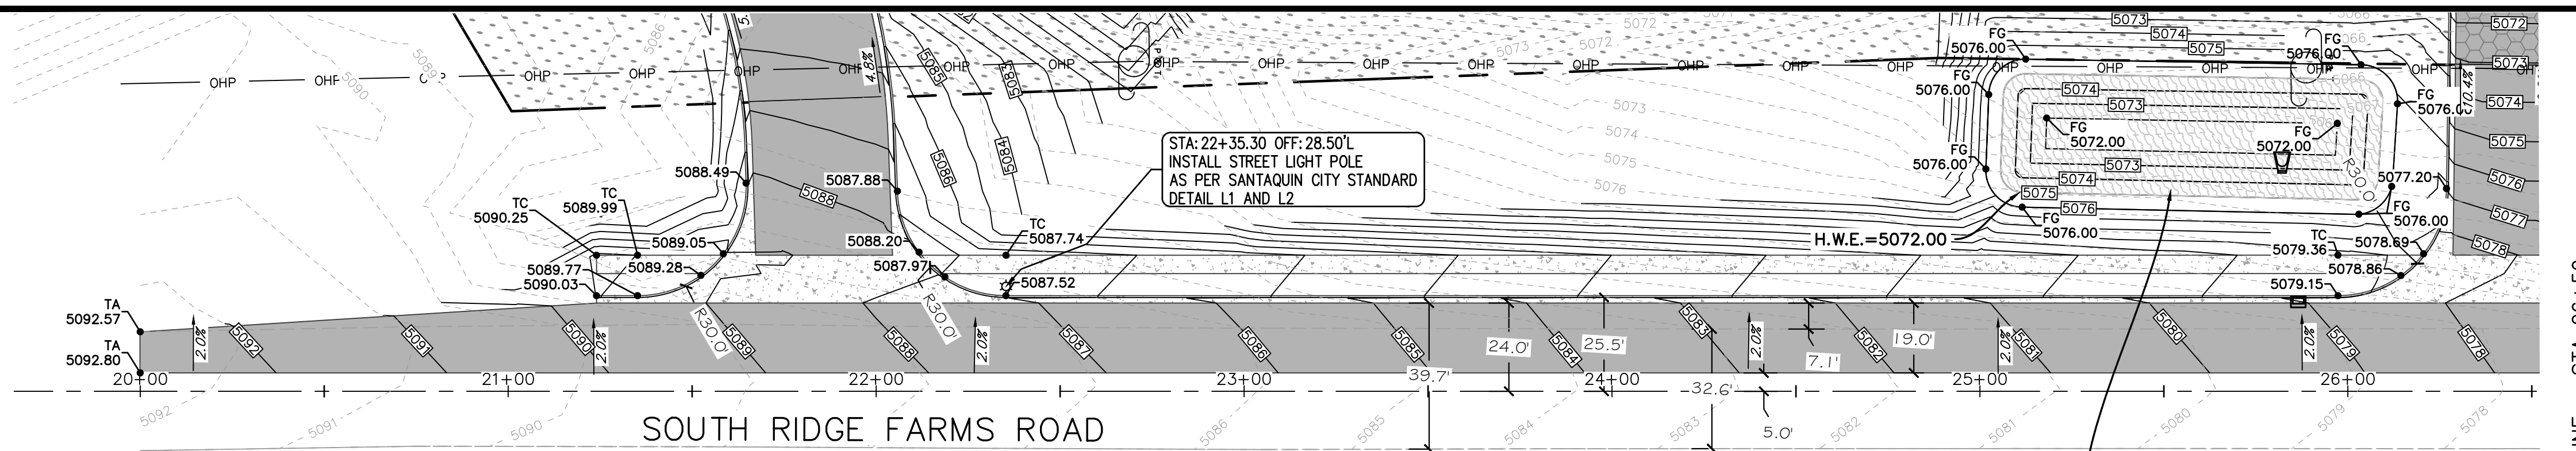


PROPOSED RETENTION POND 1 OF 3
 DESIGN STORM EVENT = 100 YEAR 24 HOUR
 RELEASE RATE = 0 CFS (FULL RETENTION)
 REQUIRED RETENTION VOLUME = 5,635 CF
 PROVIDED RETENTION VOLUME = 9,120 CF
 FREEBOARD = 1.0 FEET
 SIDE SLOPES = 4:1 MAX
 TOP OF POND ELE. = 5076.0
 BOTTOM OF POND ELE. = 5072.0
 H.W.E. = 5075.0


SOUTH RIDGE FARMS ROAD CROSS-SECTION
 STA: 20+00 TO 33+00

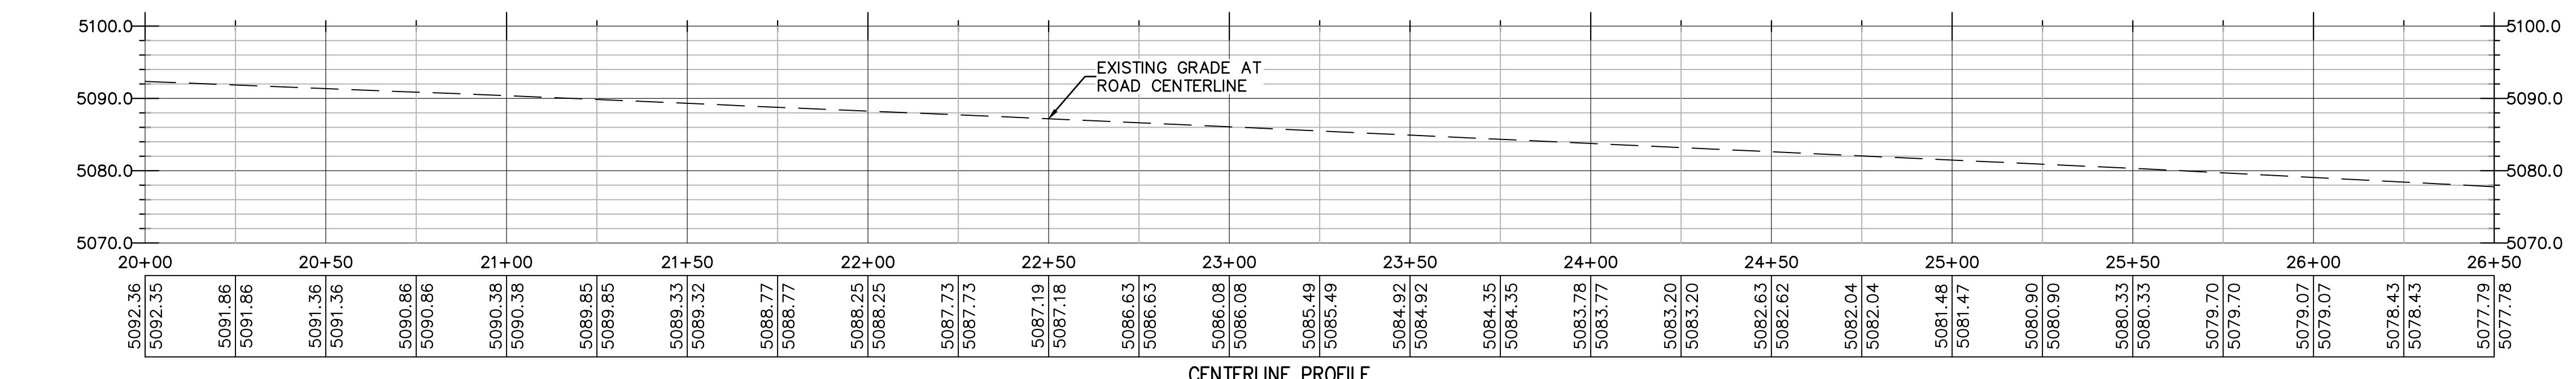


MATCHLINE - STA 26+50
 SEE SHEET C4.2

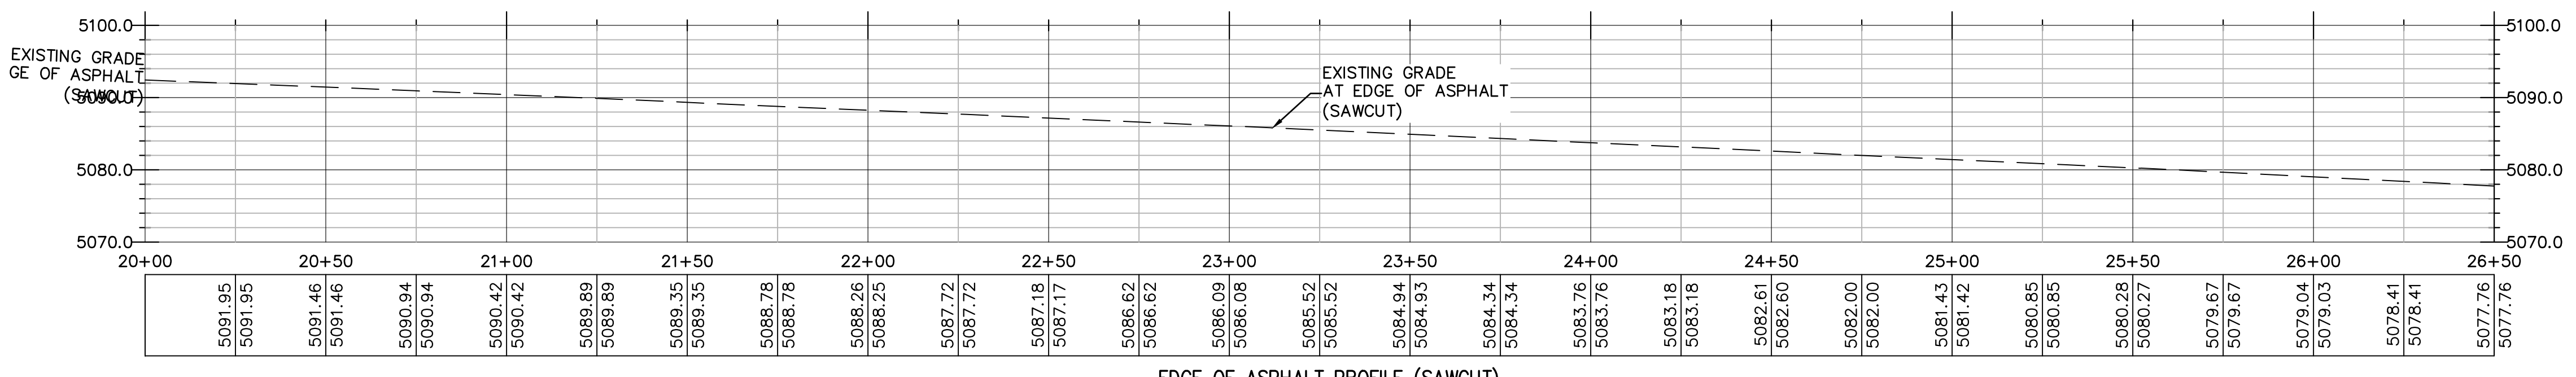

MATCHLINE - STA 26+50
 SEE SHEET C4.2

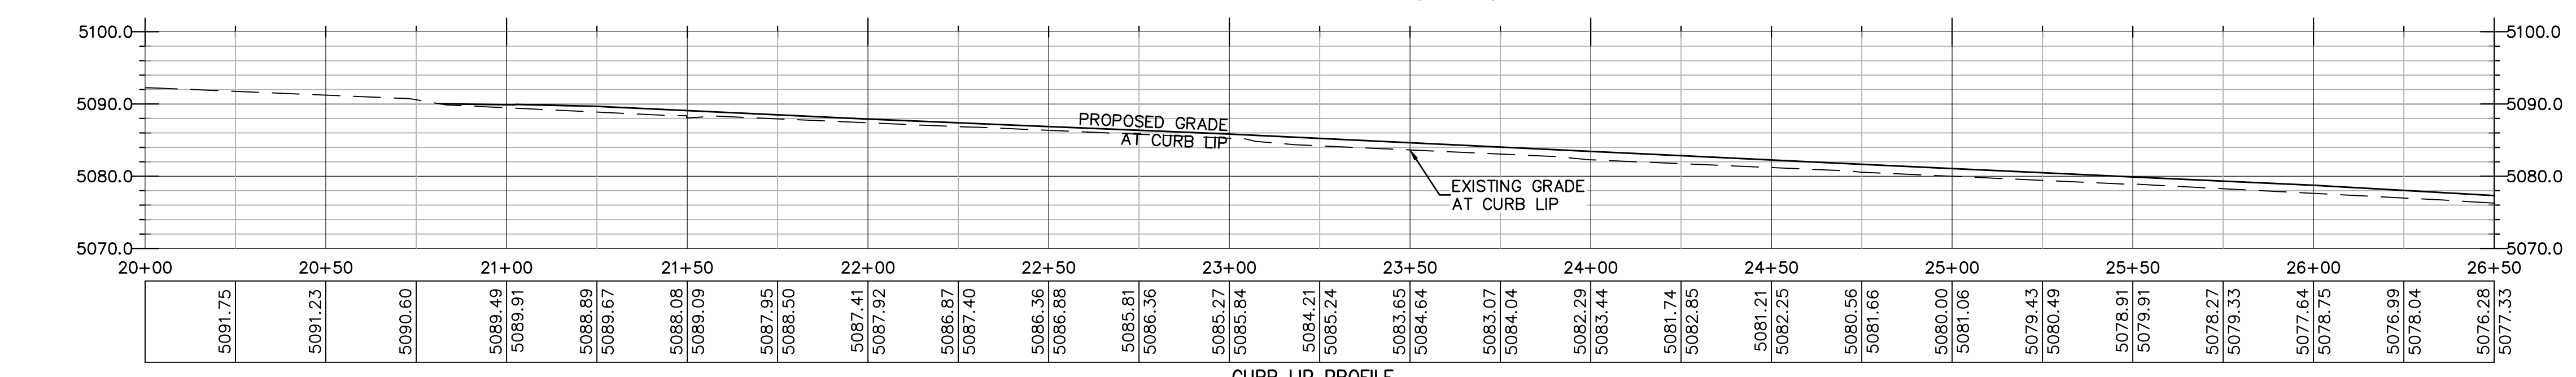

MATCHLINE - STA 26+50
 SEE SHEET C4.2

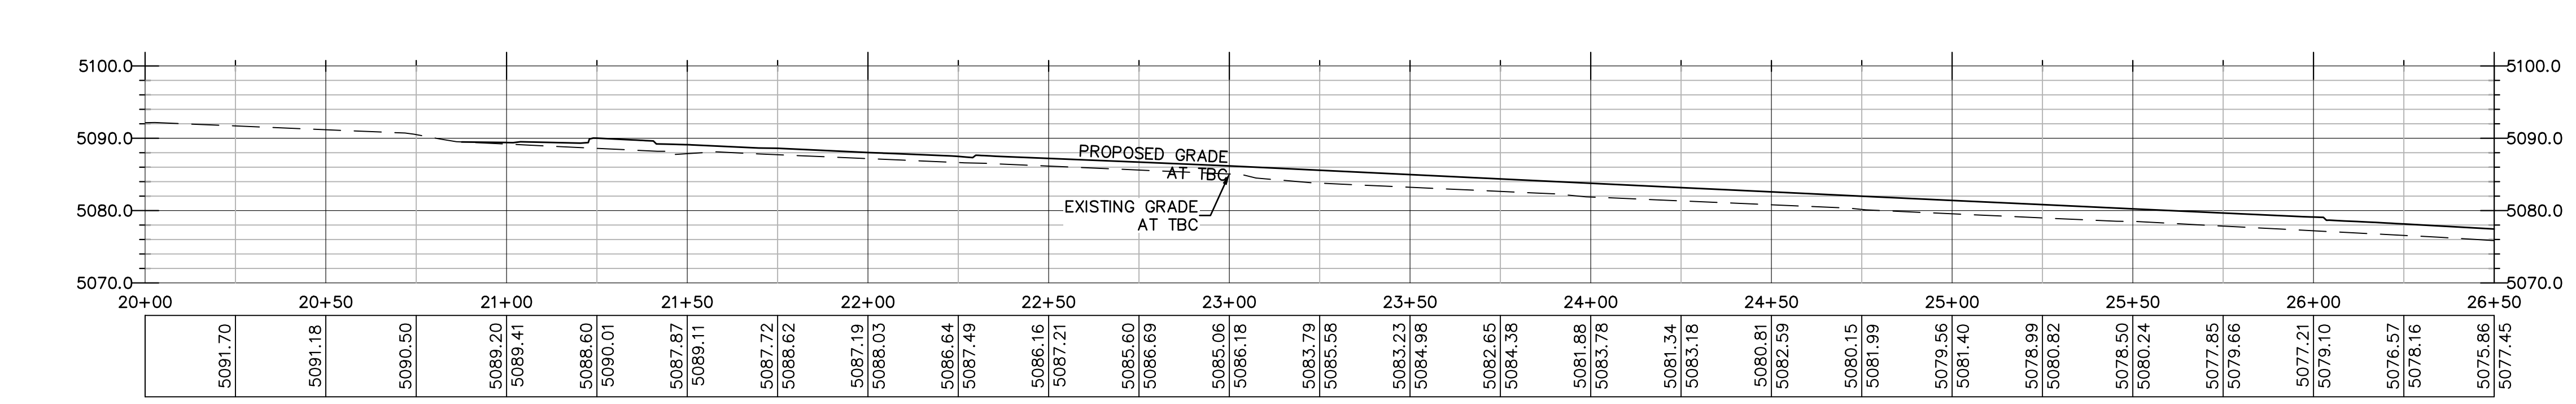

MATCHLINE - STA 26+50
 SEE SHEET C4.2

NO.	REVISIONS	BY	DATE


DESIGNER: SDT
 PROJECT ENGINEER: SDT

CIVIL ENGINEERING + SURVEYING
 10718 S BECKSTEAD LANE, SUITE 102
 South Jordan, Utah - 801-549-6296

SANTAQUIN RESEARCH & TECH CENTER - PHASE 1
 SOUTH RIDGE FARMS ROAD, SANTAQUIN UT, 84655
ROAD WIDENING PLAN AND PROFILE
 STA: 20+00 TO 26+50




SHEET NO.	C4.1
PROJECT ID	E23-143
DATE	12/15/23
FILE NAME	PRJ-SJT
SCALE	1"=30'




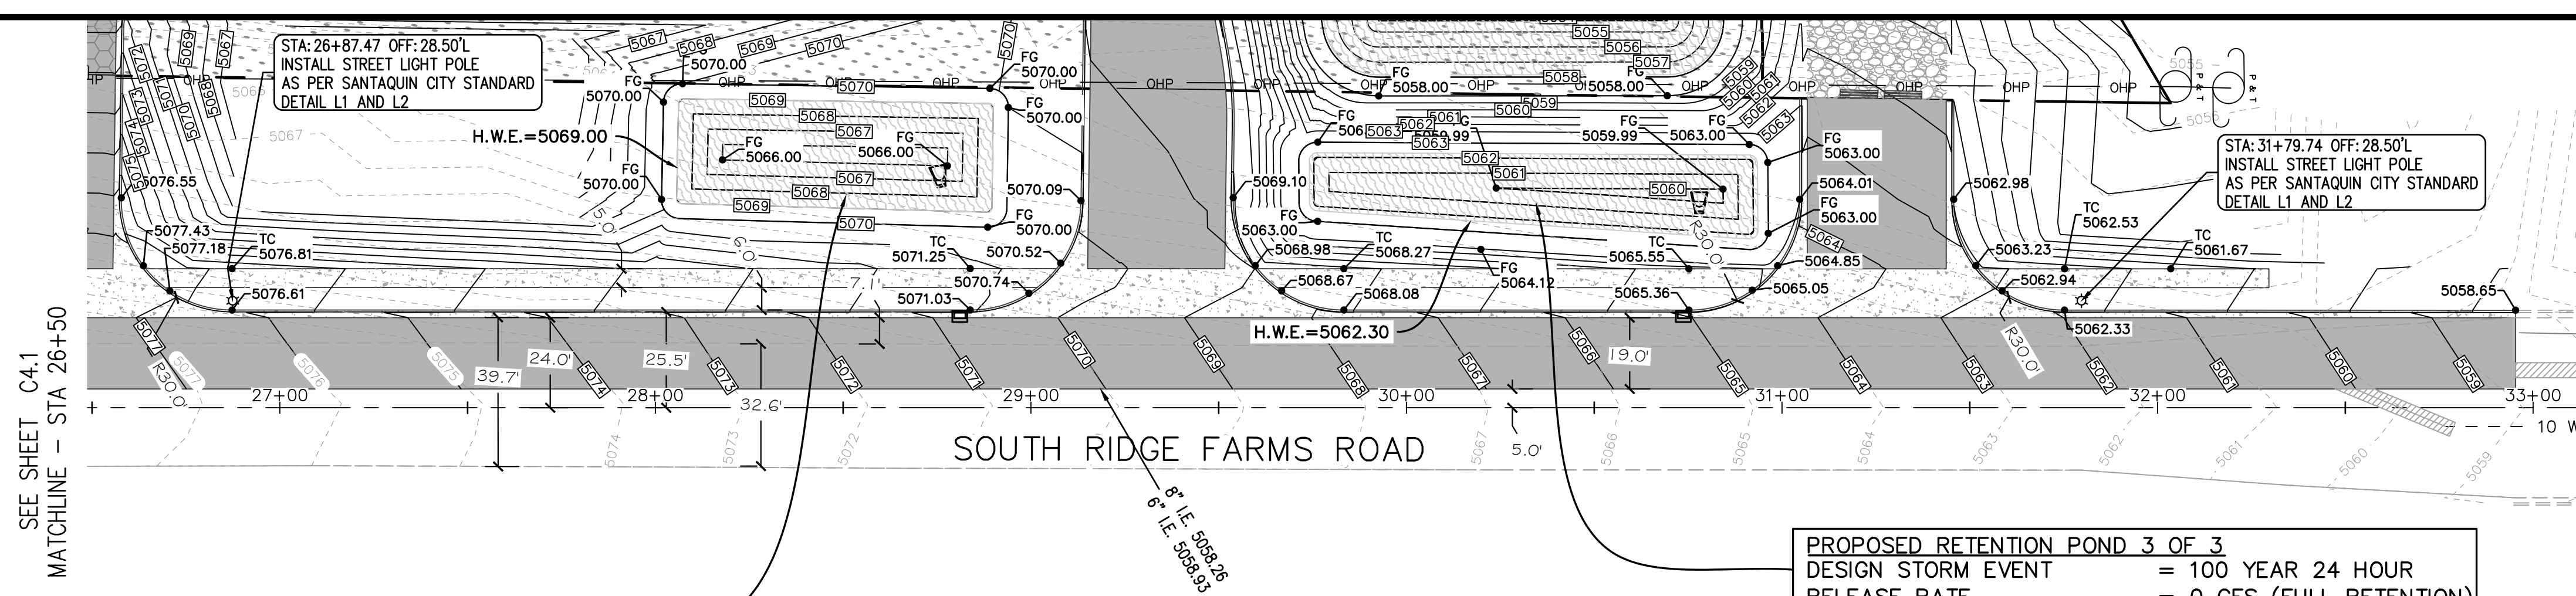


PROPOSED RETENTION POND 2 OF 3
 DESIGN STORM EVENT = 100 YEAR 24 HOUR
 RELEASE RATE = 0 CFS (FULL RETENTION)
 REQUIRED RETENTION VOLUME = 3,675 CF
 PROVIDED RETENTION VOLUME = 6,204 CF
 FREEBOARD = 1.0 FEET
 SIDE SLOPES = 4:1 MAX
 TOP OF POND ELE. = 5070.0
 BOTTOM OF POND ELE. = 5066.0
 H.W.E. = 5069.0

PROPOSED RETENTION POND 3 OF 3
 DESIGN STORM EVENT = 100 YEAR 24 HOUR
 RELEASE RATE = 0 CFS (FULL RETENTION)
 REQUIRED RETENTION VOLUME = 2,450 CF
 PROVIDED RETENTION VOLUME = 4,069 CF
 FREEBOARD = 0.7 FEET
 SIDE SLOPES = 4:1 MAX
 TOP OF POND ELE. = 5063.0
 BOTTOM OF POND ELE. = 5060.0
 H.W.E. = 5062.3

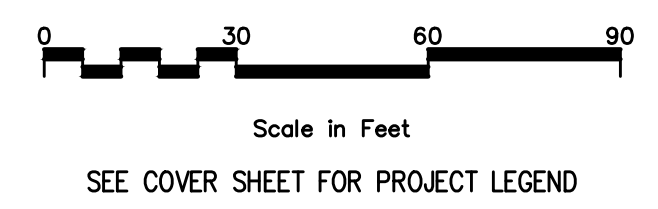

- SHEET LEGEND**
- DETENTION AREA
 - ASPHALT REPLACEMENT
 - PROP. ASPHALT

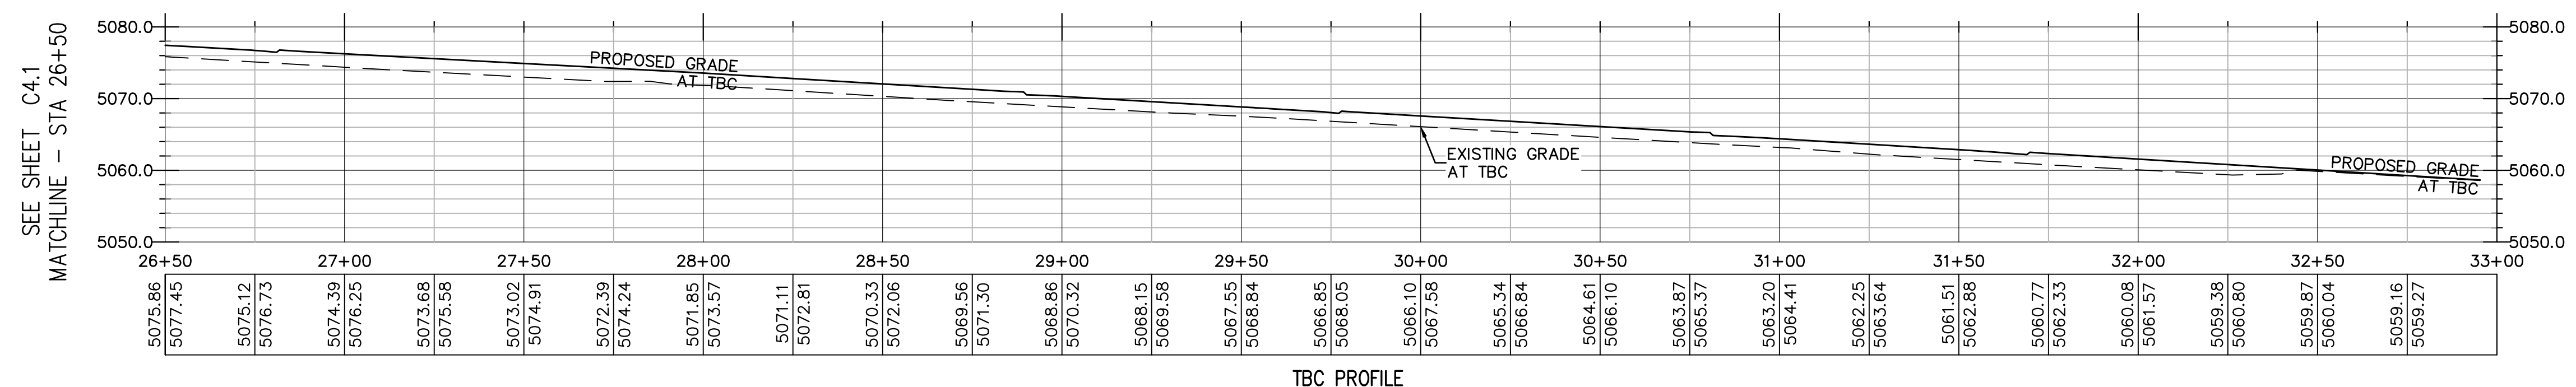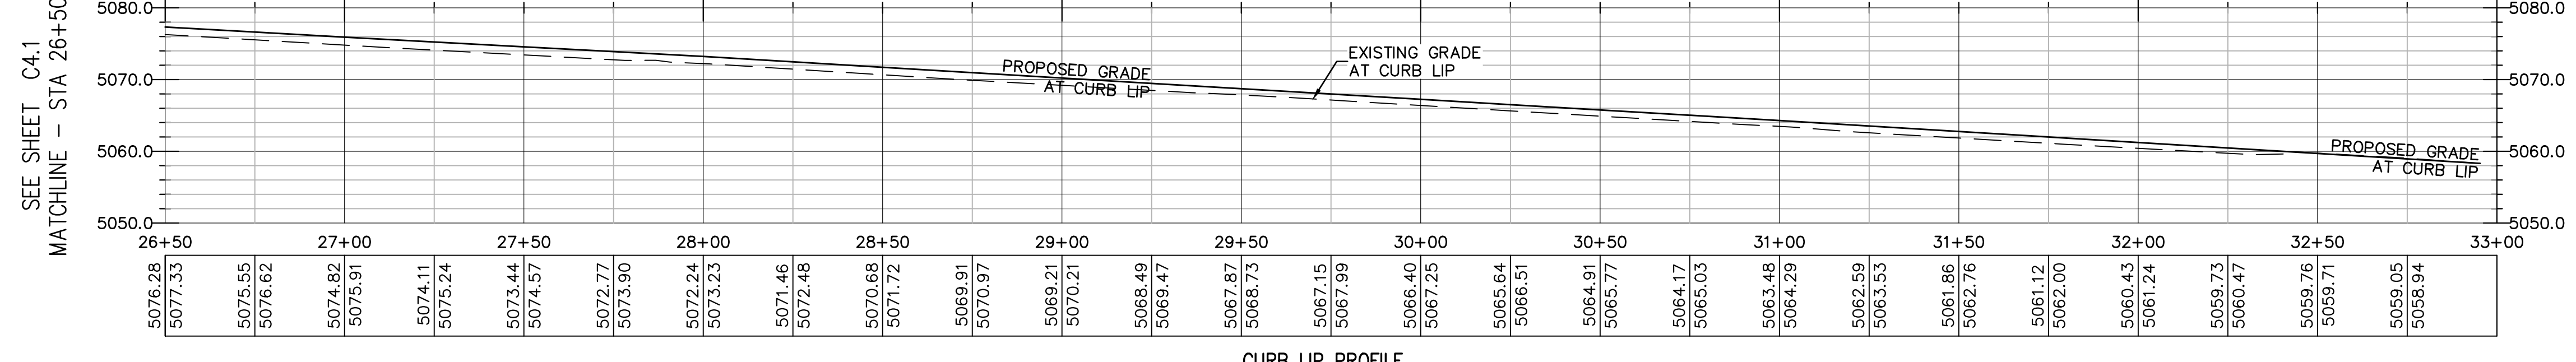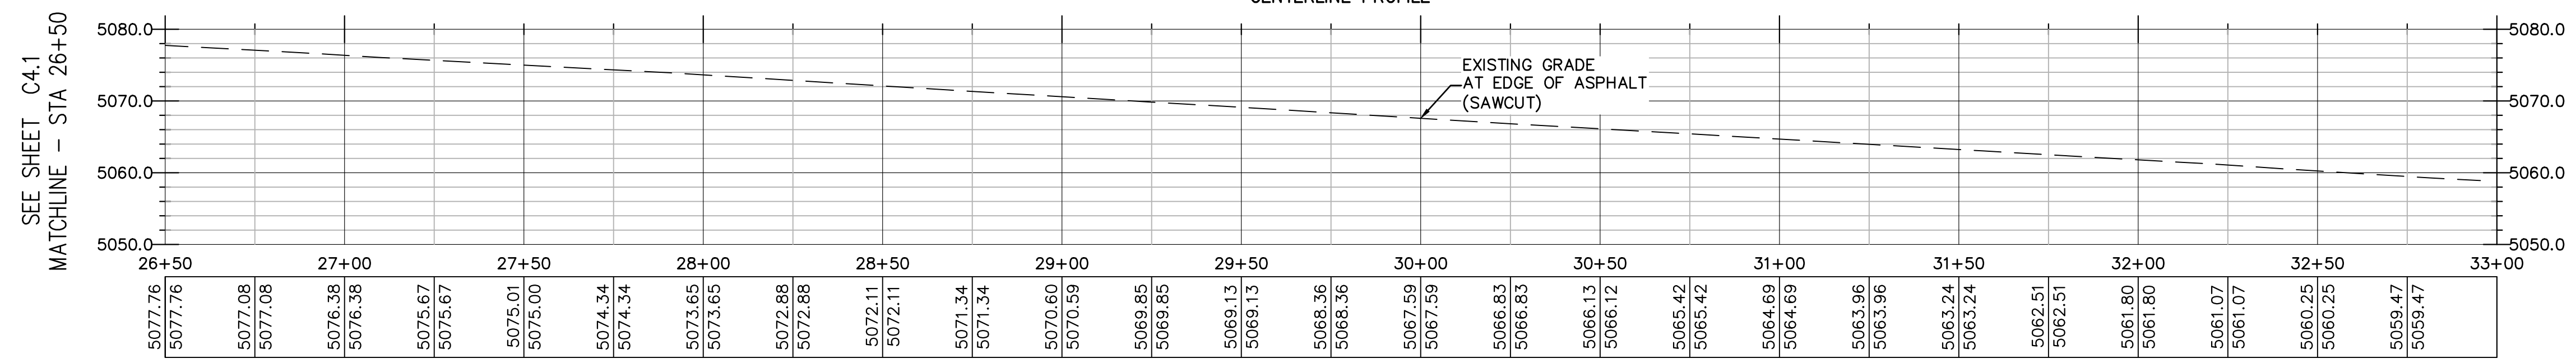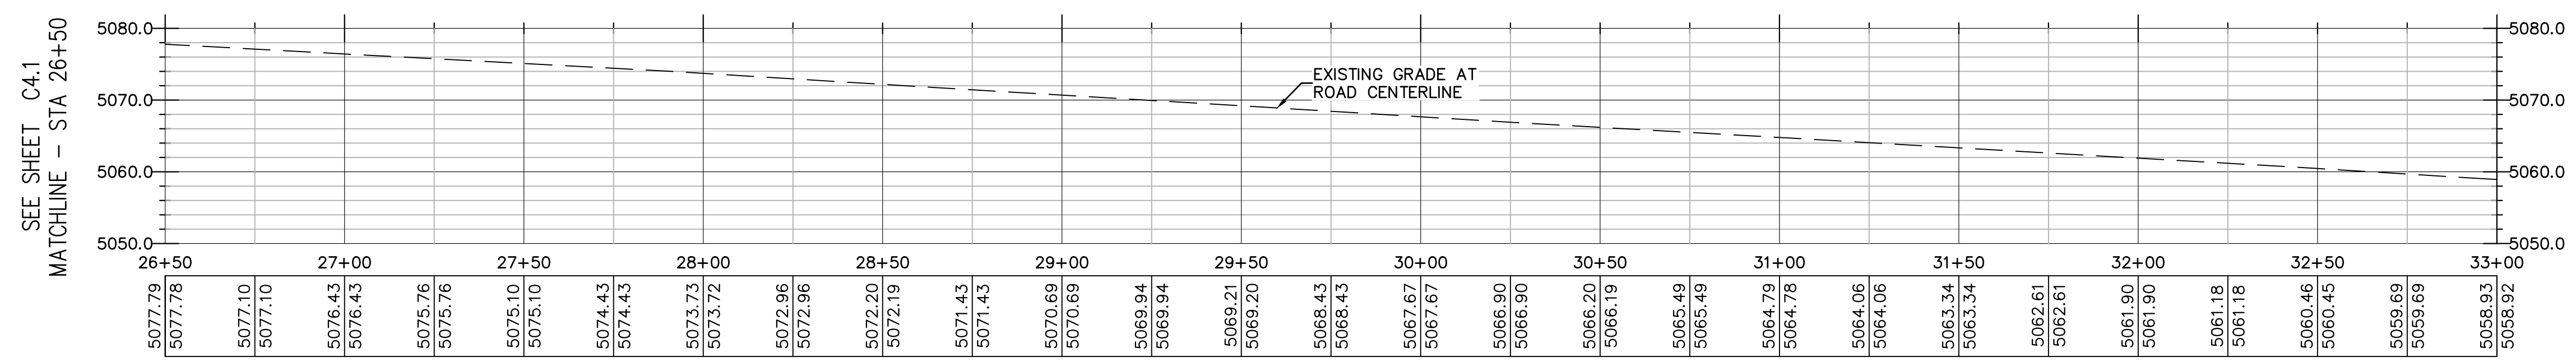



NO.	REVISIONS	BY	DATE

CIVIL ENGINEERING + SURVEYING
 10718 S BECKSTEAD LANE, SUITE 102
 South Jordan, Utah - 801-949-6296

SANTAQUIN RESEARCH & TECH CENTER - PHASE 1
 SOUTH RIDGE FARMS ROAD, SANTAQUIN UT, 84655
 ROAD WIDENING PLAN AND PROFILE
 STA: 26+50 TO 33+00


SHEET NO. **C4.2**
 PROJECT ID: E23-143
 DATE: 12/15/23
 FILE NAME: PRJ-SJT
 SCALE: 1"=30'



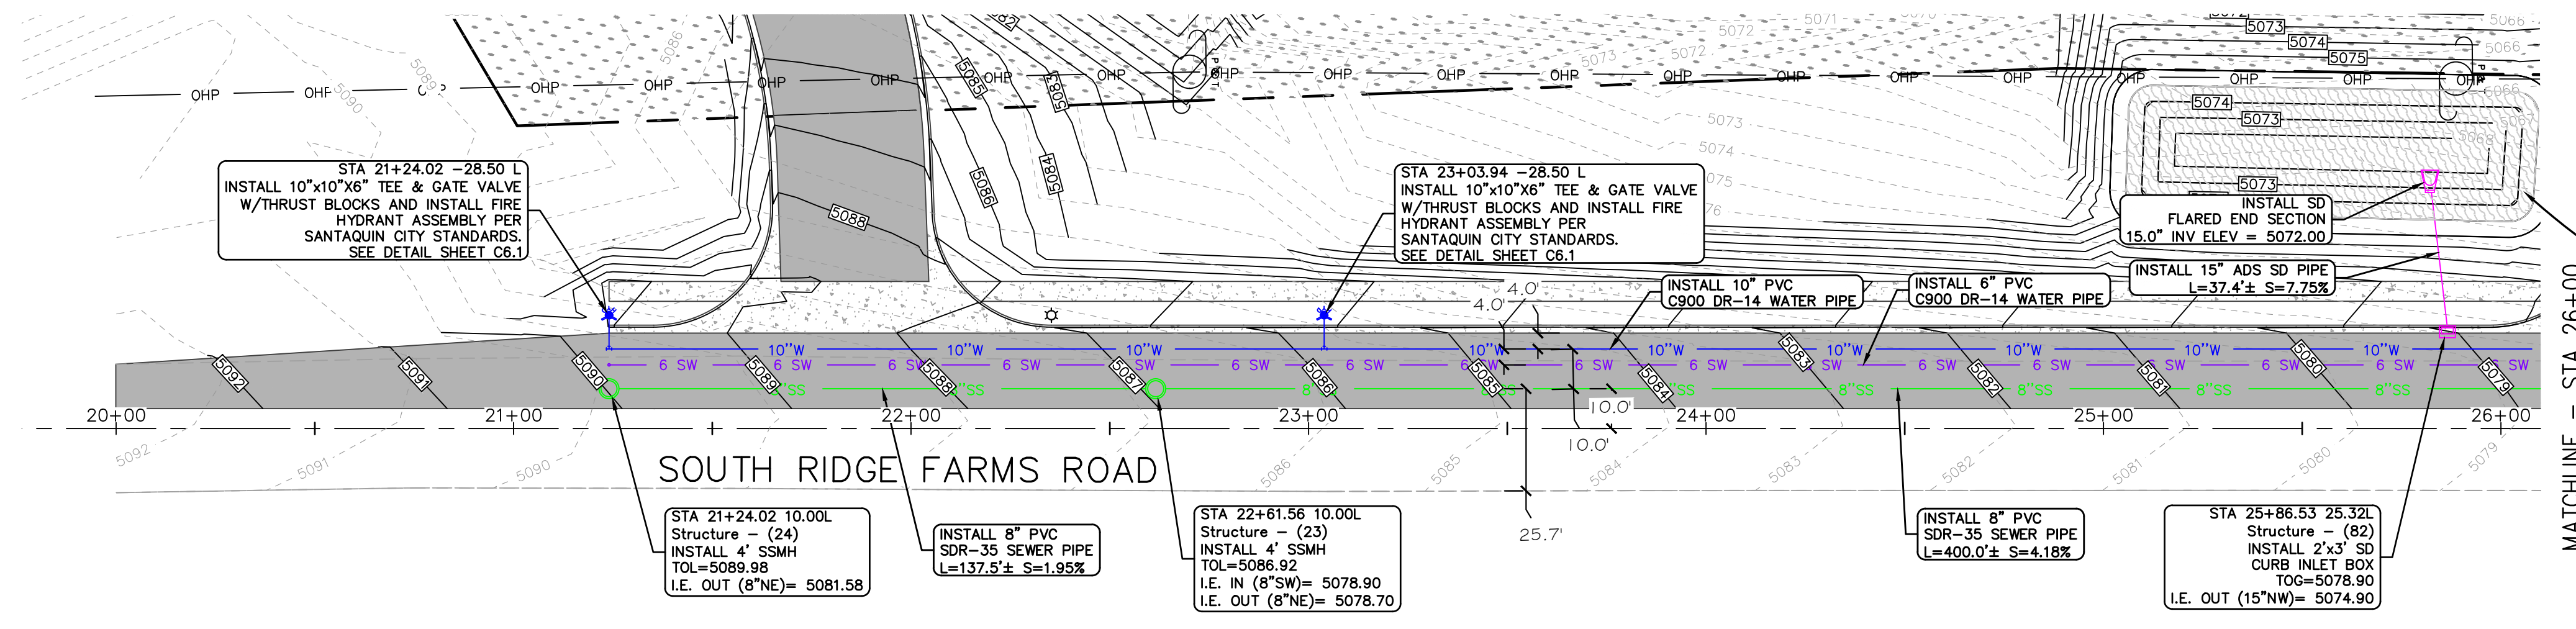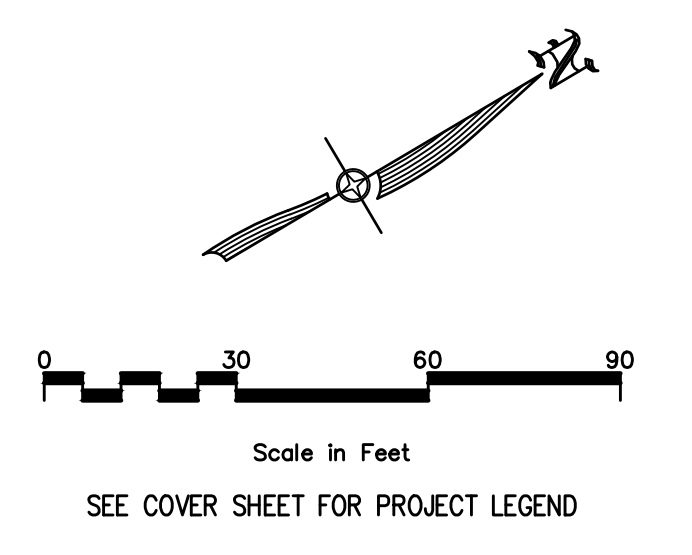

PROPOSED RETENTION POND 1 OF 3



DESIGN STORM EVENT	= 100 YEAR 24 HOUR
RELEASE RATE	= 0 CFS (FULL RETENTION)
REQUIRED RETENTION VOLUME	= 5,635 CF
PROVIDED RETENTION VOLUME	= 9,120 CF
FREEBOARD	= 1.0 FEET
SIDE SLOPES	= 4:1 MAX
TOP OF POND ELE.	= 5076.0
BOTTOM OF POND ELE.	= 5072.0
H.W.E.	= 5075.0

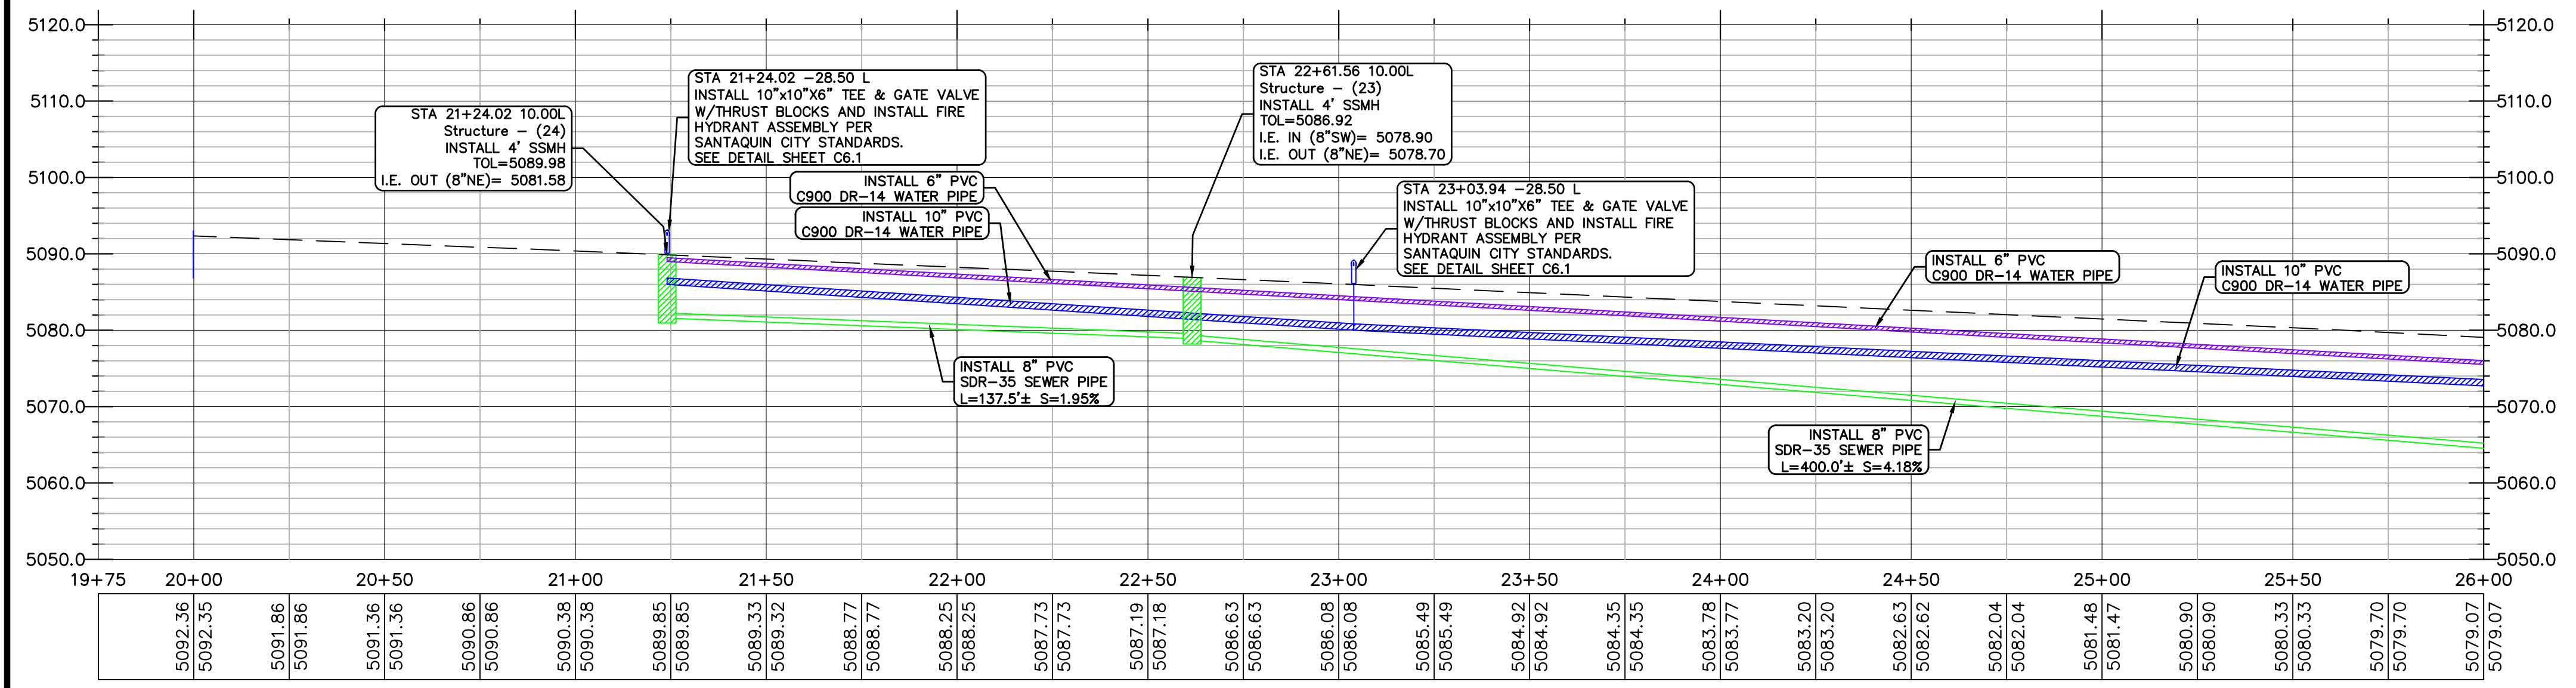


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5092.35	5091.86	5091.36	5090.86	5089.85	5089.63	5088.77	5088.25	5087.73	5087.19	5086.63	5086.08	5085.49	5084.92
5091.86	5091.36	5090.86	5089.85	5089.63	5088.77	5088.25	5087.73	5087.19	5086.63	5086.08	5085.49	5084.92	5084.35
5091.36	5090.86	5089.85	5089.63	5088.77	5088.25	5087.73	5087.19	5086.63	5086.08	5085.49	5084.92	5084.35	5083.78
5090.86	5089.85	5089.63	5088.77	5088.25	5087.73	5087.19	5086.63	5086.08	5085.49	5084.92	5084.35	5083.78	5083.20
5090.86	5089.85	5089.63	5088.77	5088.25	5087.73	5087.19	5086.63	5086.08	5085.49	5084.92	5084.35	5083.78	5083.20
5090.38	5089.37	5089.15	5088.77	5088.25	5087.73	5087.19	5086.63	5086.08	5085.49	5084.92	5084.35	5083.78	5083.20
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5088.36	5087.35	5087.13	5086.76	5086.24	5085.70	5085.15	5084.60	5084.04	5083.48	5082.92	5082.36	5081.80	5081.24
5087.83	5086.82	5086.60	5086.23	5085.71	5085.17	5084.62	5084.07	5083.51	5082.95	5082.39	5081.83	5081.27	5080.71
5087.35	5086.34	5086.12	5085.75	5085.23	5084.69	5084.14	5083.59	5083.03	5082.47	5081.91	5081.35	5080.79	5080.23
5086.82	5085.81	5085.59	5085.22	5084.70	5084.16	5083.61	5083.06	5082.50	5081.94	5081.38	5080.82	5080.26	5079.70
5086.34	5085.33	5085.11	5084.74	5084.22	5083.68	5083.13	5082.58	5082.02	5081.46	5080.90	5080.34	5079.78	5079.22
5085.81	5084.80	5084.58	5084.21	5083.69	5083.15	5082.60	5082.05	5081.49	5080.93	5080.37	5079.81	5079.25	5078.69
5085.33	5084.32	5084.10	5083.73	5083.21	5082.67	5082.12	5081.57	5081.01	5080.45	5079.89	5079.33	5078.77	5078.21
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5084.32	5083.31	5083.09	5082.72	5082.20	5081.66	5081.11	5080.56	5079.99	5079.43	5078.87	5078.31	5077.75	5077.19
5083.79	5082.78	5082.56	5082.19	5081.67	5081.13	5080.58	5080.03	5079.47	5078.91	5078.35	5077.79	5077.23	5076.67
5083.31	5082.30	5082.08	5081.71	5081.19	5080.65	5080.10	5079.55	5078.99	5078.43	5077.87	5077.31	5076.75	5076.19
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5081.77	5080.76	5080.54	5080.17	5079.65	5079.11	5078.56	5078.01	5077.45	5076.89	5076.33	5075.77	5075.21	5074.65
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PROPOSED RETENTION POND 2 OF 3
 DESIGN STORM EVENT = 100 YEAR 24 HOUR
 RELEASE RATE = 0 CFS (FULL RETENTION)
 REQUIRED RETENTION VOLUME = 3,675 CF
 PROVIDED RETENTION VOLUME = 6,204 CF
 FREEBOARD = 1.0 FEET
 SIDE SLOPES = 4:1 MAX
 TOP OF POND ELE. = 5070.0
 BOTTOM OF POND ELE. = 5066.0
 H.W.E. = 5069.0

PROPOSED RETENTION POND 3 OF 3
 DESIGN STORM EVENT = 100 YEAR 24 HOUR
 RELEASE RATE = 0 CFS (FULL RETENTION)
 REQUIRED RETENTION VOLUME = 2,450 CF
 PROVIDED RETENTION VOLUME = 4,069 CF
 FREEBOARD = 0.7 FEET
 SIDE SLOPES = 4:1 MAX
 TOP OF POND ELE. = 5063.0
 BOTTOM OF POND ELE. = 5060.0
 H.W.E. = 5062.3

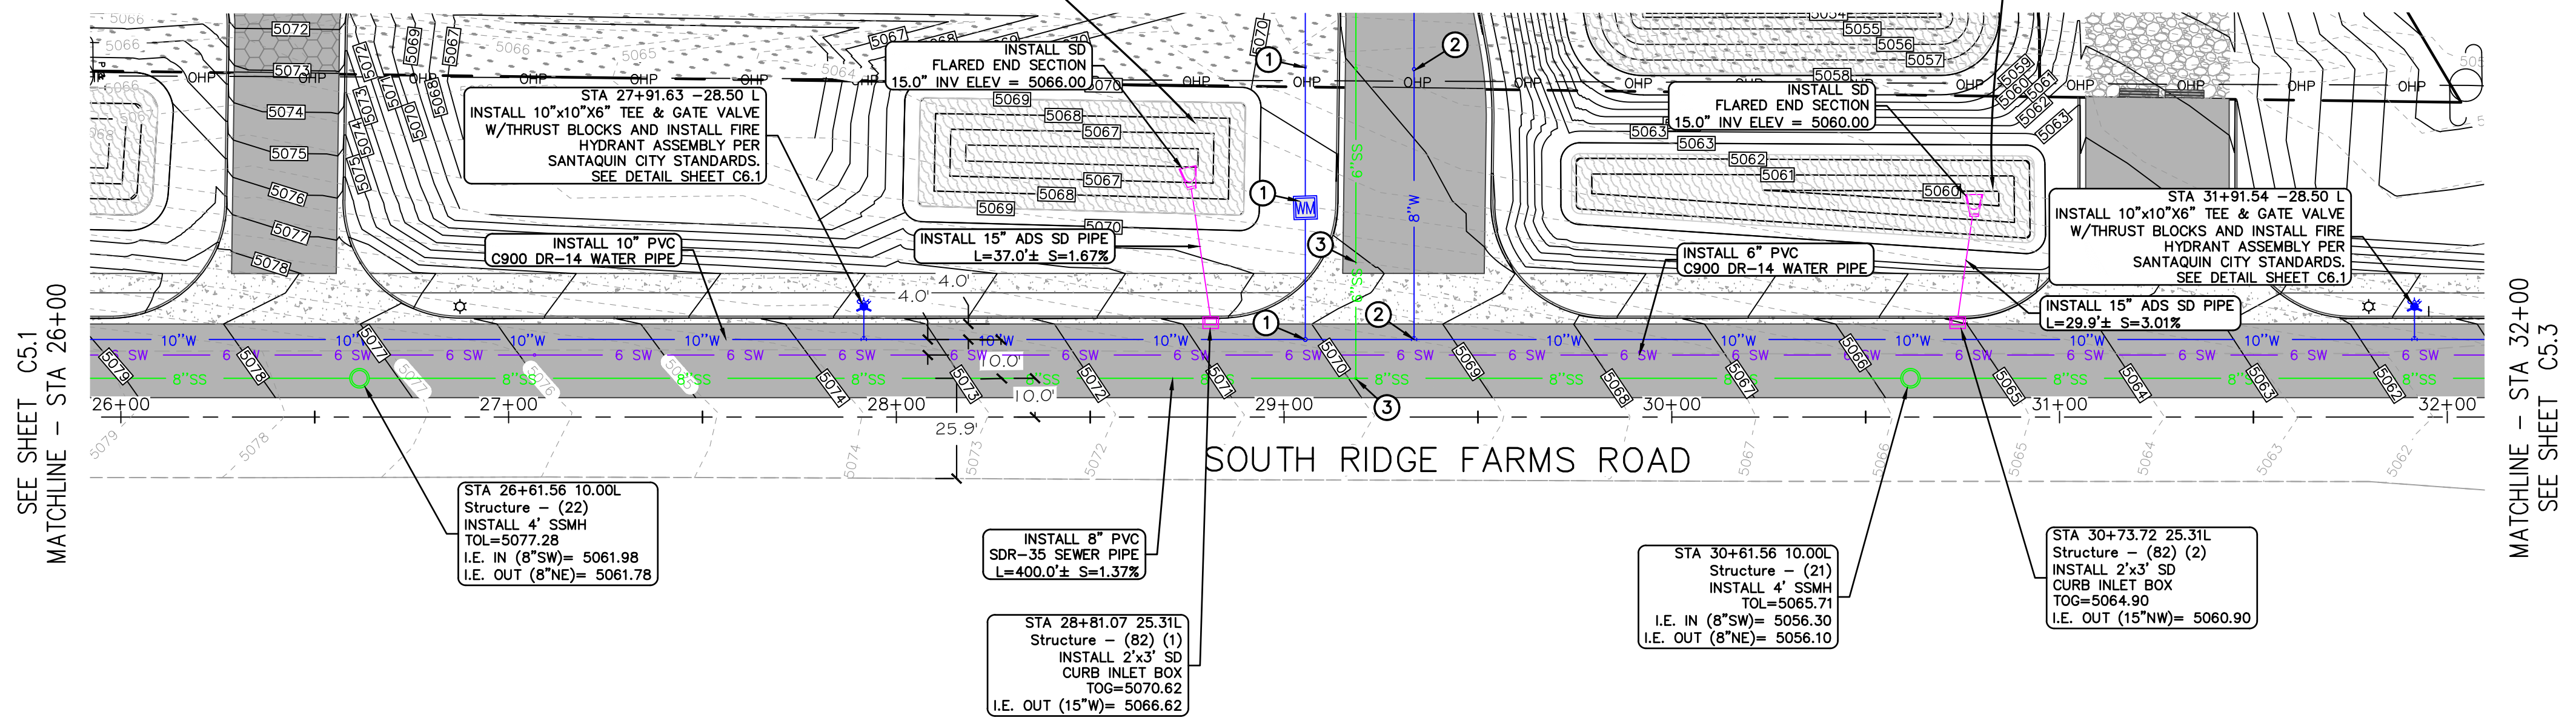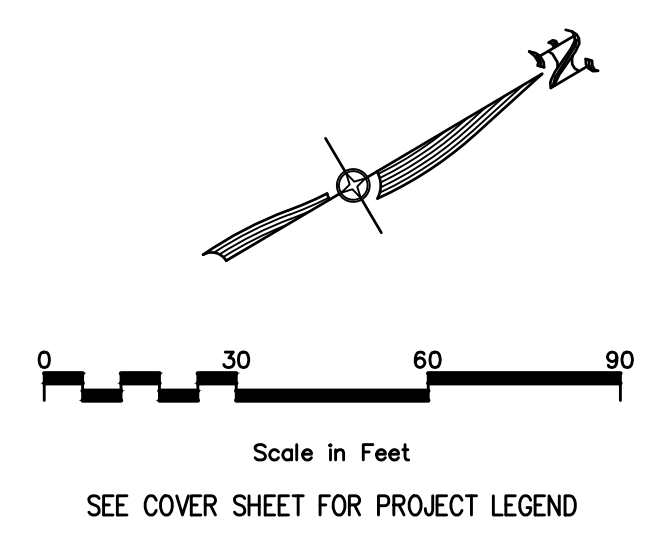

- UTILITY PLAN NOTES:
- CONNECT TO PROPOSED 10" WATER MAIN AND INSTALL 2" WATER LATERAL AND 2" WATER METER FOR CULINARY PURPOSES. CAP AND MARK LATERAL 5' PAST PROPERTY LINE FOR FUTURE CONNECTION. ALL WORK TO BE DONE PER SANTAQUIN STANDARDS.
 - CONNECT TO PROPOSED 10" WATER MAIN VIA TEE (W/8" GATE VALVE AND THRUST BLOCKS) AND INSTALL 8" FIRE LINE LATERAL. CAP AND MARK LATERAL 5' PAST PROPERTY LINE FOR FUTURE CONNECTION.
 - CONNECT TO PROPOSED 8" SEWER MAIN (I.E.(8"MAIN)=5058.26, I.E.(6"LAT)=5068.93) AND INSTALL 84.9' OF 6" PVC SDR-35 SEWER LATERAL, S=1.48%. CAP AND MARK LATERAL 5' PAST PROPERTY LINE FOR FUTURE CONNECTION (I.E.(CAP)=5060.19). ALL WORK TO BE DONE PER SANTAQUIN STANDARDS.

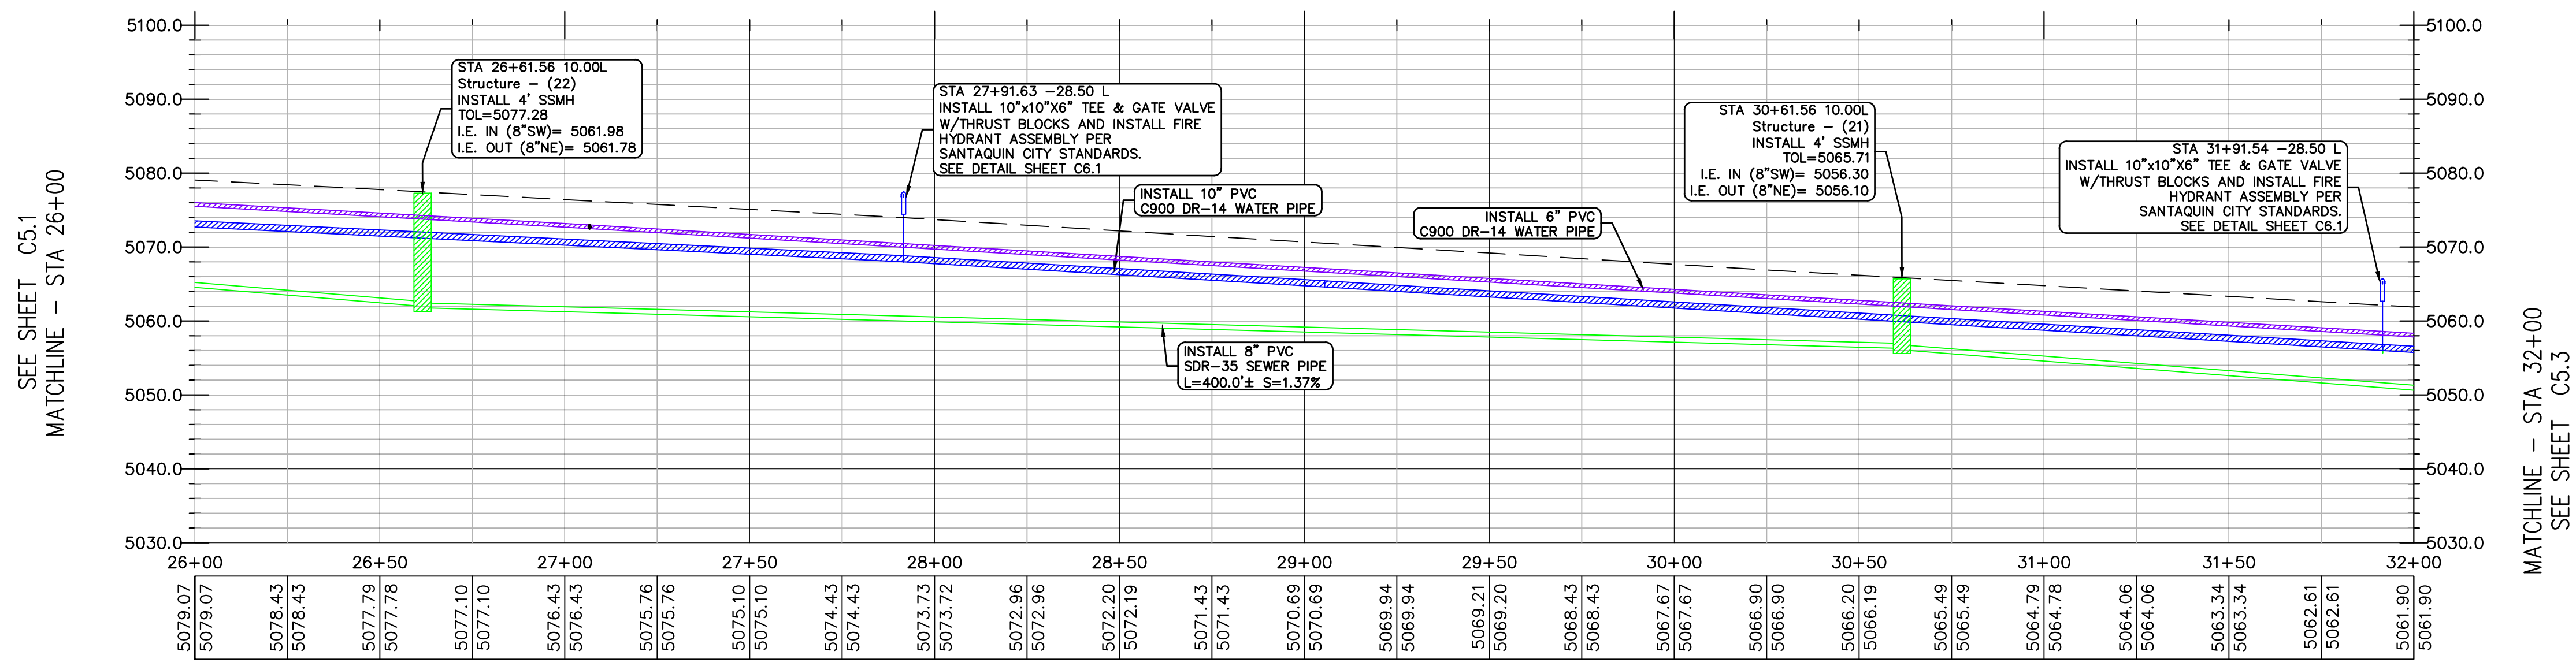

NO.	REVISIONS	BY	DATE




DESIGNER: SDT
 PROJECT ENGINEER: SDT

CIVIL ENGINEERING + SURVEYING
 10718 S BECKSTEAD LANE, SUITE 102
 South Jordan, Utah - 801-549-6296

SANTAQUIN RESEARCH & TECH CENTER - PHASE 1
 SOUTH RIDGE FARMS ROAD, SANTAQUIN UT, 84655
 UTILITY PLAN AND PROFILE
 STA: 26+00 TO 32+00



SHEET NO. C5.2
 PROJECT ID: E23-143
 DATE: 12/15/23
 FILE NAME: PRJ-SJT
 SCALE: 1"=30'

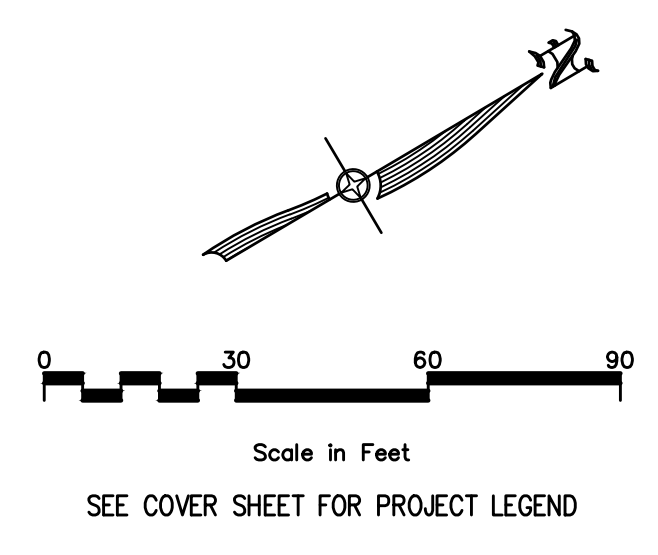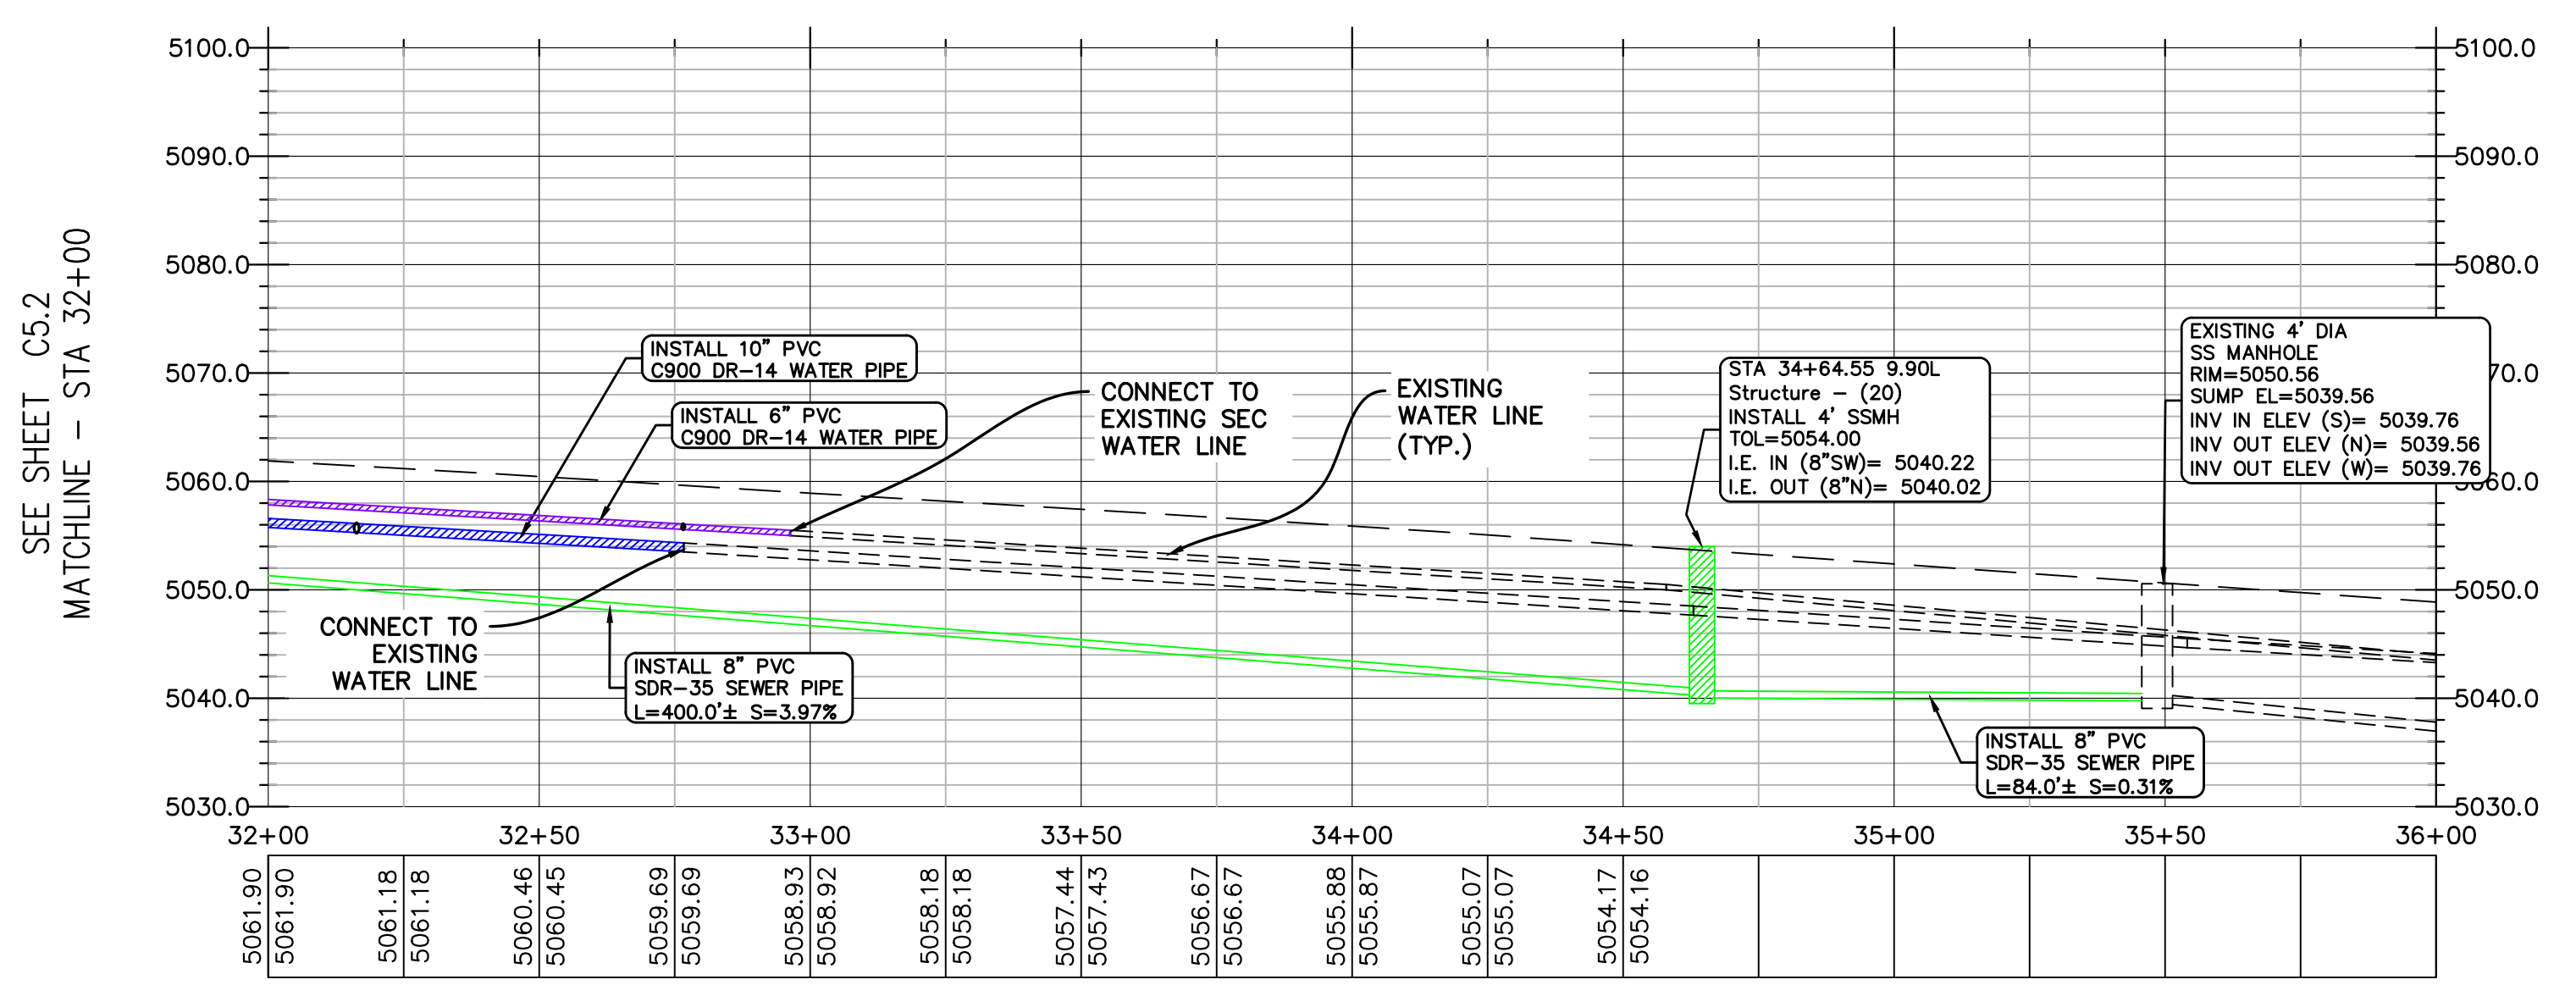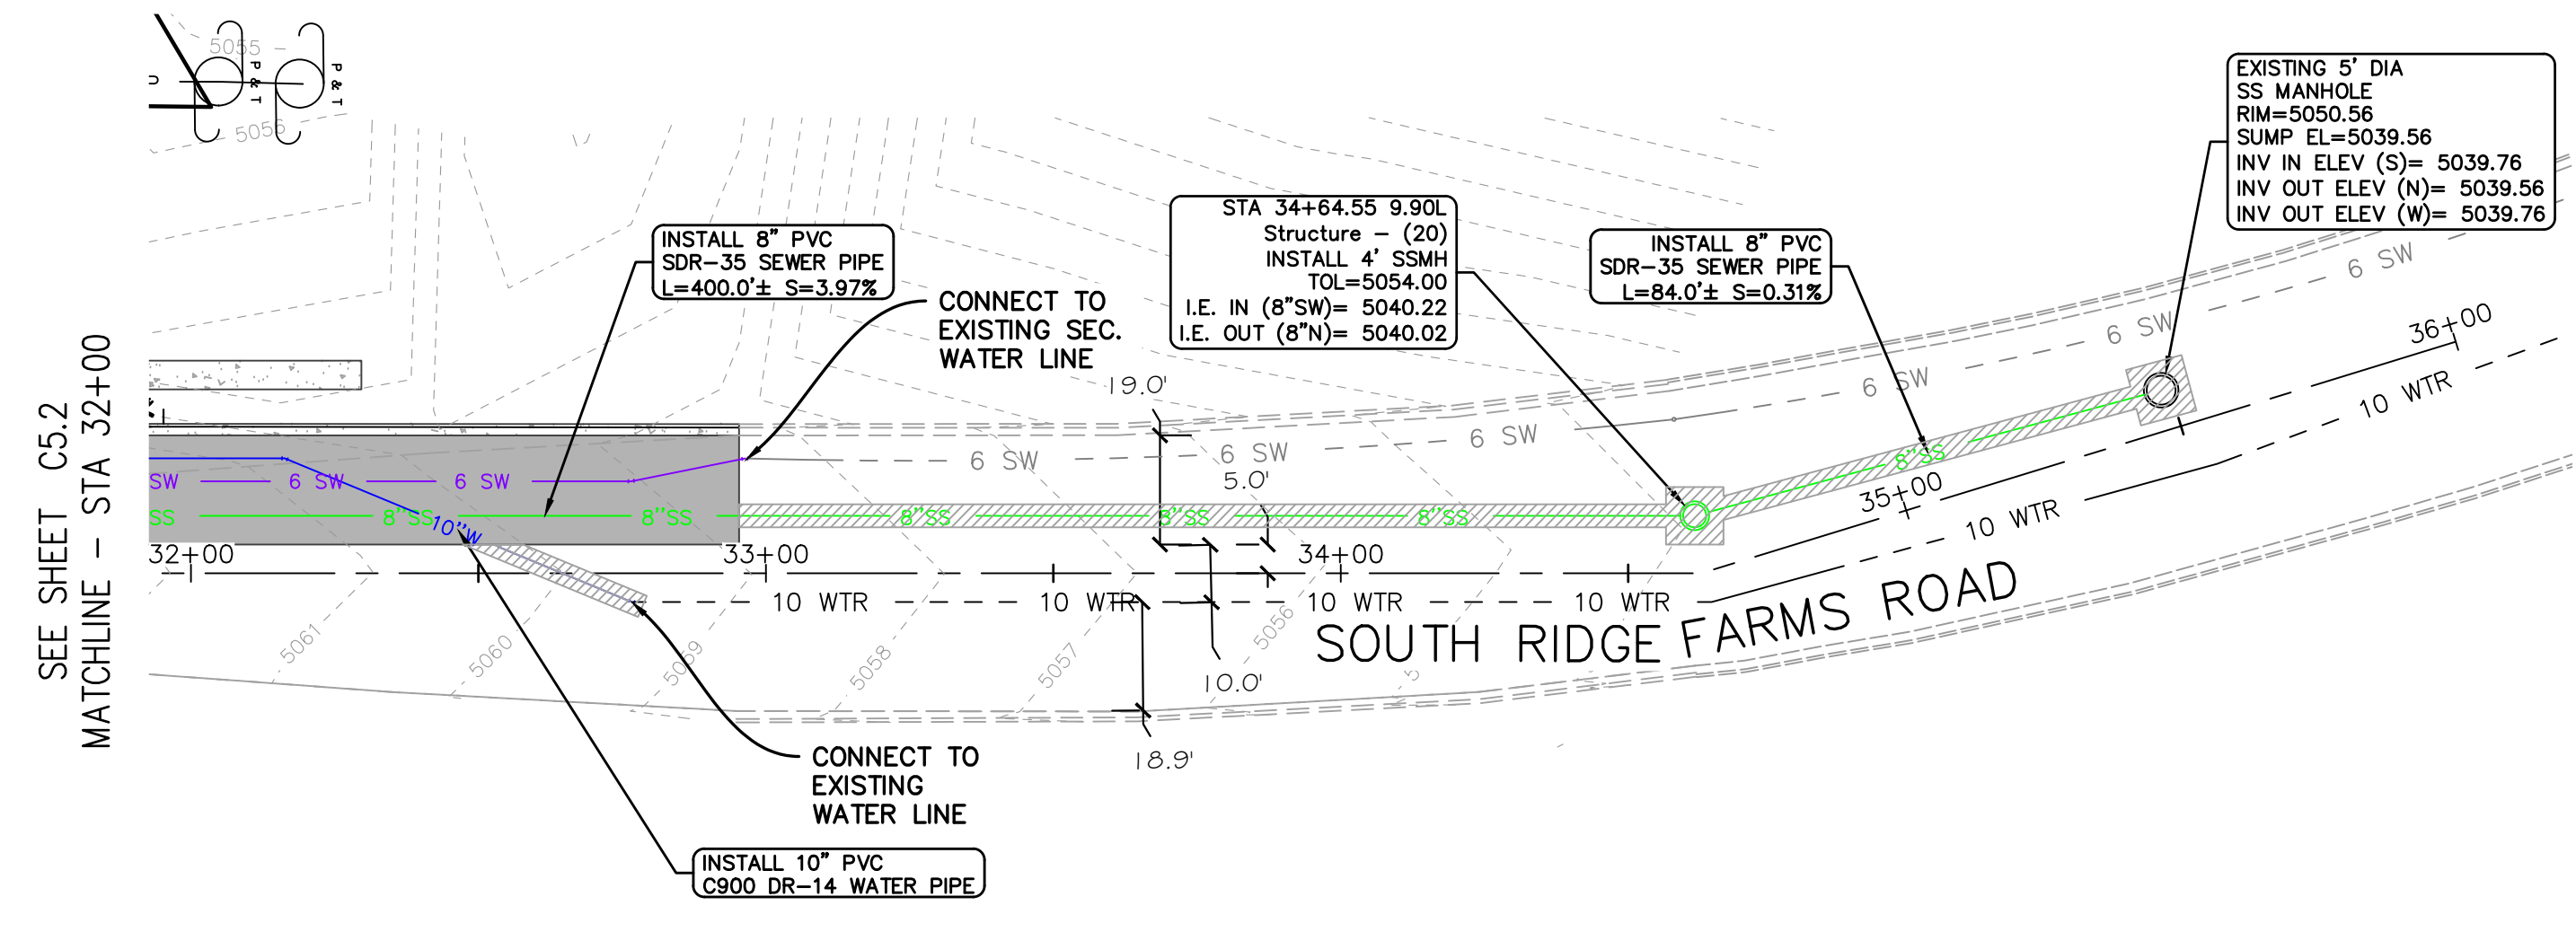

SEE COVER SHEET FOR PROJECT LEGEND

SHEET LEGEND

- PROPOSED ASPHALT
- ASPHALT REPLACEMENT

NO.	REVISIONS	BY	DATE

DESIGNER: SDT PROJECT ENGINEER: SDT

CIVIL ENGINEERING + SURVEYING


CIR

10718 S BECKSTEAD LANE, SUITE 102
South Jordan, Utah - 801-549-6296


SANTAQUIN RESEARCH & TECH CENTER - PHASE 1
SOUTH RIDGE FARMS ROAD, SANTAQUIN UT, 84655
UTILITY PLAN AND PROFILE
STA: 32+00 TO 36+00




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PROJECT ID	E23-143
DATE	12/15/23
FILE NAME	PRJ-SJ
SCALE	1" = 30'

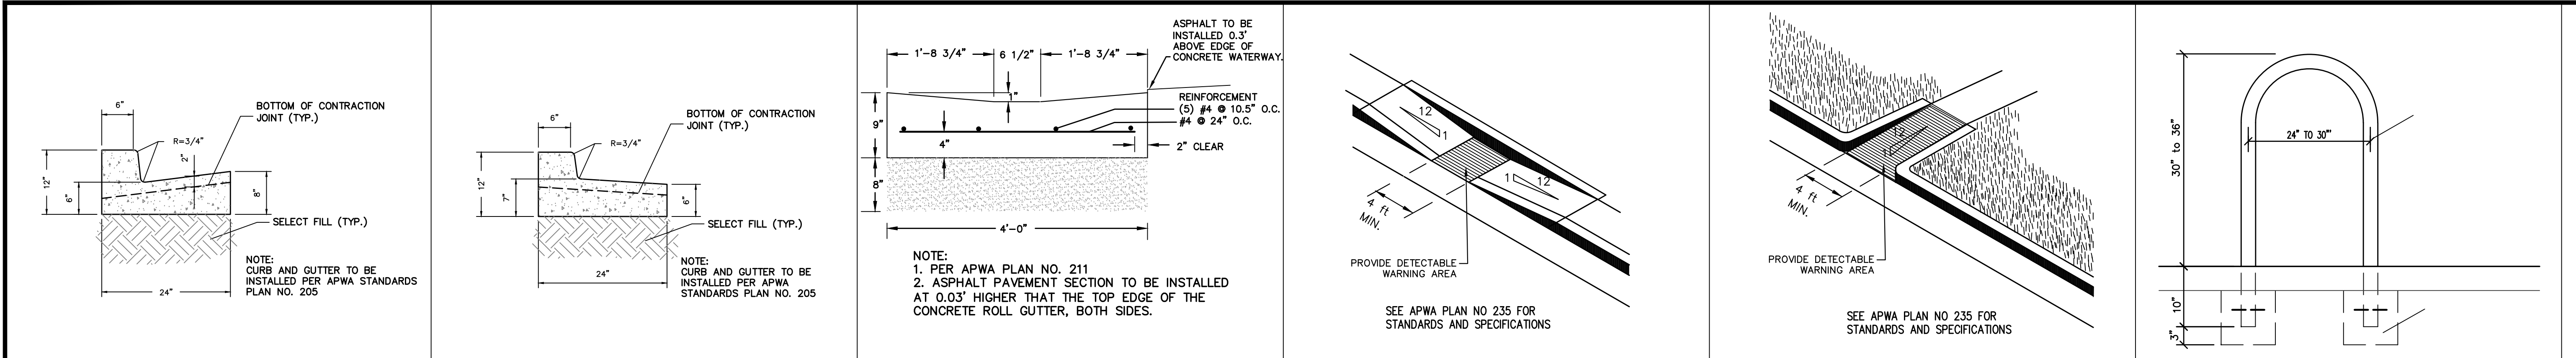


1 24" CURB & GUTTER N.T.S. 2 24" REVERSE PAN CURB & GUTTER N.T.S. 3 4'-0" ROLL GUTTER N.T.S. 4 ADA RAMP N.T.S. 5 ADA RAMP N.T.S. 6 INVERTED "U" BIKE RACK

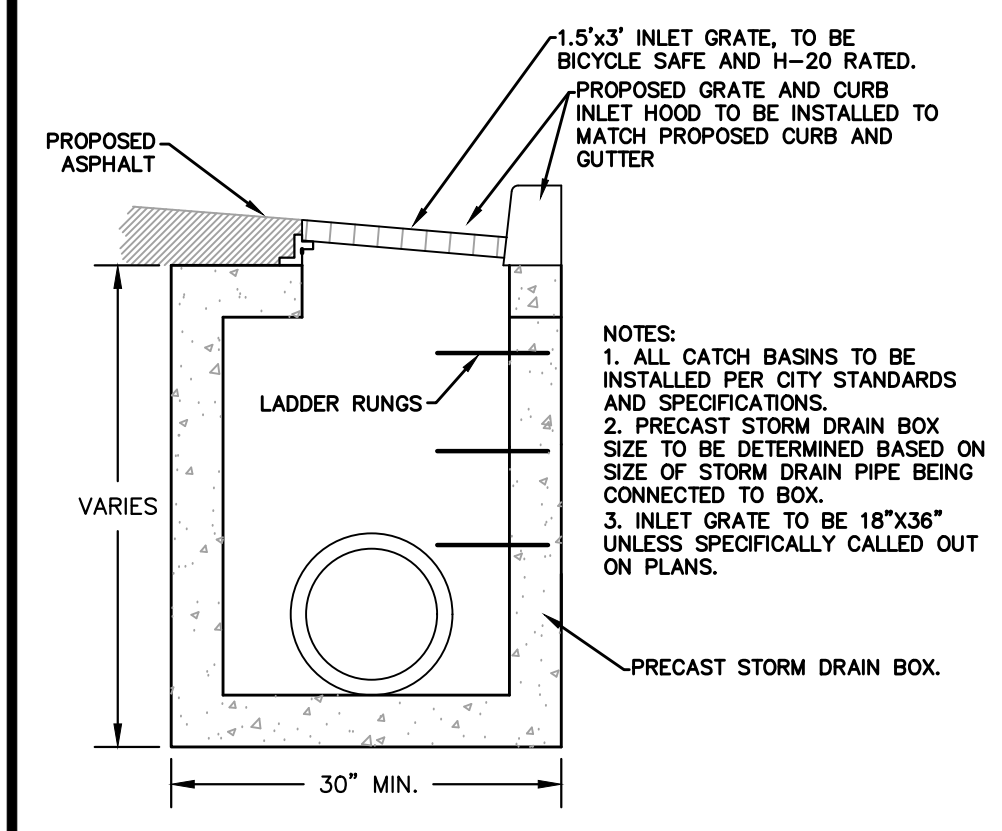


6 STANDARD STORM DRAIN CURB INLET BOX N.T.S.

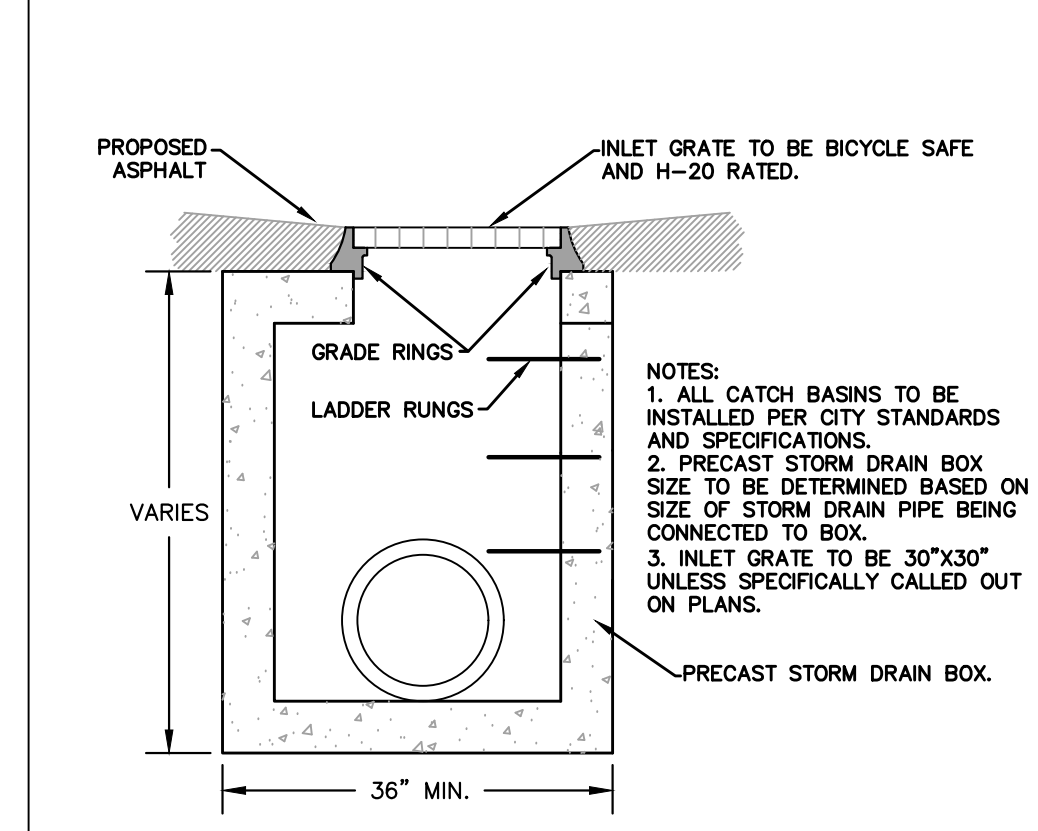


7 STANDARD STORM DRAIN INLET BOX N.T.S.

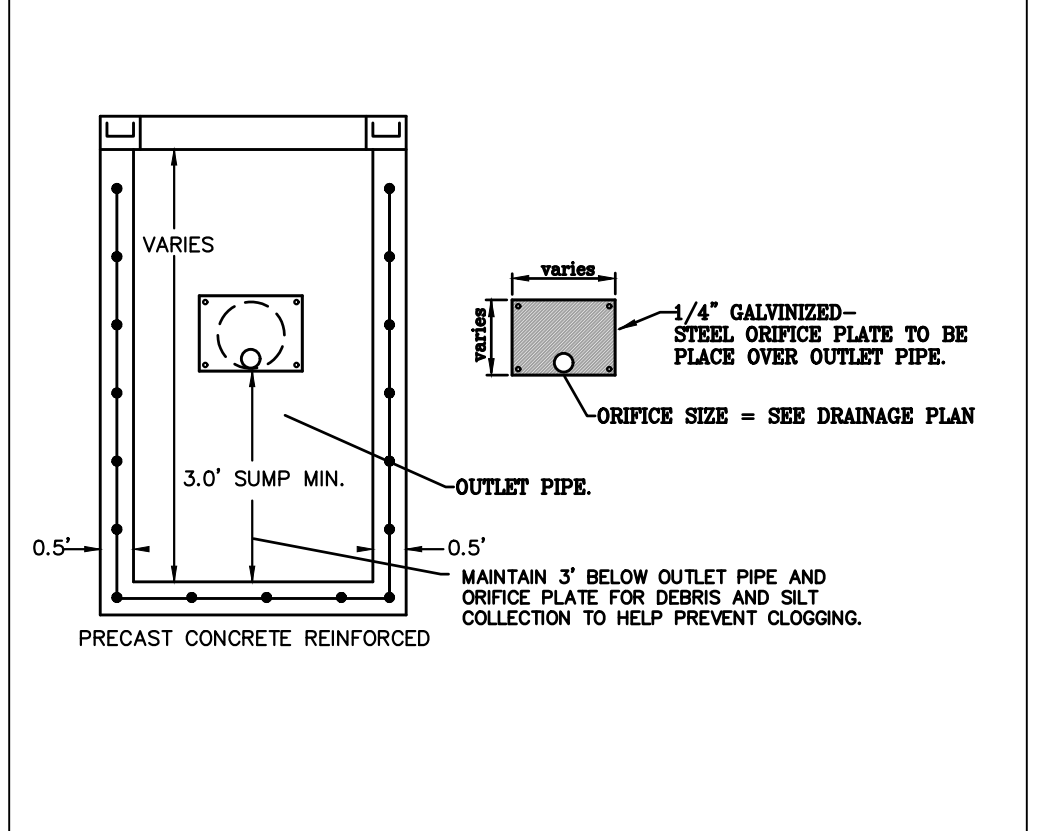


8 ORIFICE PLATE N.T.S.

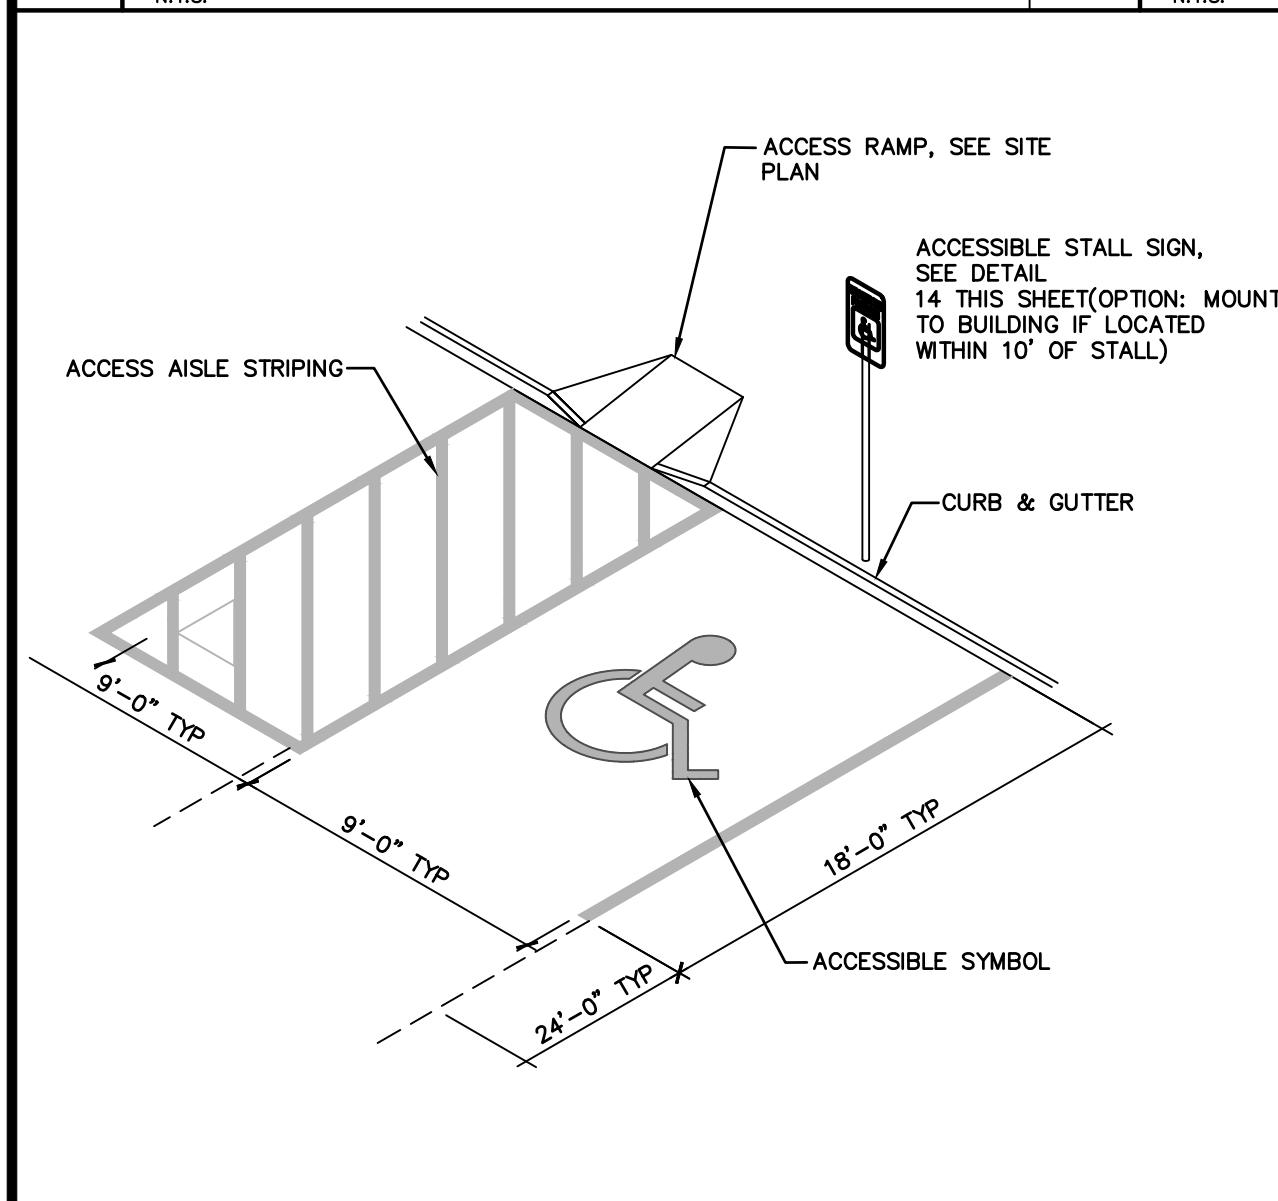


9 ACCESSIBLE PARKING STALL N.T.S.

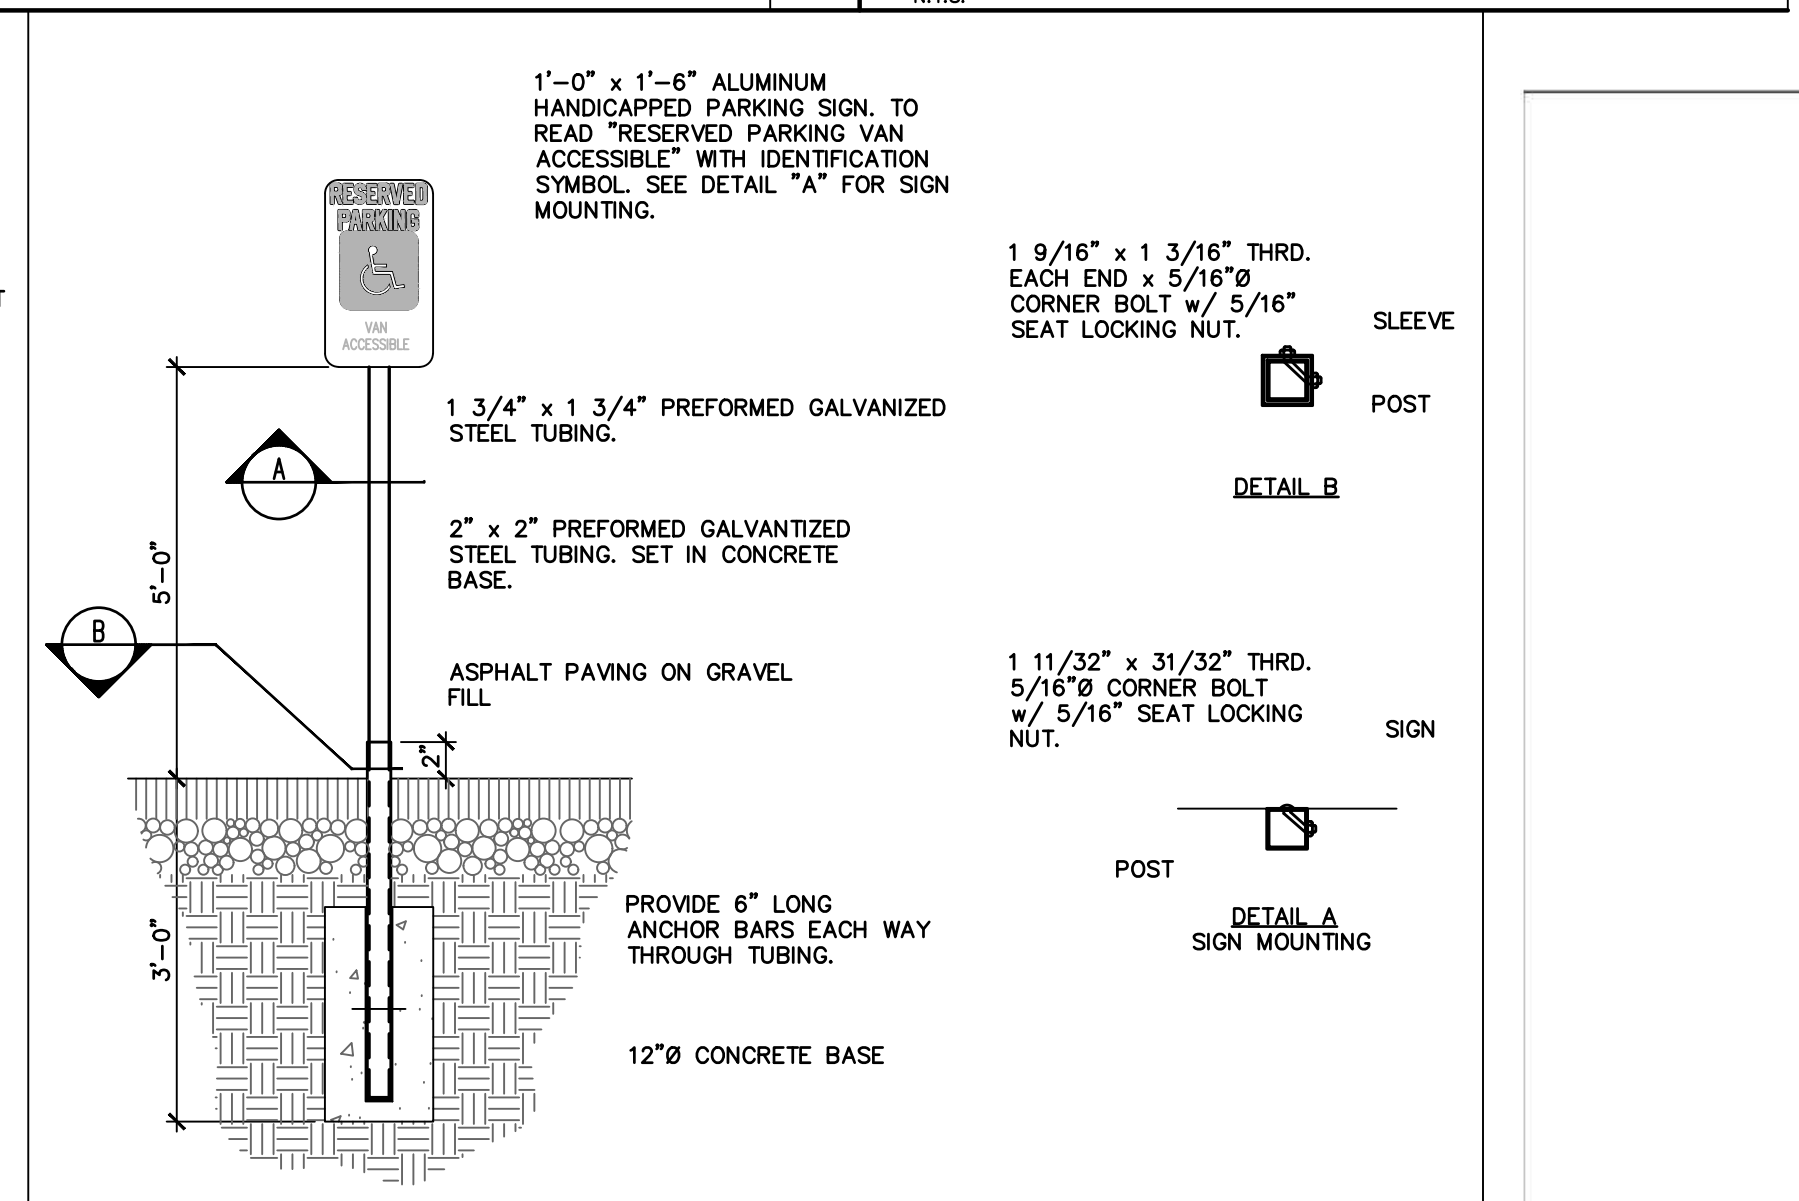

10 HANDICAPPED PARKING SIGN N.T.S.

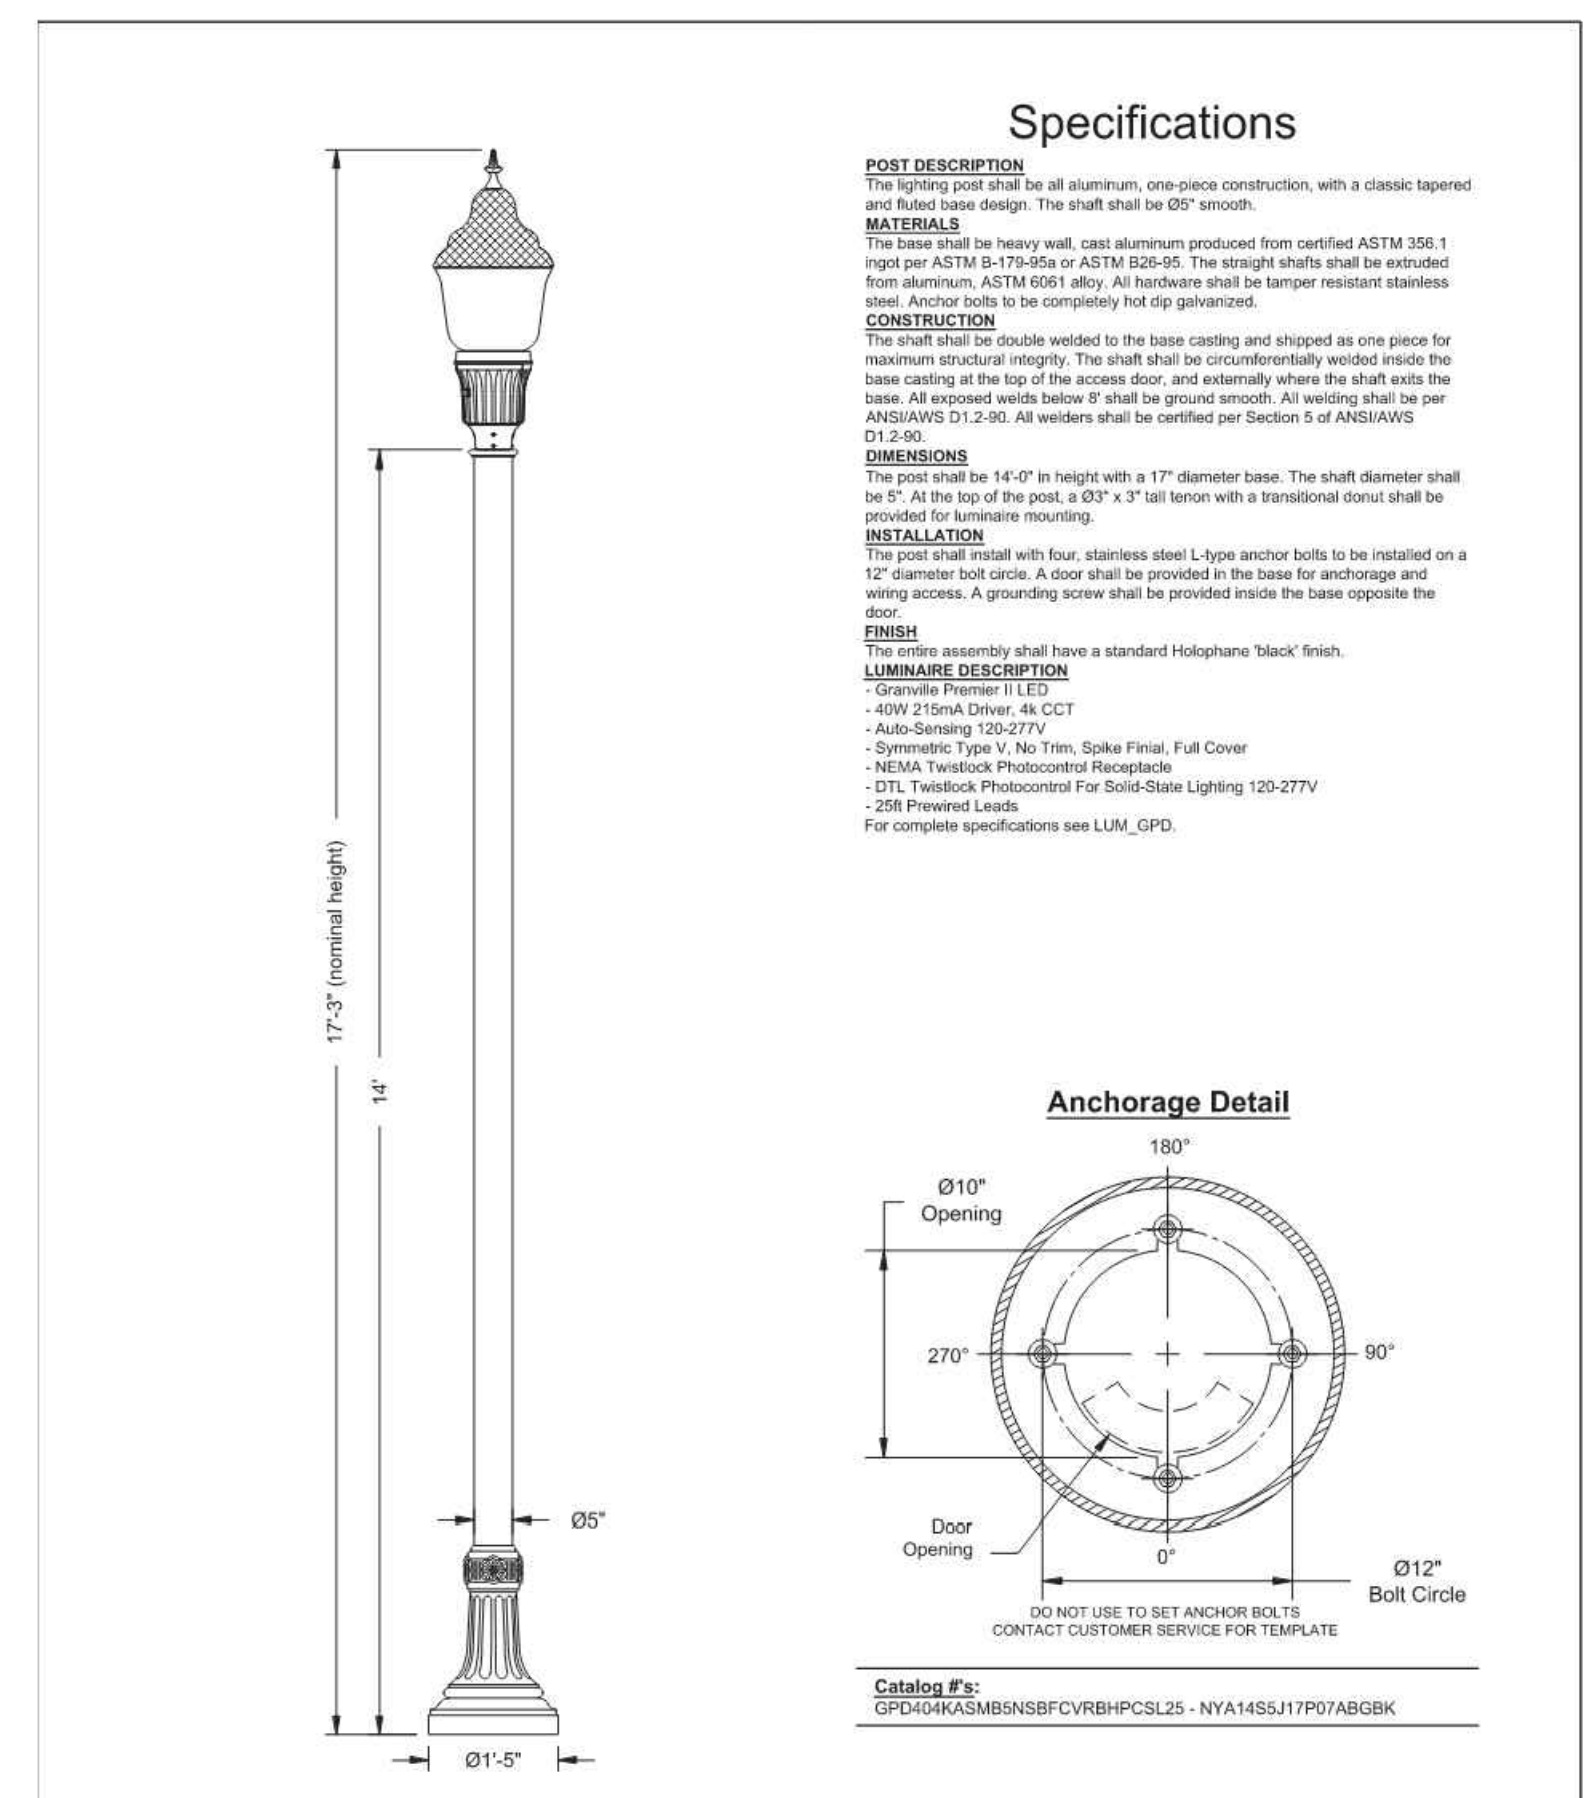

11 LOCAL AND COLLECTOR STREET LIGHTING DETAILS SANTAQUIN CITY 275 WEST MAIN STREET L1

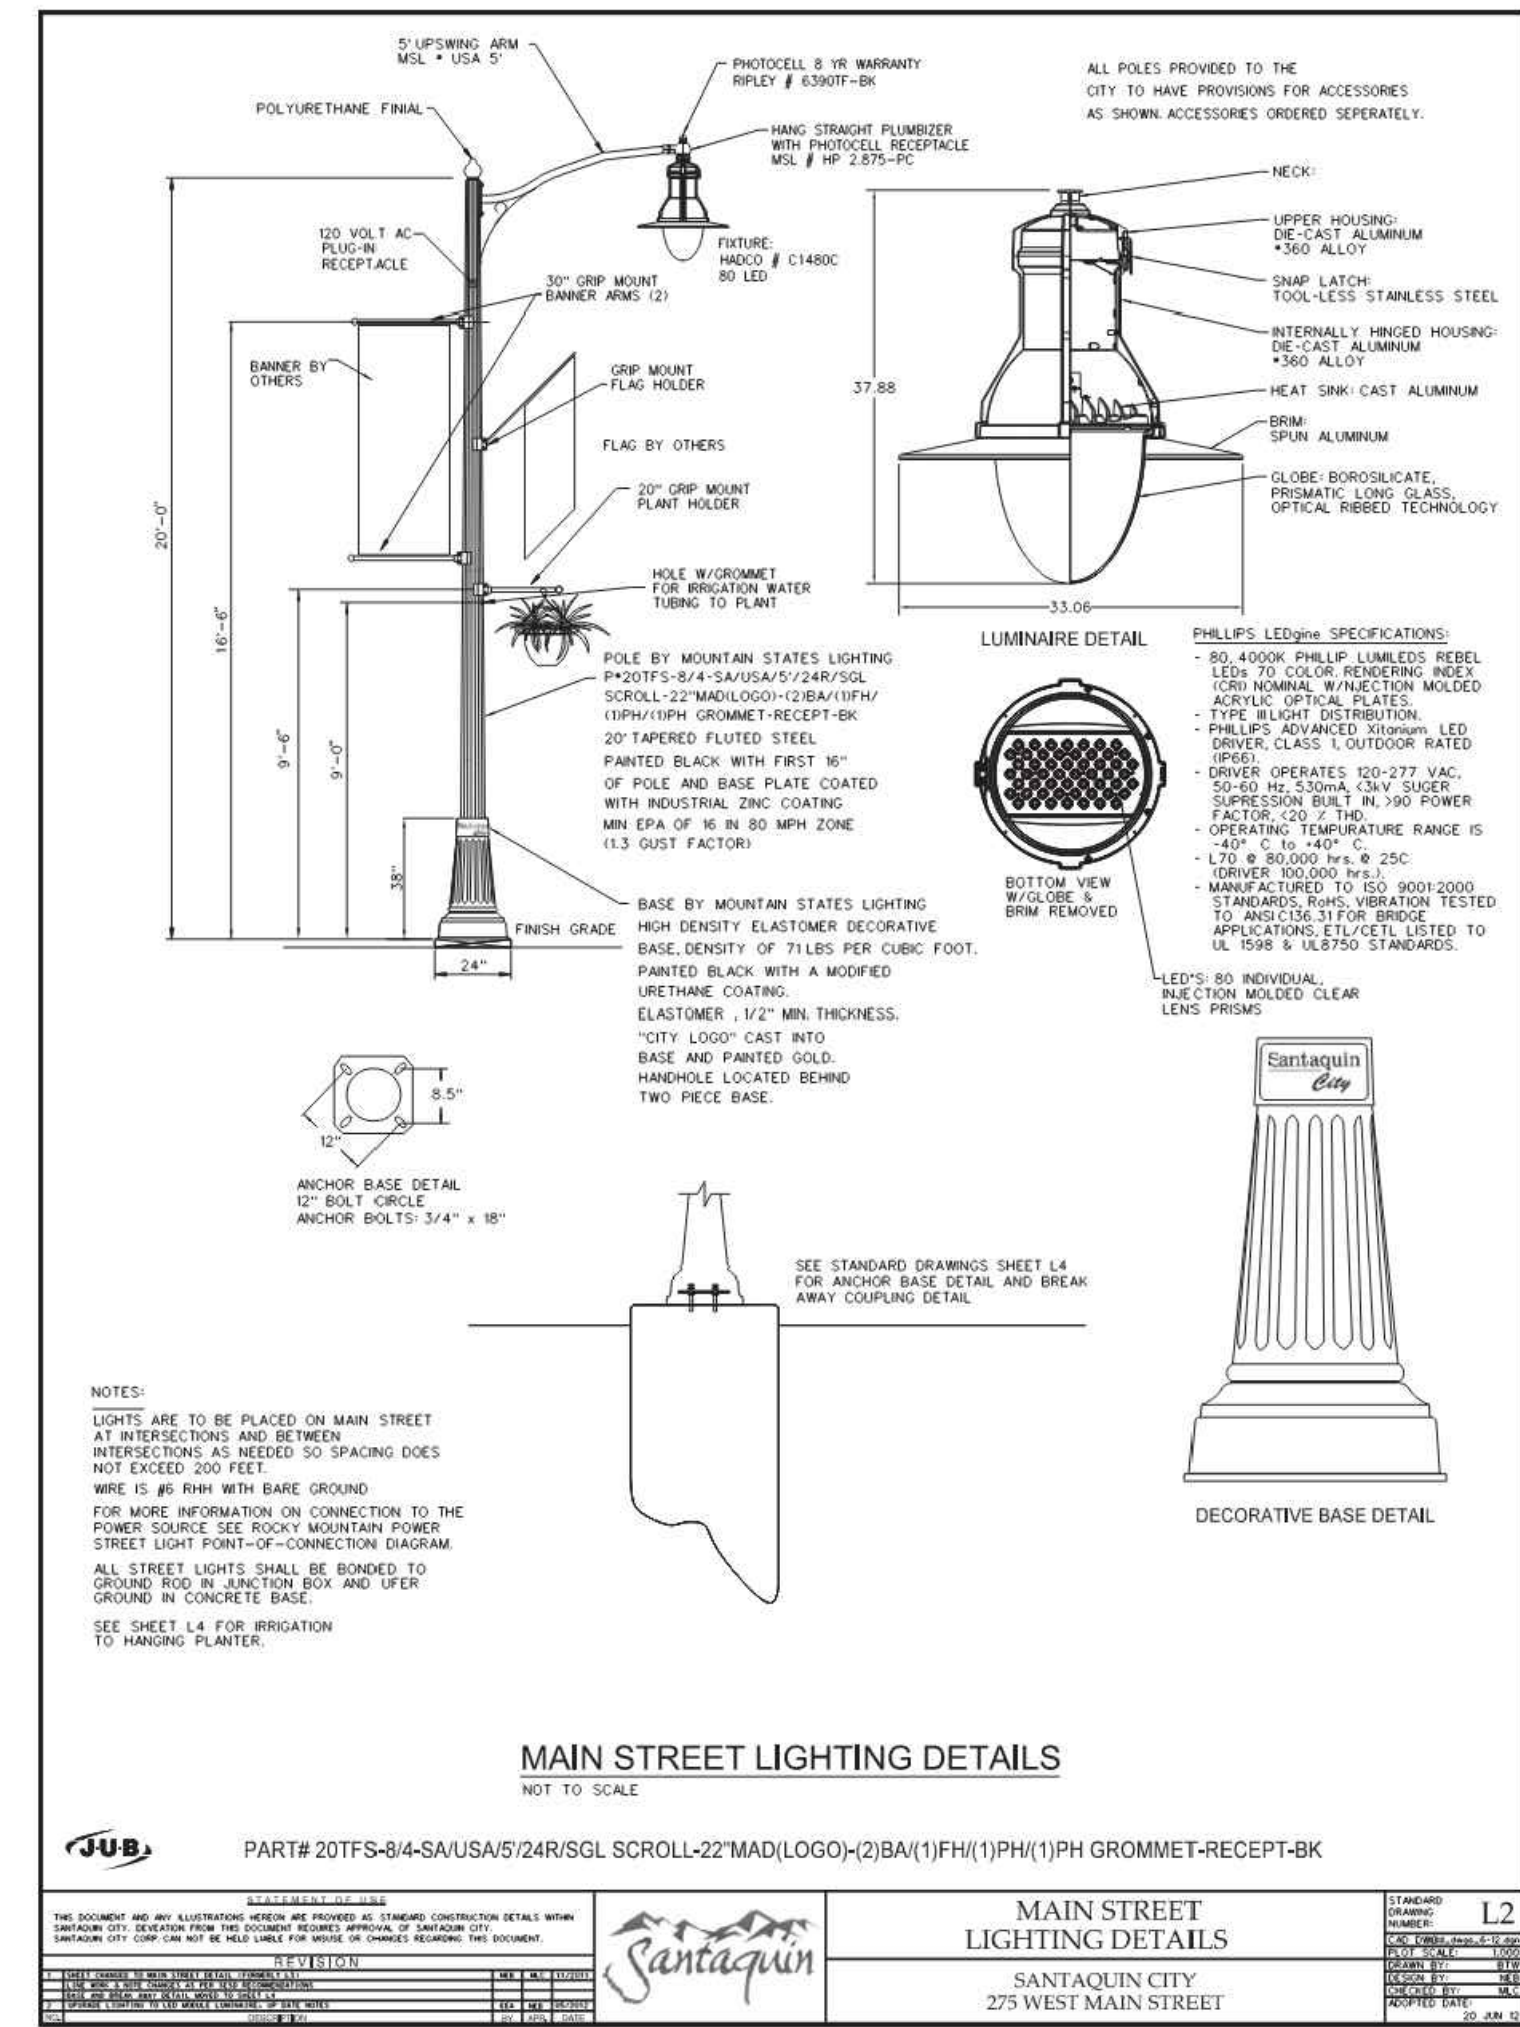









12 MAIN STREET LIGHTING DETAILS SANTAQUIN CITY 275 WEST MAIN STREET L2



NO.	REVISIONS	BY	DATE

DESIGNER: SDT PROJECT ENGINEER: SDT

SANTAQUIN RESEARCH & TECH CENTER - PHASE 1 SOUTH RIDGE FARMS ROAD, SANTAQUIN UT, 84655

BlueStakes.com

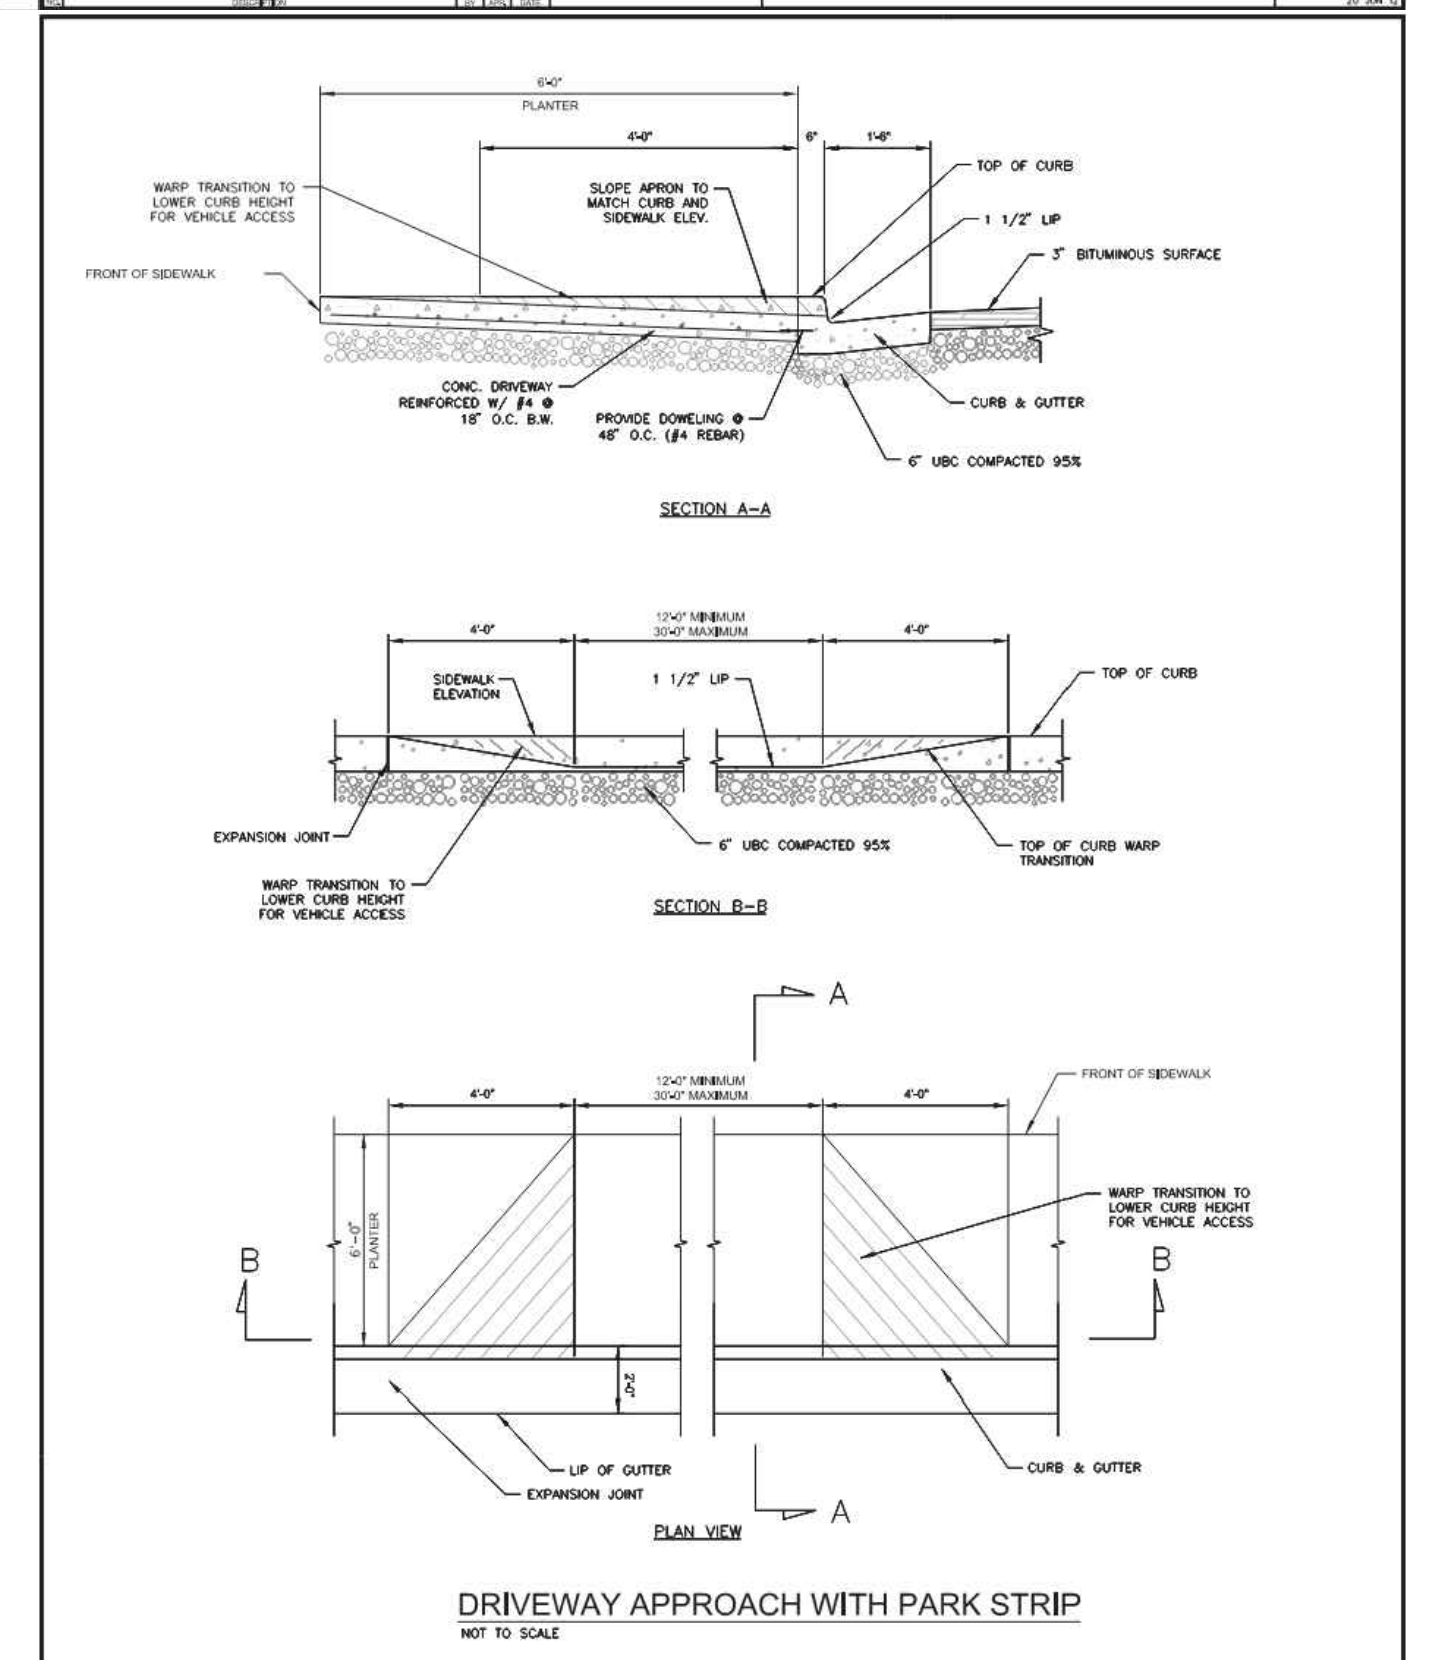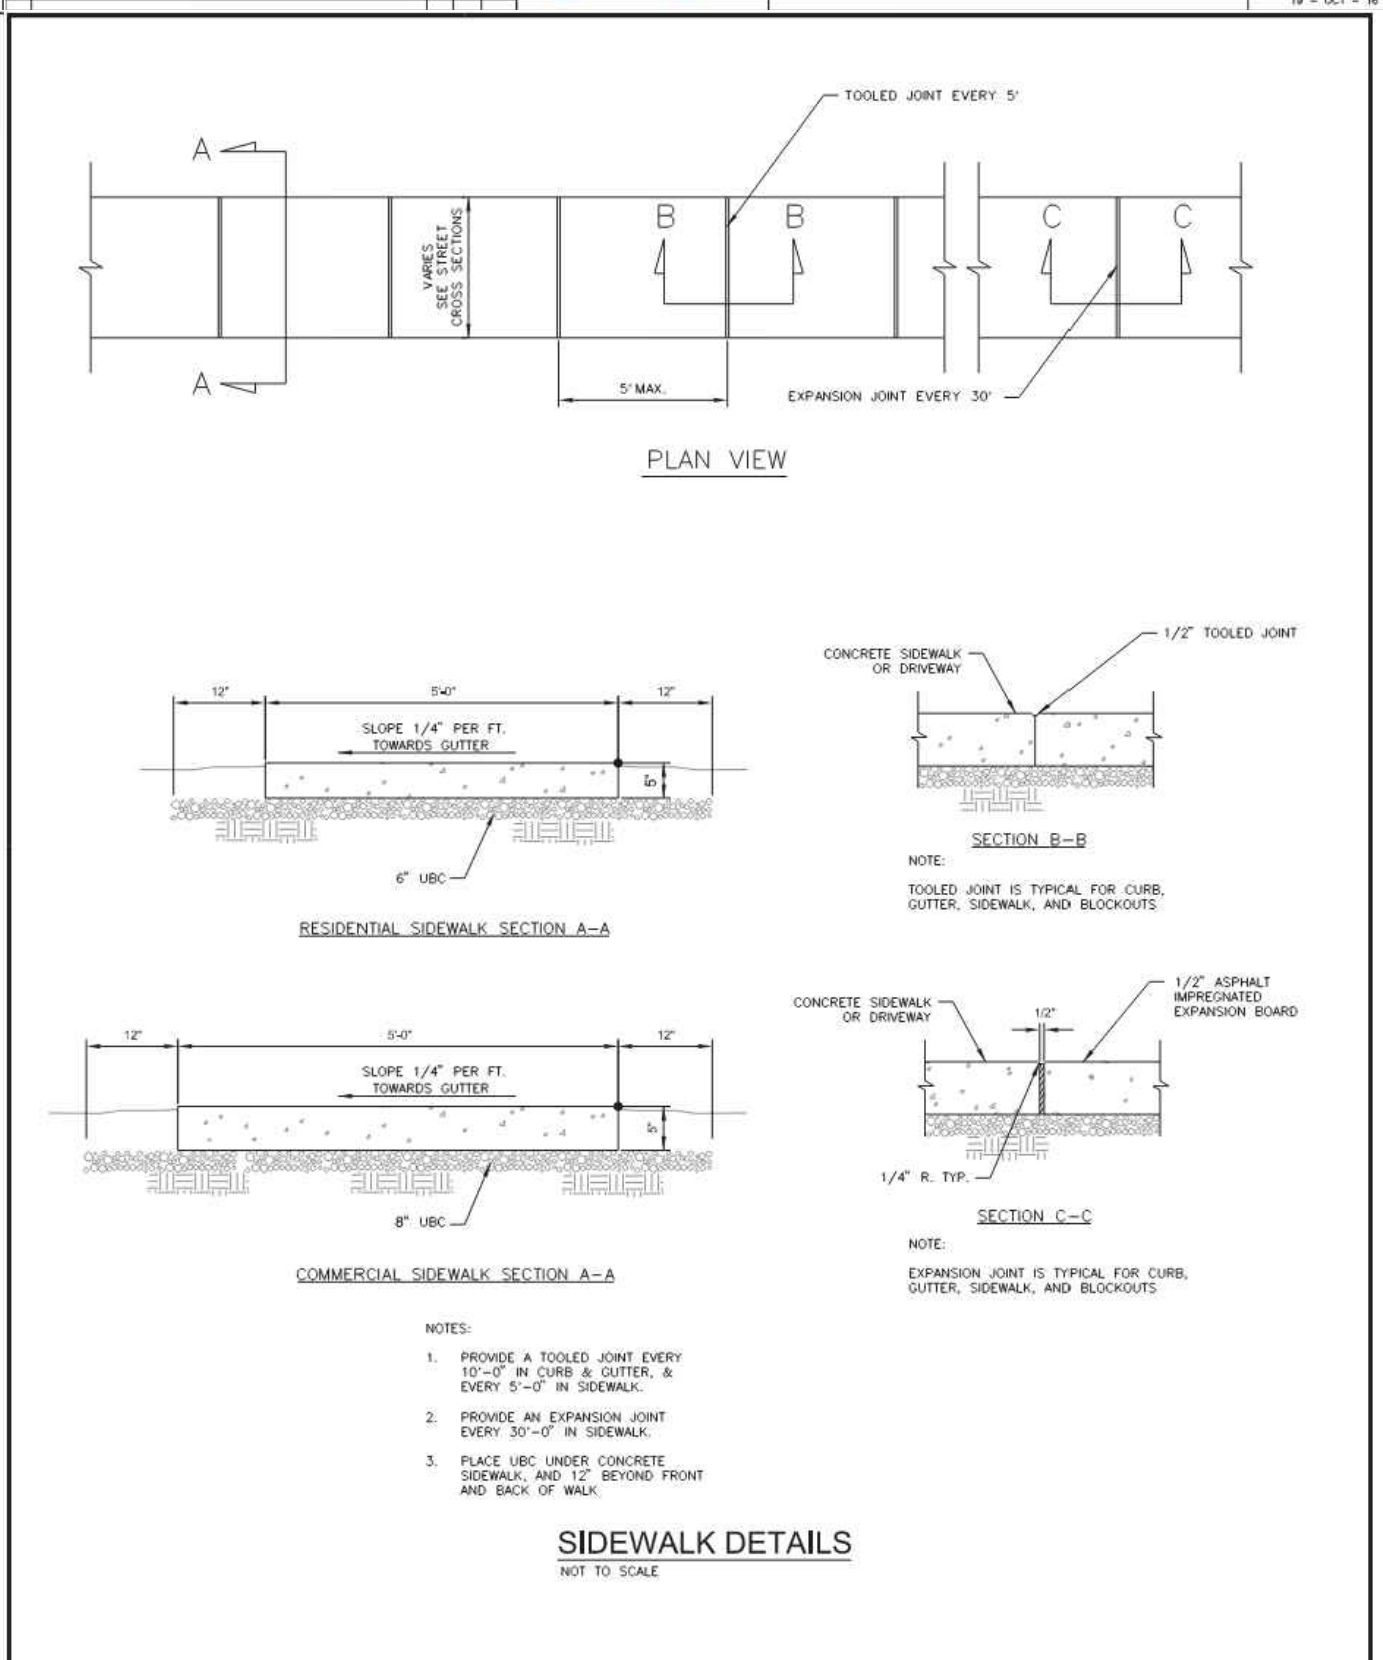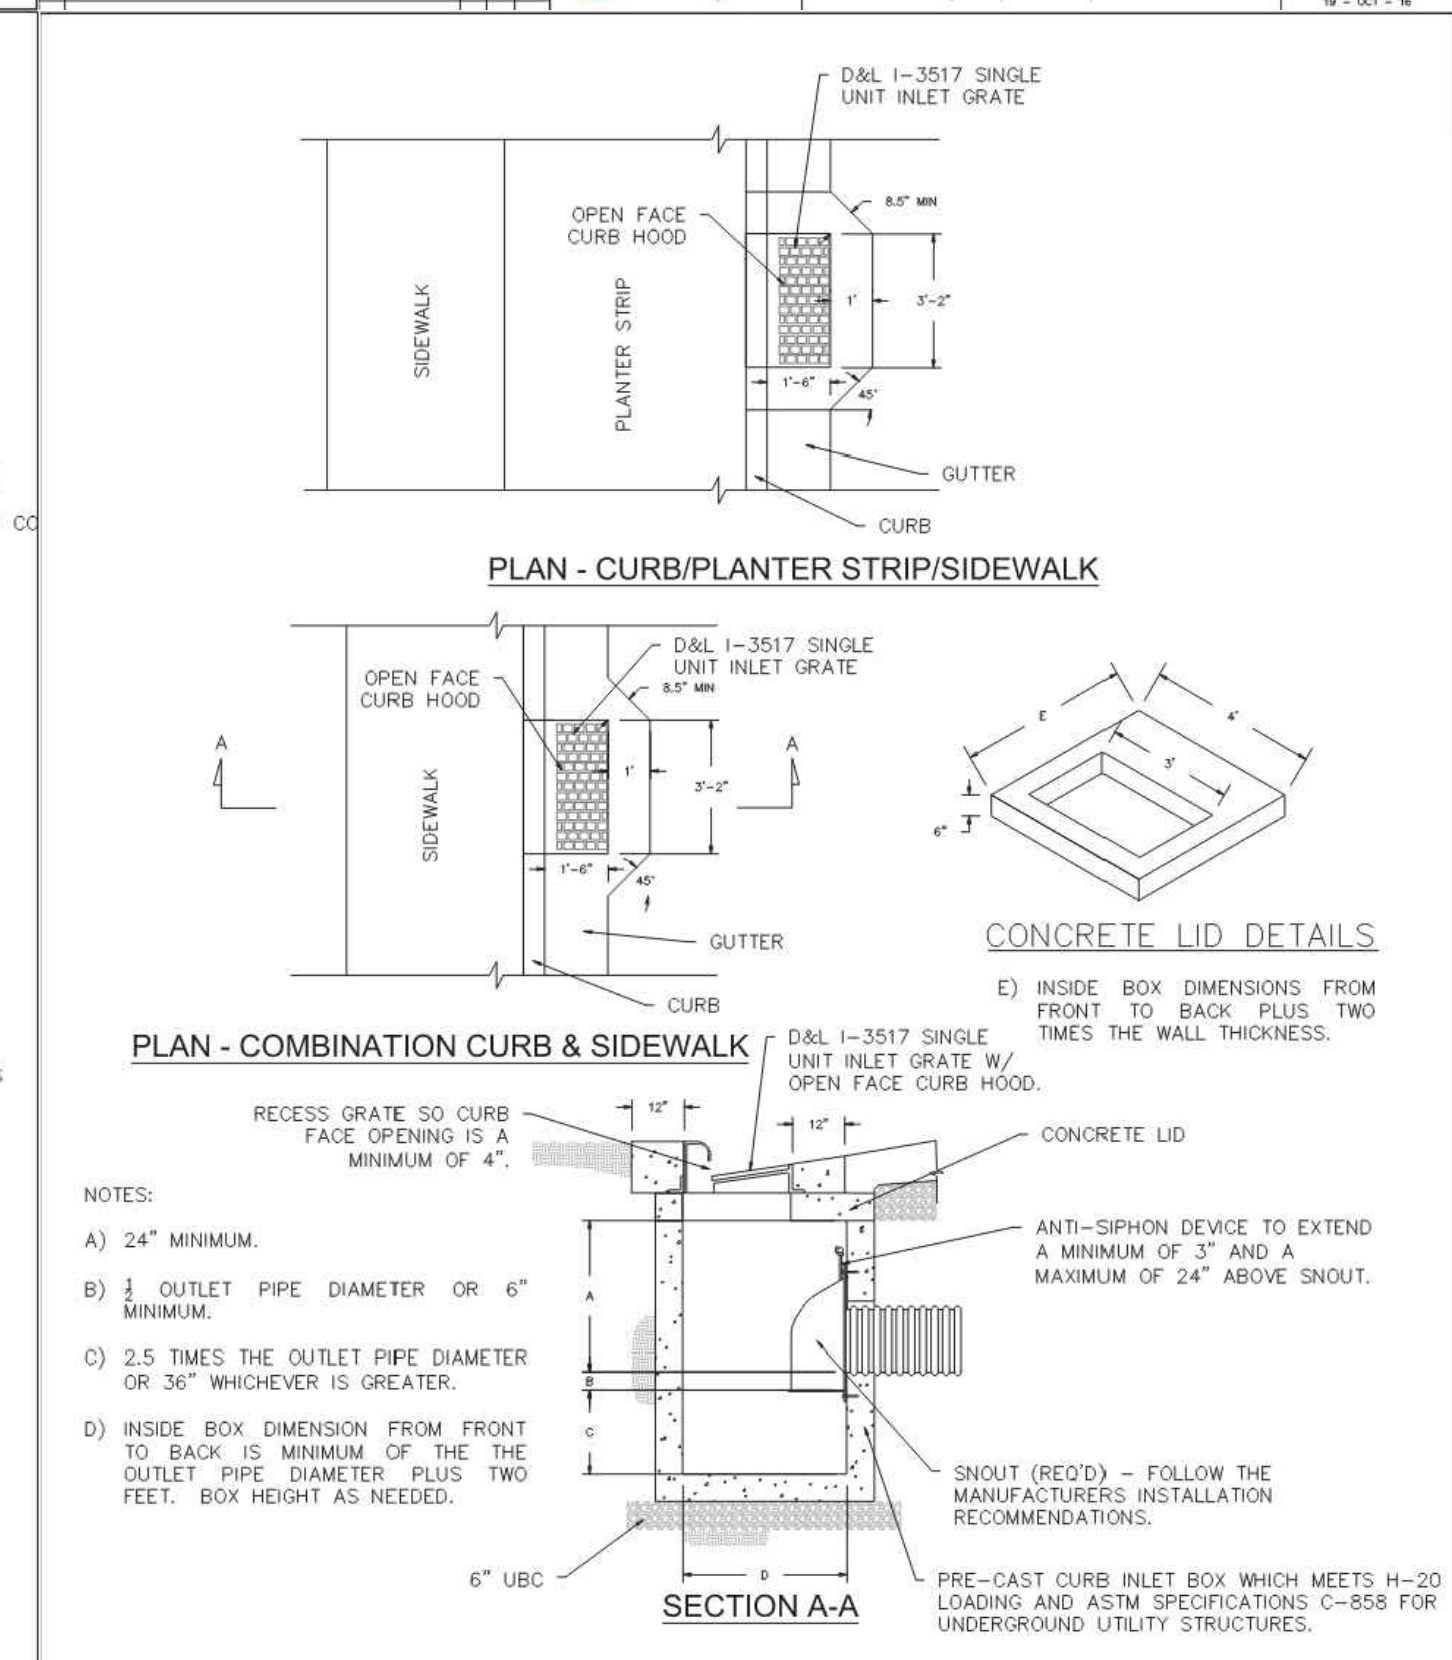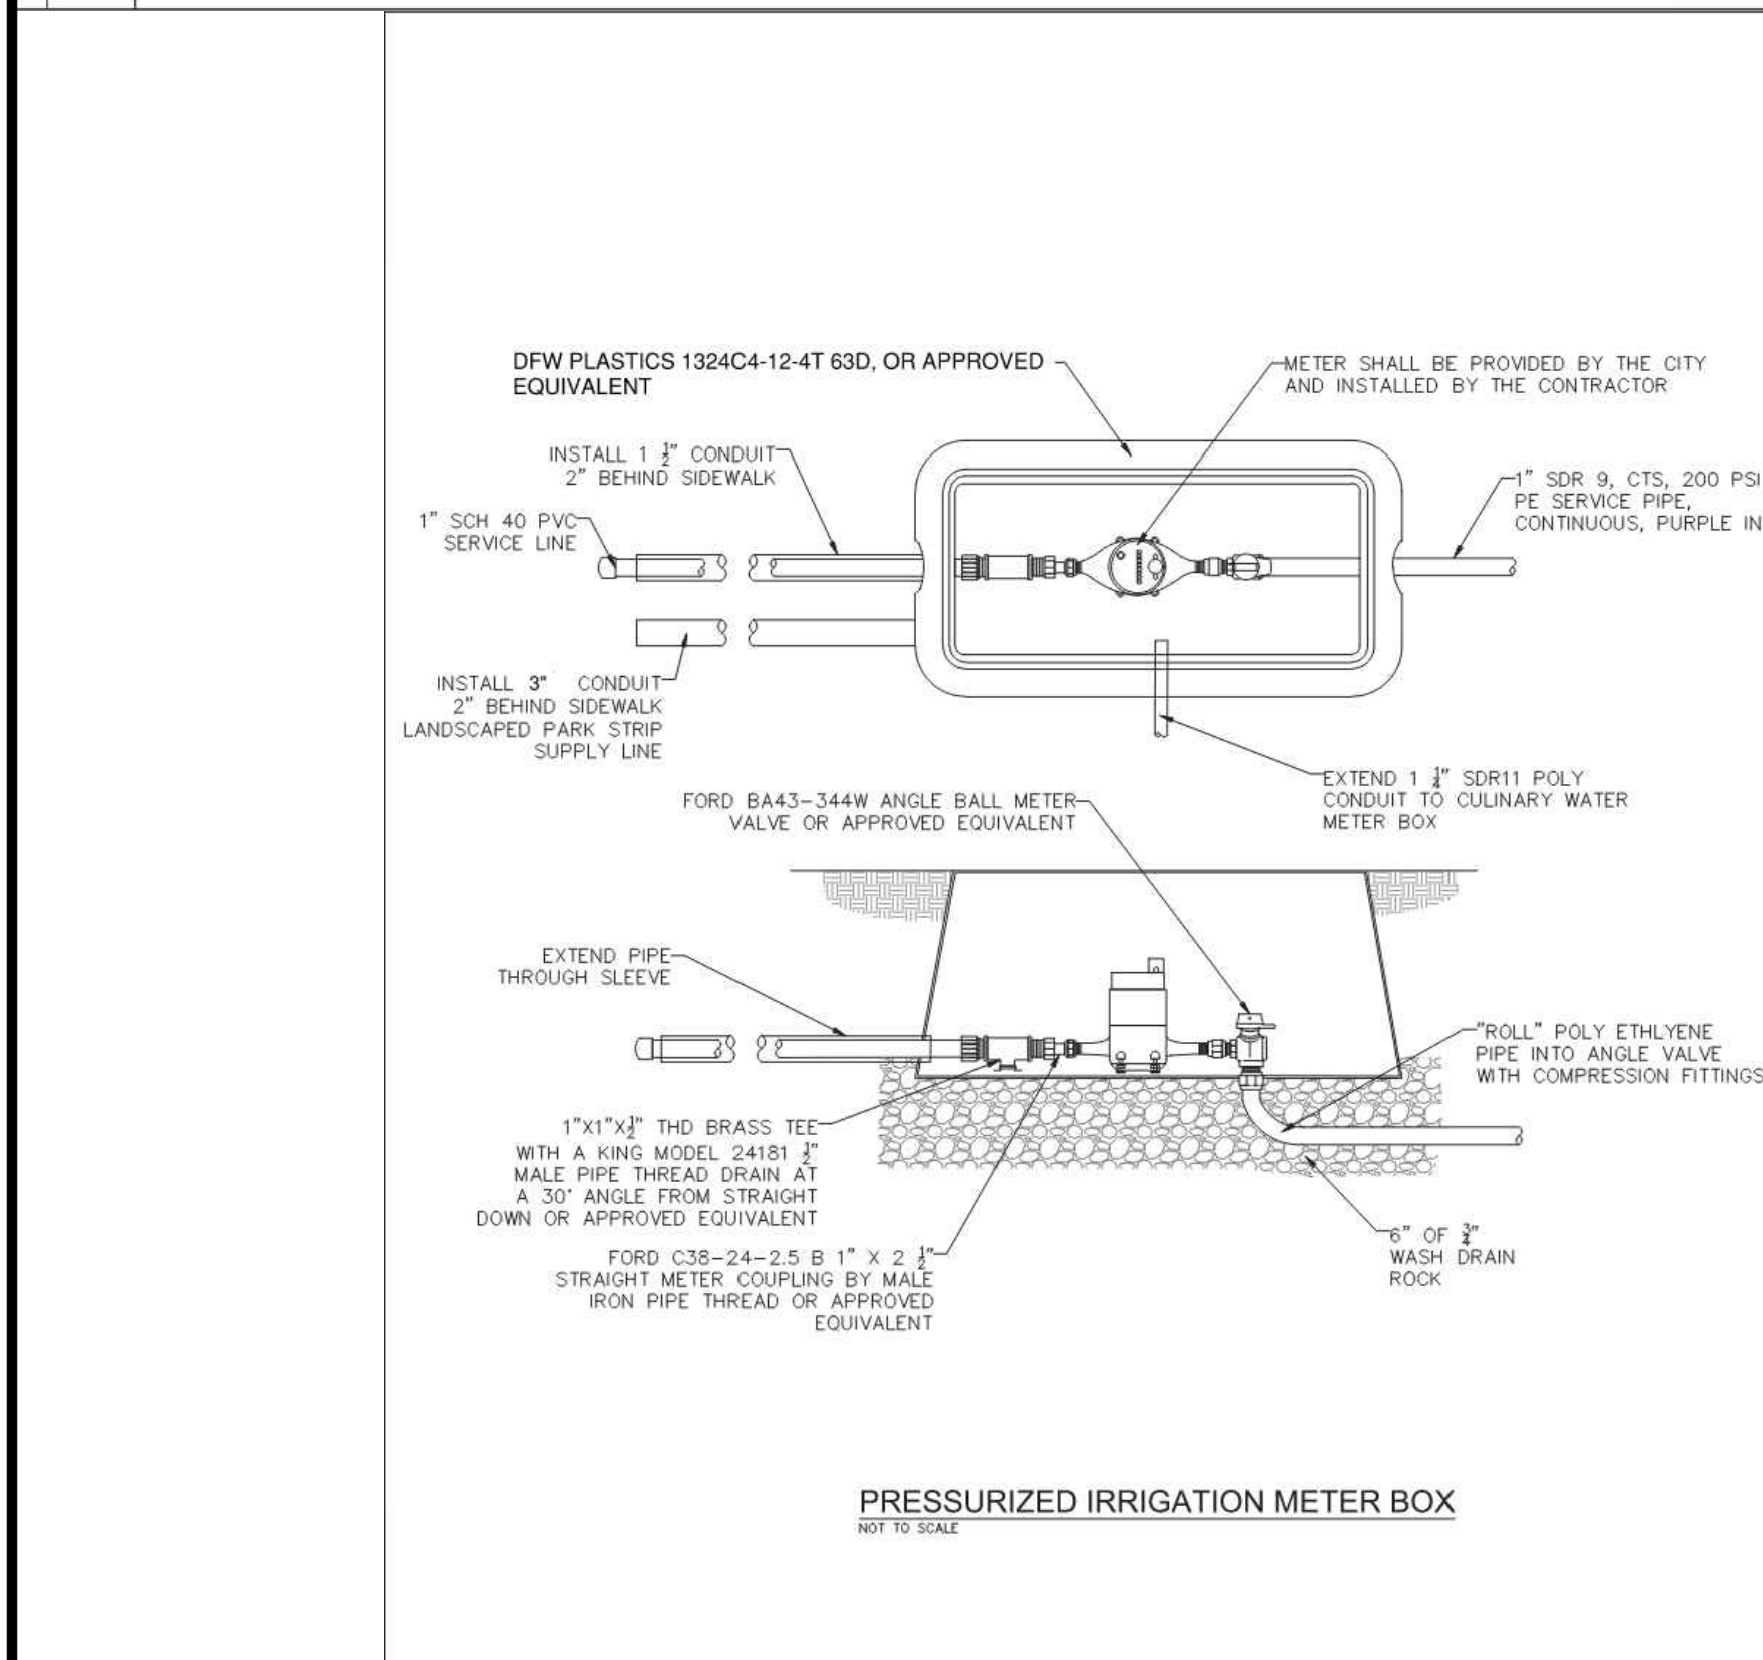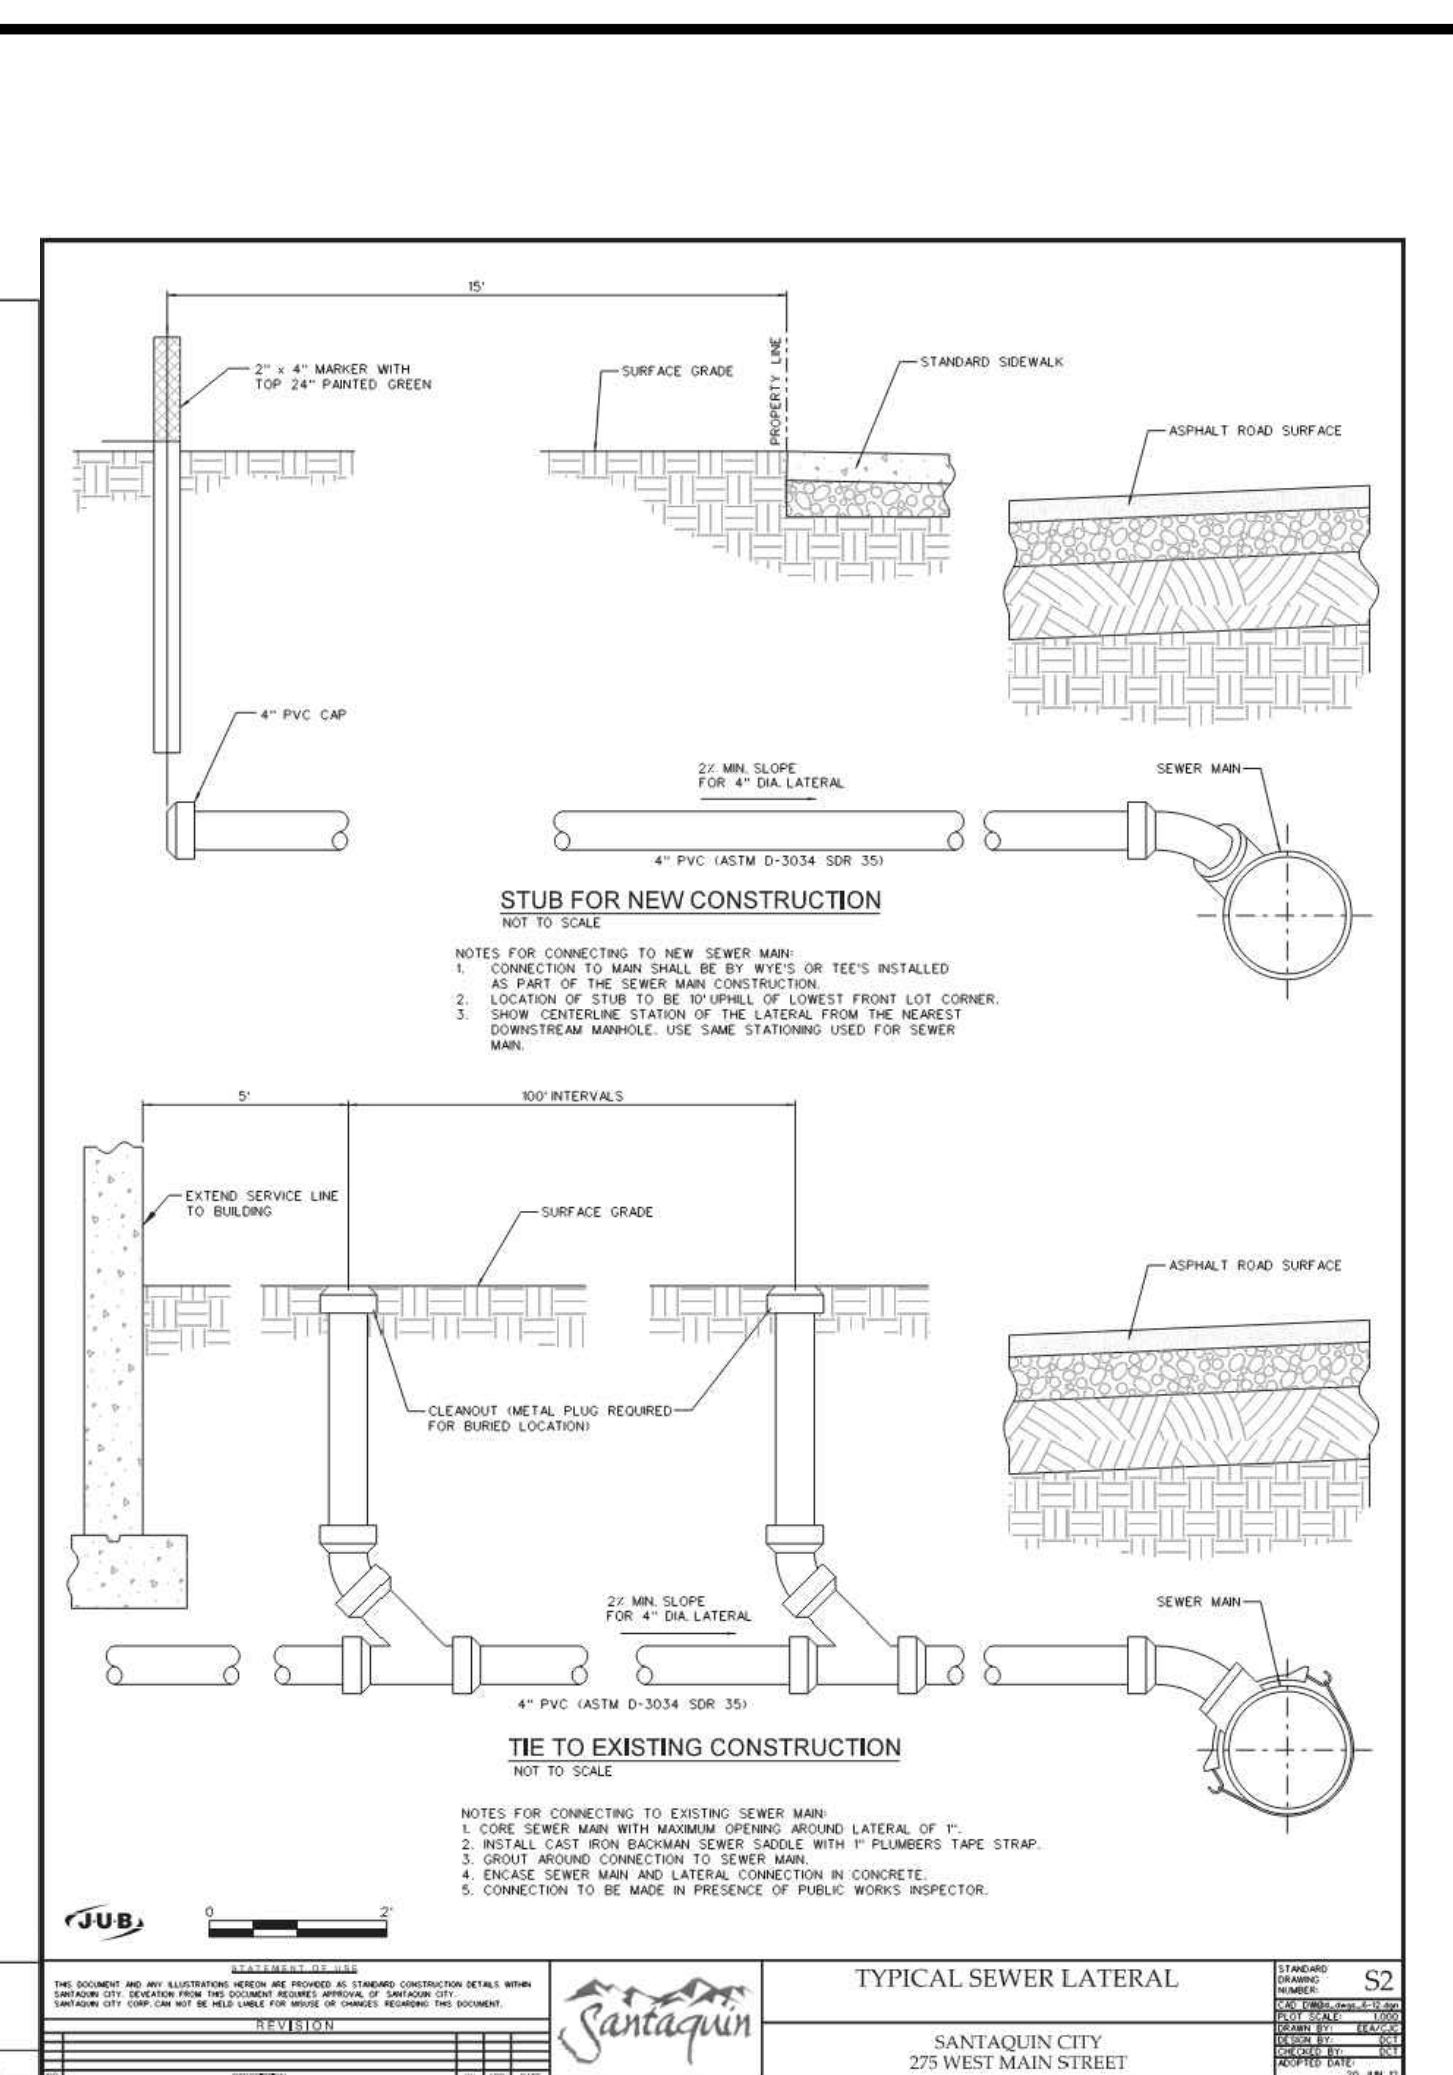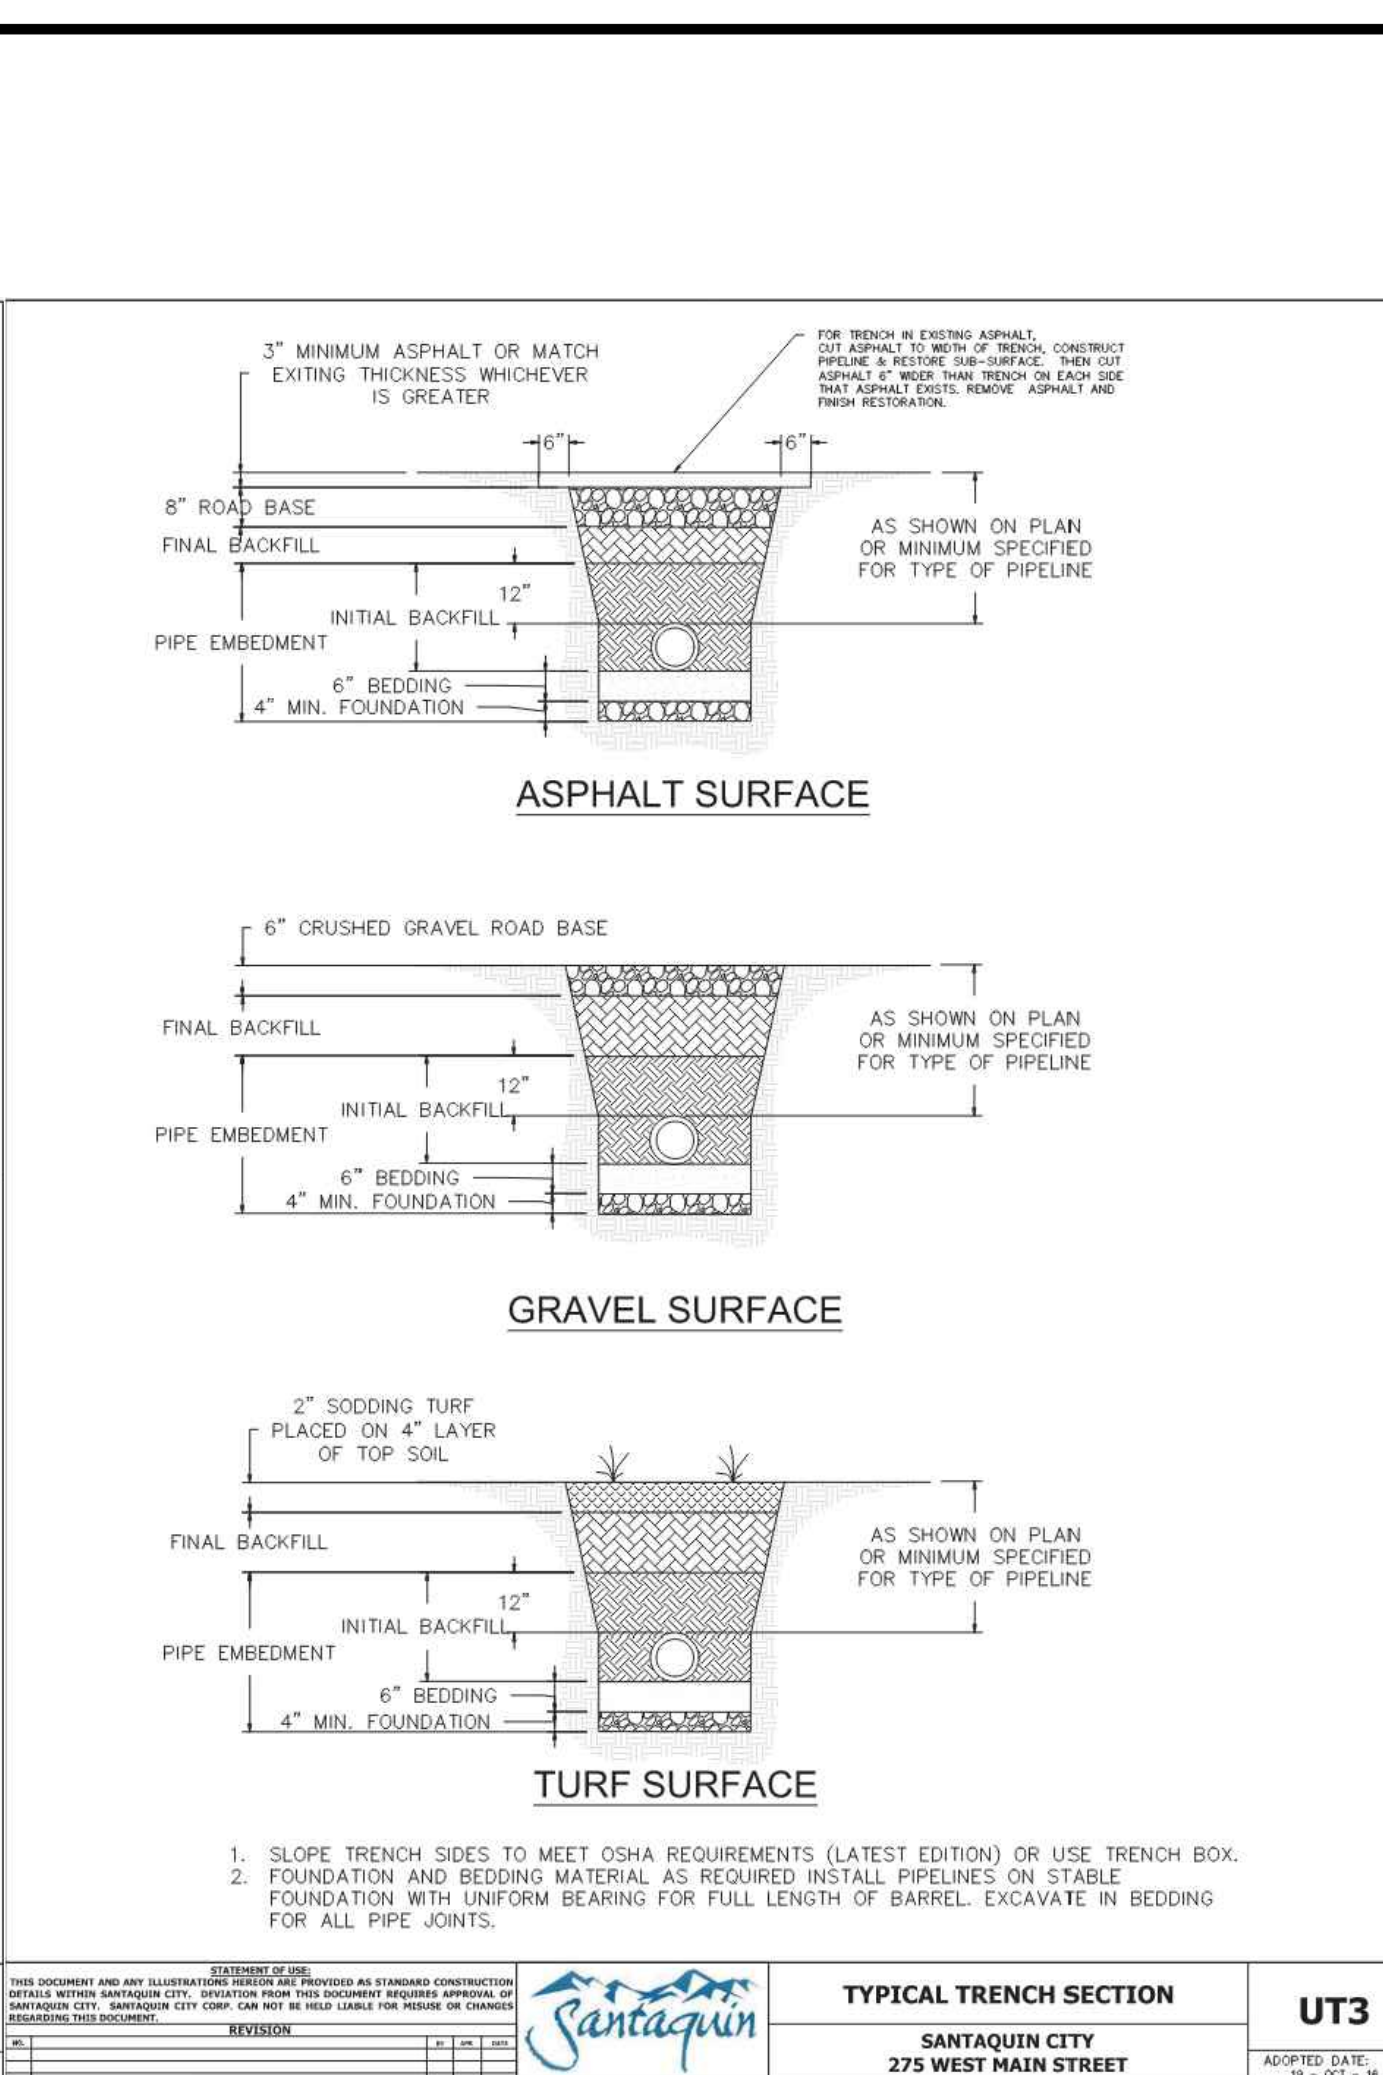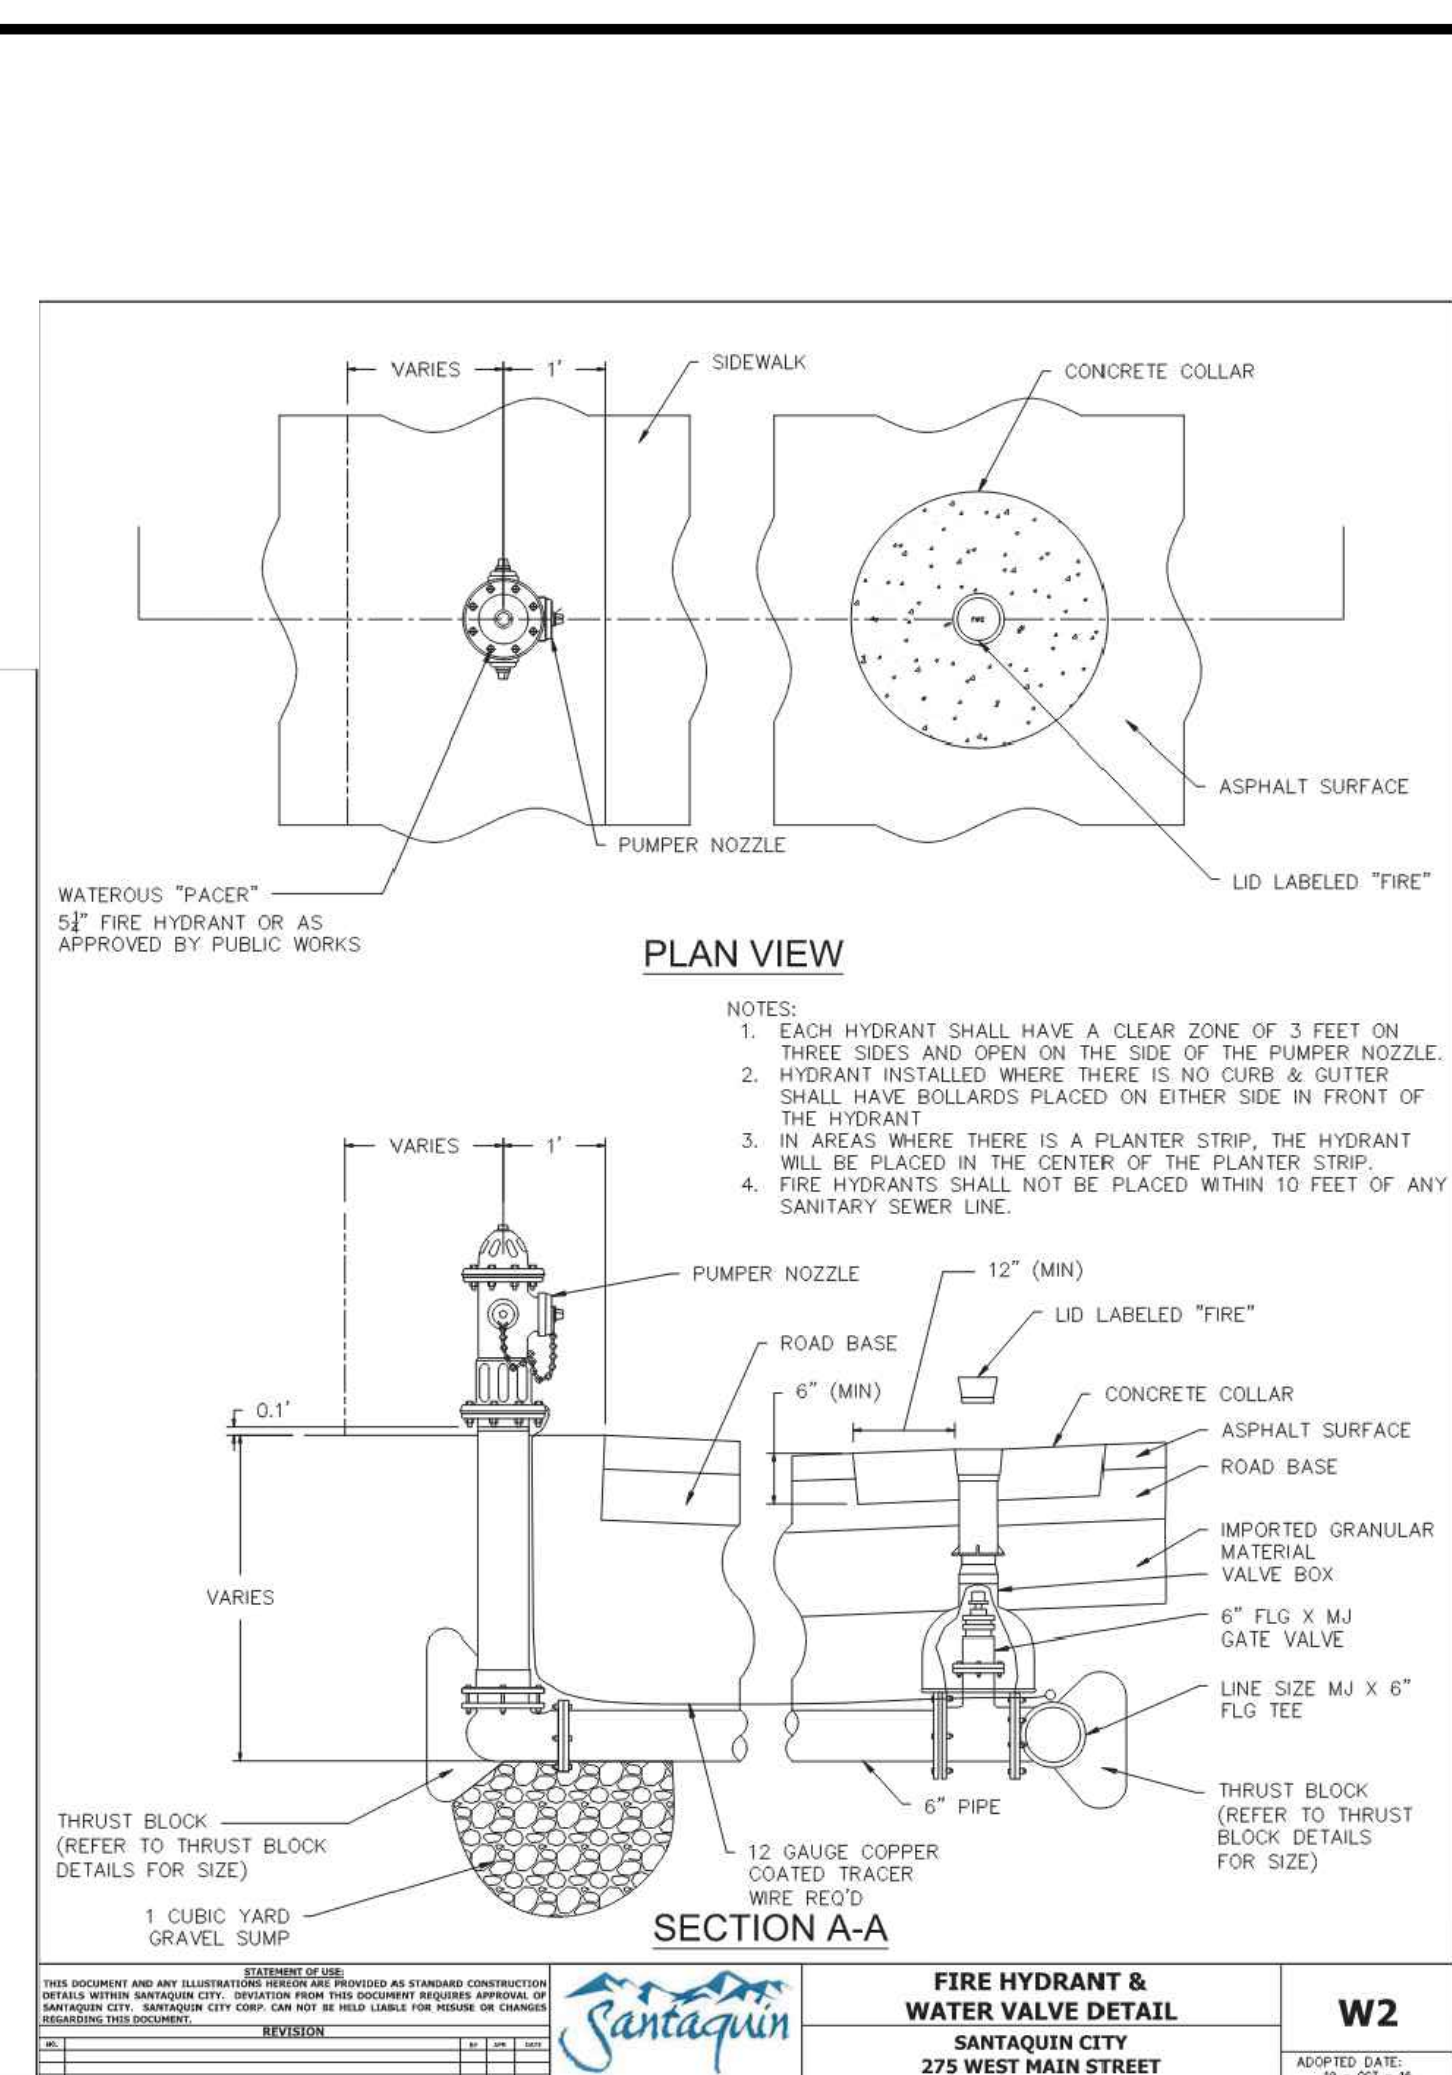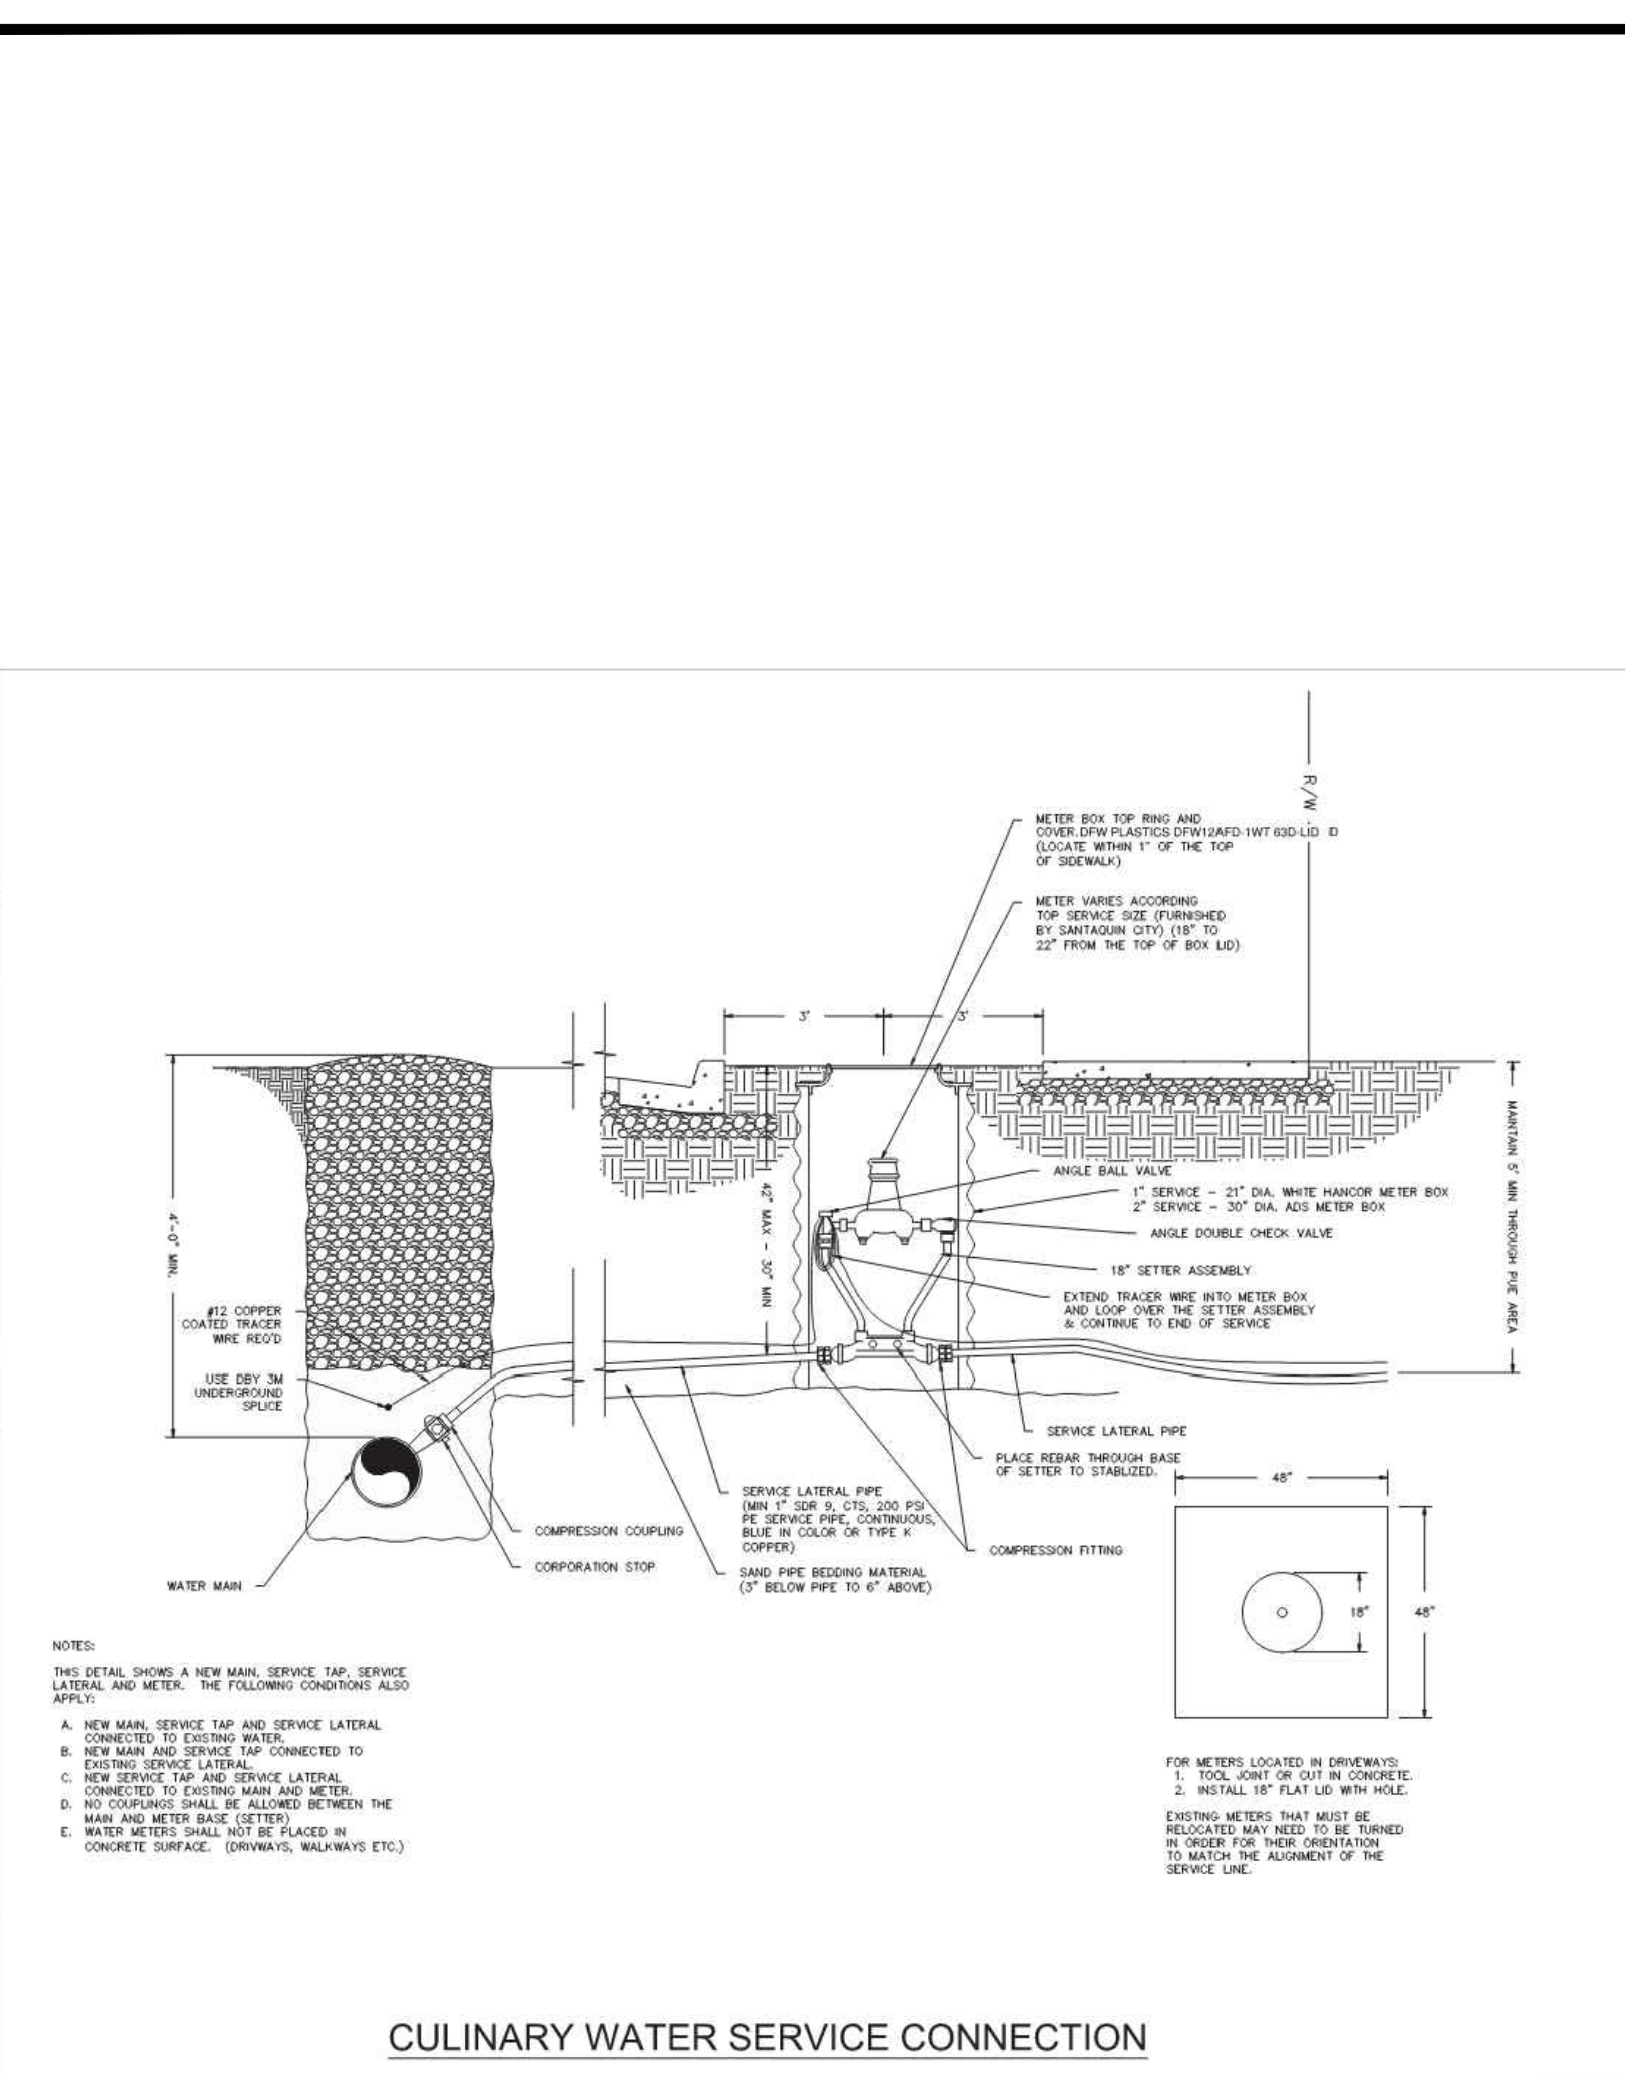

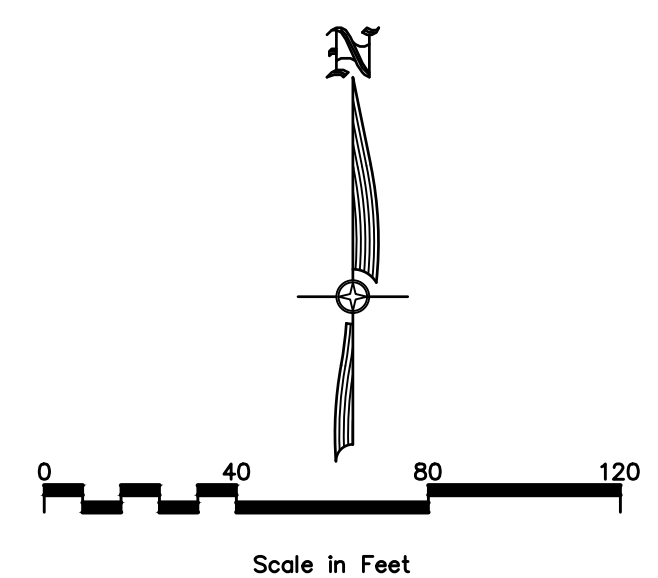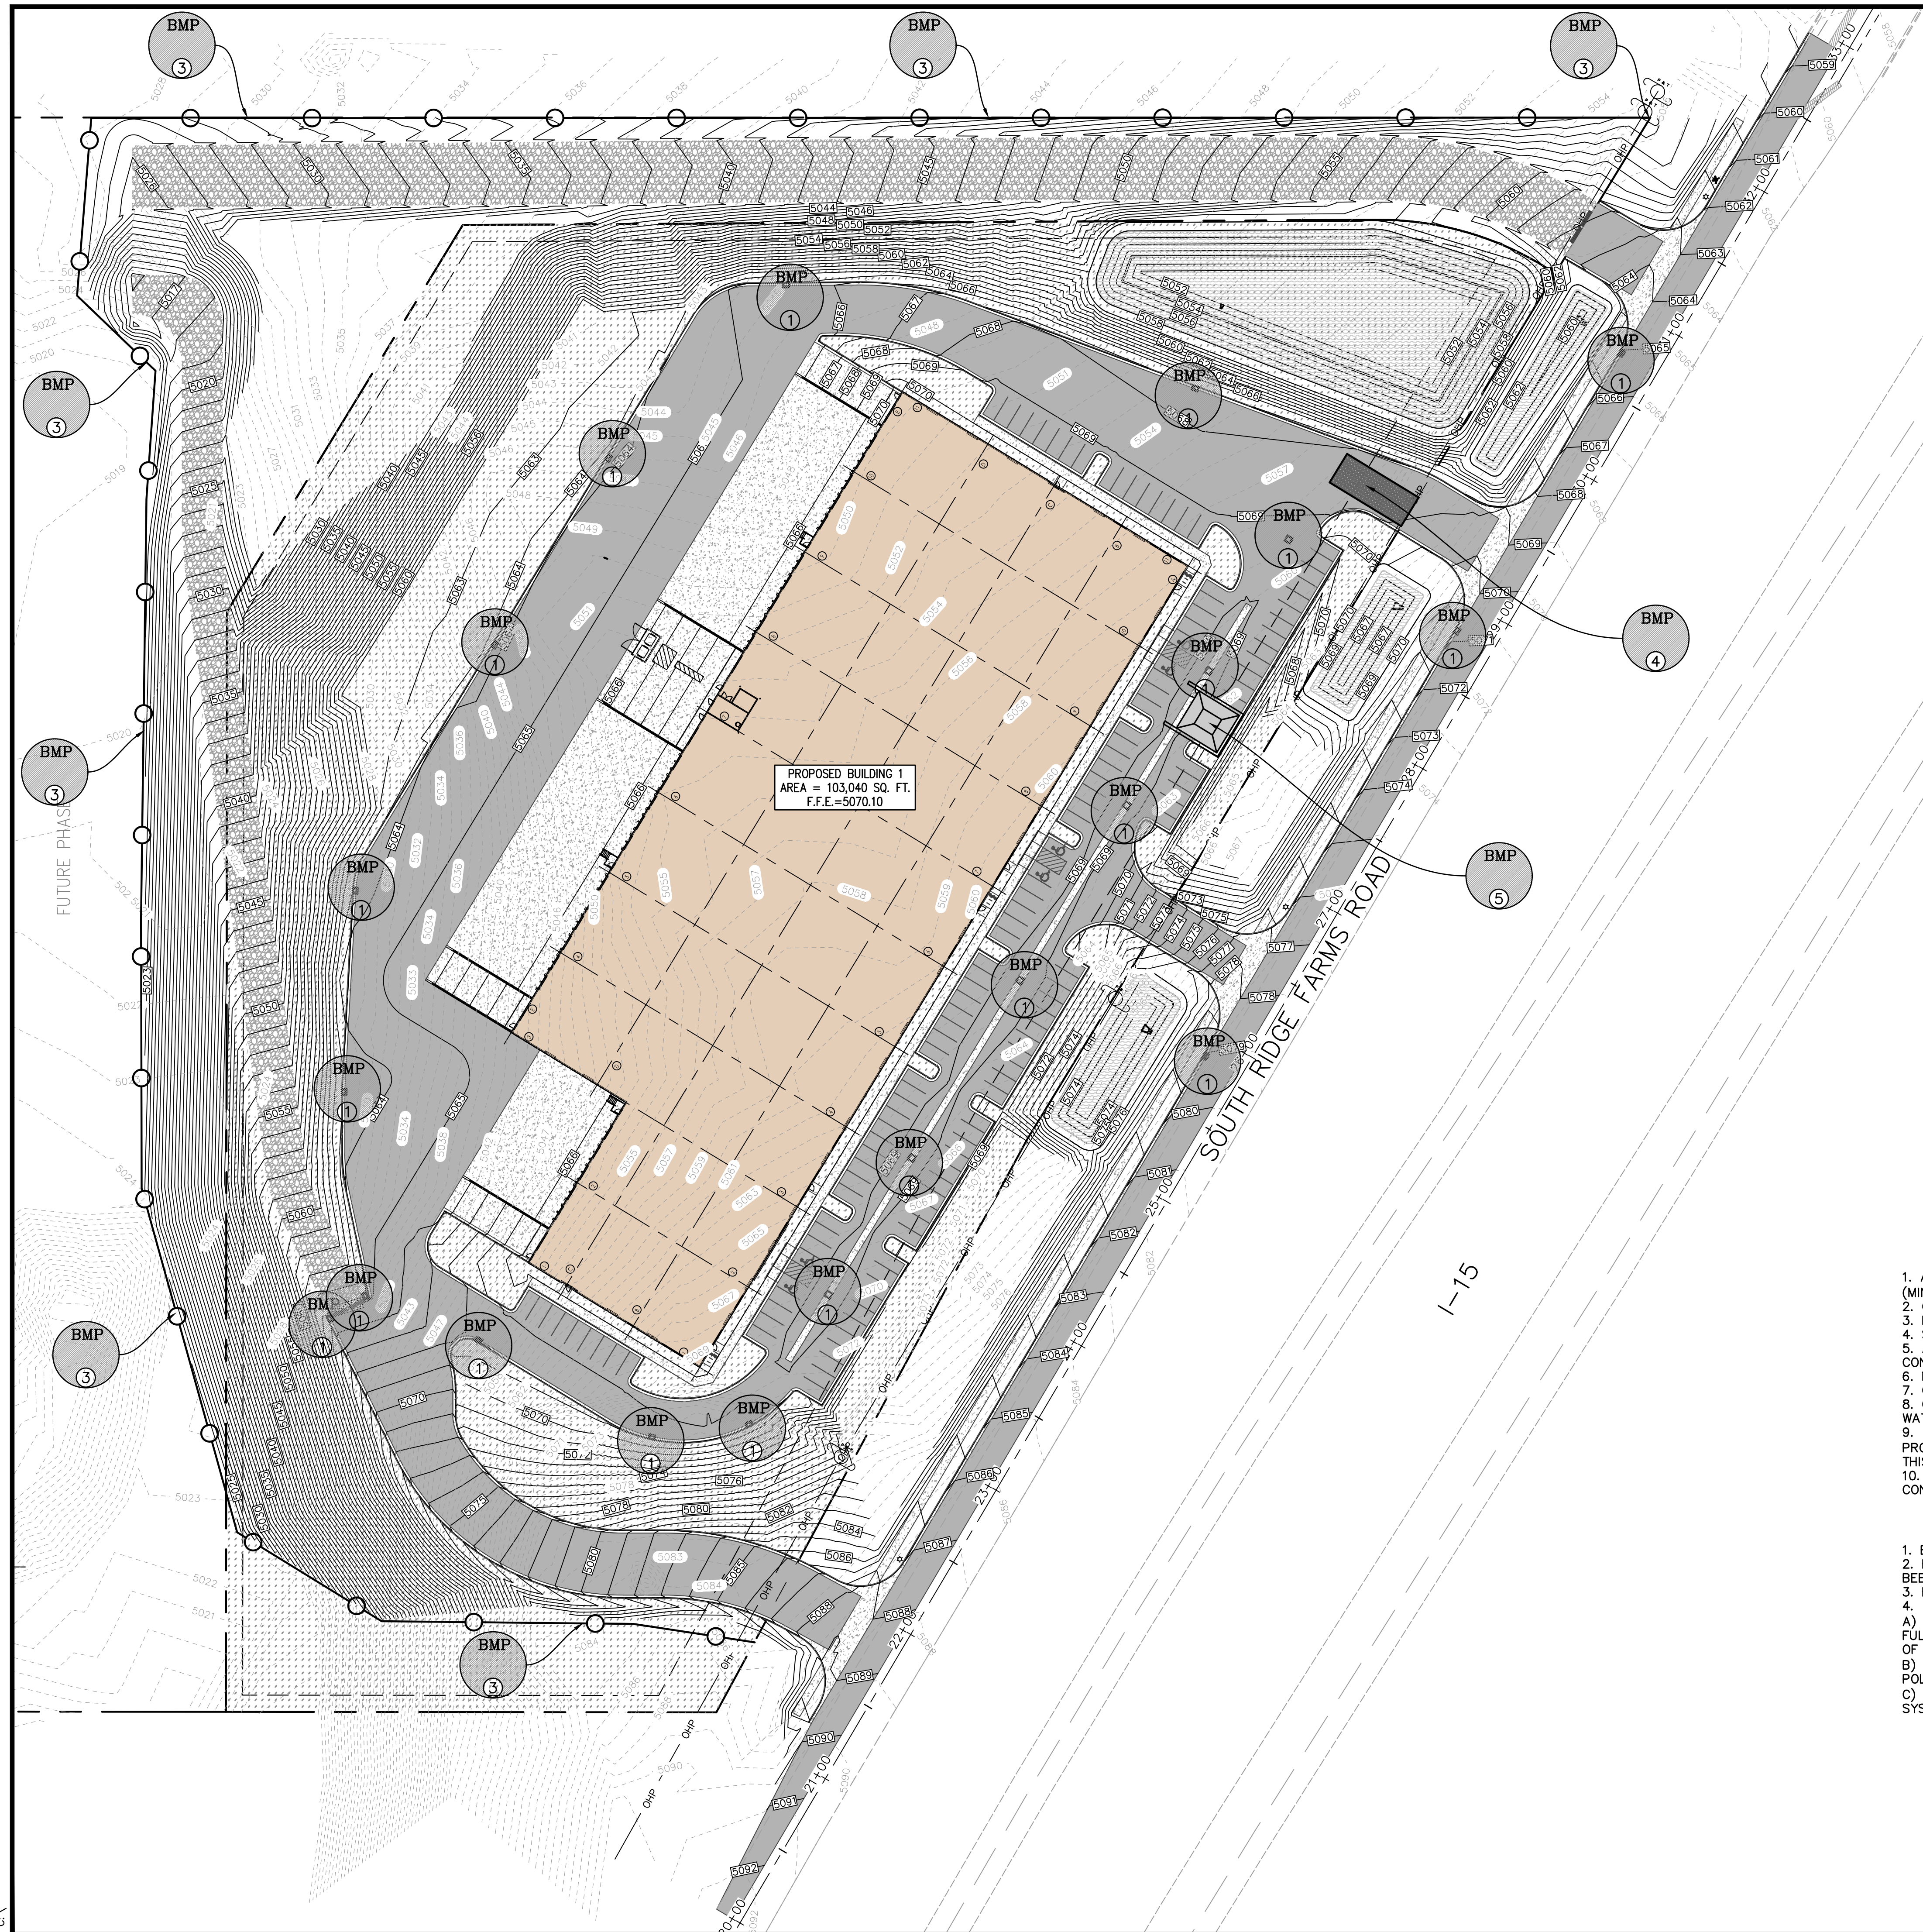

SHEET LEGEND

- SILT FENCE
- WHEEL WASH AREA
- BMP AREA
- CONCRETE WASHOUT

BMP CALLOUTS

- 1 PLACE A SILT FENCE AROUND THE PERIMETER OF THE INLET, ONCE PAVEMENT AND/OR CURB HAS BEEN INSTALLED PLACE GRAVEL BAGS AROUND THE INLET. GRAVEL BAGS TO BE USED ON PAVED OR CONCRETE SURFACES AND SILT FENCE TO BE USED ON UNIMPROVED SURFACES.
NOTE: IN HIGH TRAFFIC AREAS CONTRACTOR TO USE INSERT FILTER FABRIC. IF INLET HAS CURB OPENING, THE FILTER FABRIC IS TO BE EXTENDED UP TO COVER THE CURB OPENING AND GRAVEL BAGS PLACED IN CUTTER AT EACH SIDE OF OPENING TO KEEP FILTER FABRIC SNUG AGAINST CURB WALL.
- 2 PLACE GRAVEL BAGS AS NECESSARY TO PREVENT SEDIMENT FROM DRAINING INTO EXISTING CATCH BASINS. *SEE NOTE IN CALLOUT 1.*
- 3 INSTALL TYPICAL SILT FENCE, SILT FENCE TO BE INSTALLED PERPENDICULAR TO STORM WATER FLOW. INSTALLATION TO BE DONE SO AS TO PREVENT SEDIMENT FROM LEAVING THE SITE.
NOTE: CONTRACTOR TO USE VEGETATIVE BUFFER AND OR CUT BACK INSTEAD OF SILT FENCE WHERE POSSIBLE.
- 4 CONTRACTOR TO INSTALL A MINIMUM OF 6" DEEP GRAVEL (3" TO 6") OF SUFFICIENT SIZE (MINIMUM OF 50' IN LENGTH AND 20' WIDE) AS TO PROVIDE A WHEEL WASH AREA TO PREVENT THE TRACKING OF MUD OFFSITE. THE LOCATION OF WHEEL WASH MAY VARY FROM LOCATION SHOWN ON PLANS SO AS TO PROVIDE THE BEST PROTECTION AGAINST TRACKING MUD OFFSITE. CONTRACTOR TO MAINTAIN AND CLEAN WHEEL WASH AREA AS NEEDED TO PREVENT THE TRACKING OF MUD OFFSITE.
- 5 CONTRACTOR TO INSTALL CONCRETE WASHOUT AREA. THE LOCATION MAY VARY FROM LOCATION SHOWN ON PLANS.

DURING CONSTRUCTION

1. ALL EROSION CONTROL BEST MANAGEMENT PRACTICES SHALL BE INSPECTED AND MAINTAINED REGULARLY (MINIMUM ONCE A WEEK) AND AFTER EVERY STORM EVENT
2. CONTRACTOR TO KEEP LAND DISTURBANCE TO MINIMUM TO CONTROL RUNOFF FROM THE SITE
3. LIMIT LAND CLEARING AND RESTORE ALL GRADING AS SOON AS POSSIBLE
4. STAGED SEEDING TO RE-VEGETATE CUT AND FILL SLOPES AS THE WORK IS IN PROGRESS
5. AT ALL TIMES DURING CONSTRUCTION, THE CONTRACTOR SHALL BE RESPONSIBLE FOR PREVENTING AND CONTROLLING EROSION DUE TO WIND AND OTHER EROSION
6. MAINTENANCE OF STREET: STREETS TO BE KEPT CLEAN AND FREE FROM DEBRIS
7. CONTRACTOR SHALL PROVIDE DUST CONTROL MEASURES AT ALL TIMES DURING CONSTRUCTION.
8. CONTRACTOR TO HAVE WATER TRUCK AVAILABLE AS WATER SOURCE FOR WHEEL WASH AREA, OR ALTERNATE WATER SOURCE MAY BE USED IF APPROVED BY CITY.
9. IF GROUND WATER IS ENCOUNTERED DURING THE CONSTRUCTION ACTIVITIES AND REQUIRES PUMPING OFF THE PROJECT, THE CONTRACTOR IS TO FILTER THE WATER THROUGH THE USE OF SAND BAGS AND/OR GEO FABRIC. THIS IS TO BE DONE PRIOR TO IT BEING INTRODUCED INTO THE PUBLIC STORM DRAIN SYSTEM.
10. A COPY OF THE STORM WATER POLLUTION PREVENTION PLAN SHALL BE KEPT ON THE SITE DURING ALL CONSTRUCTION ACTIVITY

POST CONSTRUCTION

1. EROSION CONTROL STRUCTURES MAY BE REMOVED ONCE FINAL LANDSCAPING IS IN PLACE
2. EROSION CONTROL STRUCTURES BELOW SEEDING AREAS MUST REMAIN IN PLACE UNTIL THE ENTIRE AREA HAS BEEN ESTABLISHED
3. EROSION CONTROL IN PROPOSED PAVEMENT AREAS SHALL REMAIN IN PLACE UNTIL PAVEMENT IS COMPLETE
4. THE FOLLOWING PRECAUTIONS SHALL BE PERFORMED:
 - A) PERIODIC INSPECTION OF CATCH BASIN SEDIMENT TRAPS AND CLEANING WHEN THE BASIN IS MORE THAN 1/4 FULL. INSPECTION SHALL BE DONE AFTER EVERY MAJOR RAINFALL AND EVERY 6 MONTHS AS A MINIMUM. DISPOSAL OF ANY GREASE OR OIL MUST BE DONE IN ACCORDANCE WITH CURRENT ENVIRONMENTAL REGULATIONS
 - B) LITTER, DEBRIS AND CHEMICALS MUST BE PICKED UP AND KEPT IN A CONTAINED LOCATION TO PREVENT POLLUTION OF STORM WATER DISCHARGE
 - C) PARKING AREAS SHALL BE KEPT FREE FROM AUTOMOBILE FLUIDS THAT COULD WASH INTO THE STORM DRAIN SYSTEM

NO.	REVISIONS	BY	DATE

DESIGNER: SDT
PROJECT ENGINEER: SDT


CIVIL ENGINEERING + SURVEYING
 10718 S BECKSTEAD LANE, SUITE 102
 South Jordan, Utah - 801-949-6296

SANTAQUIN RESEARCH & TECH CENTER - PHASE 1
 SOUTH RIDGE FARMS ROAD, SANTAQUIN UT, 84655
 EROSION CONTROL PLAN (SWPPP)


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PROJECT ID:	E23-143
DATE:	12/15/23
FILE NAME:	PRJ-SJI
SCALE:	1"=50'



VICINITY MAP

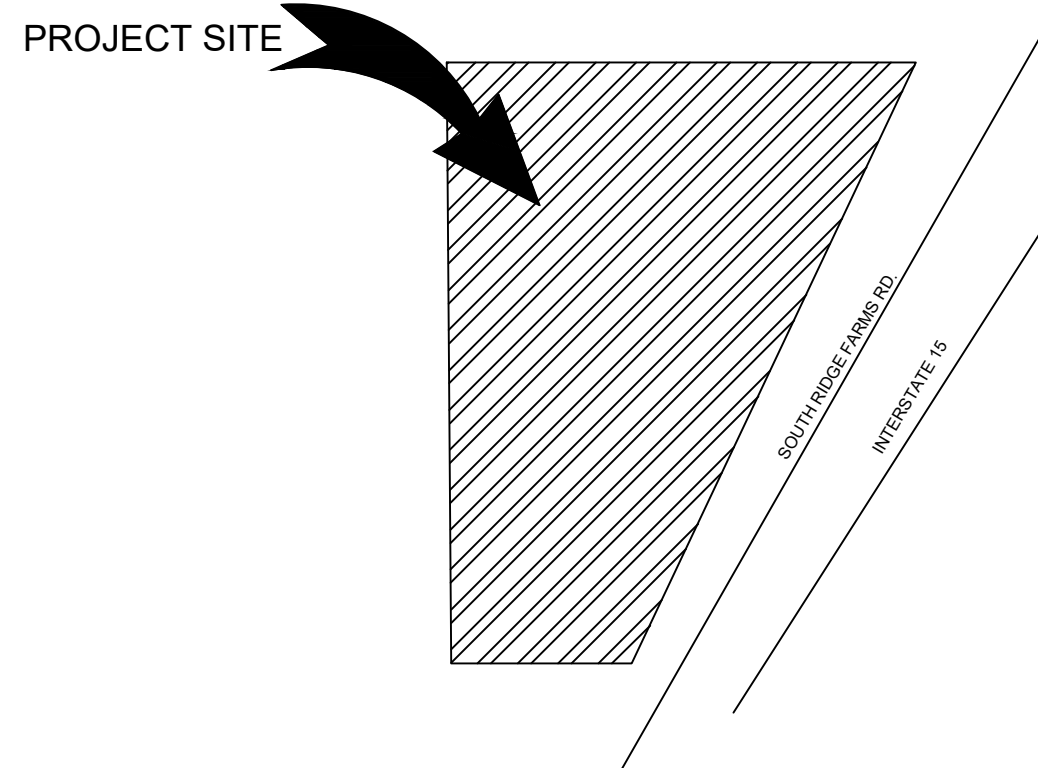

SHEET INDEX

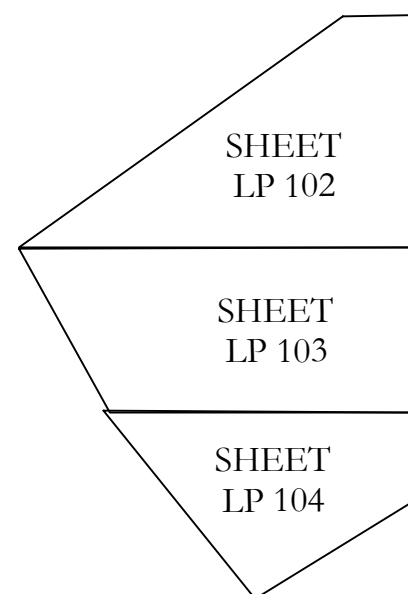


BUILDING 11
1,003,025 S.F.F.

ISSUE DATE	PROJECT NUMBER	PLAN INFORMATION	PROJECT INFORMATION	DEVELOPER / PROPERTY OWNER / CLIENT	LANDSCAPE ARCHITECT / PLANNER	LICENSE STAMP	DRAWING INFO
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1/26/2024 UT24015

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1	XXXX	XX-XX-XX
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RESEARCH AND TECH CENTER

PH. 1

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LANDSCAPE OVERALL PLAN
CITY PERMIT SET

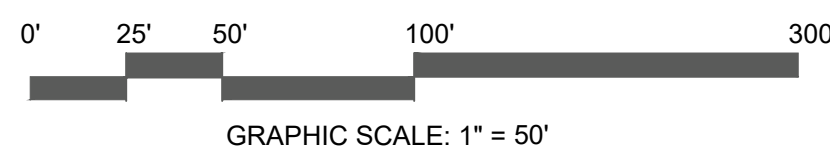LP-100

LANDSCAPE PLAN SPECIFICATIONS

PART I - GENERAL

1.1 SUMMARY

A. This section includes landscape procedures for the Project including all labor, materials, and installation necessary, but not limited to, the following:

1. Site Conditions
2. Guarantees
3. Maintenance
4. Soil Amendments
5. Fine Grading
6. Landscape Edging
7. Furnish and Installing Plant
8. Turf Planting
9. Weed Barrier

1.2 SITE CONDITIONS

A. Examination: Before submitting a Bid, each Contractor shall carefully examine the Contract Documents; shall visit the site of the Work; shall fully inform themselves as to all existing conditions and limitations; and shall include in the Bid the cost of all items required by the Contract Documents as at a variance with the applicable laws, building codes, rules, regulations, or contain obvious erroneous or uncoordinated information, the Contractor shall promptly notify the Project Representative and the necessary changes shall be accomplished by Addendum.

B. Protection: Contractor to conduct the Work in such a manner to protect all existing underground utilities or structures. Contractor to repair or replace any damaged utility or structure using identical materials to match existing at no expense to the Owner.

C. Irrigation System: Do not begin planting until the irrigation system is completely installed, is adjusted for full coverage and is completely operational.

1.3 PERMITS

A. Blue Stake / Dig Line: When digging is required, "Blue Stake" or "Dig Line" the work site and identify the approximate location of all known underground utilities or structures.

1.4 PLANT DELIVERY, QUALITY, AND AVAILABILITY

A. Unauthorized substitutions will not be accepted. If proof is submitted that specific plants or plant sizes are unobtainable, written substitution requests will be considered for the nearest equivalent plant or size. All substitution requests must be made in writing and preferably before the bid due date.

1.5 FINAL INSPECTION

A. All plants will be inspected at the time of Final Inspection prior to receiving a Landscape Substantial Completion for conformance to specified planting procedures, and for general appearance and vitality. Any plant not approved by the Project Representative will be rejected and replaced immediately.

1.6 LANDSCAPE SUBSTANTIAL COMPLETION

A. A Substantial Completion Certificate will not be issued by the Project Representative for "landscape and irrigation" in their entirety. Substantial Completion will not be proportioned to be designated areas of a project.

1.7 MAINTENANCE

A. Plant Material: The Contractor is responsible to maintain all planted materials in a healthy and growing condition for 30 days after receiving a Landscape Substantial Completion at which time the Guarantee period commences. This guarantee is to include mowing, weeding, cultivating, fertilizing, monitoring water schedules, controlling insects and diseases, re-guying and staking, and all other operations of care necessary for the promotion of root growth and plant life so that all plants are in a condition satisfactory at the end of the guarantee period. The Contractor shall be held responsible for failure to monitor watering operations and shall replace any and all plant material that is lost due to improper application of water.

1.8 GUARANTEE

A. Guarantee: A guarantee period of one year shall begin from end of maintenance period and final acceptance for trees, shrubs, and ground covers. All plants shall grow and be healthy for the guarantee period and trees shall live and grow in acceptable upright position. Any plant not alive, in poor health, or in poor condition at the end of the guarantee period will be replaced immediately. Any plant will only need to be replaced once during the guarantee period. Contractor to provide documentation showing where each plant to be replaced is located. Any outside factors, such as vandalism or lack of maintenance on the part of the Owner, shall not be part of the guarantee.

PART II - PRODUCTS

2.1 LANDSCAPE MATERIALS

A. Tree Staking: All trees shall be staked for one year warranty period. All trees not planted shall be replaced. Staked trees shall use vinyl tree ties and tree stakes two (2) inch by two (2) by eight (8) foot common pine stakes used as shown on the details.

B. Tree Wrap: Tree wrap is not to be used.

C. Mulch/Rock: See Plans. All planter beds to receive a minimum 3" layer for trees, shrubs, and perennials and 1" for groundcovers.

D. Weed Barrier: DeWitt 5 oz. weed barrier fabric. Manufactured by DeWitt Company, dewittcompany.com or approved equal.

E. Tree, Shrub, and Grass Backfill Mixture: Backfill mixture to be 75% native soil and 25% topsoil, thoroughly mixed together prior to placement.

F. Topsoil: Required for turf areas, planter beds and Backfill Mixture. Acceptable topsoil shall meet the following standards:

- a. PH: 5.5-7.5
- b. EC (electrical conductivity): < 2.0 mmhos per centimeter
- c. SAR (sodium absorption ratio): < 3.0
- d. % OM (percent organic matter): >1%
- e. Texture (particle size per USDA soil classification): Sand <70%; Clay < 30%; Silt < 70%; Stone fragments (gravel or any soil particle greater than two (2) mm in size) < 5% by volume.

G. Turf Sod: All sod shall be 18 month old as specified on plans (or approved equal) that has been cut fresh the morning of installation. Only sod that has been grown on a commercial sod farm shall be used. Only use sod from a single source.

H. Landscape Curb Edging: six (6) inches by four (4) inches extruded concrete curb made up of the following materials:

- a. Washed mortar sand free of organic material.
- b. Portland Cement (see concrete spec. below for type)
- c. Reinforced fiber - Specifically produced for compatibility with aggressive alkaline environment of Portland cement-based composites.
- d. Only potable water for mixing.

I. Landscape Metal Edging: 5.5" steel edging with 18" dowels into the ground for stabilization.

PART III - EXECUTION

3.1 GRADING

A. Topsoil Preparation: Grade planting areas according to the grading plan. Eliminate uneven areas and low spots. Provide for proper grading and drainage.

B. Topsoil Placement: Slope surfaced away from building at two (2) percent slope with no pockets of standing water. Establish finish grades of one (1) inches for planters below grade of adjacent paved surfaced. Provide neat, smooth, and uniform finish grades. Remove surplus sub-soil and topsoil from the site.

C. Compaction: compaction under hard surface areas (asphalt paths and concrete surfaces) shall be ninety-five (95) percent. Compaction under planting areas shall be between eighty-five (85) and ninety (90) percent.

3.2 TURF GRADING

A. The surface on which the sod is to be laid shall be firm and free from footprints, depressions, or undulations of any kind. The surface shall be free of all materials larger than 1/2" in diameter.

B. The finish grade of the topsoil adjacent to all sidewalks, mow-strips, etc. prior to the laying of sod, shall be set such that the crown of the grass shall be at the same level as the adjacent concrete or hard surface. No exceptions.

3.3 PLANTING OPERATIONS

A. Review the exact locations of all trees and shrubs with the Project Representative for approval prior to the digging of any holes. Prepare all holes according to the details on the drawings.

B. Water plants immediately upon arrival at the site. Maintain in moist condition until planted.

C. Before planting, locate all underground utilities prior to digging. Do not place plants on or near utility lines.

D. The tree planting hole should be the same depth as the root ball, and two times the diameter of the root ball.

E. Trees must be placed on undisturbed soil at the bottom of the planting hole.

F. The tree hole depth shall be determined so that the tree may be set slightly high of finish grade, 1" to 2" above the base of the trunk flare, using the top of the root ball as a guide.

G. Plant immediately after removal of container for container plants.

H. Set tree on soil and remove all burlap, wire baskets, twine, wrappings, etc. before beginning and backfilling operations. Do not use planting stock if the ball is cracked or broken before or during planting operation.

J. Upon completion of backfilling operation, thoroughly water tree to completely settle the soil and fill any voids that may have occurred. Use a watering hose, not the area irrigation system. If additional prepared topsoil mixture needs to be added. It should be a coarser mix as required to establish finish grade as indicated on the drawings.

K. The amount of pruning shall be limited to the minimum necessary to remove dead or injured twigs and branches. All cuts, scars, and bruises shall be properly treated according to the direction of the Project Representative. Proper pruning techniques shall be used. Do not leave stubs and do not cut the leader branch. Improper pruning shall be cause for rejection of the plant material.

L. Prepare a watering circle of 2' diameter around the trunk. For conifers, extend the watering well to the drip line of the tree canopy. Place mulch around the planted trees.

4. TURF - SOD LAYING

A. Top Soil Amendments: Prior to laying sod, commercial fertilizer shall be applied and incorporated into the upper four (4) inches of the topsoil at a rate of four pounds of nitrogen per one thousand (1,000) square feet. Adjust fertilization mixture and rate of application as needed to meet recommendations given by topsoil analysis. Include other amendments as required.

B. Fertilization: Three weeks after sod placement fertilize the turf at a rate of 1/2 pound of nitrogen per 1000 square feet. Use fertilizer specified above. Adjust fertilization mixture and rates to meet recommendations given by topsoil analysis.

C. Sod Availability and Condition: Sod is to be delivered to the site in good condition. It is to be inspected upon arrival and installed within 24 hours. Sod is to be moist and cool to ensure that decomposition has not begun and is to be free of pests, diseases, or blight. The Contractor shall satisfy himself as to the existing conditions prior to any construction. The Contractor shall be fully responsible for furnishing and laying all sod required on the plans. He shall furnish new sod as specified above and lay it so as to completely satisfy the intent and meaning of the plans and specification at no extra cost to the owner. In the case of any discrepancy in the amount of sod to be removed or amount to be used, it shall be the Contractor's responsibility to report such to the Project Representative prior to commencing the work.

D. Sod Laying: The surface upon which the new sod to be laid will be prepared as specified in the detail and be lightly watered before laying. Areas where sod is to be laid shall be cut trimmed, or shaped to receive full width sod (minimum twelve (12) inches). No partial strip or pieces will be accepted.

E. Sod shall be stamped lightly at each piece as each piece is set to ensure that good contact is made between edges and also the ground. If voids or holes are discovered, the sod piece(s) is (are) to be raised and topsoil is to be added to fill the areas until level. Sod laid on any sloped areas shall be anchored with wooden dowels or other materials which are accepted by the grass sod industry.

F. Sod shall be rolled with a roller that is at least 50% full immediately after installation to ensure the full contact with soil is made.

G. Apply water directly after laying sod. Rainfall is not acceptable.

H. Watering of the sod shall be the complete responsibility of the Contractor by whatever means necessary to establish the sod in an acceptable manner to the end of the Maintenance period. If an irrigation system is in place on the site, but for whatever reason, water is not available in the system. It is the responsibility of the Contractor to water the sod by whatever means, until the sod is accepted by the Project Representative.

I. Protection of the newly laid sod shall be the complete responsibility of the Contractor. The Contractor shall provide acceptable visual barriers, to include barricades set appropriate distances with strings or tapes between barriers, as an indication of new work. The Contractor is to restore any damaged areas caused by others (including vehicular traffic), erosion, etc, until such time as the lawn is accepted by the Owner.

J. All sod that has not been laid within 24 hours shall be deemed unacceptable and will be removed from the site.

3.5 WEED BARRIER

A. For the health of the soil and the microorganisms, weed barrier is not recommended. If use is required or requested, do not place in annual or grass areas.

B. Cut weed barrier back to the edge of the plant rootball.

C. Overlap rows of fabric min. 6"

D. Stable fabric edges and overlaps to ground.

END OF SECTION

SITE MATERIALS LEGEND

SYMBOL	LANDSCAPE DESCRIPTION	QTY
	1-10 NON-IRRIGATED REVEGETATION SEED MIX HYDROSEED WITH PLS (PURE LIVE SEED) AT 35LBS/ACRE 1.75 LBS SANDBERG BLUEGRASS 5% 3.50 LBS ANNUAL RYEGRASS 10% 3.50 LBS SHEEP FESCUE 10% 3.50 LBS STANDARD CRESTED WHEATGRASS 10% 3.50 LBS SLENDER WHEATGRASS 10% 3.50 LBS PERENNIAL RYEGRASS 10% 5.25 LBS CRESTED WHEATGRASS 15% 5.25 LBS SMOOTH BROME 15% 5.25 LBS INTERMEDIATE WHEATGRASS 15% SEE SUBMIT SEED. DARRELL@SUMMITSEEDING.COM 435-709-8003. REFER TO SEED LANDSCAPE NOTES FOR FURTHER INFORMATION. SHEET LP-101.	159,516 sf
	1-16 1" MINUS BROWN CRUSHED ROCK. SUBMIT SAMPLES FOR LANDSCAPE ARCHITECT AND OWNER APPROVAL. PROVIDE 3" DEPTH OF ROCK MULCH TOP DRESSING. SEE INORGANIC MULCH LANDSCAPE NOTES FOR ADDITIONAL INFORMATION. SHEET LP-101.	30,444 sf
	1-19 2-4" GREY CRUSHED ROCK. SUBMIT SAMPLES FOR LANDSCAPE ARCHITECT AND OWNER APPROVAL. PROVIDE 4" DEPTH OF ROCK MULCH TOP DRESSING. SEE INORGANIC MULCH LANDSCAPE NOTES FOR ADDITIONAL INFORMATION. SHEET LP-101.	9,700 sf
	1-22 4-6" TAN CRUSHED ROCK. SUBMIT SAMPLES FOR LANDSCAPE ARCHITECT AND OWNER APPROVAL. PROVIDE 6" DEPTH OF ROCK MULCH TOP DRESSING. SEE INORGANIC MULCH LANDSCAPE NOTES FOR ADDITIONAL INFORMATION. SHEET LP-101.	26,632 sf
	2-01 BOULDERS - DECORATIVE 24-48 INCHES. SUBMIT COLOR SAMPLES FOR ARCHITECT AND OWNER APPROVAL. SEE PLACEMENT INSTRUCTIONS ON DETAIL SHEET LP-501.	19
	2-02 BOULDERS - DECORATIVE 42-72 INCH. SUBMIT COLOR SAMPLES FOR ARCHITECT AND OWNER APPROVAL. SEE PLACEMENT INSTRUCTIONS ON DETAIL SHEET LP-501.	99
	2-05 5" DEEP STEEL EDGING - INSTALL PER MANUFACTURER SPECIFICATION.	1,405 lf

GENERAL LANDSCAPE NOTES

GRADING AND DRAINAGE REQUIREMENTS

- AS PER CODE, ALL GRADING IS TO SLOPE AWAY FROM ANY STRUCTURE. SURFACE OF THE GROUND WITHIN 10' FEET OF THE FOUNDATION SHOULD DRAIN AWAY FROM THE STRUCTURE WITH A MINIMUM FALL OF 6"
- AS PER CODE, FINISHED GRADE WILL NOT DRAIN ON NEIGHBORING PROPERTIES
- A MINIMUM OF 6" OF FOUNDATION WILL BE LEFT EXPOSED AT ALL CONDITIONS
- LANDSCAPE CONTRACTOR TO MAINTAIN OR IMPROVE FINAL GRADE AND PROPER DRAINAGE ESTABLISHED BY EXCAVATOR, INCLUDING BUT NOT LIMITED TO ANY MAINTENANCE, PRESERVATION, OR EXAGGERATION OF SLOPES, BERMS, AND SWALES.
- LANDSCAPE CONTRACTOR IS RESPONSIBLE TO CORRECT ANY DAMAGED OR IMPROPER WATERFLOW OF ALL SWALES, BERMS, OR GRADE
- DEVICES FOR CHANNELING ROOF RUN-OFF SHOULD BE INSTALLED FOR COLLECTION AND DISCHARGE OF RAINWATER AT A MINIMUM OF 10' FROM THE FOUNDATION, OR BEYOND THE LIMITS OF FOUNDATION WALL BACKFILL, WHICHEVER DISTANCE IS GREATER

GENERAL LANDSCAPE NOTES

- LANDSCAPE CONTRACTOR SHALL HAVE ALL UTILITIES BLUE STAKED PRIOR TO DIGGING. ANY DAMAGE TO UTILITIES SHALL BE REPAIRED AT CONTRACTOR'S EXPENSE WITH NO ADDITIONAL COST TO THE OWNER.
- DURING THE BIDDING AND INSTALLATION PROCESS, THE LANDSCAPE CONTRACTOR IS RESPONSIBLE FOR VERIFYING QUANTITIES OF ALL MATERIALS. IF DISCREPANCIES EXIST, THE PLAN SHALL DICTATE QUANTITIES TO BE USED.
- ALL PLANT MATERIAL SHALL BE PLANTED ACCORDING TO ANSI STANDARDS WITH CONSIDERATION TO INDIVIDUAL SOIL AND SITE CONDITIONS, AND NURSERY CARE AND INSTALLATION INSTRUCTIONS.
- SELECTED PLANTS WILL BE ACCORDING TO THE PLANT LEGEND. IF SUBSTITUTIONS ARE NECESSARY, PROPOSED LANDSCAPE CHANGES MUST BE SUBMITTED TO THE LANDSCAPE ARCHITECT FOR APPROVAL PRIOR TO LAYING SOD.
- SHOULD THE SITE REQUIRE ADDITIONAL TOPSOIL, REFER TO SOIL TEST WHEN MATCHING EXISTING SOIL. IF A MATCHING SOIL IS NOT LOCATABLE, A 6" DEPTH OF SANDY LOAM TOPSOIL (MIXED PRIOR TO SPREADING WITH 1% ORGANIC MATTER) CAN BE INCORPORATED INTO THE EXISTING SOIL USING THE FOLLOWING DIRECTIONS: SCARIFY TOP 6" OF EXISTING SUBSOIL AND INCORPORATE 3" OF NEW COMPOST ENRICHED TOPSOIL. SPREAD REMAINING TOPSOIL TO REACH FINISHED GRADE.
- EDGING, AS INDICATED ON PLAN, IS TO BE INSTALLED BETWEEN ALL LAWN AND PLANTER AREAS. ANY TREES LOCATED IN LAWN MUST HAVE A 4-6" TREE RING OF THE SAME EDGING.

LAWN/GRASS AREA

- SOD
 - ALL LAWN AREAS TO RECEIVE MIN. 6" DEPTH OF QUALITY TOPSOIL. IF TOPSOIL IS PRESENT ON SITE, PROVIDE SOIL TEST TO DETERMINE SOIL QUALITY FOR PROPOSED HYDROSEEDING. FINE LEVEL ALL AREAS PRIOR TO LAYING SOD. ALL LAWN AREAS SHALL BE IRRIGATED WITH 100% COVERAGE BY POP-UP SPRAY HEADS AND GEAR-DRIVEN ROTORS. ALL DECIDUOUS AND CONIFER TREES PLANTED WITHIN SOD AREAS SHALL HAVE A FOUR FOOT(4') DIAMETER TREE RING COVERED WITH CHOCOLATE BROWN BARK MULCH, NO SHREDED FINES. SUBMIT SAMPLES TO BE APPROVED BY LANDSCAPE ARCHITECT AND OWNER BEFORE INSTALLATION.
- SEED
 - SOIL TEST SOIL FOR ADEQUATE FERTILITY. ANY WEEDS CURRENTLY ON THE SITE SHALL BE REMOVED BY EITHER MECHANICAL MEANS SUCH AS HAND PULLING OR SPRAYING WITH AN HERBICIDE SUCH AS GLYPHOSATE MIXED WITH A SURFACTANT. HERBICIDES SHOULD BE APPLIED BY A CERTIFIED PESTICIDE APPLICATOR. COMPACTED SOIL SHALL BE SCARIFIED TO A DEPTH OF 18 INCHES BEFORE ADDING 6" OF WEED FREE TOPSOIL WITH HIGH ORGANIC MATTER. FINE LEVEL ALL AREAS PRIOR TO HYDROSEEDING AND SET THE GRADE FOR POSITIVE DRAINAGE. TOPSOIL SHOULD BE SOFT AT TIME OF APPLICATION. FERTILIZER IS TO BE ADDED WHEN HYDROSEEDING. REFER TO SOIL TEST RESULTS AND HYDROSEEDING CONTRACTOR FOR APPLICATION RATES.
 - SEED - USE SEED MIXES AS SPECIFIED BY LANDSCAPE ARCHITECT OF PURE LIVE SEED (PLS) ON A BASIS/ACRE. THE OPTIMUM TIME TO PANT IS IN NOVEMBER BEFORE THE FIRST SNOW. DO NOT SOW OVER HEAVY SNOWPACK. SEED WILL LAY DORMANT AND BE READY TO GERMINATE ONCE THE GROUND THAWS AND WARMS IN LATE WINTER. IF SEEDING IN LATE FALL IS NOT POSSIBLE, SEED BEFORE APRIL 1. CONTACT SUMMIT SEED. DARRELL@SUMMITSEEDING.COM 435-709-8003.
- APPLICATION: HYDROSEEDING SHALL CONSIST OF SEED, TACKIFIER, WOOD FIBER MULCH AND FERTILIZER IN A WATER BASED SLURRY. TANK MOUNTED TRUCK SHALL HAVE CONTINUOUS AGITATION. THE PUMP ON THE TRUCK WILL FORCE THE SLURRY THROUGH A TOP-MOUNTED DISCHARGE NOZZLE (TOWER). USE 2000 POUNDS WOOD FIBER MULCH AND 50-100 POUNDS OF TACKIFIER PER ACRE.
- IRRIGATION: ALL AREAS MUST BE KEPT MOST WITHOUT PUDDLES OR RUNOFF USING FREQUENT DAYTIME WATER CYCLES. ADJUST AND MONITOR SPRINKLERS AND CLOCK TO ACHIEVE PROPER IRRIGATION.
 - IF PERMANENT IRRIGATION IS NOT PLANNED, TEMPORARY IRRIGATION IS REQUIRED AT THE FOLLOWING SCHEDULE: FOR 8 WEEKS SOIL SHALL REMAIN DAMP DURING ESTABLISHMENT PERIOD WITHOUT PUDDING ON SOIL SURFACE. APPLY WATER APPROXIMATELY THREE TIMES A DAY FOR 5-7 MINUTES FOR EACH IRRIGATION EVENT DEPENDING ON TEMPERATURE AND TIME OF YEAR. A SPARSE DENSITY IS EXPECTED. CONTINUE TEMPORARY IRRIGATION FOR ONE YEAR EVENTUALLY REDUCING WATER APPLICATION TO ONCE A WEEK, THEN ONCE EVERY TWO WEEKS TO FINALLY ONCE A MONTH. MONITOR PROGRESS OF ESTABLISHMENT AND ADJUST SPRINKLERS ACCORDINGLY. THE GOAL IS TO CREATE A HEALTHY STAND OF GRASSES WITH LITTLE TO NO IRRIGATION.
- WEED CONTROL AND MAINTENANCE: MANDATORY WEED CONTROL IS REQUIRED TO REDUCE COMPETITION AND WEED SEED PRODUCTION. WEEDS MUST BE KEPT UNDER CONTROL BY MECHANICALLY PULLING OR CHEMICALLY SPRAYING AS DIRECTED BY THE APPLICATOR. APPLY A BROADLEAF HERBICIDE BIENNIALY AND ESTABLISH A CONSISTENT REGIMEN OF MOWING AND FERTILIZING TO PREVENT WEED SEED. MOW ONCE IN THE SPRING AND ONCE IN THE FALL BEFORE FERTILIZATION. FERTILIZER OPTION IS SUSTAIN 4-4-4 DEPENDING ON SOIL FERTILITY. DO NOT MOW SHORTER THAN 4 INCHES. BAG ALL CUTTINGS TO REMOVE WEED SEED FROM PROPERTY. KEEP WEEDS CUT DOWN AND DO NOT LET THEM GO TO SEED. WEED SEED PRODUCTION IS THE GAUGE FOR WHEN TO MOW, WHICH GENERALLY OCCURS IN APRIL OR MAY AS WELL AS EARLY FALL DEPENDING ON TEMPERATURE AND MOISTURE. THIS PROCEDURE WILL BE REQUIRED UNTIL A HEALTHY STAND OF GRASSES IS EVIDENT AND COMPETING WELL WITH WEEDS. EXPECT FROM 1 TO 3 YEARS.
- PROGANICS BIOTIC SOIL MEDIA: WHERE CONDITIONS MAY PROHIBIT ADDING TOPSOIL, PROGANICS BIOTIC SOIL MEDIA SHOULD BE APPLIED BY HYDROSEEDER AT 3500LBS/ACRE WITH SEED AND FERTILIZER PRIOR TO THE APPLICATION OF WOOD MULCH(2000LBS/ACRE) COMBINED WITH TACKIFIER (50-100 LBS/ACRE)
- ADDING FORBS: SHRUBS AND PERENNIALS, BY SEED OR CONTAINER, CAN BE ADDED ONCE WEEDS ARE UNDER CONTROL AND HERBICIDE IS NO LONGER NEEDED. USUALLY 1-2 YEARS AFTER HYDROSEEDING.

MULCH

- ORGANIC
 - PLANTING AREAS TO BE FREE OF WEEDS AND RECEIVE MIN. 12" DEPTH OF QUALITY TOPSOIL. IF TOPSOIL IS PRESENT ON SITE, PROVIDE SOIL TEST TO DETERMINE SOIL QUALITY FOR PROPOSED PLANTINGS. PROVIDE 3" DEPTH OF ORGANIC MULCH TOP DRESSING. KEEP MULCH AWAY FROM TOP OF ROOT BALL OF ALL PLANT MATERIAL.
 - IF REQUIRED BY CITY, INSTALL DEWITT 50Z WEED BARRIER LANDSCAPE FABRIC UNDER ALL MULCH AREAS. KEEP WEED BARRIER 1 FOOT AWAY FROM EDGE OF ROOT BALL OF ALL PLANT MATERIAL. IF WEED BARRIER IS NOT REQUIRED OR INSTALLED, AT OWNER'S APPROVAL, USE TREFLAN 1D AS A PRE-EMERGENT. APPLY ACCORDING TO LABEL DIRECTIONS BY CERTIFIED PESTICIDE APPLICATOR AFTER PLANTING AND AFTER APPLYING MULCH.
 - IF USING TREFLAN 1D WITHOUT WEED BARRIER, THIS AREA WILL ALSO NEED AN YEARLY MANAGEMENT PROGRAM. SUBMIT PROGRAM TO OWNER.
 - ANNUAL PLANTING AREAS AS SHOWN ON PLAN TO RECEIVE 4" OF SOIL AID MATERIAL (ORGANIC MULCH). NO MULCH SHALL BE PLACED WITHIN 12" OF TREE TRUNK AND 6" WITHIN BASE OF SHRUBS AND PERENNIALS. DO NOT COVER LOW BRANCHES OF SHRUBS WITH ROCK.
- INORGANIC
 - ROCK MULCH PLANTING AREAS TO BE FREE OF WEEDS AND RECEIVE MIN. 12" DEPTH OF QUALITY TOPSOIL. IF TOPSOIL IS PRESENT ON SITE, PROVIDE SOIL TEST TO DETERMINE SOIL QUALITY FOR PROPOSED PLANTINGS. WHERE PLANTING IS SPARSE (GREATER THAN 4' DISTANCE BETWEEN PLANTS OR 20' BETWEEN GROUPINGS), ADDITIONAL TOPSOIL IS NOT NECESSARY EXCEPT FOR BACKFILLING PLANTING HOLE. PREPARE A HOLE TWICE THE WIDTH OF THE CONTAINER. WATER IN PLANT. BACKFILL WITH 4-6:1 RATIO OF SOIL TO COMPOST. TAMP LIGHTLY AND WATER AGAIN. KEEP ROCK 12" AWAY FROM TRUNK OF TREES AND 6" AWAY FROM BASE OF SHRUBS AND PERENNIALS. DO NOT COVER LOW BRANCHES OF SHRUBS WITH ROCK.
 - IF REQUIRED BY CITY, INSTALL DEWITT 50Z WEED BARRIER LANDSCAPE FABRIC UNDER ALL ROCK AREAS. KEEP WEED BARRIER 1 FOOT AWAY FROM EDGE OF ROOT BALL OF ALL PLANT MATERIAL. IF WEED BARRIER IS NOT REQUIRED OR INSTALLED, AT OWNER'S APPROVAL, USE TREFLAN 1D AS A PRE-EMERGENT. APPLY ACCORDING TO LABEL DIRECTIONS BY CERTIFIED PESTICIDE APPLICATOR AFTER PLANTING AND AFTER APPLYING MULCH.
 - IF USING TREFLAN 1D WITHOUT WEED BARRIER, THIS AREA WILL ALSO NEED AN YEARLY MANAGEMENT PROGRAM. SUBMIT PROGRAM TO OWNER. UPON REQUEST, A PLANT GUIDE IS AVAILABLE WITH OUR RECOMMENDATIONS REGARDING WEED BARRIER, PLANT CARE AND MAINTENANCE.

GENERAL IRRIGATION NOTES

- A NEW UNDERGROUND, AUTOMATIC IRRIGATION SYSTEM IS TO BE INSTALLED BY CONTRACTOR IN ALL LANDSCAPED AREAS. LAWN AREAS TO RECEIVE AT LEAST 100% HEAD TO HEAD COVERAGE AND PLANTER AREAS TO RECEIVE A FULL DRIP SYSTEM TO EACH TREE AND SHRUB. POINT SOURCE DRIP OR IN-LINE DRIP TUBING TO BE SECURED AT CENTER OF ROOT BALL, NOT AGAINST TRUNK. SEE IRRIGATION PLAN.

INSTALLER RESPONSIBILITIES AND LIABILITIES

- THESE PLANS ARE FOR BASIC DESIGN LAYOUT AND INFORMATION. LANDSCAPE CONTRACTOR IS REQUIRED TO USE TRADE KNOWLEDGE FOR IMPLEMENTATION. OWNER ASSUMES NO LIABILITIES FOR INADEQUATE ENGINEERING CALCULATIONS, MANUFACTURER PRODUCT DEFECTS, INSTALLATION OF ANY LANDSCAPING AND COMPONENTS, OR TIME EXECUTION.
- LANDSCAPE CONTRACTOR IS RESPONSIBLE AND LIABLE FOR INSTALLATION OF ALL LANDSCAPING AND IRRIGATION SYSTEMS INCLUDING CODE REQUIREMENTS, TIME EXECUTIONS, INSTALLED PRODUCTS AND MATERIALS.

PLANT LEGEND

SYMBOL	CODE	QTY	BOTANICAL / COMMON NAME	CONT
	JSW	18	Juniper scopulorum 'Woodward' Woodward Columnar Juniper	B & B 6'
	A'CR	7	Acer giseum 'JFS KW22A'GRU' Copper Rocket Copper Rocket™ Paperbark Maple	B & B 2"Cal
	M'PF	19	Malus x 'Prairifire' Prairifire Crabapple	B & B 2"Cal
	Q'UP	4	Quercus macrocarpa 'Urban Pinnacle' Urban Pinnacle Oak	B & B 2"Cal
	S'RT	5	Syringa reticulata 'Bainne' Snowdrace Tree Lilac	B & B 2"Cal
	T'TS	2	Tilia tomentosa 'Sterling' Sterling Silver Linden	B & B 2"Cal
	U'XT	2	Ulmus x 'Frontier' Frontier Elm	B & B 2"Cal
	Z'SW	2	Zelkova serrata 'Wireless' Wireless Zelkova	B & B 2"Cal
	A'AO	11	Amelanchier alnifolia 'Obelisk'™ Standing Ovation Serviceberry	5 gal
	A'AMS	21	Annonia melanocarpa 'SMANMPEM' Low Scapc Snowfire™ Black Chokeberry	5 gal
	C'BS	6	Caryopteris x clandonensis 'Blauer Splatz' Sapphire Surt™ Bluebeard	5 gal
	C'MF	3	Chamaebutaria millefolium Fernbush	5 gal
	C'NR	97	Chrysanthemum nasuosus Rubber Rabbitbush	5 gal
	G'LS	48	Genista hyda 'Select'™ Genista hyda Bangle	1 gal
	P'BPT	56	Prunus besseyi 'D'WHIS' Pawnee Buttes' Pawnee Buttes Sand Cherry	5 gal
	P'PF	37	Potentilla fruticosa 'Targe' Dakota Sunspot™ Fargo Yellow Shrubby Cinquefoil	5 gal
	R'TT	6	Rhus typhina 'Tiger Eyes' Tiger Eyes Sumac	5 gal
	C'LC	17	Cercocarpus ledifolius Curl-Leaf Mountain Mahogany	5 gal
	J'HT	28	Juniperus horizontalis 'Monber'™ Icee Blue Juniper	5 gal
	J'SM	18	Juniperus scopulorum 'Moonsglow' Moonsglow Juniper	15 gal
	B'GB	148	Bouteloua gracilis 'Blonde Ambition' Blonde Ambition Blue Grama	1 gal
	F'MA	591	Festuca mairii Atlas Fescue	1 gal
	M'GB	156	Miscanthus sinensis 'Gold Bar' Gold Bar Maiden Grass	1 gal
	M'ML	152	Miscanthus sinensis 'Morning Light' Morning Light Maiden Grass	2 gal
	N'TM	485	Nassella tenuissima Mexican Feather Grass	1 gal
	A'TB	40	Asclepias tuberosa Butterfly Milkweed	1 gal
	G'LR	64	Gaara Indubium 'Rosy Jane' Rosy Jane Gaara	1 gal
	L'SK	66	Liatris spicata 'Kobold' Gayfeather	1 gal
	P'SR	82	Penstemon strictus Rocky Mountain Penstemon	1 gal
	R'CM	174	Ranibida columnifera 'Mexican Hat' Praire Coneflower	1 gal
	R'RD	65	Rosa x 'Meigalpis'™ Red Drift Groundcover Rose	5 gal

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1/26/2024	UT24015			JON JENSEN JJJENSENCM@GMAIL.COM	PKJ DESIGN GROUP		PLOT DATE: 1/26/2024 DRAWN: ACP CHECKED: JMA PLOT DATE: 1/26/2024

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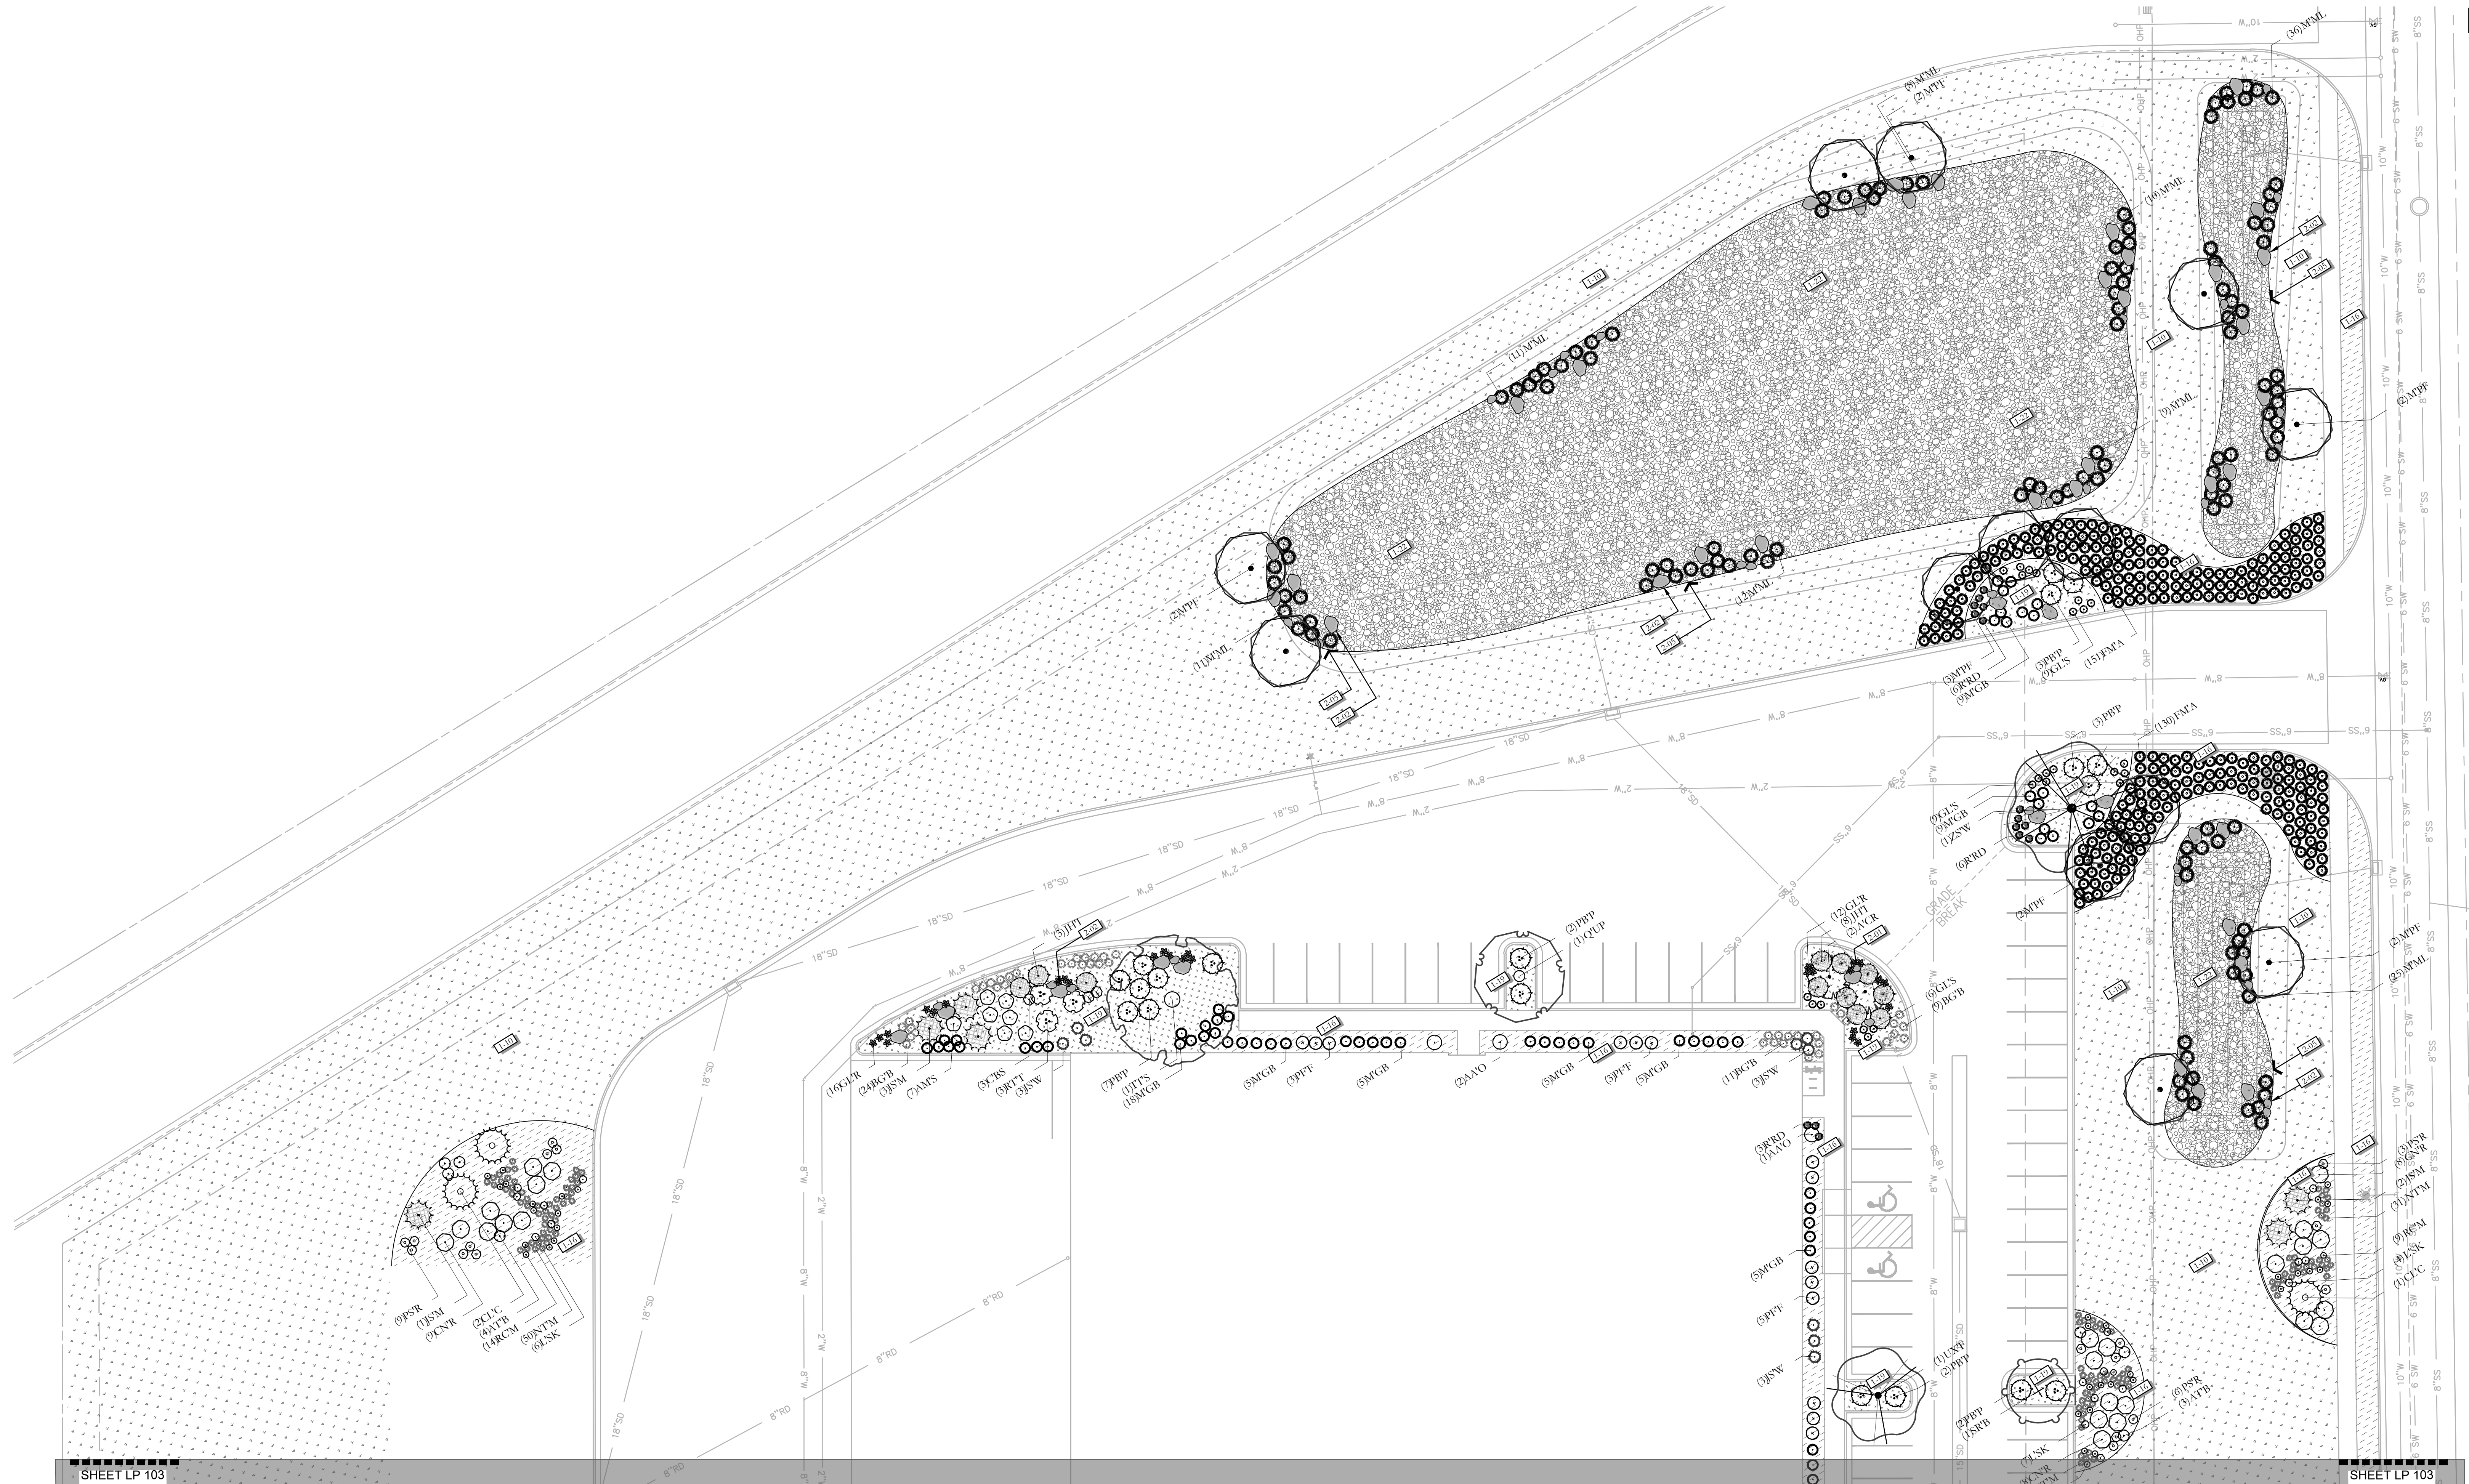
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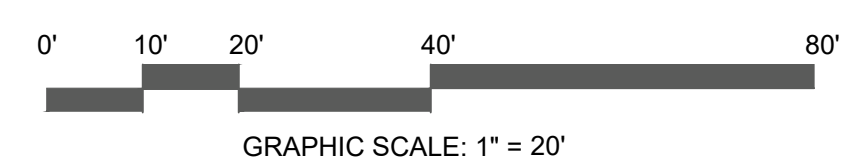
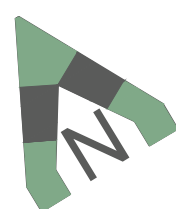
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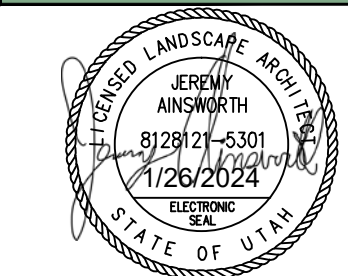
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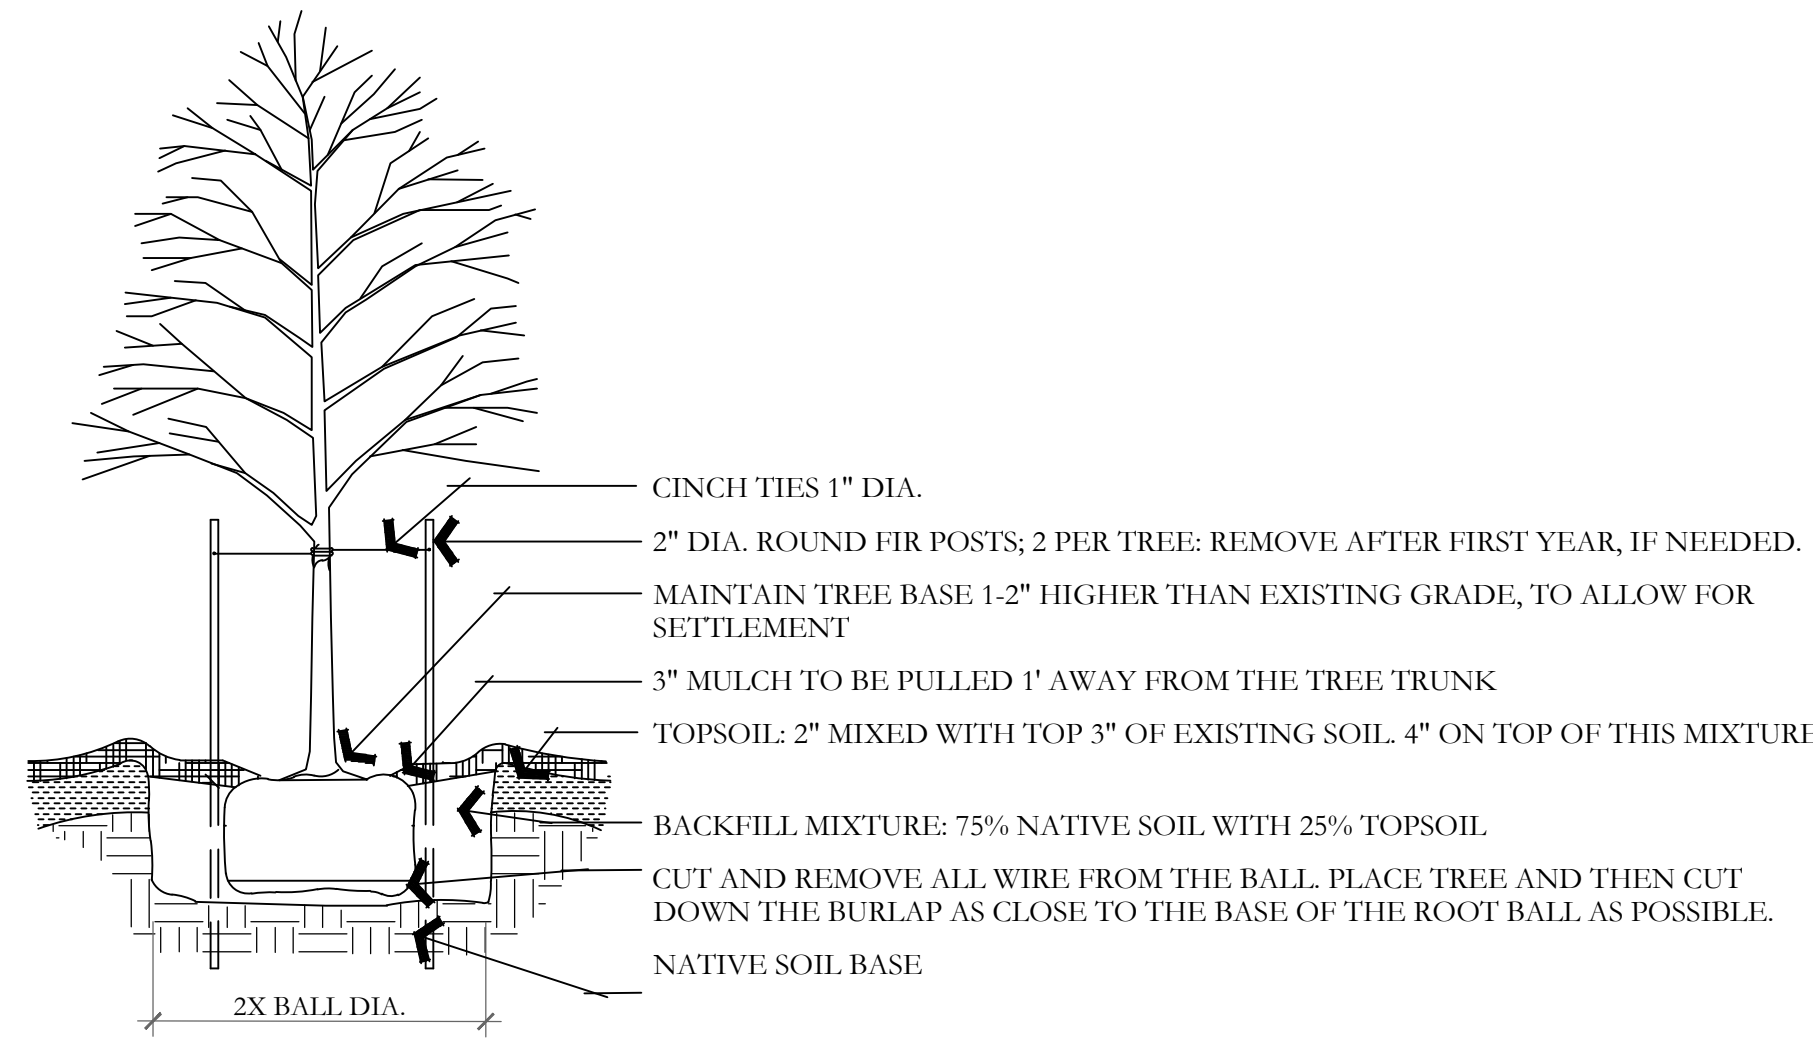
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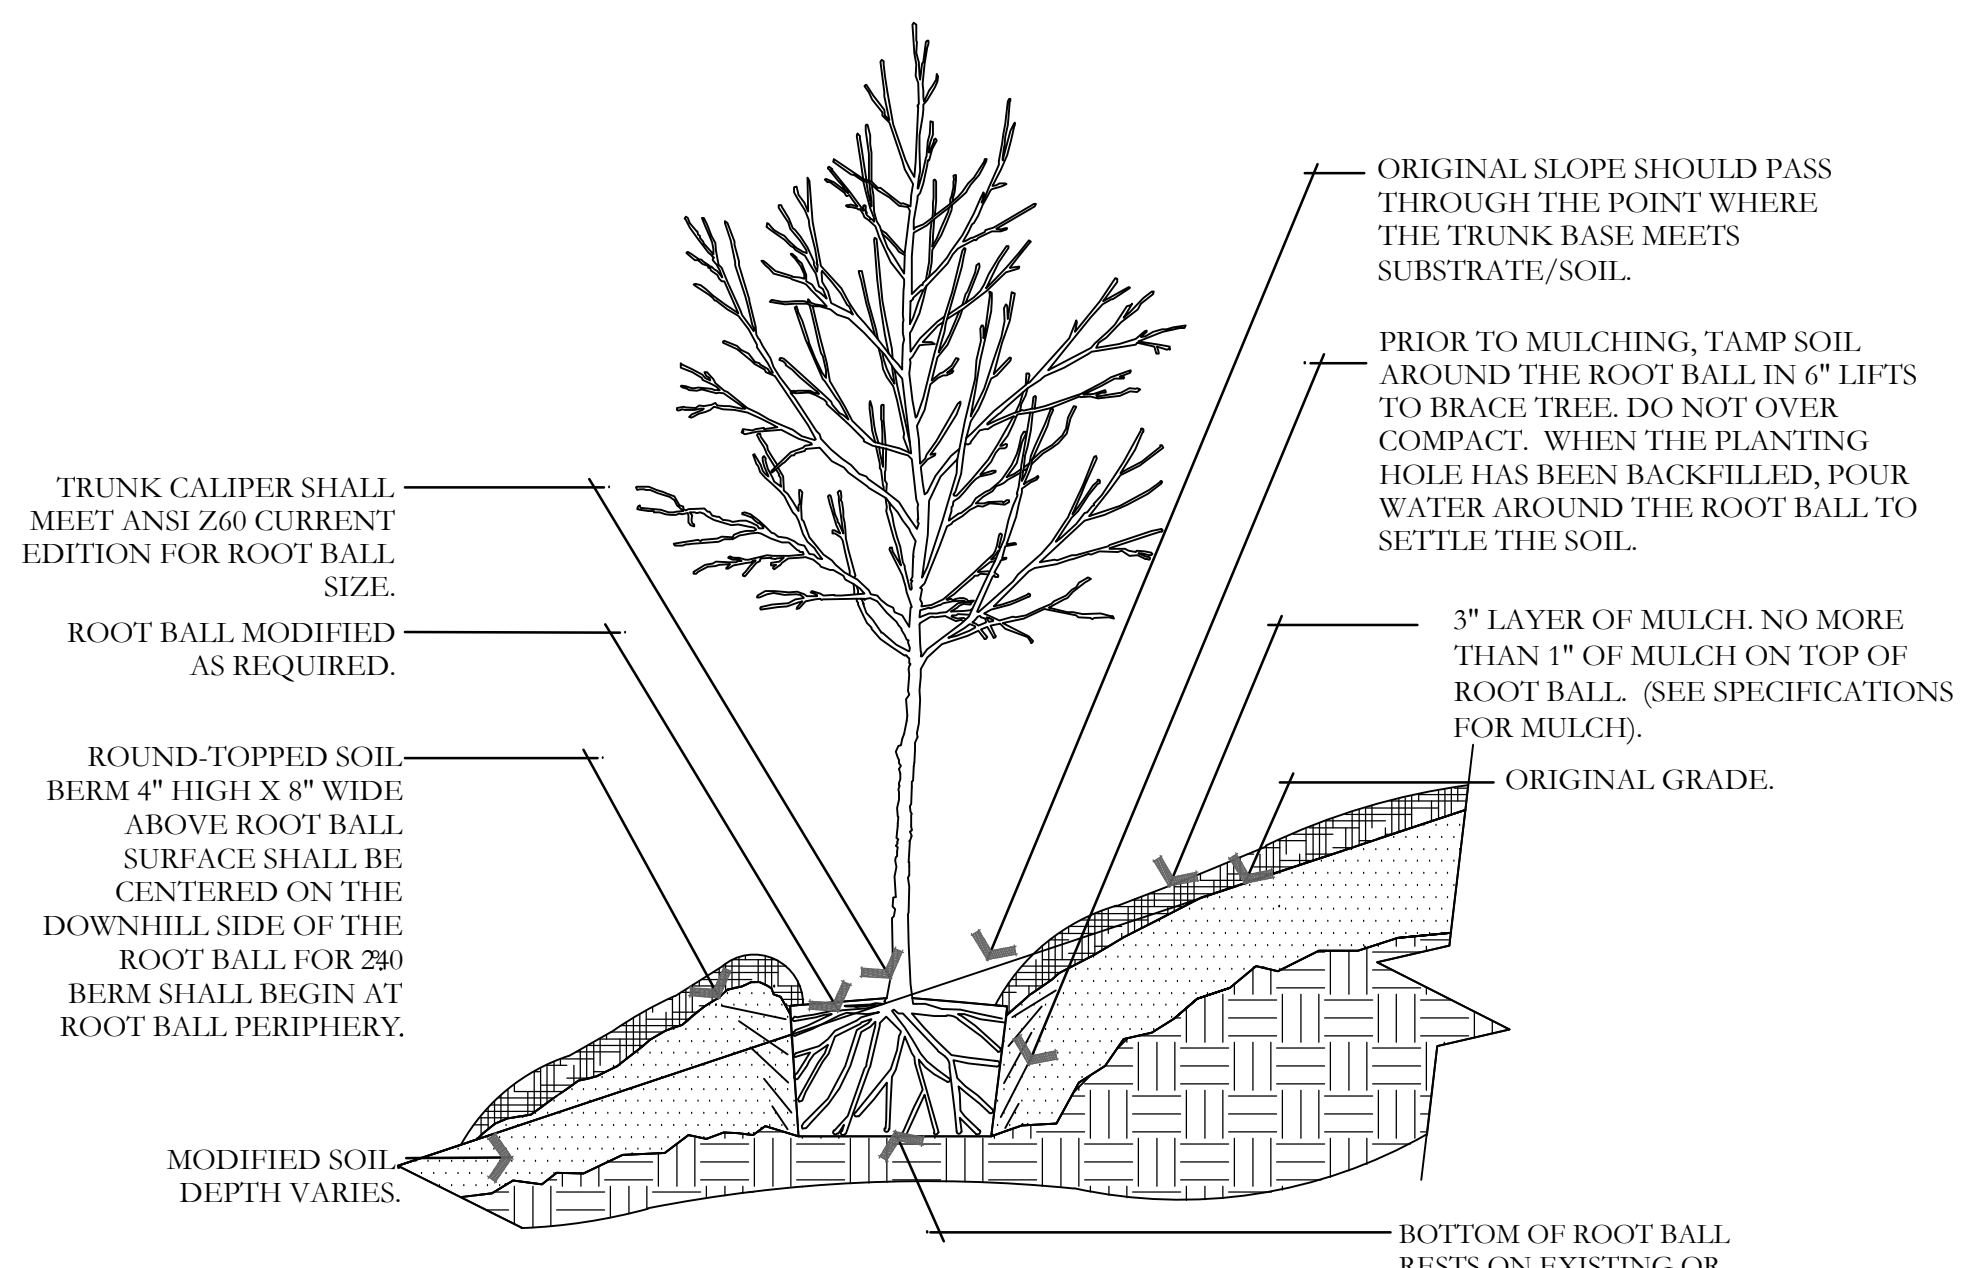
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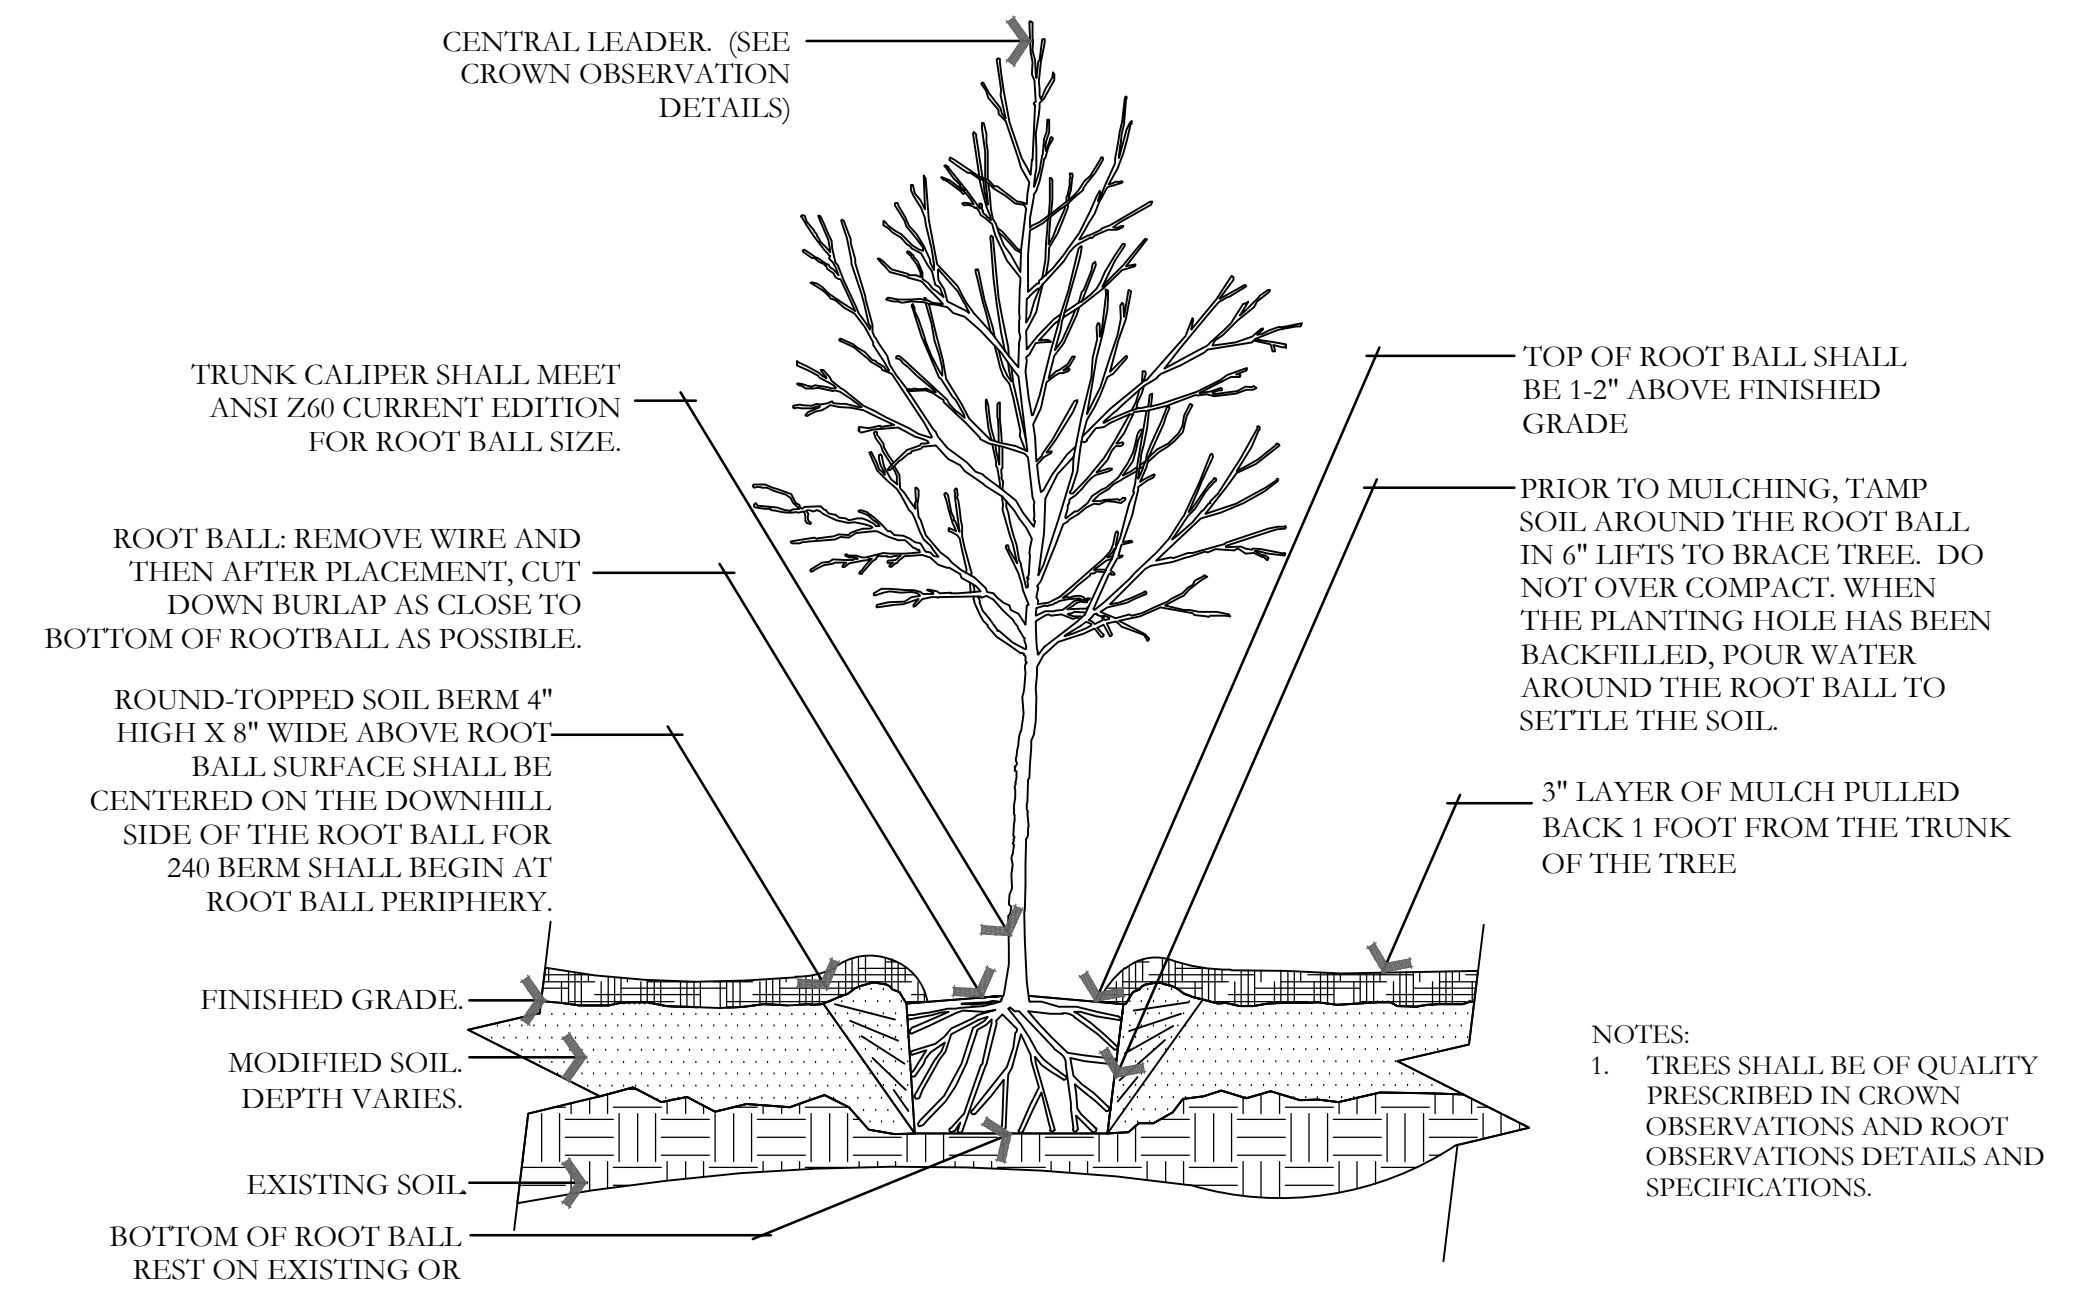
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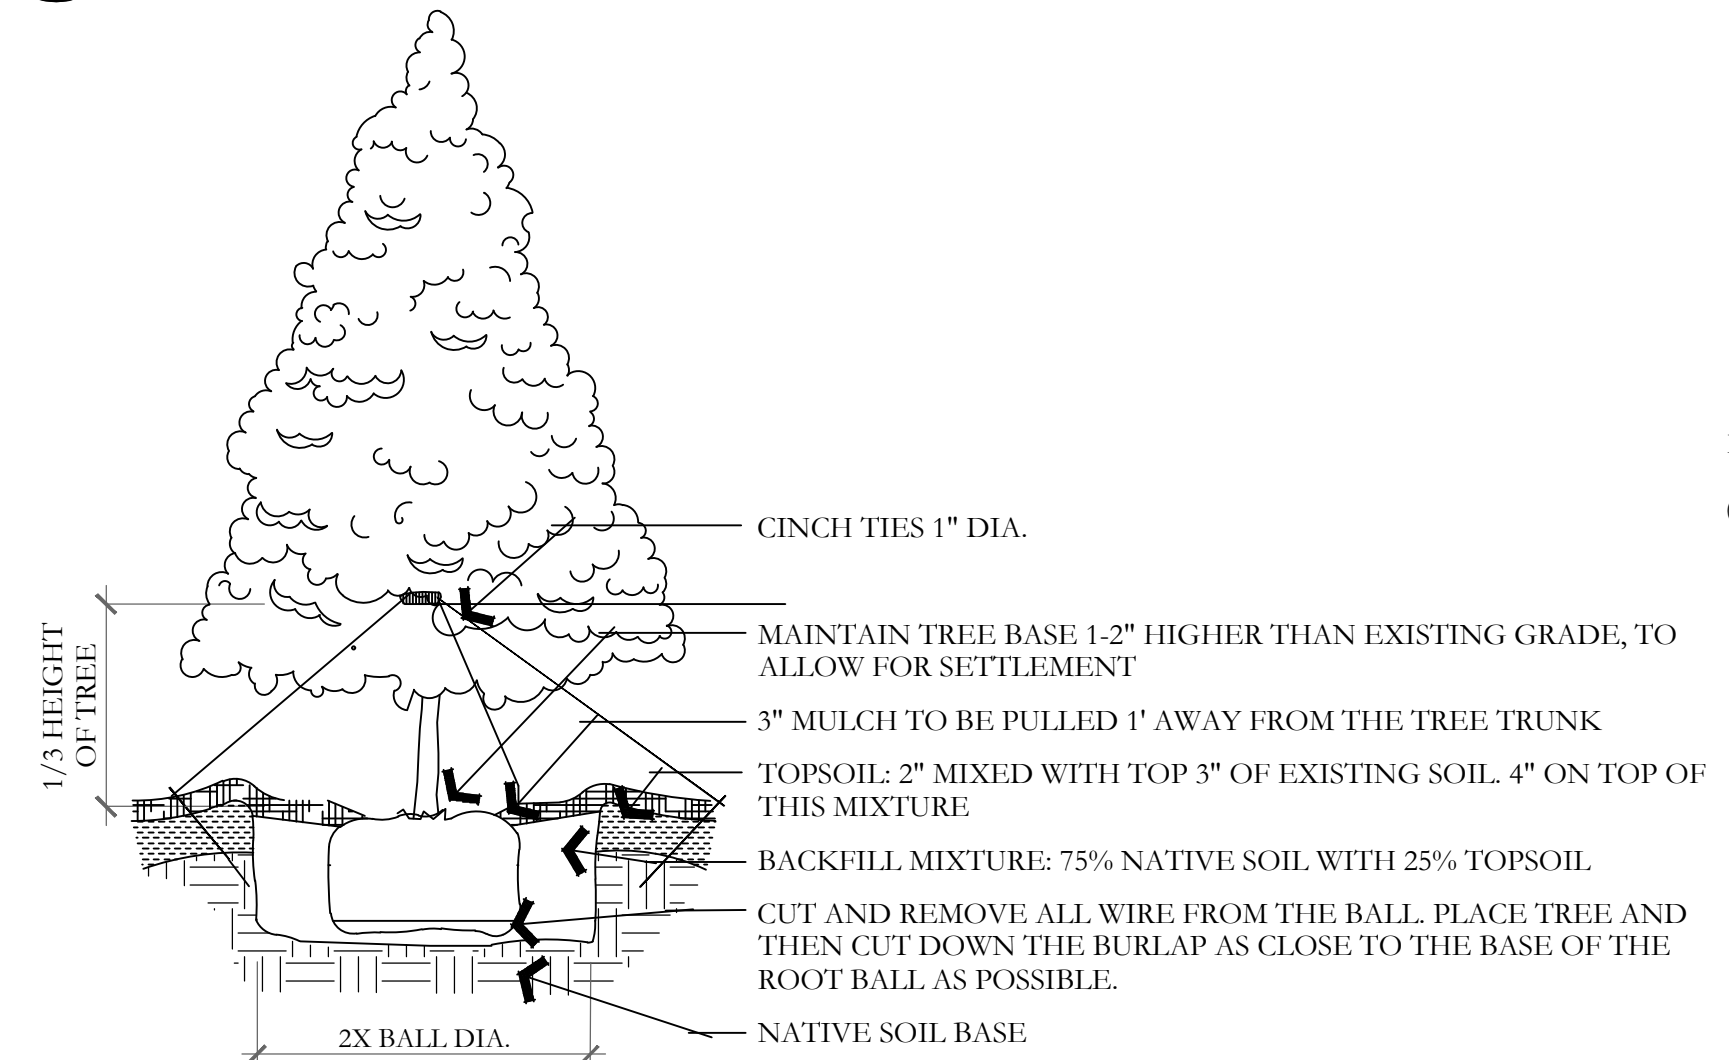
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NOT TO SCALE




B TREE ON SLOPE 5% (20:1) TO 50% (2:1)
NOT TO SCALE




C TREE W/ BERM (EXISTING SOIL MODIFIED)
NOT TO SCALE




D EVERGREEN TREE PLANTING
NOT TO SCALE

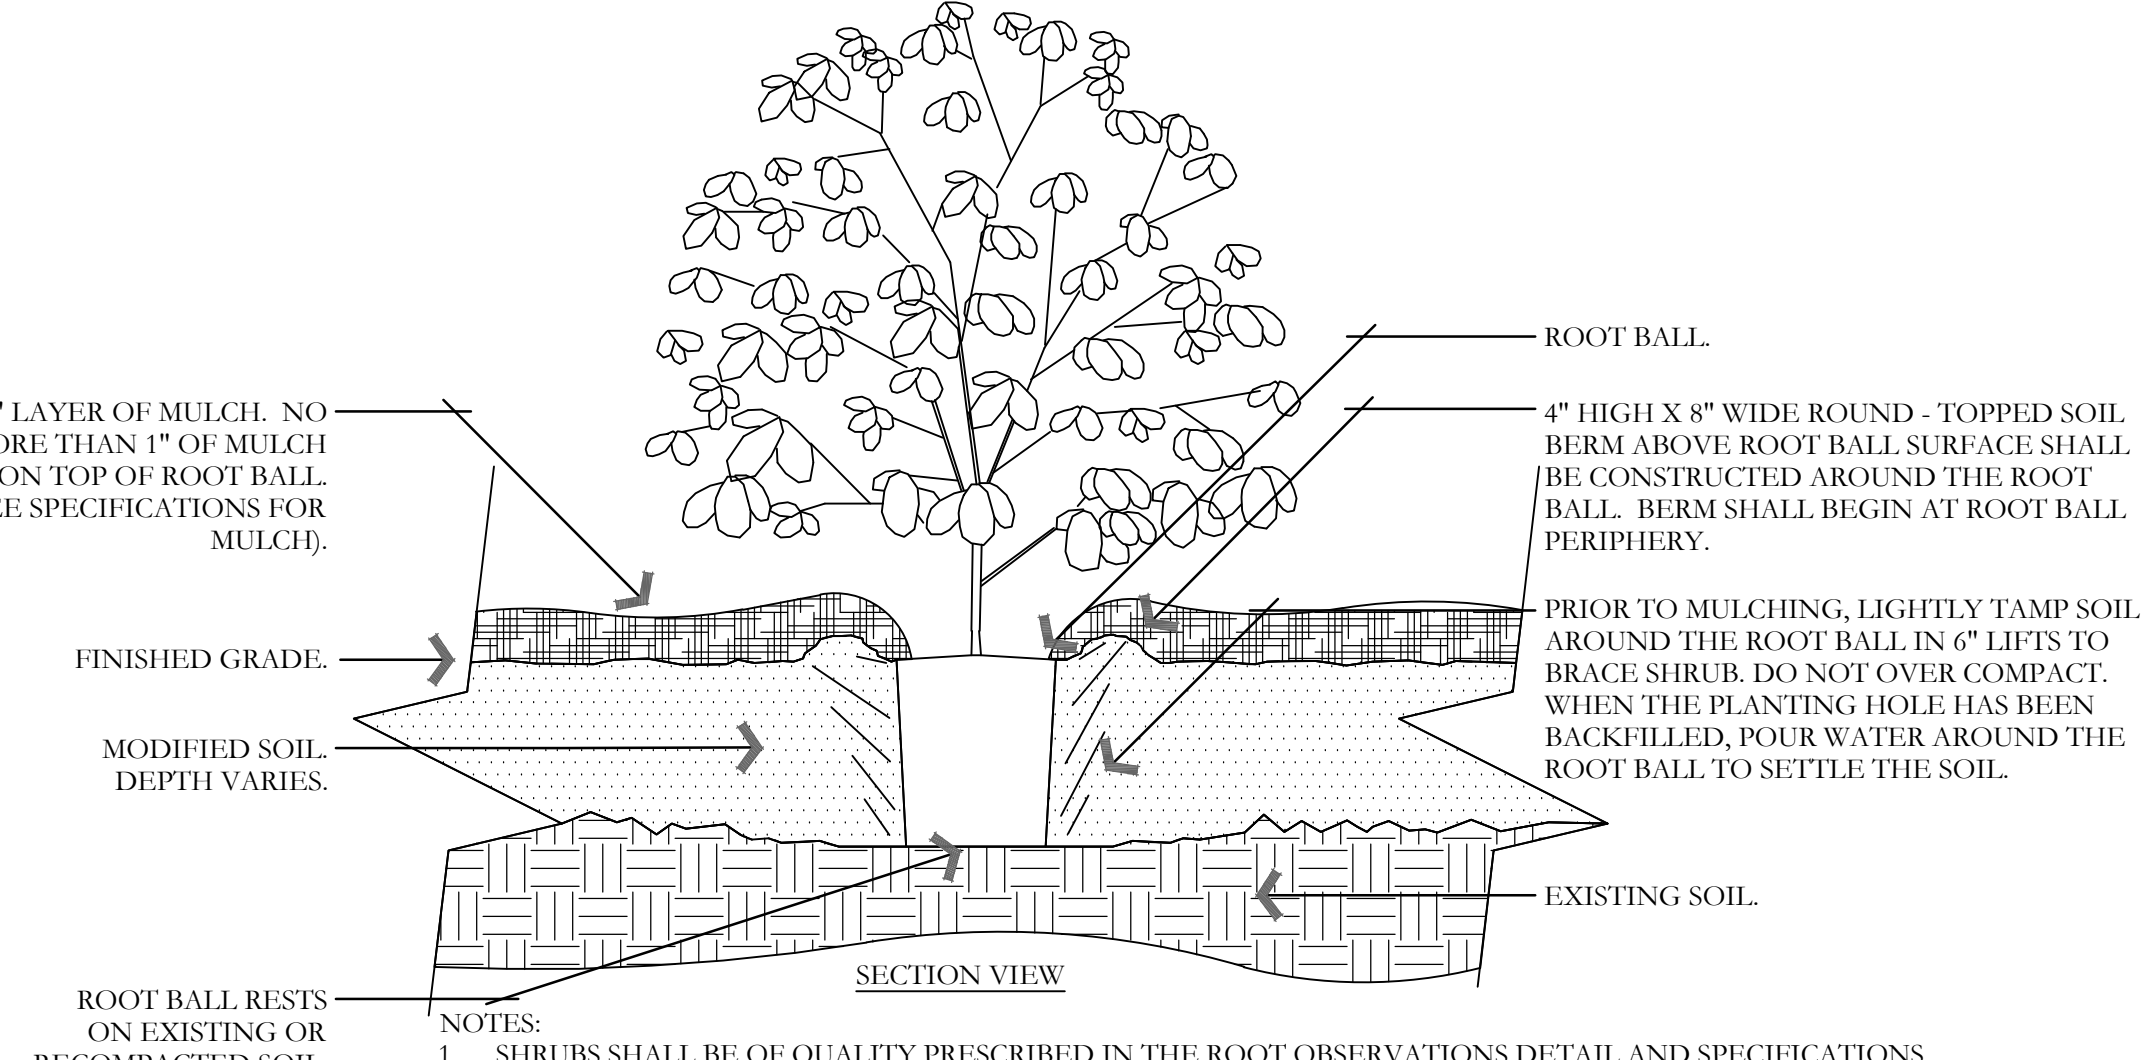


E SHRUB - MODIFIED SOIL
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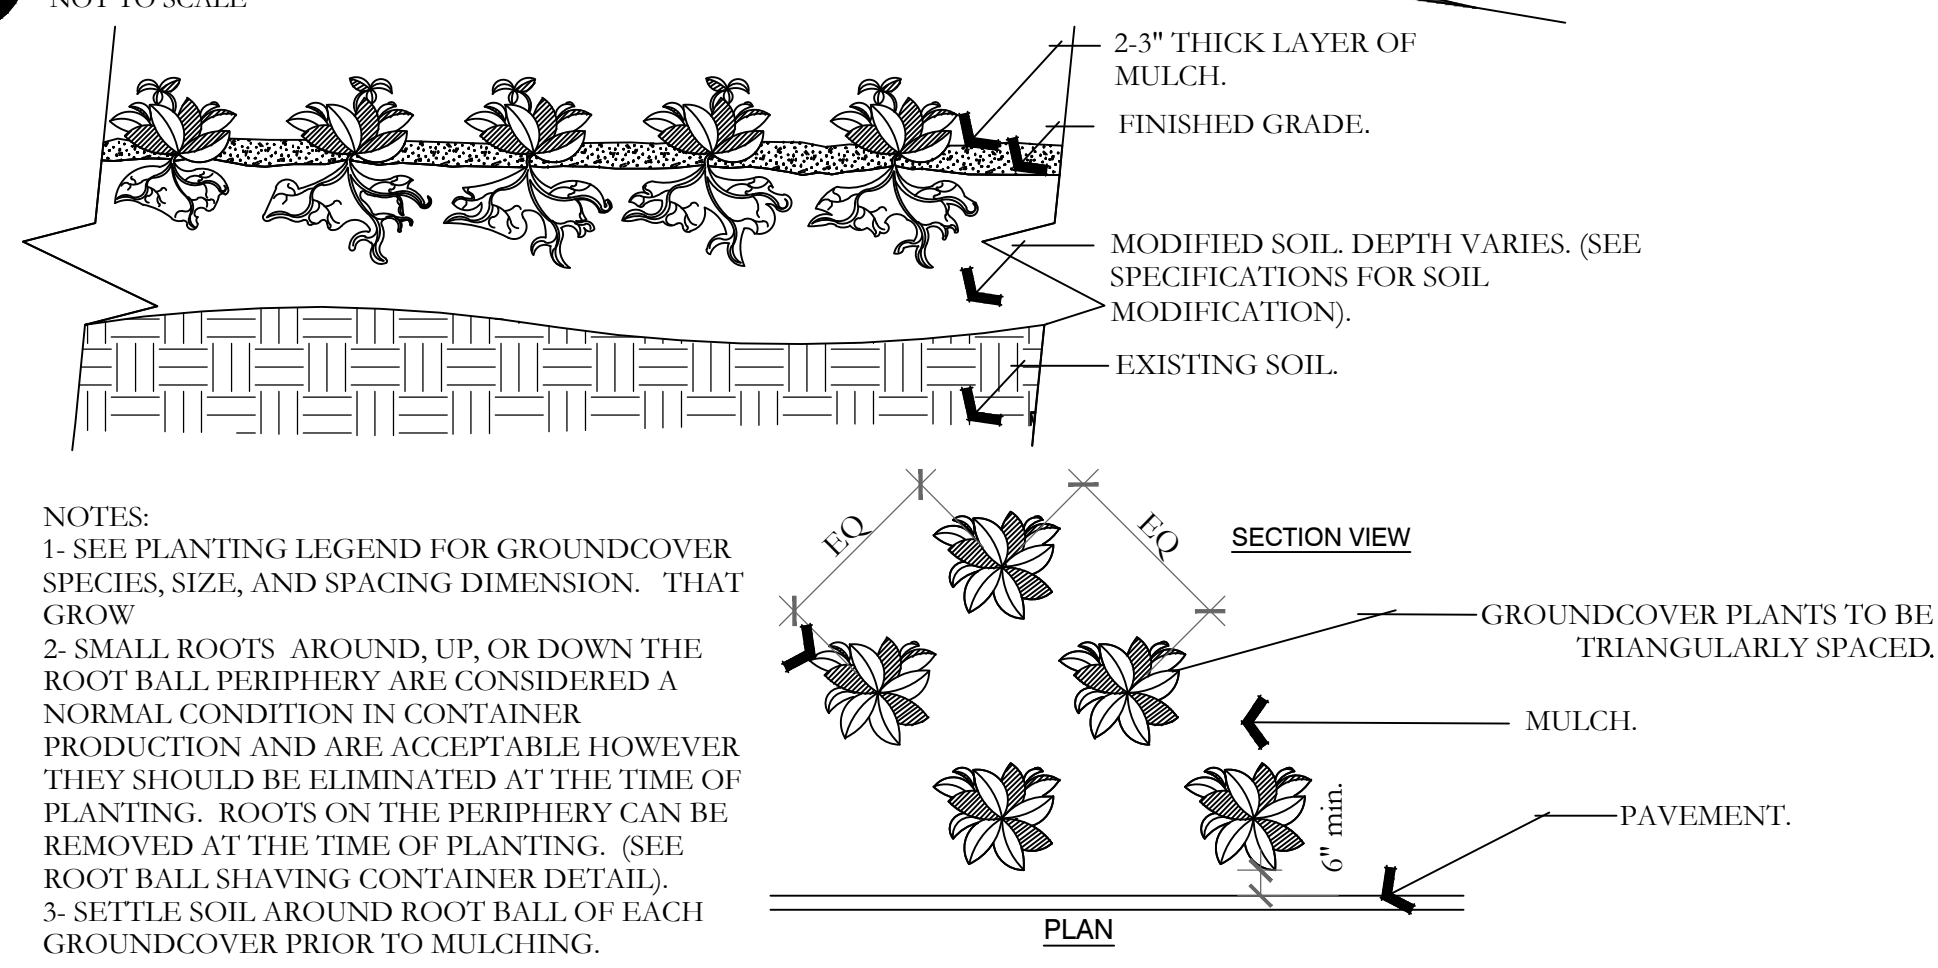
F PERENNIAL PLANTING
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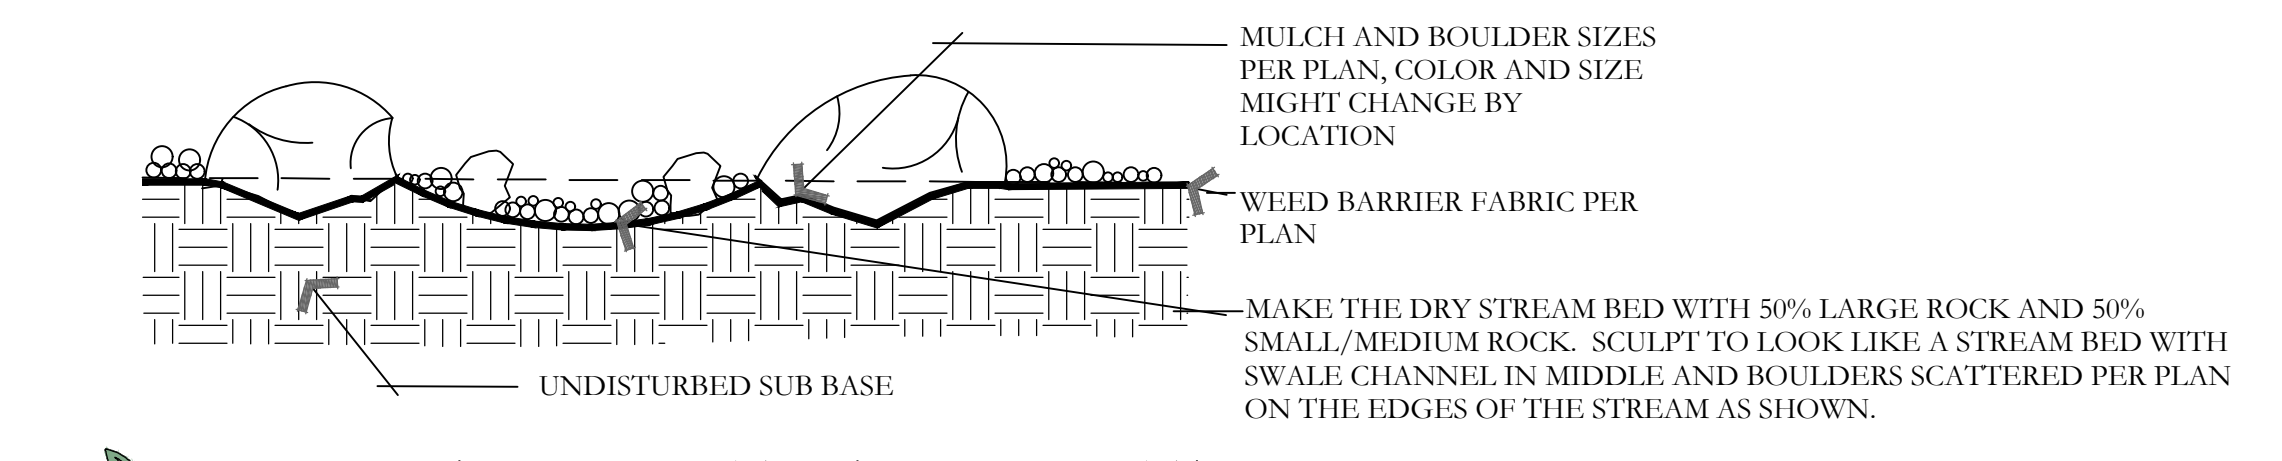
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G METAL EDGING DETAIL
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H PERENNIAL/GROUNDCOVER PLANTING
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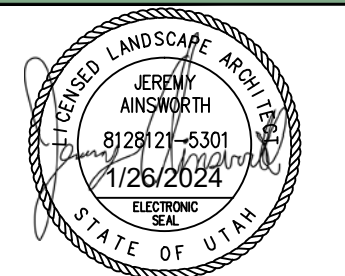
J BOULDER AND DRY STREAM BED DETAIL
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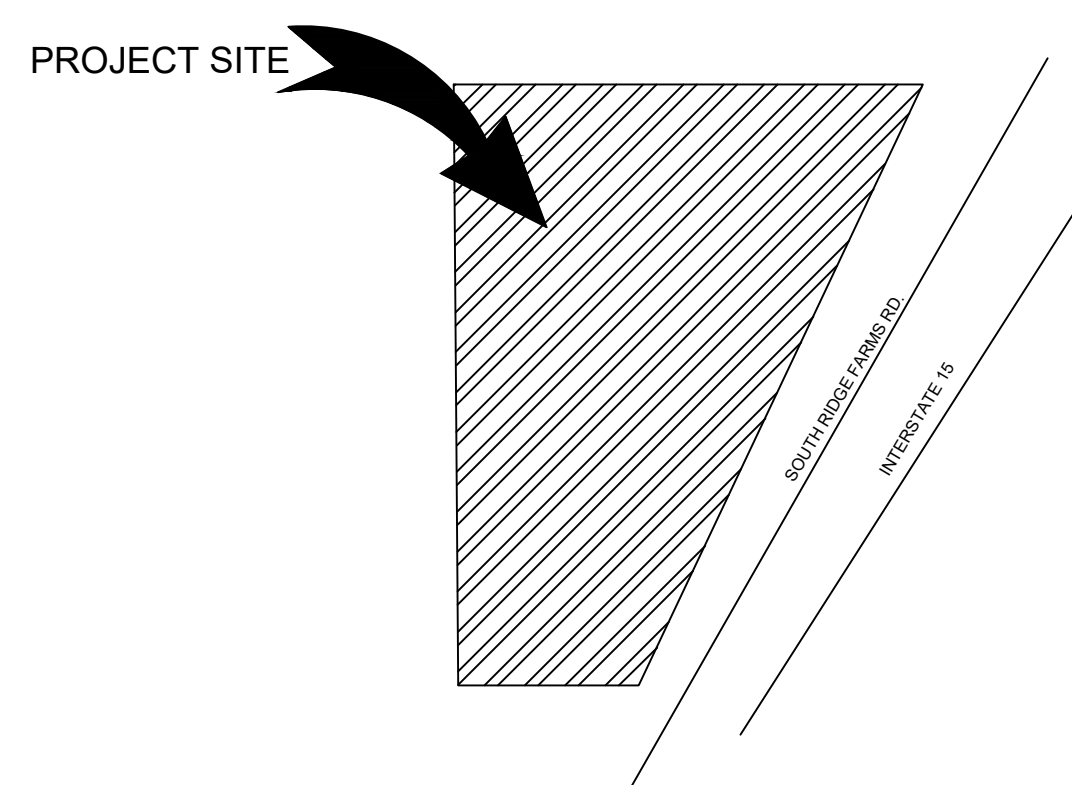
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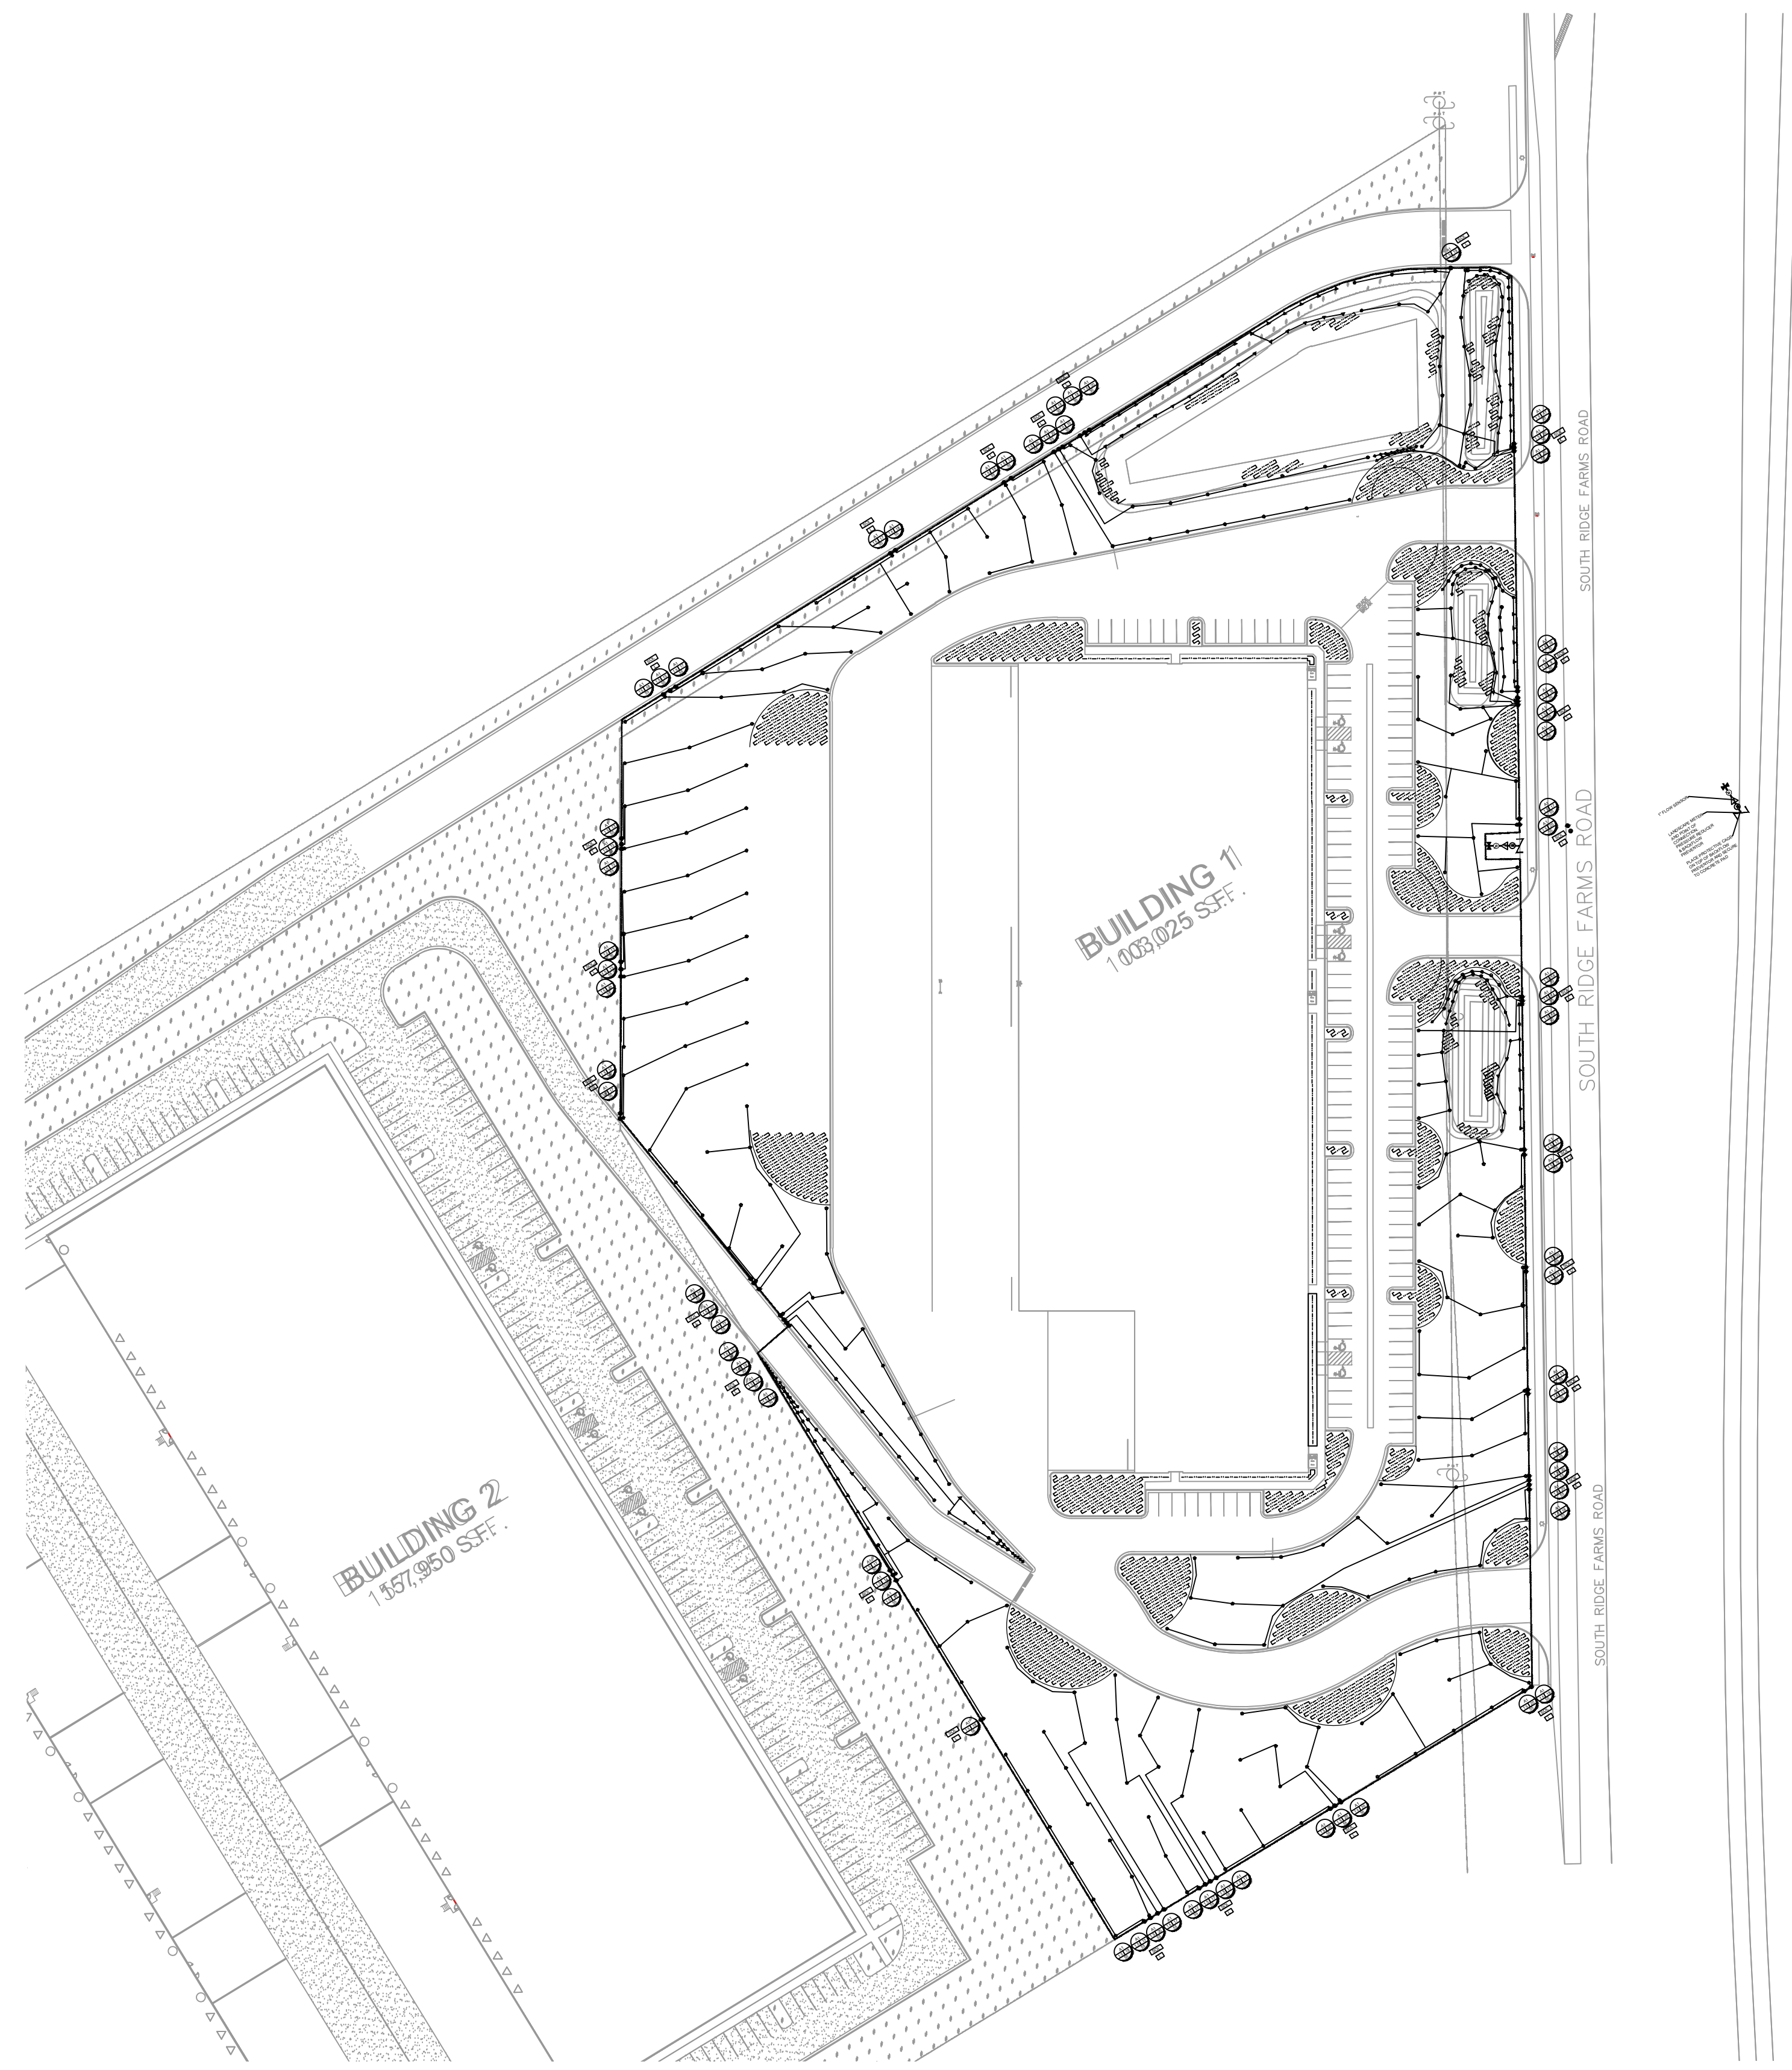
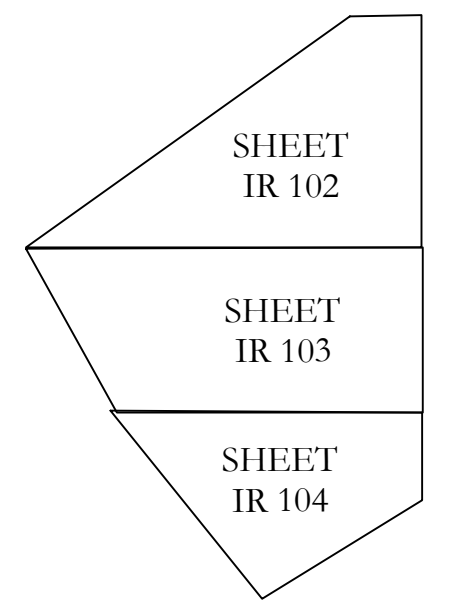
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VICINITY MAP

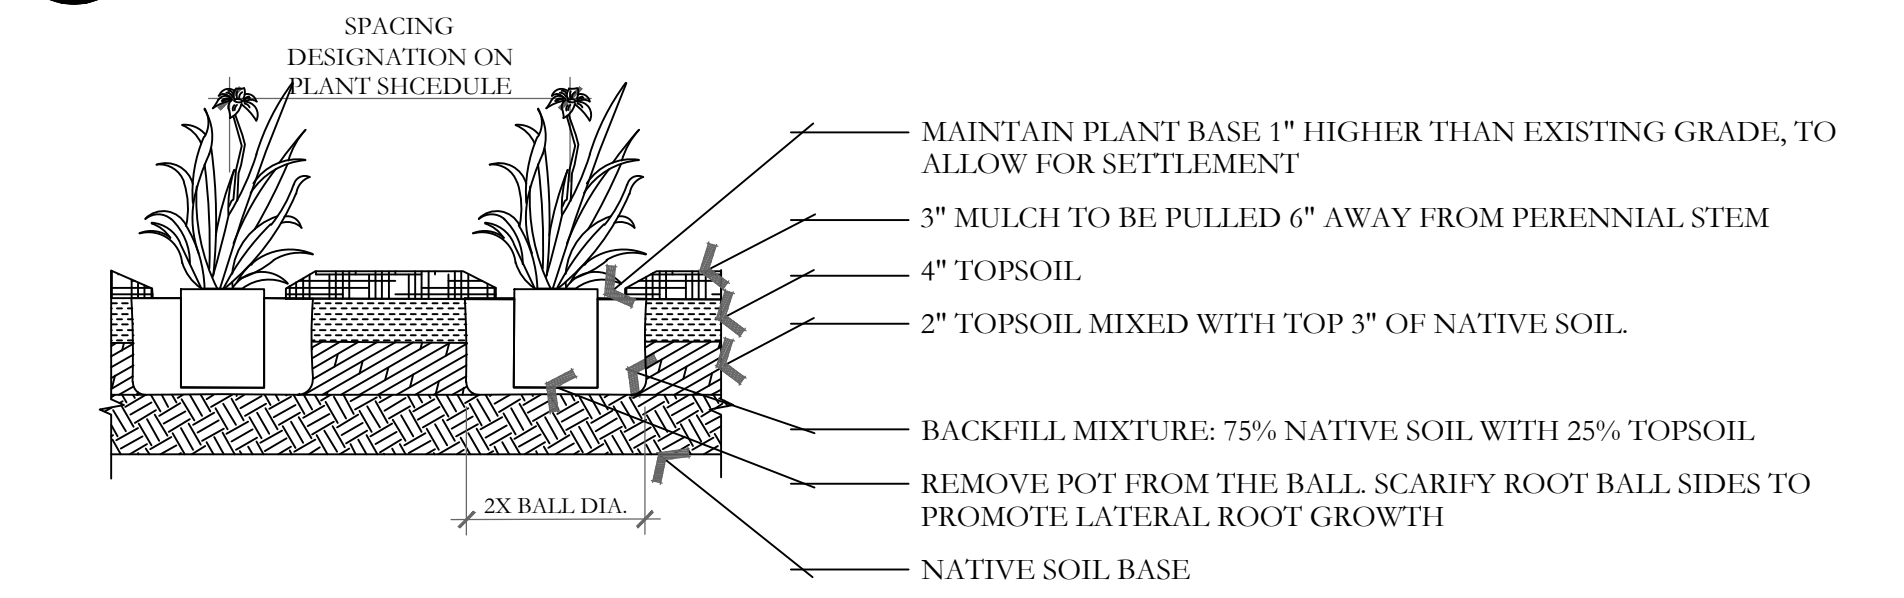


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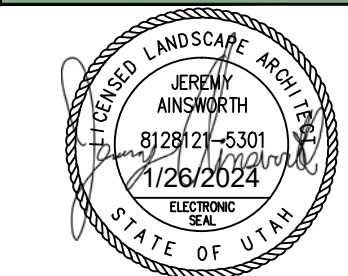
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IRRIGATION PLAN SPECIFICATIONS

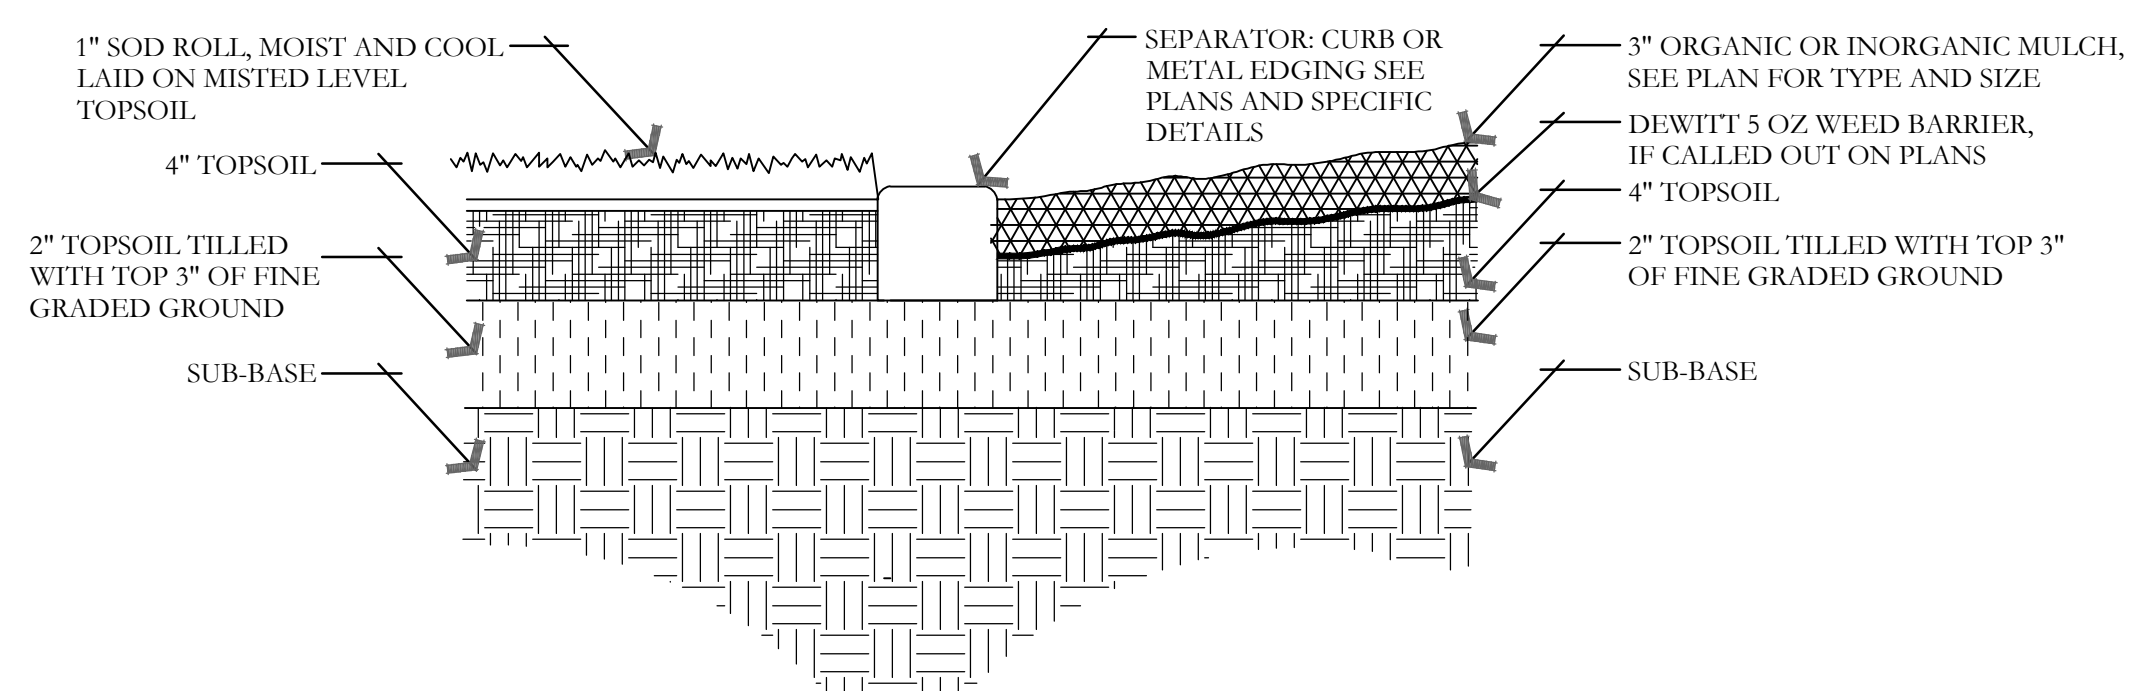IRRIGATION SPECIFICATIONS

PART 1 - SUMMARY

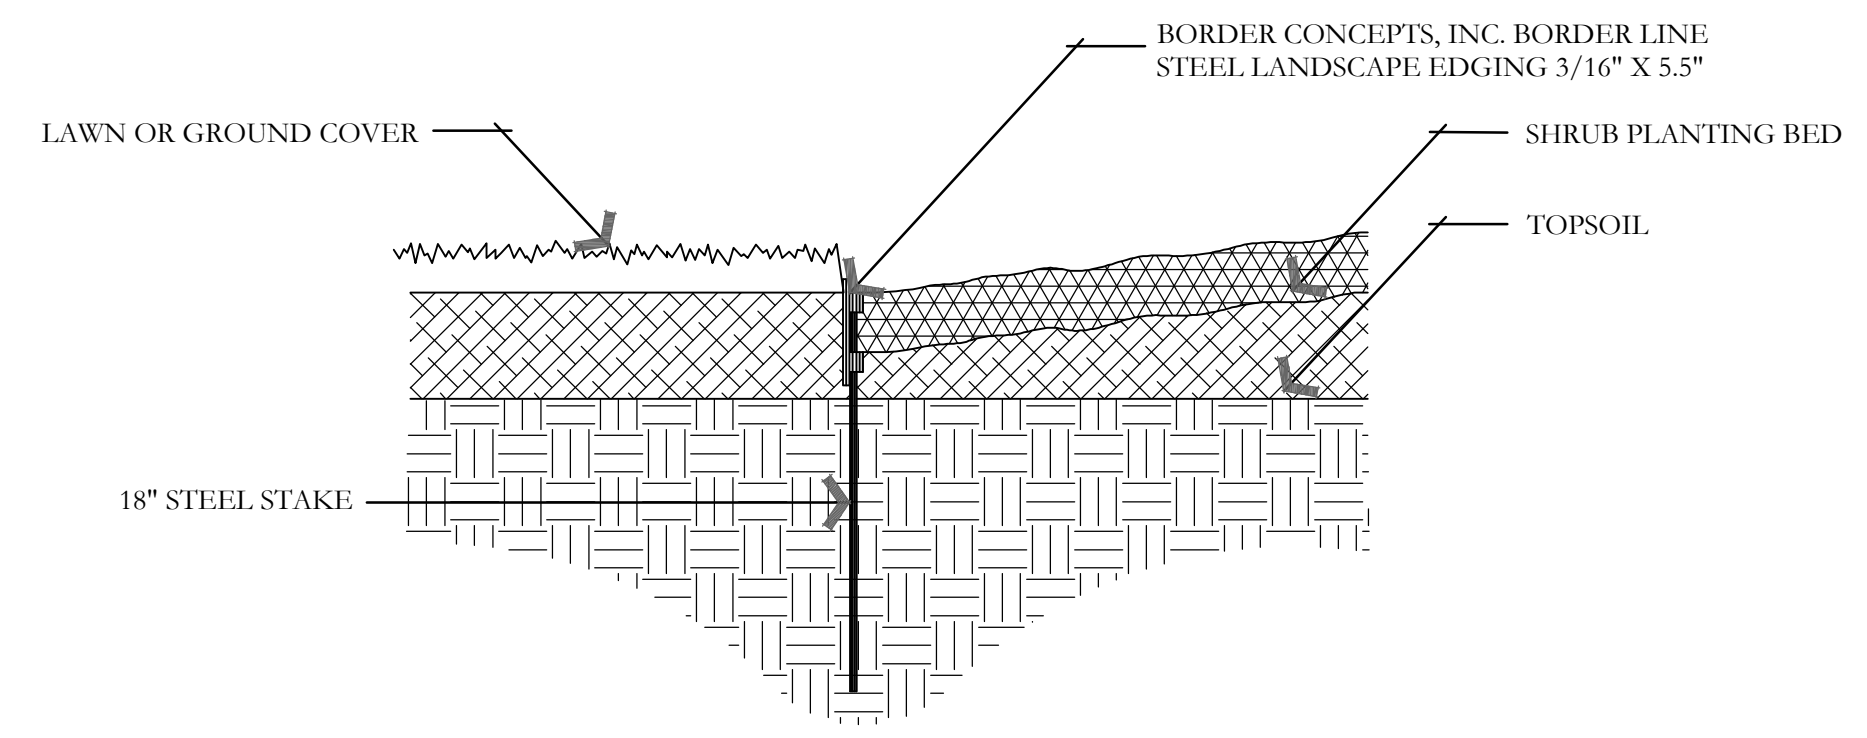1.1 SUMMARY

Work to be done includes all labor, materials, equipment and services required to complete the Project irrigation system as indicated on the Construction Drawings, and as specified herein. Includes but is not limited to: Furnishing and installing underground and above ground sprinkler system complete with any accessories necessary for proper function and operation of the system. All plant material on the Project shall be irrigated. Remove and dispose of any existing sprinkler system components which are disturbed during the construction process and are not to be saved. Restoration of any altered or damaged existing landscape to original state and condition.

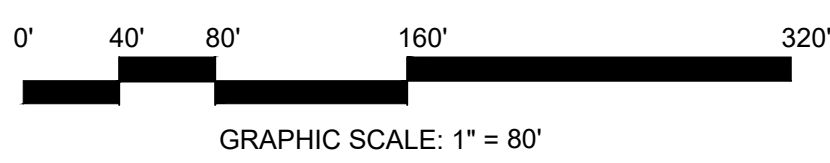1.2 SYSTEM DESCRIPTION

A.Design of irrigation components: Locations of irrigation components on Construction Drawings may be approximate. Piping, sleeving and/or other components shown on Construction drawings may be shown schematically for graphic clarity and demonstration of component groupings and separations. All irrigation components shall be placed in landscaped areas, with the exception of pipe and wire in sleeving under hardscapes. Actual routing of pipe, wire or other components may be altered due to site conditions not accounted for in the design process.

B.Construction requirements: Actual placement may vary as required to achieve a minimum of 100% coverage without overlap onto hardscape, buildings or other features.

C.Layout of Irrigation Components: During layout and staking, consult with Owner Approved Representative (hereafter referred to as OAR) to verify proper placement of irrigation components, and to provide Contractor recommendations for changes where revisions may be advisable. Small or minor adjustments to system layout are permissible to avoid existing field obstructions such as utility boxes or street light poles. Contractor shall place remote control valves in groups as practical to demonstrate on quantity of manifold isolation valves. Quick coupler valves shall be placed with manifold groups and protected by manifold isolation valves. Quick coupler valves are shown on Construction Documents in approximate locations.

1.3 DEFINITIONS

A.Water Supply: Secondary water piping and components, furnished and installed by others to provide irrigation water to this Project, including, but not limited to filter, saddles, nipples, spools, shut off valves, corporation stop valves, water meters, pressure regulation valves, and piping upstream of (or prior to) the Point of Connection.

B.Point of Connection: Location where the Contractor shall tie into the water supply. May require filter, saddle, nipples, spools, isolation valves or Stop and Waste valve for landscape irrigation needs and use.

C.Main Line Piping: Pressurized piping downstream of the Point of Connection to provide water to remote control valves and quick couplers. Normally under constant pressure.

D. Lateral Line Piping: Circuit piping downstream of remote control valves to provide water to sprinkler heads, drip systems or bubblers.

1.4 REFERENCES

A.The following standards will apply to the work of this Section:

- a. ASTM-American Society for Testing and Materials
b. IA - The Irrigation Association: Main BMP Document, Landscape Irrigation Scheduling and Water Management Document.

1.5 SUBMITTALS

A.At least thirty (30) days prior to ordering of any materials, the Contractor shall provide manufacturer catalog cut sheet and current printed specifications for each element or component of the irrigation system. Submittals shall be in three ring binders or other similar bound form. Provide five copies of submittals to OAR for distribution. Place cover or index sheet indicating order in submittal document. No material shall be ordered, delivered or any work proceeded in the field until the required submittals have been reviewed in its entirety and stamped approved. Delivered material shall match the approved samples.

B. Operation and Maintenance Manual:

- a. At least thirty (30) days prior to final inspection, the Contractor shall provide Operation and Maintenance manual to OAR, containing:
i. Manufacturer catalog cut sheet and current printed specifications for each element or component of the irrigation system.
ii. Parts list for each operating element of the system.
iii. Manufacturer printed literature on operation and maintenance of operating elements of the system.
iv. Section listing instructions for overall system operation and maintenance. Include directions for Spring Start-up and Winterization.
b. Project Record Copy
i. Maintain at project site one copy of all project documents clearly marked "Project Record Copy". Mark any deviation in material installation on Construction drawings. Maintain and update drawing at least weekly. Project Record Copy to be available to OAR on demand.
ii. Completed Project As-Built Drawings

- 1. Prior to final inspection, prepare and submit to OAR accurate as-built drawings.
2. Show detail and dimension changes made during installation. Show significant details and dimensions that were not shown in original Contract Documents.
3. Field dimension locations of sleeving, points of connection, main line piping, wiring runs not contained in main line pipe trenches, valves and valve boxes, quick coupler valves.
4. Dimensions are to be taken from permanent constructed surfaces, features, or finished edges located at or above finished grade.
5. Controller May: upon completion of system, place in each controller a color coded copy of the area that controller services: including zone number, type of plant material and location on project that zone services. Laminate map with heat shrink clear plastic.

1.6 QUALITY ASSURANCE

A. Acceptance: Do not install work in this section prior to acceptance by OAR.
B. Regulatory Requirements: All work and materials shall be according to any and all rules, regulations or codes, whether they are State or local laws and ordinances. Contract documents, drawings or specifications may not be construed or interpreted to permit work or materials not conforming to the above codes.
C. Adequate Water Supply: Water supply to this Project exists, installed by others. Connections to these supply lines shall be by this Contractor. Verify that proper connection is available to supply line and is of adequate size. Verify that secondary connection components may be installed if necessary. Perform static pressure test prior to commencement of work. Notify OAR in writing of problems encountered prior to proceeding.

D. Workmanship and Materials:

- a. It is the intent of this specification that all material herein specified and shown on the construction documents shall be of the highest quality available and meeting the requirements specified.
b. All work shall be performed in accordance with the best standards of practice relating to the trade.
E. Contractor Qualifications:
a. Contractor shall provide document or resume including at least the following items:
i. That Contractor has been installing sprinklers on commercial projects for five previous consecutive years.
ii. Contractor is licensed to perform Landscape and Irrigation construction in the State of this Project.
iii. Contractor is bondable for the work to be performed.
iv. References of five projects of similar size and scope completed within the last five years. Three of the projects listed shall be local.
v. Listing of suppliers where materials will be obtained for use on this Project.
vi. Project site Foreman or Supervisor has at least five consecutive years of commercial irrigation installation experience.

This person shall be a current Certified Irrigation Contractor in good standing as set forth by the Irrigation Association. This person shall be on Project site at least 75% of each working day.

- vii. Evidence that Contractor currently employs workers in sufficient quantities to complete Project within time limits that are established by the Contract.
viii. All General laborers or workers on the Project shall be previously trained and familiar with sprinkler installation and have a minimum of one-year experience. Those workers performing tasks related to PVC pipe shall have certificates designated below.

1.7 DELIVERY-STORAGE-HANDLING

A. During delivery, installation and storage of materials for Project, all materials shall be protected from contamination, damage, vandalism, and prolonged exposure to sunlight. All material stored at Project site shall be neatly organized in a compact arrangement and storage shall not disrupt Project Owner or other trades on Project site. All material to be installed shall be handled by Contractor with care to avoid leakage or damage. Damaged materials attributed to Contractor shall be replaced with new at Contractor's expense.

1.8 SEQUENCING

A. Perform site survey, research utility records, contact utility location services. The Contractor shall familiarize himself with all hazards and utilities prior to work commencement. Install sleeving prior to installation of concrete, paving or other permanent site elements. Irrigation system Point of Connection components, backflow prevention and pressure regulation devices shall be installed and operational prior to all downstream components. All main lines shall be thoroughly flushed of all debris prior to installation of any sprinkler heads.

1.9 WARRANTY

A. Contractor shall provide one year Warranty. Warranty shall cover all materials, workmanship and labor. Warranty shall include filling and/or repairing depressions or replacing turf or other plantings due to settlement of irrigation trenches or irrigation system elements. Valve boxes, sprinklers or other components settled from original finish grade shall be restored to proper grade. Irrigation system shall have been adjusted to provide proper, adequate coverage of irrigated areas.

1.10 OWNERS INSTRUCTION

A. After system is installed, inspected, and approved, instruct Owner's Representatives in complete operation and maintenance procedures. Coordinate instruction with references to previously submitted Operation and Maintenance Manual.

1.11 MAINTENANCE:

- A. Furnish the following items to Owner's Representative:
a. Two quick coupler keys with hose swivels.
b. One of each type or size of quick coupler valve and remote control valve. Five percent of total quantities used of each sprinkler and sprinkler nozzle.

B. Provide the following services:

- a. Winterize entire irrigation system installed under this contract. Winterize by 'blow-out' method using compressed air. Compressor shall be capable of minimum of 175 CFM. This operation shall occur at the end of first growing season after need for plant irrigation but prior to freezing. Compressor shall be capable of evacuating system of all water pressure regulation devices. Compressor shall be regulated to not more than 60 PSI. Start up system the following spring after danger of freezing has passed. Contractor shall train Owner's Representative in proper start-up and winterization procedure.

PART 2 - PRODUCTS

2.1 GENERAL NOTES

A. Contractor shall provide materials to be used on this Project. Contractor shall not remove any material purchased for this Project from the Project Site, nor mix Project materials with other Contractor owned materials. Owner retains right to purchase and provide project material.

2.2 POINT OF CONNECTION

A. The Contractor shall connect onto existing irrigation or water main line as needed for Point(s) of Connection. Contractor shall install new main line as indicated.

2.3 CONNECTION ASSEMBLY

A. Secondary water shall be used on this Project. Install filter and RPZ as needed.

2.4 CONTROL SYSTEM

- A. Power supply to the irrigation controller shall be provided for by this Contractor.
B. Controller shall be as specified in the drawings. Controller shall be surge protected.
a. Installation of wall-mount/ground pedestal timer controllers: Irrigation contractor shall be responsible for this task. Power configuration for wall-mount/ground pedestal timer controllers shall be 120 VAC, unless otherwise noted.
b. Locate Controller(s) in general location shown on Construction drawings. Coordinate power supply and breaker allocation with electrical contractor. Contractor shall be responsible for all power connections to Controllers, whether they are wall mount or pedestal mount. Contractor shall coordinate with electrical or other Project trades as needed to facilitate installation of power to controllers.
C. Wires connecting the remote control valves to the irrigation controller are single conductors, type PE. Wire construction shall incorporate a solid copper conductor and polyethylene (PE) insulation with a minimum thickness of 0.045 inches. The wires shall be UL listed for direct burial in irrigation systems and be rated at a minimum of 30 VAC. Paige Electric Co., LP specification number P9079D.
a. A minimum of 24" of additional wire shall be left at each valve, each red pipe box and at each controller.
b. Common wire shall be white in color, 12 gauge. Control wire shall be red in color, 14 gauge. Spare/extra wire (3 ft.) shall be looped within each valve box of the grouping it is to service.
D. RGV wire splicing connectors shall be 3M brand DBY or DBR. Wire splicing between controller and valves shall be avoided if at all possible. Any wire splices shall be contained within a valve box. Splices within a valve box that contains no control valves shall be stamped "WIRE SPLICED" or "WS" on box lid.

2.5 SLEEVING

A. Contractor shall be responsible to protect existing underground utilities and components. Sleeving minimum size shall be 2". Sleeving 2" through 4" in size shall be S/40 PVC solvent weld. Sleeving 4" and larger shall be CI, 200 PVC gasketed. Sleeve diameter shall be at least two times the diameter of the pipe within the sleeve. Sleeves shall be extended 6" minimum beyond walk or edge of pavement. Wire or cable shall not be installed in the same sleeve as piping, but shall be installed in separate sleeves. Sleeve ends on sleeve sizes 4" and larger shall be capped with integral corresponding sized PVC slip cap, pressure fit, until used, to prevent contamination. Sleeves shall be installed at appropriate depths for main line pipe or lateral pipe.

2.6 MAIN LINE PIPE

- A. All main line pipe 4" and larger shall be Class 200 gasketed bell end. All main line pipe 3" in size and smaller shall be Schedule 40 PVC solvent weld bell end.
a. Maximum flows allowed through main line pipe shall be:
3/4" 8 GPM
1" 12 GPM
1-1/2" 30 GPM
2" 53 GPM
2-1/2" 75 GPM
3" 110 GPM
4" 180 GPM
b. Main line pipe shall be buried with 24" cover

2.7 MAIN LINE FITTINGS

A. All main line fittings 3" and larger shall be gasketed ductile iron material. All ductile iron fittings having change of

direction shall have proper concrete thrust block installed. All main line fittings smaller than 3" in size shall be Schedule 80 PVC.

2.8 ISOLATION VALVES

- A. Isolation valves 3" and larger shall be Watereuse brand model 2500 cast iron gate valve, resilient wedge, push on type, with 2" square operating nut. Place sleeve of 6" or larger pipe over top of valve vertically and then extend to grade. Place 10" round valve box over sleeve at grade.
B. Isolation valves 2-1/2" and smaller shall be Apollo brand 70 series brass ball valves, contained in a Carson Standard size valve box. Valves shall be installed with S/80 PVC TOE Nipples on both sides of the valve. Valve shall be placed so that the handle is vertical toward the top of the valve box in the 'off' position.

2.9 MANIFOLDS

A. Action Manifold fittings shall be used to create unions on both sides of each control valve, allowing the valve to be removed from the box without cutting piping. Valves shall be located in boxes with ample space surrounding them to allow access for maintenance and repair. Where practical, group remote control valves in close proximity, and protect each grouping with a manifold isolation valve as shown in details. Manifold Main Line (or Sub-Main Line) and all manifold components and isolation valves shall be at least as large as the largest diameter lateral served by the respective manifold.

2.10 REMOTE CONTROL VALVES

A. Remote control valves shall be as specified on the drawings. Remote control valves shall be located separately and individually in separate control boxes.

2.11 MANUAL CONTROL VALVES

A. Quick coupler valve shall be attached to the manifold sub-main line using a Lasco G175212 swing joint assembly with snap-lock outlet and brass stabilizer elbow. Quick coupler valve shall be placed within a Carson 10" round valve box. Top of quick coupler valve cover shall allow for complete installation of valve box lid, but also allow for insertion and operation of key. Base of quick coupler valve and top of quick coupler swing joint shall be encased in 1/4" gravel. Contractor shall not place quick coupler valves further than 200 feet apart, to allow for spot watering or supplemental irrigation of new plant material. Quick coupler valve at POC shall not be eliminated or relocated.

2.12 LATERAL LINE PIPE

A. All lateral piping shall be Schedule 40 PVC, solvent weld, and bell end. Lateral pipe shall be buried with 12-18" of cover typically. Lateral pipe shall be 3/4", 1", 1 1/4", 1 1/2" or 2" in size as indicated on Construction Drawings.

2.13 LATERAL LINE FITTINGS

A. All lateral line fittings shall be S/40 PVC.

2.14 SPRAY SPRINKLERS

A. Spray head sprinklers shall be as specified on the drawings. Nozzles shall be as specified on the drawings.

2.15 VALVE BOXES

A. Rainbird valve boxes shall be used on this project. Sizes are as directed in these Specifications, detail sheets or plan sheets. Valve boxes shall be centered over the control valve or element they cover. Valve box shall be sized large enough to allow ample room for services access, removal or replacement of valve or element. Valve box shall be set to flush to finish grade of topsoil or hardscape areas. Contractor shall provide extensions or stack additional valve boxes as necessary to bring valve box pit to proper grade.

2.16 IMPORT BACKFILL

A. All main line pipe, lateral line pipe and other irrigation elements shall be bedded and backfilled with clean soil, free of rocks 1" and larger. Contractor shall furnish and install additional backfill material as necessary due to rocky conditions. Trenches and other elements shall be compacted and/or water settled to eliminate settling. Debris from trenching operations un-suitable for fill shall be removed from project and disposed of properly by Contractor.

2.17 OTHER PRODUCTS

A. Substitution of equivalent products is subject to the OAR's approval and must be designated as accepted in writing.
a. The Contractor shall provide materials to make the system complete and operational.

PART 3 - EXECUTION

3.1 PREPARATION

A. Contractor shall repair or replace work damaged by irrigation system installation. If damaged work is new, repair or replacement shall be performed by the original installer of that work. The existing landscape of this Project shall remain in place. Contractor shall protect and work around existing plant material. Coordination of trench and valve locations shall be laid out for the OAR prior to any excavation occurring. Plant material deemed damaged by the OAR shall be replaced with new plant material at Contractor's expense. Contractor shall not cut existing tree roots larger than 2" to install this Project. Route pipe, wire and irrigation elements around tree canopy drip line to minimize damage to tree roots. Contractor shall have no part of existing system used by other portions of site landscape without water for more than 24 hours at a time.

3.2 TRENCHING AND BACKFILLING

A. Pulling of pipe shall not be permitted on this project. Over excavate trenches both in width and depth. Ensure base of trench is rock or debris free to protect pipe and wire. Grade trench base to ensure flat, even support of piping. Backfill with clean soil or import material. Contractor shall backfill no less than 2" around entire pipe with clean, rock free fill. Main line piping and fittings shall not be backfilled until after soil has inspected and pipe has passed pressure testing. Perform balance of backfill operation to eliminate any settling.

3.3 SLEEVING

A. Sleeve all piping and wiring that pass under paving or hardscape features. Wiring shall be placed in separate sleeving from piping. Sleeves shall be positioned relative to structures or obstructions to allow for pipe or wire within to be removed if necessary.

3.4 GRADES AND DRAINAGE

A. Place irrigation pipe and other elements at uniform grades. Winterization shall be by evacuation with compressed air. Automatic drains shall not be installed on this Project. Manual drains shall only be installed at POC where designated on Construction Drawings.

3.5 PVC PIPE

- A. Install pipe to allow for expansion and contraction as recommended by pipe manufacturer.
B. Install main line pipes with 18" of cover, lateral line pipes with 12" of cover.
C. Drawings show diagrammatic or conceptual location of piping - Contractor shall install piping to minimize change of direction, avoid placement under large trees or large shrubs, avoid placement under hardscape features.
D. Plastic pipe shall be cut squarely. Burrs shall be removed. Spigot ends of pipes 3" and larger shall be beveled.
E. Pipe shall not be glued unless ambient temperature is at least 50 degrees F. Pipe shall not be glued in rainy conditions unless properly tented. All solvent weld joints shall be assembled using IPS 711 glue and P701 primer according to manufacturer's specification, no exceptions. All workers performing glue operations shall provide evidence of certification. Glued main line pipe shall cure a minimum of 24 hours prior to being energized. Lateral lines shall cure a minimum of 2 hours prior to being energized and shall not remain under constant pressure unless cured for 24 hours.

F. Appropriate thrust blocking shall be performed on fittings 3" and larger. All threaded joints shall be wrapped with Teflon tape or paste unless directed by product manufacturer or sealing by o-ring.

3.6 CONTROLLERS

- A. All grounding for pedestal controllers shall be as directed by controller manufacturer and ASIC guidelines, not to exceed a resistance reading of 5 OHMS.
B. Locate controllers in protected, inconspicuous places, when possible. Coordinate location of pedestal controllers with Landscape Architect to minimize visibility.
C. Coordinate location of wall mount controllers with building or electrical contractor to facilitate electrical service and future maintenance needs. Wall mount shall be securely fastened to surface. If exterior mounted, wall mount controllers shall have electrical service wire and field control wire in separate, appropriate sized weatherproof electrical conduit, PVC pipe shall not be used.

D. Wiring under hardscape surfaces shall be placed continuously in conduit. Contractor shall be responsible to coordinate sleeving needs for conduit or sweeps elbows from exterior to interior of building.

E. Pedestal controllers shall be placed upon VTI-Strong Box Quick Pad as per manufacturer's recommendations. Controllers shall be oriented such that Owner's Representative maintenance personnel may access easily and perform field system tests efficiently.

F. Place Standard valve box at base of controller or nearby to allow for three to five feet of slack field control wire to be placed at each controller. This Contractor shall provide conduit access if needed for Electrical Contractor. Electrical supply and installation, as well as hook-up to controller shall be by this Contractor.

G. Electrical contractor is in charge of providing 1.5" conduit from controller to outside landscape area. Provide power and room for controller. Provide ethernet to hardware power into the controller.

3.7 VALVES

- A. Isolation valves, remote control valves, and quick coupler valves shall be installed according to manufacturer recommendation and Contract Specifications and Details.
B. Valve boxes shall be set over valves so that all parts of the valve can be reached for service.
C. Valve box and lid shall be set to be flush with finished grade. Only one remote control valve may be installed in a valve box. Place a minimum of 4" of 3/4" washed gravel beneath valve box for drainage. Bottom of remote control valve shall be a minimum of 2" above gravel.

3.8 SPRINKLER HEADS

- A. No sprinkler shall be located closer than 6" to walls, fences, or buildings.
B. Heads adjacent to walks, curbs, or paths shall be located at grade and 2" away from hardscape.
C. Control valves shall be opened. Then fully flush lateral line pipe and swing joints prior to installation of sprinklers.
D. Spray heads shall be installed and flushed again prior to installation of nozzles.
E. Contractor shall be responsible for adjustment if necessary due to grade changes during landscape construction.

3.9 FIELD QUALITY CONTROL

- A. Main line pipes shall not be backfilled or accepted until the system has been tested for 2 hours at 100 psi.
B. Main line pressure test shall include all pipe and components from the point of connection to the upstream side of remote control valves. Test shall include all manifold components under constant pressure. Piping may be tested in sections that can be isolated.
C. Contractor shall provide pressurized water pump to increase or boost pressure where existing static pressure is less than 100 psi.
D. Schedule testing with OAR 48 hours in advance for approval.
E. Leaks or defects shall promptly be repaired or rectified at the Contractors expense and retested until able to pass testing.
F. Grounding resistance at pedestal controller shall also be tested and shall not exceed 5 OHMS.

3.10 ADJUSTMENT

- A. Sprinkler heads shall be adjusted to proper height when installed. Changes in grade or adjustment of head height after installation shall be considered a part of the original contract and a Contractor's expense.
B. Adjust all sprinkler heads for arc, radius, proper trim and distribution to cover all landscaped areas that are to be irrigated.
C. Adjust sprinklers so they do not water buildings, structures, or other hardscape features.
D. Adjust run times of station to meet needs of plant material the station services.

3.11 CLEANING

- A. Contractor shall be responsible for cleanliness of jobsite. Work areas shall be swept cleanly and picked up daily.
B. Open trenches or hazards shall be protected with yellow caution tape.
C. Contractor is responsible for removal and disposal of off-site trash and debris generated as a result of this Project.
D. OAR shall perform periodic as well as a final cleanliness inspection.
E. Contractor shall leave Project in at least a 'broom clean' condition.

END OF SECTION

WATERING SCHEDULE

Table with 12 columns: TYPE, IR HEAD, AMT. H2O, SUNDAY, MONDAY, TUESDAY, WEDNESDAY, THURSDAY, FRIDAY, SATURDAY, OPERATING PRESSURE. Rows for HYDROZONE A (TURF) and HYDROZONE B (SHRUBS).

Note: Begin irrigation 4:00 am. Use cycle and soak method in clay soils-divide into 3 waterings for each turf irrigation event. Shrubs to be watered so soil is moist 6" below root ball. Do not overwater shrubs, allow to dry between waterings especially in clay soils. Watch for water stress.

Table for SPRING REGULAR IRRIGATION SCHEDULE: BEGIN WATERING MAY 15 (Turf irrigation event once every 5-7 days; shrubs 2-3 times/month). Columns include TYPE, IR HEAD, AMT. H2O, SUNDAY, MONDAY, TUESDAY, WEDNESDAY, THURSDAY, FRIDAY, SATURDAY, OPERATING PRESSURE.


Note: Begin irrigation 4:00 am. Use cycle and soak method in clay soils-divide into 3 waterings for each turf irrigation event. Do not overwater shrubs, allow to dry between waterings especially in clay soils. Watch for water stress.

Table for SUMMER REGULAR IRRIGATION SCHEDULE: BEGIN WATERING JUNE 15 (Turf irrigation event once every 3-5 days; shrubs 1 time/week). Columns include TYPE, IR HEAD, AMT. H2O, SUNDAY, MONDAY, TUESDAY, WEDNESDAY, THURSDAY, FRIDAY, SATURDAY, OPERATING PRESSURE.

Note: Begin irrigation 4:00 am. Use cycle and soak method in clay soils-divide into 3 waterings for each turf irrigation event. Do not overwater shrubs, allow to dry between waterings especially in clay soils. Watch for water stress.

Table for FALL REGULAR IRRIGATION SCHEDULE: BEGIN WATERING SEPT. 1, END WATERING OCT. 15 (Turf irrigation event every 5-7 days; shrubs 2-3 times/month). Columns include TYPE, IR HEAD, AMT. H2O, SUNDAY, MONDAY, TUESDAY, WEDNESDAY, THURSDAY, FRIDAY, SATURDAY, OPERATING PRESSURE.

Note: Begin irrigation 4:00 am. Use cycle and soak method in clay soils-divide into 3 waterings for each turf irrigation event. Do not overwater shrubs, allow to dry between waterings especially in clay soils. Watch for water stress.

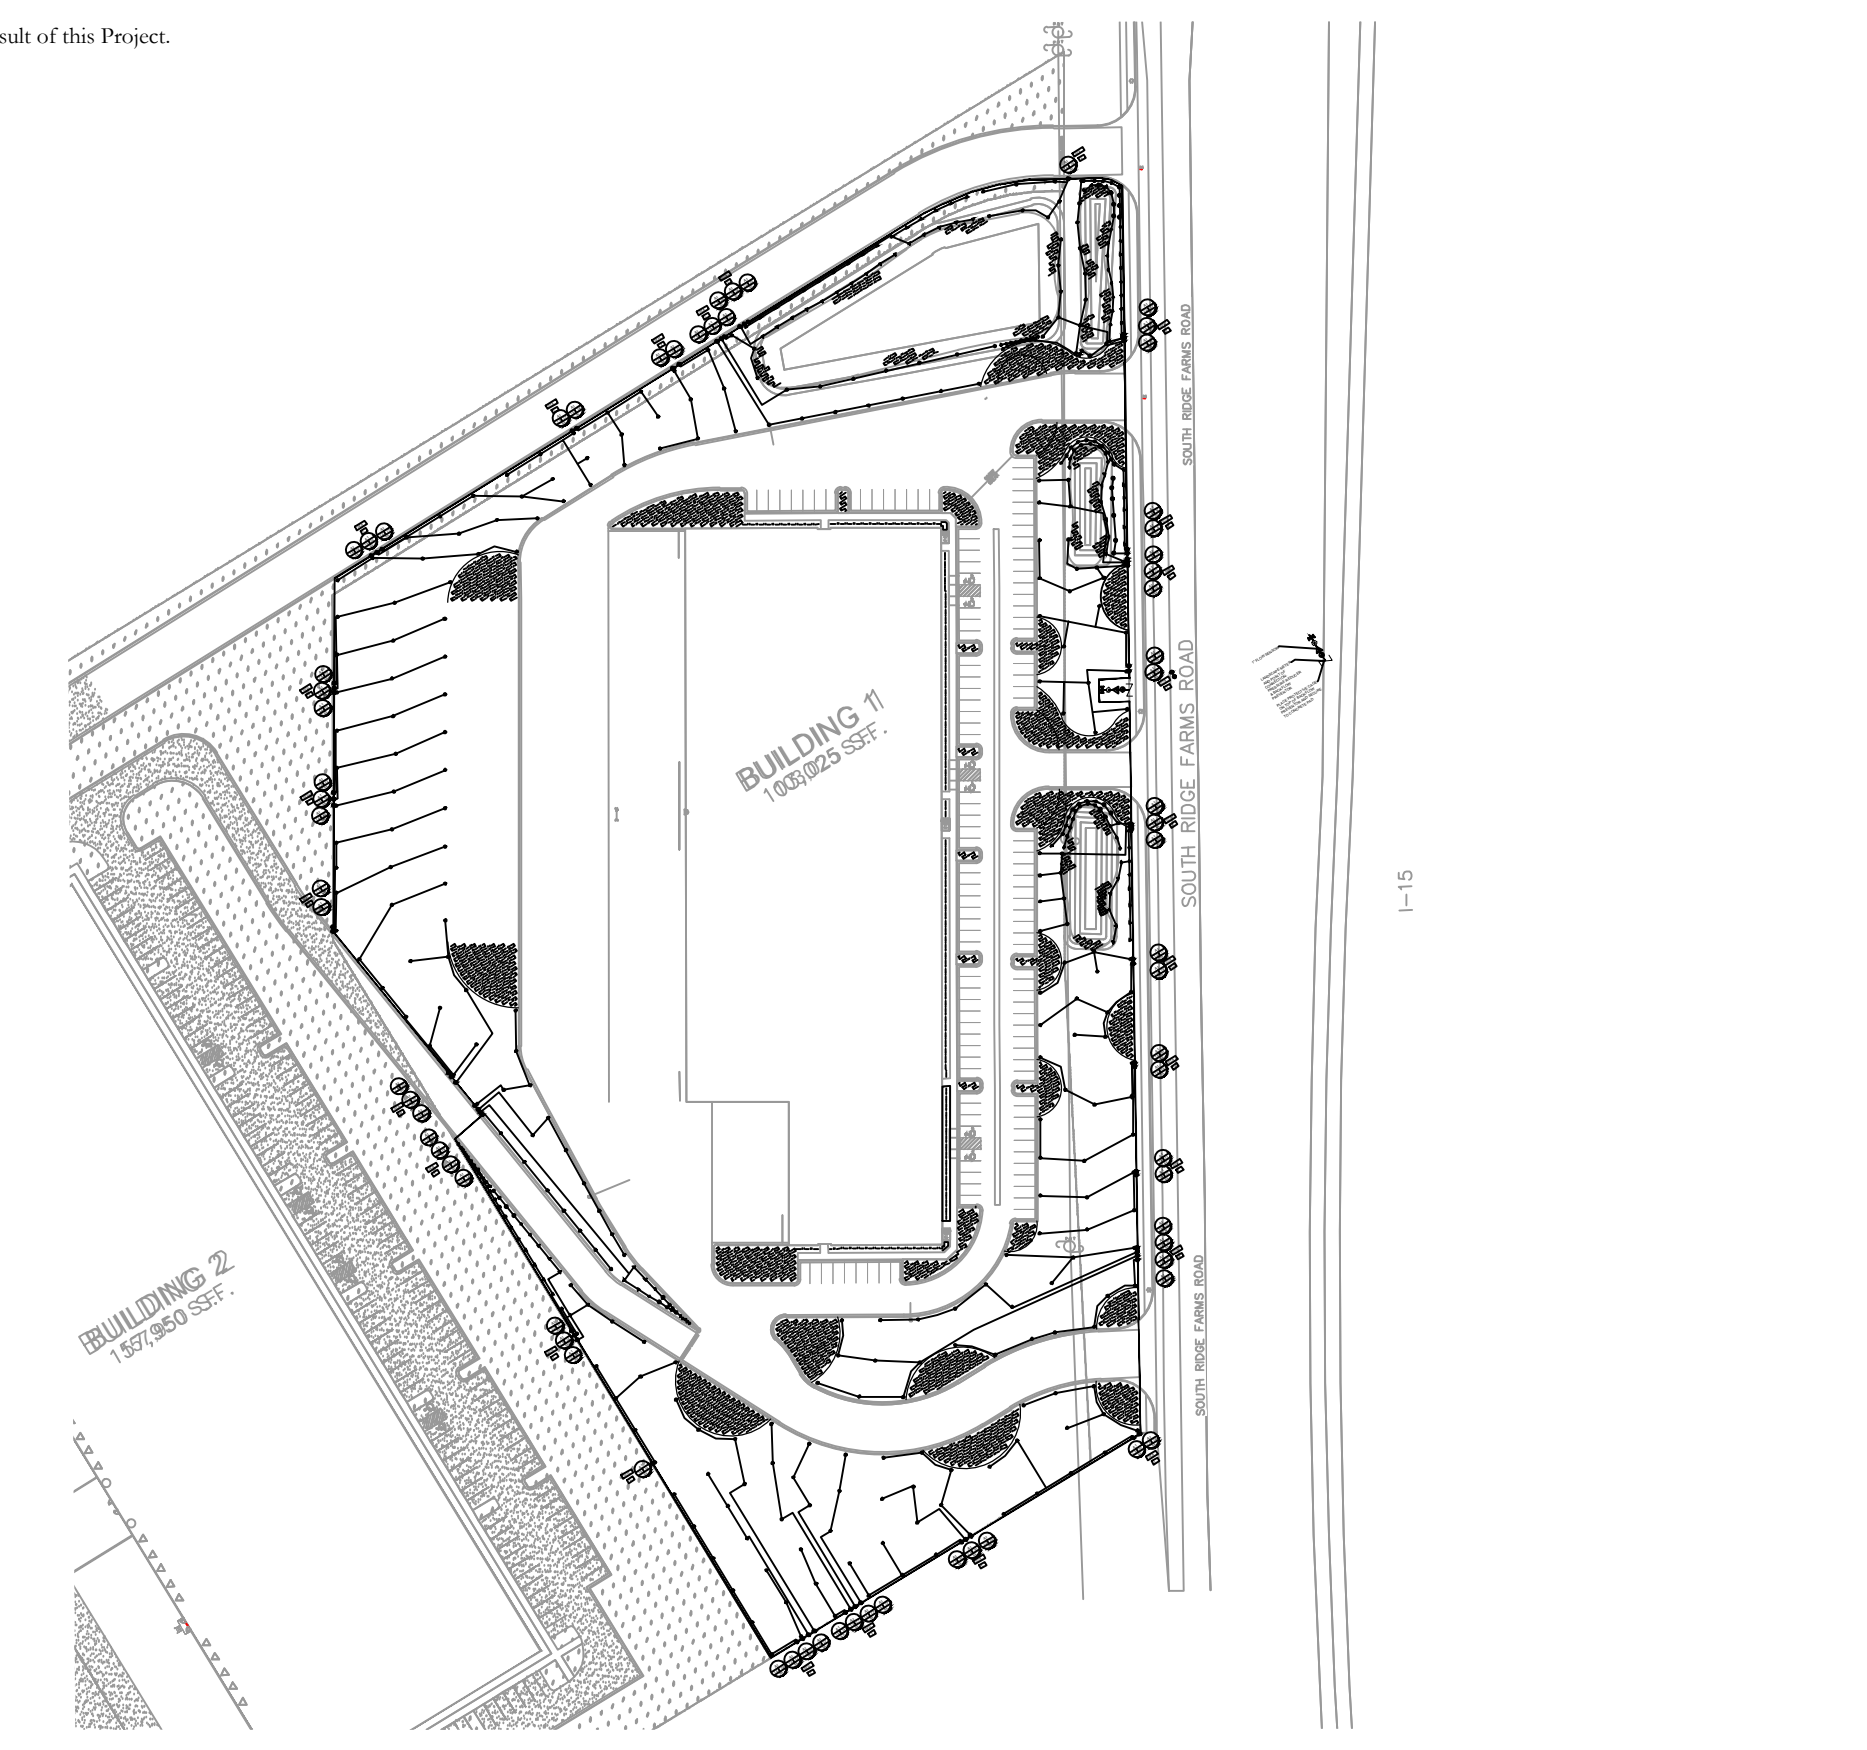

2" MAINLINE ROUTING ,CONTROLLER AND P.O.C. LOCATION OVERVIEW


Table with 6 columns: ISSUE DATE, PROJECT NUMBER, PLAN INFORMATION, PROJECT INFORMATION, DEVELOPER / PROPERTY OWNER / CLIENT, LANDSCAPE ARCHITECT / PLANNER, LICENSE STAMP, DRAWING INFO.

Project information including date (1/26/2024), project number (UT24015), and contact information for Blue Stakes of Utah Utility Notification Center, Inc. (811, 1-800-662-4111, www.bluestakes.org). Includes a graphic scale from 0' to 600'.

Project title and address: RESEARCH AND TECH CENTER PH. 1, 1940 S. RIDGE FARMS RD., SANTAQUIN, UTAH.

Contact information for Jon Jensen, JJENSENCM@GMAIL.COM, and copyright notice for PKJ Design Group.

Design Group logo and address (3450 N. TRIUMPH BLVD, SUITE 102, LEHI, UTAH 84043), license stamp, and drawing info (JTA, ACP, JMA, 1/26/2024, IR-101).

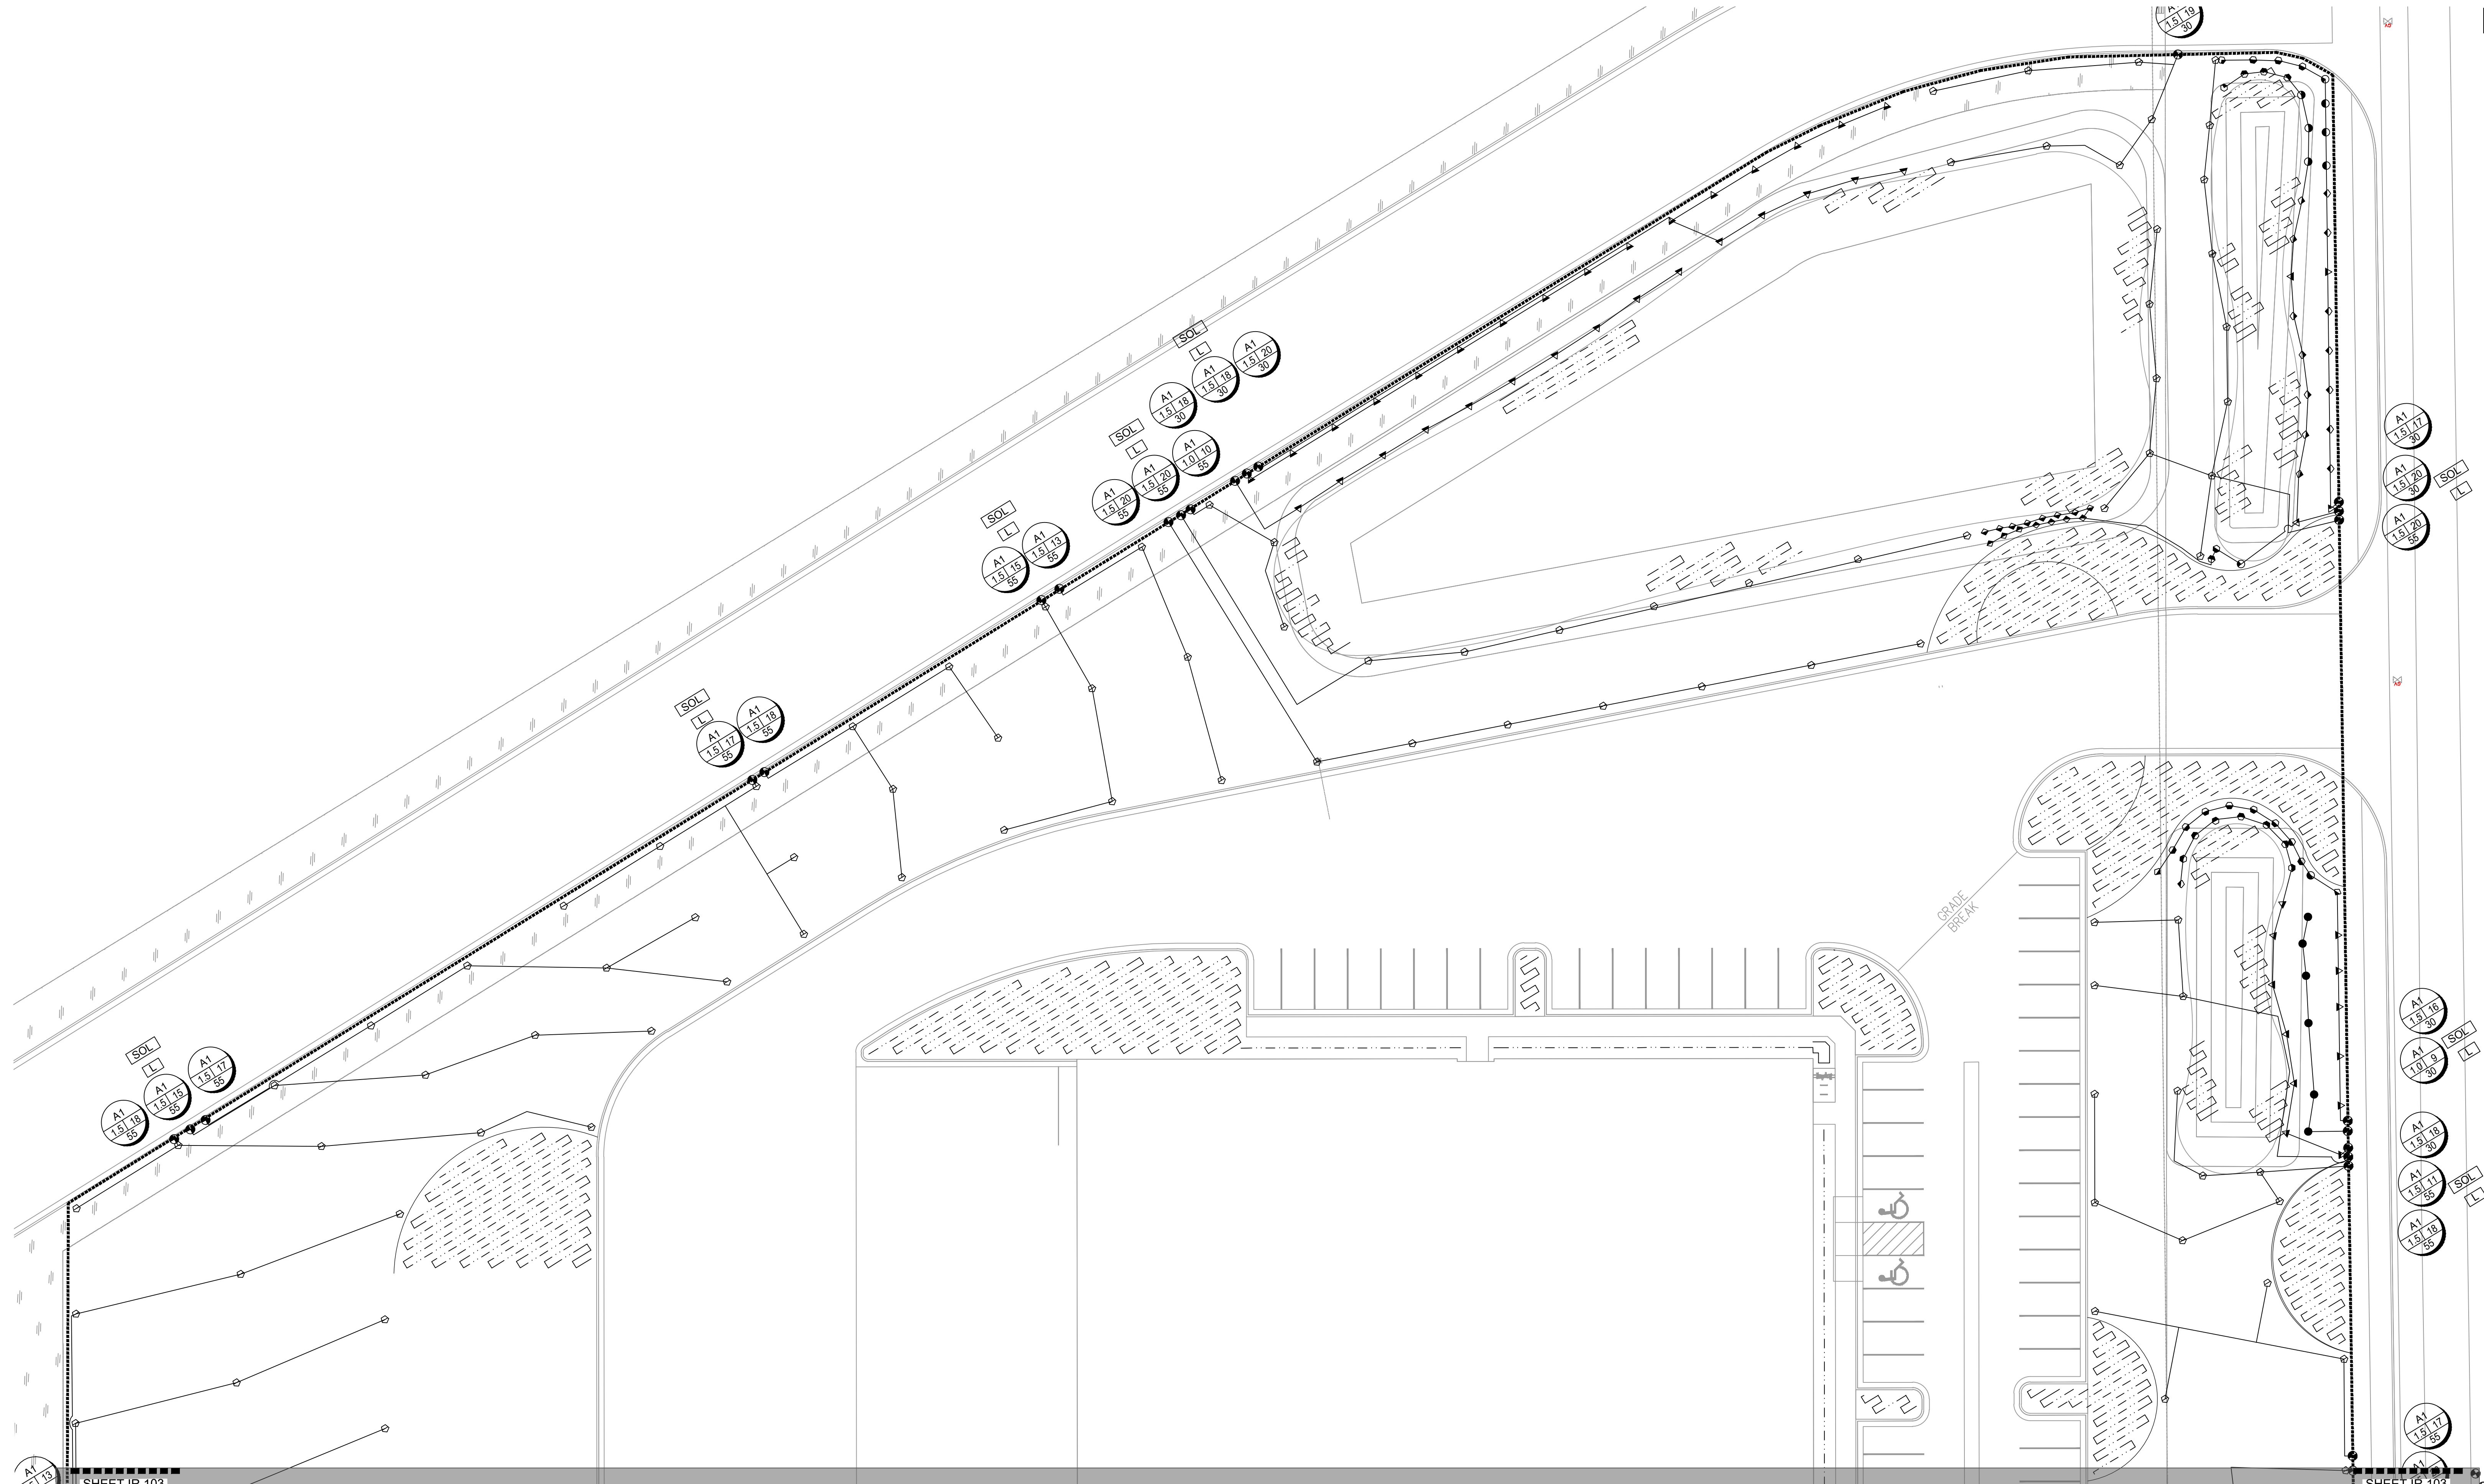

ISSUE DATE	PROJECT NUMBER	PLAN INFORMATION	PROJECT INFORMATION	DEVELOPER / PROPERTY OWNER / CLIENT	LANDSCAPE ARCHITECT / PLANNER	LICENSE STAMP	DRAWING INFO
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1/26/2024	UT24015						
NO.	REVISION	DATE					
1	XXXX	XX-XX-XX					
2							
3							
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6							
7							

811 BLUE STAKES OF UTAH
 UTILITY NOTIFICATION CENTER, INC.
 1-800-662-4111
 www.bluestakes.org

GRAPHIC SCALE: 1" = 20'

RESEARCH AND TECH CENTER

PH. 1

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 SANTAQUIN, UTAH

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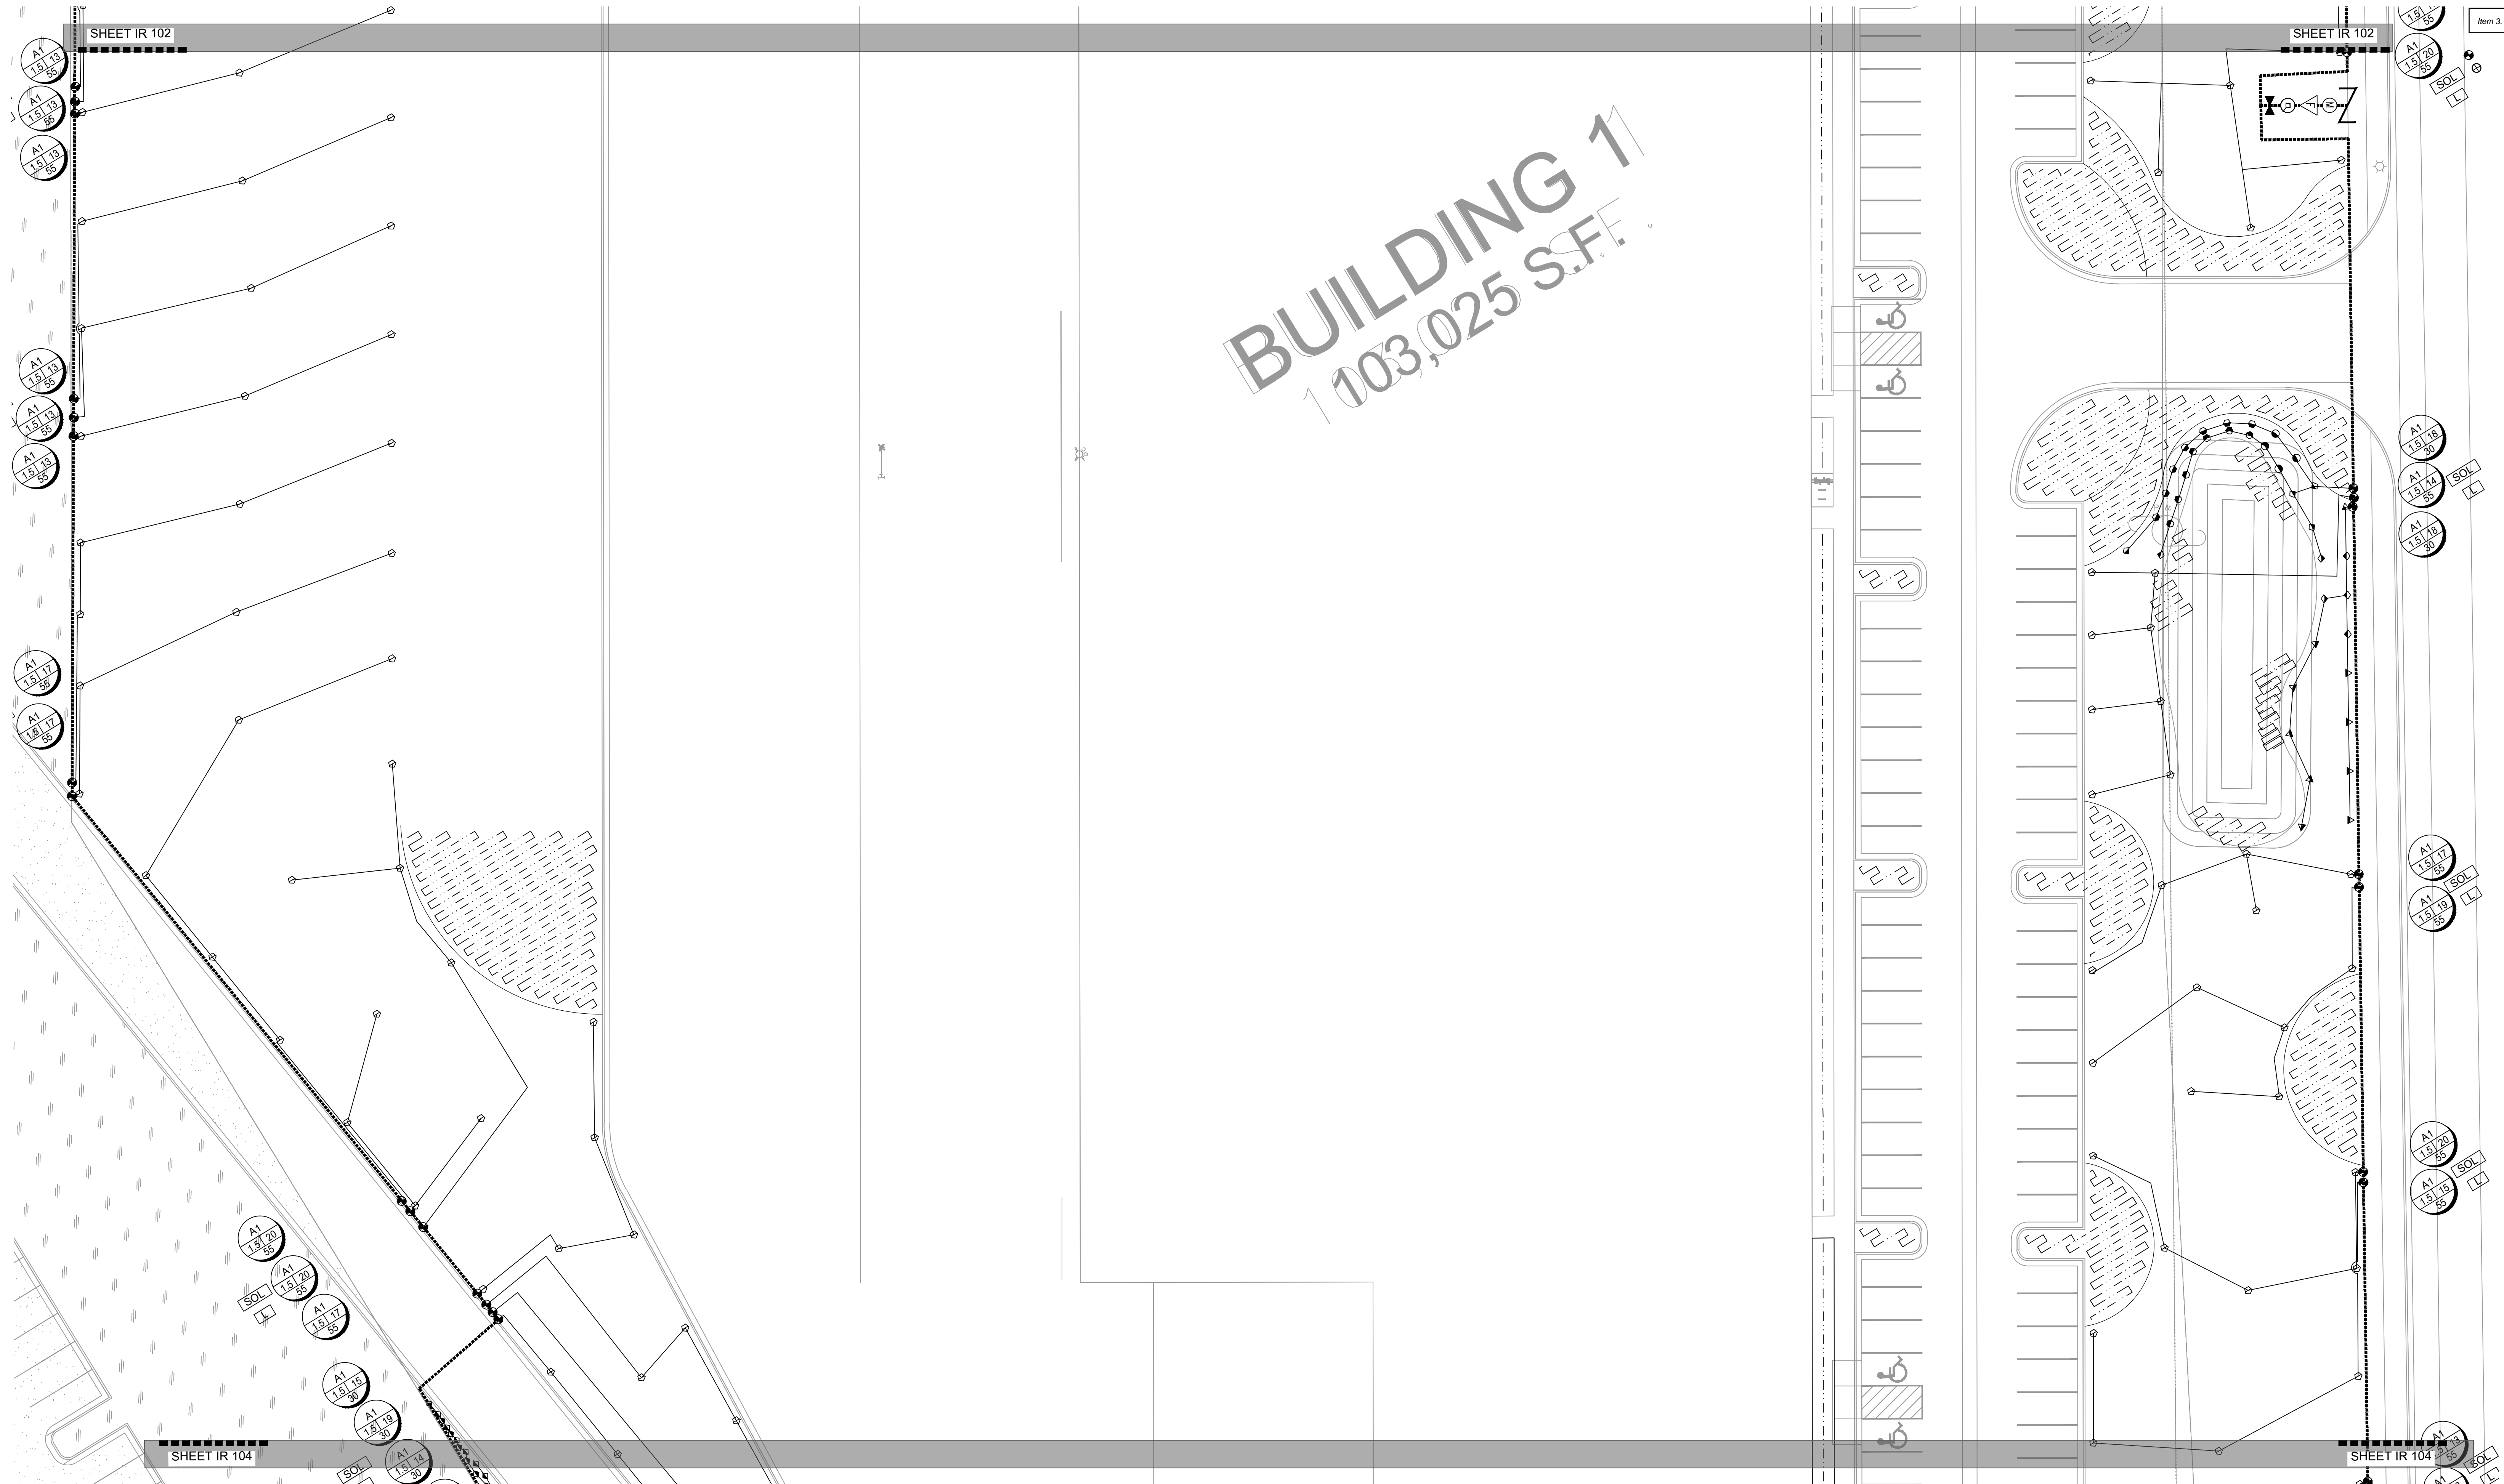
PKJ
 DESIGN GROUP
 Landscape Architecture / Planning & Visualization

3450 N. TRIUMPH BLVD. SUITE 102
 LEHI, UTAH 84043 (801) 753-5644
 www.pkjdesigngroup.com

IRRIGATION PLAN
 CITY PERMIT SET

IR-102

PM:	JTA
DRAWN:	ACP
CHECKED:	JMA
PLOT DATE:	1/26/2024



BUILDING 1
103,025 S.F.

ISSUE DATE	PROJECT NUMBER	PLAN INFORMATION	PROJECT INFORMATION	DEVELOPER / PROPERTY OWNER / CLIENT	LANDSCAPE ARCHITECT / PLANNER	LICENSE STAMP	DRAWING INFO
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1/26/2024	UT24015						
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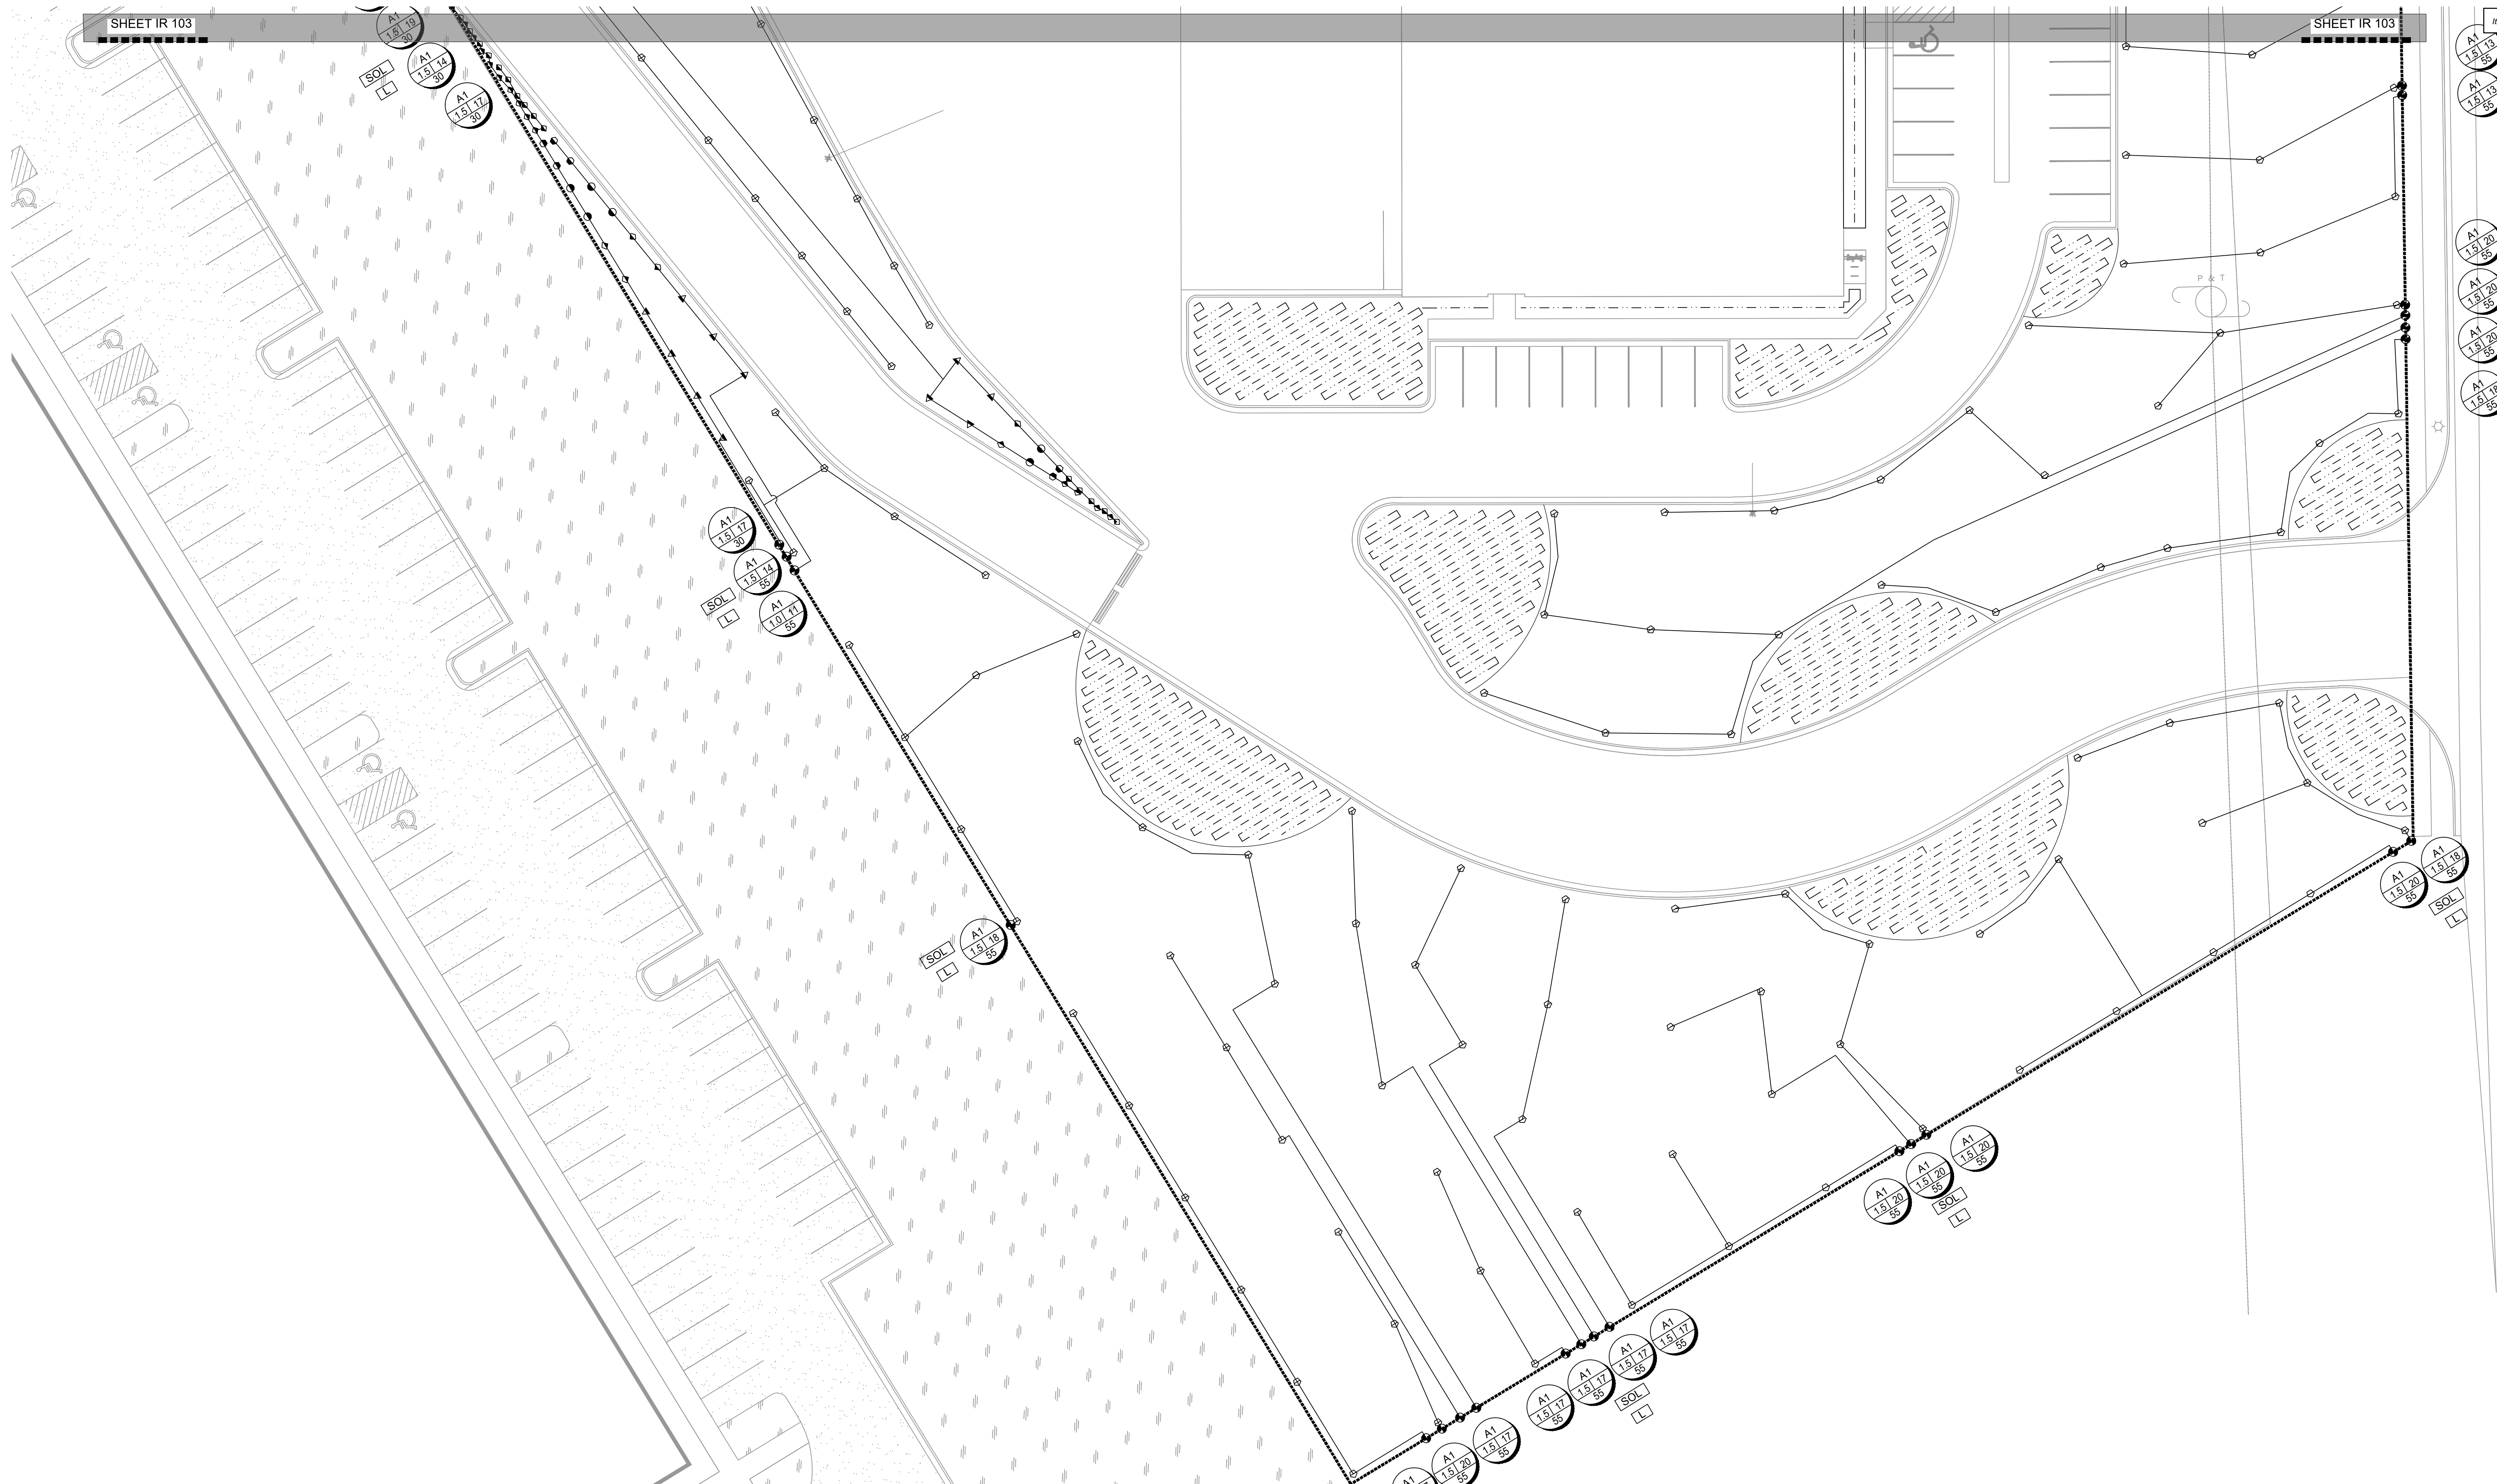
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IRRIGATION PLAN
CITY PERMIT SET

IR-103

PM:	JTA
DRAWN:	ACP
CHECKED:	JMA
PLOT DATE:	1/26/2024



ISSUE DATE	PROJECT NUMBER	PLAN INFORMATION	PROJECT INFORMATION	DEVELOPER / PROPERTY OWNER / CLIENT	LANDSCAPE ARCHITECT / PLANNER	LICENSE STAMP	DRAWING INFO
1/26/2024	UT24015			JON JENSEN JJENSENCM@GMAIL.COM			PM: JTA DRAWN: ACP CHECKED: JMA PLOT DATE: 1/26/2024

NO.	REVISION	DATE
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RESEARCH AND TECH CENTER

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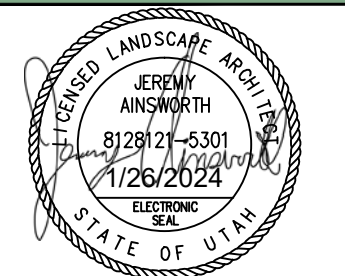
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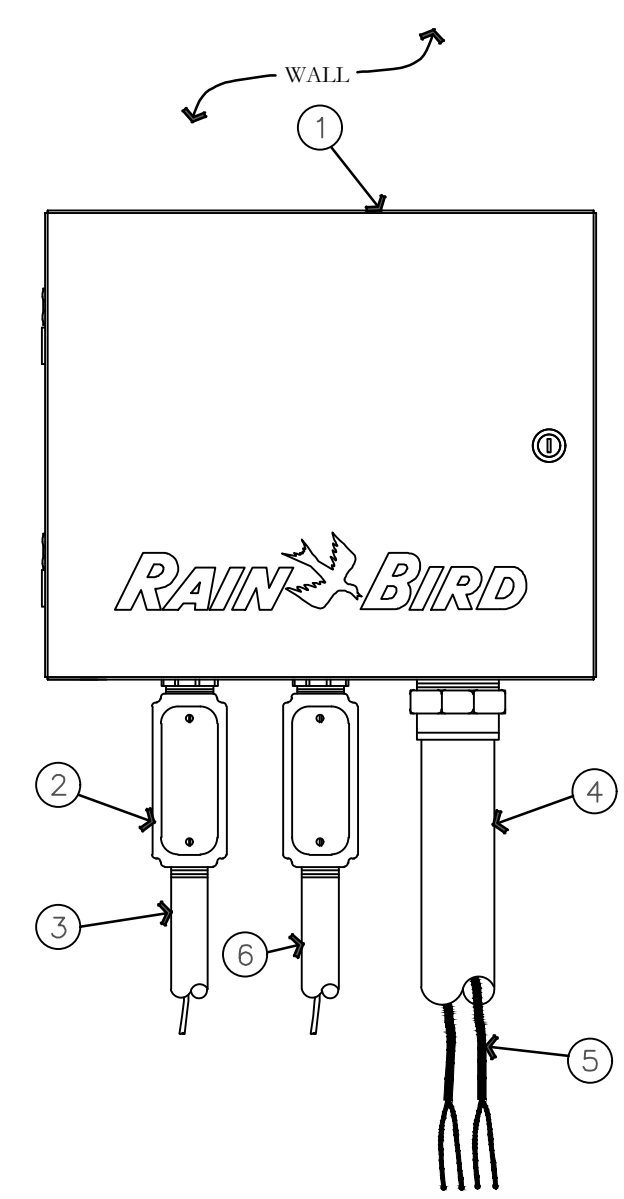
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IRRIGATION PLAN
 CITY PERMIT SET

IR-104




- ① TWO-WIRE CONTROLLER: RAIN BIRD ESP-LXIVM/PRO IN LXMM METAL CABINET WITH OUTSIDE WALL MOUNT. INSTALL CONTROLLER AND CABINET ON WALL PER MANUFACTURER'S RECOMMENDATIONS.
- ② JUNCTION BOX
- ③ 1-INCH CONDUIT AND FITTINGS FOR POWER SUPPLY WIRE
- ④ 2-INCH CONDUIT AND FITTINGS FOR TWO-WIRE CABLE
- ⑤ MAXICABLE TWO-WIRE PATH TO FIELD DEVICES. USE A DIFFERENT CABLE JACKET COLOR FOR EACH PATH.
- ⑥ 1-INCH CONDUIT AND FITTINGS FOR GROUND WIRE. ONLY FOR OUTDOOR INSTALLATIONS.

NOTES:
 1. ESP-LXIVM CONTROLLER IS AVAILABLE IN TWO MODELS. THE LXIVM WITH 60 STATIONS AND THE LXIVM-PRO WITH 240 STATIONS. REFER TO THE CHART BELOW FOR DIFFERENCES BETWEEN THE TWO MODELS.
 2. USE STEEL CONDUIT FOR ABOVE GRADE AND SCH 40 PVC CONDUIT FOR BELOW GRADE CONDITIONS.
 3. PROVIDE PROPER GROUNDING COMPONENTS TO ACHIEVE GROUND RESISTANCE OF 10 OHMS OR LESS. IF CONTROLLER IS MOUNTED INDOORS, USE POWER SUPPLY GROUND.


KEY SPECIFICATIONS

FEATURE	MAX PROGRAMS	MAX STATIONS	MAX SIMULATIONS	MASTER VALVES	FLOW SENSORS	WEATHER SENSORS
LX-IVM	10	60	8	5	5	4
LX-IVM PRO	40	240	16	10	10	8

A ESP-LXIVM/PRO TWO-WIRE CONTROLLER IN METAL CABINET
NOT TO SCALE


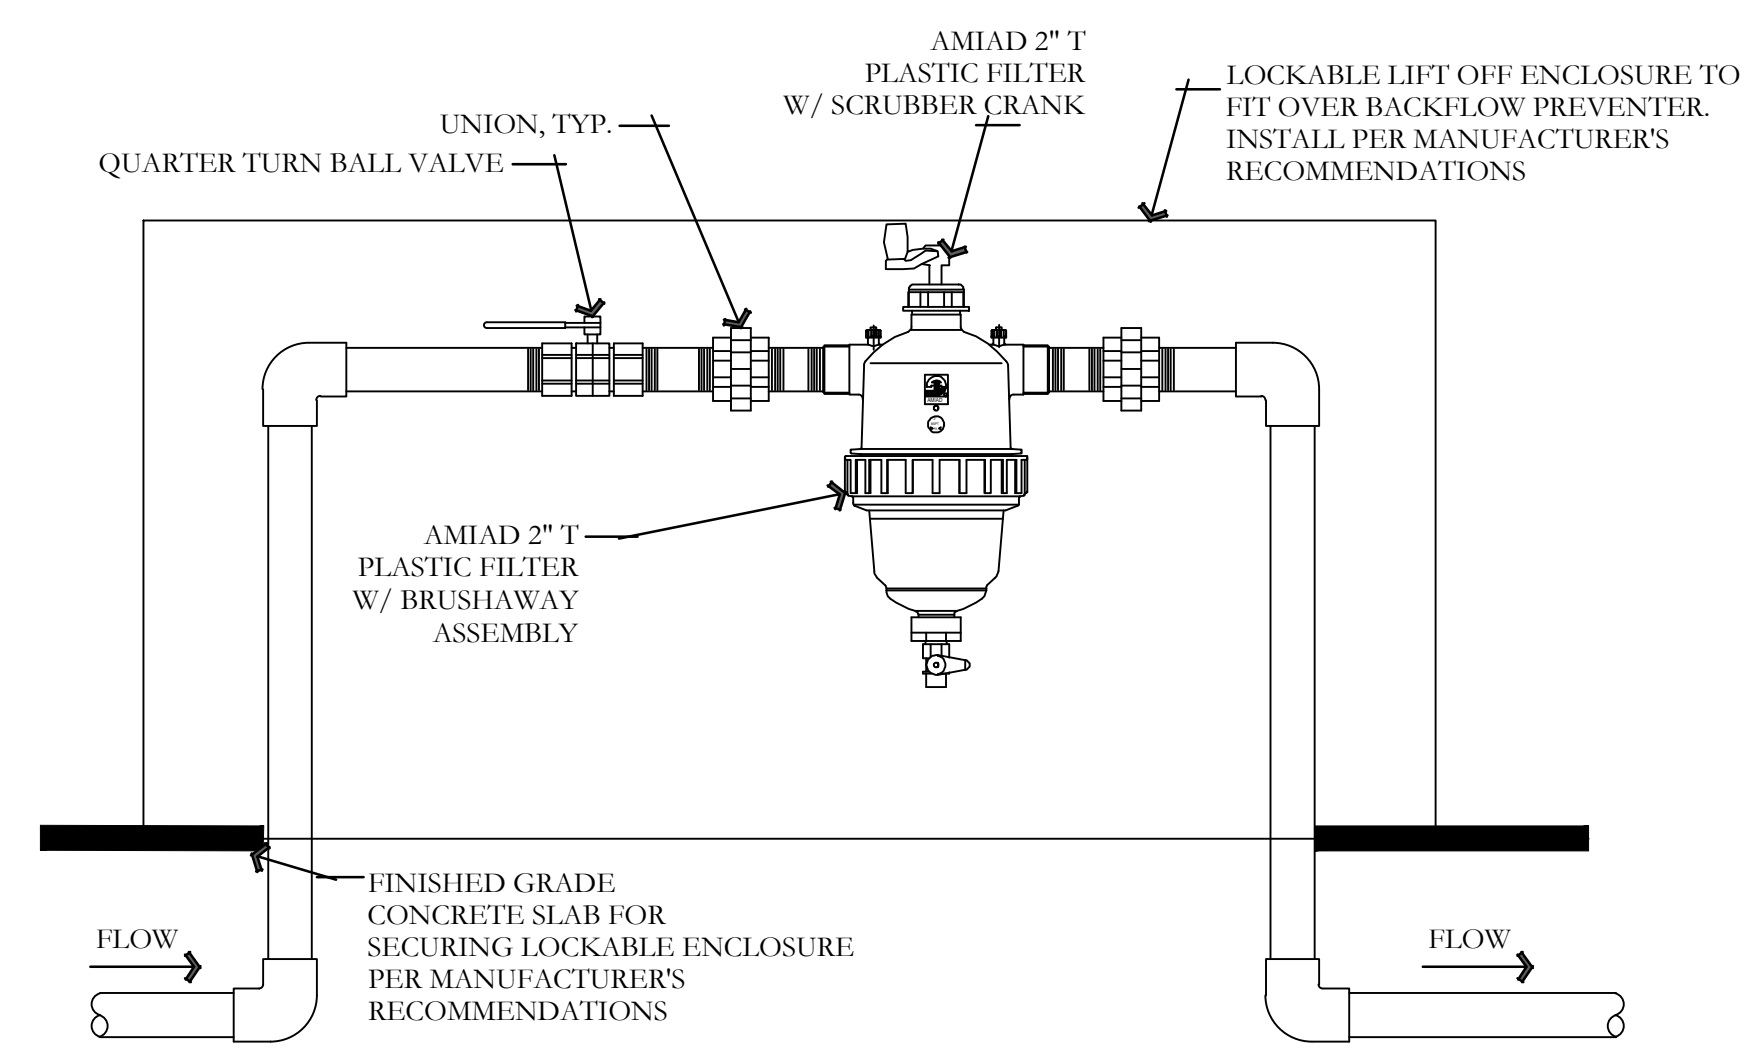


B 2" PLASTIC FILTER W/ BRUSHAWAY ASSEMBLY
NOT TO SCALE

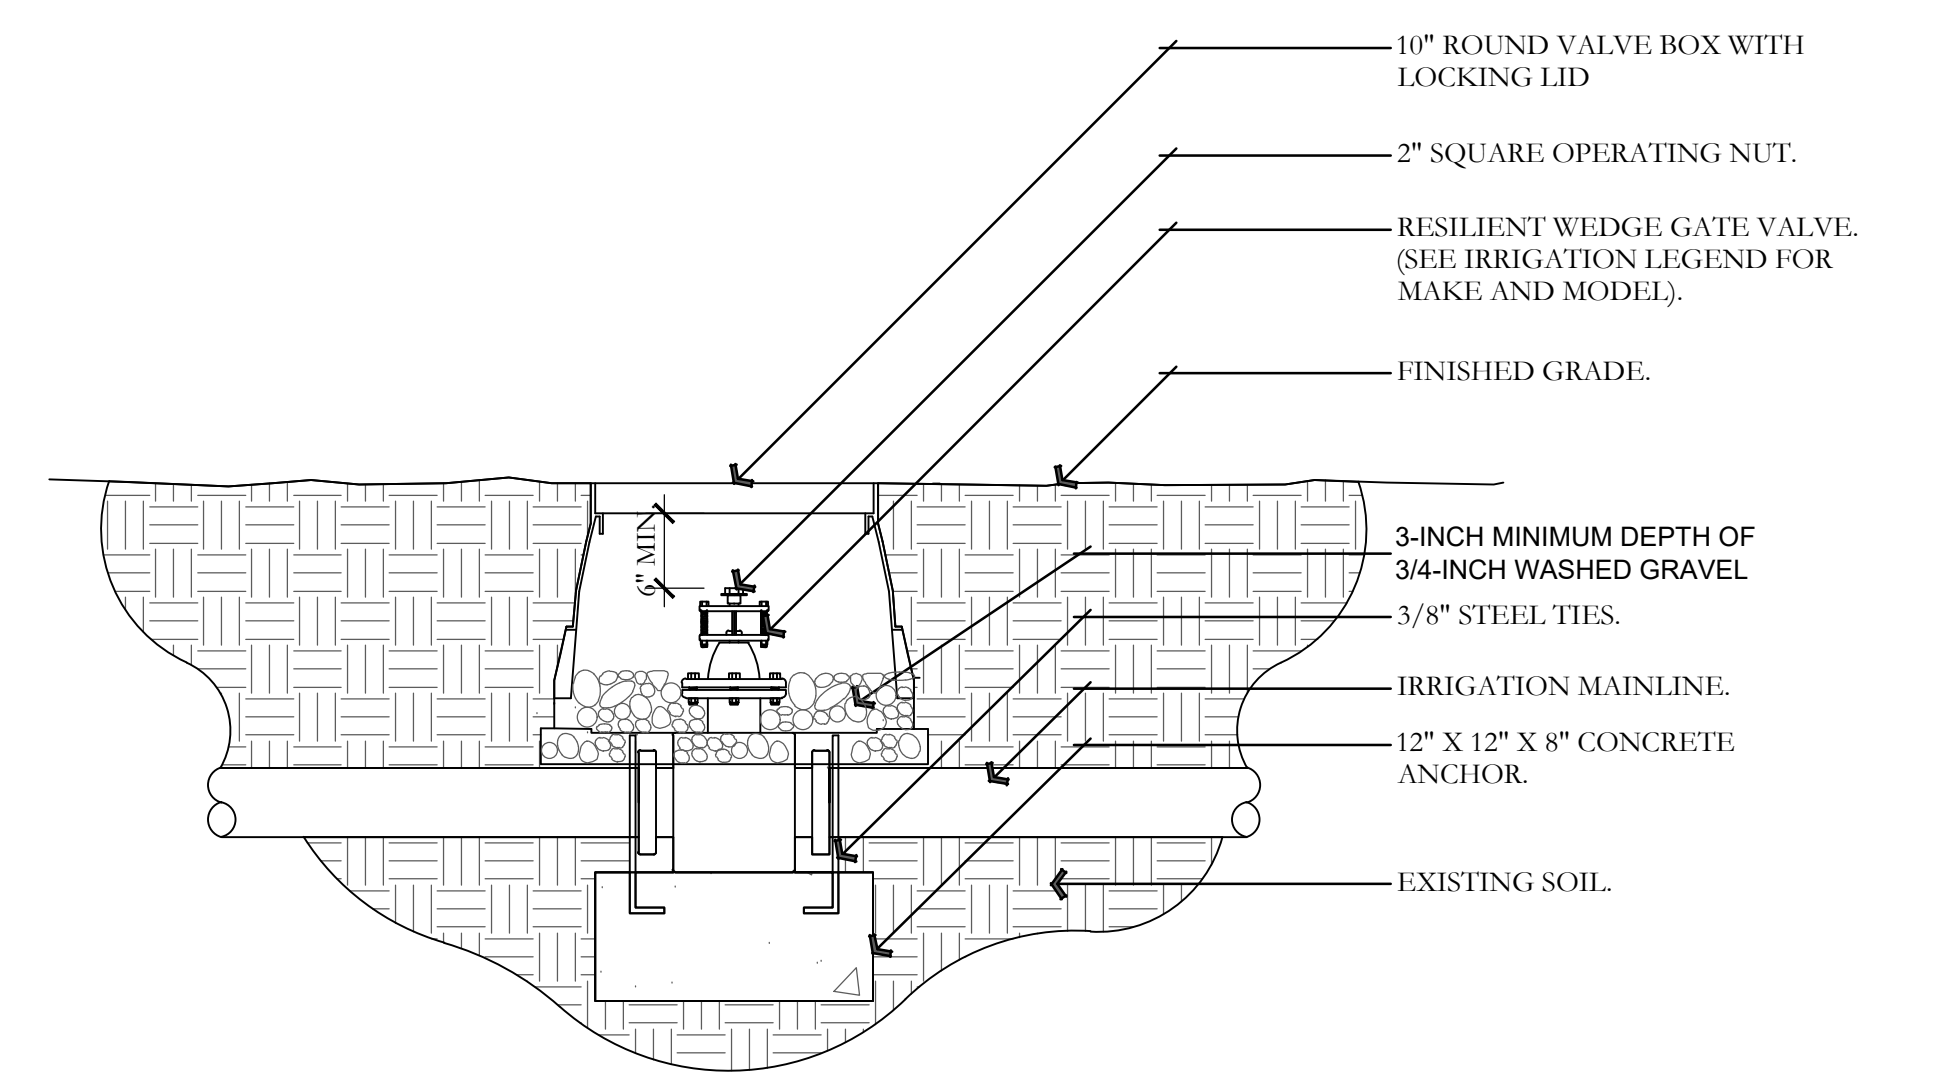


- NOTES:
 1. INSTALL GATE VALVE PER MANUFACTURER'S SPECIFICATIONS AND RECOMMENDATIONS.
 2. VALVE BOX SHALL BE WRAPPED WITH MINIMUM 3 MIL THICK PLASTIC AND SECURE IT TO VALVE BOX USING DUCT TAPE OR ELECTRICAL TAPE.
 3. VALVE BOX SHALL BE LOCATED IN PLANTING AREA.

C GATE VALVE AND ANCHOR DETAIL
NOT TO SCALE

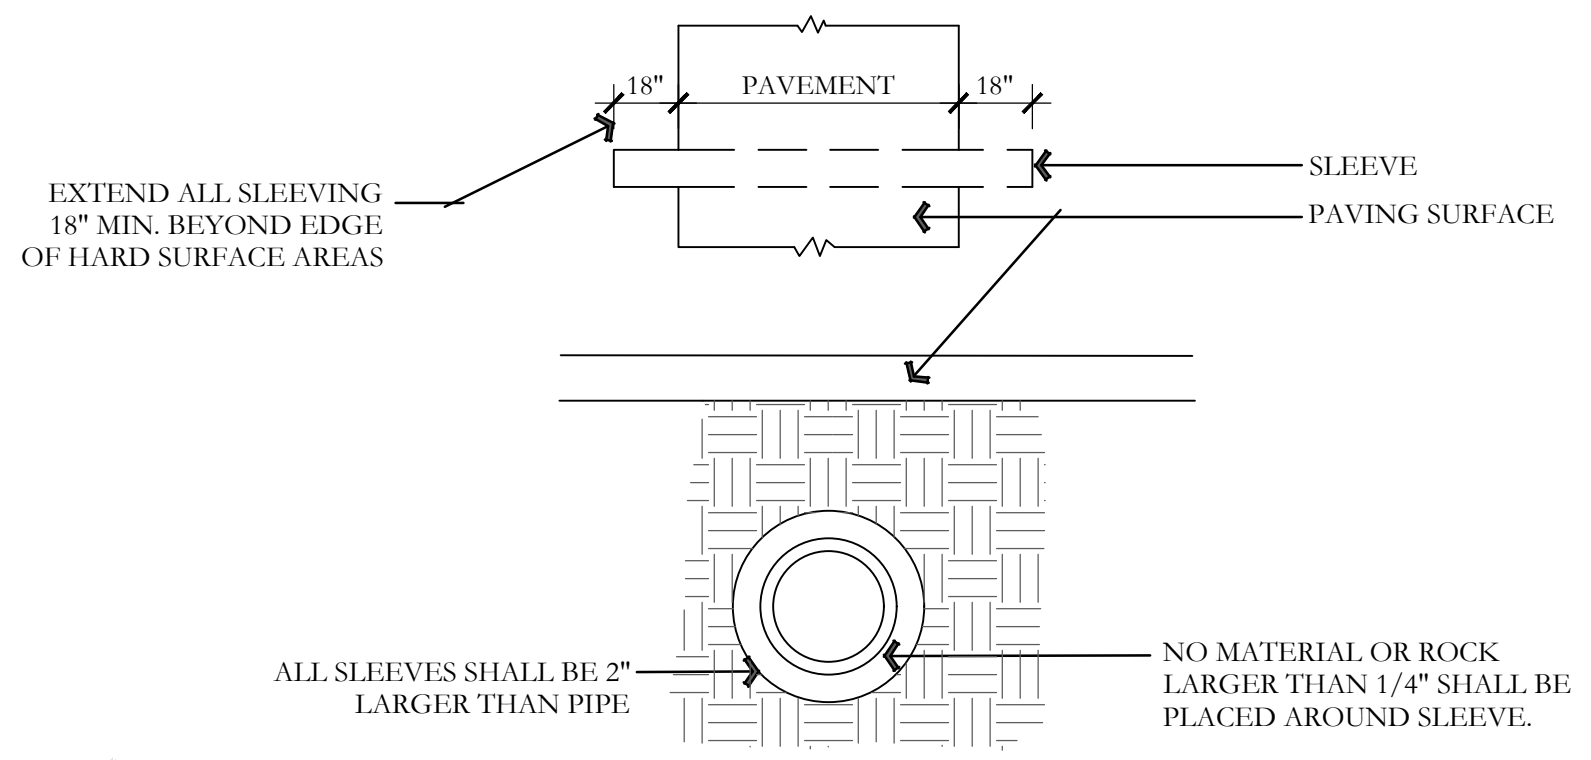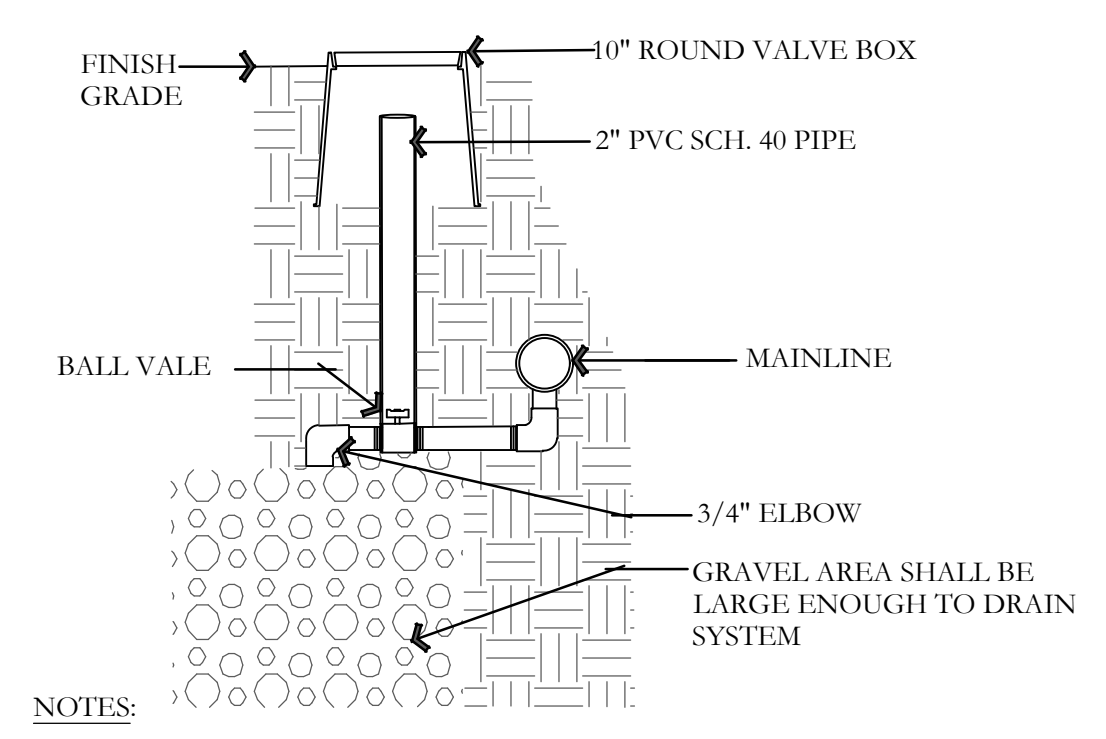


- NOTES:
 1. SEE IRRIGATION LEGEND FOR MAINLINE AND LATERAL LINE PIPE SIZE AND TYPE.
 2. DIRECT BURIAL CONTROL WIRES SHALL BE INSTALLED IN SCH. 40 PVC ELECTRICAL CONDUIT IF REQUIRED.
 3. 2-WIRE IRRIGATION WIRE SHALL BE INSTALLED IN SCH. 40 PVC ELECTRICAL CONDUIT.
 4. DETECTABLE LOCATOR TAPE SHALL BE LOCATED SIX INCHES (6") ABOVE THE ENTIRE MAINLINE RUN.

E IRRIGATION TRENCHING DETAIL
NOT TO SCALE

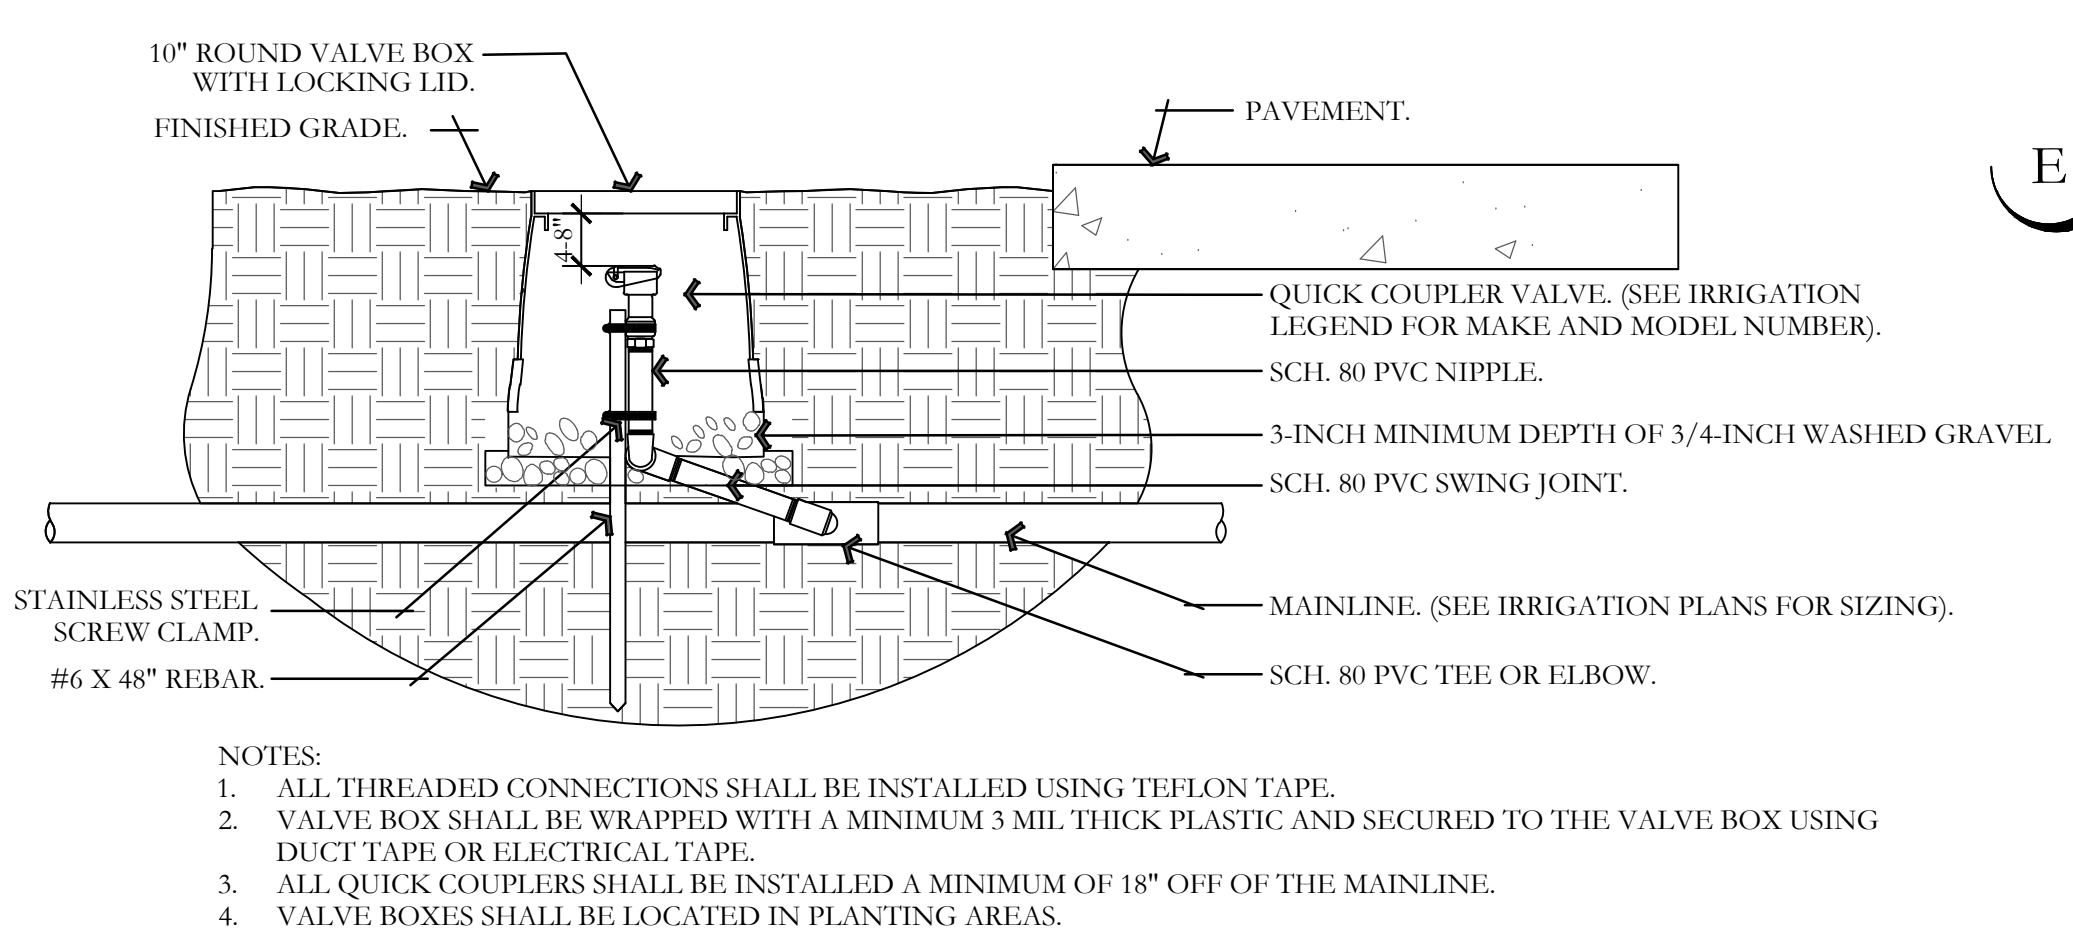


- NOTES:
 1. ALL THREADED CONNECTIONS SHALL BE INSTALLED USING TEFLON TAPE.
 2. VALVE BOX SHALL BE WRAPPED WITH A MINIMUM 3 MIL THICK PLASTIC AND SECURED TO THE VALVE BOX USING DUCT TAPE OR ELECTRICAL TAPE.
 3. ALL QUICK COUPLERS SHALL BE INSTALLED A MINIMUM OF 18" OFF OF THE MAINLINE.
 4. VALVE BOXES SHALL BE LOCATED IN PLANTING AREAS.

G QUICK COUPLER DETAIL
NOT TO SCALE

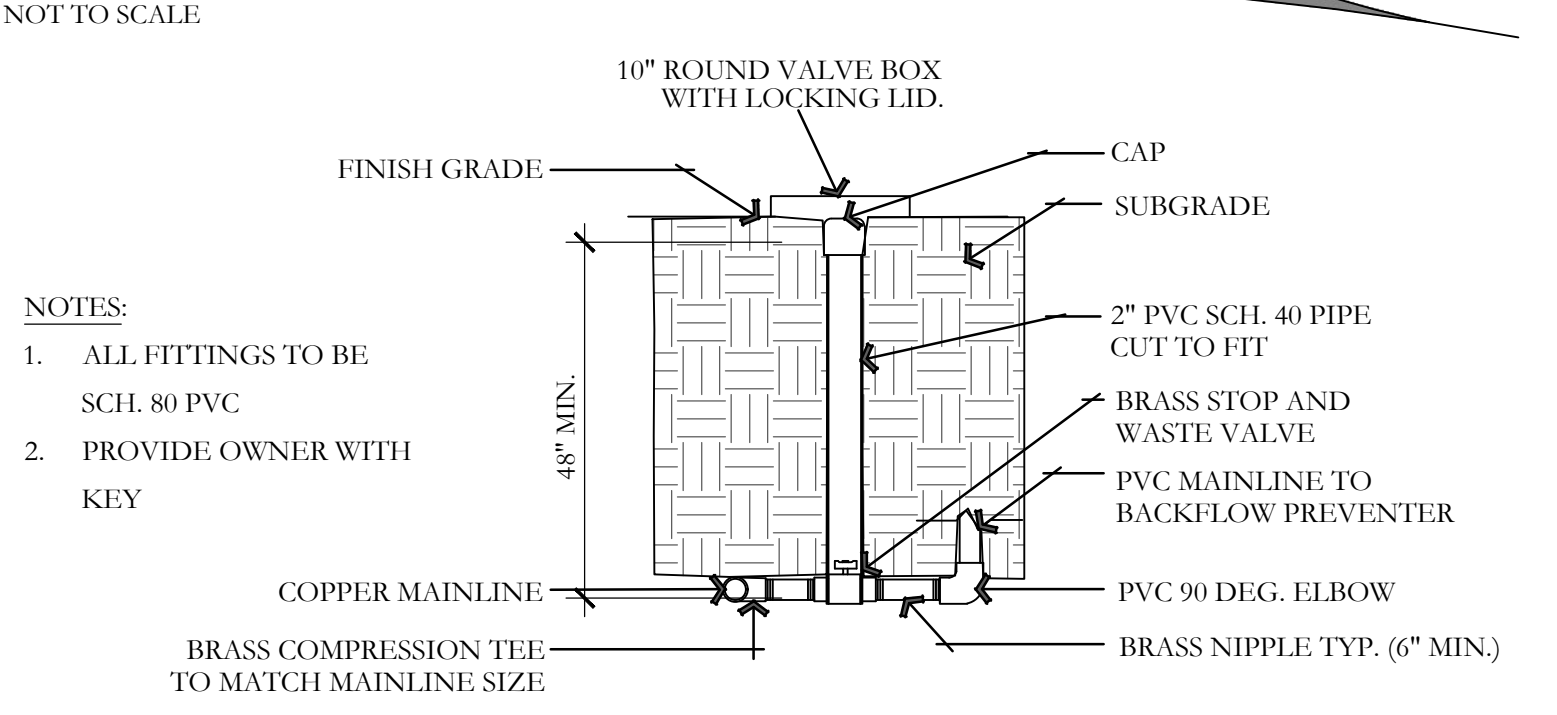


- NOTES:
 1. ALL FITTINGS TO BE SCH. 80 PVC
 2. PROVIDE OWNER WITH KEY

H STOP AND WASTE VALVE ASSEMBLY DETAIL
NOT TO SCALE

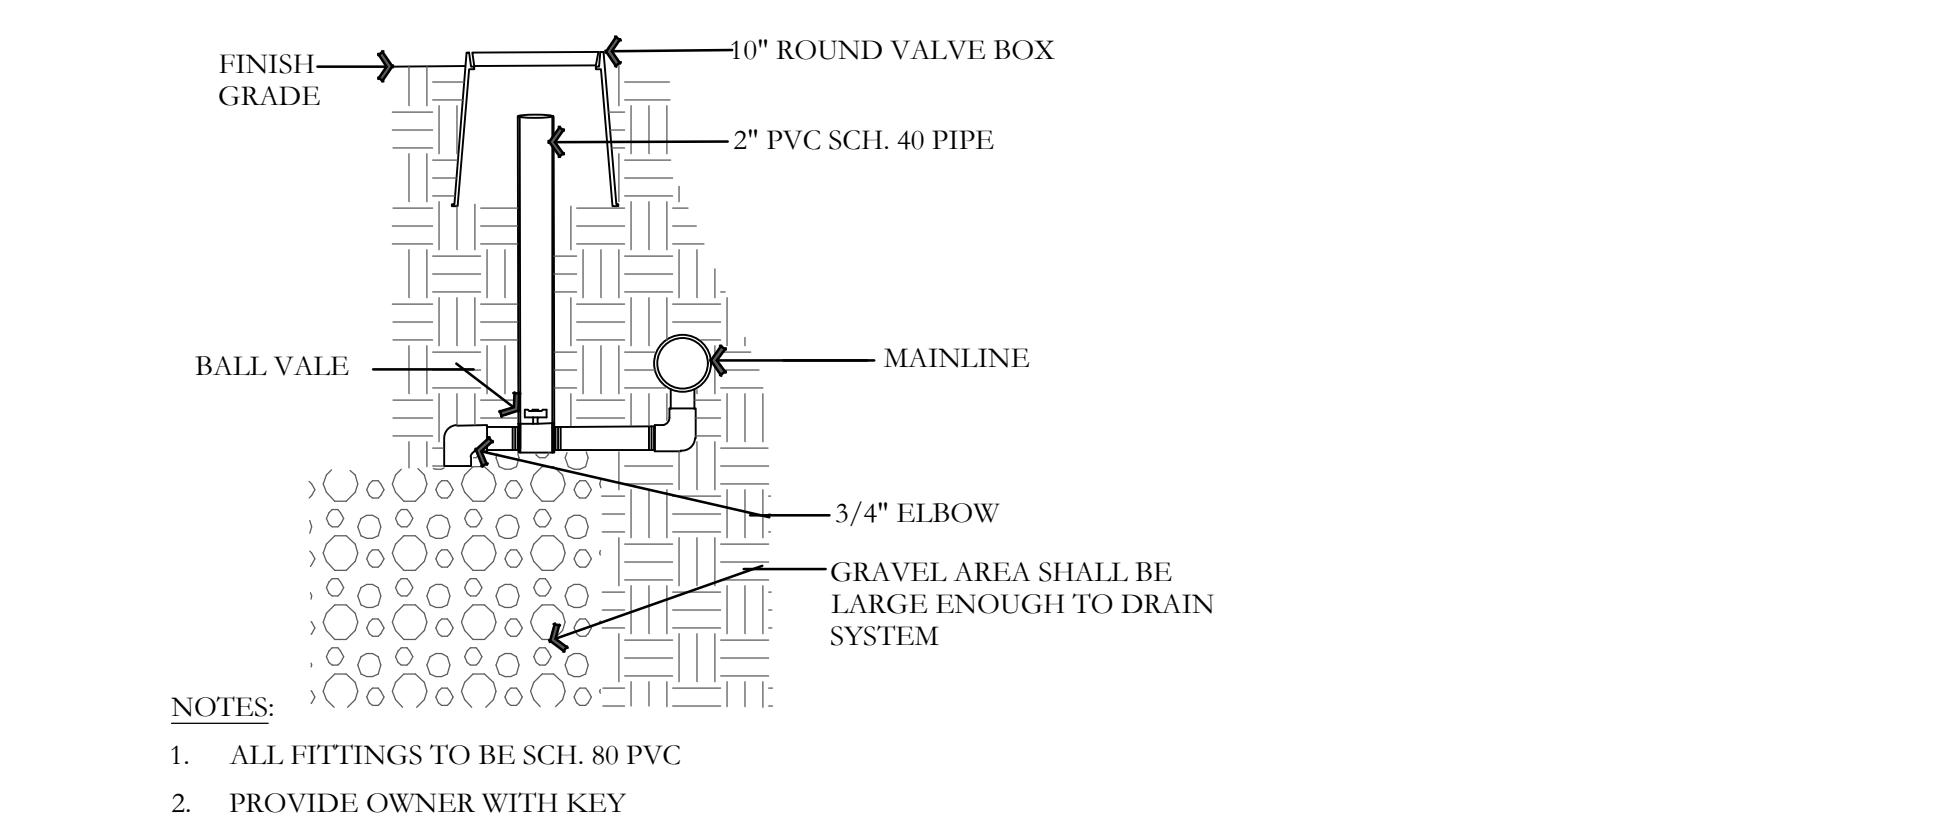

- NOTES:
 1. ALL FITTINGS TO BE SCH. 80 PVC
 2. PROVIDE OWNER WITH KEY

F MANUAL DRAIN DETAIL
NOT TO SCALE

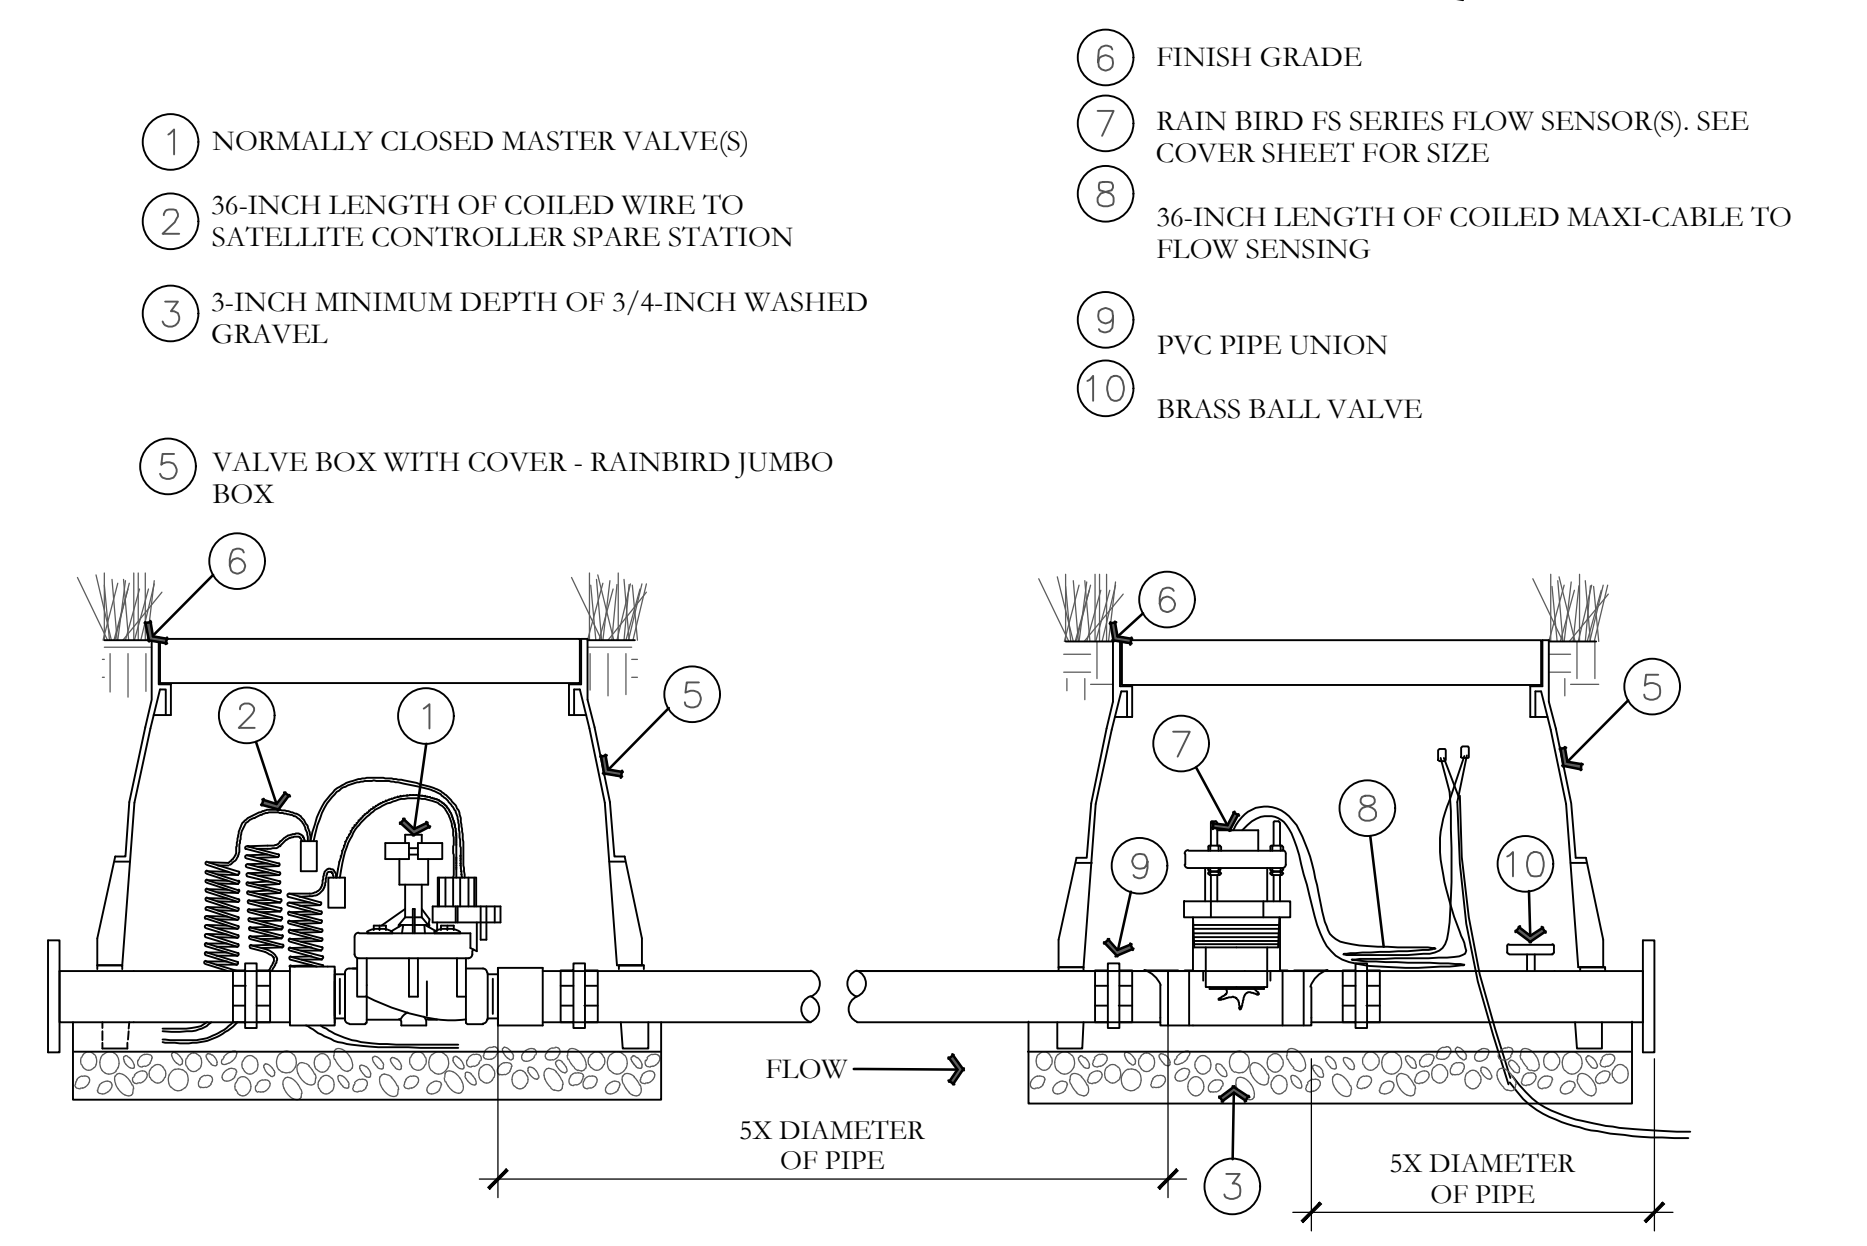

- ① NORMALLY CLOSED MASTER VALVE(S)
- ② 36-INCH LENGTH OF COILED WIRE TO SATELLITE CONTROLLER SPARE STATION
- ③ 3-INCH MINIMUM DEPTH OF 3/4-INCH WASHED GRAVEL
- ④ FINISH GRADE
- ⑤ VALVE BOX WITH COVER - RAINBIRD JUMBO BOX
- ⑥ FINISH GRADE
- ⑦ RAIN BIRD FS SERIES FLOW SENSOR(S). SEE COVER SHEET FOR SIZE
- ⑧ 36-INCH LENGTH OF COILED MAX-CABLE TO FLOW SENSING
- ⑨ PVC PIPE UNION
- ⑩ BRASS BALL VALVE

I MASTER VALVE AND FLOW SENSOR DETAIL
NOT TO SCALE


ISSUE DATE	PROJECT NUMBER	PLAN INFORMATION	PROJECT INFORMATION	DEVELOPER / PROPERTY OWNER / CLIENT	LANDSCAPE ARCHITECT / PLANNER	LICENSE STAMP	DRAWING INFO
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1/26/2024 UT24015

RESEARCH AND TECH CENTER
 PH. 1
 1940 S. RIDGE FARMS RD.
 SANTAQUIN, UTAH

JON JENSEN
 JJENSENCM@GMAIL.COM

PKJ
 DESIGN GROUP
 Landscape Architecture / Planning & Visualization
 3450 N. TRIUMPH BLVD. SUITE 102
 LEHI, UTAH 84043 (801) 753-5644
 www.pkjdesigngroup.com

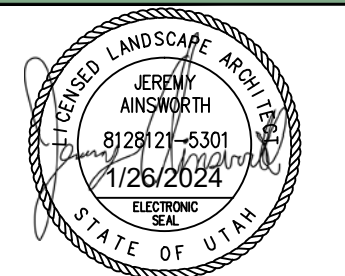

DATE: 1/26/2024
 DRAWN: ACP
 CHECKED: JMA
 PLOT DATE: 1/26/2024


IRRIGATION DETAILS
 CITY PERMIT SET

IR-501


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 www.bluestakes.org


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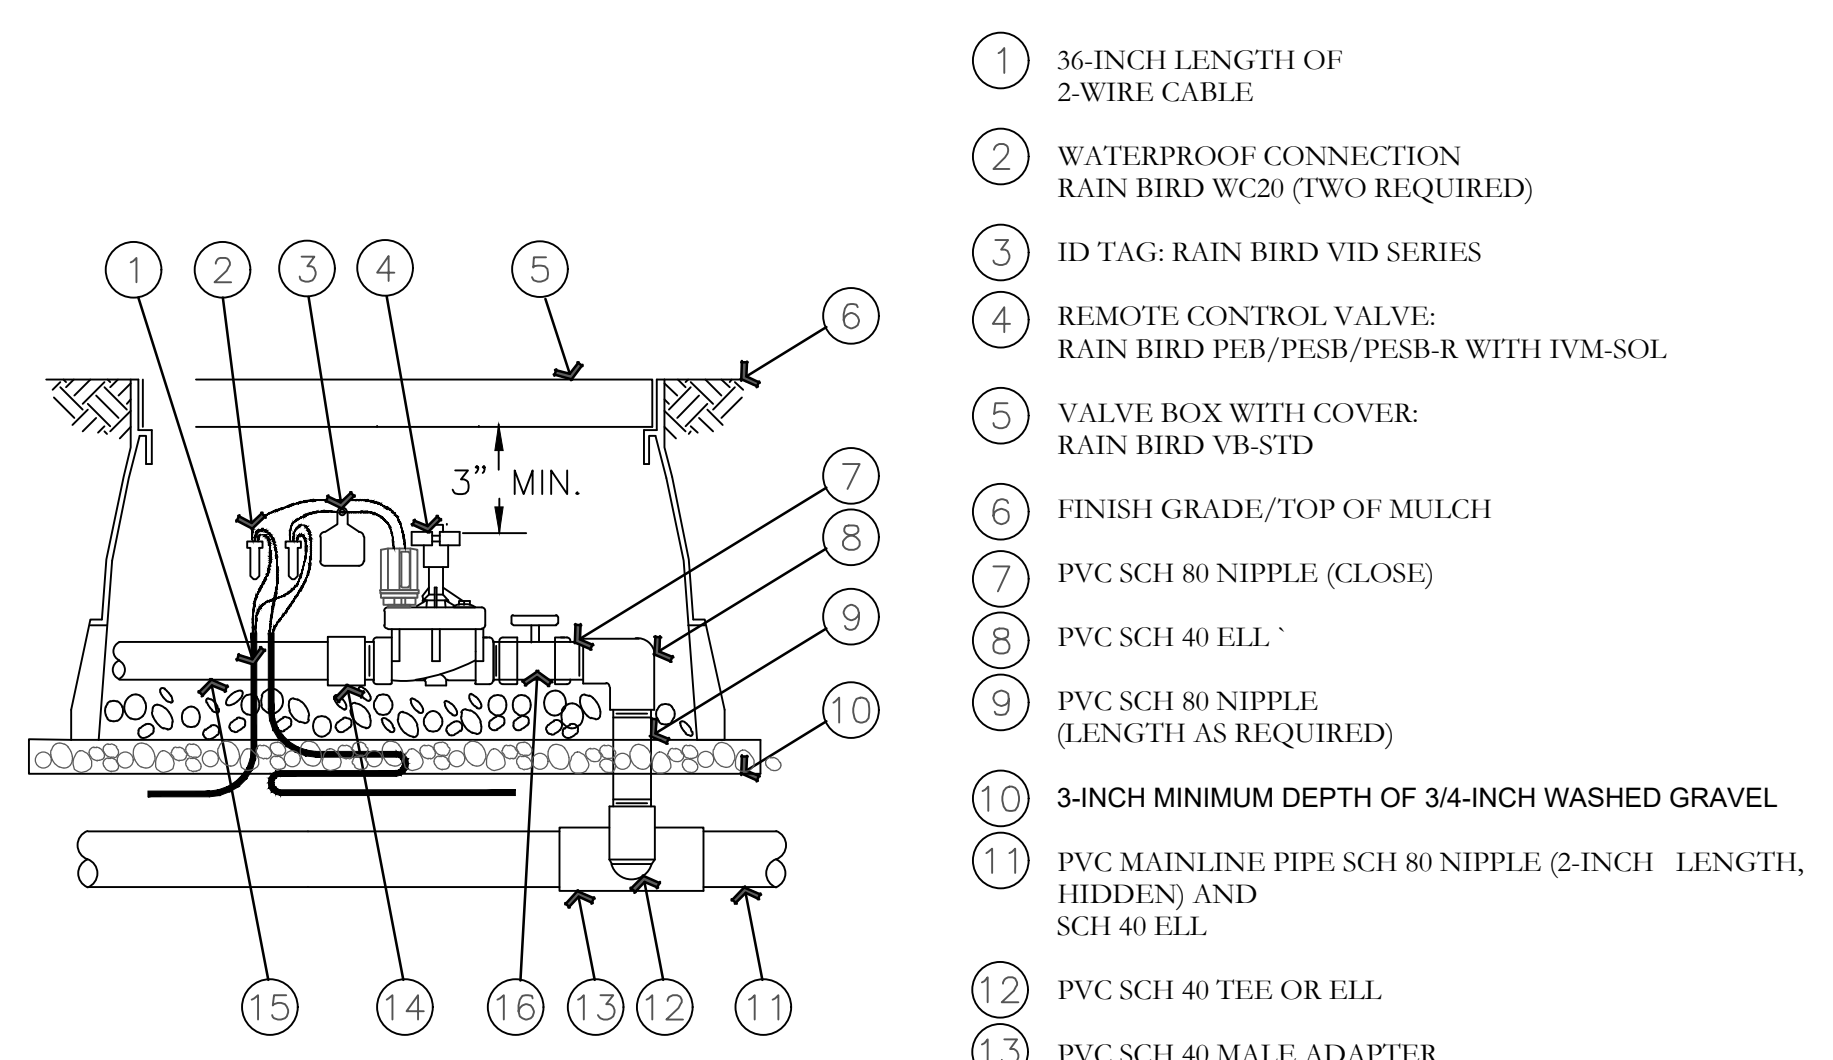
J 2-WIRE CONNECTION DETAIL
NOT TO SCALE

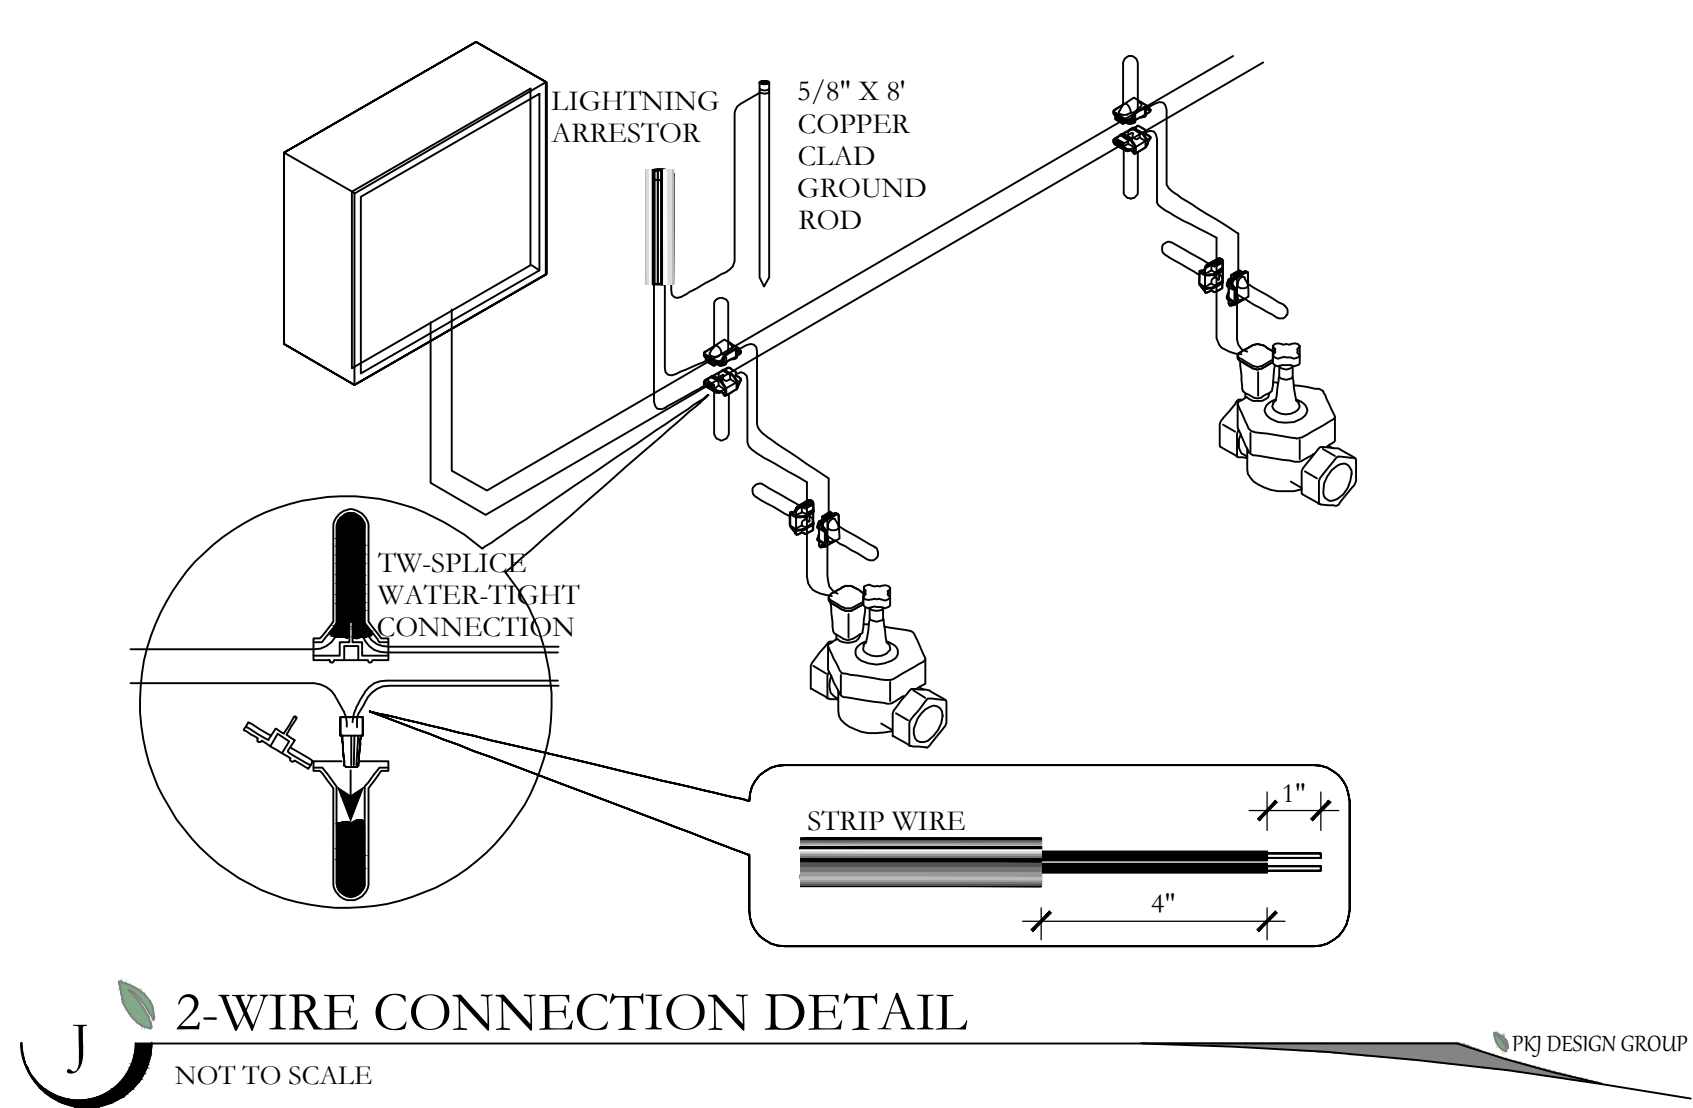


K GROUNDING ROD DETAIL
NOT TO SCALE

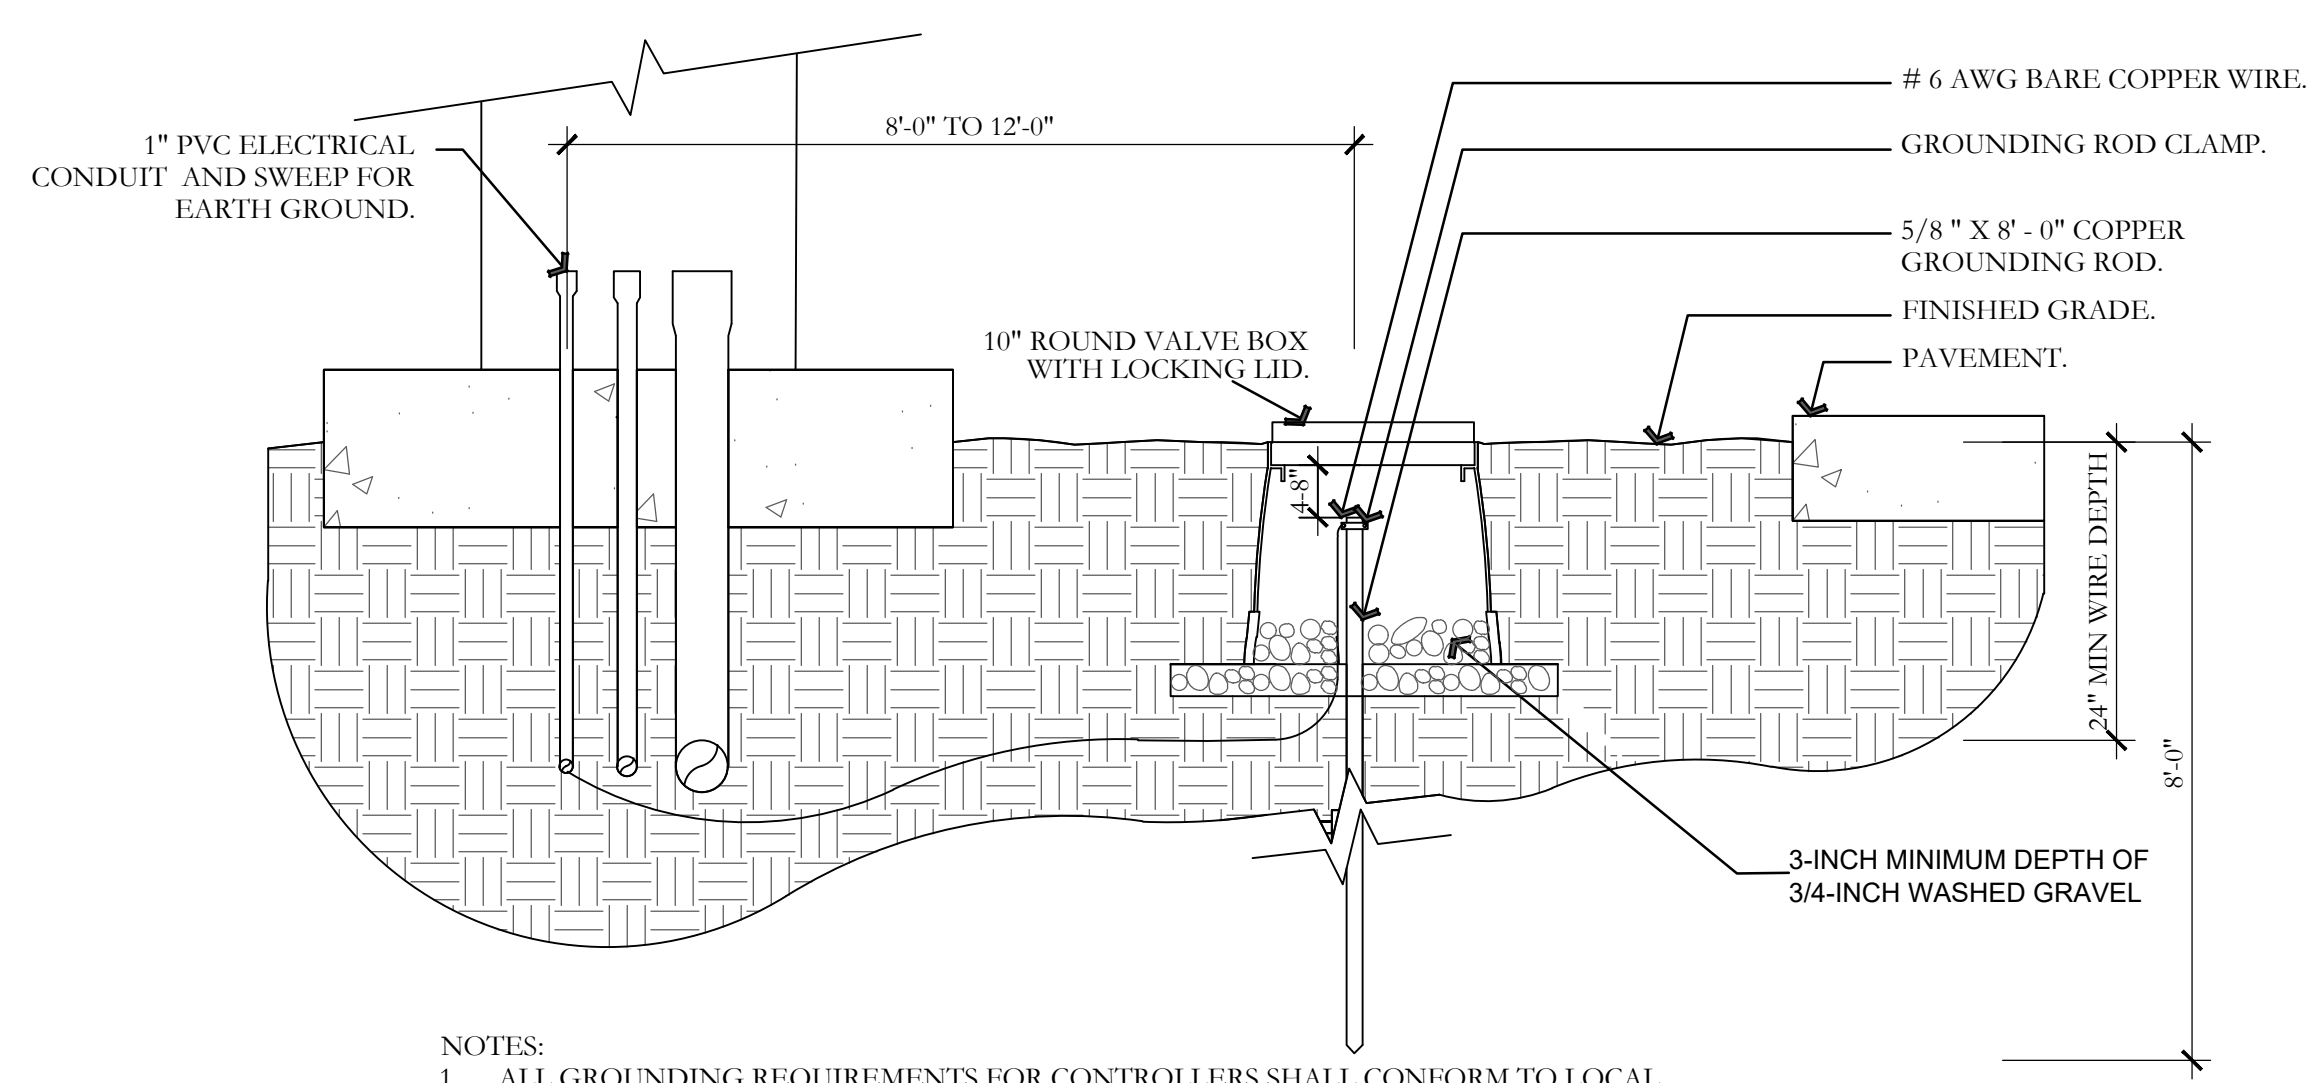


L MANUAL LINE DRAIN VALVE DETAIL
NOT TO SCALE

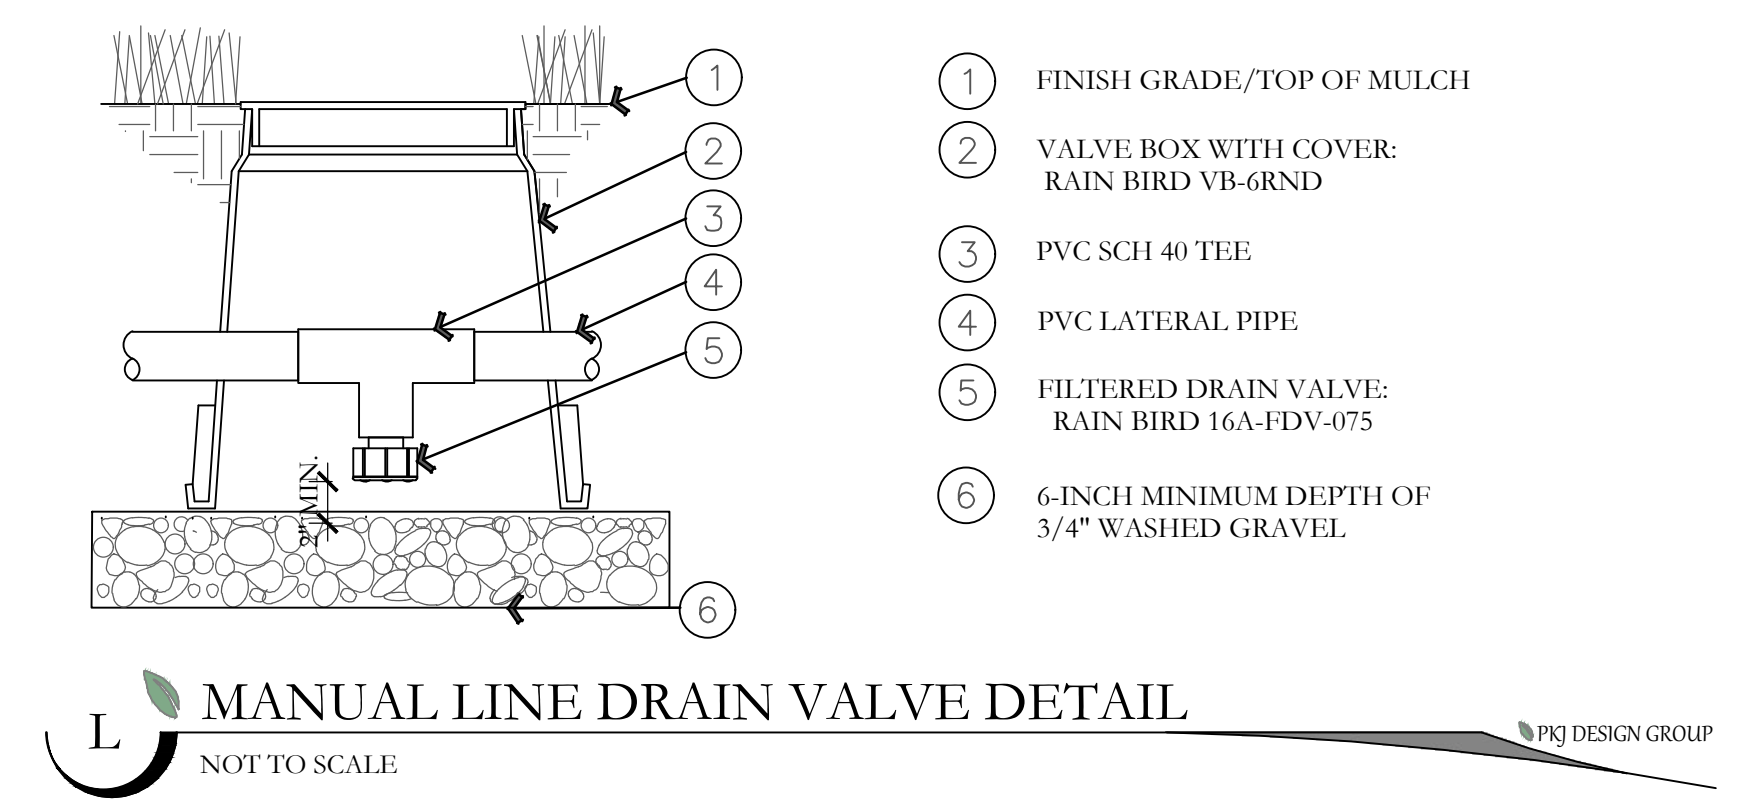

M ELECTRIC REMOTE-CONTROL VALVE PEB OR PESB SERIES WITH IVM-SOL
NOT TO SCALE

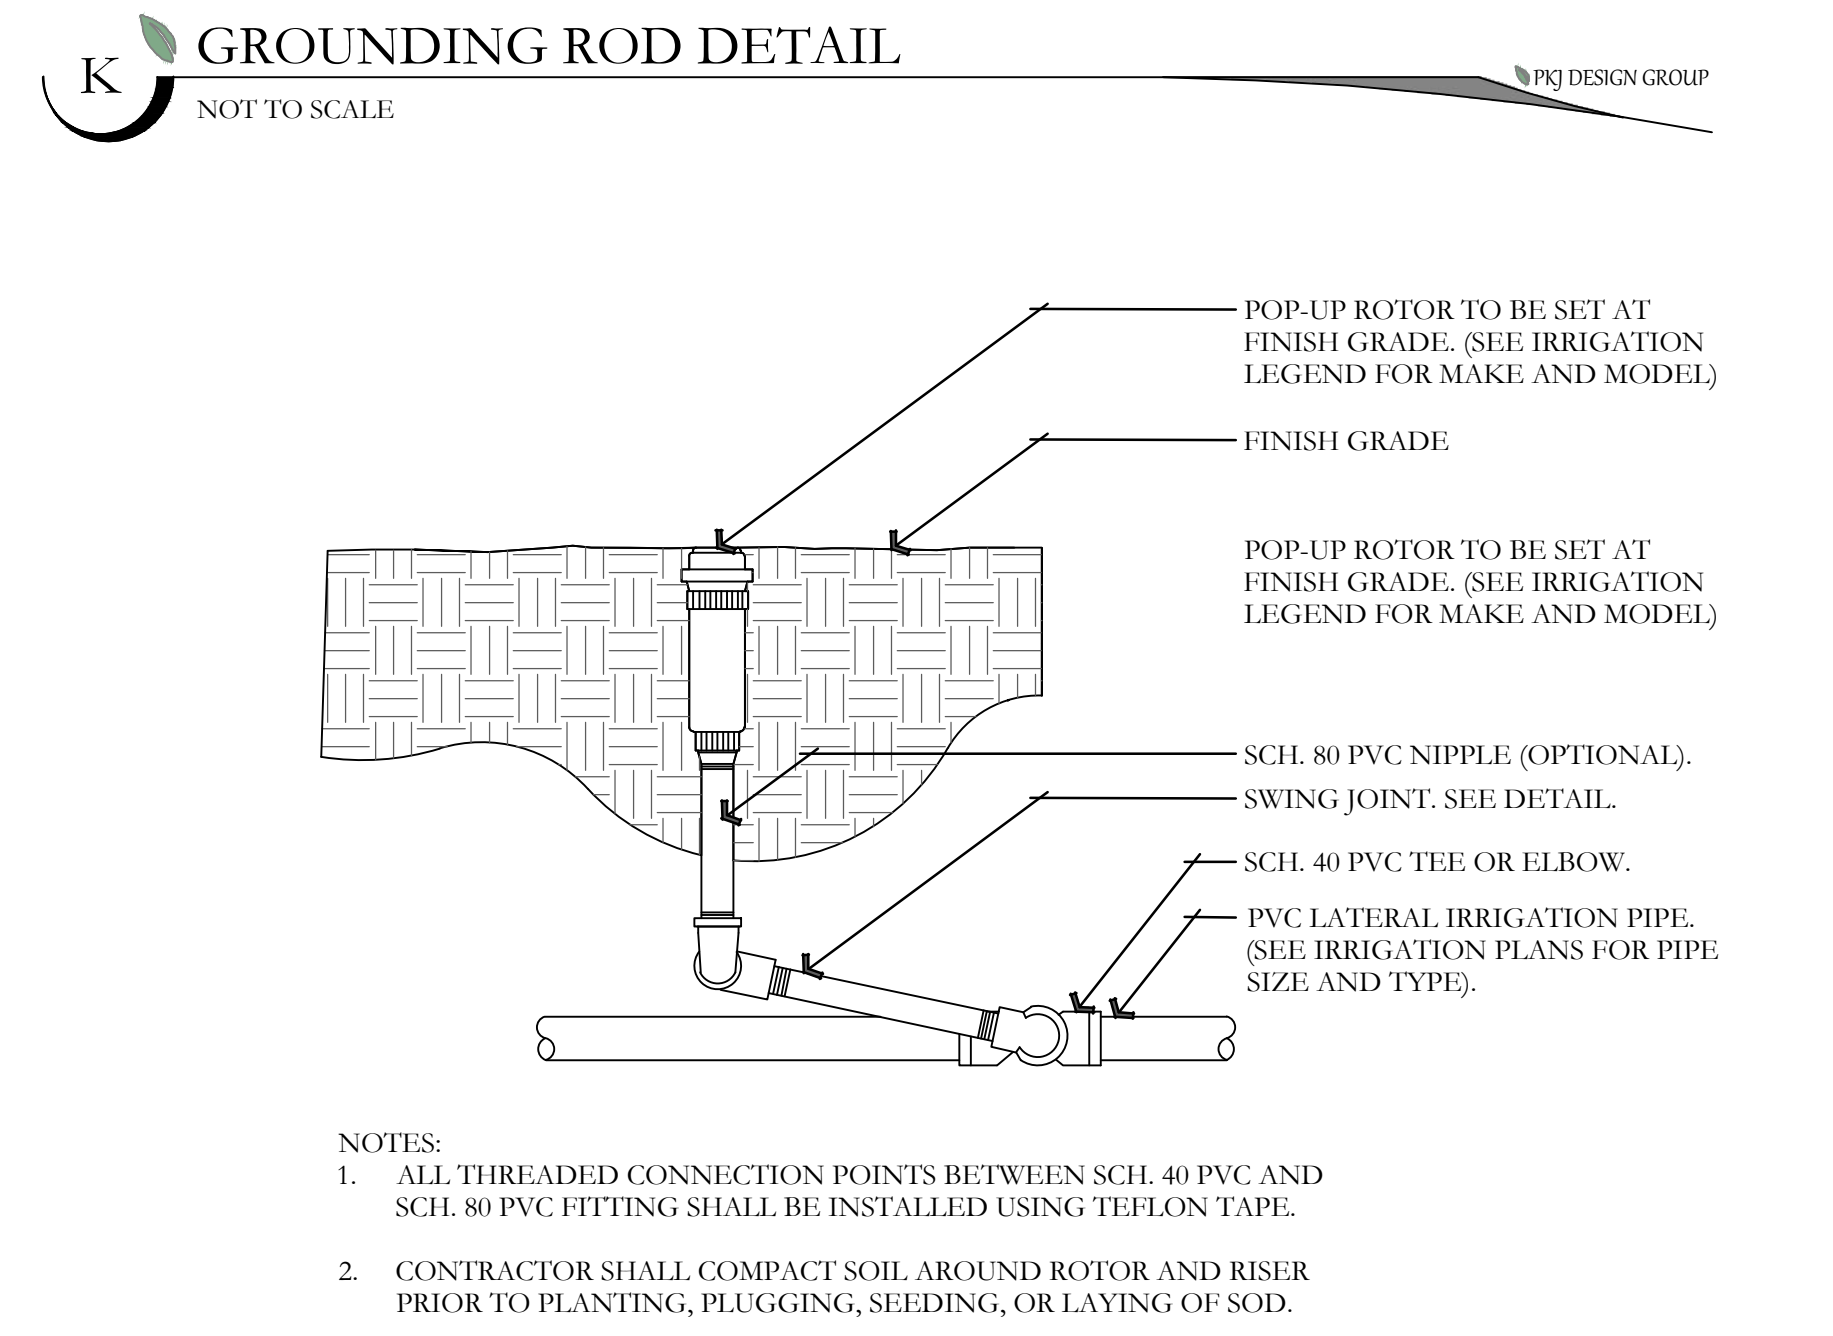

N ROTOR HEAD DETAIL
NOT TO SCALE

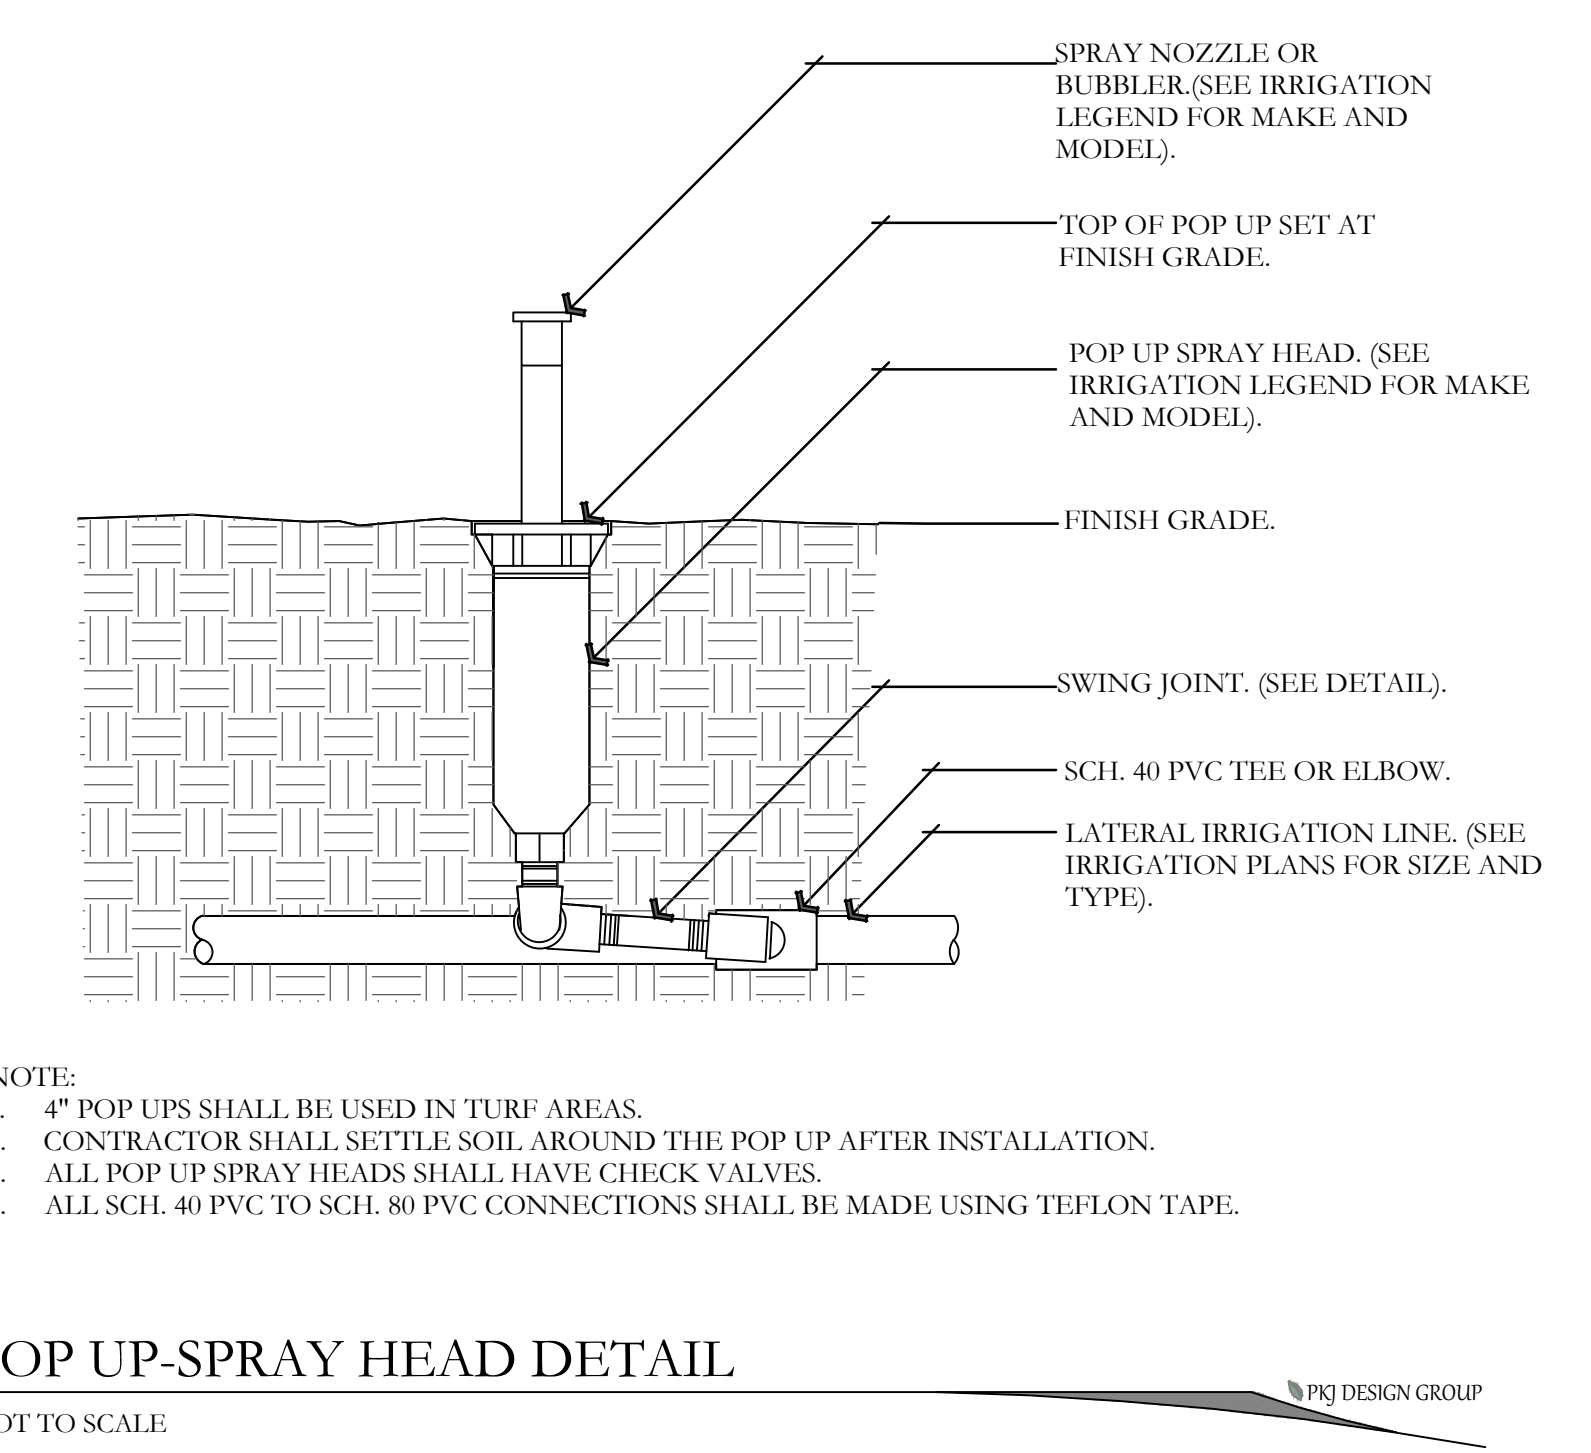

O POP UP-SPRAY HEAD DETAIL
NOT TO SCALE


ISSUE DATE	PROJECT NUMBER	PLAN INFORMATION	PROJECT INFORMATION	DEVELOPER / PROPERTY OWNER / CLIENT	LANDSCAPE ARCHITECT / PLANNER	LICENSE STAMP	DRAWING INFO
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1/26/2024 UT24015

RESEARCH AND TECH CENTER
PH. 1
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SANTAQUIN, UTAH

JON JENSEN
JJENSENCM@GMAIL.COM

PKJ DESIGN GROUP
Landscape Architecture • Planning & Visualization
3450 N. TRIUMPH BLVD. SUITE 102
LEHI, UTAH 84043 (801) 753-5644
www.pkjdesigngroup.com

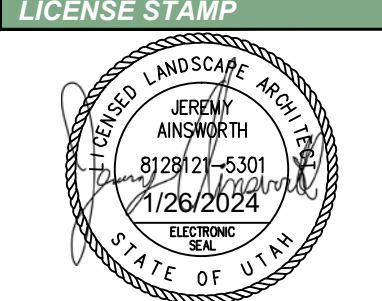

PM:	JTA
DRAWN:	ACP
CHECKED:	JMA
PLOT DATE:	1/26/2024


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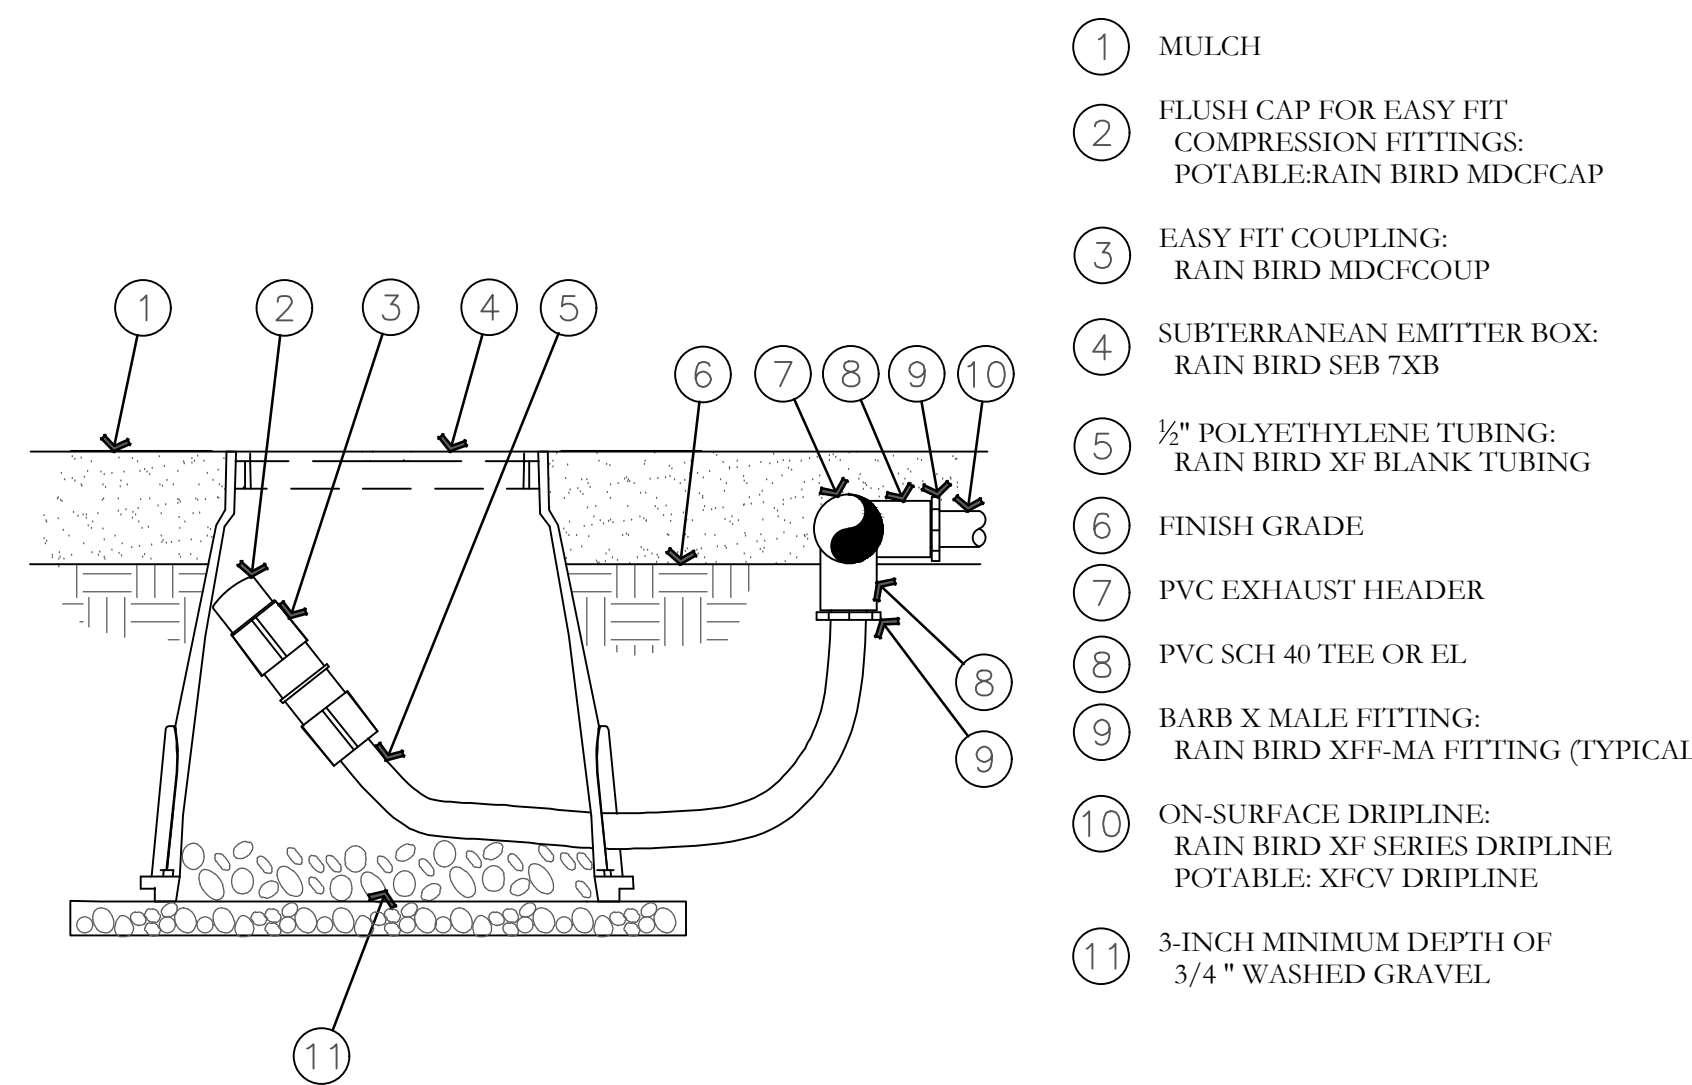
IRRIGATION DETAILS
CITY PERMIT SET

IR-502



- 1 FINISH GRADE/TOP OF MULCH
- 2 VALVE BOX WITH COVER: RAIN BIRD VB-STD
- 3 30-INCH LINEAR LENGTH OF WIRE, COILED
- 4 WATERPROOF CONNECTION: RAIN BIRD DB SERIES
- 5 1-INCH BALL VALVE (INCLUDED IN XCZ-PRB-100-COM KIT)
- 6 ID TAG
- 7 REMOTE CONTROL VALVE: RAIN BIRD PERS (INCLUDED IN XCZ-PRB-100-COM KIT)
- 8 PRESSURE REGULATING AND FLOW INDICATING BASKET FILTER: RAIN BIRD XCZ-100-FLOW
- 9 PVC SCH 40 FEMALE ADAPTOR
- 10 LATERAL PIPE
- 11 PVC SCH 80 NIPPLE (LENGTH AS REQUIRED)
- 12 PVC SCH 40 ELL
- 13 PVC SCH 80 NIPPLE (2-INCH LENGTH, HIDDEN) AND PVC SCH 40 ELL
- 14 PVC SCH 40 TEE OR ELL
- 15 MAINLINE PIPE
- 16 3-INCH MINIMUM DEPTH OF 3/4-INCH WASHED GRAVEL
- 17 PVC SCH 80 NIPPLE, CLOSE (INCLUDED IN XCZ-PRB-100-COM KIT)


P DRIP CONTROL ZONE KIT DETAIL
NOT TO SCALE

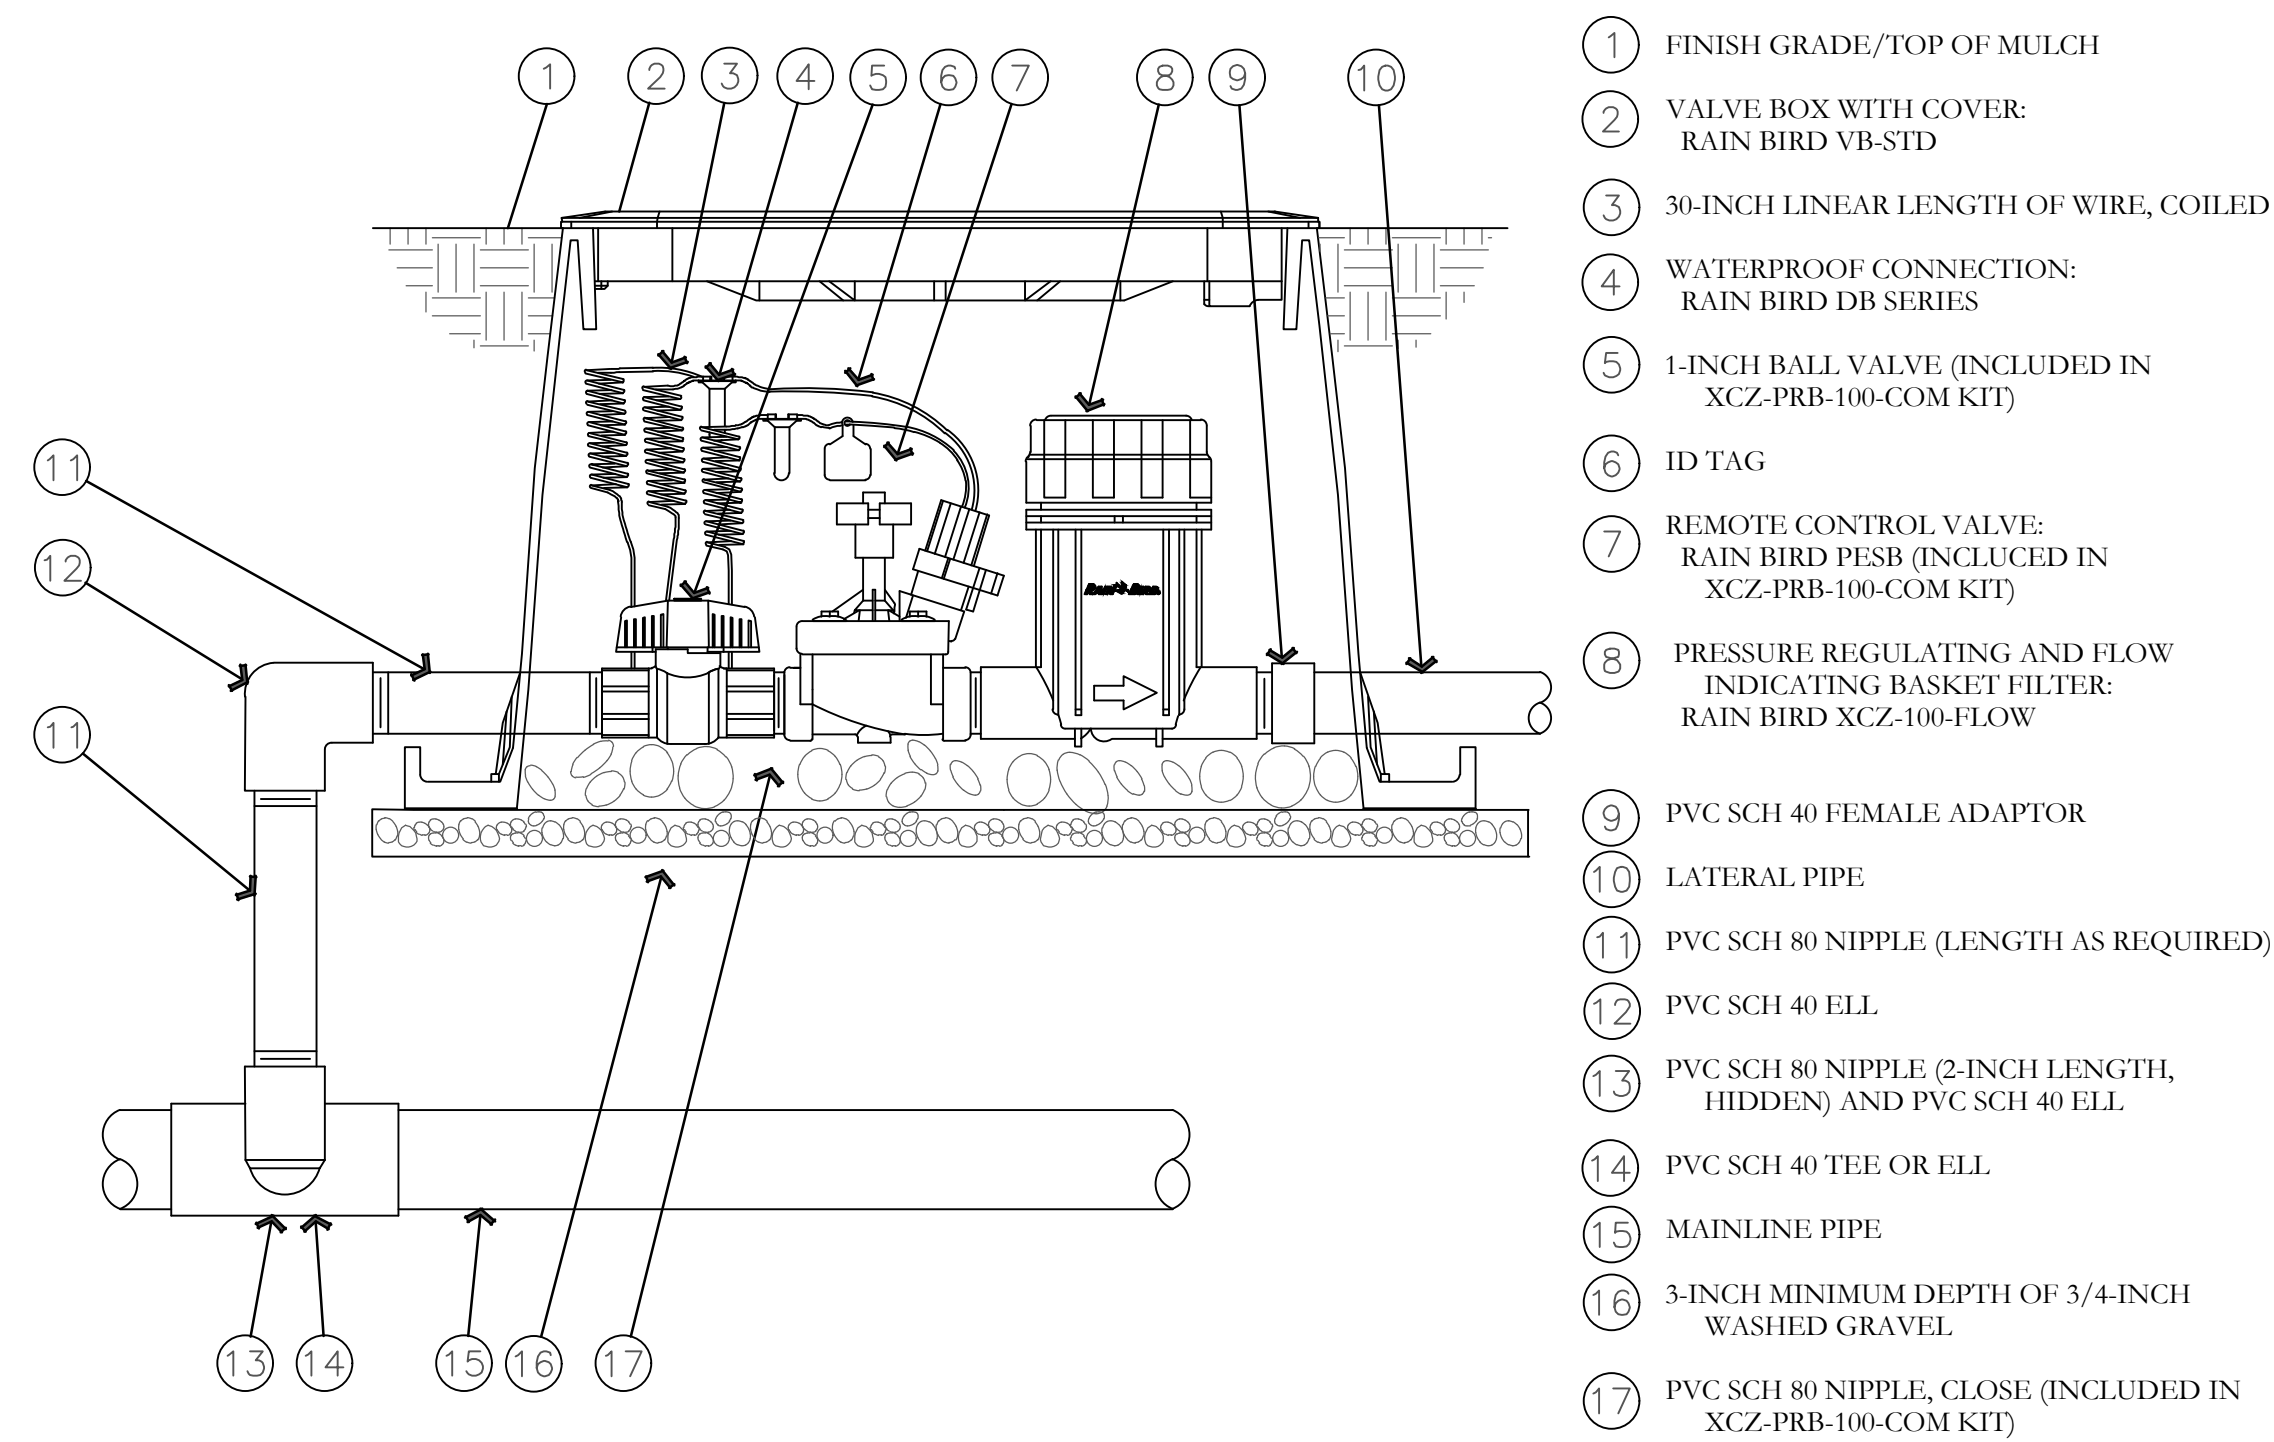

- 1 MULCH
- 2 FLUSH CAP FOR EASY FIT COMPRESSION FITTINGS: POTABLE:RAIN BIRD MDCFCAP
- 3 EASY FIT COUPLING: RAIN BIRD MDCFCOUP
- 4 SUBTERRANEAN EMITTER BOX: RAIN BIRD SEB 7XB
- 5 1/2" POLYETHYLENE TUBING: RAIN BIRD XF-BLANK TUBING
- 6 FINISH GRADE
- 7 PVC EXHAUST HEADER
- 8 PVC SCH 40 TEE OR EL
- 9 BARB X MALE FITTING: RAIN BIRD XFF-MA FITTING (TYPICAL)
- 10 ON-SURFACE DRIPLINE: RAIN BIRD XF SERIES DRIPLINE POTABLE: XFCV DRIPLINE
- 11 3-INCH MINIMUM DEPTH OF 3/4" WASHED GRAVEL


NOTE:
1. ALLOW A MINIMUM OF 6-INCHES OF DRIPLINE TUBING IN VALVE BOX IN ORDER TO DIRECT FLUSHED WATER OUTSIDE VALVE BOX.

Q ON-SURFACE DRIPLINE FLUSH POINT DETAIL
NOT TO SCALE

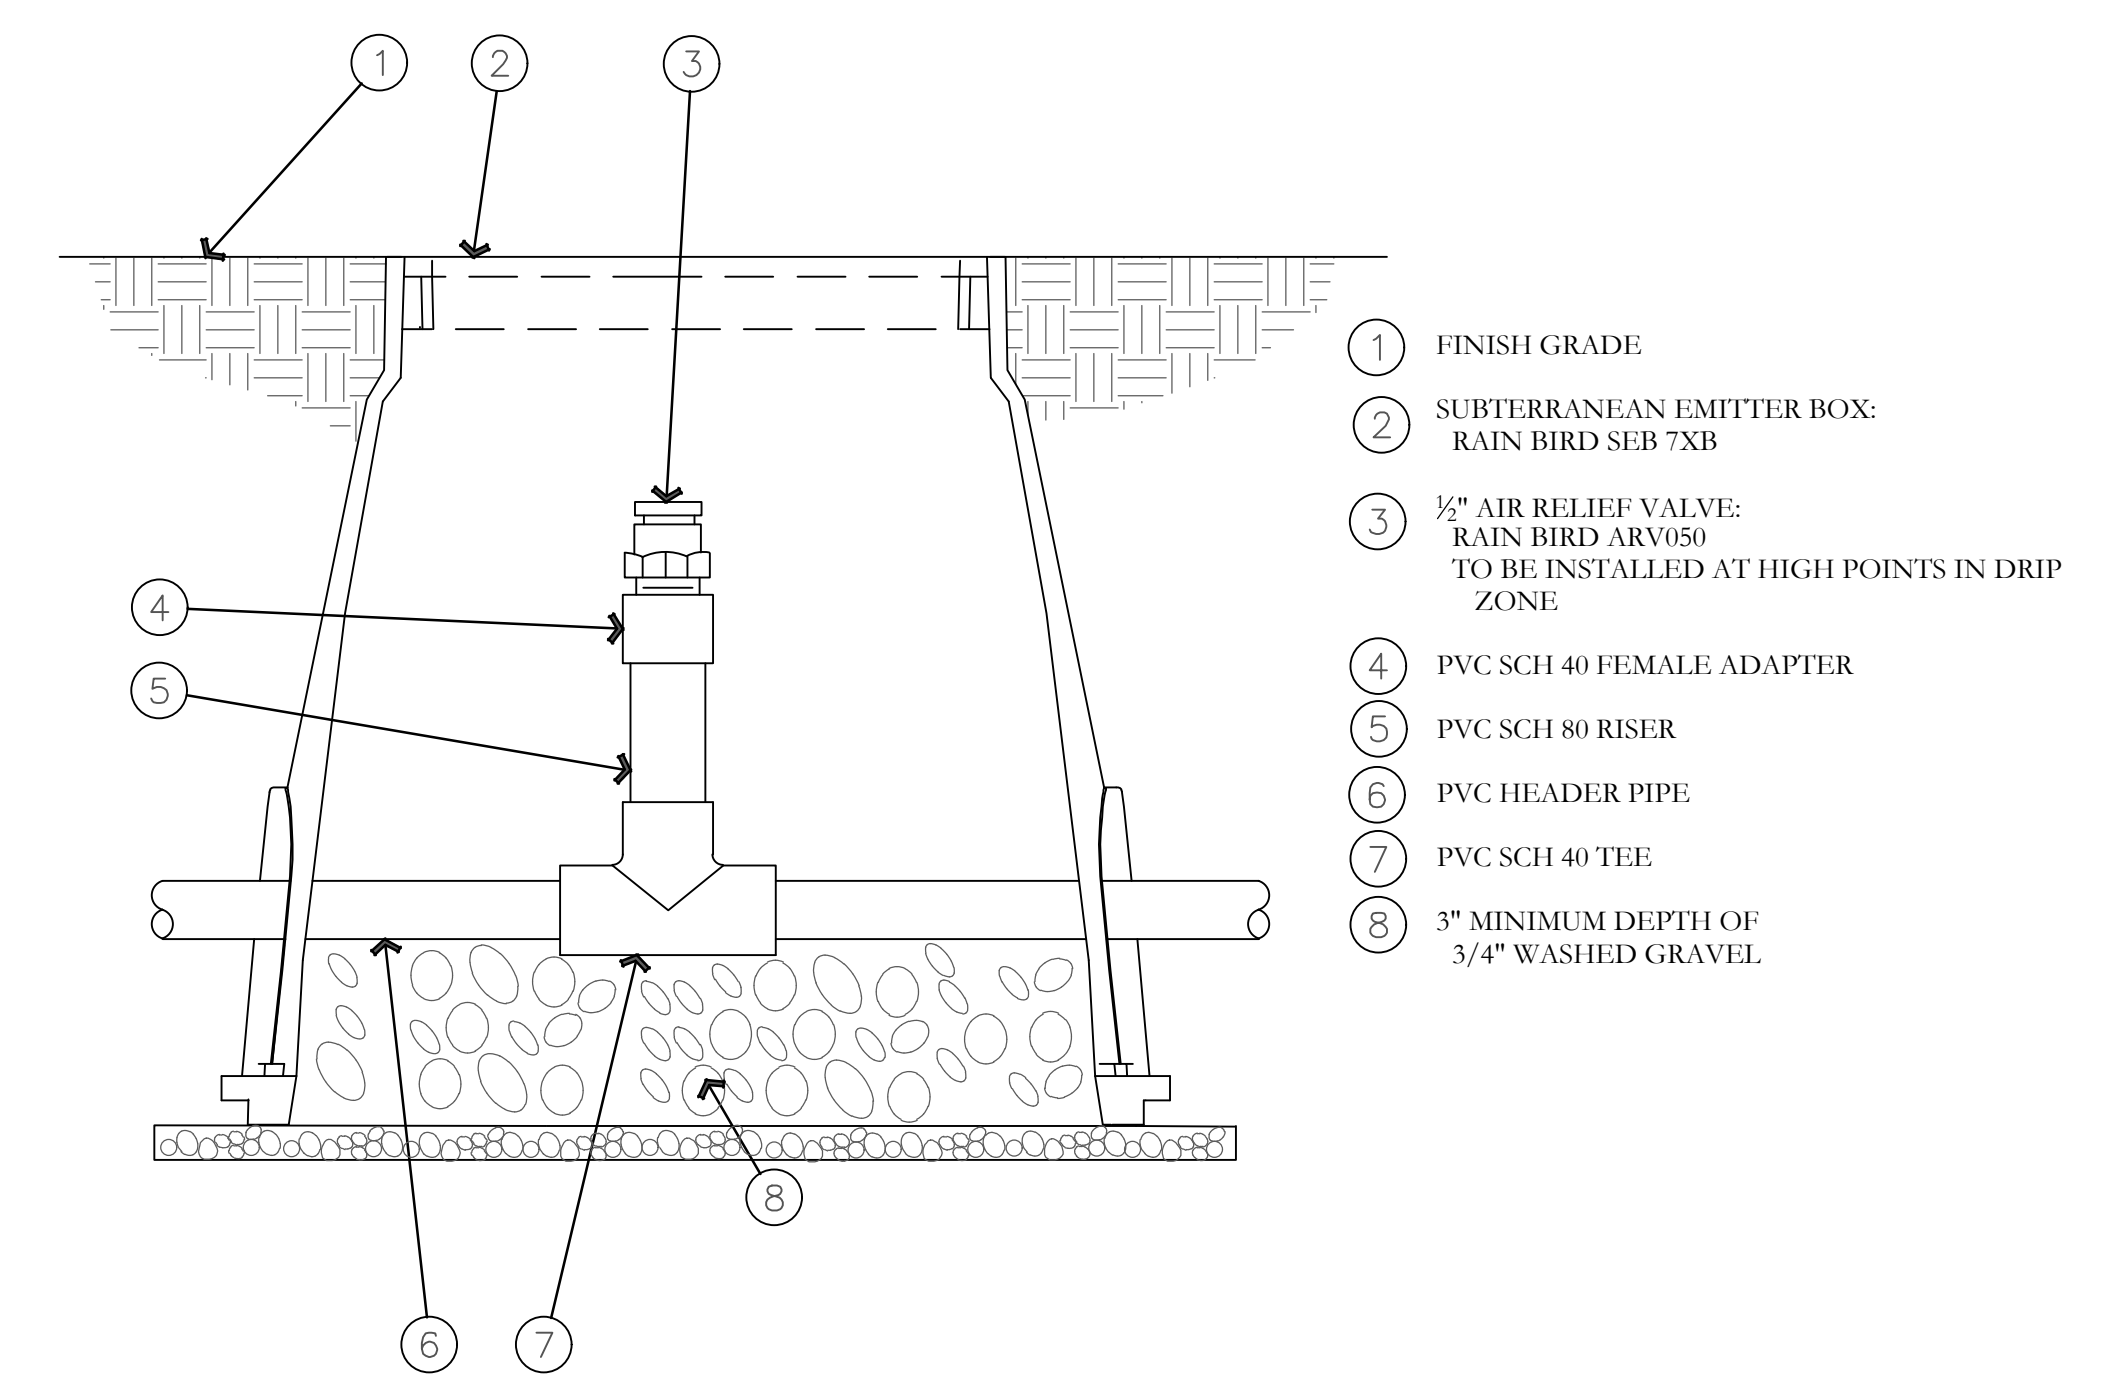

- 1 FINISH GRADE
- 2 SUBTERRANEAN EMITTER BOX: RAIN BIRD SEB 7XB
- 3 1/2" AIR RELIEF VALVE: RAIN BIRD ARV050 TO BE INSTALLED AT HIGH POINTS IN DRIP ZONE
- 4 PVC SCH 40 FEMALE ADAPTER
- 5 PVC SCH 80 RISER
- 6 PVC HEADER PIPE
- 7 PVC SCH 40 TEE
- 8 3" MINIMUM DEPTH OF 3/4" WASHED GRAVEL

R AIR RELIEF VALVE DETAIL
NOT TO SCALE

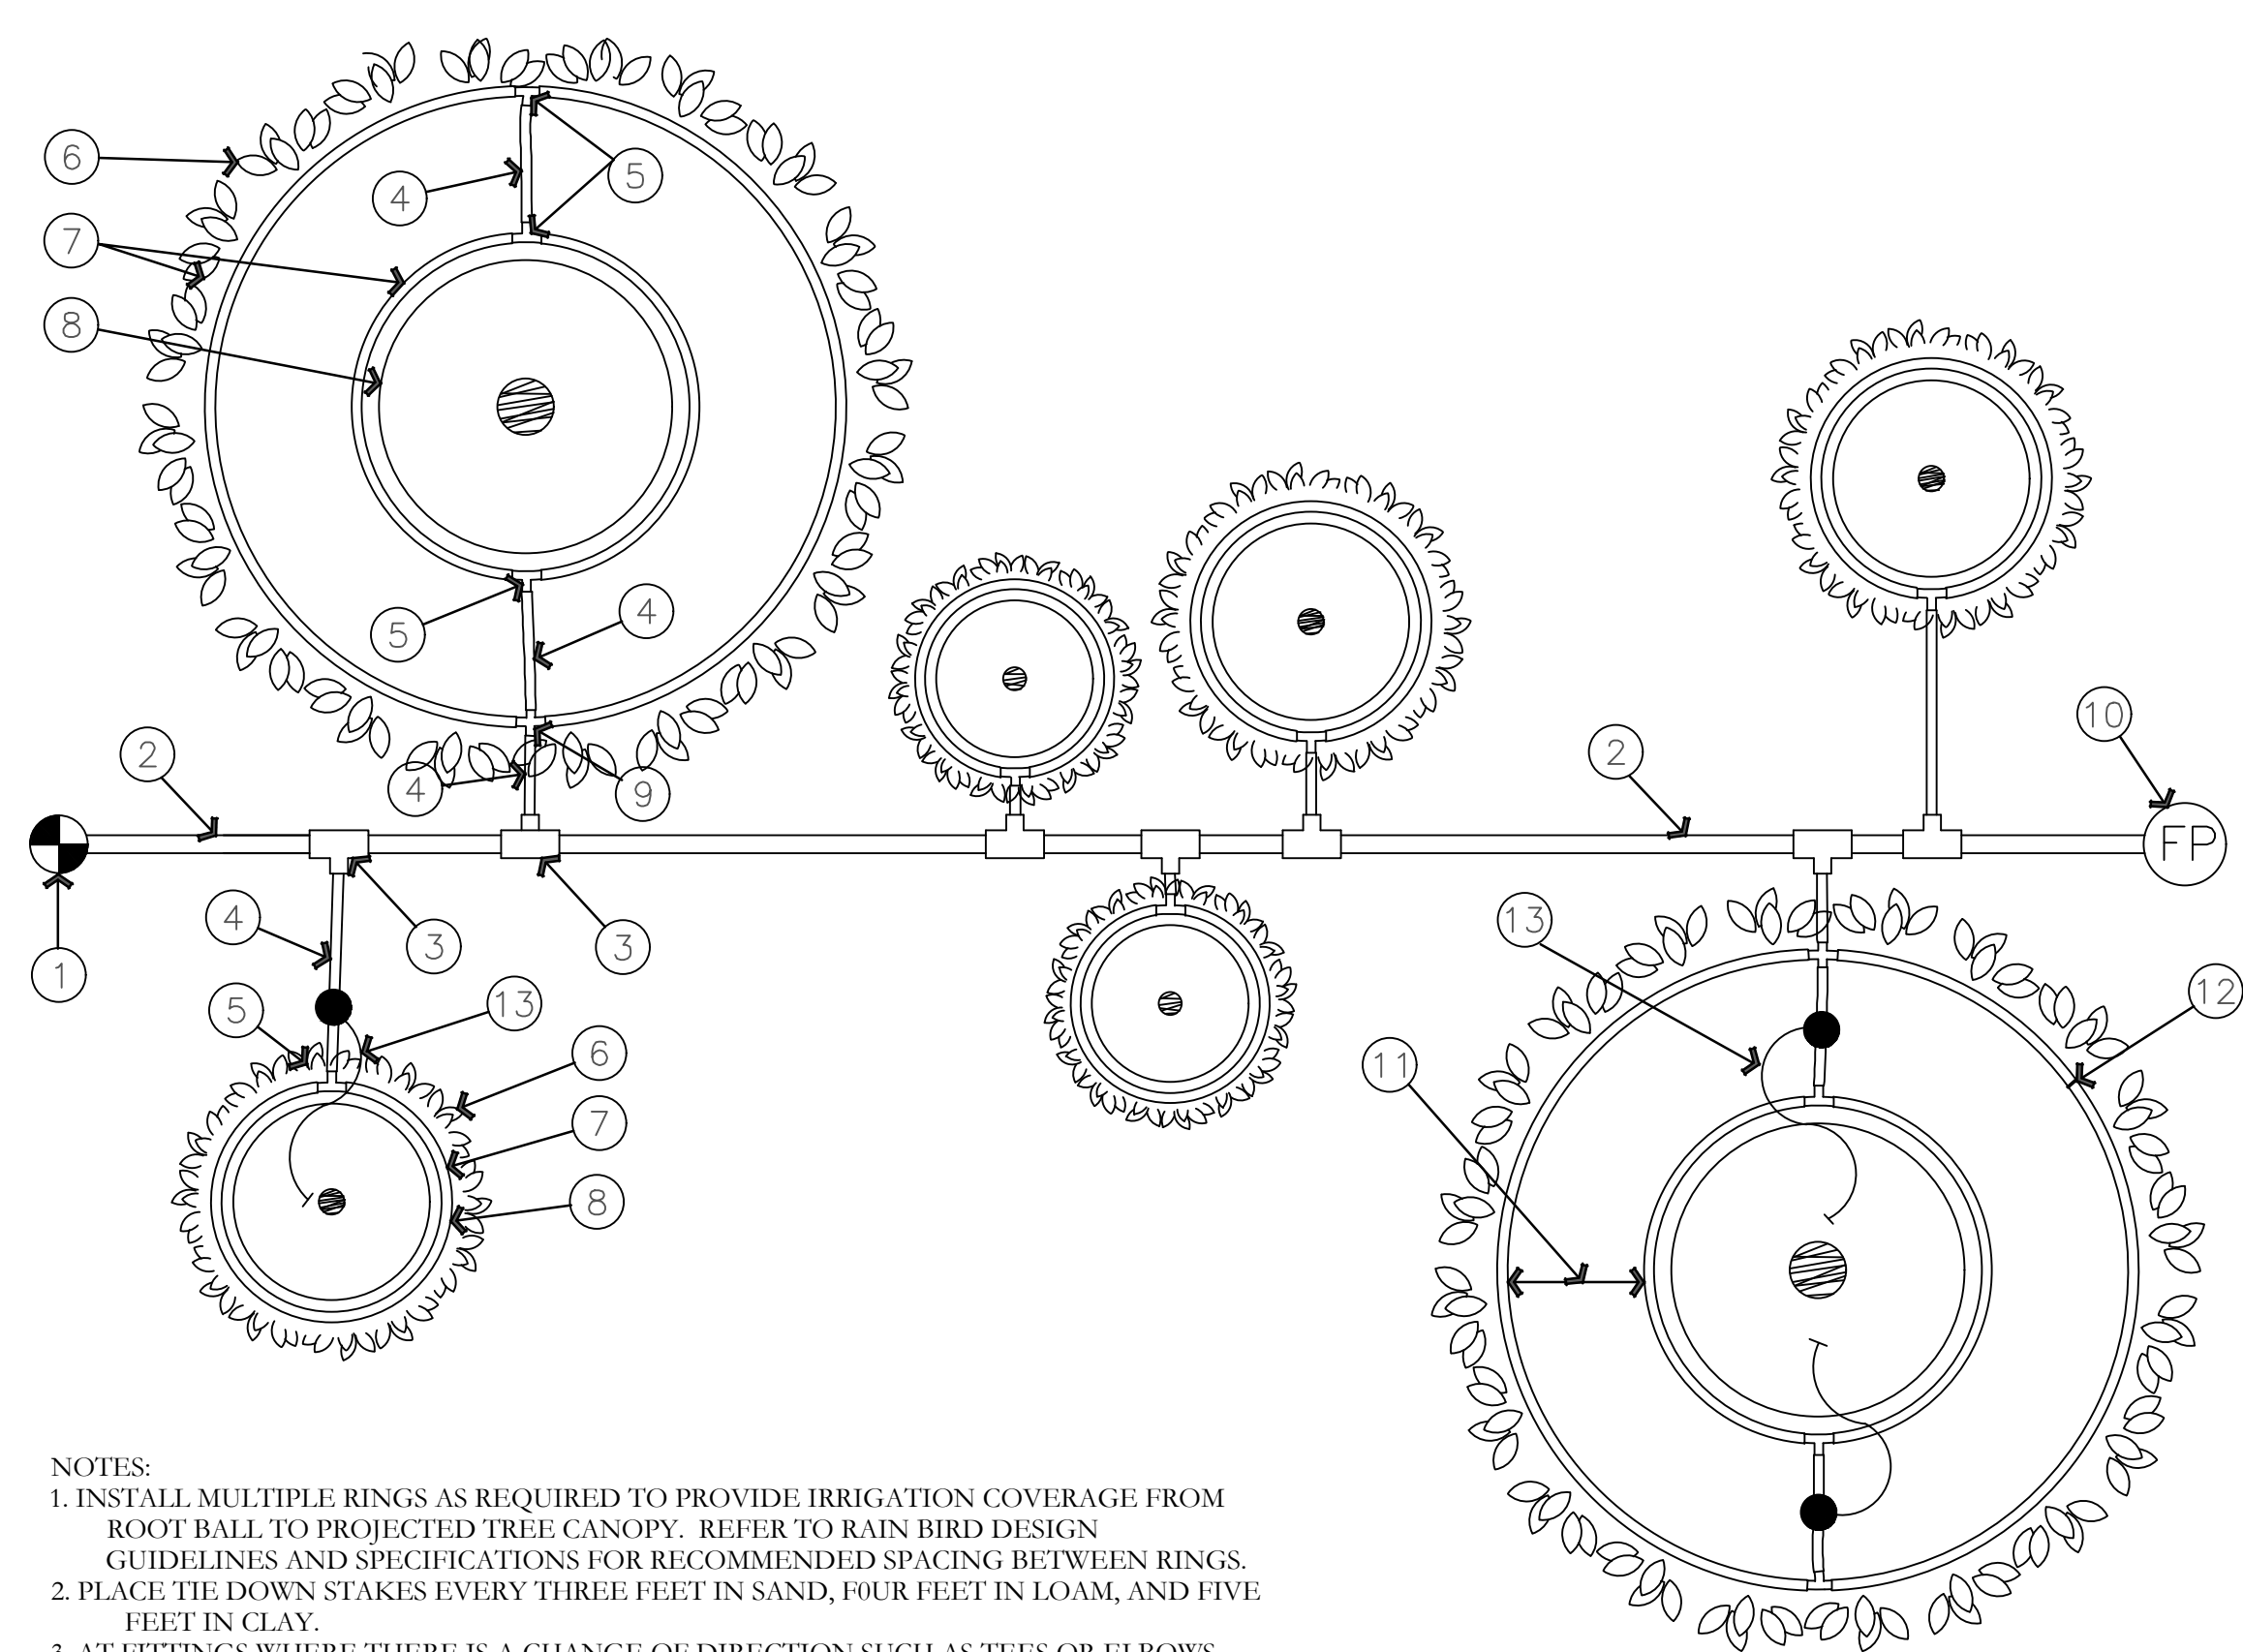

- 1 RAIN BIRD CONTROL ZONE KIT (SIZED TO ACCOMMODATE LATERAL FLOW DEMAND)
- 2 PVC DRIP LATERAL PIPE
- 3 PVC SCH 40 TEE OR EL (TYPICAL)
- 4 1/2" POLYETHYLENE TUBING: RAIN BIRD XF SERIES-S FOR COPPER SHEILD (TYPICAL)
- 5 BARB X BARB INSERT TEE: RAIN BIRD XFF-TEE (TYPICAL)
- 6 PROJECTED CANOPY LINE OF TREE OR SHRUB (TYPICAL)
- 7 ON-SURFACE DRIPLINE: RAIN BIRD XF SERIES DRIPLINE POTABLE: XFCV SERIES PLACE AS SHOWN (LENGTH AS REQUIRED, TYPICAL)
- 8 ROOT BALL (TYPICAL)
- 9 BARB X BARB INSERT CROSS: RAIN BIRD XFD-CROSS (TYPICAL)
- 10 DRIPLINE FLUSH POINT (SEE RAIN BIRD DETAIL: "XFCV DRIPLINE FLUSH POINT WITH BALL VALVE")
- 11 SPACING PER SPECIFICATION
- 12 TIE DOWN STAKE: RAIN BIRD TDS-050 WITH BEND (QUANTITY AS REQUIRED, SEE NOTES 2-3 BELOW)
- 13 POINT SOURCE EMITTERS FOR ESTABLISHMENT PERIOD. REMOVE AFTER ESTABLISHMENT PERIOD.

NOTES:
1. INSTALL MULTIPLE RINGS AS REQUIRED TO PROVIDE IRRIGATION COVERAGE FROM ROOT BALL TO PROJECTED TREE CANOPY. REFER TO RAIN BIRD DESIGN GUIDELINES AND SPECIFICATIONS FOR RECOMMENDED SPACING BETWEEN RINGS.
2. PLACE TIE DOWN STAKES EVERY THREE FEET IN SAND, FOUR FEET IN LOAM, AND FIVE FEET IN CLAY.
3. AT FITTINGS WHERE THERE IS A CHANGE OF DIRECTION SUCH AS TEES OR ELBOWS, USE TIE-DOWN STAKES ON EACH LEG OF THE CHANGE OF DIRECTION.

S ON-SURFACE DRIPLINE TREE/SHRUB DETAIL
NOT TO SCALE

ISSUE DATE	PROJECT NUMBER	PLAN INFORMATION	PROJECT INFORMATION	DEVELOPER / PROPERTY OWNER / CLIENT	LANDSCAPE ARCHITECT / PLANNER	LICENSE STAMP	DRAWING INFO	
1/26/2024	UT24015			JON JENSEN JJENSENCM@GMAIL.COM			PM: JTA DRAWN: ACP CHECKED: JMA PLOT DATE: 1/26/2024	
NO. REVISION DATE 1 XXXX XX-XX-XX 2 3 4 5 6 7			<h2>RESEARCH AND TECH CENTER</h2> <h3>PH. 1</h3> <p>1940 S. RIDGE FARMS RD. SANTAQUIN, UTAH</p>		<p>COPYRIGHT: PKJ DESIGN GROUP</p> <p>THIS DOCUMENT AND THE IDEAS AND DESIGNS INCORPORATED HEREIN AS AN INSTRUMENT OF PROFESSIONAL SERVICE IS PROPERTY OF PKJ DESIGN GROUP. IT IS NOT TO BE USED IN WHOLE OR IN PART FOR ANY OTHER PROJECT WITHOUT THE WRITTEN AUTHORIZATION OF PKJ DESIGN GROUP.</p>		<p>PKJ DESIGN GROUP Landscape Architecture / Planning & Visualization</p> <p>3450 N. TRIUMPH BLVD, SUITE 102 LEHI, UTAH 84043 (801) 753-5644 www.pkjdesigngroup.com</p>	

IRRIGATION DETAILS
CITY PERMIT SET

IR-503



Polar Plot								
Symbol	Label	QTY	Manufacturer	Catalog	Description	Number Lamps	Total Output	Input Power
□	PL1	15	Lithonia Lighting	RSX1 LED P2 50K R3	RSX Area Fixture Size 1 P2 Lumen Package 5000K CCT Type R3 Distribution	1	9843	72.95
□	WL1	19	Lithonia Lighting	WDGE2 LED P2 50K 80CRI T3M	WDGE2 LED WITH P2 - PERFORMANCE PACKAGE, 5000K, 80CRI, TYPE 3 MEDIUM OPTIC	1	2038	18.9815
□	WL2	18	Lithonia Lighting	WDGE2 LED P3 50K 70CRI T3M	WDGE2 LED WITH P3 - PERFORMANCE PACKAGE, 5000K, 70CRI, TYPE 3 MEDIUM OPTIC	1	3675	32.1375

Statistics						
Description	Symbol	Avg	Max	Min	Max/Min	Avg/Min
Calc Zone #1	+	0.6 fc	2.9 fc	0.0 fc	N/A	N/A

SANTAQUIN RESEARCH AND TECH CENTER PHASE 1

SOUTH RIDGE FARMS ROAD
SANTAQUIN UT 84655

STAMP

NOT FOR CONSTRUCTION

REVISIONS

ROCKY MOUNTAIN CONSULTING ENGINEERS, INC.
2332 West 12600 South, Suite F | Riverton, UT 84065
(801) 366-0553 www.rmceui.com

PROJECT #: 24026
DRAWN BY: JG / OG
CHECKED BY: WW
DATE: 01/19/2024
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SHEET TITLE:

ELECTRICAL SITE PLAN

E001

1 ELECTRICAL SITE PLAN
E001 SCALE: 1" = 20'-0"

VINCENT OAKS

SANTAQUIN, UTAH COUNTY, UTAH

JANUARY 2024

-INDEX OF PLAN SHEETS-

GENERAL

1. ALL WORK SHALL BE DONE IN ACCORDANCE WITH THE SPECIFICATIONS AND/OR REQUIREMENTS OF THE SANTAQUIN CITY PUBLIC WORKS DEPARTMENT.
2. A PRE CONSTRUCTION CONFERENCE WILL BE HELD A MINIMUM OF 3 WORKING DAYS PRIOR TO START OF WORK. ALL CONTRACTORS, SUBCONTRACTORS AND/OR UTILITY CONTRACTORS, SANTAQUIN CITY PUBLIC WORKS AND CITY'S ENGINEER SHOULD BE PRESENT.
3. ALL LOT DIMENSIONS, EASEMENTS AND CERTAIN OFF SITE EASEMENTS ARE TO BE TAKEN FROM THE PLAT OF THE VINCENT RIDGE WITH THE COMPLETION OF ROW IMPROVEMENTS ASSOCIATED WITH VINCENT RIDGE.
4. ALL CONSTRUCTION STAKES MUST BE REQUESTED A MINIMUM OF THREE (3) WORKING DAYS PRIOR TO PLANNED USE.
5. CERTAIN CONTROL POINTS WILL BE SET BY THE ENGINEER, OR HIS REPRESENTATIVE, WHICH ARE CRITICAL TO THE CONSTRUCTION STAKING OF THE PROJECT. THESE POINTS WILL BE DESIGNATED AT THE TIME THEY ARE SET AND THE CONTRACTOR SO NOTIFIED. DESTRUCTION OF THESE POINTS BY THE CONTRACTOR OR HIS SUBCONTRACTORS SHALL BE GROUNDS FOR CHARGING THE CONTRACTOR FOR REESTABLISHING SAID POINTS.
6. ALL RECOMMENDATIONS MADE IN A PERTINENT GEOTECHNICAL REPORT/STUDY SHALL BE FOLLOWED EXPLICITLY DURING CONSTRUCTION OF BUILDING AND SITE IMPROVEMENTS.
7. THE DEVELOPER AND THE GENERAL CONTRACTOR UNDERSTAND THAT IT IS HIS/HER RESPONSIBILITY TO ENSURE THAT ALL IMPROVEMENTS INSTALLED WITHIN THIS DEVELOPMENT ARE CONSTRUCTED IN FULL COMPLIANCE WITH ALL STATE AND SANTAQUIN CITY CODES, ORDINANCES AND STANDARDS. THESE PLANS ARE NOT ALL INCLUSIVE OF ALL MINIMUM CODES, ORDINANCES AND STANDARDS. THIS FACT DOES NOT RELIEVE THE DEVELOPER OR GENERAL CONTRACTOR FROM THE FULL COMPLIANCE WITH ALL MINIMUM STATE AND SANTAQUIN CITY CODES, ORDINANCES AND STANDARDS.

SHEET	DESCRIPTION
1	COVER SHEET
2	FINAL PLAT
3	UTILITY INDEX SHEET
4	GRADING & DRAINAGE
PP-01	PLAN & PROFILE 875 EAST
PP-02	PLAN & PROFILE 900 EAST
PP-03	PLAN & PROFILE 450 SOUTH
DT-01	DETAILS
DT-02	DETAILS

TABULATIONS VINCENT RIDGE

ZONE:	R-10
PROJECT AREA:	158,877 SQ.FT 3.65 ACRES 100%
# OF LOTS:	7 LOTS (1.92 LOTS PER ACRE)
LOT AREA:	117,672 SQ.FT. 2.70 ACRES 74.07%
RIGHT-OF-WAY AREA:	41,205 SQ.FT. 0.95 ACRES 25.93%

ROADWAY/STORM DRAIN


1. ALL ROADWAY CONSTRUCTION SHALL MEET THE MINIMUM REQUIREMENTS OF SANTAQUIN CITY'S TECHNICAL SPECIFICATIONS OR AS APPROVED IN THE PLANS HEREIN.
2. WHEN DISCREPANCIES OCCUR BETWEEN PLANS AND SPECIFICATIONS, THE CONTRACTOR SHALL IMMEDIATELY NOTIFY THE ENGINEER. UNTIMELY NOTIFICATION SHALL NEGATE ANY CONTRACTORS CLAIM FOR ADDITIONAL COMPENSATION.
3. ALL STORM DRAIN PIPES TO BE REINFORCED CONCRETE PIPE (RCP) CLASS III, HDPE STORM DRAIN PIPE, OR APPROVED EQUAL UNLESS OTHERWISE NOTED.
4. CONTRACTOR IS RESPONSIBLE TO ENSURE THAT ALL CLEANOUT/ACCESS LOCATIONS MEET SANTAQUIN CITY SPECIFICATIONS AND ARE COMPLETED UNDER THE DIRECTION OF SANTAQUIN CITY.
5. ALL STORM DRAIN INLET BOXES TO MEET SANTAQUIN CITY STANDARD DRAWING SDI W/3' SEDIMENT TRAP.

SEWER

1. ALL WORK SHALL BE DONE IN ACCORDANCE WITH THE LATEST SANTAQUIN CITY DESIGN STANDARDS & PUBLIC IMPROVEMENT SPECIFICATIONS DRAWINGS OF SANTAQUIN CITY.
2. FINAL APPROVAL AND ACCEPTANCE OF ALL SEWER CONSTRUCTION WILL BE BY SANTAQUIN CITY.
3. UPON THE COMPLETION OF WORK, THE CONTRACTOR SHALL SUBMIT 3 SETS OF AS-BUILT PLANS TO SANTAQUIN CITY & (1) SET TO NORTHERN ENGINEERING, INC.
4. HORIZONTAL AND VERTICAL SEPARATION OF CULINARY WATER AND SEWER SHALL BE IN COMPLIANCE WITH SANTAQUIN CITY STANDARDS.

WATER

1. THE WATER SYSTEM SHALL BE CONSTRUCTED TO CONFORM WITH THE STANDARDS SET FORTH IN THE "UTAH REGULATIONS FOR PUBLIC DRINKING WATER SYSTEMS", AND THE SANTAQUIN CITY PUBLIC WORKS DEPARTMENT STANDARD SPECIFICATIONS AND DRAWINGS.
2. CONTRACTOR SHALL NOTIFY NORTHERN ENGINEERING, INC. THREE (3) WORKING DAYS BEFORE INITIAL CONSTRUCTION BEGINS AND SHALL ALSO REQUEST SANTAQUIN CITY WATER DEPARTMENT INSPECTION OF WATER LINES AND APPURTENANCES TWENTY-FOUR (24) HOURS IN ADVANCE OF BACKFILLING.
3. CONTRACTOR TO FIELD VERIFY ALL VALVE BOX LID ELEVATIONS TO ASSURE THAT SAID LID ELEVATIONS MATCH FINAL STREET GRADE, AND ALL METER LID ELEVATIONS TO MATCH AN EXTENSION OF THE SIDEWALK GRADE.
4. UPON THE COMPLETION OF WORK, THE CONTRACTOR SHALL SUBMIT 3 SETS OF AS-BUILT PLANS TO SANTAQUIN CITY & (1) SET TO NORTHERN ENGINEERING, INC.
5. WATER VALVE LIDS ARE TO BE LABELED "WATER" FOR CULINARY VALVES.
6. HORIZONTAL AND VERTICAL SEPARATION OF CULINARY WATER AND SEWER SHALL BE IN COMPLIANCE WITH SANTAQUIN CITY STANDARDS.
7. WATERLINES TO BE BEDDED AS PER SANTAQUIN CITY DIVISION 3A SECTION 3A.04 SUB-SECTION E.
8. ALL CULINARY WATERLINES, REGARDLESS OF SIZE, SHALL BE C-900 PVC PIPE AS PER SANTAQUIN CITY STANDARDS.


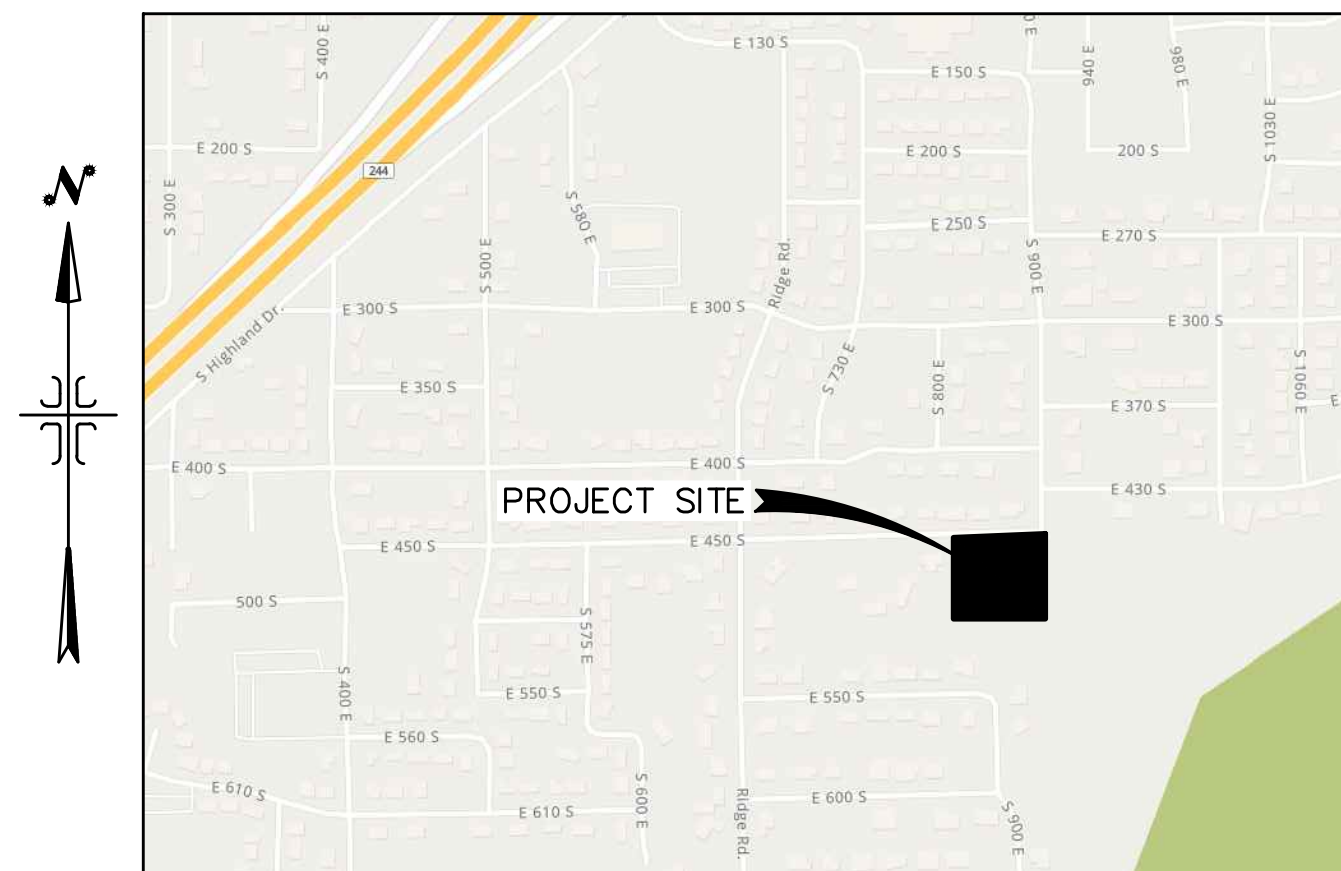


VICINITY MAP
-NTS-

ACCEPTANCE


SIGNATURE: _____	DATE _____
DEVELOPER	
SIGNATURE: _____	DATE _____
CITY ENGINEER	
SIGNATURE: _____	DATE _____
COMMUNITY DEV. DIRECTOR	
SIGNATURE: _____	DATE _____
PUBLIC WORKS	
SIGNATURE: _____	DATE _____
BUILDING DEPARTMENT	
SIGNATURE: _____	DATE _____
POLICE DEPARTMENT	
SIGNATURE: _____	DATE _____
FIRE DEPARTMENT	

DEVELOPER
LAYNE VINCENT
(801)-404-9643
LVINCENT@LEHI-UT.GOV

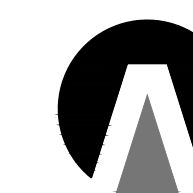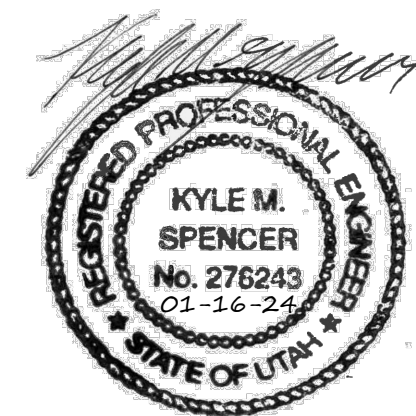

**Northern
ENGINEERING INC**
ENGINEERING-LAND PLANNING
CONSTRUCTION MANAGEMENT

1040 E. 800 N.
OREM, UTAH 84097
(801) 802-8992

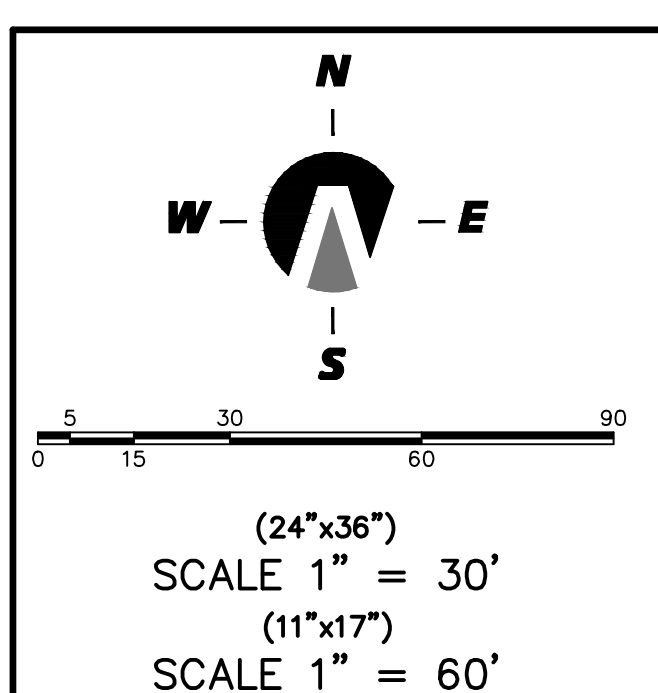


VINCENT OAKS "PRELIMINARY"

A PARCEL OF LAND LOCATED IN THE NORTHEAST QUARTER OF SECTION 12, TOWNSHIP 10 SOUTH, RANGE 1 EAST SALT LAKE BASE AND MERIDIAN

FRANK, JANET & SHANE
52: 784: 0059
[815 E.]

HAMBLIN, LARRY D & HEATHER M
52: 784: 0058
[851 E.]

HASKELL, TRACY MARIE
52: 784: 0057
[873 E.]

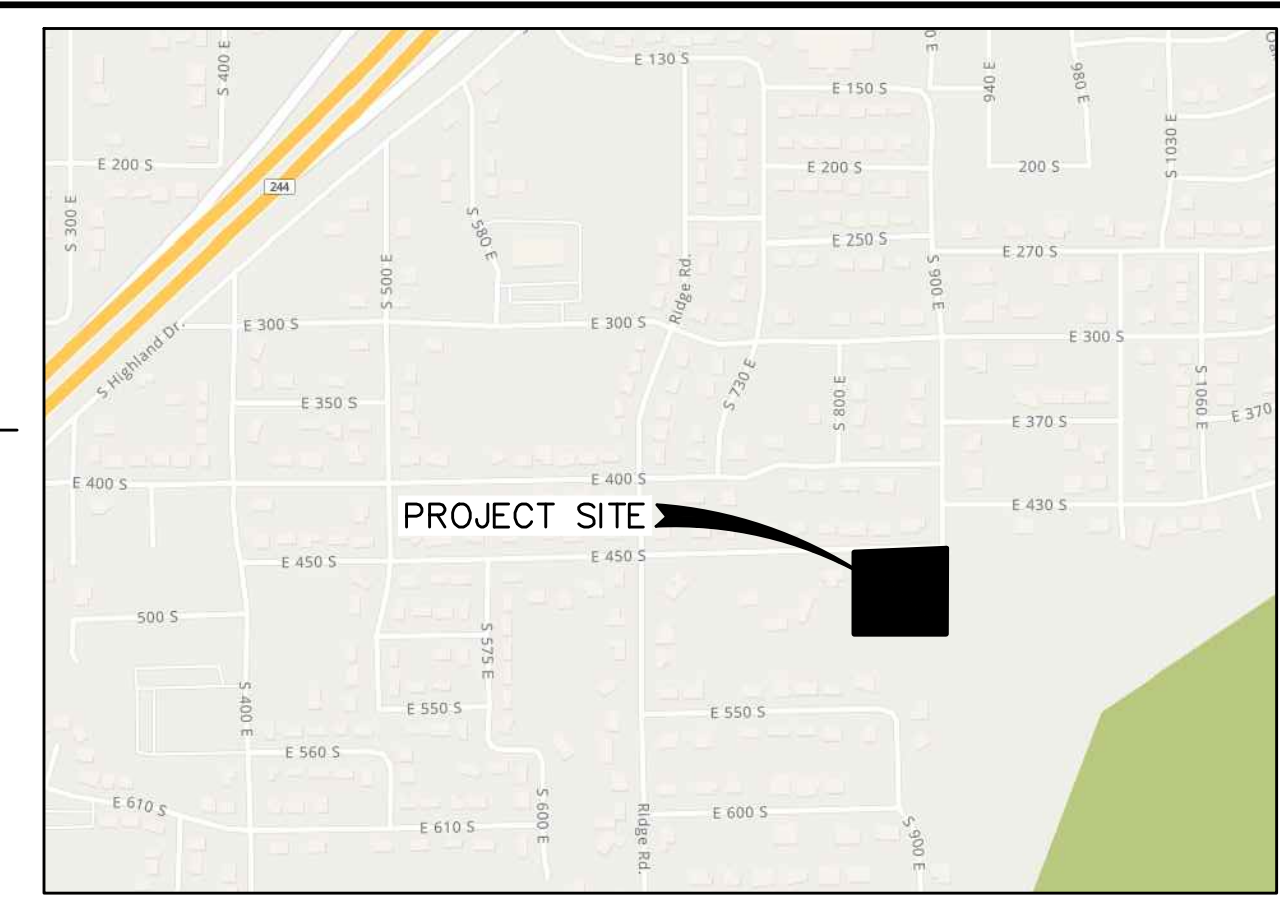

VICINITY MAP
-NTS-

SURVEYOR'S CERTIFICATE

I, KENNETH E. BARNEY, DO HEREBY CERTIFY THAT I AM A REGISTERED LAND SURVEYOR, AND THAT I HOLD A LICENSE IN ACCORDANCE WITH TITLE 58, CHAPTER 22, PROFESSIONAL ENGINEERS AND LAND SURVEYORS LICENSING ACT, UTAH CODE ANNOTATED, 1953 AS AMENDED, CERTIFICATE NO. 172762. I FURTHER CERTIFY THAT BY AUTHORITY OF THE OWNERS, I HAVE MADE A SURVEY OF THE TRACT OF LAND SHOWN ON THIS PLAT AND DESCRIBED BELOW (PARCELS 30-030-0069 & 30-030-0085), HAVE SUBDIVIDED SAID TRACT OF LAND INTO LOTS, STREETS, AND EASEMENTS, HAVE COMPLETED A SURVEY OF THE PROPERTY DESCRIBED ON THIS PLAT IN ACCORDANCE WITH SECTION 17-23-17, UTAH CODE ANNOTATED, 1953 AS AMENDED, HAVE VERIFIED ALL MEASUREMENTS, AND HAVE PLACED MONUMENTS AS REPRESENTED ON THE PLAT. I FURTHER CERTIFY THAT EVERY EXISTING RIGHT-OF-WAY AND EASEMENT GRANT OF RECORD FOR UNDERGROUND FACILITIES, AS DEFINED IN SECTION 54-80-2, UTAH CODE ANNOTATED, 1953 AS AMENDED, AND FOR OTHER UTILITY FACILITIES, IS ACCURATELY DESCRIBED ON THIS PLAT, AND THAT THIS PLAT IS TRUE AND CORRECT.

DATE _____ KENNETH E. BARNEY, P.L.S.

BOUNDARY DESCRIPTION

A PARCEL OF LAND LOCATED IN THE NORTHEAST QUARTER OF SECTION 12, TOWNSHIP 10 SOUTH, RANGE 1 EAST, SALT LAKE BASE AND MERIDIAN, UTAH COUNTY, UTAH. MORE PARTICULARLY DESCRIBED AS:

COMMENCING AT A BRASS CAP MONUMENT MARKING THE NORTHEAST CORNER OF SAID SECTION 12, THENCE S.00°45'01"E. ALONG THE SECTION LINE A DISTANCE OF 23.00 FEET TO THE REAL POINT OF BEGINNING

THENCE S.00°45'01"E. ALONG THE SECTION LINE A DISTANCE OF 392.86 FEET;
THENCE S.88°50'04"W. A DISTANCE OF 403.86 FEET;
THENCE N.00°46'18"W. A DISTANCE OF 393.81 FEET;
THENCE N.88°58'10"E. A DISTANCE OF 404.00 FEET TO THE REAL POINT OF BEGINNING

CONTAINING 158,877 sq.ft. OR 3.65 ACRES MORE OR LESS.

OWNER'S DEDICATION

KNOW ALL MEN BY THESE PRESENTS THAT WE, ALL OF THE UNDERSIGNED OWNERS OF ALL THE PROPERTY DESCRIBED IN THE SURVEYOR'S CERTIFICATE HEREON AND SHOWN ON THIS MAP, HAVE CAUSED THE SAME TO BE SUBDIVIDED INTO LOTS, STREETS, AND EASEMENTS AND DO HEREBY DEDICATE THE STREETS AND OTHER PUBLIC AREAS AS INDICATED HEREON FOR PERPETUAL USE OF THE PUBLIC.

IN WITNESS WHEREOF WE HAVE HERETO SET OUR HANDS THIS DAY OF _____, A.D. 20____.

BY: _____ BY: _____

ACKNOWLEDGMENT

STATE OF UTAH } s.s.
COUNTY OF UTAH }

ON THIS _____ DAY OF _____, IN THE YEAR 20____, BEFORE ME, _____, PERSONALLY APPEARED _____ AND _____, PROVED ON THE BASIS OF SATISFACTORY EVIDENCE TO BE THE PERSON(S) WHOSE NAMES ARE SUBSCRIBED TO IN THIS DOCUMENT, AND ACKNOWLEDGED THAT THEY EXECUTED THE SAME.

NOTARY PUBLIC _____
NOTARY FULL NAME _____ A NOTARY COMMISSIONED IN UTAH
COMMISSION NUMBER _____ MY COMMISSION EXPIRES _____

ACCEPTANCE BY LEGISLATIVE BODY

THE CITY COUNCIL OF SANTAQUIN, COUNTY OF UTAH, APPROVES THIS SUBDIVISION AND HEREBY ACCEPTS THE DEDICATION OF ALL STREETS, EASEMENTS, AND OTHER PARCELS OF LAND INTENDED FOR PUBLIC PURPOSES FOR THE PERPETUAL USE OF THE PUBLIC THIS _____ DAY OF _____, A.D. 20____.

APPROVED BY MAYOR _____
APPROVED _____ ATTEST _____
CITY ENGINEER (SEE SEAL) CITY RECORDER (SEE SEAL)

PLANNING COMMISSION APPROVAL

APPROVED THIS _____ DAY OF _____, A.D. 20____, BY THE SANTAQUIN CITY PLANNING COMMISSION.
CHAIRMAN, PLANNING COMMISSION _____ COMMUNITY DEVELOPMENT DIRECTOR _____

S.1 NORTH 1/4 CORNER SECTION 12
T. 10S., R. 1E., SLB&M

S.12 S.6 S.7
NORTHEAST CORNER SECTION 12
T. 10S., R. 1E., SLB&M

DEVELOPER
LAYNE VINCENT
(801)-404-9643
LVINCENT@LEHI-UT.GOV

STEELE, LARRY DALE & LARRY D
37:069:0009
[830 E.]

LEGEND


- ⊕ FOUND BRASS CAP
- ⊙ SET 5/8" IRON PIN
- △ CALCULATED POINT, NOT SET
- PROPERTY BOUNDARY
- - - CENTERLINE
- - - RIGHT-OF-WAY LINE
- LOT LINE
- - - SECTION LINE
- - - EASEMENT
- - - EXISTING DEED LINE
- ▨ PUBLIC ROADWAY DEDICATED TO SANTAQUIN CITY

GUNDERSEN, JOHN L.
37:096:0007
[879 E.]

LINFORD, JAMES FULLMER & CHERYL
48:214:0001
[895 E.]

LYLE J SMART
FAMILY PARTNERSHIP
32:018:0177

TYPICAL BUILDING SETBACKS & PUBLIC UTILITY EASEMENTS

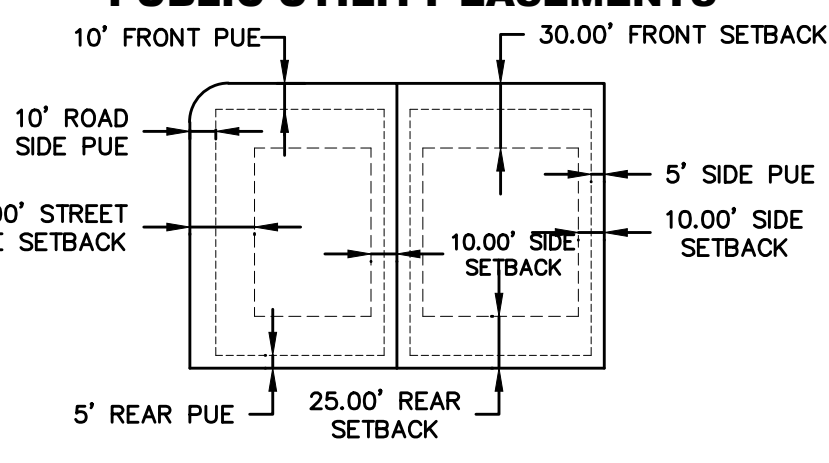

DOMINION ENERGY UTAH - NOTE:
Questar Gas Company dba Dominion Energy Utah, hereby approves this plat for the purposes of approximating the location, boundaries, course and dimensions of the rights-of-way and easement grants and existing underground facilities. Nothing herein shall be construed to warrant or verify the precise location of such items. The rights-of-way and easements are subject to numerous restrictions appearing on the recorded Right-of-Way and Easement Grant(s). Dominion Energy Utah also approves this plat for the purpose of confirming that the plat contains public utility easements; however, Dominion Energy Utah may require additional easements in order to serve this development. This approval does not constitute abrogation or waiver of any other existing rights, obligations or liabilities provided by law or equity. This approval does not constitute acceptance, approval or acknowledgment of any terms contained in the plat, including those set forth in the Owners Dedication or the Notes, and does not constitute a guarantee of particular terms or conditions of natural gas service. For further information please contact Dominion Energy Utah's Right-of-Way Department 8010-366-8532

QUESTAR GAS COMPANY dba DOMINION ENERGY UTAH
Approved this _____ day of _____, 20____
By- _____
Title - _____

ROCKY MOUNTAIN POWER ACCEPTANCE


APPROVED THIS _____ DAY OF _____, A.D. 20____, BY THE ROCKY MOUNTAIN POWER COMPANY.
BY _____ TITLE _____

CURVE	LENGTH	RADIUS	CHORD DIST.	CHORD BRG.	DELTA
C1	18.32'	15.00'	17.21'	S34°59'44"W	89°58'28"
C2	48.80'	60.00'	46.71'	S27°50'44"W	58°14'22"
C3	56.95'	60.00'	54.83'	S28°30'10"W	54°25'44"
C4	70.00'	60.00'	66.00'	S32°02'27"E	66°50'31"
C5	70.00'	60.00'	66.10'	N81°02'58"E	69°50'30"
C6	70.22'	60.00'	66.28'	N44°05'53"E	67°03'32"
C7	5.43'	60.00'	5.43'	N22°01'32"W	57°11'09"
C8	21.48'	50.00'	21.32'	N12°18'36"W	24°37'12"
C9	17.78'	15.00'	16.78'	N33°57'54"E	67°55'48"
C10	18.30'	15.00'	17.18'	S30°23'39"E	69°53'38"
C11	82.51'	645.00'	82.45'	S3°45'43"E	71°9'48"
C12	104.78'	645.00'	104.65'	S12°04'47"E	91°8'23"
C13	145.12'	645.00'	144.82'	S23°10'43"E	123°3'29"
C14	18.54'	81.00'	18.50'	N6°33'27"E	130°6'54"
C15	213.33'	600.00'	212.21'	S10°17'00"E	202°21'18"


S00°45'01"E
2660.92'
(BASIS OF BEARING)

Northern ENGINEERING INC
ENGINEERING-LAND PLANNING CONSTRUCTION MANAGEMENT
1040 E. 800 N.
OREM, UTAH 84097
(801) 802-8992



NOTARY PUBLIC SEAL SURVEYOR'S SEAL CLERK-RECORDER SEAL UTAH COUNTY RECORDER STAMP

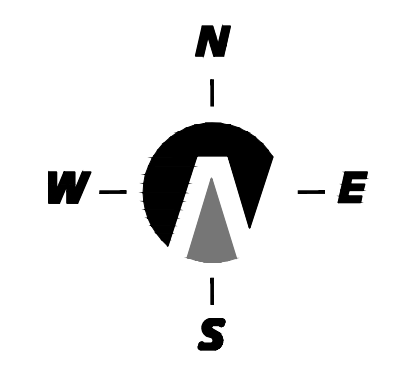

SCALE 1" = 20'
(24"x36")
SCALE 1" = 40'
(11"x17")

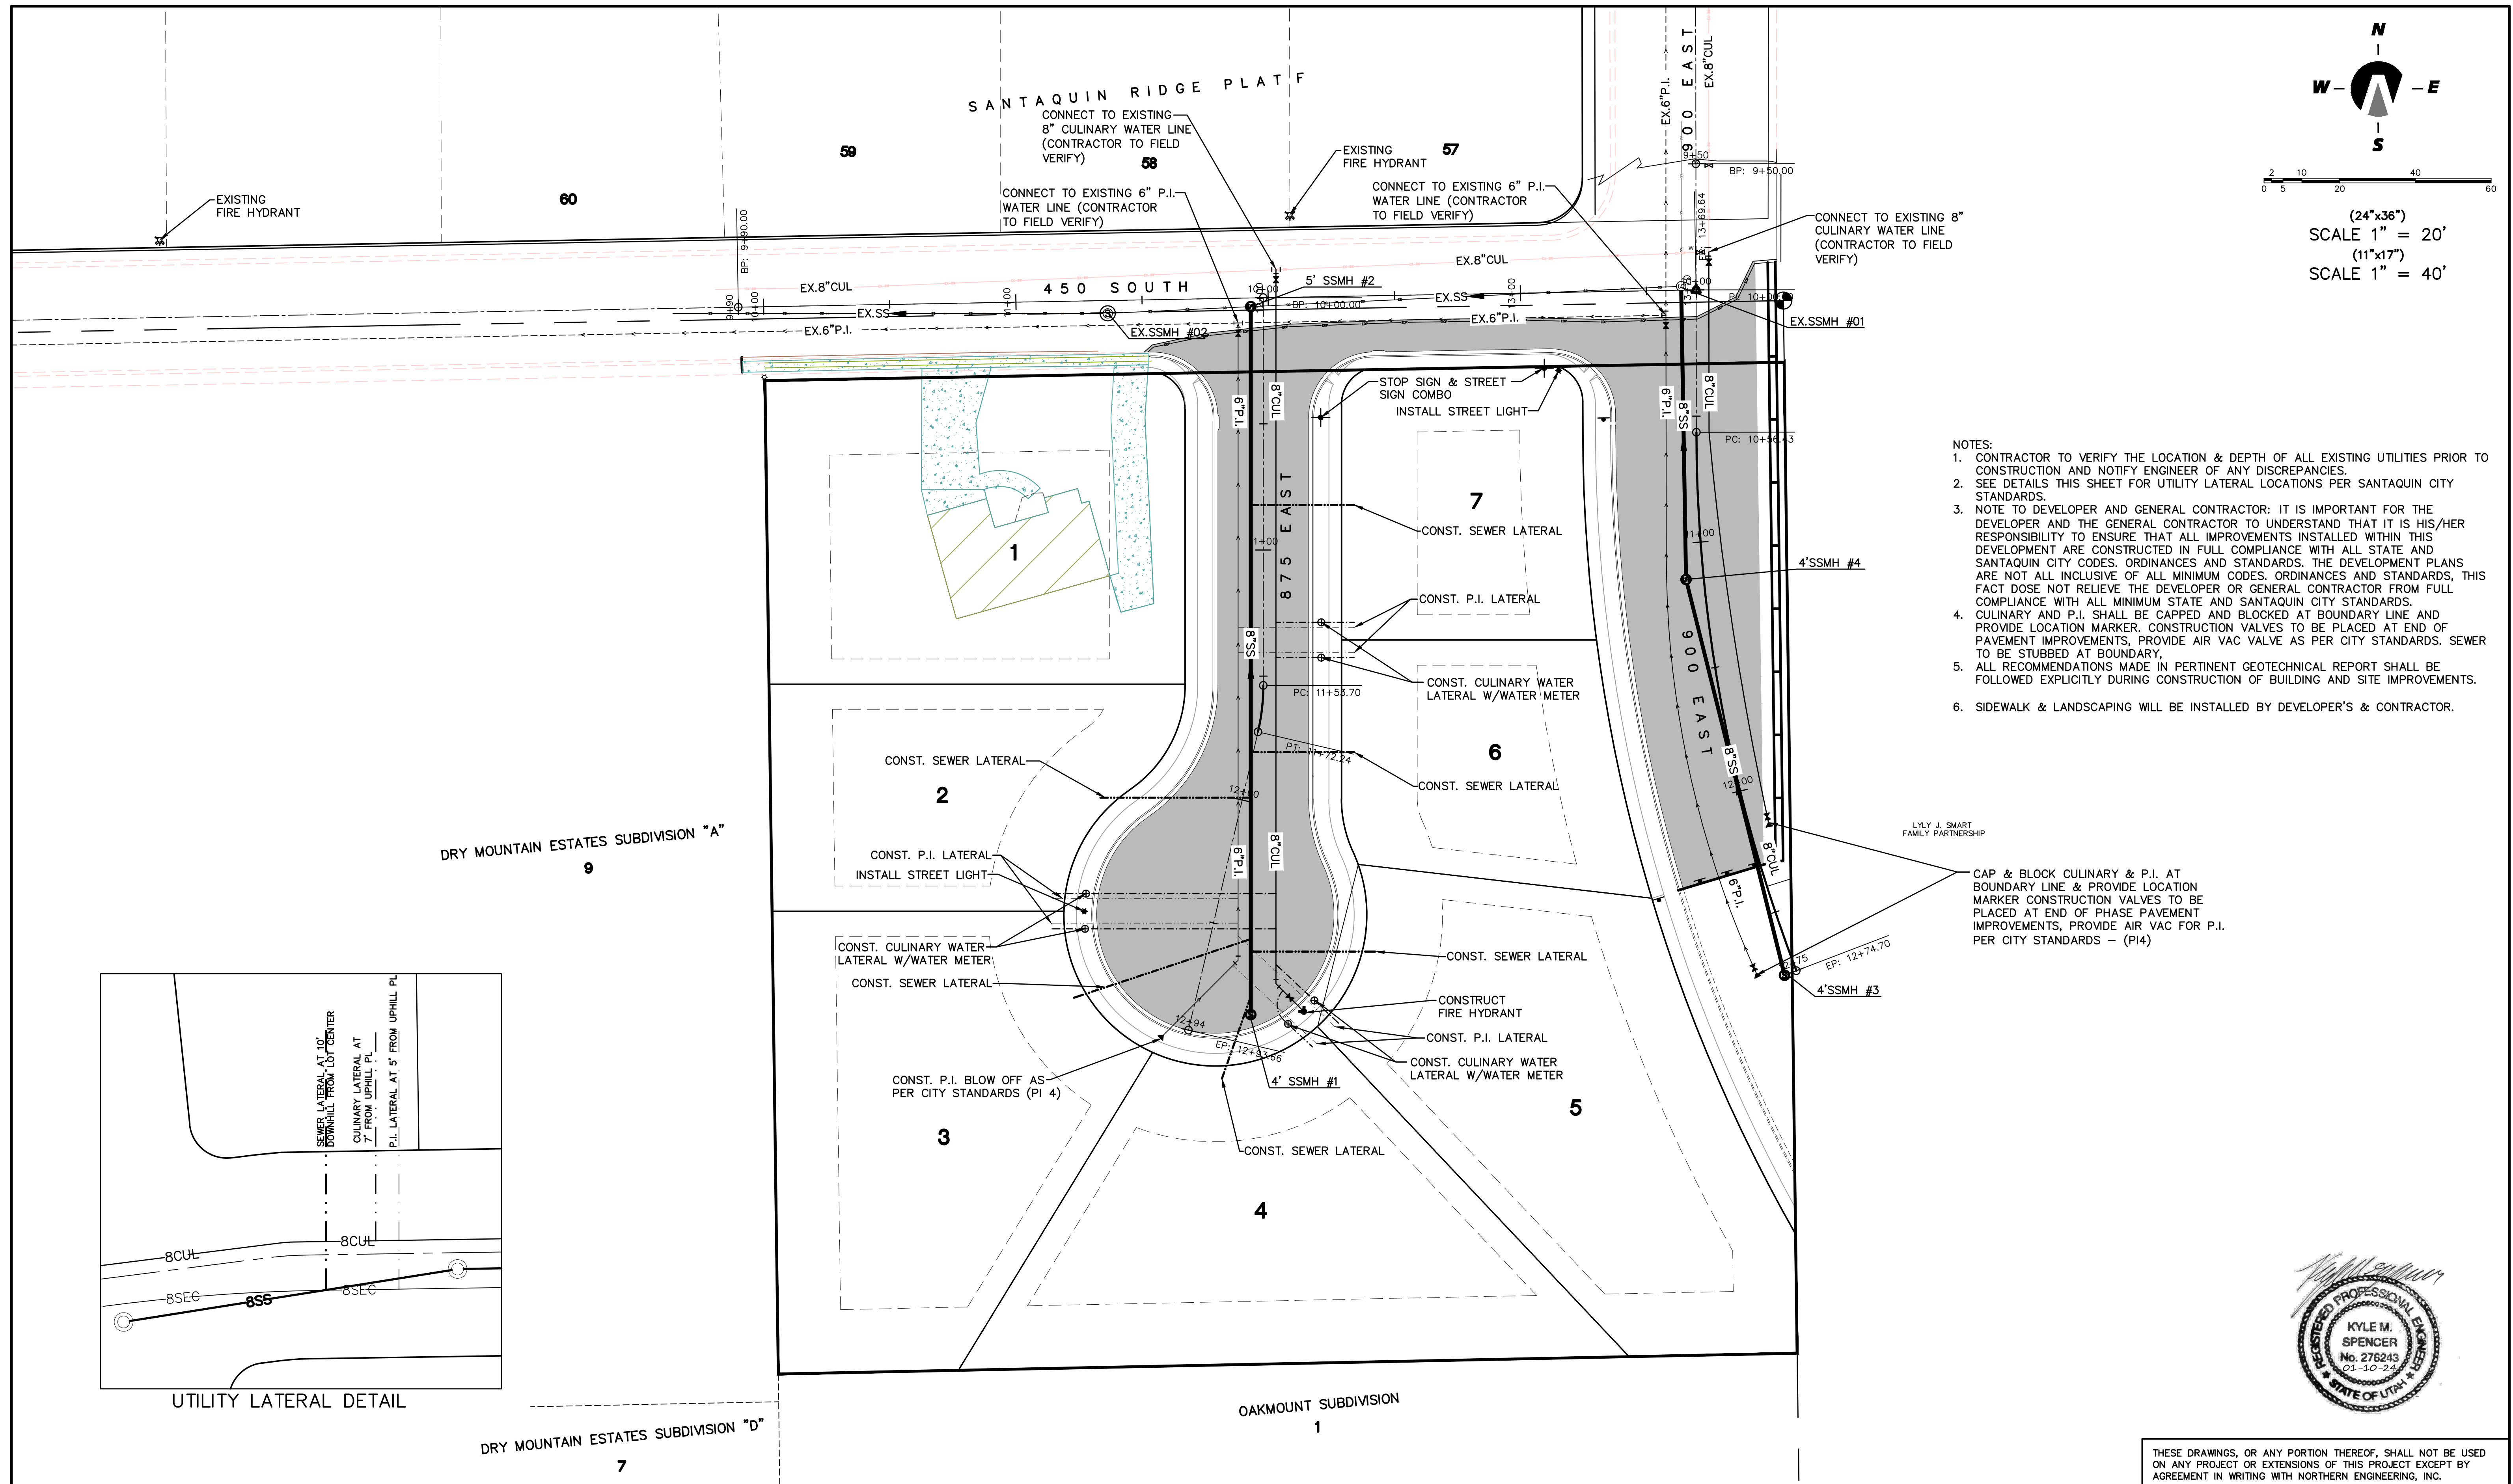

- NOTES:
1. CONTRACTOR TO VERIFY THE LOCATION & DEPTH OF ALL EXISTING UTILITIES PRIOR TO CONSTRUCTION AND NOTIFY ENGINEER OF ANY DISCREPANCIES.
 2. SEE DETAILS THIS SHEET FOR UTILITY LATERAL LOCATIONS PER SANTAQUIN CITY STANDARDS.
 3. NOTE TO DEVELOPER AND GENERAL CONTRACTOR: IT IS IMPORTANT FOR THE DEVELOPER AND THE GENERAL CONTRACTOR TO UNDERSTAND THAT IT IS HIS/HER RESPONSIBILITY TO ENSURE THAT ALL IMPROVEMENTS INSTALLED WITHIN THIS DEVELOPMENT ARE CONSTRUCTED IN FULL COMPLIANCE WITH ALL STATE AND SANTAQUIN CITY CODES, ORDINANCES AND STANDARDS. THE DEVELOPMENT PLANS ARE NOT ALL INCLUSIVE OF ALL MINIMUM CODES, ORDINANCES AND STANDARDS. THIS FACT DOES NOT RELIEVE THE DEVELOPER OR GENERAL CONTRACTOR FROM FULL COMPLIANCE WITH ALL MINIMUM STATE AND SANTAQUIN CITY STANDARDS.
 4. CULINARY AND P.I. SHALL BE CAPPED AND BLOCKED AT BOUNDARY LINE AND PROVIDE LOCATION MARKER. CONSTRUCTION VALVES TO BE PLACED AT END OF PAVEMENT IMPROVEMENTS, PROVIDE AIR VAC VALVE AS PER CITY STANDARDS. SEWER TO BE STUBBED AT BOUNDARY.
 5. ALL RECOMMENDATIONS MADE IN PERTINENT GEOTECHNICAL REPORT SHALL BE FOLLOWED EXPLICITLY DURING CONSTRUCTION OF BUILDING AND SITE IMPROVEMENTS.
 6. SIDEWALK & LANDSCAPING WILL BE INSTALLED BY DEVELOPER'S & CONTRACTOR.

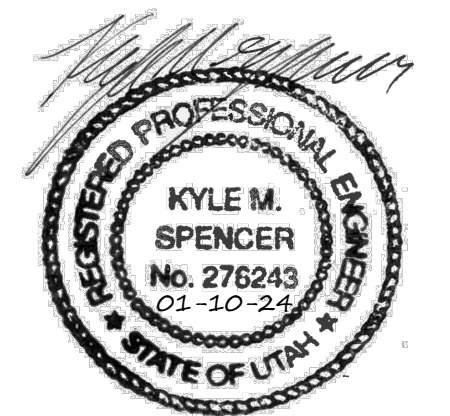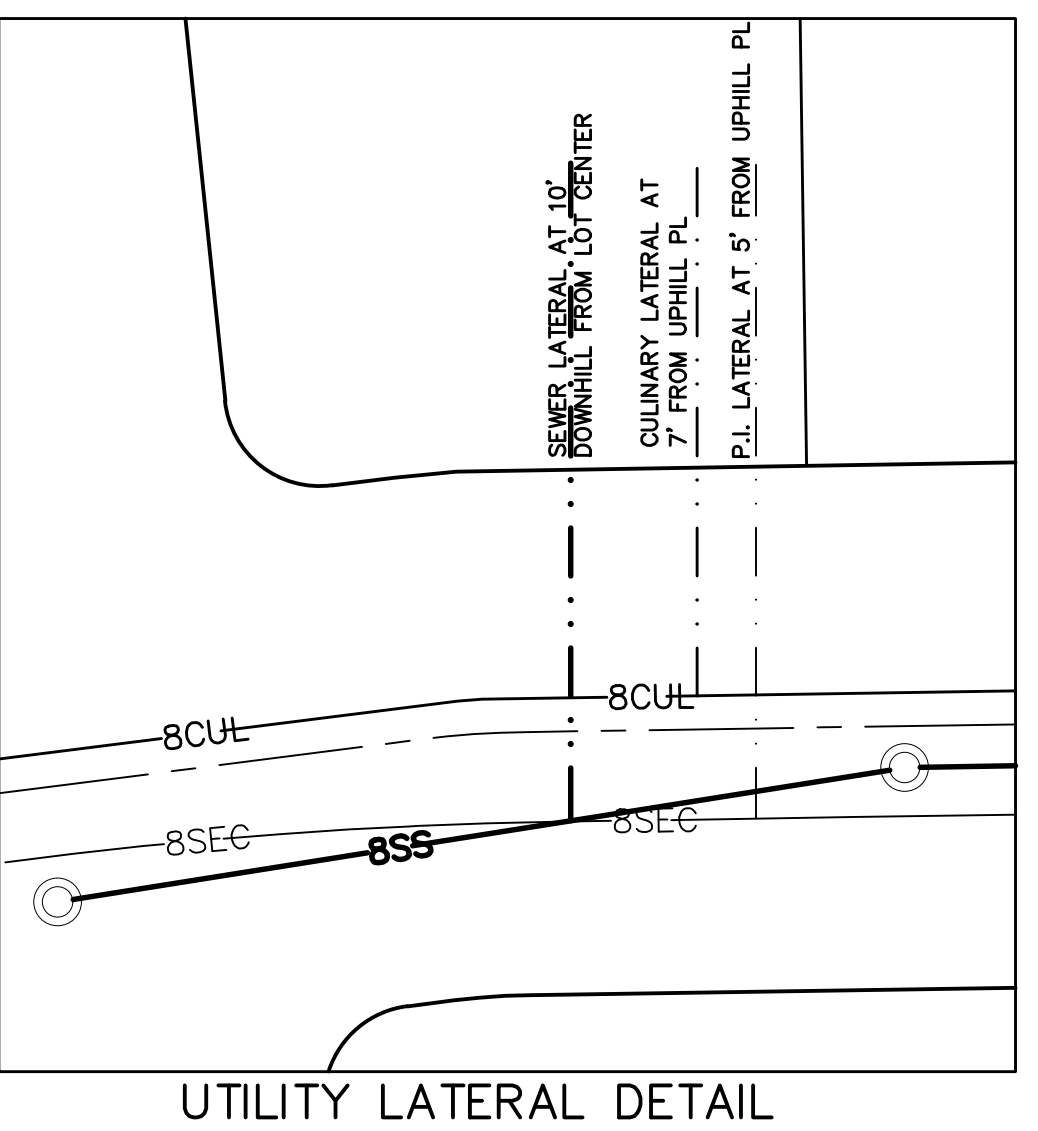

THESE DRAWINGS, OR ANY PORTION THEREOF, SHALL NOT BE USED ON ANY PROJECT OR EXTENSIONS OF THIS PROJECT EXCEPT BY AGREEMENT IN WRITING WITH NORTHERN ENGINEERING, INC.



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4		DRAWN BY:	DATE:
3		CHECKED BY:	DATE:
2		APPROVED:	DATE:
1		COGO FILE:	DATE:
NO.	REVISIONS	BY	DATE
		REV. COGO FILE:	DATE:

Northern ENGINEERING INC
ENGINEERING—LAND PLANNING
CONSTRUCTION MANAGEMENT


1040 E. 800 N.
OREM, UTAH 84097
(801) 802-8992

VINCENT OAKS

UTILITY PLAN	JOB NO. 3-23-014
SANTAQUIN, UTAH	SHEET NO. 3

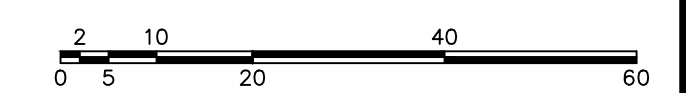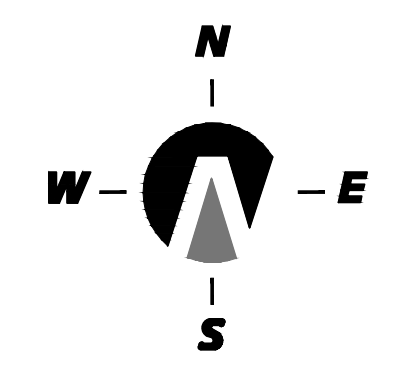


(24"x36")
SCALE 1" = 20'
(11"x17")
SCALE 1" = 40'

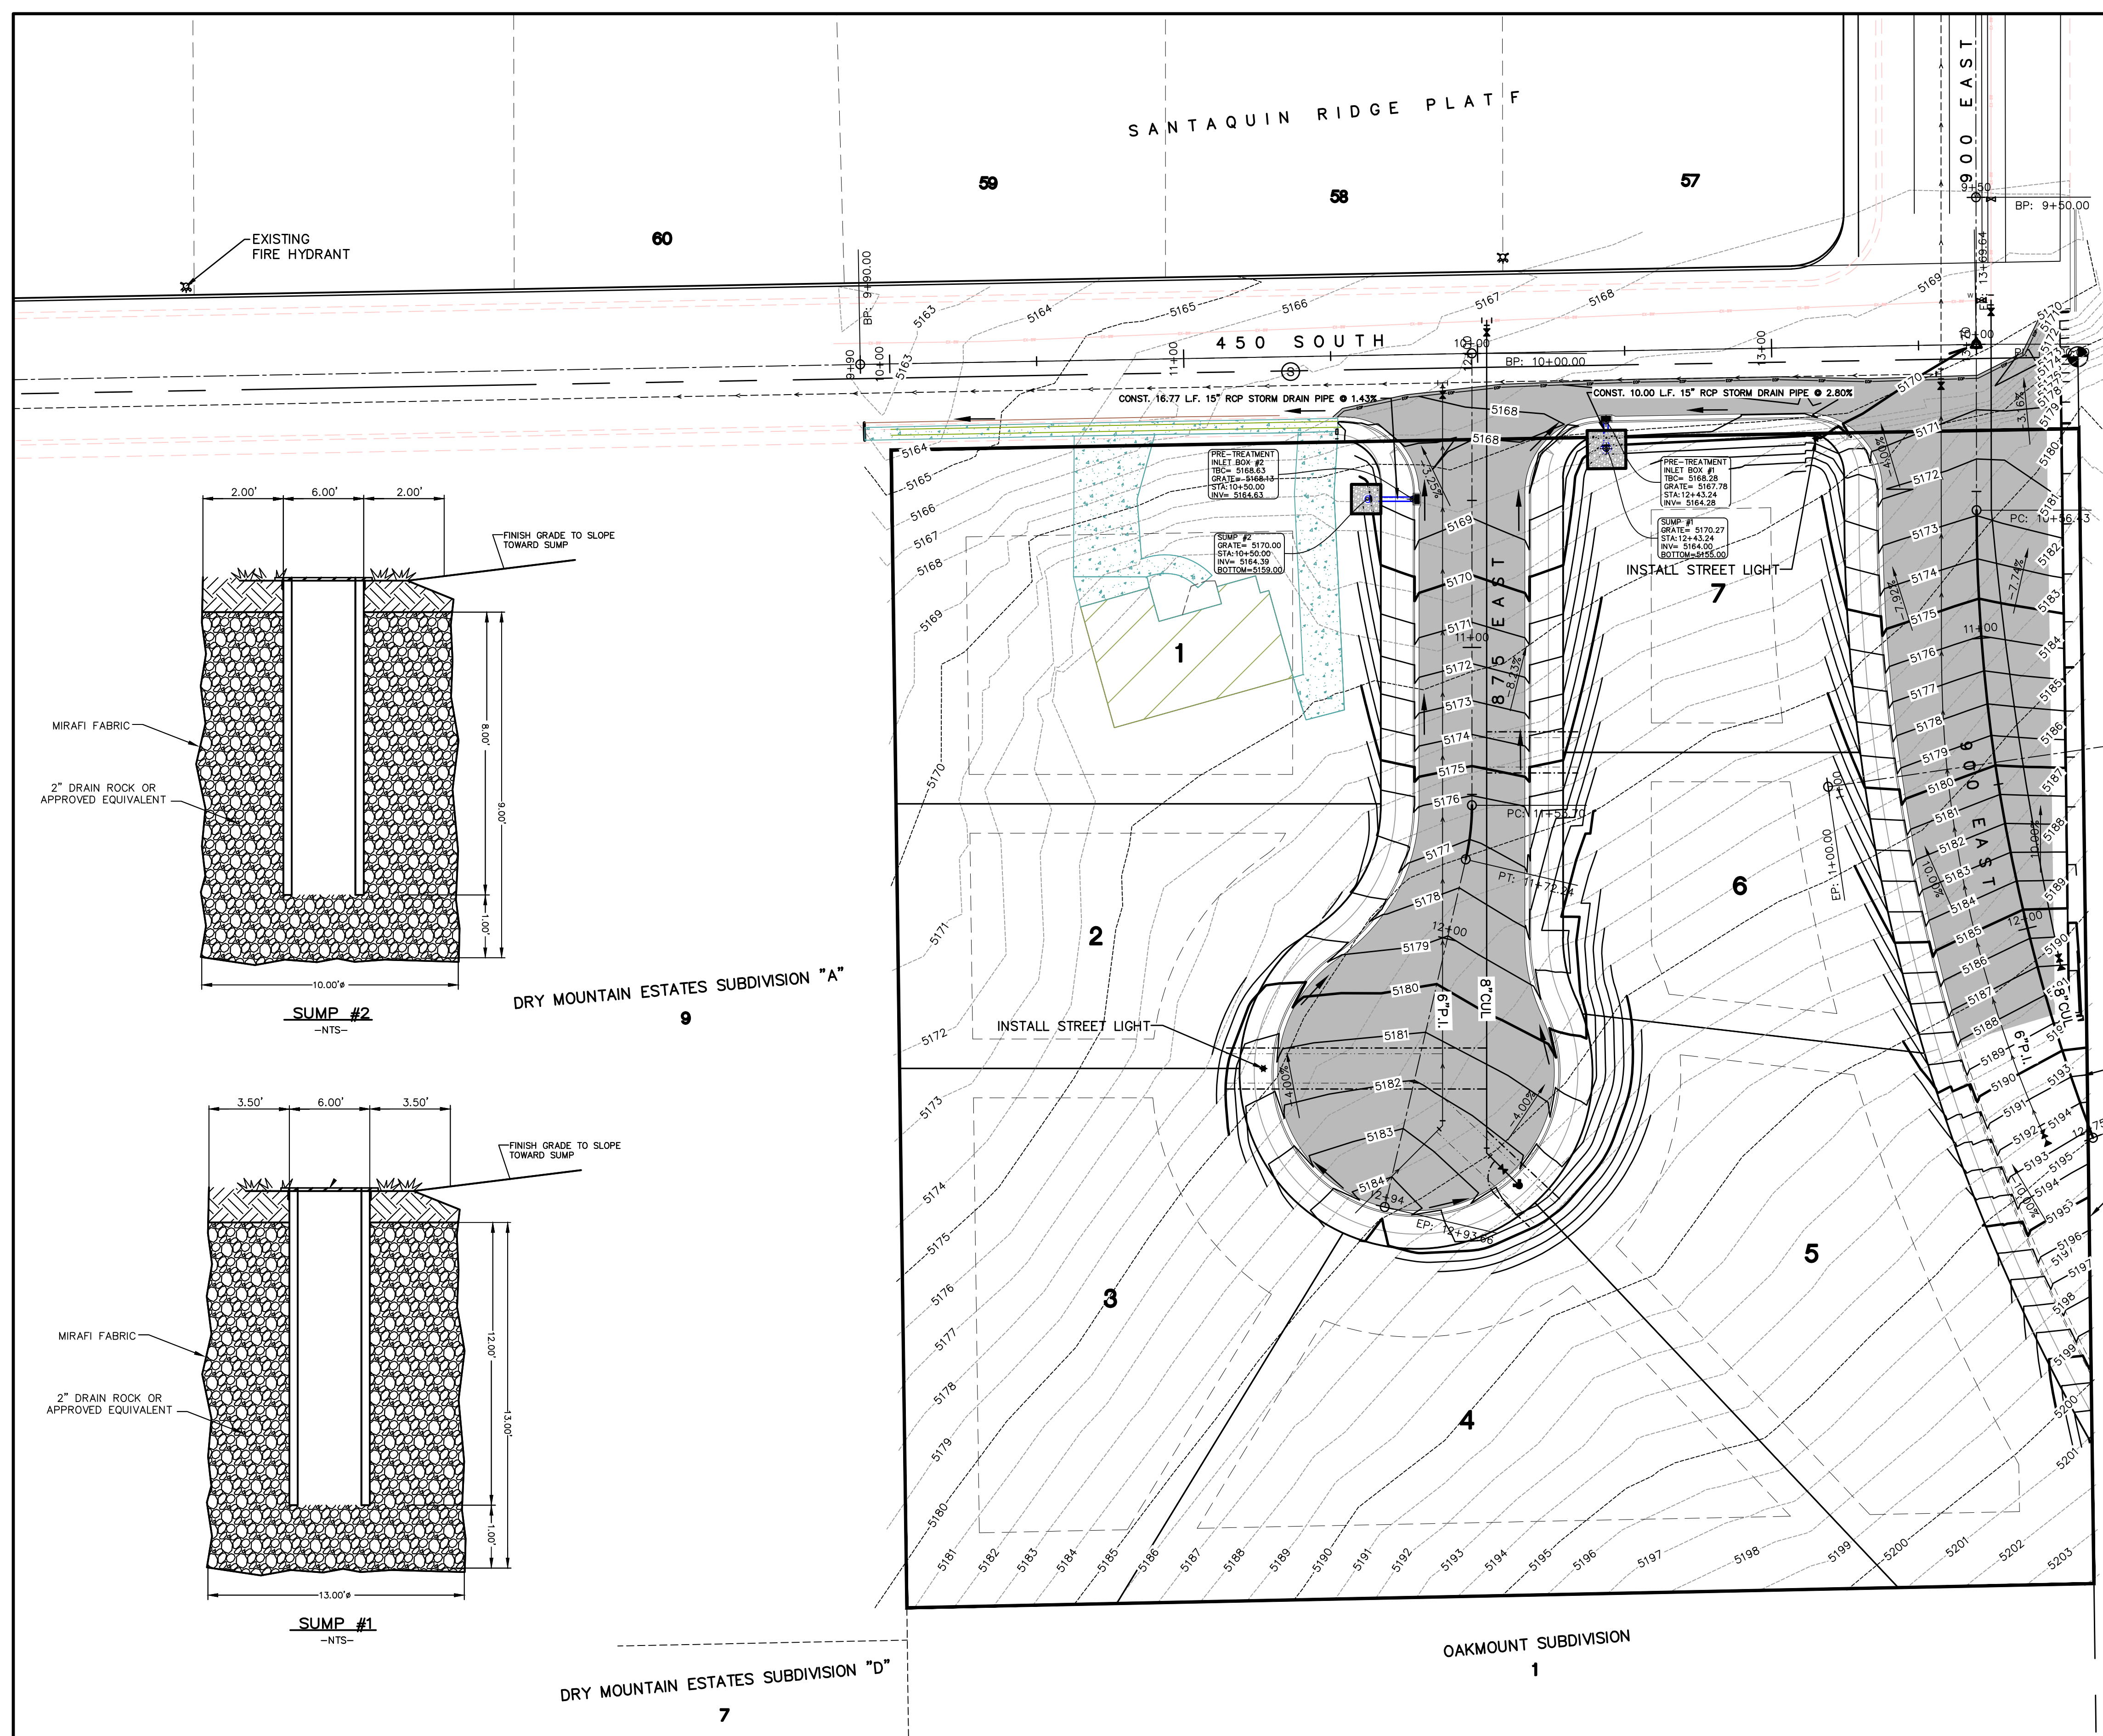

- NOTES:
1. CONTRACTOR TO VERIFY THE LOCATION & DEPTH OF ALL EXISTING UTILITIES PRIOR TO CONSTRUCTION AND NOTIFY ENGINEER OF ANY DISCREPANCIES.
 2. SEE DETAILS SHEET DT-02 FOR UTILITY LATERAL LOCATIONS PER SANTAQUIN CITY STANDARDS.
 3. NOTE TO DEVELOPER AND GENERAL CONTRACTOR: IT IS IMPORTANT FOR THE DEVELOPER AND THE GENERAL CONTRACTOR TO UNDERSTAND THAT IT IS HIS/HER RESPONSIBILITY TO ENSURE THAT ALL IMPROVEMENTS INSTALLED WITHIN THIS DEVELOPMENT ARE CONSTRUCTED IN FULL COMPLIANCE WITH ALL STATE AND SANTAQUIN CITY CODES, ORDINANCES AND STANDARDS. THE DEVELOPMENT PLANS ARE NOT ALL INCLUSIVE OF ALL MINIMUM CODES, ORDINANCES AND STANDARDS, THIS FACT DOES NOT RELIEVE THE DEVELOPER OR GENERAL CONTRACTOR FROM FULL COMPLIANCE WITH ALL MINIMUM STATE AND SANTAQUIN CITY STANDARDS.
 4. CULINARY AND P.I. SHALL BE CAPPED AND BLOCKED AT BOUNDARY LINE AND PROVIDE LOCATION MARKER. CONSTRUCTION VALVES TO BE PLACED AT END OF PAVEMENT IMPROVEMENTS, PROVIDE AIR VAC VALVE AS PER CITY STANDARDS. SEWER TO BE STUBBED AT BOUNDARY.
 5. ALL RECOMMENDATIONS MADE IN PERTINENT GEOTECHNICAL REPORT SHALL BE FOLLOWED EXPLICITLY DURING CONSTRUCTION OF BUILDING AND SITE IMPROVEMENTS.
 6. SIDEWALK & LANDSCAPING WILL BE INSTALLED BY DEVELOPER'S & CONTRACTOR.

CAP & BLOCK CULINARY & P.I. AT BOUNDARY LINE & PROVIDE LOCATION MARKER. CONSTRUCTION VALVES TO BE PLACED AT END OF PAVEMENT IMPROVEMENTS, PROVIDE AIR VAC FOR P.I. PER CITY STANDARDS.

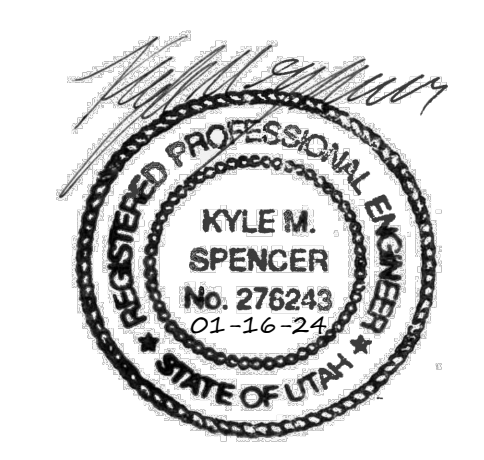

THESE DRAWINGS, OR ANY PORTION THEREOF, SHALL NOT BE USED ON ANY PROJECT OR EXTENSIONS OF THIS PROJECT EXCEPT BY AGREEMENT IN WRITING WITH NORTHERN ENGINEERING, INC.

5		DESIGNED BY:		DATE:
4		DRAWN BY:		DATE:
3		CHECKED BY:		DATE:
2		APPROVED BY:		DATE:
1		COGO FILE:		DATE:
NO.	REVISIONS	BY	DATE	REV. COGO FILE:




Northern ENGINEERING INC
ENGINEERING-LAND PLANNING
CONSTRUCTION MANAGEMENT

1040 E. 800 N.
OREM, UTAH 84097
(801) 802-8992

VINCENT OAKS

GRADING & DRAINAGE	JOB NO. 3-23-014
SANTAQUIN, UTAH	SHEET NO. 4

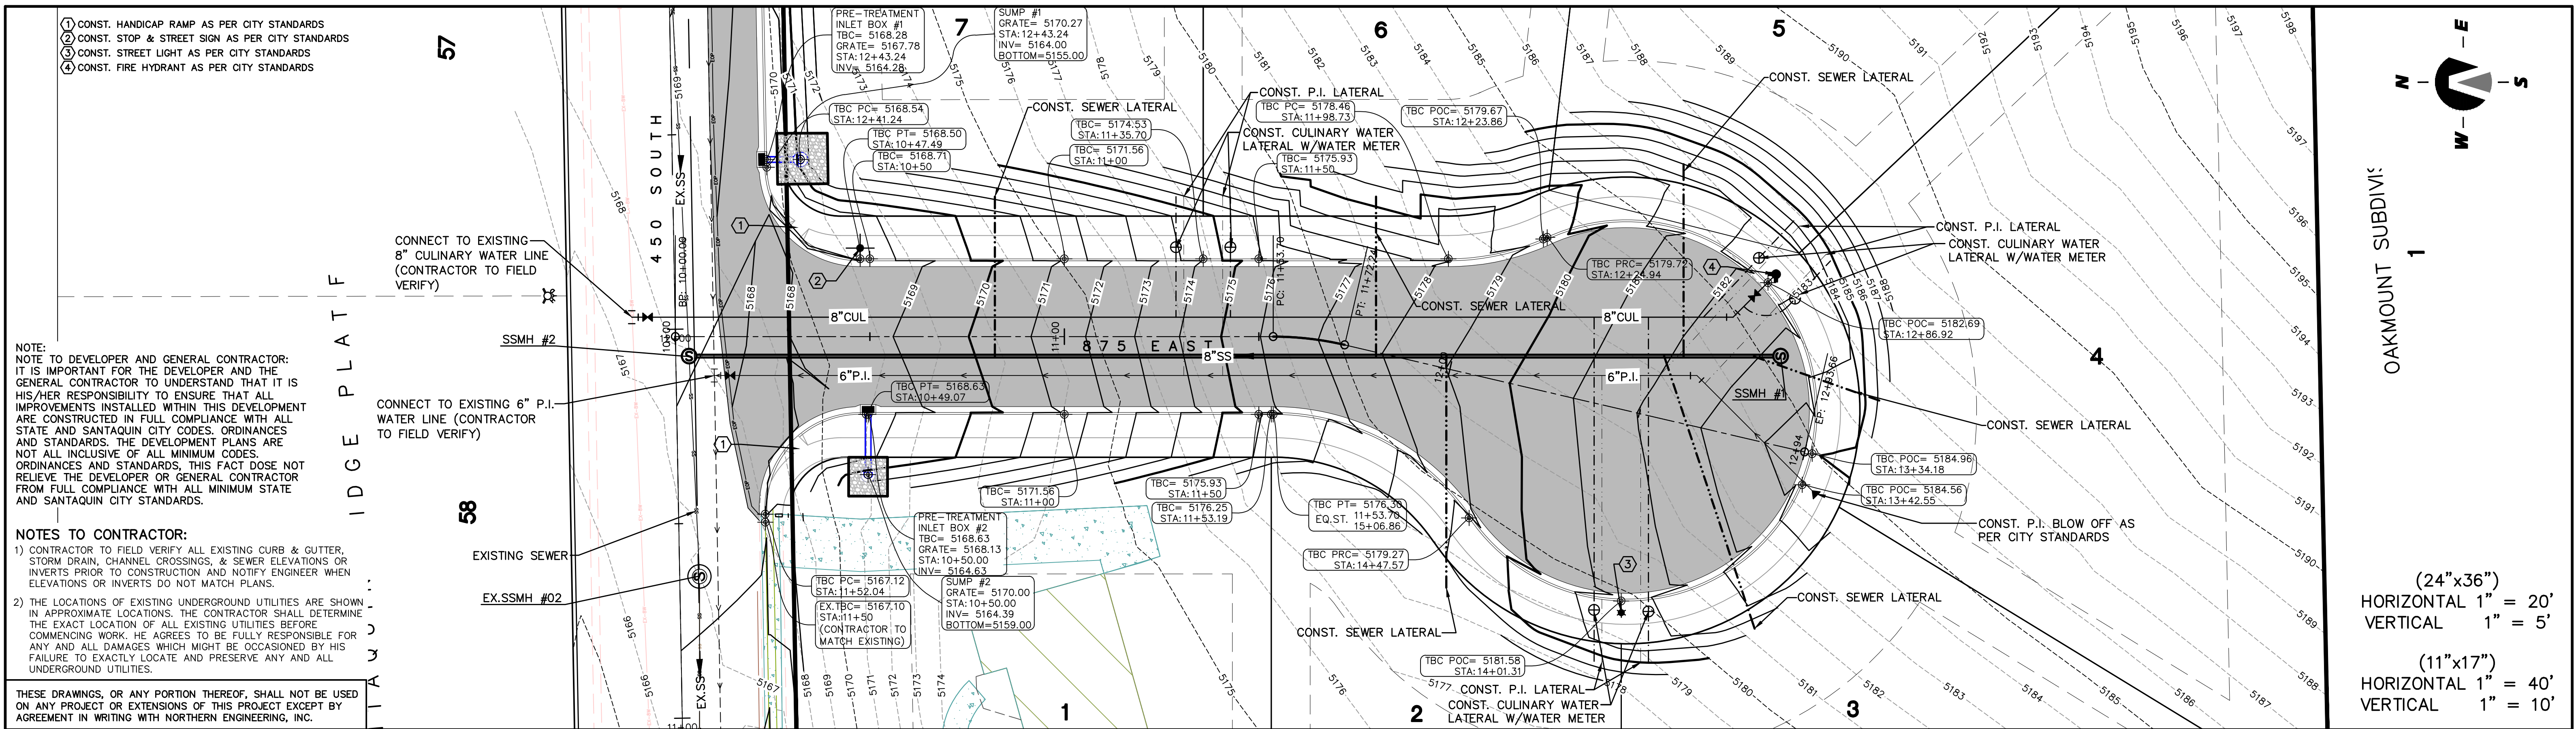

- 1 CONST. HANDICAP RAMP AS PER CITY STANDARDS
- 2 CONST. STOP & STREET SIGN AS PER CITY STANDARDS
- 3 CONST. STREET LIGHT AS PER CITY STANDARDS
- 4 CONST. FIRE HYDRANT AS PER CITY STANDARDS

NOTE:
 NOTE TO DEVELOPER AND GENERAL CONTRACTOR:
 IT IS IMPORTANT FOR THE DEVELOPER AND THE GENERAL CONTRACTOR TO UNDERSTAND THAT IT IS HIS/HER RESPONSIBILITY TO ENSURE THAT ALL IMPROVEMENTS INSTALLED WITHIN THIS DEVELOPMENT ARE CONSTRUCTED IN FULL COMPLIANCE WITH ALL STATE AND SANTAQUIN CITY CODES, ORDINANCES AND STANDARDS. THE DEVELOPMENT PLANS ARE NOT ALL INCLUSIVE OF ALL MINIMUM CODES, ORDINANCES AND STANDARDS, THIS FACT DOES NOT RELIEVE THE DEVELOPER OR GENERAL CONTRACTOR FROM FULL COMPLIANCE WITH ALL MINIMUM STATE AND SANTAQUIN CITY STANDARDS.


NOTES TO CONTRACTOR:
 1) CONTRACTOR TO FIELD VERIFY ALL EXISTING CURB & GUTTER, STORM DRAIN, CHANNEL CROSSINGS, & SEWER ELEVATIONS OR INVERTS PRIOR TO CONSTRUCTION AND NOTIFY ENGINEER WHEN ELEVATIONS OR INVERTS DO NOT MATCH PLANS.
 2) THE LOCATIONS OF EXISTING UNDERGROUND UTILITIES ARE SHOWN IN APPROXIMATE LOCATIONS. THE CONTRACTOR SHALL DETERMINE THE EXACT LOCATION OF ALL EXISTING UTILITIES BEFORE COMMENCING WORK. HE AGREES TO BE FULLY RESPONSIBLE FOR ANY AND ALL DAMAGES WHICH MIGHT BE OCCASIONED BY HIS FAILURE TO EXACTLY LOCATE AND PRESERVE ANY AND ALL UNDERGROUND UTILITIES.

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OAKMOUNT SUBDIVISION 1

(24"x36")
 HORIZONTAL 1" = 20'
 VERTICAL 1" = 5'

(11"x17")
 HORIZONTAL 1" = 40'
 VERTICAL 1" = 10'

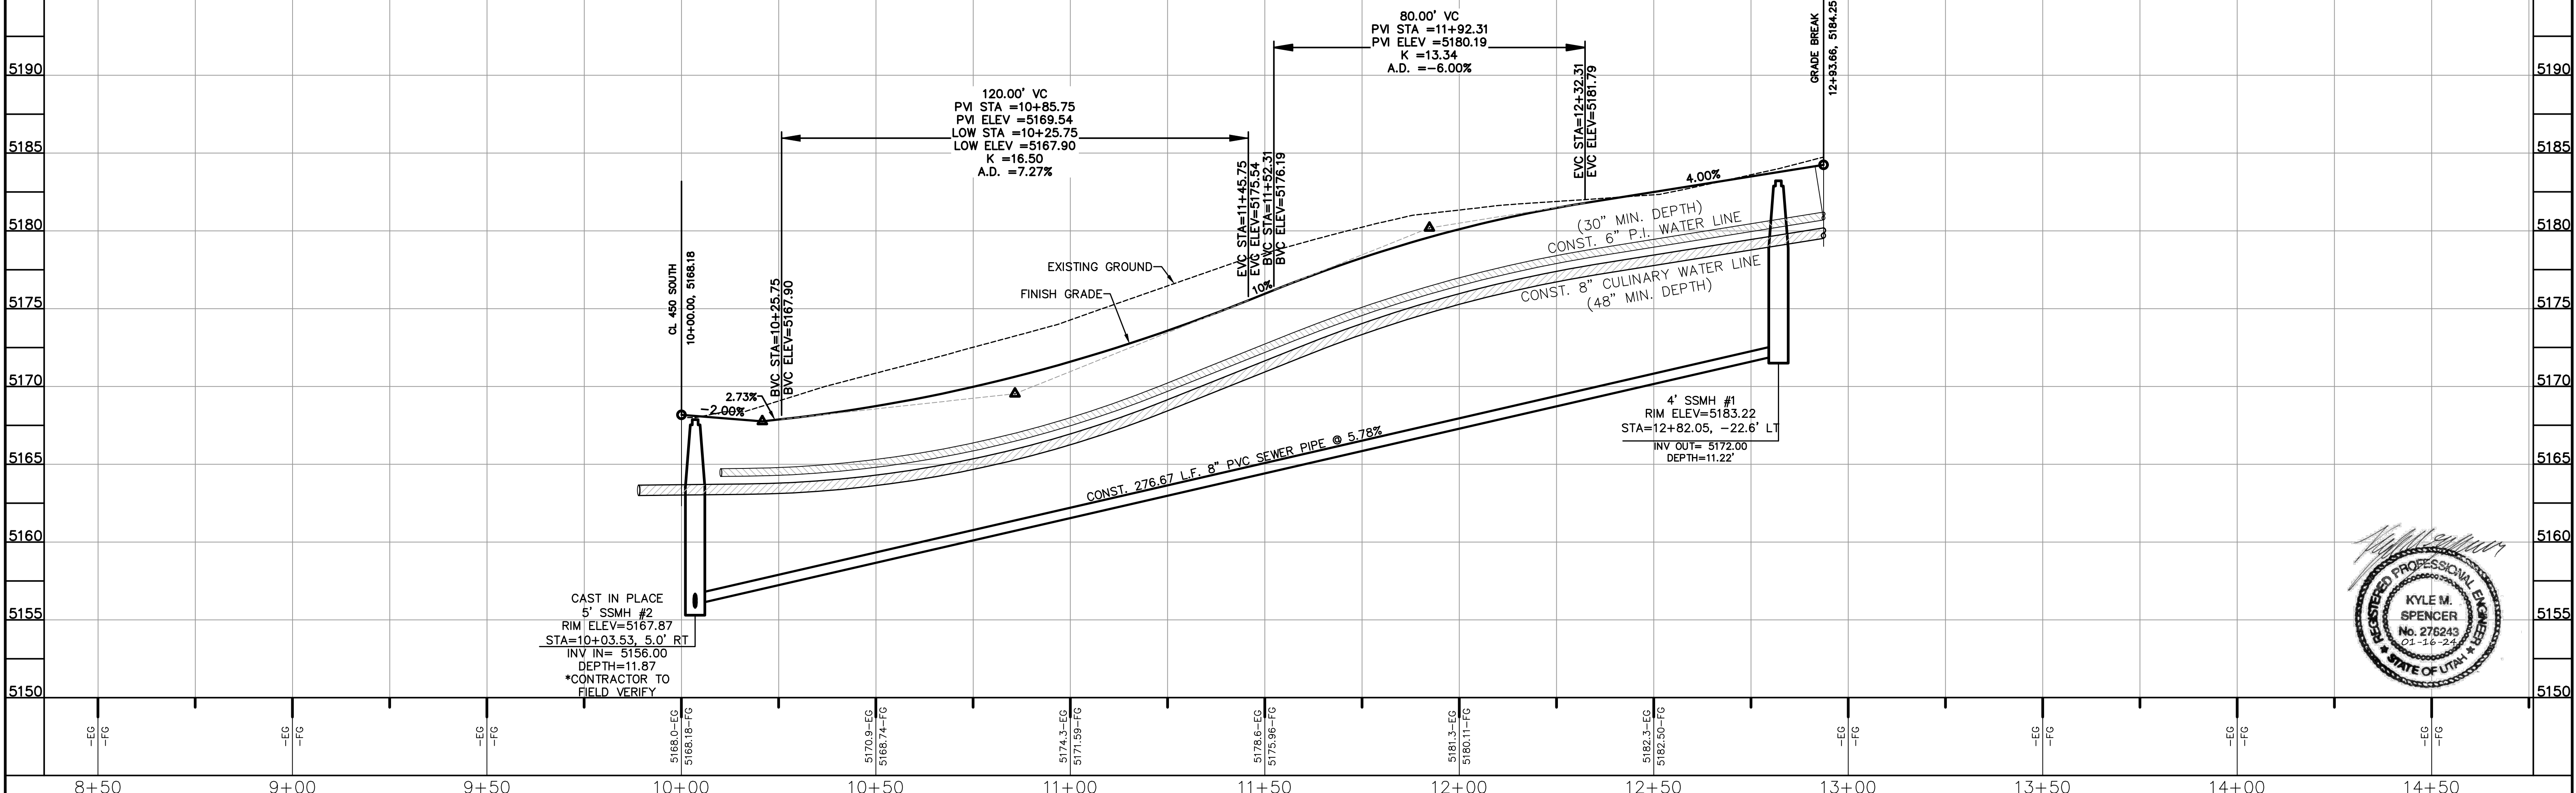

5	DESIGNED BY:	DATE:
4	DRAWN BY:	DATE:
3	CHECKED BY:	DATE:
2	APPROVED:	DATE:
1	COGO FILE:	DATE:
NO.	REVISIONS	BY DATE REV. COGO FILE:


Northern ENGINEERING INC
 ENGINEERING-LAND PLANNING
 CONSTRUCTION MANAGEMENT

1040 E. 800 N.
 OREM, UTAH 84097
 (801) 802-8992



VINCENT OAKS

875 EAST STREET PLAN & PROFILE
 SANTAQUIN, UTAH

JOB NO. 3-23-014
 SHEET NO. PP-01


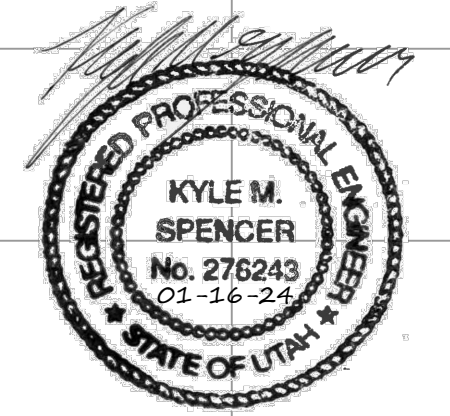


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(24"x36")
 HORIZONTAL 1" = 20'
 VERTICAL 1" = 5'

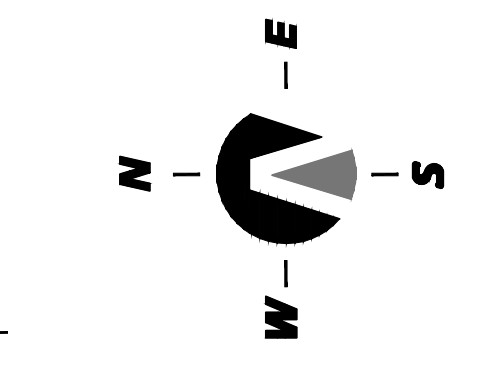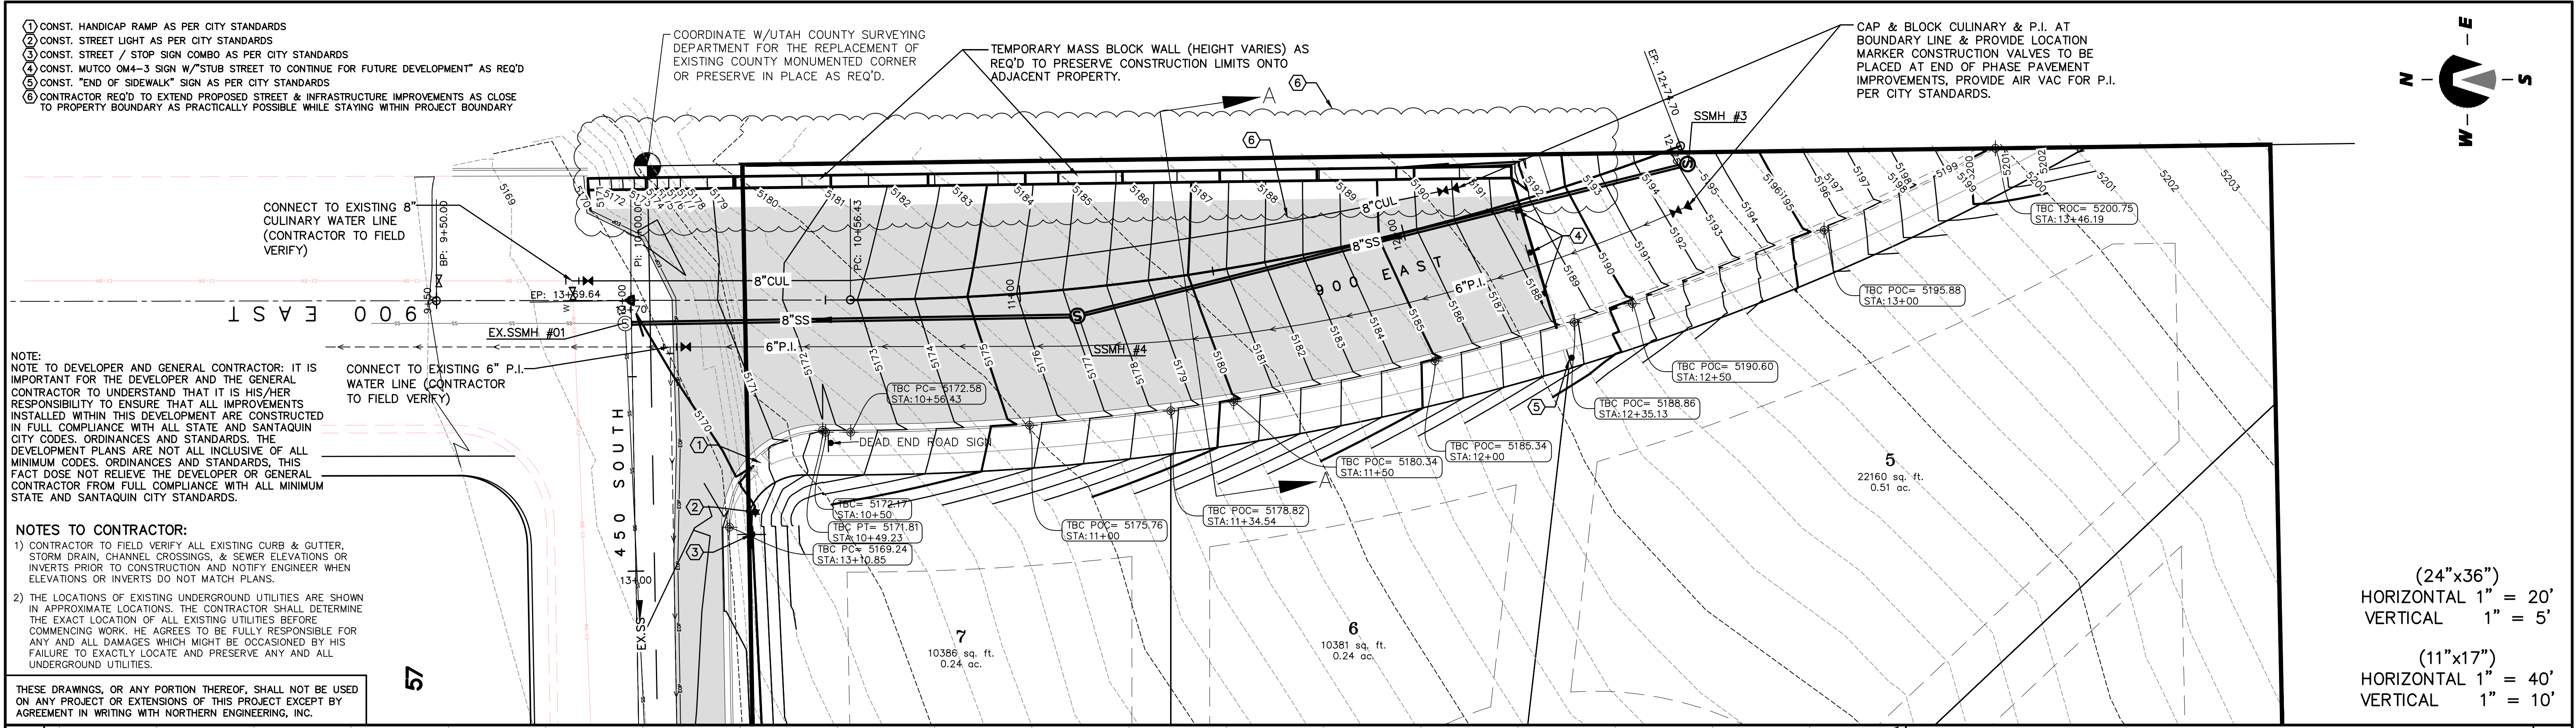(11"x17")
 HORIZONTAL 1" = 40'
 VERTICAL 1" = 10'



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4	DRAWN BY:	DATE:
3	CHECKED BY:	DATE:
2	APPROVED:	DATE:
1	COGO FILE:	DATE:
NO.	REVISIONS	BY DATE REV. COGO FILE:

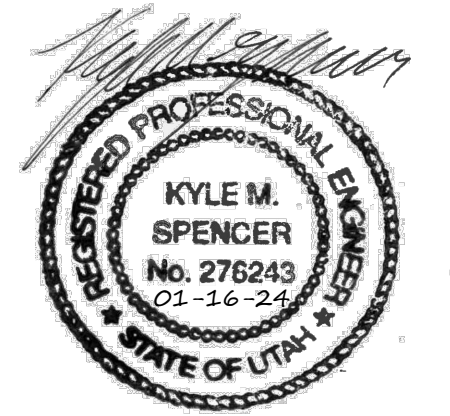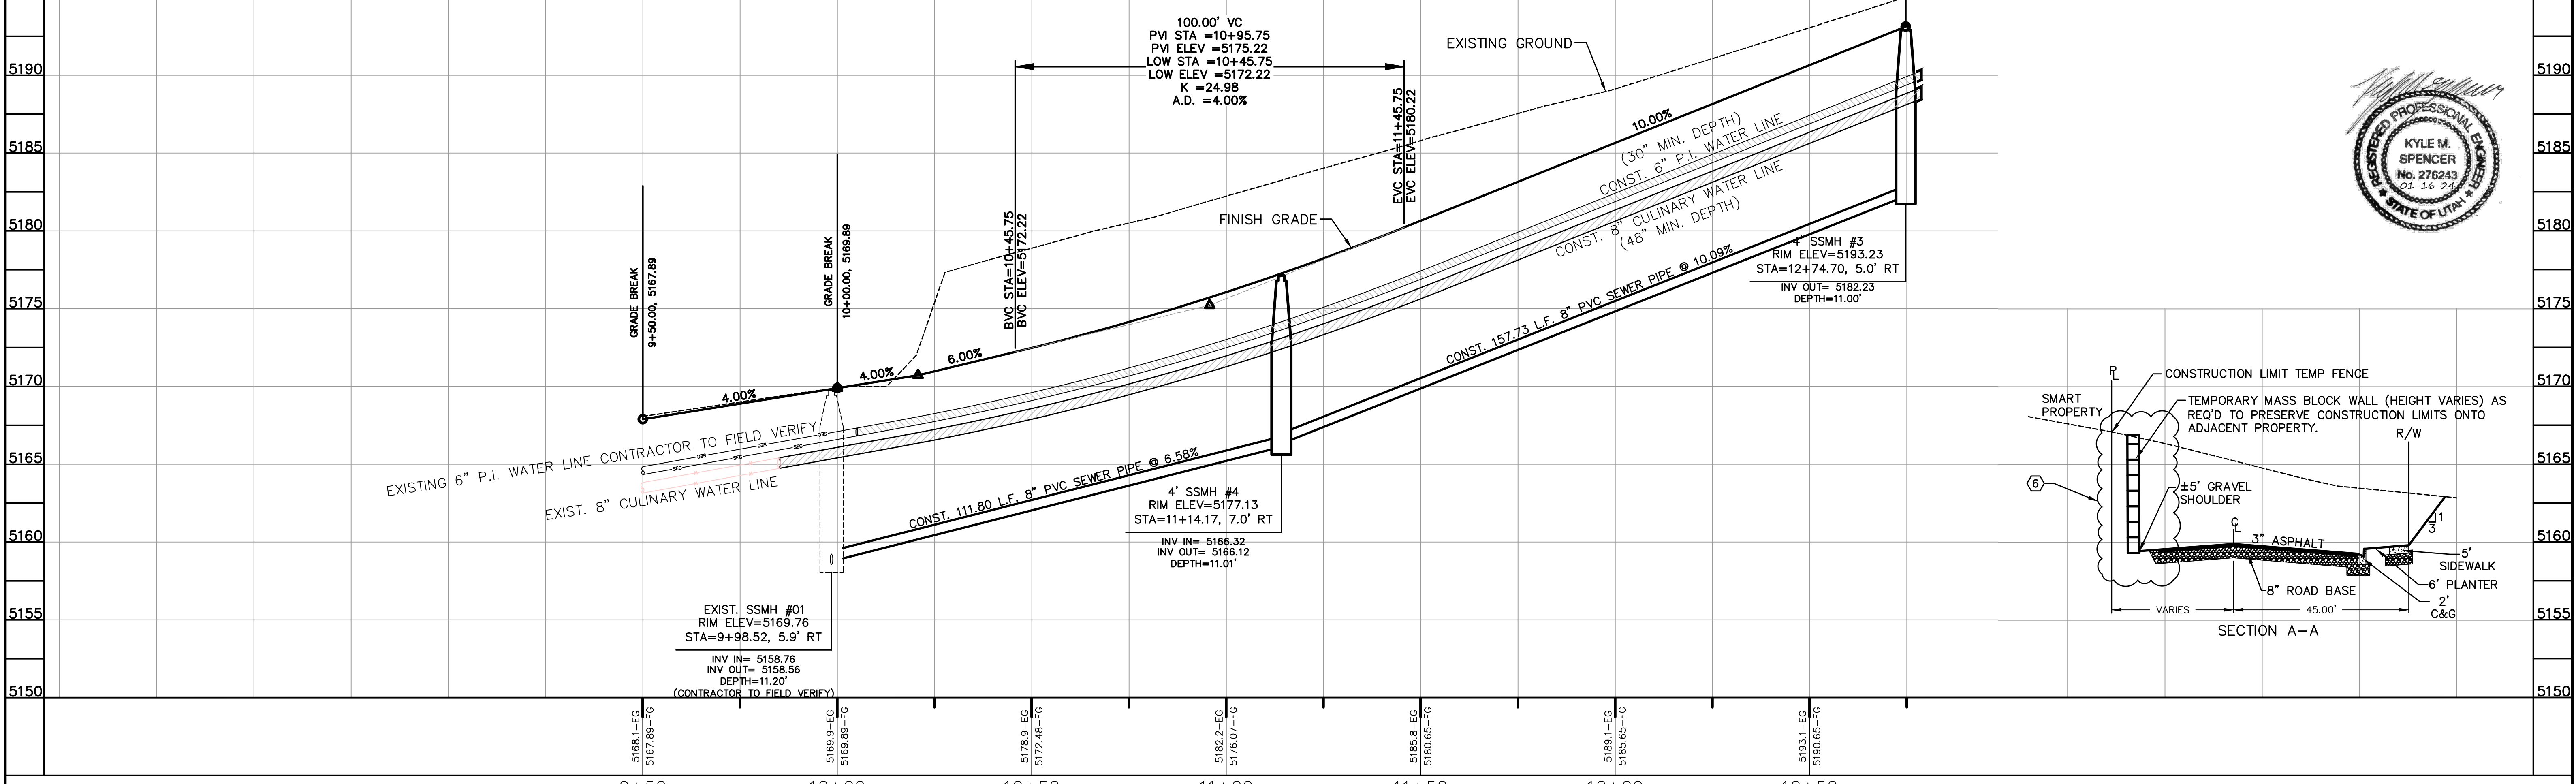Northern ENGINEERING INC
 ENGINEERING-LAND PLANNING
 CONSTRUCTION MANAGEMENT

1040 E. 800 N.
 OREM, UTAH 84097
 (801) 802-8992

VINCENT OAKS

900 EAST STREET PLAN & PROFILE
 SANTAQUIN, UTAH

JOB NO.
 3-23-014

SHEET NO.
PP-02

- 1) CONST. HANDICAP RAMP AS PER CITY STANDARDS
- 2) CONST. STOP & STREET SIGN AS PER CITY STANDARDS
- 3) CONST. STREET LIGHT AS PER CITY STANDARDS
- 4) CONTRACTOR REQ'D TO EXTEND PROPOSED STREET & INFRASTRUCTURE IMPROVEMENTS AS CLOSE TO PROPERTY BOUNDARY AS PRACTICALLY POSSIBLE WHILE STAYING WITHIN PROJECT BOUNDARY



SANTAQUIN

59

58

57

60

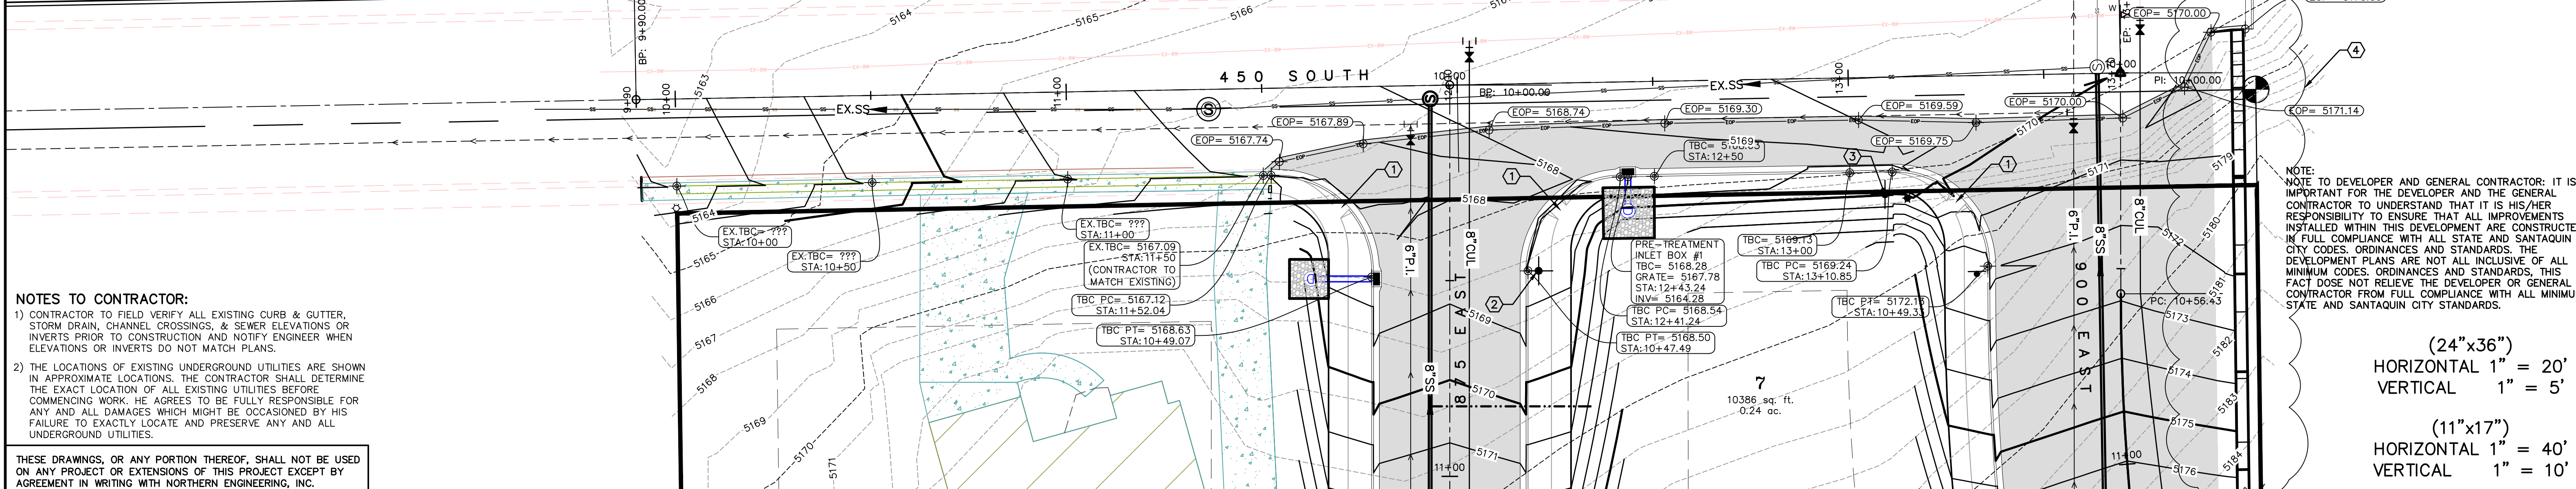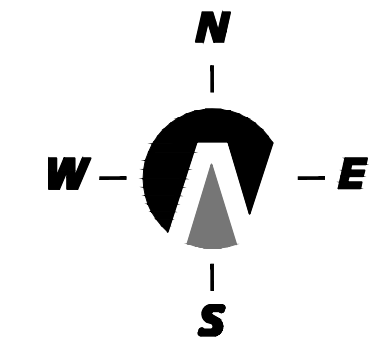



NOTES TO CONTRACTOR:

- 1) CONTRACTOR TO FIELD VERIFY ALL EXISTING CURB & GUTTER, STORM DRAIN, CHANNEL CROSSINGS, & SEWER ELEVATIONS OR INVERTS PRIOR TO CONSTRUCTION AND NOTIFY ENGINEER WHEN ELEVATIONS OR INVERTS DO NOT MATCH PLANS.
- 2) THE LOCATIONS OF EXISTING UNDERGROUND UTILITIES ARE SHOWN IN APPROXIMATE LOCATIONS. THE CONTRACTOR SHALL DETERMINE THE EXACT LOCATION OF ALL EXISTING UTILITIES BEFORE COMMENCING WORK. HE AGREES TO BE FULLY RESPONSIBLE FOR ANY AND ALL DAMAGES WHICH MIGHT BE OCCASIONED BY HIS FAILURE TO EXACTLY LOCATE AND PRESERVE ANY AND ALL UNDERGROUND UTILITIES.

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(24"x36")
 HORIZONTAL 1" = 20'
 VERTICAL 1" = 5'

(11"x17")
 HORIZONTAL 1" = 40'
 VERTICAL 1" = 10'

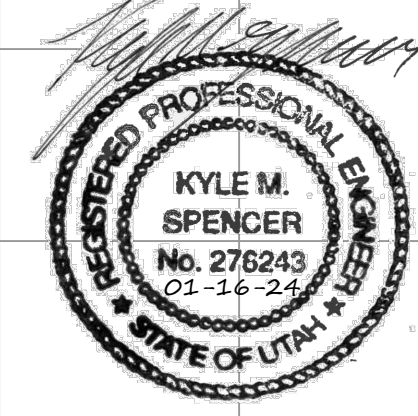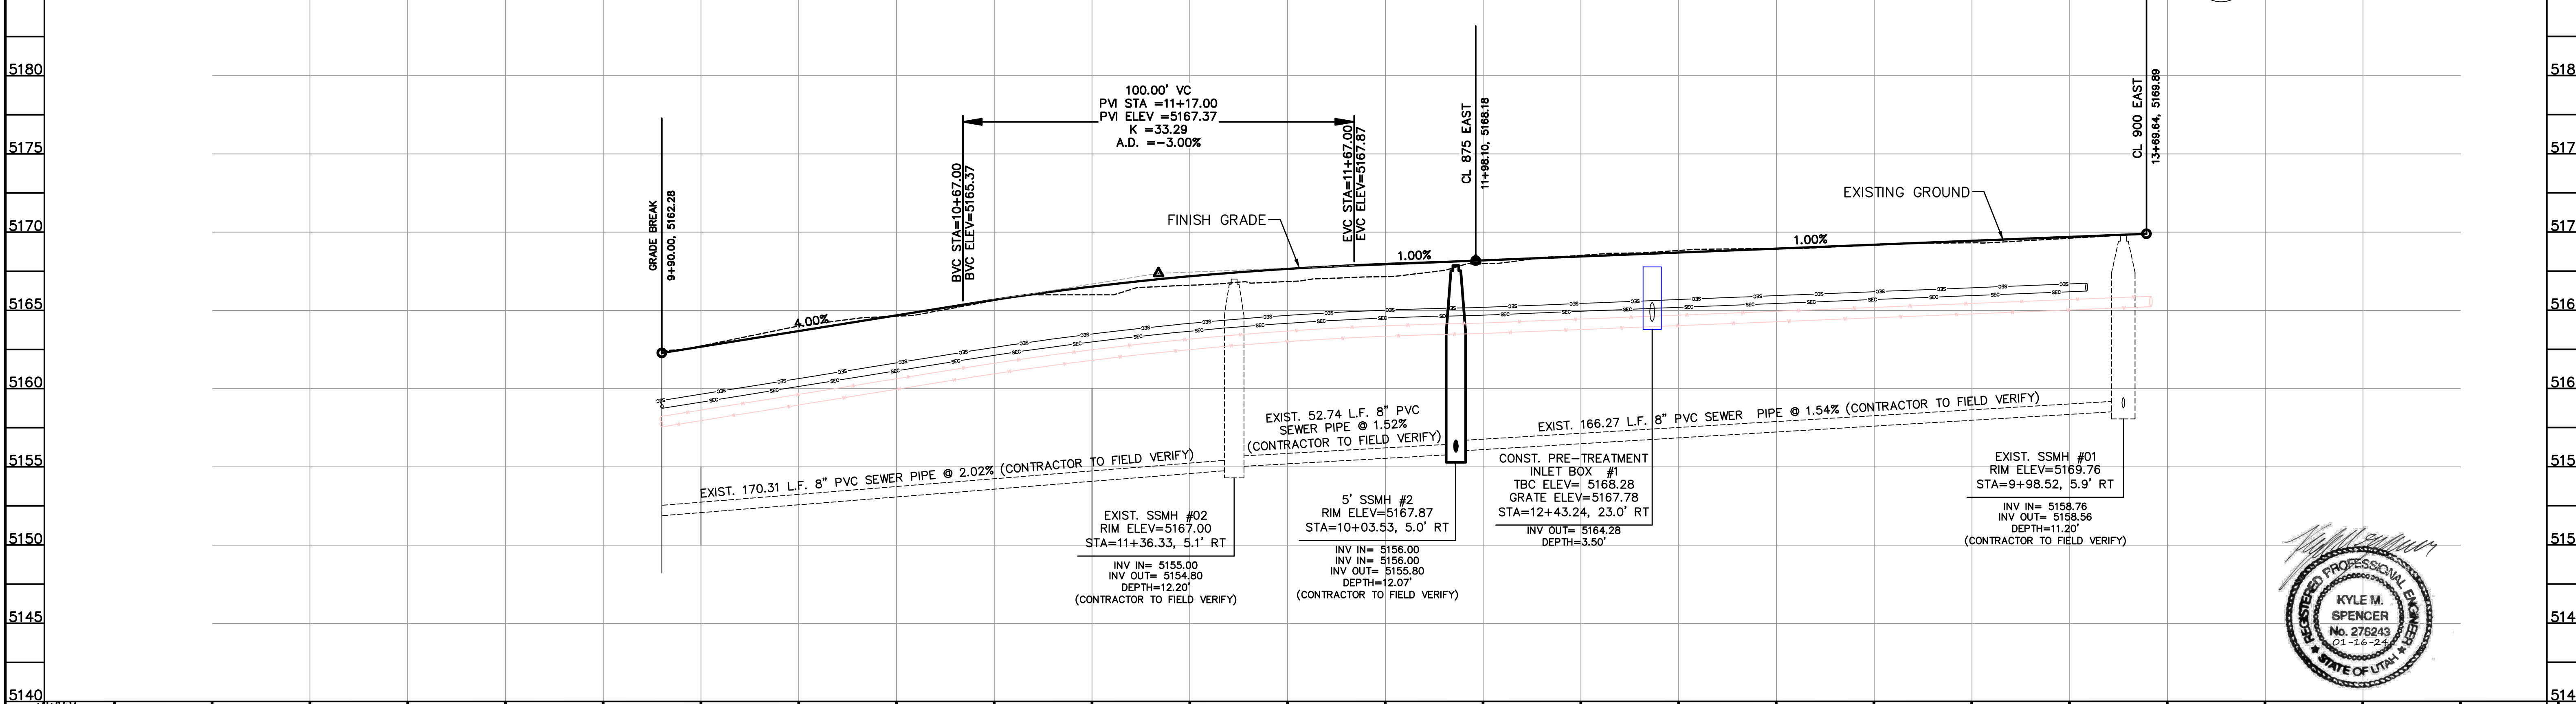

5180	5175	5170	5165	5160	5155	5150	5145	5140
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9+00	9+50	10+00	10+50	11+00	11+50	12+00	12+50	13+00	13+50	14+00	14+50
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DESIGNED BY:	DATE:				
DRAWN BY:	DATE:				
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APPROVED:	DATE:				
COGO FILE:	DATE:				
NO.	REVISIONS	BY	DATE	REV. COGO FILE:	DATE:

9+00	9+50	10+00	10+50	11+00	11+50	12+00	12+50	13+00	13+50	14+00	14+50
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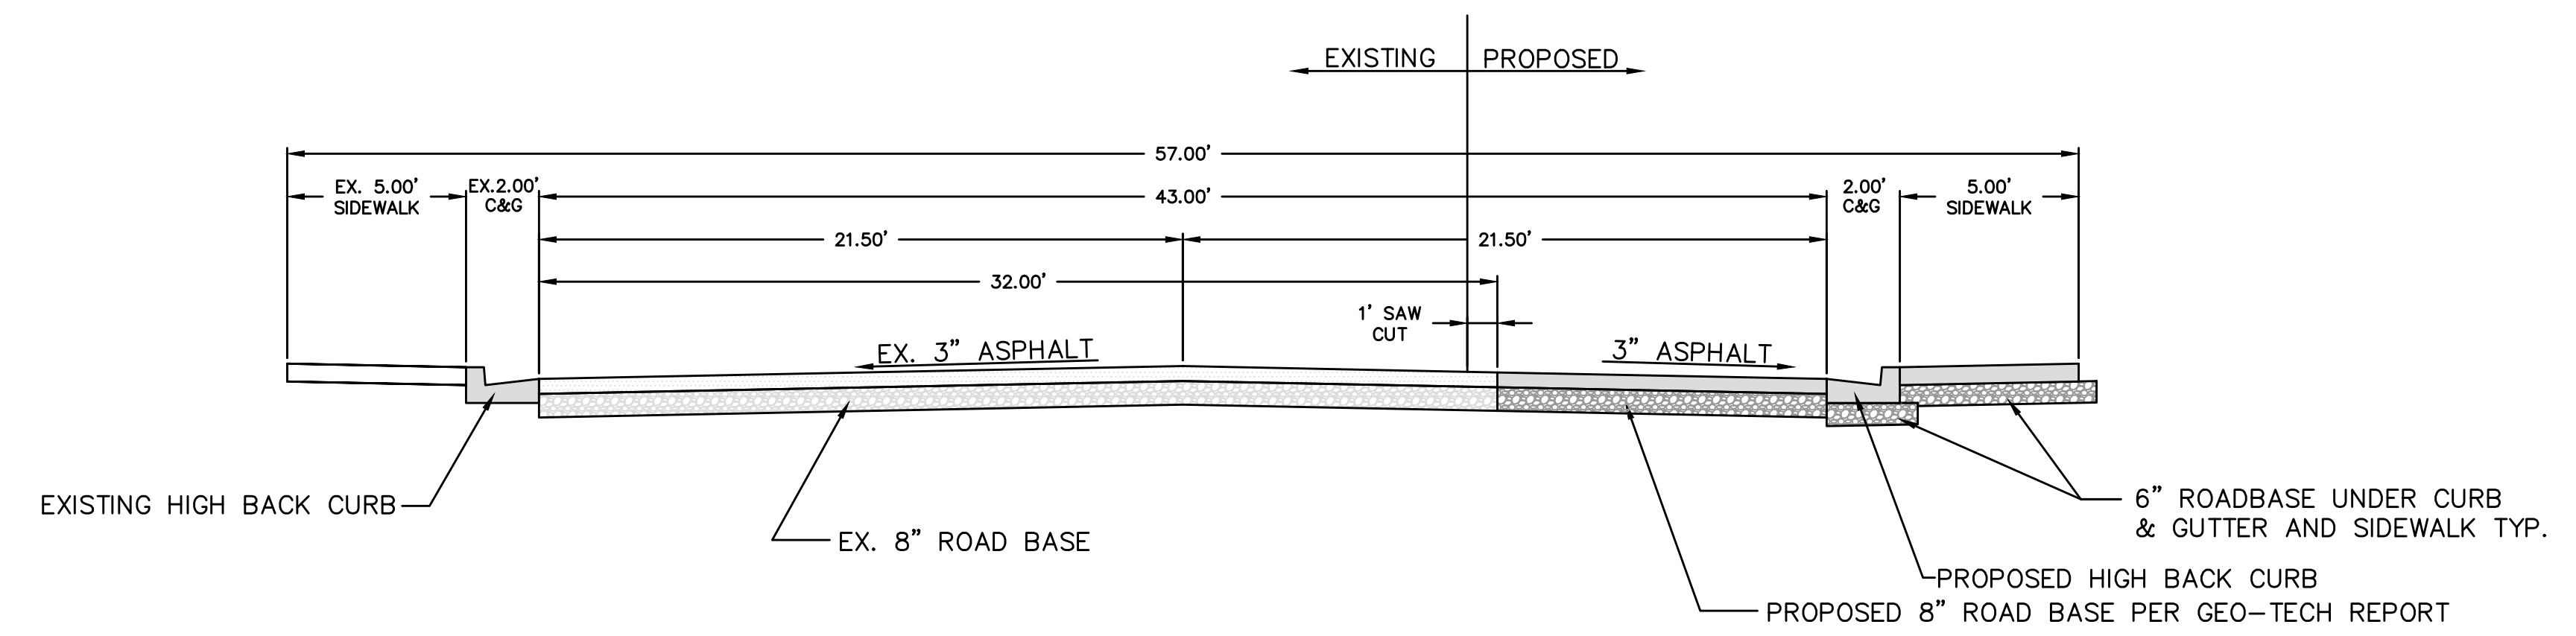
Northern ENGINEERING INC
 ENGINEERING-LAND PLANNING
 CONSTRUCTION MANAGEMENT

1040 E. 800 N.
 OREM, UTAH 84097
 (801) 802-8992


VINCENT OAKS

450 SOUTH STREET PLAN & PROFILE
 SANTAQUIN, UTAH


JOB NO. 3-23-014
 SHEET NO. PP-03






71.00' STANDARD STREET CROSS SECTION
450 SOUTH STREET
-NTS-

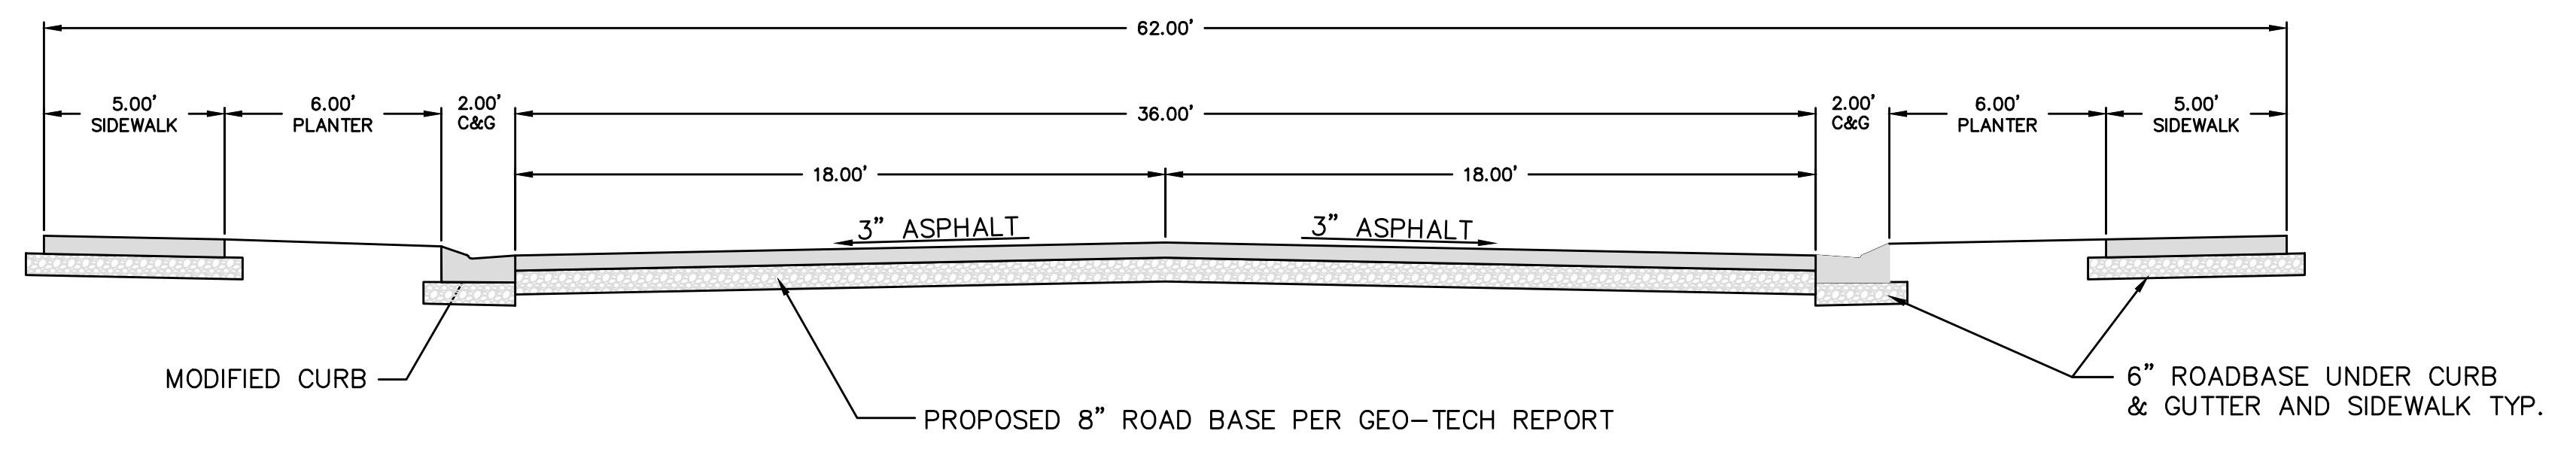

62.00' STANDARD STREET CROSS SECTION
875 EAST STREET
-NTS-

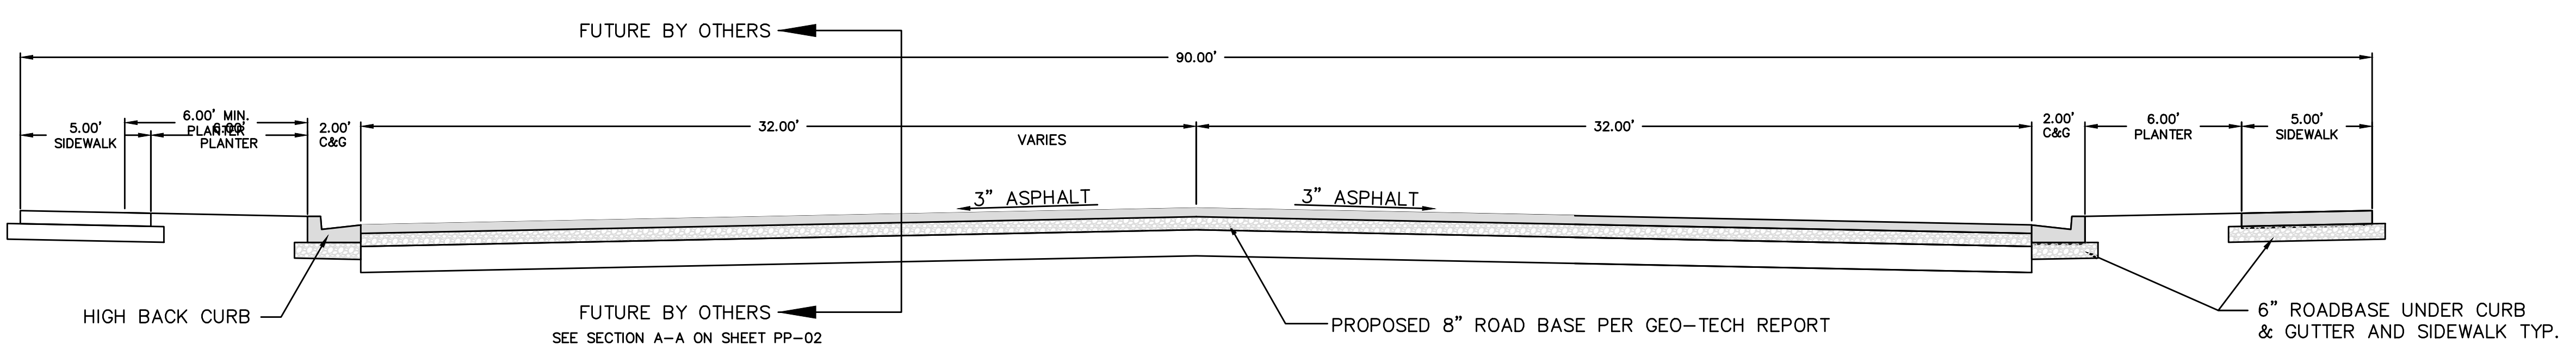

90.00' STANDARD STREET CROSS SECTION
900 EAST STREET
-NTS-

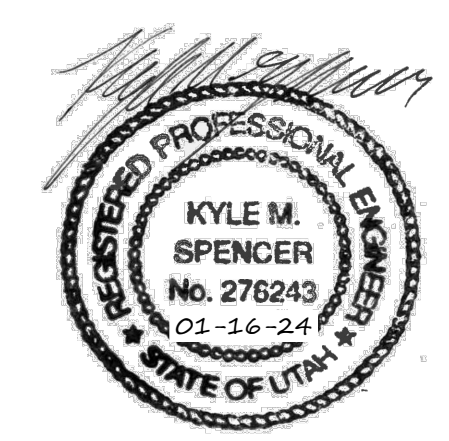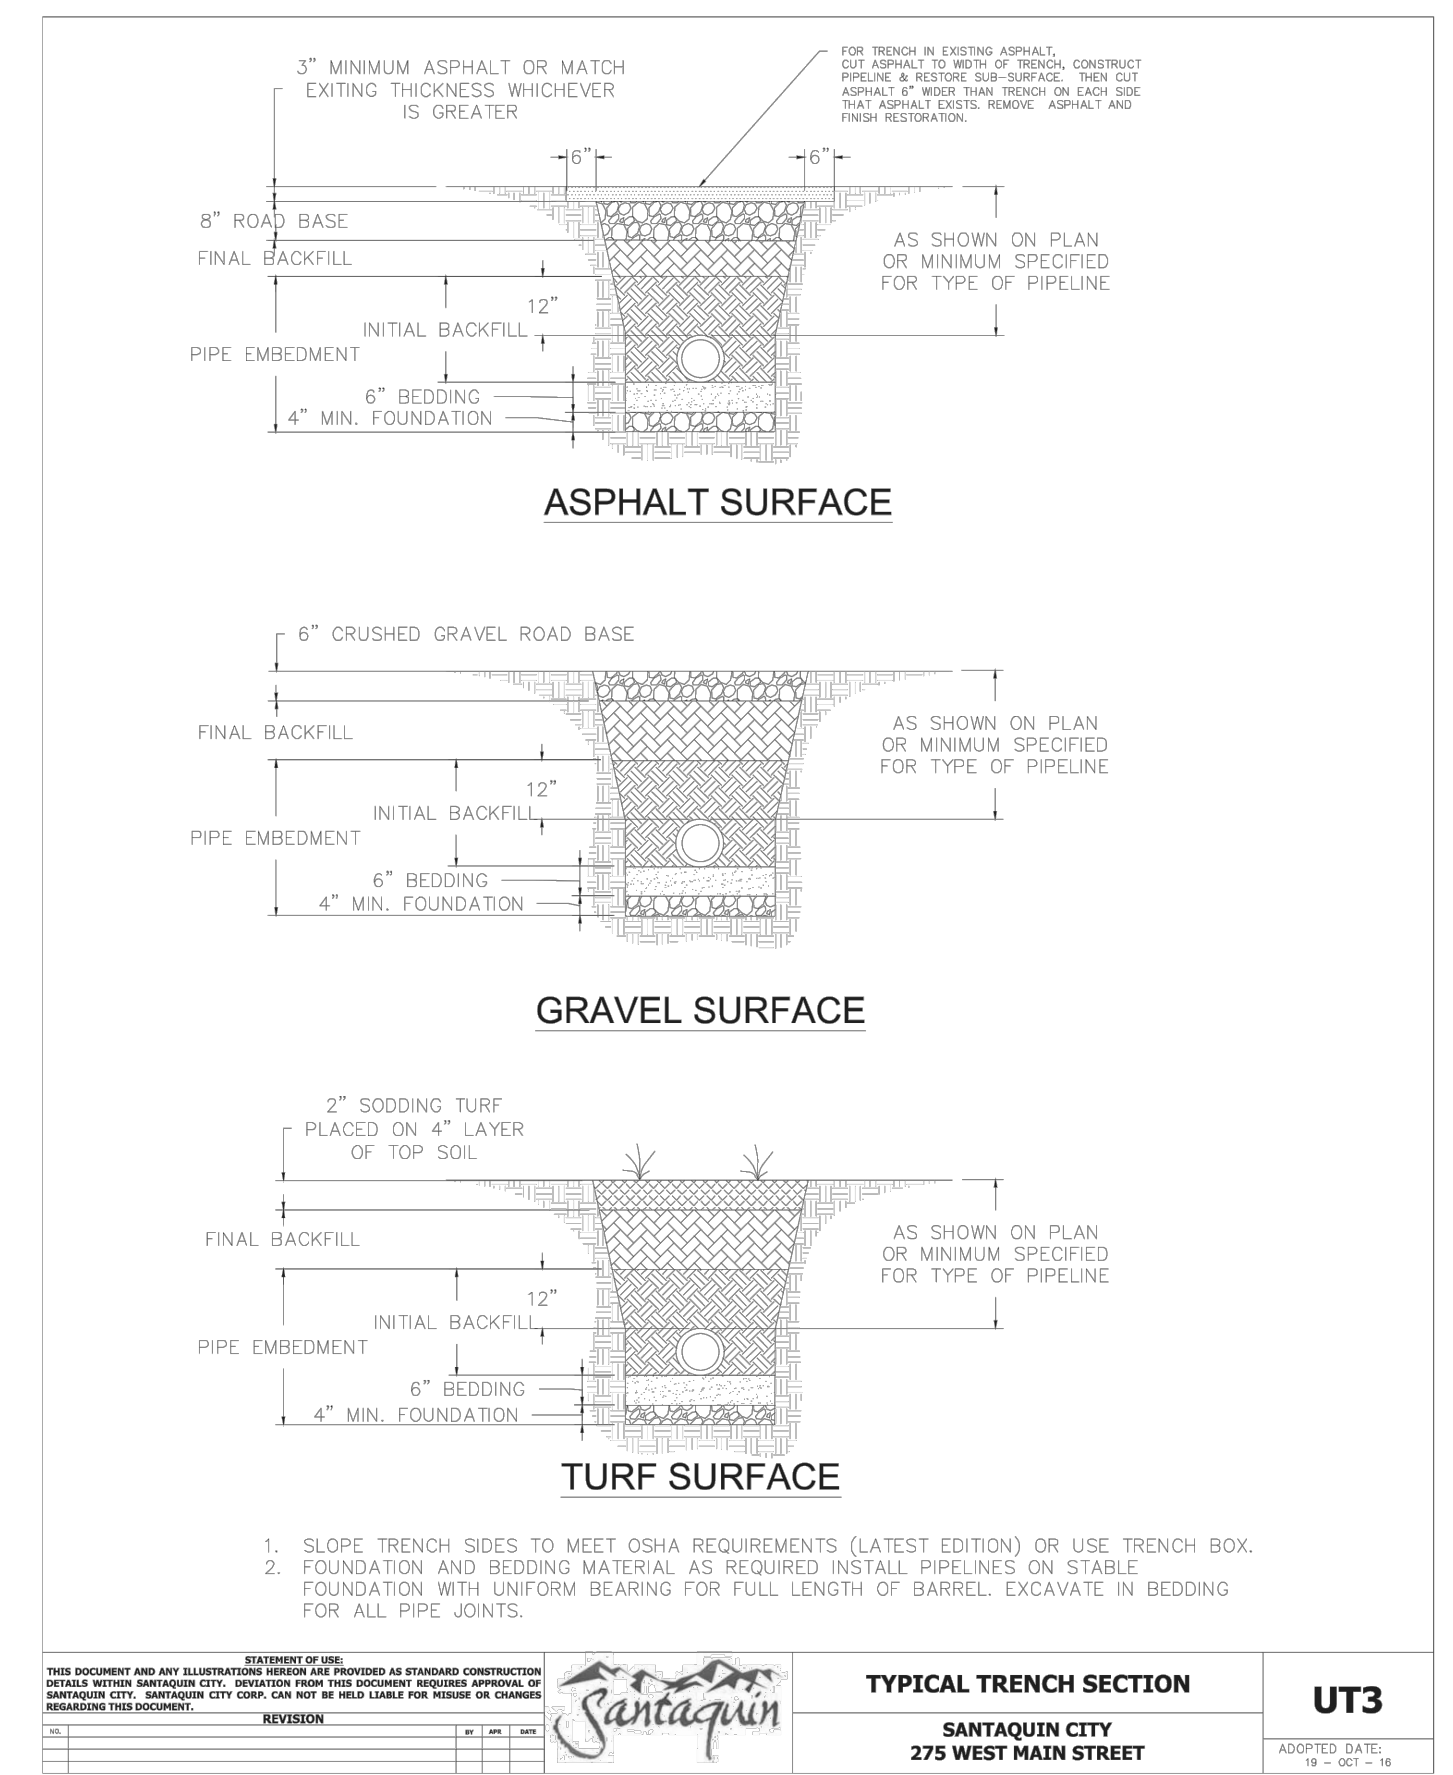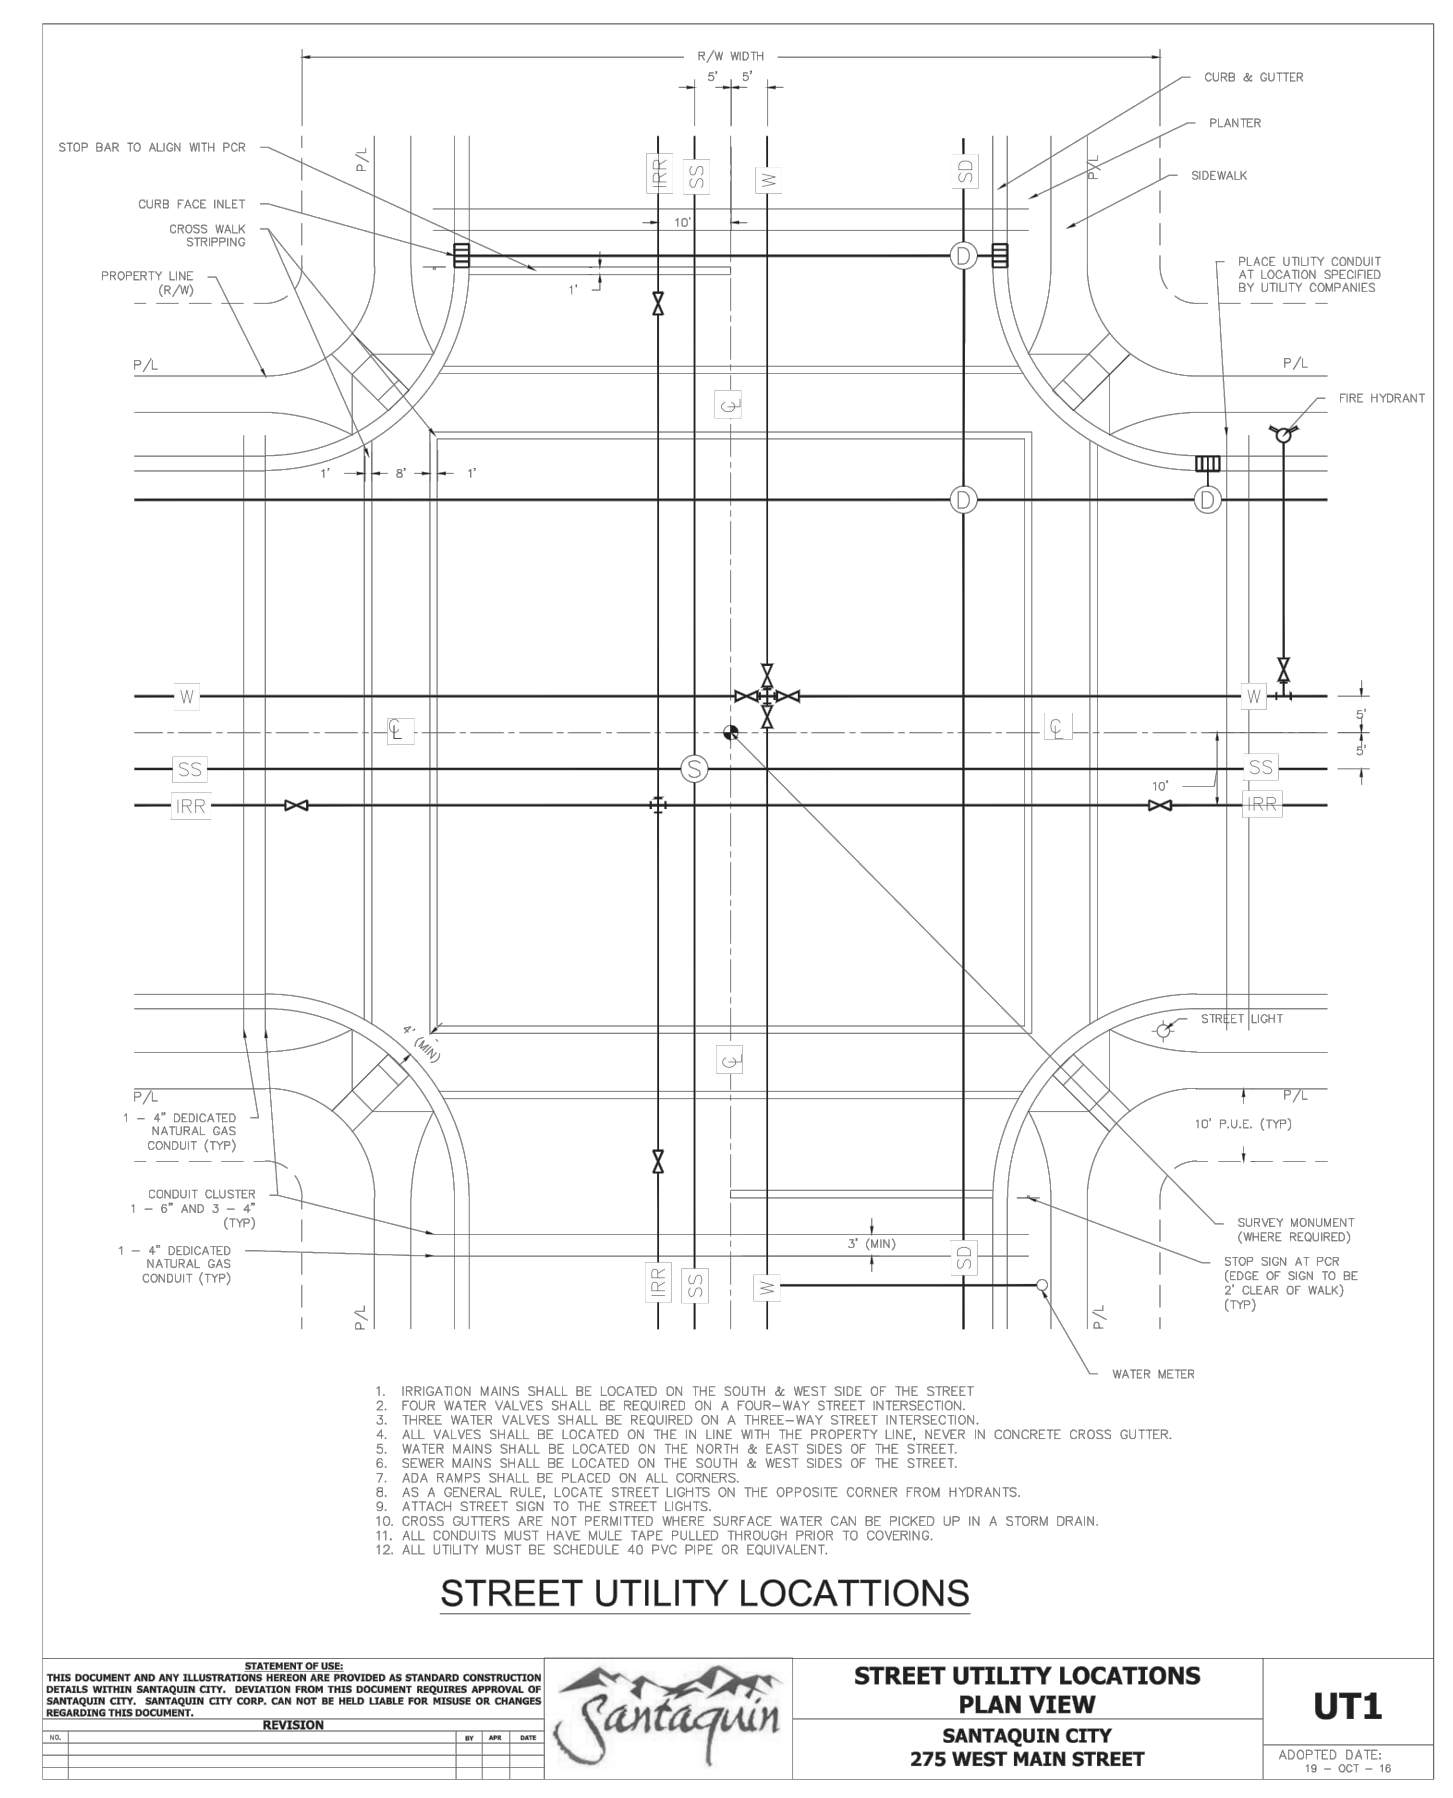

5		DESIGNED BY:		DATE:
4		DRAWN BY:		DATE:
3		CHECKED BY:		DATE:
2		APPROVED BY:		DATE:
1		COGO FILE:		DATE:
NO.	REVISIONS	BY	DATE	REV. COGO FILE:

Northern ENGINEERING INC
ENGINEERING-LAND PLANNING
CONSTRUCTION MANAGEMENT

1040 E. 800 N.
OREM, UTAH 84097
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VINCENT OAKS


DETAILS
SANTAQUIN, UTAH

JOB NO.
3-23-014


SHEET NO.
DT-01

THESE DRAWINGS, OR ANY PORTION THEREOF, SHALL NOT BE USED ON ANY PROJECT OR EXTENSIONS OF THIS PROJECT EXCEPT BY AGREEMENT IN WRITING WITH NORTHERN ENGINEERING, INC.


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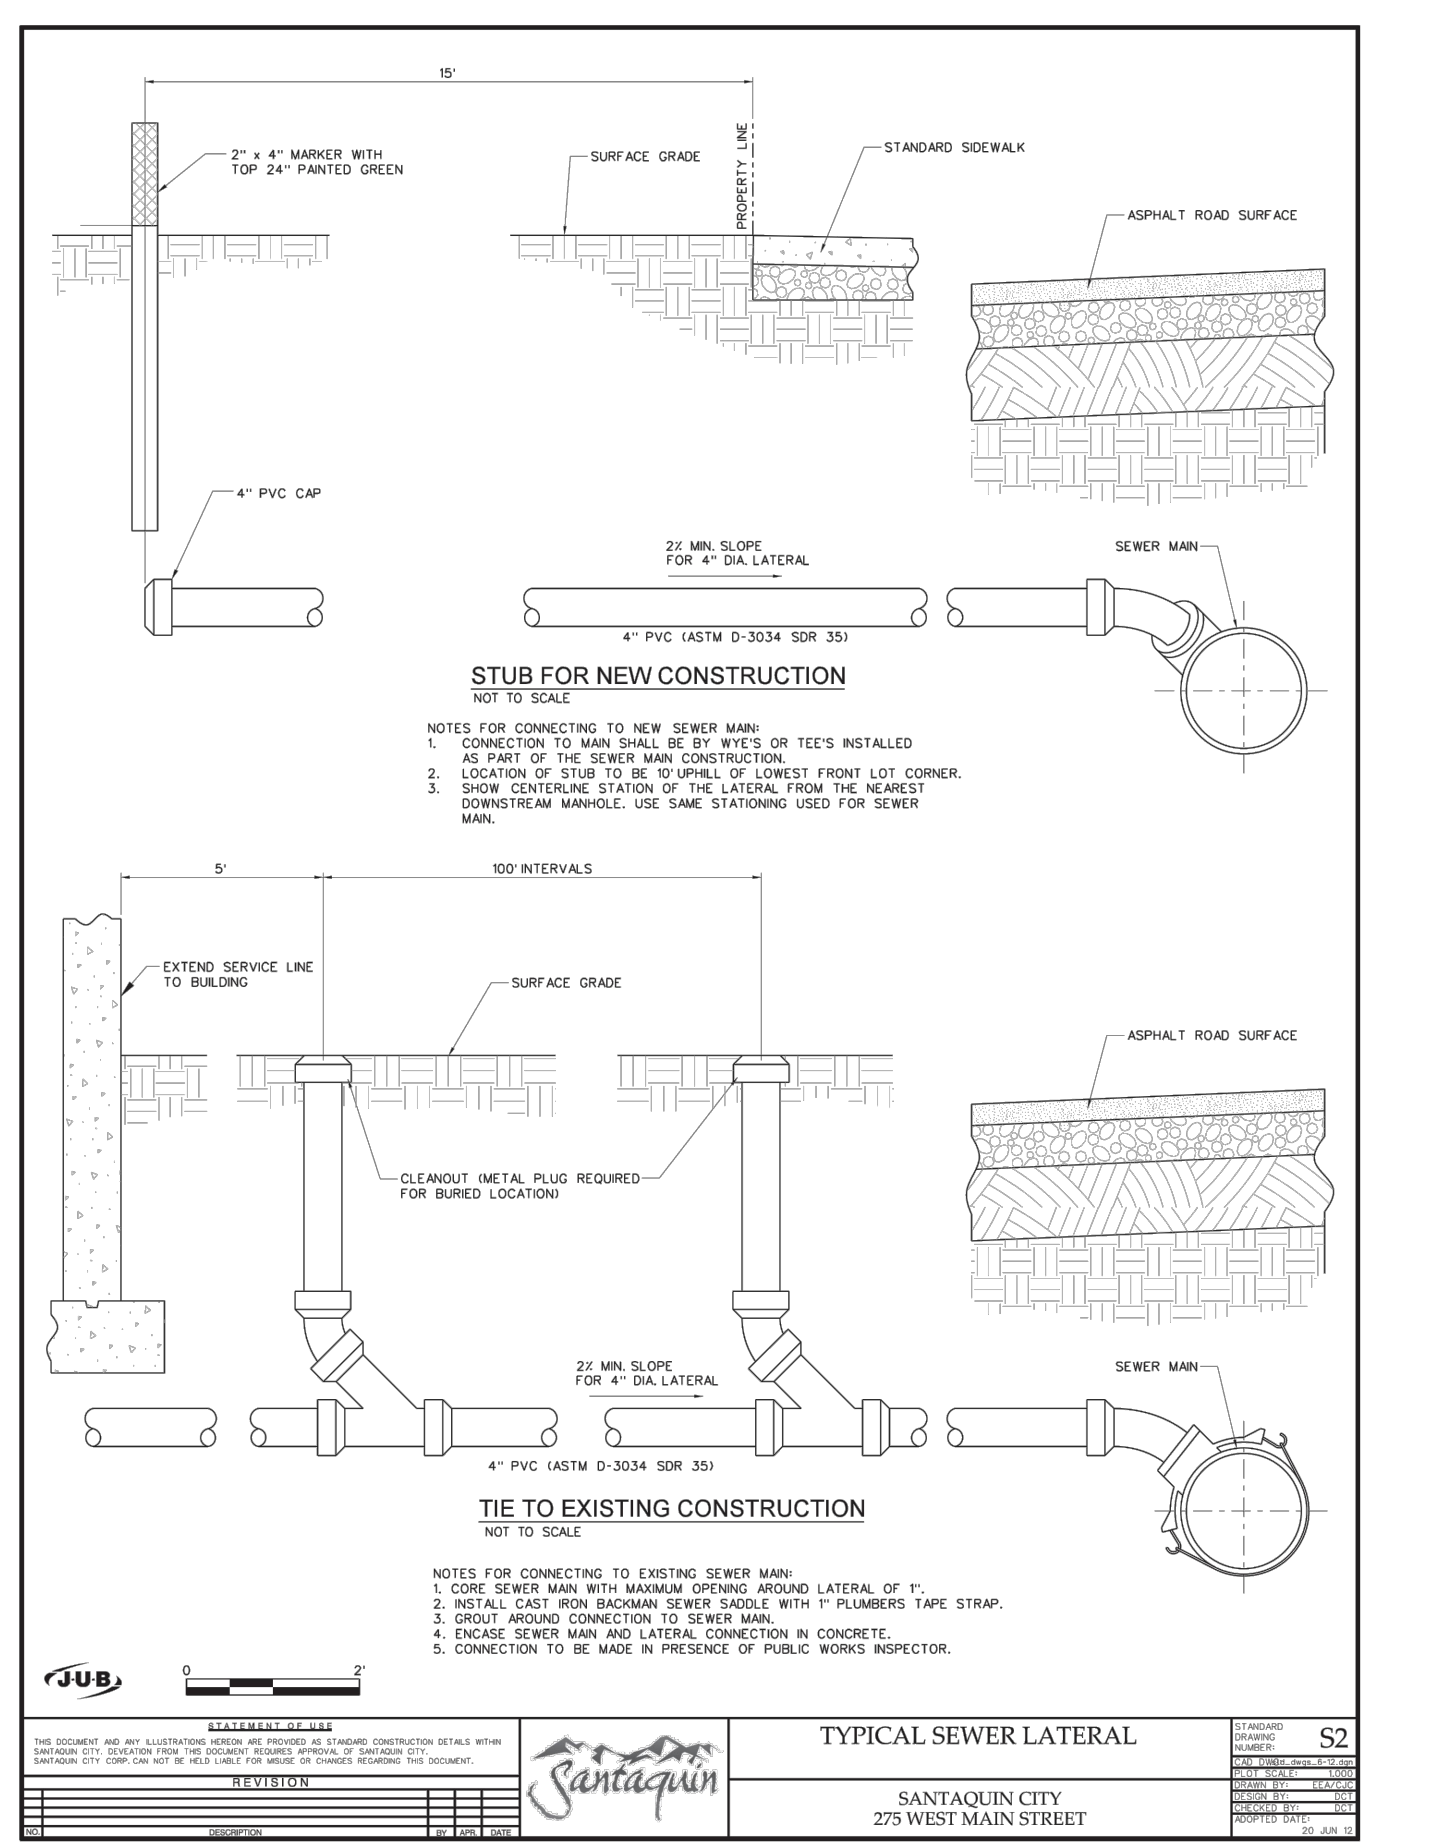
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COGO FILE: [REDACTED]	DATE: [REDACTED]
NO. [REDACTED]	REVISIONS [REDACTED]
BY [REDACTED]	DATE [REDACTED]
REV. COGO FILE: [REDACTED]	DATE: [REDACTED]

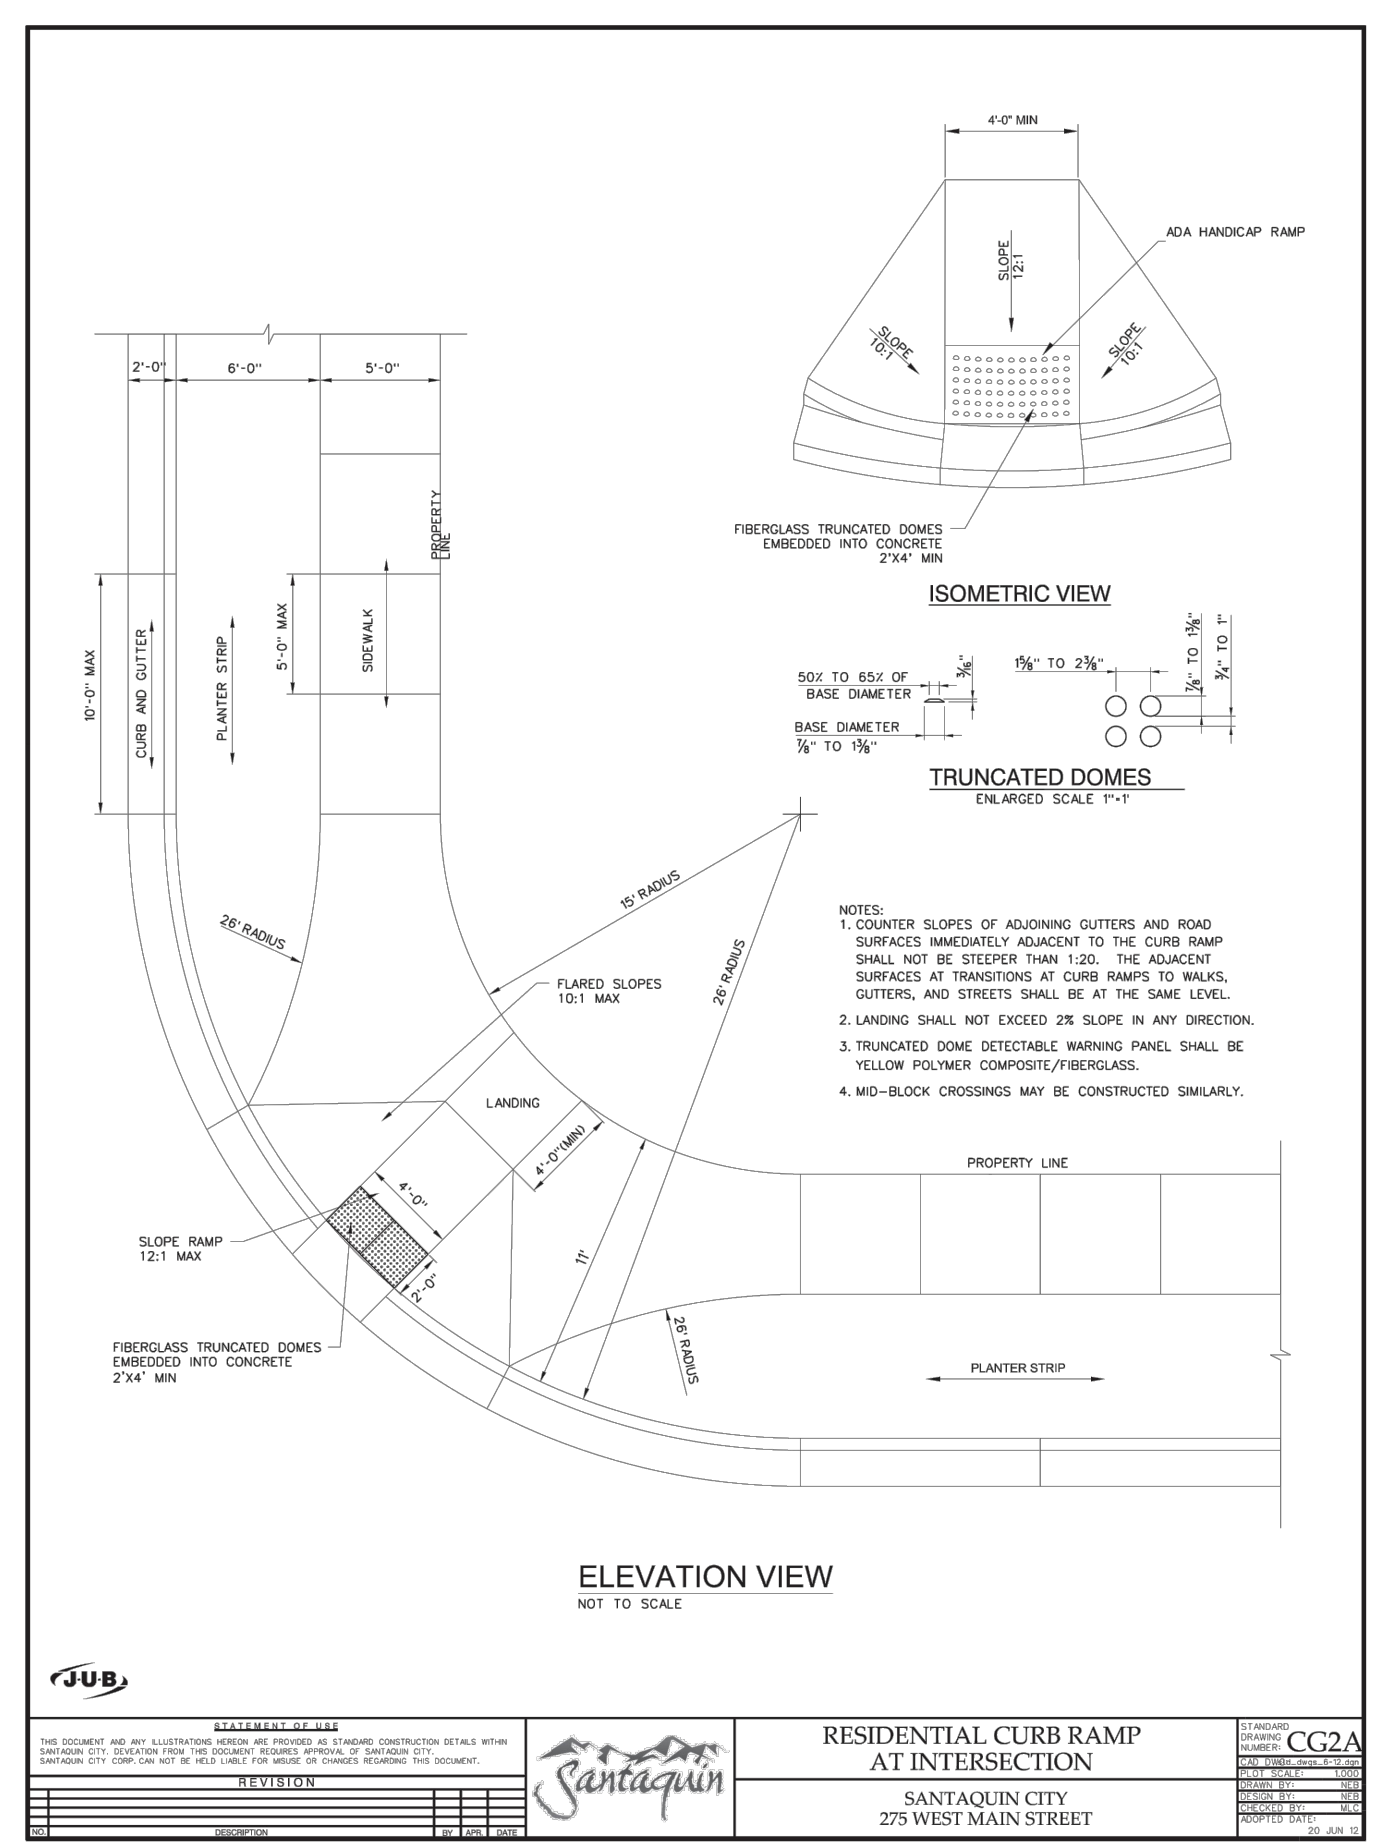


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COGO FILE: [REDACTED]	DATE: [REDACTED]
NO. [REDACTED]	REVISIONS [REDACTED]
BY [REDACTED]	DATE [REDACTED]
REV. COGO FILE: [REDACTED]	DATE: [REDACTED]

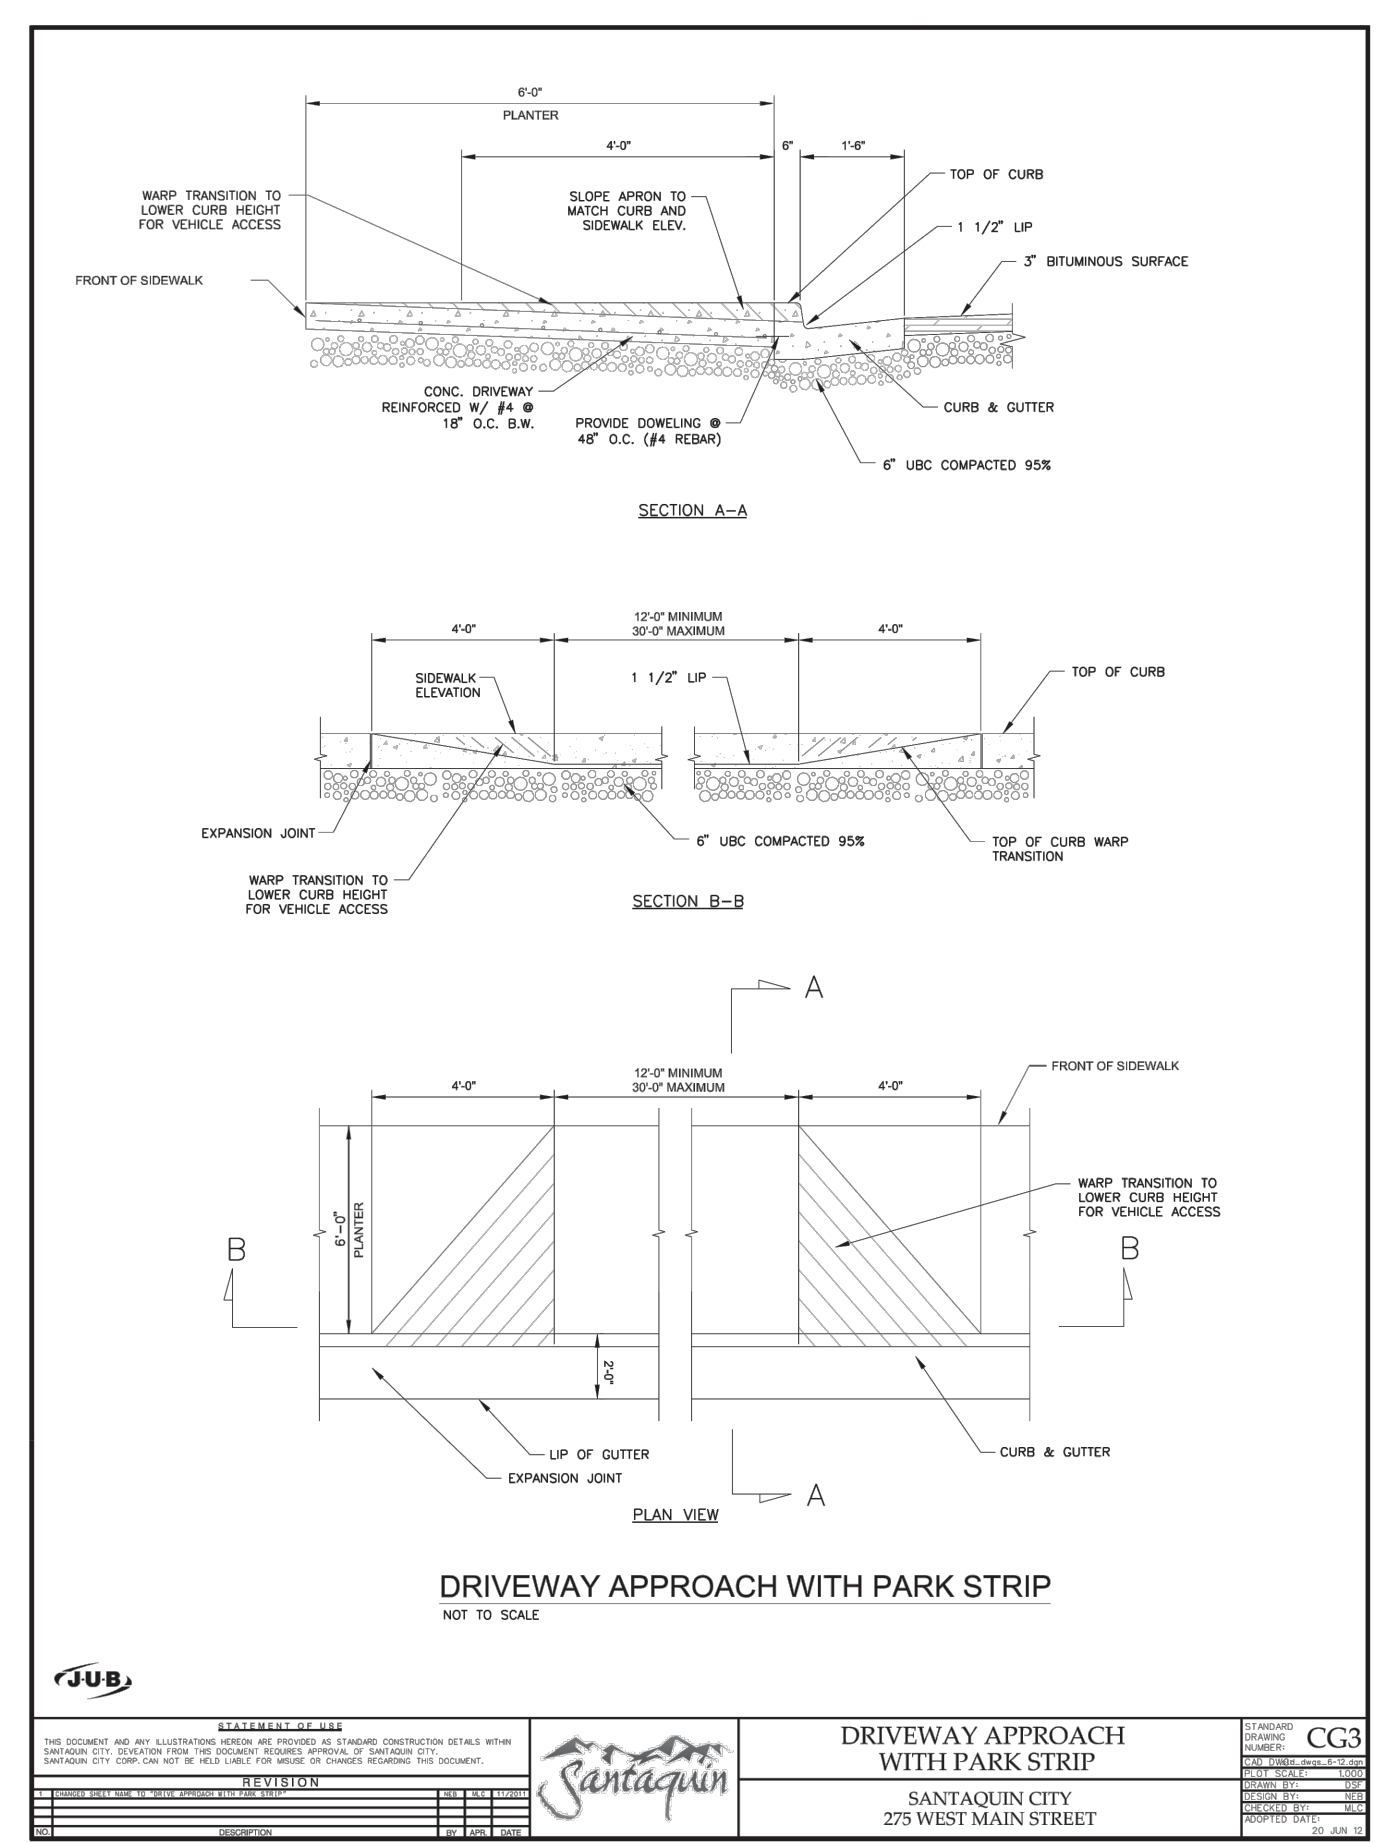


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NO. [REDACTED]	REVISIONS [REDACTED]
BY [REDACTED]	DATE [REDACTED]
REV. COGO FILE: [REDACTED]	DATE: [REDACTED]

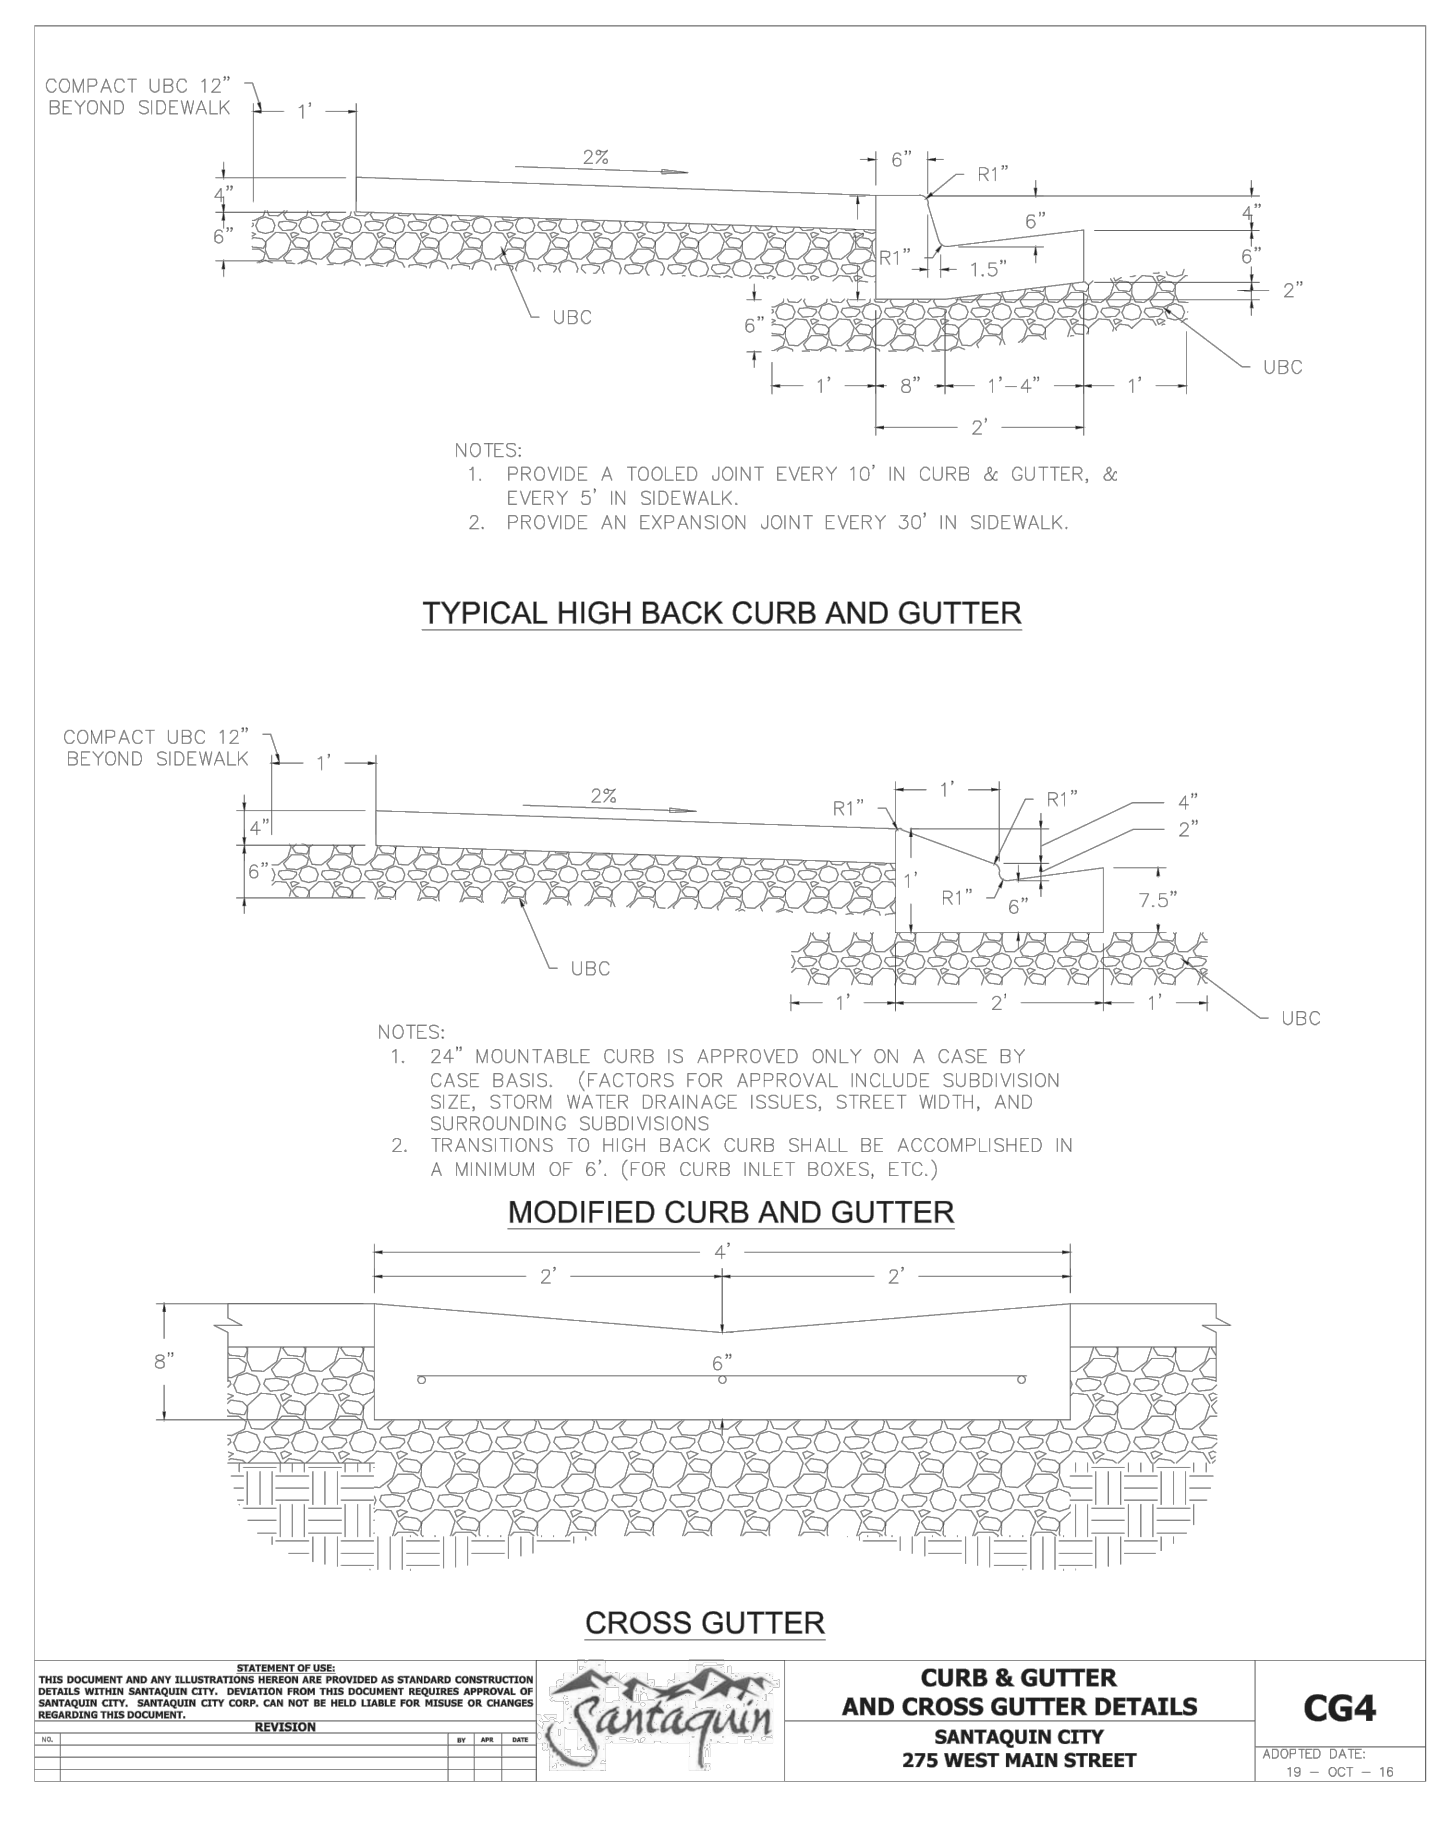


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BY [REDACTED]	DATE [REDACTED]
REV. COGO FILE: [REDACTED]	DATE: [REDACTED]

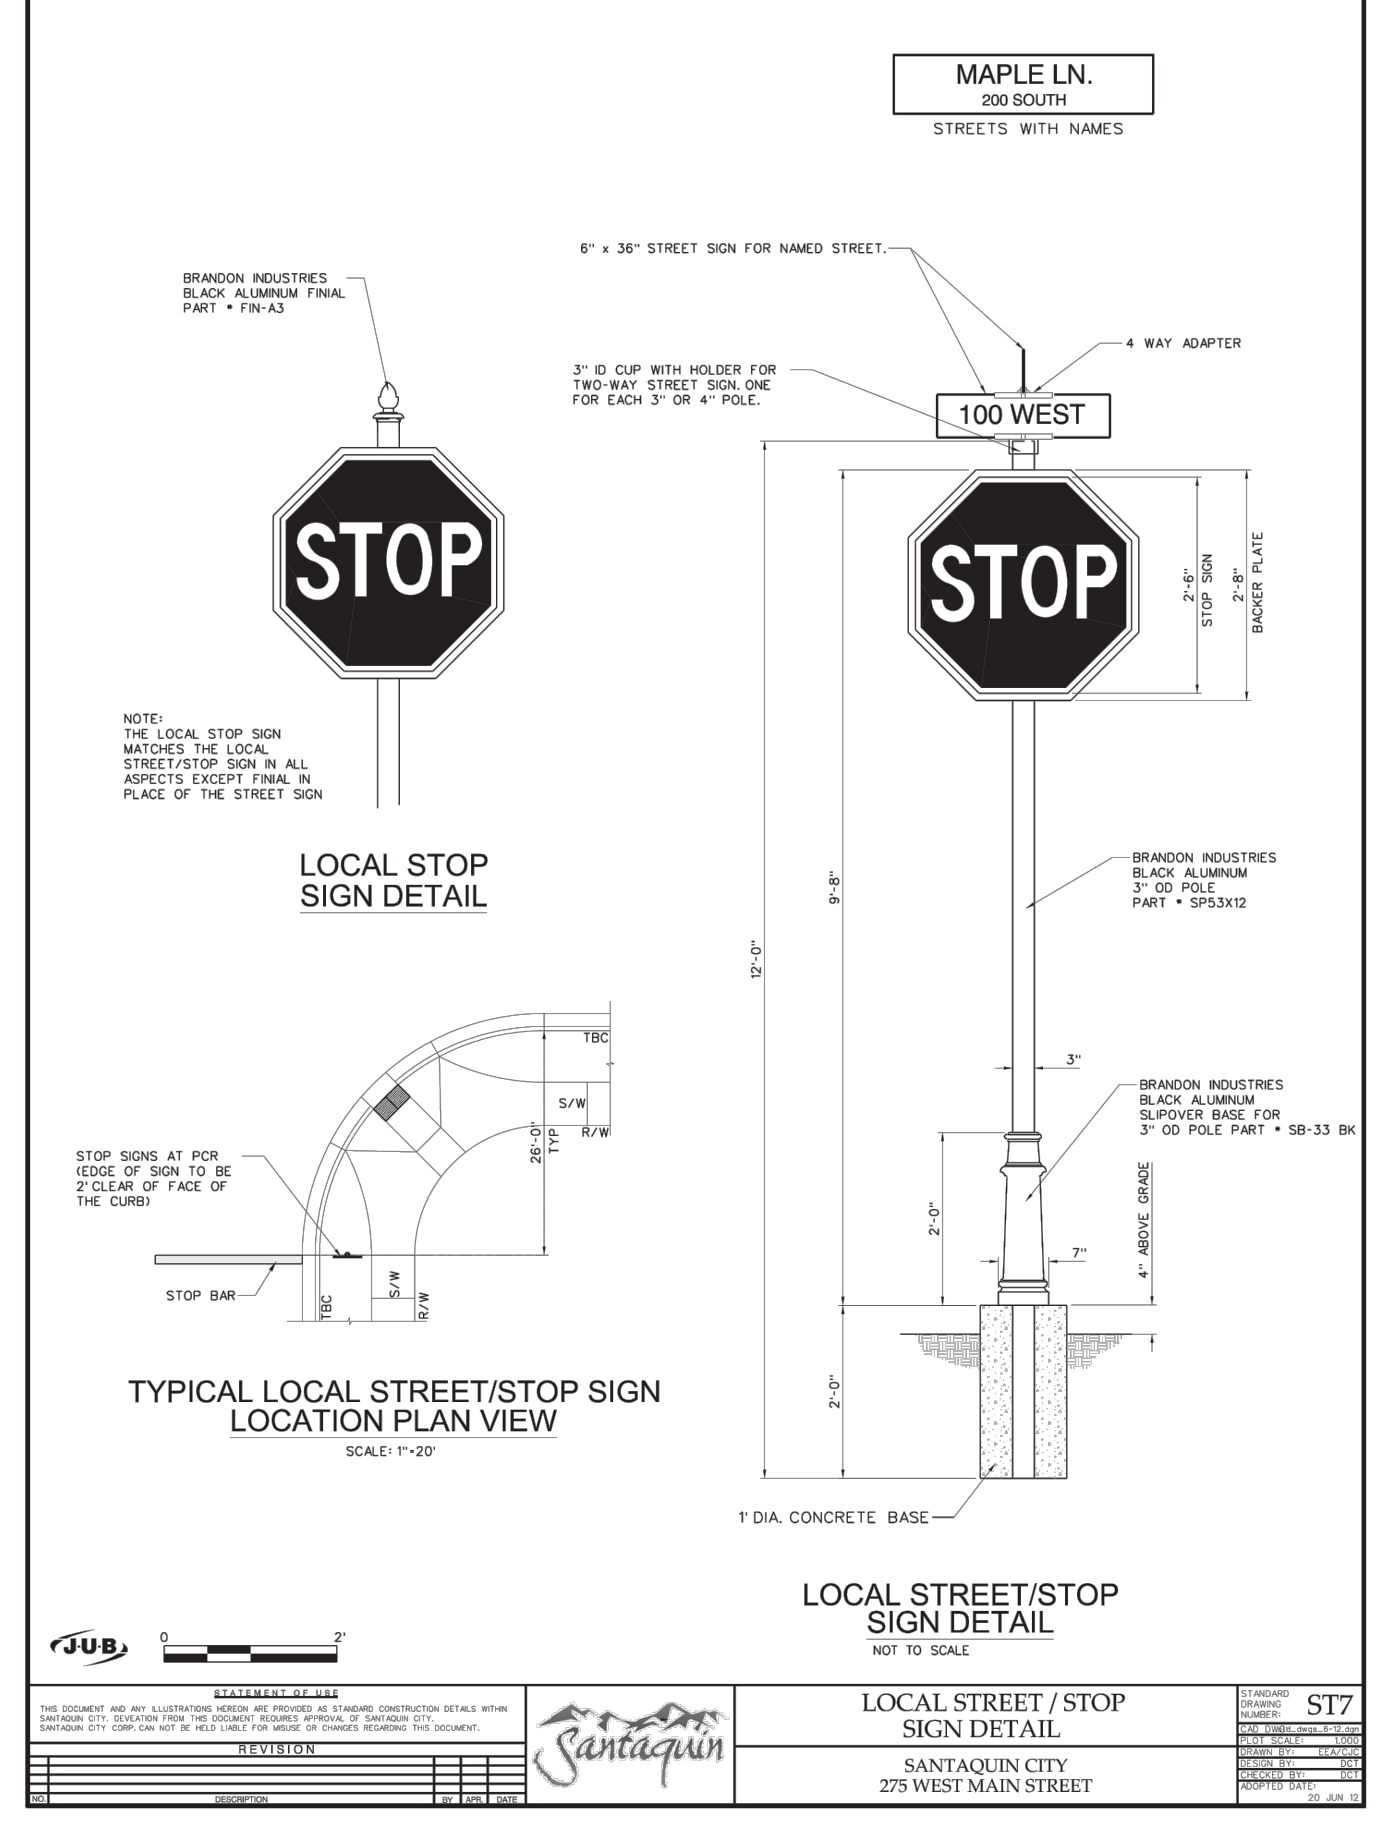

DESIGNED BY: [REDACTED]	DATE: [REDACTED]
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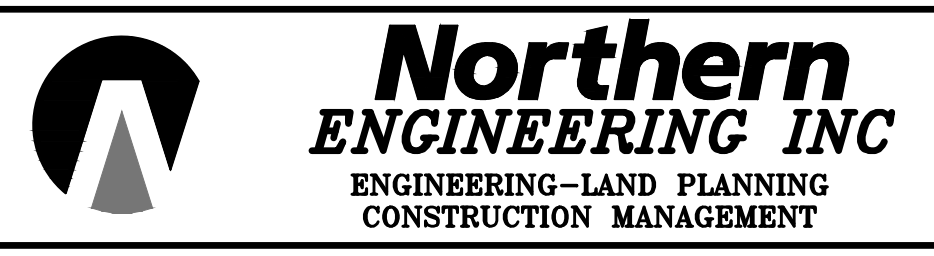
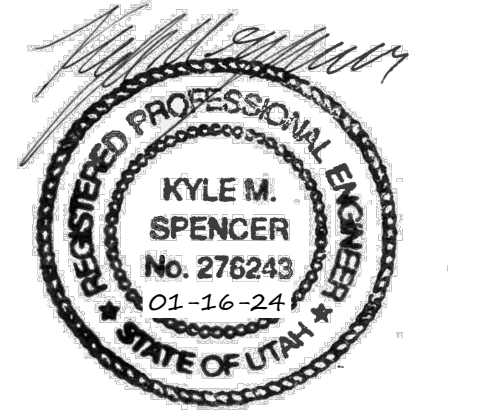

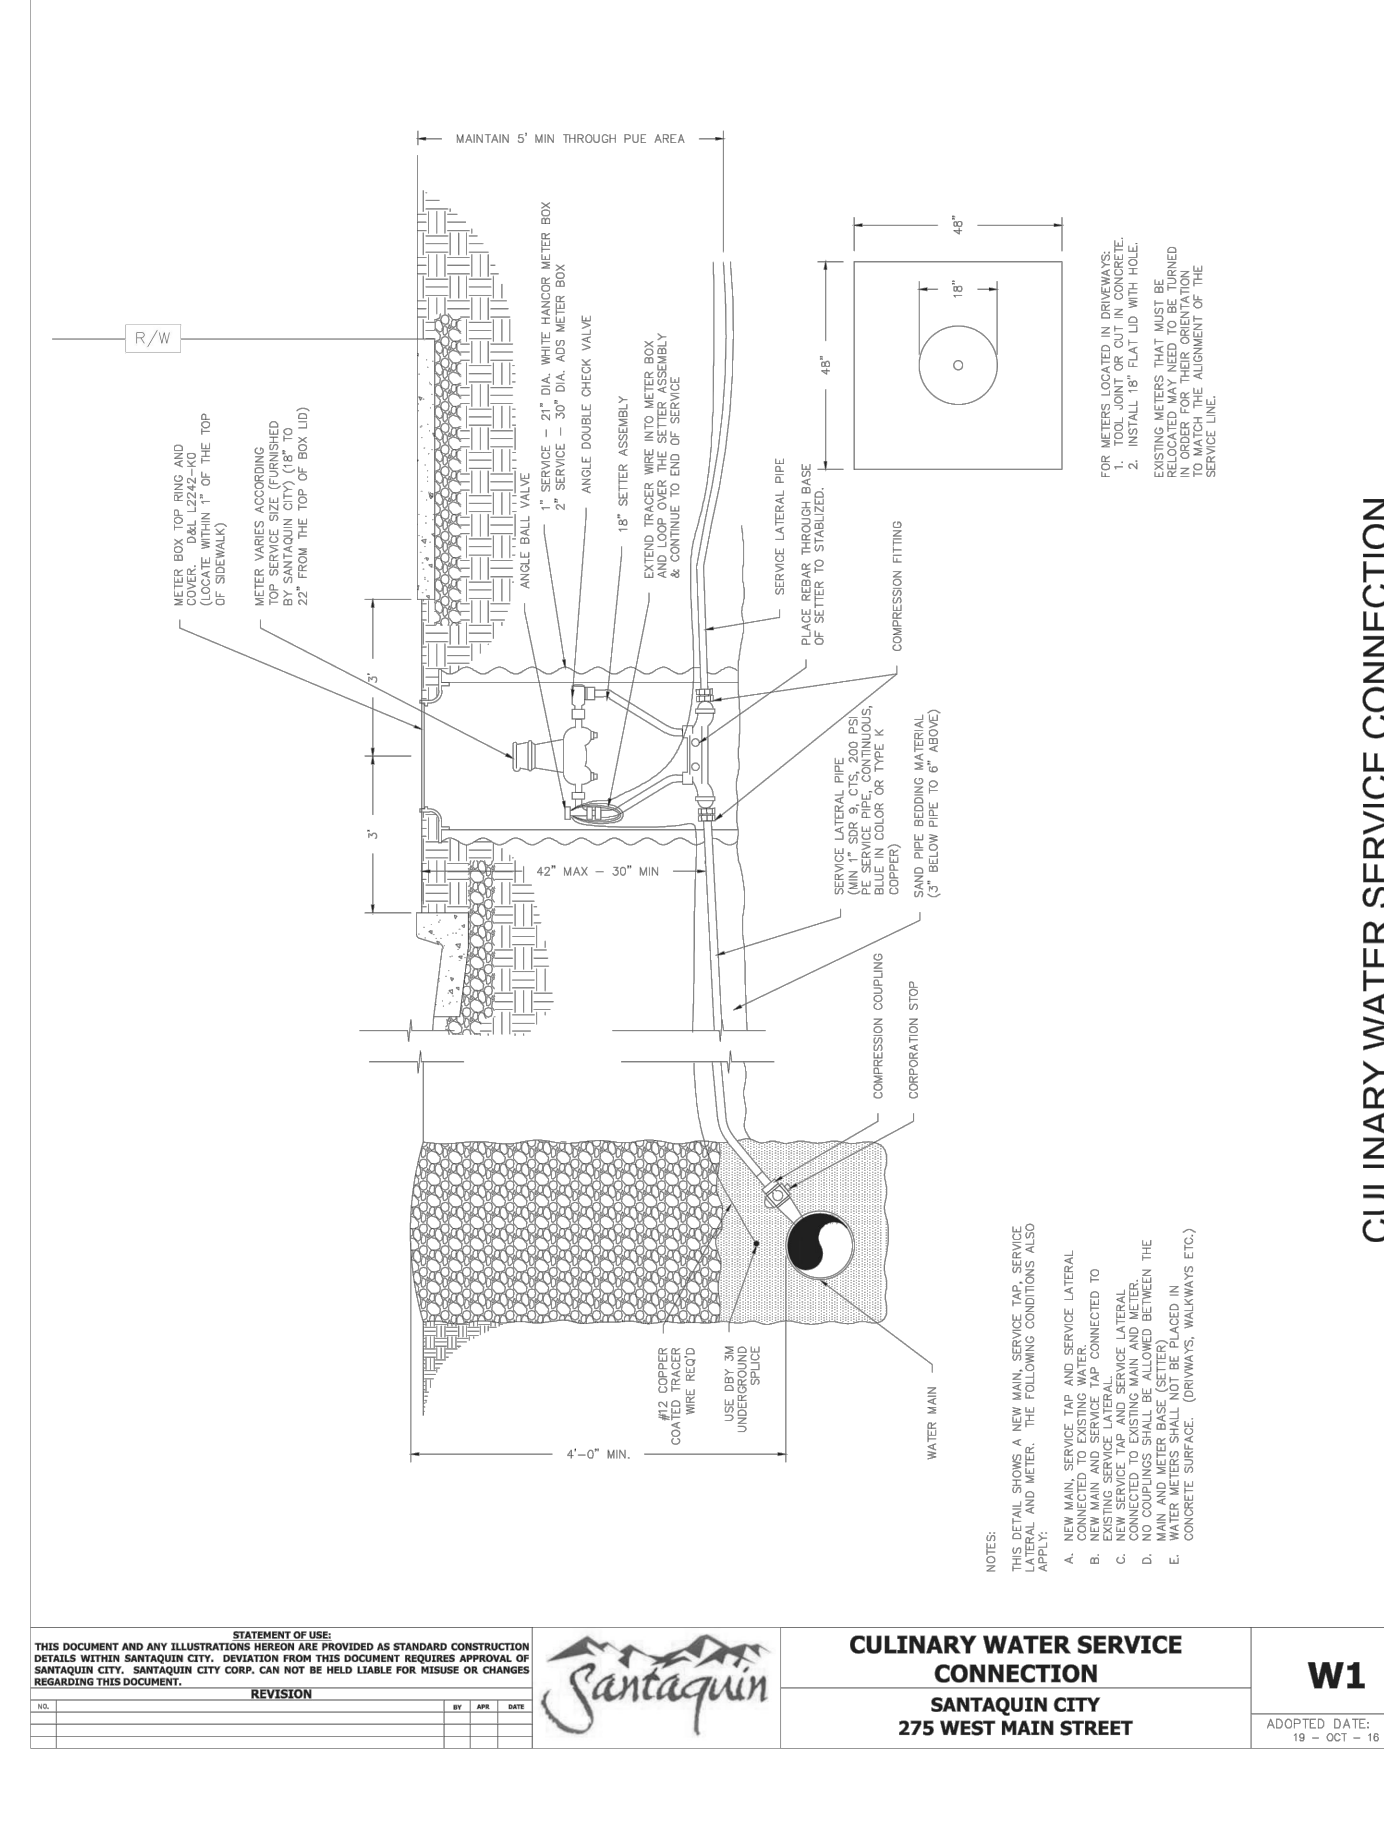
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NO. [REDACTED]	REVISIONS [REDACTED]
BY [REDACTED]	DATE [REDACTED]
REV. COGO FILE: [REDACTED]	DATE: [REDACTED]

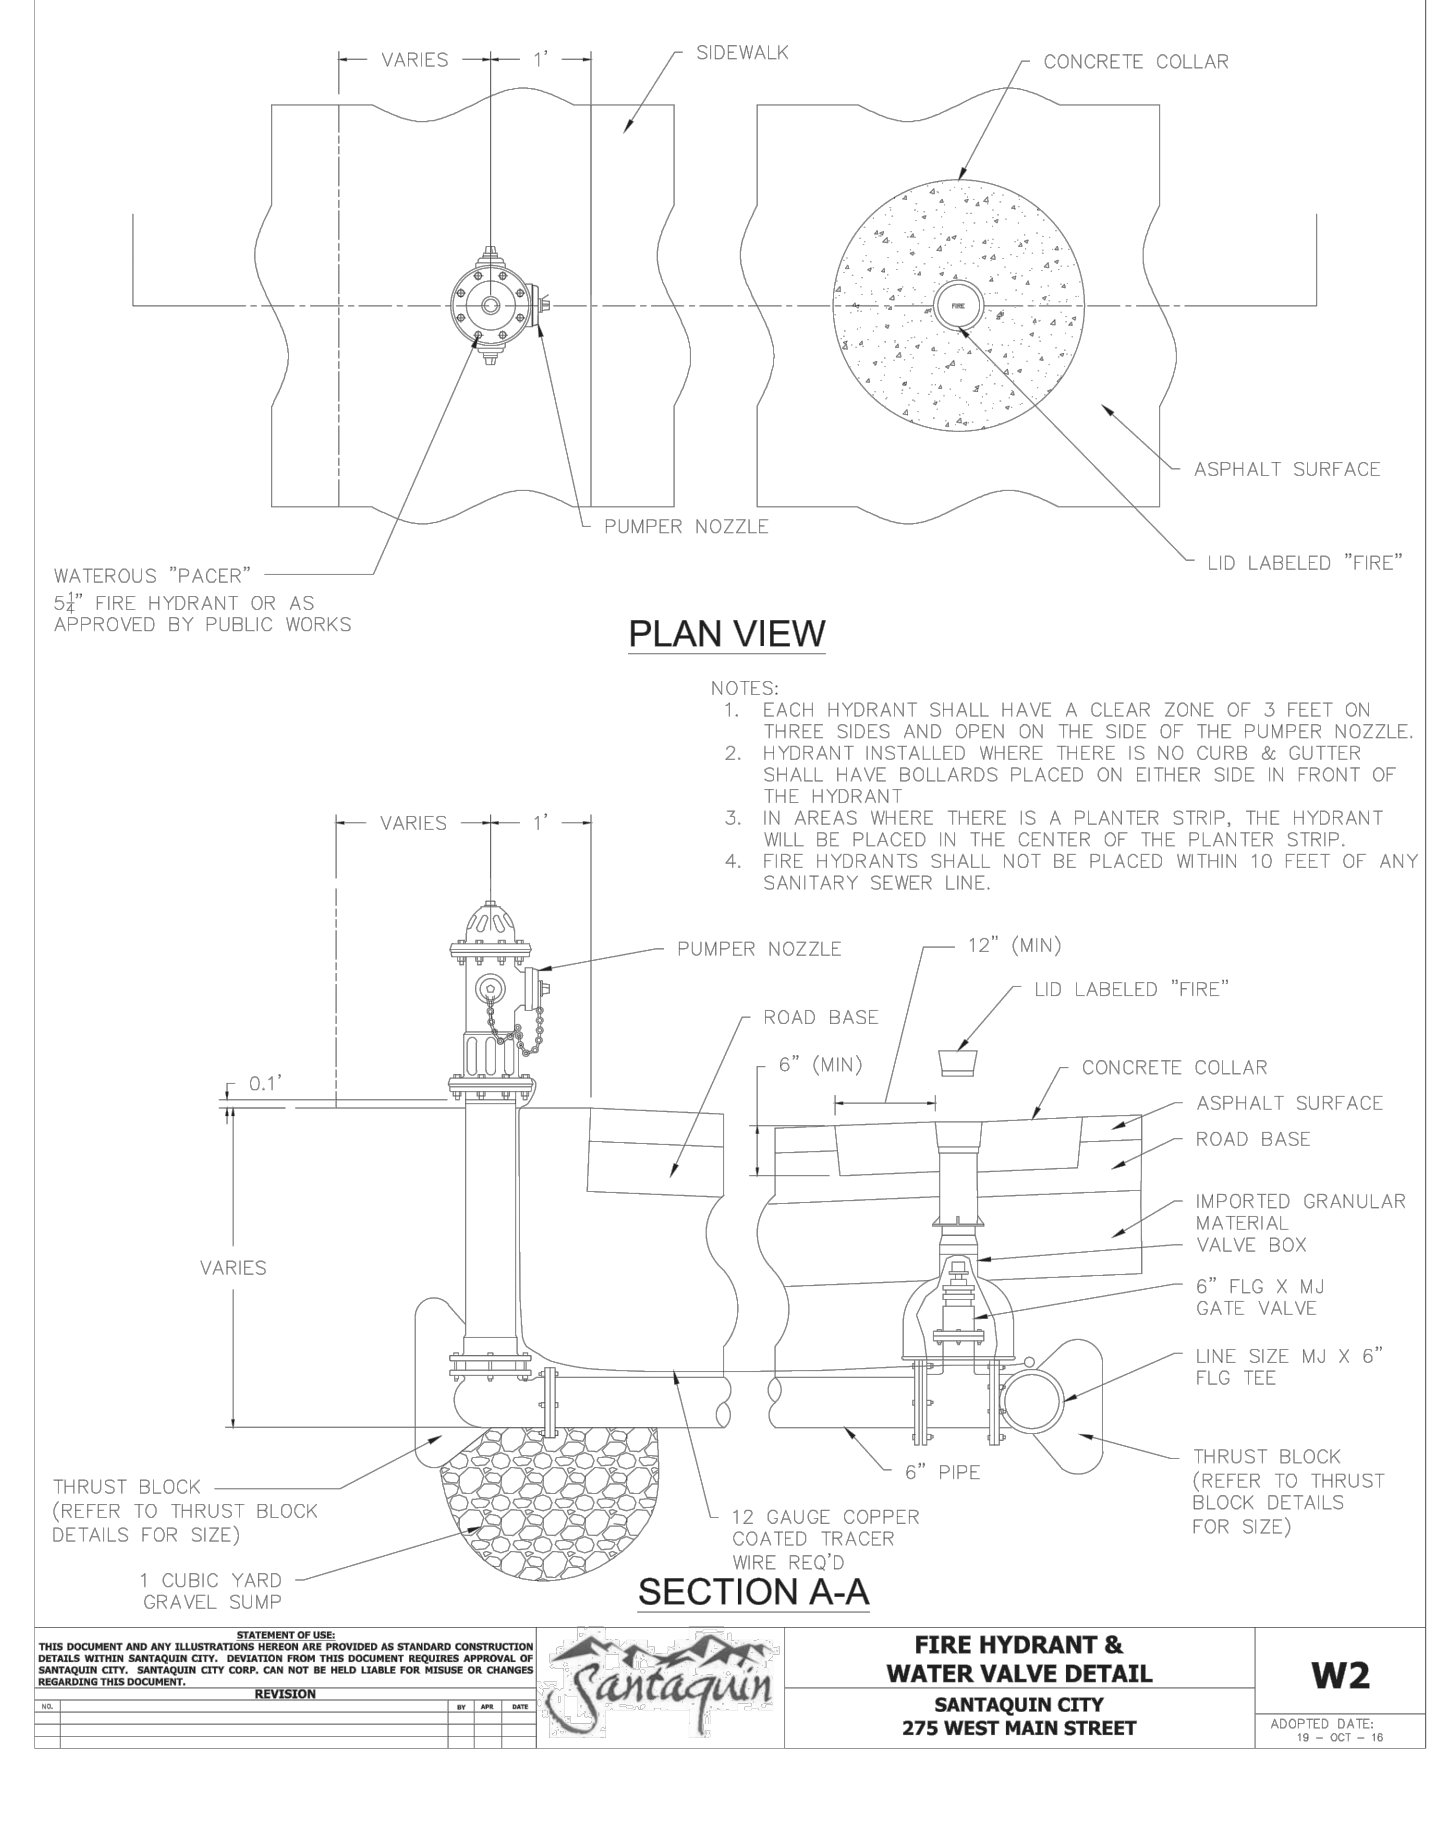

DESIGNED BY: [REDACTED]	DATE: [REDACTED]
DRAWN BY: [REDACTED]	DATE: [REDACTED]
CHECKED BY: [REDACTED]	DATE: [REDACTED]
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NO. [REDACTED]	REVISIONS [REDACTED]
BY [REDACTED]	DATE [REDACTED]
REV. COGO FILE: [REDACTED]	DATE: [REDACTED]

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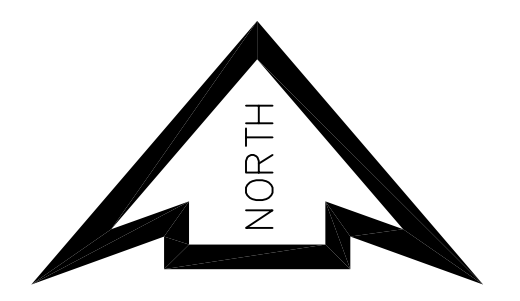
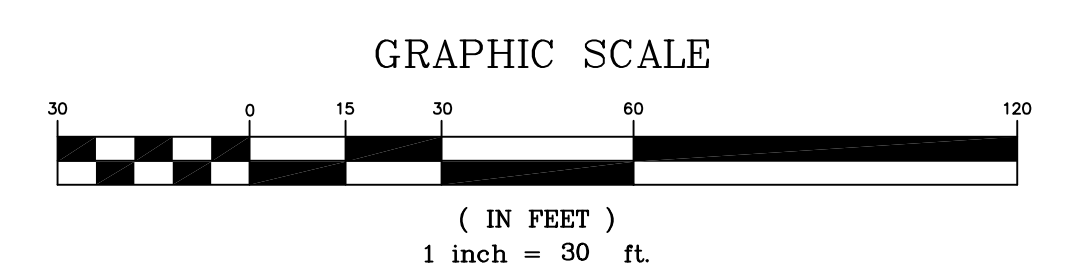
VINCENT OAKS

DETAILS
SANTAQUIN, UTAH

JOB NO.
3-23-014


SHEET NO.
DT-02

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1		COGO FILE:	DATE:
NO.	REVISIONS	BY	DATE
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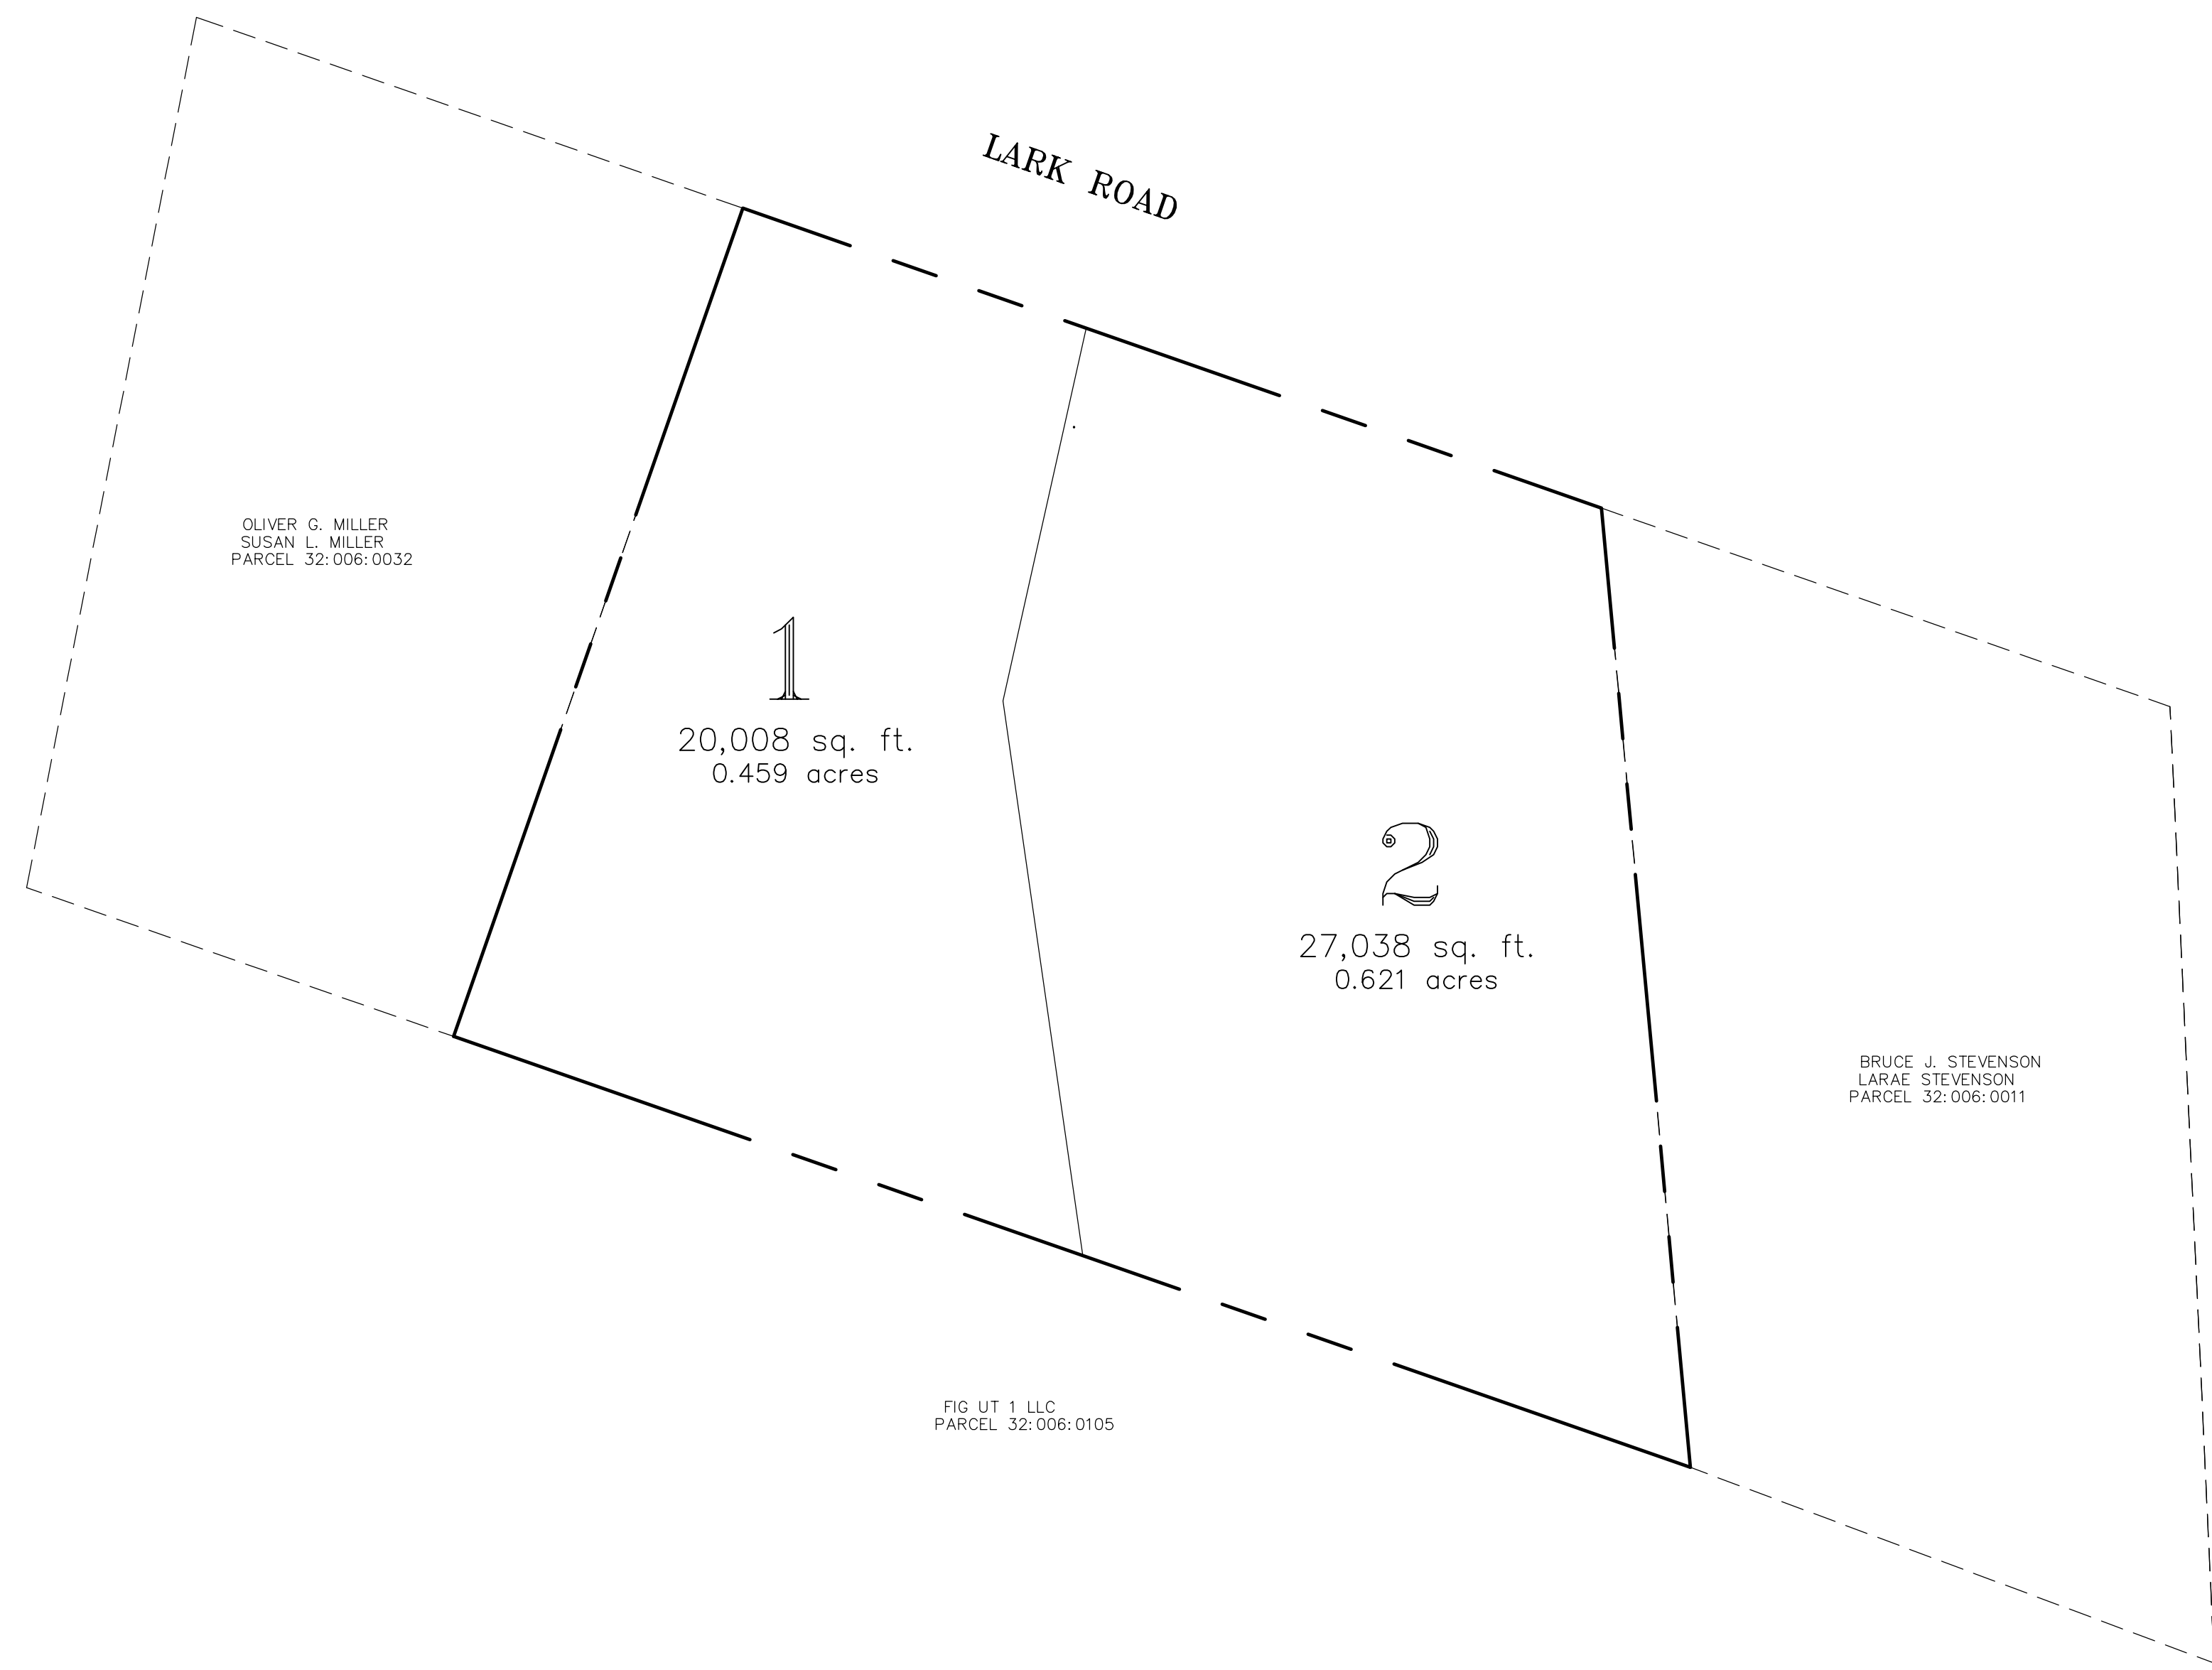


SUTHERLAND SUBDIVISION

PRELIMINARY PLANS

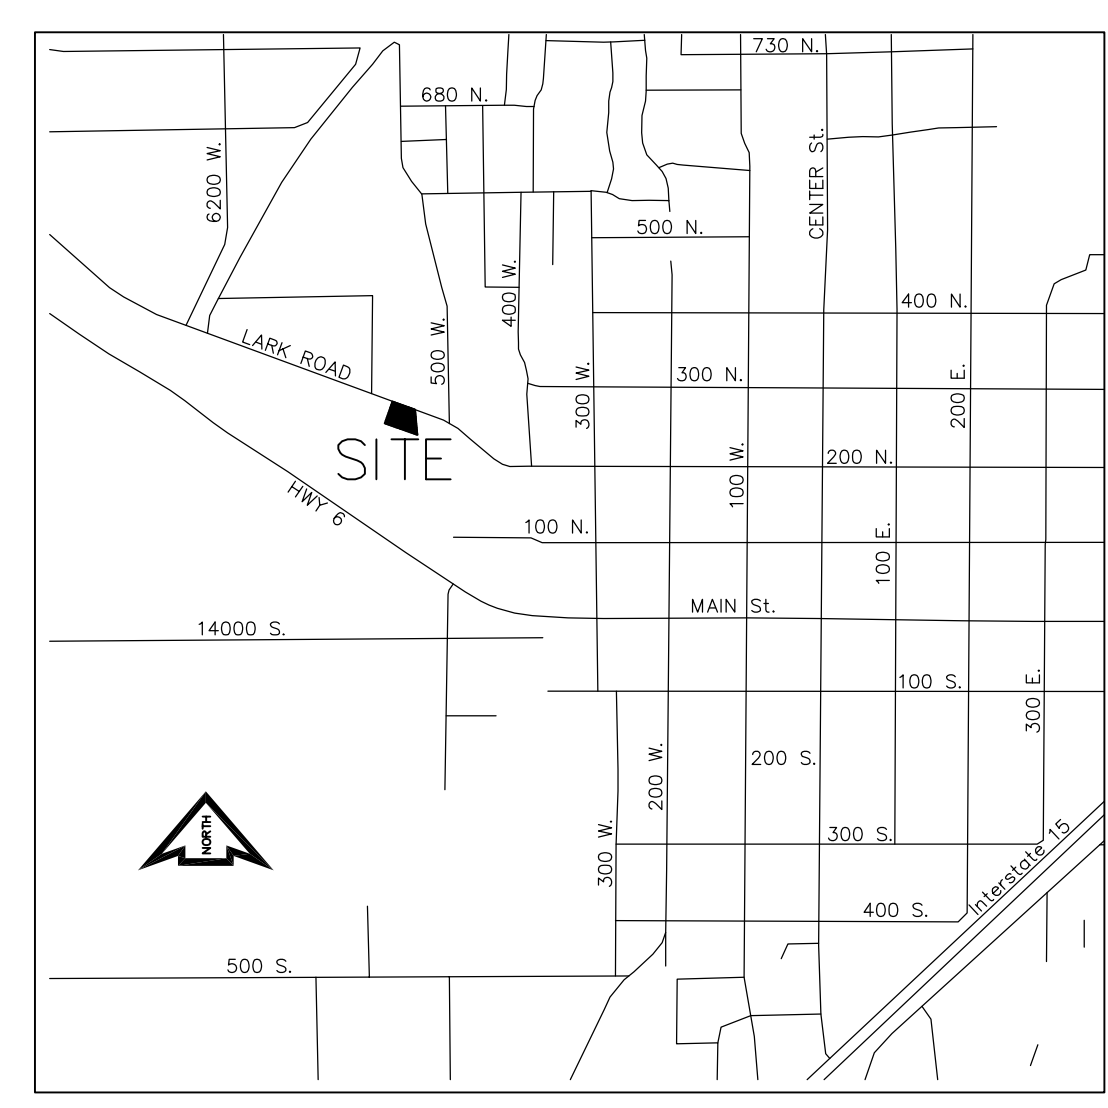

VICINITY MAP
NOT TO SCALE



OWNER/DEVELOPER:
LOGAN MOFFETT
565 WEST LARK ROAD
SANTAQUIN, UT 84655
(385) 212-4127

SURVEYOR/DESIGNER
LEVEL OF FOCUS, INC.
DAVID F. HUNT, PLS.
1334 EAST 1150 SOUTH
SPANISH FORK, UT 84660
(801) 319-5441

ENGINEER
F.J. CLARK AND ASSOCIATES
FRED J. CLARK, P.E.
9448 North Timpanogos Cove
Cedar Hills, Utah 84062
(801) 701-0268

BOUNDARY DESCRIPTION

BEGINNING AT A POINT LOCATED SOUTH 888.89 FEET AND WEST 290.62 FEET FROM THE NORTH QUARTER CORNER OF SECTION 2, TOWNSHIP 10 SOUTH, RANGE 1 EAST, SALT LAKE BASE AND MERIDIAN; THENCE SOUTH 05°17'18" EAST 211.85 FEET; THENCE NORTH 70°47'24" WEST 287.98 FEET; THENCE NORTH 19°15'00" EAST 192.91 FEET; THENCE SOUTH 70°45'00" EAST 200.00 FEET TO THE POINT OF BEGINNING.

AREA = 47,046 SQ. FT. OR 1.080 ACRES

CONTRACTOR NOTE:


THE SIZE, ELEVATION, & LOCATIONS OF EXISTING IMPROVEMENTS AND UTILITIES SHOWN HEREON ARE ASSUMED AND APPROXIMATELY SHOWN BASED UPON THE FIELD DATA FROM THE SURVEY. ALL SIZES, LOCATIONS & ELEVATIONS ARE TO BE VERIFIED. IF THERE ARE DIFFERENCES OR DISCREPANCIES, THE DESIGNER NEEDS TO BE NOTIFIED BEFORE CONSTRUCTION. THE DESIGNER WILL NOT BE LIABLE OR RESPONSIBLE FOR REMOVAL, CONSTRUCTION OR INSTALLATION OF IMPROVEMENTS THAT ARE NOT IN ACCORDANCE WITH THIS PLAN. ANY AND ALL CHANGES OR VARIATIONS IN THE REMOVAL, CONSTRUCTION OR INSTALLATION OF THE IMPROVEMENTS MADE WITHOUT THE APPROVAL OF THE DESIGNER WILL RESULT IN SOLE LIABILITY TO THE CONTRACTOR. IN ADDITION, THE DESIGNER ASSUMES NO RESPONSIBILITY FOR ANY AND ALL EXISTING UTILITIES NOT SHOWN ON THIS PLAN AND ASSUMES NO LIABILITY FOR FAILURE TO EXACTLY LOCATE ALL EXISTING UTILITIES, SHOULD THERE BE INCIDENT.

INDEX OF DRAWINGS

- COVER SHEET (1 OF 3)
- FINAL PLAT (2 OF 3)
- CONCEPT/UTILITY/IMPROVEMENT PLAN (3 OF 3)

BLUE STAKES
CALL **811**
BEFORE YOU DIG

REVISIONS	BY	<p>LEVEL OF FOCUS, INC. DAVID F. HUNT, P.L.S. 1334 EAST 1150 SOUTH SPANISH FORK, UTAH 84660 (801) 319-5441 LEVELOFFOCUS@GMAIL.COM</p>	<p>SUTHERLAND SUBDIVISION</p> <p>COVER SHEET</p> <p style="text-align: right;">UTAH</p>	<p>DESIGNER DFH</p> <p>DATE</p> <p>ADDRESS</p>	<p>DRAWN BY DFH</p> <p>SCALE 1" = 30'</p>	<p>CHECKED BY FJC</p> <p>PROJECT NO.</p>	<p>SHEET</p> <p style="font-size: 2em;">1 OF 3</p>
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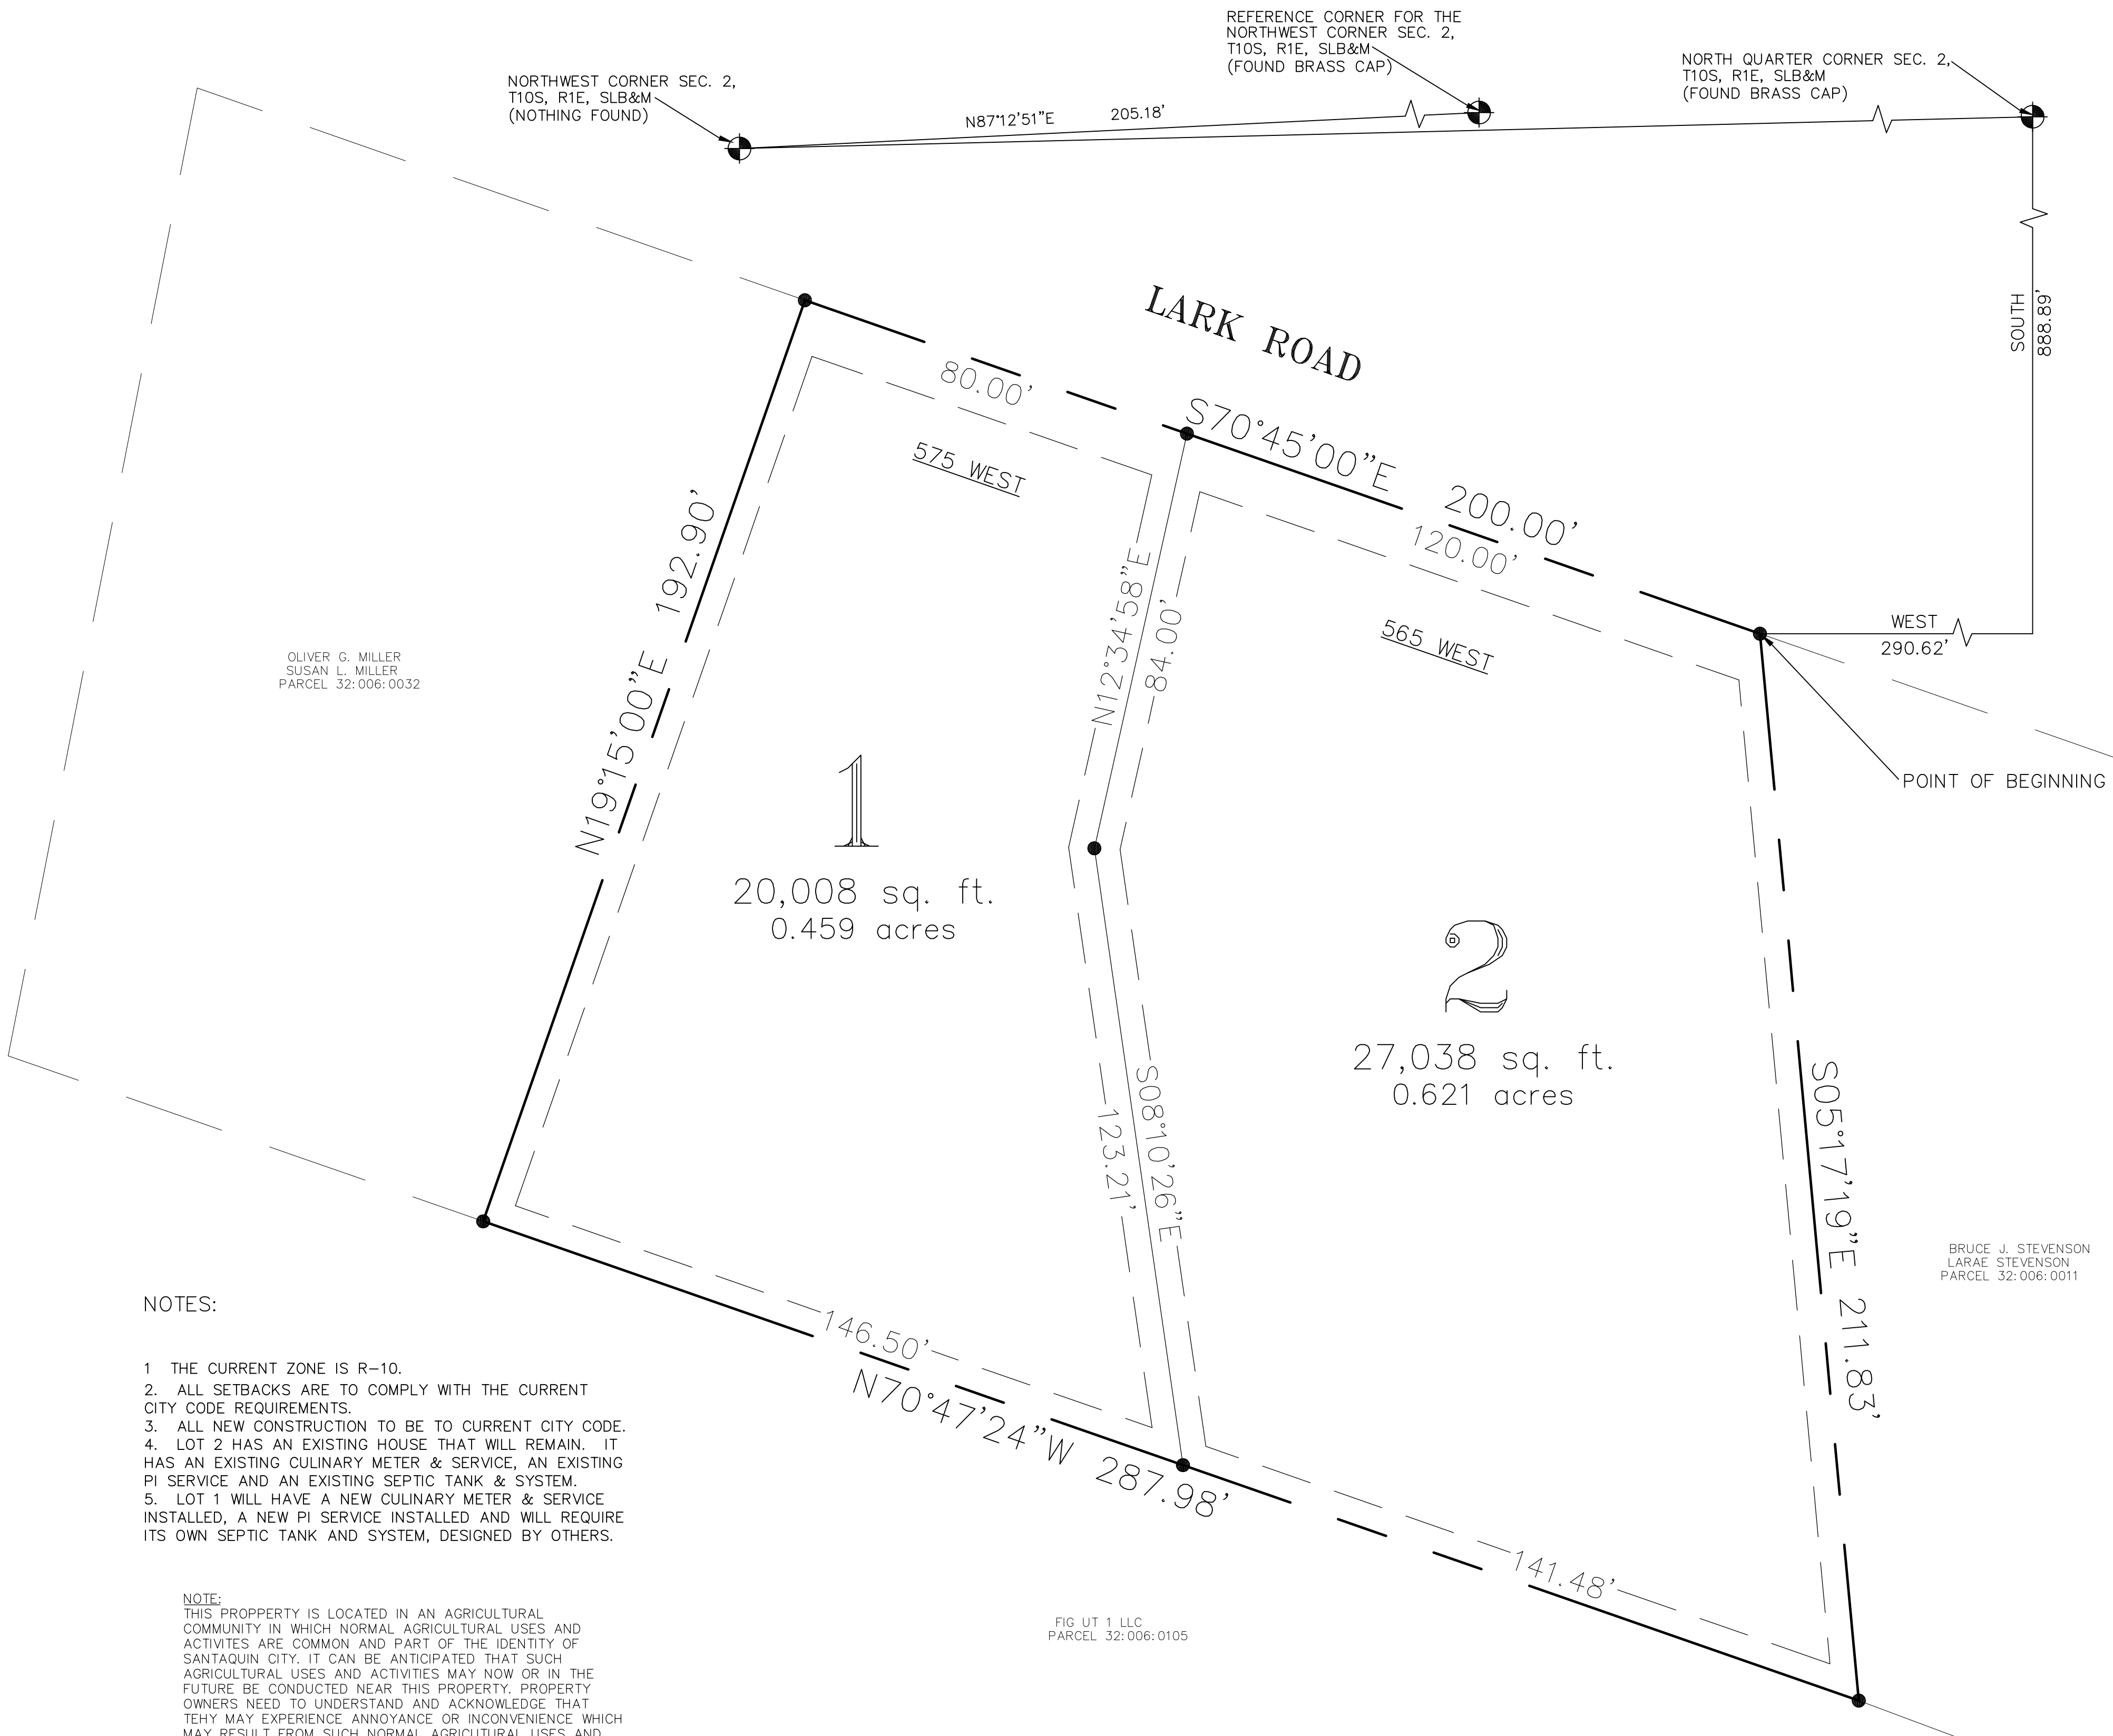
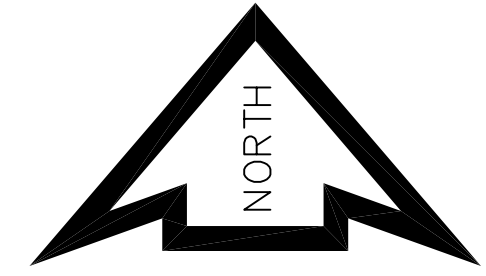
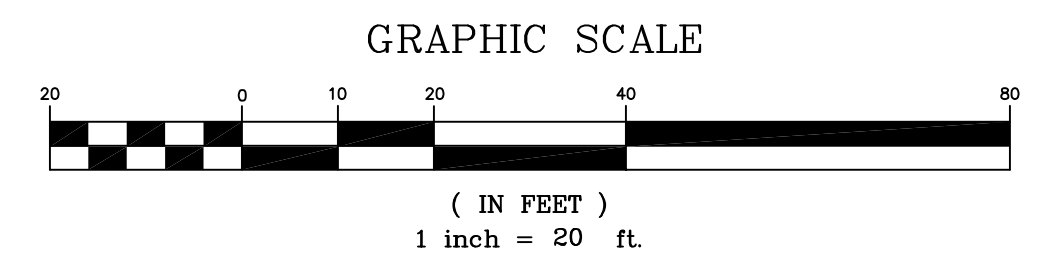
VICINITY MAP
NOT TO SCALE

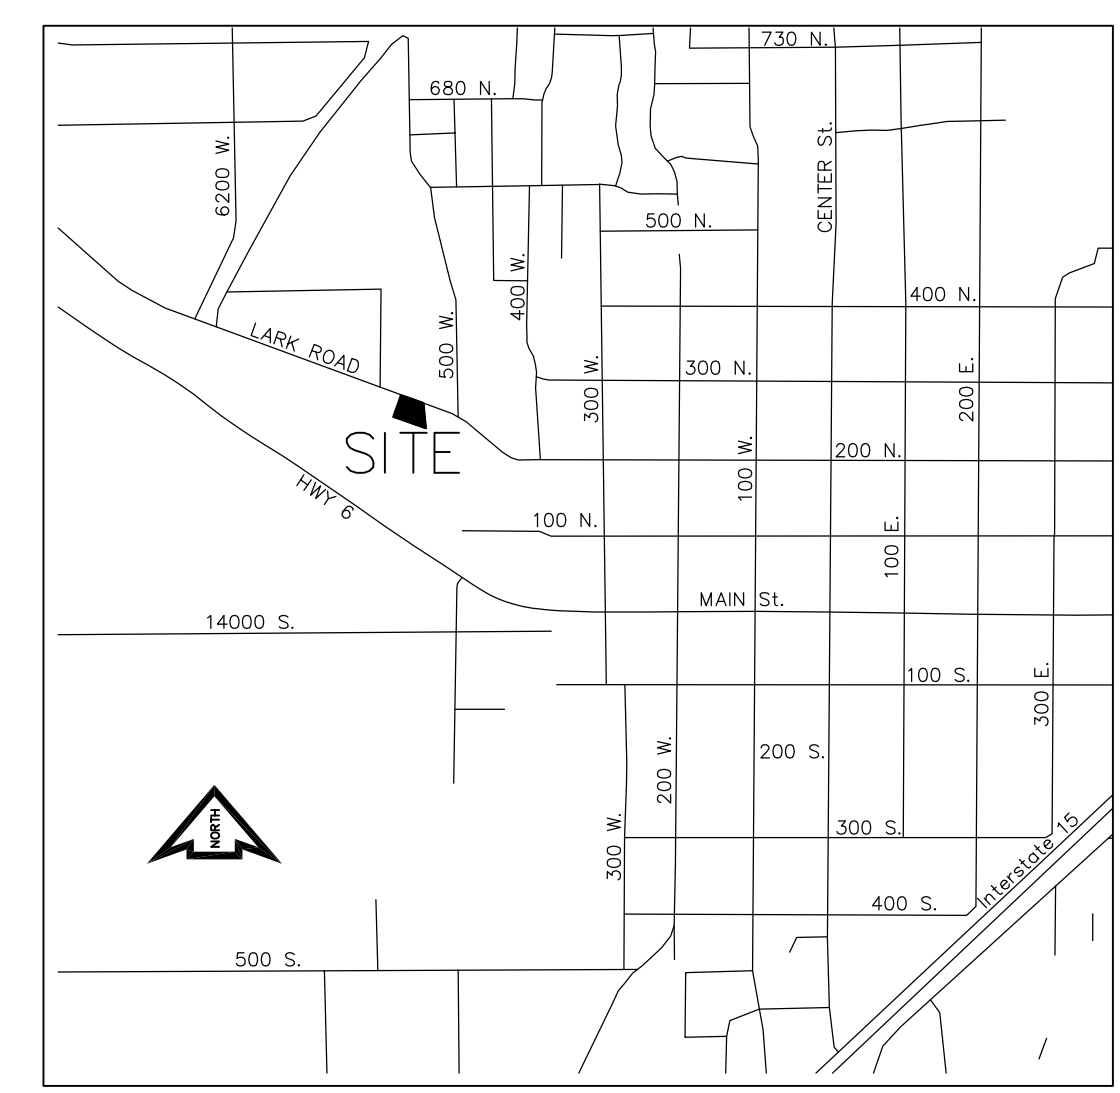SYMBOL LEGEND

- SET NEW 5/8" REBAR & CAP (OR FOUND EXISTING REBAR & CAP)
- ⊕ UTAH COUNTY MONUMENT
- ◇ NOTHING SET
- △ SET PLUG IN CURB ON LOT LINE EXTENSION (WHERE POSSIBLE)
- PROPERTY BOUNDARY
- - - SECTION LINE
- - - EASEMENT
- - - CENTERLINE
- - - CENTERLINE
- - - ADJOINER

SUTHERLAND

LOCATED IN THE NORTHWEST QUARTER OF SECTION 2, T10S, R1E, SALT LAKE BASE AND MERIDIAN



OLIVER G. MILLER
SUSAN L. MILLER
PARCEL 32:006:0032


BRUCE J. STEVENSON
LARAE STEVENSON
PARCEL 32:006:0011

NOTES:

1. THE CURRENT ZONE IS R-10.
2. ALL SETBACKS ARE TO COMPLY WITH THE CURRENT CITY CODE REQUIREMENTS.
3. ALL NEW CONSTRUCTION TO BE TO CURRENT CITY CODE.
4. LOT 2 HAS AN EXISTING HOUSE THAT WILL REMAIN. IT HAS AN EXISTING CULINARY METER & SERVICE, AN EXISTING PI SERVICE AND AN EXISTING SEPTIC TANK & SYSTEM.
5. LOT 1 WILL HAVE A NEW CULINARY METER & SERVICE INSTALLED, A NEW PI SERVICE INSTALLED AND WILL REQUIRE ITS OWN SEPTIC TANK AND SYSTEM, DESIGNED BY OTHERS.

NOTE:
THIS PROPERTY IS LOCATED IN AN AGRICULTURAL COMMUNITY IN WHICH NORMAL AGRICULTURAL USES AND ACTIVITIES ARE COMMON AND PART OF THE IDENTITY OF SANTAQUIN CITY. IT CAN BE ANTICIPATED THAT SUCH AGRICULTURAL USES AND ACTIVITIES MAY NOW OR IN THE FUTURE BE CONDUCTED NEAR THIS PROPERTY. PROPERTY OWNERS NEED TO UNDERSTAND AND ACKNOWLEDGE THAT THEY MAY EXPERIENCE ANNOYANCE OR INCONVENIENCE WHICH MAY RESULT FROM SUCH NORMAL AGRICULTURAL USES AND ACTIVITIES. ADDITIONALLY, PROPERTY OWNERS MUST REFRAIN FROM TRESPASSING ON PRIVATE PROPERTY WHICH CAN NEGATIVELY IMPACT THE INTEGRITY OF AGRICULTURAL LANDS AND BUSINESSES.

FIG UT 1 LLC
PARCEL 32:006:0105

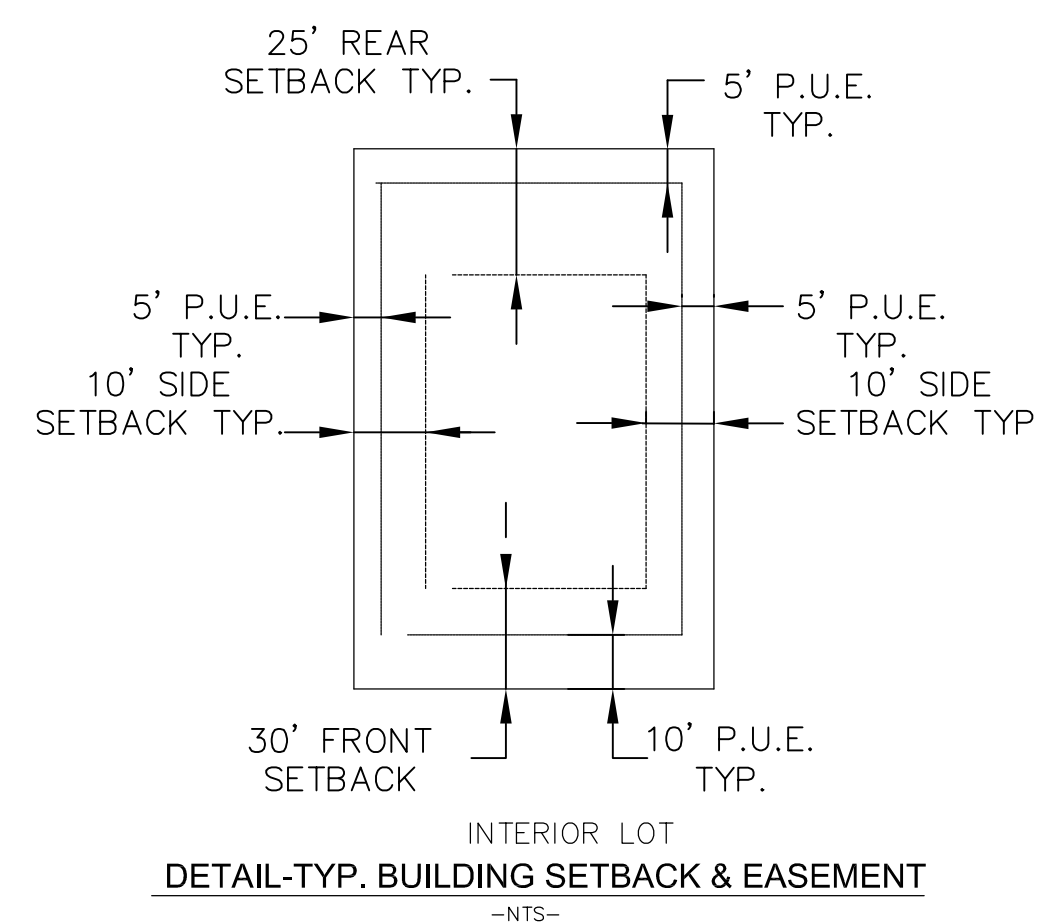

DETAIL-TYP. BUILDING SETBACK & EASEMENT

R-10 SETBACK REQUIREMENTS
FRONT: 30'
SIDE - 10'
REAR - 25'

PREPARED BY:
LEVEL OF FOCUS, INC
David F. Hunt, P.L.S.
1334 East 1150 South
Spanish Fork, Utah 84660
(801) 319-5441

SHEET
2 OF 3

CENTURYLINK APPROVAL
APPROVED THIS ____ DAY OF _____, A.D. 2021.
CENTURYLINK REPRESENTATIVE

CENTRACOM APPROVAL
APPROVED THIS ____ DAY OF _____, A.D. 2021.
CENTRACOM REPRESENTATIVE

ROCKY MOUNTAIN POWER APPROVAL
APPROVED THIS ____ DAY OF _____, A.D. 2021.
ROCKY MOUNTAIN POWER REPRESENTATIVE

DOMINION ENERGY COMPANY
DOMINION ENERGY APPROVES THIS PLAT SOLELY FOR THE PURPOSE OF CONFIRMING THAT THE PLAT CONTAINS PUBLIC UTILITY EASEMENTS. DOMINION ENERGY MAY REQUIRE OTHER EASEMENTS IN ORDER TO SERVE THIS DEVELOPMENT. THIS APPROVAL DOES NOT CONSTITUTE ABROGATION OR WAIVER OF ANY OTHER EXISTING RIGHTS, OBLIGATIONS OR LIABILITIES PROVIDED BY LAW OR EQUITY. THIS APPROVAL DOES NOT CONSTITUTE ACCEPTANCE, APPROVAL OR ACKNOWLEDGEMENT OF ANY TERMS CONTAINED IN THE PLAT, INCLUDING THOSE SET FORTH IN THE OWNERS DEDICATION AND THE NOTES AND DOES NOT CONSTITUTE A GUARENTEE OF PARTICULAR TERMS OF NATURAL GAS SERVICE. FOR FURTHER INFORMATION PLEASE CONTACT DOMINION ENERGY'S RIGHT-OF-WAY DEPARTMENT AT 1-800-366-8532.

APPROVED _____
DOMINION ENERGY REPRESENTATIVE

SURVEYOR'S CERTIFICATE

I, DAVID F. HUNT, DO HEREBY CERTIFY THAT I AM A REGISTERED LAND SURVEYOR, AND THAT I HOLD CERTIFICATE NO. 5243543-2201 AS PRESCRIBED UNDER THE LAWS OF THE STATE OF UTAH. I FURTHER CERTIFY BY AUTHORITY OF THE OWNERS, I HAVE MADE A SURVEY OF THE TRACT OF LAND SHOWN ON THIS PLAT AND DESCRIBED BELOW, AND HAVE SUBDIVIDED SAID TRACT OF LAND INTO LOTS, BLOCKS, STREETS, AND EASEMENTS AND THE SAME HAS BEEN CORRECTLY SURVEYED AND STAKED ON THE GROUND AS SHOWN ON THIS PLAT AND THAT THIS PLAT IS TRUE AND CORRECT.

BOUNDARY DESCRIPTION

BEGINNING AT A POINT LOCATED SOUTH 888.89 FEET AND WEST 290.62 FEET FROM THE NORTH QUARTER CORNER OF SECTION 2, TOWNSHIP 10 SOUTH, RANGE 1 EAST, SALT LAKE BASE AND MERIDIAN; THENCE SOUTH 05°17'18" EAST 211.85 FEET; THENCE NORTH 70°47'24" WEST 287.98 FEET; THENCE NORTH 19°15'00" EAST 192.91 FEET; THENCE SOUTH 70°45'00" EAST 200.00 FEET TO THE POINT OF BEGINNING.

AREA = 47,046 SQ. FT. OR 1.080 ACRES
BASIS OF BEARING = UTAH STATE PLANE COORDINATE SYSTEM, CENTRAL ZONE

01-25-24
DATE
David F. Hunt
SURVEYOR
(See Seal Below)

OWNER'S DEDICATION

KNOW ALL MEN BY THESE PRESENT THAT WE, ALL OF THE UNDERSIGNED OWNERS OF ALL OF THE PROPERTY DESCRIBED IN THE SURVEYOR'S CERTIFICATE HEREON AND SHOWN ON THIS MAP, HAVE CAUSED THE SAME TO BE SUBDIVIDED INTO LOTS, BLOCKS, STREETS AND EASEMENTS AND DO HEREBY DEDICATE THE STREETS AND OTHER PUBLIC AREAS AS INDICATED HEREON FOR PERPETUAL USE OF THE PUBLIC. IN WITNESS WHEREOF WE HAVE HEREUNTO SET OUR HANDS THIS ____ DAY OF _____, A.D. 20__.

A & D RE HOLDINGS INC. BY _____ ITS _____
UTAH HOLDING SERVICES LLC. BY _____ ITS _____

CORPORATE ACKNOWLEDGEMENT

STATE OF UTAH } S.S.
COUNTY OF UTAH }

ON THE ____ DAY OF _____, IN THE YEAR 20__, PERSONALLY APPEARED BEFORE ME _____ WHOSE IDENTITY IS PERSONALLY KNOWN OR PROVEN TO ME AND WHO BY ME DULY SWORN/AFFIRMED, DID SAY THAT THEY ARE THE _____ OF _____ ON BEHALF OF SAID _____ BY AUTHORITY OF ITS BYLAWS, OR RESOLUTION OF ITS BOARD OF DIRECTORS, AND SAID _____ ACKNOWLEDGED TO ME THAT SAID _____ EXECUTED THE SAME.

LLC ACKNOWLEDGEMENT

STATE OF UTAH } S.S.
COUNTY OF UTAH }

ON THE ____ DAY OF _____, IN THE YEAR 20__, PERSONALLY APPEARED BEFORE ME _____ WHOSE IDENTITY IS PERSONALLY KNOWN OR PROVEN TO ME AND WHO BY ME DULY SWORN/AFFIRMED, DID SAY THAT THEY ARE THE _____ OF _____ ON BEHALF OF SAID _____ AND SAID _____ ACKNOWLEDGED TO ME THAT SAID _____ EXECUTED THE SAME.

A NOTARY PUBLIC COMMISSIONED IN THE STATE OF UTAH

MY COMMISSION EXPIRES _____ NOTARY PUBLIC

ACCEPTANCE BY THE LEGISLATIVE BODY


THE CITY COUNCIL OF SANTAQUIN CITY, COUNTY OF UTAH, APPROVES THIS SUBDIVISION AND HEREBY ACCEPTS THE DEDICATION OF ALL STREETS, EASEMENTS, AND OTHER PARCELS OF LAND INTENDED FOR PUBLIC PURPOSES FOR THE PERPETUAL USE OF THE PUBLIC THIS ____ DAY OF _____, A.D. 20__.

APPROVED BY MAYOR _____
APPROVED _____ ATTEST _____
ENGINEER (SEE SEAL) CLERK-RECORDER




SUTHERLAND

LOCATED IN THE NORTHWEST QUARTER OF SECTION 2, T10S, R1E, SALT LAKE BASE AND MERIDIAN
CONTAINS 2 LOTS

SANTAQUIN CITY, _____ SUBDIVISION _____ UTAH COUNTY, UTAH
SCALE: 1" = 20 FEET

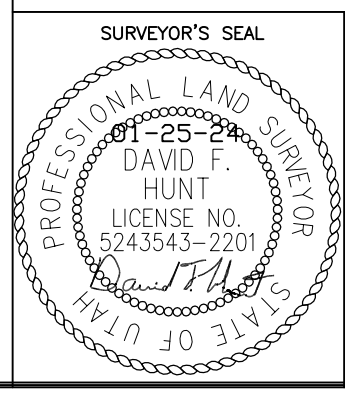

CITY ENGINEER SEAL
CLERK-RECORDER SEAL

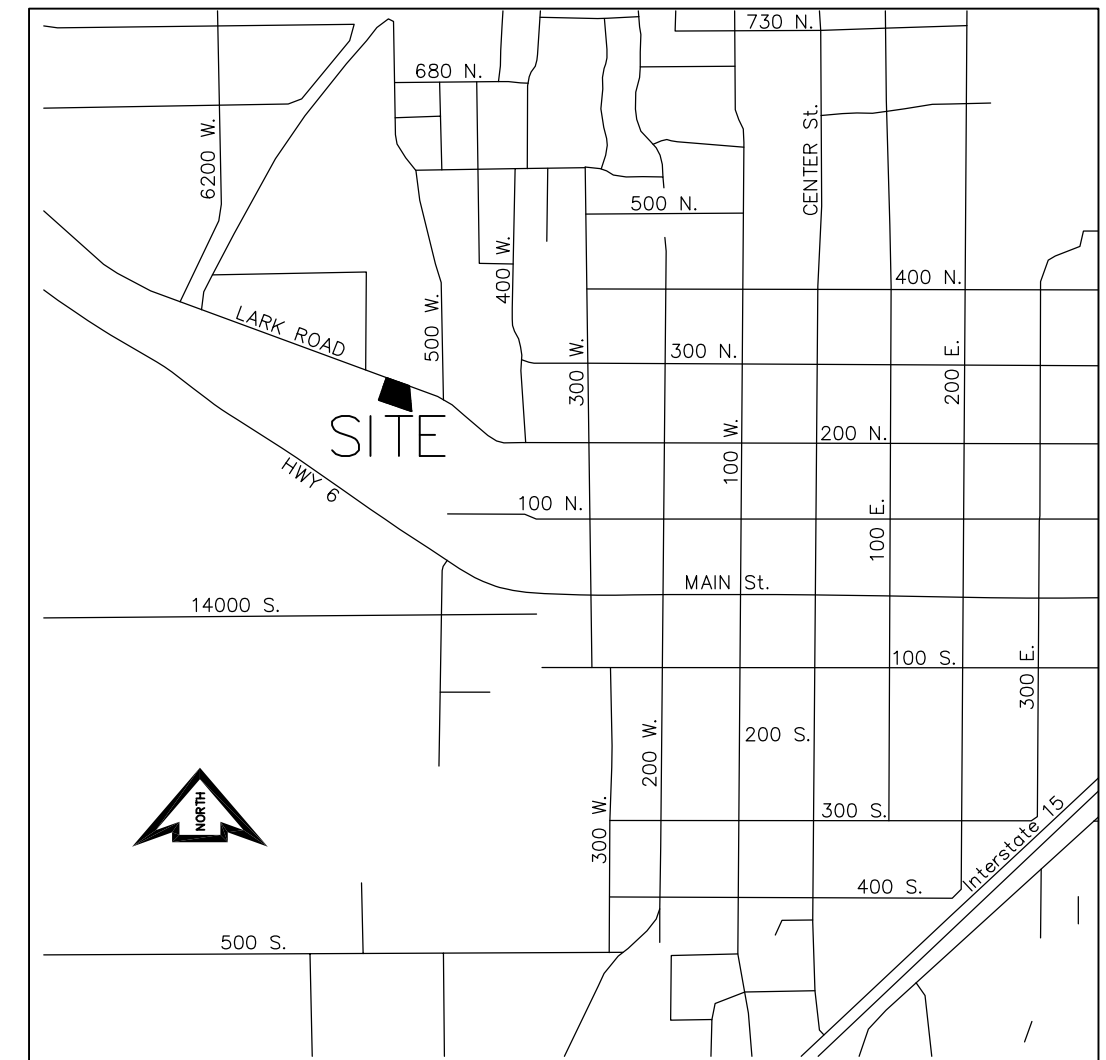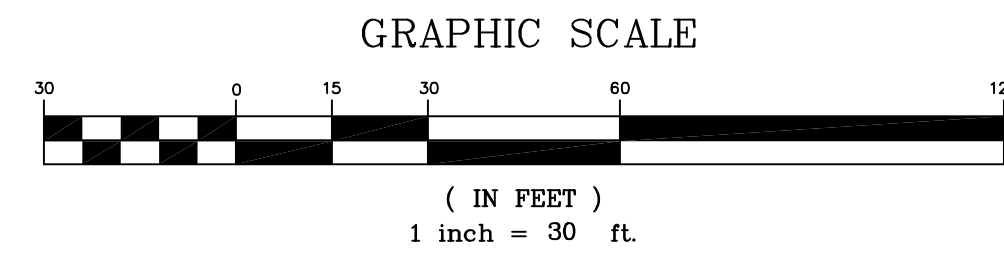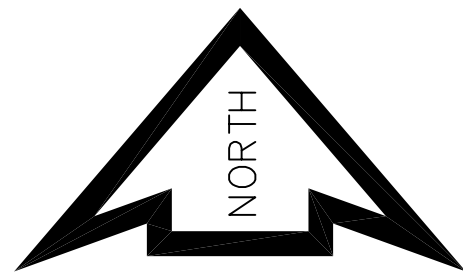



VICINITY MAP
NOT TO SCALE

SYMBOL LEGEND

- SET NEW 5/8" REBAR & CAP (OR FOUND EXISTING REBAR & CAP)
 - ⊕ UTAH COUNTY MONUMENT
 - ◇ NOTHING SET
 - △ SET PLUG IN CURB ON LOT LINE EXTENSION (WHERE POSSIBLE)
-
- — — — — PROPERTY BOUNDARY
 - - - - - SECTION LINE
 - - - - - EASEMENT
 - - - - - CENTERLINE
 - - - - - CENTERLINE
 - - - - - ADJOINER
-
- ⊙ EXISTING SEWER MANHOLE
 - PI — EXISTING PI MAIN (SIZE AS SHOWN)
 - W — EXISTING WATER VALVE
 - CUL — EXISTING WATER MAIN (SIZE AS SHOWN)
 - ⊕ EXISTING FIRE HYDRANT
 - ⊕ PROPOSED WATER SERVICE & METER
 - ⊕ PROPOSED PI SERVICE & METER
 - ⊕ EXISTING POWER/TELEPHONE POLE
 - OHP — EXISTING OVERHEAD POWER LINES
 - OHT — EXISTING OVERHEAD TELEPHONE LINES
 - X — EXISTING FENCES
 - ⊕ EXISTING SURVEY MONUMENT

TABULATIONS



CURRENT ZONE = R-10
 # OF LOTS = 2
 TOTAL AREA = 1.080 ACRES
 TOTAL LOT AREA = 1.080 ACRES
 STREET DEDICATED AREA = 0.00 ACRES
 OPEN SPACE AREA = 0 ACRES
 DENSITY = 1.85 LOTS/ACRE
 LANE MILES = 0.0379 MILES

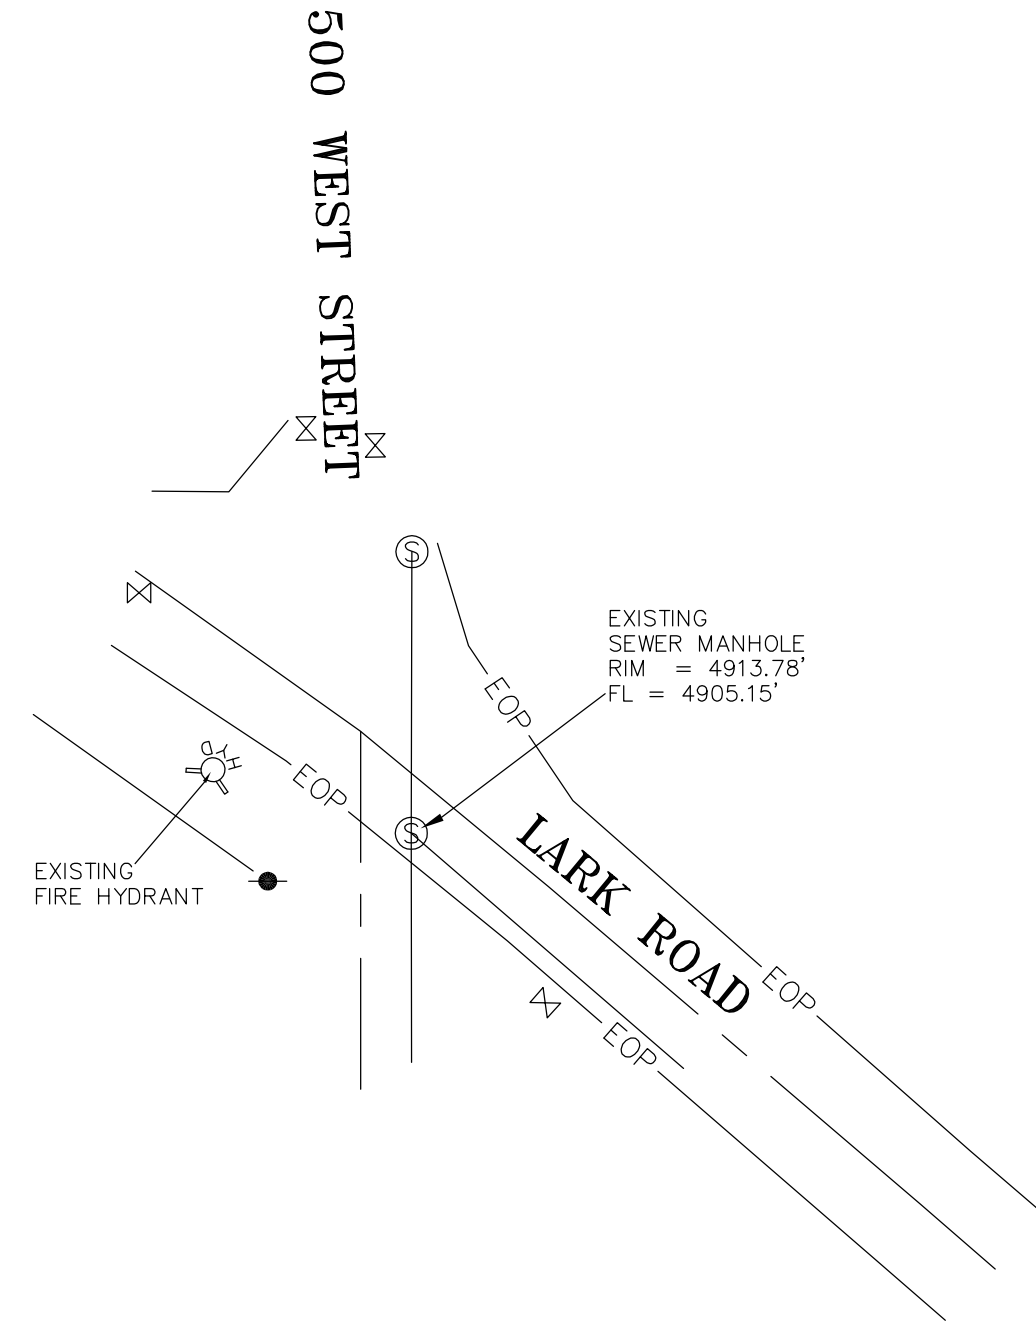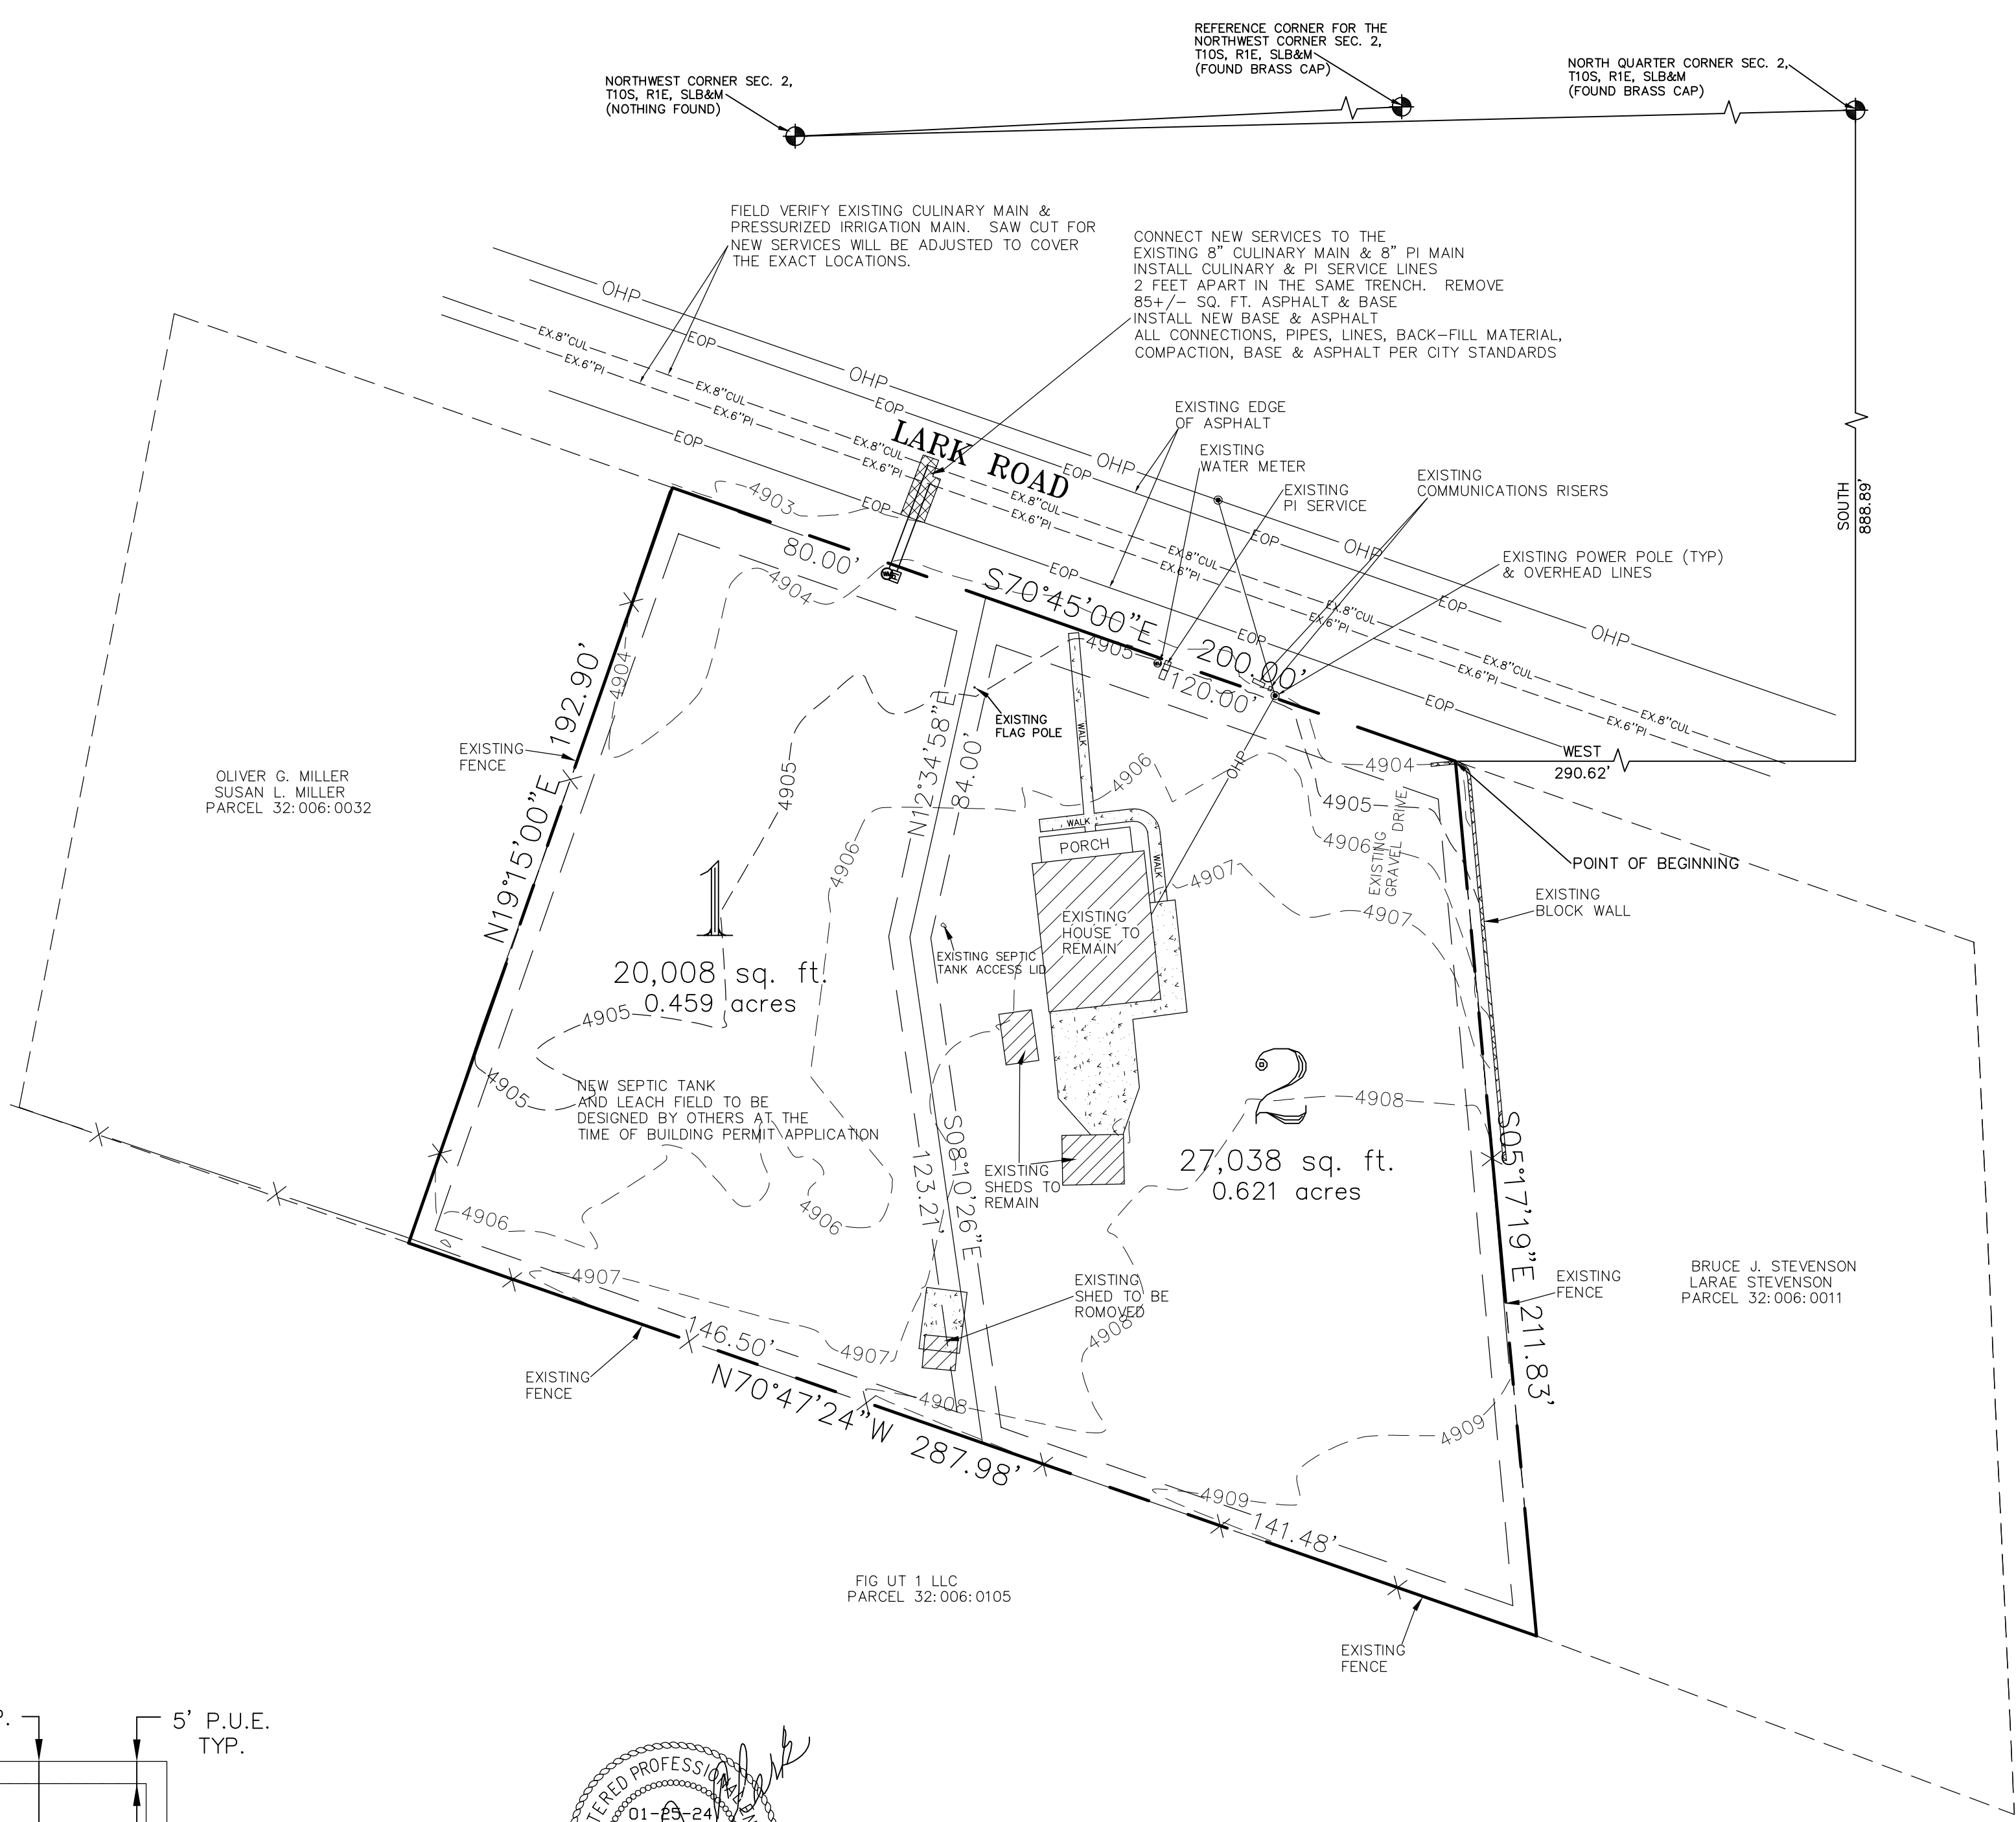

BOUNDARY DESCRIPTION

BEGINNING AT A POINT LOCATED SOUTH 888.89 FEET AND WEST 290.62 FEET FROM THE NORTH QUARTER CORNER OF SECTION 2, TOWNSHIP 10 SOUTH, RANGE 1 EAST, SALT LAKE BASE AND MERIDIAN; THENCE SOUTH 05°17'18" EAST 211.85 FEET; THENCE NORTH 70°47'24" WEST 287.98 FEET; THENCE NORTH 19°15'00" EAST 192.91 FEET; THENCE SOUTH 70°45'00" EAST 200.00 FEET TO THE POINT OF BEGINNING.

AREA = 47,046 SQ. FT. OR 1.080 ACRES

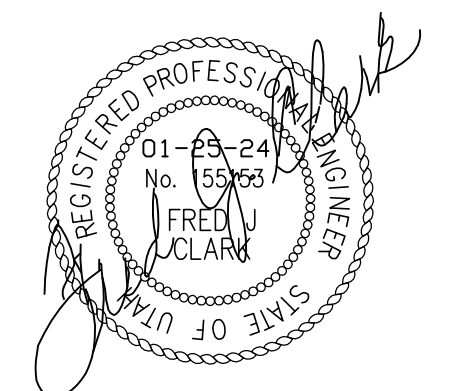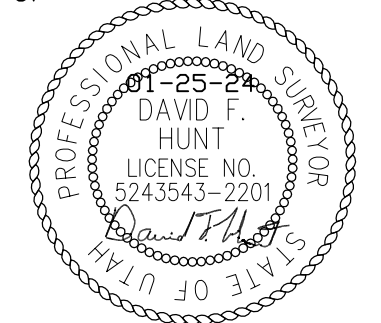


NOTES:

1. THE CURRENT ZONE IS R-10.
2. ALL SETBACKS ARE TO COMPLY WITH THE CURRENT CITY CODE REQUIREMENTS.
3. ALL NEW CONSTRUCTION TO BE TO CURRENT CITY CODE.
4. LOT 2 HAS AN EXISTING HOUSE THAT WILL REMAIN. IT HAS AN EXISTING CULINARY METER & SERVICE, AN EXISTING PI SERVICE AND AN EXISTING SEPTIC TANK & SYSTEM. THE LEACH FIELD FOR LOT 2 WILL NEED TO BE COMPLETELY WITHIN THE BOUNDS OF THE LOT LINES SHOWN. (MAY REQUIRE NEW DESIGN & RELOCATION)
5. LOT 1 WILL HAVE A NEW CULINARY METER & SERVICE INSTALLED, A NEW PI SERVICE INSTALLED AND WILL REQUIRE ITS OWN SEPTIC TANK AND SYSTEM, DESIGNED BY OTHERS. THE SEPTIC DESIGN WILL BE COORDINATED WITH THE BUILDING PERMIT PROCESS FOR THE NEW RESIDENCE.

CONTRACTOR NOTE:

THE SIZE, ELEVATION, & LOCATIONS OF EXISTING IMPROVEMENTS AND UTILITIES SHOWN HEREON ARE ASSUMED AND APPROXIMATELY SHOWN BASED UPON THE FIELD DATA FROM THE SURVEY. ALL SIZES, LOCATIONS & ELEVATIONS ARE TO BE VERIFIED. IF THERE ARE DIFFERENCES OR DISCREPANCIES, THE DESIGNER NEEDS TO BE NOTIFIED BEFORE CONSTRUCTION. THE DESIGNER WILL NOT BE LIABLE OR RESPONSIBLE FOR REMOVAL, CONSTRUCTION OR INSTALLATION OF IMPROVEMENTS THAT ARE NOT IN ACCORDANCE WITH THIS PLAN. ANY AND ALL CHANGES OR VARIATIONS IN THE REMOVAL, CONSTRUCTION OR INSTALLATION OF THE IMPROVEMENTS MADE WITHOUT THE APPROVAL OF THE DESIGNER WILL RESULT IN SOLE LIABILITY TO THE CONTRACTOR. IN ADDITION, THE DESIGNER ASSUMES NO RESPONSIBILITY FOR ANY AND ALL EXISTING UTILITIES NOT SHOWN ON THIS PLAN AND ASSUMES NO LIABILITY FOR FAILURE TO EXACTLY LOCATE ALL EXISTING UTILITIES, SHOULD THERE BE INCIDENT.

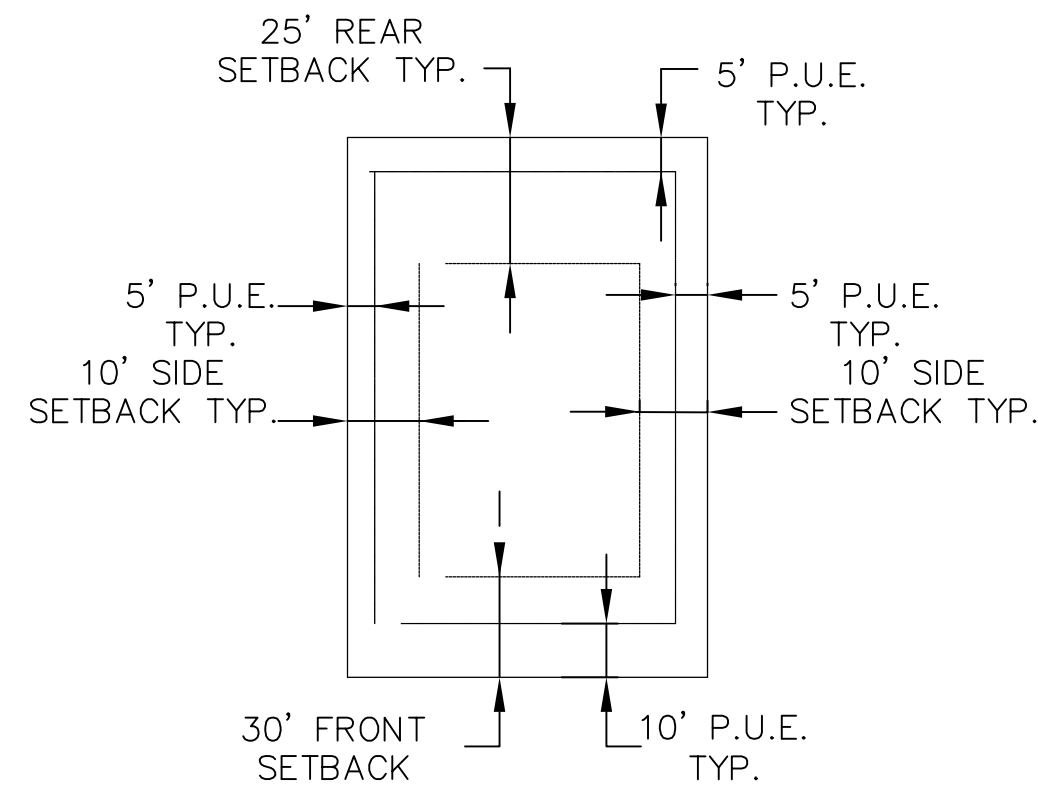

INTERIOR LOT
DETAIL-TYP. BUILDING SETBACK & EASEMENT

R-10 SETBACK REQUIREMENTS
 FRONT: 30'
 SIDE - 10'
 REAR - 25'

NOTE:
 THIS PROPERTY IS LOCATED IN AN AGRICULTURAL COMMUNITY IN WHICH NORMAL AGRICULTURAL USES AND ACTIVITIES ARE COMMON AND PART OF THE IDENTITY OF SANTAQUIN CITY. IT CAN BE ANTICIPATED THAT SUCH AGRICULTURAL USES AND ACTIVITIES MAY NOW OR IN THE FUTURE BE CONDUCTED NEAR THIS PROPERTY. PROPERTY OWNERS NEED TO UNDERSTAND AND ACKNOWLEDGE THAT THEY MAY EXPERIENCE ANNOYANCE OR INCONVENIENCE WHICH MAY RESULT FROM SUCH NORMAL AGRICULTURAL USES AND ACTIVITIES. ADDITIONALLY, PROPERTY OWNERS MUST REFRAIN FROM TRESPASSING ON PRIVATE PROPERTY WHICH CAN NEGATIVELY IMPACT THE INTEGRITY OF AGRICULTURAL LANDS AND BUSINESSES.

BLUE STAKES
 CALL 811
 BEFORE YOU DIG

REVISIONS	BY	LEVEL OF FOCUS, INC. DAVID F. HUNT, P.L.S. 1334 EAST 1150 SOUTH SPANISH FORK, UTAH 84660 (801) 319-5441 LEVELOFFOCUS@GMAIL.COM	SUTHERLAND SUBDIVISION CONCEPT/UTILITY/IMPROVEMENT PLAN	DESIGNER	DRAWN BY	CHECKED BY	SHEET
				DFH	DFH	FJC	3 OF 3
				DATE	SCALE	PROJECT NO.	
				01-25-24	1" = 30'		
				ADDRESS			
				UTAH 565 WEST LARK ROAD, UT			



DRC Members in Attendance: Building Official Randy Spadafora, City Engineer Jon Lundell, Senior Planner Ryan Harris, Police Officer Kayson Shepherd, Fire Chief Ryan Lind, Assistant City Manager Jason Bond.

City Manager Norm Beagley and Public Works Director Jason Callaway were excused from the meeting.

Others in Attendance: Recorder Amalie Ottley, Engineer in Training Megan Wilson, Alex Rugg (CentraCom)

Engineer Lundell called the meeting to order at 10:00 a.m.

1. Hollow Flats Final Plan Review (Phase 2)

A final review of Phase 2 of a 135-lot subdivision approximately located east of Summit Ridge Parkway between S. Stone Brook Lane and S. Cedar Pass Drive.

Representative for the applicant Shawn Herring attended the meeting via Zoom.

Assistant Manager Bond had no comments.

Building Official Spadafora indicated that addressing has been completed for the site.

Fire Chief Lind indicated that the fire hydrants for the site look okay as long as no roadways or exits are blocked.

Senior Planner Harris pointed out that the plans include fruit-bearing crab apple trees. Per code, fruit-bearing trees are not allowed in City maintained landscaping. As such, different trees will have to be determined.

Officer Shepherd had no comments.

City Engineer Lundell addressed the missing storm drain calculations for the phase, adding that each phase will have its own storm drain plans. He pointed out notes regarding the R-Tank LID chambers and the ADS LID chambers asking that the applicant clarify what type of storm drainage tanks will be used. The applicant indicated they plan to install ADS LID chambers and will fix the incorrect labels on the plans. Engineer Lundell inquired if the sewer laterals will be constructed in Phase 2. The applicant indicated the plans are to construct all laterals in this phase. Engineer Lundell discussed that appropriate backfill for the storm drain chambers must be installed as those chambers are placed under sidewalks and driveways. Proper backfill and protection of the chambers will prevent settling in those areas. Engineer Lundell addressed mass grading for the project, indicating that fill for the mass grading must match permits already in place. Mr. Herring asked if a mass grading permit was in place as his understanding was that it wouldn't be implemented until Phase 3 of the project. City staff will follow up with Mr. Herring regarding mass grading permits whether they're in place now or planned for future phases.

Fire Chief Lind made a motion to approve the Hollow Flats Final Plan Review of Phase 2 with the condition that all redlines be addressed. Senior Planner Harris seconded the motion.

Police Officer Kayson Shepherd	Yes
Public Works Director Jason Callaway	Absent
Fire Chief Ryan Lind	Yes
City Manager Norm Beagley	Absent
Senior Planner Ryan Harris	Yes
Building Official Randy Spadafora	Yes
City Engineer Jon Lundell	Yes
Assistant City Manager Jason Bond	Yes

The motion passed.

2. Meeting Minutes Approval

Building Official Spadafora made a motion to approve the January 9, 2024, meeting minutes. Fire Chief Lind seconded the motion.

Police Officer Kayson Shepherd	Yes
Public Works Director Jason Callaway	Absent
Fire Chief Ryan Lind	Yes
City Manager Norm Beagley	Absent
Senior Planner Ryan Harris	Yes
Building Official Randy Spadafora	Yes
City Engineer Jon Lundell	Yes
Assistant City Manager Jason Bond	Yes.


The motion passed.

Adjournment

Fire Chief Lind made a motion to adjourn.

The meeting was adjourned at 10:11 a.m.

Jon Lundell, City Engineer

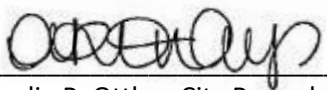

Amalie R. Ottley, City Recorder