

DEVELOPMENT REVIEW COMMITTEE

Tuesday, November 02, 2021, at 10:00 AM Court Room/Council Chambers (2nd Floor) and Online

MEETINGS HELD IN PERSON & ONLINE

The public is invited to participate as outlined below:

- In Person Meetings are held on the 2nd floor in the Court Room/Council Chambers at City Hall
- YouTube Live Public meetings will be shown live on the Santaquin City YouTube Channel, which can be found at https://bit.ly/2P7ICfQ or by searching for Santaquin City Channel on YouTube.

ADA NOTICE

If you are planning to attend this Public Meeting and due to a disability need assistance in understanding or participating in the meeting, please notify the City Office ten or more hours in advance and we will, within reason, provide what assistance may be required.

AGENDA

NEW BUSINESS

1. Santaquin Estates Preliminary Review

A preliminary review of a proposed 77-lot residential subdivision located at approximately Main Street and 900 E.

2. Ridley's 3-lot Commercial Subdivision Preliminary/Final Review

A preliminary/final review of a 3-lot commercial subdivision located at approximately Main Street and 500 E.

AJOURNMENT

CERTIFICATE OF MAILING/POSTING

The undersigned duly appointed City Recorder for the municipality of Santaquin City hereby certifies that a copy of the foregoing Notice and Agenda was e-mailed to the Payson Chronicle, Payson, UT, 84651, posted on www.santaquin.org, as well as posted on the State of Utah's Public Notice Website.

BY.

K. Aaron Shirley, City Recorder

SANTAQUIN ESTATES PRELIMINARY PLANS SANTAQUIN, UTAH

prepared for:

FLAGSHIP HOMES

170 SOUTH INTERSTATE PLAZA SUITE 250 LEHI, UT 84043

PHONE: (801)766-2592

prepared by:

TRANE ENGINEERING

27 EAST MAIN STREET

LEHI, UT 84043 PHONE: (801) 768-4544

GENERAL NOTES:

General Construction Note

1. All Mainline piping shall be placed with a minimum of 4'-0" cover over the top of the pipe. Gas lines shall be placed with a minimum of 2'-0" cover.

150 unless otherwise approved by the city.
3. All new culinary water and pressurized irrigation main line pipe shall be 8"in diameter.
4. A minimum of 50 PSI static pressure shall be required at all points in the culinary water system

2. All new culinary water and pressurized irrigation main line pipe shall be PVC C900 DR 18 class

4. A minimum of 50 PSI static pressure shall be required at all points in the culinary water system within the boundaries of all new subdivisions.

5. Culinary water service meter boxes shall be located within the 2'strip between the sidewalk and

the property line. Meters shall be located only in landscaped areas.

6. The minimum required fire flow at the fire hydrant locations shall be 1500 GPM.

7. When required, pressure reducing valve vaults (PRV) shall be located as directed by the City or City Engineer. The City or City Engineer shall provide the contractor with the appropriate downstream

8. Fire hydrants shall be located at all intersections. The maximum spacing between fire hydrants shall not exceed 500'measured along a public right—of—way.

9. Air pressure testing dry culinary water or pressurized irrigation pipe lines shall be in accordance

with manufacturers recommendations.

10. Only City personnel shall open and close city water valves, unless otherwise approved in writing by

11. All water samples for culinary water testing shall be collected and delivered by City personnel. The

contractor shall pay for the testing expense.

12. Tapping into water lines shall not be allowed in groundwater or mud.

13. All culinary water and pressurized irrigation mainline valves shall be located in line with corner lot property lines. The number of valves shall be as follows: 90° ELL -1 valve Tee -2 valves Cross -3 valves Additional valves may be required by the City.

14. ELK RIDGE City shall reserve the right to require the developer to submit a soils investigation report that has been prepared by a registered professional engineer. If in the opinion of the City staff or the City Engineer, the development site contains questionable soils or high water table.

15. All mainline sewer piping sizes 8" to 15" shall be PVC and shall be supplied in lengths no longer than 13'. Main line pipe sizes 18" and larger shall be reinforced concrete pipe.

16. All sewer service laterals taps on existing lines shall be "inserta—tee—type" connections.

17. The maximum depth of any cul-de-sac shall be 400'measured from the start of the road to the beginning of the cul-de-sac. The radius of all cul-de-sacs shall be 50'measured from the center of the cul-de-sac to the top back of curb.

18. The contractor shall provide, install, and maintain all road construction, barricades, channeling

devices, and construction signs in accordance with the Manual of Uniform Traffic Control Devices (MUTCD) for road construction activities.

19. Traffic access shall be maintained for local residents to properties along construction boundaries.

20. Work performed with the State Highway rights—of—way shall conform to State of Utah specifications for excavation on State Highway prepared by the Department of Transportation.

21. All debris resulting from work on the project shall be disposed of by the contractor. The contractor shall make appropriate arrangements for disposal sites at which debris may be lawfully disposed.

22. No open burning of construction debris shall be allowed.

23. The contractor shall provide mailboxes and posts according to US Postal Service standards and

shall place them in the planter strips at locations designated by the City.

24. Developers are required to install a minimum of half the right—of—way plus 12'.

SHEET INDEX

SHEET NO. SHEET NAME

COVER SHEET

2 PRELIMINARY UTILITY PLAN

3 PRELIMINARY GRADING & DRAINAGE PLAN

PLAT PRELIMINARY PLAT

LAND USE: PLAT "A" =

PLAT "A" = 30.86 ACRES

ZONING= R-10 (PRD)

TOTAL LOTS= 77 LOTS


ACREAGE IN LOTS= 15.15 ACRES

ACREAGE IN ROW= 8.11 ACRES

ACREAGE OPEN SPACE= 2.18 ACRES

ACREAGE COMMERCIAL= 5.42 ACRES

DENSITY OVERALL = 2.43 LOTS/ACRE

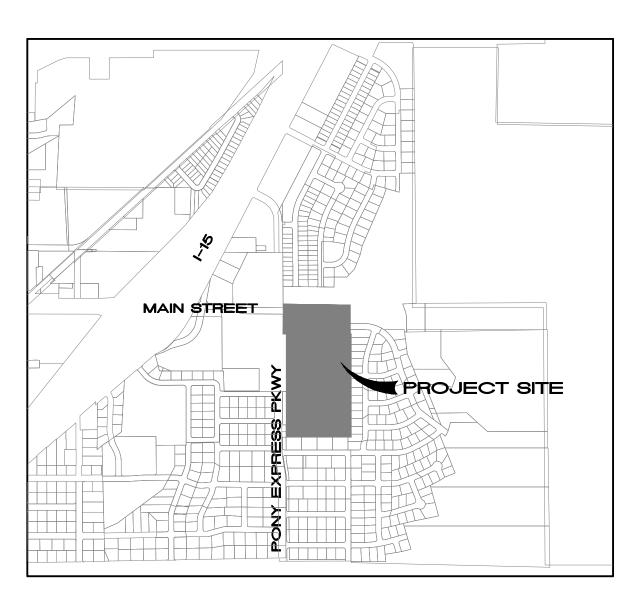

VICINITY MAP



BENCHMARK

EAST QUARTER CORNER OF SECTION 2, TOWNSHIP 9S, RANGE 2E ELEVATION = 4577.63





CONSULTING ENGINEERS AND LAND SURVEYORS
27 EAST MAIN LEHI, UTAH 84043 (801) 768-4544

SANTAQUIN, UTAH

200 SOUTH

SITE MAP

150 SOUTH

MAIN STREET


150 SOUTH


SANTAQUIN ESTATES
A RESIDENTIAL SUBDIVISION


COVER SHEET

FS HARMONY
SHEET NO.
1

REVISI□NS						
N□.	DATE	DESCRIPTION	BY	DESIGNED BY:	TGT	
1				DRAWN BY:	TT	
2				CHECK BY:	TGT	
3				DATE:	7/16/21	
4				COGO FILE:		
J:\FLAGSHIP\HARMONY\dwg\01_COVER.dwg						

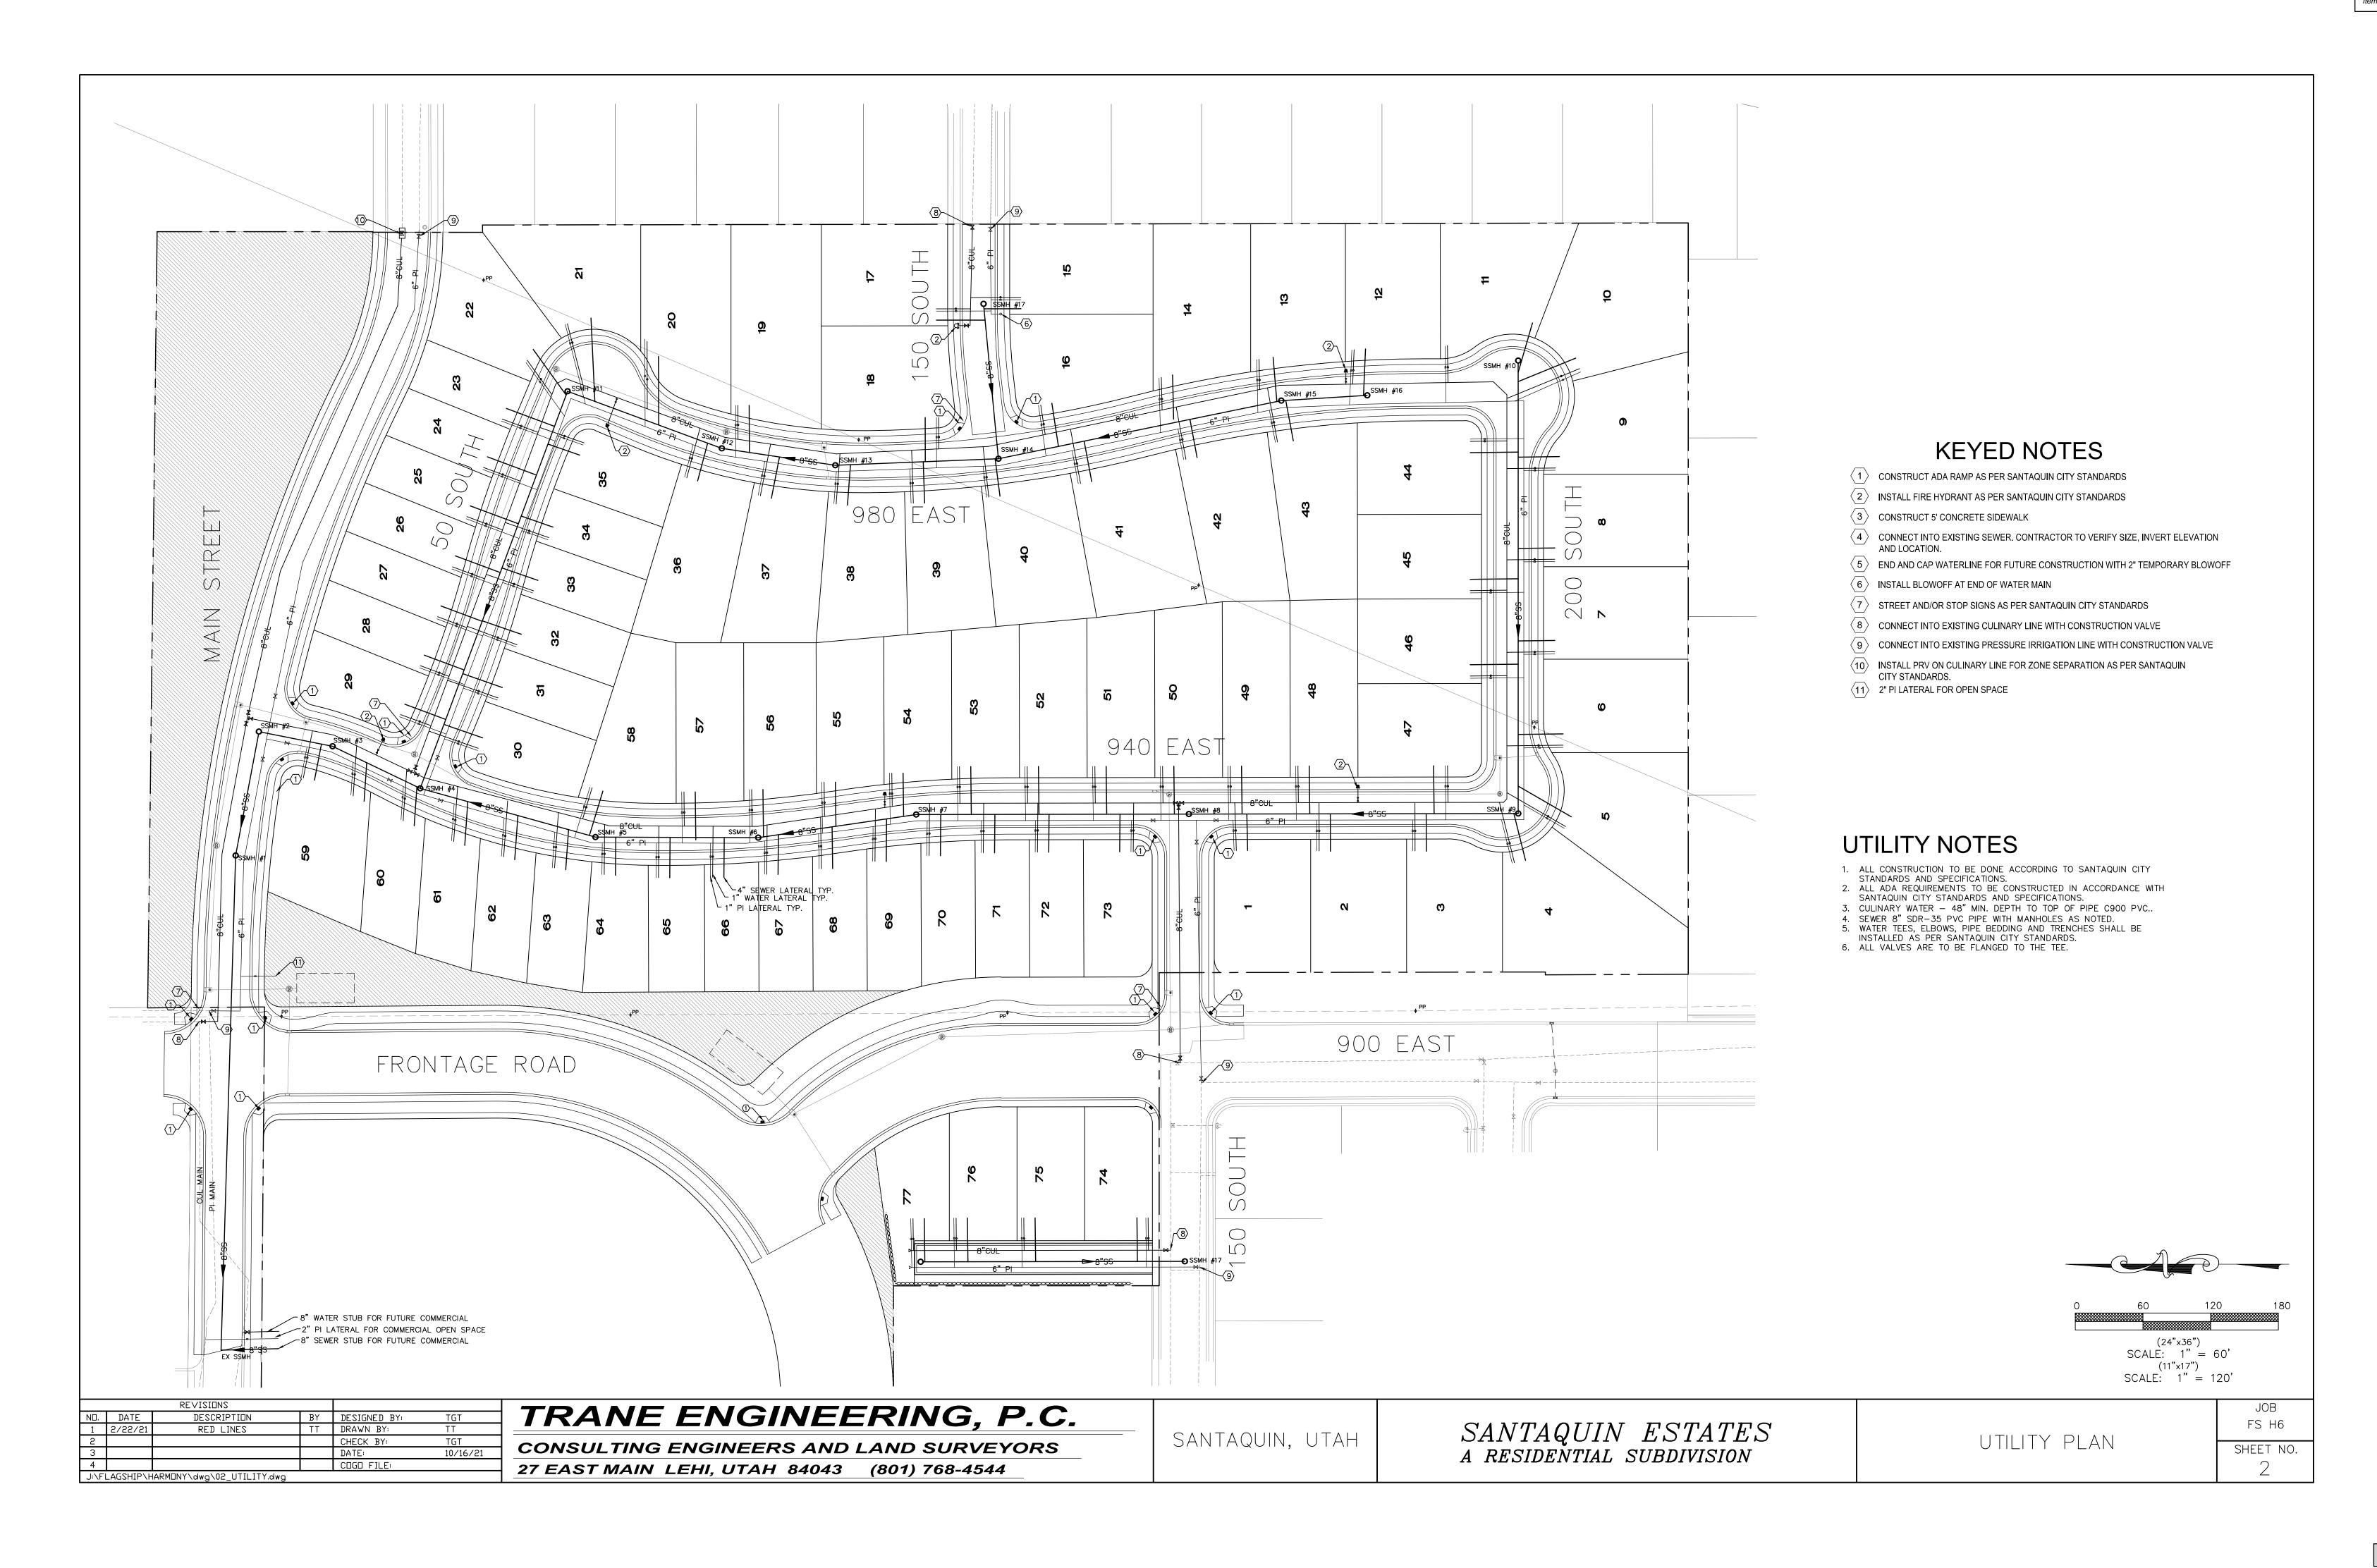

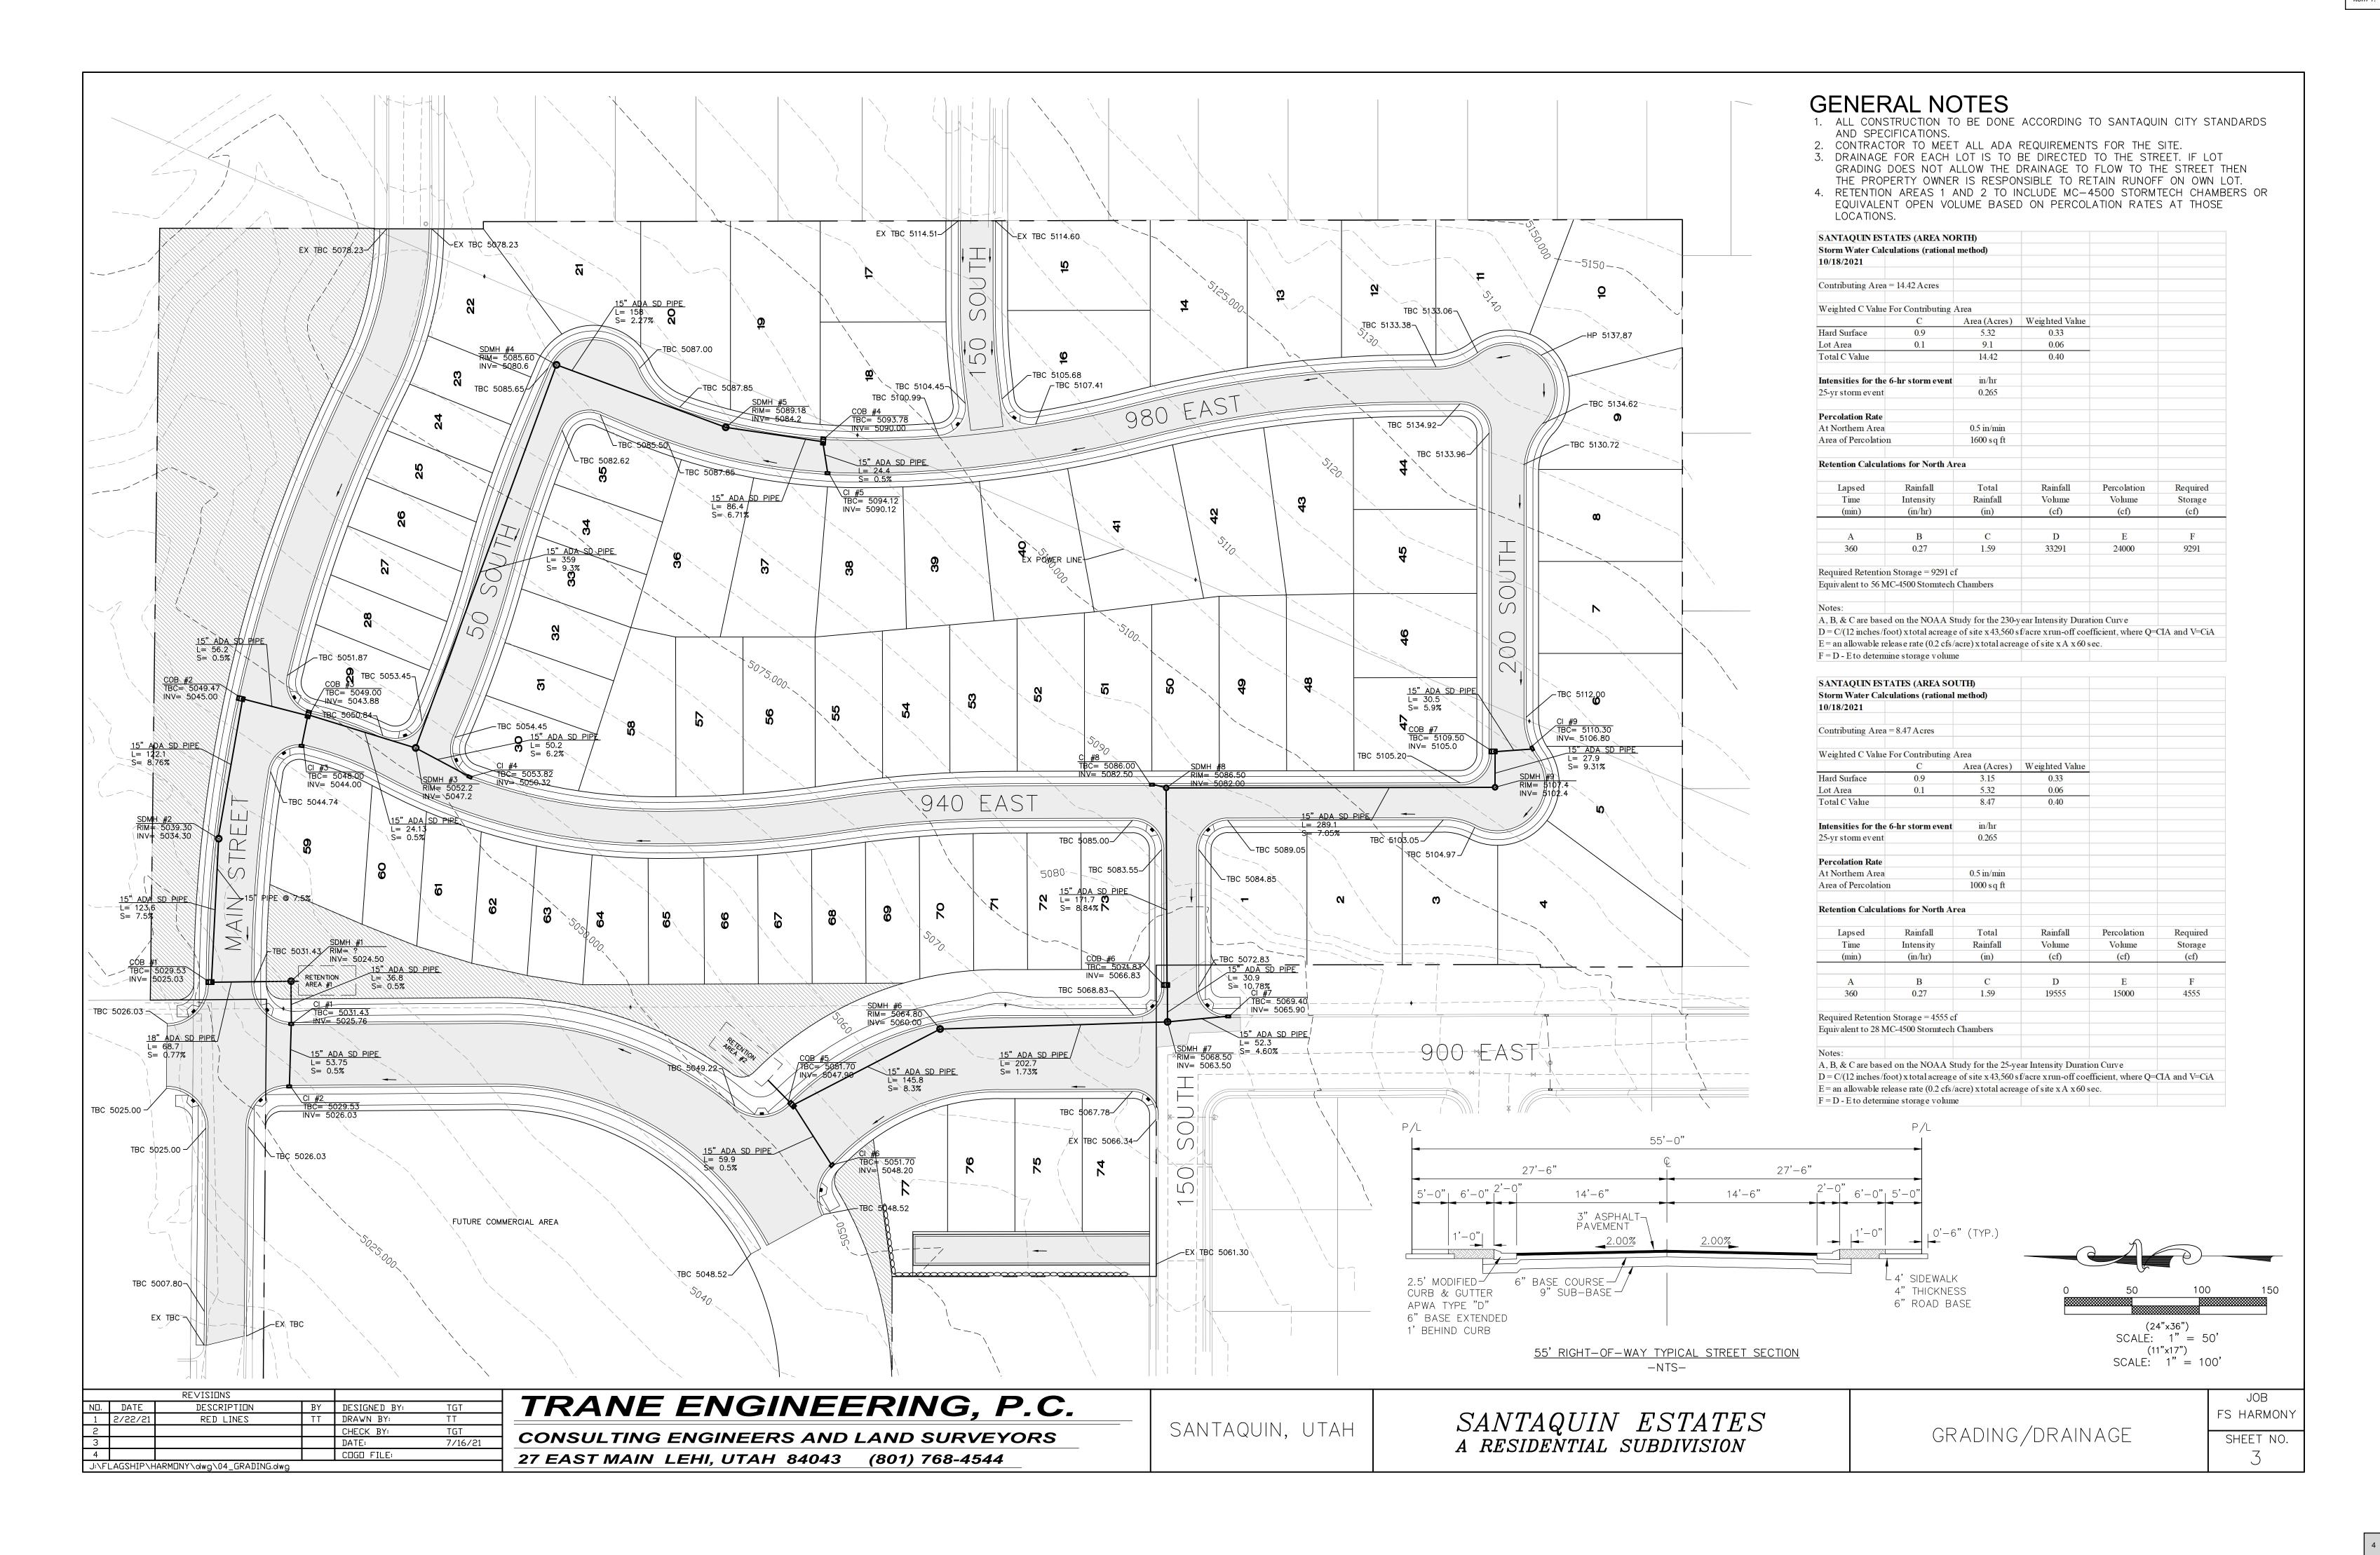

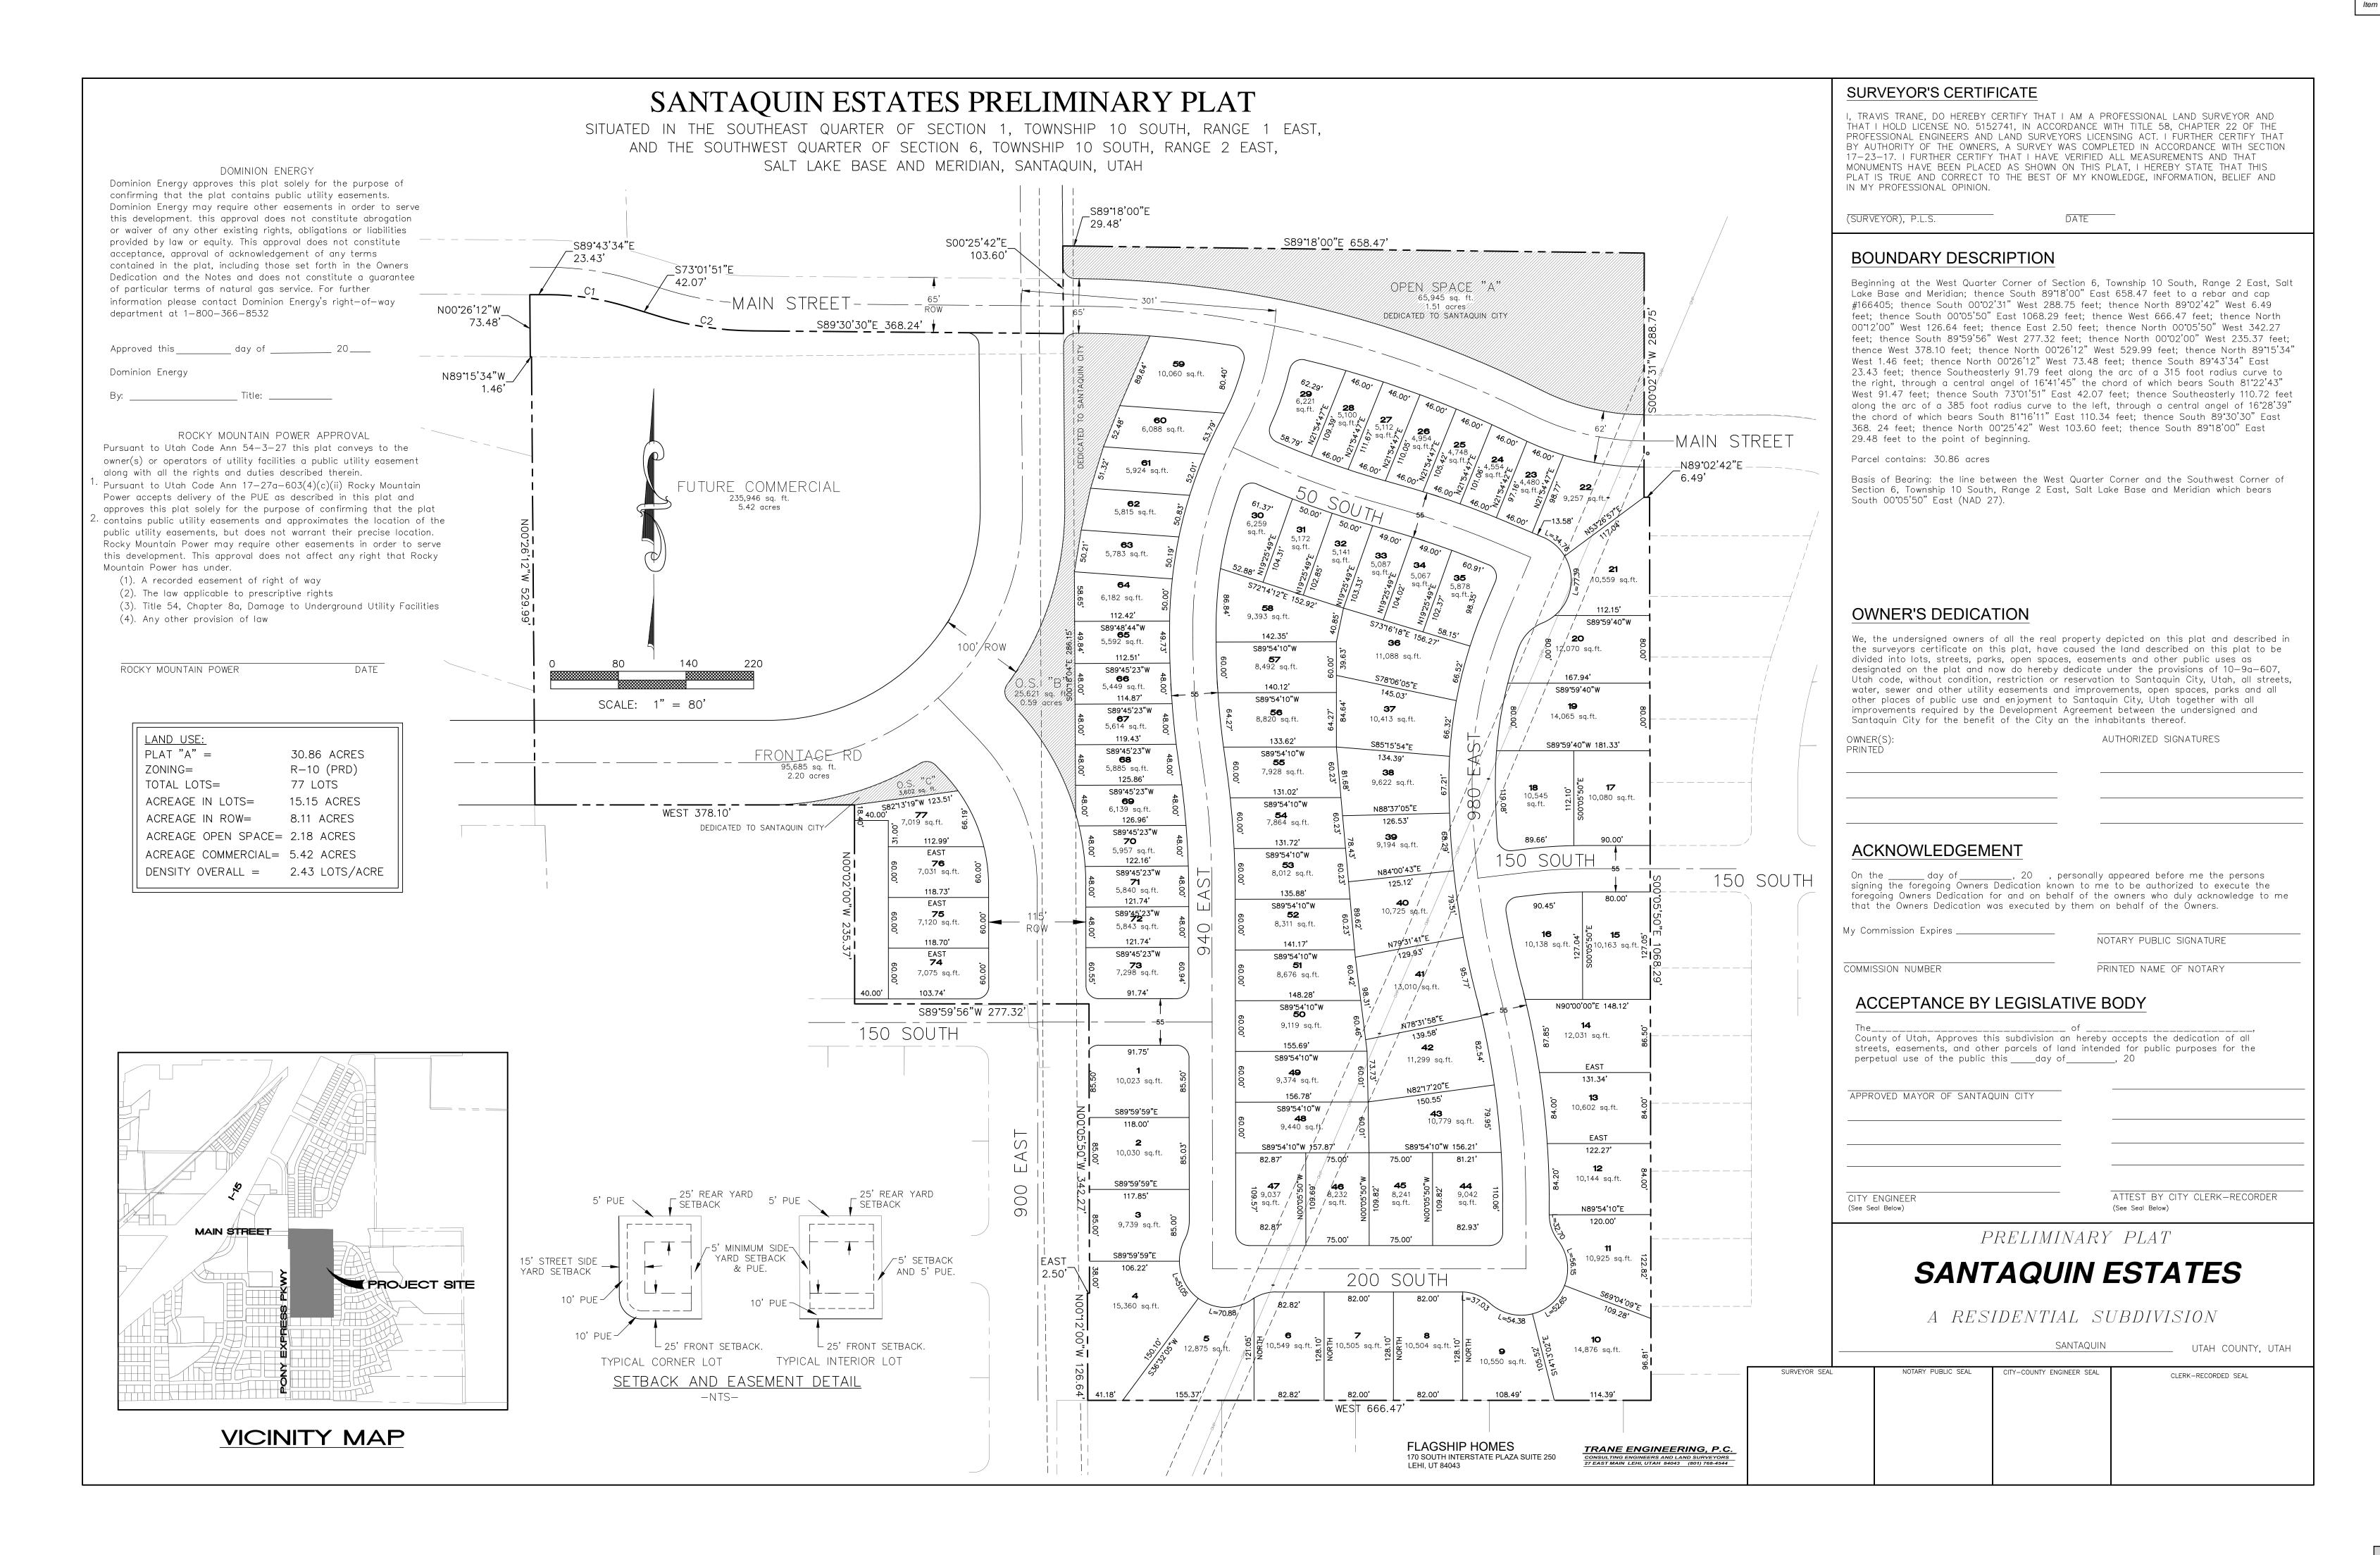

Ridley's Subdivision Phase 2

500 East Main Street Santaquin, Utah County, Utah, 84655





Civil Sheet Index

<i>CO.0</i>	Cover Sheet
	Preliminary Plat
C1.0	Phasing Plan
<i>C2.0</i>	Grading Plan
<i>C3.0</i> · · · · · · · · · · · · · · · · · · ·	

Phase 2 (3 Lots) Zone: C-1 General Commercial Overall Area = 155,025 s.f. (3.559 Acres)

Lot 7 Area = 53,498 s.f. (1.23 Acres) Lot 8 Area = 58,872 s.f. (1.35 Acres)

Lot 9 Area = 42,657 s.f. (0.98 Acres)

Future Phases

Zone: C-1 General Commercial Overall Area = 551,830 s.f. (12.67 Acres)

Santaquin City Notes

The developer and the general contractor understand that it is his/her responsibility to ensure that all improvements installed within this development are constructed in full compilicance with all state and Santaquin City codes, ordinances and standards. These plans are not all inclusive of all


Santaquin City Note to Developers & General Contractors All recommendations made in the provided geotechnical report/study shall be followed explicitly

Designed by: SY

CJM Limited


21-132 CV

Drafted by: KF

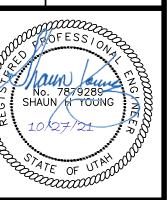

27 Oct, 2021

CO.0

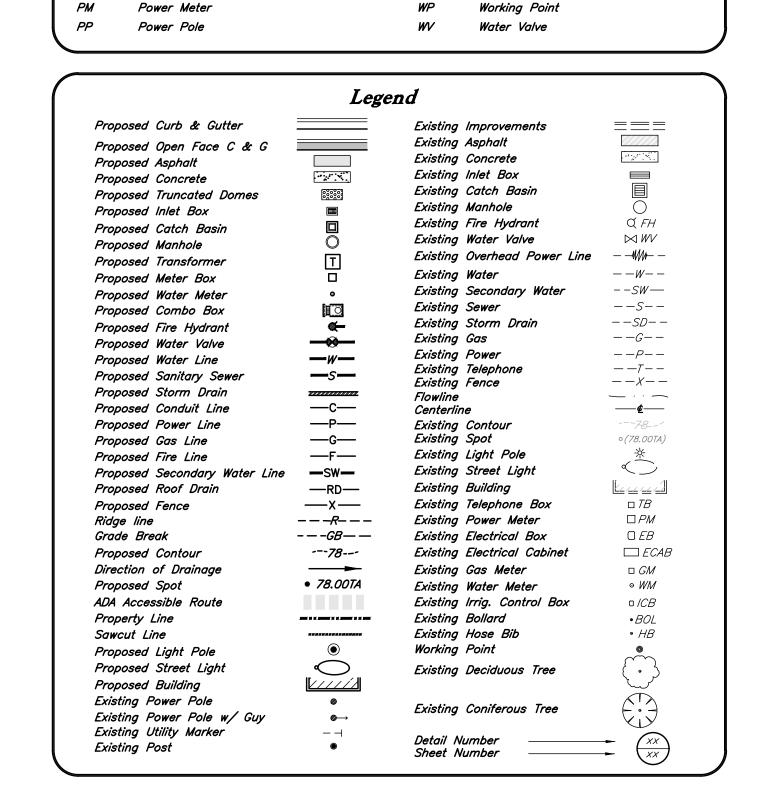

Abbreviations

Telephone Box Top Back of Curb

Top of Concrete

Waterline


Vertical Point of Curve Vertical Point of Tangency


Finish Grade - Top of Retaining Wall

Hose Bib


PCC

Ridley's Subdivision, Plat B

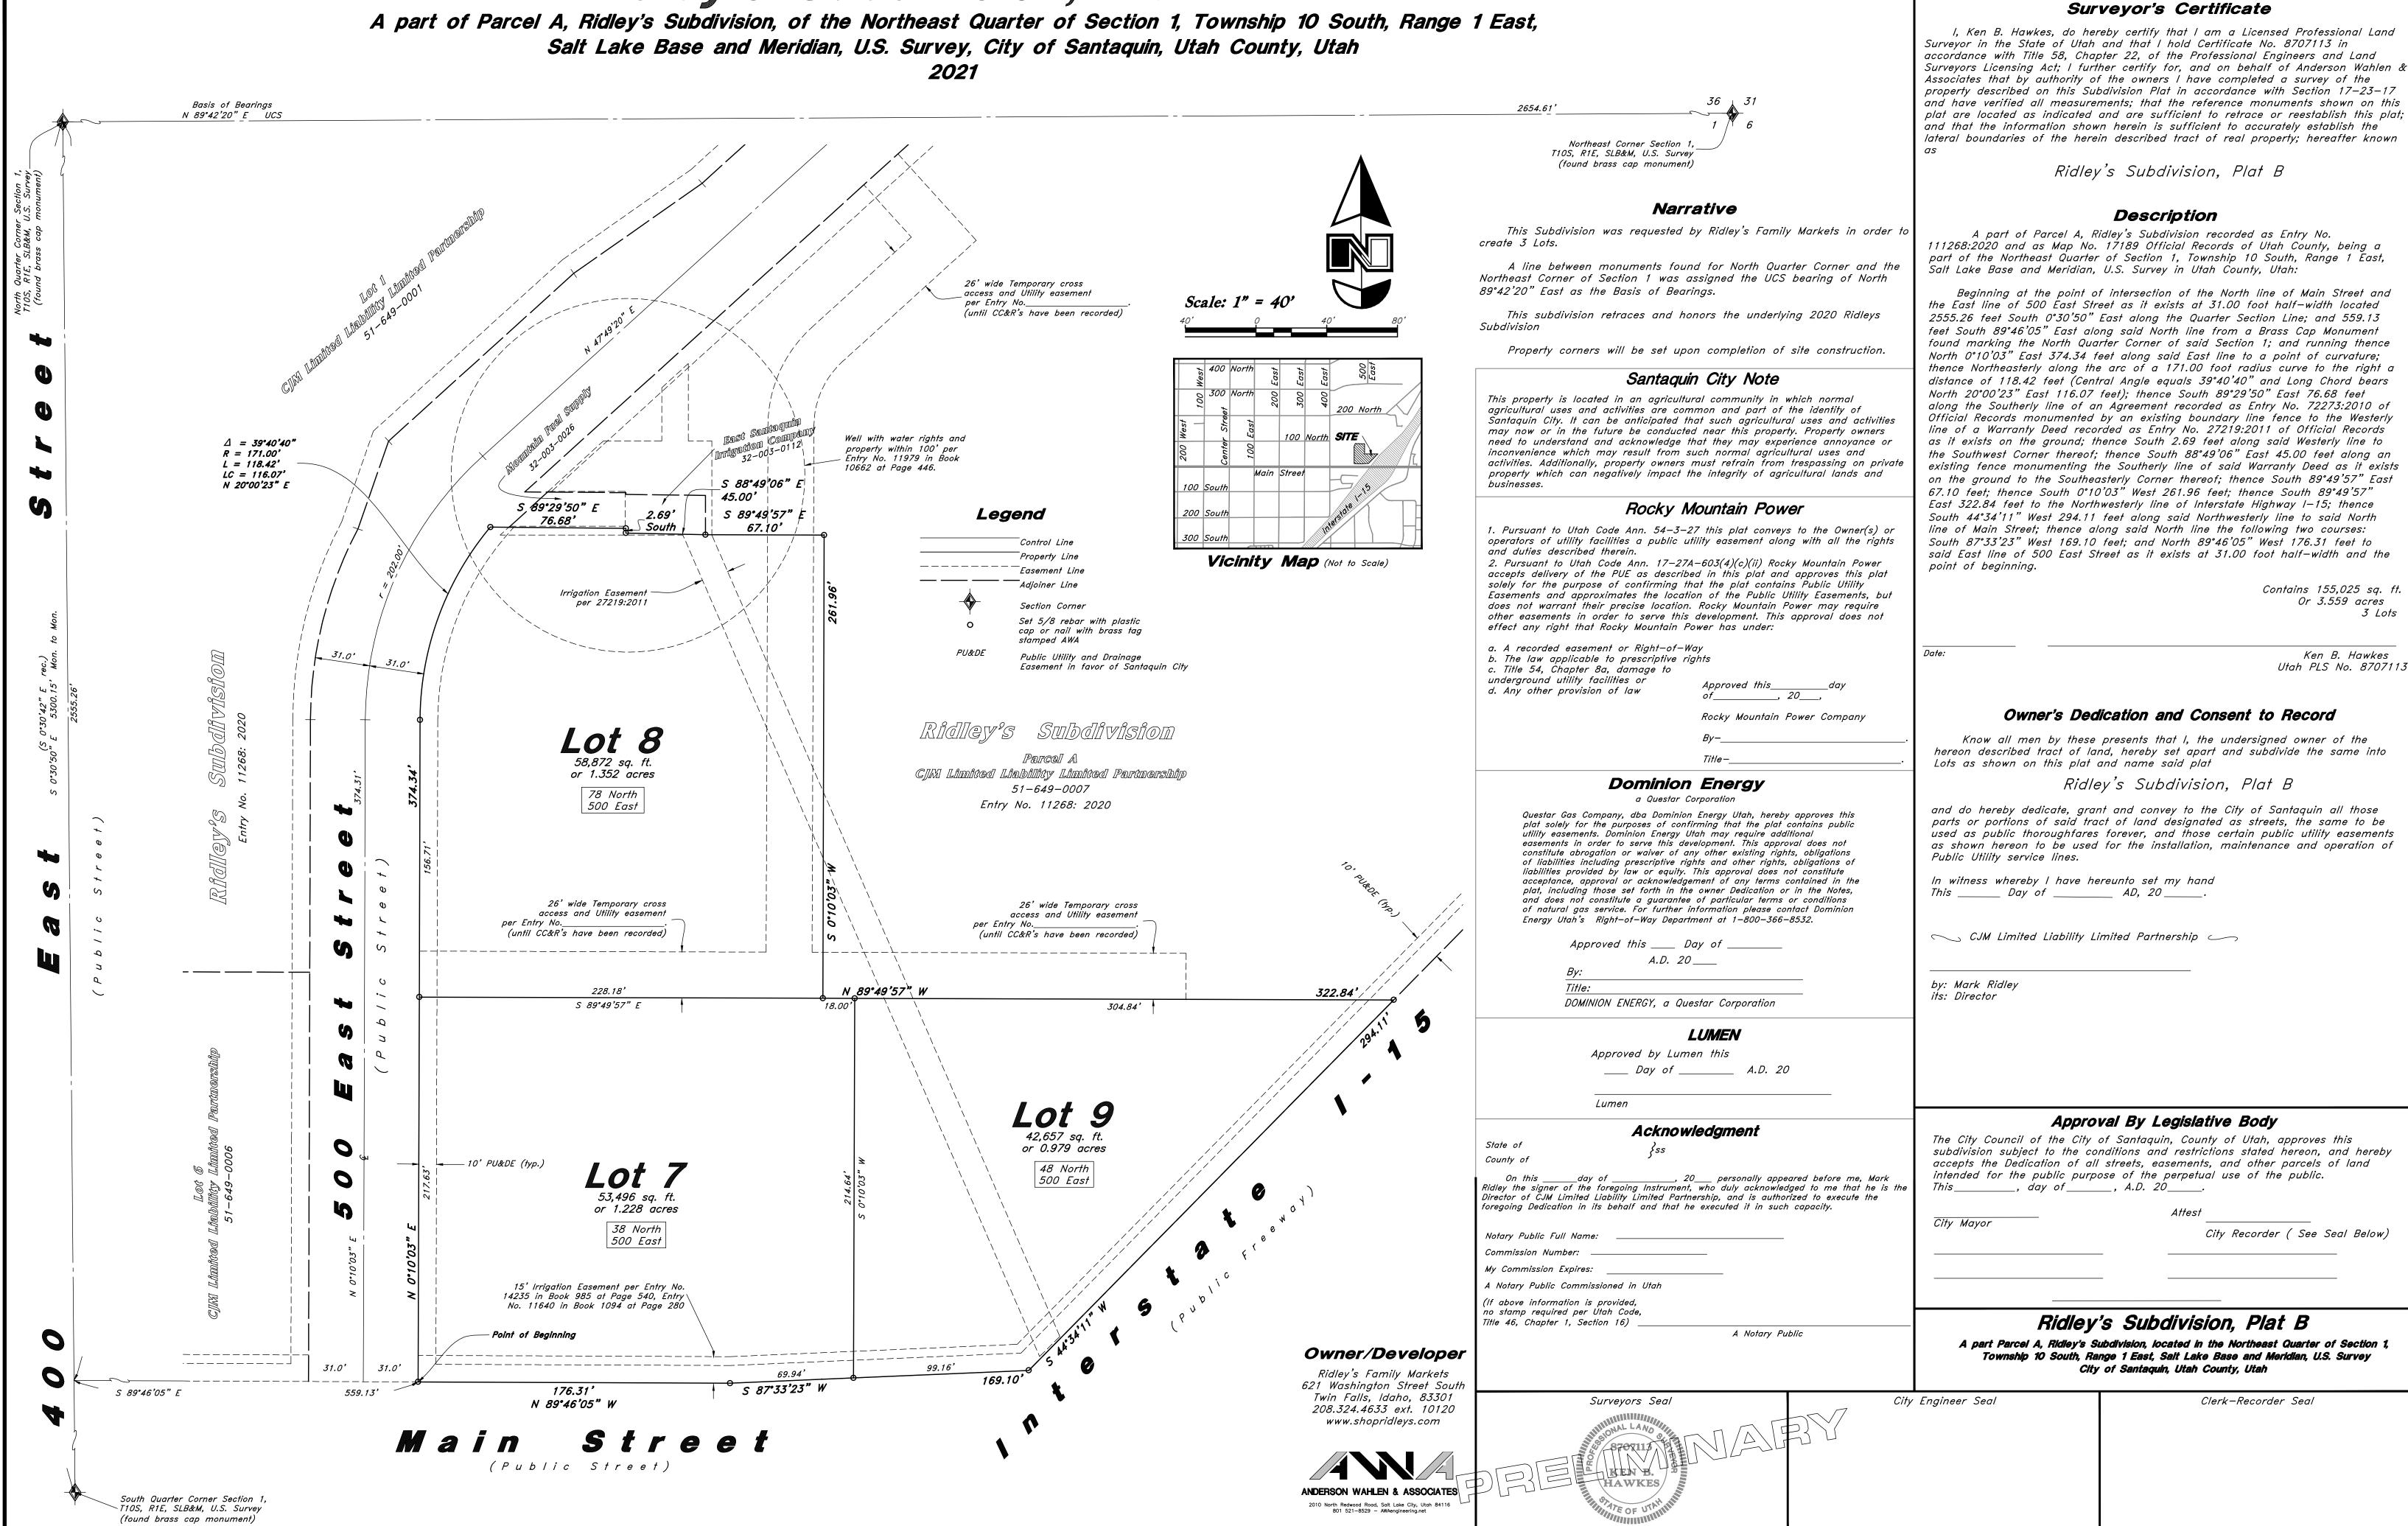

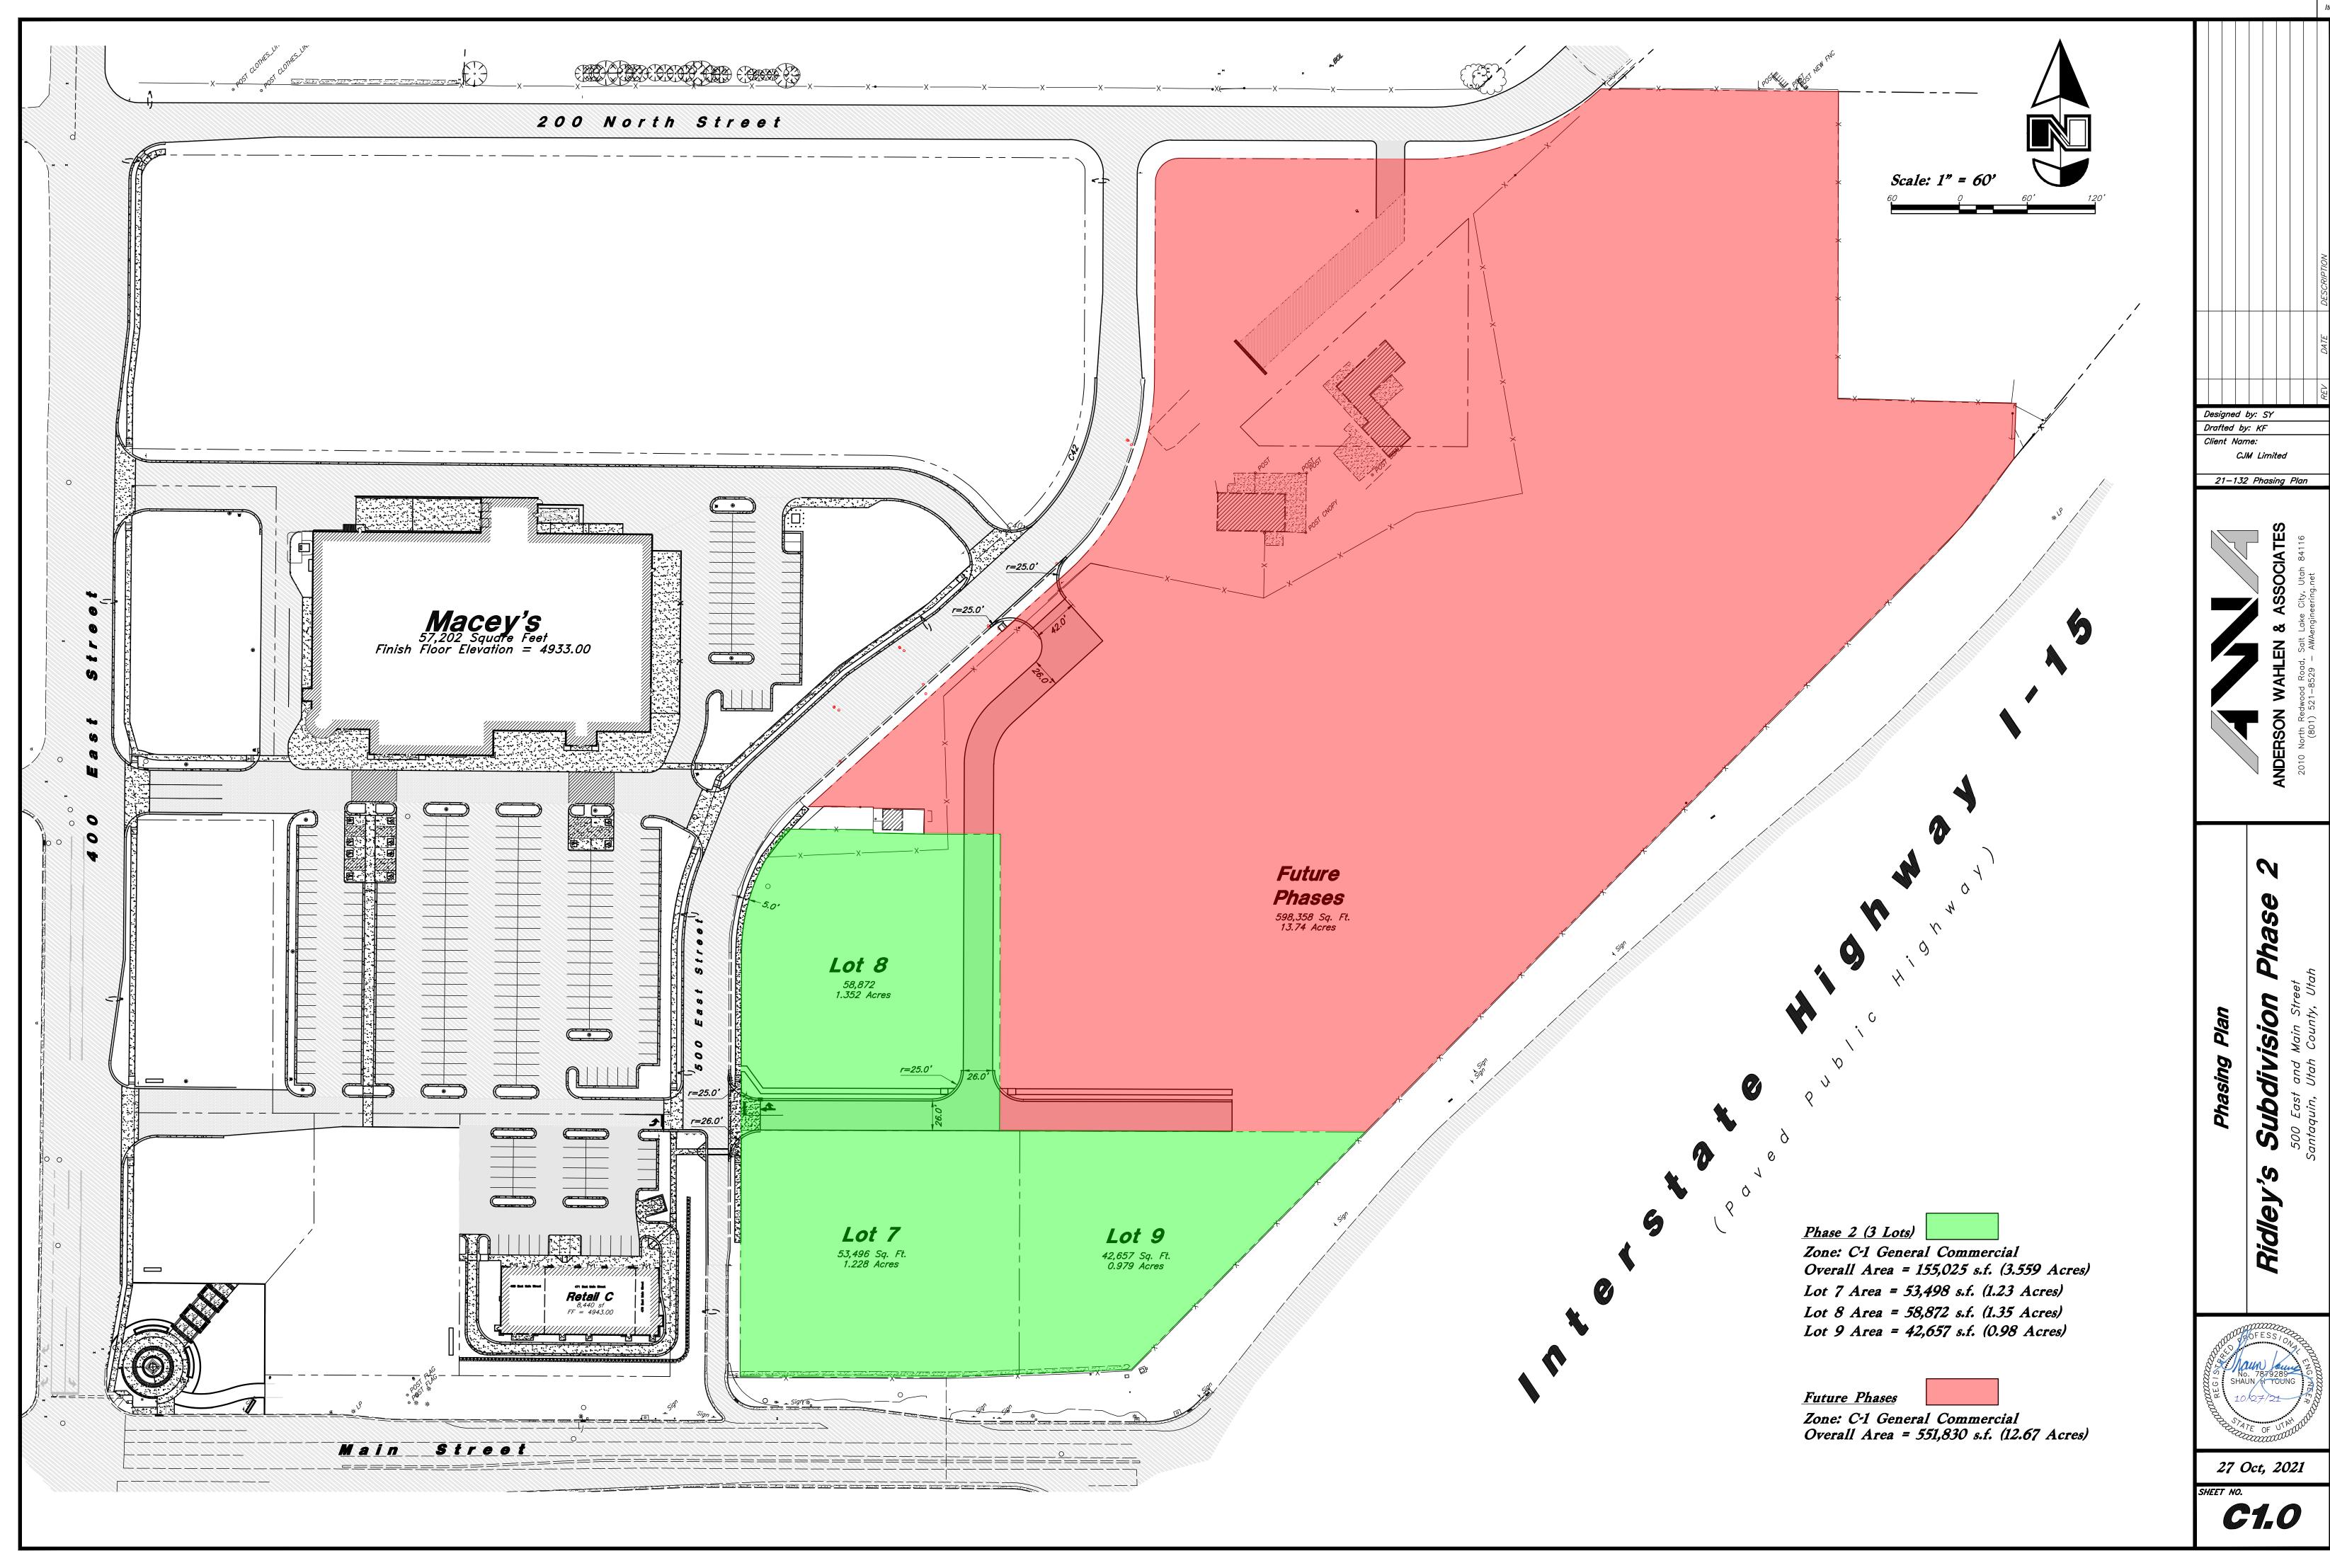

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Scale: 1" = 30'

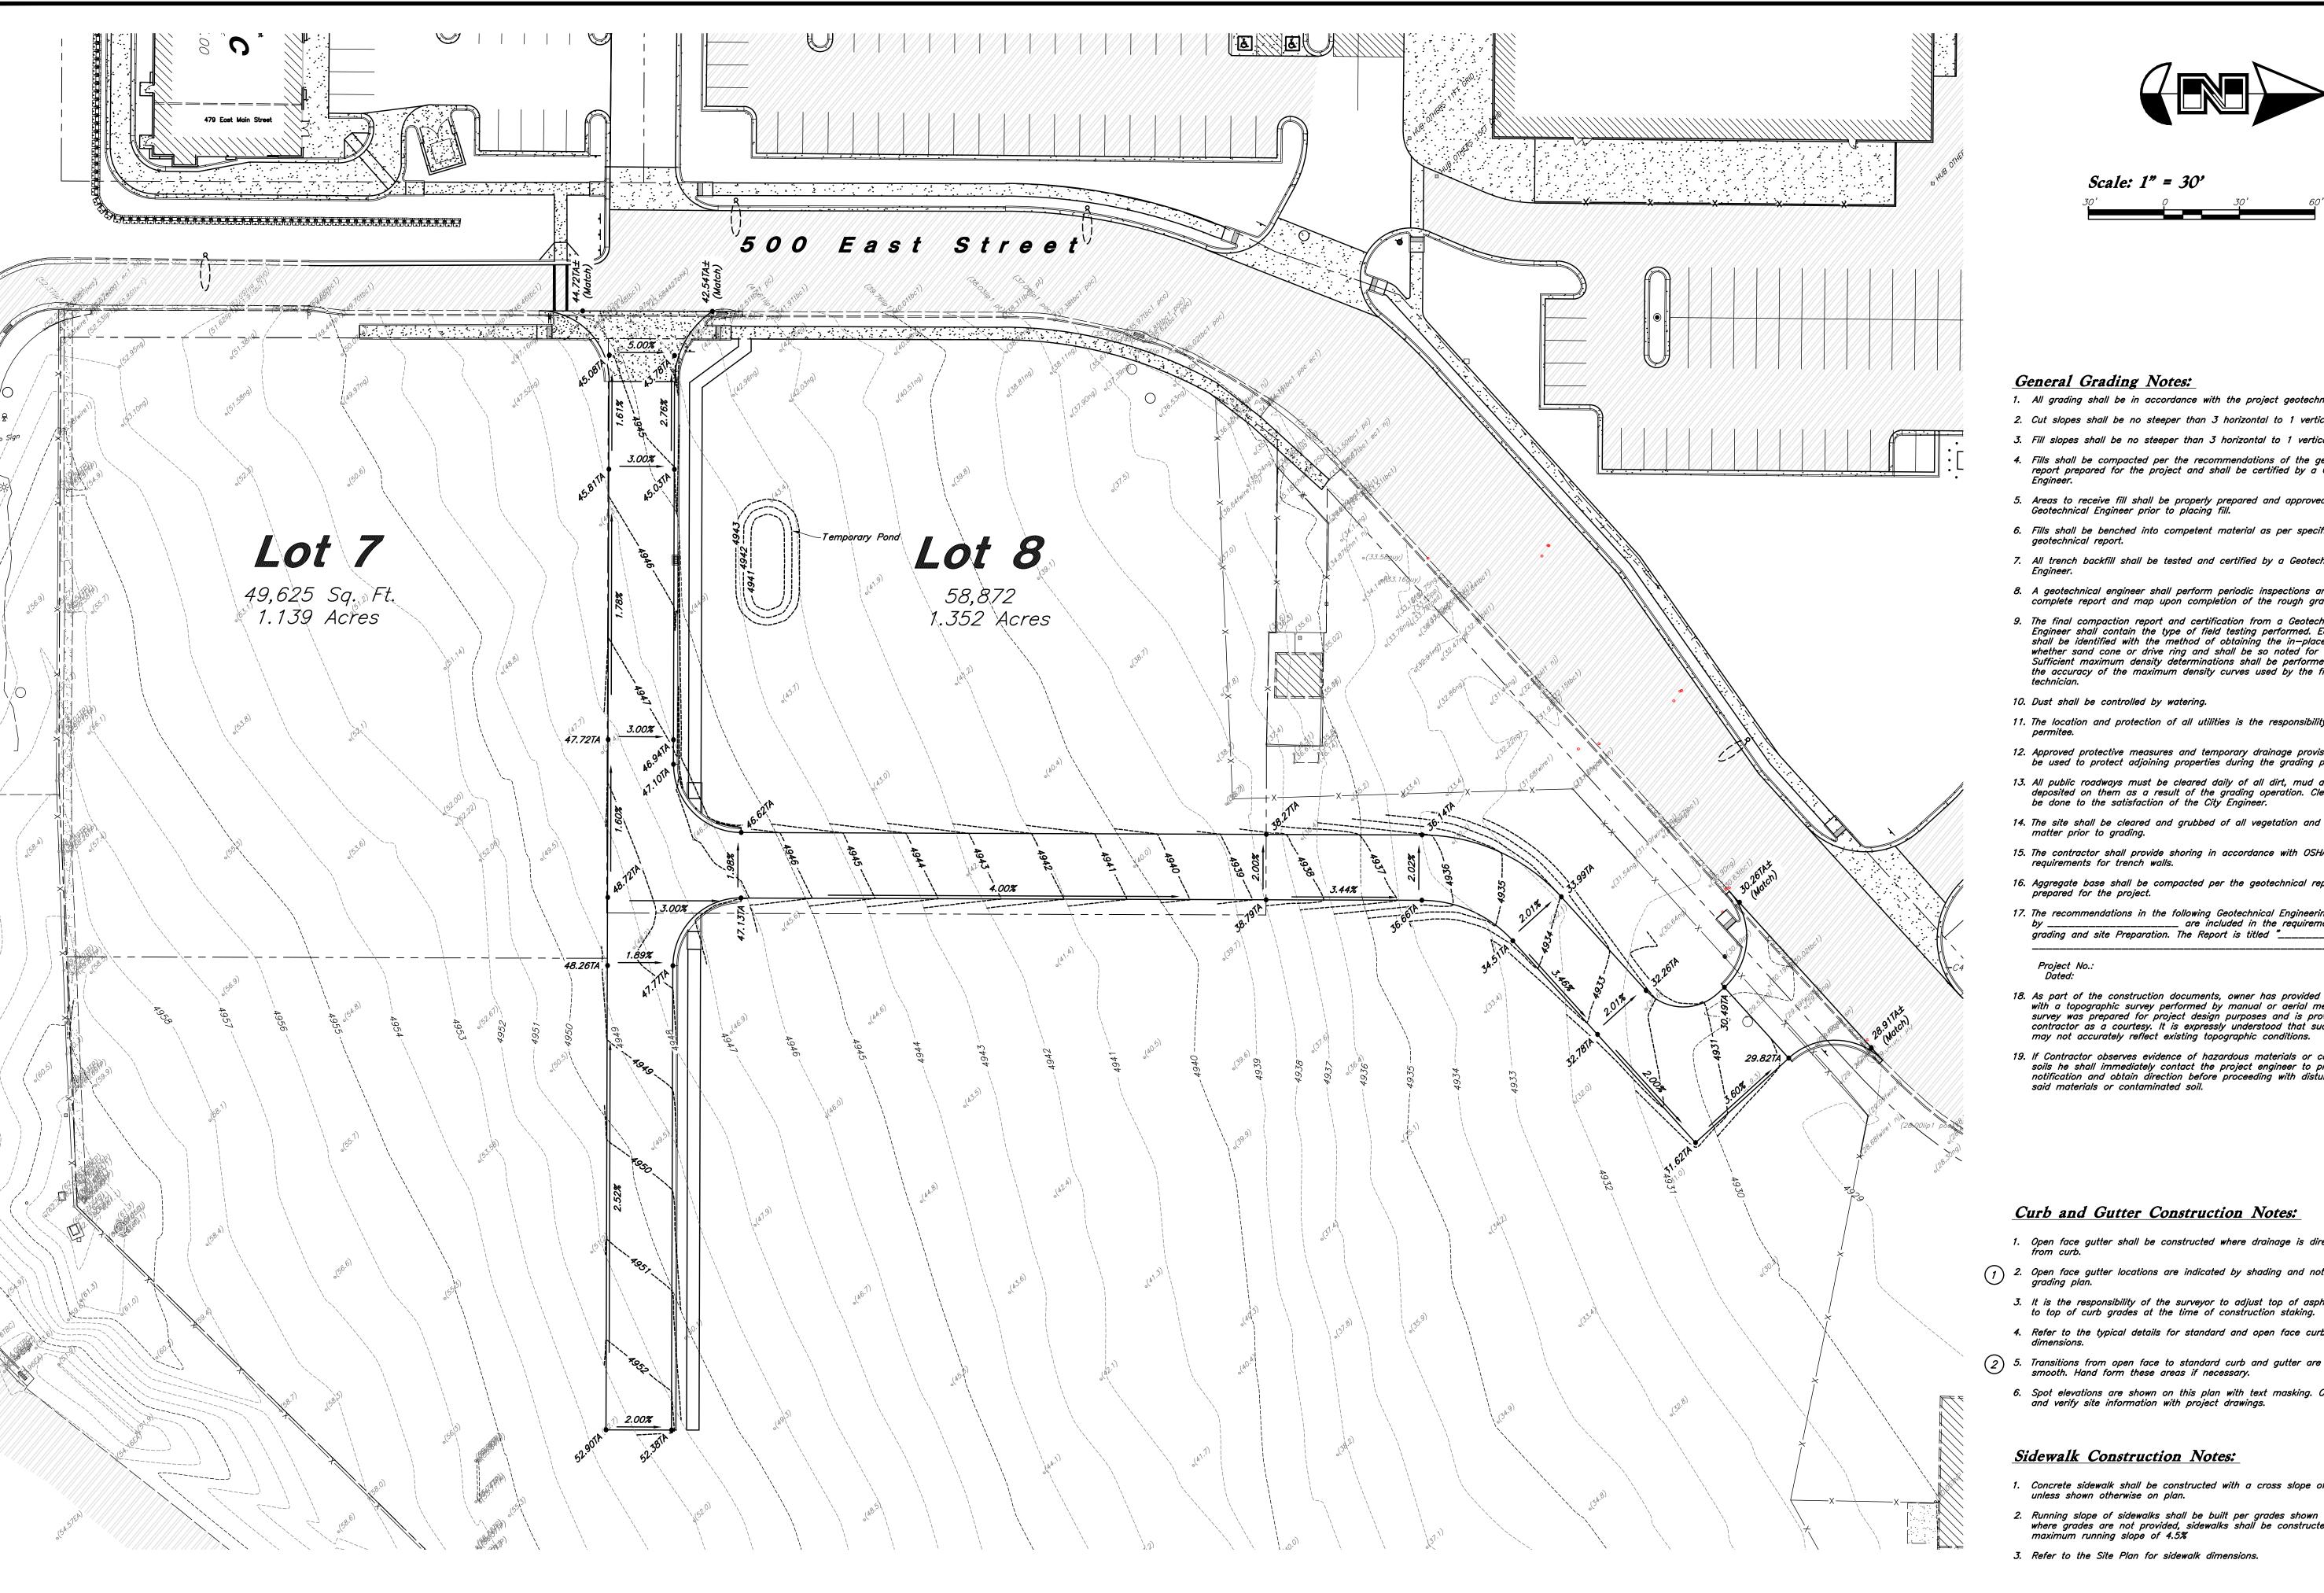General Grading Notes:

- 1. All grading shall be in accordance with the project geotechnical study.
- 2. Cut slopes shall be no steeper than 3 horizontal to 1 vertical.
- 3. Fill slopes shall be no steeper than 3 horizontal to 1 vertical.
- Fills shall be compacted per the recommendations of the geotechnical report prepared for the project and shall be certified by a Geotechnical Engineer.
- Areas to receive fill shall be properly prepared and approved by a Geotechnical Engineer prior to placing fill.
- 6. Fills shall be benched into competent material as per specifications and geotechnical report.
- 7. All trench backfill shall be tested and certified by a Geotechnical
- A geotechnical engineer shall perform periodic inspections and submit a complete report and map upon completion of the rough grading.
- 9. The final compaction report and certification from a Geotechnical Engineer shall contain the type of field testing performed. Each test shall be identified with the method of obtaining the in-place density, whether sand cone or drive ring and shall be so noted for each test. Sufficient maximum density determinations shall be performed to verify the accuracy of the maximum density curves used by the field technician.
- 10. Dust shall be controlled by watering.
- 11. The location and protection of all utilities is the responsibility of the
- Approved protective measures and temporary drainage provisions must be used to protect adjoining properties during the grading process.
- 13. All public roadways must be cleared daily of all dirt, mud and debris deposited on them as a result of the grading operation. Cleaning is to be done to the satisfaction of the City Engineer.
 - 14. The site shall be cleared and grubbed of all vegetation and deleterious matter prior to grading.
 - 15. The contractor shall provide shoring in accordance with OSHA requirements for trench walls.
 - 16. Aggregate base shall be compacted per the geotechnical report
- 17. The recommendations in the following Geotechnical Engineering Report by _____ are included in the requirements of grading and site Preparation. The Report is titled "_


- 18. As part of the construction documents, owner has provided contractor with a topographic survey performed by manual or aerial means. Such survey was prepared for project design purposes and is provided to the contractor as a courtesy. It is expressly understood that such survey may not accurately reflect existing topographic conditions.
- 19. If Contractor observes evidence of hazardous materials or contaminated soils he shall immediately contact the project engineer to provide notification and obtain direction before proceeding with disturbance of said materials or contaminated soil.

Curb and Gutter Construction Notes:

- 1. Open face gutter shall be constructed where drainage is directed away from curb.
- 2. Open face gutter locations are indicated by shading and notes on the aradina plan. grading plan.
- 3. It is the responsibility of the surveyor to adjust top of asphalt grades
- 4. Refer to the typical details for standard and open face curb and gutter
- 2 5. Transitions from open face to standard curb and gutter are to be
 - 6. Spot elevations are shown on this plan with text masking. Coordinate and verify site information with project drawings.

Sidewalk Construction Notes:

- 1. Concrete sidewalk shall be constructed with a cross slope of 1.5% unless shown otherwise on plan.
- 2. Running slope of sidewalks shall be built per grades shown on the plan. where grades are not provided, sidewalks shall be constructed with a maximum running slope of 4.5%
- 3. Refer to the Site Plan for sidewalk dimensions.

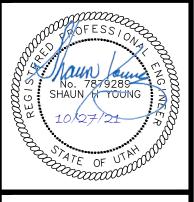


Designed by: SY

Drafted by: KF Client Name:

CJM Limited

21-132 GR

27 Oct, 2021

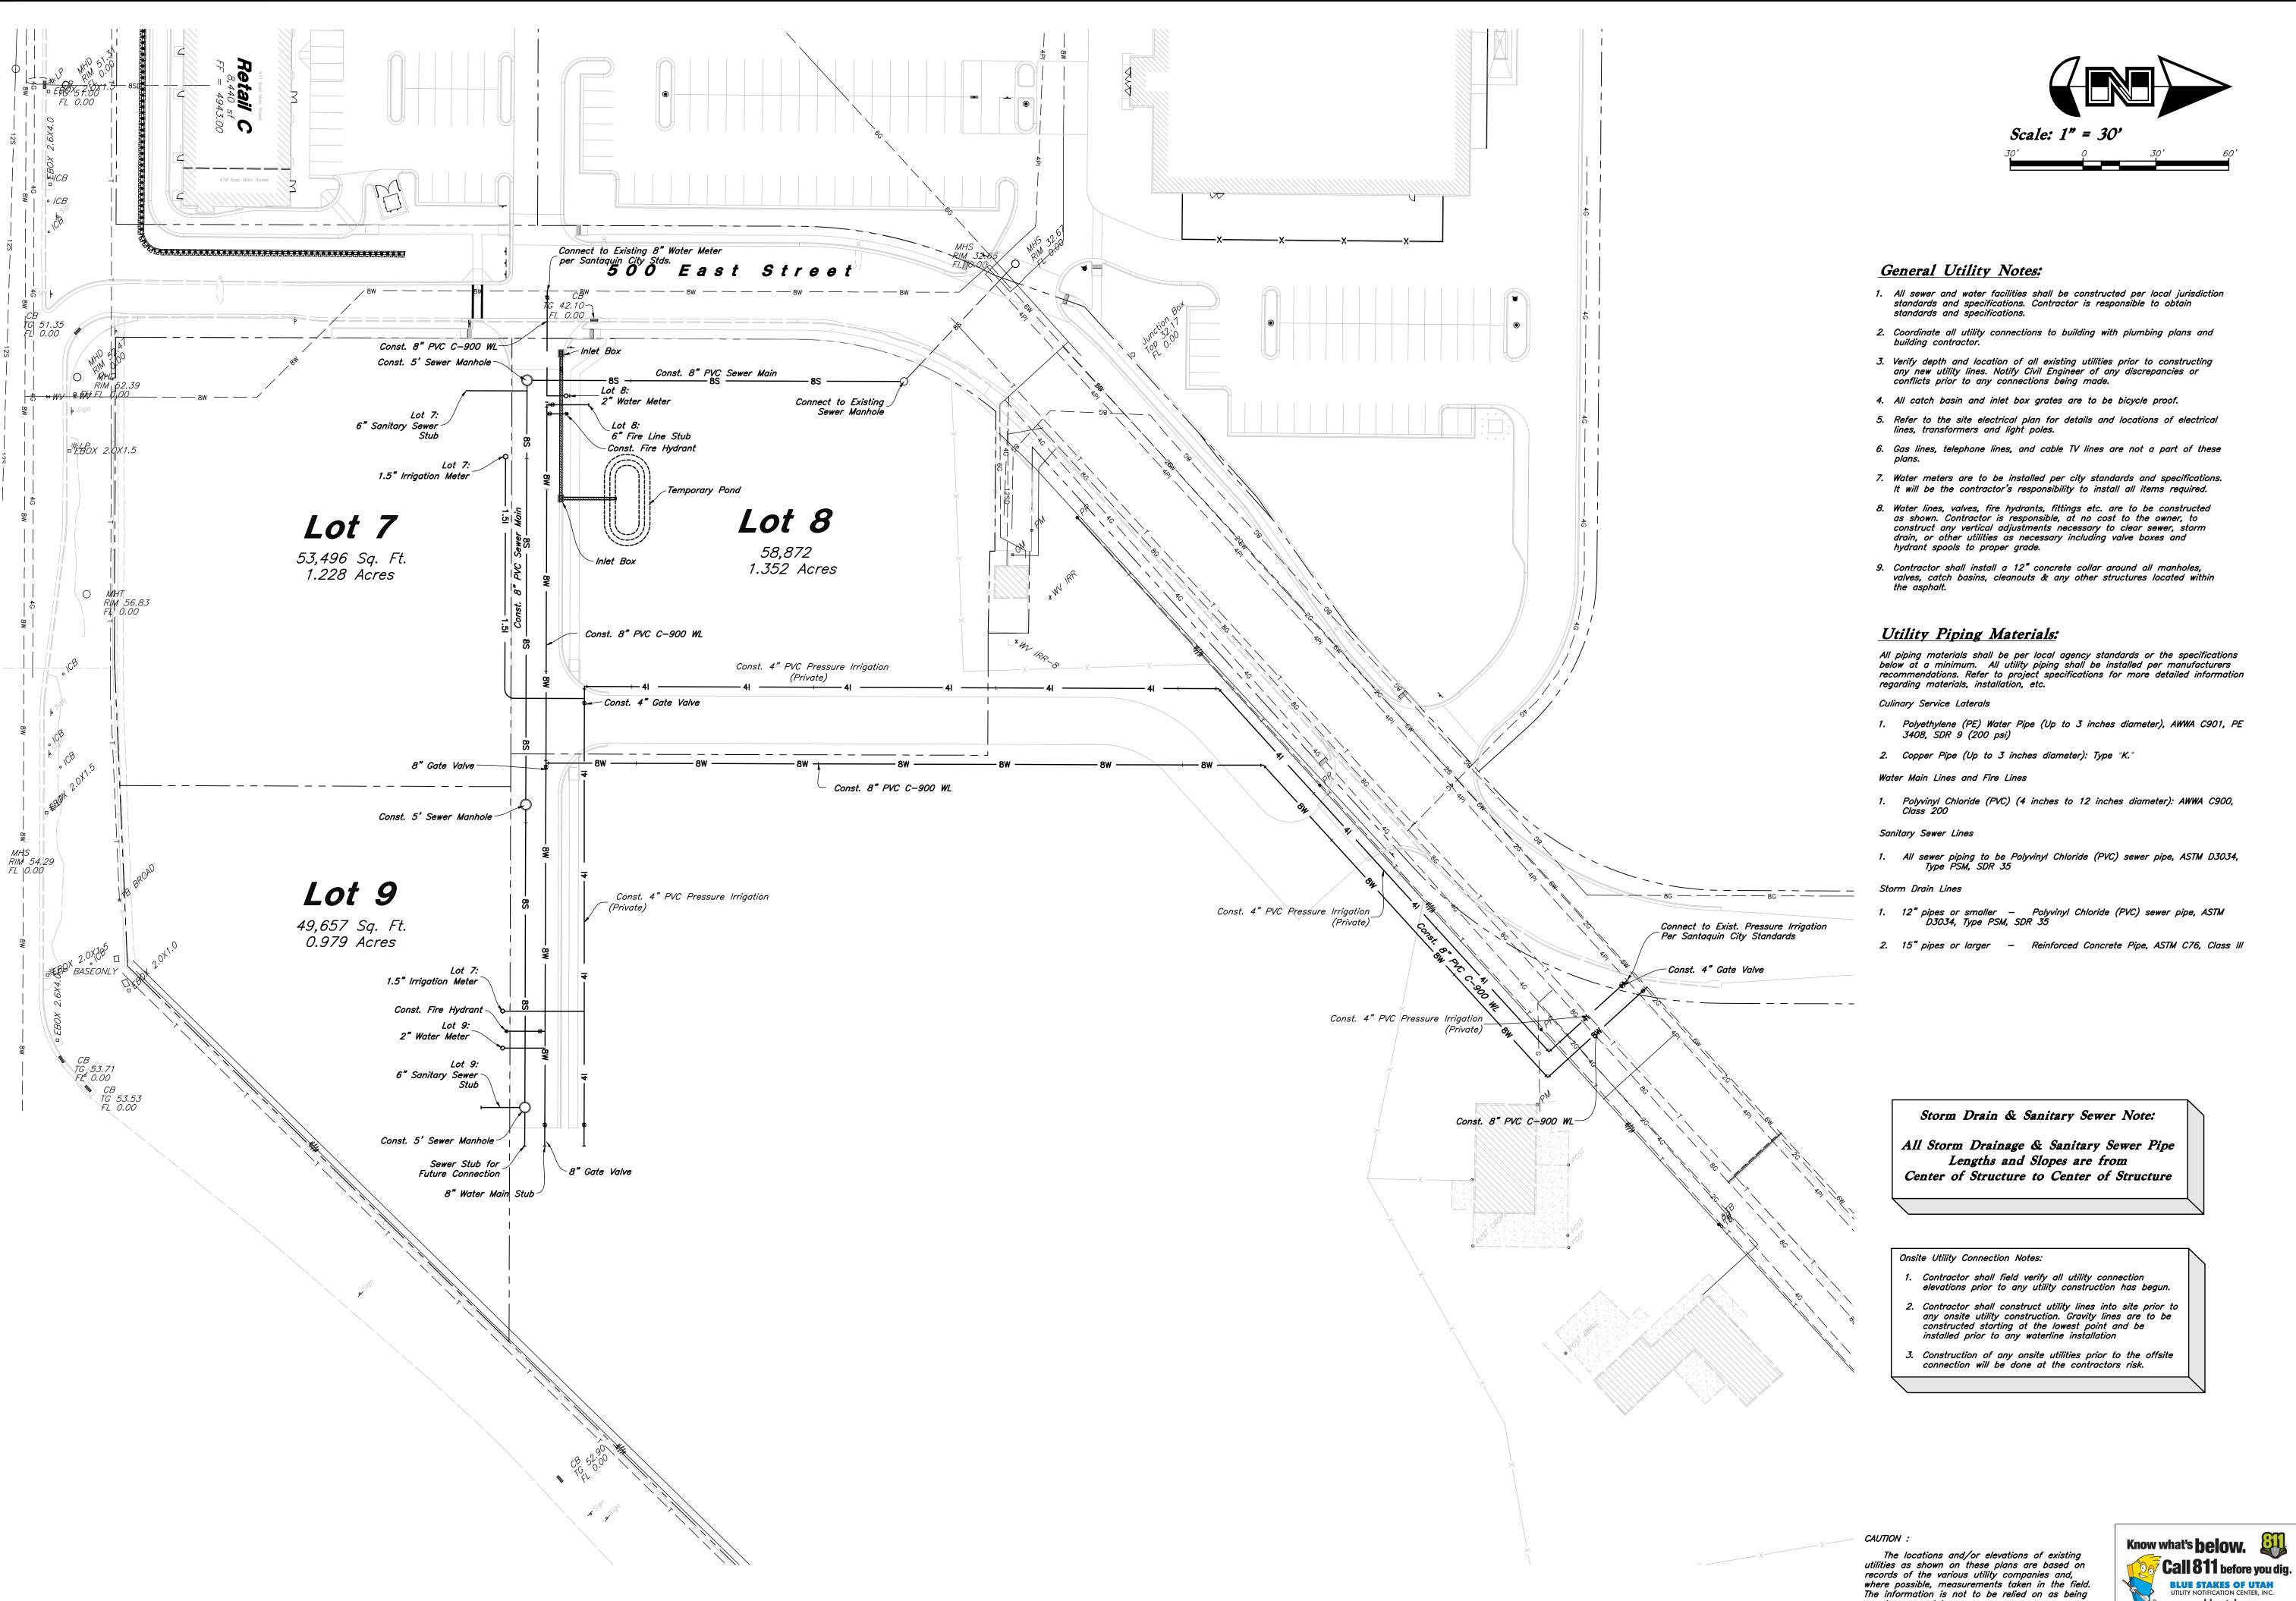

Designed by: SY


Drafted by: KF

CJM Limited

21-132 UT

Client Name:

Item 2.

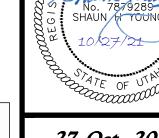

www.bluestakes.org

1-800-662-4111

exact or complete.

27 Oct, 2021

C3.0

Subdivision
500 East and Main Stree.
Santaquin, Utah County, Ut

Utility