

Planning & Zoning Meeting

Wednesday, July 07, 2021 at 6:00 PM 102 W. Bailey Street, Ponder, TX 76259

NOTICE

THE PLANNING & ZONING COMMISSION FOR THE TOWN OF PONDER, TEXAS, WILL HOLD A REGULAR SESSION P&Z MEETING AT 6:00 P.M. ON JULY 7, 2021, IN PONDER TOWN HALL, AT 102 W. BAILEY STREET, PONDER.

REGULAR SESSION AGENDA

CALL TO ORDER

ROLL CALL

OPEN FORUM FOR CITIZEN INPUT (Please limit to 5 minutes per person and if you wish to speak on a particular agenda item, please list the agenda item next to your name).

This is a time for the public to address the P & Z Commission on any subject. However, the Texas Open Meetings Act prohibits the P & Z Commission from discussing issues which the public has not been given seventy-two (72) hours' notice. Issues raised may be referred to Town Staff for research and possible future action.

CONSENT AGENDA

- 1. Consider and act on approval of the February 3, 2021 P&Z Minutes.
- 2. Consider and act on approval of the April 7, 2021 P&Z Minutes.
- 3. Consider and act on approval of the June 2, 2021 P&Z / CIAC Minutes.
- 4. Consider and act on approval of the June 8, 2021 P&Z / CIAC Minutes.

ITEMS OF BUSINESS

Conduct a public hearing to hear public comments and consider recommendations regarding a Zoning Change Request for Lot 2, Block 2, Merrifield Estates, First Section in the Town limits of Ponder. This 1.74 acre vacant lot is physically located on the west side of the 1000 Block of N FM 156, south King George Rd. and north of Owendale Way. The property owner requests rezoning from MF to C2 to build a Sonic Drive-in restaurant.

- 6. Consider and act to recommend approval to the Town Council for the rezoning of Lot 2, Block 2, Merrifield Estates, First Section from MF to C2 to build a Sonic Drive-in restaurant.
- Conduct a public hearing to hear public comments and consider recommendations regarding an SUP/Site Plan for Ferti Technologies for Tieszen Industrial Park, Block A Lot 1, DCAD Property ID 201828. This property is physically located at 100 E FM 2449, in Ponder's Town limits and is zoned M1 (Manufacturing/Industrial Light) Ferti Technologies proposes to remodel the existing building and bring it up to code for the blending and distribution of dry lawn-grade fertilizers, which is allowed in this zoning designation. They request a Specific Use Permit to be approved with the Site Plan allowing for deviations in the maximum height allowance from 50 ft to 70 ft, fewer parking spaces from 111 to 75, and a phased landscape and buffer plan.
- 8. Consider and act on the SUP/Site Plan for Ferti Technologies for Tieszen Industrial Park, Block A Lot 1, DCAD Property ID 201828. This property is physically located at 100 E FM 2449, in Ponder's Town limits and is zoned M1 (Manufacturing/Industrial Light) Ferti Technologies proposes to remodel the existing building and bring it up to code for the blending and distribution of dry lawn-grade fertilizers, which is allowed in this zoning designation. They request a Specific Use Permit to be approved with the Site Plan allowing for deviations in the maximum height allowance from 50 ft to 70 ft, fewer parking spaces from 111 to 75, and a phased landscape and buffer plan.

ITEMS FOR NEXT AGENDA

ADJOURN

CERTIFICATION

I hereby certify that the above notice was posted on the bulletin board at the Ponder Town Hall at 102 W. Bailey Street, Ponder, Texas on the <u>2nd</u> day of July 2021, at 11:00 a.m.

Carolyn Farmer, Planning & Zoning Director

If you plan to attend this public meeting and you have a disability that requires special arrangements at the meeting, please contact our office at 940-479-7009. Reasonable accommodations will be made to assist your needs.

THE TOWN OF PONDER, TEXAS U.S.A.

102 W BAILEY ST, PONDER, TEXAS 76259 940-479-2396

MINUTES FROM PLANNING & ZONING MEETING HELD FEBRUARY 3, 2021

1. CALL TO ORDER.

Meeting called to order at 6:05 PM by Carolyn Farmer, P&Z Director for the Town of Ponder

2. ROLL CALL.

- Planning & Zoning Board Members present were Brandon Mitchell, John Estes and Crystal Ramsey
- Planning & Zoning Board Member not present was Staci Johnson

3. CONSENT AGENDA:

- May 11, 2020 Planning & Zoning meeting minutes
- December 2, 2020 Planning & Zoning meeting minutes
 - > P&Z Member John Estes motioned to approve both the May and December 2020 P&Z meeting minutes.
 - > P&Z Member Crystal Ramsey seconded the motion.
 - Minutes approved with 3 Ayes and 0 Nays.
- **4. OPEN FORUM FOR CITIZEN INPUT** (Please limit to 5 minutes per person and if you wish to speak on a specific agenda item, please list the agenda item next to your name).
 - > No one signed up to speak
- **5. CONSIDER AND ACT** on a Final Plat for DCAD property ID# 181610, physically located in the 500 block of W FM 2449. Town Engineer George Belcheff recommends conditional approval of this Final Plat (no date) by Castlerock Surveying, PLLC, Justin, Texas, subject resolution of the following conditions: Applicant, Pastor Daryl Baker represents the Christian Faith Fellowship Church.
 - Revise Final Engineering concerns listed in his review letter dated January 6, 2021, to the satisfaction of the Town Engineer.
 - Town concurrence with Town Engineer's Rough Proportionality conditions
 - Town concurrence with driveway connection to FM 2449, subject to TxDOT review and approval
 - Town acceptance of TxDOT water line crossing permit
 - Developer funding to upgrade Park Road to a reinforced concrete section
 - Approval of a Special Use Permit
 - > P&Z Member Brandon Mitchell asked the square footage of the proposed building.
 - > David Bond with Spiars Engineering stated approximately 35,000 square feet.
 - ➤ P&Z Member Brandon Mitchell motioned to approve the Final Plat conditionally as recommended by George Belcheff's review letter dated January 6, 2021. (Attached in full)
 - P&Z Member Crystal Ramsey seconded the motion
 - Motion passed with 3 Ayes and 0 Nays.

Item 1.

6. ADJOURN.

- > P&Z Member Brandon Mitchell motioned to adjourn
- > P&Z Member John Estes seconded.
- ➤ Meeting adjourned at 6:20 PM

APPROVED:		
Mayor Matthew Poole	Date	
ATTEST:		
Carolyn Farmer Planning & Zoning Director	_	

THE TOWN OF PONDER, TEXAS U.S.A.

102 W BAILEY ST, PONDER, TEXAS 76259 940-479-2396

MINUTES FROM PLANNING & ZONING MEETING HELD APRIL 7, 2021

CALL TO ORDER

*P&Z Member Staci Johnson called the meeting to order at 6:01 PM

ROLL CALL

- *P&Z Members present were John Estes, Staci Johnson, and Crystal Ramsey
- *P&Z Member not present was Brandon Mitchell

OPEN FORUM FOR CITIZEN INPUT

*No one signed up

CONSENT AGENDA

- 1. Consider and act on approval of the February 3, 2021 minutes.
 - *Tabled until the next meeting.

ITEMS OF BUSINESS

- 2. Conduct a Public Hearing to hear comments and suggestions to allow a Site Plan/Specific Use Permit allowing Church/Rectory use within an A-Agricultural District.
 - *P&Z Member John Estes motioned to open the public hearing
 - *P&Z Member Crystal Ramsey seconded
 - * Public Hearing open with 3 Ayes and 0 Nays.
 - *David Bond with Spiars Engineering for the Church was available for questions.
 - *No one spoke
 - * P&Z Member John Estes motioned to close the public hearing
 - * P&Z Member Crystal Ramsey seconded
 - *Public hearing closed
- 3. Consider and act on approval of Site Plan/Specific Use Permit allowing Church/Rectory use within A-Agricultural District for the Christian Faith Fellowship Church.
 - *P&Z Member Staci Johnson motioned to conditionally approve the Site Plan/SUP for the Church following Town Engineer's recommendations in his review letter dated March 31, 2021. (Attached in full)
 - *P&Z Member John Estes seconded.
 - *Motion passed with 3 Ayes and 0 Nays.

ITEMS FOR NEXT AGENDA

Item 2.

ADJOURN

*P&Z Member Staci Johnson motioned to adjourn

*P&Z Member John Estes seconded

*Meeting adjourned at 6:17 PM

APPROVED:		
Mayor Matthew Poole	Date	
ATTEST:		
Carolyn Farmer Planning & Zoning Director	_	

THE TOWN OF PONDER, TEXAS U.S.A.

102 W BAILEY ST, PONDER, TEXAS 76259 940-479-2396

MINUTES FROM PLANNING & ZONING MEETING AND THE CAPITAL IMPROVEMENTS ADVISORY COMMITTEE HELD JUNE 2, 2021

CALL TO ORDER

This meeting was called to order at 6:12 pm by Carolyn Farmer, Planning & Zoning Director

ROLL CALL

Members present were John Estes, Brandon Mitchell and Stephanie Johnso Member Crystal Ramsey was not present

OPEN FORUM FOR CITIZEN INPUT (Please limit to 5 minutes per person and if you wish to speak on a particular agenda item, please list the agenda item next to your name).

No one signed up

APPOINT OFFICERS FOR PLANNING & ZONING COMMISSION

- 1. Chairman -Stephanie Johnson was voted in as Chairperson
- 2. Co-Chairman- John Estes was voted in as Co-Chair

CONSENT AGENDA

- 1. Consider and act on approval of the February 3, 2021 minutes.
- 2. Consider and act on approval of the April 7, 2021 minutes.

Not enough members present for a quorum, consent agenda tabled.

ITEMS OF BUSINESS – <u>NO BUSINESS ITEMS FOR THE P&Z COMMISSION</u>

ITEMS OF BUSINESS – CAPITAL IMPROVEMENTS ADVISORY COMMITTEE

- 1. Presentation of the 2021 Impact Fee Study results by Belcheff and Associates to the Planning & Zoning Commission acting as the Capital Improvements Advisory Committee.
- 2. Consider and act on approval of proposed amendments to the current land use assumptions, capital improvement plans, and imposition of water and sewer impact fees with recommendation to Town Council.

Not enough members present for a quorum. Item 2 for the CIAC tabled.

ITEMS FOR NEXT AGENDA

A special meeting of the CIAC will be planned for Tuesday June 8th.

Item 3.

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Meeting adjourned at 7:00 pm

APPROVED:		
Mayor Matthew Poole	Date	
ATTEST:		
Carolyn Farmer Planning & Zoning Director	-	

THE TOWN OF PONDER, TEXAS U.S.A.

102 W BAILEY ST, PONDER, TEXAS 76259 940-479-2396

MINUTES FROM THE CAPITAL IMPROVEMENTS ADVISORY COMMITTEE SPECIAL SESSION HELD JUNE 8, 2021

CALL TO ORDER

Meeting called to order at 6:00 pm by Staci Johnson, Chairperson, via Zoom.

ROLL CALL

Members present were Brandon Mitchell, Crystal Ramsey, and John Estes

OPEN FORUM FOR CITIZEN INPUT (Please limit to 5 minutes per person and if you wish to speak on a particular agenda item, please list the agenda item next to your name).

No one signed up to speak

ITEMS OF BUSINESS – CAPITAL IMPROVEMENTS ADVISORY COMMITTEE

Consider and act on approval of proposed amendments to the current land use assumptions, capital
improvement plans, and imposition of water and sewer impact fees with recommendation to Town
Council.

Member John Estes motioned to recommend approval of the updated water and sewer impact fees to the Town Council.

Member Brandon Mitchell seconded.

Motion passed with 4 Ayes, 0 Nays and 0 Abstentions.

ADJOURN


Member John Estes motioned to adjourn. Member Brandon Mitchell seconded. Meeting adjourned at 6:02 pm

APPROVED:		
Mayor Matthew Poole	Date	
ATTEST:		
Carolyn Farmer Planning & Zoning Director	_	



ZONING CHANGE REQUEST APPLICATION

Fee \$	350			
Applic	eant:Marc DeGenaro	Phone:_940-565-8215		
Mailin	g Address:725 S. Locust St. Denton, To	exas 76201		
Phone	e: Fax:			
Owne	r's name if different: Wayne Peters			
Genei	ral Location of Property: 1000 block of N	. FM 156, Ponder, Texas		
Legal	Description of Property: Lot 2, Block 2, Mer (Attach complete m	rifield Est, First Section etes and bounds)		
Curre	nt Zoning Designation: MF - MultiFamil	y		
l here Genei	by request that the Zoning Designation be c	hanged to: <u>C-2 Commercial</u>		
Existir	ng Use: <u>Vacant</u> Proposed Use: <u>Sc</u>	onic Drivethrough		
	ct Email: arc@colemansurveying.com	- 		
I certify that the information concerning this proposed zoning change is true and correct and that I am the owner of record or the authorized agent ¹ for the owner of the above described property.				
Applic	cant Signature	St Date 6/14/21		
_				
F	Application Complete See Paid	Received by		
□	Pate to appear P&Z Council	(Time/date stamp)		
L				

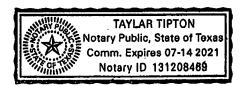

x Aff



Coleman & Assoc. Land Surveying

P. O. Box 686
Denton, Texas 76202
Phone (940)565-8215 Fax (940)565-9800
REGISTRATION #10095100

June 11, 2021

Town of Ponder 102 W. Bailey St. Ponder, Texas

Gentlemen:

This letter is to serve as authorization for Marc G. DeGenaro or William M. Coleman of Coleman & Assoc. Land Surveying to prepare and submit Applications and other appropriate documents as required for the Zoning Change Request and development of the Lot 2, Block 2, Merrifield Estates, First Section property located in the 1000 block of N. FM 156 in Ponder, Texas and to represent me at meetings and hearings in the absence of, or at the request of, other representatives.

Handy E. Peters 4/14/2021
Kandy E. Peters

Regards,

TAYLAR TIPTON
Notary Public, State of Texas
Comm. Expires 07-14 2021

Notary ID 131208469



Coleman & Assoc. Land Surveying

P. O. Box 686 Denton, Texas 76202 Phone (940)565-8215 Fax (940)565-9800 REGISTRATION #10095100

Town of Ponder 102 W. Bailey St. Ponder, Texas 76259 940-479-2396

Project Name: Lot 2, Block 2, Merrifield Estates, First Section

Dear Sirs,

This site is currently a vacant 1.74 acre Lot 2, Block 2, Merrifield Estates, First Section. It is located on the West side of F. M. Highway 156, South of King George Road and North of Owendale Way. The property is currently zoned MF. The property owner proposes to divide the property in half by replat and then build a Sonic Drive-In on the southern lot. The property owner would like to rezone the property to C-2.

Any questions or comments concerning this document should be directed to the undersigned.

Sincerely,

Marc G. DeGenaro, Project Manager Coleman & Assoc. Land Surveying FIELD NOTES to all that certain tract of land situated in the D. Rudder Survey Abstract Number 1060, Town of Ponder, Denton County, Texas and being all of the called Lot 2, Block 2, Merrifield Estates, First Section as shown by the plat thereof recorded in Cabinet J, Page 136 of the Plat Records of Denton County, Texas; the subject tract being more particularly described as follows:

BEGINNING for the Northaest corner of the tract being described herein at a 1/2 inch iron rod with a yellow plastic cap stamped "COLEMAN RPLS 4001" set (herein after referred to as 1/2IRS) for the Northeast corner of the said Lot 2 on the West right-of-way line of F. M. Highway 156;


THENCE Southwesterly with the East line of Lot 2 and the West right-of-way line of F. M. Highway 156, along the arc of a curve to the left having a radius of 2,904.93 feet, an arc length of 255.08 feet (chord bearing South 13 Degrees 53 Minutes 12 Seconds West a distance of 255.00 feet) to a 1/2IRS for the Southeast corner of Lot 2;

THENCE North 76 Degrees 23 Minutes 38 Seconds West with the South line of Lot 2 a distance of 298.81 feet to a 1/2IRS for the Southwest corner thereof;

THENCE North 13 Degrees 47 Minutes 10 Seconds East with the West line of Lot 2 a distance of 255.07 feet to a 1/2 inch iron rod found at the Northwest corner thereof;

THENCE South 76 Degrees 22 Minutes 51 Seconds East with the North line of Lot 2 a distance of 299.26 feet to the PLACE OF BEGINNING and enclosing 1.740 acres of land.


Denton CAD Web Map

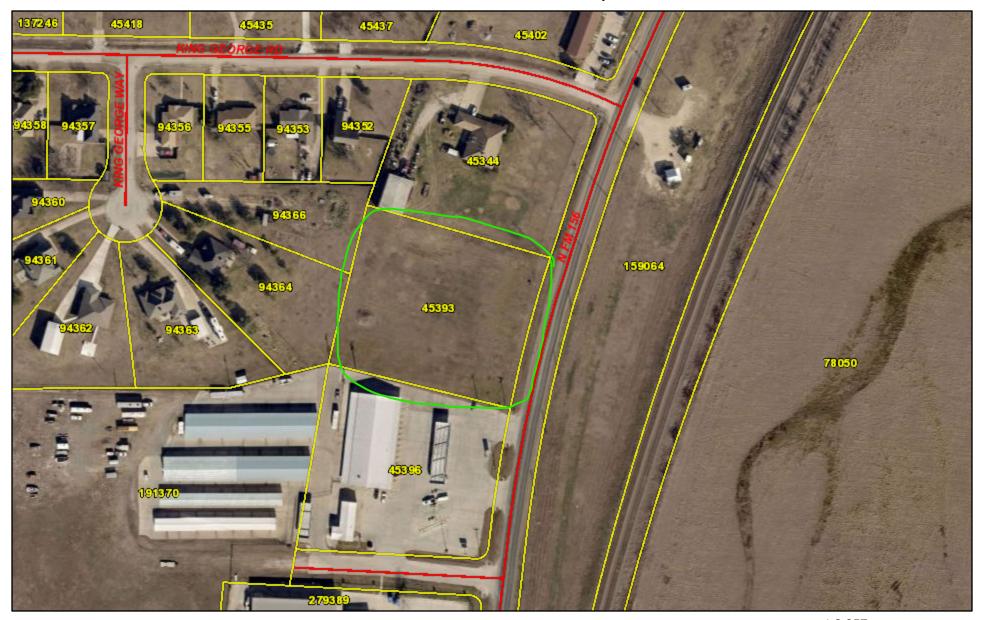

6/15/2021, 3:58:19 PM

Streets

Parcels

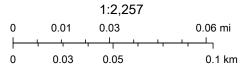

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NDER

SPECIFIC USE PERMIT APPLICATION

Specific Use Permit Fee \$100.00

Applicant: Todd Eppenbach Company: Inventure

Address: 2708 Powlett Creek Dr. Tel: (469) 989-3713 Fax:

City: Frisco State: Texas Zip: 75034

Property Owner: Hugo Provencher Company: Ferti Management Corp.

Address: 560, Chemin Rheaume, C.P. 129 Tel: (450) 454-5367

City: Saint-Michel State: Quebec, Canada Zip: J0L 2J0

Legal description* Lot 1, Block A of Tieszen Industrial Park, an addition to the Town of

Ponder, Texas, according to the plat thereof recorded in Cabinet O,

Page 335, Plat Records, Denton County, Texas. *(Attach metes and bounds description of property)

Detailed description of Proposed Use: Ferti Technologies will use this site as a fertilizer blender facility. Raw material is brought into the site and stored in large bins within the building. The raw material is then mixed to create different blends of fertilizer, bagged, staged on pallets then shipped out to end-users. Facility will also office and support areas within the building.

Total Area of Land: Acres 23.23 Lots: 1 Blocks: A Streets: F.M. Road 2449

Current Zoning Classification: M-1 Existing Use Manufacturing/Industrial Light

Contact Email: todd@inventure.design

I have carefully examined the completed application and know the same to be true and correct. I hereby agree to comply with all provisions set forth by the Town of Ponder whether herein specified or not.

ApplicantSignature: Date: 5/12/21

Item 7.

SPECIFIC USE PERMIT APPLICATION

*****	******	**OFFICE USE ONLY***	*******
Fee paid	Date	Accepted by	



Town of Ponder Planning & Zoning 102 W. Bailey Street Ponder, TX 76259

May 11, 2021

Re: Ferti Technologies Specific Use Permit

Dear Sir/Madame,

Ferti Technologies is requesting a Specific Use Permit for deviations from the Town of Ponder Code of Ordinances for the following items:

- 1) A deviation from Appendix B, Table 2: Height, Area and Setback Regulations. The current allowable height for a M-1 district is 50-feet. We request a deviation to allow the two proposed receiving elevators to be 70-feet tall and the two proposed unloading elevators with hoppers to be 60-feet tall. This equipment at the requested height is essential to the efficient operation of the plant.
- 2) A deviation from section 154.38 Off-Street Parking and Loading Requirements division (F) items 20, 25 & 36. Per the current guidelines a total of 111 parking spaces is required. We request a reduction in the requirement for a total of 75 parking spaces. Our average daily use for number of employees will be 20 during non-peak. At a peak time, our maximum parking needs would be 30 which would include employee parking as well as visitors to the facility.
- 3) A deviation from section 154.41 Landscape and Buffer Requirements division (M) item 5. The current requirement is to install an 8-foot high solid block wall from the start of the SF-3 development along the east property line down to the south property line, approximately 1,970 liner foot of wall. We request a deviation for an Alternative Landscape Plan per 154.41 division (I) to substitute the solid wall with evergreen trees to create the screening requirement. We also request a reduction in the length of the screening requirement to screen the current developed part of the site, 845 liner foot. We agree to continue the screening for any future development on the site. The current site sheet flows from the west to the east into the existing drainage swale along the east property line. An evergreen tree screening wall would allow for the site to continue sheet drainage into the swale.

We appreciate your consideration of these requests.

Very truly yours,

Hugo Provencher Vice President Ferti Technologies

Staff Report

SUP/SITE PLAN – 100 E FM 2449 – FERTI TECHNOLOGIES			
P & Z Meeting: July 7, 2021	Agenda Item No.: 4		

Here is an excerpt from Town Engineer, George Belcheff's review letter (attached in full)

Submittal information suggests that the proposed use is allowed in an M1 district subject to certain clarifications. The applicant has provide certification from a corporate representative stating that "the proposed uses do not emit dust, smoke, odor, gas, fumes, or present a possible hazard beyond the bounding property lines of the lot or tract upon which the use or uses are located, and which do not generate noise or vibration at the boundary of the lot or tract which is generally perceptible in frequency or pressure above the ambient level of noise or vibration in the adjacent area."

Town Engineer's Recommendation –

If the Town is inclined to approve the requested SUP with Site Plan, it is recommended that the following conditions be included:

- 1. Acceptance of certain structure heights in excess of the allowed 50' to a maximum of 70' as shown in the Site Plan
- 2. Acceptance of phased Landscaping Plan as shown in the Site Plan
- 3. Approval of reduced parking to 75 spaces as shown in the Site Plan
- 4. Resolution of construction plan comments to the satisfaction of the Town Engineer and Public Works Director
- 5. Authorizing the Mayor to enter the Town into a Development Agreement to include provisions for:
 - a. Developer design/installation and funding of onsite 8" public water lines
 - b. Developer funding of onsite 8" portion with Town design/installation and funding of oversizing to 12" as shown on the Site Plan
 - c. Town design/installation and funding of offsite 12" FM 156/BNSF RR water line crossing
- 6. Dedication of all necessary water/sewer utility easements by separate instrument

Belcheff & Associates, Inc.

Municipal Engineering & Management TBPE Reg. No. F-368

> 1660 Keller Pkwy., Ste. 103 Keller, Texas 76248

June 16, 2021

Via e-mail to cfarmer@pondertx.com

Matthew Poole, Mayor Chairperson Planning & Zoning Commission Town of Ponder 102 W Bailey St Ponder, TX 76259

Re: Site Plan – Lot 1 Block A Tieszen Industrial Park Addition (Ferti Technologies Plant Renovation)

Dear Mayor Poole:

The Town has received a Site Plan submittal from KAZ Surveying, Denton, Texas, representing Ferti Management Corp., of Phoenix, Arizona. The application is requesting to perform certain renovations to the industrial site located at 100 E. FM 2449 within the Town.

This letter provides review comments on the submittal "Ferti Technologies – Plant Renovation, which includes certain sheets culled from a construction plan set dated 03/22/2021, as amended, namely those sheets that provide the Town with data required for a Site Plan as required by the Town's Zoning Ordinance. Those sheets have been attached with comments included by the Town Engineer.

<u>Location</u> – south side of FM 2449 approx. east of FM 156, within Ponder Corporate Limits (City)

Comprehensive Plan – Proposed Use - Industrial

- 1. Future Land Use Plan Industrial
- 2. Thoroughfare Plan
 - a) P5U at north boundary (FM 2449) no additional ROW proposed or required
- 3. Sewer Master Plan
 - a) service to be provided via existing 8" collector at east boundary
- 4. Water Master Plan
 - a) existing 8" waterline at northeast boundary of lot (south side FM 2449)
 - b) required 8" extension at north side of lot (12" oversizing by Town)
 - c) required 8" crossing extension to west side of FM 156 existing 12" (12" oversizing by Town)
 - d) required 8" waterline loop around building for fire hydrant coverage

Z:\Ponder\PermitReviews\Lot 1 Blk A Tieszen Ind Prk Ferti Technologies\3rd Submittal - SUP with Site Plan\Site Plan Rev Lot 1 Blk A Tieszen Ind Prk - Ferti Techn R3.docx

Mayor Mathew Poole June 16, 2021 Page 2 of 5

e) required 8" extension to south boundary of lot for fire flow capability (10" at Robinson Rd Pump Station)

Zoning

a) M1 (Manufacturing/Industrial District - Light) - proposed use should certify as compliant with current zoning

Height, Area and Setback Regulations	SF-3 (ad- joins)	C-1 (ad- joins)	M-1	Compliance?
Maximum height (feet)			50	No – towers at 70' (SUP condition)
Minimum lot area (square feet)	6,000	В	В	Yes
Minimum front yard setback (feet)	25	В	В	Yes
Minimum side yard setback (feet) ^D	5	В	В	Yes
Minimum rear yard setback (feet)	10	В	В	Yes
Minimum lot width (feet)	60	В	В	Yes
Minimum lot depth (feet)	100	В	В	Yes
Maximum lot coverage (%)	50	В	В	Yes
Minimum living area (square feet)	1,200	NA	NA	NA

- A. Total lot area shall not be less than 9,000 SF, or 1,500 SF per dwelling unit, whichever is greater. A maximum of 25 units may be constructed per acre.
- B. None required, except where **nonresidential use abuts a residential** or agricultural lot, in which case the requirements shall be the same as the adjoining residential zone and shall comply with visibility and parking requirements as provided within this chapter. (**SUP condition**)
- C. At the most extruding point of the outside wall excluding the overhang only.
- D. If the lot size is greater than 15,000 square feet, then the side yard adjacent to the street setback will be 25 feet. If the lot size is less than 15,000 square feet, then the side yard adjacent to the street setback will be 15 feet. Key lot setbacks will be 25 feet with 2 front yards.

Submittal Analysis

The referenced site was reportedly occupied by Southwest Molding, a non-conforming use with respect to site requirements of the Town's development regulations. Southwest Molding ceased operations (use) in excess of six months; and as such is no longer grandfathered. Any reoccupation of the property is therefore required to be compliant with the Town's regulations. This analysis is therefore provided with the intent of evaluating the applicant's submittal package with respect to the Town's current development ordinances, more specifically, Zoning and Subdivision requirements.

Submittal information suggests that the proposed use is allowed in an M1 district subject to certain clarifications. The applicant has provide certification from a corporate representative stating that "the proposed uses do not emit dust, smoke, odor, gas, fumes, or present a possible hazard beyond the bounding property lines of the lot or tract upon which the use or uses are located, and which do not generate noise or vibration at the boundary of the lot or tract which is generally perceptible in frequency or pressure above the ambient level of noise or vibration in the adjacent area." (Ref. letter dated May 11, 2021 by Hugo Provencher, Vice President)

Current data indicates that the Town does not have adequate water distribution capacity to serve projected demands (potable uses and fire flows) of the proposed redevelopment. To

Mayor Mathew Poole June 16, 2021 Page 3 of 5

meet such demands, certain water system extensions are necessary, both onsite and off. The development proposes to install an 8" waterline along the east side of the lot and around the building, connecting two existing lines north and south of the lot; and an 8" along the northwest side of the lot, connecting to an existing 12" line on the west side of FM 156.

The Town's Water Master Plan recommends this northwest extension as a 12" in which the Town should participate in oversizing, as well as providing the 12" extension under FM 156 and RR property. Additional easements are necessary and are shown on the comment mark-up plans.

Additional onsite fire hydrants/fire department connections/emergency vehicle (fire lanes) access routing will also be necessary, subject to Fire Marshal concurrence. Such provisions have been shown in the Site Plan packet. [3500 gpm; 4 hydrants; 210' coverage]

The submittal drawings reference a proposed fire suppression (sprinkler) system which is to include a booster pump. Such pumps can cause the Town's water system to violate TCEQ operating requirements and will need additional study once the distribution system improvements are available. The Site Plan provides an agreement to resolve.

The existing 8" sewer line at the east side of the lot should have sufficient capacity for typical wastewater generators shown in the Site Plans but is subject to periodic overcharging. This line is funded by the Town for replacement with a larger sewer line to assure capacity for this and other properties. Additional easement space will be necessary and is shown on the comment mark-ups. No special pre-treatment requirements are evident from the submittal.

The submitted Site Plan information does not provide sufficient drainage study/planning information to ensure that stormwater will be appropriately managed. While the lot appears to be within a designated flood plain, no information has been provided to allow for proper review and permitting under the Town's Floodplain Development regulations.

Access to the site is via an existing single drive to FM 2449. The applicant has submitted a preliminary vehicle trip report indicating that the drive should be sufficient for the proposed use; therefore, no further Traffic Impact Analysis should be required.

Two separate entrances are usually required to meet the Town's Fire code requirements. The applicant has proposed to maintain the existing single drive in which case the Town's Fire Marshal was consulted to verify adequacy due to certain allowances in the Fire Code since the applicant will be installing a full fire sprinkler system.

An ongoing TxDOT FM 2449 Feasibility Study does not suggest that this development accommodate future ROW expansion to the south of the current limits.

The proposed parking areas (111 spaces) do not meet space counts as required for this project; however, the applicant has provided additional information to justify a reduction to 75 spaces as proposed in the Site Plan.

The submittal packet includes a Landscaping Plan, which appears to generally comply with the Town's Screening and Landscaping requirements for the existing developed portion of Mayor Mathew Poole June 16, 2021 Page 4 of 5

the Lot. The applicant has requested via their SUP to defer future expansion of their screening until the remaining southern portion of the Lot is developed as noted on the attached mark-up.

The Site Plan includes a Photometric Analysis demonstrating that proposed lighting within the Site Plan should meet the limitations of this zoning district.

Please note that a Development Agreement is required for proposed public improvements.

<u>Town Engineer's Recommendation – </u>

If the Town is inclined to approve the requested SUP with Site Plan, it is recommended that the following conditions be included:

- 1. Acceptance of certain structure heights in excess of the allowed 50' to a maximum of 70' as shown in the Site Plan
- 2. Acceptance of phased Landscaping Plan as shown in the Site Plan
- 3. Approval of reduced parking to 75 spaces as shown in the Site Plan
- 4. Resolution of construction plan comments to the satisfaction of the Town Engineer and Public Works Director
- 5. Authorizing the Mayor to enter the Town into a Development Agreement to include provisions for:
 - a. Developer design/installation and funding of onsite 8" public water lines
 - b. Developer funding of onsite 8" portion with Town design/installation and funding of oversizing to 12" as shown on the Site Plan
 - c. Town design/installation and funding of offsite 12" FM 156/BNSF RR water line crossing
- 6. Dedication of all necessary water/sewer utility easements by separate instrument

Sincerely,

George Belcheff, P.E. Town Engineer for Ponder

Attached: <u>Ferti Technologies Plant Renovation [Site Plan]</u> dated 03/22/2021 as amended Review Mark-up

cc: Planning & Zoning Commission/Town Council Members *via meeting packets* Sheri Clearman, Town Secretary *via e-mail* Gary Morris, Director of Public Works *via e-mail* Mayor Mathew Poole June 16, 2021 Page 5 of 5

Carolyn Farmer, Planning & Zoning Director *via e-mail* Applicant/Engineer/Surveyor



Town of Ponder Planning & Zoning 102 W. Bailey Street Ponder, TX 76259

May 11, 2021

Re: Ferti Technologies Specific Use Permit

Dear Sir/Madame,

Ferti Technologies is requesting a Specific Use Permit for deviations from the Town of Ponder Code of Ordinances for the following items:

- 1) A deviation from Appendix B, Table 2: Height, Area and Setback Regulations. The current allowable height for a M-1 district is 50-feet. We request a deviation to allow the two proposed receiving elevators to be 70-feet tall and the two proposed unloading elevators with hoppers to be 60-feet tall. This equipment at the requested height is essential to the efficient operation of the plant.
- 2) A deviation from section 154.38 Off-Street Parking and Loading Requirements division (F) items 20, 25 & 36. Per the current guidelines a total of 111 parking spaces is required. We request a reduction in the requirement for a total of 75 parking spaces. Our average daily use for number of employees will be 20 during non-peak. At a peak time, our maximum parking needs would be 30 which would include employee parking as well as visitors to the facility.
- 3) A deviation from section 154.41 Landscape and Buffer Requirements division (M) item 5. The current requirement is to install an 8-foot high solid block wall from the start of the SF-3 development along the east property line down to the south property line, approximately 1,970 liner foot of wall. We request a deviation for an Alternative Landscape Plan per 154.41 division (I) to substitute the solid wall with evergreen trees to create the screening requirement. We also request a reduction in the length of the screening requirement to screen the current developed part of the site, 845 liner foot. We agree to continue the screening for any future development on the site. The current site sheet flows from the west to the east into the existing drainage swale along the east property line. An evergreen tree screening wall would allow for the site to continue sheet drainage into the swale.

We appreciate your consideration of these requests.

Very truly yours,

Hugo Provencher Vice President Ferti Technologies



Town of Ponder Planning & Zoning 102 W. Bailey Street Ponder, TX 76259

May 11, 2021

Re: Ferti Technologies Specific Use Permit

Dear Sir/Madame,

As you are aware, Ferti Technologies is applying for a special use permit for our new facility in Ponder. This is confirmation that the proposed use of the facility shall not emit dust, smoke, odor, gas, fumes, or present a possible hazard beyond the bounding property lines of Lot 1 Block A, Tieszen Industrial Park, and shall not generate noise or vibration at the boundary of the lot which is generally perceptible in frequency or pressure above the ambient level of noise or vibration in the adjacent area. The facility is self-contained and will have no environmental impact on the surrounding area.

Very truly yours,

Hugo Provencher Vice President Ferti Technologies

Item 7.

Voigt Associates, Inc.

Professional Traffic Engineers Texas Registered Firm F-5333 2631 Lakecrest Drive Pearland, Texas 77584 832.264.0429 tony@voigtassociates.com

May 20, 2021

Mr. Todd Eppenbach Inventure Design 3118 Richmond Avenue, Suite 200 Houston, Texas 77098

RE: Trip Generation Estimate, Ferti Technologies 100 East FM 2449, Ponder, Texas 76259

Dear Mr. Eppenbach:

Per the City of Ponder's request, this brief letter report documents the anticipated trip generation for Ferti Technologies redevelopment of the existing industrial building located at 100 East FM 2449. Ferti Technologies provides granular fertilizer products and is planning to repurpose the existing 98,000 SF industrial building on 23.2 acres to a fertilizer manufacturing facility. Access to the site is via one 56' wide driveway located on FM 2449 about 360' east of FM 156. Exhibit A1 (attached in Appendix A) shows the project location. Exhibit A2 shows the site layout.

To estimate trip generation of the fertilizer manufacturing facility, the Institute of Transportation Engineers' *Trip Generation Manual* (10th Edition) was used to estimate trips to the site using Land Use #140 – Manufacturing. Information from Ferti Technologies indicates that the site will employ 30 persons and will have fewer than 20 truck trips (ten in and ten out) during the typical weekday.

Based on using the most relevant independent variable of *employees* for the proposed facility, the manufacturing land use generates trips at the following trip rates:

- Total Daily Trips: 2.47 trips/employee
- Weekday AM Peak Hour Trips (of trip generator): 0.43 trips/employee
- Weekday PM Peak Hour Trips (of trip generator): 0.45 trips/employee.

Based on *trip rates*, with 30 employees, the site is expected to generate the following number of trips:

- Total Daily Trips: 74 (37 entering and 37 exiting)
- Weekday AM Peak Hour: Total: 13 trips; Entering: 10 vehicles; Exiting: 3 vehicles
- Weekday PM Peak Hour: Total: 14 trips; Entering: 6 vehicles; Exiting: 8 vehicles.

The *Trip Generation Manual* also provides the option to generate trip estimates based on regression analysis and fitted curves. Based on these *fitted curves*, with 30 employees, the site is expected to generate the following number of trips:

- Total Daily Trips: 112 (56 entering and 56 exiting)
- Weekday AM Peak Hour: Total: 49 trips; Entering: 40 vehicles; Exiting: 9 vehicles
- Weekday PM Peak Hour: Total: 36 trips; Entering: 16 vehicles; Exiting: 20 vehicles.

Per Section 153.118 (Traffic Impact Analysis Required) of the Ponder city ordinances, a traffic impact analysis may be required if a site generates more then 250 trips per peak hour. Since

Voigt Associates, Inc.

Professional Traffic Engineers Texas Registered Firm F-5333

Mr. Todd Eppenbach May 20, 2021 Page 2

this development would be expected to generate less than 250 trips per hour (with peak hour trip estimates ranging from 13 to 49 trips per hour), a formal traffic impact analysis should not be required.

Voigt Associates appreciates the opportunity to assist you with this project. If you have any questions about the analysis or the results of this report, please feel free to contact me at 832-264-0429.

Sincerely,

Anthony Voigt, P.E., PTOE

Principal


Attachments:

Appendix A. Exhibits



Exhibit A1. Site Location Map.

North to top of page. Not to scale.

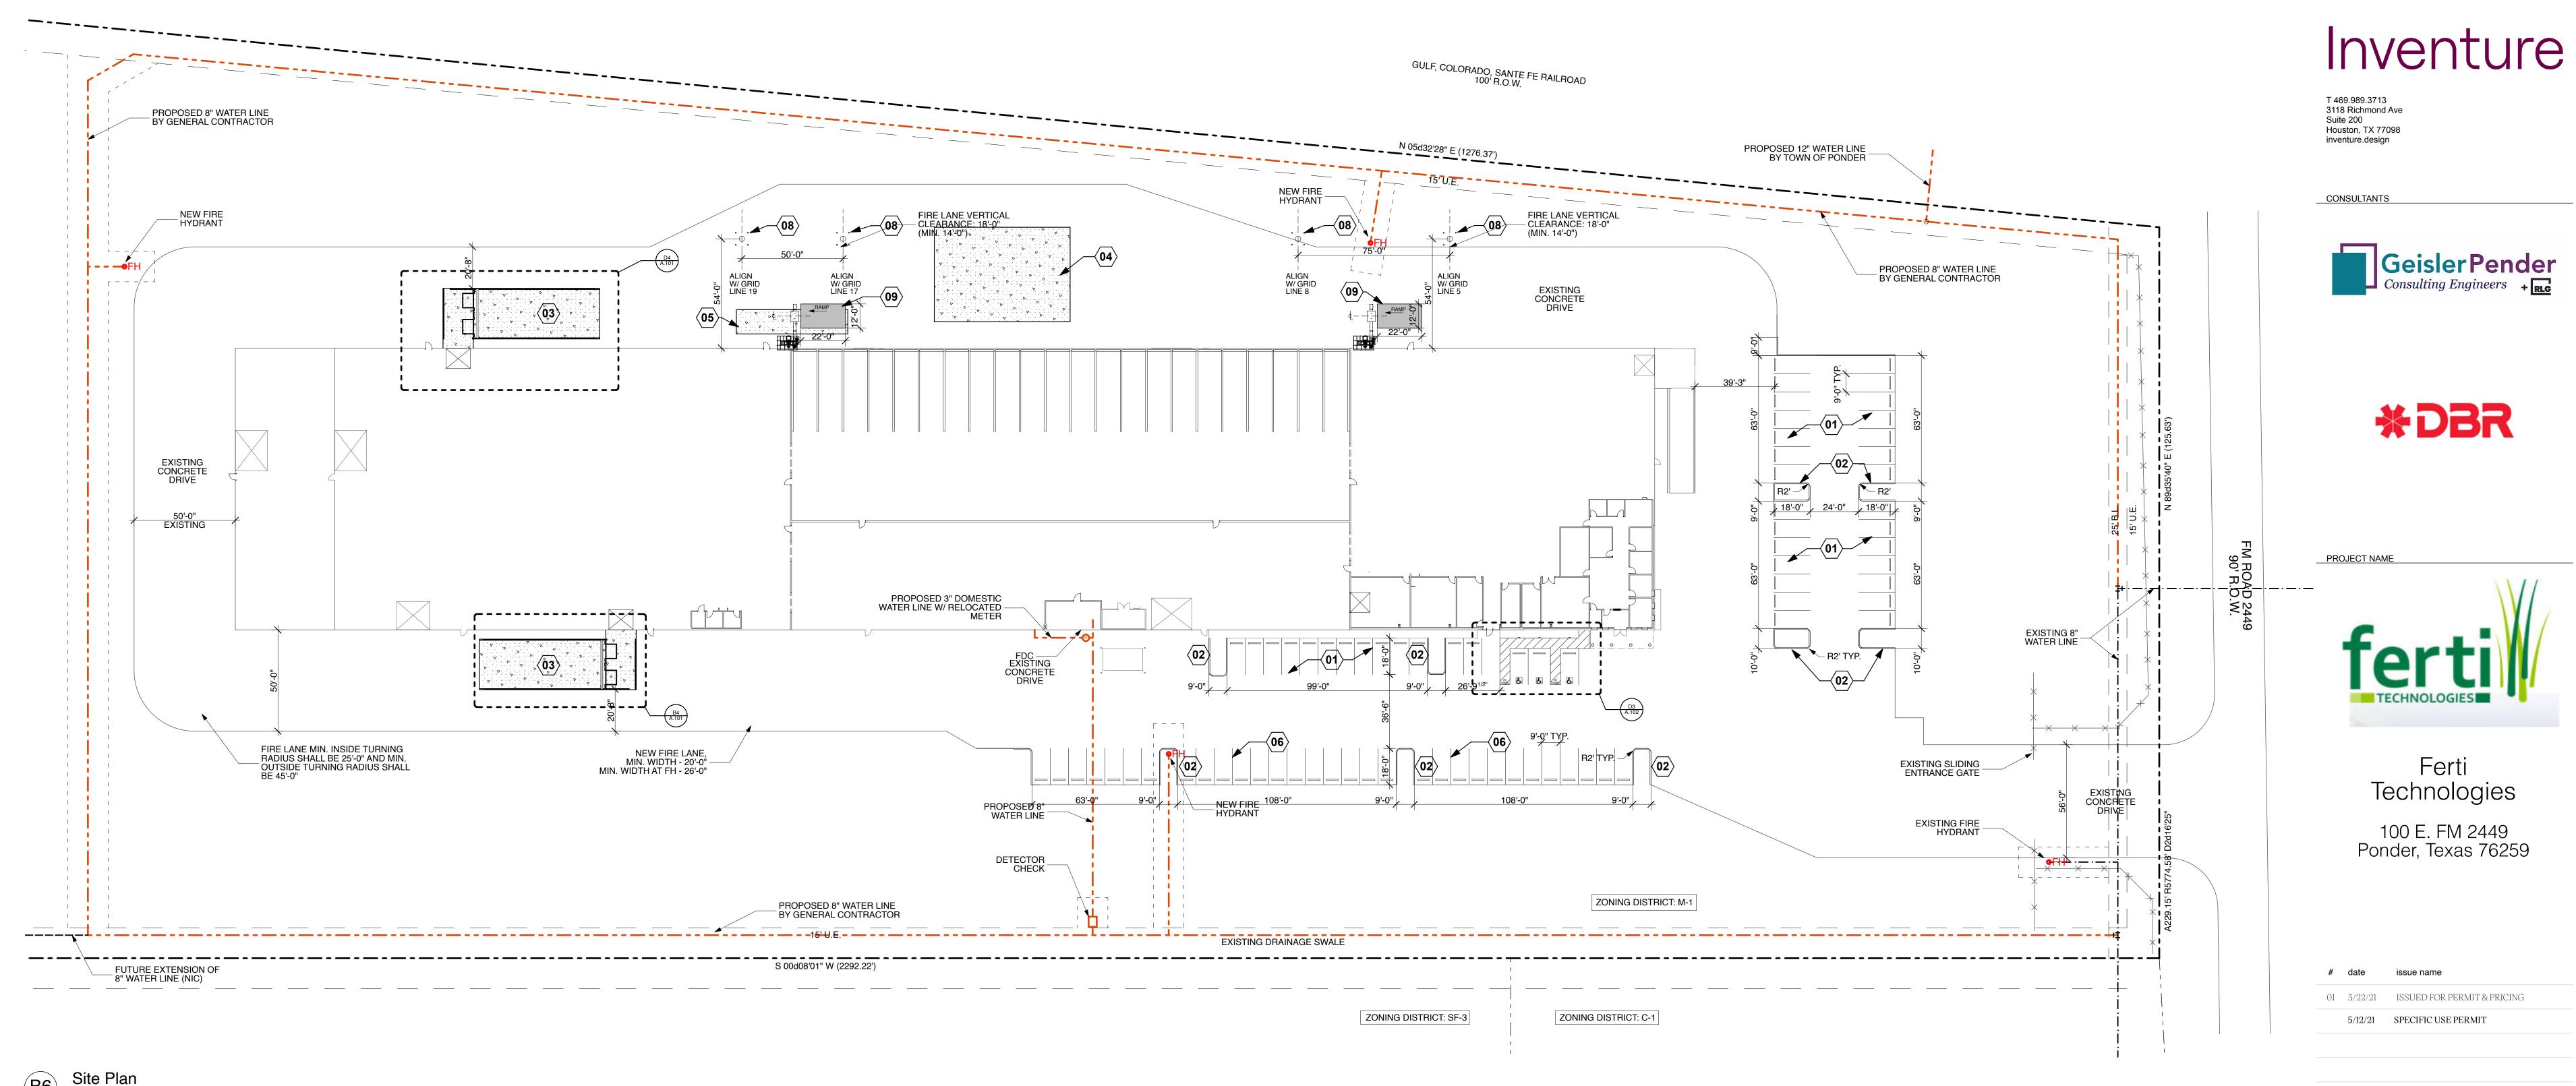

SCALE: 1/32" = 1'-

Site Plan Notes

Note

15

Note

16

RE-STRIPE EXISITING PARKING LOT AS SHOWN AND INSTALL CONCRETE WHEEL STOPS AT EACH PARKING STALL; 4" STRIPES PAINTED WHITE

17

18

19

NEW LANDSCAPE ISLAND WITH 6" CONCRETE CURB

18

NEW DEPRESSED TRUCK LOADING DOCK

NEW CONCRETE PAVING WHERE ELEVATED CONCRETE PADS WERE REMOVED; RE:
CIVIL DRAWINGS

NEW CONCRETE PAVING WHERE DEPRESSED LOADING DOCK WAS REMOVED; RE:
CIVIL DRAWINGS

06 STRIPE EXISITNG CONCRETE PAVING AS SHOWN; 4" STRIPES PAINTED WHITE

NEW STRUCTURAL SUPPORT FOR UNLOADING ELEVATORS; RE: STRUCTURAL DRAWINGS. PROVIDE FOUR PIPE BOLLARDS AT EACH SUPPORT, RE: DETAIL B1/A.102

NEW CONCRETE RAMP FOR TRUCK UNLOADING, 22' LONG, 12' WIDE, 1' HIGH AT TOP OF RAMP. RE: CIVIL DRAWINGS

DIV. F 20: MANUFACTURING, PROCESSING OR REPAIRING:
ONE PARKING SPACE FOR EACH 2 EMPLOYEES ON THE MAXIMUM WORKING
SHIFT, PLUS SPACE TO ACCOMMODATE ALL VEHICLES USED IN CONNECTION
THEREWITH, BUT NOT LESS THAN 1 SPACE FOR EACH 1,000 SQUARE FEET OF
FLOOR AREA, WHICHEVER IS GREATER.

54,670 SQ. FT. / 1,000 = 55 PARKING SPACES

DIV. F 25: OFFICE, GENERAL:
ONE SPACE FOR EACH 300 SQUARE FEET OF TOTAL FLOOR AREA.

4,851 SQ. FT. / 300 = 17 PARKING SPACES

DIV. F 36: STORAGE OR WAREHOUSING:
ONE SPACE FOR EACH 2 EMPLOYEES, OR 1 SPACE FOR EACH 1,000 SQUARE FEET OF TOTAL FLOOR AREA, WHICHEVER IS GREATER.

ONE SPACE FOR EACH 2 EMPLOYEES, OR 1 SPAC OF TOTAL FLOOR AREA, WHICHEVER IS GREATER 38,371 SQ. FT. / 1,000 = 39 PARKING SPACES REQUIRED: 55+17+39 = 111 PARKING SPACES; TOTAL PARKING SPACES PROVIDED = 106

REQUIRED ACCESSIBLE PARKING SPACES = 5 (1 VAN);
TOTAL ACCESSIBLE PARKING SPACES PROVIDED = 5
TOTAL PROVIDED = 111

NOTE - A SPECIFIC USE PERMIT HAS BEEN SUBMITTED FOR APPROVAL TO REDUCE THE REDUCE THE PARKING FROM 111 SPACE DOWN TO 75 SPACES



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PROJECT NUMBER

20.175.00

DRAWING NAME

Site Plan

DRAWING NUMBER

A 400

National Flood Hazard Layer FIRMette



Legend

SEE FIS REPORT FOR DETAILED LEGEND AND INDEX MAP FOR FIRM PANEL LAYOUT

Item 7.

Without Base Flood Elevation (BFE) With BFE or Depth Zone AE, AO, AH, VE, AR SPECIAL FLOOD **HAZARD AREAS** Regulatory Floodway 0.2% Annual Chance Flood Hazard, Areas of 1% annual chance flood with average depth less than one foot or with drainage areas of less than one square mile Zone X **Future Conditions 1% Annual** Chance Flood Hazard Zone X Area with Reduced Flood Risk due to Levee. See Notes. Zone X OTHER AREAS OF FLOOD HAZARD Area with Flood Risk due to Levee Zone D NO SCREEN Area of Minimal Flood Hazard Zone X Effective LOMRs OTHER AREAS Area of Undetermined Flood Hazard Zone D - - Channel, Culvert, or Storm Sewer **GENERAL** STRUCTURES | LILLI Levee, Dike, or Floodwall 20.2 Cross Sections with 1% Annual Chance 17.5 Water Surface Elevation **Coastal Transect** ---- 513---- Base Flood Elevation Line (BFE) Limit of Study Jurisdiction Boundary **Coastal Transect Baseline** OTHER Profile Baseline **FEATURES** Hydrographic Feature

Digital Data Available

No Digital Data Available

Ilnmanned

Unmapped

MAP PANELS

an authoritative property location.

The pin displayed on the map is an approximate point selected by the user and does not represent

This map complies with FEMA's standards for the use of digital flood maps if it is not void as described below. The basemap shown complies with FEMA's basemap accuracy standards

The flood hazard information is derived directly from the authoritative NFHL web services provided by FEMA. This map was exported on 5/21/2021 at 8:59 AM and does not reflect changes or amendments subsequent to this date and time. The NFHL and effective information may change or become superseded by new data over time.

This map image is void if the one or more of the following map elements do not appear: basemap imagery, flood zone labels, legend, scale bar, map creation date, community identifiers, FIRM panel number, and FIRM effective date. Map image unmapped and unmodernized areas cannot be used for regulatory purposes.



Ferti Technologies

Plant Renovation

100 E. FM 2449 Ponder, Texas 76259

Architectural Design:



Civil / Structural Design:



MEP Design:



214,217,9500 Kenneth Roland, PE









Ferti Technologies 100 E. FM 2449 Ponder, Texas 76259

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0 2021 Inventors. At rights reserved. No part of this document may reproduced or all lead in any form without prior written authorization leads in.	r to

20.175.00 DRAWING NAME

G.000

Architectural Abbreviations Architectural Symbol Legend Fire Department Notes Vicinity Map PROVIDE A PORTABLE FIRE EXTÍNGUÍSHER WITH A RATING OF NOT LESS THAN 2-7 WITHIN 75 POOT TRAVEL DISTANCE TO ALL PORTIONS OF THE BUILDING ON EACH FLOOR (ALCOHOMAL (EXTINGUÍSHERS AS REQUIRED BY PIRE DEPARTMENT FIELD (NESPECTOR OR BUILDING DEPARTMENT (NESPECTOR). ssue Sheet# SPEAKER SQUARE SQUARE FEET SQUARE INCH STANDARD STANDARD STANDARD STOME STOME STOME STOME STRUCTURAL SUBFROE SUSPENDED STAINLESS STEEL CONDITIONING VE FINISHED FLOOR ACC AD AC BD. AC BD. ACSTL ACT ADD. ACT ALT ALUM ANCH ANCH ANCH ANCH ASPH ASPH ASSY AUTO APPRO A APPRO A APPRO APPRO A A PROVIDE EXIT SIGNS) WITH 6" LETTERS OVER REQUIRED EXITS WHERE SHOWN O DRAWINGS AND ADDITIONAL SIGNS AS REQUIRED BY BUILDING DEPARTMENT INSPECTOR OR RISE DEPARTMENT FIELD INSPECTOR, CONNECT EXIT SIGNS TO EMERICARY POWER CROUNTS, COMPLY WITH BUILDING COOS. 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GC SHALL FREPROOF AS REQUIRED BY CODE ALL NEW PENETRATION GENERATED BY THE WORK DESCRIBED IN THESE DOCUMENTS. NOTE - A SPECIFIC USE PERMIT HAS BEEN SUBMITTED FOR APPROVAL TO ALLOW OFF-LOADING AND LOADING ELEVATOR EQUIPMENT AT A HEIGHT NO GREATER THAN 70! GAS GASNET GAUGE GENERAL GENERAL GENERATOR GLASSIGLAZING GRADE GRADE Electrical Schedule Electrical Schedule Project Jobsite MINIMUM LOT AREA. NONE REQUIRED EXCEPT WHERE ABUTS RESIDENTIAL (SF-3: 6,000 SF). ** PROPERTY IN COMPLIANCE ** GC SHALL COOPEDINATE WORK WITH THE OWNER, INCLUDING SCHEDUL INS TIME AND LOCATIONS FOR DELIVERIES BUILDING ACCESS, USE OF BUILDING SECRES AND FACILITIES AND USE OF ELEWTORS, MINIMIZE DISTURBANCE OF BUILDING FUNCTIONS AND DOCUMENTS. MIMIMUM FRONT YARD SETBACK - NONE REQUIRED EXCEPT WHERE ABUTS RESIDENTIAL (SF-3: 25 FEET) ** PROPERTY IN COMPLIANCE ** GROUND FAULT GROUND FAULT CIRCUIT INTERRUPTER GROUND FAULT CIRCUIT GC SHALL COORDINATE TELECOMMUNICATIONS, DATA AND SECURITY SYSTEM INSTALLATIONS. GFI GET GER GYP GYP BI GWB GP MINIMUM SIDE YARD SETBACK - NONE REQUIRED EXCEPT WHERE ABUTS RESIDENTIAL (SF3:5 FEET) ** PROPERTY IN COMPLIANCE ** GROUND PAGE UM GROUT GUARD RAIL GYPSUM GYPSUM BOARD GYPSUM WALL BOA GYPSUM PLASTER PROTECTION OF THE PROTECTION DEVICES AND ALL MANYAM ENTITS ENTIT LIGHTING, FIRE PROTECTION DEVICES AND ALL MANYAM ENCONFERENCE WITH CODES AND OPDIVANCES DUFFING CONSTRUCTION RECIERT POR ADDITIONAL ENTONALISM. 4. GC SHALL PROTECT AREA OF WORK AND ADJACENT AREAS FROM DAMAGE. Warer Clases MINIMUM REAR YARD SETBACK - NONE REQUIRED EXCEPT WHERE ABUTS RESIDENTIAL (SF-3: 10 FEET) *** PROPERTY IN COMPLIANCE *** MINIMUM LOT WIDTH: NOVE REQUIRED EXCEPT WHERE ABUTS RESIDENTIAL (SF-3: YO FEET) ** PROPERTY IN COMPLIANCE ** SAFIGL. SOMED SOT STG SECT SEP SERV SHPL SHT SHVL SHVL SIM SC. SAFETY GLASS SCHEDULE SEALANT SEATING SECTION SEPARATE SEPARE SHEAP PLATE SHEAT HDWE HD HTR HVAC Lavatories Lavatories GC SHALL WORK AREAS TO BE SECURE AND LOCKABLE DURING CONSTRUCTION. COORDINATE WITH TENANT AND LANDLORD TO ENSURE SECURITY. MINIMUM LOT DEPTH - NONE REQUIRED EXCEPT WHERE ABUTS RESIDENTIAL (SF-3: 100 FEET) ** PROPERTY IN COMPLIANCE ** HARDWARE HEAD HEATER HEATING/VENTING AIR CONDITIONING HEIGHT HIGH POINT HIGH LINE HOLLOW METAL OS SHALLALL TRAISH AND DEBRIS CREATED DUPING CONSTRUCTION SHALL BE REMOVED TRAISH AND DEBRIS CONTRIBUTE WITH BUILDING MANAGEDING CONSCIENT MESCAL TO SHALL OF BUILDING SHALL BUILDING AND CONSTRUCTIONS BUILDING COMMON AREA CONFIDENCE DEPARTORS. AND LOGISIES FROM DAMAGE. MAXIMUM LOT COVERAGE (%) - NONE REQUIRED EXCEPT WHERE ABUTS RESIDENTIAL (\$F-3:50%) ** PROPERTY IN COMPLIANCE **

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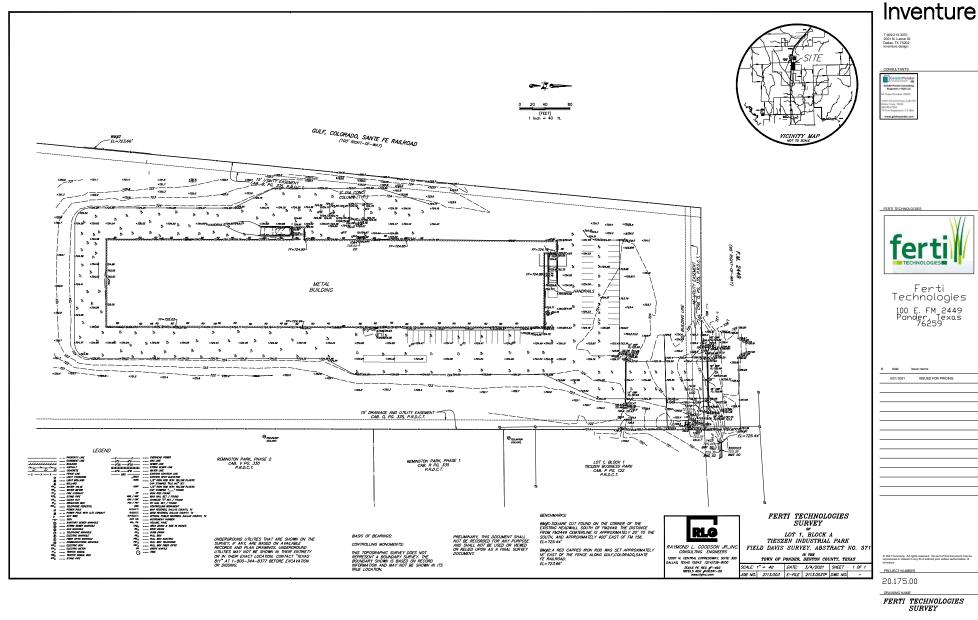


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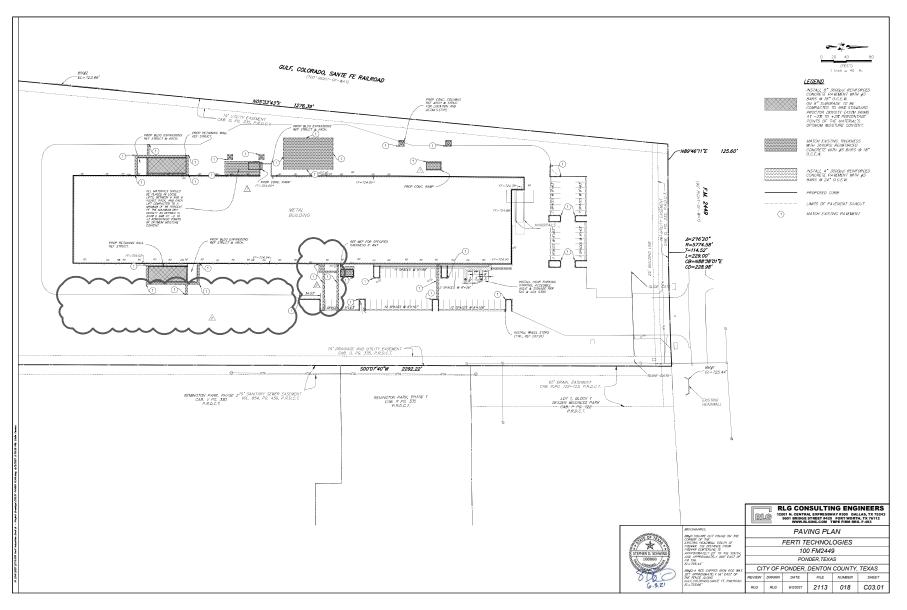
General Notes, Abbreviations, & Project Information

G.001



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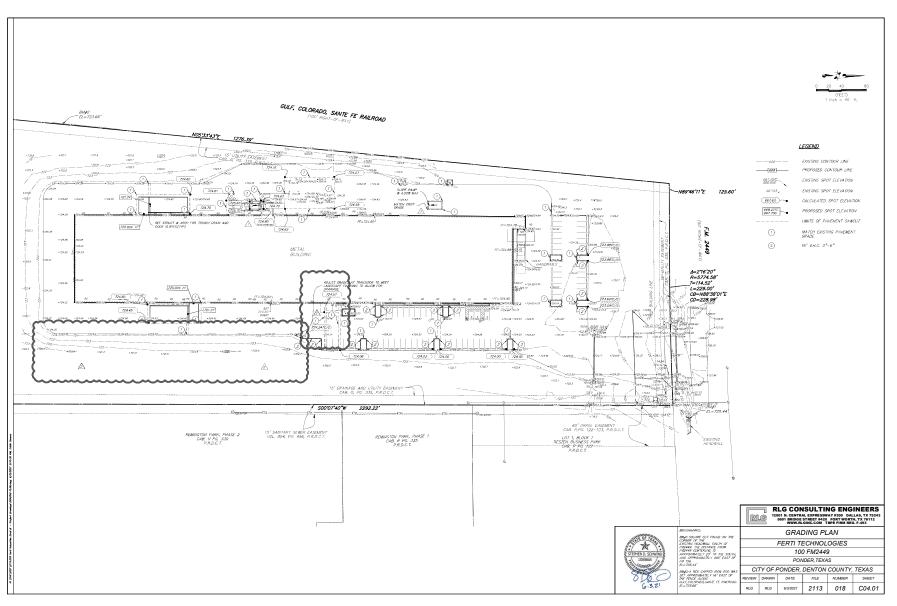
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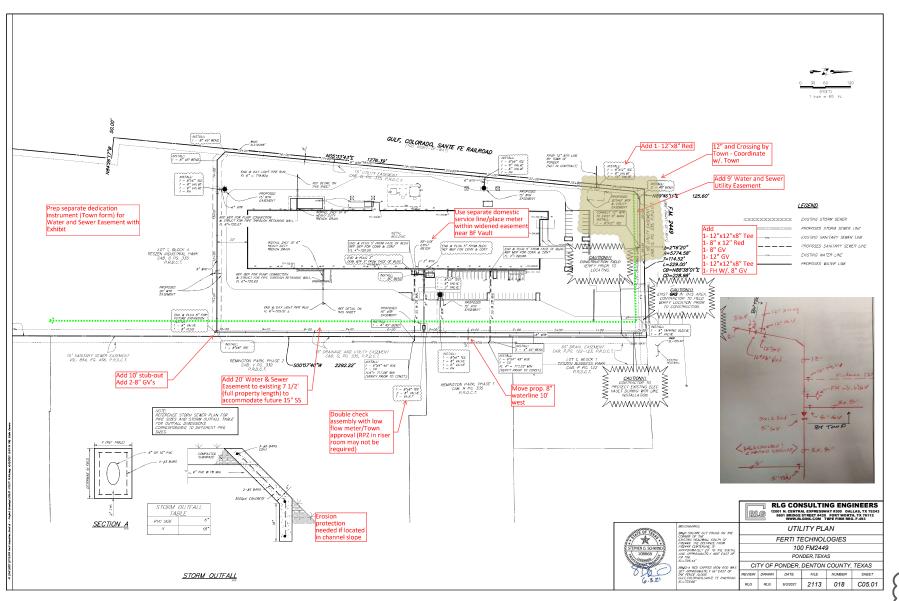
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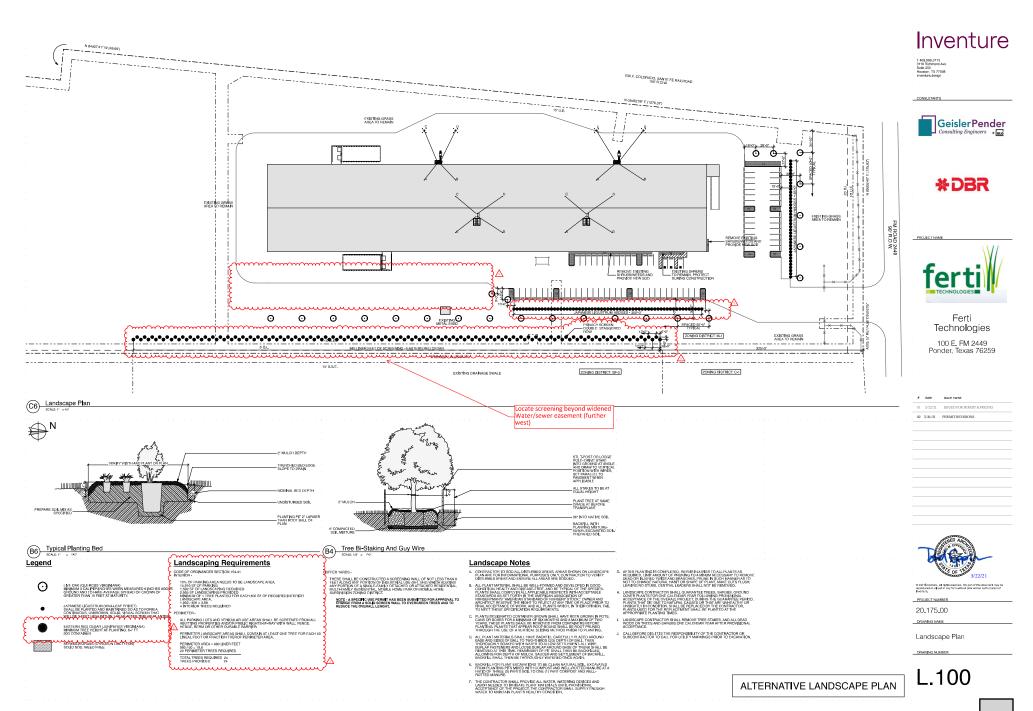



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SITE IMPROVEMENTS


SITE TOTAL SQUARE FOOTAGE - 1,012,073 SF
EXISTING SITE IMPERVIOUS SURFACE AREA - 234,545 SF (23,2%) PROPOSED SITE IMPERVIOUS SURFACE AREA - 233,433 (23.0%)
THE PROPOSED SITE WORK DECREASES THE IMPERVIOUS SURFACE AREA BY 1,112 SF OR 0.2%



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Site Plan

A.001

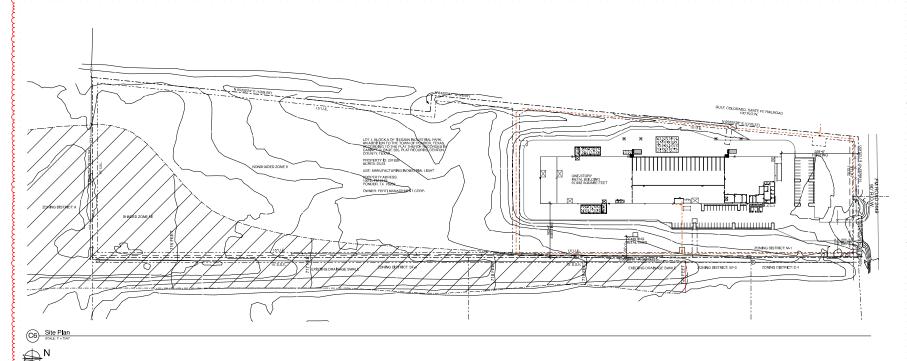


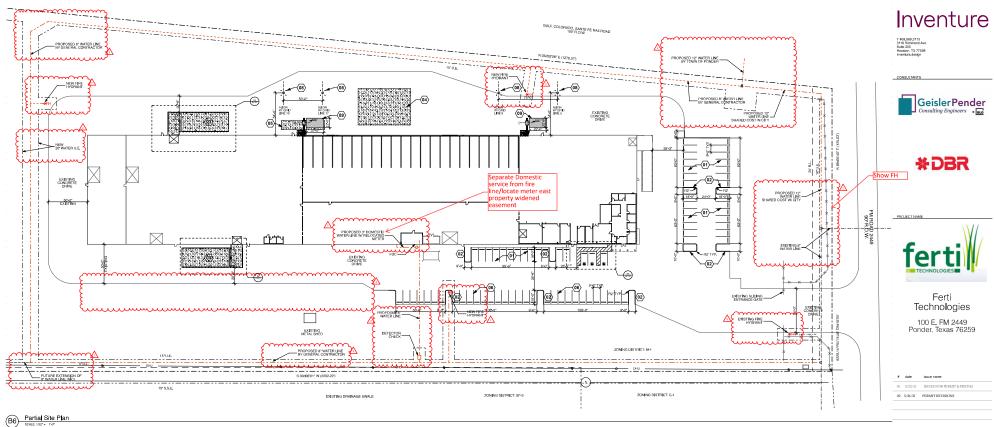



		1549	or operated periods and cooling recurrences	
	Site Plan Notes	1010	DIV F20: MANUFACTURING PROCESSING OR REPAIRING	Mary Control of the
. #	Note		ONE PARKING SPACE FOR EACH 2 EMPLOYEES ON THE MAXIMUM WORKING SHIFT, PLUS SPACE TO ACCOMMICONTE ALL VEHICLES USED IN CONNECTION THEREWITH, BUT NOT LESS THAN 1 SPACE FOR EACH 1,000 SQUARE FREET OF	F OF TECON 3/22/21
- 01	RE-STRIPE EXISTING PARKING LOT AS SHOWN AND INSTALL CONCRETE WHEEL STOPS AT EACH PARKING STALL: 4" STRIPES PAINTED WHITE		THEREWITH, BUT NOT LESS THAN 1 SPACE FOR EACH 1,000 SQUARE FEET OF FLOOR AREA, WHICHEVER IS GREATER.	
	STOPS AT EACH MANING STALL; 4" STM MES MAINTED WHITE		54,670 9Q, FT, / 1,000 = 55 PARK ING SPACES	© 2021 Inventure. All rights reserved. No part of this document may be reproduced or utilized in any form without prior written authorization of learning.
02	NEW LANDSCAPE ISLAND WITH 6" CONCRETE CURB		DIV. F.25: OFFICE, GENERAL: ONE SPACE FOR EACH 380 SQUARE FEET OF TOTAL FLOOR AREA.	PROJECT NUMBER
	NEW DEPRESSED TRUCK LOADING DOCK		4,851 SQ. FT / 300 = 17 PARK NG SPACES	00.175.00
	NEW DEPRESSED INDOLEDWAND DOOR		DIV. F 36: STORAGE OR WAREHOUSING: ONE SPACE FOR EACH 2 EMPLOYEES, OR 1 SPACE FOR EACH 1,000 SQUARE FEET OF TOTAL FLOOR AREA, WHICHEVER IS GREATER.	20.175.00
.04	NEW CONCRETE PAVING WHERE ELEVATED CONCRETE PADS WERE REMOVED; RE: CIVIL DRAWINGS			DRAWING NAME
	of the constitution		38,371 SQ. FT. / 1,000 = 39 PARKING SPACES	
05	NEW CONCRETE PAYING WHERE DEPRESSED LOADING DOCK WAS REMOVED: RE: CIVIL DRAWINGS		REQUIRED; 55+17+39 = 111 PAPIKING SPACES; TOTAL PARKING SPACES PROVIDED = 108	Partial Site Plan
06	STRIPE EXISTING CONCRETE PAVING AS SHOWN; 4" STRIPES PAINTED WHITE		REQUIRED ACCESSIBLE PARKING SPACES = 5 (1 WAG); TOTAL ACCESSIBLE WARKING SPACES PROVIDED = 5 TOTAL PROVIDED = 111	
	NEW STRUCTURAL SUPPORT FOR UNLOADING FLEVATORS: RE-STRUCTURAL	••	NOTE - A SPECIFIC USE PERMIT HAS BEEN SUBMITTED FOR APPROVAL TO	DRAWING NUMBER
. 08	DRAWINGS. PROVIDE FOUR PIPE BOLLARDS AT EACH SUPPORT, RE: DETAIL B1/A 102		REDUCE THE REDUCE THE PARKING FROM 111 SPACE DOWN TO 75 SPACES	


09 NEW CONCRETE RAMP FOR TRUCK UNLOADING, 22 LONG, 12 WIDE, 1 HIGH AT TOP OF BALLS, RE-CIVIL DRAWINGS


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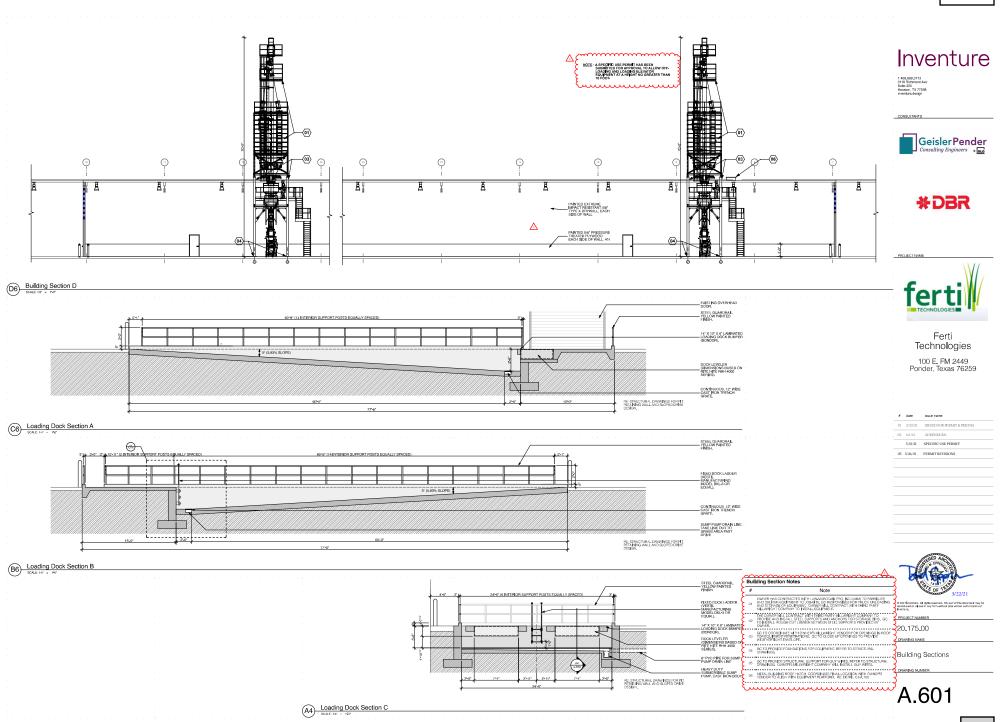


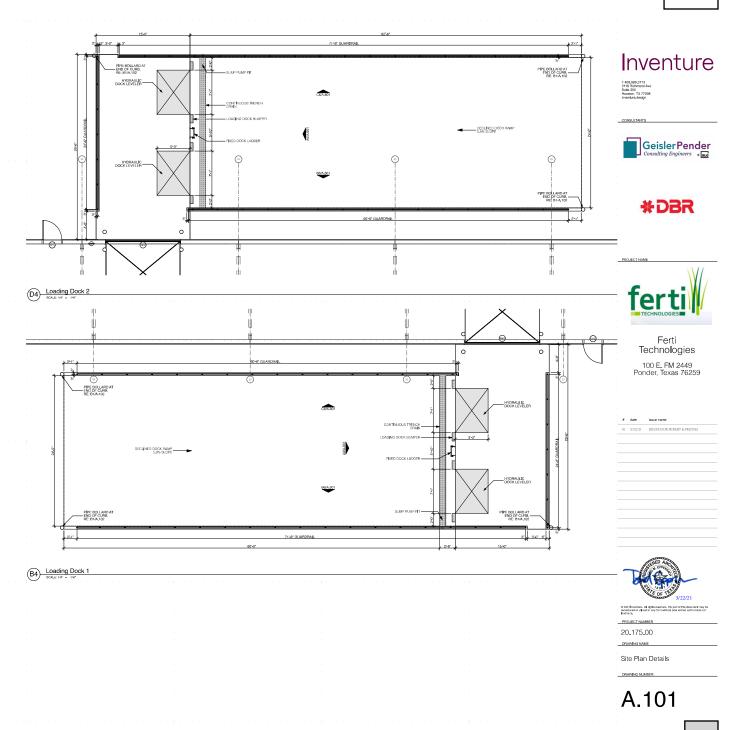

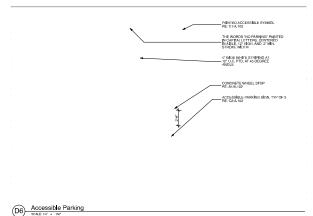


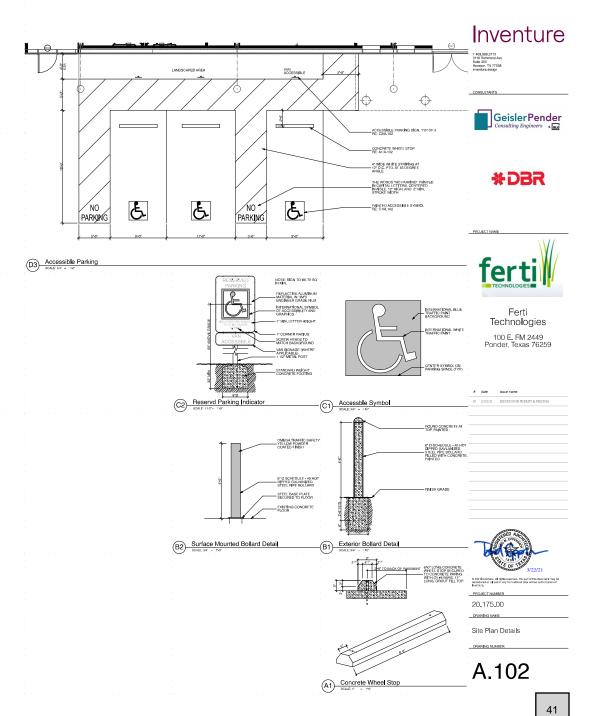

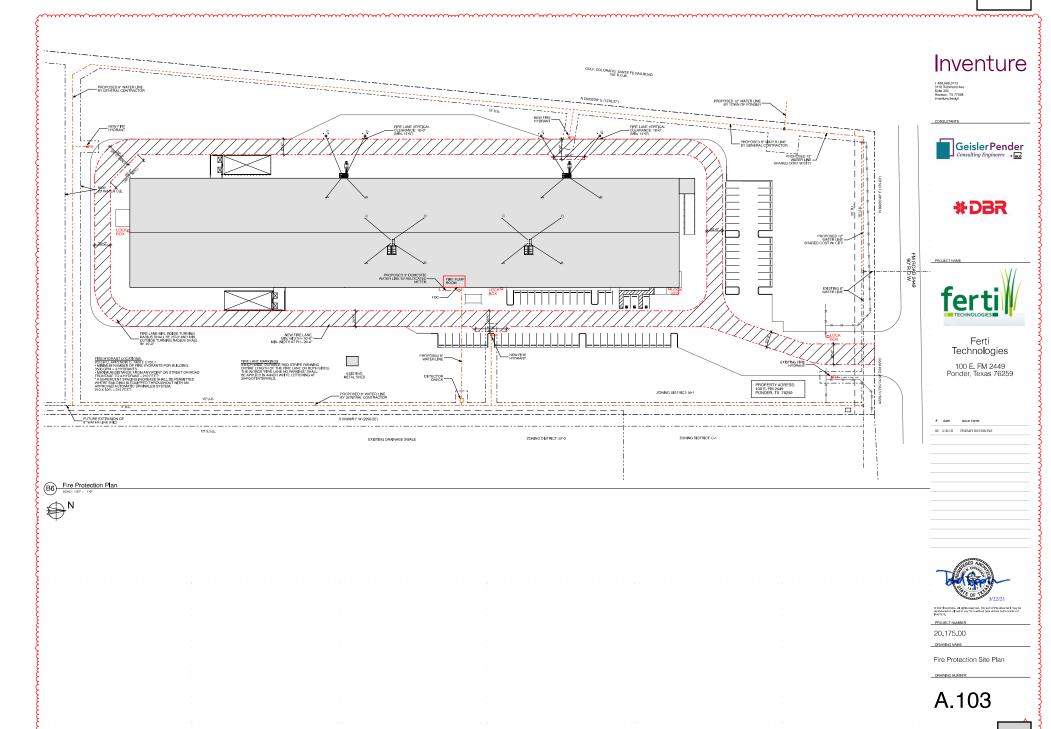

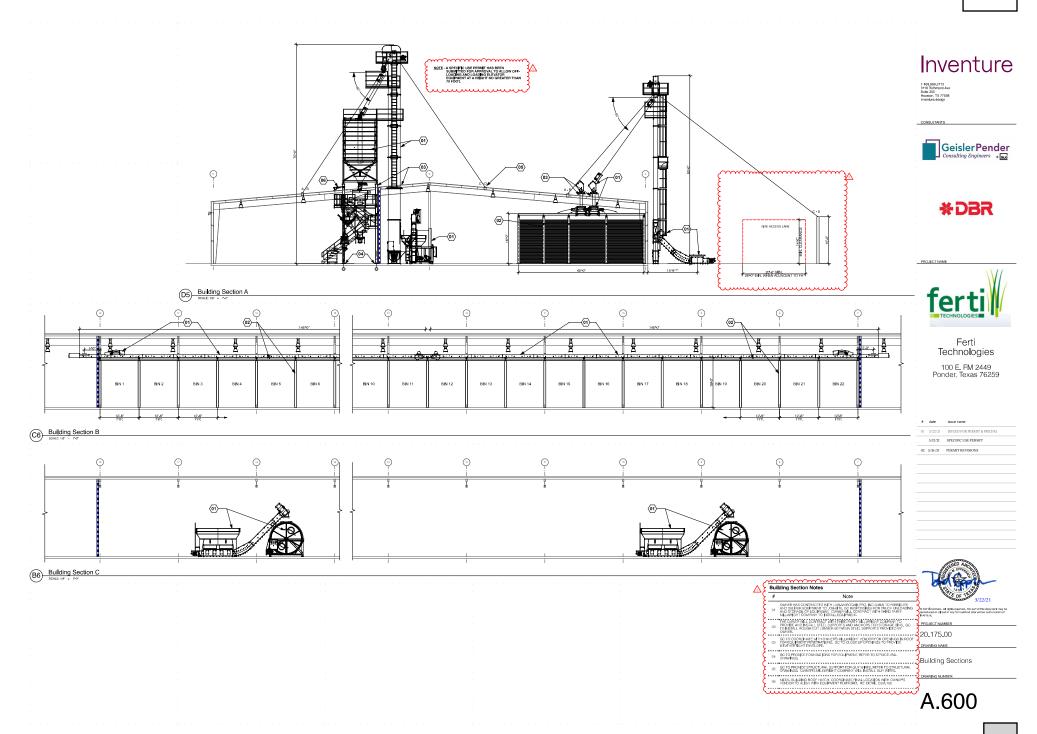

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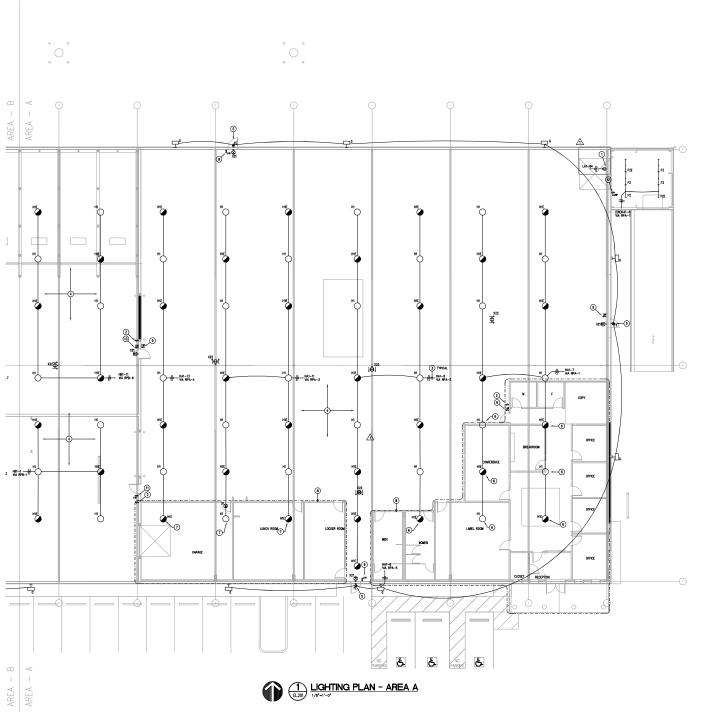
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MEP SITE PLAN -PHOTOMETRICS

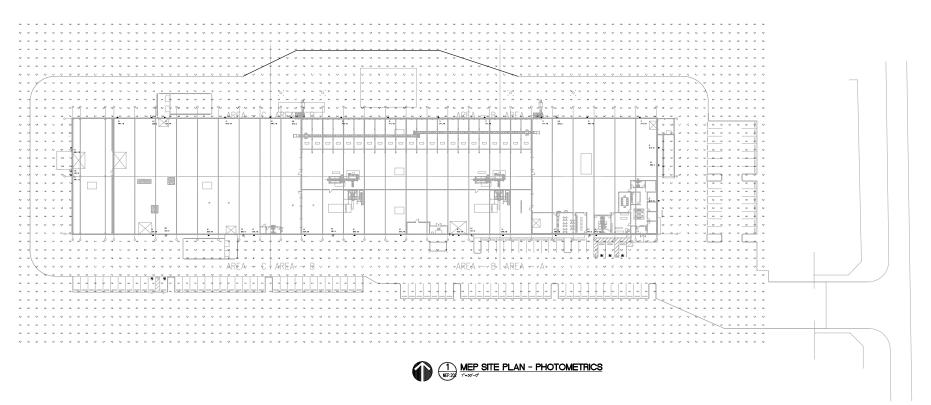MEP.202



ELECTRICAL GENERAL NOTES:

A REFER TO E.402 FOR LIGHT FIXTURE SCHEDULE

- L. REFER TO LIGHTING RELAY PANE SCHEDULE ON SHEET E-402.
- M. ALL EXIT SIGNS WITHIN AREA A SHALL BE CONNECTED UN-SWITCHED TO CIRCUIT HAI-4. UNLESS NOTED OTHERWISE.
- N. ALL EXTERIOR WALL PACKS SHALL BE INSTALLED IN THE SAME LOCATION AS FIXTURES PRIOR TO DEMOLITION UNLESS NOTED OTHERWISE.

ELECTRICAL KEYED NOTES:

- 2. PROVIDE MUTI-BUTTON SWITCH TO SERVE WINDHOUSE, COORDINATE ALL PROGRAMMING, SETTINES, SCHEDILLING, AND ANY OTHER ETABLES MOJOR FRANCIOUS WITH CONSTRUCTION, STREET ON INSTILLATION, CONFIRM ALL PROGRAMMING, SETTINES, TIME DELIYS, IMEDITS, SOSEDUM, AND ANY OTHER TEATHERS AND/OFF DETAINED WITH TO SETTING AND ANY TOTAINGS WITH ORBEST CONCESSTREM IS

- 7. NEW HIGH BAY FIXTURE ABOVE OFFICE SPACE AREA.
- 8. REFER TO DRAWING #1/E.301 FOR LIGHTING LAYOUT WITHIN THIS AREA.

- PROVIDE LOW VOLTAGE SMITCH ROUTED TO RELAY PANEL FOR LOADING DOCK AREA MANUAL OVERRIDE, PROVIDE WEATHERPROOF BOX AND COVER.

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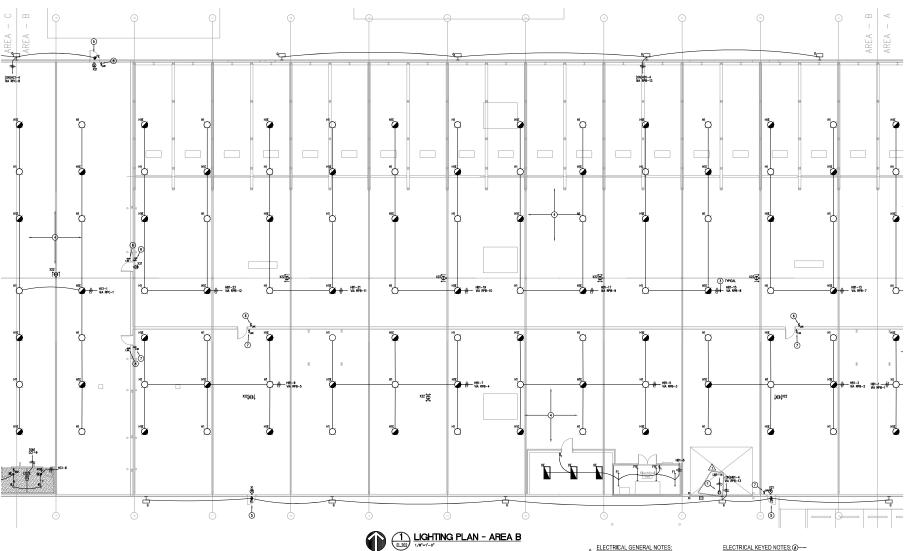
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20.175.00 DRAWING NAME

LIGHTING PLAN - AREA A

DRAWING NUMBER

EL.201



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ELECTRICAL KEYED NOTES:

ELECTRICAL GENERAL NOTES:

B. ALI HIGH BAY FIXTURES SHALL BE INSTALLED IN THE SAME LOCATION A FIXTURES PRIOR TO DEMOLITION UNLESS MOTED OTHERWISE.

M. ALL DIT SIGNS WITHIN AREA B SHALL BE CONNECTED UN-SWITCHED TO CIPCUIT HER-2. UNLESS NOTED OTHERWISE.

N. ALL EXTERIOR WALL PACKS SHALL BE INSTALLED IN THE SAME LOCATION AS FIXTURES PRIOR TO DEMOLITION UNLESS NOTED OTHERWISE.

A REFER TO E-1022 FOR LIGHT FIXTURE SCHEDULE.

- PROVDE INTE-UTE FLEX NEXT LED DOOK UGHT TO SERVE DOOKS FELD COORDINATE EXACT LOCATION PRIOR TO SEQUE-IN, REPER TO EXCIT-ESSE FOR DRUTHING INFOSMATION, MAY EARLY FOR FITTING INFOSMATION, COORDINATE IN MANUFACTURES WHORKED TO PROPER INSTITUTION, COORDINATE IN MANUFACTURES WHORKED TO SPECIFICATION, PRIOR TO GREENING.
- PROVIDE MUTH-BUTTON SWITCH TO SERVE WARSHOUSE, COORDINATE ALL PROCRAMANN, SCHINGS, SO/EDULING, AND ANY OTHER FEATRES AND/OR PRINCIPIONS WITH OWNER PRIOR TO INSTITULITION, CONTRIMA ALL PROCRAMANN, SCHING, THE DELLYS, INDICATES STRUCK, AND ANY OTHER TRADIES AND/OR FUNCTIONS WITH OWNER ONCE SYSTEM IS
- PROVIDE EAT SIGNS ON ALL THE COLUMNS LEADING TO IT'S NEAREST EXIT TOP SECTION OF WAREHOUSE SHALL LEAD TO TOP EXITS AND LOWER SECTION OF WAREHOUSE SHALL LEAD TO LOWER EXITS. ALL EXIT SIGNS LOCATION SHALL BE WISBLE.
- 5. NEW EXTERIOR FEXTURE IN NEW LOCATION ABOVE DOOR.
- 6. PROVIDE KEYED LOW VOLTAGE SWITCH ROUTED TO RELAY PANEL FOR AREA B MANUAL OVERROE
- 7. PROVIDE KEYED LOW VOLTAGE SWITCH ROUTED TO RELAY PANEL FOR PACKING AREA MANUAL OVERFIDE.
- 8. PROVIDE KEYED LOW VOLTAGE SWITCH ROUTED TO RELAY PANEL FOR AREA C MANUAL OVERRIDE.


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LIGHTING PLAN - AREA B

DRAWING NUMBER


EL.202



8. PROVIDE LOW VOLTAGE SWITCH ROUTED TO RELAY PANEL FOR LOADING DOCK AREA MANUAL OVERRORE PROVIDE WEATHERPROOF ROY AND COVER

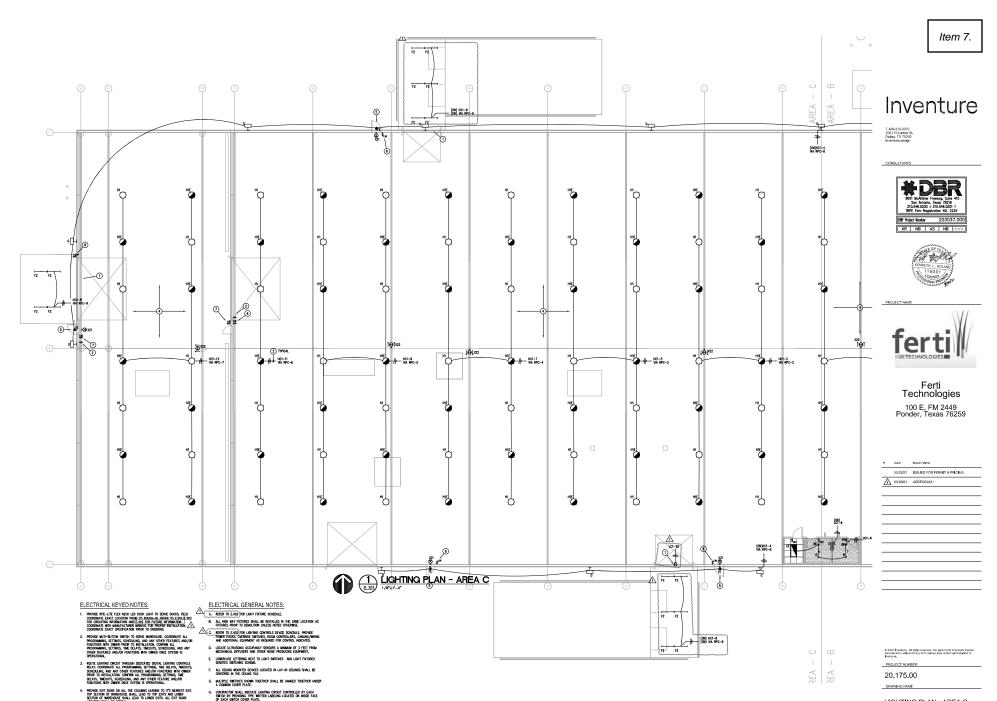L. REFER TO LICHTING CONTACTOR SCHEDULE ON SHEET E-402. \triangle M. ALL EXIT SIGNS WITHIN AREA B SHALL BE CONNECTED UN-SWITCHED TO CIRCUIT HC1-2, UNLESS NOTED OTHERWISE. N. ALL EXTERIOR WALL PACKS SHALL BE INSTALLED IN THE SAME LOCATION AS FIXTURES PRIOR TO DEMOLITION UNLESS NOTED OTHERWISE. LIGHTING PLAN - AREA C DRAWING NUMBER

EL.203

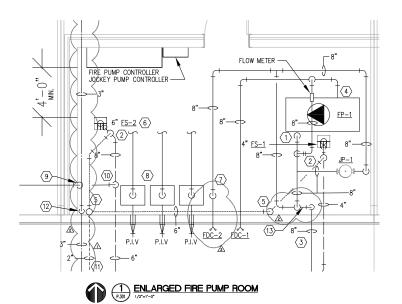

PLUMBING GENERAL NOTES 1. REFER TO P.001 FOR PLUMBING GENERAL NOTES.

2. REFER TO 1/P.801 FOR FIRE PROTECTION SCHEMATIC DIAGRAM.

PLUMBING KEYED NOTES

- 8* FIRE CONNECTED TO SUCTION SIDE OF FIRE PUMP; CONNECT PER MANUFACTURERS
- 2° SANTARY VENT OFF TOP OF DRAIN LINE BELOW FLOOR WITH SLOPING VENT BELOW FLOOR TO R
- 3 8" FIRE WATER MAIN, REFER TO MEP SITE PLAN FOR CONTINUATION.
- 8" FIRE WATER CONNECTION TO FIRE PUMP ON DISCHARGE SIDE; CONNECT PER MANUFACTUR RECOMMENDATIONS
- (5) 2" SANITARY VENT UP FROM BELOW FLOOR, SIZE AS NOTED; PROVIDE WALL CLEANOUT ABOVE GRADI
- (6) FLOOR SINK TO BE POURED IN A CONCRETE CURB AND PROVIDE FIELD FABRICATED STAINLESS STEE
- 8" FIRE WATER DOWN TO FIRE SPRINKLER HEADER; REFER TO 12/P.401.
- (8) FIRE SPRINKLER ZONE VALVE ASSEMBLY PIPMQ; REFER TO SPRINKLER CONTRACTOR DRAWINGS FOR PIPMG CONTINUATION, HEAD LOCATIONS AND HYDRAULIC CALCULATIONS.
- $\ensuremath{\mathfrak{D}}$ 2" santary line down in wall routed underground as shown.
- (ID) CONNECT 2" LINE FROM SUMP PUMP TO TOP OF 6" SANITARY LINE.
- (1) 2' VENT-ROUTED-UNDERGROUND FROM FLOOR SINK-ON SITE. ROUTE VENT-UP-THRU-FLOOR IN PUMP BROOM AND CONNECT TO BOTTOM OF VENT SISES. SEEP. MER 201 FOR CONTINUATION. CONTRACTOR SHALL NOTE THE ORBEIT OF THE AIR TENENTS IS ANY ORDERED.
- △ 12) NEW 3" DOMESTIC MATER SERVICE UP IN PUMP ROOM, REFER TO P.202 FOR CONTINUATION, RE 18,PR6,01
- 18/P4.01

Add note to verify design flow availability determined after installation of water

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ENLARGED PLUMBING PLAN

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P.301