

Planning Commission Meeting Agenda

Tuesday, February 11, 2025 at 6:00 PM

The Tom Hardin Room - 100 Public Square, Mount Pleasant, TN

- 1. Call to Order
- 2. Pledge of Allegiance / Invocation
- 3. Roll Call
 - A. John Hunter Chair

Jennifer Graham - Vice Chair

Pam Johnston - Secretary / City Commissioner

Kris Irvin - Member

Cedric Hollis - Member

- 4. Approval / Correction of Minutes from Prior Meetings
 - A. 1-14-2025 meeting minutes
- 5. Completion / Review of Unfinished Business from prior meeting
- 6. Special reports from other City Departments or Committees if applicable
- 7. New Business

(Comments from citizens may or may not be included, dependent on the issues.)

- A. Applicant Doster Construction Company on behalf of Maury Regional Airport Authority has submitted application for a new 5,436 square foot Airport Terminal to be located at 1200 N Main Street better described as Map 127, Parcel 041.00. The property is zoned IL Light Industrial.
- 8. General comments from citizens (May be limited in time and/or number of comments.)
- 9. Board / Staff Comments / Adjournment



Planning Commission Meeting Minutes

Tuesday, January 14, 2025 at 6:00 PM

The Tom Hardin Room - 100 Public Square, Mount Pleasant, TN

1. Call to Order

John Hunter called the meeting to order.

2. Pledge of Allegiance / Invocation

Kris Irvin led the Pledge of Allegiance and Pam Johnston said the invocation.

3. Roll Call

A. John Hunter - Chair

Jennifer Graham - Vice Chair

Pam Johnston - Secretary / City Commissioner

Kris Irvin - Member

Cedric Hollis - Member

All members present.

4. Approval / Correction of Minutes from Prior Meetings

Kris Irvin made a motion to approve the agenda and minutes from the last regular meeting and Cedric Hollis seconded, motion carried.

A. Regular Session - 12-10-2024

5. Completion / Review of Unfinished Business from prior meeting

None at this time.

A. None at this time

6. Special reports from other City Departments or Committees if applicable

None at this time.

A. Elect Officers for 2025

Jennifer Graham made a motion to keep John Hunter as Chairperson and Pam Johnston seconded and motion carried.

John Hunter made a motion to keep Jennifer Graham as Vice Chairperson and Cedric Hollis seconded, and motion carried.

Cedric Hollis made a motion to keep Pam Johnston as Secretary and John Hunter seconded, and motion carried.

7. New Business

(Comments from citizens may or may not be included, dependent on the issues.)

- A. Owner applicant Berchell Properties LLC has submitted a rezone request for a property located along Magnolia Drive, better described as Map 127, Parcel 25.00. The rezone request includes a piece of property currently zoned IL Light Industrial. The request asks to split zone the property. The request asks for 20.5 acres (+/-) that is north east of Magnolia Drive to be zoned R-3 High Density Residential.
 - Jennifer Graham made a motion to approve of the rezoning and Kris Irvin seconded and motion carried.
- B. Owner applicant Rose Ogilivie McClain and Yvonne Ogilivie McClain request to do a subdivision of 1.47 acres into two parcels containing .771 and .699 acres. The property is located on map 133J group G parcel 018.00, also known as 115 Columbian Ave. The property is currently zoned R-3 High Density Residential.
 - Jennifer Graham made a motion to approve the request with a contingency that the lot is to be cleaned up and maintained in the future and Pam Johnston seconded, motion carried.
- 8. General comments from citizens (May be limited in time and/or number of comments.)
 No comments
- 9. Board / Staff Comments / Adjournment

Cedric Hollis made a motion to adjourn the meeting and Kris Irvin seconded, motion carried.

Maury County Airport Authority Columbia / Mount Pleasant, Tennessee With Garver - Aviation Team Garver Project No. 21A08011

BUILDING CODE INFORMATION

NAME OF JURISDICTION: CITY OF MOUNT PLEASANT - MAURY COUNTY, TENNESSEE 38474

MUNICIPAL AIRPORT TERMINAL BUILDING

2018 INTERNATIONAL BUILDING CODE WITH LOCAL AMENDMENTS

2018 INTERNATIONAL PLUMBING CODE WITH LOCAL AMENDMENTS

2018 INTERNATIONAL GAS CODE WITH LOCAL AMENDMENTS

2018 NATIONAL ELECTRICAL CODE WITH LOCAL AMENDMENTS

TYPE II-B CONSTRUCTION, UNPROTECTED, NON-COMBUSTIBLE SPRINKLERED.

2018 INTERNATIONAL MECHANICAL CODE WITH LOCAL AMENDMENTS

2018 INTERNATIONAL ENERGY CONSERVATION CODE

MAURY COUNTY REGIONAL AIRPORT

2009 ANSI A - 117.1 HANDICAP CODE

2018 INTERNATIONAL FIRE CODE

REFER TO CIVIL DOCUMENTS

WAITING/GATHERING HALL 1/100 S.F. GENERAL OFFICE AREA 1/300 S.F. MECH/ELECT/SPRINKLER ROOM

2018 LIFE SAFETY CODE (NFPA 101)

IBC 2018
BUSINESS GROUP B
ASSEMBLY GROUP A-3 (GATHERING HALL)

5,463 G.S.F.

STRUCTURE:

SQUARE FOOTAGE:

BUILDING CODES:

PROJECT NAME:

CONSTRUCTION:

OCCUPANCY:

ZONING:

PARKING

PROJECT TEAM

CLIENT MAURY COUNTY REGIONAL AIRPORT 1200 N. MAIN STREET MT. PLEASANT, TN 38474 TEL: (931) 379-5511

CONTACT: AIRPORT BOARD CIVIL ENGINEERING (UNDER SEPARATE CONTRACT

4701 NORTHSHORE DRIVE LITTLE ROCK, AR 72118-5325 TEL: (256) 684-5512 CONTACT: ZAC SIMPSON, PE, SR. PROJECT MGR.

LANDSCAPE SEC ENGINEERING CONSULTANTS, INC 410 NEW SALEM HIGHWAY, SUITE 100 MURFREESBORO, TN 37129 TEL: (615) 890-7901 CONTACT: ROB MOLCHAN, PLAZ, ASLA

CONTACT JAMES LOWEN, PROJECT ARCHITECT

S. MITCHELL HODGE, AIA TEL: (615) 386-3357

TEL (615) 890-9405 ARCHITECTURE/INTERIOR DESIGN LOWEN + ASSOCIATES, LLC 2700 BELMONT BOULEVARD, SUITE A NASHVILLE, TENNESSEE 37212

STRUCTURAL ENGINEERING LOGAN PATRI ENGINEERING, INC. 630 SOUTHGATE AVENUE, SUITE C NASHVILLE, TENNESSEE 37203 CONTACT: RAO PATRI, P.E.

MECHANICAL/PLUMBING ENGIN HARPETH PARK ENGINEERING 256 SEABOARD LANES, SUITE G101 FRANKLIN, TN 37067 TEL: (615) 814–6001 CONTACT: CHRIS GRESHAM, PE

ELECTRICAL ENGINEERING HARPETH PARK ENGINEERING 256 SEABOARD LANES, SUITE G101 FRANKLIN, TN 37067 TEL: (615) 814-6001 CONTÀCT: TRES REED, PE

FIRE PROTECTION T.K. ENGINEERING 2787 HIGHWAY 31 W WHITE HOUSE, TN 37188

architecture | planning | interiors | design

DEMOLITION PLAN OVERALL SITE PLAN

CP-200 TYPICAL SECTIONS

CF-200 FENCING DETAILS

CU-101 CIVIL UTILITIES PLAN

CU-201 CIVIL UTILITIES PLAN
EL-101 ELECTRIC UTILITIES PLAN
ED-101 ELECTRICAL DETAILS 1

ED-102 ELECTRICAL DETAILS 2 XS-101 CROSS SECTIONS

XS-103 CROSS SECTIONS

CROSS SECTIONS

L1.0 LANDSCAPE PLAN L2.0 LANDSCAPE DETAILS & NOTES

L3.0 IRRIGATION ZONES PLAN

A1.0 WINDOW ELEVATIONS

A2.2 LOW ROOF PLAN A2.3 UPPER ROOF PLAN

A4.1 BUILDING SECTIONS A4.2 BUILDING SECTIONS A4.3 WALL SECTIONS A4.4 WALL SECTIONS A4.5 WALL SECTIONS

A4.9 PLAN DETAILS
A5.1 INTERIOR ELEVATIONS

A5.2 INTERIOR ELEVATIONS A5.3 INTERIOR ELEVATIONS A6.1 REFLECTED CEILING PLAN A7.1 FINISH FLOOR PLAN

S000 STRUCTURAL COVER SHEET

STRUCTURAL GENERAL NOTES S002 SPECIAL INSPECTION NOTES S003 TYPICAL DETAIL AND SCHEDULES

TYPICAL DETAILS AND SCHEDULES TYPICAL DETAILS AND SCHEDULES TYPICAL DETAILS AND SCHEDULES TYPICAL DETAILS AND SCHEDULES S008 TYPICAL DETAILS AND SCHEDULES S009 TYPICAL DETAILS AND SCHEDULES

S010 FOUNDATION AND FIRST FLOOR SLAB PLAN

S120 MEZZANINE AND PARTIAL ROOF FRAMING PLAN

S300 MEZZANINE FRAMING SECTIONS AND DETAILS

S400 LOW ROOF FRAMING SECTIONS & DETAILS

S401 LOW ROOF FRAMING SECTIONS & DETAILS

S402 LOW ROOF FRAMING SECTIONS & DETAILS

S403 HIGH ROOF FRAMING SECTIONS & DETAILS

S501 STOREFRONT WALL ELEVATIONS AND DETAILS S601 ENTRY MONUMENT SIGN PLAN & DETAILS

E2.1 MAIN LEVEL FLOOR PLAN - POWER & SYSTEMS

E2.3 MEZZANINE FLOOR PLAN - POWER & SYSTEMS

S200 FOUNDATION AND FIRST FLOOR SECTIONS AND DETAILS

S012 LOAD MAP - ROOF SNOW LOAD MAP

S013 LOAD MAP - ROOF WIND LOAD MAP

S110 FOUNDATION & FIRST FLOOR PLAN

S130 LOW ROOF FRAMING PLAN S140 HIGH ROOF FRAMING PLAN

S602 PLANTING PLANS AND DETAILS

E2.0 MAIN LEVEL FLOOR PLAN - LIGHTING

E2.2 MEZZANINE FLOOR PLAN - LIGHTING

M1.0 MECHANICAL SCHEDULES AND DETAILS

P1.0 PLUMBING SCHEDULES AND DETAILS

P2.0 PLUMBING WASTE/VENT/RWL PIPING PLAN

M1.1 MECHANICAL SPECIFICATIONS & COM CHECK

E1.0 SITE PLAN - ELECTRICAL

E3.0 LEGEND AND SCHEDULES

M2.0 MECHANICAL ROOF PLAN

M2.1 MECHANICAL MAIN FLOOR PLAN

M2.2 MECHANICAL MEZZANINE PLAN

P1.1 PLUMBING SPECIFICATIONS

E3.1 POWER DISTRIBUTION

E3.2 DETAILS

A3.1 ELEVATIONS A3.2 ELEVATIONS

A1.1 ARCHITECTURAL SITE PAN

A2.1 MAIN LEVEL FLOOR PLAN

LANDSCAPE DETAILS & NOTES

CF-101 FENCING PLAN

MK-200 MARKING PLAN DETAILS

FENCING DETAILS 2

MK-101

CF-201

XS-102

LANDSCAPE

STRUCTURAL

ELECTRICAL

MECHANICAL

PLUMBING

ARCHITECTURAL

COVER SHEET SURVEY CONTROL AND PROJECT LAYOUT PLAN

CONSTRUCTION SAFETY AND PHASING PLAN

GEOTECHNICAL INVESTIGATION PLAN

PARKING PLAN AND PROFILE SHEET

PARKING PLAN AND PROFILE SHEET 2

CE-101 GRADING, DRAINAGE AND EROSION CONTROL PLAN

CE-201 GRADING, DRAINAGE AND EROSION CONTROL DETAILS

A0.1 DOOR SCHEDULE, DOOR ELEVATIONS AND LIFE SAFETY PLAN A0.2 GRAPHIC DESIGN – SIGNAGE

A1.2 ENLARGED ARCHITECTURAL SITE LAYOUT PLAN A2.0 STRUCTURAL GRID LAYOUT PLAN

A4.6 SECTIONS AND DETAILS CONT. INSULATION

A7.2 ENLARGED MAIN HALL FLOOR PATTERN PLAN

SECTIONS AND DETAILS AND SITE FURNISHINGS A4.8 LINEAR DRAIN AND ROTUNDA METAL SEGMENT PLAN

CP-102 DRIVEWAY PLAN AND PROFILE SHEET
CP-103 PARKING PLAN AND PROFILE SHEET

PARKING LOT MARKING PLAN

CE-200 GRADING DITCH PLAN AND PROFILE

GC-001 CONSTRUCTION SAFETY AND PHASING PLAN
GC-002 CONSTRUCTION SAFETY AND PHASING OVERVIEW
GC-101 CSPP PHASE 1
GC-102 CSPP PHASE 2
GC-103 CSPP PHASE 3
CV-101 EXISTING CONDITIONS
CD-101 DEMOLITION PLAN

INDEX OF DRAWINGS

A0.0 COVER SHEET

TEL: (615) 566-3614 CONTÀCT: STEVE ESCUE, RE

MENS AND WOMENS ROOM ACCESSORIES:

2. AUTOMATIC SOAP DISPENSER

4. TOILET PAPER DISPENSER

DISPOSAL COMBO.

6. COAT HOOKS

3. 36". 42" AND 18" VERT. GRAB BARS

5. AUTOMATIC PAPER TOWEL DISPENSER/

1. KOALA KARE GREY BABY CHANGING STATION

Section 7, Item A

LOWEN+ASSOCIATES, LLC

2700 Belmont Boulevard, Suite A Nashville, Tennessee 37212 www.Lowen-Associates.com p (615) 386-3357 f (615) 386-3329

PROFESSIONAL SEAL



egional Airport onstruction Project

PHASE: CONSTRUCTION DOCUMENTS

24-04 **ISSUE DATE:**

REVISIONS:

P2.1 PLUMBING WATER PIPING PLAN P2.2 PLUMBING GAS PIPING MAIN FLOOR PLAN P2.3 PLUMBING GAS PIPING ROOF PLAN

FIRE PROTECTION

FP1.0 MAIN LEVEL PLAN FP1.1 MEZZANINE LEVEL PLAN FP2.0 DETAILS

OCCUPANTS

OCCUPANT LOAD INFORMATION


·ハ											
ונ	MAIN GATHERING HA	LL	ASSEM	IBLY	1,4	32		1:15			96
∩	CONFERENCE ROOM		ASSEM	IBLY	46	4		1:15			31
₹	ADMINISTRATION		BUSIN	ESS	1,5	39		1:100	0		16
7	OPEN AREA/CIRCULATION				1,1	1,114			-		-
>	BATHROOMS/CLOSETS	_		812	812			1:100		9	
Щ			_		-			_			_
┥╽											
\prec \vert	TOTAL OCCUPANCY		-		-			-			152
<u>B</u>	PLUMBING FIXTURE CALCULATION - 506 OCCUPANTS										
_	FIXTURES	REQUIRED			PROVIDE	D				NOTES	
7					MEN		WOME	N F	PRIVATE		
<u>\</u>	WATER CLOSETS	MEN 1/150 (76 /150	= 0.5)	1	3	1 URINAL					FOUR TOTAL PROVIDED

WOMEN 1/75 (76 /75=1.01) 2

LAVATORIES 1 PER 200 (152 /200 = 2) 2 SEVEN TOTAL PROVIDED DRINKING FOUNTAINS | 1 PER 1000 (152 /1000 = 0.16) | 1 | 1 WITH HIGH/LOW ONE TOTAL PROVIDED 1 PER BUILDING ONE TOTAL PROVIDED

PLAN ELEVATIONS /ACCESSORIES GENERAL TOILET LAYOUT PLAN

1,797/100 S.F. = 18 3,014/300 S.F. = 11 (651 LESS RR AND UTILITY SPACES) 306/NA

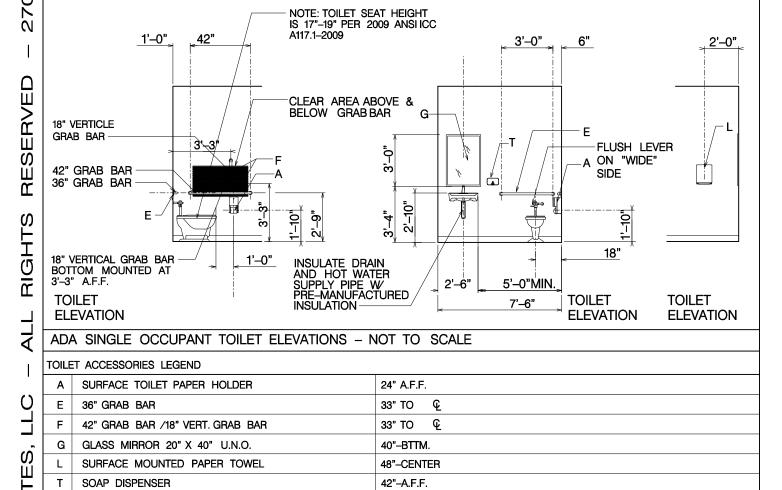

1. ALL PLAN VIEW DIMENSIONS ARE TO FACE OF WALL, UNLESS OTHERWISE NOTED

6. REFER TO MECHANICAL FOR FIRE EXTINQUISHER LOCATIONS, IN ACCORDANCE

8. PROVIDE MOISTURE RESISTANT GYPSUM BOARD AT ALL WET WALL LOCATIONS.

ALL FIRESTOPPING MATERIAL MUST MEET ASTM-E-114 FOR ALL FIRESTOPS.

12. PROTECT DOOR HARDWARE/CABINETS, SWITCHES, OUTLETS, PLATE COVERS

9. IT IS THE RESPONSIBILITY OF THE CONTRACTOR TO PROVIDE FOR ALL RELEVANT

WEATHER STRIPPING, THERMOSTAT COVERS AND OTHER "FINISHES" FROM

PAINT AND DRYWALL OVERSPRAY. CLEAN OR REPLACE IF OVERSPRAY OCCURS.

3. ALL TOILET PAPER DISPENSERS TO BE MOUNTED 24" AFF.

5. ALL CLEARANCES ARE TO BE VERIFIED BY CONTRACTOR

4. PROVIDE BLOCKING AT HANDRAIL ANCHORING IN ALL BATHROOMS.

ALL PENETRATIONS THRU RATED ASSEMBLIES ARE TO BE THE

2. DO NOT SCALE DRAWINGS. IF DIMENSIONS ARE IN QUESTION, THE CONTRACTOR SHALL BE RESPONSIBLE FOR OBTAINING CLARIFICATION FROM THE ARCHITECT BEFORE CONTINUING WITH CONSTRUCTION.


MINIMUM DIMENSIONS REQUIRED. PLACE FIRESTOPPING IN RESIDUAL VOIDS TO COMPLETELY SEAL OPENINGS

FIRE PROTECTION REQUIREMENTS IN ACCORDANCE WITH APPLICABLE CODES. (LOCAL, STATE, AND NATIONAL).

10. ALL PENETRATIONS THROUGH RATED WALLS AND CEILINGS AND FLOORS ARE TO BE SEALED WITH THE PROPER MATERIALS CAPABLE OF PREVENTING THE PASSAGE OF FLAMES AND HOT GASES

NOTE: SOME ITEMS LISTED ABOVE, MAY NOT BE USED.

GENERAL NOTES

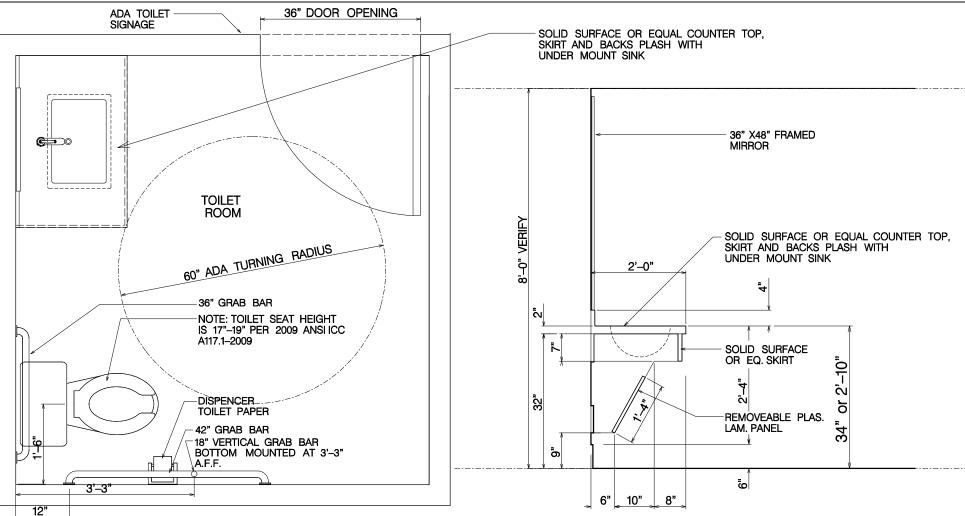

FEATURES (CHANGE FILTERS PRIOR TO TURN-OVER). 15. COORDINATE THE LOCATION OF THE OFFICE TRAILER AND STORAGE TRAILER WITH THE CIVIL ENGINEER AND CITY OF MURFREESBORO.

TURN-OVER TO OWNER. 17. PROVIDE SCHEDULE FINISH BASE ALONG THE BOTTOM OF ALL EXPOSED

20. CAULK AT JUNCTURE OF INTERIOR FACES OF DOOR FRAMES, VIEW WINDOW FRAMES. EXTERIOR WINDOW FRAMES, MILLWORK, CASEWORK, TOILET FIXTURES, INTERIOR TRIM, ETC...

21. MILLWORK / CASEWORK DIMENSIONS SHALL BE FIELD VERIFIED PRIOR TO FABRICATION AND INSTALLATION. 22. CASEWORK SHALL BE PLASTIC LAMINATE CLAD, CASEWORK TO CONFORM TO AMERICAN

23. CASEWORK HARDWARE SHALL BE SELF CLOSING HINGES AND BALL BEARING DRAWER SLIDES. DOOR AND DRAWER PULLS TO BE SELECTED BY ARCHITECT

13. ALL ELECTRICAL PANEL CIRCUIT SCHEDULES TO BE TYPED AND PLACED ON INSIDE OF EACH PANEL DOOR.

14. INSTALL HVAC COMPRESSORS LEVEL, PLUMB AND TRUE, SQUARE TO BUILDING

16. CONDUCT A FULL FUNCTION TEST OF ALL BUILDING SYSTEMS PRIOR TO

FRONTS, SIDES, BACKS AND ENDS OF FIXED CASEWORK. 18. FURNITURE SHOWN IN PLANS ARE FOR SPACE LAYOUT ONLY. FURNITURE IS TO BE

PROVIDED BY THE OWNER 19. ALL APPLIANCES ARE TO BE FURNISHED BY THE OWNER AND INSTALLED BY THE GENERAL CONTRACTOR.

WOODWORK INSTITUTE (AWI) CUSTOM GRADE FLUSH OVERLAY STYLE. PLASTIC LAMINATE SHALL BE AS SELECTED BY ARCHITECT.

24. UNLESS OTHERWISE INDICATED THE BASE CABINETS SHALL BE 2'-0" DEEP

UL DESIGN: U465 - ONE HOUR WALL

SOUND INSULATION NOTE:

INTERIOR SIGNAGE NOTE:

PROVIDE INTERIOR SIGNAGE FOR ALL INTERIOR ROOMS, MECHANCINAL, ELECTRICAL, ADA BATHROOMS ETC.

CONTACT: CRAIG BERRY, RADIUS DESIGN WORKS

PROVIDE SOUND INSULATION AROUND ALL BATHROOMS, OFFICES AND

TOILET ACCESSORY:

TOILET ROOM NOTES:

DIAMETER

ALL GRAB BARS SHALL BE 1 1/4"

- 1 1/2" IN WIDTH OR OUTSIDE

CLEAR HAND SPACE MUST BE

GRAB BARS ARE REQUIRED TO

SUPPORT 250-POUND LOAD

ABOVE FINISHED FLOOR

REFER TO THIS SHEET FOR

CONFERENCE ROOM

LIST OF TOILET ACCESSORRIES

1 1/2" FROM INNER FACE TO WALL


GRAB BARS ARE TO BE MOUNTED

THAN 33" OR NOT MORE THAN 36"

PROVIDE 18" VERTICLE GRAB BAR

AT END OF 33" WALL MOUNTED BAR

ON EACH SIDE WALL NOT LESS

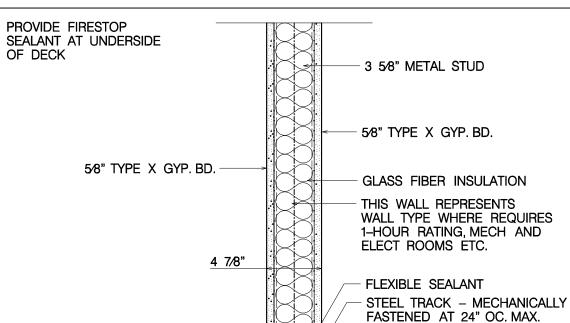


PROJECT NUMBER:

December 11, 2024

Cover Sheet and General

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February 13, 2024

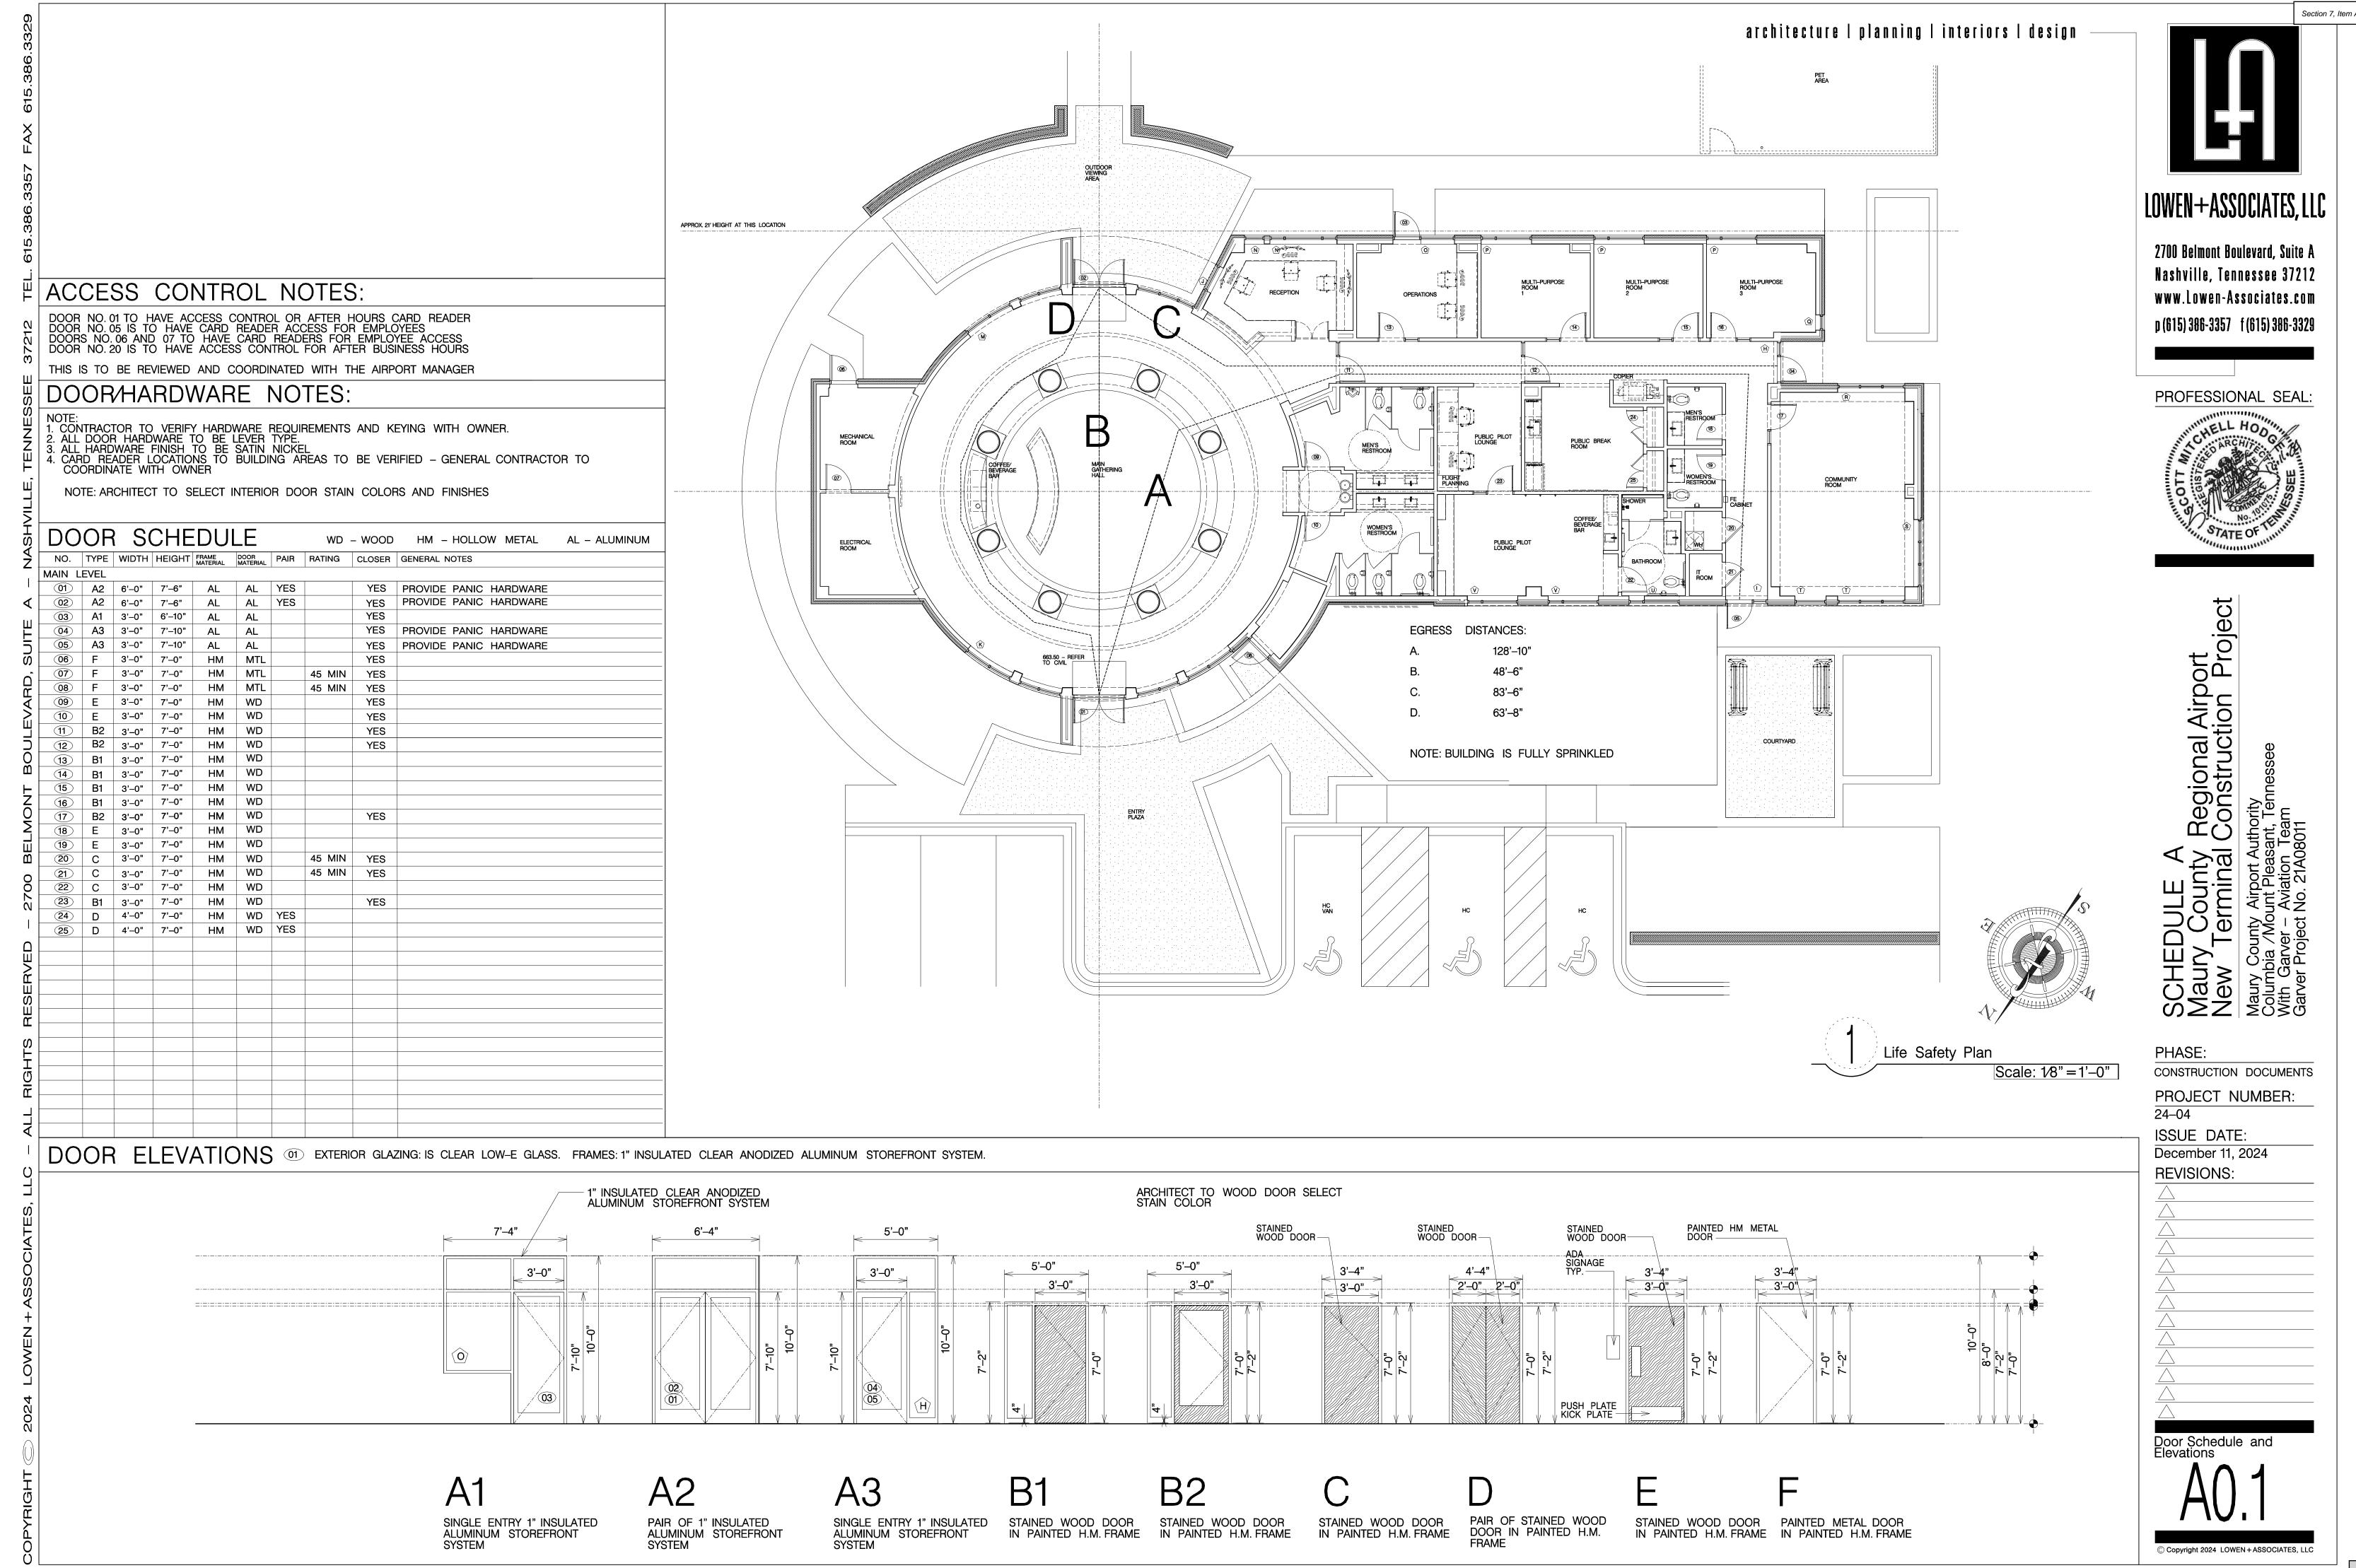Jim Lowen Lowen + Associates 2700 Belmont Blvd., Suite A Nashville, TN 37212

> RE: Maury Regional Airport Signage & History Graphics

I am pleased to have this opportunity to bid on graphic design and signage project for the Maury Regional Airport Terminal Building. Our graphic design / fabrication team is excited about this opportunity and we look forward to working with your team. This proposal outlines our proposed project budget based on the graphic design and signage opportunities we identified from our review of your project documents. Once a project scope and budget are agreed upon, we will develop conceptual graphic design drawings reflecting the design and signage elements included within that scope. Upon completion of presentation drawings and approval of the Graphic Design / Signage Plan, we will generate a "not to exceed" quote for fabrication / installation services.

APPROACH

This proposal outlines our approach, scope, schedule and projected fees for the Maury Regional Airport Terminal Building. Radius Design Works, LLC, will act as a direct consultant to Maury Regional Airport. All graphic design presentation drawings, fabrication documentation and invoices will be submitted directly to MRA for review, approval and payment.

SCOPE


- Develop a Graphic Design / Signage Plan to include all or part of the following components:
 - I. Interior Destination Signage for Reception Area, Pilot Lounge / Briefing Room and Community Room.
 - 2. ADA compliant Room I.D. Signage & Office Signage.
 - 3. History Wall Graphics for (5) areas.
- 4. Exterior Building & Site Signage.
- Develop fabrication / installation costs based on approved Graphic Design / Signage Plan.
- Develop necessary in-house fabrication documentation.
- Oversee fabrication / installation process.

SCHEDULE

We anticipate the following project schedule:

Design Development (6-8 weeks) Fabrication (5-8 weeks) Travel / Installation (7-10 days)

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We would like to thank you again for this opportunity and we look forward to the success of this project. Please feel free to contact me with any questions about this proposal.

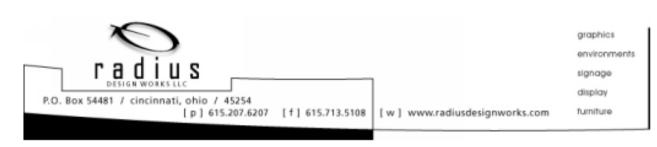Craig Berry, Creative Director

Radius Design Works, LLC.

MAURY 1021324.docx

Proposal & Terms Accepted By:	
	Name
	Title
	Company
	Date

TERMS & CONDITIONS

Representation

The client represents that it has full power and authority to enter into this Agreement and that it is binding and enforceable in accordance with its terms. The design firm represents that it has full power and authority to enter into this agreement and that it is binding and enforceable in accordance with its

Time for Payment

Radius Design Works, LLC ("Radius") shall provide itemized invoices on a monthly basis. Invoices shall be paid in full 30 days after the receipt of the invoice. The grant of any use license or copyright is conditioned on the receipt of full payment. Payments will be made to Radius Design Works, LLC.

3. Sales Tax

The client shall pay any sales, use or other taxes that may be applicable to the services provided under this agreement, including any tax that may be assessed on a subsequent audit.

4. Work in Progress

Client shall provide accurate and complete information and materials to the Graphic Designer and shall be solely responsible for the accuracy and completeness of all information provided. Client guarantees that all information and materials provided to the Graphic Designer are owned by the Client, or that the Client has obtained necessary rights to use such materials or permit their use by the Graphic Designer. Unless otherwise agreed, Graphic Design check-sets shall be provided to Client for review. Client shall

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signage display P.O. Box 54481 / cincinnati, ohio / 45254 [p] 615.207.6207 [f] 615.713.5108 [w] www.radiusdesignworks.com

Our budgetary cost estimates for graphic design, fabrication and installation of display components, signage and graphics are as follows:

Graphic Design / Signage Layout Plan

Graphic Design Services will be billed at our hourly rate of \$150 hr.

Interior & ADA Signage Components

We anticipate an hourly project range of 30-45 hours and fee range of \$4,500-\$6,750. Additions to the scope of services will be billed hourly at the rate of \$150 hour.

Exterior Site & Building Signage

We anticipate an hourly project range of 20-35 hours and fee range of \$3,000-\$5,250. Additions to the scope of services will be billed hourly at the rate of \$150 hour.

History Wall Components

Research, Design & Image Collecting / Photography / Retouching. We anticipate an hourly project range of 50-65 hours and fee range of \$7,500-\$9,750. Additions to the scope of services will be billed hourly at the rate of \$150 hour.

Fabrication / Mobilization / Installation

The following estimate is based on our evaluation of potential graphics / signage opportunities. This estimate will be revised upon approval of the Graphic Design / Signage Plan to reflect actual fabrication / installation costs for the approved scope of work.

Destination Signage (5 @ \$1,000-\$1,500)	\$ 5,000-\$ 7,500	
ADA / Office Signage (20 @ \$275-\$350)	\$ 5,500-\$ 7,000	
History Graphic Walls (1250sf-1500sf @ \$20-\$25)	\$ 25,000-\$ 37,500	
Exterior Front - Fly Maury Logo	\$ 3,500-\$ 5,000	
Exterior Front - Monument Wall (31 @ 11" Letters)	\$ 4,650-\$ 9,300	
Exterior Airside - Wall Letters (20 @ 20" Letters)	\$ 3,550-\$ 6,000	
Installation (2-3 men 40hrs @ \$85hr)	\$ 6,800-\$ 10,200	
Equipment Rental (Transportation & Lift)	\$ 2,500-\$ 3,500	
Mobilization (Site Visits & Installation Trip)	\$ 3,350-\$ 4,800	


Graphic Design Development

Graphic Design Services will be billed monthly for time spent. Invoices are net 14.

Fabrication | Installation

A 60% material deposit is due upon notice to proceed and balance is due upon completion of installation and calculation of reimbursable mobilization expenses. Invoices are net 14.

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promptly proofread and approve or reject the Graphic Design check-set by returning the check-set along with any changes. Client is fully responsible for errors or omissions not indicated to Graphic Designer. Client approval of a Graphic Design check-set includes: graphic design concept drawings, fabrication documentation, photographs, colors, finish boards, specifications and message schedules. Client will sign and return such Graphic Design check-sets. Email, Faxed copies and verbal approval are

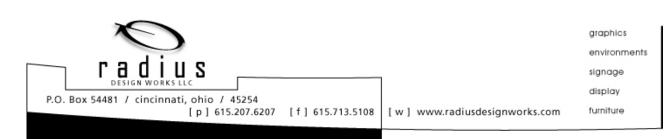5. Change Orders

Revision made by Client subsequent to final approved Graphic Design intent drawings shall constitute additional work outside the scope of this agreement, and the Graphic Designer will be entitled to additional compensation for time and materials spent. Client's revisions will be charged at the allowable rate stated in the agreement or determined by RS Means uniform price book. The Client shall offer the Graphic Designer the first opportunity to make any changes.

6. Cancellation


In the event the Client terminates this agreement prior to completion of the work, the Graphic Designer shall be entitled to compensation for all work completed including design work, partially completed fabrication, purchased materials and any products delivered prior to date of cancellation.

7. Media / Promotional Credit Lines

Radius Design Works, LLC shall be credited as the Environmental Graphic Design Firm and shall receive a credit line within any editorial publication, graphic design competition or public recognition. Should the project be professionally photographed, the Client agrees to provide Radius Design Works, LLC (1) set of slides, prints or digital files and usage license at the Client's expense.

8. Ownership / Copyright / Usage

Radius retains ownership and copyright of all artistic expressions, graphic designs, design materials, pricing documents, construction documents, photographs, electronic files and all other materials used to convey design intent and illustrate fabrication processes. Client shall not sell or license graphic design/production materials to any third party, or permit the use of graphic design/production materials by a third party prior to receipt of all final payments and completion of fabrication by Radius. Upon receipt of all final fees and expenses, the graphic designer will transfer ownership to the client, of all final logos, logotypes and/or typography, for use in advertising, marketing and day-to-day operations of the project for which this agreement was drafted. Client understands that the graphic design/production materials are designed by Radius Design Works, LLC specifically for each campus and are unique to each individual project and location, and that Radius Design Works, LLC makes no warranties or representations whatsoever and disclaims all liability with respect to the suitability, adequacy, merchantability or fitness of its graphic design, production materials or derivative works to any other project or location other than specified herein. Client agrees to not use or re-use itself or permit the use or re-use by a third party any graphic design/production materials or derivative works, in any manner, for any other project or location without prior written consent from Radius Design Works, LLC. If Client in any manner uses or re-uses itself or permits use or re-use by a third party graphic designs, production materials or any derivative works for any other project or location other than specified herein, Client solely assumes all risk, responsibility, and liability whatsoever relating, directly or indirectly, to such use or re-use.

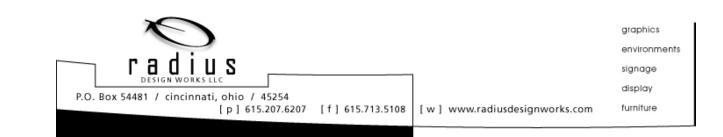

The Graphic Designer shall produce graphic design intent documents including specifications for materials, finish selections, color selections and shop drawing details. Client acknowledges that the Graphic Designer and Fabricators are not licensed engineers or architects, and when deemed necessary, the responsibility to produce design and engineering calculations / drawings will be the responsibility of the client or a third party architect and/or engineer.

Modifications

The Agreement, together with these Terms and Conditions and any exhibits referenced herein or in the Proposal or attached hereto, contain the entire agreement between the parties related to its subject matter and supersedes all prior or contemporaneous understandings, statements or agreements between the parties on such subject matter. No changes, amendments or clarifications of these Terms and Conditions will be valid or effective unless in writing and signed by an authorized representative of the party to be bound. Any failure by Radius to require strict compliance with any provision of this Agreement shall not be construed as a waiver of such provision, and Radius may subsequently require strict compliance at any time, notwithstanding any prior failure to do so. This Agreement, all rights and obligations between the parties to this Agreement, and all claims arising out of or relating to the subject matter of this Agreement (including tort claims), will be governed by the laws of the Ohio, without regard to conflict of laws principles.

Severability

If any provision hereof is deemed to be invalid or unenforceable under applicable law, this Agreement shall be considered divisible as to such provision and the same shall thereafter be inoperative, provided however, the remaining provisions of this Agreement shall be valid and

Page 5 of 5

LOWEN+ASSOCIATES, LLC

2700 Belmont Boulevard. Suite A

Nashville, Tennessee 37212

www.lowen-Associates.com

p (615) 386-3357 f (615) 386-3329

PROFESSIONAL SEAL


Section 7, Item A


Regional Airport Construction Project

PHASE:

CONSTRUCTION DOCUMENTS

PROJECT NUMBER: 24–04 ISSUE DATE: December 11, 2024 REVISIONS:

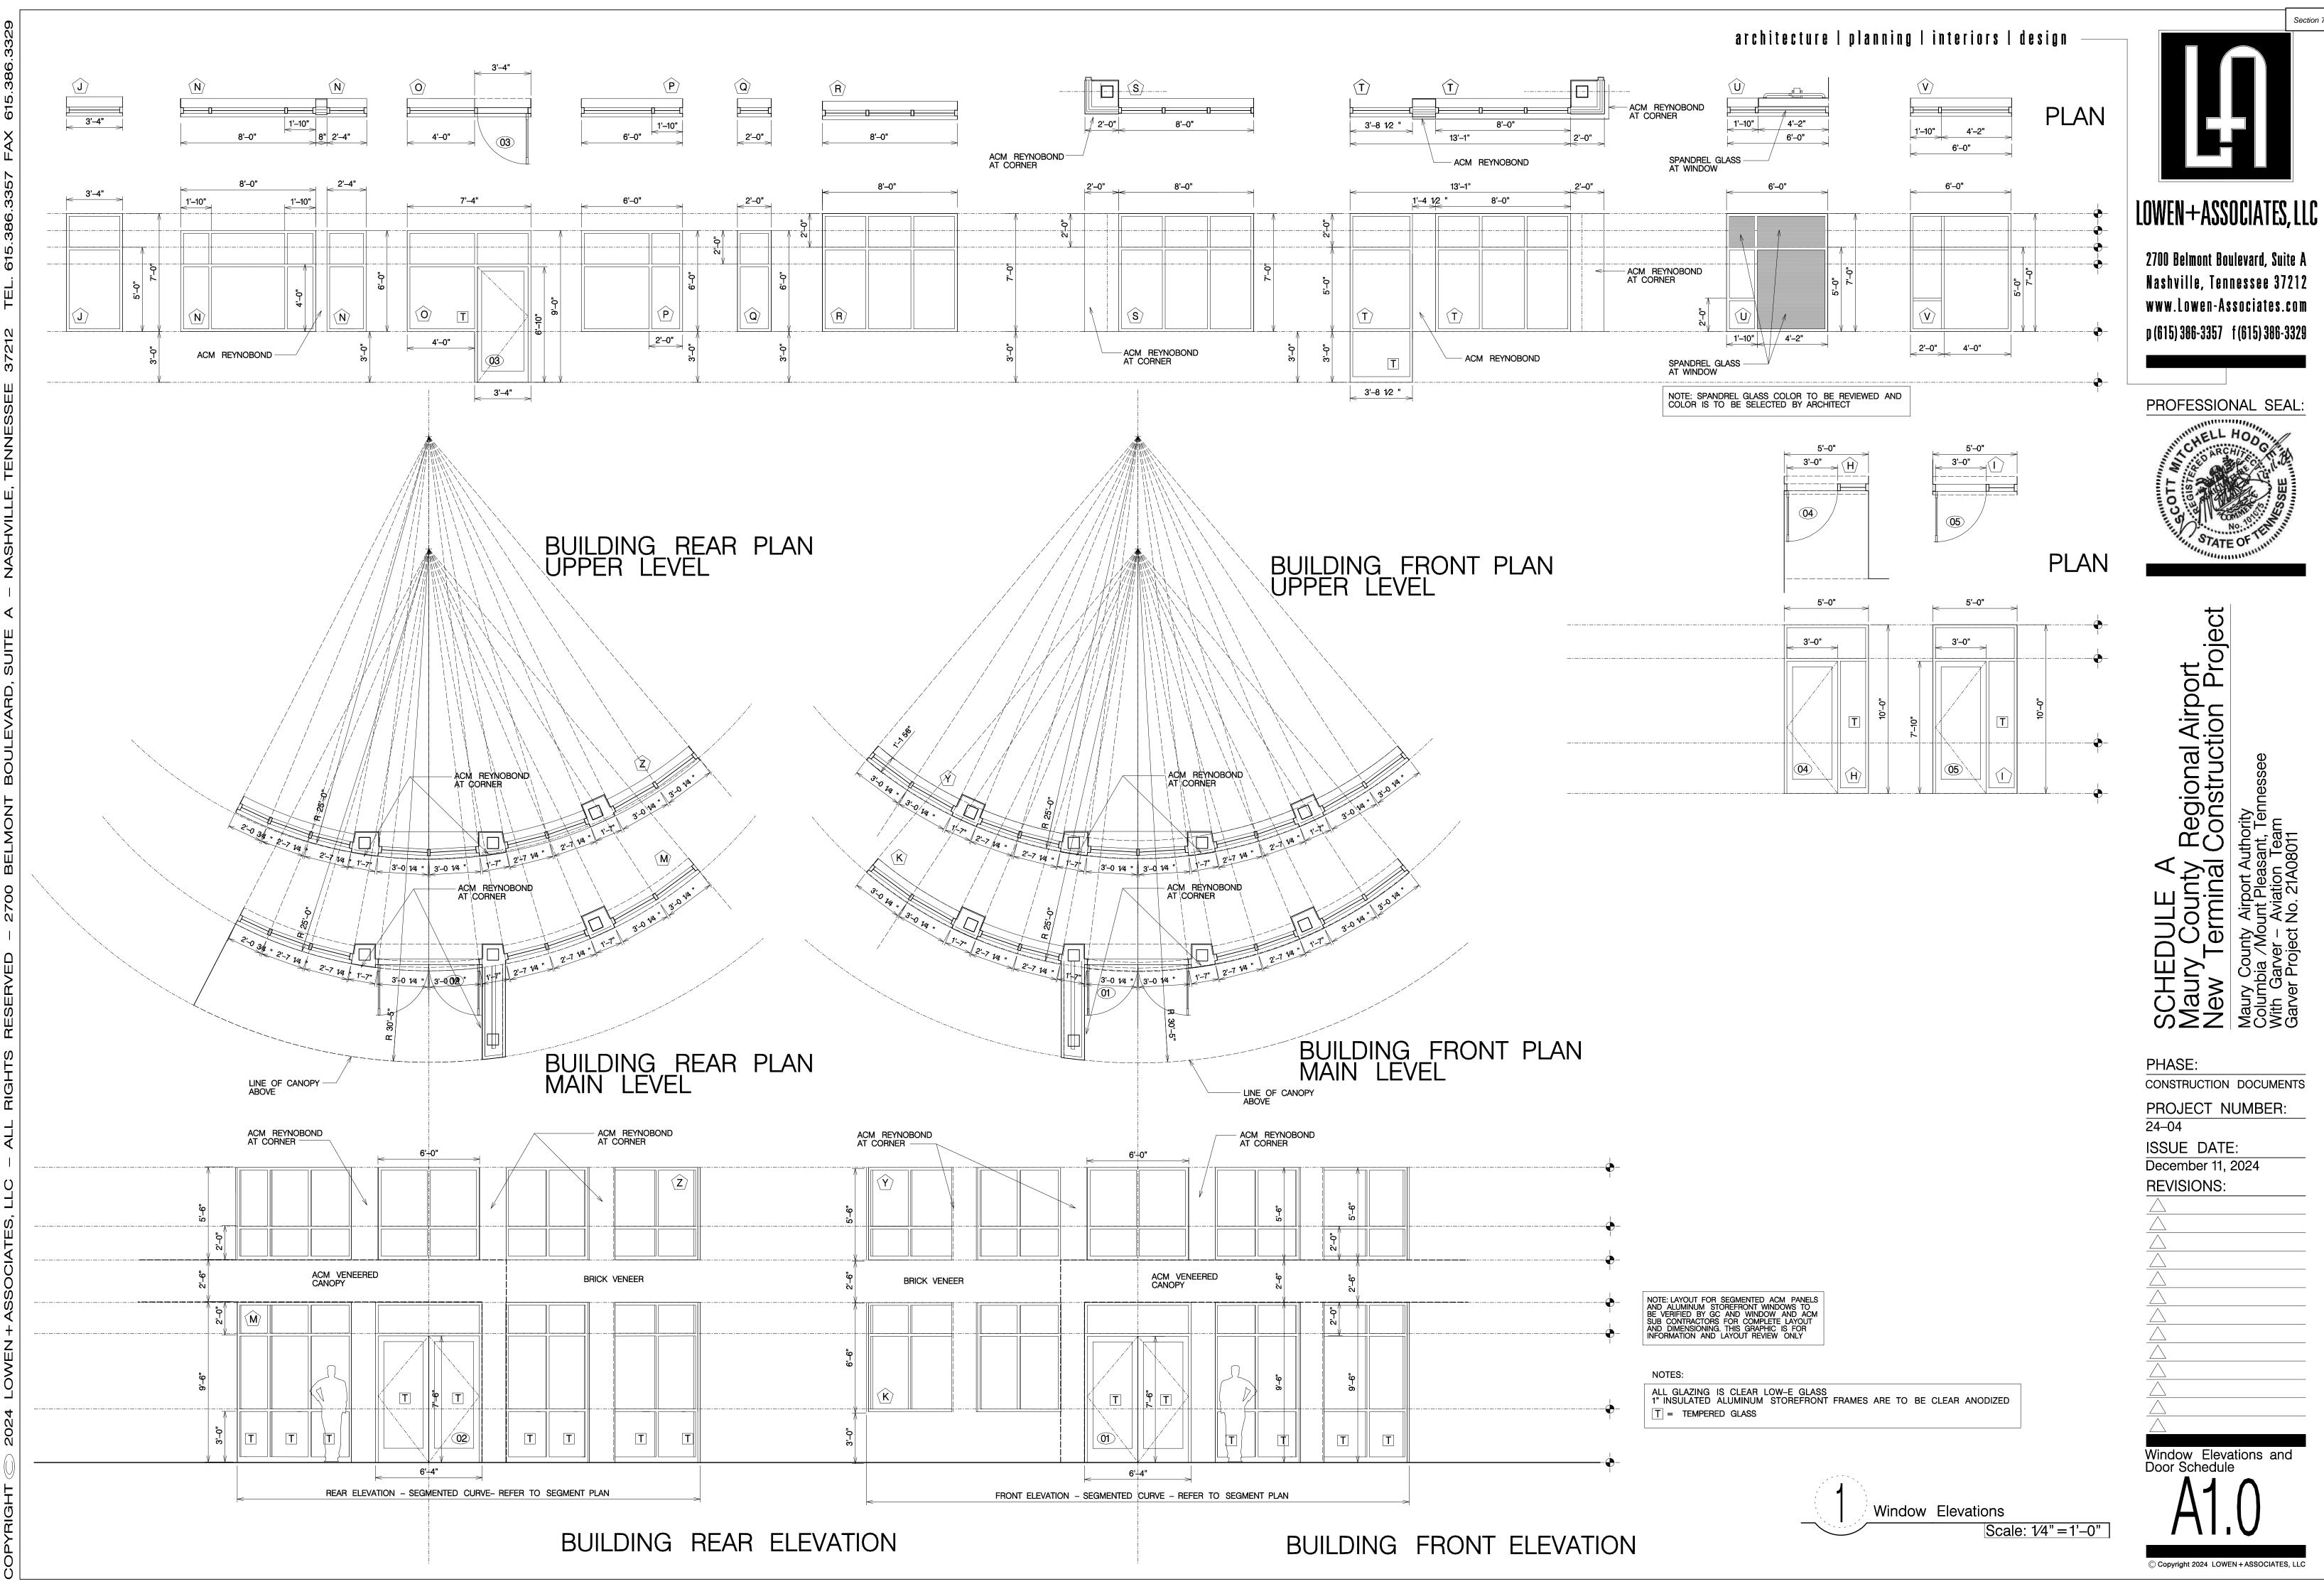

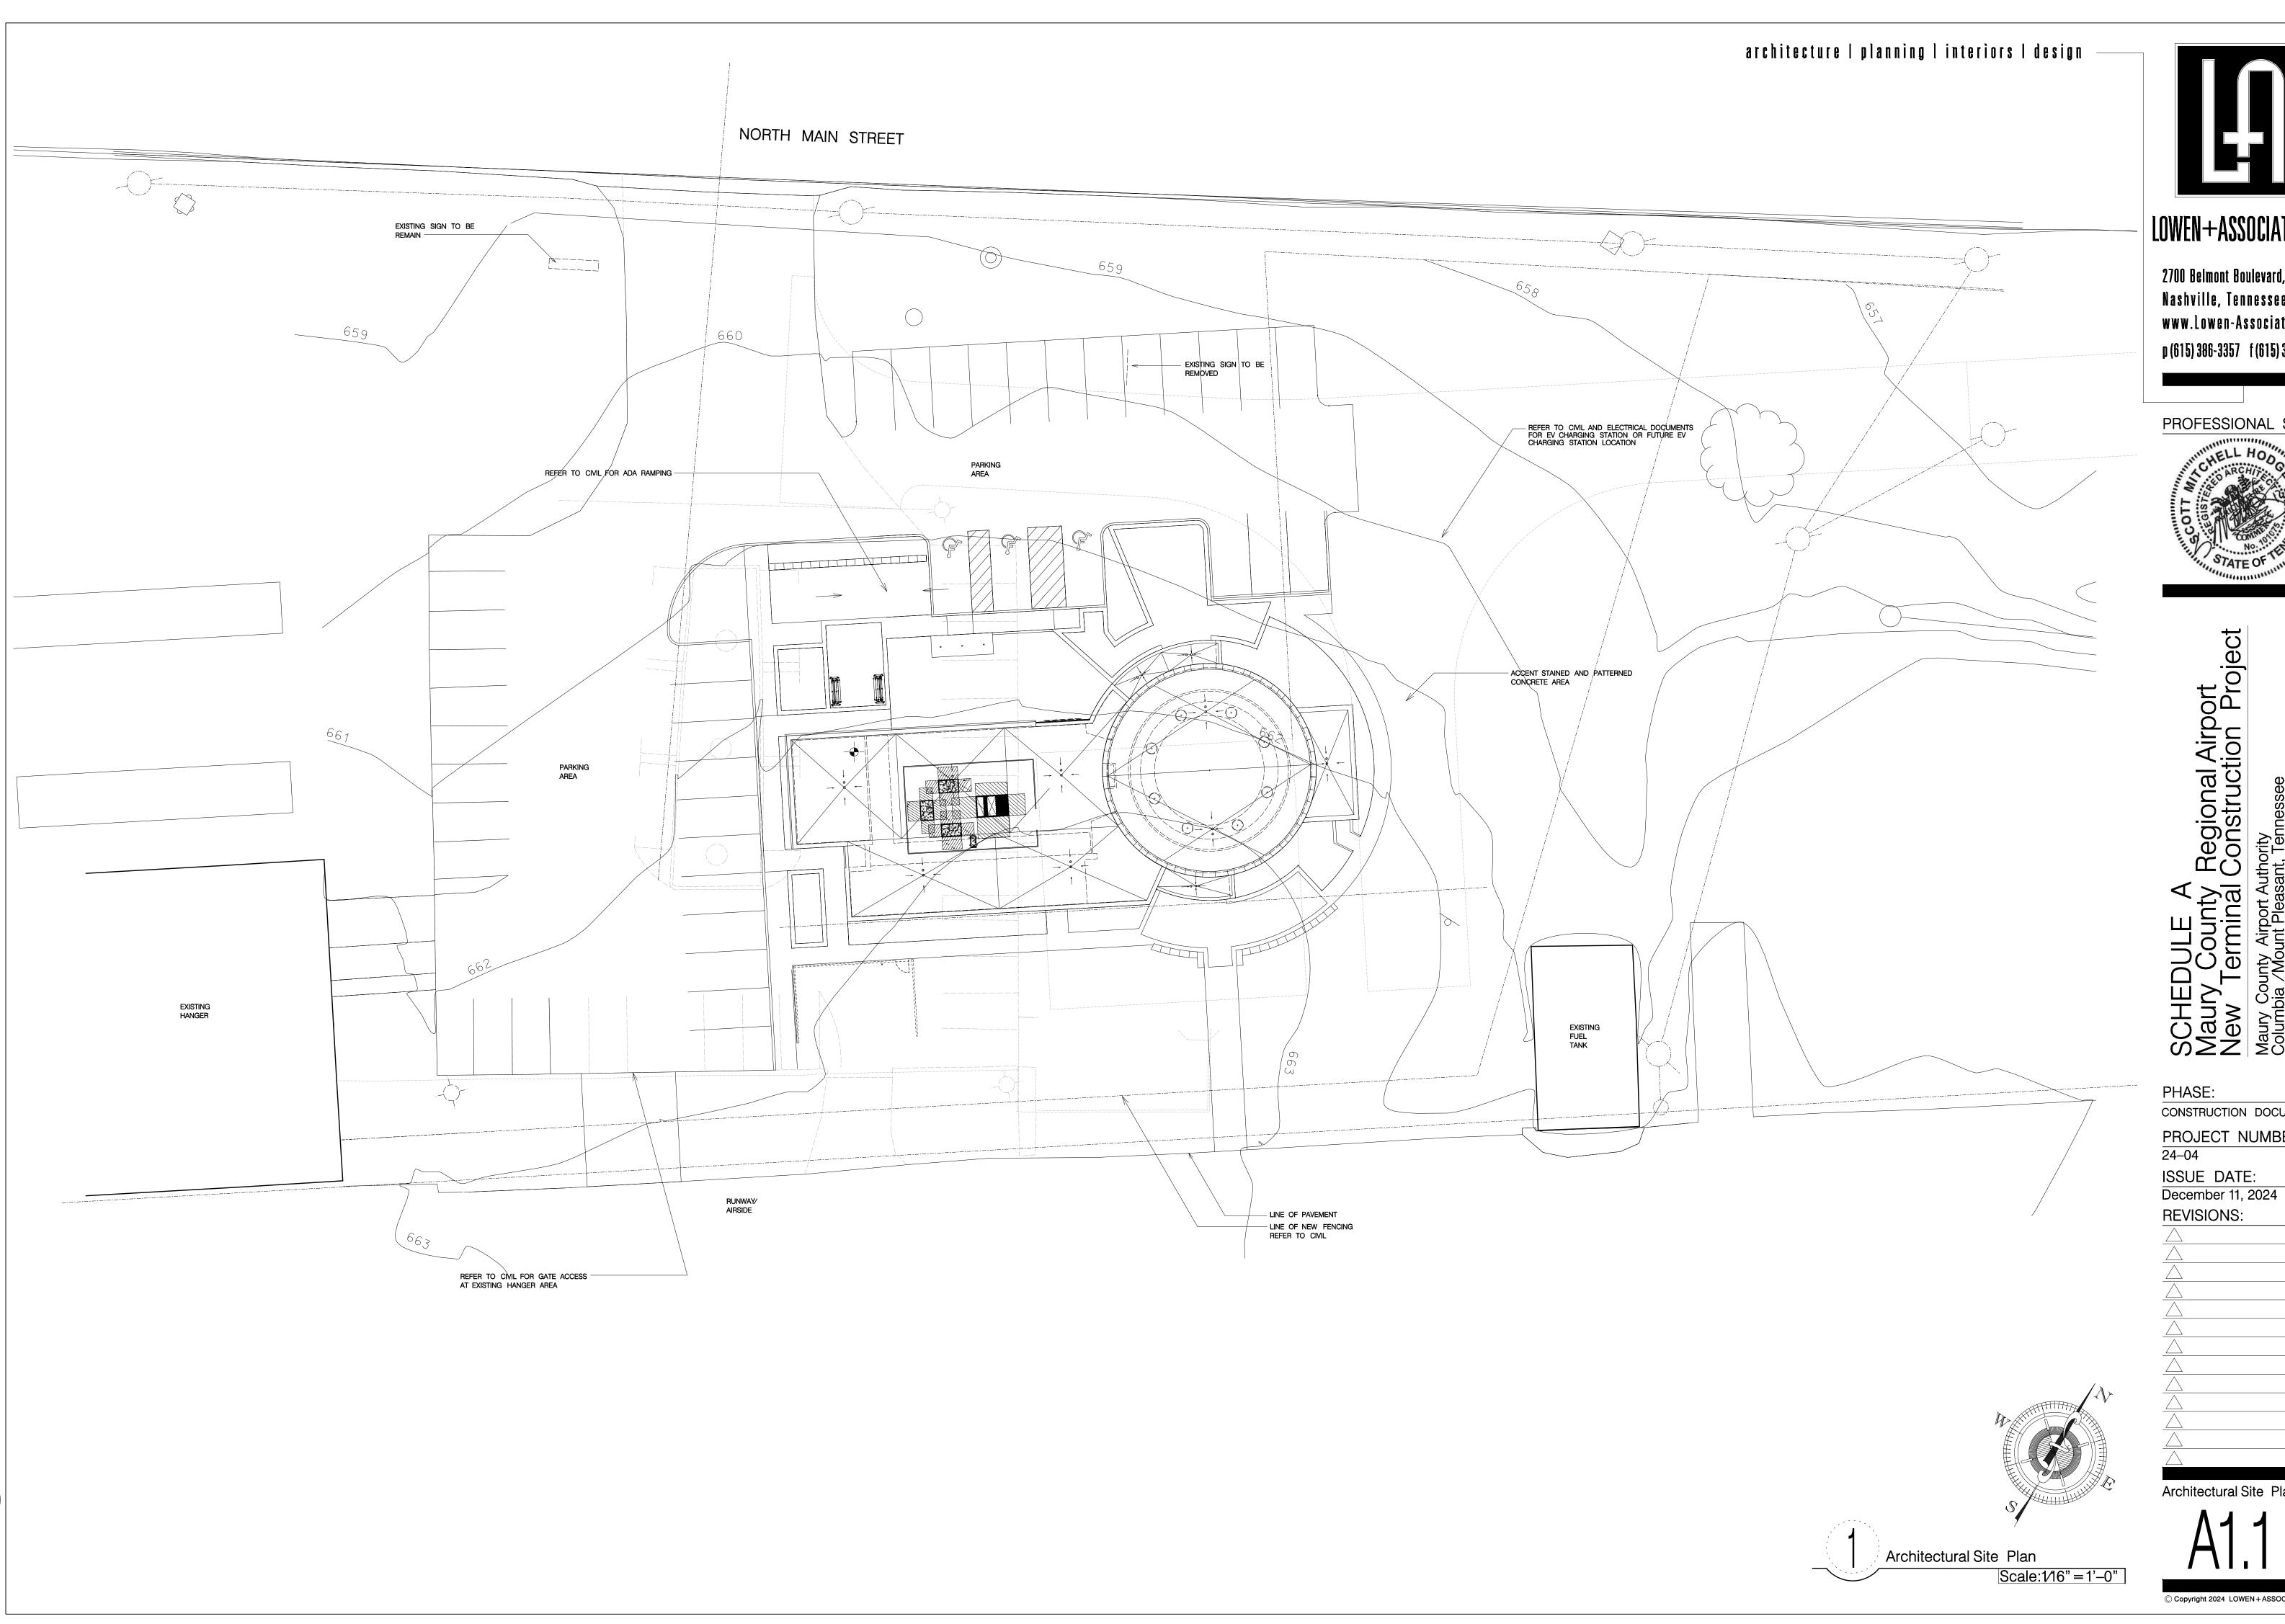

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PROFESSIONAL SEAL:




CONSTRUCTION DOCUMENTS


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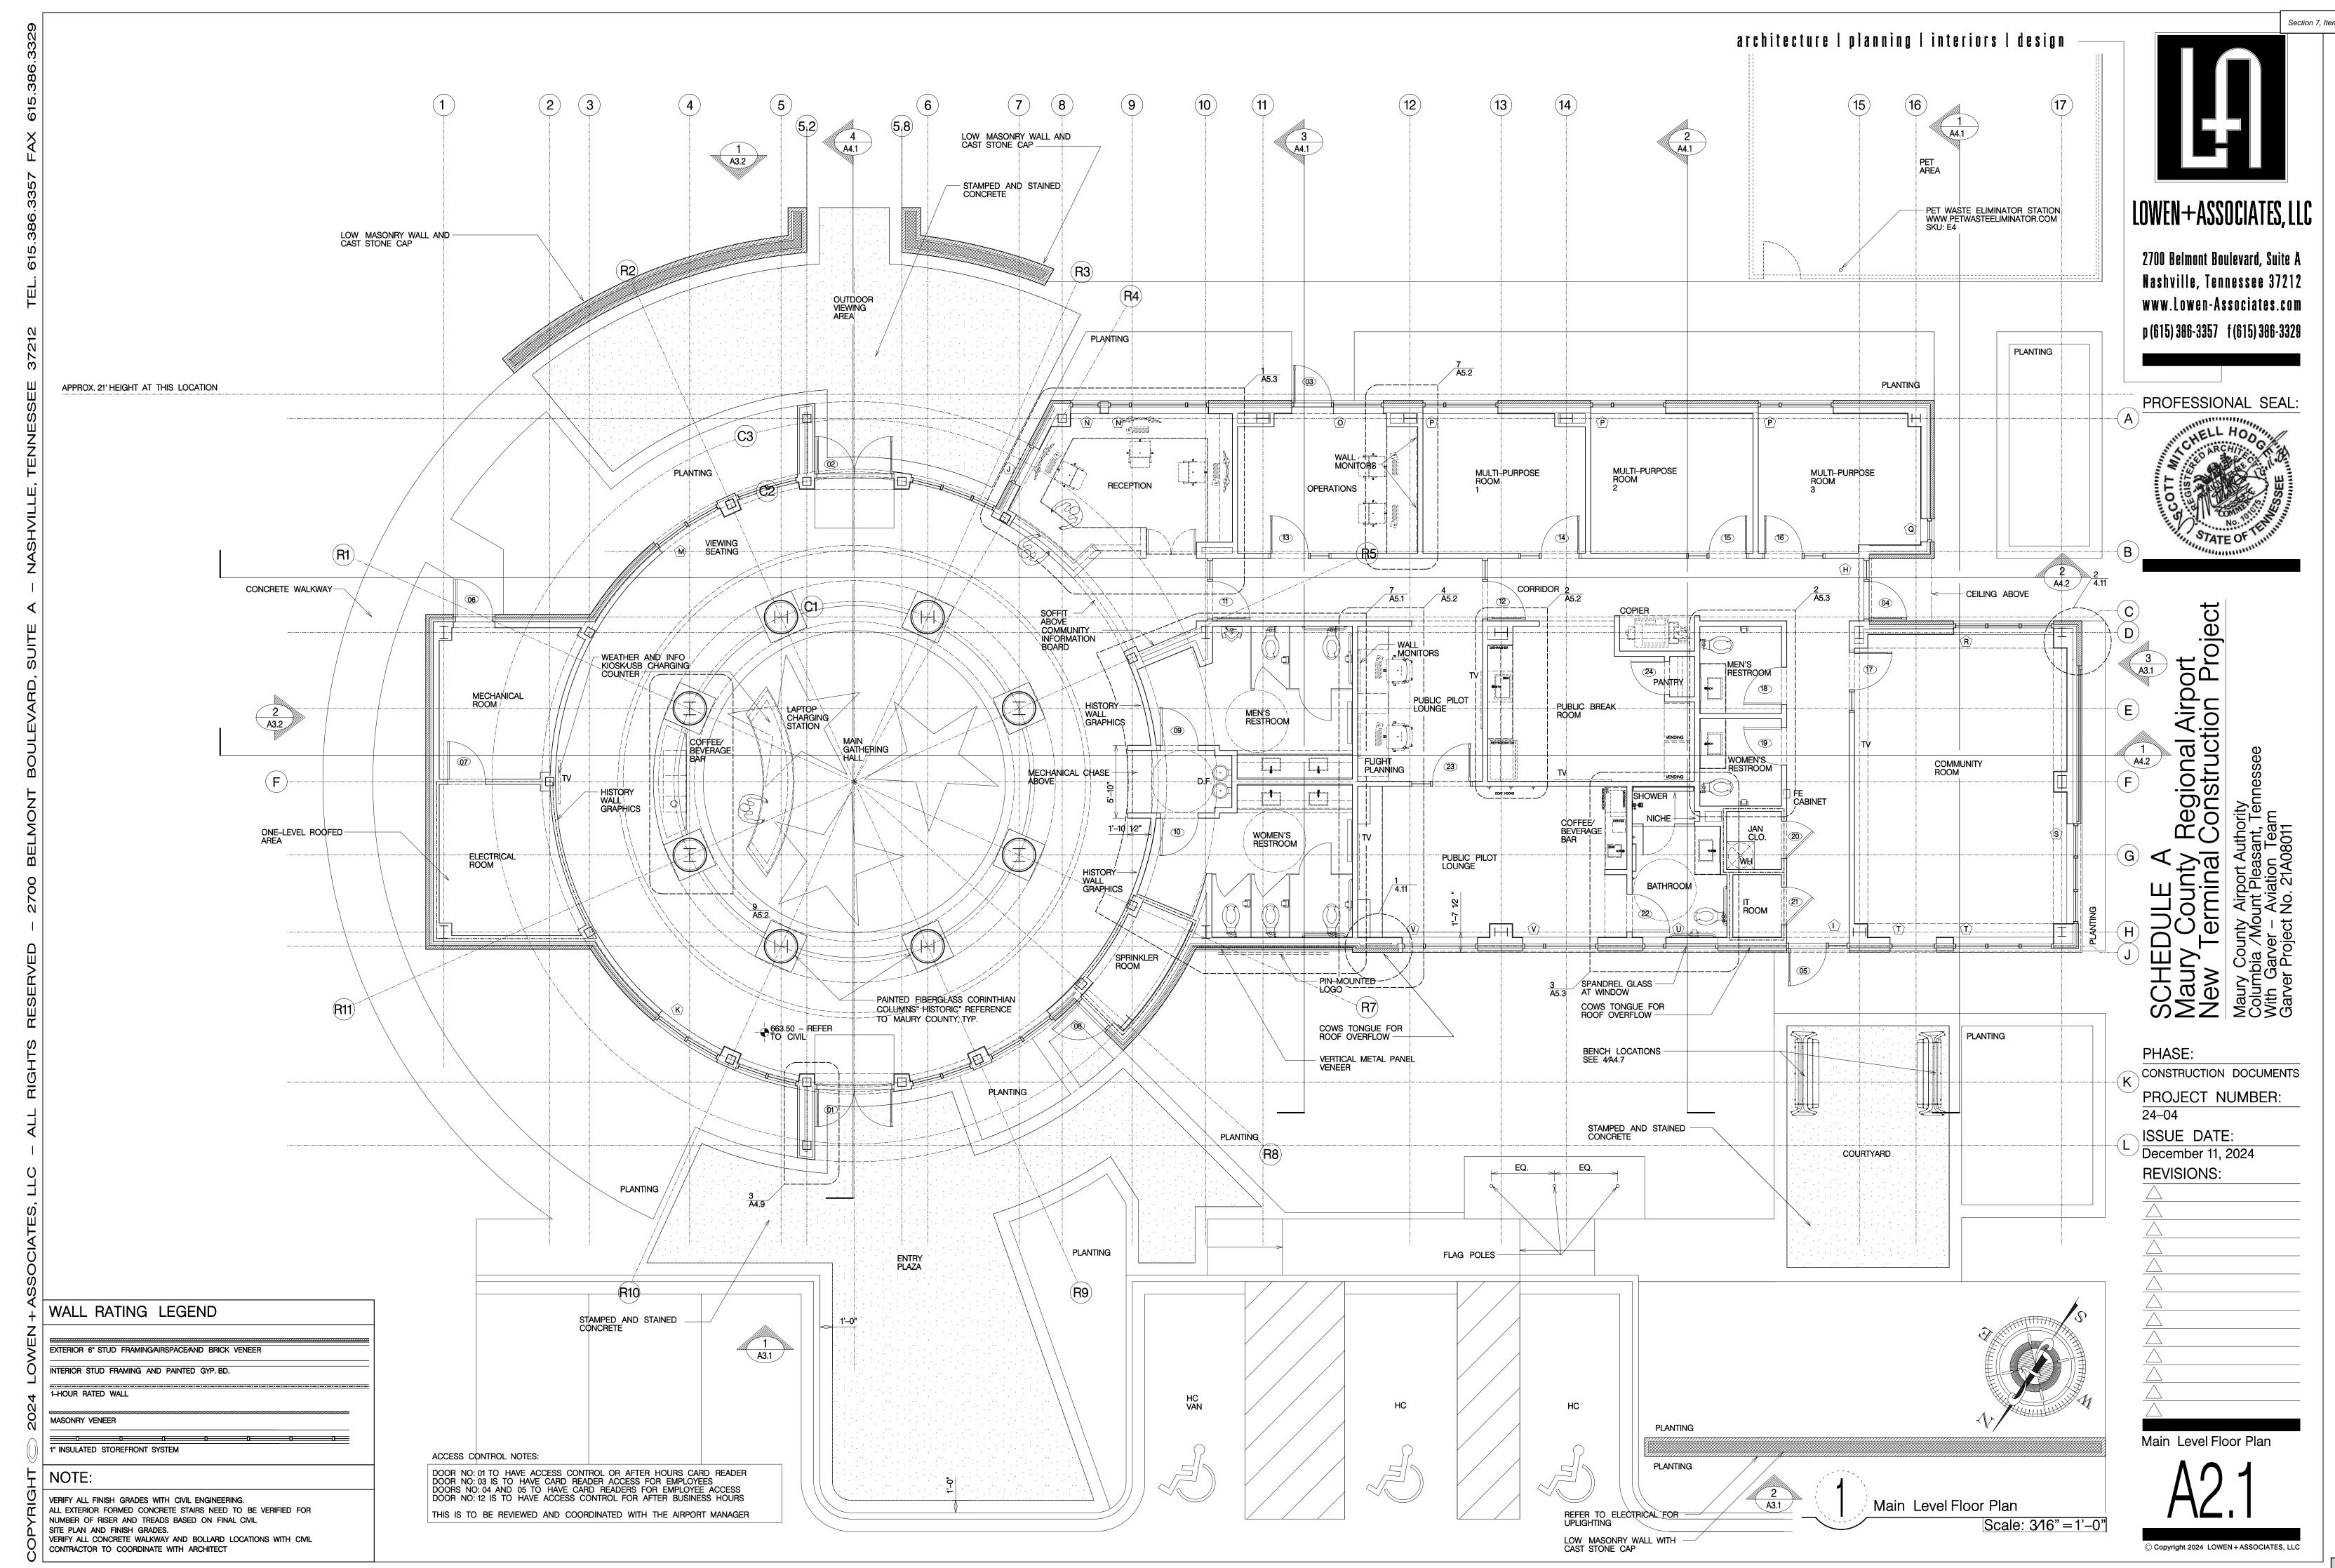
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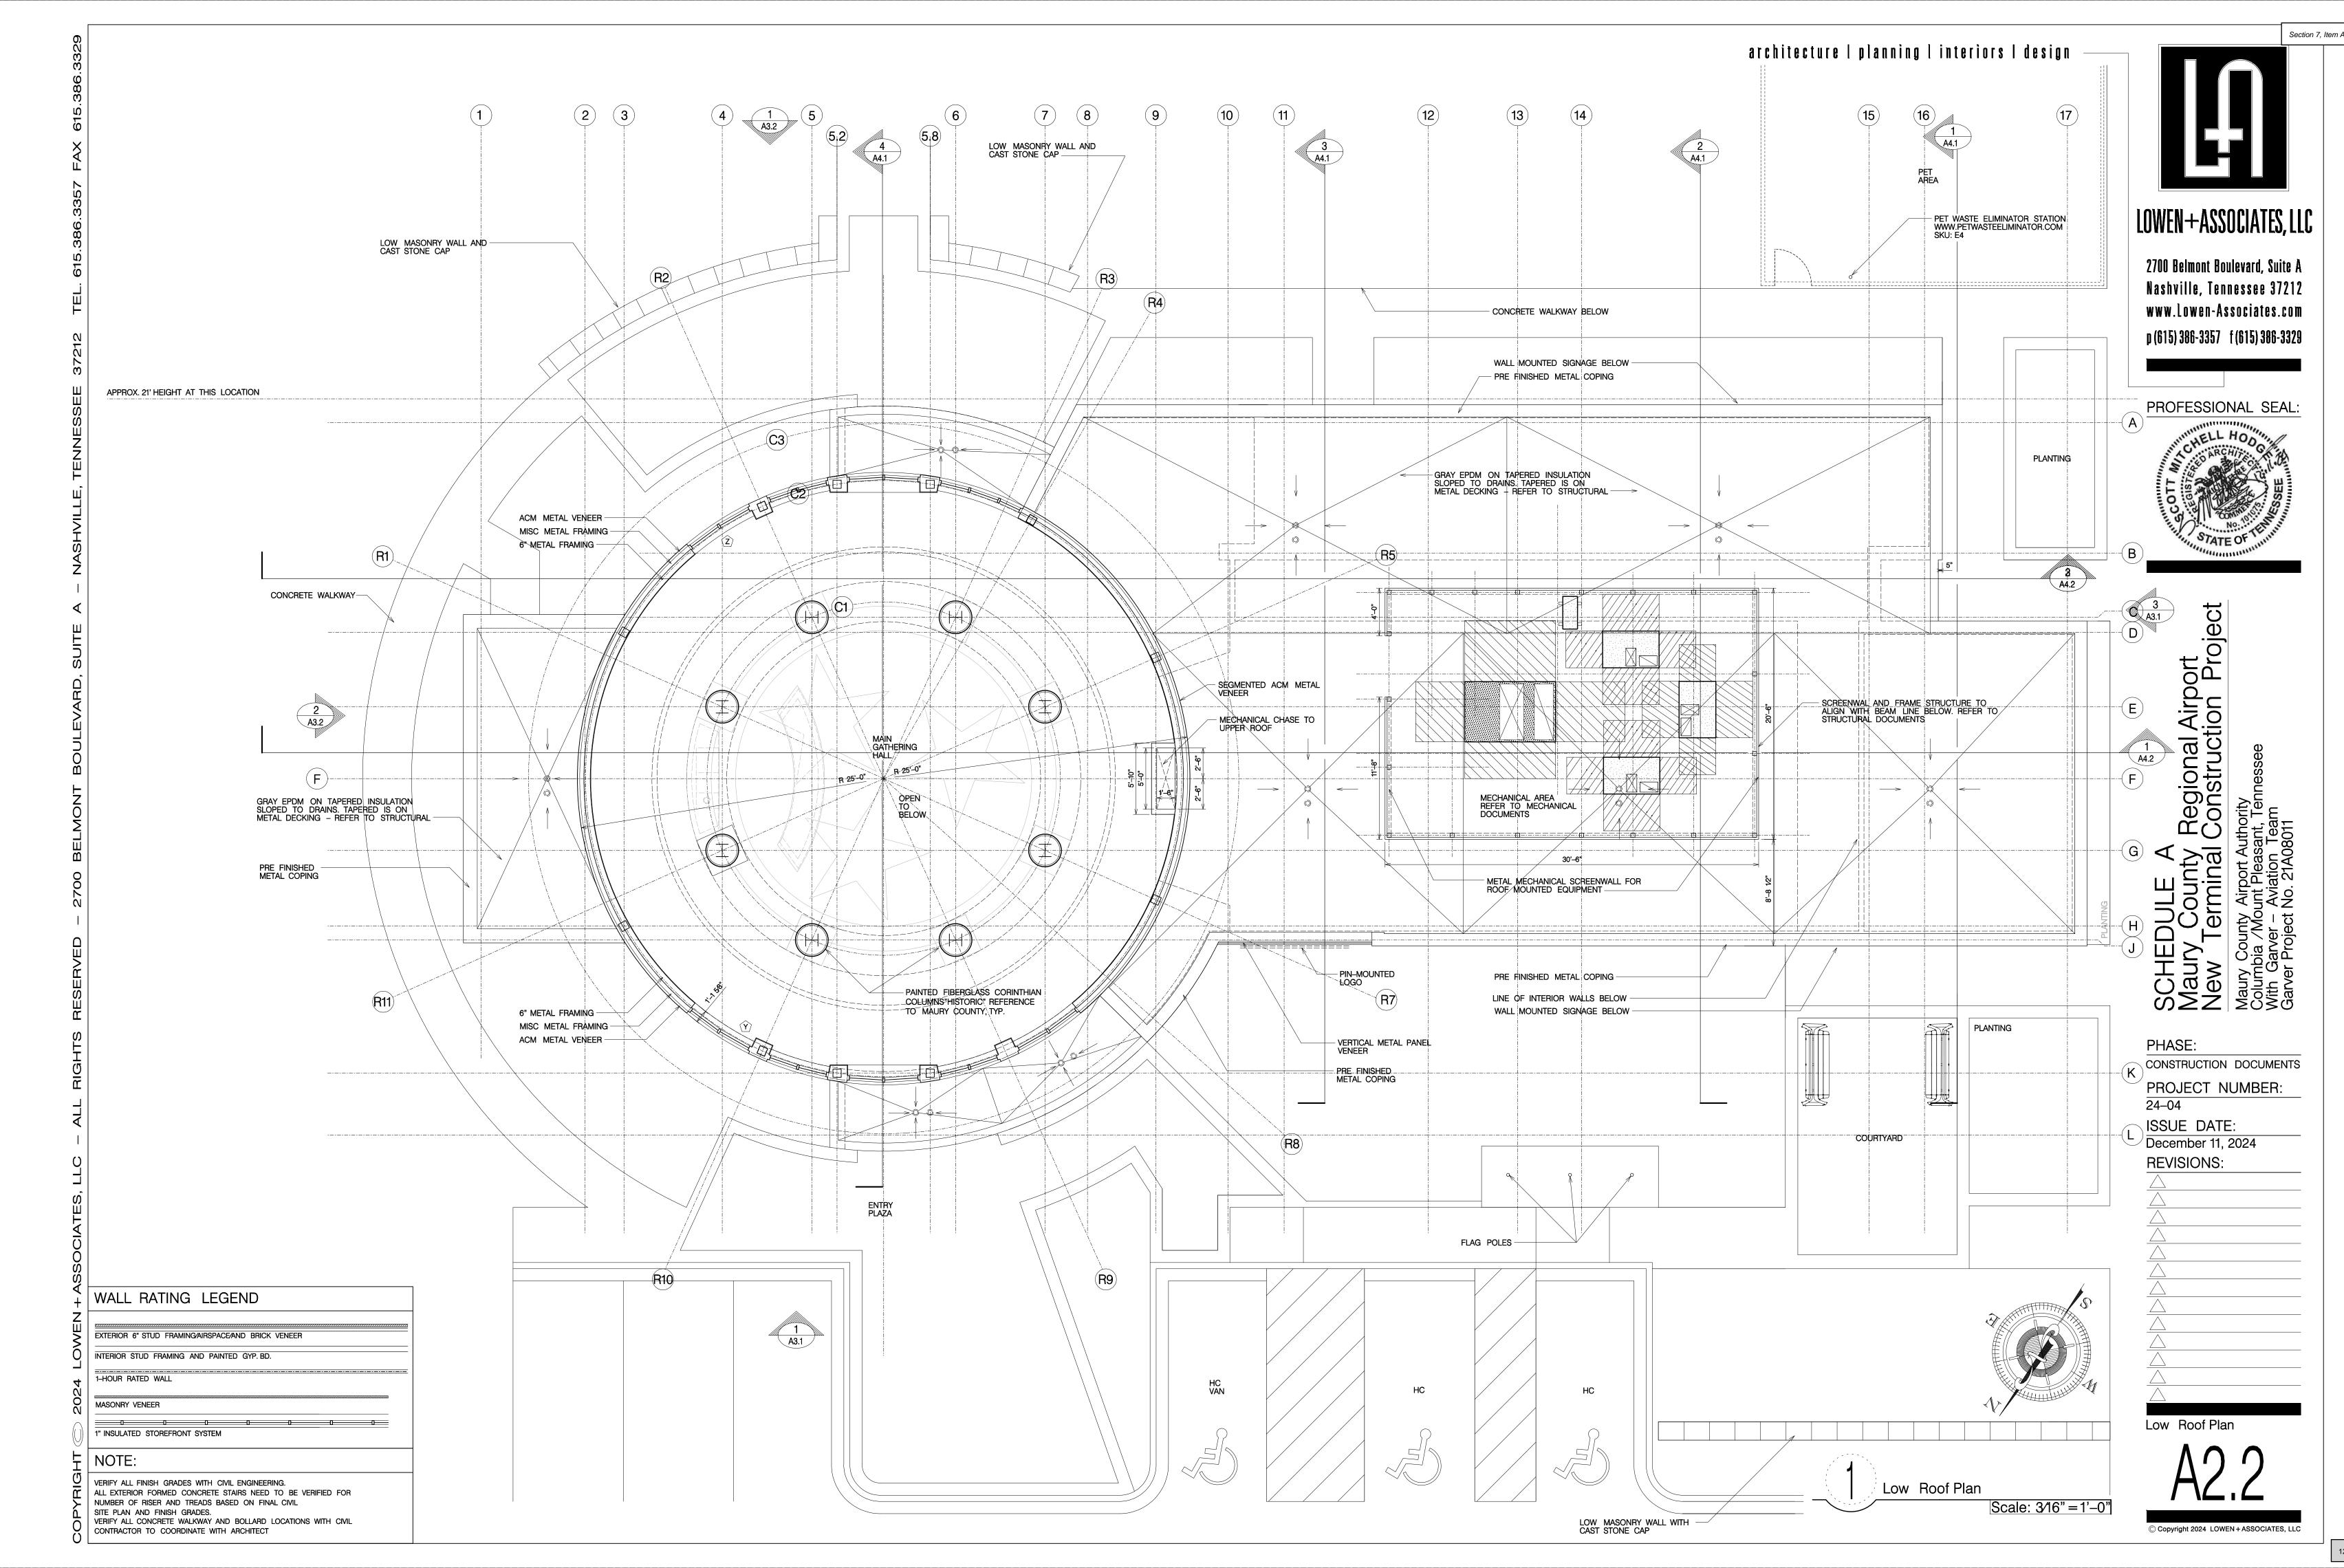
Architectural Site Plan


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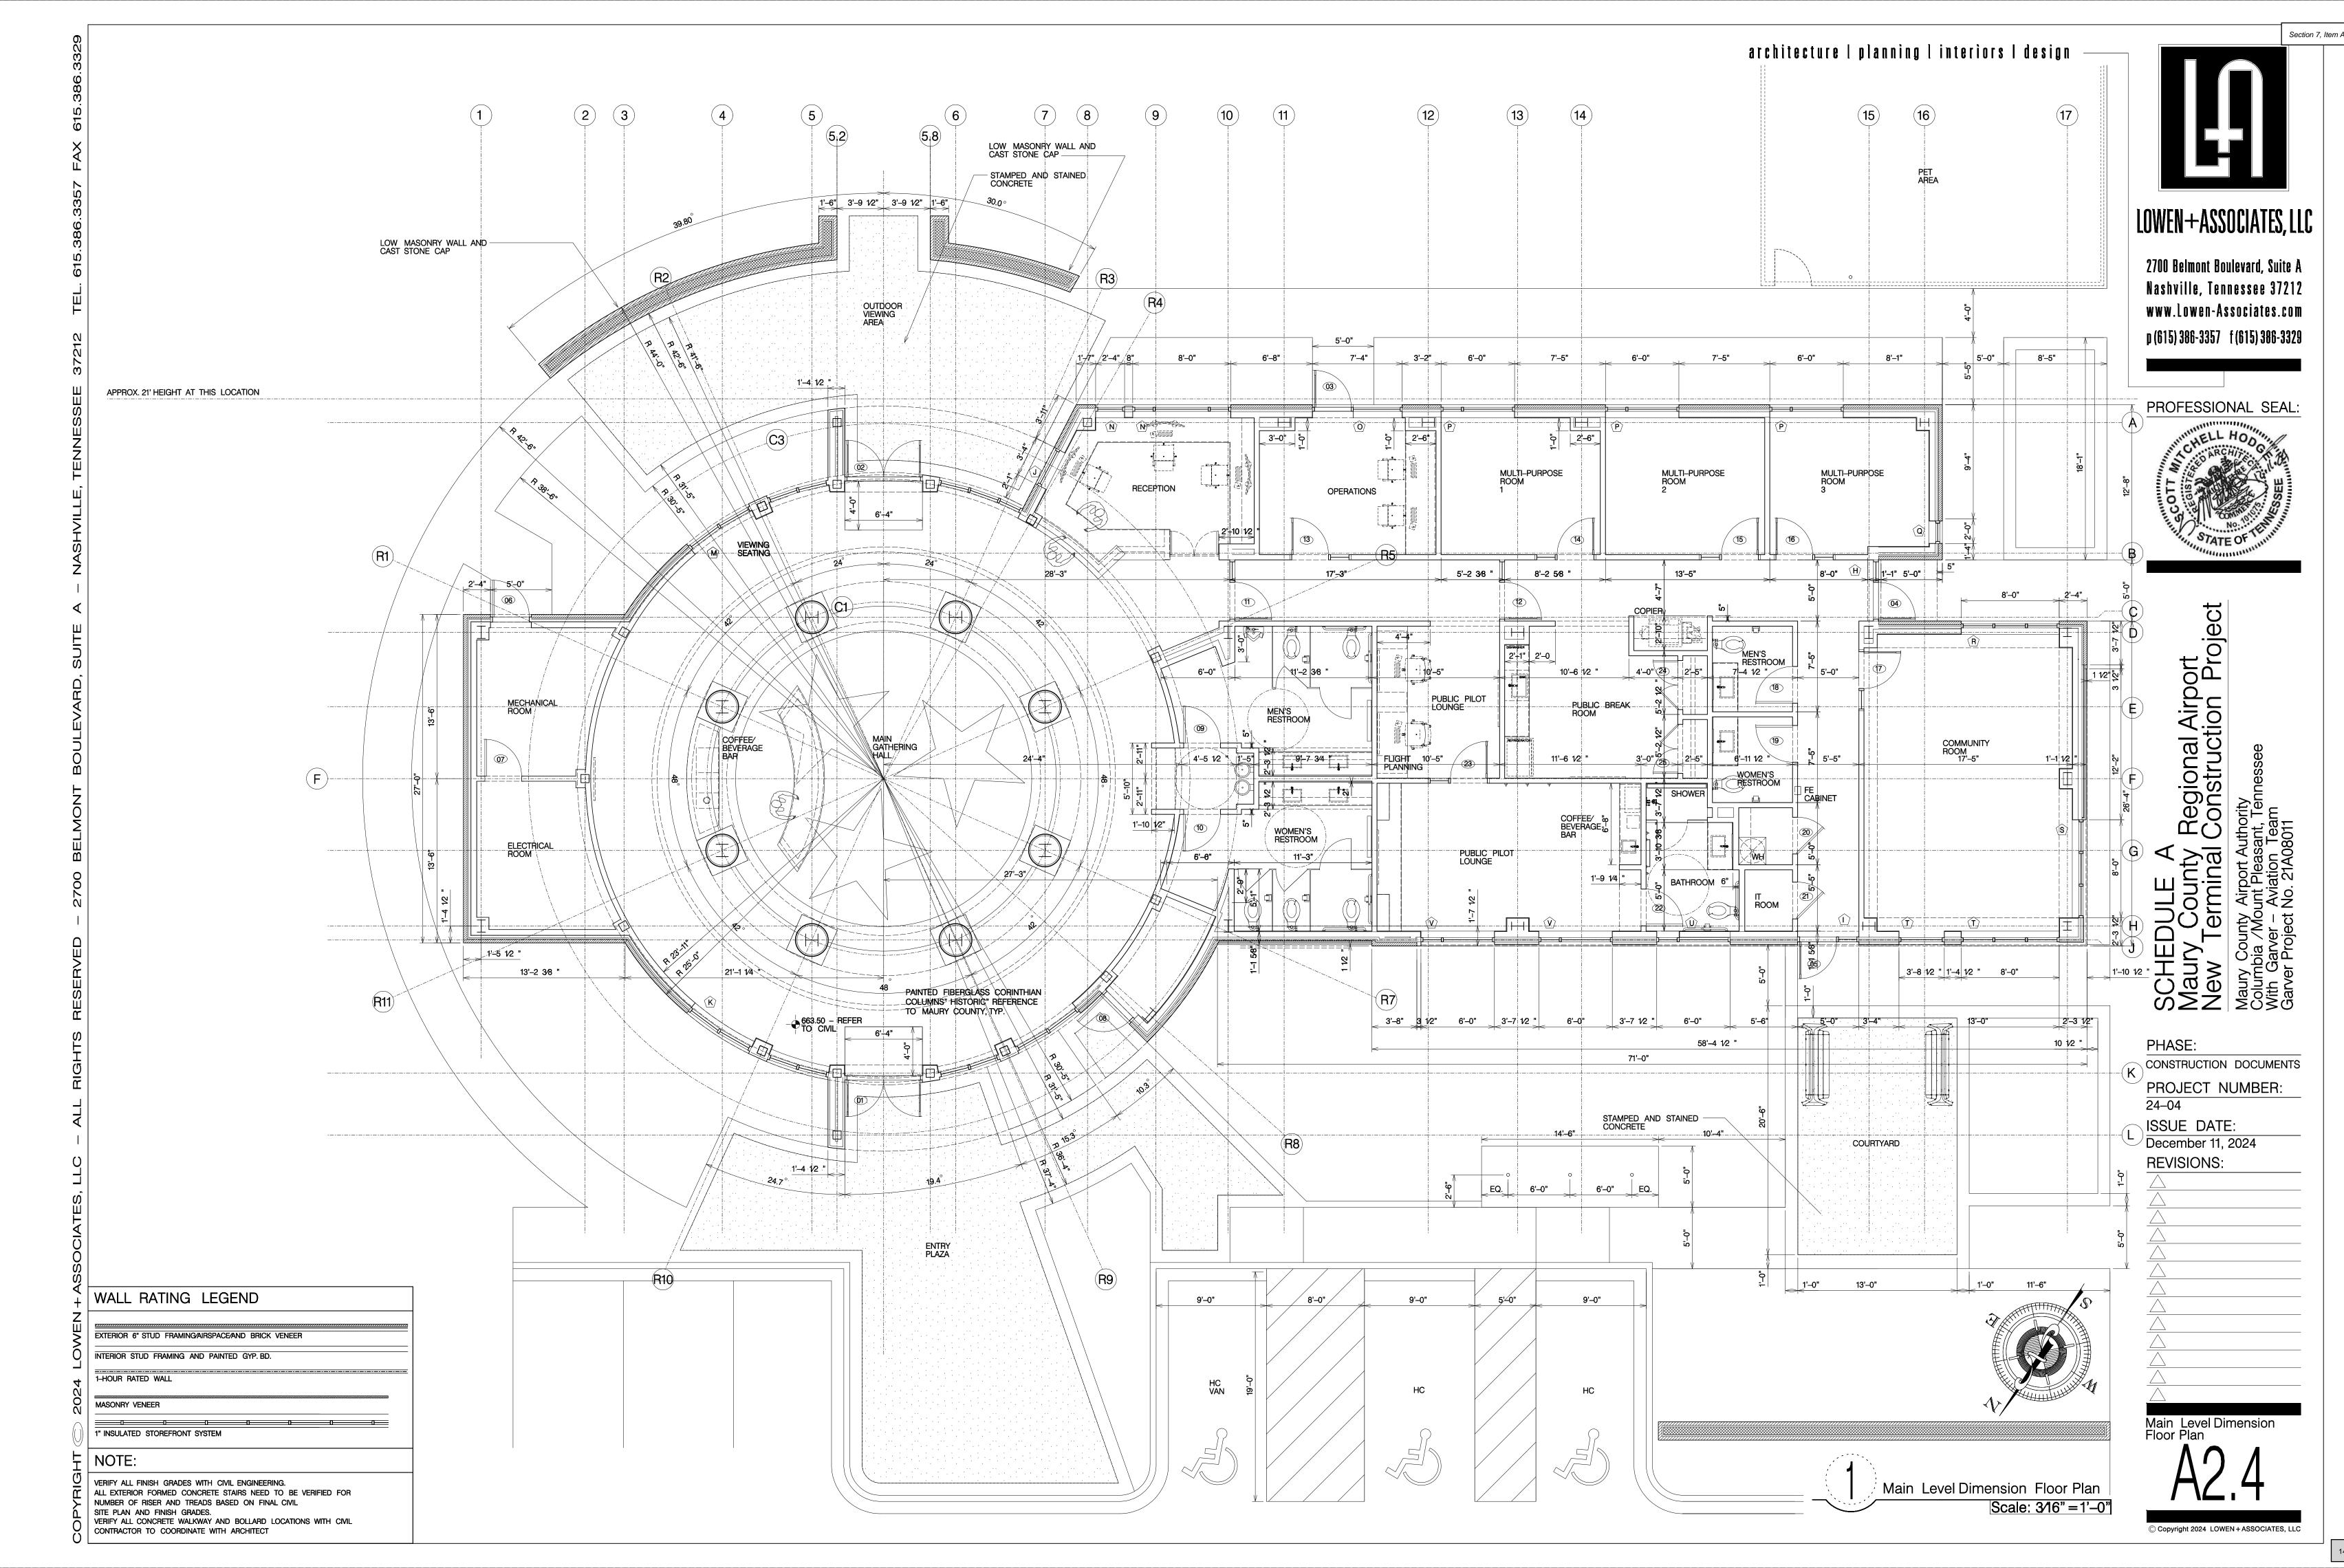








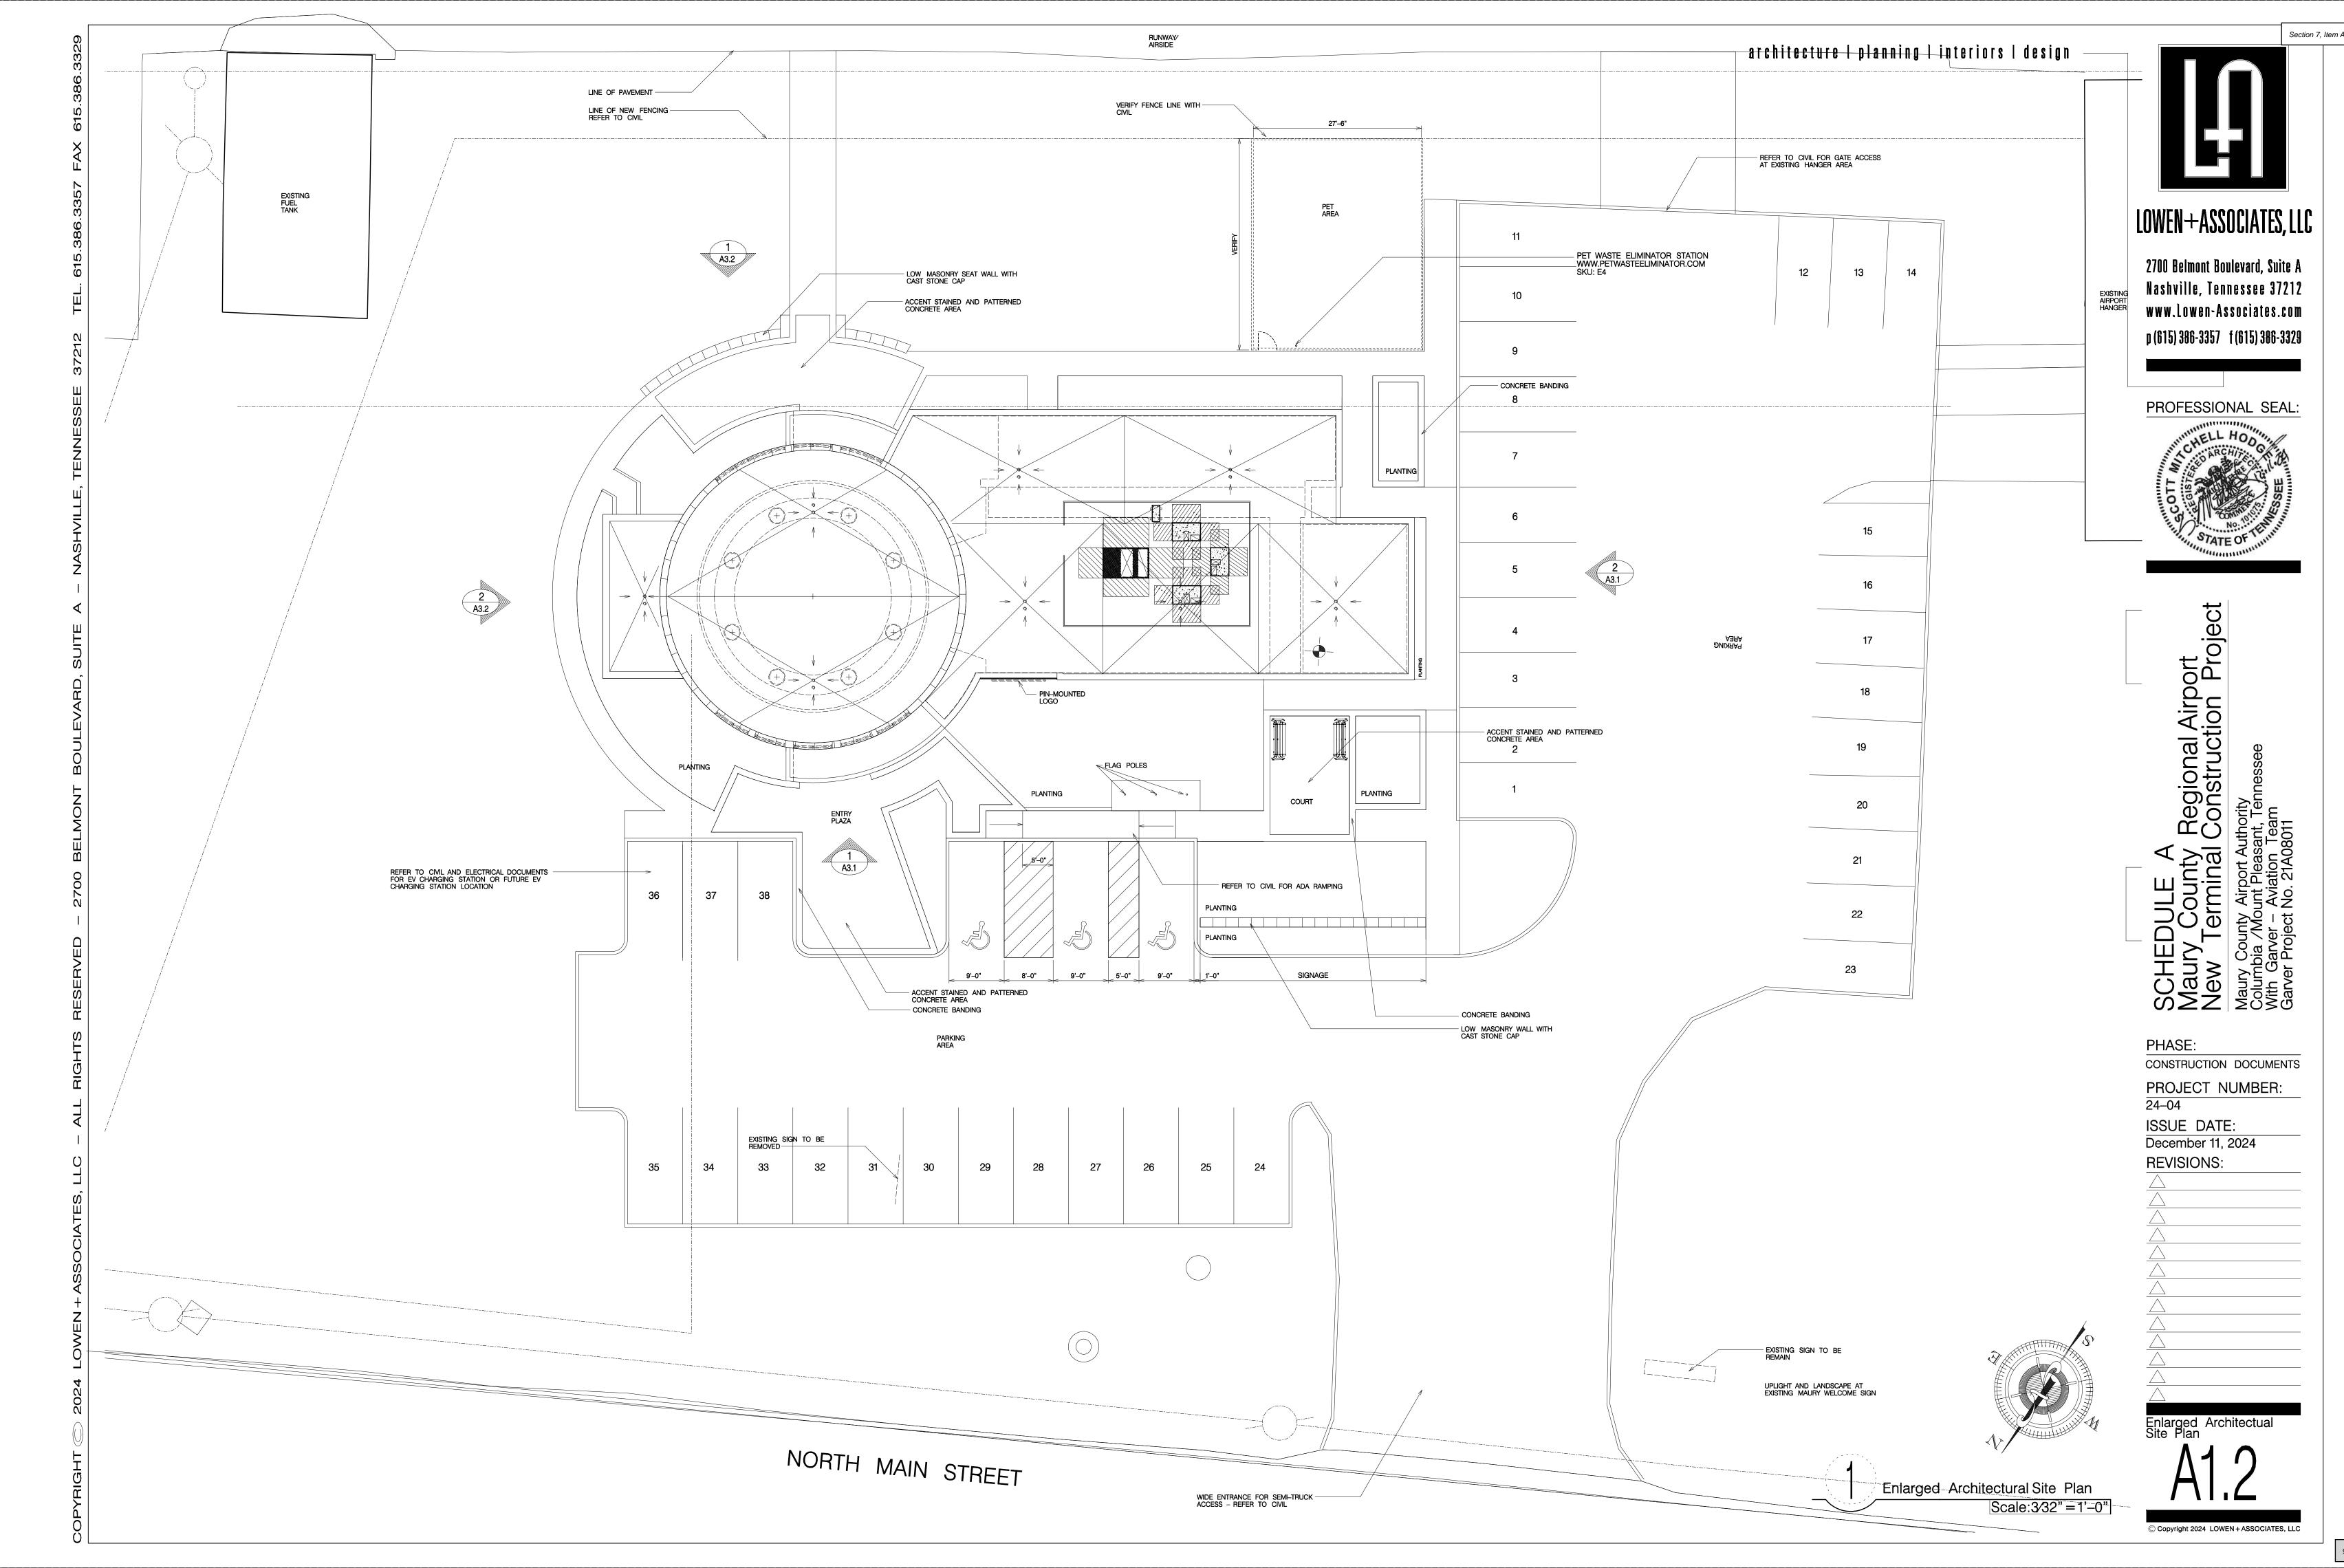


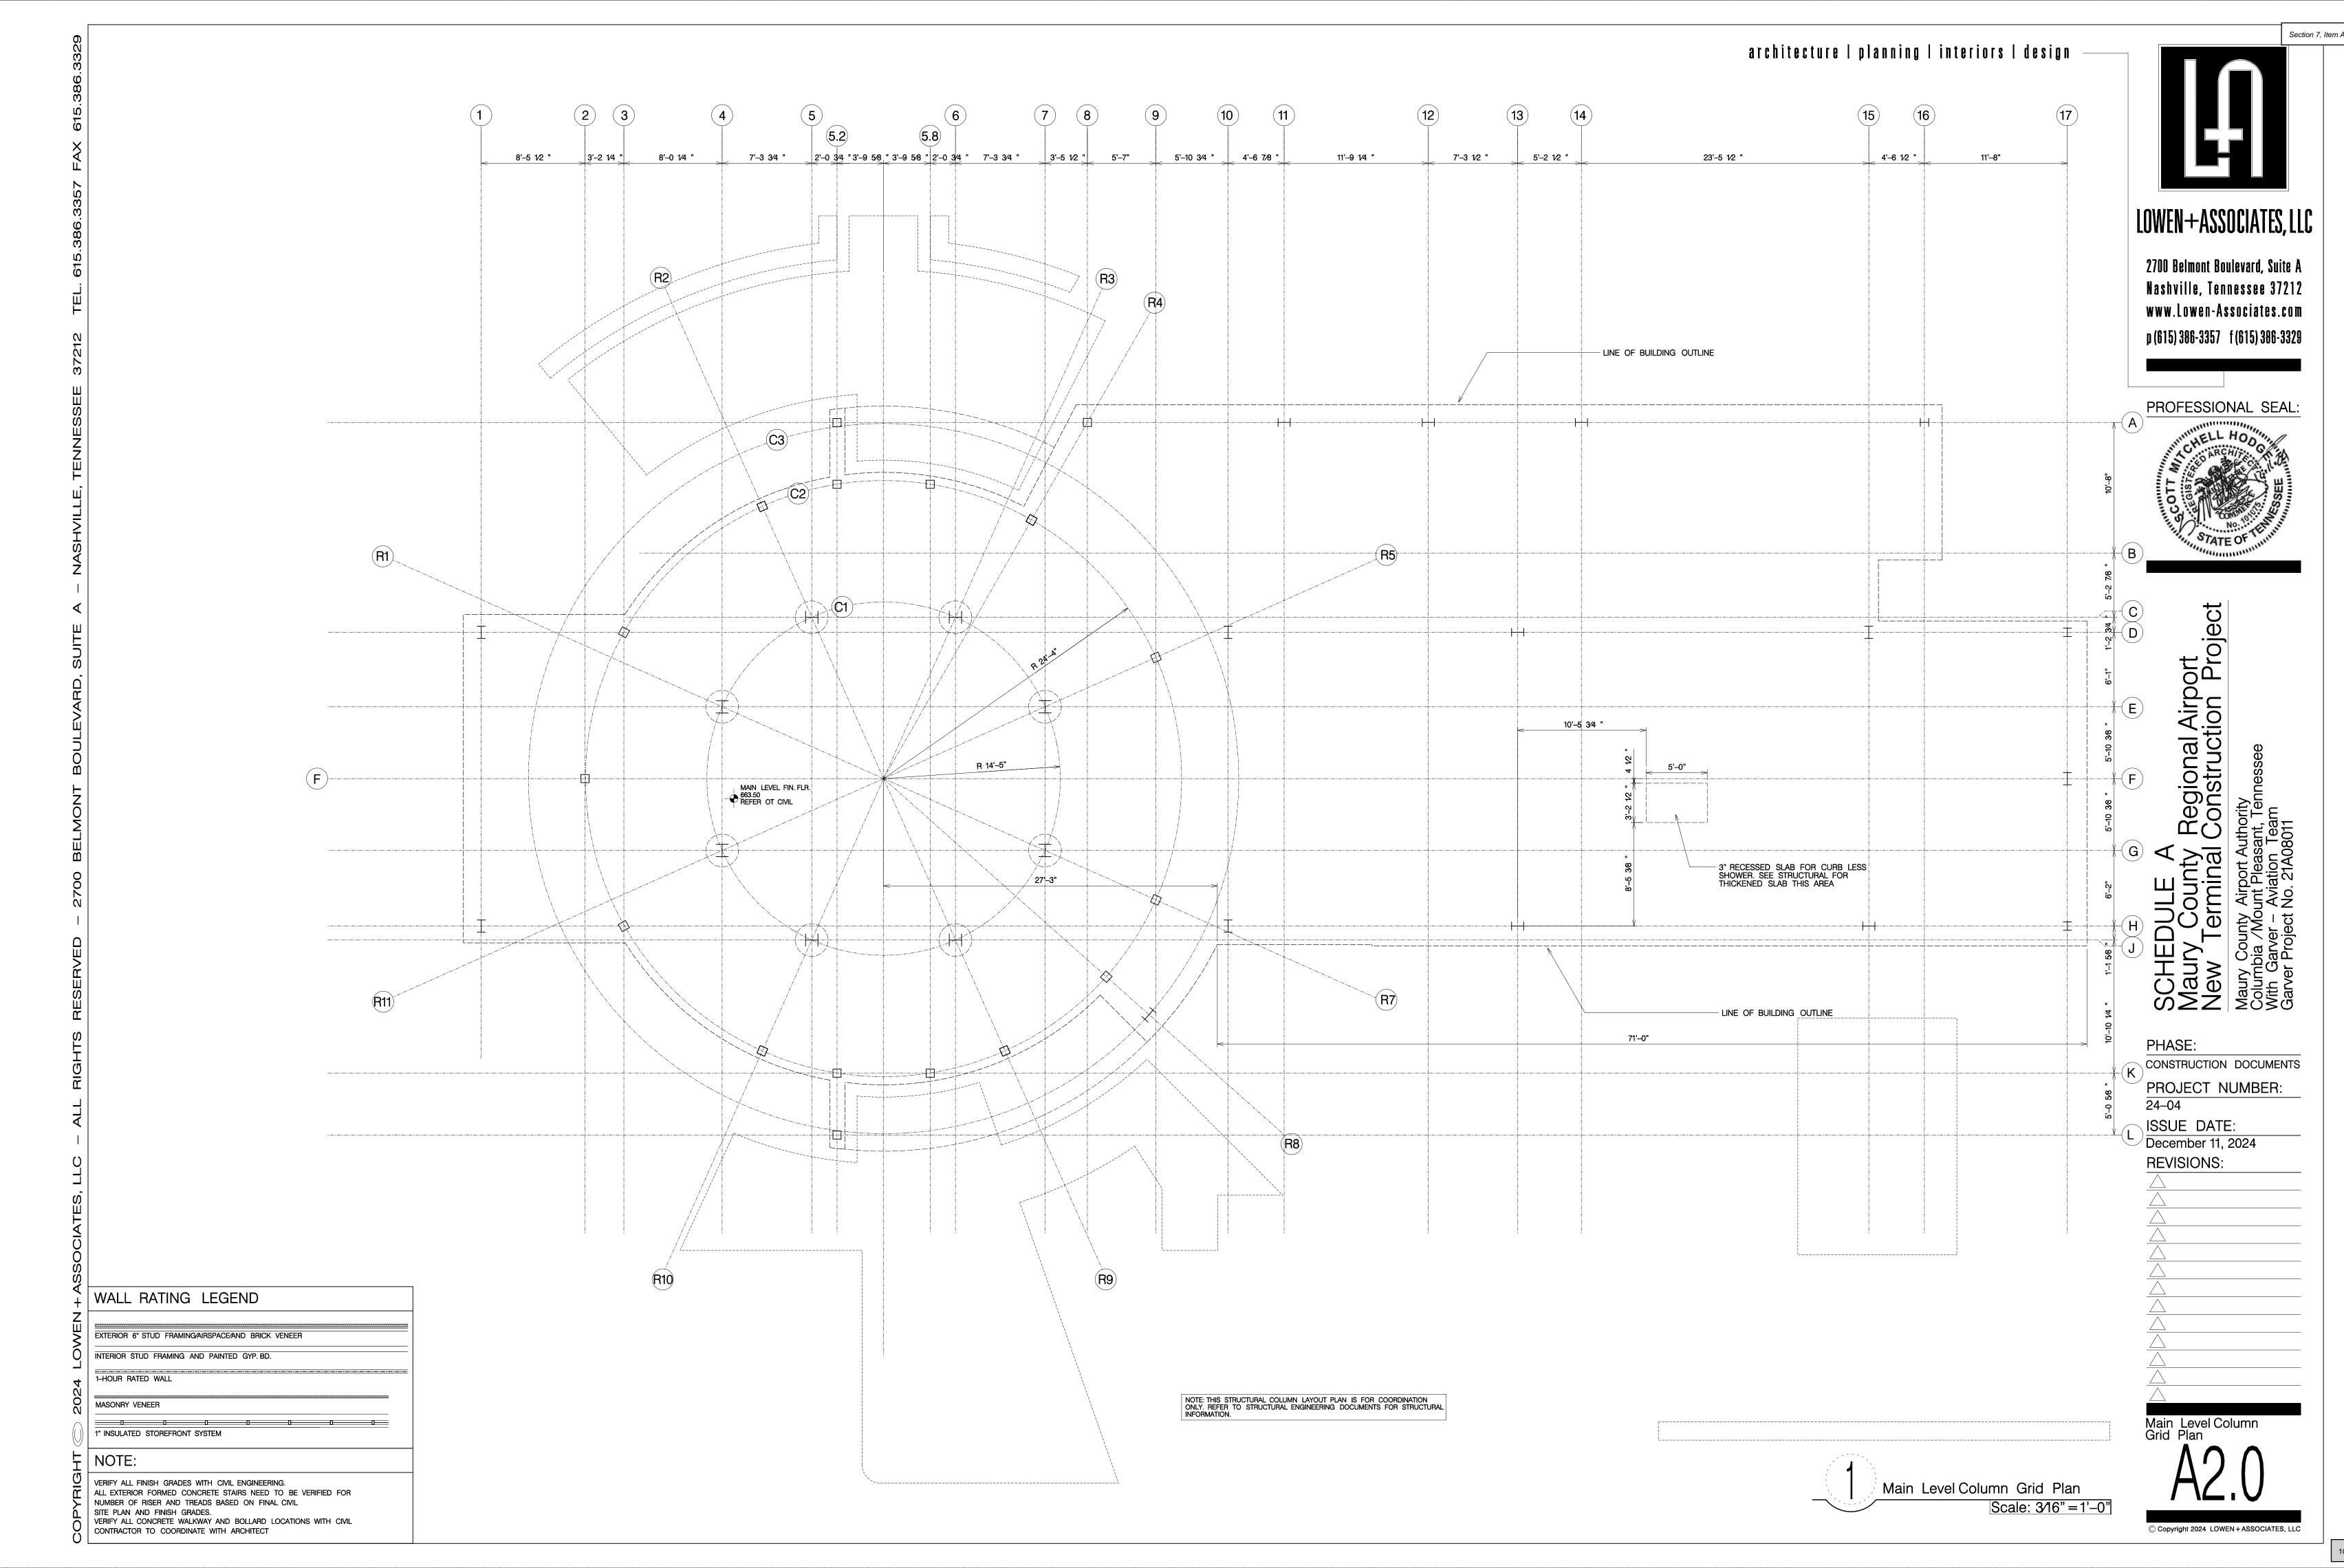

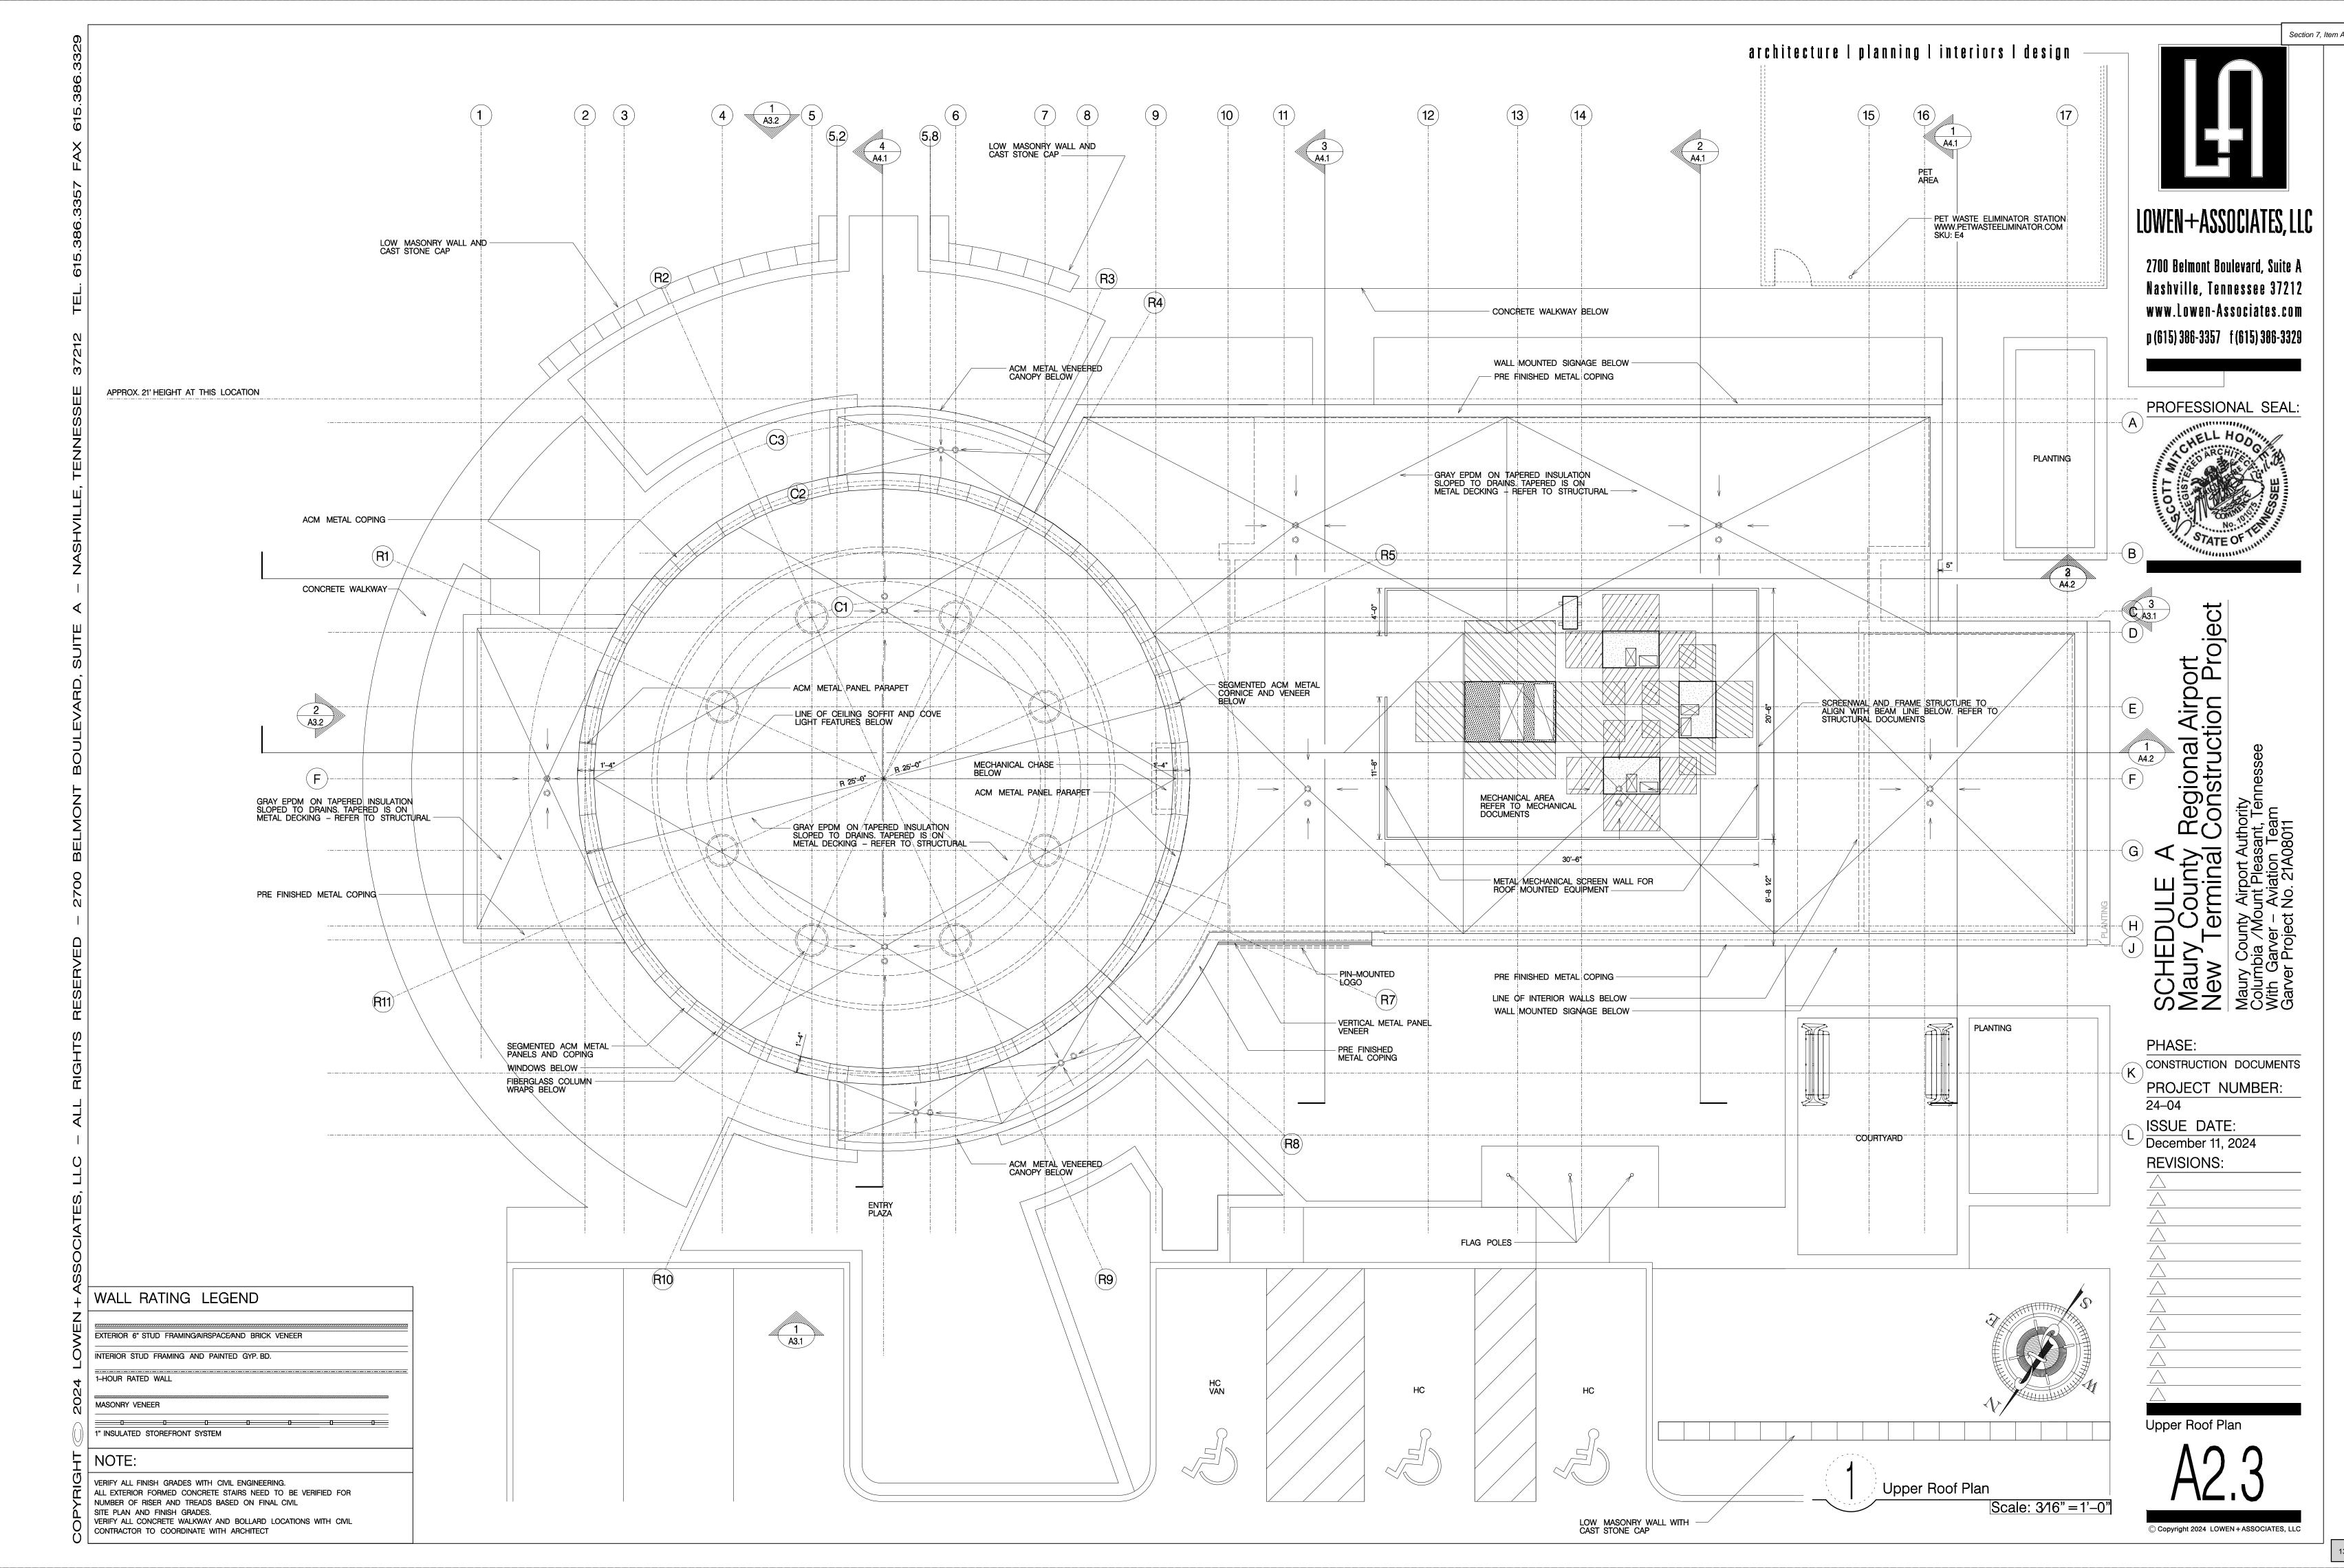

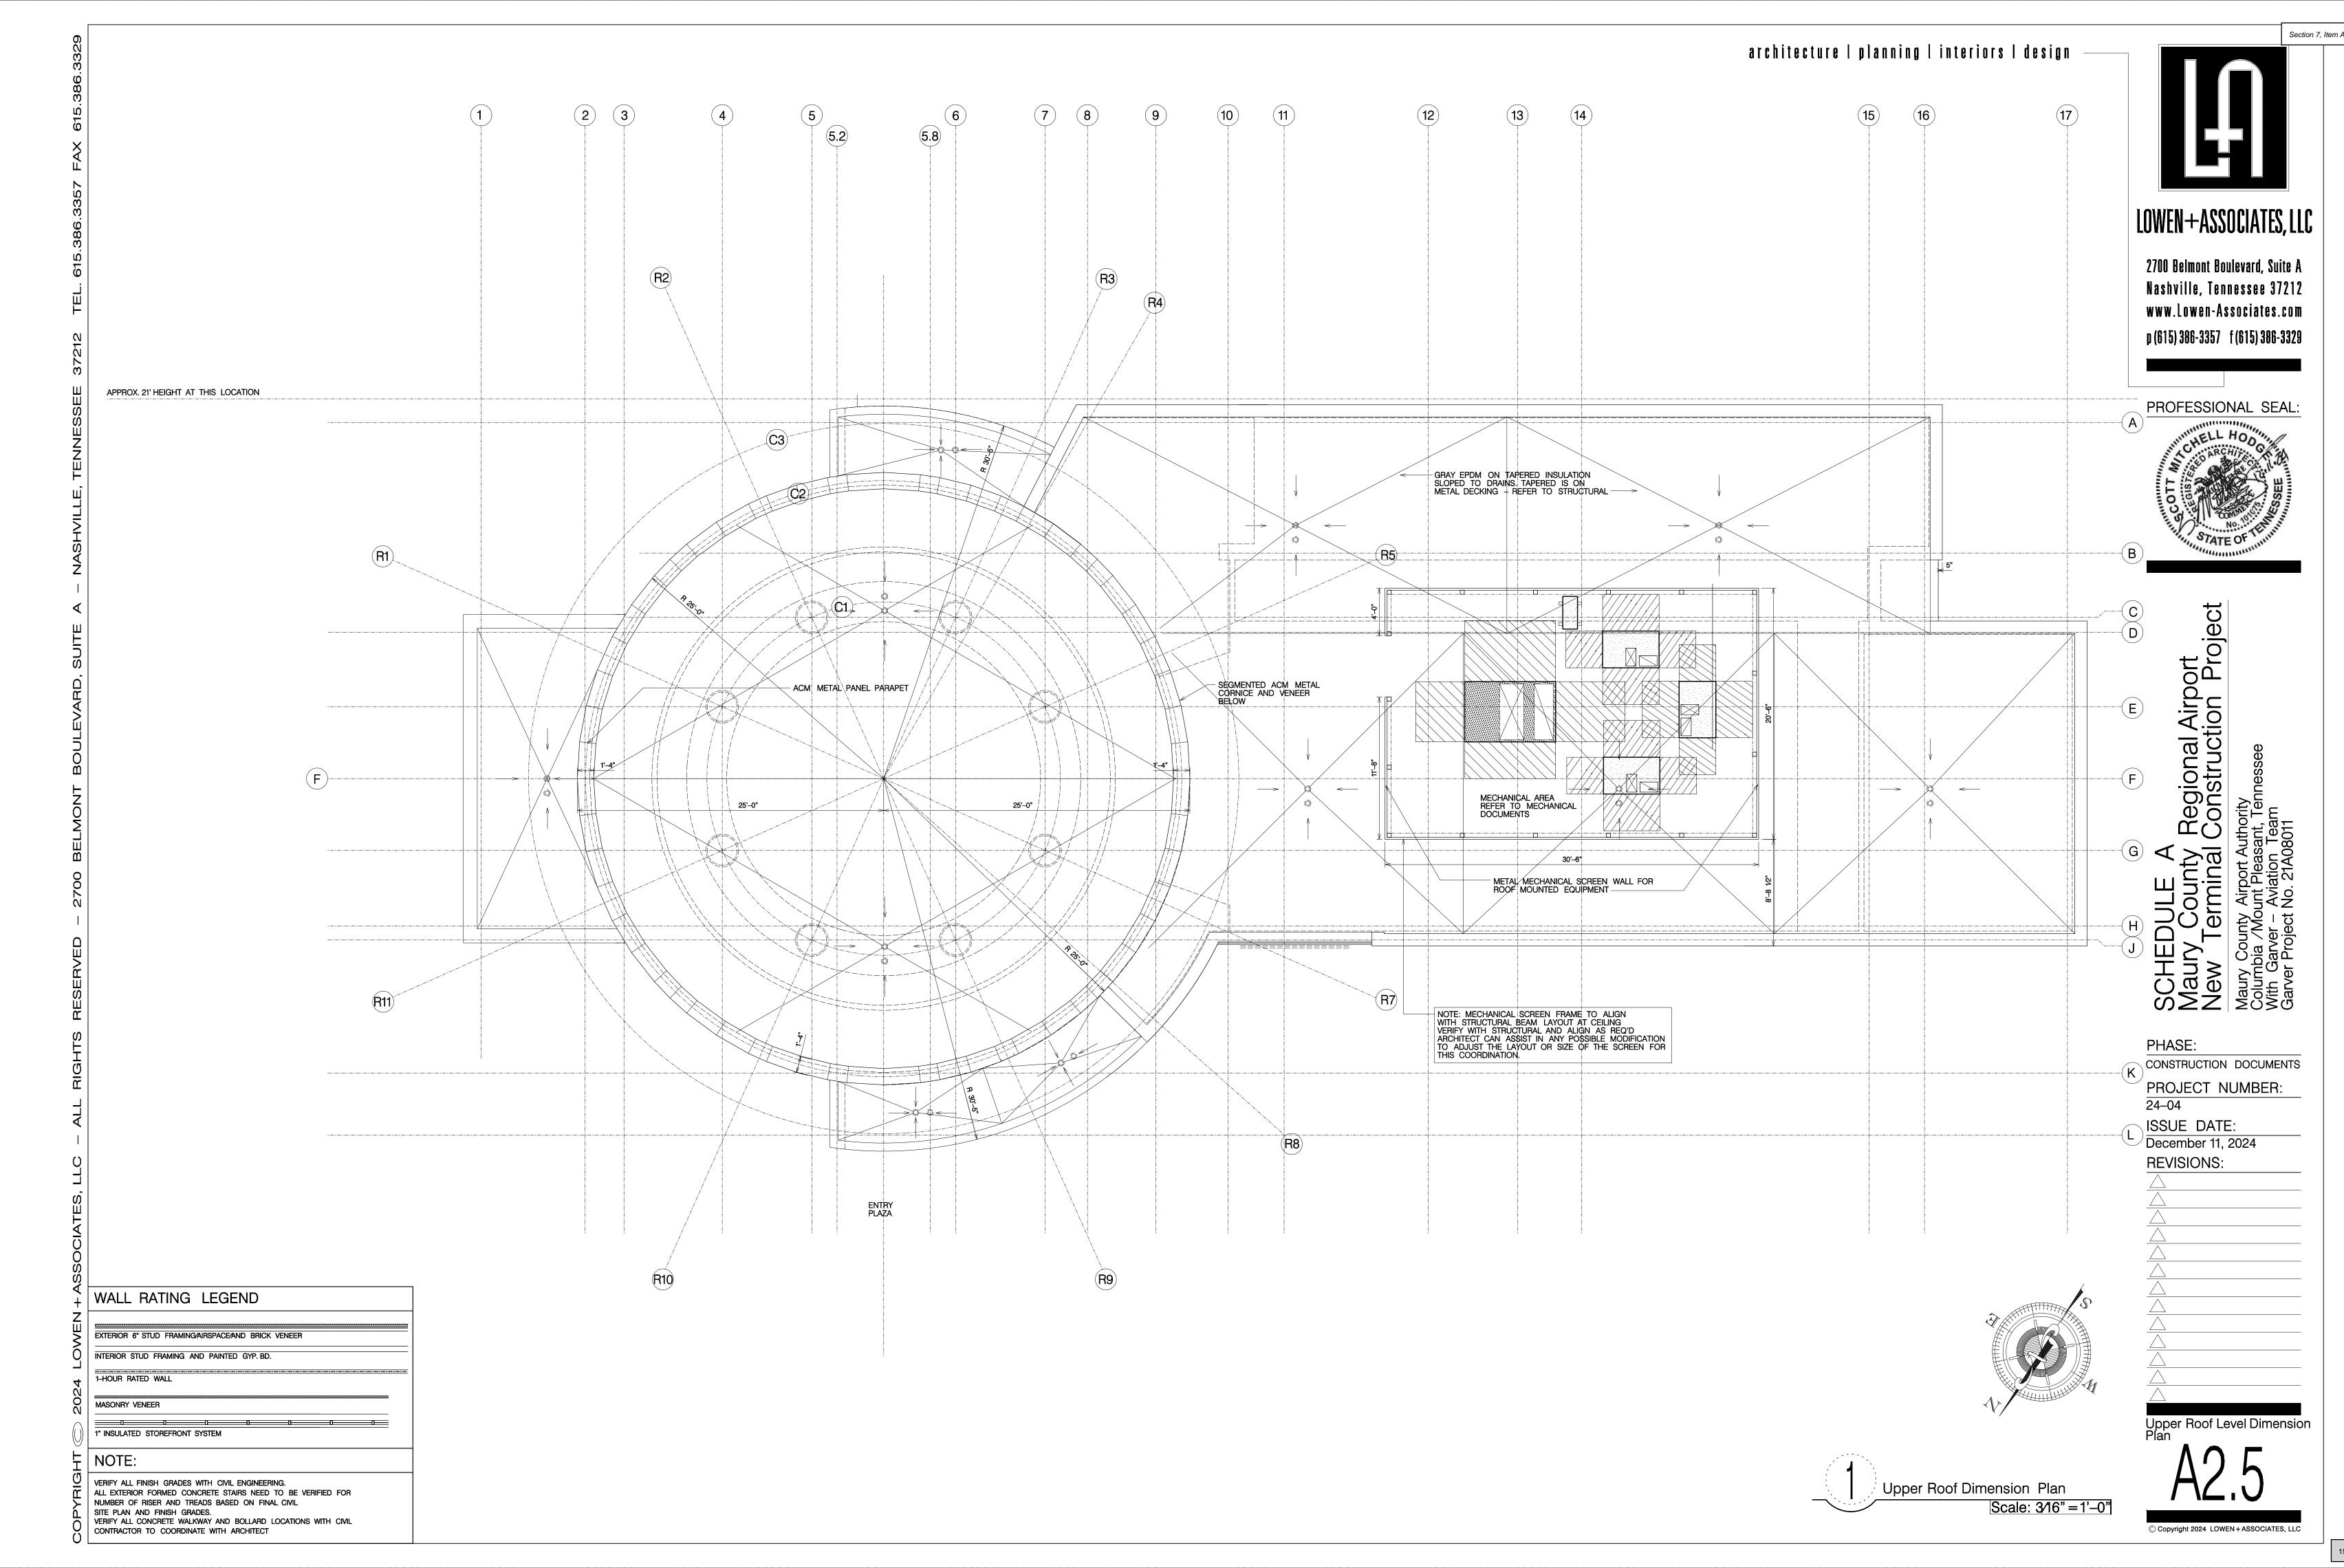

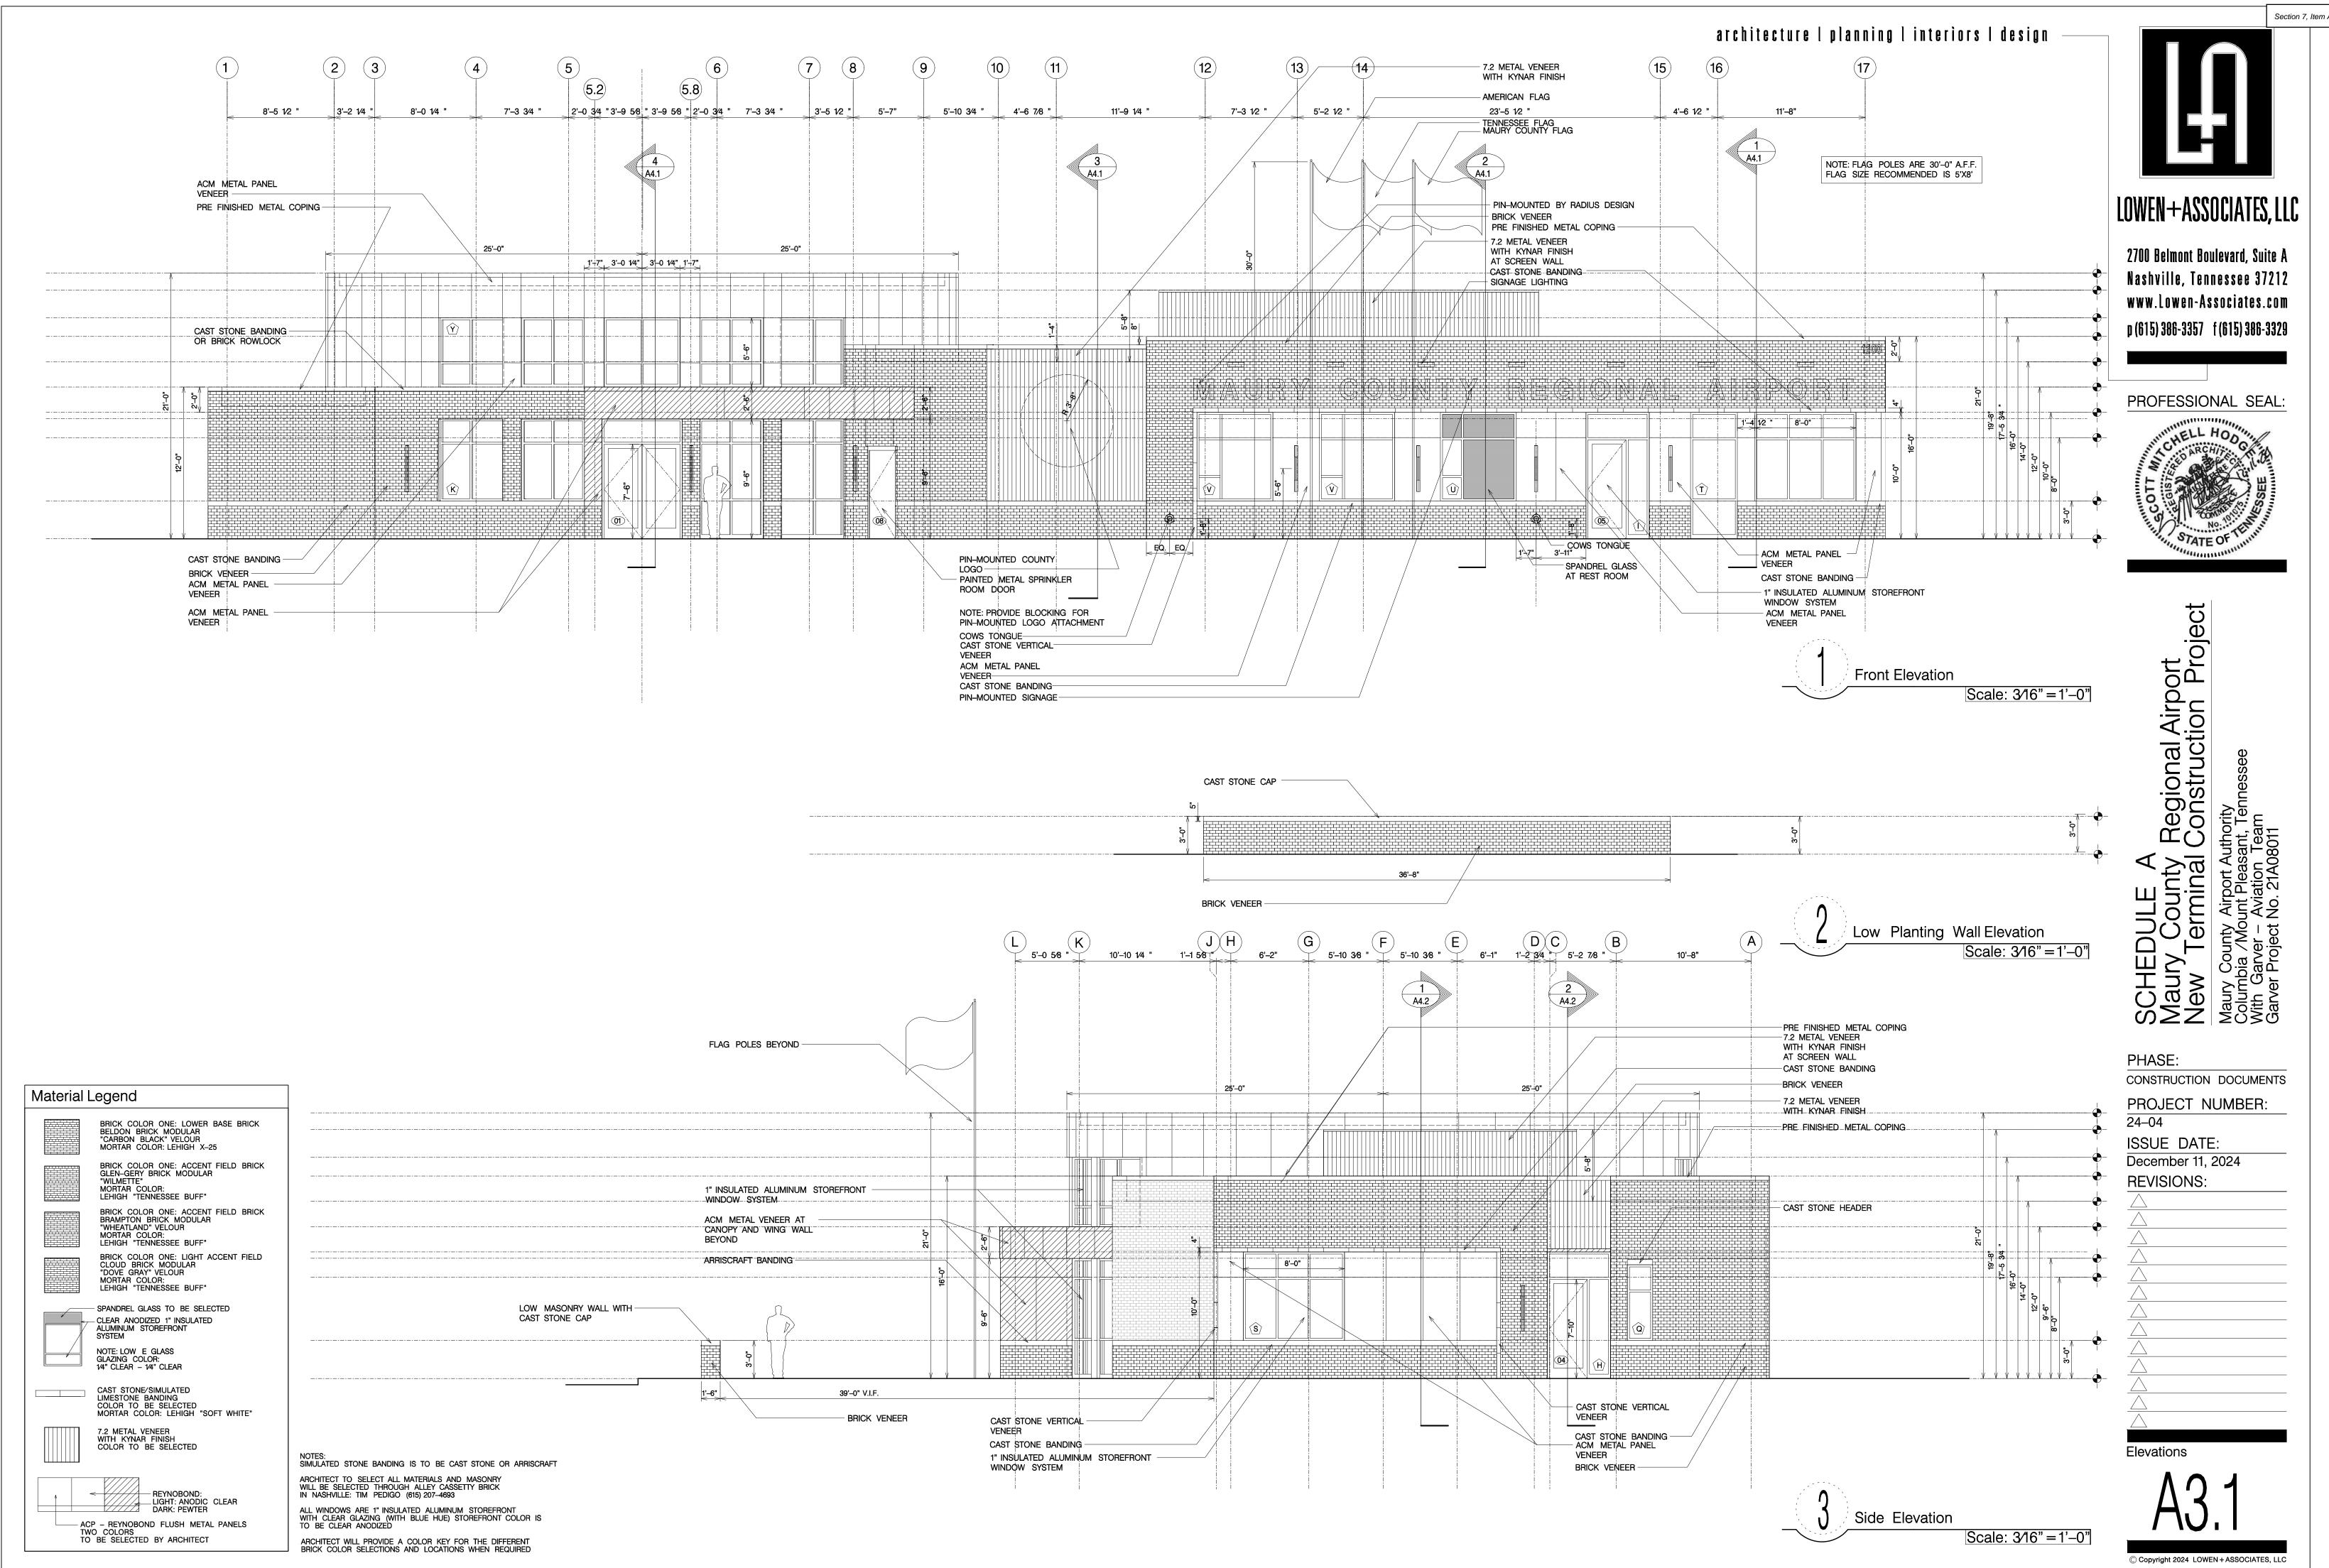

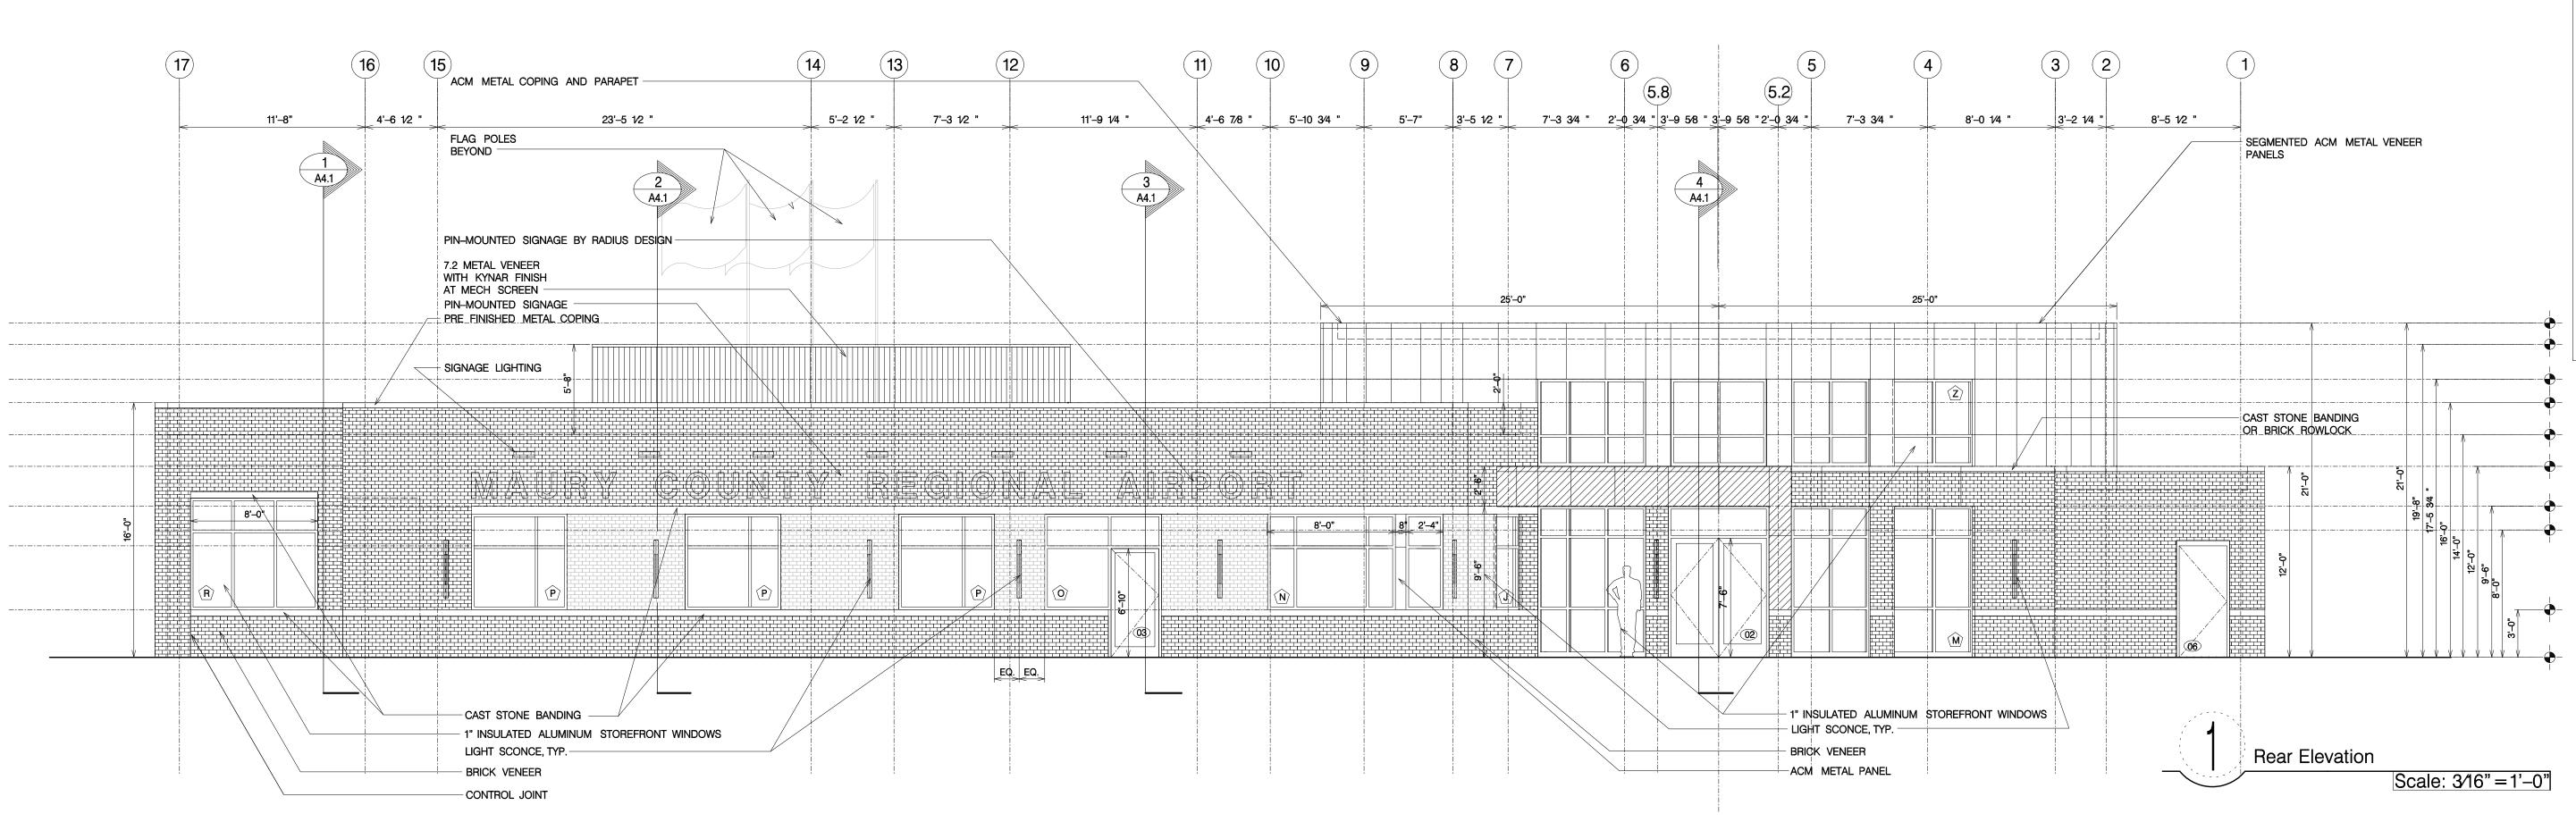

Material Legend

BRICK COLOR ONE: LOWER BASE BRICK BELDON BRICK MODULAR "CARBON BLACK" VELOUR MORTAR COLOR: LEHIGH X-25

BRICK COLOR ONE: ACCENT FIELD BRICK GLEN-GERY BRICK MODULAR "WILMETTE" MORTAR COLOR: LEHIGH "TENNESSEE BUFF"

BRICK COLOR ONE: ACCENT FIELD BRICK BRAMPTON BRICK MODULAR "WHEATLAND" VELOUR MORTAR COLOR: LEHIGH "TENNESSEE BUFF"

BRICK COLOR ONE: LIGHT ACCENT FIELD CLOUD BRICK MODULAR "DOVE GRAY" VELOUR

MORTAR COLOR: LEHIGH "TENNESSEE BUFF"

- SPANDREL GLASS TO BE SELECTED

CAST STONE/SIMULATED LIMESTONE BANDING COLOR TO BE SELECTED MORTAR COLOR: LEHIGH "SOFT WHITE"

REYNOBOND: LIGHT: ANODIC CLEAR DARK: PEWTER

- ACP - REYNOBOND FLUSH METAL PANELS TWO COLORS TO BE SELECTED BY ARCHITECT


ARCHITECT WILL PROVIDE A COLOR KEY FOR THE DIFFERENT BRICK COLOR SELECTIONS AND LOCATIONS WHEN REQUIRED

CLEAR ANODIZED 1" INSULATED ALUMINUM STOREFRONT SYSTEM

Note: Low e glass Glazing Color: 1⁄4" Clear – 1⁄4" Clear

7.2 METAL VENEER

WITH KYNAR FINISH COLOR TO BE SELECTED

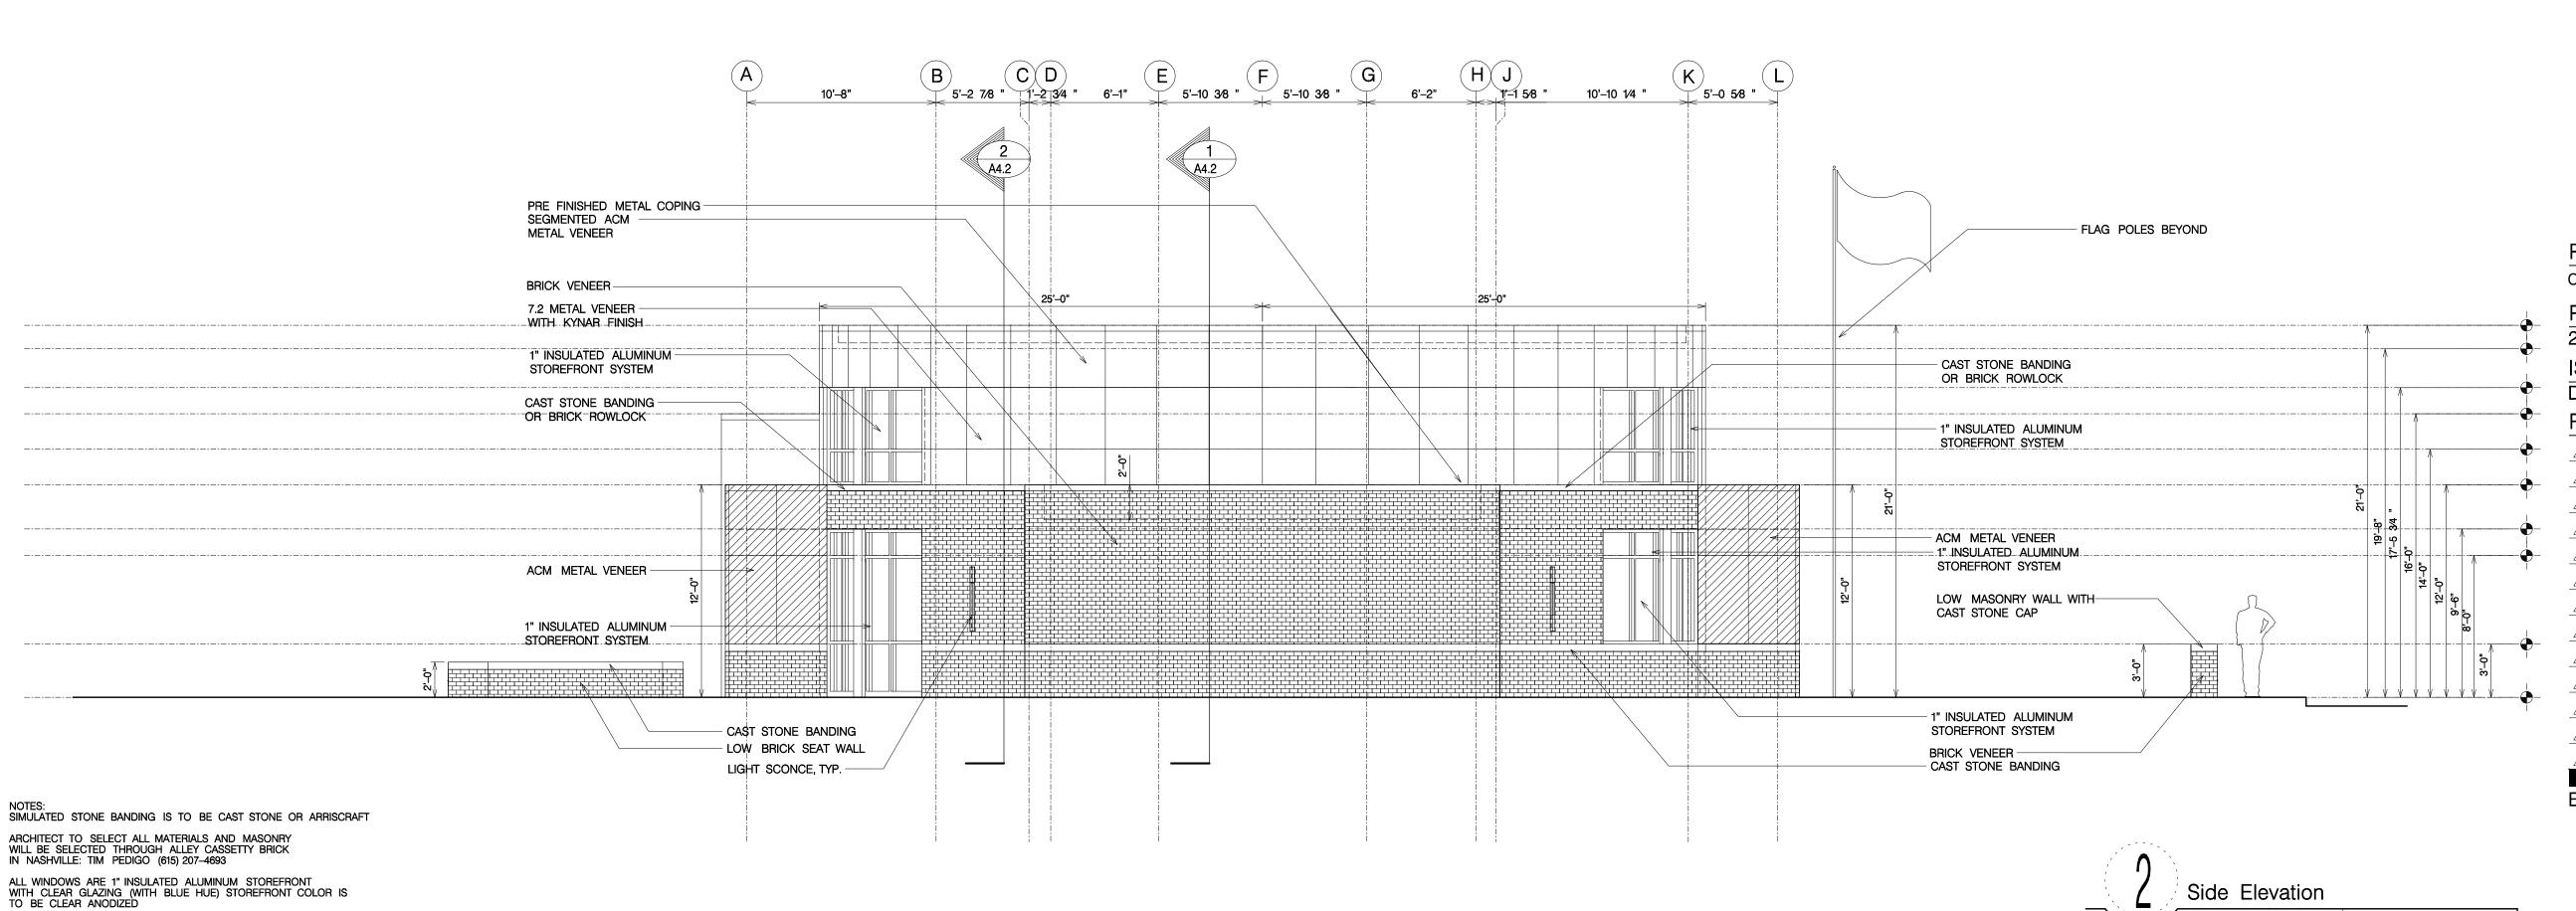


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PHASE: CONSTRUCTION DOCUMENTS PROJECT NUMBER:


24-04 ISSUE DATE: December 11, 2024


REVISIONS:


Elevations

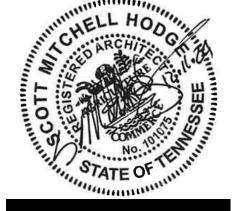Scale: 3/16" = 1'-0"

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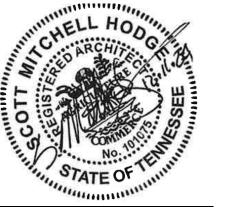


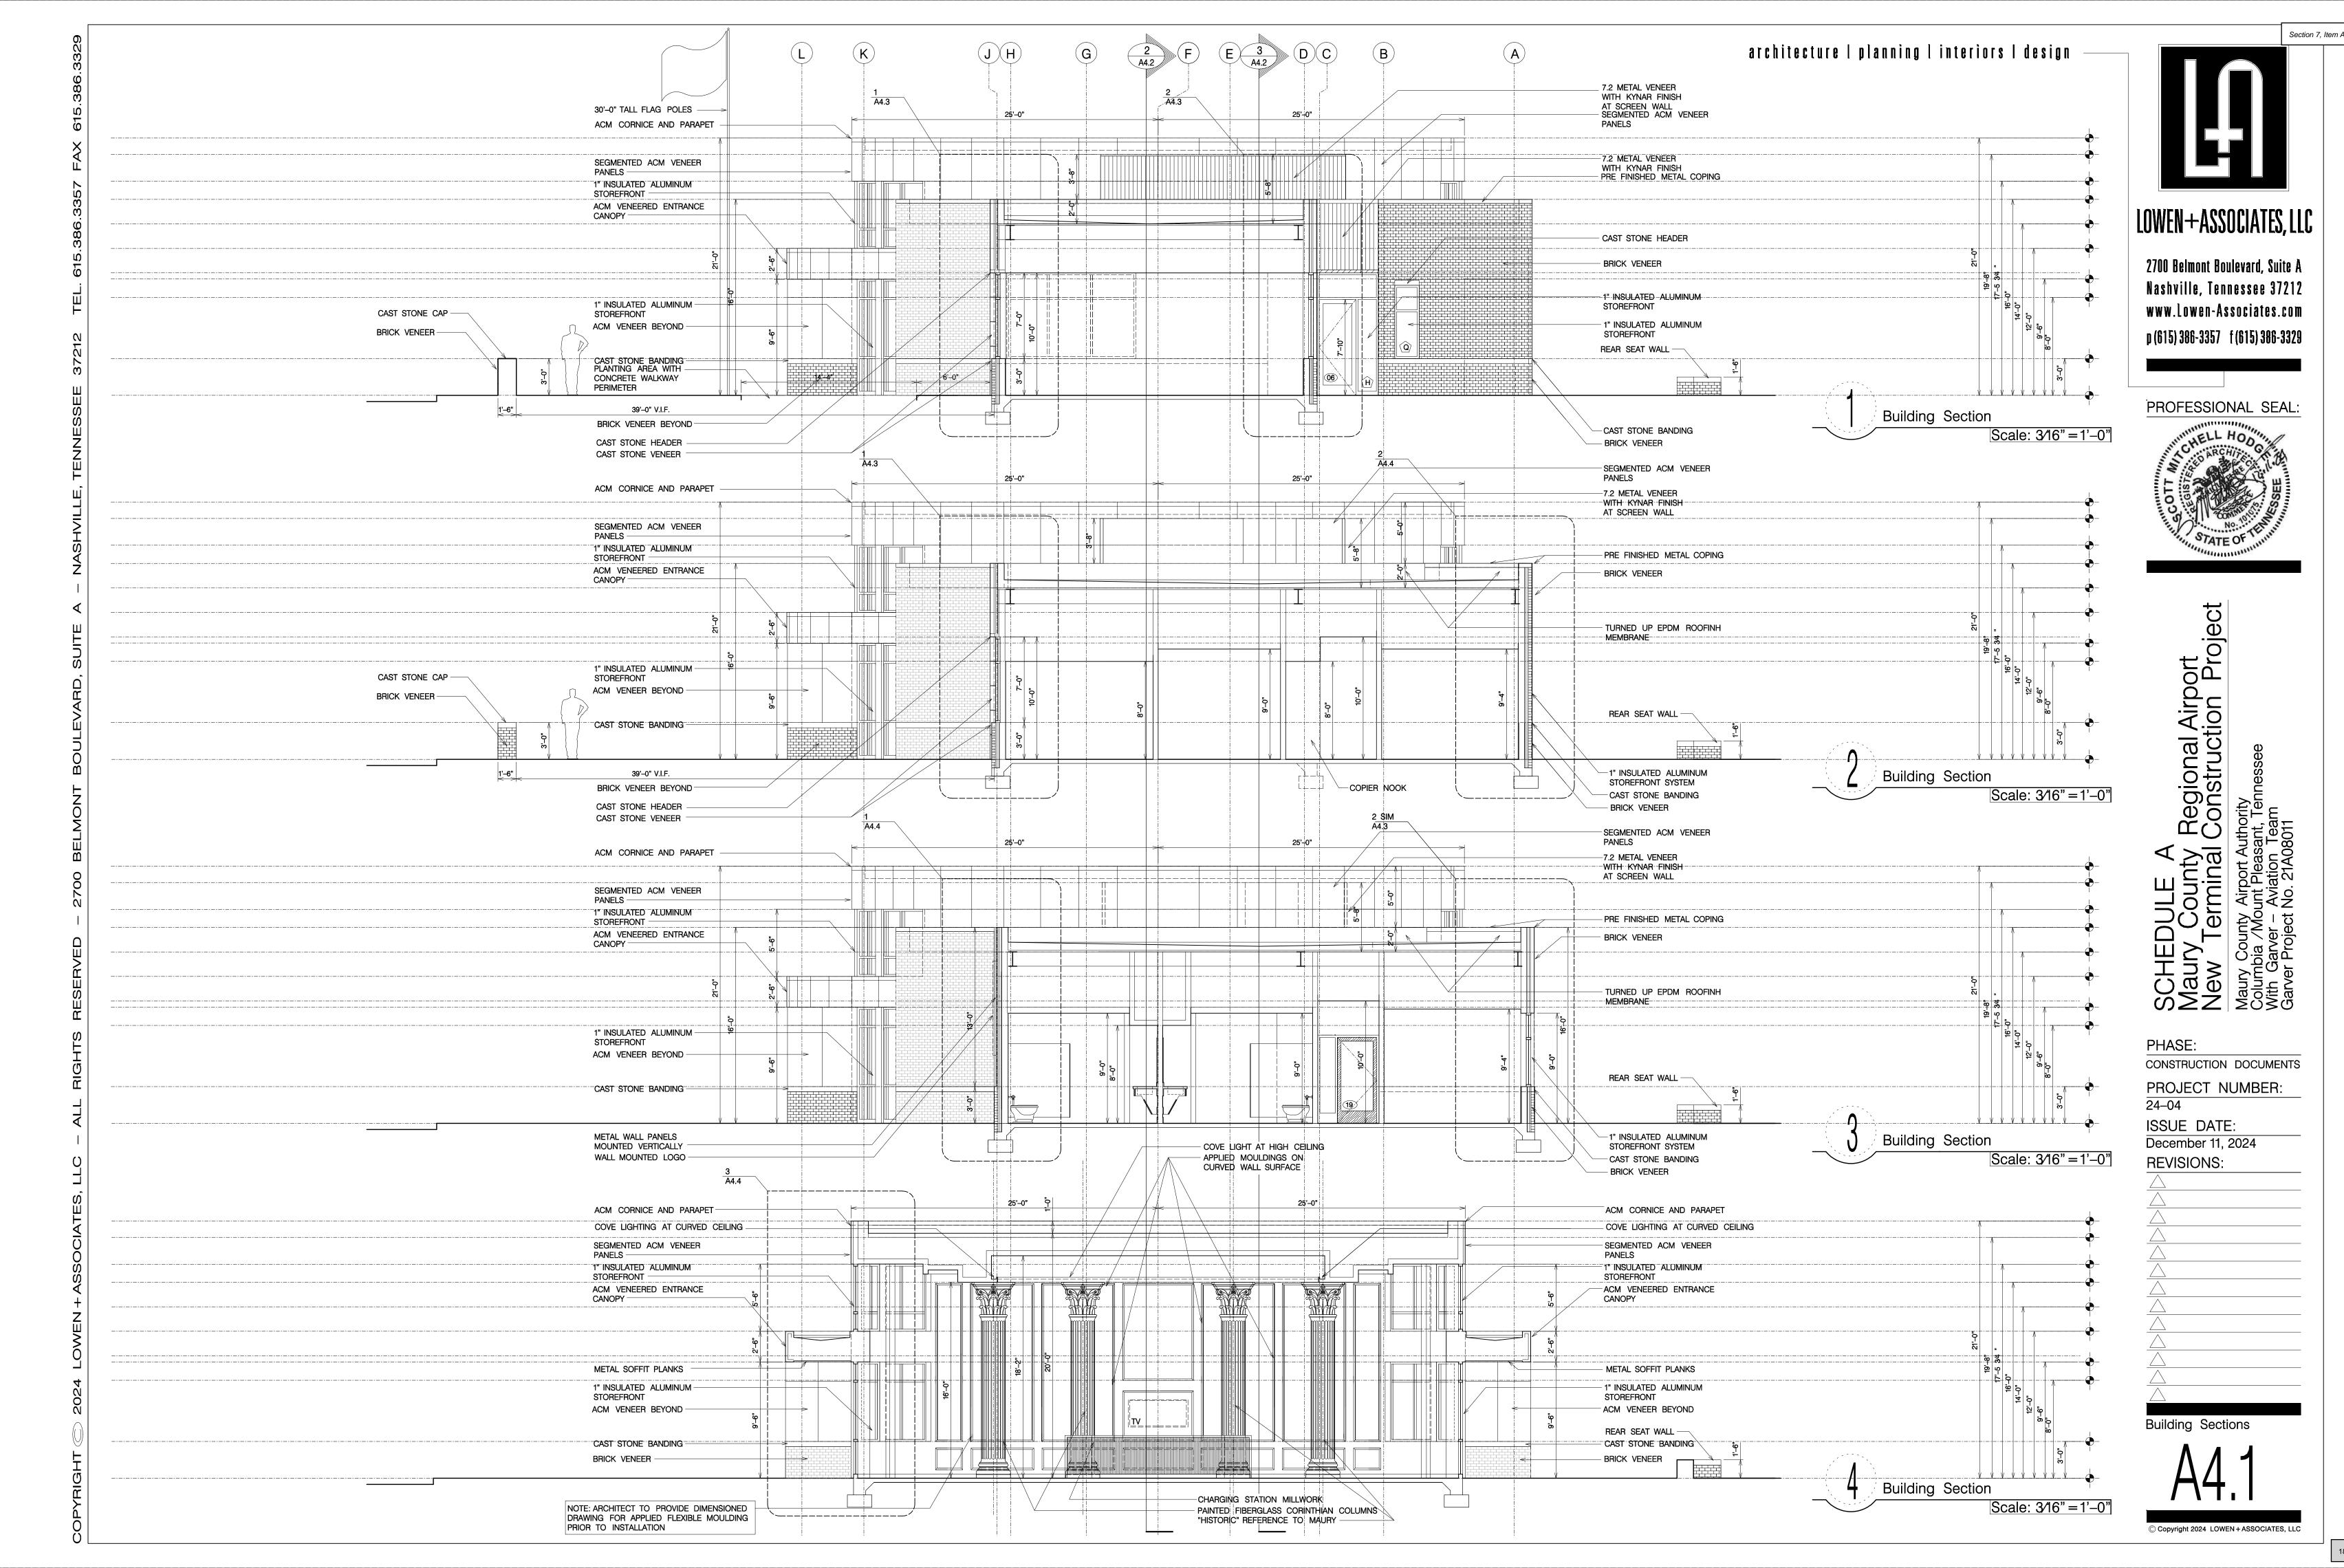
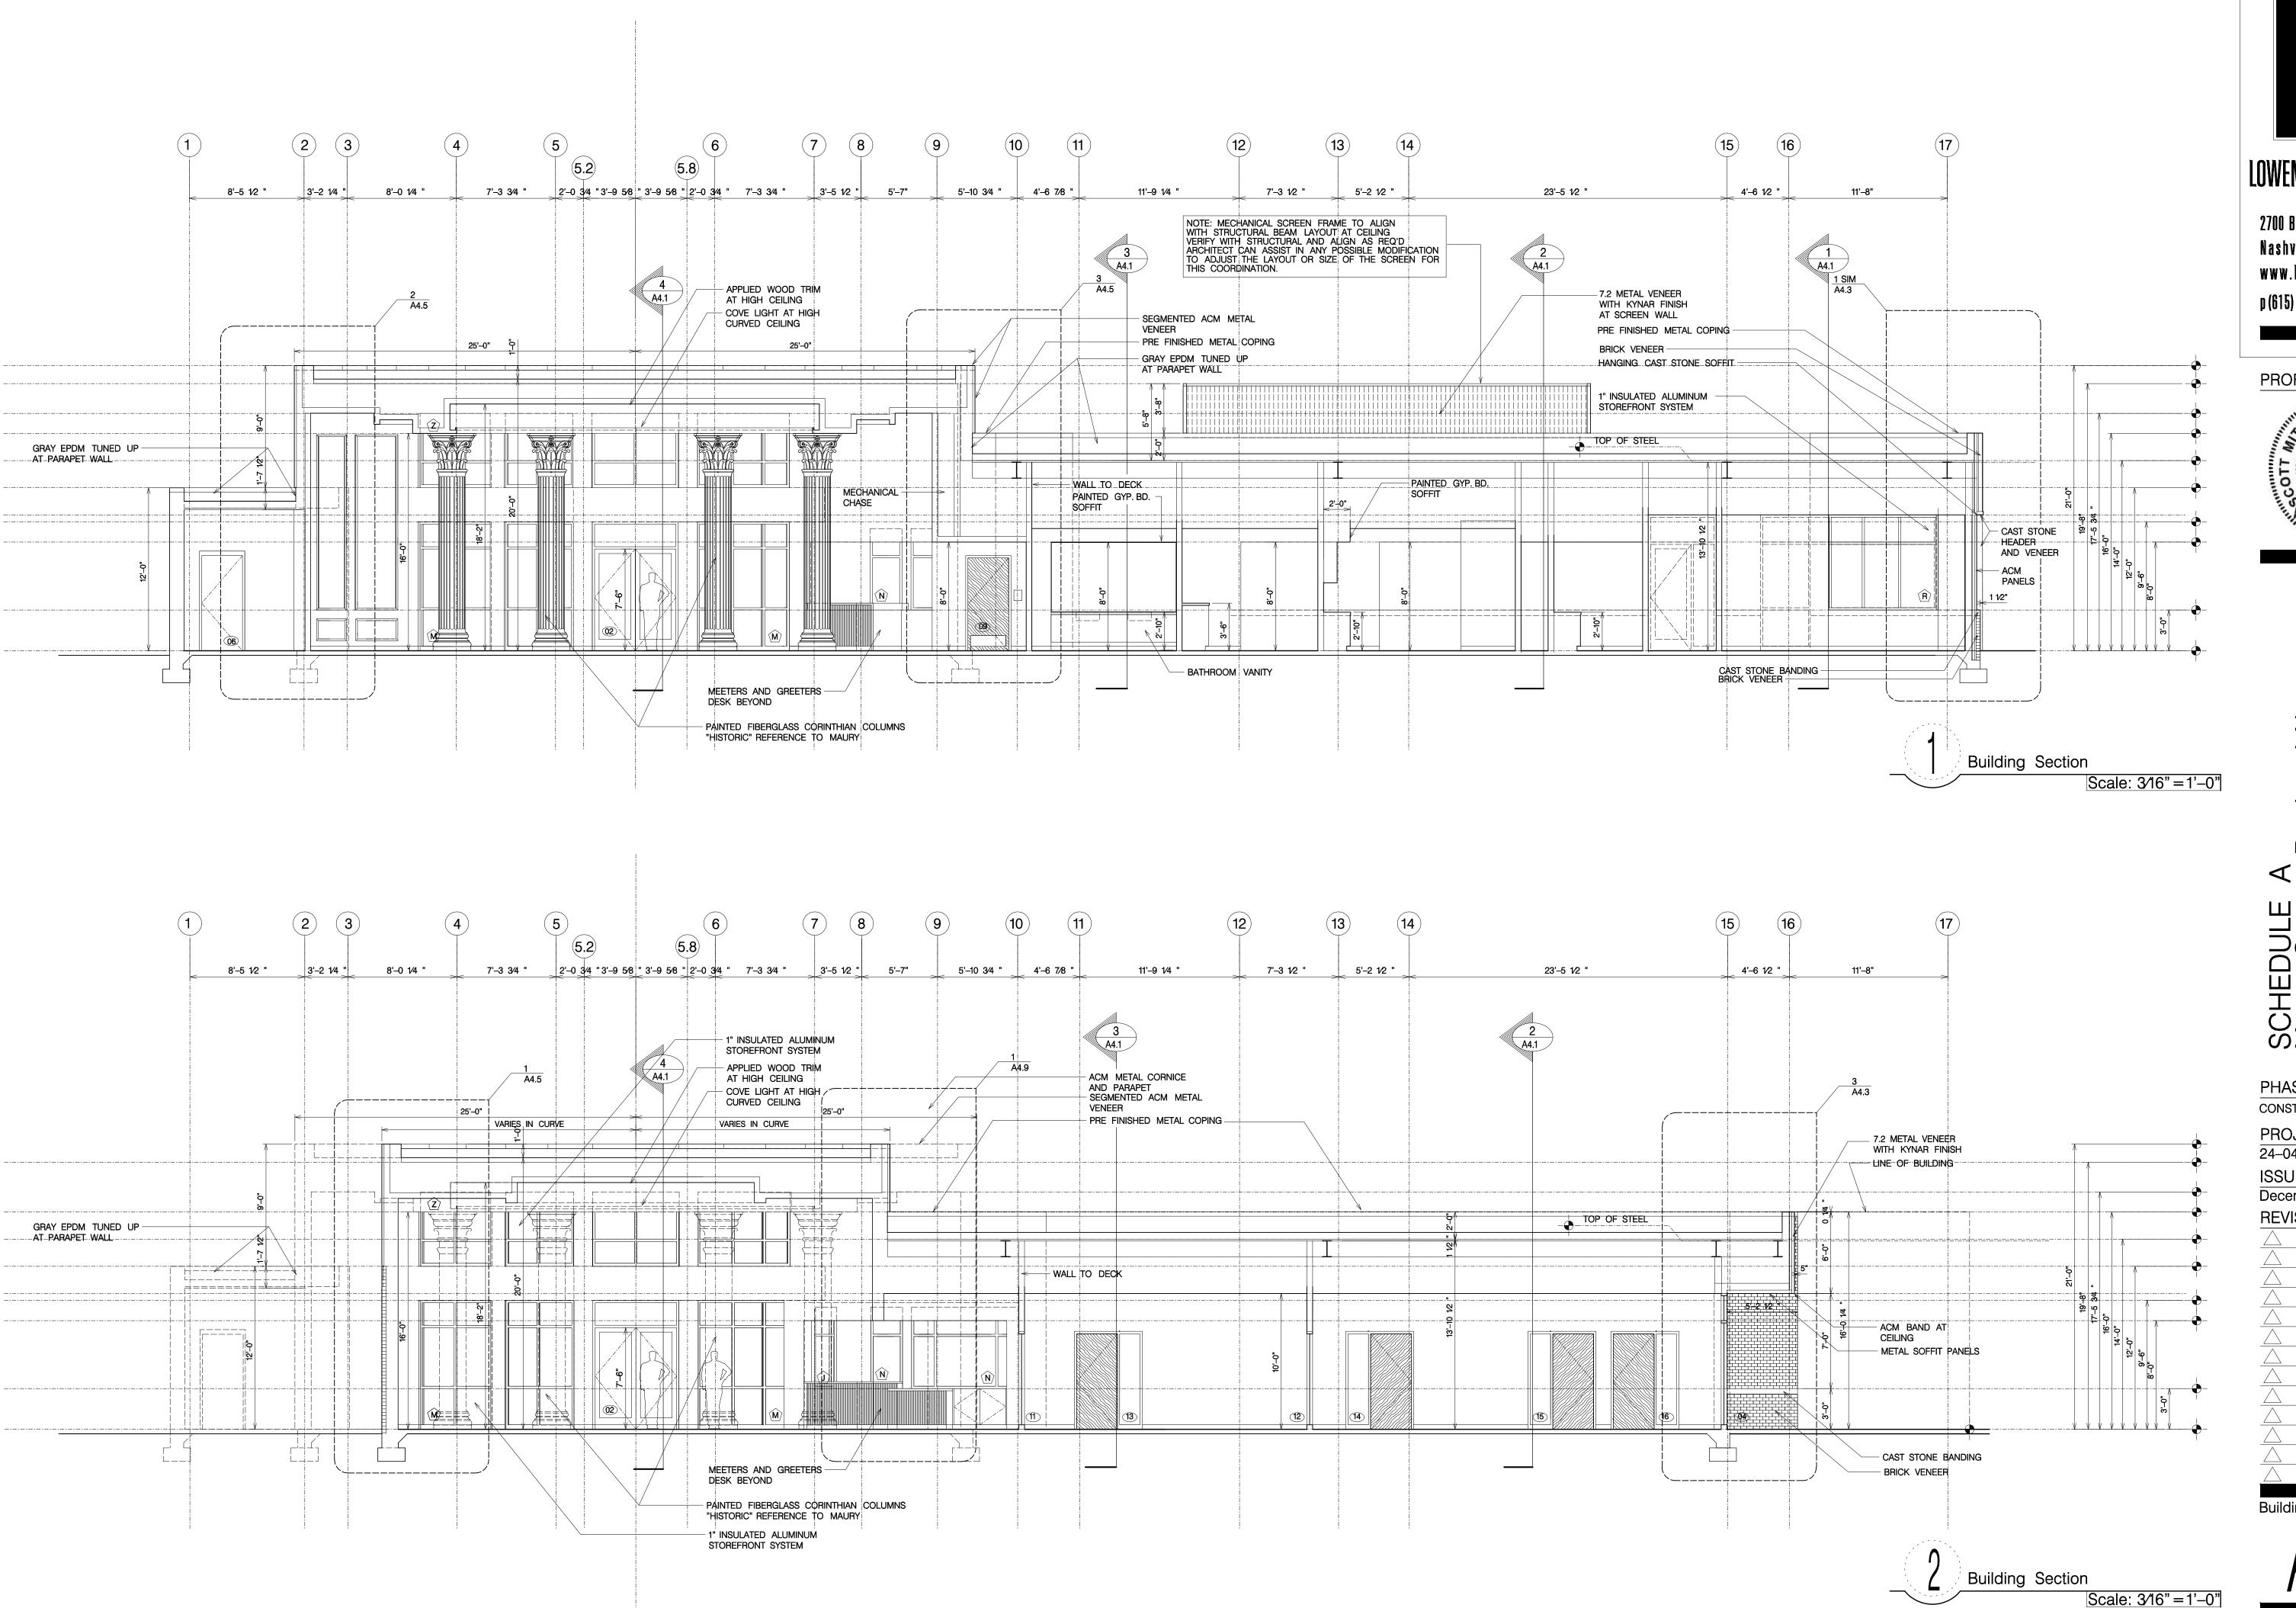
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PROFESSIONAL SEAL:

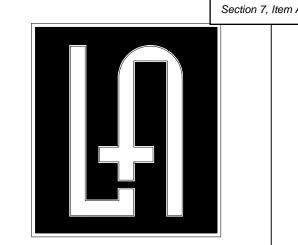

Airport on Project

Maury County Regional Air New Terminal Construction Maury County Airport Authority Columbia / Mount Pleasant, Tennessee


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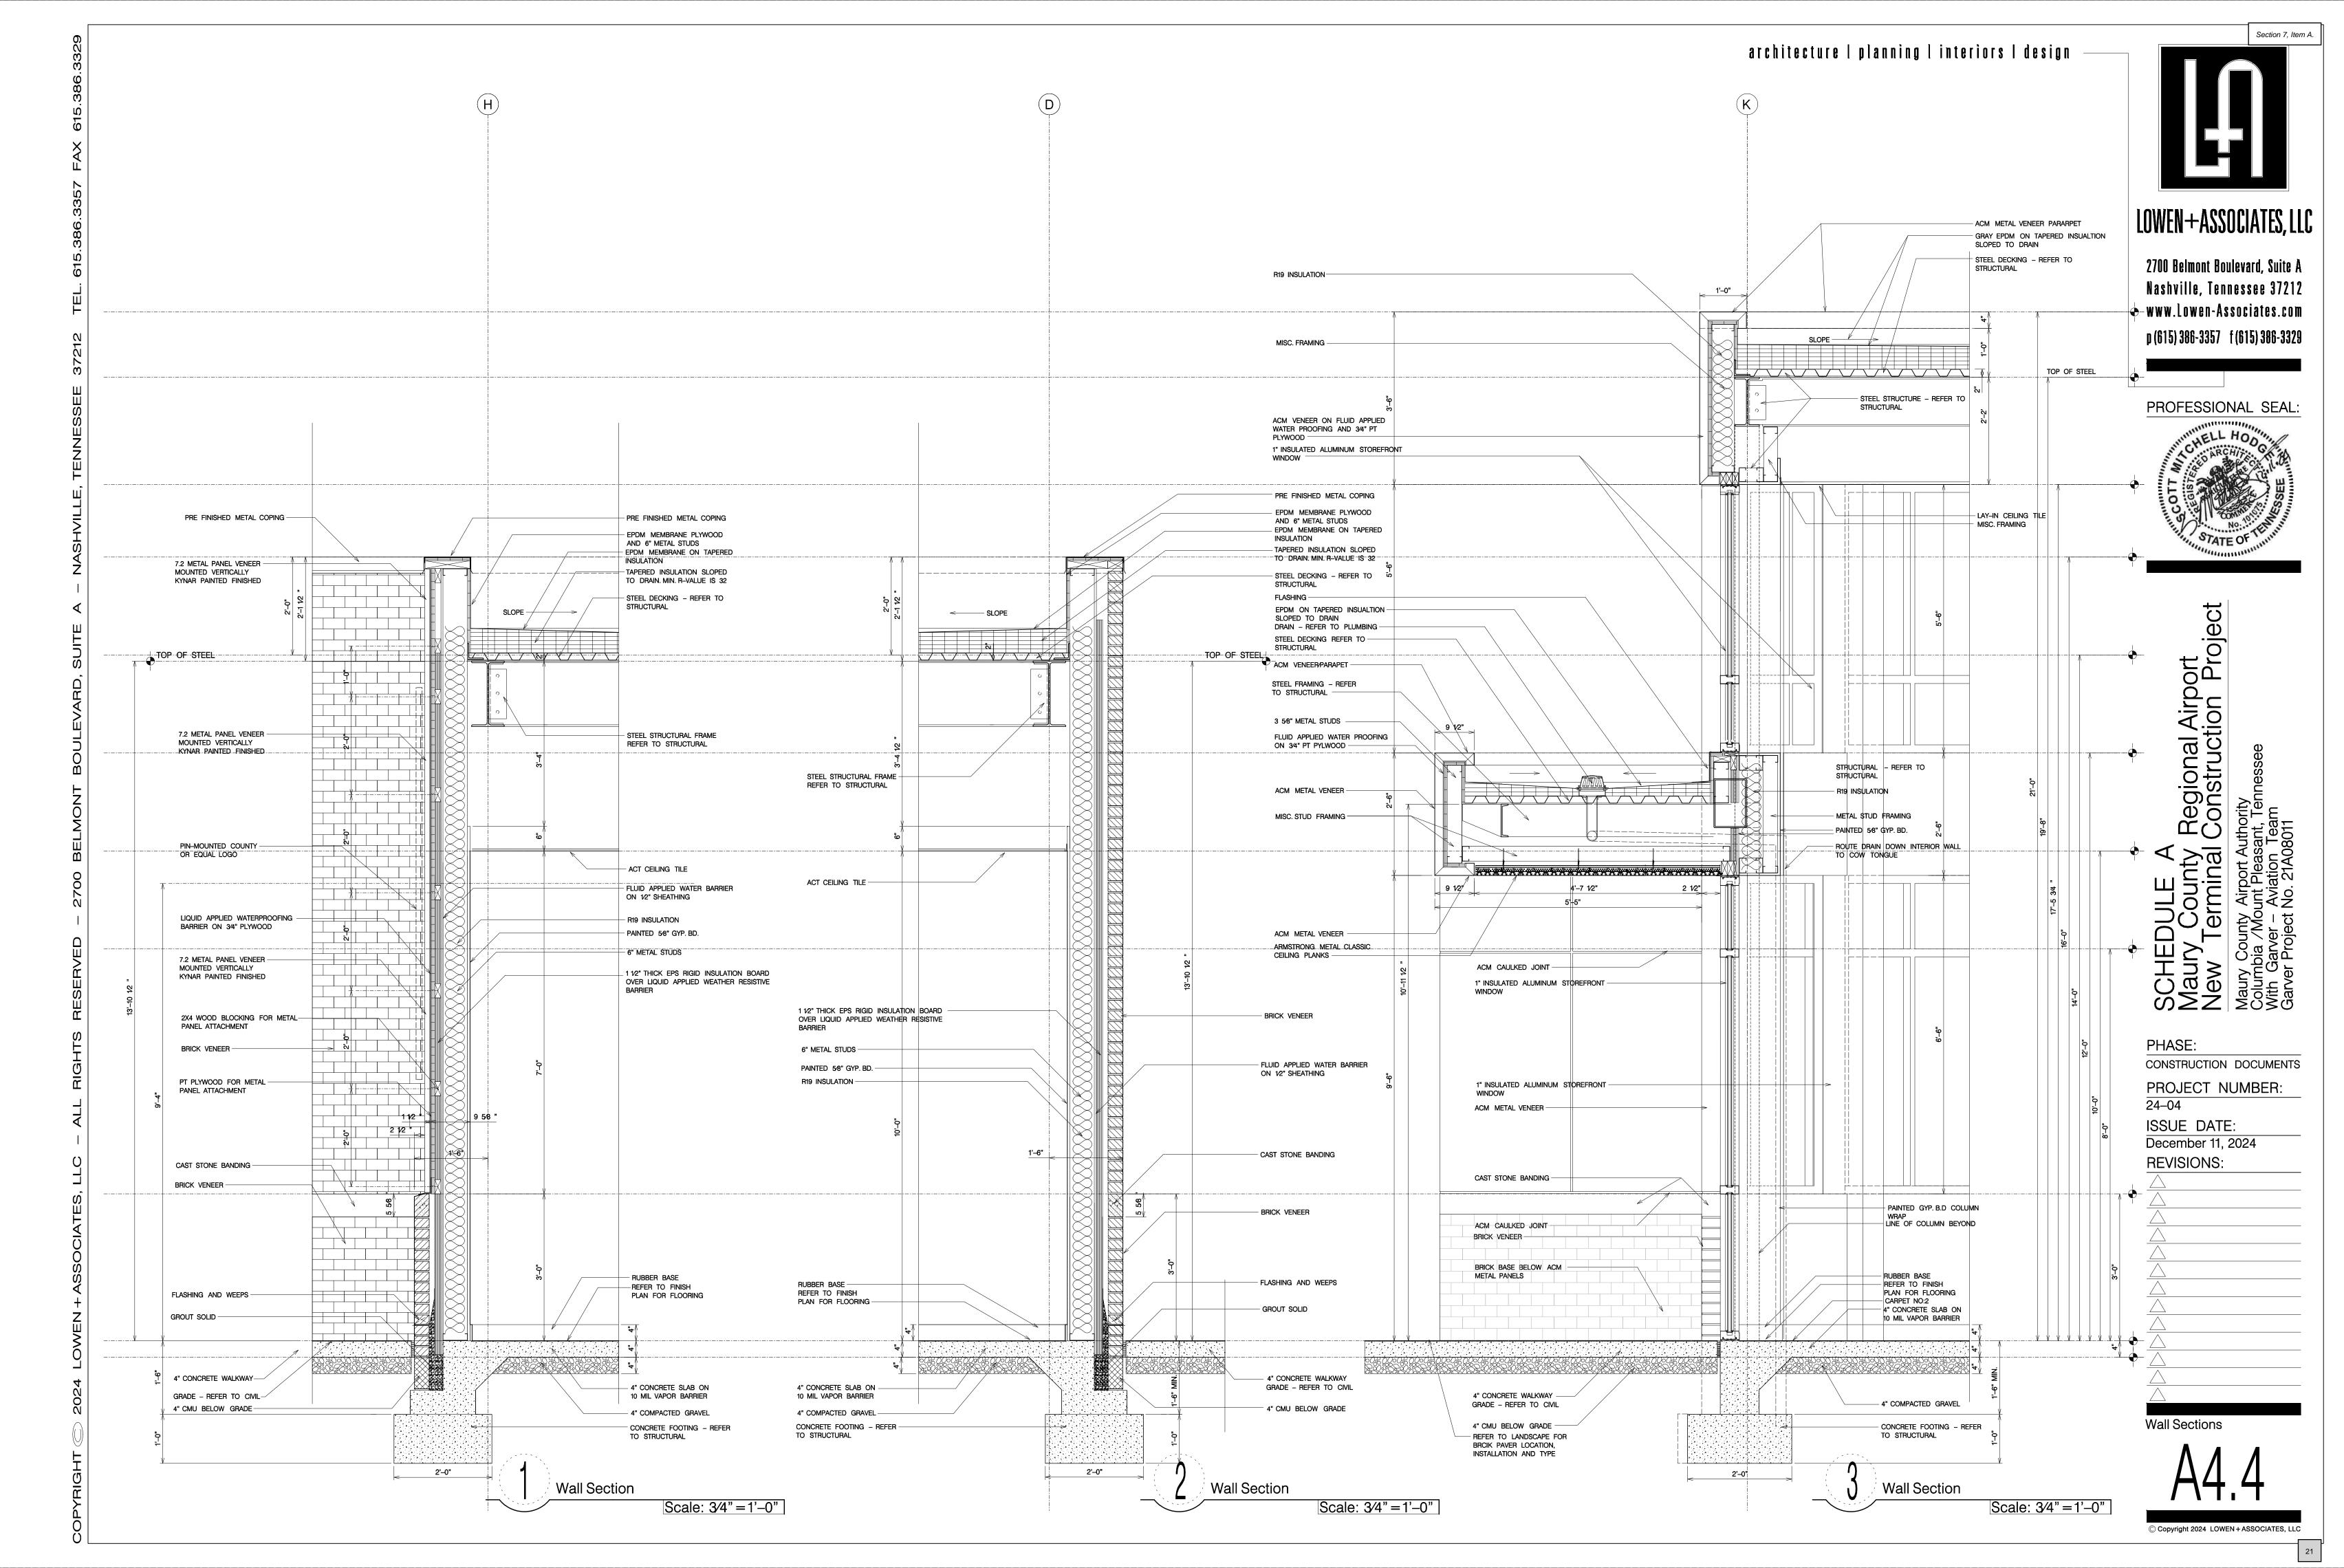
PROJECT NUMBER:
24-04
ISSUE DATE:
December 11, 2024
REVISIONS:


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Building Sections


A4.2


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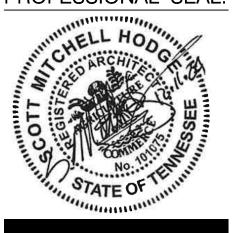




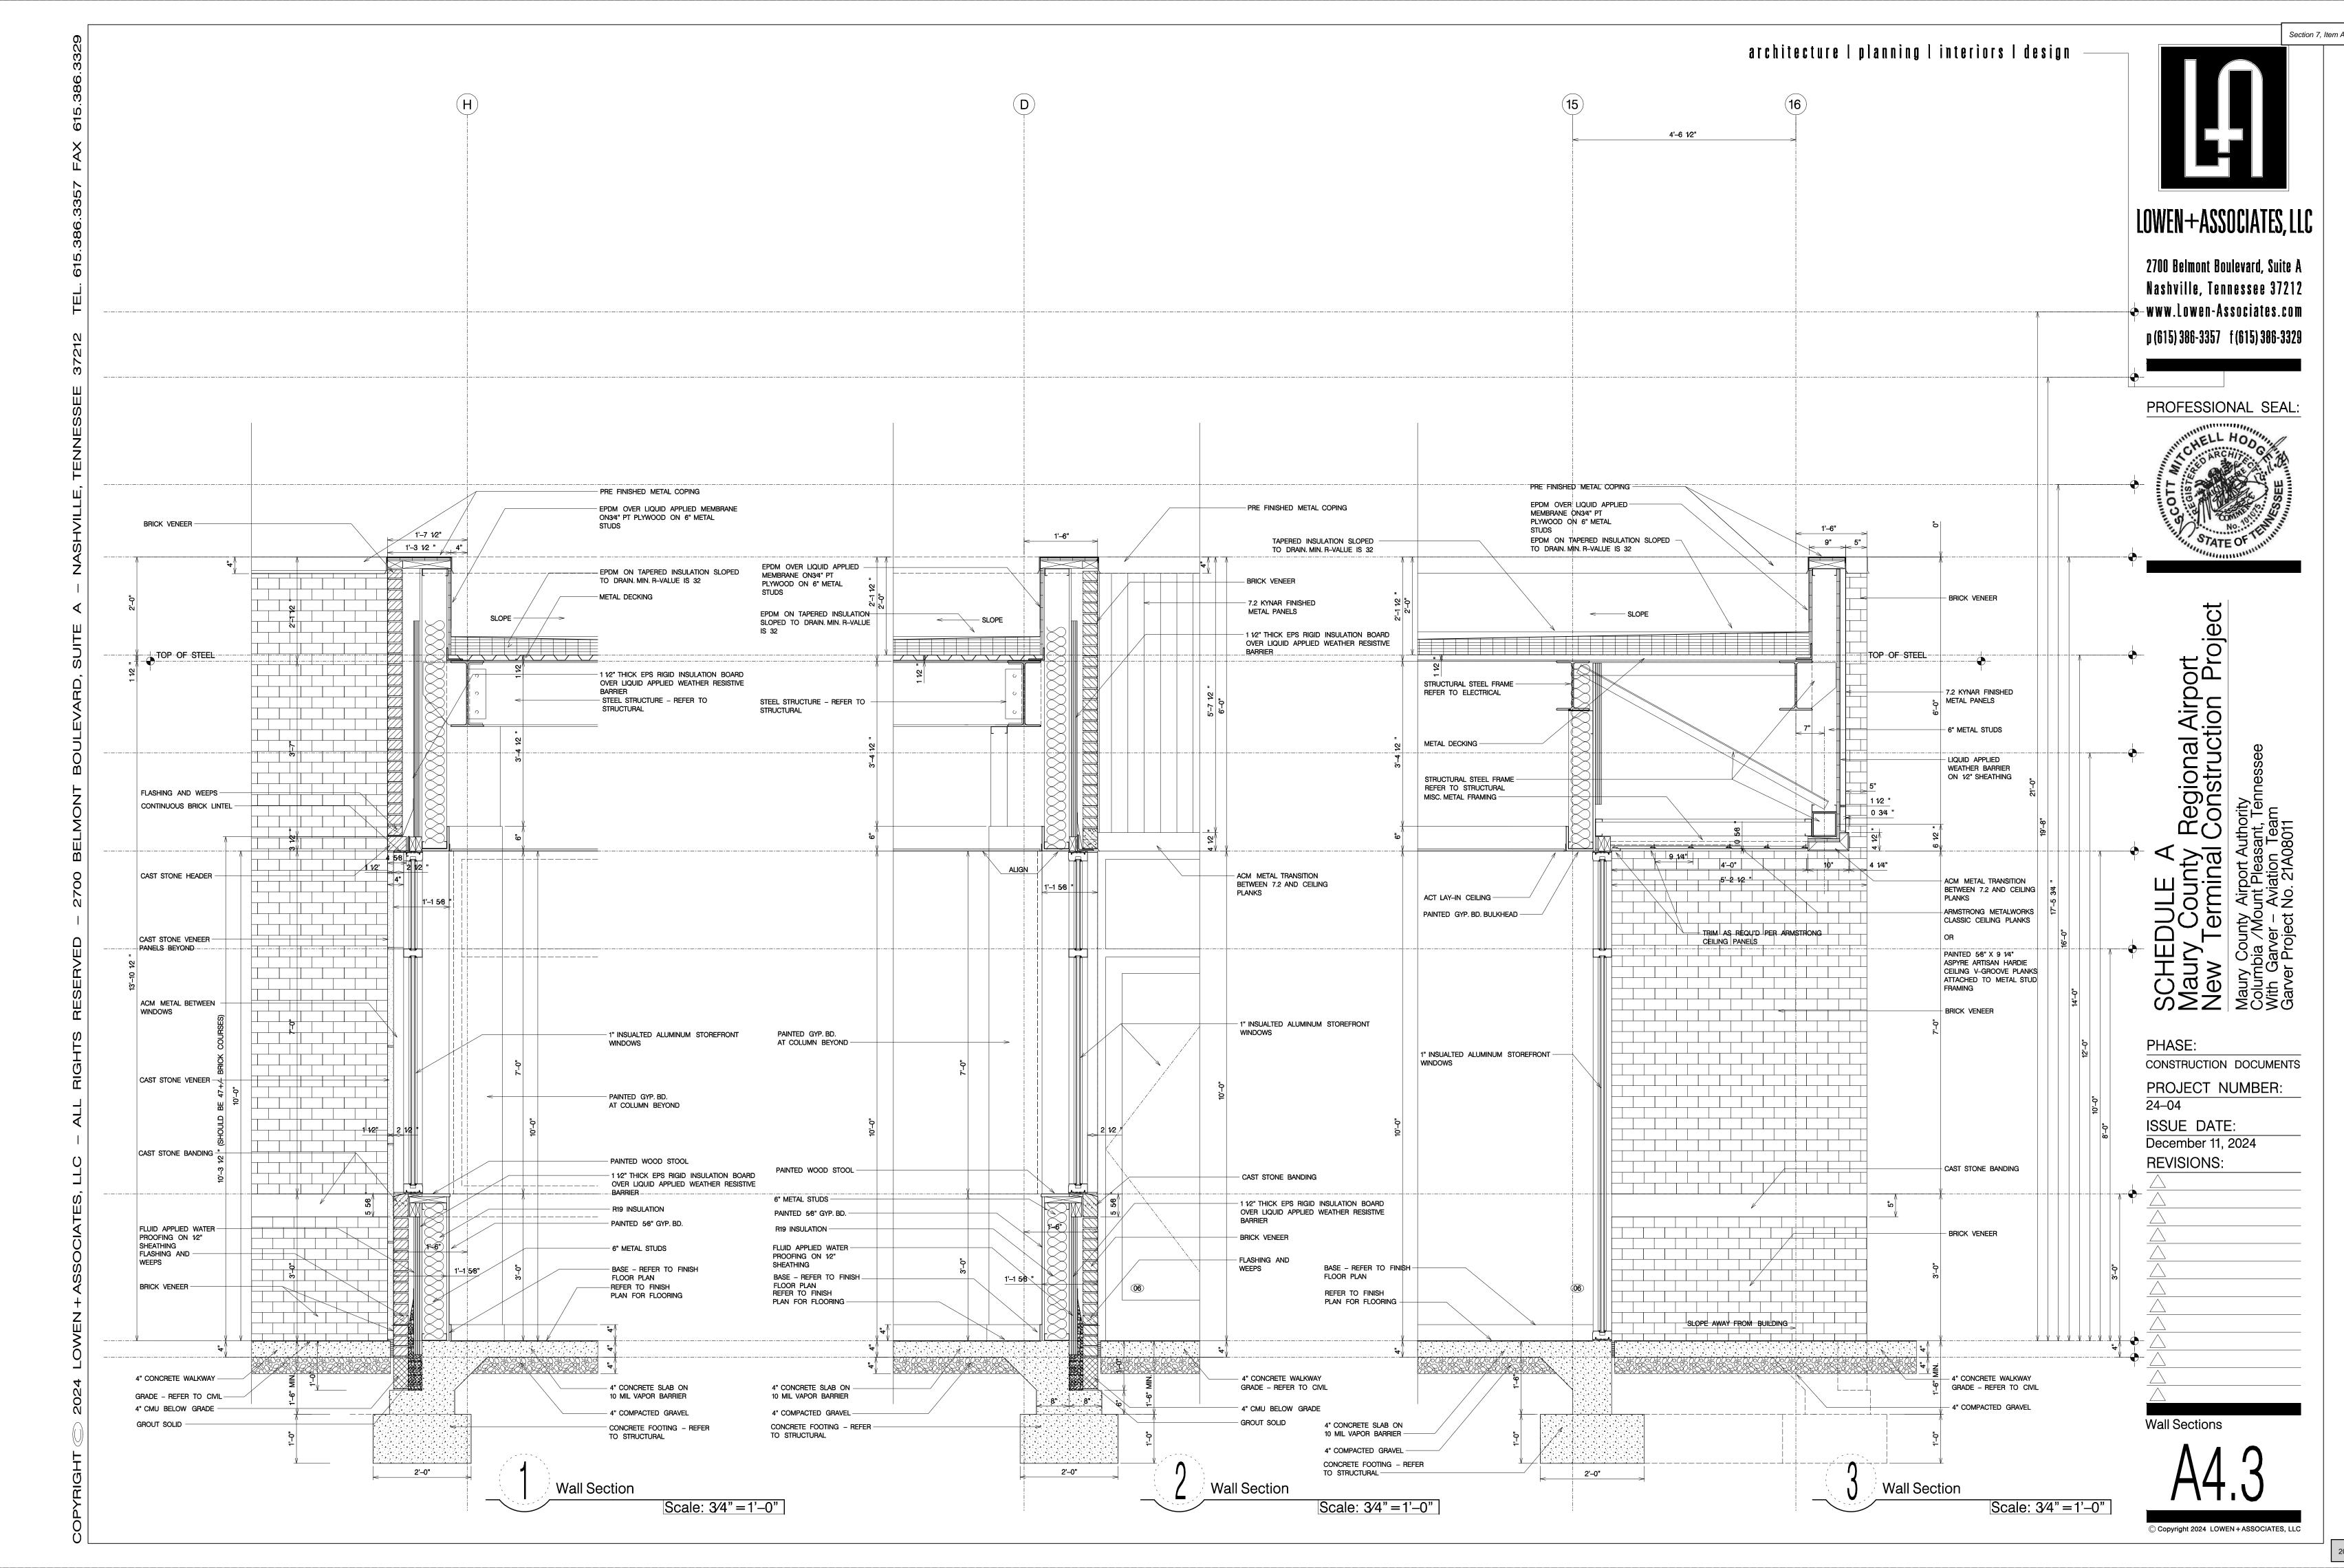


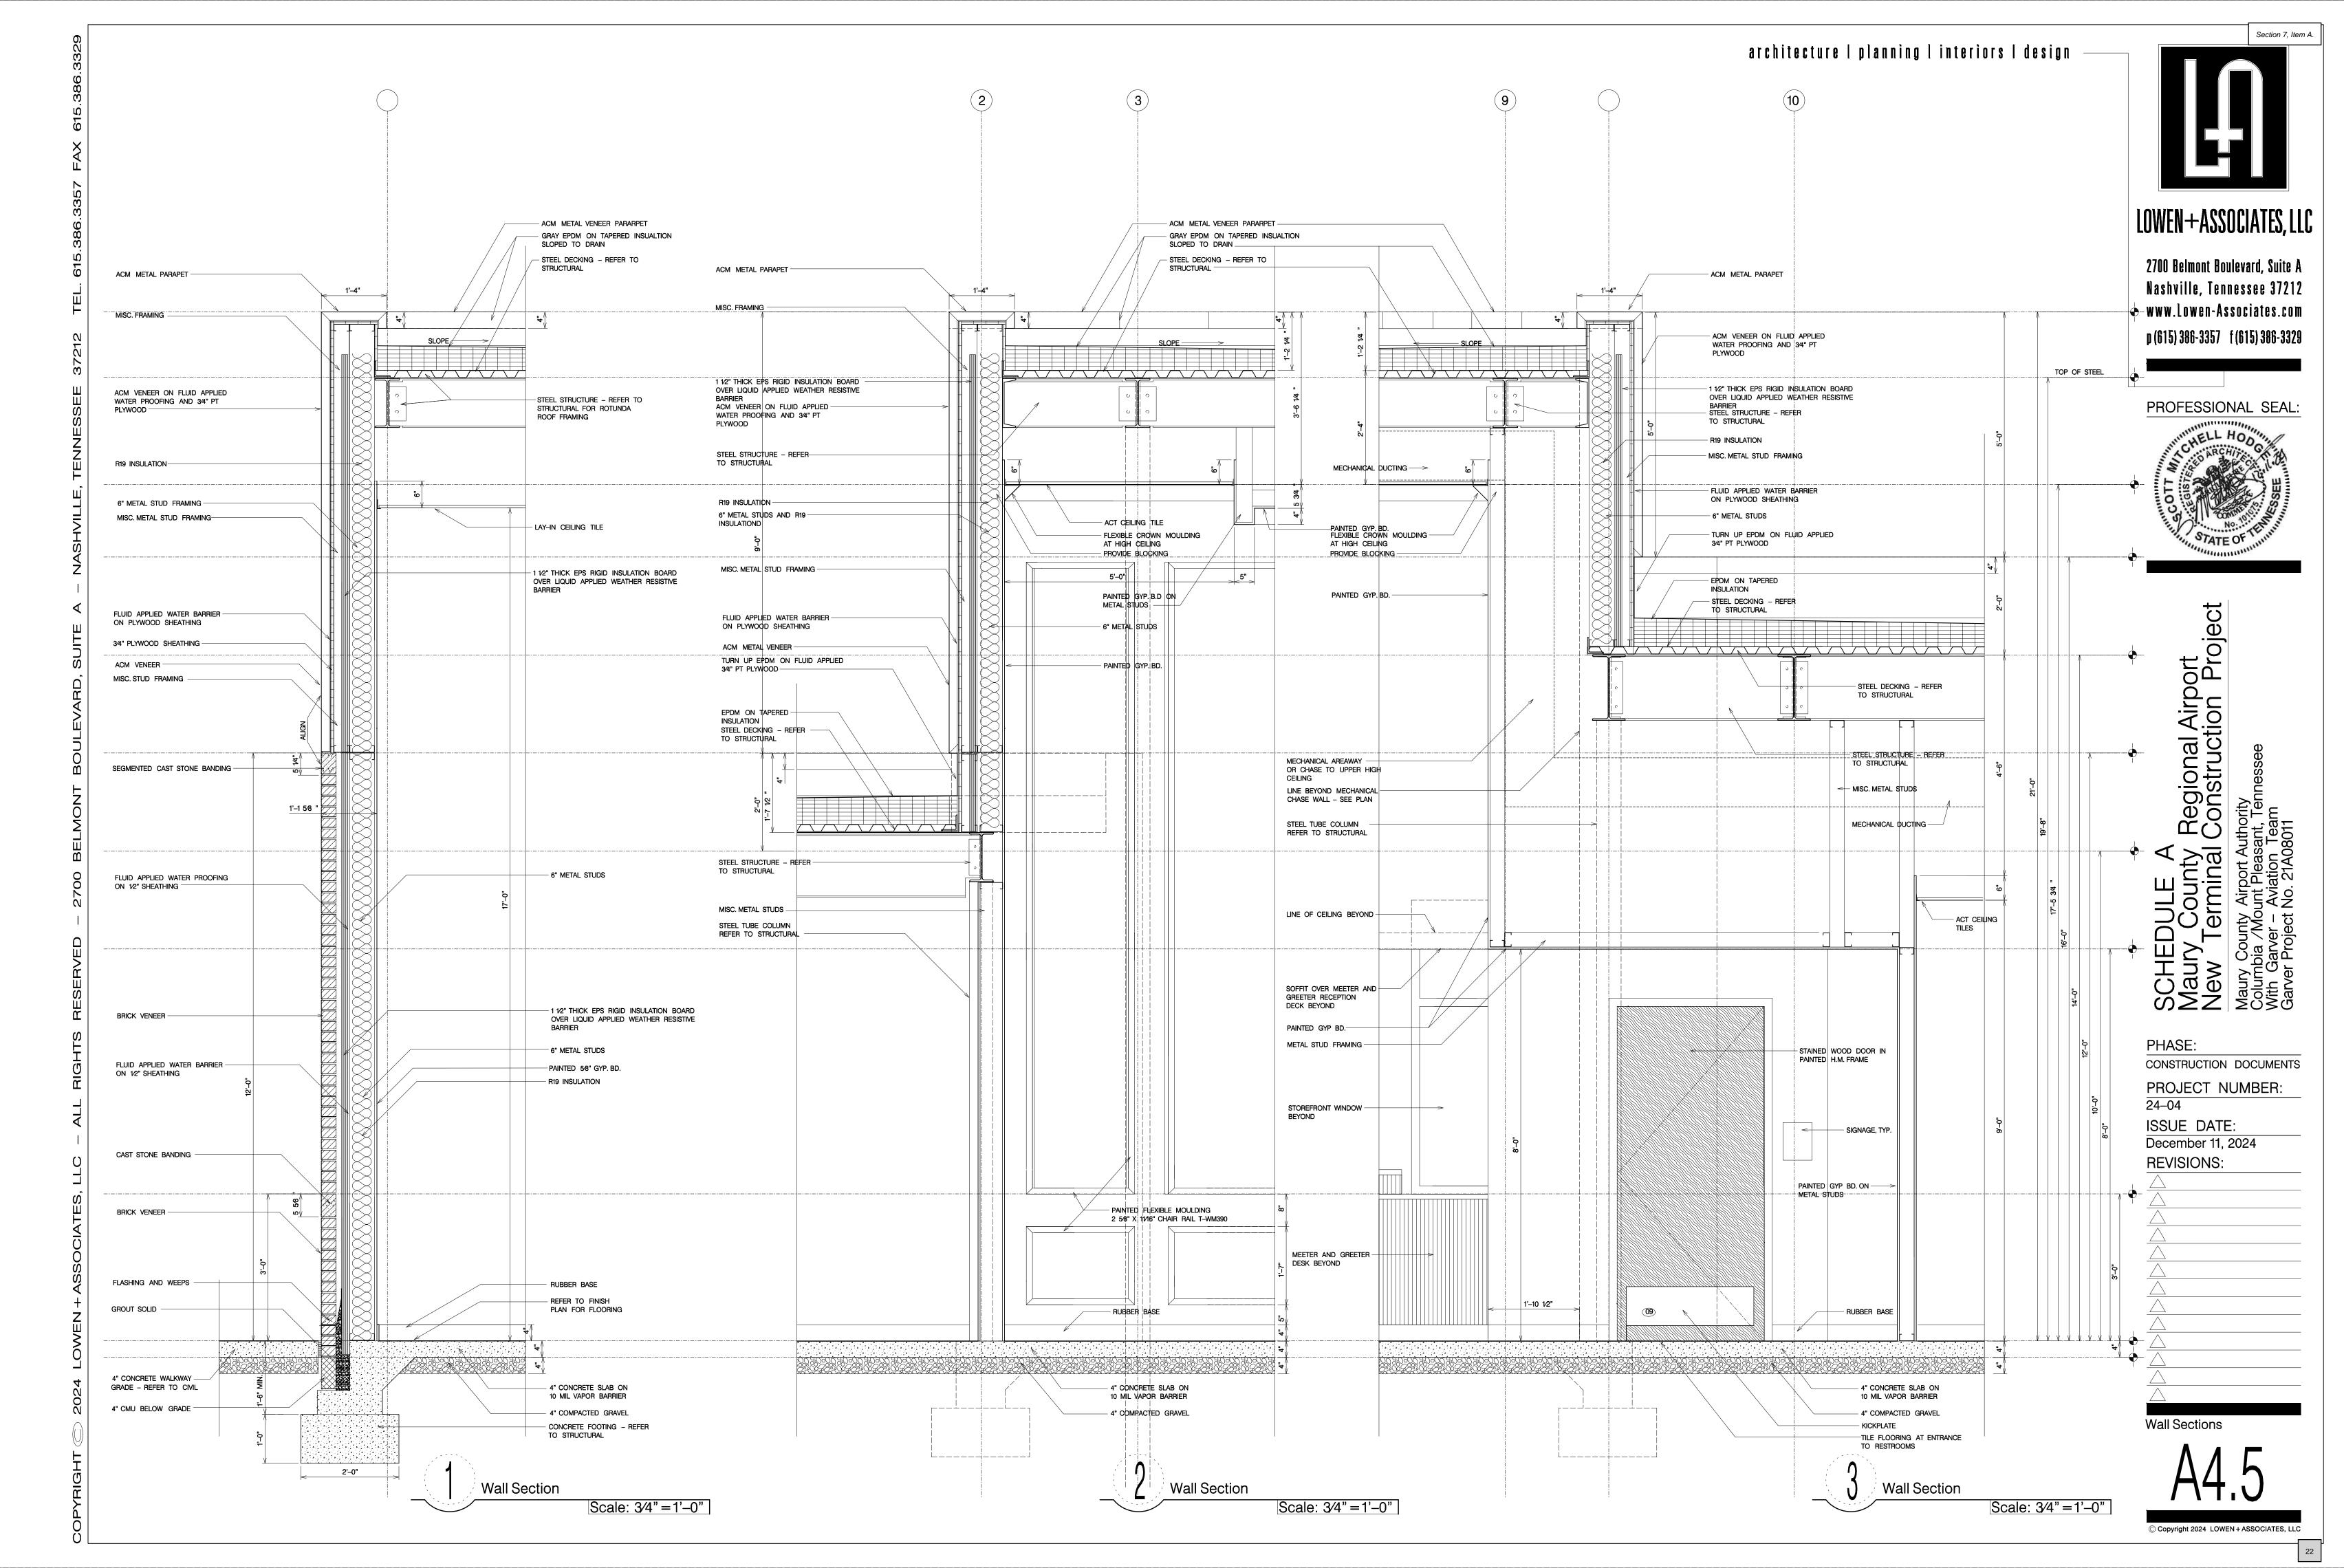


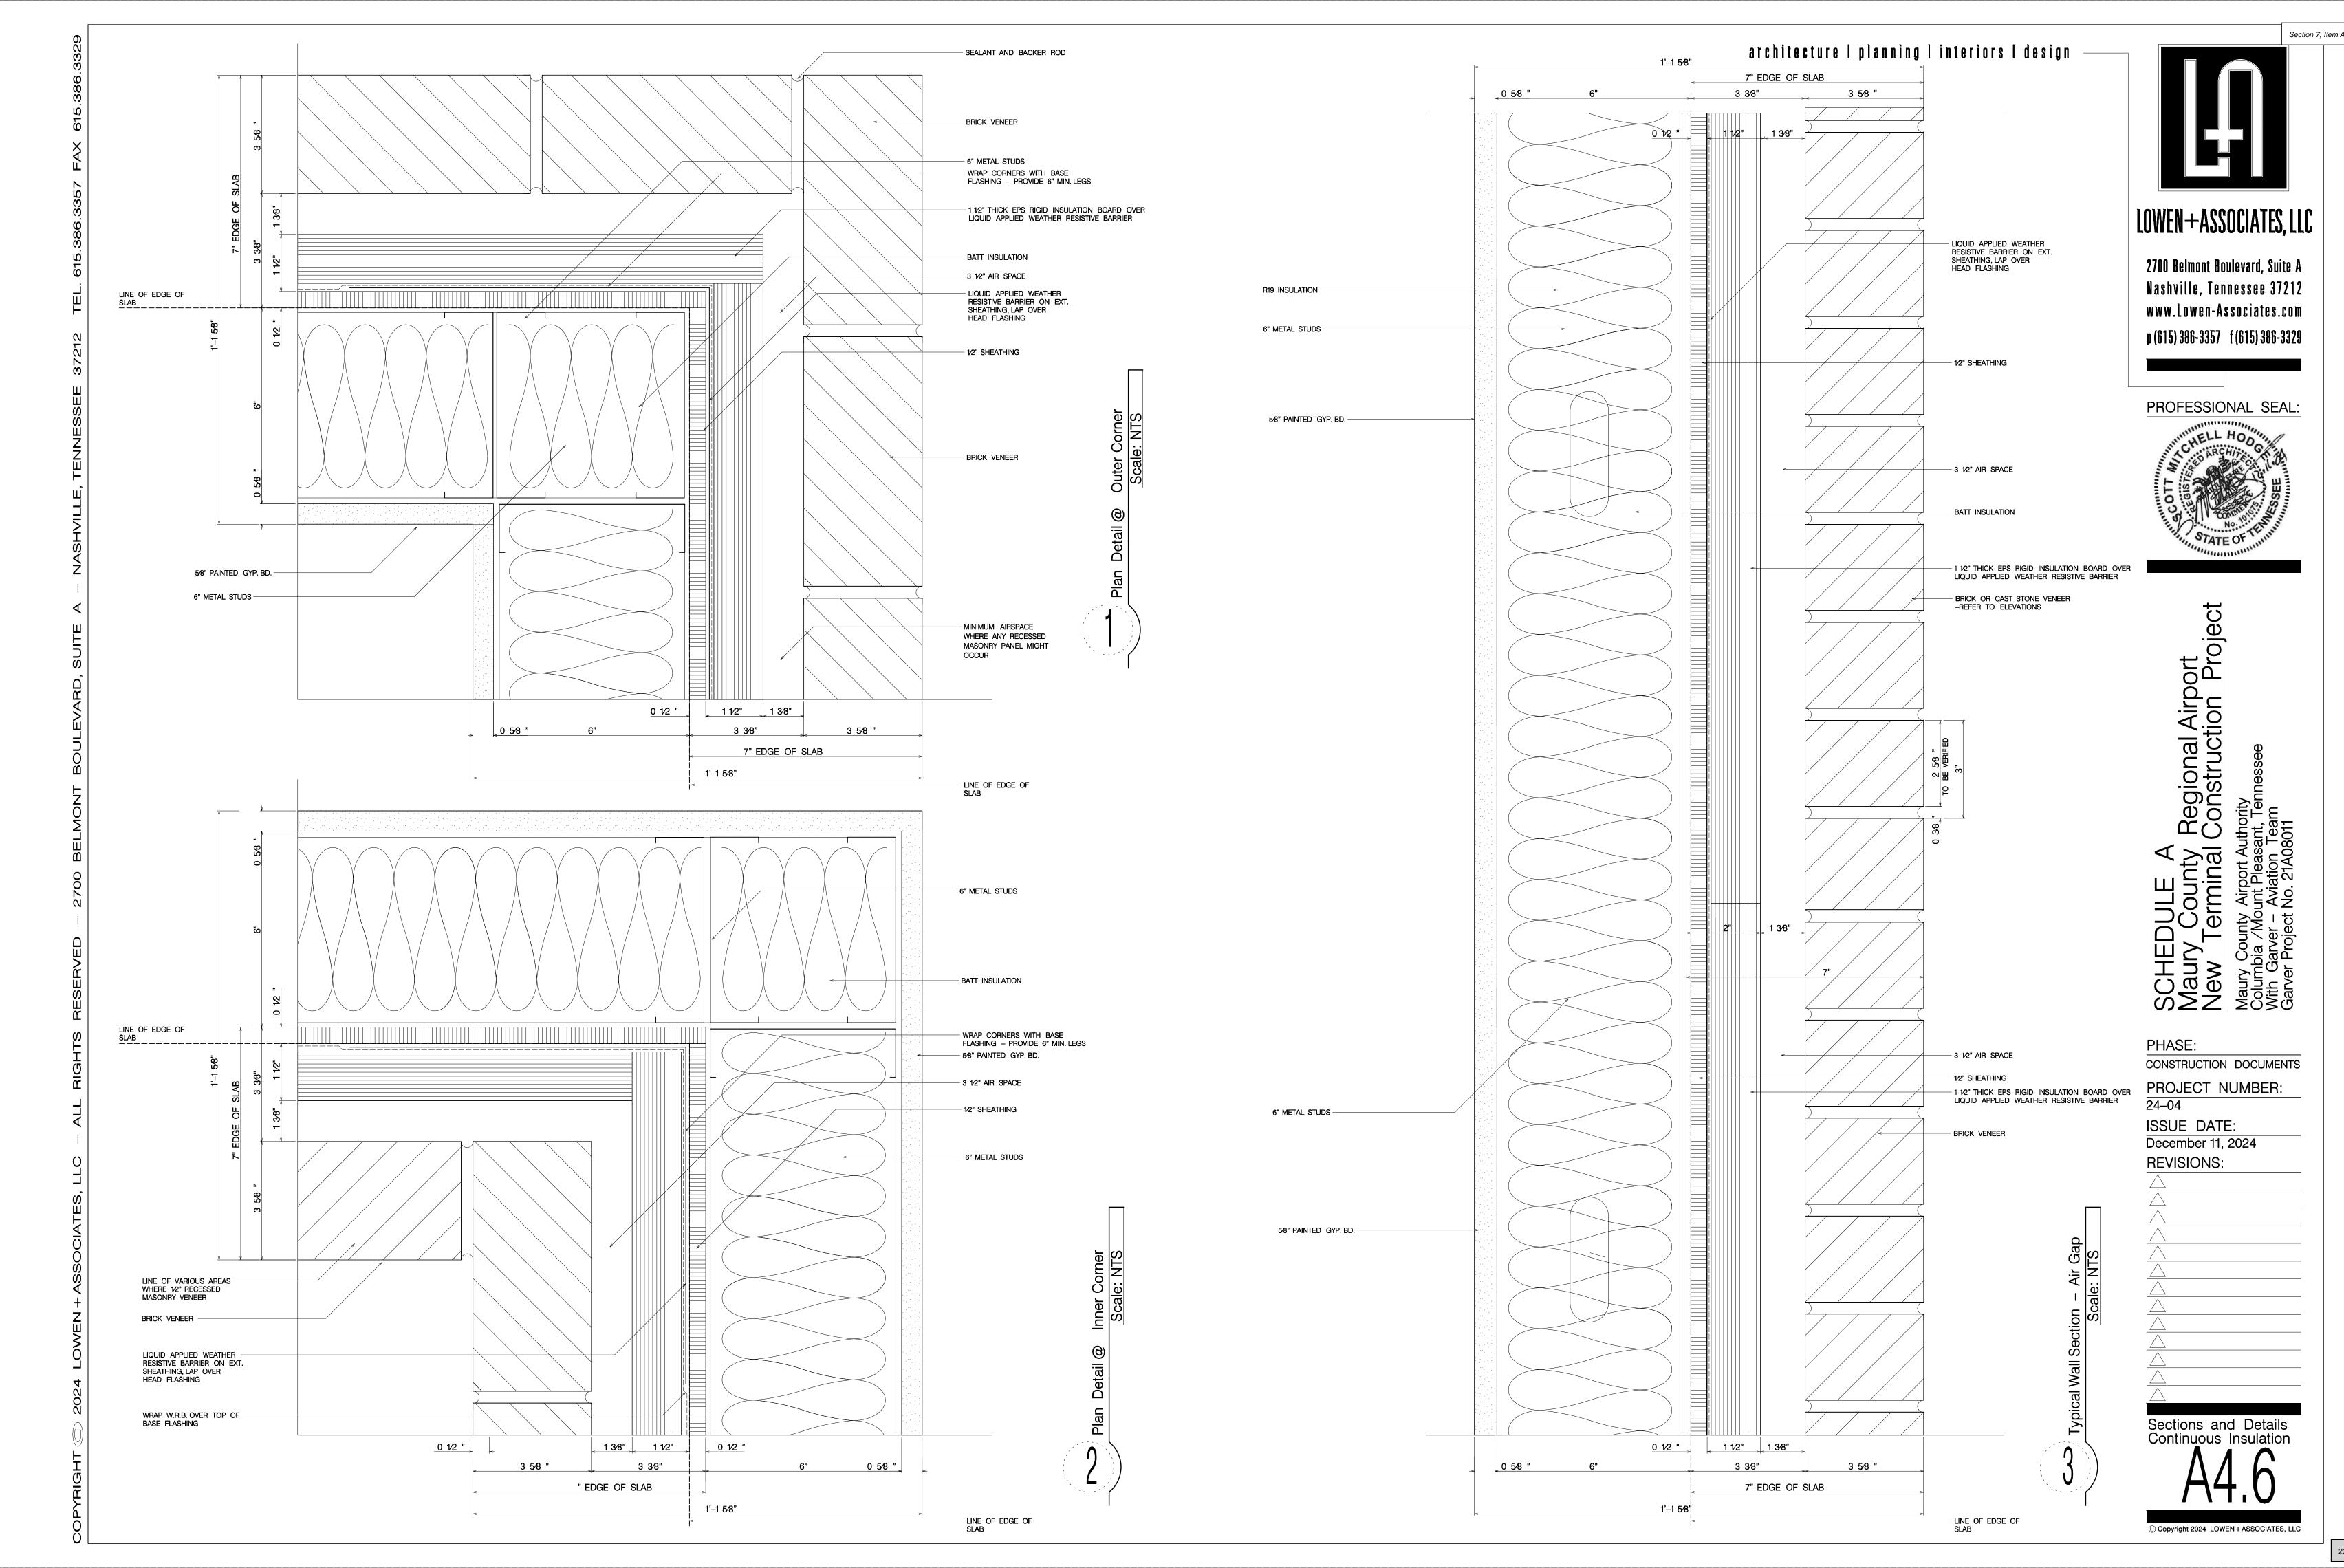

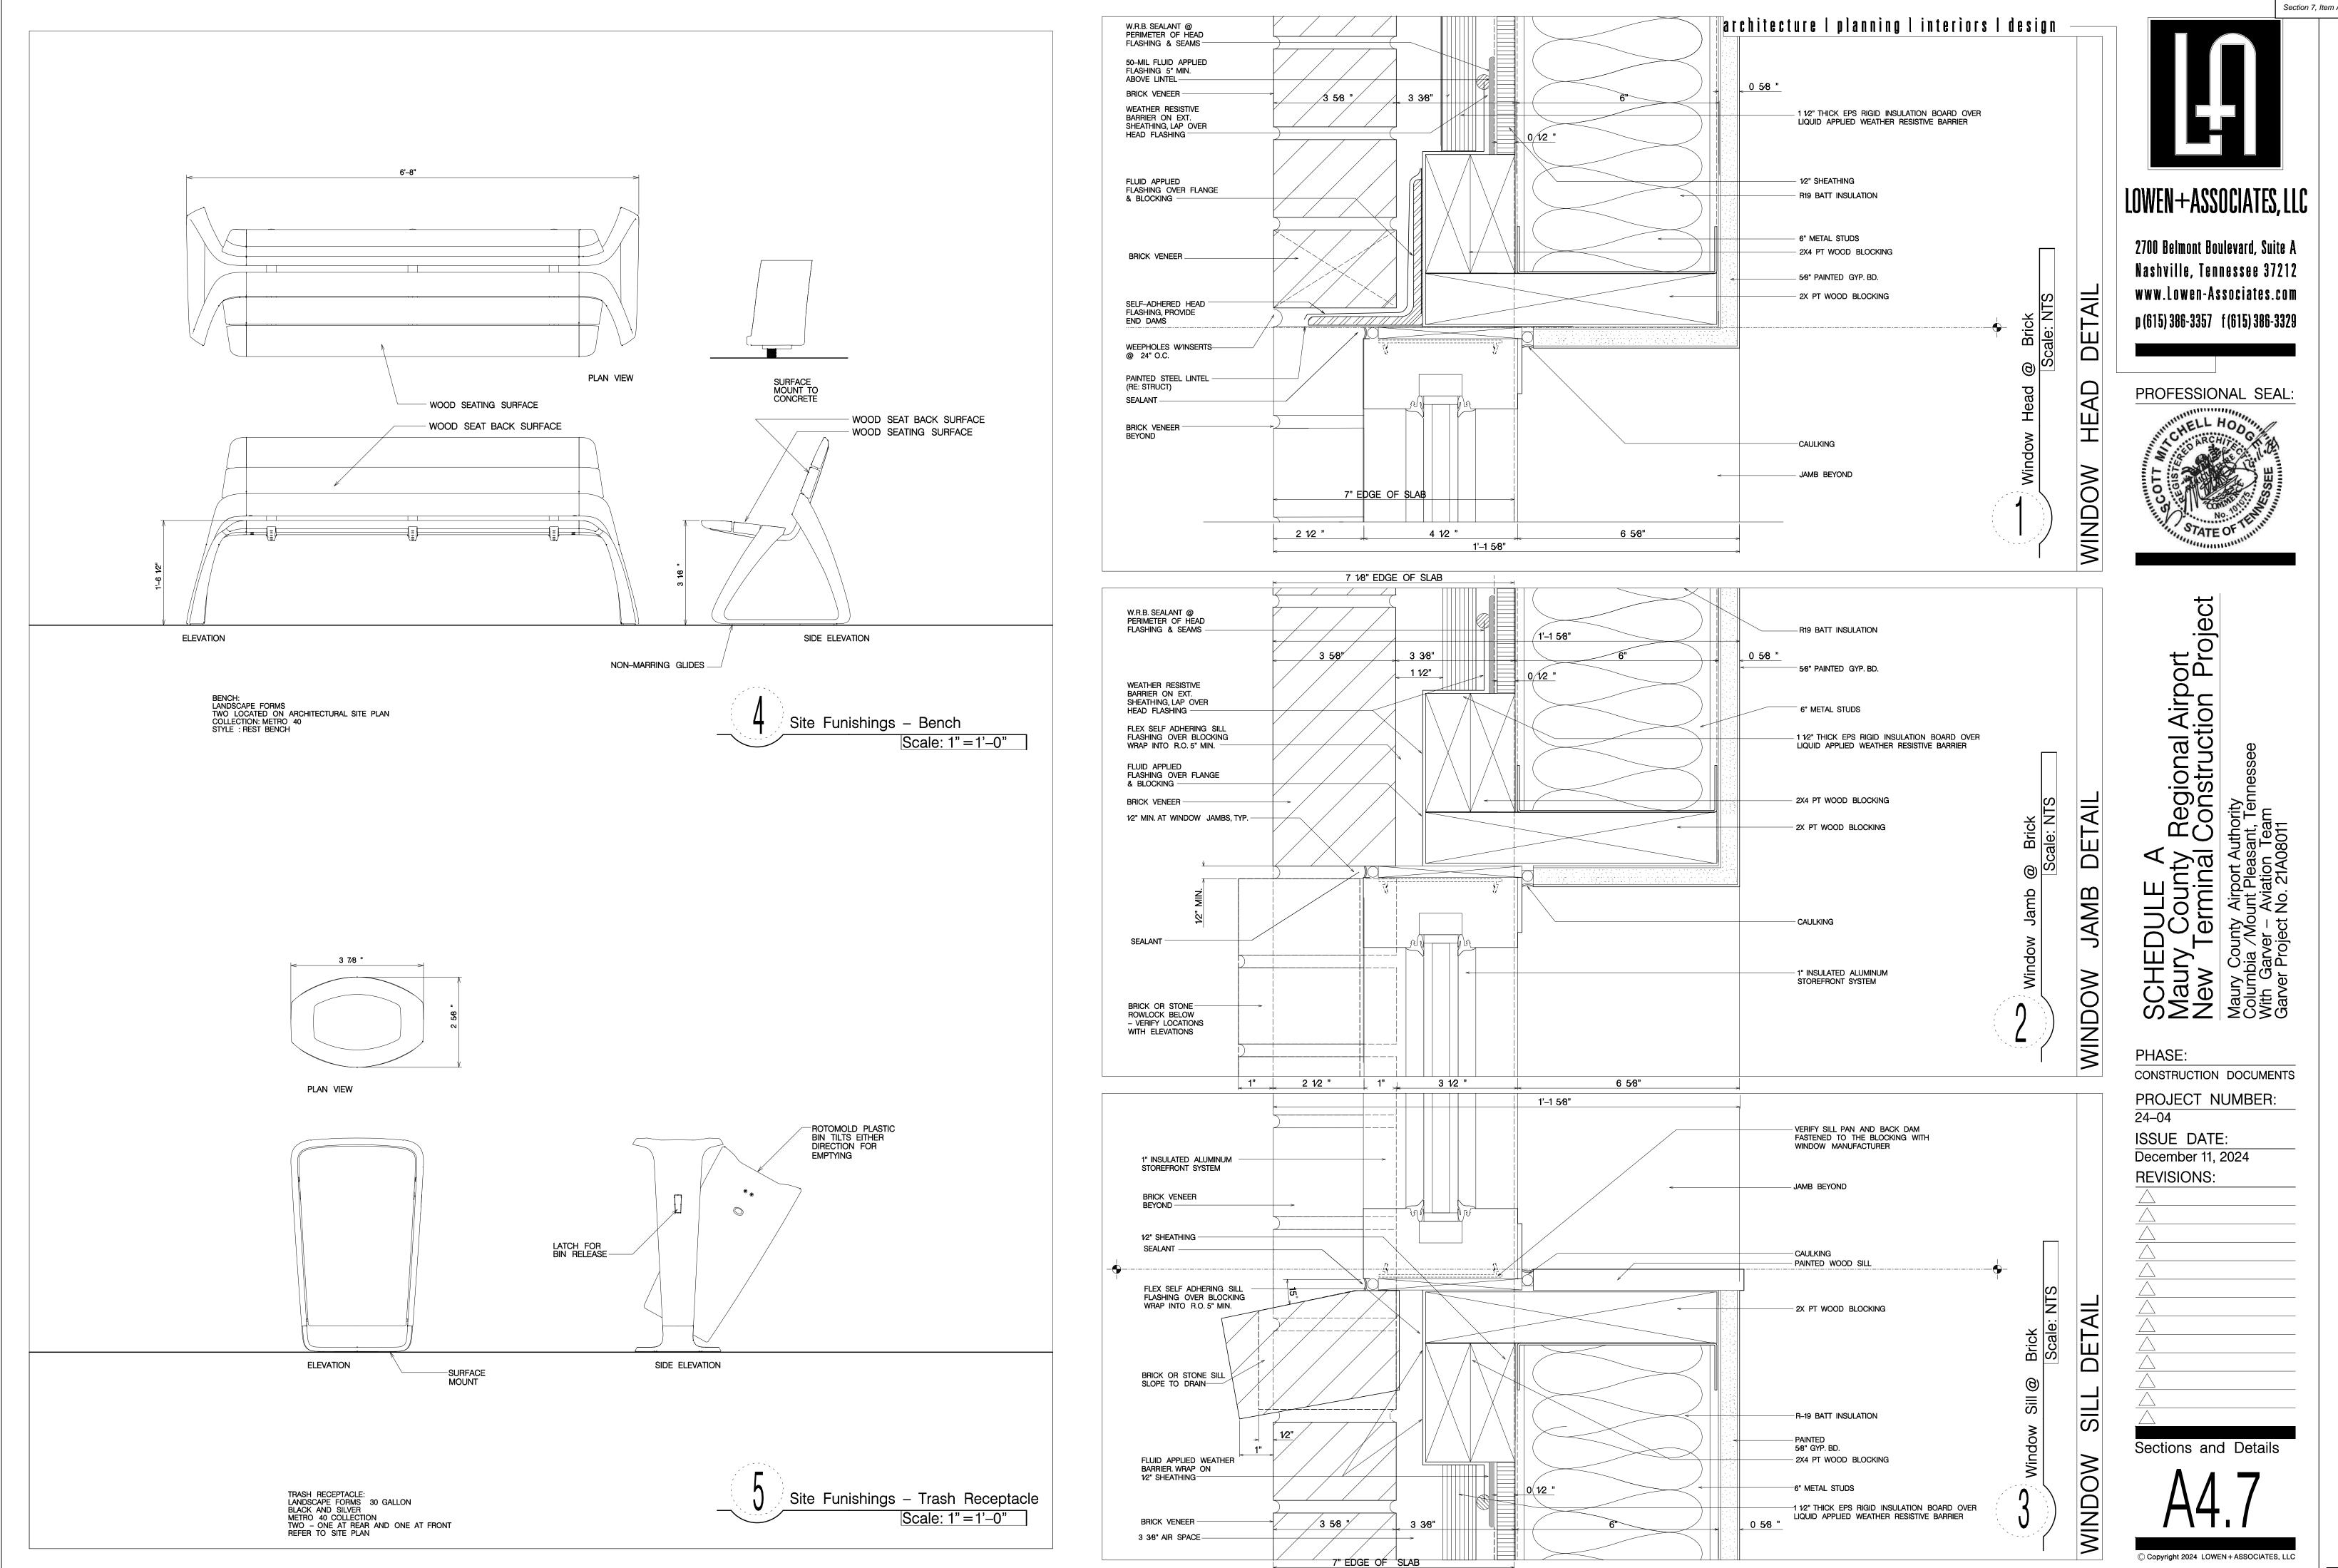

CONSTRUCTION DOCUMENTS

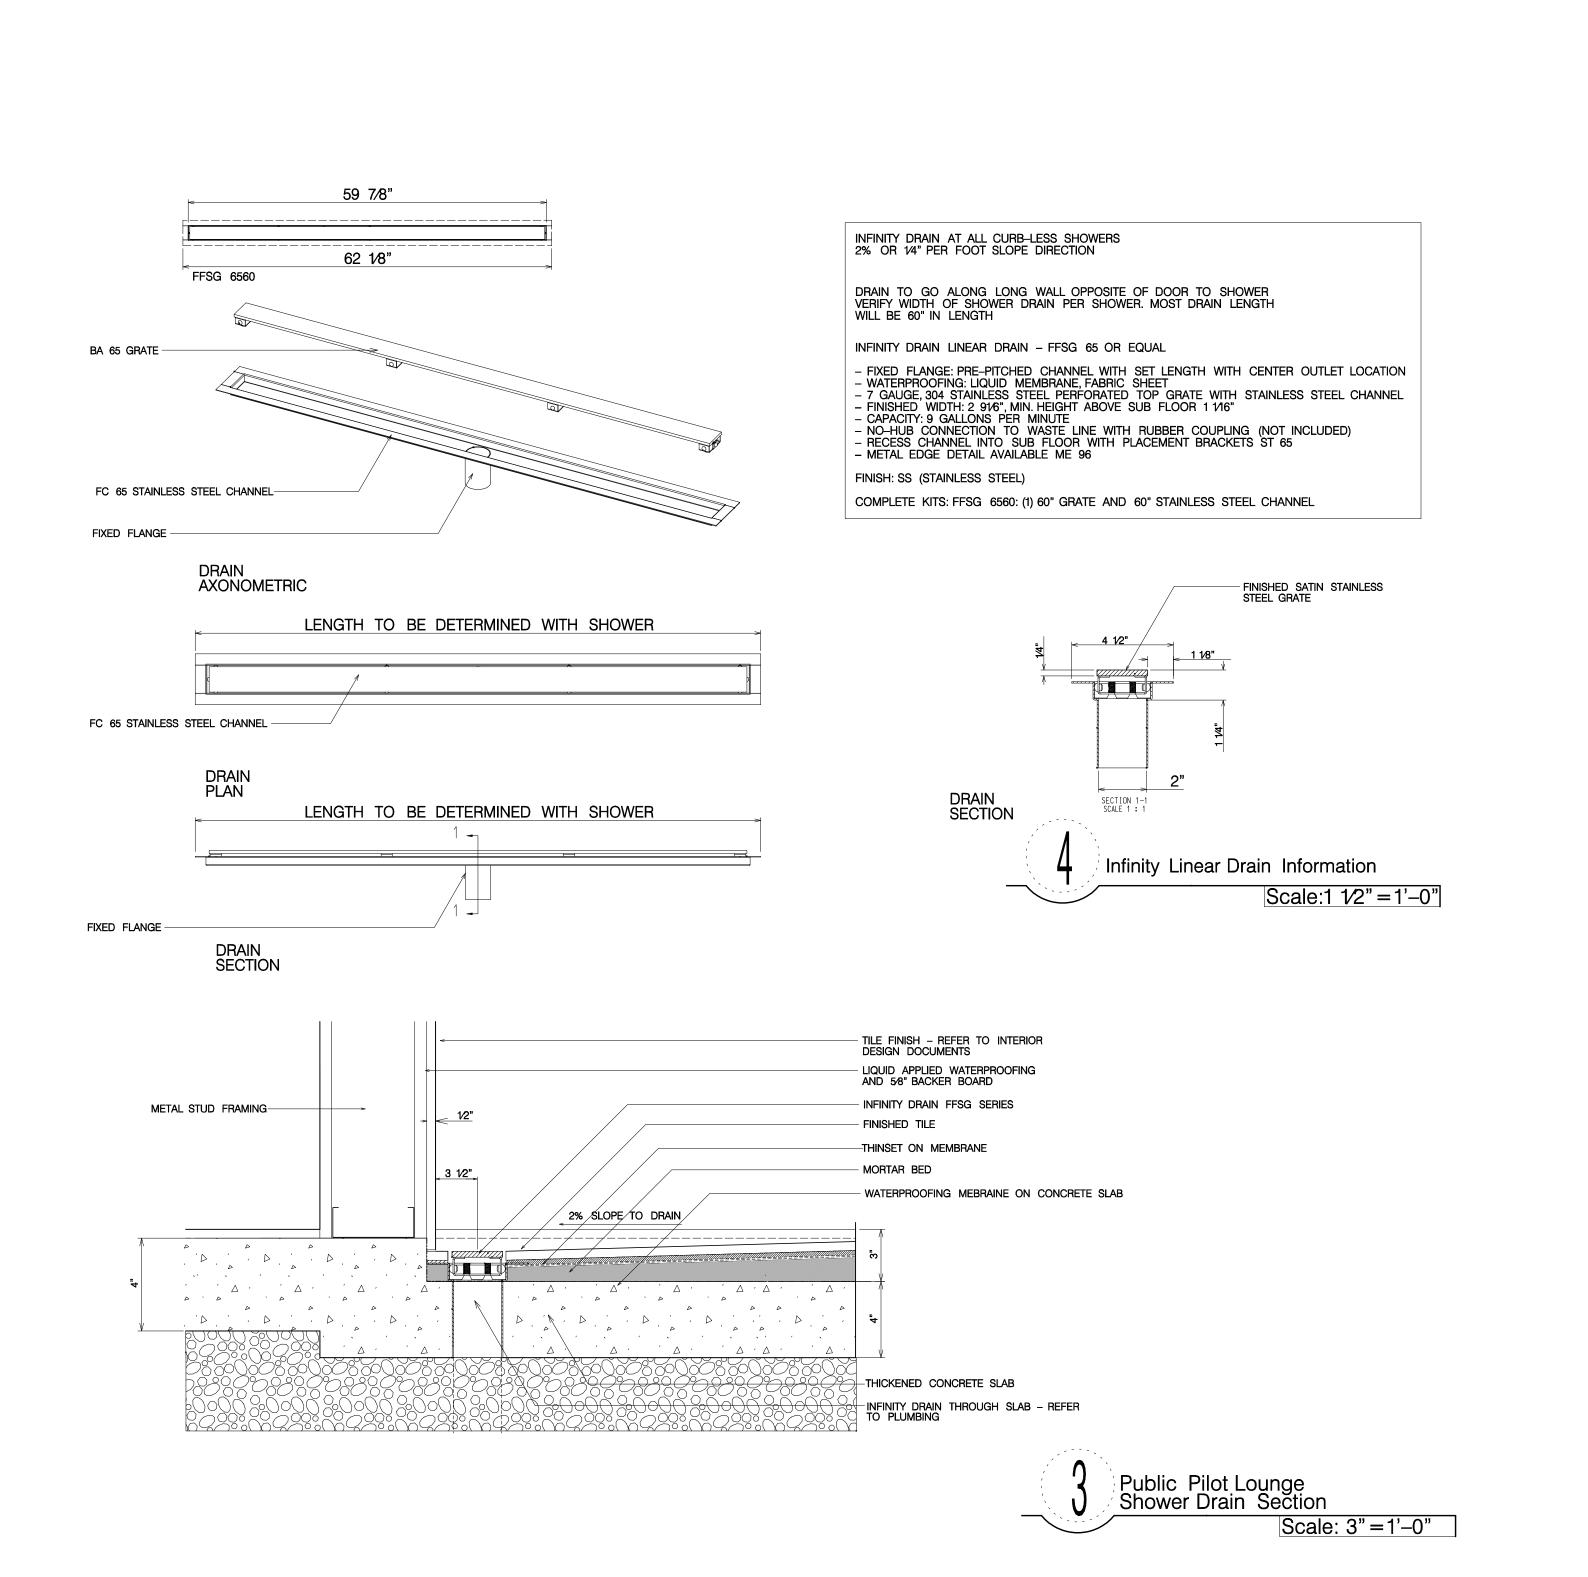

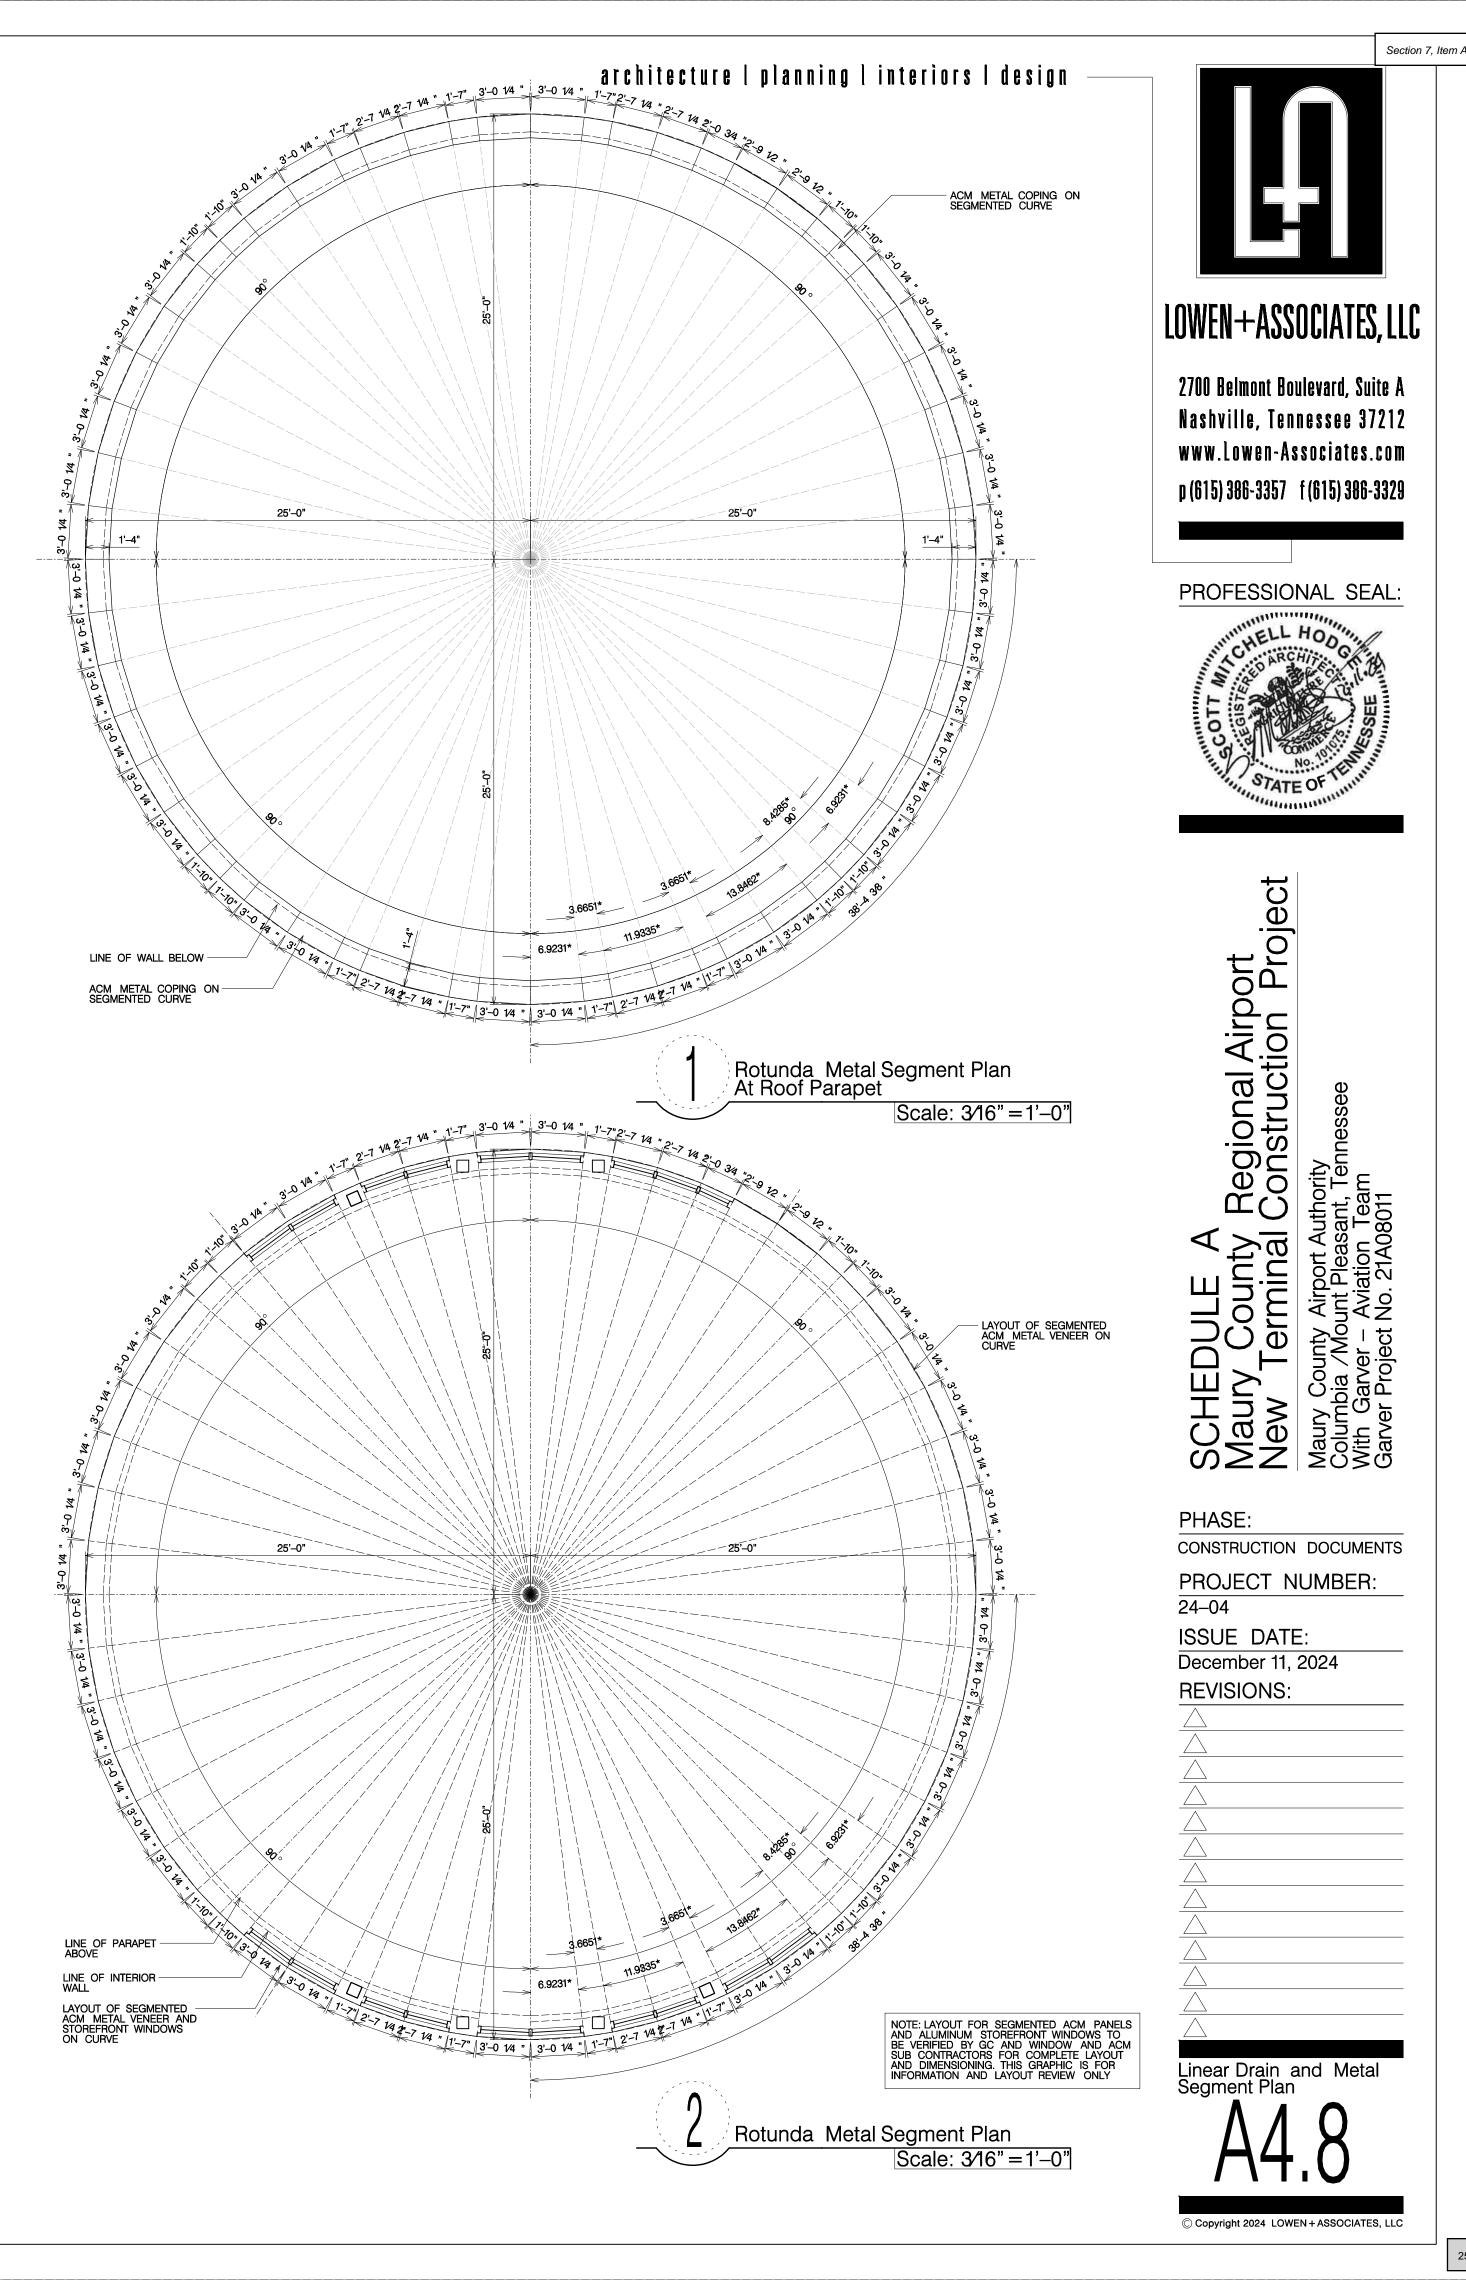


architecture | planning | interiors | design

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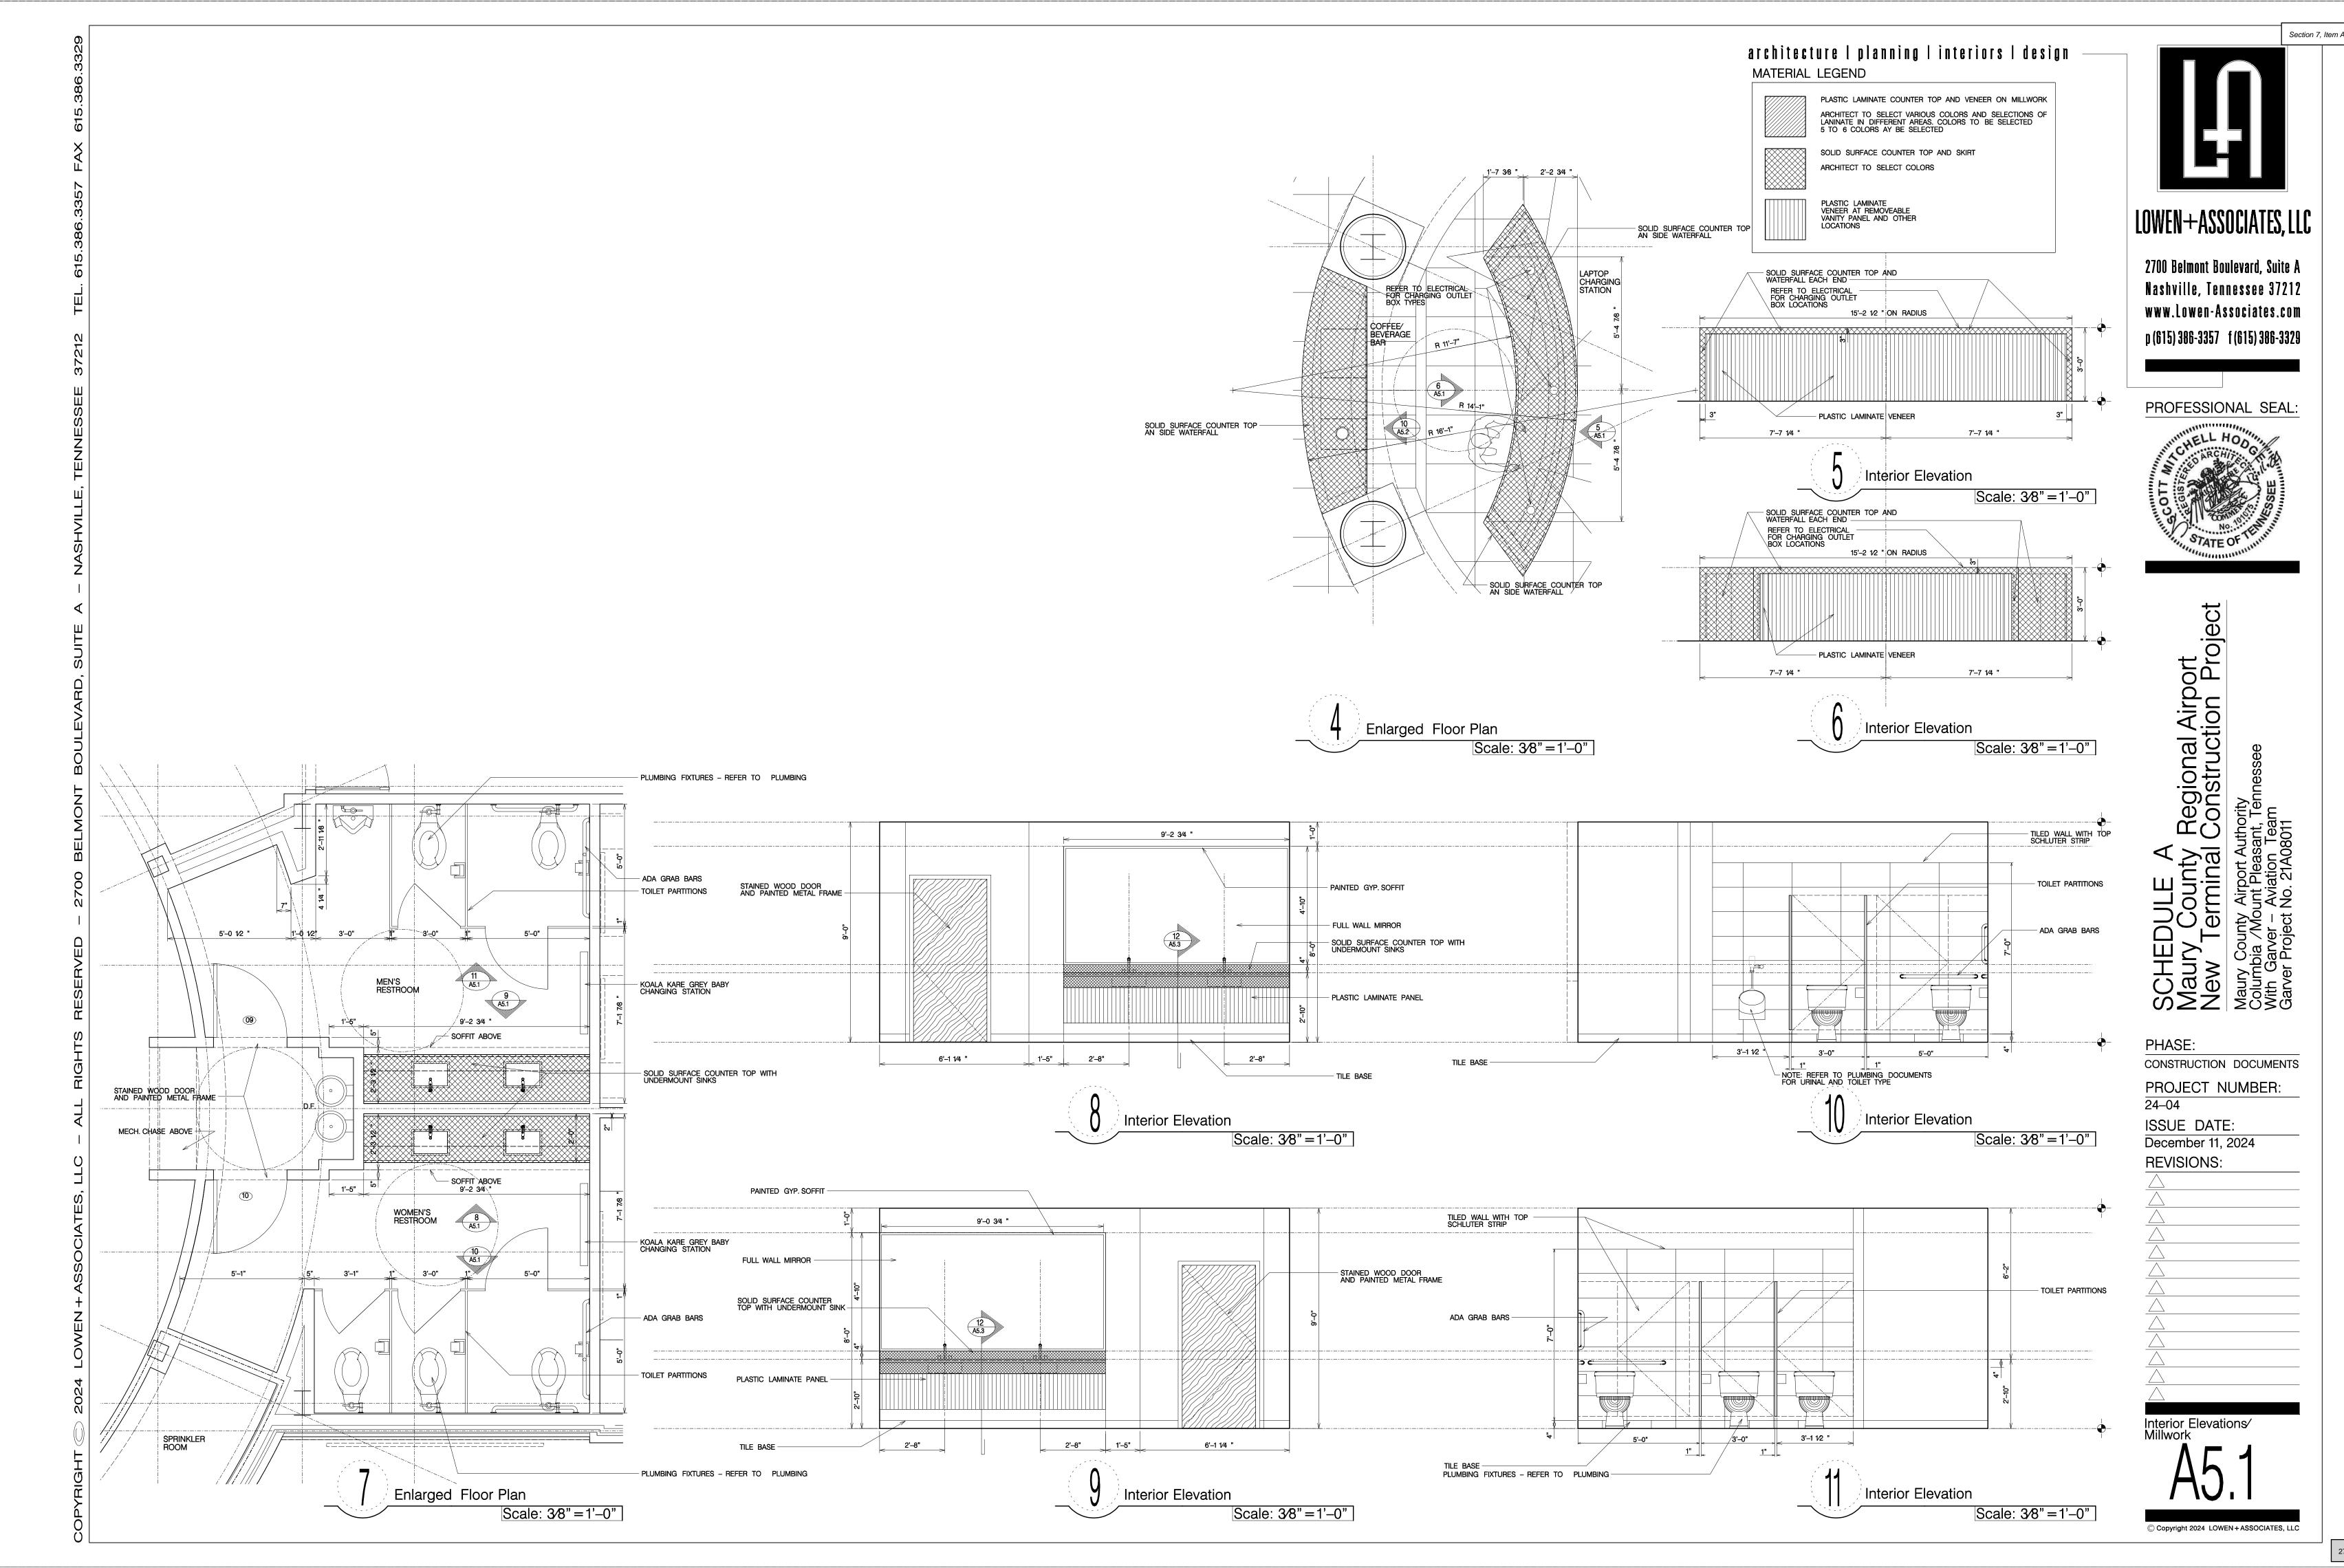
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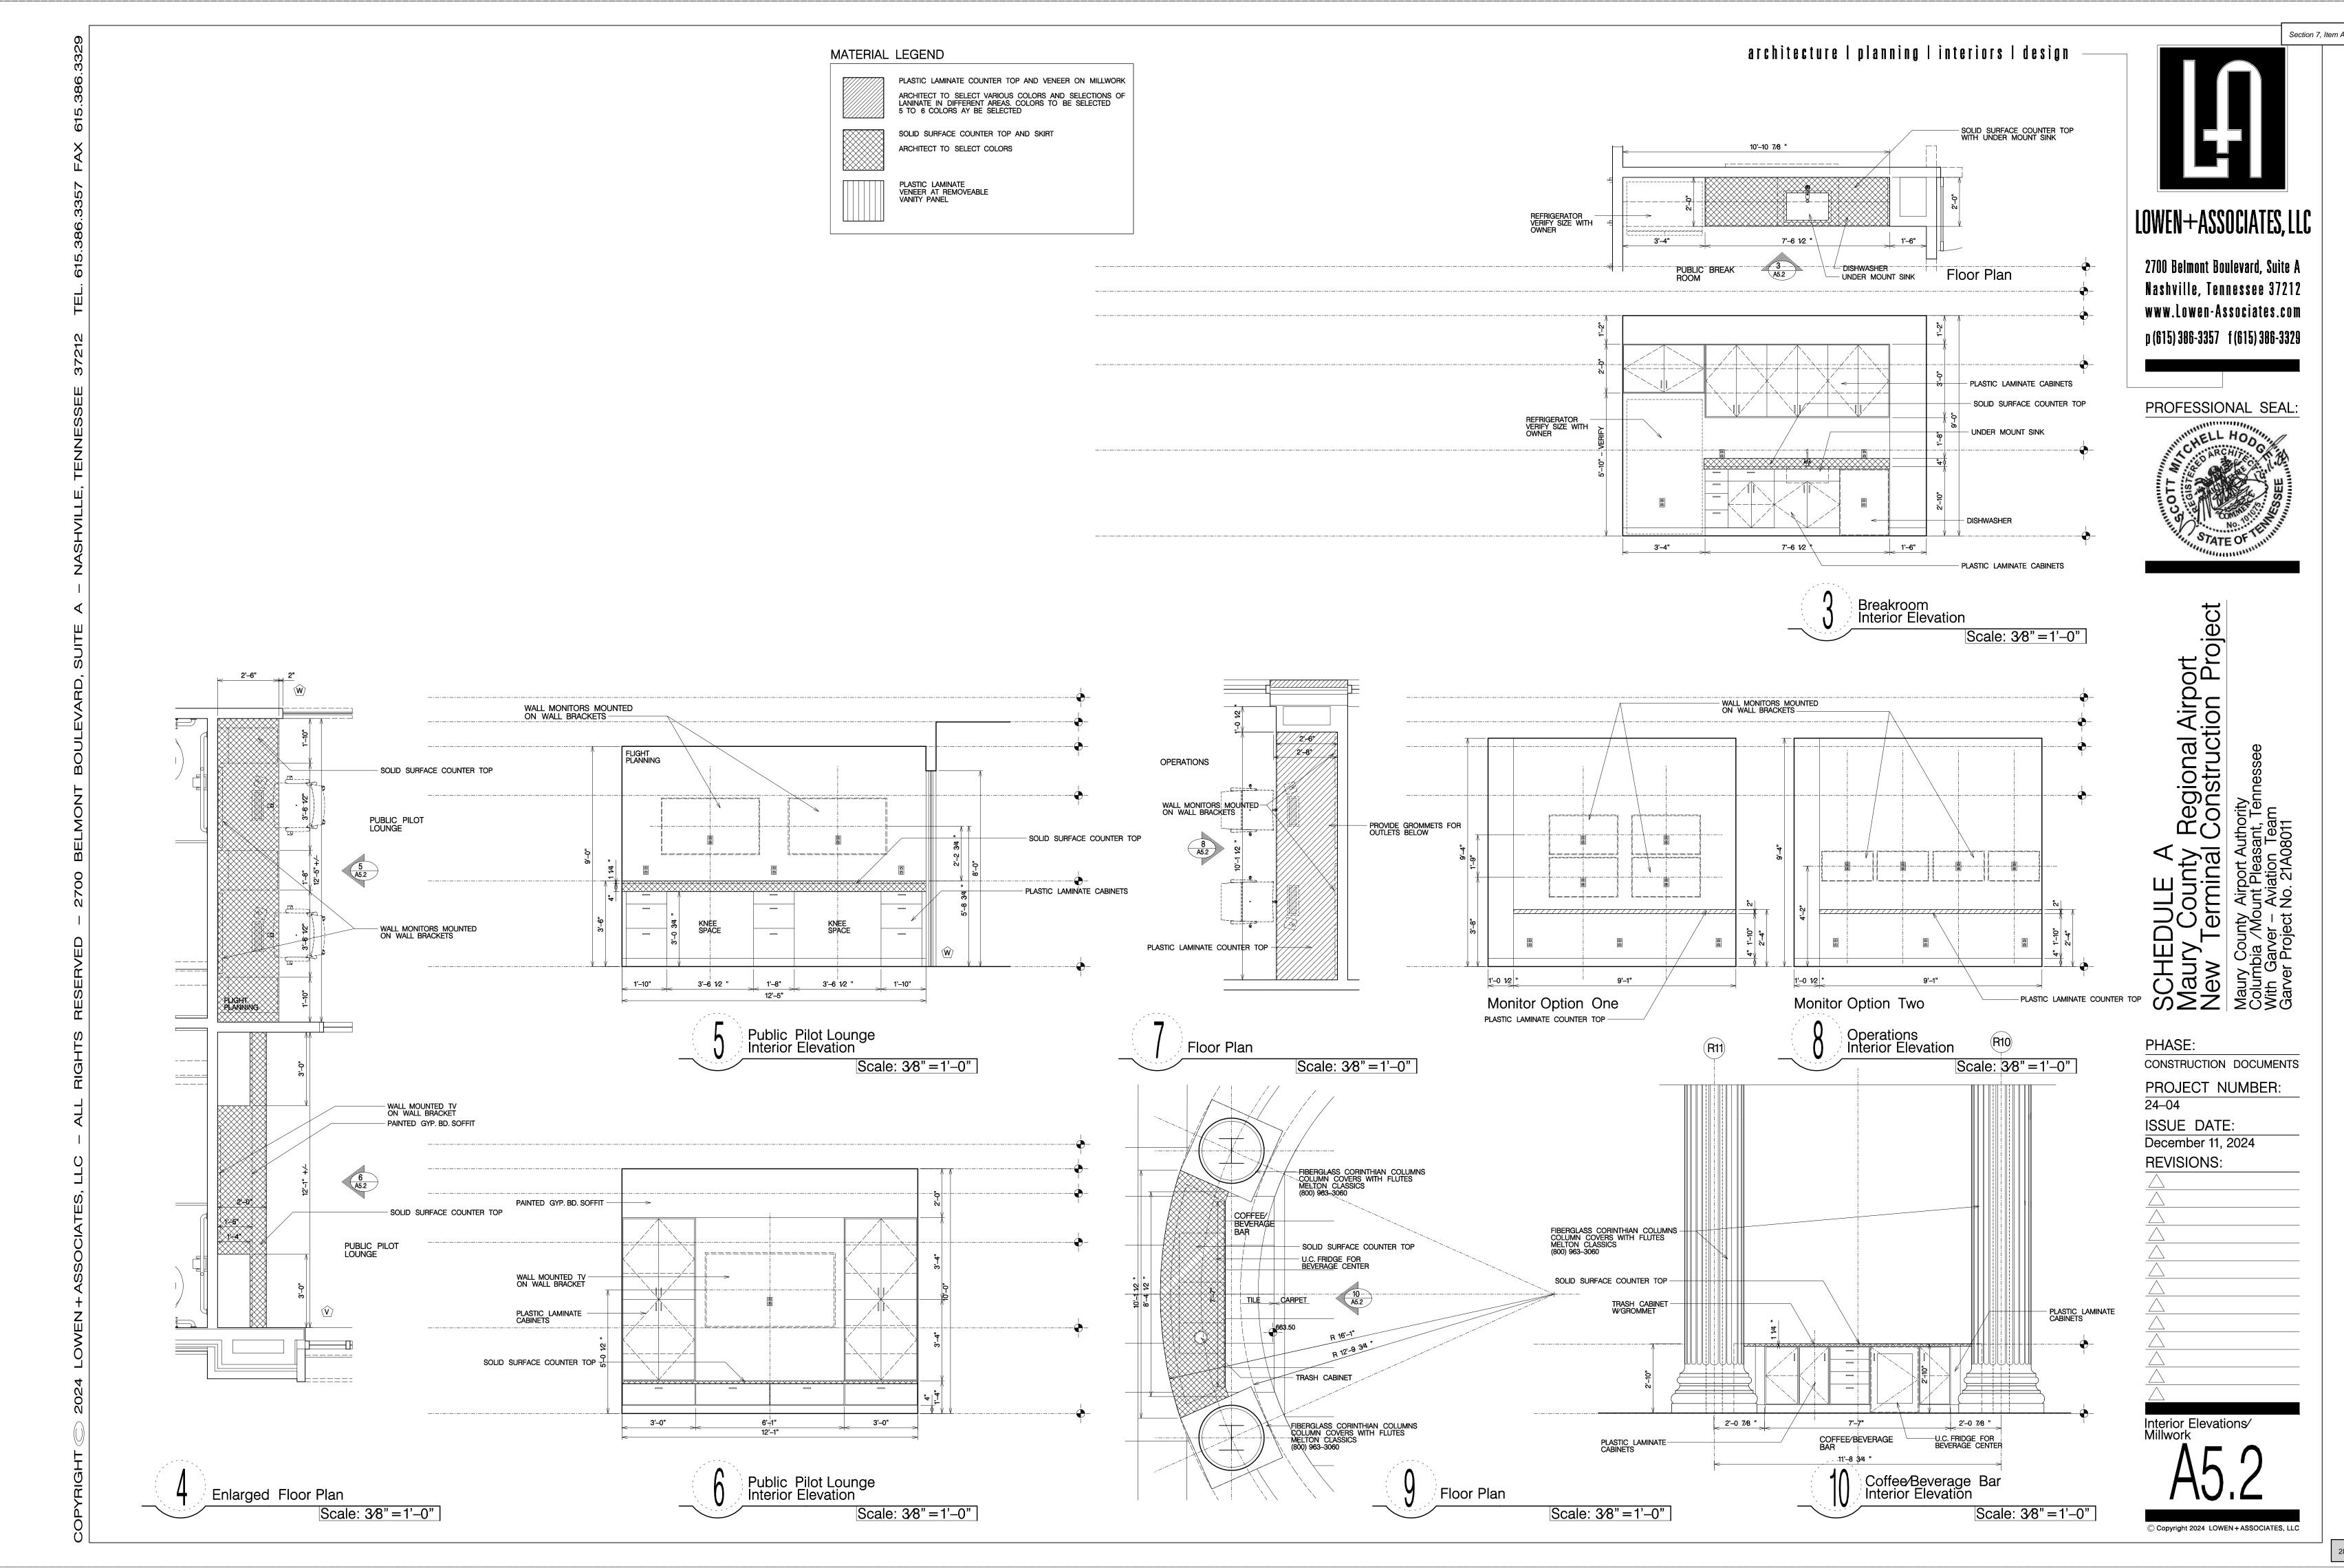



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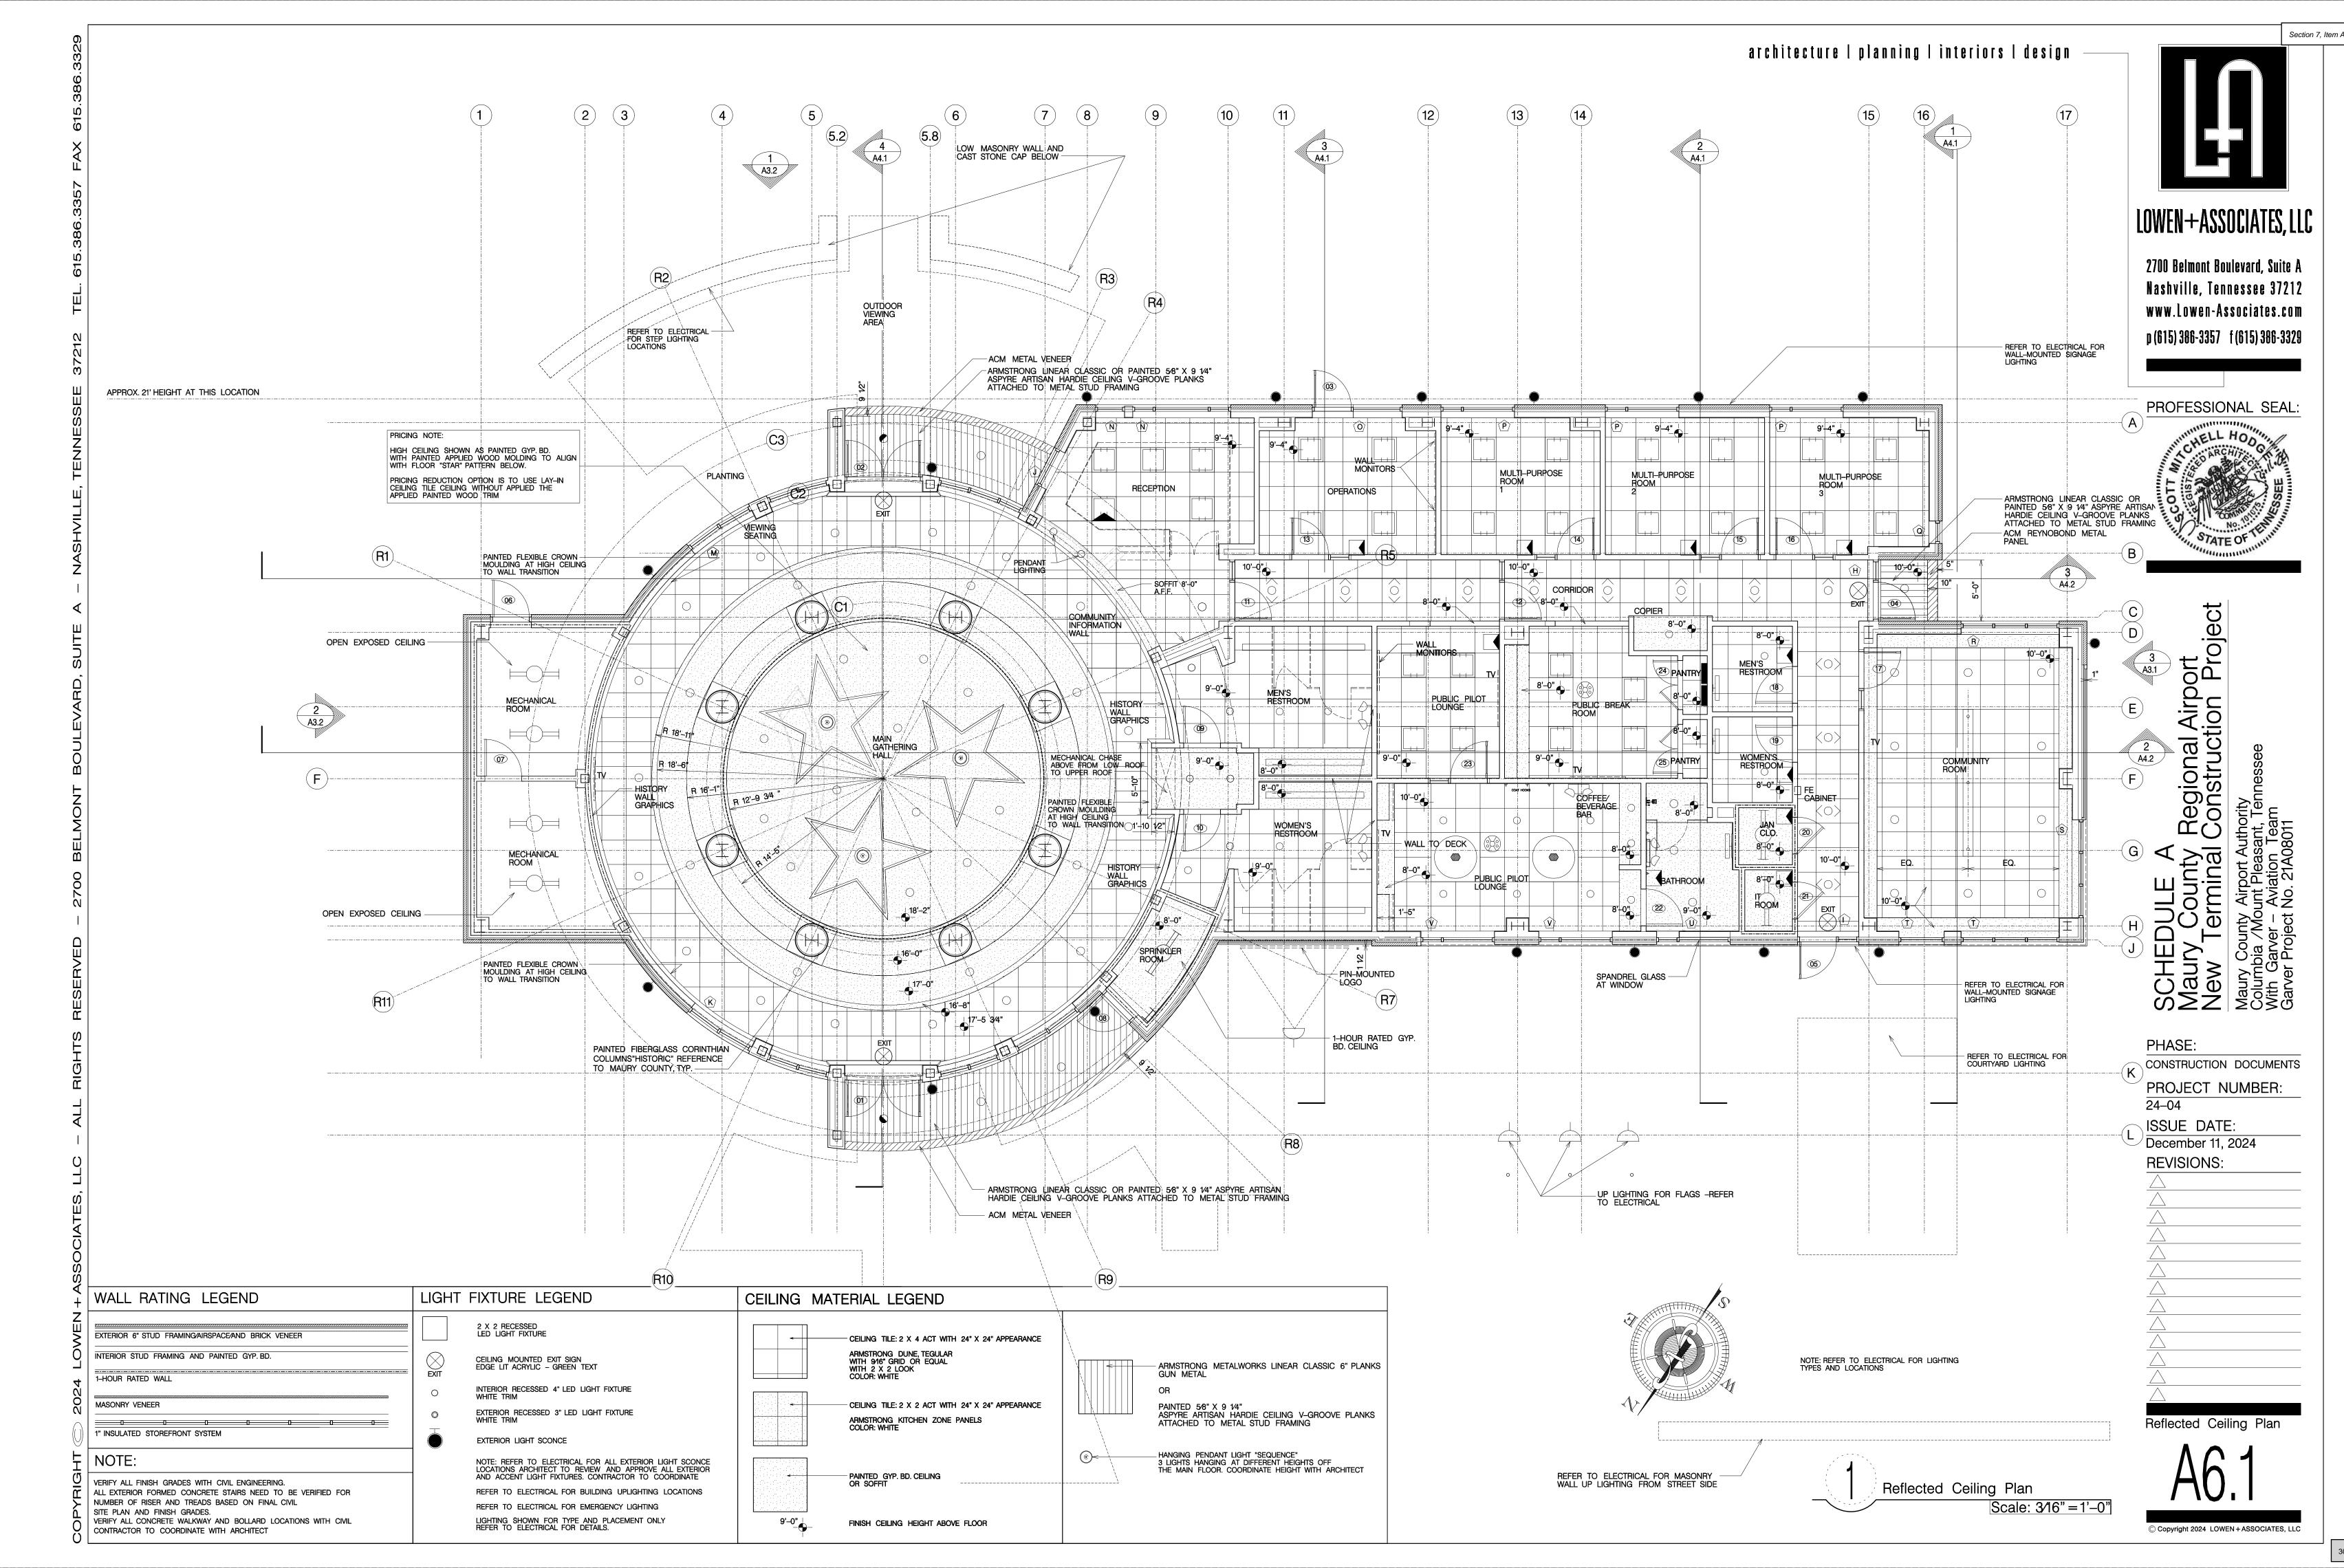
Plan Details


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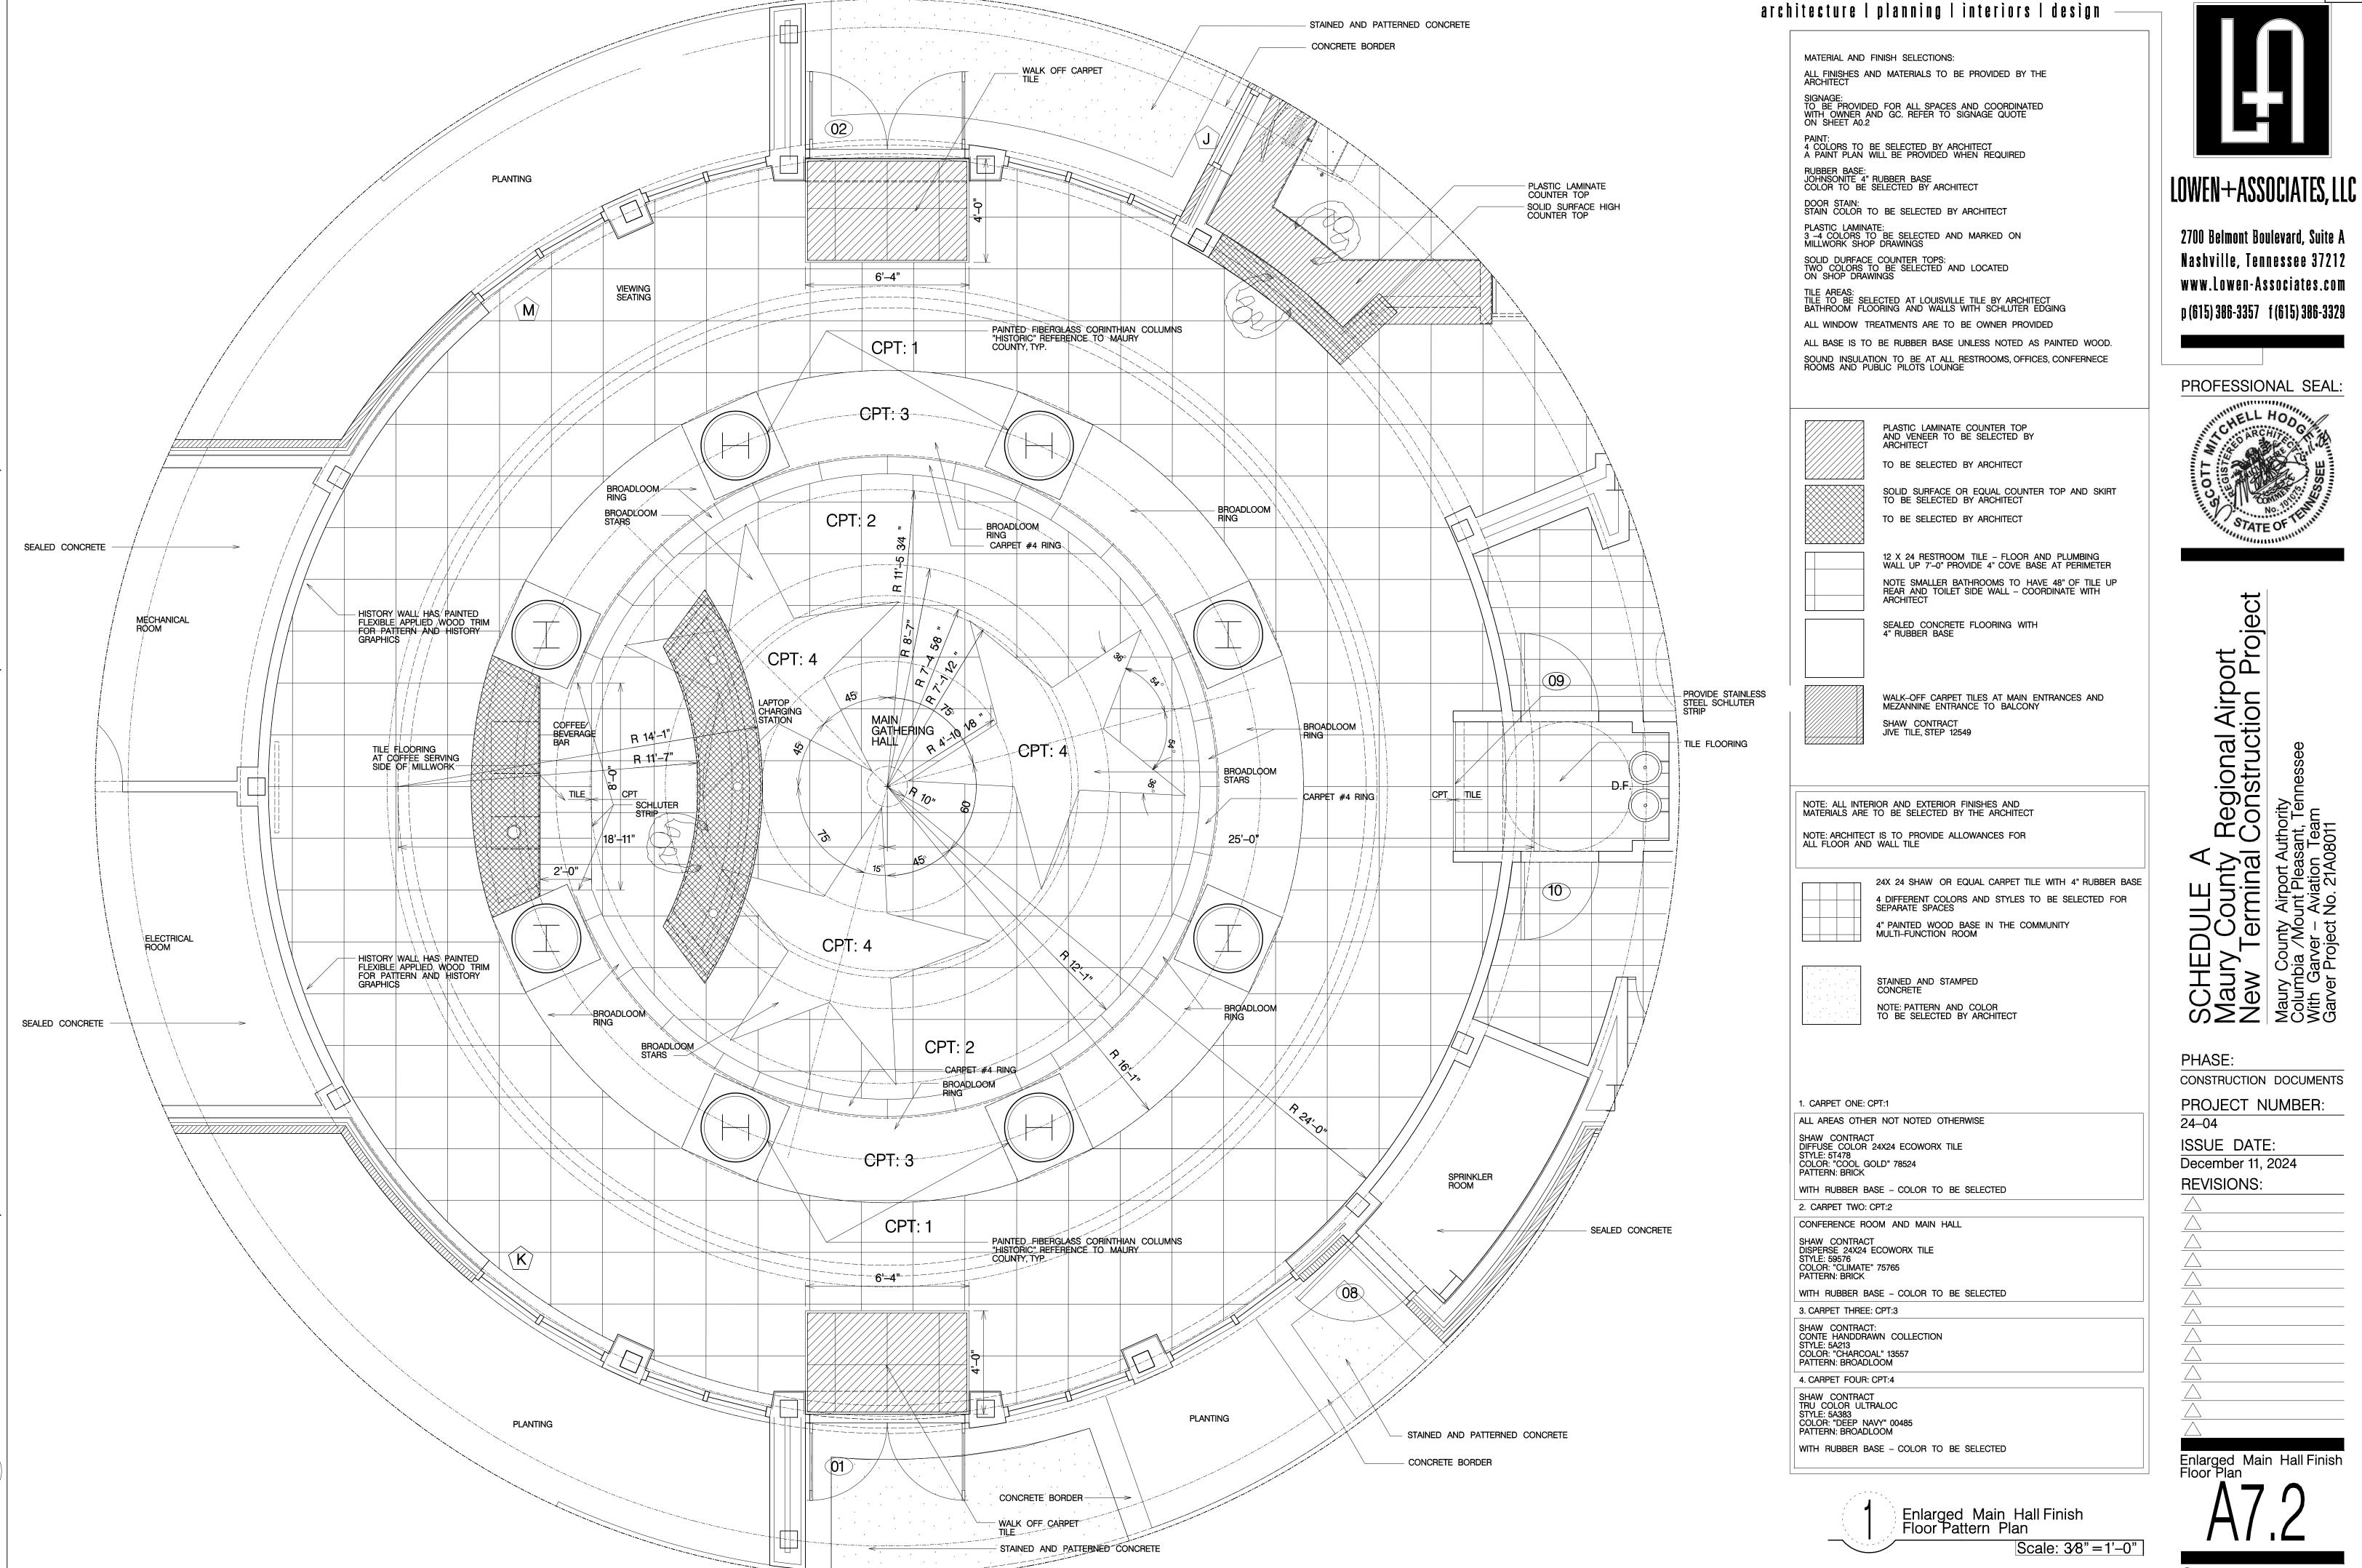




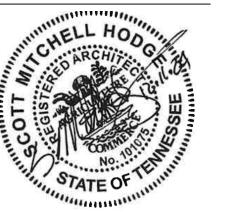



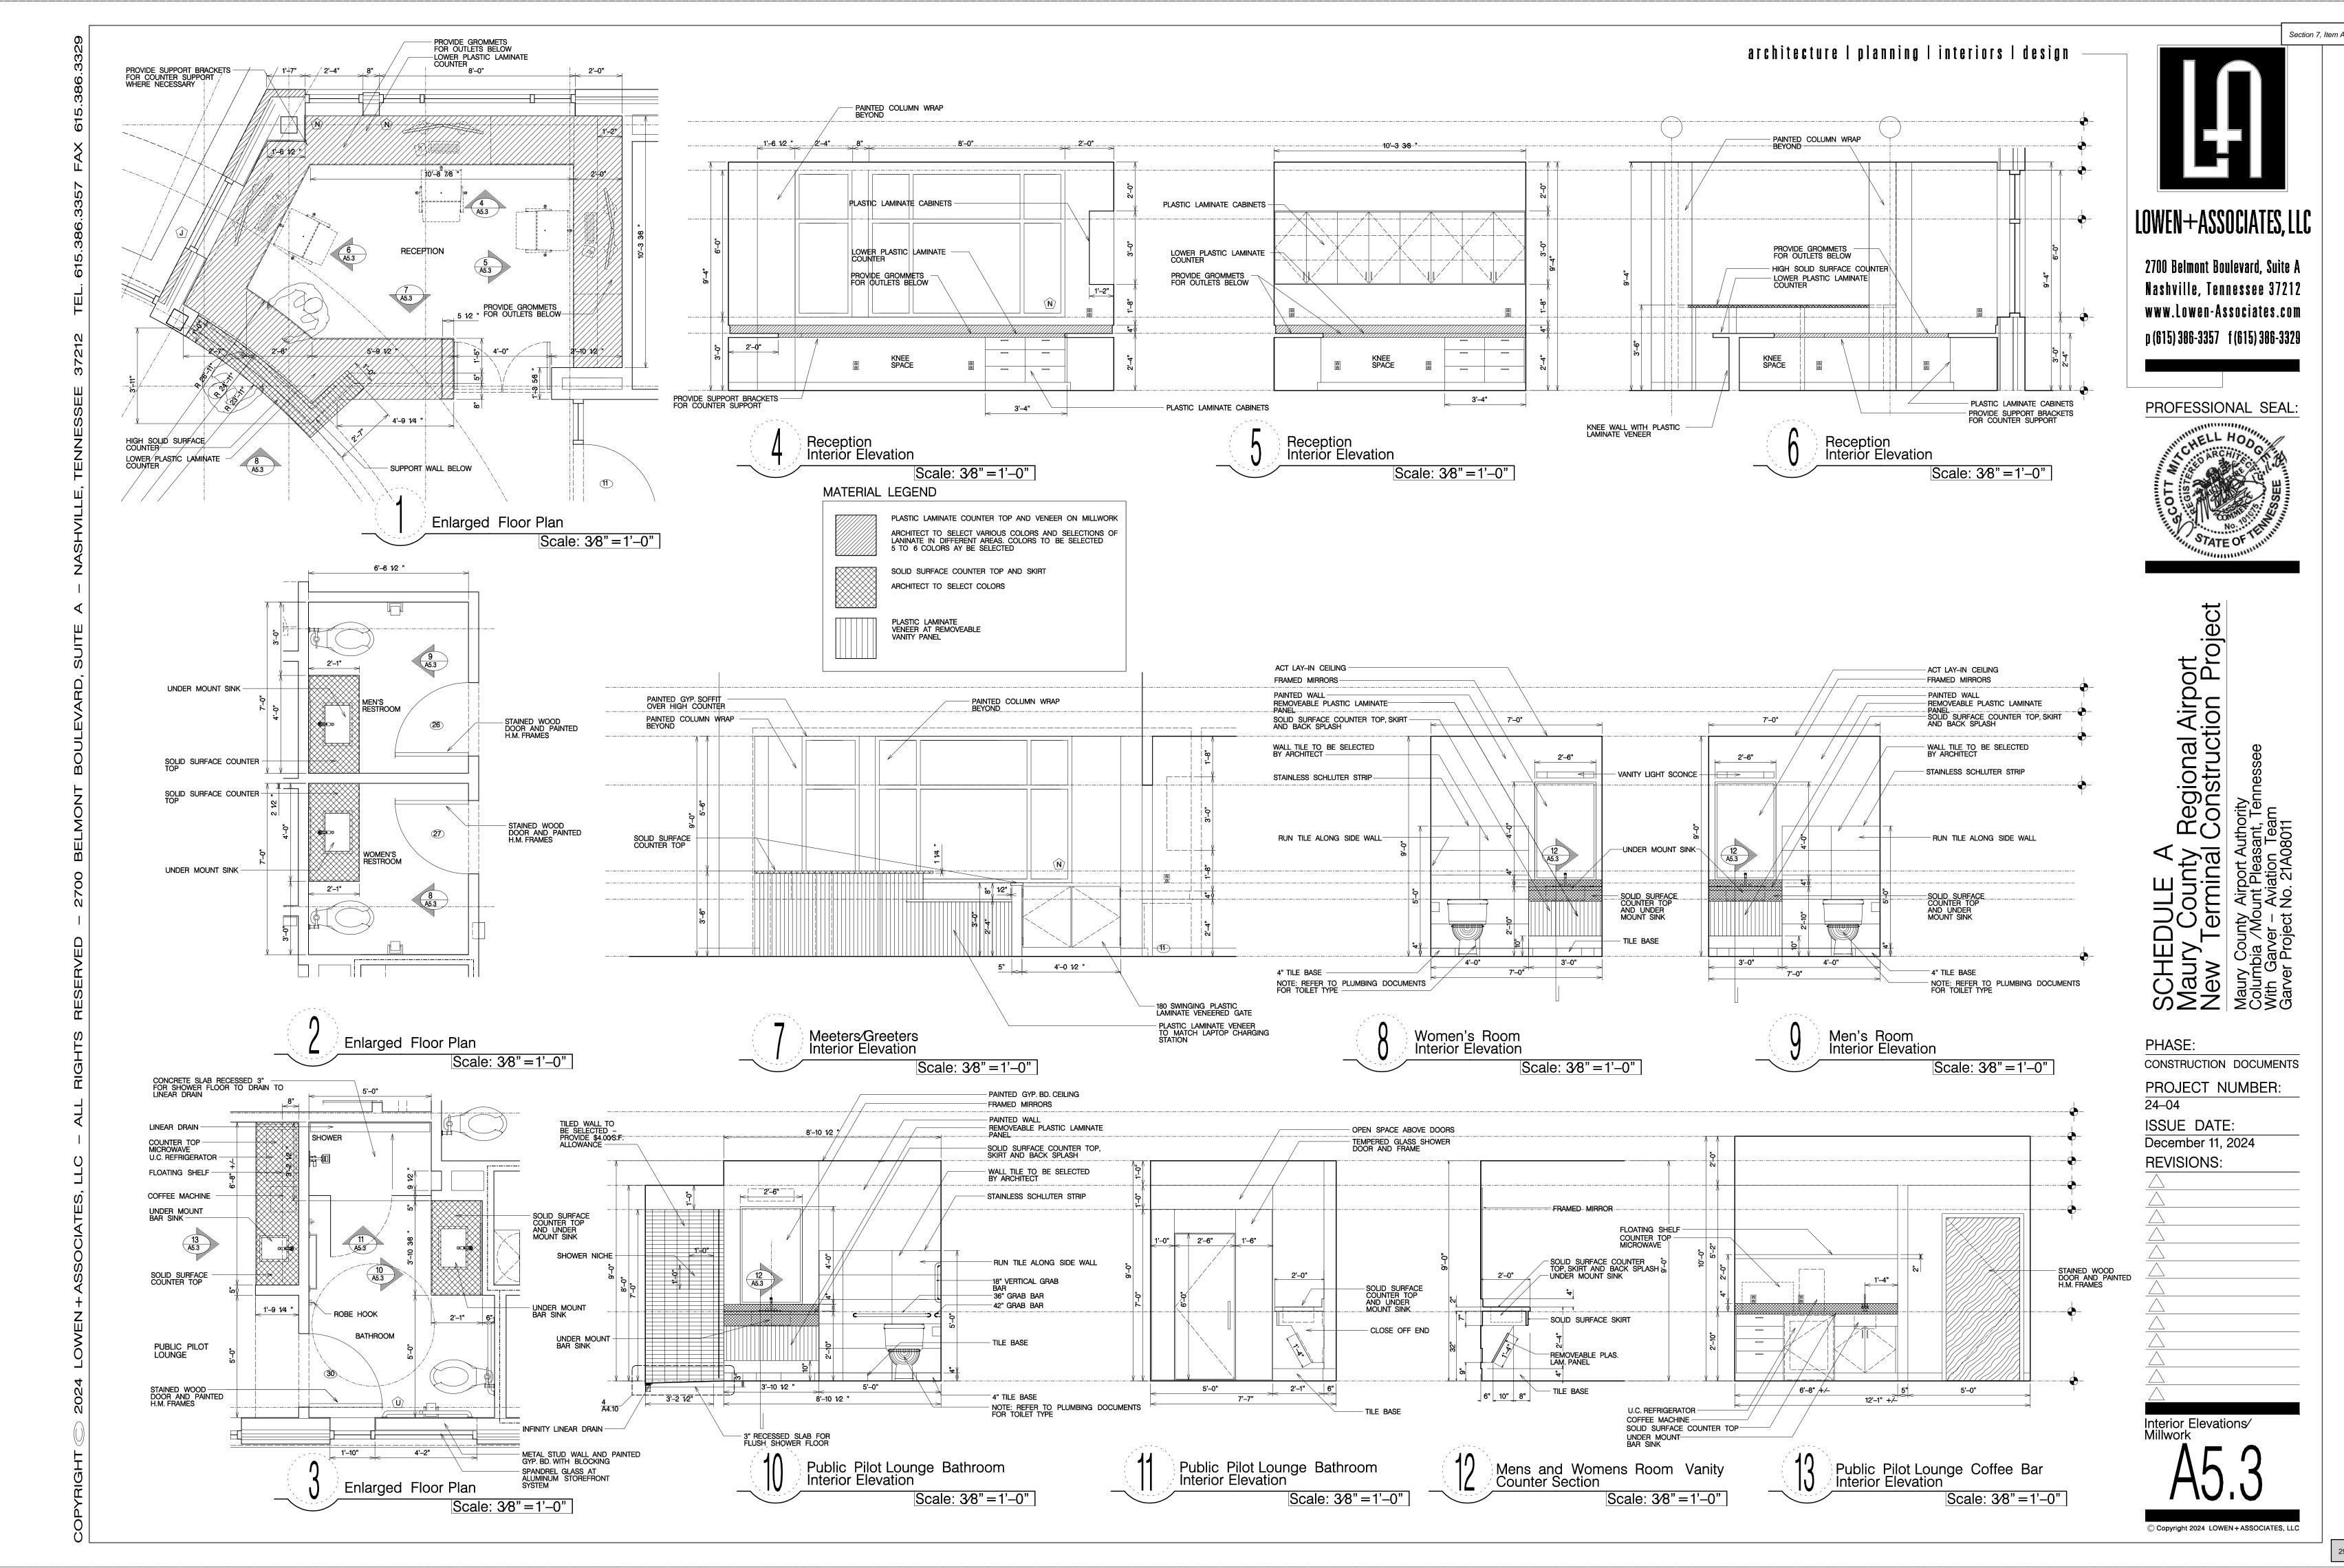

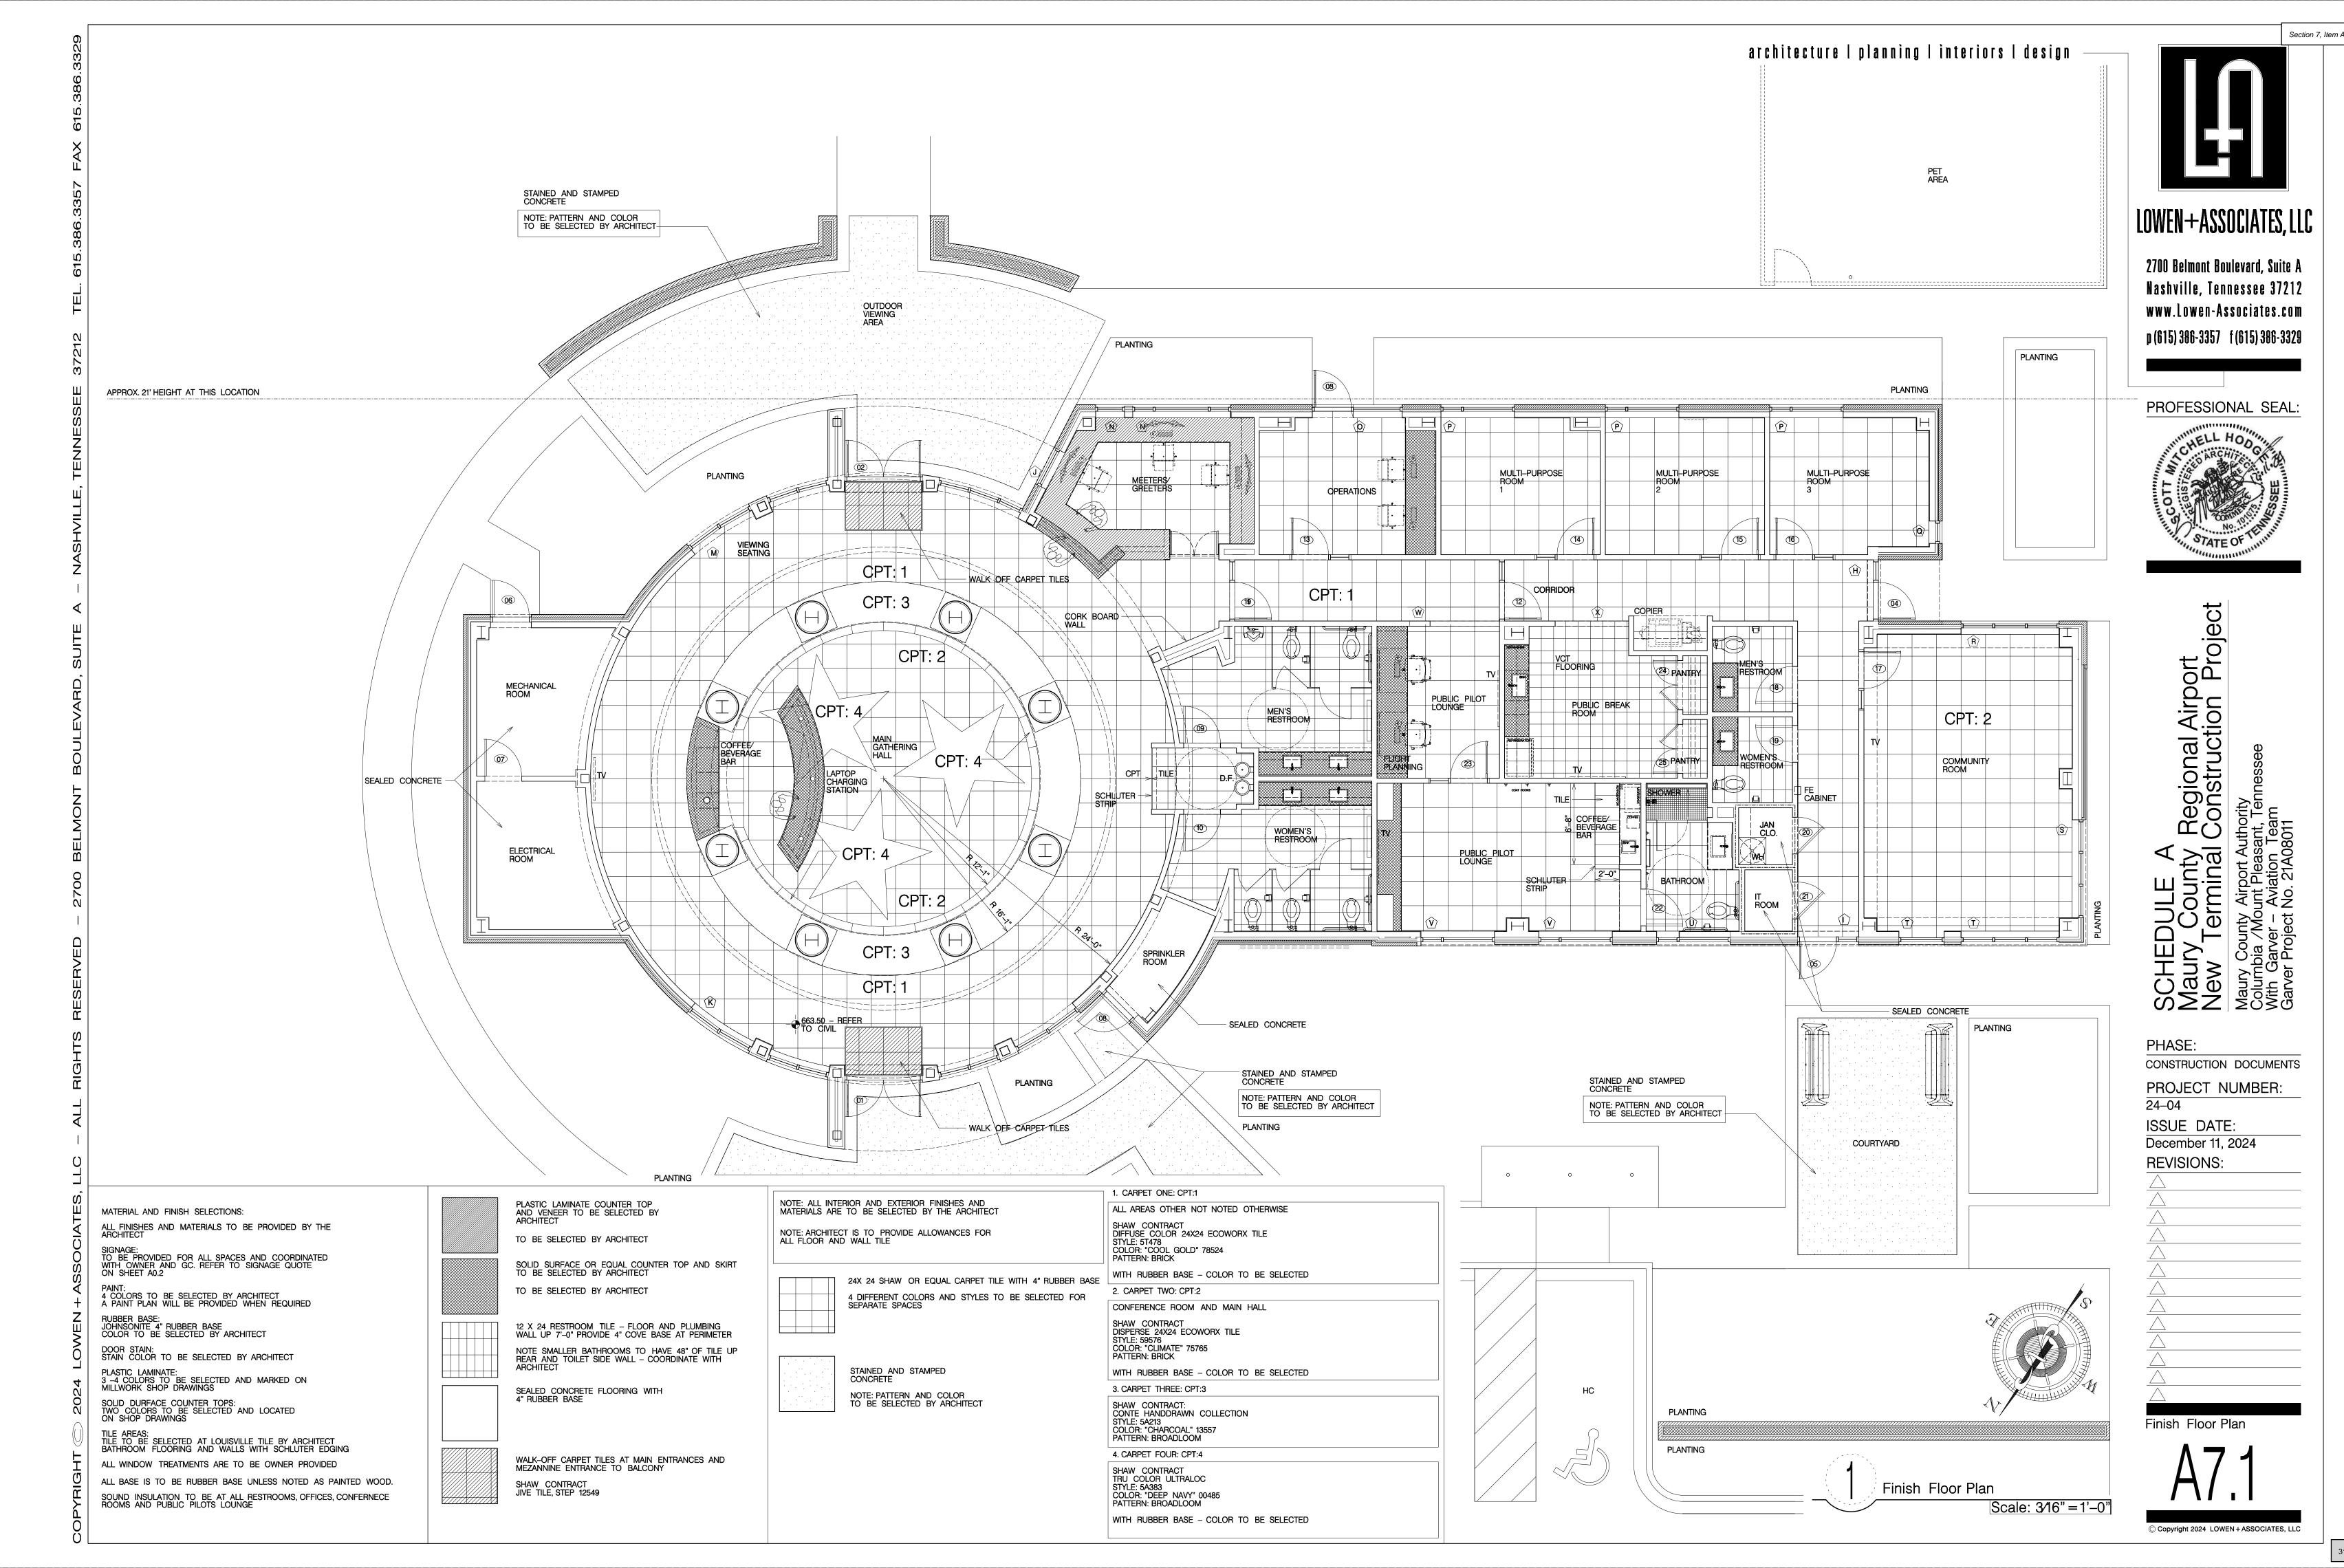



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MAURY COUNTY REGIONAL AIRPORT NEW TERMINAL CONSTRUCTION PROJECT MAURY COUNTY AIRPORT AUTHORITY MAURY COUNTY, TENNESSEE





VICINITY MAP

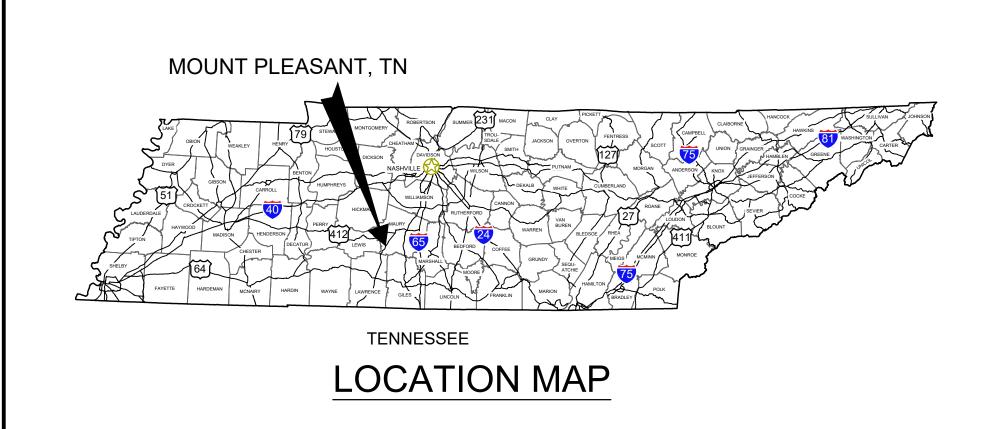GARVER PROJECT NO. 21A08011 DECEMBER 2024

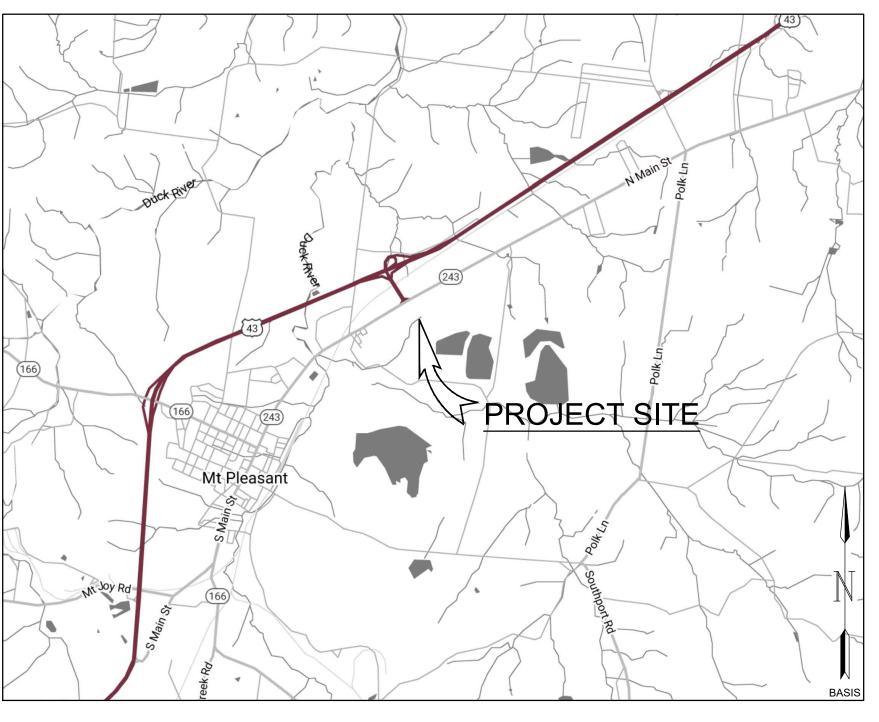

SHEET INDEX				
DRAWING NO.	SHEET NO.	TITLE		
G1-001	1	COVER SHEET		
G1-101	2	SURVEY CONTROL AND PROJECT LAYOUT PLAN		
BL-101	3	GEOTECHNICAL INVESTIGATION PLAN		
GC-001	4	CONSTRUCTION SAFETY AND PHASING PLAN NOTES		
GC-002	5	CONSTRUCTION SAFETY AND PHASING PLAN OVERVIEW		
GC-101	6	CSPP PHASE 1		
GC-102	7	CSPP PHASE 2		
GC-103	8	CSPP PHASE 3		
CV-101	9	EXISTING CONDITIONS PLAN		
CD-101	10	DEMOLITION PLAN		
SP-101	11	OVERALL SITE PLAN		
CP-101	12	PLAN AND PROFILE SHEETS		
CP-200	13	TYPICAL SECTIONS		
MK-101	14	PARKING LOT MARKING PLAN		
MK-200	15	MARKING PLAN DETAILS		
CF-101	16	FENCING PLAN		
CF-200-202	17-19	FENCING DETAILS		
CE-101	20	GRADING, DRAINAGE, AND EROSION CONTROL PLAN		
CE-200	21	GRADING, DRAINAGE, AND EROSION PLAN AND PROFILE SHEET		
CE-201	22	GRADING, DRAINAGE, AND EROSION CONTROL DETAILS		
CU-101	23	CIVIL UTILITIES PLAN		
CU-201	24	CIVIL UTILITIES DETAILS		


ISSUED FOR CONSTRUCTION



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RPORT AUTHORITY
AURY COUNTY, TENNESSEE
AURY COUNTY REGIONAL
RPORT NEW TERMINAL
ONSTRUCTION PROJECT

SCHEDULE B COVER

JOB NO.: 21A08011 DATE: DEC 2024 DESIGNED BY: ZCS DRAWN BY: ADG

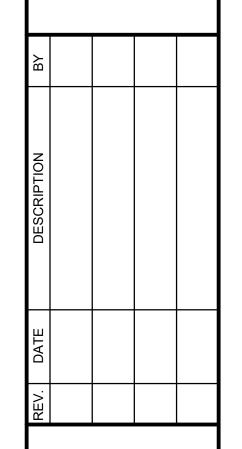BAR IS ONE INCH ON ORIGINAL DRAWING

0 1"

IF NOT ONE INCH ON THIS SHEE'
ADJUST SCALES ACCORDINGLY

GI-001

SHEET NUMBER 1

|garverinc.local\gdata\Projects\2021\21a0


33



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PROPOSED TERMINAL

FUEL FARM

APRON

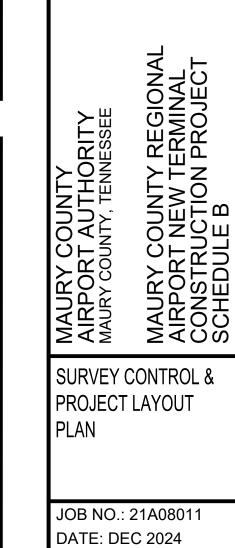VAULT

INSET 1

N. MAIN ST.

3+50 4+00 5+00

HANGAR 7

PROPOSED

VEHICLE GATE

6+Ø0 6+05 **TEMPORARY TRAILER** TEMPORARY TRAILER

0+00

PROPOSED

TERMINAL

PROJECT LAYOUT


JOB NO.: 21A08011 DATE: DEC 2024 **DESIGNED BY: ZCS** DRAWN BY: ADG

BAR IS ONE INCH ON ORIGINAL DRAWING

F NOT ONE INCH ON THIS SHEET ADJUST SCALES ACCORDINGLY DRAWING NUMBER

GI-101

SHEET NUMBER

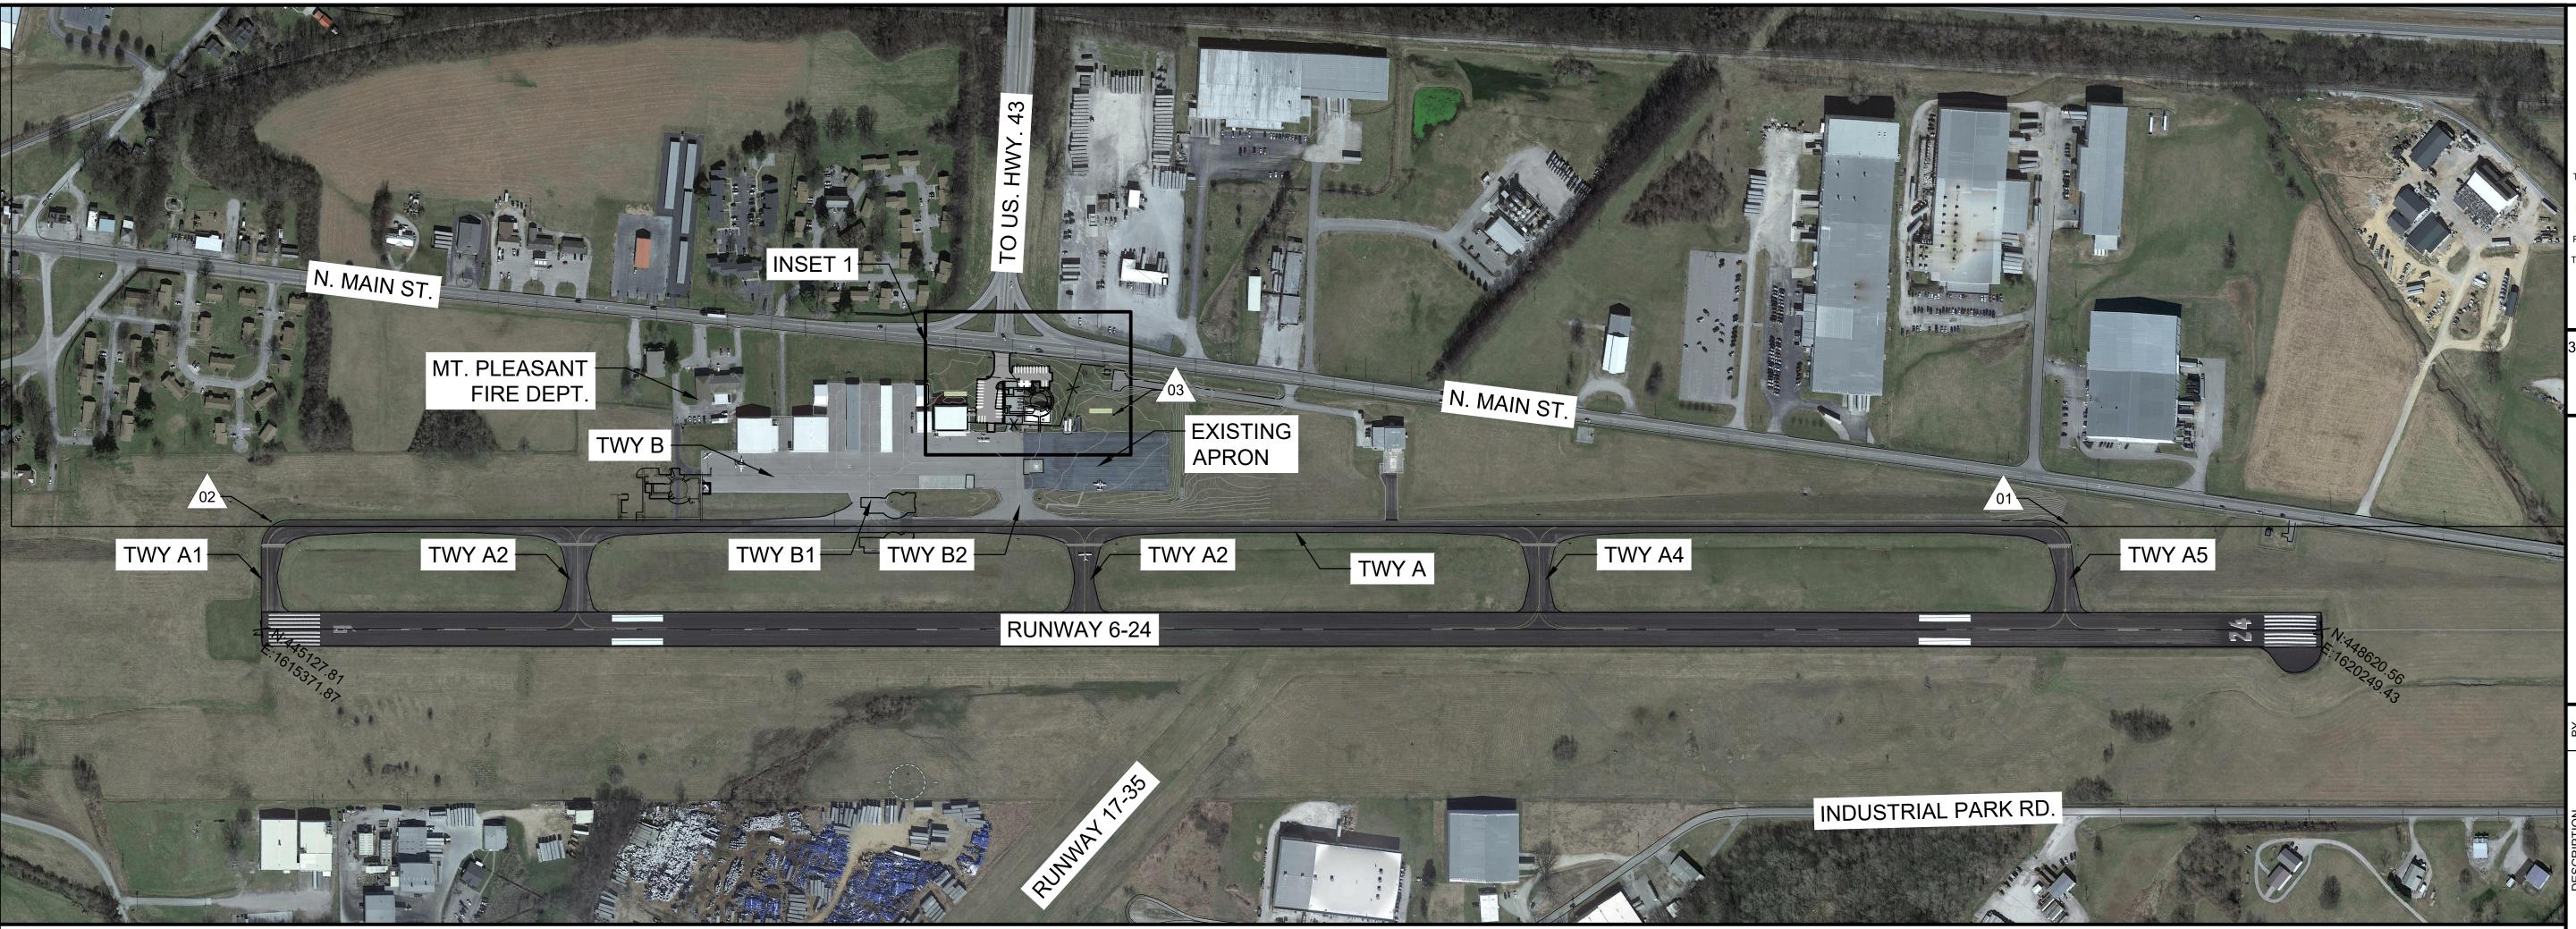

SURVEY CONTROL TABLE

6+05

2+27

1619466.21

1615210.80

1617025.99

ALIGNMENT TABLE

EASTING

1616622.75

1616779.52

1. CONTRACTOR SHALL PROTECT ALL CONTROL POINTS. ANY DAMAGE TO THESE CONTROL

SURVEYOR. FINAL RESULTS OF THE RE-SET MONUMENT SHALL BE SUBMITTED TO THE

BASIS FOR BEARINGS SHOWN HEREON IS THE TN STATE PLANE COORDINATE SYSTEM,

NORTH AMERICAN DATUM OF 1983 (NAD 83) (2002). SURVEY CONDUCTED BY CIA ON

POINTS SHALL BE REPAIRED AT NO COST TO THE OWNER. REPAIRS SHALL BE

2. CONTRACTOR SHALL VERIFY CONTROL POINTS AND NOTIFY ENGINEER OF ANY

MARCH 29, 2022 WITH ADDITIONAL WORK COMPLETED ON DEC. 5, 2023.

COORDINATED WITH THE ENGINEER AND SHALL BE COMPLETED BY A LICENSED

EASTING ELEVATION DESCRIPTION

NORTHING

447080.14

447035.15

673.32

661.66

¹/₂" REBAR WITH CAP

 $\frac{1}{2}$ " REBAR WITH CAP

1/2" REBAR WITH CAP

EASTING


1616835.66

1616907.64

ITEMS OF WORK


- TERMINAL CONSTRUCTION
- TEMPORARY TERMINAL TRAILER INSTALLATION
- **EXISTING TERMINAL BUILDING DEMOLITION**
- UTILITY RELOCATION PER PLANS
- GRADING AND DRAINAGE INSTALLATION
- PARKING AND ENTRANCE DRIVE CONSTRUCTION
- EXISTING PARKING AND ENTRANCE DRIVE DEMOLITION
- FENCE RELOCATION PER PLANS & SPECIFICTIONS
- UTILITY RELOCATION PER PLANS
- GRADING AND DRAINAGE INSTALLATION PER PLANS &
- **SPECIFICATIONS** ENTRANCE DRIVE AND PARKING CONSTRUCTION PER PLANS & **SPECIFICATIONS**
- FENCE AND ENTRANCE GATE CONSTRUCTION
- FENCE RELOCATION PER PLANS & SPECIFICATIONS
- GRADING AND DRAINAGE INSTALLATION PER PLANS & **SPECIFICATIONS**
- UTILITY RELOCATION PER PLANS

LEGEND

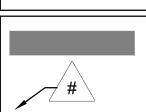

PROPOSED ASPHALT PAVEMENT

SURVEY CONTROL POINT

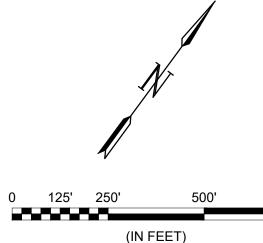

4. THIS SURVEY WAS LIMITED TO A TOPOGRAPHIC SURVEY AND DOES NOT INCLUDE ANY INVESTIGATION OF THE PROPERTY BOUNDARY. 5. NO UNDERGROUND UTILITIES WERE MARKED OR VERIFIED BY UNCOVERING AS A PART OF THIS SURVEY. WHILE NO UTILITIES WERE ABLE TO BE LOCATED IN THE FIELD, EVIDENCE OF UNDERGROUND UTILITIES IN THE SURVEYED AREA DO EXIST. THEREFORE, A TN 811

DISCREPANCIES PRIOR TO BEGINNING CONSTRUCTION.

POINT # NORTHING

446927.46

446867.60

ALIGNMENT BEGINNING NORTHING

STATION

3+50

0+00

ENGINEER FOR APPROVAL.

NOTES:

448439.99

445398.30

447080.74


SHOULD BE COMPLETED PRIOR TO ANY EARTH MOVING WORK OR DISTURBANCES. 6. UTILITIES OTHER THAN THOSE SHOWN MAY EXIST.

7. SURVEY COMPLETED USING GNSS LOCAL RTK METHODS AND ROBOTIC TOTAL STATION SURVEYING WHILE OCCUPYING PREVIOUSLY ESTABLISHED CONTROL POINTS.

REQUEST (IF AVAILABLE) AND A THOROUGH INVESTIGATION OF UNDERGROUND UTILITIES

8. 1-FOOT CONTOUR INTERVAL SHOWN.

BORING#	TOPSOIL (INCHES)	ASPHALT (INCHES)	AGGREGATE BASE (INCHES)	FILL (FEET)	LEAN CLAY (FEET)	FAT CLAY (FEET,
B1	N/A	2	3	2.6	2	3
B2	5	N/A	N/A	7.6		1.9
B3	6	N/A	N/A	2	2.3	
B4	4	N/A	N/A	4	2.7	
B5	5	N/A	N/A	7	1.4	
B6	1	N/A	N/A	4	2.7	
P1	N/A	3	3	2.5		4
P2	N/A	2	4	N/A	2.4	4.9
P3	6	N/A	N/A	5.8		N/A
P4	6	N/A	N/A	2.5	2.9	N/A

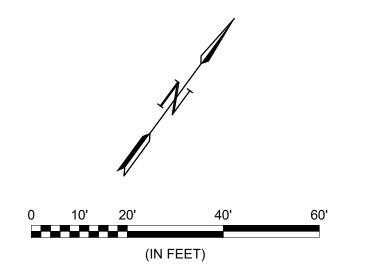



N. MAIN STREET

LEGEND
EXISTING CONCRETE PAVEMEN
EXISTING ASPHALT PAVEMENT
 PROPOSED PARKING LIMITS

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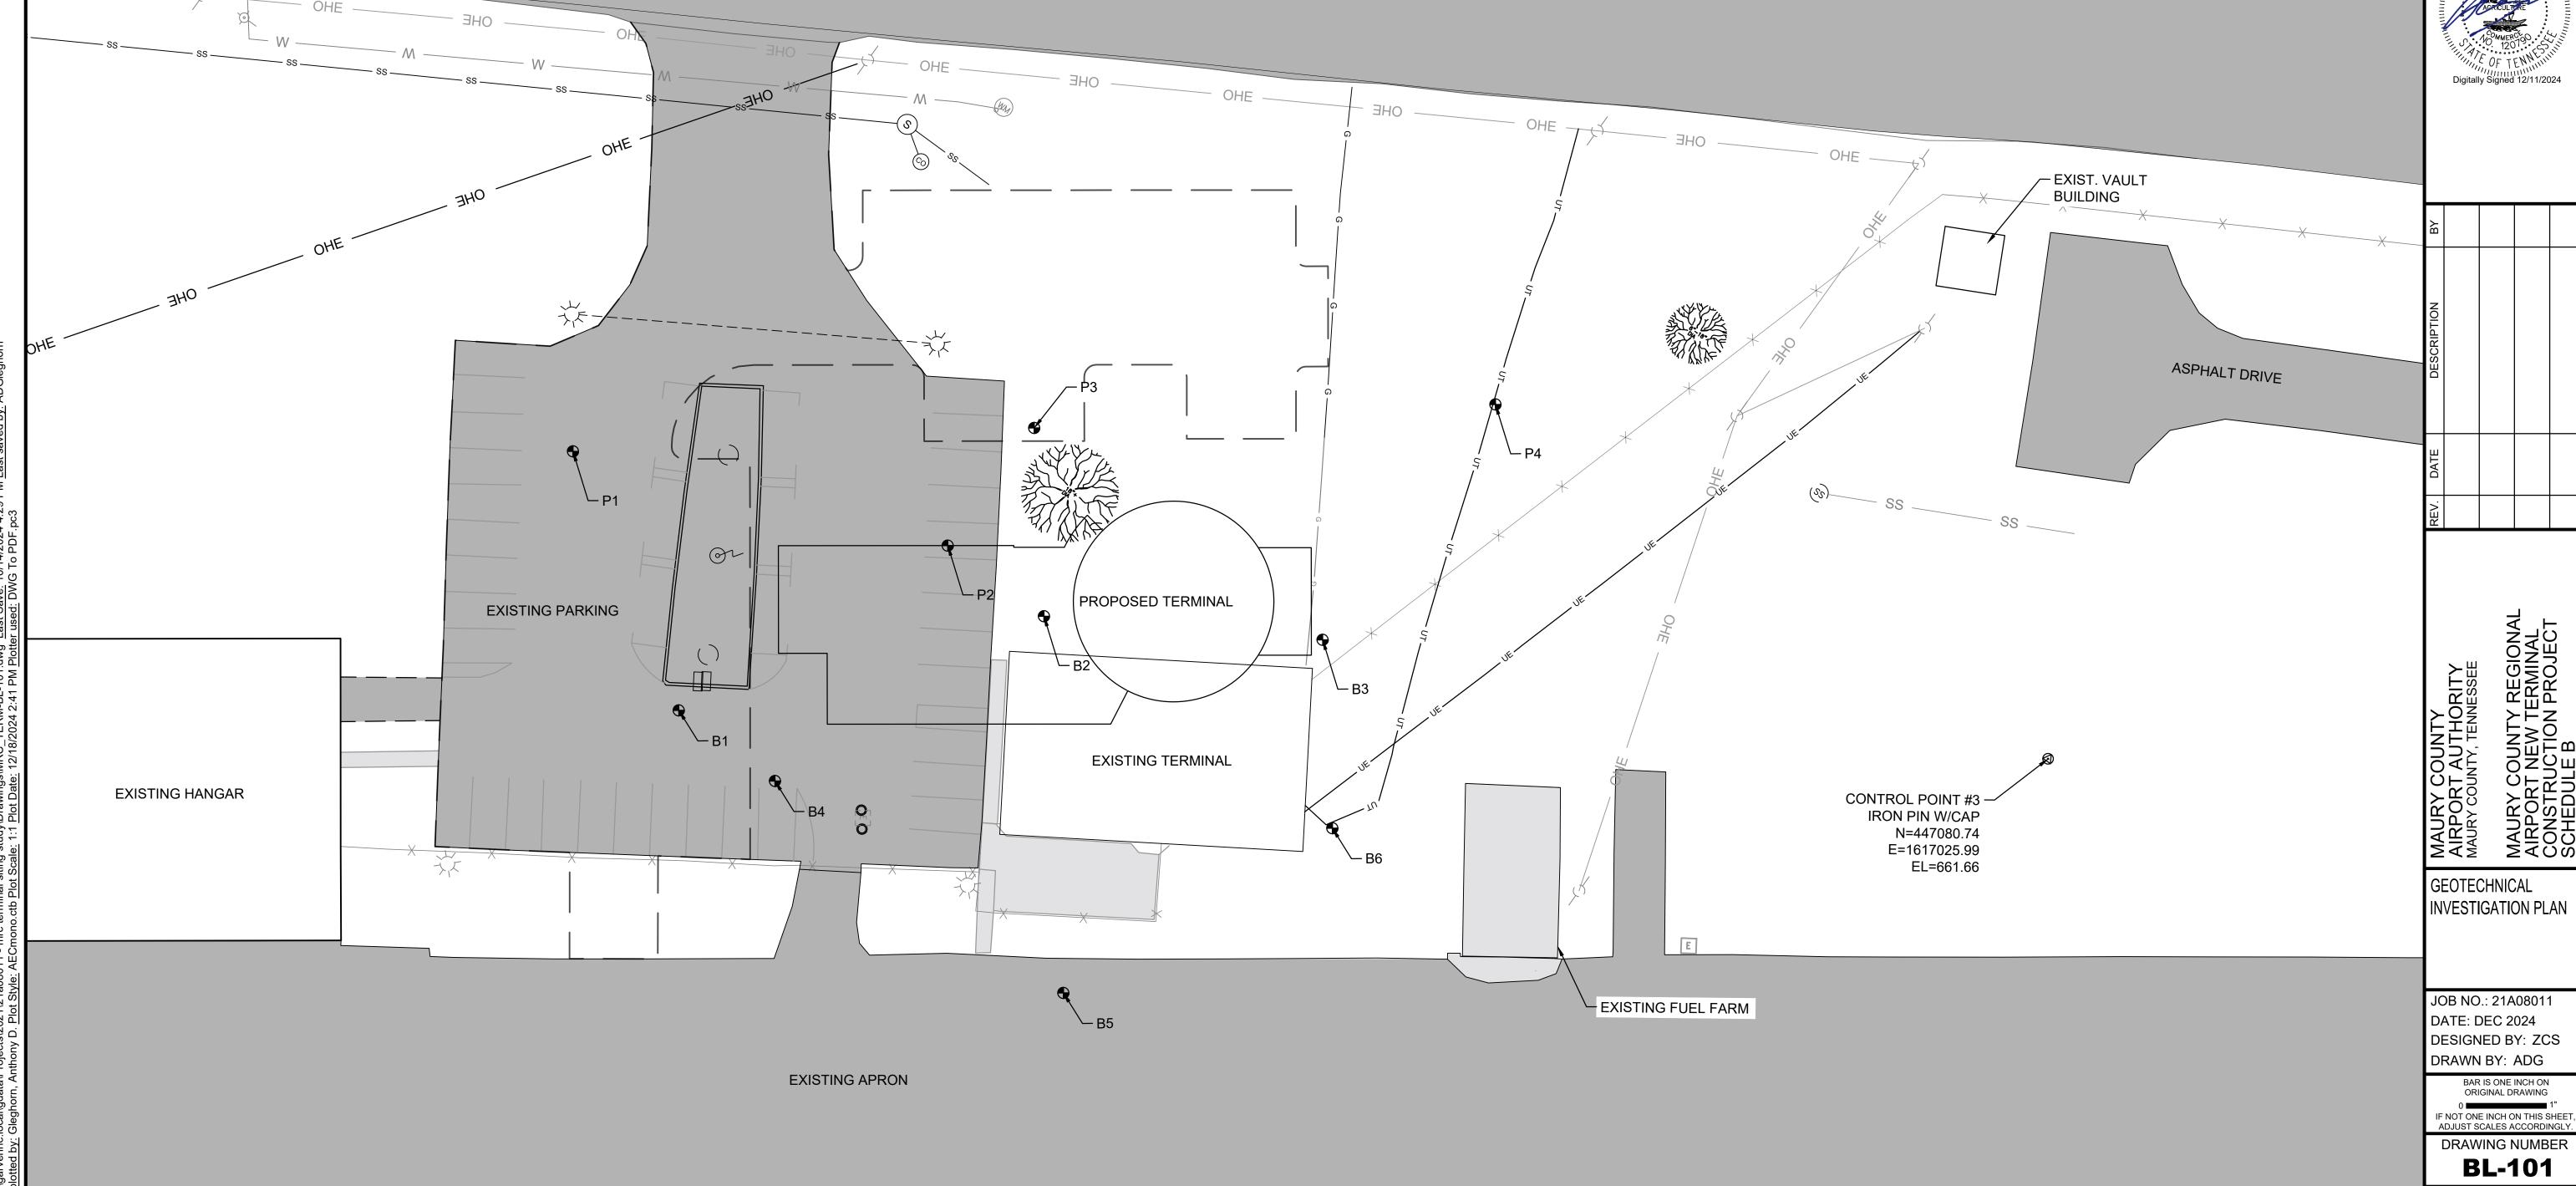
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DATE: DEC 2024 DESIGNED BY: ZCS DRAWN BY: ADG

SHEET NUMBER

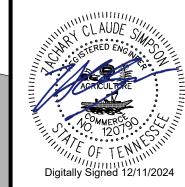

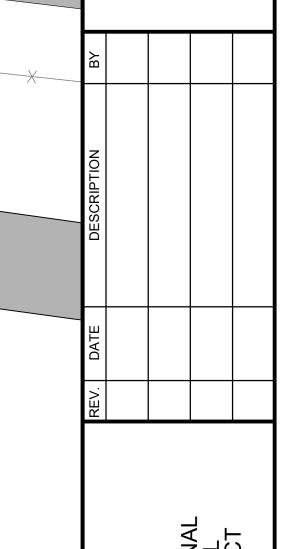- A. CONTRACTOR PROGRESS MEETINGS THE OWNER, ENGINEER AND CONTRACTOR WILL HOLD PROGRESS MEETINGS ON A COORDINATED SCHEDULE DURING CONSTRUCTION. OPERATIONAL SAFETY WILL BE A STANDING AGENDA ITEM IN SUCH MEETINGS.
- B. SCOPE OR SCHEDULE CHANGES THE OWNER AND/OR ENGINEER WILL CALL SUCH COORDINATION CONFERENCES AS MAY SEEM EXPEDIENT TO HIM FOR THE PURPOSE OF ASSURING COORDINATION OF THE WORK COVERED BY THIS CONTRACT AND/OR SCOPE OR SCHEDULE CHANGES. THE CONTRACTOR SHALL ATTEND ALL SUCH CONFERENCES.

2. PHASING

DURING PERFORMANCE OF THIS PROJECT, THE AIRPORT RUNWAYS, TAXIWAYS, AND AIRCRAFT PARKING APRONS SHALL REMAIN IN USE BY AIRCRAFT TO THE MAXIMUM EXTENT POSSIBLE. THE PROJECT SHALL BE PHASED TO REDUCE OPERATIONAL IMPACTS AT THE AIRPORT.

- A. PHASE ELEMENTS IF NECESSARY FOR A GIVEN PHASE, EACH PHASE OF THE CONSTRUCTION SAFETY DRAWINGS SHALL DETAIL THE AREAS CLOSED TO AIRCRAFT OPERATIONS, ESTIMATED DURATION OF CLOSURES, TAXI ROUTES, ARFF ACCESS ROUTES, CONSTRUCTION STAGING AREAS, CONSTRUCTION ACCESS AND HAUL ROUTES, NAVAID IMPACTS, LIGHTING AND MARKING CHANGES, AVAILABLE RUNWAY LENGTH, DECLARED DISTANCES, HAZARD MARKING AND LIGHTING, AND REQUIRED LEAD TIME FOR NOTAMS.
- B. CONSTRUCTION SAFETY DRAWINGS SEE SHEET GC-101 THROUGH GC-103 FOR CONSTRUCTION SAFETY DRAWINGS.
- 3. AREAS OF OPERATIONS AFFECTED BY CONSTRUCTION ACTIVITY
 - A. IDENTIFICATION OF AFFECTED AREAS SEE "AIRFIELD AREAS OF OPERATION AFFECTED BY CONSTRUCTION" TABLE AND CONSTRUCTION SAFETY DRAWINGS FOR AIRFIELD AREAS OF OPERATIONS AFFECTED BY CONSTRUCTION.

4. CONTRACTOR ACCESS

- A. NO CONSTRUCTION EQUIPMENT OR PERSONNEL SHALL BE PERMITTED ON ACTIVE AIRFIELD PAVEMENTS AT ANY TIME.
- B. ALL MATERIAL DELIVERIES SHALL BE RECEIVED IN THE STAGING AREA RESERVED BY THE CONTRACTOR. NO DELIVERY TRUCKS WILL BE ALLOWED ACCESS TO A SECURED AREA OF THE AIRPORT BEYOND THIS STAGING AREA. ALL CONSTRUCTION VEHICLES SHALL BE CLEARLY IDENTIFIED FOR CONTROL PURPOSES BY PROMINENTLY DISPLAYING THE COMPANY NAME ON EACH SIDE OF THE VEHICLE.
- C. VEHICLE AND PEDESTRIAN OPERATIONS SEE THE CONSTRUCTION SAFETY DRAWINGS FOR CONSTRUCTION SITE PARKING, EQUIPMENT STORAGE AREAS, AND ACCESS AND HAUL ROUTES. VEHICULAR TRAFFIC SHALL ALWAYS YIELD TO AIRCRAFT TRAFFIC.

WHEN ANY VEHICLE, OTHER THAN ONE THAT HAS PRIOR APPROVAL FROM THE AIRPORT OPERATOR, MUST TRAVEL OVER ANY PORTION OF AN AIRCRAFT MOVEMENT AREA, IT WILL BE ESCORTED AND PROPERLY IDENTIFIED. TO OPERATE IN THOSE AREAS DURING DAYLIGHT HOURS, THE VEHICLE MUST HAVE A FLAG OR BEACON ATTACHED TO IT. ANY VEHICLE OPERATING ON THE MOVEMENT AREAS DURING HOURS OF DARKNESS OR REDUCED VISIBILITY MUST BE EQUIPPED WITH A FLASHING DOME-TYPE LIGHT, THE COLOR OF WHICH IS IN ACCORDANCE WITH LOCAL OR STATE CODES.

D. CONTROL OF GATES - THE CONTRACTOR SHALL BE RESPONSIBLE FOR MAINTAINING THE SECURITY OF THE ACCESS GATES BY KEEPING THE ACCESS GATE LOCKED OR GUARDED AT ALL TIMES.

6. WILDLIFE MANAGEMENT

IF APPLICABLE, THE CONTRACTOR SHALL REVIEW AND ADHERE TO THE CONTENTS OF THE AIRPORT OPERATOR'S WILDLIFE HAZARD MANAGEMENT PLAN. THE CONTRACTOR SHALL ALSO REVIEW AC 150/5200-33, HAZARDOUS WILDLIFE ATTRACTANTS ON OR NEAR AIRPORTS, AND CERTALERT 98-05, GRASSES ATTRACTIVE TO HAZARDOUS WILDLIFE (www.faa.gov). THE CONTRACTOR SHALL CAREFULLY CONTROL AND CONTINUOUSLY REMOVE WASTE OR LOOSE MATERIALS THAT MIGHT ATTRACT WILDLIFE. CONTRACTOR PERSONNEL MUST BE AWARE OF AND AVOID CONSTRUCTION ACTIVITIES THAT CAN CREATE WILDLIFE HAZARDS ON AIRPORTS. THE CONTRACTOR SHALL MITIGATE THE FOLLOWING ITEMS.

- A. TRASH THE CONTRACTOR SHALL PERFORM TRASH CLEAN-UP ON A DAILY BASIS
- B. STANDING WATER THE CONTRACTOR SHALL PROVIDE TEMPORARY DRAINAGE DURING CONSTRUCTION TO AVOID STANDING WATER.
- C. TALL GRASS AND SEEDS THE CONTRACTOR SHALL ADHERE TO THE REQUIREMENTS OF SECTION T-901, SEEDING OF THE CONTRACT DOCUMENTS AND SPECIFICATIONS.
- D. POORLY MAINTAINED FENCING AND GATES THE CONTRACTOR SHALL IMMEDIATELY REPORT ANY DAMAGE TO GATES OR FENCES. THE CONTRACTOR WILL BE RESPONSIBLE FOR REPAIRS TO ANY GATES OR FENCES CAUSED BY NEGLIGENCE BY THE CONTRACTOR.

931-379-5511

256-684-1936

931-379-3233

931-379-7717

E. DISRUPTION OF EXISTING WILDLIFE HABITAT - THE CONTRACTOR SHALL NOTIFY THE AIRPORT IMMEDIATELY OF ANY WILDLIFE SIGHTINGS.

24 HOUR EMERGENCY CONTACT INFORMATION

MT. PLEASANT POWER, GAS, WATER, AND SEWER

MAURY COUNTY REGIONAL AIRPORT

GARVER PROJECT MANAGER

MT. PLEASANT POWER

7. FOREIGN OBJECT DEBRIS (FOD) MANAGEMENT

PAUL TURNER

ZAC SIMPSON

WATER/GAS/SEWER

ELECTRIC

THE CONTRACTOR SHALL ENSURE THAT THE PAVEMENT SURFACES ARE KEPT CLEAN FROM DIRT, MUD, AND OTHER DEBRIS FROM THE CONTRACTOR'S EQUIPMENT. FREQUENT CLEAN UP IN THE VICINITY OF CONTRACTOR'S WORK AREAS IS REQUIRED. SEE AC 150/5210-24, FOREIGN OBJECT DEBRIS (FOD) MANAGEMENT (www.faa.gov) FOR FURTHER INSTRUCTION.

8. HAZARDOUS MATERIALS (HAZMAT) MANAGEMENT

IF ANY CONSTRUCTION VEHICLE OR EQUIPMENT IS OPERATED WITHIN AIRPORT PROPERTY, THE CONTRACTOR MUST BE ADEQUATELY PREPARED TO EXPEDITIOUSLY CONTAIN AND CLEAN-UP SPILLS RESULTING FROM FUEL OR HYDRAULIC FLUID LEAKS. SPECIAL CARE MUST ALSO BE TAKEN WHEN HANDLING OR TRANSPORTING HAZARDOUS MATERIALS ON AIRPORT PROPERTY. SEE AC 150/5320-15, MANAGEMENT OF AIRPORT INDUSTRIAL WASTE (www.faa.gov), FOR FURTHER INSTRUCTION.

9. NOTIFICATION OF CONSTRUCTION ACTIVITIES

- A. LIST OF RESPONSIBLE REPRESENTATIVES A POINT OF CONTACT LIST WILL BE COMPLETED AS PART OF THE SAFETY PLAN COMPLIANCE DOCUMENT (SPCD) AND WILL BE DELIVERED TO ALL PARTIES PRIOR TO CONSTRUCTION.
- B. NOTICES TO AIR MISSIONS (NOTAM) BEFORE BEGINNING ANY CONSTRUCTION ACTIVITY, THE CONTRACTOR MUST, THROUGH THE AIRPORT OPERATOR, GIVE NOTICE USING THE NOTAM SYSTEM OF PROPOSED LOCATION, TIME, AND DATE OF COMMENCEMENT OF CONSTRUCTION. UPON COMPLETION OF WORK AND RETURN OF ALL SUCH AREAS TO STANDARD CONDITIONS, THE CONTRACTOR MUST, THROUGH THE AIRPORT OPERATOR, VERIFY THE CANCELLATION OF ALL NOTICES ISSUED VIA THE NOTAM SYSTEM.
- C. EMERGENCY NOTIFICATION PROCEDURES IN THE EVENT OF AN EMERGENCY, THE CONTRACTOR SHALL CALL 911, THEN NOTIFY THE ENGINEER AND AIRPORT MANAGER.
- D. COORDINATION WITH ARFF PERSONNEL ANY DEACTIVATION OF WATER LINES OR HYDRANTS, REROUTING OF ACCESS ROUTES, OR USE OF HAZARDOUS MATERIALS ON THE AIRFIELD SHALL BE COORDINATED AND APPROVED BY THE AIRPORT'S ARFF PERSONNEL PRIOR TO EXECUTION OF SUCH ACTIVITIES.
- E. NOTIFICATION TO THE FAA THE CONTRACTOR SHALL ENSURE, THROUGH THE ENGINEER, THAT ALL CONSTRUCTION EQUIPMENT OVER XX FT IN HEIGHT IS AIR SPACED THROUGH THE APPROPRIATE FAA REGIONAL OR DISTRICT OFFICE PRIOR TO USING SUCH EQUIPMENT ON SITE.

10. INSPECTION REQUIREMENTS

- A. DAILY INSPECTIONS THE CONTRACTOR SHALL PERFORM DAILY SAFETY INSPECTIONS TO VERIFY ALL CONSTRUCTION OPERATIONS ARE IN CONFORMANCE WITH THE CONSTRUCTION SAFETY AND PHASING PLAN (CSPP).
- B. INTERIM INSPECTIONS PRIOR TO OPENING ANY PORTION OF THE AIRPORT TO TRAFFIC, THE CONTRACTOR, ENGINEER, AND AIRPORT OPERATOR SHALL PERFORM A SAFETY INSPECTION OF THE AREA TO BE OPENED TO TRAFFIC TO VERIFY CONFORMANCE WITH THE CSPP AND FAA STANDARDS.
- C. FINAL INSPECTIONS PRIOR TO OPENING ANY PORTION OF THE AIRPORT TO TRAFFIC, THE CONTRACTOR, ENGINEER, AND AIRPORT OPERATOR SHALL PERFORM A SAFETY INSPECTION OF THE AREA TO BE OPENED TO TRAFFIC TO VERIFY CONFORMANCE WITH THE CSPP AND FAA STANDARDS.

11. UNDERGROUND UTILITIES

UNDERGROUND UTILITIES EXIST WITHIN AND ADJACENT TO THE LIMITS OF CONSTRUCTION. AN ATTEMPT HAS BEEN MADE TO LOCATE THESE UTILITIES ON THE PLANS. HOWEVER, ALL EXISTING UTILITIES MAY NOT BE SHOWN AND THE ACTUAL LOCATIONS OF THE UTILITIES MAY VARY FROM THE LOCATIONS SHOWN.

PRIOR TO BEGINNING ANY TYPE OF EXCAVATION, THE CONTRACTOR SHALL CONTACT THE UTILITIES INVOLVED AND MAKE ARRANGEMENTS FOR THE LOCATION OF THE UTILITIES ON THE GROUND. THE CONTRACTOR SHALL MAINTAIN THE UTILITY LOCATION MARKINGS UNTIL THEY ARE NO LONGER NECESSARY.

TENNESSEE STATE LAW, THE UNDERGROUND FACILITIES DAMAGE PREVENTION ACT, REQUIRES TWO WORKING DAYS ADVANCE NOTIFICATION THROUGH THE ONE-CALL SYSTEM CENTER BEFORE EXCAVATING USING MECHANIZED EQUIPMENT OR EXPLOSIVES (EXCEPT IN THE CASE OF AN EMERGENCY). THE ONE-CALL SYSTEM PHONE NUMBER IS 1-800-351-1111. THE CONTRACTOR IS ADVISED THAT THERE IS A SEVERE PENALTY FOR NOT MAKING THIS CALL. NOT ALL UTILITY COMPANIES ARE MEMBERS OF THE TENNESSEE ONE-CALL SYSTEM; THEREFORE, THE CONTRACTOR IS ADVISED TO CONTACT ALL NON-MEMBER UTILITIES AS WELL AS THE ONE-CALL SYSTEM.

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REV. DATE DESCRIPTION BY

AIRPORT AUTHORITY
MAURY COUNTY, TENNESSEE
MAURY COUNTY REGION
AIRPORT NEW TERMINAL
CONSTRUCTION PROJEC

CONSTRUCTION
SAFETY AND PHASING
NOTES

JOB NO.: 21A08011 DATE: DEC 2024 DESIGNED BY: ZCS DRAWN BY: ADG

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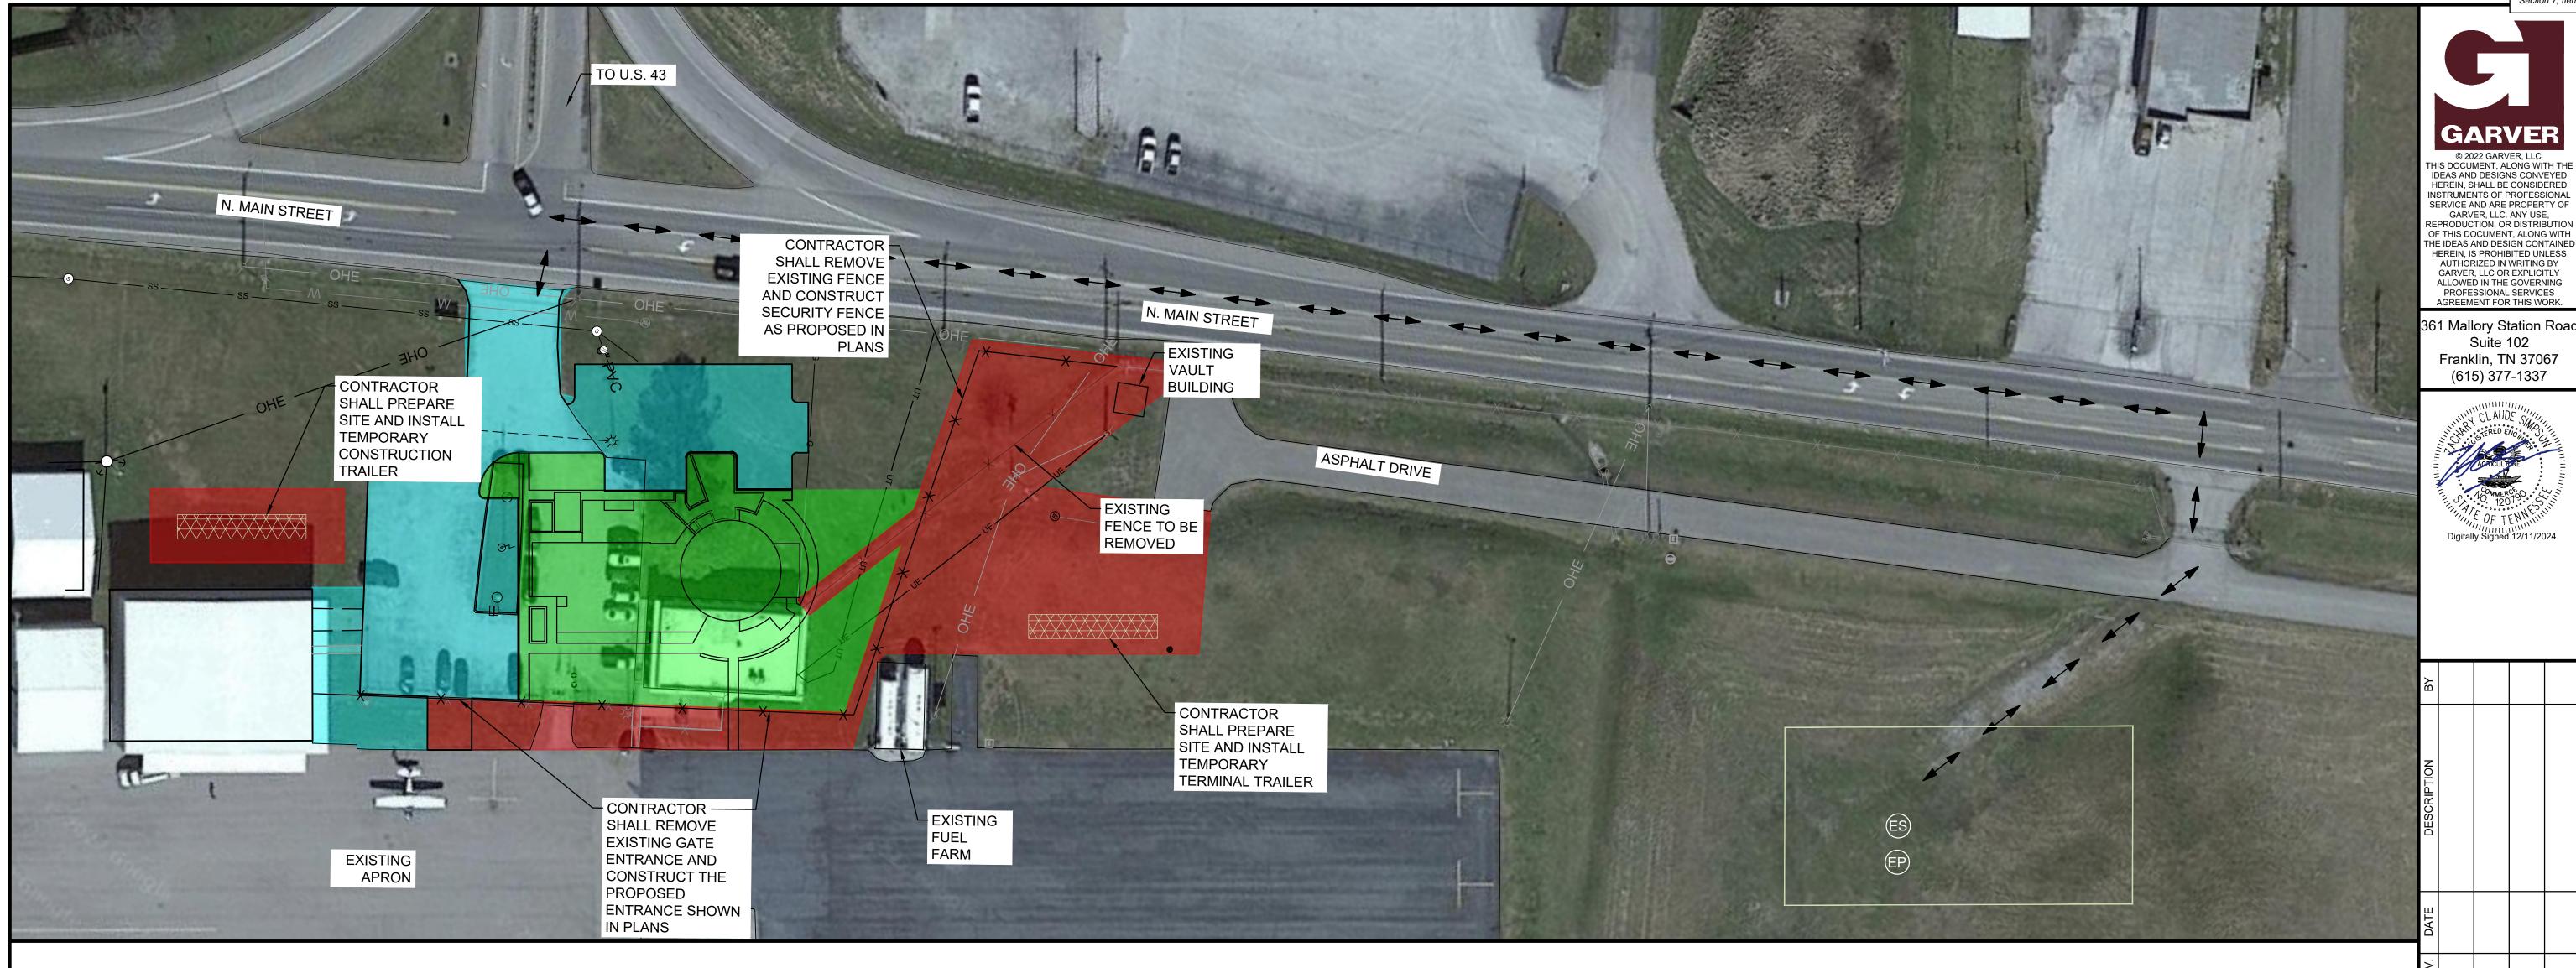
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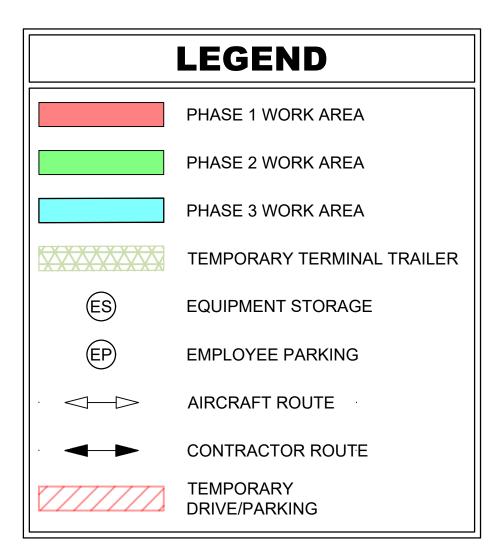
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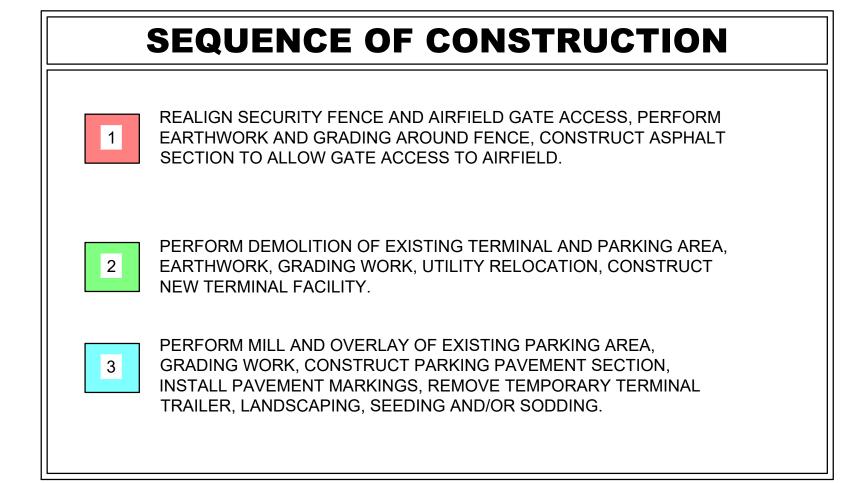
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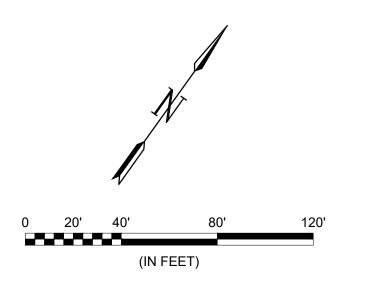


IT IS THE CONTRACTORS RESPONSIBILITY TO CONTACT UTILITY COMPANIES PRIOR TO ANY CONSTRUCTION. THE LOCATION OF UTILITIES SHOWN ON THESE PLANS ARE APPROXIMATE AND POSSIBLY INCOMPLETE. THEREFORE CERTIFICATION TO THE LOCATION OF ALL UNDERGROUND UTILITIES IS WITHHELD.









- 1. SEE CONSTRUCTION SAFETY AND PHASING NOTES FOR ADDITIONAL DETAILS.
- 2. CONTRACTOR SHALL HAVE AN APPROVED PAVEMENT BROOM OR VACUUM TRUCK AVAILABLE ON SITE AT ALL
- 3. THE CONTRACTOR WILL BE RESPONSIBLE FOR PROVIDING SUFFICIENT LIGHTING TO ADEQUATELY ILLUMINATE THE WORK AREA DURING NIGHTTIME OPERATIONS. PORTABLE LIGHTING SHALL NOT BE ORIENTED IN SUCH A WAY TO CAUSE IMPACT TO AIRPORT OPERATIONS.
- 4. IN NO EVENT SHALL CONSTRUCTION VEHICLES, EQUIPMENT, OR MATERIALS BE PARKED/STORED WITHIN 50' OF BARRICADES OR ACTIVE AIRFIELD PAVEMENT.
- 5. PERIMETER FENCE SHALL BE MAINTAINED AT ALL TIMES. TEMPORARY FENCING SHALL BE INSTALLED AS NECESSARY. METHODS FOR TEMPORARY FENCING SHALL BE APPROVED BY THE ENGINEER. TEMPORARY FENCING SHALL BE CONSIDERED SUBSIDIARY TO CONSTRUCTION SAFETY AND SECURITY.
- 6. PHASING PLAN MAY BE ALTERED TO FACILITATE CONSTRUCTION BASED UPON COORDINATION BETWEEN CONTRACTOR AND ENGINEER. CONTRACTOR MUST NOTIFY ENGINEER AND GAIN APPROVAL PRIOR TO ANY PHASING ALTERATIONS.
- 7. CONTRACTOR SHALL MAINTAIN THAT GATES ARE GUARDED OR LOCKED AT ALL TIMES THROUGHOUT CONSTRUCTION.

MAURY COUNTY REGIONAL AIRPORT NEW TERMINAL CONSTRUCTION PROJECT SCHEDULE B OUNTY AUTHORITY NTY, TENNESSEE

CONSTRUCTION SAFETY AND PHASING OVERVIEW

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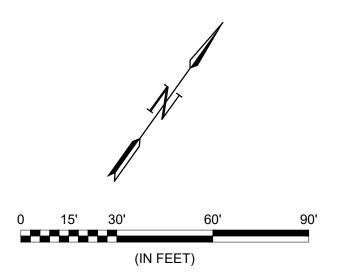
PHASE 1 WORK AREA EXISTING PERIMETER FENCE PROPOSED PERIMETER FENCE TEMPORARY TERMINAL OR CONSTRUCTION TRAILER TEMPORARY TERMINAL VEHICLE ACCESS TEMPORARY DRIVE/PARKING ES EQUIPMENT STORAGE EP EMPLOYEE PARKING

CONTRACTOR ROUTE

SEQUENCE OF CONSTRUCTION

1

- CONTRACTOR SHALL INSTALL REQUIRED EROSION CONTROL MEASURES.
- CONTRACTOR SHALL PERFORM ALL EARTHWORK AND GRADING REQUIRED FOR DITCH CONSTRUCTION AND FENCE REALIGNMENT.
- CONTRACTOR SHALL REALIGN SECURITY FENCE AND AIRFIELD GATE ACCESS.
- CONTRACTOR SHALL CONSTRUCT ASPHALT SECTION TO ALLOW GATE ACCESS TO AIRFIELD.
- CONTRACTOR SHALL CONSTRUCT TEMPORARY DRIVE/PARKING ADDITION TO ENABLE PARKING AND AIRFIELD ACCESS.
- CONTRACTOR SHALL CONNECT TEMPORARY POWER FOR VEHICLE GATE ACCESS.
- CONTRACTOR SHALL CONNECT TEMPORARY POWER FOR FUEL TANKS.
- CONTRACTOR SHALL PREPARE SITE AND INSTALL TEMPORARY TRAILER TERMINAL BUILDING.
- CONTRACTOR SHALL PREPARE SITE AND INSTALL TEMPORARY CONSTRUCTION TRAILER.



- 1. SEE CONSTRUCTION SAFETY AND PHASING NOTES FOR ADDITIONAL DETAILS.
- THE CONTRACTOR WILL BE RESPONSIBLE FOR PROVIDING SUFFICIENT LIGHTING TO ADEQUATELY ILLUMINATE THE WORK AREA DURING NIGHTTIME OPERATIONS. PORTABLE LIGHTING SHALL NOT BE ORIENTED IN SUCH A WAY TO CAUSE IMPACT TO AIRPORT OPERATIONS.
- 3. IN NO EVENT SHALL CONSTRUCTION VEHICLES, EQUIPMENT, OR MATERIALS BE PARKED/STORED WITHIN 50' OF BARRICADES OR ACTIVE AIRFIELD PAVEMENT.
- 4. PERIMETER FENCE SHALL BE MAINTAINED AT ALL TIMES. TEMPORARY FENCING SHALL BE INSTALLED AS NECESSARY. METHODS FOR TEMPORARY FENCING SHALL BE APPROVED BY THE ENGINEER. TEMPORARY FENCING SHALL BE CONSIDERED SUBSIDIARY TO CONSTRUCTION SAFETY AND SECURITY.
- 5. CONTRACTOR SHALL MAINTAIN THAT GATES ARE GUARDED OR LOCKED AT ALL TIMES THROUGHOUT CONSTRUCTION.

MAURY COUNTY
AIRPORT AUTHORITY
AIRPORT AUTHORITY
MAURY COUNTY REGIONAL
AIRPORT NEW TERMINAL
CONSTRUCTION PROJECT
SCHEDULE B

CSPP PHASE 1


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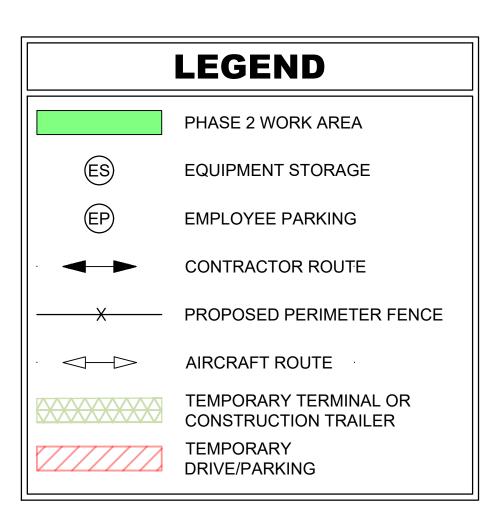
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SEQUENCE OF CONSTRUCTION

- CONTRACTOR SHALL DEMOLISH EXISTING TERMINAL BUILDING AND PARKING AREA WITHIN PHASE LIMITS
- CONTRACTOR SHALL PERFORM ALL ASSOCIATED EARTHWORK, GRADING WORK, AND UTILITY RELOCATION,
- CONTRACTOR SHALL CONSTRUCT NEW TERMINAL FACILITY, INCLUDING ALL ASSOCIATED UTILITY CONNECTIONS, BUILDING DRAINAGE, PLUMBING, ELECTRICAL, AND GAS
- CONTRACTOR SHALL COMPLETE ANY REQUIRED TEMPORARY SEEDING

- 1. SEE CONSTRUCTION SAFETY AND PHASING NOTES FOR ADDITIONAL DETAILS.
- 2. CONTRACTOR SHALL HAVE AN APPROVED PAVEMENT BROOM OR VACUUM TRUCK AVAILABLE ON SITE AT ALL TIMES. HYDRANTS TO FILL VACUUM TRUCK WILL BE AVAILABLE ON AIRPORT PROPERTY.
- 3. THE CONTRACTOR WILL BE RESPONSIBLE FOR PROVIDING SUFFICIENT LIGHTING TO ADEQUATELY ILLUMINATE THE WORK AREA DURING NIGHTTIME OPERATIONS. PORTABLE LIGHTING SHALL NOT BE ORIENTED IN SUCH A WAY TO CAUSE IMPACT TO AIRPORT OPERATIONS.
- 4. IN NO EVENT SHALL CONSTRUCTION VEHICLES, EQUIPMENT, OR MATERIALS BE PARKED/STORED WITHIN 50' OF BARRICADES OR ACTIVE AIRFIELD PAVEMENT.
- 5. PERIMETER FENCE SHALL BE MAINTAINED AT ALL TIMES. TEMPORARY FENCING SHALL BE INSTALLED AS NECESSARY. METHODS FOR TEMPORARY FENCING SHALL BE APPROVED BY THE ENGINEER. TEMPORARY FENCING SHALL BE CONSIDERED SUBSIDIARY TO CONSTRUCTION SAFETY AND SECURITY.
- 6. CONTRACTOR SHALL MAINTAIN THAT GATES ARE GUARDED OR LOCKED AT ALL TIMES THROUGHOUT CONSTRUCTION.

MAURY COUNTY REGIONAL AIRPORT NEW TERMINAL CONSTRUCTION PROJECT SCHEDULE B MAURY COUNTY AIRPORT AUTHORITY MAURY COUNTY, TENNESSEE

CSPP PHASE 2
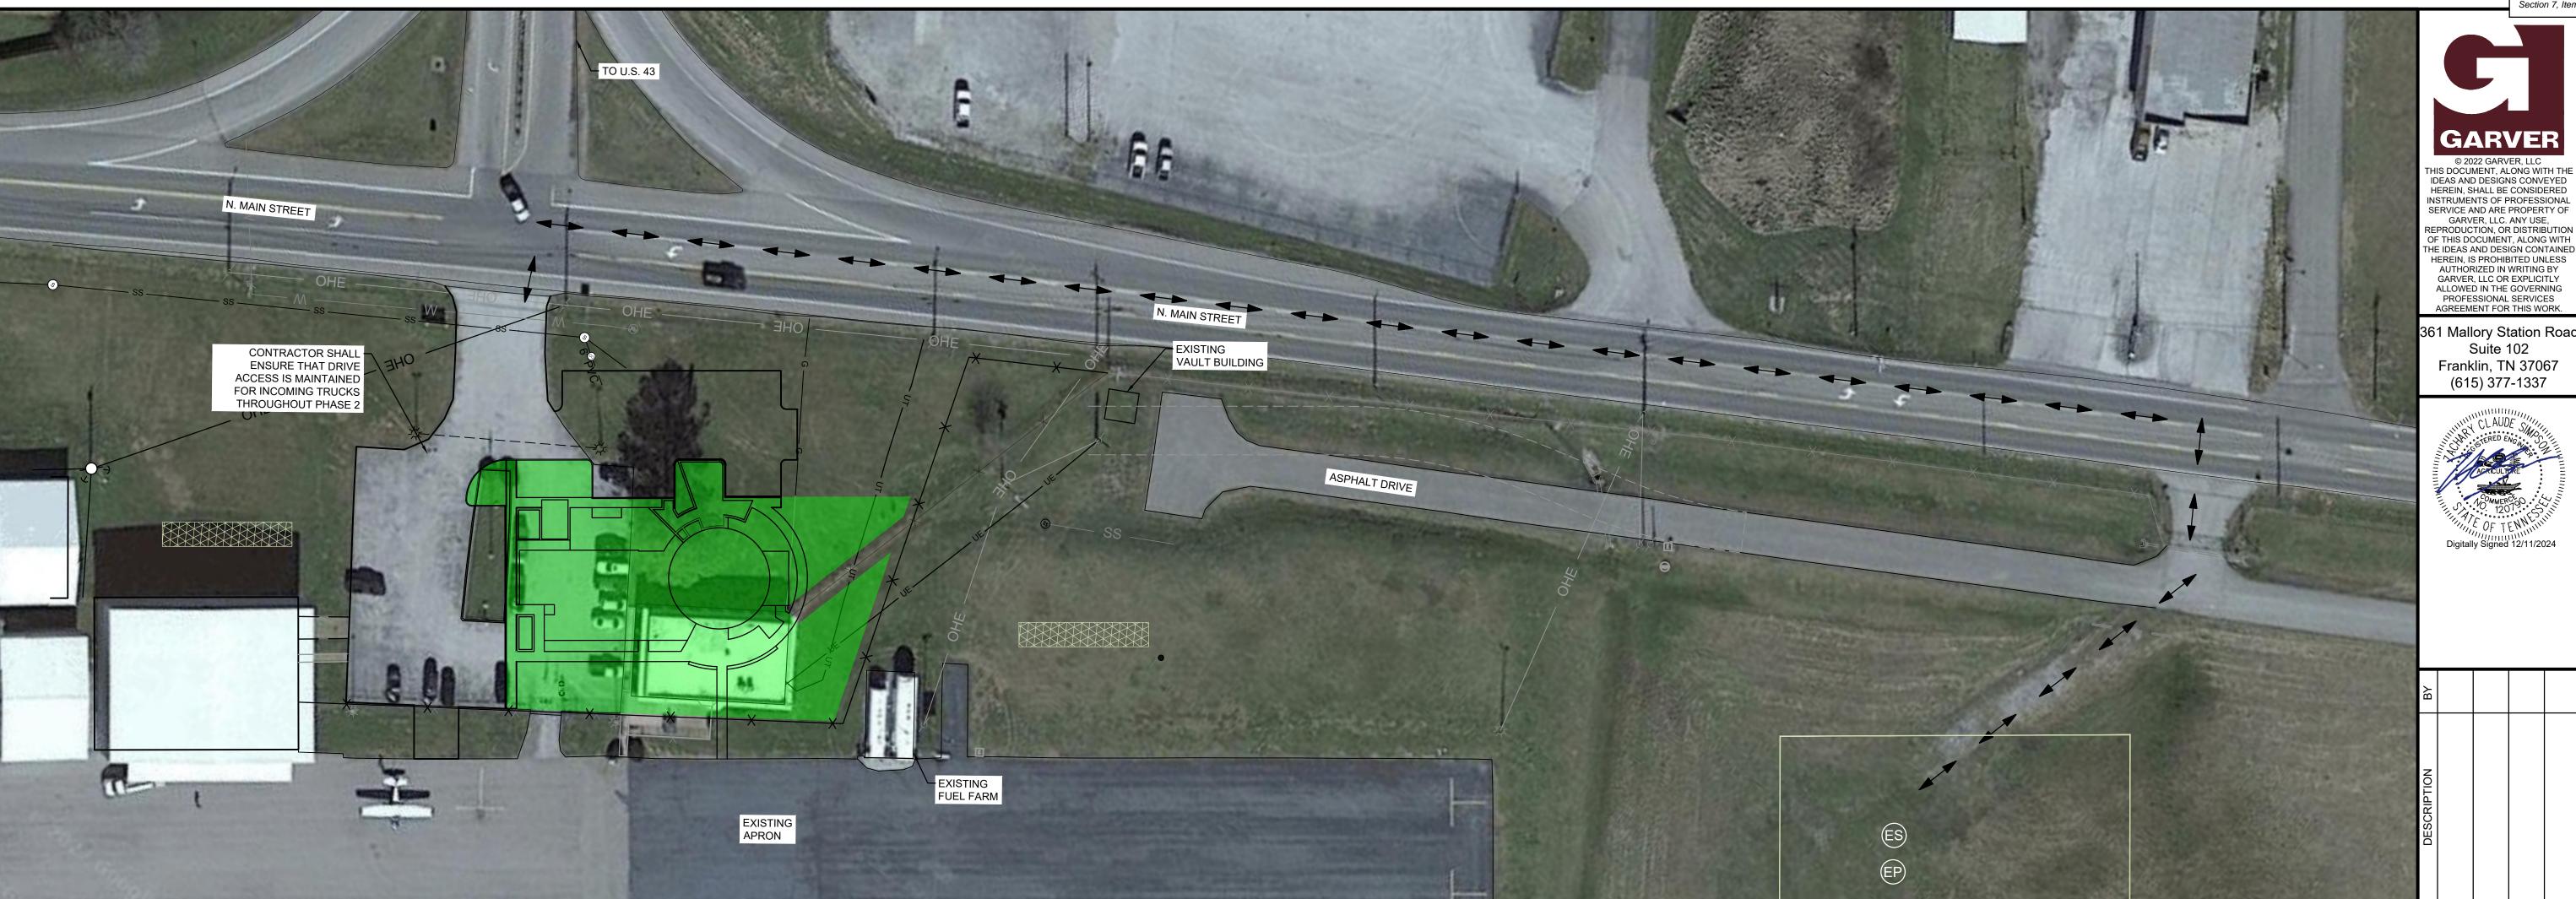
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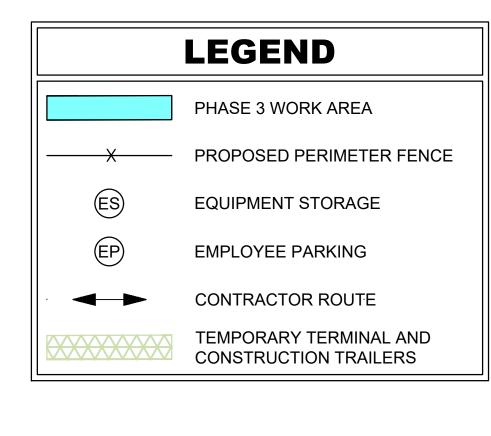
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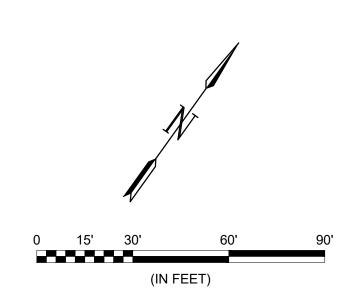
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(IN FEET)

NUMBER







SEQUENCE OF CONSTRUCTION

CONTRACTOR SHALL MILL AND OVERLAY EXISTING PARKING AREA AS SHOWN IN PLANS

 CONTRACTOR SHALL PERFORM ALL ASSOCIATED GRADING WORK ACCORDING TO THE PLANS

CONTRACTOR SHALL CONSTRUCT REMAINING PARKING PAVEMENT

- CONTRACTOR SHALL INSTALL PAVEMENT MARKINGS
- CONTRACTOR SHALL COMPLETE LANDSCAPING IMPROVEMENTS
- CONTRACTOR SHALL REMOVE TEMPORARY TERMINAL AND CONSTRUCTION TRAILERS AND RESTORE SITE TO PRE-CONSTRUCTION CONDITIONS
- CONTRACTOR SHALL COMPLETE ANY ASSOCIATED SEEDING OR SODDING

- 1. SEE CONSTRUCTION SAFETY AND PHASING NOTES FOR ADDITIONAL DETAILS.
- 2. CONTRACTOR SHALL HAVE AN APPROVED PAVEMENT BROOM OR VACUUM TRUCK AVAILABLE ON SITE AT ALL TIMES. HYDRANTS TO FILL VACUUM TRUCK WILL BE AVAILABLE ON AIRPORT PROPERTY.
- 3. THE CONTRACTOR WILL BE RESPONSIBLE FOR PROVIDING SUFFICIENT LIGHTING TO ADEQUATELY ILLUMINATE THE WORK AREA DURING NIGHTTIME OPERATIONS. PORTABLE LIGHTING SHALL NOT BE ORIENTED IN SUCH A WAY TO CAUSE IMPACT TO AIRPORT OPERATIONS.
- 4. IN NO EVENT SHALL CONSTRUCTION VEHICLES, EQUIPMENT, OR MATERIALS BE PARKED/STORED WITHIN 50' OF BARRICADES OR ACTIVE AIRFIELD PAVEMENT.
- 5. PERIMETER FENCE SHALL BE MAINTAINED AT ALL TIMES. TEMPORARY FENCING SHALL BE INSTALLED AS NECESSARY. METHODS FOR TEMPORARY FENCING SHALL BE APPROVED BY THE ENGINEER. TEMPORARY FENCING SHALL BE CONSIDERED SUBSIDIARY TO CONSTRUCTION SAFETY AND SECURITY.
- 6. CONTRACTOR SHALL MAINTAIN THAT GATES ARE GUARDED OR LOCKED AT ALL TIMES THROUGHOUT CONSTRUCTION.

MAURY COUNTY REGIONAL AIRPORT NEW TERMINAL CONSTRUCTION PROJECT SCHEDULE B MAURY COUNTY AIRPORT AUTHORITY MAURY COUNTY, TENNESSEE

CSPP PHASE 3


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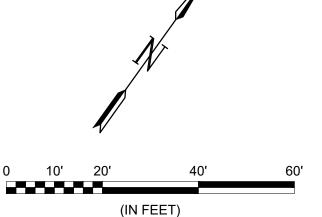
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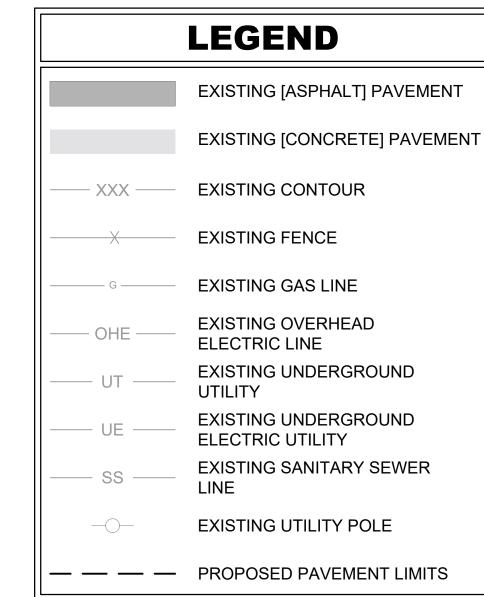
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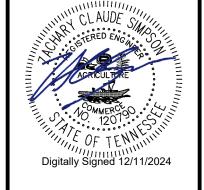
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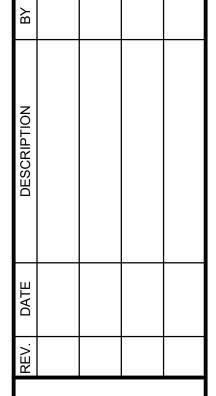
- 1. EXISTING UTILITIES AND UNDERGROUND FACILITIES ARE LOCATED FROM AVAILABLE SURFACE INFORMATION OR RECORDS RESEARCH. THE LOCATION AND ELEVATIONS SHOWN ARE APPROXIMATED AND ARE BASED ON THE INFORMATION AVAILABLE AT THE TIME OF DESIGN. THE CONTRACTOR IS RESPONSIBLE FOR FIELD VERIFYING EXACT LOCATION, DEPTH, AND CONDITION OF ALL UTILITIES AND AIRPORT FACILITIES DURING THE CONSTRUCTION PERIOD. ANY CONFLICTING UTILITY INFORMATION SHALL BE REPORTED TO THE ENGINEER FOR ASSESSMENT PRIOR TO THE START OF DEMOLITION OPERATIONS.
- 2. ALL EXISTING INFRASTRUCTURE SHALL REMAIN UNLESS OTHERWISE NOTED ON CIVIL AND /OR ELECTRICAL DEMOLITION SHEETS.
- 3. FOR ADDITIONAL DETAIL ON ELECTRICAL ITEMS, SEE E-100 SERIES FOR ELECTRICAL REMOVAL SHEETS.



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MAURY COUNTY
AIRPORT AUTHORITY
MAURY COUNTY, TENNESSEE
MAURY COUNTY REGIONAL
AIRPORT NEW TERMINAL
CONSTRUCTION PROJECT
SCHEDULE B

EXISTING CONDITIONS

JOB NO.: 21A08011 DATE: DEC 2024 DESIGNED BY: ZCS DRAWN BY: ADG
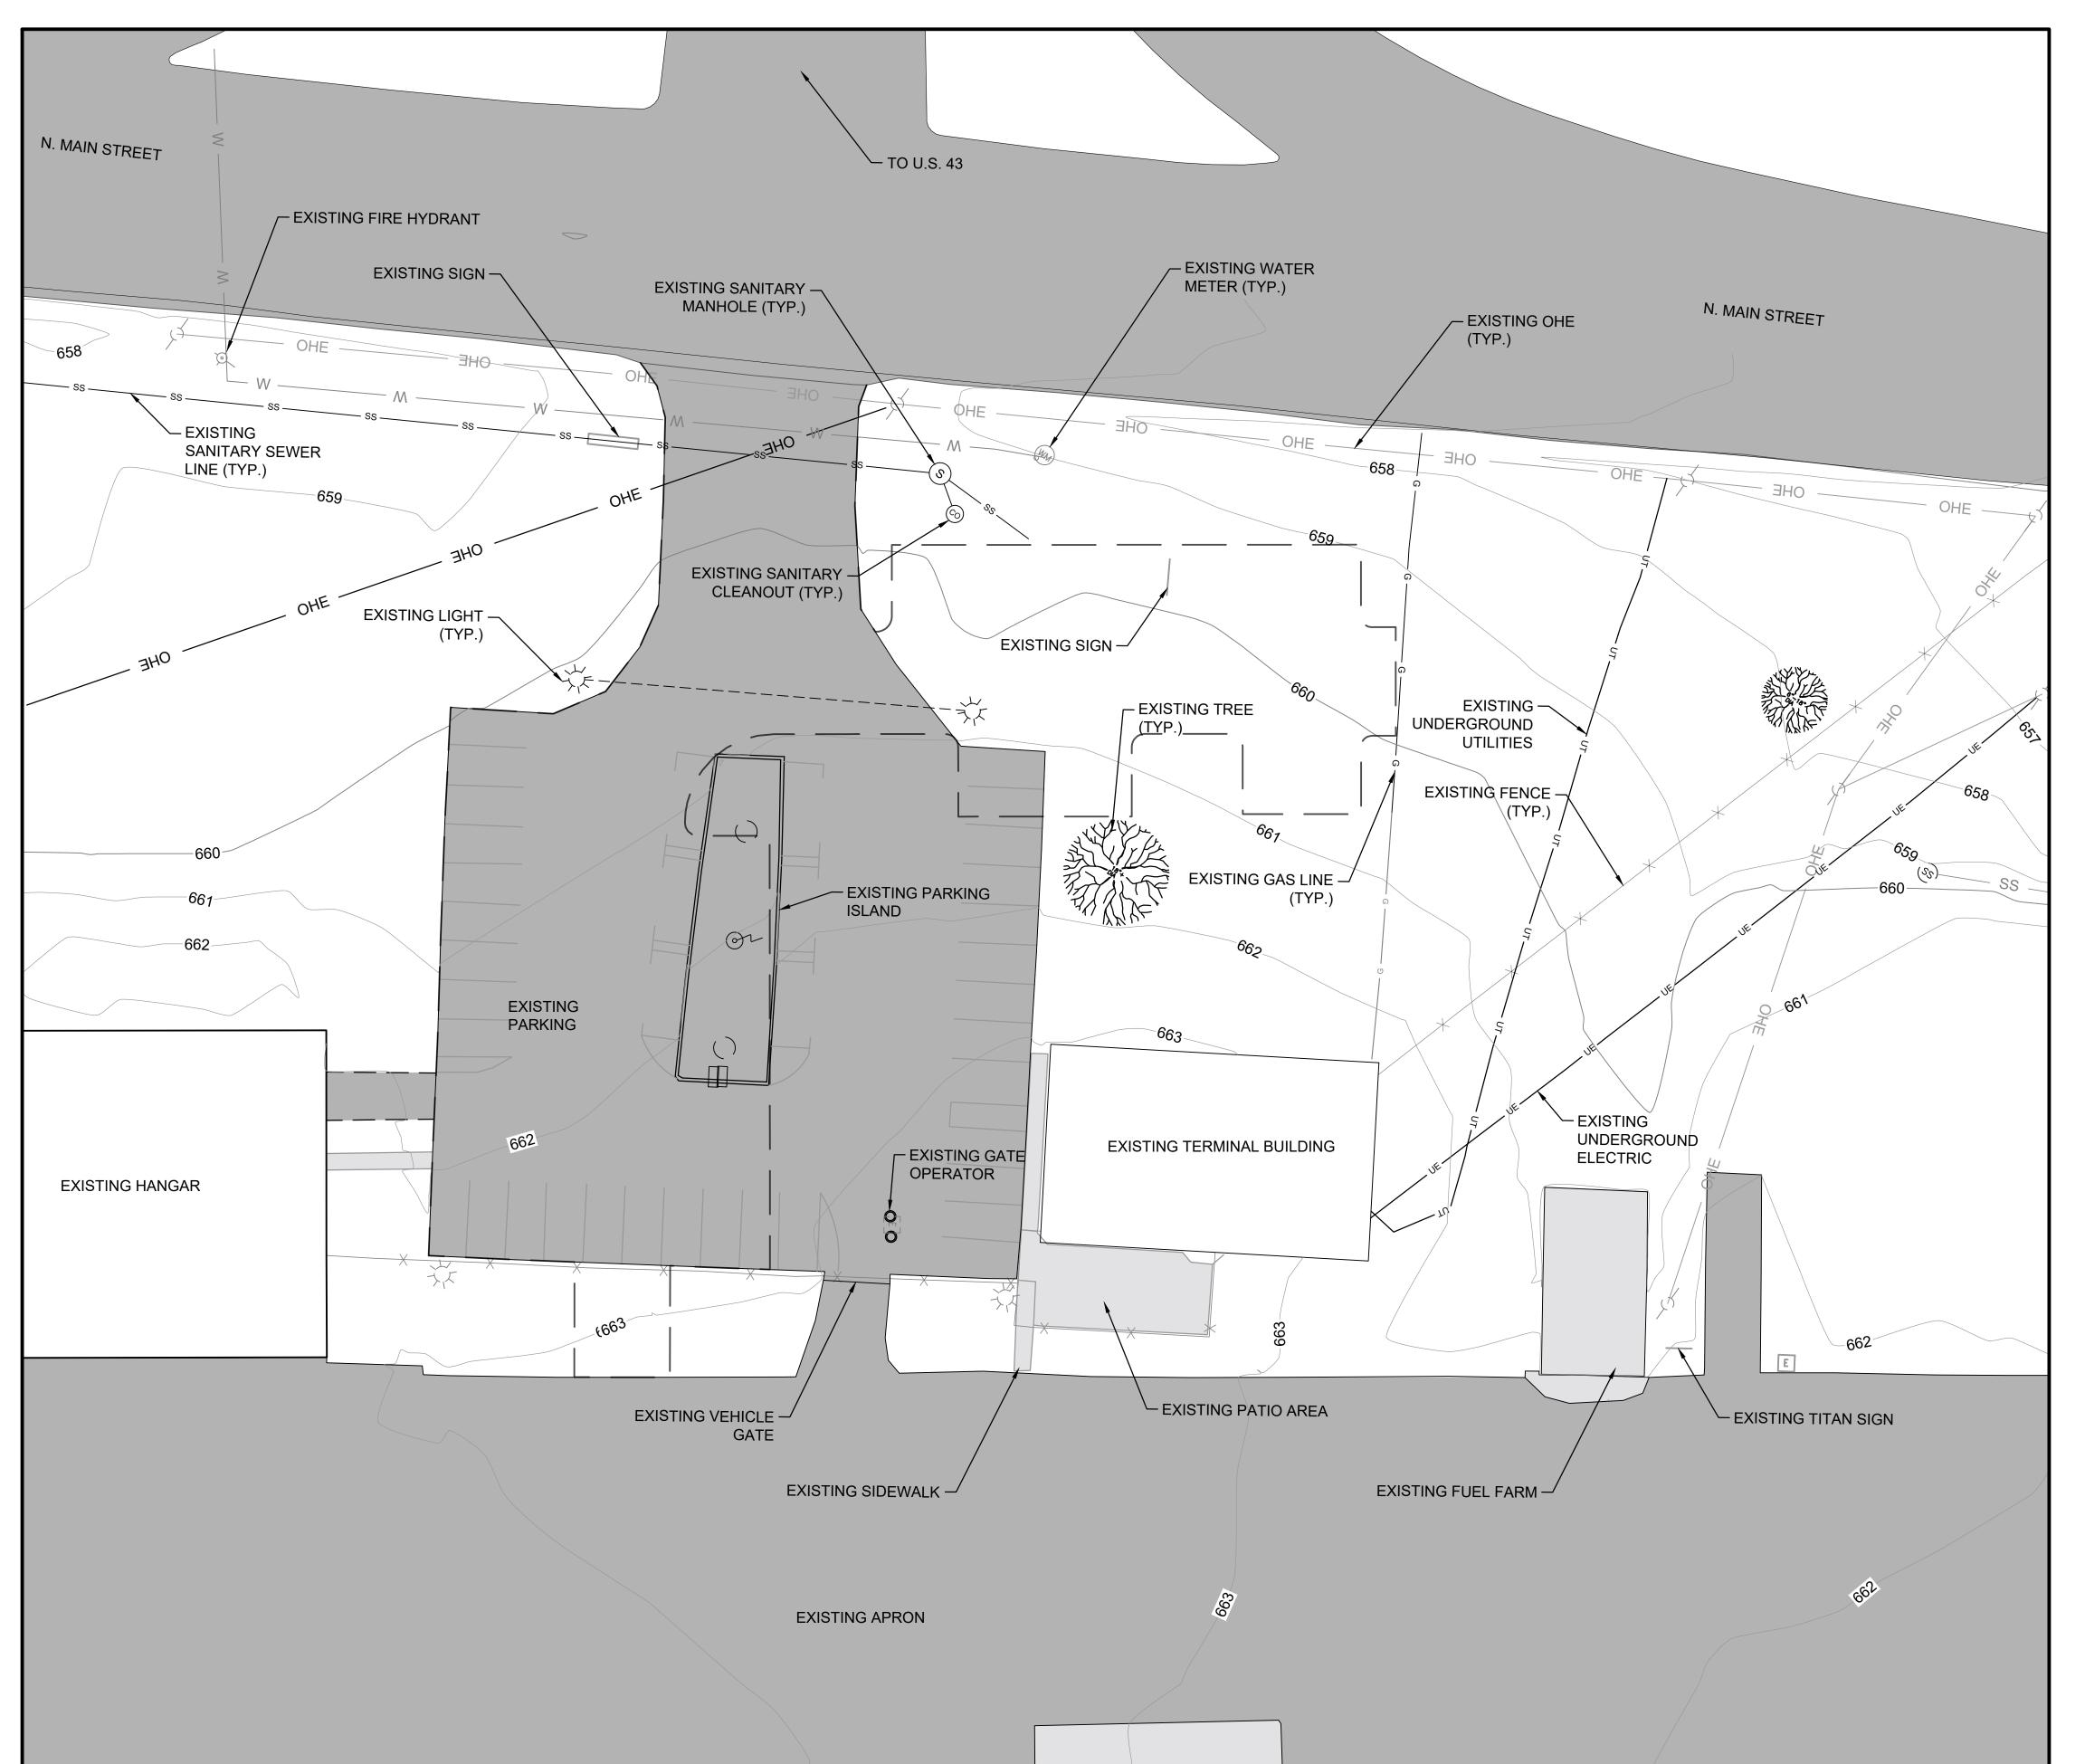
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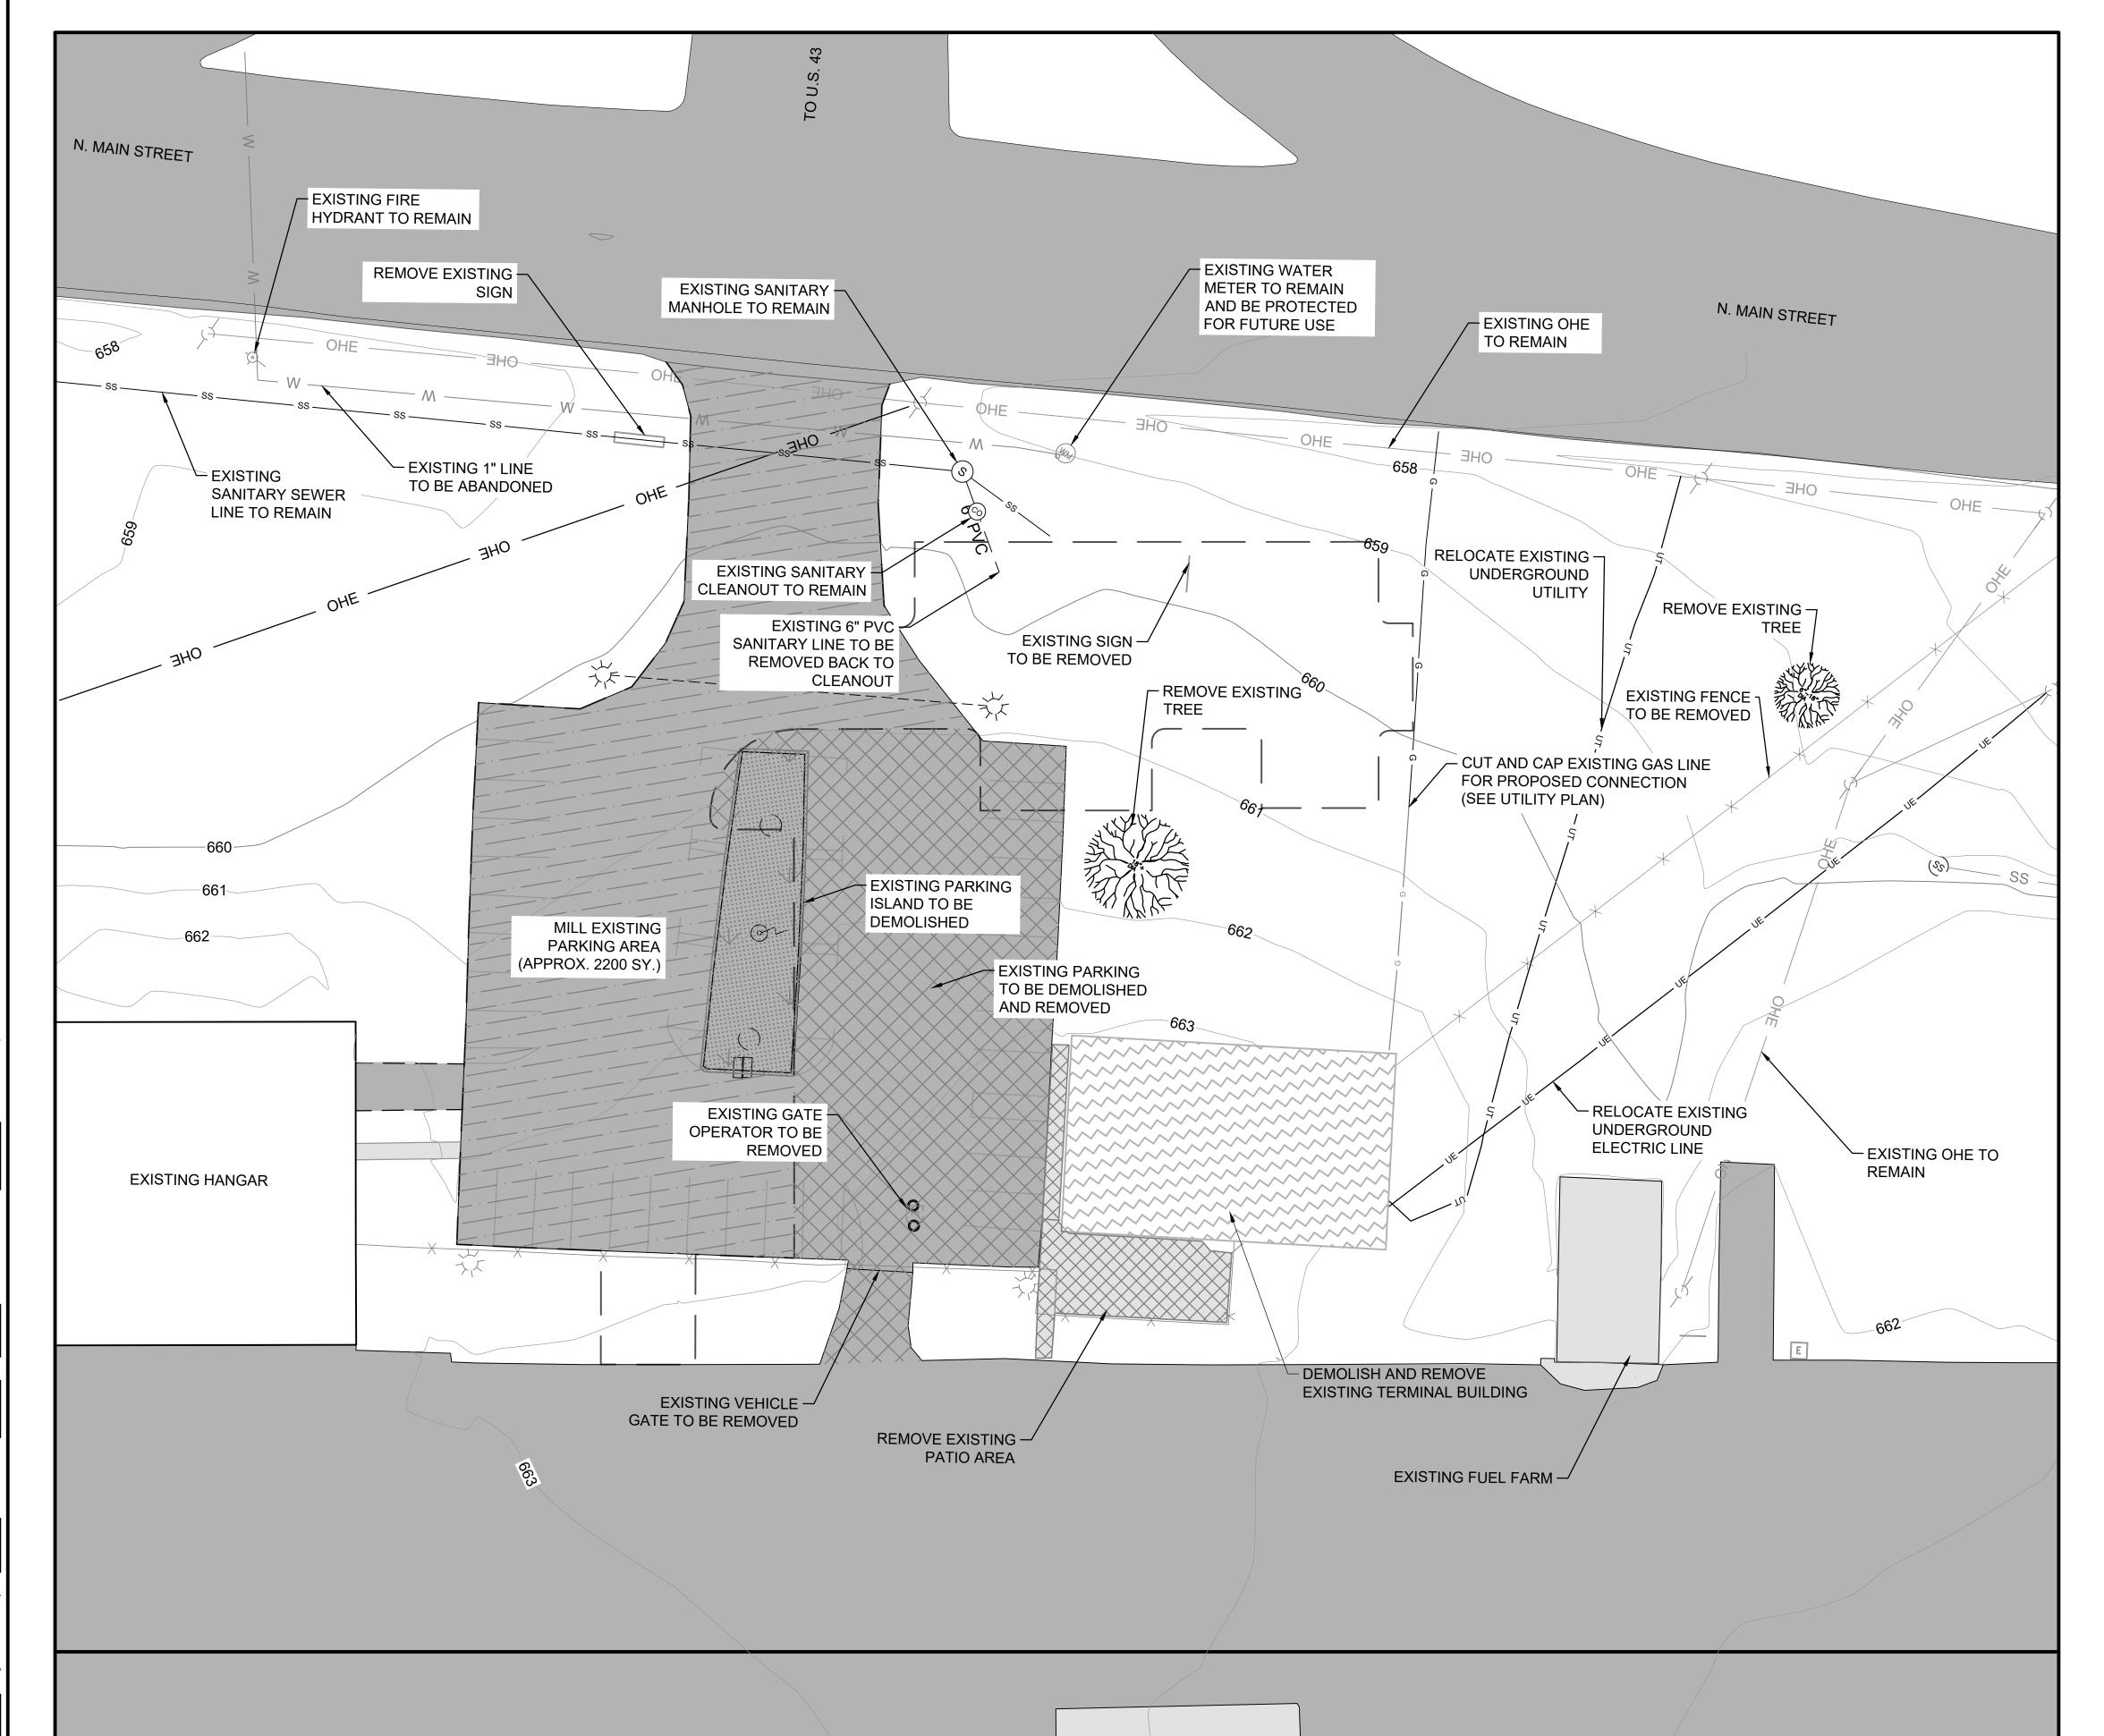
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DRAWING NUMBER

CV-101

SHEET 9

41



LEGEND

EXISTING ASPHALT PAVEMENT

EXISTING CONCRETE PAVEMENT TO

BE REMOVED

BE REMOVED

EXISTING ASPHALT PAVEMENT

TO BE REMOVED

EXISTING ASPHALT PAVEMENT
TO BE MILLED AND OVERLAID

EXISTING TERMINAL
TO BE REMOVED


EXISTING PARKING ISLAND

EXISTING PARKING ISLAND
TO BE REMOVED

EXISTING CONTOUR

— — — PROPOSED PAVEMENT LIMITS

—— EXISTING FENCE

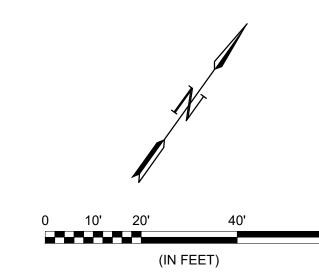

NOTES:

- 1. CONTRACTOR SHALL PROTECT ALL EXISTING UTILITIES, HAND HOLES, AIRFIELD EQUIPMENT, DRAINAGE STRUCTURES, AND BUILDINGS NOT SHOWN FOR DEMOLITION. ANY DAMAGE AS A RESULT OF CONSTRUCTION ACTIVITIES SHALL BE REPAIRED BY THE CONTRACTOR AT NO COST TO THE OWNER.
- 2. SEE ED-100 SERIES FOR AIRFIELD ELECTRICAL DEMOLITION EXTENTS AND DETAILS.
- 3. WHERE INDICATED IN THE PLANS, THE CONTRACTOR SHALL SAWCUT AT THE PROPOSED EDGE OF CONSTRUCTION, AND 6" INSIDE THE PROPOSED EDGE OF CONSTRUCTION TO PROVIDE A CLEAN VERTICAL EDGE OF EXISTING PAVEMENT. THE CONTRACTOR SHALL NOT REMOVE THE REMAINING 6" PORTION OF PAVEMENT UNTIL NECESSARY FOR CONSTRUCTION OF THE PROPOSED PAVEMENT SECTION.



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EV. DATE DESCRIPTION B

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AIRPORT AUTHORITY
MAURY COUNTY, TENNESSEE
MAURY COUNTY REGIONAL
AIRPORT NEW TERMINAL
CONSTRUCTION PROJECT
SCHEDULE B

DEMOLITION PLAN

JOB NO.: 21A08011 DATE: DEC 2024 DESIGNED BY: ZCS DRAWN BY: ADG

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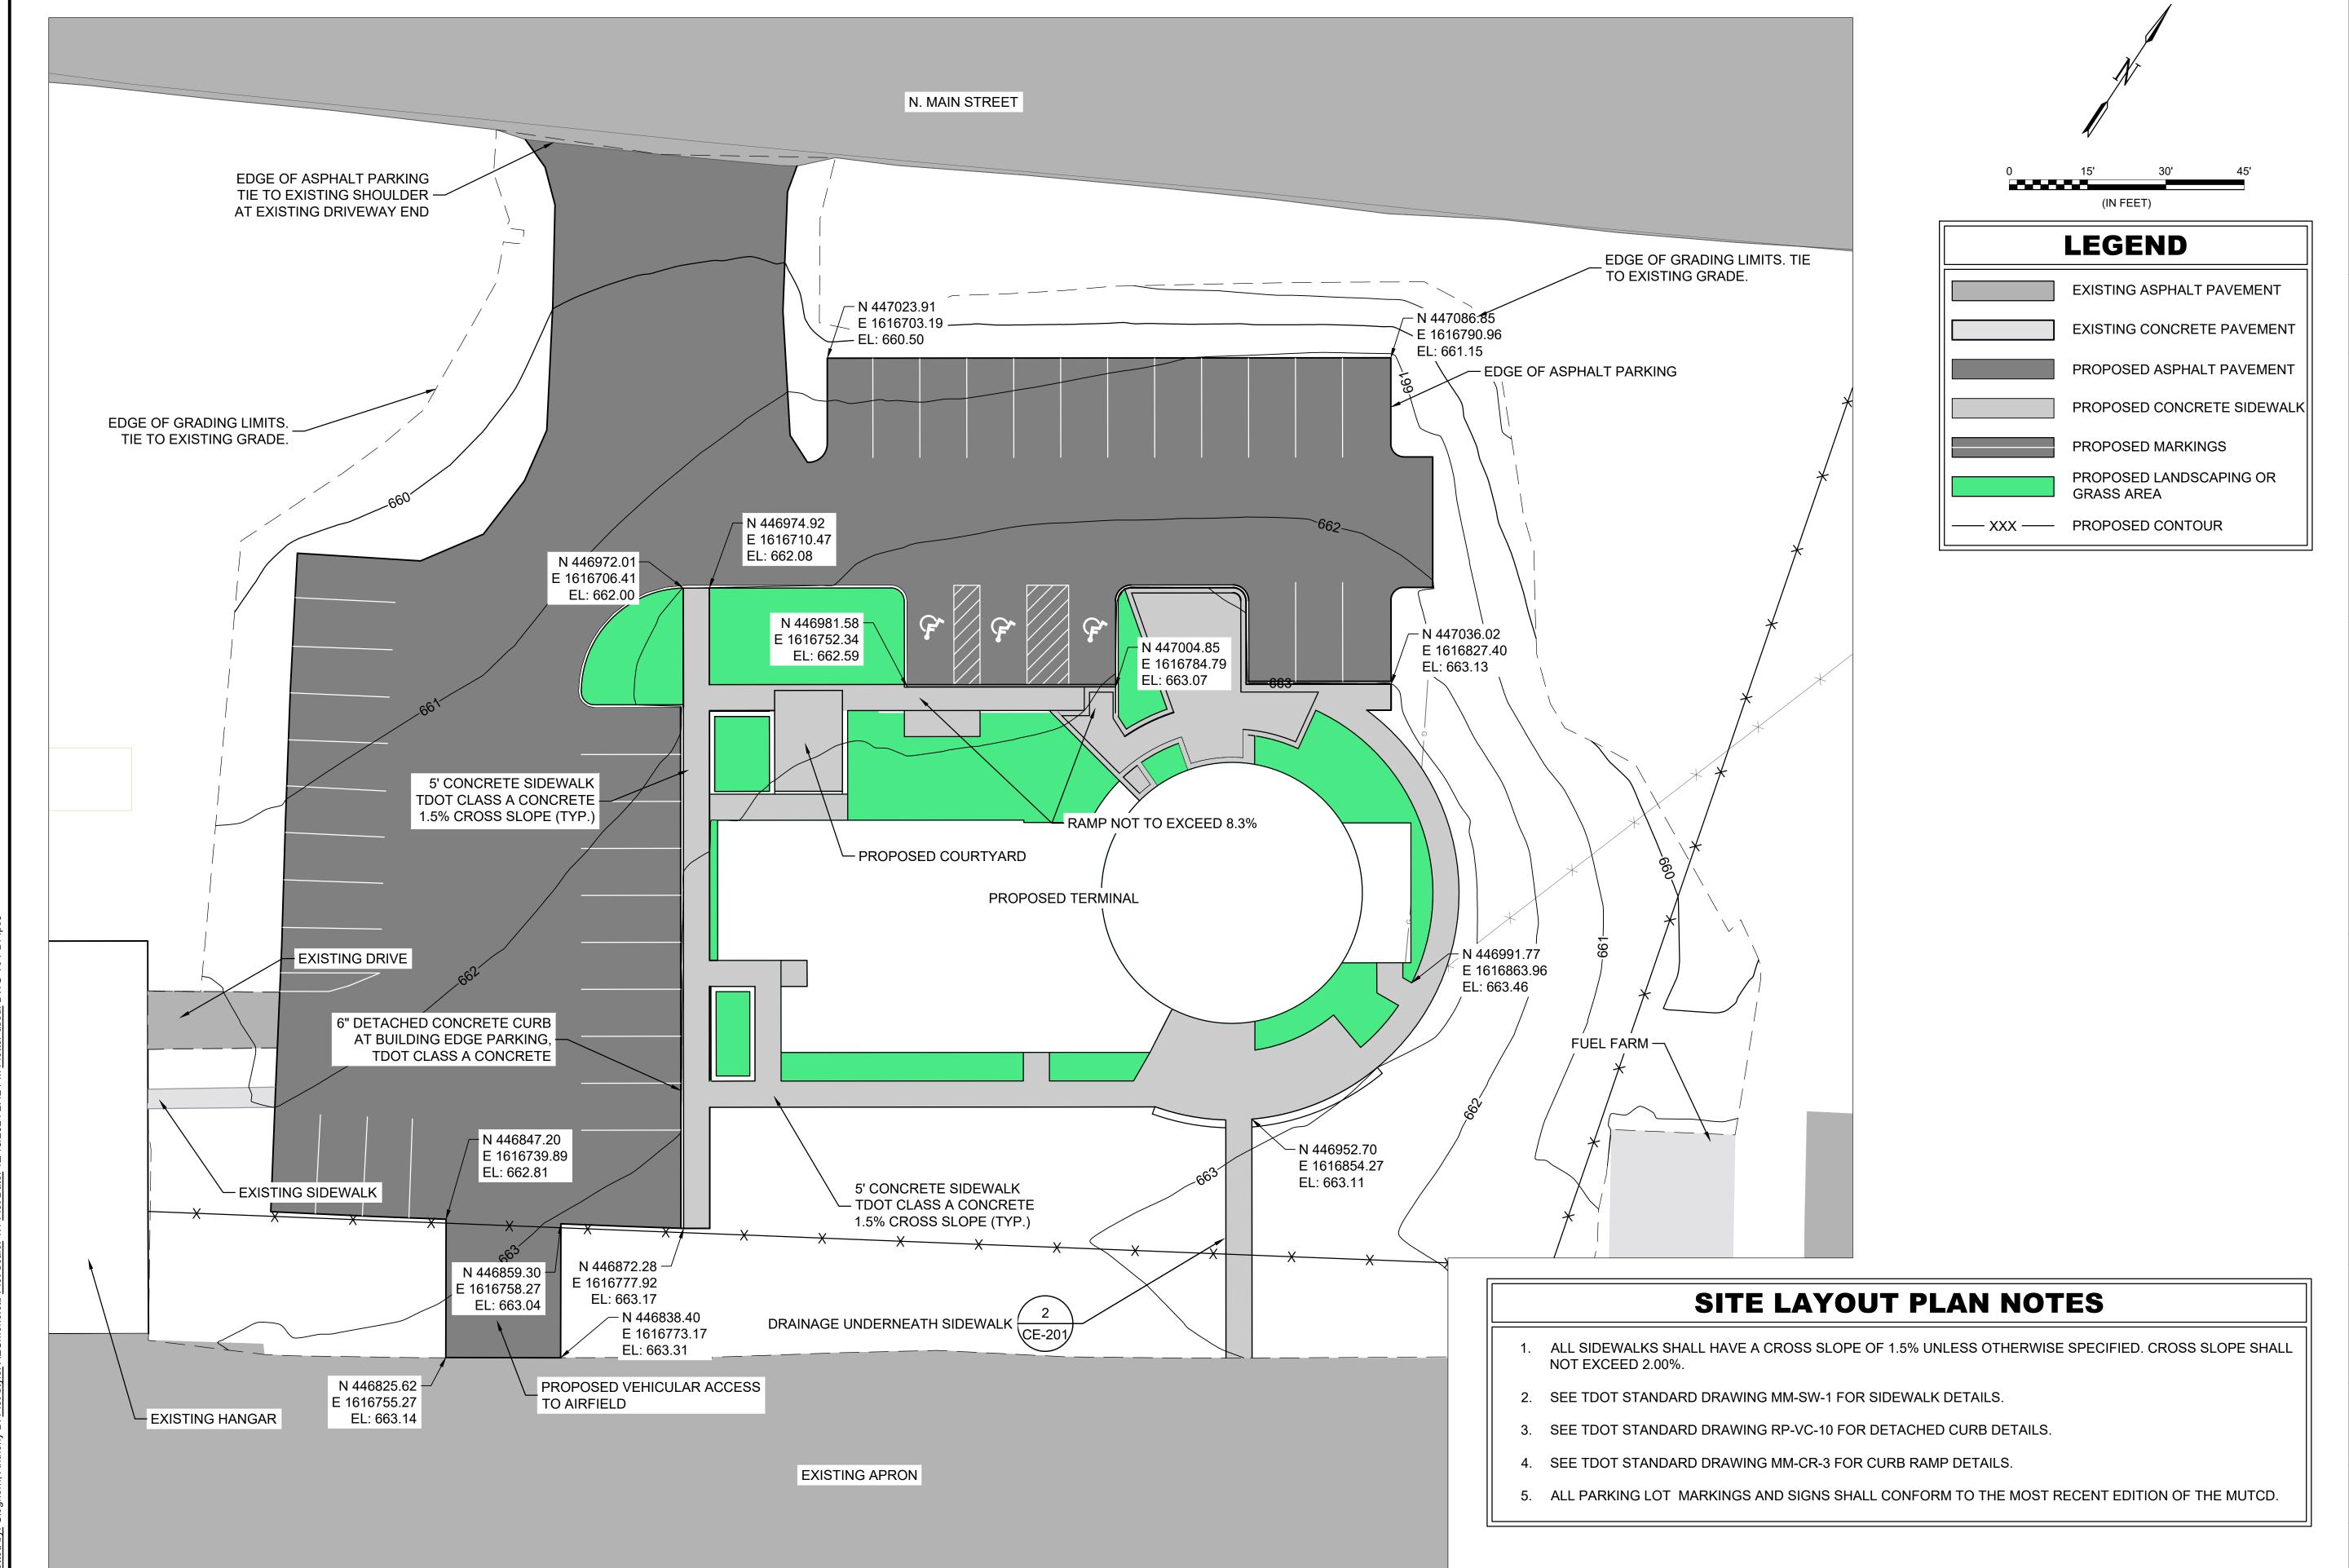
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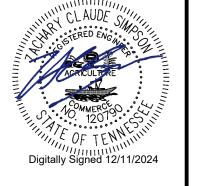
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MAURY COUNTY
AIRPORT AUTHORITY
MAURY COUNTY, TENNESSEE
MAURY COUNTY REGIONA
AIRPORT NEW TERMINAL
CONSTRUCTION PROJECT


OVERALL SITE PLAN


JOB NO.: 21A08011 DATE: DEC 2024 DESIGNED BY: ZCS DRAWN BY: ADG


> BAR IS ONE INCH ON ORIGINAL DRAWING


IF NOT ONE INCH ON THIS SHEET, ADJUST SCALES ACCORDINGLY.

SP-101

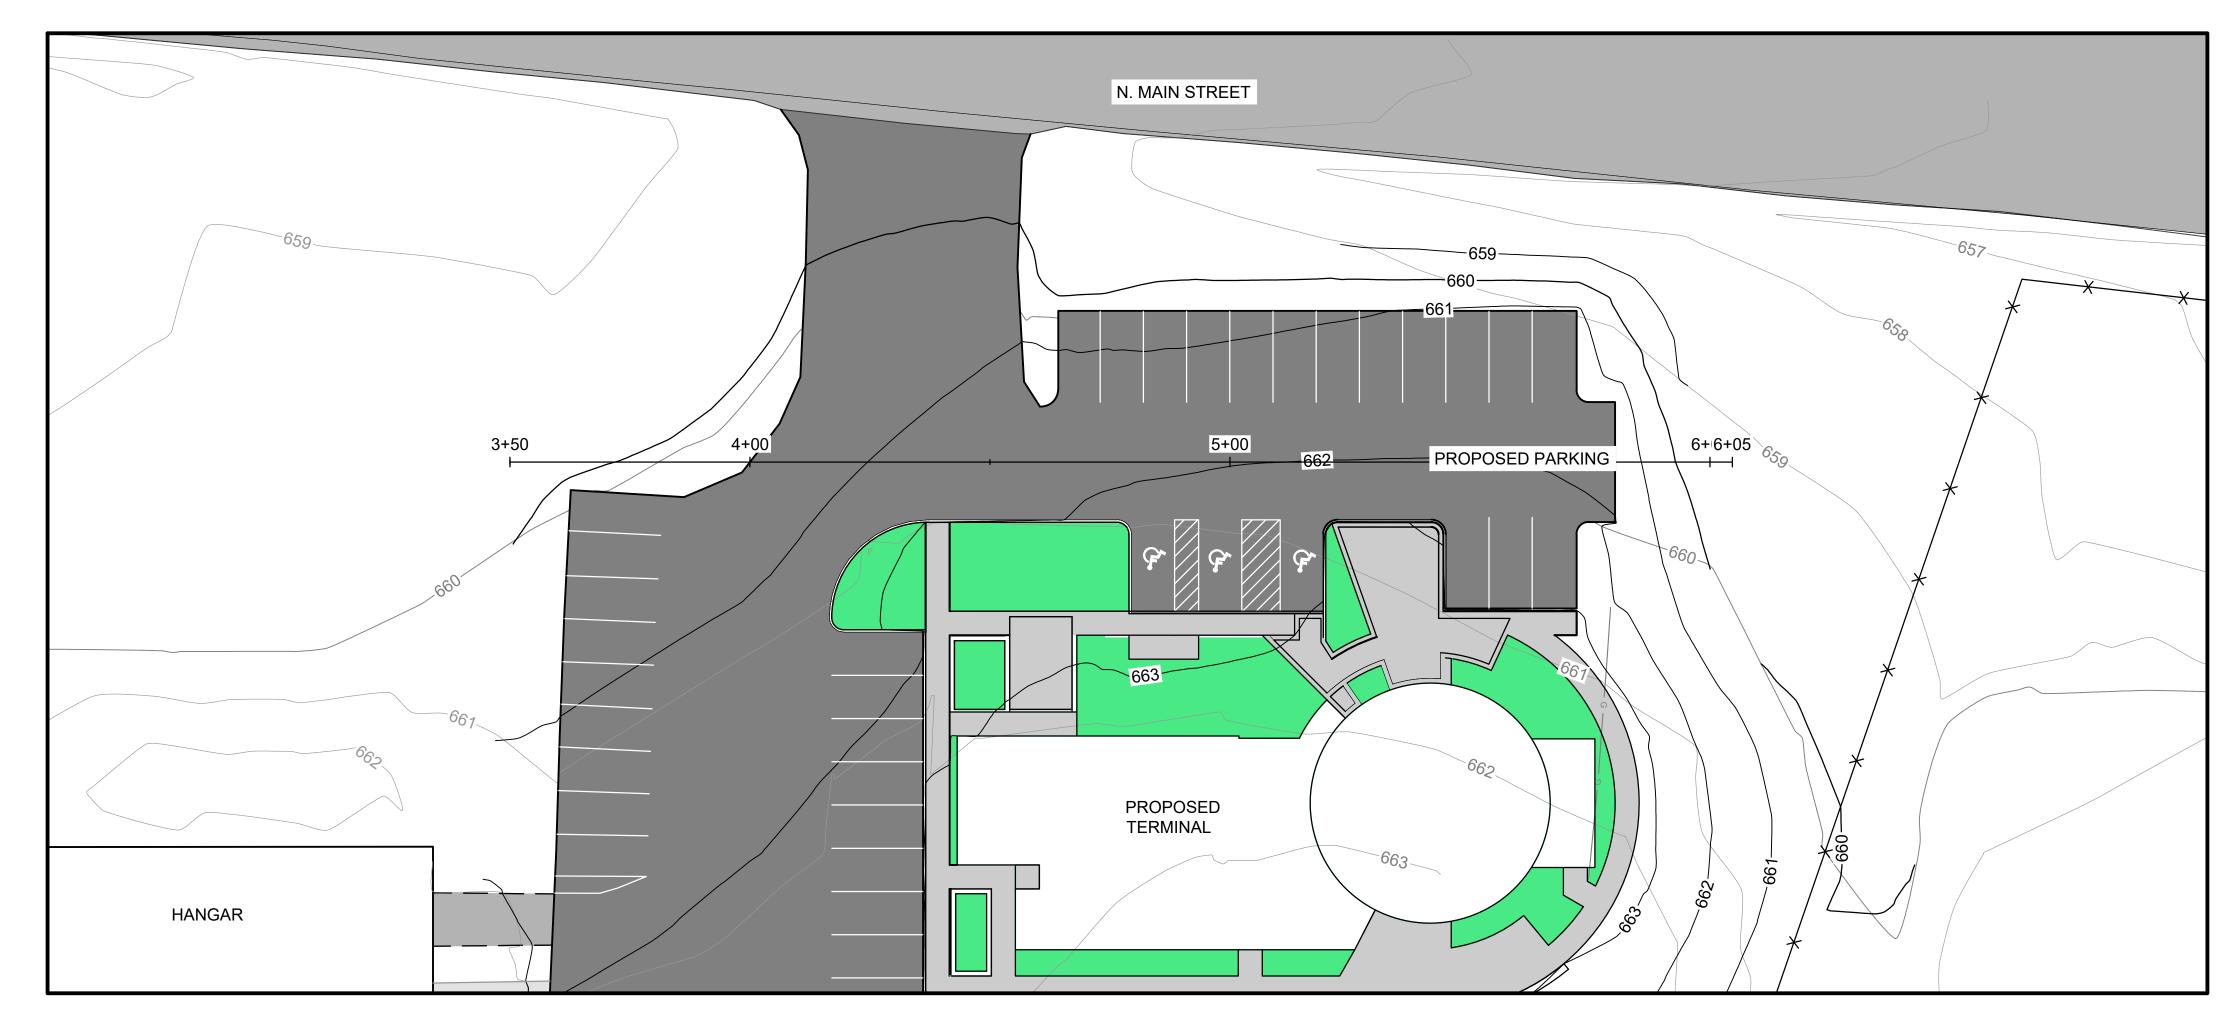

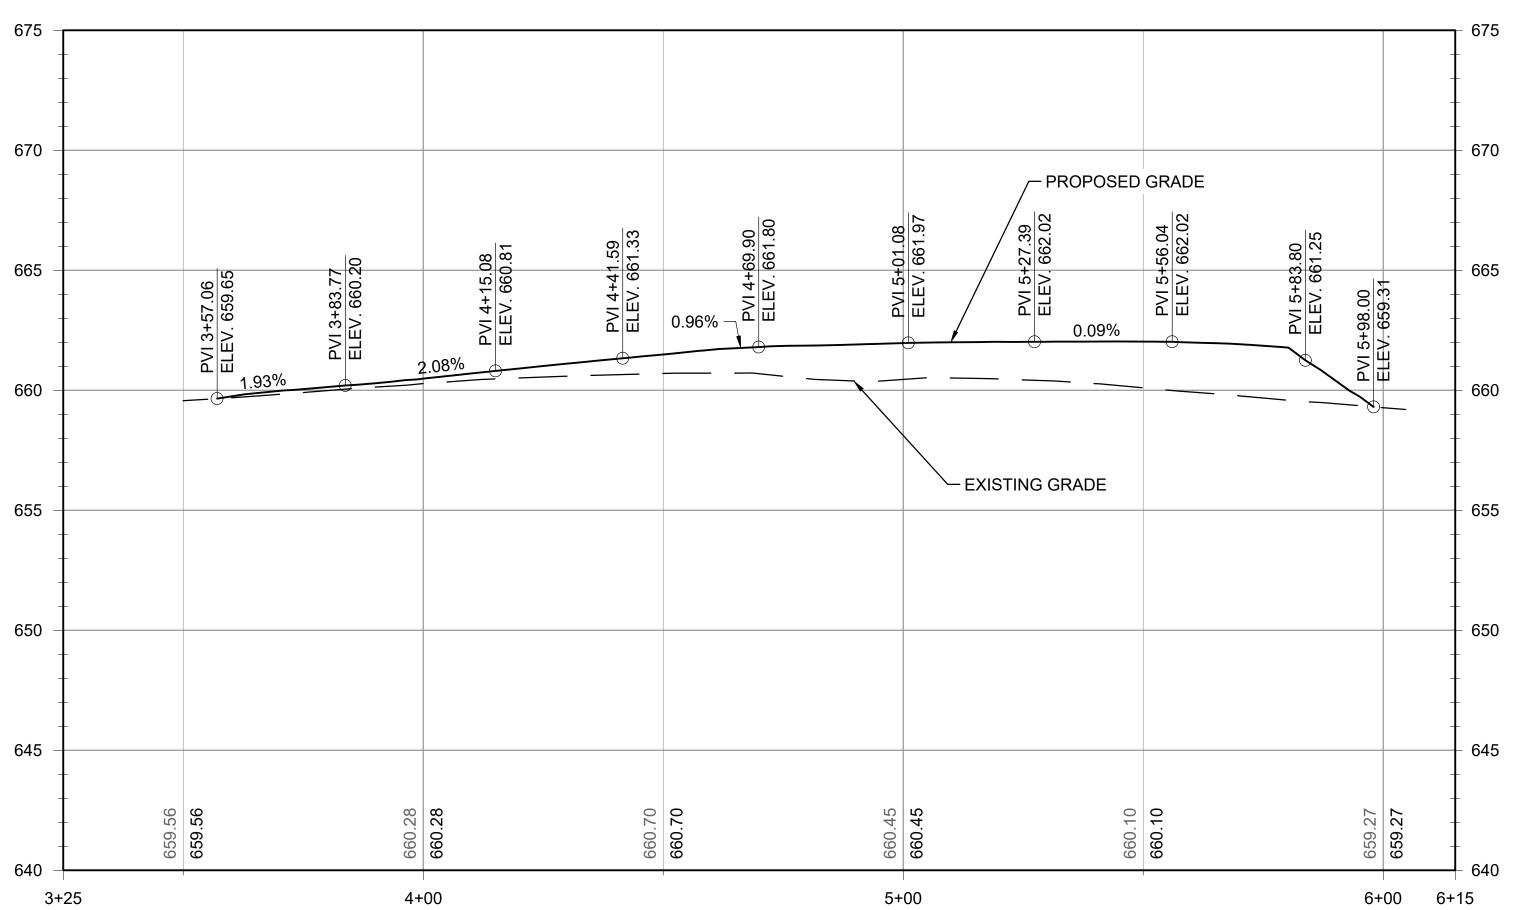


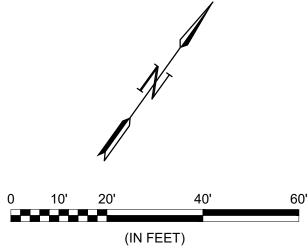

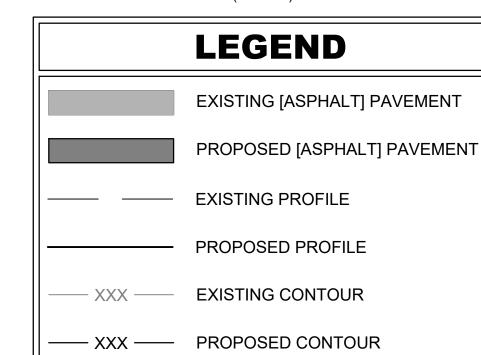

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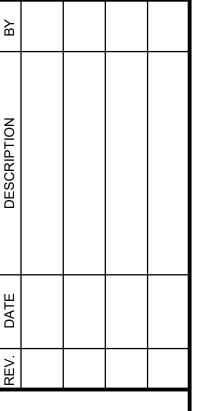
- 1. PROFILE VERTICAL EXAGGERATION = 5.
- 2. SEE SHEET(S) CP-200 FOR TYPICAL SECTIONS.
- 3. CONTRACTOR SHALL SAWCUT A CLEAN VERTICAL EDGE AT ALL PAVEMENT TIE-INS.

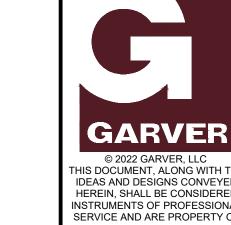

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MAURY COUNTY
AIRPORT AUTHORITY
MAURY COUNTY, TENNESSEE
MAURY COUNTY REGIONAL
AIRPORT NEW TERMINAL
CONSTRUCTION PROJECT

PARKING PLAN AND PROFILE SHEET 1

JOB NO.: 21A08011 DATE: DEC 2024 DESIGNED BY: ZCS DRAWN BY: ADG

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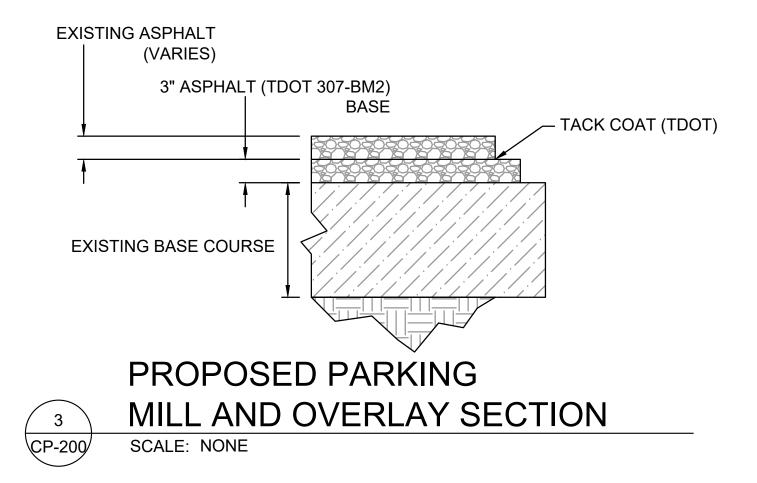
0 1"
IF NOT ONE INCH ON THIS SHEET,
ADJUST SCALES ACCORDINGLY.


DRAWING NUMBER


CP-101



PARKING LOT TYPICAL SECTION



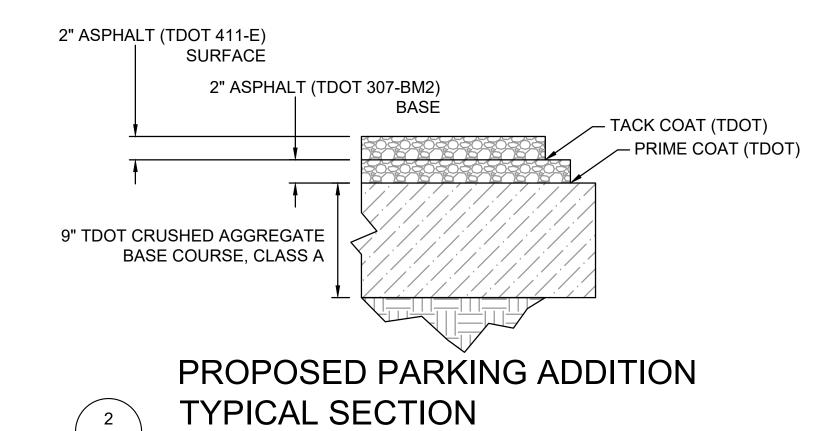

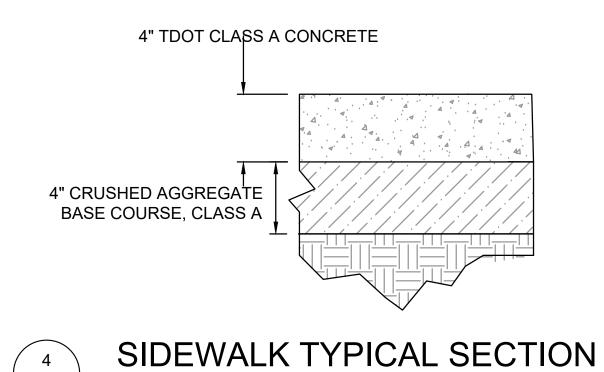

CP-200/

CP-200

SCALE: NONE

SCALE: NONE

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TYPICAL SECTIONS

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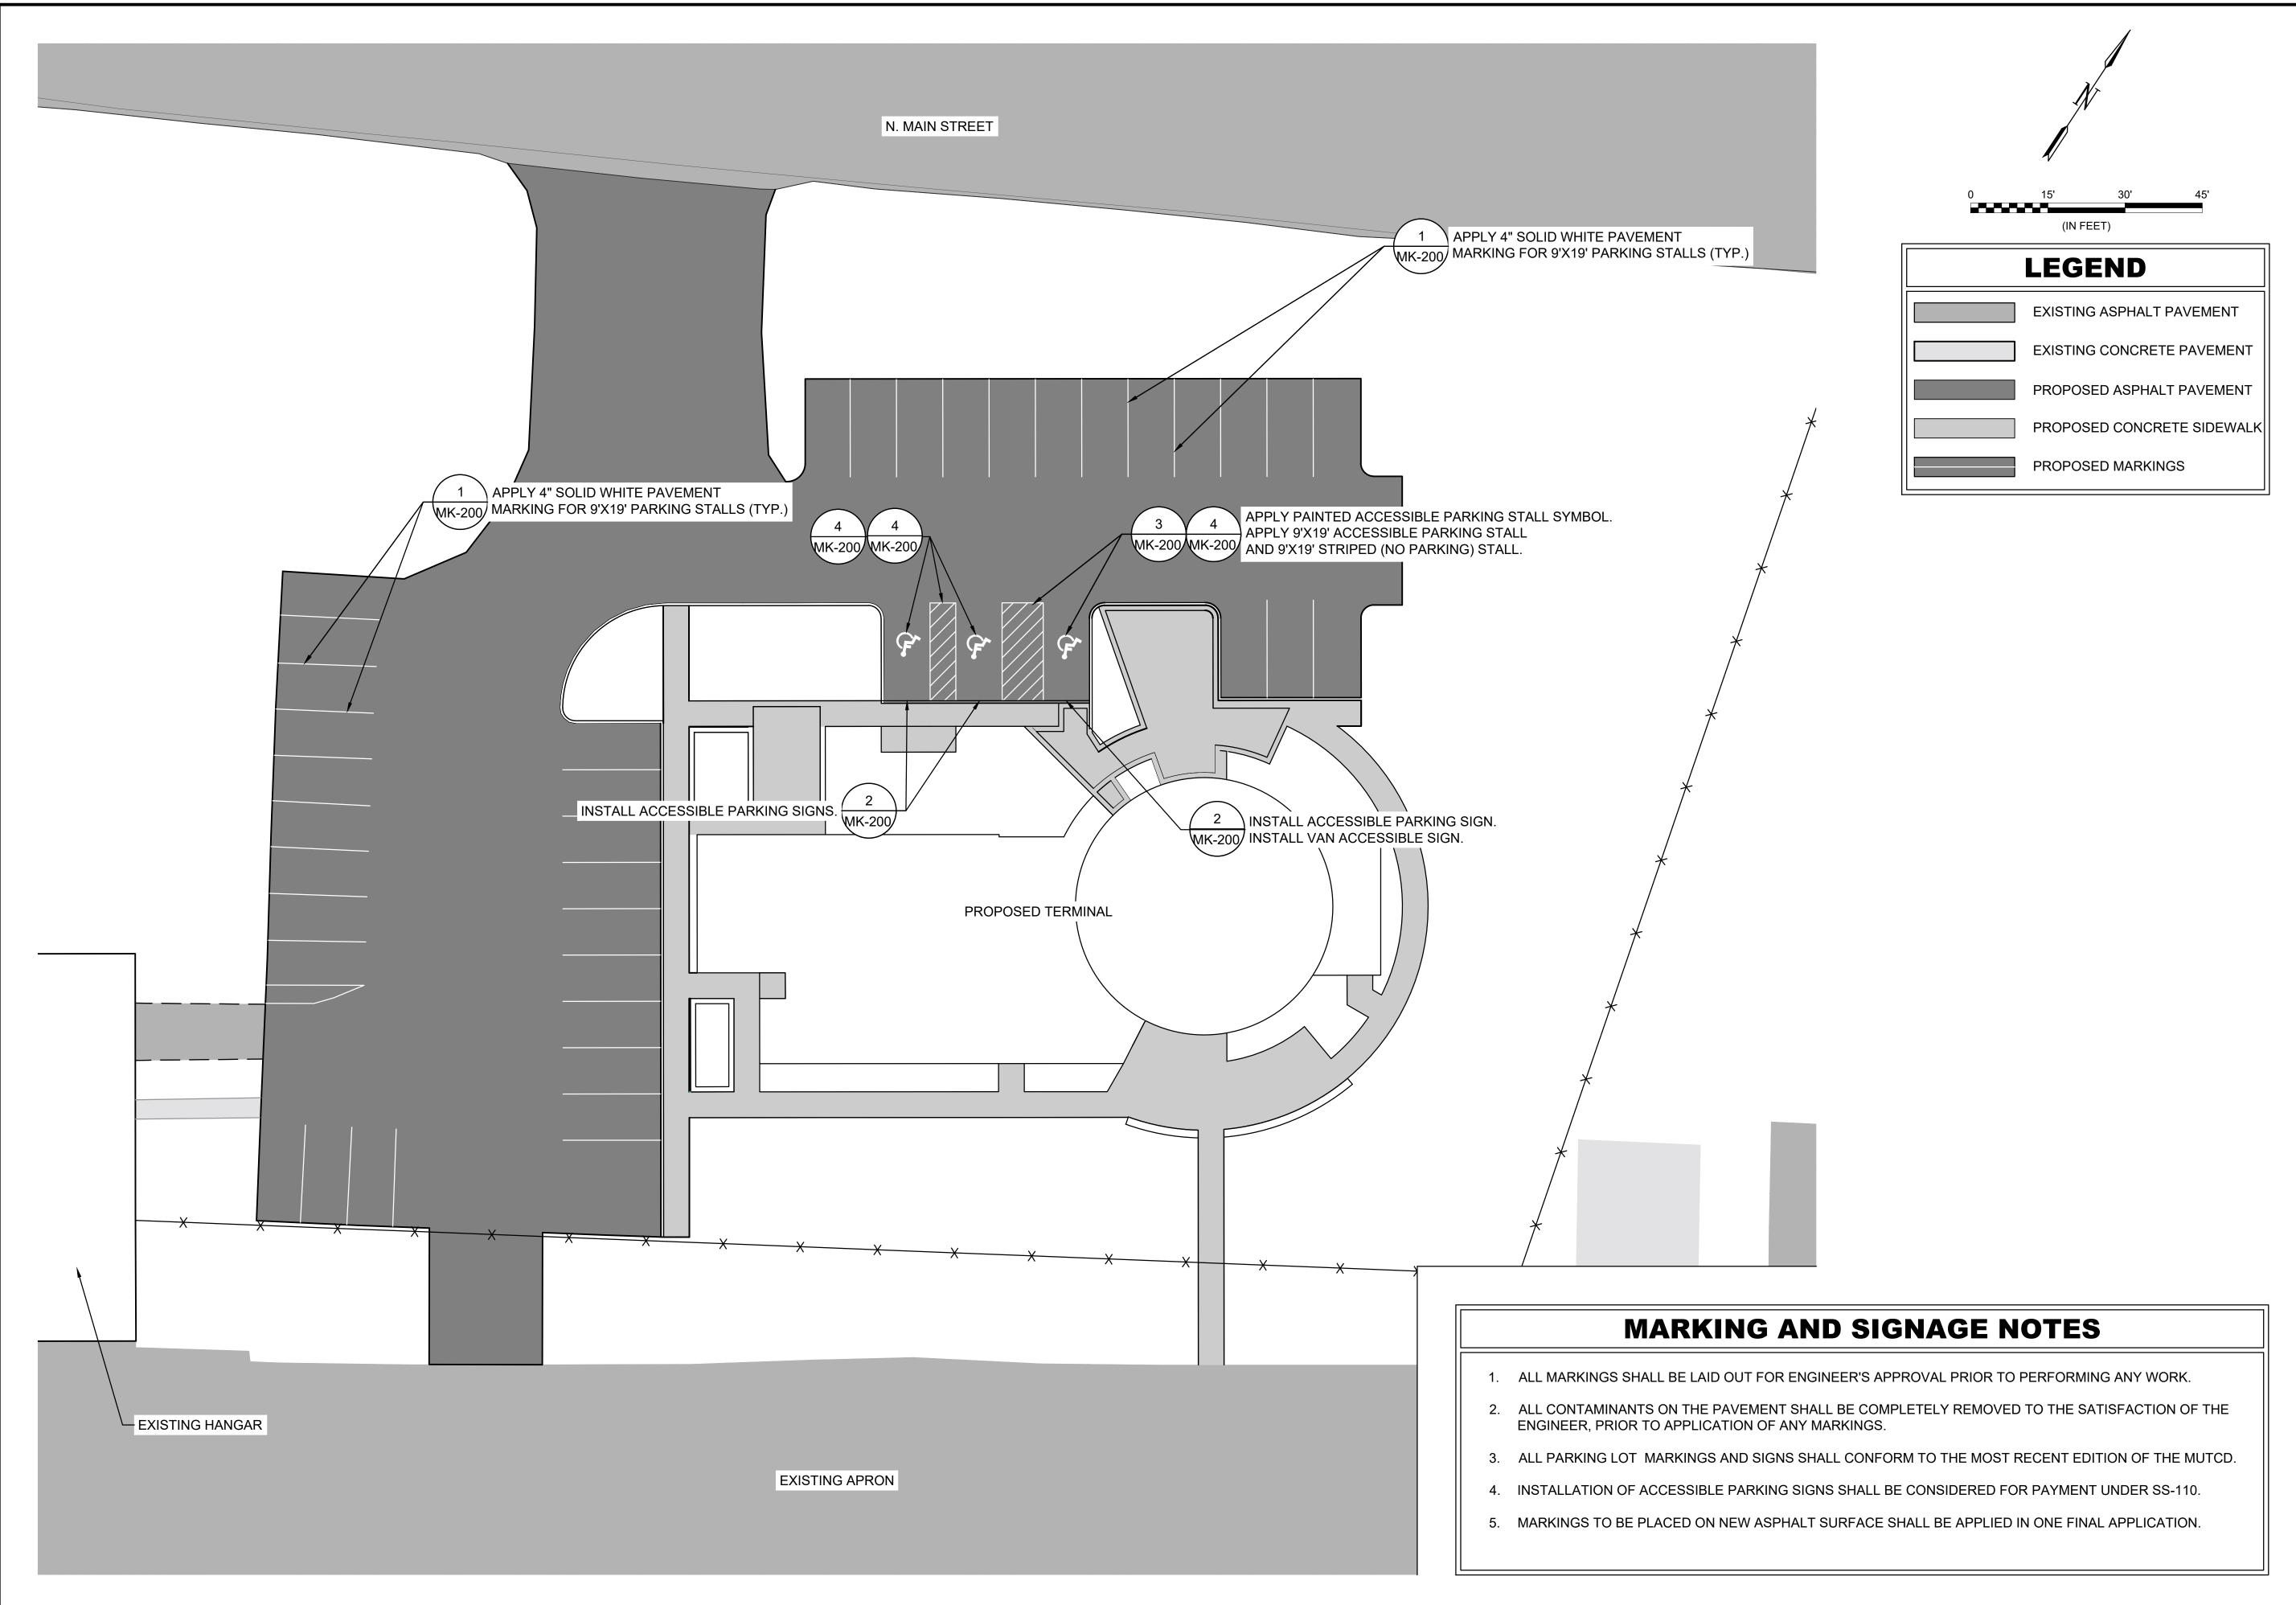
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CP-200

SHEET 13

DRAWING NUMBER



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REV. DATE DESCRIPTION BY

MAURY COUNTY
IRPORT AUTHORITY
IAURY COUNTY, TENNESSEE
MAURY COUNTY REGIONAL
IRPORT NEW TERMINAL

PARKING LOT MARKING PLAN

JOB NO.: 21A08011 DATE: DEC 2024 DESIGNED BY: ZCS DRAWN BY: ADG

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DRAWING NUMBER

MK-101


(R7-8P) (12" X 6")

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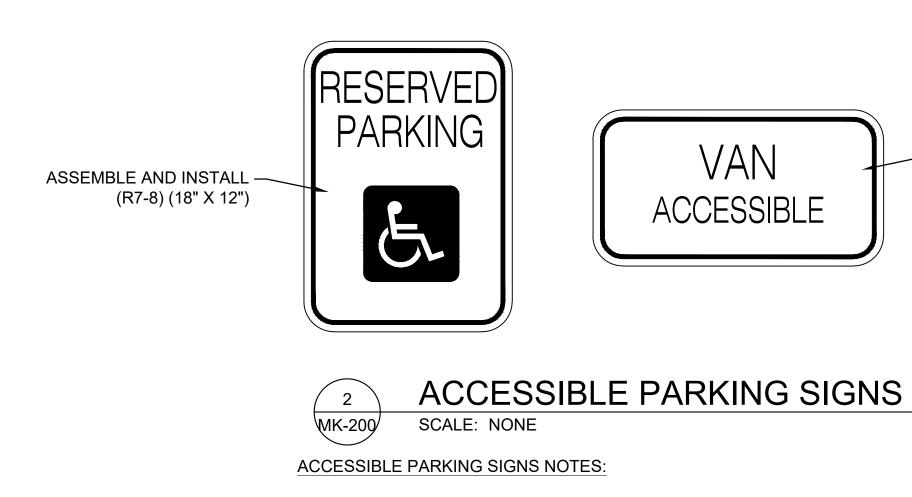
MARKING PLAN DETAILS

JOB NO.: 21A08011 DATE: DEC 2024 **DESIGNED BY: ZCS** DRAWN BY: ADG


BAR IS ONE INCH ON ORIGINAL DRAWING


IF NOT ONE INCH ON THIS SHEET ADJUST SCALES ACCORDINGLY. DRAWING NUMBER

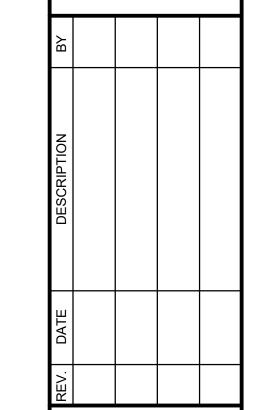MK-200 SHEET 15



- 1. INSTALLED SIGNS SHALL COMPLY WITH THE LATEST EDITION OF THE MUTCD.
- 2. ALL SIGNS ARE TO BE INSTALLED AT THE LOCATIONS SHOWN IN THE PLANS, AND IN ACCORDANCE WITH THE DETAILS IN THE PLANS.
- 3. SIGNS SHALL BE MOUNTED TO 2" EMT USING STAINLESS STEEL CONDUIT CLAMPS. ANCHOR SIGNAGE TO PREVENT VERTICAL SLIPPING.

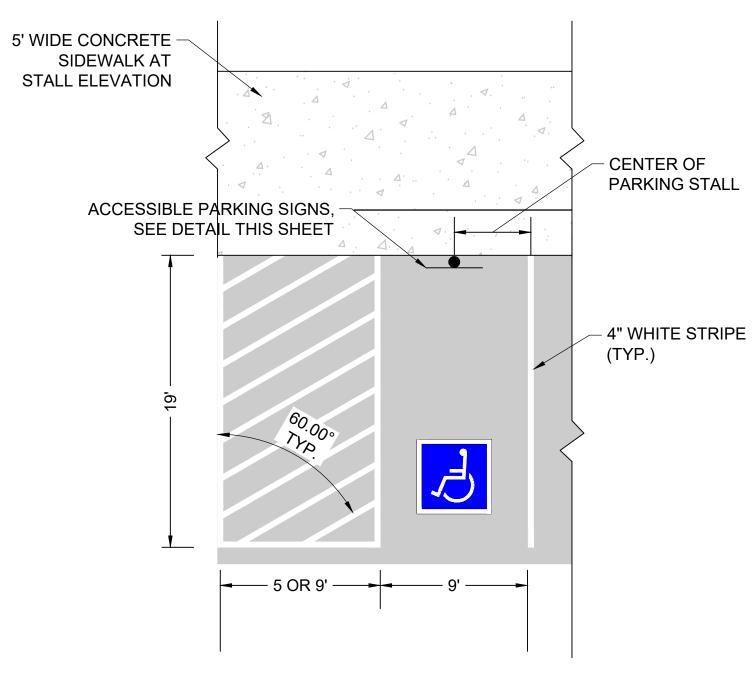


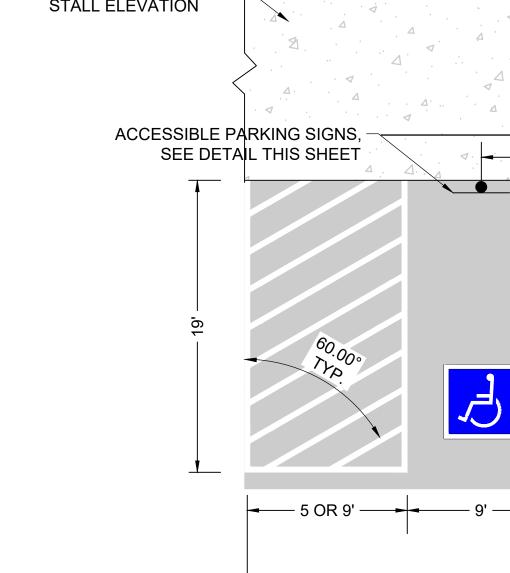

ACCESSIBLE PARKING STALL MK-200 SCALE: NONE


NOTES:

- 1. SEE PAVEMENT MARKING AND SIGNAGE PLAN FOR ACCESSIBLE LAYOUT.
- 2. ALL DIMENSIONS ARE TO CENTERLINE OF STRIPE UNLESS OTHERWISE NOTED.

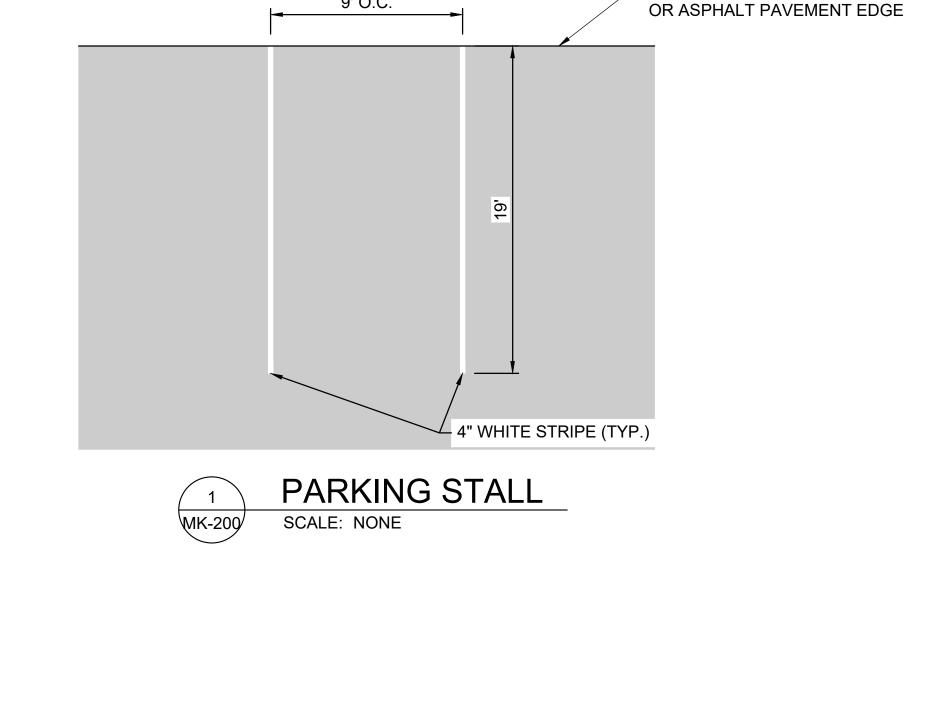


9' O.C.


6" CONCRETE CURB

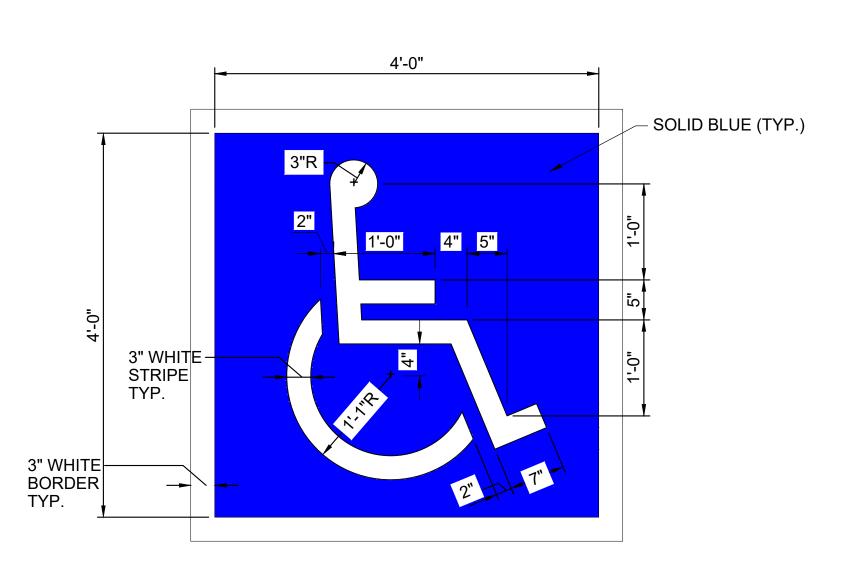



1. ACCESSIBLE PARKING STALL SYMBOL SHALL BE PAINTED, TWO COLOR (BLUE/WHITE).

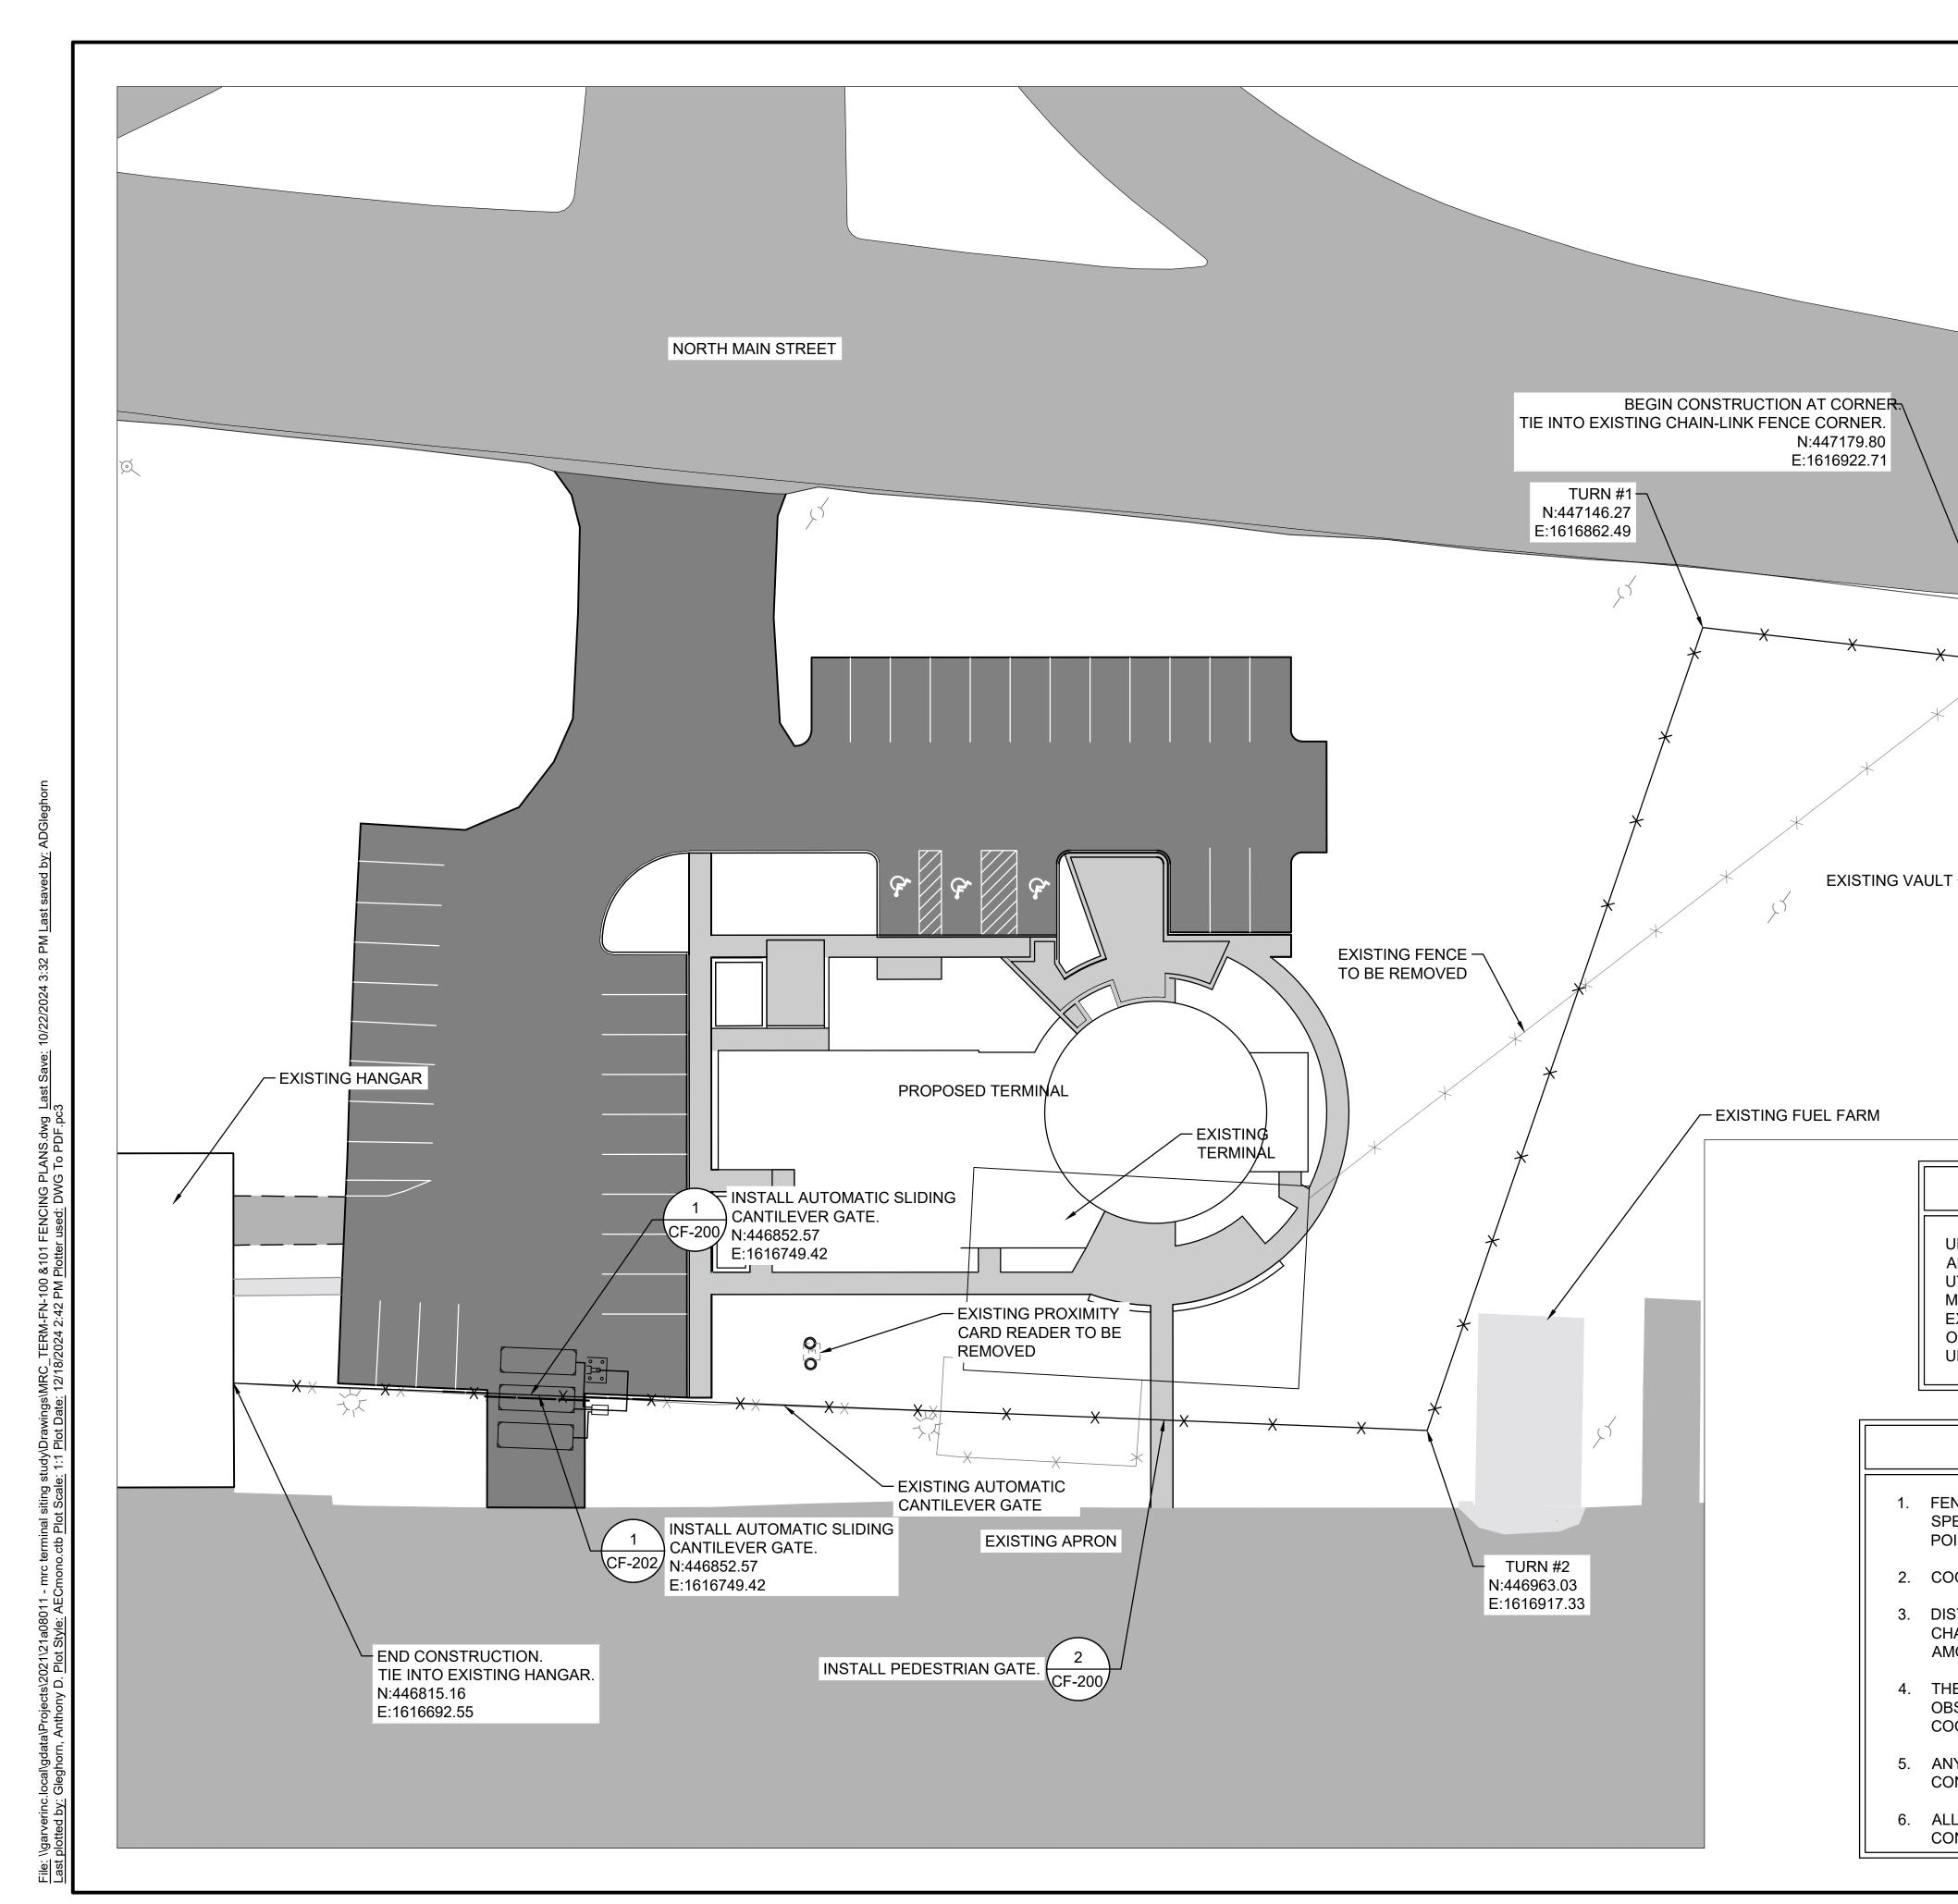

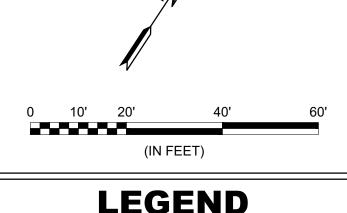

LEGEND EXISTING [CONCRETE] PAVEMENT EXISTING FENCE PROPOSED FENCE **EXISTING GAS LINE EXISTING OVERHEAD** ELECTRIC LINE **EXISTING UNDERGROUND** UTILITY EXISTING UNDERGROUND ELECTRIC UTILITY **EXISTING SANITARY SEWER**

EXISTING [ASPHALT] PAVEMENT

EXISTING UTILITY POLE

CAUTION - UNDERGROUND UTILITIES

UNDERGROUND UTILITIES EXIST WITHIN AND ADJACENT TO THE LIMITS OF CONSTRUCTION. AN ATTEMPT HAS BEEN MADE TO LOCATE THESE UTILITIES ON THE PLANS. ALL EXISTING UTILITIES MAY NOT BE SHOW ON THE PLANS, AND THE LOCATION OF THE UTILITIES SHOWN MAY VARY FROM THE LOCATION SHOWN ON THE PLANS. PRIOR TO BEGINNING ANY TYPE OF EXCAVATION. THE CONTRACTOR SHALL CONTACT TENNESSEE ONE CALL FOR THE LOCATION OF ALL UTILITIES. THE CONTRACTOR SHALL MAINTAIN THE UTILITY LOCATION MARKINGS UNTIL THEY ARE NO LONGER NECESSARY.

FENCE INSTALLATION NOTES


- 1. FENCE SHALL BE INSTALLED PER DETAILS GIVEN ON THE FENCING DETAIL SHEETS AND AS SPECIFIED IN THE SPECIFICATIONS. CONTRACTOR SHALL STAKE/LAYOUT ALL FENCE TURN POINTS PRIOR TO BEGINNING CONSTRUCTION.
- 2. COORDINATES ARE GIVEN FOR ALL FENCE CORNERS.
- 3. DISTANCES SHOWN ARE APPROXIMATE AND DO NOT TAKE INTO ACCOUNT VERTICAL CHANGES, HOWEVER THE BID QUANTITIES HAVE BEEN DEVELOPED WITH AN ESTIMATED AMOUNT OF ADDITIONAL LINEAR FOOTAGE.
- 4. THE FENCE LOCATION IN THE FIELD MAY VARY FROM THE PLANS DUE TO TERRAIN OBSTACLES. ANY FENCE INSTALLATION THAT VARIES FROM THE PLANS MUST BE COORDINATED WITH THE ENGINEER.
- 5. ANY RUTS CREATED BY THE CONTRACTORS WORK SHALL BE FILLED BACK TO EXISTING CONDITIONS AT NO EXPENSE TO THE OWNER.
- 6. ALL GATE LOCATIONS SHALL BE FIELD LOCATED AND APPROVED BY THE ENGINEER PRIOR TO CONSTRUCTION.



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MAURY COUNTY REGIONAL AIRPORT NEW TERMINAL CONSTRUCTION PROJECT SCHEDULE B MAURY COUNTY
AIRPORT AUTHORITY
MAURY COUNTY, TENNESSEE

FENCING PLAN

JOB NO.: 21A08011 DATE: DEC 2024 DESIGNED BY: MRM DRAWN BY: JAH

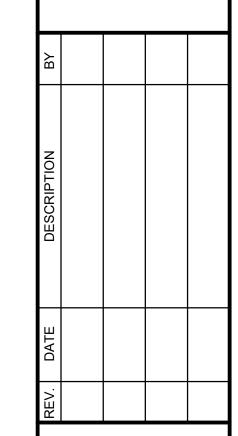BAR IS ONE INCH ON ORIGINAL DRAWING

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DRAWING NUMBER **CF-101**

GARVER

Suite 102

CF-200

AUTOMATIC SLIDING CANTILEVER GATE

SCALE: NONE

AUTOMATIC SLIDING CANTILEVER GATES SHALL BE AS SHOWN, INCLUDING THE SUPPORTING ELECTRICAL IMPROVEMENTS AS DESCRIBED IN ITEM SS-350.

VEHICLE MUST WAIT FOR GATE TO CLOSE.




SLIDING GATE SIGN SCALE: NONE





NOTES:

- SIGNS SHALL BE PERMANENT, NON-FADING, OUTDOOR TYPE. NO TRESPASSING SIGNS SHALL BE INSTALLED AT 200' INTERVALS AND AT EACH GATE.
- 2. THE CONTRACTOR SHALL SUBMIT SHOP DRAWINGS TO THE ENGINEER FOR APPROVAL BEFORE INSTALLATION.
- SIGNS WILL NOT BE MEASURED FOR SEPARATE PAYMENT BUT WILL BE CONSIDERED SUBSIDIARY TO ITEM F-162.
- 4. RED LEGEND, WHITE BACKGROUND, RED BORDER. (12" x 18")
- THE NUMBER LEGEND OF THE GATE SIGN SHALL BE COORDINATED WITH THE OWNER.

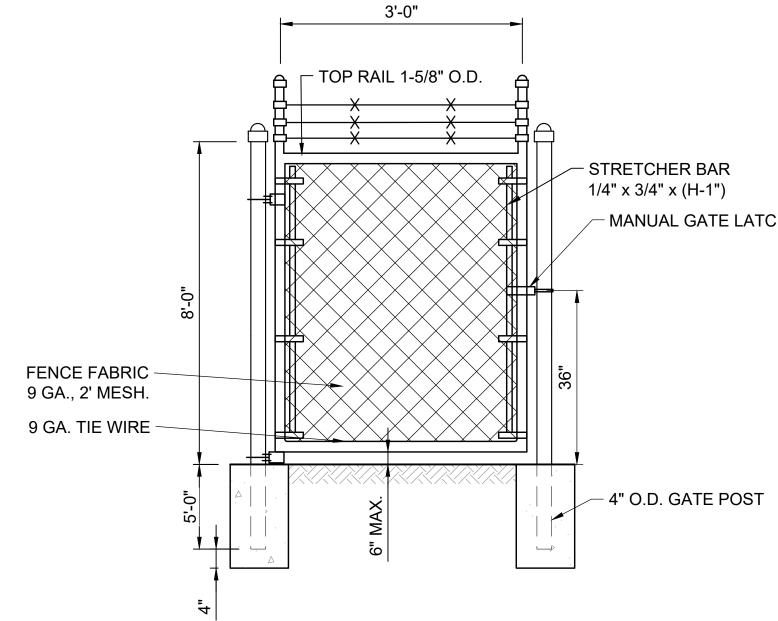

CF-200


PEDESTRIAN GATE

SCALE: NONE

NOTE:

SEE SCHEDULE A ELECTRICAL PLAN FOR ACCESS CONTROL DETAILS.

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FENCING DETAILS 1

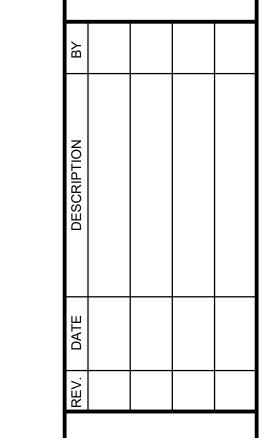
JOB NO.: 21A08011 DATE: DEC 2024 **DESIGNED BY: ZCS** DRAWN BY: ADG

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CF-200

NUMBER 17




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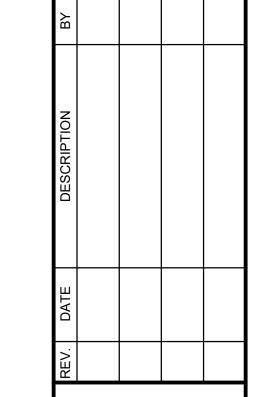
361 Mallory Station Road

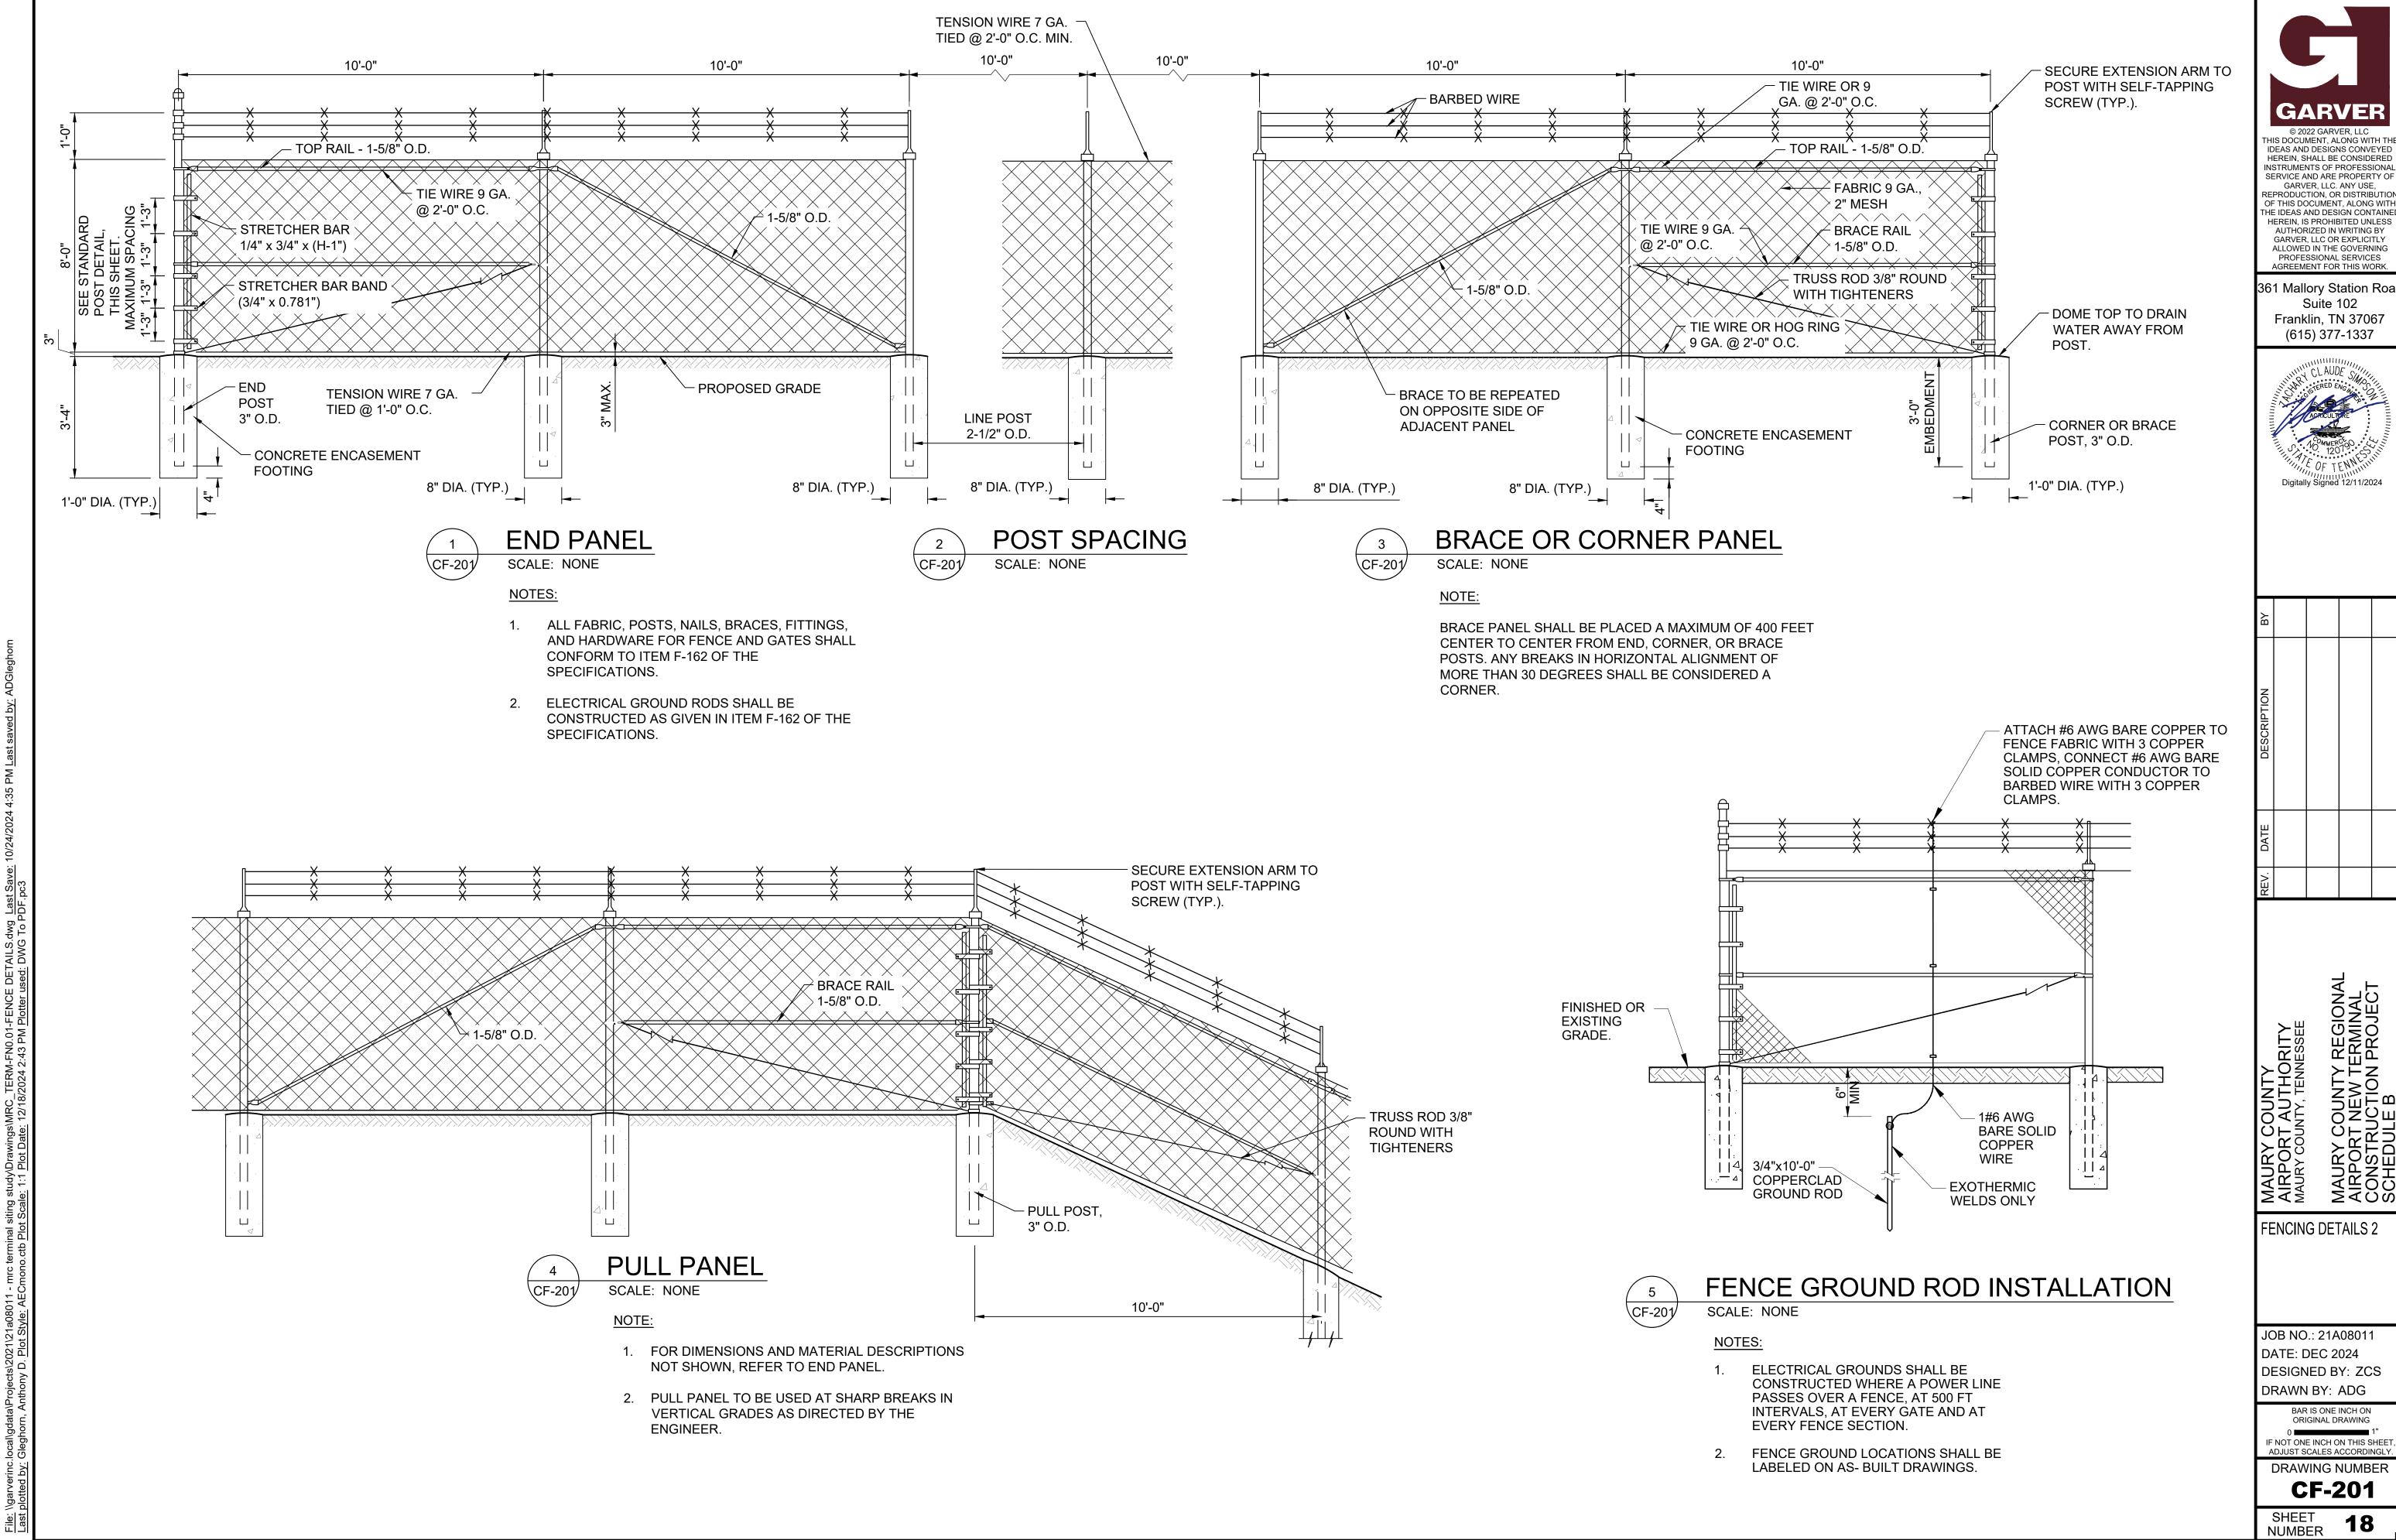

PROFESSIONAL SERVICES AGREEMENT FOR THIS WORK. 361 Mallory Station Road Suite 102 Franklin, TN 37067 (615) 377-1337

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GATE OPERATOR DETAILS 1


JOB NO.: 21A08011 DATE: DEC 2024 **DESIGNED BY: ZCS**

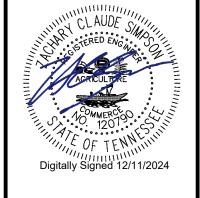DRAWN BY: ADG BAR IS ONE INCH ON ORIGINAL DRAWING

F NOT ONE INCH ON THIS SHEET ADJUST SCALES ACCORDINGLY DRAWING NUMBER

CF-202

NUMBER 19

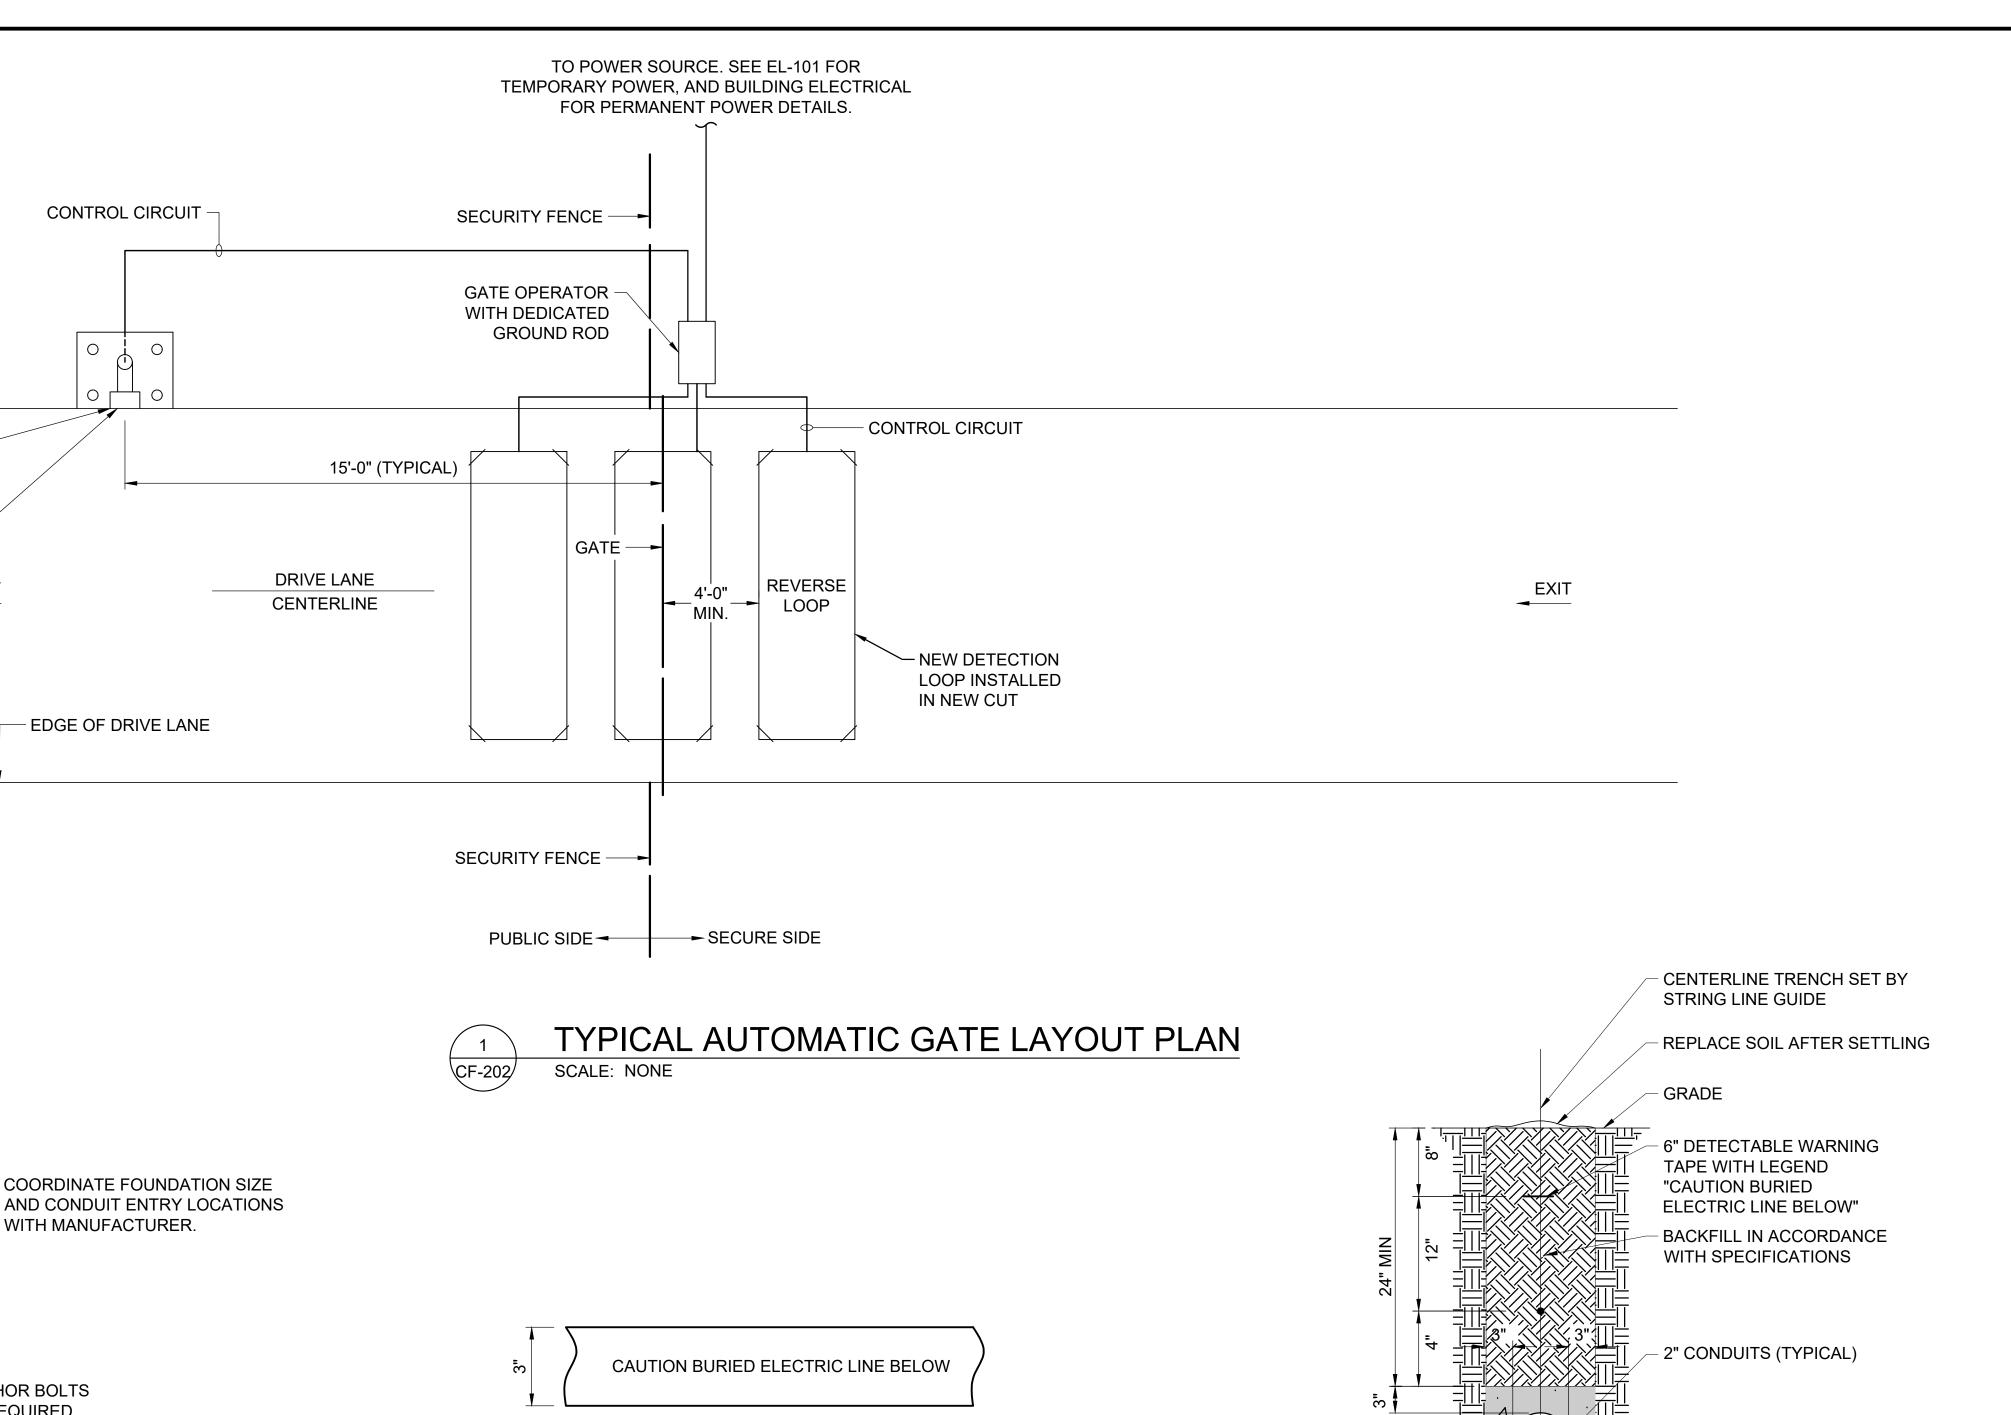

NOTES:

- 1. POWER MARKING TAPES SHALL BE DETECTABLE TYPE CONSTRUCTION WITH RED BACKGROUND AND BLACK LETTERING
- 2. COMMUNICATION MARKING TAPES SHALL BE DETECTABLE TYPE CONSTRUCTION WITH ORANGE BACKGROUND AND BLACK LETTERING, "TELEPHONE LINE" OR "FIBER OPTIC LINE" RESPECTIVELY.
- 3. TAPE SHALL BE DETECTABLE, DURABLE, HIGHLY VISIBLE, RESISTANT TO ELEMENTS, MEETING AND / OR EXCEEDING ALL INDUSTRY STANDARDS.
- 4. PROVIDE MULTIPLE AND / OR WIDER TAPES FOR WIDER DUCT BANKS. COORDINATE WITH ENGINEER.

CF-202

CONTROL CIRCUIT

EDGE OF DRIVE LANE

WITH MANUFACTURER.

FINISHED

CONDUIT AS REQUIRED

30"x24"x24" FOUNDATION

USING 3500 PSI CONCRETE

OR INDICATED

- ANCHOR BOLTS AS REQUIRED

-2-#4'S EACH WAY

UNDERGROUND DETECTABLE WARNING TAPE SCALE: NONE

FOUNDATION NOTE:

DEDICATED 3/4" x 10' COPPERCLAD

GROUND ROD WITH #6 GROUND

WIRE AND EXOTHERMIC WELD

1. CONTRACTOR IS RESPONSIBLE FOR INSTALLING STEEL STILTS FOR GATE OPERATORS WHERE NECESSARY TO FACILITATE REQUIRED ELEVATION OF GATE OPERATOR PER MANUFACTURER'S INSTRUCTIONS. INSTALLATION OF STILTS SHALL BE SUBSIDIARY TO GATE OPERATOR PAY ITEM.

└─ 3" CLEAR

PROXIMITY CARD READER

PRIOR TO INSTALLATION.

APPROX. 24"

AS REQ'D

GROUNDING

BUSHINGS

DRIVE LANE

FRONT EDGE WITH EDGE OF

FIRE ACCESS BOX, MOUNTED ON ARM ABOVE

KEYPAD. CONTRACTOR SHALL COORDINATE THE

SPECIFIC DEVICE REQUIRED WITH THE CITY MT. PLEASANT FIRE DEPARTMENT AND ENGINEER

APPROX.

INDUSTRIAL SLIDING ---

GATE OPERATOR

3/4" CHAMFER

3' SLACK

#6 BARE COPPER -

GROUND WIRE WITH

WATERTIGHT

BUSHING

SLIDING GATE OPERATOR FOUNDATION DETAIL 2 CF-202 SCALE: NONE

ENCASED NOTES

1. INSTALL 3/4" x 10'-0" COPPERCLAD GROUND RODS AT EACH END OF ELECTRICAL DUCT AND BOND COUNTERPOISES USING EXOTHERMIC WELDS.

3500 PSI CONCRETE


2. INSTALL DUCT MARKERS IN ACCORDANCE WITH ADVISORY CIRCULAR 150/5340-30 REQUIREMENTS, INCLUDING AT THE ENDS OF DUCT BANKS.

1-WAY

3. SIMILAR FOR OTHER DUCT SIZES.



Suite 102

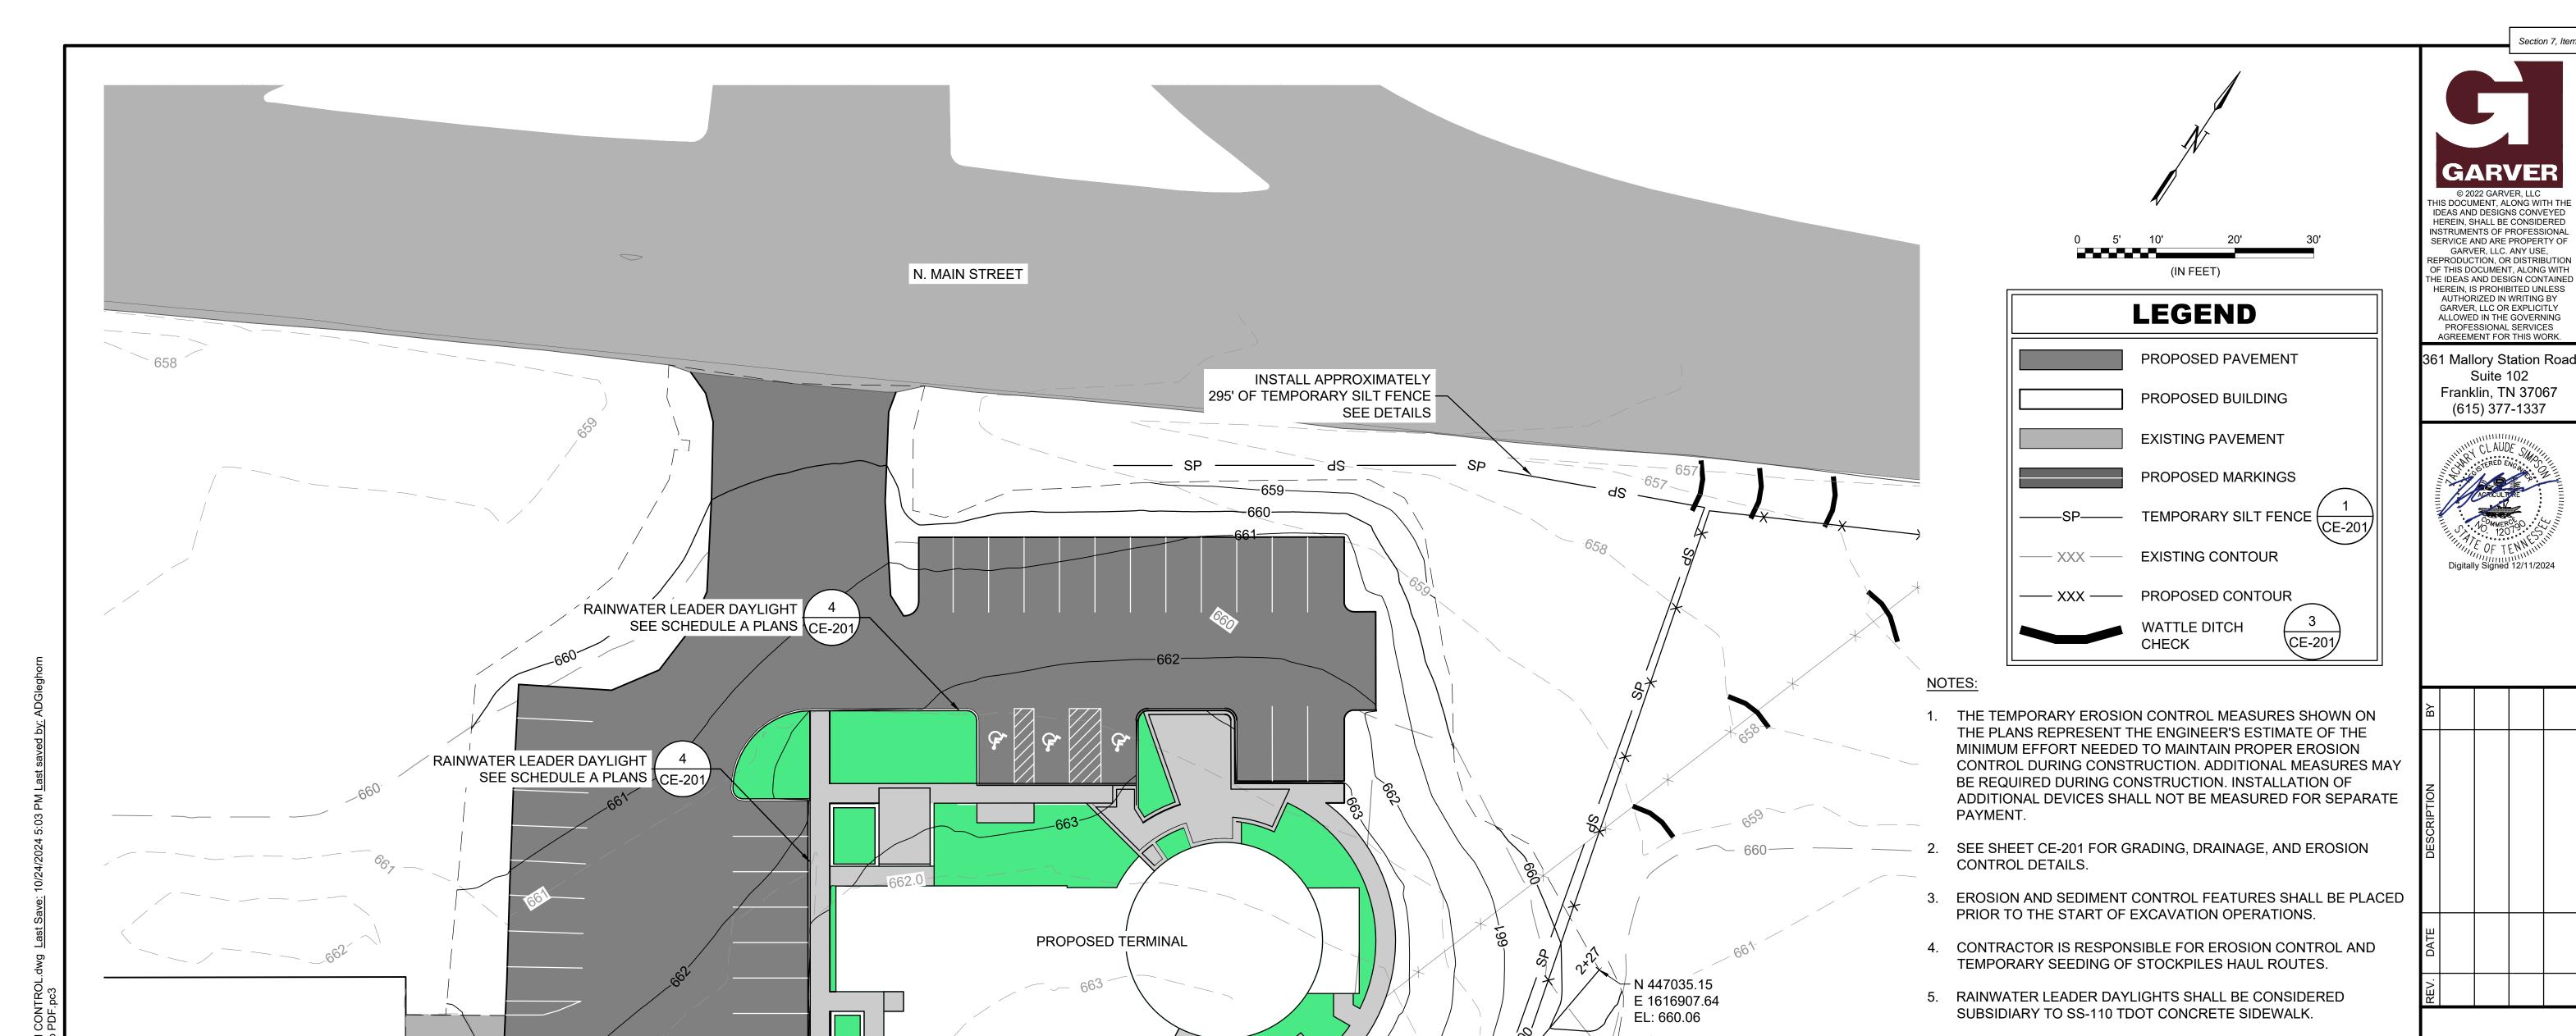

STA. 1+58.33-

ELEV: 661.35

_STA. 1+10.37

OFF. 0.50' RT

ELEV: 662.60

N 446951.18 -

E 1616889.94

STA. 1+05.36 OFF. 0.51' RT

ELEV: 662.68

STA. 0+98.54-

OFF. 0.54' RT

ELEV: 662.81

CE-201/

STÁ. 0+21.98

OFF. 0.50' RT

N 446867.60

E 1616779.52

EL: 662.71

EXISTING HANGAR

ELEV: 663.58

STA. 0+64.46—

OFF. 0.72' LT

ELEV: 663.15

УSTA. 0+09.14

OFF. 2.51' RT

ELEV: 663.51

DITCH CROSSING AT SIDEWALK

EXISTING APRON

OFF. 0.00'

- N 446967.02 E 1616901.89

∕−STA. 1+38.49

ELEV: 662.00

OFF. 0.00'

EXISTING HANGAR

MAURY COUNTY AIRPORT AUTHORITY MAURY COUNTY, TENNESSEE

CUT AND FILL VOLUME TABLE

FILL (CYD)

1154.37

NET FILL (CYD)

1098.64

CUT (CYD)

55.73


GRADING, DRAINAGE, AND EROSION CONTROL PLAN


JOB NO.: 21A08011 DATE: DEC 2024 **DESIGNED BY: ZCS** DRAWN BY: ADG

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DRAWING NUMBER **CE-101**






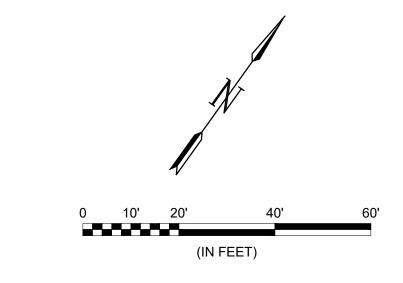

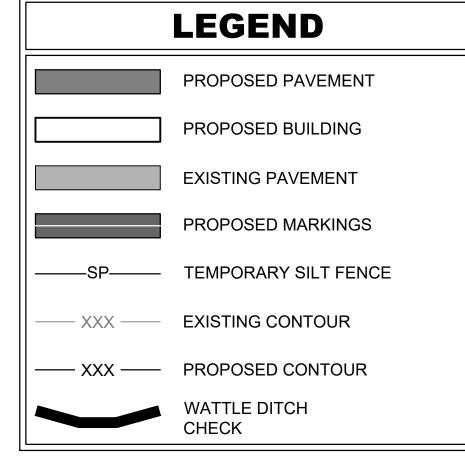NOTES:

1. PROFILE VERTICAL EXAGGERATION = 5.

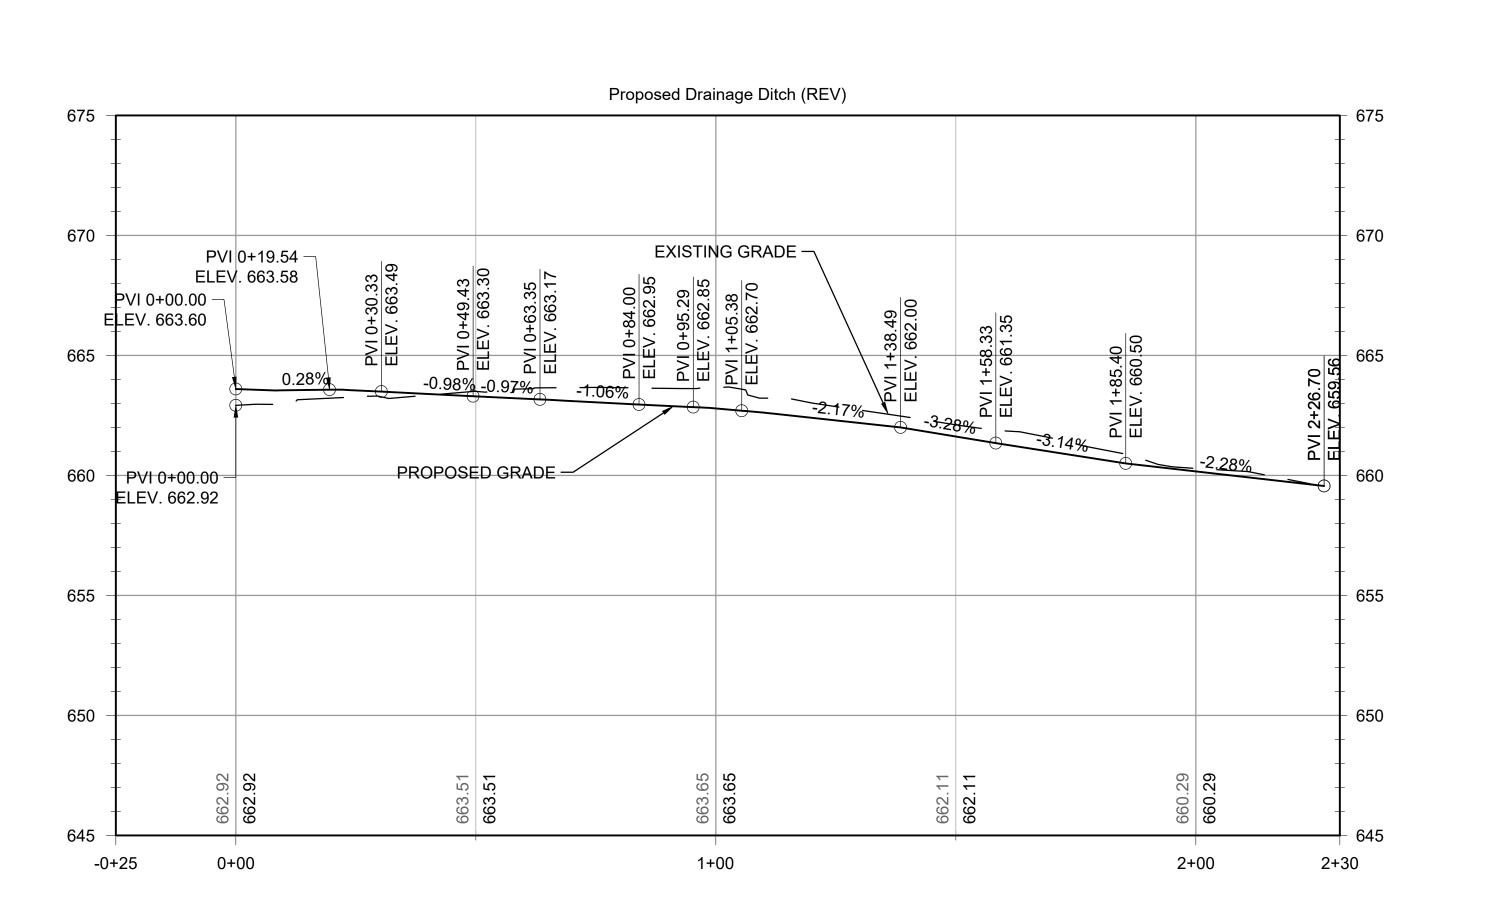

STA. 1+58.33-OFF. 0.00'

ELEV: 661.35

− N 446967.02 E 1616901.89

∕-STA. 1+38.49

ELEV: 662.00

OFF. 0.00'

_STA. 1+10.37

OFF. 0.50' RT

ELEV: 662.60

N 446951.18 ^{__}

E 1616889.94

STA. 1+05.36

OFF. 0.51' RT

STA. 0+98.54-

OFF. 0.54' RT

ELEV: 662.81

ELEV: 662.68

STÁ. 0+21.98

OFF. 0.50' RT

ELEV: 663.58

N 446867.60

E 1616779.52

EL: 662.71

STA. 0+64.46~

OFF. 0.72' LT

ELEV: 663.15

-STA. 0+09.14

OFF. 2.51' RT

ELEV: 663.51

N 447035.15

E 1616907.64


EL: 660.06

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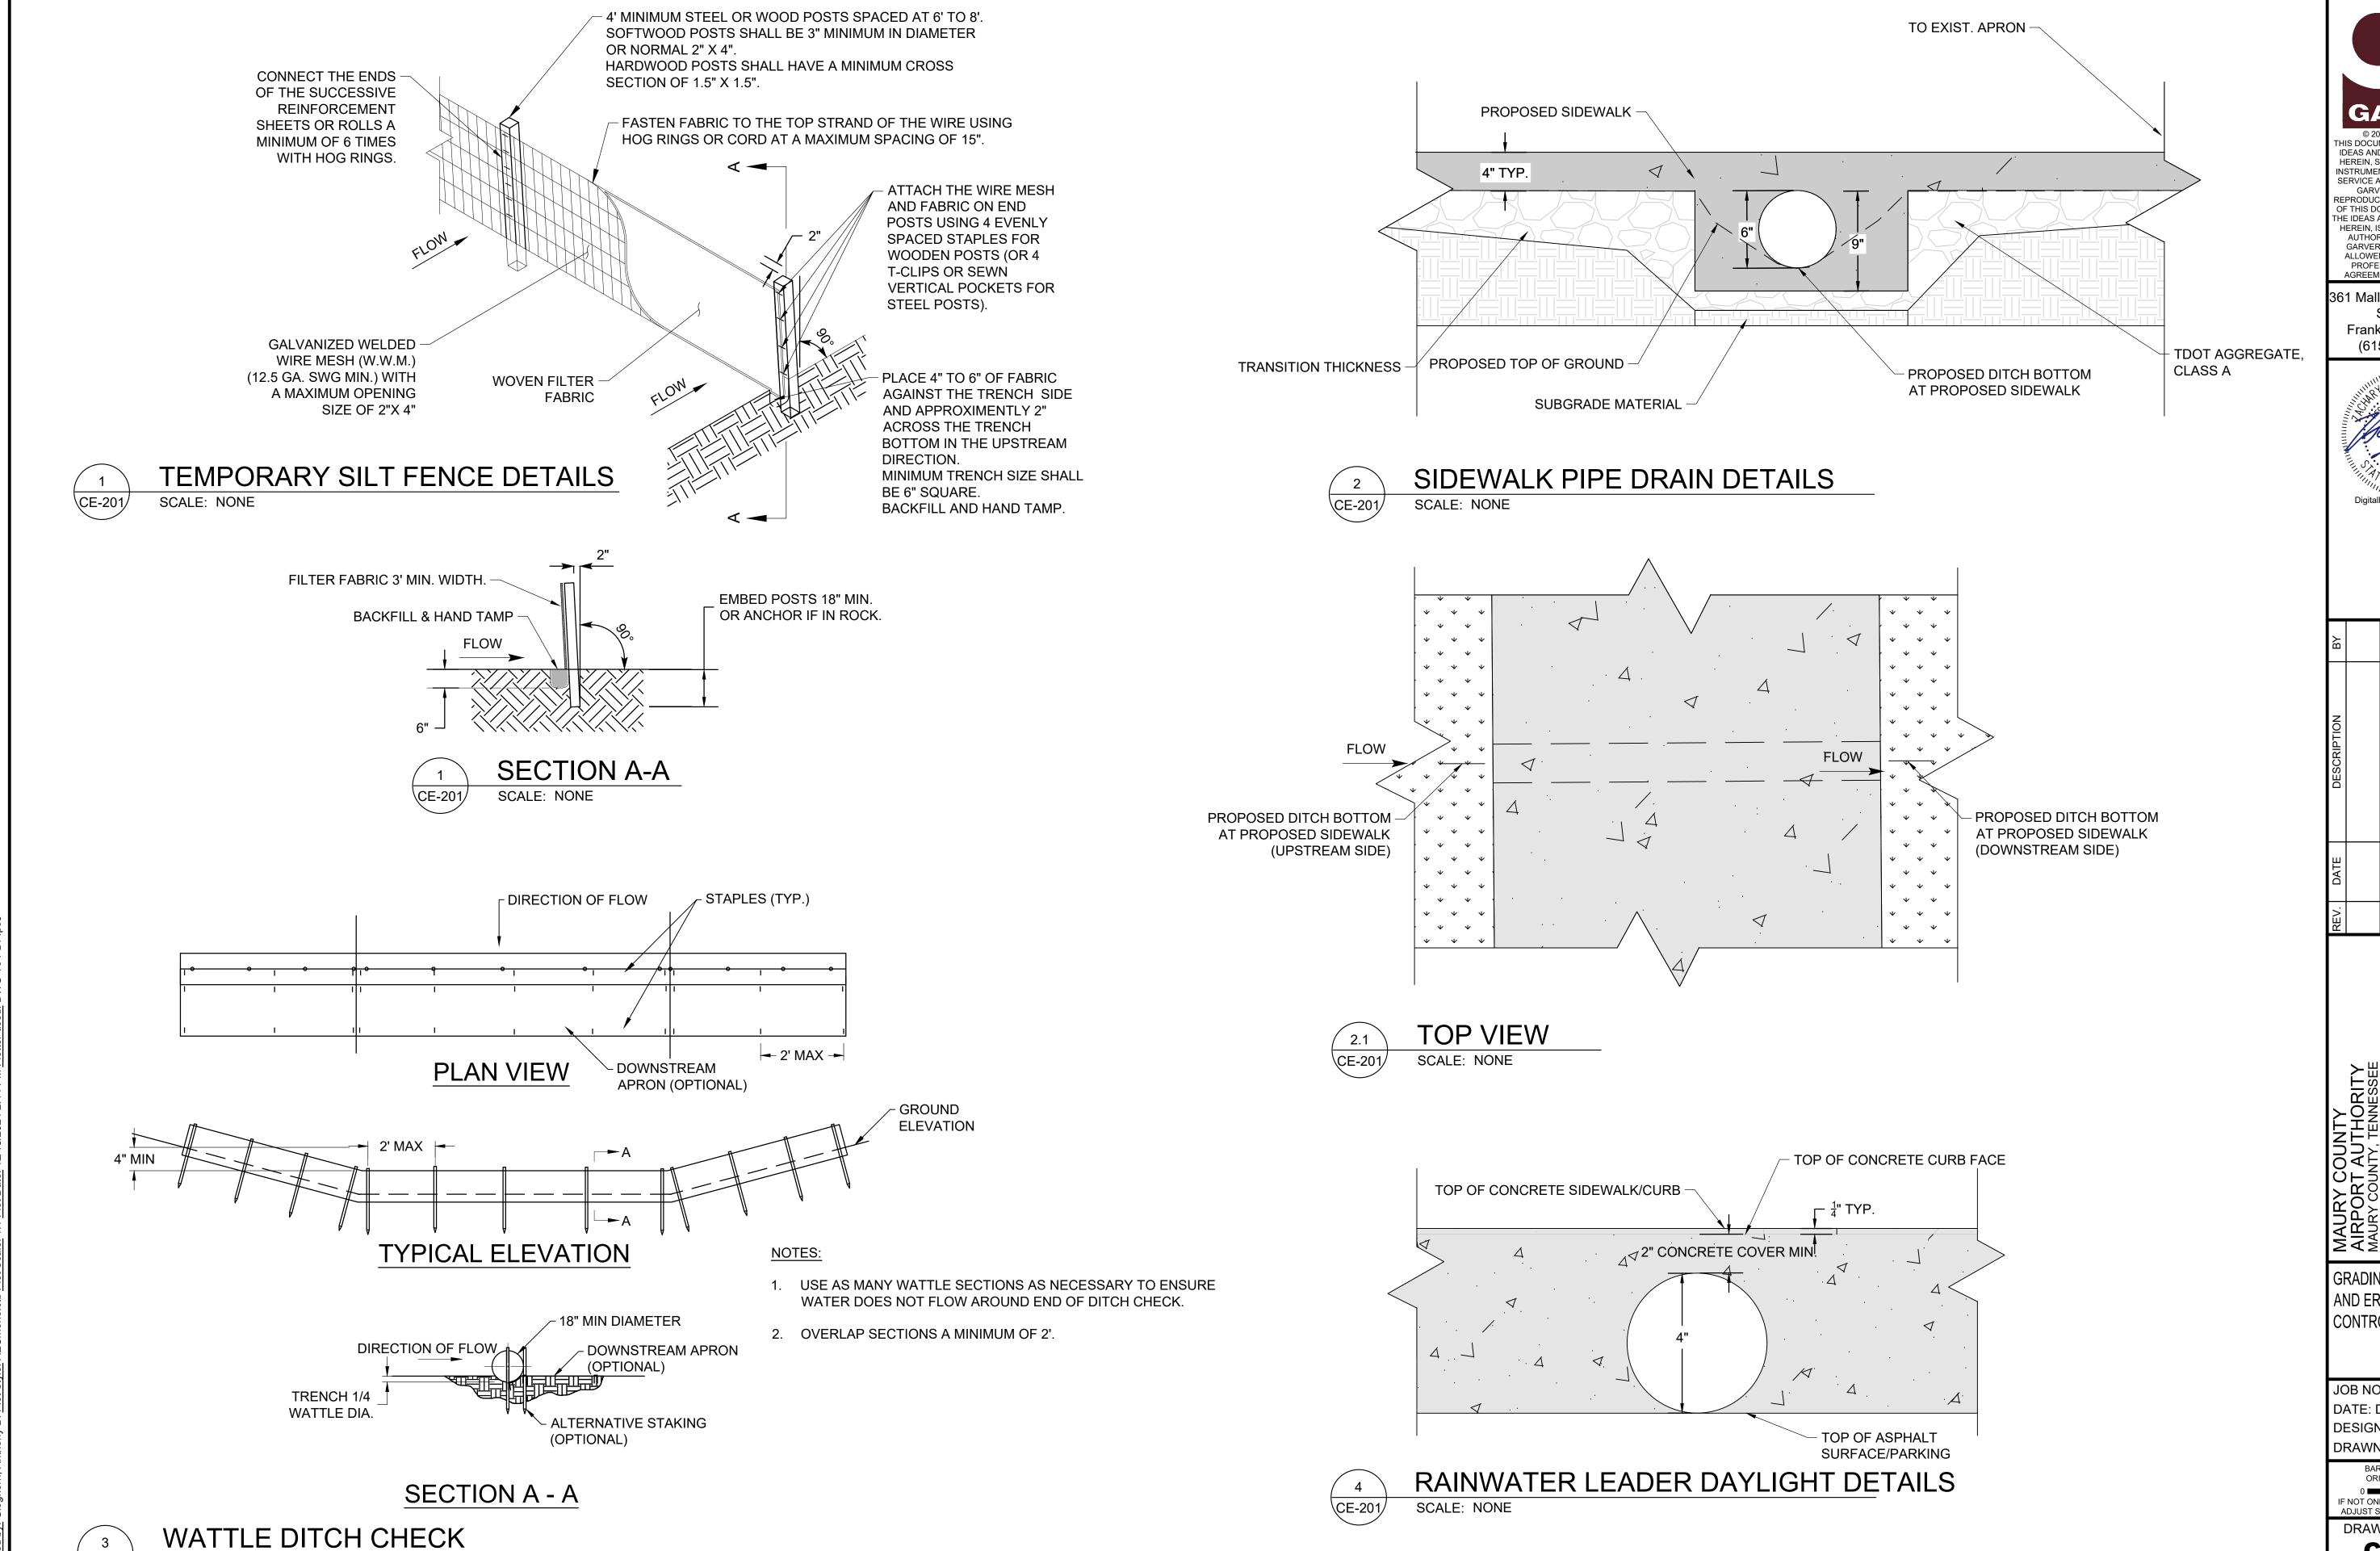
GRADING DITCH PLAN AND PROFILE

JOB NO.: 21A08011 DATE: DEC 2024 DESIGNED BY: ZCS DRAWN BY: ADG

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CE-200

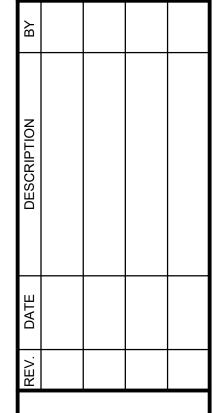

CE-201

SCALE: NONE

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REV. DATE DESCRIPTION BY

AIRPORT AUTHORITY
MAURY COUNTY, TENNESSEE
MAURY COUNTY REGIONA
AIRPORT NEW TERMINAL
CONSTRUCTION PROJECT

GRADING, DRAINAGE, AND EROSION CONTROL DETAILS

JOB NO.: 21A08011 DATE: DEC 2024 DESIGNED BY: ZCS DRAWN BY: ADG

BAR IS ONE INCH ON ORIGINAL DRAWING


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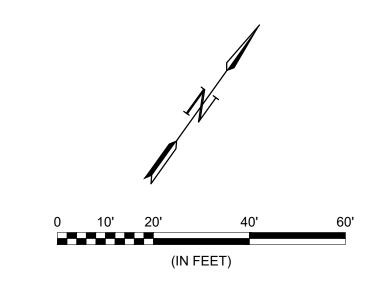
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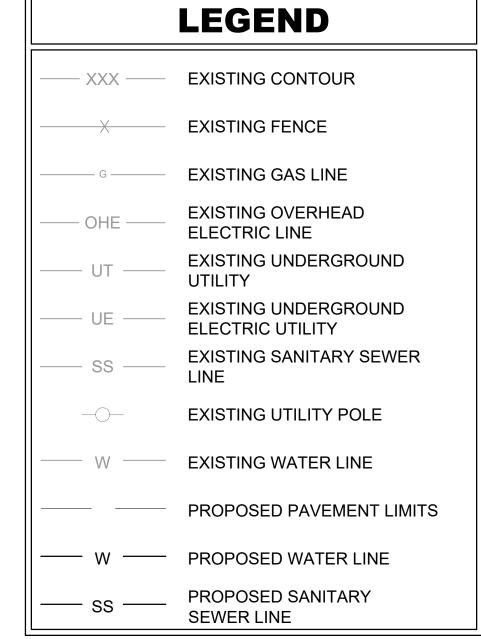
CE-201

SHEET 22

54





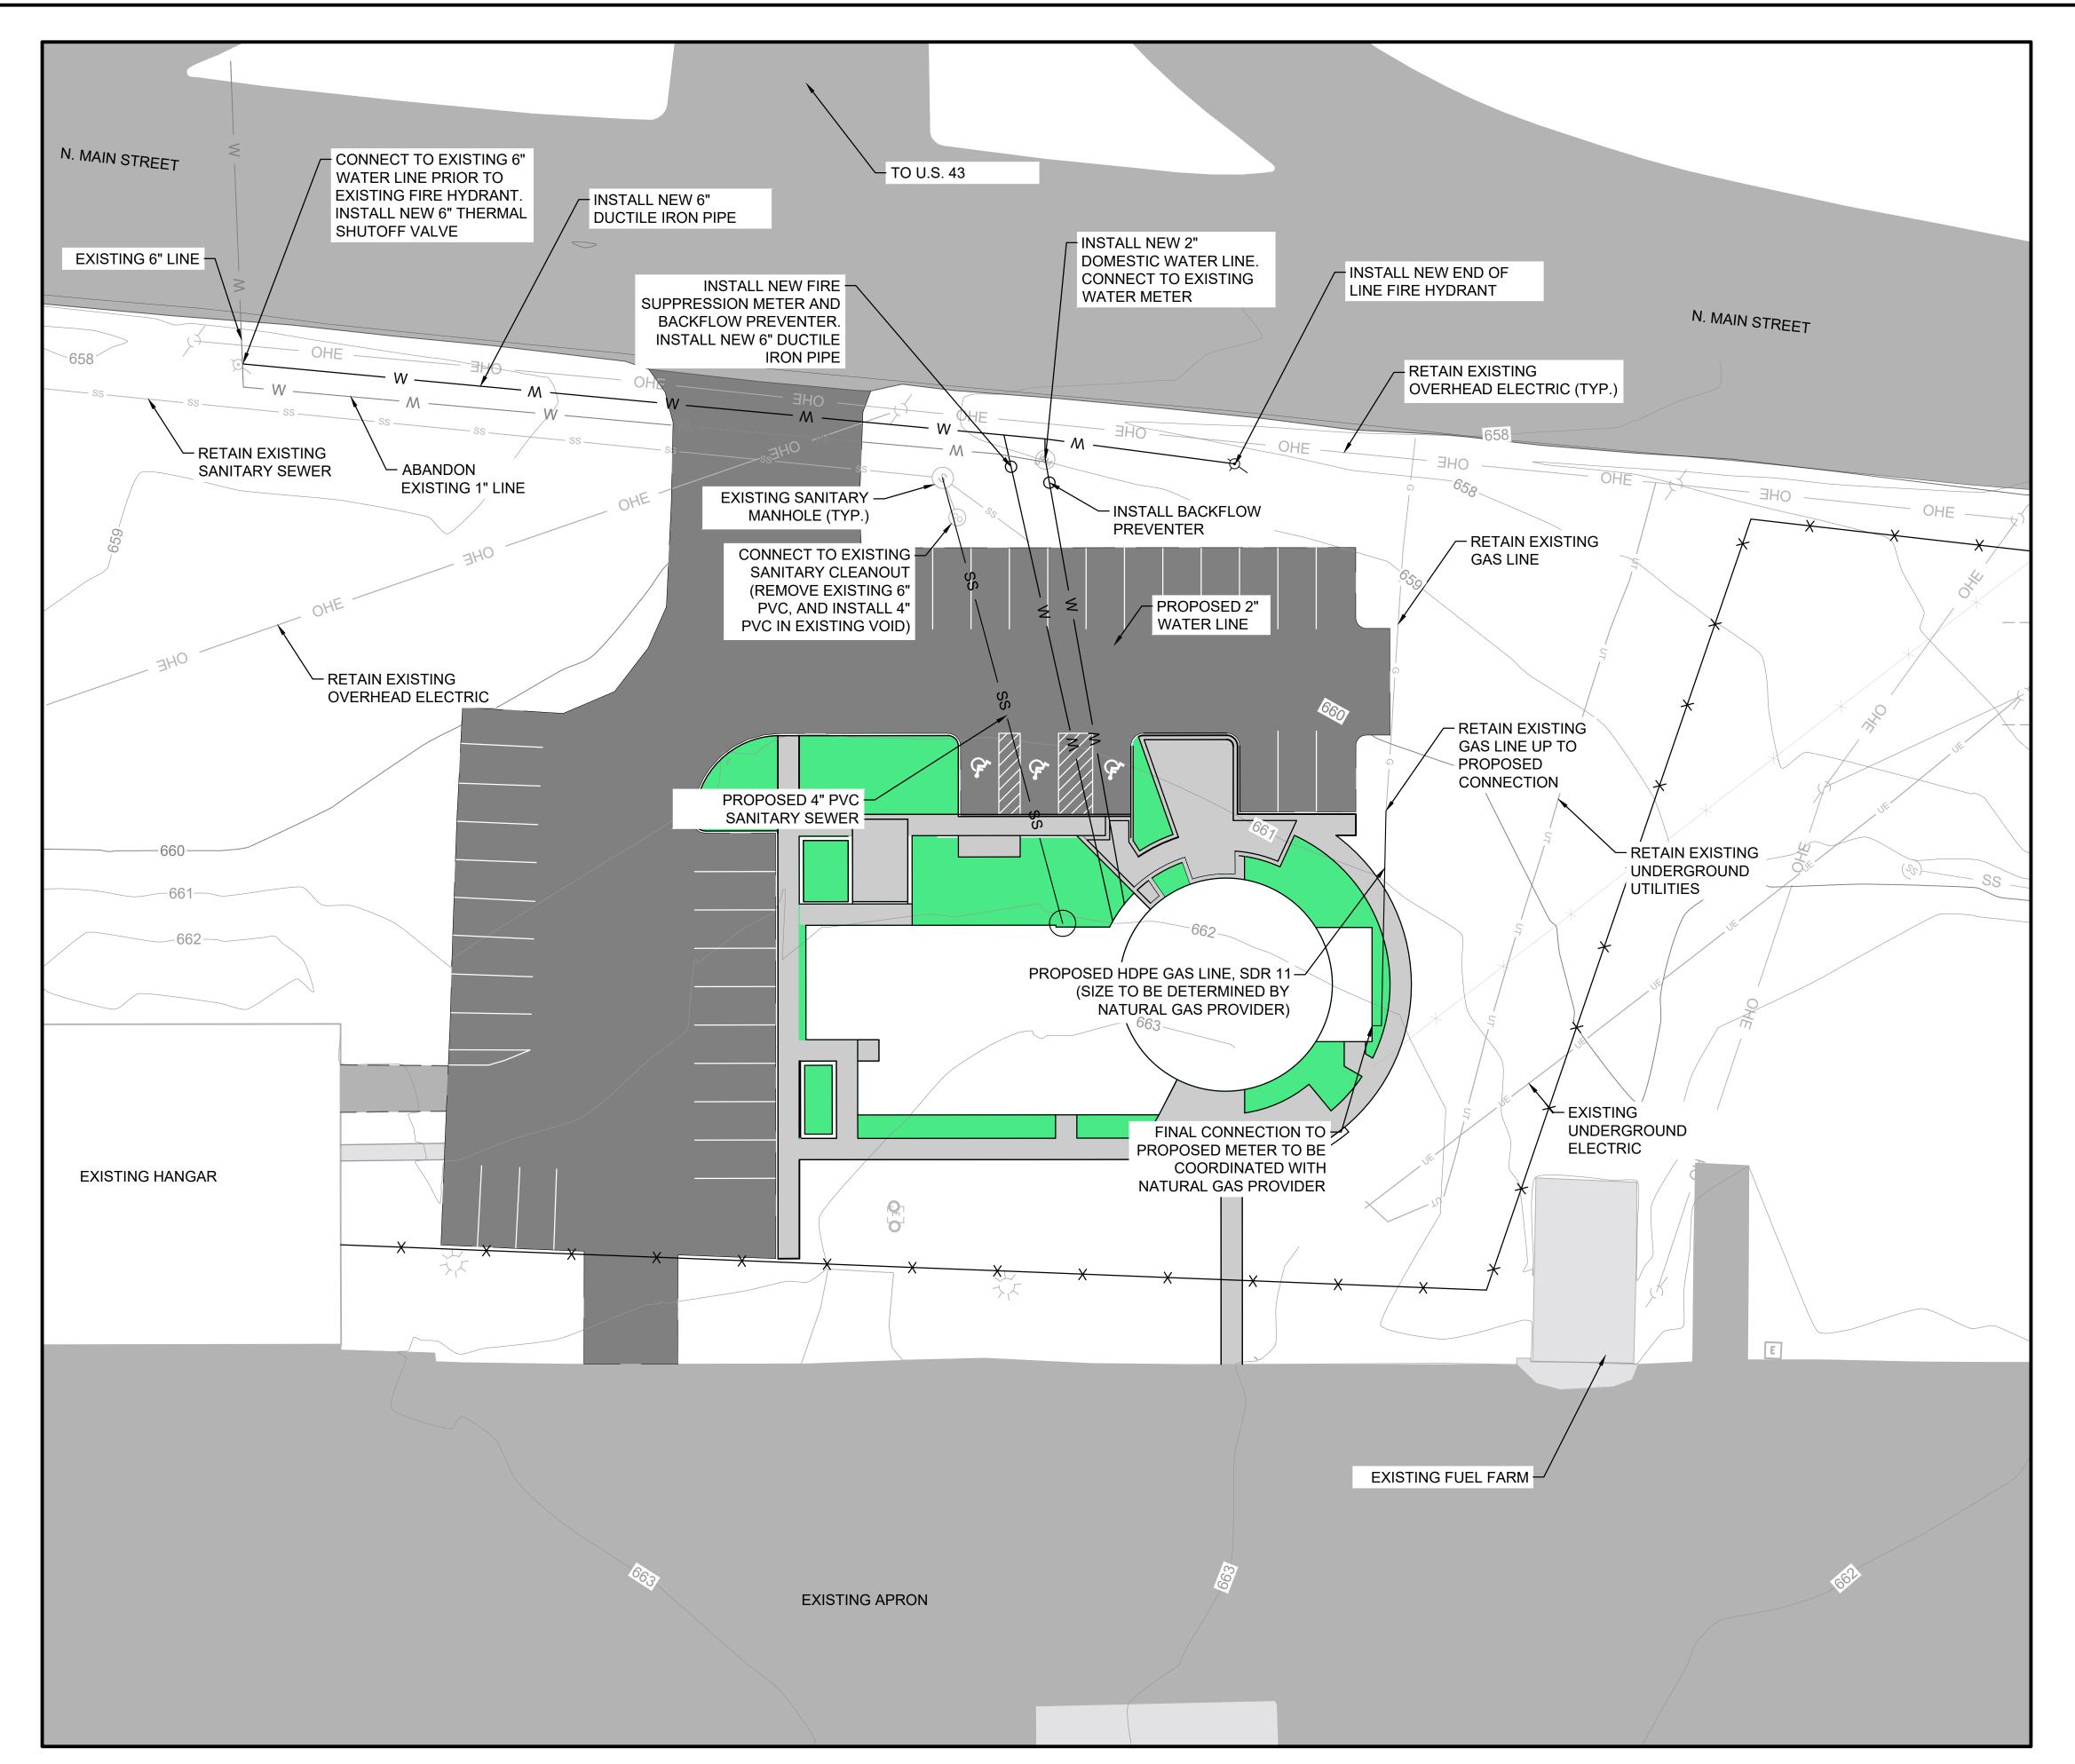


NOTES:


- EXISTING UTILITIES AND UNDERGROUND FACILITIES ARE LOCATED FROM AVAILABLE SURFACE INFORMATION OR RECORDS RESEARCH. THE LOCATION AND ELEVATIONS SHOWN ARE APPROXIMATED AND ARE BASED ON THE INFORMATION AVAILABLE AT THE TIME OF DESIGN. THE CONTRACTOR IS RESPONSIBLE FOR FIELD VERIFYING EXACT LOCATION, DEPTH, AND CONDITION OF ALL UTILITIES AND AIRPORT FACILITIES DURING THE CONSTRUCTION PERIOD. ANY CONFLICTING UTILITY INFORMATION SHALL BE REPORTED TO THE ENGINEER FOR ASSESSMENT PRIOR TO THE START OF DEMOLITION OPERATIONS.
- 2. ALL EXISTING INFRASTRUCTURE SHALL REMAIN UNLESS OTHERWISE NOTED ON CIVIL AND /OR ELECTRICAL DEMOLITION SHEETS.
- 3. FOR ADDITIONAL DETAIL ON ELECTRICAL ITEMS, SEE E-100 SERIES FOR ELECTRICAL REMOVAL SHEETS.



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361 Mallory Station Road Suite 102 Franklin, TN 37067 (615) 377-1337



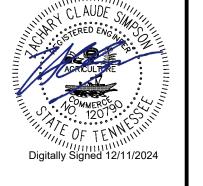

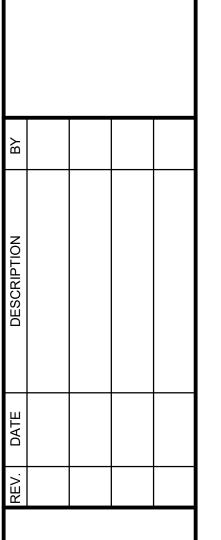MAURY COUNTY
AIRPORT AUTHORITY
MAURY COUNTY, TENNESSEE


CIVIL UTILITIES PLAN

JOB NO.: 21A08011 DATE: DEC 2024 **DESIGNED BY: ZCS** DRAWN BY: ADG

> BAR IS ONE INCH ON ORIGINAL DRAWING

IF NOT ONE INCH ON THIS SHEET ADJUST SCALES ACCORDINGLY. DRAWING NUMBER

CU-101

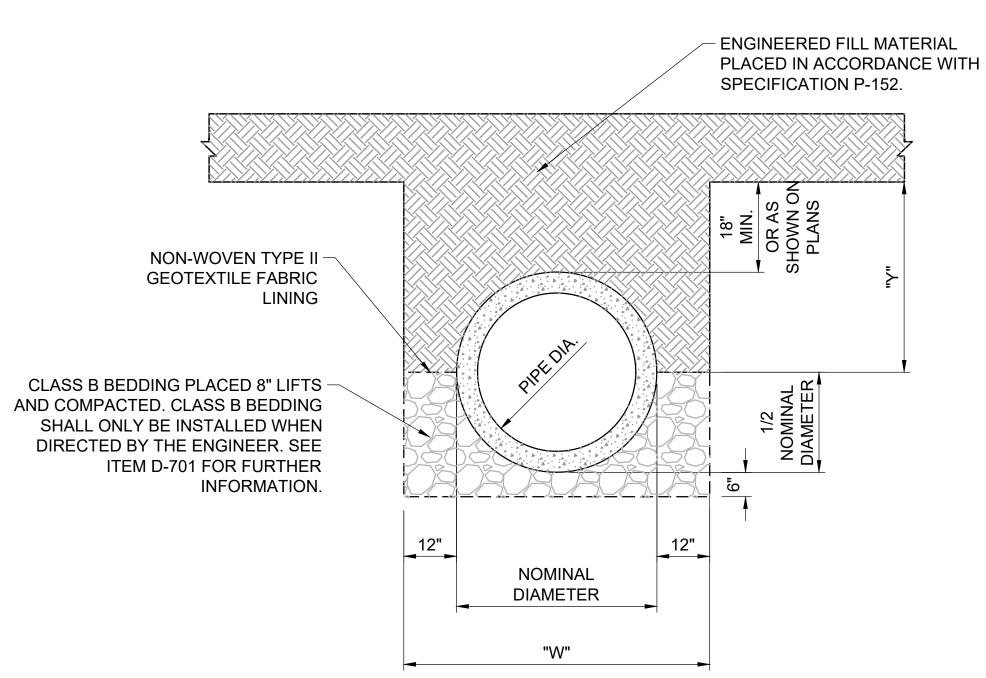


"W" = PIPE NOMINAL DIAMETER + 2' MINIMUM. TRENCH WIDTH SHALL MEET OSHA STANDARDS.



CONSTRUCTION SEQUENCE:

- 1. EXCAVATE A TRENCH AT A WIDTH OF "W". THE DITCH SHALL COMPLY WITH OSHA REGULATIONS AT ALL TIMES AND MAY REQUIRE A TRENCH SAFETY SYSTEM.
- 2. LINE TRENCH WITH NON-WOVEN TYPE II GEOTEXTILE FABRIC AND FOLD EXCESS MATERIAL OVER EDGES OF TRENCH AND SECURE IN PLACE WITH SMALL PILES OF CLASS B BEDDING.
- 3. PLACE 6" OF CLASS B BEDDING IN BOTTOM OF TRENCH FOR BEDDING MATERIAL. ENSURE SLOPE ON SURFACE OF CLASS B BEDDING COMPLIES WITH PLANS AND SPECIFICATION D-701.
- 4. PLACE STORM PIPE IN TRENCH USING STANDARD CONSTRUCTION PRACTICE WITH CARE TAKEN NOT TO DAMAGE PIPE.
- 5. BACKFILL TO 1/2 NOMINAL DIAMETER OF PIPE WITH CLASS B BEDDING PLACED IN 8" LIFTS AND COMPACTED.
- 6. FOLD THE TYPE II GEOTEXTILE FABRIC OVER THE BACKFILLED MATERIAL SO THAT THE FABRIC MEETS THE EDGE OF THE STORM PIPE WITH NO GAPS PRESENT.
- 7. PLACE ENGINEERED FILL ON TOP OF TYPE II GEOTEXTILE FABRIC PER SPECIFICATION P-152.

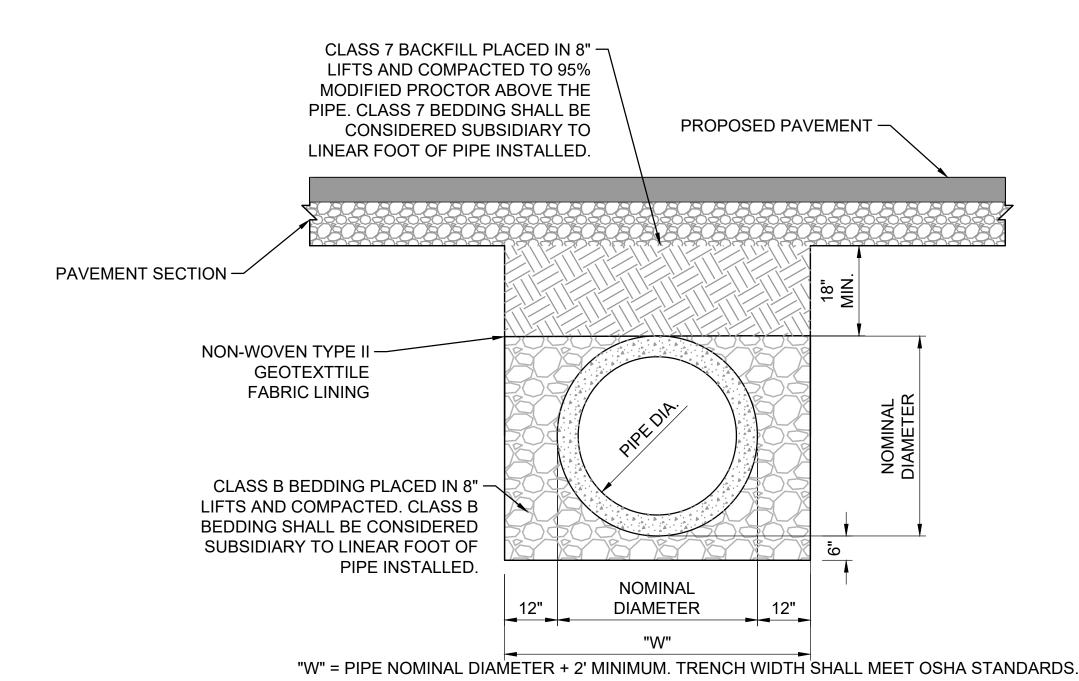

PIPE BACK FILLING UNDER PAVEMENT
SCALE: NONE

CONSTRUCTION SEQUENCE:

- 1. EXCAVATE A TRENCH AT A WIDTH OF "W". THE DITCH SHALL COMPLY WITH OSHA REGULATIONS AT ALL TIMES AND MAY REQUIRE A TRENCH SAFETY SYSTEM.
- 2. LINE TRENCH WITH NON-WOVEN TYPE II GEOTEXTILE FABRIC AND FOLD EXCESS MATERIAL OVER EDGES OF TRENCH AND SECURE IN PLACE WITH SMALL PILES OF CLASS B BEDDING.
- 3. PLACE 6" OF CLASS B BEDDING IN BOTTOM OF TRENCH FOR BEDDING MATERIAL. ENSURE SLOPE ON SURFACE OF CLASS B BEDDING COMPLIES WITH PLANS AND SPECIFICATION D-701.
- 4. PLACE STORM PIPE IN TRENCH USING STANDARD CONSTRUCTION PRACTICE WITH CARE TAKEN NOT TO DAMAGE PIPE.
- 5. BACKFILL TO 1/2 NOMINAL DIAMETER OF PIPE WITH CLASS B BEDDING PLACED IN 8" LIFTS AND COMPACTED.
- 6. FOLD THE TYPE II GEOTEXTILE FABRIC OVER THE BACKFILLED MATERIAL SO THAT THE FABRIC MEETS THE EDGE OF THE STORM PIPE WITH NO GAPS PRESENT.
- 7. PLACE ENGINEERED FILL ON TOP OF TYPE II GEOTEXTILE FABRIC PER SPECIFICATION P-152.



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REV. DATE DESCRIPTION BY

MAURY COUNTY
AIRPORT AUTHORITY
MAURY COUNTY, TENNESSEE
MAURY COUNTY REGIONAL
AIRPORT NEW TERMINAL
CONSTRUCTION PROJECT

CIVIL UTILITY DETAILS

JOB NO.: 21A08011 DATE: DEC 2024 DESIGNED BY: RGP DRAWN BY: ABC

> BAR IS ONE INCH ON ORIGINAL DRAWING

0 1"

IF NOT ONE INCH ON THIS SHEET

ADJUST SCALES ACCORDINGLY.

CU-201

CU-201

MAURY COUNTY REGIONAL AIRPORT (KMRC)

LANDSCAPE PLAN

SITE DATA SITE ZONING: IL - LIGHT INDUSTRIAL

PLAN NOTES:


- 1. ANY TREES OR SHRUBS THAT ARE DEAD, DYING OR MISSING OUTSIDE THE SCOPE OF THE CURRENT WORK WILL NEED TO BE REPLACED PRIOR TO ISSUANCE OF CERTIFICATE OF OCCUPANCY.
- 2. ALL LANDSCAPE BEDS TO HAVE NEATLY TRENCHED BED EDGE AND HAVE 4" MINIMUM DEPTH OF HARDWOOD MULCH.
 3. ALL TREES AND SHRUBS SHALL BE COORDINATED WITH LIGHTING PLAN PRIOR TO INSTALLATION.
 4. ALL NEW PLANT MATERIAL AND TURF AREAS SHOULD BE IRRIGATED.
- 5. ALL SHRUBS TO BE 3' BACK OF CURB.

931-375-3001 PRIOR TO INSTALLATION.


- 6. ALL AREAS OF DISTURBANCE OUTSIDE OF LANDSCAPE BEDS SHALL BE REPAIRED WITH REBEL III FESCUE SEED OR SOD.
- 7. ANY UTILITY STRUCTURE, LIGHT POLES, SIGN, OR OTHER FEATURE MAY NOT BE ADDED TO ANY REQUIRED LANDSCAPE ISLAND IN SUCH A MANNER THAT WOULD DISPLACE THE REQUIRED ELEMENT(S) (TREES, SHRUBS, ETC.)
- 8. PROPERTY OWNER IS RESPONSIBLE FOR MAINTAINING ALL LANDSCAPING MATERIALS, INCLUDING TURF, AND IRRIGATION MATERIALS BOTH ON SITE, AND INSIDE THE ROW.


PLANTING SCHEDULE NOTES

- 2. NO SUBSTITUTIONS ALLOWED WITHOUT PRIOR WRITTEN APPROVAL OF THE OWNER AND LANDSCAPE ARCHITECT OF RECORD. 3. SUBSTITUTIONS AND DEVIATIONS MAY OR MAY NOT BE APPROVED.
- 4. REVISED LANDSCAPE PLANS MUST BE SUBMITTED AND APPROVED BY THE MAURY COUNTY PLANNING DEPARTMENT
- 5. ALL IRRIGATION, LAWN AND PLANT MATERIALS WITHIN THE ROW MUST BE MAINTAINED BY THE PROPERTY OWNER.

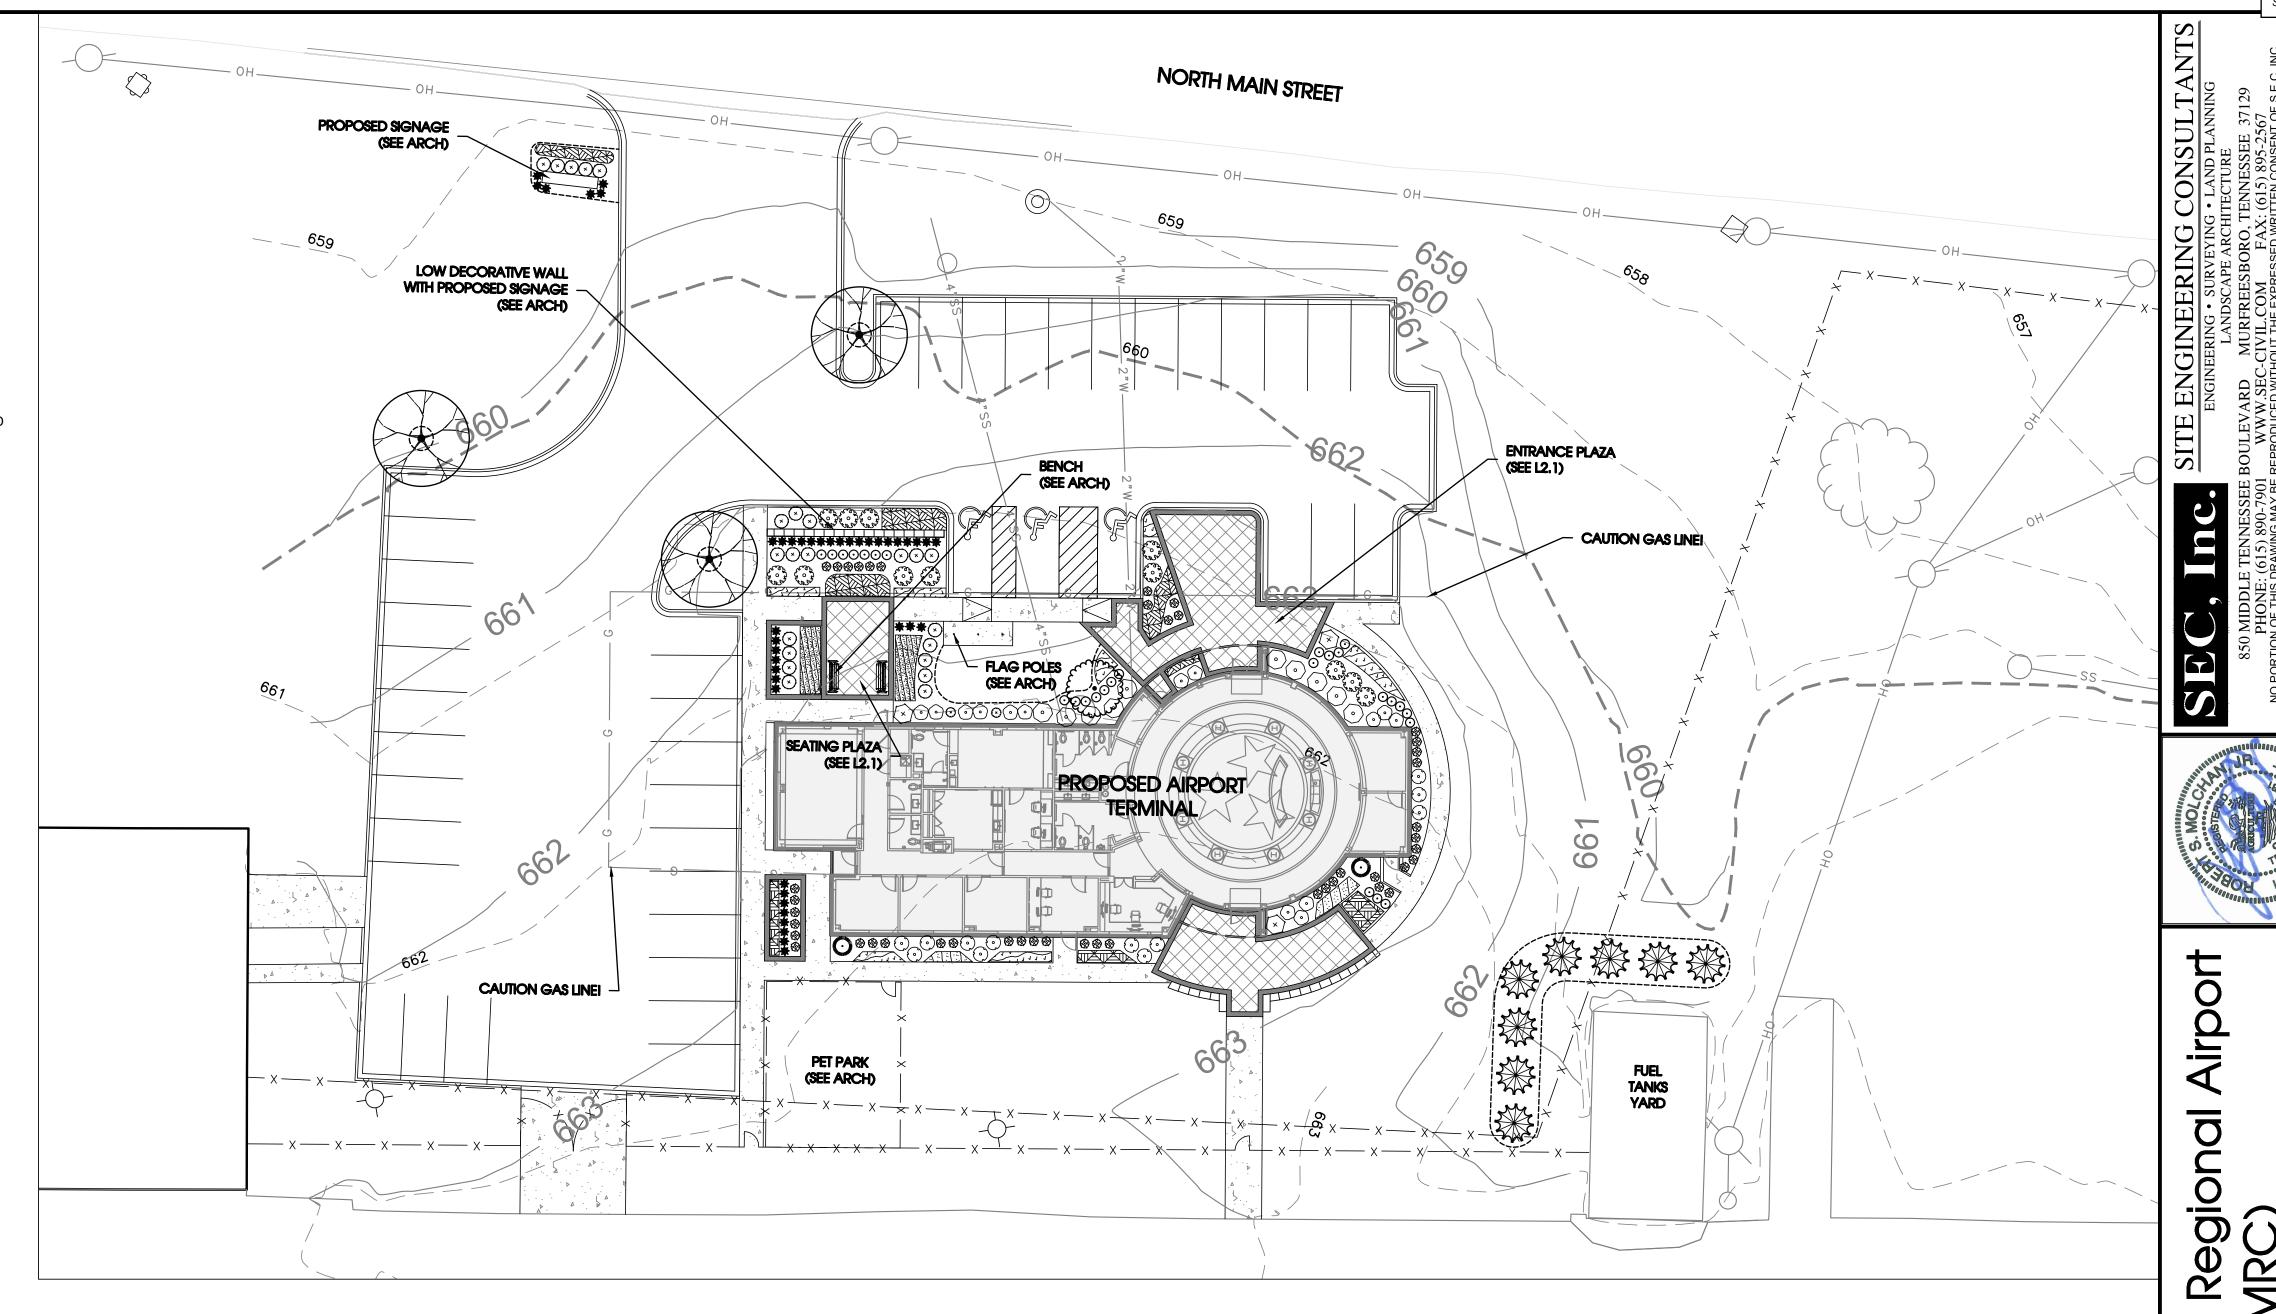




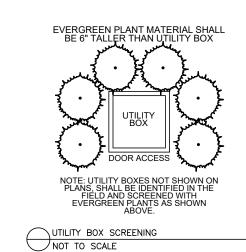

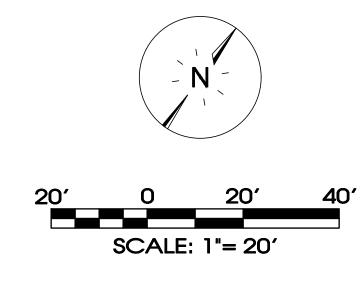

DRAWN: SWL DATE: 10-21-2024 CHECKED: FILE NAME: 24102project_LA SCALE: 24102

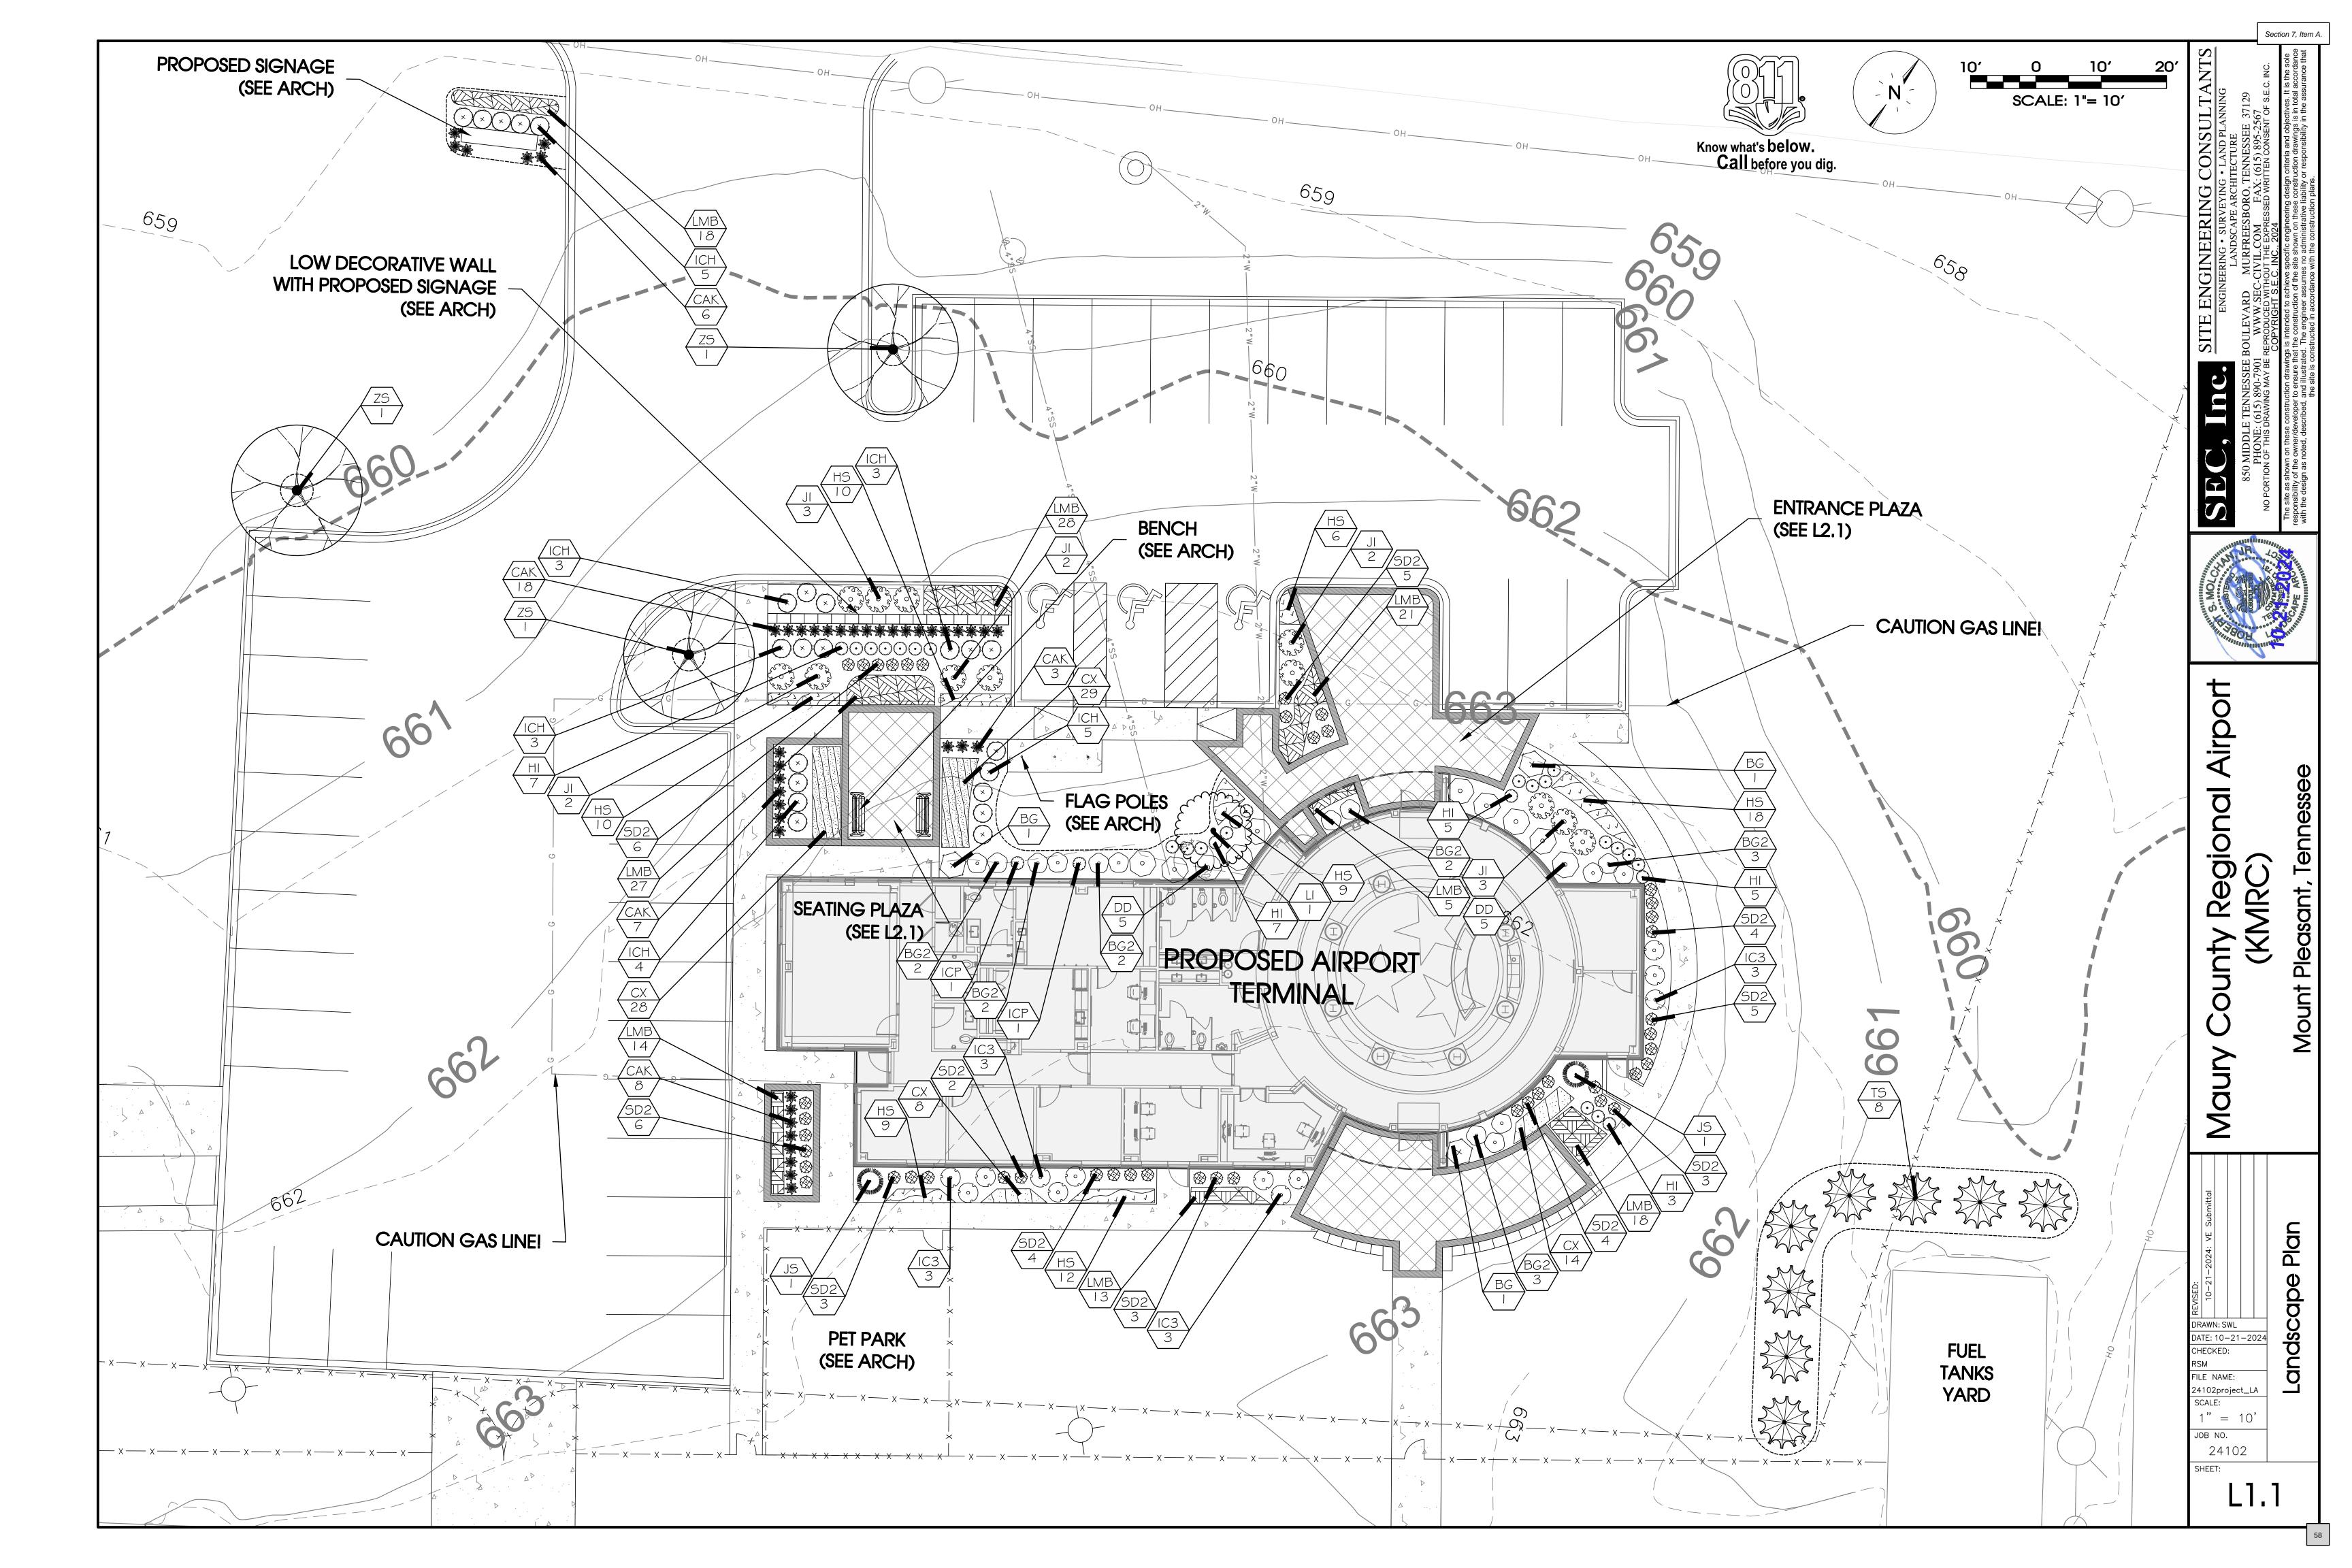

Know what's below. Call before you dig. SITE

11 SE


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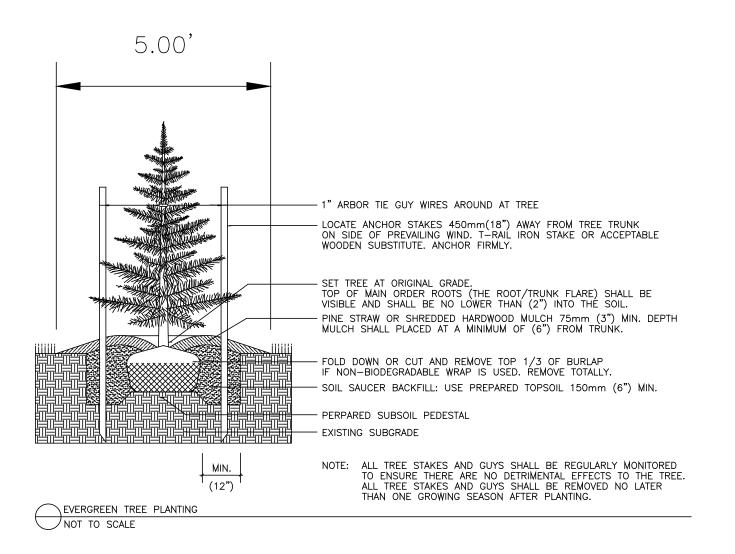
5


SCALE: N/A JOB NO.

24102 SHEET:


5.00' " ARBORTIE GUY WIRES (3), WHITE FLAG ON EACH O INCREASE VISIBILITY. AVOID TIGHT GUY WIRES AS THEY PREVENT NATURAL SWAY 1" ARBORTIE ON EACH MAJOR STEM. ALL MAJOR STEMS SHOULD BE WIRED TOGETHER. SET TREE AT ORIGINAL GRADE TOP OF MAIN ORDER ROOTS (THE ROOT/TRUNK FLARE) SHALL BE VISIBLE AND SHALL BE NO LOWER THAN (2") INTO THE SOIL. - MULCH: SHREDDED HARDWOOD 75mm (3") MIN. DEPTH MULCH SHALL BE A MINIMUM OF (6") FROM TRUNK. - WOOD STAKES (3) IN FIRM SOIL - ROPES AT TOP OF BALL SHALL BE CUT. REMOVE TOP 1/3 OF BURLAP. NON-BIODEGRADABLE MATERIAL SHALL BE TOTALLY REMOVED — SOIL SAUCER BACKFILL: USE PREPARED TOPSOIL 150mm (6") MIN. — EXISTING SUBGRADE NOTE: ALL TREE STAKES AND GUYS SHALL BE REGULARLY MONITORED TO ENSURE THERE ARE NO DETRIMENTAL EFFECTS TO THE TREE. ALL TREE STAKES AND GUYS SHALL BE REMOVED NO LATER THAN ONE GROWING SEASON AFTER PLANTING. MULTI-STEM TREE PLANTING NOT TO SCALE



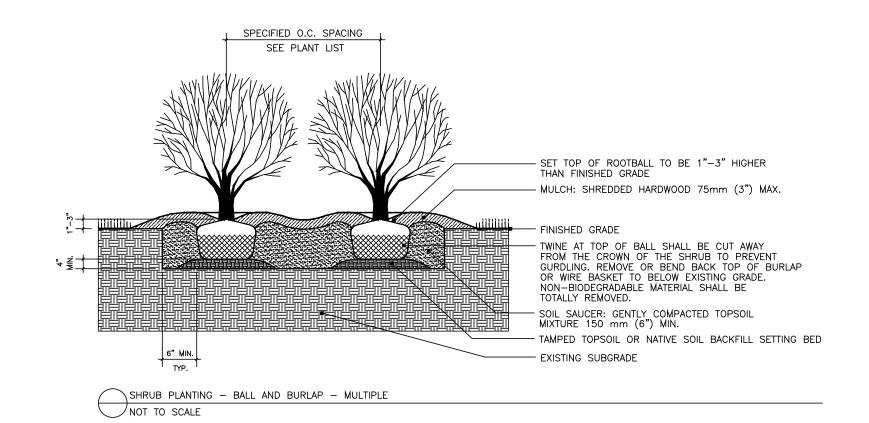

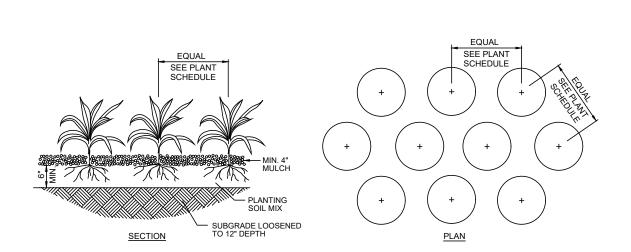




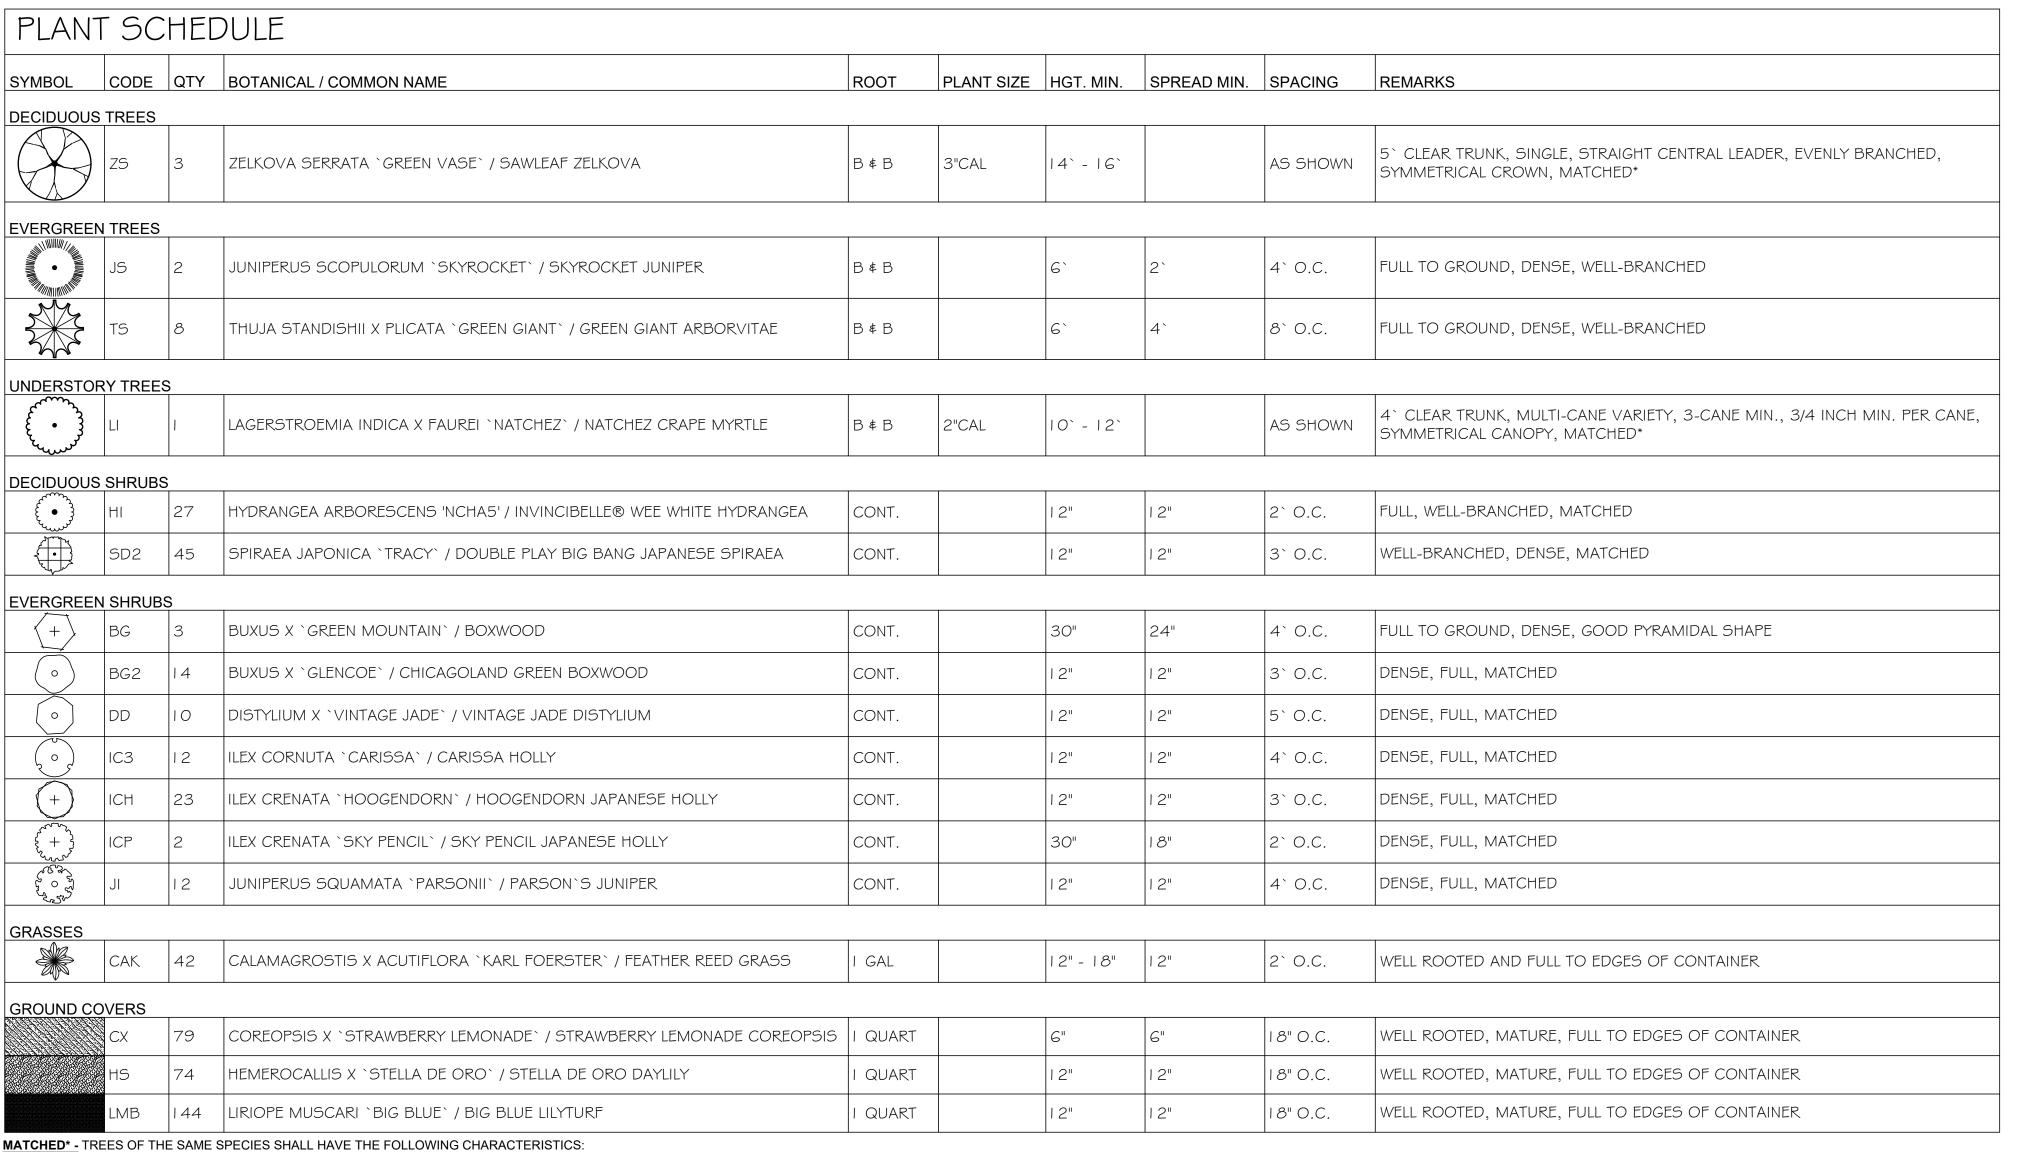


MATCHED BY BRANCH HEIGHT, CALIPER, HEIGHT OF TREE, SPREAD OF BRANCHES AND BRANCHING STRUCTURE, AND OVERALL CANOPY SHAPE

LANDSCAPE NOTES


- 1. THE LANDSCAPE CONTRACTOR SHALL VERIFY THE EXACT LOCATION OF ALL UTILITIES AND TAKE NECESSARY PRECAUTIONS TO PREVENT DAMAGE TO THESE UTILITIES. 2. THE LANDSCAPE CONTRACTOR SHALL COORDINATE ALL CONSTRUCTION WITH THE APPROPRIATE UTILITY COMPANY AND SHALL BE RESPONSIBLE FOR AND DAMAGE TO UTILITIES.
- PLANT MATERIALS AND STUMPS INDICATED FOR REMOVAL SHALL BE REMOVED AND DISPOSED OFF-SITE BY THE CONTRACTOR. BACKFILL HOLES WITH TOPSOIL FREE OF ROOTS AND ROCKS.
- 4. TREAT ALL LANDSCAPE BEDS WITH PRE-EMERGENT HERBICIDE PRIOR TO PLANTING. THE LANDSCAPE CONTRACTOR IS RESPONSIBLE FOR ALL WEEDING UNTIL FINAL ACCEPTANCE. 5. THE LANDSCAPE CONTRACTOR SHALL BE RESPONSIBLE FOR THE FINE GRADING OF ALL PLANTING AREAS.
- 6. THE LANDSCAPE CONTRACTOR SHALL BE RESPONSIBLE FOR COMPLETELY MAINTAINING THE WORK (INCLUDING BUT NOT LIMITED TO: WATERING, MULCHING, SPRAYING, FERTILIZING, ETC.) OF ALL PLANTING AREAS AND LAWNS PER PROJECT SPECIFICATIONS UNTIL FINAL ACCEPTANCE OF THE WORK BY THE OWNER. 7. PROVIDE TREES, SHRUBS, AND PLANTS OF QUALITY, SIZE, GENUS, SPECIES AND VARIETY SHOWN AND SCHEDULED FOR LANDSCAPE WORK AND COMPLYING WITH RECOMMENDATIONS AND REQUIREMENTS OF ANSI Z60.1 "AMERICAN STANDARD
- FOR NURSERY STOCK". HEIGHT AND WIDTH SHOWN ARE MINIMUM SIZES.
- 8. THE LANDSCAPE CONTRACTOR SHALL COMPLETELY GUARANTEE ALL WORK FOR A PERIOD OF ONE YEAR BEGINNING AT THE DATE OF ACCEPTANCE. THE LANDSCAPE CONTRACTOR SHALL MAKE ALL REPLACEMENTS PROMPTLY (AS PER
- 9. THE LANDSCAPE CONTRACTOR SHALL PROVIDE THE OWNER WITH WRITTEN INSTRUCTIONS ON THE PROPER CARE OF ALL SPECIFIED PLANT MATERIALS PRIOR TO FINAL PAYMENT. 10. THE QUANTITIES INDICATED ON THE PLANT SCHEDULE AND PLAN ARE FOR THE CONVENIENCE OF THE CONTRACTOR. THE CONTRACTOR SHALL BE RESPONSIBLE FOR HIS/HER OWN QUANTITY CALCULATION AND THE LIABILITY WHICH PERTAINS
- TO THOSE QUOTATIONS. ANY DISCREPANCY SHALL BE CALLED TO THE ATTENTION OF THE LANDSCAPE ARCHITECT IMMEDIATELY.
- 11. EXISTING TREES TO REMAIN SHALL BE PROTECTED FROM CONSTRUCTION DAMAGE. SELECTIVELY PRUNE DEAD WOOD. 12. SEED OR SOD ALL AREAS DISTURBED BY CONSTRUCTION AND NOT DESIGNATED AS PLANTING BEDS.
- 13. SHRUBS AND GROUNDCOVER BEDS TO BE PLANTED IN A TRIANGULAR SPACING. SEE PLANTING SCHEDULE FOR DISTANCES.
- 14. UPON COMPLETION AND FINAL ACCEPTANCE OF THE LANDSCAPE INSTALLATION, A THREE (3) YEAR LANDSCAPE MAINTENANCE BOND WILL BE REQUIRED. THIS BOND SHOULD BE SUBMITTED IN THE NAME OF THE PROPERTY OWNER OF RECORD OR A LEASE HOLDER WHO HAS TEN (10) YEARS OR MORE REMAINING ON A CURRENT LEASE. THE PROPERTY OWNER/LEASE HOLDER SHOULD ALLOW ADEQUATE TIME TO OBTAIN THE BOND AS THIS PROCESS MAY BE LENGTHY AND MAY DELAY THE ISSUEANCE OF THE CERTIFICATE OF OCCUPANCY.

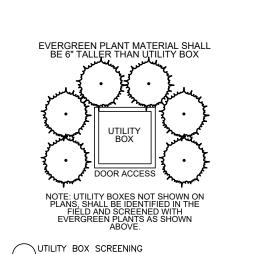




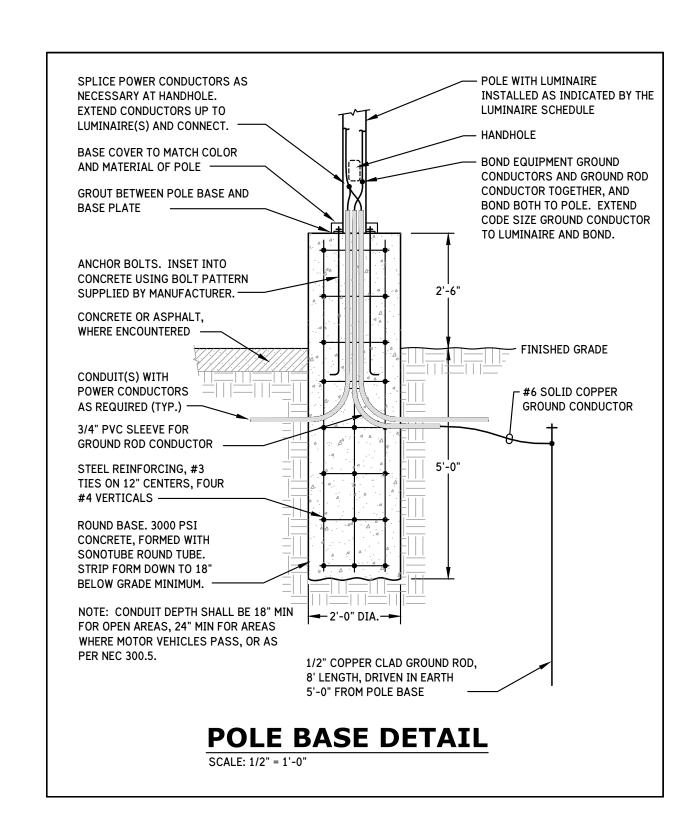

	L	JMINAIRE SCHEDULE
AA	POST-TOP MOUNTED AREA LIGHT, TYPE 4 MEDIUM DISTRIBUTION, HOUSE SIDE SHIELD, POLYCARBONATE LENS, BLACK FINISH.	
	108 W	LED, 6,600 LUMENS, 4000K
	KENALL #SA26-PT-MB-4-M-H-P-108L-40K7-DCC-DV	
BB	SAME AS TYPE "AA" EXCEPT NO HOUSE SIDE SHIELD.	
	108 W	LED, 14,900 LUMENS, 4000K
	KENALL #SA26-PT-MB-4-M-S-P-108L-40K7-DCC-DV	
LL	WALL MOUNTED OUTDOOR AREA LIGHT, BLACK FINISH. MOUNT 9'-0" AFG.	
	17 W	LED, 2000 LUMENS/FT, 4000K
	LITHONIA #ARC1 LED P2 40K MVOLT DBLXD	
D4	4" DOWNLIGHT, AL02 DRIVER, CLEAR REFLECTOR, WIDE DISTRIBUTION, FLANGE TO MATCH REFLECTOR. SWITCHABLE LUMENS SET TO "MEDIUM".	
	19 W	LED, 1500 LUMENS, 4000K
	LITHONIA #LDN4-AL02-40K-L04-AR-LSS-WD-MVOLT-UGZ	

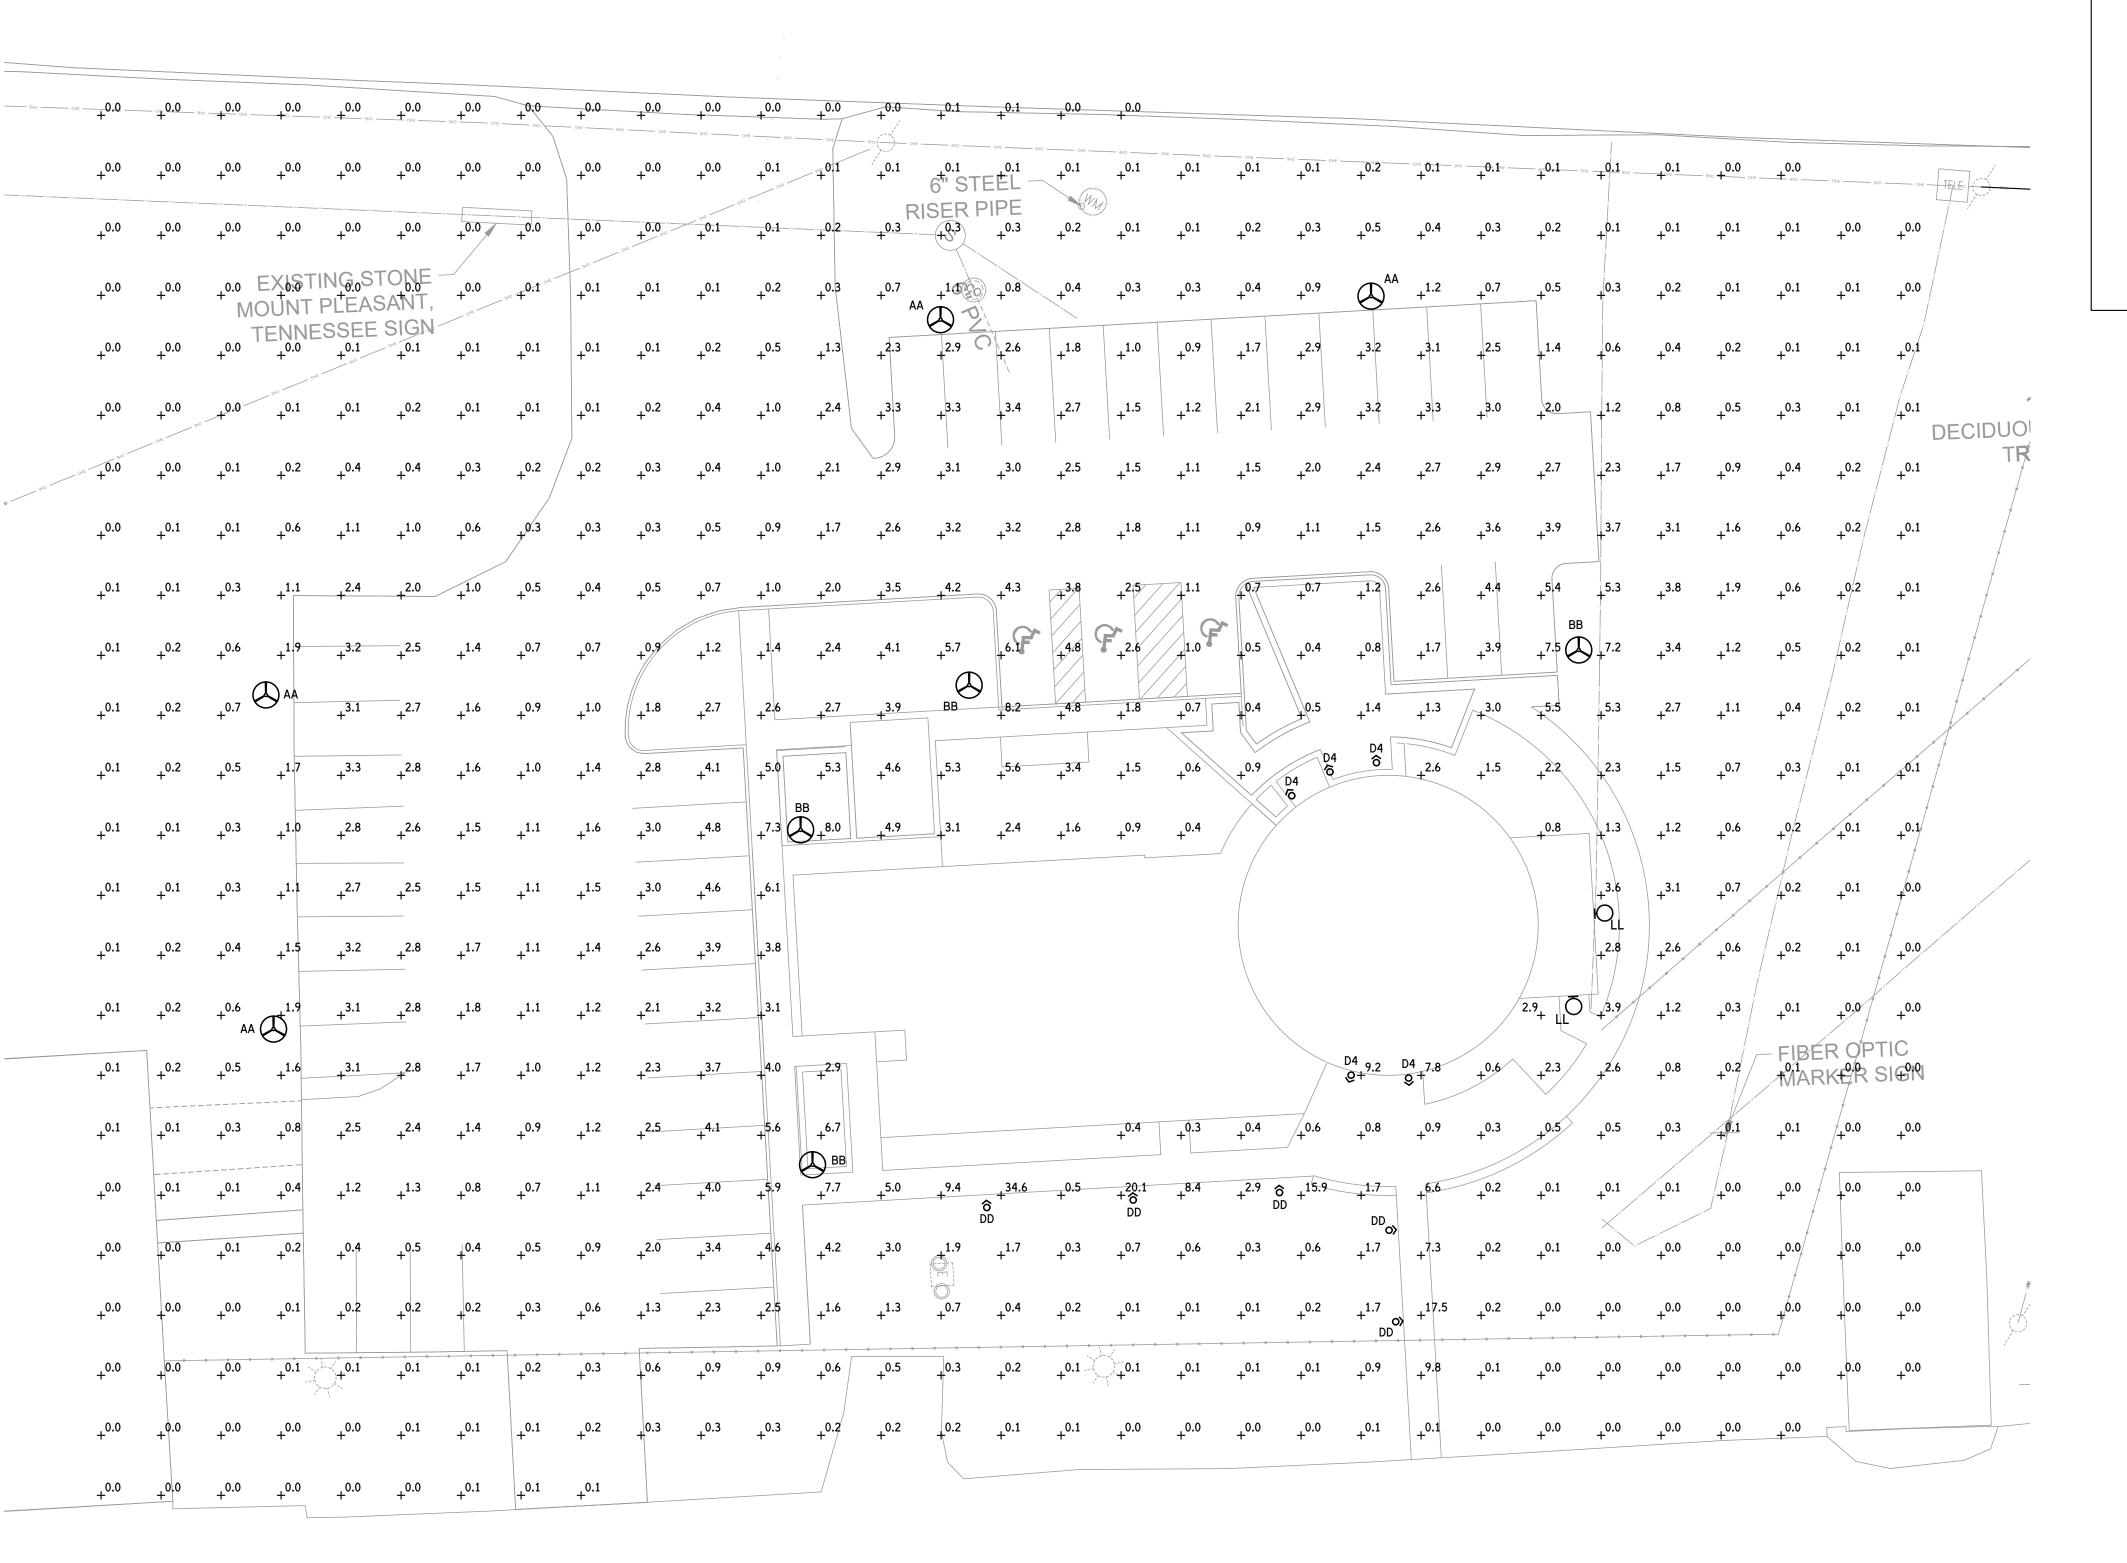

SITE PLAN - PHOTOMETRIC SCALE: 1/16" = 1'-0"

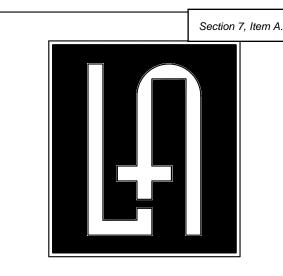

LOWEN+ASSOCIATES, LLC

2700 Belmont Boulevard, Suite A Nashville, Tennessee 37212 www.Lowen-Associates.com p (615) 386-3357 f (615) 386-3329

PROFESSIONAL SEAL:



Maury County Regional Airport

New Terminal Construction Project

Maury County Airport Authority
Columbia / Mount Pleasant, Tennessee
With Garver - Aviation Team
Garver Project No. 21A08011

PHASE:

CONSTRUCTION DOCUMENTS PROJECT NUMBER:

24-04 ISSUE DATE:

FEBRUARY 6, 2024 **REVISIONS:**

SITE PLAN - PHOTOMETRIC

ENGINEERING LLC

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LUMINAIRE CUTSHEETS

LUMINAIRE TYPES "AA" AND "BB"

(Photocell by others)

ICM^{A*} Integrated Camera Module

BG Bird Guard

www.kenall.com P: 800-4-Kenall F: 262-891-9701 10200 55th Street Kenosha, Wisconsin 53144
This product may be covered by patents found at www.kenall.com/patents. Content of specification sheets is subject to change, please consult www.kenall.com/patents.

PROJECT INFORMATION

(Click here for specifications)

Please consult Kenall Applications if your application requirements are not listed here.

* n/a with 5S Distribution Type ‡ n/a with 132L lamp * Flexible integration with 3rd party video or security platforms via Wiffi or Ethernet (CATS). Embedded camera supports 1080p at 30 frames per second 1 n/a with PT Mounting or 5S Distribution Type * N/P; ICM and TL2000 are not available in conjunction.

SENSCAPE™

SA26 SERIES

SPECIFICATIONS

Luminaires for Parks, Campus and Commercial Areas

POST TOP MOUNT

the TL2000 system features advanced scheduling and energy management capabilities with cloud-based control of system settings, reporting, and notification

PHOTOMETRICS: Photometry tested to the IESNA LM-79-08 standard by an ILAC/ISO17025 accredited laboratory. For photometric data, please go to www.kenall.com.

HOUSING: Marine-grade die-cast aluminum construction. Integral aluminum heat sink with concealed air inlet and convection fins. All power electronics removed from primary thermal path; all divers with dedicated heatsink to exterior of luminaire. TGIC polyester powder coat finish with five-step pre-treatment; salt-spray test 1,000 hours. See Ordering Information for available finishes.

MOUNTING: Post Top: Fitter assembly mounts over a 2-3/8" tenon on 3, 4 and 5 inch round and square poles and secured via six recessed, corrosion resistant set screws. Fitter design provide

ntle transition to 3st O.D. round pole. Pole Mount: Internal bracket and hardware provided for drilled round and square 3 inch and larger poles. Wall Mount: Quick and simple mounting bracket

OPTICS: Type II, III, IV and V Square optical distributions. Each type available with Narrow, Medium and Wide options for glare mitigation (Wide has the lowest level of glare mitigation, Narrow the highest). Internal house-side shield available (does not impact EPA). Injection-molded acrylic or polycarbonate tertiary outer lens.

ELECTRICAL: Replaceable high-brightness LED array. See Ordering Information for color temperature options. 120-277VAC or 277V-480VAC, 50/60Hz input with replaceable high power factor electronic constant-current driver (<10% THD, >0.95 PF). Standard 0-10V dimming with 10-100% range. Dim-to-dark capabilities on 108L/166L with CV input voltage, otherwise non-dim-to-dark. 0.9mA max. driver source current. Minimum 85% driver efficiency. EMC performance compliant with FCC CFR Part 15. Serviceable surge protection device rated to 6kV per ANSI C62.41-2002

TEKLINK TL2000: An adaptive lighting control system that utilizes a wireless communication scheme between system nodes. In addition to occupancy detection via camera and daylight harvesting,

INTEGRATED CAMERA MODULE: Flexible integration with 3rd party video or security platforms via Wifi or Ethernet. Camera supports 1080p at 30 frames per second. The ICM option is a stand-

LISTINGS: Luminaire is certified to UL Standards by Intertek Testing Laboratory for Wet Location. IP65 rating per IEC 60598. Luminaire is 3G tested for vibration per ANSI C136.31. Suitable for installation into -40°C to 40°C ambient environments.

» Architectural, modern design aesthetic scaled for mounting heights

» Lumen outputs up to 43,000lm with color temperatures ranging

to suit all common area lighting scenarios

Integrated Camera Module options

» TekLink advanced wireless networked control and inno

Closed-cell silicone gasketing at all housing interfaces.

WARRANTY: Limited five (5) year warranty.

ORDERING INFORMATION (Ex: SA26-PM-MB-4-M-H-P-166L-40K8-DCC-DV)


(I) (IP65) (3G)


KENALL


LUMINAIRE TYPE "DD"

LUMINAIRE TYPE "LL"

LUMINAIRE TYPE "D4"

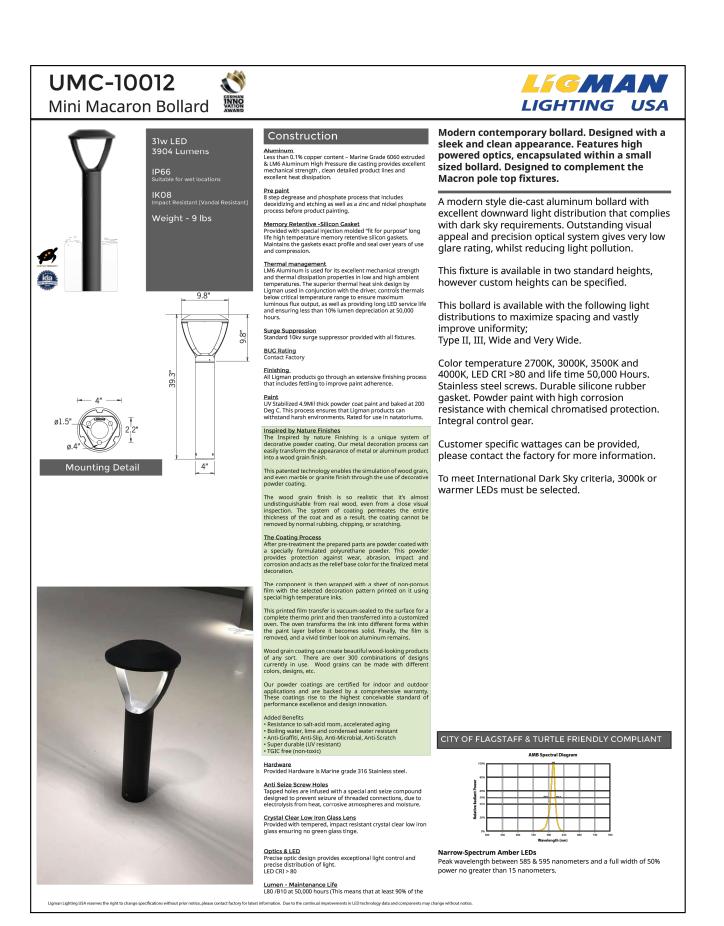

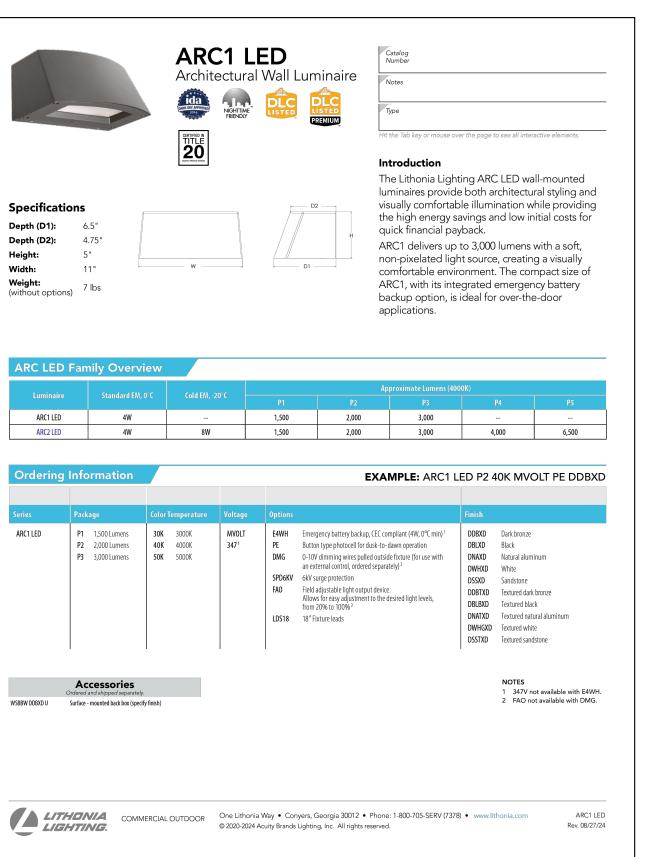

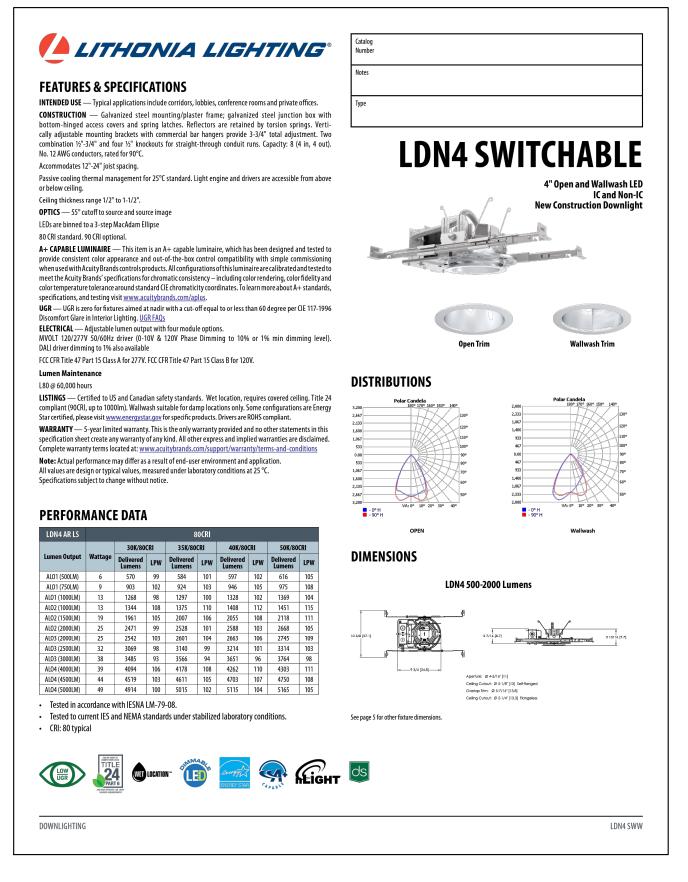

2700 Belmont Boulevard, Suite A Nashville, Tennessee 37212 www.Lowen-Associates.com p (615) 386-3357 f (615) 386-3329

PROFESSIONAL SEAL:

Airport tion Projec

egional .

PHASE:

24-04

ISSUE DATE:

REVISIONS:

FEBRUARY 6, 2024

CONSTRUCTION DOCUMENTS

PROJECT NUMBER:

LOWEN+ASSOCIATES, LLC

Section 7, Item A.