

# P&R COMMISSION – SUBCOMMITTEE SPECIAL VIDEO MEETING

Thursday, October 28, 2021 at 10:00 AM

## COMMISSIONERS:

Chair Peter Struck Commissioners: Lyn Gualtieri & Rory Westberg LOCATION & CONTACT

Zoom Meeting Phone: 206.275.7626 | www.mercerisland.gov

## **Virtual Meeting Notice**

The virtual meeting will be broadcast live on Zoom and recorded and saved on the City Council's YouTube Channel

Join by Telephone at 10:00 AM: To listen to the meeting via telephone, please call 253.215.8782 and enter Webinar ID 822 0801 2927 and Password 043130 when prompted.

Join by Internet at 10:00 AM: To watch the meeting over the internet via your computer, follow these steps:

- 1) Click this link
- 2) If the Zoom app is not installed on your computer, you will be prompted to download it.
- 3) If prompted for Webinar ID, enter 822 0801 2927 Enter Password 043130


**For the safety and wellbeing of the public and staff,** the City strongly recommends that community members attend the meeting by viewing the live feed on Zoom or watching the recording of the video conference on the City Council's <u>YouTube Channel</u>, which will be available approximately 24-48 hours after the meeting.

## CALL TO ORDER & ROLL CALL – 10:00 AM

## **SPECIAL BUSINESS**

- 1. Presentation of Revised Landscape Plan (20 min)
- 2. Presentation of Cost Estimate and discussion (45 min)
- 3. Permitting Issues update (15 min)
- 4. Next Steps and Meeting Discussion (10 min)


## **ADJOURNMENT**

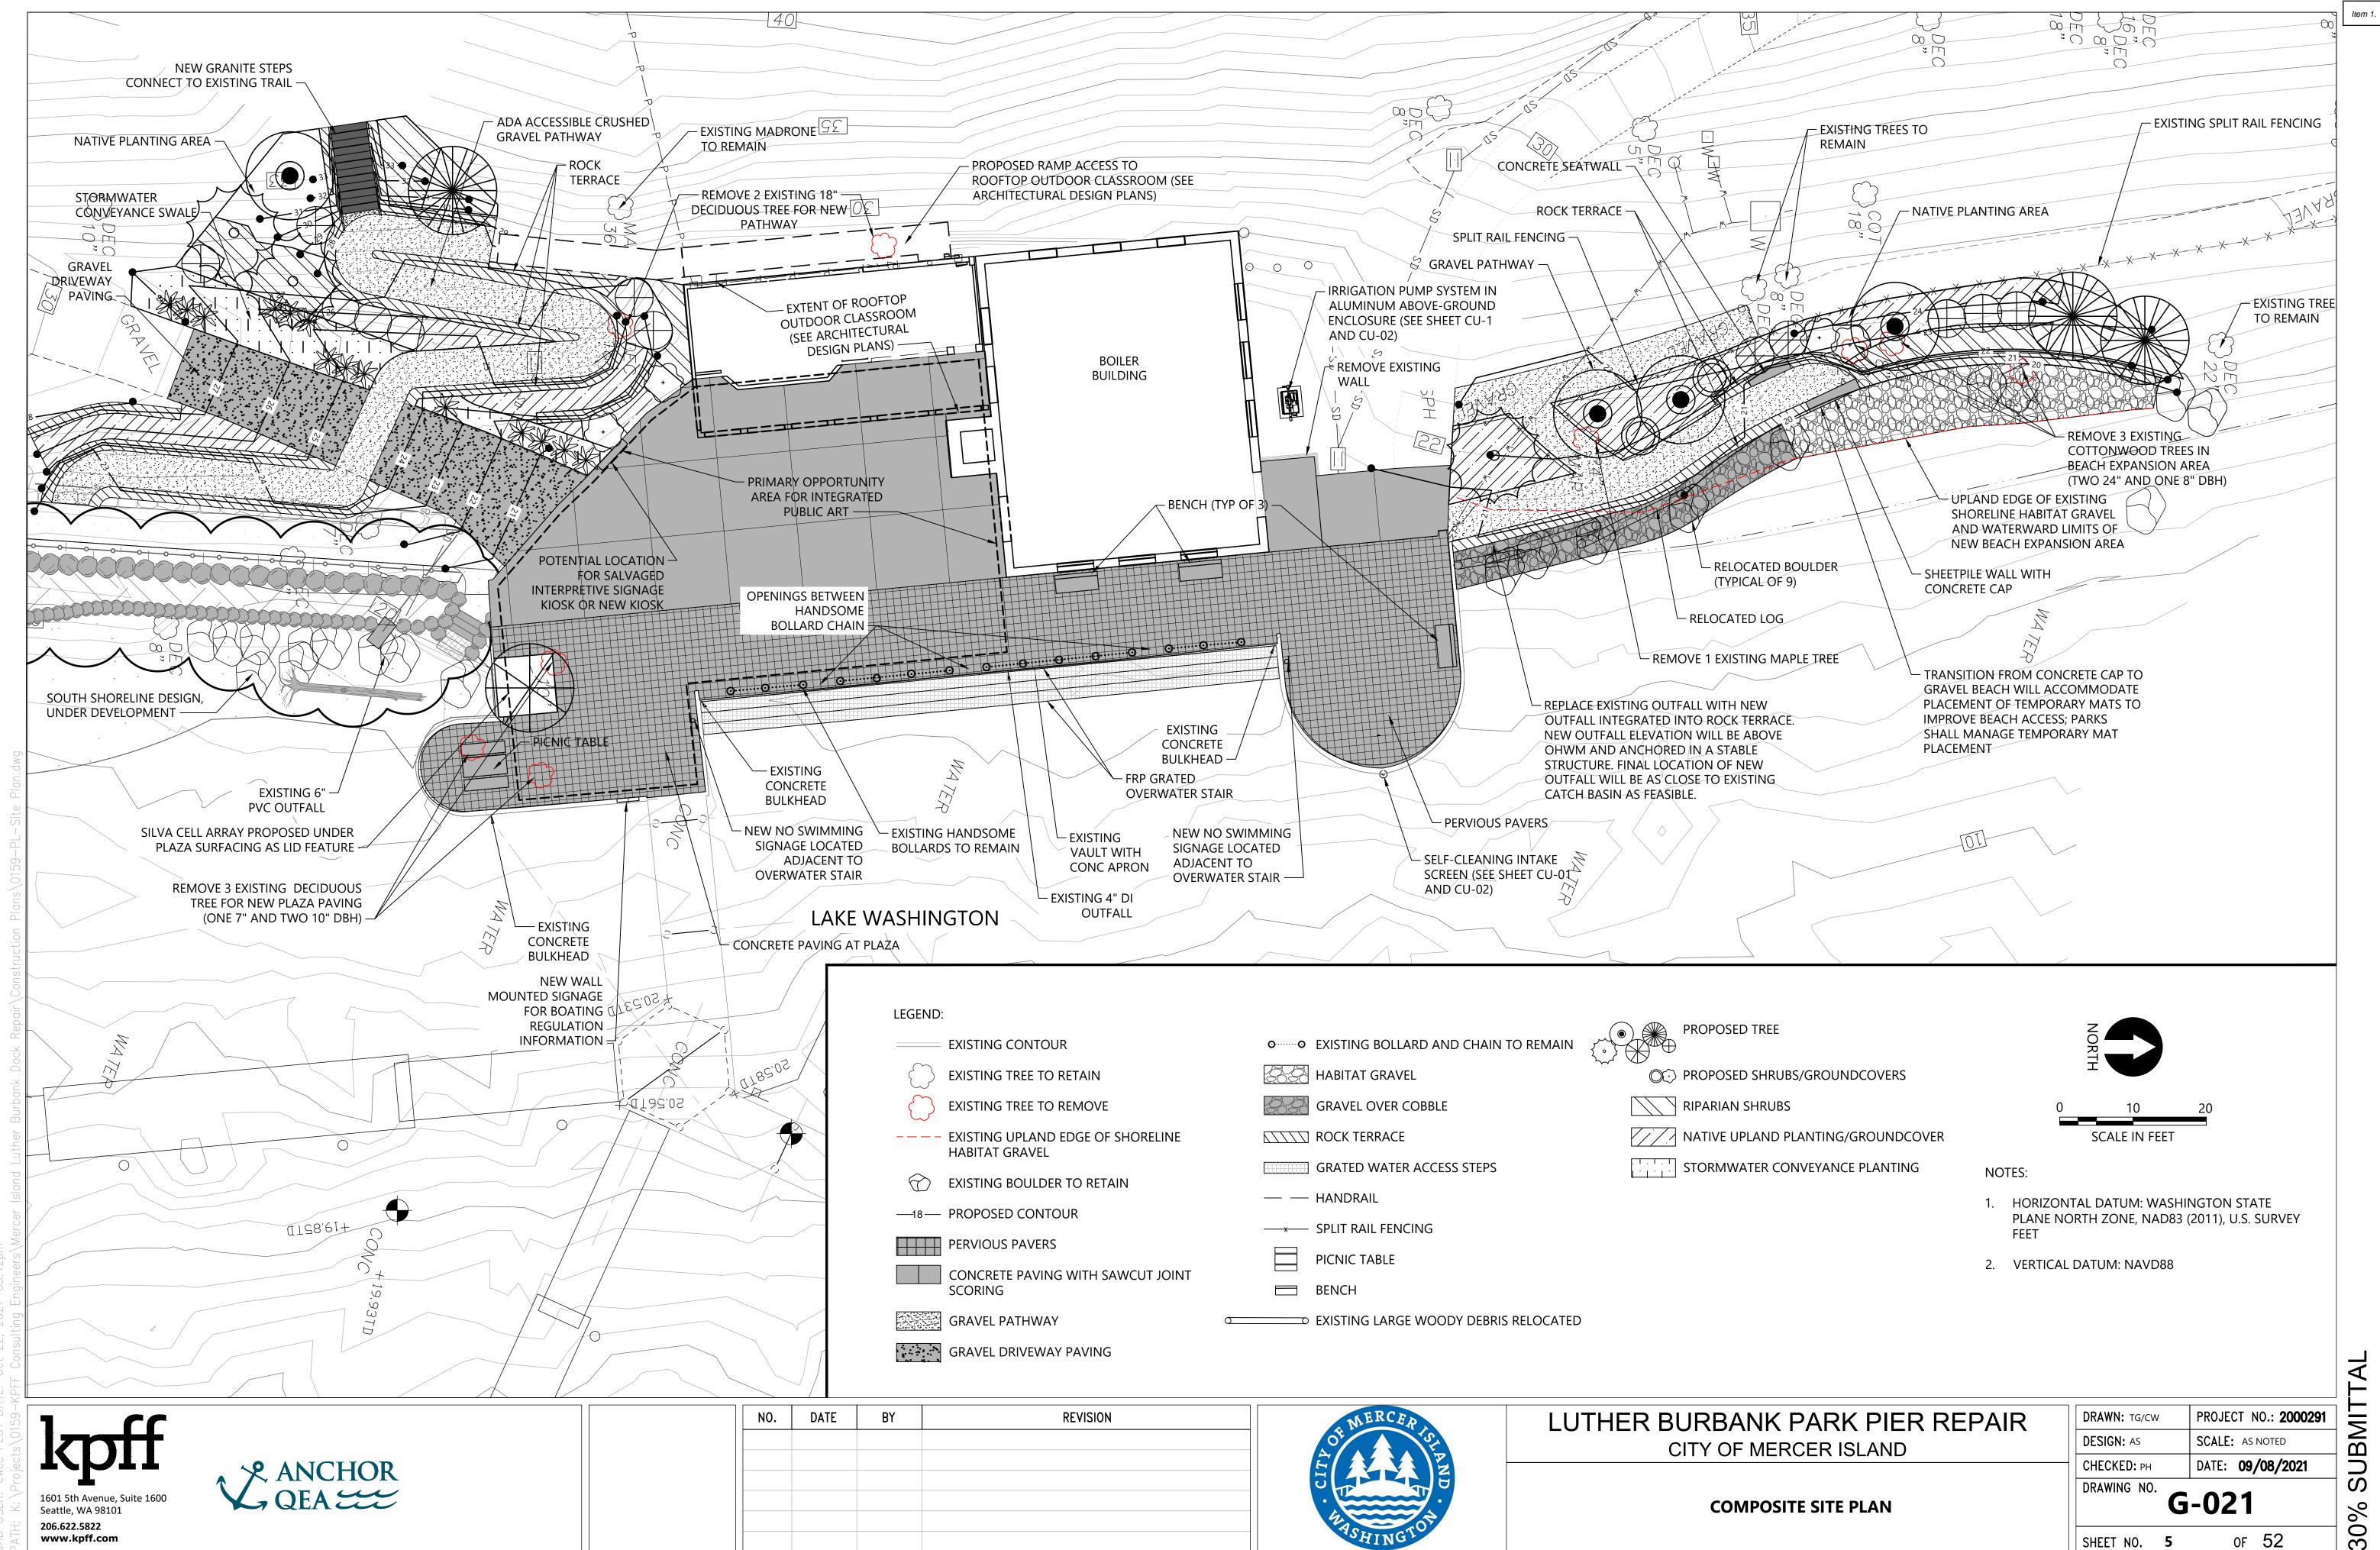

	EXISTING CONTOUR	ØØ	EXISTING BOLLARD AND CHAIN TO REMAIN		PROPOSED T
$\bigcirc$	EXISTING TREE TO RETAIN		HABITAT GRAVEL		PROPOSED S
$\bigcirc$	EXISTING TREE TO REMOVE	69-69	GRAVEL OVER COBBLE		RIPARIAN SH
	EXISTING UPLAND EDGE OF SHORELINE HABITAT GRAVEL		ROCK TERRACE		NATIVE UPLA
$\bigcirc$			GRATED WATER ACCESS STEPS		STORMWATE
$\bigcirc$	EXISTING BOULDER TO RETAIN		HANDRAIL		
	PROPOSED CONTOUR	x	SPLIT RAIL FENCING		
	PERVIOUS PAVERS		PICNIC TABLE		
	CONCRETE PAVING WITH SAWCUT JOINT				
5- 5- 5-5	SCORING		BENCH		
	GRAVEL PATHWAY	00	EXISTING LARGE WOODY DEBRIS RELOCATED	1	
8	GRAVEL DRIVEWAY PAVING				

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NK PARK PIER REPAIR	DRAWN: TG/CW	PROJECT NO.: 2000291
MERCER ISLAND	DESIGN: AS	SCALE: AS NOTED
	СНЕСКЕД: РН	DATE: <b>09/08/2021</b>
MPOSITE SITE PLAN	DRAWING NO.	G-021
	SHEET NO. 5	OF 52

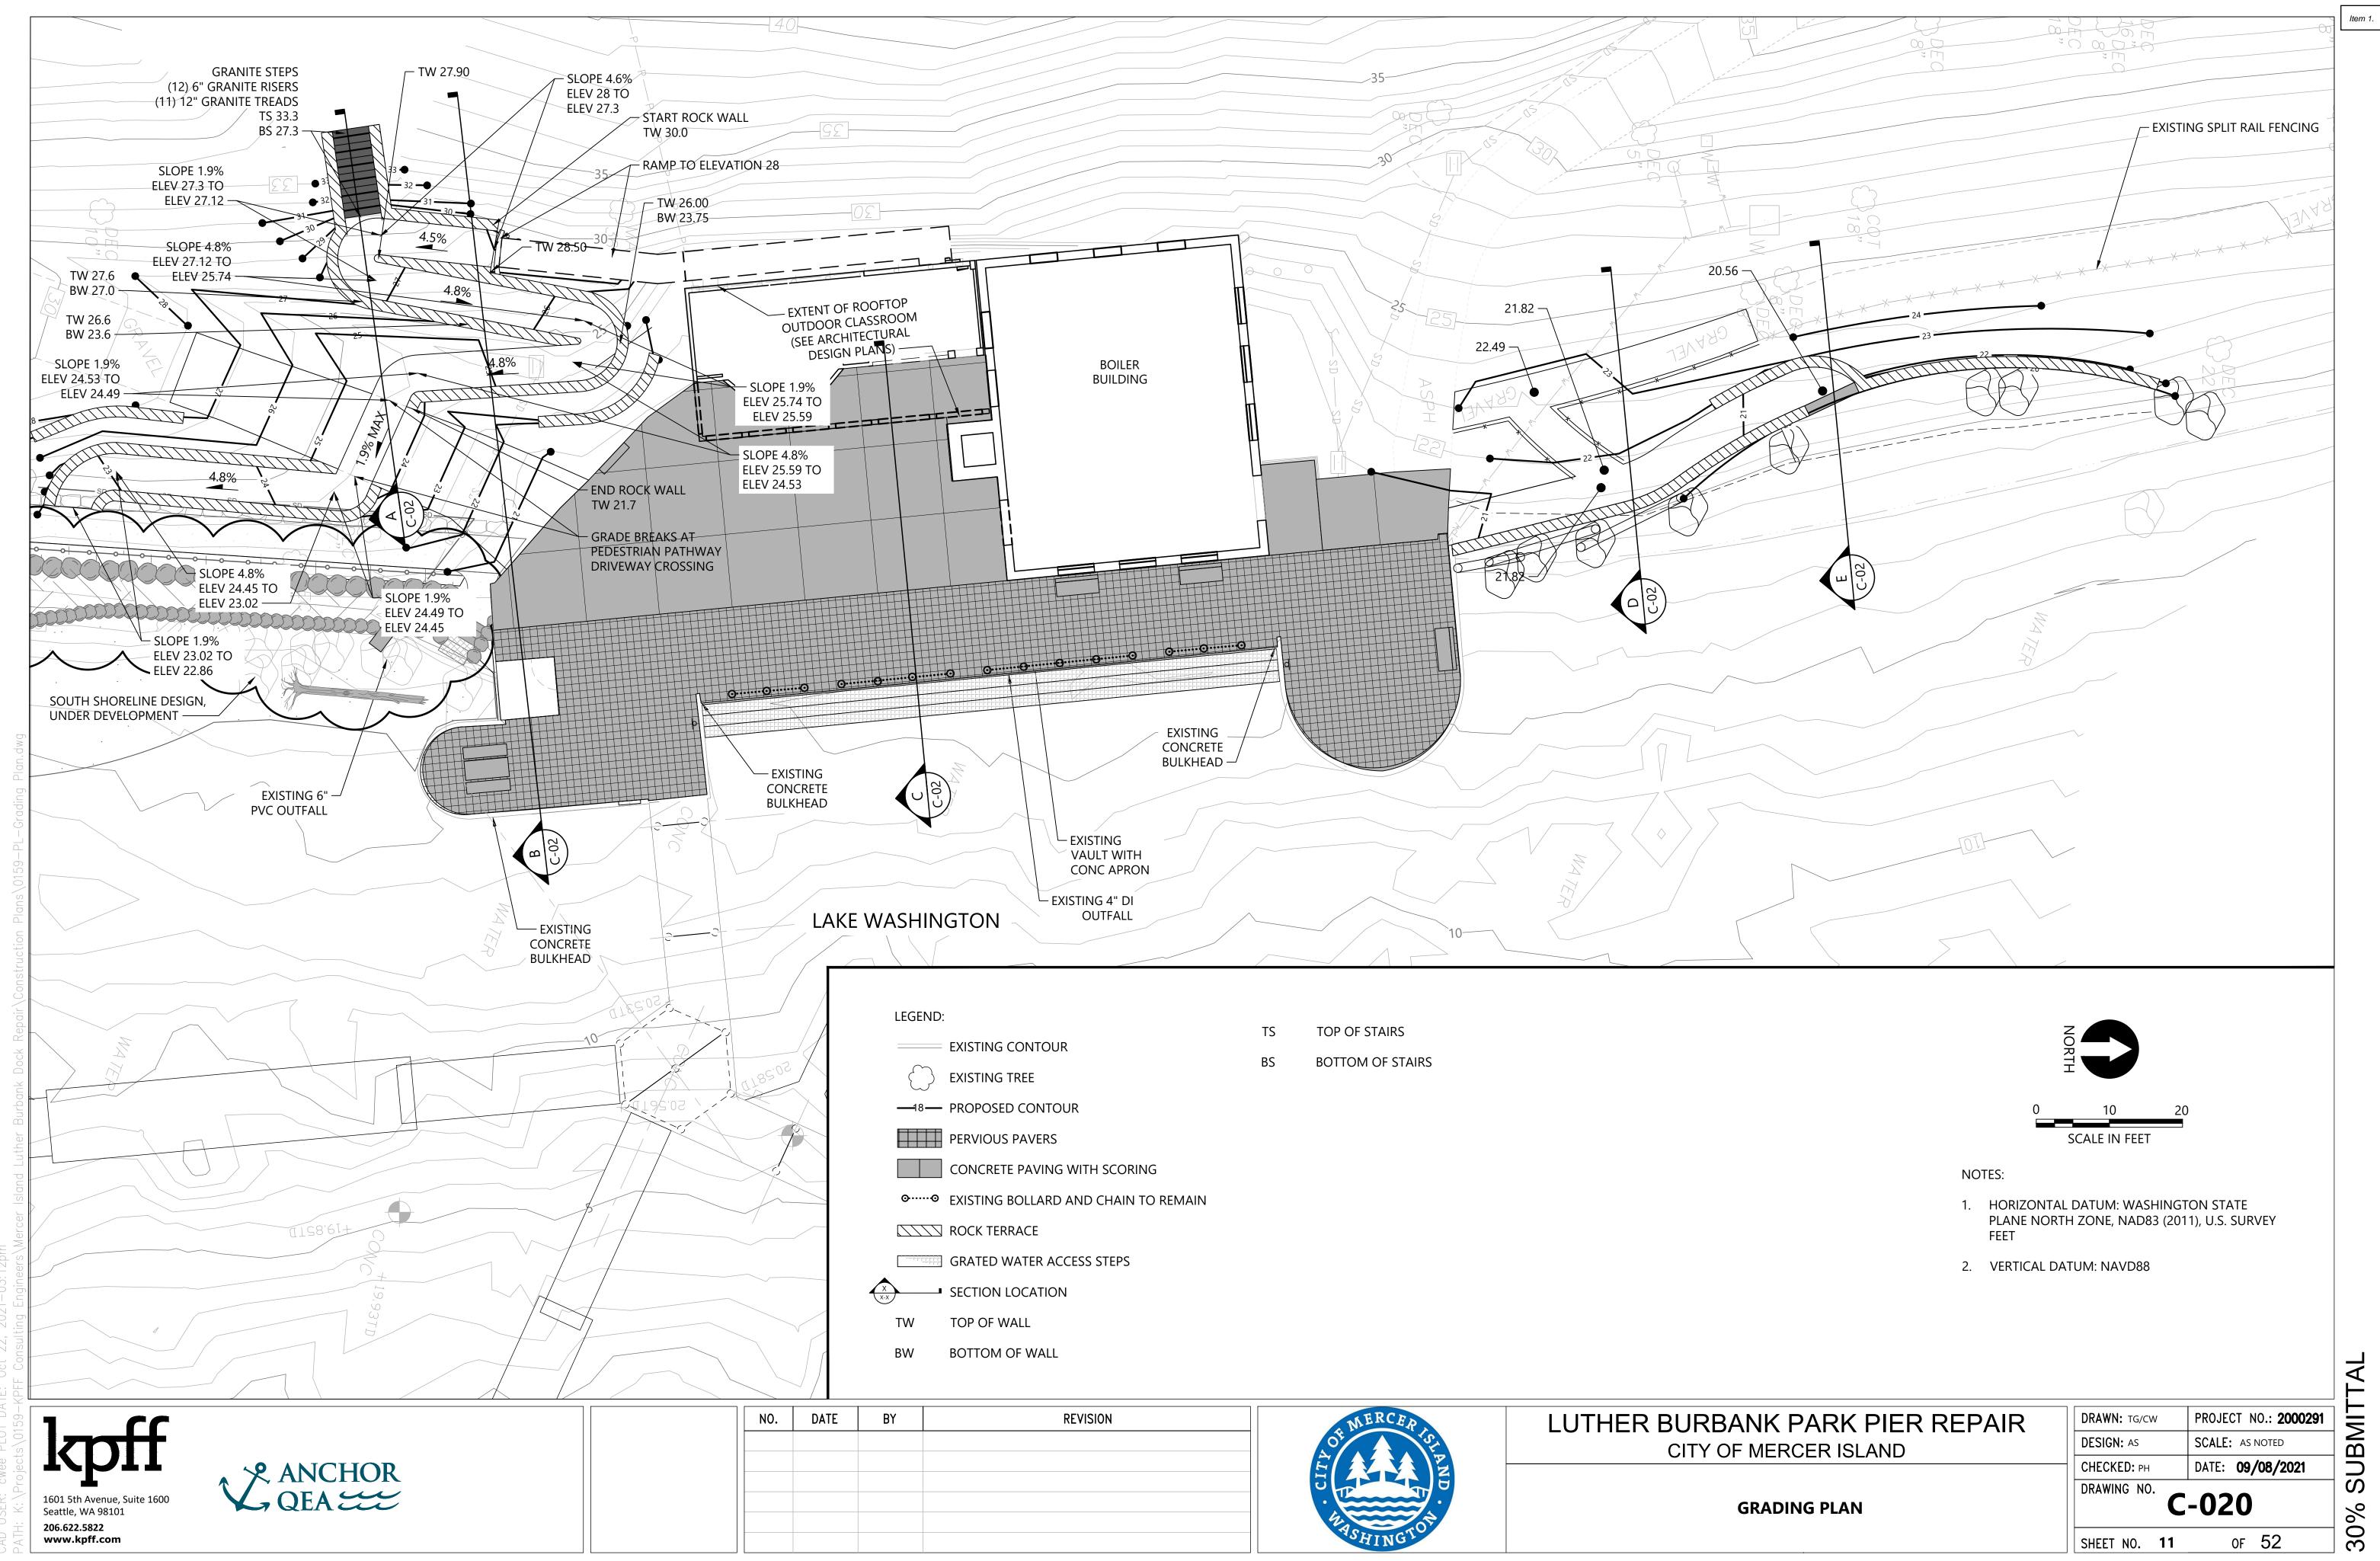


LEGEND			
		TS	TOP OF STAIRS
$\sim$	EXISTING CONTOUR	BS	BOTTOM OF STAIRS
$\left( \right)$	EXISTING TREE		
<del>—1</del> 8—	PROPOSED CONTOUR		
	PERVIOUS PAVERS		
	CONCRETE PAVING WITH SCORING		
<u>ه</u>	EXISTING BOLLARD AND CHAIN TO REMAIN		
	ROCK TERRACE		
	GRATED WATER ACCESS STEPS		
x -x	SECTION LOCATION		
TW	TOP OF WALL		

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DRAWING NO.		-020
	SHEET NO. 11	OF 52



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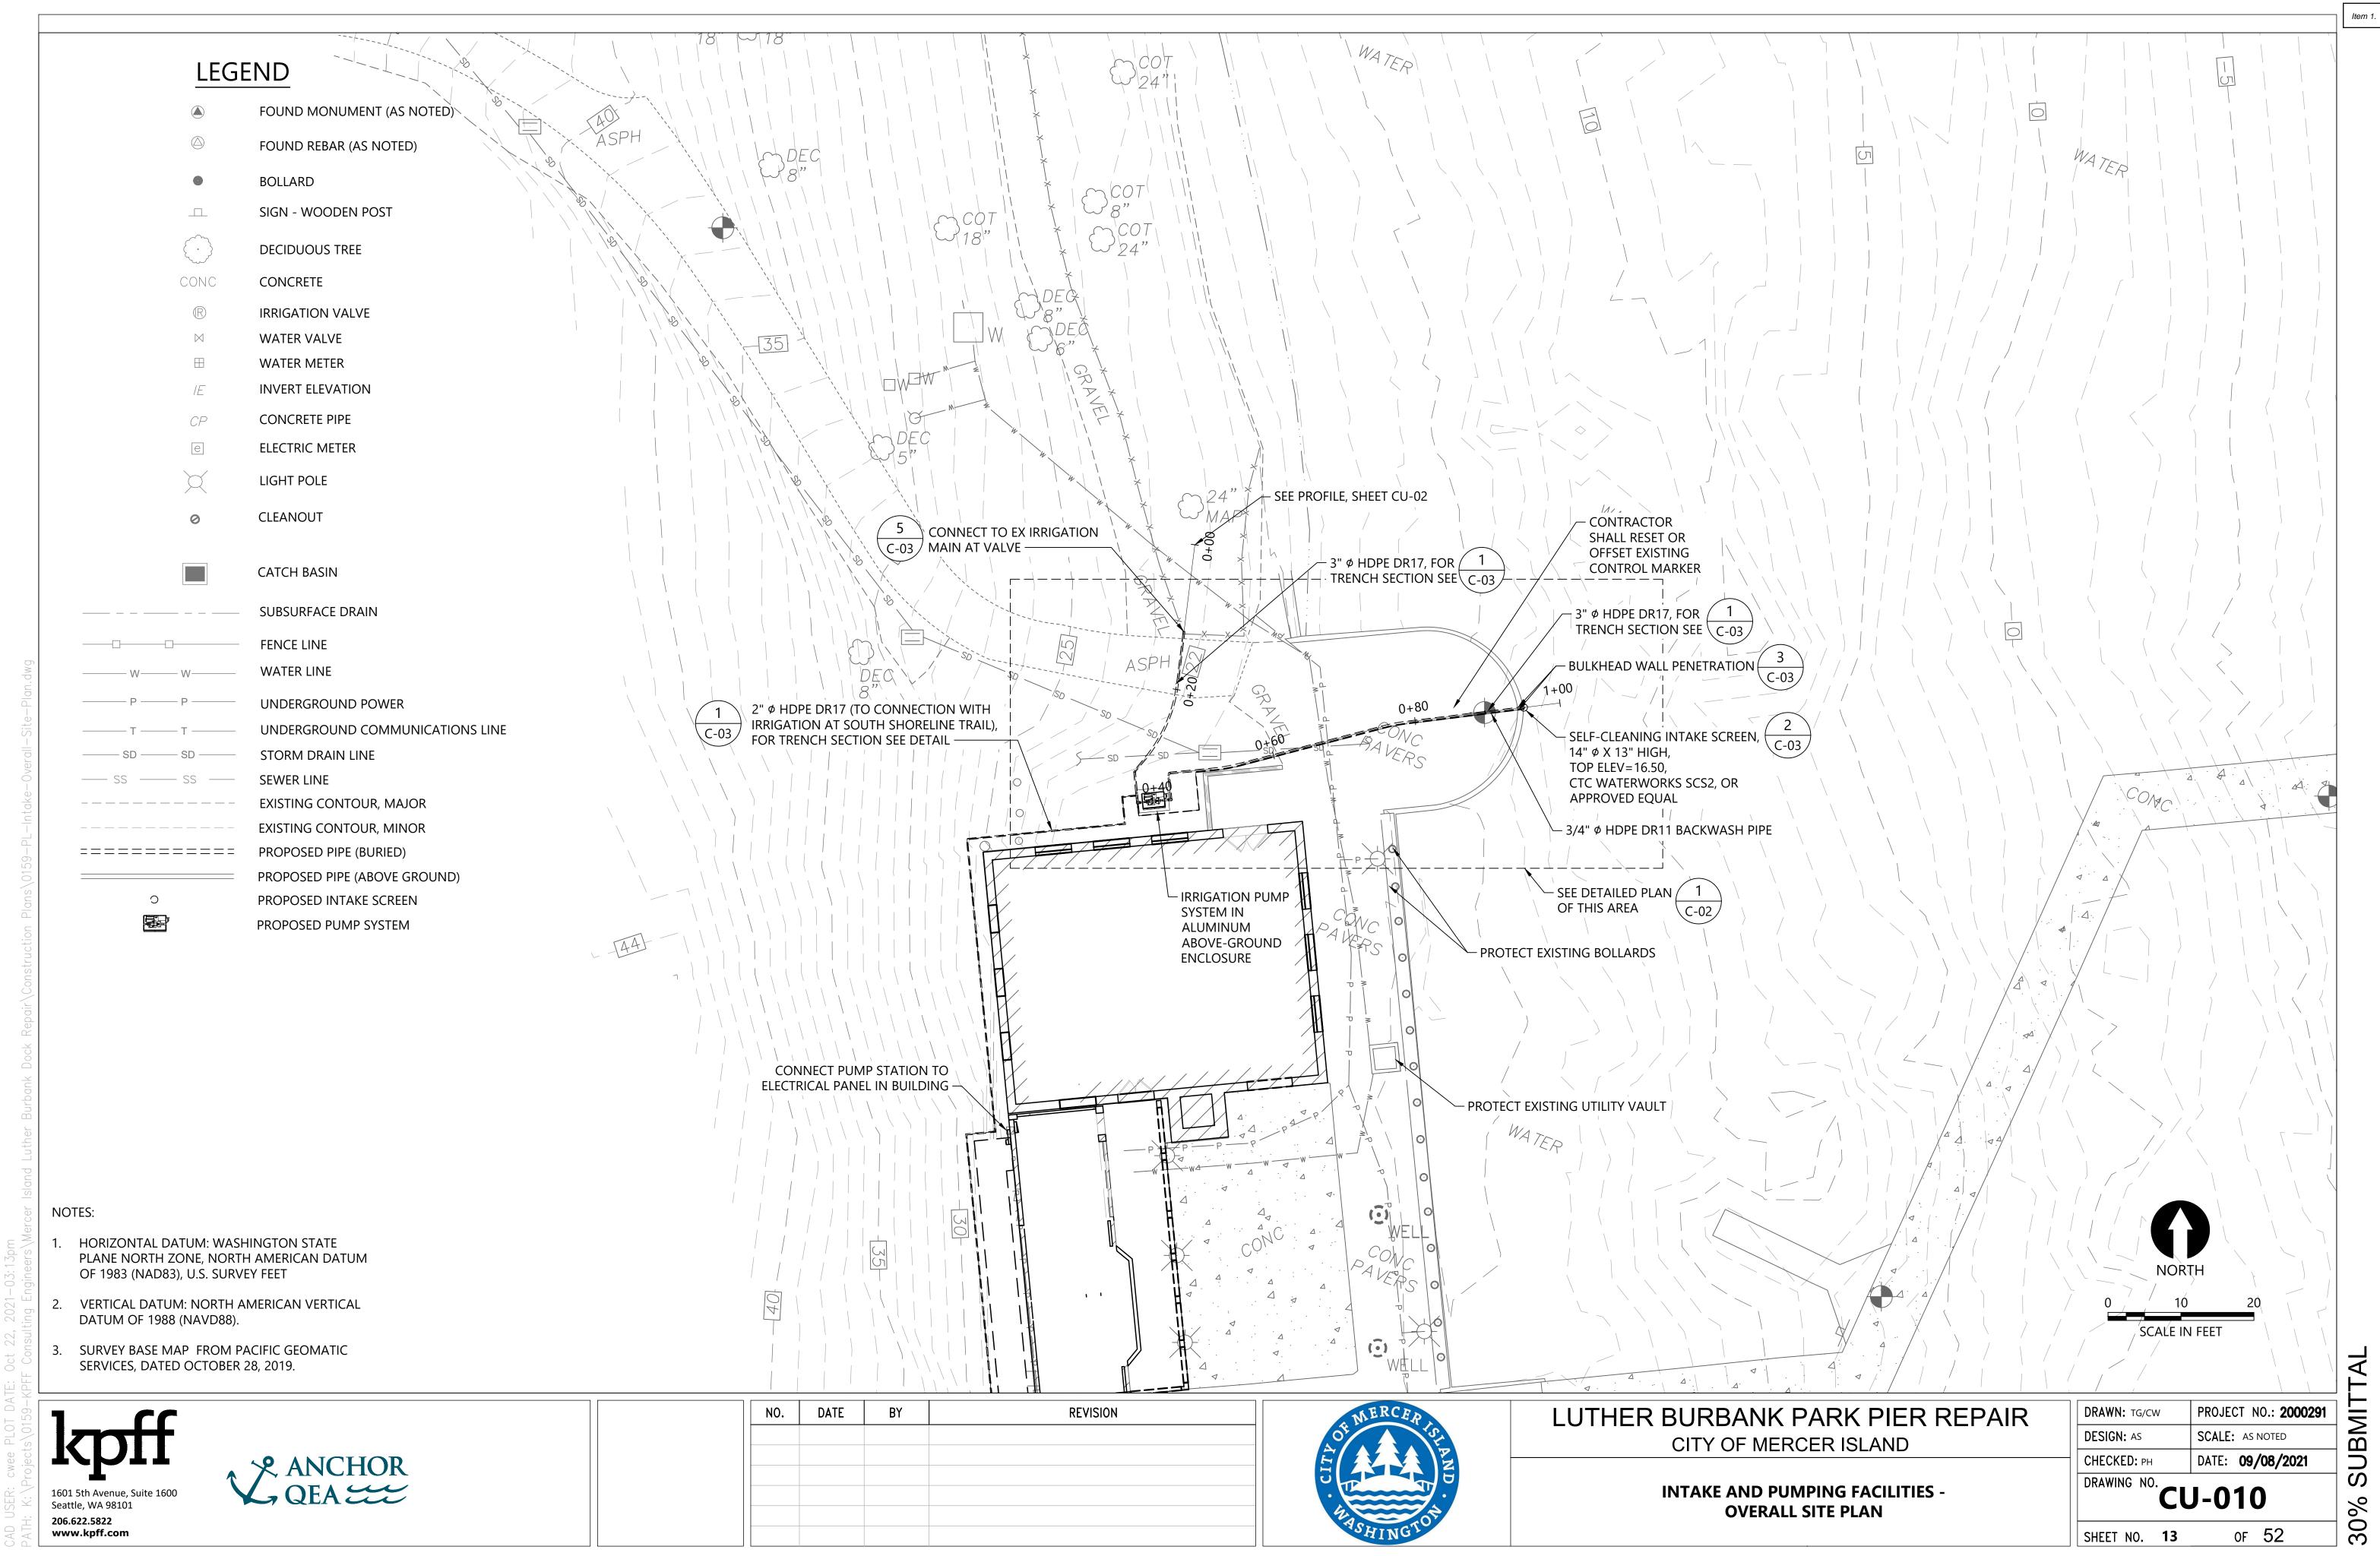
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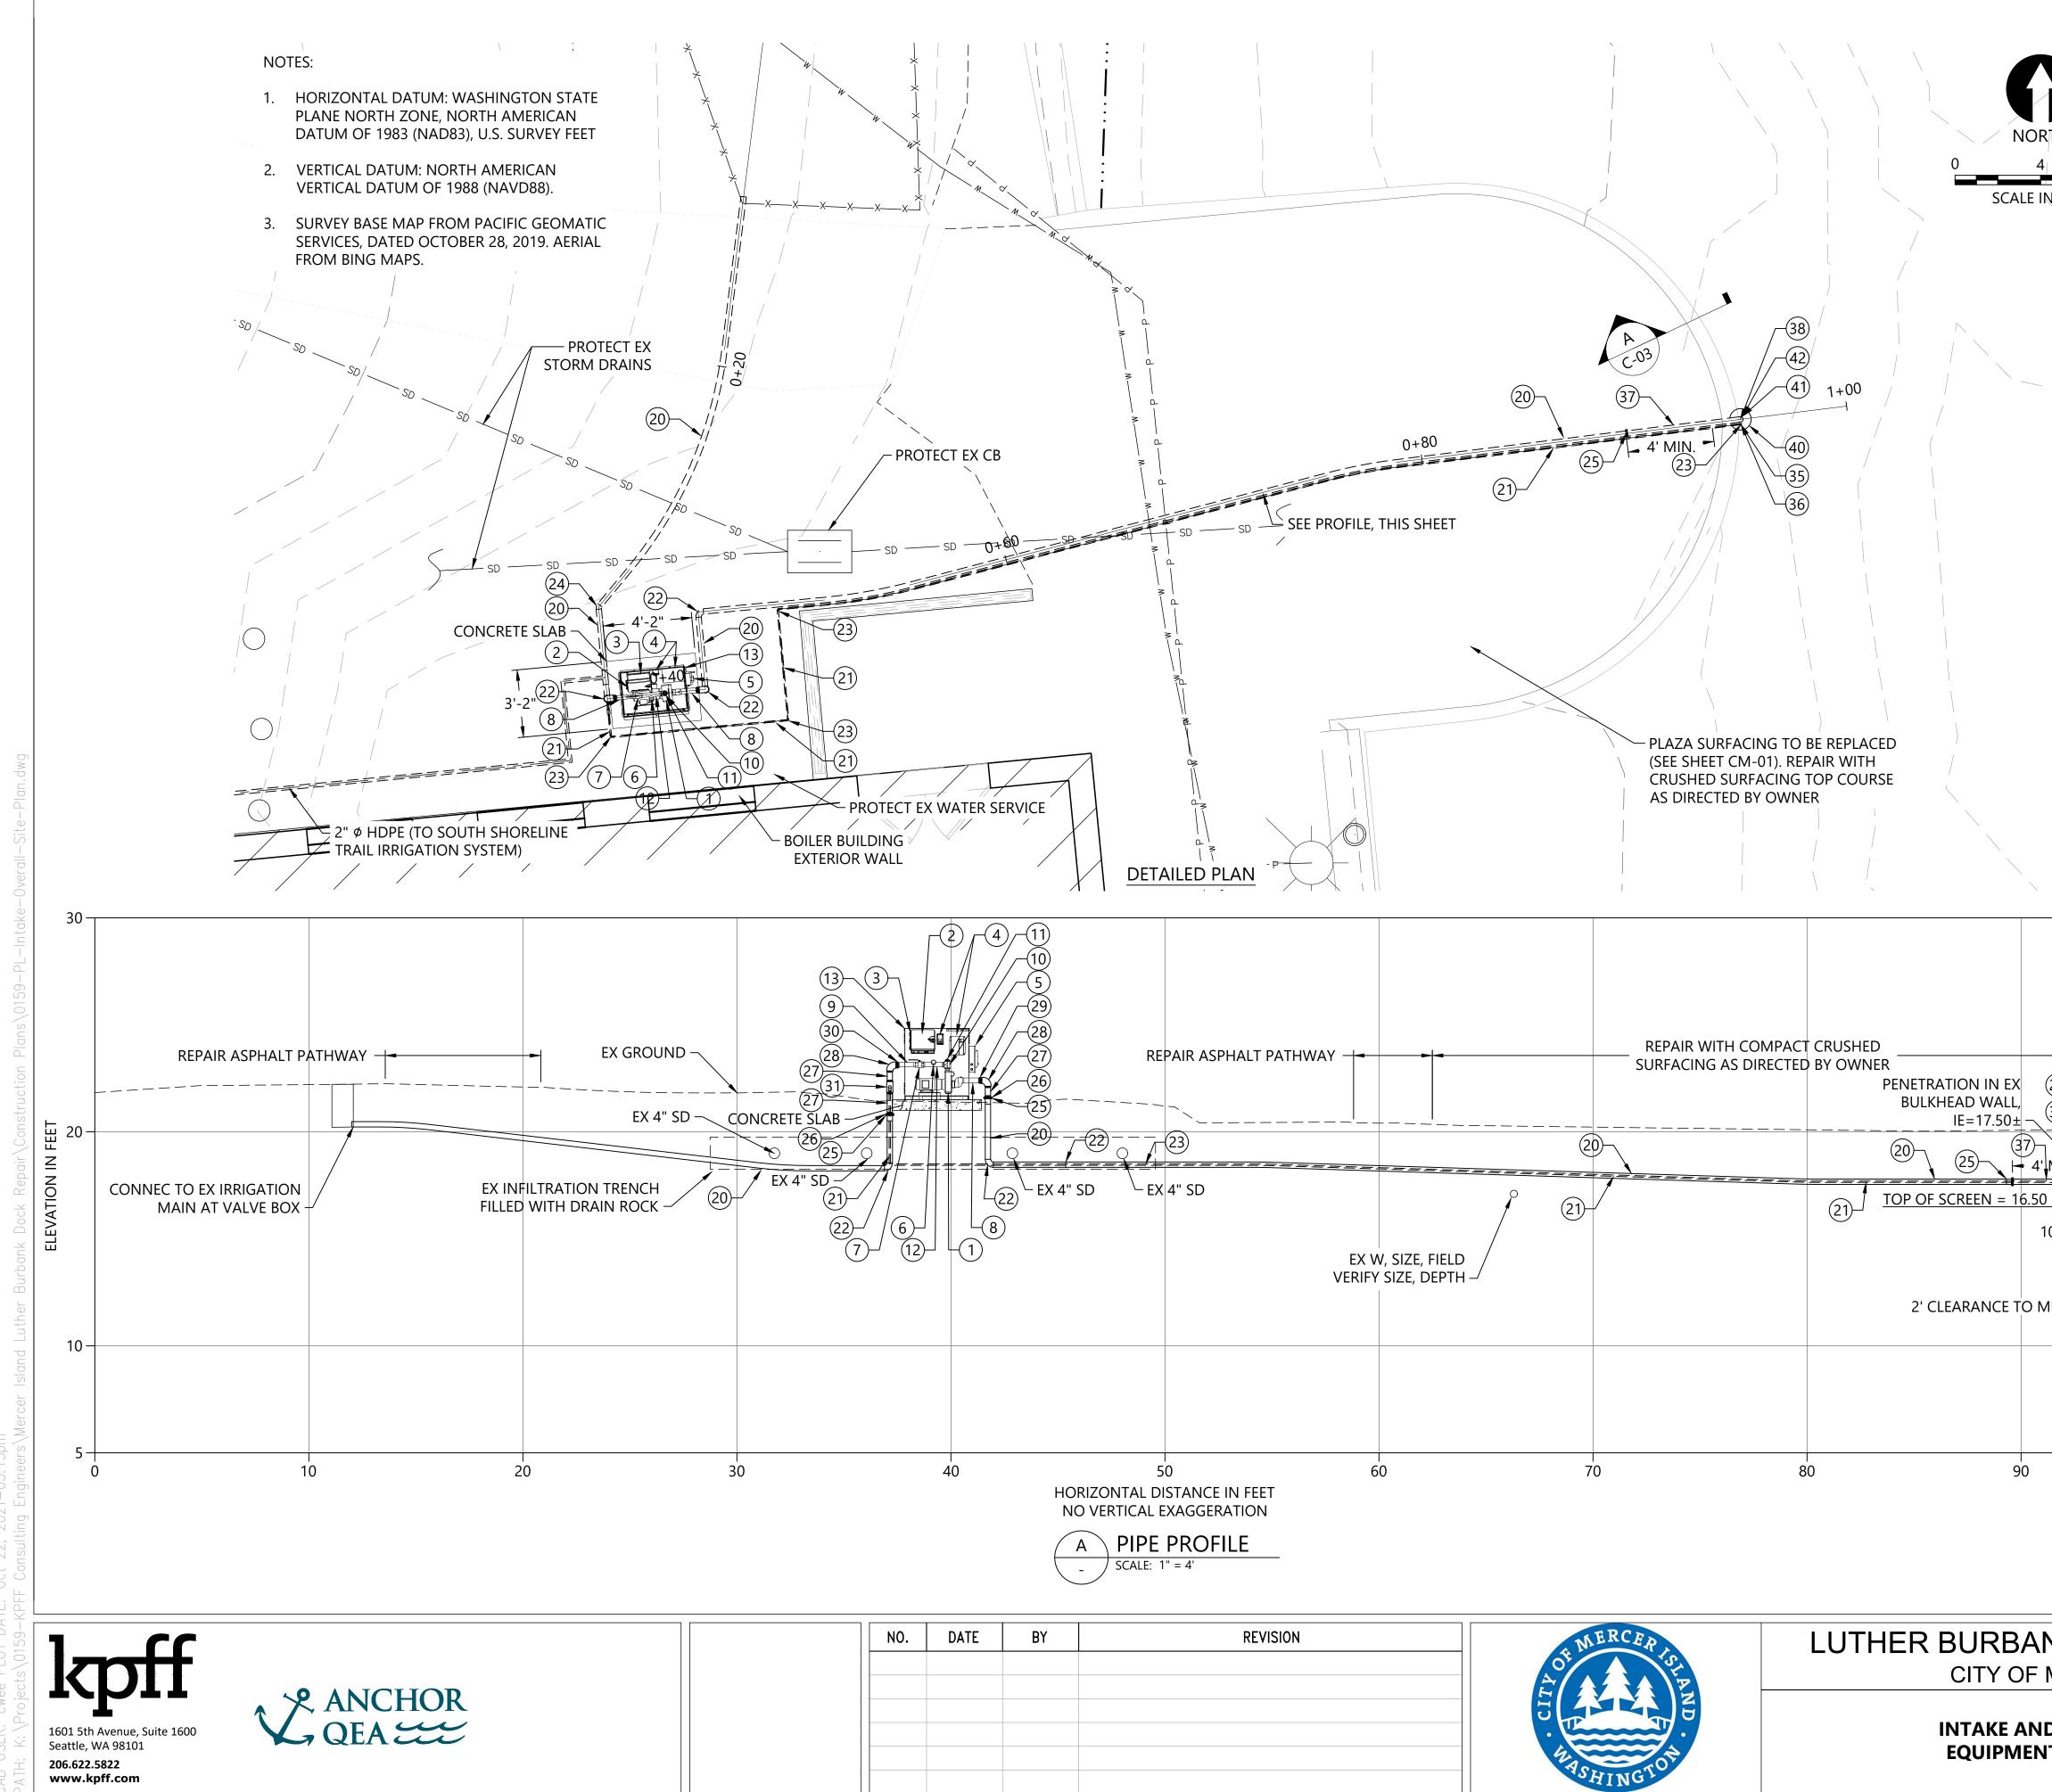


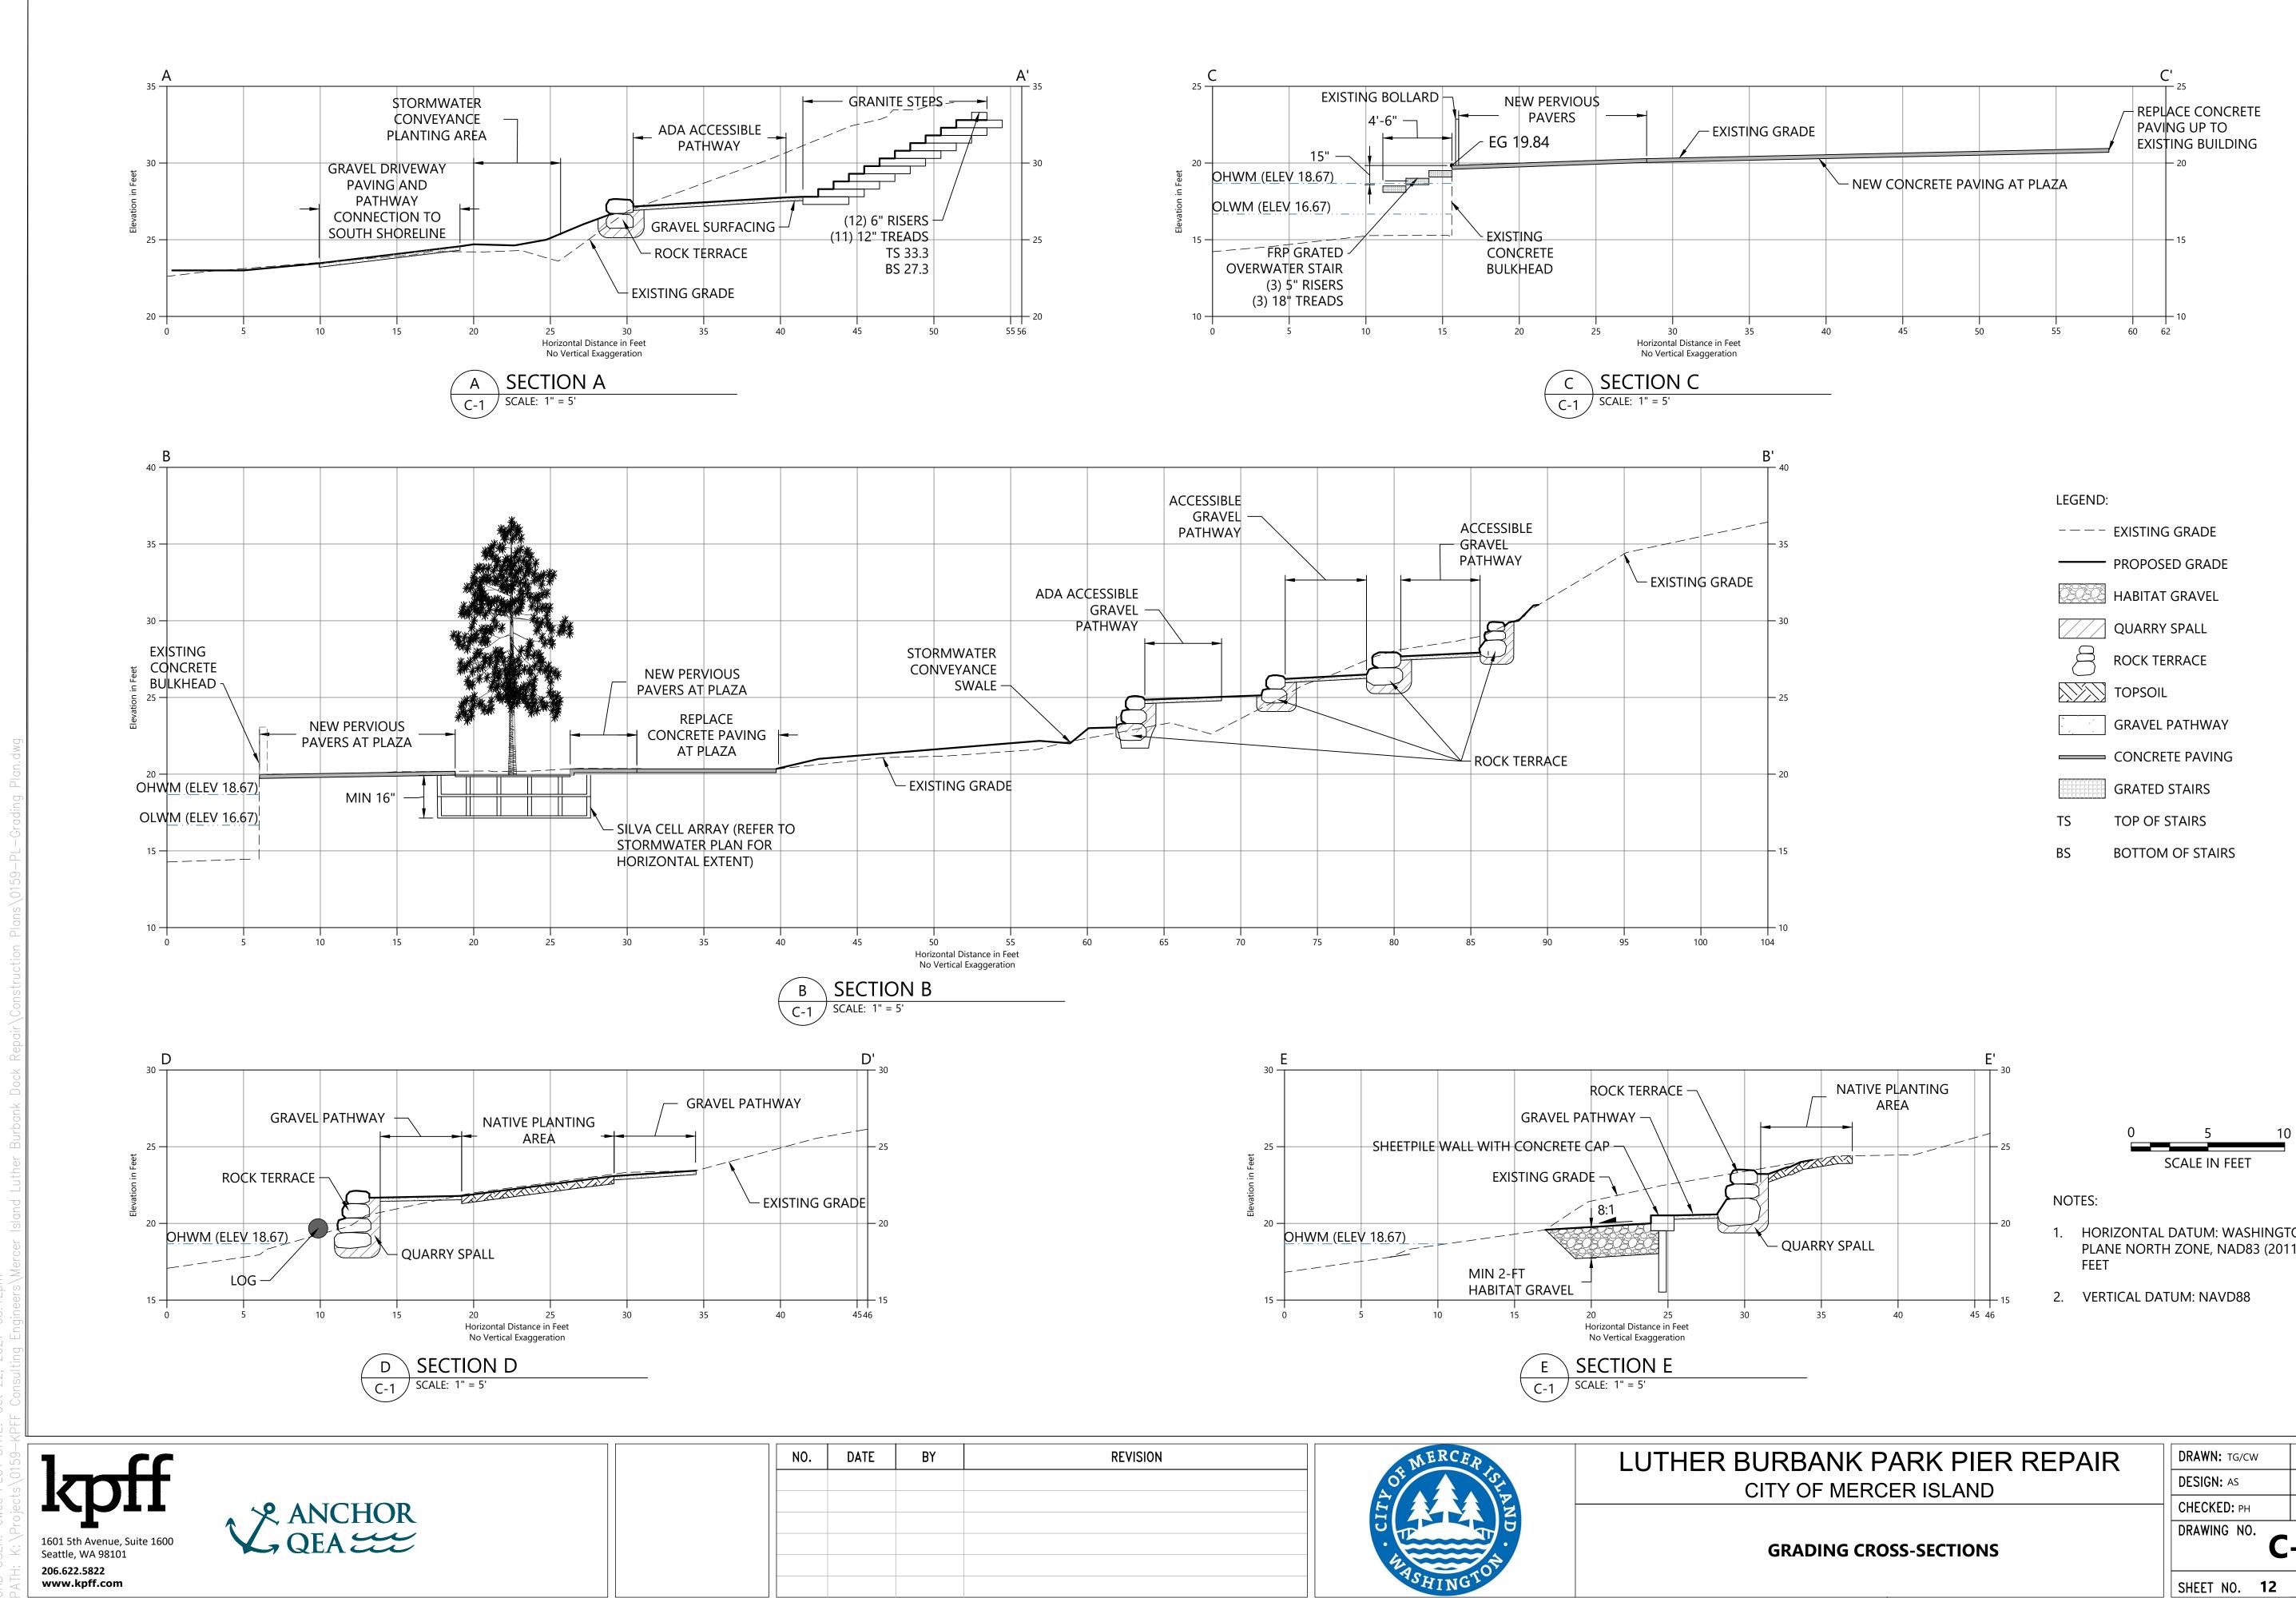- HORIZONTAL DATUM: WASHINGTON STATE PLANE NORTH ZONE, NAD83 (2011), U.S. SURVEY

ANK PARK PIER REPAIR	DRAWN: TG/CW	PROJECT NO.: 2000291
F MERCER ISLAND	DESIGN: AS	SCALE: AS NOTED
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ING CROSS-SECTIONS	DRAWING NO.	-021
	SHEET NO. 12	OF 52

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	EQU	IPN	/IEN

		EQUIPMENT LEGEND PACKAGED PUMP SYSTEM (RAINBIRD CLP5VAAS OR APPROVED EQUAL):		
		NUMBER	DESCRIPTION	
PRTH		1	"SELF-PRIMING, END-SUCTION, CENTRIFUGAL PUMP W/ VFD, 50 GPM	
4 8		2	@ 150 FEET TDH, ~ 5 HP" IRRIGATION SYSTEM CONTROLLER	
IN FEET		3	MOUNTING BRACKET FOR IRRIGATION SYSTEM CONTROLLER	
		4	208V 1-PHASE POWER DISCONNECT, PUMP START RELAY	
] / /		5	MANUAL SWITCH (PROGRAMMBLE CONTROLLER OVERRIDE)	
		6	LIQUID-FILLED PRESSURE GAUGE, SST, DISCHARGE	
/ /		7	2" ISOLATION VALVE	
		8	2-1/2" THREADED PIPE NIPPLE, SST, MNPT	
/		9	2" THREADED NIPPLE, SST, MNPT	
$\langle$		10	2" THREADED TEE, SST, FNPT	
		11	2" THREADED PLUG, SST, MNPT	
		12	2" THREADED NIPPLE, SST, MNPT, WITH WELDED OUTLET FOR PRESSURE GAGE AND AIR RELEASE VALVE	
``		13	MARINE GRADE ALUMINUM DECK AND ENCLOSURE	
		SUCTION AN	ND DISCHARGE PIPE AND FITTINGS:	
		NUMBER	DESCRIPTION	
		20	3" HDPE PIPE, DR 17, BUTT-FUSED	
		21	3/4" HDPE PIPE, DR 11, BUTT-FUSED (BACKWASH LINE)	
		22	3" HDPE 90° BEND, DR 17, BUTT-FUSED	
		23	3/4" HDPE 90° BEND, DR11, BUTT-FUSED	
		24	3" HDPE 45° BEND, DR 17, BUTT-FUSED	
, \		25	3" HDPE FLANGE ADAPTER W/ DI BACKING RING	
		26	3" COMPANION FLANGE, SST, FNPT X FL	
		27	3" THREADED NIPPLE, SST, MNPT	
		28	3" 90° BEND, SST, FNPT	
	30	29	3" X 2-1/2" HEX BUSHING, SST, MNPT X FNPT	
		30	3" X 2" HEX BUSHING, SST, MNPT X FNPT	
		31	3" X 1" TEE, SST, FNPT	
EXISTING BULKHEAD		32	1" THREADED NIPPLE, SST, MNPT	
WALL		33	1" 90° BEND, SST, FNPT	
		34	1" X 3/4" COUPLING, SST, MNPT X PACK JOINT	
	- 20	35	3/4" COUPLING, SST, MNPT X PACK JOINT	
		36	3/4" UNION, FNPT X FNPT	
= (41)	16.67	37	3" PIPE SPOOL, SST, FL X FL	
10"±		38	3" 90° BEND, SST, FL X FL	
36-(40)			NAND ASSOCIATED FITTINGS:	
		NUMBER	DESCRIPTION	
	- 10	40	CTC WATERWORKS SCS2, 100 GPM MAX., SELF-CLEANING INTAKE SCREEN, OR APPROVED EQUAL	
		41	3" COMPANION FL, SST	
		42	3" DOUBLE DOOR CHECK VALVE, WAFER STYLE	
1(	- 5			

# LUTHER BURBANK PARK PIER REPAIR CITY OF MERCER ISLAND


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## ND PUMPING FACILITIES -NT PLAN AND SECTIONS

DRAWN: TG/CW	PROJECT NO.: 2000291			
DESIGN: AS	SCALE: AS NOTED			
CHECKED: PH	DATE: <b>09/08/2021</b>			
DRAWING NO. CU-011				
SHEET NO. 14	of 52			

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Item 1.




1. PIPE BEDDING - PIPE BEDDING SHALL BE AT LEAST 6 INCHES DEEP AND SHALL MEET THE REQUIREMENTS OF SECTION 9-03.12(3) OF THE STANDARD SPECIFICATIONS. IF EXCAVATED TRENCH BOTTOM IS UNSTABLE OR NOT SUITABLE, THE CONTRACTOR SHALL EXCAVATE TO A DEPTH REQUIRED BY THE ENGINEER AND BACKFILL WITH PIPE BEDDING. PLACE PIPE BEDDING IN MAXIMUM 6-INCH LIFTS AND COMPACT TO 90% OF MAXIMUM DRY DENSITY.

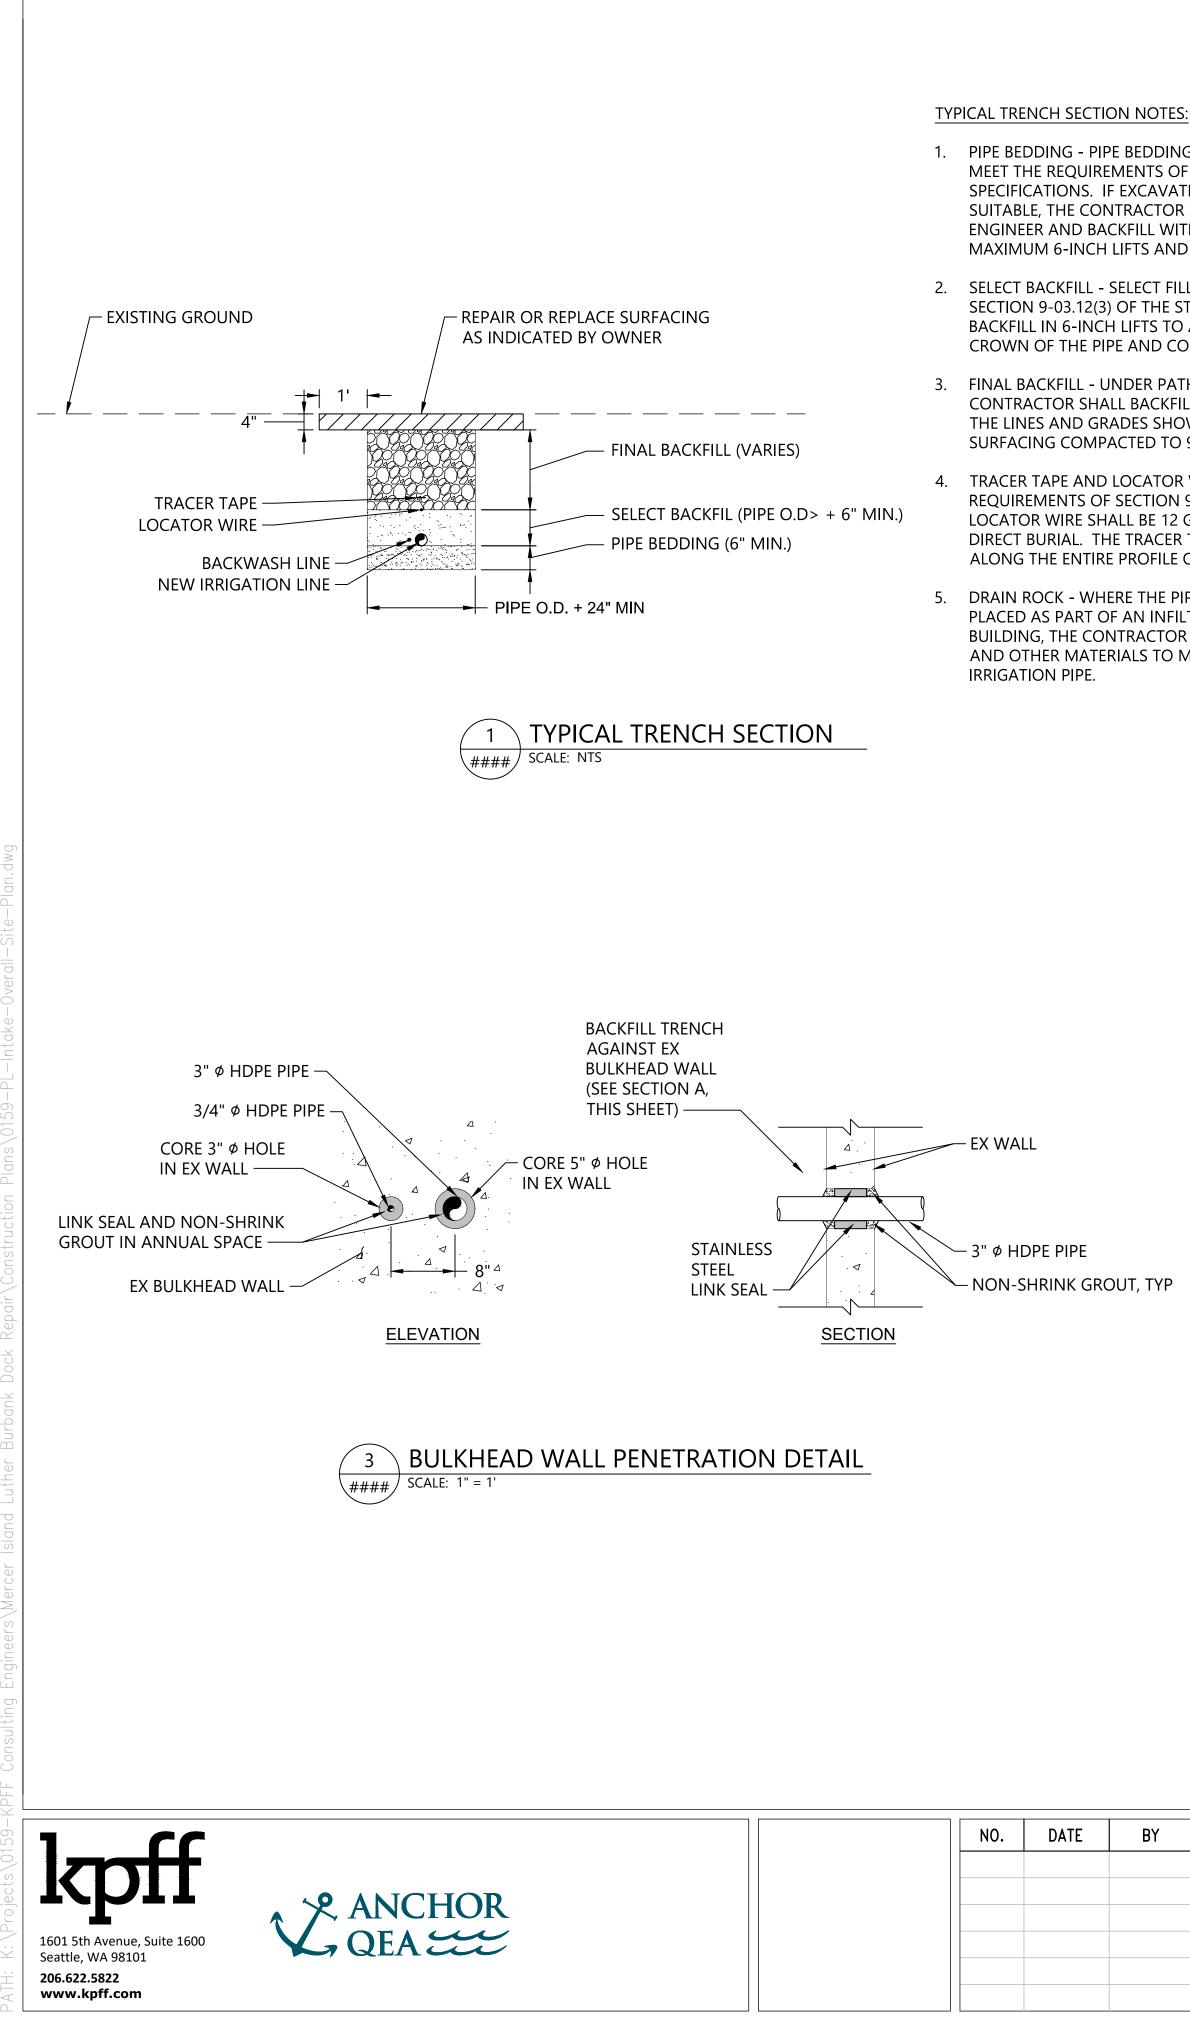SELECT BACKFILL - SELECT FILL SHALL ALSO MEET THE REQUIREMENTS OF SECTION 9-03.12(3) OF THE STANDARD SPECIFICATIONS. PLACE SELECT BACKFILL IN 6-INCH LIFTS TO A MINIMUM DEPTH OF 6 INCHES ABOVE THE CROWN OF THE PIPE AND COMPACT TO 90% OF MAXIMUM DRY DENSITY.

3. FINAL BACKFILL - UNDER PATHWAYS AND OTHER HARD SURFACES, THE CONTRACTOR SHALL BACKFILL THE REMAINING PORTION OF THE TRENCH TO THE LINES AND GRADES SHOW WITH 5/8-INCH MINUS CRUSHED ROCK SURFACING COMPACTED TO 95% OF MAXIMUM DRY DENSITY.

4. TRACER TAPE AND LOCATOR WIRE - TRACER TAPE SHALL MEET THE REQUIREMENTS OF SECTION 9-15.18 OF THE STANDARD SPECIFICATIONS. LOCATOR WIRE SHALL BE 12 GA. COPPER MULTI-STRAND RHW, CERTIFIED FOR DIRECT BURIAL. THE TRACER TAPE AND LOCATOR WIRE SHALL BE INSTALLED ALONG THE ENTIRE PROFILE OF THE PIPE.

DRAIN ROCK - WHERE THE PIPE IS INSTALLED ACROSS OR UNDER DRAIN ROCK PLACED AS PART OF AN INFILTRATION TRENCH ADJACENT TO THE BOILER BUILDING, THE CONTRACTOR SHALL BACKFILL THE TRENCH WITH DRAIN ROCK AND OTHER MATERIALS TO MATCH THE MATERIALS EXCAVATED TO PLACE THE

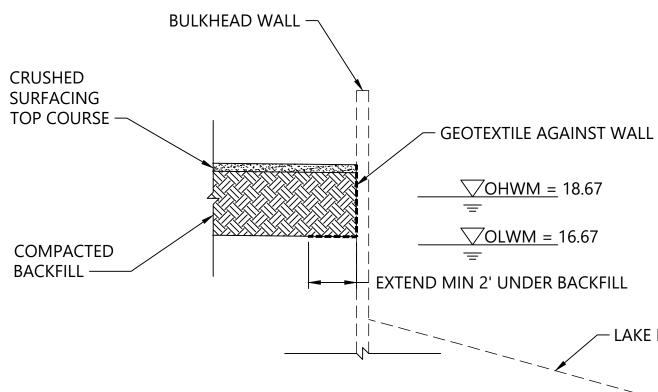



PLACEHOLDER - DETAIL TO BE ADDED AT 90% DESIGN

DRAIN VALVE DETAIL ´4 ` #### SCALE: NTS



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LUTHER BURBANK PARK PIER REPAIR CITY OF MERCER ISLAND

- LAKE BOTTOM

PLACEHOLDER - DETAIL TO BE ADDED AT 90% DESIGN



PLACEHOLDER - DETAIL TO BE ADDED AT 90% DESIGN


5 EXISTING IRRIGATION MAIN CONNECTION DETAIL

**INTAKE AND PUMPING FACILITIES -**DETAILS

DRAWN: TG/CW	PROJECT NO.: 2000291								
DESIGN: AS	SCALE: AS NOTED								
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DRAWING NO. CU-012									
SHEET NO. 15	OF 52								

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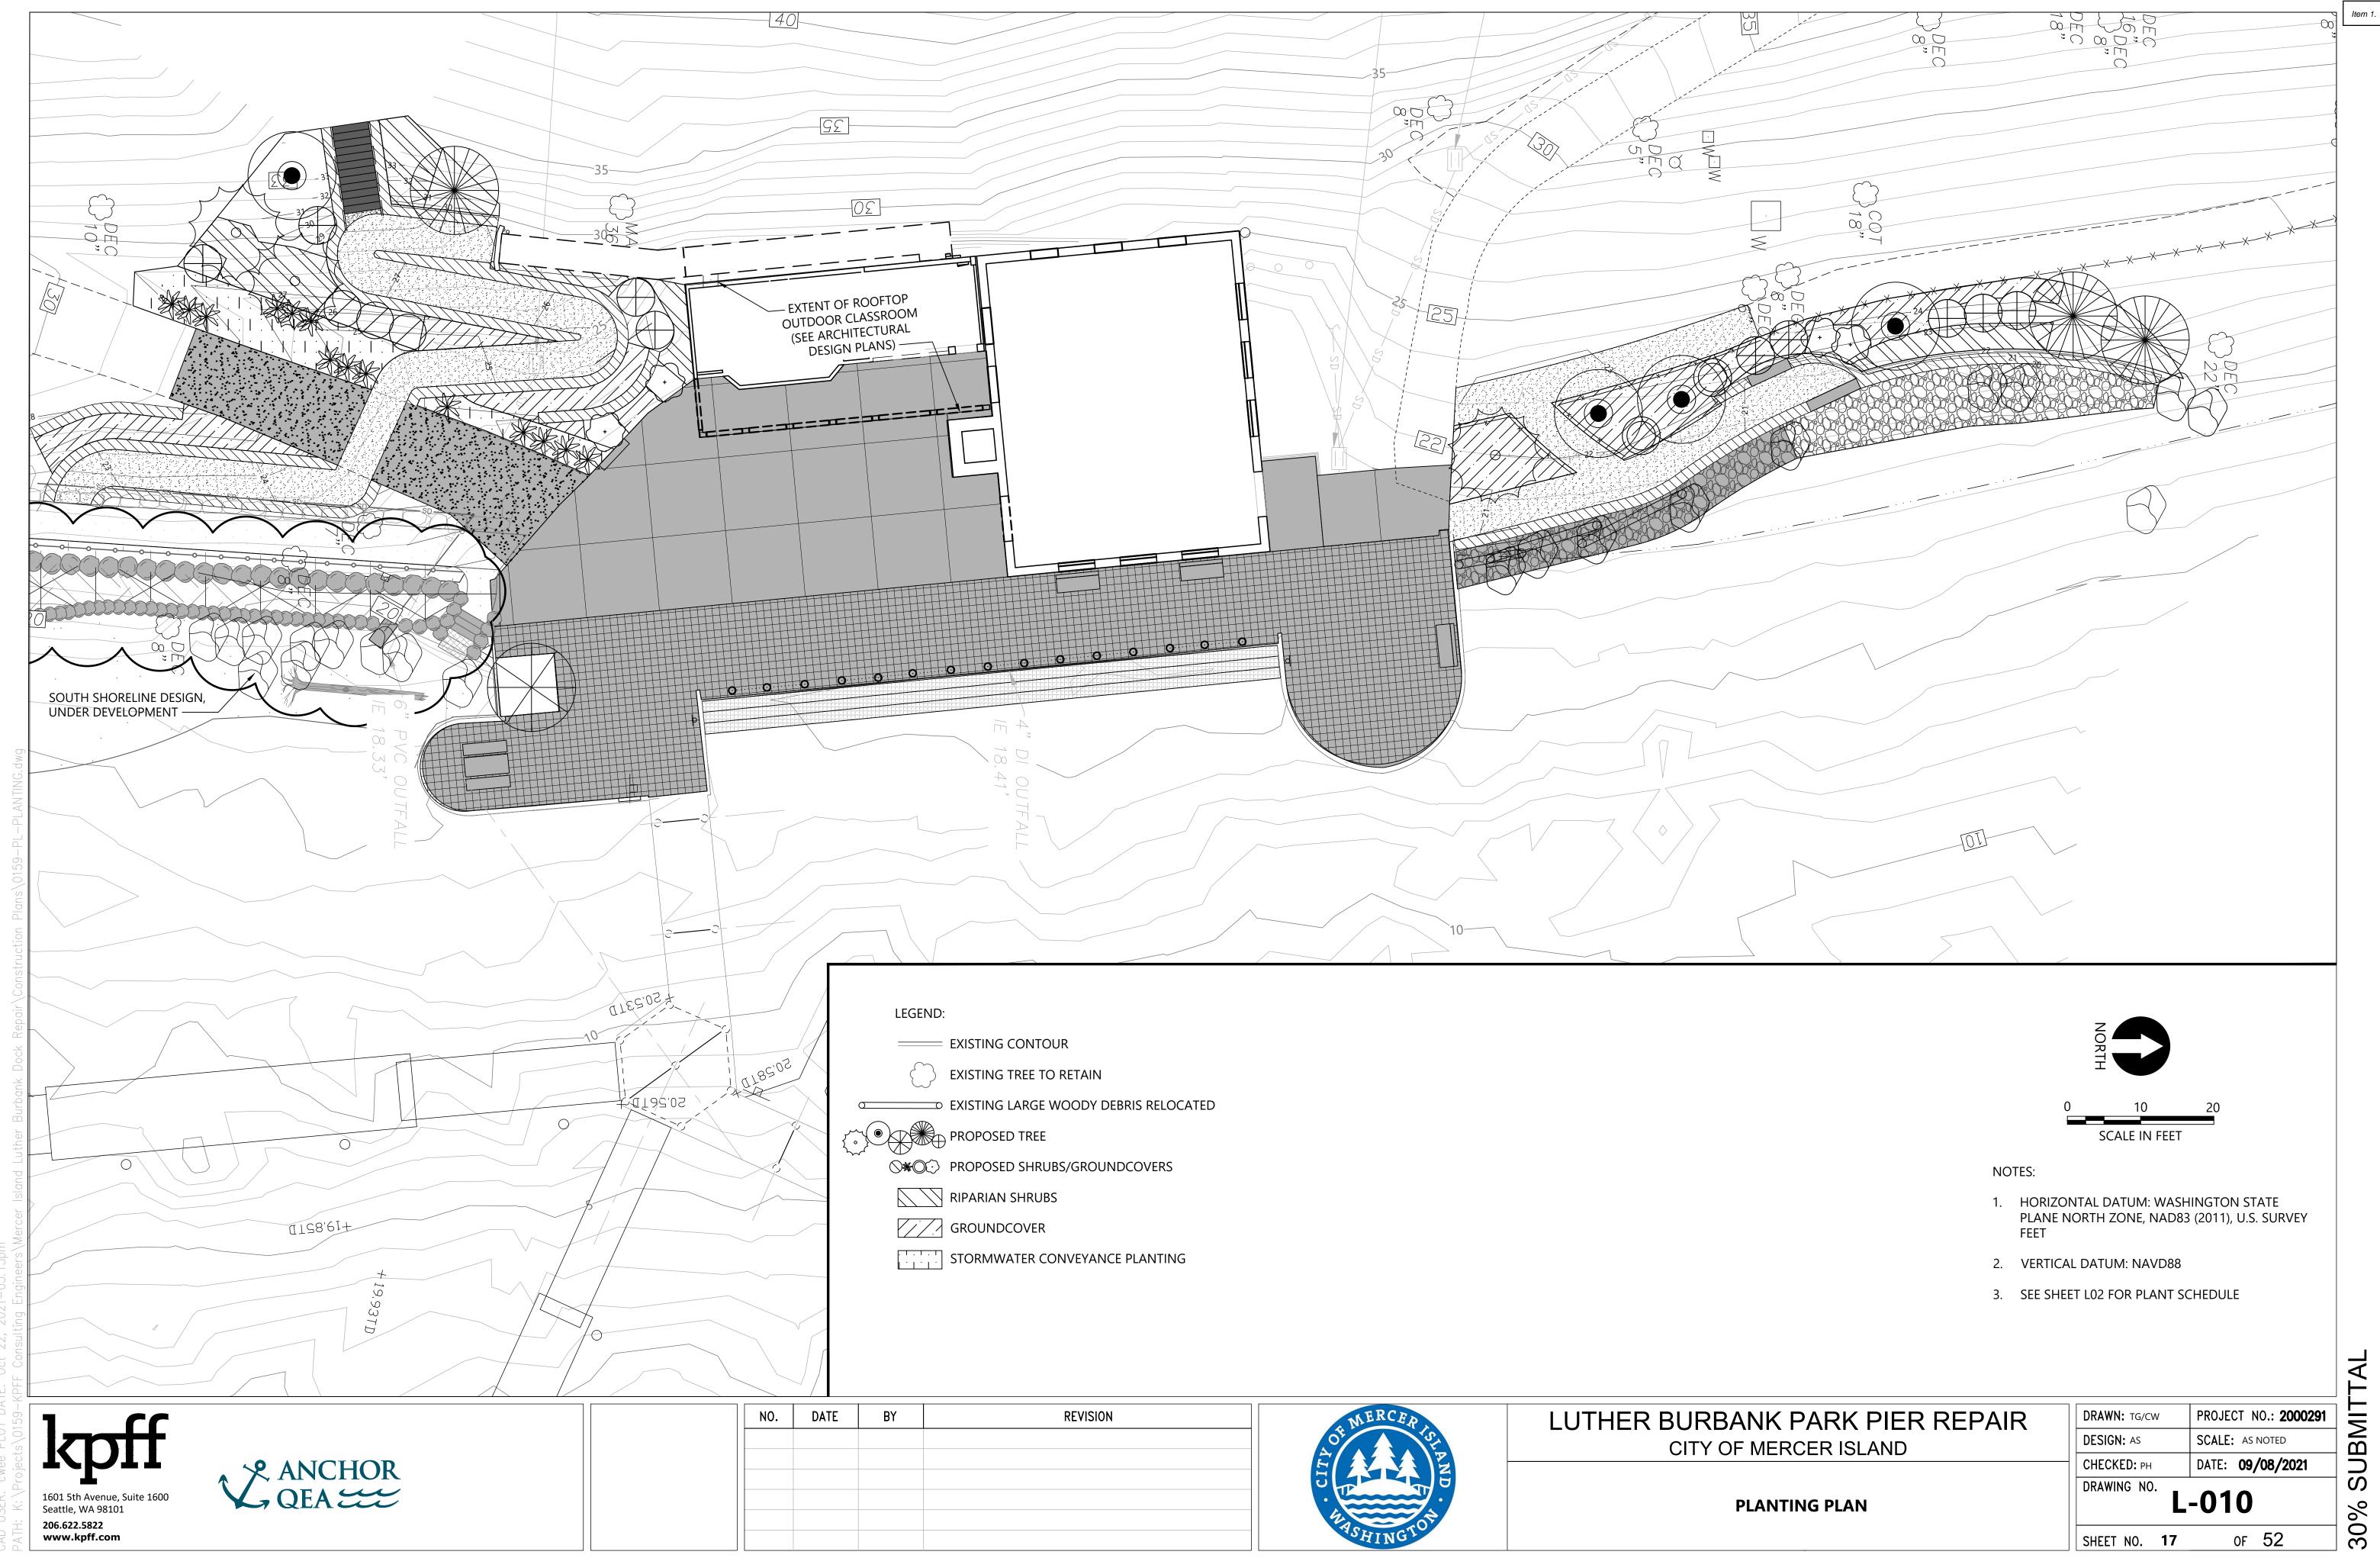
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			TOPSOIL
	EXISTING CONTOUR		ROCK TERRACE
$\left\{ \right\}$	EXISTING TREE TO RETAIN		
$\widehat{\mathcal{C}}$	EXISTING BOULDER TO RETAIN		GRATED WATER ACCESS STEPS
			HANDRAIL
	PERVIOUS PAVERS	<b>x</b>	SPLIT RAIL FENCING
	CONCRETE PAVING WITH SAWCUT JOINT	-	
	SCORING		PICNIC TABLE
	GRAVEL PATHWAY		BENCH
8	GRAVEL DRIVEWAY PAVING	00	EXISTING LARGE WOODY DEBRIS RELOCATED
<b>⊙</b> ⊙	EXISTING BOLLARD AND CHAIN TO REMAIN		
	HABITAT GRAVEL		
62.62	GRAVEL OVER COBBLE		


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ANK PARK PIER REPAIR	DRAWN: TG/CW	PROJECT NO.: 2000291
F MERCER ISLAND	DESIGN: AS	SCALE: AS NOTED
	СНЕСКЕД: РН	DATE: <b>09/08/2021</b>
MATERIALS PLAN	DRAWING NO.	/I-010
	SHEET NO. 16	OF 52

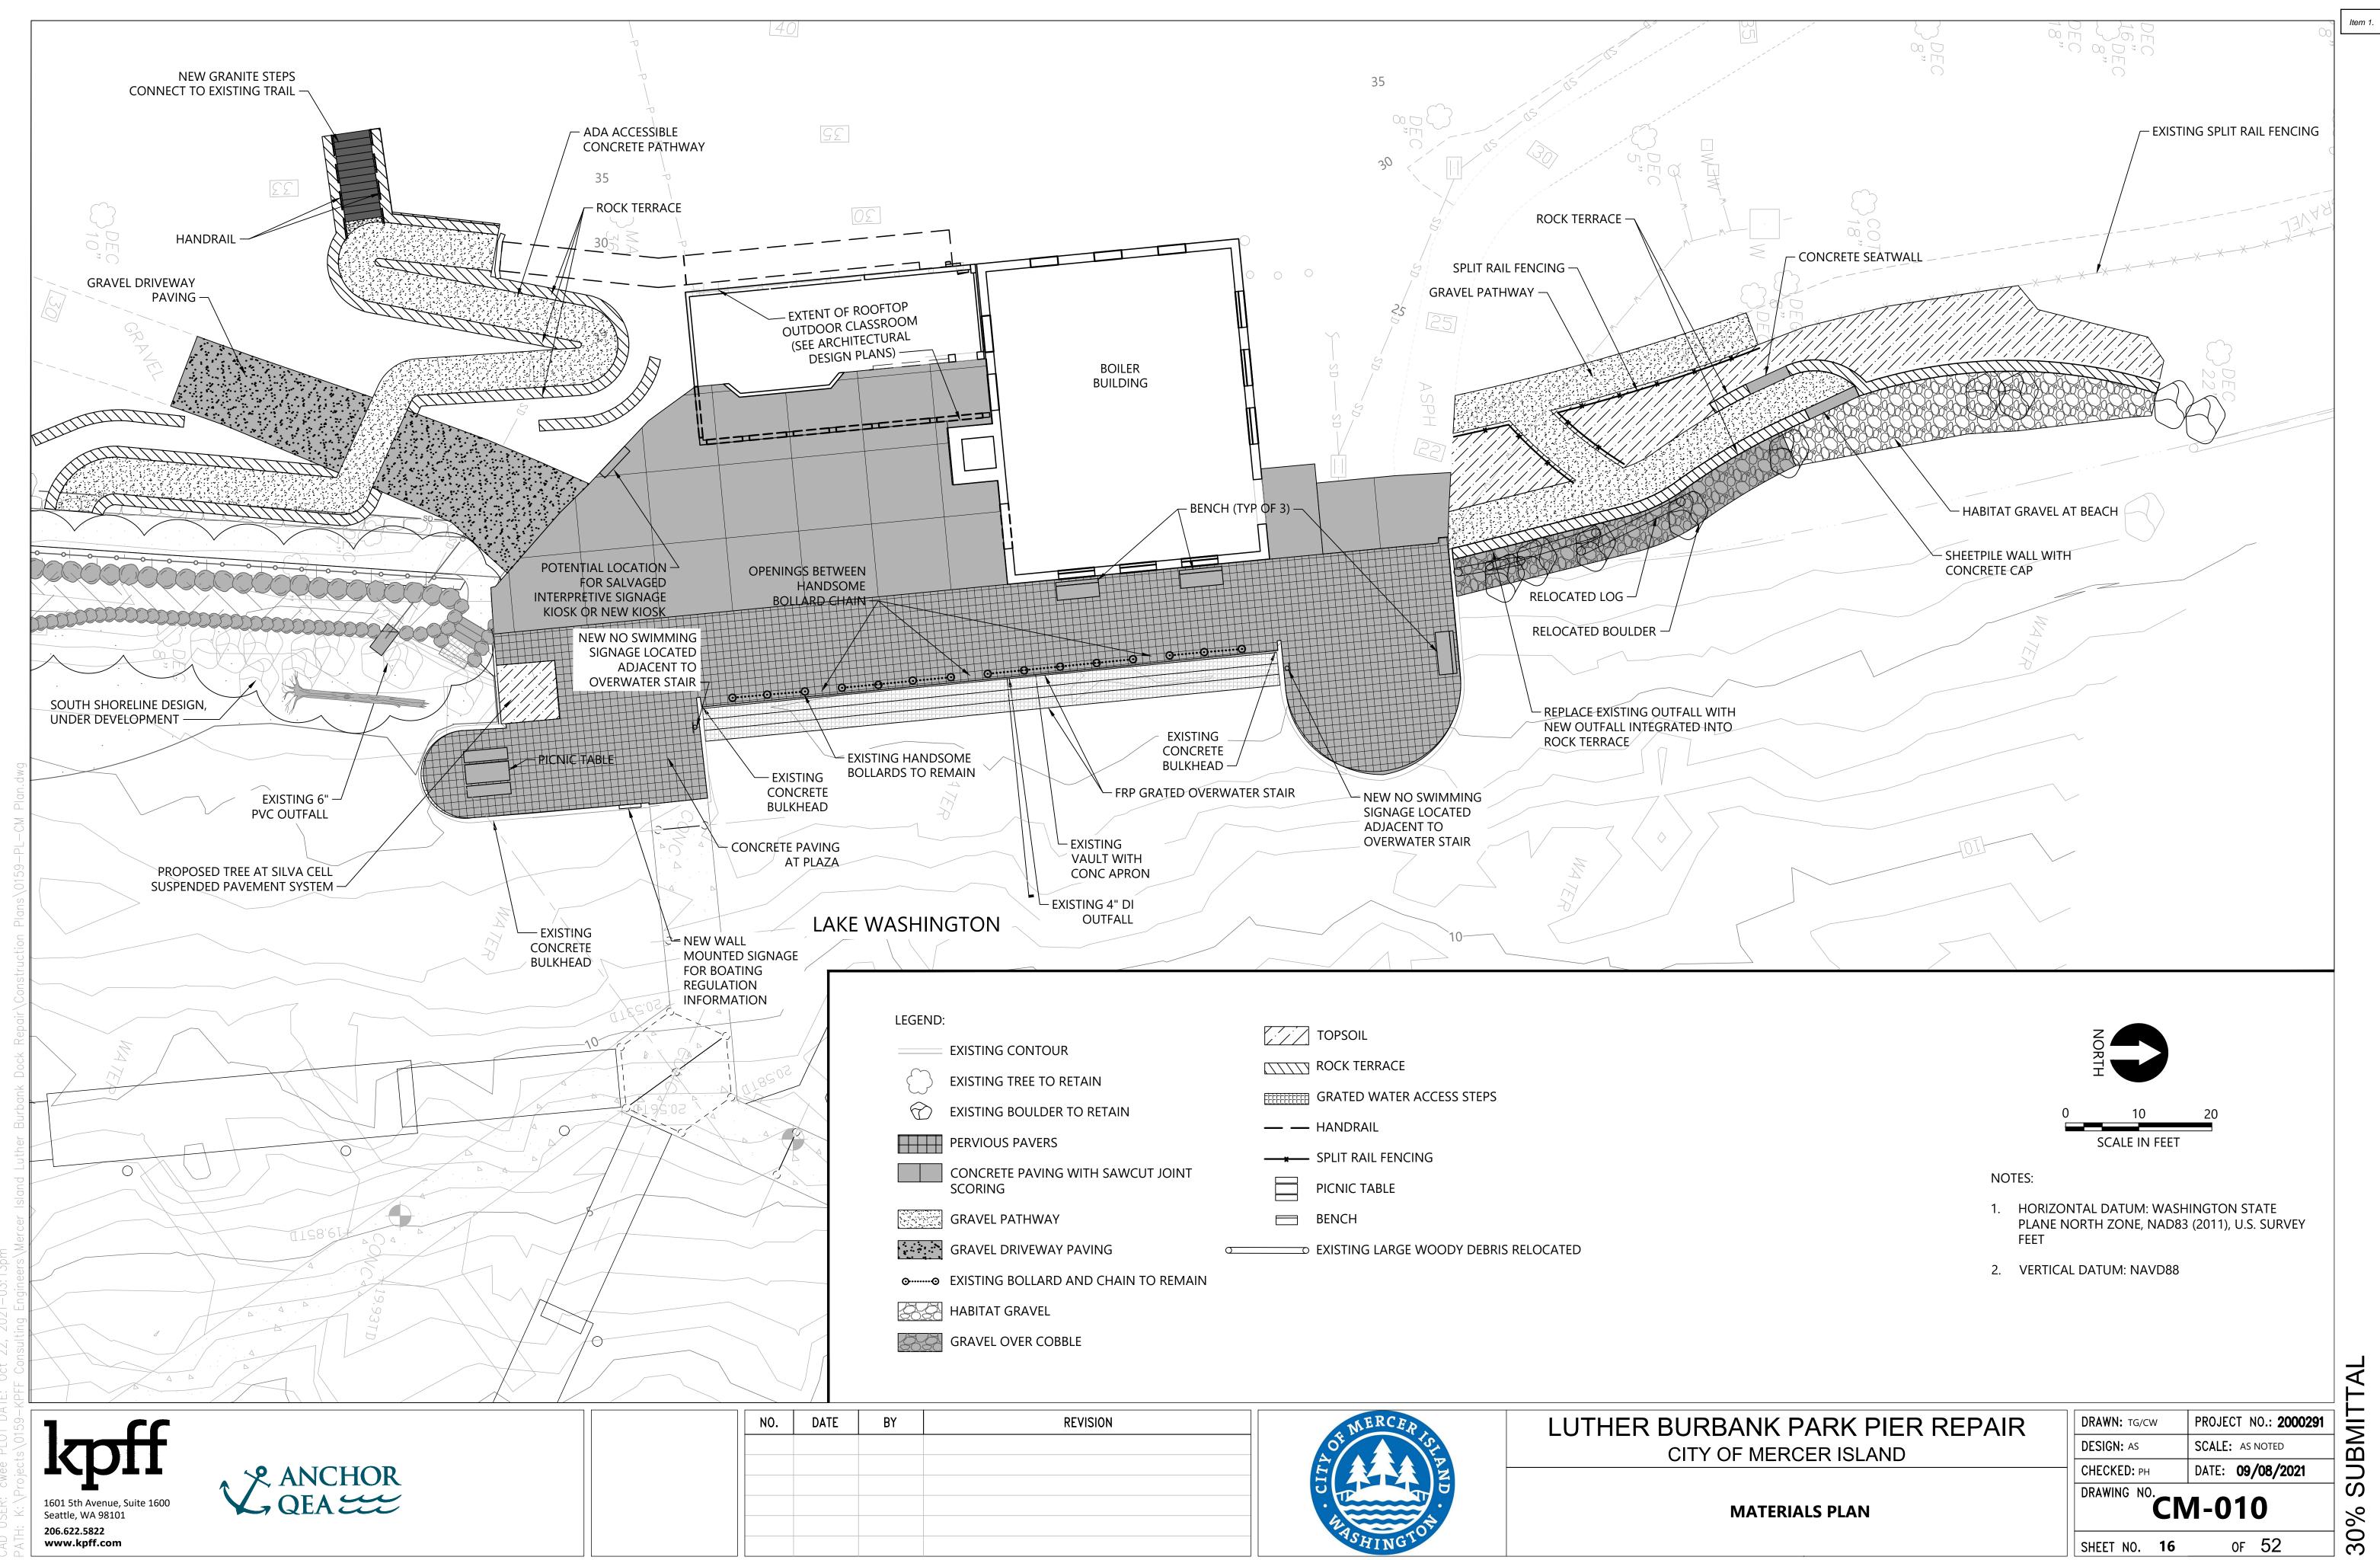

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MERCER ISLAND	DESIGN: AS	SCALE: AS NOTED
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ANTING PLAN	DRAWING NO.	L-010
	SHEET NO. 17	OF 52



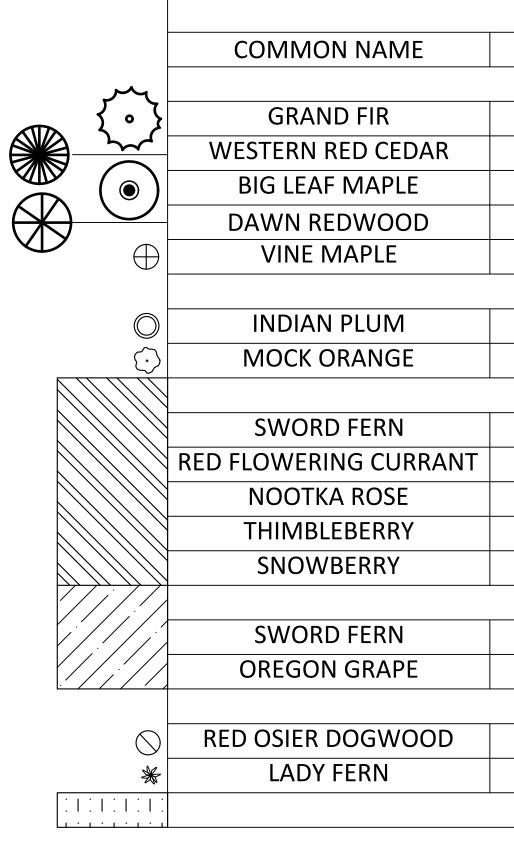


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Seattle, WA 98101 206.622.5822 www.kpff.com

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SCIENTIFIC NAME	SIZE	SPACING	QUANTITY	NOTES							
TR	EES										
ABIES GRANDIS	5-6' HT	AS SHOWN	3								
THUJA PLICATA	5-6' HT	AS SHOWN	3								
ACER MACROPHYLLUM	1.5" CAL	AS SHOWN	4								
METASEQUOIA GLYPTOSTROBOIDES	2" CAL	AS SHOWN	1								
ACER CIRCINATUM	5 GAL	AS SHOWN	9								
HIGH SHRUBS											
OEMLERIA CERASIFORMIS	2 GAL	AS SHOWN	2								
PHILADELPHUS LEWISII	2 GAL	AS SHOWN	4								
SHRUBS -	RIPARIAN										
POLYSTICHUM MUNITUM	1 GAL	3' O.C.									
RIBES SANGUINEUM	1 GAL	3' O.C.									
ROSA NUTKANA	1 GAL	3' O.C.									
RUBUS PARVIFLORUS	1 GAL	3' O.C.									
SYMPHORICARPOS ALBUS	1 GAL	3' O.C.									
GROUNI	DCOVERS										
POLYSTICHUM MUNITUM	1 GAL	3' O.C.									
MAHONIA NERVOSA	1 GAL	3' O.C.									
SHRUBS/GROUNDCOVERS - STO	DRMWATER CON	IVEYANCE AREA									
CORNUS SERICEA	1 GAL	AS SHOWN	3								
ATHYRIUM FELIX FEMINA	1 GAL	AS SHOWN	14								
SEED MIX - STORMWA	TER CONVEYANC	CE AREA	· I								

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# LUTHER BURBANK PARK PIER REPAIR CITY OF MERCER ISLAND

# PLANT SCHEDULE

DRAWN: TG/CW	PROJECT NO.: 2000291						
DESIGN: AS	SCALE: AS NOTED						
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DRAWING NO.	-011						
SHEET NO. 18	OF 52						

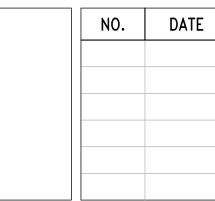		Estimated		Design			Construction				Escalation			Total			
Project Element	Co	ontract Cost	Со	ntingency	М	obilization	C	ontingency	М	I Sales Tax	1	to 2024	Pro	bable Cost			
				20.00%		10.00%		10.00%		10.10%		8.36%					
Large (>26') Powerboat Moorage	\$	304,235	\$	60,847	\$	30,424	\$	30,424	\$	30,728	\$	38,177	\$	494,833			
Small (<26') Powerboat Moorage	\$	1,071,020	\$	214,204	\$	107,102	\$	107,102	\$	108,173	\$	134,395	\$	1,741,996			
Non-Powered Watercraft Moorage	\$	210,740	\$	42,148	\$	21,074	\$	21,074	\$	21,285	\$	26,444	\$	342,765			
Waterfront Access Improvements	\$	37,464	\$	7,493	\$	3,746	\$	3,746	\$	3,784	\$	4,701	\$	60,935			
Stormwater Management Improvements	\$	317,929	\$	63 <i>,</i> 586	\$	31,793	\$	31,793	\$	32,111	\$	39 <i>,</i> 895	\$	517,106			
Non-Eligible Project Elements	\$	682,713	\$	53,289	\$	26,645	\$	26,645	\$	26,911	\$	33,435	\$	849,638			
Plaza & Landscape Improvements	\$	113,287	\$	22,657	\$	11,329	\$	11,329	\$	11,442	\$	14,216	\$	184,259			
On-grade ramp to Outdoor Classroom	\$	83,124	\$	16,625	\$	8,312	\$	8,312	\$	8,396	\$	10,431	\$	135,200			
Building Improvements	\$	416,267											\$	416,267	All costs i	ncluded in	oase cost
Outdoor Classroom	\$	116,136											\$	116,136	All costs i	ncluded in	base cost
Access Ramp	\$	76,993											\$	76,993	All costs i	ncluded in	oase cost
Other Improvements	\$	223,137											\$	223,137	All costs i	ncluded in	oase cost
Irrigation Intake	\$	29,745	\$	5,949	\$	2,975	\$	2,975	\$	3,004	\$	3,733	\$	48,380			
North Beach Expansion	\$	15,224	\$	3,045	\$	1,522	\$	1,522	\$	1,538	\$	1,910	\$	24,762			
Site Furnishings	\$	14,755	\$	2,951	\$	1,476	\$	1,476	\$	1,490	\$	1,852	\$	23,999			
Plantings	\$	10,311	\$	2,062	\$	1,031	\$	1,031	\$	1,041	\$	1,294	\$	16,771			
Integrated Art @ 1%	\$	26,241	\$	5,248	\$	2,624	\$	2,624	\$	2,650	\$	3,293	\$	42,681			
Total Project Construction Cost	\$	2,650,342											\$	4,049,953			
Total for Outdoor Classroom													\$	328,330			