

DESIGN COMMISSION REGULAR HYBRID MEETING AGENDA

Wednesday, October 4, 2023 at 6:00 PM

DESIGN COMMISSIONERS LOCATION

Chair: Suzanne ZahrMercer Island Community & Event Center and ZoomVice Chair: Anthony PerezLuther Burbank Meeting Room 103Commissioners: Megan Atkinson, Traci Granbois,8236 SE 24th Street | Mercer Island, WA 98040Claire McPherson, Catherine Lategan, and Christopher Patano(206) 275-7706 | www.mercerisland.gov

We strive to create an inclusive and accessible experience. Those requiring accommodation for Pla Commission meetings should notify the Deputy City Clerk's Office 3 days prior to the meeting at (206) 275-7791 or by emailing deborah.estrada@mercerisland.gov.

Registering to Speak: Individuals wishing to speak live during appearances, must register with the Deputy City Clerk by 4pm on the day of the Design Commission meeting. Register at (206) 858-3150 or email deborah.estrada@mercerisland.gov. Each speaker will be allowed three (3) minutes to speak.

If providing comments using Zoom, staff will permit temporary video access when it is your turn to speak. Please activate the video option on your phone or computer, ensure your room is well lit, and kindly ensure that your background is appropriate for all audience ages. Screen sharing will not be permitted, but documents may be emailed to design.commission@mercergov.org.

Join by Telephone at 6:00 pm: Call 253.215.8782 and enter Webinar ID 862 8359 6284, Passcode 581756.

Join by Internet at 6:00 pm:

- 1) Click this Link
- 2) If the Zoom app is not installed on your computer, you will be prompted to download it.
- 3) If prompted for Webinar ID, enter 862 8359 6284, Passcode 581756

Join in person at 6:00 pm: Mercer Island Community & Event Center – 8236 SE 24th Street, Mercer Island

CALL TO ORDER & ROLL CALL, 6 PM

PUBLIC APPEARANCES

This is the opportunity for anyone to speak to the Commission about issues of concern.

REGULAR BUSINESS

1. Design Commission Meeting Minutes for November 2, 2022

Recommended Action: Approve minutes.

2. DSR22-014 – Review a proposal to construct a new 10-unit apartment building at 2900 78th Avenue SE. **Recommended Action:** Discussion only

OTHER BUSINESS

- 3. Planning Manager's Report
- 4. Announcements & Communications

ADJOURNMENT

DESIGN COMMISSION

MEETING MINUTES



Wednesday, November 2, 2022

CALL TO ORDER

Vice Chair Anthony Perez called the virtual meeting to order at 6:01 PM from a remote location.

ROLL CALL

Vice Chair Anthony Perez, Commissioners Megan Atkinson, Traci Granbois, Catherine Lategan, Claire McPherson (6:04), Christopher Patano, and Suzanne Zahr.

STAFF PRESENT

Ryan Harriman, Planning Manager Jeff Thomas, CPD Interim Director Deborah Estrada, Deputy City Clerk

APPEARANCES

There were no public appearances.

PUBLIC HEARING

Vice Chair Perez opened the public hearing at 6:04 PM. There being no one present to speak, the public hearing was closed at 6:05 PM

REGULAR BUSINESS

Election of Officers

Commissioner Lategan nominated Vice Chair Anthony Perez for Chair, which he declined.

Commissioner Perez nominated Suzane Zahr to be Chair, which she accepted.

Motion by Perez; seconded by Lategan to:

Approve Commissioner Zahr as Chair of the Design Commission.

Passed: 6-0-1 (Atkinson, Lategan, McPherson, Patano, Perez, and Zahr)

Abstain: 1 (Granbois)

Commissioner Zahr nominated Perez to be Vice Chair, which he accepted.

Motion by Patano; seconded by Atkinson to:

Approve Commissioner Perez as Vice Chair for the Design Commission.

Passed: 6-0-1 (Atkinson, Lategan, McPherson, Patano, Perez, and Zahr)

Abstain: 1 (Granbois)

Approve the minutes of the May 12, 2022, Regular Meeting.

Motion by Lategan; seconded by Perez to:

Approve the minutes of the May 12, 2022, Regular Meeting.

Passed: 6-0-1 (Atkinson, Granbois, Lategan, McPherson, Patano, and Perez)

Abstain: 1 (Zahr)

File No. DSR21-012: permit Type IV

Motion by Perez; seconded by Atkinson to:

Adopt the staff findings and conclusions contained within this staff report and APPROVE the proposed development subject to the recommended conditions of approval also contained in this staff report and approve, with one additional condition, Number 8, is that the applicant provide a continuous visual barrier in line with the proposed cedar fence to the adjacent southern buildingborder.

Motion to Lategan; seconded by Perez to amend the original motion to:

Replace "building" with "border."

Passed: 7-0: (Atkinson, Granbois, Lategan, McPherson, Patano, Perez, and Zahr)

Passed: 7-0; (Atkinson, Granbois, Lategan, McPherson, Patano, Perez, and Zahr)

OTHER BUSINESS

Ryan Harriman, Planning Manager, introduced himself.

Announcements & Communications - None

Next Schedule Meeting – tentatively scheduled for December 7, 2022.

ADJOURNMENT

The meeting adjourned at 7:16 PM

CITY OF MERCER ISLAND

COMMUNITY PLANNING & DEVELOPMENT

9611 SE 36TH STREET | MERCER ISLAND, WA 98040 PHONE: 206.275.7605 | www.mercerisland.gov



STAFF REPORT DESIGN COMMISSION STUDY SESSION

Project No: DSR22-014

Description: A Study Session with the Design Commission to discuss a proposal to construct a

new 10-unit apartment building.

Applicant/ Owner: Kelly Hallstrom (Medici Architects) / 2900 Development LLC

Site Address: 2900 78th Ave SE, Mercer Island WA 98040

Identified by King County Assessor tax parcel number: 531510-1219

Zoning District Town Center (TC), TC-4 Subarea

Staff Contact: Ryan Harriman, EMPA, AICP – Planning Manager

Exhibits: 1. Project Narrative

2. Plan Set

3. Building Study Session Comments

I. INTRODUCTION:

On December 13, 2022, the applicant applied for a study session with the Design Commission to review a proposal for a 10-unit residential apartment building located at 2900 78th Avenue SE. Applicants for Design Commission Design Review are required to take part in a study session with the Design Commission prior to public hearing pursuant to MICC 19.15.220(C)(2)(a); this study session fulfills this requirement.

On July 26, 2022, the Applicant submitted a complete site development permit application, 2207-281, which the City subsequently determined vests the application to the design and development regulations in place at that time.

The subject property is located 2900 78th Ave SE, in the Town Center zone. The neighboring properties to the north, south, and east are also within the Town Center zone and the TC-4 subarea. The intersection of SE 29th Street and 78th Avenue SE is located to the west of the subject property.

The subject property is developed with a commercial building, formerly Baskin Robbins. Neighboring development includes a senior living facility to the east, multi-story mixed use building to the north, and a parking lot for a financial institution to the south.

The Applicant will need to submit a formal design review application for proposed development, which will require approval by the Design Commission prior to issuance of any construction permits. Following completion of this study session and receipt of an application for design review, an open record public hearing in front of the Design Commission will be scheduled pursuant to MICC 19.15.220(C)(2).

II. STAFF ANALYSIS AND CRITERIA FOR REVIEW

A. MICC 19.11.015 - Town Center subareas.

The subject property is located within TC-4 subarea which allows a broad of land uses and building up to four stories in height. The proposed development is four stories and does not exceed the maximum height of 51-feet. Pursuant to MICC 19.11.015(B)(2), the purpose of the TC-4 subarea is to be a transition between the taller buildings in the TC-5 subarea and the lower structures in the TC-3 and TCMF-3 subareas. A broad mix of land uses is allowed. Buildings may be up to four stories in height.

B. MICC 19.11.020 - Land uses.

Pursuant to MICC 19.11.020, the proposed development is listed as a permitted use. On July 26, 2022, the Applicant applied for a site development permit, 2207-281. The application vests the proposed development to the regulations in place at the time the application. The application is vested to the former version of Chapter 19.11 MICC, which did not require commercial development to be located on the first floor of a proposed development.

C. MICC 19.11.030 - Bulk regulations.

Base Building Height Allowed: 27 Feet

proposed: 51-feet

Based Building Stories Allowed: 2

proposed: 4 stories

Max Allowable Building Height: 51 Feet

proposed: 51-feet

Max Allowable Building Stories: 4

proposed: 4 stories

Ground Floor Adjacent to Streets: 15 Feet

proposed: 15-foot ground floor level along 78th Ave SE

Setback From Property Lines: No Minimum

proposed: North - 0-feet / East - 0-feet / South - 12-feet / West - 15-feet from face of curb Required Upper Story Setback: Meets average daylight plane standards as described in

subsection (A)7

D. MICC 19.11.040 - Affordable housing.

The incentives and regulations offered in MICC 19.11.040 are used by the City as one means of meeting its commitment to encourage housing affordable to all economic groups, and to meet its regional share of affordable housing requirements. The purpose of MICC 19.11.040 is to: (1) implement through regulations the responsibility of the city under state law to provide for housing opportunities for all economic segments of the community, (2) help address the shortage of housing in the city for persons of moderate-income households, (3) promote development of affordable housing that would not otherwise be built in the city, and (4) offer incentives to encourage construction of affordable housing units in Town Center.

To qualify for the addition two stories that is allowed within the TC-4 subarea, the Applicant proposes to provide affordable housing that is equal to 10 percent of the total units in the development. The total number of units proposed is 10, which means that 1 (10%) of those units will be affordable. As the proposed development moves forward and agreement between the city and owner will be established per MICC 19.11.040.F.

E. MICC 19.11.050 - Green building standards.

Pursuant to MICC 19.11.050, any major new construction shall meet the LEED Gold standard. Projects that are primarily residential (at least 50 percent of the gross floor area is composed of residential uses) may

instead meet the Built Green 4 Star standard. The applicant shall provide proof of LEED or Built Green certification within 180 days of issuance of a final certificate of occupancy, or such later date as may be allowed by the code official for good cause, by submitting a report analyzing the extent credits were earned toward such rating. Failure to submit a timely report regarding LEED or Built Green ratings by the date required is a violation of this Code.

F. MICC 19.11.060 - Site design.

The Applicant proposes to incorporate three minor site features into the proposed development. These features include:

- Water fountain within the public open space
- Bike rack on the public sidewalk near the walkway to the building entrance
- Clock located on the building above the public open space will be incorporated into the facade and become a piece of art."

Since this proposed development exceeds three stories in height, at least one of the major site features is required. Due to the small size of the lot, it is not feasible to provide a Through-block connection so this project is proposing to incorporate a public open space that meets the requirements of MICC 19.11.040(D). The public open space shall be an informal gathering area for not only residents, but for anyone passing by. The proposed public open space is 465 SF which is 3.2 percent of the proposed GFA (minimum requirement is 3 percent), and the width is 20 feet which extends from the north property line to the driveway. The proposed public open space incorporates these design elements into the design:

- It is located at the same level as the sidewalk, will serve as a focal point, and is integrated with the pedestrian connection between the building and the public right of way.
- It includes amenities such as 8 linear feet of seating, a water fountain, landscape lighting, landscaping, a green wall, and decorative paving.
- Pedestrian oriented frontage is provided on the west (ROW) and the south (building entry) edges of the open space.
- 25 percent of the open space is landscaped with groundcover and shrubs.
- Apart from a small awning above the entry door, the public open space is open to the sky.
- The public open space will be always available to the public.

G. MICC 19.11.070 - Greenery and outdoor spaces.

B.1 - Landscaped area requirement

The landscaped surfaces shall equal at least 25 percent of the development site. This site is 7,200 SF so at least 1,800 SF (25 percent) shall be landscaped. Because of the small site, a combination of ground level planting, green walls, and a green roof will be utilized to meet this requirement.

- Ground Level Planting: The available space is very limited. The public open space and the planter strip south of the driveway combine for a total of 250 SF of available space for planting of shrubs and ground cover.
- Green Wall: A green wall will be incorporated into the public open space along the north property line that will cover up the blank wall of the adjacent property. This will be approximately 226 SF, which at a rate of 75 percent, 169.5 SF will count towards the landscape requirement.
- Green Roof: This will be the largest portion of landscaping on site. There will be approximately 3,250 SF of sedum trays on the roof, which 1,625 SF will count towards the requirement.

These elements combine for a total of 2,044.5 SF in landscaped area, or 28.4% of the site.

B.2 - Landscaping standards

All new plantings shall be selected from a city approved list. Per the landscape plans, all new plantings shall meet the City of Mercer Island's installation standards and plans. And all new planting areas shall be irrigated with an automatic irrigation system.

H. MICC 19.11.080 - Screening.

As required per code, the solid waste enclosure will be screened around the perimeter, concealed on the top, and will have self-closing doors. The proposed walls of the enclosure will be comprised of CMU blocks for durability and will have a roof and fascia that correspond to the color palette of the main building. The height of the enclosure will be approximately 10-feet. Self-closing doors will be provided as a man-door on the parking garage side and a double door that can be opened from the loading zone side.

I. MICC 19.11.090 - Lighting.

Lighting standards are contained in MICC 19.11.090. Lighting should be designed to be pedestrian scale, LED or low wattage, shielded, and integrated into the overall design. The proposed design meets the standards in this section by including LED lighting will be provided at all building entrances, within the parking garage, as landscape lighting, and at all private deck spaces.

J. MICC 19.11.100 - Building design.

B.1 – Fenestration

In the TC-4 along 78th Ave SE, it is required that at least 75 percent of the length of the ground floor façade between the height of 2-feet and 7-feet shall be comprised of windows and doors with views of retail, office, or lobby spaces. Due to the 60-foot width of the street frontage, easement, loading zone and garage access requirements that must fit within this area, fenestration in this area is very limited. As proposed, the building width at the garage level is 46-feet-6-inches and the width of the windows at the lobby (only conditioned spaced at the ground floor) is 13-feet. In addition, the secure garage entrance will have a 20-feet wide roll-up, open grille security door that will all additional transparency at the ground floor level. The total width of transparency at this level is 70 percent. The remainder of this ground floor facade is comprised of structural components and an exit passageway door.

B.2 - Street-facing façade elements

Per 19.11.100.B.2, new construction requires at least (7) façade elements as described in this section or as approved by the design commission. This project is proposing:

- 1) A combination of Trespa Lumen panels that highlight the building massing over the public open space and will change appearance as they absorb the light differently throughout the day.
- 2) Clerestory windows above the curtainwall of the lobby
- 3) Recessed balconies for individual residential units.
- 4) Accent material to highlight the recessed balconies.
- 5) Artistic clock that will be integrated into the design of the facade above the public open space.
- 6) Slanted structural columns that support the cantilevered upper floors.
- 7) Powder coated steel sheets that create the perimeter of the raised gravel bed along the north property line turn downward at the front corner of the facade and will blend seamlessly with color coordinated exit passageway door, so it won't detract from the overall design.

B.3 - Major façade modulation

The street-facing façade is modulated into two major vertical massing. The cantilevered massing that stacks on all upper floors is 27-feet wide. The second major massing is recessed 28-feet from the face of the cantilevered mass and features a mixture of materials that highlight this form as a distinct massing that sits on top of the lobby structure. This massing also features a parapet roofline whereas the cantilevered massing shows a flat roof with overhangs.

At least (3) minor façade modulations shall be incorporated in the design of the building. Some of these minor modulations include:

- 1) Recessed balconies for each residential unit.
- 2) Bumpouts are highlighted by a change in material.
- 3) Fenestration patterns break up the opaque massing.

K. MICC 19.11.110 - Materials and color.

The proposed color palette was chosen to not detract from the surrounding elements. The main materials are white aluminum and gray Trespa panels, the vertical form above the public open space is accented with Trespa's Lumen panels with an oblique finish. This is a combination of a matte and gloss finish that will reflect the light differently as the sun moves across the sky.

On the portion of the massing that is more obscured from public view on the north and east elevations, the main material is comprised of fiber cement panels to match the color of the gray Trespa panels. These panels are then accented with black infill panels to help break up the massing of the blank wall which has limited window opening due to its proximity to the property line.

The recessed elevator shaft and private balcony spaces use a v-groove style fiber cement siding in Urbane Bronze that complements the other materials.

At the ground floor level, the parking garage is constructed out of concrete which is used as an architectural accent at the garage entrance and is used to separate the parking garage use from the lobby/residential use.

L. MICC 19.11.120 - Street standards.

The ROW improvements along 78th Ave SE shall include widening the public sidewalk to 15 feet. This measurement is from the face of curb to the back of sidewalk. This frontage shall also follow the Mercer Island Town Center Streetscape Manual and incorporate design elements such as city approved street lights, street sign, and bike rack. Existing street trees are located on both sides of the property, but none will be added due to the 60-foot width of the property, and it's required access points.

M. MICC 19.11.130 - Parking, vehicular and pedestrian circulation.

Parking standards are established in MICC 19.11.130. The minimum number of required parking stalls for residential use is 1 to 1.4 per unit. All parking for this project will be located in an at-grade, open parking garage below the proposed residential units. The configuration of this garage allows for a total of 11 parking stalls, which includes one van accessible stall. Will the proposed 10 units, this is 1.1 stalls per unit. The proposed parking garage conforms to the standards set forth in Appendix A which includes standard stalls having dimensions of 9-feet x 18.5-feet, compact stalls with dimensions of 8.5-feet x16-feet, and a two-way drive aisle with a width of 24-feet.

Due to the compact nature of the site and so all required dimensions can be met, this project is proposing an increase of compact stalls above the allowed 50 percent. Out of a total of 11 off-street parking stalls, the Applicant proposes seven or 63 percent of these stalls be compact.

The required off-street loading zone is accessed from 78th Ave SE and has a separate curb cut at the south end of the property. From the back of the sidewalk, the loading zone has a depth of 40-feet-10-inches, a width of 13-feet and has a vertical clearance of 34-feet-8-inches. These dimensions have been discussed with the City and have been approved by Recology.

III. RECOMMENDATION

There is no recommended motion at this time, as this is a Design Commission study session.



ARCHITECTURE, PROGRAMMING, ACCESSIBLE DESIGN, INTERIOR DESIGN

December 12, 2022

Project Name: 2900 78th Ave SE Apartments

Project Address: 2900 78th Ave SE, Mercer Island, WA 98040

Parcel #: 531510-1219

To Whom It May Concern,

The project at 2900 78th Ave SE proposes to demolish existing structures, uses, and improvements, and construct a new 4 story multi-family building with shared garage parking. The proposal intends to conform to Town Center Development and Design standards, while taking advantage of the maximum height and stories increase by providing community benefits as outlined within chapter 19.11. The site fronts the intersection of 78th Ave SE and SE 29th Street, with vehicular access coming from 78th Ave SE.

The attached plans address code compliance items for review and discussion.

- The proposed development provides a public open-space facing 78th Ave SE, and utilizes the existing easement for uncovered surface parking and a solid waste enclosure.
- The proposed development provides stacked multi-family residences with primary pedestrian and vehicular access from 78th Ave SE.
- The proposed development conforms to the 2018 IBC for R2 residences.

In the TC-4 zone, this project is proposing to utilize the maximum allowed height of 51' and the maximum allowed stories of 4. In order to achieve this requirement the proposed development is proposing these additional features:

- Per MICC 19.11.040(B) At least ten percent of the total units must be affordable, so one of the (10) proposed units will be designated for affordable housing.
- Per MICC 19.11.060(B) Any major new construction exceeding three stories shall include at least one major site feature. Due to the small lot size, this project is proposing to incorporate a public open space that meets the requirements of MICC 19.11.040(D).

The Proposed public open space is 465 SF which is 3.2% of the proposed GFA, and is 20' in width which extends from the north property line to the driveway. Because of the existing at-grade PSE easement in the NW corner of the site, a walkway and planter strip connect the public open space to the public ROW before opening up to the remainder of the space. This public open space shall be at the same level as the public sidewalk and as the building wraps around it, it helps to create a focal point at this intersection. While the proposed public open space is limited, it still incorporates design elements such as (8) linear feet of bench, 120 SF (25.8% of the open space) of planting and a water fountain that is part of the proposed minor site features. The surface of the public open space will feature decorative paving that distinguishes it from the public sidewalk as well as the walkway to the building entry.

As required for any new construction project, the site will feature a minimum of (3) minor site features. As mentioned above, a water fountain will be incorporated in the public open space adjacent to the bench. Per the landscaping plans, a bike rack is proposed on the public sidewalk next to the walkway and public open space, and a clock is proposed on the recessed portion of the building directly above the building entry and public open space.



ARCHITECTURE, PROGRAMMING, ACCESSIBLE DESIGN, INTERIOR DESIGN

The proposed building is designed to maximize the small site by stacking three floors of units above an open parking garage that's entrance is centered at the intersection. The parking garage allows for a total of 11 parking stalls for the site, which includes one ADA van stall. Utilizing that number of stalls, the development is able to incorporate (10) units with floors 1 and 2 be identical floor plans with (4) unit each, and the 3rd floor having (2) larger units. To provide adequate sizing of these units, the floor plates are cantilevered above the driveway entry and are supported by the PT slab as wells as 12" angled steel columns that create visual interest.

The push and pull of the building masses along with the articulation of the balconies help create modulation that is highly visible from the street while the change in materials help to accentuate those forms. While the main materials are white aluminum cladding and gray Trespa, the vertical form above the public open space is accented with Trespa's Lumen panels with an oblique finish. This is a combination of a matte and gloss finish that will reflect the light differently as the sun moves across the sky.


Per MICC 19.11.070, landscaped surfaces should equal 25% of the site. To meet this requirement on such a small site, the proposed development is proposing a few options.

- Ground Level Planting The available space is very limited. Between the public open space
 and the planter strip south of the driveway there is 250 SF of available space for planting of
 shrubs and ground cover.
- Green Wall A green wall will be incorporated into the public open space along the north property line that will cover up the blank wall of the adjacent property. This will be approximately 226 SF, which at a rate of 75%, 169.5 SF will count towards the landscape requirement.
- Green Roof This will be largest portion of landscaping on site. There will be approximately 3,250 SF of sedum trays on the roof, which 1,625 SF will count towards the requirement.

Adding these up brings a landscaping total of 2,044.50 SF, or 28.4% of the site.

Thank you,

Kelly Hallstrom Project Manager

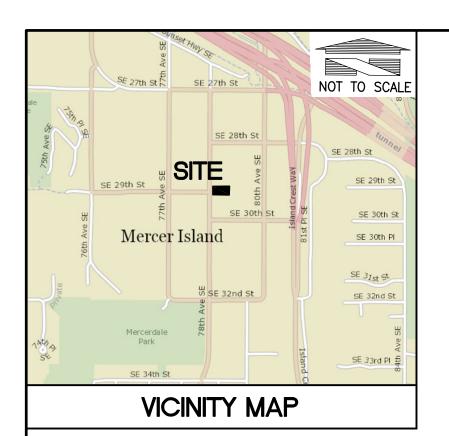

GENERAL SITE DEVELOPMENT NOTES:

THE CONTRACTOR SHALL OBTAIN AND HAVE AVAILABLE COPIES OF THE APPLICABLE GOVERNING AGENCY STANDARDS AT THE JOB SITE DURING THE RELATED CONSTRUCTION OPERATIONS.

- CONTRACTOR SHALL ASSURE THAT ALL NECESSARY PERMITS HAVE BEEN OBTAINED PRIOR TO COMMENCING WORK.
- THE CONTRACTOR SHALL BE RESPONSIBLE FOR VERIFYING THE LOCATION, DIMENSION AND DEPTH OF ALL EXISTING UTILITIES PRIOR TO CONSTRUCTION WHETHER SHOWN ON THESE PLANS OR NOT. UTILITIES OTHER THAN THOSE SHOWN MAY EXIST ON THIS SITE. ONLY THOSE UTILITIES WITH EVIDENCE OF THEIR INSTALLATION VISIBLE AT GROUND SURFACE OR SHOWN ON RECORD DRAWING PROVIDED BY OTHERS ARE SHOWN HEREON. EXISTING UNDERGROUND UTILITY LOCATIONS SHOWN ARE APPROXIMATE ONLY AND ARE SUBJECT TO A DEGREE OF UNKNOWN VARIATION. SOME UNDERGROUND LOCATIONS SHOWN HEREON MAY HAVE BEEN TAKEN FROM PUBLIC RECORDS. TEBALDI ENGINEERING, LLC ASSUMES NO LIABILITY FOR THE ACCURACY OF PUBLIC RECORDS OR RECORDS OF OTHERS. IF CONFLICTS SHOULD OCCUR, THE CONTRACTOR SHALL CONSULT TEBALDI ENGINEERING, LLC, TO RESOLVE ALL PROBLEMS PRIOR TO PROCEEDING
- IT IS THE RESPONSIBILITY OF THE CONTRACTOR TO REVIEW ALL OF THE DRAWINGS AND SPECIFICATIONS ASSOCIATED WITH THE PROJECT WORK SCOPE PRIOR TO THE INITIATION OF CONSTRUCTION. SHOULD THE CONTRACTOR FIND A CONFLICT WITH THE DOCUMENTS RELATIVE TO THE SPECIFICATIONS OR THE RELATIVE CODES, IT IS THE CONTRACTOR'S RESPONSIBILITY TO NOTIFY THE PROJECT ENGINEER OF RECORD IN WRITING PRIOR TO THE START OF CONSTRUCTION. FAILURE BY THE CONTRACTOR TO NOTIFY THE PROJECT ENGINEER SHALI CONSTITUTE ACCEPTANCE OF FULL RESPONSIBILITY BY THE CONTRACTOR TO COMPLETE THE SCOPE OF WORK AS DEFINED BY THE DRAWINGS AND IN FULL COMPLIANCE WITH LOCAL
- IT SHALL BE THE CONTRACTOR'S RESPONSIBILITY TO NOTIFY THE APPROPRIATE UTILITIES INVOLVED PRIOR TO CONSTRUCTION.
- INSPECTION OF SITE WORK WILL BE ACCOMPLISHED BY A REPRESENTATIVE OF THE AUTHORITY HAVING JURISDICTION. INSPECTION OF PRIVATE FACILITIES WILL BE ACCOMPLISHED BY A REPRESENTATIVE OF THE OWNER. IT SHALL BE THE CONTRACTOR'S RESPONSIBILITY TO NOTIFY THE INSPECTOR OF THE AUTHORITY HAVING JURISDICTION 24 HOURS IN ADVANCE OF BACKFILLING ALL CONSTRUCTION OR AS REQUIRED BY THE AUTHORITY HAVING JURISDICTION.
- PRIOR TO ANY CONSTRUCTION OR DEVELOPMENT ACTIVITY THE CONTRACTOR SHALL CONTACT THE AGENCY AND/OR UTILITY INSPECTION PERSONNEL AND ARRANGE ANY REQUIRED PRE-CONSTRUCTION MEETING(S). CONTRACTOR SHALL PROVIDE 72 HRS MIN. ADVANCE NOTIFICATION TO OWNER, FIELD ENGINEER AND ENGINEER OF PRE-CONSTRUCTION MEETINGS.
- THE CONTRACTOR IS RESPONSIBLE FOR WORKER AND SITE SAFETY AND SHALL COMPLY WITH THE LATEST OSHA STANDARDS AND REGULATIONS, OR ANY OTHER AGENCY HAVING JURISDICTION FOR EXCAVATION AND TRENCHING PROCEDURES. THE CONTRACTOR IS RESPONSIBLE FOR DETERMINING THE "MEANS AND METHODS" REQUIRED TO MEET THE INTENT AND PERFORMANCE CRITERIA OF OSHA, AS WELL AS ANY OTHER ENTITY THAT HAS JURISDICTION FOR EXCAVATION AND/OR TRENCHING PROCEDURES.
- THE CONTRACTOR SHALL BE RESPONSIBLE FOR PROVIDING ADEQUATE SAFEGUARDS, SAFETY DEVICES. PROTECTIVE EQUIPMENT, FLAGGERS, AND ANY OTHER NEEDED ACTIONS TO PROTECT THE LIFE, HEALTH, AND SAFETY OF THE PUBLIC, AND TO PROTECT PROPERTY IN CONNECTION WITH THE PERFORMANCE OF WORK COVERED BY THE CONTRACTOR. ANY WORK WITHIN THE TRAVELED RIGHT-OF-WAY THAT MAY INTERRUPT NORMAL TRAFFIC FLOW SHALL REQUIRE AT LEAST ONE FLAGGER FOR EACH LANE OF TRAFFIC AFFECTED.
- 10. PROTECTIVE MEASURES SHALL BE TAKEN BY THE CONTRACTOR TO PROTECT ALL ADJACENT PUBLIC AND PRIVATE PROPERTIES AT ALL TIMES DURING CONSTRUCTION. THE CONTRACTOR SHALL BE RESPONSIBLE FOR PROTECTION OF ALL EXISTING UTILITY SERVICES THAT ARE TO REMAIN OPERATIONAL WITHIN THE CONSTRUCTION AREA WHETHER SHOWN OR NOT SHOWN ON
- 1. STRUCTURAL BMPs MUST BE ACCESSIBLE FOR INSPECTION BY THE AUTHORITY HAVING JURISDICTION DURING REGULAR BUSINESS HOURS.
- 12. TWO (2) COPIES OF THESE APPROVED PLANS MUST BE ON THE JOB SITE WHENEVER CONSTRUCTION IS IN PROGRESS. ONE (1) SET WITH RECORDS OF AS-BUILT INFORMATION SHALL BE SUBMITTED TO TEBALDI ENGINEERING, LLC AT COMPLETION OF PROJECT.

SOILS REPORT NOTES:

- THE FOLLOWING SOILS REPORT FOR THE SITE SHALL BE CONSIDERED PART OF THESE CONSTRUCTION DOCUMENTS:
- GEOTECHNICAL ENGINEERING REPORT PREPARED BY COBALT GEOSCIENCES DATED DECEMBER 16, 2021.

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2. IT SHALL BE THE RESPONSIBILITY OF THE CONTRACTOR TO ENSURE THAT ALL PROVISIONS OF THE SOILS REPORT FOR THE SITE BE OBSERVED AND COMPLIED WITH DURING ALL PHASES OF CONSTRUCTION.

ANY PROVISIONS OF THE SOILS REPORT WHICH CONFLICT WITH

INFORMATION SHOWN ON THESE DRAWINGS, OR WHICH REQUIRE FURTHER CLARIFICATION, SHALL BE BROUGHT TO THE ATTENTION OF TEBALDI ENGINEERING, LLC.

Know what's **below**. Call before you dig. **Dial 811**

(1-800-424-5555)

A REPRESENTATIVE OF THE SOILS ENGINEER SHALL BE AVAILABLE TO OBSERVE AND APPROVE THE EARTHWORK OPERATIONS AND TO VERIFY FIELD CONDITIONS AS WORK PROCEEDS.

BENCHMARK:

REC. NO. 20160728900015.

VERTICAL DATUM: NAVD88

LEGAL DESCRIPTION:

BASIS OF BEARING:

SEE RECORD OF SURVEY UNDER

BASIS OF BEARINGS: N 01°19'57" E

ALONG THE CENTERLINE OF 32nd AVE S

MONUMENTS AND TIES TO MONUMENTS.

BASED ON THE GPS OBSERVATION OF EXISTING

PER QUIT CLAIM DEED RECORDED UNDER AUDITOR'S FILE NUMBER 20160615000759, RECORDS OF KING COUNTY, WASHINGTON.

NORTH 15 FEET OF LOT 10 AND ALL OF LOT 11, TURNER BELL ADDITION, ACCORDING TO THE PLAT THEREOF RECORDED IN VOLUME 40 OF PLATS, PAGE 19, RECORDS OF KING COUNTY, WASHINGTON.

EXISTING TOPOGRAPHY/SURVEY INFORMATION NOTE:

THESE DRAWINGS HAVE BEEN PREPARED BASED ON TOPOGRAPHIC SURVEY PREPARED BY 4SITE SURVEYING.

TEBALDI ENGINEERING, LLC DOES NOT WARRANT THAT THE TOPOGRAPHY SHOWN ON THESE DRAWINGS IS REPRESENTATIVE OF WHAT IS CONSTRUCTED. IT IS THE CONTRACTOR'S RESPONSIBILITY TO COORDINATE WITH THE OWNER TO HAVE ALL IMPROVEMENTS FIELD VERIFIED PRIOR TO CONSTRUCTION. DISCREPANCIES SHALL BE BROUGHT TO THE ATTENTION OF THE ENGINEER PRIOR TO WORK.

CONTRACTOR SHALL BE FULLY RESPONSIBLE FOR OBTAINING PERMITS FROM THE WASHINGTON STATE DEPARTMENT OF NATURAL RESOURCES FOR REMOVING AND REPLACING ALL SURVEY MONUMENTATION THAT MAY BE AFFECTED BY CONSTRUCTION ACTIVITY, PURSUANT TO WAC 332-120. APPLICATIONS MUST BE COMPLETED BY A REGISTERED LAND SURVEYOR. APPLICATIONS FOR PERMITS TO REMOVE MONUMENTS MAY BE OBTAINED FROM THE WASHINGTON STATE DEPARTMENT OF NATURAL RESOURCES, OR BY CONTACTING THEIR OFFICE BY TELEPHONE AT (206) 902-1190.

2900 78TH AVENUE SE

7,200 S.F. (0.17 AC)

11,068 S.F. (0.25 AC)

CUT/FILL BALANCE:

NET IMPORT/EXPORT:

5315101219

TOTAL

CUT:

FILL:

EARTHWORK QUANTITIES ARE APPROXIMATE. CONTRACTOR TO VERIFY

EARTHWORK QUANTITIES PRIOR TO CONSTRUCTION.

MERCER ISLAND, WA 98040

- 5,063 SF

– 271 S.F.

200 CY

200 CY

200 CY

0 CY

 ON-SITE PAVEMENT
 - 1,866 SF

 TOTAL
 - 6,929 SF

WASHINGTON STATE DEPARTMENT OF NATURAL RESOURCES PUBLIC LAND SURVEY OFFICE

1111 WASHINGTON STREET S.E. P.O. BOX 47060

PROPOSED APARTMENT

BUILDING (UNDER

S88°29'51"E

SITE DATA:

PROPERTY AREA:

DISTURBED AREA:

IMPERVIOUS AREA:

PERVIOUS AREA:

EST. EARTHWORK

QUANTITIES:

ADDRESS:

SEPARATE PERMIT)

OLYMPIA, WASHINGTON 98504-7060

A PORTION OF SECTION 12, TOWNSHIP 24N, RANGE 4E, W.M., KING COUNTY

2900 DEVELOPMENT

COVER SHEET

PROPERTY

-PROPOSED SIDEWALK

UPON COMPLETION OF CONSTRUCTION, ALL MONUMENTS DISPLACED, REMOVED, OR DESTROYED SHALL BE REPLACED BY A REGISTERED LAND SURVEYOR. AT THE COST AND AT THE DIRECTION OF THE CONTRACTOR, PURSUANT TO THESE REGULATIONS. THE APPROPRIATE FORMS FOR REPLACEMENT OF SAID MONUMENTATION SHALL ALSO BE THE RESPONSIBILITY OF THE CONTRACTOR.

WATER: CITY OF MERCER ISLAND 9611 SE 36TH STREET MERCER ISLAND, WA 98040

UTILITIES:

PHONE: (206) 275-7600 SEWER: CITY OF MERCER ISLAND 9611 SE 36TH STREET MERCER ISLAND, WA 98040

PHONE: (206) 275-7600

CABLE:

PHONE (800) 266-2278 POWER:

PUGET SOUND ENERGY PHONE (888) 321-7779

PUGET SOUND ENERGY PHONE (888) 321-7779

TELEPHONE

PHONE (866) 415-2950

PROJECT TEAM:

ARCHITECT

MEDICI ARCHITECTS 11711 SE 8TH STREET, SUITE 100 BELLEVUE, WA 98005

ENGINEER

TEBALDI ENGINEERING, LLC 4625 126TH AVENUE EAST EDGEWOOD, WA 98372 PHONE: (206) 450-5096 EMAIL: CHRIS@TEBALDIENGINEERING.COM

SURVEYOR:

SITE SURVEYING, INC 21923 NE 11TH ST SAMMAMISH, WA 98074

GEOTECHNICAL ENGINEER

GEOTECH CONSULTANTS, INC. 2401 10TH AVE E SEATTLE, WA 98102

OWNER:

2900 DEVELOPMENT LLC 2900 78TH AVE SE MERCER ISLAND, WA 98040


CIVIL SHEET INDEX:


- **COVER SHEET**
- TESC PLAN
- CIVIL SITE PLAN
- GRADING AND STORM DRAINAGE PLAN
- WATER AND SANITARY SEWER PLAN
- C6 NOTES AND DETAILS
- C7 NOTES AND DETAILS TOPOGRAPHIC SURVEY


CONCRETE PADS AND ANY OTHER ABOVE GROUND PERMANENT STRUCTURE DEPICTED ON THESE PLANS STAKED FOR CONSTRUCTION BY A LICENSED SURVEYOR. LICENSED SURVEYOR SHALL STAKE ALL ITEMS USING COORDINATE GEOMETRY (RECTIFIED TO SITE CONTROL) CONTAINED IN CAD DRAWING FILES PROVIDED BY TEBALDI ENGINEERING, LLC. IT IS THE CONTRACTORS RESPONSIBILITY TO RETRIEVE LATEST CAD FILES FROM THE ENGINEER REFLECTING ANY ISSUED PLAN REVISIONS. THE ENGINEER SHALL IMMEDIATELY BE NOTIFIED OF ANY DISCREPANCIES PRIOR TO THE START OF CONSTRUCTION.


UTILITY CONFLICT NOTE:

THE CONTRACTOR SHALL BE RESPONSIBLE FOR VERIFYING THE LOCATION, DIMENSION, AND DEPTH OF ALL EXISTING UTILITIES WHETHER SHOWN ON THESE PLANS OR NOT BY POTHOLING THE UTILITIES AND SURVEYING THE HORIZONTAL AND VERTICAL LOCATION PRIOR TO CONSTRUCTION. THIS SHALL INCLUDE CALLING UTILITY LOCATE @ 811 AND THEN POTHOLING ALL OF THE EXISTING UTILITIES AT LOCATIONS OF NEW UTILITY CROSSINGS TO PHYSICALLY VERIFY WHETHER OR NOT CONFLICTS EXIST. LOCATIONS OF SAID UTILITIES AS SHOWN ON THESE PLANS ARE BASED UPON THE UNVERIFIED PUBLIC INFORMATION AND ARE SUBJECT TO VARIATION. IF CONFLICTS SHOULD OCCUR, THE CONTRACTOR SHALL NOTIFY TEBALDI ENGINEERING, LLC. TO RESOLVE ALL PROBLEMS PRIOR TO PROCEEDING WITH CONSTRUCTION.

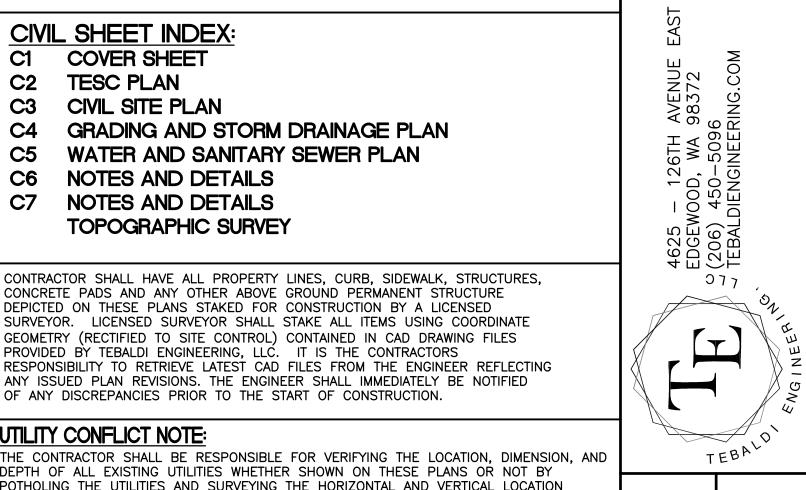


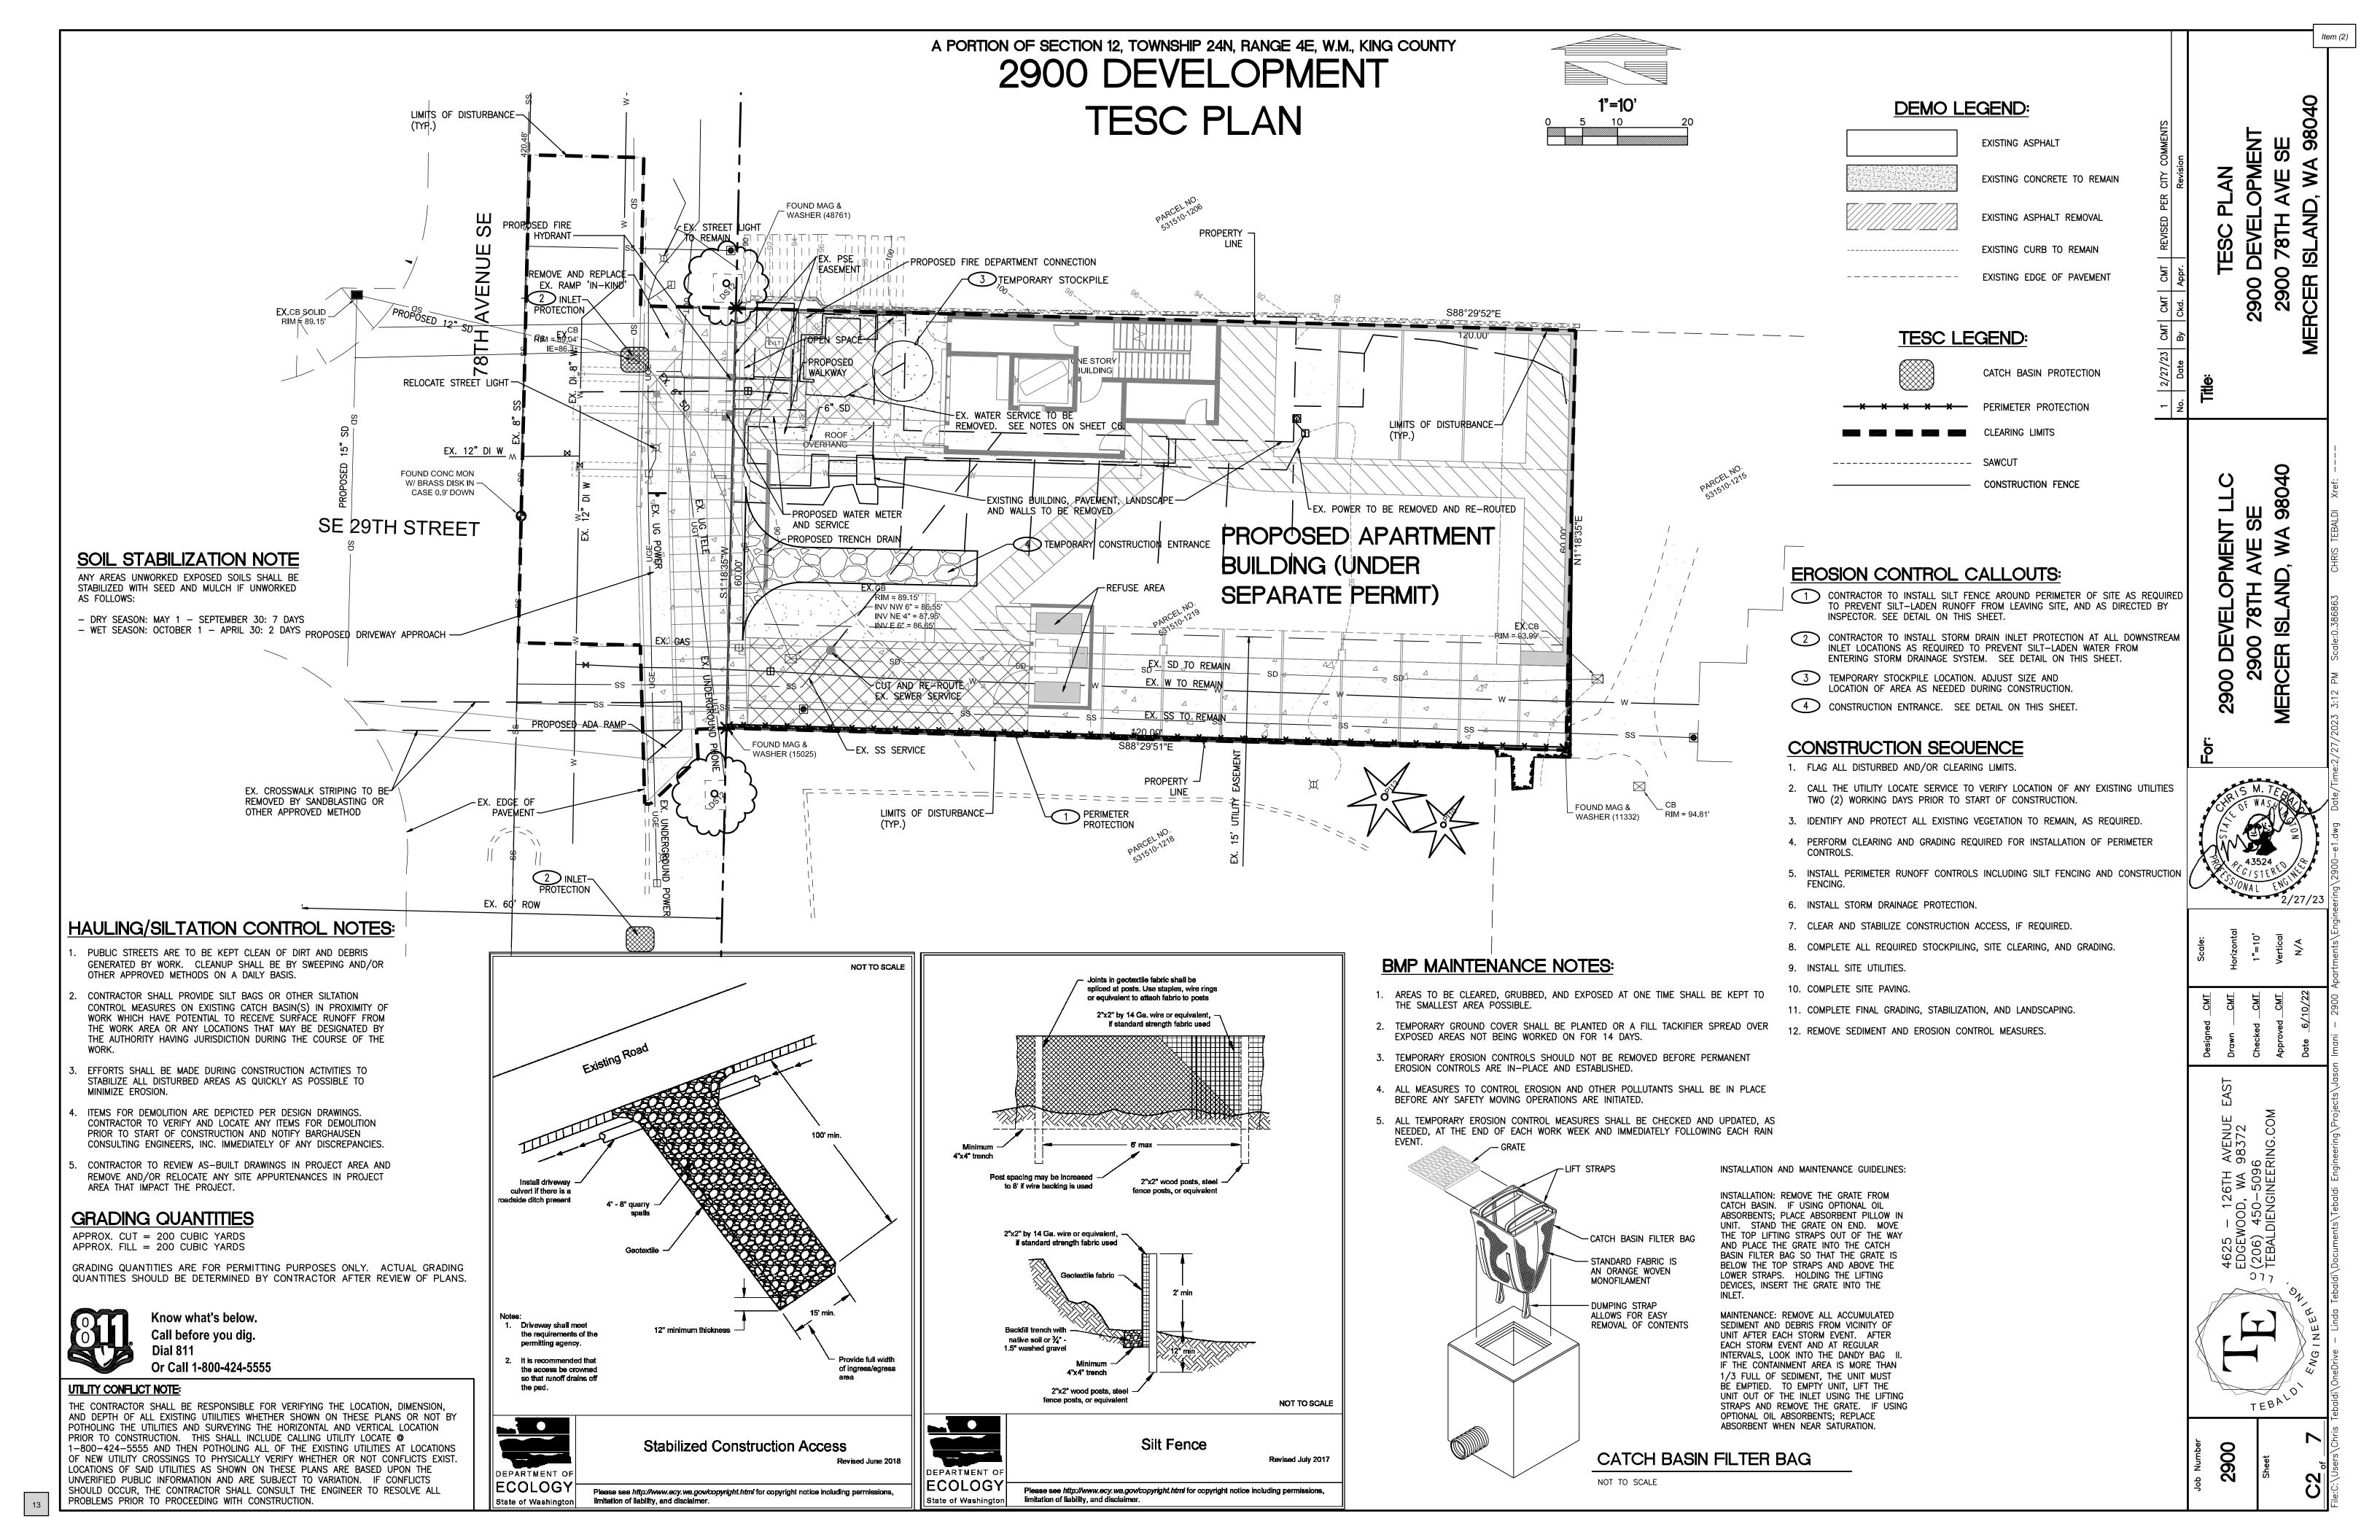

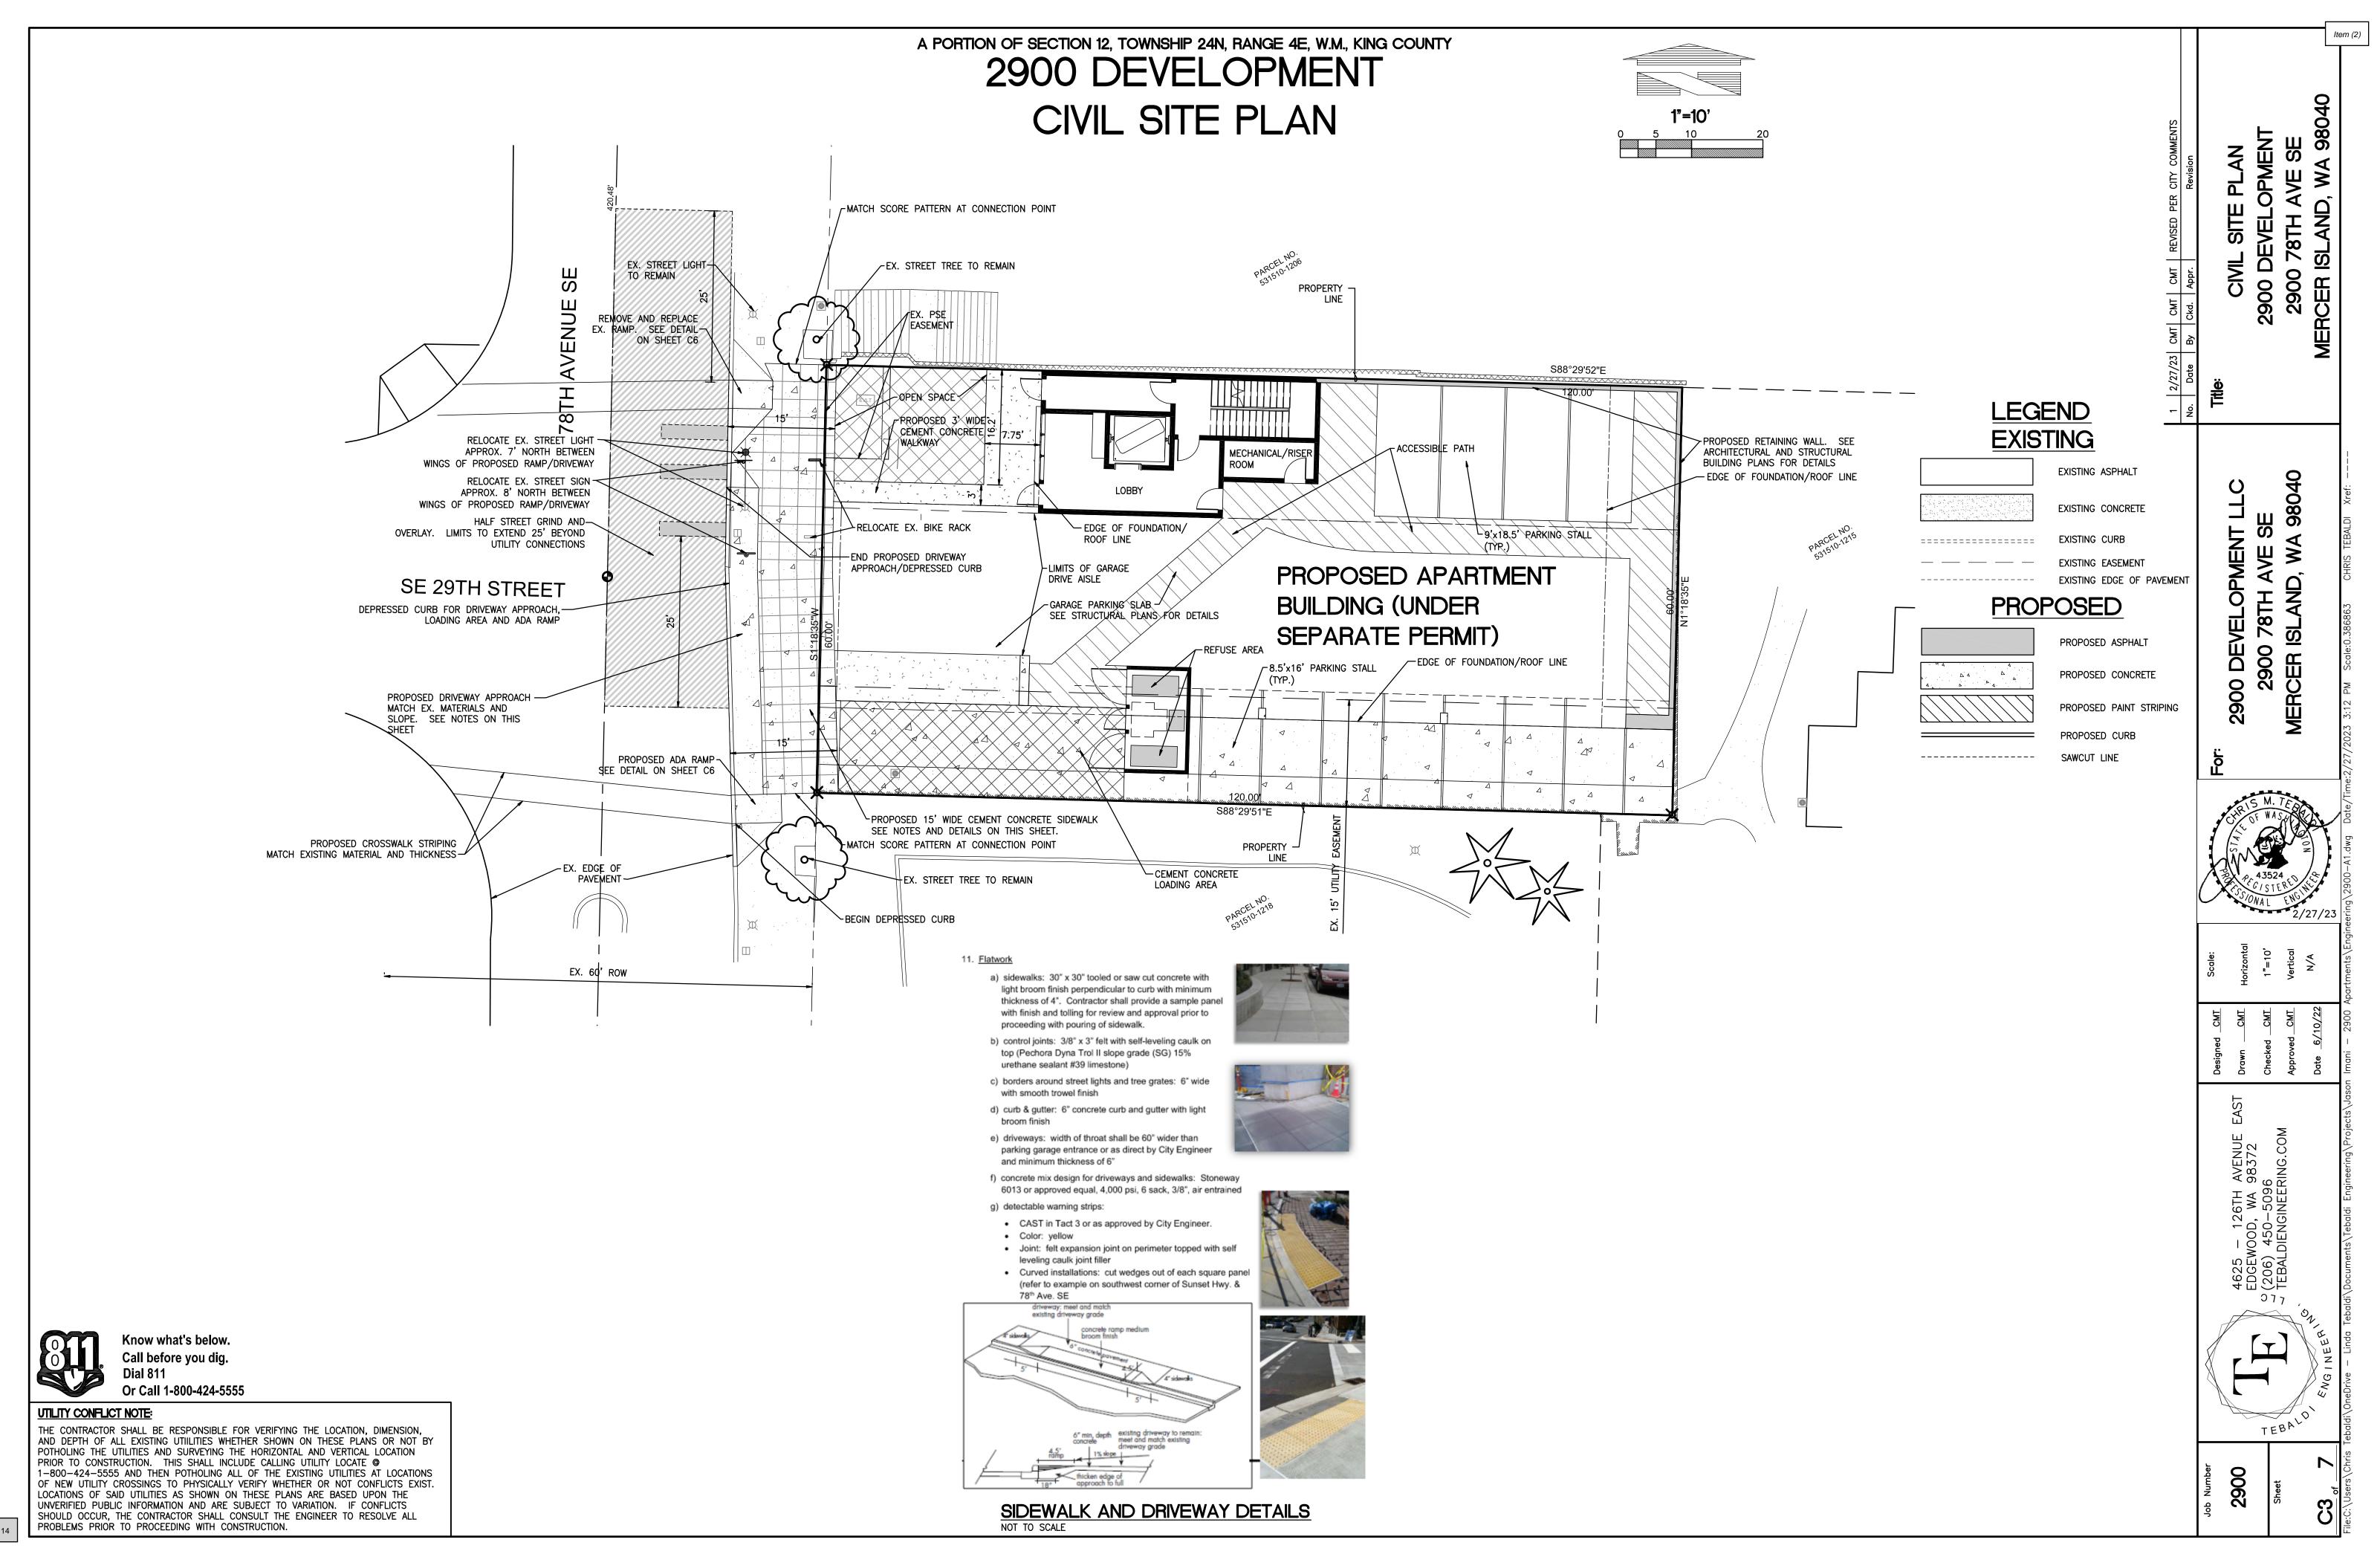

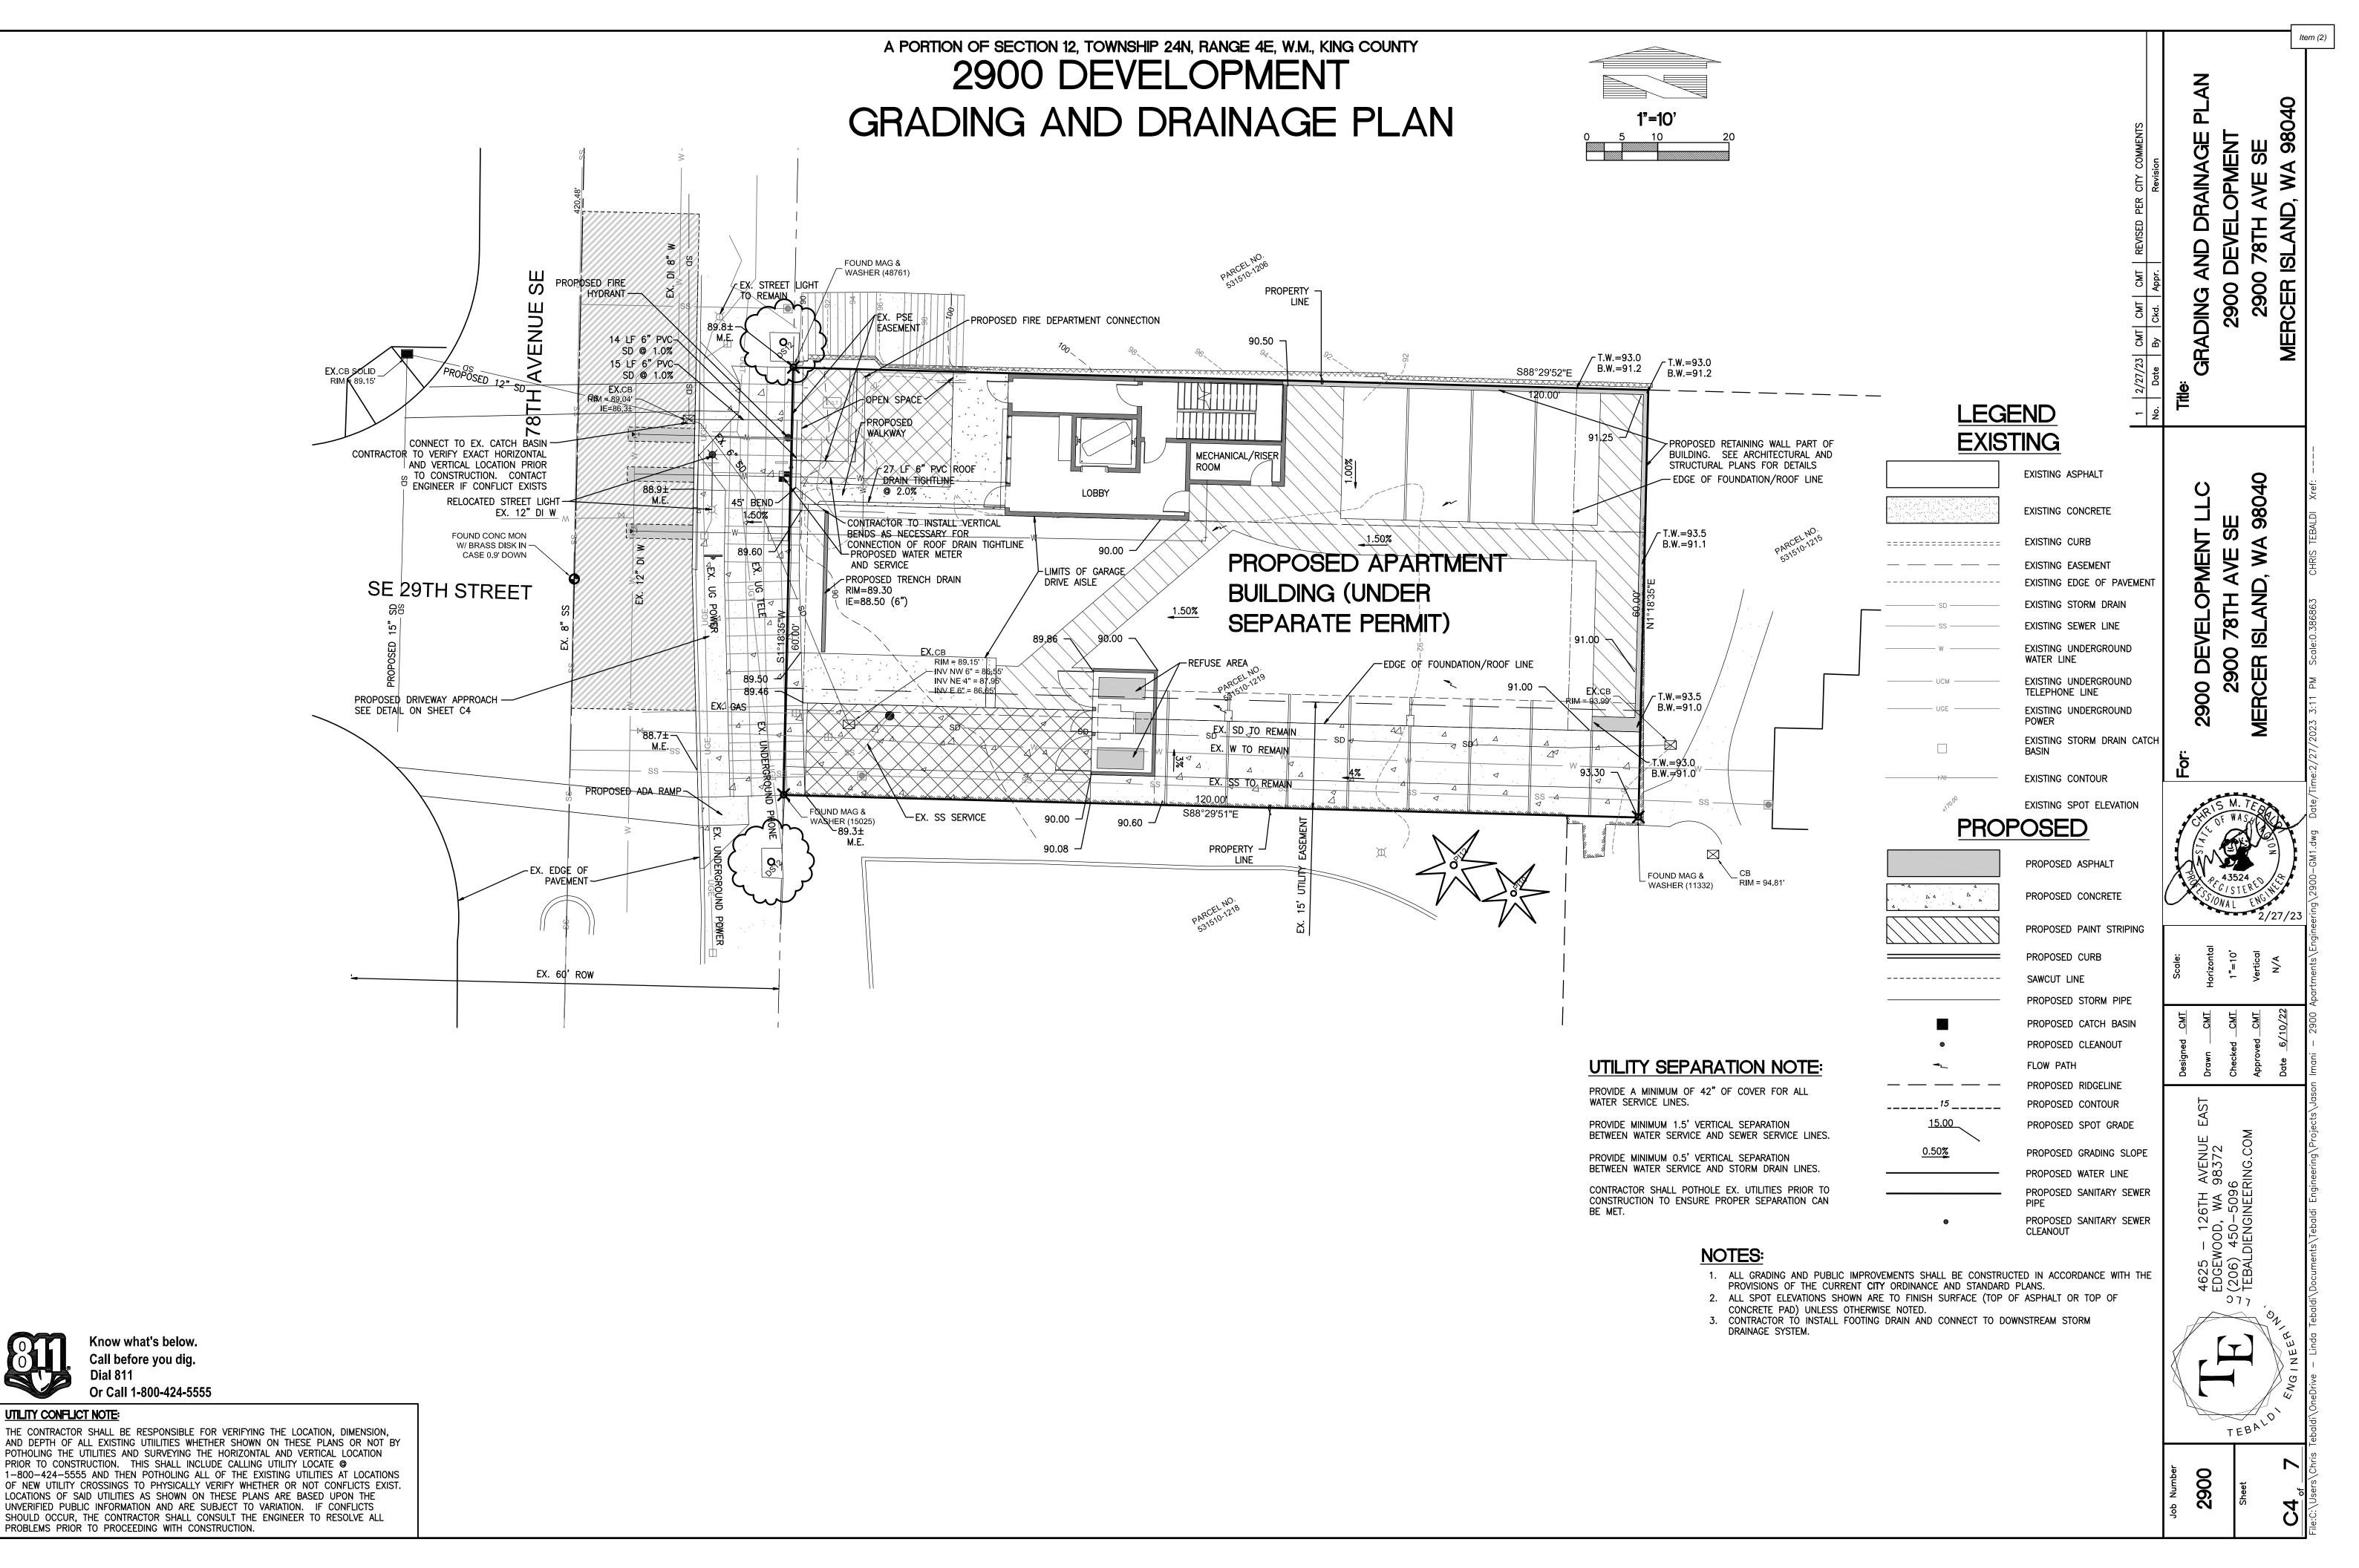

UTILITY CONFLICT NOTE:

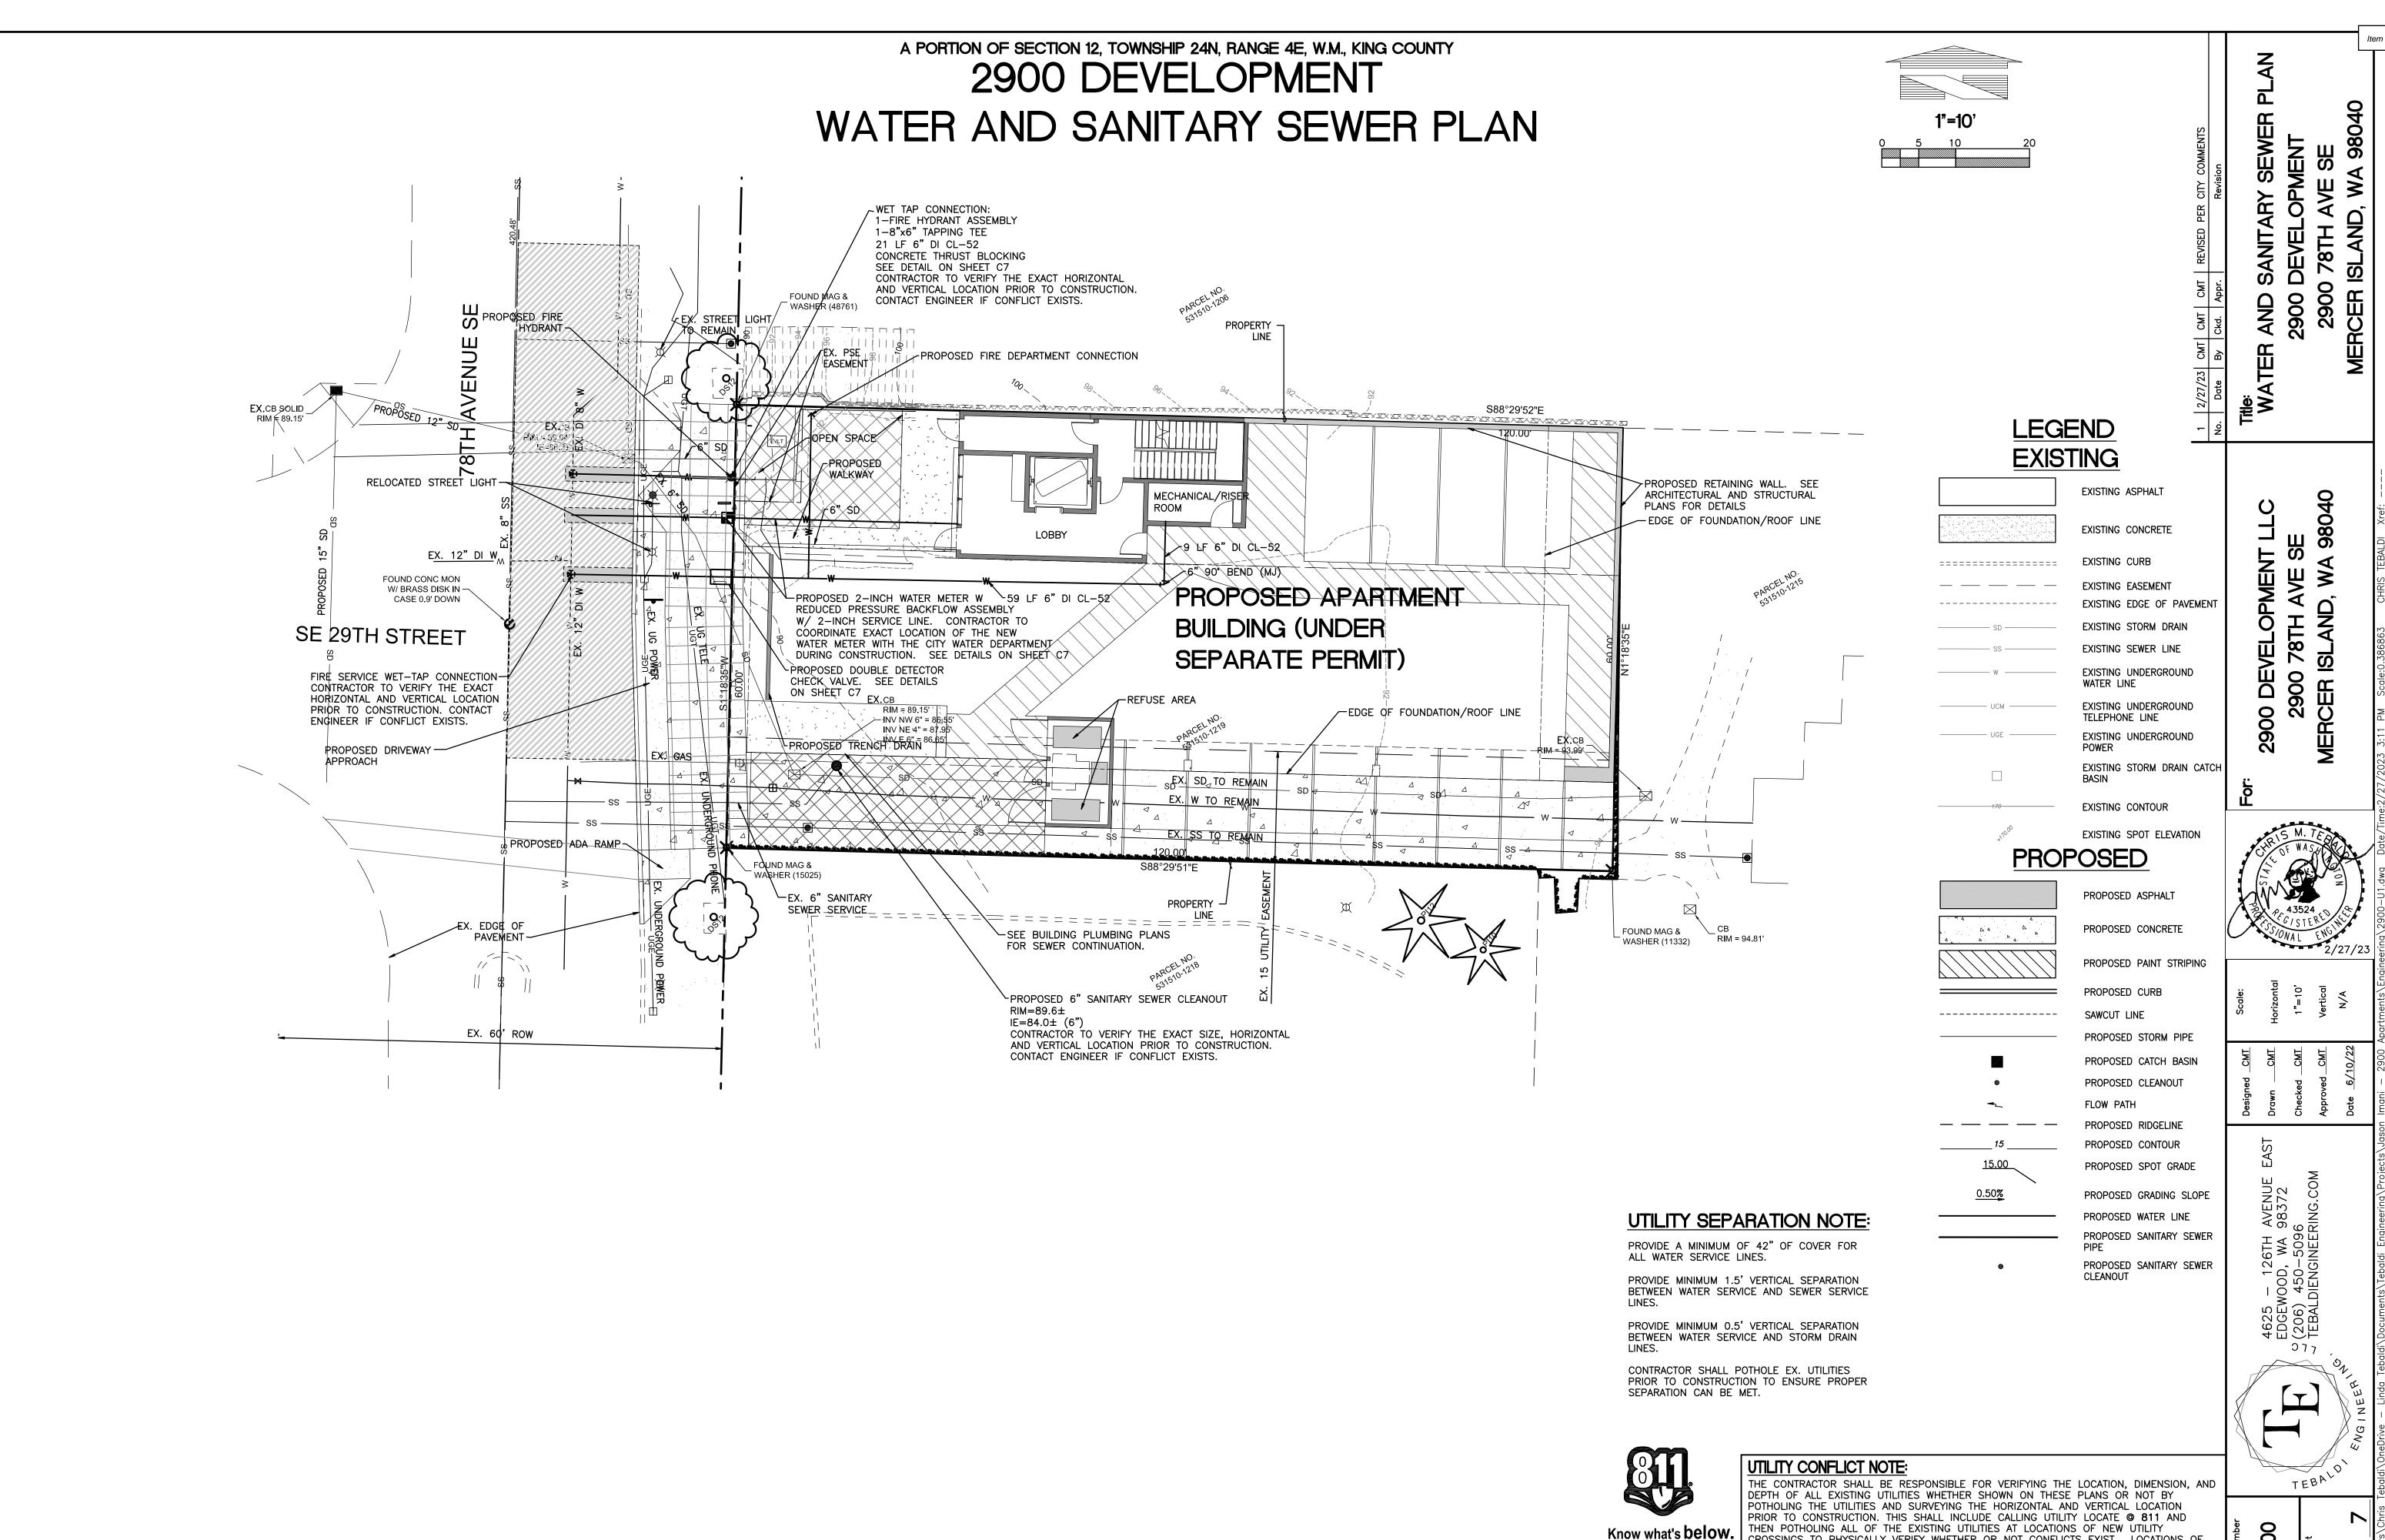


Call before you dig.

(1-800-424-5555)

THEN POTHOLING ALL OF THE EXISTING UTILITIES AT LOCATIONS OF NEW UTILITY CROSSINGS TO PHYSICALLY VERIFY WHETHER OR NOT CONFLICTS EXIST. LOCATIONS OF SAID UTILITIES AS SHOWN ON THESE PLANS ARE BASED UPON THE UNVERIFIED PUBLIC INFORMATION AND ARE SUBJECT TO VARIATION. IF CONFLICTS SHOULD OCCUR, THE CONTRACTOR SHALL NOTIFY TEBALDI ENGINEERING, LLC. TO RESOLVE ALL PROBLEMS PRIOR TO PROCEEDING WITH CONSTRUCTION.


CEMENT CONCRETE CURB

CURB RADIUS DETAIL (B

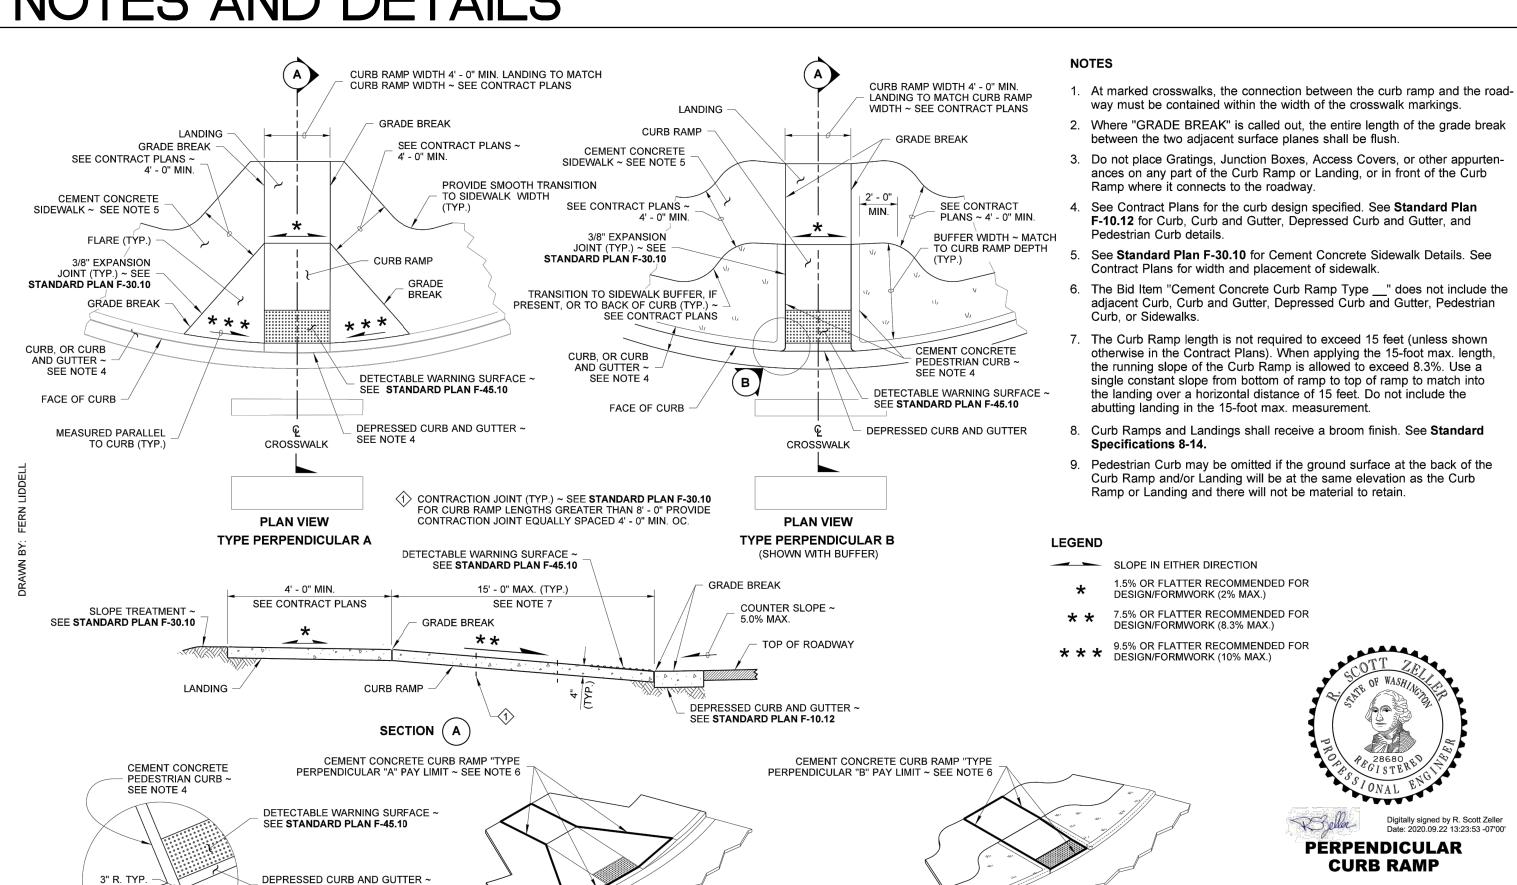

ISOMETRIC VIEW

TYPE PERPENDICULAR A PAY LIMIT

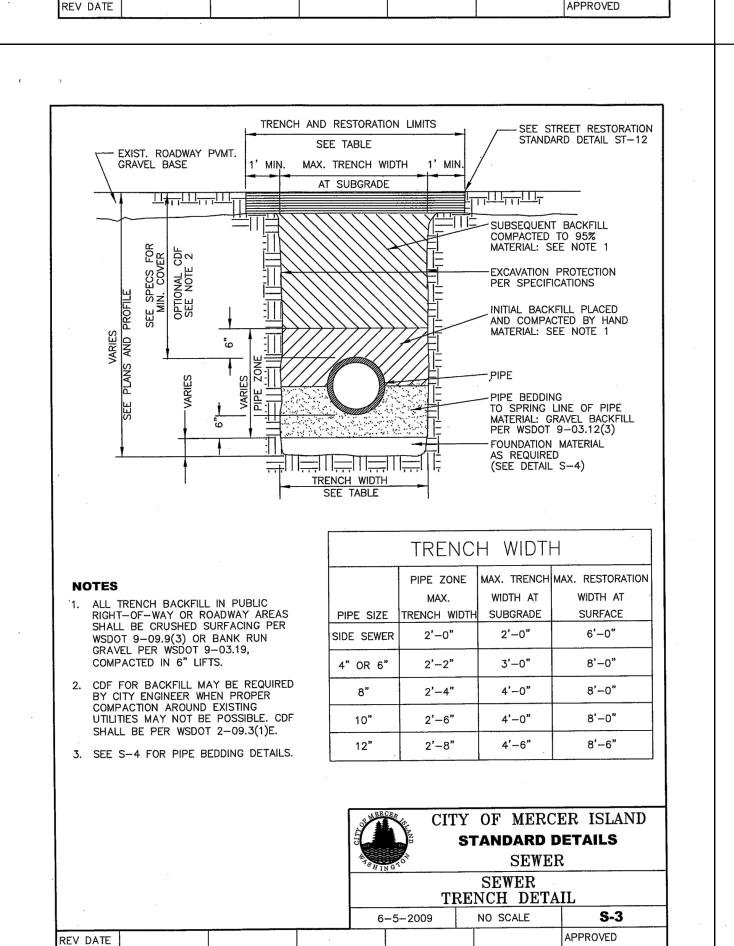

WATER MAIN-

10'-0" (SEE NOTE 4)

PARALLEL INSTALLATION

CROSSING WATER OVER SEWER

STANDARD SINGLE 18'-0" NOMINAL LENGTH DUCTILE IRON WATER MAIN

WHERE MINIMUM CLEARANCES CANNOT BE MET, SEWER SHALL BE CONSTRUCTED OF MATERIALS AND WITH

JOINTS THAT ARE EQUIVALENT TO WATER MAIN STANDARDS INCLUDING WATER MAIN PRESSURE TESTING

IF VERTICAL SEPARATION CANNOT BE MET, WATER MAIN SHALL BE A STANDARD SINGLE 18'-0' NOMINAL

CROSSING WATER UNDER SEWER

6-5-2009

SECTION CENTERED AT THE POINT OF CROSSING.

ANY EXCEPTIONS TO THE STANDARD PLAN MAY BE APPROVED BY THE CITY ENGINEER.

LENGTH DUCTILE IRON WATER MAIN SECTION CENTERED AT THE POINT OF CROSSING.

"SEWER" INCLUDES SANITARY SEWER, COMBINED SEWER AND SIDE SEWER.

NO VERTICAL CLEARANCE REQUIRED.

WATER MAIN JOINTS.

THAN 45° SEE NOTE 1

SEWER SHALL HAVE ADEQUATE FOUNDATION

SUPPORT TO PREVENT SETTLEMENT ON THE

WATER MAIN AN TO PREVENT DEFLECTION OF

CROSSINGS AT AN ANGLE BETWEEN 90° AND

WATER MAIN JOINT FOR CROSSINGS LESS

45' MAY OCCUR BETWEEN 9'-0" AND 6'-0" OF

-SEWER (SEE NOTE 6)

CITY OF MERCER ISLAND

STANDARD DETAILS

S-2


WATER & SEWER CLEARANCES


AND MATERIAL REQUIREMENTS


NO SCALE

--WATER MAIN

(SEE NOTE 3)

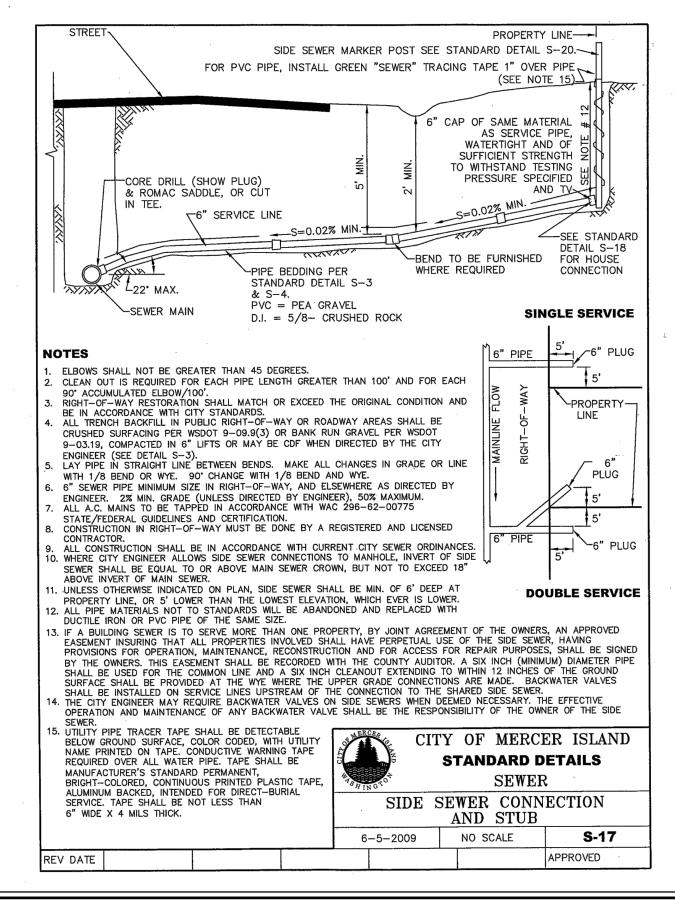

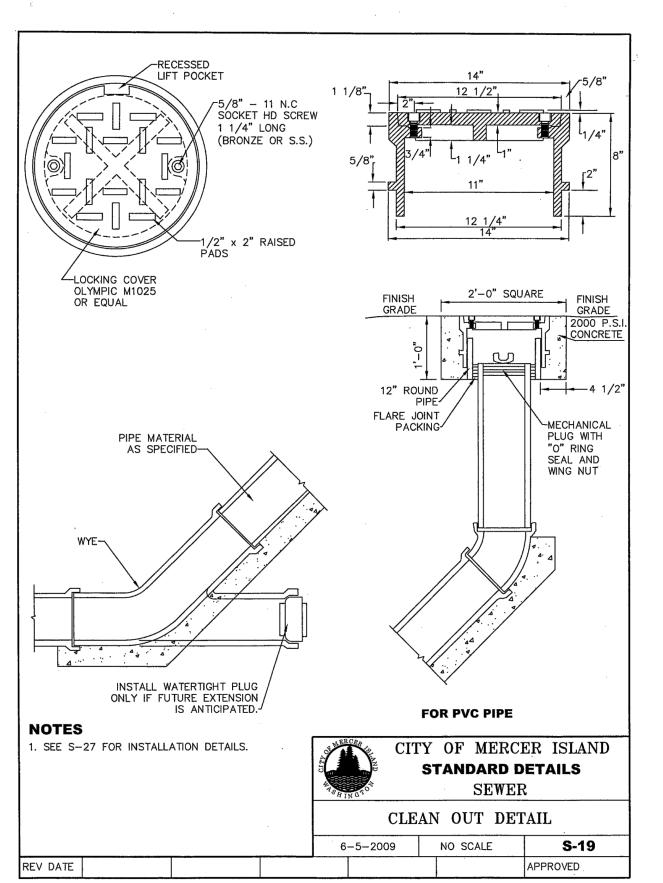

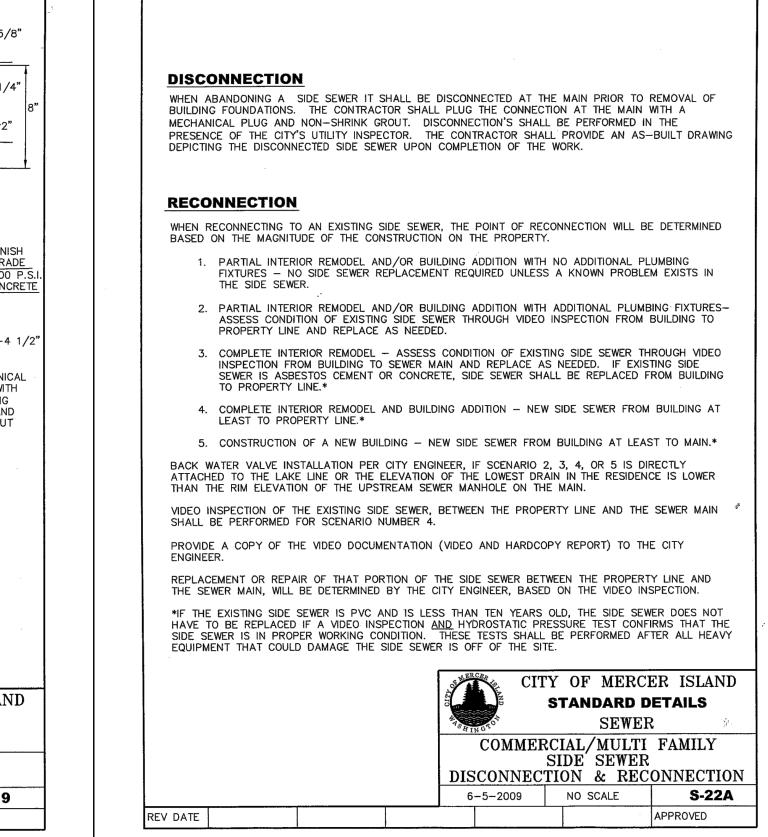

ISOMETRIC VIEW

TYPE PERPENDICULAR B PAY LIMIT

Digitally signed by R. Scott Zeller Date: 2020.09.22 13:23:53 -07'00

CURB RAMP

STANDARD PLAN F-40.15-04


SHEET 1 OF 1 SHEET


APPROVED FOR PUBLICATION


Washington State Department of Transportation


Date: 2020.09.25 14:44:37 -07'00'


NOTES AND DETAILS

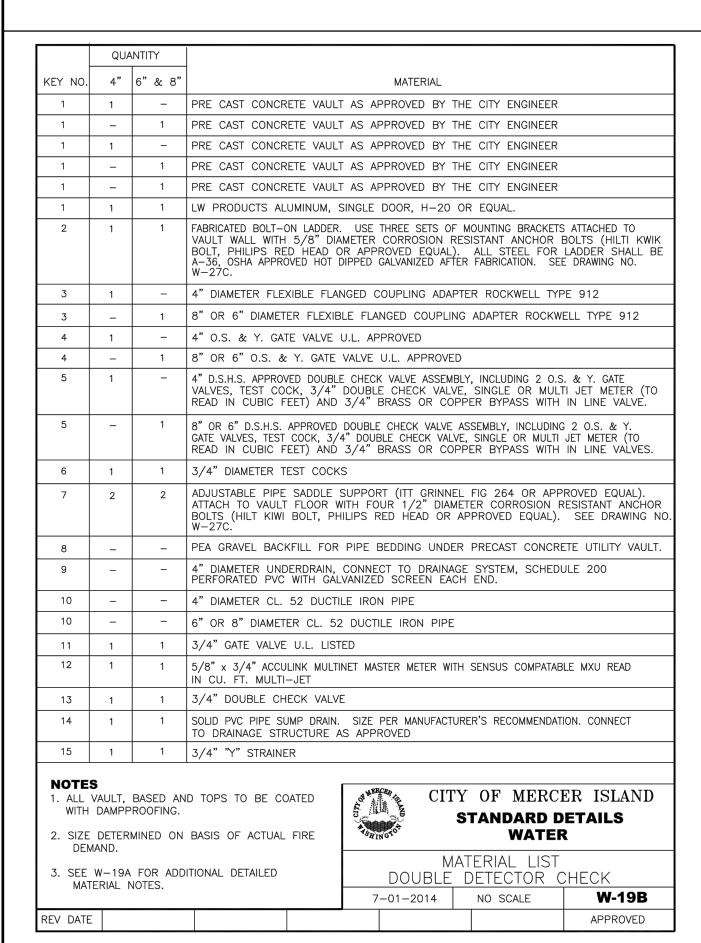

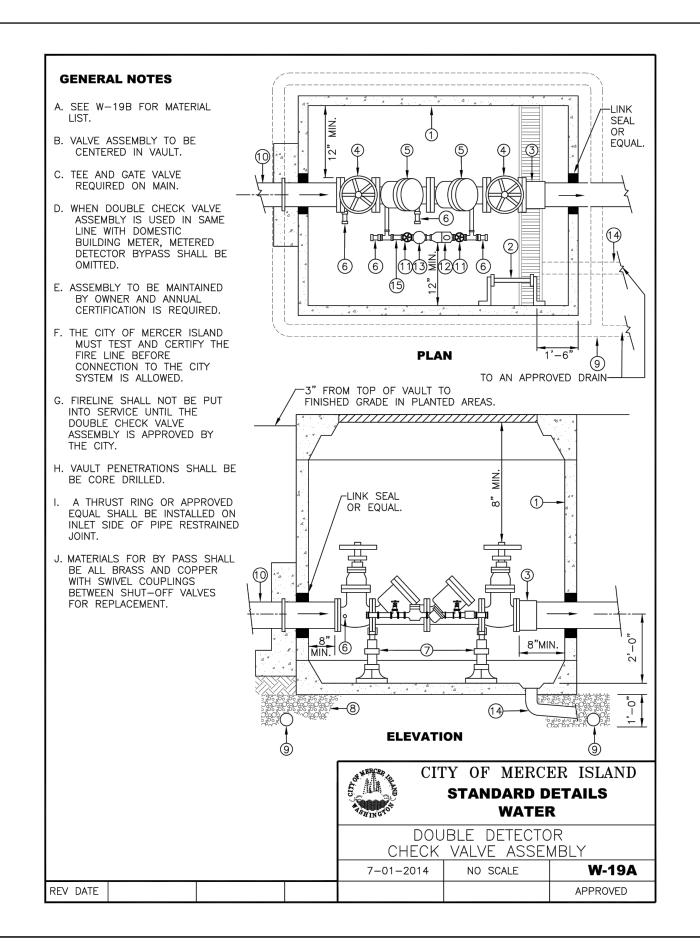

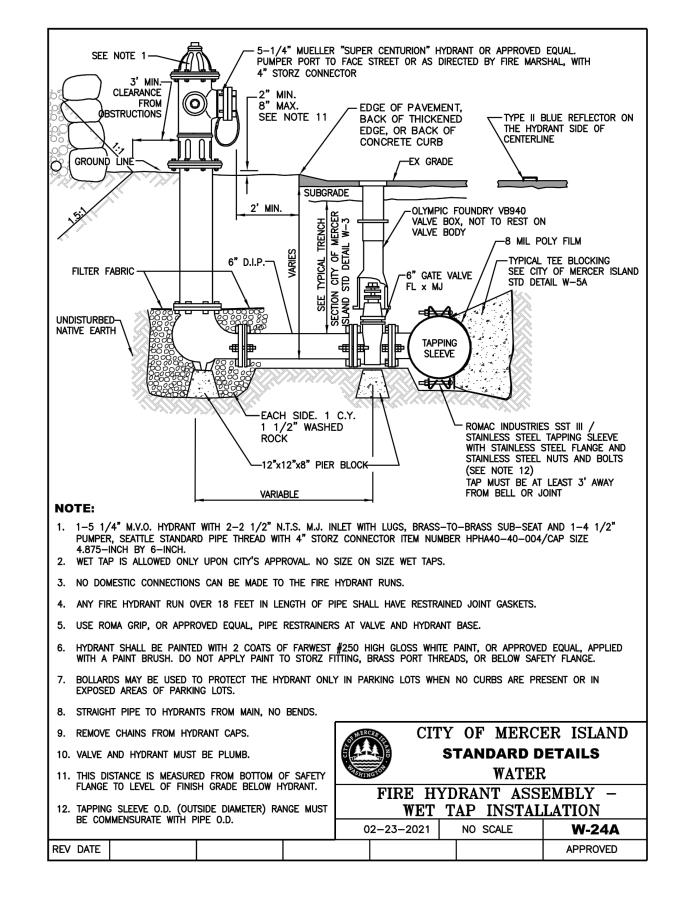

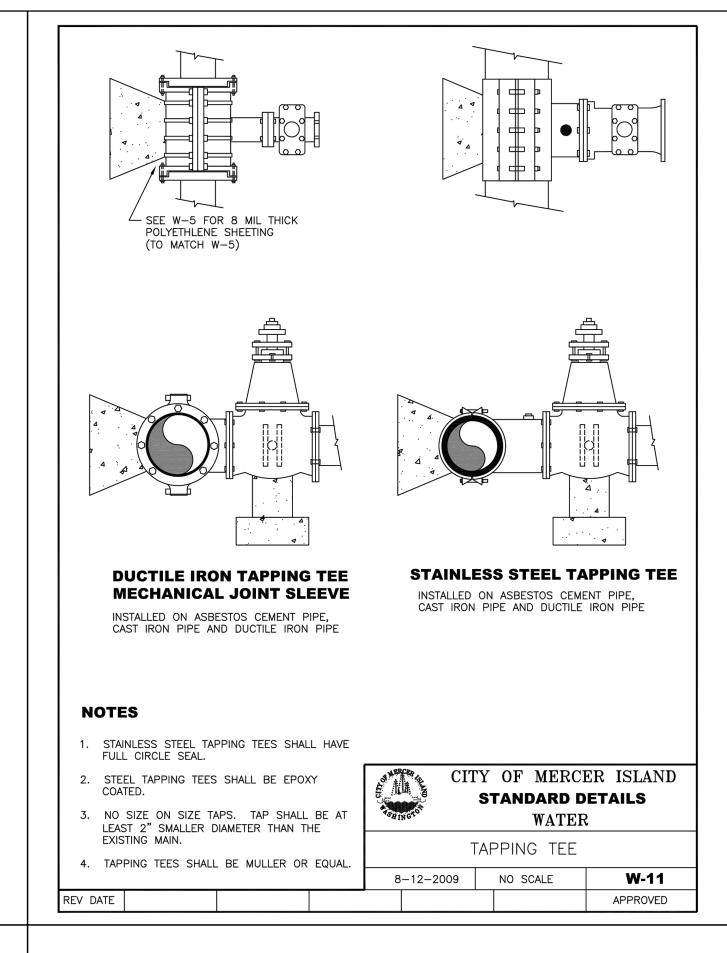

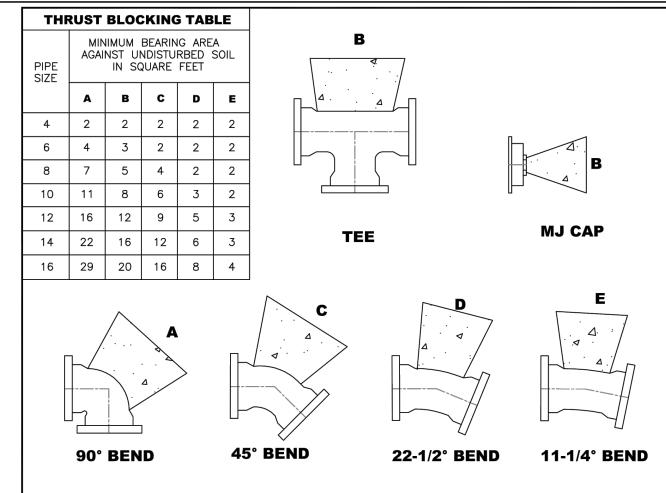


NOTES


- 1. ROMAC MJ WEDGE ACTION RETAINER MAY BE SUBSTITUTED FOR VERTICAL BLOCKING UPON PRIOR APPROVAL OF THE CITY ENGINEER.
- 2. CONCRETE THRUST BLOCKING SHALL BE POURED AGAINST UNDISTURBED EARTH.
- 3. THRUST BLOCKS SHALL BE CAST—IN—PLACE AND BE CONSTRUCTED WITH CLASS 3000 OR COMMERCIAL CONCRETE.
- 4. BLOCK SHALL BEAR AGAINST FITTINGS ONLY AND SHALL BE CLEAR OF BOLTS AND JOINTS TO PERMIT TAKING UP OR DISMANTLING JOINT. WRAP FITTINGS WITH 8 MIL THICK POLYETHYLENE SHEETING PRIOR TO POURING CONCRETE.
- 5. BEARING AREA MUST BE ADJUSTED FOR HIGHER INTERNAL PRESSURES AND LOWER SOIL BEARING VALUES.
- 6. THE CONTRACTOR SHALL INSTALL BLOCK WHICH IS ADEQUATE TO WITHSTAND FULL TEST PRESSURE AS WELL AS TO CONTINUOUSLY STAND OPERATING PRESSURE UNDER ALL CONDITIONS OF SERVICE.





HORIZONTAL CONCRETE BLOCKING
3-30-2021 NO SCALE W-5A


CITY	\mathbf{OF}	MERCE	$^{\mathrm{cR}}$	ISLAND	۱	
STANDARD DETAILS						
		WATER				
ITAL	CON	ICRETE	BL	OCKING		

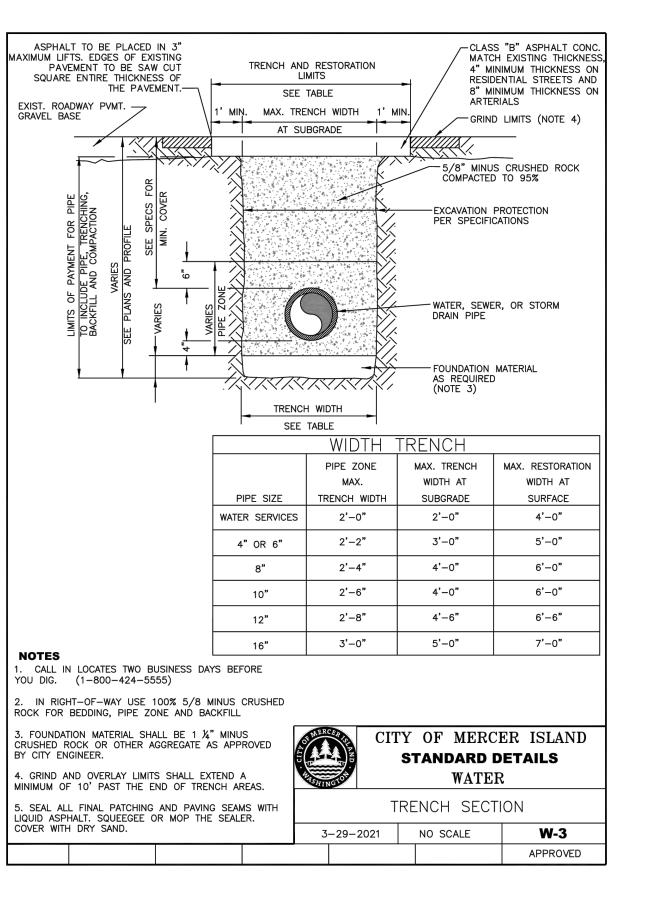

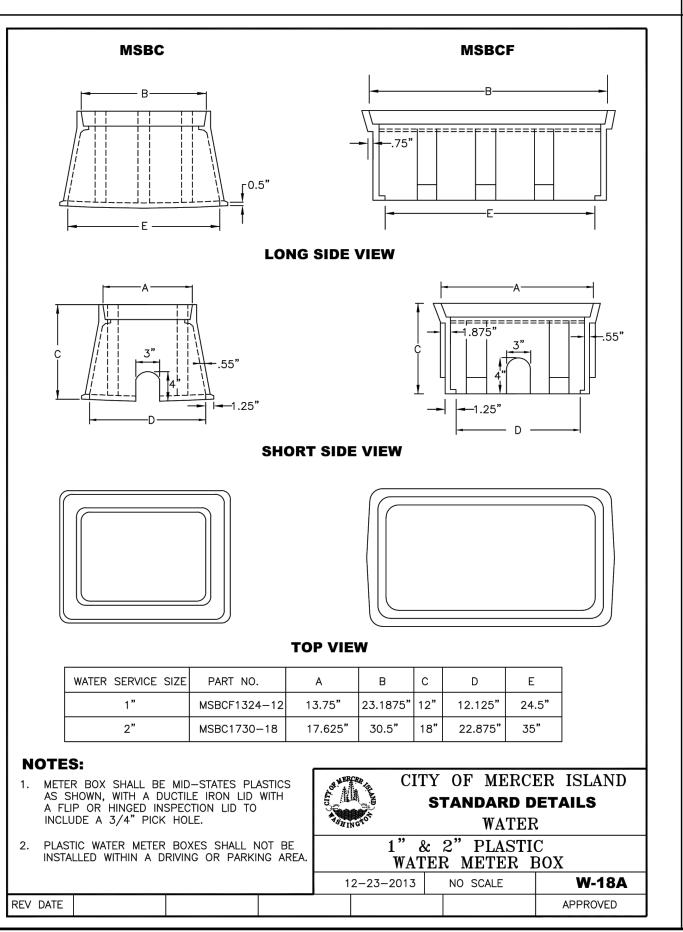

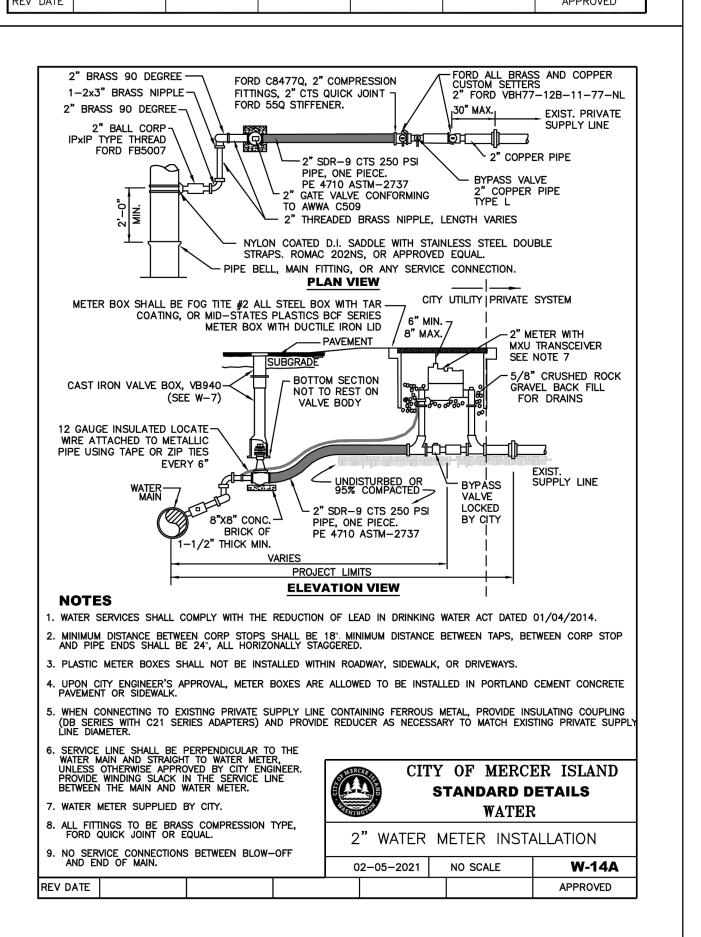

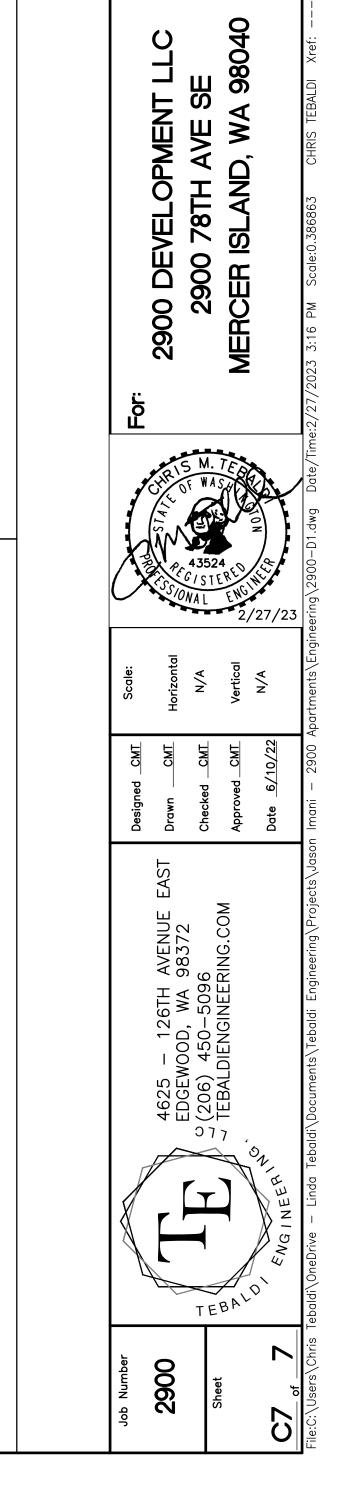

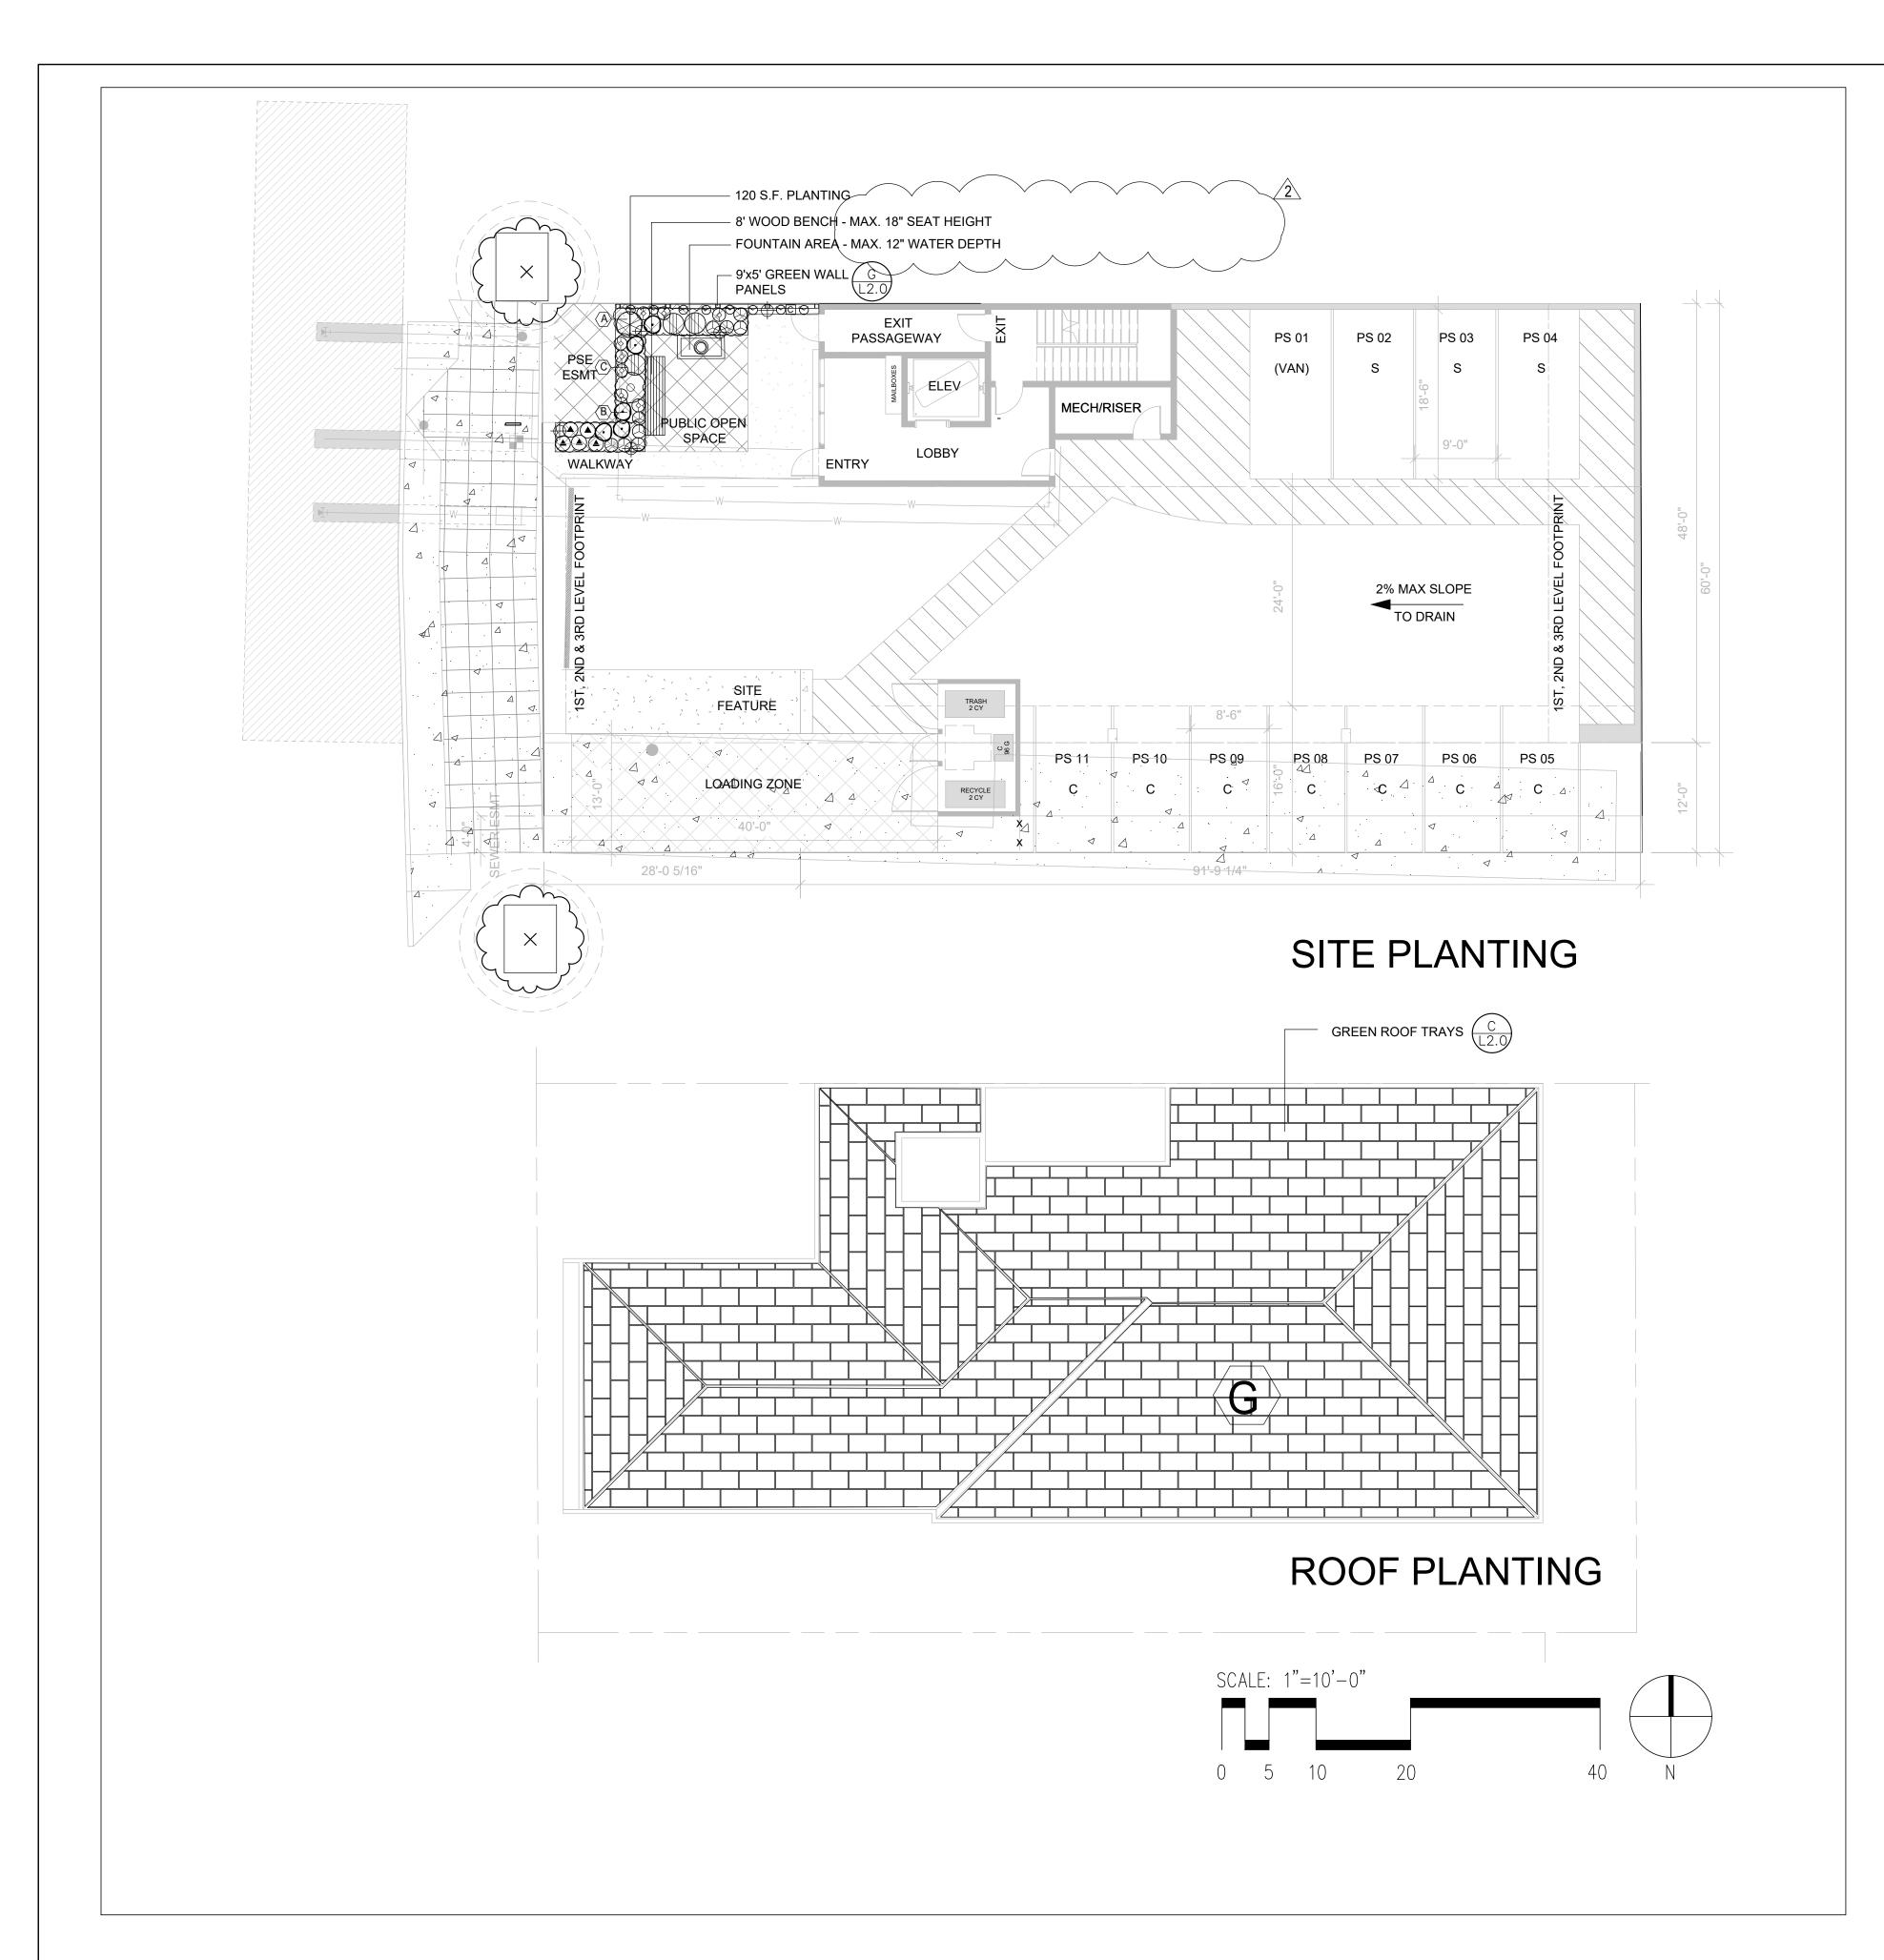

SYMBOL	BOTANICAL NAME/ COMMON NAME	SIZE AT PLANTING	QTY.	NATIVE ADAPTIV
<u>TREES</u>				
$\left(\begin{array}{c} \times \\ \end{array}\right)$	INDICATES EXISTING SIGNIFICANT TREE AND CRITICAL ROOT ZONE AT CANOPY EDGE — SAVE AND PROTECT.			
SHRUBS_				
\bigcirc	RIBES SANGUINIUM / RED FLOWERING CURRENT	24" HT., 5-GAL POT	1	YES
\bigoplus	RHODODENDRON OCCIDENTALE / WESTERN AZALEA	24" HT., 5-GAL POT	1	YES
\bigcirc	MAHONIA NERVOSA/ LONG-LEAF MAHONIA	12" HT., 2-GAL POT MAX. HT. 20"	8	YES
	BLECHNUM SPICANT / DEER FERN	18" HT., 1-GAL POT	3	YES
\odot	CORNUS STOLONIFERA 'KELSEYI'/DWARF RED-TWIG	12" HT., 2-GAL POT MAX. HT. 20"	9	YES
(A)	AQUILEGIA FORMOSA / WESTERN COLUMBINE	12" HT., 1-GAL POT MAX. HT. 18"	5	YES
\odot	LIRIOPE MUSCARI / BIG BLUE LILY TURF	12" HT., 1-GAL POT MAX. HT. 18"	5	NO
♡	LONICERA CILIOSA / TRUMPET HONEYSUCKLE	24" HT., 1-GAL POT, PLANT (2) BELOW EA. GREEN SCREEN 5' PANEL	8	YES
GROUNDCOVERS				
(A)	LIRIOPE SPICAPA / CREEPING LILY TURF	4-INCH POT	1'-0" O.C.	NO
B	CORNUS CANADENSIS / BUNCHBERRY	4-INCH POT	1'-0" O.C.	YES
	MAHONIA REPENS / CREEPING MAHONIA	4-INCH POT	1'-0" O.C.	YES
	SEDUM DIVERGENS / STONECROP,	2'X4'X4-1/2" DEEP GREENROOF TRAYS	4,131 S.F.	YES

NOTES

- ALL NEW PLANTING SHALL BE INSTALLED AS PER CITY OF MERCER ISLAND INSTALLATION STANDARDS AND PLANS.
- 2. ALL NEW ON-GRADE PLANTING AREAS SHALL RECEIVE MINIMUM 12" OF IMPORTED TOPSOIL TILLED INTO THE TOP 12" AND MINIMUM 2" OF BARK
- 3. ALL NEW PLANTING AREAS SHALL BE IRRIGATED BY AUTOMATIC IRRIGATION SYSTEM WITH RAIN SHUT OFF DEVICE.

 4. PROPOSED APARTMENT BUILDING WILL BE PERMITTED UNDER A SEPARATE BUILDING PERMIT.

IGHTING	SCHEDULE:	

SYMBOL	DESCRIPTION	MANUFACTURER	QUANTITY
QUIPMENT			
+	INDICATES PATHWAY LIGHT FIXTURE	KICHLER LED SHALLOW SHADE—SMALL MODEL 15805—BKT—4W 12 VOLT LED LAMP, 23" HT. WITH GROUND STAKE MOUNTING; TEXTURED BLACK COLOR	5
С	INDICATES LIGHTING CONTROLLER, TRANSFORMER, TIMER, PHOTOCELL	100 AMP CONTROLLER 120 TO 12 VOLT TRANSFORMER, PHOTOCELL, TIMER – WALL MOUNT AT 4' HT. FROM FINISH GRADE	1



INCORPORATED P.S.

LANDSCAPE ARCHITECTURE

URBAN DESIGN

SITE PLANNING

PARKS AND
RECREATION PLANNING


12610 NE 104TH ST.
KIRKLAND WA 98033
PH: 425.454.5723
FX: 425.822.3525
E-: jgm@jgm-inc.com

2900 78TH AVE. S.E. MERCER ISLAND, WA 98040

REVISIONS/DRAWING ISSUES:

7-20-2022 2 2-7-2023

Drawn by: CL Checked by: CL

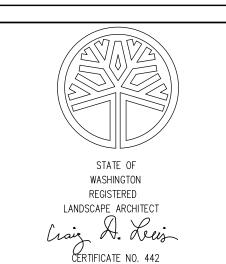


DATE: 6-10-2022 LAST UPDATE:

DRAWING TITLE


PLANTING PLAN


SHEET NUMBER

40

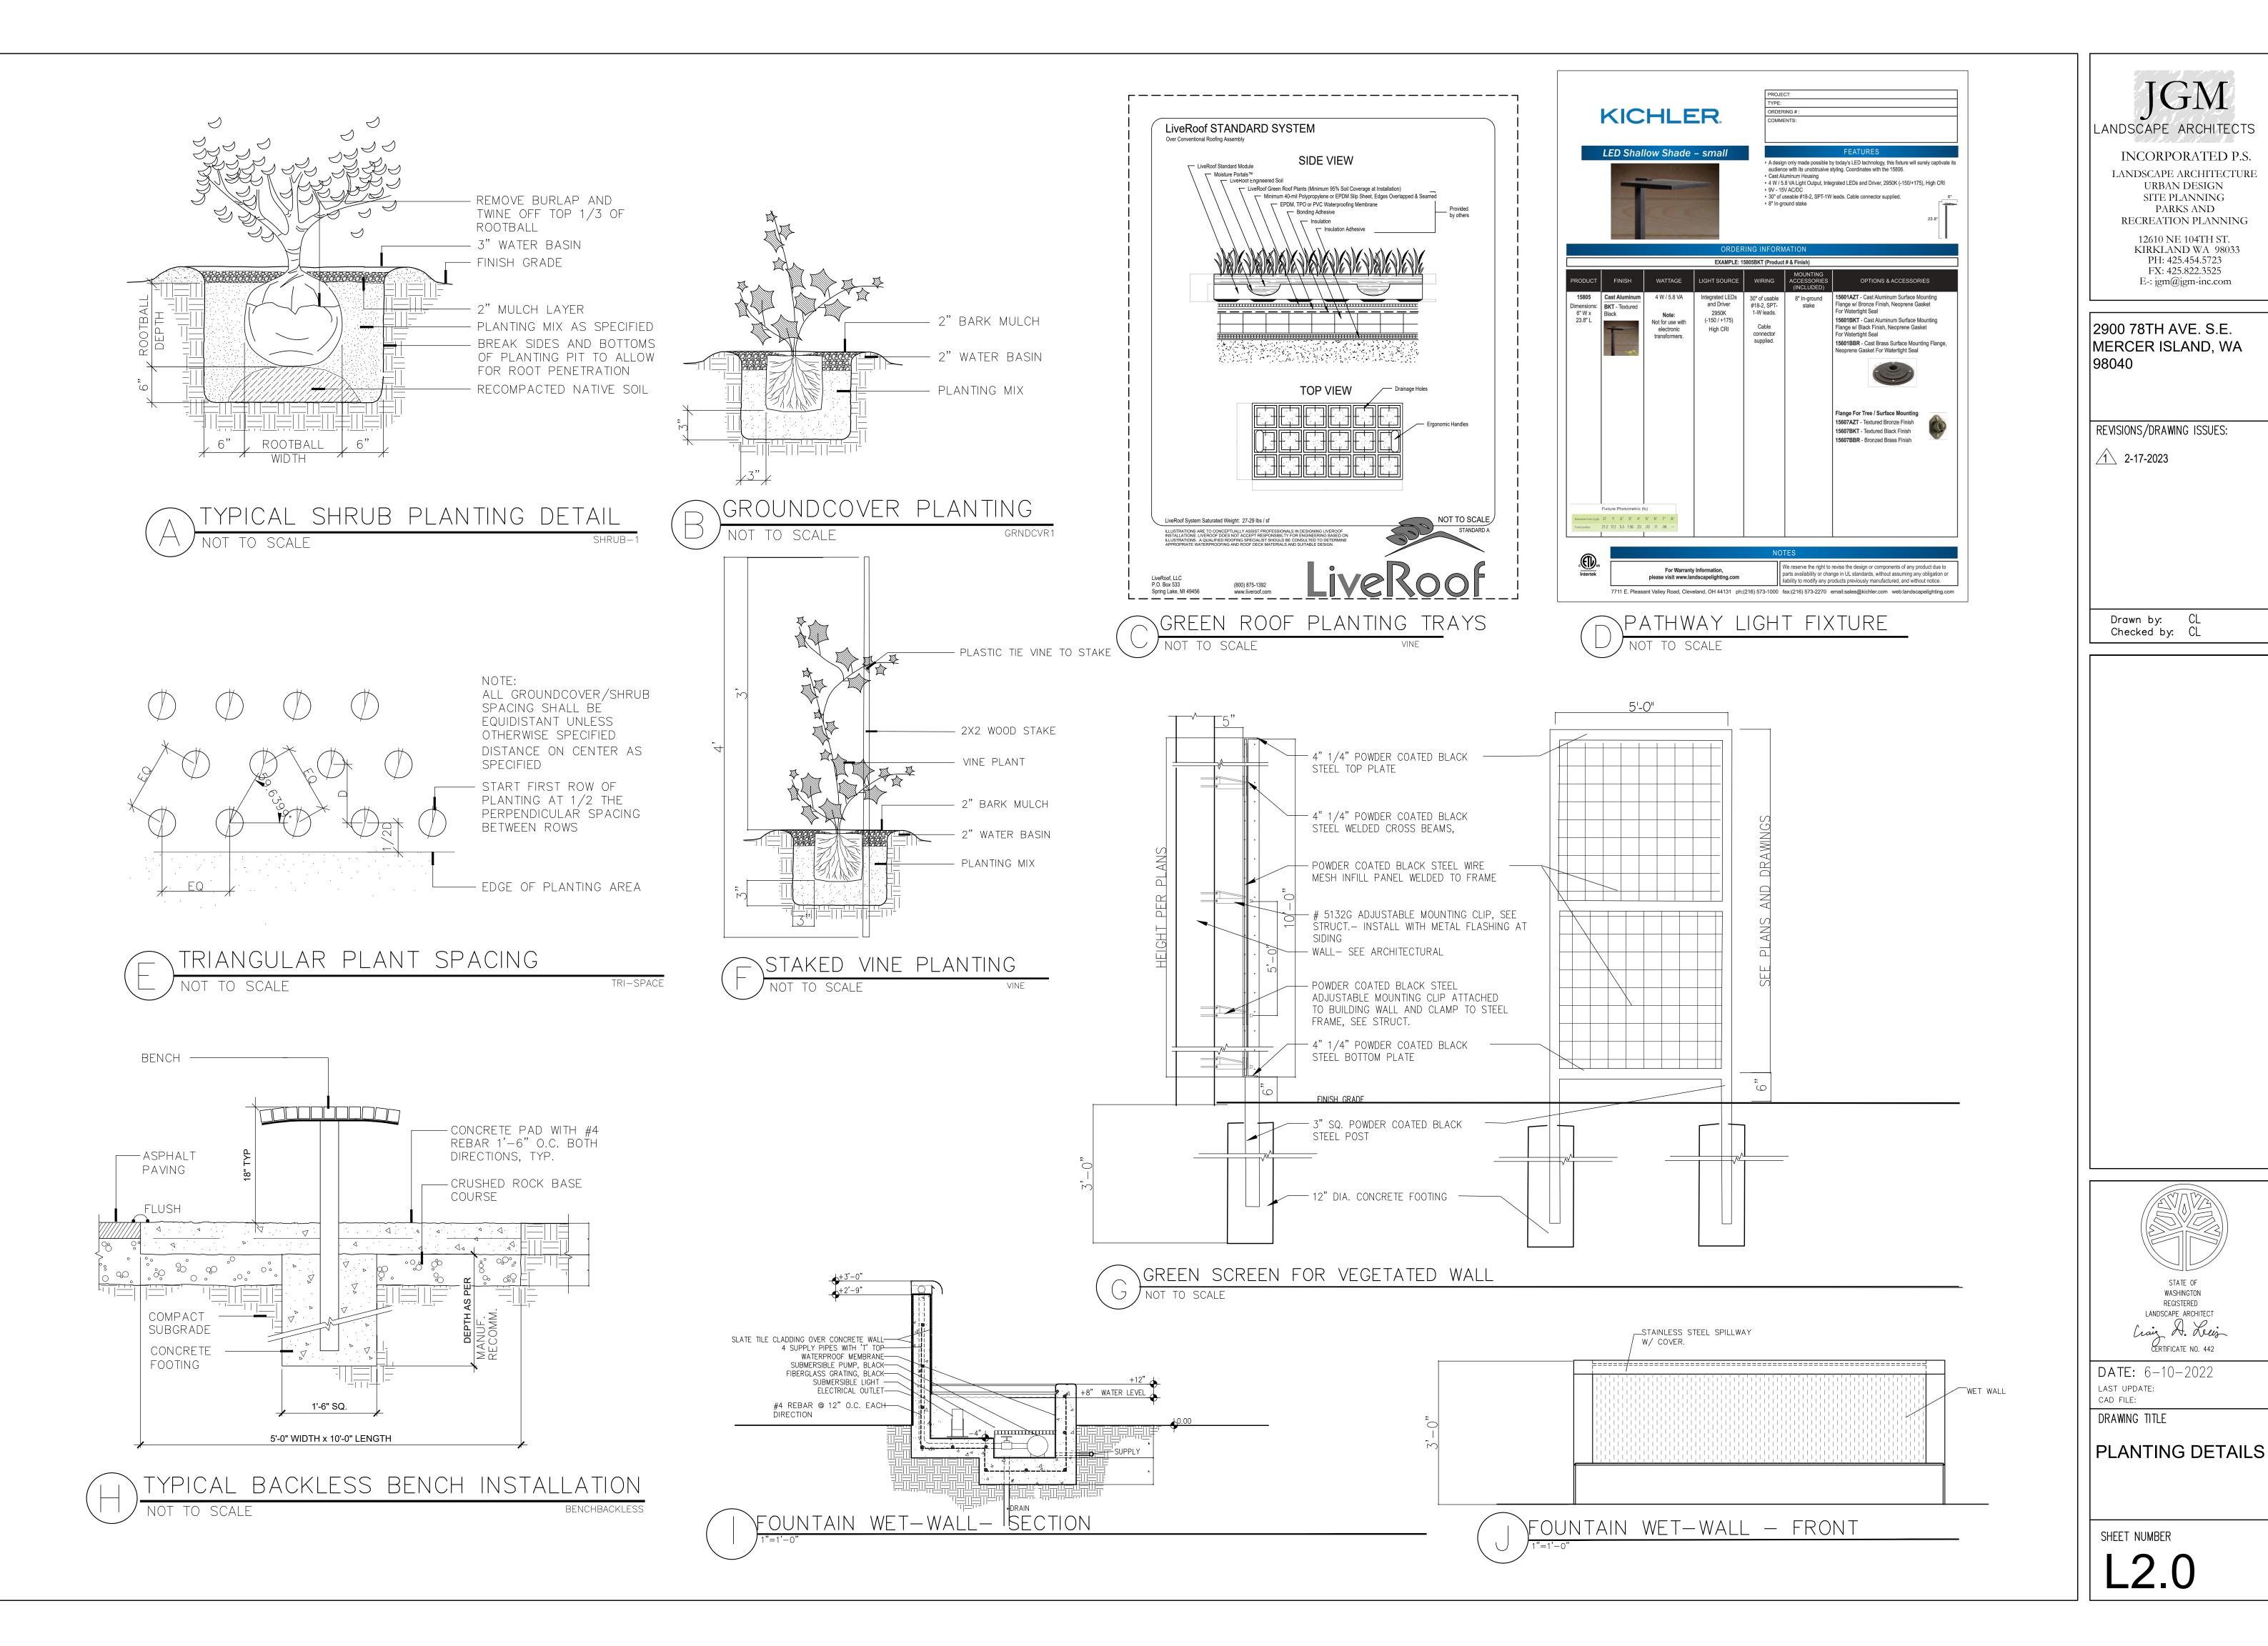

20

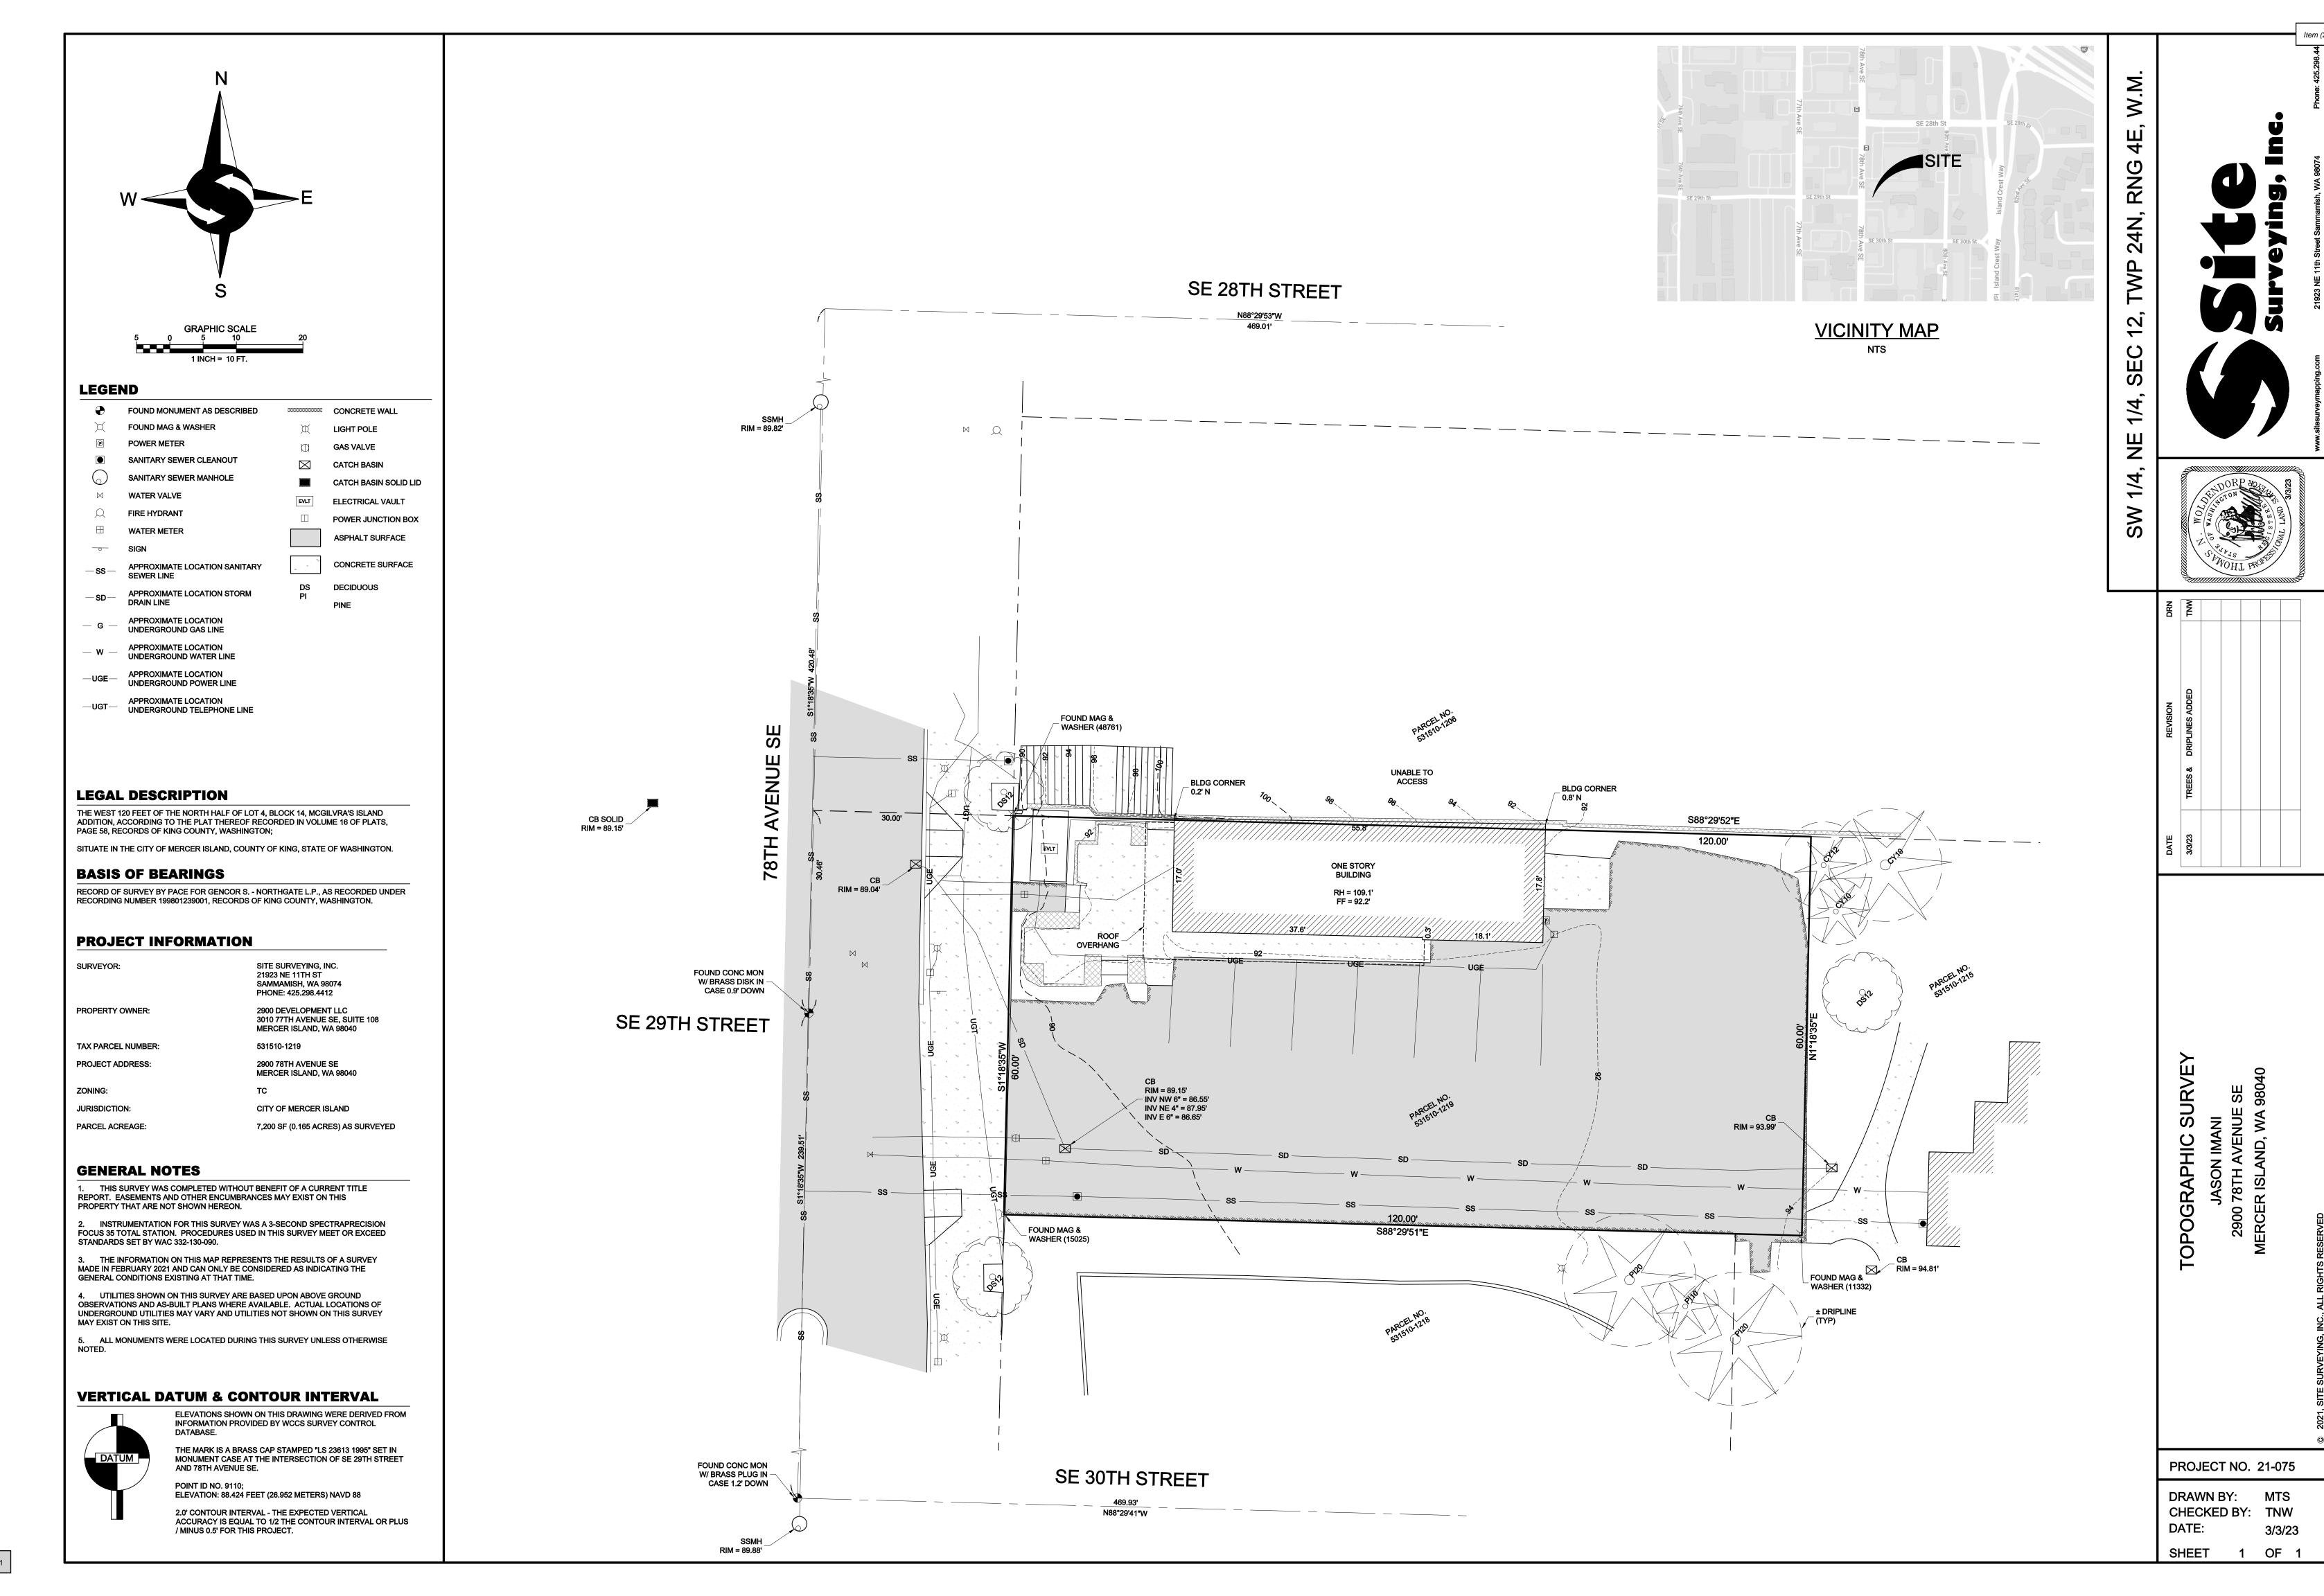

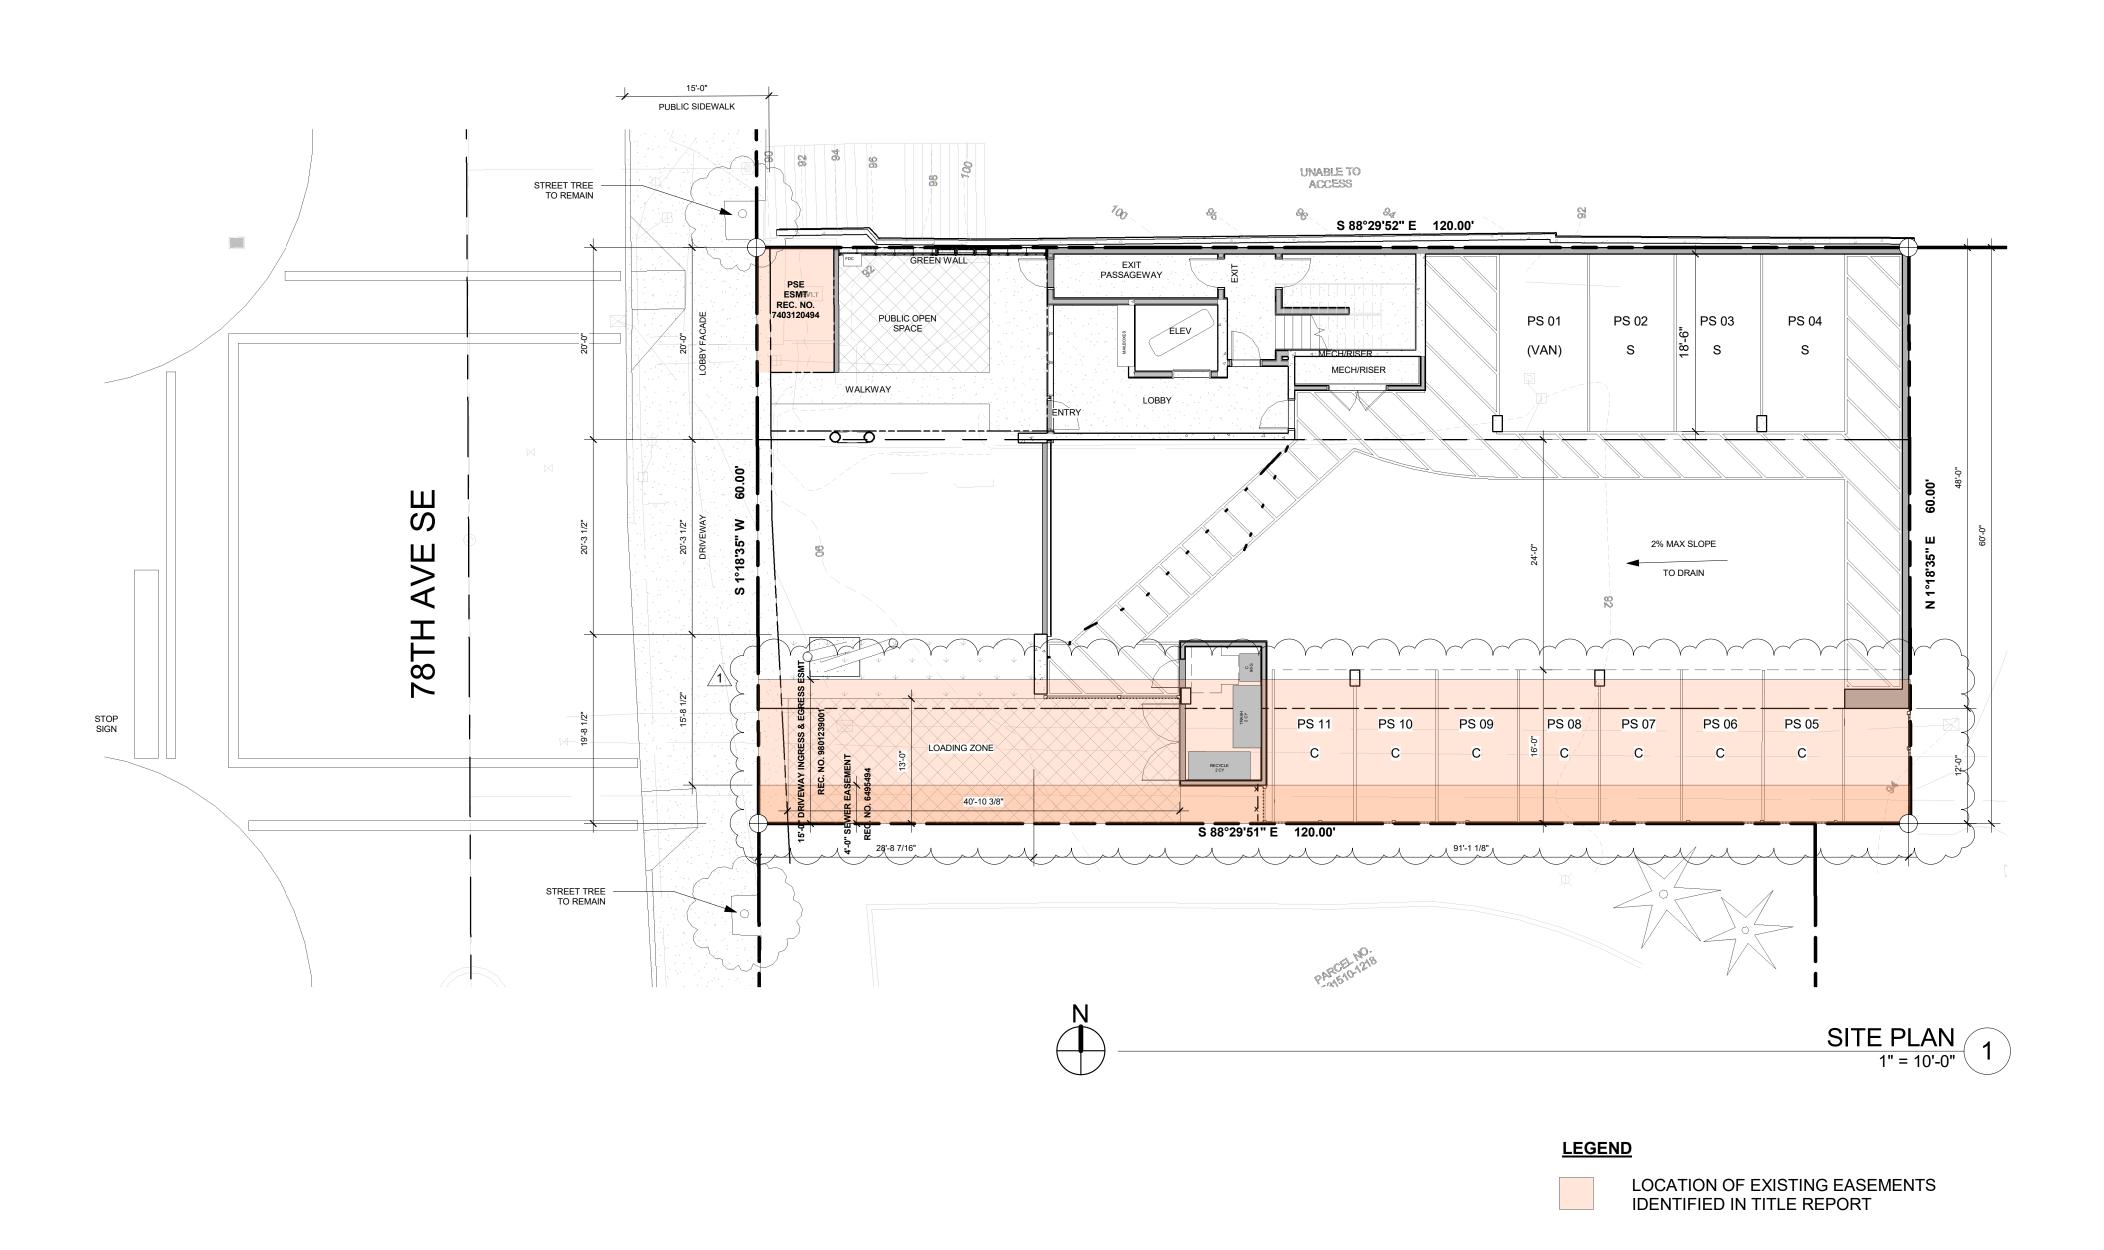

ZONING REQUIREMENTS

JURISDICTION: ZONING: CITY OF MERCER ISLAND TC-4 531510-1219 PARCEL ASSESSOR'S #: 7200 SF = 0.17 ACRE

LOT SIZE:

ADDITION, ACCORDING TO THE PLAT THEREOF RECORDED IN VOLUME 16 OF PLATS, PAGE 58, RECORDS OF KING COUNTY, WASHINGTON.

SITUATE IN THE CITY OF MERCER ISLAND, COUNTY OF KING, STATE OF WASHINGTON.

2.3 (X SF) MUST MEET THE STANDARDS OF SUBSECTION

MAX. HEIGHT: 51' MAX HEIGHT (REQUIRES MIN. 10% AFFORDABLE

MAX. STORIES:

4 MAX STORIES (REQUIRES MIN. 10% AFFORDABLE

GROUND FLOOR HEIGHT: 15' MINIMUM / 27' MAXIMUM

REQUIRED SIDE: REQUIRED REAR: PROVIDED: 0' MIN. 0' MIN

SIDEWALK: MICC 19.11.030(A)(6)

ALONG 78TH AVE SE, ALL STRUCTURES SHALL BE SET BACK SO THAT SPACE IS PROVIDED FOR AT LEAST 15 FEET OF SIDEWALK BETWEEN THE STRUCTURE AND THE FACE OF THE STREET CURB.

BLOCK FRONTAGES MAY PROJECT BEYOND THE DAYLIGHT PLANE CONCEPT

1 TO 1.4 STALLS PER UNIT (10 UNITS = MIN. 10 STALLS)

STANDARD: (22.2%)COMPACT: TOTAL: <u>(66.7%)</u> JOB ADDRESS: 2900 78TH AVE SE

PROJECT / CLIENT:

2900 Development LLC

MERCER ISLAND, 98040

2900 78TH AVE SE

DRAWING NAME:

SITE PLAN

Drawn By: KH Checked By: ST Owner Approval:

PHASE:

DESIGN REVIEW

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APPROVED FOR CONSTRUCTION:

PROJECT No.: A21 021 DATE: 4/29/2023



BELLEVUE, WA 98005 KETCHUM, ID 83340

TEL: (425) 453-9298 TEL: (208) 726-0194

200 W. RIVER ST.

12/13/22

DATE:

4/19/2023

SUITE 301

11711 SE 8TH STREET

REGISTRATION:

INTAKE DATE:

REVISIONS:

CORRECTIONS

SUITE 100

LEGAL DESCRIPTION:
THE WEST 120 FEET OF THE NORTH HALF OF LOT 4, BLOCK 14, MCGILVRA'S ISLAND

MAXIMUMS: MAX. FAR:

23.45.530, GREEN BUILDING STANDARDS 27' BASE HEIGHT

HOUSING) 2 BASE STORIES

SETBACKS:
TOWN CENTER - TC-4 SUBAREA, PER MICC 19.11.030
REQUIRED FRONT: MIN. 0' MIN PE PROVIDED: SEE SIDEWALK REQ'T PROVIDED: 0' NORTH, 12' SOUTH

DAYLIGHT PLANE: MICC 19.11.030(A)(7)


BLOCK FRONTÀGÈS ALONG STREETS MUST INTEGRATE AVERAGE MINIMUM UPPER BUILDING SETBACK. FROM A HEIGHT OF 25 FEET AT THE FRONT PROPERTY LINE, BUILDINGS SHALL STEP BACK AT A 45-DEGREE ANGLE UP TO THE MAXIMUM HEIGHT


SINCE THE DAYLIGHT PLANE STANDARDS APPLY A MINIMUM AVERAGE, PORTIONS OF DESCRIBED IN SUBSECTION (A)(7)(a) OF THIS SECTION, PROVIDED THE APPLICABLE BLOCK FRONTAGE AS A WHOLE COMPLIES WITH THE MINIMUM AVERAGE.

VEHICULAR PARKING: MICC 19.11.130

REQUIRED: PROVIDED:

VAN ACCESSIBLE:

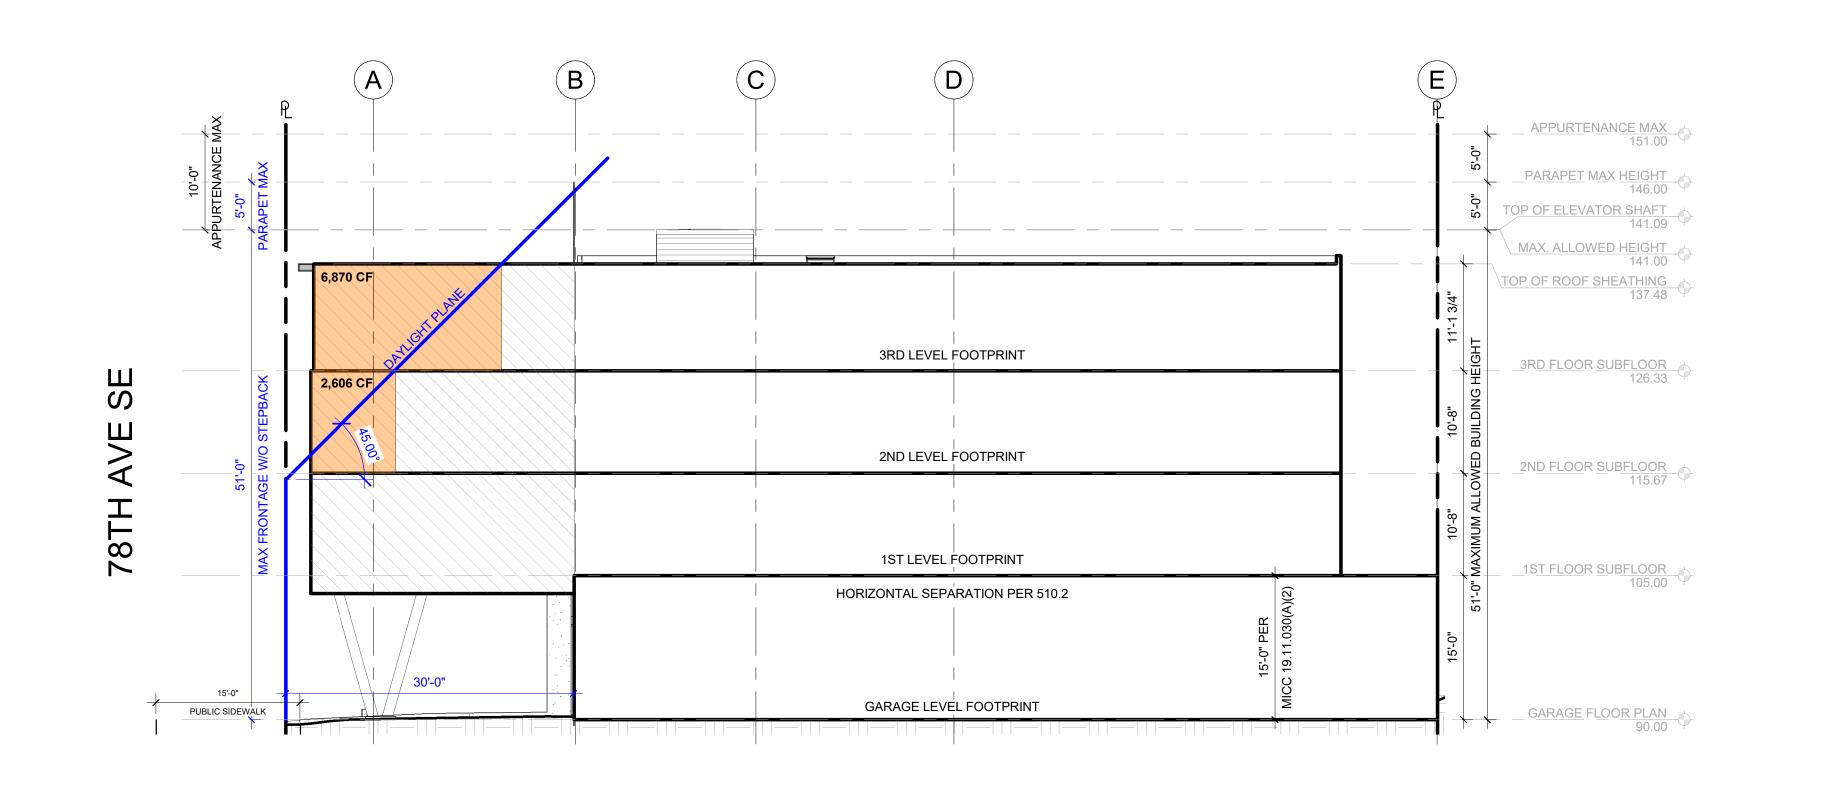

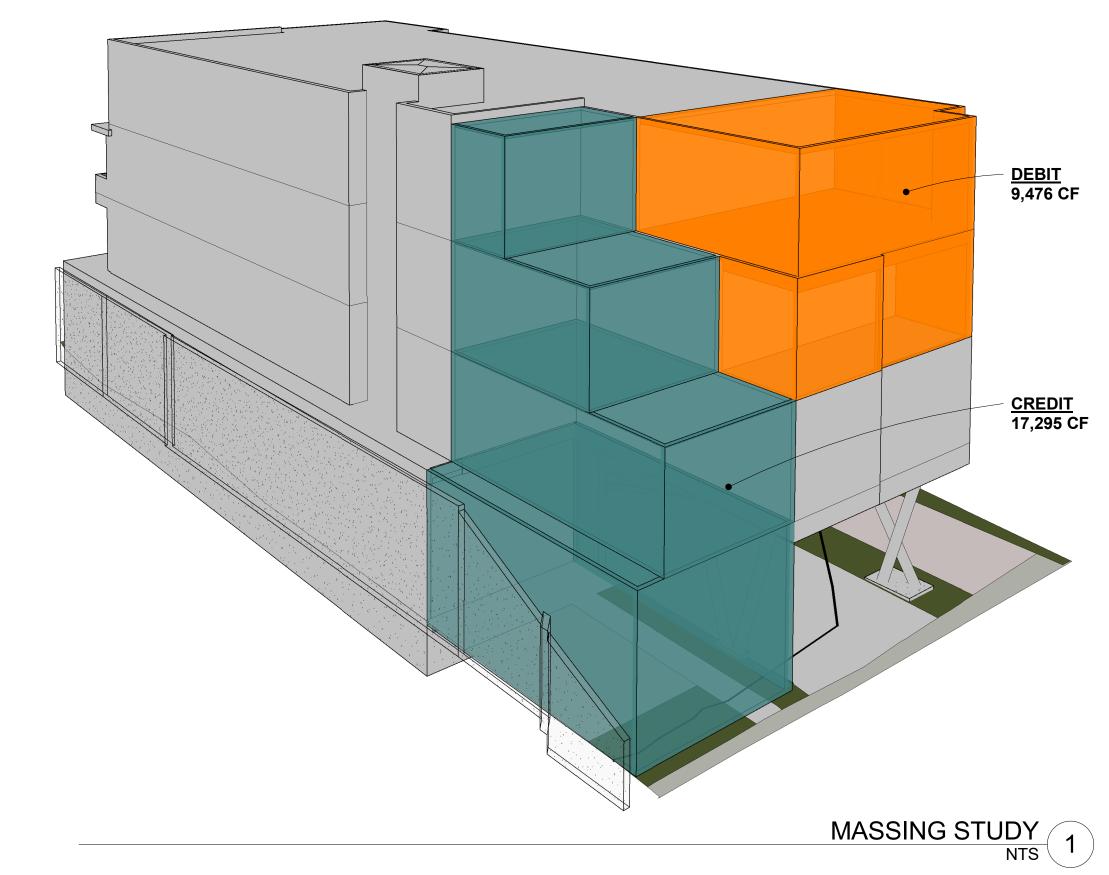

DEBIT 9,476 CF CREDIT 17,295 CF

11711 SE 8TH STREET 200 W. RIVER ST. SUITE 100 SUITE 301 BELLEVUE, WA 98005 KETCHUM, ID 83340 TEL: (425) 453-9298 TEL: (208) 726-0194 REGISTRATION: 12/13/22 INTAKE DATE:

MEDICI ARCHITECTS

REVISIONS: DATE: PROJECT / CLIENT:

2900 78TH AVE SE

2900 Development LLC

JOB ADDRESS: 2900 78TH AVE SE MERCER ISLAND, 98040

D \bigcirc B (E) APPURTENANCE MAX 151.00 PARAPET MAX HEIGHT 146.00 TOP OF ELEVATOR SHAFT 141.09 MAX. ALLOWED HEIGHT 141.00 TOP OF ROOF SHEATHING 137.48 3RD LEVEL FOOTPRINT 3RD FLOOR SUBFLOOR 126.33 3,237 CF 2ND LEVEL FOOTPRINT 2ND FLOOR SUBFLOOR 115.67 4,768 CF 1ST LEVEL FOOTPRINT _1ST FLOOR SUBFLOOR 105.00 HORIZONTAL SEPARATION PER 510.2 7,940 CF GARAGE LEVEL FOOTPRINT GARAGE FLOOR PLAN 90.00

DAYLIGHT PLANE - CREDIT VOLUME

1" = 10'-0"

3

DAYLIGHT PLANE - DEBIT VOLUME
1" = 10'-0" 2

AVERAGE DAYLIGHT PLANE CALCULATION

<u>DEBIT VOLUME</u> 2ND FLOOR: 3RD FLOOR: 2,606 6,870 **DEBIT TOTAL:** 9,476 CF CREDIT VOLUME GARAGE LEVEL: 1ST FLOOR: 7,940 4,768 3,237

2ND FLOOR: 3RD FLOOR: 1,350 **CREDIT TOTAL:** 17,295 CF 17,295 - 9,476 DIFFERENCE

TOTAL CREDIT VOLUME: 7,819 CF

DRAWING NAME:

ZONING DIAGRAMS

Drawn By: KH Checked By: ST Owner Approval:

PHASE:


DESIGN REVIEW

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APPROVED FOR CONSTRUCTION:

PROJECT No.: A21 021 DATE: 4/29/2023



LONG DASHED LINE OF BUILDING ABOVE.
2-HOUR RATED NON-COMBUSTIBLE WALL; WP 1522. 3 5/8" STEEL STUDS. SEE ASSEMBLY DETAIL ON A0.5a 271 3-HOUR RATED CONCRETE COLUMN PER STRUCTURAL.

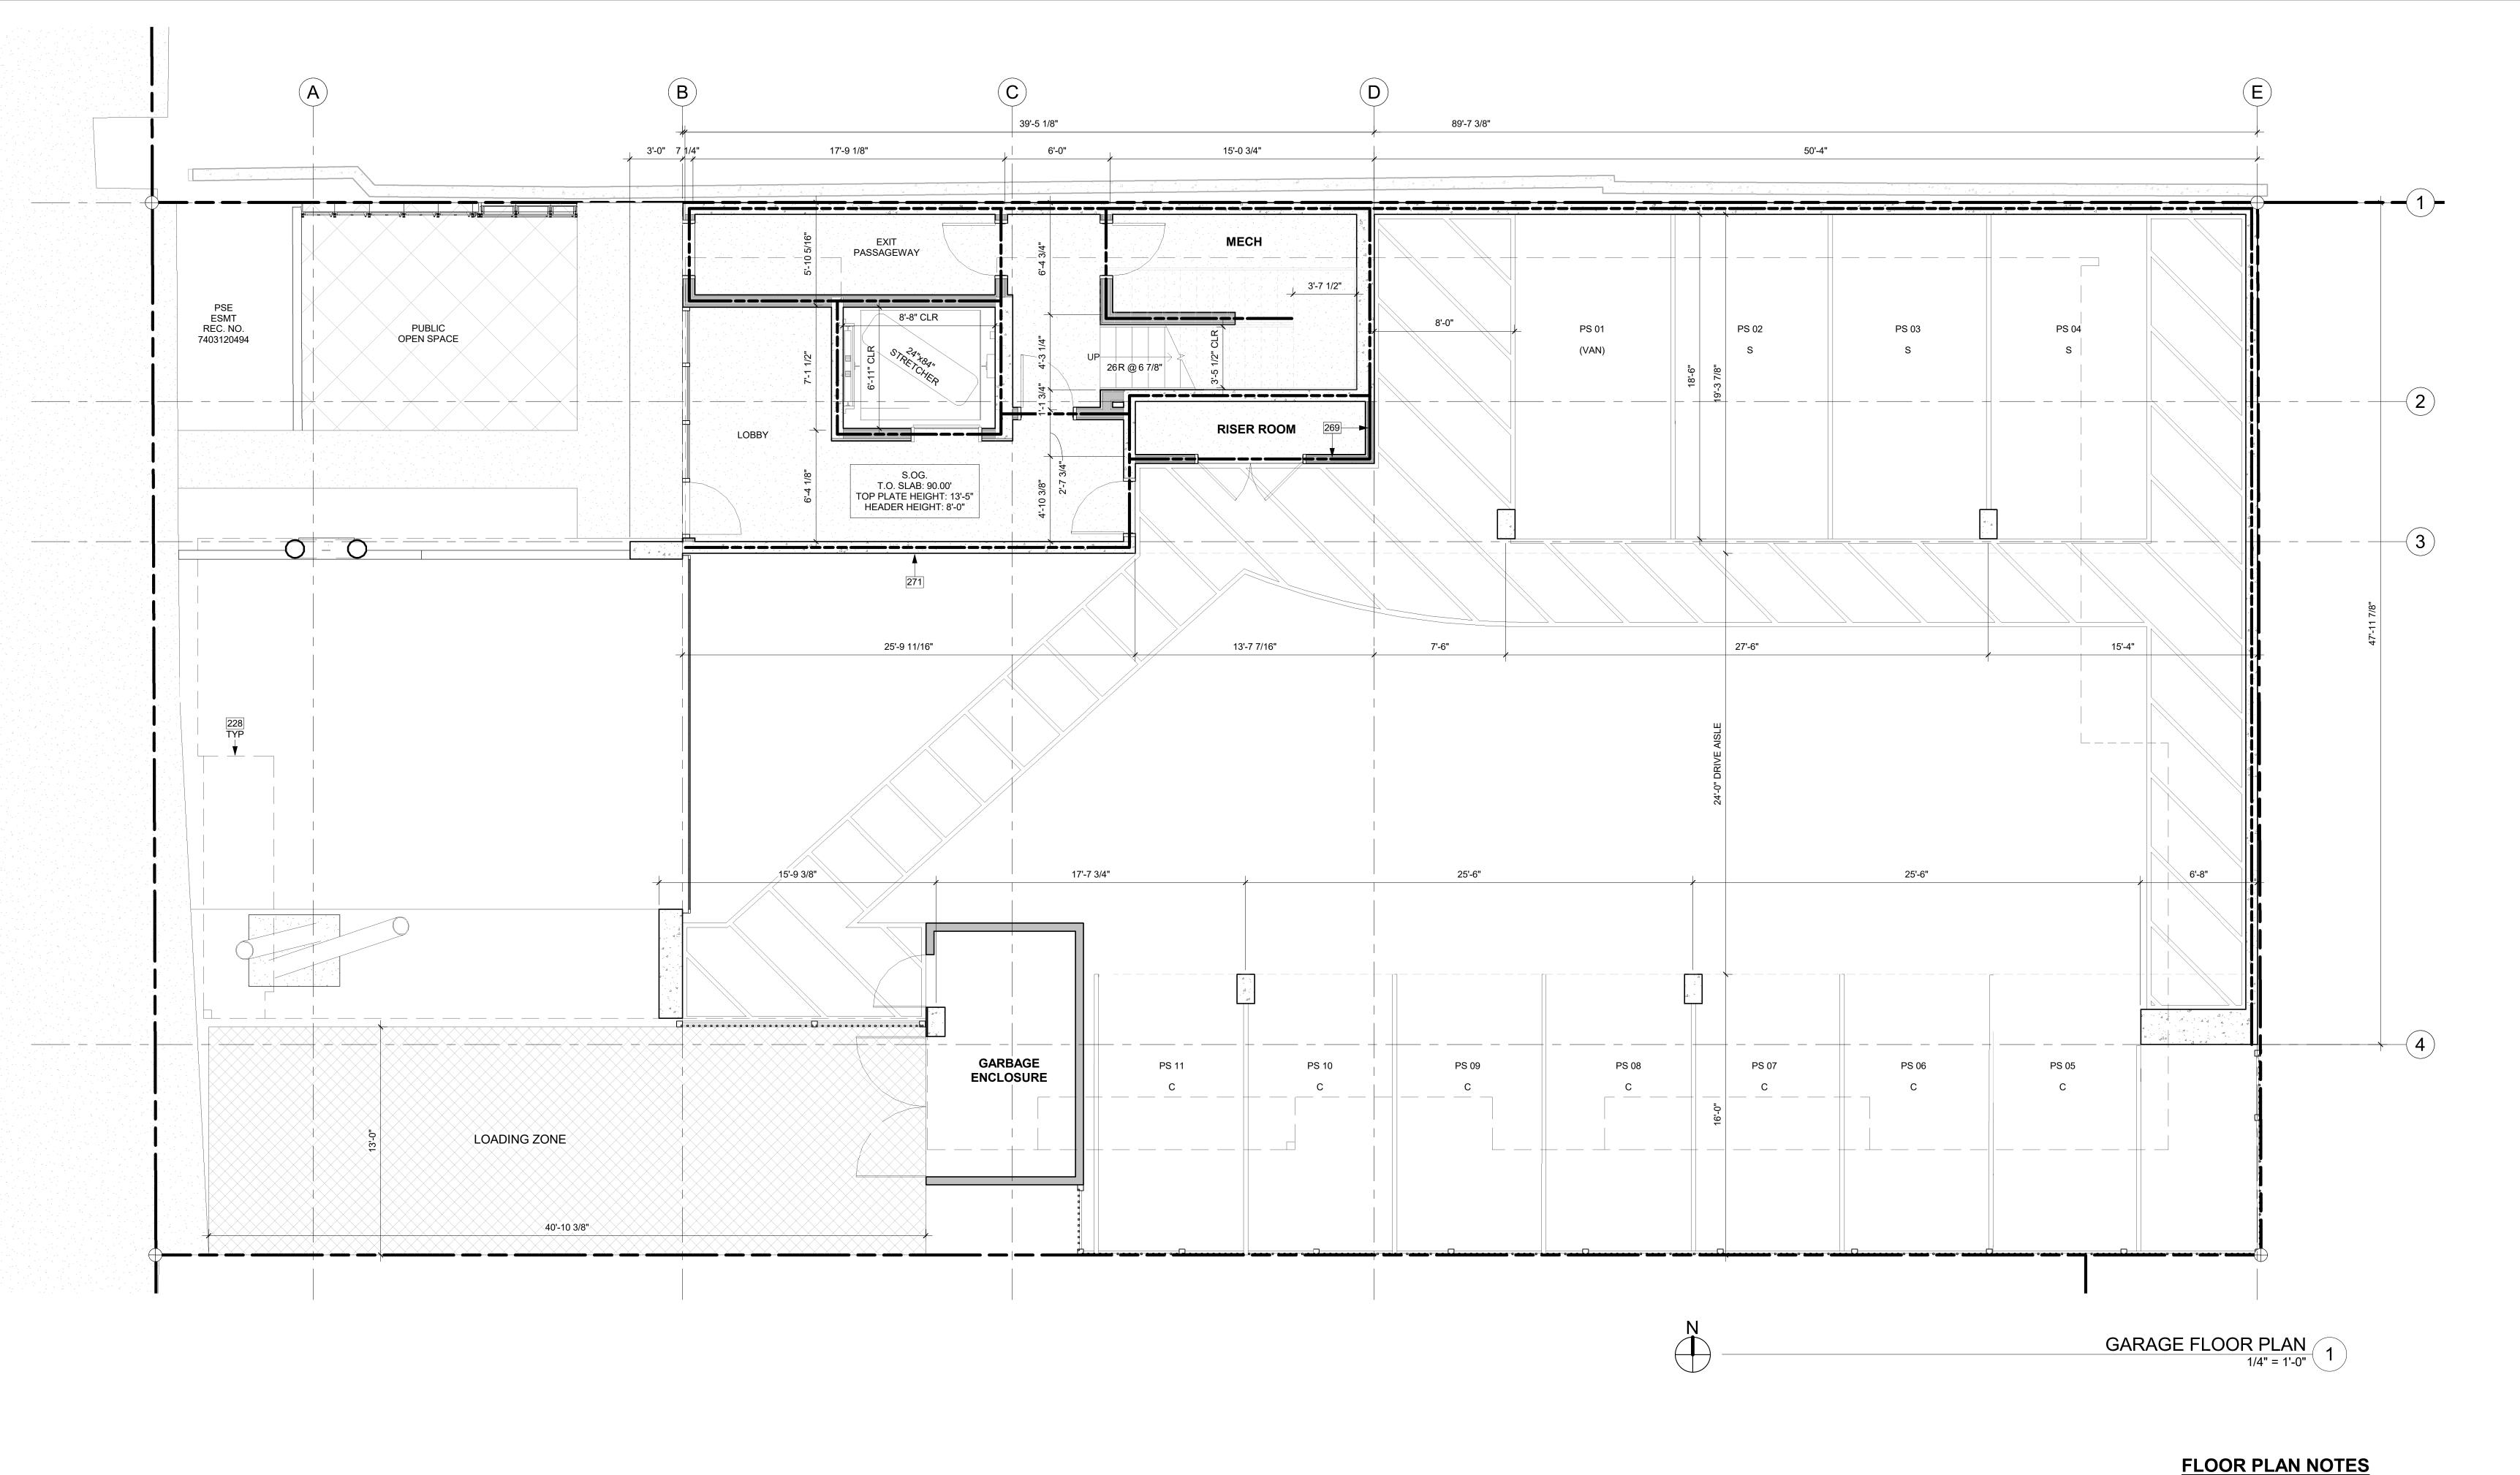ABOVE FINISHED FLOOR.

- CONTRACTOR SHALL VERIFY ALL NOTES, DIMENSIONS & CONDITIONS PRIOR TO CONSTRUCTION. SEE STRUCTURAL DRAWINGS FOR ALL POSTS, BEAMS AND HEADERS.
- PROVIDE SOLID BLOCKING OVER SUPPORTS. PROVIDE FIRE BLOCKING @ ALL PLUMBING PENETRATIONS. WINDOWS & DOORS ARE SHOWN & NOTED AS NOMINAL SIZES. DOOR JAMB 4.5" FROM CORNER TYP., U.N.O.
 SEE SHEETS A0.3, A4.0 & A4.1 FOR WINDOW & DOOR HEADER HEIGHTS
- ALL WOOD IN CONTACT WITH CONCRETE TO BE PRESSURE TREATED. EXTERIOR WALLS TO BE 2x6 STUDS @ 16" O.C., U.N.O. INSTALL SIMPSON CONC. TO WOOD HOLDOWNS PER STRUCTURAL DRAWINGS, ALSO SEE MANUFACTURER'S SPECS.
- 11. SMOKE & CARBON MONOXIDE DETECTORS: • SHALL BE 110V INTERCONNECTED W/ BATTERY BACKUP. • SHALL SOUND AN ALARM AUDIBLE IN ALL SLEEPING ROOMS. • SHALL BE INSTALLED ON EACH FLOOR AND IN ALL BEDROOMS. • SHALL BE INSTALLED IN EACH LOCATION WHERE THERE IS A CEILING CHANGE OF GREATER THAN 24"
- 12. FRESH AIR PROVIDED BY WHOLE-HOUSE EXHAUST FAN WITH FRESH AIR PORT (NET 4 SF IN MIN. OPENING) AT EACH HABITABLE ROOM. A TIMER OPERÀTES AN EXHAUST FAN WHICH PULLS OUTSIDE AIR THROUGH AIR
- INLETS LOCATED IN EACH HABITABLE ROOM. 13. LIMITING DEVICE FOR TUBS TO PROVIDE MAX. 120°F HOT WATER
 - TEMPERATURE. FOOTINGS SHALL BEAR ON SOLID UNDISTURBED EARTH (CONTROLLED, COMPACTED STRUCTURAL FILL OR BOTH). DEPTH OF FOOTINGS TO BE DETERMINED BY STRUCTURAL ENGINEER. FOUNDATION EXCAVATION, BACKFILL AND COMPACTION SHALL CONFORM TO SPECIFICATION REQUIREMENTS. THIS CONSTRUCTION WORK, INCLUDING DRAINAGE, SHORING AND SUCH OTHER RELATED WORK AS REQUIRED, SHALL BE CONDUCTED BY THE CONTRACTOR. STOP WORK IF RECOMMENDED EXCAVATION CUT OR BEARING SOIL CHANGES OCCUR IN EITHER HORIZONTAL OR VERTICAL DIRECTION AND NOTIFY IMMEDIATELY THE GEOTECHNICAL ENGINEER AND STRUCTURAL ENGINEER. AT WHICH POINT THE ENGINEERS SHALL DETERMINE CAUSE OF DISPLACEMENT AND

FIRE-RESISTANCE ASSEMBLIES

DEVELOP AND IMPLEMENT REMEDIAL MEASURES.

■ • ■ • ■ 1-HOUR RATED WALL ASSEMBLY 2-HOUR RATED WALL ASSEMBLY 3-HOUR RATED WALL ASSEMBLY

SYMBOL LEGEND

SEE TITLE SHEET A0.0 FOR COMPLETE SYMBOL INDEX.

DRAWING NAME:

GARAGE PLAN

Drawn By: KH Checked By: ST

Owner Approval:

PHASE:

DESIGN REVIEW

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MEDICI ARCHITECTS

BELLEVUE, WA 98005 KETCHUM, ID 83340

TEL: (425) 453-9298 TEL: (208) 726-0194

REGISTRATION:

INTAKE DATE:

REVISIONS:

PROJECT / CLIENT:

2900 Development LLC

JOB ADDRESS: 2900 78TH AVE SE MERCER ISLAND, 98040

2900 78TH AVE SE

200 W. RIVER ST.

12/13/22

SUITE 301

APPROVED FOR CONSTRUCTION:

written permission from the Architect.

PROJECT No.: A21 021


DATE: 4/29/2023

HOUSE VENTILATION

2018 IRC - PROVIDE WHOLE HOUSE VENTILATION PER M1505.4, INTERMITTENT WHOLE HOUSE VENTILATION USING EXHAUST FAN PER 1505.4.1.2 (WA) AND TABLE 1505.4.3(1) & (3) (WA); PROVIDE CONTROLS PER 1505.4.2. COMPLY WITH WSEC R403. SYMBOL LOCATION MINIMUM FAN DEOLUDEMENTS

SYMBOL	LOCATION	MINIMUM FAN REQUIREMENTS
A	BATH & POWDER	MIN. 50 CFM (INTERMITTENT) @ 0.25" WG (TABLE M1505.4.4
- B	KITCHEN	MIN. 100 CFM (INTERMITTENT) @ 0.25" WG (TABLE M1505.4.4) RANGE HOOD OR DOWN DRAFT EXHAUST FAN RATED AT MIN. 100 CFM AT 0.10" WG MAY BE USED FOR EXHAUST FAN REQUIREMENT. IF OVER 400 CFM, MAKEUP AIR IS REQUIRED IN THE SAME ROOM PER M1503.6.
-C	LAUNDRY ROOM	MIN. 2100 A (INTERMITTENT) @ 0.25" WG - TO FUNCTION AND LIP ABELED AS WHOLE HOUSE FAN (4-5 BEDTO AMS 4501<6000 SF) TO OPERATE 50% OF TIME IN EAUTHOUR SEGMENT

** MAKEUP AIR IS NOT REQUIRED IF ALL GAS APPLIANCES IN THE HOUSE HAVE A DIRECT VENT OR MECHANICAL DRAFT VENT SYSTEM, PER MODIFICATION M1503.6.

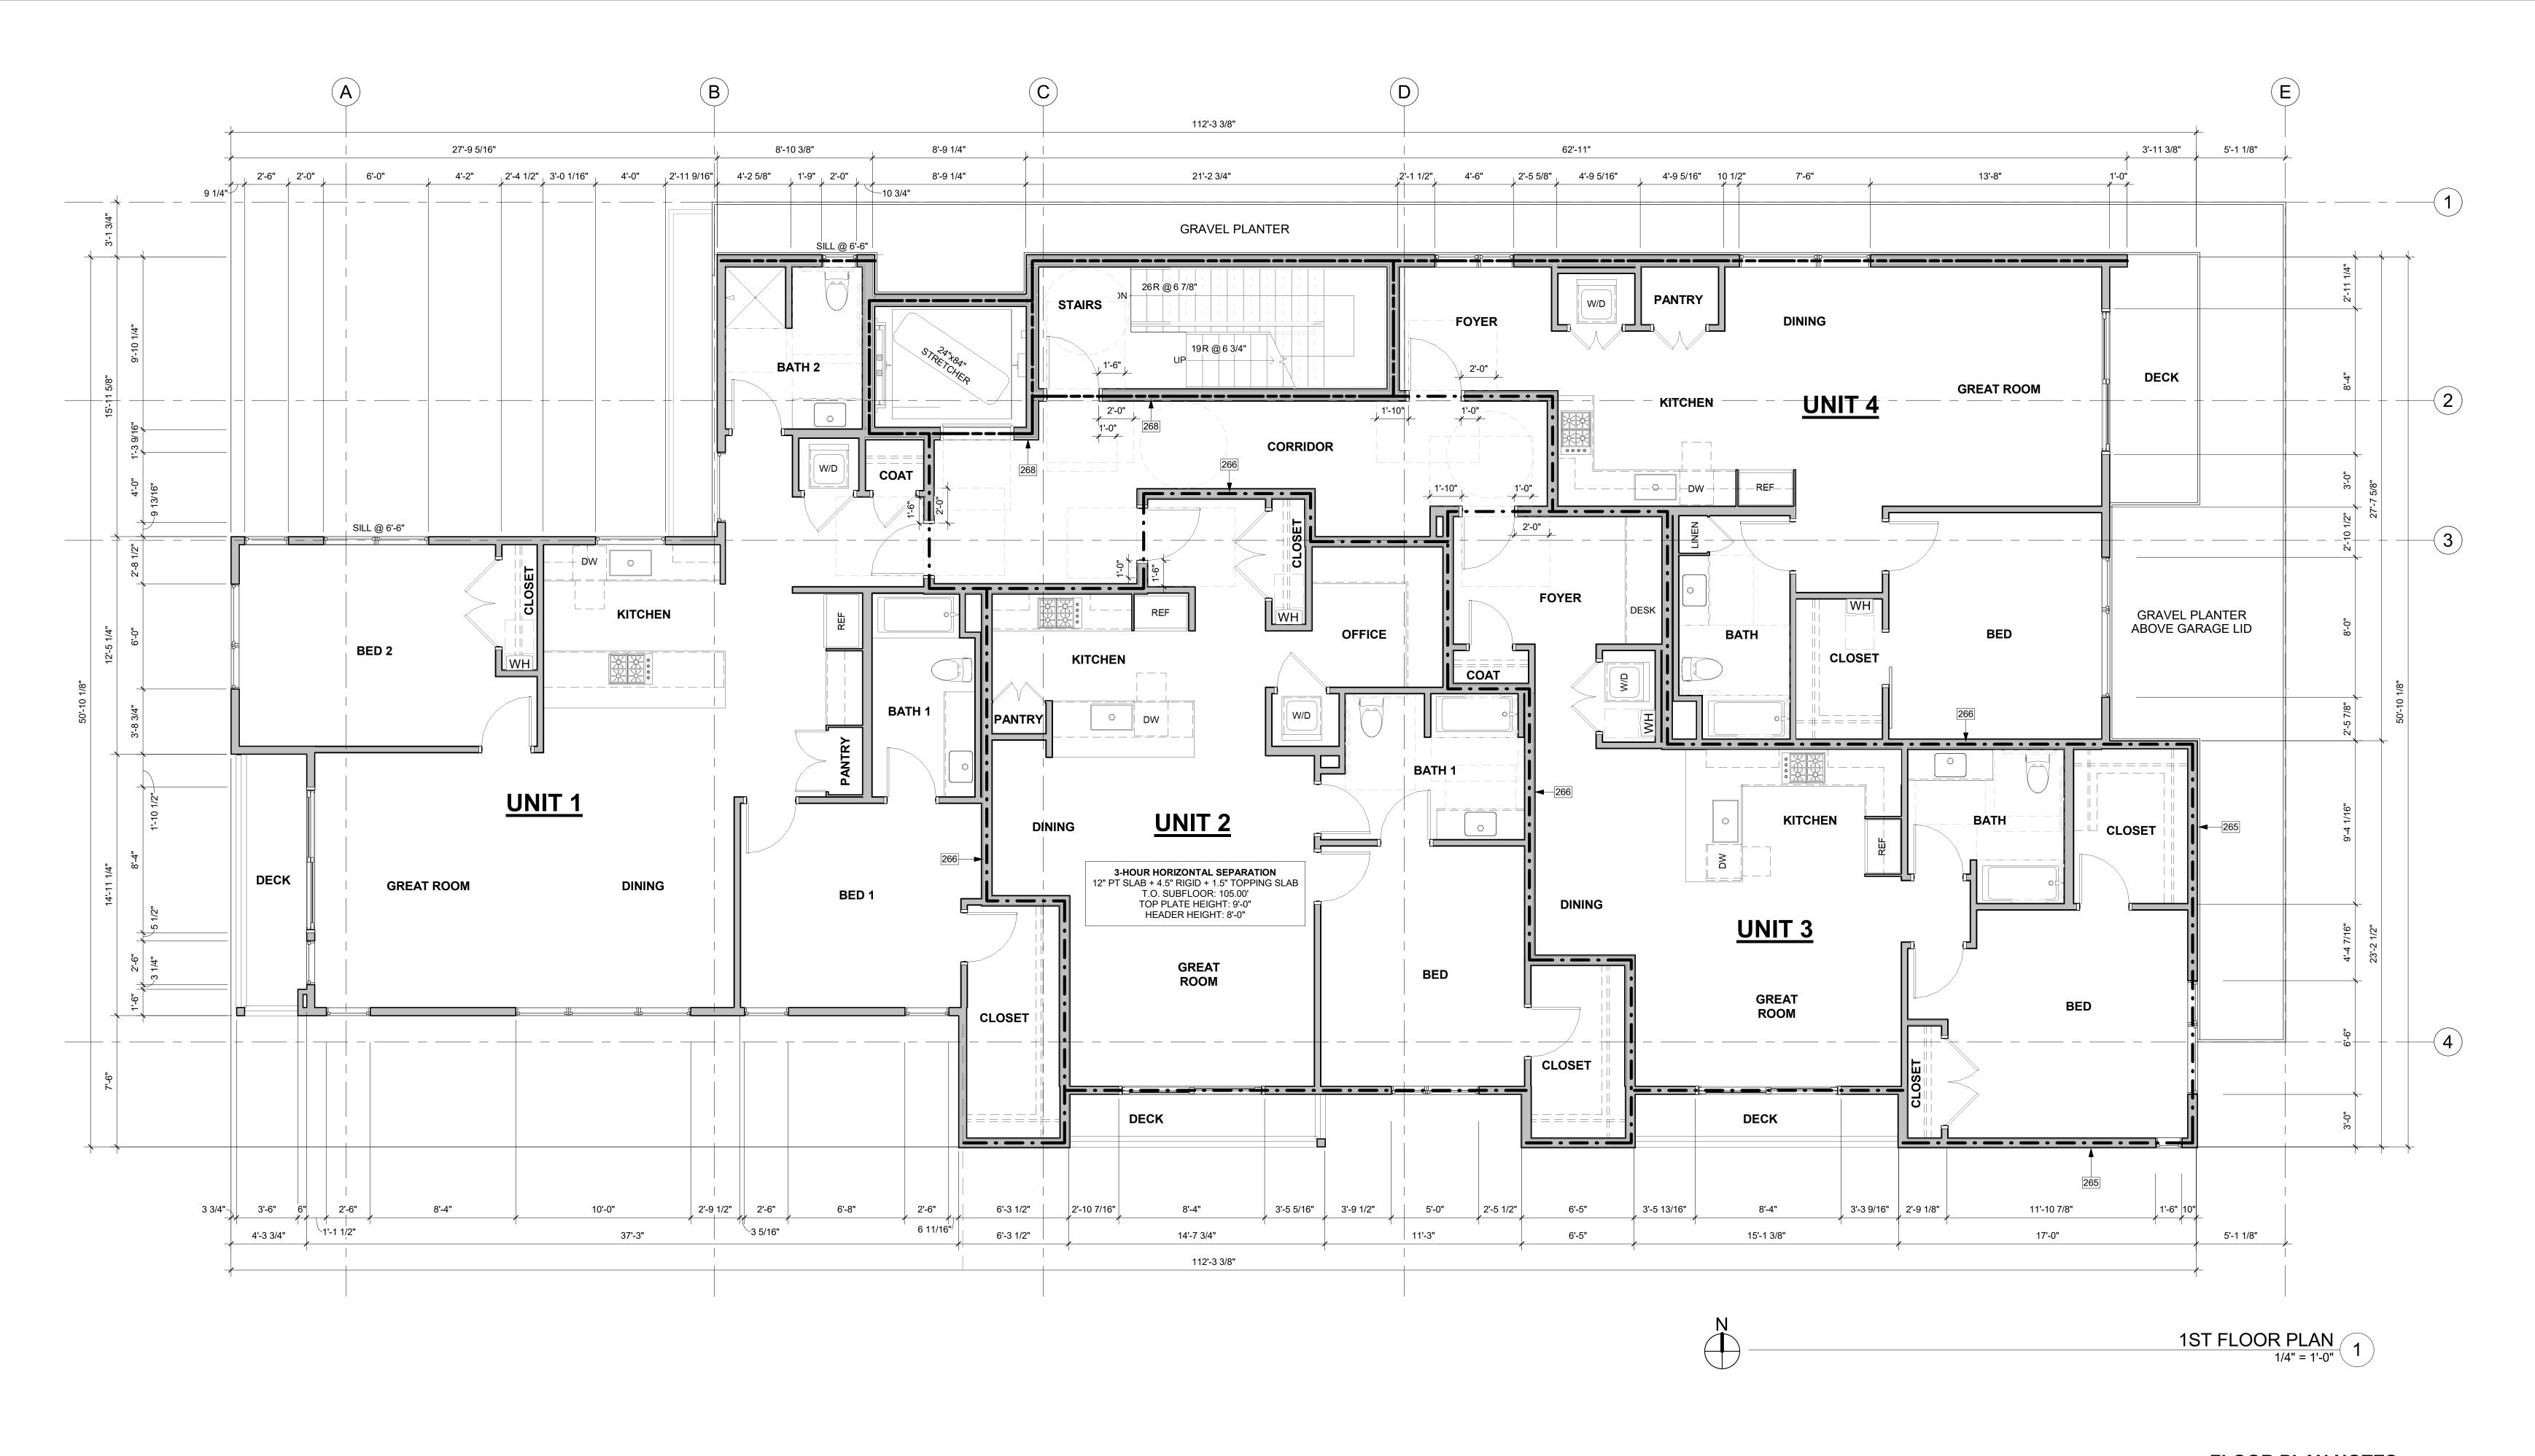

1-HOUR RATED EXTERIOR WALL; WP 8105. SEE ASSEMBLY DETAIL ON A0.5a.
 1-HOUR RATED FIRE PARTITION; WP 3242. STC RATING OF 50-54. SEE ASSEMBLY DETAIL ON A0.5a
 2-HOUR RATED ELEVATOR SHAFT; WP 3825. STC RATING OF 55-59. SEE ASSEMBLY DETAIL ON A0.5a.

FLOOR PLAN NOTES

- CONTRACTOR SHALL VERIFY ALL NOTES, DIMENSIONS & CONDITIONS PRIOR TO CONSTRUCTION.
- SEE STRUCTURAL DRAWINGS FOR ALL POSTS, BEAMS AND HEADERS.
 PROVIDE SOLID BLOCKING OVER SUPPORTS.
- PROVIDE FIRE BLOCKING @ ALL PLUMBING PENETRATIONS.
 WINDOWS & DOORS ARE SHOWN & NOTED AS NOMINAL SIZES.
 DOOR JAMB 4.5" FROM CORNER TYP., U.N.O.
- 7. SEE SHEETS A0.3, A4.0 & A4.1 FOR WINDOW & DOOR HEADER HEIGHTS ABOVE FINISHED FLOOR.
- ALL WOOD IN CONTACT WITH CONCRETE TO BE PRESSURE TREATED.
 EXTERIOR WALLS TO BE 2x6 STUDS @ 16" O.C., U.N.O.
- 10. INSTALL SIMPSON CONC. TO WOOD HOLDOWNS PER STRUCTURAL DRAWINGS, ALSO SEE MANUFACTURER'S SPECS.
 11. SMOKE & CARBON MONOXIDE DETECTORS:
- SHALL BE 110V INTERCONNECTED W/ BATTERY BACKUP.
 SHALL SOUND AN ALARM AUDIBLE IN ALL SLEEPING ROOMS.
 SHALL BE INSTALLED ON EACH FLOOR AND IN ALL BEDROOMS.
 SHALL BE INSTALLED IN EACH LOCATION WHERE THERE IS A CEILING CHANGE OF GREATER THAN 24"
- 12. FRESH AIR PROVIDED BY WHOLE-HOUSE EXHAUST FAN WITH FRESH AIR PORT (NET 4 SF IN MIN. OPENING) AT EACH HABITABLE ROOM. A TIMER OPERATES AN EXHAUST FAN WHICH PULLS OUTSIDE AIR THROUGH AIR
- INLETS LOCATED IN EACH HABITABLE ROOM.

 13. LIMITING DEVICE FOR TUBS TO PROVIDE MAX. 120°F HOT WATER

 TEMPERATURE
- TEMPERATURE.

 FOOTINGS SHALL BEAR ON SOLID UNDISTURBED EARTH (CONTROLLED, COMPACTED STRUCTURAL FILL OR BOTH). DEPTH OF FOOTINGS TO BE DETERMINED BY STRUCTURAL ENGINEER. FOUNDATION EXCAVATION, BACKFILL AND COMPACTION SHALL CONFORM TO SPECIFICATION REQUIREMENTS. THIS CONSTRUCTION WORK, INCLUDING DRAINAGE, SHORING AND SUCH OTHER RELATED WORK AS REQUIRED, SHALL BE CONDUCTED BY THE CONTRACTOR. STOP WORK IF RECOMMENDED EXCAVATION CUT OR BEARING SOIL CHANGES OCCUR IN EITHER HORIZONTAL OR VERTICAL DIRECTION AND NOTIFY IMMEDIATELY THE GEOTECHNICAL ENGINEER AND STRUCTURAL ENGINEER. AT WHICH POINT

THE ENGINEERS SHALL DETERMINE CAUSE OF DISPLACEMENT AND

DEVELOP AND IMPLEMENT REMEDIAL MEASURES.

1-HOUR RATED WALL ASSEMBLY
2-HOUR RATED WALL ASSEMBLY
3-HOUR RATED WALL ASSEMBLY

FIRE-RESISTANCE ASSEMBLIES

SYMBOL LEGEND

HOUSE VENTILATION

POWDER

SYMBOL LOCATION MINIMUM FAN REQUIREMENTS

SEGMENT.

2018 IRC - PROVIDE WHOLE HOUSE VENTILATION PER M1505.4, INTERMITTENT

WHOLE HOUSE VENTILATION USING EXHAUST FAN PER 1505.4.1.2 (WA) AND TABLE

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KITCHEN MIN. 100 CFM (INTERMITTENT) @ 0.25" WG (TABLE

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BATH & MIN. 50 CFM (INTERMITTENT) @ 0.25" WG (TABLE M1505.4.4)

LAUNDRY MIN. 210 A (INTERMITTENT) @ 0.25" WG - TO FUNCTION AND LOPABELED AS WHOLE HOUSE FAN (4-5 BEDSOALIS

M1505.4.4) RANGE HOOD OR DOWN DRAFT EXHAUST FAN

4501<6000 SF) TO OPERATE 50% OF TIME IN EACHOUR

RATED AT MIN. 100 CFM AT 0.10" WG MAY BE USED FOR EXHAUST FAN REQUIREMENT. IF OVER 400 CFM, MAKEUP

AIR IS REQUISED IN THE SAME ROOM PER M1503.6.

SEE TITLE SHEET A0.0 FOR COMPLETE SYMBOL INDEX.

MEDICI ARCHITECTS

11711 SE 8TH STREET 200 W. RIVER ST. SUITE 100 SUITE 301
BELLEVUE, WA 98005 KETCHUM, ID 83340
TEL: (425) 453-9298 TEL: (208) 726-0194

REGISTRATION:



REVISIONS: DATE:

2900 78TH AVE SE

2900 Development LLC

PROJECT / CLIENT:

JOB ADDRESS: 2900 78TH AVE SE MERCER ISLAND, 98040

DRAWING NAME:

1ST FLOOR PLAN

Drawn By: KH
Checked By: ST

PHASE:

Owner Approval:


DESIGN REVIEW

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APPROVED FOR CONSTRUCTION:

PROJECT No.: A21 021

DATE: 4/29/2023

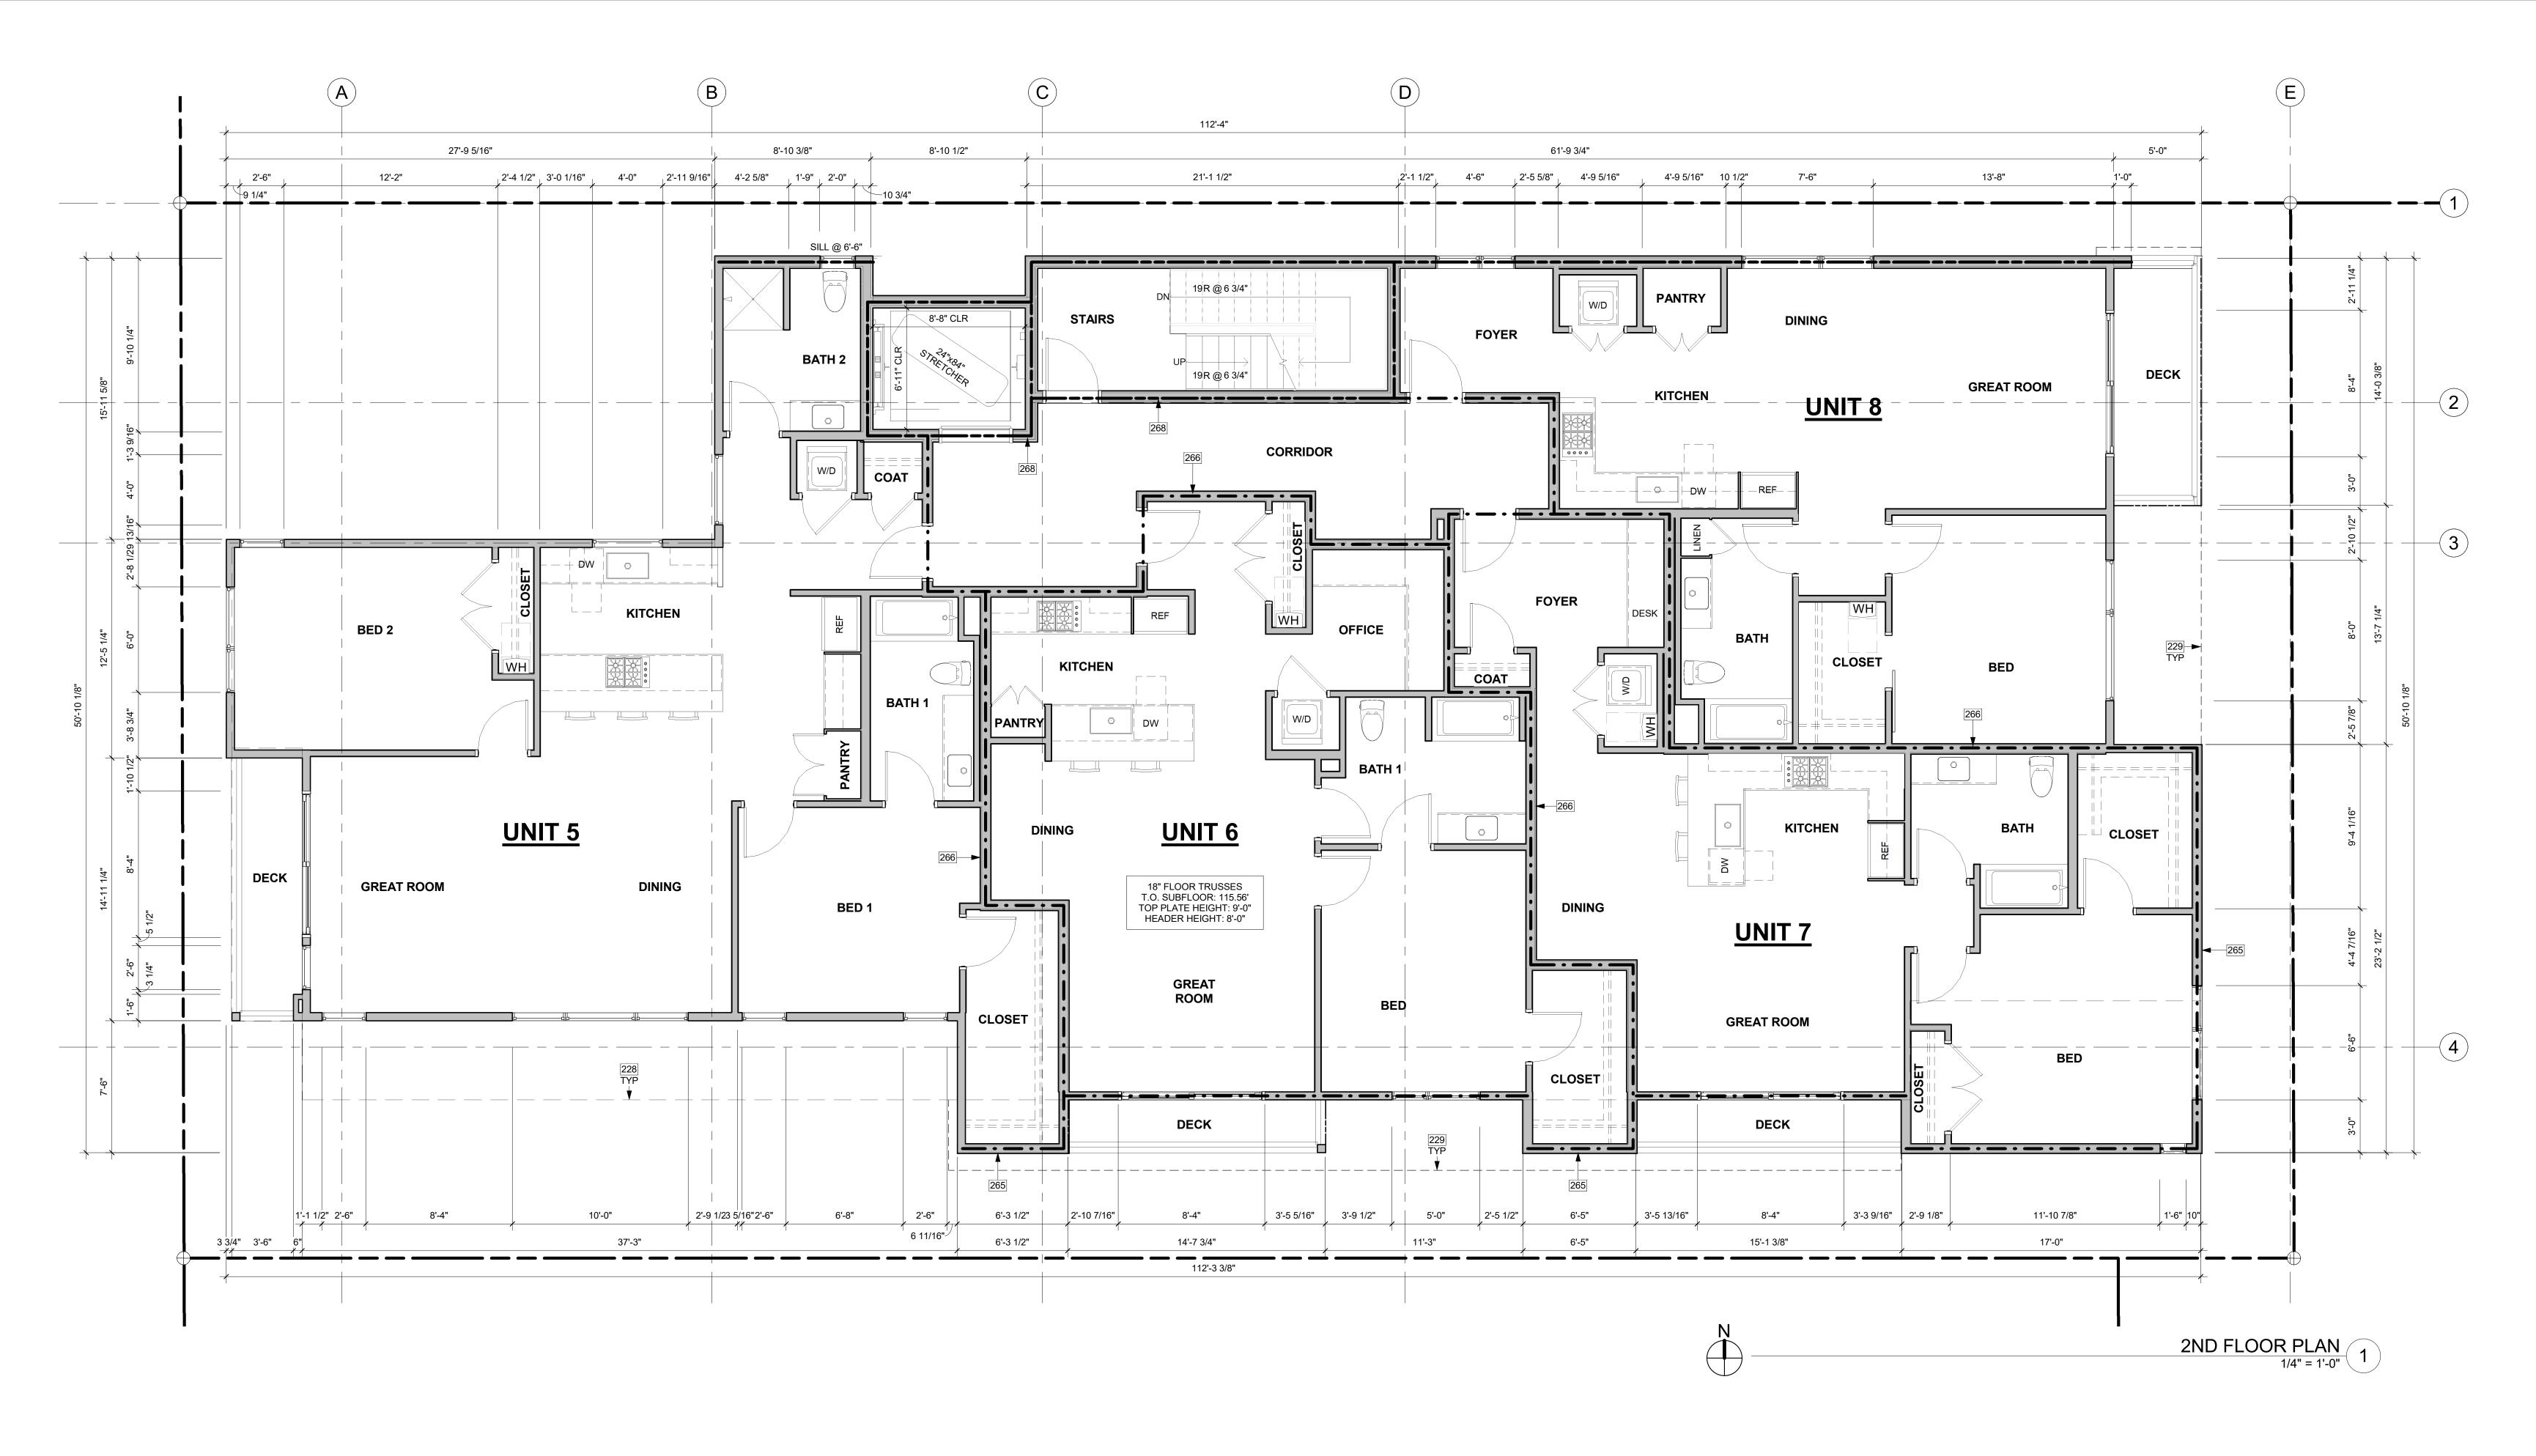

228 LONG DASHED LINE OF BUILDING ABOVE.

ASSEMBLY DETAIL ON A0.5a.

229 LONG DASHED LINE OF ROOF ABOVE.

265 1-HOUR RATED EXTERIOR WALL; WP 8105. SEE ASSEMBLY DETAIL ON A0.5a. 266 1-HOUR RATED FIRE PARTITION; WP 3242. STC RATING OF 50-54. SEE

ASSEMBLY DETAIL ON A0.5a 268 2-HOUR RATED ELEVATOR SHAFT; WP 3825. STC RATING OF 55-59. SEE

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HOUSE VENTILATION

SYMBOL	LOCATION	MINIMUM FAN REQUIREMENTS
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FLOOR PLAN NOTES

- CONTRACTOR SHALL VERIFY ALL NOTES, DIMENSIONS & CONDITIONS PRIOR TO CONSTRUCTION.
- SEE STRUCTURAL DRAWINGS FOR ALL POSTS, BEAMS AND HEADERS.
- PROVIDE SOLID BLOCKING OVER SUPPORTS.
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- DOOR JAMB 4.5" FROM CORNER TYP., U.N.O.
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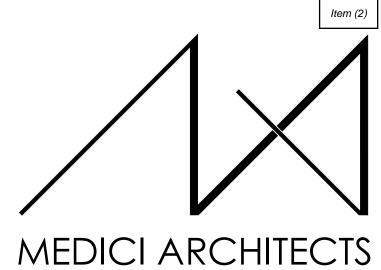
HORIZONTAL OR VERTICAL DIRECTION AND NOTIFY IMMEDIATELY THE GEOTECHNICAL ENGINEER AND STRUCTURAL ENGINEER. AT WHICH POINT THE ENGINEERS SHALL DETERMINE CAUSE OF DISPLACEMENT AND DEVELOP AND IMPLEMENT REMEDIAL MEASURES.

FIRE-RESISTANCE ASSEMBLIES

- - - 1-HOUR RATED WALL ASSEMBLY 2-HOUR RATED WALL ASSEMBLY 3-HOUR RATED WALL ASSEMBLY


SYMBOL LEGEND

SEE TITLE SHEET A0.0 FOR COMPLETE SYMBOL INDEX.



200 W. RIVER ST.

BELLEVUE, WA 98005 KETCHUM, ID 83340

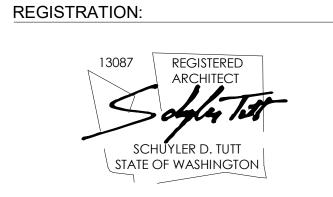

12/13/22 INTAKE DATE: **REVISIONS:** PROJECT / CLIENT:

2900 78TH AVE SE

2900 Development LLC

JOB ADDRESS: 2900 78TH AVE SE MERCER ISLAND, 98040

DRAWING NAME:

2ND FLOOR PLAN

Drawn By: KH Checked By: ST

Owner Approval:

PHASE:

DESIGN REVIEW


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written permission from the Architect.

PROJECT No.: A21 021

DATE: 4/29/2023



- 227 SHORT DASHED LINE OF BUILDING BELOW.
- 229 LONG DASHED LINE OF ROOF ABOVE.
- 265 1-HOUR RATED EXTERIOR WALL; WP 8105. SEE ASSEMBLY DETAIL ON A0.5a. 266 1-HOUR RATED FIRE PARTITION; WP 3242. STC RATING OF 50-54. SEE
- ASSEMBLY DETAIL ON A0.5a 268 2-HOUR RATED ELEVATOR SHAFT; WP 3825. STC RATING OF 55-59. SEE ASSEMBLY DETAIL ON A0.5a.

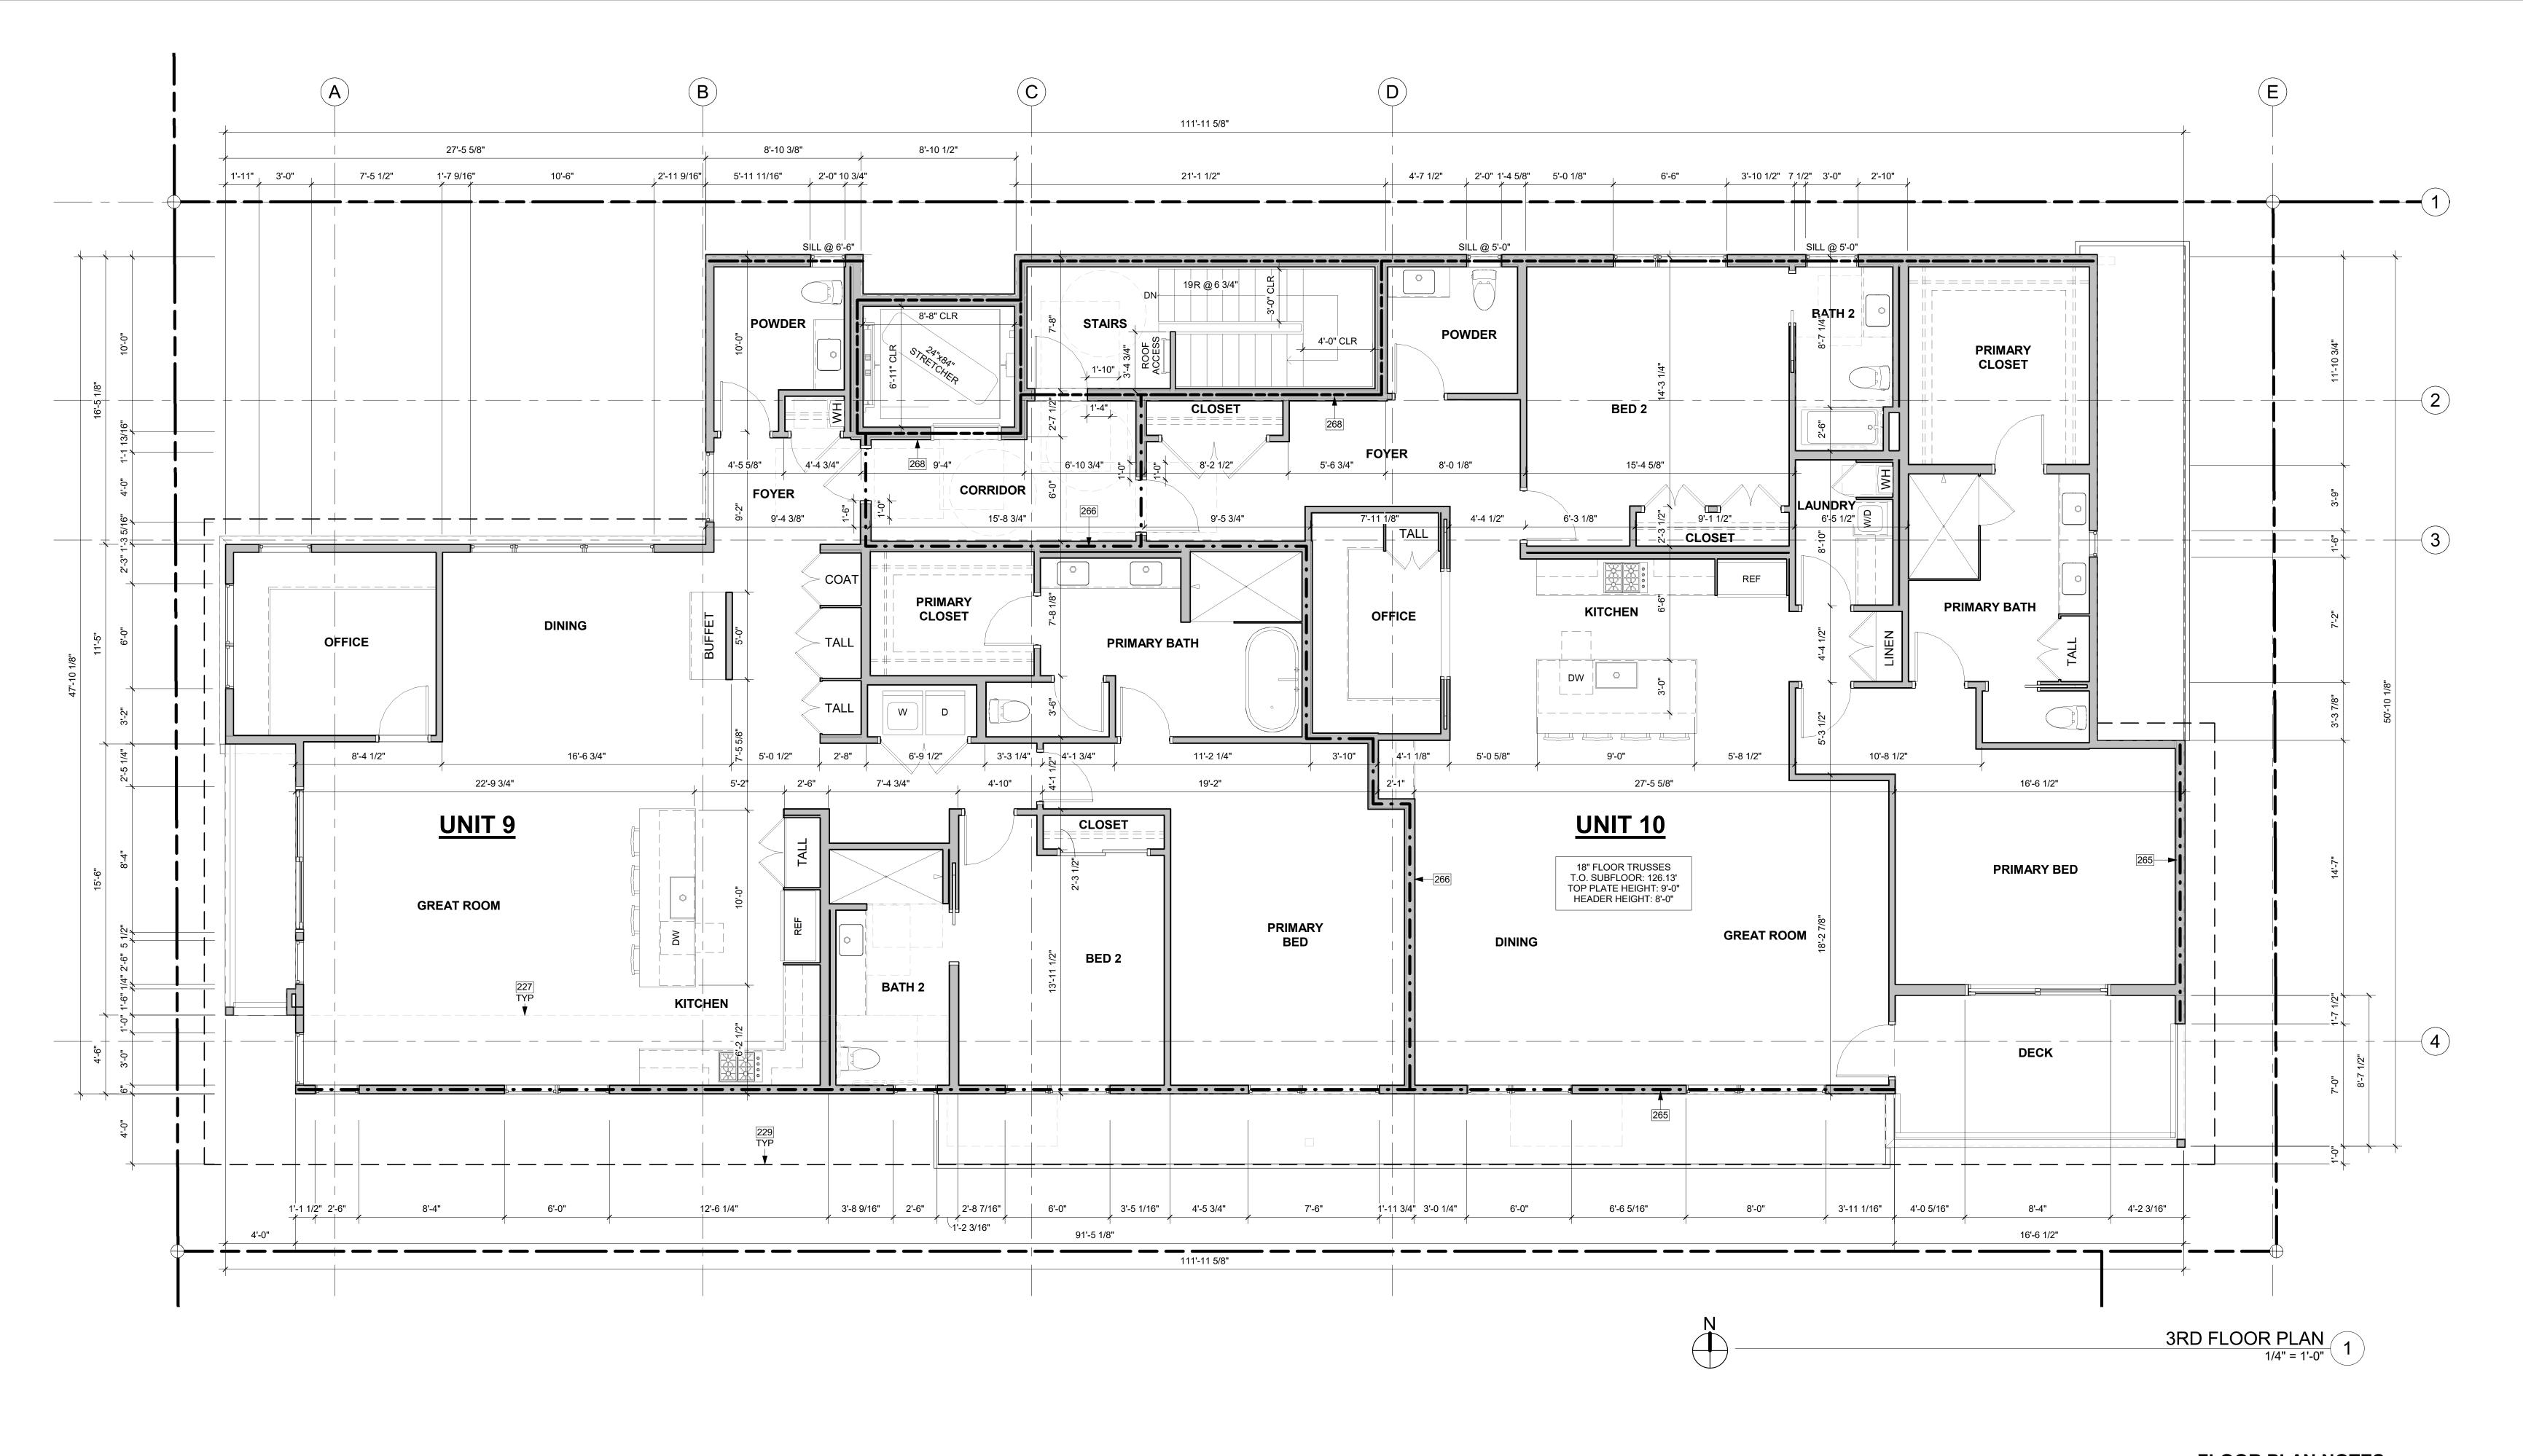FLOOR PLAN NOTES

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- SEE STRUCTURAL DRAWINGS FOR ALL POSTS, BEAMS AND HEADERS. PROVIDE SOLID BLOCKING OVER SUPPORTS.
- PROVIDE FIRE BLOCKING @ ALL PLUMBING PENETRATIONS. WINDOWS & DOORS ARE SHOWN & NOTED AS NOMINAL SIZES.
- DOOR JAMB 4.5" FROM CORNER TYP., U.N.O. SEE SHEETS A0.3, A4.0 & A4.1 FOR WINDOW & DOOR HEADER HEIGHTS ABOVE FINISHED FLOOR.
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DEVELOP AND IMPLEMENT REMEDIAL MEASURES.

- - - 1-HOUR RATED WALL ASSEMBLY 2-HOUR RATED WALL ASSEMBLY 3-HOUR RATED WALL ASSEMBLY

SYMBOL LEGEND

HOUSE VENTILATION

POWDER

SYMBOL LOCATION MINIMUM FAN REQUIREMENTS

SEGMENT.

2018 IRC - PROVIDE WHOLE HOUSE VENTILATION PER M1505.4, INTERMITTENT

WHOLE HOUSE VENTILATION USING EXHAUST FAN PER 1505.4.1.2 (WA) AND TABLE

1505.4.3(1) & (3) (WA); PROVIDE CONTROLS PER 1505.4.2. COMPLY WITH WSEC R403.

KITCHEN MIN. 100 CFM (INTERMITTENT) @ 0.25" WG (TABLE

** MAKEUP AIR IS NOT REQUIRED IF ALL GAS APPLIANCES IN THE HOUSE HAVE A DIRECT VENT OR MECHANICAL DRAFT VENT SYSTEM, PER MODIFICATION M1503.6.

BATH & MIN. 50 CFM (INTERMITTENT) @ 0.25" WG (TABLE M1505.4.4)

LAUNDRY MIN. 210 PA (INTERMITTENT) @ 0.25" WG - TO FUNCTIVE AND WASELED AS WHOLE HOUSE FAN (4-5 BEDSOA VIS

M1505.4.4) RANGE HOOD OR DOWN DRAFT EXHAUST FAN

EXHAUST FAN REQUIREMENT. IF OVER 400 CFM, MAKEUP

4501<6000 SF) TO OPERATE 50% OF TIME IN EAUY -HOUR

RATED AT MIN. 100 CFM AT 0.10" WG MAY BE USED FOR

AIR IS REQUISED IN THE SAME ROOM PER M1503.6.

SEE TITLE SHEET A0.0 FOR COMPLETE SYMBOL INDEX.

MEDICI ARCHITECTS

200 W. RIVER ST.

REGISTRATION:

BELLEVUE, WA 98005



SUITE 301

KETCHUM, ID 83340

12/13/22 INTAKE DATE: **REVISIONS:**

2900 78TH AVE SE

2900 Development LLC

PROJECT / CLIENT:

JOB ADDRESS: 2900 78TH AVE SE MERCER ISLAND, 98040

DRAWING NAME:

3RD FLOOR PLAN

Drawn By: KH Checked By: ST

PHASE:

Owner Approval:

DESIGN REVIEW


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written permission from the Architect.

PROJECT No.: A21 021

DATE: 4/29/2023



DASHED LINE OF BUILDING BELOW.
 1-HOUR RATED ROOF ASSEMBLY; RC 2604. SEE ASSEMBLY DETAIL ON A0.5a
 2-HOUR RATED ROOF ASSEMBLY AT STAIRS AND ELEVATOR SHAFT; RC 2751. SEE ASSEMBLY DETAIL ON A0.5a.

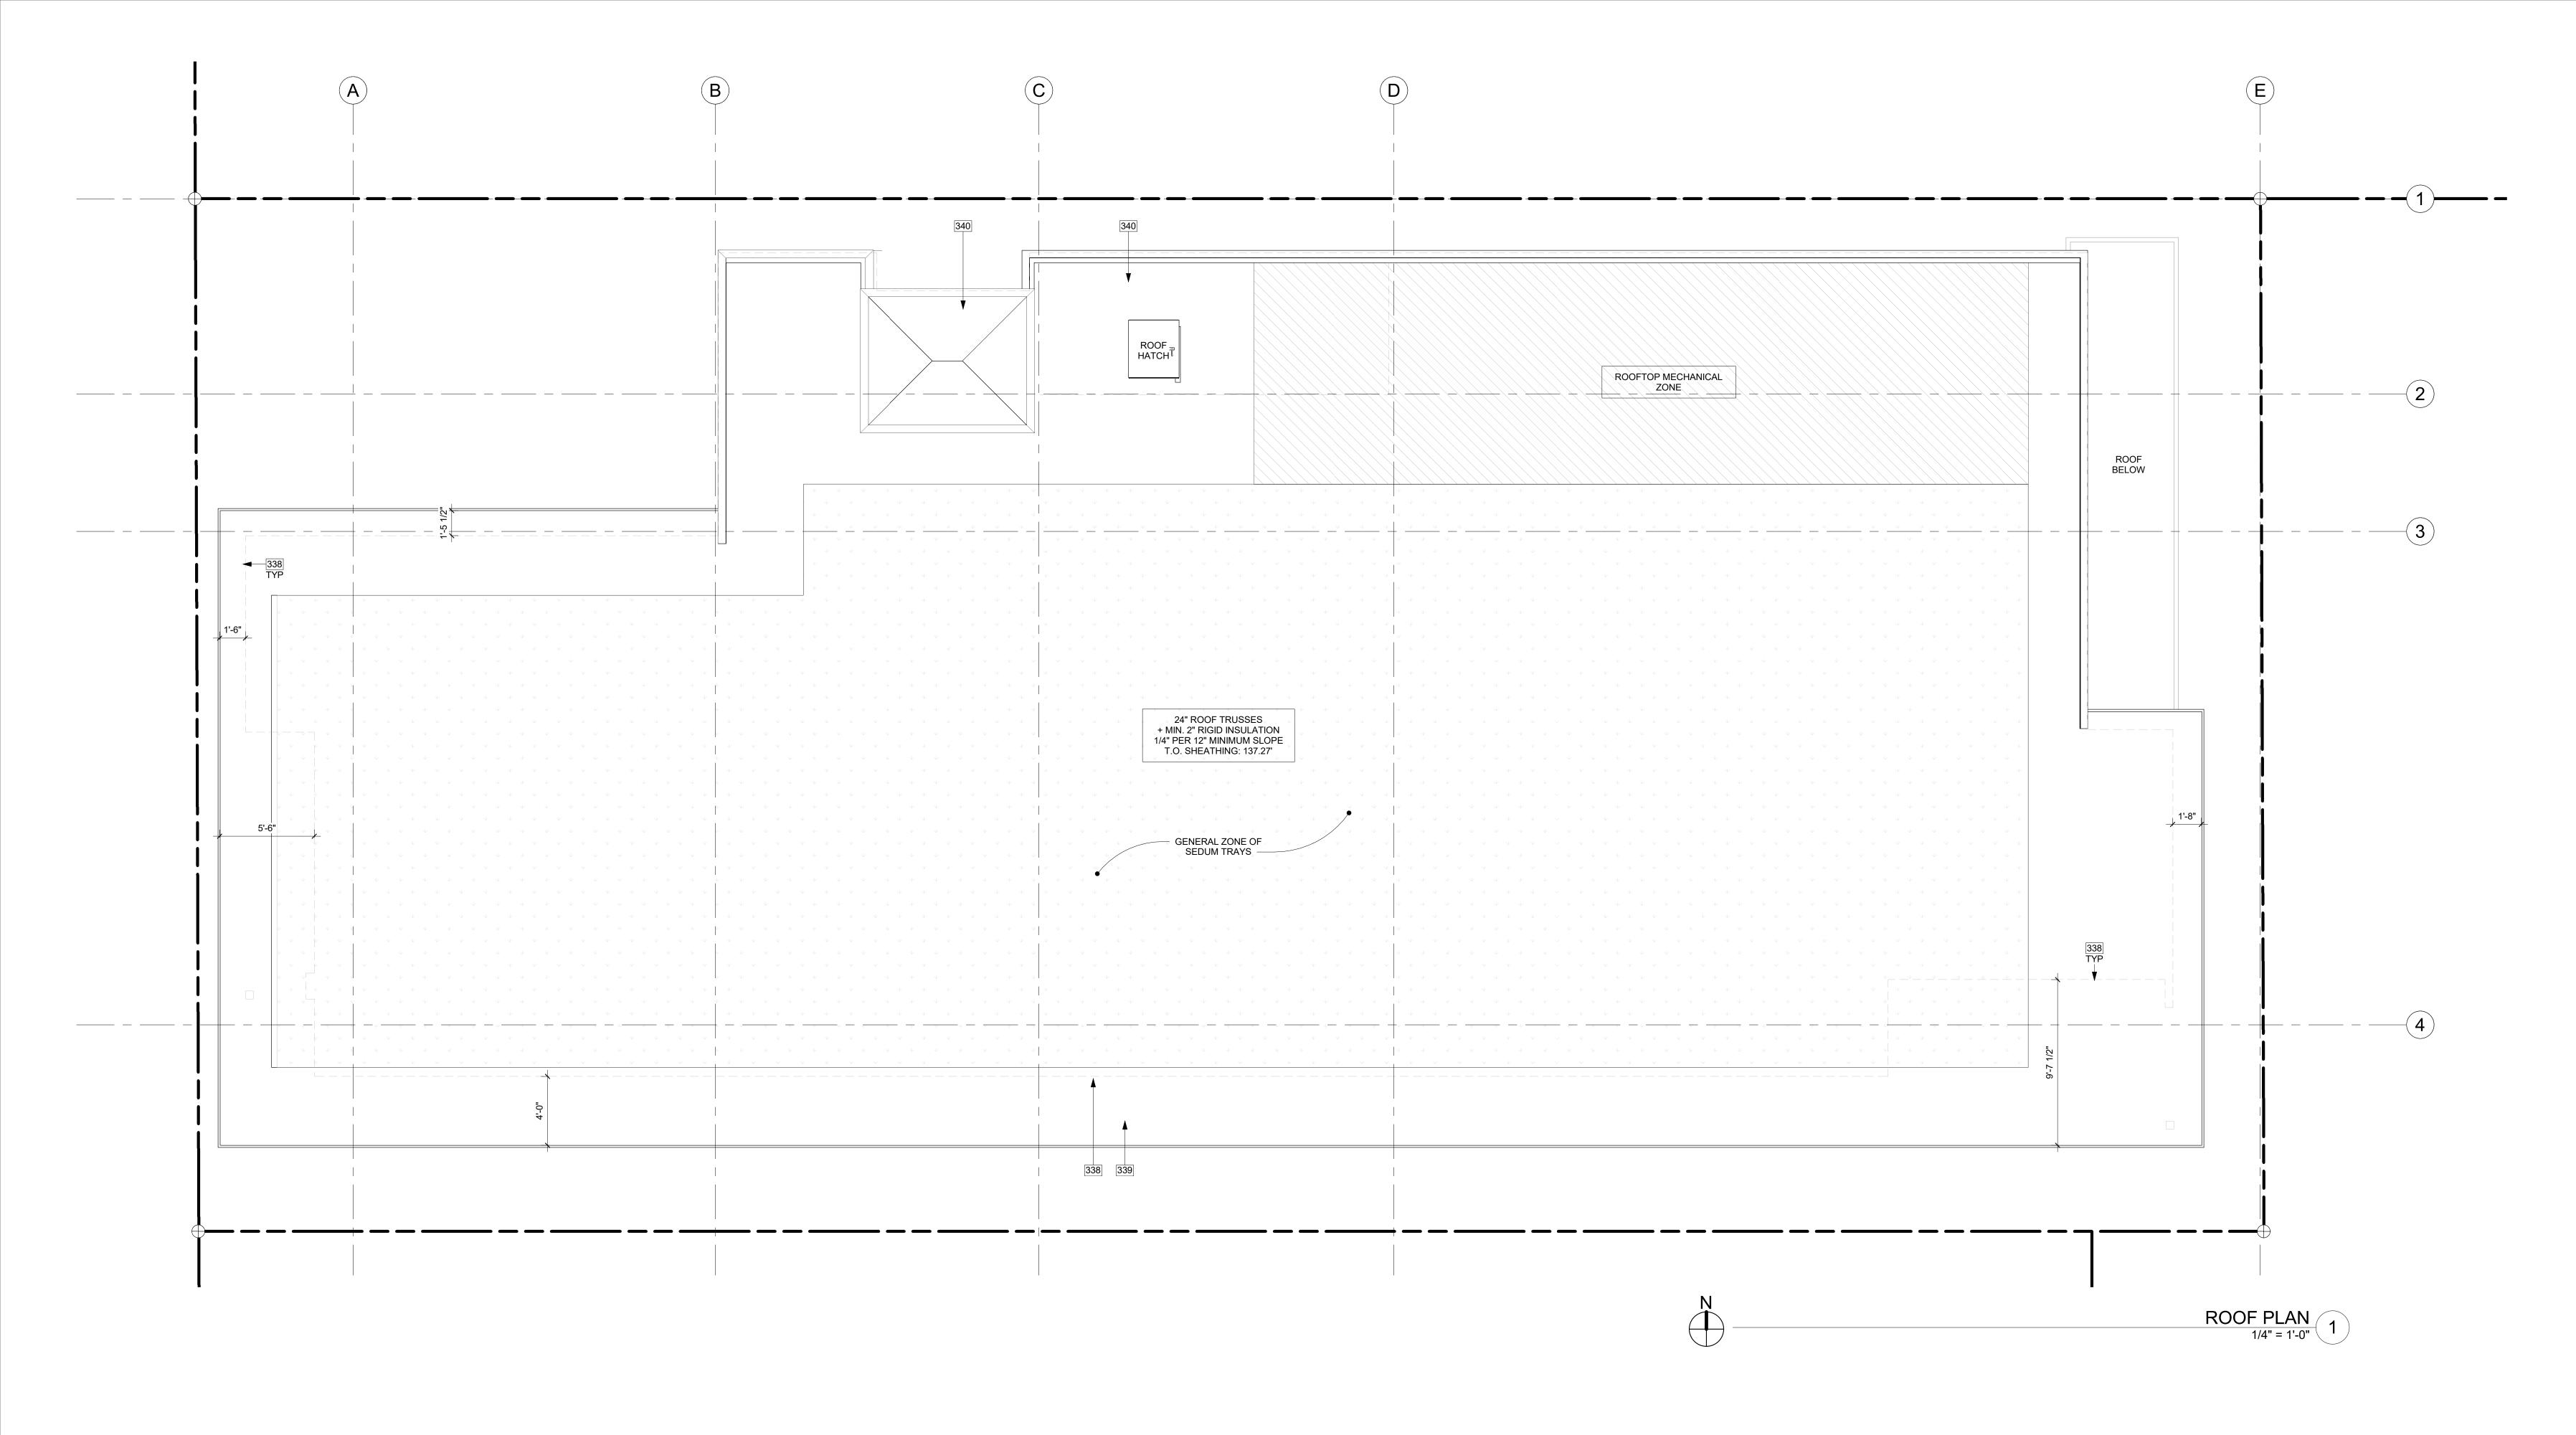

ROOF VENTILATION

ROOF CONSTRUCTION:	PARALLEL CHORD TRUSSES	
ROOF AREA:	XXX SF	
VENTILATION REQUIRED:	(XXX SF x 144 SI) / 150* = XX ^V	I REQUIRED
PROPOSED VENTILATION:		-6
(4) 2-1/2" DIA. HOLES PER 24":	9.8 SI / LF - 25°	USLF
PROVIDE:	87 LF EA'	. 15 SI
2" WIDE RIDGE VENT:	18.5	18 SI / LF
PROVIDE:	NTIL	= 0 SI
ROOF HAT VENT:	OE VEI	= 50 SI / VENT
PROVIDE:	200 NTS	= 600 SI
TOTAL MIN. VENTILATION	J.45 SI IS GREATE	R THAN 1237.9 REQ.
* PER IRC R806.2, MINIMUM N	SY VENTILATION AREA SH	
LOCATED IN THE UPPER PORT	TION OF ROOF, PER IRC SECTION	ON R806.2.2
	ROOF AREA: VENTILATION REQUIRED: PROPOSED VENTILATION: (4) 2-1/2" DIA. HOLES PER 24": PROVIDE: 2" WIDE RIDGE VENT: PROVIDE: ROOF HAT VENT: PROVIDE: TOTAL MIN. VENTILATION * PER IRC R806.2, MINIMUM IN AREA. AS AN ALTERNATIVE REDUCED TO 1/300 WHEN LO	ROOF AREA: VENTILATION REQUIRED: (XXX SF x 144 SI) / 150* = XXY PROPOSED VENTILATION: (4) 2-1/2" DIA. HOLES PER 24": 9.8 SI / LF - 25' PROVIDE: 2" WIDE RIDGE VENT: 18 S' PROVIDE: ROOF HAT VENT: PROVIDE: TOTAL MIN. VENTILATION



MEDICI ARCHITECTS

11711 SE 8TH STREET 200 W. RIVER ST.
SUITE 100 SUITE 301
BELLEVUE, WA 98005 KETCHUM, ID 83340
TEL: (425) 453-9298 TEL: (208) 726-0194

REGISTRATION:



REVISIONS: DATE:

PROJECT / CLIENT:

2900 78TH AVE SE

2000 / 0111 / (V 2 0)

2900 Development LLC

JOB ADDRESS: 2900 78TH AVE SE MERCER ISLAND, 98040

DRAWING NAME:

ROOF PLAN

Drawn By: KH
Checked By: ST
Owner Approval:

PHASE:

DESIGN REVIEW

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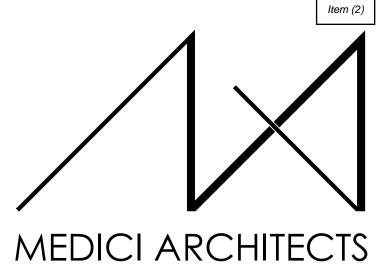
APPROVED FOR CONSTRUCTION:

PROJECT No.: A21 021

DATE: 4/29/2023

A3.0





200 W. RIVER ST. SUITE 100 SUITE 301
BELLEVUE, WA 98005
TEL: (425) 453-9298 TEL: (208) 726-0194

REGISTRATION:



12/13/22 INTAKE DATE: **REVISIONS:** PROJECT / CLIENT:

2900 78TH AVE SE

2900 Development LLC

JOB ADDRESS: 2900 78TH AVE SE MERCER ISLAND, 98040

TRESPA - LUMEN LONDON GREY OBLIQUE FINISH MATERIAL: ACCENT FACADE

SHERWIN WILLIAMS SW 6258 - TRICORN BLACK MATERIAL: INFILL PANELS FASCIA SOFFITS

CONCRETE

MATERIAL: PARKING GARAGE WALLS STRUCTURAL COLUMNS

GRAY FLASHING

MATERIAL: TRASH ENCLOSURE DOORS

TRESPA - LUMEN LONDON GREY DIFFUSE FINISH MATERIAL: **WEST FACADE** SOUTH FACADE

NORTH CLAD

BONE WHITE

MATERIAL:

ALUMINUM PANEL

WEST FACADE

SOUTH FACADE

FIBER CEMENT **PANEL** SW 7067- CITYSCAPE MATERIAL: NORTH FACADE EAST FACADE

BLACK MATERIAL: STRUCTURAL STEEL COLUMNS WINDOW AND DOOR FRAMES **RAILING** METAL AWNING EXIT DOOR STEEL PLATES LIGHT FIXTURES GUTTERS / DOWNSPOUTS



FIBER CEMENT V-GROOVE SIDING SW 7048 - URBANE BRONZE MATERIAL: RECESSED FACADES **ELEVATOR SHAFT**



CMU BLOCK MATERIAL: TRASH ENCLOSURE

FLASHING

MATERIALS

ELEVATION NOTES

- VERIFY SHEAR WALL NAILING & HOLDOWNS PER STRUCTURAL PLAN & SCHEDULE PRIOR TO INSTALLING SIDING. WOOD SIDING - SEAL & STAIN ALL SIDES BEFORE INSTALLING AND @ ALL WEATHER PROTECTION. EXTERIOR WALLS SHALL PROVIDE THE BUILDING WITH A WEATHER-RESISTANT EXTERIOR WALL ENVELOPE. THE EXTERIOR WALL ENVELOPE SHALL INCLUDE FLASHING AND BE CONSTRUCTED IN SUCH A MANNER AS TO PREVENT THE ACCUMULATION OF WATER WITHIN
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- PROVIDE CONTINUOUS GUTTERS & DOWNSPOUTS AT EAVES PER PLANS, PROVIDE WEATHER STRIPPING AT ALL EXTERIOR & GARAGE DOORS. CAULK ALL EXTERIOR JOINTS & PENETRATIONS.
- WINDOWS AND DOORS SHALL BE INSTALLED IN ACCORDANCE WITH APPROVED MANUFACTURER'S INSTRUCTIONS. SEE GENERAL NOTES SHEET A0.3 FOR ADDITIONAL NOTES.

DRAWING NAME:

ELEVATIONS

Drawn By: KH Checked By: ST Owner Approval:

PHASE:


DESIGN REVIEW


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APPROVED FOR CONSTRUCTION:

PROJECT No.: A21 021 DATE: 4/29/2023





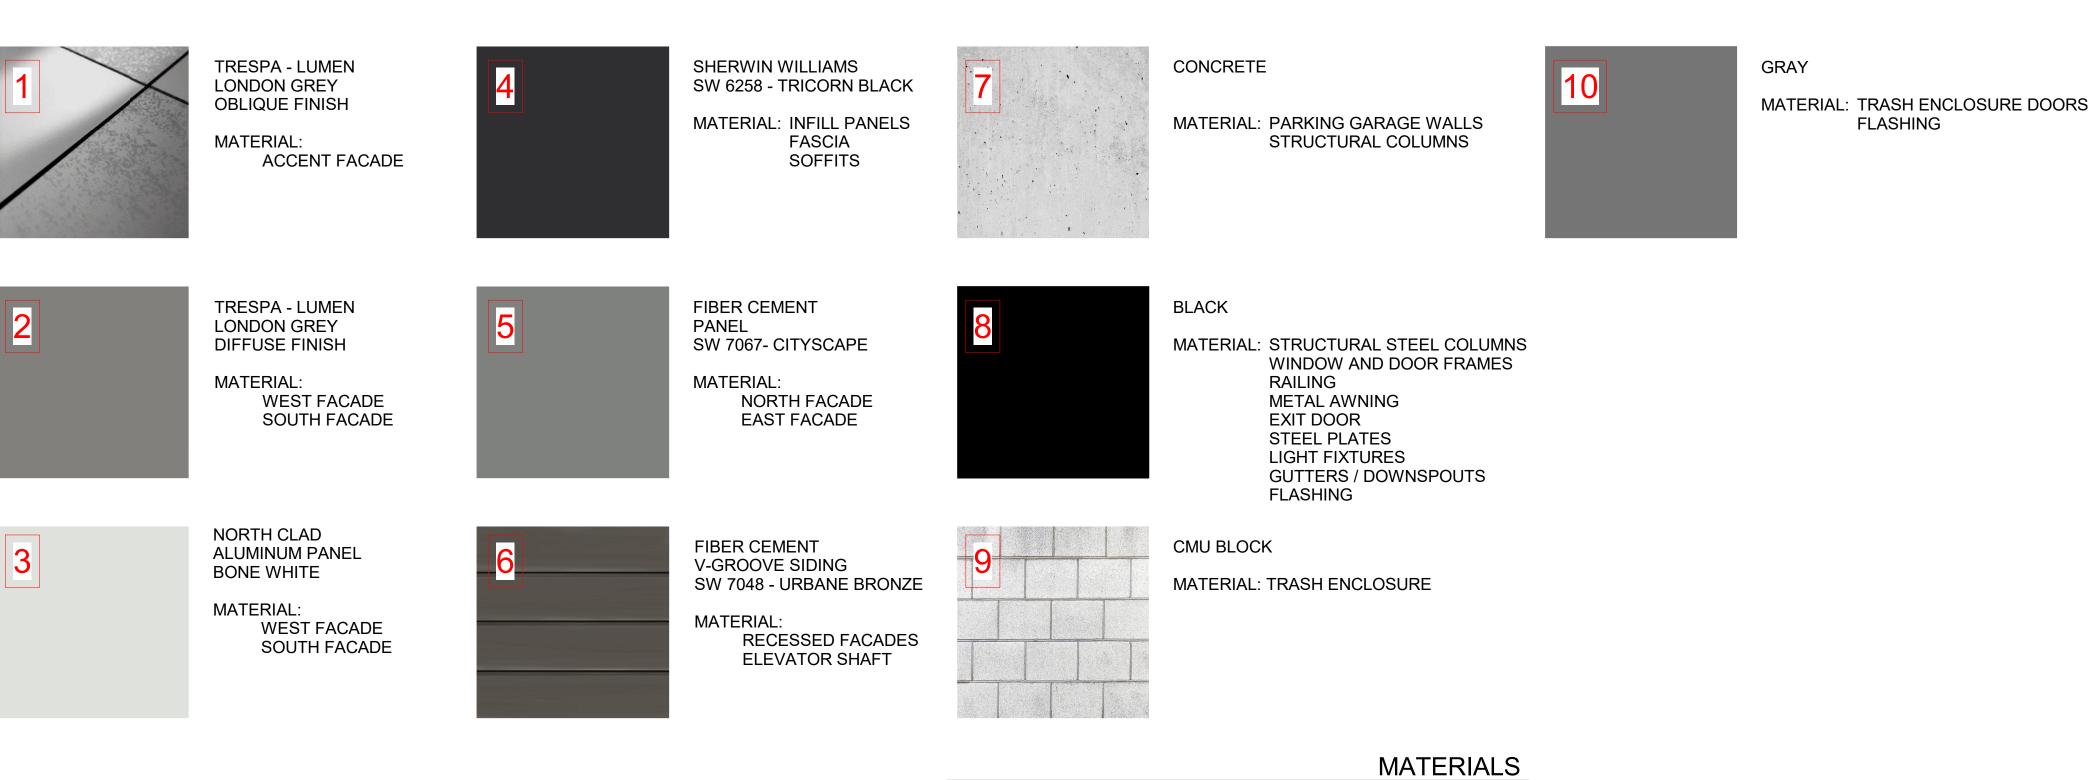

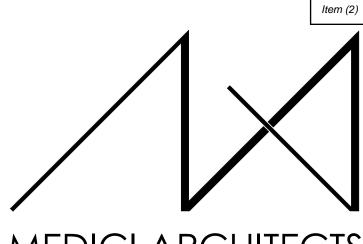200 W. RIVER ST.

MEDICI ARCHITECTS

SUITE 100 SUITE 301
BELLEVUE, WA 98005 KETCHUM, ID 83340
TEL: (425) 453-9298 TEL: (208) 726-0194

REGISTRATION:

INTAKE DATE: 12/13/22 **REVISIONS:** PROJECT / CLIENT:

2900 78TH AVE SE

2900 Development LLC

JOB ADDRESS: 2900 78TH AVE SE MERCER ISLAND, 98040

DRAWING NAME:

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ELEVATION NOTES

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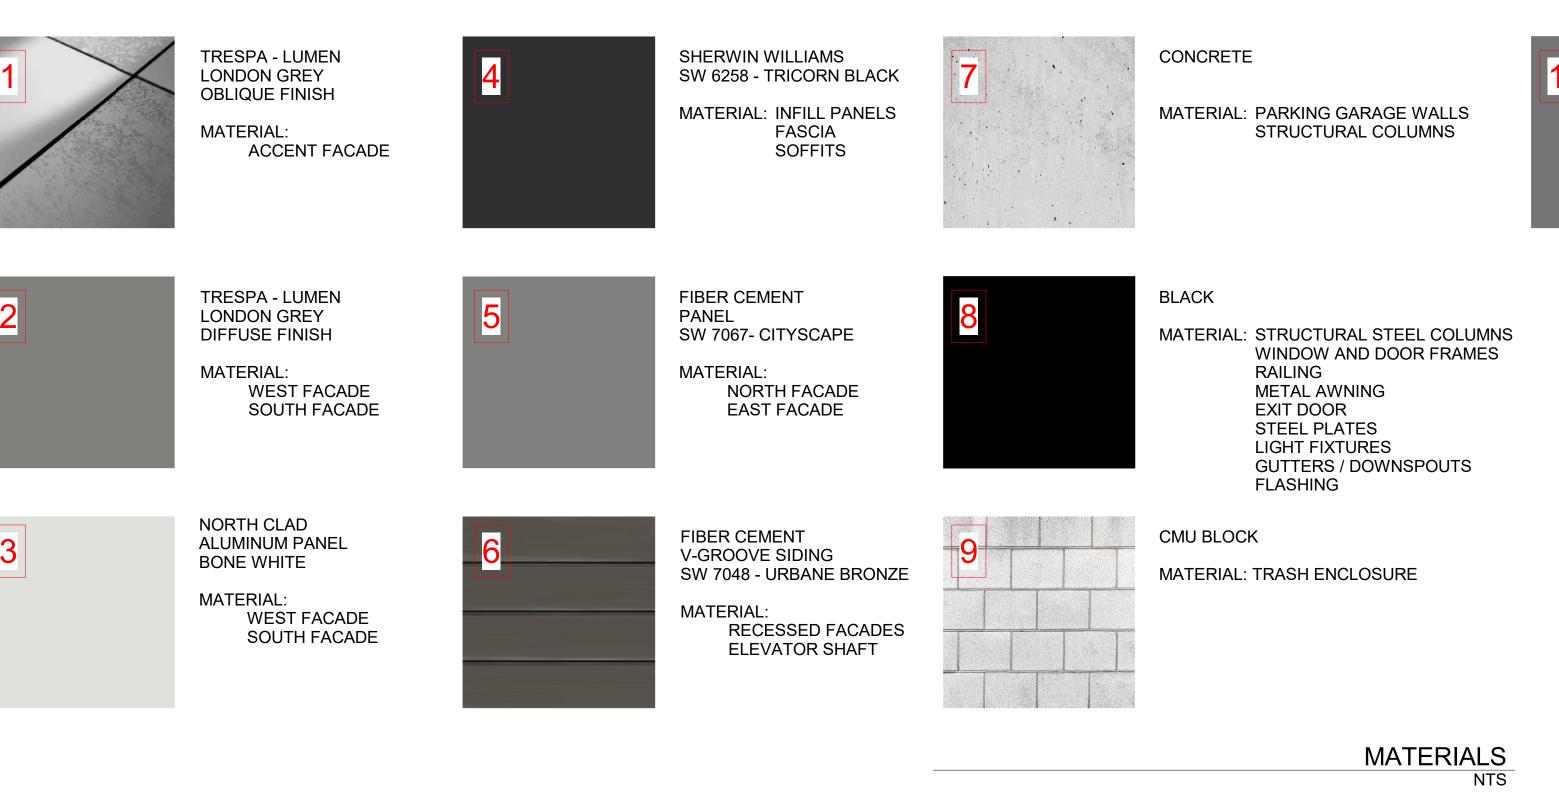
APPROVED MANUFACTURER'S INSTRUCTIONS.

WHEREVER THERE IS A CHANGE IN ROOF SLOPE OR DIRECTION AND AROUND ROOF OPENINGS. WHERE FLASHING IS OF METAL, THE METAL DATE: 4/29/2023 PROVIDE CONTINUOUS GUTTERS & DOWNSPOUTS AT EAVES PER PLANS,



MATERIAL: TRASH ENCLOSURE DOORS

FLASHING




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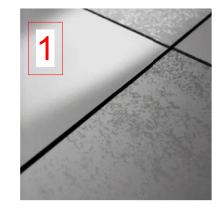
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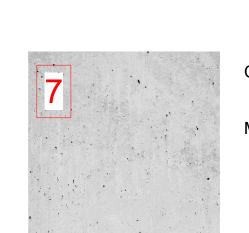
EAST ELEVATION
1/4" = 1'-0"
1




TRESPA - LUMEN **LONDON GREY OBLIQUE FINISH** MATERIAL: ACCENT FACADE



SHERWIN WILLIAMS SW 6258 - TRICORN BLACK MATERIAL: INFILL PANELS FASCIA SOFFITS

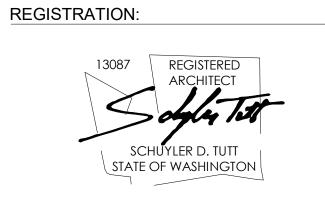

CONCRETE MATERIAL: PARKING GARAGE WALLS STRUCTURAL COLUMNS

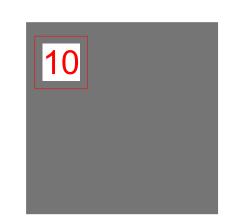

MATERIAL: TRASH ENCLOSURE DOORS FLASHING



LONDON GREY DIFFUSE FINISH MATERIAL: WEST FACADE SOUTH FACADE

NORTH CLAD


BONE WHITE

MATERIAL:


ALUMINUM PANEL

WEST FACADE


SOUTH FACADE

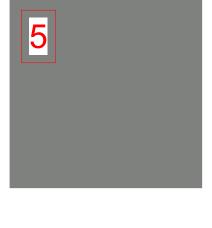


FIBER CEMENT PANEL SW 7067- CITYSCAPE MATERIAL: NORTH FACADE EAST FACADE

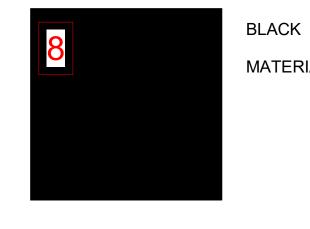

MATERIAL: STRUCTURAL STEEL COLUMNS WINDOW AND DOOR FRAMES **RAILING** METAL AWNING EXIT DOOR STEEL PLATES LIGHT FIXTURES **GUTTERS / DOWNSPOUTS FLASHING**

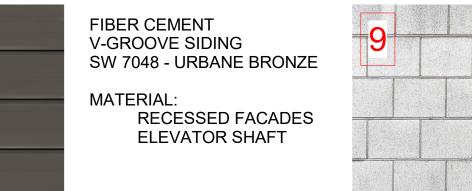

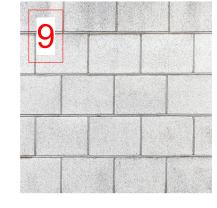

CMU BLOCK MATERIAL: TRASH ENCLOSURE

MATERIALS


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REGISTRATION:



12/13/22 INTAKE DATE: **REVISIONS:** DATE:

PROJECT / CLIENT: 2900 78TH AVE SE

2900 Development LLC

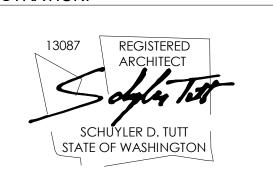JOB ADDRESS: 2900 78TH AVE SE MERCER ISLAND, 98040

DRAWING NAME:

ELEVATIONS

Drawn By: KH Checked By: ST Owner Approval:

PHASE:

DESIGN REVIEW

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DATE: 4/29/2023









SE PERSPECTIVE NTS




NE PERSPECTIVE NTS

NOTE: 3D RENDERINGS ARE FOR ILLUSTRATIVE PURPOSES ONLY. NOT TO BE USED FOR CONSTRUCTION.

MEDICI ARCHITECTS

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PROJECT No.: A21 021

DATE: 4/29/2023

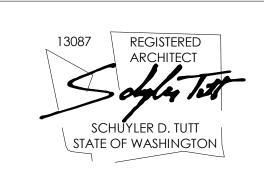

3/15/23

Kelly Hallstrom 2900 Development LLC 3010 77th Ave SE, Ste 108 Mercer Island 98040

Dear Kelly Hallstrom:

The department's Building team has generated the following review comments on the plan set submitted with your DSR22-014. These comments are advisory and have been developed to encourage discussion with the Design Commission on elements of the project which are not finalized and may contribute to or be of interest to the Design Review process.

The review was performed with an emphasis on construction code requirements which may affect the exterior presentation of the development. This is not a comprehensive building permit review and should not be used as such.

- 1. Applicable construction codes can be found in MICC 17.14.010 Section 101. The vesting of construction codes is address in MICC 17.14.101 Section 105.3.4. As of the date of this letter, a complete application for a building permit has not been received for the scope described in this DSR. Washington State is anticipated to adopt 2021-cycle construction codes on July 1, 2023. This review was performed referring to 2018-cycle codes in effect at the time of the DSR application, but a future building permit for this work will be reviewed under the codes in effect at the time of a complete building permit application.
- 2. The numbering of stories used on sheets A0.1b and all A4.x sheets is not consistent with definition for Story Above Grade Plane. WSBC definition for Story Above Grade Plane is any story in which the next story above is more than 6' above grade plane. Renumbering the stories to conform to this definition, the garage floor plan is the 1st story

- above grade plane, and the 3rd floor is the 4th story above grade plane. Table 1006.3.3(1) does not permit a 4th story above grade plane with access to only one exit.
- 3. If a second exit is provided, this site and building configuration will present challenges in addressing exit separation required by WSBC 1007. For instance, if the maximum diagonal dimension of the building is 120 feet, exits would need to be separated by a minimum of 60 feet, which is the width of the lot at the ROW. There are exceptions for reduced separation, but these should be clearly demonstrated.
- 4. An accessible route of travel will be required from the sidewalk to accessible building entrances, and 60% of entrances shall be accessible.
- 5. Considering the number of Stories Above Grade Plane, WSBC 1011.12 requires a stairway to the roof. The exception to this section will not apply if elevator equipment is located in the elevator penthouse, and a stair penthouse will contribute to the height of the structure.
- 6. Previous discussion of this proposal as part of PRE21-032 and PRE22-027 referred to occupiable roof deck. The documents submitted along with DSR22-014 do not appear to include this use, but the roofing systems and thus exterior elevations are not clear. The roof elevation on A4.x sheets is noted as top of roof sheathing and does not include consideration for slope for drainage. A 1/4" per foot slope will create at least a 1' difference in height between north and south elevations, and the roof planting plan L1.0 appears to show a hip framed roof.
- 7. The elevator penthouse is shown extending to the max allowed height. If occupiable roof deck is added to the scope of the proposal, this elevator penthouse height will increase to serve the area.
- 8. The applicant should clarify if they are providing a private garage (or garages) which are limited to 1,000 sf and Group U occupancy, or a public parking garage (either enclosed parking garage or open parking garage). The classification of the lower garage level in WSBC 406 could be significant in the design of the exterior openings, fire protectives, egress and number of exits, allowable areas, etc.
- 9. Construction type as categorized in WSBC 602 is not noted on the drawings. This will have substantial impact on required separation distances, fire resistance ratings of exterior walls, and allowable exterior openings. Exterior wall fire resistance ratings and openings must meet requirements of WSBC 705 and Table 705.8.


- 10. Parapets are not clearly shown or dimensioned on the current drawings. WSBC 705.11 requires parapets in certain conditions. If exceptions apply this should be clearly demonstrated. This could affect overall structure height.
- 11. Construction type as categorized in WSBC 602 is not noted on the drawings. This could have impact on the allowable building area and allowable building height above grade plane.
- 12. Mechanical areas are identified on the north side of the garage, and appliances with requirements for exterior ventilation are shown on floor plans along the north side wall. This wall is a zero lot line. WSMC 401.4 regulates locations of air intake openings and WSMC 501.3 regulates locations of exhaust discharge. Both sections have requirements that refer to property lines.
- 13. A rooftop mechanical zone is identified on A3.0. The rooftop mechanical units and any associated screening or required fall protection for the maintenance of the units is not included and has not been reflected on exterior elevations. These components are likely to be visible on the elevations.
- 14. The stair exit enclosure currently passes through unoccupied mechanical space.
 Special detailing will be required to document the separation assemblies if this configuration is retained. Additional square footage for separate mechanical space and continuous stair shaft would be required if it is not retained.
- 15. The door to the mechanical room is shown into an interior exit stairway. Openings to interior exit stairways are limited in WSBC 1023.4 to exit access and egress from the enclosure. Unoccupied areas can not open to the exit enclosure.
- 16. WSBC 1030 requires emergency escape and rescue openings. Exceptions to this section may not apply and minimal distance to property line will make this a challenge.


Gareth Reece

Sr. Plans Examiner

City of Mercer Island - Community Planning and Development



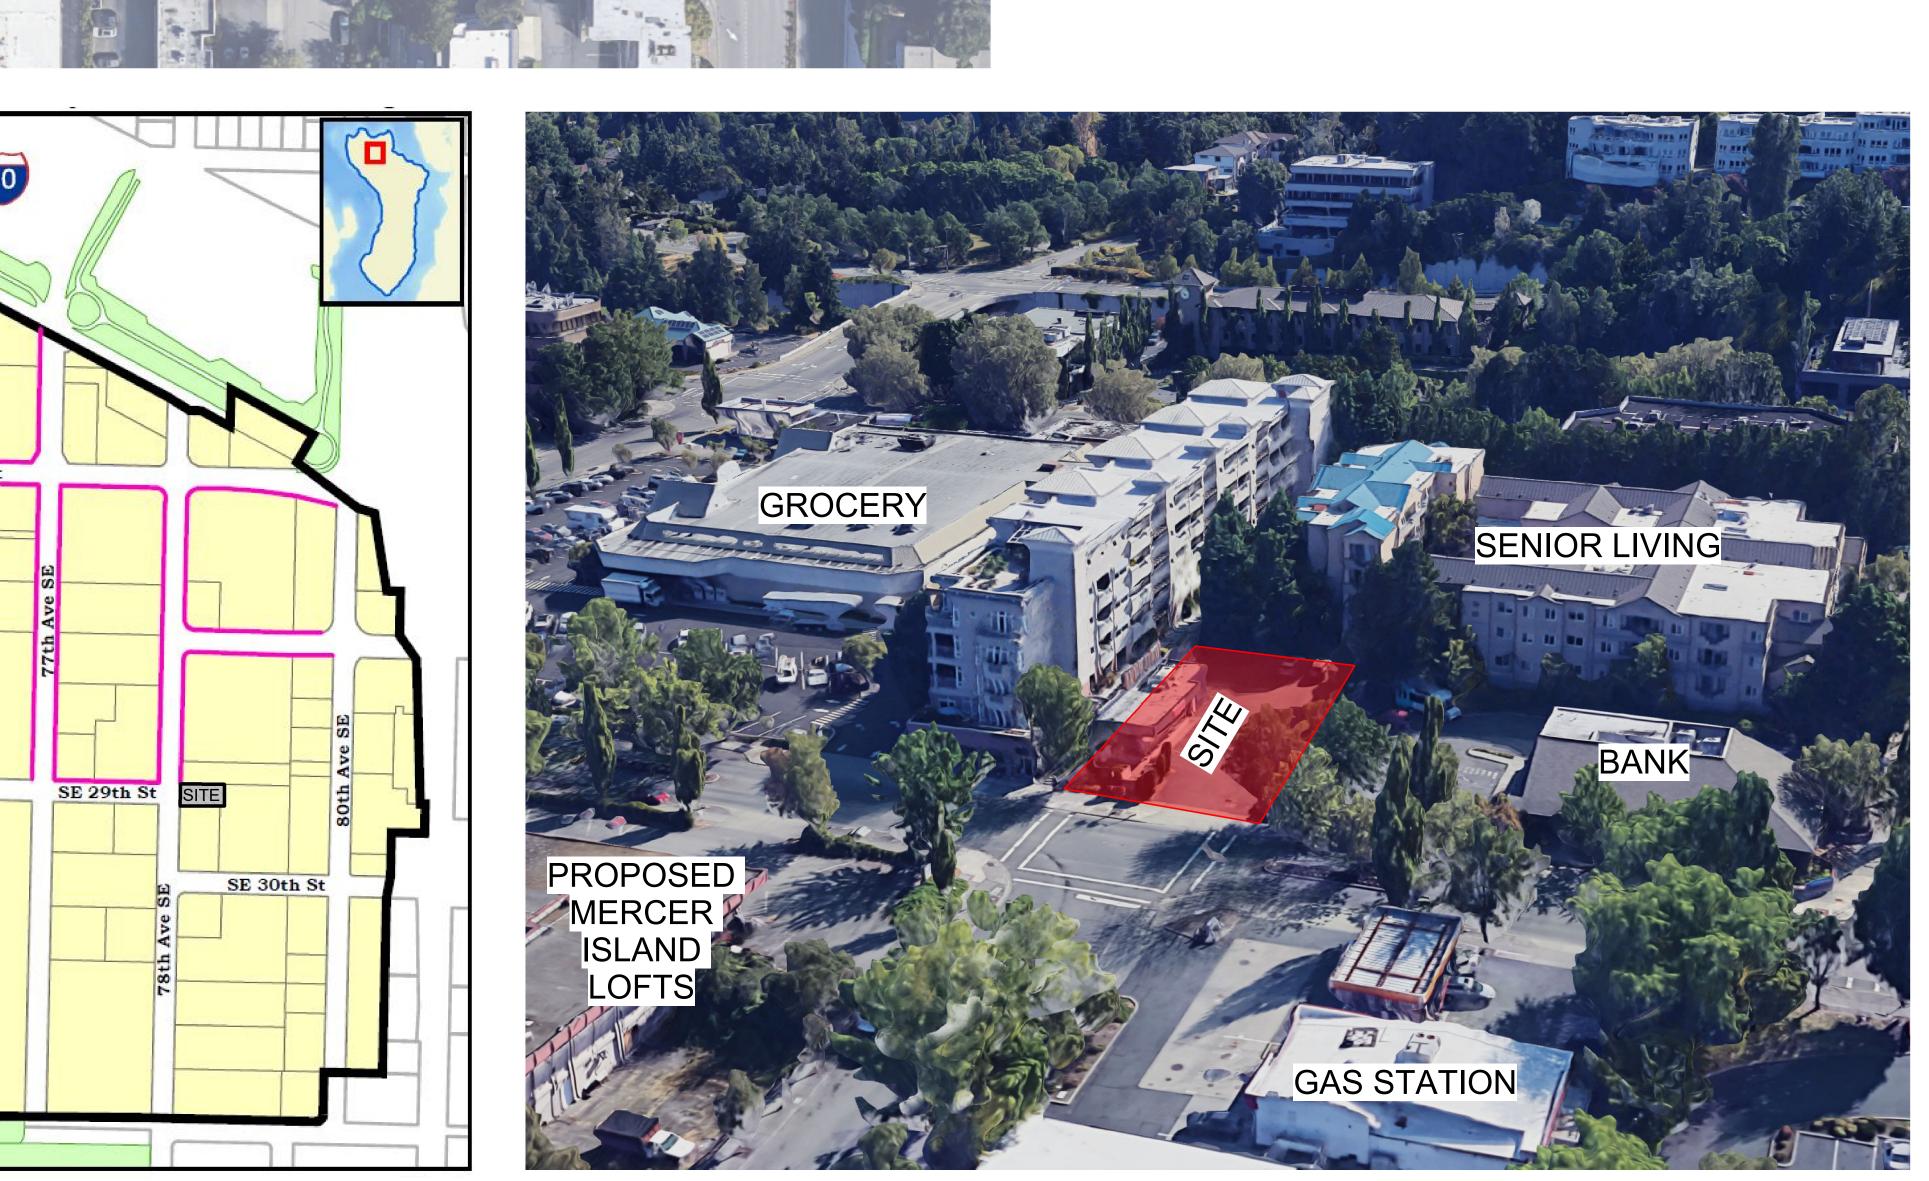


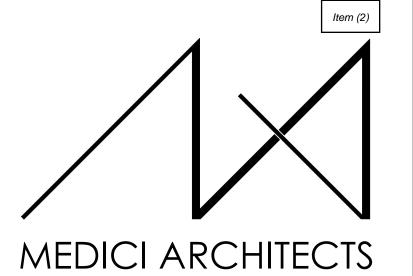

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DRAWING NAME:

SITE CONTEXT

Drawn By: Author Checked By: Checker Owner Approval:
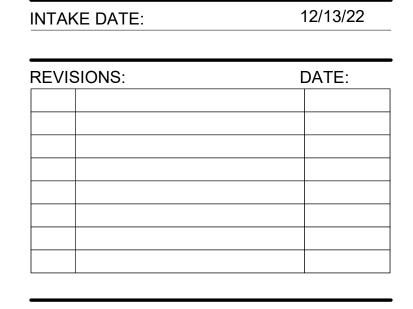
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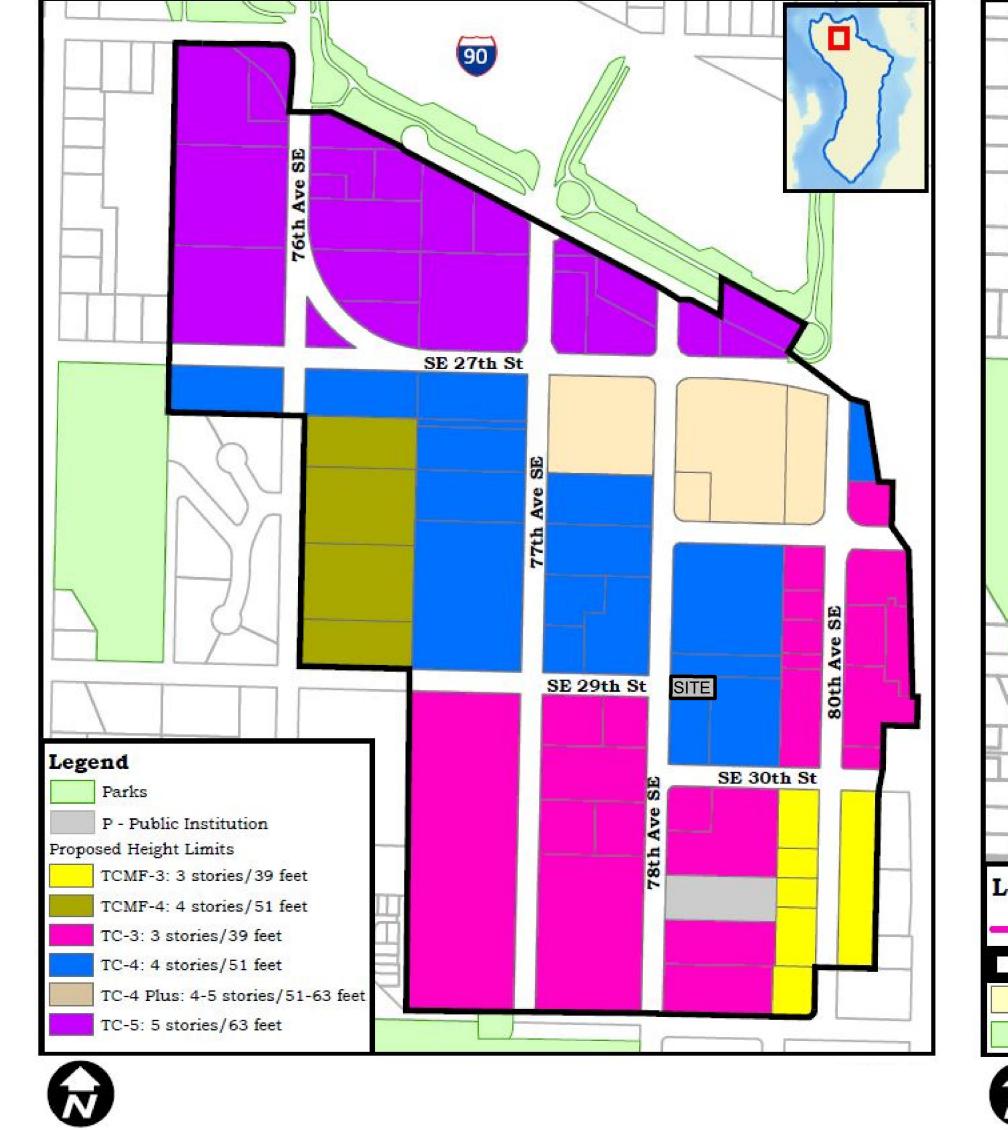
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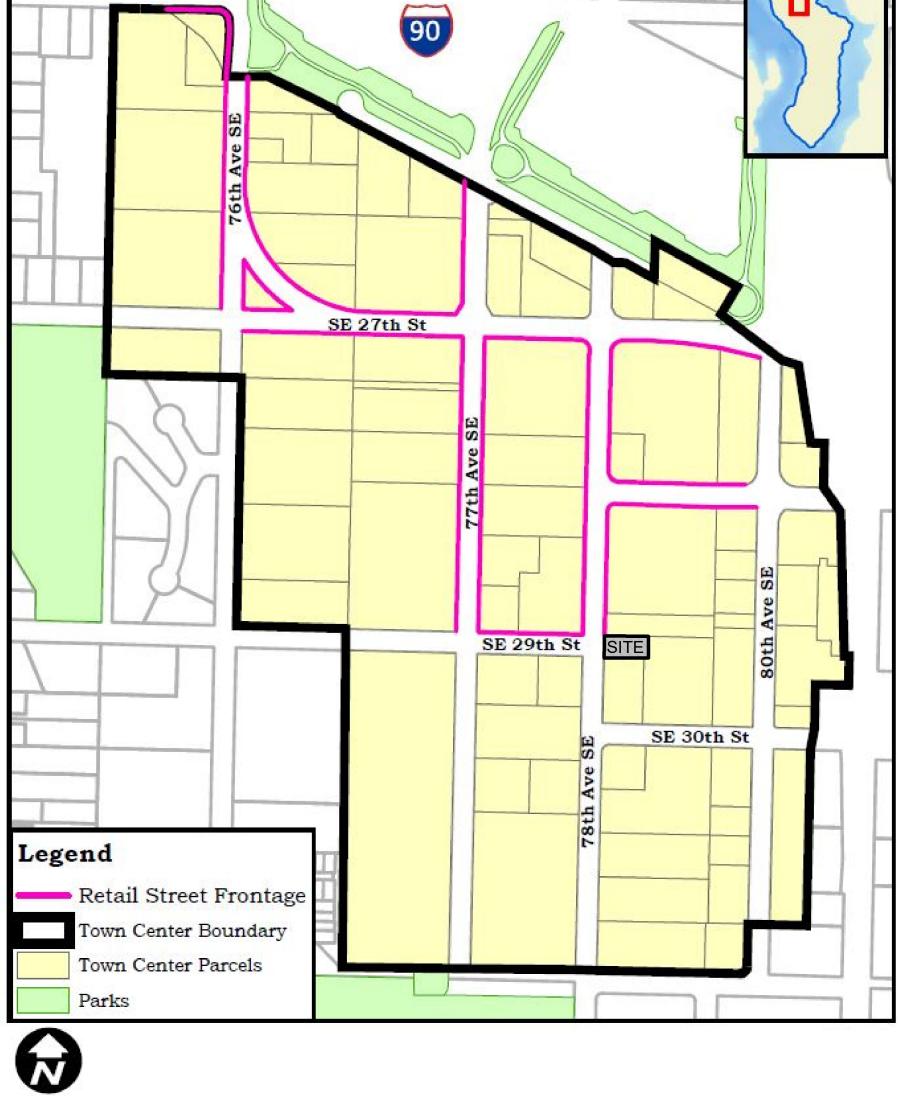
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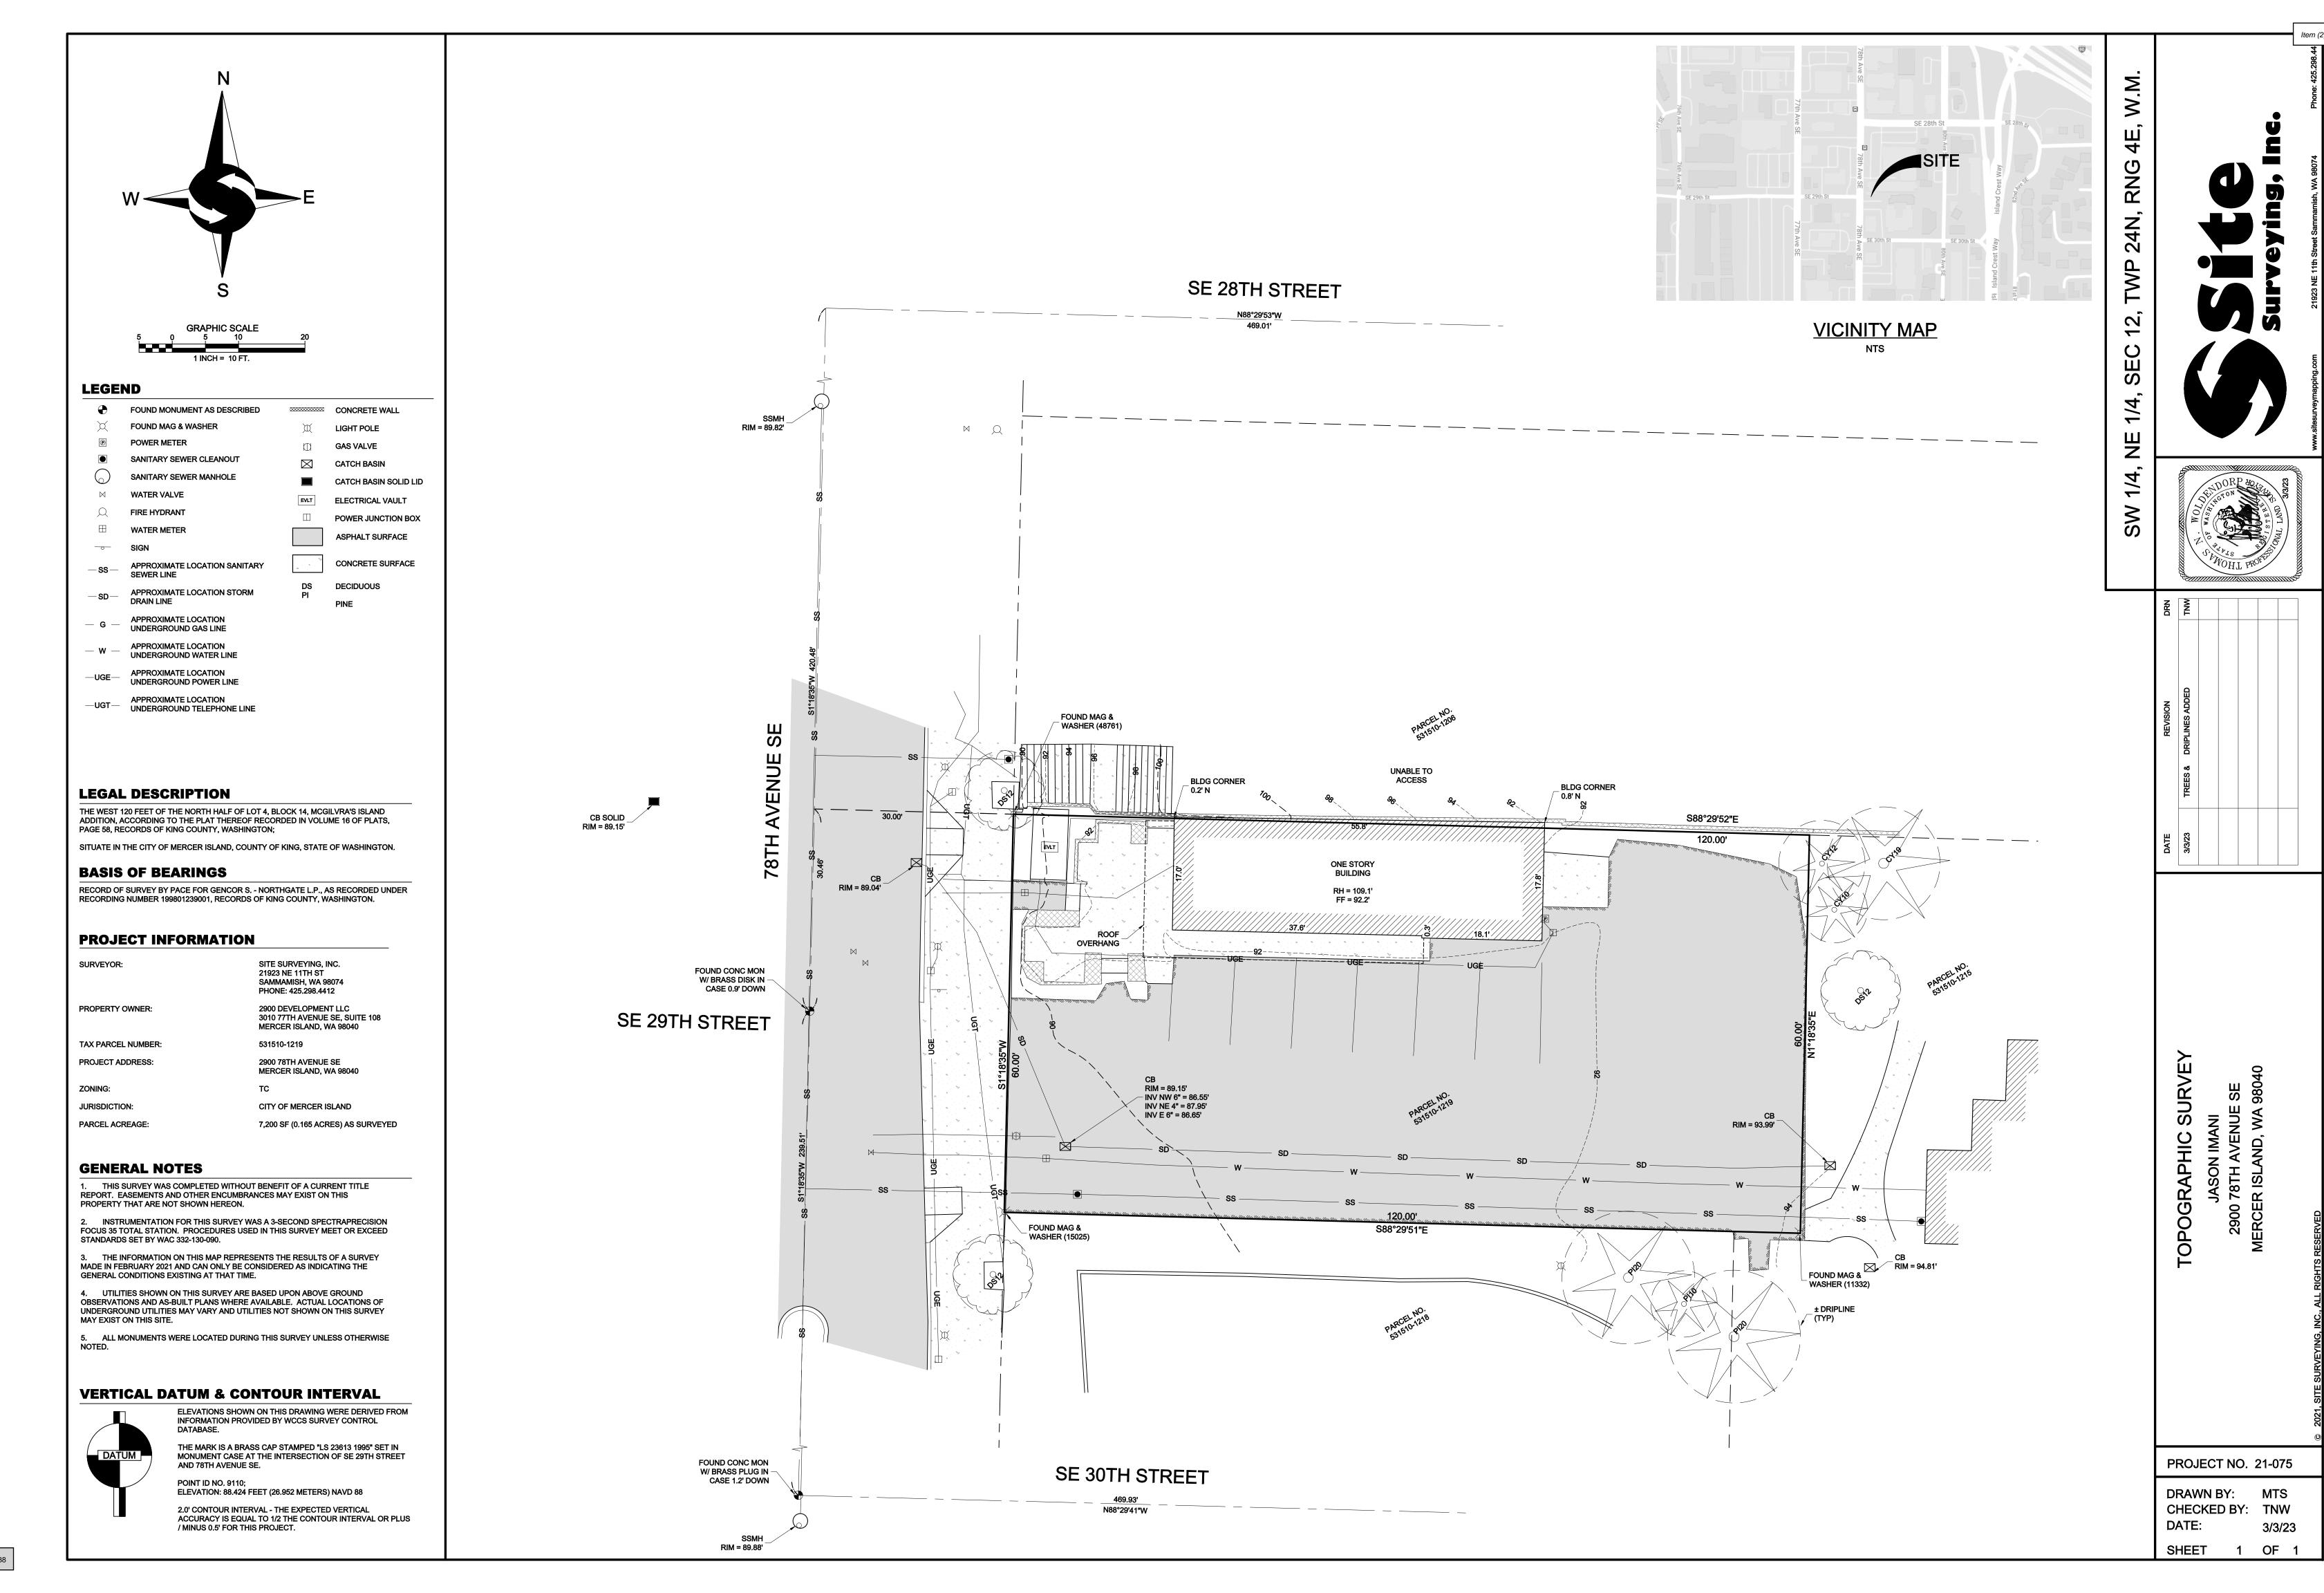
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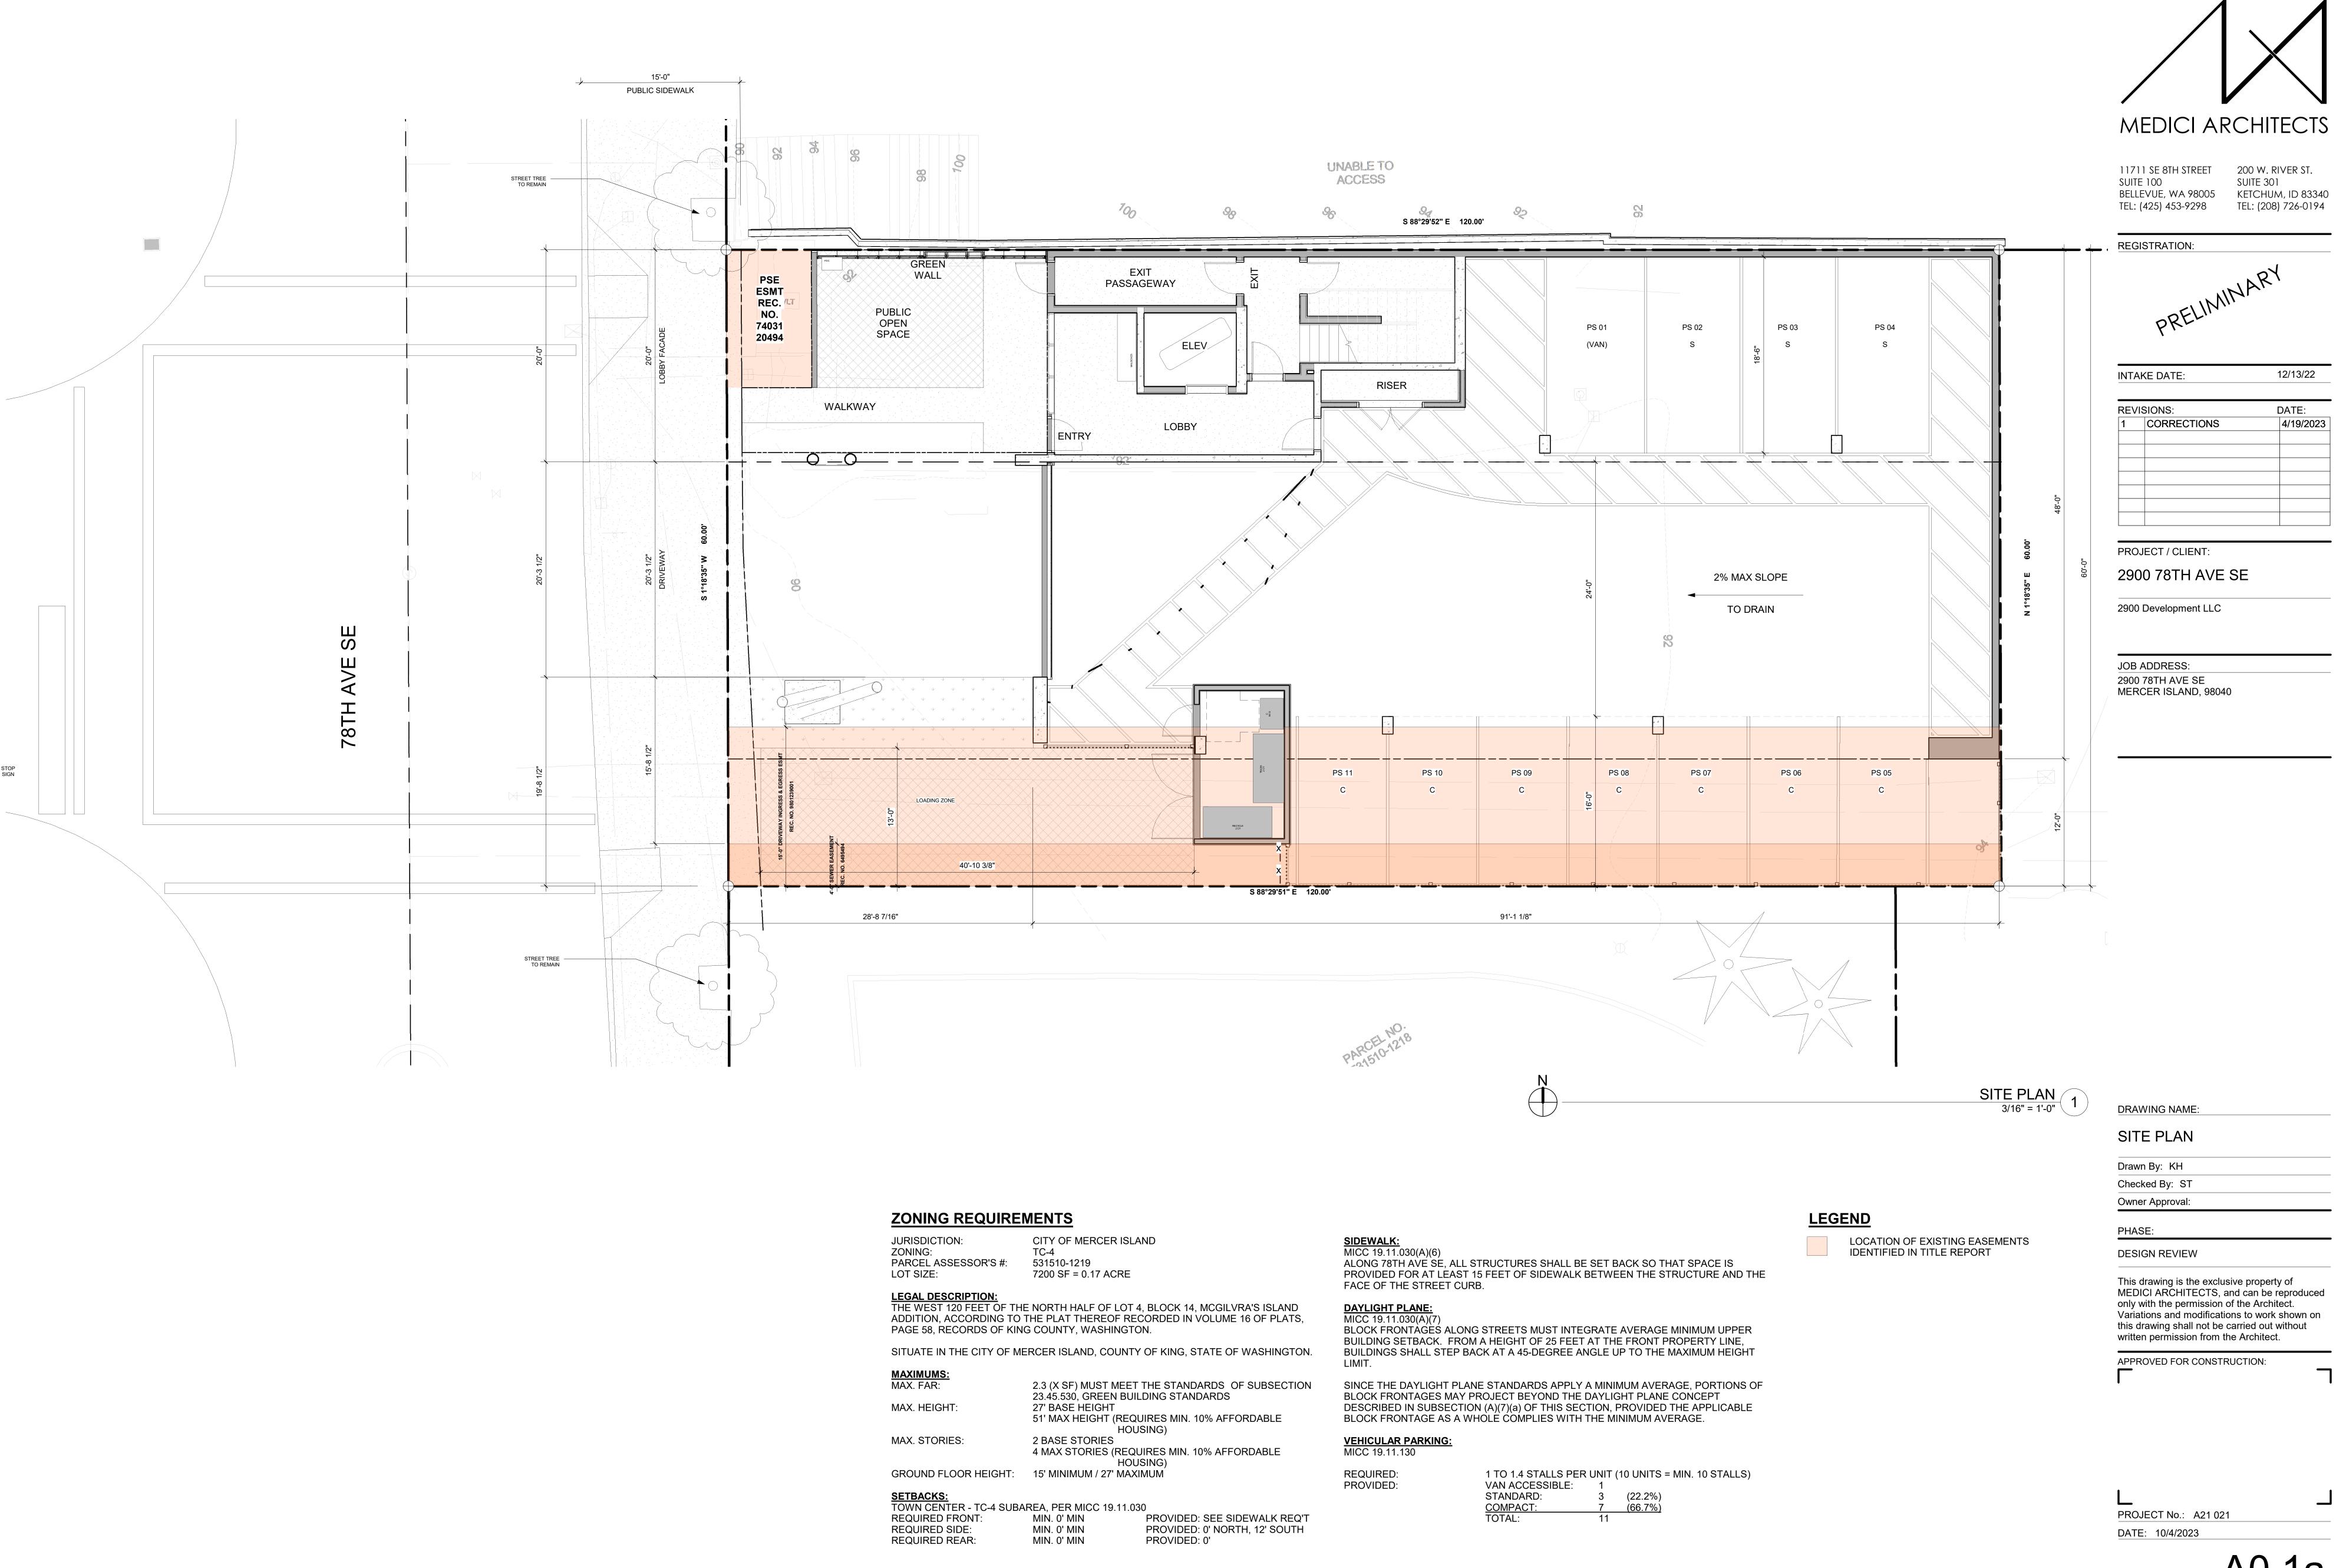
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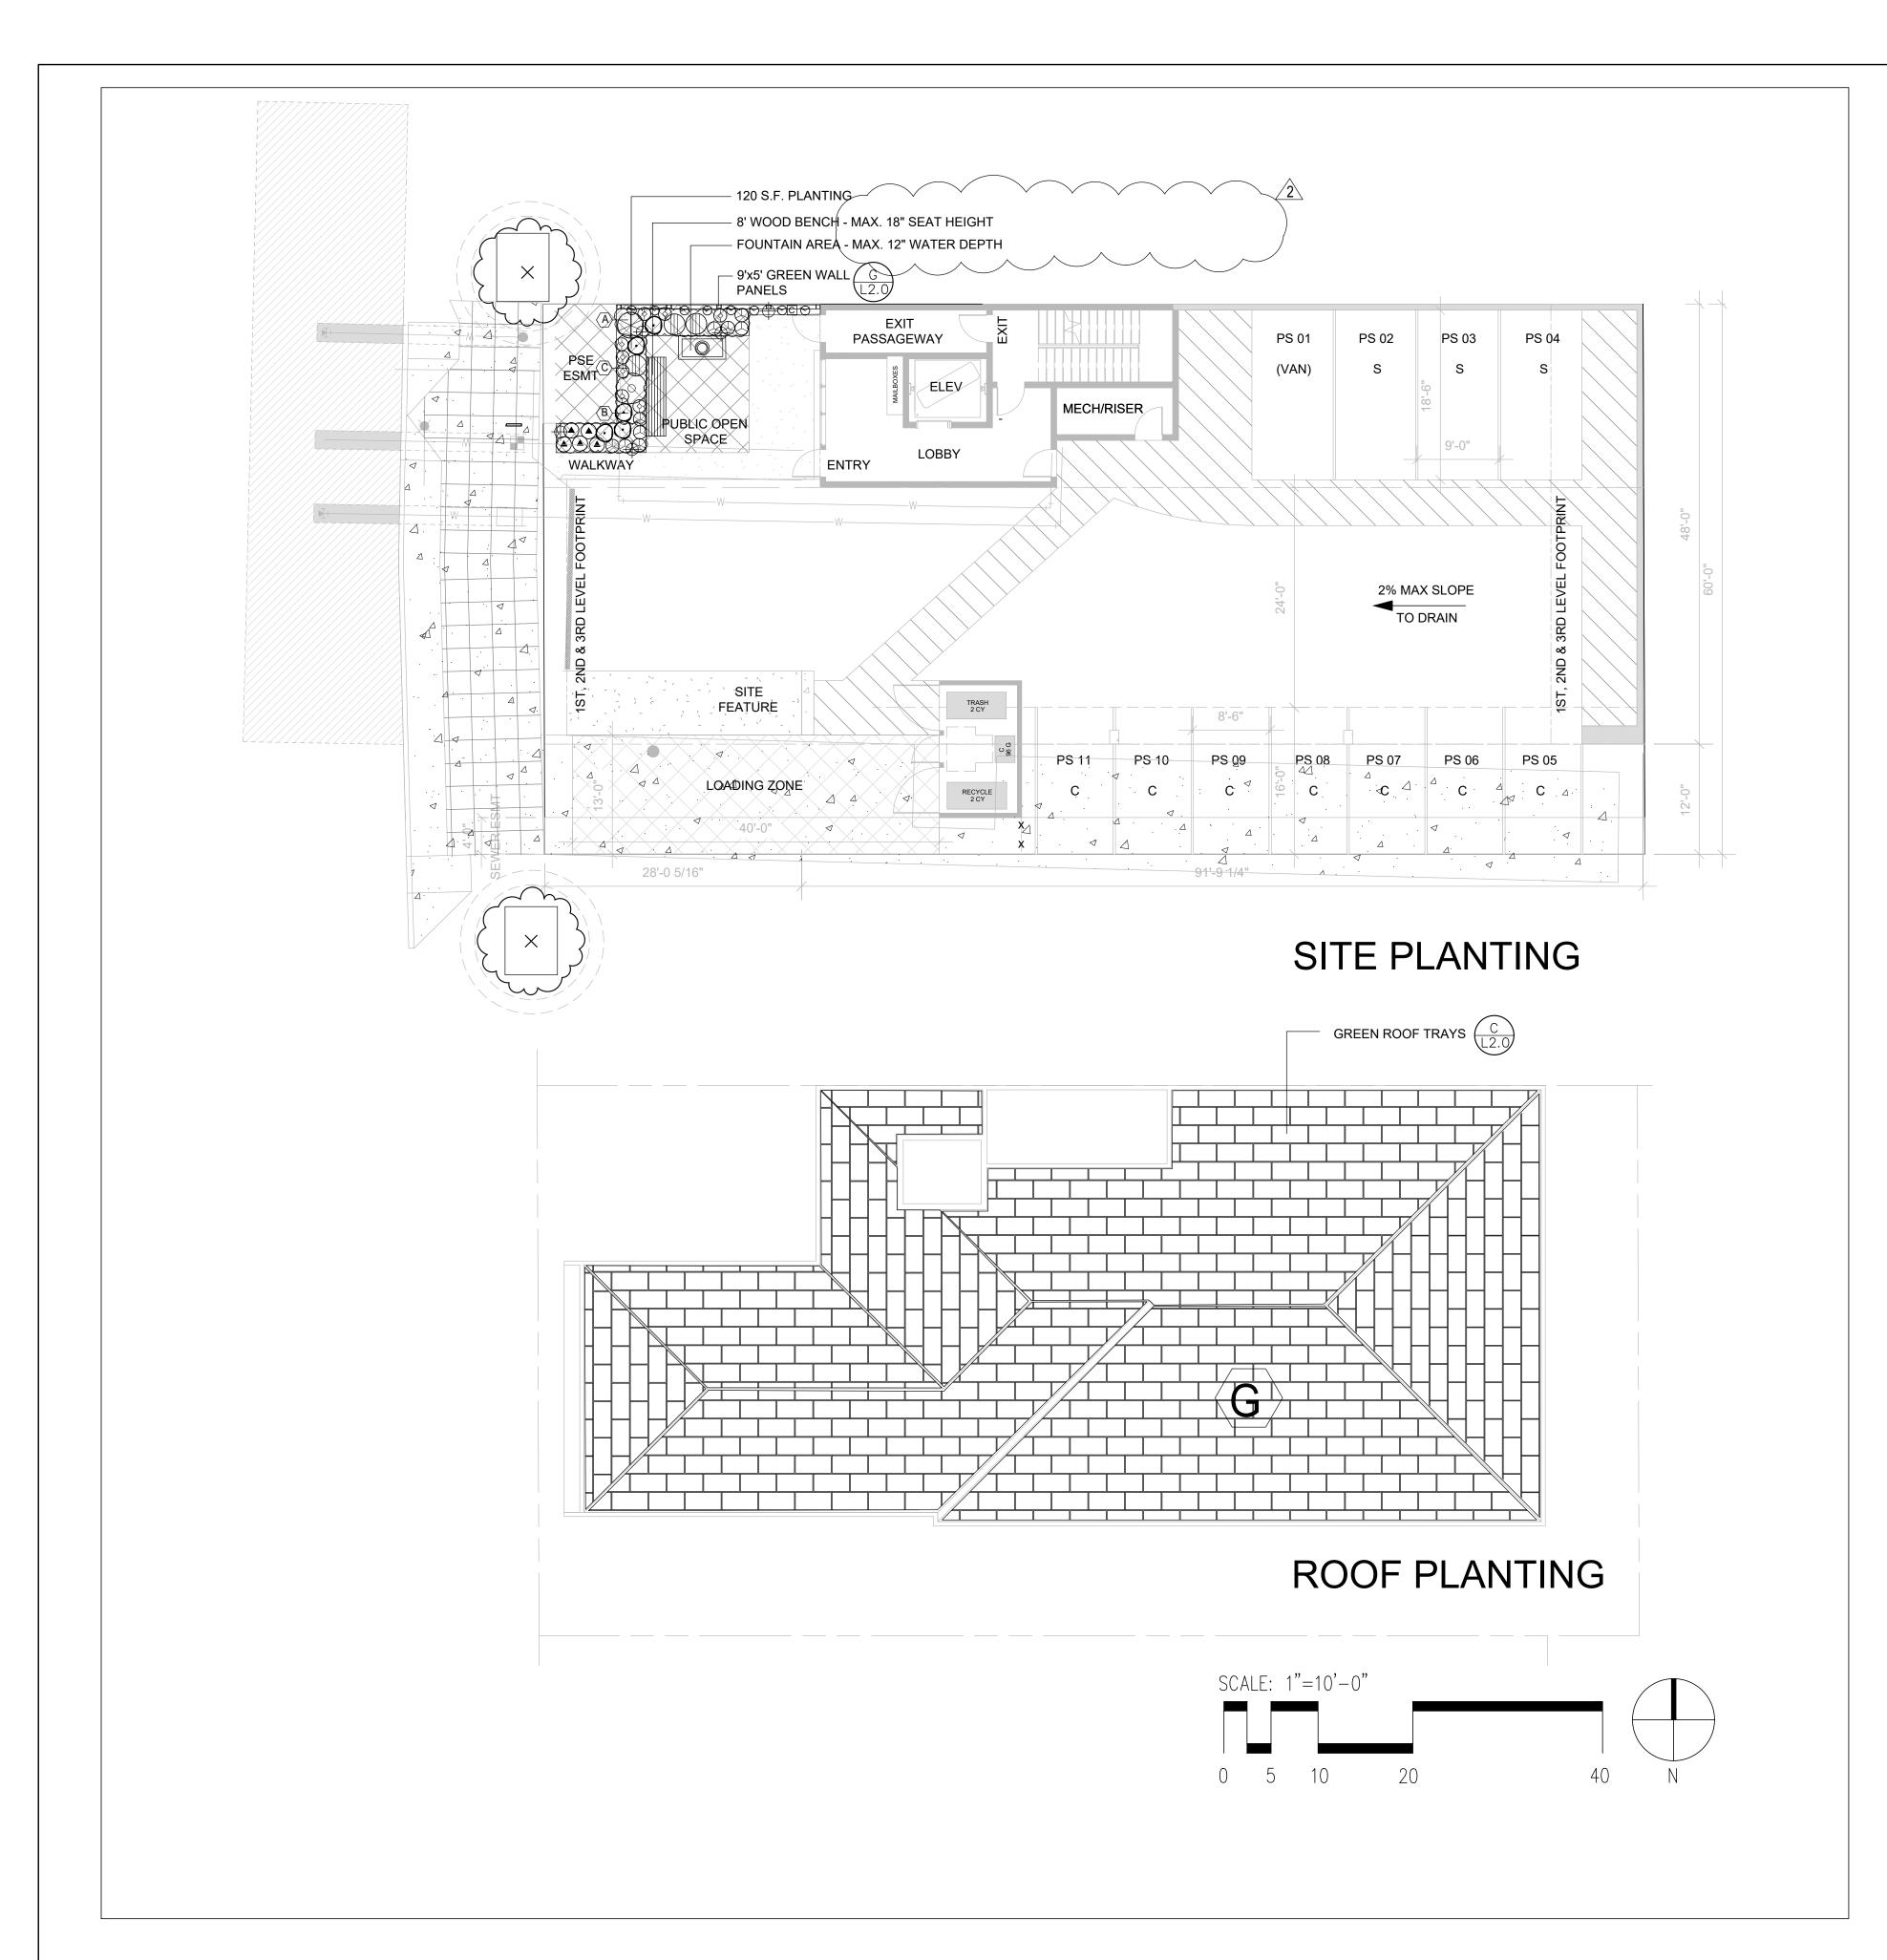
PROJECT No.: A21 021 DATE: 10/4/2023











SYMBOL	BOTANICAL NAME/ COMMON NAME	SIZE AT PLANTING	QTY.	NATIVE, ADAPTIV
TREES				
$\left(\begin{array}{c} \times \\ \end{array}\right)$	INDICATES EXISTING SIGNIFICANT TREE AND CRITICAL ROOT ZONE AT CANOPY EDGE - SAVE AND PROTECT.			
SHRUBS				
\bigcirc	RIBES SANGUINIUM / RED FLOWERING CURRENT	24" HT., 5-GAL POT	1	YES
\bigoplus	RHODODENDRON OCCIDENTALE / WESTERN AZALEA	24" HT., 5-GAL POT	1	YES
\bigcirc	MAHONIA NERVOSA/ LONG-LEAF MAHONIA	12" HT., 2-GAL POT MAX. HT. 20"	8	YES
	BLECHNUM SPICANT / DEER FERN	18" HT., 1-GAL POT	3	YES
\bigcirc	CORNUS STOLONIFERA 'KELSEYI'/DWARF RED-TWIG	12" HT., 2-GAL POT MAX. HT. 20"	9	YES
(A)	AQUILEGIA FORMOSA / WESTERN COLUMBINE	12" HT., 1-GAL POT MAX. HT. 18"	5	YES
<u></u>	LIRIOPE MUSCARI / BIG BLUE LILY TURF	12" HT., 1-GAL POT MAX. HT. 18"	5	NO
♡	LONICERA CILIOSA / TRUMPET HONEYSUCKLE	24" HT., 1-GAL POT, PLANT (2) BELOW EA. GREEN SCREEN 5' PANEL	8	YES
GROUNDCOVERS	•			
(A)	LIRIOPE SPICAPA / CREEPING LILY TURF	4-INCH POT	1'-0" O.C.	NO
B	CORNUS CANADENSIS / BUNCHBERRY	4-INCH POT	1'-0" O.C.	YES
C	MAHONIA REPENS / CREEPING MAHONIA	4-INCH POT	1'-0" O.C.	YES
	SEDUM DIVERGENS / STONECROP,	2'X4'X4-1/2" DEEP GREENROOF TRAYS	4,131 S.F.	YES

NOTES

- ALL NEW PLANTING SHALL BE INSTALLED AS PER CITY OF MERCER ISLAND INSTALLATION STANDARDS AND PLANS.
- 2. ALL NEW ON-GRADE PLANTING AREAS SHALL RECEIVE MINIMUM 12" OF IMPORTED TOPSOIL TILLED INTO THE TOP 12" AND MINIMUM 2" OF BARK
- 3. ALL NEW PLANTING AREAS SHALL BE IRRIGATED BY AUTOMATIC IRRIGATION SYSTEM WITH RAIN SHUT OFF DEVICE

 4. PROPOSED APARTMENT BUILDING WILL BE PERMITTED UNDER A SEPARATE BUILDING PERMIT.

LIGHTING SCHEDULE	
LIGHTING SCHEDULE	

SYMBOL	DESCRIPTION	MANUFACTURER	QUANTITY	
QUIPMENT	_L			
+	INDICATES PATHWAY LIGHT FIXTURE	KICHLER LED SHALLOW SHADE—SMALL MODEL 15805—BKT—4W 12 VOLT LED LAMP, 23" HT. WITH GROUND STAKE MOUNTING; TEXTURED BLACK COLOR	5	
С	INDICATES LIGHTING CONTROLLER, TRANSFORMER, TIMER, PHOTOCELL	100 AMP CONTROLLER 120 TO 12 VOLT TRANSFORMER, PHOTOCELL, TIMER – WALL MOUNT AT 4' HT. FROM FINISH GRADE	1	



INCORPORATED P.S.

LANDSCAPE ARCHITECTURE
URBAN DESIGN
SITE PLANNING
PARKS AND
RECREATION PLANNING

12610 NE 104TH ST.
KIRKLAND WA 98033


PH: 425.454.5723 FX: 425.822.3525 E-: jgm@jgm-inc.com

2900 78TH AVE. S.E. MERCER ISLAND, WA 98040

REVISIONS/DRAWING ISSUES:

7-20-2022

Drawn by: CL Checked by: CL

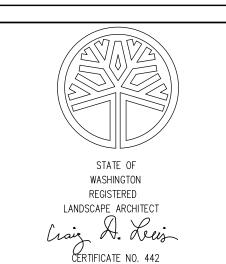


DATE: 6-10-2022

DRAWING TITLE

PLANTING PLAN

SHEET NUMBER

40

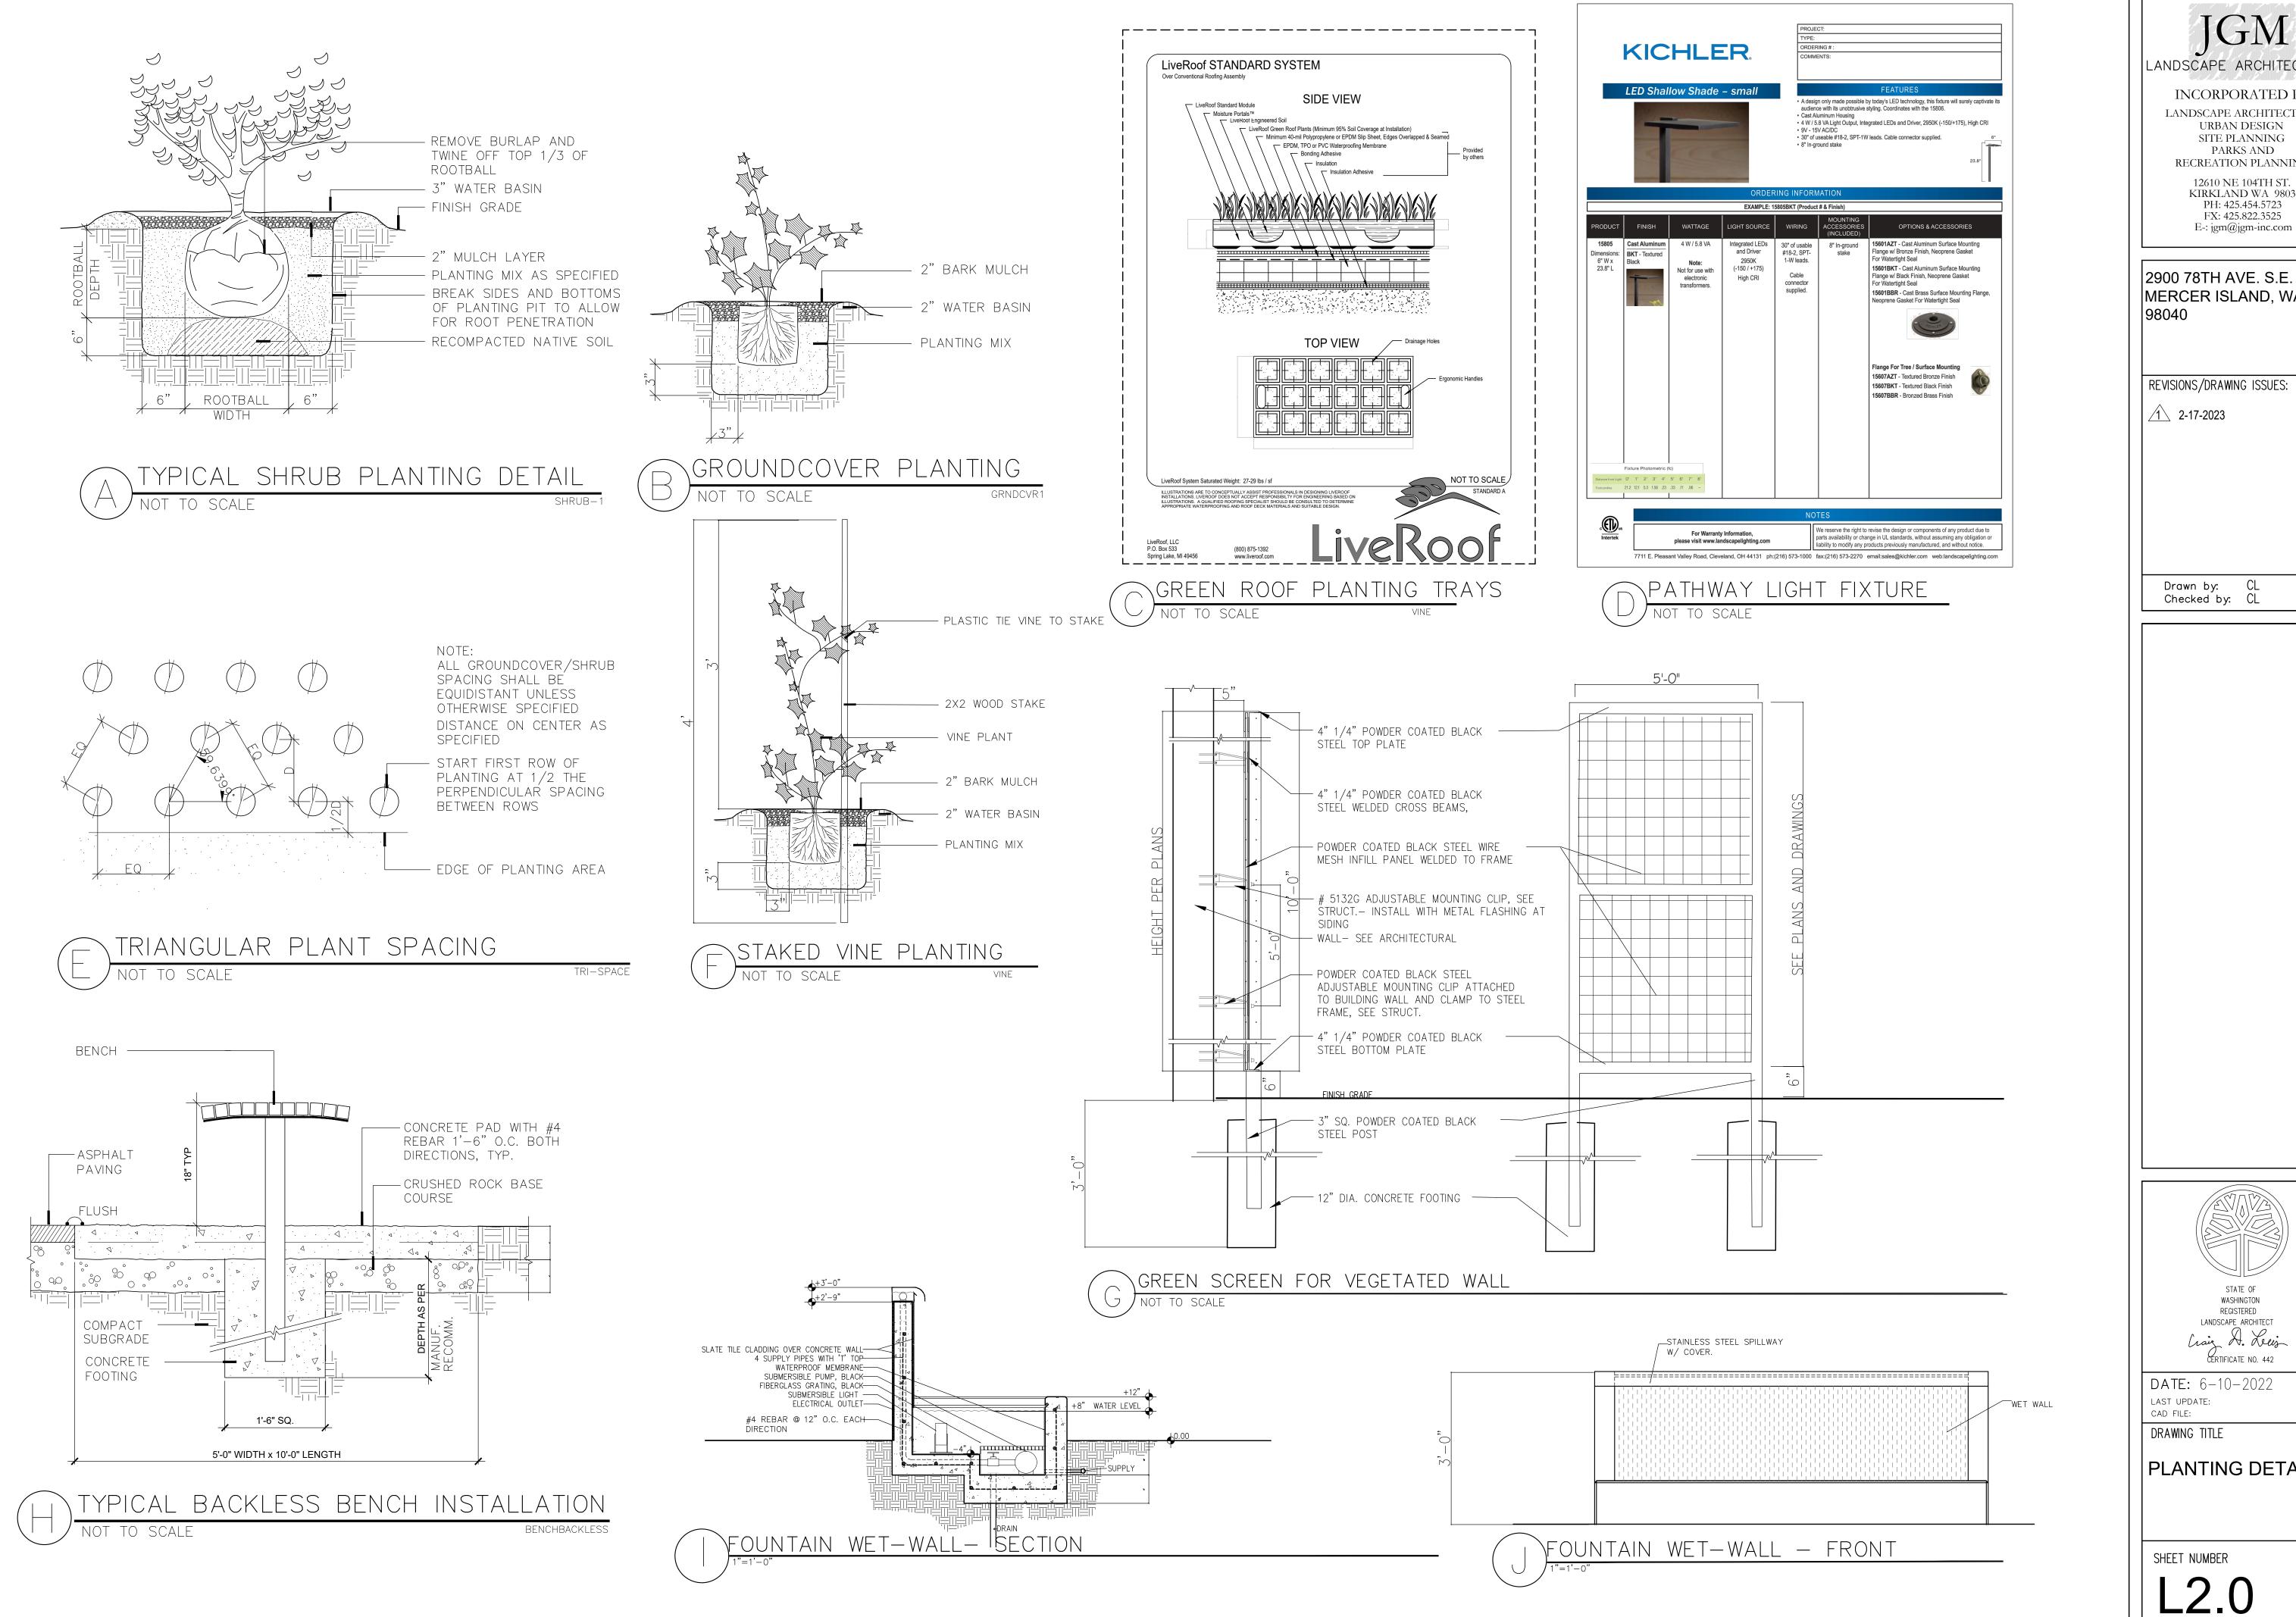

LANDSCAPE ARCHITECTS

INCORPORATED P.S. LANDSCAPE ARCHITECTURE URBAN DESIGN SITE PLANNING PARKS AND RECREATION PLANNING 12610 NE 104TH ST. KIRKLAND WA 98033

2900 78TH AVE. S.E. MERCER ISLAND, WA


REVISIONS/DRAWING ISSUES:


Checked by: CL

WASHINGTON REGISTERED


LANDSCAPE_ARCHITECT Craiz A. Leis CERTIFICATE NO. 442

PLANTING DETAILS

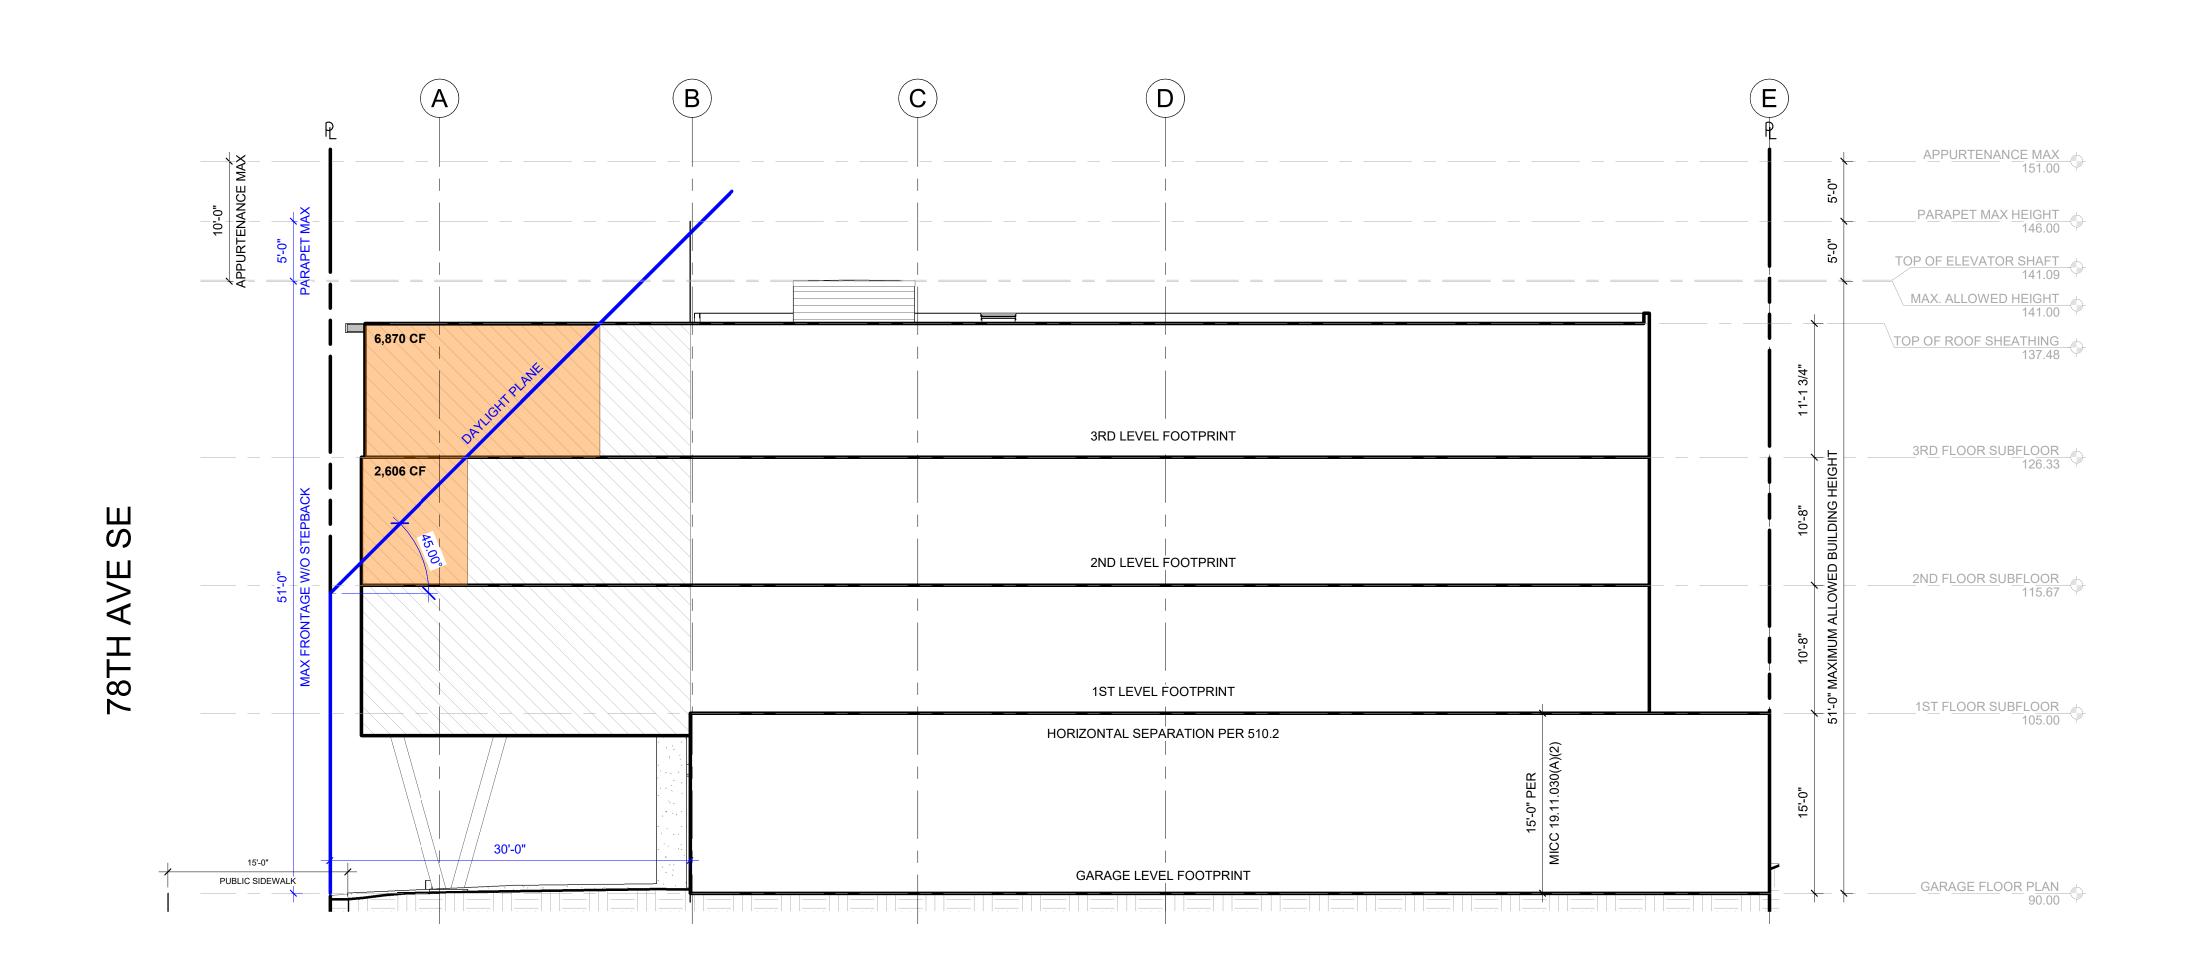

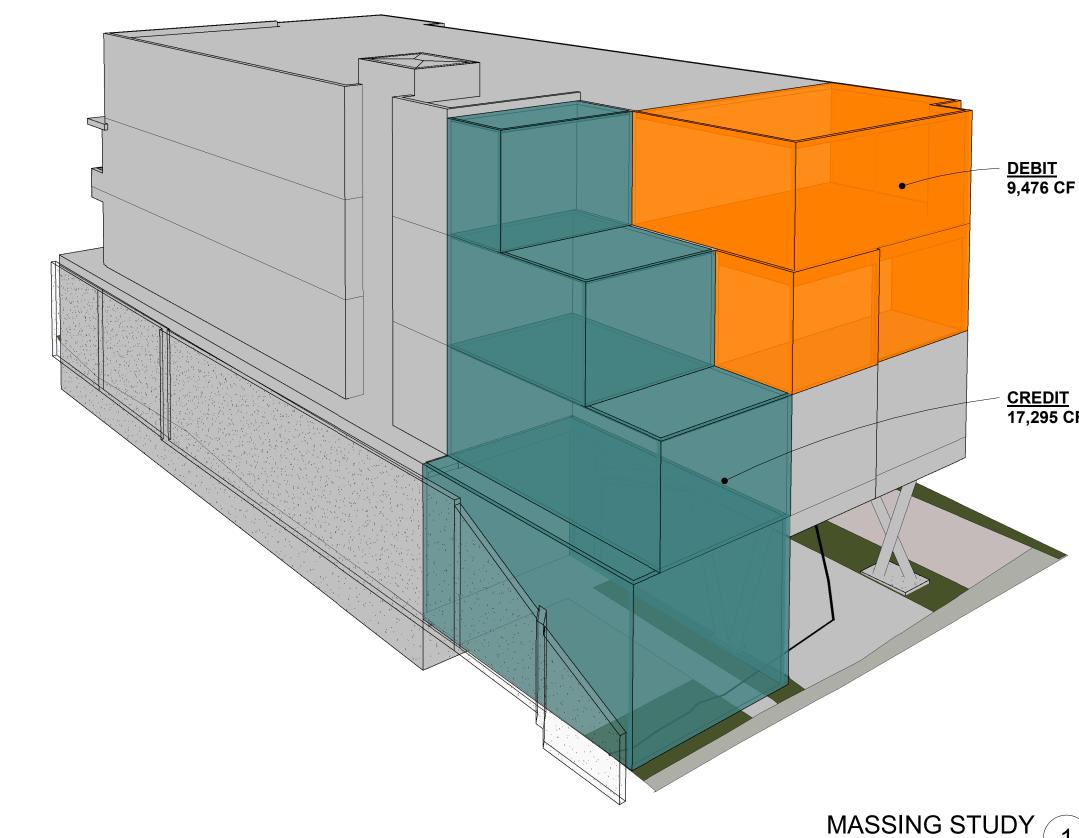

DEBIT 9,476 CF CREDIT 17,295 CF

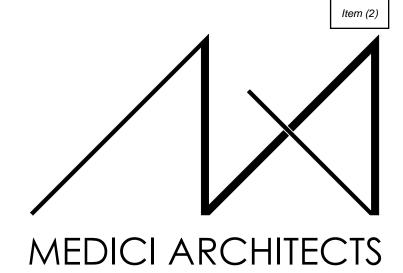

11711 SE 8TH STREET 200 W. RIVER ST.
SUITE 100 SUITE 301
BELLEVUE, WA 98005 KETCHUM, ID 83340
TEL: (425) 453-9298 TEL: (208) 726-0194

REGISTRATION:

INTAKE DATE: 12/13/22 **REVISIONS**: DATE:

PROJECT / CLIENT: 2900 78TH AVE SE

2900 Development LLC

JOB ADDRESS: 2900 78TH AVE SE MERCER ISLAND, 98040

\bigcirc (B)APPURTENANCE MAX 151.00 PARAPET MAX HEIGHT 146.00 TOP OF ELEVATOR SHAFT 141.09 MAX. ALLOWED HEIGHT 141.00 TOP OF ROOF SHEATHING 137.48 3RD LEVEL FOOTPRINT 3RD FLOOR SUBFLOOR 126.33 3,237 CF 2ND LEVEL FOOTPRINT 2ND FLOOR SUBFLOOR 115.67 4,768 CF 1ST LEVEL FOOTPRINT 1ST FLOOR SUBFLOOR 105.00 HORIZONTAL SEPARATION PER 510.2 7,940 CF GARAGE LEVEL FOOTPRINT

DAYLIGHT PLANE - DEBIT VOLUME

1/8" = 1'-0"

2

DAYLIGHT PLANE - CREDIT VOLUME

1/8" = 1'-0"

3

AVERAGE DAYLIGHT PLANE CALCULATION

<u>DEBIT VOLUME</u> 2,606 6,870 2ND FLOOR: 3RD FLOOR: **DEBIT TOTAL:** 9,476 CF CREDIT VOLUME GARAGE LEVEL: 1ST FLOOR:

7,940 4,768 3,237 2ND FLOOR: 3RD FLOOR: 1,350 **CREDIT TOTAL:** 17,295 CF 17,295 - 9,476 DIFFERENCE

TOTAL CREDIT VOLUME: 7,819 CF

DRAWING NAME:

ZONING DIAGRAMS

Drawn By: KH Checked By: ST Owner Approval:

PHASE:


DESIGN REVIEW

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APPROVED FOR CONSTRUCTION:

PROJECT No.: A21 021 DATE: 10/4/2023

MASSING STUDY 1

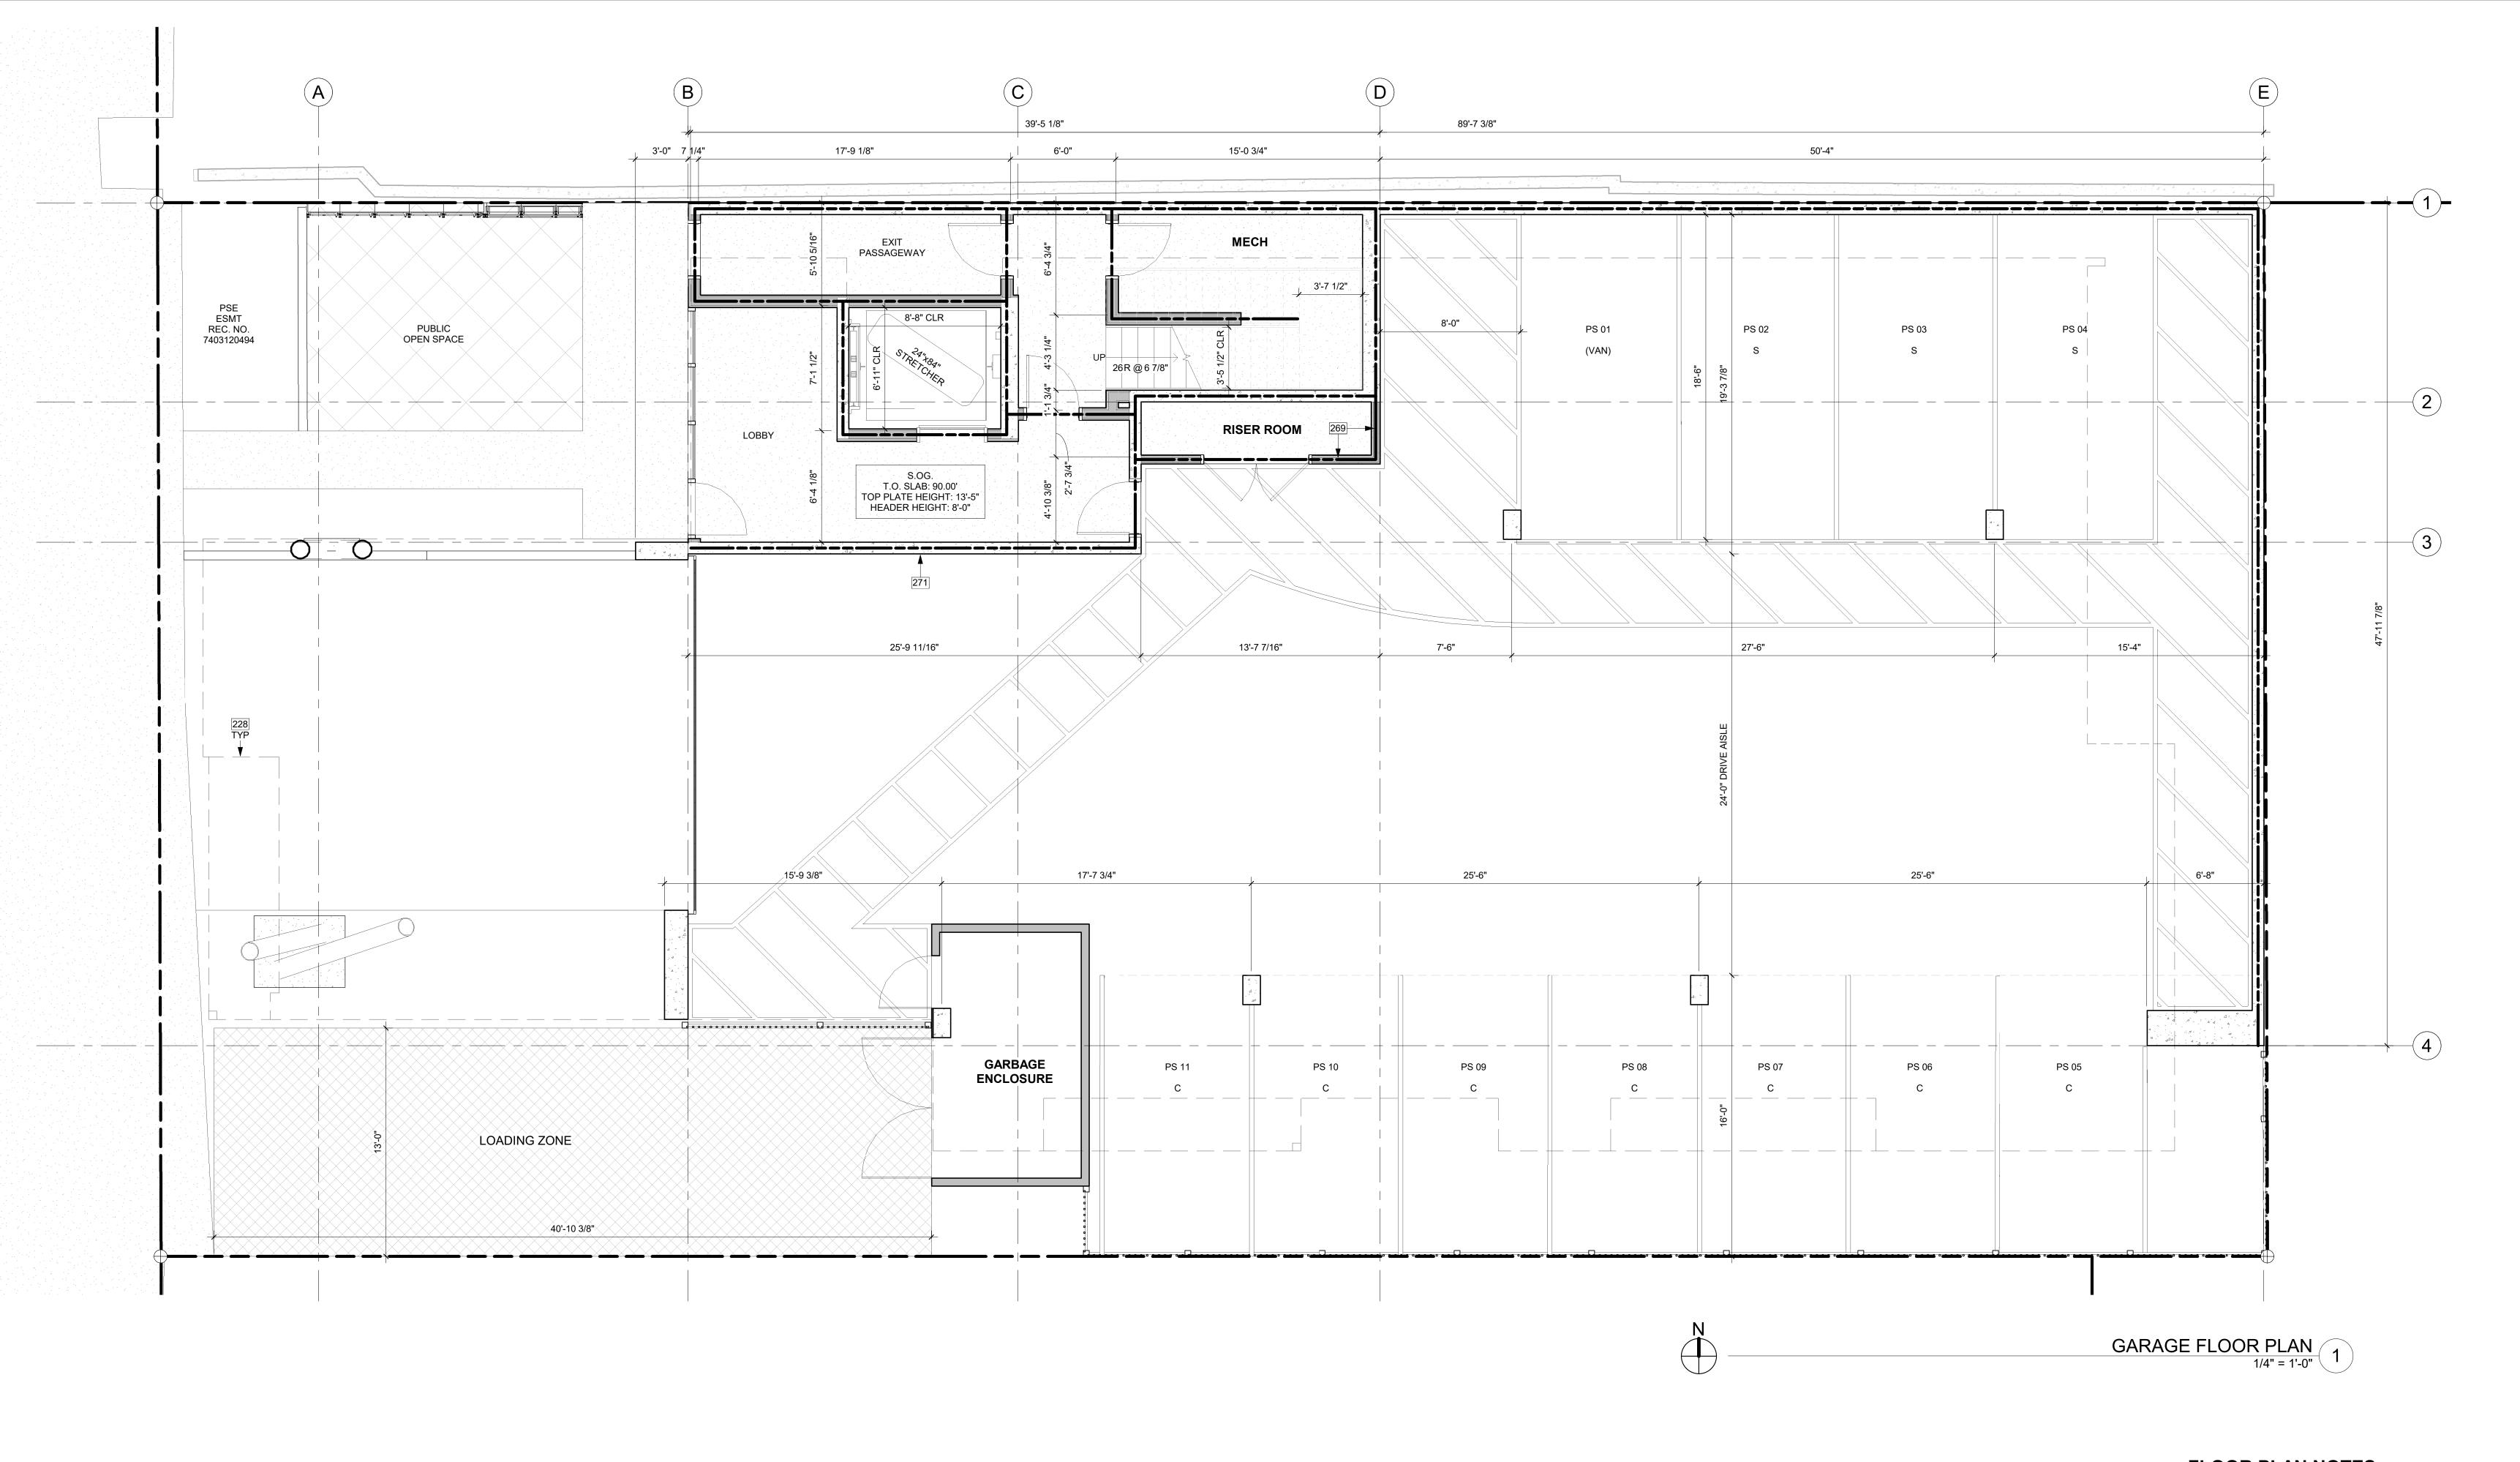

LONG DASHED LINE OF BUILDING ABOVE.
 2-HOUR RATED NON-COMBUSTIBLE WALL; WP 1522. 3 5/8" STEEL STUDS. SEE ASSEMBLY DETAIL ON A0.5a
 3-HOUR RATED CONCRETE COLUMN PER STRUCTURAL.

FLOOR PLAN NOTES

- CONTRACTOR SHALL VERIFY ALL NOTES, DIMENSIONS & CONDITIONS PRIOR TO CONSTRUCTION.
 SEE STRUCTURAL DRAWINGS FOR ALL POSTS, BEAMS AND HEADERS.
- PROVIDE SOLID BLOCKING OVER SUPPORTS.
 PROVIDE FIRE BLOCKING @ ALL PLUMBING PENETRATIONS.
 WINDOWS & DOORS ARE SHOWN & NOTED AS NOMINAL SIZES.
- WINDOWS & DOORS ARE SHOWN & NOTED AS NOMINAL SIZES.
 DOOR JAMB 4.5" FROM CORNER TYP., U.N.O.
 SEE SHEETS A0.3, A4.0 & A4.1 FOR WINDOW & DOOR HEADER HEIGHTS
- ABOVE FINISHED FLOOR.

 8. ALL WOOD IN CONTACT WITH CONCRETE TO BE PRESSURE TREATED.
- EXTERIOR WALLS TO BE 2x6 STUDS @ 16" O.C., U.N.O.
 INSTALL SIMPSON CONC. TO WOOD HOLDOWNS PER STRUCTURAL DRAWINGS, ALSO SEE MANUFACTURER'S SPECS.
- 11. SMOKE & CARBON MONOXIDE DETECTORS:
 SHALL BE 110V INTERCONNECTED W/ BATTERY BACKUP.
 SHALL SOUND AN ALARM AUDIBLE IN ALL SLEEPING ROOMS.
 SHALL BE INSTALLED ON EACH FLOOR AND IN ALL BEDROOMS.
 SHALL BE INSTALLED IN EACH LOCATION WHERE THERE IS A CEILING
- CHANGE OF GREATER THAN 24"

 12. FRESH AIR PROVIDED BY WHOLE-HOUSE EXHAUST FAN WITH FRESH AIR PORT (NET 4 SF IN MIN. OPENING) AT EACH HABITABLE ROOM. A TIMER OPERATES AN EXHAUST FAN WHICH PULLS OUTSIDE AIR THROUGH AIR
- INLETS LOCATED IN EACH HABITABLE ROOM.

 13. LIMITING DEVICE FOR TUBS TO PROVIDE MAX. 120°F HOT WATER
- TEMPERATURE.

 FOOTINGS SHALL BEAR ON SOLID UNDISTURBED EARTH (CONTROLLED, COMPACTED STRUCTURAL FILL OR BOTH). DEPTH OF FOOTINGS TO BE DETERMINED BY STRUCTURAL ENGINEER. FOUNDATION EXCAVATION, BACKFILL AND COMPACTION SHALL CONFORM TO SPECIFICATION REQUIREMENTS. THIS CONSTRUCTION WORK, INCLUDING DRAINAGE, SHORING AND SUCH OTHER RELATED WORK AS REQUIRED, SHALL BE CONDUCTED BY THE CONTRACTOR. STOP WORK IF RECOMMENDED EXCAVATION CUT OR BEARING SOIL CHANGES OCCUR IN EITHER HORIZONTAL OR VERTICAL DIRECTION AND NOTIFY IMMEDIATELY THE GEOTECHNICAL ENGINEER AND STRUCTURAL ENGINEER. AT WHICH POINT THE ENGINEERS SHALL DETERMINE CAUSE OF DISPLACEMENT AND

FIRE-RESISTANCE ASSEMBLIES

DEVELOP AND IMPLEMENT REMEDIAL MEASURES.

1-HOUR RATED WALL ASSEMBLY
2-HOUR RATED WALL ASSEMBLY
3-HOUR RATED WALL ASSEMBLY

SYMBOL LEGEND

HOUSE VENTILATION

POWDER

SYMBOL LOCATION MINIMUM FAN REQUIREMENTS

SEGMENT.

2018 IRC - PROVIDE WHOLE HOUSE VENTILATION PER M1505.4, INTERMITTENT

WHOLE HOUSE VENTILATION USING EXHAUST FAN PER 1505.4.1.2 (WA) AND TABLE

1505.4.3(1) & (3) (WA); PROVIDE CONTROLS PER 1505.4.2. COMPLY WITH WSEC R403.

KITCHEN MIN. 100 CFM (INTERMITTENT) @ 0.25" WG (TABLE

** MAKEUP AIR IS NOT REQUIRED IF ALL GAS APPLIANCES IN THE HOUSE HAVE A DIRECT VENT OR MECHANICAL DRAFT VENT SYSTEM, PER MODIFICATION M1503.6.

BATH & MIN. 50 CFM (INTERMITTENT) @ 0.25" WG (TABLE M1505.4.4)

M1505.4.4) RANGE HOOD OR DOWN DRAFT EXHAUST FAN

RATED AT MIN. 100 CFM AT 0.10" WG MAY BE USED FOR EXHAUST FAN REQUIREMENT. IF OVER 400 CFM, MAKEUP

AIR IS REQUISED IN THE SAME ROOM PER M1503.6.

ROOM

MIN. 210 A. (INTERMITTENT) @ 0.25" WG - TO FUNCTIFE
AND LUP BELED AS WHOLE HOUSE FAN (4-5 BEDTO A. IS
4501<6000 SF) TO OPERATE 50% OF TIME IN EALUP HOUR

SEE TITLE SHEET A0.0 FOR COMPLETE SYMBOL INDEX.

MEDICI ARCHITECTS

11711 SE 8TH STREET 200 W. RIVER ST. SUITE 100 SUITE 301
BELLEVUE, WA 98005 KETCHUM, ID 83340
TEL: (425) 453-9298 TEL: (208) 726-0194

REGISTRATION:



INTAKE DATE: 12/13/22

REVISIONS: DATE:

PROJECT / CLIENT:

2900 78TH AVE SE

2900 Development LLC

JOB ADDRESS: 2900 78TH AVE SE MERCER ISLAND, 98040

DRAWING NAME:

GARAGE PLAN

Drawn By: KH
Checked By: ST

PHASE:

Owner Approval:

DESIGN REVIEW

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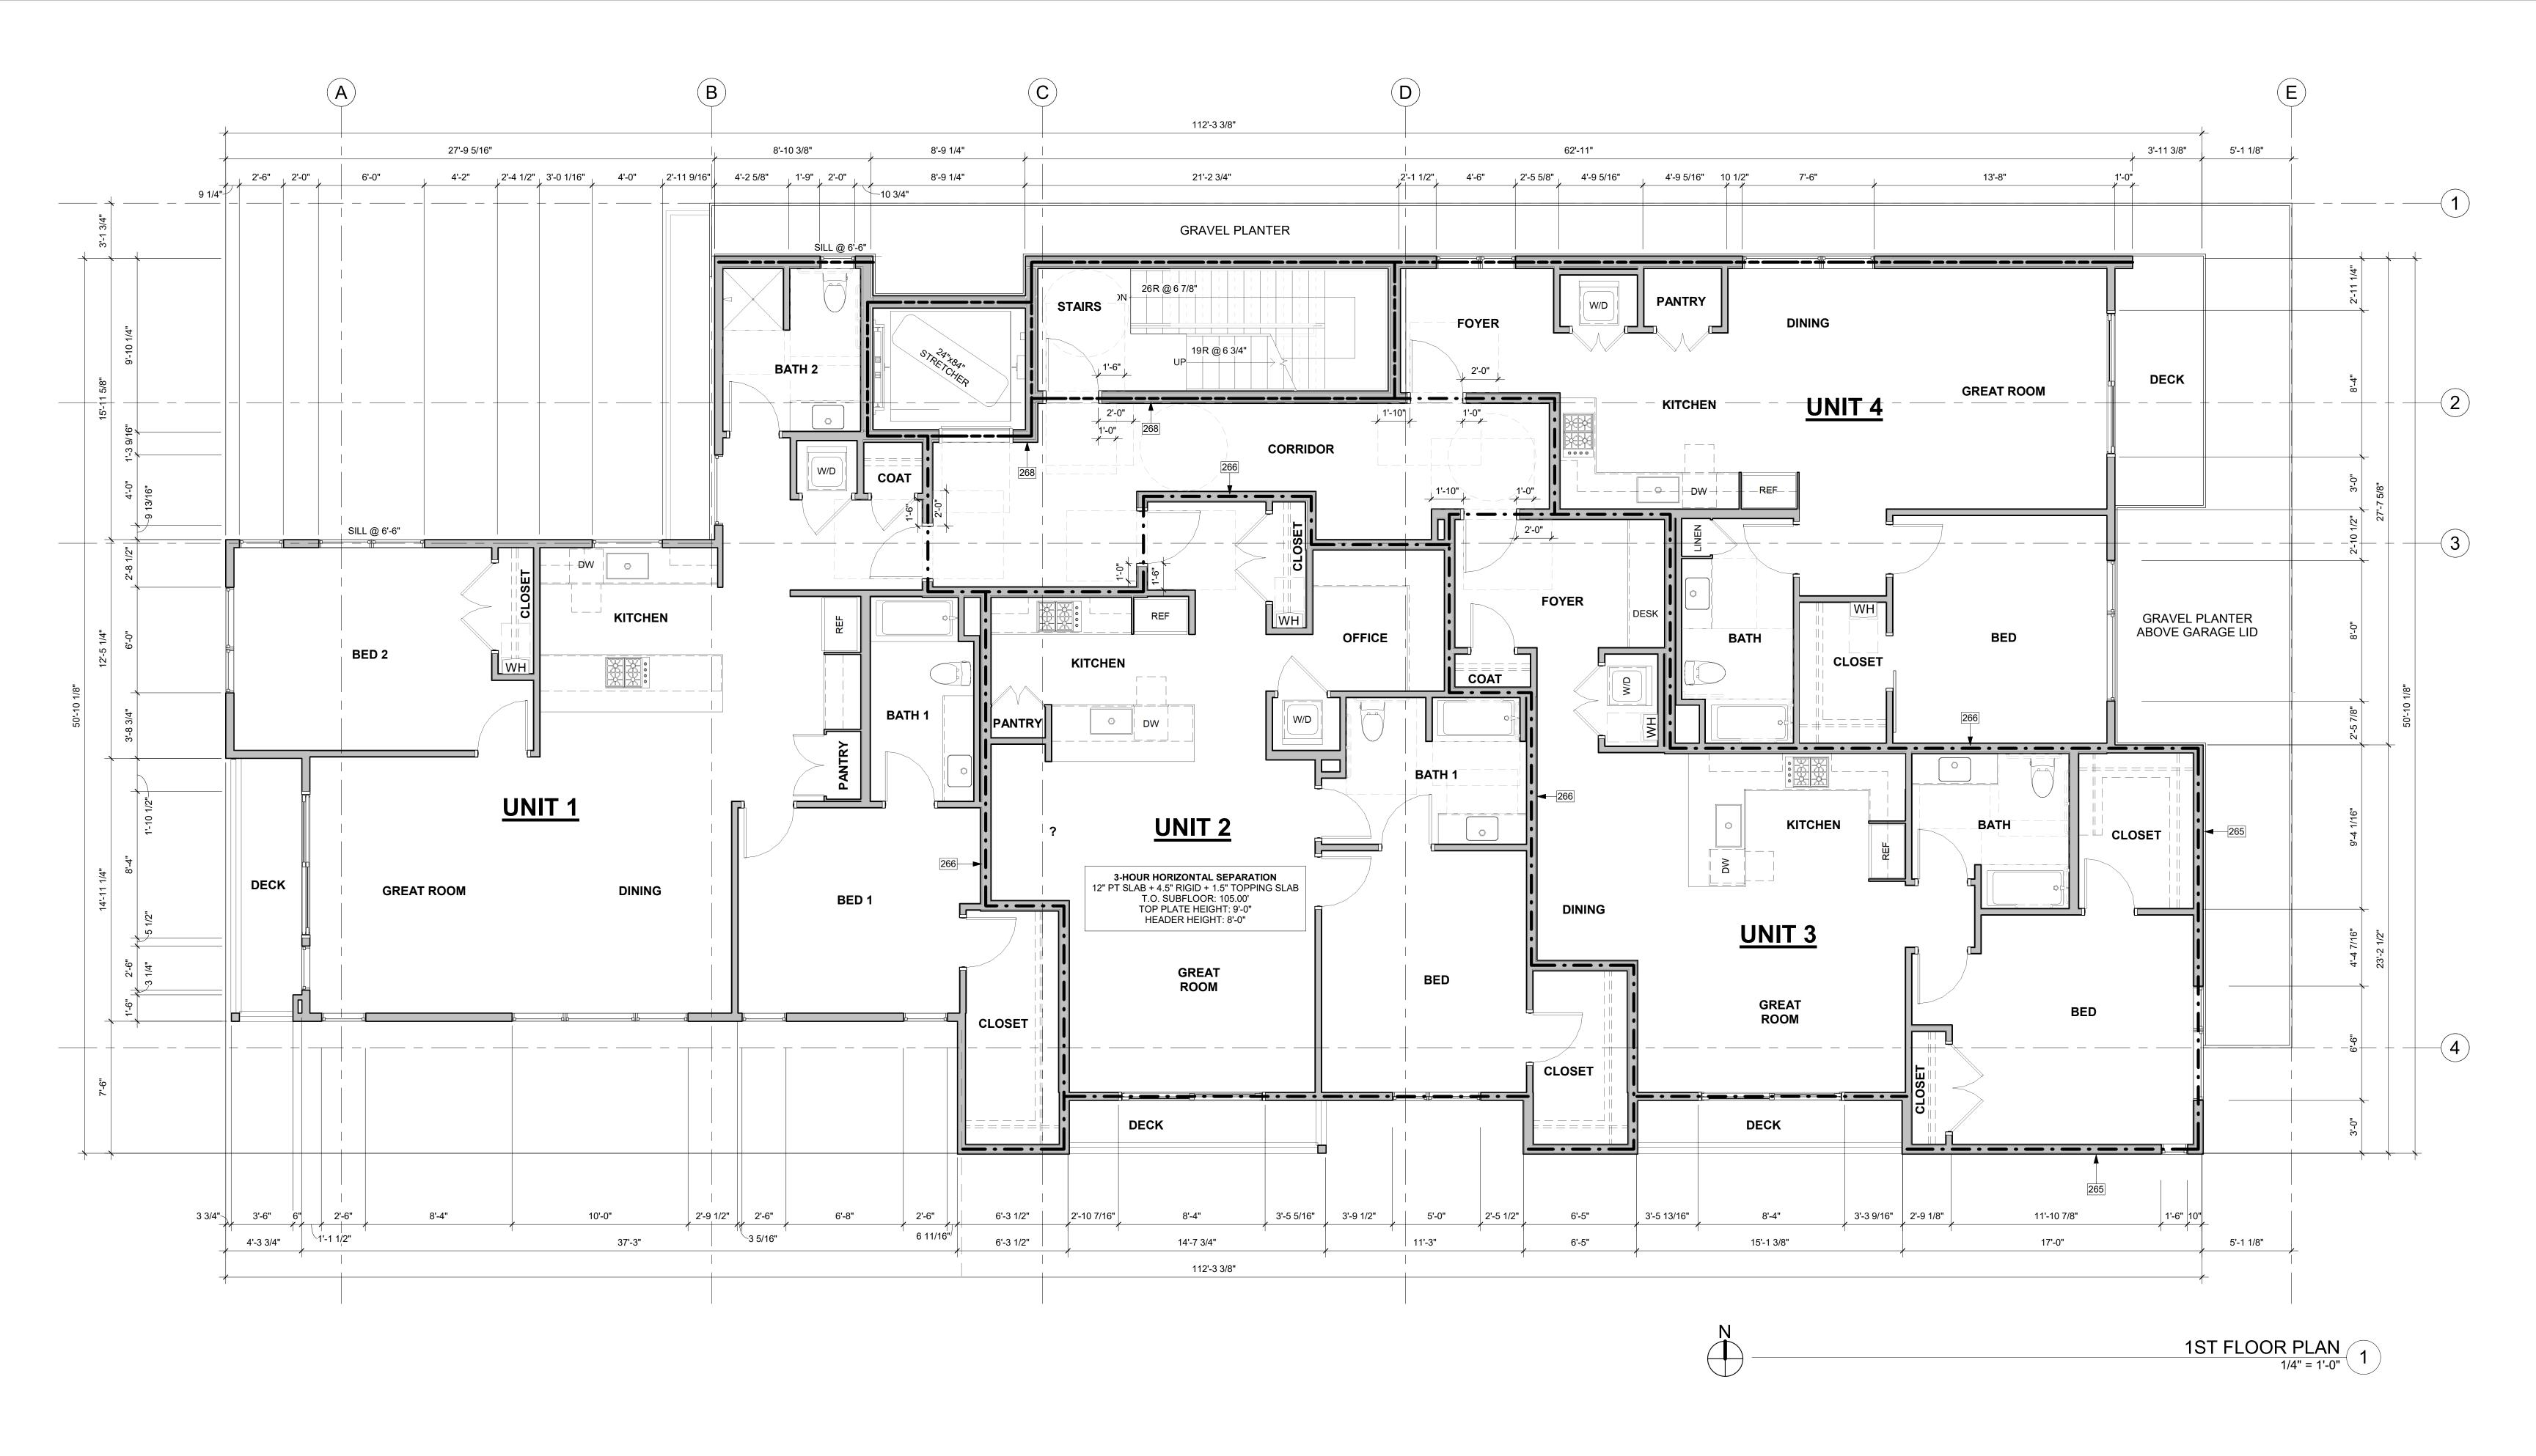
written permission from the Architect.

PROJECT No.: A21 021

DATE: 10/4/2023

Α2 (

43



- 265 1-HOUR RATED EXTERIOR WALL; WP 8105. SEE ASSEMBLY DETAIL ON A0.5a. 266 1-HOUR RATED FIRE PARTITION; WP 3242. STC RATING OF 50-54. SEE ASSEMBLY DETAIL ON A0.5a 2-HOUR RATED ELEVATOR SHAFT; WP 3825. STC RATING OF 55-59. SEE
 - ASSEMBLY DETAIL ON A0.5a.

FLOOR PLAN NOTES

- CONTRACTOR SHALL VERIFY ALL NOTES, DIMENSIONS & CONDITIONS PRIOR TO CONSTRUCTION.
- SEE STRUCTURAL DRAWINGS FOR ALL POSTS, BEAMS AND HEADERS. PROVIDE SOLID BLOCKING OVER SUPPORTS.
- PROVIDE FIRE BLOCKING @ ALL PLUMBING PENETRATIONS. WINDOWS & DOORS ARE SHOWN & NOTED AS NOMINAL SIZES.
- DOOR JAMB 4.5" FROM CORNER TYP., U.N.O. SEE SHEETS A0.3, A4.0 & A4.1 FOR WINDOW & DOOR HEADER HEIGHTS ABOVE FINISHED FLOOR.
- ALL WOOD IN CONTACT WITH CONCRETE TO BE PRESSURE TREATED. EXTERIOR WALLS TO BE 2x6 STUDS @ 16" O.C., U.N.O.
- INSTALL SIMPSON CONC. TO WOOD HOLDOWN'S PER STRUCTURAL DRAWINGS, ALSO SEE MANUFACTURER'S SPECS.
- 11. SMOKE & CARBON MONOXIDE DETECTORS: • SHALL BE 110V INTERCONNECTED W/ BATTERY BACKUP. SHALL SOUND AN ALARM AUDIBLE IN ALL SLEEPING ROOMS. • SHALL BE INSTALLED ON EACH FLOOR AND IN ALL BEDROOMS.
- CHANGE OF GREATER THAN 24" 12. FRESH AIR PROVIDED BY WHOLE-HOUSE EXHAUST FAN WITH FRESH AIR PORT (NET 4 SF IN MIN. OPENING) AT EACH HABITABLE ROOM. A TIMER

SHALL BE INSTALLED IN EACH LOCATION WHERE THERE IS A CEILING

- OPERATES AN EXHAUST FAN WHICH PULLS OUTSIDE AIR THROUGH AIR INLETS LOCATED IN EACH HABITABLE ROOM. 13. LIMITING DEVICE FOR TUBS TO PROVIDE MAX. 120°F HOT WATER
- TEMPERATURE. FOOTINGS SHALL BEAR ON SOLID UNDISTURBED EARTH (CONTROLLED, COMPACTED STRUCTURAL FILL OR BOTH). DEPTH OF FOOTINGS TO BE DETERMINED BY STRUCTURAL ENGINEER. FOUNDATION EXCAVATION, BACKFILL AND COMPACTION SHALL CONFORM TO SPECIFICATION REQUIREMENTS. THIS CONSTRUCTION WORK, INCLUDING DRAINAGE, SHORING AND SUCH OTHER RELATED WORK AS REQUIRED. SHALL BE CONDUCTED BY THE CONTRACTOR. STOP WORK IF RECOMMENDED EXCAVATION CUT OR BEARING SOIL CHANGES OCCUR IN EITHER HORIZONTAL OR VERTICAL DIRECTION AND NOTIFY IMMEDIATELY THE GEOTECHNICAL ENGINEER AND STRUCTURAL ENGINEER. AT WHICH POINT

THE ENGINEERS SHALL DETERMINE CAUSE OF DISPLACEMENT AND

DEVELOP AND IMPLEMENT REMEDIAL MEASURES.

- - - - 1-HOUR RATED WALL ASSEMBLY 2-HOUR RATED WALL ASSEMBLY

SEE TITLE SHEET A0.0 FOR COMPLETE SYMBOL INDEX.

FIRE-RESISTANCE ASSEMBLIES

3-HOUR RATED WALL ASSEMBLY SYMBOL LEGEND

APPROVED FOR CONSTRUCTION:

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this drawing shall not be carried out without

MEDICI ARCHITECTS

BELLEVUE, WA 98005 KETCHUM, ID 83340

TEL: (425) 453-9298

REGISTRATION:

INTAKE DATE:

REVISIONS:

PROJECT / CLIENT:

2900 78TH AVE SE

2900 Development LLC

JOB ADDRESS:

2900 78TH AVE SE

MERCER ISLAND, 98040

200 W. RIVER ST.

12/13/22

PROJECT No.: A21 021 DATE: 10/4/2023

DRAWING NAME:

Drawn By: KH

Checked By: ST

Owner Approval:

DESIGN REVIEW


PHASE:

1ST FLOOR PLAN

PLOT SCALE: 1:1

HOUSE VENTILATION


2018 IRC - PROVIDE WHOLE HOUSE VENTILATION PER M1505.4, INTERMITTENT WHOLE HOUSE VENTILATION USING EXHAUST FAN PER 1505.4.1.2 (WA) AND TABLE 1505.4.3(1) & (3) (WA); PROVIDE CONTROLS PER 1505.4.2. COMPLY WITH WSEC R403.

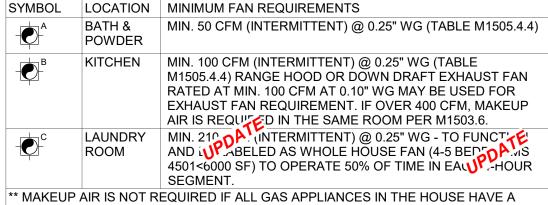

M1505.4.4) RANGE HOOD OR DOWN DRAFT EXHAUST FAN RATED AT MIN. 100 CFM AT 0.10" WG MAY BE USED FOR EXHAUST FAN REQUIREMENT. IF OVER 400 CFM, MAKEUP AIR IS REQUITED IN THE SAME ROOM PER M1503.6. ROOM

MIN. 210 A (INTERMITTENT) @ 0.25" WG - TO FUNCTIFE AND LUP ABELED AS WHOLE HOUSE FAN (4-5 BEDSOA LIS 4501<6000 SF) TO OPERATE 50% OF TIME IN EACH CHOUR

** MAKEUP AIR IS NOT REQUIRED IF ALL GAS APPLIANCES IN THE HOUSE HAVE A DIRECT VENT OR MECHANICAL DRAFT VENT SYSTEM, PER MODIFICATION M1503.6.

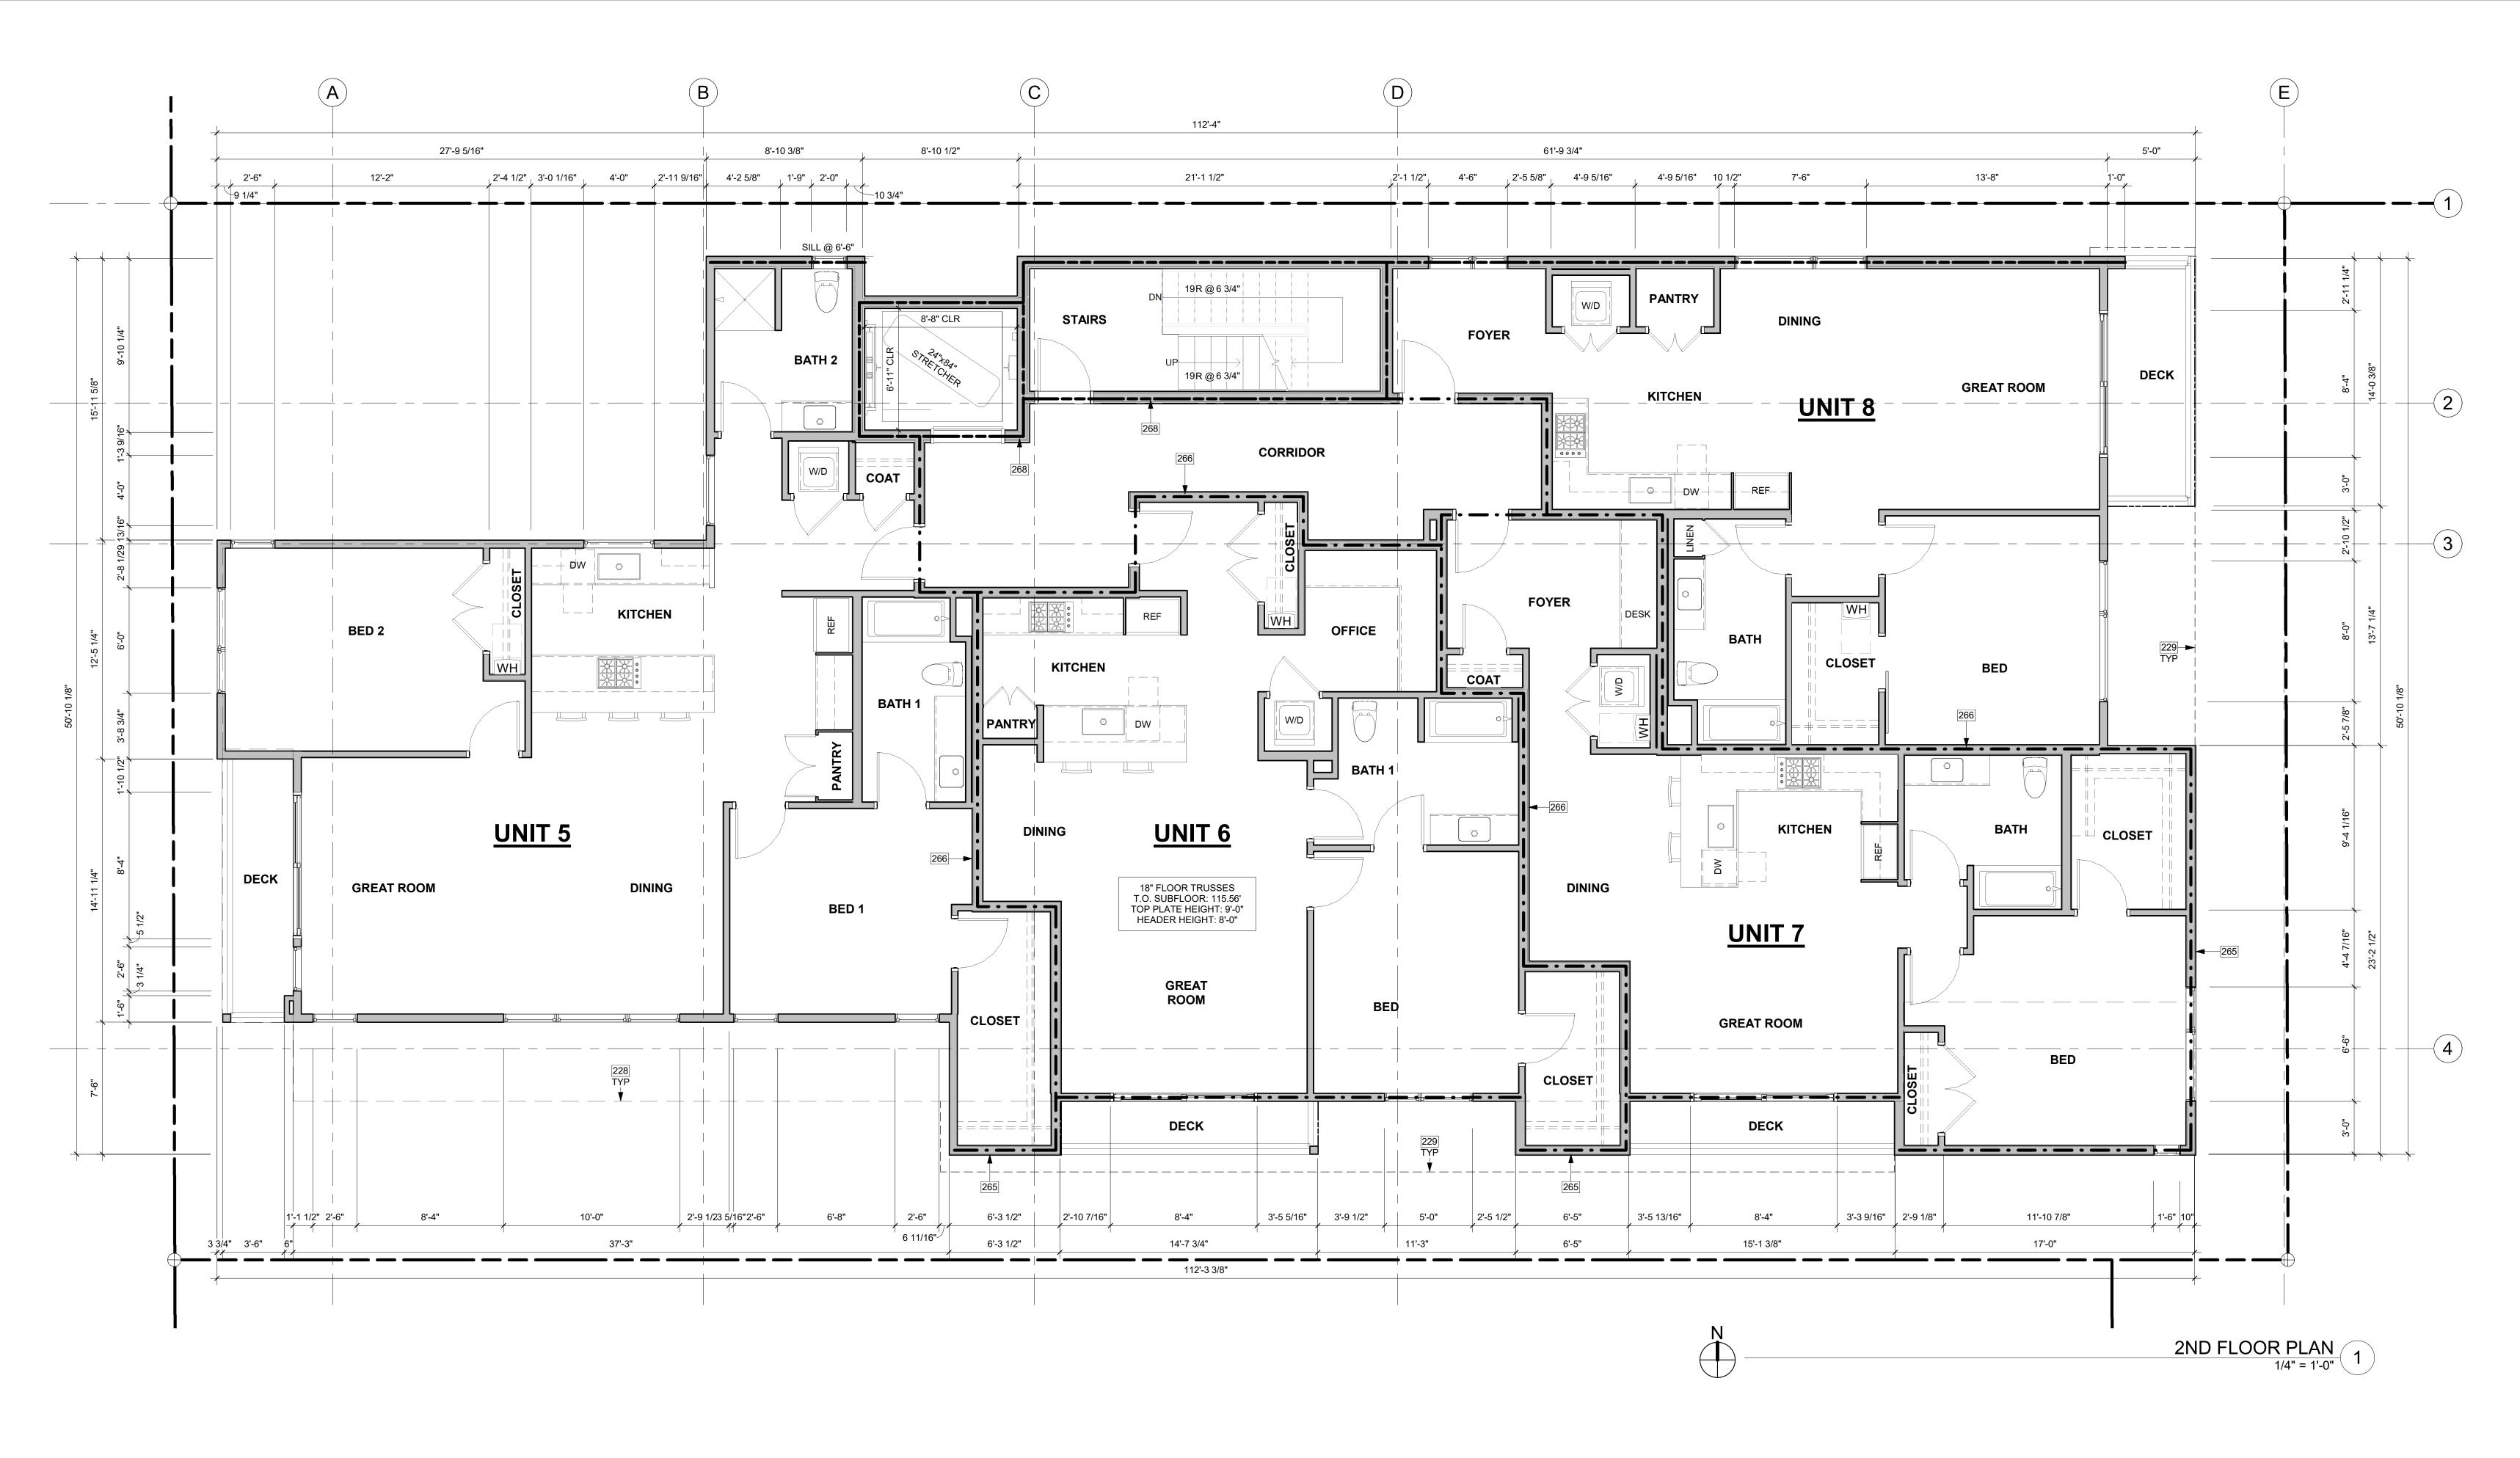

228 LONG DASHED LINE OF BUILDING ABOVE.
229 LONG DASHED LINE OF ROOF ABOVE

ASSEMBLY DETAIL ON A0.5a.

LONG DASHED LINE OF ROOF ABOVE.
 1-HOUR RATED EXTERIOR WALL; WP 8105. SEE ASSEMBLY DETAIL ON A0.5a.

266 1-HOUR RATED FIRE PARTITION; WP 3242. STC RATING OF 50-54. SEE

ASSEMBLY DETAIL ON A0.5a

268 2-HOUR RATED ELEVATOR SHAFT; WP 3825. STC RATING OF 55-59. SEE

• S

HOUSE VENTILATION

2018 IRC - PROVIDE WHOLE HOUSE VENTILATION PER M1505.4, INTERMITTENT WHOLE HOUSE VENTILATION USING EXHAUST FAN PER 1505.4.1.2 (WA) AND TABLE 1505.4.3(1) & (3) (WA); PROVIDE CONTROLS PER 1505.4.2. COMPLY WITH WSEC R403.

	SYMBOL	LOCATION	MINIMUM FAN REQUIREMENTS
	- A	BATH & POWDER	MIN. 50 CFM (INTERMITTENT) @ 0.25" WG (TABLE M1505.4.4)
	- P -B	KITCHEN	MIN. 100 CFM (INTERMITTENT) @ 0.25" WG (TABLE M1505.4.4) RANGE HOOD OR DOWN DRAFT EXHAUST FAN RATED AT MIN. 100 CFM AT 0.10" WG MAY BE USED FOR EXHAUST FAN REQUIREMENT. IF OVER 400 CFM, MAKEUP AIR IS REQUIRED IN THE SAME ROOM PER M1503.6.
	c	LAUNDRY ROOM	AIR IS REQUITED IN THE SAME ROOM PER M1503.6. MIN. 210 A (INTERMITTENT) @ 0.25" WG - TO FUNCTIFE AND LABELED AS WHOLE HOUSE FAN (4-5 BEDED AND LABELED AND LABELE
			EQUIRED IF ALL GAS APPLIANCES IN THE HOUSE HAVE A ANICAL DRAFT VENT SYSTEM, PER MODIFICATION M1503.6.

FLOOR PLAN NOTES

- CONTRACTOR SHALL VERIFY ALL NOTES, DIMENSIONS & CONDITIONS PRIOR TO CONSTRUCTION.
- 2. SEE STRUCTURAL DRAWINGS FOR ALL POSTS, BEAMS AND HEADERS.
- PROVIDE SOLID BLOCKING OVER SUPPORTS.
 PROVIDE FIRE BLOCKING @ ALL PLUMBING PENETRATIONS.
 WINDOWS & DOORS ARE SHOWN & NOTED AS NOMINAL SIZES.
- DOOR JAMB 4.5" FROM CORNER TYP., U.N.O.
 SEE SHEETS A0.3, A4.0 & A4.1 FOR WINDOW & DOOR HEADER HEIGHTS ABOVE FINISHED FLOOR.
- ALL WOOD IN CONTACT WITH CONCRETE TO BE PRESSURE TREATED.
 EXTERIOR WALLS TO BE 2x6 STUDS @ 16" O.C., U.N.O.
- 10. INSTALL SIMPSON CONC. TO WOOD HOLDOWNS PER STRUCTURAL DRAWINGS, ALSO SEE MANUFACTURER'S SPECS.
 11. SMOKE & CARBON MONOXIDE DETECTORS:
- SHALL BE 110V INTERCONNECTED W/ BATTERY BACKUP.
 SHALL SOUND AN ALARM AUDIBLE IN ALL SLEEPING ROOMS.
 SHALL BE INSTALLED ON EACH FLOOR AND IN ALL BEDROOMS.
 SHALL BE INSTALLED IN EACH LOCATION WHERE THERE IS A CEILING CHANGE OF GREATER THAN 24"
- 12. FRESH AIR PROVIDED BY WHOLE-HOUSE EXHAUST FAN WITH FRESH AIR PORT (NET 4 SF IN MIN. OPENING) AT EACH HABITABLE ROOM. A TIMER OPERATES AN EXHAUST FAN WHICH PULLS OUTSIDE AIR THROUGH AIR
- INLETS LOCATED IN EACH HABITABLE ROOM.

 13. LIMITING DEVICE FOR TUBS TO PROVIDE MAX. 120°F HOT WATER
- TEMPERATURE.

 4. FOOTINGS SHALL BEAR ON SOLID UNDISTURBED EARTH (CONTROLLED, COMPACTED STRUCTURAL FILL OR BOTH). DEPTH OF FOOTINGS TO BE DETERMINED BY STRUCTURAL ENGINEER. FOUNDATION EXCAVATION, BACKFILL AND COMPACTION SHALL CONFORM TO SPECIFICATION REQUIREMENTS. THIS CONSTRUCTION WORK, INCLUDING DRAINAGE, SHORING AND SUCH OTHER RELATED WORK AS REQUIRED, SHALL BE CONDUCTED BY THE CONTRACTOR. STOP WORK IF RECOMMENDED EXCAVATION CUT OR BEARING SOIL CHANGES OCCUR IN EITHER HORIZONTAL OR VERTICAL DIRECTION AND NOTIFY IMMEDIATELY THE

GEOTECHNICAL ENGINEER AND STRUCTURAL ENGINEER. AT WHICH POINT

THE ENGINEERS SHALL DETERMINE CAUSE OF DISPLACEMENT AND

DEVELOP AND IMPLEMENT REMEDIAL MEASURES.

1-HOUR RATED WALL ASSEMBLY
2-HOUR RATED WALL ASSEMBLY

3-HOUR RATED WALL ASSEMBLY

FIRE-RESISTANCE ASSEMBLIES

SYMBOL LEGEND

SEE TITLE SHEET A0.0 FOR COMPLETE SYMBOL INDEX.

MEDICI ARCHITECTS

11711 SE 8TH STREET 200 W. RIVER ST.
SUITE 100 SUITE 301
BELLEVUE, WA 98005 KETCHUM, ID 83340

REGISTRATION:

TEL: (425) 453-9298



REVISIONS: DATE:

PROJECT / CLIENT:

2900 78TH AVE SE

2900 Development LLC

JOB ADDRESS: 2900 78TH AVE SE MERCER ISLAND, 98040

DRAWING NAME:

2ND FLOOR PLAN

Drawn By: KH
Checked By: ST

Owner Approval:

PHASE:

DESIGN REVIEW

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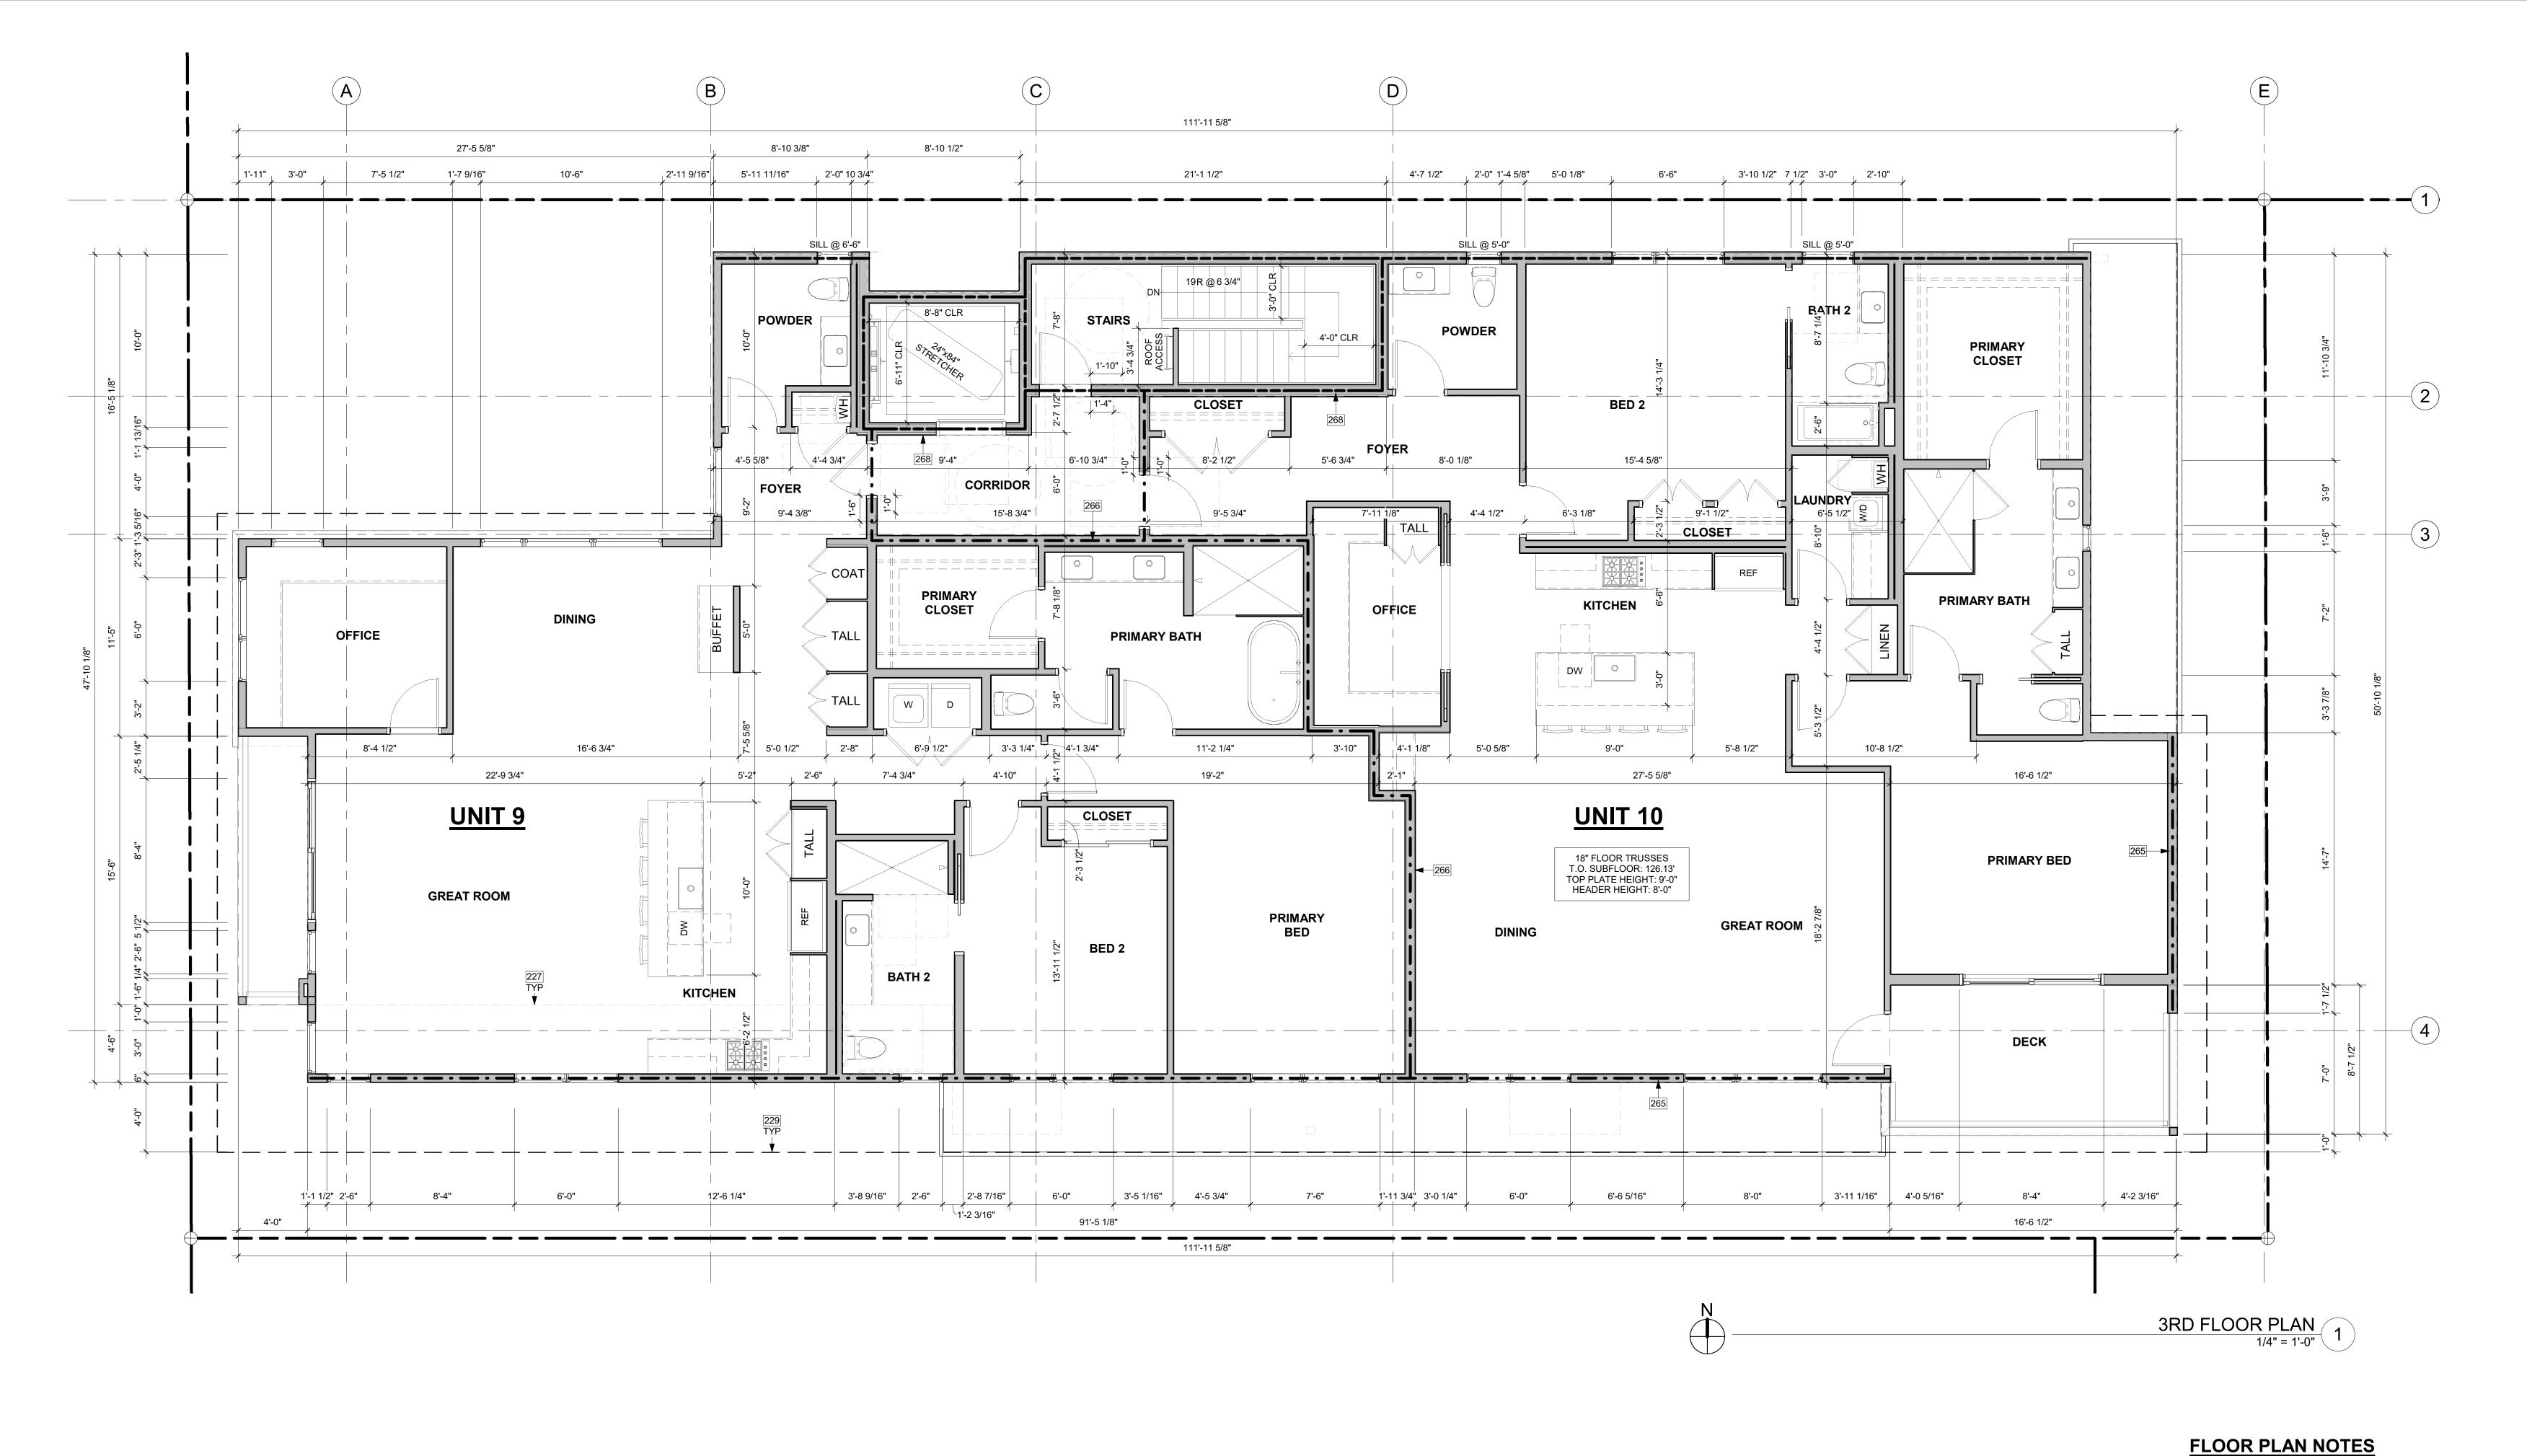
APPROVED FOR CONSTRUCTION:

written permission from the Architect.

PROJECT No.: A21 021

DATE: 10/4/2023

A2.2



- 227 SHORT DASHED LINE OF BUILDING BELOW. 229 LONG DASHED LINE OF ROOF ABOVE.
- 265 1-HOUR RATED EXTERIOR WALL; WP 8105. SEE ASSEMBLY DETAIL ON A0.5a. 266 1-HOUR RATED FIRE PARTITION; WP 3242. STC RATING OF 50-54. SEE
- ASSEMBLY DETAIL ON A0.5a 268 2-HOUR RATED ELEVATOR SHAFT; WP 3825. STC RATING OF 55-59. SEE ASSEMBLY DETAIL ON A0.5a.

- CONTRACTOR SHALL VERIFY ALL NOTES, DIMENSIONS & CONDITIONS PRIOR TO CONSTRUCTION.
- SEE STRUCTURAL DRAWINGS FOR ALL POSTS, BEAMS AND HEADERS. PROVIDE SOLID BLOCKING OVER SUPPORTS.
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- EXTERIOR WALLS TO BE 2x6 STUDS @ 16" O.C., U.N.O. INSTALL SIMPSON CONC. TO WOOD HOLDOWN'S PER STRUCTURAL
- DRAWINGS, ALSO SEE MANUFACTURER'S SPECS. 11. SMOKE & CARBON MONOXIDE DETECTORS:
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THE ENGINEERS SHALL DETERMINE CAUSE OF DISPLACEMENT AND DEVELOP AND IMPLEMENT REMEDIAL MEASURES.

GEOTECHNICAL ENGINEER AND STRUCTURAL ENGINEER. AT WHICH POINT

- - - - 1-HOUR RATED WALL ASSEMBLY 2-HOUR RATED WALL ASSEMBLY

3-HOUR RATED WALL ASSEMBLY

FIRE-RESISTANCE ASSEMBLIES

HOUSE VENTILATION

POWDER

SYMBOL LOCATION MINIMUM FAN REQUIREMENTS

SEGMENT.

2018 IRC - PROVIDE WHOLE HOUSE VENTILATION PER M1505.4, INTERMITTENT

WHOLE HOUSE VENTILATION USING EXHAUST FAN PER 1505.4.1.2 (WA) AND TABLE

1505.4.3(1) & (3) (WA); PROVIDE CONTROLS PER 1505.4.2. COMPLY WITH WSEC R403.

KITCHEN MIN. 100 CFM (INTERMITTENT) @ 0.25" WG (TABLE

** MAKEUP AIR IS NOT REQUIRED IF ALL GAS APPLIANCES IN THE HOUSE HAVE A

BATH & MIN. 50 CFM (INTERMITTENT) @ 0.25" WG (TABLE M1505.4.4)

M1505.4.4) RANGE HOOD OR DOWN DRAFT EXHAUST FAN

RATED AT MIN. 100 CFM AT 0.10" WG MAY BE USED FOR EXHAUST FAN REQUIREMENT. IF OVER 400 CFM, MAKEUP

AIR IS REQUITED IN THE SAME ROOM PER M1503.6.

ROOM MIN. 210 0A (INTERMITTENT) @ 0.25" WG - TO FUNCTIFE AND LUP ABELED AS WHOLE HOUSE FAN (4-5 BECOAL)

4501<6000 SF) TO OPERATE 50% OF TIME IN EACH CHOUR SYMBOL LEGEND DIRECT VENT OR MECHANICAL DRAFT VENT SYSTEM, PER MODIFICATION M1503.6. SEE TITLE SHEET A0.0 FOR COMPLETE SYMBOL INDEX.




SUITE 301

KETCHUM, ID 83340

TEL: (208) 726-0194

200 W. RIVER ST.

BELLEVUE, WA 98005 TEL: (425) 453-9298

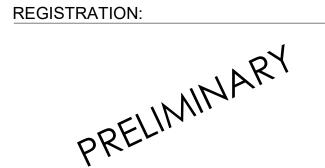

12/13/22 INTAKE DATE: **REVISIONS:**

PROJECT / CLIENT:

2900 78TH AVE SE

2900 Development LLC

JOB ADDRESS: 2900 78TH AVE SE MERCER ISLAND, 98040

DRAWING NAME:

3RD FLOOR PLAN

Drawn By: KH Checked By: ST

PHASE:

Owner Approval:


DESIGN REVIEW

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APPROVED FOR CONSTRUCTION:

PROJECT No.: A21 021

DATE: 10/4/2023

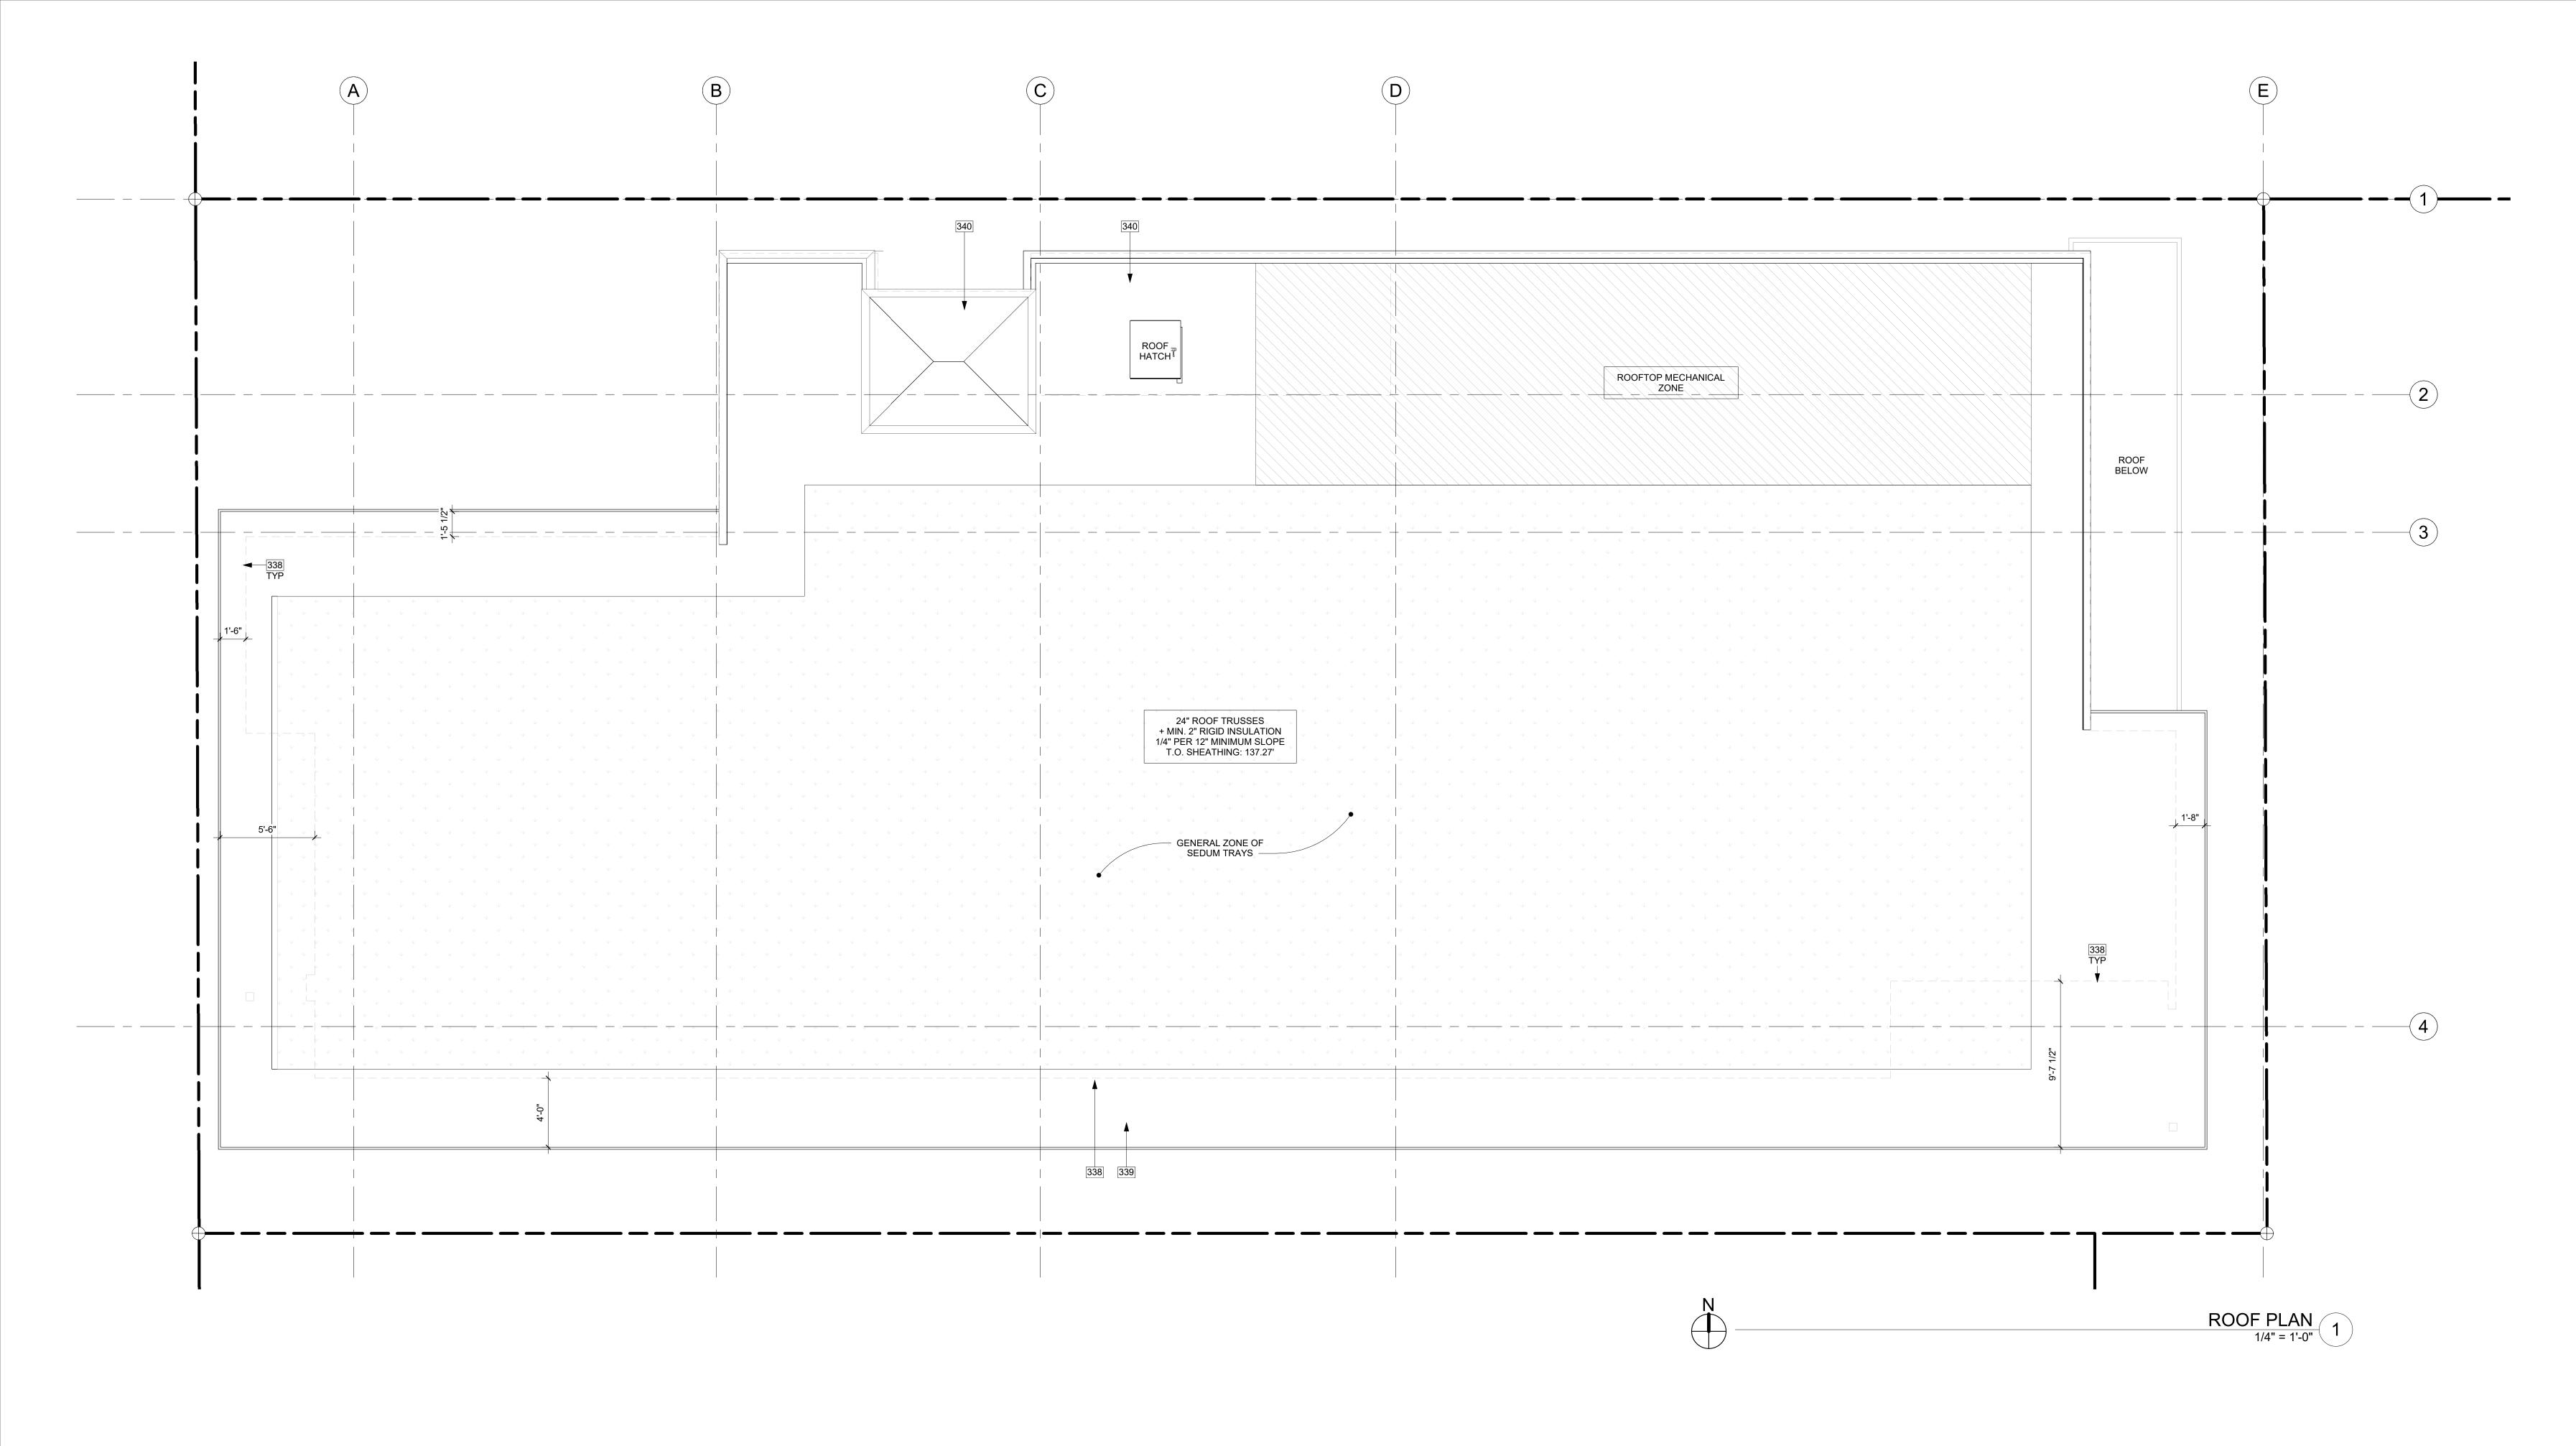

DASHED LINE OF BUILDING BELOW.
 1-HOUR RATED ROOF ASSEMBLY; RC 2604. SEE ASSEMBLY DETAIL ON A0.5a
 2-HOUR RATED ROOF ASSEMBLY AT STAIRS AND ELEVATOR SHAFT; RC 2751. SEE ASSEMBLY DETAIL ON A0.5a.

SYMBOL LEGE WUSE

WENT TYPES IN USE

BUILDING BELOW

ROOF HAT VENT

ROOF VENTILATION

ROOF CONSTRUCTION:
ROOF AREA:

XXX SF

VENTILATION REQUIRED:

(XXX SF x 144 SI) / 150* = XXY SI REQUIRED

PROPOSED VENTILATION:
(4) 2-1/2" DIA. HOLES PER 24": 9.8 SI / LF - 2F'
PROVIDE:
87 LF EAY
2" WIDE RIDGE VENT: 18 S'
PROVIDE:
ROOF HAT VENT: = 50 SI
PROVIDE:

TOTAL MIN. VENTILATION
* PER IRC R806.2, MINIMUM NATERIAL AS AN ALTERNATIVE AREA. AS AN ALTERNATIVE AREA AS AN ALTERNATIVE ARE



11711 SE OTH STREET 200 M

11711 SE 8TH STREET 200 W. RIVER ST.
SUITE 100 SUITE 301
BELLEVUE, WA 98005 KETCHUM, ID 83340
TEL: (425) 453-9298 TEL: (208) 726-0194

REGISTRATION:

PRELIMINARY

INTAKE DATE: 12/13/22

REVISIONS: DATE:

2900 78TH AVE SE

2900 Development LLC

JOB ADDRESS: 2900 78TH AVE SE MERCER ISLAND, 98040

DRAWING NAME:

ROOF PLAN

Drawn By: KH
Checked By: ST
Owner Approval:

PHASE:

DESIGN REVIEW

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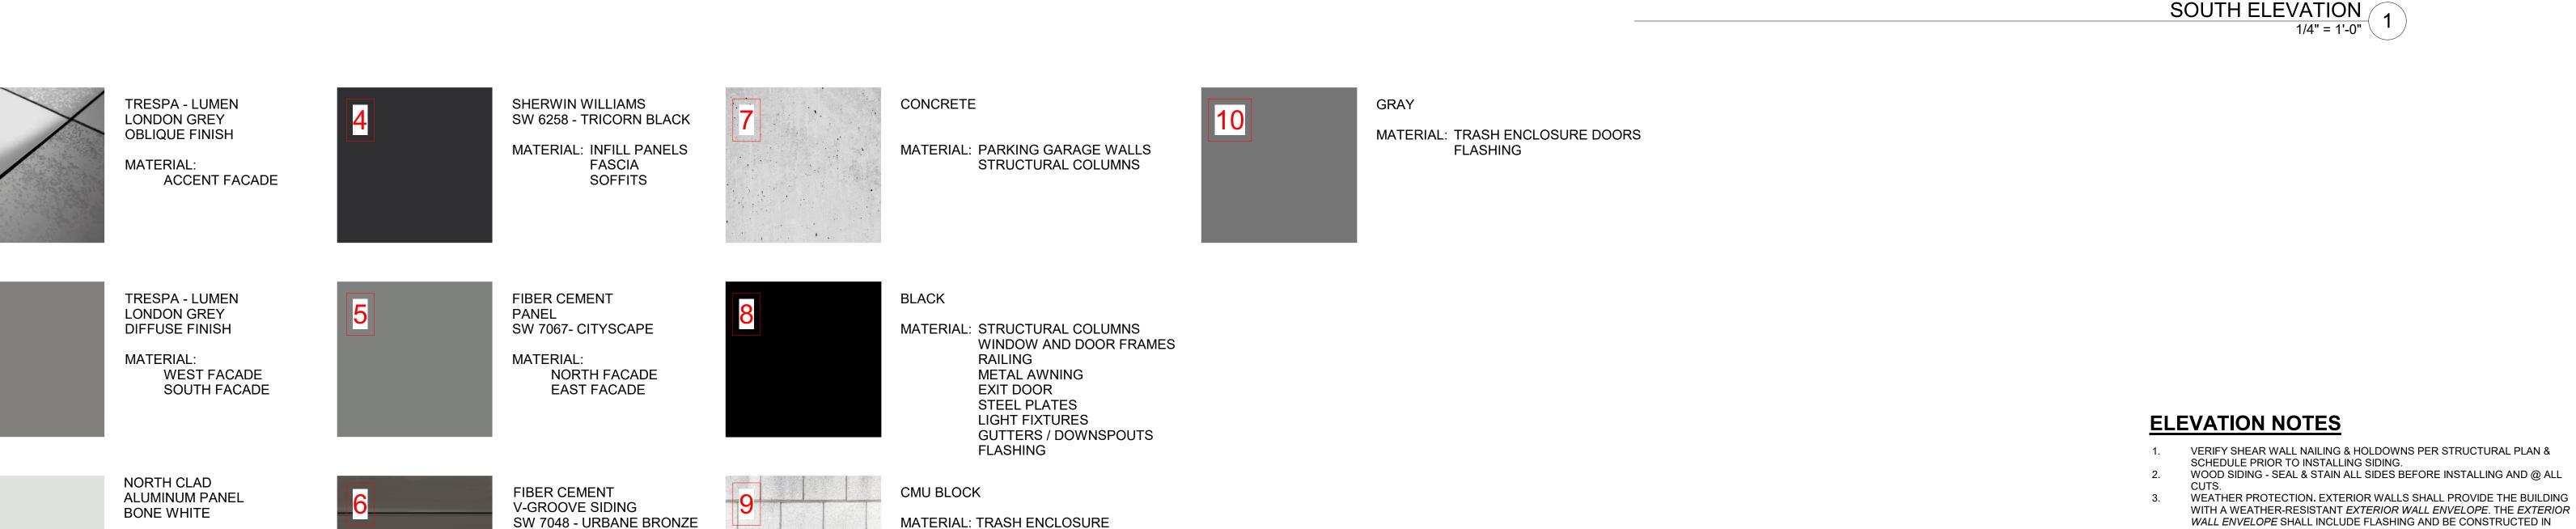
APPROVED FOR CONSTRUCTION:

PROJECT No.: A21 021

DATE: 10/4/2023

A3.0





MATERIALS

A A E D I C I A D C I II TE C T S

MEDICI ARCHITECTS

11711 SE 8TH STREET 200 W. RIVER ST.
SUITE 100 SUITE 301
BELLEVUE, WA 98005 KETCHUM, ID 83340
TEL: (425) 453-9298 TEL: (208) 726-0194

REGISTRATION:



REVISIONS: DATE:

PROJECT / CLIENT:

2900 78TH AVE SE

2900 Development LLC

JOB ADDRESS: 2900 78TH AVE SE MERCER ISLAND, 98040

DRAWING NAME:

ELEVATIONS

Drawn By: KH

Checked By: ST

Owner Approval:

PHASE:

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APPROVED FOR CONSTRUCTION:

PROJECT No.: A21 021

DATE: 10/4/2023

A4.0

ı

MATERIAL:

WEST FACADE

SOUTH FACADE

MATERIAL:

RECESSED FACADES

ELEVATOR SHAFT

WHEREVER THERE IS A CHANGE IN ROOF SLOPE OR DIRECTION AND AROUND ROOF OPENINGS. WHERE FLASHING IS OF METAL, THE METAL SHALL BE CORROSION RESISTANT.

6. PROVIDE CONTINUOUS GUTTERS & DOWNSPOUTS AT EAVES PER PLANS,

CONTINUOUSLY ABOVE PROJECTING TRIM.

PROVIDE WEATHER STRIPPING AT ALL EXTERIOR & GARAGE DOORS. CAULK ALL EXTERIOR JOINTS & PENETRATIONS.
WINDOWS AND DOORS SHALL BE INSTALLED IN ACCORDANCE WITH

SUCH A MANNER AS TO PREVENT THE ACCUMULATION OF WATER WITHIN

CONDENSATION IN THE EXTERIOR WALL ASSEMBLY SHALL BE PROVIDED. PER IRC R703.8. FLASHING AT WALLS. FLASHING SHALL BE INSTALLED IN SUCH A MANNER SO AS TO PREVENT MOISTURE FROM ENTERING THE WALL OR TO REDIRECT THAT MOISTURE TO THE EXTERIOR. FLASHING SHALL BE INSTALLED AT THE PERIMETERS OF EXTERIOR DOOR AND WINDOW ASSEMBLIES, PENETRATIONS AND TERMINATIONS OF EXTERIOR WALL ASSEMBLIES, EXTERIOR WALL INTERSECTIONS WITH ROOFS,

CHIMNEYS, PORCHES, DECKS, BALCONIES AND SIMILAR PROJECTIONS AND

AT BUILT-IN GUTTERS AND SIMILAR LOCATIONS WHERE MOISTURE COULD ENTER THE WALL. FLASHING WITH PROJECTING FLANGES SHALL BE

INSTALLED ON BOTH SIDES AND THE ENDS OF COPINGS, UNDER SILLS AND

PROVIDE FLASHING AT ROOF PENETRATIONS PER IRC R903.2.1. FLASHING SHALL BE INSTALLED AT WALL AND ROOF INTERSECTIONS, AT GUTTERS,

THE EXTERIOR VENEER AND A MEANS FOR DRAINING WATER THAT


ENTERS THE ASSEMBLY TO THE EXTERIOR. PROTECTION AGAINST

THE WALL ASSEMBLY BY PROVIDING A WATER-RESISTIVE BARRIER BEHIND


APPROVED MANUFACTURER'S INSTRUCTIONS.
SEE GENERAL NOTES SHEET A0.3 FOR ADDITIONAL NOTES.



MATERIAL: TRASH ENCLOSURE DOORS FLASHING

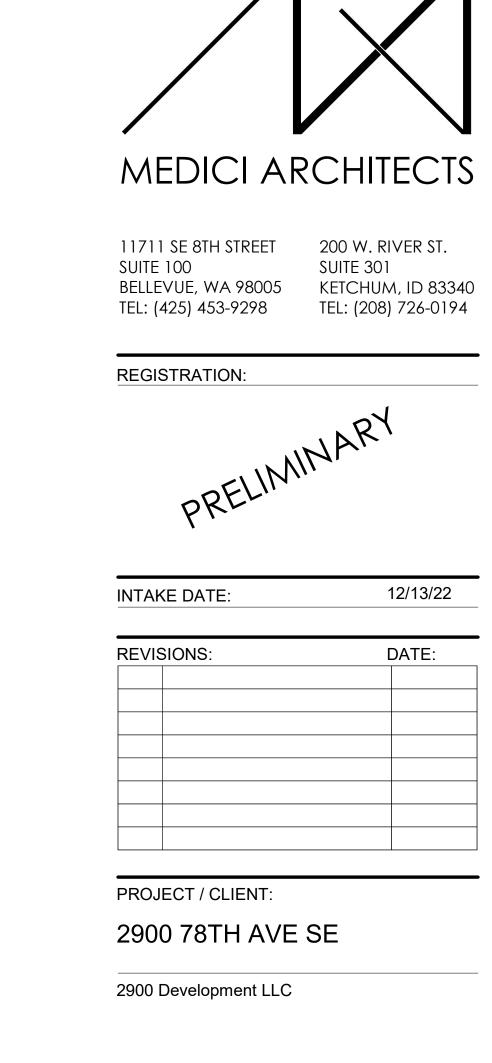

NORTH ELEVATION
1/4" = 1'-0"
1

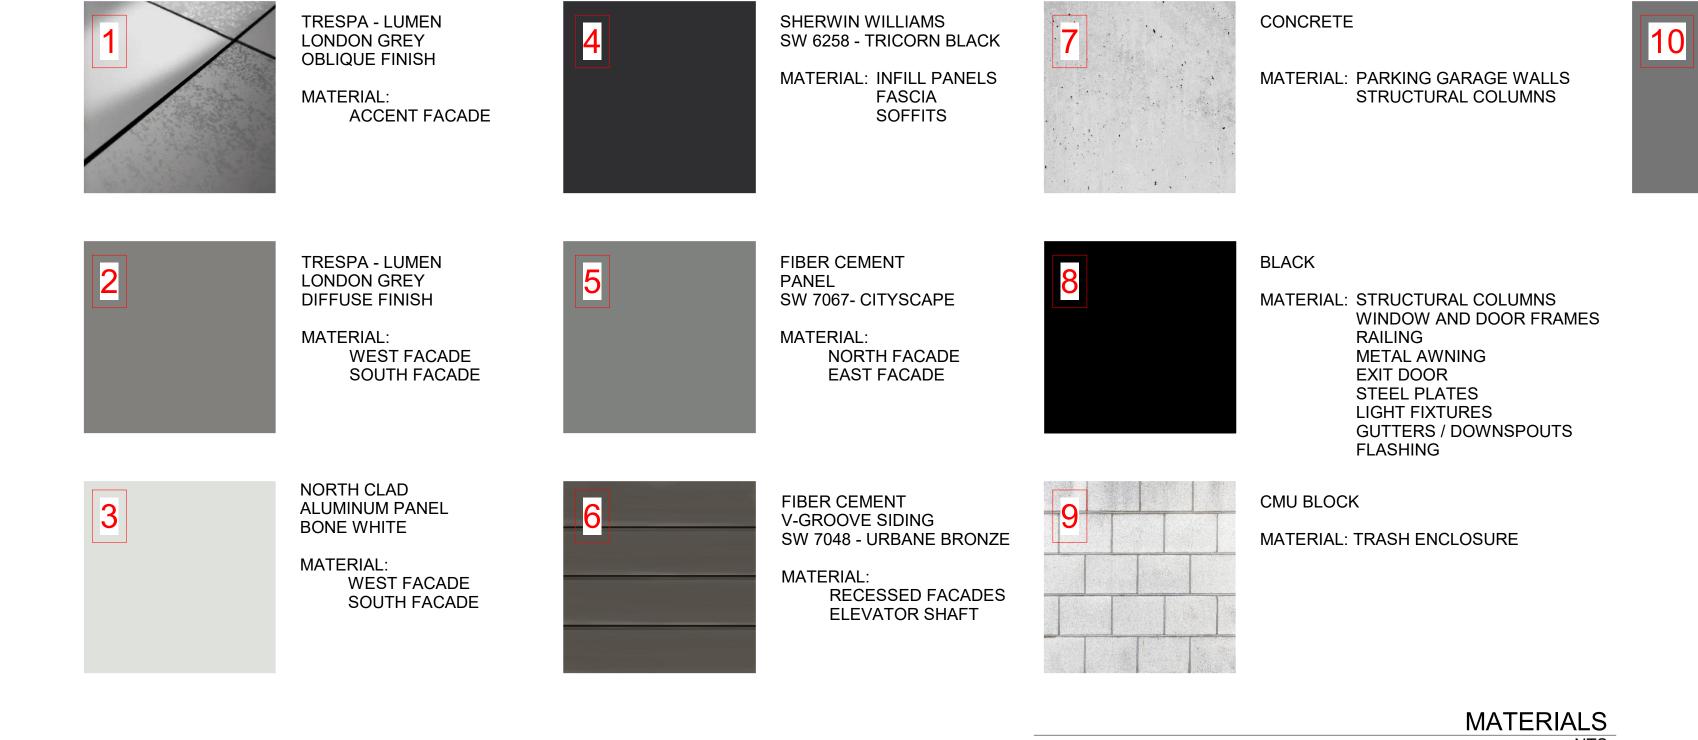

ELEVATION NOTES

- VERIFY SHEAR WALL NAILING & HOLDOWNS PER STRUCTURAL PLAN & SCHEDULE PRIOR TO INSTALLING SIDING. WOOD SIDING - SEAL & STAIN ALL SIDES BEFORE INSTALLING AND @ ALL
- WEATHER PROTECTION. EXTERIOR WALLS SHALL PROVIDE THE BUILDING WITH A WEATHER-RESISTANT EXTERIOR WALL ENVELOPE. THE EXTERIOR WALL ENVELOPE SHALL INCLUDE FLASHING AND BE CONSTRUCTED IN SUCH A MANNER AS TO PREVENT THE ACCUMULATION OF WATER WITHIN THE WALL ASSEMBLY BY PROVIDING A WATER-RESISTIVE BARRIER BEHIND THE EXTERIOR VENEER AND A MEANS FOR DRAINING WATER THAT ENTERS THE ASSEMBLY TO THE EXTERIOR. PROTECTION AGAINST
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- INSTALLED ON BOTH SIDES AND THE ENDS OF COPINGS, UNDER SILLS AND PROVIDE FLASHING AT ROOF PENETRATIONS PER IRC R903.2.1. FLASHING SHALL BE INSTALLED AT WALL AND ROOF INTERSECTIONS, AT GUTTERS, WHEREVER THERE IS A CHANGE IN ROOF SLOPE OR DIRECTION AND AROUND ROOF OPENINGS. WHERE FLASHING IS OF METAL, THE METAL
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DRAWING NAME:

JOB ADDRESS:

2900 78TH AVE SE

MERCER ISLAND, 98040

ELEVATIONS

Drawn By: KH Checked By: ST

Owner Approval:

PHASE:

DESIGN REVIEW

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APPROVED FOR CONSTRUCTION:

PROJECT No.: A21 021

DATE: 10/4/2023







TRESPA - LUMEN **LONDON GREY OBLIQUE FINISH** MATERIAL: ACCENT FACADE



SHERWIN WILLIAMS SW 6258 - TRICORN BLACK MATERIAL: INFILL PANELS FASCIA SOFFITS

FIBER CEMENT


SW 7067- CITYSCAPE

NORTH FACADE


EAST FACADE

PANEL

MATERIAL:

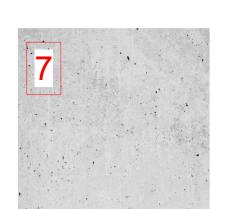

MATERIAL: PARKING GARAGE WALLS STRUCTURAL COLUMNS

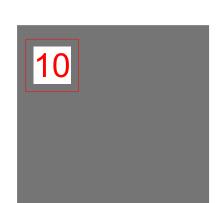

MATERIAL: TRASH ENCLOSURE DOORS FLASHING

TRESPA - LUMEN **LONDON GREY** DIFFUSE FINISH MATERIAL: WEST FACADE SOUTH FACADE

NORTH CLAD

BONE WHITE

MATERIAL:

ALUMINUM PANEL

WEST FACADE

SOUTH FACADE



FIBER CEMENT V-GROOVE SIDING SW 7048 - URBANE BRONZE MATERIAL: RECESSED FACADES **ELEVATOR SHAFT**



MATERIAL: STRUCTURAL COLUMNS WINDOW AND DOOR FRAMES RAILING METAL AWNING EXIT DOOR STEEL PLATES LIGHT FIXTURES GUTTERS / DOWNSPOUTS **FLASHING**



CMU BLOCK MATERIAL: TRASH ENCLOSURE

MATERIALS

ELEVATION NOTES

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SEE GENERAL NOTES SHEET A0.3 FOR ADDITIONAL NOTES.

PLOT SCALE: 1:1

PROJECT No.: A21 021

DATE: 10/4/2023



SUITE 100 SUITE 301
BELLEVUE, WA 98005 KETCHUM, ID 83340
TEL: (425) 453-9298 TEL: (208) 726-0194

REGISTRATION:

INTAKE DATE:

REVISIONS:

PROJECT / CLIENT:

2900 Development LLC

MERCER ISLAND, 98040

JOB ADDRESS: 2900 78TH AVE SE

DRAWING NAME:

Drawn By: KH

Checked By: ST

Owner Approval:

DESIGN REVIEW

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PHASE:


ELEVATIONS

2900 78TH AVE SE


200 W. RIVER ST.

12/13/22



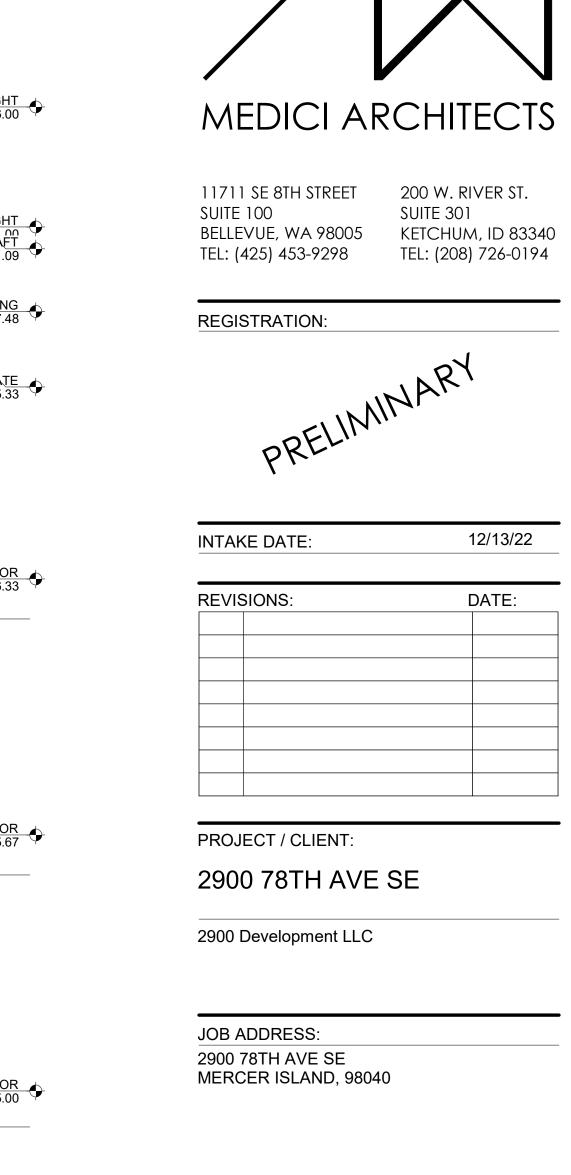


EAST ELEVATION
1/4" = 1'-0"
1

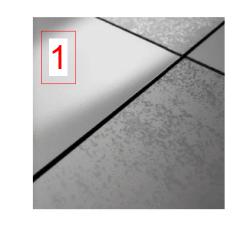

TRESPA - LUMEN **LONDON GREY OBLIQUE FINISH** MATERIAL: ACCENT FACADE



SHERWIN WILLIAMS SW 6258 - TRICORN BLACK MATERIAL: INFILL PANELS FASCIA SOFFITS

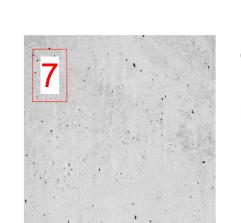

CONCRETE MATERIAL: PARKING GARAGE WALLS STRUCTURAL COLUMNS

MATERIAL: STRUCTURAL COLUMNS

EXIT DOOR STEEL PLATES

METAL AWNING


LIGHT FIXTURES

RAILING

FLASHING

WINDOW AND DOOR FRAMES

GUTTERS / DOWNSPOUTS

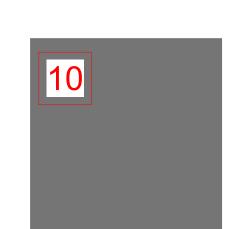

MATERIAL: TRASH ENCLOSURE DOORS FLASHING



TRESPA - LUMEN **LONDON GREY** DIFFUSE FINISH MATERIAL: WEST FACADE SOUTH FACADE

NORTH CLAD


BONE WHITE

MATERIAL:

ALUMINUM PANEL

WEST FACADE

SOUTH FACADE

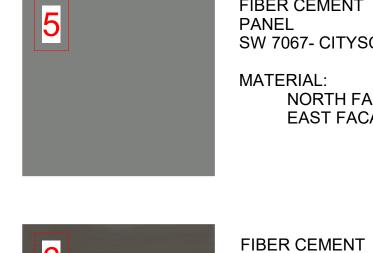

FIBER CEMENT PANEL SW 7067- CITYSCAPE MATERIAL: NORTH FACADE EAST FACADE

V-GROOVE SIDING

MATERIAL:

SW 7048 - URBANE BRONZE

RECESSED FACADES

ELEVATOR SHAFT



CMU BLOCK MATERIAL: TRASH ENCLOSURE

BLACK

MATERIALS

ELEVATION NOTES

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DRAWING NAME:

ELEVATIONS

Drawn By: KH Checked By: ST Owner Approval:

PHASE:

DESIGN REVIEW

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APPROVED FOR CONSTRUCTION:

PROJECT No.: A21 021 DATE: 10/4/2023









SE PERSPECTIVE NTS



NE PERSPECTIVE NTS

NOTE: 3D RENDERINGS ARE FOR ILLUSTRATIVE PURPOSES ONLY. NOT TO BE USED FOR CONSTRUCTION.

PROJECT No.: A21 021 DATE: 10/4/2023

MEDICI ARCHITECTS

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