

COMPLETE STREETS COMMISSION SPECIAL MEETING AGENDA

6:00 PM - Thursday, April 10, 2025

Los Altos Community Center - Sequoia Room

PARTICIPATION: Members of the public may participate by being present at the Los Altos Community Center - Sequoia Room located at 97 Hillview Avenue, Los Altos, CA during the meeting. Public comment is accepted in person at the physical meeting location, or via email to transportation@losaltosca.gov.

REMOTE MEETING OBSERVATION: Members of the public may view the meeting via the link below, but will not be permitted to provide public comment via Zoom. Public comment will be taken in-person, and members of the public may provide written public comment by following the instructions below.

Webinar ID: 885 5491 7517 | Passcode: 901533

<https://losaltosca.gov.zoom.us/j/88554917517?pwd=2MlCqIyXg0fjHYpaUa5e95P4I0yvGX.1>

SUBMIT WRITTEN COMMENTS: Verbal comments can be made in-person at the public hearing or submitted in writing prior to the meeting. Written comments can be mailed or delivered in person to the City Clerk's Office or emailed to transportation@losaltosca.gov.

Correspondence must be received by 2 PM on the day of the meeting to ensure distribution prior to the meeting. Comments provided after 2 PM will be distributed the following day and included with public comment in the packet.

PLEASE NOTE: Commissioner Venkatraman will participate in the meeting via videoconference from the site listed below. The meeting agenda will be posted at the videoconference site, which is accessible to the public. Anyone wishing to address the Commission from the videoconference site will be provided with an opportunity to do so.

Location: 25 Hutchins Road, 6th Cross, St. Thomas Town, Bangalore 560084, India

CALL MEETING TO ORDER

ESTABLISH QUORUM

PLEDGE OF ALLEGIANCE

PUBLIC COMMENTS ON ITEMS NOT ON THE AGENDA

Members of the audience may bring to the Commission's attention any item that is not on the agenda. Please complete a "Request to Speak" form and submit it to the Staff Liaison. Speakers are generally given two or three minutes, at the discretion of the Chair. Please be advised that, by law, the Commission is unable to discuss or take action on issues presented during the Public Comment Period. According to State Law (also known as "the Brown Act") items must first be noticed on the agenda before any discussion or action.

[04-10-2025](#) Written Public Comments

DISCUSSION ITEMS

1. FY24-25 Annual Street Resurfacing Project

City Staff will present the preliminary plans.

A) Microsurfacing

B) Mill and Overlay

ADJOURNMENT**SPECIAL NOTICES TO PUBLIC**

In compliance with the Americans with Disabilities Act, the City of Los Altos will make reasonable arrangements to ensure accessibility to this meeting. If you need special assistance to participate in this meeting, please contact the City Clerk 72 hours prior to the meeting at (650) 947-2720.

If you wish to provide written materials, please provide the Commission Staff Liaison with 10 copies of any document that you would like to submit to the Commissioners in order for it to become part of the public record.

From: [Jim Wing](#)
To: [Transportation](#)
Subject: CSC 04/10/25 Meeting Agenda Item 1 Main, State, University
Date: Tuesday, April 8, 2025 1:26:21 PM

Complete Streets Chair Helmholtz and Distinguished Commission Members

Subject: Comments on Main, State, and University Pavement Markings

I would like to thank staff for upgrading Pavement Markings on streets I walk every day! I have even spent many hours counting peak PM traffic on University. Design drawings show many welcomed pedestrian improvements. Would you please consider the following changes, that I have experienced near accidents?

Main

- Change **Main** Centerline “Paddles” to Green K-71 style at Red Berry Coffee midblock crosswalk because you can clearly see them in daylight and night. Car head light reflector is extra wide and they are recommended by California Vehicle Code for pedestrian safety use.
- Add Green K-71 Paddle to **State** centerline at **Main** intersection. Large number of both Main and State cars make turns at this intersection and do not seem to know where travel lanes are.
- Add “PED” to **Main** travel lane in direction to San Antonio ahead of crosswalk at **State**. Keep in mind that even cars parked parallel can hide pedestrians entering crosswalk.
- I agree with recommendation to stripe old Main / State colored cement crosswalks because the colors have faded over almost past 10 years

University

- **University / Burke** intersection crosswalks should be “ladder” style not “continental” as shown on drawing. Add two Green K-71 Paddles to University crosswalk centerline at Chamber of Commerce side. Traffic turning left “cuts” this corner. This has been successively done before
- **University / Milverton** add ladder crosswalk on University at intersection westside for daily 30 to 50 pedestrians to use. Right now, pedestrians do not where to cross.
- Refresh stop bar stripe for **Quinnhill Road** at University intersection. Quinnhill has medium traffic volume that often stop into University travel lane
- Refresh stop bar at **Presbyterian Church and School** exit to University. School has medium traffic volume.
- Paint **University** curb red 20 feet from Sherman / University corner. High volume of traffic from three churches use Sherman for left turns onto University in direction of El Monte. Parked cars block visibility of on-coming University traffic.
- Repair **University** damaged pavement in westbound travel lane from El Monte at Manresa entrance to Jesuit Retreat and Event Center. Root cause of damage is from double decker buses stopping to turn into Manresa / Jesuit entrance. Travel lane damage is about 25 feet long with muddy water “squirting up” when cars drive over after rains. Noticeable increased in damage from this year rains
- **Do not shift eastbound travel lanes at University / El Monte intersection to compensate for miss alignment of University travel lanes! The correct design change is to “phase-shift” University “thru / left” turn signal lights. County did**

“phase-shift” at Foothill intersections at Main and Edith to reduce accidents and congestion. The shift in lanes shown on drawings will cause PM commute intersection backups on eastbound University of at least 10 to 20 cars and not reduce 3 to 5 intersection accidents per year. Keep mind that University from Edith and Main is a PM commute cut-through street for traffic going to 280. I do not know if consultant or staff use traffic count data to support design. I have reported my traffic count data to County Airport & Roads and prior Los Altos staff.

I am disappointed that University Milverton Gap-fill CIP TS-01051 was deferred again this year. Been requesting this “Safe Routes to School” project for 21 years and will now have to wait until next year.

Thank you for your consideration! Jim Wing Milverton Road Los Altos

From: [Jim Wing](#)
To: [Transportation](#)
Subject: CSC 4-10-2025 Meeting Agenda Item 1 Pavement Improvement
Date: Wednesday, April 9, 2025 7:50:32 AM



706 University looking east to Milverton
Safe Route to School University-Milverton Gap Fill CIP TS 01051

To CSC Chair Helmholtz and Distinguished Commission Members,

Los Altos Council has required that pavement improvement projects like University - Burke to Anita to include “safe-route-to school” improvement projects like CIP TS 01051. Please consider following Council direction?

Los Altos Zoning Administrator and Planning Manager

At 706 University, developer has just purchased a 1950 two-bedroom home and is planning to “scrape” / build new home that will easily sell in current market. Would you please consider reclaiming most of University street right-away so that “safe-route-to school” students and pedestrians [some with dogs], going to / from Redwood Grove and Shoup Park will not have to walk in busy University travel lane?

Prior to homeowner front yard landscape project about 30 years ago, pedestrians and some dogs had full use of street shoulder right-away, that provided about 8 feet of safe walking space. Landscape project added about 3 feet of soil to front of grass area and a permitted retaining wall. Overgrown bushes shown in picture were planted on grass side of wall. Safe walking space was reduced to 6 feet. About 5 years later, most of retaining wall was extended without permit, leaving safe walking space of 4 feet. Over the years bushes planted behind original permitted retaining wall were allowed to grow into street travel lane leaving no safe space to walk.

University is a “safe routes to school” street as noted in Complete Streets Master Plan that requires a minimum of 5 feet for student walking space. Santa Clara County Plat Maps show that Los Altos right-away for 706 University is 28 feet from street center line.

Thank You for your consideration!
Jim Wing, Milverton Road, Los Altos



April 9, 2025

Dear Staff & Commissioners:

We have reviewed the agenda packet for the meeting dated April 10, 2025 regarding the FY24-25 Annual Street Resurfacing Project and have the following comments.

In general - we are in support of the grading and paving plans but want to make sure there are not missed opportunities for this plan to adhere to the Complete Streets Master plan, and past studies looked at by the Council and Commission.

1. In 2020 during Covid the commission considered one-way traffic for Downtown Los Altos [\[See maps attached\]](#) both in an East on Main, West on State route and vise-versa. Granted this was with the express goal of more social distance during the pandemic, but the plan itself should be considered, especially with the increased numbers of bikes downtown. If the council were to consider one-way traffic in this restriping plan - then travel lanes could be added for bikes in the downtown area which would make our streets safer for all users including pedestrians.
2. [The Complete Streets Master Plan](#) specifically calls out using raised crosswalks for pedestrian safety on pages 34 & 35. We believe all crosswalks in the downtown area should be raised crosswalks. In particular the following locations should be prioritized in this plan::
 - a. Main Street between 3rd and Edith [Sheet C2 page 9]
 - b. Intersection of State and Main [Sheet C2 page 9]
 - c. Intersection of State and 4th [Sheet C4 page 11]

If the existing colored concrete crosswalks are not to be modified - the notes in the plan are unclear if they are to be protected or modified, then at a minimum, any new crosswalks in the downtown that necessitate new curb cuts should instead be designed as raised crosswalks.

Furthermore, we recommend curb-level raised intersections at all 4-way stops on Main and State St for increased visibility and safety.

3. “Ladder” crosswalks should be the standard and used instead of “Continental”..
4. Safe Routes to School
 - a. Consider raised crosswalks at stop sign-controlled intersections as per page 34 & 35 of the Complete Streets Master Plan. For example, we feel these locations are of most importance:
 - i. University at Burke [Sheet C5 page 12] and University at W. Edith. [Sheet C4.28 page 57]
 - ii. Hawthorne and El Monte, on the north side of the intersection. [Sheet C13 page 20]


- iii. S.Clark and El Monte, with diagonal green conflict marking for bikes coming from the Almond shared use pathway toward S. Clark. [Sheet C15 page 22]
- iv. Berry and Springer, on the south side of the intersection as cars approach from Foothill [Sheet C4.22 page 51]

Sincerely,
Safe Routes to Downtown Los Altos Committee
Jill Woodford
Taylor Robinson
Marc Sidel
Harry Guy

saferoutesdtla@gmail.com

2025 PAVEMENT REHABILITATION PROJECT

CITY PROJECT NO. _____

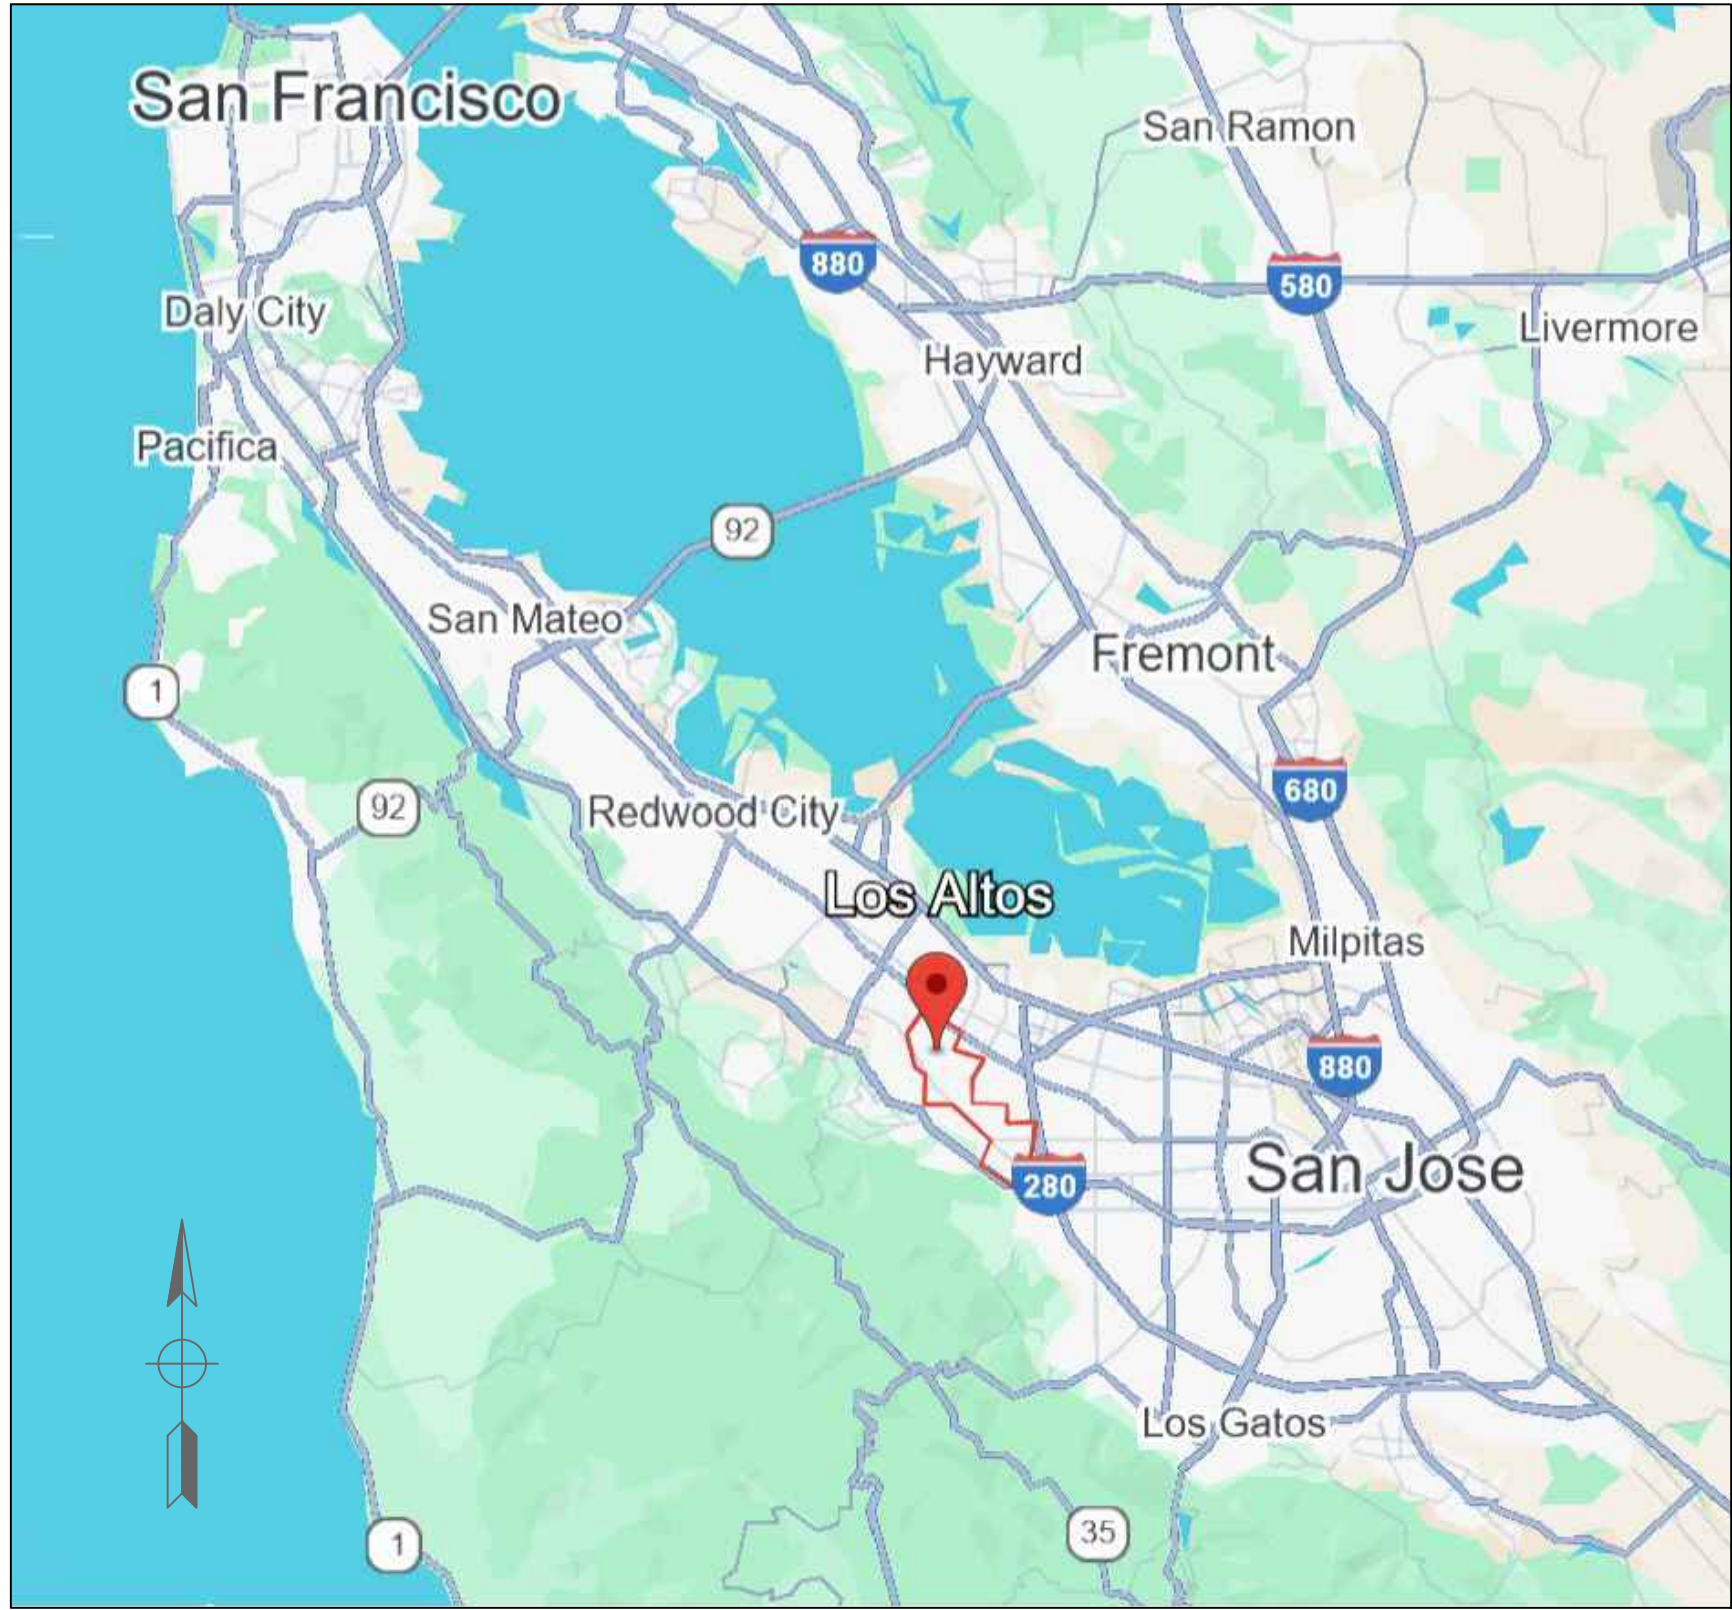


PROJECT LOCATION

SCALE: NOT TO SCALE

CITY OF
Los Altos
SANTA CLARA COUNTY, CALIFORNIA

SCHEDULE OF DRAWINGS		
GENERAL SHEETS		
SHEET	DRAWING	DESCRIPTION
1	G1	TITLE SHEET AND KEY MAP
2	G2	GENERAL NOTES, LEGEND & ABBREVIATIONS
3	G3	CONSTRUCTION DETAILS
4	G4	ACCESSIBLE PARKING AND SPEED LUMP DETAILS
5	G5	BIKE, PEDESTRIAN & PARKING PAVEMENT MARKING DETAILS
STREET SEGMENTS		
SHEET	DRAWING	DESCRIPTION
6-7	C1-C2	MAIN STREET - FROM FOOTHILL EXPRESSWAY TO STATE STREET
8-9	C3-C4	STATE STREET - FROM FIRST STREET TO MAIN STREET
10-16	C5-C11	UNIVERSITY AVENUE - FROM BURKE ROAD TO ANITA AVENUE
17-20	C12-C15	S. EL MONTE AVENUE - FROM CUESTA DRIVE TO CLARK AVENUE

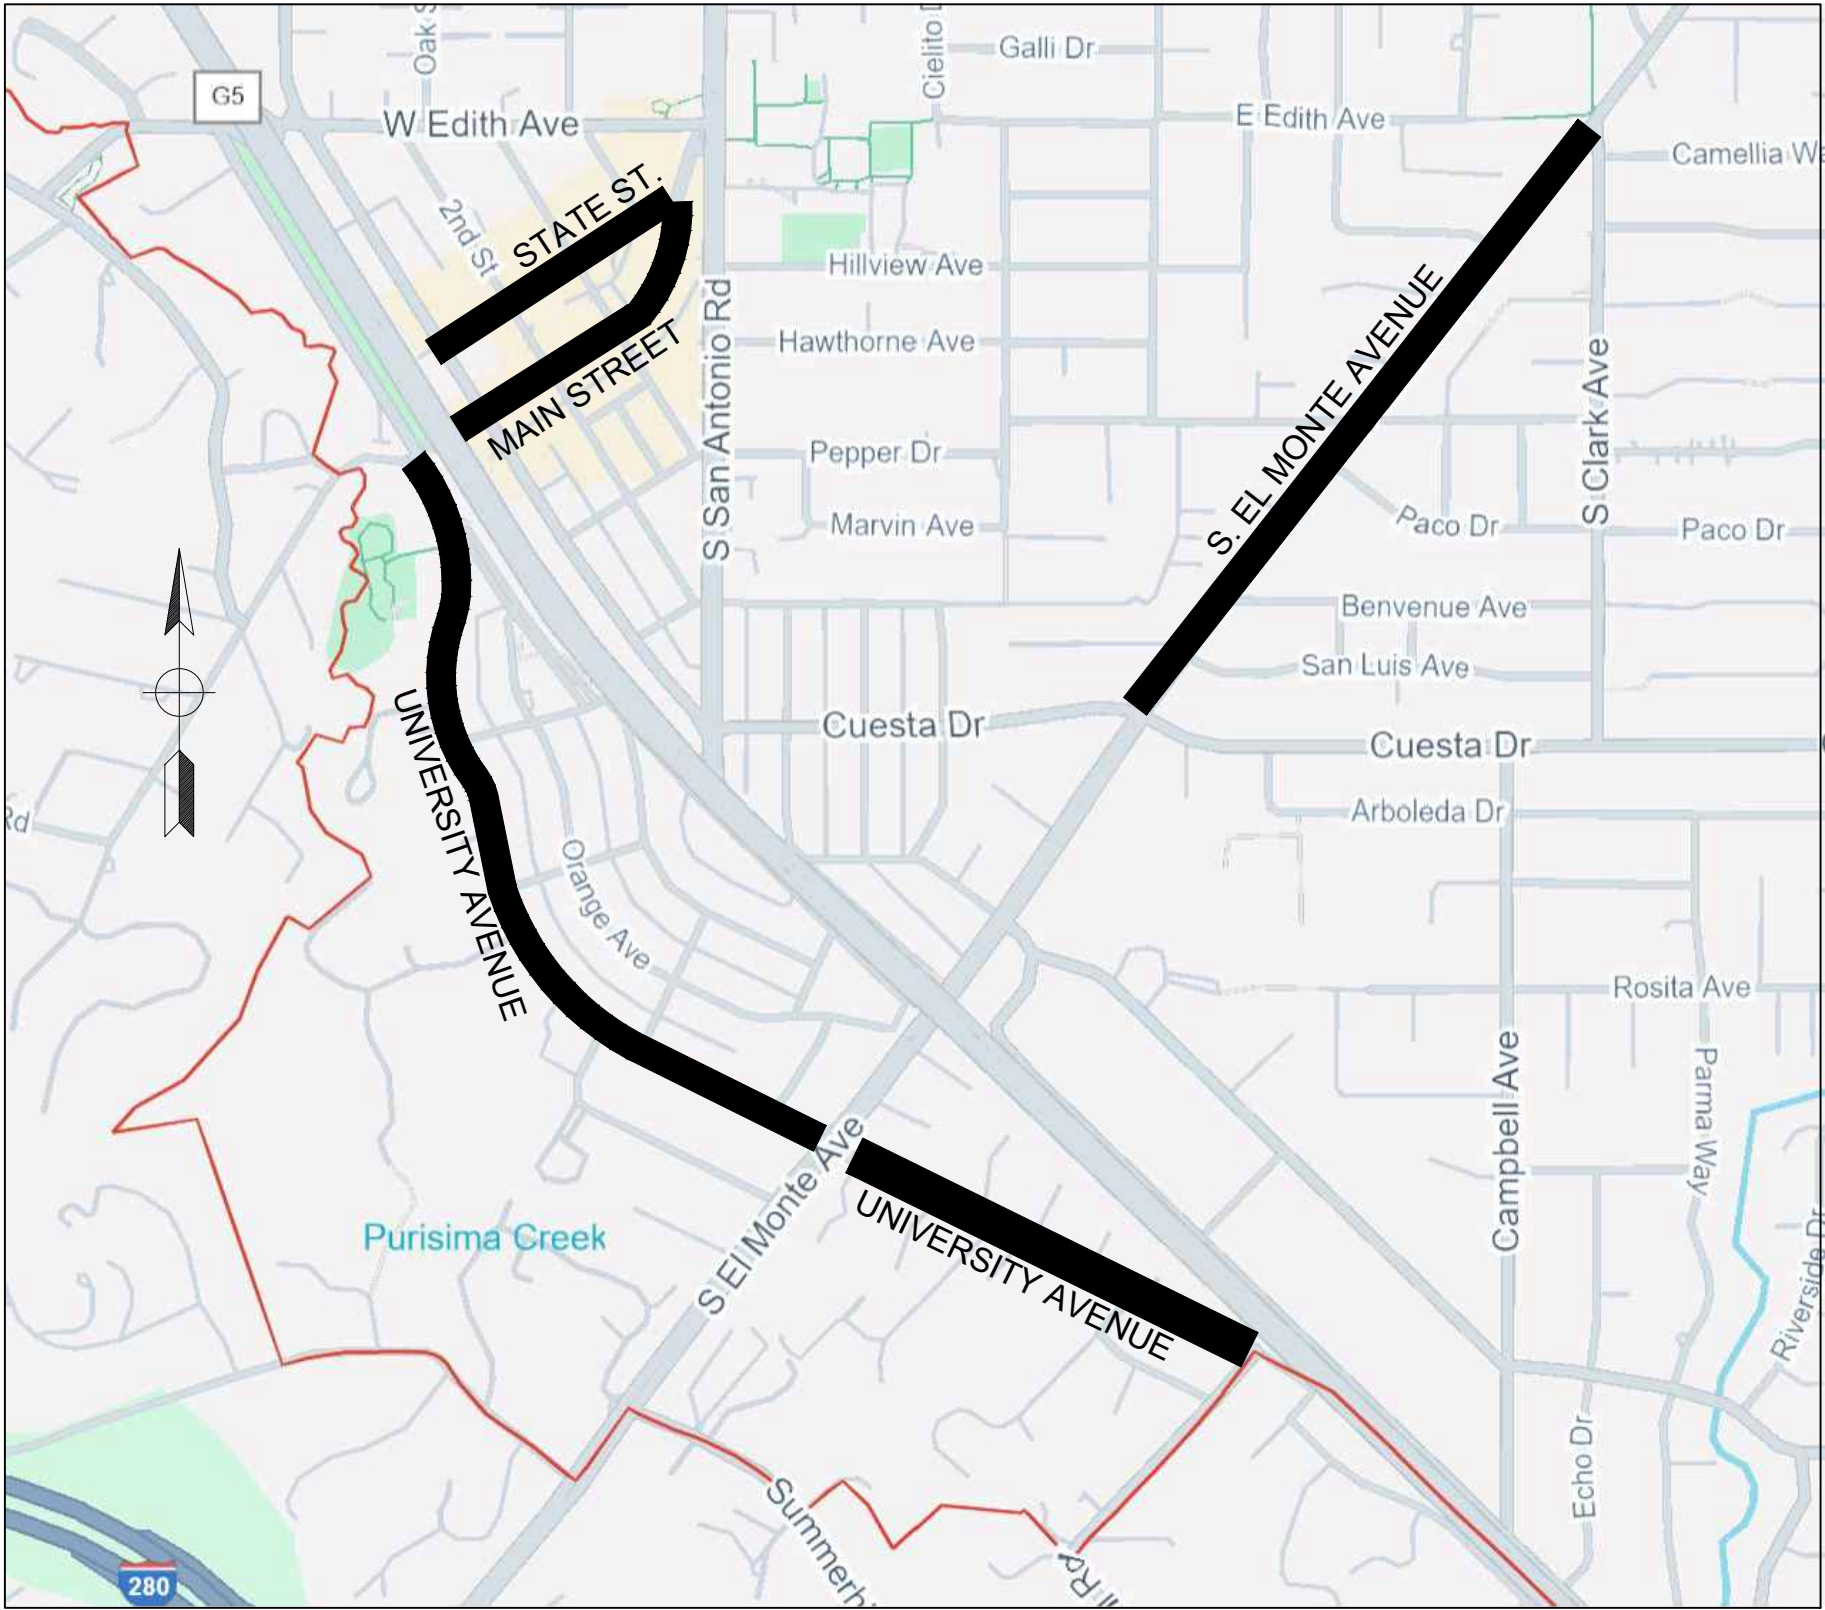

STREET SEGMENT LOCATIONS

SCALE: NOT TO SCALE



XX/XX/2025
APPROVED --- CITY ENGINEER DATE

No.	DATE	REVISION	BY	APPD
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5424 SUNOL BLVD. STE-10-256
PLEASANTON, CALIFORNIA 94566


AIM
Engineering Consultants

CITY OF LOS ALTOS
2025 PAVEMENT REHABILITATION PROJECT
TITLE SHEET

PUBLIC WORKS DEPARTMENT

APPROVED -- PRINCIPAL ENGINEER

DATE

RECOMMENDED -- PROJECT MANAGER

DATE
XX / XX / 202X

CITY PROJECT:
PWC XXXX

FEDERAL PROJECT:

DESIGNED BY:
WPM

CHECKED BY:
DA

DRAWN BY:
WPM

DATE:
APRIL 2025

SCALE:

0 1" 1"

NOTE: VERIFY SCALE.
BAR IS ONE INCH ON
ORIGINAL DRAWING.
ADJUST SCALES
ACCORDINGLY IF BAR
IS NOT ONE INCH.

DRAWING:

G1

SHEET 1 OF 20

PLOT DATE: Apr 06, 2025 -- 9:53pm FILE: D:\City of Los Altos\DWG -- Mar 5 2025\PLAN_001_G2_NOTES LEGEND DETAILS.dwg

GENERAL NOTES

1. THE CONTRACTOR SHALL INSPECT THE EXISTING CONDITIONS ON ALL PROJECT STREET SECTIONS PRIOR TO SUBMITTING A BID.
2. THE CONTRACTOR AGREES THAT IN ACCORDANCE WITH GENERALLY ACCEPTED CONSTRUCTION PRACTICES, CONTRACTOR SHALL BE REQUIRED TO ASSUME COMPLETE RESPONSIBILITY FOR JOB SITE CONDITIONS DURING THE COURSE OF CONSTRUCTION OF THE PROJECT. THESE PLANS DO NOT INCLUDE COMPONENTS NECESSARY FOR CONSTRUCTION SAFETY. IT IS THE CONTRACTOR’S RESPONSIBILITY TO PROVIDE FOR THE SAFETY OF ALL PERSONS AND PROPERTY DURING THE COURSE OF THE PROJECT.
3. THE CONTRACTOR SHALL COMPLY WITH THE RULES AND REGULATIONS OF THE STATE CONSTRUCTION SAFETY ORDERS AND CAL/OSHA. THIS REQUIREMENT SHALL APPLY CONTINUOUSLY AND NOT BE LIMITED TO NORMAL WORKING HOURS.
4. UNLESS OTHERWISE SPECIFIED ON THE PLANS OR CONTRACT DOCUMENTS FOR 'HIGH-RISK' UNDERGROUND FACILITIES, THE LOCATION OF EXISTING FACILITIES WERE TAKEN PARTIALLY FROM RECORDS AND MAY BE INCOMPLETE. THE CONTRACTOR SHALL DETERMINE THE EXACT LOCATION OF ALL UTILITIES PRIOR TO ANY EXCAVATION OR TRENCHING IN THEIR LOCALITY.

THE UTILITY AGENCIES IN THE CITY OF LOS ALTOS ARE:

5. AT LEAST TWO WORKING DAYS PRIOR TO CONSTRUCTION, THE CONTRACTOR SHALL CALL THE UNDERGROUND SERVICE ALERT FOR UTILITY LOCATIONS. PHONE: 1-800-227-2600.
6. THE CONTRACTOR SHALL PROVIDE FOR INGRESS AND EGRESS FOR PRIVATE PROPERTY ADJACENT TO THE WORK THROUGHOUT THE PERIOD OF CONSTRUCTION.
7. THE CONTRACTOR SHALL PROVIDE ALL LIGHTS, SIGNS, BARRICADES, FLAGGERS OR OTHER DEVICES NECESSARY TO PROVIDE FOR PUBLIC SAFETY.
8. REFER TO OTHER SHEETS FOR ADDITIONAL NOTES AND LEGENDS PERTAINING TO SPECIFIC ITEMS OF WORK.
9. THE CONTRACTOR SHALL COORDINATE ALL NECESSARY UTILITY ADJUSTMENTS AND RELOCATIONS WITH THE APPROPRIATE UTILITY COMPANY.
10. THE CONTRACTOR IS ENCOURAGED TO USE RECLAIMED WATER GENERATED BY _____ FOR CONSTRUCTION ACTIVITIES. FOR FURTHER INFORMATION, CONTACT _____ AT (XXX) XXX-XXXX.
11. IF, DURING THE COURSE OF THE WORK, THE CONTRACTOR ENCOUNTERS ANY SURFACE OR SUBSURFACE MATERIAL THAT HE/SHE BELIEVES IS HAZARDOUS (AS DEFINED IN SECT. 25117 OF THE HEALTH AND SAFETY CODE), THE CONTRACTOR MUST INFORM THE ENGINEER IN WRITING IMMEDIATELY. MATERIAL IS TO REMAIN UNDISTURBED UNTIL AN INVESTIGATION BY THE CITY. REMOVAL AND/OR DISPOSAL OF HAZARDOUS MATERIALS IS NOT PART OF THE SCOPE OF WORK.

ROADWAY PAVEMENT NOTES

1. LIMITS AND DEPTHS SHOWN FOR HMA RECONSTRUCTION (DIG-OUTS) ARE APPROXIMATE ONLY. FINAL AREAS AND DEPTHS WILL BE DETERMINED IN THE FIELD BY THE ENGINEER.
2. UNLESS DIRECTED BY THE ENGINEER OR OTHERWISE SPECIFICALLY NOTED ON THE PLANS, ALL TRAFFIC DETECTOR LOOPS SHALL BE PLACED NEW, AS SHOWN ON THE PLANS, BEFORE THE TOP LIFT OF THE HMA RECONSTRUCTION IS PLACED, AND WILL BE TESTED AND APPROVED BY THE ENGINEER PRIOR TO PLACEMENT OF THE TOP LIFT. REPLACEMENT OF TRAFFIC LOOPS MAY INCLUDE, BUT NOT LIMITED TO, STUB OUTS, PULL BOX, CONDUITS, CONDUCTORS AND ALL OTHER LABOR AND MATERIALS NEEDED IN THE SATISFACTORY OPERATION OF THE LOOPS AND APPROVAL OF THE ENGINEER.
3. CONTRACTOR’S ATTENTION IS DIRECTED TO THE PRESENCE OF EXISTING ROCKWHEEL TRENCHES. CONTRACTOR SHALL PROTECT ALL EXISTING ROCKWHEEL TRENCHES AND ASSOCIATED CONDUIT IN PLACE. ALL GRINDING, ASPHALT OVERLAY AND HMA RECONSTRUCTION SHALL BE PERFORMED UP TO EDGE OF EXISTING ROCKWELL TRENCHES.
4. CONTRACTOR’S ATTENTION IS DIRECTED TO THE REQUIREMENTS OF THE SECTION ENTITLED “MAINTAINING TRAFFIC/TRAFFIC CONTROL” OF THE CONTRACT DOCUMENTS REGARDING LANE CLOSURE RESTRICTIONS. TRAFFIC SHALL NOT BE DIVERTED ON TO ANY SURFACE NOT PAVED WITH ASPHALT CONCRETE UNLESS AUTHORIZED BY THE ENGINEER.
5. UNLESS OTHERWISE SPECIFIED, CONTRACTOR SHALL REPLACE ALL STRIPING AND PAVEMENT MARKINGS REMOVED DURING THE PAVEMENT REMOVAL OPERATION WITH PAINT MATERIAL. ALL STRIPING AND PAVEMENT MARKINGS ON STREETS RECEIVING AN ASPHALT OVERLAY SHALL BE PLACED WITH THERMOPLASTIC MATERIAL.
6. ALL PAVEMENT MARKINGS SHALL FOLLOW THE LATEST CALIFORNIA MANUAL ON UNIFORM TRAFFIC CONTROL DEVICES (CA MUTCD).
7. CONTRACTOR SHALL PROTECT ALL MONUMENTS, UTILITY MANHOLES, VALVES AND COVERS FROM DAMAGE DURING CONSTRUCTION ACTIVITIES.
8. THE QUANTITY FOR ENTIRE ROADWAY AREA REPRESENTS THE TOTAL AREA OF EXISTING ASPHALT CONCRETE PAVEMENT ON A GIVEN STREET SEGMENT; WHETHER WORK IS PERFORMED ON IT OR NOT. THE BOUNDARY ENCLOSING THIS AREA ENCOMPASSES THE FULL WIDTH OF THE STREET (FROM LIP OF GUTTER TO LIP OF GUTTER) AND THE FULL LENGTH OF THE ROADWAY SHOWN ON THE PLANS (STARTING FROM THE LIMIT OF PAVEMENT WORK ON ONE END OF THE STREET TO THE LIMIT OF PAVING WORK ON THE OPPOSITE END) WITH NO BREAKS IN BETWEEN.
9. “SCHOOL STREETS” ARE LOCATIONS THAT ARE WITHIN 500 FEET OF A PUBLIC SCHOOL AND ARE SUBJECT TO A MORE RESTRICTIVE CONSTRUCTION SCHEDULE. SEE CONTRACT DOCUMENTS FOR MORE DETAILS. “SCHOOL STREETS” ARE IDENTIFIED ON THE KEY MAP OF THESE PLANS.
10. FOR STREETS RECEIVING AN ASPHALT OVERLAY, THE NEW ASPHALT PAVEMENT AT PEDESTRIAN TRAVEL WAYS ALONG THE LENGTH AND WIDTH MARKED AND UNMARKED CROSSWALKS SHALL HAVE A RUNNING SLOPE THAT DOES NOT EXCEED 5% AND A CROSS SLOPE THAT DOES NOT EXCEED 2%.
11. NEW ASPHALT PLACED ADJACENT TO AN EXISTING CURB RAMP LANDING SHALL BE FLUSH WITH THE LIP OF GUTTER.

NIGHT WORK NOTES:

PAVEMENT WORK AT THE FOLLOWING LOCATIONS SHALL BE PERFORMED AT NIGHT AS SPECIFIED IN THE CONTRACT DOCUMENTS:

1. XXXXXXXXX

EXISTING ROCK & ASPHALT CHART NOTES

1. ACTUAL PAVEMENT SECTION MAY VARY IN DIFFERENT AREAS OF THE STREET.
2. THE DATA FOR THE EXISTING ROCK AND ASPHALT CHART WERE OBTAINED FROM THE ORIGINAL SUBDIVISION PLANS, MAINTENANCE RECORDS, AND RECORD DRAWINGS. THE DATA IS INTENDED TO SERVE AS AN INDICATOR OF THE EXISTING PAVEMENT SECTION, BUT SHOULD NOT BE ASSUMED TO BE A COMPLETE RECORD. THE ACTUAL EXISTING PAVEMENT SECTION MAY VARY FROM THE DATA AS SHOWN ON THIS SHEET.

EXISTING ROCK & ASPHALT CHART (INCHES)

ROAD NAME	AC	AB	ASB	OVERLAY
MAIN STREET	X"	XX"	XX"	X"
STATE STREET	X"	XX"	XX"	X"
UNIVERSITY AVENUE	X"	XX"	XX"	X"
S. EL MONTE AVENUE	X"	XX"	XX"	X"

ABBREVIATIONS

AB	AGGREGATE BASE	MH	MANHOLE
AC	ASPHALT CONCRETE	MIN	MINIMUM
ACFC	ALAMEDA COUNTY FLOOD CONTROL	MON	MONUMENT
ACWD	ALAMEDA COUNTRY WATER DISTRICT	MPH	MILES PER HOUR
ASB	AGGREGATE SUBBASE	NB, N/B	NORTHBOUND
CATV	CABLE TV	NSF	NON-STANDARD FEATURE
CB	CATCH BASIN	OC	ON CENTER
C/G	CURB AND GUTTER	OH	OVERHEAD
COLA	CITY OF LOS ALTOS	PB	PULL BOX
CTB	CEMENT-TREATED BASE	PVT	PRIVATE
DESC	DESCRIPTION	PVMT	PAVEMENT
DET	DETAIL	ROW, R/W	RIGHT OF WAY
DI	DRAINAGE INLET	SB, S/B	SOUTHBOUND
DLC	DETECTOR LEAD-IN CABLE	SD	STORM DRAIN
DWG	DRAWING	SDMH	STORM DRAIN MANHOLE
DWY	DRIVEWAY	SF	SQUARE FEET
E	ELECTRIC	SHT	SHEET
EB, E/B	EASTBOUND	SNS	STREET NAME SIGN
ELEV	ELEVATION	SS	SANITARY SEWER
EP	EDGE OF PAVEMENT	SSMH	SANITARY SEWER MANHOLE
ETS	ELECTROLYSIS TEST STATION	STD	STANDARD
EX, (E)	EXISTING	SW, S/W	SIDEWALK
FC	FACE OF CURB	SY	SQUARE YARDS
FG	FINISHED GRADE	TEL	TELECOM
FH	FIRE HYDRANT	TC	TOP OF CURB
FO	FIBER OPTIC	TOT	TOTAL
G	GAS	TSPB	TRAFFIC SIGNAL PULL BOX
GB	GRADE BREAK	TYP	TYPICAL
HH	HAND HOLE	USD	UNION SANITARY DISTRICT
HMA	HOT MIX ASPHALT	VAR	VARIES
LF	LINEAR FEET	W	WATER
MAX	MAXIMUM	WB, W/B	WESTBOUND
		WM	WATER METER
		WV	WATER VALVE

PAVING LEGEND

	BASE REPAIR (DEPTH PER PLAN)
	GRIND AREA & HMA OVERLAY AREA (DEPTH PER PLAN/SPEC)
	MICROSURFACING

MISC LEGEND

	HEADER & STAKES
TYPE	NEW STREET SIGN ON NEW POST
TYPE	NEW STREET SIGN ON (E) POST
TYPE	NEW STREET SIGN ON (E) POST REMOVE (E) STREET SIGN
TYPE	REMOVE (E) POST AND REMOVE/RELOCATE (E) SIGN(S)
	PROPERTY / ROW LINE
	SHARED ROADWAY BICYCLE MARKING (SHARROW)
	BICYCLE LOOP DETECTOR MARKING
	YIELD TRIANGLE LIMIT LINE
	DELINEATOR
	SPEED HUMP
	FIRE HYDRANT BLUE MARKER

TREE LEGEND

	TRIM TREE
	TRIM TREE (PRIVATE PROPERTY)

UTILITY LEGEND

TO REMAIN	ADJUST *	
		VALVE (WATER)
		VALVE (GAS)
		TELECOM HANDHOLE
		USD CLEANOUT
		MANHOLE (TYPE AS NOTED)
		VAULT OR BOX (TYPE AS NOTED)
		MONUMENT
	—	FIRE HYDRANT
	—	UTILITY POLE
	—	OVERHEAD LINE


* REFER TO CONTRACT DOCUMENTS REGARDING ADJUSTMENT OF EXISTING FACILITIES

No.	DATE	REVISION	BY	APPD


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5424 SUNOL BLVD. STE-10-256
PLEASANTON, CALIFORNIA 94566



<div>CITY OF LOS ALTOS</div> <div>2025 PAVEMENT REHABILITATION PROJECT</div> <div>NOTES, LEGEND & ABBREVIATIONS</div> <div>PUBLIC WORKS DEPARTMENT</div>				CITY PROJECT: PWC XXXX		SCALE: AS SHOWN	<div>DRAWING:</div> <div><div>G2</div><div>10</div></div> <div>SHEET 3 OF 20</div>
				FEDERAL PROJECT:		0 ----- 1" <div>NOTE: VERIFY SCALE. BAR IS ONE INCH ON ORIGINAL DRAWING. ADJUST SCALES ACCORDINGLY IF BAR IS NOT ONE INCH.</div>	
				DESIGNED BY: WPM	CHECKED BY: DA		
				DRAWN BY: WPM	DATE: APRIL 2025		
APPROVED -- PRINCIPAL ENGINEER	DATE	RECOMMENDED -- PROJECT MANAGER	DATE XX / XX / 202X				

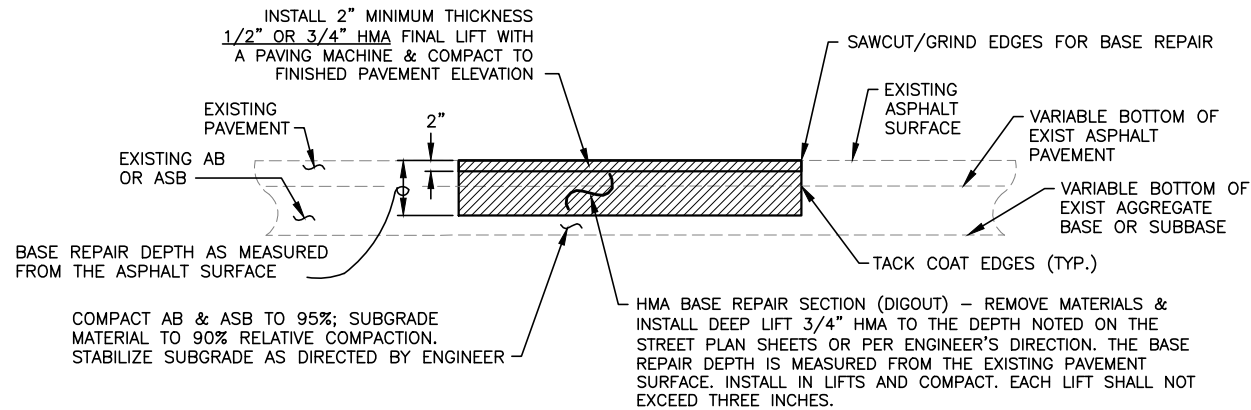

**HOT MIX ASPHALT PAVEMENT BASE REPAIR
HMA RECONSTRUCTION (DIGOUT) - TYPICAL**
NOT TO SCALE

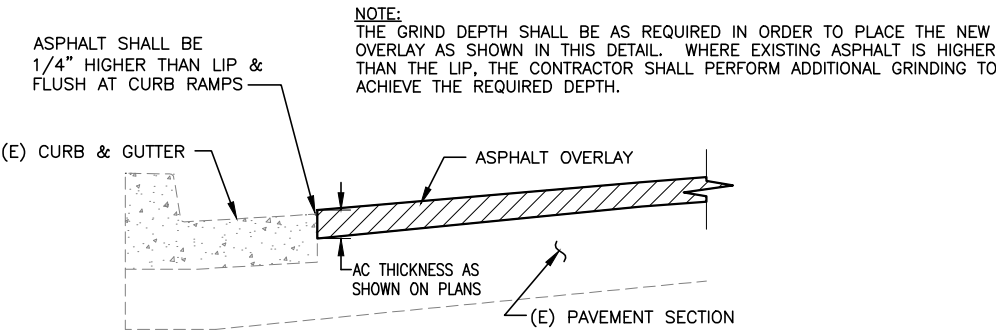

GRIND AND OVERLAY AT CURB & GUTTER
NOT TO SCALE

PLOT DATE: Apr 06, 2025 - 9:56pm FILE: D:\City of Los Altos\DWG - Mar 5 2025\PLAN_001_G3_CONSTRUCTION DETAILS.dwg

No.	DATE	REVISION	BY	APPD
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CONSULTANTS INC.

5424 SUNOL BLVD. STE-10-256
PLEASANTON, CALIFORNIA 94566



CITY OF LOS ALTOS 2025 PAVEMENT REHABILITATION PROJECT CONSTRUCTION DETAILS PUBLIC WORKS DEPARTMENT			
APPROVED -- PRINCIPAL ENGINEER	DATE	RECOMMENDED -- PROJECT MANAGER	DATE XX / XX / 202X


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FEDERAL PROJECT:		
DESIGNED BY: WPM	CHECKED BY: DA	
DRAWN BY: WPM	DATE: APRIL 2025	

DRAWING:

G3

11

SHEET 3 OF 20

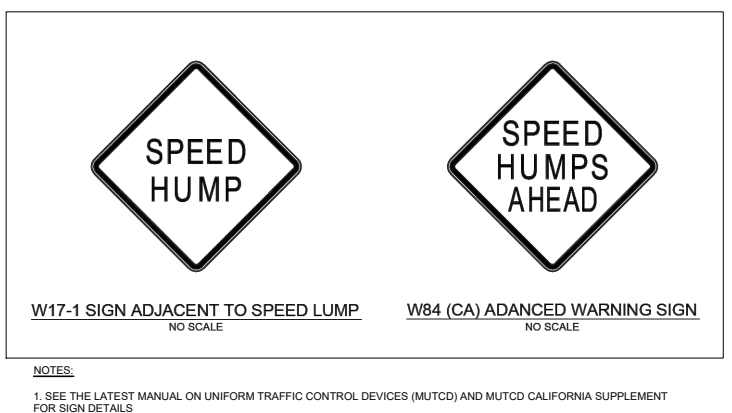

SPEED LUMP SIGNING AND STRIPING DETAILS

SCALE: NOT TO SCALE

No.	DATE	REVISION	BY	APPD
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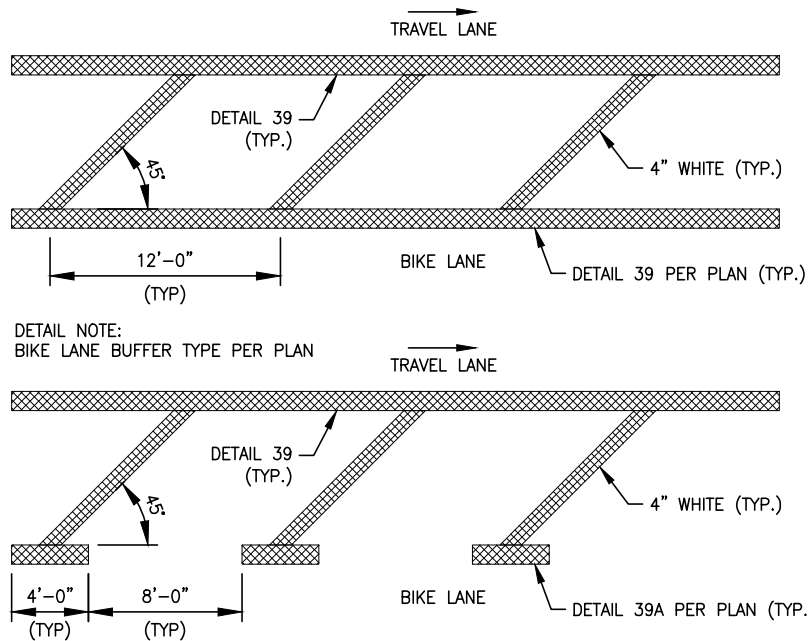


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Engineering Consultants


PUBLIC WORKS DEPARTMENT

CITY PROJECT: PWC XXXX		SCALE: AS SHOWN 0 ——— 1" NOTE: VERIFY SCALE. BAR IS ONE INCH ON ORIGINAL DRAWING. ADJUST SCALES ACCORDINGLY IF BAR IS NOT ONE INCH.
FEDERAL PROJECT:		
DESIGNED BY: WPM	CHECKED BY: DA	
DRAWN BY: WPM	DATE: APRIL 2025	


G4




BIKE LANE BUFFER DETAILS
SCALE: NOT TO SCALE

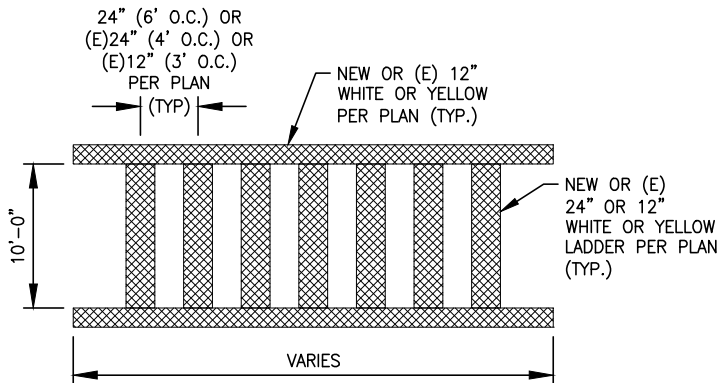


LADDER CROSSWALK
SCALE: NOT TO SCALE

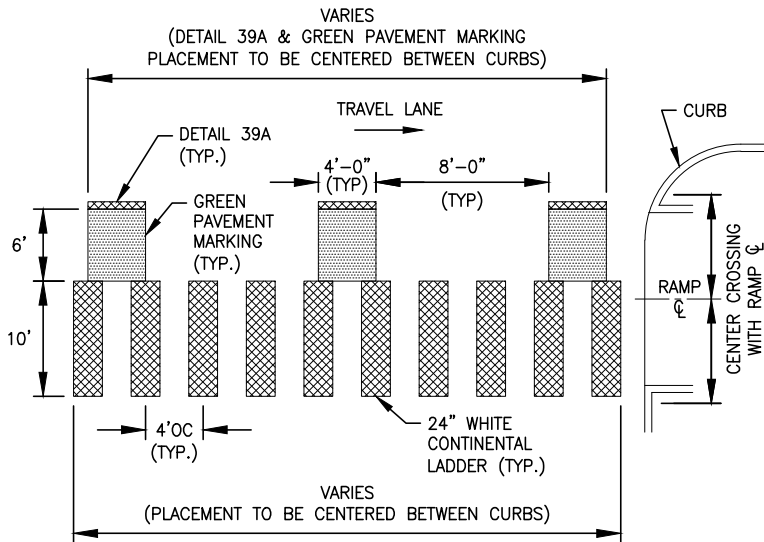


PED & 1-WAY BIKE CROSSING
SCALE: NOT TO SCALE

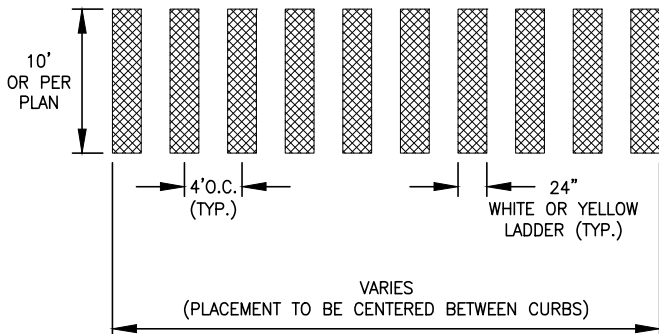


CONTINENTAL CROSSWALK
SCALE: NOT TO SCALE

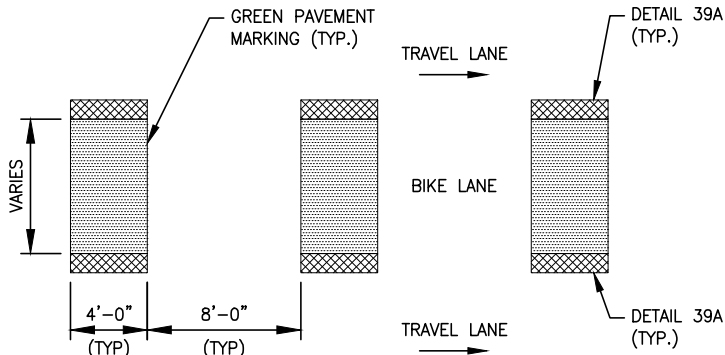

CONFLICT ZONE GREEN BIKE LANE
SCALE: NOT TO SCALE

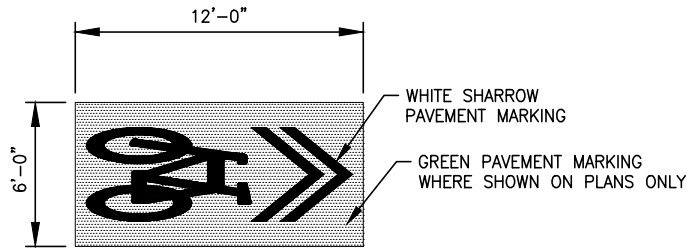

GREEN BIKE LANE SHARROW
SCALE: NOT TO SCALE

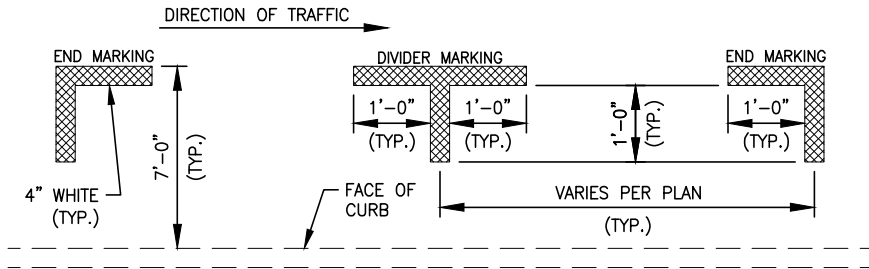

PARALLEL PARKING STALL DETAIL
SCALE: NOT TO SCALE

PLOT DATE: Apr 06, 2025 - 9:59pm FILE: D:\City of Los Altos\DWG - Mar 5 2025\PLAN_001_G5_STRIPING & MARKING DETAILS.dwg

No.	DATE	REVISION	BY	APPD
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CONSULTANTS INC.
5424 SUNOL BLVD. STE-10-256
PLEASANTON, CALIFORNIA 94566




CITY OF LOS ALTOS
2025 PAVEMENT REHABILITATION PROJECT
BIKE, PEDESTRIAN & PARKING PAVEMENT MARKING DETAILS
PUBLIC WORKS DEPARTMENT

APPROVED -- PRINCIPAL ENGINEER DATE RECOMMENDED -- PROJECT MANAGER DATE XX / XX / 202X

CITY PROJECT: PWC XXXX	SCALE: AS SHOWN
FEDERAL PROJECT:	0 +-----+ 1" NOTE: VERIFY SCALE. BAR IS ONE INCH ON ORIGINAL DRAWING. ADJUST SCALES ACCORDINGLY IF BAR IS NOT ONE INCH.
DESIGNED BY: WPM	CHECKED BY: DA
DRAWN BY: WPM	DATE: APRIL 2025


DRAWING:
G5
13
SHEET 5 OF 20

FILE: D:\City of Los Altos\DWG - Mar 5 2025\PLAN_01_MAIN STREET.dwg
PLOT DATE: Apr 06, 2025 - 10:01pm

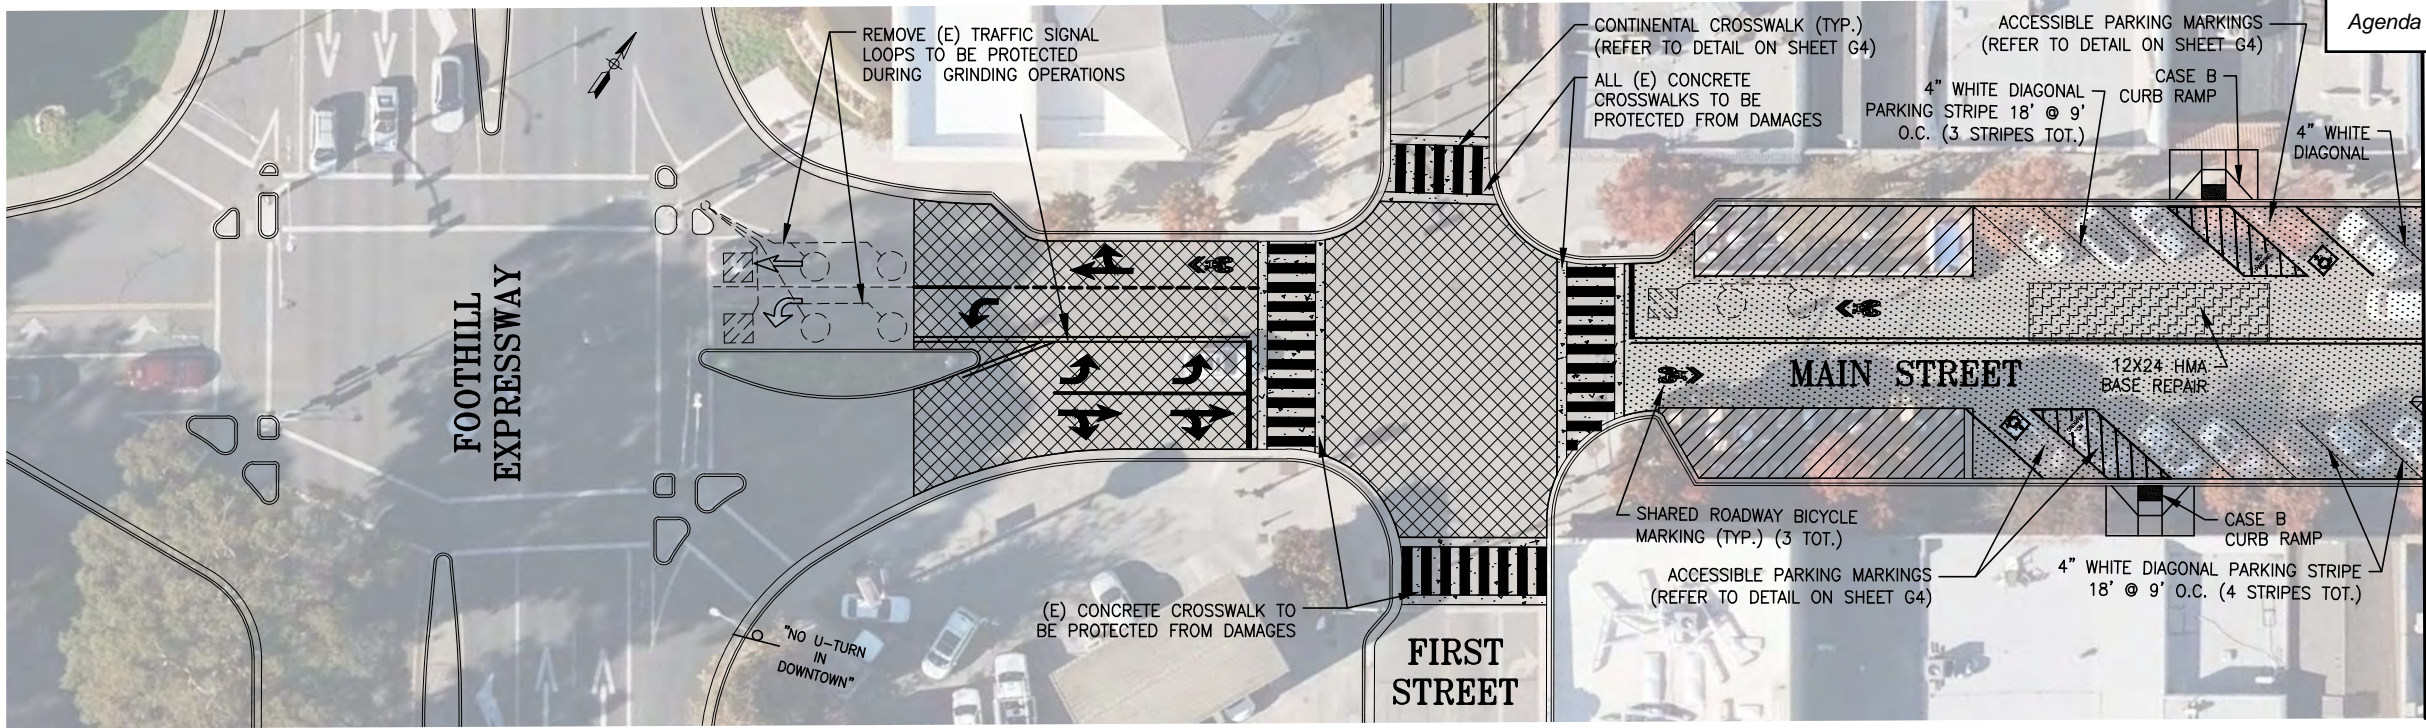

Agenda Item 1.

MATCHLINE (SEE BELOW)

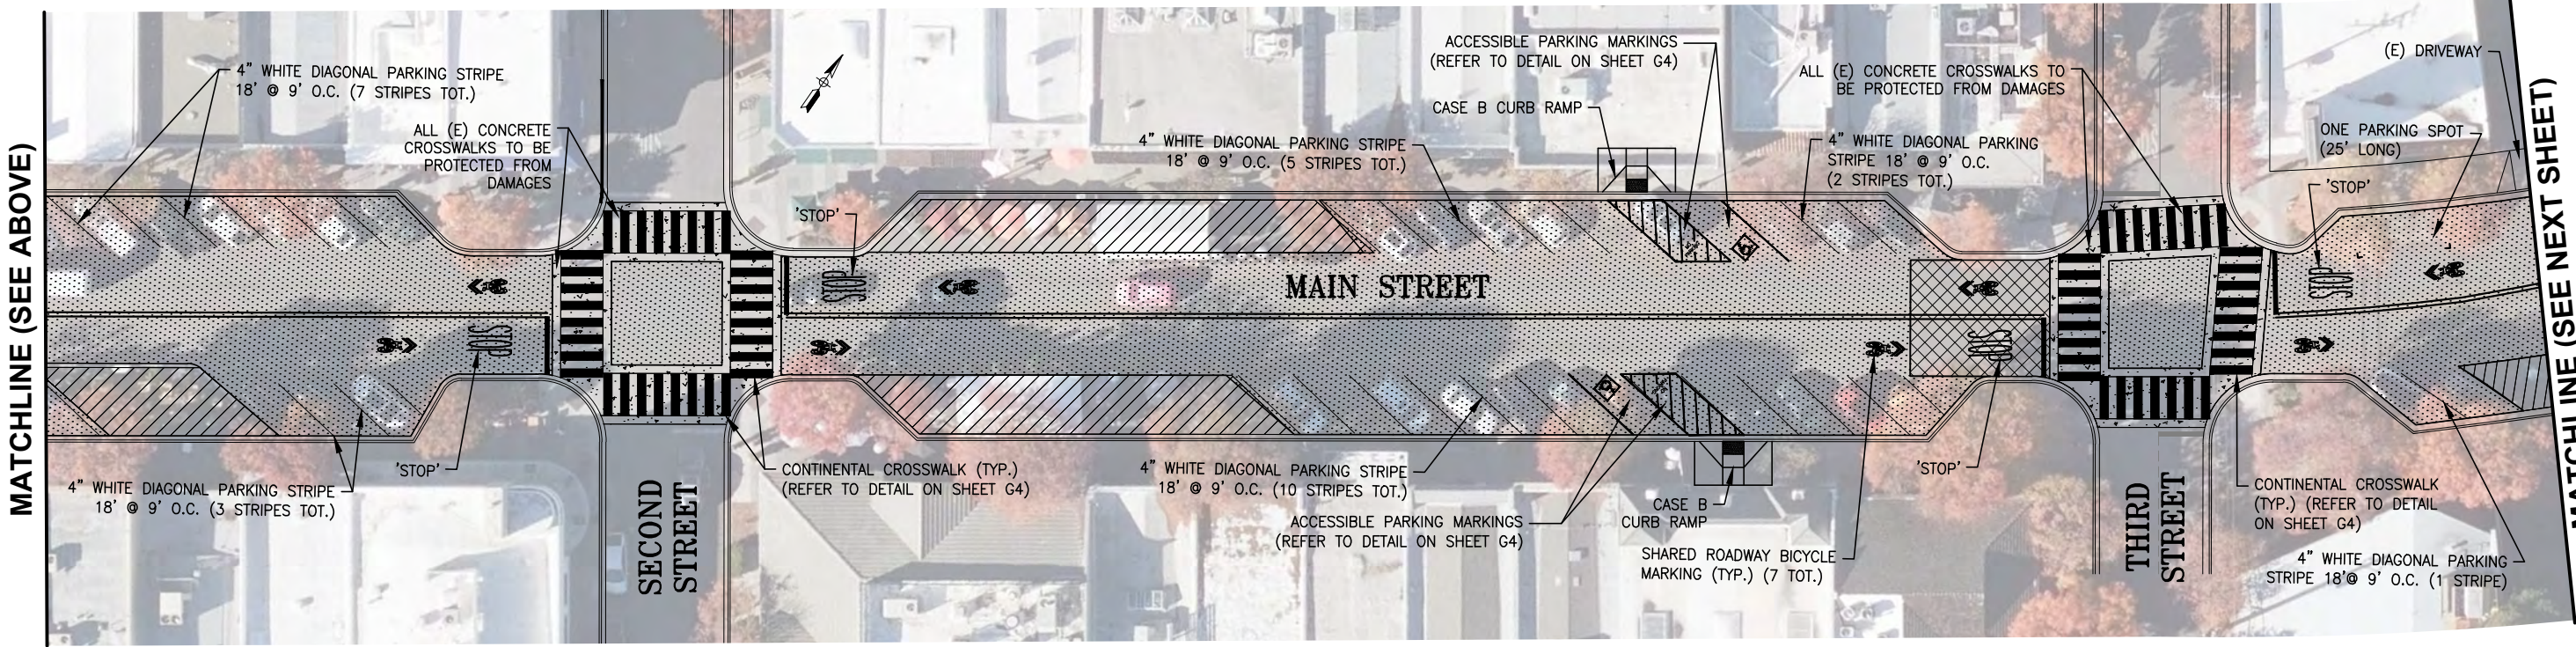

MATCHLINE (SEE ABOVE)


MATCHLINE (SEE NEXT SHEET)

LEGEND & QUANTITY TABLE			
	4" HMA BASE REPAIR	2,090 SF	232 SY
	2" GRIND AND OVERLAY	7,251 SF	806 SY
	MICROSURFACE	50,577 SF	5,620 SY
	PARKLET AREA		

NOTE:
ALL TRAFFIC STRIPES AND PAVEMENT MARKINGS SHALL BE THERMOPLASTIC.

MAIN STREET

FROM FOOTHILL EXPRESSWAY TO STATE STREET
SCALE: 1" = 20'

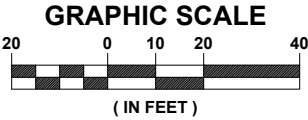

No.	DATE	REVISION	BY	APPD
1				
2				
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4				

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PLEASANTON, CALIFORNIA 94566



CITY OF LOS ALTOS
2025 PAVEMENT REHABILITATION PROJECT
MAIN STREET - FROM FOOTHILL EXPRESSWAY TO STATE ST
PUBLIC WORKS DEPARTMENT

APPROVED -- PRINCIPAL ENGINEER

DATE

RECOMMENDED -- PROJECT MANAGER

DATE
XX / XX / 202X

CITY PROJECT:
PWC XXXX
FEDERAL PROJECT:
DESIGNED BY:
WPM
CHECKED BY:
DA
DRAWN BY:
WPM
DATE:
APRIL 2025



SCALE:
AS SHOWN
0 1"
NOTE: VERIFY SCALE.
BAR IS ONE INCH ON
ORIGINAL DRAWING.
ADJUST SCALES
ACCORDINGLY IF BAR
IS NOT ONE INCH.

DRAWING:


C1

14

SHEET 6 OF 20

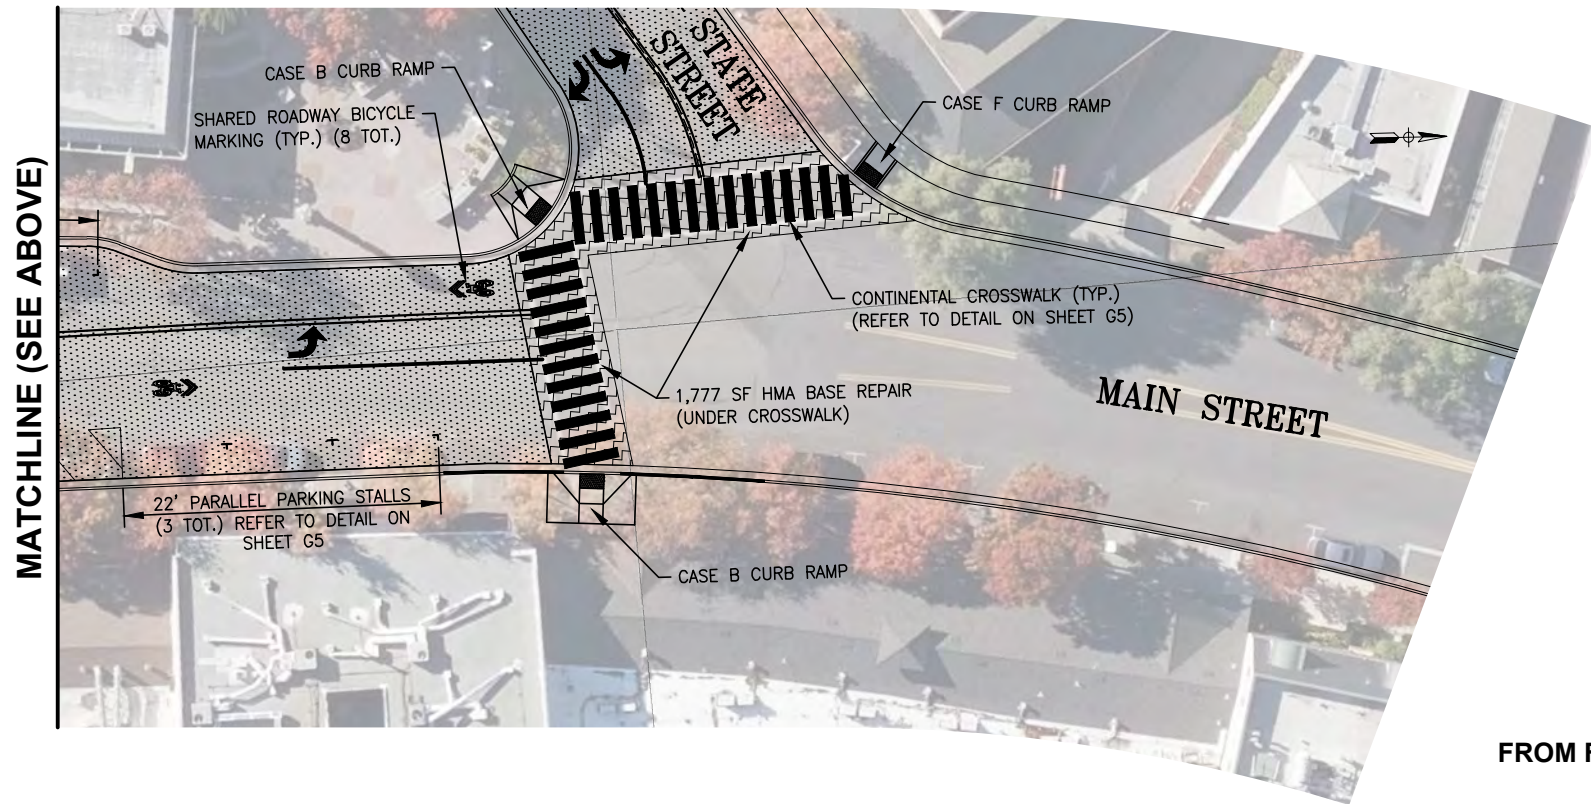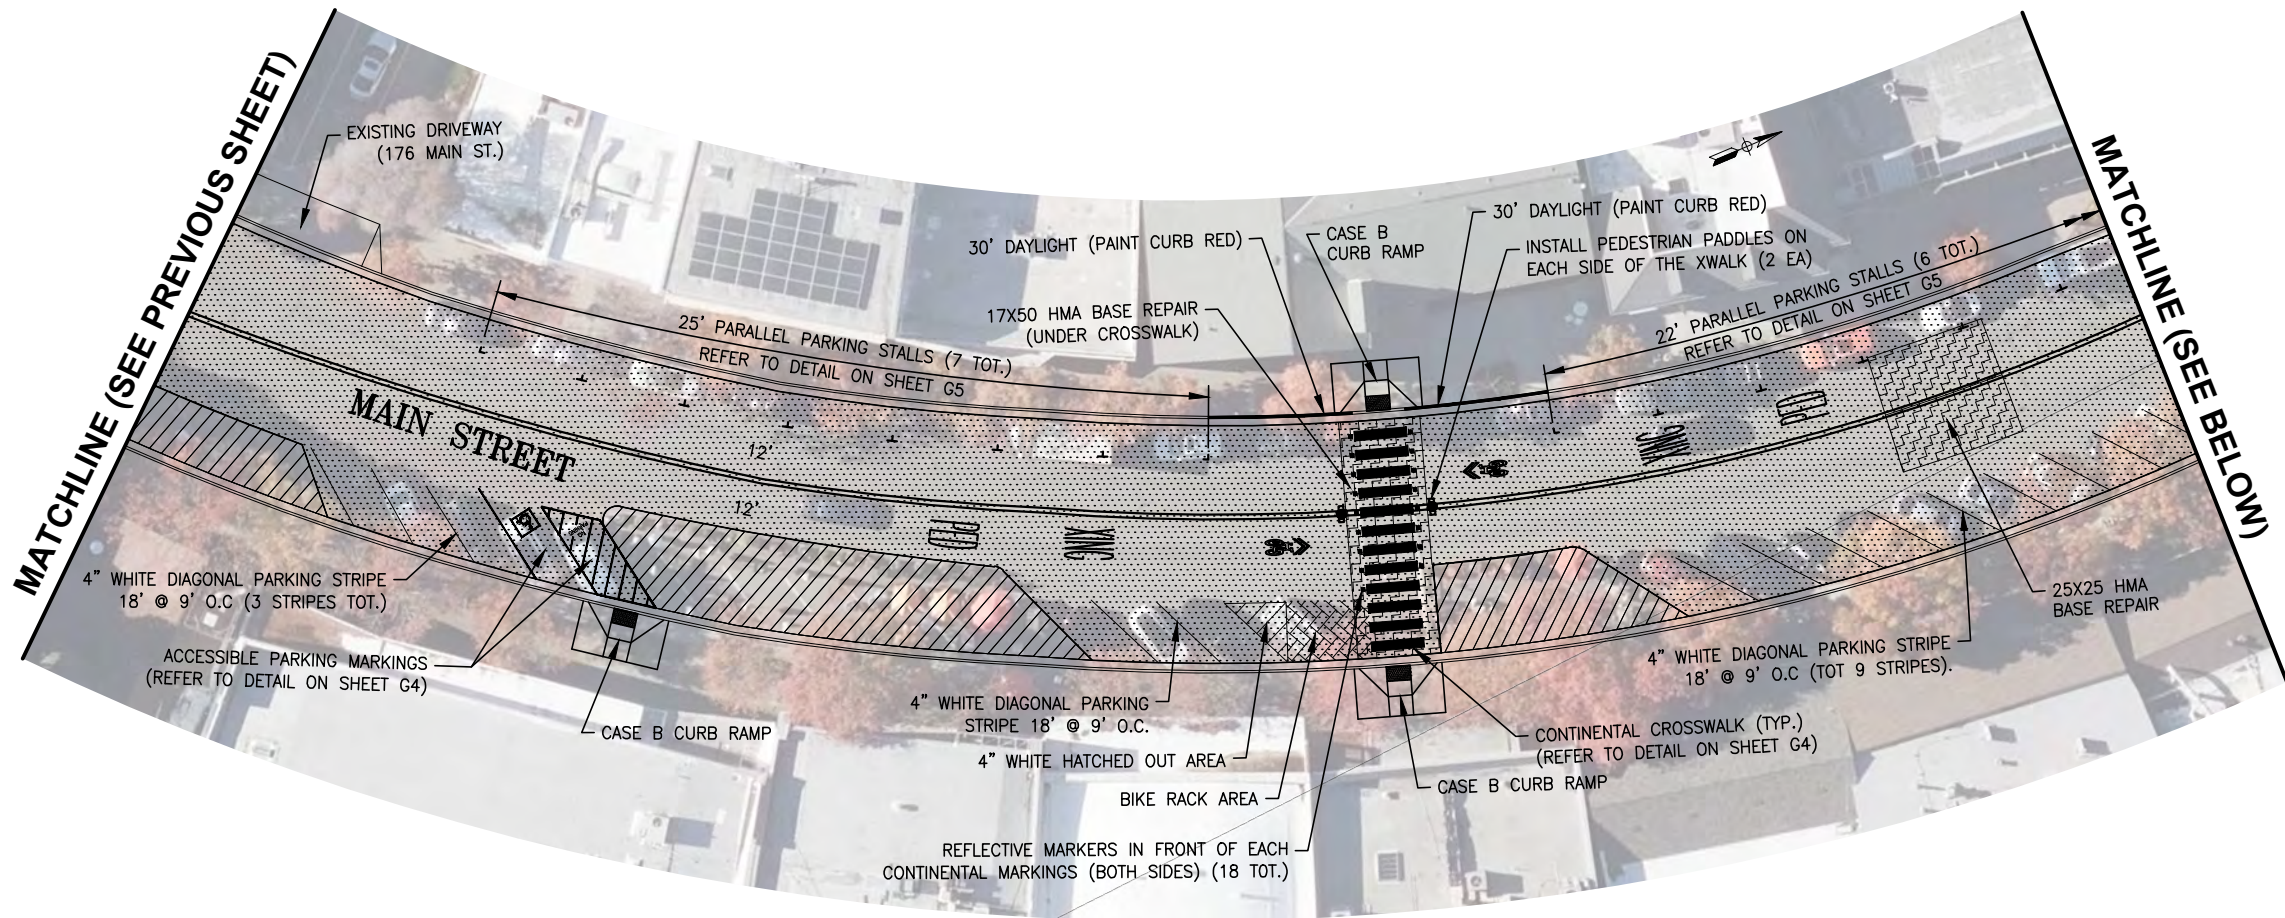

MAIN STREET
FROM FOOTHILL EXPRESSWAY TO STATE STREET
SCALE: 1" = 20'

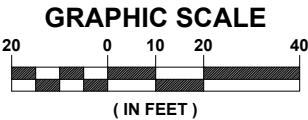

FILE: D:\City of Los Altos\DWG - Mar 5 2025\PLAN_01_MAIN STREET.dwg
PLOT DATE: Apr 06, 2025 - 10:04pm

No.	DATE	REVISION	BY	APPD
1				
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CITY OF LOS ALTOS
2025 PAVEMENT REHABILITATION PROJECT
MAIN STREET - FROM FOOTHILL EXPRESSWAY TO STATE ST
PUBLIC WORKS DEPARTMENT

APPROVED -- PRINCIPAL ENGINEER

DATE

RECOMMENDED -- PROJECT MANAGER

DATE
XX / XX / 202X

CITY PROJECT:
PWC XXXX

FEDERAL PROJECT:

DESIGNED BY:
WPM

CHECKED BY:
DA

DRAWN BY:
WPM

DATE:
APRIL 2025

SCALE:
AS SHOWN

0 1" 1"



NOTE: VERIFY SCALE.
BAR IS ONE INCH ON
ORIGINAL DRAWING.
ADJUST SCALES
ACCORDINGLY IF BAR
IS NOT ONE INCH.

DRAWING:

C2

15


SHEET 7 OF 20

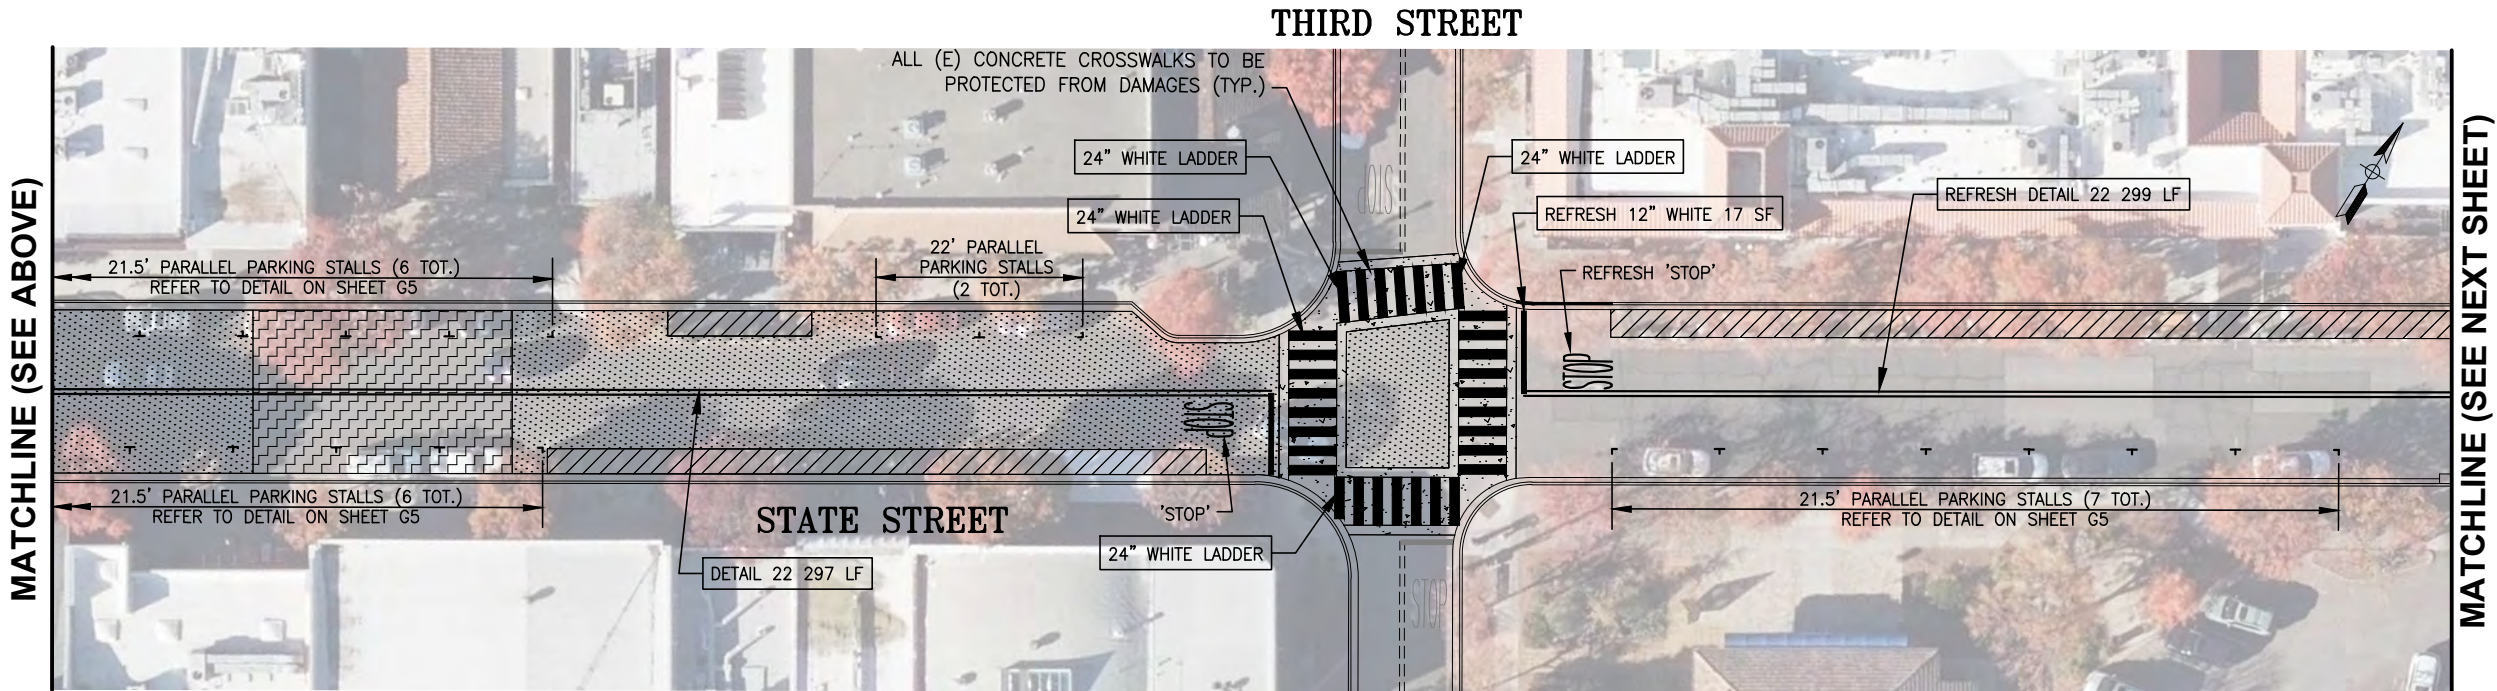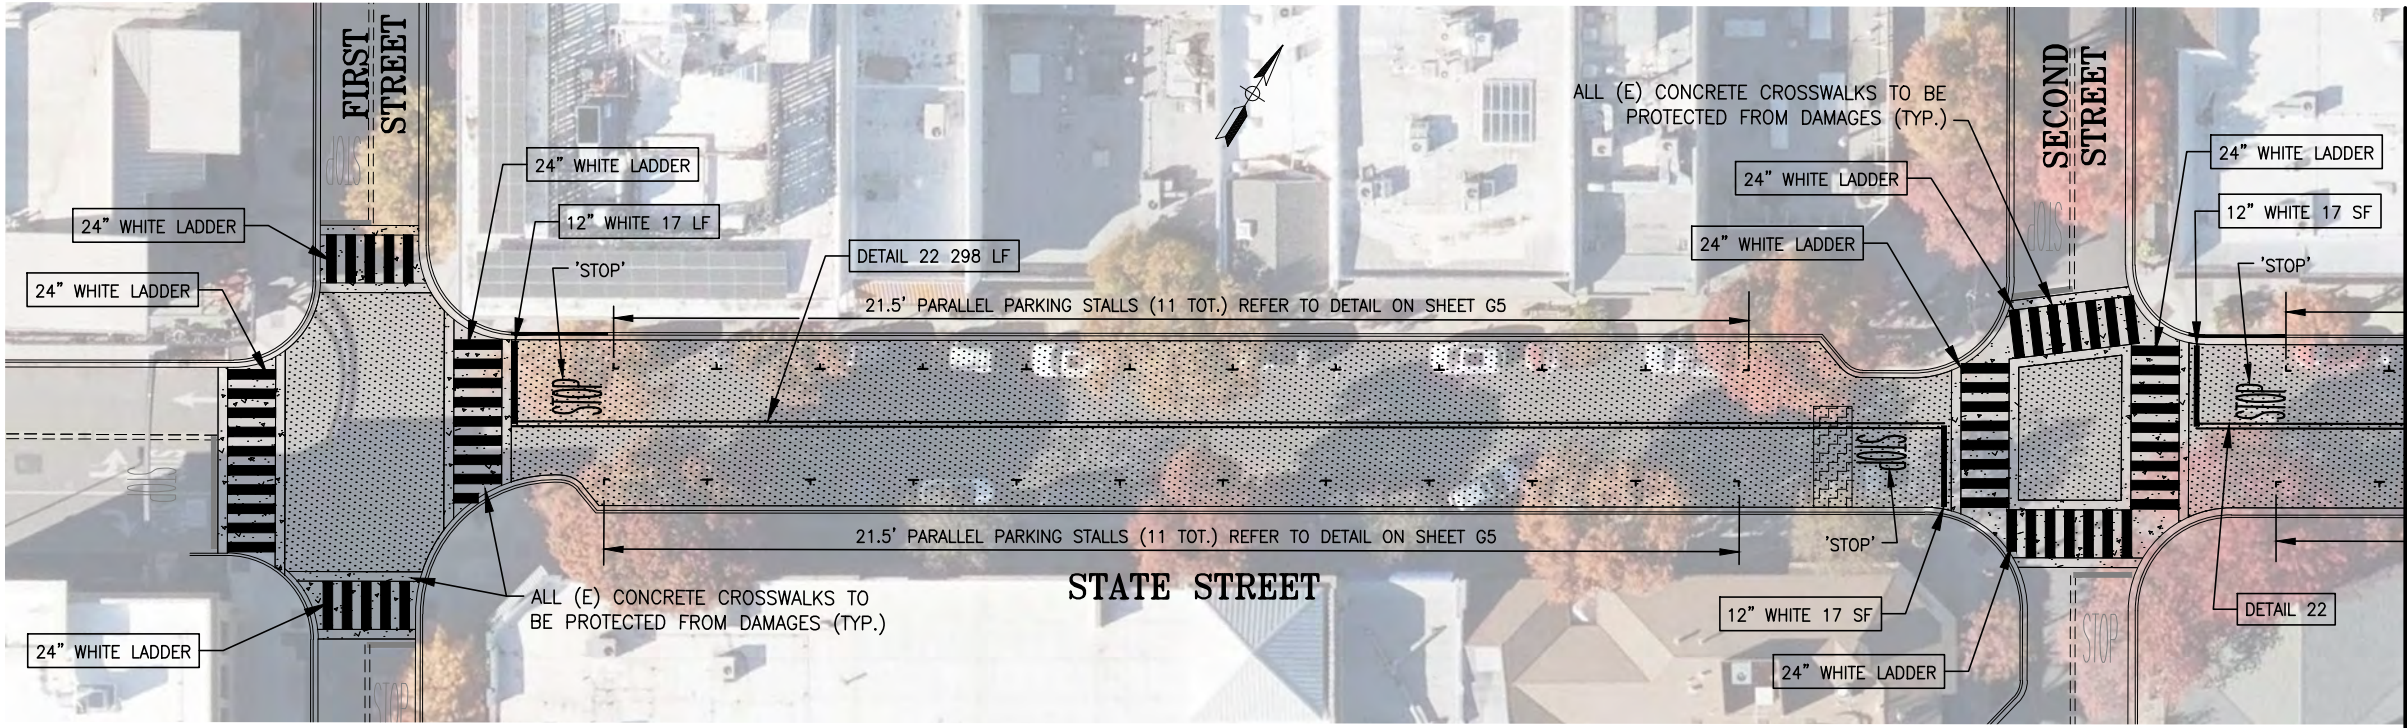

LEGEND & QUANTITY TABLE			
	4" HMA BASE REPAIR	2,005 SF	223 SY
	MICROSURFACE	24,610 SF	2,735 SY
	PARKLET AREA		

NOTE:
ALL TRAFFIC STRIPES AND PAVEMENT MARKINGS SHALL BE THERMOPLASTIC.

STATE STREET
FROM 1ST STREET TO MAIN STREET
SCALE: 1" = 20'

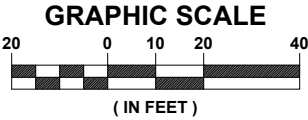

No.	DATE	REVISION	BY	APPD
1				
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CITY OF LOS ALTOS
2025 PAVEMENT REHABILITATION PROJECT
STATE STREET - FROM 1ST STREET TO MAIN STREET
PUBLIC WORKS DEPARTMENT

APPROVED -- PRINCIPAL ENGINEER

DATE

RECOMMENDED -- PROJECT MANAGER

DATE
XX / XX / 202X

CITY PROJECT:
PWC XXXX

FEDERAL PROJECT:

DESIGNED BY:
WPM

CHECKED BY:
DA

DRAWN BY:
WPM

DATE:
APRIL 2025

SCALE:
AS SHOWN



0 1" 1"

NOTE: VERIFY SCALE.
BAR IS ONE INCH ON
ORIGINAL DRAWING.
ADJUST SCALES
ACCORDINGLY IF BAR
IS NOT ONE INCH.

DRAWING:

C3
16

SHEET 8 OF 20

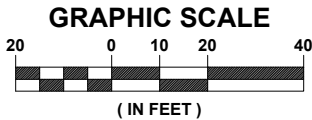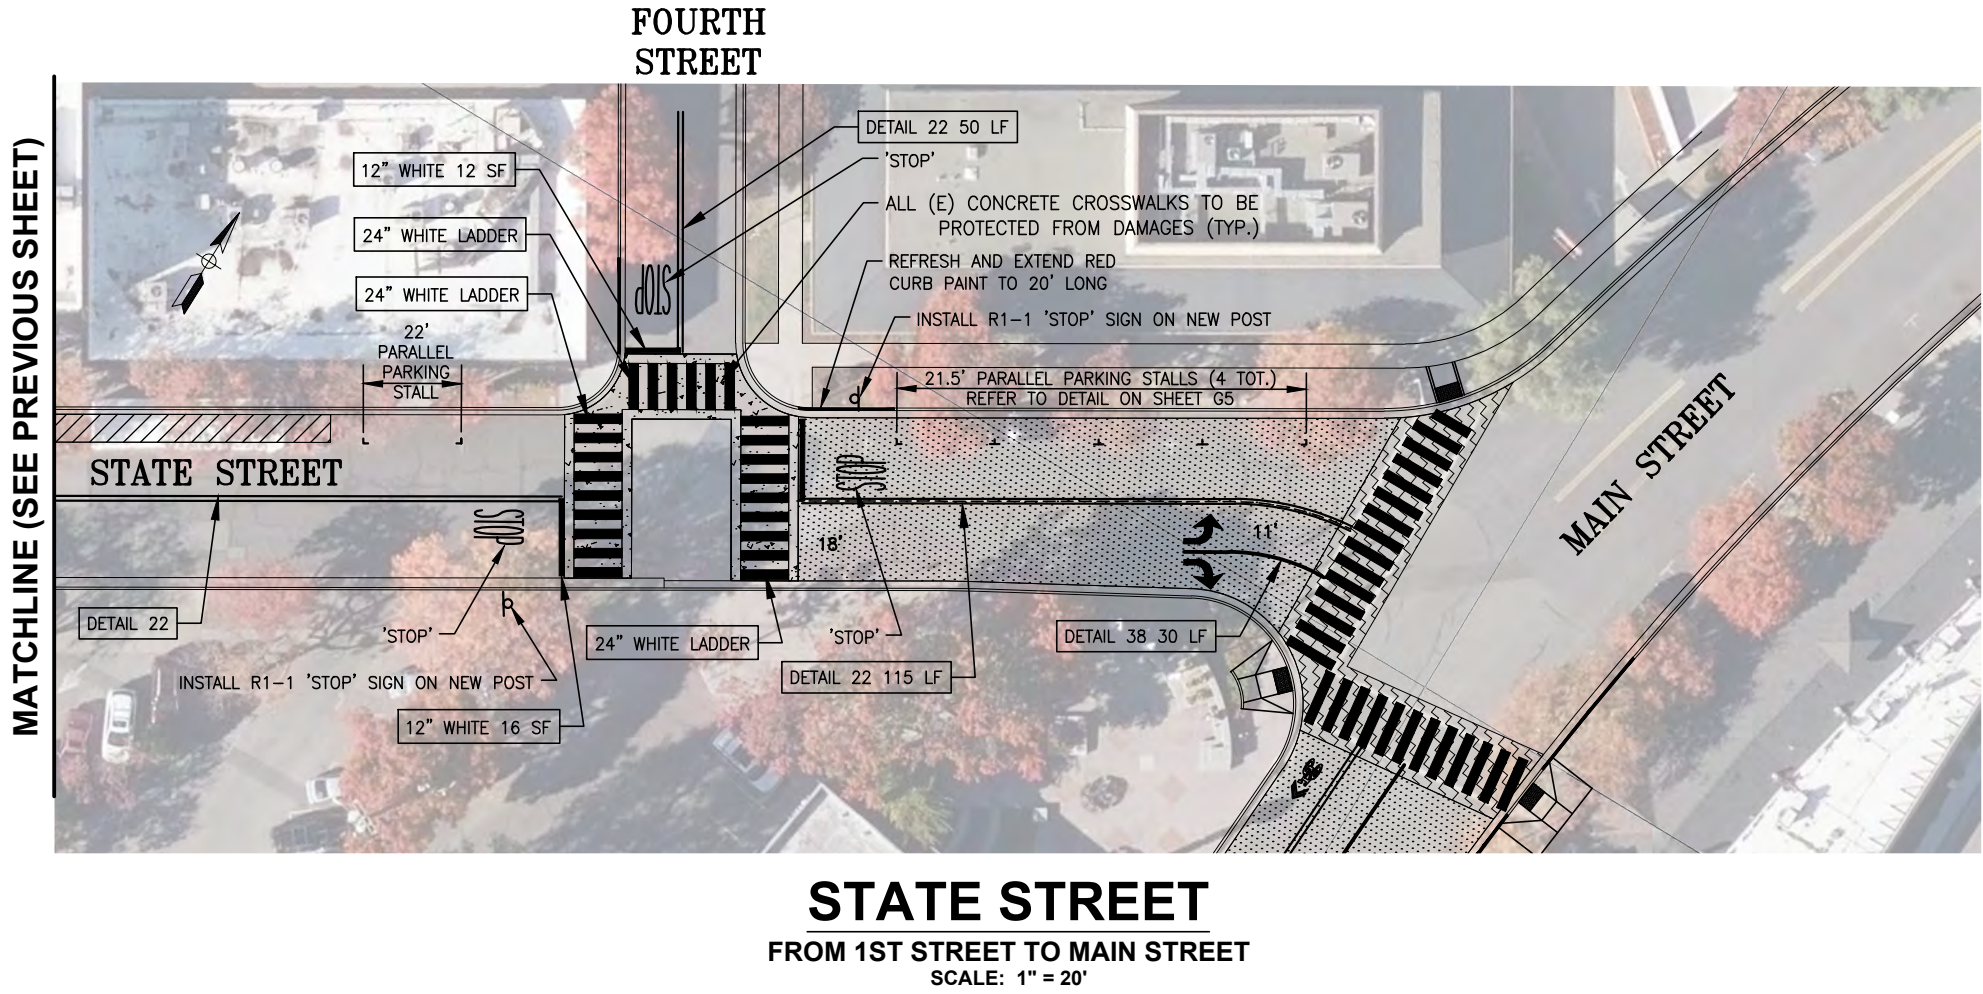

PLOT DATE: Apr 06, 2025 - 10:14pm FILE: D:\City of Los Altos\DWG - Mar 5 2025\PLAN_02_STATE STREET.dwg

No.	DATE	REVISION	BY	APPD
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CITY OF LOS ALTOS
2025 PAVEMENT REHABILITATION PROJECT
STATE STREET - FROM 1ST STREET TO MAIN STREET
PUBLIC WORKS DEPARTMENT

APPROVED -- PRINCIPAL ENGINEER

DATE

RECOMMENDED -- PROJECT MANAGER

DATE
XX / XX / 202X

CITY PROJECT: PWC XXXX

FEDERAL PROJECT:

DESIGNED BY: WPM

CHECKED BY: DA

DRAWN BY: WPM

DATE: APRIL 2025

SCALE: AS SHOWN

0 1"

NOTE: VERIFY SCALE. BAR IS ONE INCH ON ORIGINAL DRAWING. ADJUST SCALES ACCORDINGLY IF BAR IS NOT ONE INCH.


DRAWING:

C4

17

SHEET 9 OF 20


FOOTHILL EXPRESSWAY

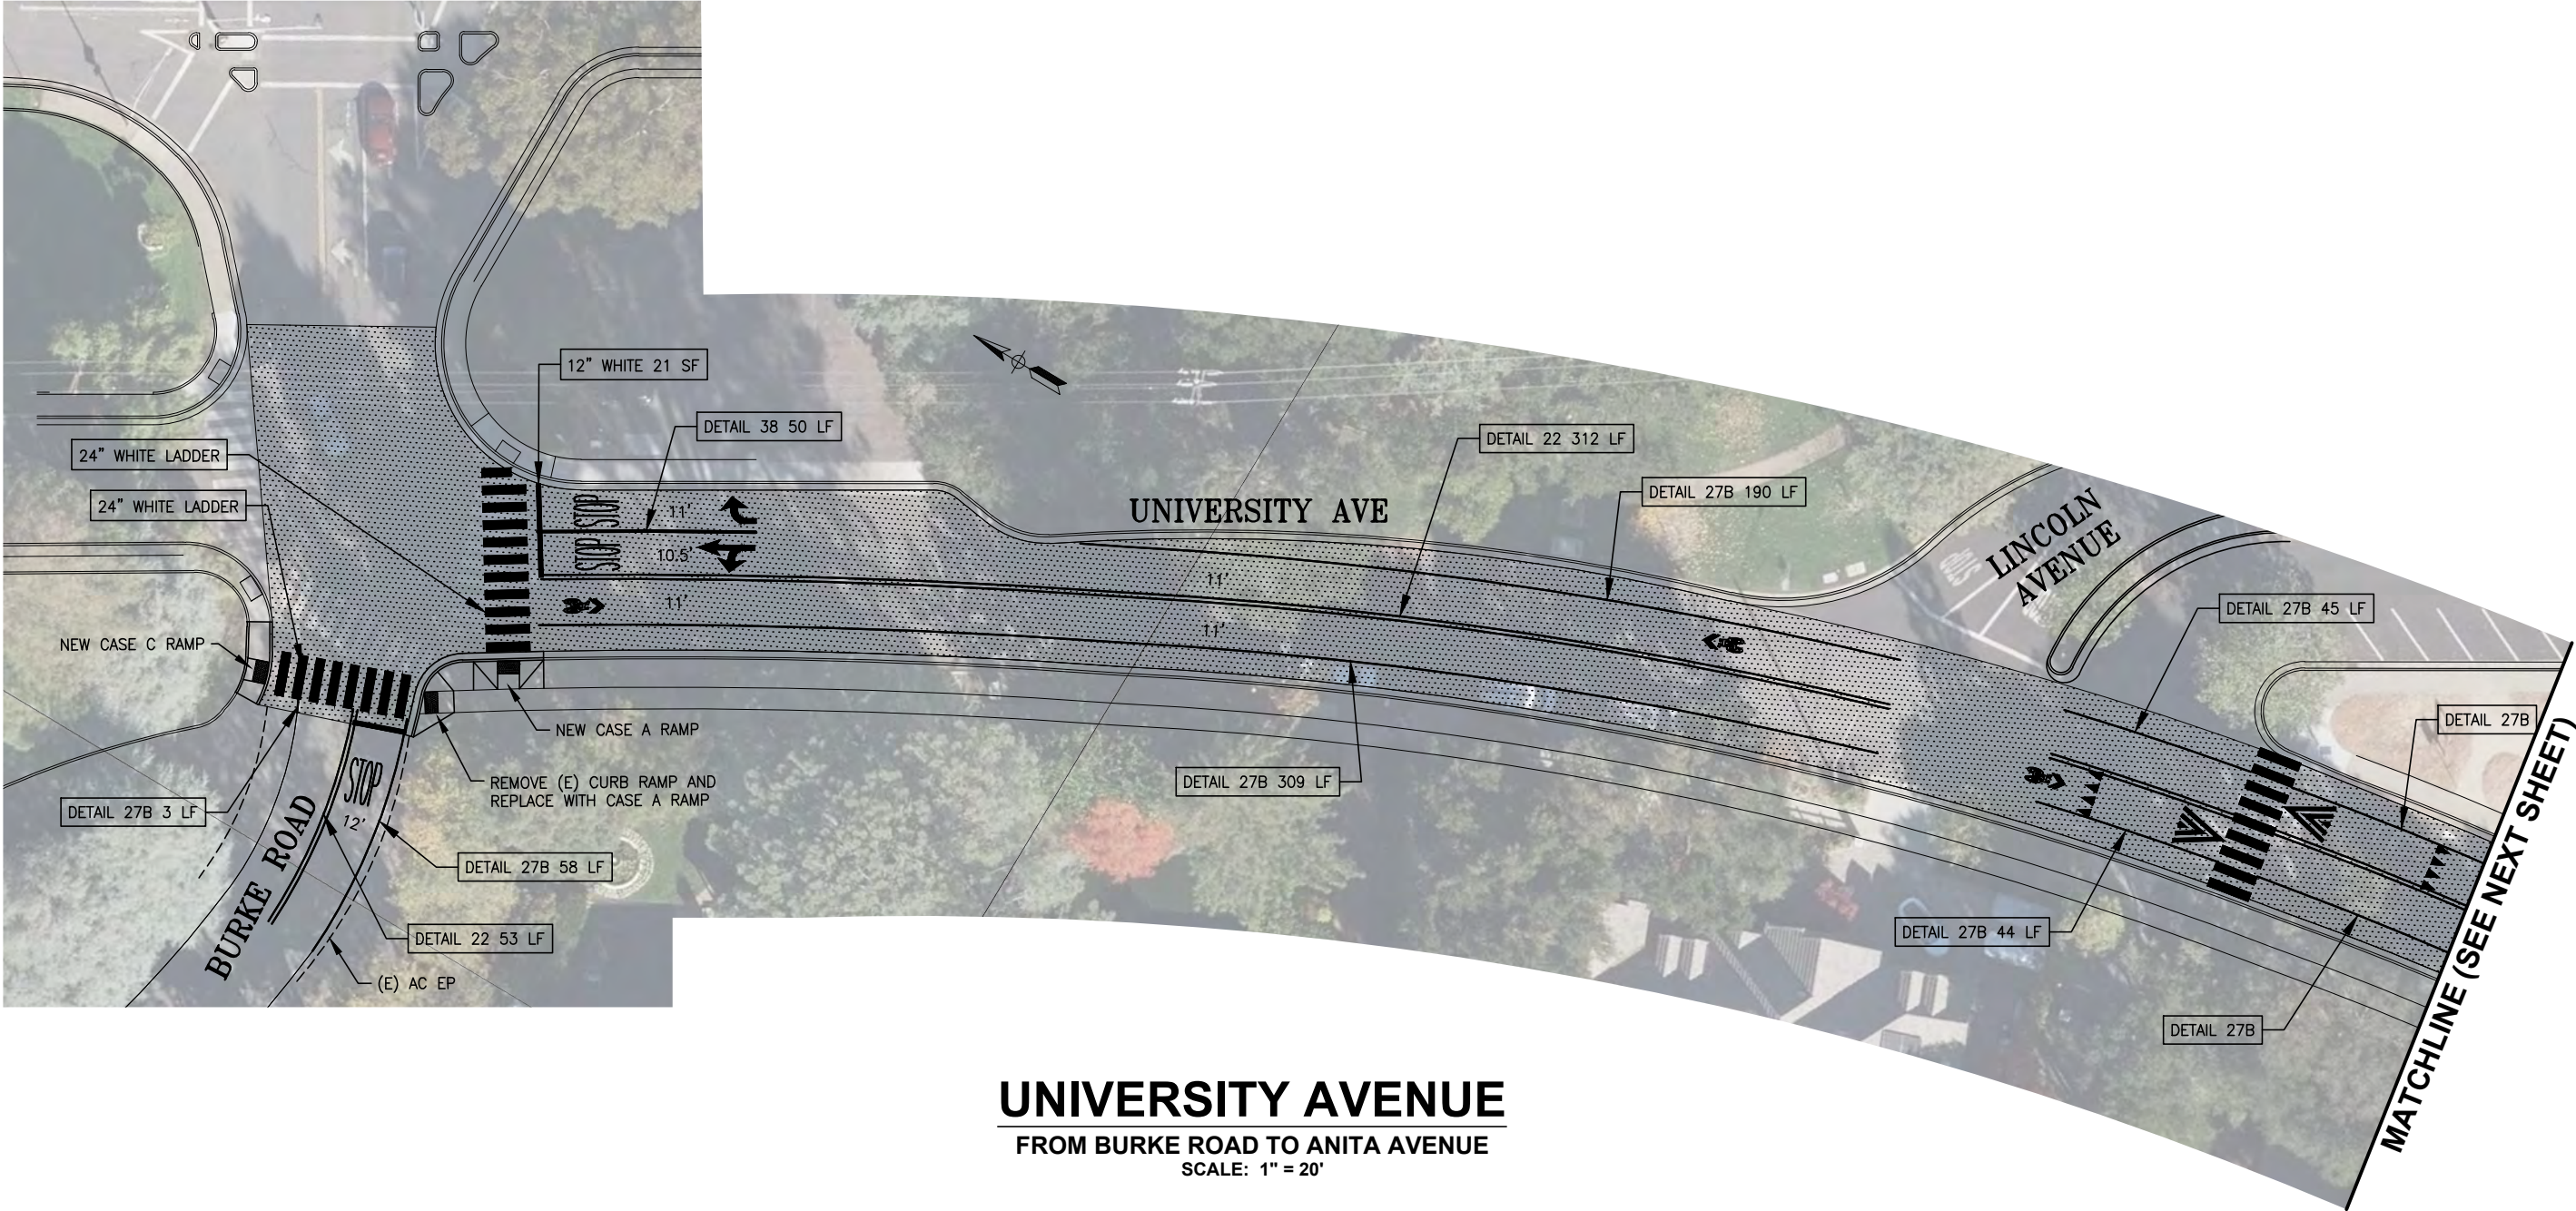

UNIVERSITY AVENUE
FROM BURKE ROAD TO ANITA AVENUE
SCALE: 1" = 20'

LEGEND & QUANTITY TABLE			
	4" HMA BASE REPAIR	1,306 SF	145 SY
	MICROSURFACE	217,504 SF	24,168 SY

NOTE:
ALL TRAFFIC STRIPES AND PAVEMENT
MARKINGS SHALL BE THERMOPLASTIC.

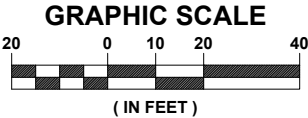

No.	DATE	REVISION	BY	APPD
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CITY OF LOS ALTOS
2025 PAVEMENT REHABILITATION PROJECT
UNIVERSITY AVE - FROM BURKE ROAD TO ANITA AVENUE
PUBLIC WORKS DEPARTMENT

APPROVED -- PRINCIPAL ENGINEER

DATE

RECOMMENDED -- PROJECT MANAGER

DATE
XX / XX / 202X

CITY PROJECT:
PWC XXXX

FEDERAL PROJECT:

DESIGNED BY:
WPM

CHECKED BY:
DA

DRAWN BY:
WPM

DATE:
APRIL 2025

SCALE:
AS SHOWN

0 1" 1"


NOTE: VERIFY SCALE.
BAR IS ONE INCH ON
ORIGINAL DRAWING.
ADJUST SCALES
ACCORDINGLY IF BAR
IS NOT ONE INCH.

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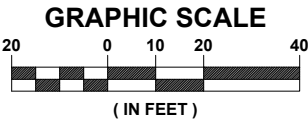
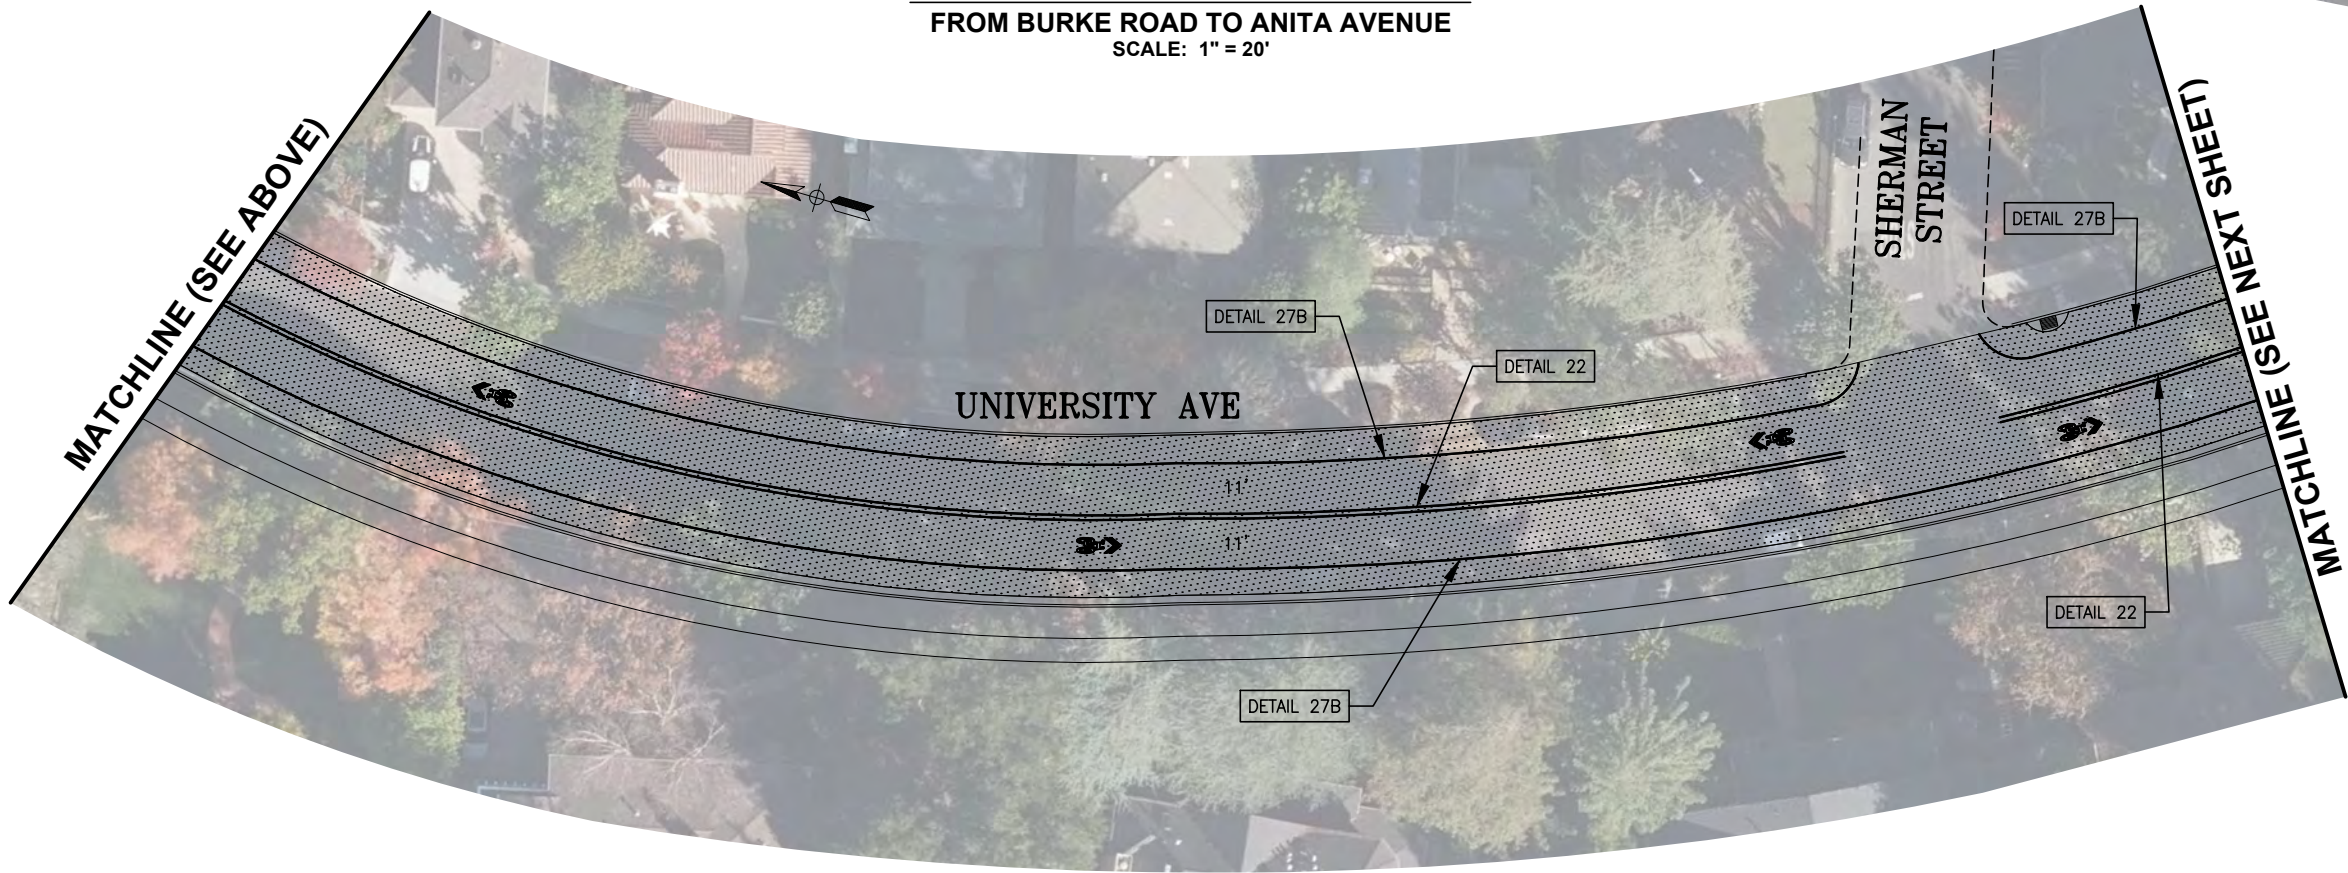
C5

18

SHEET 10 OF 20

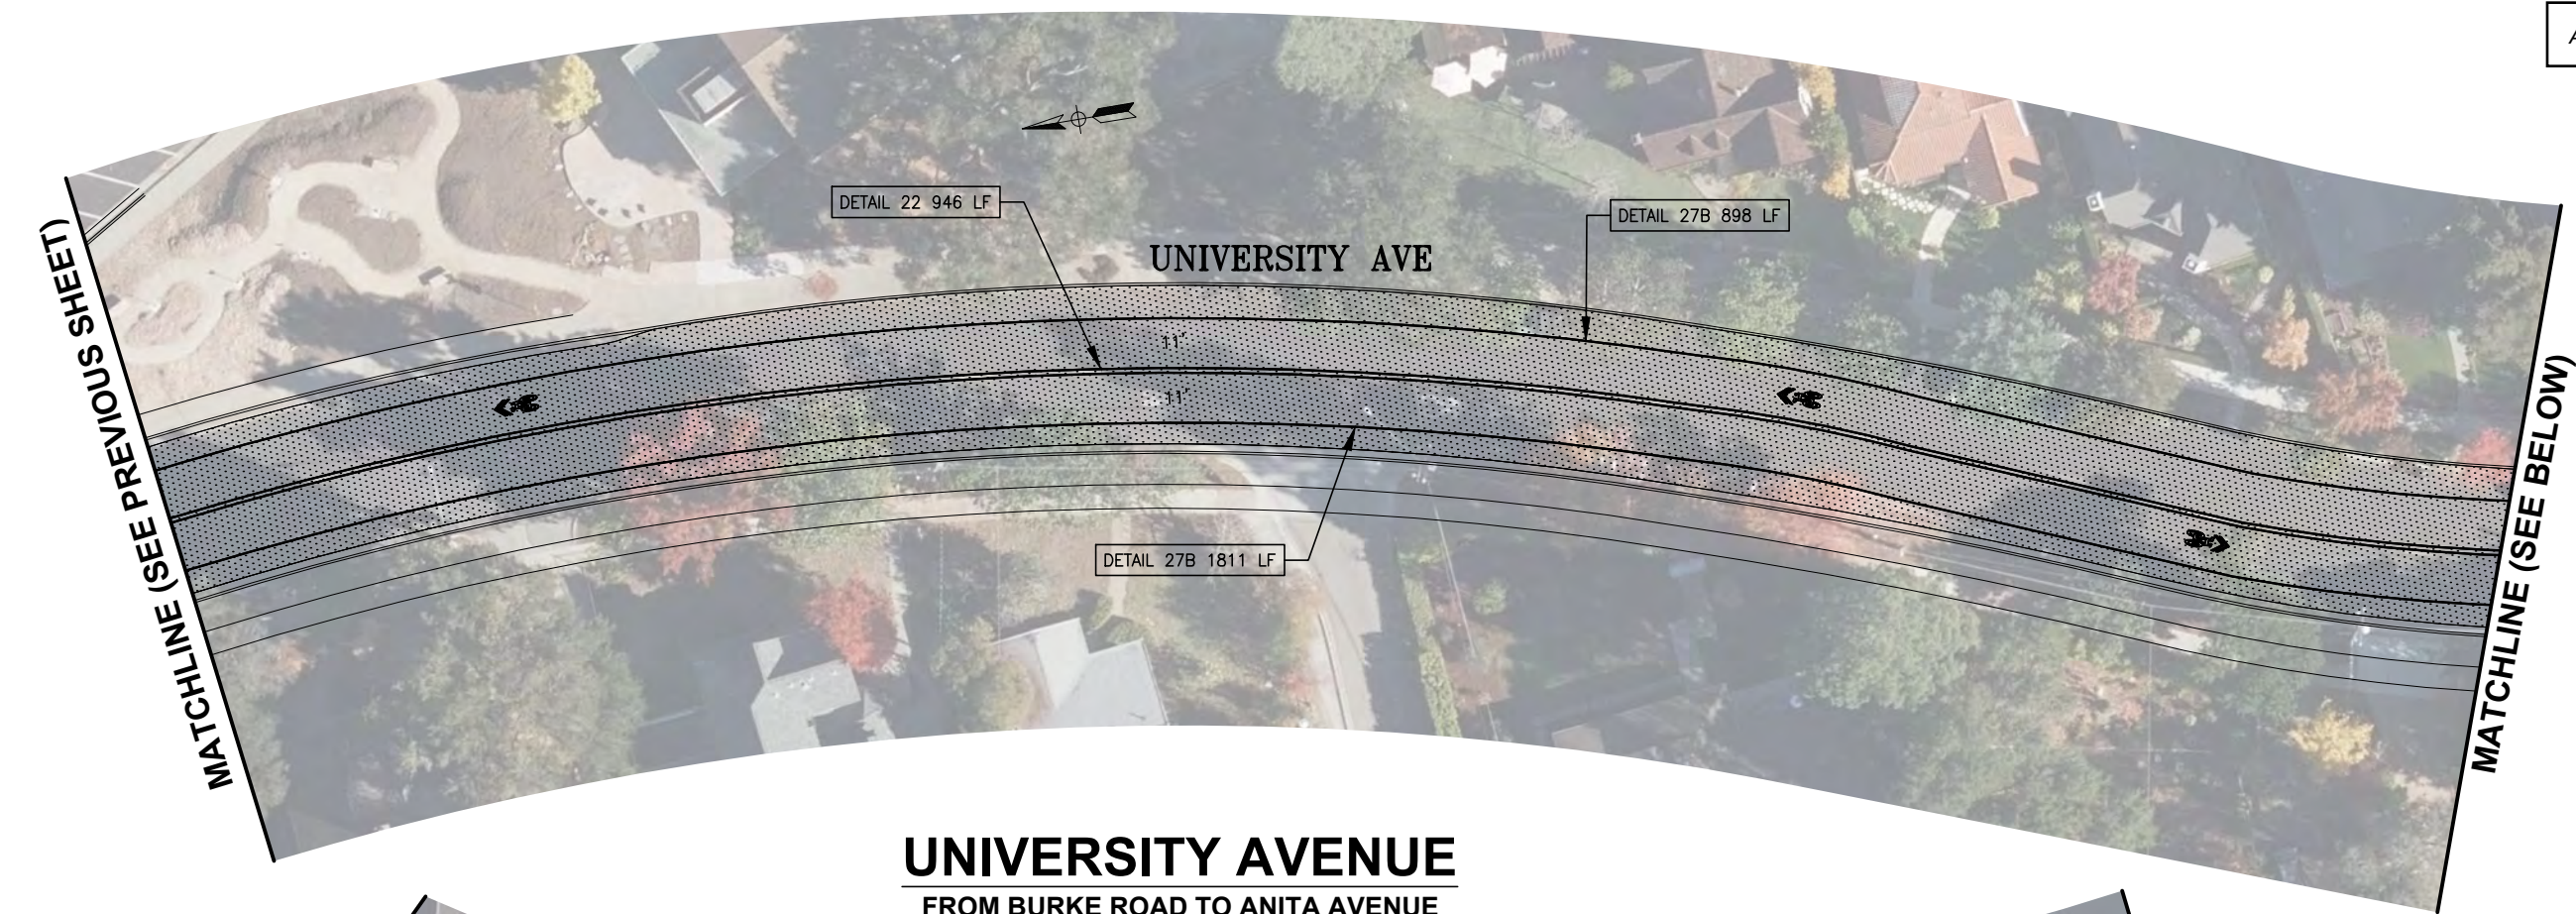

UNIVERSITY AVENUE
FROM BURKE ROAD TO ANITA AVENUE
SCALE: 1" = 20'



PLOT DATE: Apr 06, 2025 - 11:14pm FILE: D:\City of Los Altos\DWG - Mar 5 2025\PLAN_03_UNIVERSITY.dwg

No.	DATE	REVISION	BY	APPD
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PLEASANTON, CALIFORNIA 94566

CITY OF LOS ALTOS
2025 PAVEMENT REHABILITATION PROJECT
UNIVERSITY AVE - FROM BURKE ROAD TO ANITA AVENUE
PUBLIC WORKS DEPARTMENT

APPROVED -- PRINCIPAL ENGINEER

DATE

RECOMMENDED -- PROJECT MANAGER

DATE
XX / XX / 202X

CITY PROJECT:
PWC XXXX

FEDERAL PROJECT:

DESIGNED BY:
WPM

CHECKED BY:
DA

DRAWN BY:
WPM

DATE:
APRIL 2025

SCALE:
AS SHOWN

0 1" 1"


NOTE: VERIFY SCALE.
BAR IS ONE INCH ON
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ADJUST SCALES
ACCORDINGLY IF BAR
IS NOT ONE INCH.

DRAWING:



C6

19

SHEET 11 OF 20

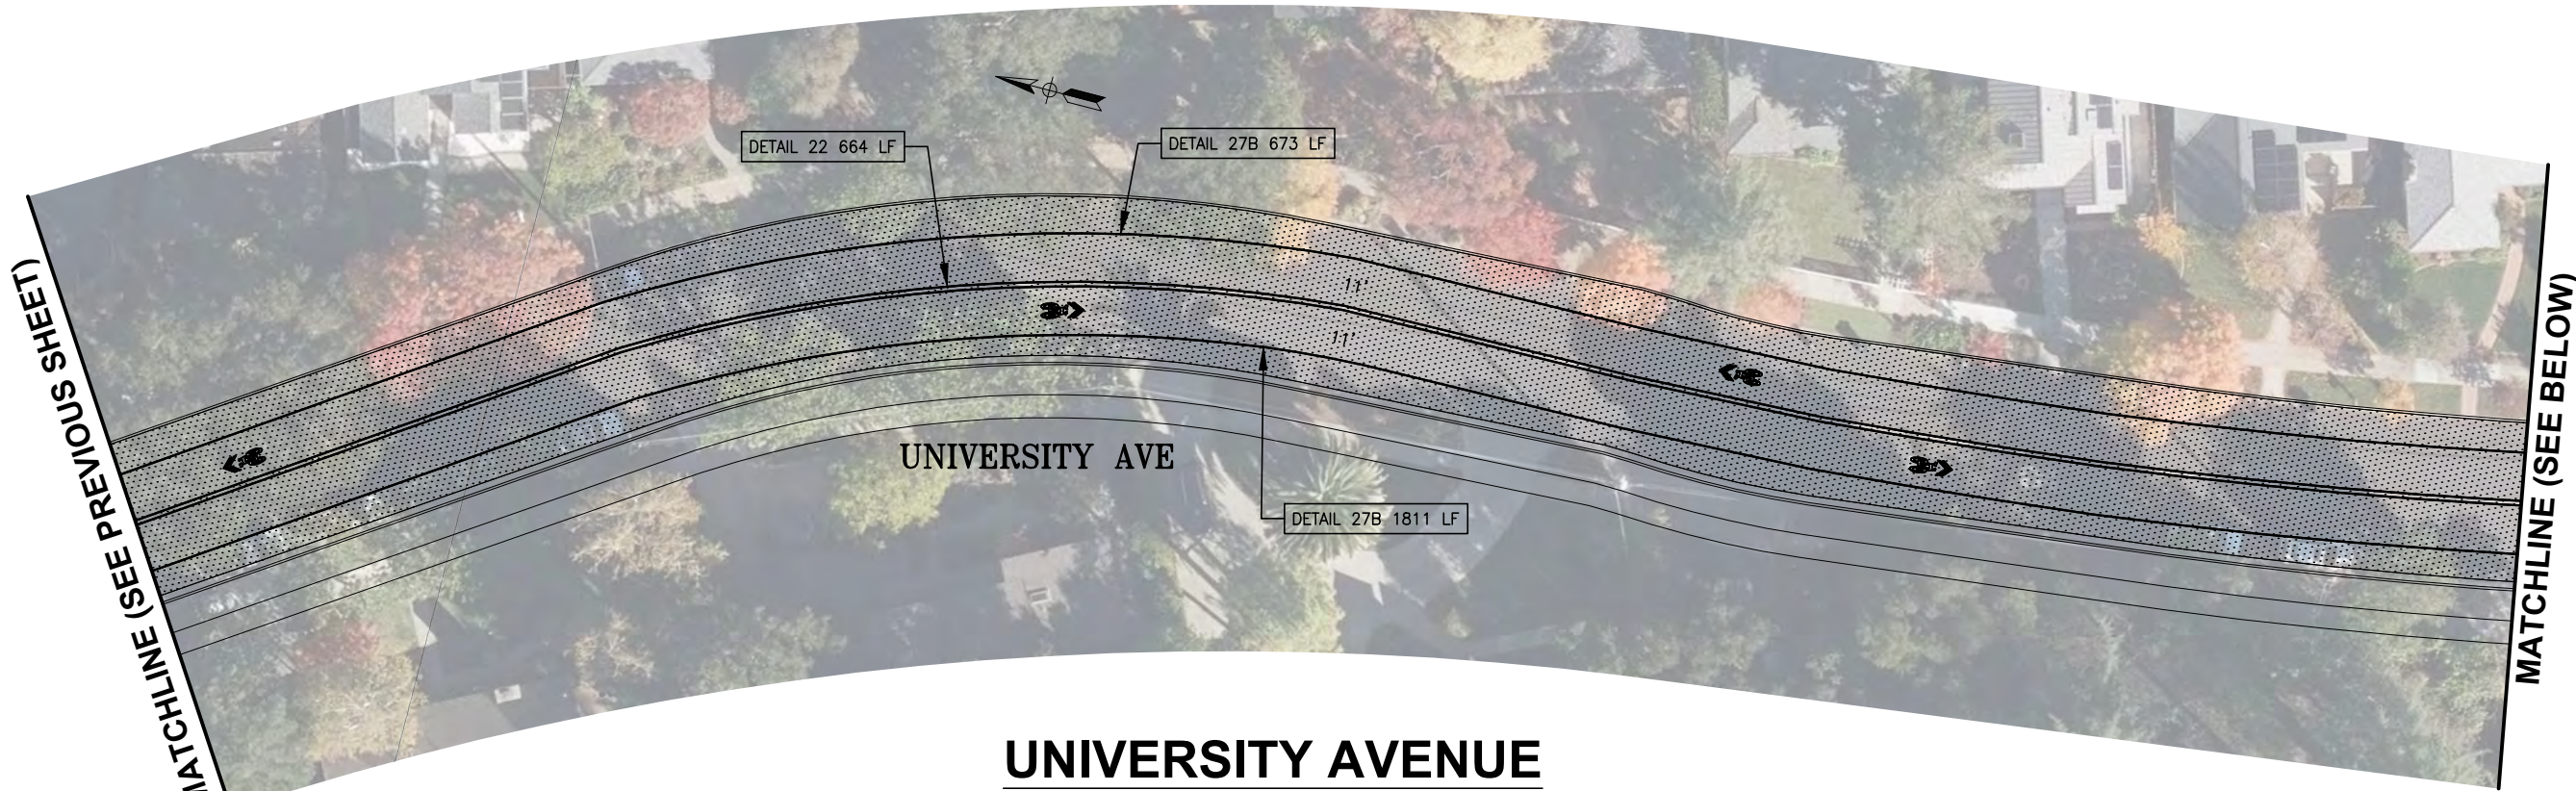

UNIVERSITY AVENUE
FROM BURKE ROAD TO ANITA AVENUE
SCALE: 1" = 20'

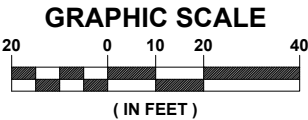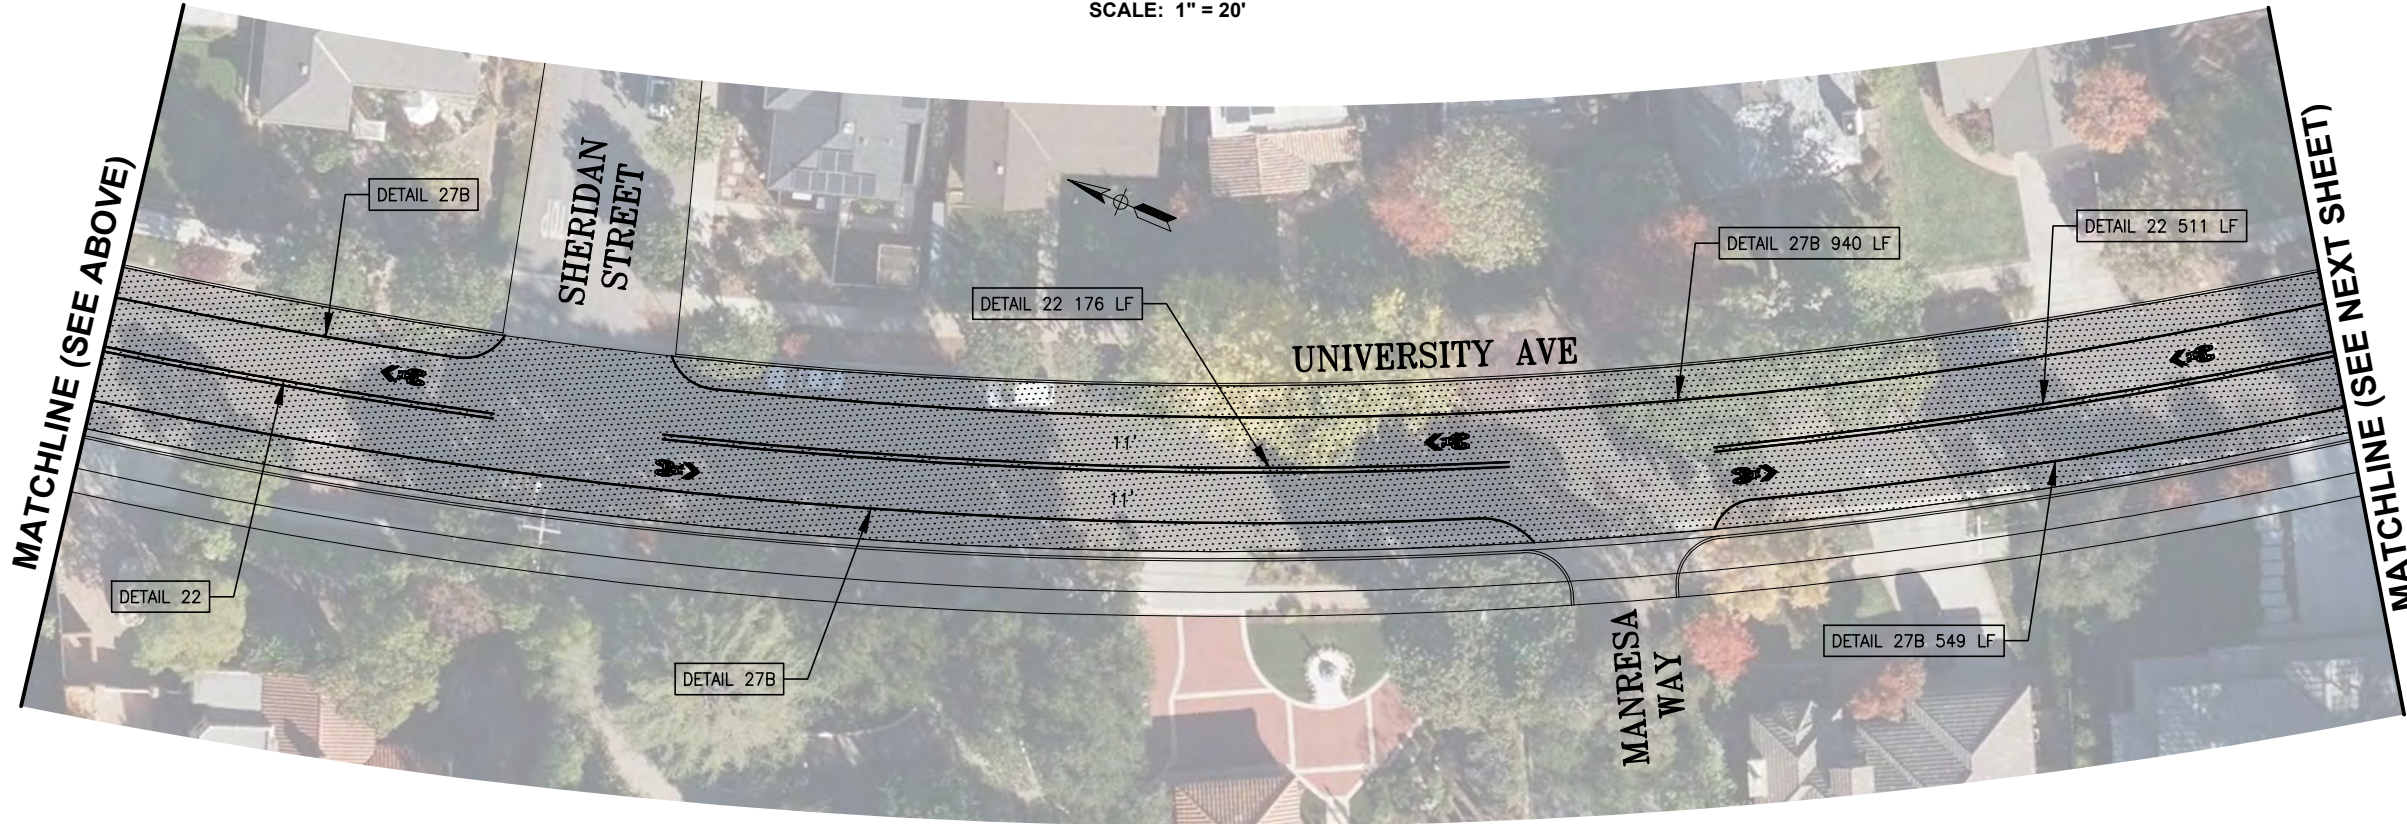

PLOT DATE: Apr 06, 2025 - 11:16pm FILE: D:\City of Los Altos\DWG - Mar 5 2025\PLAN_03_UNIVERSITY.dwg

No.	DATE	REVISION	BY	APPD
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PLEASANTON, CALIFORNIA 94566



CITY OF LOS ALTOS
2025 PAVEMENT REHABILITATION PROJECT
UNIVERSITY AVE - FROM BURKE ROAD TO ANITA AVENUE
PUBLIC WORKS DEPARTMENT

APPROVED -- PRINCIPAL ENGINEER

DATE

RECOMMENDED -- PROJECT MANAGER

DATE
XX / XX / 202X

CITY PROJECT:
PWC XXXX

FEDERAL PROJECT:

DESIGNED BY:
WPM

CHECKED BY:
DA

DRAWN BY:
WPM

DATE:
APRIL 2025

SCALE:
AS SHOWN


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NOTE: VERIFY SCALE.
BAR IS ONE INCH ON
ORIGINAL DRAWING.
ADJUST SCALES
ACCORDINGLY IF BAR
IS NOT ONE INCH.



DRAWING:

C7
20

SHEET 12 OF 20

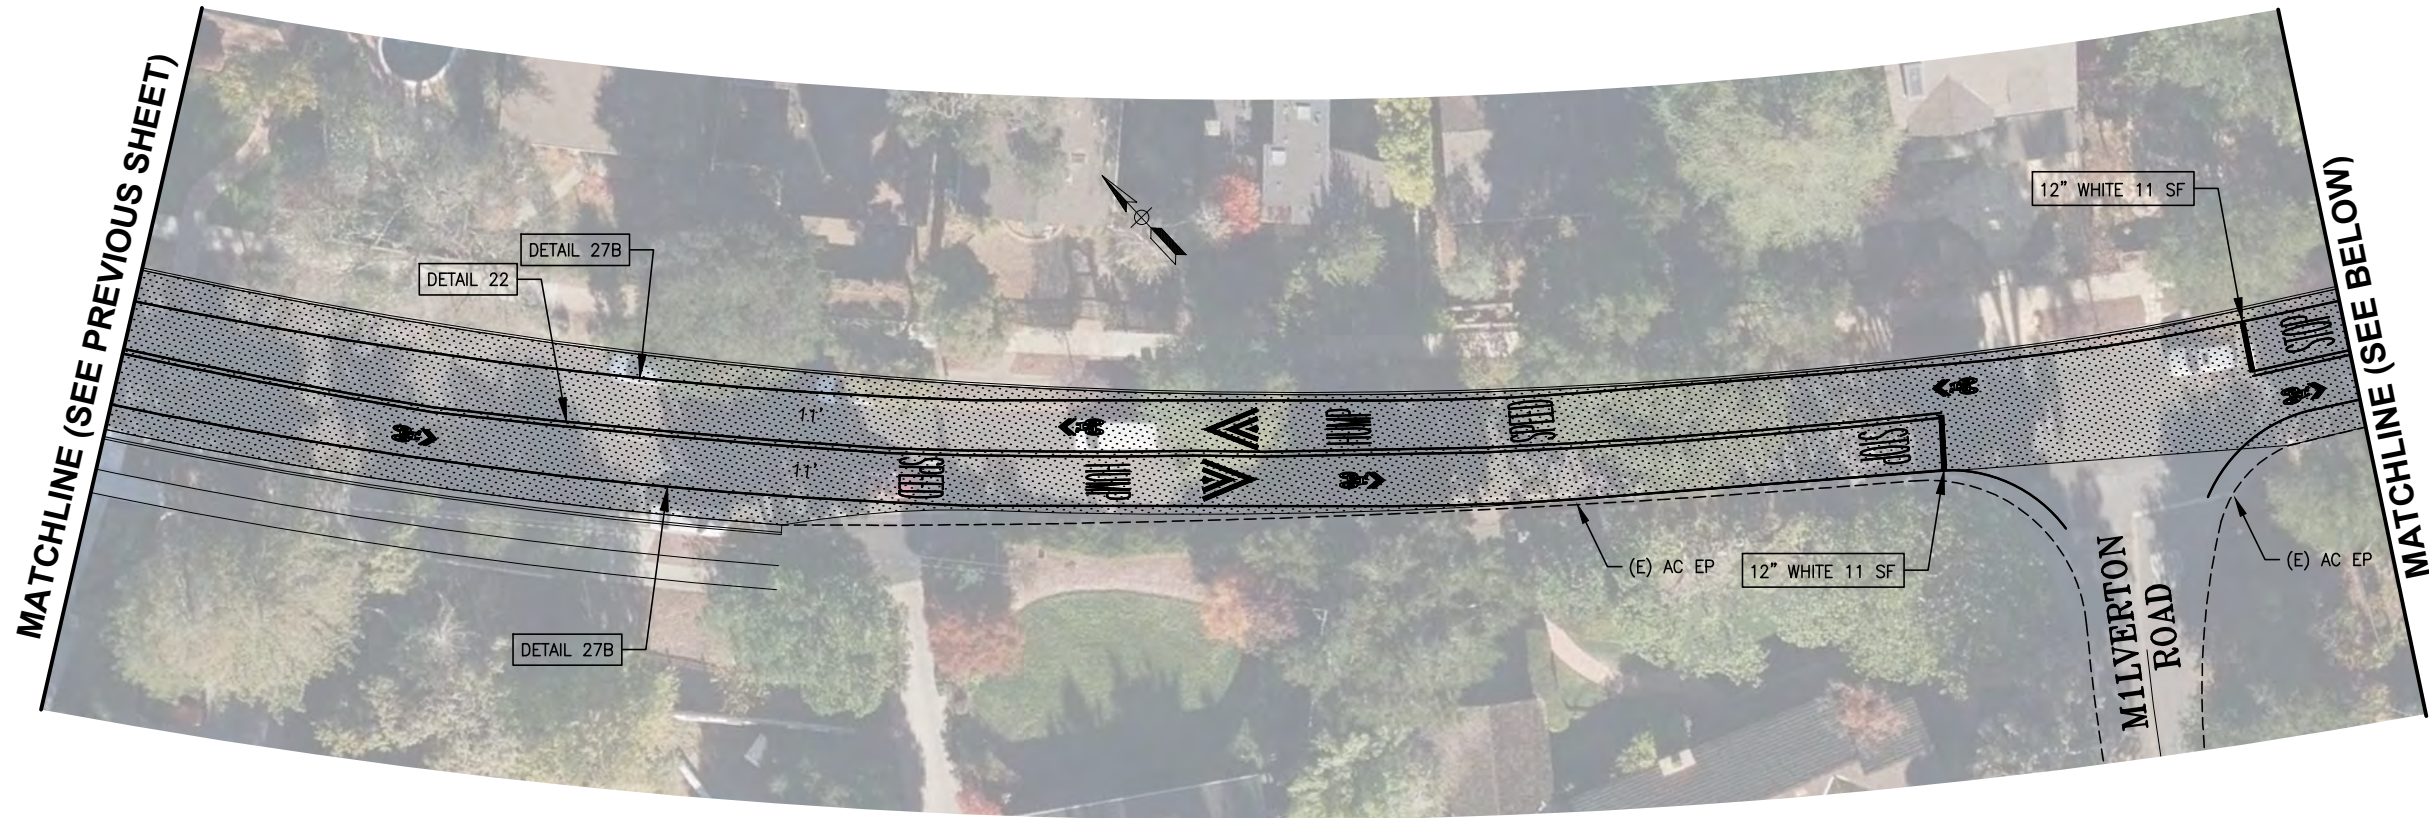

UNIVERSITY AVENUE
FROM BURKE ROAD TO ANITA AVENUE
SCALE: 1" = 20'

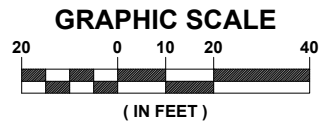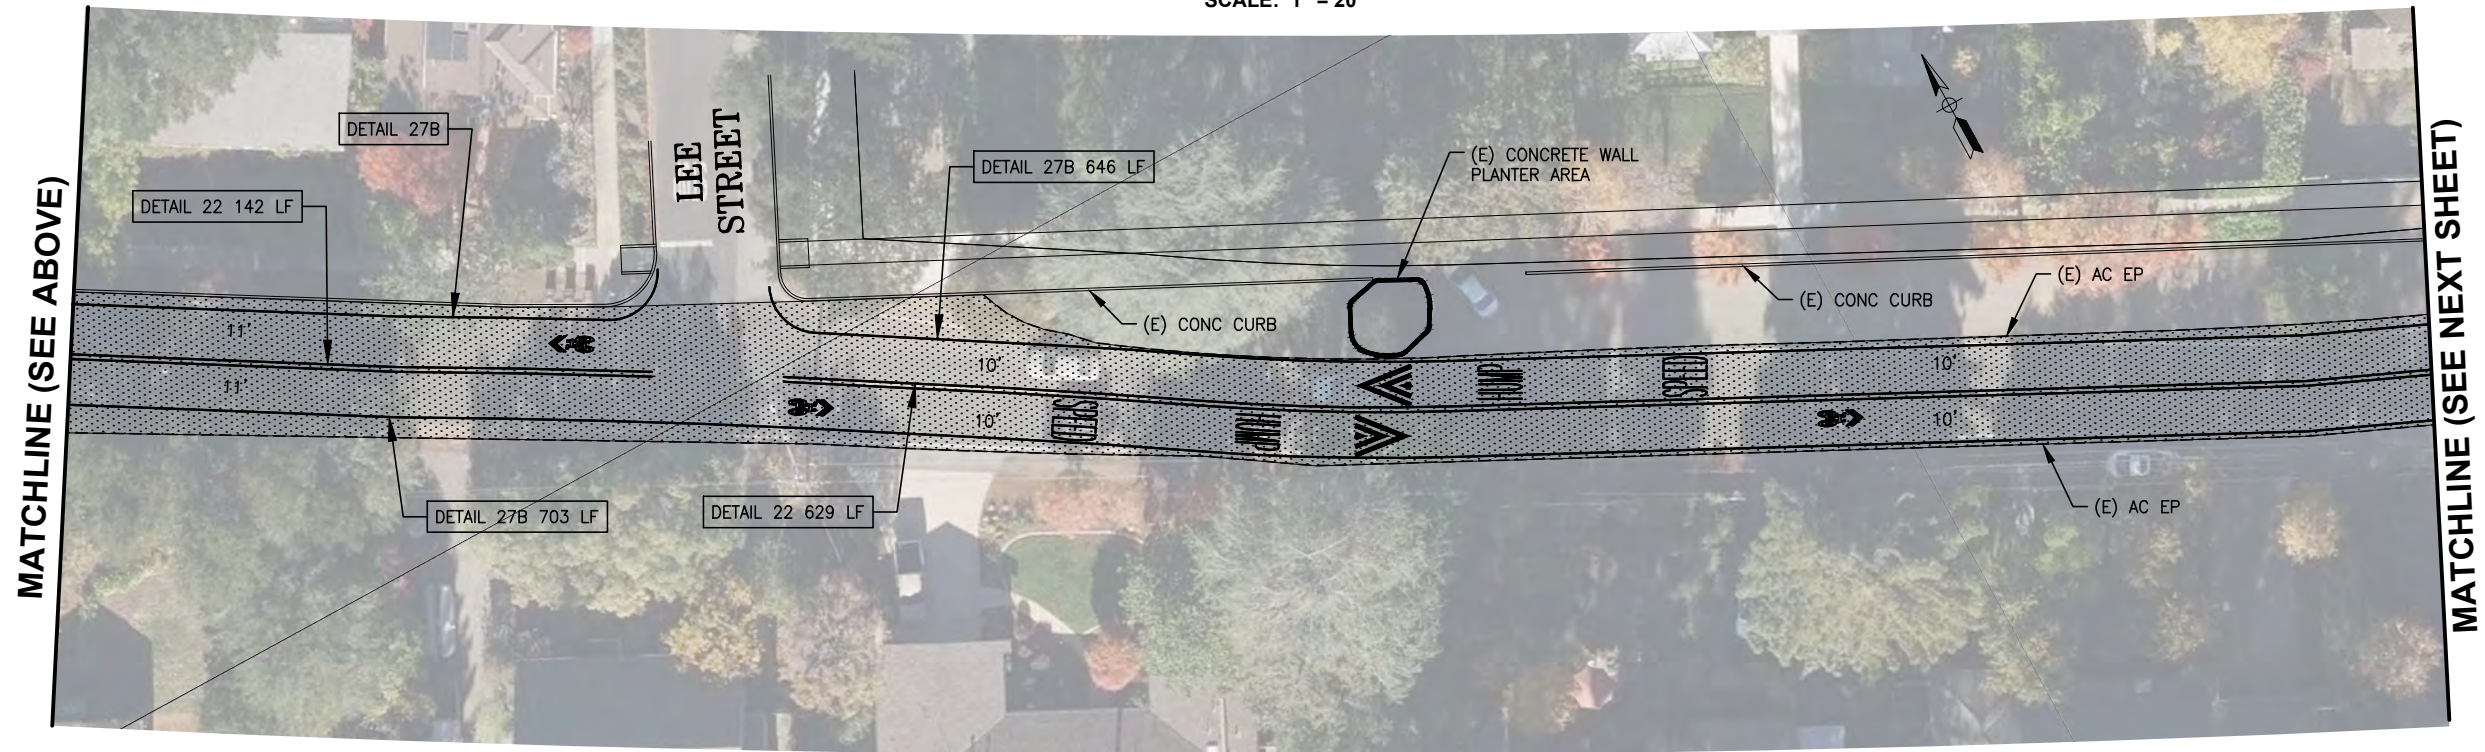

FILE: D:\City of Los Altos\DWG - Mar 5 2025\PLAN_03_UNIVERSITY.dwg

No.	DATE	REVISION	BY	APPD
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PLEASANTON, CALIFORNIA 94566

CITY OF LOS ALTOS

2025 PAVEMENT REHABILITATION PROJECT

UNIVERSITY AVE - FROM BURKE ROAD TO ANITA AVENUE

PUBLIC WORKS DEPARTMENT

APPROVED -- PRINCIPAL ENGINEER

DATE

RECOMMENDED -- PROJECT MANAGER

DATE XX / XX / 202X

CITY PROJECT: PWC XXXX

FEDERAL PROJECT:

DESIGNED BY: WPM

CHECKED BY: DA

DRAWN BY: WPM

DATE: APRIL 2025


SCALE: AS SHOWN

0 1" NOTE: VERIFY SCALE. BAR IS ONE INCH ON ORIGINAL DRAWING. ADJUST SCALES ACCORDINGLY IF BAR IS NOT ONE INCH.

DRAWING: C8

21


SHEET 13 OF 20

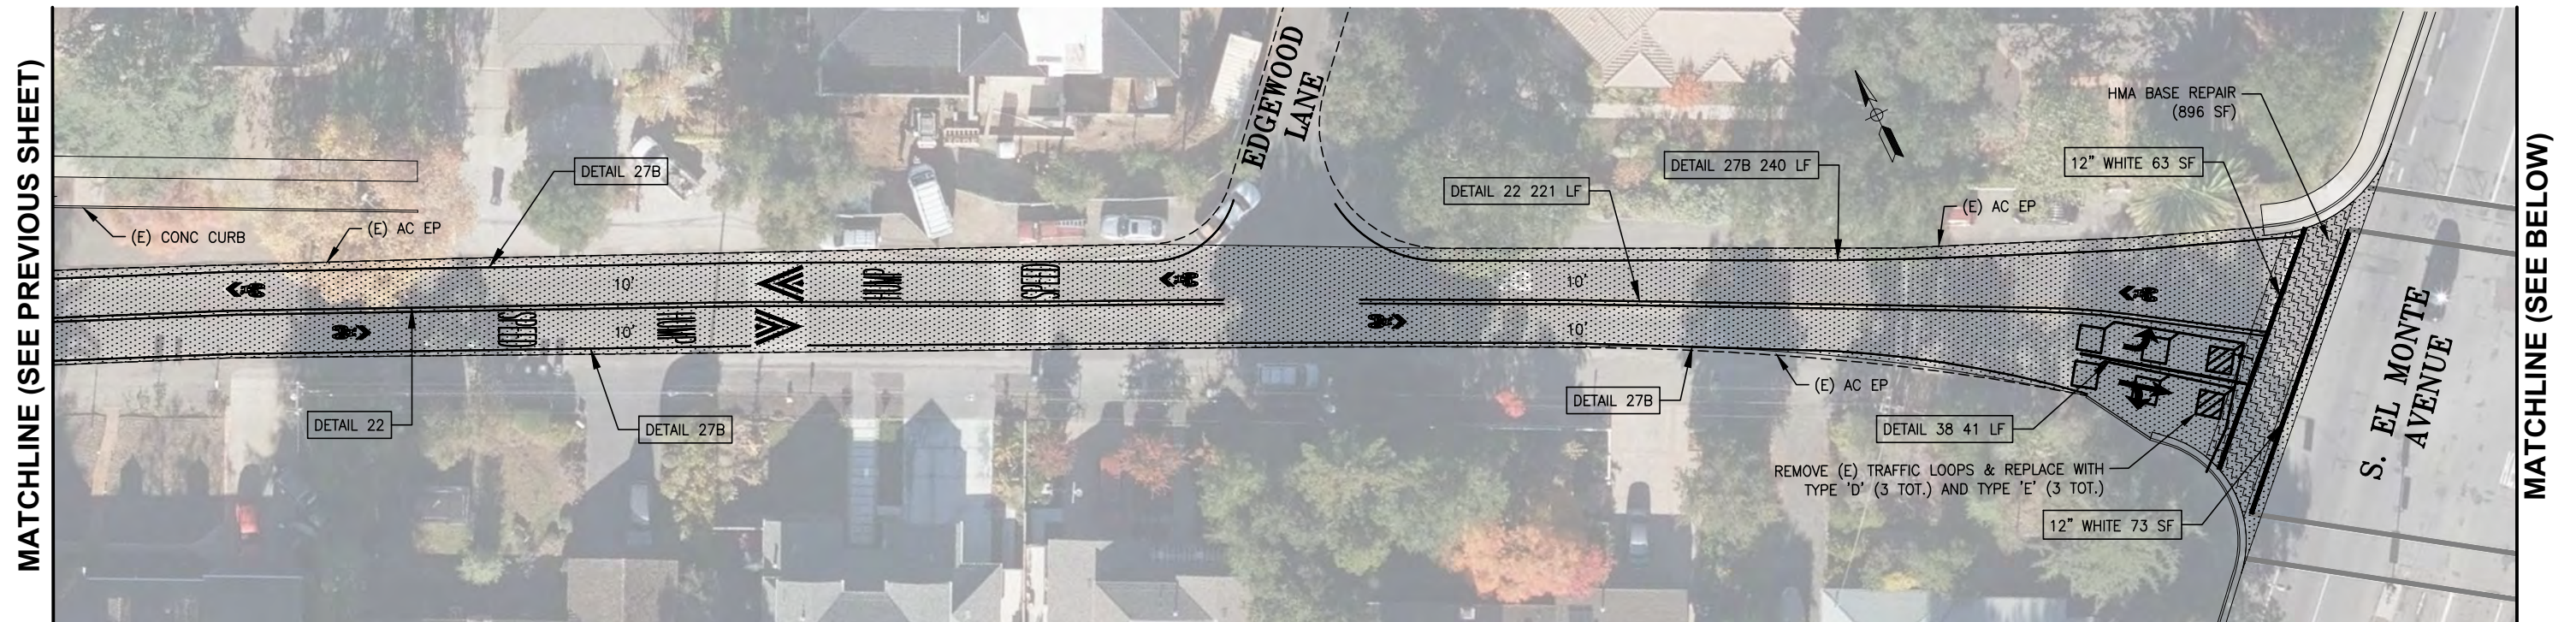


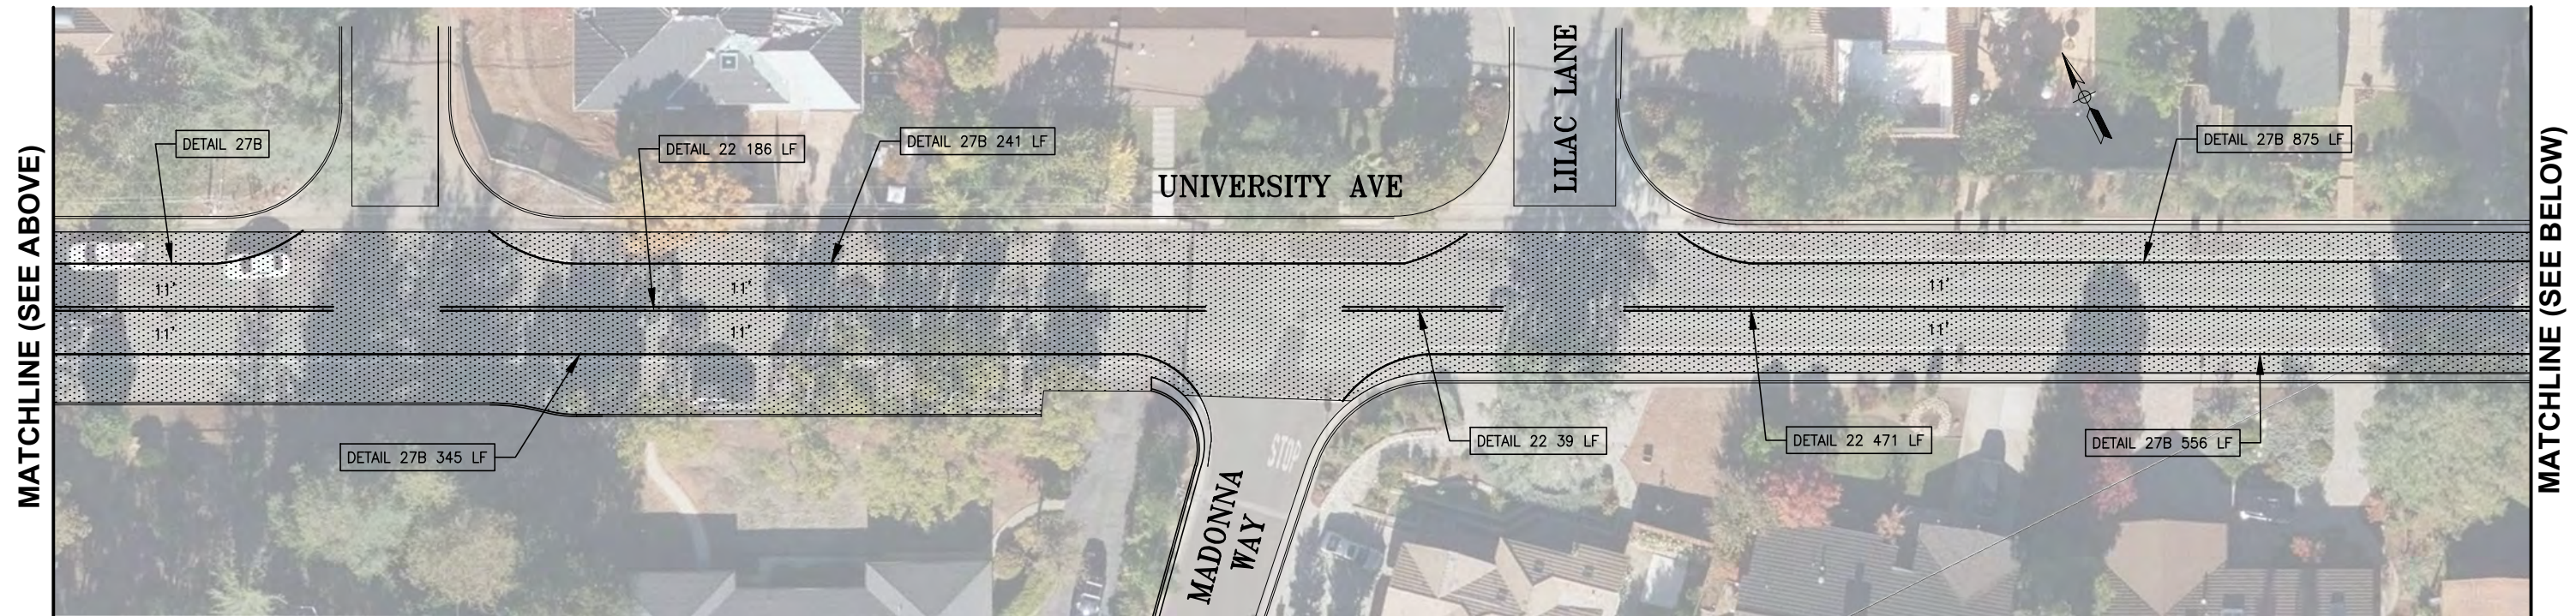
UNIVERSITY AVENUE

FROM BURKE ROAD TO ANITA AVENUE

SCALE: 1" = 20'

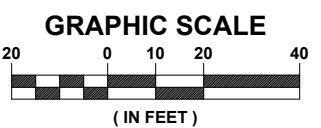


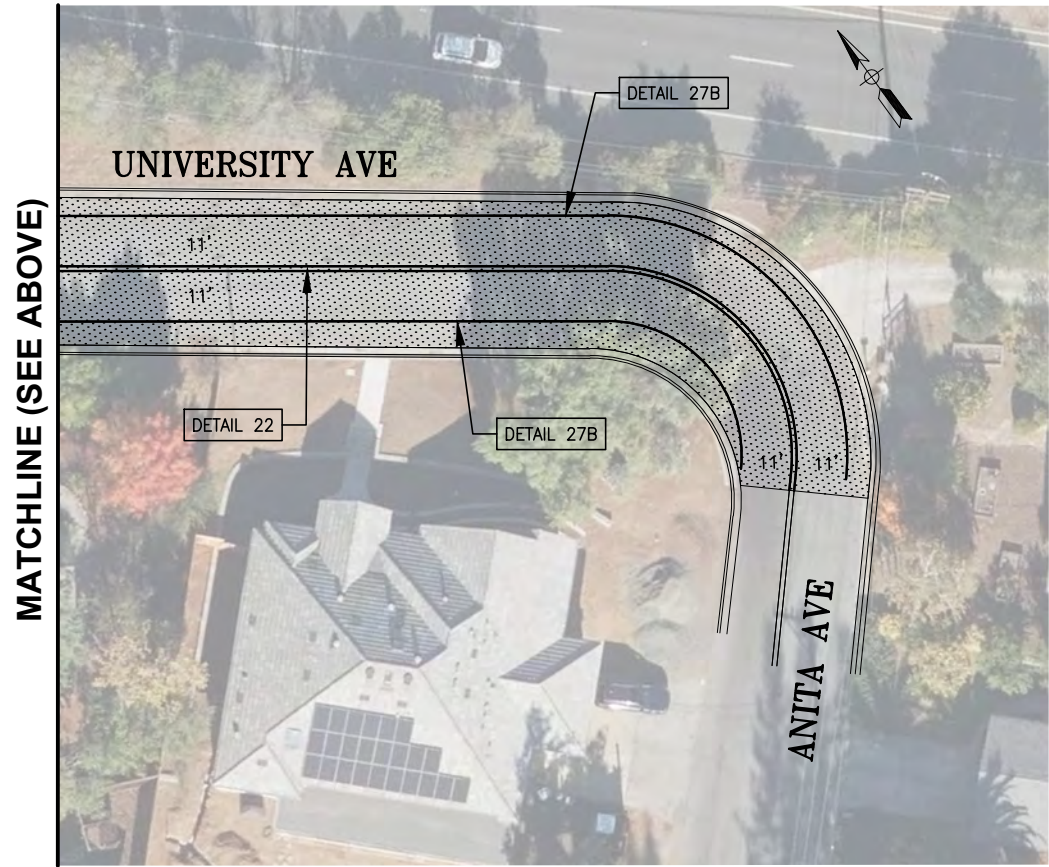
No.	DATE	REVISION	BY	APPD	<div>AIM ENGINEERING CONSULTANTS INC. 5424 SUNOL BLVD. STE-10-256 PLEASANTON, CALIFORNIA 94566</div> <div></div>	CITY OF LOS ALTOS 2025 PAVEMENT REHABILITATION PROJECT UNIVERSITY AVE - FROM BURKE ROAD TO ANITA AVENUE PUBLIC WORKS DEPARTMENT				CITY PROJECT: PWC XXXX		SCALE: AS SHOWN	DRAWING: <div>C9</div> <div>22</div> <div>SHEET 14 OF 20</div>
<div>△</div>						FEDERAL PROJECT:		0 ----- 1" NOTE: VERIFY SCALE. BAR IS ONE INCH ON ORIGINAL DRAWING. ADJUST SCALES ACCORDINGLY IF BAR IS NOT ONE INCH.					
<div>△</div>						DESIGNED BY: WPM		CHECKED BY: DA		DRAWN BY: WPM	DATE: APRIL 2025		
<div>△</div>						APPROVED -- PRINCIPAL ENGINEER		DATE	RECOMMENDED -- PROJECT MANAGER		DATE XX / XX / 202X		




GRAPHIC SCALE

(IN FEET)

No.	DATE	REVISION	BY	APPD	<div>AIM ENGINEERING CONSULTANTS INC. 5424 SUNOL BLVD. STE-10-256 PLEASANTON, CALIFORNIA 94566</div> <div> AIM Engineering Consultants</div>	CITY OF LOS ALTOS 2025 PAVEMENT REHABILITATION PROJECT UNIVERSITY AVE - FROM BURKE ROAD TO ANITA AVENUE PUBLIC WORKS DEPARTMENT				CITY PROJECT: PWC XXXX		SCALE: AS SHOWN	DRAWING: <div>C10</div> <div>23</div> SHEET 15 OF 20
<div>△</div>						FEDERAL PROJECT:				0 --- 1" NOTE: VERIFY SCALE. BAR IS ONE INCH ON ORIGINAL DRAWING. ADJUST SCALES ACCORDINGLY IF BAR IS NOT ONE INCH.			
<div>△</div>						DESIGNED BY: WPM		CHECKED BY: DA		DRAWN BY: WPM		DATE: APRIL 2025	
<div>△</div>						APPROVED -- PRINCIPAL ENGINEER		DATE	RECOMMENDED -- PROJECT MANAGER		DATE XX / XX / 202X		



UNIVERSITY AVENUE
FROM BURKE ROAD TO ANITA AVENUE
SCALE: 1" = 20'

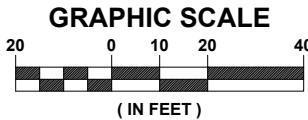

PLOT DATE: Apr 06, 2025 - 11:44pm FILE: D:\City of Los Altos\DWG - Mar 5 2025\PLAN_03_UNIVERSITY.dwg

No.	DATE	REVISION	BY	APPD
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PLEASANTON, CALIFORNIA 94566



CITY OF LOS ALTOS
2025 PAVEMENT REHABILITATION PROJECT
UNIVERSITY AVE - FROM BURKE ROAD TO ANITA AVENUE
PUBLIC WORKS DEPARTMENT

APPROVED -- PRINCIPAL ENGINEER

DATE

RECOMMENDED -- PROJECT MANAGER

DATE
XX / XX / 202X

CITY PROJECT:
PWC XXXX

FEDERAL PROJECT:

DESIGNED BY:
WPM

CHECKED BY:
DA

DRAWN BY:
WPM

DATE:
APRIL 2025

SCALE:
AS SHOWN


0 1"
NOTE: VERIFY SCALE.
BAR IS ONE INCH ON
ORIGINAL DRAWING.
ADJUST SCALES
ACCORDINGLY IF BAR
IS NOT ONE INCH.

DRAWING:


C11
24
SHEET 16 OF 20

FILE: D:\City of Los Altos\DWG - Mar 5 2025\PLAN_04_EL MONTE.dwg
PLOT DATE: Apr 06, 2025 - 11:47pm

Agenda Item 1.

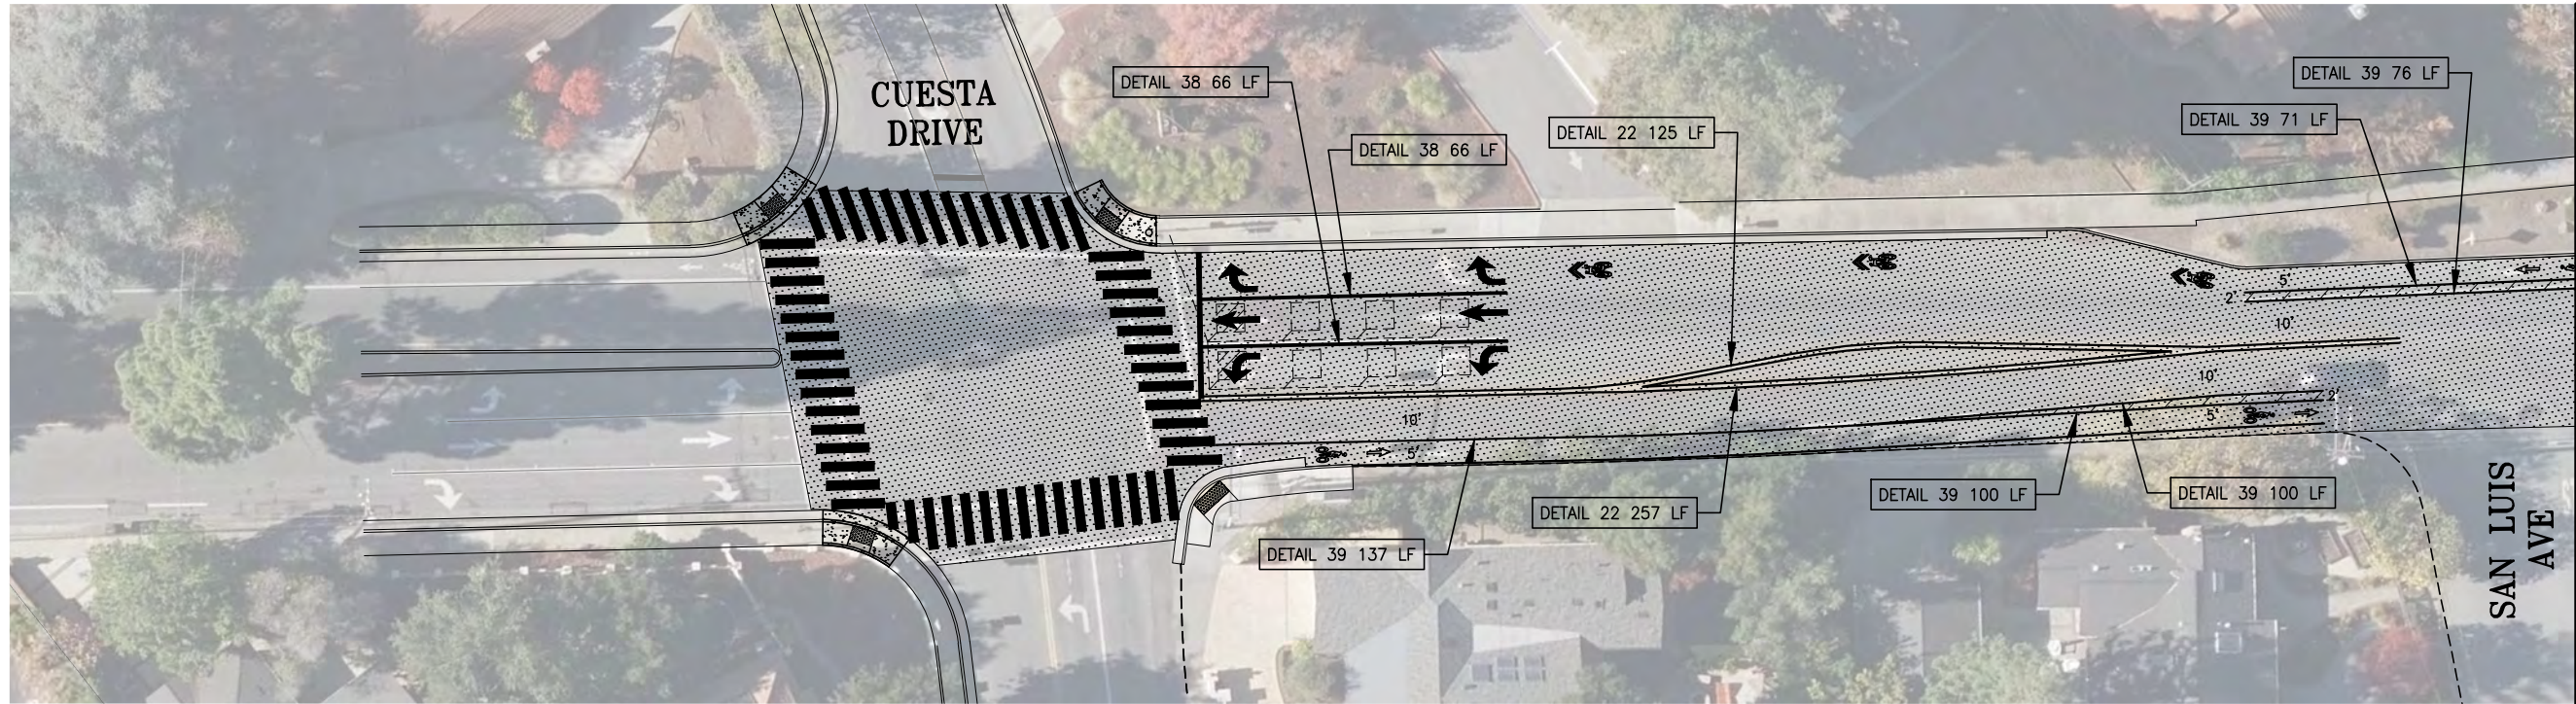

MATCHLINE (SEE BELOW)

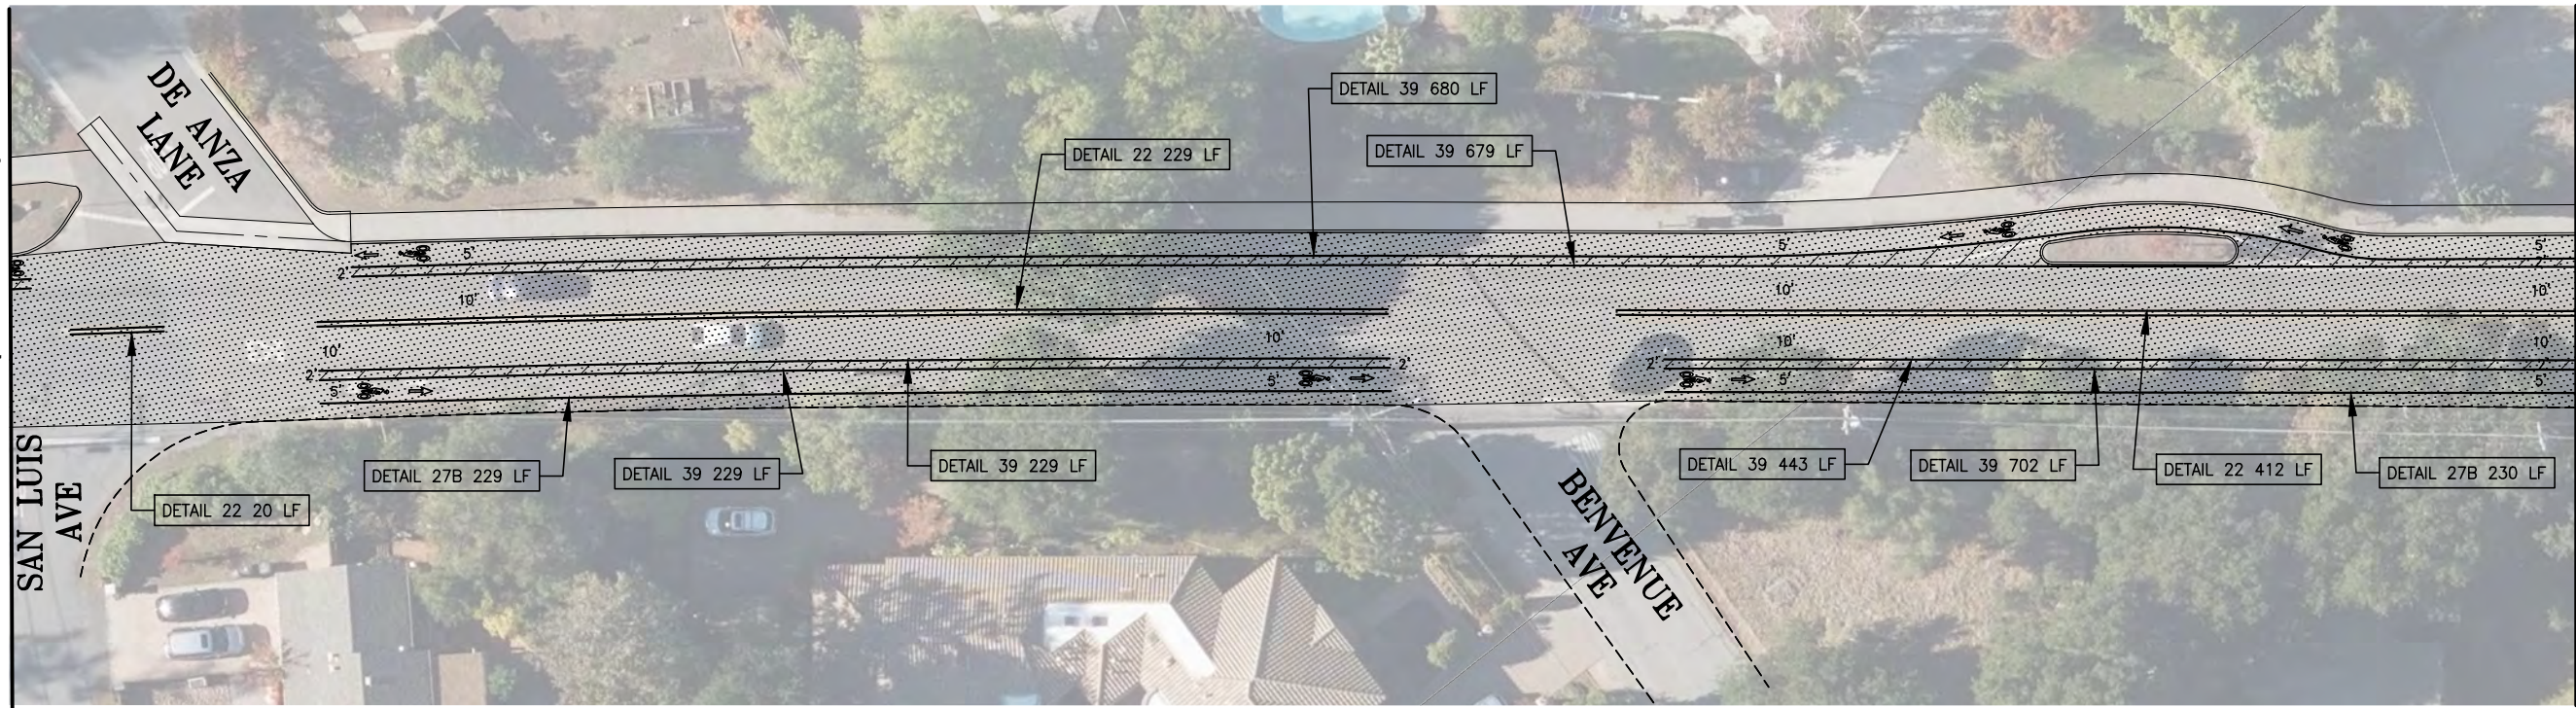


MATCHLINE (SEE NEXT SHEET)

S. EL MONTE AVENUE
FROM CUESTA DRIVE TO CLARK AVENUE
SCALE: 1" = 20'

LEGEND & QUANTITY TABLE			
	4" HMA BASE REPAIR	TBA SF	TBA SY
	MICROSURFACE	145,736 SF	16,193 SY
	PARKLET AREA		

NOTE:
ALL TRAFFIC STRIPES AND PAVEMENT MARKINGS SHALL BE THERMOPLASTIC.

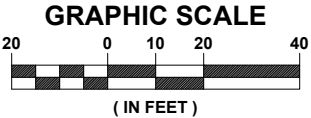

No.	DATE	REVISION	BY	APPD
1				
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AIM
ENGINEERING
CONSULTANTS INC.
5424 SUNOL BLVD. STE-10-256
PLEASANTON, CALIFORNIA 94566



CITY OF LOS ALTOS
2025 PAVEMENT REHABILITATION PROJECT
S. EL MONTE AVE - FROM CUESTA DRIVE TO CLARK AVE
PUBLIC WORKS DEPARTMENT

APPROVED -- PRINCIPAL ENGINEER

DATE

RECOMMENDED -- PROJECT MANAGER

DATE
XX / XX / 202X

CITY PROJECT:
PWC XXXX
FEDERAL PROJECT:
DESIGNED BY:
WPM
CHECKED BY:
DA
DRAWN BY:
WPM
DATE:
APRIL 2025


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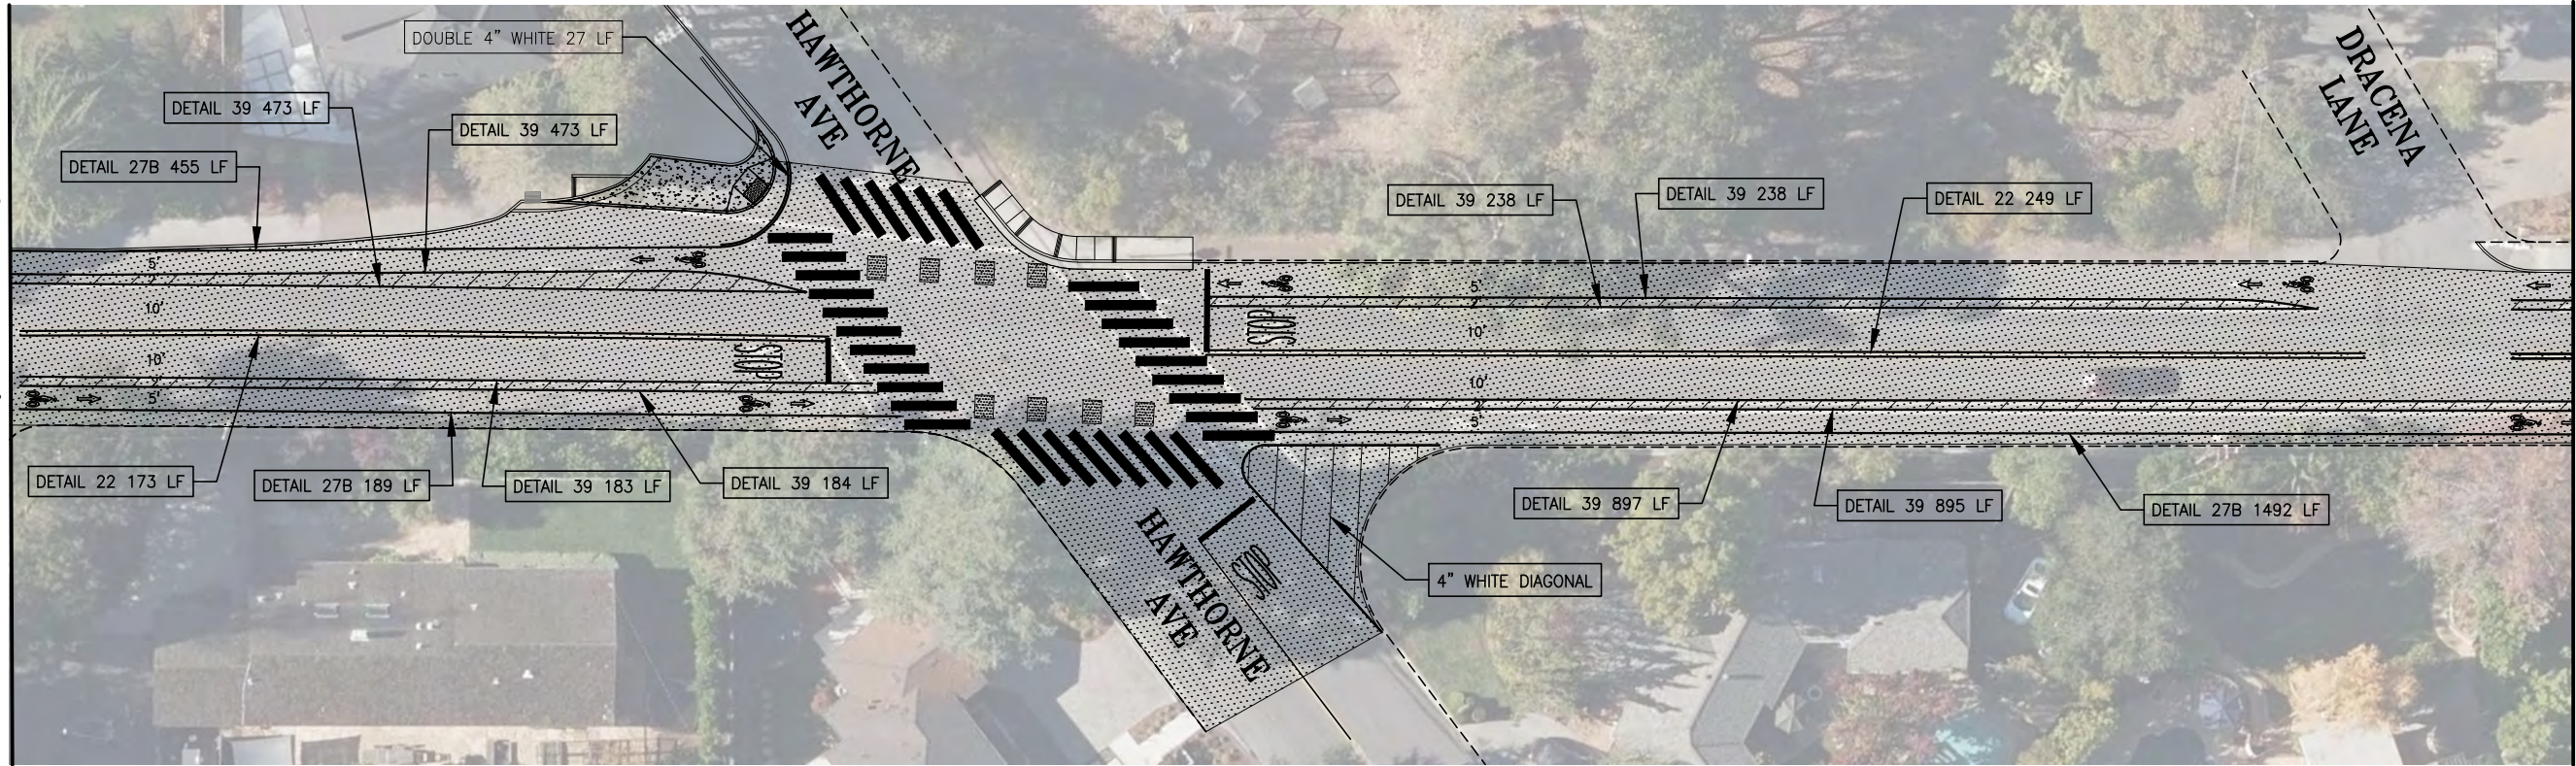
SHEET 17 OF 20

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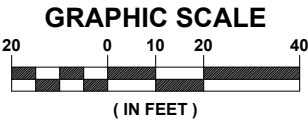
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MATCHLINE (SEE NEXT SHEET)

S. EL MONTE AVENUE
FROM CUESTA DRIVE TO CLARK AVENUE
SCALE: 1" = 20'



PLOT DATE: Apr 06, 2025 - 11:54pm FILE: D:\City of Los Altos\DWG - Mar 5 2025\PLAN_04_EL MONTE.dwg
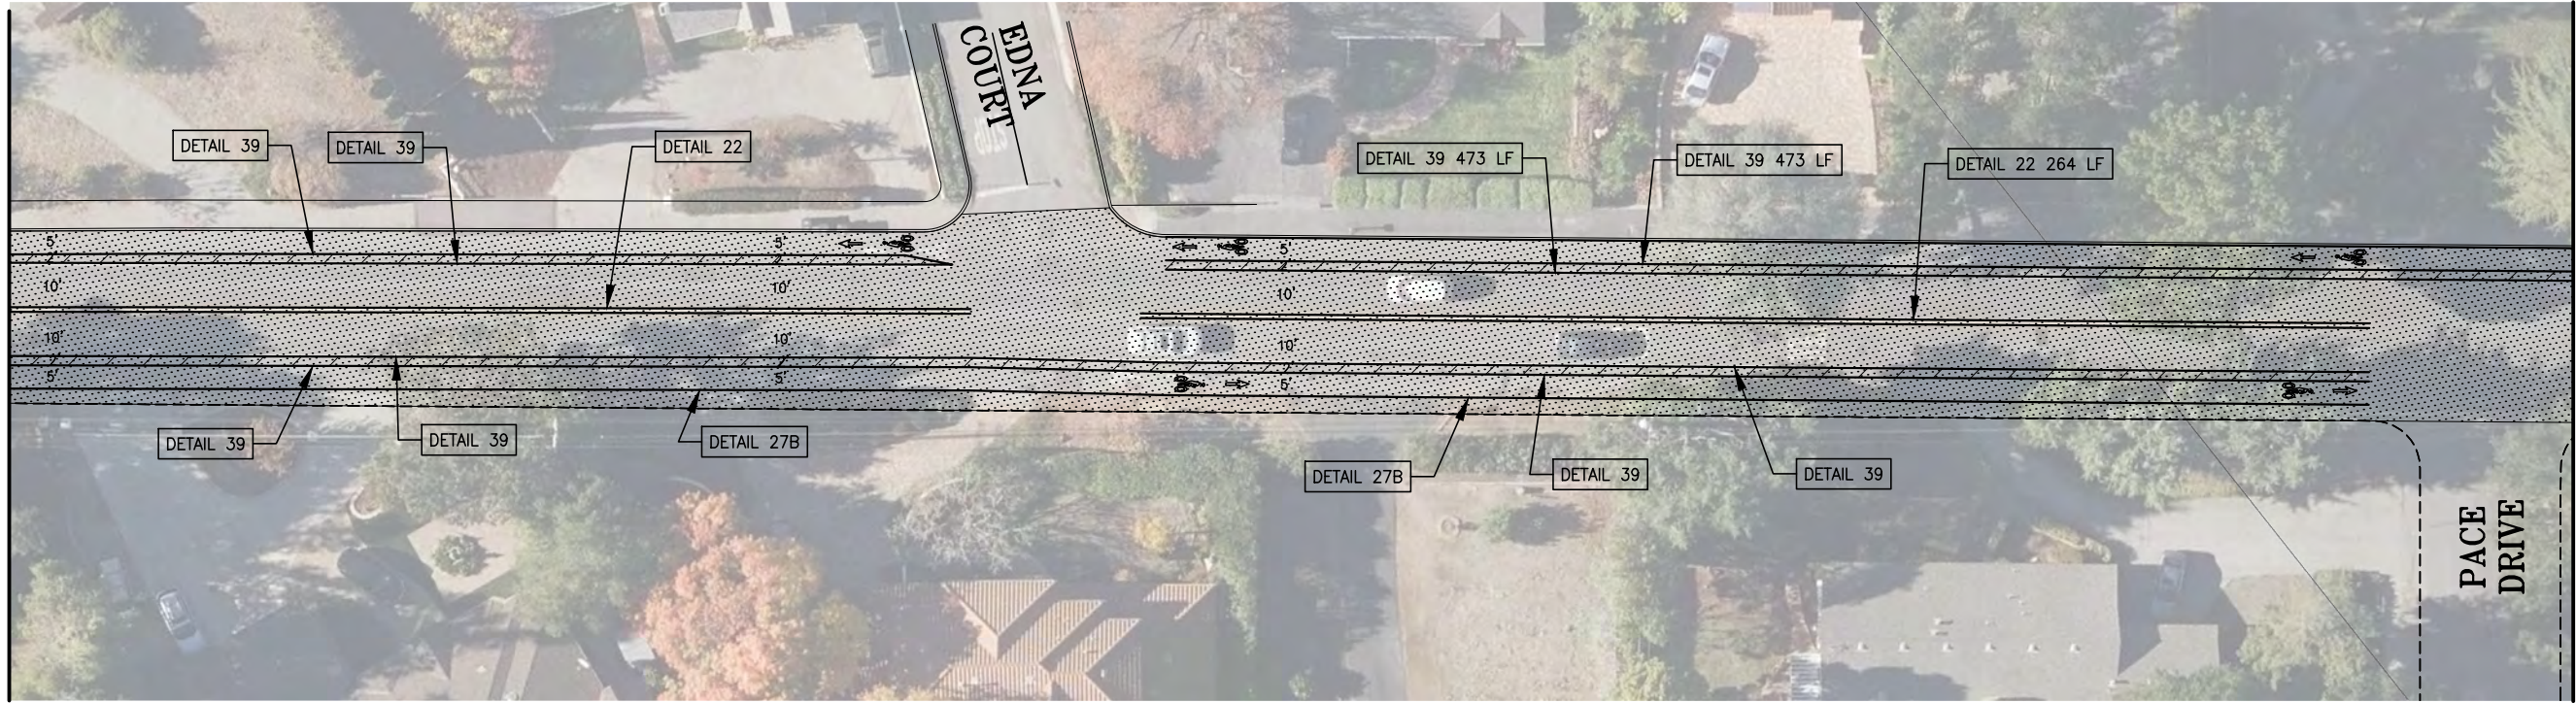
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AIM
ENGINEERING
CONSULTANTS INC.
5424 SUNOL BLVD. STE-10-256
PLEASANTON, CALIFORNIA 94566



CITY OF LOS ALTOS
2025 PAVEMENT REHABILITATION PROJECT
S. EL MONTE AVE - FROM CUESTA DRIVE TO CLARK AVE
PUBLIC WORKS DEPARTMENT


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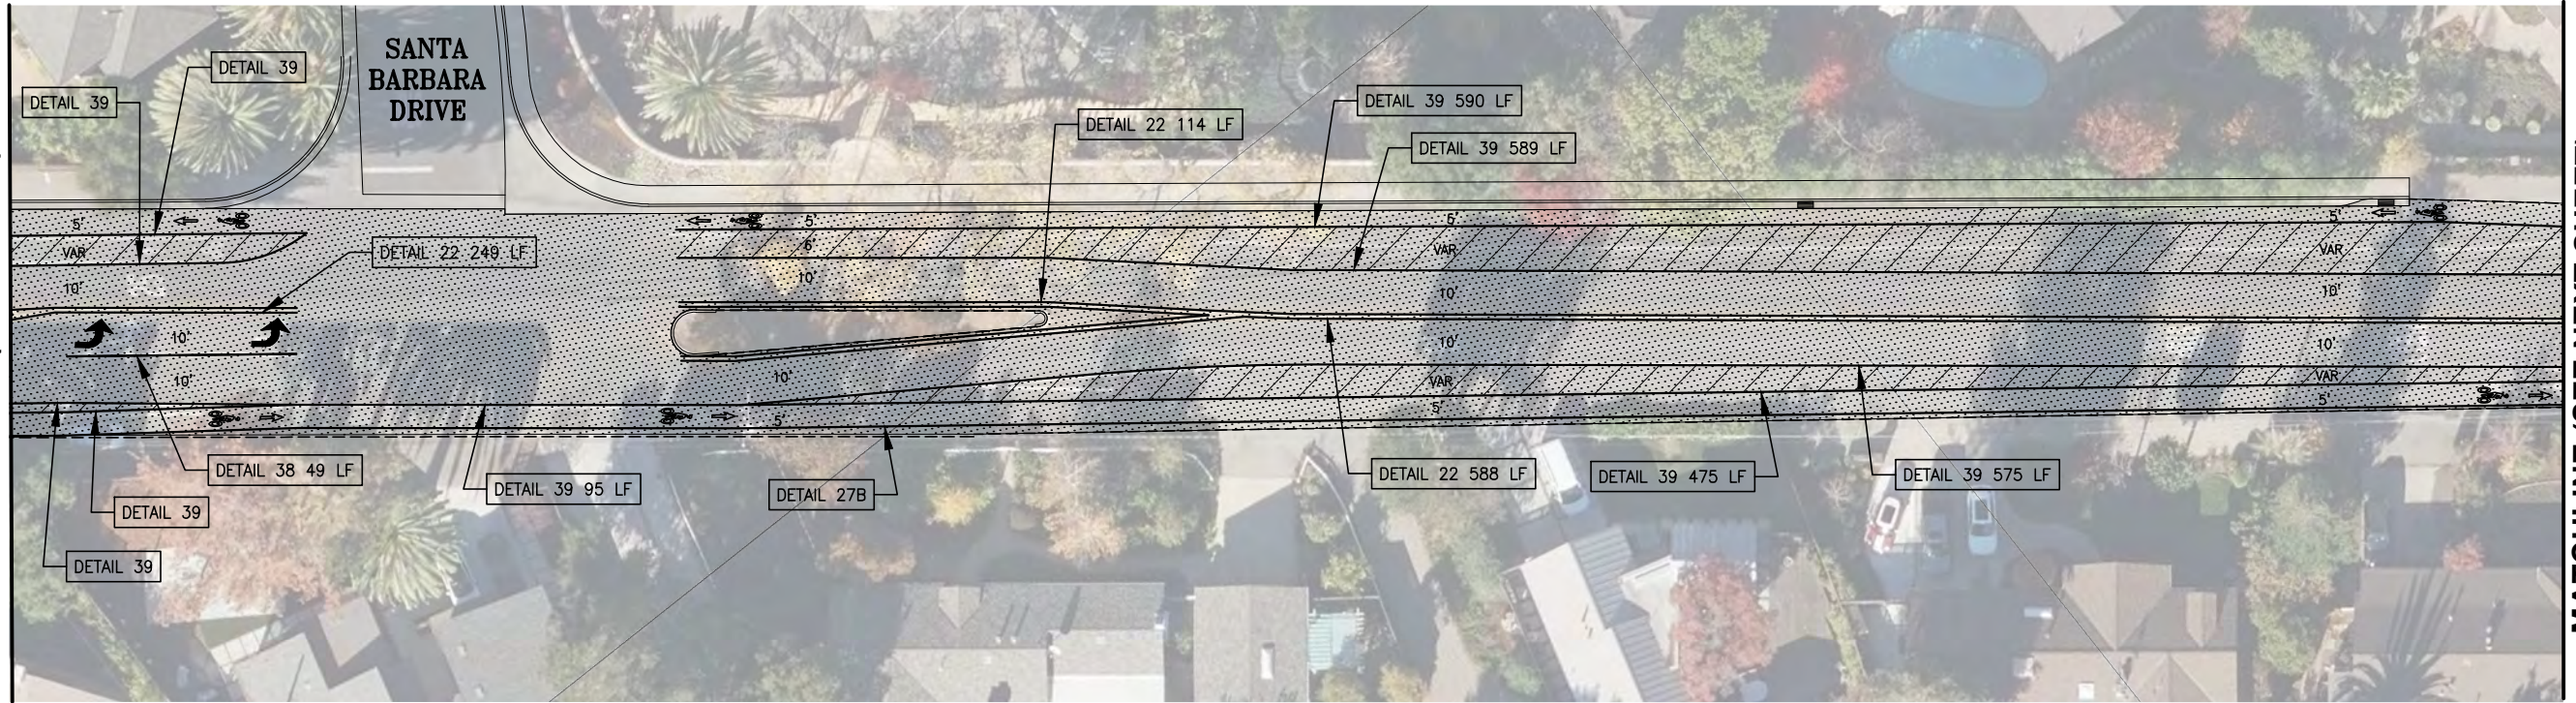
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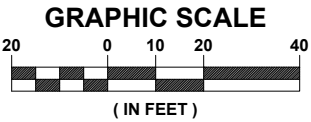
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MATCHLINE (SEE NEXT SHEET)

S. EL MONTE AVENUE
FROM CUESTA DRIVE TO CLARK AVENUE
SCALE: 1" = 20'



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CITY OF LOS ALTOS
2025 PAVEMENT REHABILITATION PROJECT
S. EL MONTE AVE - FROM CUESTA DRIVE TO CLARK AVE
PUBLIC WORKS DEPARTMENT

APPROVED -- PRINCIPAL ENGINEER

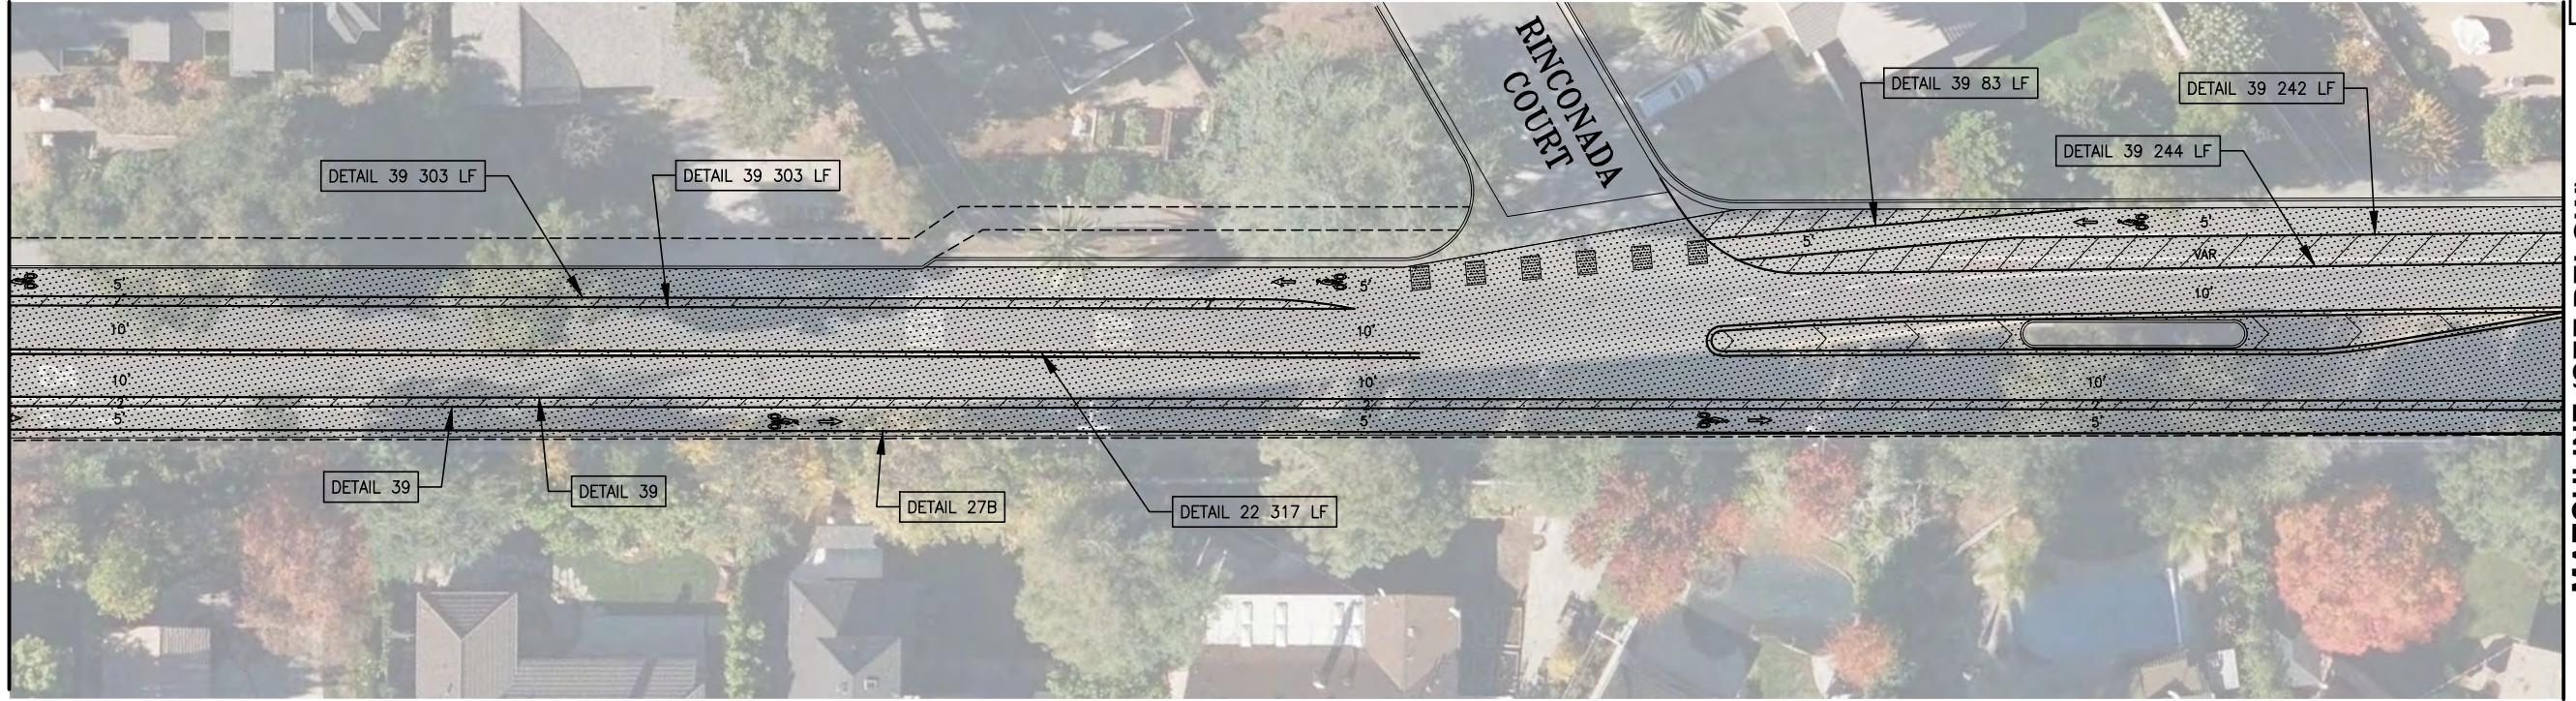DATE

RECOMMENDED -- PROJECT MANAGER


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PWC XXXX
FEDERAL PROJECT:
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DATE:
APRIL 2025


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SHEET 19 OF 20



S. EL MONTE AVENUE
FROM CUESTA DRIVE TO CLARK AVENUE
SCALE: 1" = 20'

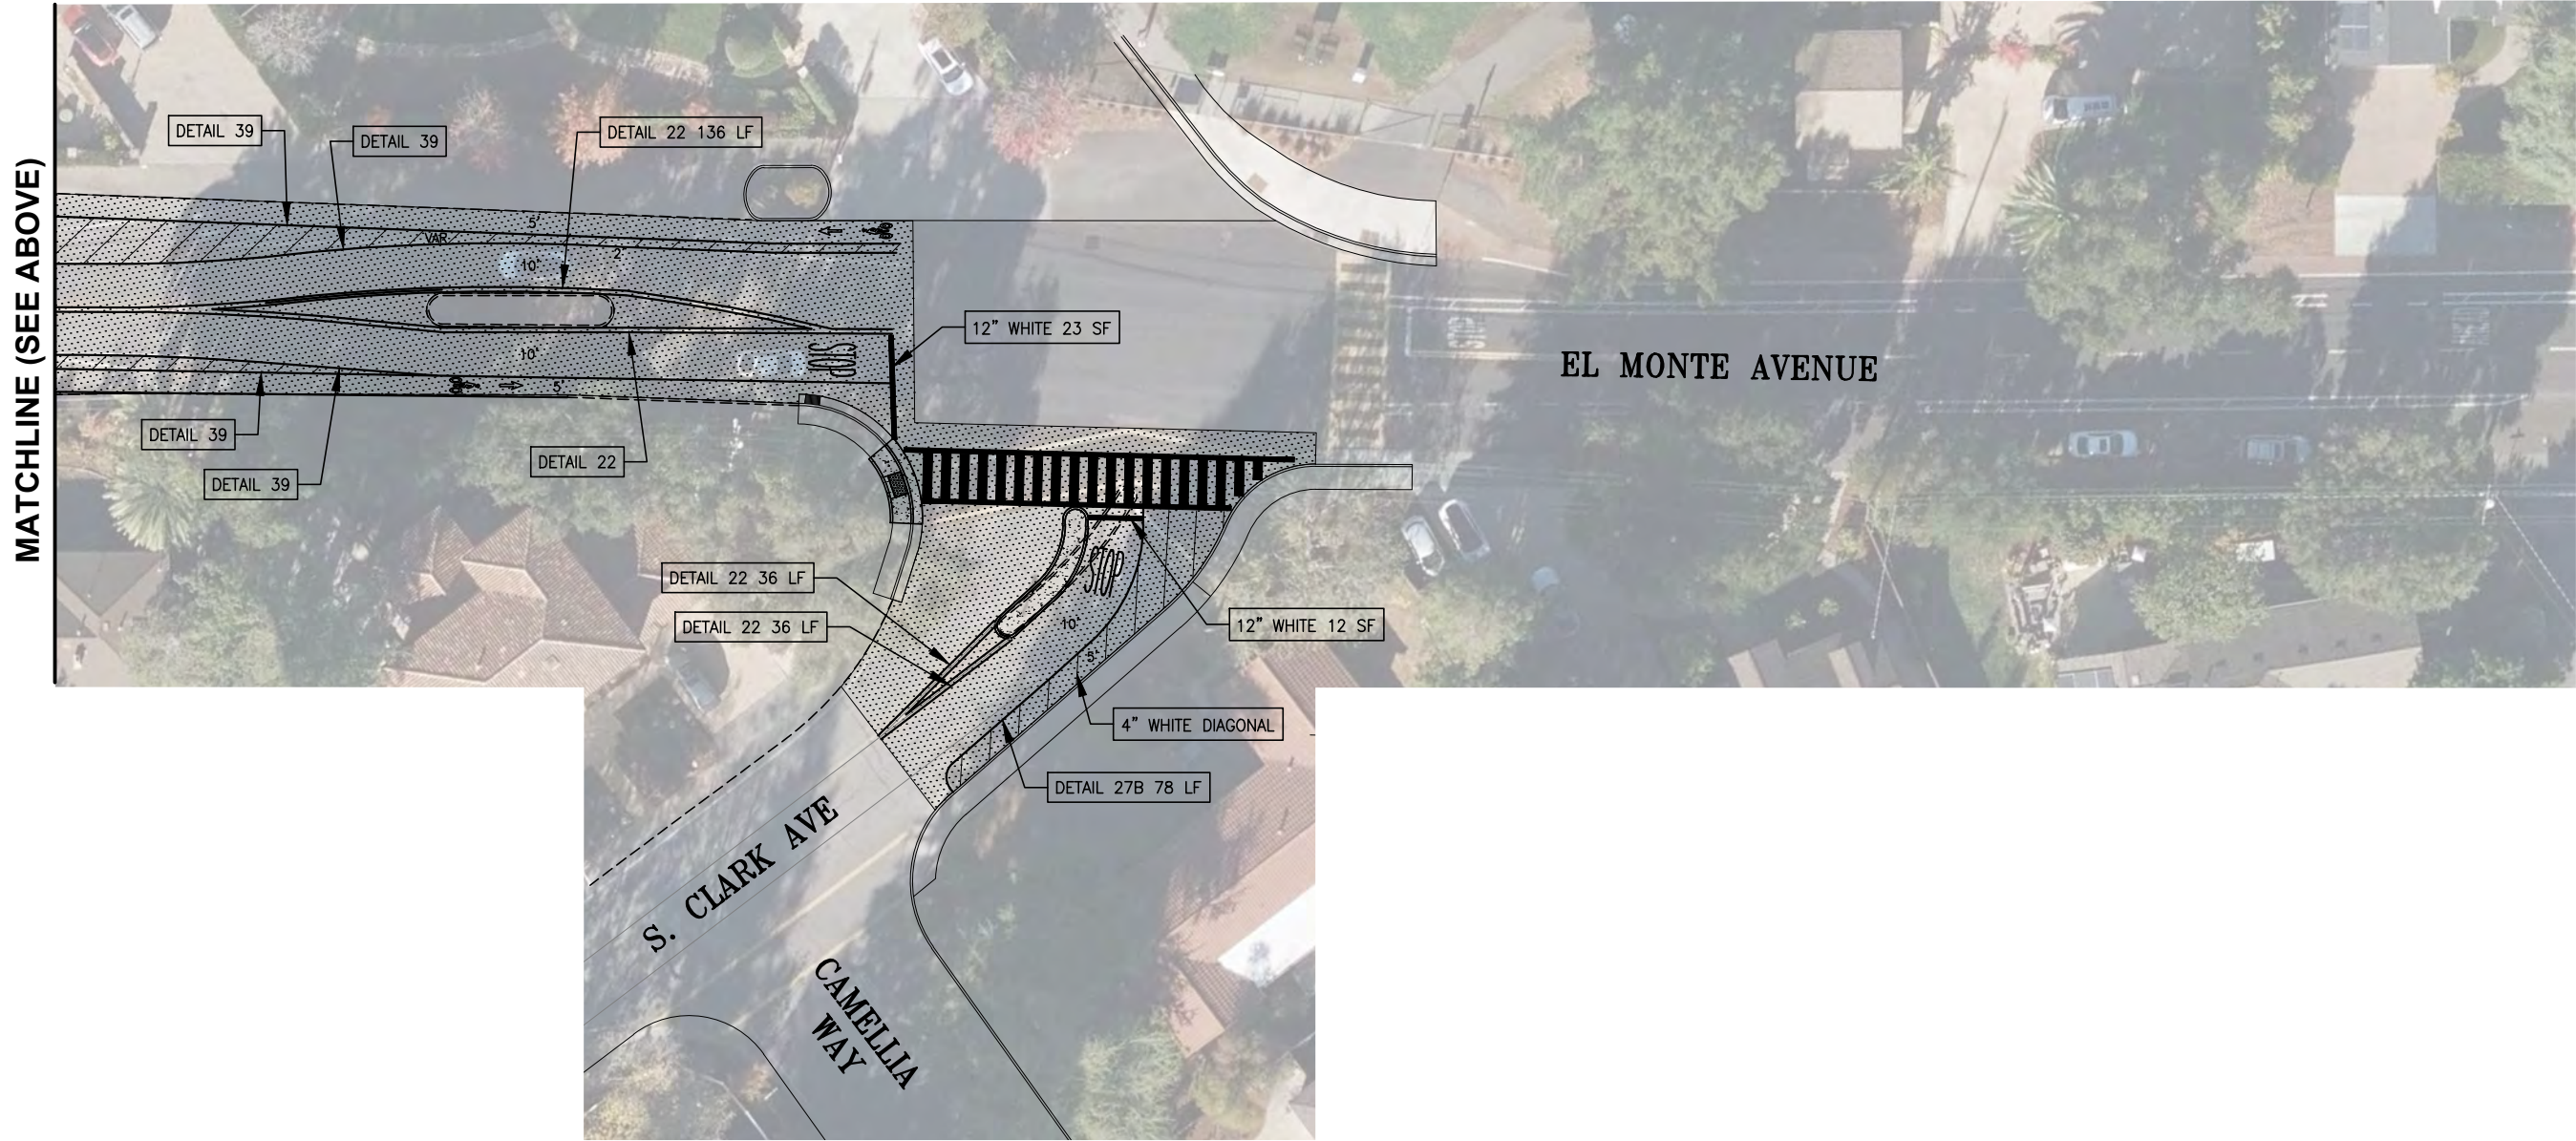

FILE: D:\City of Los Altos\DWG - Mar 5 2025\PLAN_04_EL_MONTE.dwg
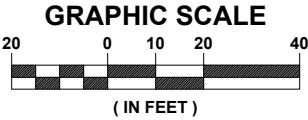
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ENGINEERING
CONSULTANTS INC.
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CITY OF LOS ALTOS
2025 PAVEMENT REHABILITATION PROJECT
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PWC XXXX

FEDERAL PROJECT:

DESIGNED BY:
WPM

CHECKED BY:
DA

DRAWN BY:
WPM

DATE:
APRIL 2025

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SHEET 20 OF 20

ABBREVIATIONS:

AB	AGGREGATE BASE	MW	MONITORING WELL
AC	ASPHALT CONCRETE	N	NORTHING
ACP	ASBESTOS CEMENT PIPE	NTS	NOT TO SCALE
AT&T	AMERICAN TELEPHONE & TELEGRAPH	OC	ON-CENTER
BC	BEGIN CURVE, BOTTOM OF CURB	OH	OVERHEAD UTILITY LINE
BW	BACK OF WALK	PB	PACIFIC BELL
C	CURVE	PCC	PORTLAND CEMENT CONCRETE
C&G	CURB & GUTTER	PE	POLYETHYLENE
CDF	CONTROLLED DENSITY FILL	PG&E	PACIFIC GAS & ELECTRIC
CI	CAST IRON	PIP	PROTECT IN PLACE
CL	CENTERLINE	PL	PLASTIC
CMP	CORRUGATED METAL PIPE	POC	POINT OF CONNECTION
COM	COMMUNICATION	PT	POINT
CONC	CONCRETE	PVC	POLYVINYL CHLORIDE
CY	CUBIC YARD	R	RADIUS, RIGHT
DI	DRAIN INLET	RC	RELATIVE COMPACTION
DIFF	DIFFERENCE IN ELEVATION BETWEEN NEW & EX	RCP	REINFORCED CONCRETE PIPE
DWY	DRIVEWAY	REHAB	REHABILITATION
E	ELECTRICAL, EASTING	RT	RIGHT
EC	EDGE OF CONCRETE, END CURVE	R/W	RIGHT OF WAY
EP	EDGE OF PAVEMENT	S	SOUTH
EX	EXISTING	SD	STORM DRAIN
FDAC	FULL DEPTH ASPHALT CONCRETE	SDMH	STORM DRAIN MANHOLE
FG	FINISH GRADE	SDR	STANDARD DIMENSION RATIO
FH	FIRE HYDRANT	SL	STATION LINE, STREET LIGHT
FL	FLOW LINE	SM	SURVEY MARKER
FO	FIBER OPTICS	SS	SANITARY SEWER
FS	FIRE SERVICE	SSCO	SANITARY SEWER CLEANOUT
FW	FACE OF WALK	SSMH	SANITARY SEWER MANHOLE
G	GAS	STA	STATION
GB	GRADE BREAK	STD	STANDARD
HDPE	HIGH DENSITY POLYETHYLENE PIPE	SW	SIDEWALK
HP	HIGH POINT	TC	TOP OF CURB
HV	HIGH VOLTAGE	TEL	TELEPHONE, TELECOM
HYD	FIRE HYDRANT	TFL	THEORETICAL FLOW LINE
INV	INVERT	TTC	THEORETICAL TOP OF CURB
IRR	IRRIGATION	TYP	TYPICAL
JP	JOINT POLE	UT	UTILITY
L	LEFT, LINE, LENGTH	VCP	VITRIFIED CLAY PIPE
LF	LINEAR FEET	W	WEST, WATER
LP	LOW POINT	WTR	WATER
LT	LEFT	WM	WATER METER
MH	MANHOLE	WV	WATER VALVE
MISC	MISCELLANEOUS	WW	WELDED WRAP
MON, M	MONUMENT		


GENERAL NOTES:

- ALL MATERIAL AND WORKMANSHIP SHALL FULLY CONFORM WITH THE SPECIFICATIONS, STANDARDS, AND ORDINANCES OF THE CITY OF LOS ALTOS. STANDARD SPECIFICATIONS AND DETAILS ARE AVAILABLE IN THE OFFICE OF THE CITY ENGINEER.
- THE OFFICE OF PUBLIC WORKS INSPECTION SHALL BE NOTIFIED AT LEAST 72 HOURS IN ADVANCE OF ANY WORK.
- IT SHALL BE THE CONTRACTOR'S RESPONSIBILITY TO DETERMINE THE EXISTENCE AND LOCATION OF ALL UTILITIES. THE UNDERGROUND CONTRACTOR SHALL NOTIFY UTILITY COMPANIES AT LEAST 48 HOURS IN ADVANCE OF CONSTRUCTION TO FIELD LOCATE UTILITIES. CONTACT UNDERGROUND SERVICE ALERT AT 800-227-2600.
- THE CONTRACTOR SHALL BE HELD RESPONSIBLE FOR ANY FIELD CHANGES MADE WITHOUT WRITTEN AUTHORIZATION FROM THE CITY ENGINEER.
- CONTRACTOR SHALL PROVIDE ADEQUATE TRAFFIC CONTROLS & SHALL SUBMIT A TRAFFIC CONTROL PLAN.
- ALL EXISTING UTILITIES AND PRIVATE IMPROVEMENTS THAT BECOME DAMAGED DURING CONSTRUCTION SHALL BE COMPLETELY RESTORED TO THE SATISFACTION OF THE CITY ENGINEER, AT CONTRACTOR'S SOLE EXPENSE.
- THE CONTRACTOR AGREES THAT, IN ACCORDANCE WITH GENERALLY ACCEPTED CONSTRUCTION PRACTICES, THE CONTRACTOR WILL BE REQUIRED TO ASSUME SOLE AND COMPLETE RESPONSIBILITY FOR JOB SITE CONDITIONS DURING THE COURSE OF CONSTRUCTION OF THE PROJECT, INCLUDING SAFETY OF ALL PERSONS AND PROPERTY AND THAT THIS REQUIREMENT SHALL BE MADE TO APPLY CONTINUOUSLY AND NOT JUST DURING NORMAL WORKING HOURS.
- EXCAVATIONS SHALL BE ADEQUATELY SHORED, BRACED AND SHEETED SO THAT THE EARTH WILL NOT SLIDE OR SETTLE AND SO THAT ALL EXISTING IMPROVEMENTS OF ANY KIND WILL BE FULLY PROTECTED FROM DAMAGE. ANY DAMAGE RESULTING FROM A LACK OF ADEQUATE SHORING, BRACING OR SHEETING, SHALL BE THE RESPONSIBILITY OF THE CONTRACTOR AND SHALL MAKE NECESSARY REPAIRS OR RECONSTRUCTION AT CONTRACTOR OWN EXPENSE.WHERE THE EXCAVATION FOR A CONDUIT TRENCH, AND/OR STRUCTURE IS FOUR FEET OR MORE IN DEPTH, THE CONTRACTOR SHALL PROVIDE ADEQUATE SHEETING, SHORING AND BRACING OR EQUIVALENT METHOD, FOR THE PROTECTION OF LIFE, OR LIMB, WHICH SHALL CONFORM TO THE APPLICABLE CONSTRUCTION SAFETY ORDERS OF THE DIVISION OF INDUSTRIAL SAFETY OF THE STATE OF CALIFORNIA. THE CONTRACTOR SHALL ALWAYS COMPLY WITH OSHA REQUIREMENTS.
- SHOULD IT APPEAR THAT THE WORK TO BE DONE, OR ANY MATTER RELATIVE THERETO, IS NOT SUFFICIENTLY DETAILED OR EXPLAINED ON THESE PLANS, THE CONTRACTOR SHALL CONTACT THE ENGINEER FOR SUCH FURTHER EXPLANATIONS AS MAY BE NECESSARY.
- EXISTING UTILITIES SHALL BE MAINTAINED IN SERVICE AND IN PLACE BY THE CONTRACTOR DURING CONSTRUCTION UNLESS OTHERWISE SHOWN.
- CONTRACTOR SHALL PROTECT ALL MONUMENTS.
- ALL USA MARKINGS TO BE REMOVED AT END OF CONSTRUCTION.

Call Two Working
Days Before You
Dig!



1-800-227-2600

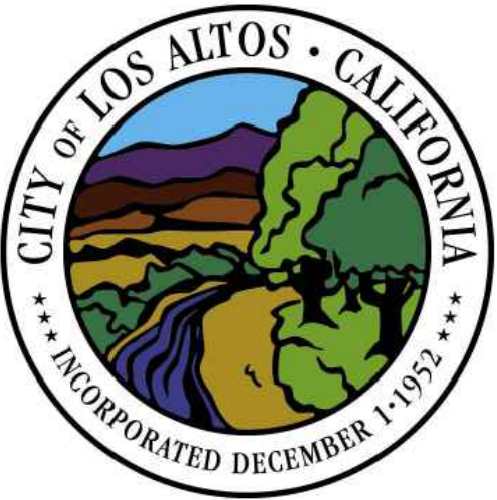

CITY OF LOS ALTOS


2024-2025 ANNUAL STREET RESURFACING PROJECT

(CXXXX-XX)



VICINITY MAP:

NTS

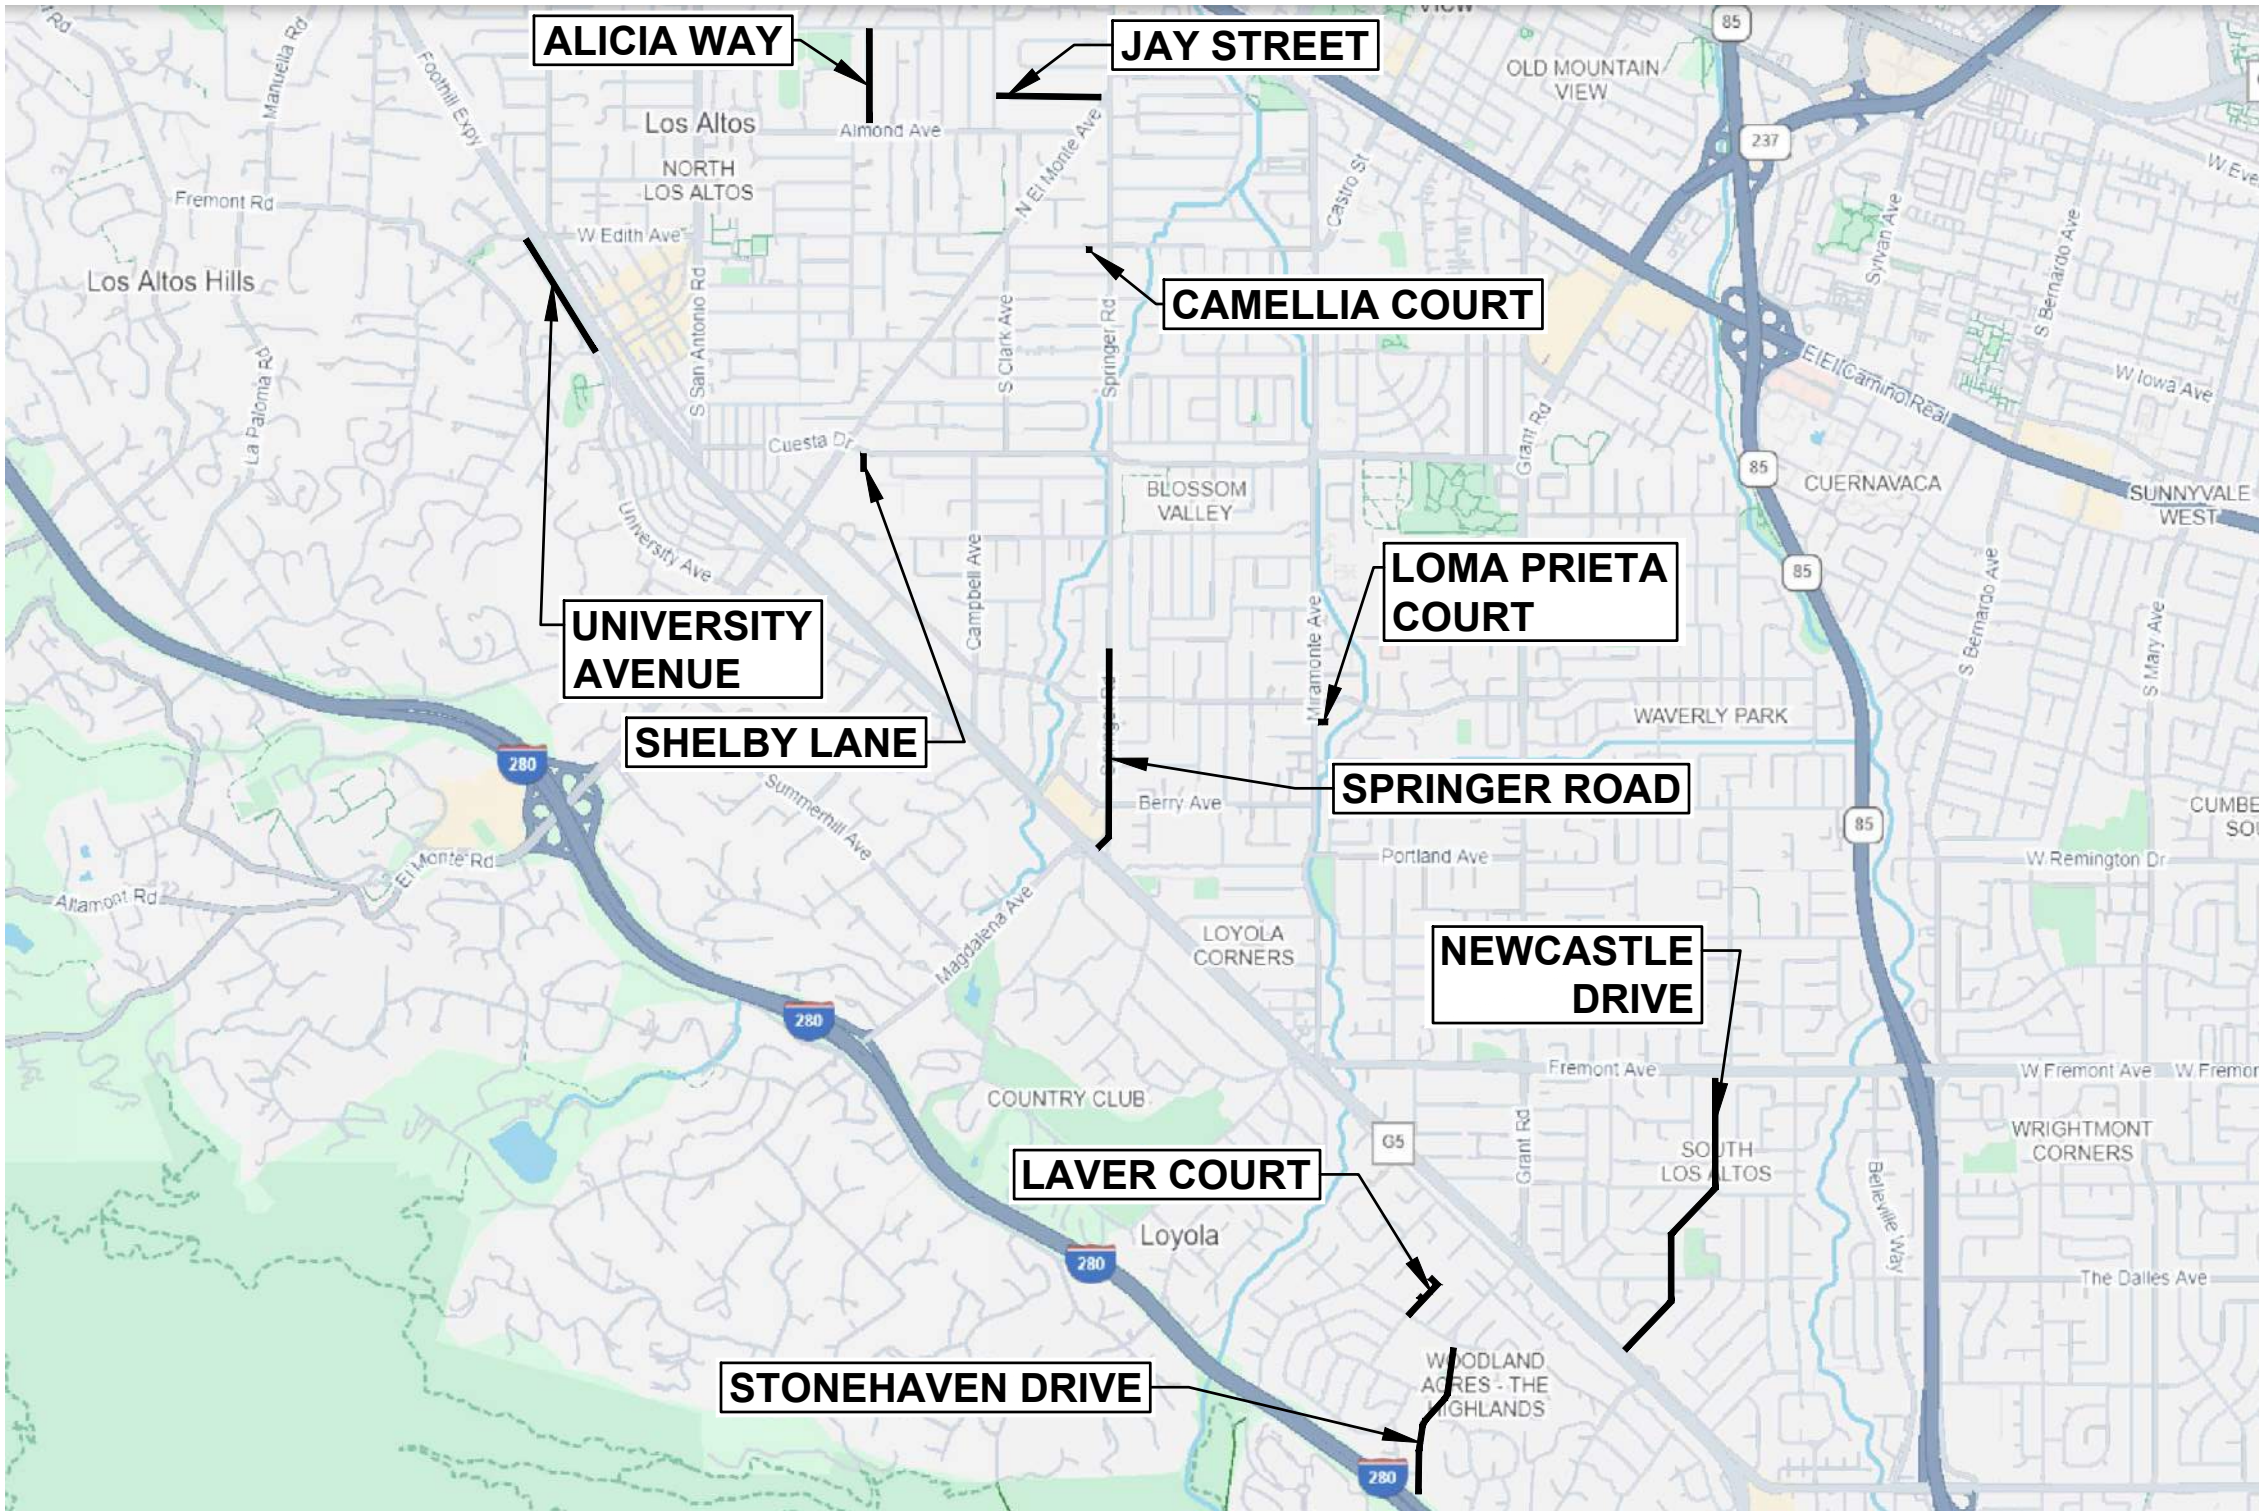

LOCATION MAP:

NTS

SHEET INDEX:

SHEET NUMBER	DESCRIPTION
1	C1.1
2	C2.1
3	C3.1
4	C3.2
5	C3.3
6	C3.4
7	C3.5
8	C4.1
9	C4.2
10	C4.3
11	C4.4
12	C4.5
13	C4.6
14	C4.7
15	C4.8
16	C4.9
17	C4.10
18	C4.11
19	C4.12
20	C4.13
21	C4.14
22	C4.15
23	C4.16
24	C4.17
25	C4.18
26	C4.19
27	C4.20
28	C4.21
29	C4.22
30	C4.23
31	C4.24
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34	C4.27
35	C4.28
36	C4.29
37	C4.30
38	C4.31
39	C5.1
40	C5.2
41	C5.3
42	C5.4
43	C5.5
44	C5.6
45	C5.7
46	C5.8
47	C5.9
48	C5.10
49	C5.11
50	C5.12

Agenda Item 1.

REVISIONS

DATE

BY

sanbell

Intelligent Infrastructure Enduring Communities

925 • 685 • 4569

sanbell.com

CITY OF LOS ALTOS

1 NORTH SAN ANTONIO ROAD

CALIFORNIA 94022

PROFESSIONAL ENGINEER

JOSEPH ARICAR

REGISTERED CIVIL ENGINEER

No. 87431

STATE OF CALIFORNIA

2024-2025 ANNUAL STREET RESURFACING PROJECT

COVER SHEET

LOS ALTOS

SANTA CLARA COUNTY

CALIFORNIA

DWG NO.

C1.1

1 OF 50

JOB NO.

250007

65% SUBMITTAL

APRIL 07, 2025


29



Call Two Working Days Before You Dig!

General Construction And Site Supervision

Best Management Practices For Construction

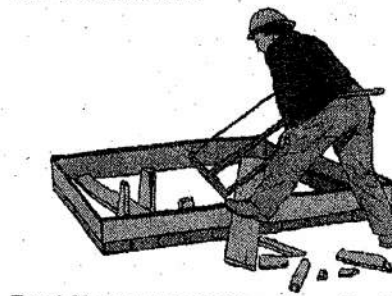

Best Management Practices for the

- General contractors
- Site supervisors
- Inspectors
- Home builders
- Developers

Storm Drain Pollution from Construction Activities

Construction sites are common sources of storm water pollution. Materials and wastes that blow or wash into a storm drain, gutter, or street have a direct impact on local creeks and the Bay.

As a contractor, or site supervisor, owner or operator of a site, you may be responsible for any environmental damage caused by your subcontractors or employees.

Doing The Job Right

General Principles

- Keep an orderly site and ensure good housekeeping practices are used.
- Maintain equipment properly.
- Cover materials when they are not in use.
- Keep materials away from streets, storm drains and drainage channels.
- Ensure dust control water doesn't leave site or discharge to storm drains.

Advance Planning To Prevent Pollution

- Schedule excavation and grading activities for dry weather periods. To reduce soil erosion, plant temporary vegetation or place other erosion control before rain begins. Use the Erosion and Sediment Control Manual, available from the Regional Water Quality Control Board, as a reference.
- Control the amount of runoff crossing your site (especially during excavation) by using berms or temporary or permanent drainage ditches to divert water flow around the site. Reduce storm water runoff velocities by constructing temporary check dams or berms where appropriate.
- Train your employees and subcontractors. Make these best management practices available to everyone who works on the construction site. Inform subcontractors about the storm water requirements and their own responsibilities.

Good Housekeeping Practices

- Designate one area of the site for auto parking, vehicle refueling, and routine equipment maintenance. The designated area should be well away from streams or storm drain inlets, berms if necessary. Make major repairs off site.
- Keep materials out of the rain - prevent runoff contamination at the source. Cover exposed piles of soil or construction materials with plastic sheeting or temporary rocks. Before it rains, sweep and remove materials from surfaces that drain to storm drains, creeks, or channels.
- Keep pollutants off exposed surfaces. Place treatable and recycling receptacles around the site to minimize litter.

Doing The Job Right

General Principles


- Clean up leaks, drips and other spills immediately so they do not contaminate soil or groundwater or leave residue on paved surfaces. Use dry cleanup methods whenever possible. If you must use water, use just enough to keep the dust down.
- Cover and maintain dumpsters. Check frequently for leaks. Place dumpsters under roofs or cover with tarp or plastic sheeting secured around the outside of the dumpster. Never clean out a dumpster by hosing it down on the construction site.
- Set portable toilets away from storm drains. Make sure portable toilets are in good working order. Check frequently for leaks.

Materials/Waste Handling

- Practice Source Reduction - minimize waste when you order materials. Order only the amount you need to finish the job.
- Use recyclable materials whenever possible. Arrange for pickup of recyclable materials such as concrete, asphalt, scrap metal, solvents, degreasers, cleaned wood, and cleared vegetation that can be recycled. Materials that cannot be recycled must be taken to an appropriate landfill or disposed of as hazardous waste. Never bury waste materials or leave them in the street or near a creek or storm drain.
- In addition to local building permits, you will need to obtain coverage under the State's General Construction Activity Storm Water Permit if your construction site disturbs one acre or more. Obtain information from the Regional Water Quality Control Board.

Earth-Moving And Dewatering Activities

Best Management Practices for the Construction Industry

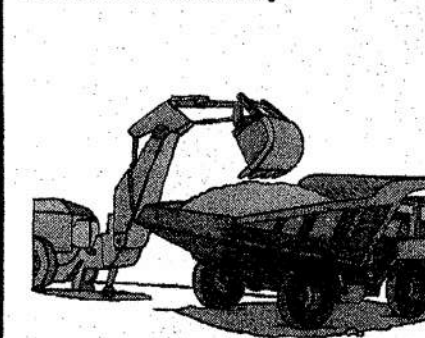

Best Management Practices for the

- Bulldozer, back hoe, and grading machine operators
- Dump truck drivers
- Site supervisors
- General contractors
- Home builders
- Developers

Doing The Job Right

General Business Practices

- Schedule excavation and grading work during dry weather.
- Perform major equipment repairs away from the job site.
- When refueling or vehicle/equipment maintenance must be done on site, designate a location away from storm drains.
- Do not use diesel oil to lubricate equipment parts, or clean equipment.

Practices During Construction

- Remove existing vegetation only when absolutely necessary. Plant temporary vegetation for erosion control on slopes or where construction is not immediately planned.
- Protect down slope drainage courses, streams, and storm drains with wattles, or temporary drainage swales. Use check dams or ditches to divert runoff around excavations. Refer to the Regional Water Quality Control Board's Erosion and Sediment Control Field Manual for proper erosion and sediment control measures.

Storm Drain Pollution from Earth-Moving Activities and Dewatering

Soil excavation and grading operations loosen large amounts of soil that can flow or blow into storm drains when handled improperly. Sediments in runoff can clog storm drains, smother aquatic life, and destroy habitats in creeks and the Bay. Effective erosion control practices reduce the amount of runoff crossing a site and slow the flow with check dams or roughened ground surfaces.

Contaminated groundwater is a common problem in the Santa Clara Valley. Depending on soil type and site history, groundwater pumped from construction sites may be contaminated with toxics (such as oil or solvents) or laden with sediments. Any of these pollutants can harm wildlife in creeks or the Bay, or interfere with wastewater treatment plant operation.

Discharging sediment-laden water from a dewatering site into any water of the state without treatment is prohibited.

Heavy Equipment Operation

Best Management Practices for the Construction Industry



Best Management Practices for the

- Vehicle and equipment operators
- Site supervisors
- General contractors
- Home builders
- Developers

Doing the Job Right

Site Planning and Preventive Vehicle Maintenance

- Maintain all vehicles and heavy equipment. Inspect frequently for and repair leaks.
- Perform major maintenance, repair jobs, and vehicle and equipment washing off site where cleanup is easier.
- If you must drain and replace motor oil, radiator coolant, or other fluids on site, use drip pans or drop cloths to catch drips and spills. Collect all spent fluids, store in separate containers, and properly dispose as hazardous waste (recycle whenever possible).
- Do not use diesel oil to lubricate equipment parts, or clean equipment. Use only water for any onsite cleaning.
- Cover exposed fifth wheel hitch and other oily or greasy equipment during rain events.

Storm water Pollution from Heavy Equipment on Construction Sites

Poorly maintained vehicles and heavy equipment that leak fuel, oil, antifreeze or other fluids on the construction site are common sources of storm drain pollution. Prevent spills and leaks by isolating equipment from runoff channels, and by watching for leaks and other maintenance problems. Remove construction equipment from the site as soon as possible.

Spill Cleanup

- Clean up spills immediately when they happen.
- Never hose down "dirty" pavement or impermeable surfaces where fluids have spilled. Use dry cleanup methods (absorbent materials, cat litter, and/or rags) whenever possible and properly dispose of absorbent materials.
- Sweep up spilled dry materials immediately. Never attempt to "wash them away" with water, or bury them.
- Use as little water as possible for dust control. Ensure water used doesn't leave silt or discharge to storm drains.
- Clean up spills on dirt areas by digging up and properly disposing of contaminated soil.
- Report significant spills to the appropriate local spill response agencies immediately.
- If the spill poses a significant hazard to human health and safety, property or the environment, you must also report it to the State Office of Emergency Services.

Roadwork and Paving

Best Management Practices for the Construction Industry



Best Management Practices for the

- Road crews
- Driveway/sidewalk/parking lot construction crews
- Seal coat contractors
- Operators of grading equipment, paving machines, dump trucks, concrete mixers
- Construction inspectors
- General contractors
- Home builders
- Developers

Doing The Job Right

General Business Practices

- Develop and implement erosion/sediment control plans for roadway embankments.
- Schedule excavation and grading work during dry weather.
- Check for and repair leaking equipment.
- Perform major equipment repairs at designated areas in the maintenance yard, where cleanup is easier. Avoid performing equipment repairs at construction sites.
- When refueling or when vehicle/equipment maintenance must be done on site, designate a location away from storm drains and creeks.
- Do not use diesel oil to lubricate equipment parts or clean equipment.
- Recycle used oil, concrete, broken asphalt, etc. whenever possible, or dispose of properly.

During Construction


- Avoid paving and seal coating in wet weather, or when rain is forecast, to prevent fresh materials from contacting stormwater runoff.
- After breaking up old pavement, be sure to remove all chunks and pieces. Make sure broken pavement does not come in contact with rainfall or runoff.
- Cover and seal catch basins and manholes when applying seal coat, slurry seal, fog seal, or similar materials.
- Protect drainage ways by using earth dikes, sand bags, or other controls to divert or trap and filter runoff.

Storm Drain Pollution from Roadwork

Road paving, surfacing, and pavement removal happen right in the street, where there are numerous opportunities for asphalt, saw-cut slurry, or excavated material to illegally enter storm drains. Extra planning is required to store and dispose of materials properly and guard against pollution of storm drains, creeks, and the Bay.

Fresh Concrete and Mortar Application

Best Management Practices for the Construction Industry

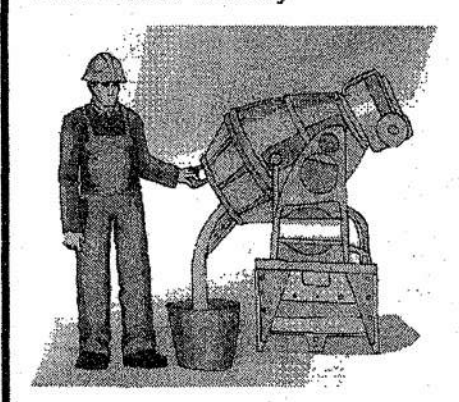

Best Management Practices for the

- Masons and bricklayers
- Sidewalk construction crews
- Patio construction workers
- Construction inspectors
- General contractors
- Home builders
- Developers
- Concrete delivery/pumping workers

Doing The Job Right

General Business Practices

- Wash out concrete mixers only in designated wash-out areas in your yard, away from storm drains and waterways, where the water will flow into a temporary waste pit in a dirt area. Let water percolate through soil and dispose of settled, hardened concrete as garbage. Whenever possible, recycle washout by pumping back into mixers for reuse.
- Wash out chutes onto dirt areas at site that do not flow to streets or drains.
- Always store both dry and wet materials under cover, protected from rainfall and runoff and away from storm drains or waterways. Protect dry materials from wind.
- Secure bags of cement after they are open. Be sure to keep wind-blown cement powder away from streets, gutters, storm drains, rainfall, and runoff.
- Do not use diesel fuel as a lubricant on concrete forms, tools, or trailers.

Storm Drain Pollution from Fresh Concrete and Mortar Applications

Fresh concrete and cement-related mortar that wash into lakes, streams, or estuaries are toxic to fish and the aquatic environment. Disposing of these materials to the storm drains or creeks can block storm drains, cause serious problems, and is prohibited by law.

During Construction

- Don't mix up more fresh concrete or cement than will be used in a two-hour period.
- Set up and operate small mixers on tarps or heavy plastic drop cloths.
- When cleaning up after driveway or sidewalk construction, wash fines into dirt areas, not down the driveway or into the street or storm drain.
- Protect applications of fresh concrete and mortar from rainfall and runoff until the material has dried.
- Wash down exposed aggregate concrete only when the wash water can (1) flow onto a dirt area, (2) drain onto a bermed surface from which it can be pumped and disposed of properly, or (3) be vacuumed from a catchment created by blocking a storm drain inlet. If necessary, divert runoff with temporary berms. Make sure runoff does not reach gutters or storm drains.
- When breaking up pavement, be sure to pick up all the pieces and dispose of properly. Recycle large chunks of broken concrete at a landfill.
- Never bury waste material. Dispose of small amounts of excess dry concrete, grout, and mortar in the trash.
- Never dispose of washout into the street, storm drains, drainage ditches, or streams.

Preventing Pollution: It's Up to Us

In the Santa Clara Valley, storm drains transport water directly to local creeks and San Francisco Bay without treatment. Storm water pollution is a serious problem for wildlife dependent on our waterways and for the people who live near polluted streams or bay lands. Some common sources of this pollution include spilled oil, fuel, and fluids from vehicles and heavy equipment; construction debris; sediment created by erosion; landscaping runoff containing pesticides or weed killers; and materials such as used motor oil, antifreeze, and paint products that people pour or spill into a street or storm drain.

Thirteen valley municipalities have joined together with Santa Clara County and the Santa Clara Valley Water District to educate local residents and businesses and fight storm water pollution. To comply with this program, contractors must comply with the practices described in this drawing sheet.

Spill Response Agencies

DIAL 9-1-1
State Office of Emergency Services Warning Center (24 hours): 800-852-7550
Santa Clara County Environmental Health Services: (408) 299-6930

Local Pollution Control Agencies

County of Santa Clara Pollution Prevention Program: (408) 441-1195
County of Santa Clara Integrated Waste Management Program: (408) 441-1198
County of Santa Clara District Attorney Environmental Crimes Hotline: (408) 299-TIPS

Santa Clara County Recycling Hotline: 1-800-533-8414
Santa Clara Valley Water District: (408) 265-2600
Santa Clara Valley Water District Pollution Hotline: 1-888-510-5151
Regional Water Quality Control Board San Francisco Bay Region: (510) 622-2300
Palo Alto Regional Water Quality Control Plant: (650) 329-2598
Serving East Palo Alto Sanitary District, Los Altos, Los Altos Hills, Mountain View, Palo Alto, Stanford


City of Los Altos

Building Department: (650) 947-2752
Engineering Department: (650) 947-2780


Blueprint for a Clean Bay

Remember: The property owner and the contractor share ultimate responsibility for the activities that occur on a construction site. You may be held responsible for any environmental damage caused by your subcontractors or employees.

Best Management Practices for the Construction Industry

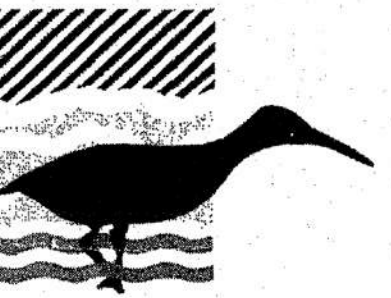

Santa Clara Urban Runoff Pollution Prevention Program

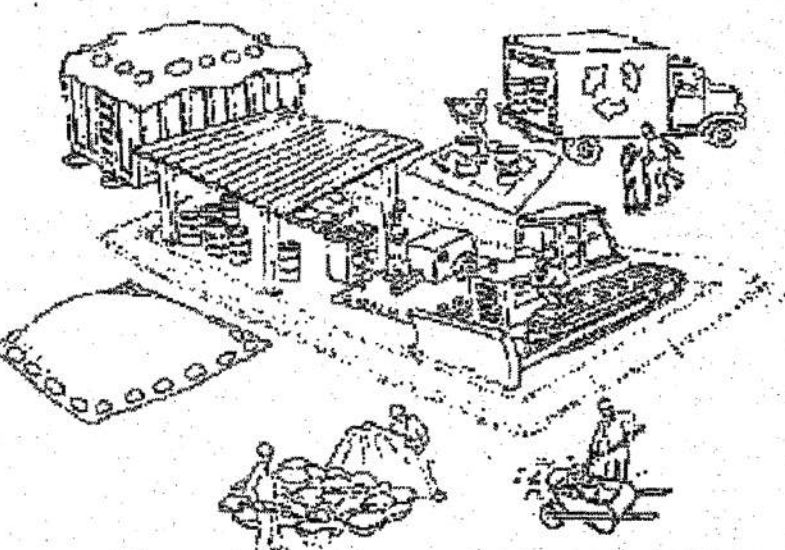

DESIGNED BY: LARRY LIND	APPROVED BY: <i>[Signature]</i> CITY ENGINEER	CITY OF LOS ALTOS RCE	DATE: OCTOBER, 2003
DRAWN BY: VICTOR CHEN	CHECKED BY: JIM GUSTAFSON	SHEET OF SHEETS	SCALE: N.T.S.
			DRAWING NO:

65% SUBMITTAL
APRIL 07, 2025

2024-2025 ANNUAL STREET RESURFACING PROJECT

BLUEPRINT FOR A CLEAN BAY

SANTA CLARA COUNTY

LOS ALTOS

DWG NO. C2.1

2 OF 50

JOB NO. 250007

Agenda Item 1.

REVISIONS

DATE


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APRIL 07, 2025

DWG NO.
C3.1
3 OF 50
JOB NO.
250007

2024-2025 ANNUAL STREET RESURFACING PROJECT
TYPICAL SECTION
LOS ALTOS
SANTA CLARA COUNTY
CALIFORNIA

CITY OF LOS ALTOS
1 NORTH SAN ANTONIO ROAD
CALIFORNIA 94022

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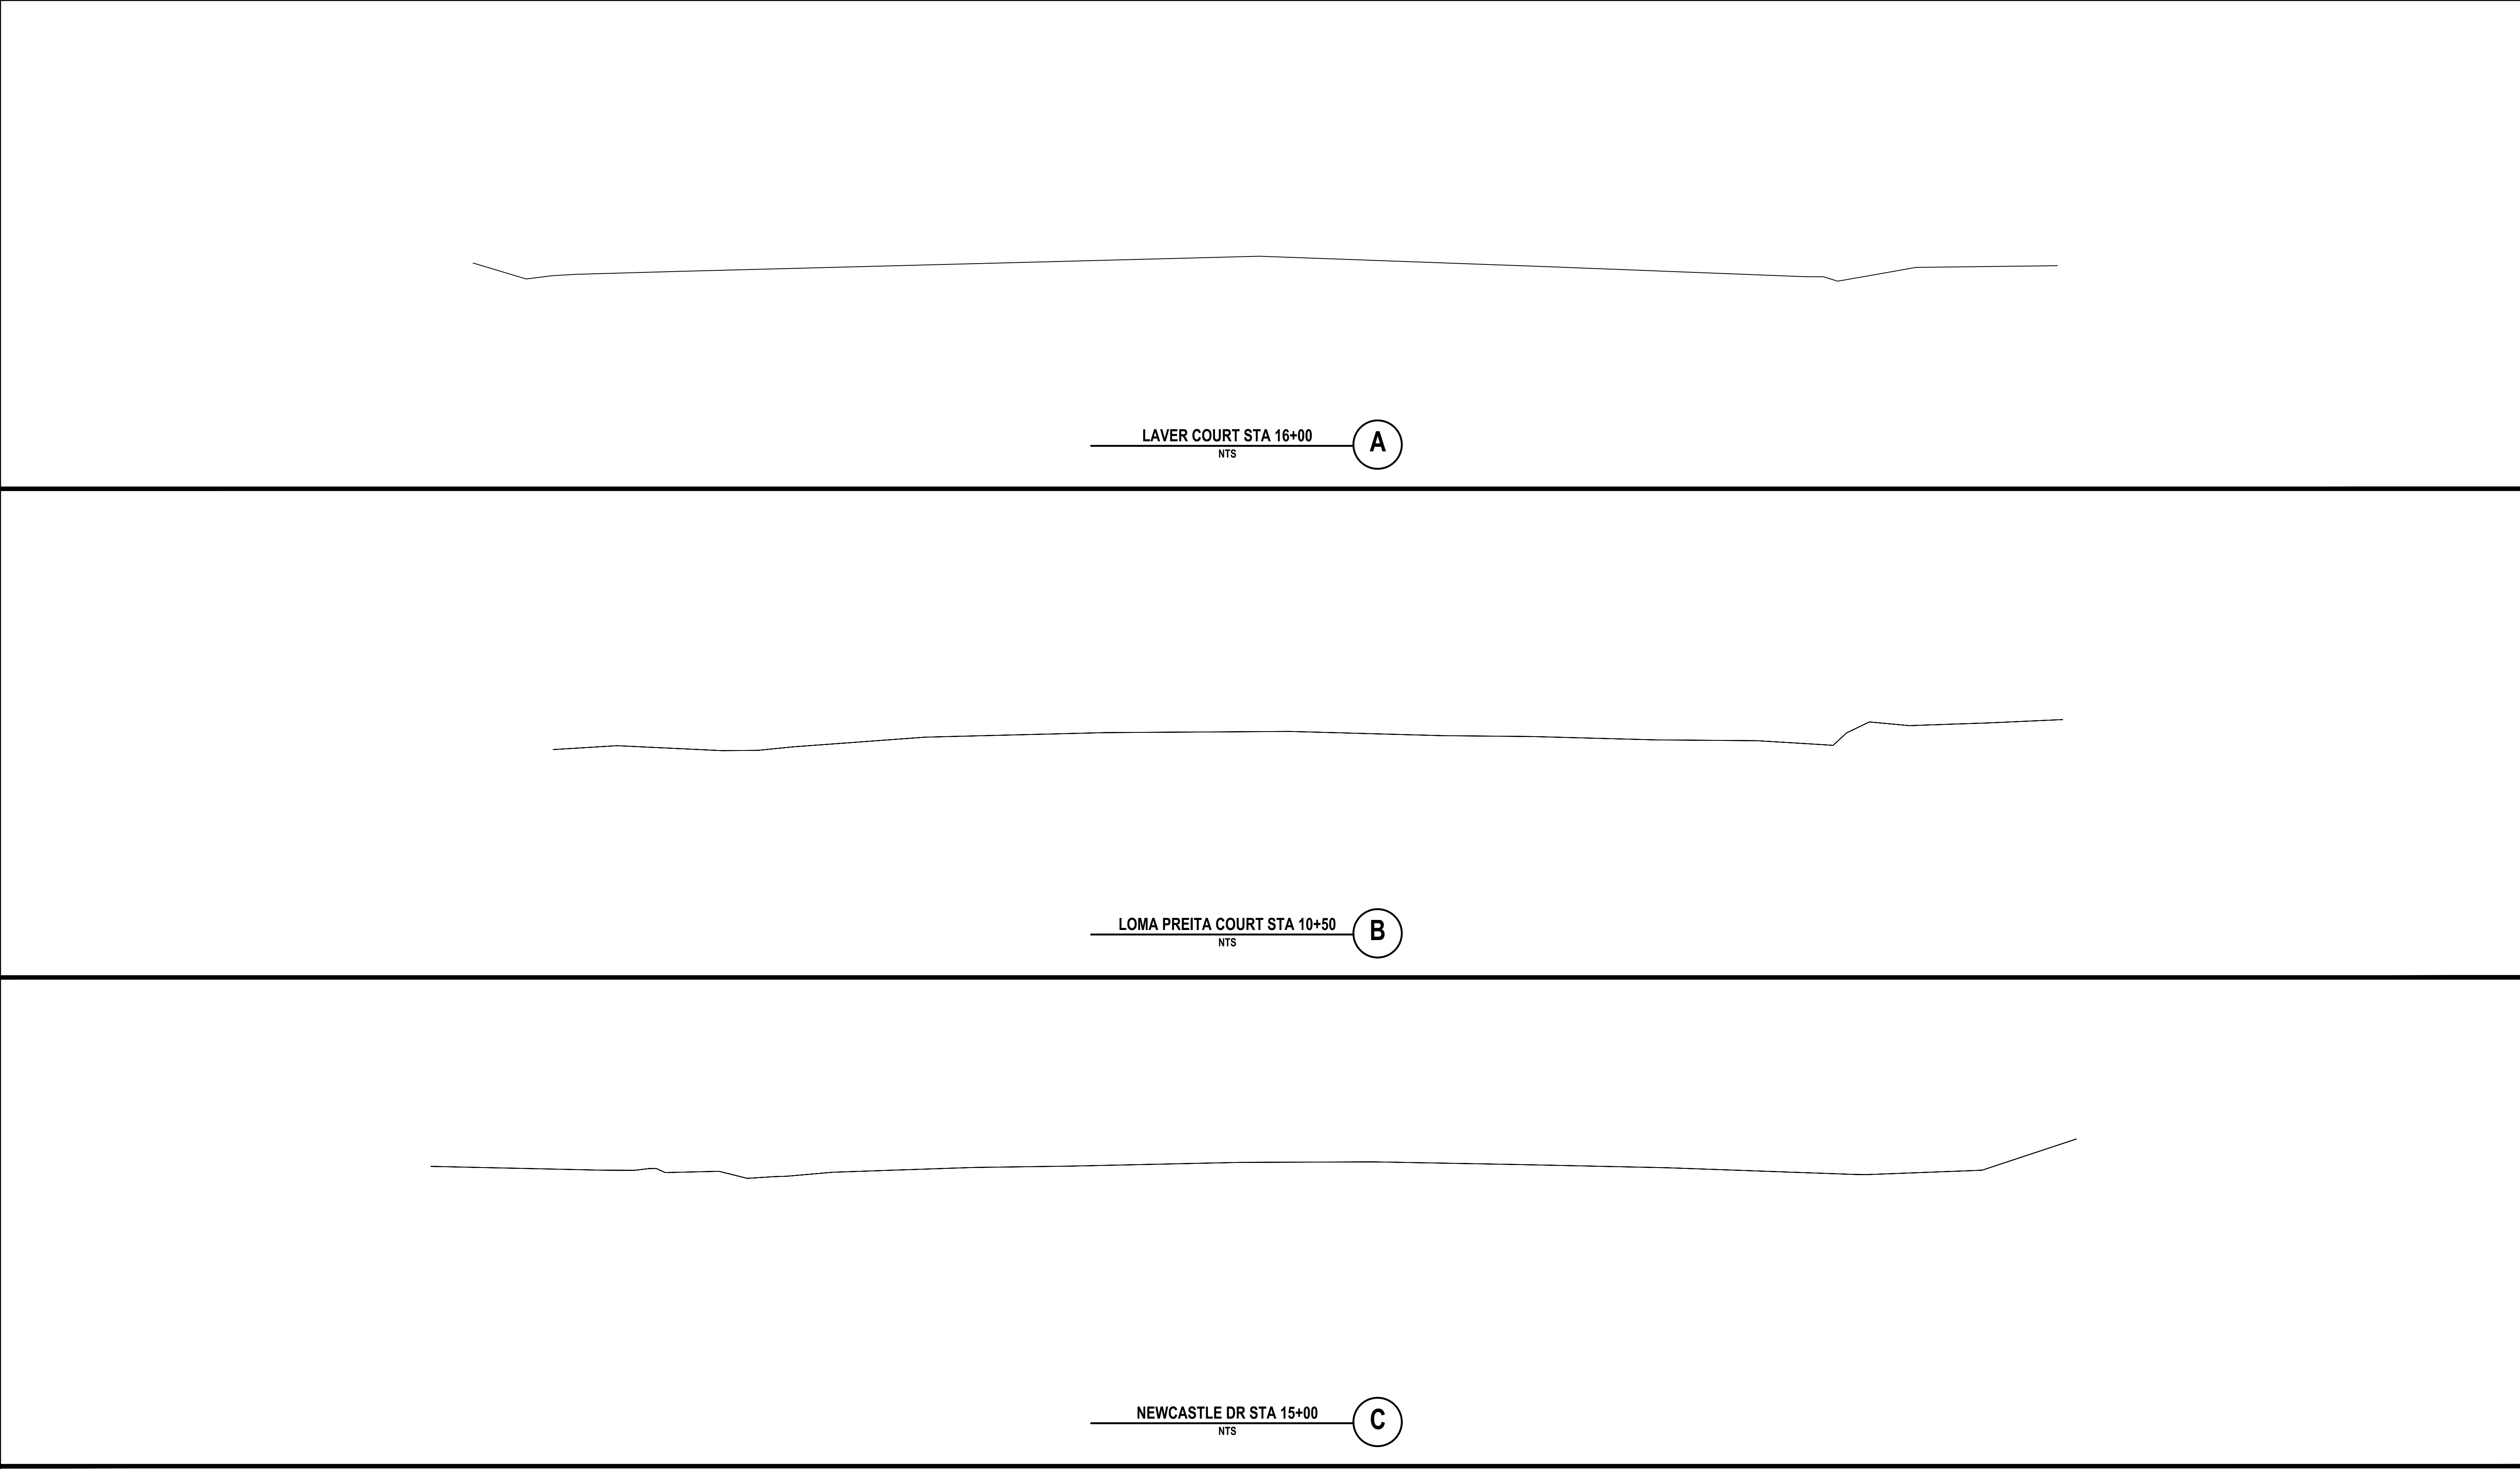
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31

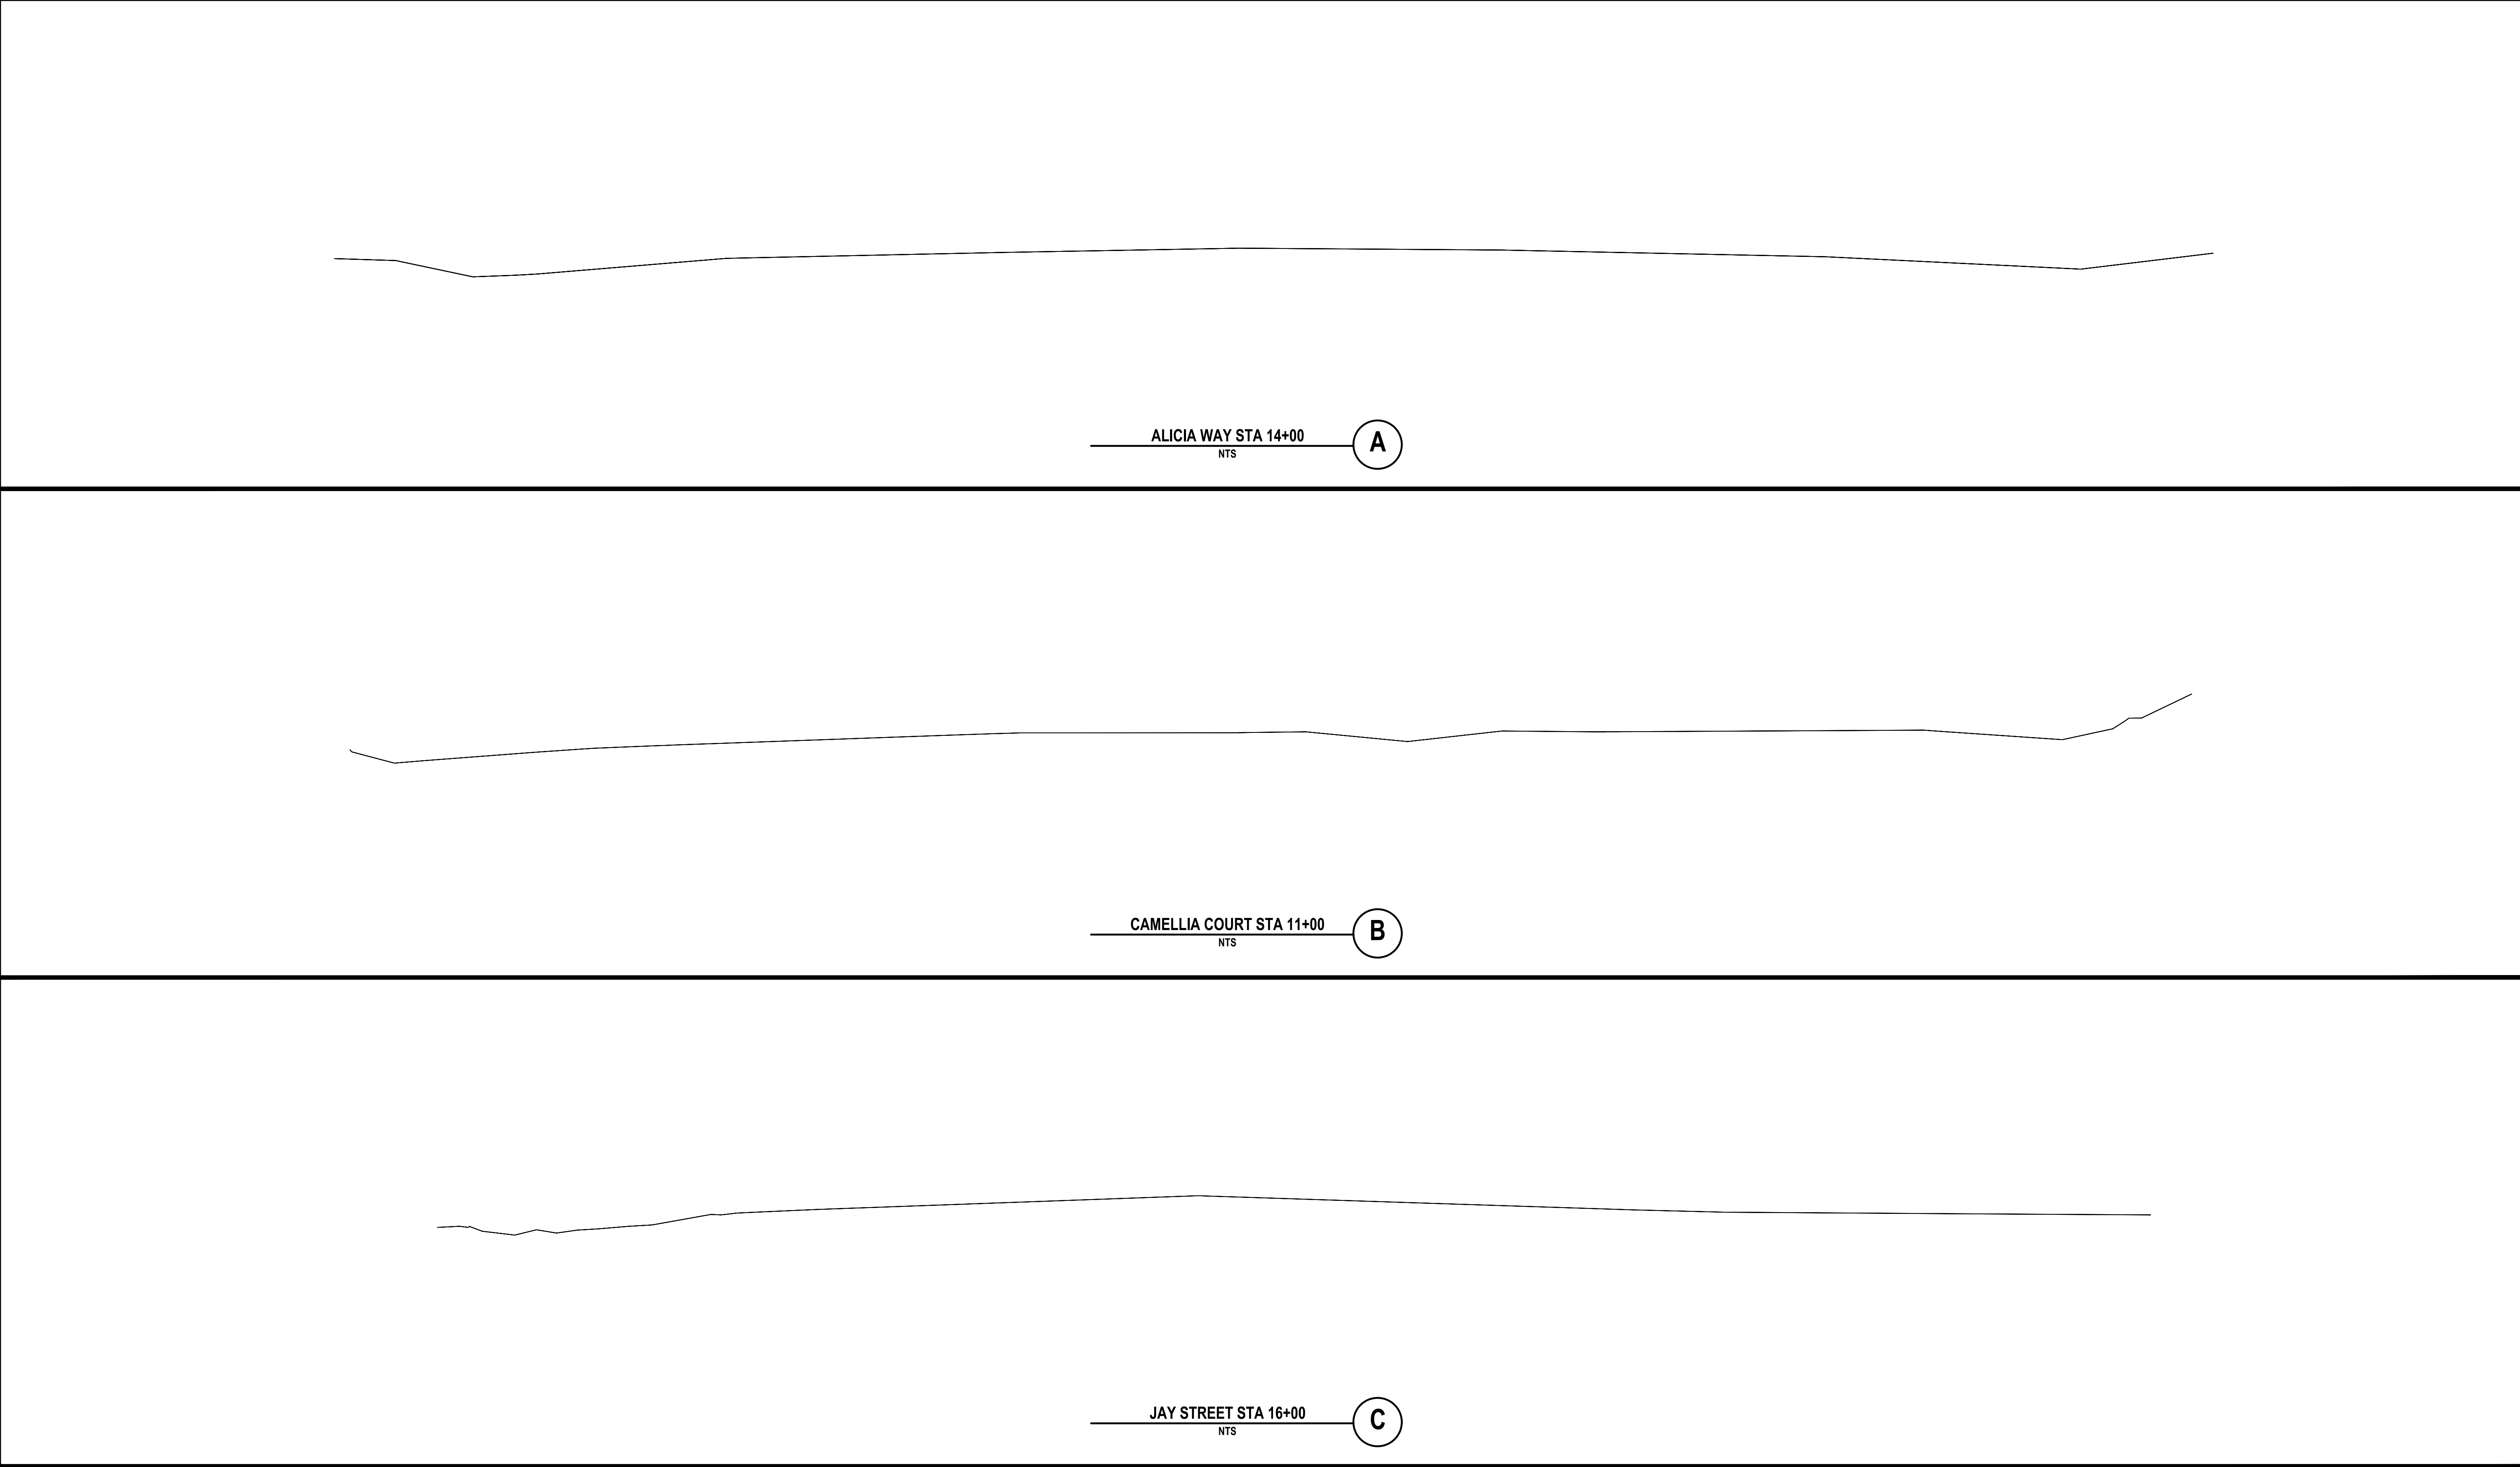



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DWG NO.
C3.2
4 OF 50
JOB NO.
250007

2024-2025 ANNUAL STREET RESURFACING PROJECT
TYPICAL SECTION
LOS ALTOS
SANTA CLARA COUNTY
CALIFORNIA



CITY OF LOS ALTOS
1 NORTH SAN ANTONIO ROAD
CALIFORNIA 94022


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32





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DWG NO.
C3.3

5 OF 50

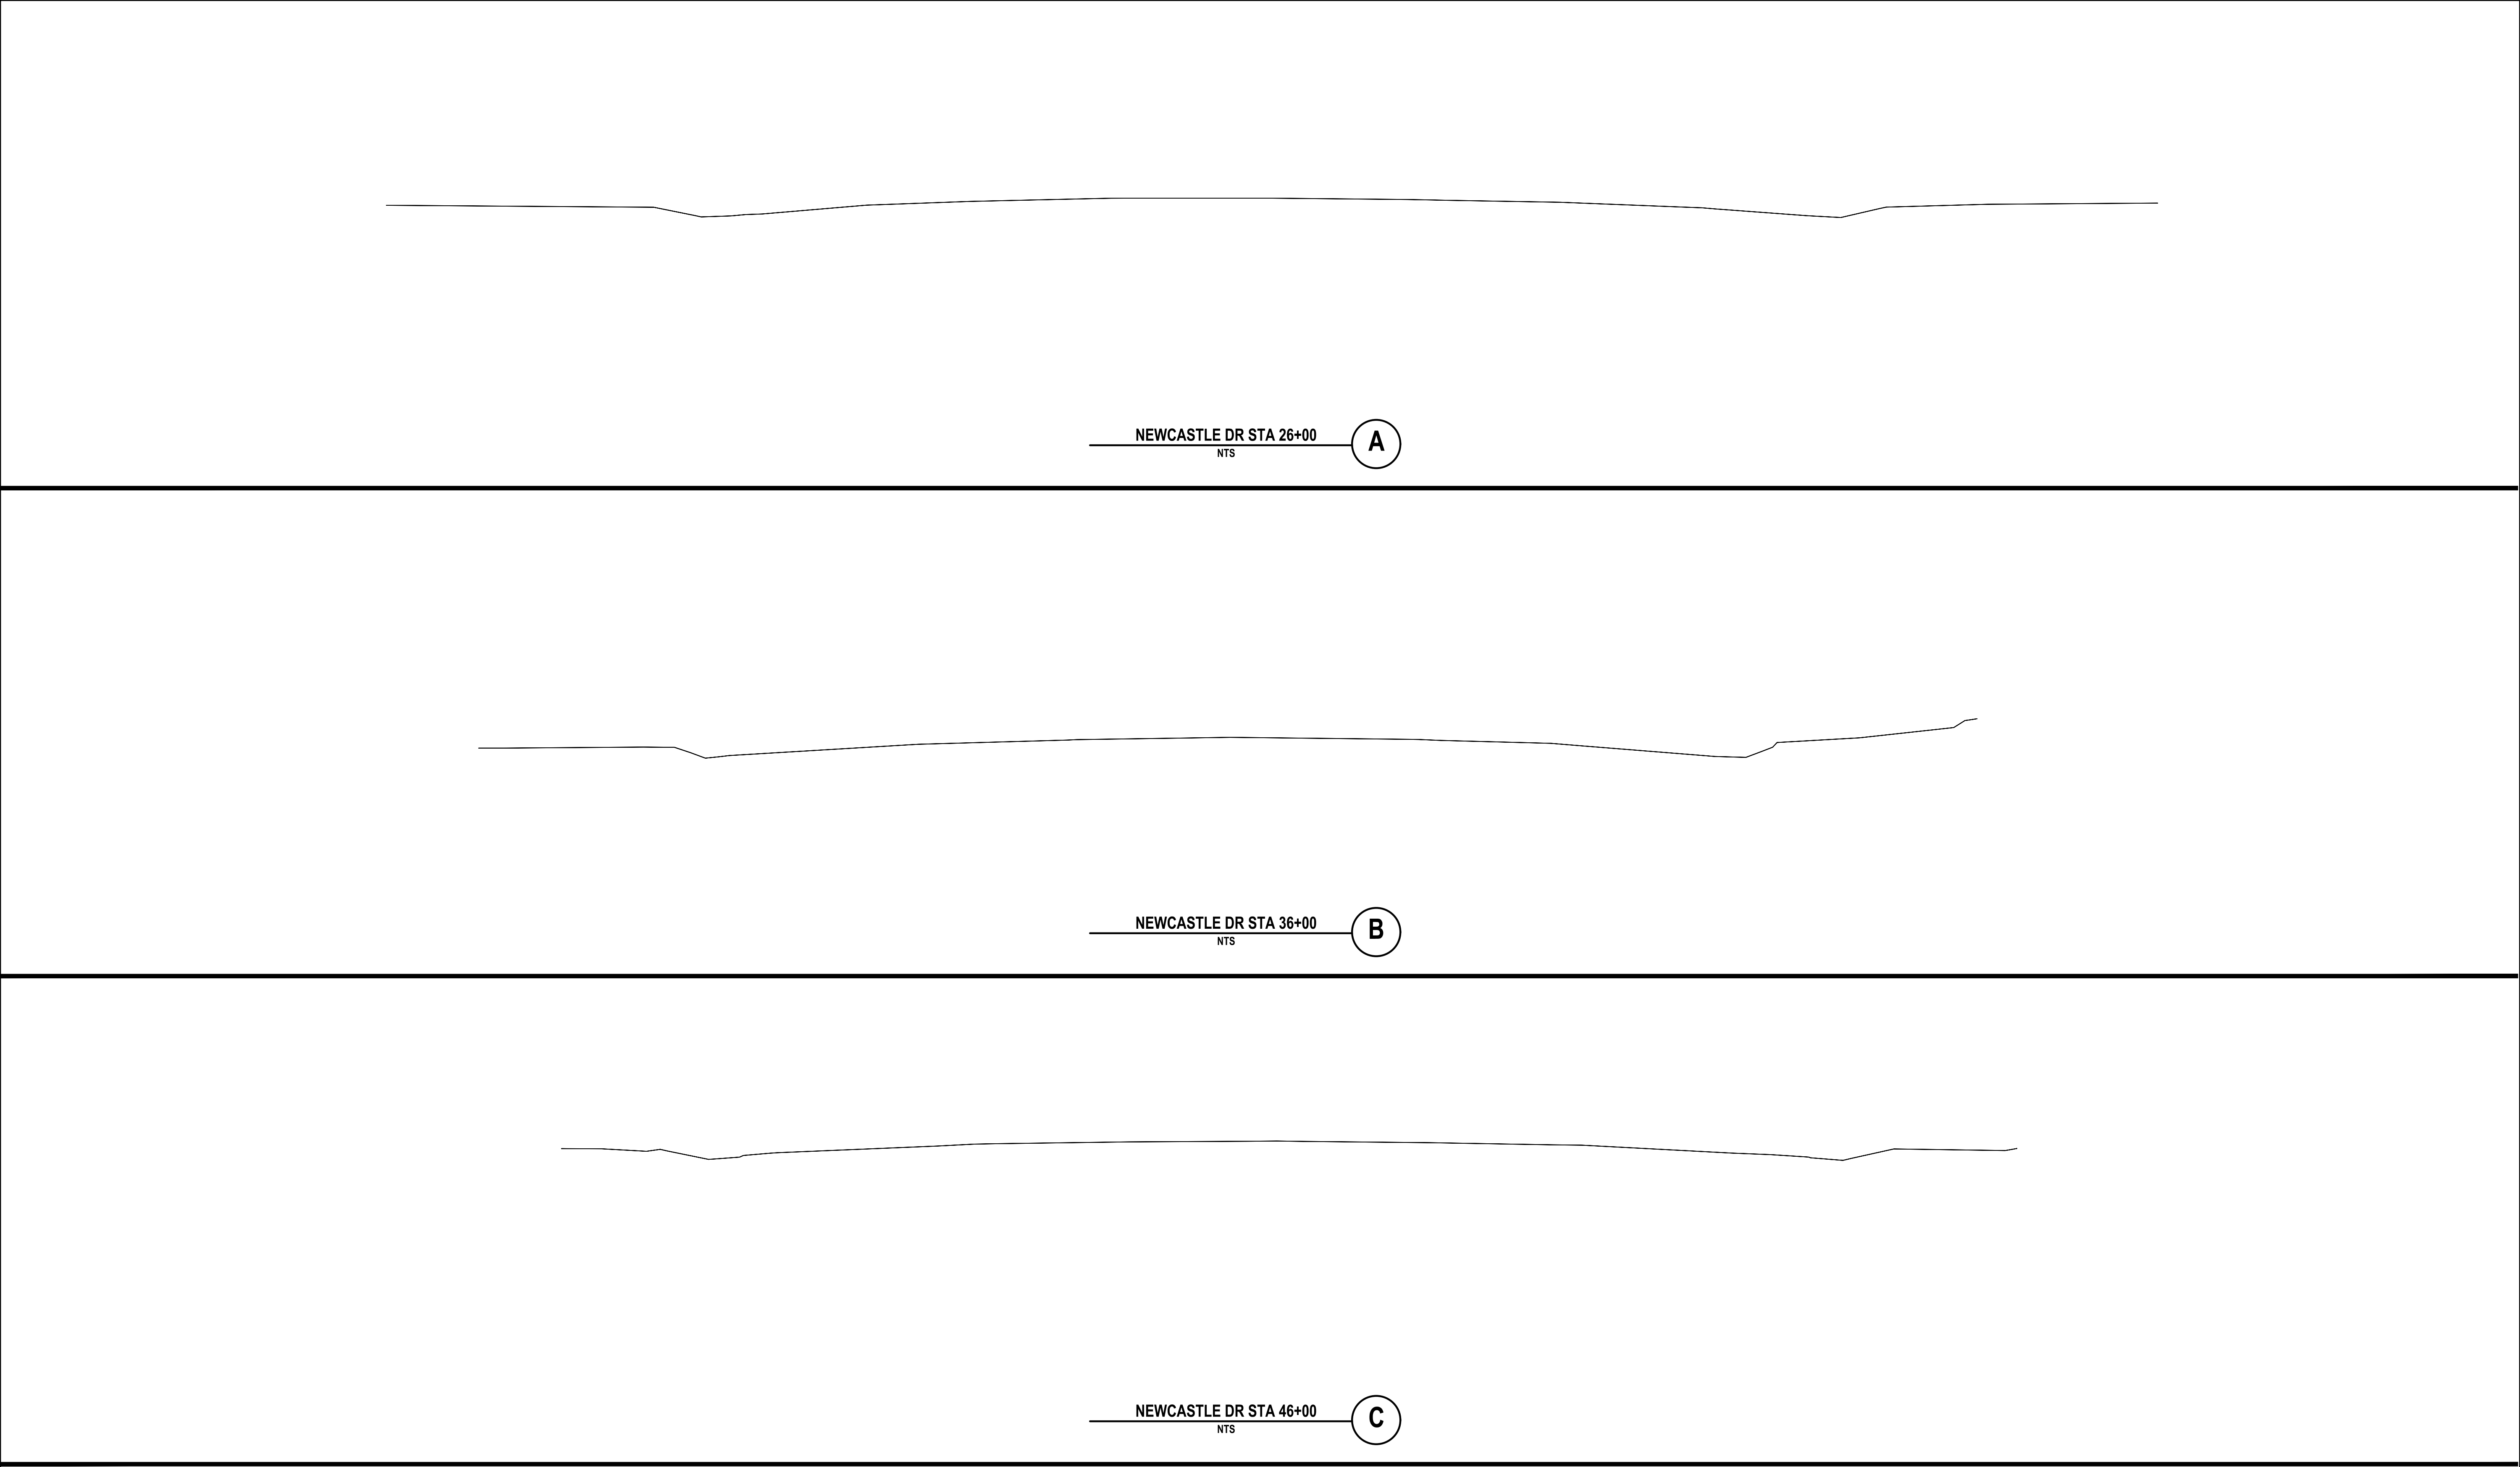JOB NO.
250007


65% SUBMITTAL

APRIL 07, 2025


2024-2025 ANNUAL STREET RESURFACING PROJECT

TYPICAL SECTION

LOS ALTOS SANTA CLARA COUNTY CALIFORNIA

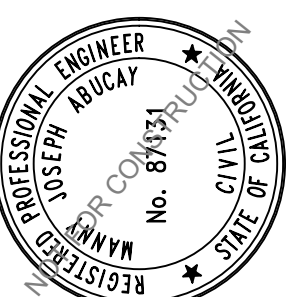

CITY OF LOS ALTOS
1 NORTH SAN ANTONIO ROAD
CALIFORNIA 94022



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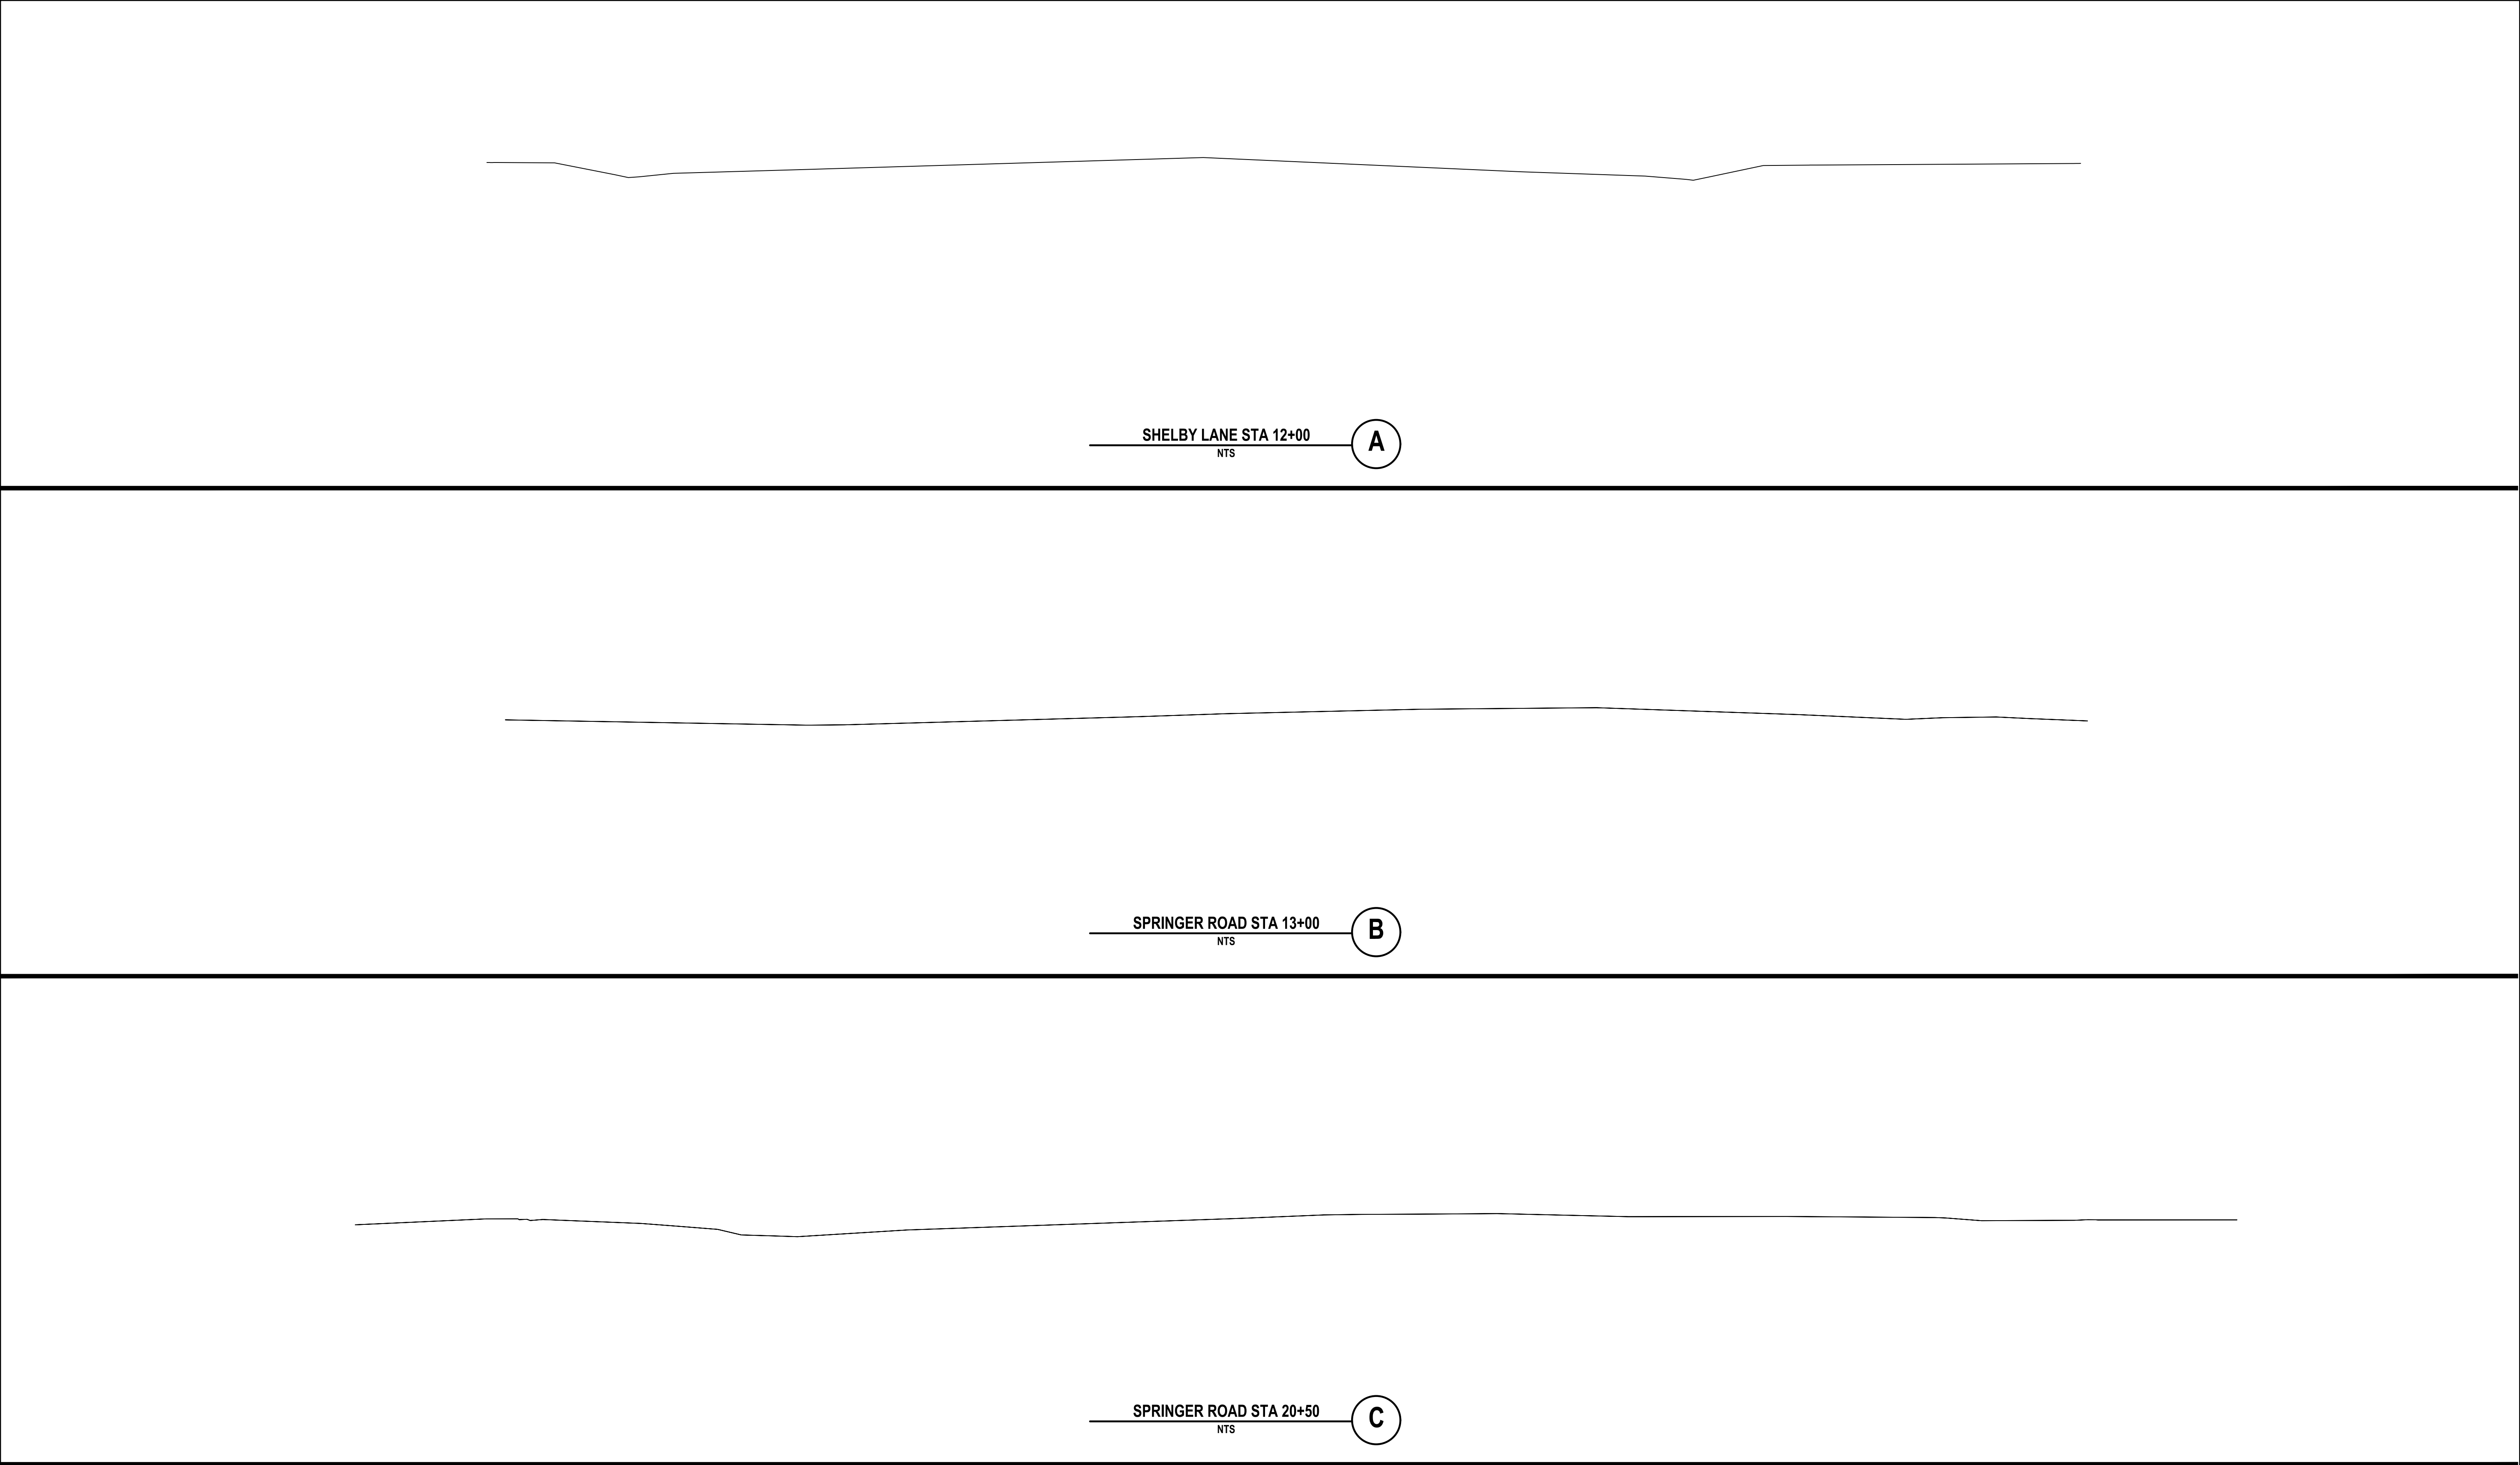
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33



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DWG NO.
C3.4
6 OF 50
JOB NO.
250007

2024-2025 ANNUAL STREET RESURFACING PROJECT
TYPICAL SECTION
LOS ALTOS
SANTA CLARA COUNTY
CALIFORNIA

CITY OF LOS ALTOS
1 NORTH SAN ANTONIO ROAD
CALIFORNIA 94022

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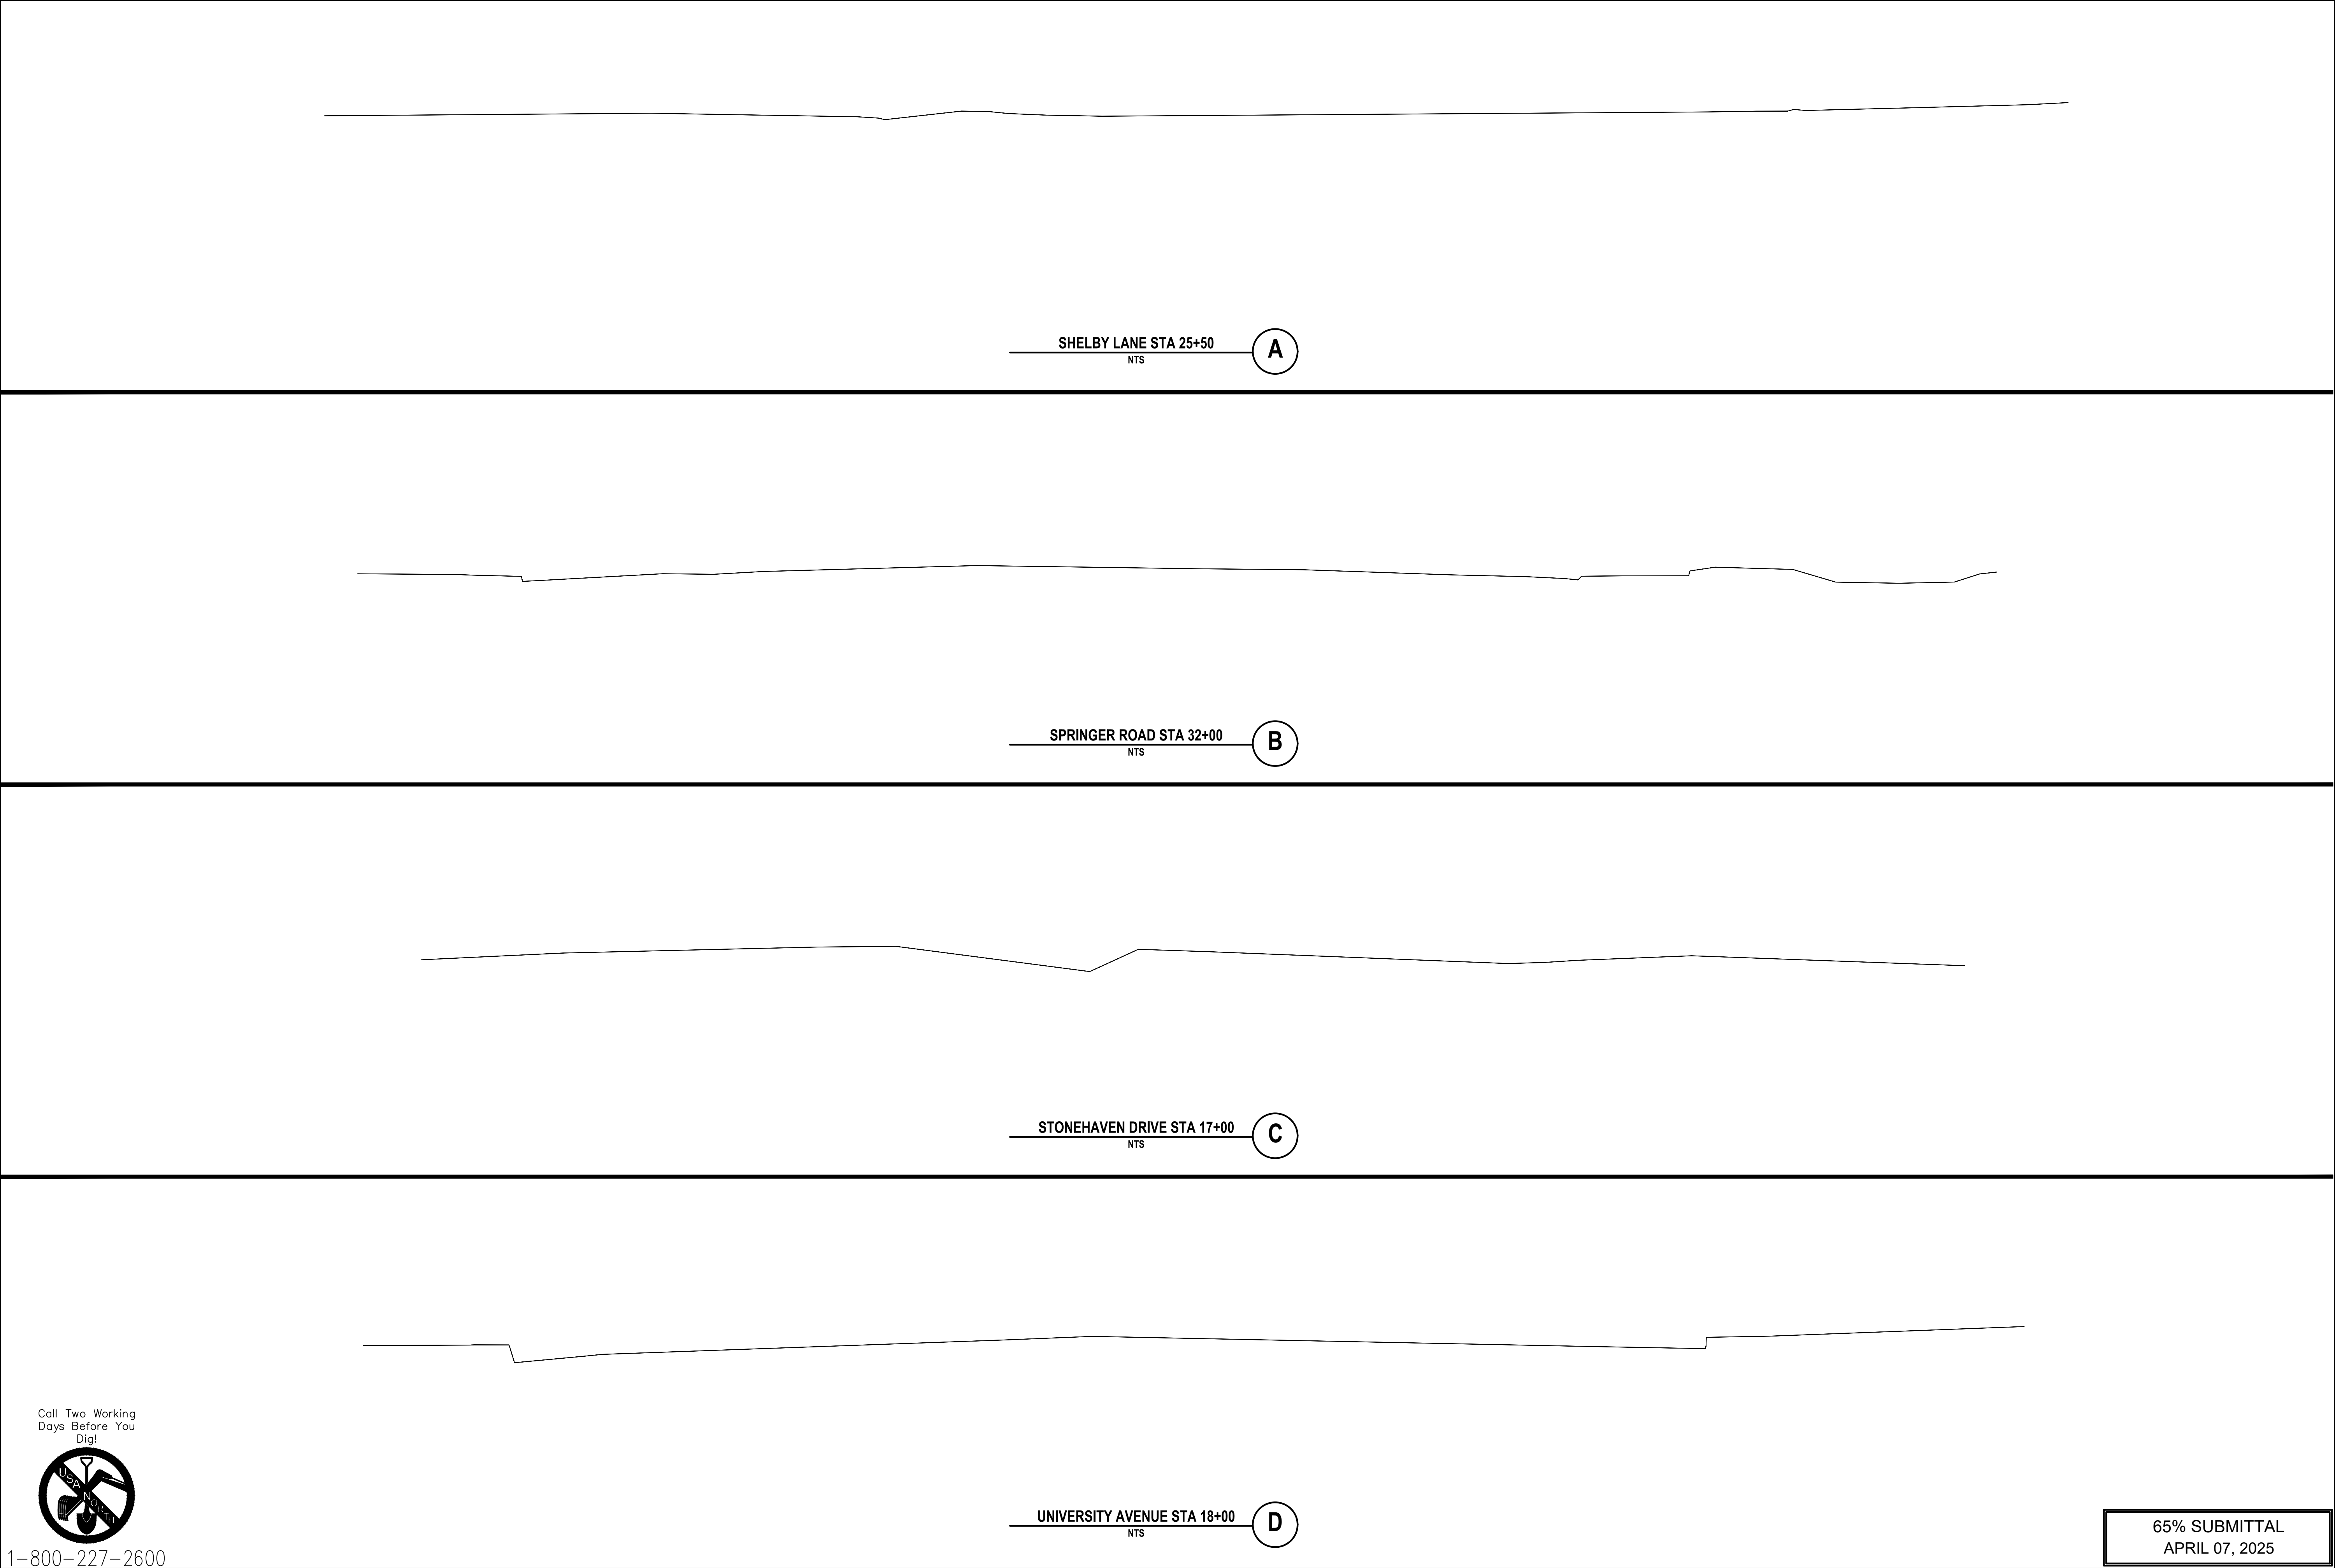
BY



DATE

REVISIONS

Agenda Item 1.

34

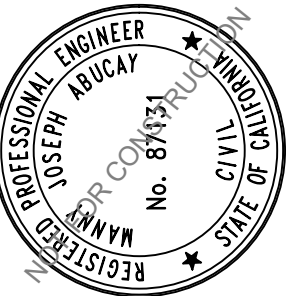

DWG NO. C3.5	7 OF 50	JOB NO. 250007	LOS ALTOS	SANTA CLARA COUNTY	CALIFORNIA		CITY OF LOS ALTOS 1 NORTH SAN ANTONIO ROAD CALIFORNIA 94022		BY	DATE	REVISIONS

2024-2025 ANNUAL STREET RESURFACING PROJECT
TYPICAL SECTION

Agenda Item 1.

35


BY	DATE	REVISIONS



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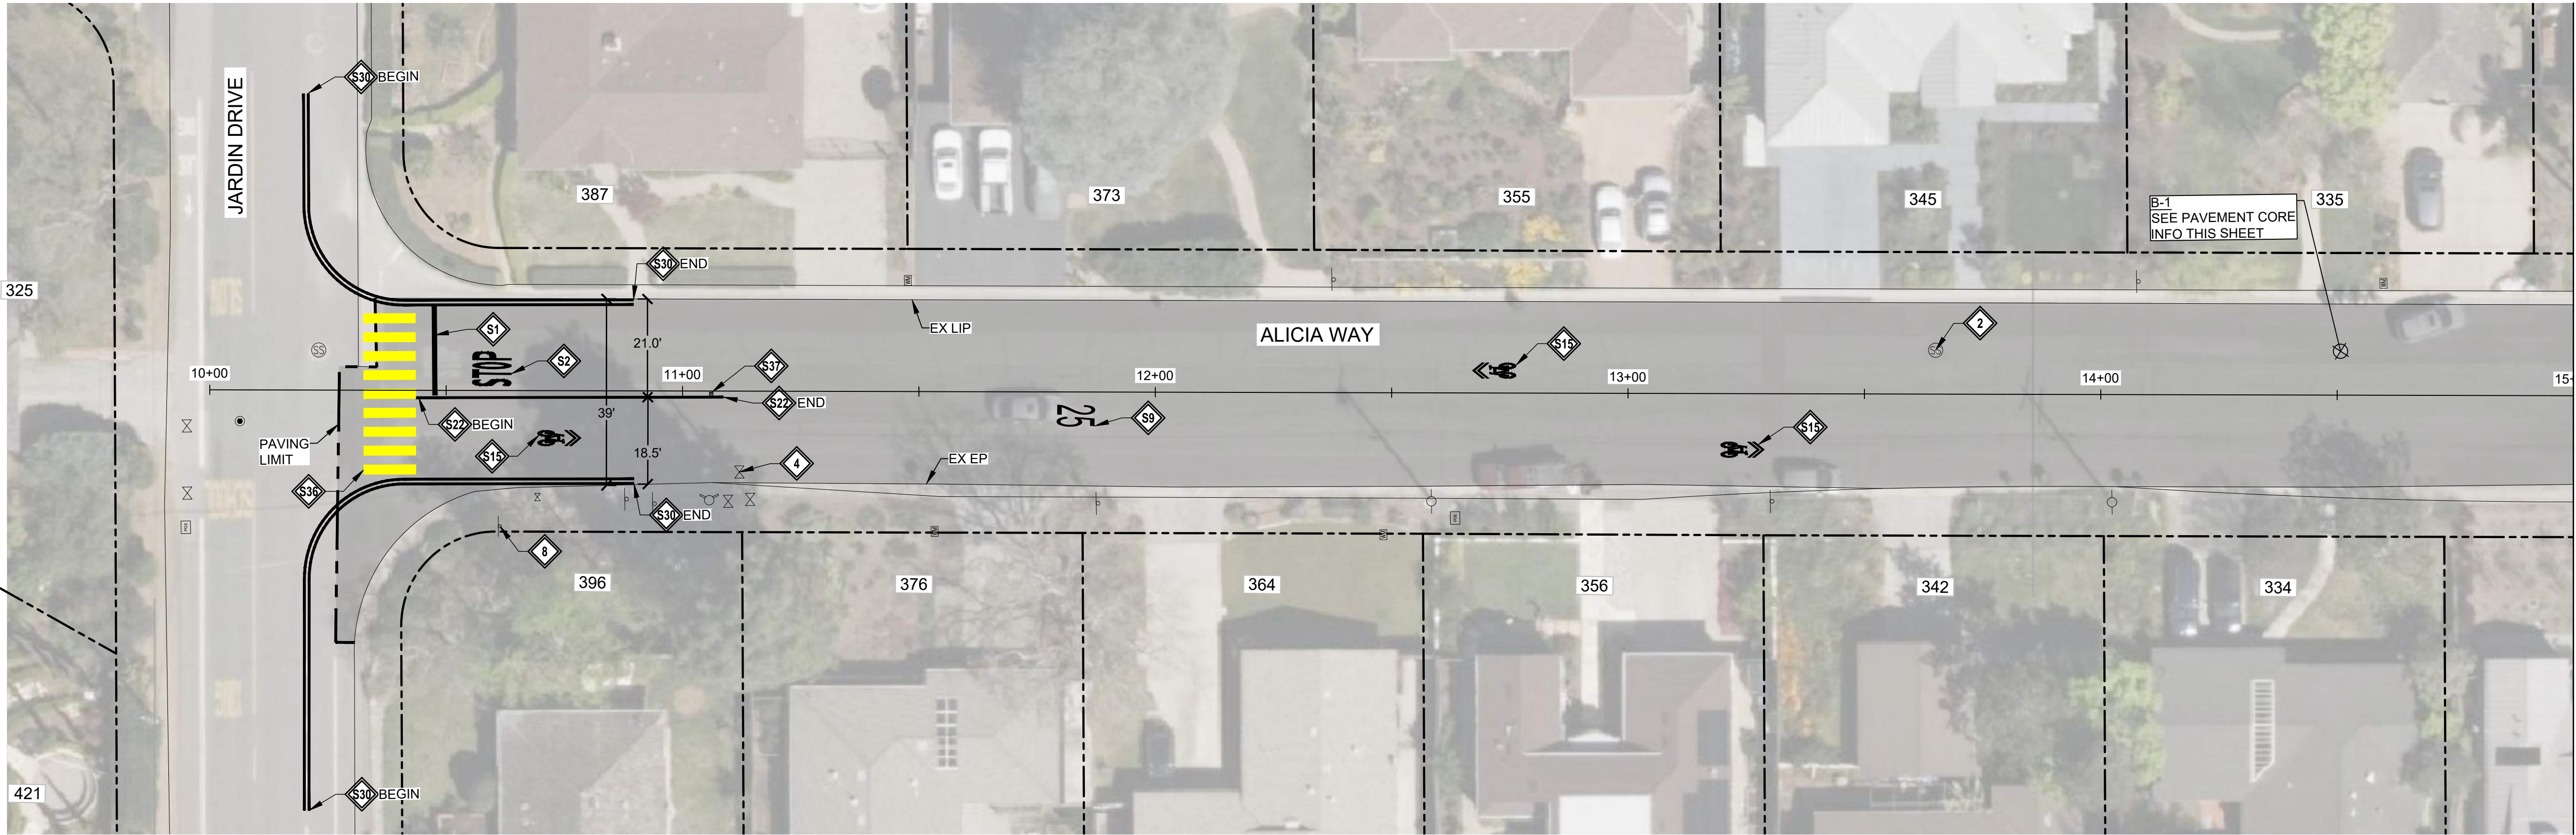
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CITY OF LOS ALTOS
1 NORTH SAN ANTONIO ROAD
CALIFORNIA 94022



2024-2025 ANNUAL STREET RESURFACING PROJECT
IMPROVEMENT PLAN - ALICIA WAY
10+00 to 15+00
SANTA CLARA COUNTY
CALIFORNIA
LOS ALTOS

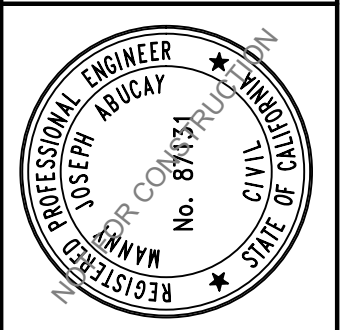DWG NO. C4.01
8 OF 50
JOB NO. 250007



PAVEMENT REPAIR SITE - ALICIA WAY

CONSTRUCTION NOTES:

- 1

LOWER & RESTORE TO GRADE STORM MANHOLE
- 2

LOWER & RESTORE TO GRADE SEWER MANHOLE (TEMPORARY FALSE BOTTOM TO BE INSTALLED PRIOR TO ANY MANHOLE WORK, & REMOVED AFTER)
- 3

LOWER & RESTORE TO GRADE UTILITY MANHOLE (NOTIFY & COORDINATE WITH UTILITY COMPANY PRIOR TO WORK)
- 4

LOWER & RESTORE TO GRADE WATER VALVE
- 5

LOWER & RESTORE TO GRADE GAS VALVE
- 6

LOWER & RESTORE TO GRADE UTILITY BOX
- 7

REINSTALL SURVEY MONUMENT. UNDER CALIFORNIA LICENSED SURVEYOR:
 - REFERENCE OUT PRIOR TO START OF CONSTRUCTION
 - FILE PROPER DOCUMENTATION SHOWING ORIGINAL AND REPLACEMENT MONUMENTS AFTER CONSTRUCTION

X

CX.X
- 8

INSTALL W11-1 & W16-1 SIGNS ON NEW POST. SEE DETAIL
- 9

LOWER & RESTORE TO GRADE SEWER CLEANOUT

STRIPING NOTES:

- S1

WHITE LIMIT LINE (STOP LINE)
- S2

MARKING WORD "STOP"
- S15

MARKING SHARROW
- S22

DETAIL 22
- S30

DOUBLE 6" WHITE LINE
- S36

YELLOW CONTINENTAL CROSSWALK
- S37

BLUE HYDRANT MARKER
- S42

REPAINT RED CURB
- S46

36" HIGH YELLOW FLEXIBLE CHANNELIZER

LEGEND:

- 3" AC GRIND & INLAY. SEE TYPICAL SECTIONS
- #

4" AC BASE REPAIR. REFERENCE ALLOCATION QUANTITIES TABLE THIS SHEET. SEE DETAIL
- APPROXIMATE LIMIT OF WORK
- APPROXIMATE RIGHT OF WAY

GENERAL NOTES:

1. SEE THE CURRENT VERSION OF CALTRANS STANDARD PLANS FOR PAVEMENT MARKINGS, TRAFFIC LINES, AND MARKERS.
2. A TACK COAT EMULSION SHALL BE APPLIED TO CLEAN DRY PAVEMENT BETWEEN (E) AND (N) PAVEMENT SECTIONS PRIOR TO INLAY/OVERLAY

AC BASE REPAIR ALLOCATION QUANTITIES

AC PAVEMENT REPAIR #	AREA (SF)
1	0.0
2	0.0
3	0.0
4	0.0
5	0.0
6	0.0
SUBTOTAL AREA (SF)	0.0


PAVEMENT REPAIR QUANTITY NOTES

1. ACTUAL PAVEMENT REPAIR EXTENTS AND QUANTITIES MAY VARY. ENGINEER SHALL DETERMINE PAVEMENT REPAIR EXTENTS AFTER COLD PLANE OPERATIONS ARE COMPLETE AND PRIOR TO PAVING.

Call Two Working Days Before You Dig!




MATCHLINE (STA 15+00): SEE C4.01

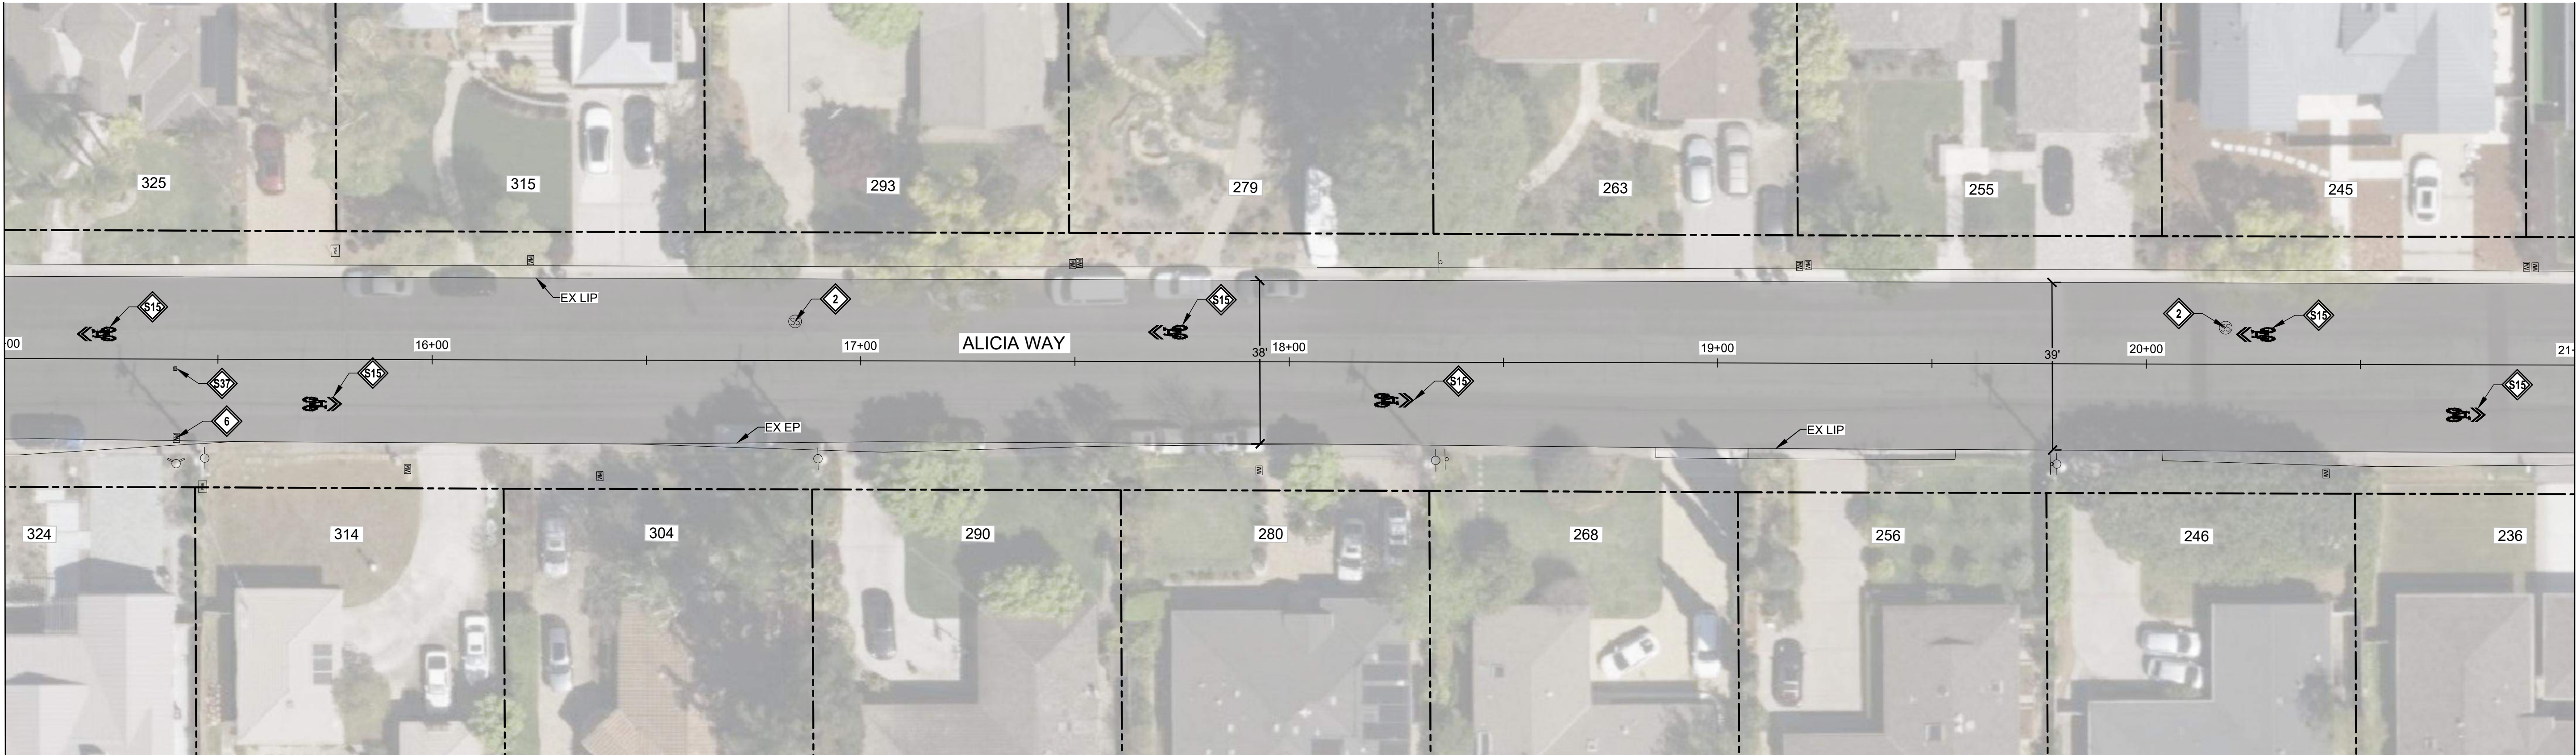

MATCHLINE (STA 21+00): SEE C4.03

PAVEMENT REPAIR SITE - ALICIA WAY

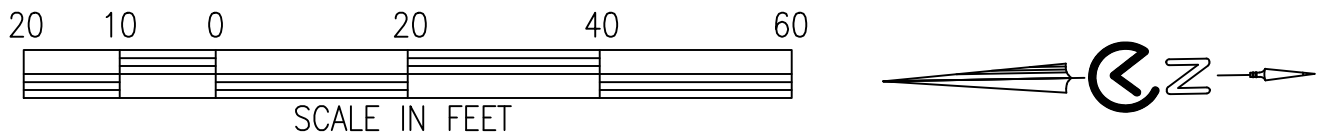

CONSTRUCTION NOTES:

- 1 LOWER & RESTORE TO GRADE STORM MANHOLE
- 2 LOWER & RESTORE TO GRADE SEWER MANHOLE (TEMPORARY FALSE BOTTOM TO BE INSTALLED PRIOR TO ANY MANHOLE WORK, & REMOVED AFTER)
- 3 LOWER & RESTORE TO GRADE UTILITY MANHOLE (NOTIFY & COORDINATE WITH UTILITY COMPANY PRIOR TO WORK)
- 4 LOWER & RESTORE TO GRADE WATER VALVE
- 5 LOWER & RESTORE TO GRADE GAS VALVE
- 6 LOWER & RESTORE TO GRADE UTILITY BOX
- 7 REINSTALL SURVEY MONUMENT. UNDER CALIFORNIA LICENSED SURVEYOR:
 - REFERENCE OUT PRIOR TO START OF CONSTRUCTION
 - FILE PROPER DOCUMENTATION SHOWING ORIGINAL AND REPLACEMENT MONUMENTS AFTER CONSTRUCTION
- 8 INSTALL W11-1 & W16-1 SIGNS ON NEW POST. SEE DETAIL
- 9 LOWER & RESTORE TO GRADE SEWER CLEANOUT

STRIPING NOTES:

- S1 WHITE LIMIT LINE (STOP LINE)
- S2 MARKING WORD "STOP"
- S15 MARKING SHARROW
- S22 DETAIL 22
- S30 DOUBLE 6" WHITE LINE
- S34 YELLOW BASIC CROSSWALK
- S36 YELLOW CONTINENTAL CROSSWALK
- S37 BLUE HYDRANT MARKER
- S42 REPAINT RED CURB
- S44 36" HIGH YELLOW FLEXIBLE CHANNELIZER

LEGEND:

- 3" AC GRIND & INLAY. SEE TYPICAL SECTIONS
- 4" AC BASE REPAIR. REFERENCE ALLOCATION QUANTITIES TABLE THIS SHEET. SEE DETAIL
- APPROXIMATE LIMIT OF WORK
- APPROXIMATE RIGHT OF WAY

GENERAL NOTES:

- SEE THE CURRENT VERSION OF CALTRANS STANDARD PLANS FOR PAVEMENT MARKINGS, TRAFFIC LINES, AND MARKERS.
- A TACK COAT EMULSION SHALL BE APPLIED TO CLEAN DRY PAVEMENT BETWEEN (E) AND (N) PAVEMENT SECTIONS PRIOR TO INLAY/OVERLAY

AC BASE REPAIR ALLOCATION QUANTITIES

AC PAVEMENT REPAIR #	AREA (SF)
1	0.0
2	0.0
3	0.0
4	0.0
5	0.0
6	0.0
SUBTOTAL AREA (SF)	0.0

PAVEMENT REPAIR QUANTITY NOTES

- ACTUAL PAVEMENT REPAIR EXTENTS AND QUANTITIES MAY VARY. ENGINEER SHALL DETERMINE PAVEMENT REPAIR EXTENTS AFTER COLD PLANE OPERATIONS ARE COMPLETE AND PRIOR TO PAVING.

PAVEMENT CORING LOG

CORE #	SUBGRADE	AC (IN)	AB (IN)	FABRIC ²
B-1	CLAYEY SAND / SILTY SAND (SC/SM)	3.0	3.5	N/A

PAVEMENT CORING NOTES

- PAVEMENT CORING WAS PERFORMED IN SELECT LOCATIONS AND IS NOT REPRESENTATIVE OF ALL EXISTING PAVEMENT CONDITIONS WITHIN THE WORK LIMITS.
- PAVEMENT TO BE COLD PLANED OR REMOVED MAY CONTAIN PAVEMENT FABRIC. PAVEMENT BORINGS ARE NOT REPRESENTATIVE OF ENTIRE STREET WORK LIMITS. ANY ASSUMPTION OF THE PRESENCE OF PAVEMENT FABRIC SHALL BE AT THE CONTRACTOR'S SOLE RISK. THERE SHALL BE NO ADJUSTMENT IN COMPENSATION TO THE CONTRACTOR FOR COLD PLANING, REMOVING, AND DISPOSING AC PAVEMENT THAT CONTAINS PAVEMENT FABRIC.

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APRIL 07, 2025

Agenda Item 1.

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CITY OF LOS ALTOS

1 NORTH SAN ANTONIO ROAD

CALIFORNIA 94022

PROFESSIONAL ENGINEER

JOSEPH A. BUCAR

REGISTERED CIVIL ENGINEER

NO. 87131

STATE OF CALIFORNIA

2024-2025 ANNUAL STREET RESURFACING PROJECT

IMPROVEMENT PLAN - ALICIA WAY

15+00 to 21+00

LOS ALTOS

SANTA CLARA COUNTY

CALIFORNIA

DWG NO.

C4.02

9 OF 50

JOB NO.

250007


37

BY	DATE	REVISIONS




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CITY OF LOS ALTOS
1 NORTH SAN ANTONIO ROAD
CALIFORNIA 94022

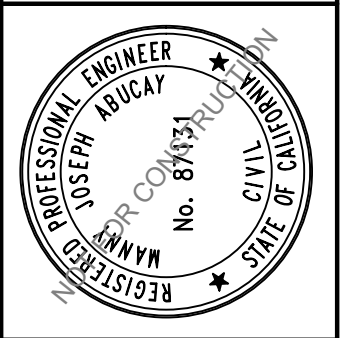

2024-2025 ANNUAL STREET RESURFACING PROJECT
IMPROVEMENT PLAN - ALICIA WAY
21+00 to 23+39
LOS ALTOS
SANTA CLARA COUNTY
CALIFORNIA

DWG NO.	C4.03	10 OF 50	JOB NO.	250007
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PAVEMENT REPAIR SITE - ALICIA WAY

CONSTRUCTION NOTES:

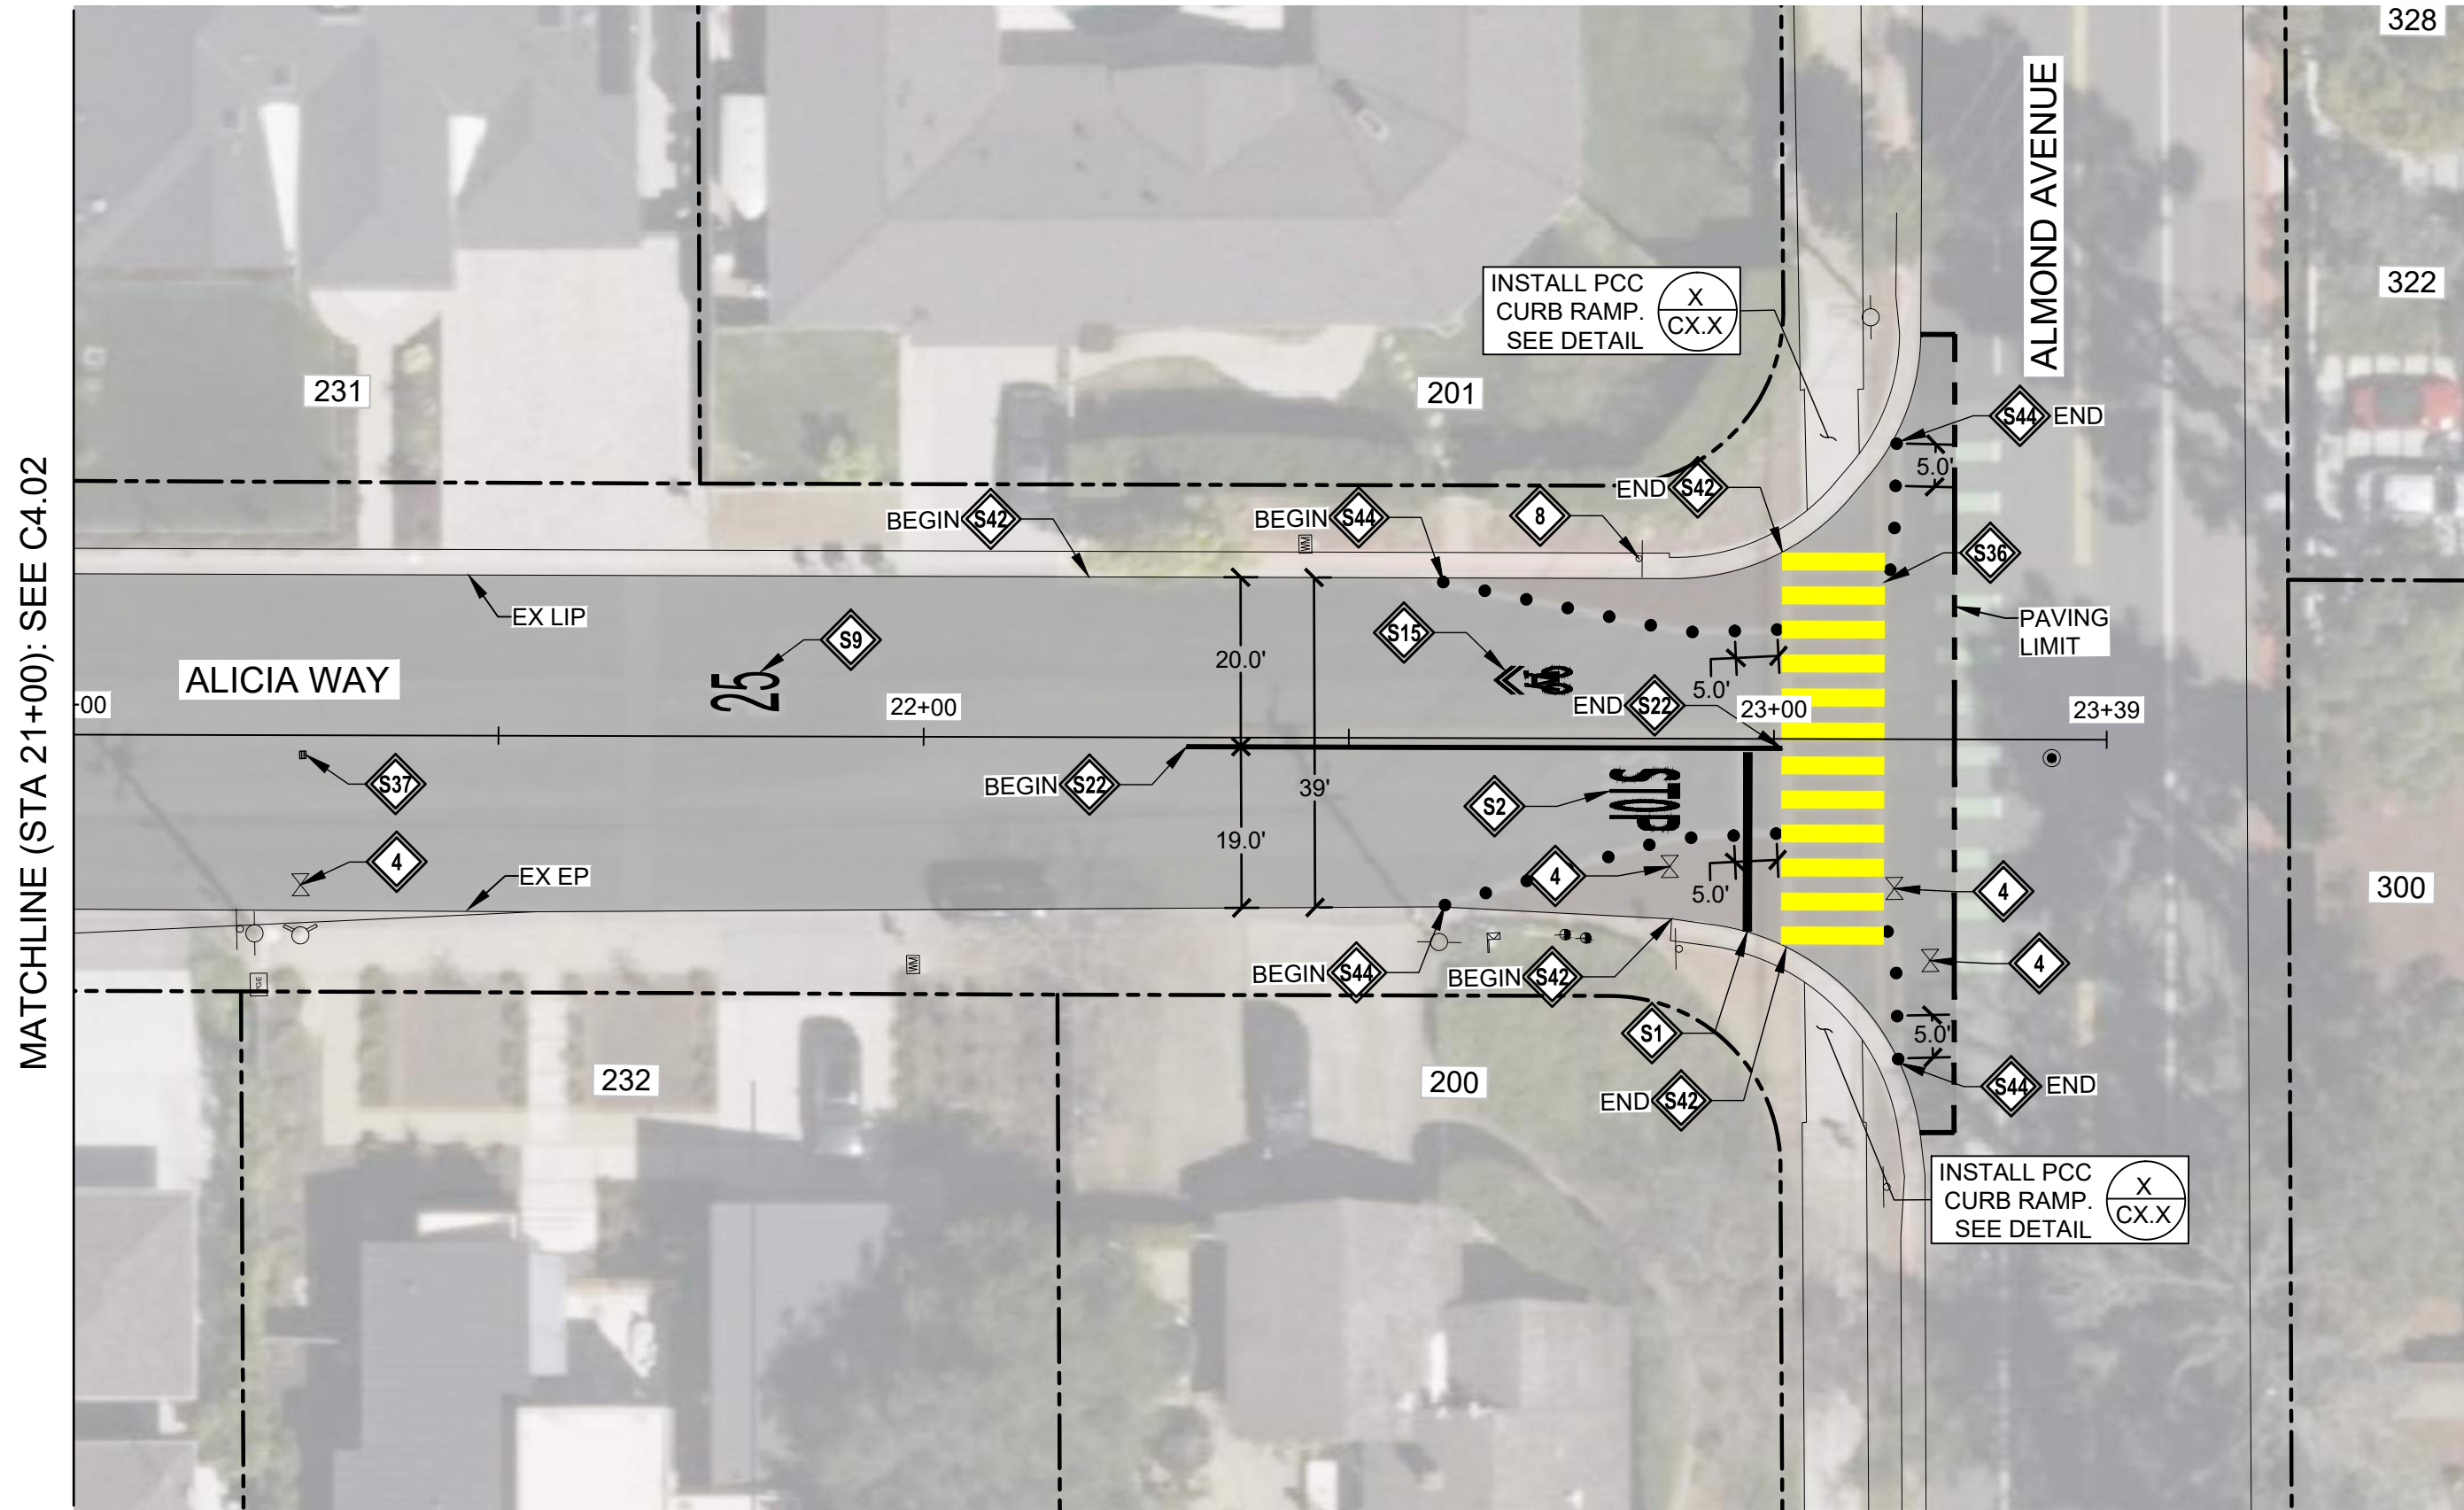- 1

LOWER & RESTORE TO GRADE STORM MANHOLE
- 2

LOWER & RESTORE TO GRADE SEWER MANHOLE (TEMPORARY FALSE BOTTOM TO BE INSTALLED PRIOR TO ANY MANHOLE WORK, & REMOVED AFTER)
- 3

LOWER & RESTORE TO GRADE UTILITY MANHOLE (NOTIFY & COORDINATE WITH UTILITY COMPANY PRIOR TO WORK)
- 4

LOWER & RESTORE TO GRADE WATER VALVE
- 5

LOWER & RESTORE TO GRADE GAS VALVE
- 6

LOWER & RESTORE TO GRADE UTILITY BOX
- 7

REINSTALL SURVEY MONUMENT. UNDER CALIFORNIA LICENSED SURVEYOR:
 - REFERENCE OUT PRIOR TO START OF CONSTRUCTION
 - FILE PROPER DOCUMENTATION SHOWING ORIGINAL AND REPLACEMENT MONUMENTS AFTER CONSTRUCTION

X

CX.X
- 8

INSTALL W11-1 & W16-1 SIGNS ON NEW POST. SEE DETAIL
- 9

LOWER & RESTORE TO GRADE SEWER CLEANOUT

STRIPING NOTES:

- S1

WHITE LIMIT LINE (STOP LINE)
- S2

MARKING WORD "STOP"
- S15

MARKING SHARROW
- S22

DETAIL 22
- S30

DOUBLE 6" WHITE LINE
- S36

YELLOW CONTINENTAL CROSSWALK
- S37

BLUE HYDRANT MARKER
- S42

REPAINT RED CURB
- S44

36" HIGH YELLOW FLEXIBLE CHANNELIZER

LEGEND:

- 3" AC GRIND & INLAY. SEE TYPICAL SECTIONS
- #

4" AC BASE REPAIR. REFERENCE ALLOCATION QUANTITIES TABLE THIS SHEET. SEE DETAIL
- APPROXIMATE LIMIT OF WORK
- APPROXIMATE RIGHT OF WAY

GENERAL NOTES:

1. SEE THE CURRENT VERSION OF CALTRANS STANDARD PLANS FOR PAVEMENT MARKINGS, TRAFFIC LINES, AND MARKERS.
2. A TACK COAT EMULSION SHALL BE APPLIED TO CLEAN DRY PAVEMENT BETWEEN (E) AND (N) PAVEMENT SECTIONS PRIOR TO INLAY/OVERLAY

AC BASE REPAIR ALLOCATION QUANTITIES

AC PAVEMENT REPAIR #	AREA (SF)
1	0.0
2	0.0
3	0.0
4	0.0
5	0.0
6	0.0
SUBTOTAL AREA (SF)	0.0

PAVEMENT REPAIR QUANTITY NOTES

1. ACTUAL PAVEMENT REPAIR EXTENTS AND QUANTITIES MAY VARY. ENGINEER SHALL DETERMINE PAVEMENT REPAIR EXTENTS AFTER COLD PLANE OPERATIONS ARE COMPLETE AND PRIOR TO PAVING.

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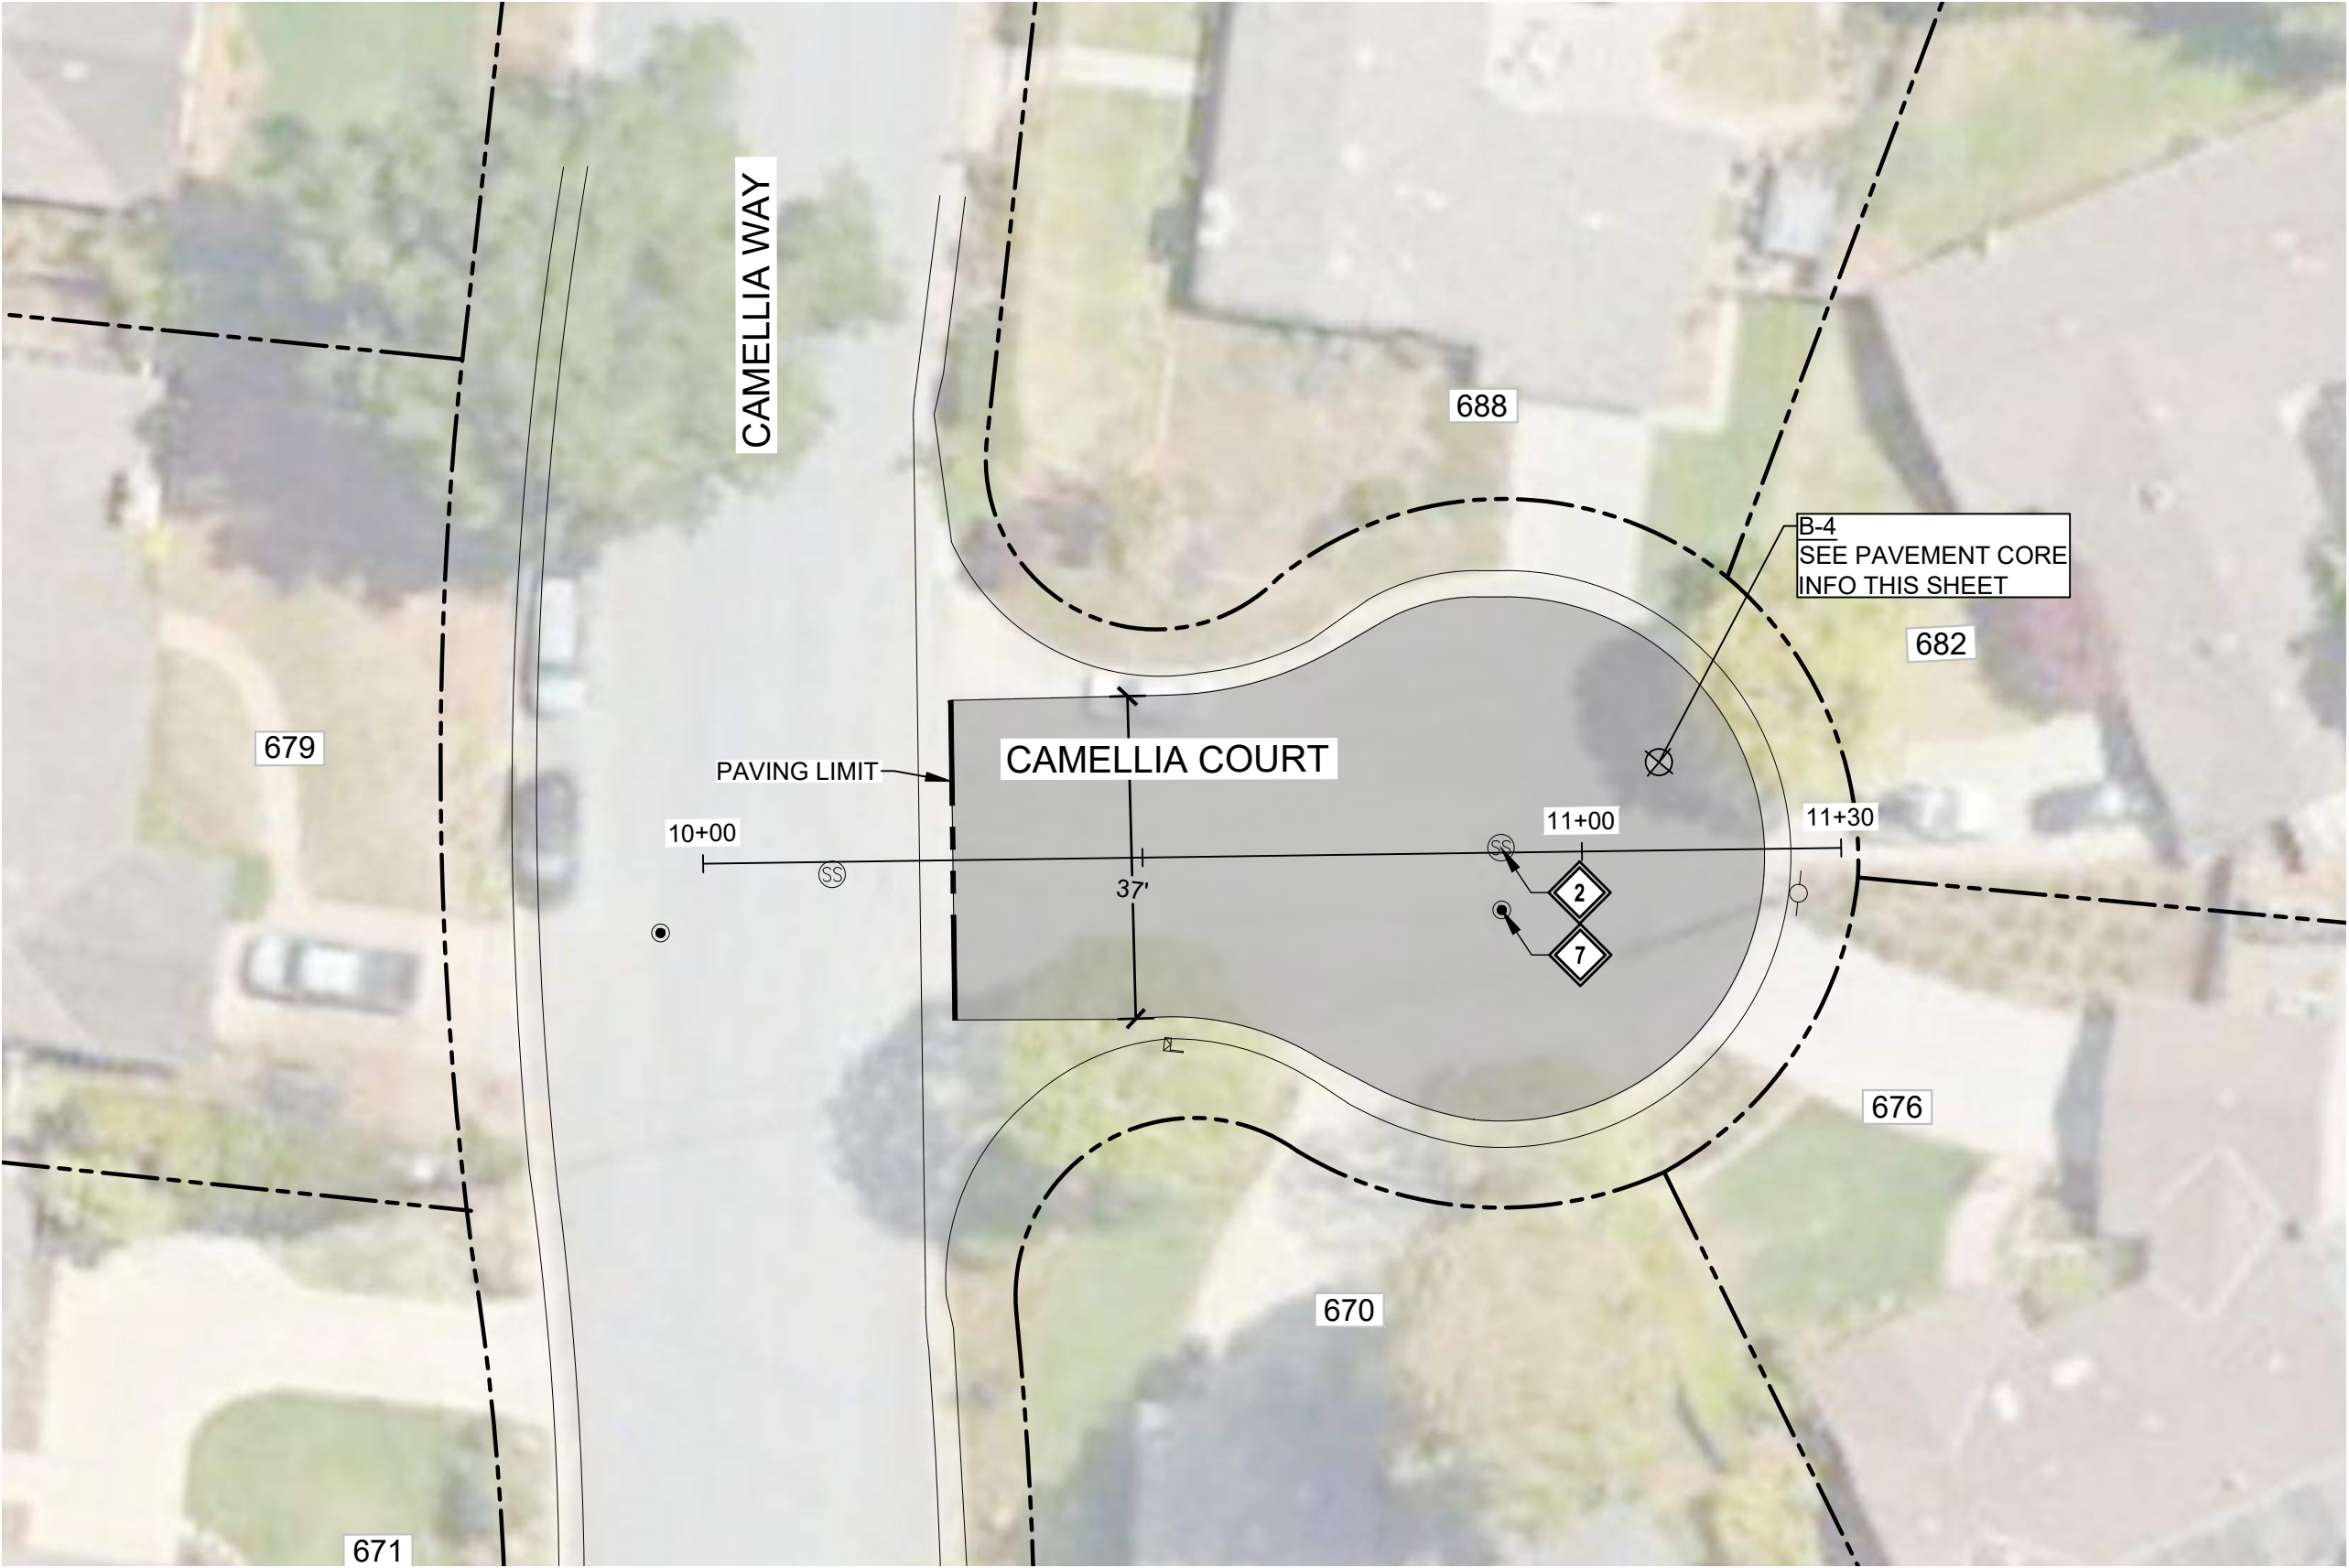
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Days Before You
Dig!




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CONSTRUCTION NOTES:

- 1 LOWER & RESTORE TO GRADE STORM MANHOLE
- 2 LOWER & RESTORE TO GRADE SEWER MANHOLE (TEMPORARY FALSE BOTTOM TO BE INSTALLED PRIOR TO ANY MANHOLE WORK, & REMOVED AFTER)
- 3 LOWER & RESTORE TO GRADE UTILITY MANHOLE (NOTIFY & COORDINATE WITH UTILITY COMPANY PRIOR TO WORK)
- 4 LOWER & RESTORE TO GRADE WATER VALVE
- 5 LOWER & RESTORE TO GRADE GAS VALVE
- 6 LOWER & RESTORE TO GRADE UTILITY BOX
- 7 REINSTALL SURVEY MONUMENT. UNDER CALIFORNIA LICENSED SURVEYOR:
 - REFERENCE OUT PRIOR TO START OF CONSTRUCTION
 - FILE PROPER DOCUMENTATION SHOWING ORIGINAL AND REPLACEMENT MONUMENTS AFTER CONSTRUCTION
- 8 SEE DETAIL
- 9 INSTALL W11-1 & W16-1 SIGNS ON NEW POST. SEE DETAIL
- 10 LOWER & RESTORE TO GRADE SEWER CLEANOUT



PAVEMENT REPAIR SITE - CAMELLIA COURT

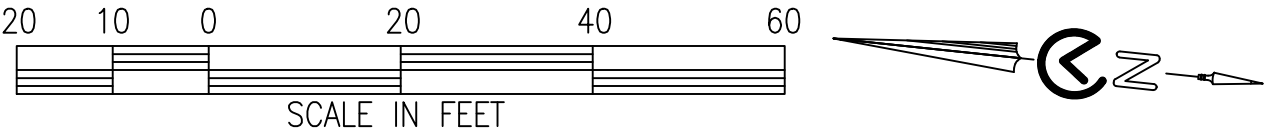

LEGEND:

- 3" AC GRIND & INLAY. SEE TYPICAL SECTIONS
- 4" AC BASE REPAIR. REFERENCE ALLOCATION QUANTITIES TABLE THIS SHEET. SEE DETAIL
- APPROXIMATE LIMIT OF WORK
- APPROXIMATE RIGHT OF WAY

PAVEMENT CORING LOG

CORE #	SUBGRADE	AC (IN)	AB (IN)	FABRIC ²
B-4	SILTY SAND / SAND WITH SILT (SM/SP)	3.5	5.0	N/A

PAVEMENT CORING NOTES

1. PAVEMENT CORING WAS PERFORMED IN SELECT LOCATIONS AND IS NOT REPRESENTATIVE OF ALL EXISTING PAVEMENT CONDITIONS WITHIN THE WORK LIMITS.
2. PAVEMENT TO BE COLD PLANED OR REMOVED MAY CONTAIN PAVEMENT FABRIC. PAVEMENT BORINGS ARE NOT REPRESENTATIVE OF ENTIRE STREET WORK LIMITS. ANY ASSUMPTION OF THE PRESENCE OF PAVEMENT FABRIC SHALL BE AT THE CONTRACTOR'S SOLE RISK. THERE SHALL BE NO ADJUSTMENT IN COMPENSATION TO THE CONTRACTOR FOR COLD PLANING, REMOVING, AND DISPOSING AC PAVEMENT THAT CONTAINS PAVEMENT FABRIC.

GENERAL NOTES:

1. SEE THE CURRENT VERSION OF CALTRANS STANDARD PLANS FOR PAVEMENT MARKINGS, TRAFFIC LINES, AND MARKERS.
2. A TACK COAT EMULSION SHALL BE APPLIED TO CLEAN DRY PAVEMENT BETWEEN (E) AND (N) PAVEMENT SECTIONS PRIOR TO INLAY/OVERLAY

AC BASE REPAIR ALLOCATION QUANTITIES

AC PAVEMENT REPAIR #	AREA (SF)
1	0.0
2	0.0
3	0.0
4	0.0
5	0.0
6	0.0
SUBTOTAL AREA (SF)	0.0

PAVEMENT REPAIR QUANTITY NOTES

1. ACTUAL PAVEMENT REPAIR EXTENTS AND QUANTITIES MAY VARY. ENGINEER SHALL DETERMINE PAVEMENT REPAIR EXTENTS AFTER COLD PLANE OPERATIONS ARE COMPLETE AND PRIOR TO PAVING.

Agenda Item 1.

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DATE

BY

CITY OF LOS ALTOS
1 NORTH SAN ANTONIO ROAD
CALIFORNIA 94022

2024-2025 ANNUAL STREET RESURFACING PROJECT

IMPROVEMENT PLAN - CAMELLIA COURT
10+00 to 11+30

LOS ALTOS

SANTA CLARA COUNTY

CALIFORNIA

DWG NO.

C4.04

11 OF 50


JOB NO.

250007

65% SUBMITTAL

APRIL 07, 2025

39

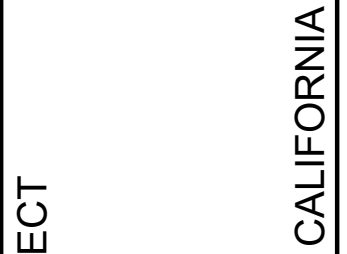

 INSTALL W11-1 & W16-1 SIGNS ON NEW POST. SEE DETAIL

 REPAINT WHITE CURB

— — — — — APPROXIMATE LIMIT OF WORK


2. A TACK COAT EMULSION SHALL BE APPLIED TO CLEAN DRY PAVEMENT BETWEEN (E) AND (N) PAVEMENT SECTIONS PRIOR TO INLAY/OVERLAY

1. ACTUAL PAVEMENT REPAIR EXTENTS AND QUANTITIES MAY VARY. ENGINEER SHALL DETERMINE PAVEMENT REPAIR EXTENTS AFTER COLD PLANE OPERATIONS ARE COMPLETE AND PRIOR TO PAVING.



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APRIL 07, 2025

MATCHLINE (STA 15+00): SEE C4.05

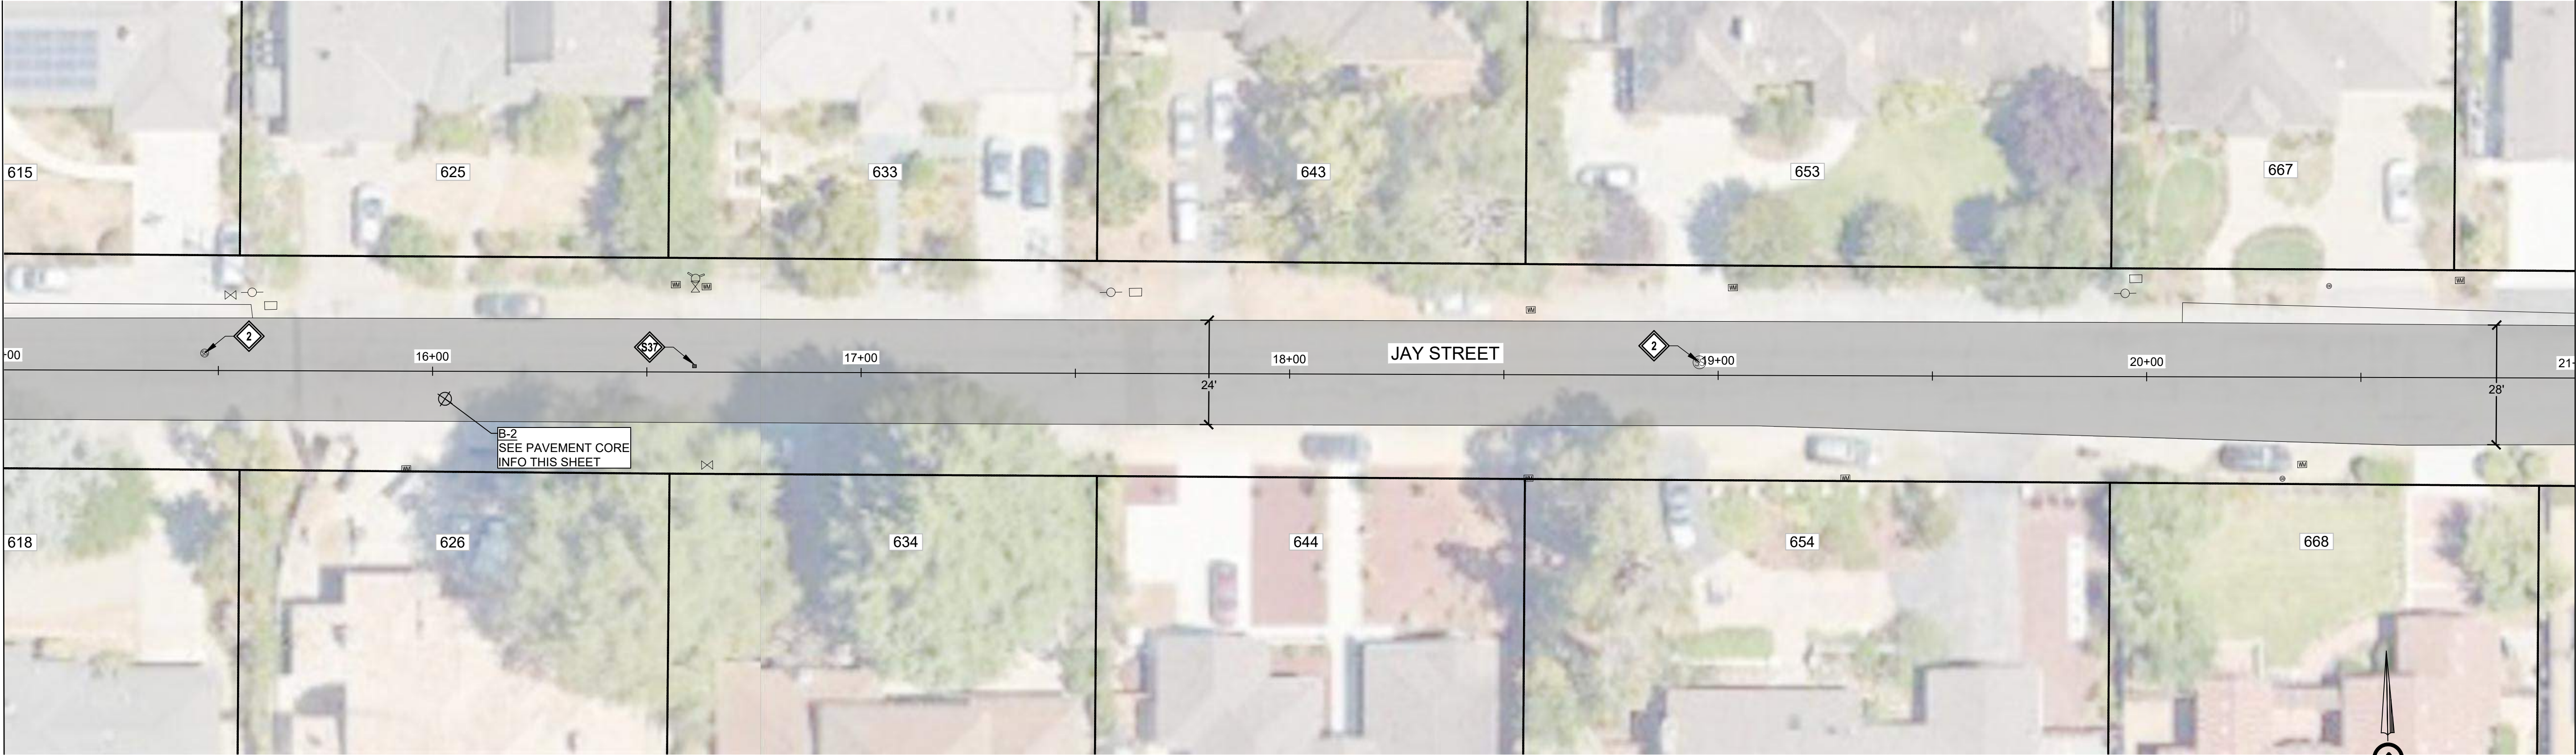

MATCHLINE (STA 21+00): SEE C4.07

PAVEMENT REPAIR SITE - JAY STREET

CONSTRUCTION NOTES:

- 1 LOWER & RESTORE TO GRADE STORM MANHOLE
- 2 LOWER & RESTORE TO GRADE SEWER MANHOLE (TEMPORARY FALSE BOTTOM TO BE INSTALLED PRIOR TO ANY MANHOLE WORK, & REMOVED AFTER)
- 3 LOWER & RESTORE TO GRADE UTILITY MANHOLE (NOTIFY & COORDINATE WITH UTILITY COMPANY PRIOR TO WORK)
- 4 LOWER & RESTORE TO GRADE WATER VALVE
- 5 LOWER & RESTORE TO GRADE GAS VALVE
- 6 LOWER & RESTORE TO GRADE UTILITY BOX
- 7 REINSTALL SURVEY MONUMENT. UNDER CALIFORNIA LICENSED SURVEYOR:
 - REFERENCE OUT PRIOR TO START OF CONSTRUCTION
 - FILE PROPER DOCUMENTATION SHOWING ORIGINAL AND REPLACEMENT MONUMENTS AFTER CONSTRUCTION
- 8 INSTALL W11-1 & W16-1 SIGNS ON NEW POST. SEE DETAIL
- 9 LOWER & RESTORE TO GRADE SEWER CLEANOUT

STRIPING NOTES:

- \$1 WHITE LIMIT LINE (STOP LINE)
- \$2 MARKING WORD "STOP"
- \$3 MARKING WORD "AHEAD"
- \$8 MARKING "25"
- \$13 MARKING ARROW TYPE IV (R)
- \$22 DETAIL 22
- \$36 YELLOW CONTINENTAL CROSSWALK
- \$37 BLUE HYDRANT MARKER
- \$43 REPAINT WHITE CURB

LEGEND:

- 3" AC GRIND & INLAY. SEE TYPICAL SECTIONS
- 4" AC BASE REPAIR. REFERENCE ALLOCATION QUANTITIES TABLE THIS SHEET. SEE DETAIL
- APPROXIMATE LIMIT OF WORK
- APPROXIMATE RIGHT OF WAY

GENERAL NOTES:

- SEE THE CURRENT VERSION OF CALTRANS STANDARD PLANS FOR PAVEMENT MARKINGS, TRAFFIC LINES, AND MARKERS.
- A TACK COAT EMULSION SHALL BE APPLIED TO CLEAN DRY PAVEMENT BETWEEN (E) AND (N) PAVEMENT SECTIONS PRIOR TO INLAY/OVERLAY

AC BASE REPAIR ALLOCATION QUANTITIES

AC PAVEMENT REPAIR #	AREA (SF)
1	0.0
2	0.0
3	0.0
4	0.0
5	0.0
6	0.0
SUBTOTAL AREA (SF)	0.0

PAVEMENT REPAIR QUANTITY NOTES

- ACTUAL PAVEMENT REPAIR EXTENTS AND QUANTITIES MAY VARY. ENGINEER SHALL DETERMINE PAVEMENT REPAIR EXTENTS AFTER COLD PLANE OPERATIONS ARE COMPLETE AND PRIOR TO PAVING.

PAVEMENT CORING LOG

CORE #	SUBGRADE	AC (IN)	AB (IN)	FABRIC ²
B-2	CLAYEY SAND (SC)	5.0	2.0	N/A

PAVEMENT CORING NOTES

- PAVEMENT CORING WAS PERFORMED IN SELECT LOCATIONS AND IS NOT REPRESENTATIVE OF ALL EXISTING PAVEMENT CONDITIONS WITHIN THE WORK LIMITS.
- PAVEMENT TO BE COLD PLANED OR REMOVED MAY CONTAIN PAVEMENT FABRIC. PAVEMENT BORINGS ARE NOT REPRESENTATIVE OF ENTIRE STREET WORK LIMITS. ANY ASSUMPTION OF THE PRESENCE OF PAVEMENT FABRIC SHALL BE AT THE CONTRACTOR'S SOLE RISK. THERE SHALL BE NO ADJUSTMENT IN COMPENSATION TO THE CONTRACTOR FOR COLD PLANING, REMOVING, AND DISPOSING AC PAVEMENT THAT CONTAINS PAVEMENT FABRIC.

Call Two Working Days Before You Dig!



1-800-227-2600

65% SUBMITTAL
APRIL 07, 2025

Agenda Item 1.

REVISIONS

DATE

BY

CITY OF LOS ALTOS
1 NORTH SAN ANTONIO ROAD
CALIFORNIA 94022

2024-2025 ANNUAL STREET RESURFACING PROJECT

IMPROVEMENT PLAN - JAY STREET
15+00 to 21+00

LOS ALTOS

SANTA CLARA COUNTY

CALIFORNIA

DWG NO.

C4.06

13 OF 50

JOB NO.
250007

Call Two Working
Days Before You
Dig!



CONSTRUCTION NOTES:

- 1 LOWER & RESTORE TO GRADE STORM MANHOLE
- 2 LOWER & RESTORE TO GRADE SEWER MANHOLE (TEMPORARY FALSE BOTTOM TO BE INSTALLED PRIOR TO ANY MANHOLE WORK, & REMOVED AFTER)
- 3 LOWER & RESTORE TO GRADE UTILITY MANHOLE (NOTIFY & COORDINATE WITH UTILITY COMPANY PRIOR TO WORK)
- 4 LOWER & RESTORE TO GRADE WATER VALVE
- 5 LOWER & RESTORE TO GRADE GAS VALVE
- 6 LOWER & RESTORE TO GRADE UTILITY BOX
- 7 REINSTALL SURVEY MONUMENT. UNDER CALIFORNIA LICENSED SURVEYOR:
 - REFERENCE OUT PRIOR TO START OF CONSTRUCTION
 - FILE PROPER DOCUMENTATION SHOWING ORIGINAL AND REPLACEMENT MONUMENTS AFTER CONSTRUCTION
 - SEE DETAIL
- 8 INSTALL W11-1 & W16-1 SIGNS ON NEW POST. SEE DETAIL
- 9 LOWER & RESTORE TO GRADE SEWER CLEANOUT

STRIPING NOTES:

- S1 WHITE LIMIT LINE (STOP LINE)
- S2 MARKING WORD "STOP"
- S3 MARKING WORD "AHEAD"
- S5 MARKING "25"
- S13 MARKING ARROW TYPE IV (R)
- S22 DETAIL 22
- S36 YELLOW CONTINENTAL CROSSWALK
- S37 BLUE HYDRANT MARKER
- S43 REPAINT WHITE CURB

LEGEND:

- 3" AC GRIND & INLAY. SEE TYPICAL SECTIONS
- 4" AC BASE REPAIR. REFERENCE ALLOCATION QUANTITIES TABLE THIS SHEET. SEE DETAIL
- APPROXIMATE LIMIT OF WORK
- APPROXIMATE RIGHT OF WAY

GENERAL NOTES:


1. SEE THE CURRENT VERSION OF CALTRANS STANDARD PLANS FOR PAVEMENT MARKINGS, TRAFFIC LINES, AND MARKERS.
2. A TACK COAT EMULSION SHALL BE APPLIED TO CLEAN DRY PAVEMENT BETWEEN (E) AND (N) PAVEMENT SECTIONS PRIOR TO INLAY/OVERLAY

AC BASE REPAIR ALLOCATION QUANTITIES

AC PAVEMENT REPAIR #	AREA (SF)
1	0.0
2	0.0
3	0.0
4	0.0
5	0.0
6	0.0
SUBTOTAL AREA (SF)	0.0

PAVEMENT REPAIR QUANTITY NOTES

1. ACTUAL PAVEMENT REPAIR EXTENTS AND QUANTITIES MAY VARY. ENGINEER SHALL DETERMINE PAVEMENT REPAIR EXTENTS AFTER COLD PLANE OPERATIONS ARE COMPLETE AND PRIOR TO PAVING.

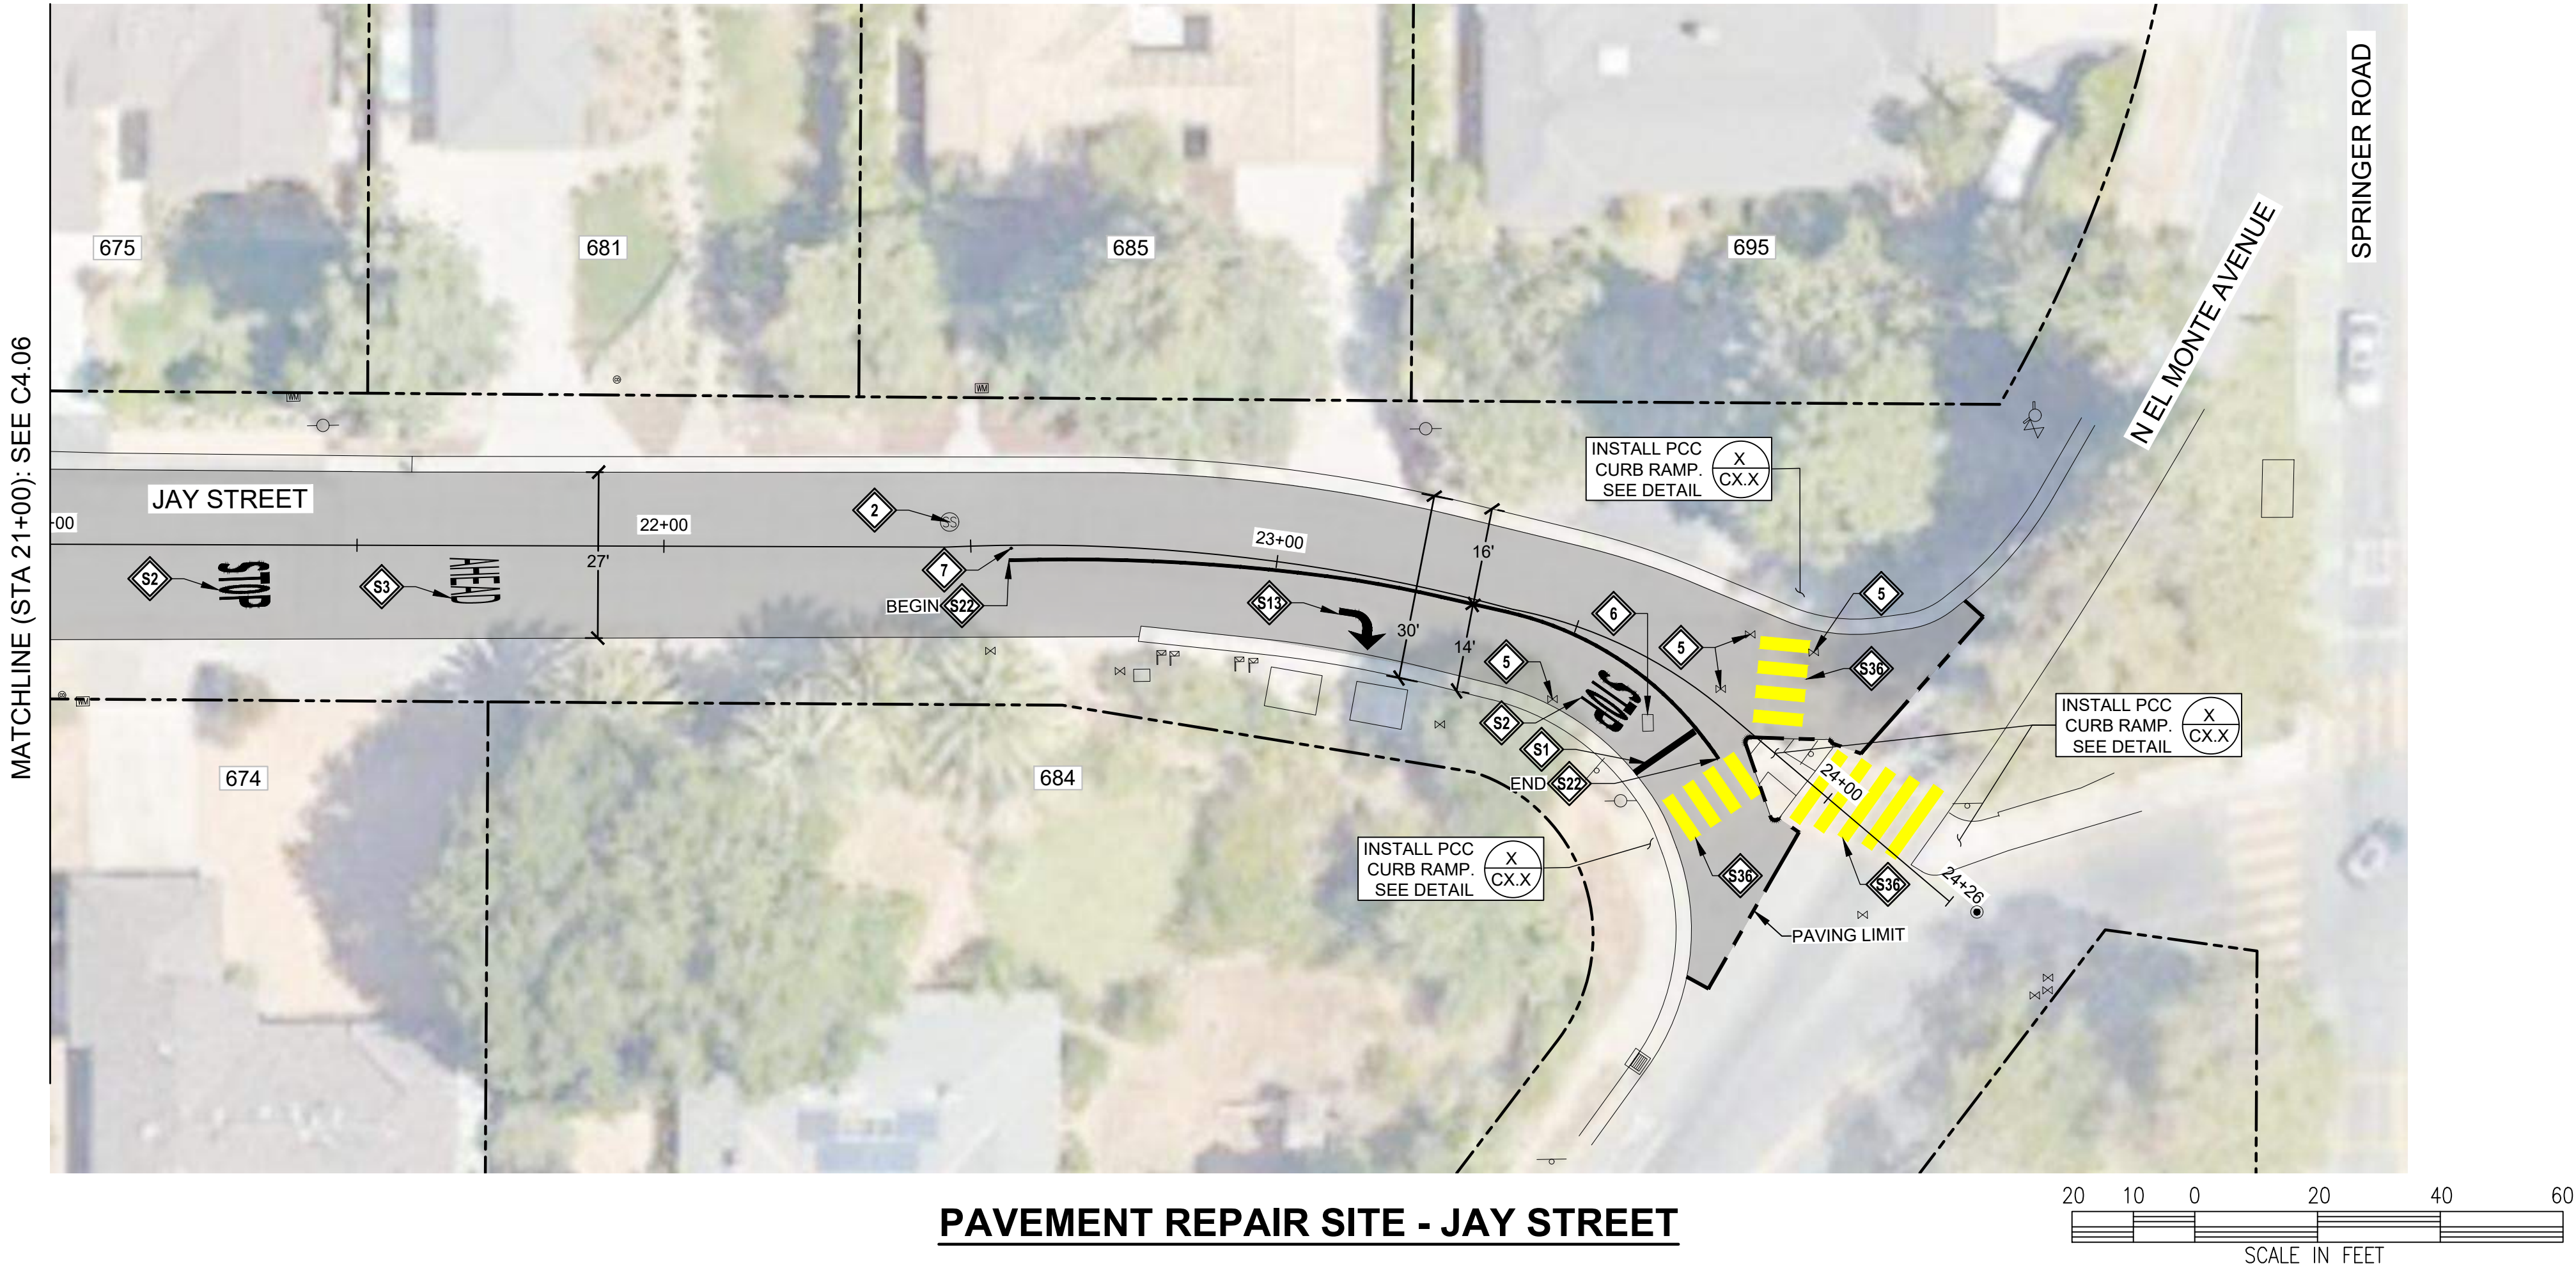

Agenda Item 1.

REVISIONS

DATE

BY

CITY OF LOS ALTOS
1 NORTH SAN ANTONIO ROAD
CALIFORNIA 94022

REGISTERED PROFESSIONAL ENGINEER
JOSEPH AVUCAP
No. 87131
CIVIL
STATE OF CALIFORNIA

2024-2025 ANNUAL STREET RESURFACING PROJECT

IMPROVEMENT PLAN - JAY STREET
21+00 to 24+26

LOS ALTOS

SANTA CLARA COUNTY

CALIFORNIA



DWG NO.
C4.07

14 OF 50

JOB NO.
250007

65% SUBMITTAL
APRIL 07, 2025

42

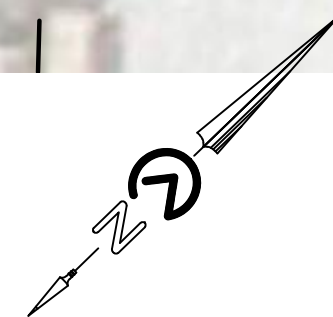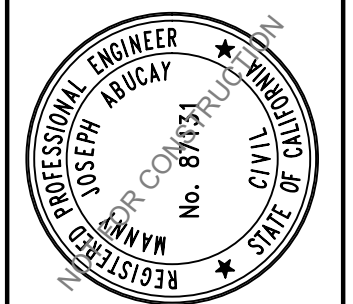


1. ACTUAL PAVEMENT REPAIR EXTENTS AND QUANTITIES MAY VARY. ENGINEER SHALL DETERMINE PAVEMENT REPAIR EXTENTS AFTER COLD PLANE OPERATIONS ARE COMPLETE AND PRIOR TO PAVING.



65% SUBMITTAL
APRIL 07, 2025



CITY OF LOS ALTOS
1 NORTH SAN ANTONIO ROAD
CALIFORNIA 94022

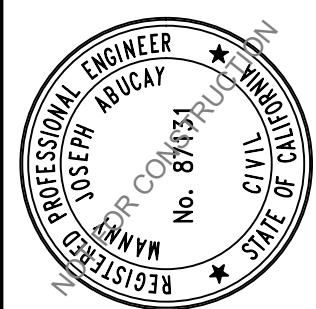

2024-2025 ANNUAL STREET RESURFACING PROJECT

ENT PLAN - LAVER COURT
14+50 to 17+00

SANTA CLARA COUNTY

LOS ALTOS


DWG NO.

C4.09



16 OF 50

250007

44

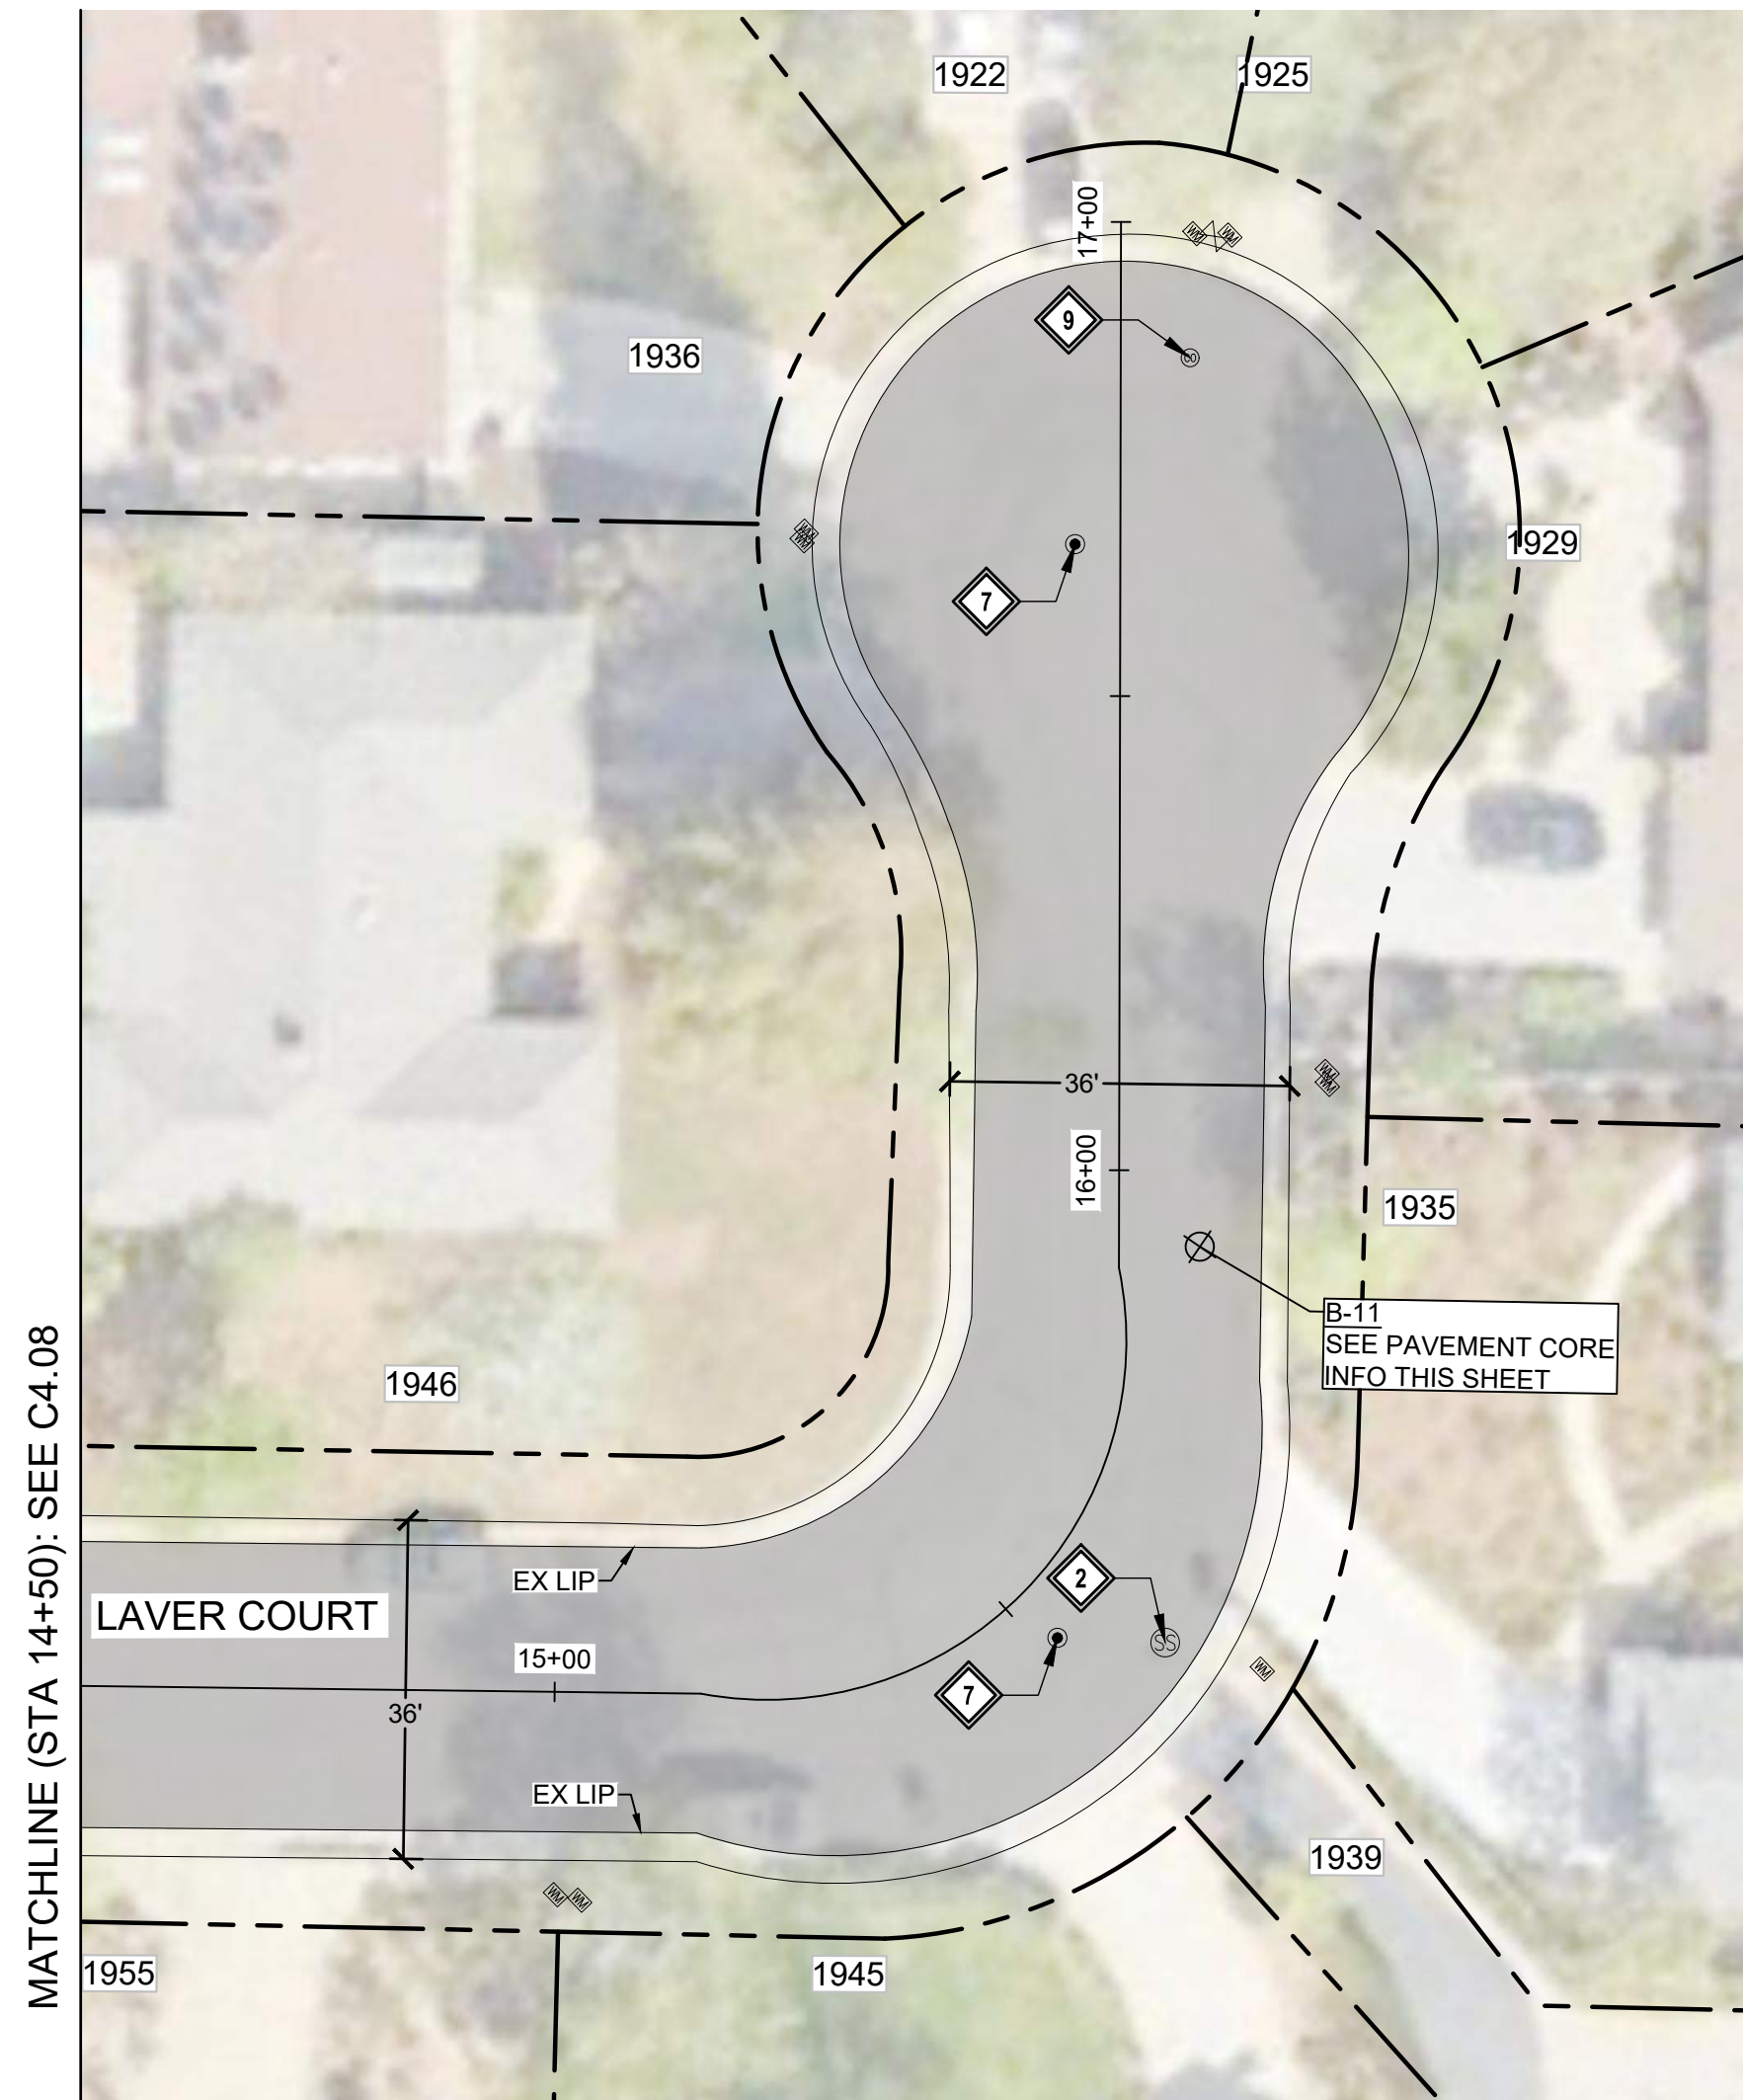

PAVEMENT REPAIR SITE - LAVER COURT

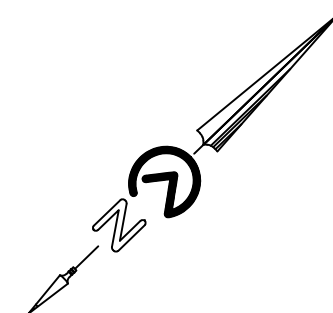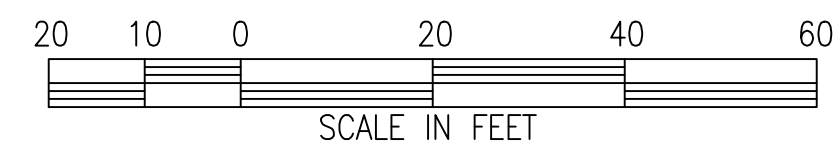

- 1 LOWER & RESTORE TO GRADE STORM MANHOLE
- 2 LOWER & RESTORE TO GRADE SEWER MANHOLE (TEMPORARY FALSE BOTTOM TO BE INSTALLED PRIOR TO ANY MANHOLE WORK, & REMOVED AFTER)
- 3 LOWER & RESTORE TO GRADE UTILITY MANHOLE (NOTIFY & COORDINATE WITH UTILITY COMPANY PRIOR TO WORK)
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- 5 LOWER & RESTORE TO GRADE GAS VALVE
- 6 LOWER & RESTORE TO GRADE UTILITY BOX
- 7 REINSTALL SURVEY MONUMENT. UNDER CALIFORNIA LICENSED SURVEYOR:
 - REFERENCE OUT PRIOR TO START OF CONSTRUCTION
 - FILE PROPER DOCUMENTATION SHOWING ORIGINAL AND REPLACEMENT MONUMENTS AFTER CONSTRUCTION
- 8 • SEE DETAIL 
- 9 INSTALL W11-1 & W16-1 SIGNS ON NEW POST. SEE DETAIL
- 9 LOWER & RESTORE TO GRADE SEWER CLEANOUT

	WHITE LIMIT LINE (STOP LINE)
	MARKING WORD "STOP"
	YELLOW CONTINENTAL CROSSWALK
	BLUE HYDRANT MARKER

-  3" AC GRIND & INLAY. SEE TYPICAL SECTIONS
-  4" AC BASE REPAIR. REFERENCE ALLOCATION QUANTITIES TABLE THIS SHEET. SEE DETAIL 
-  APPROXIMATE LIMIT OF WORK
-  APPROXIMATE RIGHT OF WAY


1. SEE THE CURRENT VERSION OF CALTRANS STANDARD PLANS FOR PAVEMENT MARKINGS, TRAFFIC LINES, AND MARKERS.
2. A TACK COAT EMULSION SHALL BE APPLIED TO CLEAN DRY PAVEMENT BETWEEN (E) AND (N) PAVEMENT SECTIONS PRIOR TO INLAY/OVERLAY

AC PAVEMENT REPAIR #	AREA (SF)
1	0.0
2	0.0
3	0.0
4	0.0
5	0.0
6	0.0
SUBTOTAL AREA (SF)	0.0

1. ACTUAL PAVEMENT REPAIR EXTENTS AND QUANTITIES MAY VARY. ENGINEER SHALL DETERMINE PAVEMENT REPAIR EXTENTS AFTER COLD PLANE OPERATIONS ARE COMPLETE AND PRIOR TO PAVING.

CORE #	SUBGRADE	AC (IN)	AB (IN)	FABRIC ²
B-11	CLAY WITH SAND AND GRAVEL (CL/CH)	3.0	4.0	N/A

1. PAVEMENT CORING WAS PERFORMED IN SELECT LOCATIONS AND IS NOT REPRESENTATIVE OF ALL EXISTING PAVEMENT CONDITIONS WITHIN THE WORK LIMITS.
2. PAVEMENT TO BE COLD PLANNED OR REMOVED MAY CONTAIN PAVEMENT FABRIC. PAVEMENT BORINGS ARE NOT REPRESENTATIVE OF ENTIRE STREET WORK LIMITS. ANY ASSUMPTION OF THE PRESENCE OF PAVEMENT FABRIC SHALL BE AT THE CONTRACTOR'S SOLE RISK. THERE SHALL BE NO ADJUSTMENT IN COMPENSATION TO THE CONTRACTOR FOR COLD PLANNING, REMOVING, AND DISPOSING AC PAVEMENT THAT CONTAINS PAVEMENT FABRIC.

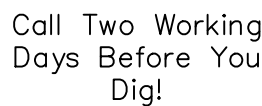


1-800-227-2600

65% SUBMITTAL
APRIL 07, 2025



PAVEMENT REPAIR SITE - LOMA PRIETA COURT

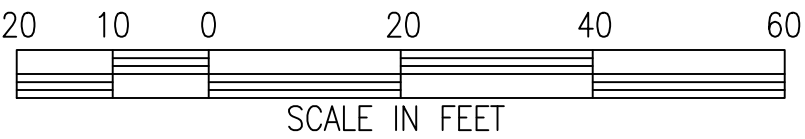

CONSTRUCTION NOTES:

- 1 LOWER & RESTORE TO GRADE STORM MANHOLE
- 2 LOWER & RESTORE TO GRADE SEWER MANHOLE (TEMPORARY FALSE BOTTOM TO BE INSTALLED PRIOR TO ANY MANHOLE WORK, & REMOVED AFTER)
- 3 LOWER & RESTORE TO GRADE UTILITY MANHOLE (NOTIFY & COORDINATE WITH UTILITY COMPANY PRIOR TO WORK)
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- 7 REINSTALL SURVEY MONUMENT. UNDER CALIFORNIA LICENSED SURVEYOR:
 - REFERENCE OUT PRIOR TO START OF CONSTRUCTION
 - FILE PROPER DOCUMENTATION SHOWING ORIGINAL AND REPLACEMENT MONUMENTS AFTER CONSTRUCTION
- 8 INSTALL W11-1 & W16-1 SIGNS ON NEW POST. SEE DETAIL
- 9 LOWER & RESTORE TO GRADE SEWER CLEANOUT

STRIPING NOTES:

- S1 WHITE LIMIT LINE (STOP LINE)
- S2 WHITE "STOP" MARKING

LEGEND:

- 3" AC GRIND & INLAY. SEE TYPICAL SECTIONS
- 4" AC BASE REPAIR. REFERENCE ALLOCATION QUANTITIES TABLE THIS SHEET. SEE DETAIL
- APPROXIMATE LIMIT OF WORK
- APPROXIMATE RIGHT OF WAY

GENERAL NOTES:

- SEE THE CURRENT VERSION OF CALTRANS STANDARD PLANS FOR PAVEMENT MARKINGS, TRAFFIC LINES, AND MARKERS.
- A TACK COAT EMULSION SHALL BE APPLIED TO CLEAN DRY PAVEMENT BETWEEN (E) AND (N) PAVEMENT SECTIONS PRIOR TO INLAY/OVERLAY

AC BASE REPAIR ALLOCATION QUANTITIES

AC PAVEMENT REPAIR #	AREA (SF)
1	0.0
2	0.0
3	0.0
4	0.0
5	0.0
6	0.0
SUBTOTAL AREA (SF)	0.0

PAVEMENT REPAIR QUANTITY NOTES

- ACTUAL PAVEMENT REPAIR EXTENTS AND QUANTITIES MAY VARY. ENGINEER SHALL DETERMINE PAVEMENT REPAIR EXTENTS AFTER COLD PLANE OPERATIONS ARE COMPLETE AND PRIOR TO PAVING.

PAVEMENT CORING LOG

CORE #	SUBGRADE	AC (IN)	AB (IN)	FABRIC ²
B-10	CLAYEY SAND (SC)	2.5	0.0	N/A

PAVEMENT CORING NOTES

- PAVEMENT CORING WAS PERFORMED IN SELECT LOCATIONS AND IS NOT REPRESENTATIVE OF ALL EXISTING PAVEMENT CONDITIONS WITHIN THE WORK LIMITS.
- PAVEMENT TO BE COLD PLANED OR REMOVED MAY CONTAIN PAVEMENT FABRIC. PAVEMENT BORINGS ARE NOT REPRESENTATIVE OF ENTIRE STREET WORK LIMITS. ANY ASSUMPTION OF THE PRESENCE OF PAVEMENT FABRIC SHALL BE AT THE CONTRACTOR'S SOLE RISK. THERE SHALL BE NO ADJUSTMENT IN COMPENSATION TO THE CONTRACTOR FOR COLD PLANING, REMOVING, AND DISPOSING AC PAVEMENT THAT CONTAINS PAVEMENT FABRIC.

Call Two Working
Days Before You
Dig!



1-800-227-2600

65% SUBMITTAL
APRIL 07, 2025

Agenda Item 1.

REVISIONS

DATE

BY

sanbell

Intelligent Infrastructure

Enduring Communities

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sanbell.com

CITY OF LOS ALTOS

1 NORTH SAN ANTONIO ROAD

CALIFORNIA 94022

2024-2025 ANNUAL STREET RESURFACING PROJECT

IMPROVEMENT PLAN - LOMA PRIETA COURT

10+00 to 12+00

LOS ALTOS

SANTA CLARA COUNTY

CALIFORNIA

DWG NO.

C4.10



17 OF 50

JOB NO.

250007



PAVEMENT REPAIR SITE - NEWCASTLE DRIVE

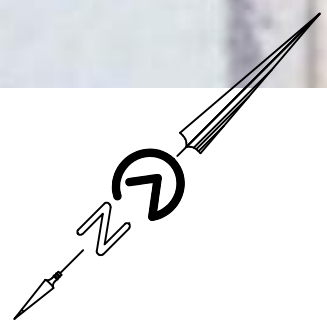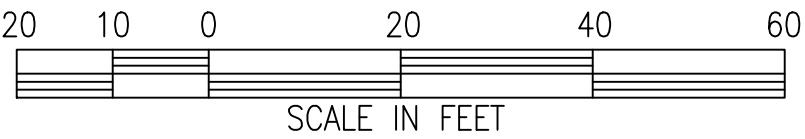

CONSTRUCTION NOTES:

- 1 LOWER & RESTORE TO GRADE STORM MANHOLE
- 2 LOWER & RESTORE TO GRADE SEWER MANHOLE (TEMPORARY FALSE BOTTOM TO BE INSTALLED PRIOR TO ANY MANHOLE WORK, & REMOVED AFTER)
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 - REFERENCE OUT PRIOR TO START OF CONSTRUCTION
 - FILE PROPER DOCUMENTATION SHOWING ORIGINAL AND REPLACEMENT MONUMENTS AFTER CONSTRUCTION
- 8 SEE DETAIL
- 9 INSTALL W11-1 & W16-1 SIGNS ON NEW POST. SEE DETAIL
- 9 LOWER & RESTORE TO GRADE SEWER CLEANOUT

STRIPING NOTES:

- S1 WHITE LIMIT LINE (STOP LINE)
- S2 MARKING WORD "STOP"
- S3 MARKING WORD "AHEAD"
- S5 MARKING WORD "XING"
- S9 MARKING "25"
- S16 MARKING BIKE LANE SYMBOL WITH ARROW & GREEN BACKING. SEE DETAIL
- S17 GREEN DASHED BIKE LANE. SEE DETAIL
- S19 DETAIL 2
- S22 DETAIL 22
- S27 DETAIL 39
- S32 WHITE BASIC CROSSWALK
- S35 WHITE CONTINENTAL CROSSWALK
- S37 BLUE HYDRANT MARKER
- S38 MARKING WORD "PED"

LEGEND:

- 3" AC GRIND & INLAY. SEE TYPICAL SECTIONS
- 4" AC BASE REPAIR. REFERENCE ALLOCATION QUANTITIES TABLE THIS SHEET.
- APPROXIMATE LIMIT OF WORK
- APPROXIMATE RIGHT OF WAY

GENERAL NOTES:

- SEE THE CURRENT VERSION OF CALTRANS STANDARD PLANS FOR PAVEMENT MARKINGS, TRAFFIC LINES, AND MARKERS.
- A TACK COAT EMULSION SHALL BE APPLIED TO CLEAN DRY PAVEMENT BETWEEN (E) AND (N) PAVEMENT SECTIONS PRIOR TO INLAY/OVERLAY

AC BASE REPAIR ALLOCATION QUANTITIES

AC PAVEMENT REPAIR #	AREA (SF)
1	0.0
2	0.0
3	0.0
4	0.0
5	0.0
6	0.0
SUBTOTAL AREA (SF)	0.0

PAVEMENT REPAIR QUANTITY NOTES

- ACTUAL PAVEMENT REPAIR EXTENTS AND QUANTITIES MAY VARY. ENGINEER SHALL DETERMINE PAVEMENT REPAIR EXTENTS AFTER COLD PLANE OPERATIONS ARE COMPLETE AND PRIOR TO PAVING.

PAVEMENT CORING LOG

CORE #	SUBGRADE	AC (IN)	AB (IN)	FABRIC ²
B-16	SILTY SAND WITH GRAVEL (SM)	5.0	2.5	N/A

PAVEMENT CORING NOTES

- PAVEMENT CORING WAS PERFORMED IN SELECT LOCATIONS AND IS NOT REPRESENTATIVE OF ALL EXISTING PAVEMENT CONDITIONS WITHIN THE WORK LIMITS.
- PAVEMENT TO BE COLD PLANED OR REMOVED MAY CONTAIN PAVEMENT FABRIC. PAVEMENT BORINGS ARE NOT REPRESENTATIVE OF ENTIRE STREET WORK LIMITS. ANY ASSUMPTION OF THE PRESENCE OF PAVEMENT FABRIC SHALL BE AT THE CONTRACTOR'S SOLE RISK. THERE SHALL BE NO ADJUSTMENT IN COMPENSATION TO THE CONTRACTOR FOR COLD PLANING, REMOVING, AND DISPOSING AC PAVEMENT THAT CONTAINS PAVEMENT FABRIC.



1-800-227-2600

65% SUBMITTAL
APRIL 07, 2025

Agenda Item 1.

REVISIONS

DATE

BY

sanbell

Intelligent Infrastructure Enduring Communities

925 • 685 • 4569

sanbell.com

CITY OF LOS ALTOS

1 NORTH SAN ANTONIO ROAD

CALIFORNIA 94022

REGISTERED PROFESSIONAL ENGINEER

JOSEPH ARICAR

NO. 87131

CIVIL

STATE OF CA

2024-2025 ANNUAL STREET RESURFACING PROJECT

IMPROVEMENT PLAN - NEWCASTLE DRIVE

10+00 TO 15+68

LOS ALTOS

SANTA CLARA COUNTY

CALIFORNIA

DWG NO.


C4.11

18 OF 50

JOB NO.

250007

MATCHLINE (STA 15+68): SEE C4.11

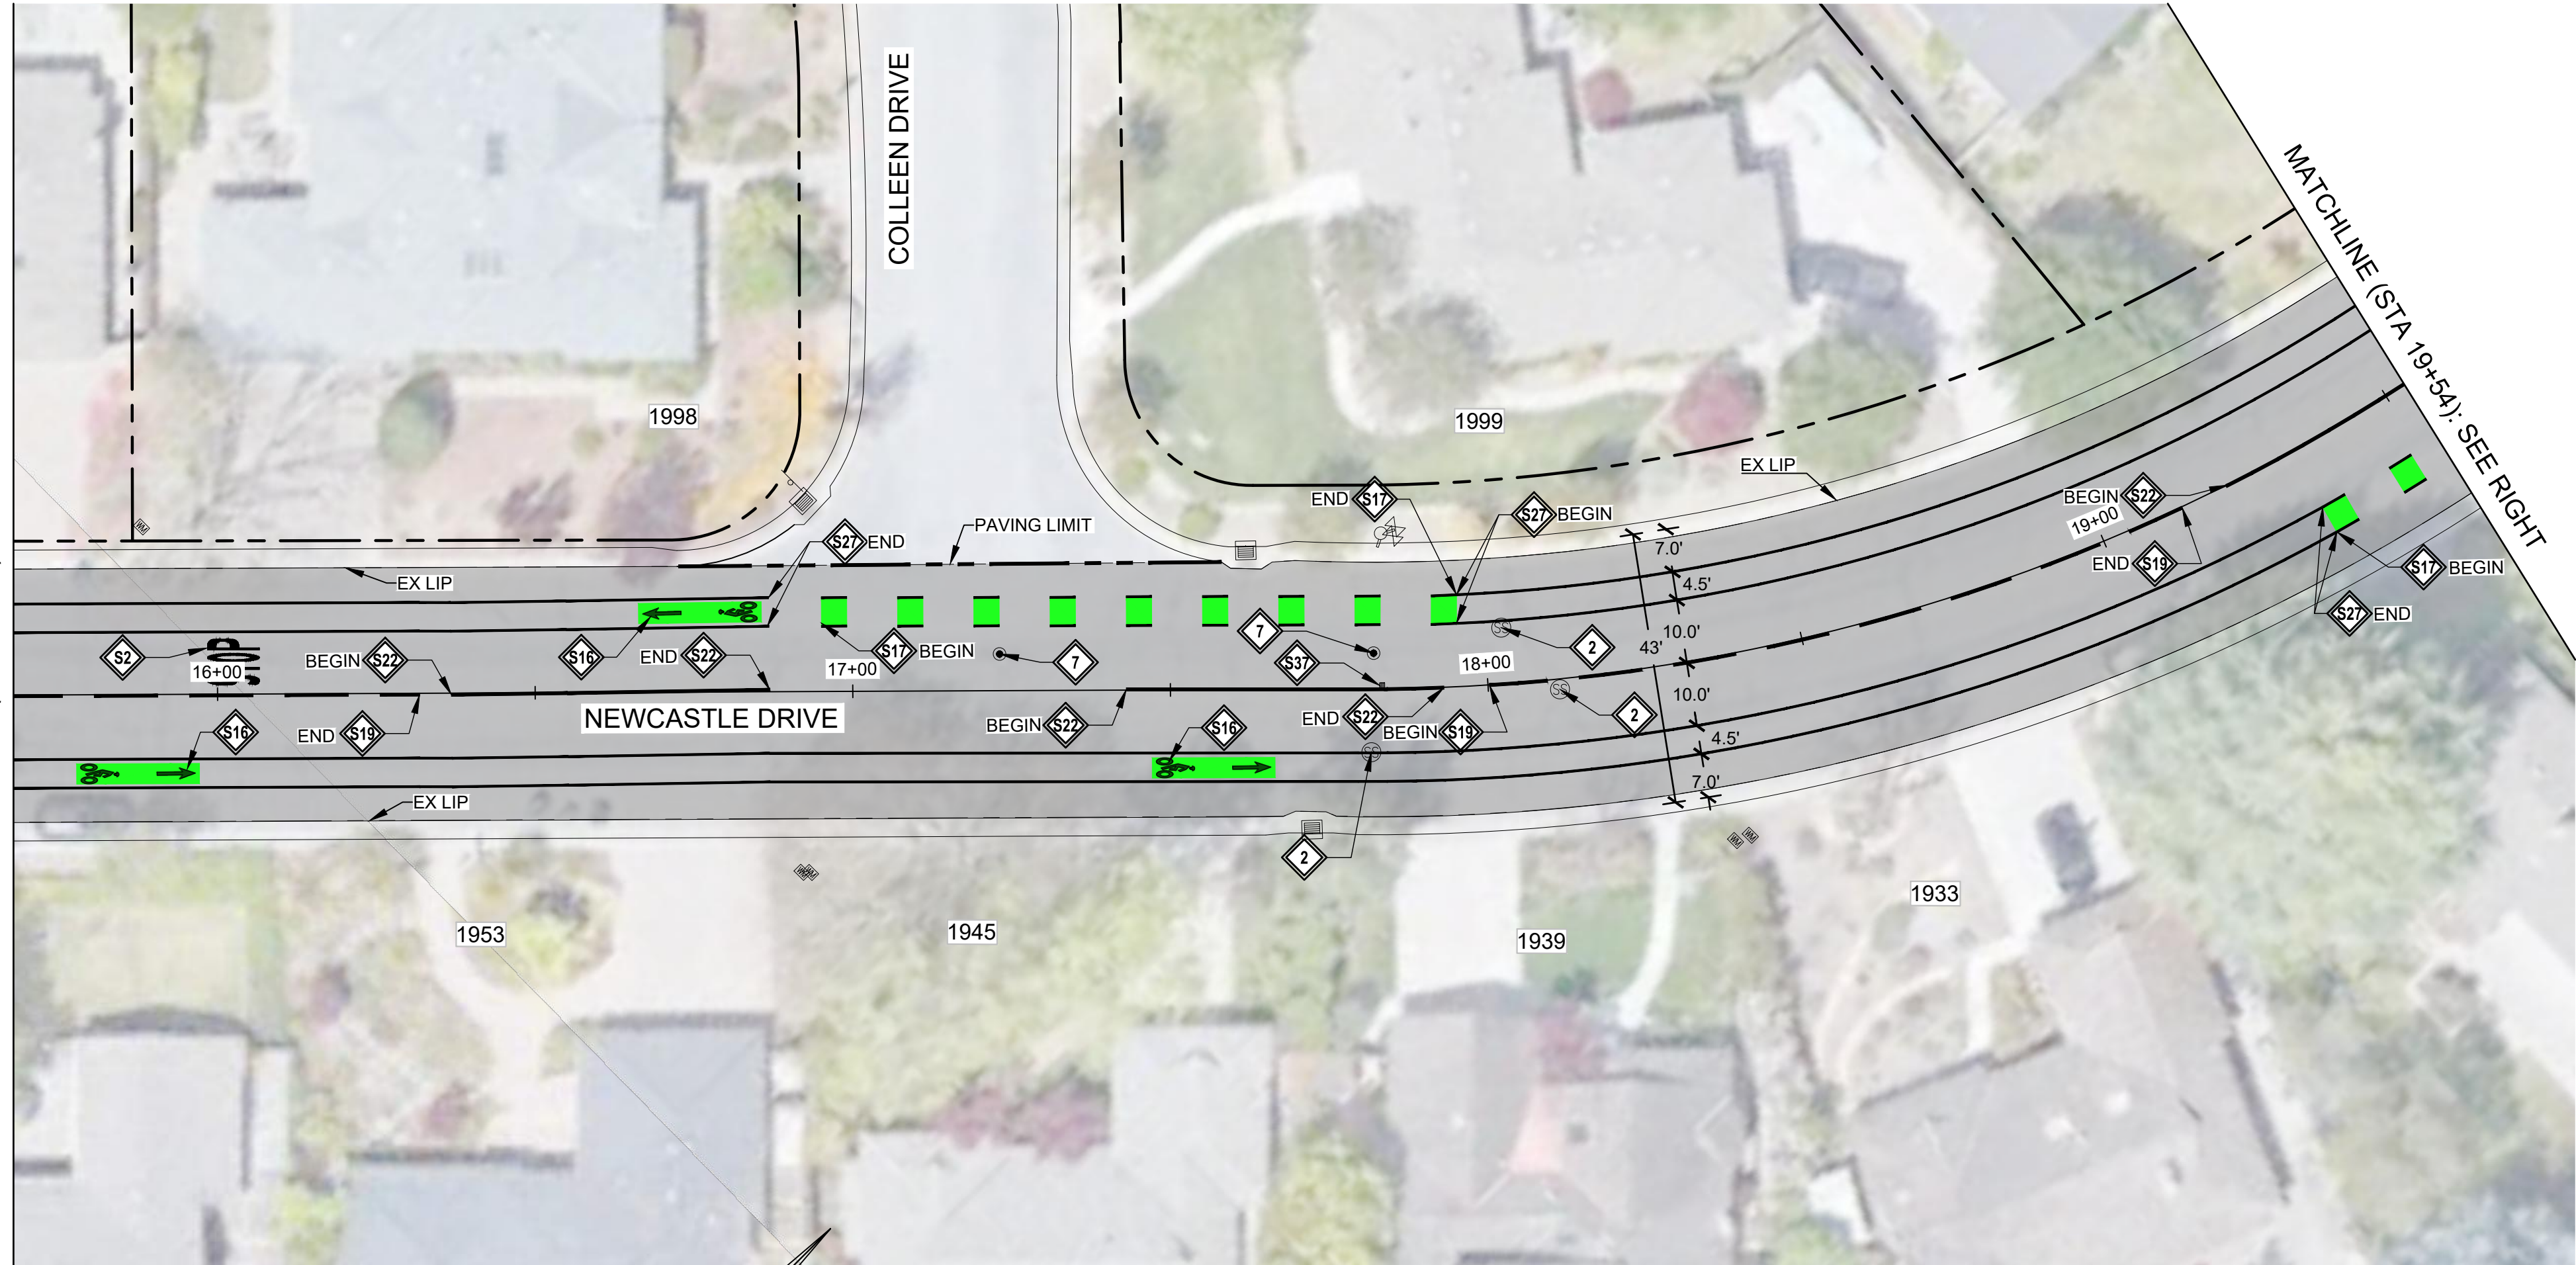

PAVEMENT REPAIR SITE - NEWCASTLE DRIVE

CONSTRUCTION NOTES:

- 1 LOWER & RESTORE TO GRADE STORM MANHOLE
- 2 LOWER & RESTORE TO GRADE SEWER MANHOLE (TEMPORARY FALSE BOTTOM TO BE INSTALLED PRIOR TO ANY MANHOLE WORK, & REMOVED AFTER)
- 3 LOWER & RESTORE TO GRADE UTILITY MANHOLE (NOTIFY & COORDINATE WITH UTILITY COMPANY PRIOR TO WORK)
- 4 LOWER & RESTORE TO GRADE WATER VALVE
- 5 LOWER & RESTORE TO GRADE GAS VALVE
- 6 LOWER & RESTORE TO GRADE UTILITY BOX
- 7 REINSTALL SURVEY MONUMENT. UNDER CALIFORNIA LICENSED SURVEYOR:
 - REFERENCE OUT PRIOR TO START OF CONSTRUCTION
 - FILE PROPER DOCUMENTATION SHOWING ORIGINAL AND REPLACEMENT MONUMENTS AFTER CONSTRUCTION
- 8 INSTALL W11-1 & W16-1 SIGNS ON NEW POST. SEE DETAIL
- 9 LOWER & RESTORE TO GRADE SEWER CLEANOUT

STRIPING NOTES:

- S1 WHITE LIMIT LINE (STOP LINE)
- S2 MARKING WORD "STOP"
- S3 MARKING WORD "AHEAD"
- S5 MARKING WORD "XING"
- S9 MARKING "25"
- S16 MARKING BIKE LANE SYMBOL WITH ARROW & GREEN BACKING. SEE DETAIL
- S17 GREEN DASHED BIKE LANE. SEE DETAIL
- S18 DETAIL 2
- S22 DETAIL 22
- S27 DETAIL 39
- S35 WHITE BASIC CROSSWALK
- S36 WHITE CONTINENTAL CROSSWALK
- S37 BLUE HYDRANT MARKER
- S38 MARKING WORD "PED"

LEGEND:

- 3" AC GRIND & INLAY. SEE TYPICAL SECTIONS
- 4" AC BASE REPAIR. REFERENCE ALLOCATION QUANTITIES TABLE THIS SHEET. SEE DETAIL
- APPROXIMATE LIMIT OF WORK
- APPROXIMATE RIGHT OF WAY

GENERAL NOTES:



- SEE THE CURRENT VERSION OF CALTRANS STANDARD PLANS FOR PAVEMENT MARKINGS, TRAFFIC LINES, AND MARKERS.
- A TACK COAT EMULSION SHALL BE APPLIED TO CLEAN DRY PAVEMENT BETWEEN (E) AND (N) PAVEMENT SECTIONS PRIOR TO INLAY/OVERLAY

AC BASE REPAIR ALLOCATION QUANTITIES

AC PAVEMENT REPAIR #	AREA (SF)
1	0.0
2	0.0
3	0.0
4	0.0
5	0.0
6	0.0
SUBTOTAL AREA (SF)	0.0

PAVEMENT REPAIR QUANTITY NOTES

- ACTUAL PAVEMENT REPAIR EXTENTS AND QUANTITIES MAY VARY. ENGINEER SHALL DETERMINE PAVEMENT REPAIR EXTENTS AFTER COLD PLANE OPERATIONS ARE COMPLETE AND PRIOR TO PAVING.

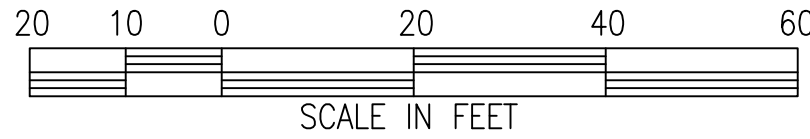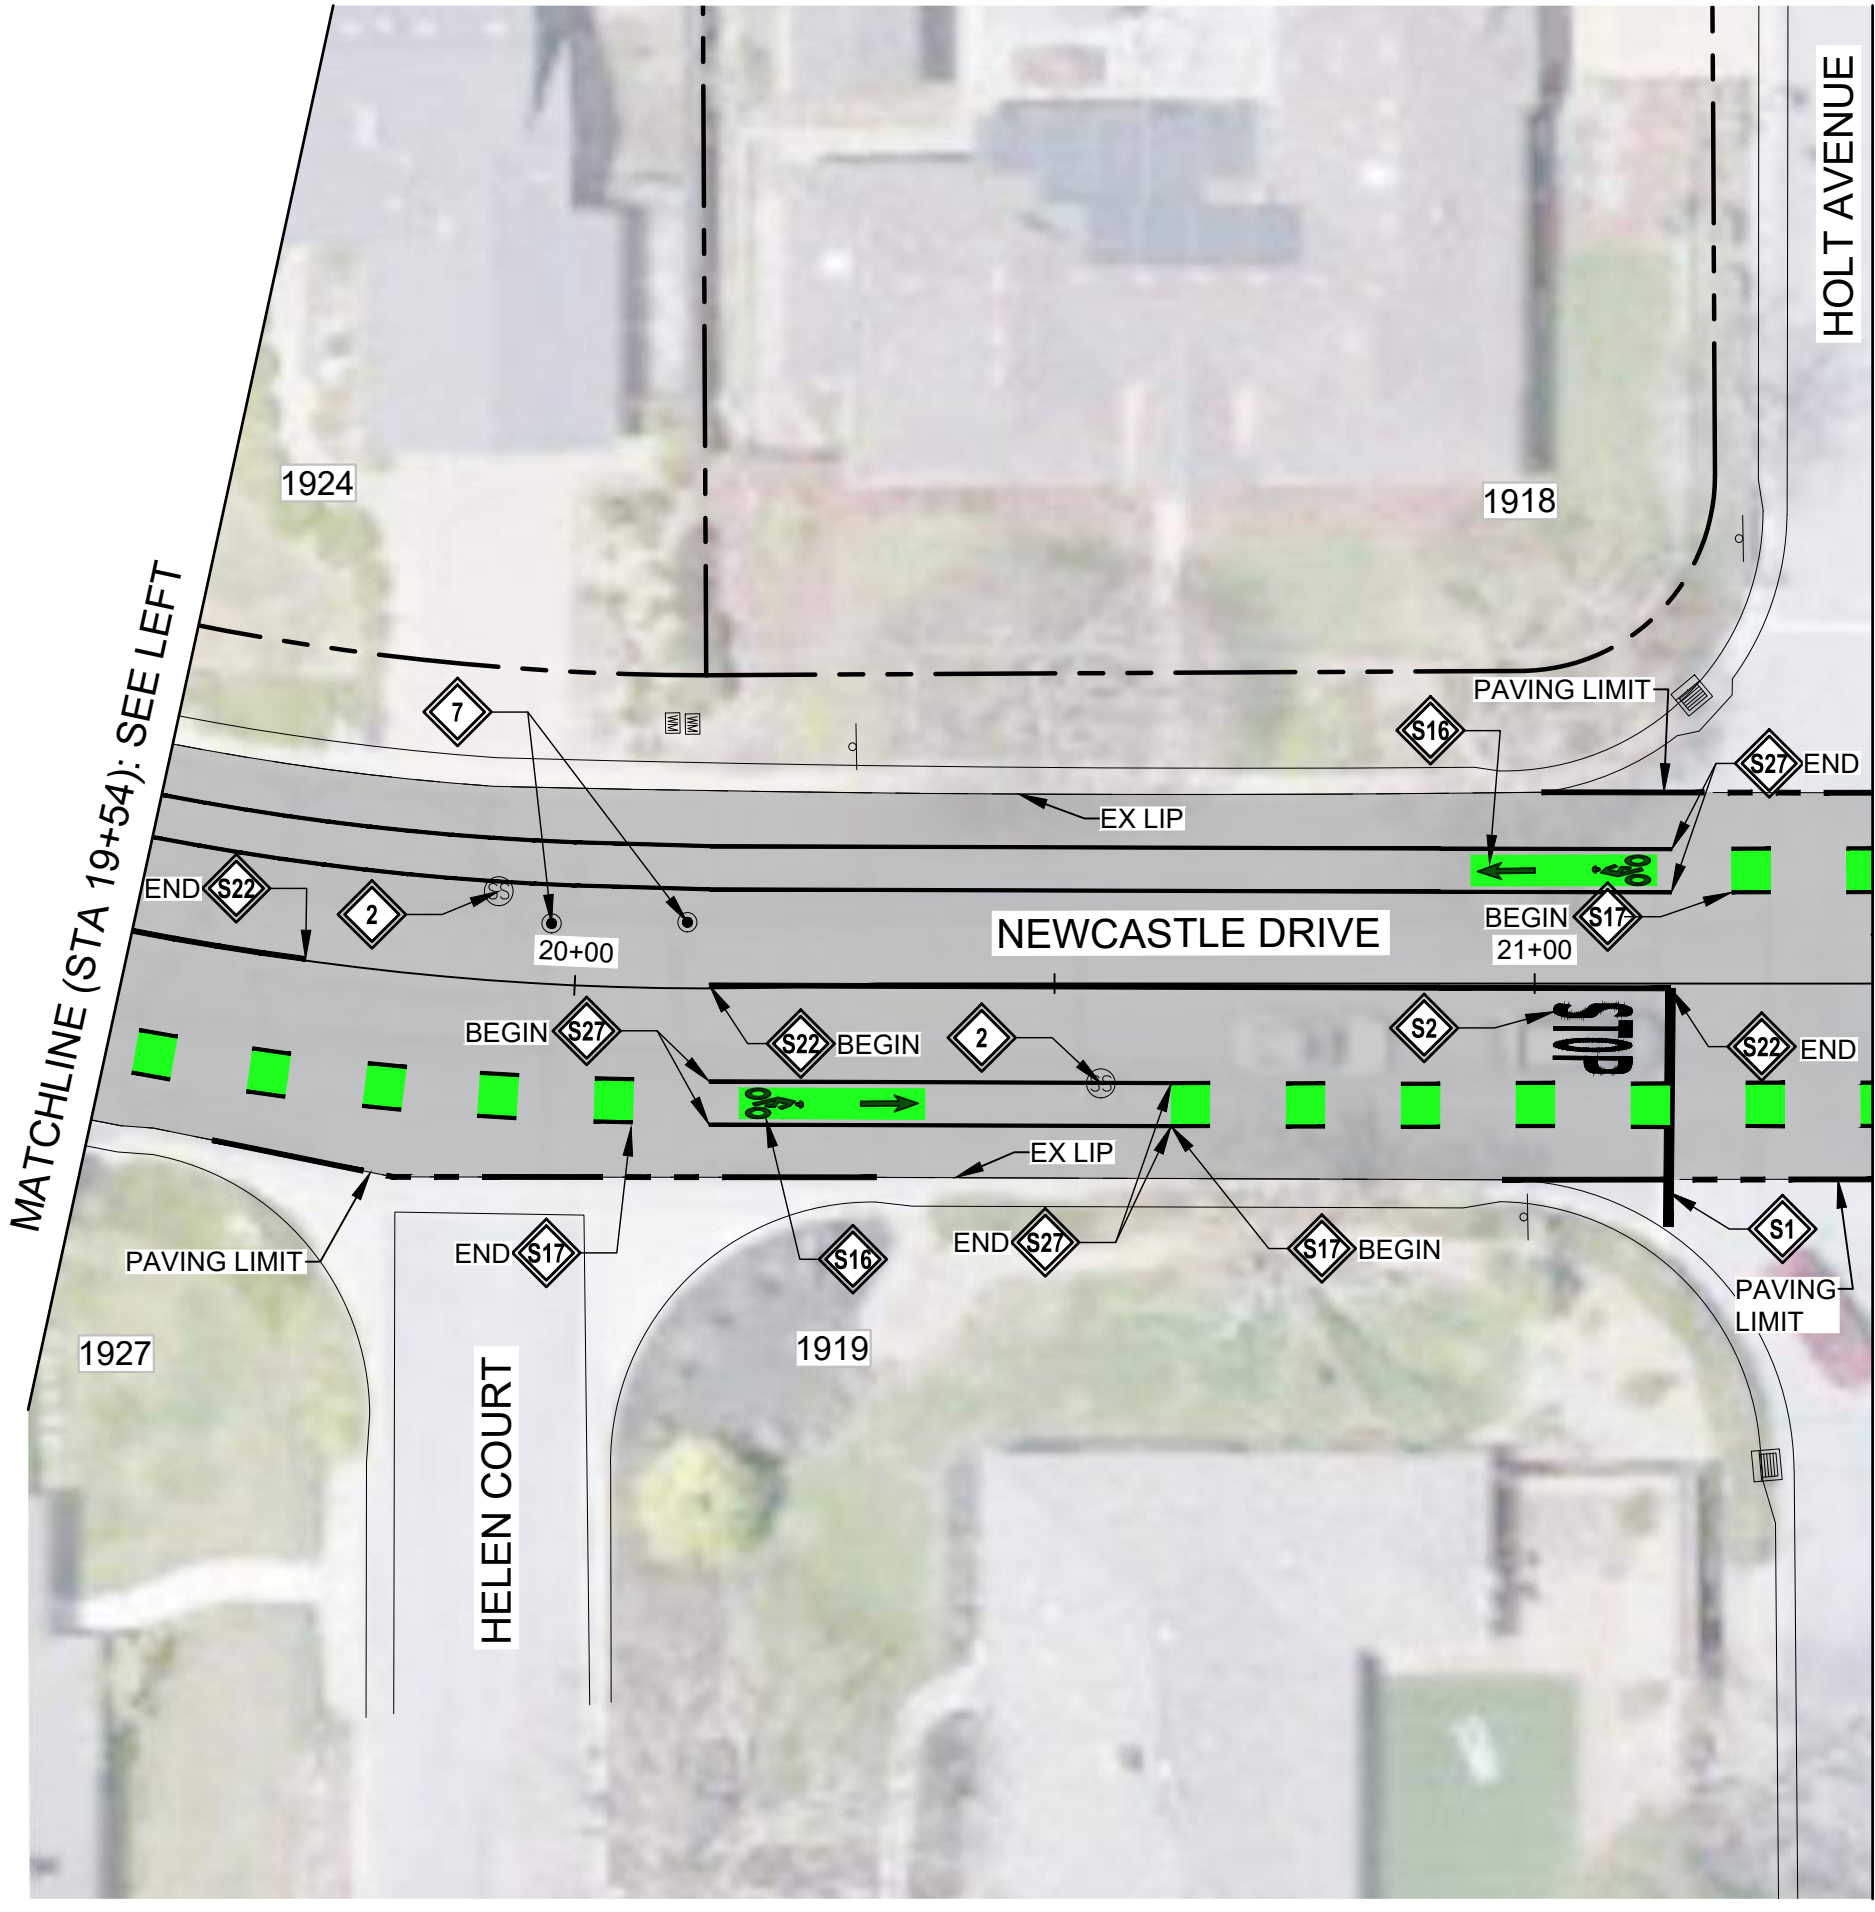

MATCHLINE (STA 21+35): SEE C4.13

Call Two Working Days Before You Dig!



1-800-227-2600

65% SUBMITTAL
APRIL 07, 2025


2024-2025 ANNUAL STREET RESURFACING PROJECT

IMPROVEMENT PLAN - NEWCASTLE DRIVE
15+68 to 21+35

SANTA CLARA COUNTY

LOS ALTOS

CALIFORNIA

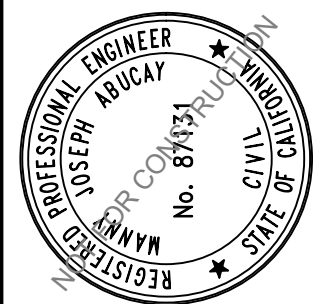


CITY OF LOS ALTOS
1 NORTH SAN ANTONIO ROAD
CALIFORNIA 94022




BY	DATE	REVISIONS

DWG NO. C4.12
19 OF 50
JOB NO. 250007

MATCHLINE (STA 21+35): SEE C4.12

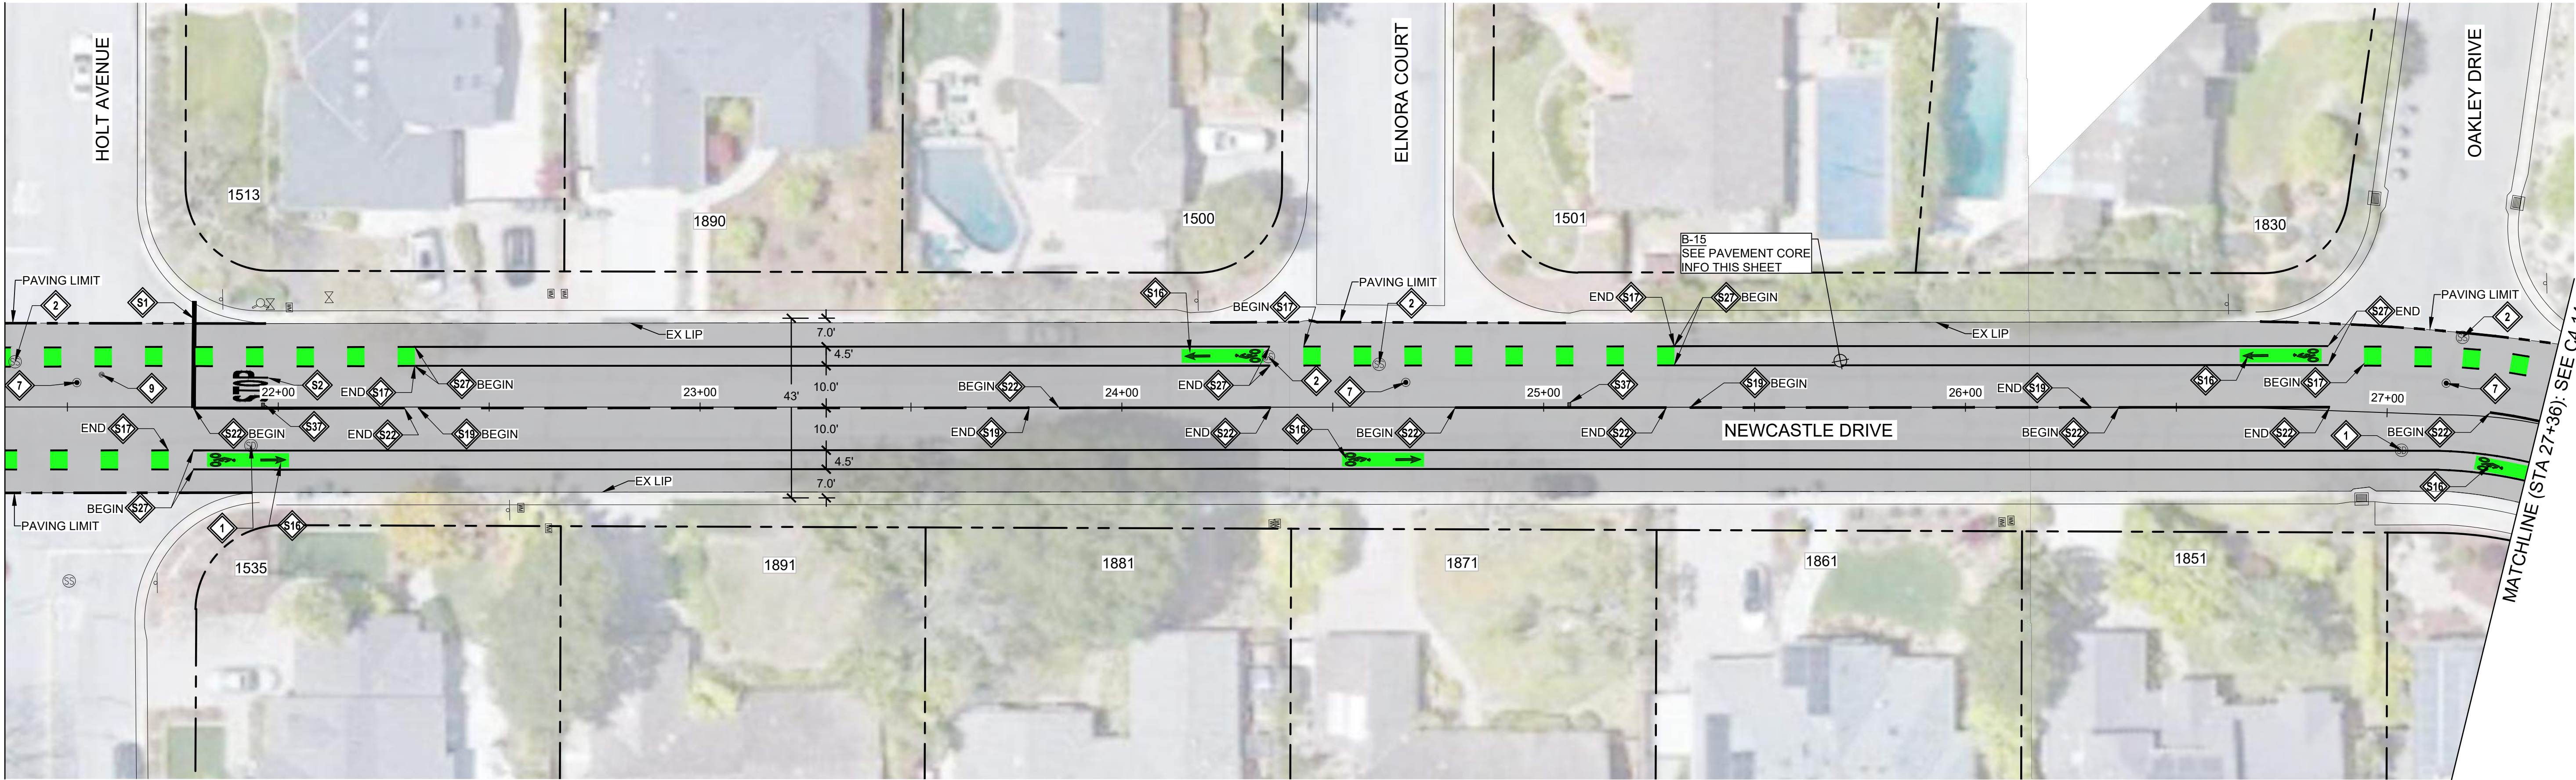

PAVEMENT REPAIR SITE - NEWCASTLE DRIVE

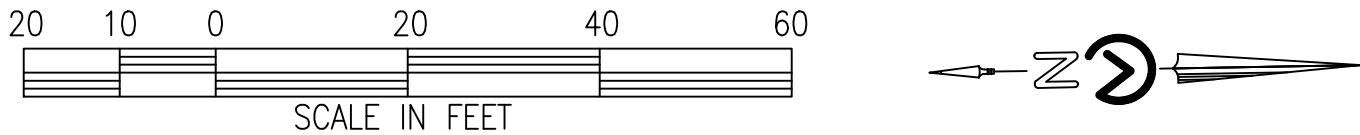

CONSTRUCTION NOTES:

- 1 LOWER & RESTORE TO GRADE STORM MANHOLE
- 2 LOWER & RESTORE TO GRADE SEWER MANHOLE (TEMPORARY FALSE BOTTOM TO BE INSTALLED PRIOR TO ANY MANHOLE WORK, & REMOVED AFTER)
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 - REFERENCE OUT PRIOR TO START OF CONSTRUCTION
 - FILE PROPER DOCUMENTATION SHOWING ORIGINAL AND REPLACEMENT MONUMENTS AFTER CONSTRUCTION
 - SEE DETAIL (X CX X)
- 8 INSTALL W11-1 & W16-1 SIGNS ON NEW POST. SEE DETAIL
- 9 LOWER & RESTORE TO GRADE SEWER CLEANOUT

STRIPING NOTES:

- S1 WHITE LIMIT LINE (STOP LINE)
- S2 MARKING WORD "STOP"
- S3 MARKING WORD "AHEAD"
- S5 MARKING WORD "XING"
- S9 MARKING "25"
- S16 MARKING BIKE LANE SYMBOL WITH ARROW & GREEN BACKING. SEE DETAIL (A C4.3)
- S17 GREEN DASHED BIKE LANE. SEE DETAIL (B,C C4.3)
- S18 DETAIL 2
- S22 DETAIL 22
- S27 DETAIL 39
- S32 WHITE BASIC CROSSWALK
- S35 WHITE CONTINENTAL CROSSWALK
- S37 BLUE HYDRANT MARKER
- S39 MARKING WORD "PED"

LEGEND:

- 3" AC GRIND & INLAY. SEE TYPICAL SECTIONS
- 4" AC BASE REPAIR. REFERENCE ALLOCATION QUANTITIES TABLE THIS SHEET. SEE DETAIL (X XX X)
- APPROXIMATE LIMIT OF WORK
- APPROXIMATE RIGHT OF WAY

GENERAL NOTES:

- SEE THE CURRENT VERSION OF CALTRANS STANDARD PLANS FOR PAVEMENT MARKINGS, TRAFFIC LINES, AND MARKERS.
- A TACK COAT EMULSION SHALL BE APPLIED TO CLEAN DRY PAVEMENT BETWEEN (E) AND (N) PAVEMENT SECTIONS PRIOR TO INLAY/OVERLAY

AC BASE REPAIR ALLOCATION QUANTITIES

AC PAVEMENT REPAIR #	AREA (SF)
1	0.0
2	0.0
3	0.0
4	0.0
5	0.0
6	0.0
SUBTOTAL AREA (SF)	0.0

PAVEMENT REPAIR QUANTITY NOTES

- ACTUAL PAVEMENT REPAIR EXTENTS AND QUANTITIES MAY VARY. ENGINEER SHALL DETERMINE PAVEMENT REPAIR EXTENTS AFTER COLD PLANE OPERATIONS ARE COMPLETE AND PRIOR TO PAVING.

PAVEMENT CORING LOG

CORE #	SUBGRADE	AC (IN)	AB (IN)	FABRIC ²
B-15	SILTY CLAY (SC/CL)	4.0	4.0	N/A

PAVEMENT CORING NOTES

- PAVEMENT CORING WAS PERFORMED IN SELECT LOCATIONS AND IS NOT REPRESENTATIVE OF ALL EXISTING PAVEMENT CONDITIONS WITHIN THE WORK LIMITS.
- PAVEMENT TO BE COLD PLANED OR REMOVED MAY CONTAIN PAVEMENT FABRIC. PAVEMENT BORINGS ARE NOT REPRESENTATIVE OF ENTIRE STREET WORK LIMITS. ANY ASSUMPTION OF THE PRESENCE OF PAVEMENT FABRIC SHALL BE AT THE CONTRACTOR'S SOLE RISK. THERE SHALL BE NO ADJUSTMENT IN COMPENSATION TO THE CONTRACTOR FOR COLD PLANING, REMOVING, AND DISPOSING AC PAVEMENT THAT CONTAINS PAVEMENT FABRIC.

Call Two Working Days Before You Dig!



1-800-227-2600

65% SUBMITTAL
APRIL 07, 2025

Agenda Item 1.

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DATE

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CITY OF LOS ALTOS

1 NORTH SAN ANTONIO ROAD

CALIFORNIA 94022

2024-2025 ANNUAL STREET RESURFACING PROJECT

IMPROVEMENT PLAN - NEWCASTLE DRIVE

21+35 to 27+36

LOS ALTOS

SANTA CLARA COUNTY

CALIFORNIA


DWG NO.

C4.13

20 OF 50

JOB NO.

250007

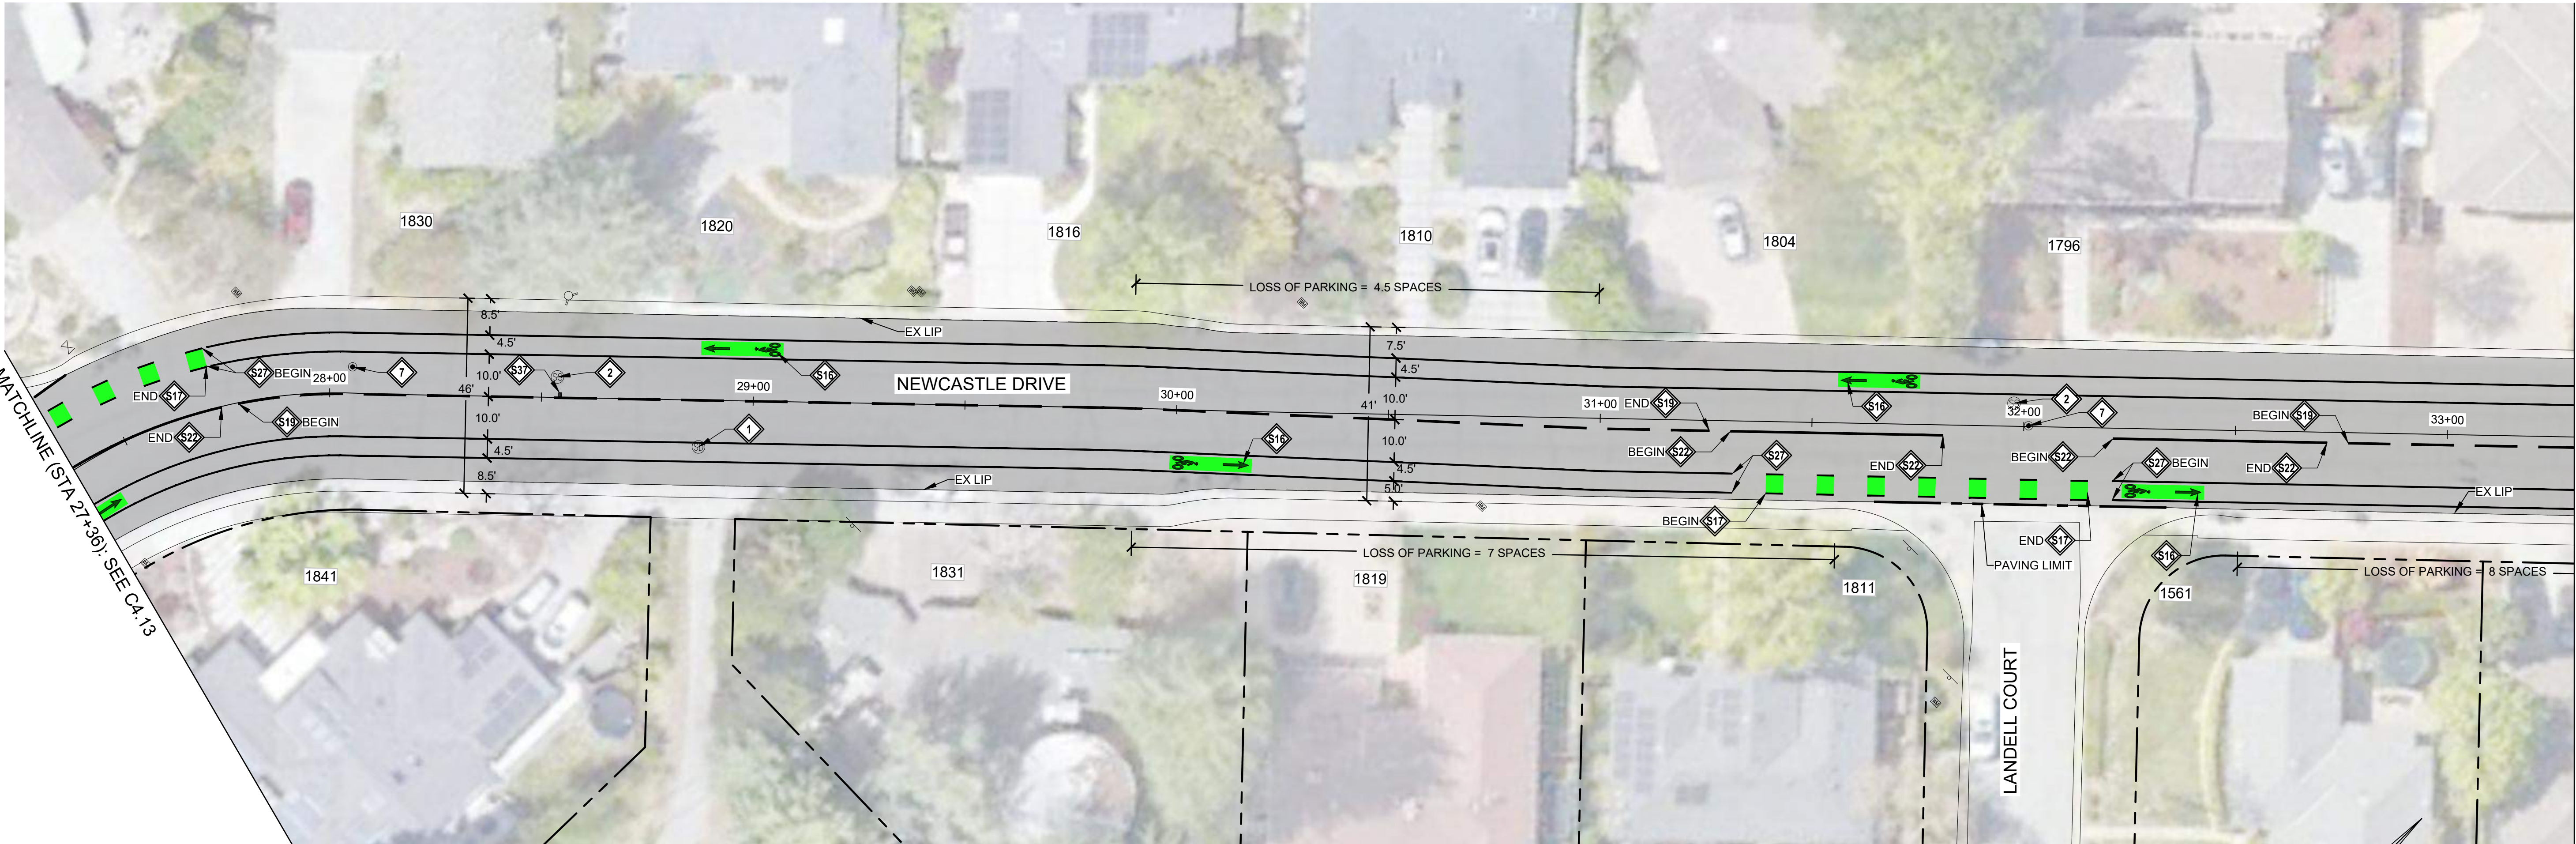

PAVEMENT REPAIR SITE - NEWCASTLE DRIVE

CONSTRUCTION NOTES:

- 1 LOWER & RESTORE TO GRADE STORM MANHOLE
- 2 LOWER & RESTORE TO GRADE SEWER MANHOLE (TEMPORARY FALSE BOTTOM TO BE INSTALLED PRIOR TO ANY MANHOLE WORK, & REMOVED AFTER)
- 3 LOWER & RESTORE TO GRADE UTILITY MANHOLE (NOTIFY & COORDINATE WITH UTILITY COMPANY PRIOR TO WORK)
- 4 LOWER & RESTORE TO GRADE WATER VALVE
- 5 LOWER & RESTORE TO GRADE GAS VALVE
- 6 LOWER & RESTORE TO GRADE UTILITY BOX
- 7 REINSTALL SURVEY MONUMENT. UNDER CALIFORNIA LICENSED SURVEYOR:
 - REFERENCE OUT PRIOR TO START OF CONSTRUCTION
 - FILE PROPER DOCUMENTATION SHOWING ORIGINAL AND REPLACEMENT MONUMENTS AFTER CONSTRUCTION
- 8 SEE DETAIL X CX.X
- 9 INSTALL W11-1 & W16-1 SIGNS ON NEW POST. SEE DETAIL
- 9 LOWER & RESTORE TO GRADE SEWER CLEANOUT

STRIPING NOTES:

- 1 WHITE LIMIT LINE (STOP LINE)
- 2 MARKING WORD "STOP"
- 3 MARKING WORD "AHEAD"
- 5 MARKING WORD "XING"
- 9 MARKING "25"
- 16 MARKING BIKE LANE SYMBOL WITH ARROW & GREEN BACKING. SEE DETAIL A C4.3
- 17 GREEN DASHED BIKE LANE. SEE DETAIL B.C C4.3
- 19 DETAIL 2
- 22 DETAIL 22
- 27 DETAIL 39
- 32 WHITE BASIC CROSSWALK
- 33 WHITE CONTINENTAL CROSSWALK
- 37 BLUE HYDRANT MARKER
- 38 MARKING WORD "PED"

LEGEND:

- 3" AC GRIND & INLAY. SEE TYPICAL SECTIONS
- 4" AC BASE REPAIR. REFERENCE ALLOCATION QUANTITIES TABLE THIS SHEET. SEE DETAIL X XX.X
- APPROXIMATE LIMIT OF WORK
- APPROXIMATE RIGHT OF WAY

GENERAL NOTES:

- SEE THE CURRENT VERSION OF CALTRANS STANDARD PLANS FOR PAVEMENT MARKINGS, TRAFFIC LINES, AND MARKERS.
- A TACK COAT EMULSION SHALL BE APPLIED TO CLEAN DRY PAVEMENT BETWEEN (E) AND (N) PAVEMENT SECTIONS PRIOR TO INLAY/OVERLAY

AC BASE REPAIR ALLOCATION QUANTITIES

AC PAVEMENT REPAIR #	AREA (SF)
1	0.0
2	0.0
3	0.0
4	0.0
5	0.0
6	0.0
SUBTOTAL AREA (SF)	0.0

PAVEMENT REPAIR QUANTITY NOTES

- ACTUAL PAVEMENT REPAIR EXTENTS AND QUANTITIES MAY VARY. ENGINEER SHALL DETERMINE PAVEMENT REPAIR EXTENTS AFTER COLD PLANE OPERATIONS ARE COMPLETE AND PRIOR TO PAVING.

Call Two Working Days Before You Dig!



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65% SUBMITTAL
APRIL 07, 2025

MATCHLINE (STA 33+30): SEE C4.15

Agenda Item 1.

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CITY OF LOS ALTOS

1 NORTH SAN ANTONIO ROAD

CALIFORNIA 94022

PROFESSIONAL ENGINEER

JOSEPH ARICAR

MEMBER CIVIL ENGINEER

No. 87131

REREGISTERED

CIVIL

STATE OF CA

2024-2025 ANNUAL STREET RESURFACING PROJECT

IMPROVEMENT PLAN - NEWCASTLE DRIVE

27+36 to 33+30

LOS ALTOS

SANTA CLARA COUNTY

CALIFORNIA

DWG NO.

C4.14



21 OF 50

JOB NO.

250007

49

MATCHLINE (STA 33+30): SEE C4.14

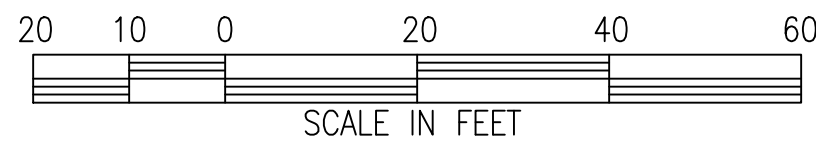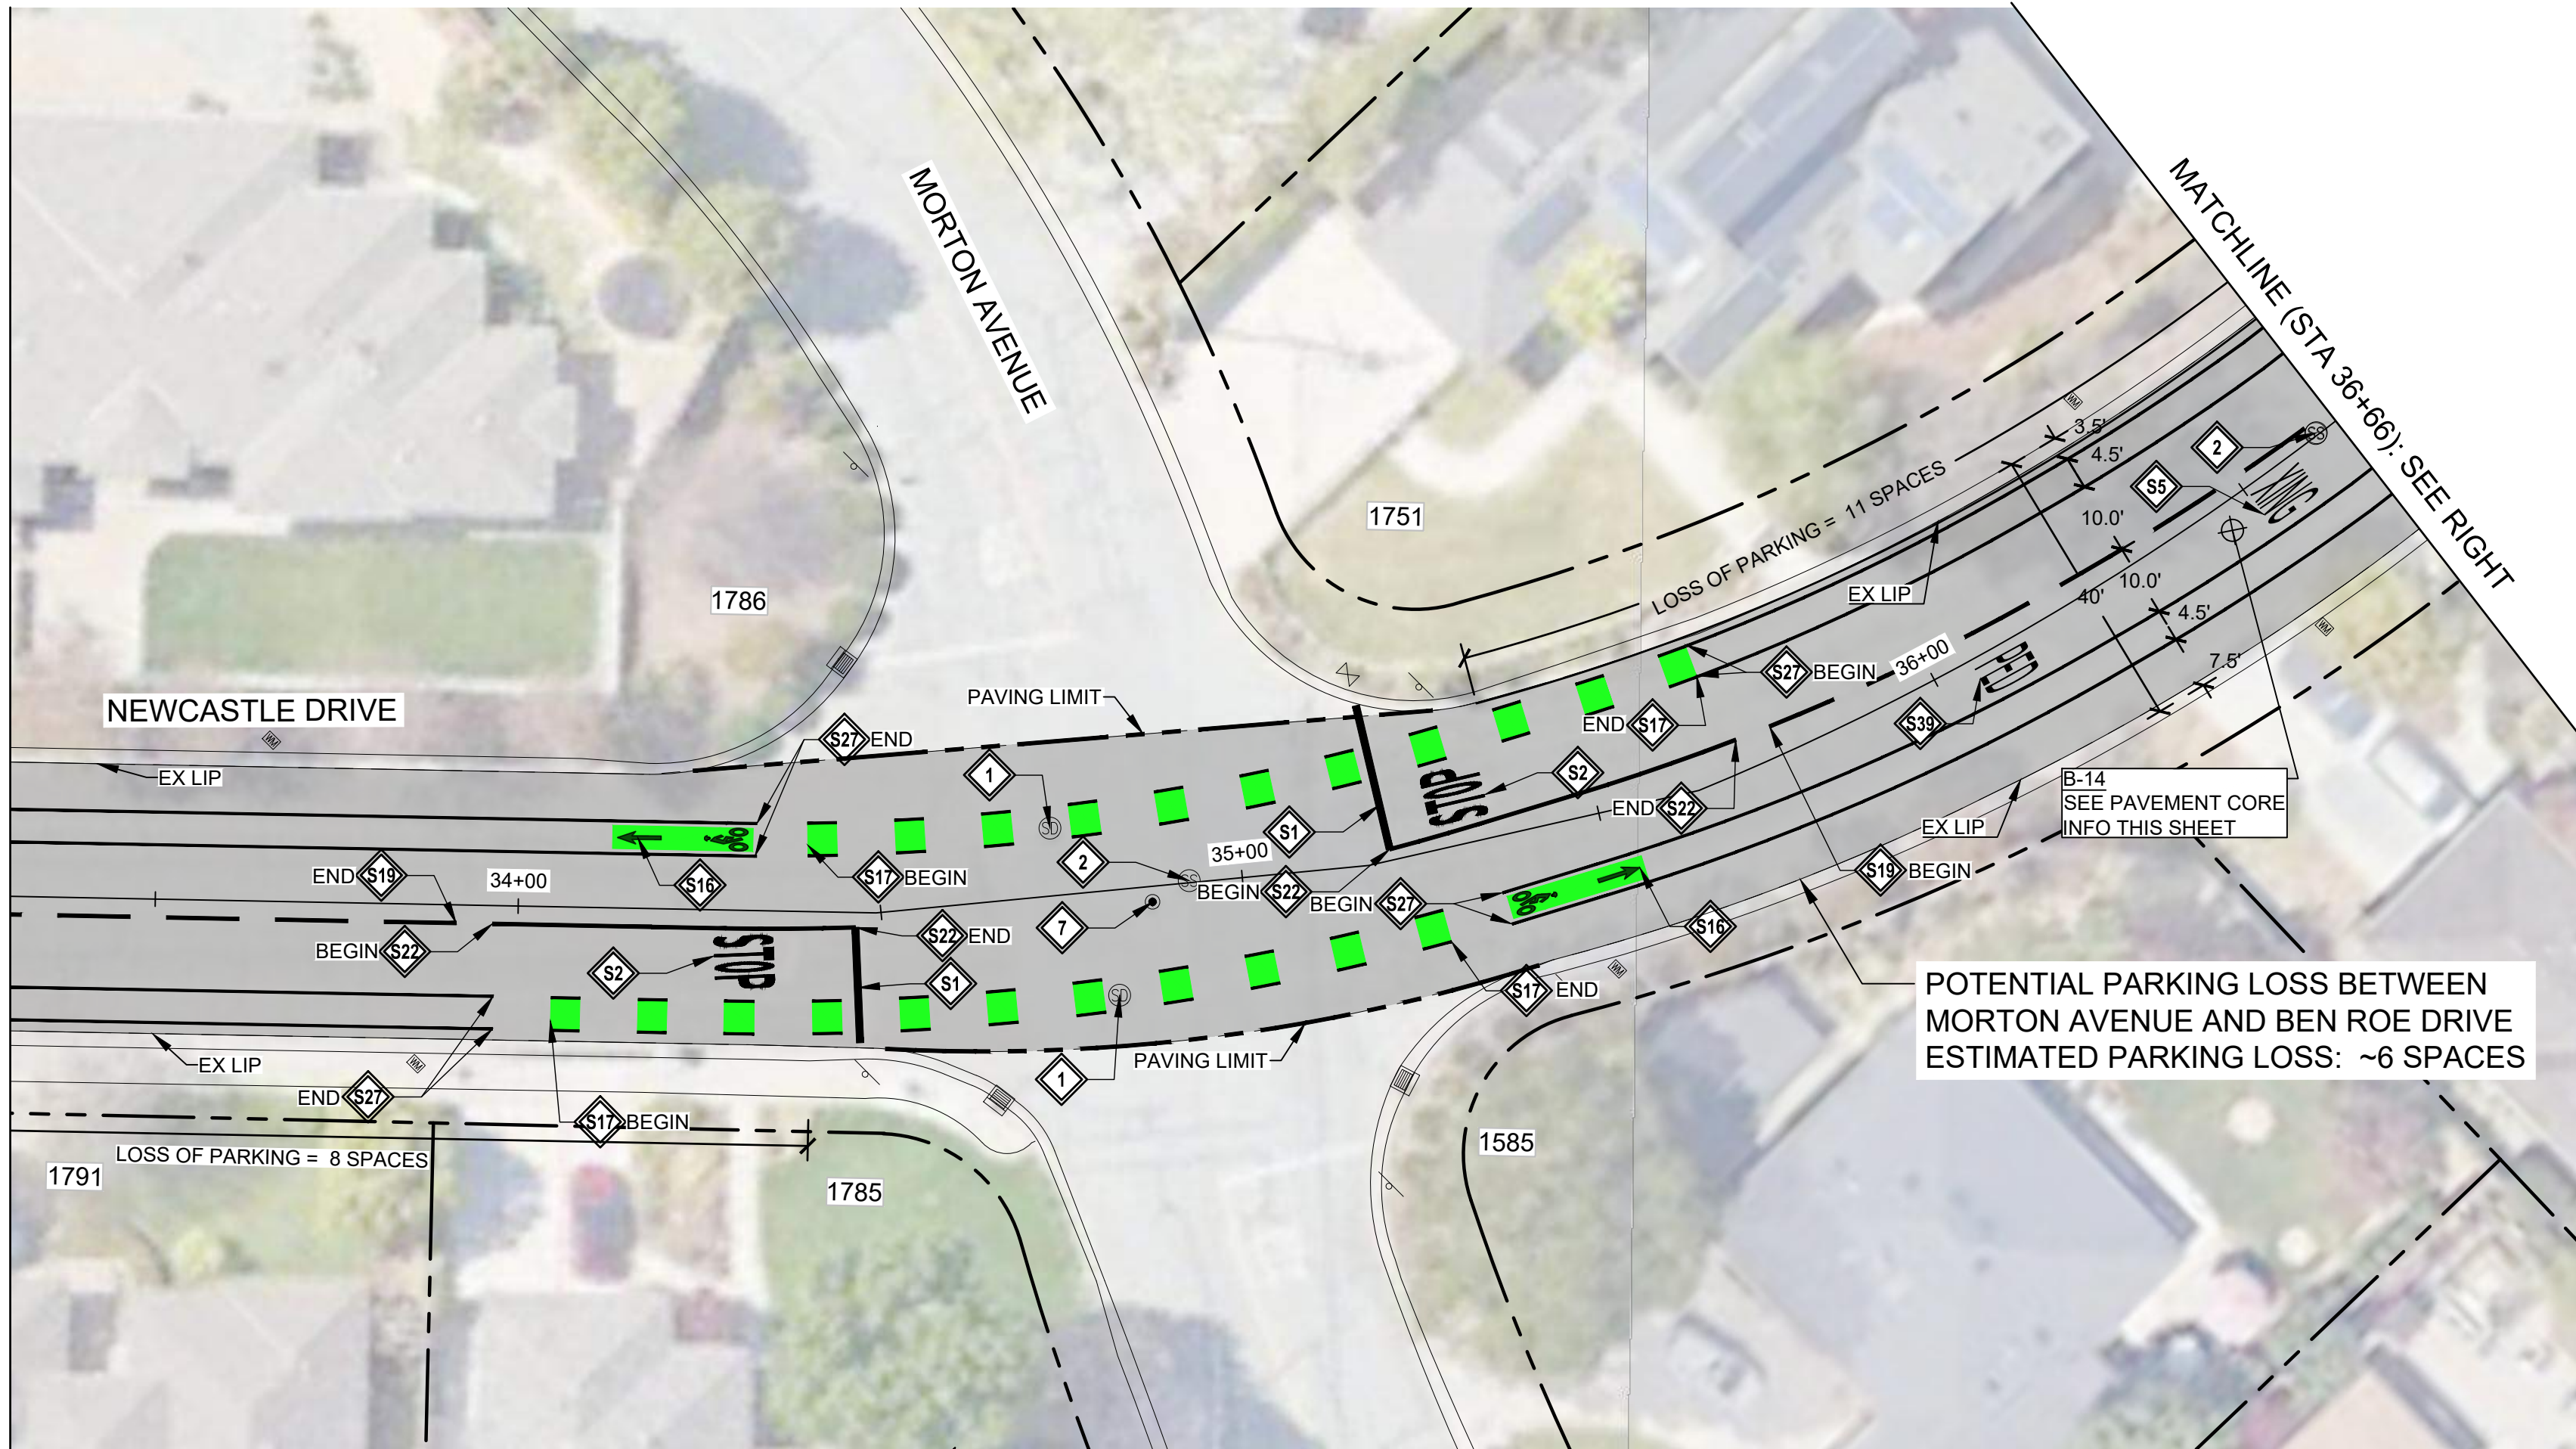

CONSTRUCTION NOTES:

- 1 LOWER & RESTORE TO GRADE STORM MANHOLE
- 2 LOWER & RESTORE TO GRADE SEWER MANHOLE (TEMPORARY FALSE BOTTOM TO BE INSTALLED PRIOR TO ANY MANHOLE WORK, & REMOVED AFTER)
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 - REFERENCE OUT PRIOR TO START OF CONSTRUCTION
 - FILE PROPER DOCUMENTATION SHOWING ORIGINAL AND REPLACEMENT MONUMENTS AFTER CONSTRUCTION
- 8 SEE DETAIL X CX.X
- 9 INSTALL W11-1 & W16-1 SIGNS ON NEW POST. SEE DETAIL
- 10 LOWER & RESTORE TO GRADE SEWER CLEANOUT

STRIPING NOTES:

- S1 WHITE LIMIT LINE (STOP LINE)
- S2 MARKING WORD "STOP"
- S3 MARKING WORD "AHEAD"
- S5 MARKING WORD "XING"
- S9 MARKING "25"
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- S17 GREEN DASHED BIKE LANE. SEE DETAIL B.C C4.3
- S19 DETAIL 2
- S22 DETAIL 22
- S27 DETAIL 39
- S32 WHITE BASIC CROSSWALK
- S35 WHITE CONTINENTAL CROSSWALK
- S37 BLUE HYDRANT MARKER
- S38 MARKING WORD "PED"

PAVEMENT REPAIR SITE - NEWCASTLE DRIVE

LEGEND:



- 3" AC GRIND & INLAY. SEE TYPICAL SECTIONS
- 4" AC BASE REPAIR. REFERENCE ALLOCATION QUANTITIES TABLE THIS SHEET. SEE DETAIL X XX.X
- APPROXIMATE LIMIT OF WORK
- APPROXIMATE RIGHT OF WAY

PAVEMENT CORING LOG

CORE #	SUBGRADE	AC (IN)	AB (IN)	FABRIC ²
B-14	SAND WITH SILT AND GRAVEL (SW)	6.0	2.0	N/A

PAVEMENT CORING NOTES

- PAVEMENT CORING WAS PERFORMED IN SELECT LOCATIONS AND IS NOT REPRESENTATIVE OF ALL EXISTING PAVEMENT CONDITIONS WITHIN THE WORK LIMITS.
- PAVEMENT TO BE COLD PLANED OR REMOVED MAY CONTAIN PAVEMENT FABRIC. PAVEMENT BORINGS ARE NOT REPRESENTATIVE OF ENTIRE STREET WORK LIMITS. ANY ASSUMPTION OF THE PRESENCE OF PAVEMENT FABRIC SHALL BE AT THE CONTRACTOR'S SOLE RISK. THERE SHALL BE NO ADJUSTMENT IN COMPENSATION TO THE CONTRACTOR FOR COLD PLANING, REMOVING, AND DISPOSING AC PAVEMENT THAT CONTAINS PAVEMENT FABRIC.

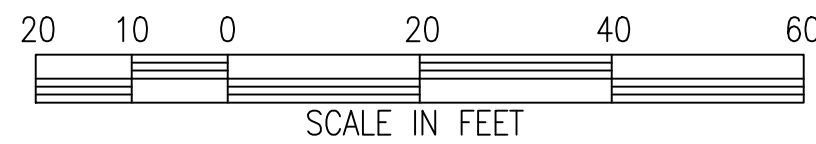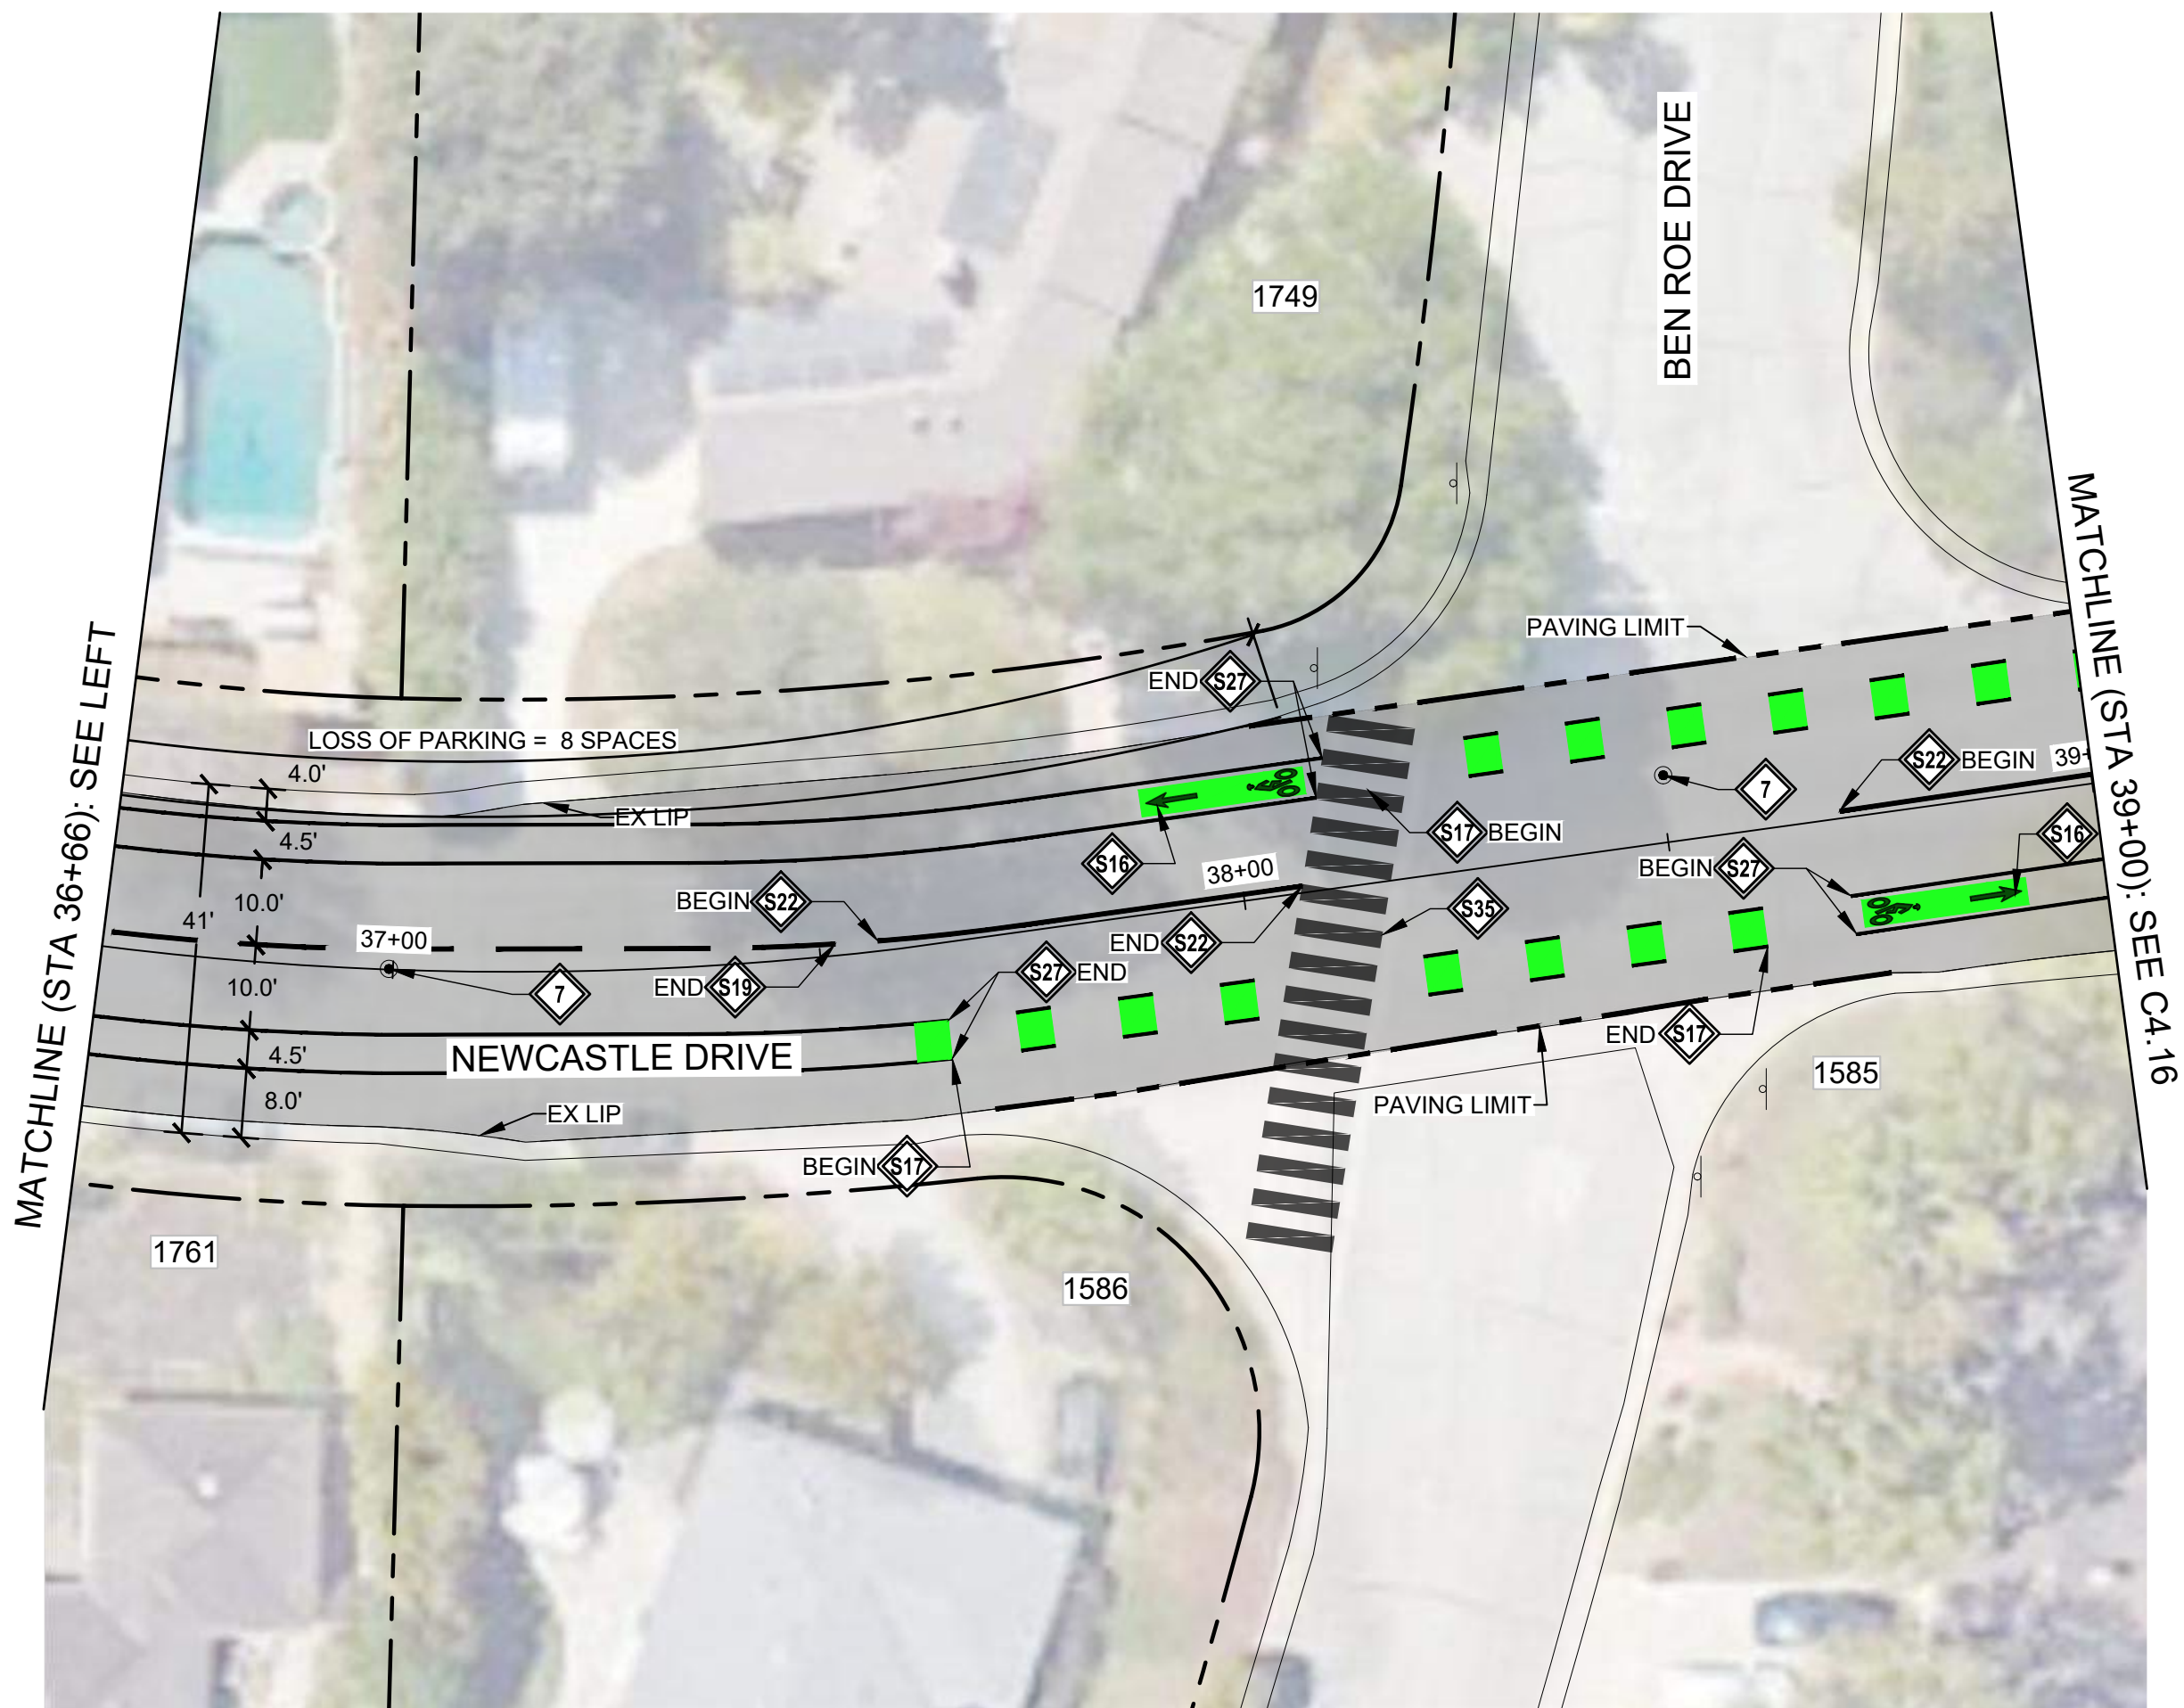

GENERAL NOTES:

- SEE THE CURRENT VERSION OF CALTRANS STANDARD PLANS FOR PAVEMENT MARKINGS, TRAFFIC LINES, AND MARKERS.
- A TACK COAT EMULSION SHALL BE APPLIED TO CLEAN DRY PAVEMENT BETWEEN (E) AND (N) PAVEMENT SECTIONS PRIOR TO INLAY/OVERLAY

AC BASE REPAIR ALLOCATION QUANTITIES

AC PAVEMENT REPAIR #	AREA (SF)
1	0.0
2	0.0
3	0.0
4	0.0
5	0.0
6	0.0
SUBTOTAL AREA (SF)	0.0

PAVEMENT REPAIR QUANTITY NOTES

- ACTUAL PAVEMENT REPAIR EXTENTS AND QUANTITIES MAY VARY. ENGINEER SHALL DETERMINE PAVEMENT REPAIR EXTENTS AFTER COLD PLANE OPERATIONS ARE COMPLETE AND PRIOR TO PAVING.

Call Two Working Days Before You Dig!



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APRIL 07, 2025

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CITY OF LOS ALTOS

1 NORTH SAN ANTONIO ROAD

CALIFORNIA 94022

PROFESSIONAL ENGINEER

JOSEPH ARICAR

REGISTERED CIVIL ENGINEER

No. 87131

STATE OF CALIFORNIA

2024-2025 ANNUAL STREET RESURFACING PROJECT

IMPROVEMENT PLAN - NEWCASTLE DRIVE

33+30 to 39+00

LOS ALTOS

SANTA CLARA COUNTY

CALIFORNIA

DWG NO.

C4.15

22 OF 50

JOB NO.

250007


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MATCHLINE (STA 39+00): SEE C4.15

MATCHLINE (STA 45+00): SEE C4.17

PAVEMENT REPAIR SITE - NEWCASTLE DRIVE



CONSTRUCTION NOTES:

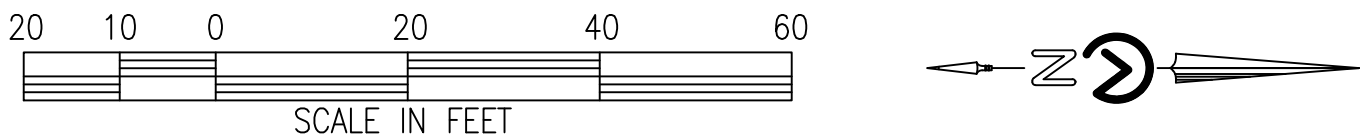- 1 LOWER & RESTORE TO GRADE STORM MANHOLE
- 2 LOWER & RESTORE TO GRADE SEWER MANHOLE (TEMPORARY FALSE BOTTOM TO BE INSTALLED PRIOR TO ANY MANHOLE WORK, & REMOVED AFTER)
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 - REFERENCE OUT PRIOR TO START OF CONSTRUCTION
 - FILE PROPER DOCUMENTATION SHOWING ORIGINAL AND REPLACEMENT MONUMENTS AFTER CONSTRUCTION
- 8 INSTALL W11-1 & W16-1 SIGNS ON NEW POST. SEE DETAIL
- 9 LOWER & RESTORE TO GRADE SEWER CLEANOUT

STRIPING NOTES:

- S1 WHITE LIMIT LINE (STOP LINE)
- S2 MARKING WORD "STOP"
- S3 MARKING WORD "AHEAD"
- S5 MARKING WORD "XING"
- S9 MARKING "25"
- S16 MARKING BIKE LANE SYMBOL WITH ARROW & GREEN BACKING. SEE DETAIL
- S17 GREEN DASHED BIKE LANE. SEE DETAIL
- S19 DETAIL 2
- S22 DETAIL 22
- S27 DETAIL 39
- S32 WHITE BASIC CROSSWALK
- S35 WHITE CONTINENTAL CROSSWALK
- S37 BLUE HYDRANT MARKER
- S38 MARKING WORD "PED"

LEGEND:

- 3" AC GRIND & INLAY. SEE TYPICAL SECTIONS
- 4" AC BASE REPAIR. REFERENCE ALLOCATION QUANTITIES TABLE THIS SHEET. SEE DETAIL
- APPROXIMATE LIMIT OF WORK
- APPROXIMATE RIGHT OF WAY

GENERAL NOTES:

- SEE THE CURRENT VERSION OF CALTRANS STANDARD PLANS FOR PAVEMENT MARKINGS, TRAFFIC LINES, AND MARKERS.
- A TACK COAT EMULSION SHALL BE APPLIED TO CLEAN DRY PAVEMENT BETWEEN (E) AND (N) PAVEMENT SECTIONS PRIOR TO INLAY/OVERLAY

AC BASE REPAIR ALLOCATION QUANTITIES

AC PAVEMENT REPAIR #	AREA (SF)
1	0.0
2	0.0
3	0.0
4	0.0
5	0.0
6	0.0
SUBTOTAL AREA (SF)	0.0

PAVEMENT REPAIR QUANTITY NOTES

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CITY OF LOS ALTOS

1 NORTH SAN ANTONIO ROAD

CALIFORNIA 94022

PROFESSIONAL ENGINEER

JOSEPH M. MURPHY

REGISTERED

NO. 87131

CIVIL

STATE OF CALIFORNIA

2024-2025 ANNUAL STREET RESURFACING PROJECT

IMPROVEMENT PLAN - NEWCASTLE DRIVE

39+00 to 45+00

LOS ALTOS

SANTA CLARA COUNTY

CALIFORNIA

DWG NO.


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23 OF 50


JOB NO.

250007

MATCHLINE (STA 45+00): SEE C4.16

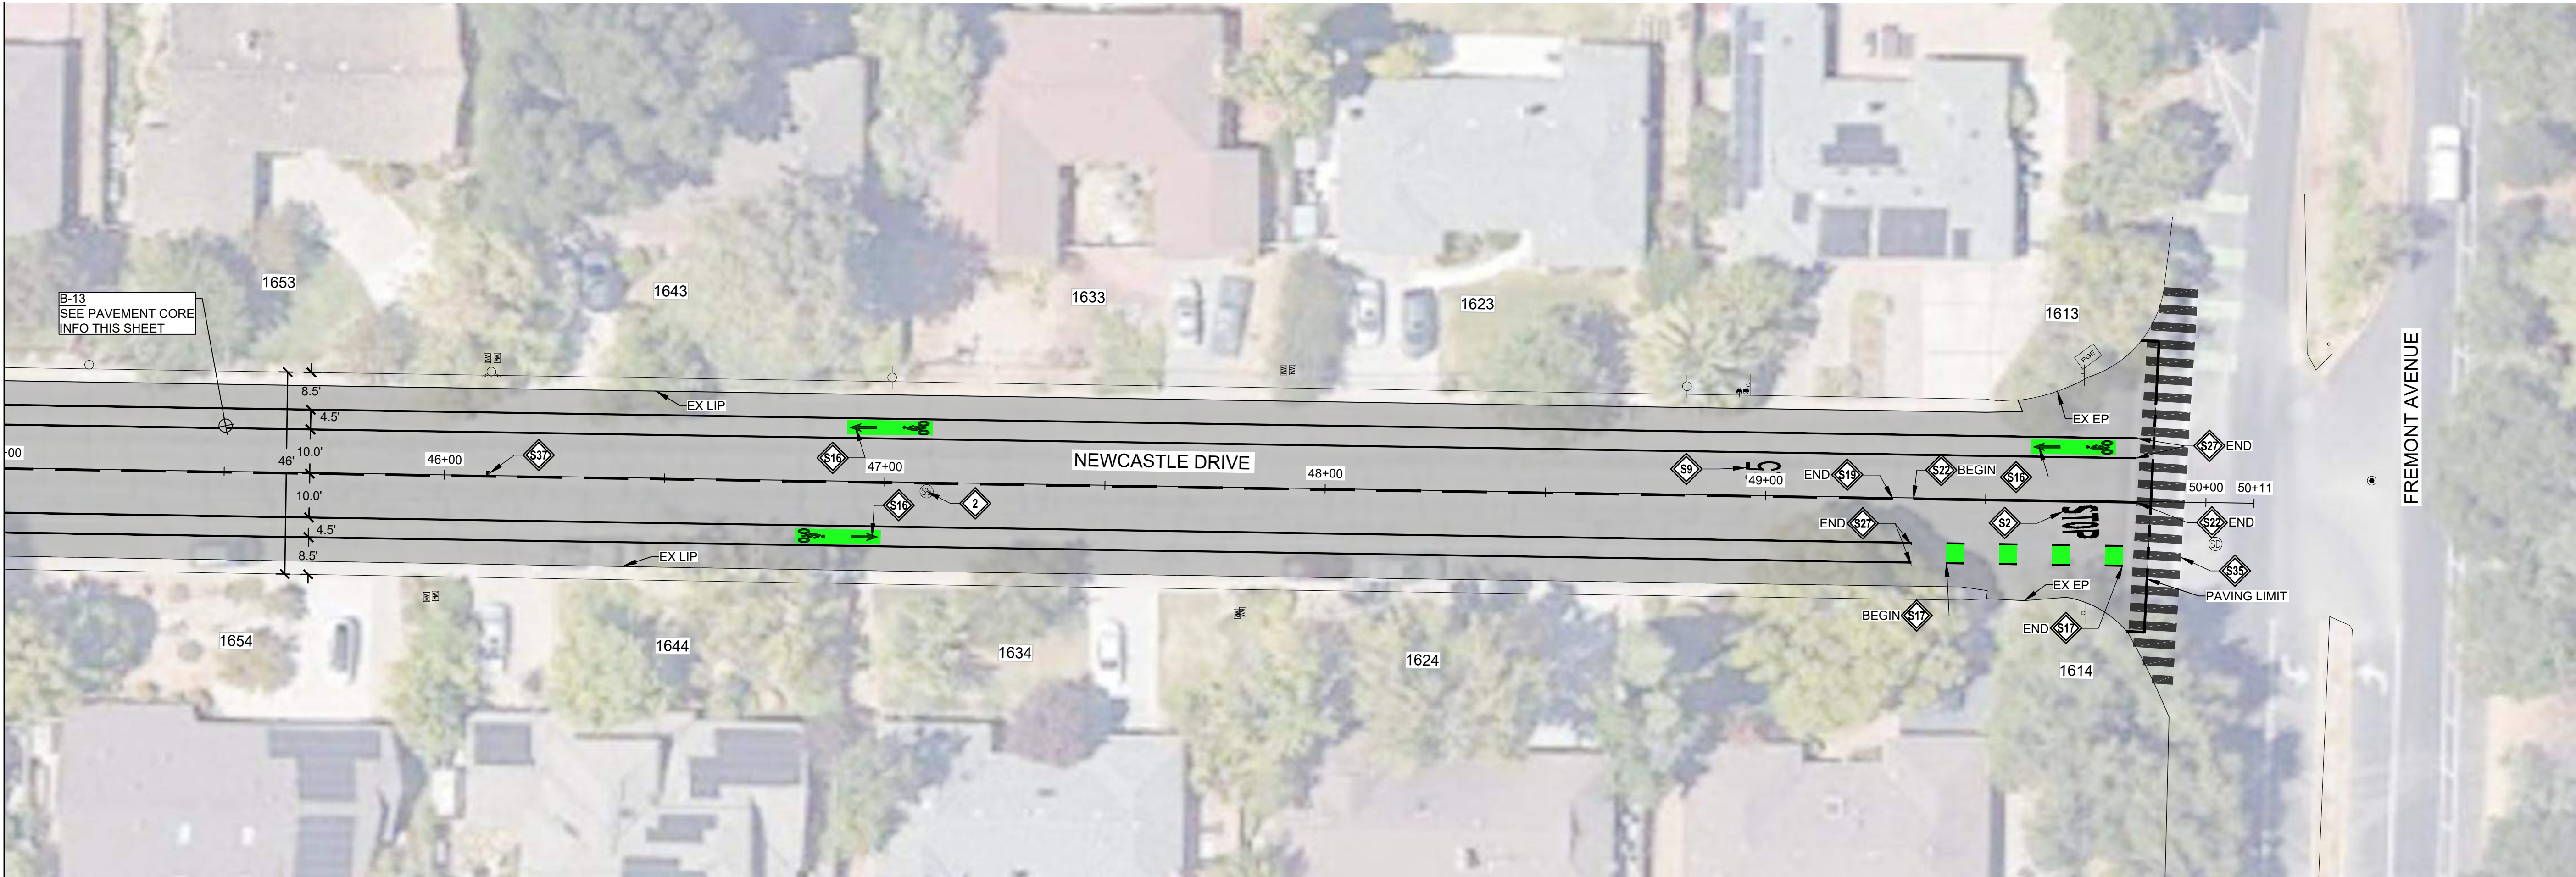

PAVEMENT REPAIR SITE - NEWCASTLE DRIVE

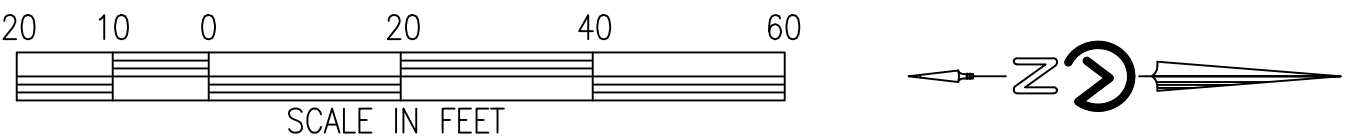

CONSTRUCTION NOTES:

- 1 LOWER & RESTORE TO GRADE STORM MANHOLE
- 2 LOWER & RESTORE TO GRADE SEWER MANHOLE (TEMPORARY FALSE BOTTOM TO BE INSTALLED PRIOR TO ANY MANHOLE WORK, & REMOVED AFTER)
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 - FILE PROPER DOCUMENTATION SHOWING ORIGINAL AND REPLACEMENT MONUMENTS AFTER CONSTRUCTION
- 8 INSTALL W11-1 & W16-1 SIGNS ON NEW POST. SEE DETAIL
- 9 LOWER & RESTORE TO GRADE SEWER CLEANOUT

STRIPING NOTES:

- S1 WHITE LIMIT LINE (STOP LINE)
- S2 MARKING WORD "STOP"
- S3 MARKING WORD "AHEAD"
- S5 MARKING WORD "XING"
- S9 MARKING "25"
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- S17 GREEN DASHED BIKE LANE. SEE DETAIL
- S19 DETAIL 2
- S22 DETAIL 22
- S27 DETAIL 39
- S32 WHITE BASIC CROSSWALK
- S35 WHITE CONTINENTAL CROSSWALK
- S37 BLUE HYDRANT MARKER
- S39 MARKING WORD "PED"

LEGEND:

- 3" AC GRIND & INLAY. SEE TYPICAL SECTIONS
- 4" AC BASE REPAIR. REFERENCE ALLOCATION QUANTITIES TABLE THIS SHEET.
- APPROXIMATE LIMIT OF WORK
- APPROXIMATE RIGHT OF WAY

GENERAL NOTES:

- SEE THE CURRENT VERSION OF CALTRANS STANDARD PLANS FOR PAVEMENT MARKINGS, TRAFFIC LINES, AND MARKERS.
- A TACK COAT EMULSION SHALL BE APPLIED TO CLEAN DRY PAVEMENT BETWEEN (E) AND (N) PAVEMENT SECTIONS PRIOR TO INLAY/OVERLAY

AC BASE REPAIR ALLOCATION QUANTITIES

AC PAVEMENT REPAIR #	AREA (SF)
1	0.0
2	0.0
3	0.0
4	0.0
5	0.0
6	0.0
SUBTOTAL AREA (SF)	0.0

PAVEMENT REPAIR QUANTITY NOTES

- ACTUAL PAVEMENT REPAIR EXTENTS AND QUANTITIES MAY VARY. ENGINEER SHALL DETERMINE PAVEMENT REPAIR EXTENTS AFTER COLD PLANE OPERATIONS ARE COMPLETE AND PRIOR TO PAVING.

PAVEMENT CORING LOG

CORE #	SUBGRADE	AC (IN)	AB (IN)	FABRIC ²
B-13	SILTY SAND (SMMH)	5.0	4.5	NA

PAVEMENT CORING NOTES

- PAVEMENT CORING WAS PERFORMED IN SELECT LOCATIONS AND IS NOT REPRESENTATIVE OF ALL EXISTING PAVEMENT CONDITIONS WITHIN THE WORK LIMITS.
- PAVEMENT TO BE COLD PLANED OR REMOVED MAY CONTAIN PAVEMENT FABRIC. PAVEMENT BORINGS ARE NOT REPRESENTATIVE OF ENTIRE STREET WORK LIMITS. ANY ASSUMPTION OF THE PRESENCE OF PAVEMENT FABRIC SHALL BE AT THE CONTRACTOR'S SOLE RISK. THERE SHALL BE NO ADJUSTMENT IN COMPENSATION TO THE CONTRACTOR FOR COLD PLANING, REMOVING, AND DISPOSING AC PAVEMENT THAT CONTAINS PAVEMENT FABRIC.

Call Two Working Days Before You Dig!



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65% SUBMITTAL
APRIL 07, 2025

Agenda Item 1.

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CITY OF LOS ALTOS

1 NORTH SAN ANTONIO ROAD

CALIFORNIA 94022

PROFESSIONAL ENGINEER

JOSEPH A. ARICAR

REGISTERED CIVIL ENGINEER

No. 87131

STATE OF CALIFORNIA

2024-2025 ANNUAL STREET RESURFACING PROJECT

IMPROVEMENT PLAN - NEWCASTLE DRIVE

45+00 TO 50+11

SANTA CLARA COUNTY

CALIFORNIA

DWG NO.








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


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JOB NO.




250007

CONSTRUCTION NOTES:


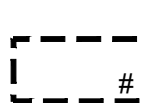
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



-  INSTALL W11-1 & W16-1 SIGNS ON NEW POST. SEE DETAIL
-  LOWER & RESTORE TO GRADE SEWER CLEANOUT

STRIPING NOTES:

-  WHITE LIMIT LINE (STOP LINE)
-  WHITE "STOP" MARKING
-  BLUE HYDRANT MARKER

LEGEND:

-  3" AC GRIND & INLAY. SEE TYPICAL SECTIONS
-  4" AC BASE REPAIR. REFERENCE ALLOCATION QUANTITIES TABLE THIS SHEET. SEE DETAIL


-  APPROXIMATE LIMIT OF WORK
-  APPROXIMATE RIGHT OF WAY

PAVEMENT CORING LOG

CORE #	SUBGRADE	AC (IN)	AB (IN)	FABRIC ²
B-5	SILTY SAND (SM)	1.0	3.0	N/A

PAVEMENT CORING NOTES

1. PAVEMENT CORING WAS PERFORMED IN SELECT LOCATIONS AND IS NOT REPRESENTATIVE OF ALL EXISTING PAVEMENT CONDITIONS WITHIN THE WORK LIMITS.
2. PAVEMENT TO BE COLD PLANED OR REMOVED MAY CONTAIN PAVEMENT FABRIC. PAVEMENT BORINGS ARE NOT REPRESENTATIVE OF ENTIRE STREET WORK LIMITS. ANY ASSUMPTION OF THE PRESENCE OF PAVEMENT FABRIC SHALL BE AT THE CONTRACTOR'S SOLE RISK. THERE SHALL BE NO ADJUSTMENT IN COMPENSATION TO THE CONTRACTOR FOR COLD PLANING, REMOVING, AND DISPOSING AC PAVEMENT THAT CONTAINS PAVEMENT FABRIC.

GENERAL NOTES:


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2. A TACK COAT EMULSION SHALL BE APPLIED TO CLEAN DRY PAVEMENT BETWEEN (E) AND (N) PAVEMENT SECTIONS PRIOR TO INLAY/OVERLAY

AC BASE REPAIR ALLOCATION QUANTITIES



AC PAVEMENT REPAIR #	AREA (SF)
1	0.0
2	0.0
3	0.0
4	0.0
5	0.0
6	0.0
SUBTOTAL AREA (SF)	0.0

PAVEMENT REPAIR QUANTITY NOTES

1. ACTUAL PAVEMENT REPAIR EXTENTS AND QUANTITIES MAY VARY. ENGINEER SHALL DETERMINE PAVEMENT REPAIR EXTENTS AFTER COLD PLANE OPERATIONS ARE COMPLETE AND PRIOR TO PAVING.

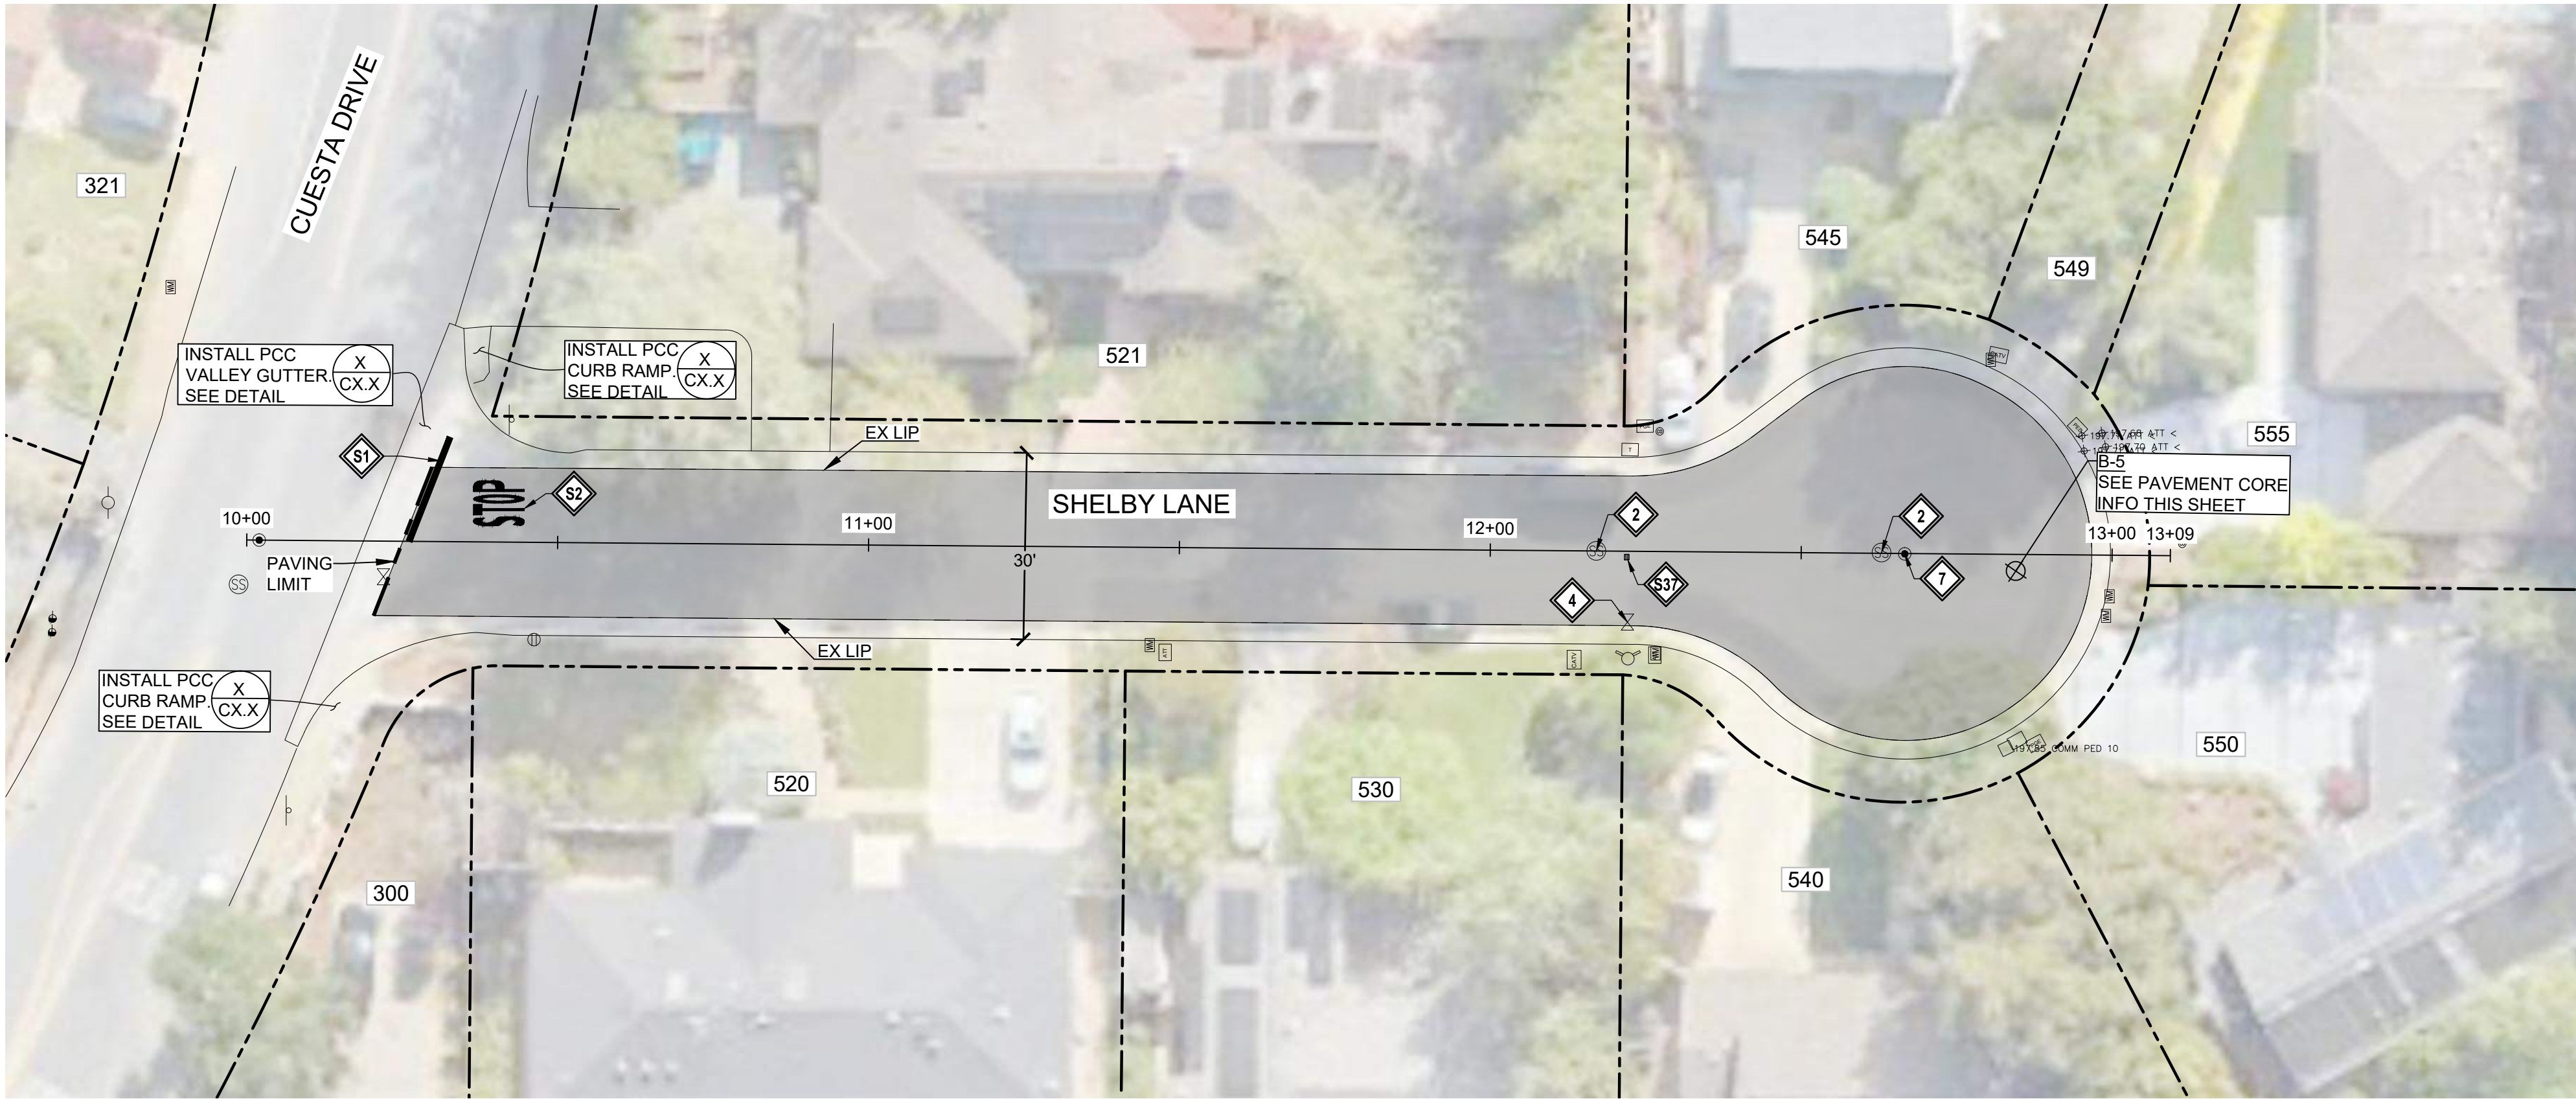


PAVEMENT REPAIR SITE - SHELBY LANE

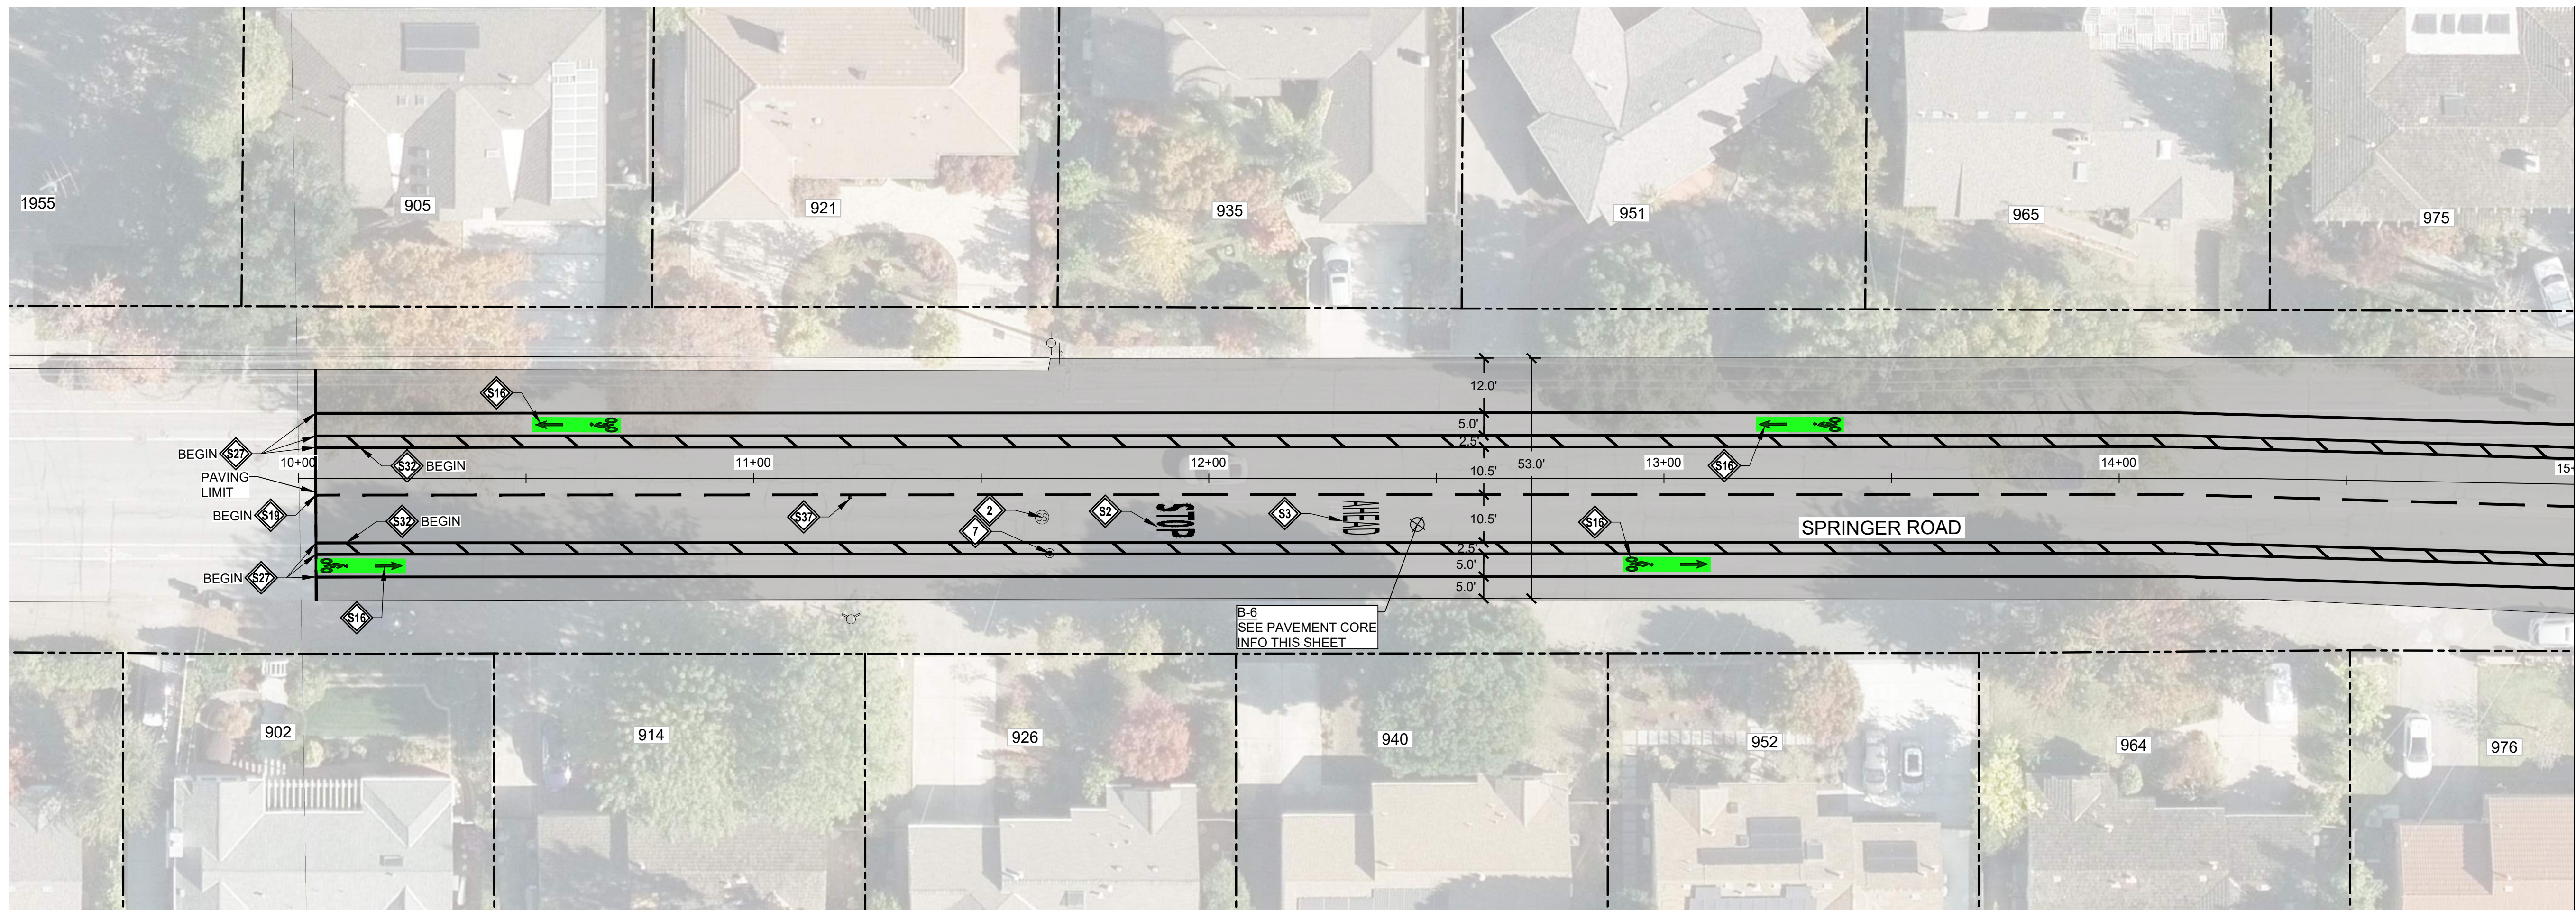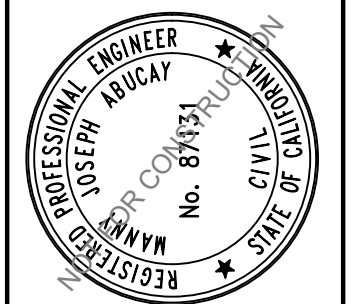

MATCHLINE (STA 15+00): SEE C4.20

SPRINGER ROAD REPAIR

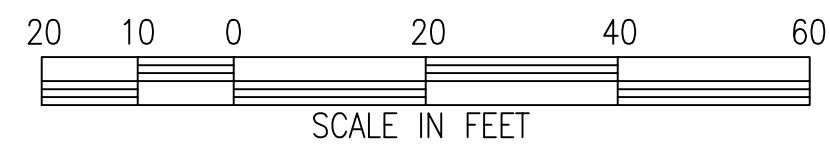

- 1 LOWER & RESTORE TO GRADE STORM MANHOLE
- 2 LOWER & RESTORE TO GRADE SEWER MANHOLE (TEMPORARY FALSE BOTTOM TO BE INSTALLED PRIOR TO ANY MANHOLE WORK, & REMOVED AFTER)
- 3 LOWER & RESTORE TO GRADE UTILITY MANHOLE (NOTIFY & COORDINATE WITH UTILITY COMPANY PRIOR TO WORK)
- 4 LOWER & RESTORE TO GRADE WATER VALVE
- 5 LOWER & RESTORE TO GRADE GAS VALVE
- 6 LOWER & RESTORE TO GRADE UTILITY BOX
- 7 REINSTALL SURVEY MONUMENT. UNDER CALIFORNIA LICENSED SURVEYOR:
 - REFERENCE OUT PRIOR TO START OF CONSTRUCTION
 - FILE PROPER DOCUMENTATION SHOWING ORIGINAL AND REPLACEMENT MONUMENTS AFTER CONSTRUCTION
 - SEE DETAIL 
- 8 INSTALL W11-1 & W16-1 SIGNS ON NEW POST. SEE DETAIL
- 9 LOWER & RESTORE TO GRADE SEWER CLEANOUT

	WHITE LIMIT LINE (STOP LINE)
	MARKING WORD "STOP"
	MARKING WORD "AHEAD"
	MARKING WORD "ONLY"
	MARKING "30"
	MARKING ARROW TYPE I
	MARKING ARROW TYPE IV (L)
	MARKING ARROW TYPE IV (R)
	MARKING SHARROW
	MARKING BIKE LANE SYMBOL
	GREEN DASHED BIKE LANE. S
	GREEN BACK
	DETAIL 2
	DETAIL 8
	DETAIL 15

	DETAIL 22
	DETAIL 25
	DETAIL 27B
	DETAIL 37B
	DETAIL 38
	DETAIL 39
	DETAIL 39A
	DETAIL 40
	6" DIAGONAL YELLOW STRIPE
	4" DIAGONAL WHITE STRIPE
	WHITE LADDER CROSSWALK
	YELLOW CONTINENTAL CROSSWALK
	BLUE HYDRANT MARKER
	36" HIGH YELLOW FLEXIBLE CHANNELIZER
	MARKING ARROW TYPE VII

 3" AC GRIND & INLAY. SEE TYPICAL SECTIONS

 4" AC BASE REPAIR. REFERENCE ALLOCATION QUANTITIES TABLE THIS SHEET. SEE DETAIL



 APPROXIMATE LIMIT OF WORK

 APPROXIMATE RIGHT OF WAY

CORE #	SUBGRADE	AC (IN)	AB (IN)	FABRIC ²
B-6	CLAYEY SAND / SILTY SAND (SC/SM)	7.0	4.0	2.0" DEPTH

1. PAVEMENT CORING WILL BE PERFORMED IN SELECT LOCATIONS AND IS NOT REPRESENTATIVE OF ALL EXISTING PAVEMENT CONDITIONS WITHIN THE WORK LIMITS.
2. PAVEMENT TO BE COLD PLANED OR REMOVED MAY CONTAIN PAVEMENT FABRIC. PAVEMENT BORINGS ARE NOT REPRESENTATIVE OF ENTIRE STREET WORK LIMITS. ANY ASSUMPTION OF THE PRESENCE OF PAVEMENT FABRIC SHALL BE AT THE CONTRACTOR'S SOLE RISK. THERE SHALL BE NO ADJUSTMENT IN COMPENSATION TO THE CONTRACTOR FOR COLD PLANING, REMOVING, AND DISPOSING AC PAVEMENT THAT CONTAINS PAVEMENT FABRIC.

1. SEE THE CURRENT VERSION OF CALTRANS STANDARD PLANS FOR PAVEMENT MARKINGS, TRAFFIC LINES, AND MARKERS.
2. A TACK COAT EMULSION SHALL BE APPLIED TO CLEAN DRY PAVEMENT BETWEEN (E) AND (N) PAVEMENT SECTIONS PRIOR TO INLAY/OVERLAY

AC PAVEMENT REPAIR #	AREA (SF)
1	0.0
2	0.0
3	0.0
4	0.0
5	0.0
6	0.0
SUBTOTAL AREA (SF)	0.0

1. ACTUAL PAVEMENT REPAIR EXTENTS AND QUANTITIES MAY VARY. ENGINEER SHALL DETERMINE PAVEMENT REPAIR EXTENTS AFTER COLD PLANE OPERATIONS ARE COMPLETE AND PRIOR TO PAVING.


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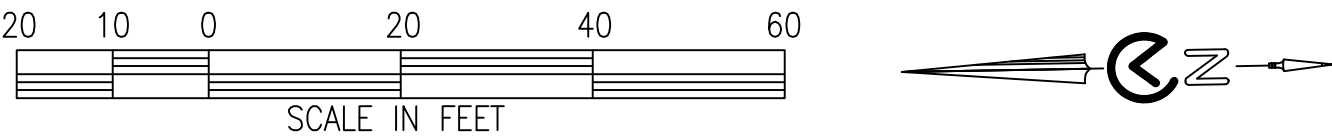
65% SUBMITTAL
APRIL 07, 2025

MATCHLINE (STA 15+00): SEE C4.19



MATCHLINE (STA 21+00): SEE C4.21

SPRINGER ROAD REPAIR

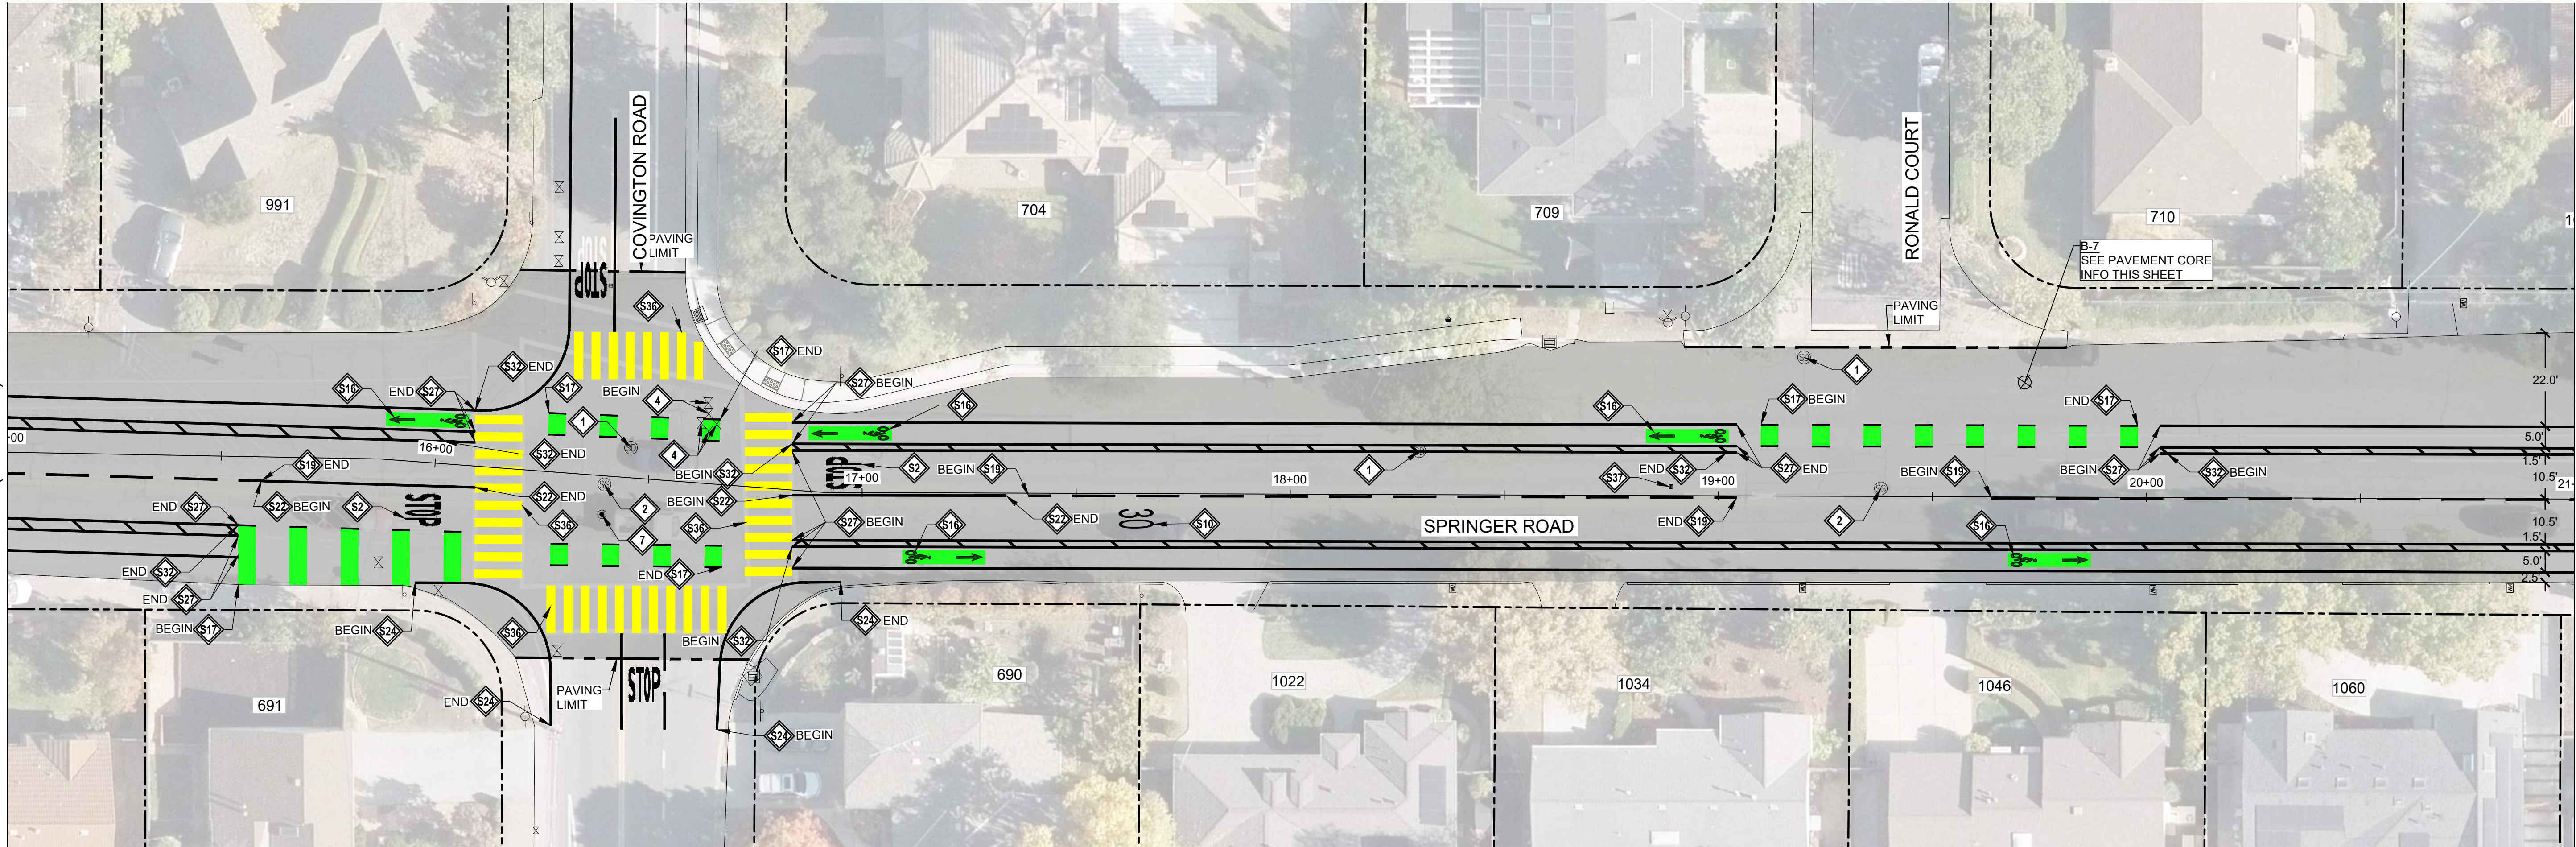

CONSTRUCTION NOTES:

- 1 LOWER & RESTORE TO GRADE STORM MANHOLE
- 2 LOWER & RESTORE TO GRADE SEWER MANHOLE (TEMPORARY FALSE BOTTOM TO BE INSTALLED PRIOR TO ANY MANHOLE WORK, & REMOVED AFTER)
- 3 LOWER & RESTORE TO GRADE UTILITY MANHOLE (NOTIFY & COORDINATE WITH UTILITY COMPANY PRIOR TO WORK)
- 4 LOWER & RESTORE TO GRADE WATER VALVE
- 5 LOWER & RESTORE TO GRADE GAS VALVE
- 6 LOWER & RESTORE TO GRADE UTILITY BOX
- 7 REINSTALL SURVEY MONUMENT. UNDER CALIFORNIA LICENSED SURVEYOR:
 - REFERENCE OUT PRIOR TO START OF CONSTRUCTION
 - FILE PROPER DOCUMENTATION SHOWING ORIGINAL AND REPLACEMENT MONUMENTS AFTER CONSTRUCTION
- 8 SEE DETAIL (X/CX.X)
- 9 INSTALL W11-1 & W16-1 SIGNS ON NEW POST. SEE DETAIL
- 10 LOWER & RESTORE TO GRADE SEWER CLEANOUT

STRIPING NOTES:

- S1 WHITE LIMIT LINE (STOP LINE)
- S2 MARKING WORD "STOP"
- S3 MARKING WORD "AHEAD"
- S4 MARKING WORD "ONLY"
- S10 MARKING "30"
- S11 MARKING ARROW TYPE I
- S12 MARKING ARROW TYPE IV (L)
- S13 MARKING ARROW TYPE IV (R)
- S15 MARKING SHARROW
- S16 MARKING BIKE LANE SYMBOL. SEE DETAIL (A/C4.3)
- S17 GREEN DASHED BIKE LANE. SEE DETAIL (B,C/C4.3)
- S18 GREEN BACK
- S19 DETAIL 2
- S20 DETAIL 8
- S21 DETAIL 15

STRIPING NOTES:

- S22 DETAIL 22
- S23 DETAIL 25
- S24 DETAIL 27B
- S25 DETAIL 37B
- S26 DETAIL 38
- S27 DETAIL 39
- S28 DETAIL 39A
- S29 DETAIL 40
- S31 6" DIAGONAL YELLOW STRIPE
- S32 4" DIAGONAL WHITE STRIPE
- S33 WHITE LADDER CROSSWALK
- S36 YELLOW CONTINENTAL CROSSWALK
- S37 BLUE HYDRANT MARKER
- S44 36" HIGH YELLOW FLEXIBLE CHANNELIZER
- S45 MARKING ARROW TYPE VII

LEGEND:

- 3" AC GRIND & INLAY. SEE TYPICAL SECTIONS
- 4" AC BASE REPAIR. REFERENCE ALLOCATION QUANTITIES TABLE THIS SHEET. SEE DETAIL (X/XXX)
- APPROXIMATE LIMIT OF WORK
- APPROXIMATE RIGHT OF WAY

GENERAL NOTES:

- SEE THE CURRENT VERSION OF CALTRANS STANDARD PLANS FOR PAVEMENT MARKINGS, TRAFFIC LINES, AND MARKERS.
- A TACK COAT EMULSION SHALL BE APPLIED TO CLEAN DRY PAVEMENT BETWEEN (E) AND (N) PAVEMENT SECTIONS PRIOR TO INLAY/OVERLAY

AC BASE REPAIR ALLOCATION QUANTITIES

AC PAVEMENT REPAIR #	AREA (SF)
1	0.0
2	0.0
3	0.0
4	0.0
5	0.0
6	0.0
SUBTOTAL AREA (SF)	0.0

PAVEMENT REPAIR QUANTITY NOTES

- ACTUAL PAVEMENT REPAIR EXTENTS AND QUANTITIES MAY VARY. ENGINEER SHALL DETERMINE PAVEMENT REPAIR EXTENTS AFTER COLD PLANE OPERATIONS ARE COMPLETE AND PRIOR TO PAVING.

PAVEMENT CORING LOG

CORE #	SUBGRADE	AC (IN)	AB (IN)	FABRIC ²
B-7	SAND WITH GRAVEL / GRAVELLY SAND (SWG/C)	5.0	3.0	1.5" DEPTH

PAVEMENT CORING NOTES

- PAVEMENT CORING WAS PERFORMED IN SELECT LOCATIONS AND IS NOT REPRESENTATIVE OF ALL EXISTING PAVEMENT CONDITIONS WITHIN THE WORK LIMITS.
- PAVEMENT TO BE COLD PLANED OR REMOVED MAY CONTAIN PAVEMENT FABRIC. PAVEMENT BORINGS ARE NOT REPRESENTATIVE OF ENTIRE STREET WORK LIMITS. ANY ASSUMPTION OF THE PRESENCE OF PAVEMENT FABRIC SHALL BE AT THE CONTRACTOR'S SOLE RISK. THERE SHALL BE NO ADJUSTMENT IN COMPENSATION TO THE CONTRACTOR FOR COLD PLANING, REMOVING, AND DISPOSING AC PAVEMENT THAT CONTAINS PAVEMENT FABRIC.

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APRIL 07, 2025

Agenda Item 1.

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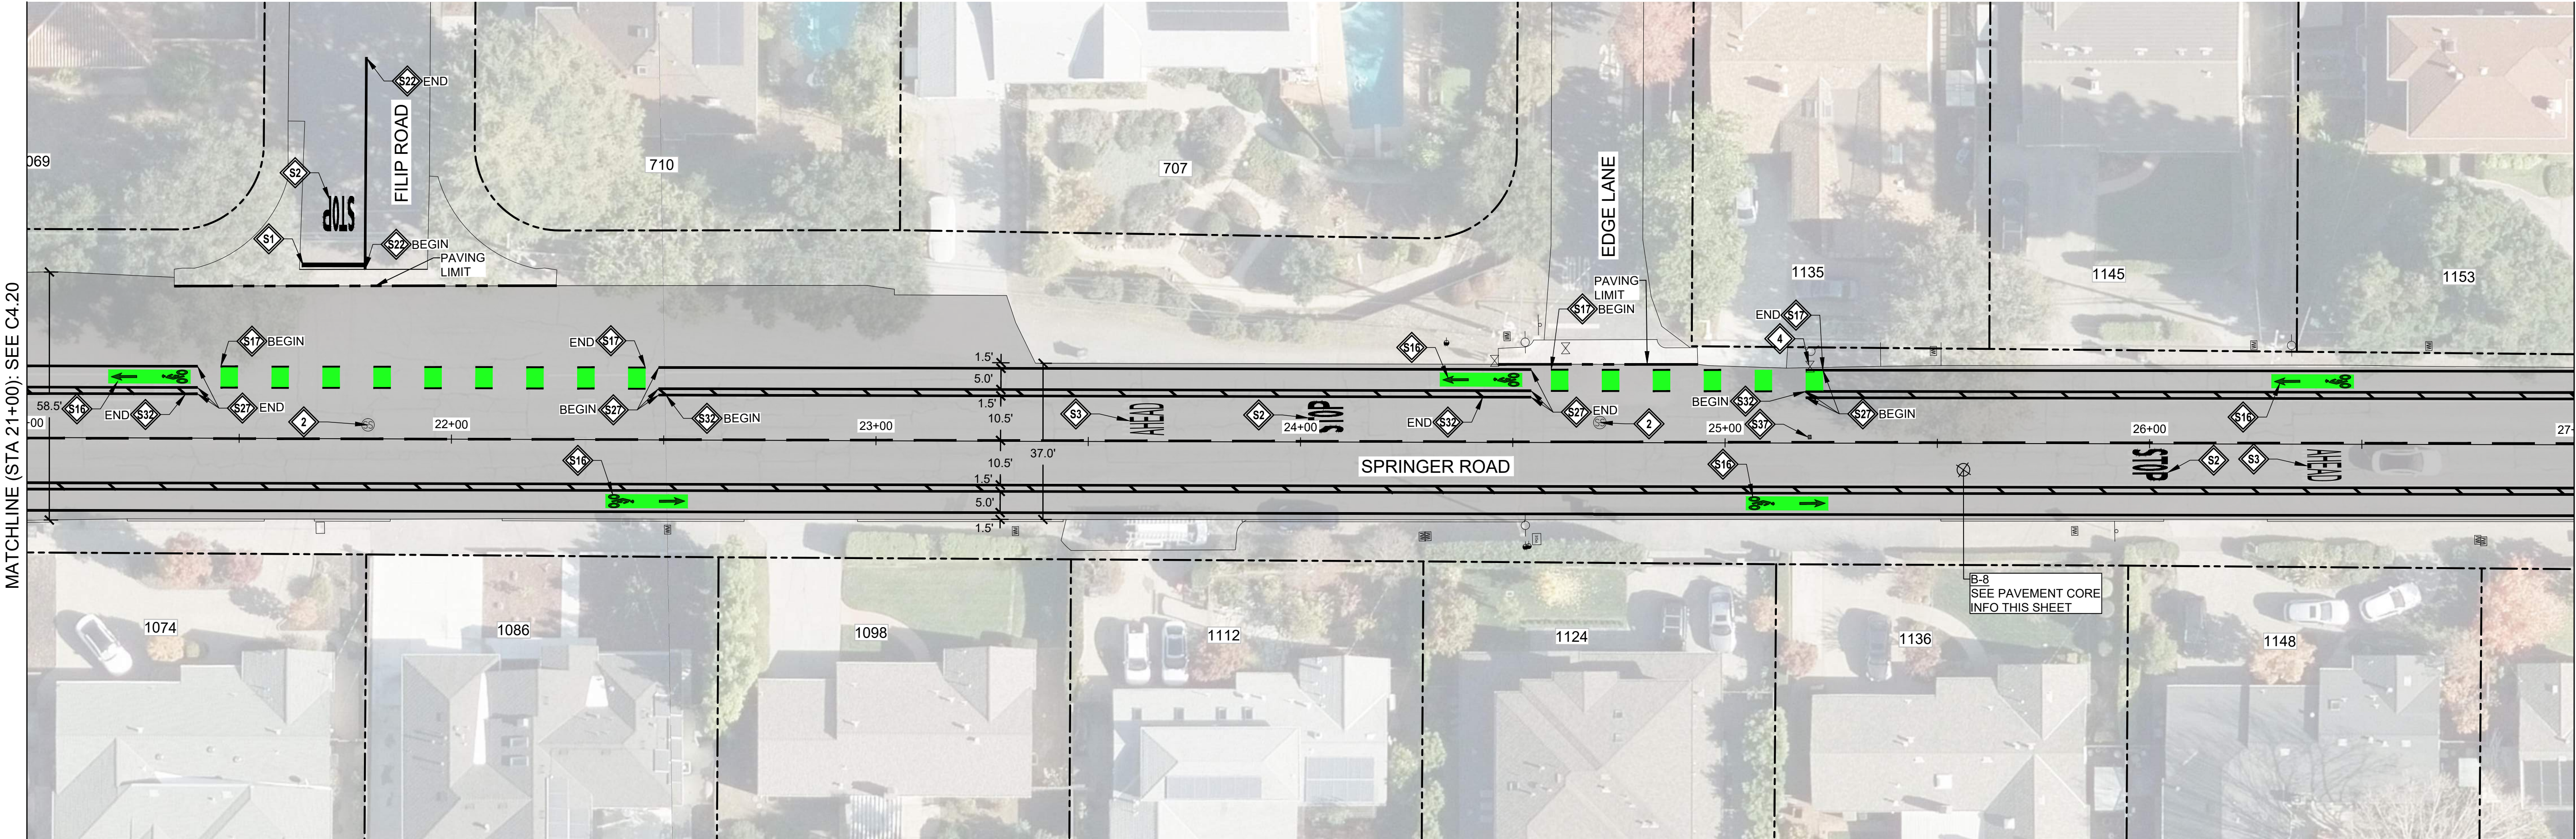
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CITY OF LOS ALTOS
1 NORTH SAN ANTONIO ROAD
CALIFORNIA 94022

2024-2025 ANNUAL STREET RESURFACING PROJECT
STREET IMPROVEMENT PLAN - SPRINGER ROAD
15+00 to 21+00
SANTA CLARA COUNTY
LOS ALTOS
CALIFORNIA

DWG NO. C4.20
27 OF 50
JOB NO. 250007

55



SPRINGER ROAD REPAIR



CONSTRUCTION NOTES:

- 1 LOWER & RESTORE TO GRADE STORM MANHOLE
- 2 LOWER & RESTORE TO GRADE SEWER MANHOLE (TEMPORARY FALSE BOTTOM TO BE INSTALLED PRIOR TO ANY MANHOLE WORK, & REMOVED AFTER)
- 3 LOWER & RESTORE TO GRADE UTILITY MANHOLE (NOTIFY & COORDINATE WITH UTILITY COMPANY PRIOR TO WORK)
- 4 LOWER & RESTORE TO GRADE WATER VALVE
- 5 LOWER & RESTORE TO GRADE GAS VALVE
- 6 LOWER & RESTORE TO GRADE UTILITY BOX
- 7 REINSTALL SURVEY MONUMENT. UNDER CALIFORNIA LICENSED SURVEYOR:
 - REFERENCE OUT PRIOR TO START OF CONSTRUCTION
 - FILE PROPER DOCUMENTATION SHOWING ORIGINAL AND REPLACEMENT MONUMENTS AFTER CONSTRUCTION
- 8 INSTALL W11-1 & W16-1 SIGNS ON NEW POST. SEE DETAIL
- 9 LOWER & RESTORE TO GRADE SEWER CLEANOUT

STRIPING NOTES:

- S1 WHITE LIMIT LINE (STOP LINE)
- S2 MARKING WORD "STOP"
- S3 MARKING WORD "AHEAD"
- S4 MARKING WORD "ONLY"
- S10 MARKING "30"
- S11 MARKING ARROW TYPE I
- S12 MARKING ARROW TYPE IV (L)
- S13 MARKING ARROW TYPE IV (R)
- S15 MARKING SHARROW
- S16 MARKING BIKE LANE SYMBOL. SEE DETAIL A C4.3
- S17 GREEN DASHED BIKE LANE. SEE DETAIL B,C C4.3
- S18 GREEN BACK
- S19 DETAIL 2
- S20 DETAIL 8
- S21 DETAIL 15

STRIPING NOTES:

- S22 DETAIL 22
- S23 DETAIL 25
- S24 DETAIL 27B
- S25 DETAIL 37B
- S26 DETAIL 38
- S27 DETAIL 39
- S28 DETAIL 39A
- S29 DETAIL 40
- S31 6" DIAGONAL YELLOW STRIPE
- S32 4" DIAGONAL WHITE STRIPE
- S33 WHITE LADDER CROSSWALK
- S36 YELLOW CONTINENTAL CROSSWALK
- S37 BLUE HYDRANT MARKER
- S44 36" HIGH YELLOW FLEXIBLE CHANNELIZER
- S45 MARKING ARROW TYPE VII

LEGEND:

- 3" AC GRIND & INLAY. SEE TYPICAL SECTIONS
- 4" AC BASE REPAIR. REFERENCE ALLOCATION QUANTITIES TABLE THIS SHEET. SEE DETAIL X XX.X
- APPROXIMATE LIMIT OF WORK
- APPROXIMATE RIGHT OF WAY

PAVEMENT CORING LOG

CORE #	SUBGRADE	AC (IN)	AB (IN)	FABRIC ²
B-8	SAND WITH GRAVEL (SP/SW)	7.0	0.0	N/A

PAVEMENT CORING NOTES

- PAVEMENT CORING WAS PERFORMED IN SELECT LOCATIONS AND IS NOT REPRESENTATIVE OF ALL EXISTING PAVEMENT CONDITIONS WITHIN THE WORK LIMITS.
- PAVEMENT TO BE COLD PLANED OR REMOVED MAY CONTAIN PAVEMENT FABRIC. PAVEMENT BORINGS ARE NOT REPRESENTATIVE OF ENTIRE STREET WORK LIMITS. ANY ASSUMPTION OF THE PRESENCE OF PAVEMENT FABRIC SHALL BE AT THE CONTRACTOR'S SOLE RISK. THERE SHALL BE NO ADJUSTMENT IN COMPENSATION TO THE CONTRACTOR FOR COLD PLANING, REMOVING, AND DISPOSING AC PAVEMENT THAT CONTAINS PAVEMENT FABRIC.

GENERAL NOTES:

- SEE THE CURRENT VERSION OF CALTRANS STANDARD PLANS FOR PAVEMENT MARKINGS, TRAFFIC LINES, AND MARKERS.
- A TACK COAT EMULSION SHALL BE APPLIED TO CLEAN DRY PAVEMENT BETWEEN (E) AND (N) PAVEMENT SECTIONS PRIOR TO INLAY/OVERLAY

AC BASE REPAIR ALLOCATION QUANTITIES

AC PAVEMENT REPAIR #	AREA (SF)
1	0.0
2	0.0
3	0.0
4	0.0
5	0.0
6	0.0
SUBTOTAL AREA (SF)	0.0

PAVEMENT REPAIR QUANTITY NOTES

- ACTUAL PAVEMENT REPAIR EXTENTS AND QUANTITIES MAY VARY. ENGINEER SHALL DETERMINE PAVEMENT REPAIR EXTENTS AFTER COLD PLANE OPERATIONS ARE COMPLETE AND PRIOR TO PAVING.

Call Two Working Days Before You Dig!



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APRIL 07, 2025

Agenda Item 1.

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CITY OF LOS ALTOS

1 NORTH SAN ANTONIO ROAD

CALIFORNIA 94022

2024-2025 ANNUAL STREET RESURFACING PROJECT

STREET IMPROVEMENT PLAN - SPRINGER ROAD

21+00 TO 27+00

LOS ALTOS

SANTA CLARA COUNTY

CALIFORNIA

DWG NO.

C4.21


28 OF 50

JOB NO.

250007

56

MATCHLINE (STA 27+00): SEE C4.21

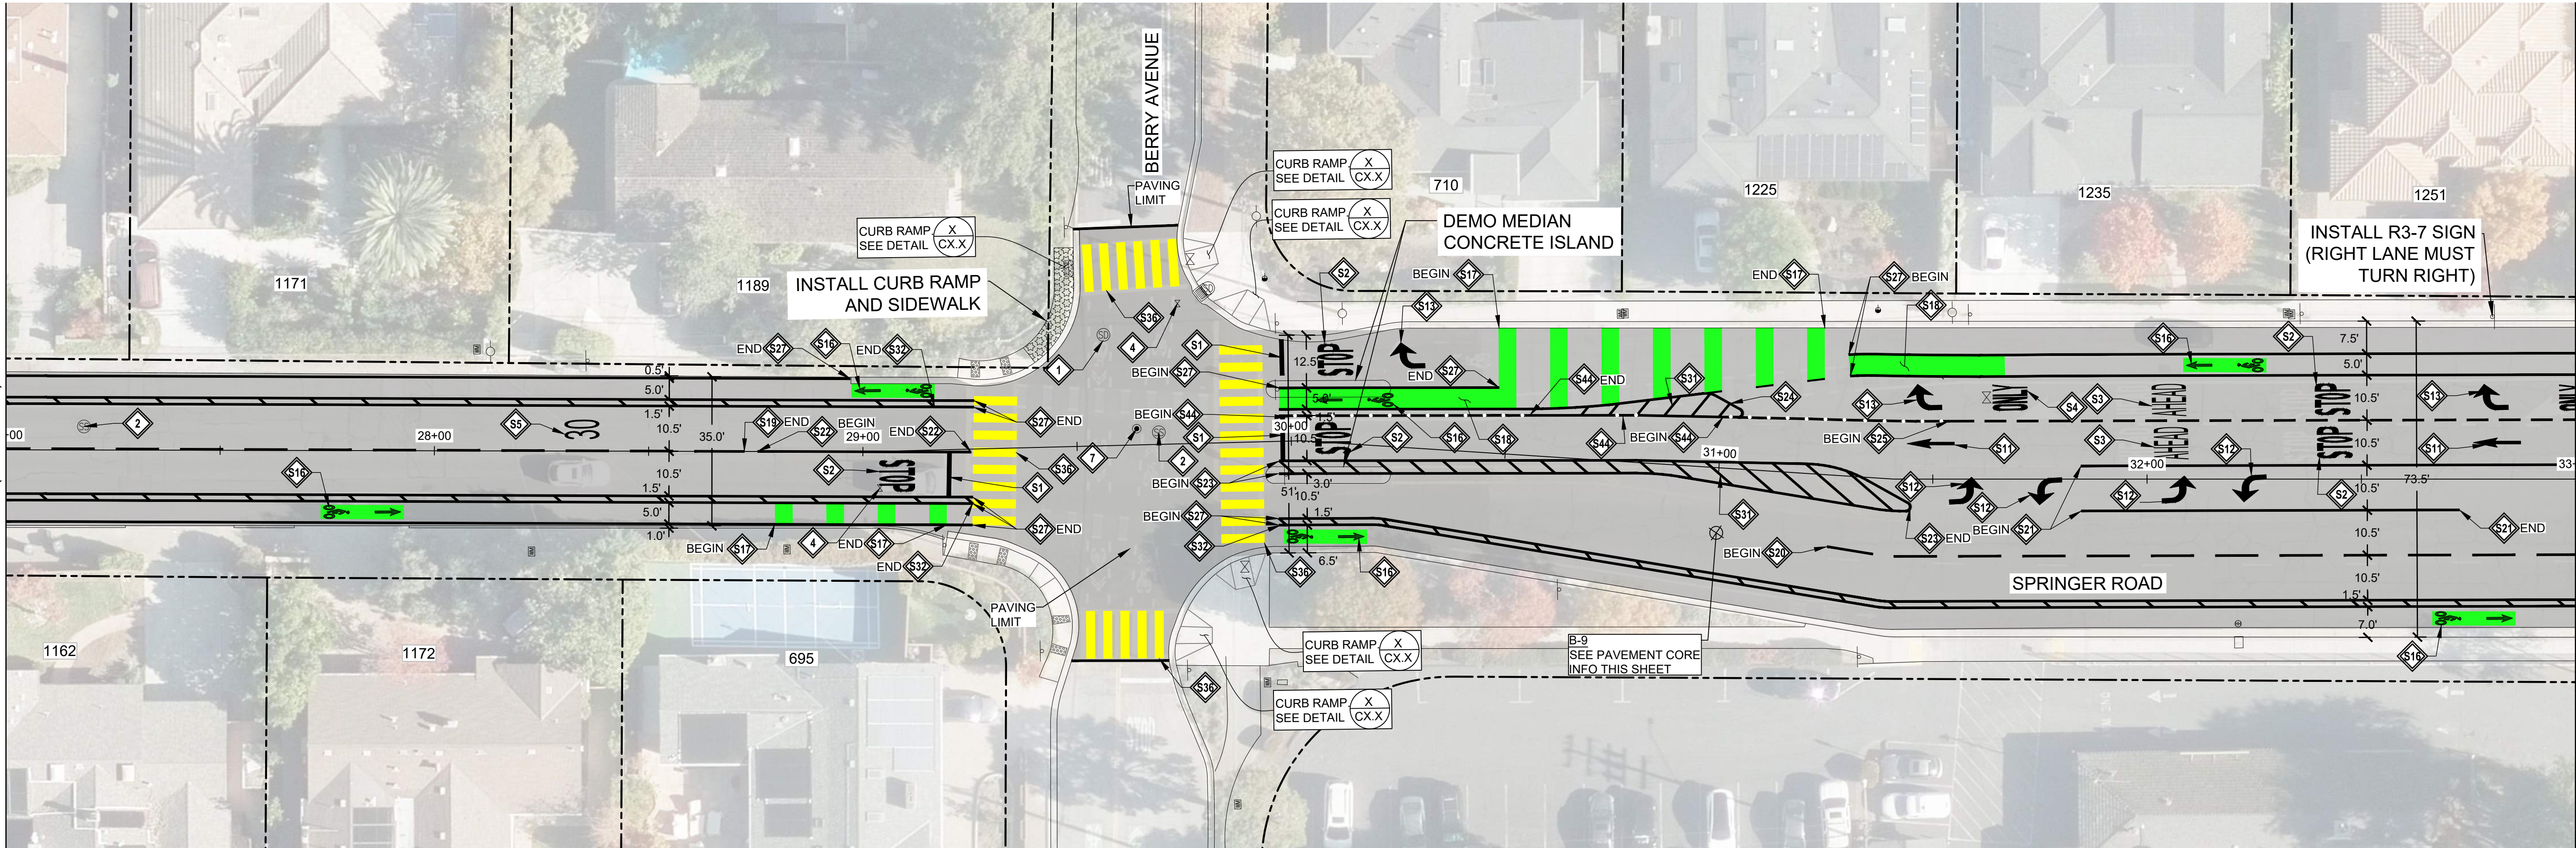

MATCHLINE (STA 33+00): SEE C4.23

SPRINGER ROAD REPAIR

CONSTRUCTION NOTES:

- 1 LOWER & RESTORE TO GRADE STORM MANHOLE
- 2 LOWER & RESTORE TO GRADE SEWER MANHOLE (TEMPORARY FALSE BOTTOM TO BE INSTALLED PRIOR TO ANY MANHOLE WORK, & REMOVED AFTER)
- 3 LOWER & RESTORE TO GRADE UTILITY MANHOLE (NOTIFY & COORDINATE WITH UTILITY COMPANY PRIOR TO WORK)
- 4 LOWER & RESTORE TO GRADE WATER VALVE
- 5 LOWER & RESTORE TO GRADE GAS VALVE
- 6 LOWER & RESTORE TO GRADE UTILITY BOX
- 7 REINSTALL SURVEY MONUMENT. UNDER CALIFORNIA LICENSED SURVEYOR:
 - REFERENCE OUT PRIOR TO START OF CONSTRUCTION
 - FILE PROPER DOCUMENTATION SHOWING ORIGINAL AND REPLACEMENT MONUMENTS AFTER CONSTRUCTION
- 8 INSTALL W11-1 & W16-1 SIGNS ON NEW POST. SEE DETAIL
- 9 LOWER & RESTORE TO GRADE SEWER CLEANOUT

STRIPING NOTES:

- S1 WHITE LIMIT LINE (STOP LINE)
- S2 MARKING WORD "STOP"
- S3 MARKING WORD "AHEAD"
- S4 MARKING WORD "ONLY"
- S10 MARKING "30"
- S11 MARKING ARROW TYPE I
- S12 MARKING ARROW TYPE IV (L)
- S13 MARKING ARROW TYPE IV (R)
- S15 MARKING SHARROW
- S16 MARKING BIKE LANE SYMBOL. SEE DETAIL A C4.3
- S17 GREEN DASHED BIKE LANE. SEE DETAIL B,C C4.3
- S18 GREEN BACK
- S19 DETAIL 2
- S20 DETAIL 8
- S21 DETAIL 15

STRIPING NOTES:

- S22 DETAIL 22
- S23 DETAIL 25
- S24 DETAIL 27B
- S25 DETAIL 37B
- S26 DETAIL 38
- S27 DETAIL 39
- S28 DETAIL 39A
- S29 DETAIL 40
- S31 6" DIAGONAL YELLOW STRIPE
- S32 4" DIAGONAL WHITE STRIPE
- S33 WHITE LADDER CROSSWALK
- S36 YELLOW CONTINENTAL CROSSWALK
- S37 BLUE HYDRANT MARKER
- S44 36" HIGH YELLOW FLEXIBLE CHANNELIZER
- S45 MARKING ARROW TYPE VII

LEGEND:

- 3" AC GRIND & INLAY. SEE TYPICAL SECTIONS
- 4" AC BASE REPAIR. REFERENCE ALLOCATION QUANTITIES TABLE THIS SHEET. SEE DETAIL CX.X
- APPROXIMATE LIMIT OF WORK
- APPROXIMATE RIGHT OF WAY

PAVEMENT CORING LOG

CORE #	SUBGRADE	AC (IN)	AB (IN)	FABRIC ²
B-9	SAND WITH GRAVEL (SP/SW)	6.0	0.0	N/A

PAVEMENT CORING NOTES

1. PAVEMENT CORING WAS PERFORMED IN SELECT LOCATIONS AND IS NOT REPRESENTATIVE OF ALL EXISTING PAVEMENT CONDITIONS WITHIN THE WORK LIMITS.
2. PAVEMENT TO BE COLD PLANED OR REMOVED MAY CONTAIN PAVEMENT FABRIC. PAVEMENT BORINGS ARE NOT REPRESENTATIVE OF ENTIRE STREET WORK LIMITS. ANY ASSUMPTION OF THE PRESENCE OF PAVEMENT FABRIC SHALL BE AT THE CONTRACTOR'S SOLE RISK. THERE SHALL BE NO ADJUSTMENT IN COMPENSATION TO THE CONTRACTOR FOR COLD PLANING, REMOVING, AND DISPOSING AC PAVEMENT THAT CONTAINS PAVEMENT FABRIC.

GENERAL NOTES:

1. SEE THE CURRENT VERSION OF CALTRANS STANDARD PLANS FOR PAVEMENT MARKINGS, TRAFFIC LINES, AND MARKERS.
2. A TACK COAT EMULSION SHALL BE APPLIED TO CLEAN DRY PAVEMENT BETWEEN (E) AND (N) PAVEMENT SECTIONS PRIOR TO INLAY/OVERLAY

AC BASE REPAIR ALLOCATION QUANTITIES

AC PAVEMENT REPAIR #	AREA (SF)
1	0.0
2	0.0
3	0.0
4	0.0
5	0.0
6	0.0
SUBTOTAL AREA (SF)	0.0

PAVEMENT REPAIR QUANTITY NOTES

1. ACTUAL PAVEMENT REPAIR EXTENTS AND QUANTITIES MAY VARY. ENGINEER SHALL DETERMINE PAVEMENT REPAIR EXTENTS AFTER COLD PLANE OPERATIONS ARE COMPLETE AND PRIOR TO PAVING.

Call Two Working Days Before You Dig!



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APRIL 07, 2025

Agenda Item 1.

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CITY OF LOS ALTOS

1 NORTH SAN ANTONIO ROAD

CALIFORNIA 94022

2024-2025 ANNUAL STREET RESURFACING PROJECT

STREET IMPROVEMENT PLAN - SPRINGER ROAD

27+00 TO 33+00

CALIFORNIA

DWG NO.

C4.22

29 OF 50

JOB NO.

250007

57

LOS ALTOS


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CALIFORNIA 94022



2024-2025 ANNUAL STREET RESURFACING PROJECT
STREET IMPROVEMENT PLAN - SPRINGER ROAD
33+00 to 64+88
LOS ALTOS
SANTA CLARA COUNTY
CALIFORNIA



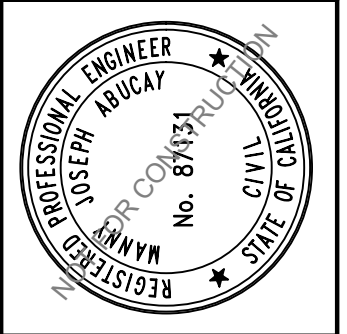


DWG NO.	C4.23	30 OF 50	JOB NO.	250007
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APRIL 07, 2025

GENERAL NOTES:

- SEE THE CURRENT VERSION OF CALTRANS STANDARD PLANS FOR PAVEMENT MARKINGS, TRAFFIC LINES, AND MARKERS.
- A TACK COAT EMULSION SHALL BE APPLIED TO CLEAN DRY PAVEMENT BETWEEN (E) AND (N) PAVEMENT SECTIONS PRIOR TO INLAY/OVERLAY

LEGEND:

-  3" AC GRIND & INLAY. SEE TYPICAL SECTIONS
-  4" AC BASE REPAIR. REFERENCE ALLOCATION QUANTITIES TABLE THIS SHEET. SEE DETAIL 
-  APPROXIMATE LIMIT OF WORK
-  APPROXIMATE RIGHT OF WAY











AC BASE REPAIR ALLOCATION QUANTITIES

AC PAVEMENT REPAIR #	AREA (SF)
1	0.0
2	0.0
3	0.0
4	0.0
5	0.0
6	0.0
SUBTOTAL AREA (SF)	0.0


















PAVEMENT REPAIR QUANTITY NOTES

- ACTUAL PAVEMENT REPAIR EXTENTS AND QUANTITIES MAY VARY. ENGINEER SHALL DETERMINE PAVEMENT REPAIR EXTENTS AFTER COLD PLANE OPERATIONS ARE COMPLETE AND PRIOR TO PAVING.



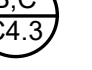












CONSTRUCTION NOTES:


-  LOWER & RESTORE TO GRADE STORM MANHOLE
-  LOWER & RESTORE TO GRADE SEWER MANHOLE (TEMPORARY FALSE BOTTOM TO BE INSTALLED PRIOR TO ANY MANHOLE WORK, & REMOVED AFTER)
-  LOWER & RESTORE TO GRADE UTILITY MANHOLE (NOTIFY & COORDINATE WITH UTILITY COMPANY PRIOR TO WORK)
-  LOWER & RESTORE TO GRADE WATER VALVE
-  LOWER & RESTORE TO GRADE GAS VALVE
-  LOWER & RESTORE TO GRADE UTILITY BOX
-  REINSTALL SURVEY MONUMENT. UNDER CALIFORNIA LICENSED SURVEYOR:
 - REFERENCE OUT PRIOR TO START OF CONSTRUCTION
 - FILE PROPER DOCUMENTATION SHOWING ORIGINAL AND REPLACEMENT MONUMENTS AFTER CONSTRUCTION
 - SEE DETAIL 
-  INSTALL W11-1 & W16-1 SIGNS ON NEW POST. SEE DETAIL
-  LOWER & RESTORE TO GRADE SEWER CLEANOUT

STRIPING NOTES:



-  WHITE LIMIT LINE (STOP LINE)
-  MARKING WORD "STOP"
-  MARKING WORD "AHEAD"
-  MARKING WORD "ONLY"
-  MARKING "30"
-  MARKING ARROW TYPE I
-  MARKING ARROW TYPE IV (L)
-  MARKING ARROW TYPE IV (R)
-  MARKING SHARROW
-  MARKING BIKE LANE SYMBOL. SEE DETAIL 
-  GREEN DASHED BIKE LANE. SEE DETAIL 
-  GREEN BACK
-  DETAIL 2
-  DETAIL 8
-  DETAIL 15

STRIPING NOTES:

-  DETAIL 22
-  DETAIL 25
-  DETAIL 27B
-  DETAIL 37B
-  DETAIL 38
-  DETAIL 39
-  DETAIL 39A
-  DETAIL 40
-  6" DIAGONAL YELLOW STRIPE
-  4" DIAGONAL WHITE STRIPE
-  WHITE LADDER CROSSWALK
-  YELLOW CONTINENTAL CROSSWALK
-  BLUE HYDRANT MARKER
-  36" HIGH YELLOW FLEXIBLE CHANNELIZER
-  MARKING ARROW TYPE VII

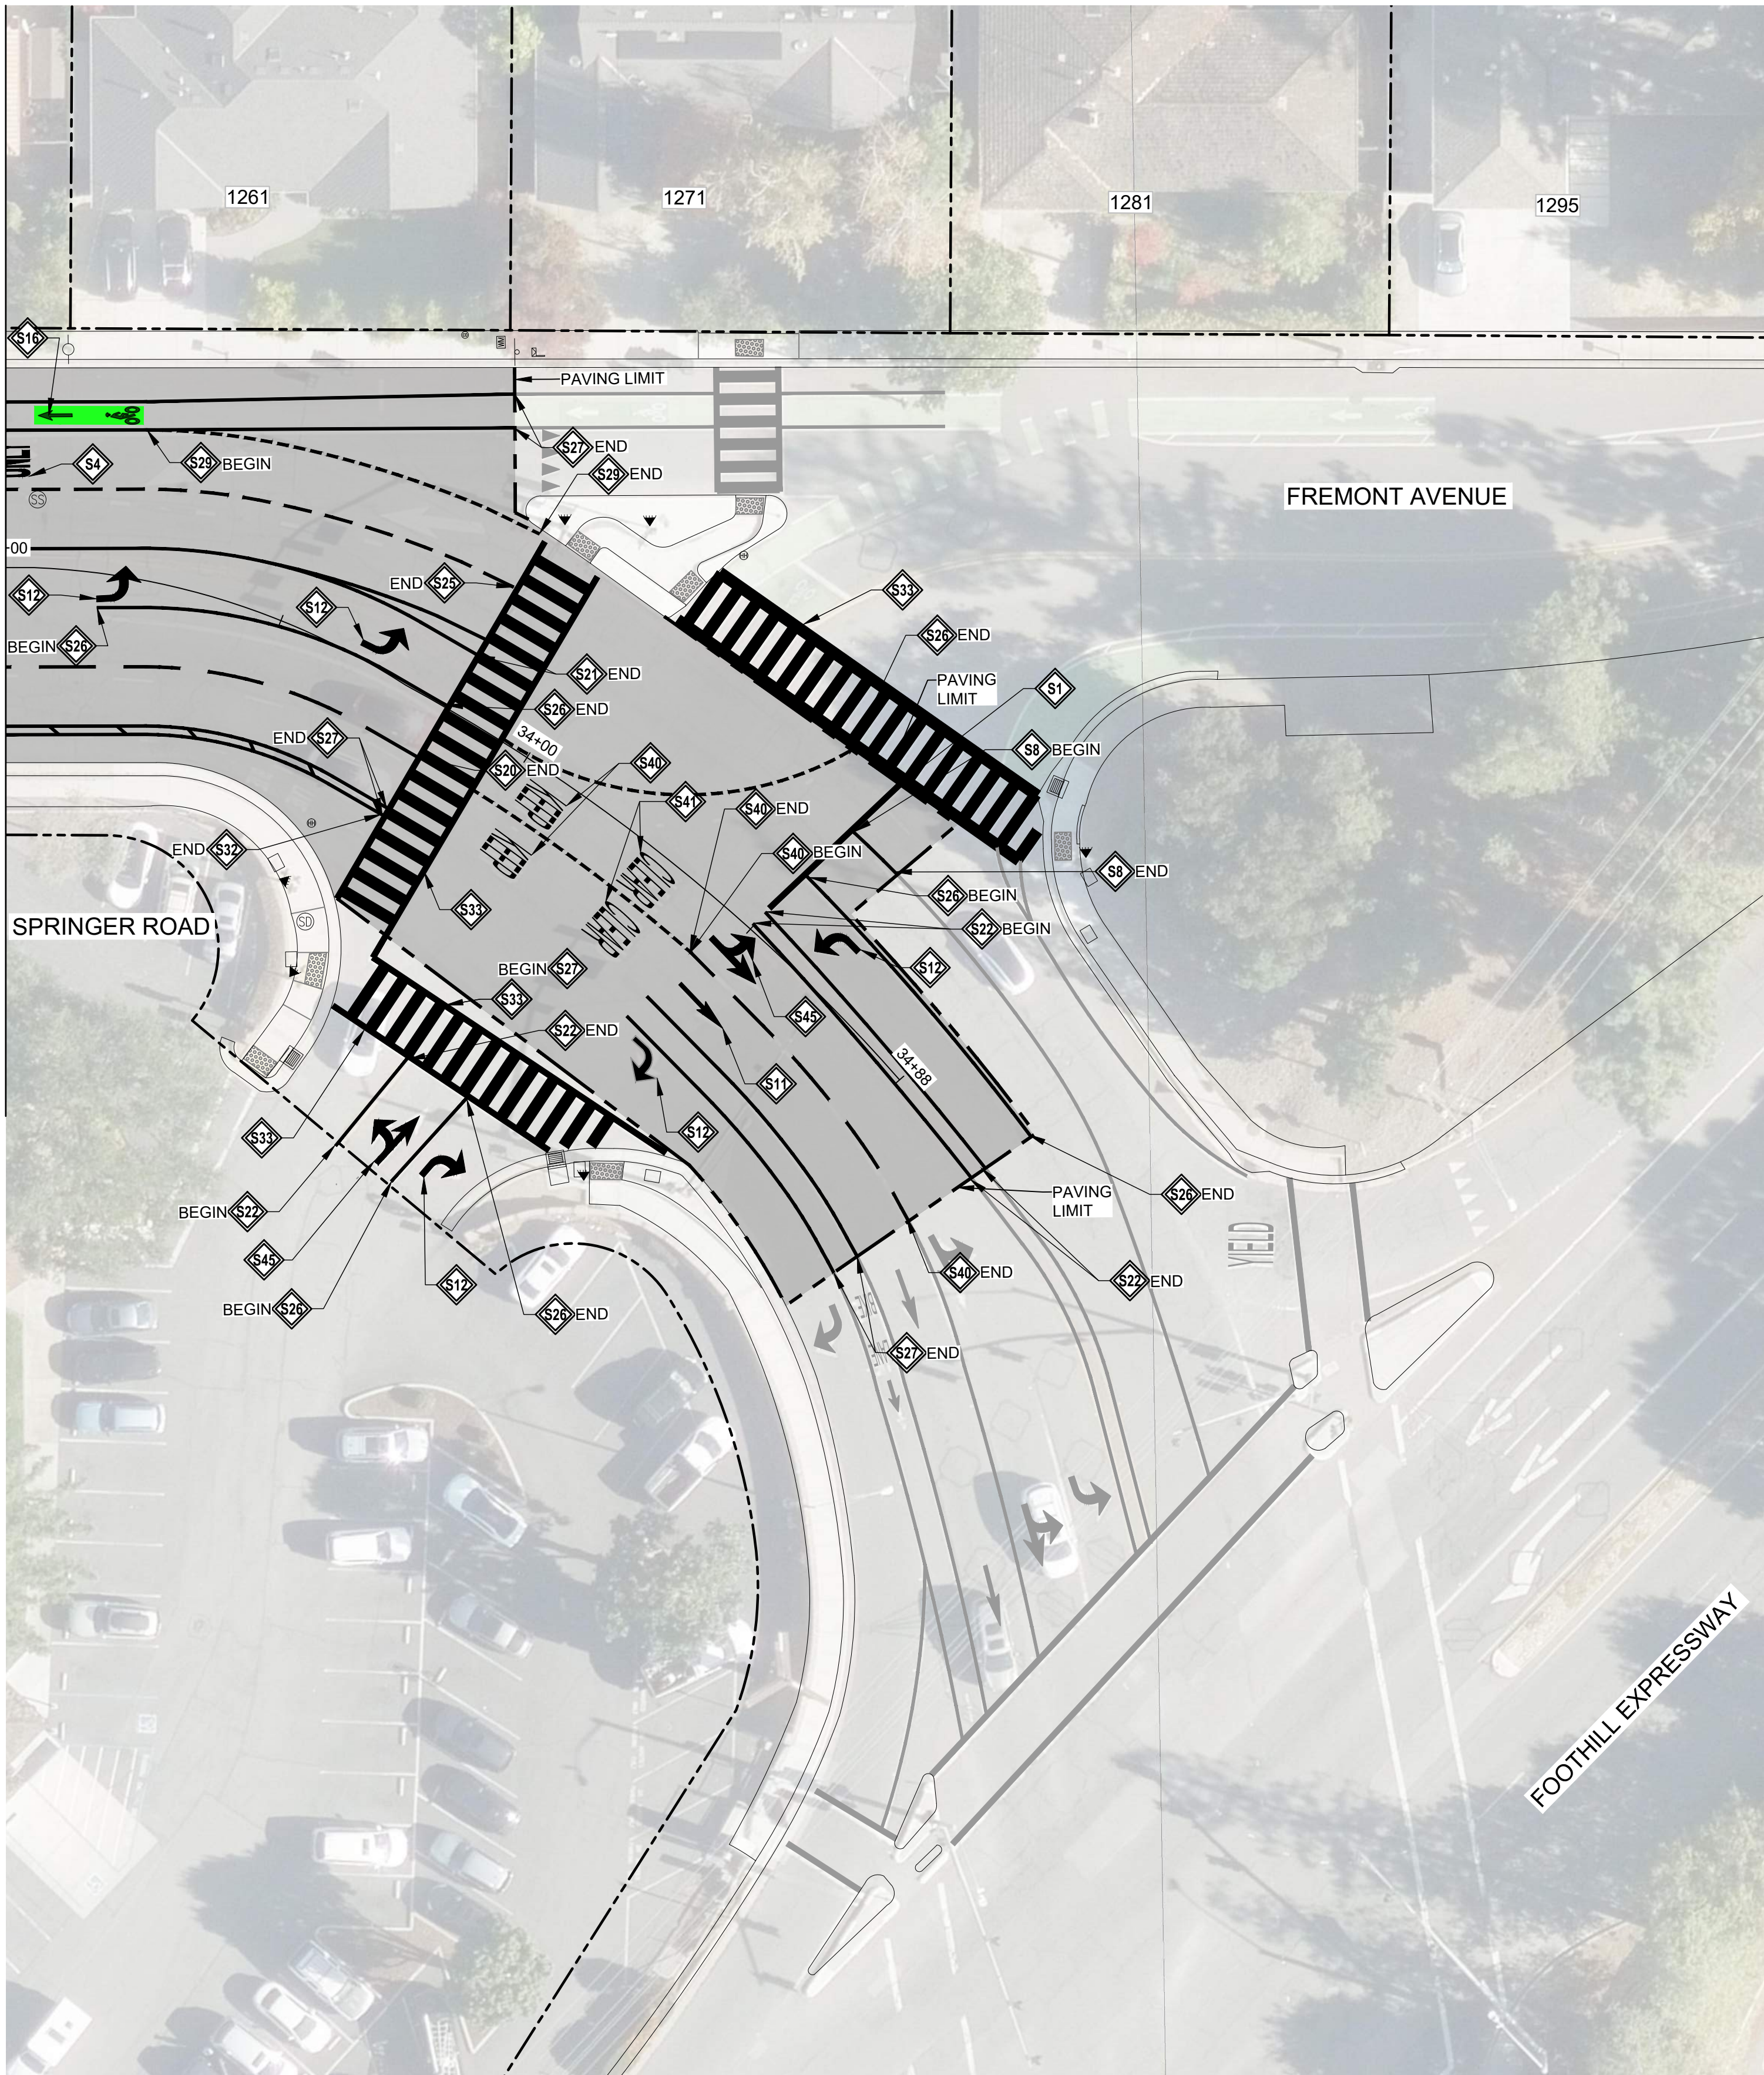

SPRINGER ROAD REPAIR

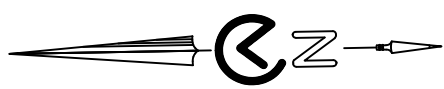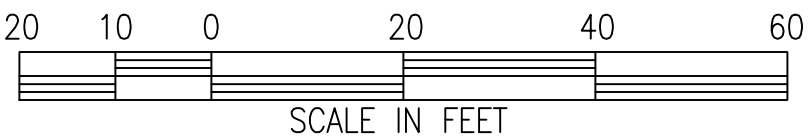

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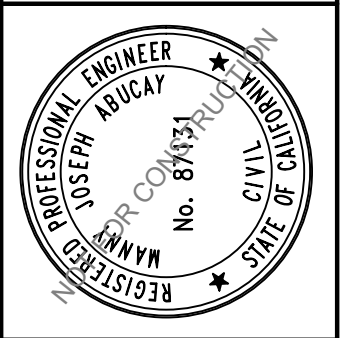


BY	DATE	REVISIONS



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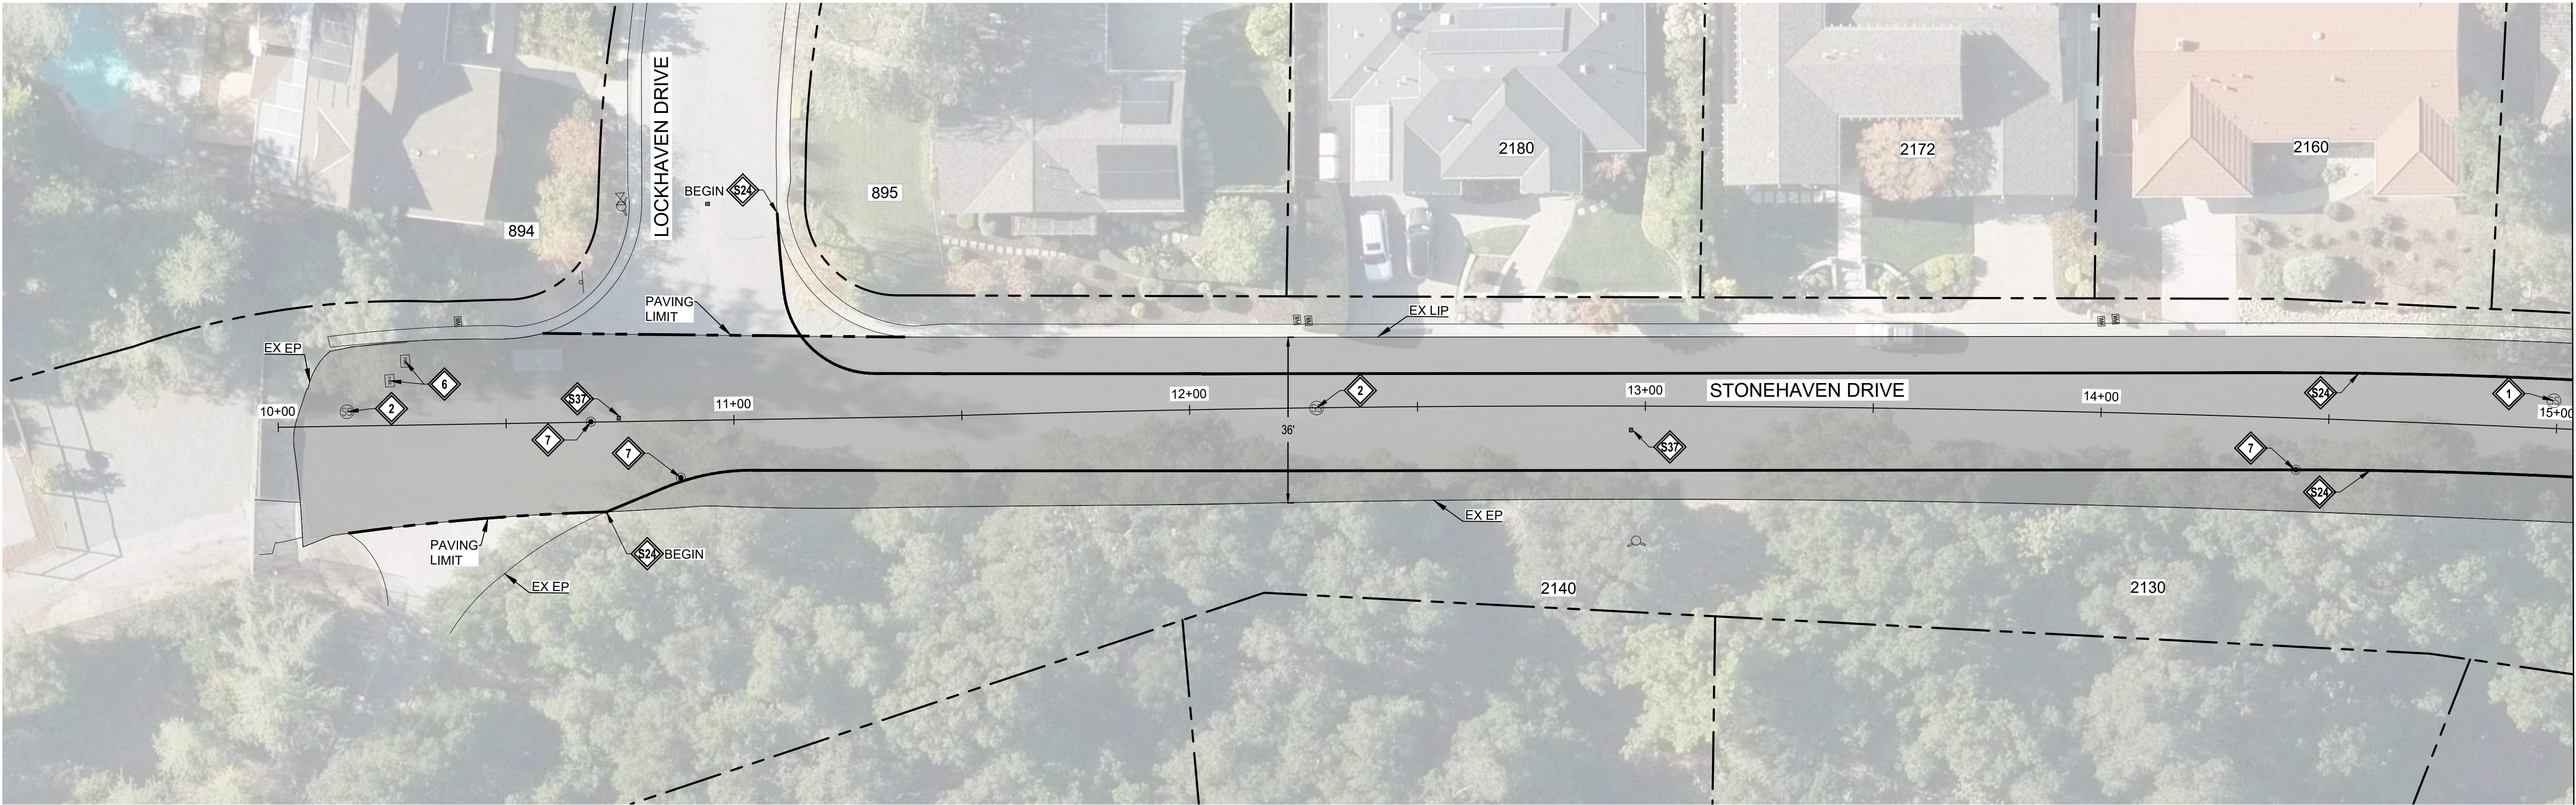
CITY OF LOS ALTOS
1 NORTH SAN ANTONIO ROAD
CALIFORNIA 94022



2024-2025 ANNUAL STREET RESURFACING PROJECT
IMPROVEMENT PLAN - STONEHAVEN DRIVE
10+00 to 15+07
SANTA CLARA COUNTY
CALIFORNIA
LOS ALTOS

DWG NO.	C4.24	JOB NO.	250007
31 OF 50			

65% SUBMITTAL
APRIL 07, 2025



PAVEMENT REPAIR SITE - STONEHAVEN DRIVE

CONSTRUCTION NOTES:

- 1

LOWER & RESTORE TO GRADE STORM MANHOLE
- 2

LOWER & RESTORE TO GRADE SEWER MANHOLE (TEMPORARY FALSE BOTTOM TO BE INSTALLED PRIOR TO ANY MANHOLE WORK, & REMOVED AFTER)
- 3

LOWER & RESTORE TO GRADE UTILITY MANHOLE (NOTIFY & COORDINATE WITH UTILITY COMPANY PRIOR TO WORK)
- 4

LOWER & RESTORE TO GRADE WATER VALVE
- 5

LOWER & RESTORE TO GRADE GAS VALVE
- 6

LOWER & RESTORE TO GRADE UTILITY BOX
- 7

REINSTALL SURVEY MONUMENT. UNDER CALIFORNIA LICENSED SURVEYOR:
 - REFERENCE OUT PRIOR TO START OF CONSTRUCTION
 - FILE PROPER DOCUMENTATION SHOWING ORIGINAL AND REPLACEMENT MONUMENTS AFTER CONSTRUCTION

X

CX.X
- 8

INSTALL W11-1 & W16-1 SIGNS ON NEW POST. SEE DETAIL
- 9

LOWER & RESTORE TO GRADE SEWER CLEANOUT

STRIPING NOTES:

- S1

WHITE LIMIT LINE (STOP LINE)
- S2

MARKING WORD "STOP"
- S3

MARKING WORD "AHEAD"
- S5

MARKING WORD "XING"
- S6

MARKING WORD "YIELD"
- S7

MARKING WORD "SLOW"
- S8

MARKING WORD "SCHOOL"
- S14

SPEED BUMP MARKING
- S15

SHARROW MARKING
- S22

DETAIL 22
- S24

DETAIL 27B
- S36

YELLOW CONTINENTAL CROSSWALK
- S37

BLUE HYDRANT MARKER
- S38

INSTALL W11-1 & W16-1 SIGNS ON NEW POST. SEE DETAIL

X

XX.X

LEGEND:

- 3" AC GRIND & INLAY. SEE TYPICAL SECTIONS
- #

4" AC BASE REPAIR. REFERENCE ALLOCATION QUANTITIES TABLE THIS SHEET. SEE DETAIL

X

XX.X
- APPROXIMATE LIMIT OF WORK
- APPROXIMATE RIGHT OF WAY

GENERAL NOTES:

1. SEE THE CURRENT VERSION OF CALTRANS STANDARD PLANS FOR PAVEMENT MARKINGS, TRAFFIC LINES, AND MARKERS.
2. A TACK COAT EMULSION SHALL BE APPLIED TO CLEAN DRY PAVEMENT BETWEEN (E) AND (N) PAVEMENT SECTIONS PRIOR TO INLAY/OVERLAY

AC BASE REPAIR ALLOCATION QUANTITIES

AC PAVEMENT REPAIR #	AREA (SF)
1	0.0
2	0.0
3	0.0
4	0.0
5	0.0
6	0.0
SUBTOTAL AREA (SF)	0.0

PAVEMENT REPAIR QUANTITY NOTES

1. ACTUAL PAVEMENT REPAIR EXTENTS AND QUANTITIES MAY VARY. ENGINEER SHALL DETERMINE PAVEMENT REPAIR EXTENTS AFTER COLD PLANE OPERATIONS ARE COMPLETE AND PRIOR TO PAVING.

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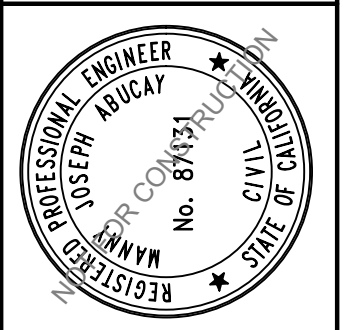
BY	DATE	REVISIONS



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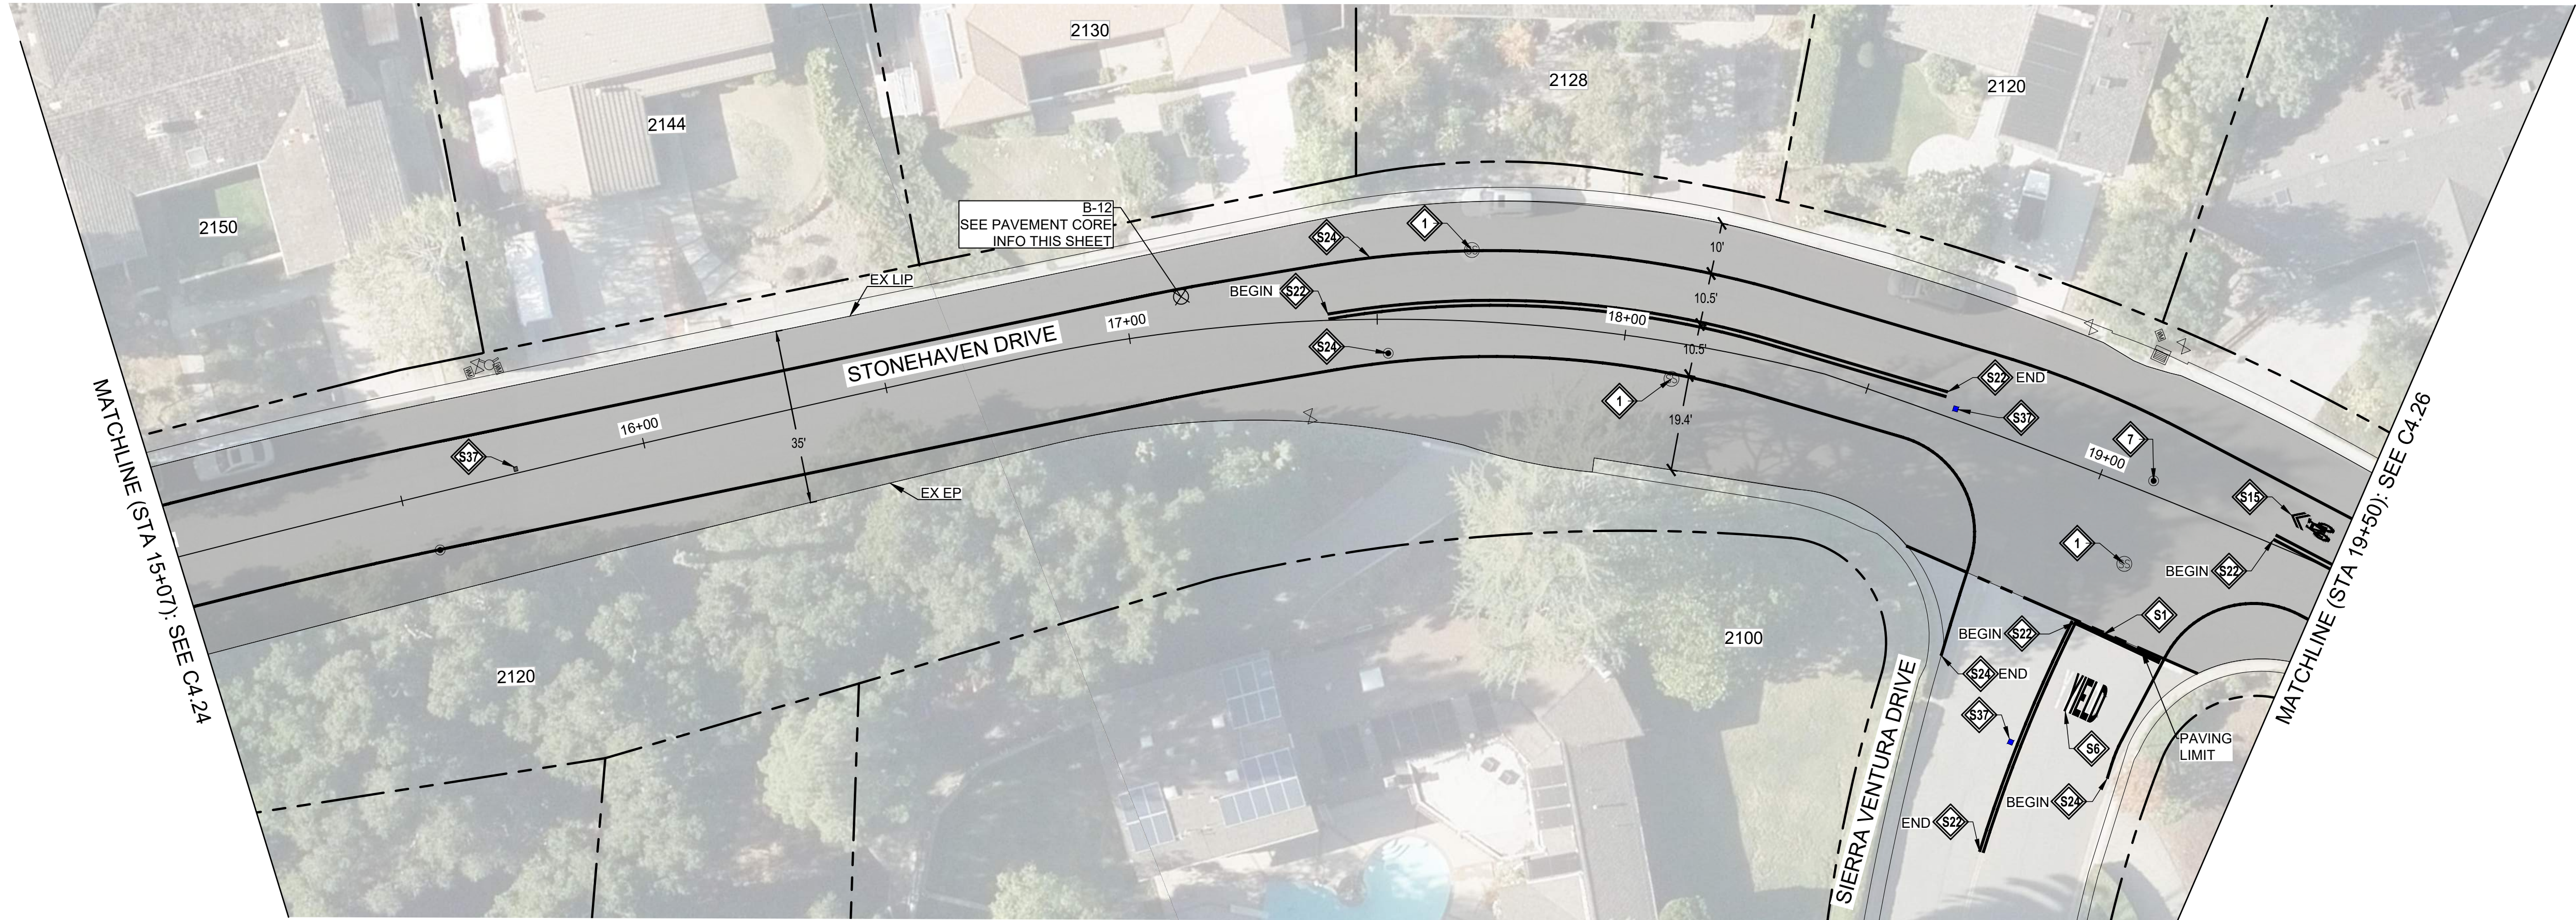
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CALIFORNIA 94022



2024-2025 ANNUAL STREET RESURFACING PROJECT
IMPROVEMENT PLAN - STONEHAVEN DRIVE
15+07 TO 19+50
SANTA CLARA COUNTY
CALIFORNIA
LOS ALTOS

DWG NO.	C4.25	32 OF 50	JOB NO.	250007
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PAVEMENT REPAIR SITE - STONEHAVEN DRIVE

CONSTRUCTION NOTES:

- 1 LOWER & RESTORE TO GRADE STORM MANHOLE
- 2 LOWER & RESTORE TO GRADE SEWER MANHOLE (TEMPORARY FALSE BOTTOM TO BE INSTALLED PRIOR TO ANY MANHOLE WORK, & REMOVED AFTER)
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- 7 REINSTALL SURVEY MONUMENT. UNDER CALIFORNIA LICENSED SURVEYOR:
 - REFERENCE OUT PRIOR TO START OF CONSTRUCTION
 - FILE PROPER DOCUMENTATION SHOWING ORIGINAL AND REPLACEMENT MONUMENTS AFTER CONSTRUCTION
- 8 INSTALL W11-1 & W16-1 SIGNS ON NEW POST. SEE DETAIL
- 9 LOWER & RESTORE TO GRADE SEWER CLEANOUT

STRIPING NOTES:

- S1 WHITE LIMIT LINE (STOP LINE)
- S2 MARKING WORD "STOP"
- S3 MARKING WORD "AHEAD"
- S5 MARKING WORD "XING"
- S6 MARKING WORD "YIELD"
- S7 MARKING WORD "SLOW"
- S8 MARKING WORD "SCHOOL"
- S14 SPEED BUMP MARKING
- S15 SHARROW MARKING
- S22 DETAIL 22
- S24 DETAIL 27B
- S38 YELLOW CONTINENTAL CROSSWALK
- S37 BLUE HYDRANT MARKER
- S38 INSTALL W11-1 & W16-1 SIGNS ON NEW POST. SEE DETAIL

LEGEND:

- 3" AC GRIND & INLAY. SEE TYPICAL SECTIONS
- 4" AC BASE REPAIR. REFERENCE ALLOCATION QUANTITIES TABLE THIS SHEET. SEE DETAIL
- APPROXIMATE LIMIT OF WORK
- APPROXIMATE RIGHT OF WAY

PAVEMENT CORING LOG

CORE #	SUBGRADE	AC (IN)	AB (IN)	FABRIC ²
B-12	SILTY SAND WITH GRAVEL (SM)	5.5	4.5	NA

PAVEMENT CORING NOTES

- PAVEMENT CORING WAS PERFORMED IN SELECT LOCATIONS AND IS NOT REPRESENTATIVE OF ALL EXISTING PAVEMENT CONDITIONS WITHIN THE WORK LIMITS.
- PAVEMENT TO BE COLD PLANED OR REMOVED MAY CONTAIN PAVEMENT FABRIC. PAVEMENT BORINGS ARE NOT REPRESENTATIVE OF ENTIRE STREET WORK LIMITS. ANY ASSUMPTION OF THE PRESENCE OF PAVEMENT FABRIC SHALL BE AT THE CONTRACTOR'S SOLE RISK. THERE SHALL BE NO ADJUSTMENT IN COMPENSATION TO THE CONTRACTOR FOR COLD PLANING, REMOVING, AND DISPOSING AC PAVEMENT THAT CONTAINS PAVEMENT FABRIC.

GENERAL NOTES:

- SEE THE CURRENT VERSION OF CALTRANS STANDARD PLANS FOR PAVEMENT MARKINGS, TRAFFIC LINES, AND MARKERS.
- A TACK COAT EMULSION SHALL BE APPLIED TO CLEAN DRY PAVEMENT BETWEEN (E) AND (N) PAVEMENT SECTIONS PRIOR TO INLAY/OVERLAY

AC BASE REPAIR ALLOCATION QUANTITIES


AC PAVEMENT REPAIR #	AREA (SF)
1	0.0
2	0.0
3	0.0
4	0.0
5	0.0
6	0.0
SUBTOTAL AREA (SF)	0.0

PAVEMENT REPAIR QUANTITY NOTES

- ACTUAL PAVEMENT REPAIR EXTENTS AND QUANTITIES MAY VARY. ENGINEER SHALL DETERMINE PAVEMENT REPAIR EXTENTS AFTER COLD PLANE OPERATIONS ARE COMPLETE AND PRIOR TO PAVING.

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PAVEMENT REPAIR SITE - STONEHAVEN DRIVE

CONSTRUCTION NOTES:

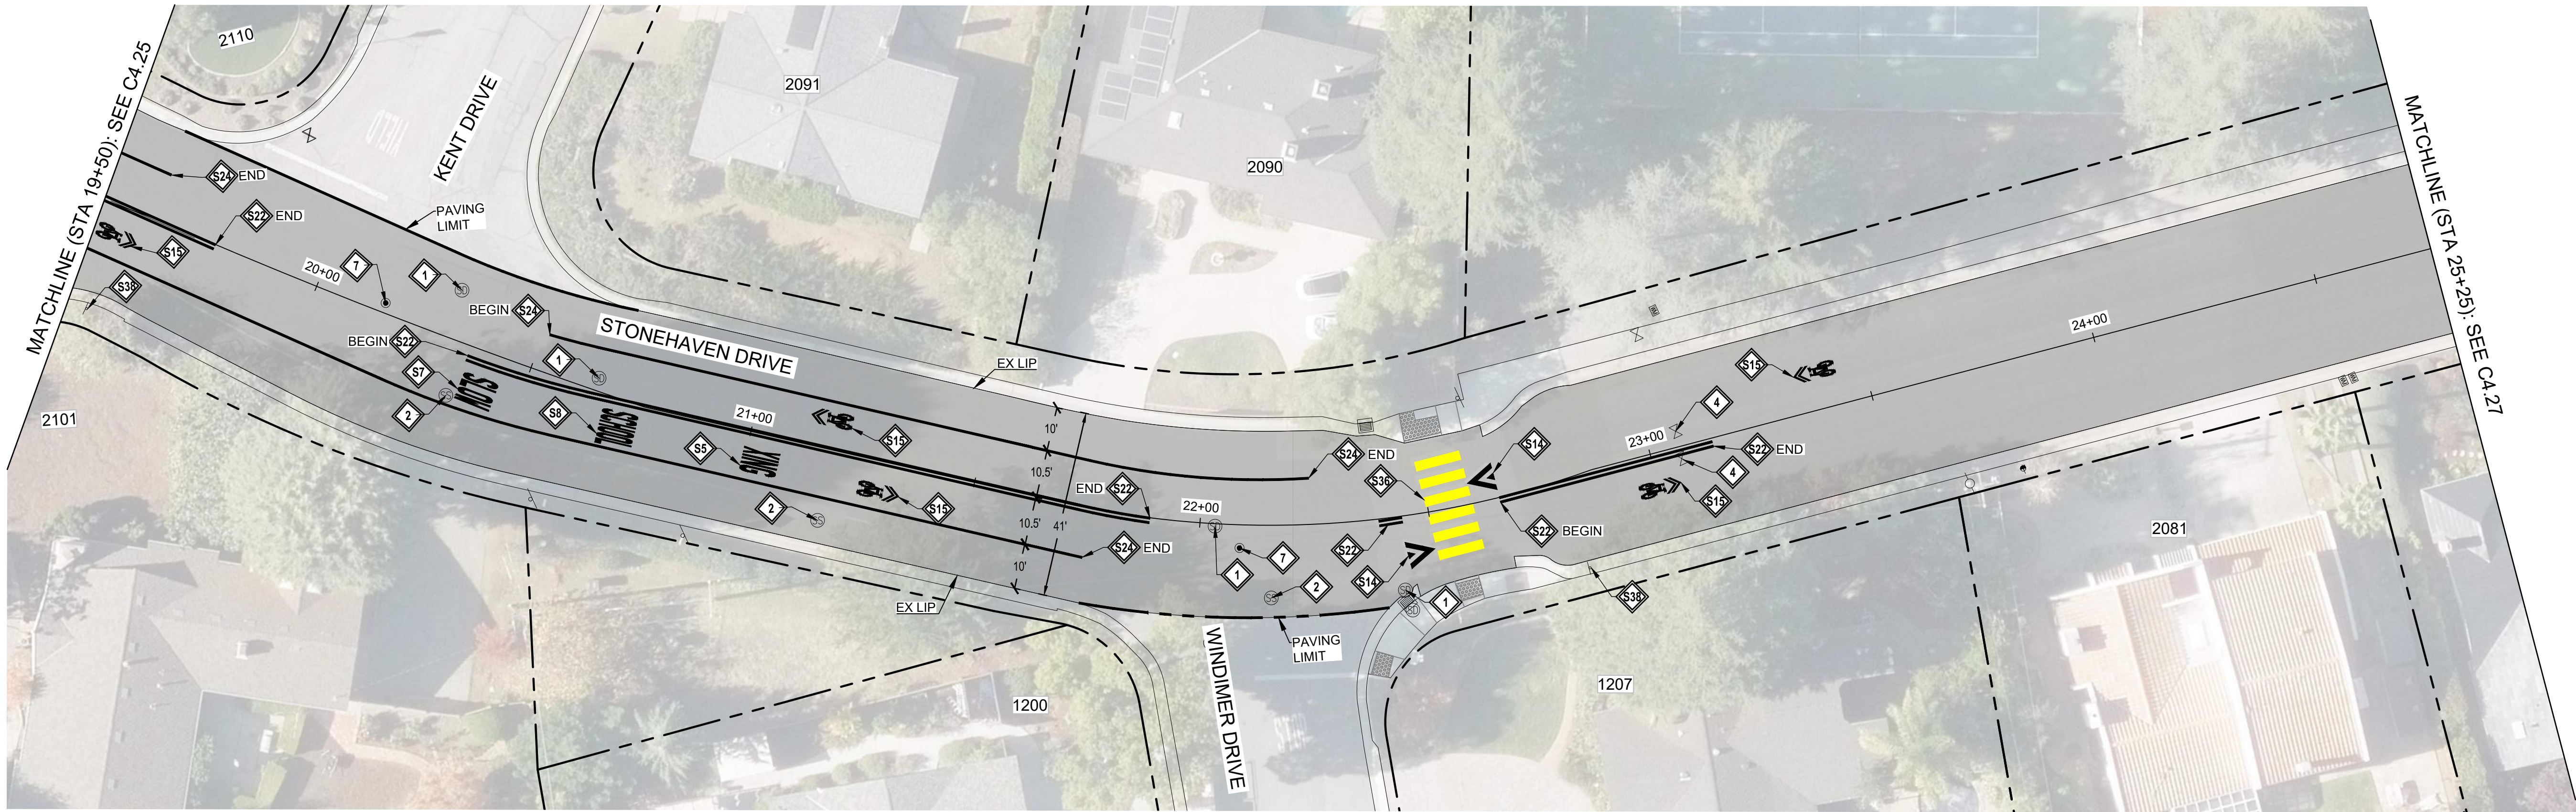- 1 LOWER & RESTORE TO GRADE STORM MANHOLE
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- 8 INSTALL W11-1 & W16-1 SIGNS ON NEW POST. SEE DETAIL
- 9 LOWER & RESTORE TO GRADE SEWER CLEANOUT

STRIPING NOTES:

- S1 WHITE LIMIT LINE (STOP LINE)
- S2 MARKING WORD "STOP"
- S3 MARKING WORD "AHEAD"
- S5 MARKING WORD "XING"
- S6 MARKING WORD "YIELD"
- S7 MARKING WORD "SLOW"
- S8 MARKING WORD "SCHOOL"
- S14 SPEED BUMP MARKING
- S15 SHARROW MARKING
- S22 DETAIL 22
- S24 DETAIL 27B
- S36 YELLOW CONTINENTAL CROSSWALK
- S37 BLUE HYDRANT MARKER
- S38 INSTALL W11-1 & W16-1 SIGNS ON NEW POST. SEE DETAIL

LEGEND:

- 3" AC GRIND & INLAY. SEE TYPICAL SECTIONS
- 4" AC BASE REPAIR. REFERENCE ALLOCATION QUANTITIES TABLE THIS SHEET. SEE DETAIL
- APPROXIMATE LIMIT OF WORK
- APPROXIMATE RIGHT OF WAY

GENERAL NOTES:

- SEE THE CURRENT VERSION OF CALTRANS STANDARD PLANS FOR PAVEMENT MARKINGS, TRAFFIC LINES, AND MARKERS.
- A TACK COAT EMULSION SHALL BE APPLIED TO CLEAN DRY PAVEMENT BETWEEN (E) AND (N) PAVEMENT SECTIONS PRIOR TO INLAY/OVERLAY

AC BASE REPAIR ALLOCATION QUANTITIES

AC PAVEMENT REPAIR #	AREA (SF)
1	0.0
2	0.0
3	0.0
4	0.0
5	0.0
6	0.0
SUBTOTAL AREA (SF)	0.0

PAVEMENT REPAIR QUANTITY NOTES


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2024-2025 ANNUAL STREET RESURFACING PROJECT

IMPROVEMENT PLAN - STONEHAVEN DRIVE
25+25 TO 29+79

SANTA CLARA COUNTY

LOS ALTOS


DWG NO.

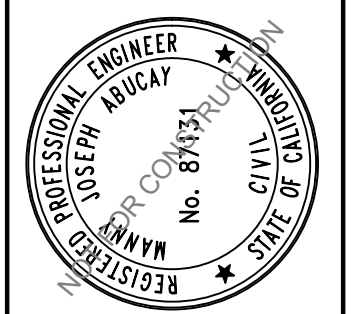C4.19


26 OF 50

JOB NO. 250007

62

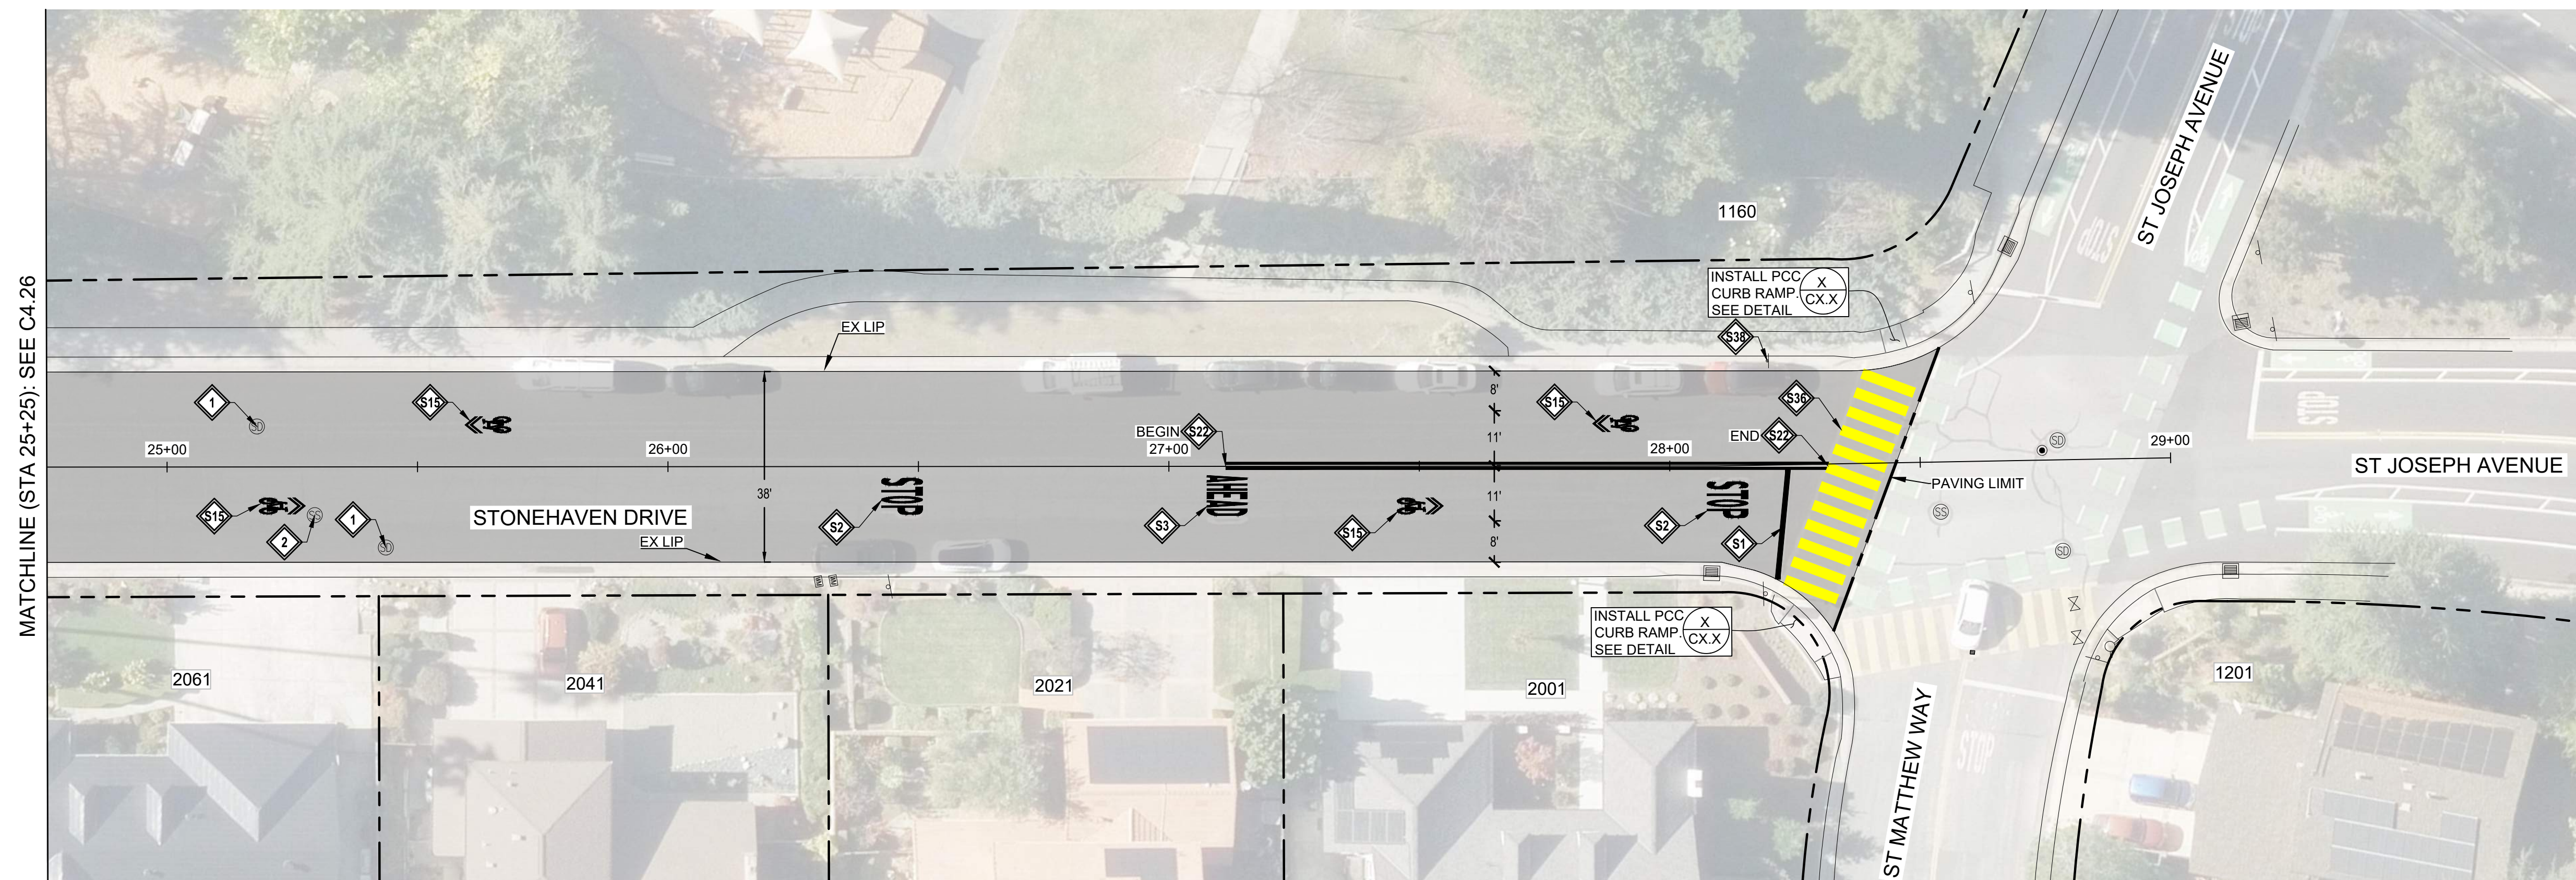

PAVEMENT REPAIR SITE - STONEHAVEN DRIVE

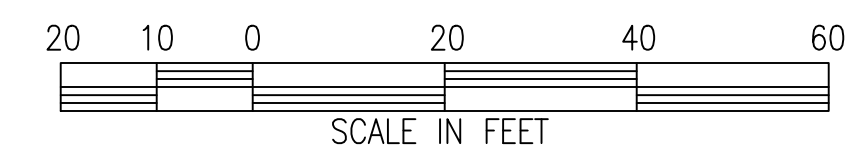

- 1 LOWER & RESTORE TO GRADE STORM MANHOLE
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 - SEE DETAIL 
- 8 INSTALL W11-1 & W16-1 SIGNS ON NEW POST. SEE DETAIL
- 9 LOWER & RESTORE TO GRADE SEWER CLEANOUT

	WHITE LIMIT LINE (STOP LINE)
	MARKING WORD "STOP"
	MARKING WORD "AHEAD"
	MARKING WORD "XING"
	MARKING WORD "YIELD"
	MARKING WORD "SLOW"
	MARKING WORD "SCHOOL"
	SPEED BUMP MARKING
	SHARROW MARKING
	DETAIL 22
	DETAIL 27B
	YELLOW CONTINENTAL CROSSWALK
	BLUE HYDRANT MARKER
	INSTALL W11-1 & W16-1 SIGNS ON NEW POST. SEE DETAIL

 3" AC GRIND & INLAY. SEE TYPICAL SECTIONS

 4" AC BASE REPAIR. REFERENCE ALLOCATION QUANTITIES TABLE THIS SHEET. SEE DETAIL 


 APPROXIMATE LIMIT OF WORK

 APPROXIMATE RIGHT OF WAY

1. SEE THE CURRENT VERSION OF CALTRANS STANDARD PLANS FOR PAVEMENT MARKINGS, TRAFFIC LINES, AND MARKERS.
2. A TACK COAT EMULSION SHALL BE APPLIED TO CLEAN DRY PAVEMENT BETWEEN (E) AND (N) PAVEMENT SECTIONS PRIOR TO INLAY/OVERLAY


AC PAVEMENT REPAIR #	AREA (SF)
1	0.0
2	0.0
3	0.0
4	0.0
5	0.0
6	0.0
SUBTOTAL AREA (SF)	0.0

1. ACTUAL PAVEMENT REPAIR EXTENTS AND QUANTITIES MAY VARY. ENGINEER SHALL DETERMINE PAVEMENT REPAIR EXTENTS AFTER COLD PLANE OPERATIONS ARE COMPLETE AND PRIOR TO PAVING.

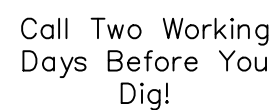

1-800-227-2600


65% SUBMITTAL
APRIL 07, 2025

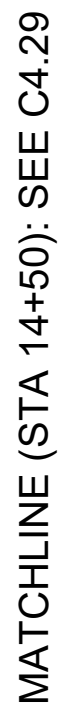

20 10 0 20 40 60

SCALE IN FEET

1. ACTUAL PAVEMENT REPAIR EXTENTS AND QUANTITIES MAY VARY. ENGINEER SHALL DETERMINE PAVEMENT REPAIR EXTENTS AFTER COLD PLANE OPERATIONS ARE COMPLETE AND PRIOR TO PAVING.

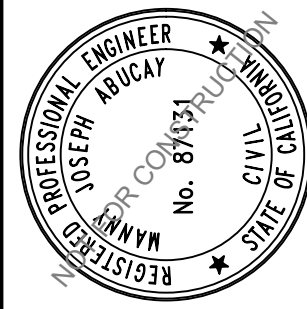

CITY OF LOS ALTOS
11 NORTH SAN ANTONIO ROAD
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2024-2025 ANNUAL STREET RESURFACING PROJECT

IMPROVEMENT PLAN - UNIVERSITY AVENUE
10+00 to 14+50

SANTA CLARA COUNTY

CALIFORNIA

DWG NO.

C4.28

35 OF 50

250007


63

65% SUBMITTAL
APRIL 07, 2025

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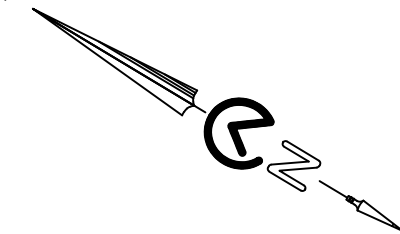
1-800-227-2600



MATCHLINE (STA 19+50): SEE C4.30

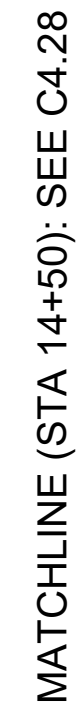20 10 0 20 40 60

SCALE IN FEET



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APRIL 07, 2025

	WHITE LIMIT LINE (STOP LINE)
	MARKING WORD "STOP"
	MARKING "25"
	DETAIL 22
	WHITE LADDER CROSSWALK
	BLUE HYDRANT MARKER
	REPAINT RED CURB


1. ACTUAL PAVEMENT REPAIR EXTENTS AND QUANTITIES MAY VARY. ENGINEER SHALL DETERMINE PAVEMENT REPAIR EXTENTS AFTER COLD PLANE OPERATIONS ARE COMPLETE AND PRIOR TO PAVING.

BY	DATE	REVISIONS



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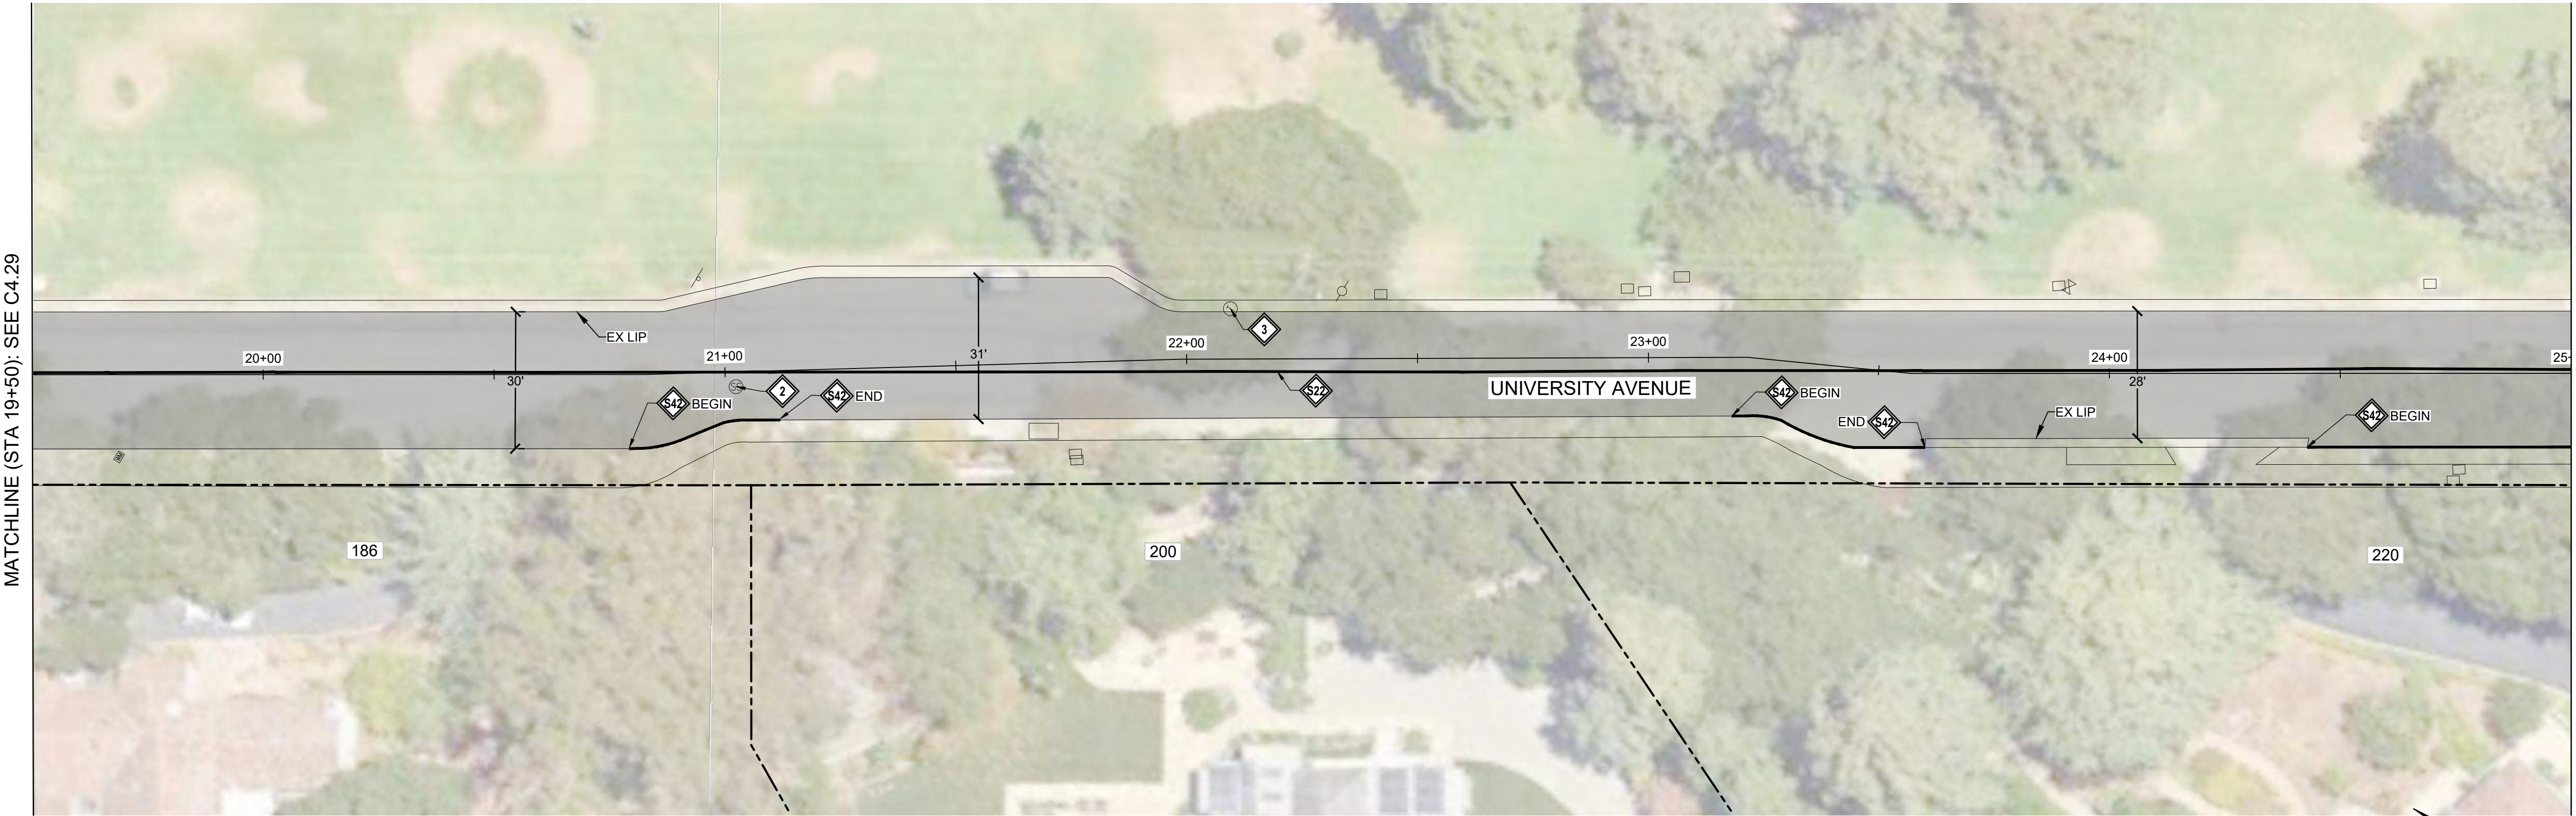
CITY OF LOS ALTOS
1 NORTH SAN ANTONIO ROAD
CALIFORNIA 94022

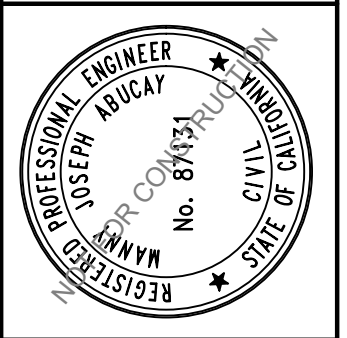



2024-2025 ANNUAL STREET RESURFACING PROJECT
IMPROVEMENT PLAN - UNIVERSITY AVENUE
19+50 to 25+00
LOS ALTOS SANTA CLARA COUNTY CALIFORNIA

DWG NO.	C4.30	JOB NO.	250007
37	OF 50		

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APRIL 07, 2025



PAVEMENT REPAIR SITE - UNIVERSITY AVENUE

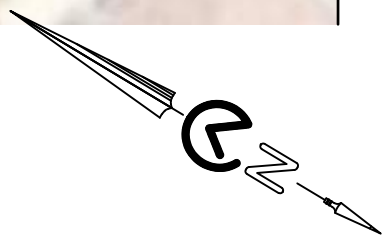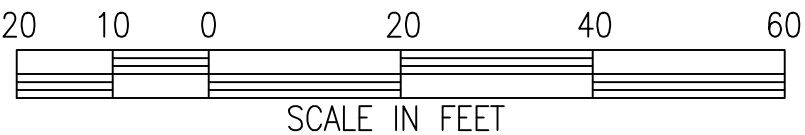

CONSTRUCTION NOTES:

- 1

LOWER & RESTORE TO GRADE STORM MANHOLE
- 2

LOWER & RESTORE TO GRADE SEWER MANHOLE (TEMPORARY FALSE BOTTOM TO BE INSTALLED PRIOR TO ANY MANHOLE WORK, & REMOVED AFTER)
- 3

LOWER & RESTORE TO GRADE UTILITY MANHOLE (NOTIFY & COORDINATE WITH UTILITY COMPANY PRIOR TO WORK)
- 4

LOWER & RESTORE TO GRADE WATER VALVE
- 5

LOWER & RESTORE TO GRADE GAS VALVE
- 6

LOWER & RESTORE TO GRADE UTILITY BOX
- 7

REINSTALL SURVEY MONUMENT. UNDER CALIFORNIA LICENSED SURVEYOR:
 - REFERENCE OUT PRIOR TO START OF CONSTRUCTION
 - FILE PROPER DOCUMENTATION SHOWING ORIGINAL AND REPLACEMENT MONUMENTS AFTER CONSTRUCTION

X

CXX
- 8

INSTALL W11-1 & W16-1 SIGNS ON NEW POST. SEE DETAIL
- 9

LOWER & RESTORE TO GRADE SEWER CLEANOUT

STRIPING NOTES:

- S1

WHITE LIMIT LINE (STOP LINE)
- S2

MARKING WORD "STOP"
- S9

MARKING "25"
- S22

DETAIL 22
- S33

WHITE LADDER CROSSWALK
- S37

BLUE HYDRANT MARKER
- S42

REPAINT RED CURB

LEGEND:

- 3" AC GRIND & INLAY. SEE TYPICAL SECTIONS
- #

4" AC BASE REPAIR. REFERENCE ALLOCATION QUANTITIES TABLE THIS SHEET. SEE DETAIL
- APPROXIMATE LIMIT OF WORK
- APPROXIMATE RIGHT OF WAY

GENERAL NOTES:

1. SEE THE CURRENT VERSION OF CALTRANS STANDARD PLANS FOR PAVEMENT MARKINGS, TRAFFIC LINES, AND MARKERS.
2. A TACK COAT EMULSION SHALL BE APPLIED TO CLEAN DRY PAVEMENT BETWEEN (E) AND (N) PAVEMENT SECTIONS PRIOR TO INLAY/OVERLAY

AC BASE REPAIR ALLOCATION QUANTITIES


AC PAVEMENT REPAIR #	AREA (SF)
1	0.0
2	0.0
3	0.0
4	0.0
5	0.0
6	0.0
SUBTOTAL AREA (SF)	0.0

PAVEMENT REPAIR QUANTITY NOTES

1. ACTUAL PAVEMENT REPAIR EXTENTS AND QUANTITIES MAY VARY. ENGINEER SHALL DETERMINE PAVEMENT REPAIR EXTENTS AFTER COLD PLANE OPERATIONS ARE COMPLETE AND PRIOR TO PAVING.

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PAVEMENT REPAIR SITE - UNIVERSITY AVENUE

CONSTRUCTION NOTES:

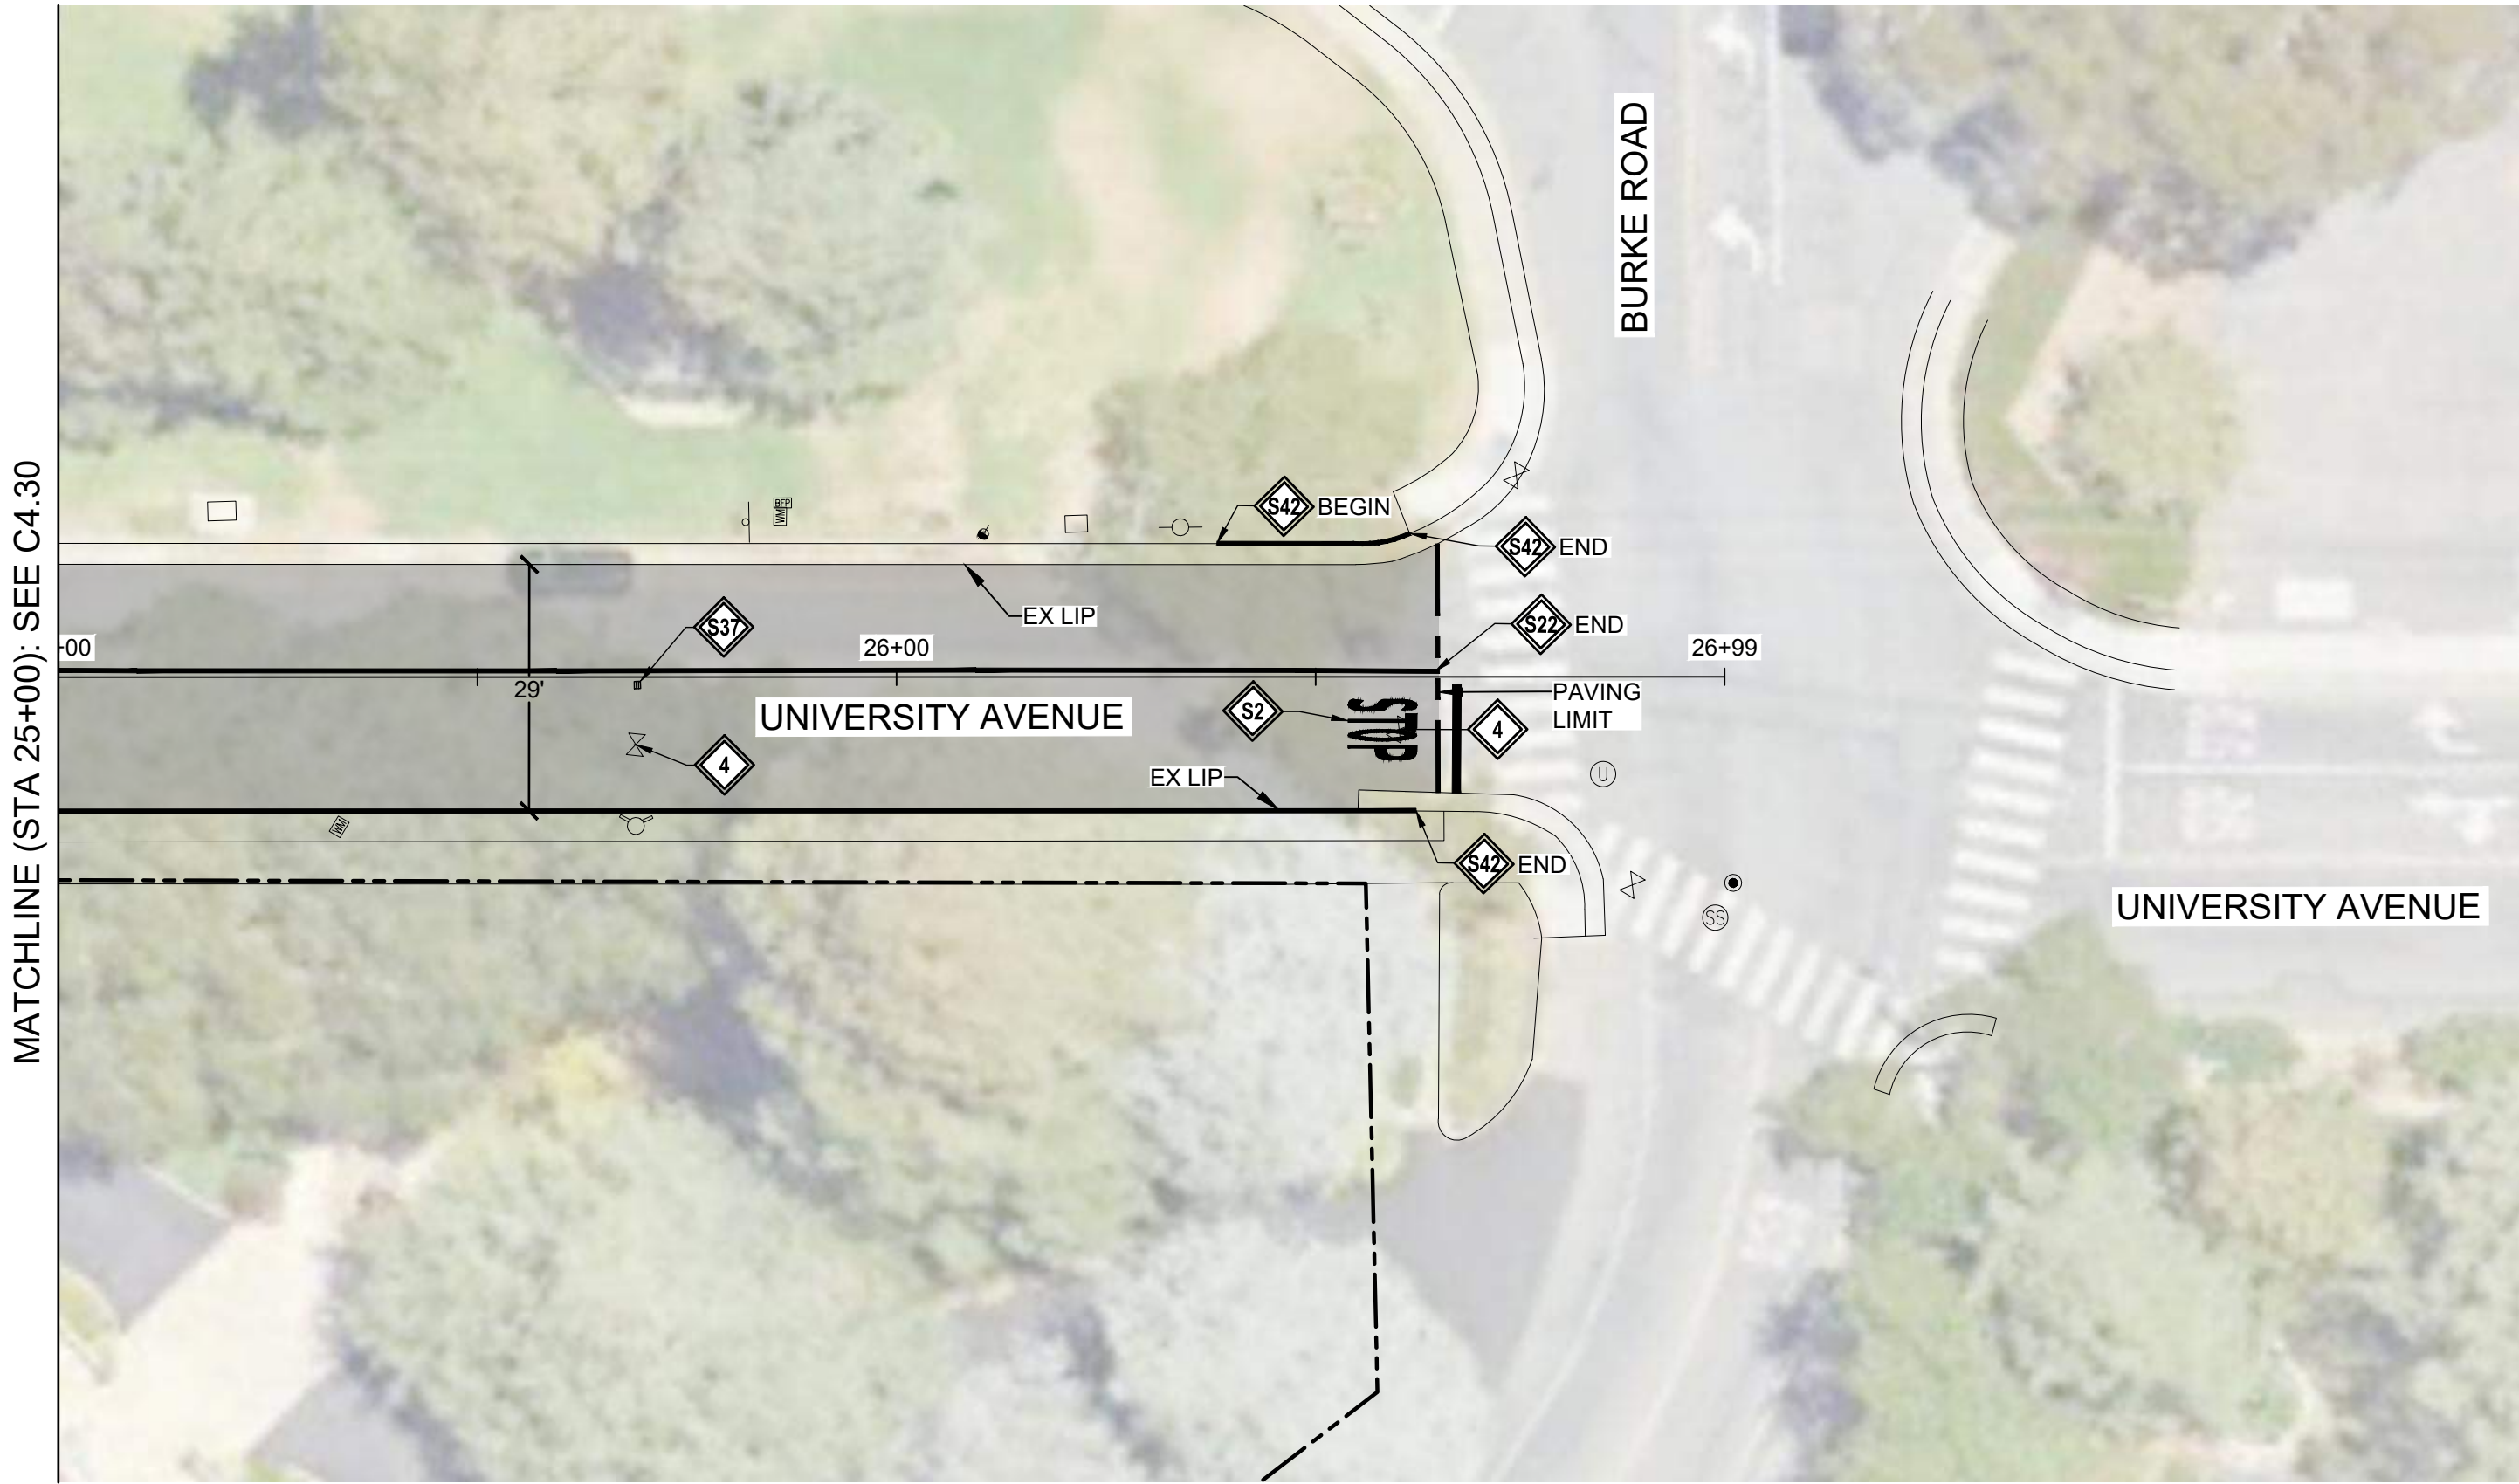- 1 LOWER & RESTORE TO GRADE STORM MANHOLE
- 2 LOWER & RESTORE TO GRADE SEWER MANHOLE (TEMPORARY FALSE BOTTOM TO BE INSTALLED PRIOR TO ANY MANHOLE WORK, & REMOVED AFTER)
- 3 LOWER & RESTORE TO GRADE UTILITY MANHOLE (NOTIFY & COORDINATE WITH UTILITY COMPANY PRIOR TO WORK)
- 4 LOWER & RESTORE TO GRADE WATER VALVE
- 5 LOWER & RESTORE TO GRADE GAS VALVE
- 6 LOWER & RESTORE TO GRADE UTILITY BOX
- 7 REINSTALL SURVEY MONUMENT. UNDER CALIFORNIA LICENSED SURVEYOR:
 - REFERENCE OUT PRIOR TO START OF CONSTRUCTION
 - FILE PROPER DOCUMENTATION SHOWING ORIGINAL AND REPLACEMENT MONUMENTS AFTER CONSTRUCTION
- 8 INSTALL W11-1 & W16-1 SIGNS ON NEW POST. SEE DETAIL
- 9 LOWER & RESTORE TO GRADE SEWER CLEANOUT

STRIPING NOTES:

- S1 WHITE LIMIT LINE (STOP LINE)
- S2 MARKING WORD "STOP"
- S9 MARKING "25"
- S22 DETAIL 22
- S33 WHITE LADDER CROSSWALK
- S37 BLUE HYDRANT MARKER
- S42 REPAINT RED CURB

LEGEND:

- 3" AC GRIND & INLAY. SEE TYPICAL SECTIONS
- 4" AC BASE REPAIR. REFERENCE ALLOCATION QUANTITIES TABLE THIS SHEET. SEE DETAIL
- APPROXIMATE LIMIT OF WORK
- APPROXIMATE RIGHT OF WAY

GENERAL NOTES:

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AC BASE REPAIR ALLOCATION QUANTITIES

AC PAVEMENT REPAIR #	AREA (SF)
1	0.0
2	0.0
3	0.0
4	0.0
5	0.0
6	0.0
SUBTOTAL AREA (SF)	0.0

PAVEMENT REPAIR QUANTITY NOTES

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CITY OF LOS ALTOS

1 NORTH SAN ANTONIO ROAD

CALIFORNIA 94022

PROFESSIONAL ENGINEER

JOSEPH ARBUCA

REGISTERED

NO. 87431

CIVIL

STATE OF CA

2024-2025 ANNUAL STREET RESURFACING PROJECT

IMPROVEMENT PLAN - UNIVERSITY AVENUE

XXXX to XXXX

LOS ALTOS

SANTA CLARA COUNTY

CALIFORNIA

DWG NO.



C4.31





38 OF 50

JOB NO.

250007

66

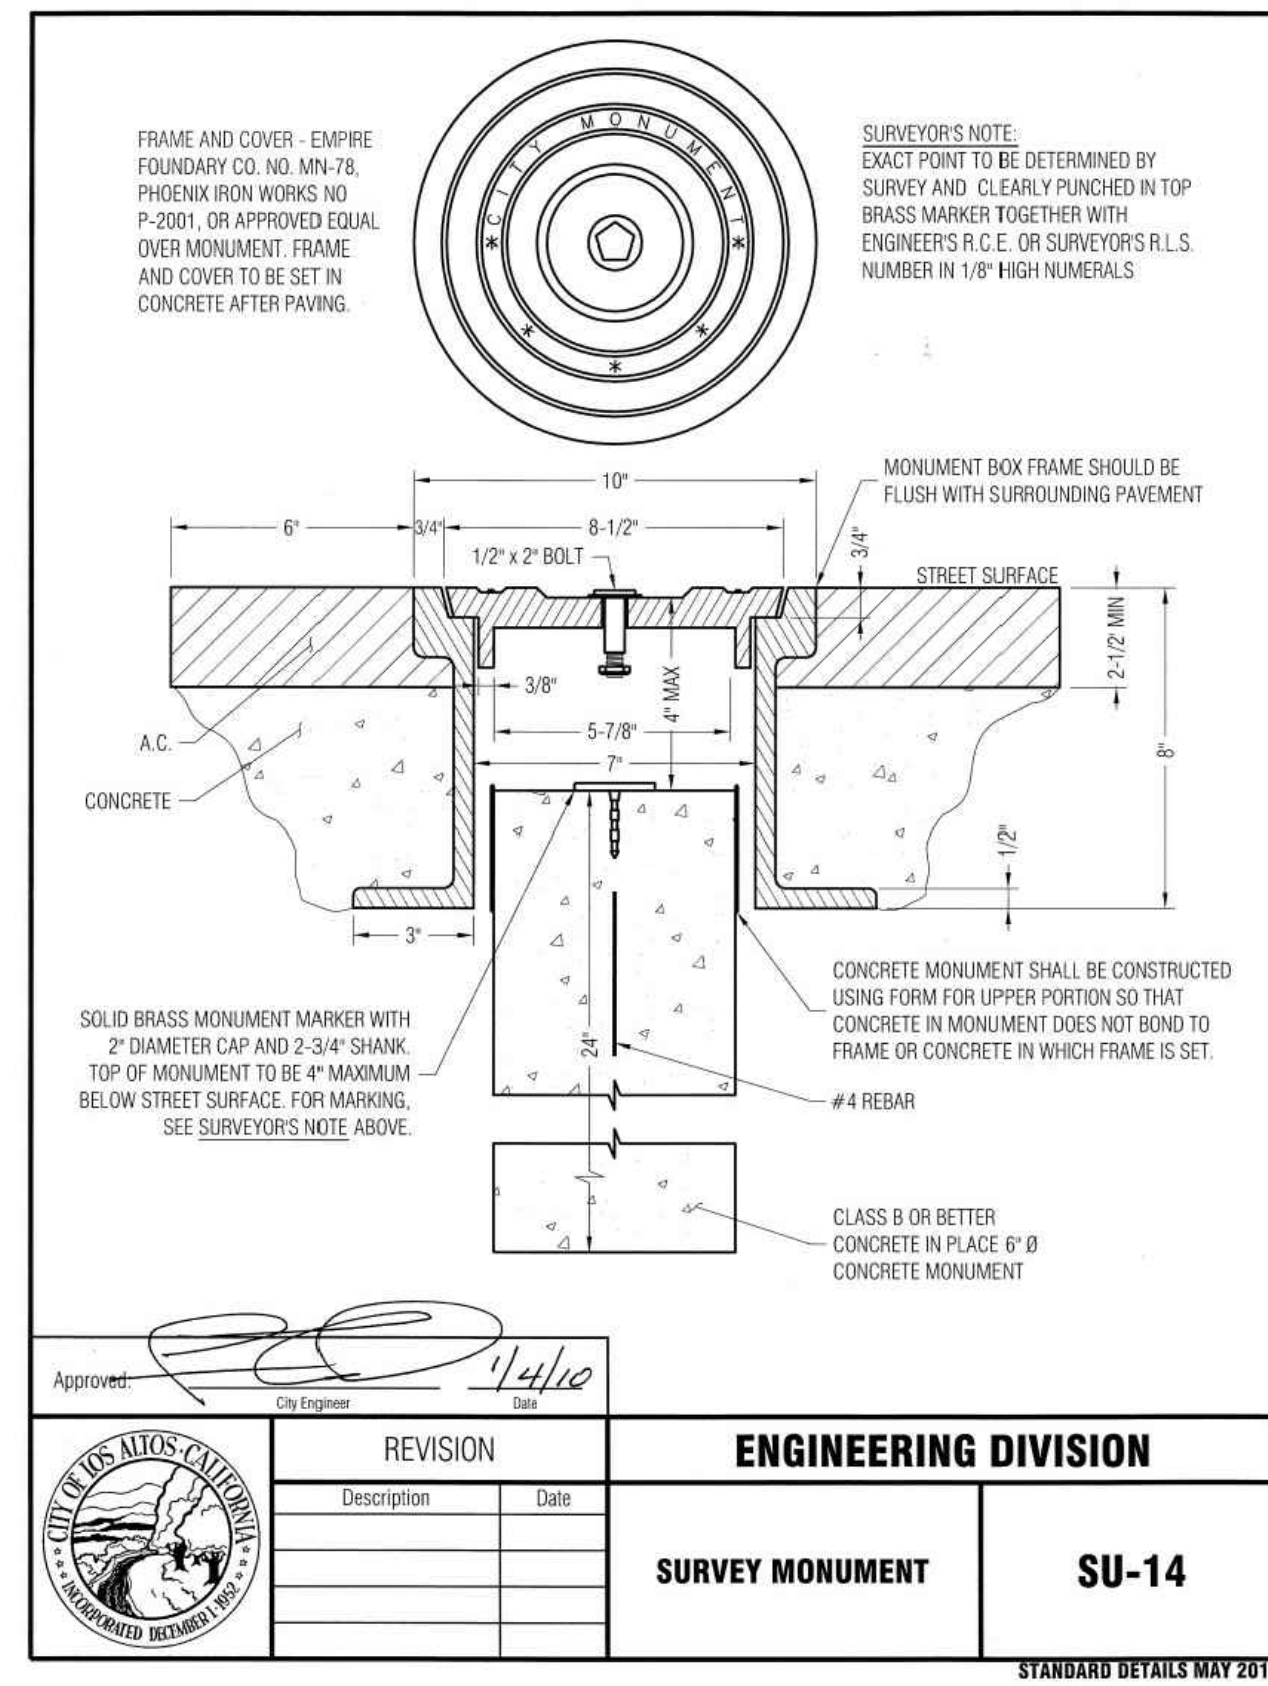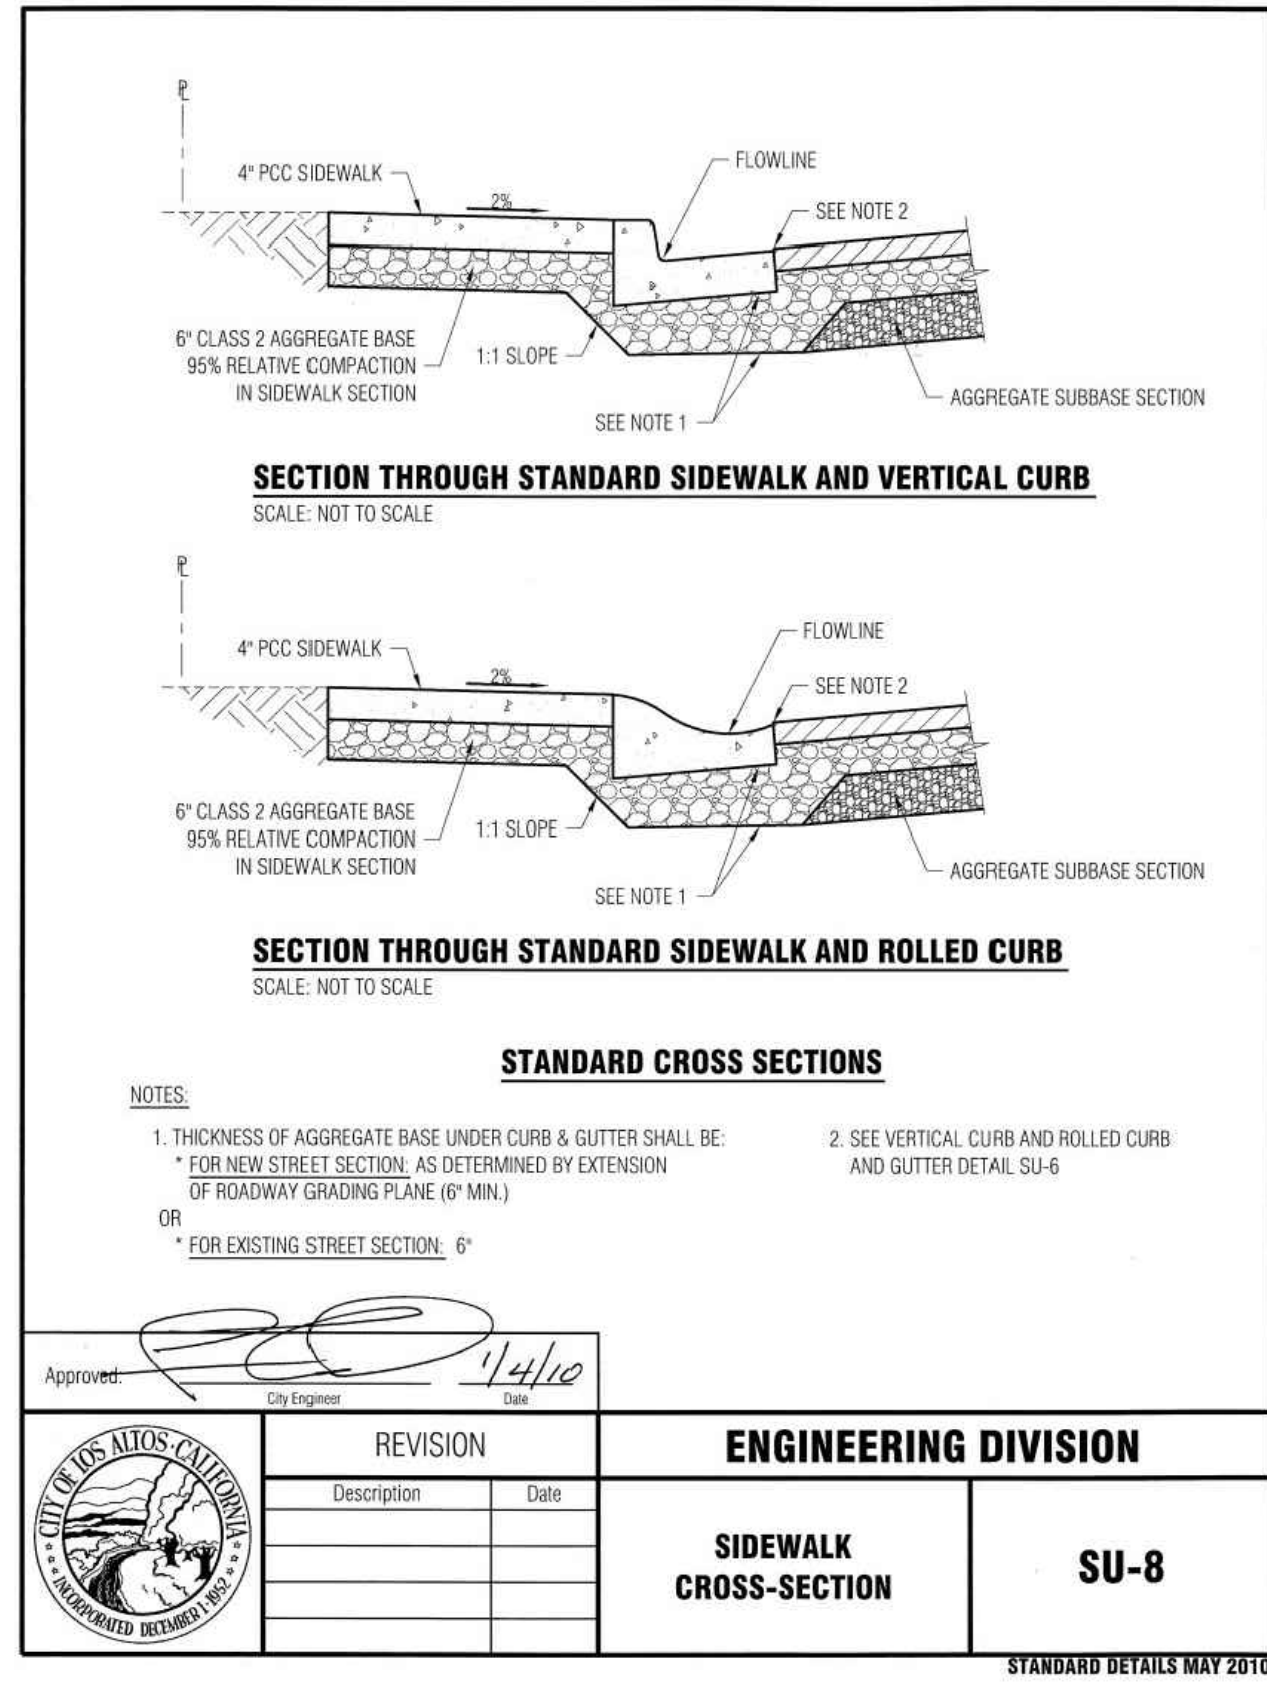

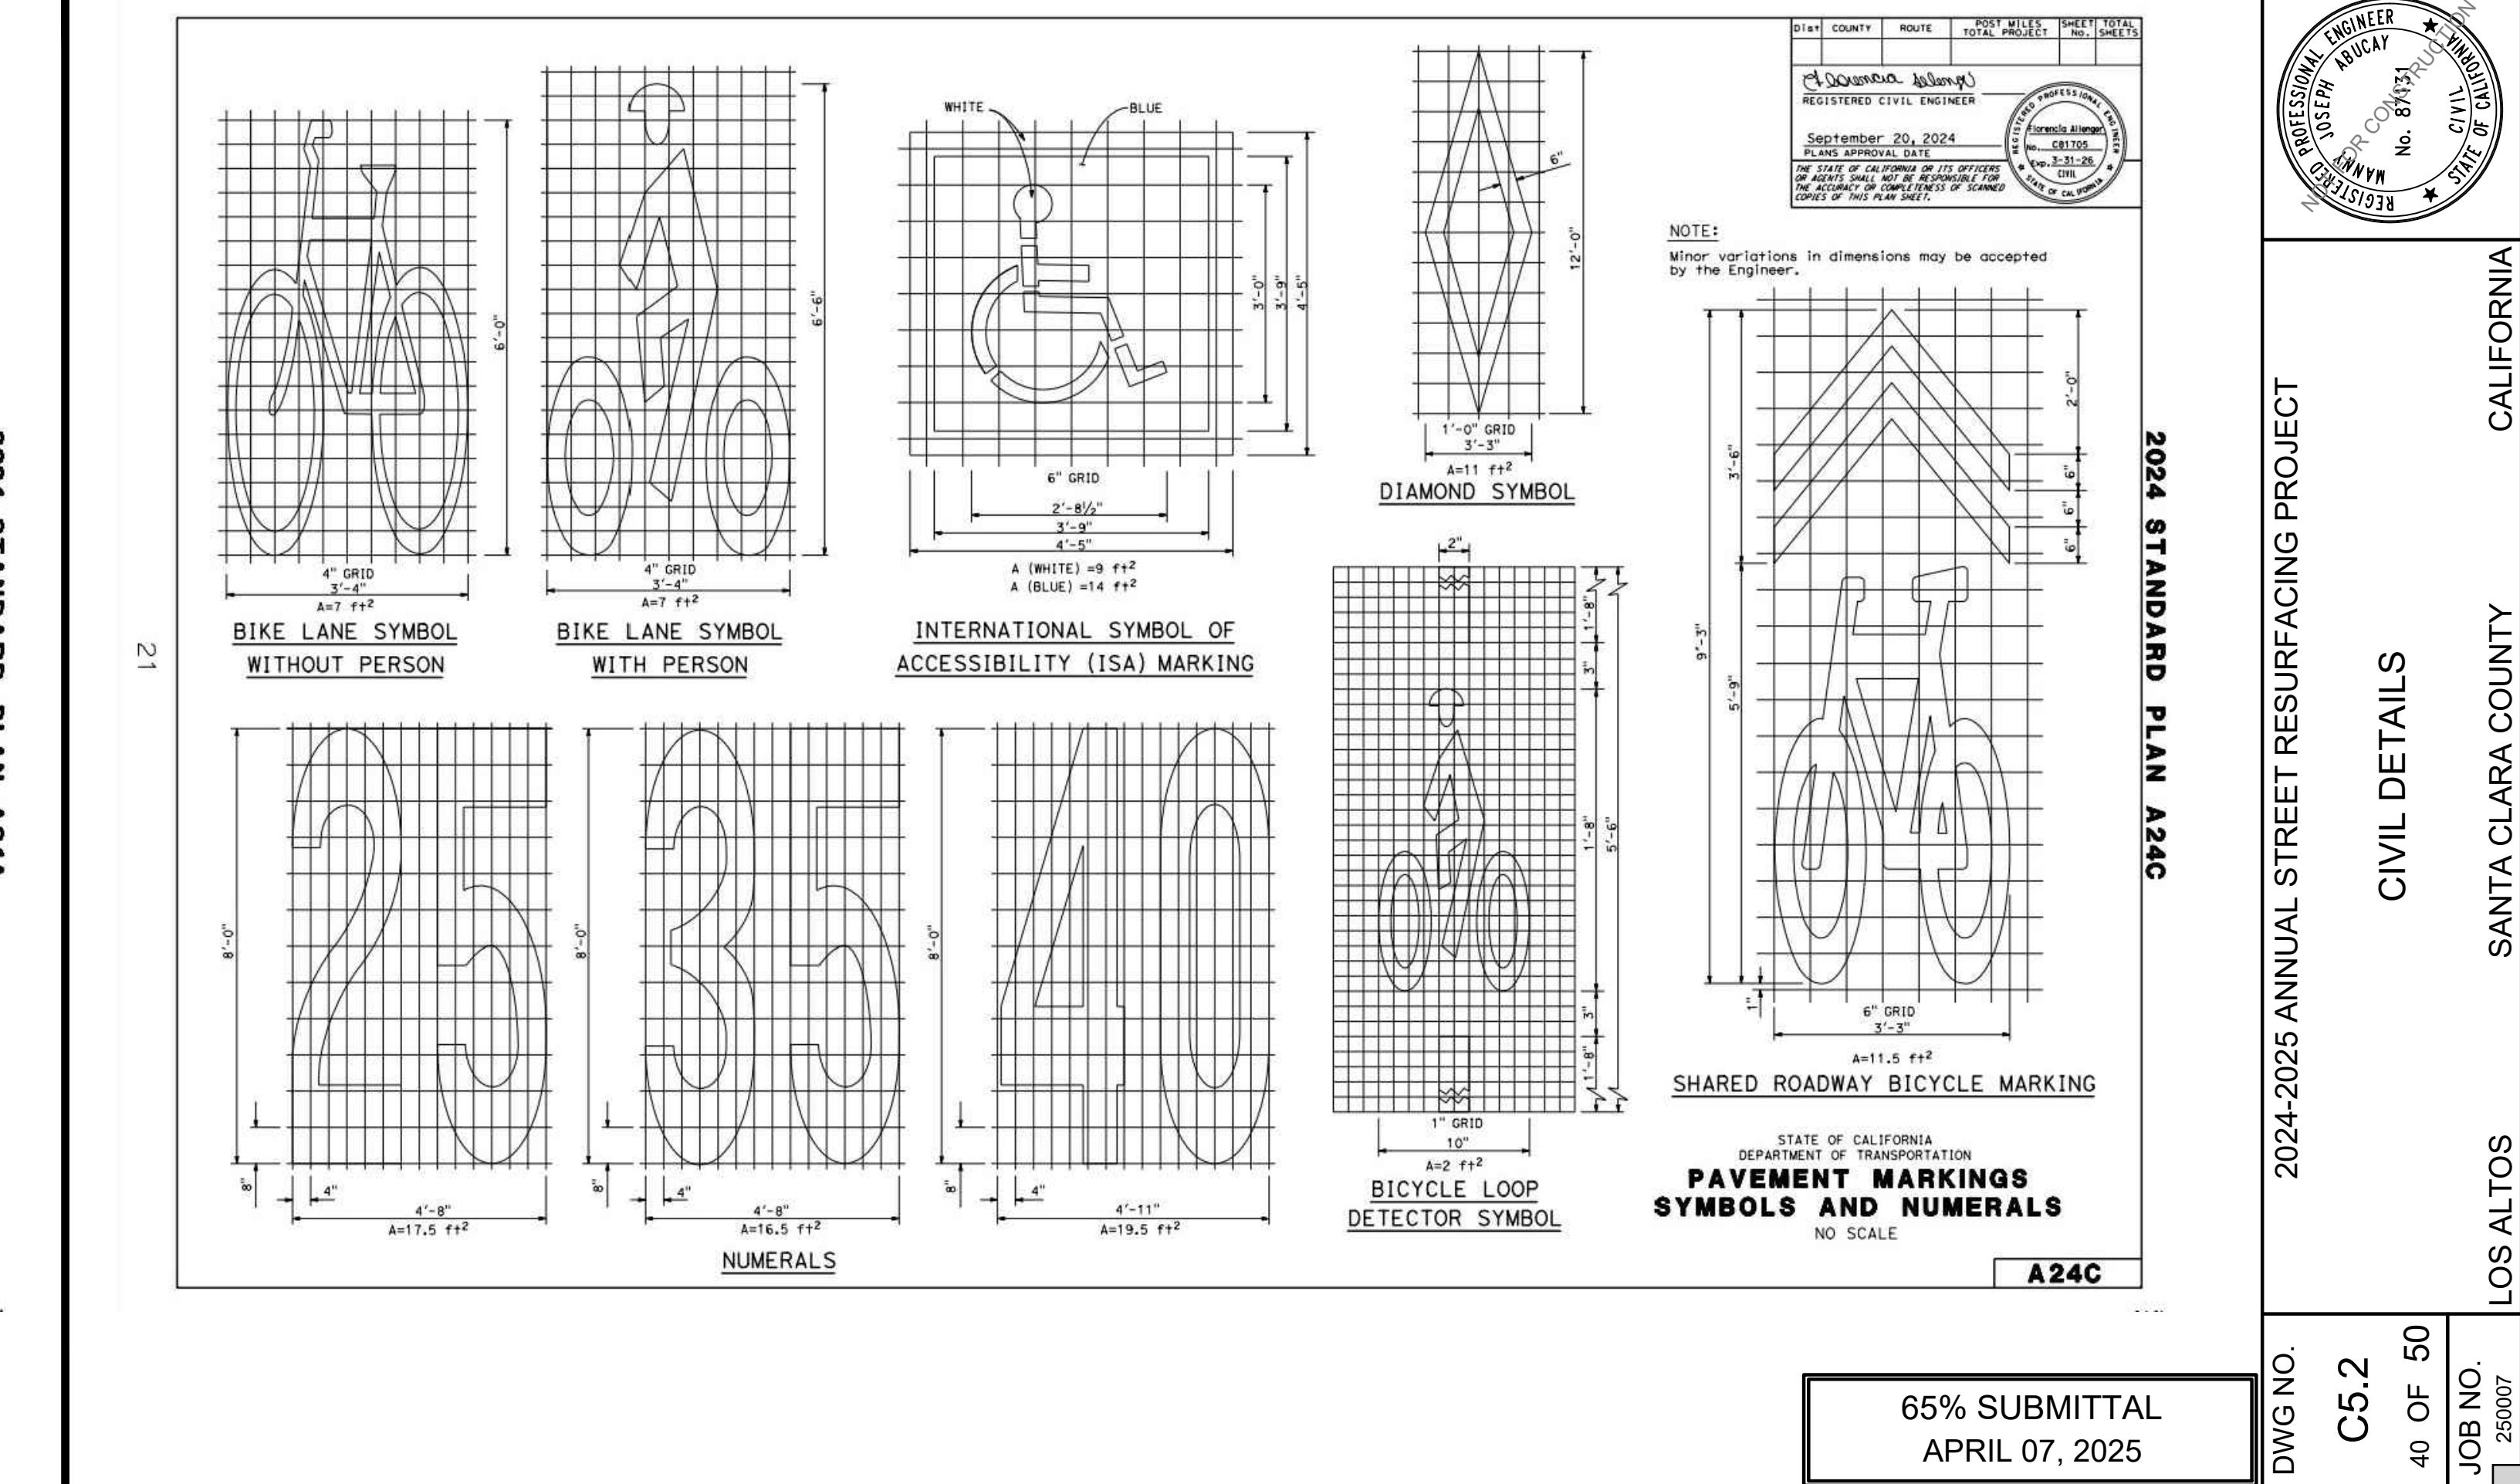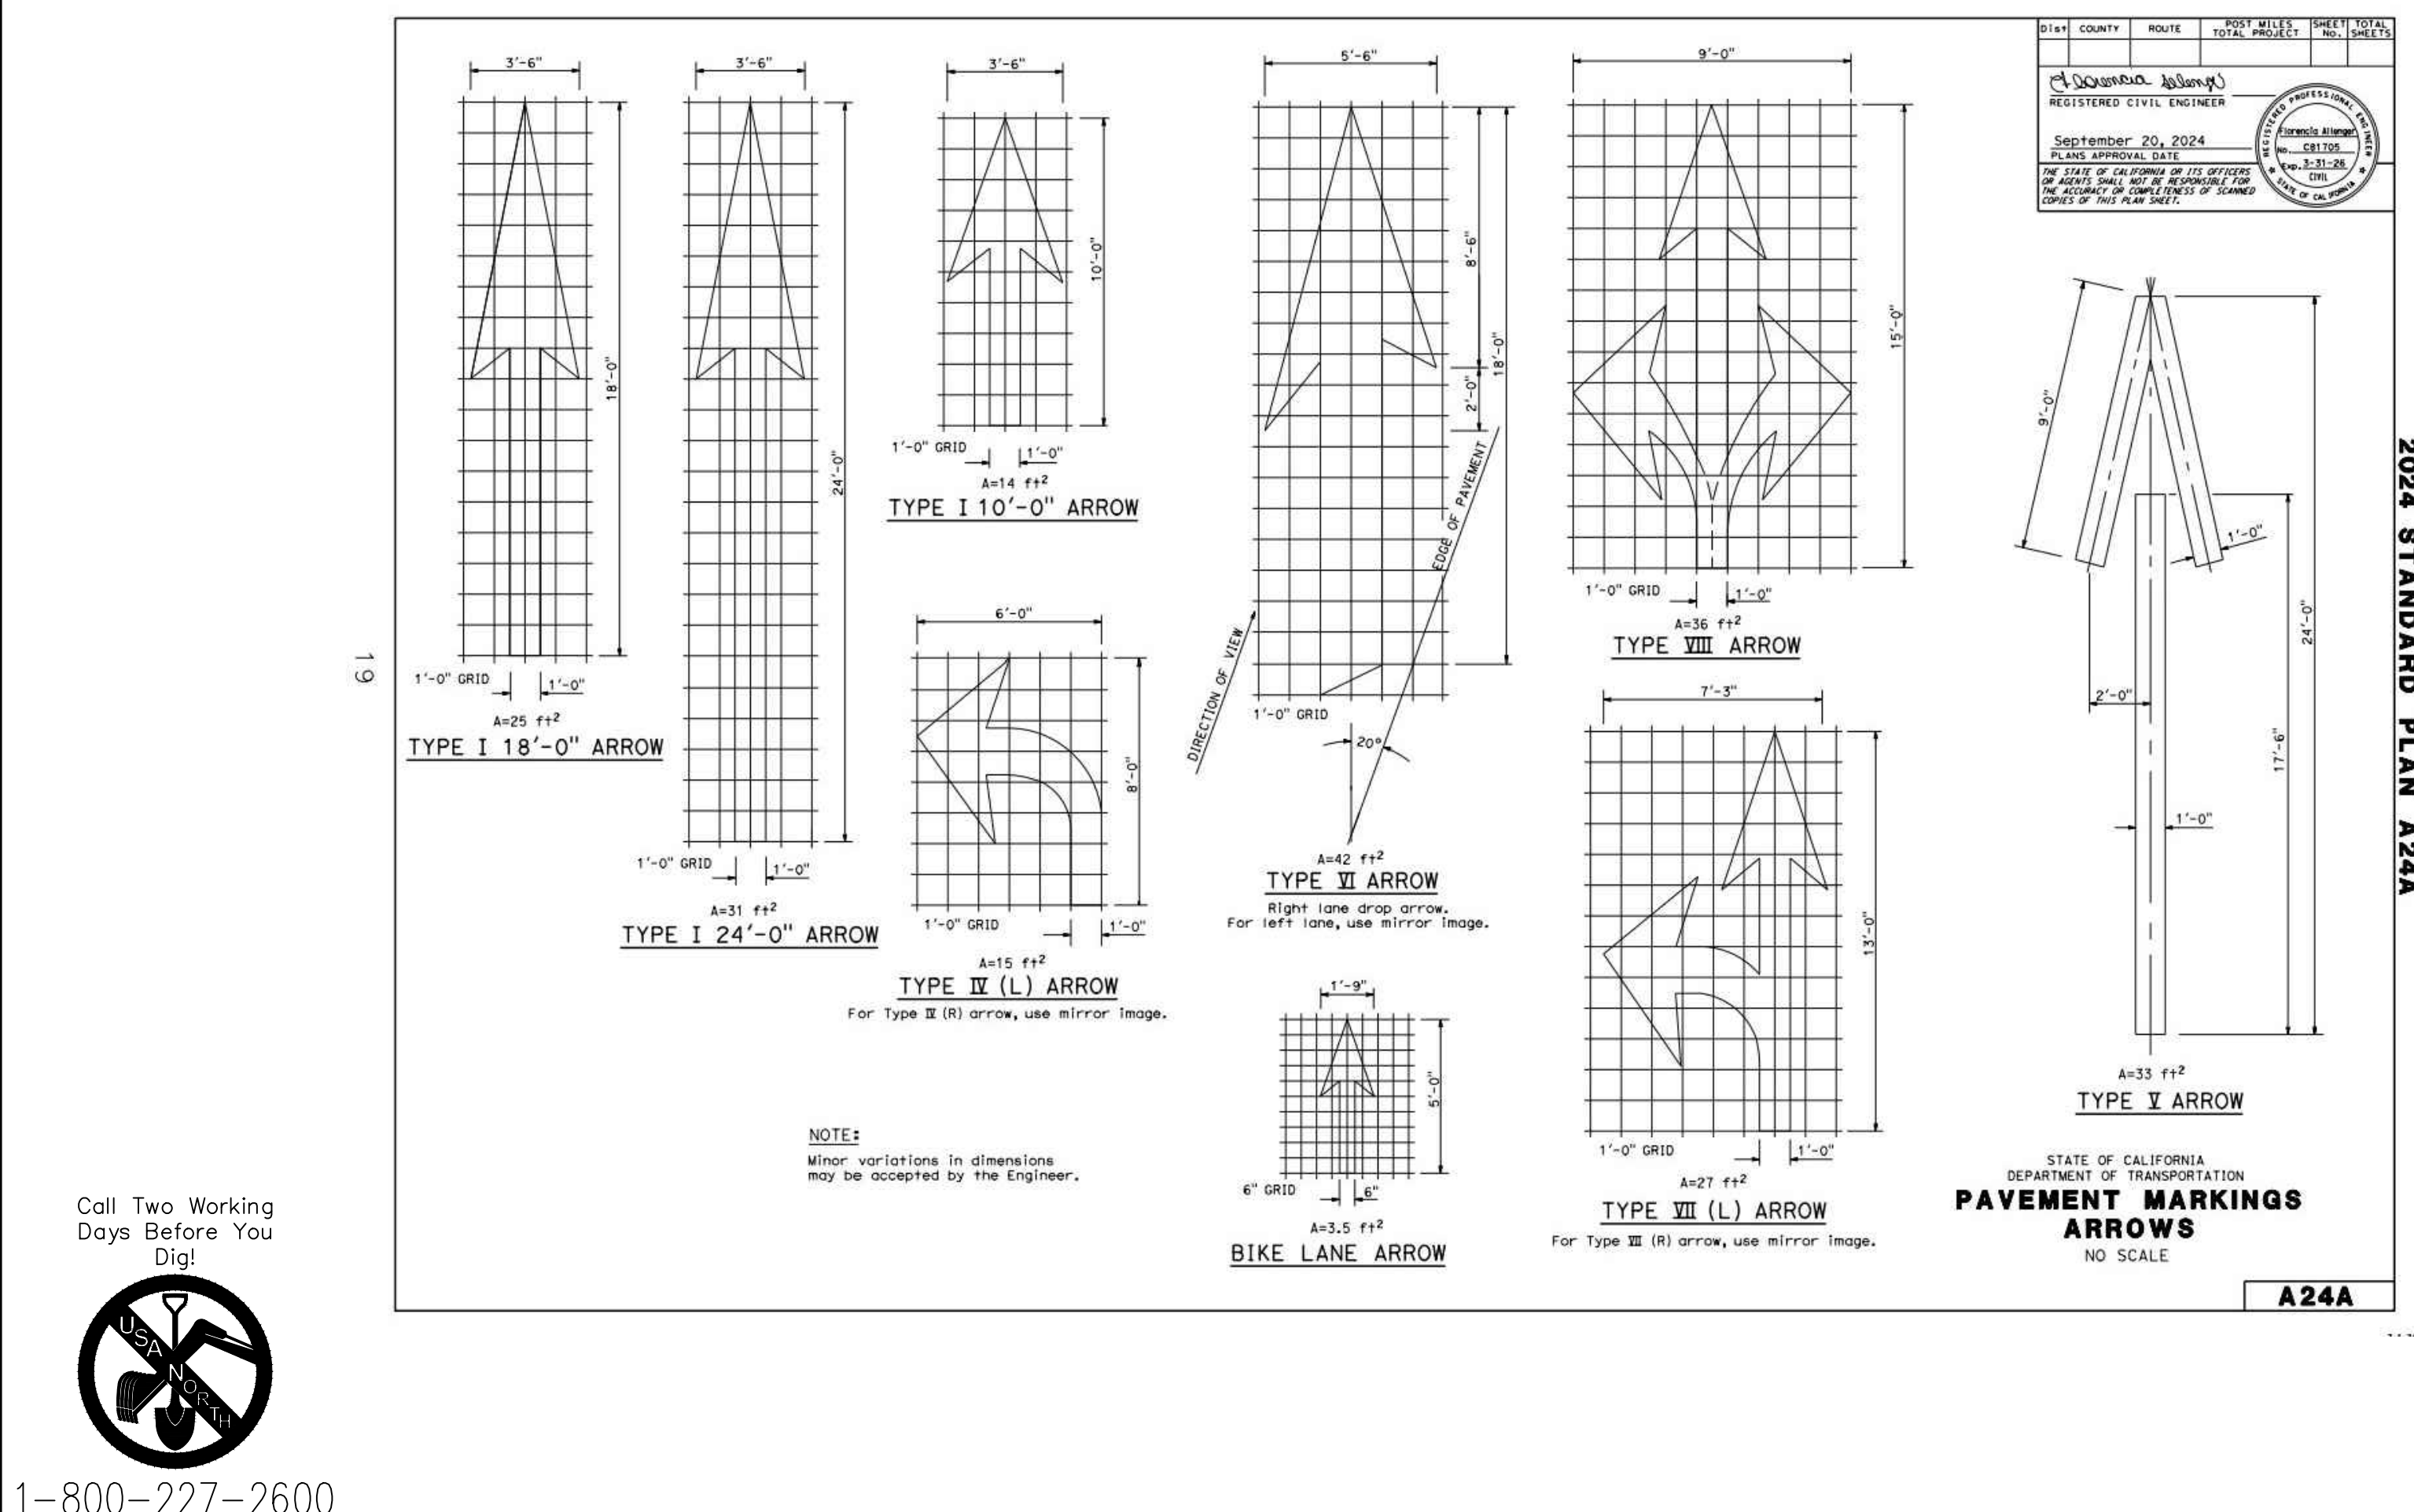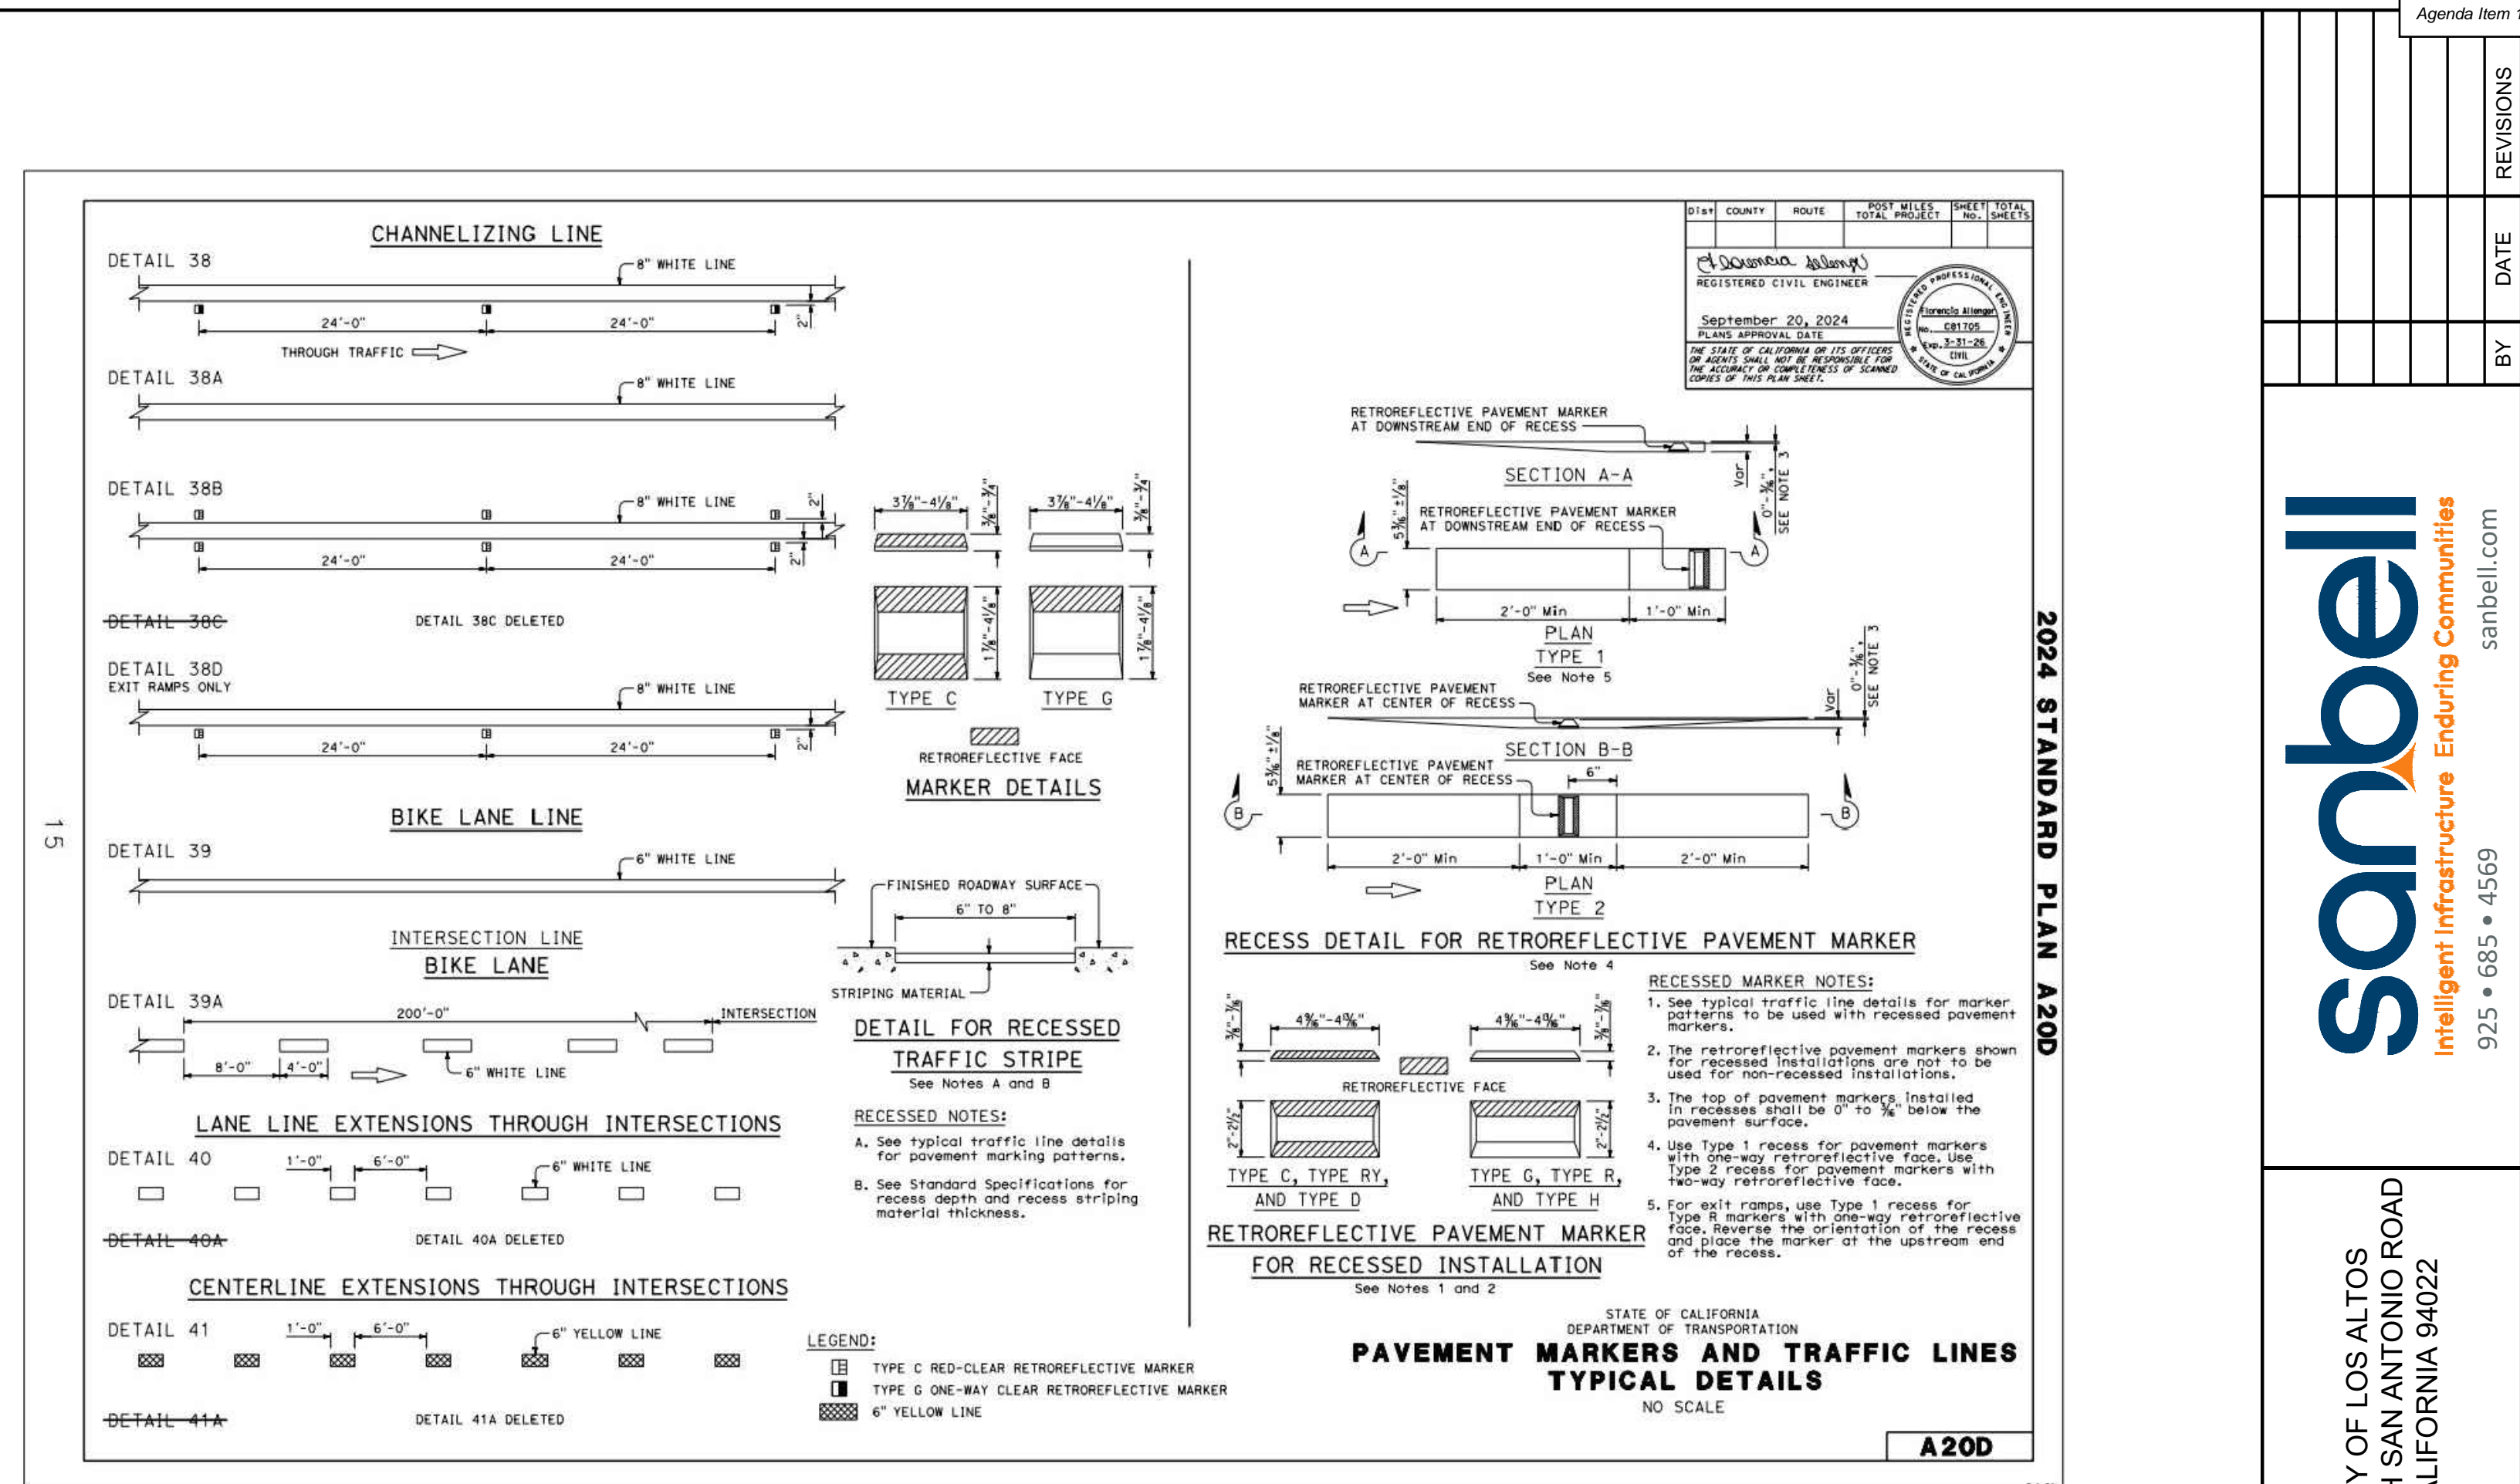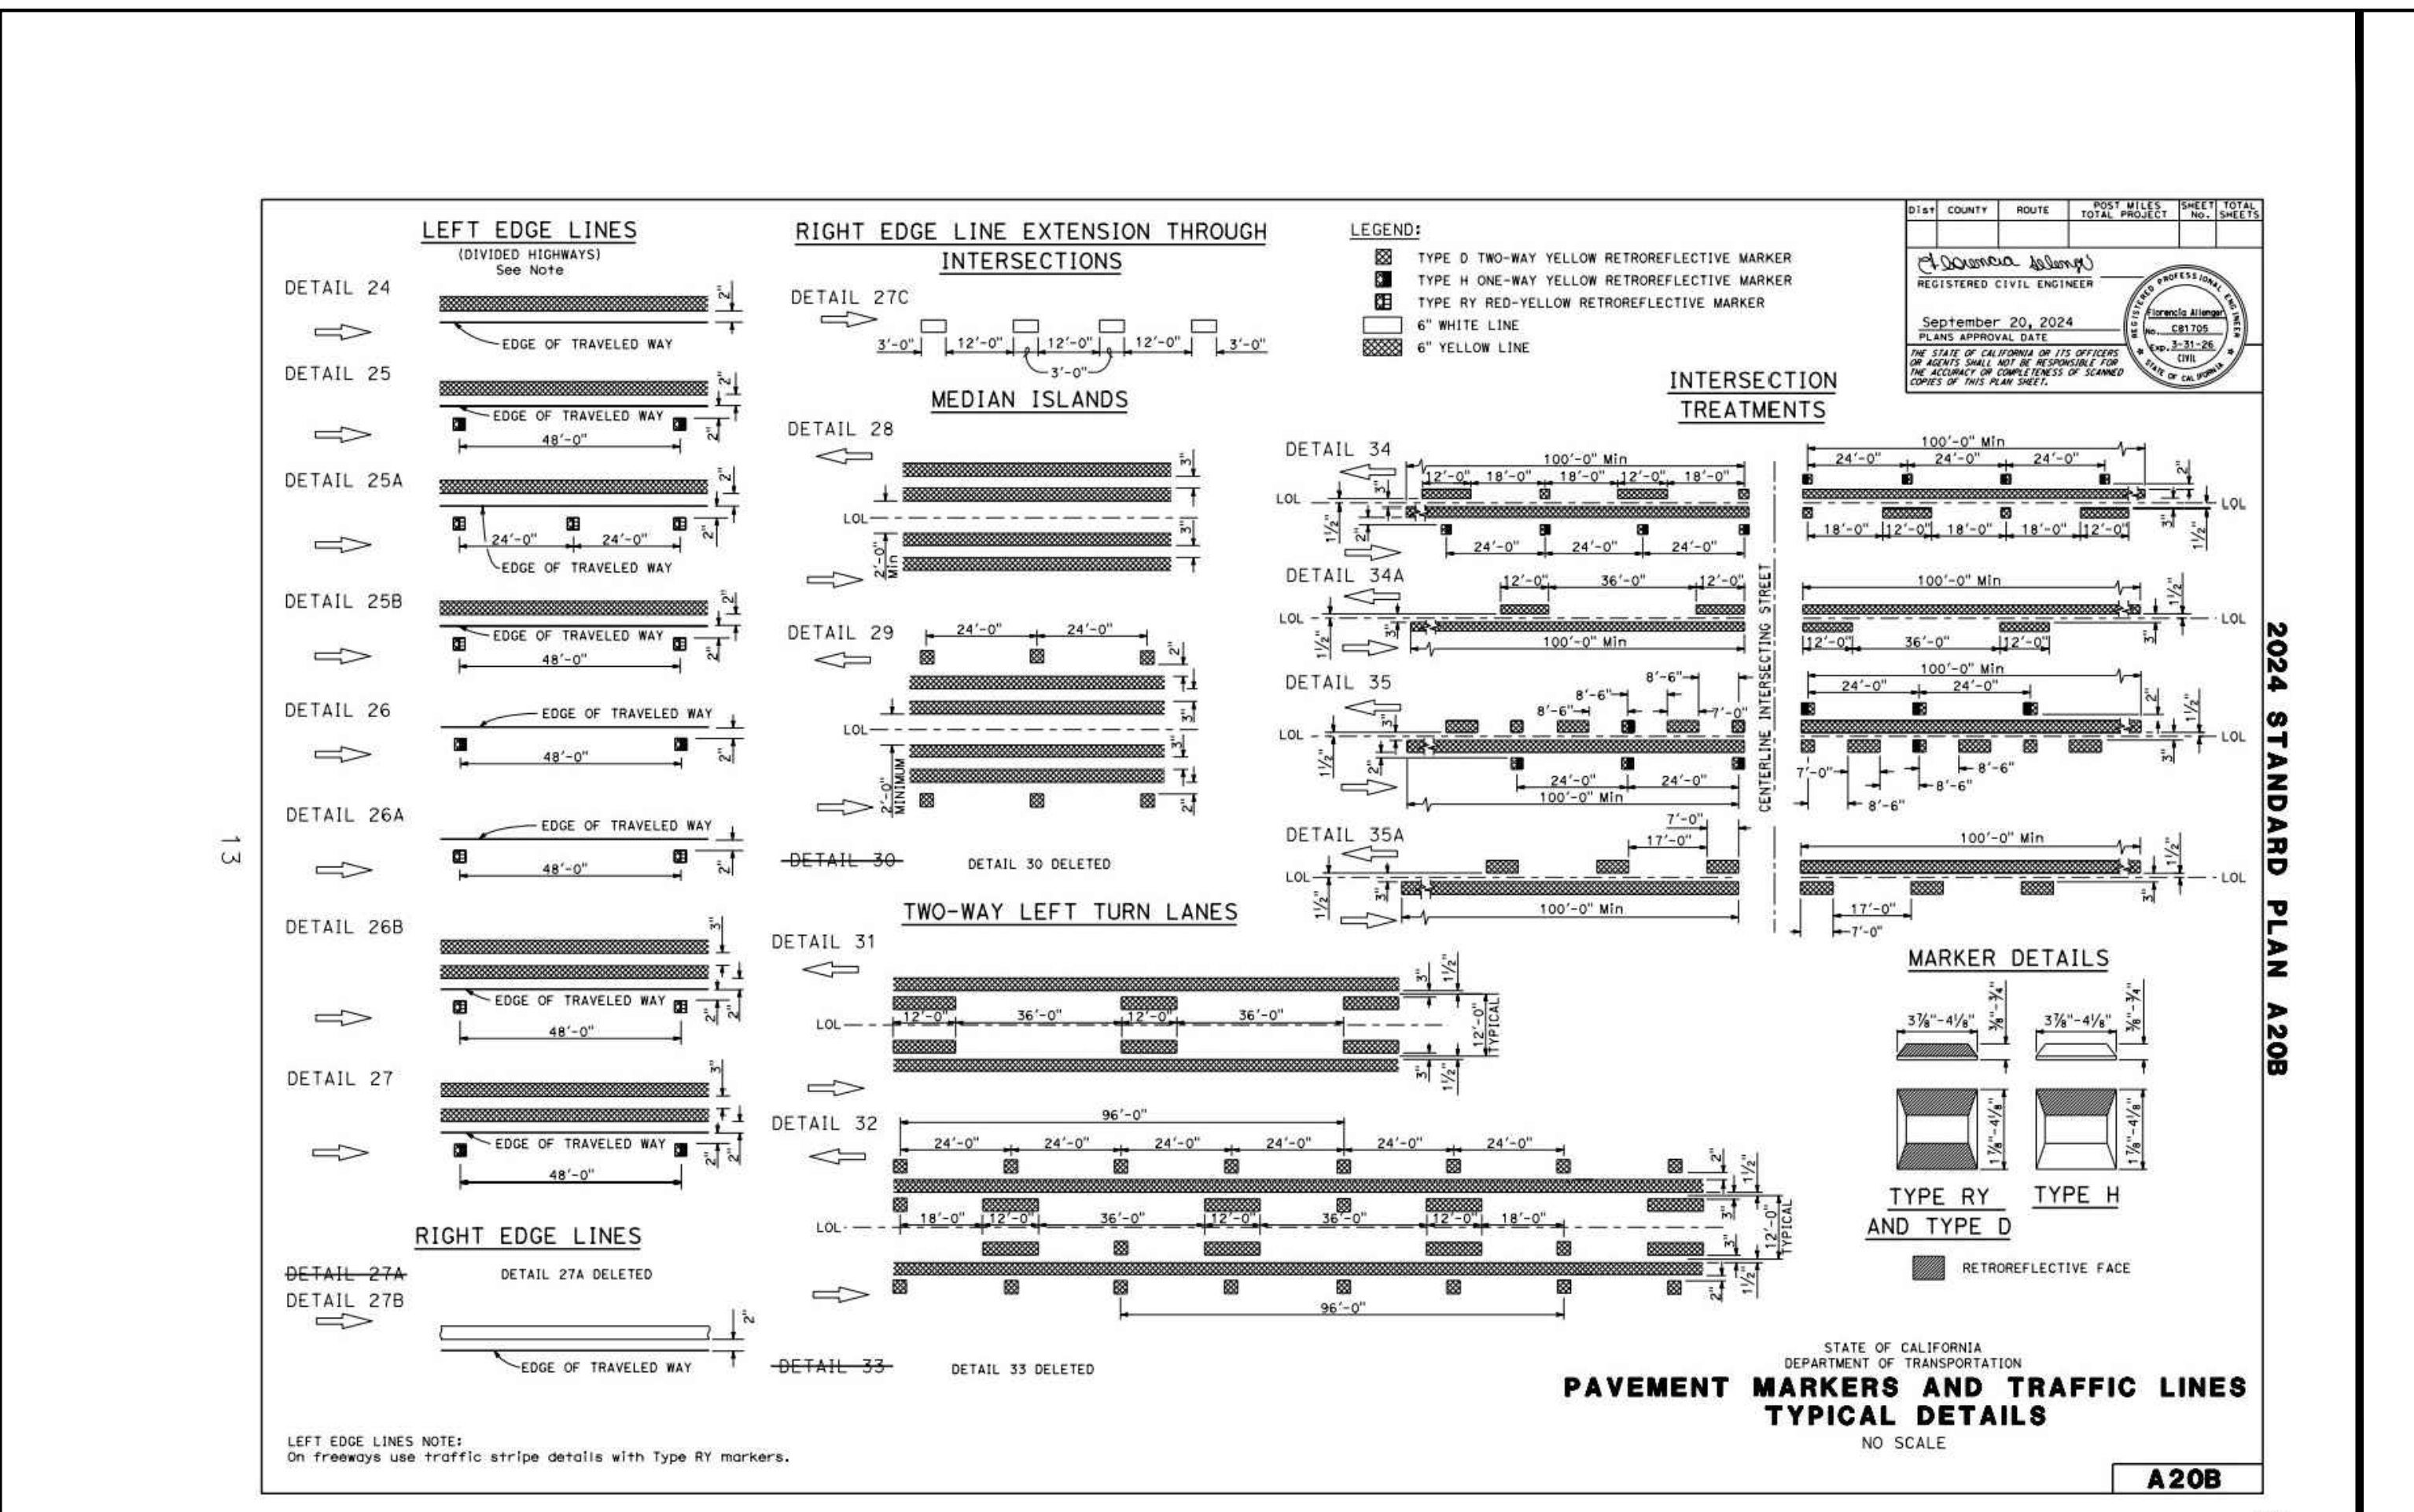

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CITY OF LOS ALTOS

1 NORTH SAN ANTONIO ROAD

CALIFORNIA 94022



2024-2025 ANNUAL STREET RESURFACING PROJECT


CIVIL DETAILS

SANTA CLARA COUNTY

CALIFORNIA

LOS ALTOS




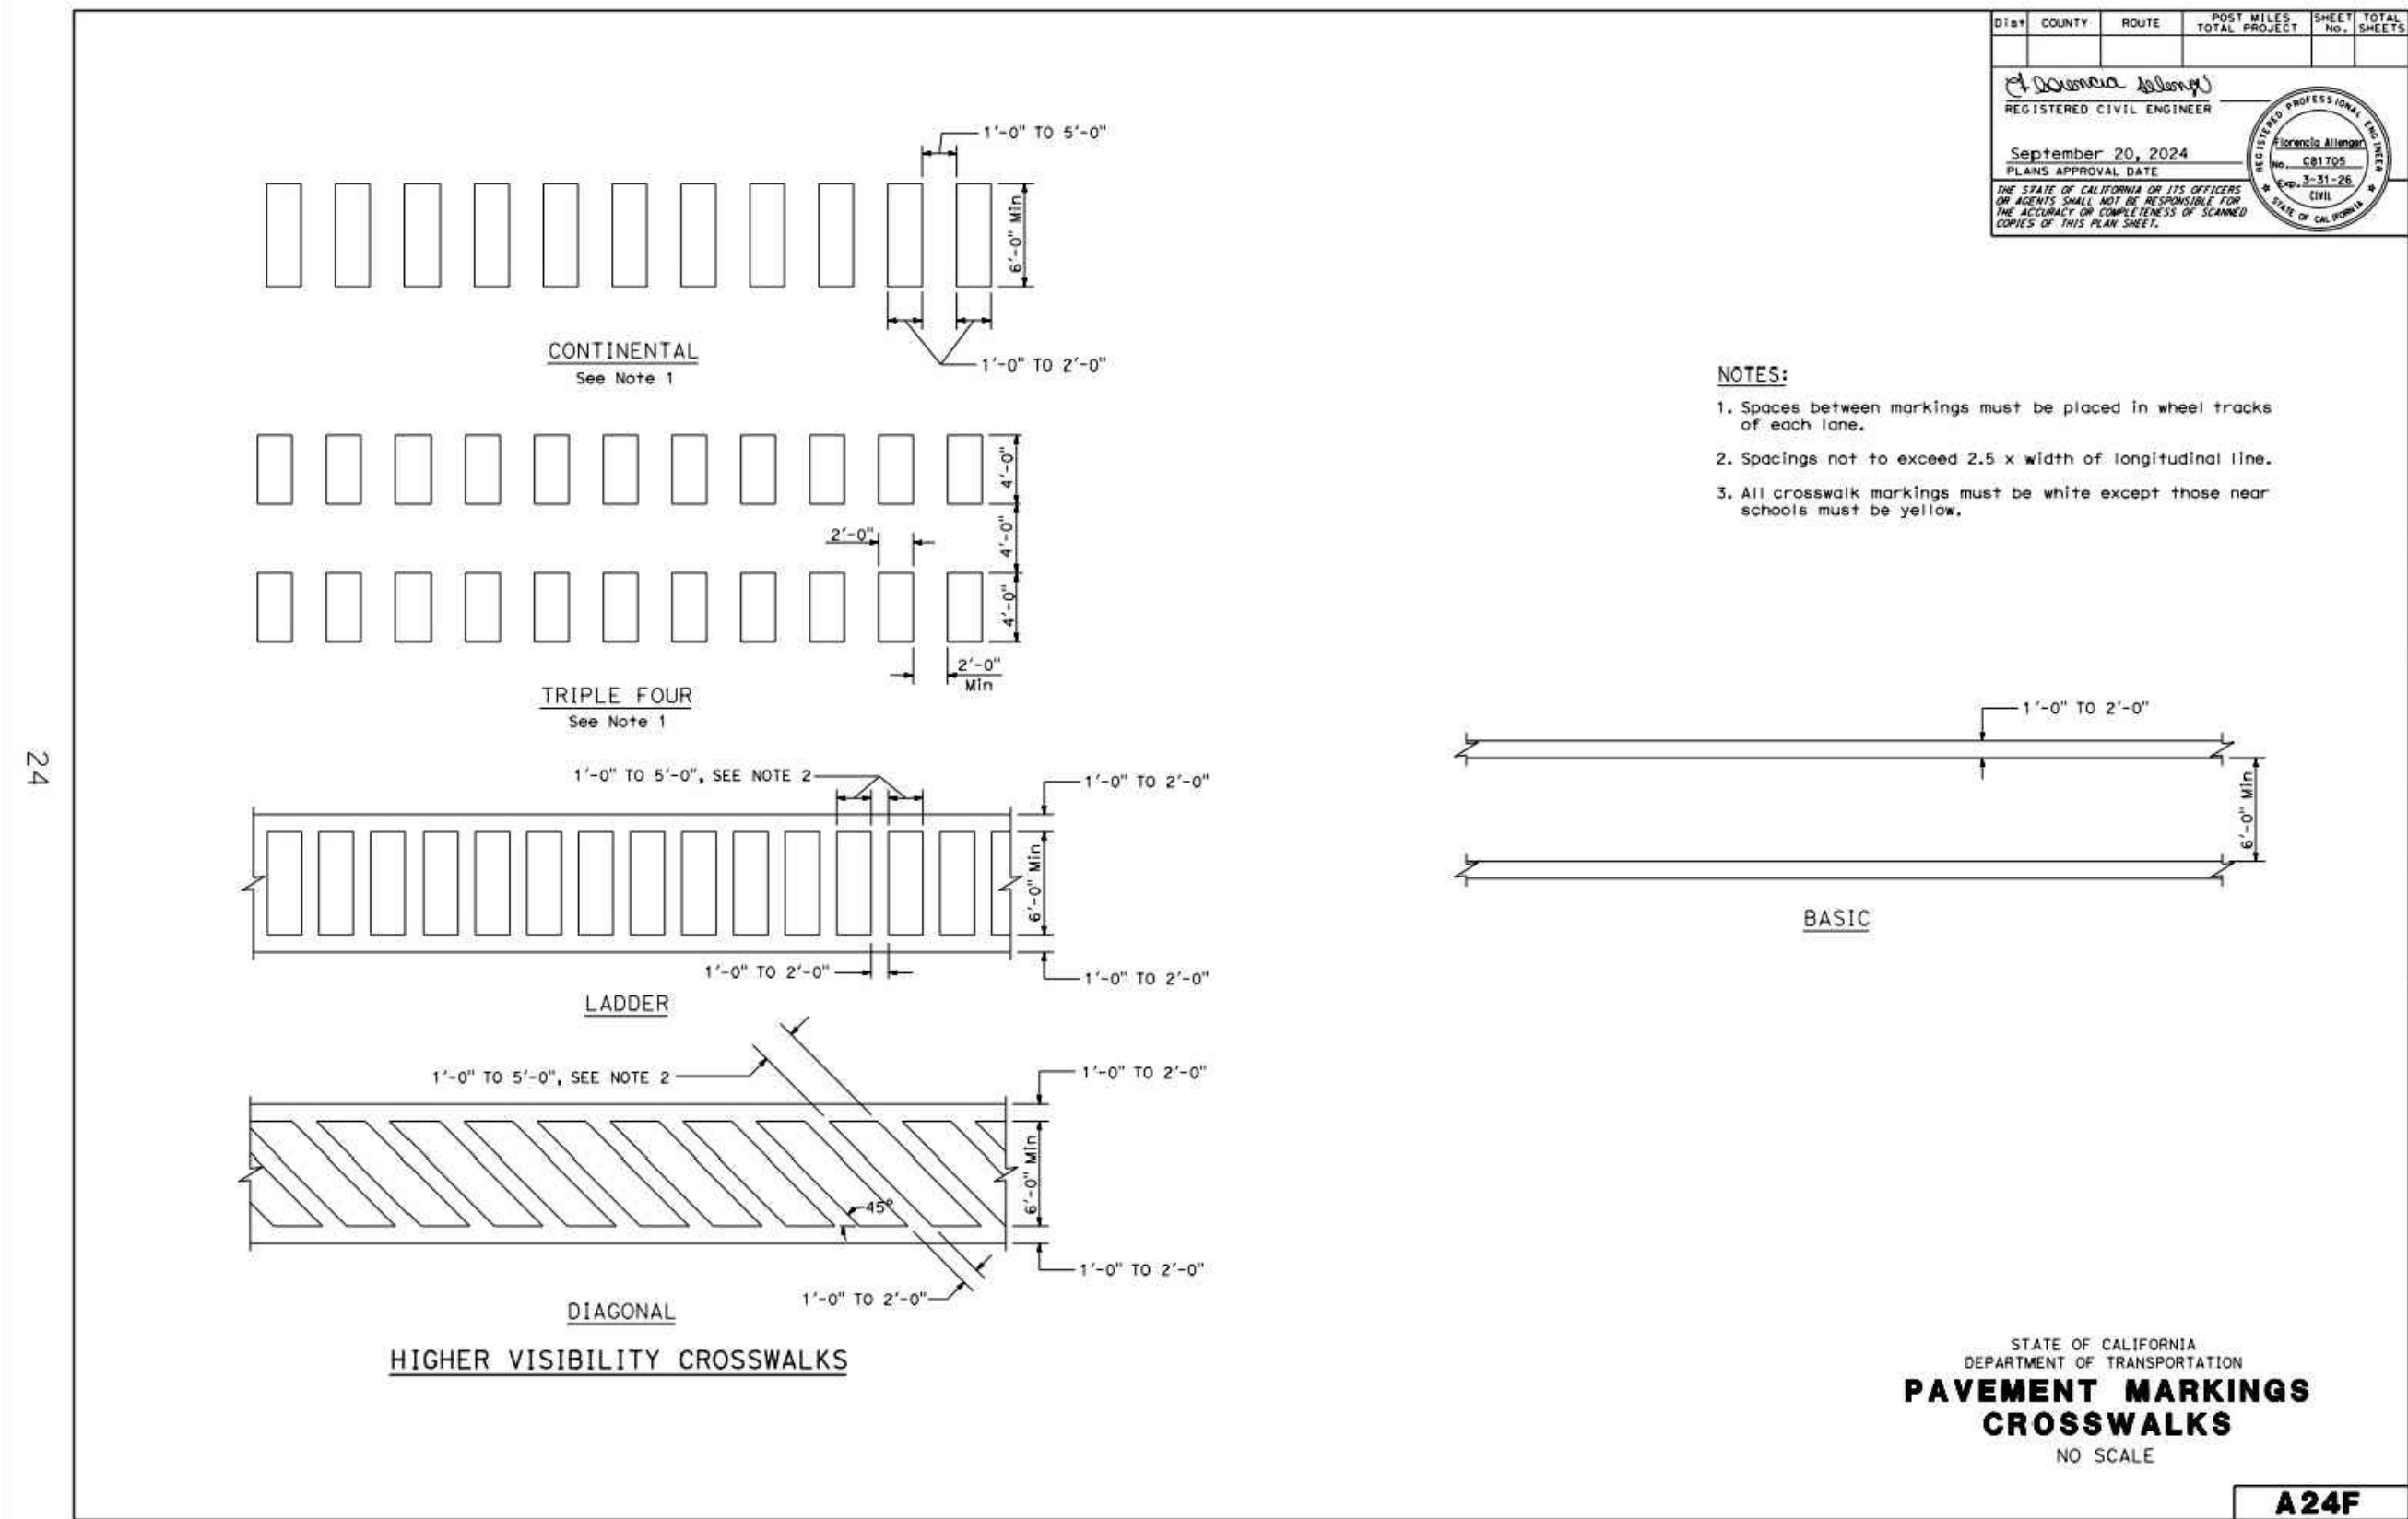
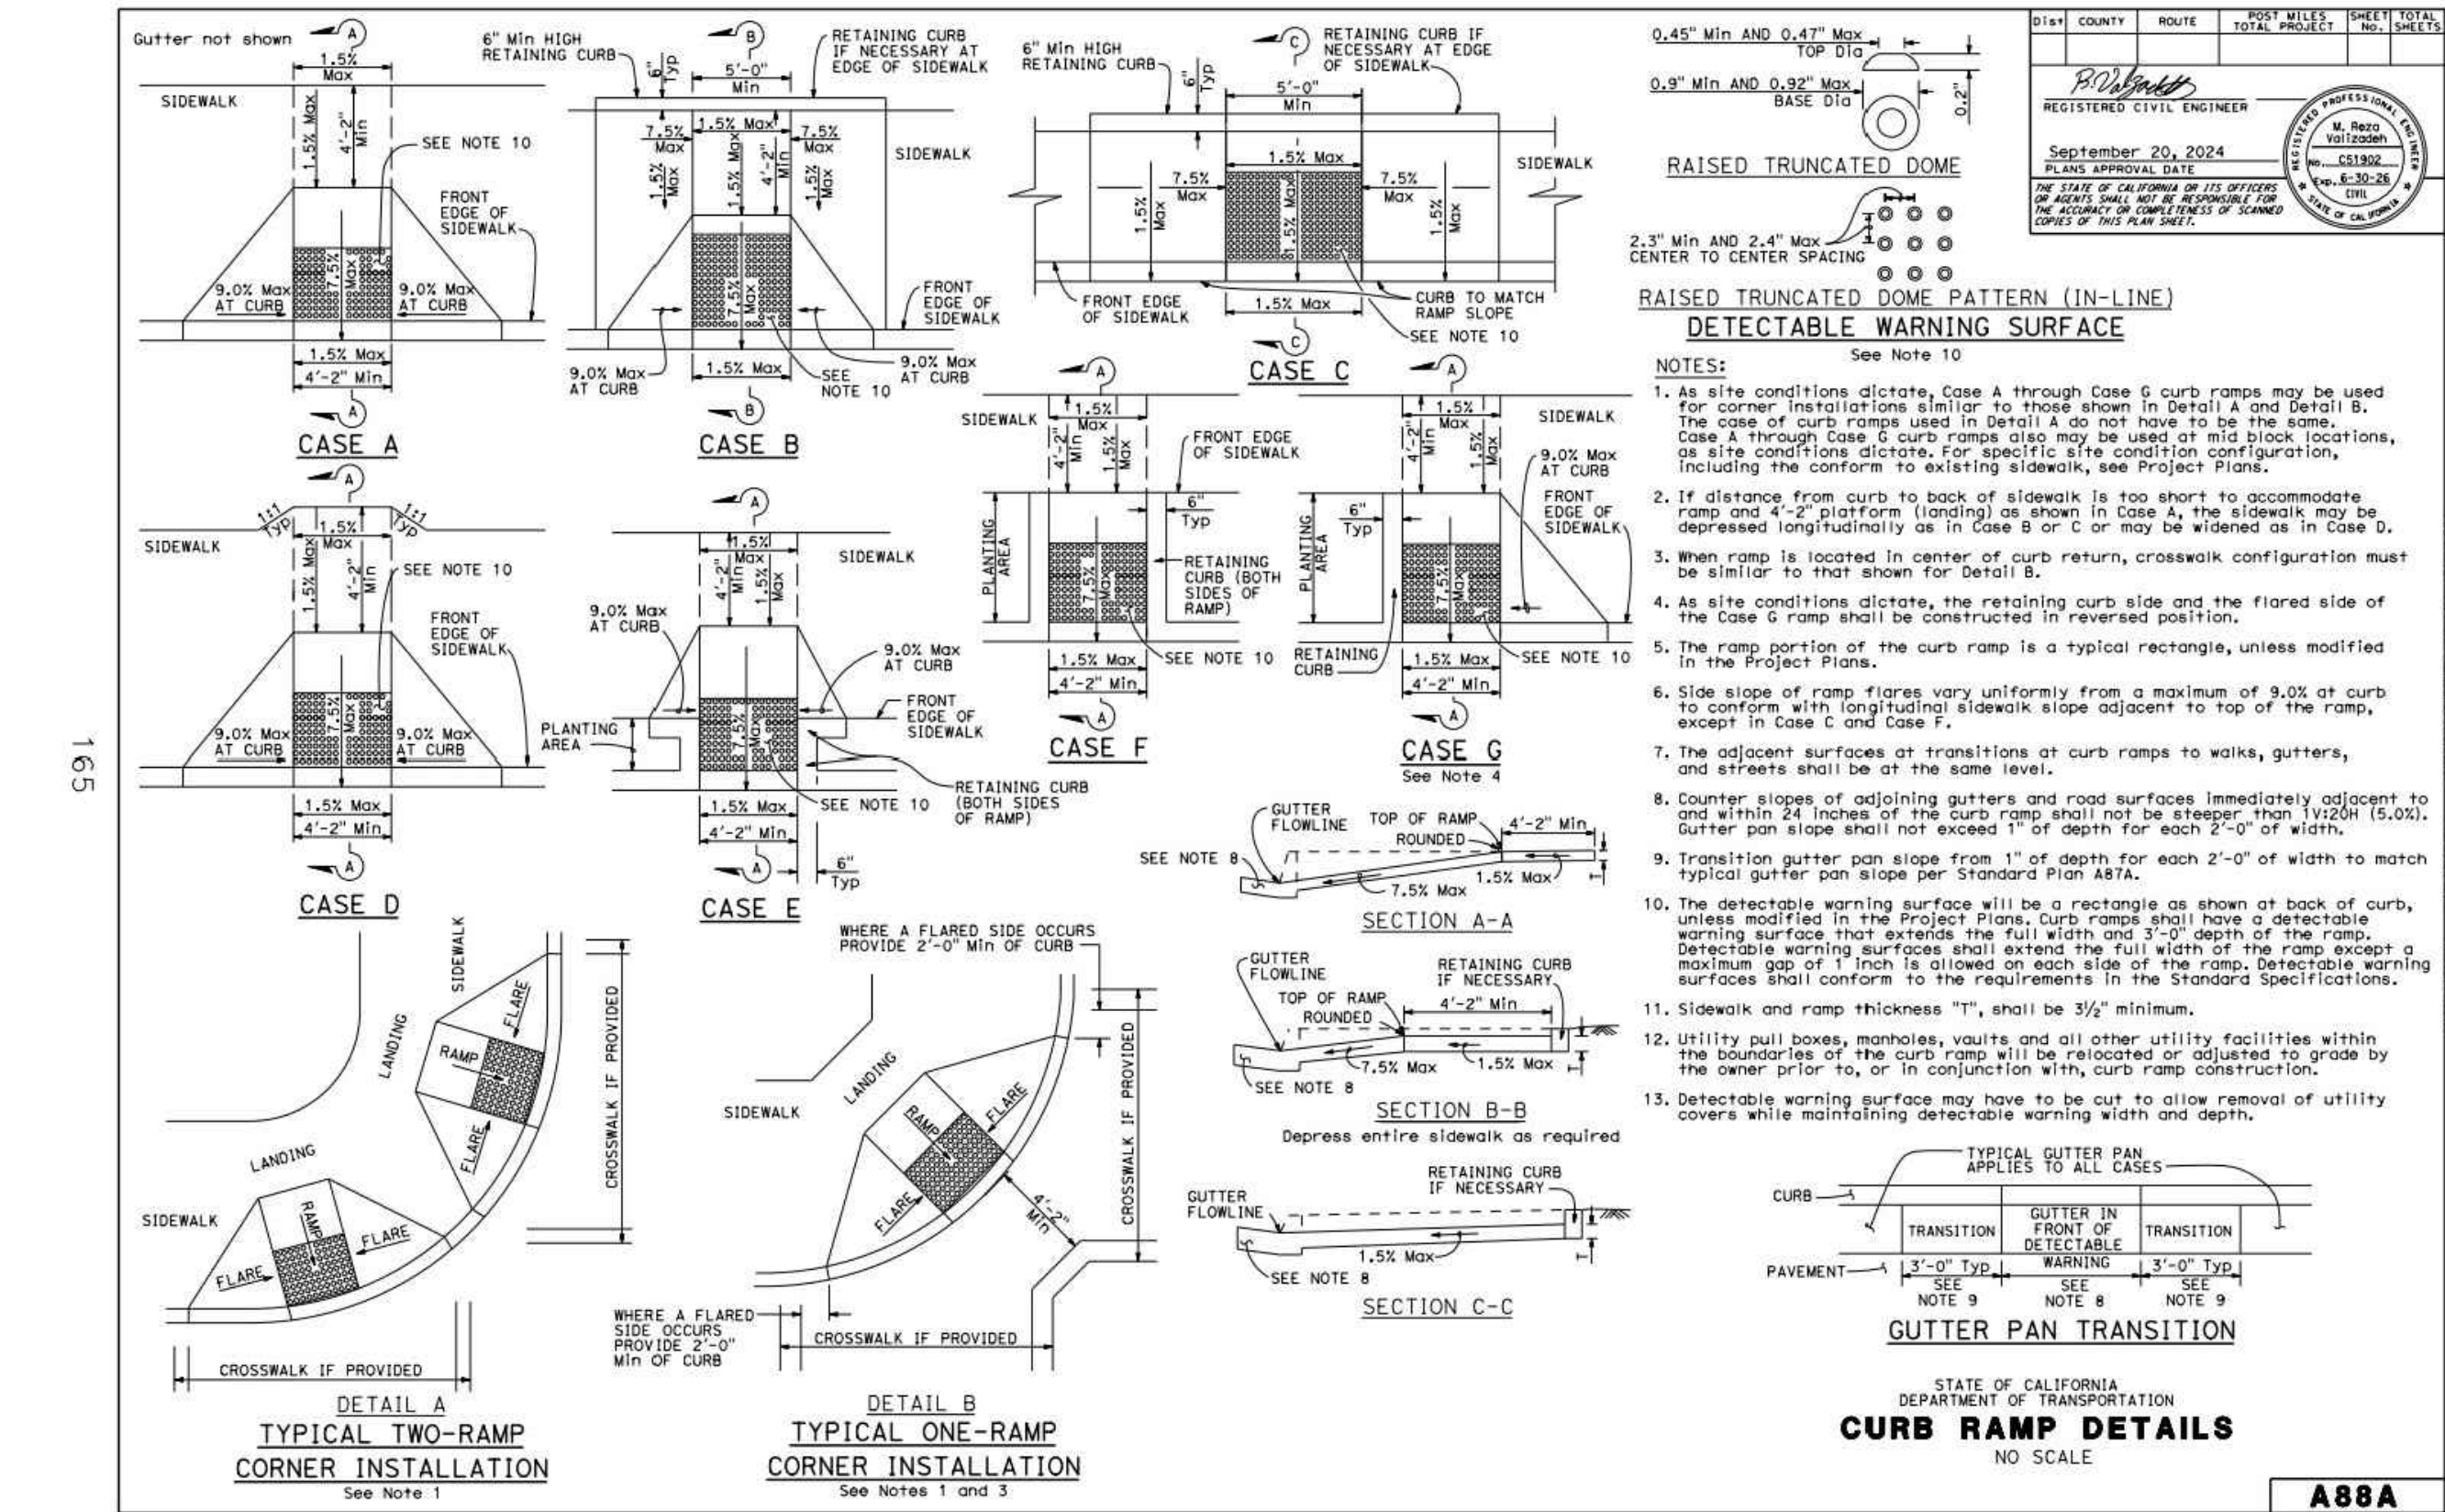


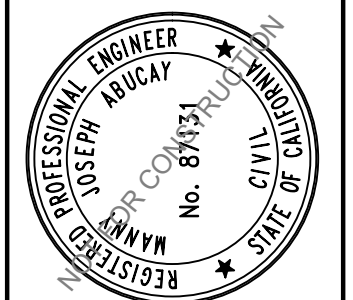




1-800-227-2600

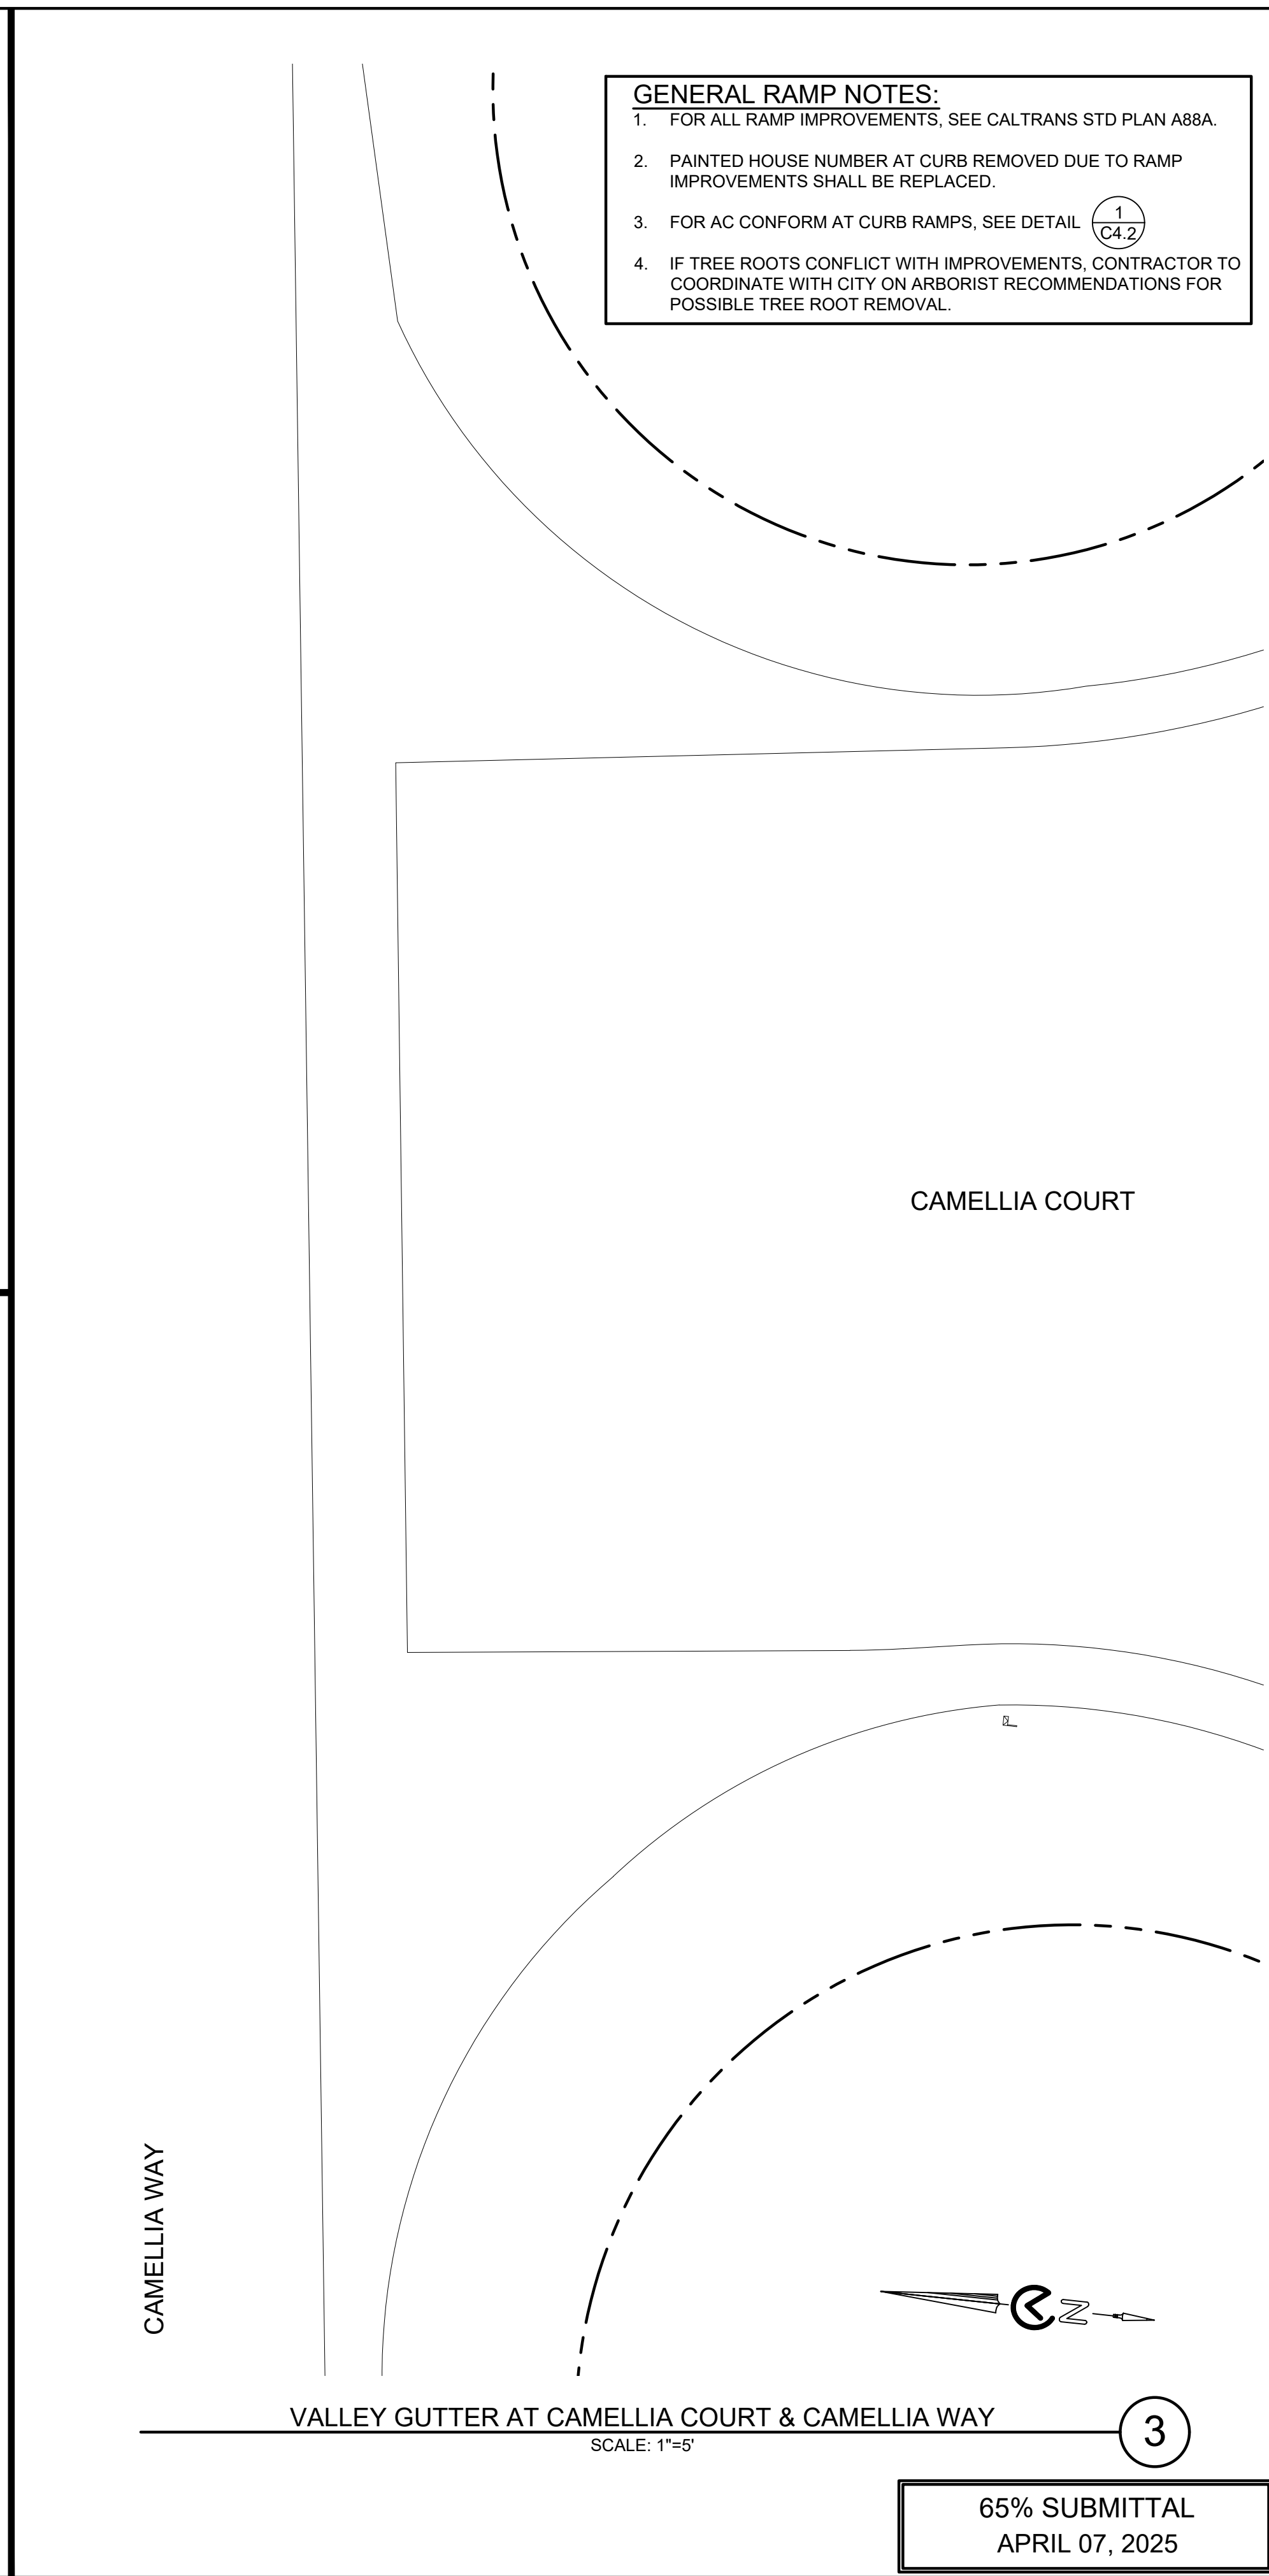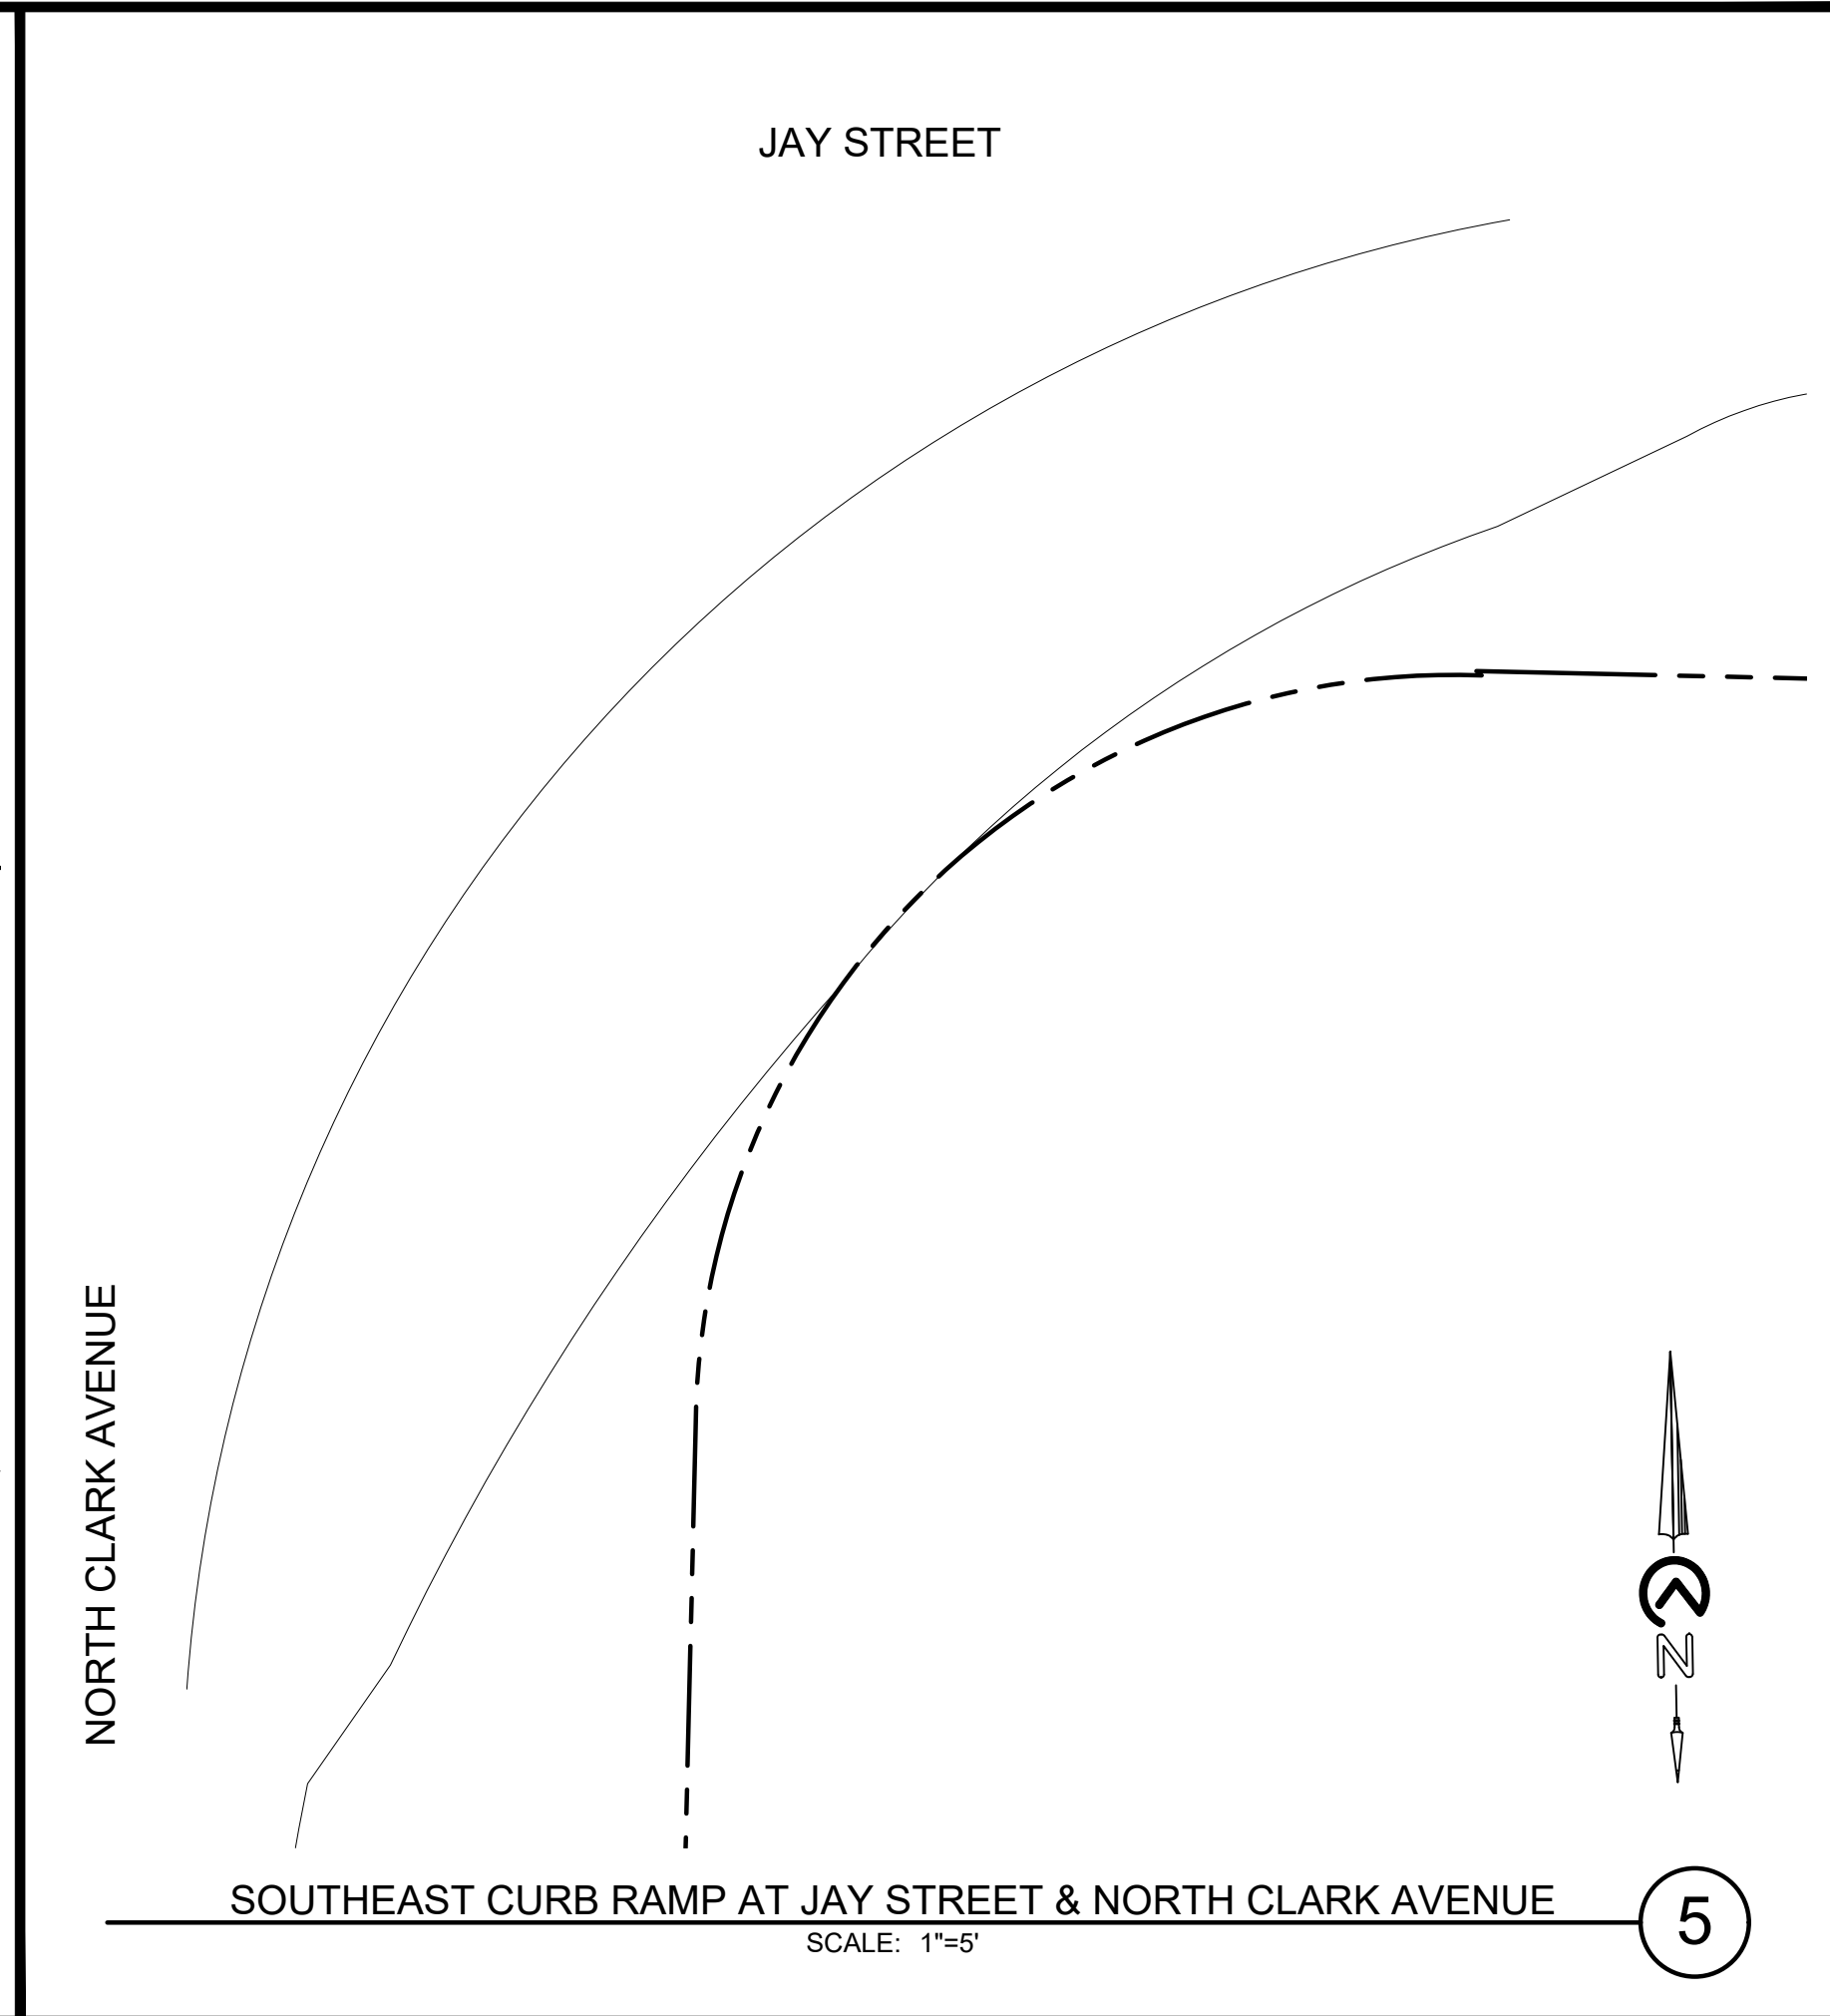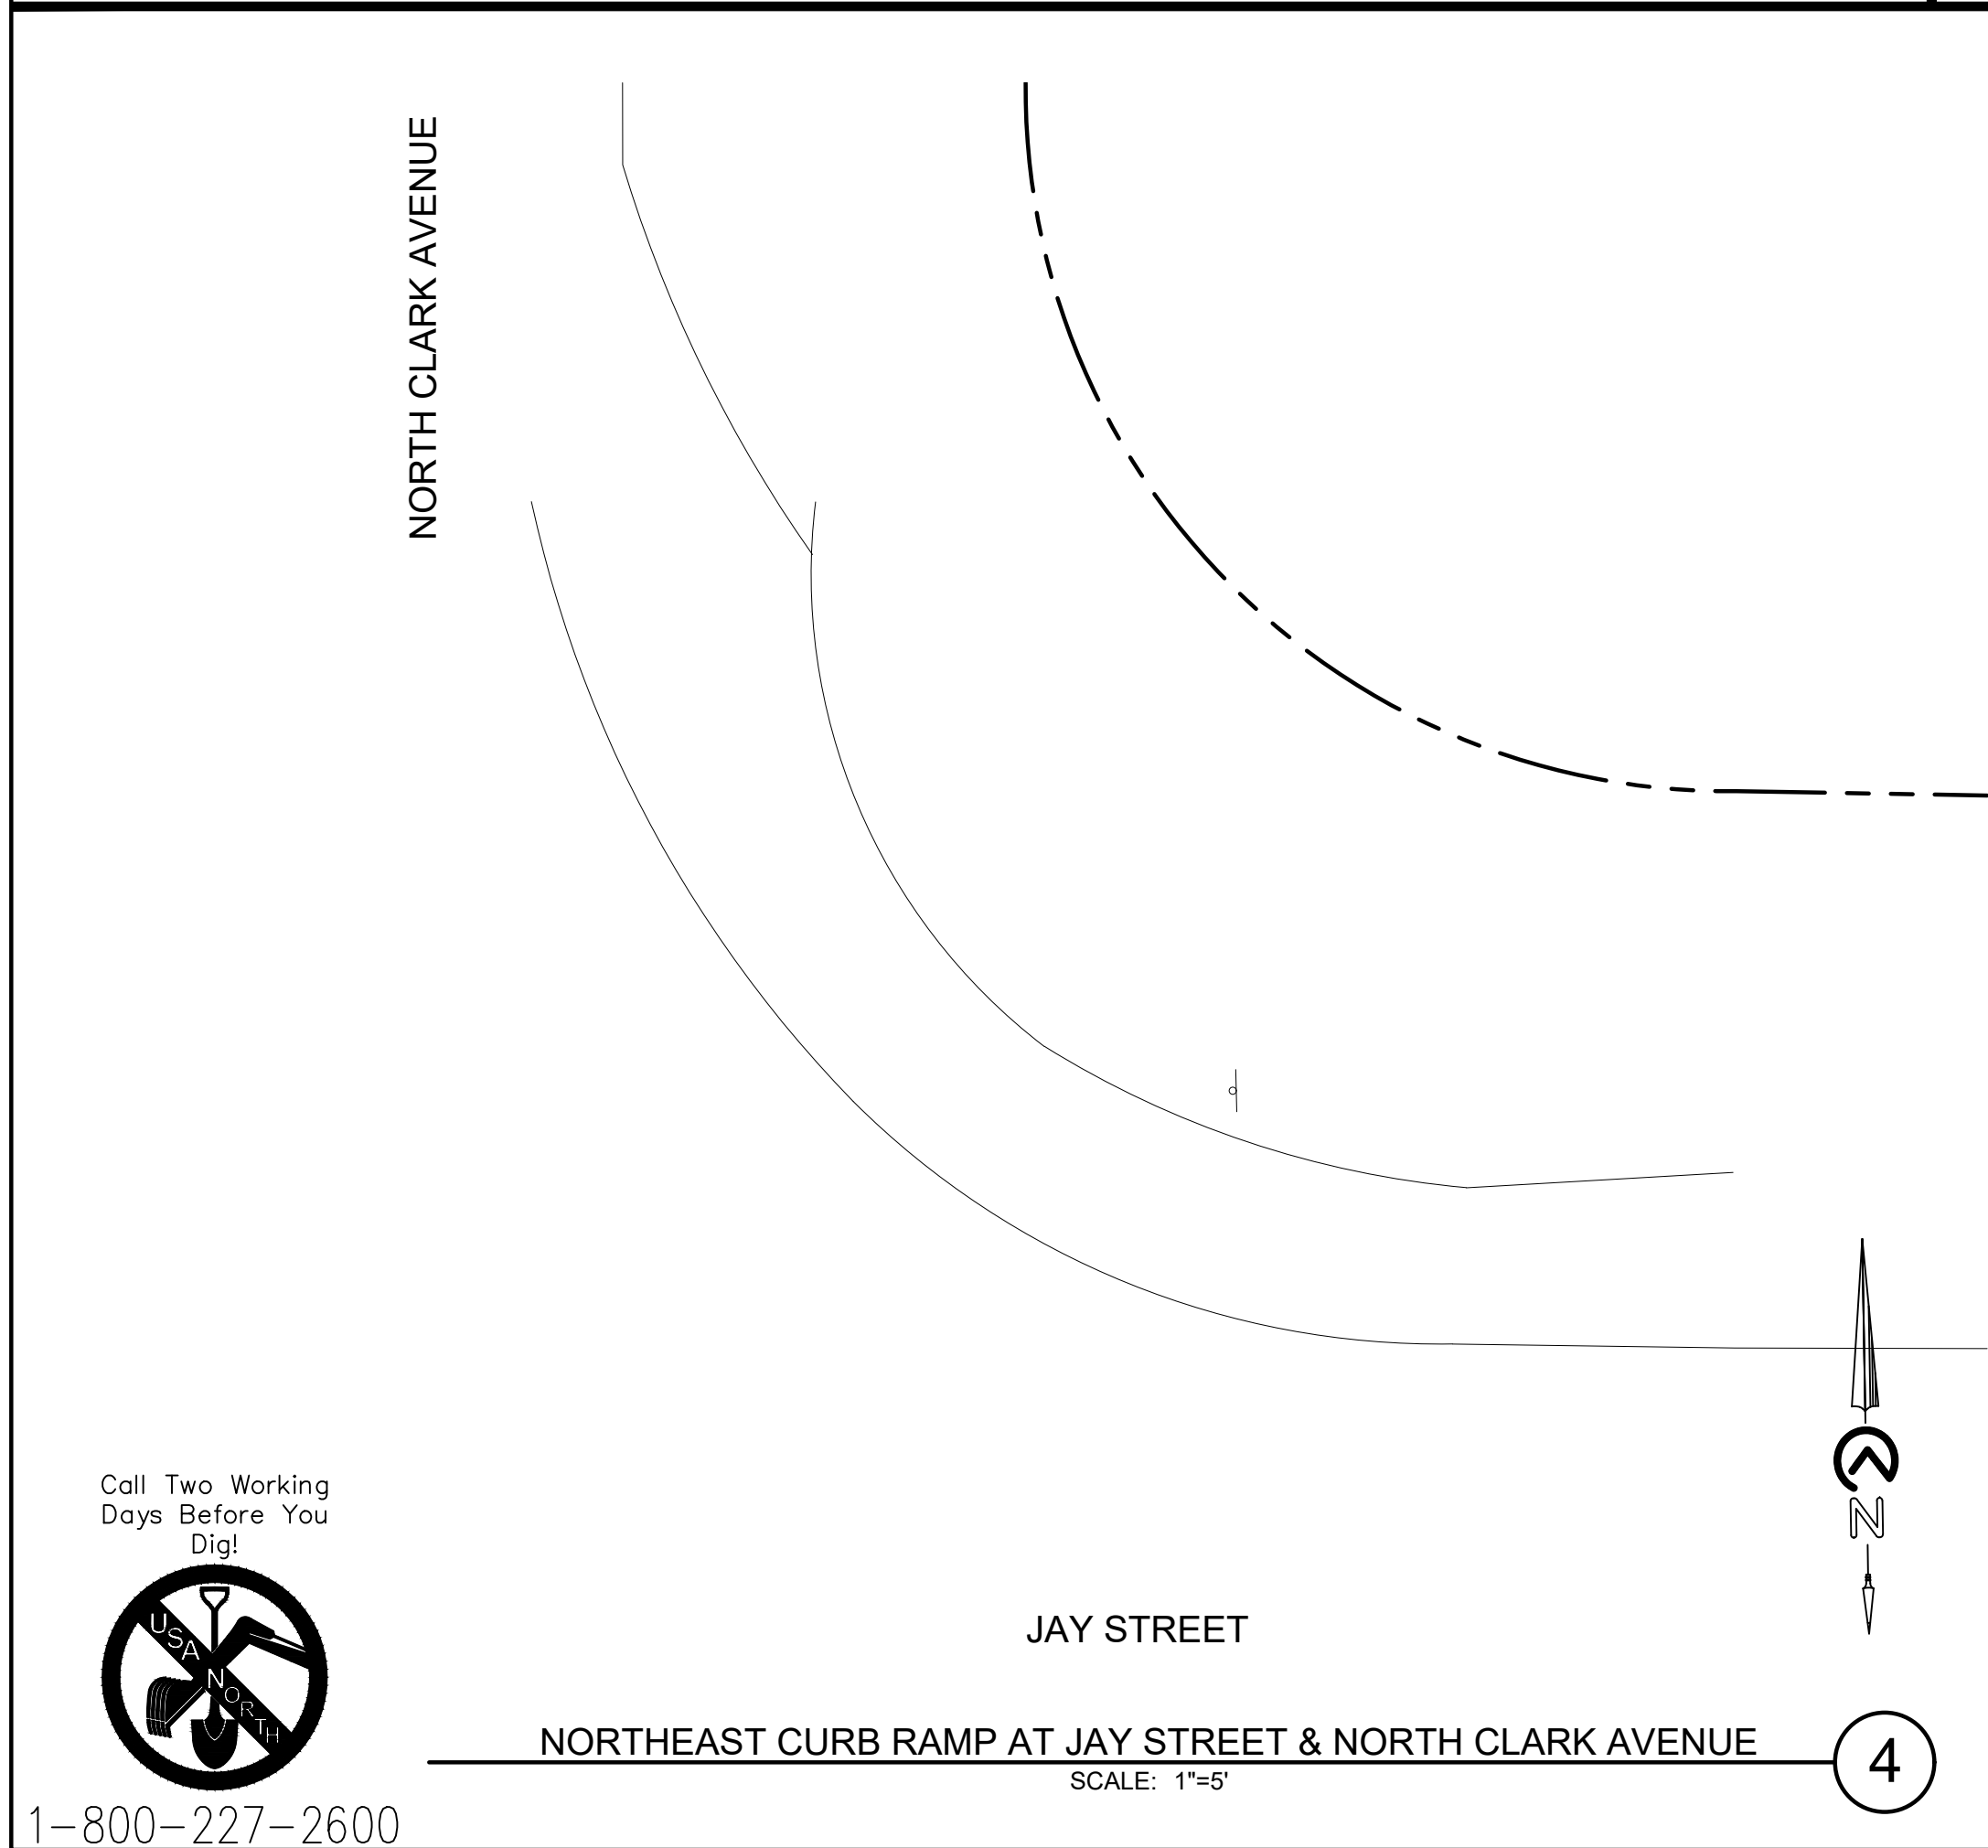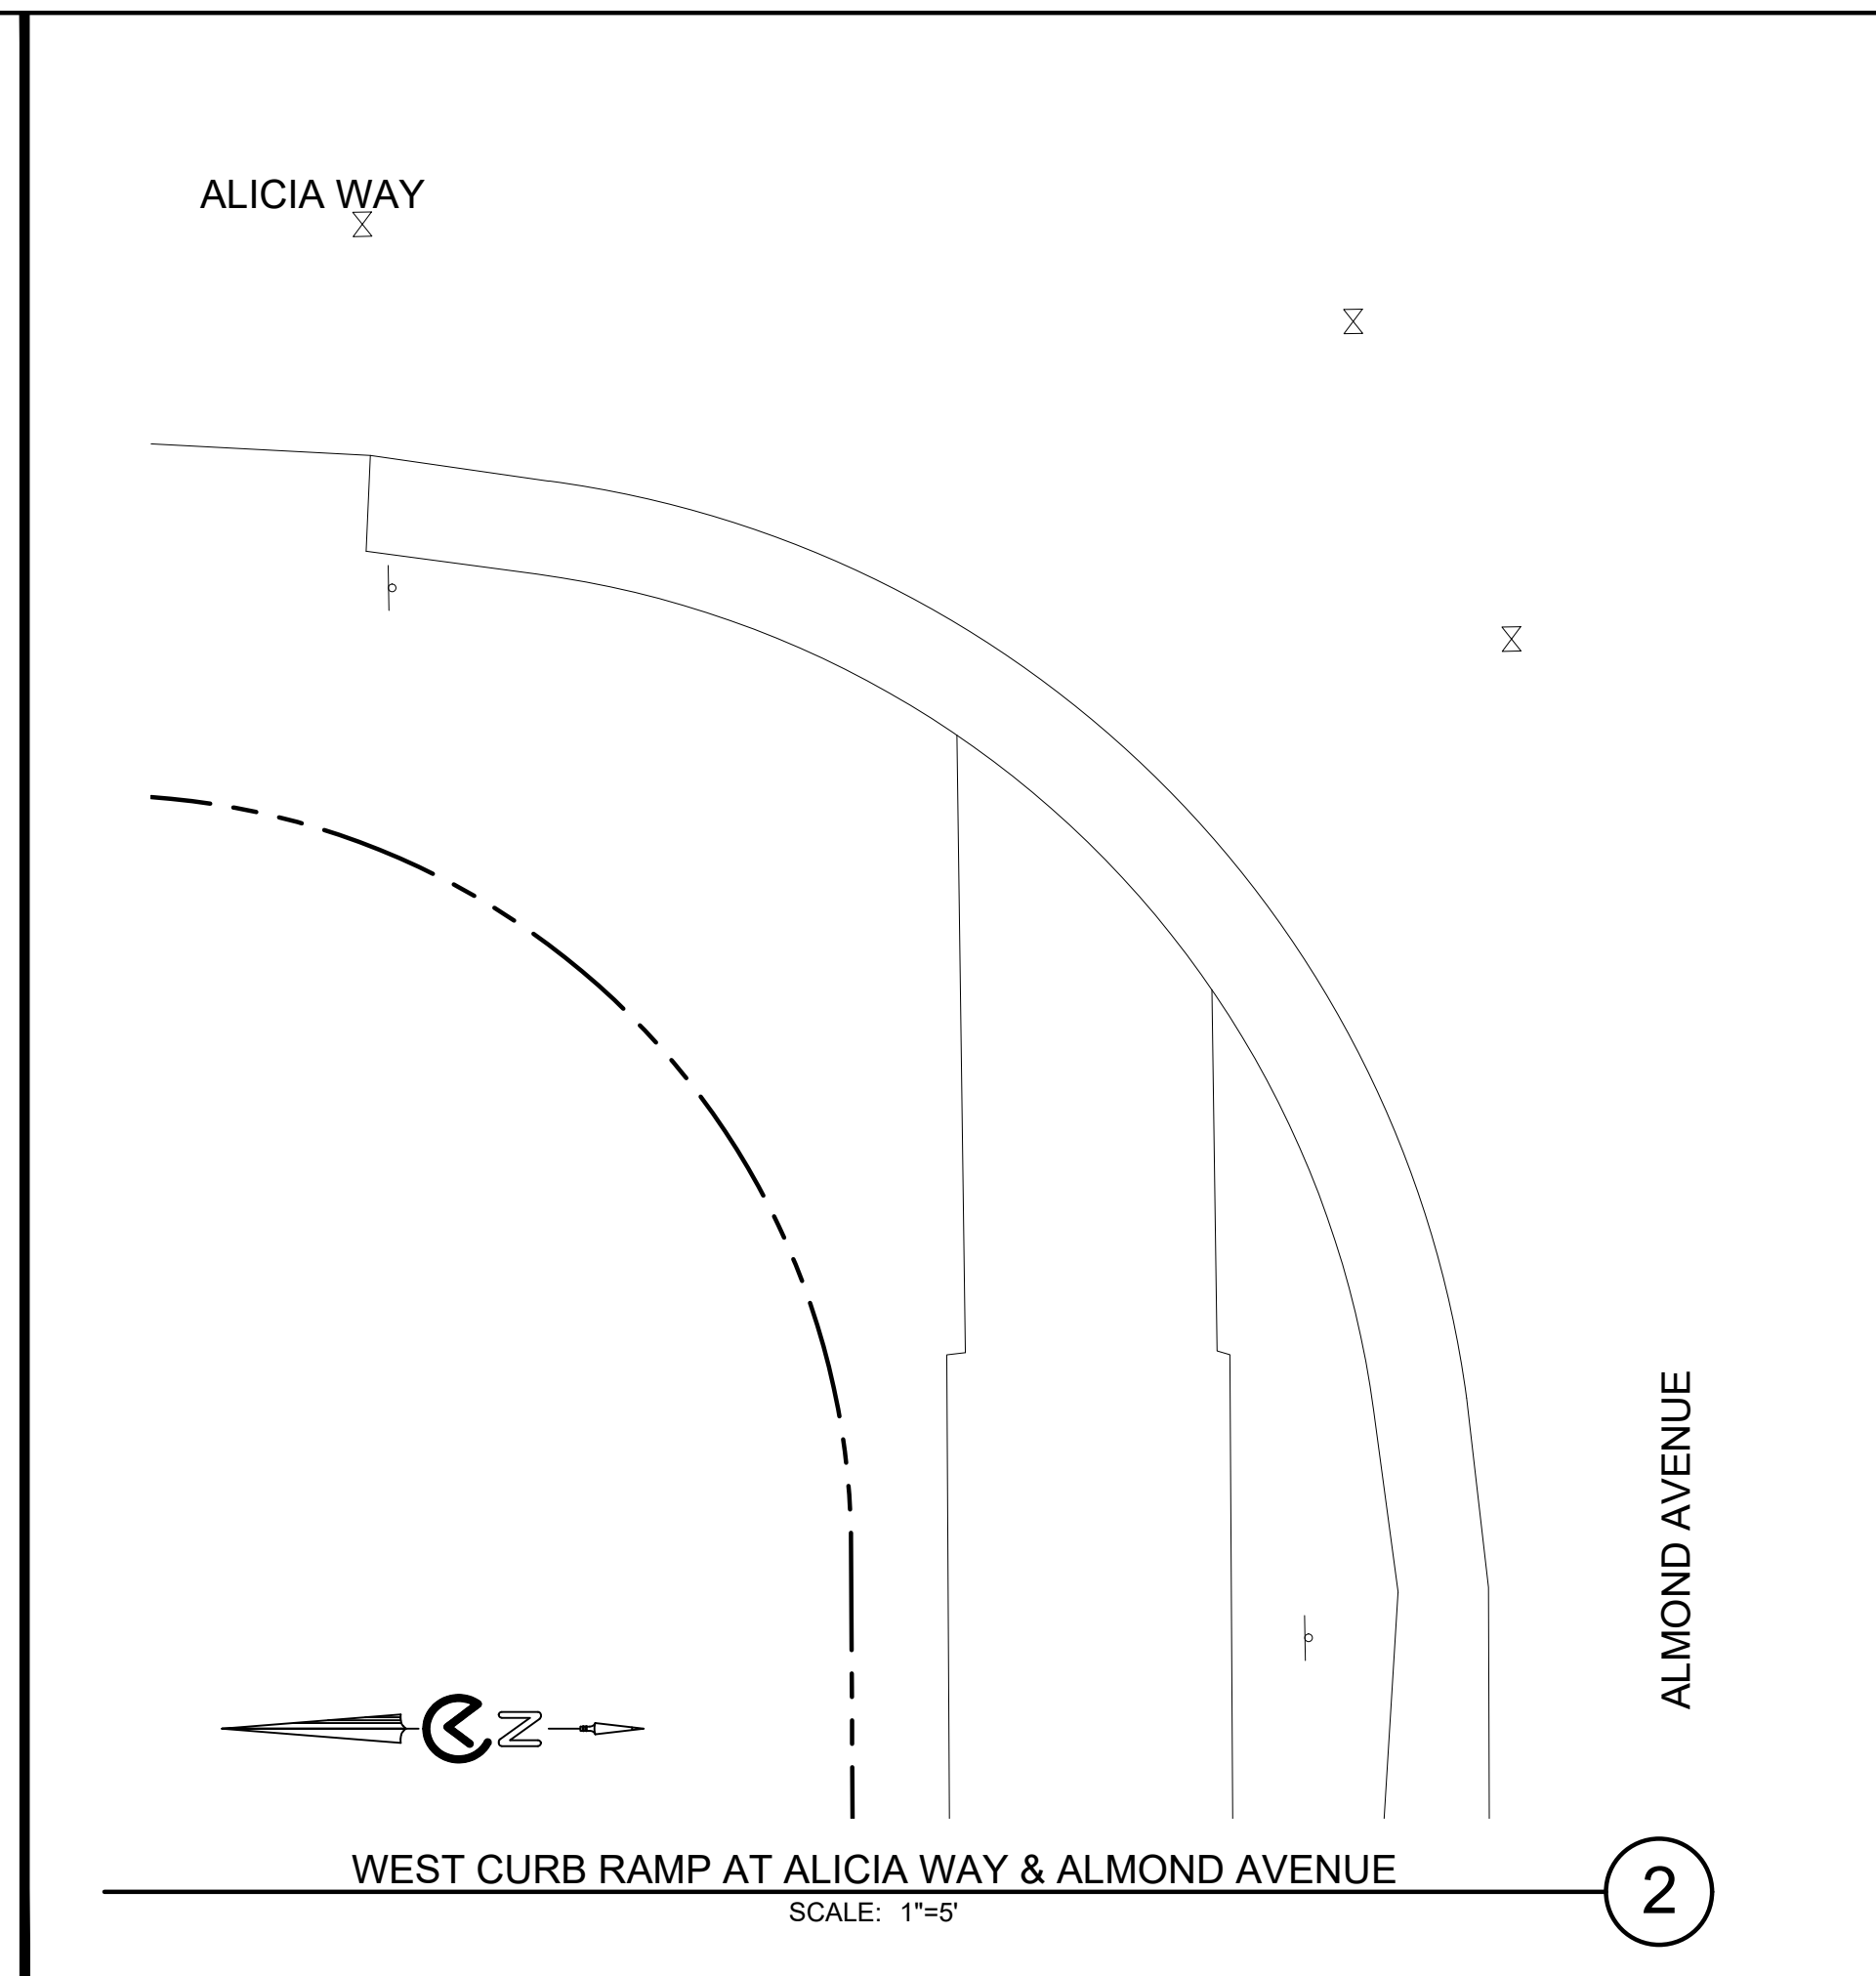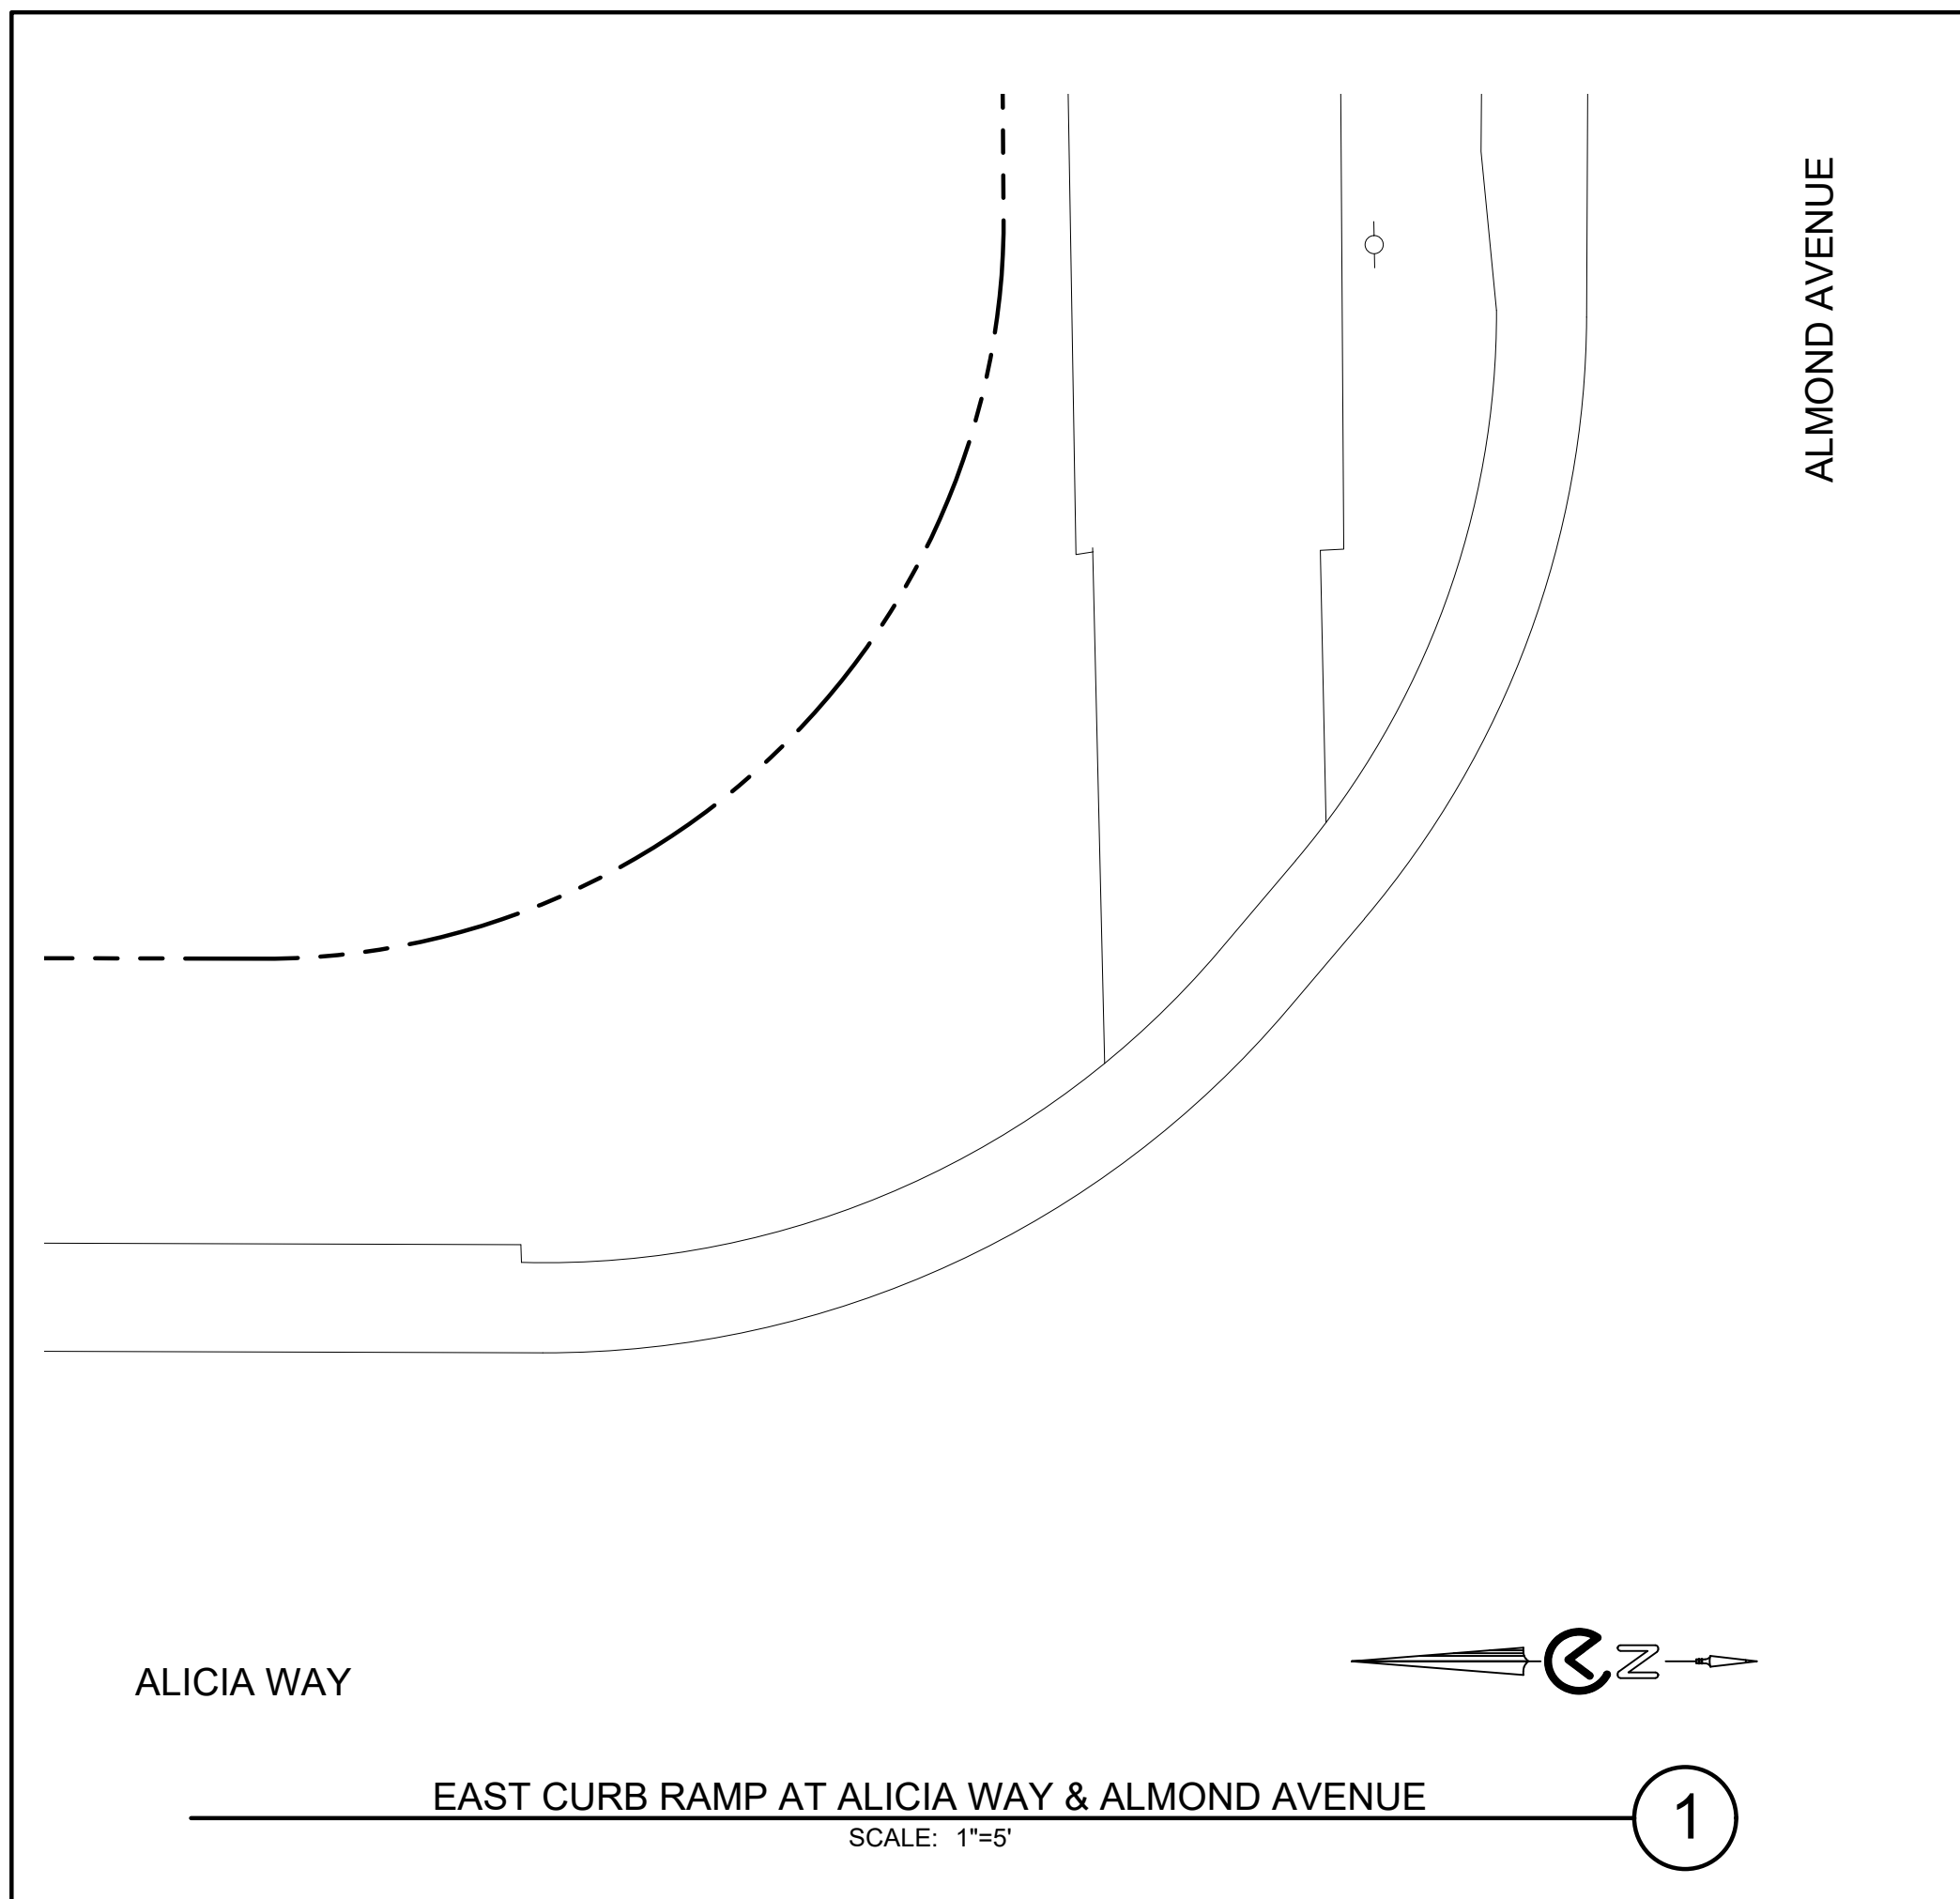

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APRIL 07, 2025



DWG NO.	2024-2025 ANNUAL STREET RESURFACING PROJECT		CITY OF LOS ALTOS 1 NORTH SAN ANTONIO ROAD CALIFORNIA 94022									
C5.5	CIVIL DETAILS											
43 OF 50												
JOB NO.	LOS ALTOS		SANTA CLARA COUNTY		CALIFORNIA							
250007							925 • 685 • 4569	sanbell.com	BY	DATE	REVISIONS	

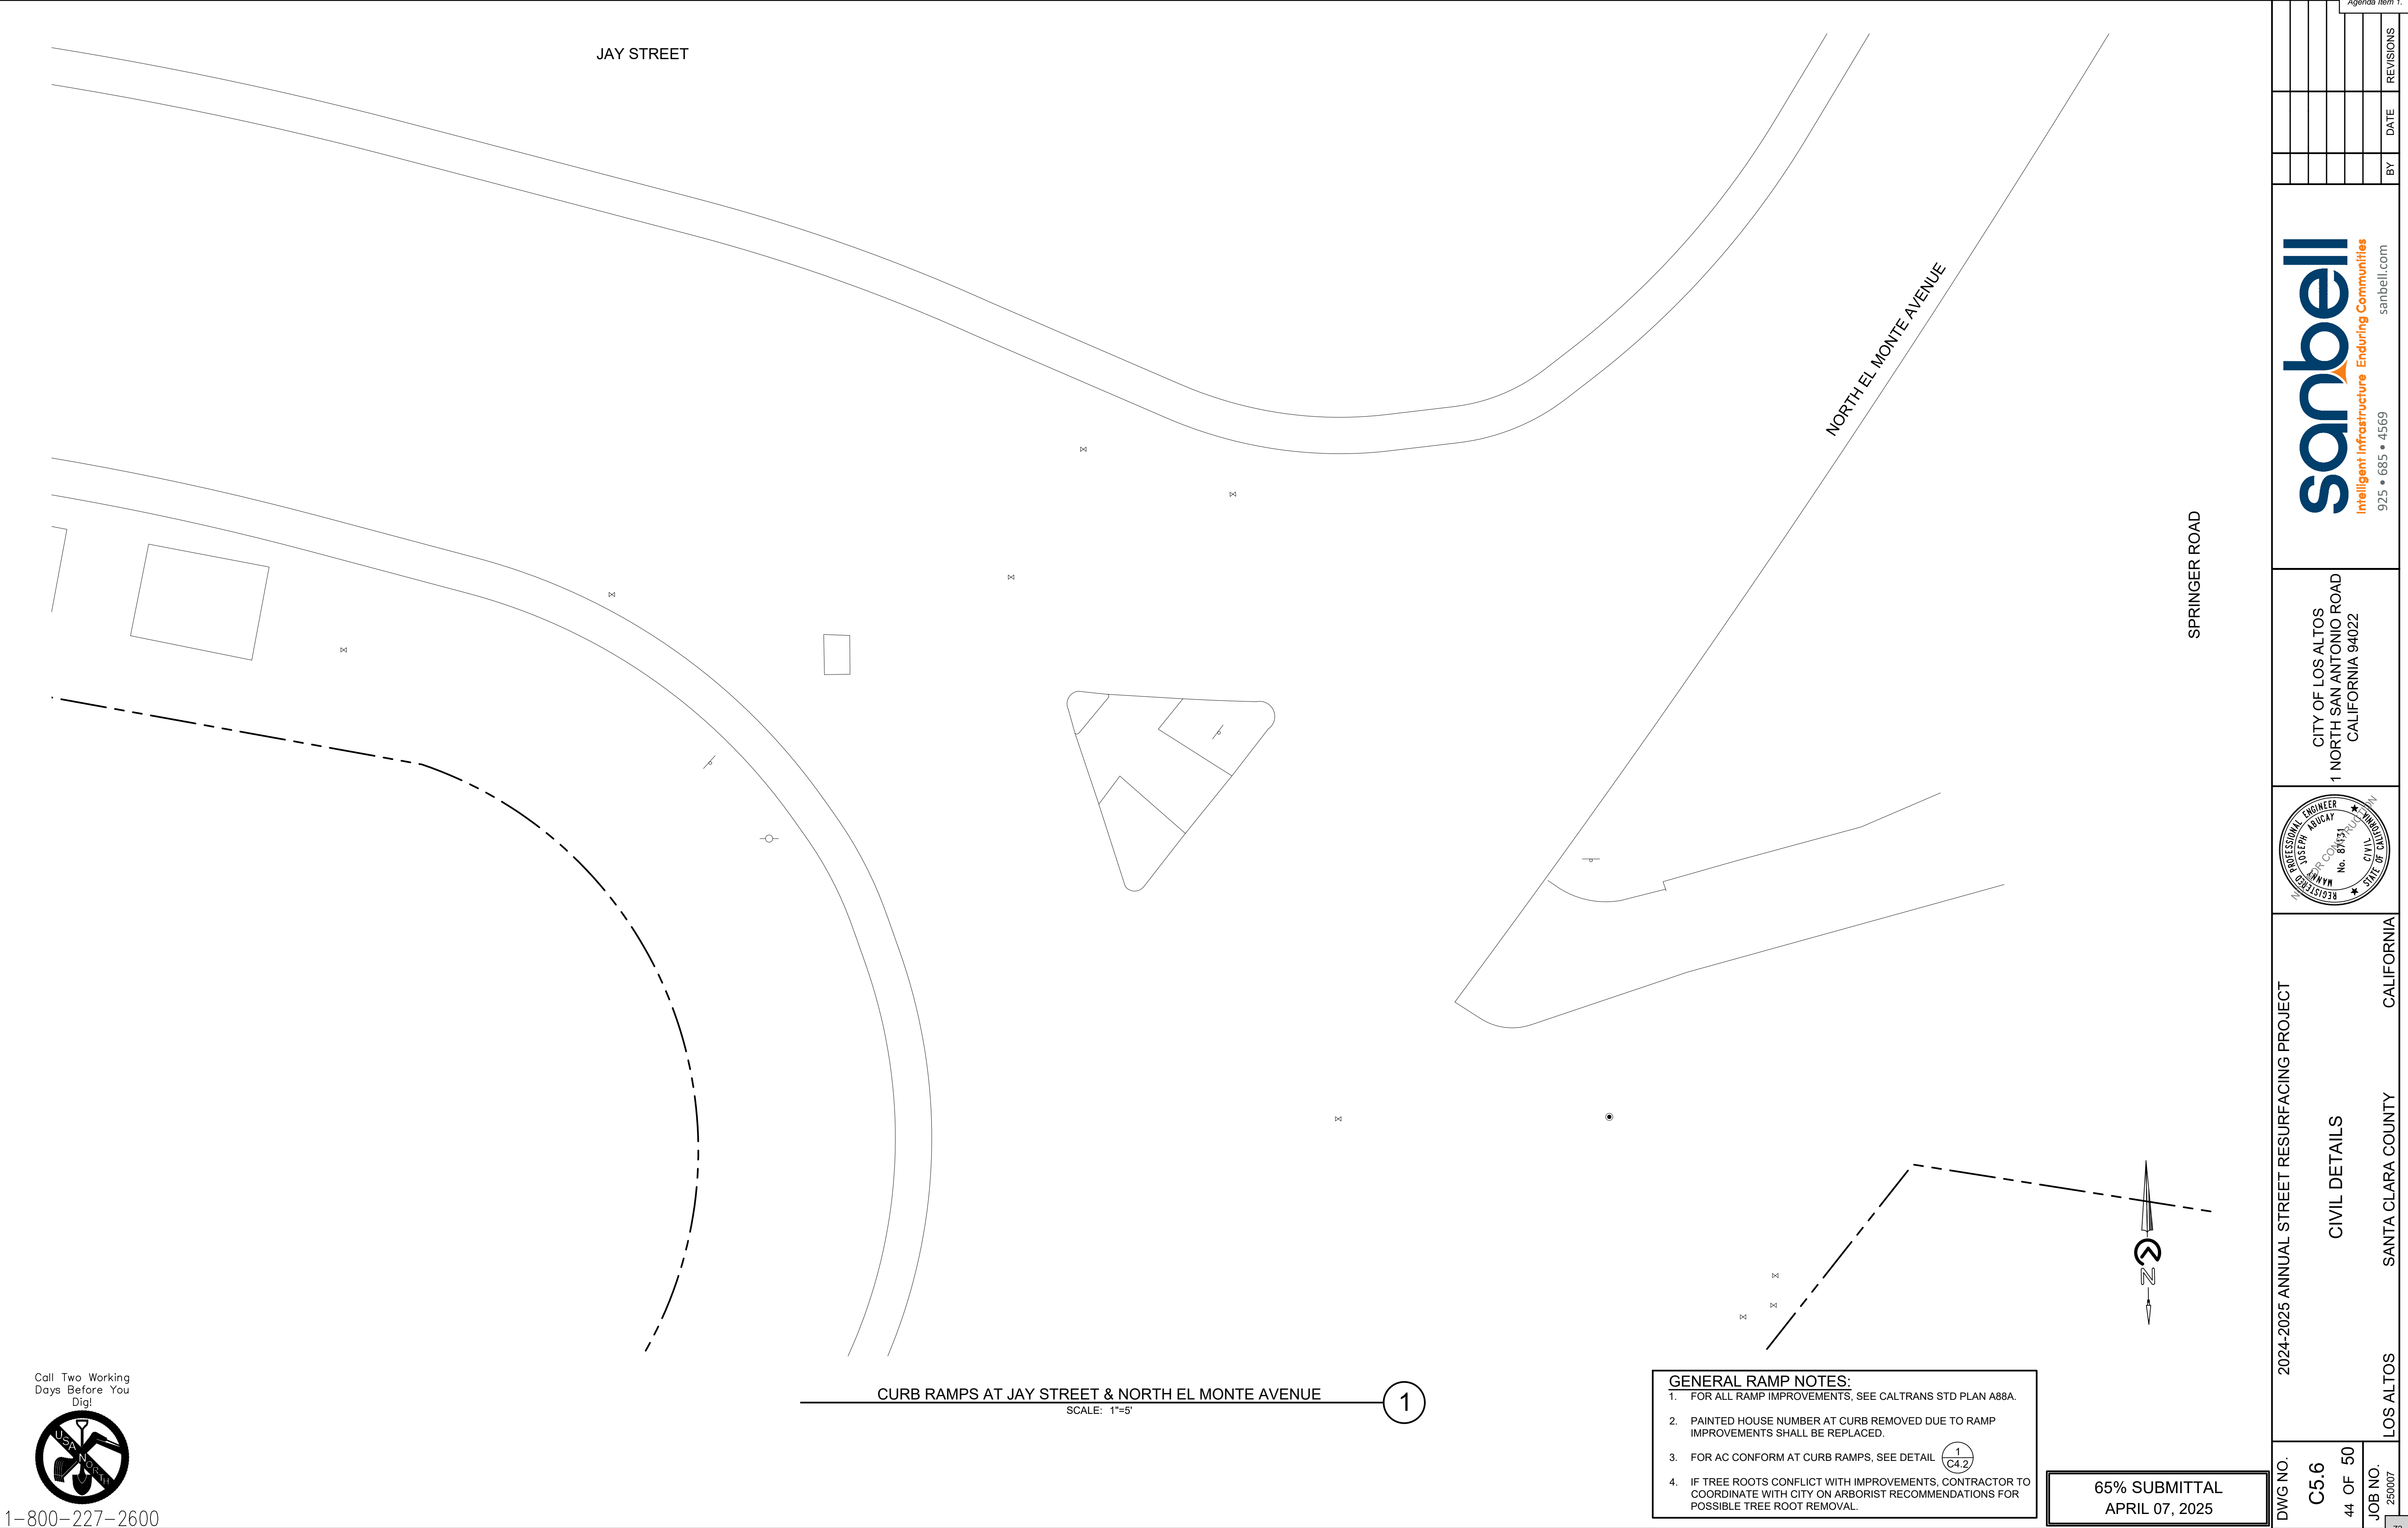

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CURB RAMPS AT JAY STREET & NORTH EL MONTE AVENUE



SCALE: 1"=5'

1

GENERAL RAMP NOTES:

- FOR ALL RAMP IMPROVEMENTS, SEE CALTRANS STD PLAN A88A.
- PAINTED HOUSE NUMBER AT CURB REMOVED DUE TO RAMP IMPROVEMENTS SHALL BE REPLACED.
- FOR AC CONFORM AT CURB RAMPS, SEE DETAIL $\frac{1}{C4.2}$
- IF TREE ROOTS CONFLICT WITH IMPROVEMENTS, CONTRACTOR TO COORDINATE WITH CITY ON ARBORIST RECOMMENDATIONS FOR POSSIBLE TREE ROOT REMOVAL.


65% SUBMITTAL
APRIL 07, 2025

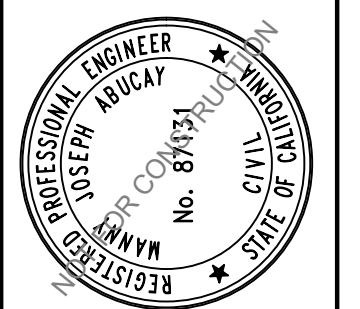DWG NO.	C5.6	44 OF 50	JOB NO. 250007	LOS ALTOS	SANTA CLARA COUNTY	CALIFORNIA		CITY OF LOS ALTOS 1 NORTH SAN ANTONIO ROAD CALIFORNIA 94022		Agenda Item 1.		
										BY	DATE	REVISIONS

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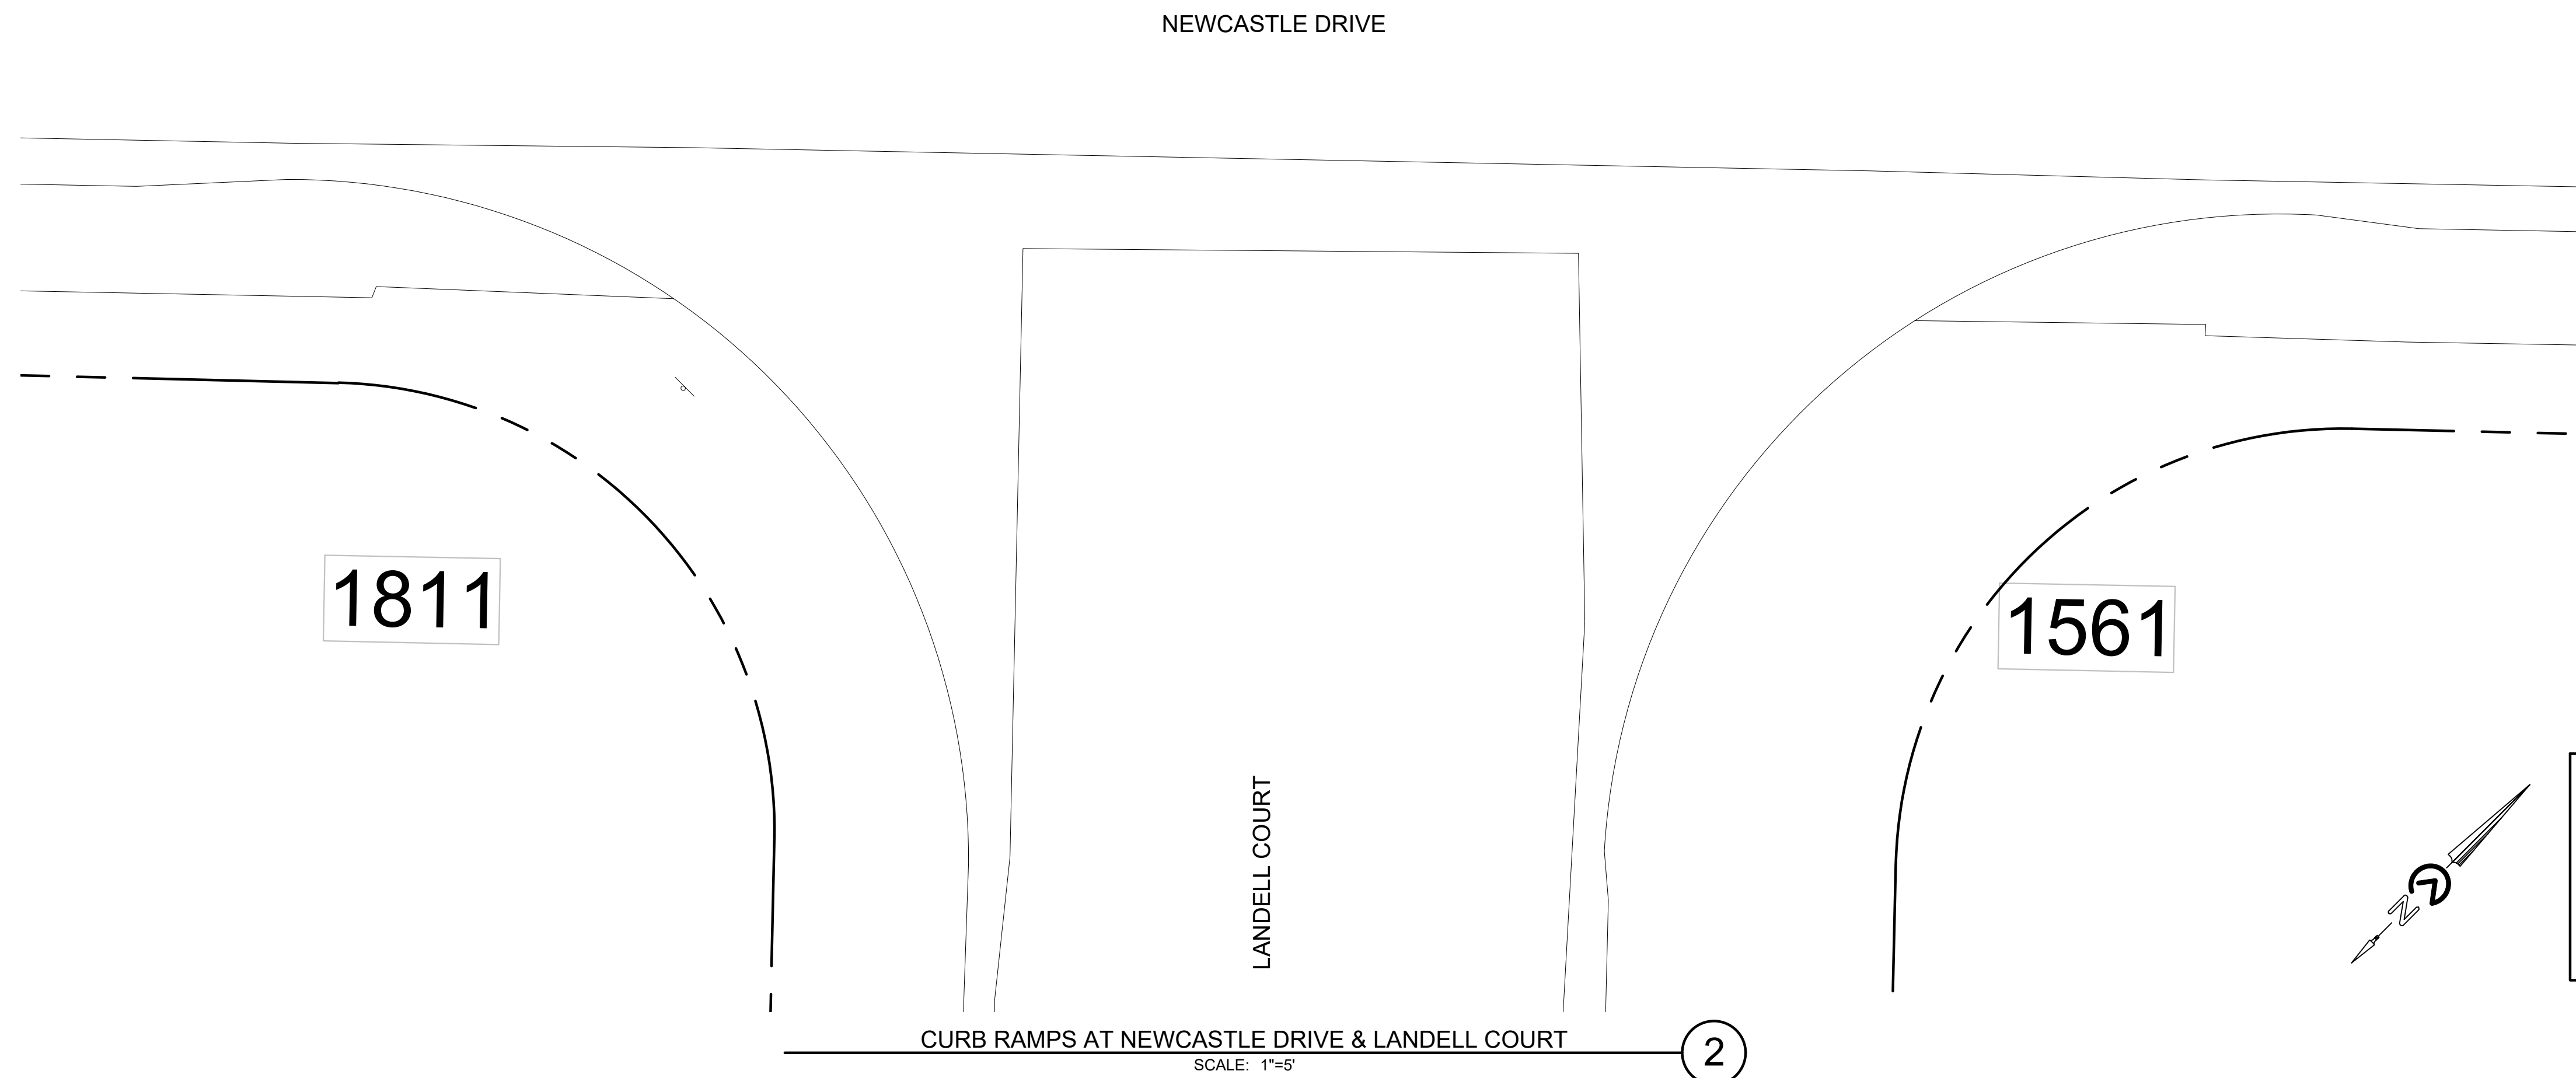
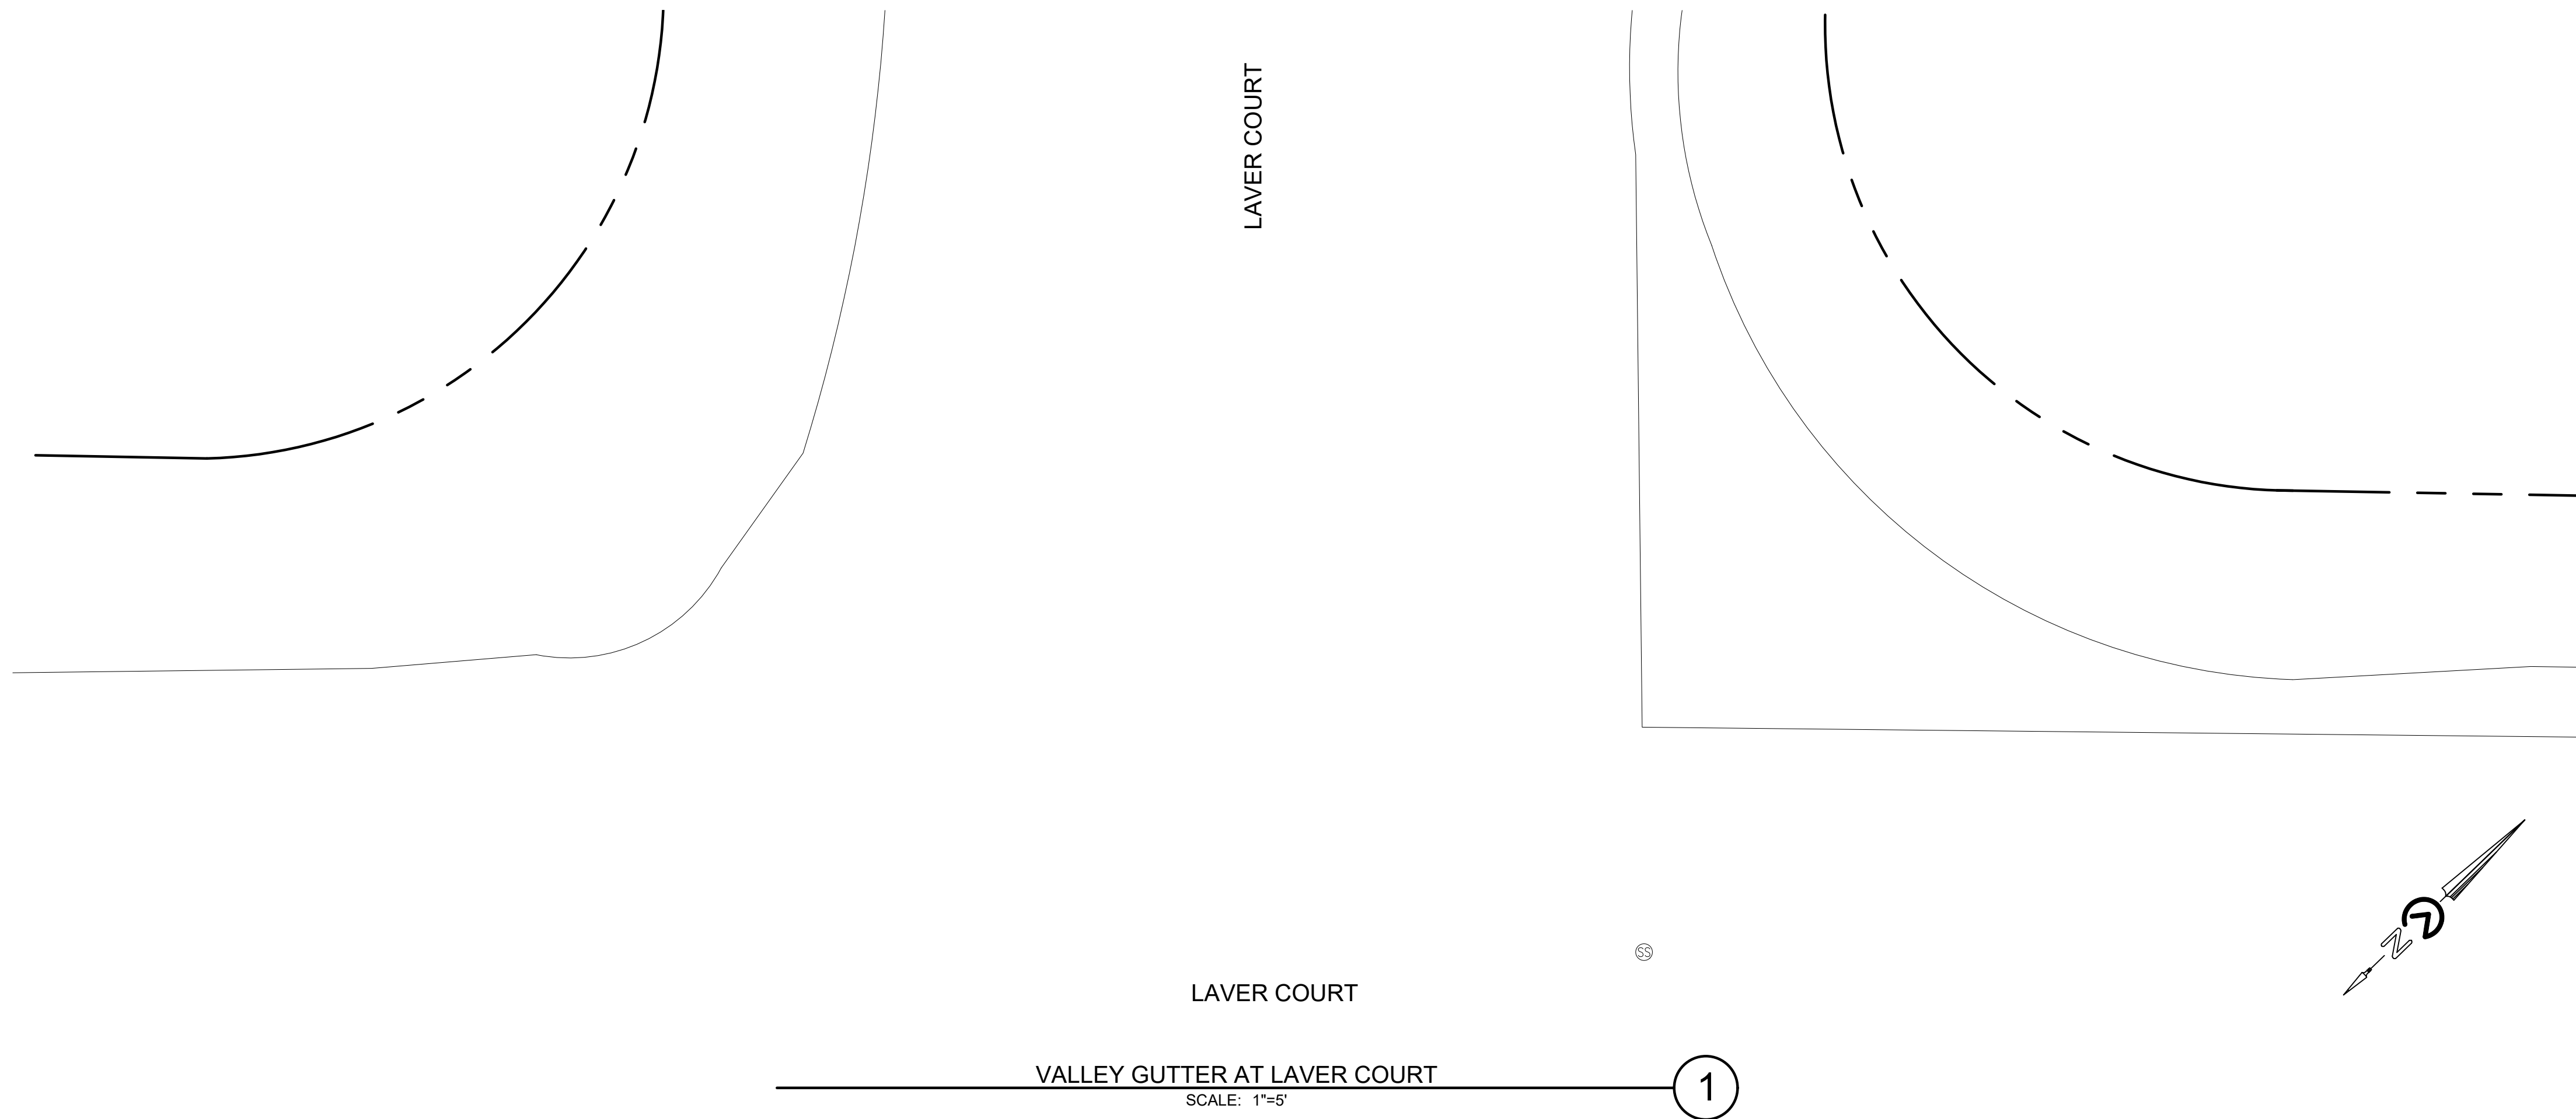
CITY OF LOS ALTOS
11 NORTH SAN ANTONIO ROAD
CALIFORNIA 94022




2024-2025 ANNUAL STREET RESURFACING PROJECT		
CIVIL DETAILS		
LOS ALTOS	SANTA CLARA COUNTY	CALIFORNIA

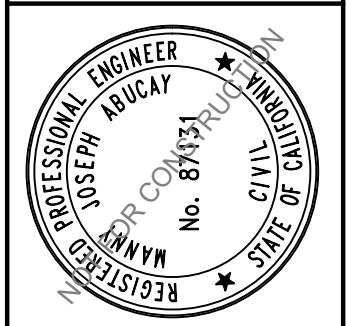DWG NO.
C5.7
45 OF 50
JOB NO.
250007

13



GENERAL RAMP NOTES:


1. FOR ALL RAMP IMPROVEMENTS, SEE CALTRANS STD PLAN A88A.
2. PAINTED HOUSE NUMBER AT CURB REMOVED DUE TO RAMP IMPROVEMENTS SHALL BE REPLACED.
3. FOR AC CONFORM AT CURB RAMPS, SEE DETAIL 
4. IF TREE ROOTS CONFLICT WITH IMPROVEMENTS, CONTRACTOR TO COORDINATE WITH CITY ON ARBORIST RECOMMENDATIONS FOR POSSIBLE TREE ROOT REMOVAL.

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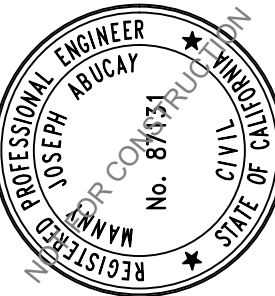
- GENERAL RAMP NOTES:**
- FOR ALL RAMP IMPROVEMENTS, SEE CALTRANS STD PLAN A88A.
 - PAINTED HOUSE NUMBER AT CURB REMOVED DUE TO RAMP IMPROVEMENTS SHALL BE REPLACED.
 - FOR AC CONFORM AT CURB RAMPS, SEE DETAIL 1
C4.2
 - IF TREE ROOTS CONFLICT WITH IMPROVEMENTS, CONTRACTOR TO COORDINATE WITH CITY ON ARBORIST RECOMMENDATIONS FOR POSSIBLE TREE ROOT REMOVAL.



CURB AND GUTTER AT LOMA PRIETA COURT



SCALE: 1"=5'

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65% SUBMITTAL
APRIL 07, 2025

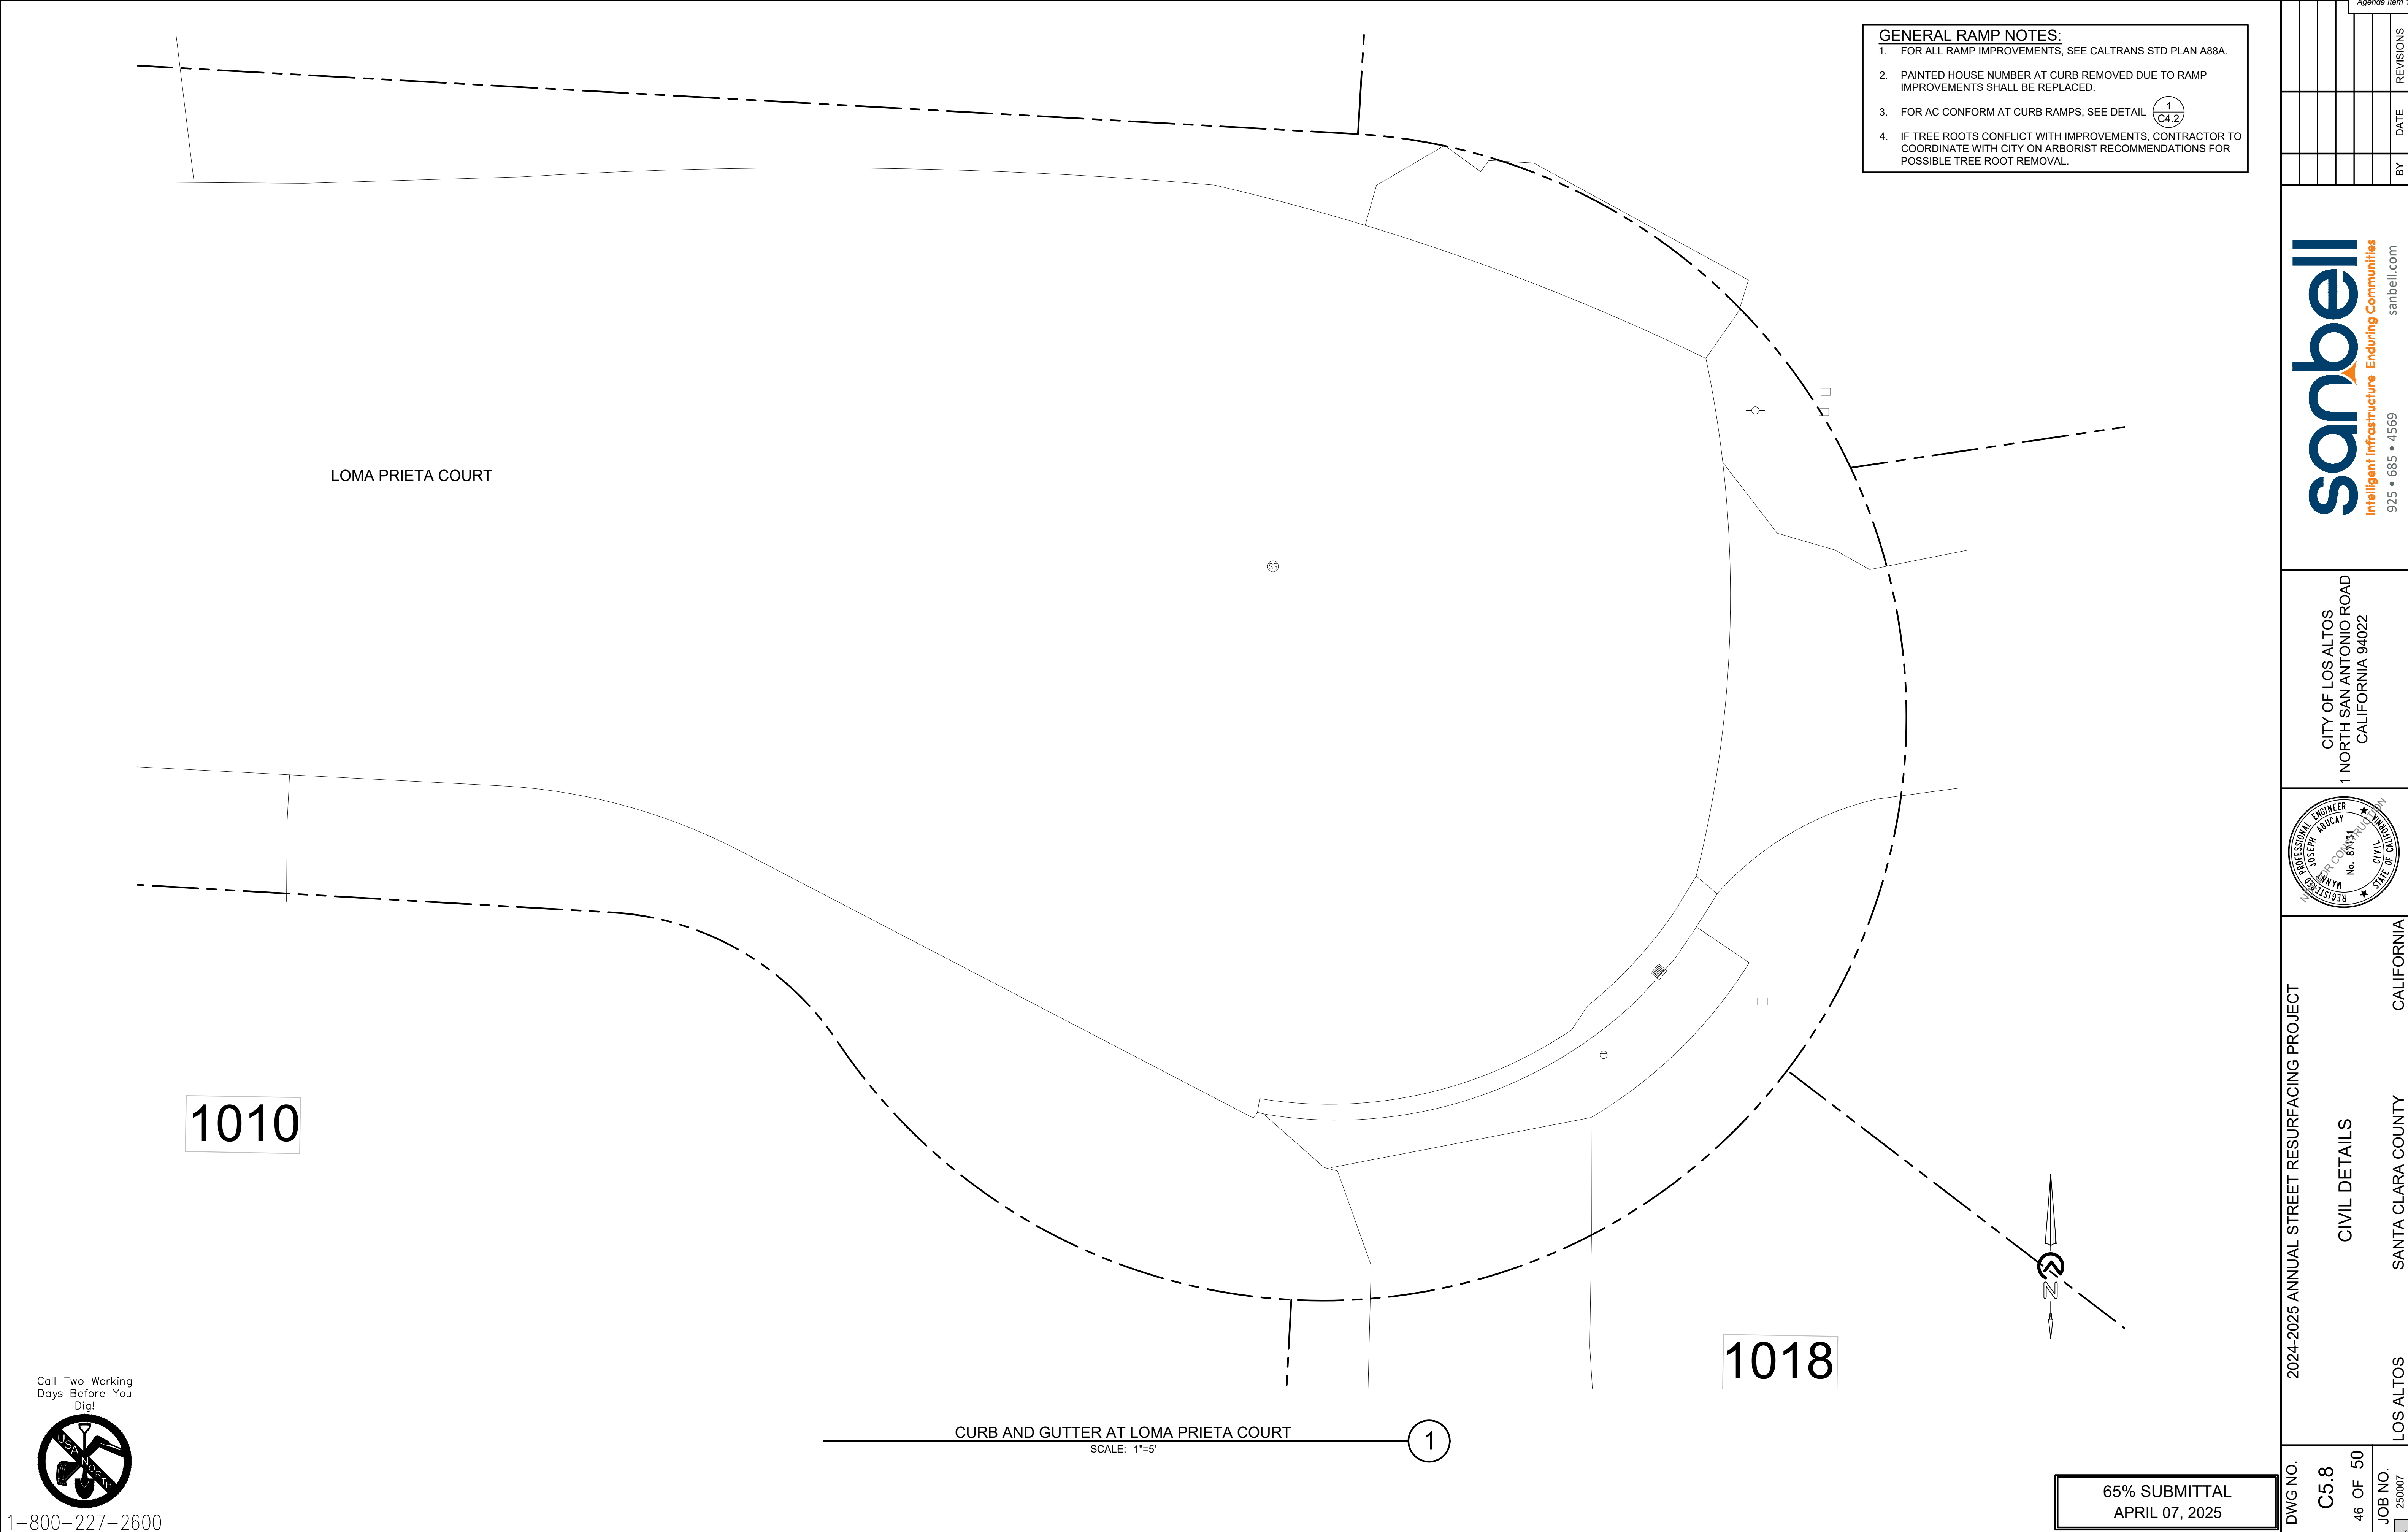DWG NO.		C5.8		JOB NO.	
2024-2025 ANNUAL STREET RESURFACING PROJECT		CIVIL DETAILS		250007	
LOS ALTOS		SANTA CLARA COUNTY		74	
CITY OF LOS ALTOS 1 NORTH SAN ANTONIO ROAD CALIFORNIA 94022				REVISIONS	
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BY		DATE		REVISIONS	

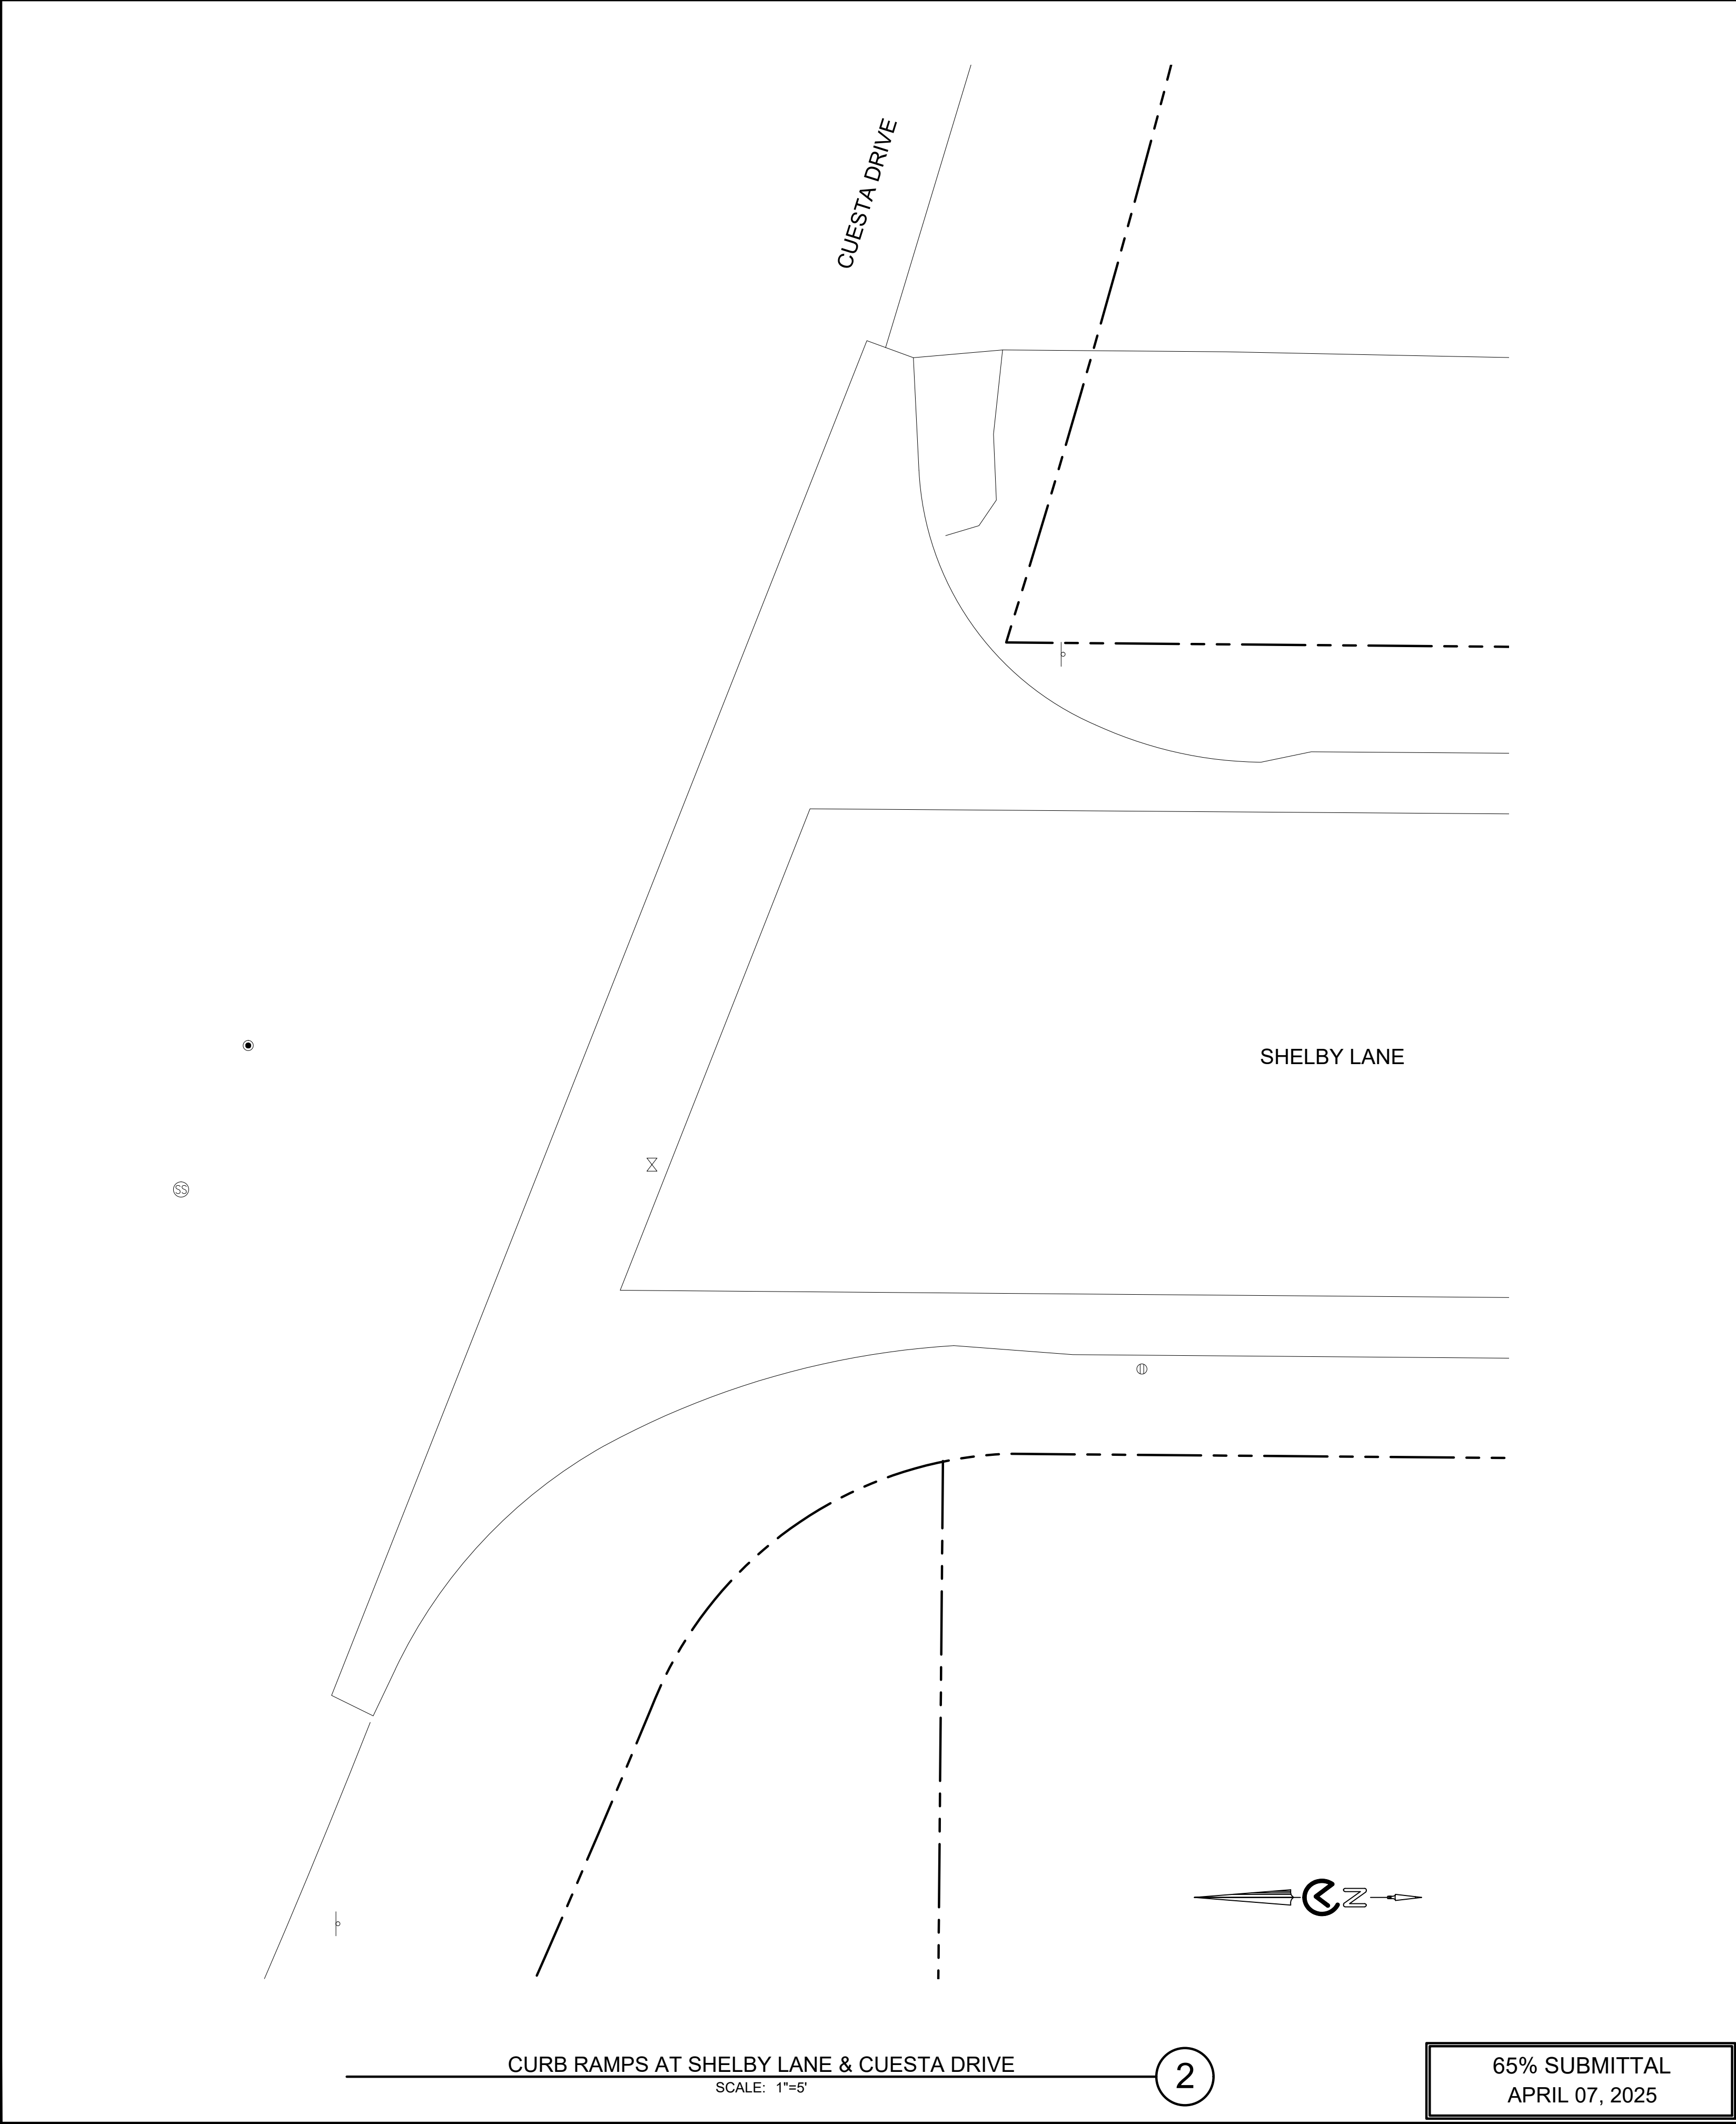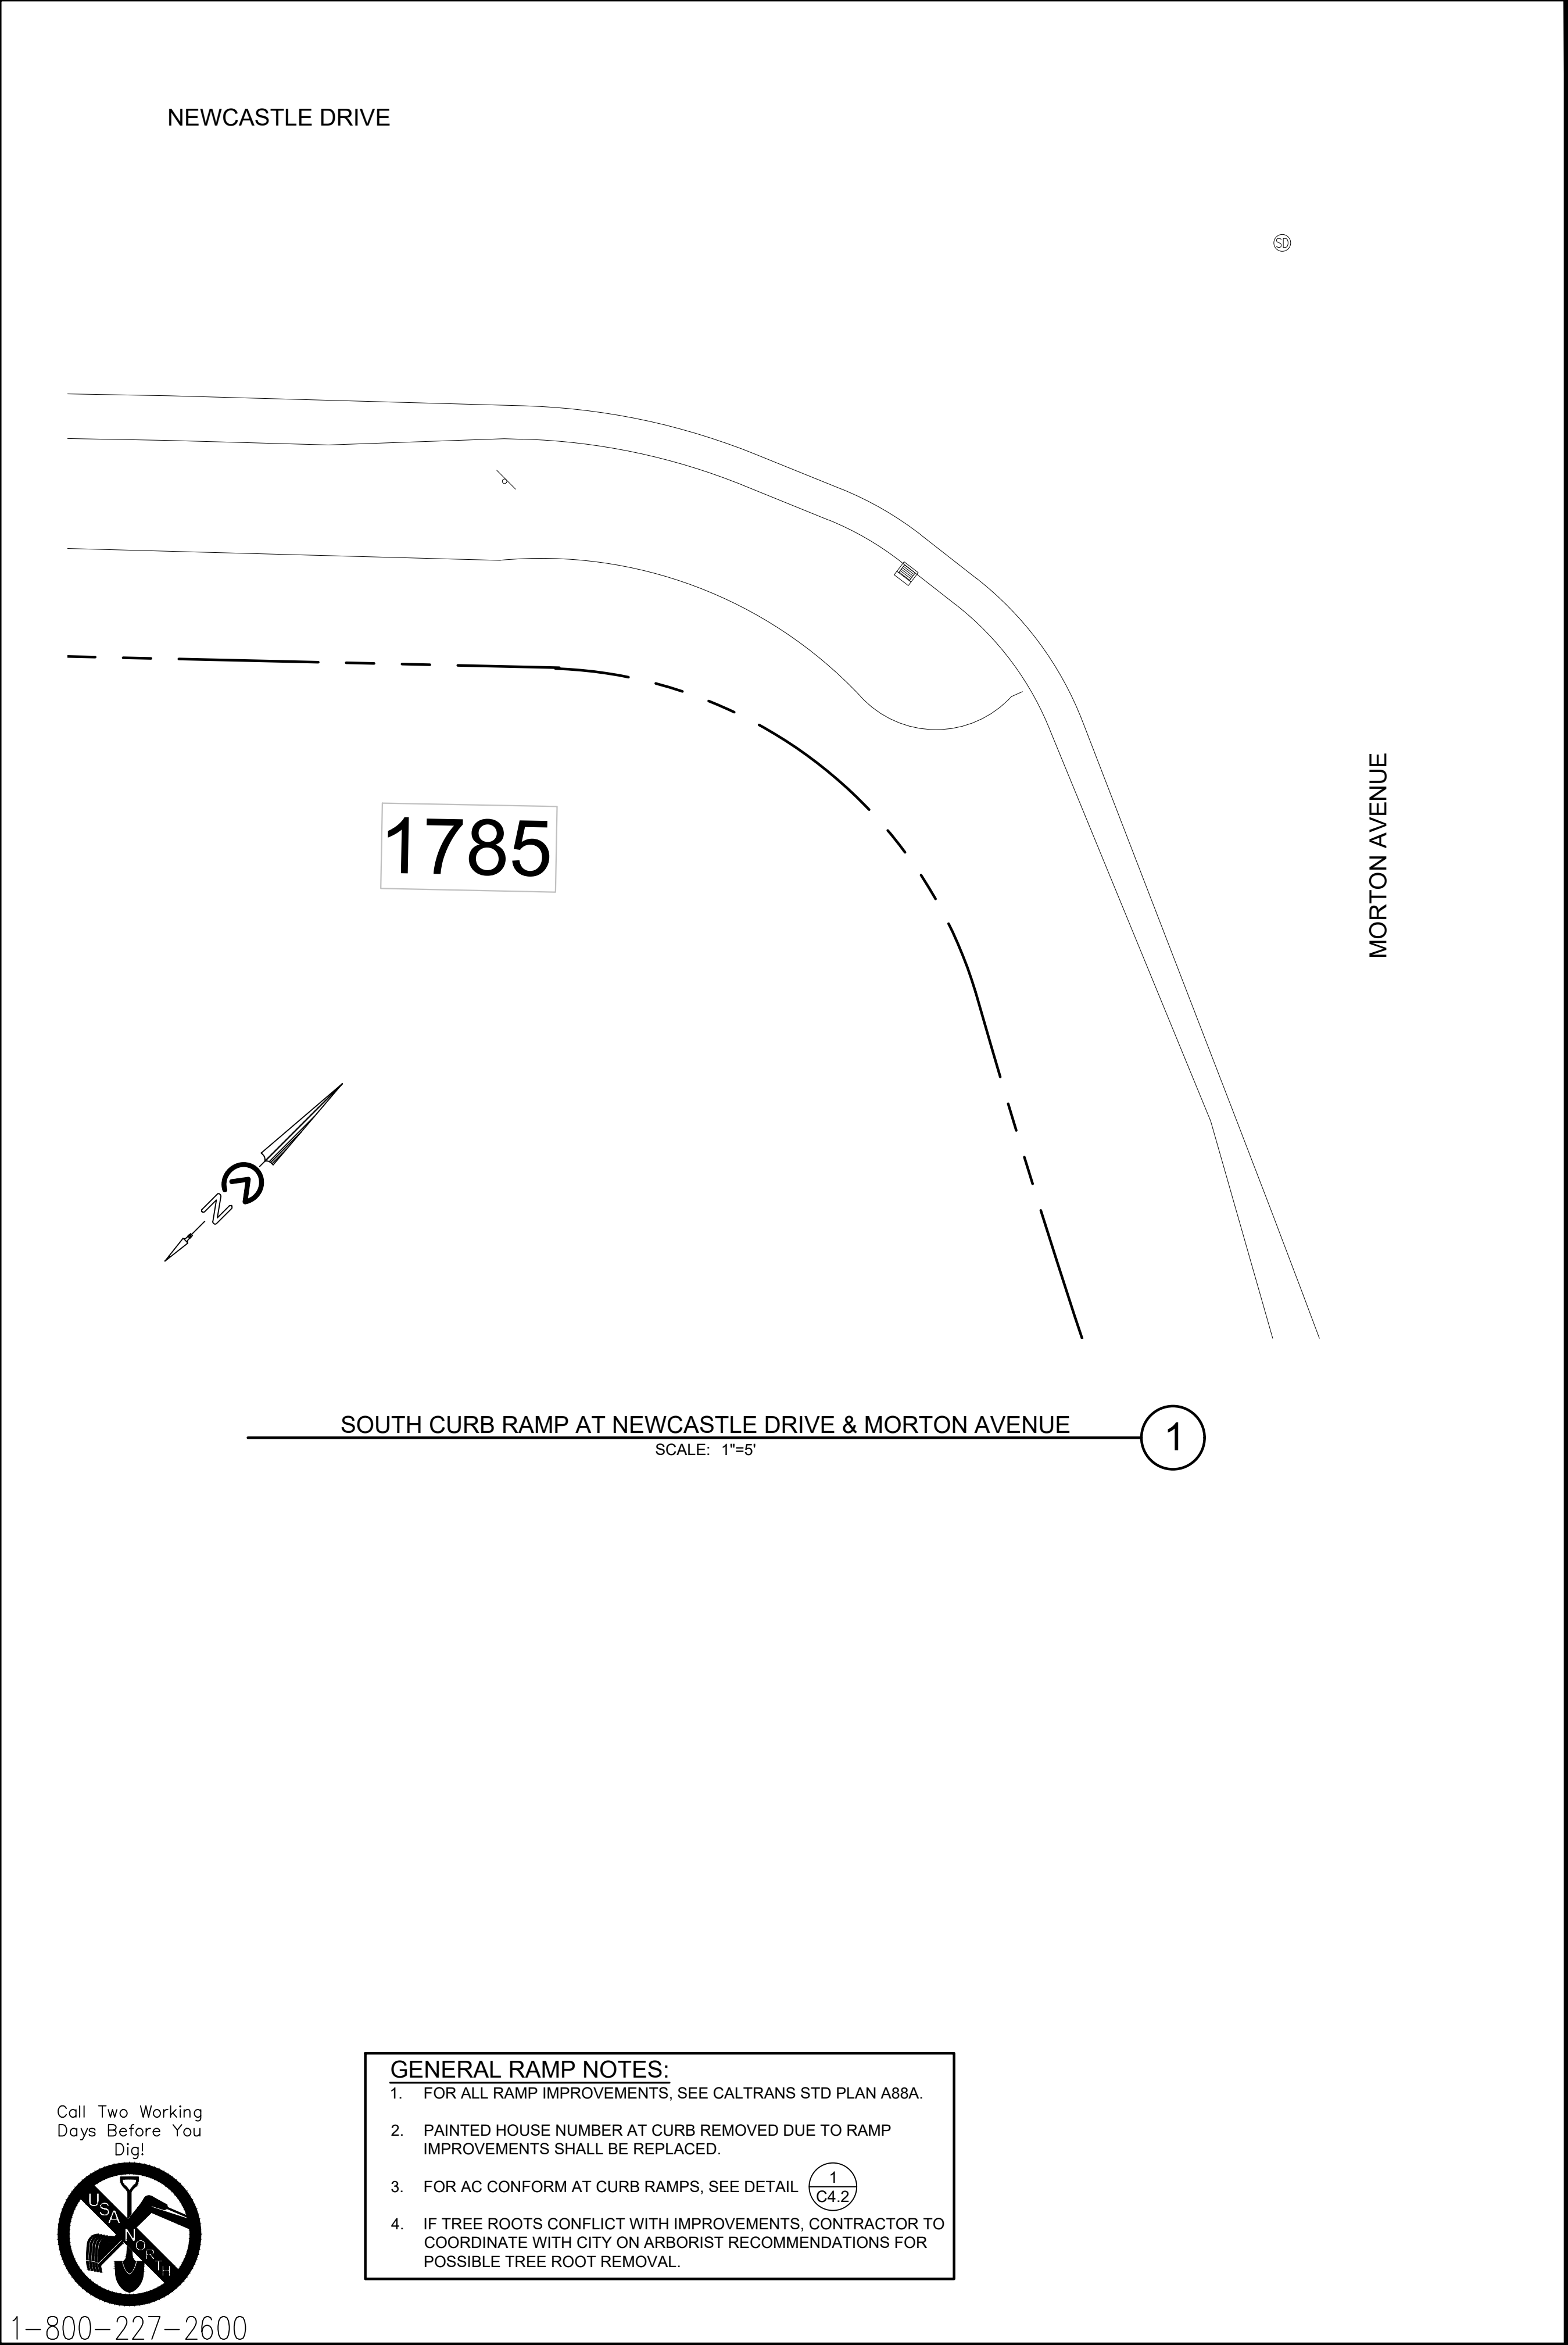


DWG NO.	C5.9	47 OF 50	JOB NO. 250007	LOS ALTOS	SANTA CLARA COUNTY	CALIFORNIA	2024-2025 ANNUAL STREET RESURFACING PROJECT	CIVIL DETAILS	CITY OF LOS ALTOS 1 NORTH SAN ANTONIO ROAD CALIFORNIA 94022			Agenda Item 1.		
												BY	DATE	REVISIONS

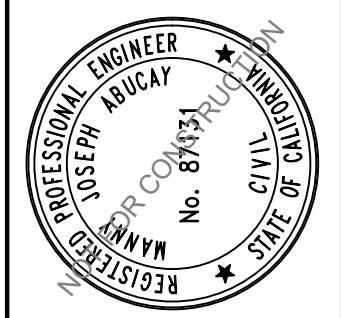Agenda Item 1.

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CITY OF LOS ALTOS
1 NORTH SAN ANTONIO ROAD
CALIFORNIA 94022

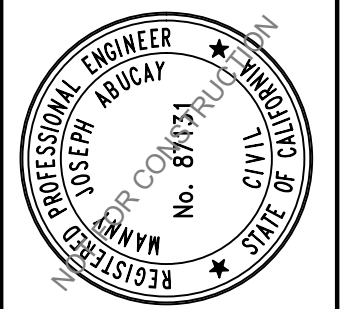

2024-2025 ANNUAL STREET RESURFACING PROJECT

CIVIL DETAILS

SANTA CLARA COUNTY

LOS ALTOS


DWG NO.

C5.10

JOB NO. 250007

76

GENERAL RAMP NOTES:

1. FOR ALL RAMP IMPROVEMENTS, SEE CALTRANS STD PLAN A88A.
2. PAINTED HOUSE NUMBER AT CURB REMOVED DUE TO RAMP IMPROVEMENTS SHALL BE REPLACED.
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4. IF TREE ROOTS CONFLICT WITH IMPROVEMENTS, CONTRACTOR TO COORDINATE WITH CITY ON ARBORIST RECOMMENDATIONS FOR POSSIBLE TREE ROOT REMOVAL.


1
C4.2

SHELBY LANE

549

55

550

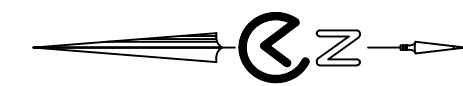

CURB AND GUTTER AT SHELBY LANE

SCALE: 1"=5'


1



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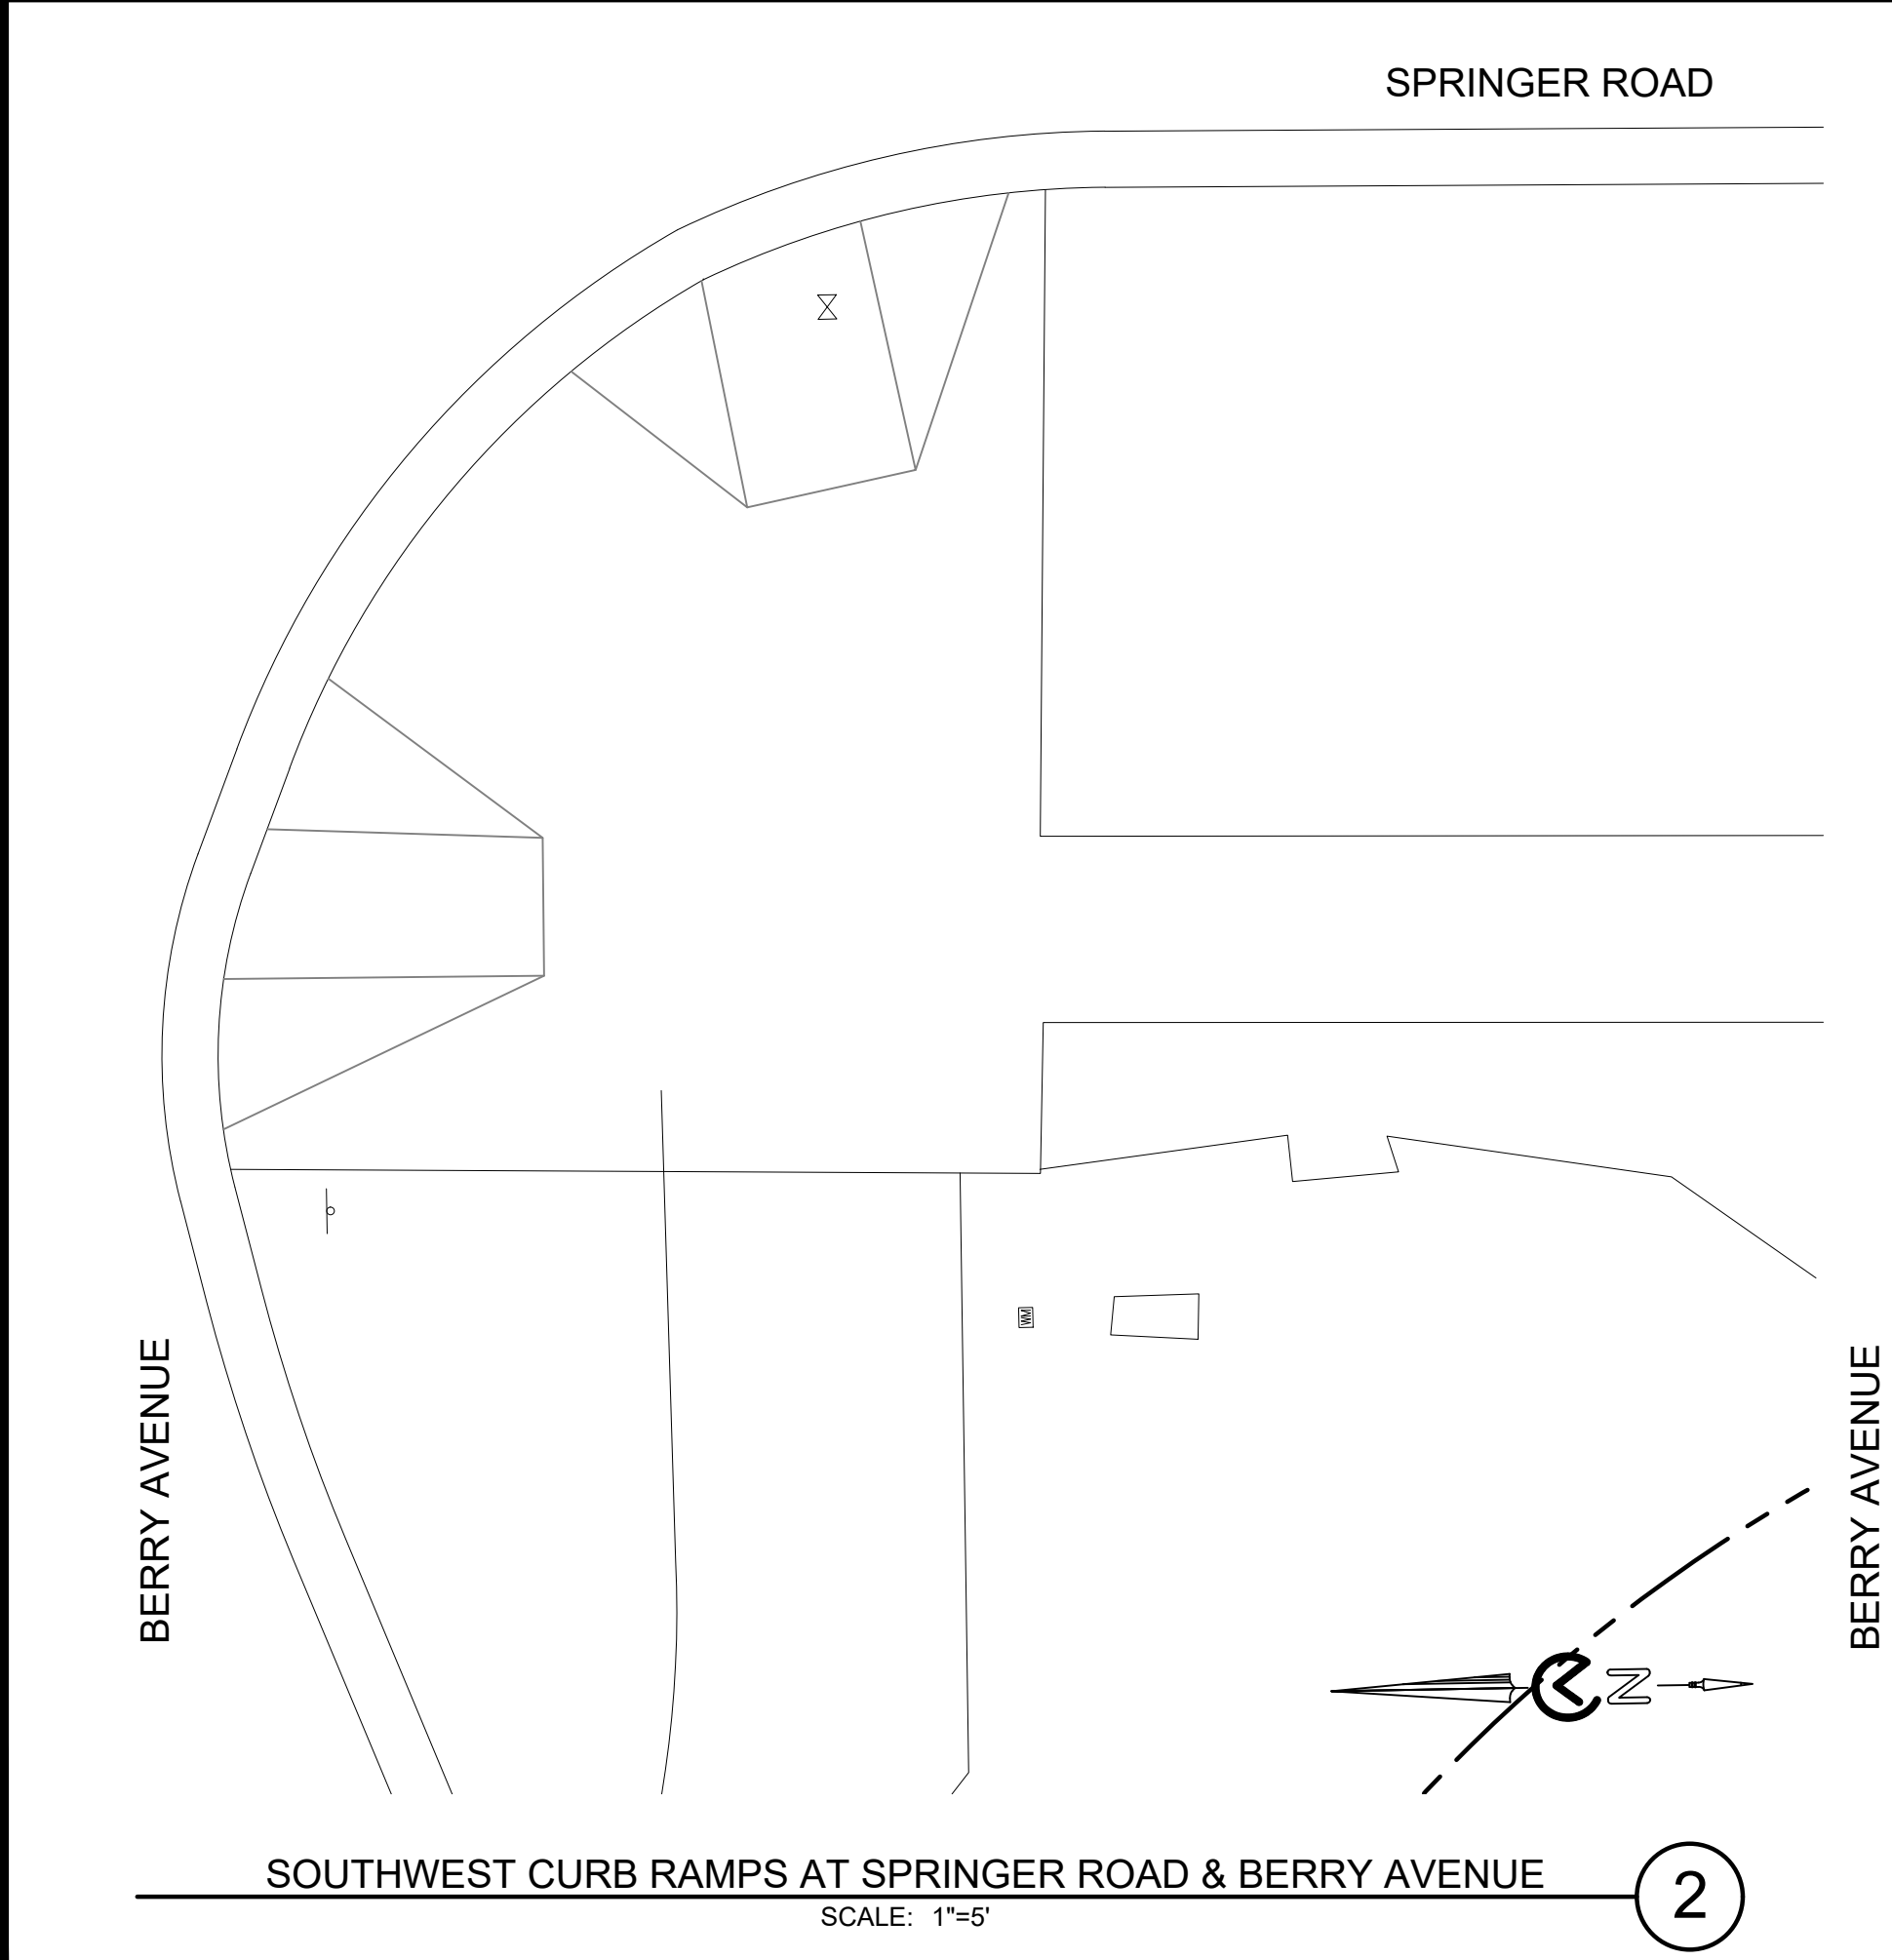
65% SUBMITTAL
APRIL 07, 2025



SOUTHEAST CURB RAMPS AT SPRINGER ROAD & BERRY AVENUE

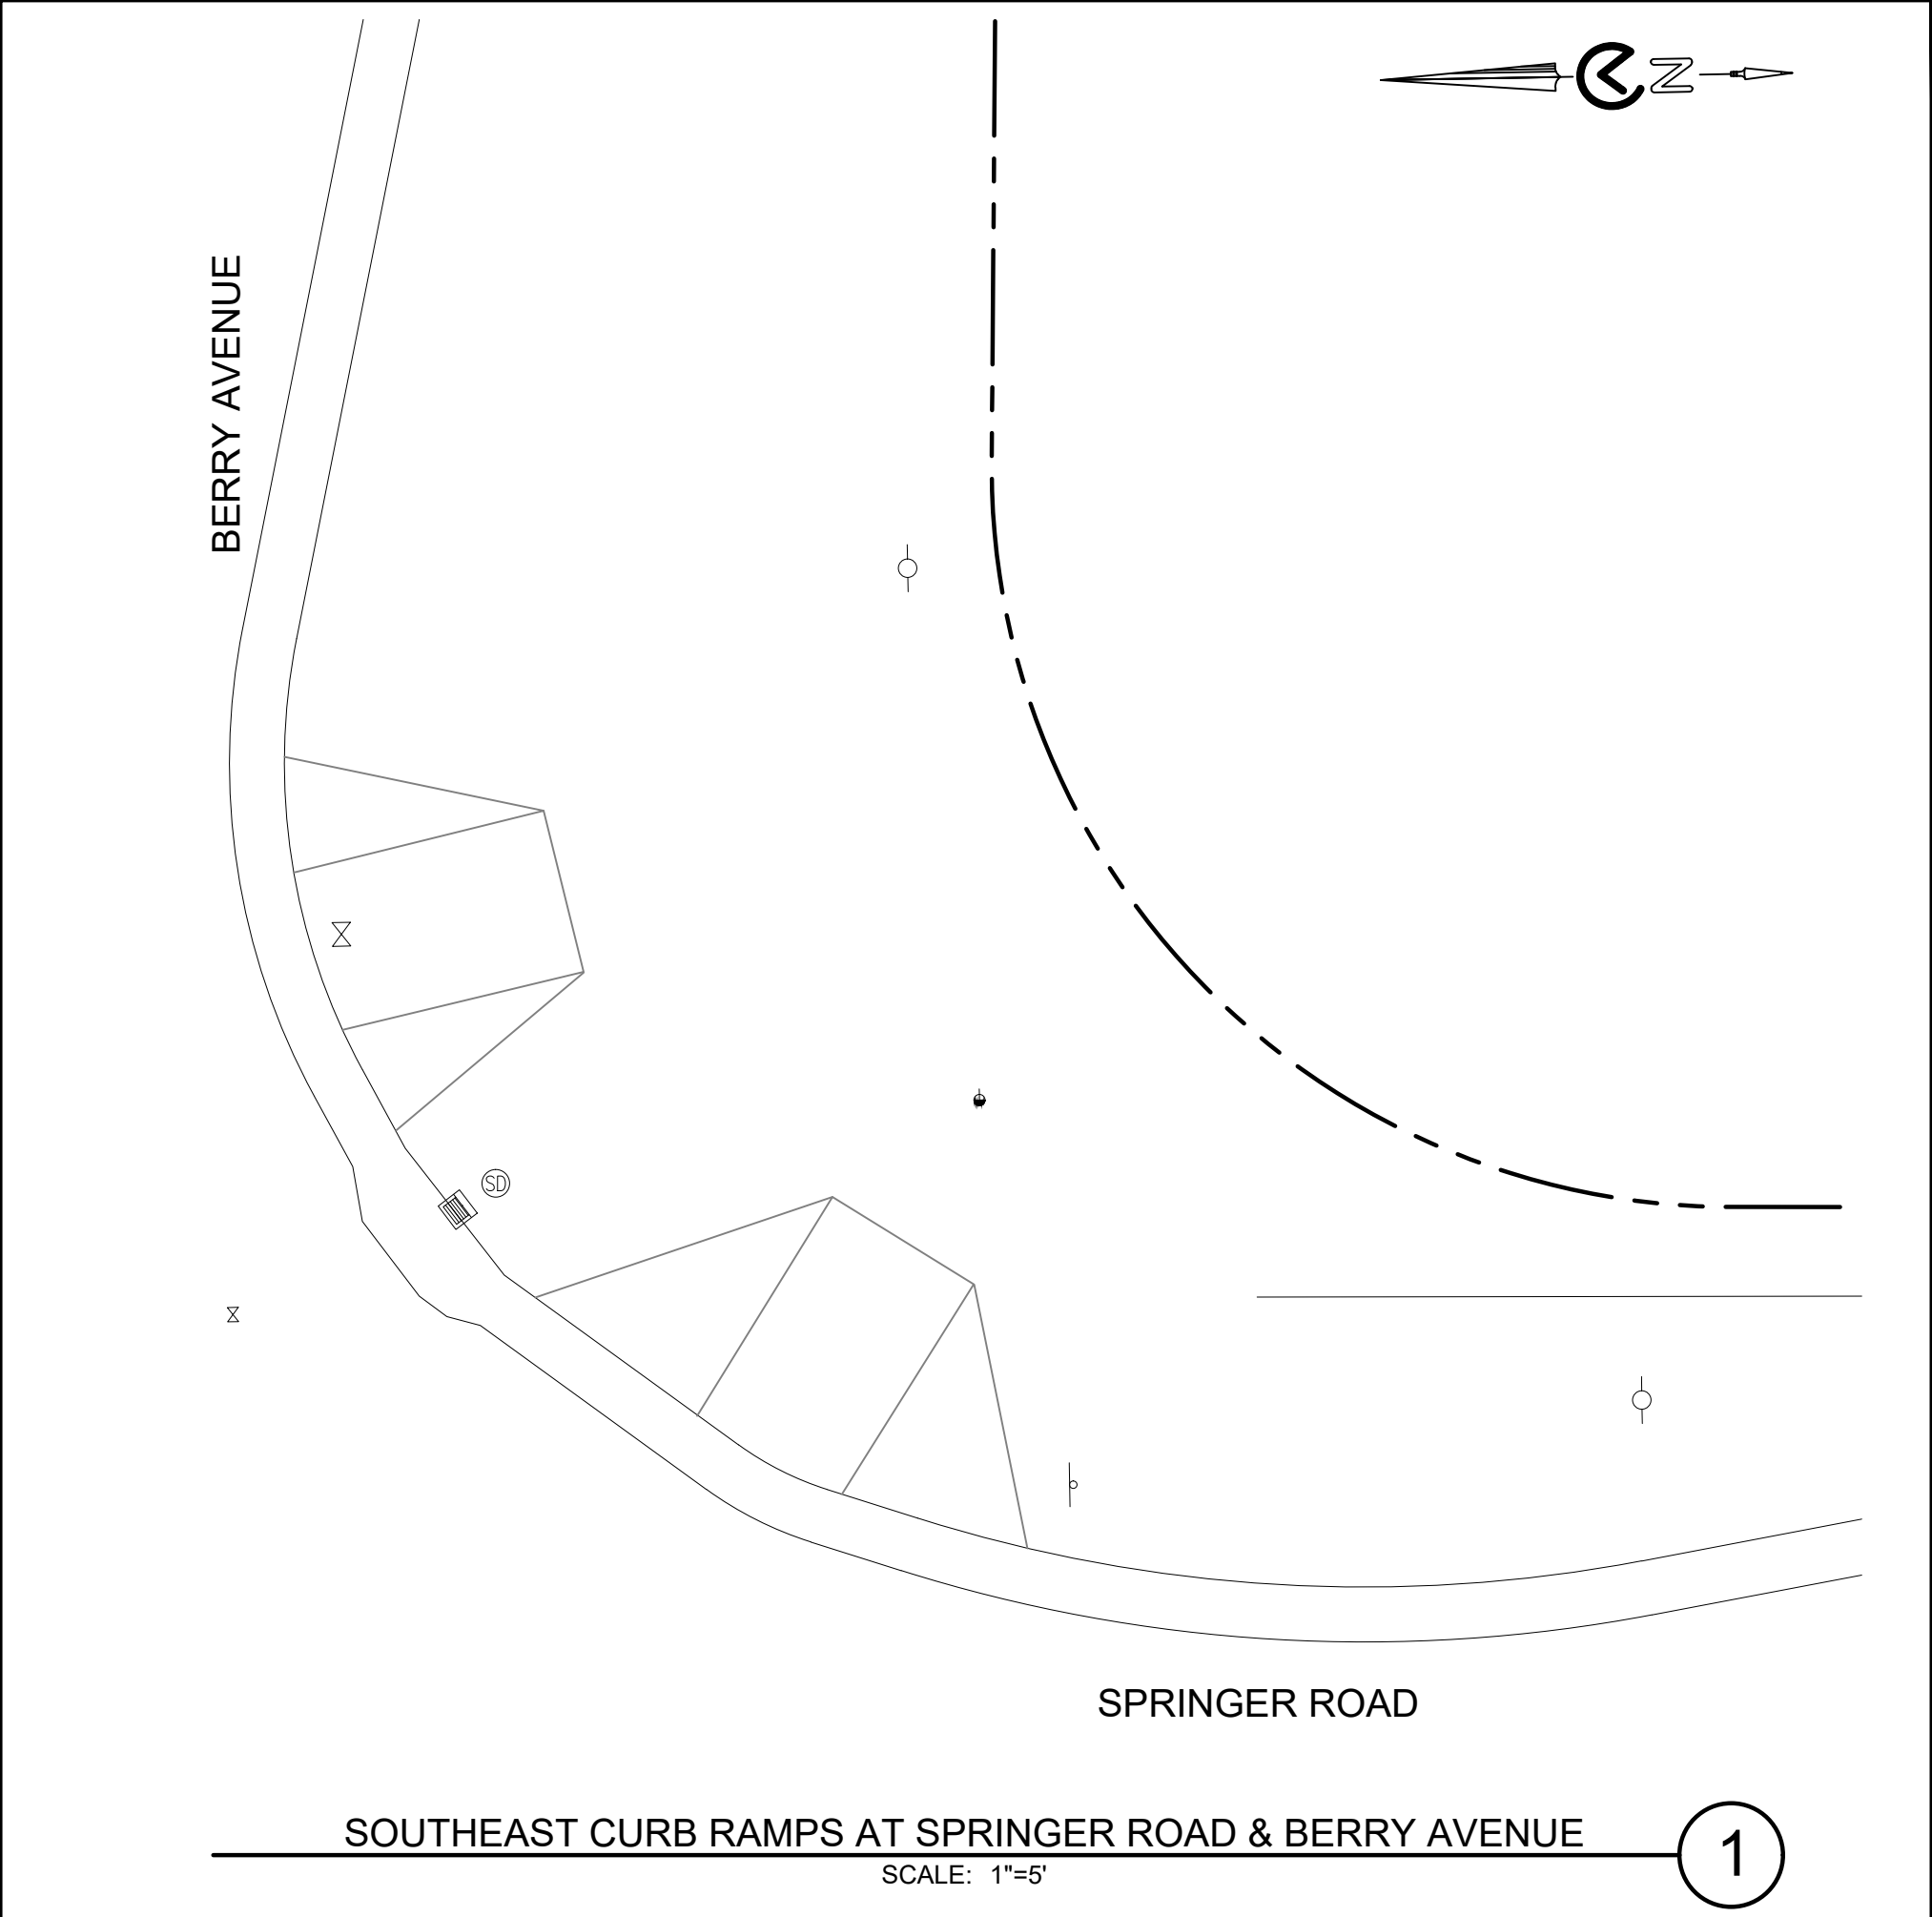SCALE: 1"=5'


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SOUTHWEST CURB RAMPS AT SPRINGER ROAD & BERRY AVENUE

SCALE: 1"=5'


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SOUTHEAST CURB RAMPS AT SPRINGER ROAD & COVINGTON ROAD

SCALE: 1"=5'


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SOUTHWEST CURB RAMP AT STONEHAVEN ROAD & ST JOSEPH AVENUE

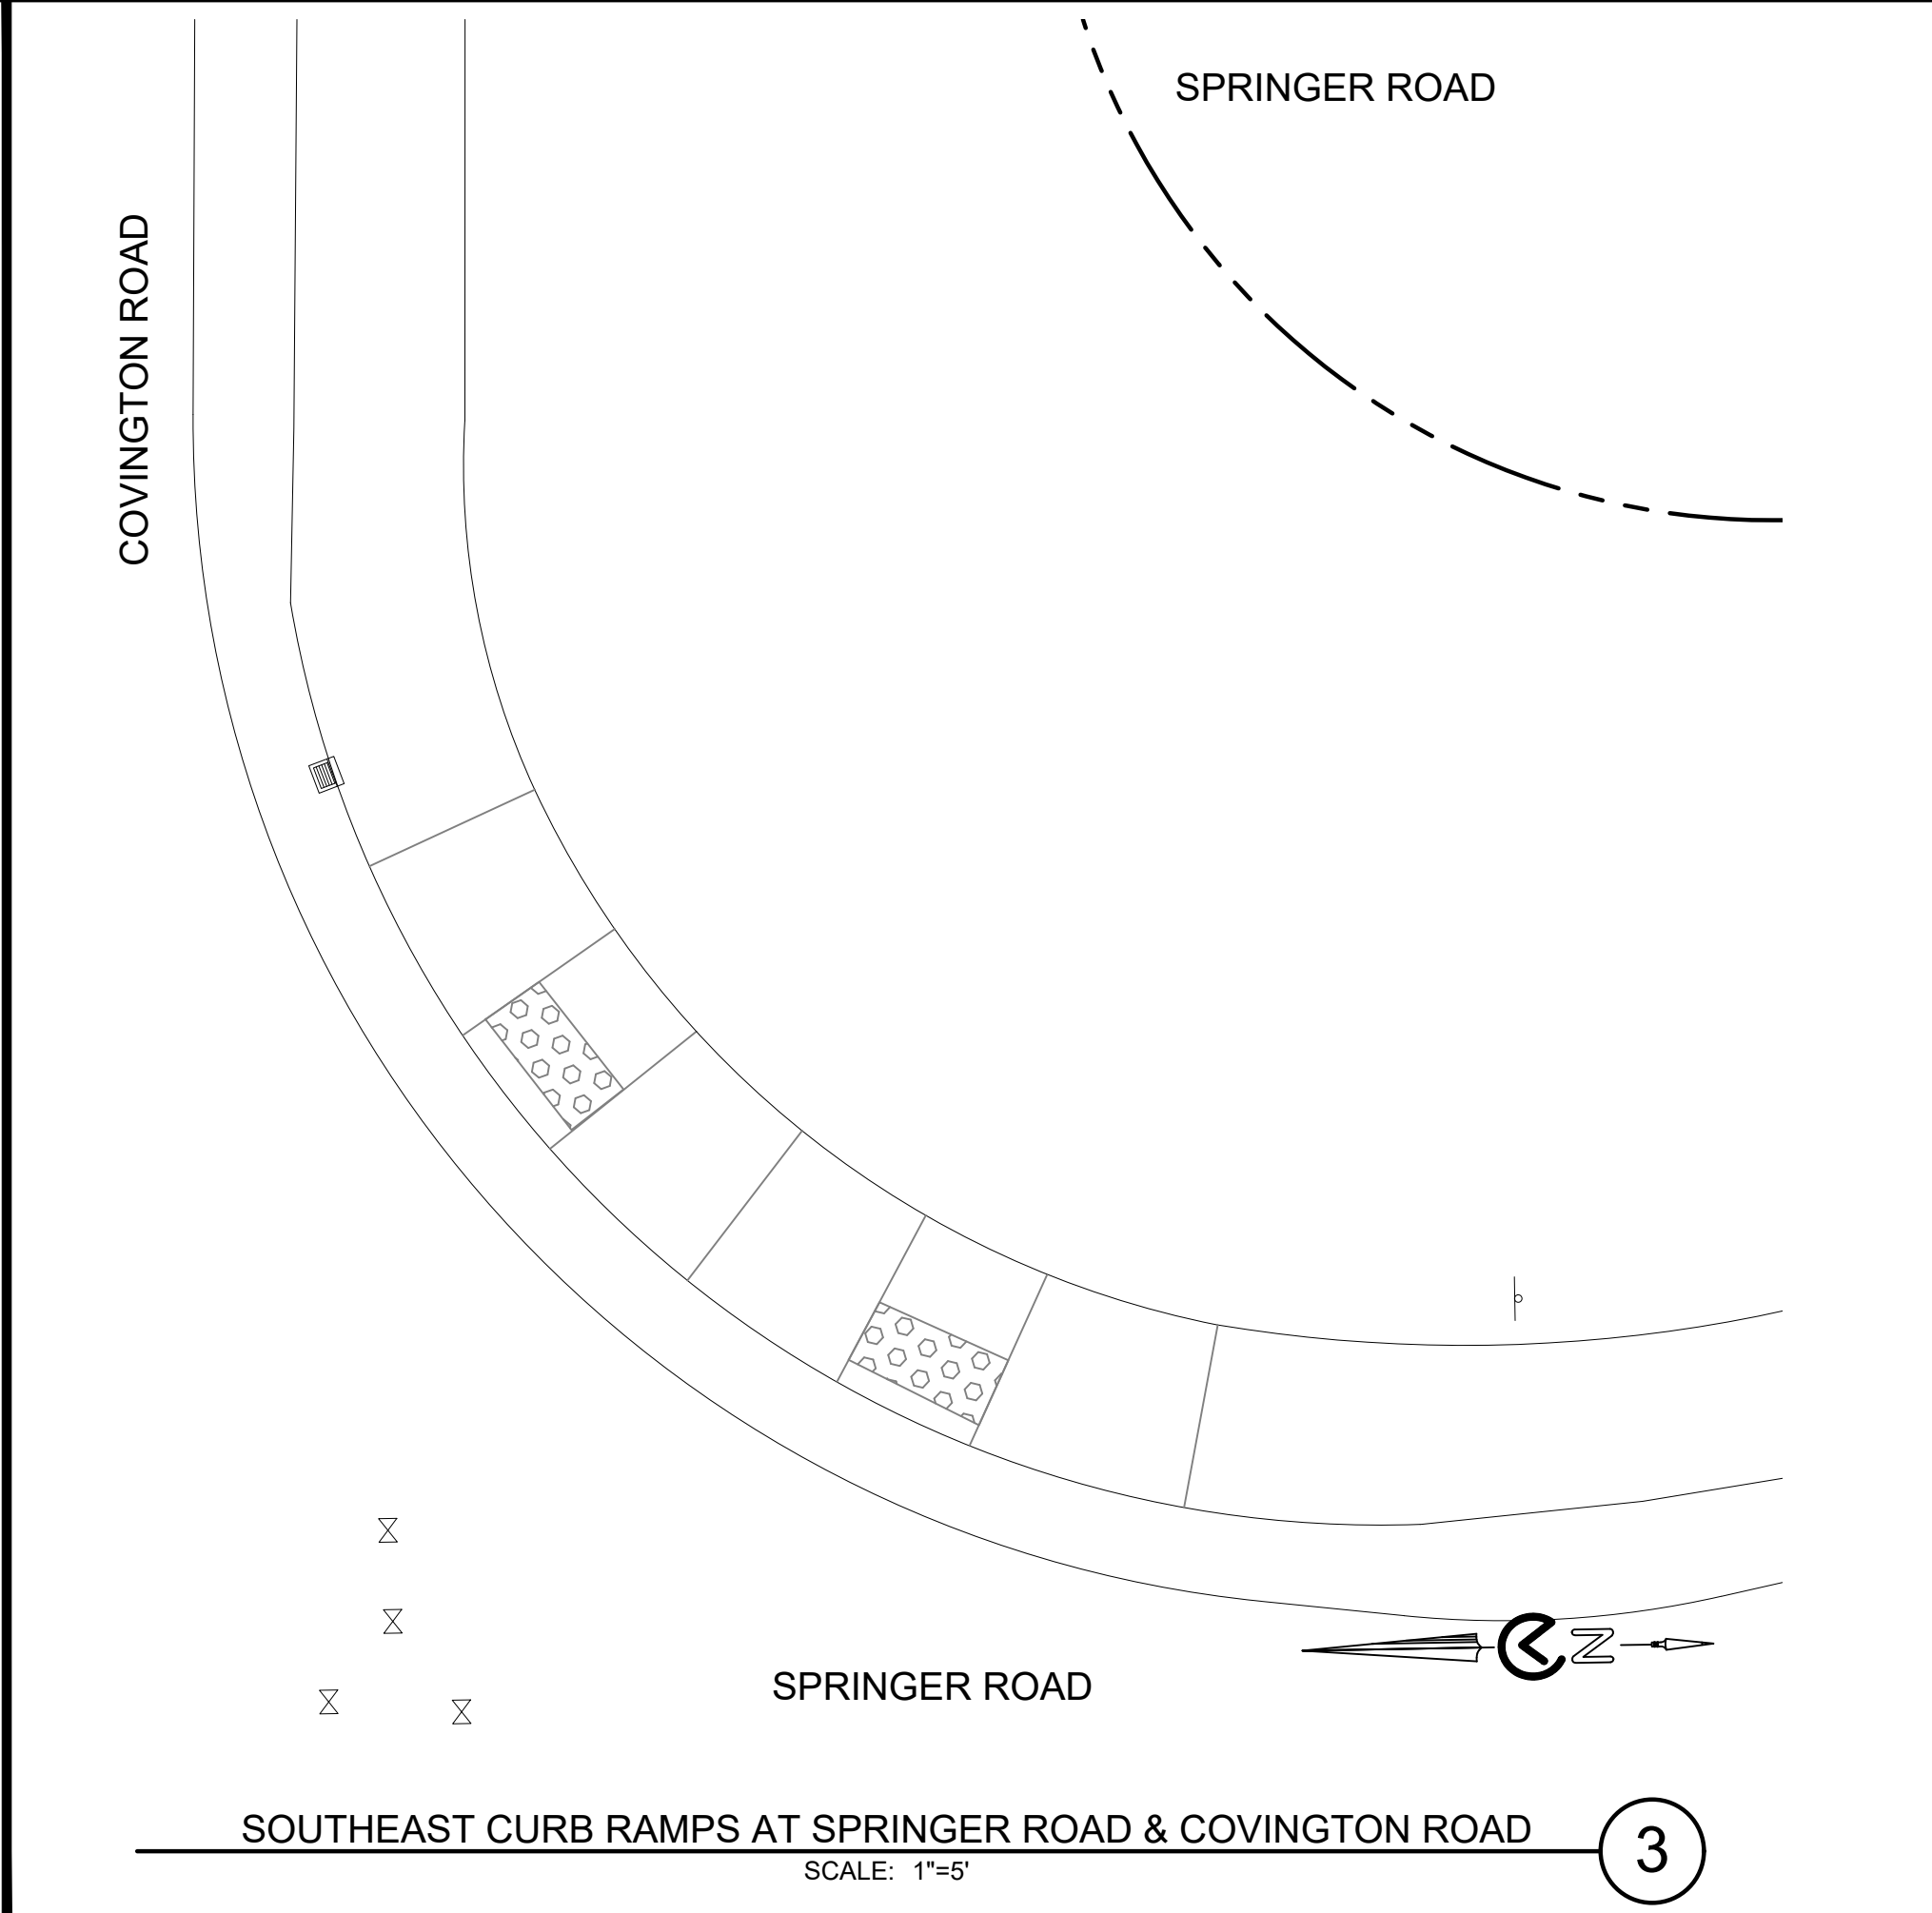SCALE: 1"=5'


4

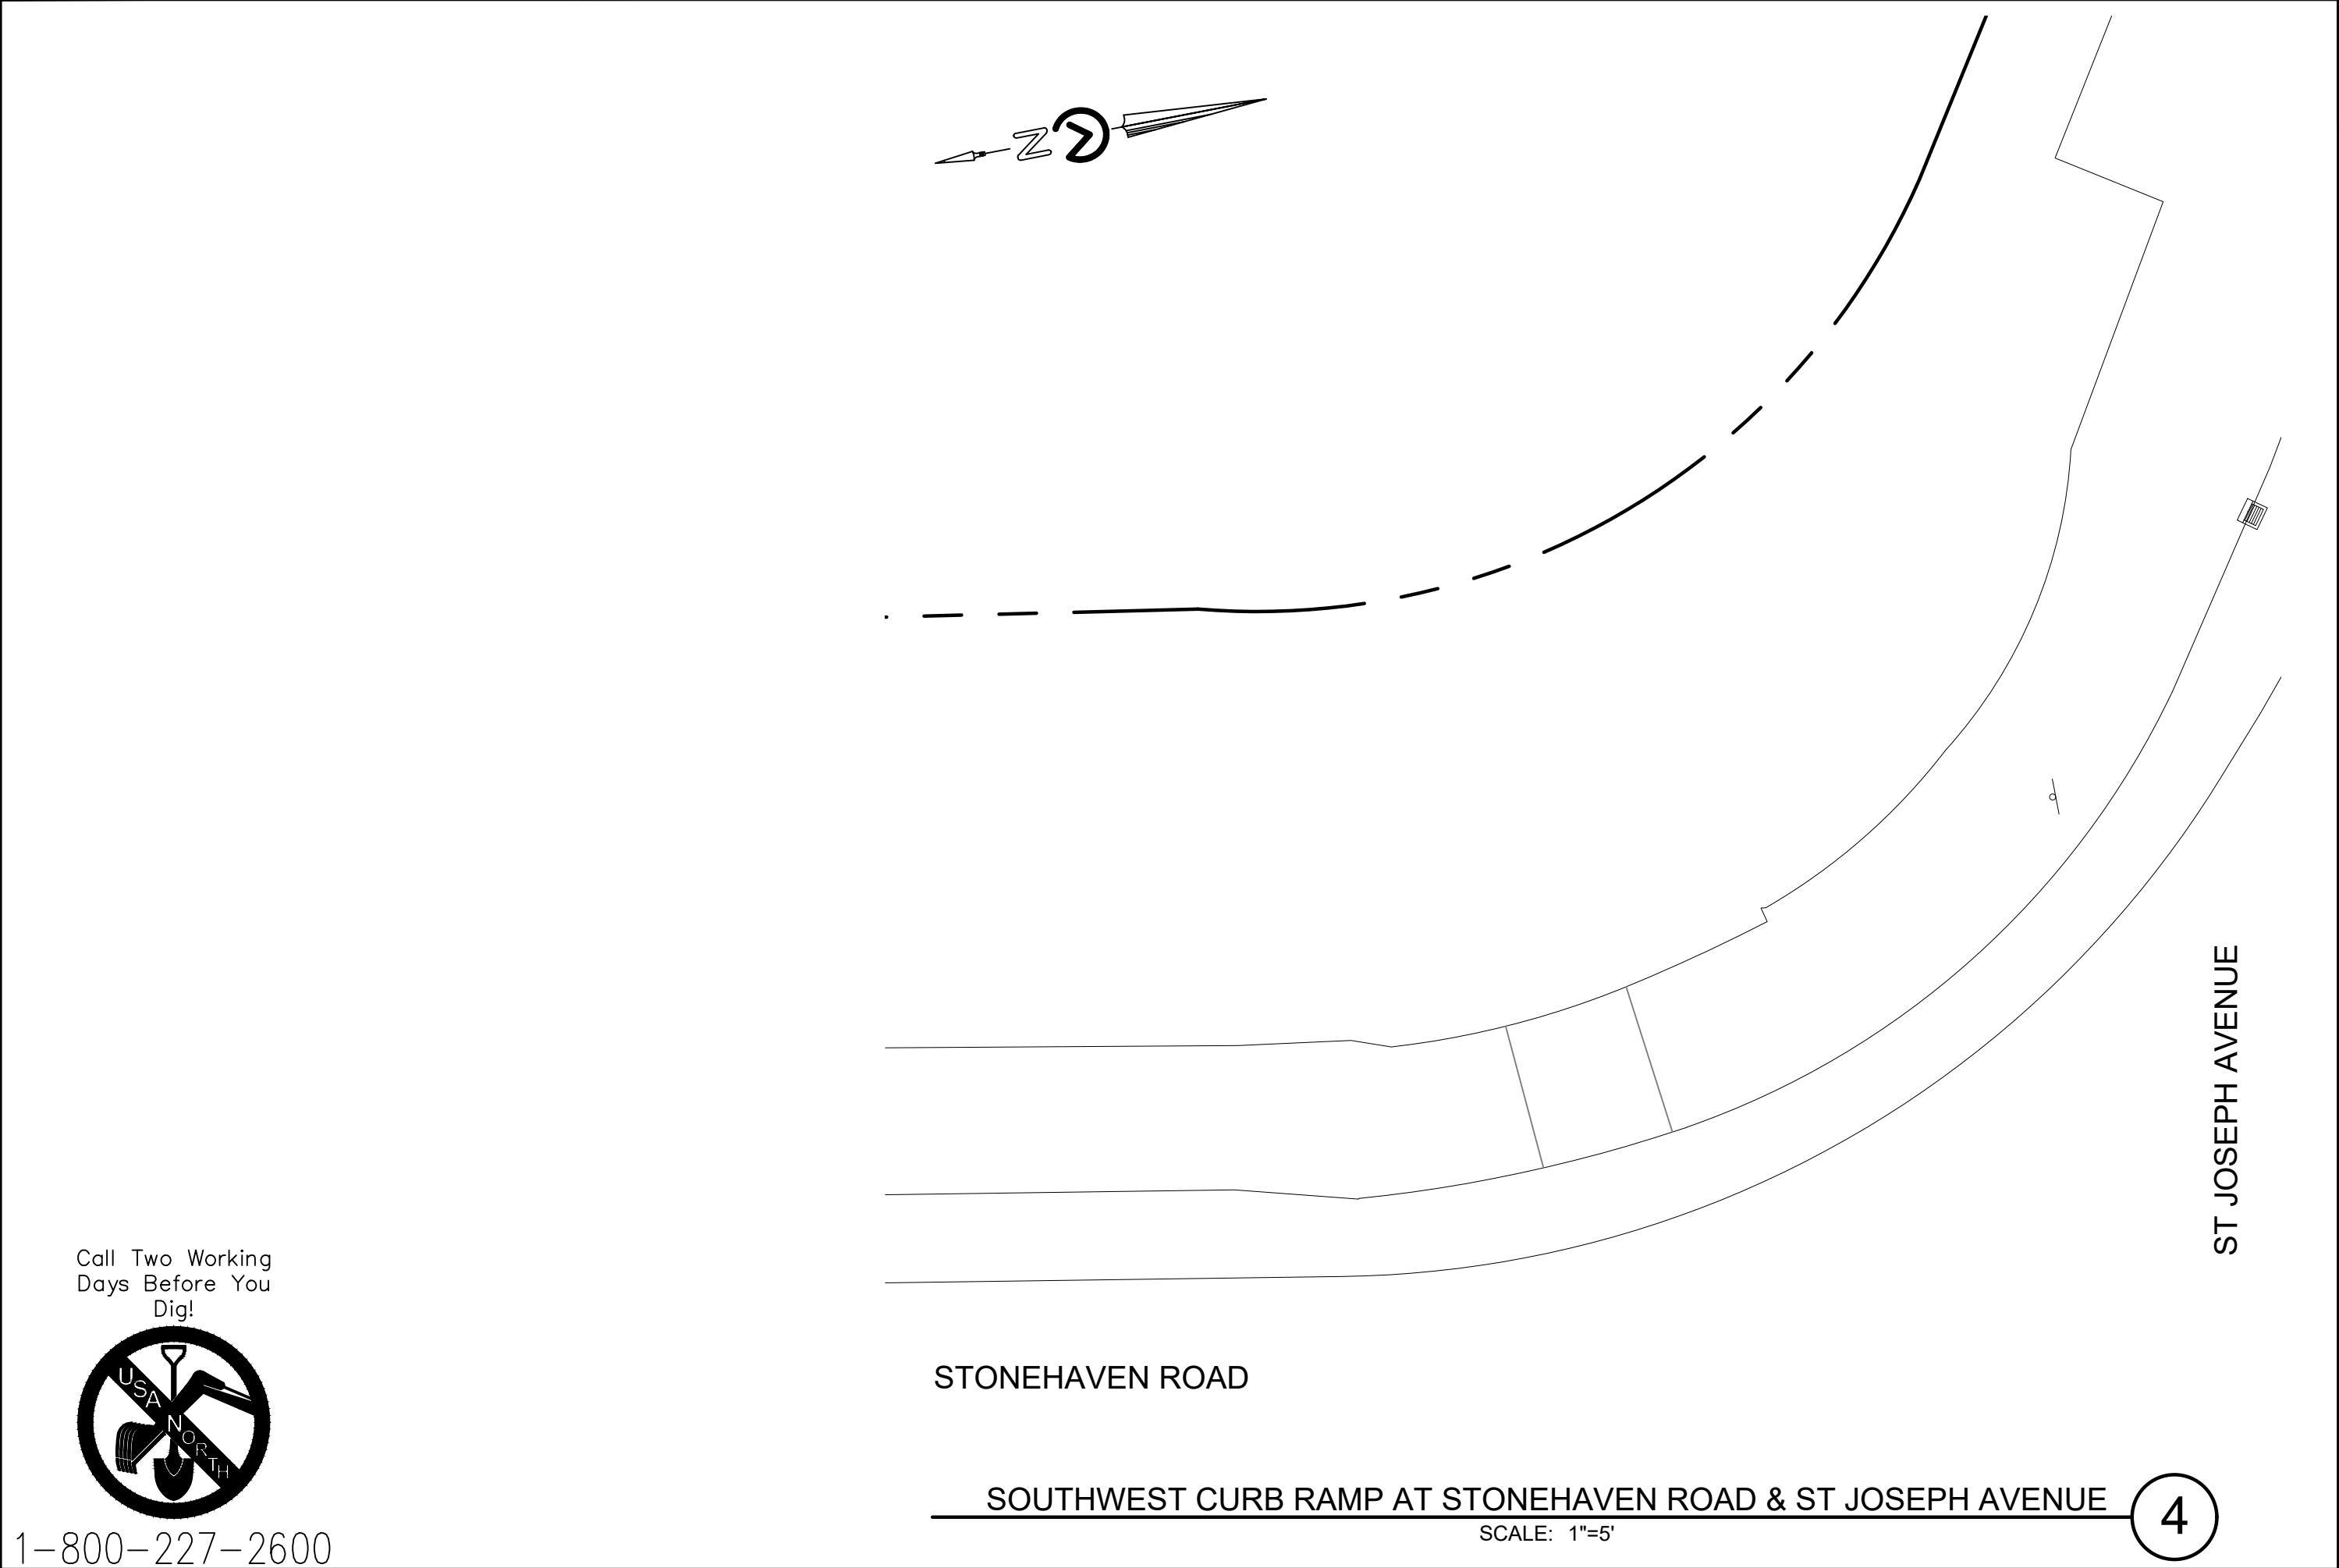



SOUTHEAST CURB RAMP AT STONEHAVEN ROAD & ST MATTHEW WAY

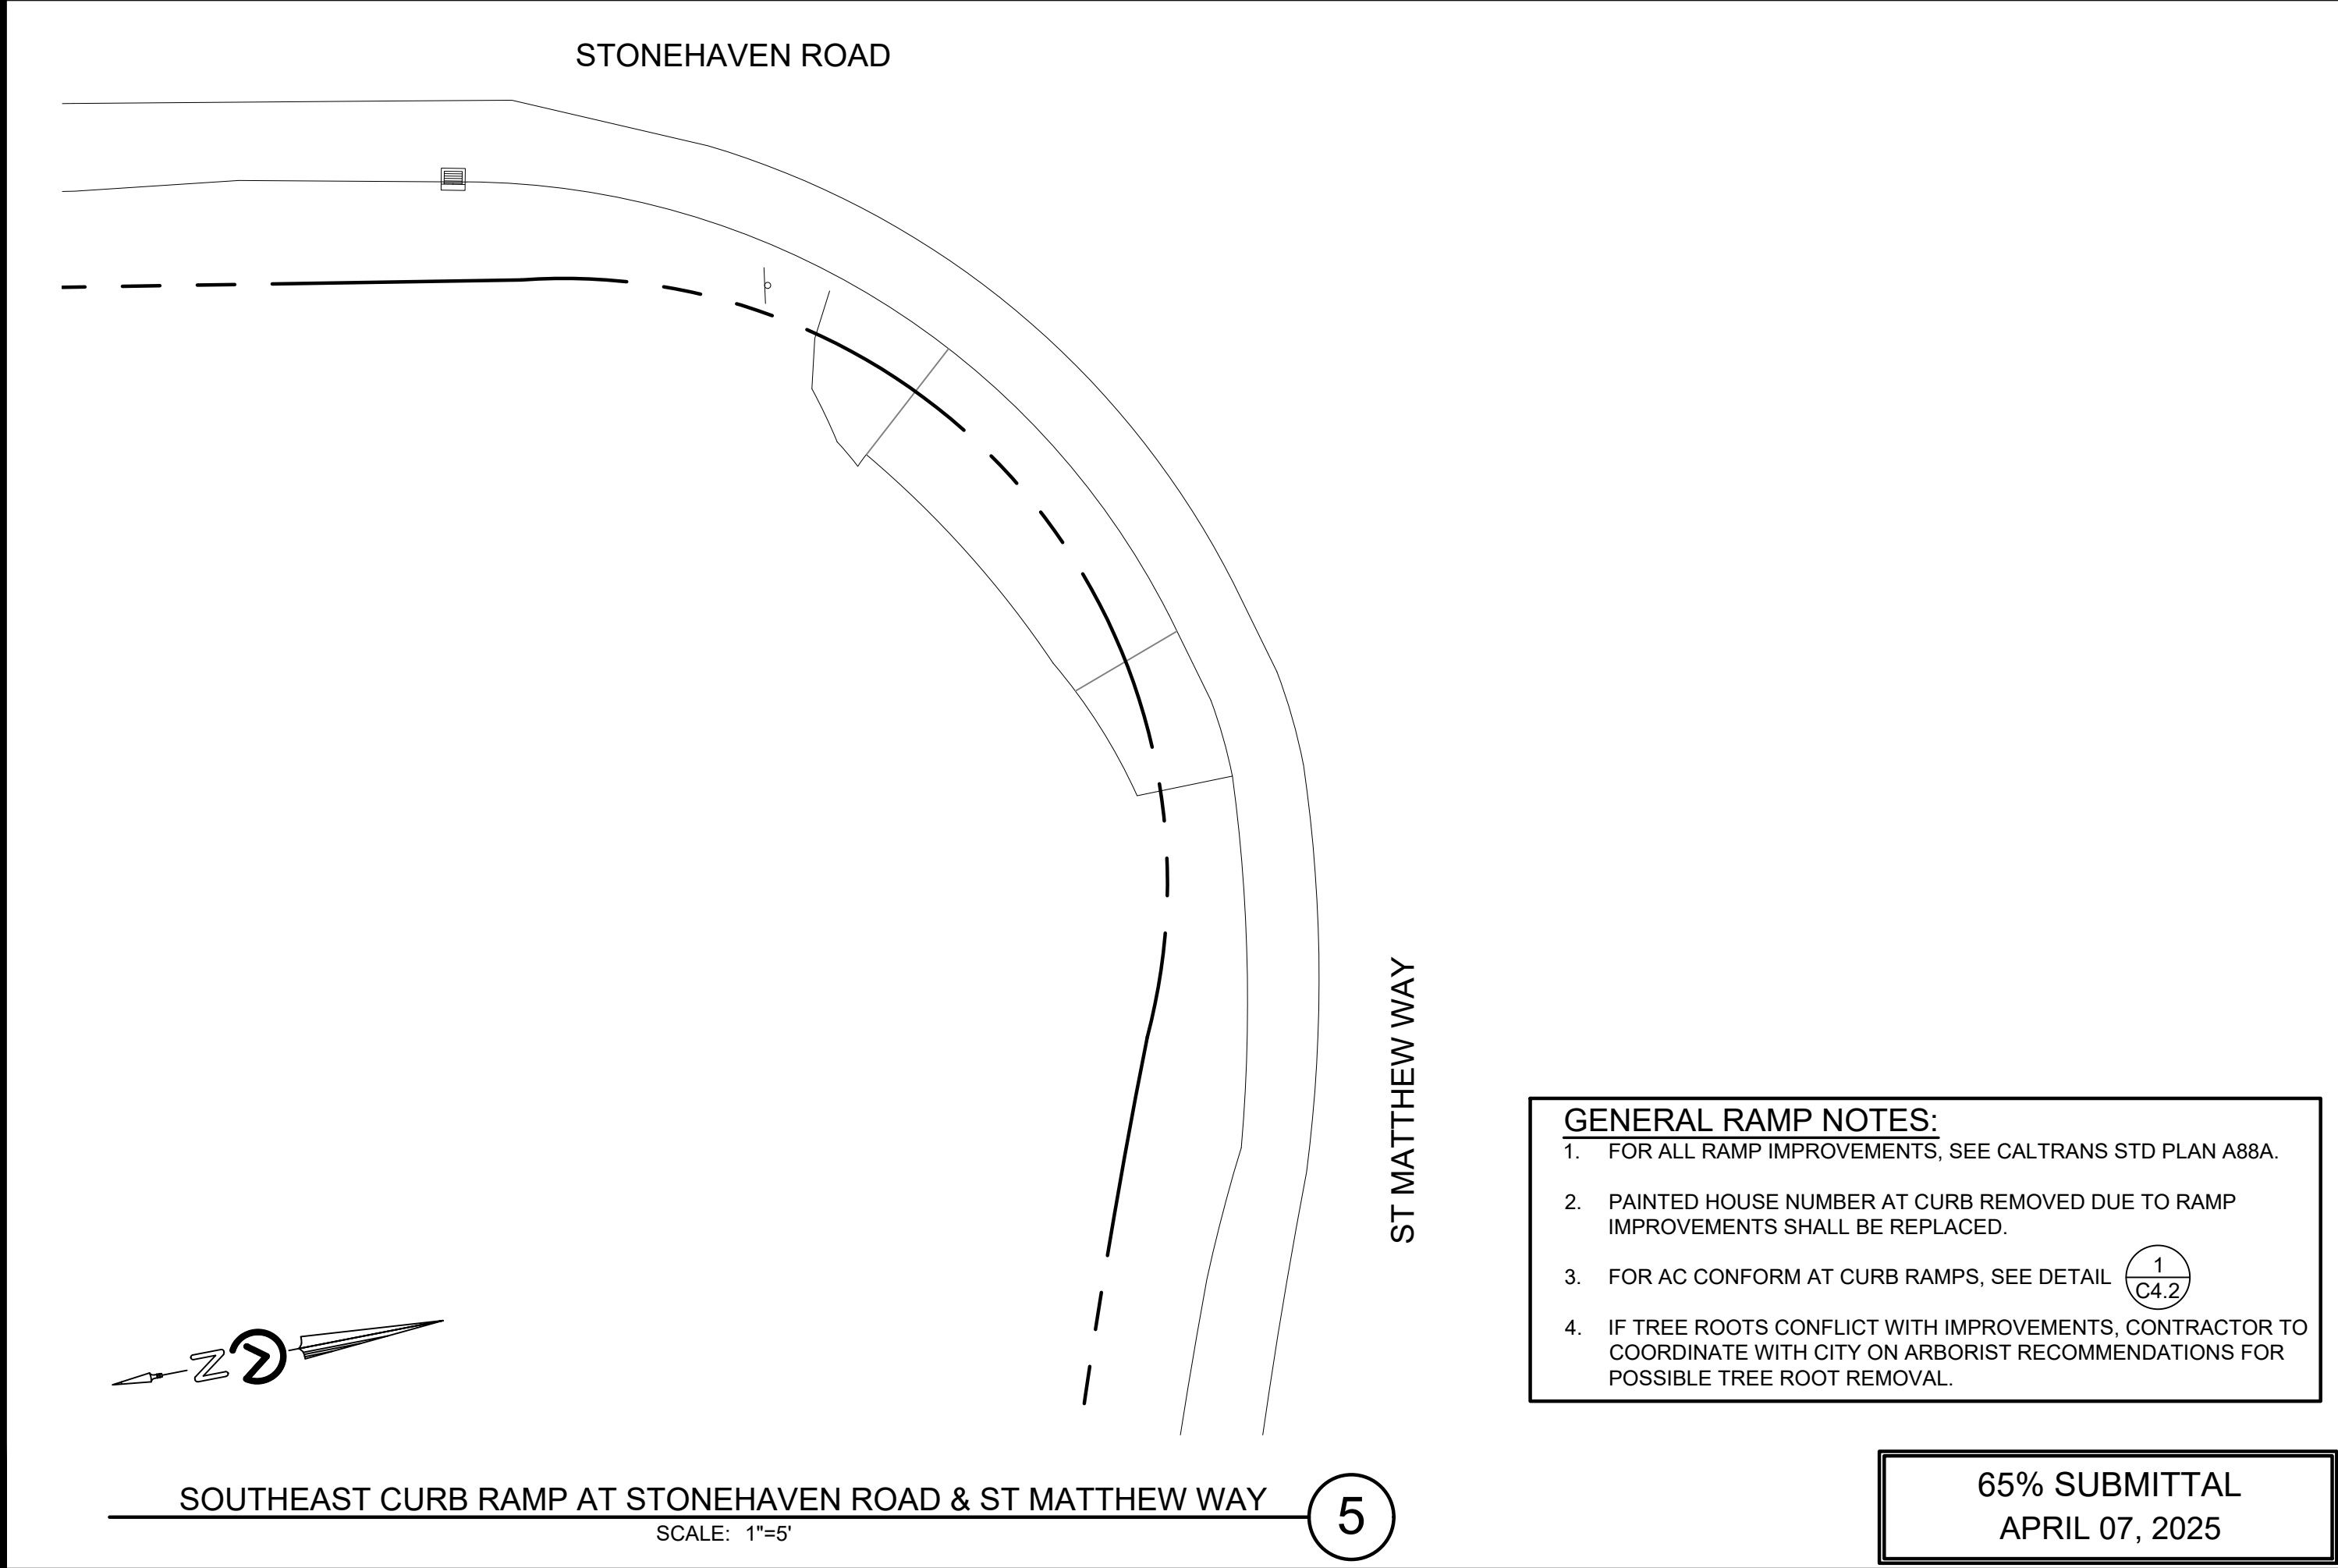
SCALE: 1"=5'

5

- GENERAL RAMP NOTES:**
1. FOR ALL RAMP IMPROVEMENTS, SEE CALTRANS STD PLAN A88A.
 2. PAINTED HOUSE NUMBER AT CURB REMOVED DUE TO RAMP IMPROVEMENTS SHALL BE REPLACED.
 3. FOR AC CONFORM AT CURB RAMPS, SEE DETAIL 
 4. IF TREE ROOTS CONFLICT WITH IMPROVEMENTS, CONTRACTOR TO COORDINATE WITH CITY ON ARBORIST RECOMMENDATIONS FOR POSSIBLE TREE ROOT REMOVAL.

65% SUBMITTAL
APRIL 07, 2025

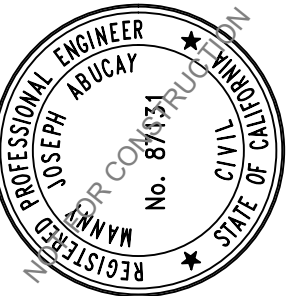DWG NO.	C5.11	49 OF 50	JOB NO. 250007	LOS ALTOS	SANTA CLARA COUNTY	CALIFORNIA	2024-2025 ANNUAL STREET RESURFACING PROJECT	CIVIL DETAILS	CITY OF LOS ALTOS 1 NORTH SAN ANTONIO ROAD CALIFORNIA 94022			BY	DATE	REVISIONS

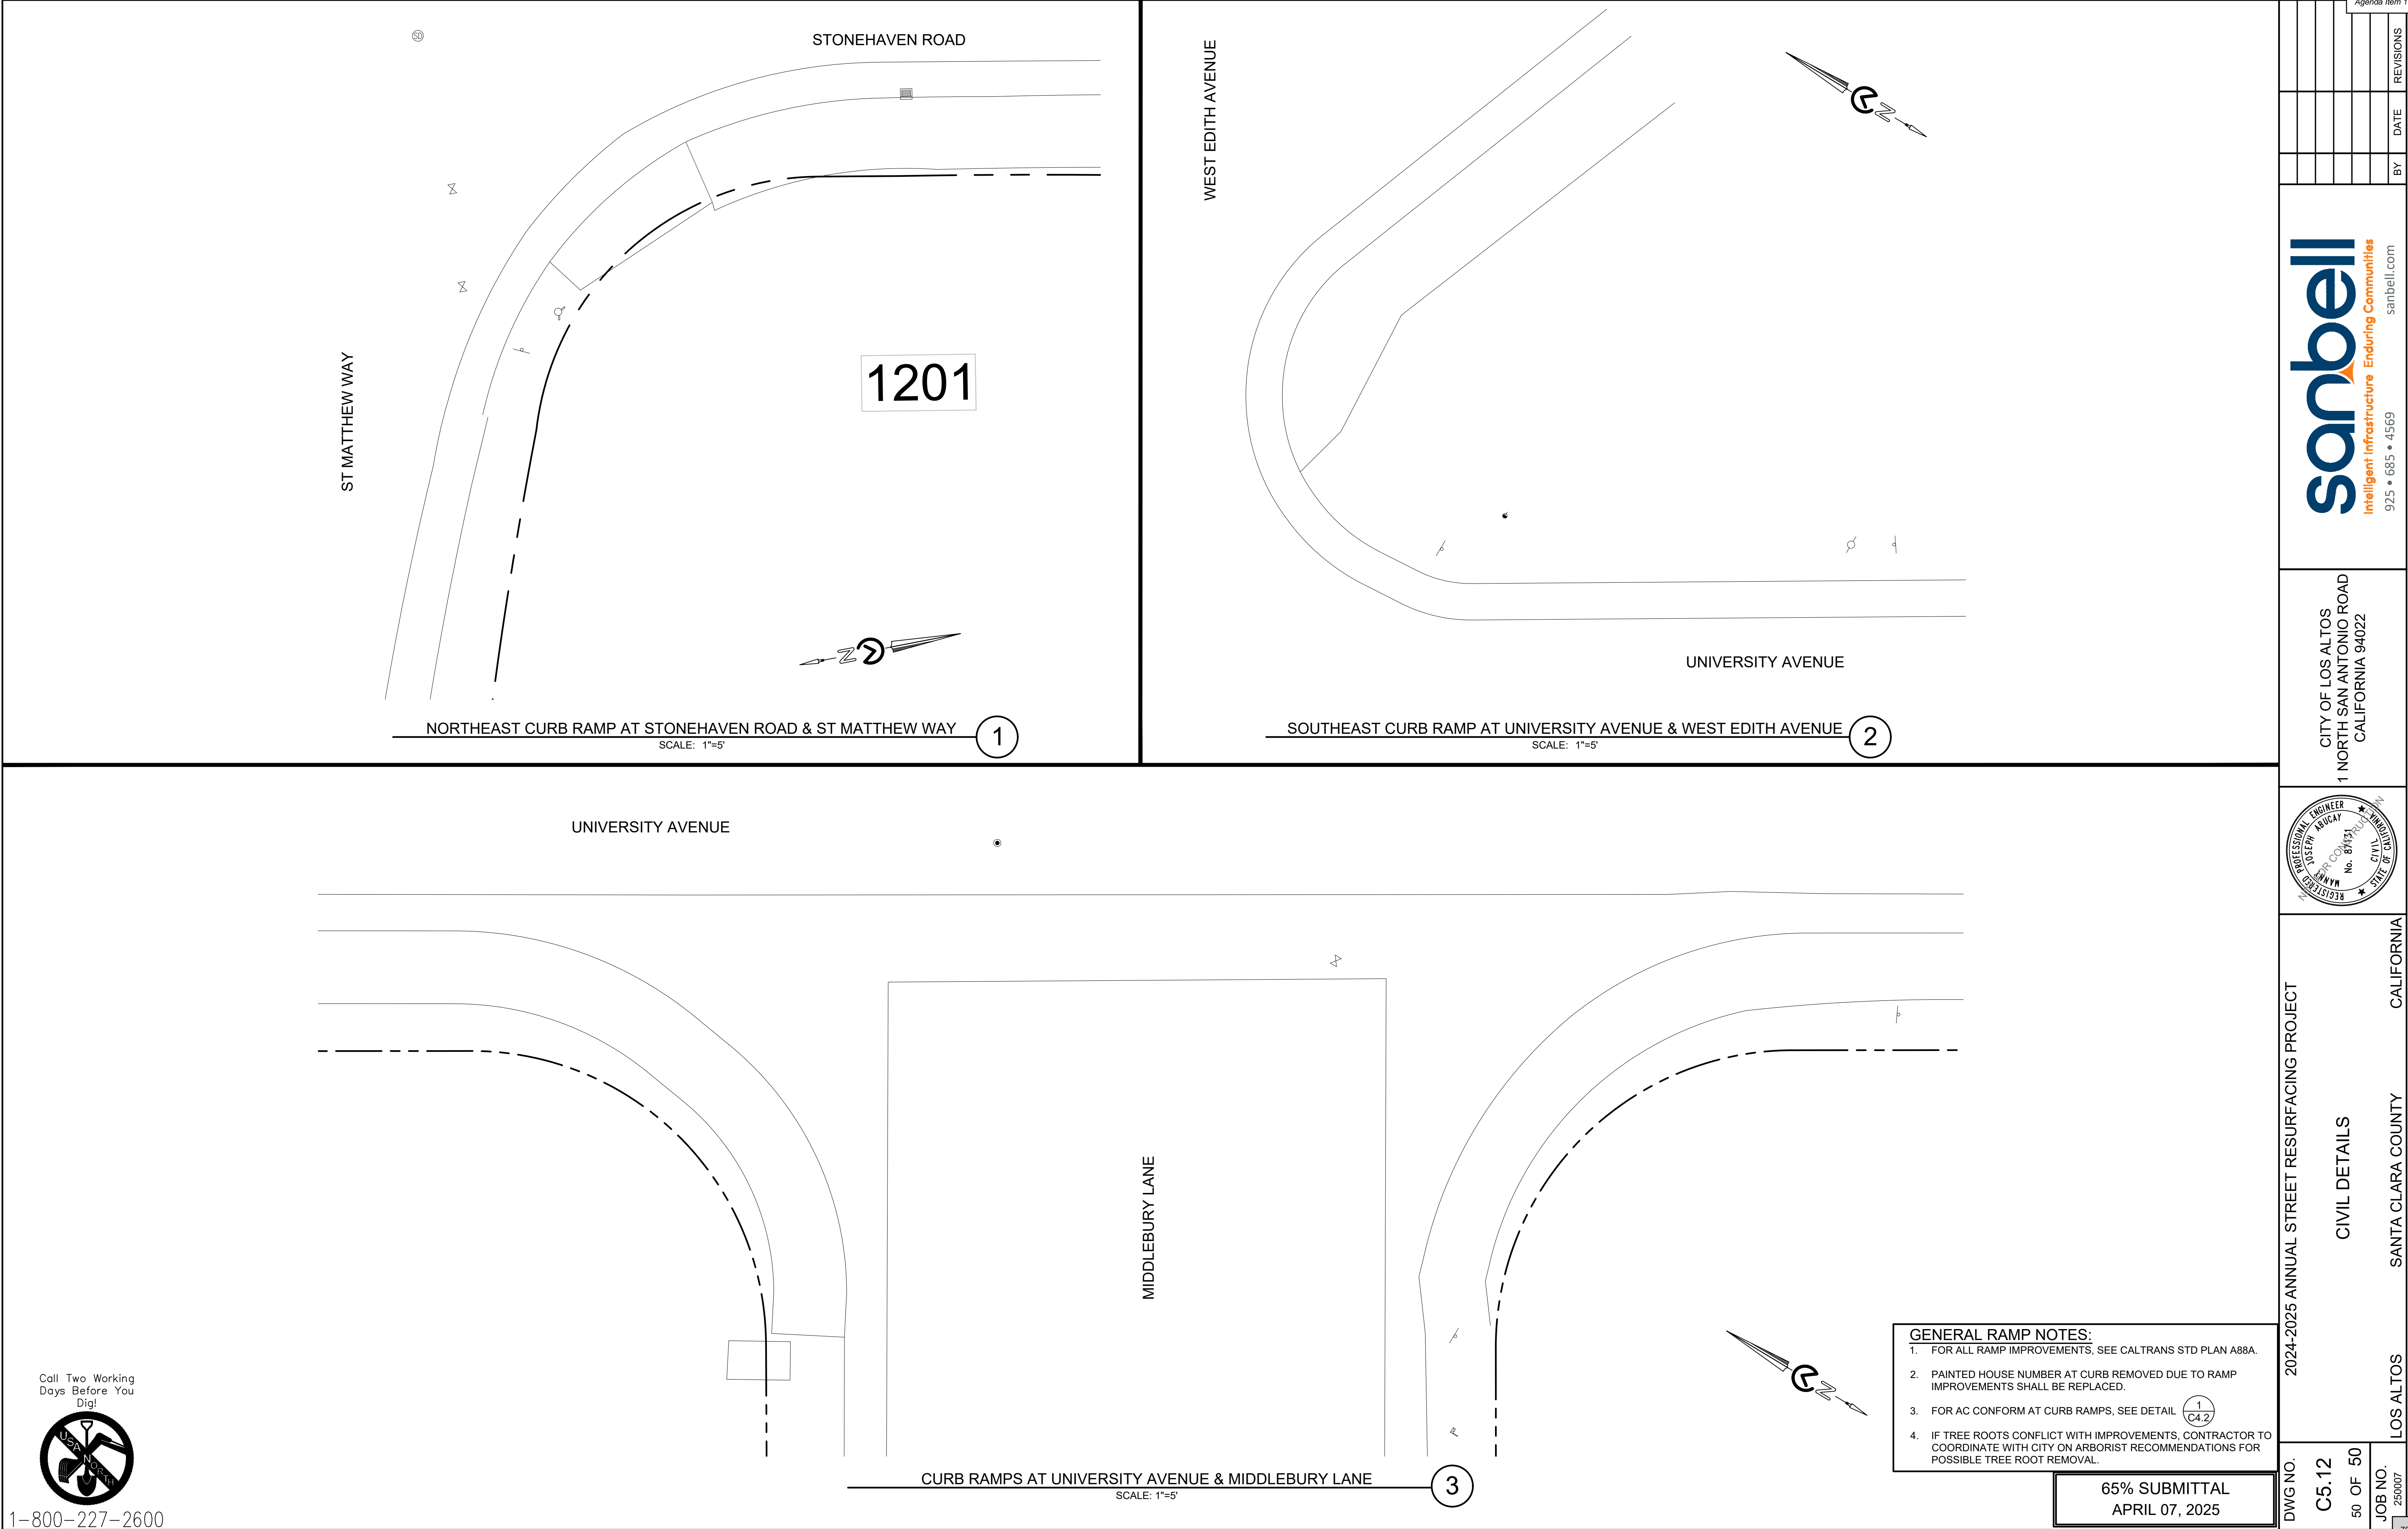

DWG NO.
C5.12
50 OF 50
JOB NO.
250007

2024-2025 ANNUAL STREET RESURFACING PROJECT
CIVIL DETAILS

LOS ALTOS
SANTA CLARA COUNTY
CALIFORNIA

Agenda Item 1.

REVISIONS

DATE

BY

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CITY OF LOS ALTOS
1 NORTH SAN ANTONIO ROAD
CALIFORNIA 94022

REGISTERED PROFESSIONAL ENGINEER
JOSEPH ARICAR
No. 87131
CIVIL
STATE OF CALIFORNIA