

ZONING ADMINISTRATOR MEETING AGENDA

4:00 PM - Wednesday, September 20, 2023

Community Meeting Chambers, Los Altos City Hall 1 North San Antonio Road, Los Altos, CA

Members of the Public may call (253) 215-8782 to participate in the conference call (Webinar ID: 876 6369 8791 or via the web at https://tinyurl.com/3ke4kzt3 with Passcode: 701956). Members of the Public may only comment during times allotted for public comments and public testimony will be taken at the direction of the Zoning Administrator. Members of the public are also encouraged to submit written testimony prior to the meeting at ZAPublicComment@losaltosca.gov. Emails received prior to the meeting will be included in the public record.

ESTABLISH QUORUM

PUBLIC COMMENTS ON ITEMS NOT ON THE AGENDA

Members of the audience may bring to the Commission's attention any item that is not on the agenda. Please complete a "Request to Speak" form and submit it to the Staff Liaison. Speakers are generally given two or three minutes, at the discretion of the Chair. Please be advised that, by law, the Commission is unable to discuss or take action on issues presented during the Public Comment Period. According to State Law (also known as "the Brown Act") items must first be noticed on the agenda before any discussion or action.

ITEMS FOR CONSIDERATION/ACTION

CONSENT CALENDAR

These items will be considered by one motion unless any member of the Commission or audience wishes to remove an item for discussion. Any item removed from the Consent Calendar for discussion will be handled at the discretion of the Chair.

1. Zoning Administrator Meeting Minutes

Approval of the DRAFT minutes of the regular meeting of September 6, 2023.

PUBLIC HEARING

2. SC23-0007 – Wanchen Cai – 226 Solana Drive

Design review for a new approximately 4,103 square-foot two-story single-family residence. This project is categorically exempt from environmental review under Section 15303 of the California Environmental Quality Act. *Project Manager: Healy*

3. SC23-0010 – Jim Maliksi – 746 Casa Bonita Court

Design review for a new approximately 3,721 square-foot two-story single-family residence. This project is categorically exempt from environmental review under Section 15303 of the California Environmental Quality Act. *Project Manager: Healy*

INFORMATIONAL ITEMS

COMMISSIONERS' REPORTS AND COMMENTS

POTENTIAL FUTURE AGENDA ITEMS

ADJOURNMENT

SPECIAL NOTICES TO PUBLIC

In compliance with the Americans with Disabilities Act and California Law, it is the policy of the City of Los Altos to offer its programs, services and meetings in a manner that is readily accessible to everyone, including individuals with disabilities. If you are a person with a disability and require information or materials in an appropriate alternative format; or if you require any other accommodation, please contact department staff. Advance notification within this guideline will enable the City to make reasonable arrangements to ensure accessibility. The City ADA Coordinator can be reached at (650) 947-2607 or by email:

Agendas, Staff Reports and some associated documents for Design Review Commission items may be viewed on the Internet at http://losaltosca.gov/meetings.

If you wish to provide written materials, please provide the Commission Staff Liaison with 10 copies of any document that you would like to submit to the Commissioners in order for it to become part of the public record.

For other questions regarding the meeting proceedings, please contact the City Clerk at (650) 947-2720.



ZONING ADMINISTRATOR MEETING MINUTES

4:00 PM - Wednesday, September 6, 2023

Community Meeting Chambers, Los Altos City Hall

1 North San Antonio Road, Los Altos, CA

CALL MEETING TO ORDER

At 4:00 p.m. the Zoning Administrator called the meeting to order.

ESTABLISH QUORUM

PRESENT: Zoning Administrator Zornes

STAFF: Planning Manager Williams and Associate Planner Liu

PUBLIC COMMENTS ON ITEMS NOT ON THE AGENDA

None.

ITEMS FOR CONSIDERATION/ACTION

CONSENT CALENDAR.

1. **Zoning Administrator Meeting Minutes**

Approval of the FINAL minutes of the regular meeting of July 19, 2023.

Action: Zoning Administrator Zornes approved meeting minutes for regular meeting of July 19, 2023.

The motion was approved (1-0) by the following vote:

AYES: Zornes NOES: None

PUBLIC HEARING

2. SC23-0004 – J. Steve Collom – 630 Arboleda Drive

Design Review for the construction of a new two-story house including 2,695 square feet at the first story and 878 square feet at the second story. An 804 square-foot attached accessory dwelling unit is also proposed, but not subject to design review. This project is categorically exempt from environmental review under 15303 of the California Environmental Quality Act (CEQA). *Project Planner: Liu*

STAFF PRESENTATION

Associate Planner Liu presented the staff report recommending approval of design review application SC2-0004 subject to the listed findings and conditions.

PUBLIC COMMENT

The property owner Andrew Mo made a presentation and made himself available for any questions.

Resident Ravi Kaw and John Maneatis provided public comment.

Zoning Administrator Zornes closed the public comment period.

<u>Action</u>: Zoning Administrator Zornes approved design review application SC23-0004 per the staff report findings and conditions.

The motion was approved (1-0) by the following vote:

AYES: Zornes NOES: None

POTENTIAL FUTURE AGENDA ITEMS

None.

ADJOURNMENT

Zoning Administrator Zornes adjourned the meeting at 4:20 PM.

Nick Zornes
Zoning Administrator

AGENDA ITEM #3



TO: Nick Zornes, Zoning Administrator

FROM: Nazaneen Healy, Associate Planner

SUBJECT: SC23-0007 – 226 Solana Drive

RECOMMENDATION

Approve design review application SC23-0007 for the construction of a new approximately 4,103 square foot, two-story home subject to the listed findings and conditions of approval; and find the project categorically exempt under the California Environmental Quality Act (CEQA) pursuant to Section 15303 ("New Construction or Conversion of Small Structures").

BACKGROUND

Project Description

- <u>Project Location</u>: 226 Solana Drive, located on the west side of Solana Drive between Almond Avenue and Jardin Drive
- <u>Lot Size</u>: 13,912 square feet
- General Plan Designation: Single-Family, Medium Lot (SF4)
- Zoning Designation: R1-10
- <u>Current Site Conditions</u>: One-story home

The proposed project includes the demolition of the existing one-story home and replacement with a new two-story home (see Attachment A – Project Plans). The proposed home incorporates traditional hipped roof forms and exterior materials that include a standing seam metal roof, stucco exterior finish with stone veneer, and painted wood trim. The proposed home is situated on the lot similar to the existing home and the proposed site improvements include a new driveway to the attached garage and new landscaping throughout the property. Ten existing protected trees and several smaller trees and shrubs are proposed for removal as part of the project due to their poor condition.

ANALYSIS

Design Review

The proposed home complies with the R1-10 district development standards found in LAMC Chapter 14.06, as demonstrated by the following table:

| | Existing | Proposed | Allowed/Required |
|---|--|--|--|
| COVERAGE: | 2,300 square feet | 3,151 square feet | 3,189 square feet |
| FLOOR AREA: First floor Second floor Total | 2,152 square feet square feet 2,152 square feet | 2,694 square feet 1,409 square feet 4,103 square feet | 4,051 square feet |
| SETBACKS: Front Rear Right side (1st/2nd) Left side (1st/2nd) | 29.9 feet 64.1 feet 20.1 feet/ feet 16.1 feet/ feet | 25.4 feet 38.2 feet 10.3 feet/19.1 feet 10.3 feet/27.8 feet | 25 feet 25 feet 10 feet/17.5 feet 10 feet/17.5 feet |
| Неіснт: | 16.3 feet | 25.6 feet | 27 feet |

Pursuant to Chapter 14.76 of the LAMC, new two-story residences shall be consistent with policies and implementation techniques described in the Single-Family Residential Design Guidelines. The proposed home minimizes bulk by insetting portions of the second story, incorporates greater side setbacks than required, and proposes a lower height than the maximum. In addition, to minimize potential privacy impacts, the second-story egress windows face the street except for one window facing the south side yard and a balcony facing the rear yard, which will be screened with evergreen trees planted along the property lines.

Seven new trees will be planted in the front and rear yards and three existing trees in the public right-of-way, one small oak tree in the front yard, and a group of existing shrubs in the rear yard will remain. The landscaping plan will comply with the Water Efficient Landscape Ordinance, which requires water-efficient landscaping for new residences with landscaping over 500 square feet.

The proposed project meets the development standards in the R1-10 zoning district and complies with the Single-Family Residential Design Guidelines because it is compatible with the character of the neighborhood as the design maintains an appropriate relationship with adjacent structures, minimizes bulk, and minimizes potential privacy impacts.

ENVIRONMENTAL REVIEW

This project is categorically exempt from environmental review under Section 15303 ("New Construction or Conversion of Small Structures") of the California Environmental Quality Act (CEQA) because it involves the construction of a single-family dwelling in a residential zone.

PUBLIC NOTIFICATION AND COMMUNITY OUTREACH

A public meeting notice was posted on the property, mailed to property owners within a 300-foot radius, and published in the Town Crier newspaper. The applicant also posted the public notice sign (24" x 36") in conformance with the Planning Division posting requirements.

The applicant also contacted 10 neighbors in the immediate area. No comments from neighbors have been

received by staff as of the writing of this report.

Attachment:

A. Project Plans

Cc: Wanchen Cai, Applicant

Ana Bertran and Roberto Angulo, Property Owner

FINDINGS

SC23-0007 – 226 Solana Dr

With regard to the proposed new two-story residence, the Zoning Administrator finds the following in accordance with Section 14.76.060 of the Municipal Code:

- A. The proposed new two-story residence complies with all provisions of this chapter because the proposed residence is consistent with the development standards of the R1-10 zoning district and policies and implementation techniques described in the Single-Family Residential Design Guidelines.
- B. The height, elevations, and placement on the site of the proposed new house is compatible when considered with reference to the nature and location of residential structures on adjacent lots, and will consider the topographic and geologic constraints imposed by particular building site conditions as the proposed home is situated on the lot similar to the existing home and complies with the allowable floor area, lot coverage, and height maximums as well as the daylight plane requirement pursuant to LAMC Chapter 14.06.
- C. The natural landscape will be preserved insofar as practicable by minimizing tree and soil removal; grade changes shall be minimized because the existing site is relatively level and does not require substantial grading or removal of soil. Ten existing protected trees and several smaller trees and shrubs are proposed for removal due to their poor condition. Seven new trees will be planted in the front and rear yards and three existing trees in the public right-of-way, one small oak tree in the front yard, and a group of existing shrubs in the rear yard will remain.
- D. The orientation of the proposed new house in relation to the immediate neighborhood will minimize excessive bulk because the proposed design insets portions of the second story, incorporates greater side setbacks than required, and proposes a lower height than the maximum.
- E. General architectural considerations, including the size and scale, the architectural relationship with the site and other buildings, building materials, and similar elements have been incorporated in order to insure the compatibility of the development with its design concept and the character of adjacent buildings. The proposed home complies with the allowable floor area, lot coverage, and height maximums as well as the daylight plane requirement pursuant to LAMC Chapter 14.06 and the design of the home incorporates consistent and compatible features including standing seam metal roofing, stucco exterior finish with stone veneer, and painted wood trim.
- F. The proposed new house has been designed to follow the natural contours of the site with minimal grading, minimum impervious cover, and maximum erosion protection because the proposed grading provides for drainage away from the home and away from adjacent properties and conforms to existing grades along the property lines.

CONDITIONS OF APPROVAL

SC23-0007 – 226 Solana Dr

GENERAL

1. Expiration

The Design Review Approval will expire on September 20, 2025 unless prior to the date of expiration, a building permit is issued, or an extension is granted pursuant to Section 14.76.090 of the Zoning Code.

2. Approved Plans

The approval is based on the plans and materials received on August 11, 2023, except as may be modified by these conditions.

3. Plan Revisions

The building permit application shall include the following plan revisions:

a. Correct the North Arrow orientation on the architectural plans to match the survey.

4. Protected Trees

Tree Nos. 3, 5-7, 9, 17, and 36 (row of oleanders), shall be protected under this application and cannot be removed without a tree removal permit from the Development Services Department or Public Works Department.

Fireplaces

Only gas fireplaces, pellet fueled wood heaters or EPA certified wood-burning appliances may be installed in all new construction pursuant to Chapter 12.64 of the Municipal Code.

6. Encroachment Permit

An encroachment permit shall be obtained from the Engineering Division prior to doing any work within the public right-of-way including the street shoulder. All work within the public right-of-way shall be in compliance with the City's Shoulder Paving Policy.

7. Landscaping

The project shall be subject to the City's Water Efficient Landscape Ordinance (WELO) pursuant to Chapter 12.36 of the Municipal Code if 500 square feet or more of new or replaced landscape area, including irrigated planting areas, turf areas, and water features is proposed.

8. Underground Utility and Fire Sprinkler Requirements

New residences and additions exceeding fifty (50) percent of the existing living area (existing square footage calculations shall not include existing basements) and/or additions of 750 square feet or more shall trigger the undergrounding of utilities and new fire sprinklers. Additional square footage calculations shall include existing removed exterior footings and foundations being replaced and rebuilt. Any new utility service drops are pursuant to Chapter 12.68 of the Municipal Code.

9. Indemnity and Hold Harmless

The applicant/owner agrees to indemnify, defend, protect, and hold the City harmless from all costs and expenses, including attorney's fees, incurred by the City or held to be the liability of the City in connection with the City's defense of its actions in any proceedings brought in any State or Federal Court, challenging any of the City's action with respect to the applicant's project. The City may withhold final maps and/or permits, including temporary or final occupancy permits, for failure to pay all costs and expenses, including attorney's fees, incurred by the City in connection with the City's defense of its actions.

INCLUDED WITH THE BUILDING PERMIT SUBMITTAL

10. Conditions of Approval

Incorporate the conditions of approval into the title page of the plans and provide a letter which explains how each condition of approval has been satisfied and/or which sheet of the plans the information can found.

11. Tree Protection Note

On the grading plan and site plan, show tree protection fencing and add the following note: "All tree protection fencing shall be chain link and a minimum of five feet in height with posts driven into the ground."

12. Water Efficient Landscape Plan

Provide a landscape documentation package prepared by a licensed landscape professional showing how the project complies with the City's Water Efficient Landscape Regulations and include signed statements from the project's landscape professional and property owner.

13. Reach Codes

Building Permit Applications submitted on or after January 1, 2023 shall comply with specific amendments to the 2022 California Green Building Standards for Electric Vehicle Infrastructure and the 2022 California Energy Code as provided in Ordinances No 2022-487 which amended Chapter 12.22 Energy Code and Chapter 12.26 California Green Building Standards Code of the Los Altos Municipal Code. The building design plans shall comply with the standards and the applicant shall submit supplemental application materials as required by the Building Division to demonstrate compliance.

14. California Water Service Upgrades

You are responsible for contacting and coordinating with the California Water Service Company any water service improvements including but not limited to relocation of water meters, increasing water meter sizing or the installation of fire hydrants. The City recommends consulting with California Water Service Company as early as possible to avoid construction or inspection delays.

15. Green Building Standards

Provide verification that the house will comply with the California Green Building Standards pursuant to Chapter 12.26 of the Municipal Code and provide a signature from the project's Qualified Green Building Professional Designer/Architect and property owner.

16. Underground Utility Location

Show the location of underground utilities pursuant to Chapter 12.68 of the Municipal Code. Underground utility trenches shall avoid the drip-lines of all protected trees unless approved by the project arborist and the Planning Division.

17. Outdoor Condensing Units

Show the location of any outdoor condensing unit(s) on the site plan including the model number of the unit(s), nominal size (i.e. tonnage) of the unit, and setback to the nearest property line. Provide the manufacturer's specifications showing the sound rating for each unit. The condensing unit(s) must be located to comply with the City's Noise Control Ordinance (Chapter 6.16) and in compliance with the Planning Division setback provisions. The units shall be screened from view of the street.

18. Storm Water Management

Show how the project is in compliance with the New Development and Construction Best Management Practices and Urban Runoff Pollution Prevention program, as adopted by the City for the purposes of preventing storm water pollution (i.e. downspouts directed to landscaped areas, minimize directly connected impervious areas, etc.).

PRIOR TO ISSUANCE OF BUILDING OR DEMOLITION PERMIT

19. Tree Protection

Tree protection fencing shall be installed around the driplines, or as required by the project arborist, of Tree Nos. 3, 5-7, 9, 17, and 36 (row of oleanders) and the existing trees on neighboring properties that overhang the subject property as shown on the site plan. Tree protection fencing shall be chain link and a minimum of five feet in height with posts driven into the ground and shall not be removed until all building construction has been completed unless approved by the Planning Division.

20. School Fee Payment

In accordance with Section 65995 of the California Government Code, and as authorized under Section 17620 of the Education Code, the property owner shall pay the established school fee for each school district the property is located in and provide receipts to the Building Division. The City of Los Altos shall provide the property owner the resulting increase in assessable space on a form approved by the school district. Payments shall be made directly to the school districts.


PRIOR TO FINAL INSPECTION

21. Landscaping Installation and Verification

All landscaping materials, including plants or trees intended to provide privacy screening, as provided on the approved landscape plans shall be installed prior to final inspection. The applicant shall also provide a landscape Certificate of Completion, signed by the project's landscape professional and property owner, verifying that the trees, landscaping, and irrigation were installed per the approved landscape documentation package.

22. Green Building Verification

Submit verification that the house was built in compliance with the City's Green Building Ordinance (Chapter 12.26 of the Municipal Code).

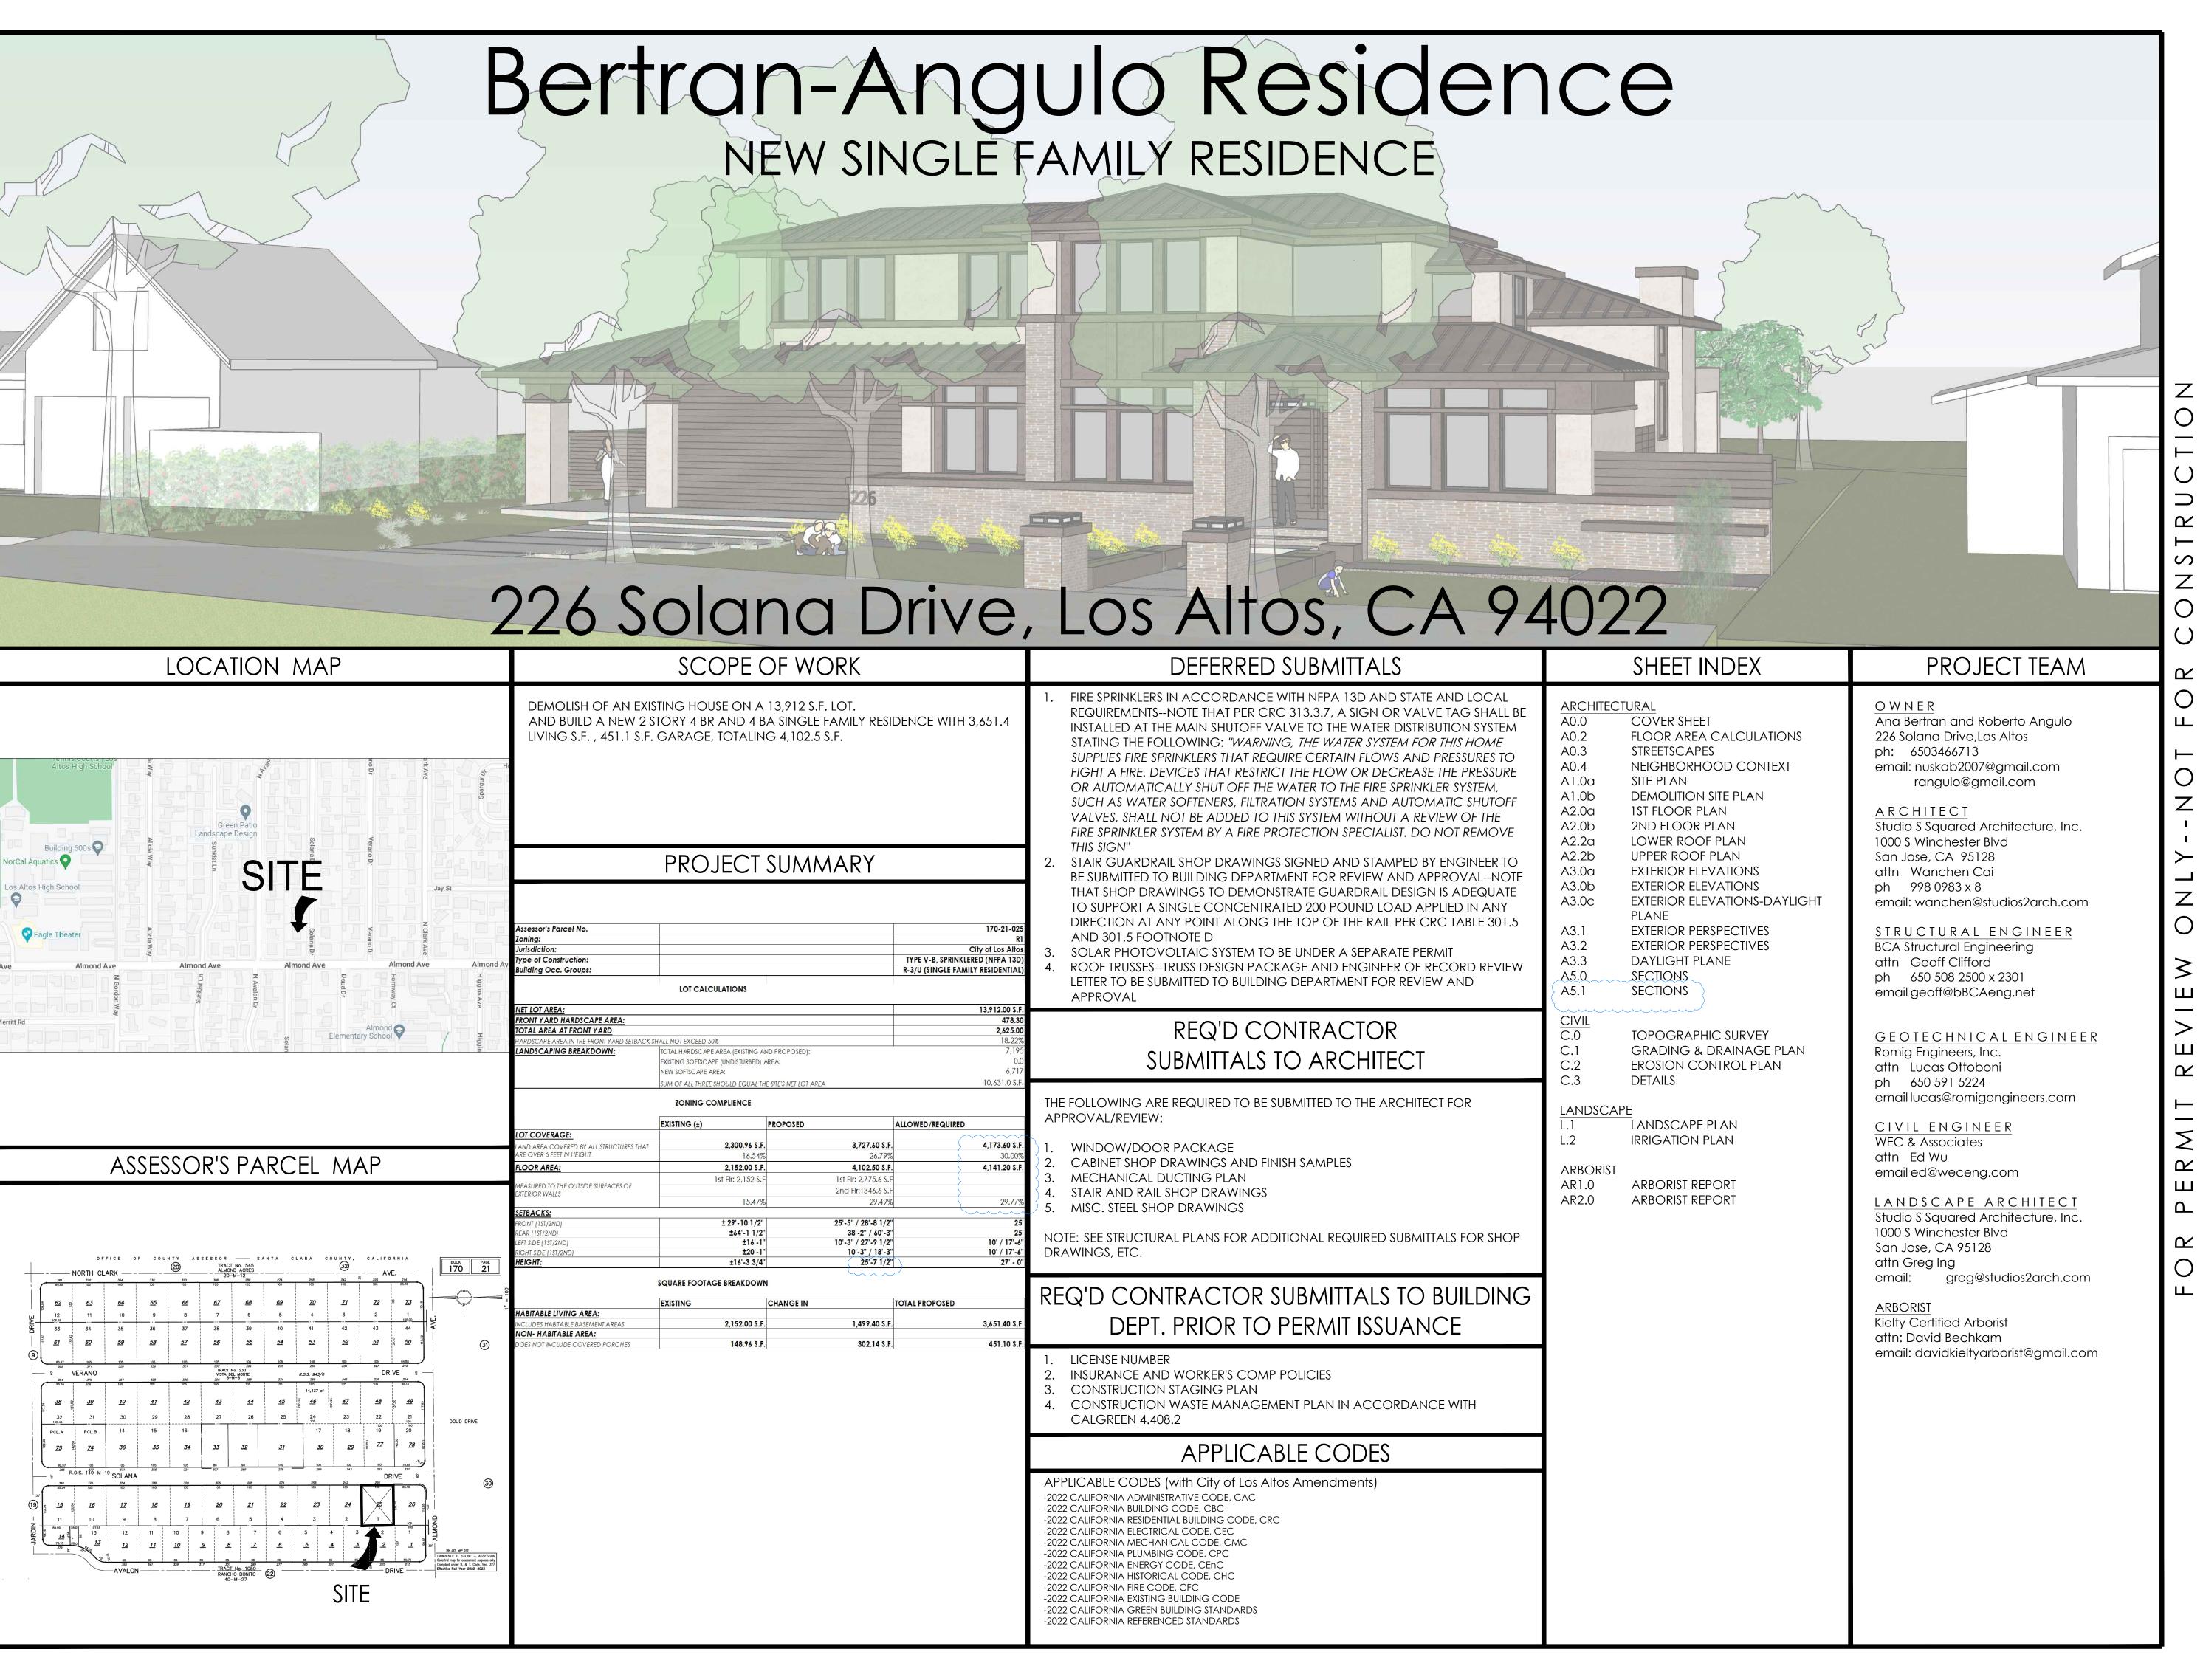



1000 S Winchester Blvd San Jose, CA 95128 P: (408) 998 - 0983

P: (408) 998 - 0983

NEW SINGLE FAMILY HOUSE

OS Altos, 226 Soland Drive

C27,719 TO THE CONTROL OF CALIFORN

22025
RIPTION
IGN REVIEW PACKAGE
IGN PACKAGE RESUBMITTAL #2 KNWC
IGN PACKAGE RESUBMITTAL #2 KN

PROJECT NO.


REVISION DATE DESCRIPTION


2023.03.31 DESIGN REVIEW PACKA

2023.07.10 DESIGN PACKAGE RESU

2023.08.11 DESIGN PACKAGE RESUI

COVER SHEET

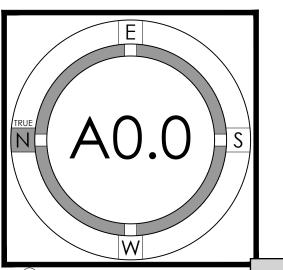

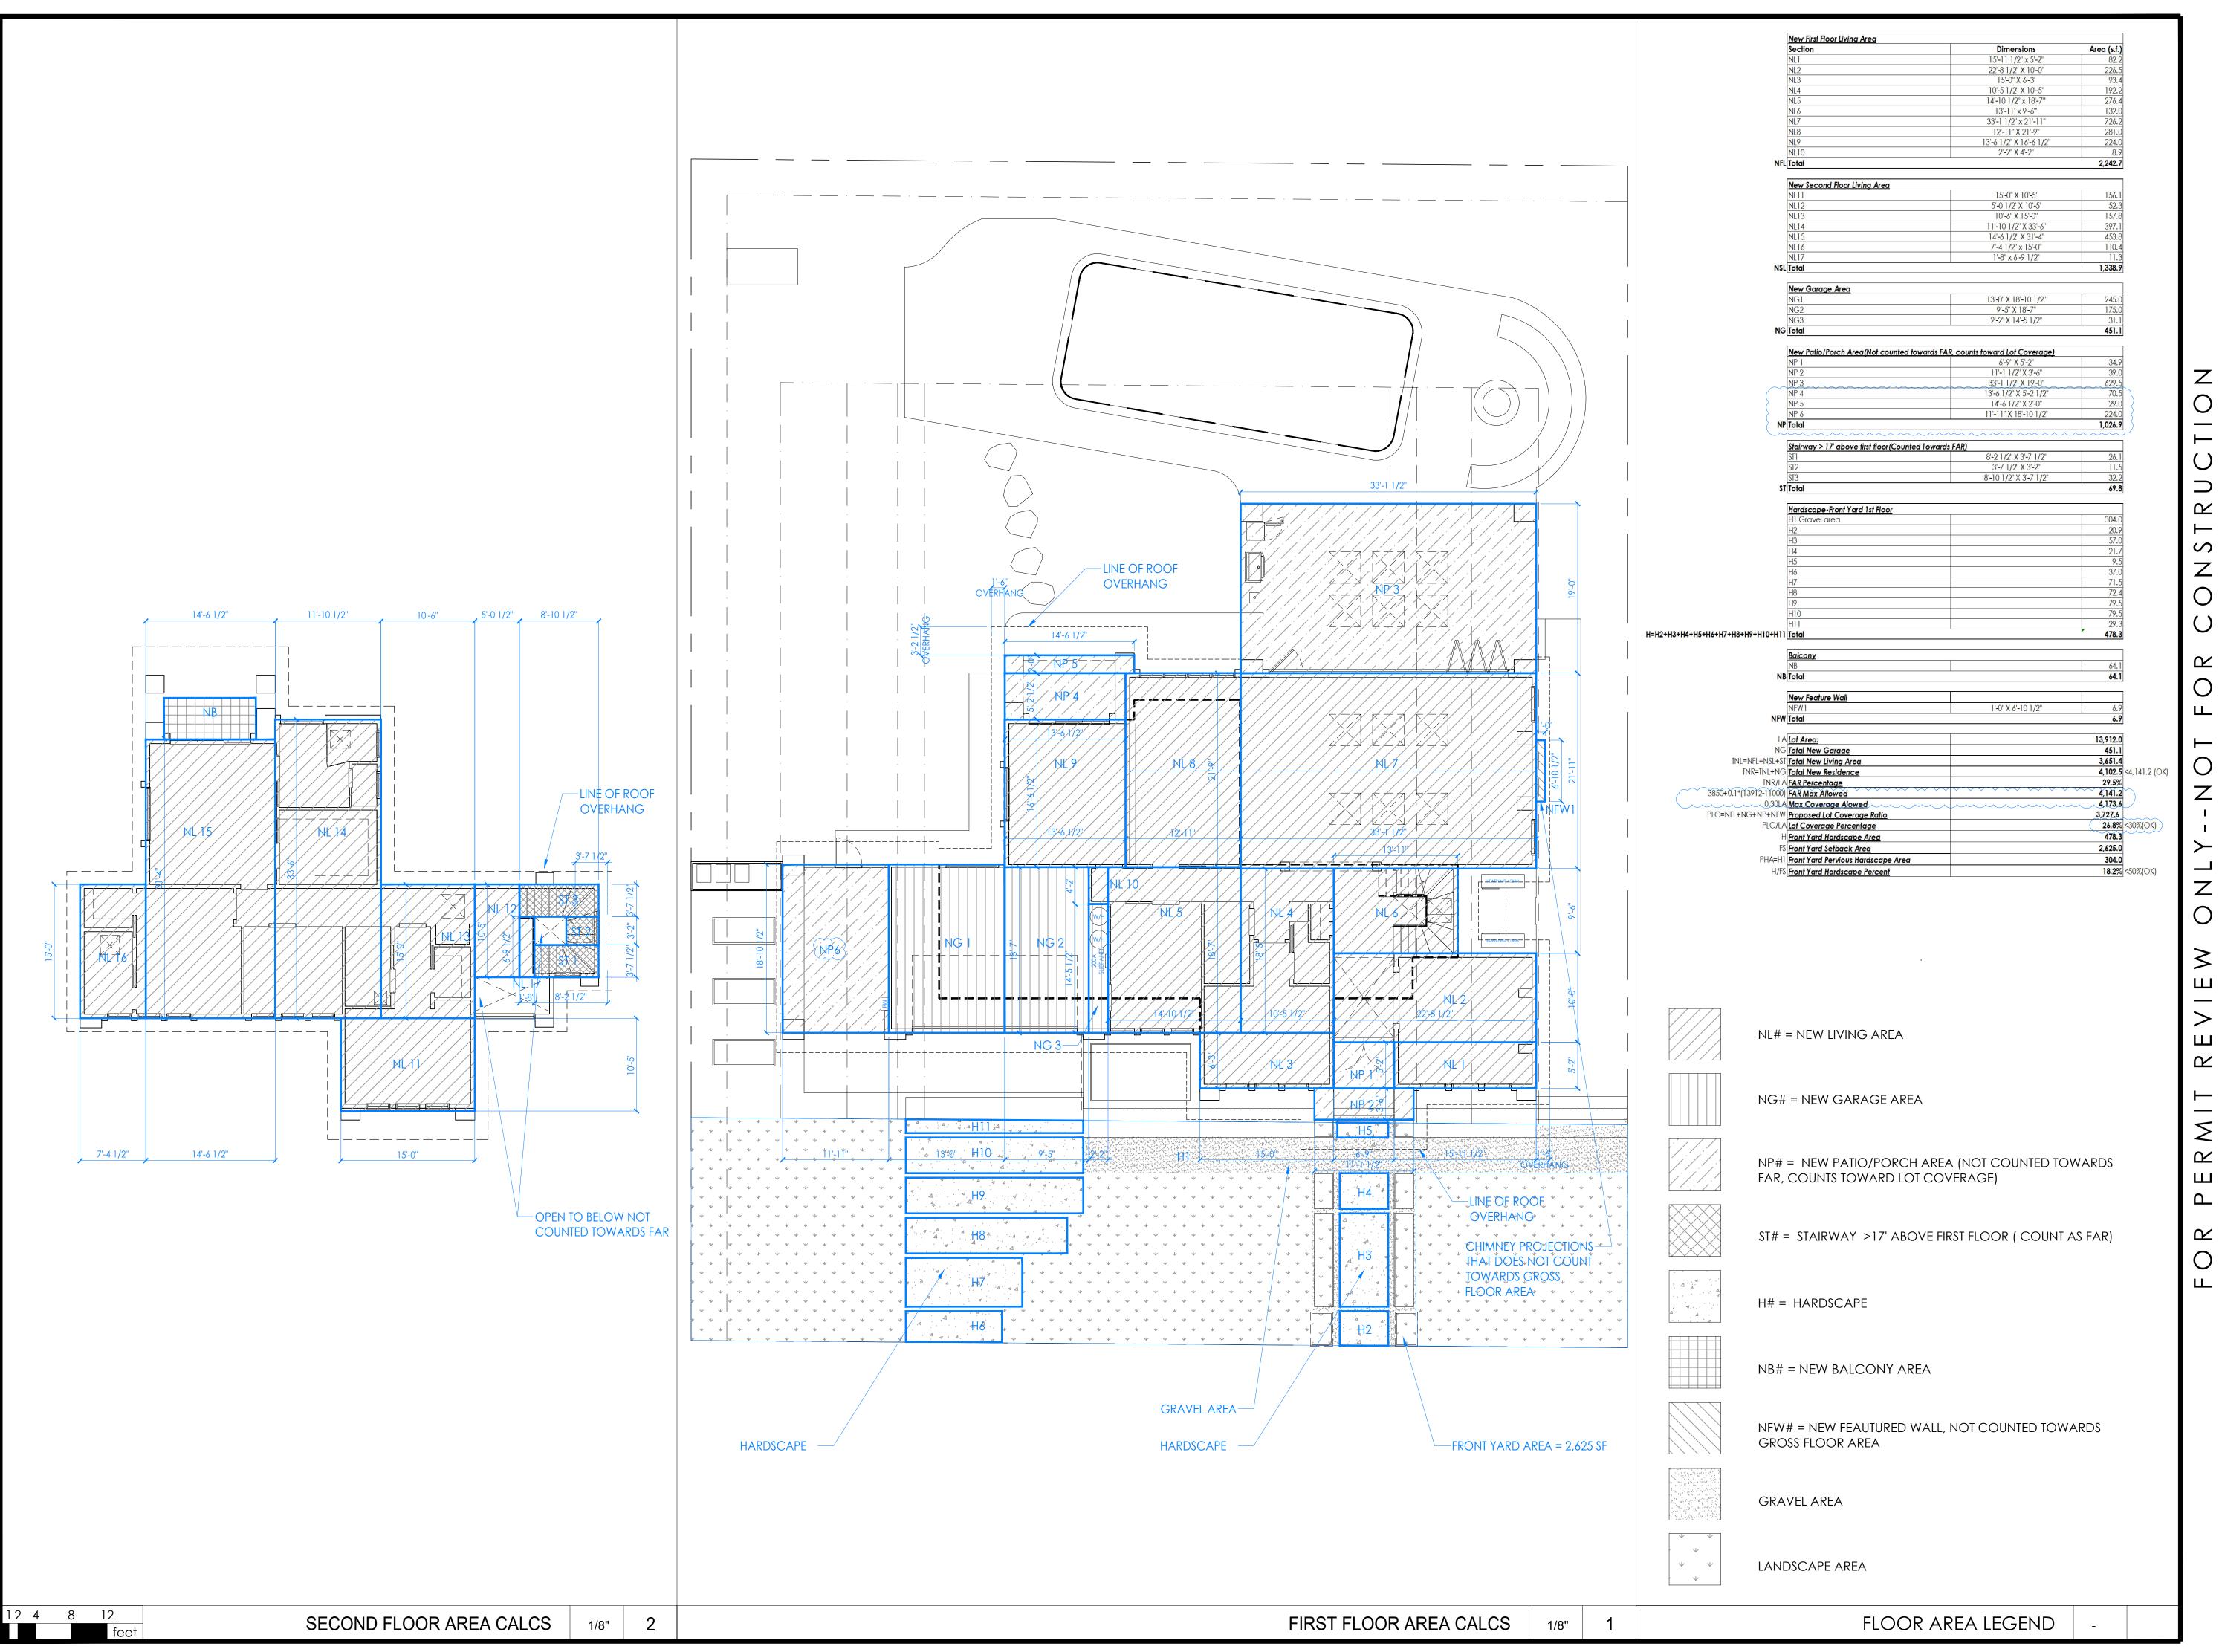





1000 S Winchester Blvd San Jose, CA 95128 P: (408) 998 - 0983


Reside Solana Drive 226

Altos, Los

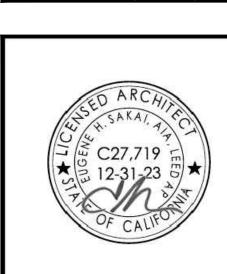

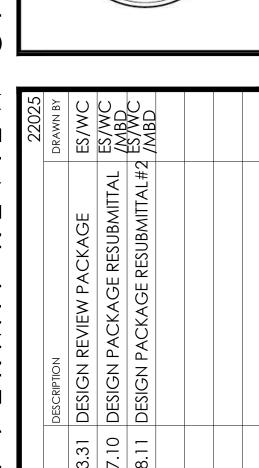


FLOOR AREA CALCULATION

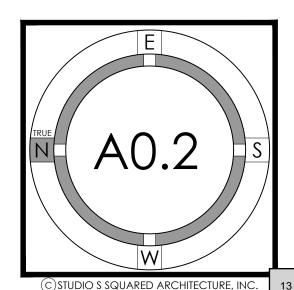






1000 S. Winchester Blvd San Jose, CA 95128 P: (408) 998 - 0983

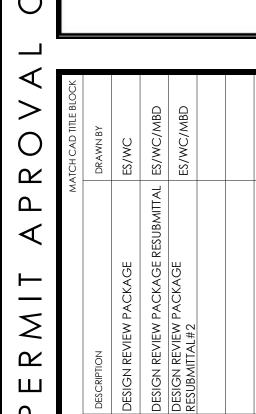



| - | <u> </u> | | - |
|-------------|------------|--|----------|
| PROJECT NO. | | VW | MATCH |
| REVISION | DATE | DESCRIPTION | R |
| | 2023.03.31 | DESIGN REVIEW PACKAGE | ES, |
| | 2023.07.10 | DESIGN REVIEW PACKAGE RESUBMITTAL ES, | ES, |
| | 2023.08.11 | DESIGN REVIEW PACKAGE RESUBMITTAL#2 | ES, |
| | | | |
| | | | |
| | | | |
| | | | |


STREETSCAPE

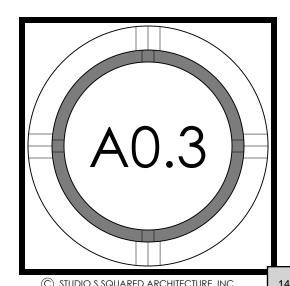



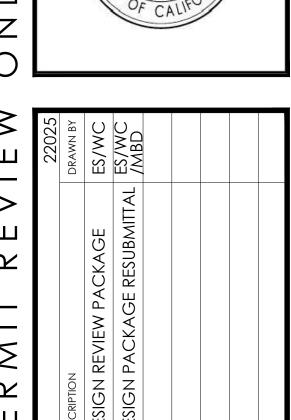

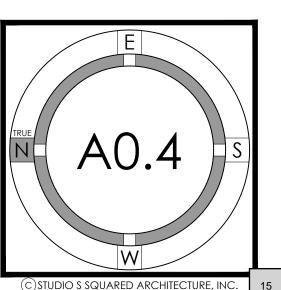

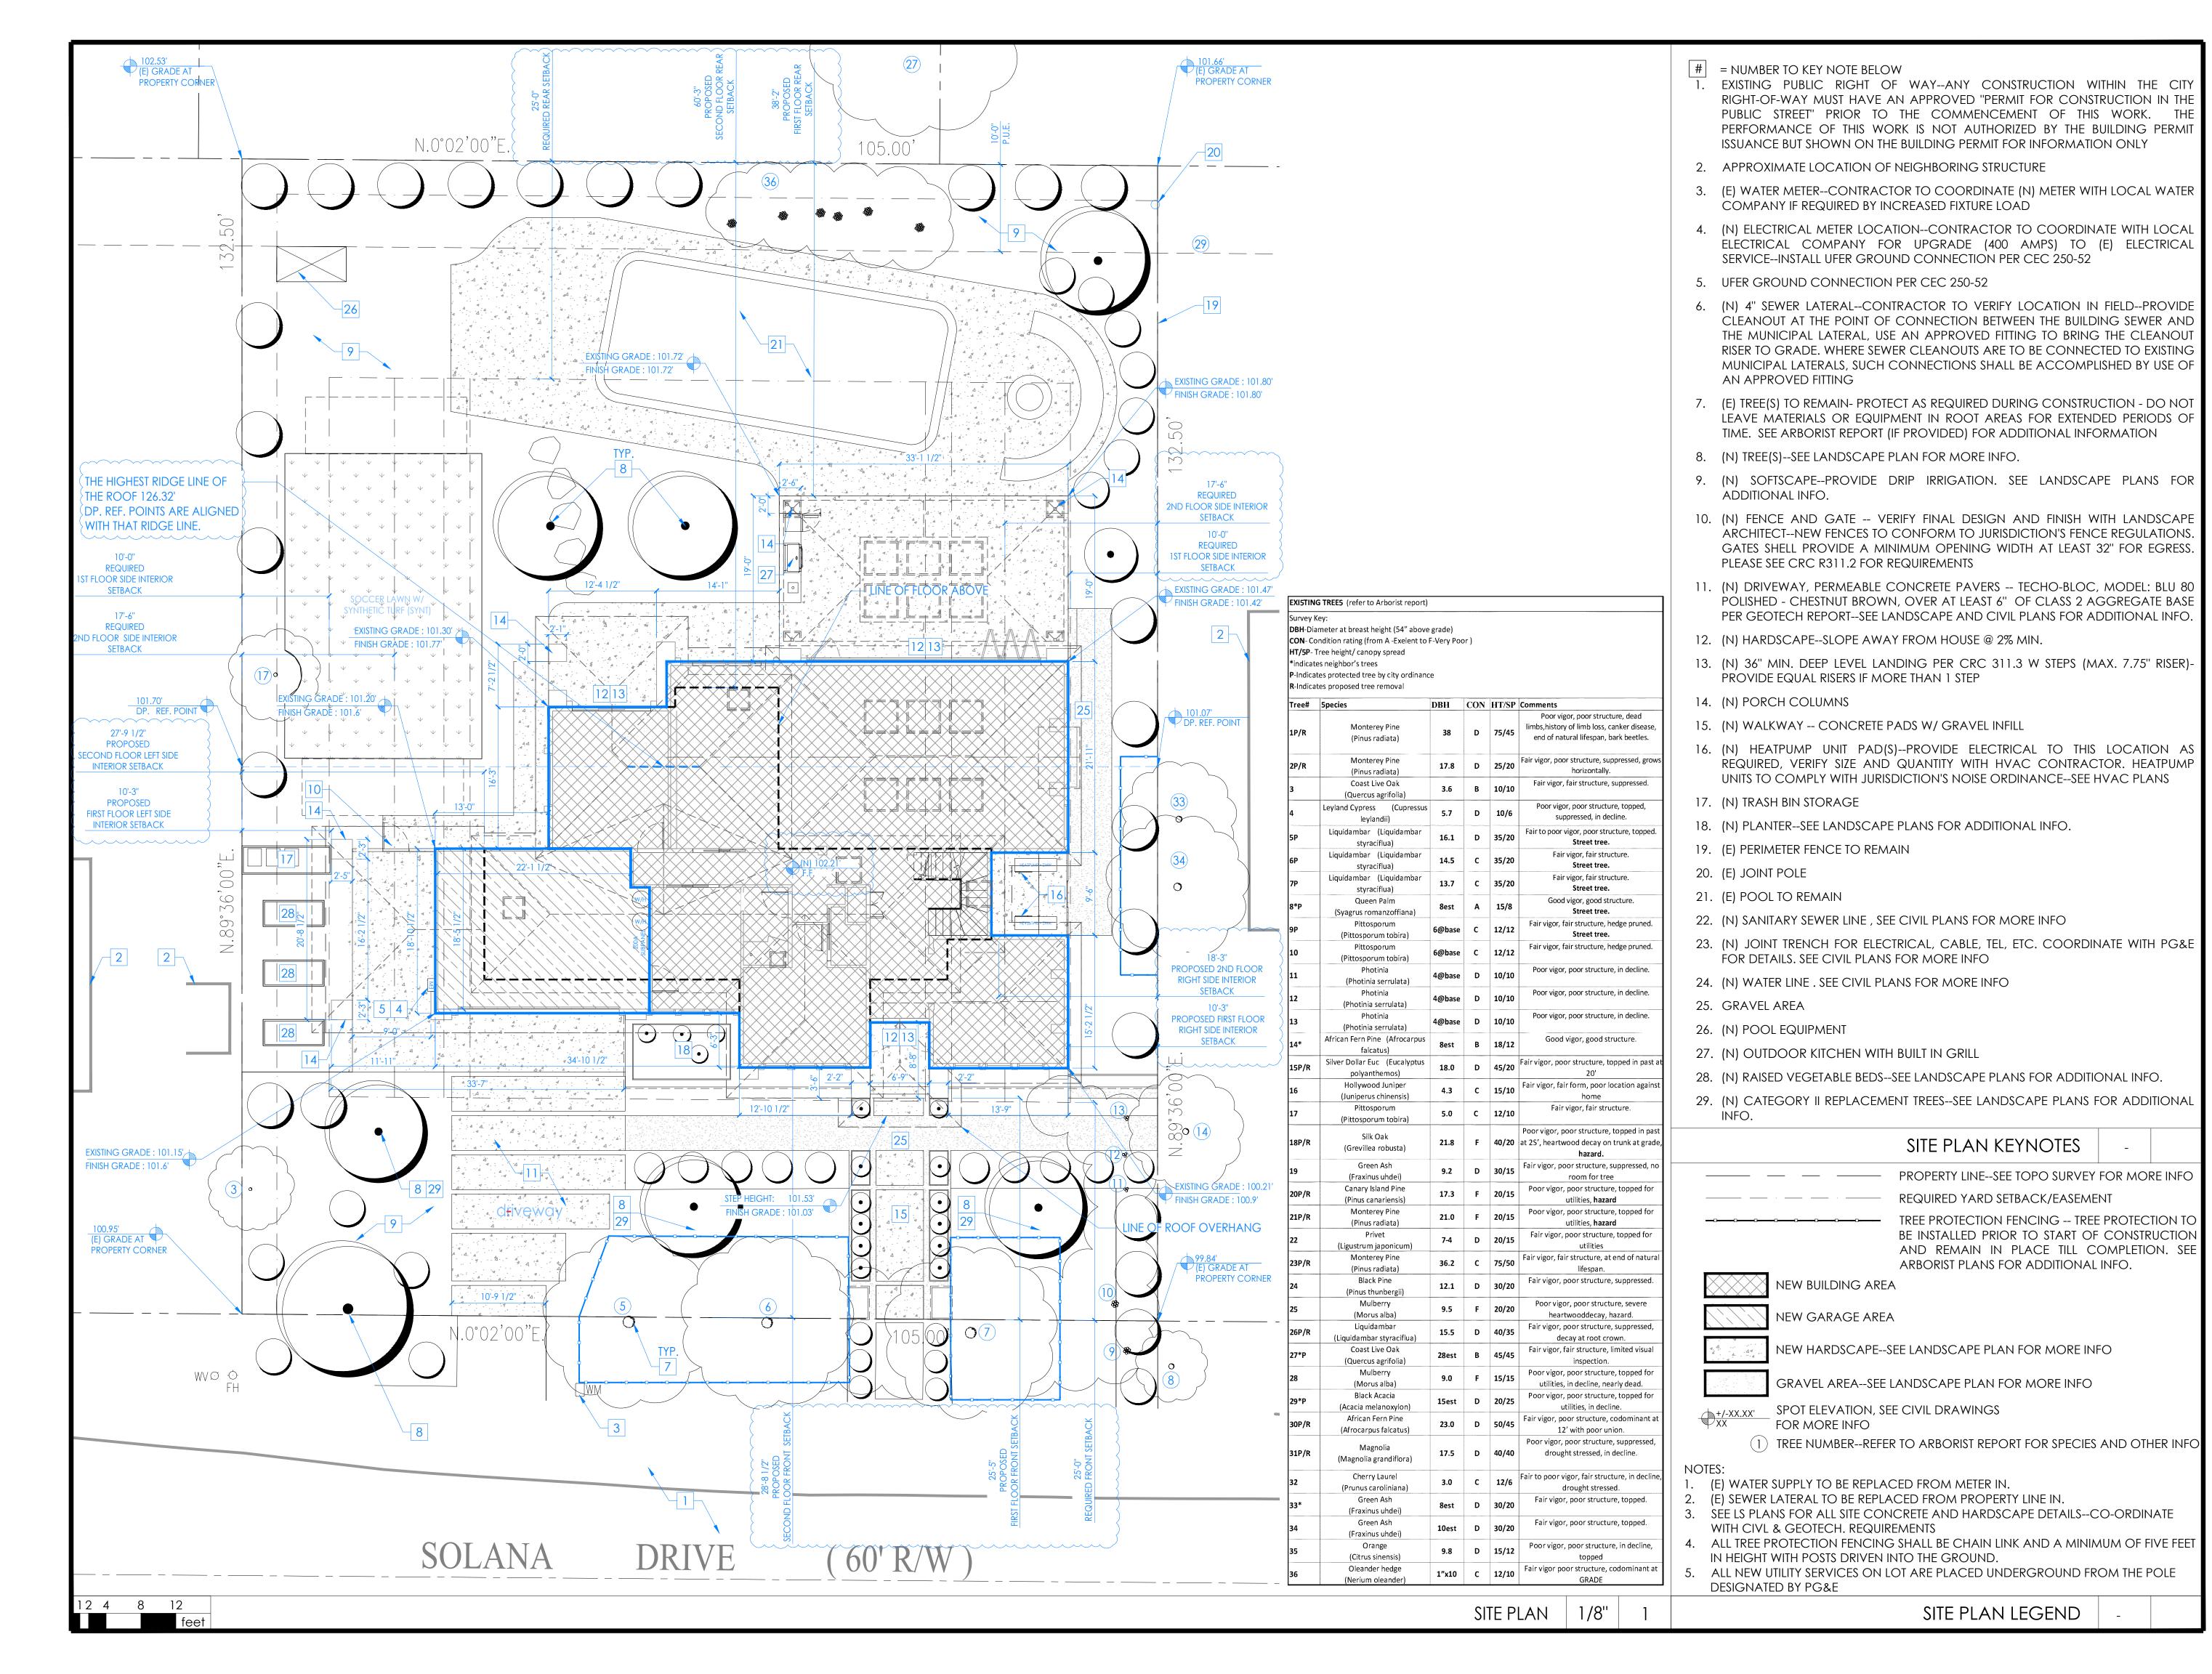



1000 S Winchester Blvd San Jose, CA 95128 P: (408) 998 - 0983

ngulo Residence
FAMILY HOUSE

S Solana Drive

22025 Bertran-Angulo Kes New SINGLE FAMILY HOUSE Los Altos, 226 Solana Driv

ARCHITECTO ARCHITECTO

PROJECT NO.

REVISION

DATE

DESCRIPTION

2023.03.31

DESIGN REVIEW PACKAGE


2023.07.10


DESIGN PACKAGE RESUBMITTAL

2023.08.11

DESIGN PACKAGE RESUBMITTAL

SITE PLAN

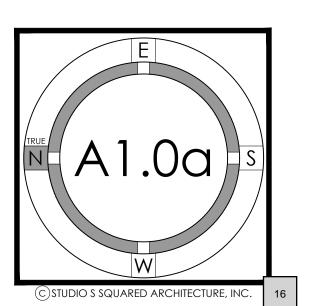

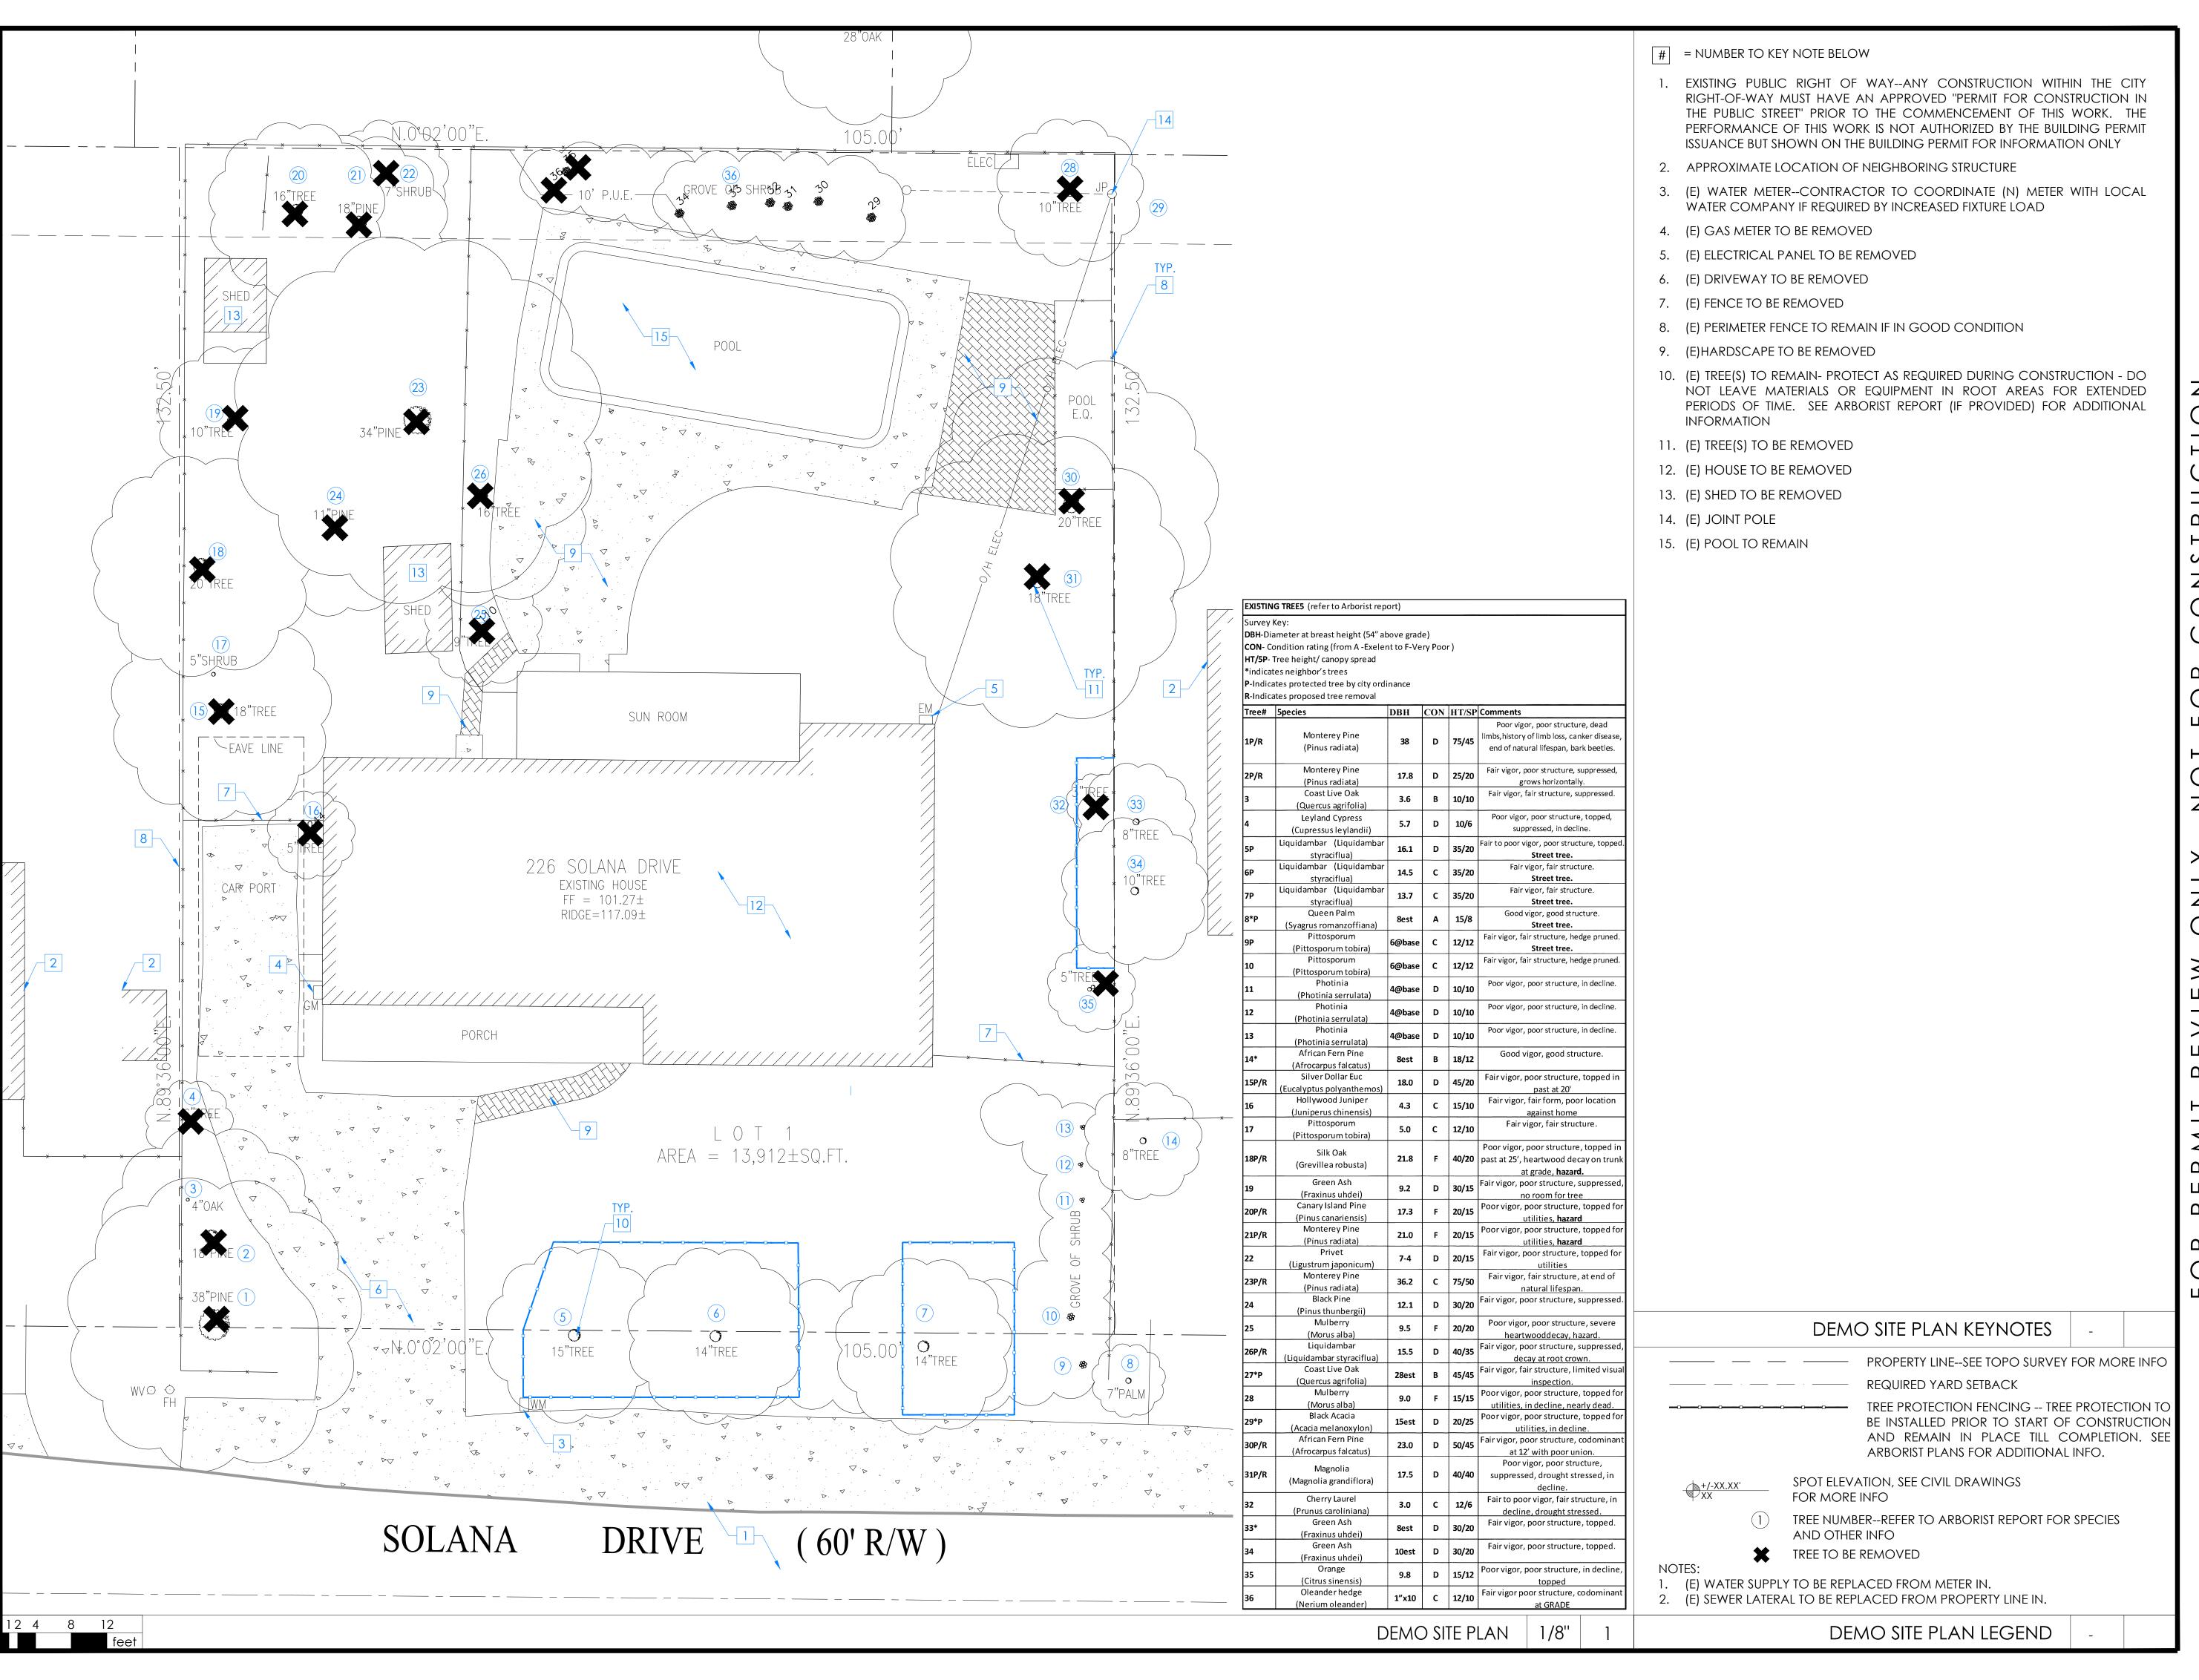





1000 S Winchester Blvd San Jose, CA 95128 P: (408) 998 - 0983


> Driv Solana

Reside 226 Altos, Los

DEMO SITE PLAN

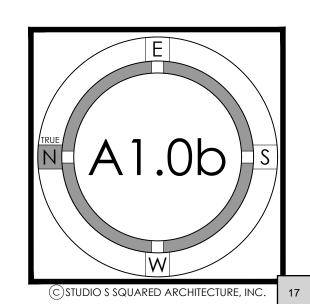

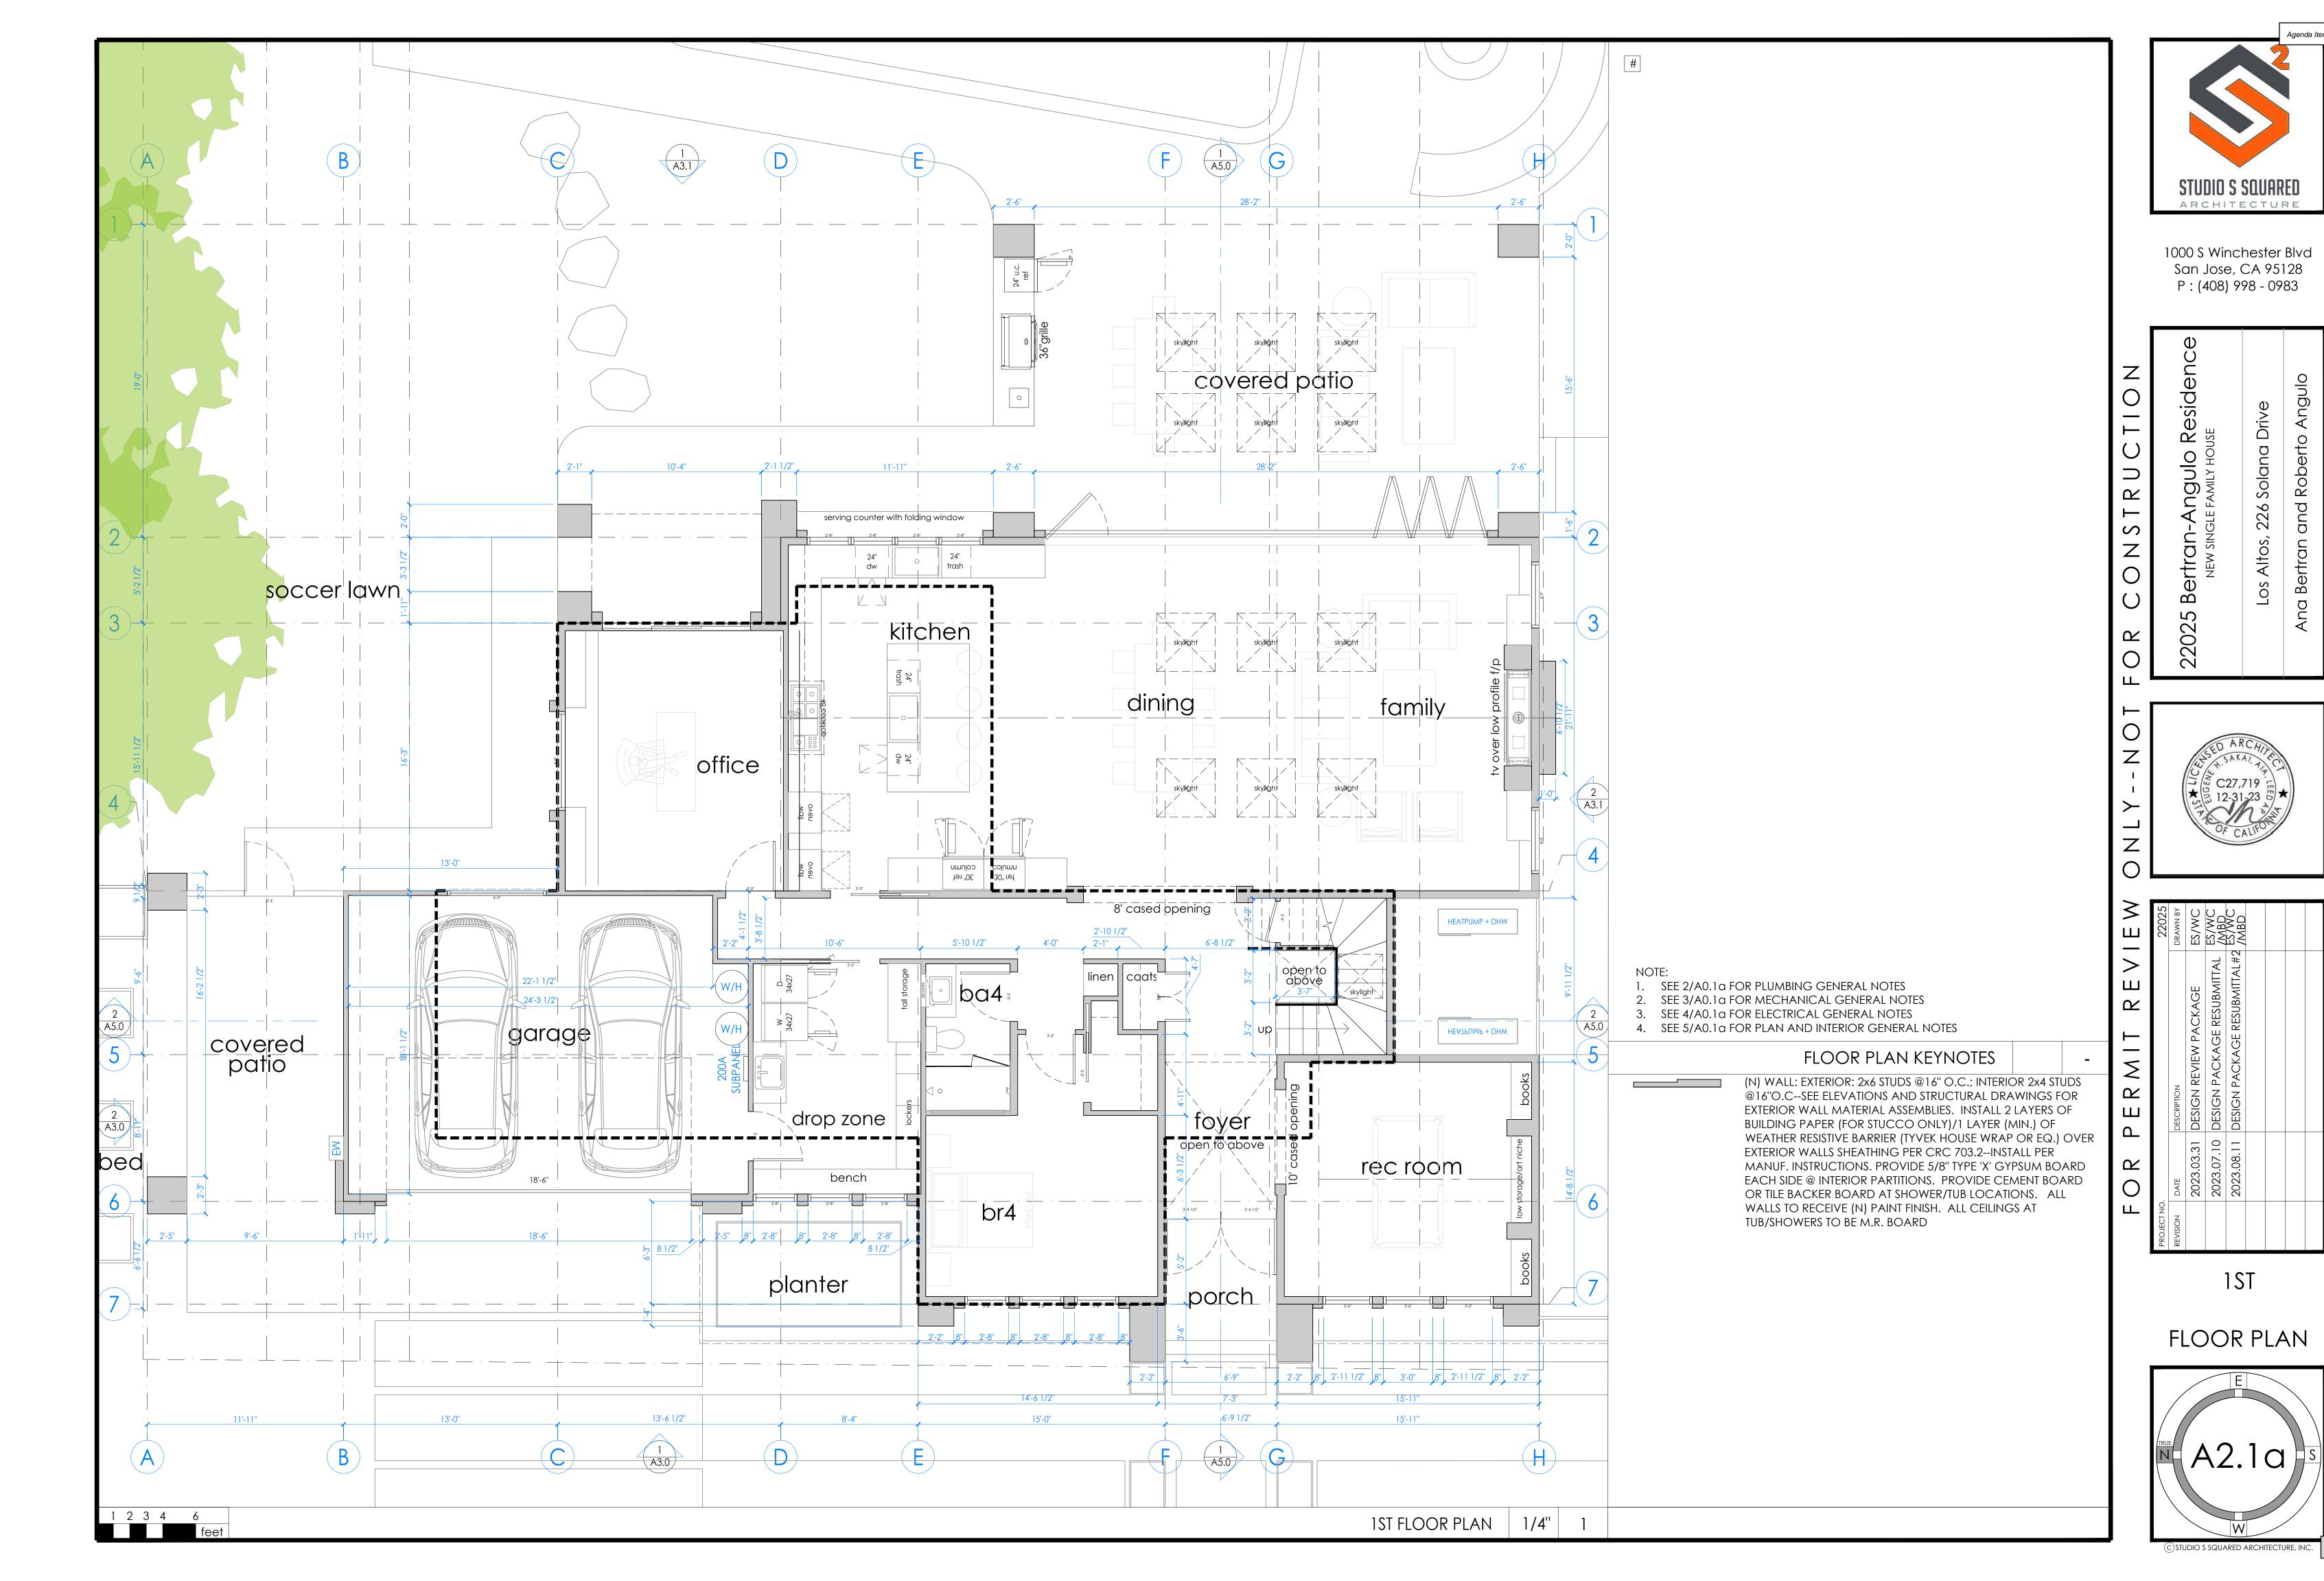

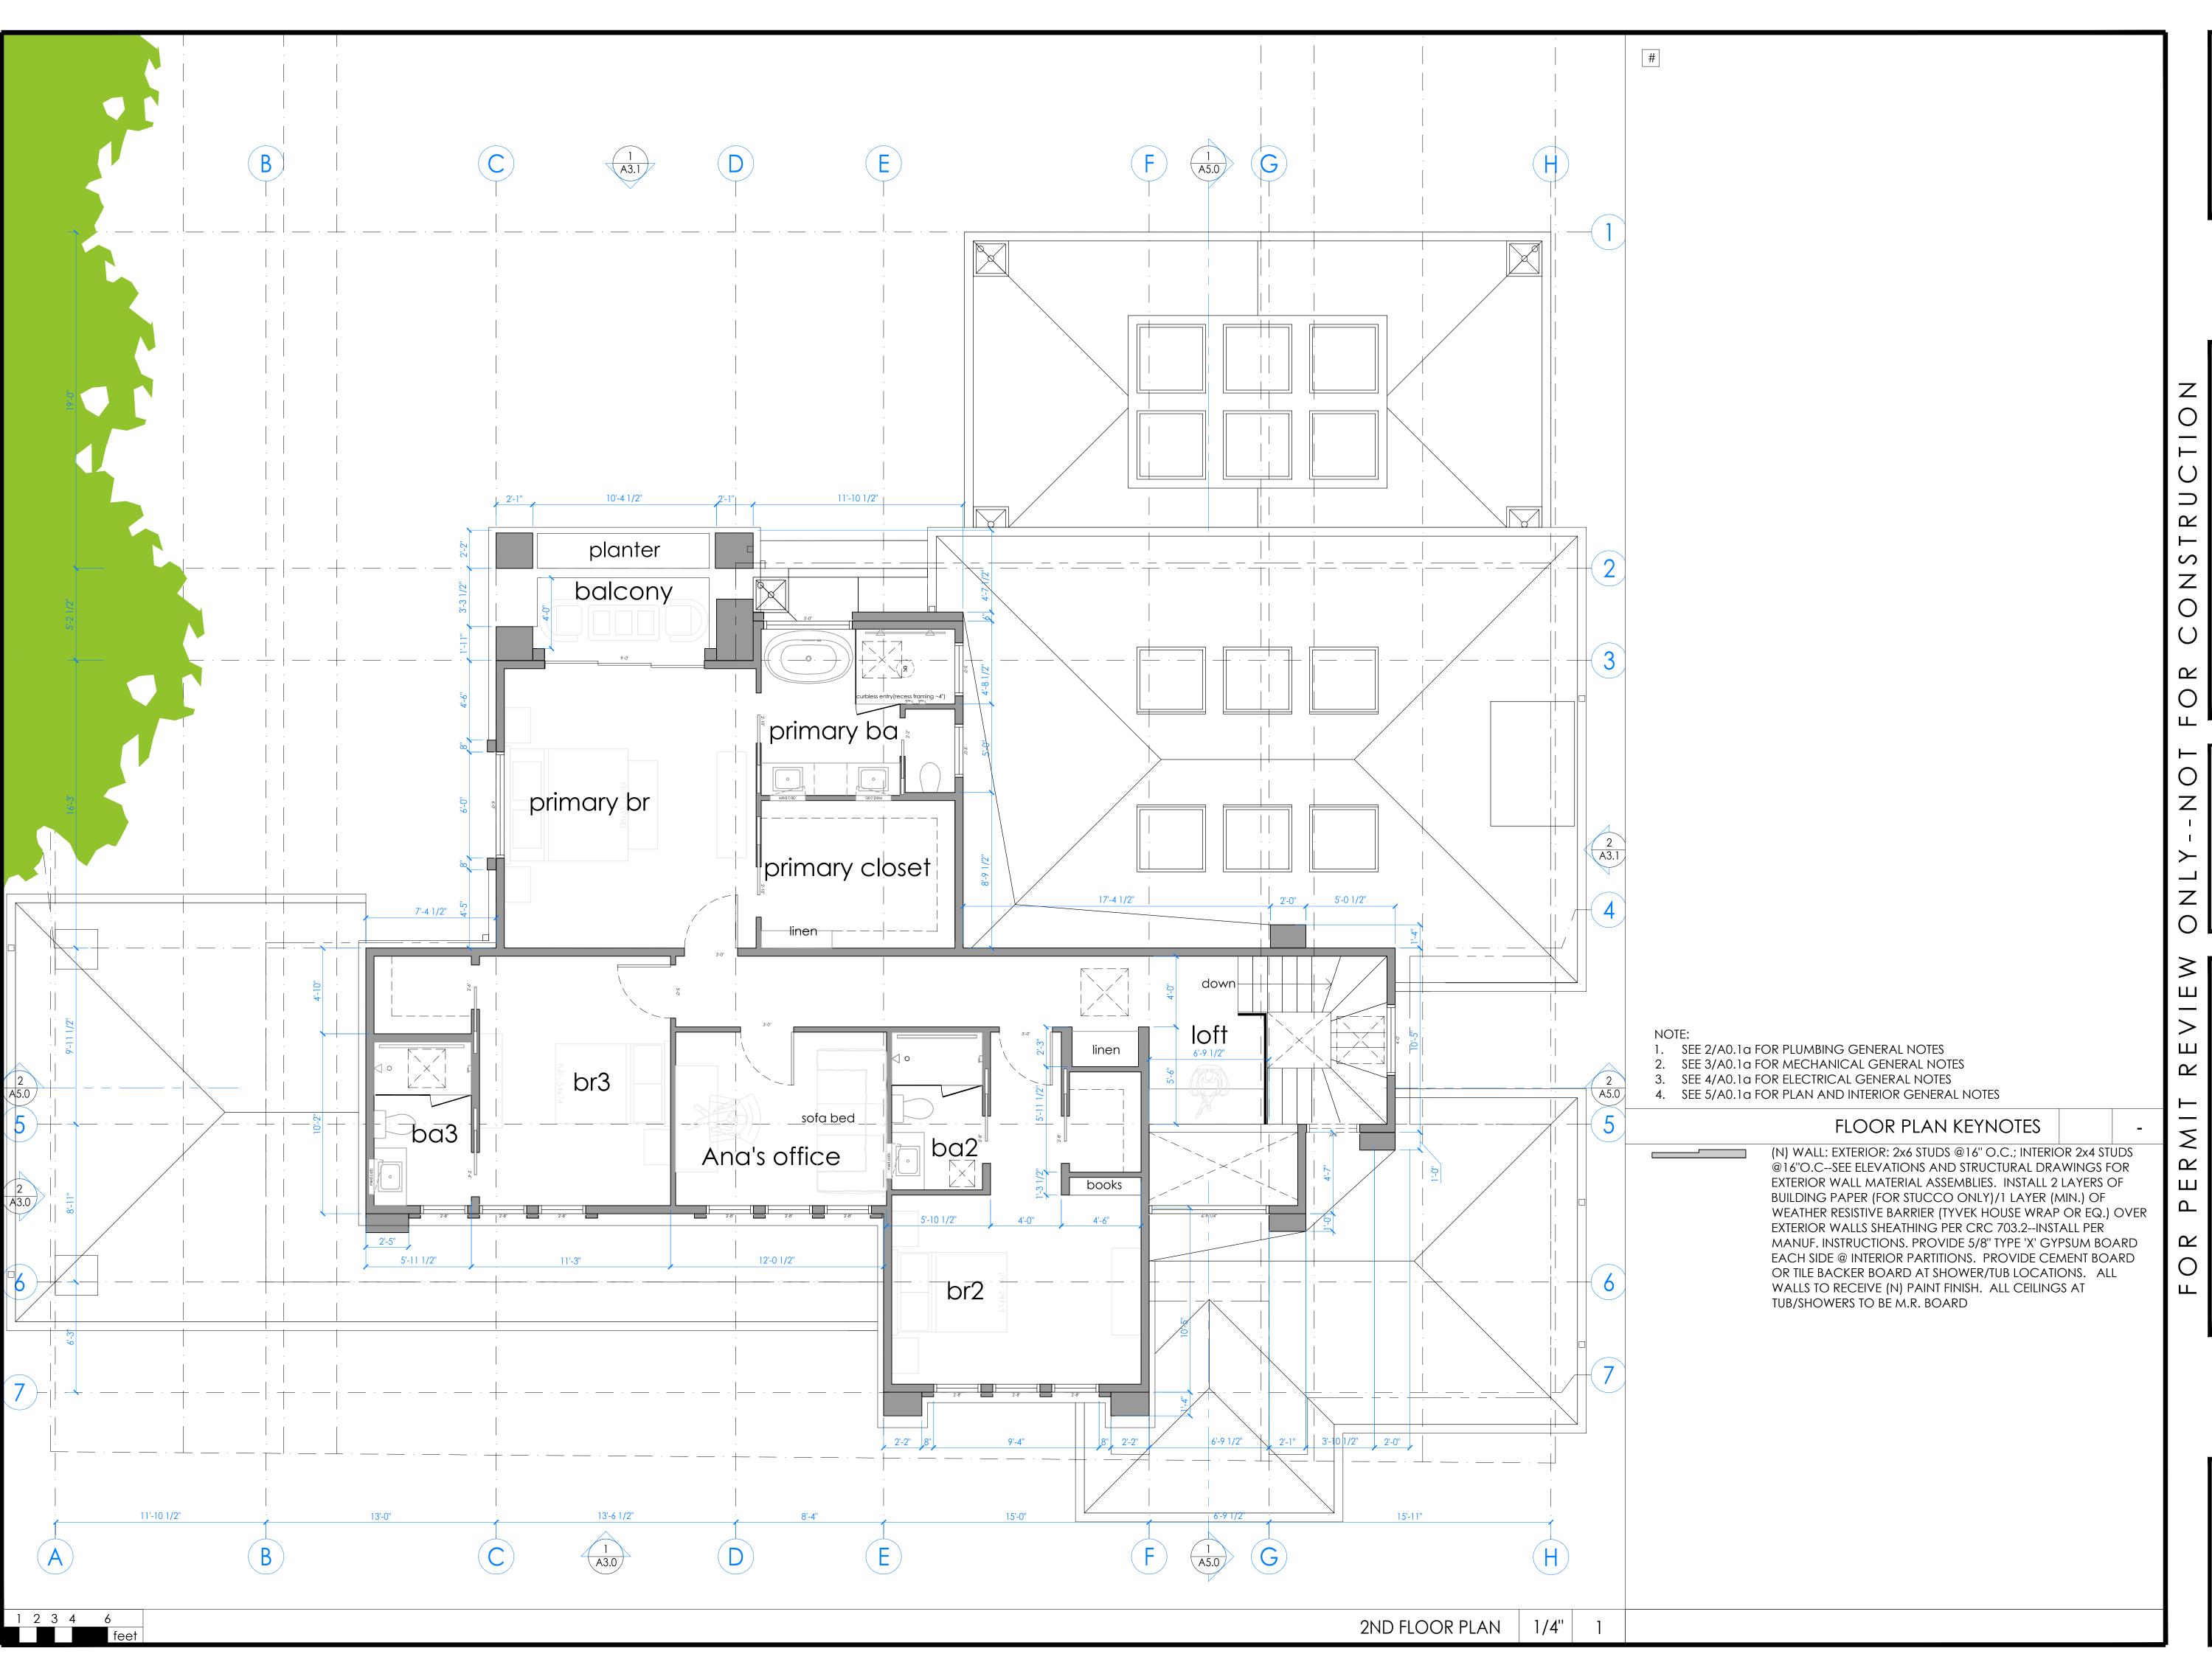

STUDIO S SQUARED


1000 S Winchester Blvd San Jose, CA 95128 P: (408) 998 - 0983

22025 Bertran-Angulo Residen NEW SINGLE FAMILY HOUSE Los Altos, 226 Solana Drive


| | ב | rekwii ke |
|---|------------|------------------------------------|
| ġ | | |
| | DATE | DESCRIPTION |
| | 2023.03.31 | 2023.03.31 DESIGN REVIEW PACKAGE |
| | 2023.07.10 | 2023.07.10 DESIGN PACKAGE RESUBMIT |
| | , , | |


2ND

FLOOR PLAN

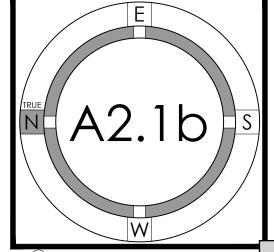

© STUDIO S SQUARED ARCHITECTURE, INC.

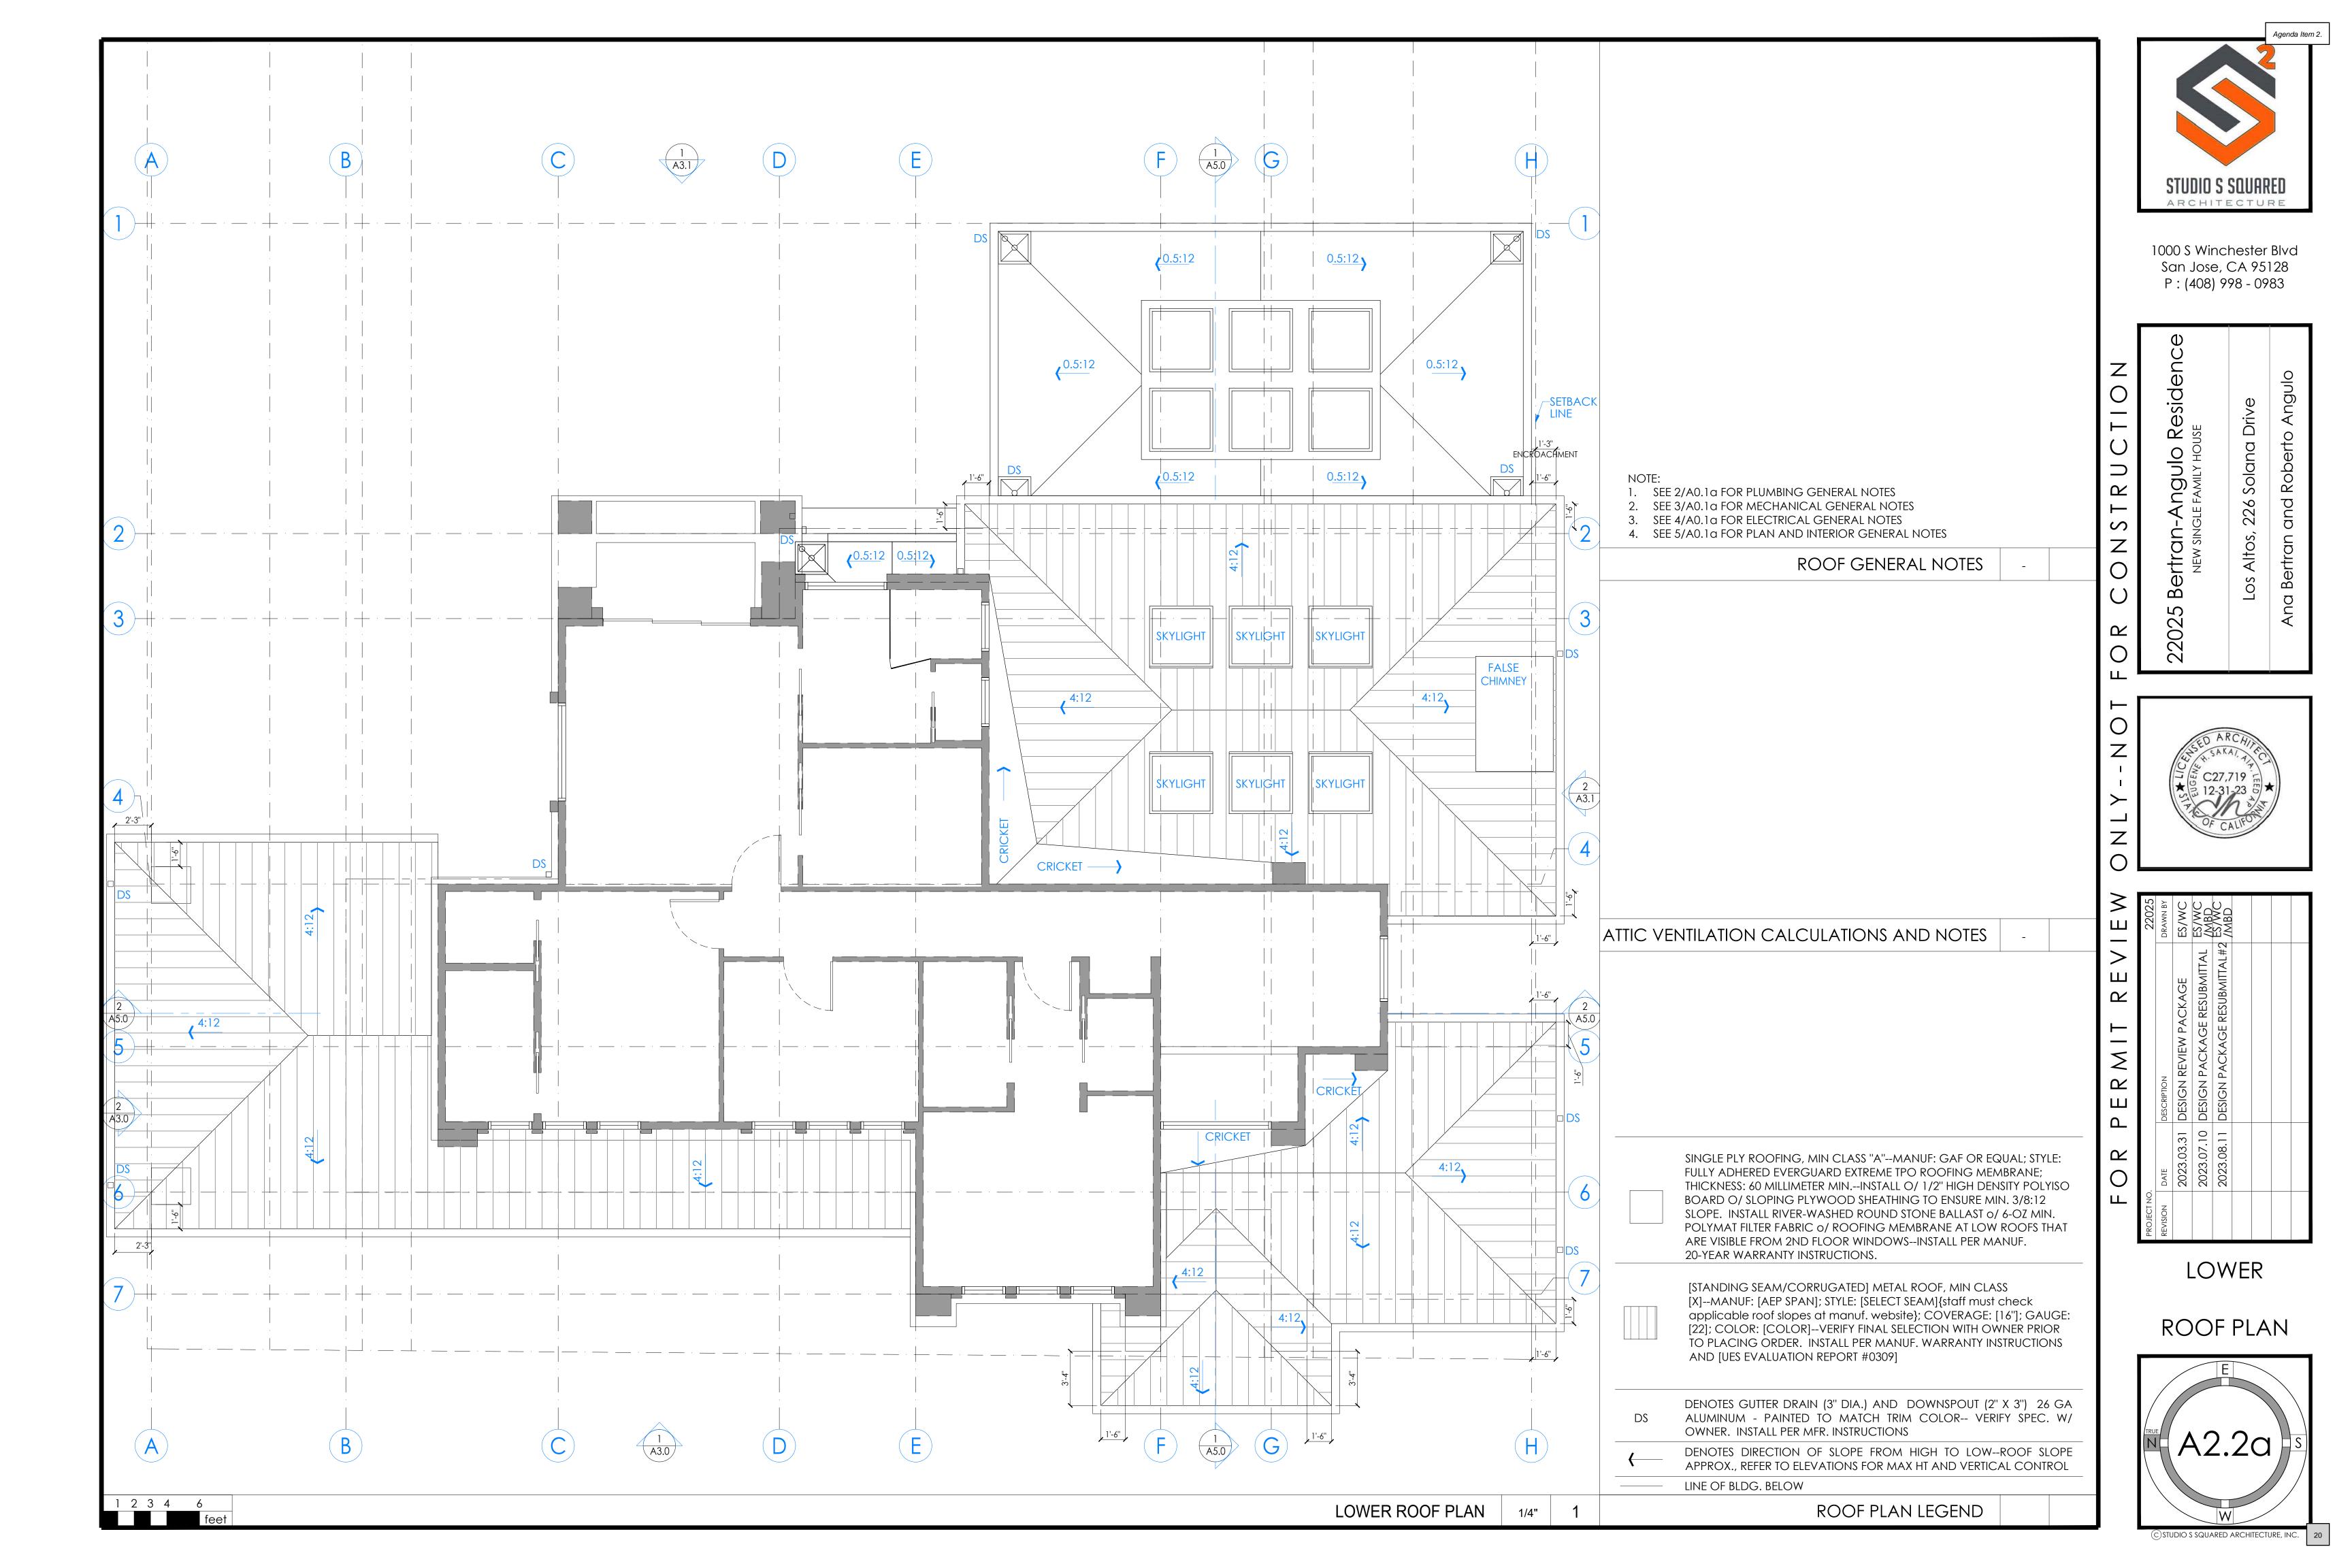

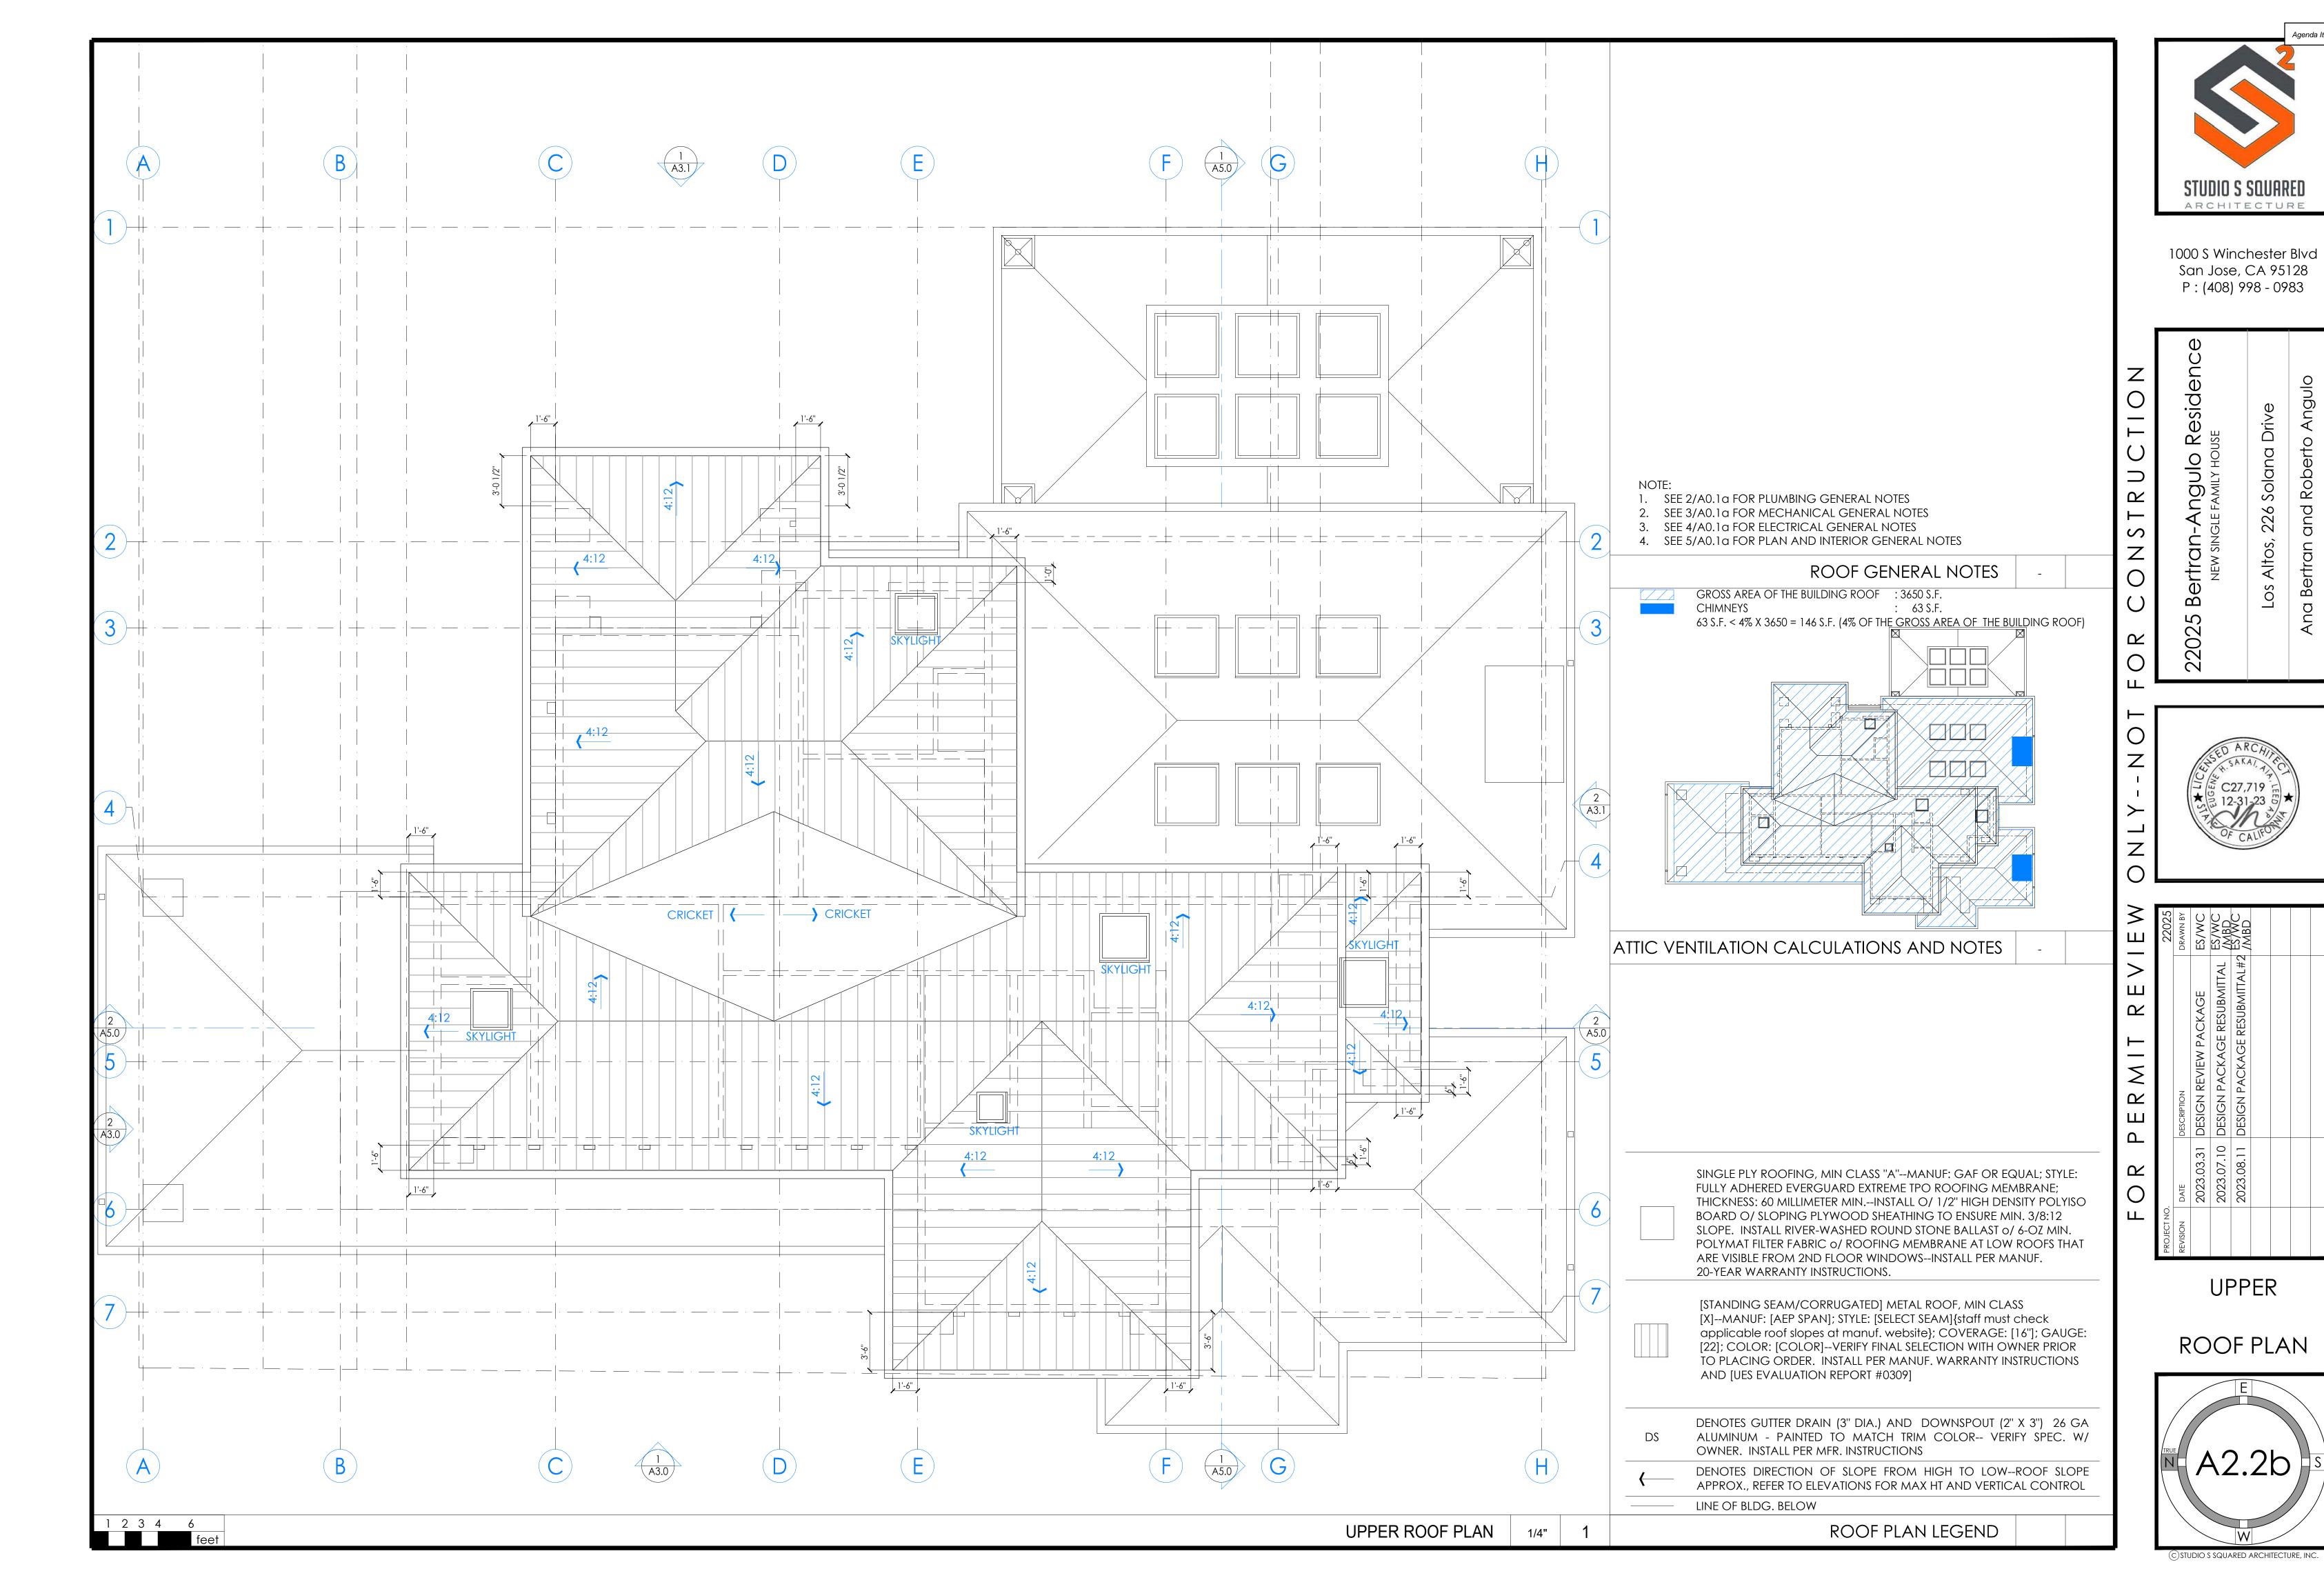



STIININ S SNIIQDEN

1000 S. Winchester Blvd San Jose, CA 95128 P: (408) 998 - 0983

ARCHITECTURE

Olugo


Bertrai

202


NEW SINGLE FAMILY HOUSE
Los Altos, 226 Solana Drive

RATCH CAD TILLE BLOCK
DESCRIPTION
DESCRIPTION
DESIGN REVIEW PACKAGE
10 DESIGN REVIEW PACKAGE RESUBMITTAL ES/WC/MBD
11 RESUBMITTAL#2
ES/WC/MBD

EXTERIOR ELEVATIONS

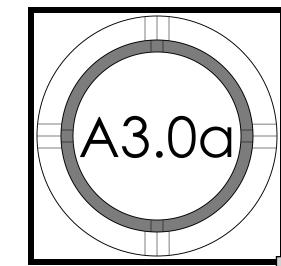

© STUDIO S SQUARED ARCHITECTURE, INC.

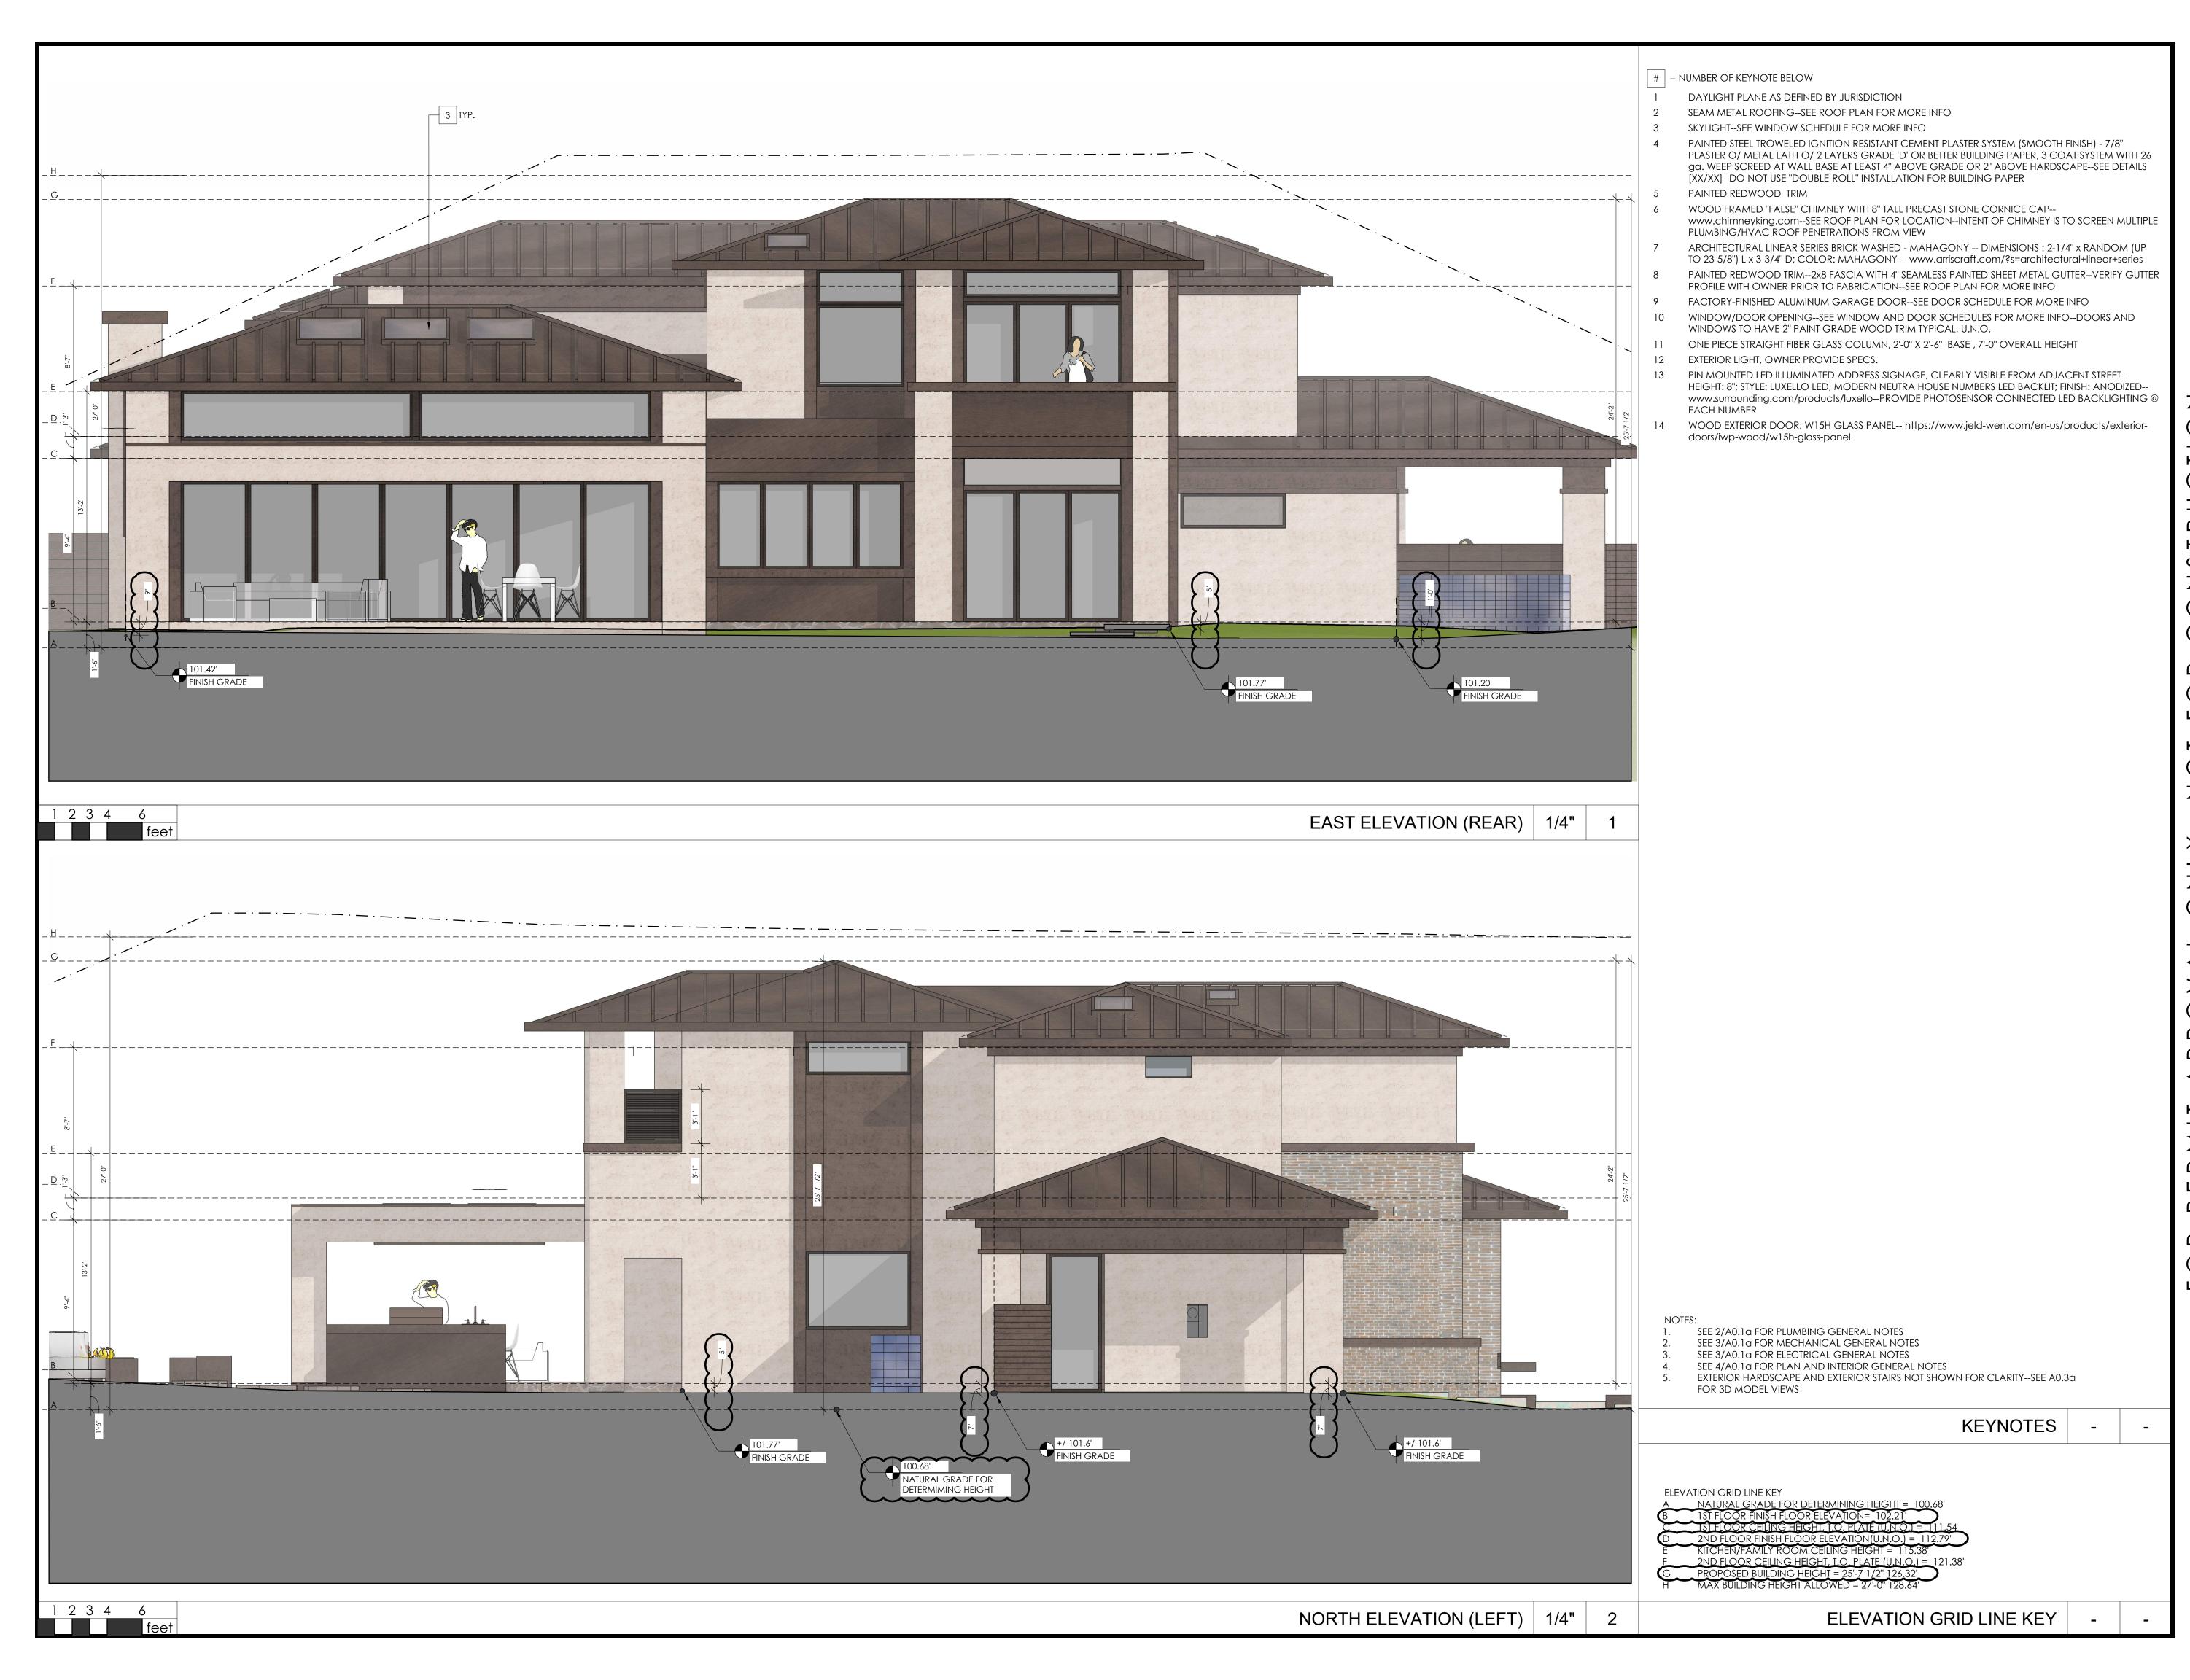

Agenda Item 2.

STUDIO S SQUARED

1000 S. Winchester Blvd San Jose, CA 95128 P: (408) 998 - 0983

ARCHITECTURE

δ 0

Bertrai

202

NEW SINGLE FAMILY HOUSE IS Altos, 226 Solana Drive

Los Altos, 226 S.

© A RCHITEC SAKAI, AJEC 12-31-23 E OF CALIFORNIA

EVISION DATE DESCRIPTION


2023.03.31 DESIGN REVIEW PACKAGE

2023.07.10 DESIGN REVIEW PACKAGE RESUBMITTAL ES/WC/MBD


2023.08.11 RESUBMITTAL#2

ES/WC/MBD

EXTERIOR ELEVATIONS

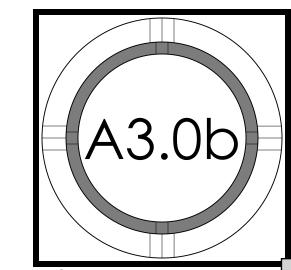

© STUDIO S SQUARED ARCHITECTURE, INC.

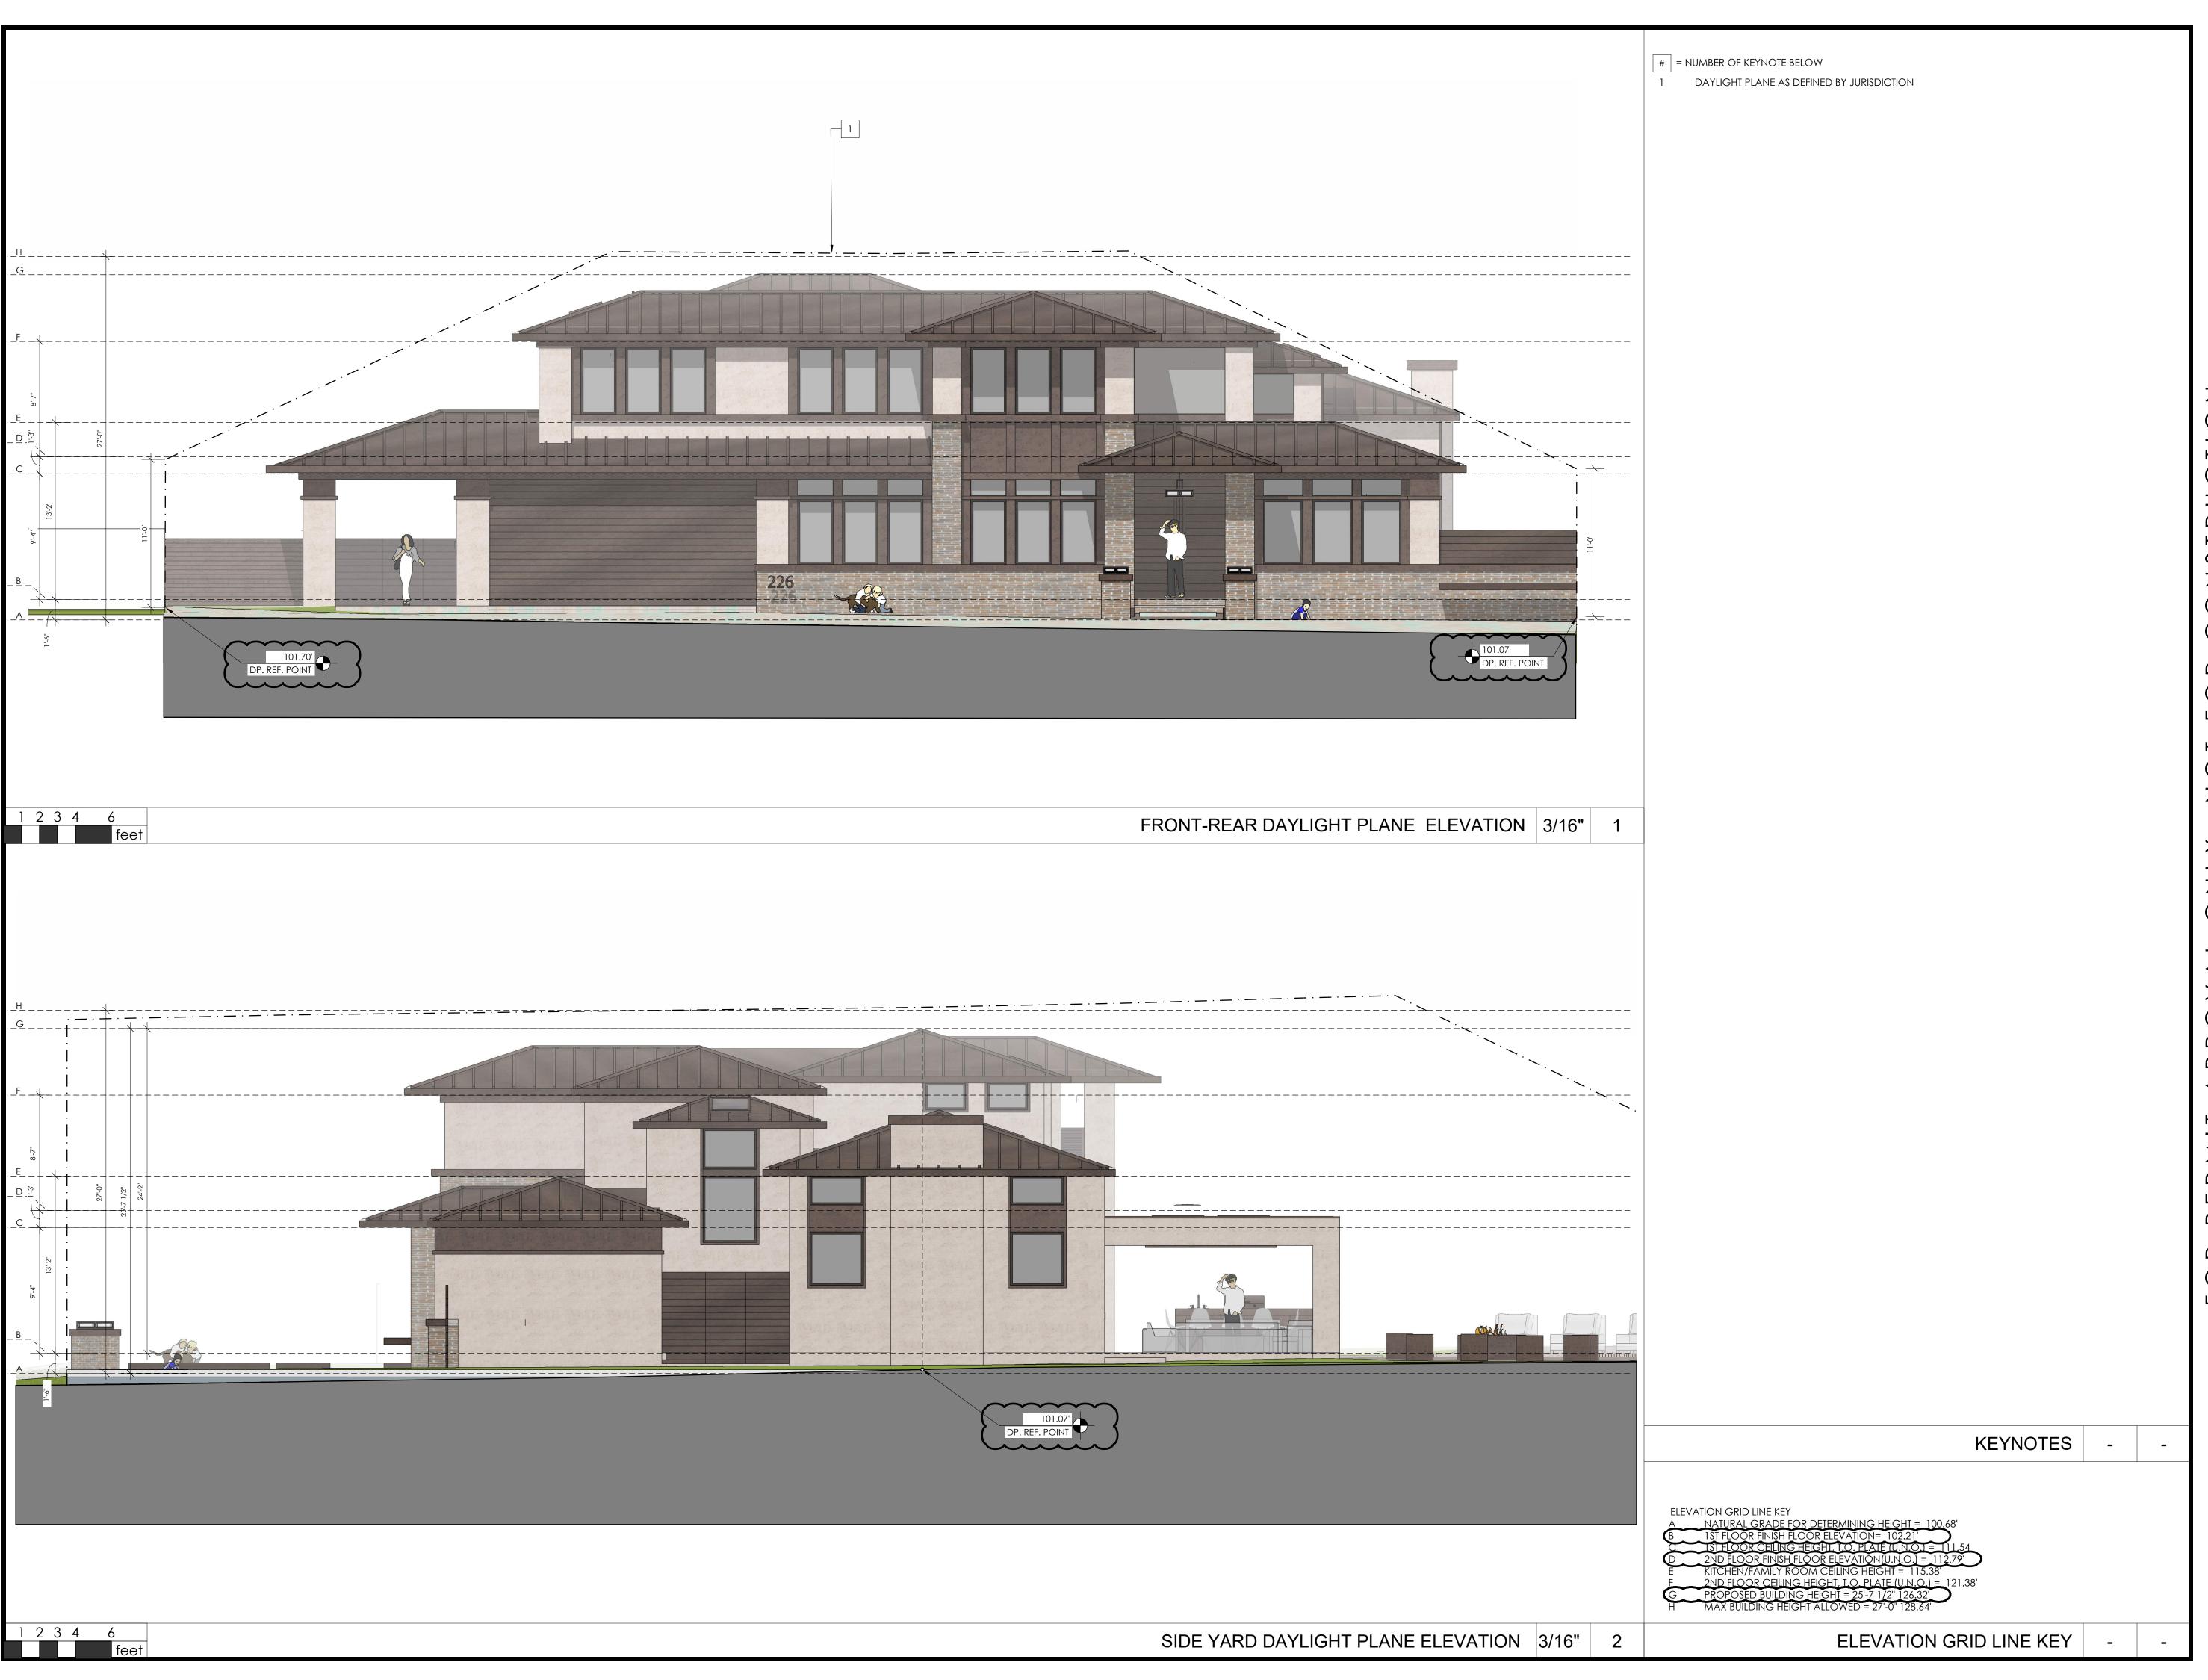




1000 S. Winchester Blvd San Jose, CA 95128 P: (408) 998 - 0983


22025 Bertran-Angulo

NEW SINGLE FAMILY HOUSI
Los Altos, 226 Solana D



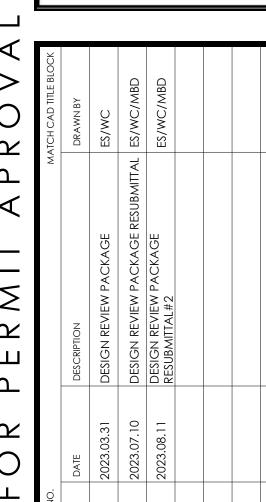

DAYLIGHT PLANE ELEVATIONS

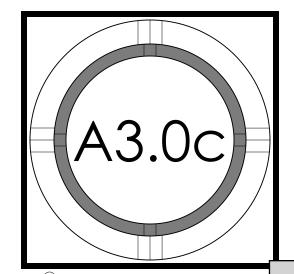


STUDIO S SQUARED ARCHITECTURE, INC.






PERSPECTIVE EXTERIOR FRONT RIGHT

1000 S. Winchester Blvd

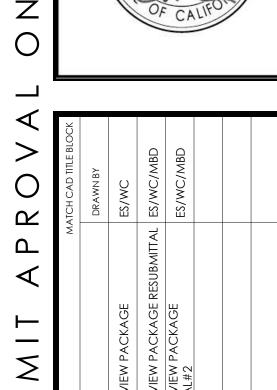

EXTERIOR PERSPECTIVES

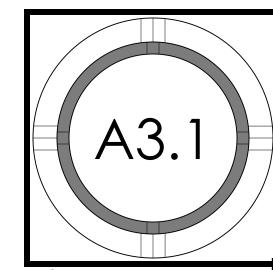

PERSPECTIVE EXTERIOR REAR RIGHT

PERSPECTIVE EXTERIOR REAR LEFT

5

PERSPECTIVE EXTERIOR REAR HIGH -

PERSPECTIVE EXTERIOR FRONT HIGH

PERSPECTIVE EXTERIOR FRONT LEFT





PERSPECTIVE EXTERIOR REAR BALCONY

PERSPECTIVE EXTERIOR FRONT ENTRY

PERSPECTIVE EXTERIOR LEFT

PERSPECTIVE EXTERIOR REAR PATIO -

PERSPECTIVE EXTERIOR FRONT TOWER -





PERSPECTIVE EXTERIOR REAR

STUDIO S SQUARED
ARCHITECTURE


1000 S. Winchester Blvd



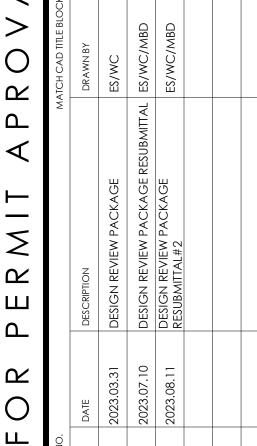

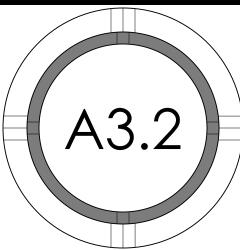



EXTERIOR PERSPECTIVES

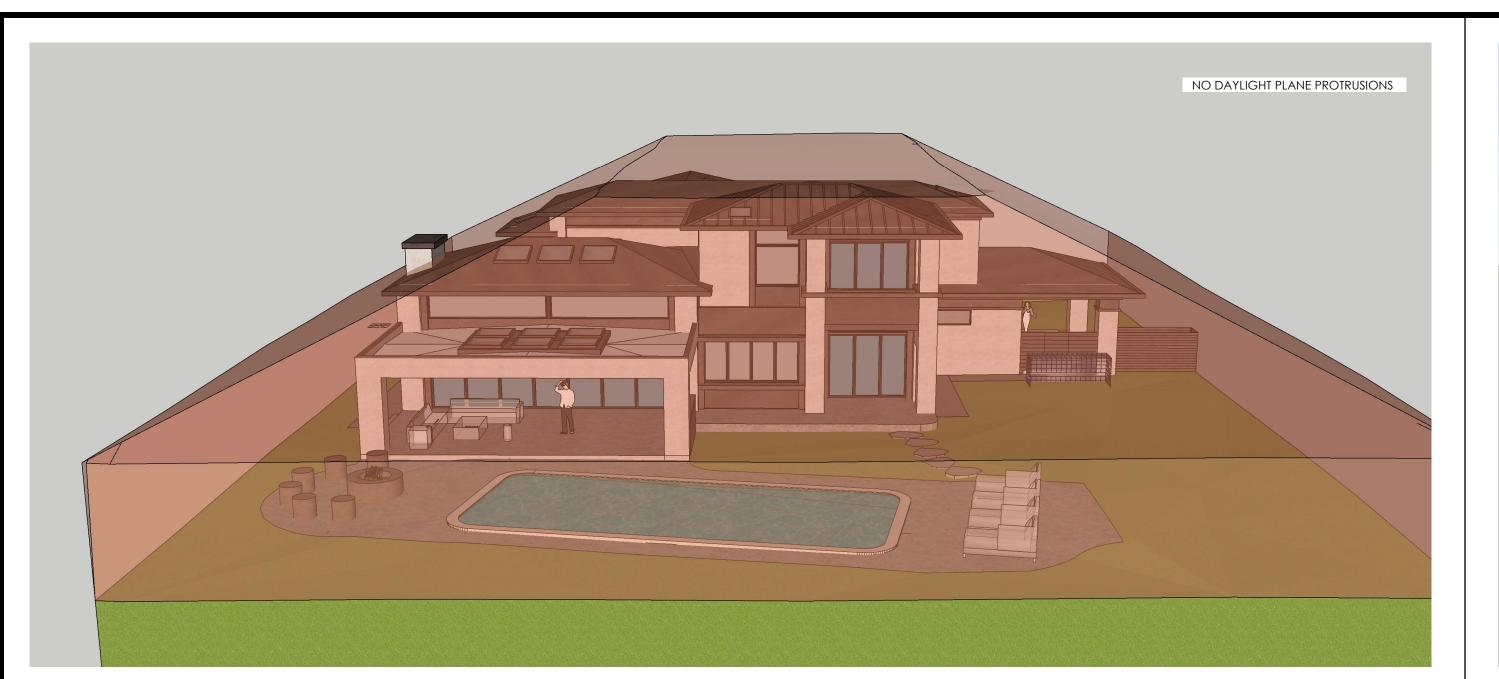




DAYLIGHT PLANE DAYLIGHT PLANE

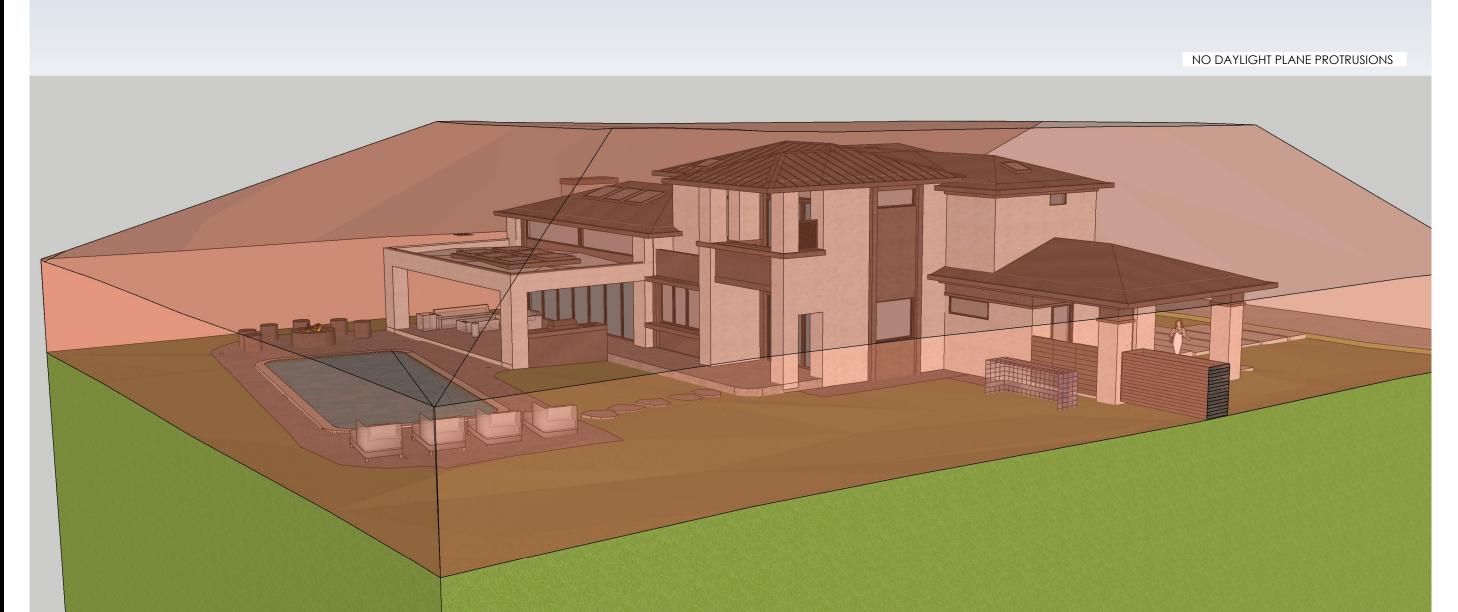

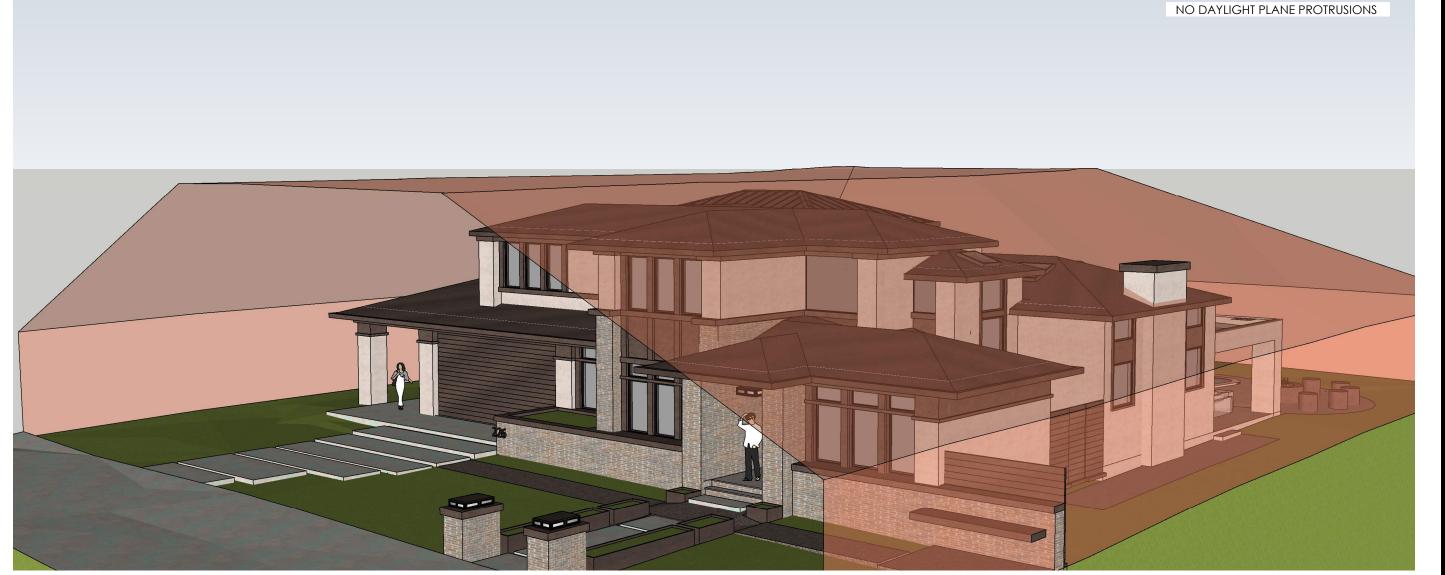

DAYLIGHT PLANE DAYLIGHT PLANE 5



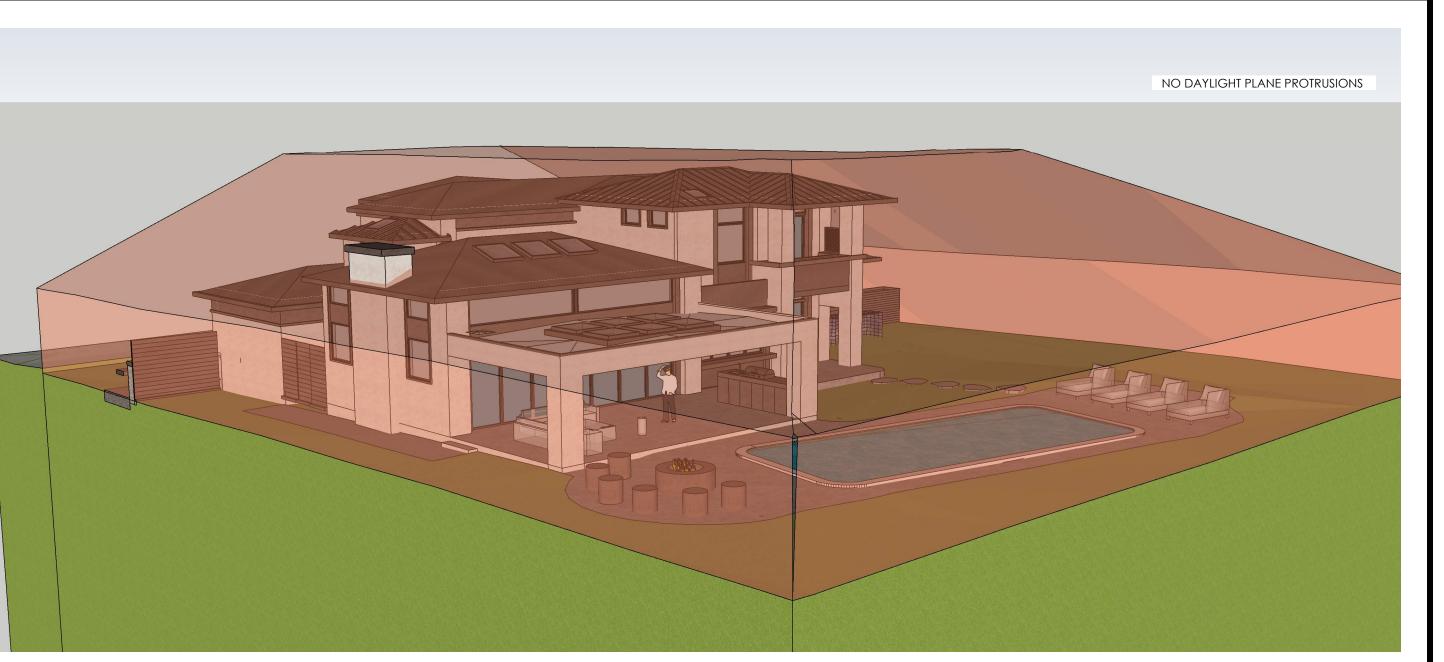


DAYLIGHT PLANE DAYLIGHT PLANE - ARCHITECTURE

1000 S. Winchester Blvd San Jose, CA 95128 P: (408) 998 - 0983




DAYLIGHT PLANE

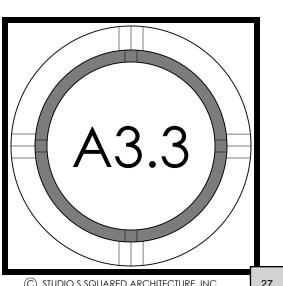




1000 S. Winchester Blvd San Jose, CA 95128 P: (408) 998 - 0983

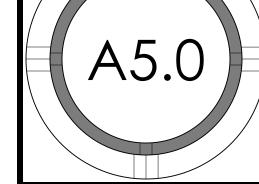



1000 S. Winchester Blvd

SECTIONS

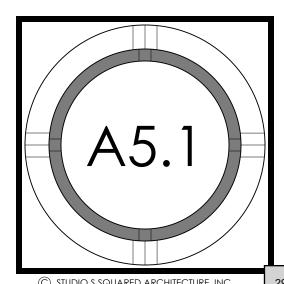

Kielty Arborist Services LLC Certified Arborist WE#10724A TRAQ Qualified P.O. Box 6187

San Mateo, CA 94403 650- 532-4418

January 30th, 2023

Ana Beltran & Roberto Angulo

Site: 226 Solana Drive, Los Altos CA

Dear Ana Beltran & Roberto Angulo,

As requested on Wednesday, November 9th, 2022, Kielty Arborist Services LLC visited the above site for the purpose of providing a Tree Inventory Report/Tree Protection Plan for the proposed construction. A new home is proposed for this site, and as needed an Arborist Report is required when submitting plans to the city of Los Altos. Site plans A1.0 through A2.1b dated 10/26/22, were reviewed for writing this report. This Tree Inventory Report/Tree protection plan is not a Tree Risk Assessment. As such, no trees were assessed for risk in accordance with industry standards, nor are there any tree risk ratings or risk mitigation recommendations provided within this preservation plan unless stated otherwise.

Method:

226 Solana

Tree# Species

34* Green Ash

All inspections were made from the ground; the trees were not climbed for this inspection. No plant tissue analysis or root crown inspections were done. The trees in question were located on an existing topography map provided by you. The trees were then measured for diameter at 48 inches above ground level (DBH or diameter at breast height). The trees were given a condition rating for form and vitality. The trees condition ratings are based on 50 percent vitality and 50 percent form, using the following scale.

> F- Very Poor **D-** Poor C- Fair **B-** Good

A- Excellent The height of the trees was measured using a Nikon Forestry 550 Hypsometer. The spread was paced off. Comments and recommendations for future maintenance are provided.

Survey Key: **DBH-**Diameter at breast height (48" above grade) **CON-** Condition rating (1-100) HT/SP- Tree height/ canopy spread *indicates neighbor's trees **P-***Indicates protected tree by city ordinance* **R-**Indicates proposed tree removal

226 Solana

having a diameter measurement of 15" or larger.

Discussion on protected trees proposed for removal:

the tree compared with average life span for that species.

economic or other enjoyment of the property.


Site Observations:

DBH CON HT/SP Comments 10est D 30/20 Fair vigor, poor structure, topped. (Fraxinus uhdei)

Suitability for preservation=Poor

35 Orange 9.8 D 15/12 Poor vigor, poor structure, in decline, (Citrus sinensis) **Suitability for preservation=Poor**

12/10 Fair vigor poor structure, codominant at 36 Oleander hedge 1"x10 C (Nerium oleander) **Suitability for preservation=Fair**

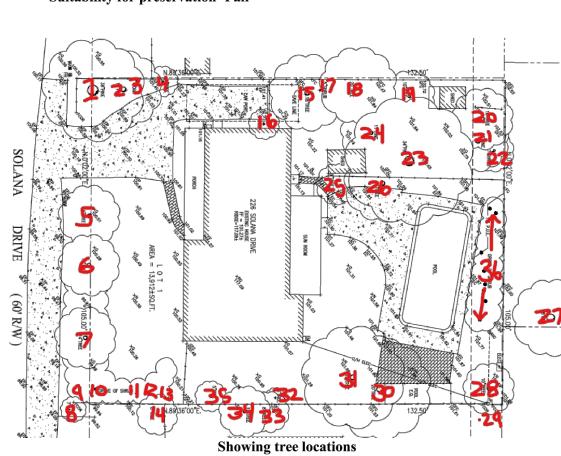

226 Solana (2)

DBH CON HT/SP Comments Tree# Species 1P/R Monterey Pine 38.0 D 75/45 Poor vigor, poor structure, dead limbs, history of limb loss, canker disease, end of (Pinus radiata) **Suitability for preservation=Poor** natural lifespan, bark beetles.

2P/R Monterey Pine 17.8 D 25/20 Fair vigor, poor structure, suppressed, grows (Pinus radiata) horizontally. Suitability for preservation=Poor

10/10 Fair vigor, fair structure, suppressed. 3 Coast Live Oak 3.6 B (Quercus agrifolia) Suitability for preservation=Good

4 Leyland Cypress 5.7 D 10/6 Poor vigor, poor structure, topped, (Cupressus leylandii) suppressed, in decline. **Suitability for preservation=Poor**

5P Liquidambar 16.1 D 35/20 Fair to poor vigor, poor structure, topped. (Liquidambar styraciflua) Street tree. Suitability for preservation=Fair

6P Liquidambar 14.5 C 35/20 Fair vigor, fair structure. (Liquidambar styraciflua) Street tree. Suitability for preservation=Fair

7P Liquidambar 13.7 C 35/20 Fair vigor, fair structure. (Liquidambar styraciflua) Street tree. **Suitability for preservation=Fair**

8est A 15/8 Good vigor, good structure. 8*P Queen Palm (Syagrus romanzoffiana) Street tree.

Suitability for preservation=Good

9P Pittosporum 6@base C 12/12 Fair vigor, fair structure, hedge pruned. (Pittosporum tobira) Street tree. Suitability for preservation=Fair

10 Pittosporum 6@base C 12/12 Fair vigor, fair structure, hedge pruned. (Pittosporum tobira) Suitability for preservation=Fair

4@base D 10/10 Poor vigor, poor structure, in decline. (Photinia serrulata) Suitability for preservation=Poor

The landscape at 226 Solana Drive is in poor condition. The site looks to be in disrepair and a

large percentage of trees are in decline. No landscape maintenance or tree maintenance has

protected trees. Trees #2, 15, 18, 20, 21, 23, 26, 27, 29, 30, and 31 are protected trees due to

Monterey pine trees are native to Monterey where they can live up to 120 years. Beyond the fog

shorter and the species can live anywhere from 50-60 years. The lifespan of Monterey Pine trees

outside their native habitat is very short when compared to native oak trees that can live upwards

of 250-300 years. Years of drought stress have stressed the species throughout the Bay Area and

has made the species more vulnerable to insect attack and disease. Bark beetles, specifically the

ips beetle, is the most destructive for the species, as the beetle bores into the tree and destroy the

vascular system of the species causing the trees to not be able to transport water from tree roots

to the foliage or food from foliage to the tree roots. Bark beetles can quickly kill the species and

the trees can go from a green canopy to a red canopy within a matter of weeks. Bark beetle frass and pitch tubes were observed on Monterey Pine tree #1. Large areas of die back and dead wood

suppressed growing conditions grows horizontally. Monterey Pine tree #21 has been topped for

line clearance and has very poor structure as a result. Pine trees #1, 2, and #21 are all in poor to

hazardous to the site and expected to die regardless of tree management. The trees are all near

the end of their natural lifespan within the landscape and have a poor suitability for preservation

rating. The trees meet the following criteria for protected tree removal in the city of Los Altos:

existing or proposed structures and interference with utility services. The approximate age of

Monterey Pine tree #23 is the only pine tree in fair condition. This tree is the largest pine tree on

the property and is poorly located within the buildable area for the site. The tree is at the end of

sense to design around the tree only to have the tree die within a few years. The presence of bark

decline. The tree meet the following criteria for protected tree removal in the city of Los Altos:

existing or proposed structures and interference with utility services. The approximate age of

the tree compared with average life span for that species. The necessity to remove the tree for

its natural lifespan within the landscape. Tree removal is recommended as the tree has a poor

suitability for preservation within the landscape due to the age of the tree. It does not make

beetles, and pine pitch canker disease on the site will likely increase the speed to the trees

The condition of the tree with respect to disease, imminent danger of falling, proximity to

were observed in the canopy of the tree. Canker disease caused die back was also observed. Monterey Pine tree #2 is growing underneath the canopy of Monterey Pine tree #1 and due to the

very poor condition due to bark beetle attack, pine pitch canker disease, and poor past

maintenance (topped tree #21). Tree removal is recommended for these trees as they are

The condition of the tree with respect to disease, imminent danger of falling, proximity to

taken place on site. Trees #1, and #5-9 are located within the public right of way and are

Four large, protected Monterey pine trees were observed on site (trees #1, 2, 21, and 23).

belt, in hotter drier areas, such as Los Altos, the lifespan of a Monterey Pine is significantly

226 Solana (3)

DBH CON HT/SPComments **Tree# Species** 12 Photinia 4@base D 10/10 Poor vigor, poor structure, in decline. (Photinia serrulata) **Suitability for preservation=Poor**

4@base D 10/10 Poor vigor, poor structure, in decline. 13 Photinia (Photinia serrulata) Suitability for preservation=Poor

14* African Fern Pine 8est B 18/12 Good vigor, good structure. (Afrocarpus falcatus) **Suitability for preservation=Good**

15P/R Silver Dollar Euc 18.0 D 45/20 Fair vigor, poor structure, topped in past at (Eucalyptus polyanthemos) Suitability for preservation=Poor

16 Hollywood Juniper 4.3 C 15/10 Fair vigor, fair form, poor location against (Juniperus chinensis) Suitability for preservation=Poor

17 Pittosporum 5.0 50 12/10 Fair vigor, fair structure. (Pittosporum tobira) Suitability for preservation=Fair

18**P/R** Silk Oak 40/20 Poor vigor, poor structure, topped in past at 21.8 F (Grevillea robusta) 25', heartwood decay on trunk at grade, **Suitability for preservation=Poor**

9.2 D 30/15 Fair vigor, poor structure, suppressed, no 19 Green Ash (Fraxinus uhdei) room for tree.

Suitability for preservation=Poor 20P/R Canary Island Pine 17.3 F 20/15 Poor vigor, poor structure, topped for (Pinus canariensis) utilities, hazard.

Suitability for preservation=Poor

21**P/R** Monterey Pine 21.0 F 20/15 Poor vigor, poor structure, topped for (Pinus radiata) utilities, hazard. Suitability for preservation=Poor

20/15 Fair vigor, poor structure, topped for (Ligustrum japonicum) utilities. Suitability for preservation=Poor

226 Solana

Suitability for preservation=Poor

(Morus alba)

(Afrocarpus falcatus)

Suitability for preservation=Poor

DBH CON HT/SP Comments **Tree# Species** 23P/R Monterey Pine 36.2 C 75/50 Fair vigor, fair structure, at end of natural (Pinus radiata) lifespan.

12.1 D 30/20 Fair vigor, poor structure, suppressed. 24 Black Pine (Pinus thunbergii) Suitability for preservation=Poor

20/20 Poor vigor, poor structure, severe heartwood 25 Mulberry (Morus alba) decay, **hazard.** Suitability for preservation=Poor

26**P/R** Liquidambar 40/35 Fair vigor, poor structure, suppressed, decay (Liquidambar styraciflua) at root crown. **Suitability for preservation=Poor**

45/45 Fair vigor, fair structure, limited visual 27*P Coast Live Oak 28est B (Quercus agrifolia) inspection.

Suitability for preservation=Good 28 Mulberry 15/15 Poor vigor, poor structure, topped for

utilities, in decline, nearly dead.

with poor union.

20/25 Poor vigor, poor structure, topped for 29*P Black Acacia 15est D (Acacia melanoxylon) utilities, in decline.

Suitability for preservation=Poor 30P/R African Fern Pine 23.0 D 50/45 Fair vigor, poor structure, codominant at 12'

Suitability for preservation=Poor 31P/R Magnolia 40/40 Poor vigor, poor structure, suppressed, 17.5 D

(Magnolia grandiflora) drought stressed, in decline. Suitability for preservation=Poor 12/6 Fair to poor vigor, fair structure, in decline, 32 Cherry Laurel 3.0 C

(Prunus caroliniana) drought stressed. Suitability for preservation=Fair

33* Green Ash 30/20 Fair vigor, poor structure, topped. (Fraxinus uhdei) Suitability for preservation=Poor

226 Solana

the past topping cut. The risk of future limb/leader failure is high with the topped Eucalyptus tree. The tree has a poor suitability for preservation within the landscape. Removal and replacement is recommended as no mitigation measures are expected to improve risk of leader failure. The tree meets the following criteria for protected tree removal in the city of Los Altos: The condition of the tree with respect to disease, imminent danger of falling, proximity to existing or proposed structures and interference with utility services.



Silk Oak tree #18 is in very poor condition. The vigor and structure of the tree are both poor. This tree, like eucalyptus tree #15 has been topped in the past at 25'. Heartwood decay at the tree's root crown was observed. Risk of tree failure is high with no mitigation measures expected to improve risk of tree failure. Tree removal is recommended as the tree is a hazard to the property. The tree meets the following criteria for protected tree removal in the city of Los Altos: *The condition of the* tree with respect to disease, imminent danger of falling, proximity to existing or proposed structures and interference with utility services.

Showing decay at root crown



Canary Island Pine tree #20 was given a very poor condition rating (F). The tree is in severe decline due to being continuously topped for utility line clearance. Tree removal is recommended as the tree is interfering with utility lines and is a hazard to the site. The tree is not expected to survive more than a couple of years regardless of management. The tree meets the following criteria for protected tree removal in the city of Los Altos: *The* condition of the tree with respect to disease, imminent danger of falling, proximity to existing or proposed structures and interference with utility services.

Showing leaning and topped Canary Island Pine tree

S Z

C27,719

STUDIO S SQUARED

ARCHITECTURE

1000 S Winchester Blvd

San Jose, CA 95128

P: (408) 998 - 0983

Driv

Ō

Solar

9

22

Altos,

OS

Rob

 ∇

esiden

& 5

Angulo I

ertran-NEW SING


 $\mathbf{\tilde{\Omega}}$

2

 \mathcal{C}

20

ARBORIST REPORT

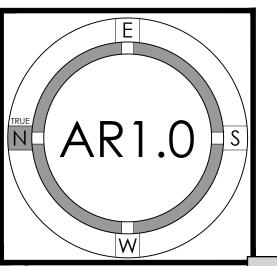

(C)STUDIO S SQUARED ARCHITECTURE, INC

Showing Monterey Pine #1 and decline in canopy Showing Pine trees #1 and #2 Silver Dollar Eucalyptus tree #15 is in poor condition. The vigor of the tree is fair, but the structure is poor. The tree has been topped in the past at 20' and now has multiple codominant trunks with poor aspect ratios.



226 Solana

Showing topped eucalyptus tree

sprout growth." The new shoots develop from latent buds hidden underneath the surface of old branches. These new shoots are not anchored into the tree like normal branches that develop in a socket of overlapping wood tissues. The new shoots are weakly attached as they are only anchored in the outermost layers of the parent branches. These sprouts grow very quickly as a survival mechanism and are prone to failure in normal weather conditions due to the limbs being weakly attached. Limb failure risk also increased as decay is likely to be found from

Topping trees is not an approved cut by any tree

standards such as ANSI A300 Pruning Standards or

Best Managements Pruning Standards as topping trees

starves trees of their food source and can weaken a tree.

Topping cuts lead to decay as the wounds made are too

large for the tree to compartmentalize the wound. This

through the branches often resulting in an unacceptable

level of risk. After a tree is topped, the tree's survival

mechanism causes a tree to produce multiple shoots

below each topping cut often referred to as "water

gives decay organisms a free path to move down



Showing tree #30

he city of Los Altos: *The condition of the tree with*

Showing decay at root crown where up against hardscapes from past root cutting

African Fern Pine tree #30 is in poor condition. The vigor of the tree is fair but for structure of the tree is poor. The tree is codominant at 12' with a poor aspect ratio. Included bark at the codominant union was observed. Included bark is a type of branch defect that develops when two codominant leaders (trunks) grow closely together in a V-shape. As both the leaders increase in size, the bark that is between them will start to work as a wedge between the growing leaders. When this occurs, the codominant leaders lack the reinforcing ridge required for the codominant leaders to be supported property. These stems can break or tear causing severe cambium damage and making them prone to failure. It increases susceptibility of failure during storms and heavy winds. Tree removal is ecommended as the tree is a hazard to the roperty. No mitigation measures are expected to elp improve the risk of leader failure due to included bark. The tree meets the following criteria for protected tree removal in the city of Los Altos: *The condition of the tree with respect to* disease, imminent danger of falling, proximity to existing or proposed structures and interference with utility services.





Magnolia tree #31 is in poor condition and has a poor suitability for preservation rating. The tree has poor vigor and poor structure. Magnolia trees are not a drought tolerant species and the past drought and no supplemental irrigation has severely stressed the tree. The tree is not expected to recover from the prolonged drought stress. The tree is nearly lead and recommended to be removed as it is a nazard to the property. The tree meets the following criteria for protected tree removal in the city of Los Altos: *The condition of the tree with respect to* disease, imminent danger of falling, proximity to existing or proposed structures and interference with utility services.

owing Magnolia #31

Protected trees to be retained:

(10)



#5 was given a poor condition rating due to being topped in the past and less vigorous than Liquidambar trees #6 and #7. This tree is recommended to be inspected in spring of 2023 to look at shoot elongation to get a better idea on the health of the tree as the tree was inspected during the fall when leaves were naturally dropping as the species is deciduous. Poor union formation with poor aspect ratios were observed in the canopies of the Liquidambar trees. Crown reduction pruning and pruning for future tree structure is recommended to reduce risk of limb failure. The trees are recommended to be deeply irrigated every other week during the dry season so that the top foot of soil is saturated starting at 5' from the trees and radiating out to 15' from the trees.

Liquidambar trees #5-7 are located within the public

right of way and are protected trees. Liquidambar tree

Showing Liquidambar trees #5-7

Neighboring Queen Palm tree #8 is in excellent condition. The tree is a street tree as it is in the public right of way. Pittosporum tree #9 is also located in the public right of way and is in fair condition. Every other week during the dry season the pittosporum tree #9 is recommended to be irrigated with 20 gallons of clean water at the edge of the tree's dripline.

226 Solana (11)



Neighboring Coast Live Oak tree #27 is in good condition. A limited visual inspection was conducted, and the root crown was not visible due to the tree being on the neighboring property.

Showing neighboring oak tree #27



Neighboring Black Acacia tree #29 is in poor ondition. The tree is in decline and has been copped for utility line clearance in the past. This species is highly invasive and generally ecommended for removal as it can easily spread roughout a property.

Showing topped Black Acacia tree #29

Non-protected trees:

The remaining trees not discussed above are small non-protected trees. Non-protected trees with a condition rating of either a D or an F are recommended to be removed or mitigated where possible as they are in poor condition. Trees in poor condition are not well suited for preservation within the landscape.

226 Solana

Plan Review:

A new driveway is proposed and shown closer to Liquidambar tree #5 than the existing driveway. Because Monterey Pine tree #1 is proposed to be removed, if possible, the proposed driveway should be moved to be outside the dripline of Liquidambar tree #5 to reduce potential impacts to the tree. The driveway excavation when within 13.5' from Liquidambar tree #5 is recommended to be done by hand under the direct supervision of the Project Arborist. Acceptable hand tools include an air spade, rotary hammer with clay spade attachment, and shovels. All encountered roots during excavation are recommended to be retained. Roots encountered within the base rock section can be retained with base rock material being packed around tree roots to avoid the need to cut roots with the driveway built on top of the tree's roots. Encountered roots to be exposed during this process are recommended to be covered in layers of wetted down burlap to help avoid root desiccation. The contractor is recommended to wet down the burlap daily while still exposed. The tree is recommended to be deep water fertilized as a mitigation measure. Impacts are expected to be minor.

A new pathway is shown underneath the dripline of Liquidambar tree #7. Excavation for the pathway is recommended to stay at a maximum of 6" below grade for rough grading purposes when within the dripline of the tree. Impacts are expected to be minor. The tree is recommended to be deep water fertilized as a mitigation measure.

Tree Protection Plan:

Tree Protection Zones Tree protection zones should be installed and maintained throughout the entire length of the project. Prior to the commencement of any Development Project, a chain link fence shall be installed at the drip line (canopy spread) of any protected tree which will or will not be affected by the construction. Non-protected trees to be retained shall also be protected in the same way. The drip line shall not be altered in any way to increase the encroachment of the construction. When work is to take place underneath a tree's dripline, fencing must be placed as close as possible to the tree proposed work. If an area of access is needed underneath a trees canopy, the area shall be protected by a landscape barrier. Fencing for the protection zones should be 6-foottall metal chain link type supported my 2-inch metal poles pounded into the ground by no less than 2 feet. The support poles should be spaced no more than 10 feet apart on center. Signs should be placed on fencing signifying "Tree Protection Zone - Keep Out". No materials or equipment should be stored or cleaned inside the tree protection zones. Excavation, grading, soil deposits, drainage and leveling is prohibited within the tree protection zones without the project arborist consent. No wires, signs or ropes shall be attached to the protected trees on site. Utility services and irrigation lines shall all be place outside of the tree protection zones when possible. When access is needed and tree protection fencing restricts access a landscape barrier shall be installed to protect the non-protected root zone.

226 Solana

(13)

Red lines showing the recommended tree protection zones

If for any reason a smaller tree protection zone is needed for access, a landscape buffer consisting of wood chips spread to a depth of six inches with plywood or steel plates placed on top will be placed where tree protection fencing is required. The landscape buffer will help to reduce compaction to the unprotected root zone.

226 Solana

Inspections

The site arborist will need to verify that tree protection fencing has been installed before the start of construction. The site arborist must inspect the site anytime excavation work is to take place underneath a protected trees dripline. It is the contractor's responsibility to contact the site arborist if excavation work is to take place underneath the protected trees on site. Kielty Arborist Services can be reached at davidkieltyarborist@gmail.com or by phone at (650) 532-4418 (David).

(14)

Root Cutting and Grading

If for any reason roots are to be cut, they shall be monitored and documented. Large roots (over 2" diameter) or large masses of roots to be cut must be inspected by the site arborist. The site arborist, at this time, may recommend irrigation or fertilization of the root zone. All roots needing to be cut should be cut clean with a saw or lopper. Roots to be left exposed for a period of time should be covered with layers of burlap and kept moist. The site arborist must first give consent if roots over 2 inches in diameter are to be cut.

Trenching and Excavation

Trenching for foundation, irrigation, drainage, electrical or any other reason shall be done by hand when inside the dripline of a protected tree. Hand digging and the careful placement of pipes below or besides protected roots will significantly reduce root loss, thus reducing trauma to the tree. All trenches shall be backfilled with native materials and compacted to near its original level, as soon as possible and if possible. Trenches to be left open for a period of time, will require the covering of all exposed roots with burlap and be kept moist. The trenches will also need to be covered with plywood to help protect the exposed roots.

Normal irrigation shall be maintained on this site at all times for the imported trees. All of the trees except the neighboring oak tree will require irrigation. On a construction site, I recommend irrigation during winter months, 1 time per month for the imported trees. Seasonal rainfall may reduce the need for additional irrigation. During the warm season, April – November, my recommendation is to use heavy irrigation, 2 times per month for the imported trees. This type of irrigation should be started prior to any excavation. The irrigation will improve the vigor and water content of the trees. The on-site arborist may make adjustments to the irrigation recommendations as needed. The foliage of the trees may need cleaning if dust levels are extreme. Removing dust from the foliage will help to reduce mite and insect infestation.

The information included in this report is believed to be true and based on sound arboricultural principles and practices. David Beckham Sincerely, David Beckham Certified Arborist WE#10724A TRAQ Qualified

226 Solana

Kielty Arborist Services P.O. Box 6187 San Mateo, CA 94403

650-532-4418

ASSUMPTIONS AND LIMITING CONDITIONS

1. Any legal description provided to the consultant/appraiser is assumed to be correct. Any titles and ownerships to any property are assumed to be good and marketable. No responsibility is assumed for matters legal in character. Any and all property is appraised or evaluated as though free and clear, under responsible ownership and competent management.

2. It is assumed that any property is not in violation of any applicable codes, ordinances, statutes, or other government regulations.

3. Care has been taken to obtain all information from reliable sources. All data has been verified insofar as possible; however the consultant/appraiser can neither guarantee nor be responsible for the accuracy of information provided by others.

4. The consultant/appraiser shall not be required to give testimony or to attend court by reason of this report unless subsequent contractual arrangements are made, including payment of an additional fee for such services as described in the fee schedule and contract of engagement.

5. Loss, alteration, or reproduction of any part of this report invalidates the entire report.

6. Possession of this report or a copy thereof does not imply right of publication or use for any purpose by any other than the person to whom it is addressed, without the prior expressed written or verbal consent of the consultant/appraiser.

7. Neither all nor any part of this report, nor any copy thereof, shall be conveyed by anyone, including the client, to the public through advertising, public relations, news, sales or other media, without the prior expressed written or verbal consent of the consultant/appraiser particularly as to value conclusions, identity of the consultant/appraiser, or any reference to any professional society or initialed designation conferred upon the consultant/appraiser as stated in his qualification.

8. This report and the values expressed herein represent the opinion of the consult/appraiser, and the consult/appraiser's fee is in no way contingent upon the reporting of a specified value, a stipulated result, the occurrence of a subsequent event, nor upon any finding to be reported.

9. Sketches, diagrams, graphs, and photographs in this report, being intended as visual aids, are not necessarily to scale and should not be construed as engineering or architectural reports or

226 Solana

10. Unless expressed otherwise: 1) information in this report covers only those items that were examined and reflects the condition of those items at the time of inspection; and 2) the inspection is limited to visual examination of accessible items without dissection, excavation, probing, or coring. There is no warranty or guarantee, expressed or implied, that problems or deficiencies of the plants or property in question may not arise in future.

ARBORIST DISCLOSURE STATEMENT

Arborists are tree specialists who use their education, knowledge, training and experience to examine trees, recommend measures to enhance the beauty and health of trees, and attempt to reduce the risk of living near trees. Clients may choose to accept or disregard the recommendations of the arborist, or seek additional advice.

Arborists cannot detect every condition that could possibly lead to the structural failure of a tree. Trees are living organisms that fail in ways we do not fully understand. Conditions are often hidden within trees and below ground. Arborists cannot guarantee that a tree will be healthy or safe under all circumstances, or for a specified period of time. Likewise, remedial treatments, like a medicine, cannot be guaranteed.

Treatment, pruning, and removal of trees may involve considerations beyond the scope of the arborist's services such as property boundaries, property ownership, site lines, disputes between neighbors, landlord-tenant matters, etc. Arborists cannot take such issues into account unless complete and accurate information is given to the arborist. The person hiring the arborist accepts full responsibility for authorizing the recommended treatment or remedial measures.

Trees can be managed, but they cannot be controlled. To live near a tree is to accept some degree of risk. The only way to eliminate all risks is to eliminate all trees.

David Beckham David Beckham

January 30th, 2023

1000 S Winchester Blvd San Jose, CA 95128 P: (408) 998 - 0983

ARCHITECTURE

Residen

Driv Angulo Ō Solar Rob 226 Altos, OS $\mathbf{\Omega}$ 2 Q


 \mathcal{L}

S


Z

 \mathcal{L} \geq \mathcal{L} Ш \mathcal{L}

> **ARBORIST REPORT**

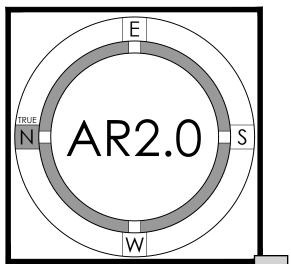

(C)STUDIO S SQUARED ARCHITECTURE, INC

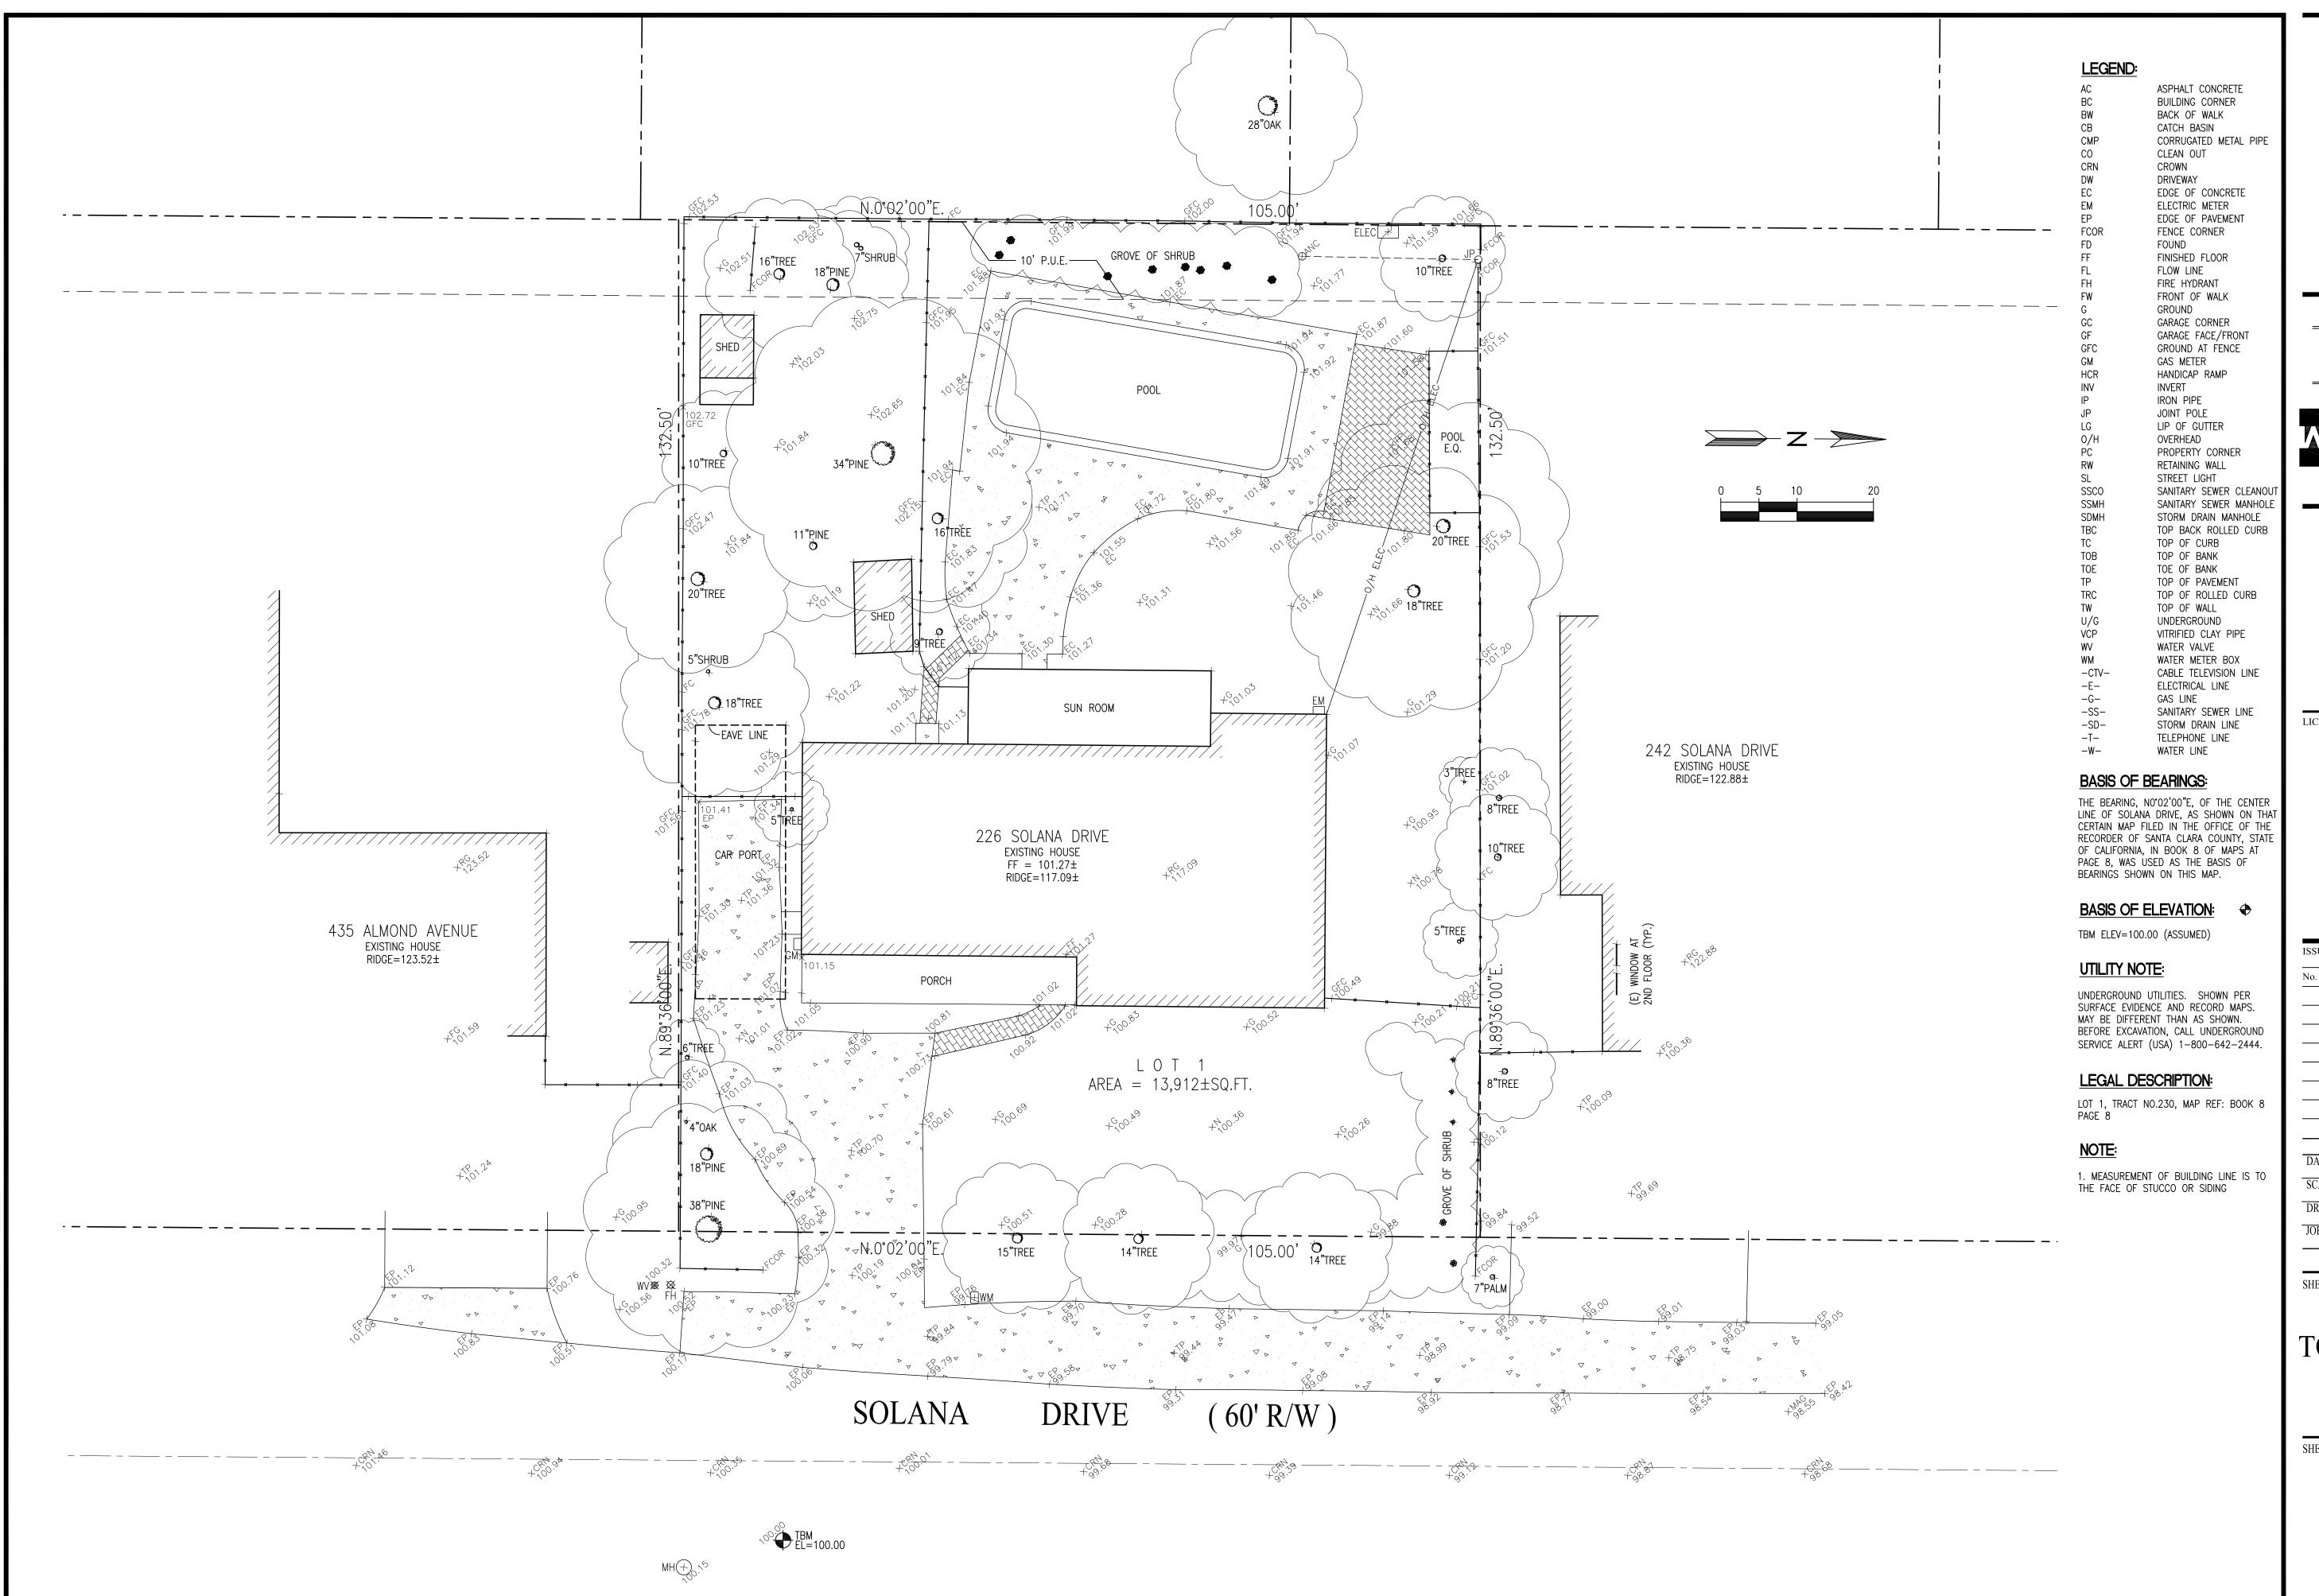

NEW RESIDENCE

226 SOLANA DRIVE LOS ALTOS, CA APN: 170-21-025

WEC & ASSOCIATES



LICENSE STAMPS AND SIGNATURE




| No. | Description | Date |
|------|-----------------|------|
| | | |
| | | |
| DAT | E: OCT 12, 2022 | |
| SCA | | |
| DRA | WN: | |
| JOB: | 10078 | |
| | | |

TOPOGRAPHIC SURVEY

SHEET NO.

C.(

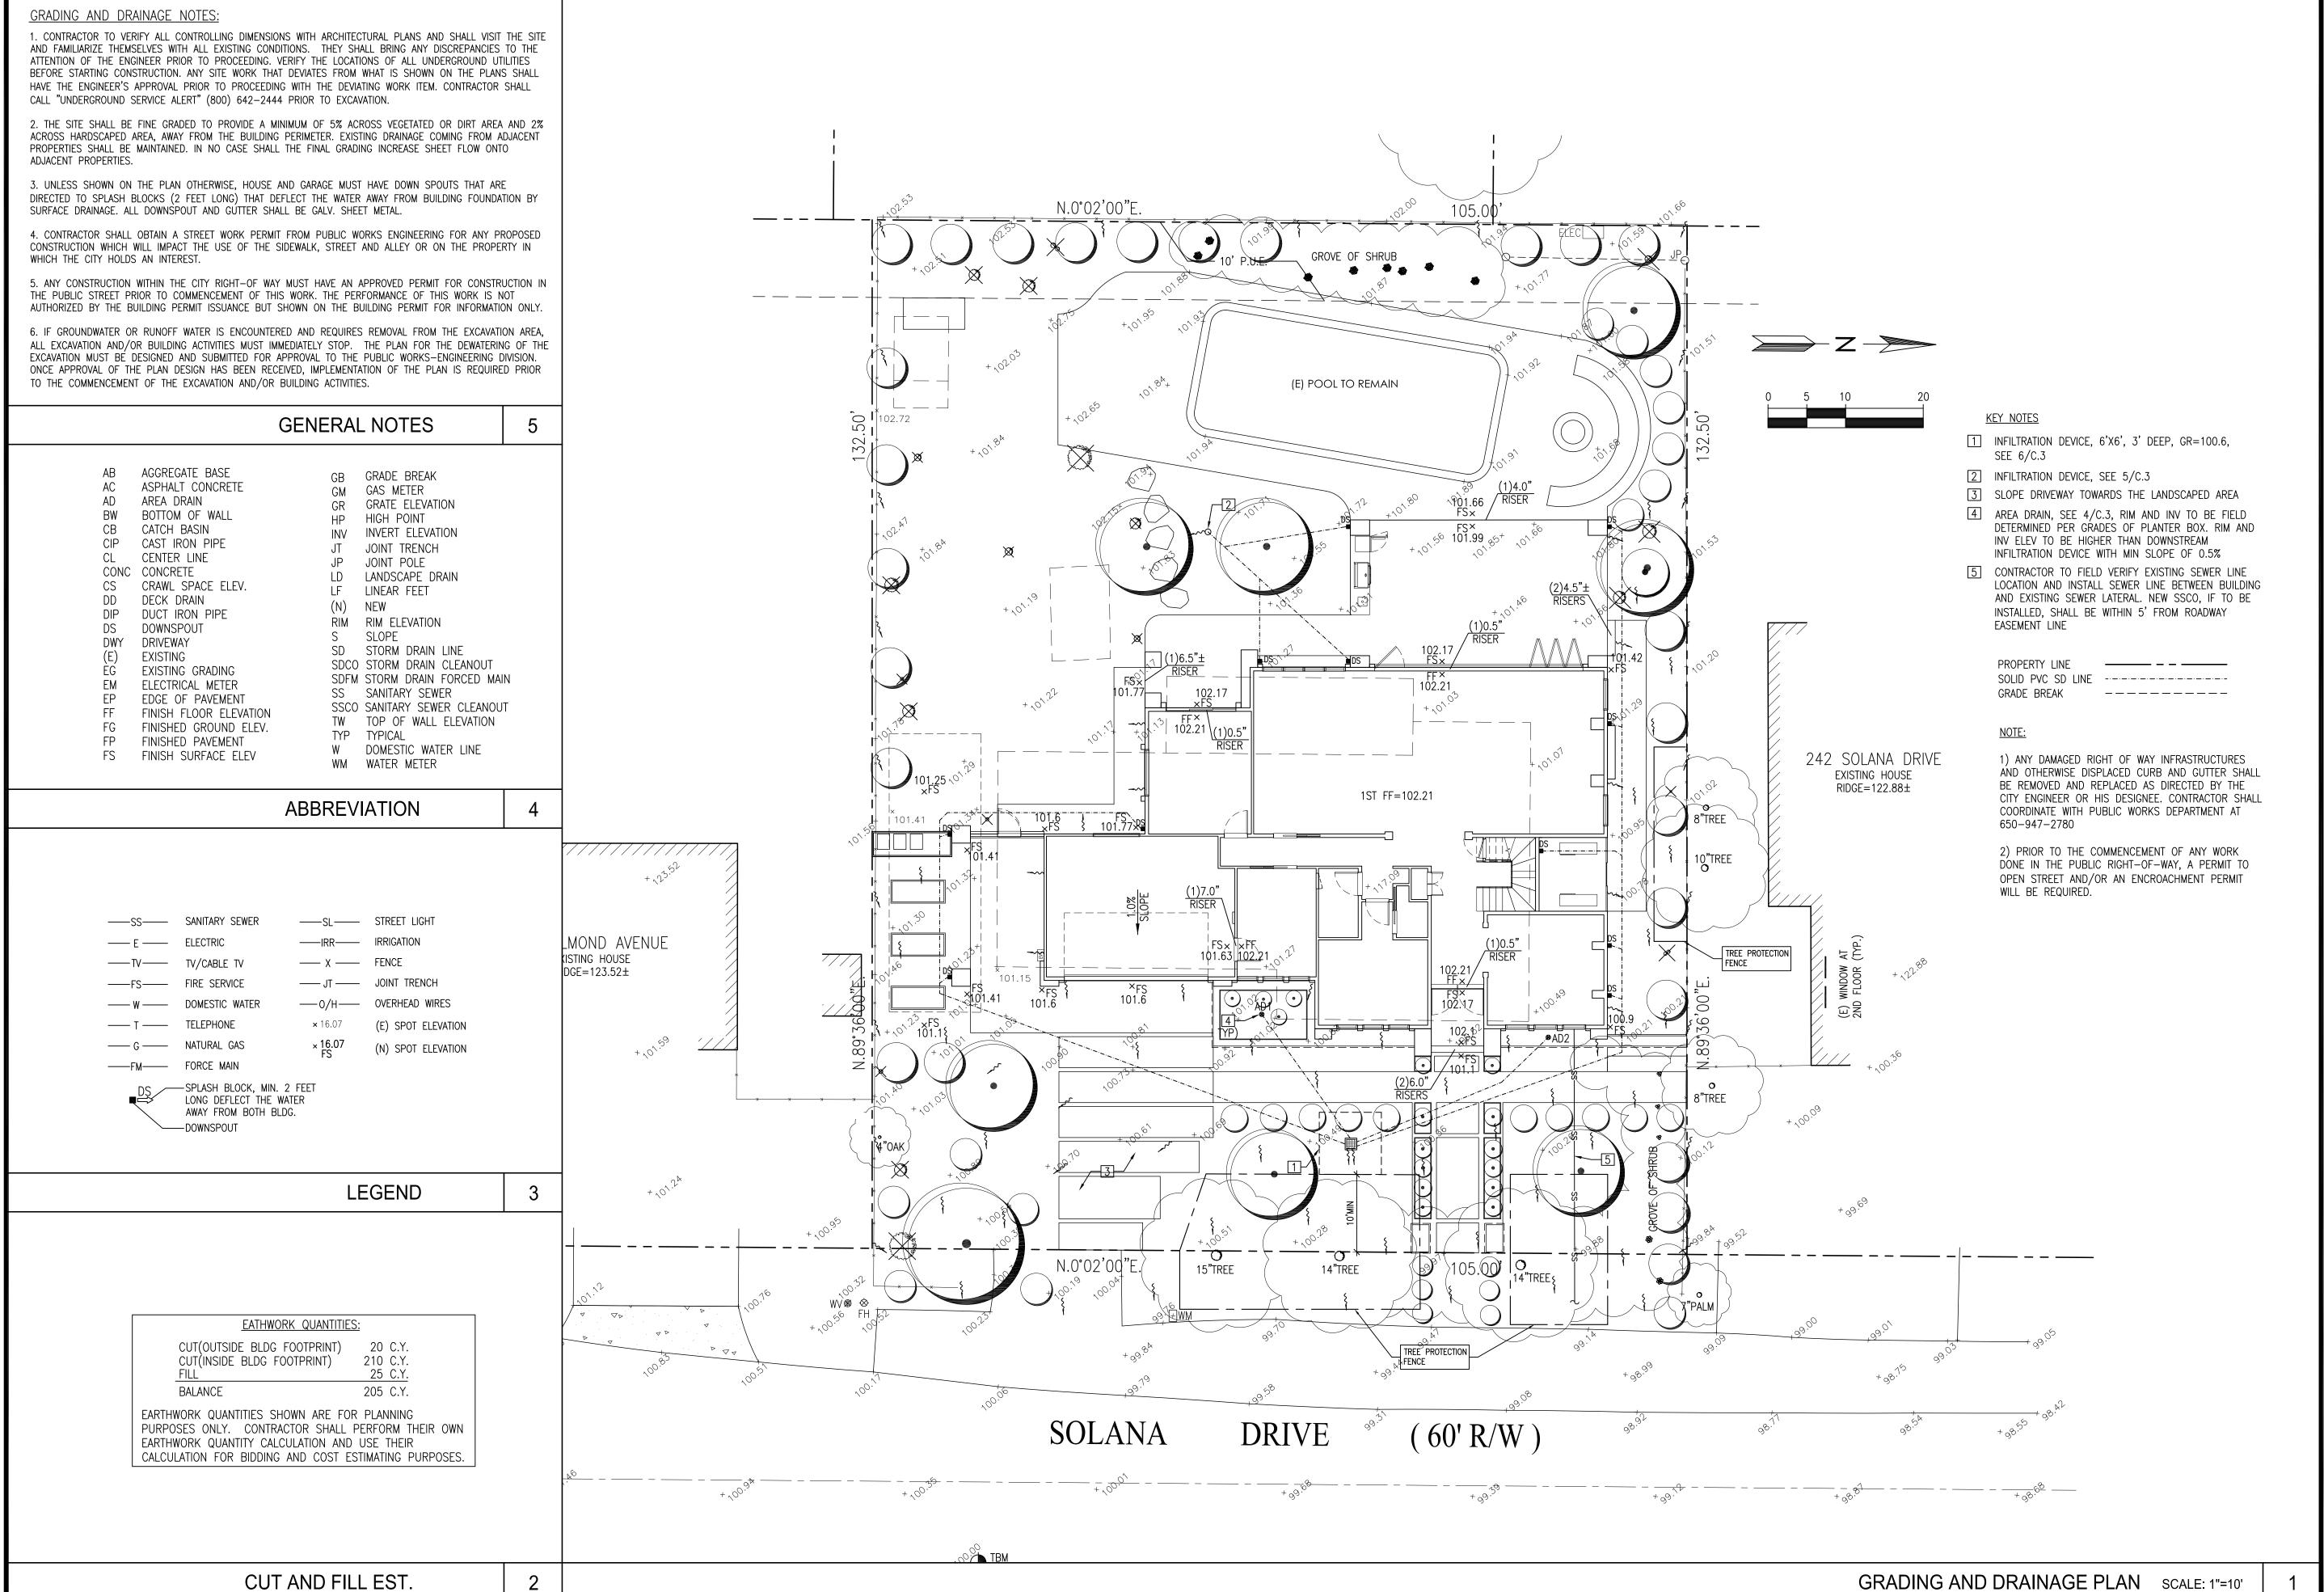

NEW

226 SOLANA DRIVE LOS ALTOS, CA APN: 170-21-025

& ASSOCIATES

2625 MIDDLEFIELD RD #658 PALO ALTO, CA 94306 TEL: (650) 823-6466 FAX: (650) 887-1294

LICENSE STAMPS AND SIGNATURE



| No. | Description | Dat |
|------|--|-----|
| | | |
| | | |
| | | |
| | | |
| | | |
| | | |
| | | |
| | | |
| DAT | <u>. </u> | |
| | APR 26, 2023 | |
| SCAI | LE: AS SHOWN | |
| DRA | WN: | |
| JOB: | 10078 | |

SHEET TITLE:

GRADING & DRAINAGE **PLAN**

SHEET NO.

EROSION CONTROL AND BEST MANAGEMENT PRACTICE:

1. CONTRACTOR SHALL ASSUME THE CONCEPTS ON THE EROSION CONTROL PLAN/NOTES, IF PROVIDED, ARE MINIMUM REQUIREMENTS, THE FULL EXTENTS OF WHICH ARE TO BE DETERMINED BY CONTRACTOR. CONTRACTOR IS RESPONSIBLE FOR THE EXACT DESIGN AND EXTENT OF CONTRACTOR'S INTENDED USE AND MANAGEMENT OF THE CONSTRUCTION SITE.

2. ALL EROSION CONTROL FACILITIES SHALL BE INSPECTED BY THE CONTRACTOR AND REPAIRED AS REQUIRED AT THE CONCLUSION OF EACH WORKING DAY DURING THE RAINY SEASON. REPAIRS TO DAMAGED FACILITIES SHALL BE MADE IMMEDIATELY UPON DISCOVERY.

3. THE CONTRACTOR SHALL REMOVE ANY ACCUMULATION OF SILT OR DEBRIS FROM THE EROSION CONTROL SEDIMENT BASINS FOLLOWING EACH STORM AND SHALL CLEAR THE OUTLET PIPES OF ANY BLOCKAGE.

4. STOCKPILED MATERIAL SHALL BE COVERED WITH VISQUEEN OR TARPAULIN UNTIL THE MATERIAL IS REMOVED FROM THE SITE. ANY REMAINING BARE SOIL THAT EXISTS AFTER THE STOCKPILE HAS BEEN REMOVED SHALL BE COVERED UNTIL A NATURAL GROUND COVER IS ESTABLISHED OR IT MAY BE SEEDED OR PLANTED TO PROVIDE GROUND COVER PRIOR TO THE FALL RAINY SEASON.


5. PROTECT ADJACENT PROPERTIES AND UNDISTURBED AREAS FROM CONSTRUCTION IMPACTS USING VEGETATIVE BUFFER STRIPS, SEDIMENT BARRIERS OR FILTER, DIKES, MULCHING OR OTHER MEASURES AS APPROPRIATE.

6. CONTRACTOR SHALL MAINTAIN ADJACENT STREETS IN A NEAT, CLEAN, DUST FREE AND SANITARY CONDITION AT ALL TIMES. CONTRACTOR SHALL BE RESPONSIBLE FOR ANY CLEAN UP ON ADJACENT STREETS AFFECTED BY THEIR CONSTRUCTION. NO STOCKPILING OF BUILDING MATERIALS WITHIN THE PUBLIC RIGHT—OF WAY IS

7. PROTECT DOWN SLOPE DRAINAGE COURSES, STREAMS AND STORM DRAINS WITH ROCK FILLED SAND BAGS, TEMPORARY DRAINAGE SWALES, SILT FENCES, EARTH BERMS, STORM DRAIN INLET FILTERS AND/OR STRAW BALES USED ONLY IN CONJUNCTION WITH PROPERLY INSTALLED SILT FENCES. PROVIDE ROCKED DRIVEWAY FOR SITE ACCESS DURING CONSTRUCTION.

GENERAL NOTES

Z

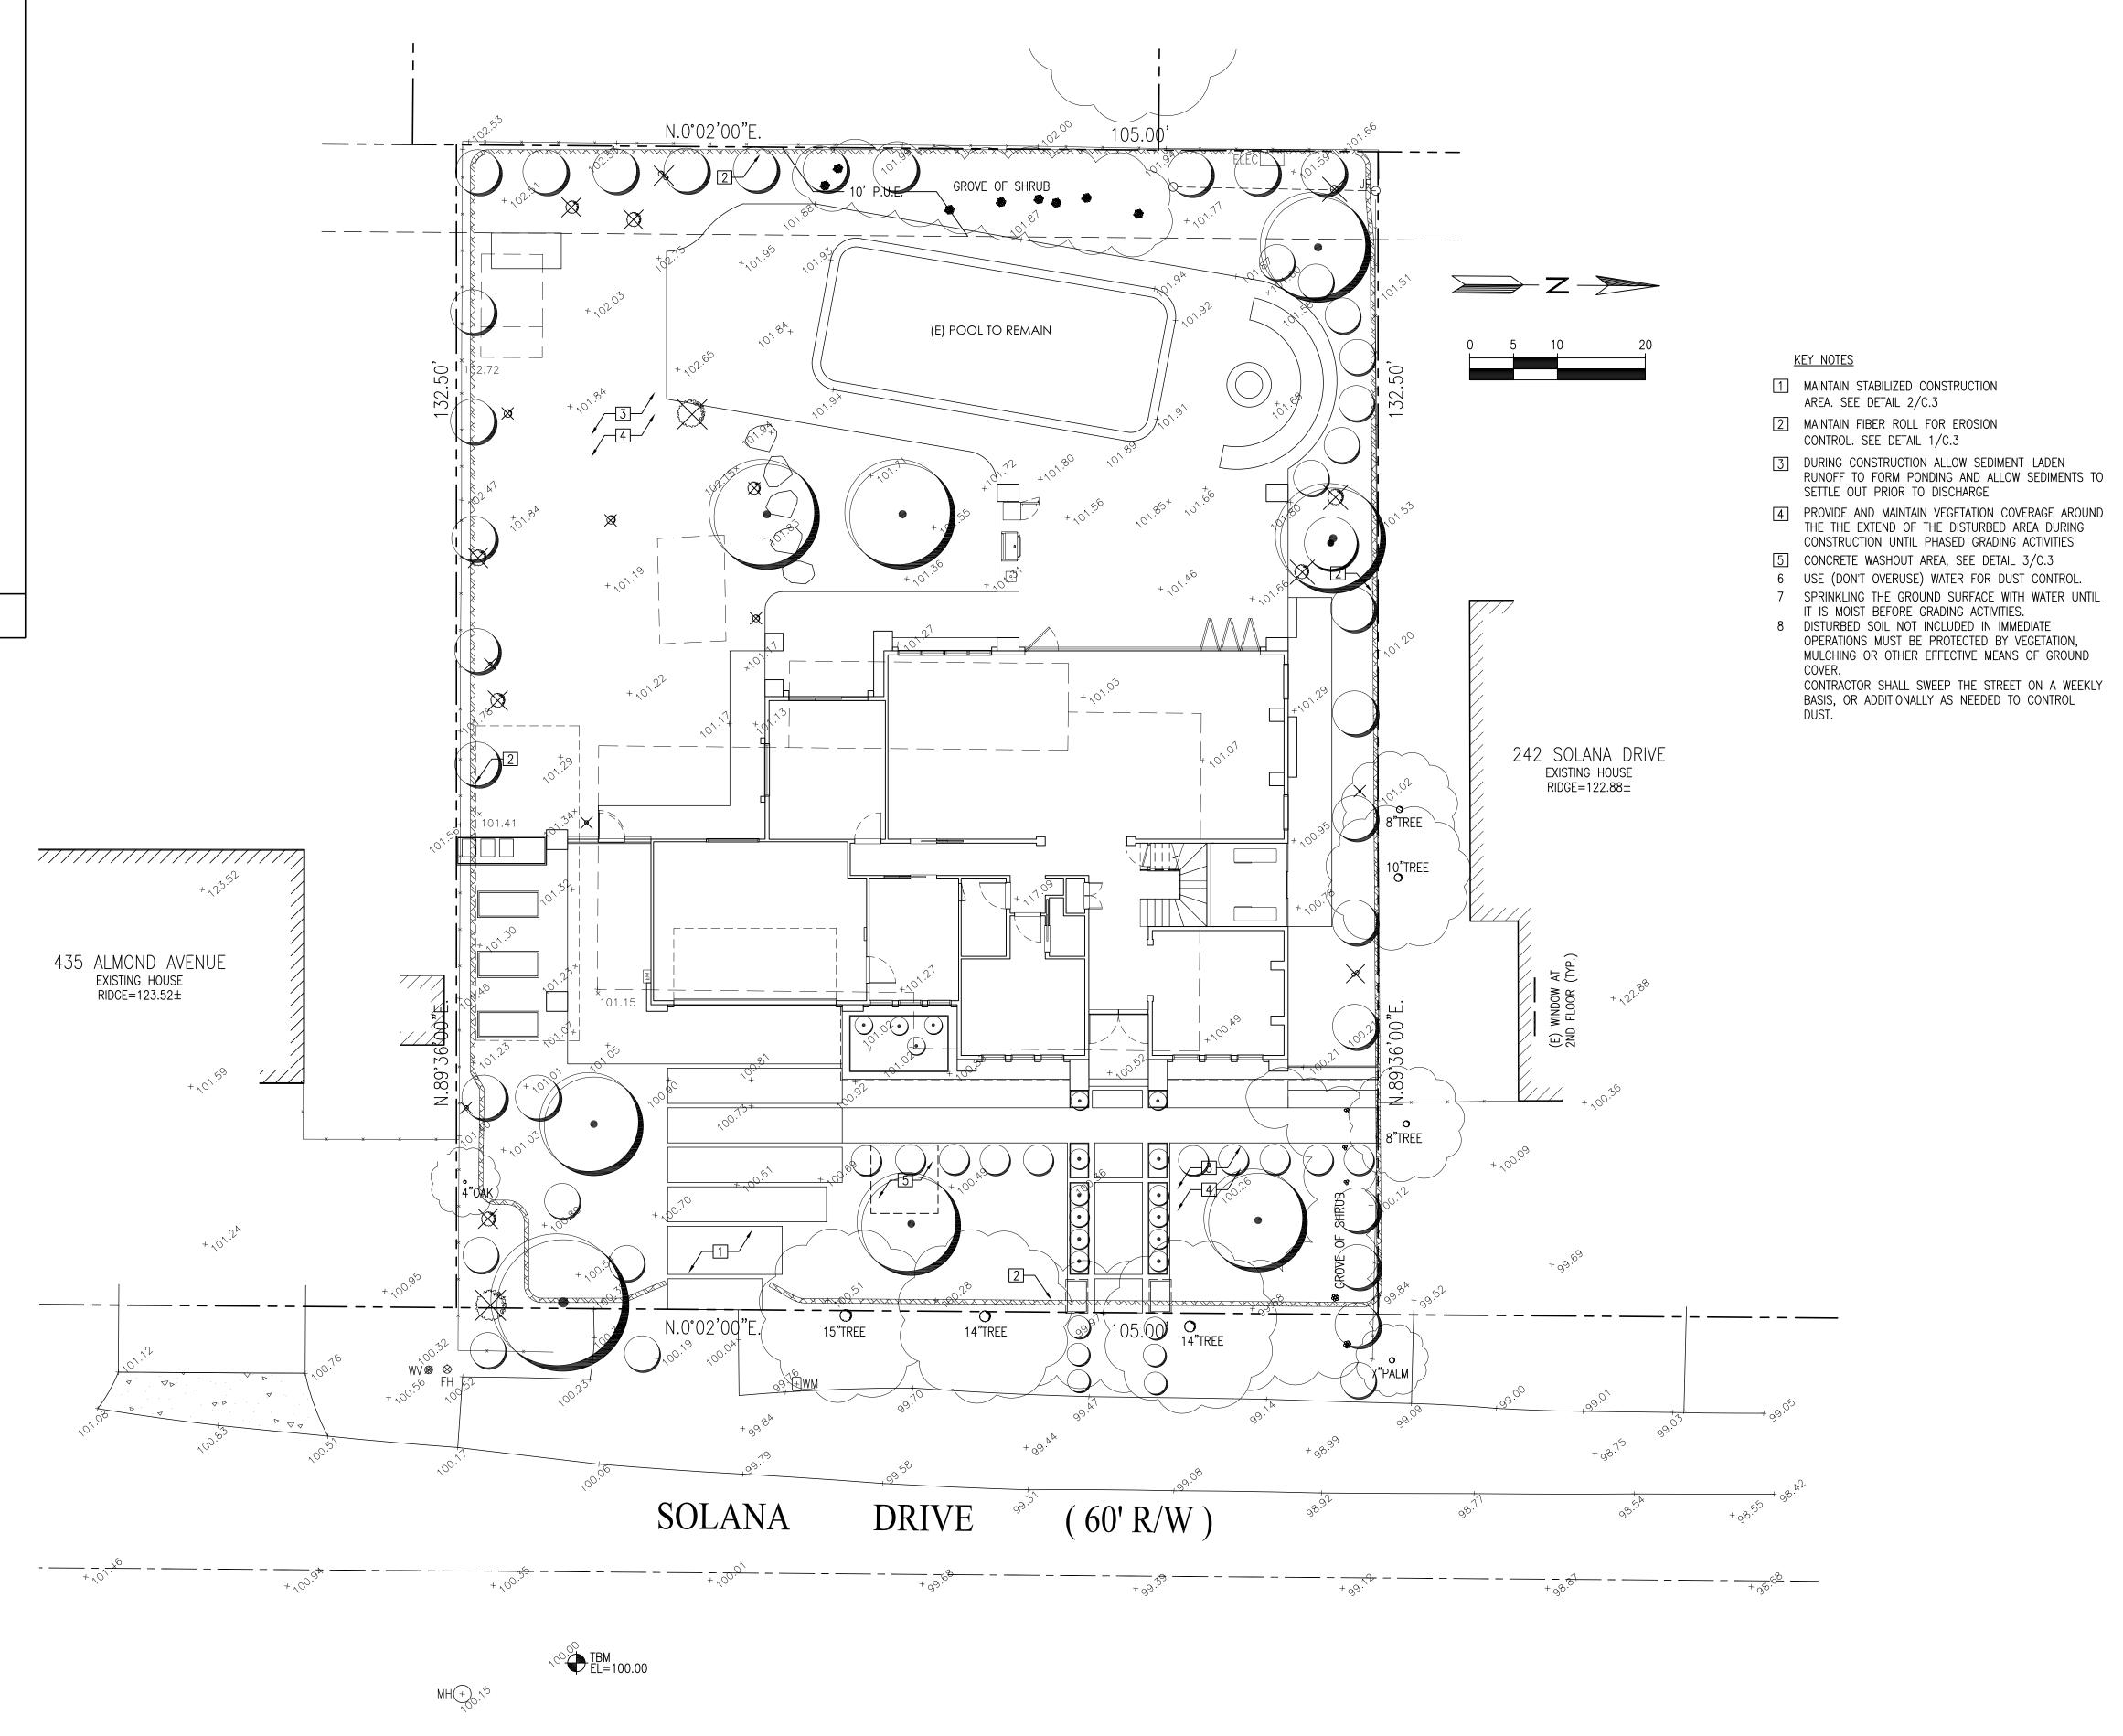

NEW RESIDENCI

226 SOLANA DRIVE LOS ALTOS, CA APN: 170-21-025

W E C & ASSOCIATES

2625 MIDDLEFIELD RD #658 PALO ALTO, CA 94306 TEL: (650) 823-6466 FAX: (650) 887-1294

LICENSE STAMPS AND SIGNATURE



| No. | Description | | Date |
|------|-------------|-------------|------|
| | | | |
| | | | |
| | | | |
| | | | |
| | | | |
| | | | |
| | | | |
| | | | |
| DAT | <u></u> | | |
| | Al | PR 26, 2023 | |
| SCA | LE: | S SHOWN | |
| DRA | WN: | J | |
| JOB: | | 10078 | |


SHEET TITLE:

EROSION CONTROL PLAN

SHEET NO.

C.2

EROSION CONTROL PLAN SCALE: 1"=10'

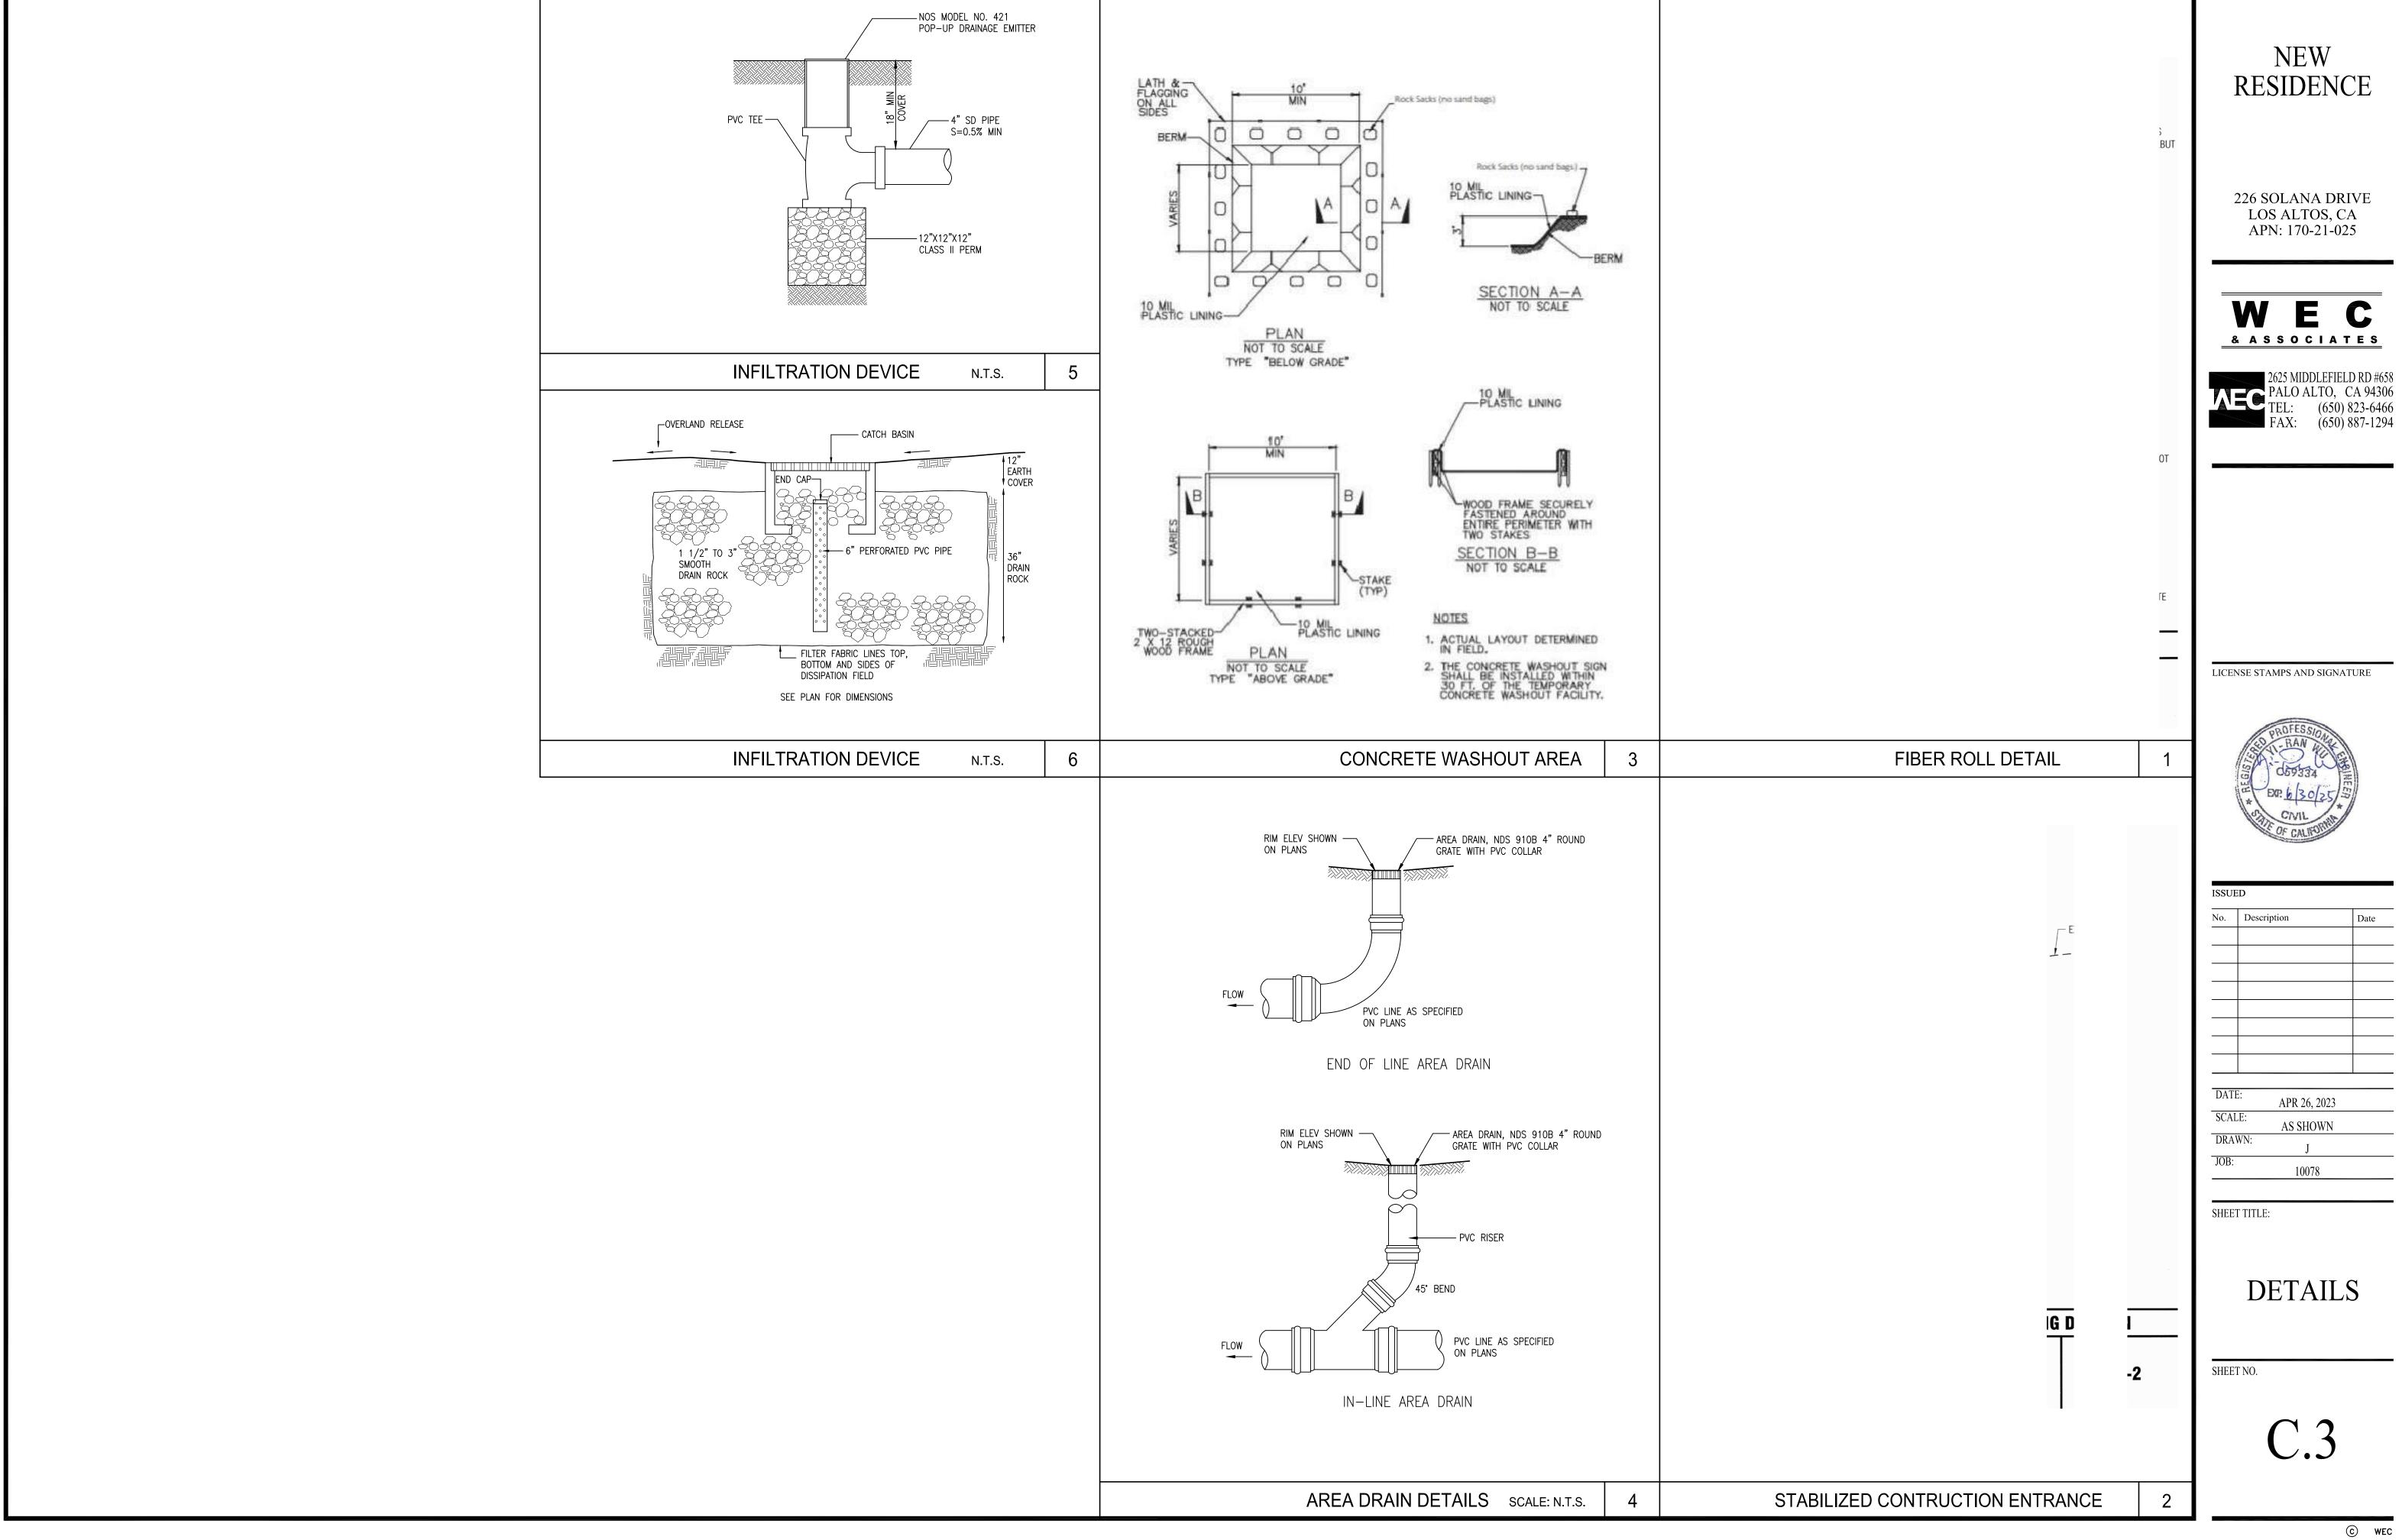

35


ARCHITECTURE

1000 S Winchester Blvd San Jose, CA 95128 P: (408) 998 - 0983

Residena

 \mathbf{B}

 \mathcal{C}

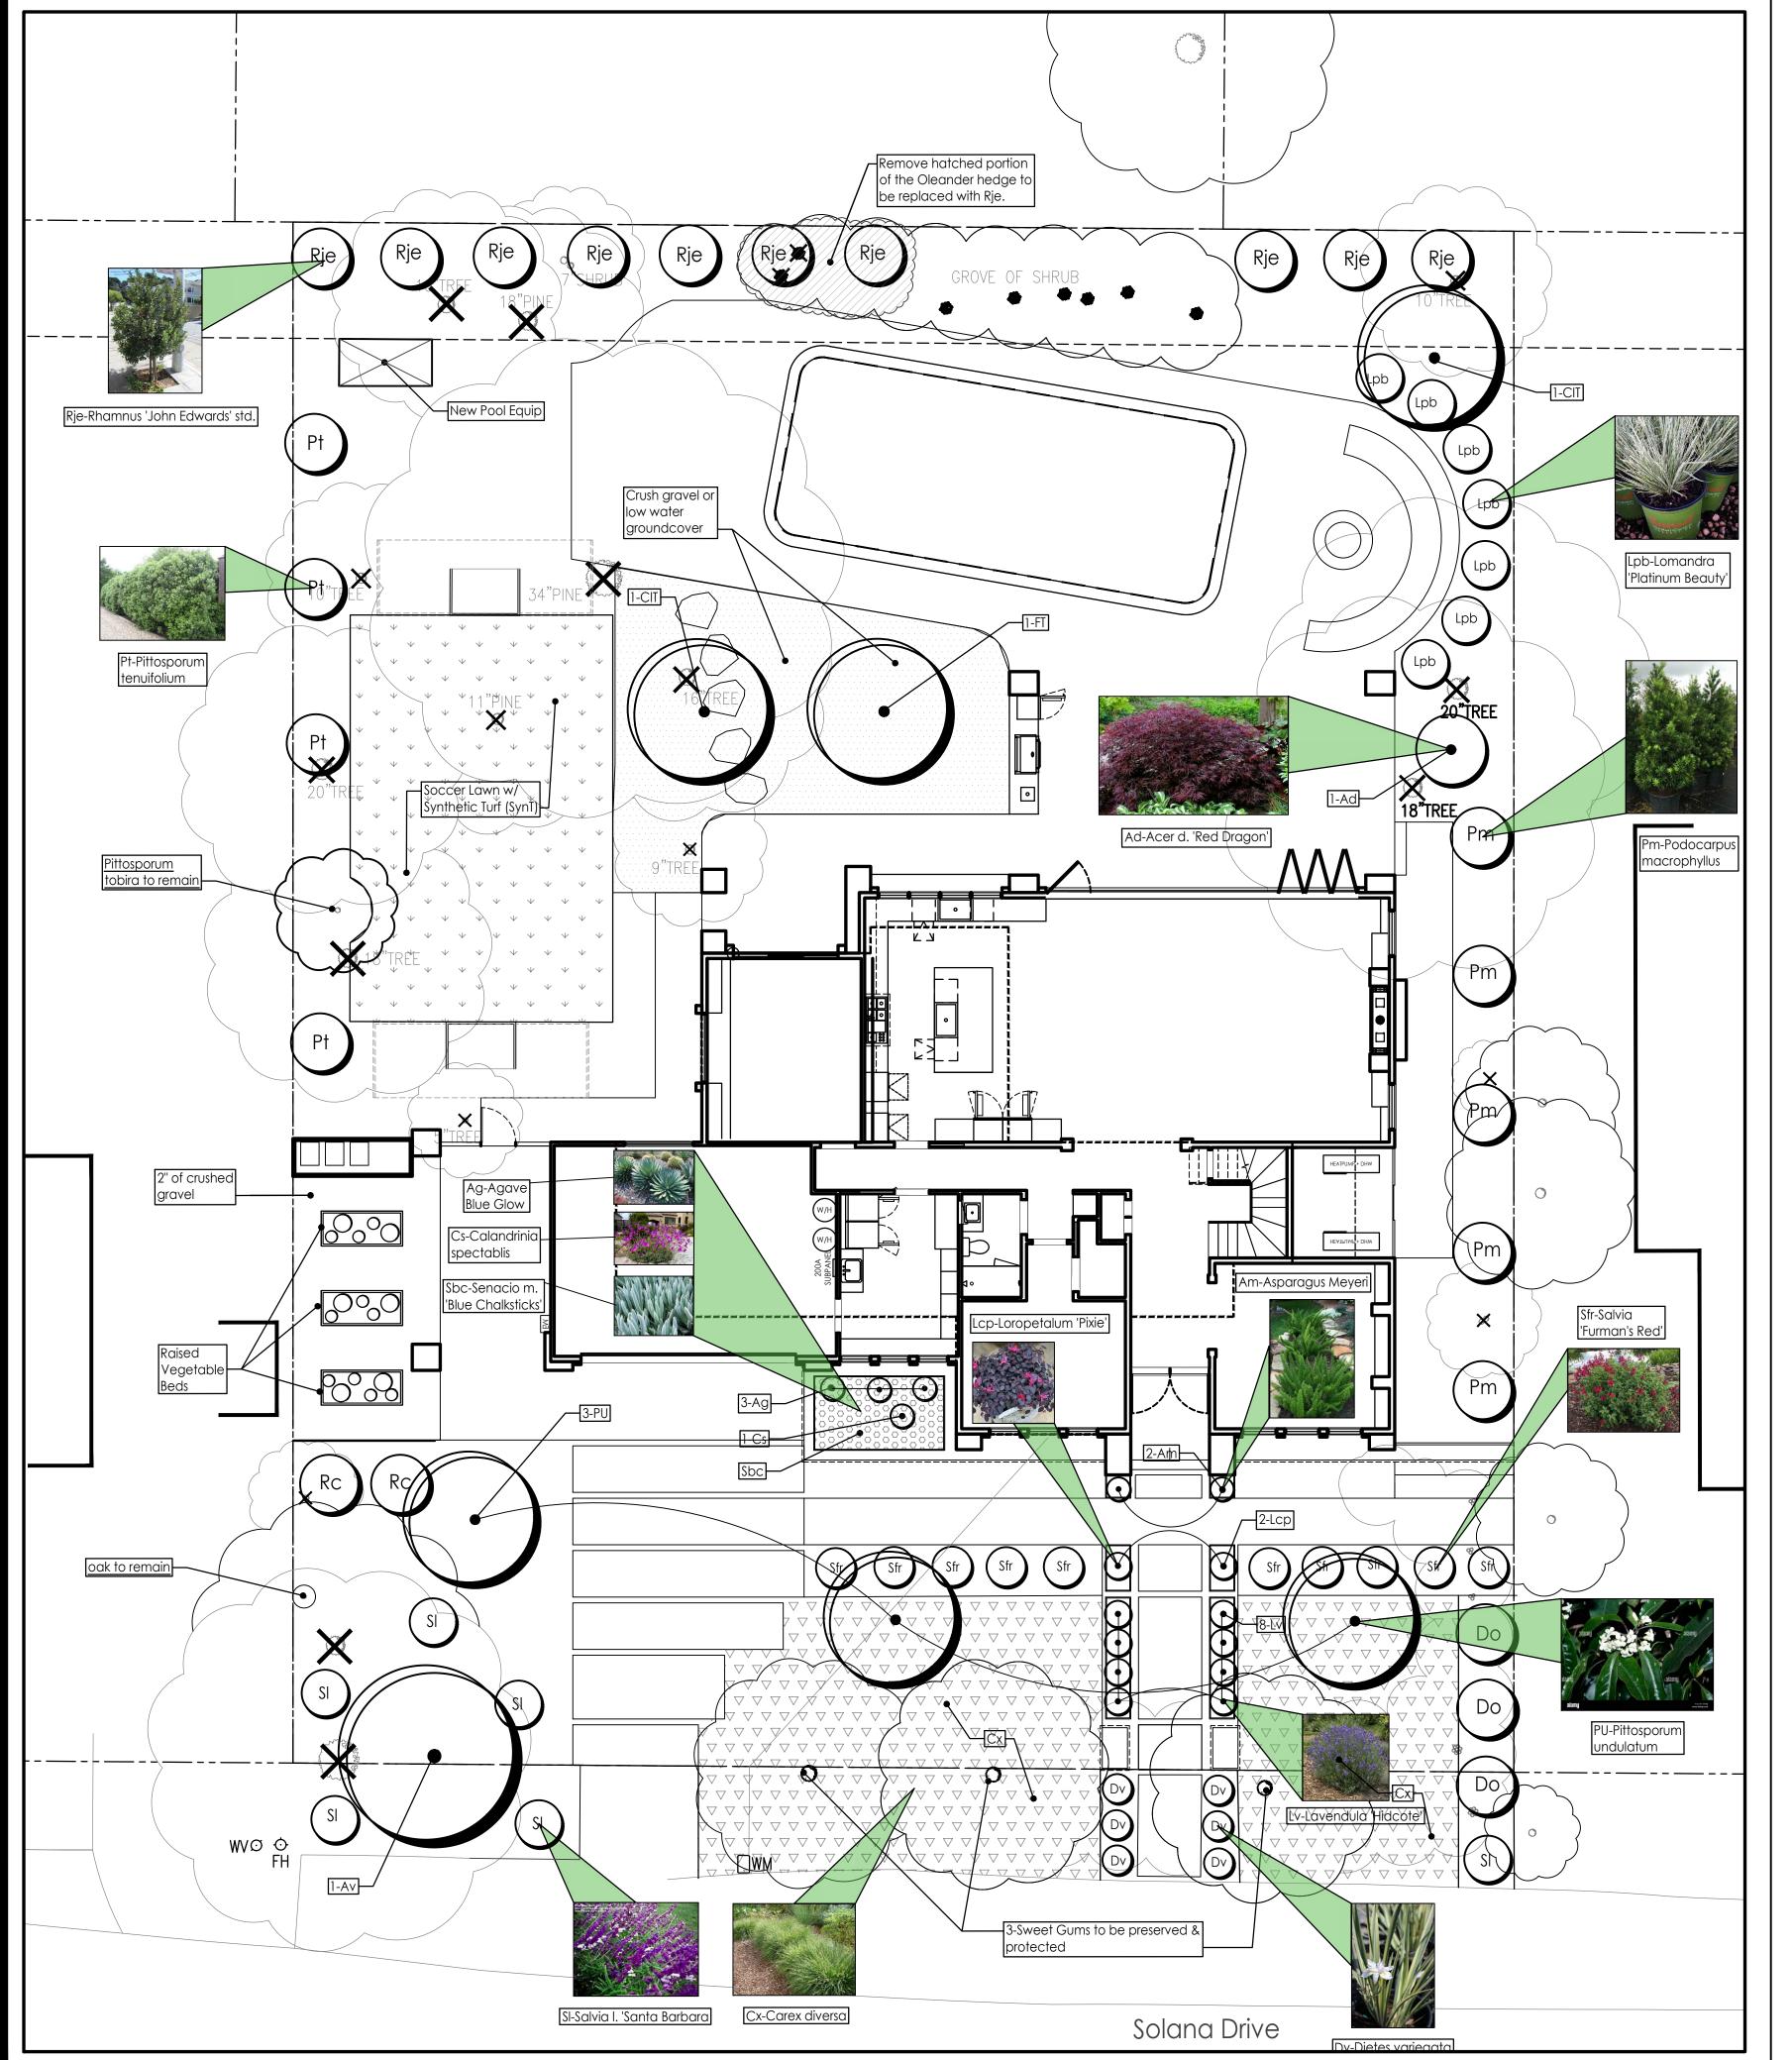


11.22 44 88 11.22 ffære


| SYM. | QTY. | SIZE | BOTANICAL NAME | COMMON NAME | COMMENTS | WATER US |
|------|---------|---------|----------------------------------|---------------------------------|----------------------------|----------|
| AV | Q I I I | 5 gal | Avocado | Avocado | Owner to determine variety | med |
| FT | | 5 gal | Fruit tree | Fruit tree | Owner to determine variety | med |
| PU | 3 | 24" box | Pittosporum undulatum std. | Victorian Box | Tree form. Dbl. staked | low |
| | | | PRIVACY SHRUBS | | | |
| Do | | 15 gal | Dodonea v. 'Purpurea' std. | Purple Hopseed Bush | Tree form | low |
| Pm | | - | Podocarpus macrophylla | Yew Pine | | med |
| Pt | | | Pittosporum tenuifolium std. | Kohuhu | Tree form | med |
| Rje | | 15 gal | Rhamnus a. 'John Edwards' std. | John Edwards Buckthorn | Tree form | low |
| | | | SHRUBS & PERENNIALS | | | |
| Ad | | 15 gal | Acer dissectum 'Red Dragon' | Red Dragon Laceleaf Maple | | med |
| Am | | 5 gal | Asparagus 'Meyeri' | Meyer's Asparagus Fern | | med |
| Cit | | 5 gal | Citrus | Citrus | Owner to determine variety | |
| Dv | | 5 gal | Dietes v. 'variegata' | White Variegated Fortnight Lily | | low |
| Lcp | | 5 gal | Loropetalum c. 'Pixie' | Pixie Fringe Flower | | low |
| Lpb | | 5 gal | Lomandra 'Platinum Beauty' | Platinum Beauty Mat Rush | | low |
| Lv | | 5 gal | Lavendula a. 'Hidcote' | Hidcote English Lavender | | low |
| Rc | | 5 gal | Rhamnus c. 'Mound San Bruno' | MSB Coffeeberry | | low |
| Sfr | | 5 gal | Salvia gregii 'Furman's Red' | Furman's Red Autumn Sage | | low |
| SI | | 5 gal | Salvia leucantha 'Santa Barbara' | S.B. Mexican Sage | | low |
| | | | Succulents in Raised Planter | | | |
| Ag | | 5 gal | Agave 'Blue Glow' | Blue Glow Agave | | low |
| Cs | | 5 gal | Calandrinia spectablis | Rock Purslane | | low |
| Sbc | | 1 gal | Senacio mandraliscae | Blue Chalksticks | 24" o.c. spacing | low |
| | | | Groundcovers | | | |
| Сх | | 1 gal | Carex divulsa | California Sedge | 24" o.c. spacing | low |



 \simeq Δ

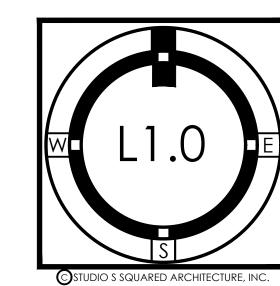

LANDSCAPE PLANTING PLAN

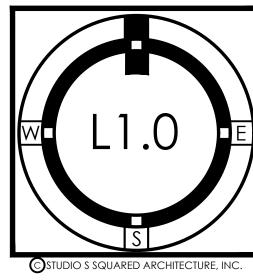

4) DON'T MULCH FLOW LINES OF SWALES SUCH THAT MULCH BLOCKS FLOW OF WATER. 5) USE 3" DEEP MULCH IN ALL PLANTING AREAS WITH MAHOGONY 'PRO CHIP' RECYCLED WOOD MULCH. 'GORILLA HAIR' WILL NOT BE ACCEPTED. PROVIDE 3"

6) ANY PLANTS WITH BUBBLERS MUST HAVE PERMANENTLY MAINTAINED WATERING BASINS 4" HIGH. 7) INSTALL PLANTS FOR ALL PLANT CIRCLES SHOWN ON THE PLAN EVEN IF THEY AREN'T LABELED. CALL FOR CLARIFICATION. PLANT QUANTITIES IN THE LEGEND ARE TO BE VERIFIED BY CONTRACTOR.

2) EXACT LOCATION OF PLANTS ON SITE TO BE ADJUSTED SO AS TO BEST COORDINATE WITH SPRINKLER HEAD LOCATIONS, LIGHTS, DRAINAGE FEATURES, AND

8) THE PLAN IS SCHEMATIC. DON'T INSTALL PLANTS CLOSE TO EDGES OF PAVING OR BUILDINGS. BE SURE PLANTS ARE NOT BLOCKING SPRINKLER SPRAY EXCESSIVELY.

9) FINE GRADING IS THE RESPONSIBILITY OF THE LANDSCAPE CONTRACTOR. INSURE ADEQUATE WATER FLOW AWAY FROM BUILDING WALLS, TO DRAINS, AND THROUGH SWALES. PROVIDE WATER WASHED COBBLES / PEBBLES AT ENDS OF DRAIN SPOUTS TO PREVENT SOIL EROSION.

10) CONTRACTOR TO INVESTIGATE EXISTING SOIL CONDITIONS AND BE RESPONSIBLE FOR PROPER SOIL PREPARATION AND AMENDING TO INSURE VIGOROUS PLANT GROWTH. SUBMIT SAMPLES FOR A LTP.3 PACKAGE AT SUNLAND ANALYTICAL, RANCHO CORDOVA, CA OR APPROVED EQUAL.

11) PESTICIDES/FERTILIZER REDUCTION: IF FERTILIZERS AND PESTICIDES ARE USED DURING THE CONSTRUCTION PHASE, CONTRACTOR MUST PROPERLY DISPOSE OF EXCESS OR SPILLED FERTILIZERS AND PESTICIDES. CONTRACTOR MUST NOT WASH SPILLED FERTILIZERS OR PESTICIDES DOWN THE STORM DRAINS OR BURY THEM IN THE SOIL. CONTRACTORS MUST DISPOSE OF EXCESS FERTILIZERS OR PESTICIDES BY RECYCLING THEM, REUSING THEM OR DISPOSING OF THEM AS HAZARDOUS WASTE.

12) NO GRADING, PLANTING, IRRIGATION, TRENCHING, UTILITIES, MATERIAL STORAGE, EQUIPMENT TRAVEL UNDER THE DRIP LINES OF EXISTING TREES, IF POSSIBLE

13) PRUNING NOTE: ALLOW ALL PLANTS TO GROW INTO THEIR NATURAL GROWTH FORM. DO NOT SHEAR ANY PLANTS INTO 'BALLS', FLAT TOPPED OR TOPIARY, ETC. WAYWARD BRANCHES MAYBE CUT BACK OR PLANT BRANCHES OR FOLIAGE MAY BE CUT BACK INDIVIDUALLY FOR WALKWAY ACCESS, IF NEED BE. EXCEPTIONS: ornamental grasses in winter can be cut nearly to the ground. REMOVE SPENT FLOWERS (DEAD HEAD) 1-2 TIMES A YEAR AS NEEDED.

WATER EFFICENT LANDSCAPE ORDINANCE STATEMENT

"I HAVE COMPLIED WITH THE CRITERIA OF THE MODEL WATER EFFICIENT LANDSCAPE ORDINANCE AND HAVE APPLIED THEM FOR THE EFFICIENT USE OF WATER IN THE LANDSCAPE DESIGN PLAN."

GREG G. ING, PROJECT LANDSCAPE ARCHITECT


LANDSCAPE PLANTING PLAN

1"=8'

3) DON'T PUT PLANTS IN BOTTOM OF SWALES.

OF DEEP MULCH UNDER EXISTING TREES.

PLANTING LEGEND & NOTES

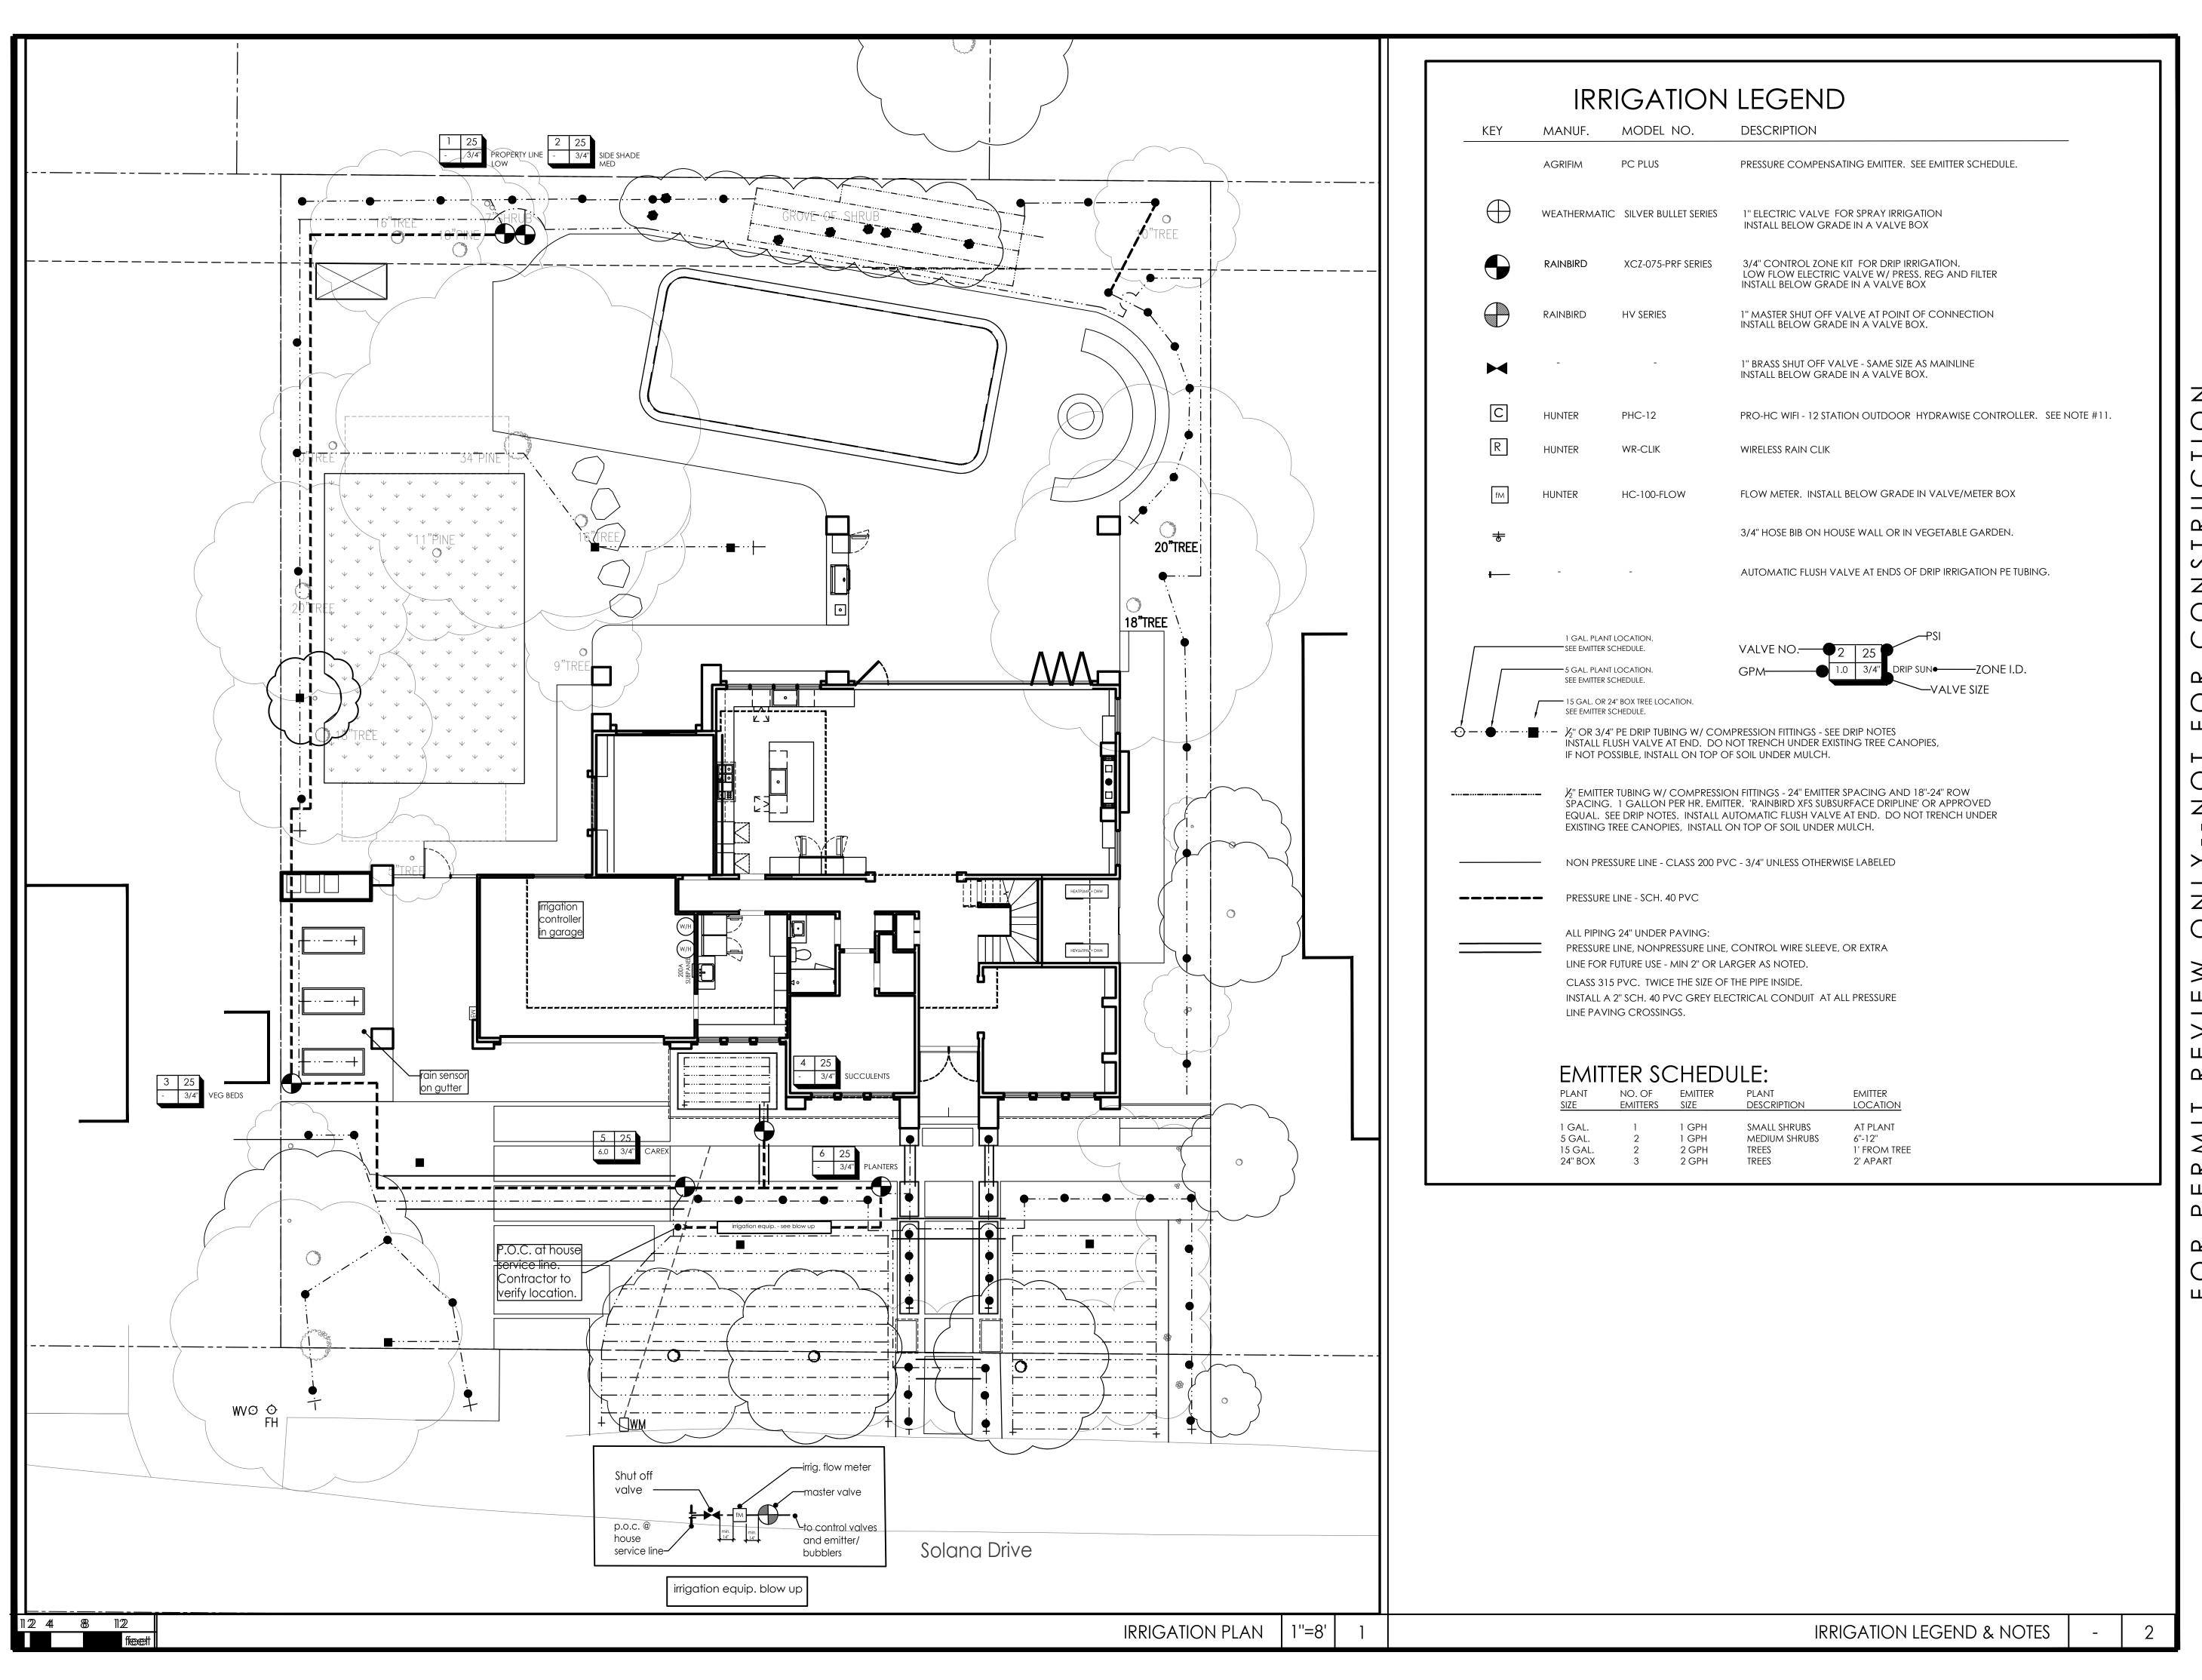




1000 S Winchester Blvd San Jose, CA 95128 P: (408) 998 - 0983

5 Bertran-Angulo Residence
NEW SINGLE FAMILY HOUSE
Los Altos, 226 Solana Drive



| ON LENWII NEVILY | 2202 | DRAWN B` | Gl | Gl | Gl | | |
|------------------|-------------|-------------|-------------------------------|-------------------------------|-------------------------------|--|--|
| _ | | _ | $\overline{}$ | | | | |
| > | | | | | | | |
| 」 | | | | | | | |
| _ | | | | | | | |
| | | | ΠAI | ΠAI | ΙЧ | | |
| - | | | M | M | MI | | |
| | | | SUB | SUB | SUB | | |
| ≥ | | | G | IG : | IG. | | |
| ∠ | | TION | \leq | Z | \leq | | |
| | | DESCRIPTION | 05.01.2023 PLANNING SUBMITTAL | 06.09.2023 PLANNING SUBMITTAL | 08.08.2023 PLANNING SUBMITTAL | | |
| | | DE | PL | PL | PL | | |
| _ | | | 23 | 23 | 23 | | |
| _ | | | .20 | .20 | .20 | | |
| - | | TE | .01 | .09 | .08 | | |
| ノ | | DATE | 05 | 90 | 80 | | |
| - | PROJECT NO. | z | | | | | |
| | OJEC | REVISION | | | | | |
| | PR | RE | | | | | |

IRRIGATION PLAN

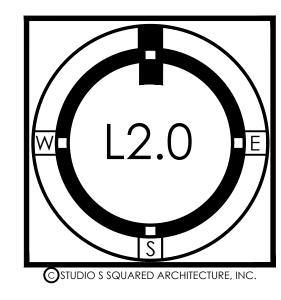

From: Diane Glazer < dianeglazer@gmail.com > Sent: Wednesday, September 20, 2023 8:31 AM To: Nazaneen Healy < nhealy@losaltosca.gov > Subject: Home Project 226 Solana Drive

To: Naz Healy

Roberto and Ana have shared their plans with me and they appear to be thoughtful and fit in with the neighborhood aesthetic. Yes, the home is a two story and generous in size, but it appears it will enhance the neighborhood as well as serve their family needs well.

I strongly urge you to allow their application to be approved and to include, if necessary, any modifications suggested by their most immediate neighbors for privacy purposes.

Thank you. Diane Glazer 259 Solana Dr, Los Altos, Ca 94022

AGENDA ITEM #2



TO: Nick Zornes, Zoning Administrator

FROM: Nazaneen Healy, Associate Planner

SUBJECT: SC23-0010 – 746 Casa Bonita Court

RECOMMENDATION

Approve design review application SC23-0010 for the construction of a new approximately 3,721 square foot, two-story home subject to the listed findings and conditions of approval; and find the project categorically exempt under the California Environmental Quality Act (CEQA) pursuant to Section 15303 ("New Construction or Conversion of Small Structures").

BACKGROUND

Project Description

- Project Location: 746 Casa Bonita Court, located on the west side of Casa Bonita Court.
- Lot Size: 10,632 square feet
- General Plan Designation: Single-Family, Medium Lot (SF4)
- Zoning Designation: R1-10
- <u>Current Site Conditions</u>: One-story home

The proposed project includes the demolition of the existing one-story home and replacement with a new two-story home with a basement (see Attachment A – Project Plans). The proposed home incorporates traditional gabled and hipped roof forms and exterior materials that include a standing seam metal roof, stucco exterior finish with stone veneer, metal trellises, and wood garage doors. The proposed home is situated on the lot similar to the existing home and the proposed site improvements include a new driveway to the attached garage and new landscaping throughout the property. There are no protected trees on the subject site.

ANALYSIS

Design Review

The proposed home complies with the R1-10 district development standards found in LAMC Chapter 14.06, as demonstrated by the following table:

| | Existing | Proposed | Allowed/Required |
|---|--|--|--|
| COVERAGE: | 2,654 square feet | 3,151 square feet | 3,189 square feet |
| FLOOR AREA: First floor Second floor Total | 2,453 square feet square feet 2,453 square feet | 2,482 square feet 1,239 square feet 3,721 square feet | 3,721 square feet |
| SETBACKS: Front Rear Right side (1 st /2 nd) Left side (1 st /2 nd) | 24.3 feet 31.9 feet 9.9 feet/ feet 9.5 feet/ feet | 25.3 feet 25.1 feet 13.6 feet/21.1 feet 12 feet/19.6 feet | 25 feet 25 feet 10 feet/17.5 feet 10 feet/17.5 feet |
| Неіснт: | 15 feet | 24.8 feet | 27 feet |

Pursuant to Chapter 14.76 of the LAMC, new two-story residences shall be consistent with policies and implementation techniques described in the Single-Family Residential Design Guidelines. The proposed home minimizes bulk by insetting the second story, minimizes two-story features, and proposes a lower height than the maximum. In addition, the design places two second-story egress windows facing the street except and one facing the rear yard, which will be screened with evergreen trees to minimize potential privacy impacts.

Nine new trees will be planted in the front and rear yards and one existing tree in the public right-of-way will remain. The landscaping plan will comply with the Water Efficient Landscape Ordinance, which requires water-efficient landscaping for new residences with landscaping over 500 square feet.

The proposed project meets the development standards in the R1-10 zoning district and complies with the Single-Family Residential Design Guidelines because it is compatible with the character of the neighborhood as the design maintains an appropriate relationship with adjacent structures, minimizes bulk, and minimizes potential privacy impacts.

ENVIRONMENTAL REVIEW

This project is categorically exempt from environmental review under Section 15303 ("New Construction or Conversion of Small Structures") of the California Environmental Quality Act (CEQA) because it involves the construction of a single-family dwelling in a residential zone.

PUBLIC NOTIFICATION AND COMMUNITY OUTREACH

A public meeting notice was posted on the property, mailed to property owners within a 300-foot radius, and published in the Town Crier newspaper. The applicant also posted the public notice sign (24" x 36") in conformance with the Planning Division posting requirements.

The applicant also contacted eight neighbors in the immediate area via email and hosted two informal meetings regarding the proposed project. No comments from neighbors have been received by staff as of the writing of this report.

Attachment:

A. Project Plans

Cc: Jim Maliksi, Applicant

Namrita and Suku Chettiar, Property Owner

FINDINGS

SC23-0010 – 746 Casa Bonita Ct

With regard to the proposed new two-story residence, the Zoning Administrator finds the following in accordance with Section 14.76.060 of the Municipal Code:

- A. The proposed residence complies with all provisions of this chapter because the proposed residence is consistent with the development standards of the R1-10 zoning district and policies and implementation techniques described in the Single-Family Residential Design Guidelines.
- B. The height, elevations, and placement on the site of the proposed new house is compatible when considered with reference to the nature and location of residential structures on adjacent lots, and will consider the topographic and geologic constraints imposed by particular building site conditions as the proposed home maintains a similar finished floor elevation and orientation on the lot as the existing home and complies with the allowable floor area, lot coverage, and height maximums as well as the daylight plane requirement pursuant to LAMC Chapter 14.06.
- C. The natural landscape will be preserved insofar as practicable by minimizing tree and soil removal; grade changes shall be minimized because the existing site is relatively level and does not require substantial grading except for the basement. There are no protected trees on the subject site. Nine new trees will be planted in the front and rear yards and one existing tree in the public right-of-way will remain.
- D. The orientation of the proposed new house in relation to the immediate neighborhood will minimize excessive bulk because the proposed design insets the second story, minimizes two-story features, and proposes a lower height than the maximum.
- E. General architectural considerations, including the size and scale, the architectural relationship with the site and other buildings, building materials, and similar elements have been incorporated in order to insure the compatibility of the development with its design concept and the character of adjacent buildings on the same project site. The proposed home complies with the allowable floor area, lot coverage, and height maximums as well as the daylight plane requirement pursuant to LAMC Chapter 14.06 and the design of the home incorporates consistent and compatible features including standing seam metal roofing, stucco exterior finish with stone veneer, metal trellises and wood doors.
- F. The proposed residence has been designed to follow the natural contours of the site with minimal grading, minimum impervious cover, and maximum erosion protection because the proposed grading provides for drainage away from the home and away from adjacent properties and conforms to existing grades along the property lines.

CONDITIONS OF APPROVAL

SC23-0010 - 746 Casa Bonita Ct

GENERAL

1. Expiration

The Design Review Approval will expire on September 20, 2025 unless prior to the date of expiration, a building permit is issued, or an extension is granted pursuant to Section 14.76.090 of the Zoning Code.

2. Approved Plans

The approval is based on the plans and materials received on August 7, 2023, except as may be modified by these conditions.

3. Protected Trees

Existing Tree Nos. 1-7 in the public right-of-way and on the adjacent properties, and the new trees shall be protected under this application and require permits from the Development Services Department or Public Works Department to remove.

4. Arborist Report

Amend the December 16, 2022 Arborist Report or provide a new report from a certified arborist confirming the proposed retaining wall replacement will not compromise the health of Tree No. 7 (the Redwood tree) and/or providing construction methods necessary to protect the tree.

Fireplaces

Only gas fireplaces, pellet fueled wood heaters or EPA certified wood-burning appliances may be installed in all new construction pursuant to Chapter 12.64 of the Municipal Code.

6. Encroachment Permit

An encroachment permit shall be obtained from the Engineering Division prior to doing any work within the public right-of-way including the street shoulder. All work within the public right-of-way shall be in compliance with the City's Shoulder Paving Policy.

7. Landscaping

The project shall be subject to the City's Water Efficient Landscape Ordinance (WELO) pursuant to Chapter 12.36 of the Municipal Code if 500 square feet or more of new or replaced landscape area, including irrigated planting areas, turf areas, and water features is proposed.

8. Underground Utility and Fire Sprinkler Requirements

Additions exceeding fifty (50) percent of the existing living area (existing square footage calculations shall not include existing basements) and/or additions of 750 square feet or more shall trigger the undergrounding of utilities and new fire sprinklers. Additional square footage calculations shall include existing removed exterior footings and foundations being replaced and rebuilt. Any new utility service drops are pursuant to Chapter 12.68 of the Municipal Code.

9. Indemnity and Hold Harmless

The applicant/owner agrees to indemnify, defend, protect, and hold the City harmless from all costs and expenses, including attorney's fees, incurred by the City or held to be the liability of the City in connection with the City's defense of its actions in any proceedings brought in any State or Federal Court, challenging any of the City's action with respect to the applicant's project. The City may withhold final maps and/or permits, including temporary or final occupancy permits, for failure to pay

all costs and expenses, including attorney's fees, incurred by the City in connection with the City's defense of its actions.

INCLUDED WITH THE BUILDING PERMIT SUBMITTAL

10. Conditions of Approval

Incorporate the conditions of approval into the title page of the plans and provide a letter which explains how each condition of approval has been satisfied and/or which sheet of the plans the information can found.

11. Tree Protection Note

On the grading plan and the site plan, show all tree protection fencing and add the following note: "All tree protection fencing shall be chain link and a minimum of five feet in height with posts driven into the ground."

12. Water Efficient Landscape Plan

Provide a landscape documentation package prepared by a licensed landscape professional showing how the project complies with the City's Water Efficient Landscape Regulations and include signed statements from the project's landscape professional and property owner.

13. Reach Codes

Building Permit Applications submitted on or after January 1, 2023 shall comply with specific amendments to the 2022 California Green Building Standards for Electric Vehicle Infrastructure and the 2022 California Energy Code as provided in Ordinances No 2022-487 which amended Chapter 12.22 Energy Code and Chapter 12.26 California Green Building Standards Code of the Los Altos Municipal Code. The building design plans shall comply with the standards and the applicant shall submit supplemental application materials as required by the Building Division to demonstrate compliance.

14. California Water Service Upgrades

You are responsible for contacting and coordinating with the California Water Service Company any water service improvements including but not limited to relocation of water meters, increasing water meter sizing or the installation of fire hydrants. The City recommends consulting with California Water Service Company as early as possible to avoid construction or inspection delays.

15. Green Building Standards

Provide verification that the house will comply with the California Green Building Standards pursuant to Chapter 12.26 of the Municipal Code and provide a signature from the project's Qualified Green Building Professional Designer/Architect and property owner.

16. Underground Utility Location

Show the location of underground utilities pursuant to Chapter 12.68 of the Municipal Code. Underground utility trenches shall avoid the drip-lines of all protected trees unless approved by the project arborist and the Planning Division.

17. Outdoor Condensing Units

Show the location of any outdoor condensing unit(s) on the site plan including the model number of the unit(s), nominal size (i.e. tonnage) of the unit, and setback to the nearest property line. Provide the manufacturer's specifications showing the sound rating for each unit. The condensing unit(s) must be located to comply with the City's Noise Control Ordinance (Chapter 6.16) and in compliance with the Planning Division setback provisions. The units shall be screened from view of the street.

18. Off-Haul Excavated Soil

The grading plan shall show specific grading cut and/or fill quantities. Cross section details showing

the existing and proposed grading through at least two perpendicular portions of the site or more shall be provided to fully characterize the site. A note on the grading plans should state that all excess dirt shall be off-hauled from the site and shall not be used as fill material unless approved by the Building and Planning Divisions.

19. Storm Water Management

Show how the project is in compliance with the New Development and Construction Best Management Practices and Urban Runoff Pollution Prevention program, as adopted by the City for the purposes of preventing storm water pollution (i.e. downspouts directed to landscaped areas, minimize directly connected impervious areas, etc.).

PRIOR TO ISSUANCE OF BUILDING OR DEMOLITION PERMIT

20. Tree Protection

Tree protection fencing shall be installed around the driplines, or as required by the project arborist, of the existing tree in the public right-of-way and the existing trees on neighboring properties that overhang the subject property as shown on the site plan. Tree protection fencing shall be chain link and a minimum of five feet in height with posts driven into the ground and shall not be removed until all building construction has been completed unless approved by the Planning Division.

21. School Fee Payment

In accordance with Section 65995 of the California Government Code, and as authorized under Section 17620 of the Education Code, the property owner shall pay the established school fee for each school district the property is located in and provide receipts to the Building Division. The City of Los Altos shall provide the property owner the resulting increase in assessable space on a form approved by the school district. Payments shall be made directly to the school districts.

PRIOR TO FINAL INSPECTION

22. Landscaping Installation and Verification

All landscaping materials, including plants or trees intended to provide privacy screening, as provided on the approved landscape plans shall be installed prior to final inspection. The applicant shall also provide a landscape Certificate of Completion, signed by the project's landscape professional and property owner, verifying that the trees, landscaping, and irrigation were installed per the approved landscape documentation package.

23. Green Building Verification

Submit verification that the house was built in compliance with the City's Green Building Ordinance (Chapter 12.26 of the Municipal Code).



TABLE OF CONTENTS

GENERAL INFORMATION

COVER SHEET NEIGHBORHOOD CONTEXT MAP NEIGHBORHOOD CONTEXT PHOTOS NEIGHBORHOOD CONTEXT PHOTOS

CIVIL

TOPOGRAPHY SURVEY PLAN PRELIMINARY GRADING AND DRAINAGE PLAN PRELIMINARY UTILITY PLAN

LANDSCAPE

COVER SHEET SCREENING PLAN PLANTING PLAN IRRIGATION & HYDROZONE PLAN

SITE DEMO & TREE PROTECTION PLAN

A-1.2SITE PLAN EXISTING FLOOR PLAN

EXISTING ROOF PLAN EXISTING EXTERIOR ELEVATIONS

BASEMENT FLOOR PLAN

A-3GROUND FLOOR PLAN

A-4SECOND FLOOR PLAN ROOF PLAN

FRONT ELEVATION & RIGHT SIDE ELEVATION

REAR ELEVATION & LEFT SIDE ELEVATION OBLIQUE ELEVATION @ DAYLIGHT PLANE & SECTION A-A

NEW FLOOR AREA DIAGRAM AND AREA CALCULATIONS

SECTION B-B & SECTION C-C

SUKU

& NAMRITA CHETTIAR

PROJECT TITLE & LOCATION

NEW RESIDENCE

FOR

746 CASA BONITA COURT LOS ALTOS, CA 94024

REVISION

J MALIKSI & ASSOC. ARCHITECTURE - INTERIOR DESIGN

675 MENLO AVENUE MENLO PARK, CA 94025 TEL. NO. 650 323 2902 FAX NO. 650 323 6433



NO. DATE ISSUE GTM 7-14-23 FOR DESIGN REVIEW GTM 5-19-23 FOR DESIGN REVIEW

ALL DRAWINGS AND MATERIALS APPEARING HEREIN CONSTITUTE THE ORIGINAL AND UNPUBLISHED WORK OF THE ARCHITECT AND MAY NOT BE DUPLICATED, USED OR DISCLOSED WITHOUT THE PRIOR WRITTEN CONSENT OF THE ARCHITECT.

© 2022 JIM MALKSI & ASSOCIATES DRAWING TITLE


> COVER SHEET, SHEET INDEX, PROJECT DATA, ZONING

COMPLIANCE

SCALE: 1/8" = 1'-0" PROJECT NAME: CHETTIAR CADD FILE NO. DRAWING NO.

NEW RESIDENCE FOR NAMRITA & SUKU CHETTIAR

CONTACT INFO: Jim Maliksi, AIA California Horticulture 753 Camden Avenue Campbell, CA 95008 J Maliksi & Associates 675 Menlo Avenue Menlo Park, CA 94025 (650) 323-2902 (408) 364-3190 Dan MacLeod MacLeod and Associates, Inc. 965 Center Street San Carlos, CA 94070 (650) 593-8580 Lucas Ottoboni, P.E. Romig Engineers Inc. 1390 El Camino Real Second Floor San Carlos, CA 94070 (650) 591-5224 Jeromey Ingalls Mayne Tree Expert Company Inc. 535 Bragato Road San Carlos, CA 94070 (650) 593-4400

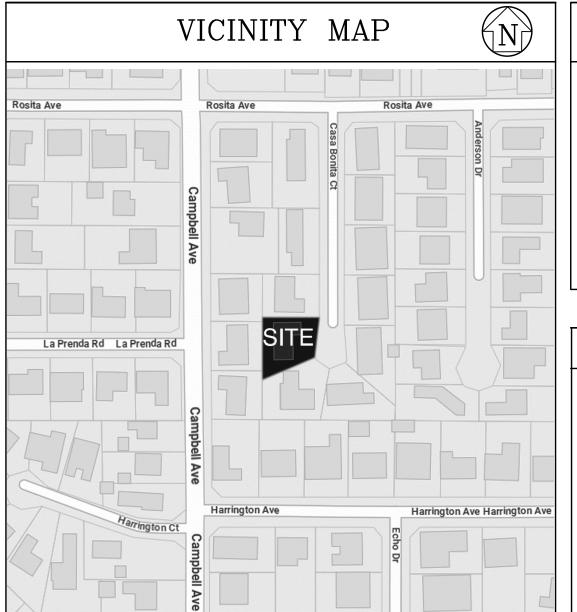

SCOPE OF WORK PROJECT INCLUDES: DEMOLITION OF EXISTING 1 STORY RESIDENCE, (E) PATIOS & HARDSCAPE SURFACES TO BE REMOVED. (N) 2 STORY RESIDENCE WITH BASEMENT, NEW COVERED SIDE PATIO, DRIVEWAY, WALKWAYS, LANDSCAPING AND OTHER HARDSCAPE SURFACES.

| G | ENERAL IN | IFORM <i>E</i> | ATION |
|--|--|--|---|
| TYP STO FIRE BAS GRO GAR SEC | CUPANCY GROUP: E OF CONSTRUCTION: RIES: E SPRINKLERS: EMENT DUND FLOOR (HABITABLE): CAGE OND FLOOR AL BUILDING AREA: | R-3/U TYPE V-B 2 ⊠-YES □-N0 1,557.9 S.F. 2,026.4 S.F. 455.3 S.F. 1,239.4 S.F. 5,279.0 S.F. | (PER SANTA CLARA COUNTY CENTRAL FIRE PROTECTION DISTRICT, INSTALL NFPA 13D FIRE SPRINKLERS) |

| OWNERS: NAMRITA & SUKU CHETTIAR | |
|---|--------------|
| | |
| ADDRESS: 746 CASA BONITA COURT LOS ALTOS, CA 94024 | |
| A.P.N.#: 189-41-085 | |
| ZONE: R1-10 | |
| LOT AREA: | 10,632 S.F. |
| MAXIMUM LOT COVERAGE =(30%)Lot Area = | 3,189.6 S.F. |
| MAXIMUM FLOOR AREA = MAXIMUM FLOOR AREA FOR LOTS = WITH A NET SITE AREA NOT EXCEEDING 11,000 SQUARE FEET, THE MAXIMUM FLOOR AREA SHALL BE THIRTY-FIVE (35) PERCENT OF THE LOT AREA. | 3,721.2 S.F. |

PROJECT DATA


| DEFERRED | SUBMITTALS |
|---------------------------------|------------------------------------|
| 4 NUDA 40D BUDE ODDINIZI ED DEG | ION & CUDATEMENT TIMEDE CEDADAMANE |

1. NFPA 13D FIRE SPRINKLER DESIGN & SUBMITTAL UNDER SEPARATATE PERMIT. FIRE SPRINKLER PLANS SHALL BE SUBMITTED DIRECTLY TO THE SANTA CLARA COUNTY FIRE DEPARTMENT BY A CALIFORNIA LICENSED C-16 FIRE SPRINKLER CONTRACTOR.

| | Existing | Proposed | Allowed/Require |
|---|--|--|---|
| Lot Coverage: Land area covered by all structures that are over 6 feet in height | 2,654.1 square feet (25.0%) | 3150.7 square feet (29.6 %) | 3,189.6 square fee |
| FLOOR AREA: Measured to the outside surfaces of exterior walls | 2,452.9 square feet (18.2%) | 3721.2 square feet (35.0%) | 3,721.2 square fee |
| SETBACKS: Front Rear Right side (1st/2nd) Left side (1st/2nd) | 24.38 feet 31.88 feet 9.88 feet/feet 9.5 feet/feet | 25.3 feet 25.13 feet 13.63 feet/ ^{21.13} feet 12.0 feet/ ^{19.63} feet | 25 feet 25 feet 10 feet/17.5feet 10 feet/17.5feet |
| Неіднт: | _15.0 _{feet} | 24.8 feet | 27 feet |
| SQUA | ARE FOOTAGE B | REAKDOWN | |
| | Existing | Change in | Total Proposed |
| HABITABLE LIVING AREA: | 1,975.1 square feet | 2,848.6 square feet | 4,823.7 square fee |

| NON- HABITABLE AREA: Does not include covered porches or open structures | 477.8 | square feet | - 22.5 | _square feet | 455.3 | _square feet |
|---|--------|-------------|--------|--------------|-------|--------------|
| | LOT CA | ALCULA | ΓΙΟΝS | | | |
| NET LOT AREA: | | | 10.632 | square feet | | |

| | 488 |
|--|--|
| RONT YARD HARDSCA ardscape area in the front yard | countre teet (\$1 %) |
| ANDSCAPING REAKDOWN: | Total hardscape area (existing and proposed): 5,917.0 sq ft Existing softscape (undisturbed) area: 0 sq ft New softscape (new or replaced landscaping) area: 4,715.0 sq ft Sum of all three should equal the site's net lot area |

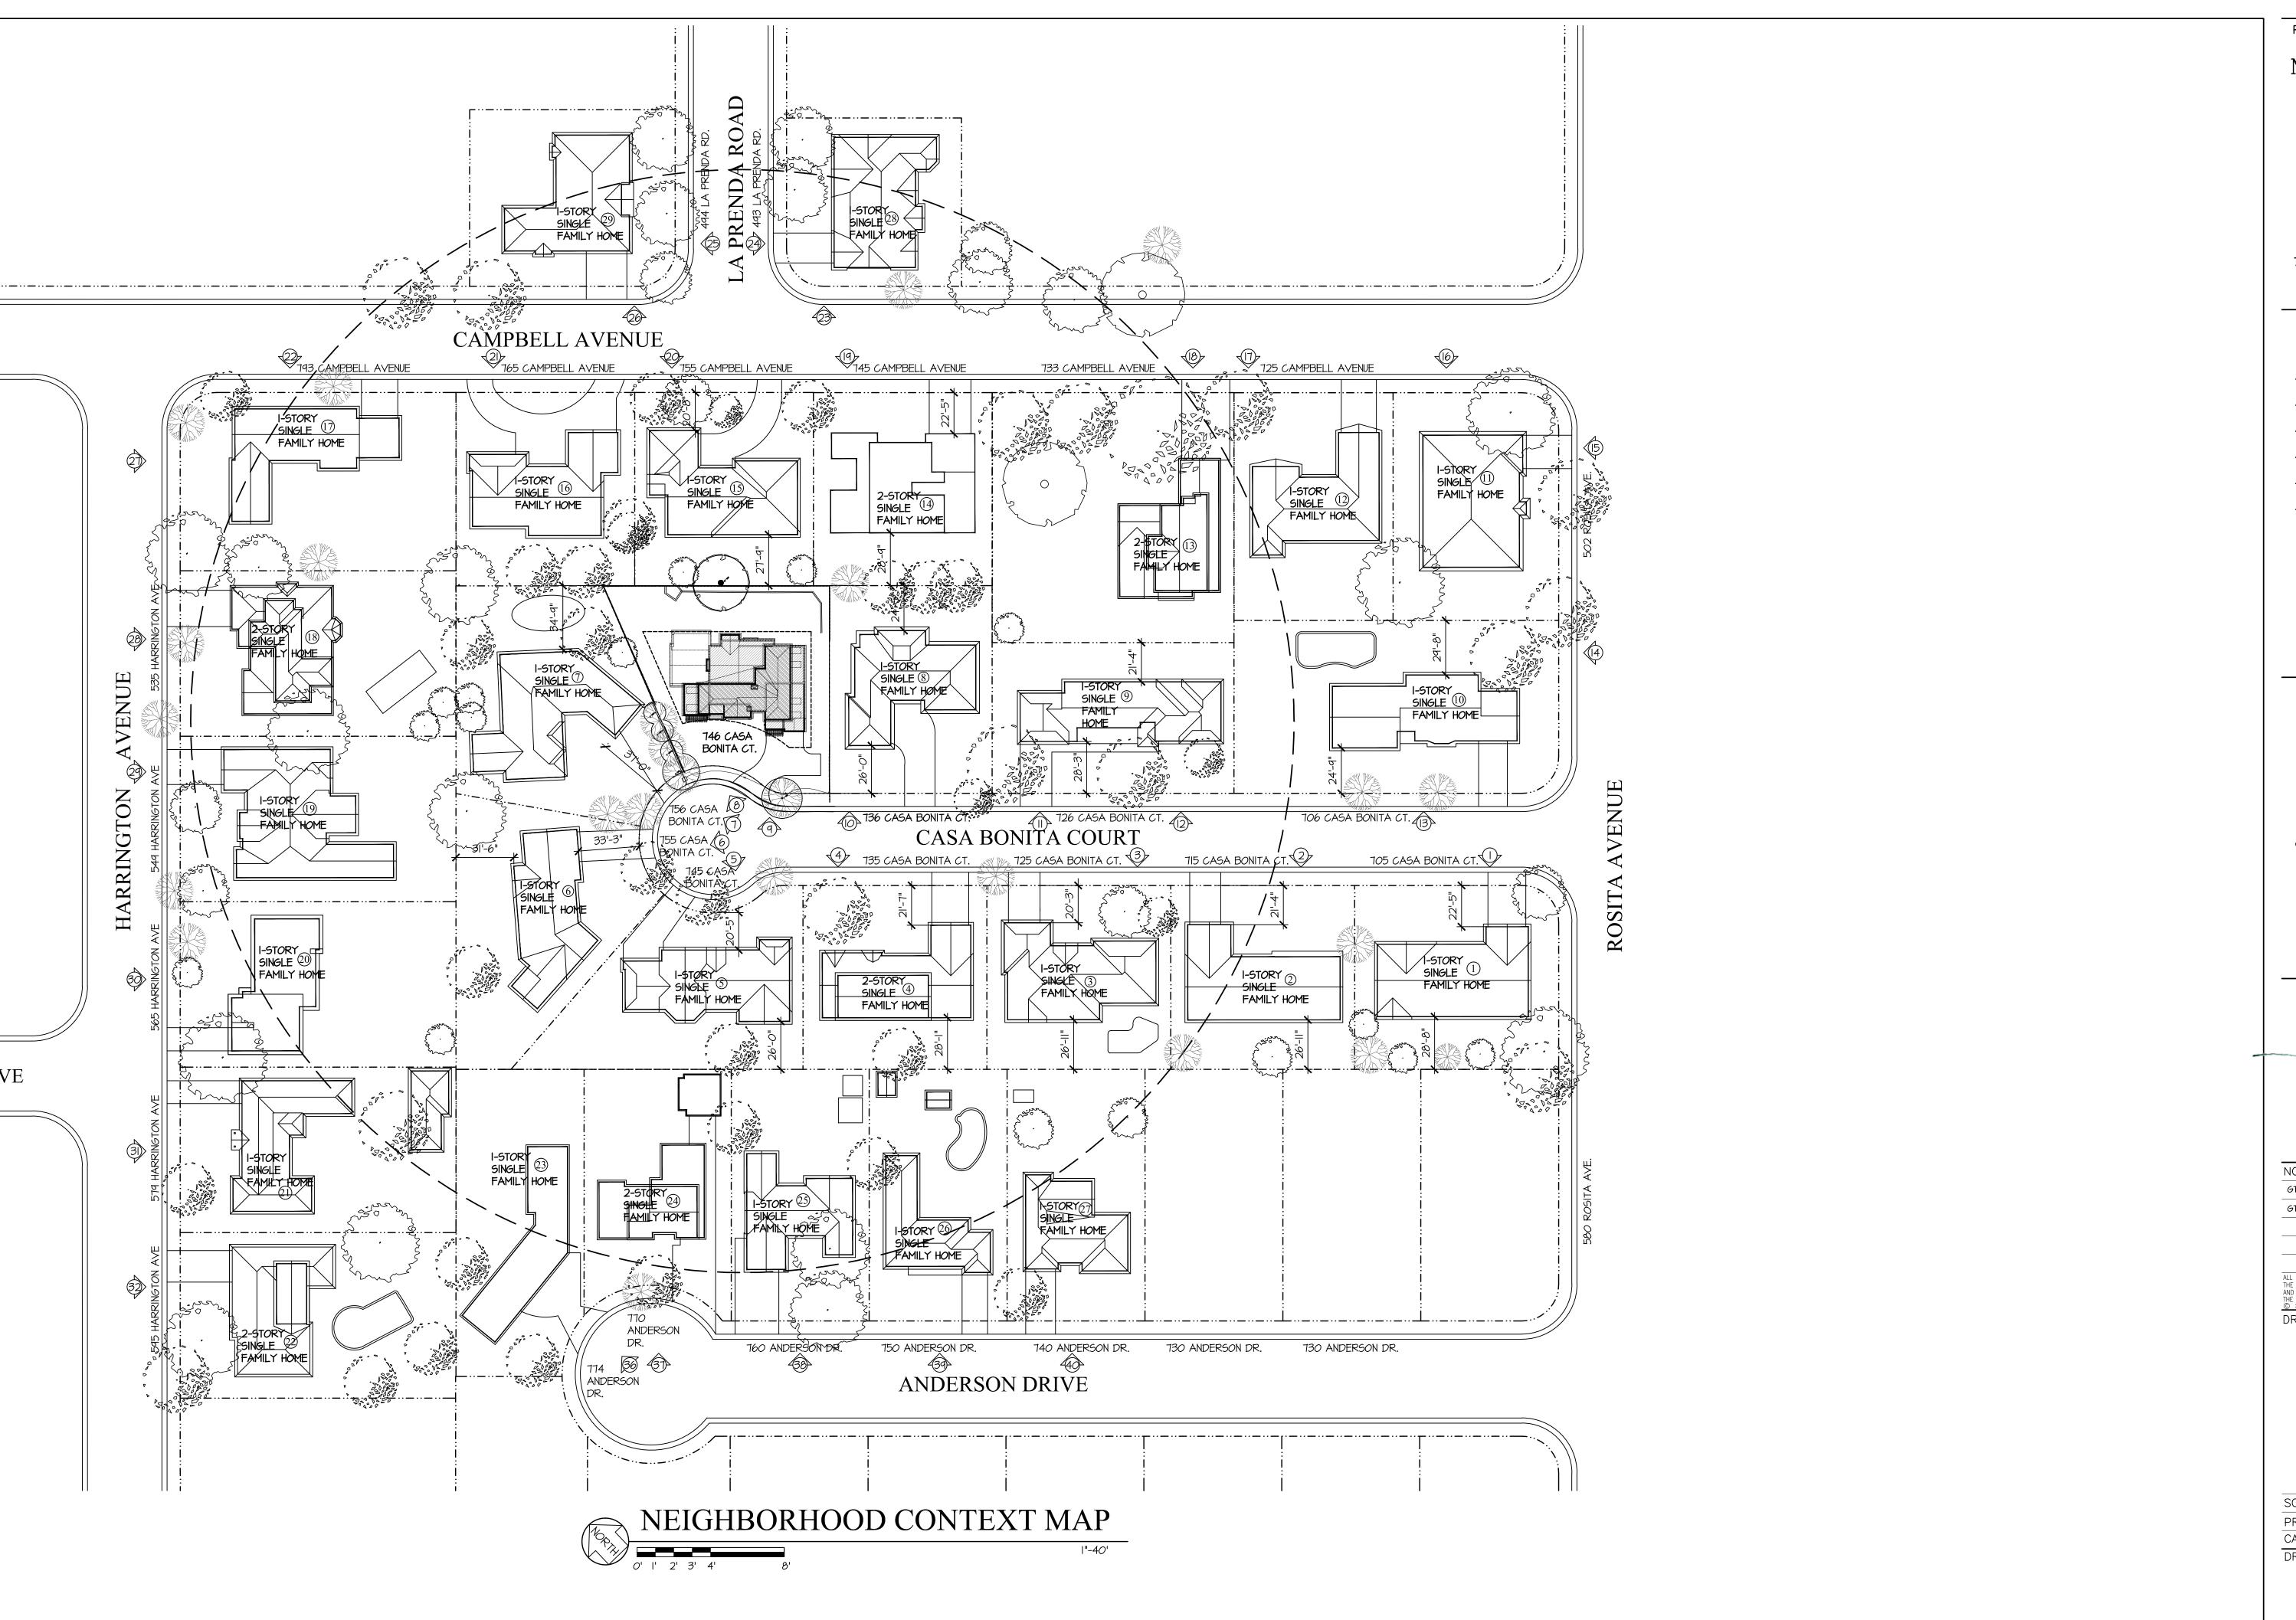

NEW RESIDENCE FOR

SUKU & NAMRITA CHETTIAR

746 CASA BONITA COURT LOS ALTOS, CA 94024

REVISION



J MALIKSI & ASSOC.

ARCHITECTURE - INTERIOR DESIGN

675 MENLO AVENUE MENLO PARK, CA 94025 TEL. NO. 650 323 2902 FAX NO. 650 323 6433



NO. DATE ISSUE

GTM 7-14-23 FOR DESIGN REVIEW

GTM 5-19-23 FOR DESIGN REVIEW

ALL DRAWINGS AND MATERIALS APPEARING HEREIN CONSTITUTE THE ORIGINAL AND UNPUBLISHED WORK OF THE ARCHITECT AND MAY NOT BE DUPLICATED, USED OR DISCLOSED WITHOUT THE PRIOR WRITTEN CONSENT OF THE ARCHITECT.

© 2022 JIM MALIKSI & ASSOCIATES

DRAWING TITLE

NEIGHBORHOOD CONTEXT MAP

SCALE:

PROJECT NAME: CHETTIAR

CADD FILE NO.

DRAWING NO.

A-0.2



NEW RESIDENCE FOR

> SUKU & NAMRITA CHETTIAR

746 CASA BONITA COURT LOS ALTOS, CA 94024

REVISION

J MALIKSI & ASSOC.

ARCHITECTURE - INTERIOR DESIGN

675 MENLO AVENUE MENLO PARK, CA 94025 TEL. NO. 650 323 2902 FAX NO. 650 323 6433



NO. DATE ISSUE

6TM 5-19-23 FOR DESIGN REVIEW

ALL DRAWINGS AND MATERIALS APPEARING HEREIN CONSTITUTINE ORIGINAL AND UNPUBLISHED WORK OF THE ARCHITECT AND MAY NOT BE DUPLICATED, USED OR DISCLOSED WITHOUTHE PRIOR WRITTEN CONSENT OF THE ARCHITECT.

© 2022 JIM MALIKSI & ASSOCIATES

NEIGHBORHOOD CONTEXT PHOTOS

SCALE: N.T.5.

PROJECT NAME: CHETTIAR

CADD FILE NO.

A-0.3



38 760 ANDERSON DRIVE

39 750 ANDERSON DRIVE

37 770 ANDERSON DRIVE

36 774 ANDERSON DRIVE

PROJECT TITLE & LOCATION

NEW RESIDENCE FOR

SUKU & NAMRITA CHETTIAR

746 CASA BONITA COURT LOS ALTOS, CA 94024

REVISIO

J MALIKSI & ASSOC.

ARCHITECTURE - INTERIOR DESIGN

675 MENLO AVENUE MENLO PARK, CA 94025 TEL. NO. 650 323 2902 FAX NO. 650 323 6433



NO. DATE ISSUE

6TM 5-19-23 FOR DESIGN REVIE

ALL DRAWINGS AND MATERIALS APPEARING HEREIN CONSTITUTE THE ORIGINAL AND UNPUBLISHED WORK OF THE ARCHITECT AND MAY NOT BE DUPLICATED, USED OR DISCLOSED WITHOUT THE PRIOR WRITTEN CONSENT OF THE ARCHITECT.

© 2022 JM MAUKSI & ASSOCIATES

DRAWING TITLE

NEIGHBORHOOD CONTEXT PHOTOS

SCALE: N.T.S.


PROJECT NAME: CHETTIAR

CADD FILE NO.


DRAWING NO.

40 740 ANDERSON DRIVE

A-0.4

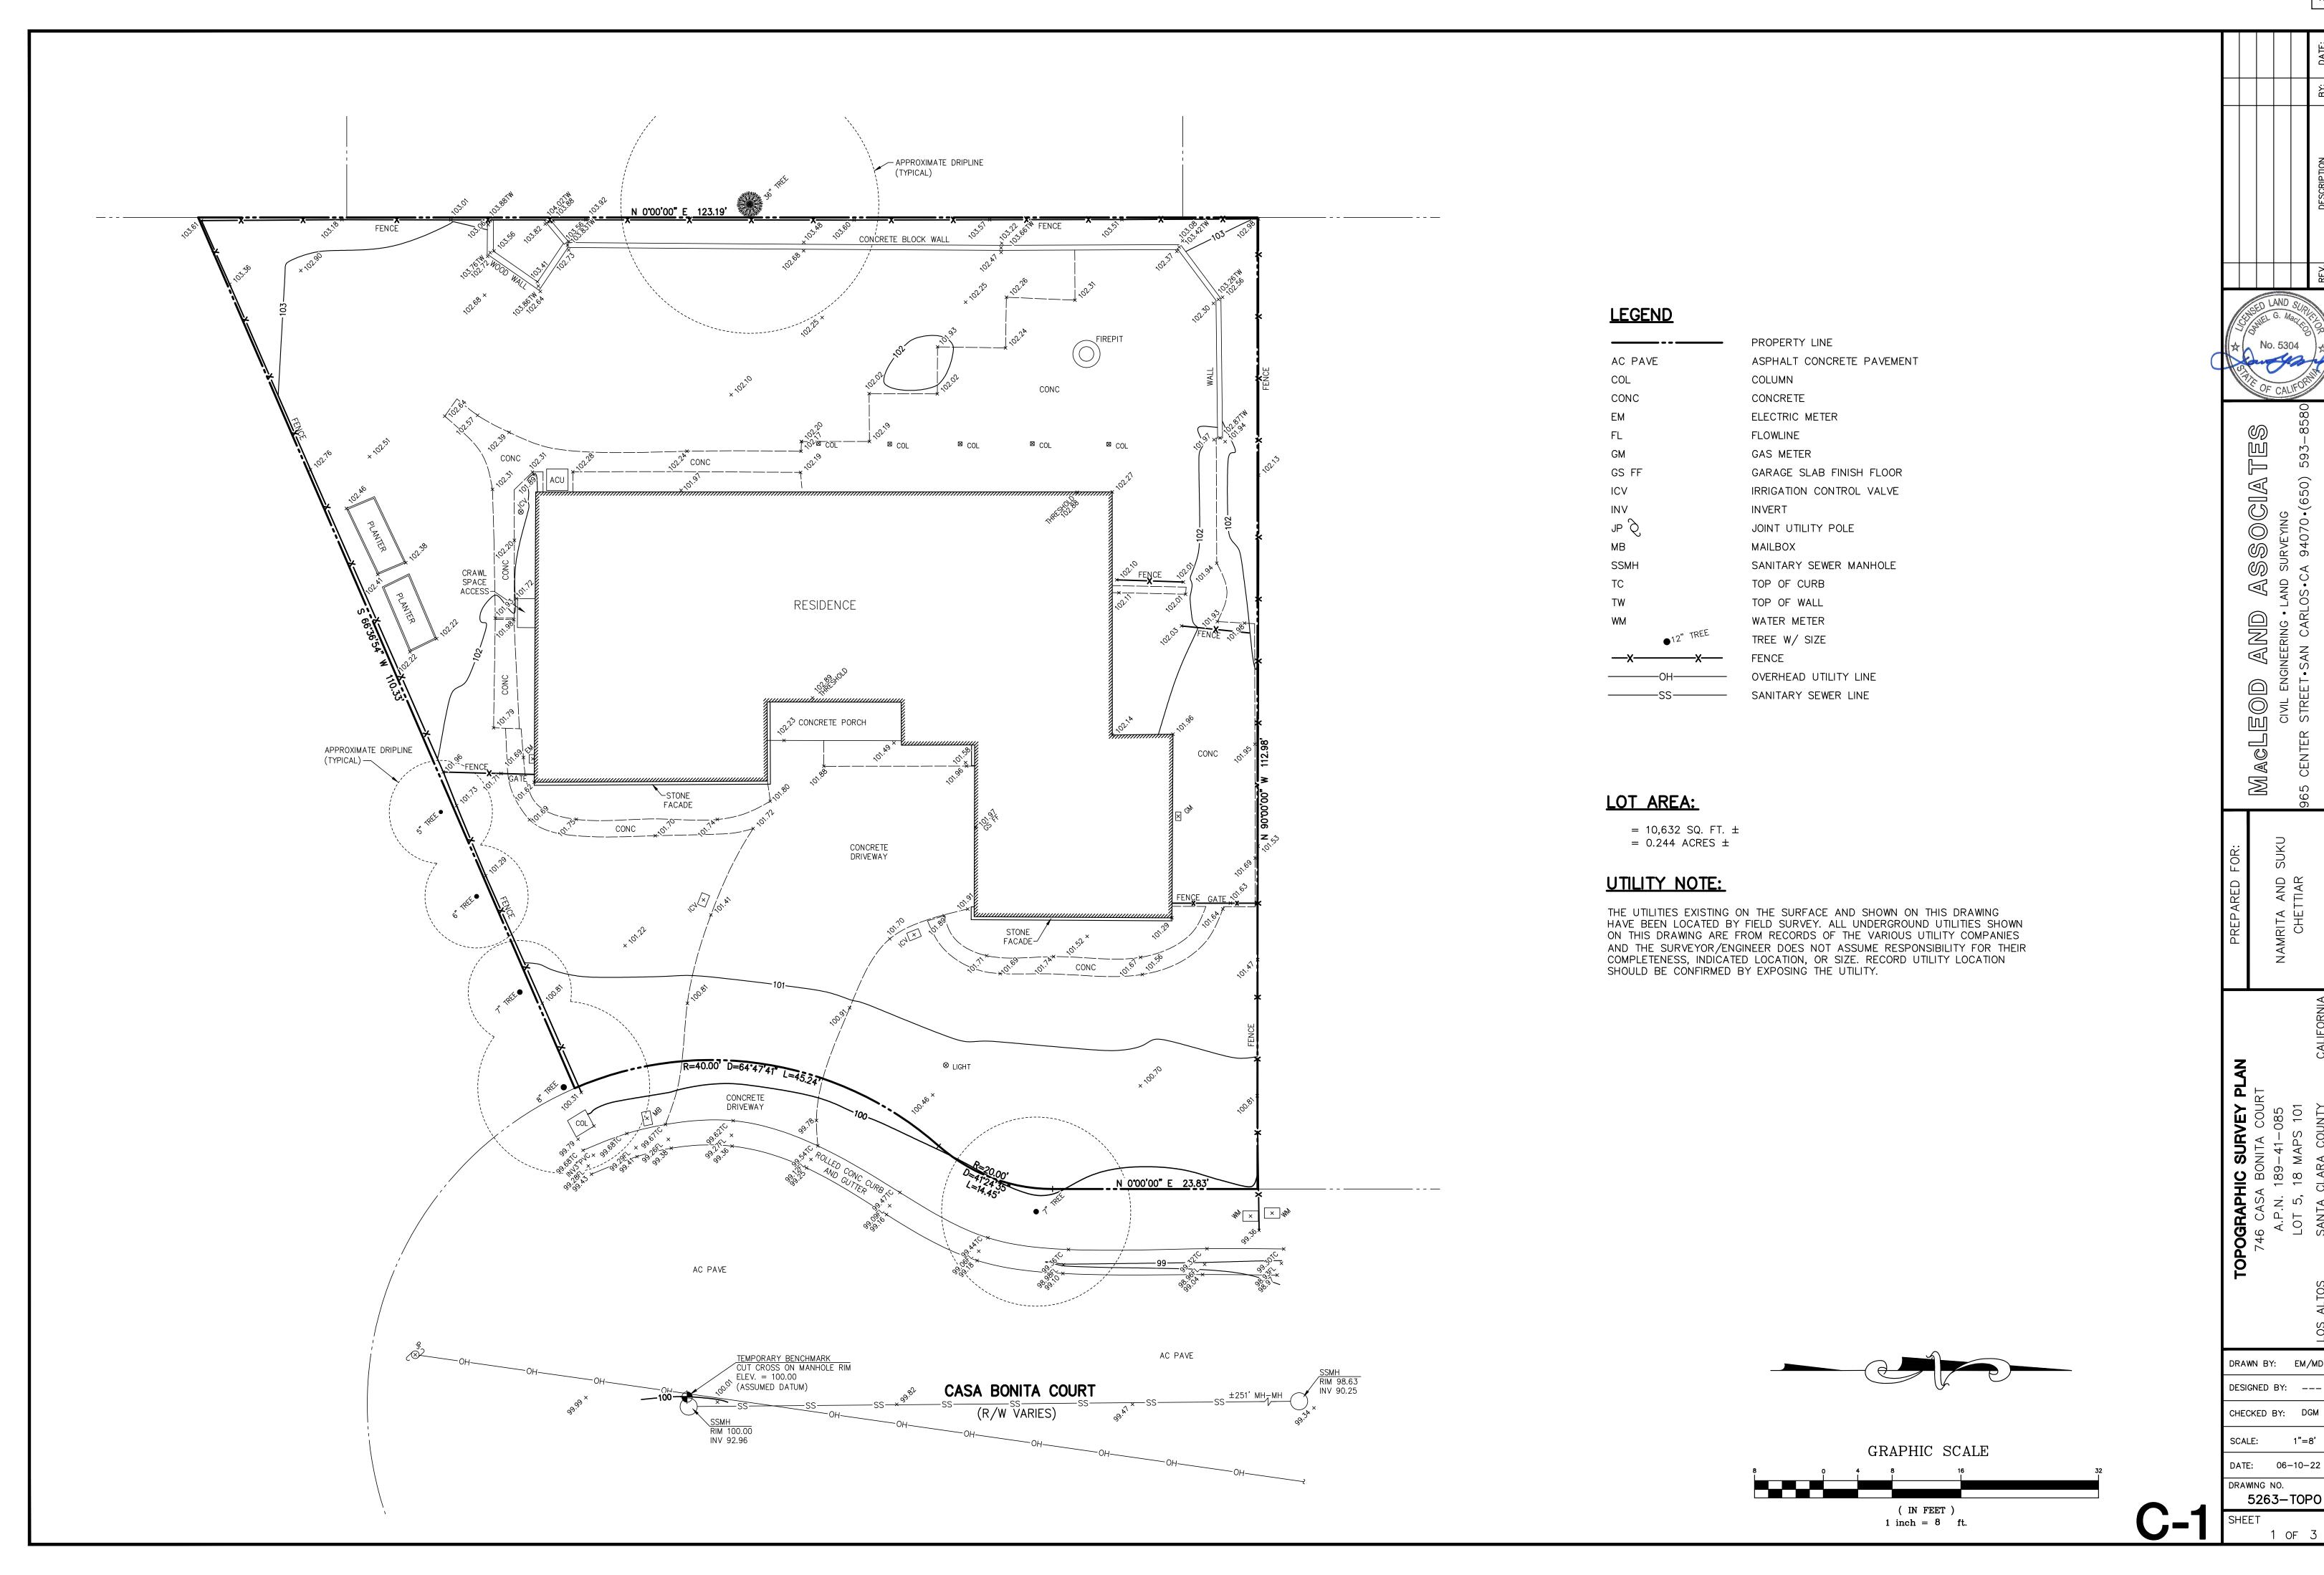

50

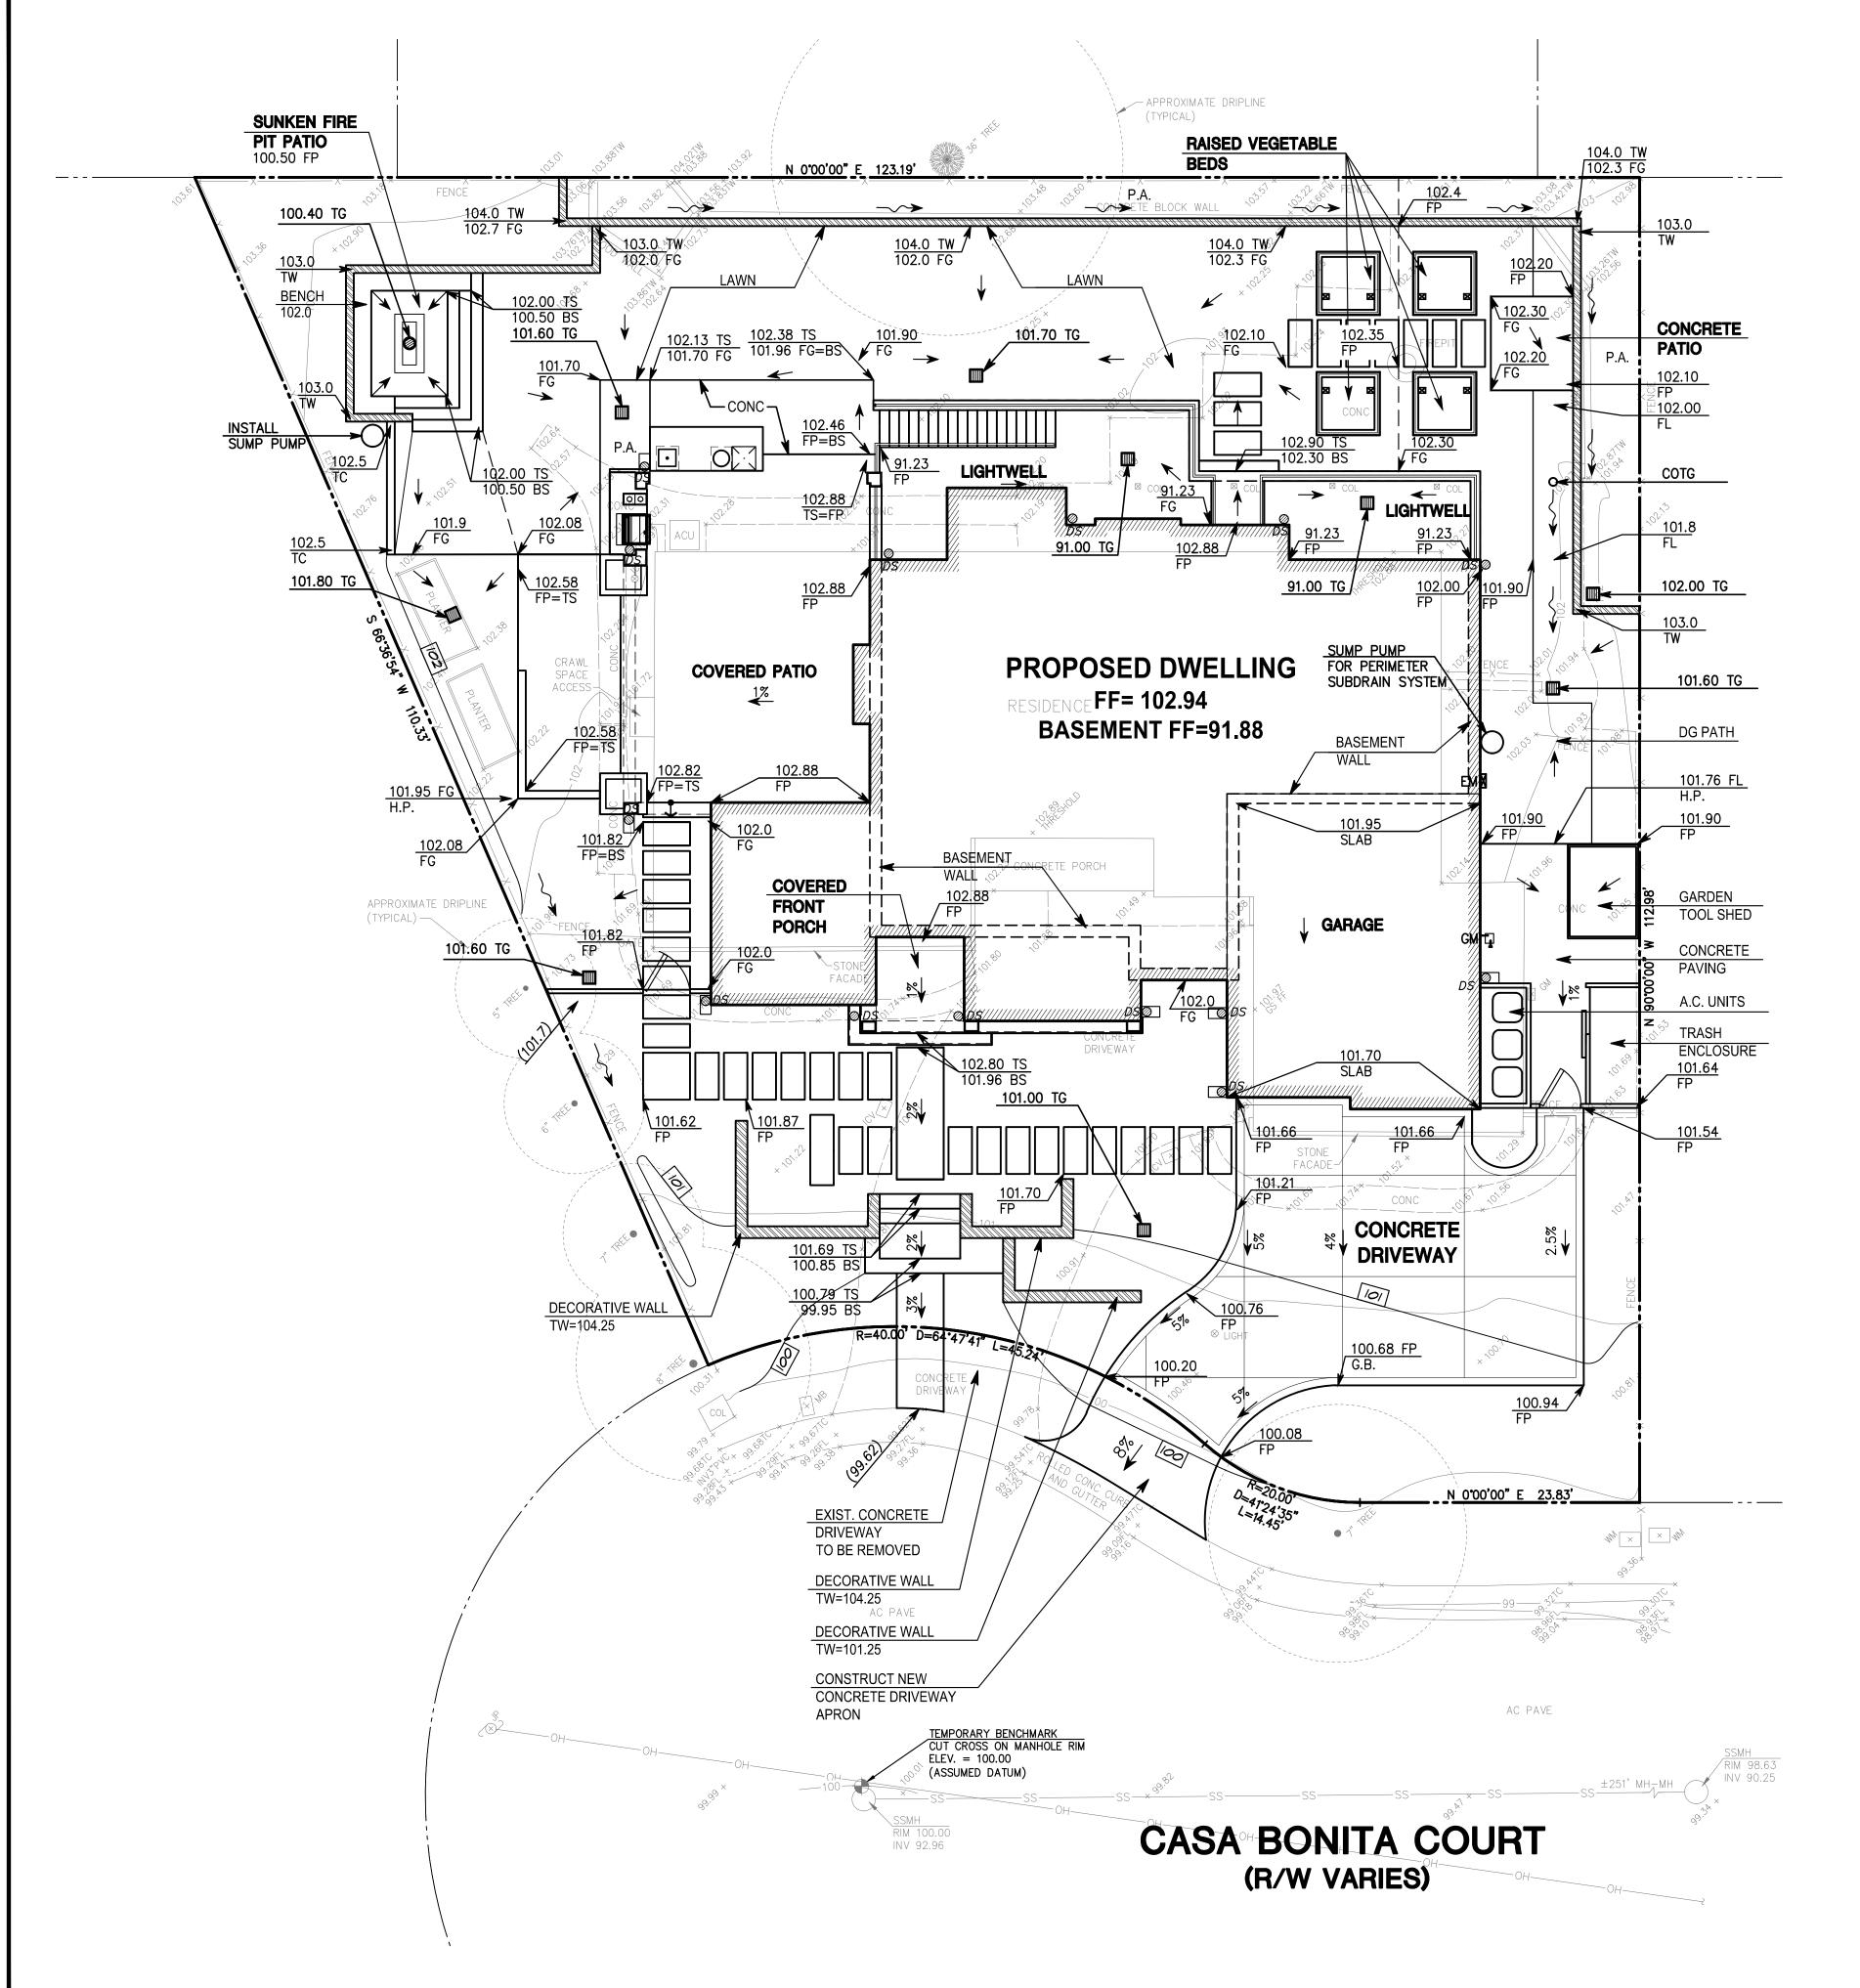

GENERAL NOTES:

- 1. ALL MATERIALS SHALL BE FURNISHED AND INSTALLED BY THE CONTRACTOR UNLESS OTHERWISE NOTED.
- 2. WHEN APPLICABLE, ALL CONSTRUCTION MATERIALS AND METHODS SHALL COMPLY WITH THE ORDINANCES, SPECIFICATIONS AND STANDARDS OF THE CITY OF LOS ALTOS, UNLESS OTHERWISE
- 3. CONTRACTOR SHALL NOTIFY UNDERGROUND SERVICE ALERT (U.S.A.) PRIOR TO START OF CONSTRUCTION. PHONE (800) 227-2600.
- 4. UNLESS OTHERWISE SPECIFIED, ALL ON-SITE AREA DRAINS SHALL BE CHRISTY-TYPE PRECAST CONCRETE OR APPROVED EQUAL.
- 5. THE CONTRACTOR SHALL BE RESPONSIBLE FOR DISTRIBUTING ANY EXCESS MATERIAL OR SUPPLYING MATERIAL FOR DEFICIENCIES TO BRING DRIVEWAY AND BUILDING PADS TO REQUIRED GRADE.
- 6. UTILITIES AND UNDERGROUND FACILITIES INDICATED ARE FOR INFORMATION ONLY. IT IS THE CONTRACTOR'S RESPONSIBILITY TO VERIFY THE LOCATION AND DEPTH WITH THE APPROPRIATE AGENCIES. NEITHER THE OWNER NOR THE CITY OR THE ENGINEER ASSUMES RESPONSIBILITY THAT THE UTILITIES AND UNDERGROUND FACILITIES INDICATED WILL BE THE UTILITIES AND UNDERGROUND FACILITIES ENCOUNTERED.
- THE CONTRACTOR IS RESPONSIBLE FOR MATCHING EXISTING SURROUNDING LANDSCAPE AND OTHER IMPROVEMENTS WITH A SMOOTH TRANSITION IN PAVING, GRADING, ETC., AND TO AVOID ABRUPT OR APPARENT CHANGES OR CROSS SLOPES, LOW SPOTS OR HAZARDOUS CONDITIONS.
- 8. THE CONTRACTOR SHALL OBTAIN NECESSARY PERMITS FOR ALL WORK SHOWN ON THIS PLAN.
- 9. UNLESS OTHERWISE SPECIFIED, ALL STORM DRAIN PIPES SHALL BE P.V.C. PER ASTM D-3034 SDR 35 BELL AND SPIGOT RUBBER GASKET JOINTS OR BETTER.
- 10. UNLESS OTHERWISE SPECIFIED, ALL SANITARY SEWER GRAVITY PIPES SHALL BE PVC SDR 26 WITH BELL AND SPIGOT RUBBER GASKET JOINTS OR BETTER.
- 11. UNLESS OTHERWISE SPECIFIED ALL FORCEMAIN LINES (SEWER EJECTOR PIPES) SHALL BE HDPE DR 11 OR BETTER
- 12. STORM DRAIN AND SANITARY SEWER INSTALLATIONS SHALL BEGIN FROM THE DOWNSTREAM POINT OF CONNECTION.
- 13. ANY DAMAGED RIGHT-OF-WAY INFRASTUCTURES AND OTHERWISE DISPLACED CURB AND GUTTER SHALL BE REMOVED AND REPLACED AS DIRECTED BY THE CITY ENGINEER OR HIS DESIGNEE. CONTRACTOR SHALL COORDINATE WITH PUBLIC WORKS DEPARTMENT AT (650) 947-2680
- 14. PRIOR TO THE COMMENCEMENT OF ANY WORK DONE IN THE PUBLIC-OF-WAY, A PERMIT TO OPEN STREET AND/OR AN ENCROACHMENT PERMIT WILL BE REQUIRED.

LEGEND:

| C PAVE | ASPHALT CONCRETE PAVEMENT |
|--------|---------------------------|
| S | BOTTOM OF STEP |
| FP | BACKFLOW PREVENTER |
| ONC | CONCRETE |
| OL | COLUMN |
| OTG | CLEANOUT TO FINISH GRADE |
| M | ELECTRIC METER |
| В | ELECTRIC BOX |
| P | EDGE OF PAVEMENT |
| F | FINISH FLOOR |
| L | FLOWLINE |

FG FINISH GRADE GS FF G.B. GRADE BREAK GAS METER H.P. HIGH POINT INVERT

INV ICV MAILBOX PLANTING AREA P.A.

SSMH TC TOP OF CURB TOP OF STEP TOP OF WALL TOP OF HEADER

WATER LINE FORCE MAIN **──**FM**──** WATER LINE

SWALE \longrightarrow DS 🔘


UTILITY NOTE:

THE UTILITIES EXISTING ON THE SURFACE AND SHOWN ON THIS DRAWING HAVE BEEN LOCATED BY FIELD SURVEY. ALL UNDERGROUND UTILITIES SHOWN ON THIS DRAWING ARE FROM RECORDS OF THE VARIOUS UTILITY COMPANIES AND THE SURVEYOR/ENGINEER DOES NOT ASSUME RESPONSIBILITY FOR THEIR COMPLETENESS, INDICATED LOCATION, OR SIZE. RECORD UTILITY LOCATION SHOULD BE CONFIRMED BY EXPOSING THE UTILITY.

GEOTECHNICAL ENGINEER NOTES:

EARTHWORK, BASEMENT SUBGRADE PREPARATION, PIER DRILLING, SUB-SLAB DRAINAGE. BASEMENT RETAINING WALL DRAINAGE AND BACKFILL, FOUNDATION CONSTRUCTION, SLAB SUBGRADE AND NON-EXPANSIVE FILL PREPARATION, UTILITY TRENCH BACKFILLING. PAVEMENT CONSTRUCTION, AND SITE DRAINAGE SHOULD BE PERFORMED IN ACCORDANCE WITH THE GEOTECHNICAL REPORT PREPARED BY ROMIG ENGINEERS, INC., DATED MARCH 14, 2023. ROMIG ENGINEERS SHOULD BE NOTIFIED AT LEAST 48 HOURS IN ADVANCE OF ANY EARTHWORK OR FOUNDATION CONSTRUCTION AND SHOULD OBSERVE AND TEST DURING EARTHWORK AND FOUNDATION CONSTRUCTION AS RECOMMENDED IN THE GEOTECHNICAL REPORT. ROMIG ENGINEERS SHOULD BE NOTIFIED AT LEAST 5 DAYS PRIOR TO EARTHWORK, TRENCH BACKFILL AND SUBGRADE PREPARATION WORK TO ALLOW TIME FOR SAMPLING OF ON-SITE SOIL AND LABORATORY COMPACTION CURVE TESTING TO BE PERFORMED PRIOR TO ON-SITE COMPACTION DENSITY TESTING.


> (IN FEET) 1 inch = 8 ft.

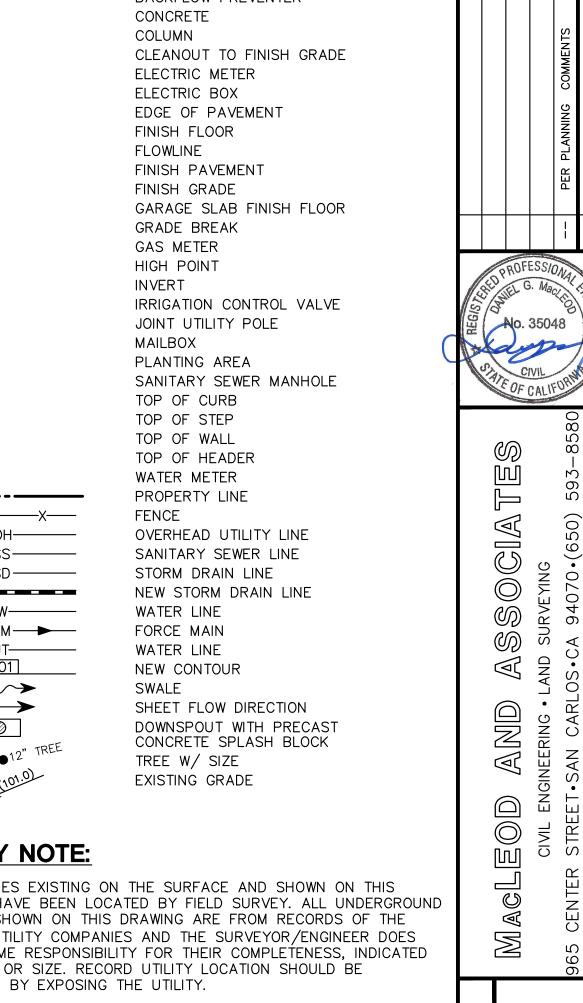




05/17/2

5263-GRAD

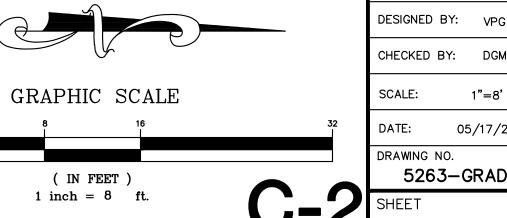

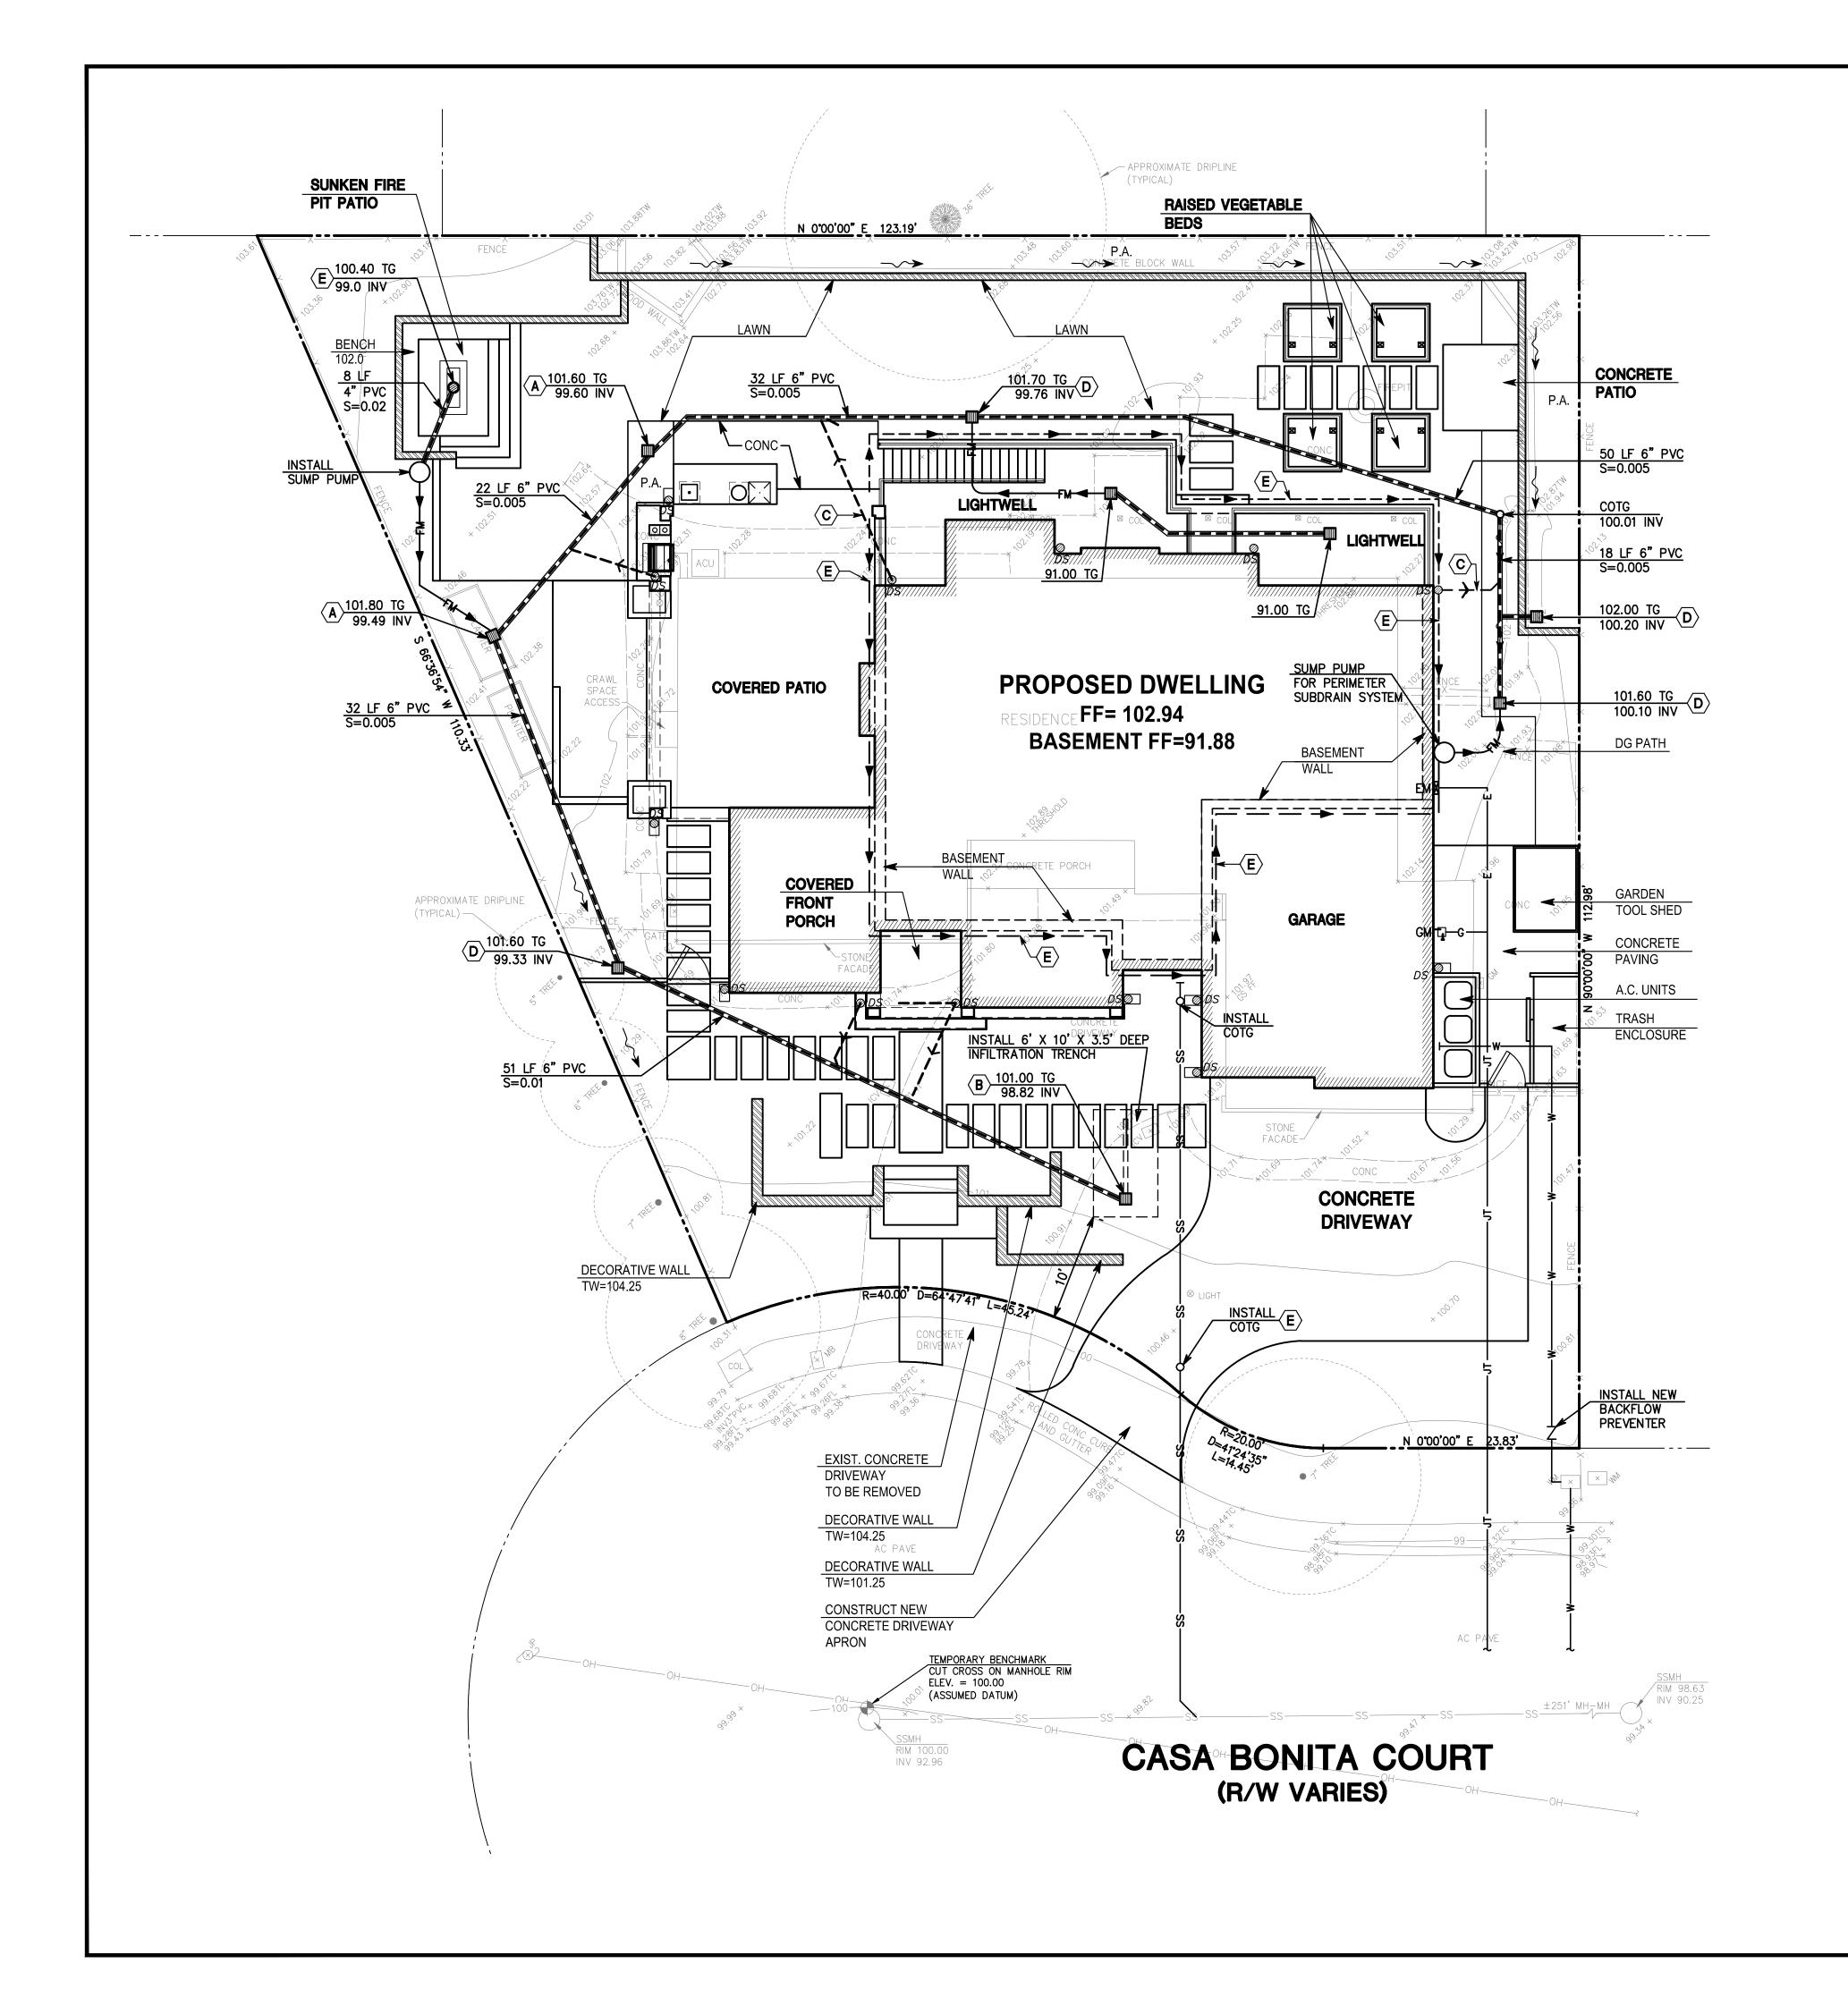

CONSTRUCTION NOTES:

- INSTALL 12" X 12" PRECAST CONCRETE DRAIN BOX
 WITH GRATE COVER COVER BY HARDCASTLE CONCRETE OR APPROVED EQUAL.
 - INSTALL BOTTOMLESS 16" X 16" PRECAST CONCRETE DRAIN BOX WITH GRATE COVER BY CHRISTY OR APPROVED EQUAL.
- CONNECT DOWNSPOUT WITH 4" PVC AT 1% MIN. SLOPE
- INSTALL 12" X 12" PLASTIC DRAIN BOX WITH GRATE COVER COVER BY NDS OR APPROVED EQUAL.
- INSTALL 4" PVC SUBDRAIN PIPE AT 1% MIN. SLOPE

LEGEND:

AC PAVE

| BFP | BACKFLOW PREVENTER |
|-------|--------------------------|
| CONC | CONCRETE |
| COL | COLUMN |
| COTG | CLEANOUT TO FINISH GRADE |
| EM | ELECTRIC METER |
| EB | ELECTRIC BOX |
| EP | EDGE OF PAVEMENT |
| FF | FINISH FLOOR |
| FL | FLOWLINE |
| FP | FINISH PAVEMENT |
| FG | FINISH GRADE |
| GS FF | GARAGE SLAB FINISH FLOOR |
| G.B. | GRADE BREAK |
| GM | GAS METER |
| ЦΒ | LICH DOINT |

ASPHALT CONCRETE PAVEMENT

BOTTOM OF STEP

H.P. HIGH POINT INV INVERT ICV IRRIGATION CONTROL VALVE JOINT UTILITY POLE MAILBOX P.A. PLANTING AREA SSMH SANITARY SEWER MANHOLE TOP OF CURB

TOP OF STEP TOP OF WALL TOP OF HEADER WATER METER PROPERTY LINE **FENCE**

SWALE DS 🔘

UTILITY NOTE:

THE UTILITIES EXISTING ON THE SURFACE AND SHOWN ON THIS DRAWING HAVE BEEN LOCATED BY FIELD SURVEY. ALL UNDERGROUND UTILITIES SHOWN ON THIS DRAWING ARE FROM RECORDS OF THE VARIOUS UTILITY COMPANIES AND THE SURVEYOR/ENGINEER DOES NOT ASSUME RESPONSIBILITY FOR THEIR COMPLETENESS, INDICATED LOCATION, OR SIZE. RECORD UTILITY LOCATION SHOULD BE CONFIRMED BY EXPOSING THE UTILITY.

GRAPHIC SCALE

(IN FEET) 1 inch = 8 ft.

OVERHEAD UTILITY LINE SANITARY SEWER LINE STORM DRAIN LINE NEW STORM DRAIN LINE WATER LINE FORCE MAIN WATER LINE NEW CONTOUR SHEET FLOW DIRECTION DOWNSPOUT WITH PRECAST CONCRETE SPLASH BLOCK TREE W/ SIZE EXISTING GRADE

\$001W

(W)

 $\overline{\mathbb{Q}}$

AND

DRAWN BY: DESIGNED BY: SCALE: DATE:

CHECKED BY: DGM DRAWING NO. 5263-UTIL



California Horticulture

CONSTRUCTION INCORPORATED 753 Camden Avenue

LANDSCAPE

95008 408-364-3190

Campbell, CA

FAX 408-364-3199 Contractors

B & C-27 & C-53

Scale: 1/8" = 1' - 0"

Sheet: Cover Sheet

Revisions: 7_26_23

Date: 5-5-2023

Drawn by: CC

SHEET

53

FRONT YARD ALLOWABLE IMPERVIOUS COVERAGE: TOTAL 2,212 SF (50%)= 1,106 SF

PROJECT DIRECTORY

SUKU AND NAMARITA CHETTIAR 746 CASA BONITA CT.

COURTNEY CAMERON

CAMPBELL, CA 95008

CARPENTRY ITEMS: VEGETABLE BEDS, CUT OFF FENCING AT

LEGEND

NEW 6X8 TRELLISES SET IN VEGETABLE

BEDS WITH REDWOOD SELECT B OR

NEW 19" HIGH RAISED VEGETABLE

NEW SOIL-SET STEPPING PADS AND PATIO. PIECES TO BE 24"X48" AND 1.5"

NEW DECORATIVE POTS MORTARED TO THE FLOORING AND SET WITH

NEW DECOMPOSED GRAVEL PATH

OF CMU WITH A SMOOTH STUCCO

RETAINING WALL

SETBACK

MIN. SIDE SETBACK

(1ST. STORY)

PA

N 00000 E 23.83

VENEER TO REPLACE THE EXISTING

- EXISTING 7' TALL WOOD PROPERTY

- NEW REDWOOD GARBAGE ENCLOSURE

TO MATCH EXISTING FENCING WITH

LARGE BARN SLIDING DOOR AND

NEW 7' HIGH CUT OFF FENCING AND

NEW BACKFLOW TO BE SCREENED WITH PLANTS AND SET BETWEEN TREES

GARDEN WALL WITH A SMOOTH STUCCO VENEER ON ALL SIDES

HARDWARE

DECORATIVE GATE

LINE FENCE TO REMAIN (TYP.)

NEW 2' HIGH MAX. RETAINING WALL OUT


DRAINAGE AND IRRIGATION

TO 2" THICK. OWNER TO SELECT STONE


BEDS WITH SELECT B OR EQUAL REDWOOD FRAMES. TO BE STAINED

EQUAL

DRIVEWAY PAVING: 6" THICK POURED COLORED CONCRETE SET OVER 6" DEPTH CLASS II BASEROCK COMPACTED TO 95%.

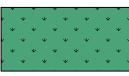

LAWN: GRASS FROM DELTA BLUEGRASS TO BE SELECTED BY OWNER.

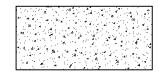

DECOMPOSED GRAVEL PAVING: 1" DEPTH WITH BINDER AS SELECTED BY OWNER OVER 4" DEPTH CLASS II BASEROCK COMPACTED TO 95%.

GARDEN WALLS: VARY IN HEIGHT NOT TO EXCEED 3' HIGH MAX, OUT OF CMU BLOCK WITH A SMOOTH STUCCO VENEER ON ALL SIDES

HEADER BOARD: BLACK STEEL HEADERBOARD & STAKES. INSTALL BETWEEN GRAVEL AREAS & LAWN & PLANTING AREAS LOCATIONS PER PLAN.

SITE DATA

189-41-085

ADDRESS: 746 CASA BONITA COURT LOS ALTOS, CA 94024

ZONING DISTRICT: R1-10

OCCUPANCY USE: SINGLE FAMILY RESIDENTIAL LOT AREA: 10,632 S.F.

MAXIMUM FLOOR AREA 30%: 3,189.6 S.F. PROPOSED FLOOR AREA: 3,135 S.F.

FRONT, REAR, SIDE SETBACKS: 25'-0" FRONT AND REAR 10'-0" SIDES

FRONT YARD IMPERVIOUS COVERAGE: 934.18 SF (42%)

LOS ALTOS, CA 94024 PH: (408) 761-8678

CALIFORNIA HORTICULTURE LANDSCAPE CONSTRUCTION INC.

753 CAMDEN AVENUE CA LIC. #641851 PH: (408) 364-3190

PROJECT DESCRIPTION

SCOPE OF WORK INDICATED IN THESE LANDSCAPE DRAWINGS INCLUDES:

SIDE YARDS WITH GATES, IPE WOOD BENCH, SUNKEN FIRE PIT IPE DECK AND REDWOOD TRELLISES FOR CLIMBING VEGETABLES.


LANDSCAPE HARDSCAPE ITEMS: CMU WALLS 3' MAX HIGH WITH STUCCO VENEER, STONE VENEER STEPS AND WALKWAYS, STEPPING PADS AND POURED COLORED CONCRETE DRIVEWAY AND SIDE YARD PATH.

LANDSCAPE STRUCTURE ITEMS: OUTDOOR KITCHEN AND

DECORATIVE POTS.

PEDESTRIAN PAVING: 4" MIN. THICK CONCRETE W/ #3 REBAR @ 18" O.C.B.W. OVER 4" DEPTH CLASS II BASEROCK COMPACTED TO 95%. THIN STONE VENEER MORTAR SET TO BE SELECTED BY HOME OWNER



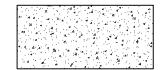

PLANTING AREA: AMENDED NATIVE SOIL WITH NEW PLANTING PER PLANTING PLAN

CODE COMPLIANCE

-NEM 2' HIGH MAX. RETAINING WALL OUT

VENEER AND STONE CAP TO REPLACE

MULCHED ARÉA FOR DOG RUN

LIVING

ROOM

LIGHTMELL

KITCHEN

PA

PA

FAMILY

ROOM

COVERED

FRONT

LANDING

-- CASA BONITA COURT --

"I have complied with the criteria of the ordinance and applied them for the efficient use

"I agree to comply with the requirements of the water efficient landscape ordinance and

WELO STATEMENTS:

of water in the landscape and irrigation design plan. "

submit a complete Landscape Documentation Package.

PORCH

OF KMU BLOCK WITH A STUCCO

THE EXISTING MOODEN ONE

NOº00'00" E 123 19'

STEP

DINING ROOM

COVERED

PATIO

SEWER EJECTOR PUMP

-EXISTING 7' TALL WOOD PROPERTY

OF GOPHER WIRE ADDED TO THE

DIGGING UNDER

LINE FENCE TO REMAIN (TYP.) WITH 12"

BOTTOM TO PREVENT CRITTERS FROM

LIGHTMELL

GUEST

STUDIO

BEDROOM

MUDROOM

2-CAR

PA

GARAGE

ALL WORK SHALL CONFORM TO LOCAL CODES & ORDINANCES INCLUDING THE FOLLOWING:

2022 CALIFORNIA BUILDING CODE 2022 CALIFORNIA FIRE CODE

2022 CALIFORNIA RESIDENTIAL CODE

NEM 3' HIGH MAX. RETAINING MALL OUT -

OF POURED CONCRETE WITH A STUCCO

VENEER AND STONE CAP

NEW POURED CONCRETE STEPS

AND IPE MOOD BENCH

TO A SUNKEN IPE FIRE PIT DECK

NEW PREFAB NATURAL GAS FIRE PIT TO BE SELECTED BY HOMEOWNER

BBQ AND ISLAND COUNTER FRAMES

OUT OF GALVANIZED STEEL FRAMES

EXISTING 7' TALL WOOD PROPERTY

8" HIGH RAISED PLANTERS ABOVE

NEW 7' HIGH CUT OFF FENCING AND

NEW SOIL-SET STEPPING PADS PIECES -

TO BE 24"X48" WITH ONE AT 4'X4' AND

BENCH OR FOCAL OBJECT TO BE

GARDEN WALLS WITH A SMOOTH STUCCO VENEER ON ALL SIDES

SELECTED BY HOMEOWNER

1.5" TO 2" THICK. OWNER TO SELECT

PATIO FINISH GRADE

GATE

STONE

WITH CEMENT BOARD VENEER.

LINE FENCE TO REMAIN (TYP.)

, ĽĄŇŊ `

2022 CALIFORNIA PLUMBING CODE 2022 CALIFORNIA MECHANICAL CODE 2022 CALIFORNIA PLUMBING CODE

2022 CEC ELECTRICAL CODE 2022 ENERGY CODE

2022 CALIFORNIA GREEN BUILDING STANDARDS CODE (CALGREEN RESIDENTIAL CHECKLIST)



Chettiar Residence

Agenda Item 3.

California Horticulture

LANDSCAPE

CONSTRUCTION INCORPORATED

*7*53 Camden

Campbell, CA 95008

408-364-3190 FAX 408-364-3199

Contractors License B & C-27 & C-53 641851

Scale: 1/8" = 1' - 0"

Date: 5-5-2023

Drawn by: CC

Revisions: 7_26_23

SHEET

L₁



15 ROSA DRIFT WHITE

16 POTATO VINE

DINING ROOM

AFM

ACACIA COGNATA 'COUSIN ITT'

ORNAMENTAL CHERRY

5G COUSIN ITT ACACIA

CHERRY TREE

LOMANDRA LONGIFOLIA 'BREÈZE' | PA

ERIOBOTRYA JAPONICA

15G LOQUAT GOLD NUGGET

36 LOMANDRA LUNUII C 16 DWARF MAT RUSH

PEACH TREE

TRANSPLANTED

11 PENNISETUM SETACEUM 'RUBRUM'

18 SEDUM SPECTABILE 'AUTUMN JOY'

ACER PALMATUM SANGO KAKU

6 HYDRANGEA MACROPHYLLA 'HORTMABLO'
3G SEASIDE SERENADE CAPE LOOKOUT HYDRANGEA

MARINA X ARBUTUS - STD FORM

GARDENIA JASMINOIDES VEITCHEII

36" B MAGNOLIA ALEXANDER

56 MANZANITA SHRUB

16 VIBE IGNITION WHITE SALVIA

3 MANZANITA HOWARD MCMINN

MAGNOLIA X SOULANGIANA

3 SALVIA X JAMENSIS 'ELK WHITE ICE'

CAMELLIA MHITE' 15G CAMELLIA JAPONICA

3 OLEA EUROPA 'MONHER'

MULTI TRUNK

36" B MAJESTIC BEAUTY FRUITLESS OLIVE

16 SEASCAPE MAT RUSH

5 HYDRANGEA OAK LEAF

14 LOMANDRA CONFERTIFOLIA 'SEASCAPE'

5G HYDRANGEA OAK LEAF MUNCHKIN

16 AUTUMN JOY SEDUM

13 SEDUM SPECTABILE 'AUTUMN JOY

5G FIELDER'S WHITE AZALEA

5G GIANT CHAIN FERN

6 RHODODENDRON FIELDER'S WHITE

4 MOODWARDIA FIMBRIATA FERN

24" B CORAL BARK MAPLE, MULTI TRUNK

6 MYOPORUM PARVIFOLIUM

16 GROUND COVER MYOPORUM

24" B STRAMBERRY ARBUTUS

5G GARDENIA EVERBLOOMING

BOUGAINVILLEA 'MONAS'

56 TEXAS DAWN BOUGAINVILLEA

16 PURPLE FOUNTAIN GRASS

AUTUMN JOY SEDUM

TRANSPLANTED

26 DRIFT WHITE FLOWER CARPET ROSE

8 LAVANDULA INTERMEDIA 'RIVERINA THOMAS'
5G RIVERINA THOMAS FRENCH LAVENDER

16 DWARF MAT RUSH

9 SALVIA X JAMENSIS 'ELK WHITE ICE',
16 VIBE IGNITION WHITE SALVIA

56 AVALANCHE EVERGREEN CLEMATIS

24" B BRUSH CHERRY COLUMN FORM

26 WHITE ICEBERG SHRUB ROSE

ROSA SPP. 'ICEBERG'

STAIR

CLEMATIS X CARTMANII BLANKOUM

EUGENIA MYRTIFOLIA MONTEREY BAY

STUDIO

2-CAR

1G DWARF MAT RUSH

GARAGE

LOMANDRA LONGIFOLIA

2 SOLANUM JASMINOIDES
16 POTATO VINE

4 LOMANDRA LONGIFOLIA 'BREEZE'

YEG.

LIGHTMELL

YEG.

VEG.

BC

BO

SB 💄

3 | BUDDLEJA DAVIDII MONITE

12 PENNISETUM ALOPECUROIDES 'HAMELN'

5G DWARF BUTTERFLY BUSH

1G DWARF FOUNTAIN GRASS

56 FRINGE FLOWER

16 DWARF MAT RUSH

14 MYOPORUM PARVIFOLIUM __ 16 GROUND COVER MYOPORUM

10 LOROPETALUM EMERALD SNOW

10 LOMANDRA LONGIFOLIA 'BREEZE'

RIB

₽B

SOLÁNUM JASMINOIDES

10 PENNISETUM ALOPECUROIDES 'HAMELN'
16 DWARF FOUNTAIN GRASS

MULCH FOR DOG RUN

LIGHTMELL &

KITCHEN

BREAKFAST

FAMILY

ROOM

3 AGAVE ATTENUATA 56 AGAVE RAY OF LIGHT FOYER

COVERED

FRONT

PORCH

LANDING

2 AGAVE BLUE GLOW

56 BLUE GLOW AGAYE


12 ACACIA COGNATA 'COUSIN IT

5G COUSIN ITT ACACIA

-- CASA BONITA COURT --

LIVING

ROOM

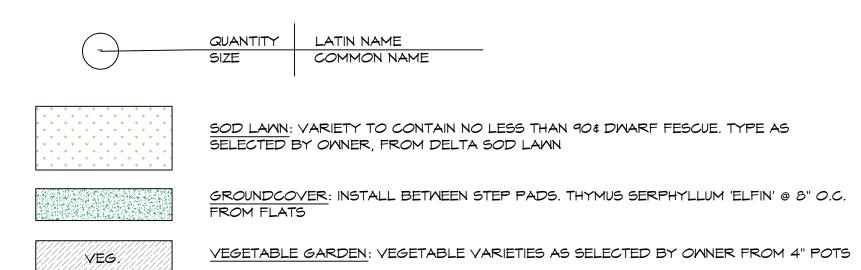

POTS: POTS SHALL BE AS SELECTED BY OWNER. GENERAL SIZES NOTED.

- A2 3' X 1'-4" X 3' TALL: PLANT WITH (1) SOLANUM JASMINOIDES FROM 5 GALLON CAN

- D1 30"Φ X 24" TALL: PLANT WITH (1) ALOE VERA FROM 5 GALLON CAN

Agenda Item 3.

California

Horticulture

LANDSCAPE

INCORPORATED

Campbell, CA

408-364-3190

FAX 408-364-3199

Contractors License B & C-27 & C-53 641851

CONSTRUCTION

Scale: 1/8" = 1' - 0"


Sheet: Planting Plan

Date: 5-5-2023 Drawn by: CC/WB

Revisions: 7_26_23

SHEET

55

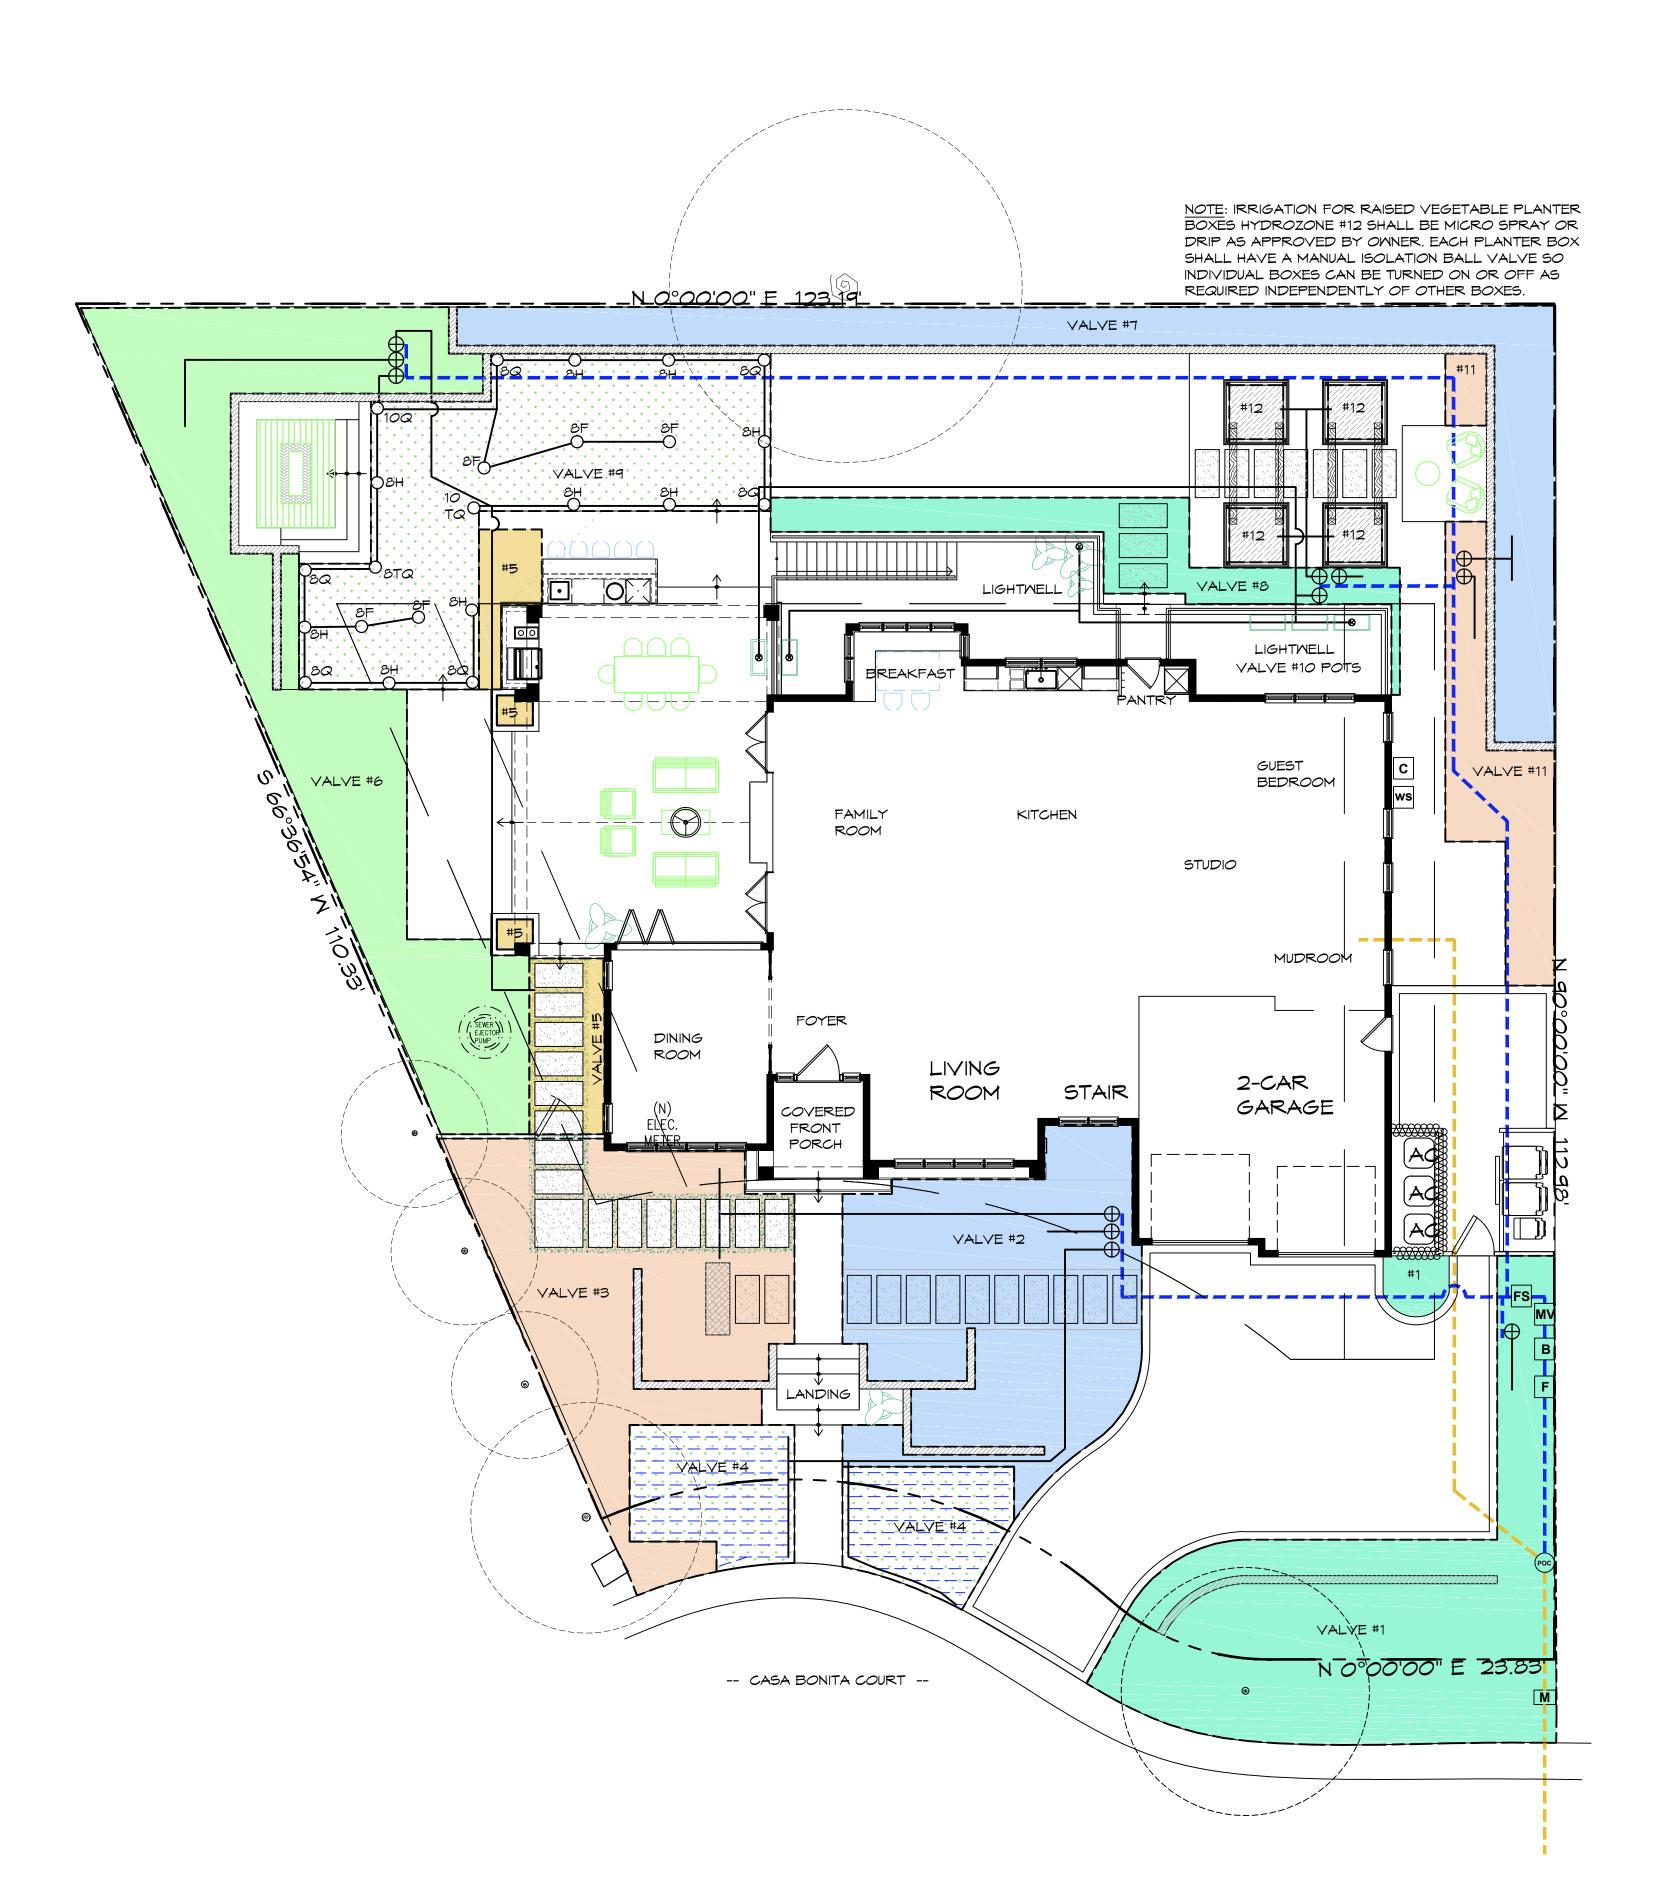

LEGEND

| <u>\alver</u> | IRRIGATION HYDROZONE: INDICATES LIMITS OF IRRIGATION ZONE AND RESPECTIVE VALVE NUMBER. ALL IRRIGATION ZONES SHALL BE 1 GPH PRESSURE COMPENSATING DRIP EMITTERS UNLESS OTHERWISE NOTED. EACH 1 AND 5 GALLON PLANT SHALL RECIEVE 2 EMITTERS. 15 GALLON PLANTS SHALL RECEIVE 6 EMITTERS. BOX PLANTS AND TRANSPLANTED MATERIAL SHALL RECEIVE 10 EMITTERS. |
|---------------|---|
| Овн | POP-UP SPRAY HEAD: LAWN SPRAY IRRIGATIO - RAIN BIRD 1800 SERIES 6" POP UP BODIES W/RAINBIRD MPR SERIES MATCHED PRECIPITATION RATE SPRAY NOZZLES W/RESPECTIVE RADIUS & PATTERN AS INDICATED |
| С | IRRIGATION CONTROL CLOCK: TORO 'TMC-424E-OD' WITH (2) x 'TSM-8F' FLOW SENSING EXPANSION MODULES (20 TOTAL STATIONS). PLUG INTO 120 VOLT GFCI OUTLET ON HOUSE EXTERIOR WALL. |
| ws | MEATHER SENSOR: TORO 'TWRS' WIRELESS RAIN SENSOR. MOUNT IN LOCATION AS APPROVED BY CONTRACTOR. |
| M | MATER METER: EXISTING DOMESTIC SERVICE METER |
| F | FILTER: RAINBIRD QUICK CHECK BASKET FILTER W/ 120 MESH SCREEN. SIZE PER MAINLINE |
| В | BACKFLOW PREVENTER: TFEBCO 825Y 1" BACKFLOW ASSEMBLY W/ ISOLATION SHUTOFF VALVES. LOCATE 12" ABOVE GRADE IN PLANTING AREA. SCREEN FROM VIEW W/ ADJACENT PLANTING. |
| MV | MASTER VALVE: IRRITROL 700 SERIES 1 $\frac{1}{2}$ " VALVE ASSEMBLY. LOCATE IN VALVE BOX. |
| FS | FLOW SENSOR: TORO 'TFS-150' FLOW SENSOR. LOCATE IN VALVE BOX |
| \oplus | SOLENOID VALVE: IRRITROL ULTRAFLOM 700 SERIES 1" VALVE W/ 30 PSI PRESSURE REGULATOR. LOCATE IN VALVE BOX. |
| ⊗ | POT STUB: STUB FOR POT IRRIGATION, TRANSITION FROM PVC TO POLY LINE W LASER SOAKER LOOP IN EACH ADJACENT POT. |
| POC | POINT OF CONNECTION: IRRIGATION MAINLINE 'T' CONNECTION TO EXISTING DOMESTIC SERVICE LINE. LOCATE IN VALVE BOX W/ BALL VALVE TO ISOLATE IRRIGATION MAINLINE. |
| | DOMESTIC WATER SERVICE LINE: EXISTING BY OTHERS |
| | IRRIGATION MAINLINE: 1 1/2" SCHEDULE 40 PVC; 18" MIN. BURIAL |
| | IRRIGATION LATERAL LINE: SCHEDULE 40 PVC SIZE AS REQUIRED. 12" MIN. BURIAL |
| | SUB SURFACE DRIPLINE: FOR SMALL LAWN AREA; RAINBIRD 'XFS-09-12' .9 GPH EMITTERS @ 12" O.C. SPACING. SET TUBES 12" O.C. BURIED UNDER SOD LAWN. STAGGER EMITTER LAYOUT BETWEEN ADJACENT ROWS. |

| | | water En | icient Lar | nascape v | Vorksheet | | | | |
|-----|-------------------------------------|--------------------------|---|------------------|------------------------------|-----------------|-------------------|----------------|------------------------------------|
| | | | | | | | | | |
| # | HYDRO ZONE NAME | HYDROZONE DESCRIPTION | PLANT FACTOR (PF) | IRRIG. METHOD | IRRIGATION EFFICENCY (IE) | ETAF (PF/IE) | LANDSCAPE AREA | ETAF x AREA | ESTIMATED TO WATER USE(ETWU |
| | Regular Landscape Areas | | | | | | | | |
| #1 | FRONT YARD - RIGHT SIDE OF DRIVEWAY | Low water use | 0.2 | Drip | 0.81 | 0.25 | 724 | 179 | 4733 |
| #2 | FRONT YARD - CENTER | Low water use | 0.3 | Drip | 0.81 | 0.37 | 458 | 170 | 4491 |
| #3 | FRONT YARD - LEFT SIDE | Med water use | 0.4 | Drip | 0.81 | 0.49 | 500 | 247 | 6537 |
| #4 | FRONT YARD - LAWN | High water use | 0.8 | Drip sub s | 0.81 | 0.99 | 281 | 278 | 7347 |
| #5 | SOUTH SIDE YARD AGAINST HOUSE | Low water use | 0.2 | Drip | 0.81 | 0.25 | 108 | 27 | 706 |
| #6 | SOUTH SIDE YARD AGAINST FENCE | Low water use | 0.2 | Drip | 0.81 | 0.25 | 729 | 180 | 4765 |
| #7 | BACK YARD AGAINST BACK FENCE | Med water use | 0.4 | Drip | 0.81 | 0.49 | 460 | 227 | 6014 |
| #8 | BACK YARD AGAINST LIGHTWELLS | Low water use | 0.3 | Drip | 0.81 | 0.37 | 140 | 52 | 1373 |
| #9 | BACK YARD LAWN | High water use | 0.8 | Spray | 0.75 | 1.07 | 609 | 650 | 17198 |
| #10 | POTS | Low water use | 0.3 | Drip | 0.81 | 0.37 | 24 | 9 | 235 |
| #11 | NORTH SIDE YARD | Low water use | 0.3 | Drip | 0.81 | 0.37 | 1 | 203 | 5374 |
| | | | | | | TOTALS | 4034 | 2220 | 58772 |
| | Special Landscape Areas | | | | | | | | |
| #12 | VEGETABLE BEDS | | | T | | 1 | 80 | 80 | 2118 |
| | | | | | | TOTALS | 80 | 80 | 2118 |
| | Eto for Los Altos = 45.4 | | | | | | ETV | NU Total | 60890 |
| | | (45.4)(.62)[(.55x4470 | (45.4)(.62)[(.55x4470)+((155)x80)] Maxim | | num Allo | wed Water A | llowance | 63465 | |
| | | Regular Landscape A | Regular Landscape Areas All Landscape Are | | eas | | | | |
| | | Total ETAF x Area | 2220 | 1 | Total ETAF x Area | 2300 | | | |
| | | Total Area | 4034 | | Total Area | 4114 | | | |
| | | Average ETAF | 0.550 | | Sitewide ETAF | 0.559 | | | |

| | | IRRIGATION SCHEDULE | | | | | | | | | Annual | Annual | | | | |
|--------------|--------------------|-------------------------------|----------------|-----------------|--------------|--------------|------------|-------------|-------------|---------------|------------------|----------------|-----------------|-----------------|---------------|--------------------------|
| Month ETO | | > | January 1.5 | February 1.8 | March 3.1 | April 4.1 | May 5.5 | June 5.8 | July 6.5 | August 5.9 | September 5.0 | October 3.3 | November 1.8 | December 1.0 | TOTAL 45.4 | Gallons Applied TOTAL |
| ZONE # | FLOW RATE (GPM) | RUN INTERVAL x PER WEEK | | | N | IONTH | ILY RU | N TIME | IN M | IINUTES | | | | | | |
| Regular La | andscape Are | as | | | | | | | | | | | | | | |
| #1 | 2.23 | 2 | 45 | 54 | 93 | 123 | 165 | 174 | 195 | 177 | 150 | 99 | 54 | 30 | 1359 | 3031 |
| #2 | 3.1 | 2 | 45 | 54 | 93 | 123 | 165 | 174 | 195 | 177 | 150 | 99 | | 30 | 1359 | 4213 |
| #3 | 1.25 | 2 | 45 | 54 | 93 | 123 | 165 | 174 | 195 | 177 | 150 | 99 | 54 | 30 | 1359 | 1699 |
| #4 | 3.72 | 3 | 135 | 162 | 279 | 369 | 495 | 522 | 585 | 531 | 450 | 297 | 162 | 90 | 4077 | 15166 |
| #5 | 1 | 2 | 45 | 54 | 93 | 123 | 165 | 174 | 195 | 177 | 150 | 99 | 100 | 30 | 1359 | 1359 |
| #6 | 4 | 2 | 45 | 54 | 93 | 123 | 165 | 174 | 195 | 177 | 150 | 99 | | 30 | 1359 | 5436 |
| #7 | 2.1 | 2 | 45 | 54 | 93 | 123 | 165 | 174 | 195 | 177 | 150 | 99 | | 30 | 1359 | 2854 |
| #8 | 1 | 2 | 45 | 54 | 93 | 123 | 165 | 174 | 195 | 177 | 150 | 99 | | 30 | 1359 | 1359 |
| #9 | 13.81 | 3 | 54 | 65 | 112 | 148 | 198 | 209 | 234 | 212 | 180 | 119 | | 36 | 1631 | 22521 |
| #10 | 1 | 4 | 60 | 72 | 124 | 164 | 220 | 232 | 260 | 236 | 200 | 132 | | 40 | 1812 | 1812 |
| #11 | 1 | 2 | 45 | 54 | 93 | 123 | 165 | 174 | 195 | 177 | 150 | 99 | 54 | 30 | 1359 | 1359 |
| Special La | Indscape Area | as | | | | | | | | | | | | | | |
| #12 | 1 | 4 | 45 | 54 | 93 | 123 | 165 | 174 | 195 | 177 | 150 | 99 | 54 | 30 | 1359 | 1359 |
| OTAL MIN | NUTES RUN PEI | R MONTH | 654 | 785 | 1352 | 1788 | 2398 | 2529 | 2834 | 2572 | 2180 | 1439 | 785 | 436 | 19751 | |
| | | | | | | | | | | | ANNUAL TOT | AL GALLON | S APPLIED | | | 62168 |

California Horticulture

Agenda Item 3.

LANDSCAPE CONSTRUCTION INCORPORATED 753 Camden

Campbell, CA 408-364-3190

FAX 408-364-3199 Contractors License B & C-27 & C-53 641851

| | | Water Effi | Water Efficient Landscape Worksheet | | | | | | |
|-----|---|------------------------|---|----------------------------|---|----------|-----------------|---------------|---------------------------|
| | | | | | | | | | |
| | | | PLANT | u I | | | | | ESTIMATED TOTAL |
| | | HYDROZONE | | IRRIG. | IRRIGATION | ETAF | LANDSCAPE | ETAF x | WATER |
| # | HYDRO ZONE NAME | DESCRIPTION | (PF) | TATA CANADA SANCE CONTRACT | A TO COUNTY TO THE SAME AND SAME AND SAME | (PF/IE) | AREA | AREA | USE(ETWU) |
| # | ,,,,,,,,,,,,,,,,,,,,,,,,,,,,,,,,,,,,,,, | DESCRIPTION | (+ +) | IVILITIOD | EFFICEINCT (IE) | (FT/IL) | ARLA | ANLA | 032(2100) |
| | Regular Landscape Areas | | | Ц | | | | | |
| #1 | FRONT YARD - RIGHT SIDE OF DRIVEWAY | Low water use | | Drip | 0.81 | 0.25 | 727 Marie 2 727 | 179 | 4733 |
| #2 | FRONT YARD - CENTER | Low water use | | Drip | 0.81 | 0.37 | 458 | 170 | 4491 |
| #3 | FRONT YARD - LEFT SIDE | Med water use | | Drip | 0.81 | 0.49 | 500 | 247 | 6537 |
| #4 | FRONT YARD - LAWN | High water use | 20 0 | Drip sub s | 0.81 | 0.99 | 281 | 278 | 7347 |
| #5 | SOUTH SIDE YARD AGAINST HOUSE | Low water use | | Drip | 0.81 | 0.25 | 108 | 27 | 706 |
| #6 | SOUTH SIDE YARD AGAINST FENCE | Low water use | | Drip | 0.81 | 0.25 | 729 | 180 | 4765 |
| #7 | BACK YARD AGAINST BACK FENCE | Med water use | 23 | Drip | 0.81 | 0.49 | 460 | 227 | 6014 |
| #8 | BACK YARD AGAINST LIGHTWELLS | Low water use | | Drip | 0.81 | 0.37 | 140 | 52 | 1373 |
| #9 | BACK YARD LAWN | High water use | 3943 | Spray | 0.75 | 1.07 | 609 | 650 | 17198 |
| #10 | POTS | Low water use | | Drip | 0.81 | 0.37 | 24 | 9 | 235 |
| #11 | NORTH SIDE YARD | Low water use | 0.3 | Drip | 0.81 | 0.37 | 1 | 203 | 5374 |
| | | | | | | TOTALS | 4034 | 2220 | 58772 |
| | Special Landscape Areas | | | | | | | | |
| #12 | VEGETABLE BEDS | | Ī | | | 1 | 80 | 80 | 2118 |
| | | | | | | TOTALS | 80 | 80 | 2118 |
| | | | | | | | | AVA (5, 1000) | autori seletti Mintelegia |
| | Eto for Los Altos = 45.4 | | | | | | ETV | VU Total | 60890 |
| | | (45.4)(.62)[(.55x4470) | +((155)x8 | 30)] | Maxim | um Allov | ved Water Al | lowance | 63465 |
| | | (//.02/[(.55% 1770) | [1-3.7](.02)[(.33,447.0] [(133],800]] [Widnii | | | | | | |
| | | Regular Landscape A | Regular Landscape Areas | | All Landscape Are | eas | | | |
| | | Total ETAF x Area 2220 | | | Total ETAF x Area | 2300 | | | |
| | | Total Area | 4034 | İ | Total Area | 4114 | | | |
| | | Δverage FTΔF | 0.550 | Sitewide FTAE | | 0.559 | | | |
| | | Average ETAF | 0.550 | | Sitewide ETAF | 0.559 | | | |

| | | IRRIGATION SCHEDULE | | | | | | | | | Annual | Annual | | | | |
|--------------|--------------------|-------------------------------|----------------|-----------------|--------------|--------------|------------|-------------|-------------|---------------|---------------|----------------|-----------------|---------------------------|-------|--------------------------|
| Month ETO | | > | January 1.5 | February 1.8 | March 3.1 | April 4.1 | May 5.5 | June 5.8 | July 6.5 | August 5.9 | September 5.0 | October 3.3 | November 1.8 | November December 1.8 1.0 | | Gallons Applied TOTAL |
| ZONE # | FLOW RATE (GPM) | RUN INTERVAL x PER WEEK | RVAL x | | | | | | | | | | | | | |
| Regular La | andscape Are | as | | | | | | | | | | | | | | |
| #1 | 2.23 | 2 | 45 | 54 | 93 | 123 | 165 | 174 | 195 | 177 | 150 | 99 | 54 | 30 | 1359 | 3031 |
| #2 | 3.1 | 2 | 45 | 54 | 93 | 123 | 165 | 174 | 195 | 177 | 150 | 99 | 54 | 30 | 1359 | 4213 |
| #3 | 1.25 | 2 | 45 | 54 | 93 | 123 | 165 | 174 | 195 | 177 | 150 | 99 | 54 | 30 | 1359 | 1699 |
| #4 | 3.72 | 3 | 135 | 162 | 279 | 369 | 495 | 522 | 585 | 531 | 450 | 297 | 162 | 90 | 4077 | 15166 |
| #5 | 1 | 2 | 45 | 54 | 93 | 123 | 165 | 174 | 195 | 177 | 150 | 99 | 54 | 30 | 1359 | 1359 |
| #6 | 4 | 2 | 45 | 54 | 93 | 123 | 165 | 174 | 195 | 177 | 150 | 99 | 54 | 30 | 1359 | 5436 |
| #7 | 2.1 | 2 | 45 | 54 | 93 | 123 | 165 | 174 | 195 | 177 | 150 | 99 | 54 | 30 | 1359 | 2854 |
| #8 | 1 | 2 | 45 | 54 | 93 | 123 | 165 | 174 | 195 | 177 | 150 | 99 | 54 | 30 | 1359 | 1359 |
| #9 | 13.81 | 3 | 54 | 65 | 112 | 148 | 198 | 209 | 234 | 212 | 180 | 119 | 65 | 36 | 1631 | 22521 |
| #10 | 1 | 4 | 60 | 72 | 124 | 164 | 220 | 232 | 260 | 236 | 200 | 132 | 72 | 40 | 1812 | 1812 |
| #11 | 1 | 2 | 45 | 54 | 93 | 123 | 165 | 174 | 195 | 177 | 150 | 99 | 54 | 30 | 1359 | 1359 |
| Special La | ndscape Area | as | | | | | | | | | | | | | | |
| #12 | 1 | 4 | 45 | 54 | 93 | 123 | 165 | 174 | 195 | 177 | 150 | 99 | 54 | 30 | 1359 | 1359 |
| TOTAL MIN | IUTES RUN PER | RMONTH | 654 | 785 | 1352 | 1788 | 2398 | 2529 | 2834 | 2572 | 2180 | 1439 | 785 | 436 | 19751 | |
| | | | | | | | | | | | ANNUAL TO | TAL GALLON | S APPLIED | | | 62168 |

Scale: 1/8" = 1' - 0"

Sheet: IRRIGATION & HYDROZONE PLAN

Drawn by: WB

Revisions: 7_26_23

SHEET

Chinese 8.2

7.0

the Project Arborist or City Arborist.

authorization from the City Arborist. d. Allow fires under and adjacent to trees. e. Discharge exhaust into the foliage.

hand digging or the use of compressed air tools.

f. Secure cable, chain, or rope to trees or shrubs.

DO NOT:

Myrtle

Crape Myrtle

Myrtle

White Birch 10.0

18 Root crown covered: multi-stem

near 6 feet; good vigor and fair

No tag; located on the neighboring

No tag; located on the neighboring property; root crown covered; multi-stem attachment at 6 feet;

No tag; located on the neighboring

multi-stem attachment at 5 feet; good vigor, and fair form. No tag; located on the neighboring

property; multi-stem attachment at

8 feet; overhangs neighbor's roof

No tag; located on the neighboring

vigor and form.

TREE PROTECTION SPECIFICATIONS

no more than 10 feet apart. This enclosed area is the Tree Protection Zone (TPZ) and should be off-limits to workers, construction debris, and construction

supported by cement blocks, can be used in place of fixed fencing in certain situations. Permission to use such panels will need to be discussed with the project arborist prior to installation. Once the location of these panels is established, they should not be moved closer to the tree without the consent of

a. Allow runoff or spillage of damaging materials into the area below any

b. Store materials, stockpile soil, or park or drive vehicles within the TPZ.

c. Cut, break, skin, or bruise roots, branches, or trunks without first obtaining

g. Trench, dig, or otherwise excavate within the dripline or TPZ of the trees

without first obtaining authorization from the City Arborist.

important to minimize the disturbance to the roots of the tree. Therefore, any

excavations within the dripline of any protected tree should be accomplished by

should be cut cleanly with hand pruners or loppers back to the wall of excavation

nearest to the tree. Any roots found that are larger than 2 inches in diameter

exposed roots of the protected trees. If any trenches are to be left open for

7. When possible, any pipes or utility lines shall be kept outside the dripline of the

8. Any damage due to construction activities shall be reported to the Project

9. An ISA Certified Arborist or ASCA Registered Consulting Arborist may be required by the city to be retained as the Project Arborist to monitor the tree protection specifications. Should the builder fail to follow the tree protection

10. Violation of any of the above provisions may result in sanctions or other

MONTHLY INSPECTIONS

protected trees or at least 10 times the trunk diameter of the protected trees.

Arborist or City Arborist within six hours so that remedial action can be taken.

specifications, it shall be the responsibility of the Project Arborist to report the

Tunneling or directional boring under the trees is an option but should take place

longer than 24 hours, then the wall of excavation that is closest to the protected

trees shall be lined with 3 to 4 layers of burlap. These burlap layers shall be kept

should be left uncut and intact; the site arborist shall be contacted immediately.

The roots in this area should be left untouched until the site arborist can identify,

h. Apply soil sterilants under pavement near existing trees.

inspect, document, and make a final decision as to the root's fate.

moist throughout the duration of the trench being open.

at least three feet below the surface of the ground.

1. Describes the effectiveness of the protective measures.

2. Identifies any problems with the tree protection zones. 3. Provides any recommendations to promote general tree health.

disciplinary action.

shall complete a write-up that:

closely as possible. This perimeter should consist of 6-foot-tall chain link fencing supported by 11/2- to 2-inch diameter metal pipes. These support pipes shall be

No-tag; located on rear neighboring property behind a 7foot fence; codominant attachment

property; behind a 7-foot fence; fair

with included bark at 15 feet; good

property; root crown covered;

multi-stem at 5 feet; good vigor and

property; root crown covered,

good vigor and fair form.

NEW RESIDENCE FOR

SUKU

746 CASA BONITA COURT LOS ALTOS, CA 94024

REVISION

J MALIKSI & ASSOC. ARCHITECTURE - INTERIOR DESIGN

675 MENLO AVENUE MENLO PARK, CA 94025 TEL. NO. 650 323 2902 FAX NO. 650 323 6433



NO. DATE ISSUE GTM 7-14-23 FOR DESIGN REVIEW

DRAWING TITLE


DRAWING NO.

GTM 5-19-23 FOR DESIGN REVIEW

ALL DRAWINGS AND MATERIALS APPEARING HEREIN CONSTITUTE THE ORIGINAL AND UNPUBLISHED WORK OF THE ARCHITECT

SITE DEMO & TREE PROTECTION PLAN

SCALE: 1/8" = 1'-0" PROJECT NAME: CHETTIAR CADD FILE NO.

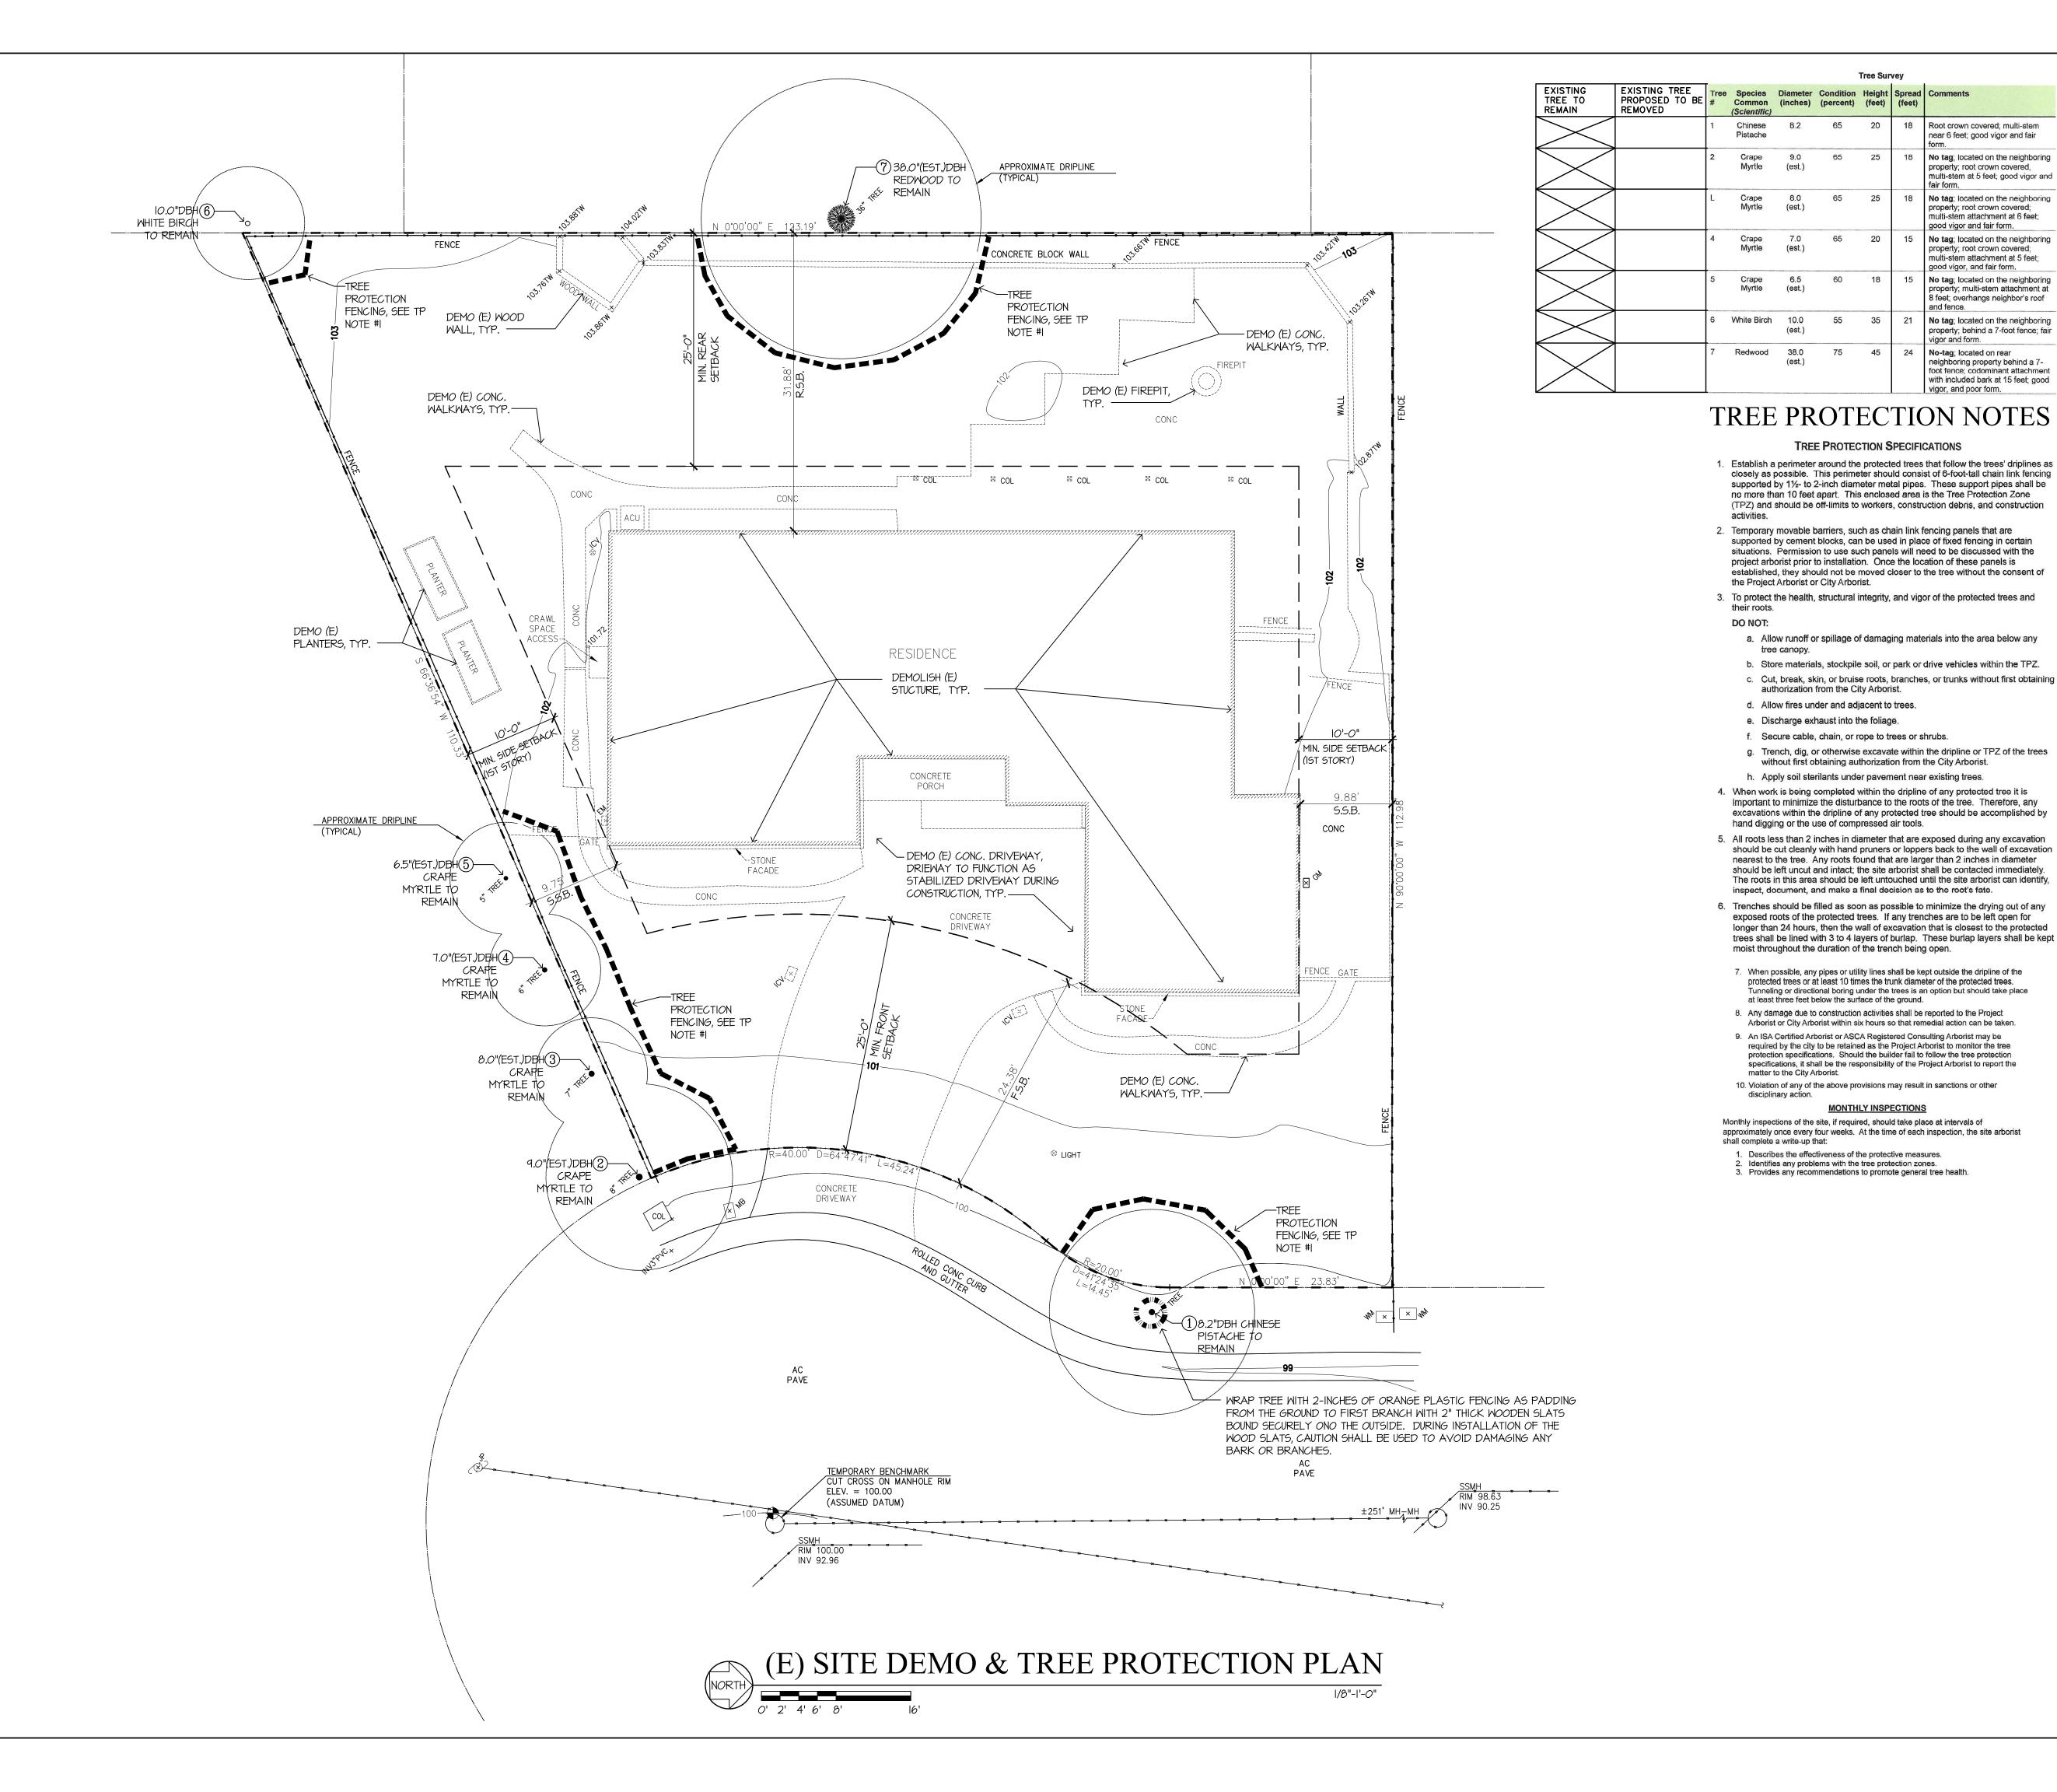

NEW RESIDENCE FOR

SUKU

746 CASA BONITA COURT LOS ALTOS, CA 94024

REVISION

J MALIKSI & ASSOC. ARCHITECTURE - INTERIOR DESIGN

675 MENLO AVENUE MENLO PARK, CA 94025 TEL. NO. 650 323 2902 FAX NO. 650 323 6433



NO. DATE ISSUE GTM 7-14-23 FOR DESIGN REVIEW

GTM 5-19-23 FOR DESIGN REVIEW GTM 12-22-22


GTM II-23-22

ALL DRAWINGS AND MATERIALS APPEARING HEREIN CONSTITUTE THE ORIGINAL AND UNPUBLISHED WORK OF THE ARCHITECT AND MAY NOT BE DUPLICATED, USED OR DISCLOSED WITHOUT THE PRIOR WRITTEN CONSENT OF THE ARCHITECT.

© 2022 JIM MALKSI & ASSOCIATES DRAWING TITLE

SITE PLAN

SCALE: 1/8" = 1'-0" PROJECT NAME: CHETTIAR CADD FILE NO. DRAWING NO.

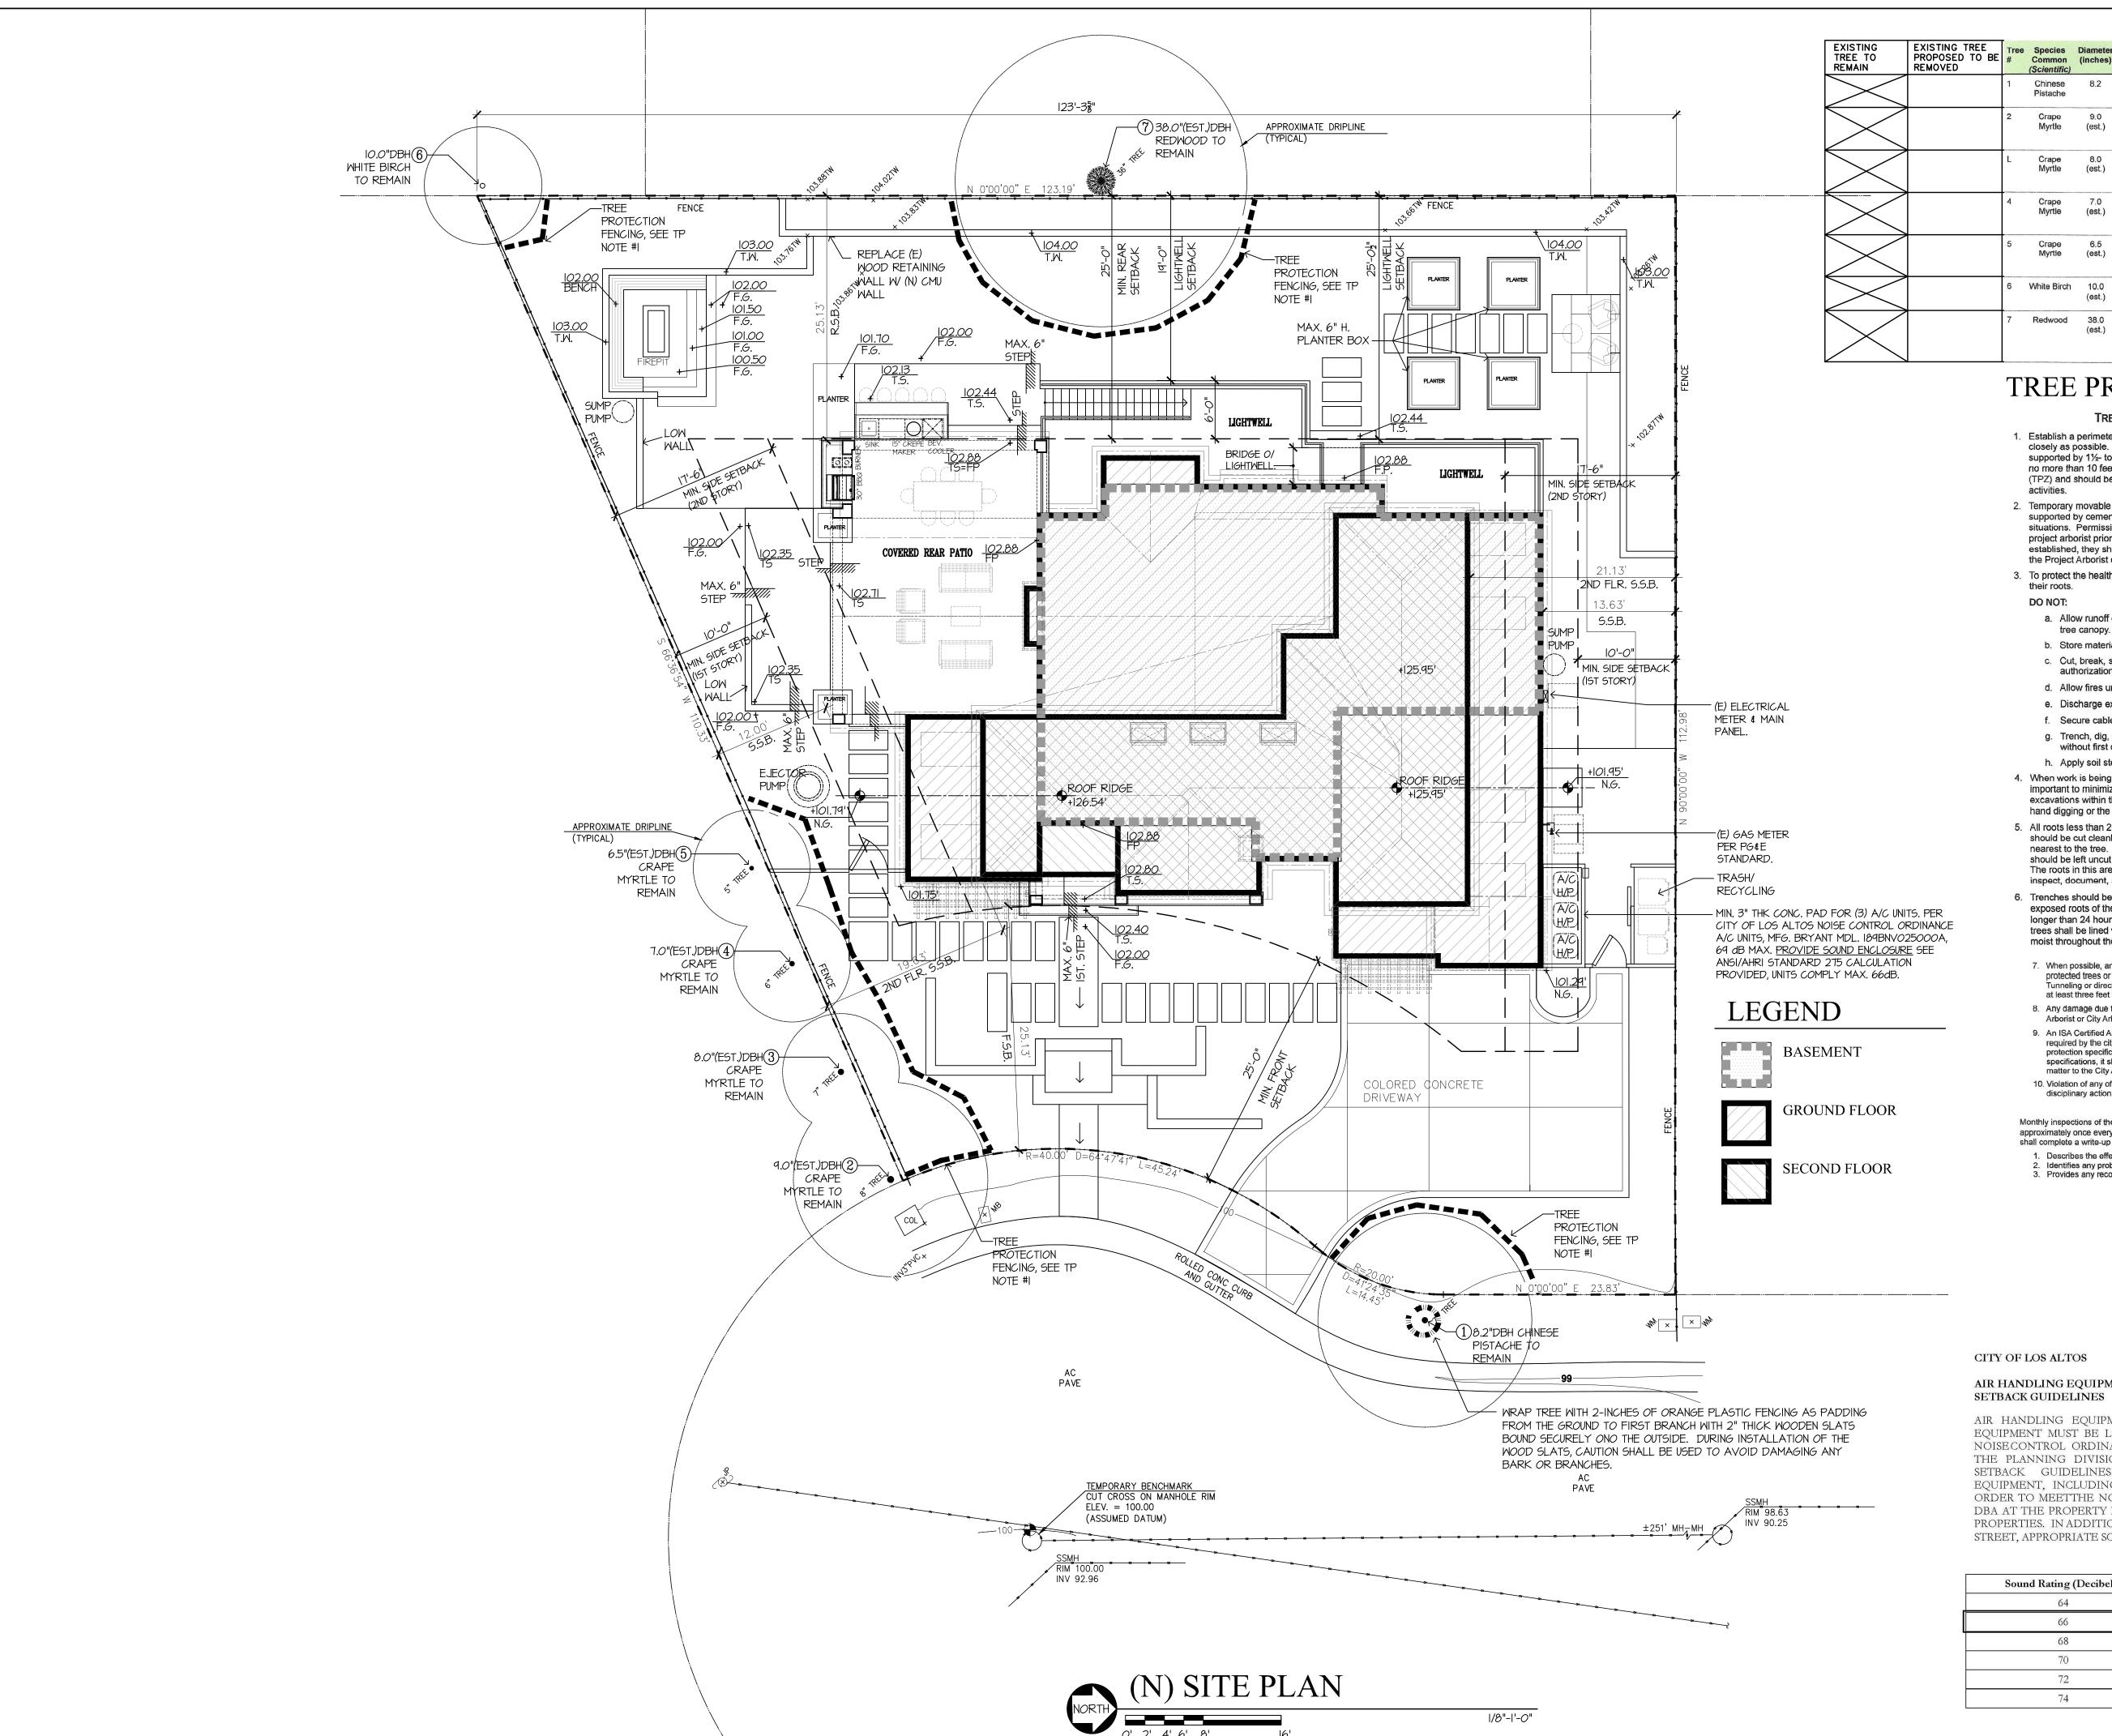

TREE PROTECTION NOTES

7.0

38.0

TREE PROTECTION SPECIFICATIONS

Root crown covered: multi-stem

property; root crown covered,

near 6 feet; good vigor and fair

No tag; located on the neighboring

No tag; located on the neighboring

No tag; located on the neighboring

multi-stem attachment at 5 feet;

No tag; located on the neighboring

No tag; located on the neighboring

neighboring property behind a 7-

foot fence; codominant attachment

with included bark at 15 feet; good

property; behind a 7-foot fence; fair

property; multi-stem attachment at 8 feet; overhangs neighbor's roof

property; root crown covered;

good vigor, and fair form.

vigor and form.

No-tag; located on rear

property; root crown covered; multi-stem attachment at 6 feet;

good vigor and fair form.

multi-stem at 5 feet; good vigor and

- 1. Establish a perimeter around the protected trees that follow the trees' driplines as closely as possible. This perimeter should consist of 6-foot-tall chain link fencing supported by 1½- to 2-inch diameter metal pipes. These support pipes shall be no more than 10 feet apart. This enclosed area is the Tree Protection Zone (TPZ) and should be off-limits to workers, construction debris, and construction
- 2. Temporary movable barriers, such as chain link fencing panels that are supported by cement blocks, can be used in place of fixed fencing in certain situations. Permission to use such panels will need to be discussed with the project arborist prior to installation. Once the location of these panels is established, they should not be moved closer to the tree without the consent of the Project Arborist or City Arborist.
- 3. To protect the health, structural integrity, and vigor of the protected trees and DO NOT:
- a. Allow runoff or spillage of damaging materials into the area below any tree canopy.
- b. Store materials, stockpile soil, or park or drive vehicles within the TPZ.
- c. Cut, break, skin, or bruise roots, branches, or trunks without first obtaining authorization from the City Arborist.
- d. Allow fires under and adjacent to trees.
- e. Discharge exhaust into the foliage.
- f. Secure cable, chain, or rope to trees or shrubs.
- g. Trench, dig, or otherwise excavate within the dripline or TPZ of the trees without first obtaining authorization from the City Arborist. h. Apply soil sterilants under pavement near existing trees.
- 4. When work is being completed within the dripline of any protected tree it is important to minimize the disturbance to the roots of the tree. Therefore, any excavations within the dripline of any protected tree should be accomplished by
- hand digging or the use of compressed air tools. 5. All roots less than 2 inches in diameter that are exposed during any excavation should be cut cleanly with hand pruners or loppers back to the wall of excavation nearest to the tree. Any roots found that are larger than 2 inches in diameter should be left uncut and intact; the site arborist shall be contacted immediately.
- The roots in this area should be left untouched until the site arborist can identify, inspect, document, and make a final decision as to the root's fate. 6. Trenches should be filled as soon as possible to minimize the drying out of any exposed roots of the protected trees. If any trenches are to be left open for
- longer than 24 hours, then the wall of excavation that is closest to the protected trees shall be lined with 3 to 4 layers of burlap. These burlap layers shall be kept moist throughout the duration of the trench being open.
- 7. When possible, any pipes or utility lines shall be kept outside the dripline of the protected trees or at least 10 times the trunk diameter of the protected trees. Tunneling or directional boring under the trees is an option but should take place at least three feet below the surface of the ground.
- 8. Any damage due to construction activities shall be reported to the Project Arborist or City Arborist within six hours so that remedial action can be taken.
- 9. An ISA Certified Arborist or ASCA Registered Consulting Arborist may be required by the city to be retained as the Project Arborist to monitor the tree protection specifications. Should the builder fail to follow the tree protection specifications, it shall be the responsibility of the Project Arborist to report the matter to the City Arborist.
- 10. Violation of any of the above provisions may result in sanctions or other disciplinary action.

MONTHLY INSPECTIONS

Monthly inspections of the site, if required, should take place at intervals of approximately once every four weeks. At the time of each inspection, the site arborist shall complete a write-up that:

1. Describes the effectiveness of the protective measures. 2. Identifies any problems with the tree protection zones. 3. Provides any recommendations to promote general tree health.

AIR HANDLING EQUIPMENT/AIR CONDITIONING UNIT SETBACK GUIDELINES

AIR HANDLING EQUIPMENT, INCLUDING AIR CONDITIONING EQUIPMENT MUST BE LOCATED TO COMPLY WITH THE CITY'S NOISE CONTROL ORDINANCE (MUNICIPAL CODE CHAPTER 6.16). THE PLANNING DIVISION HAS ESTIMATED THE FOLLOWING SETBACK GUIDELINES FOR LOCATING AIR HANDLING EQUIPMENT, INCLUDING AIR CONDITIONING EQUIPMENT IN ORDER TO MEETTHE NOISE CONTROL ORDINANCE LIMIT OF 50 DBA AT THE PROPERTY LINE FOR MOST RESIDENTIALLY ZONED PROPERTIES. IN ADDITION, IF THE UNIT IS VISIBLE FROM THE STREET, APPROPRIATE SCREENING SHOULD BE PROVIDED.

| Sound Rating (Decibels) | Distance to Property Line |
|-------------------------|---------------------------|
| 64 | 6 feet |
| 66 | 8 feet |
| 68 | 11 feet |
| 70 | 14 feet |
| 72 | 18 feet |
| 74 | 22 feet |



NEW RESIDENCE FOR

SUKU & NAMRITA CHETTIAR

746 CASA BONITA COURT LOS ALTOS, CA 94024

REVISION



J MALIKSI & ASSOC.

ARCHITECTURE - INTERIOR DESIGN

675 MENLO AVENUE MENLO PARK, CA 94025 TEL. NO. 650 323 2902 FAX NO. 650 323 6433



NO. DATE ISSUE

6TM 7-I4-23 FOR DESIGN REVIEW

GTM 5-I9-23 FOR DESIGN REVIEW
GTM I-I9-23

ALL DRAWINGS AND MATERIALS APPEARING HEREIN CONSTITUTE THE ORIGINAL AND UNPUBLISHED WORK OF THE ARCHITECT AND MAY NOT BE DUPLICATED, USED OR DISCLOSED WITHOUT THE PRIOR WRITTEN CONSENT OF THE ARCHITECT.

© 2022 JIM MALKSI & ASSOCIATES

DRAWING TITLE

EXISTING FLOOR PLAN


SCALE: N.T.S.

PROJECT NAME: CHETTIAR

CADD FILE NO.

DRAWING NO.


Δ_1 3

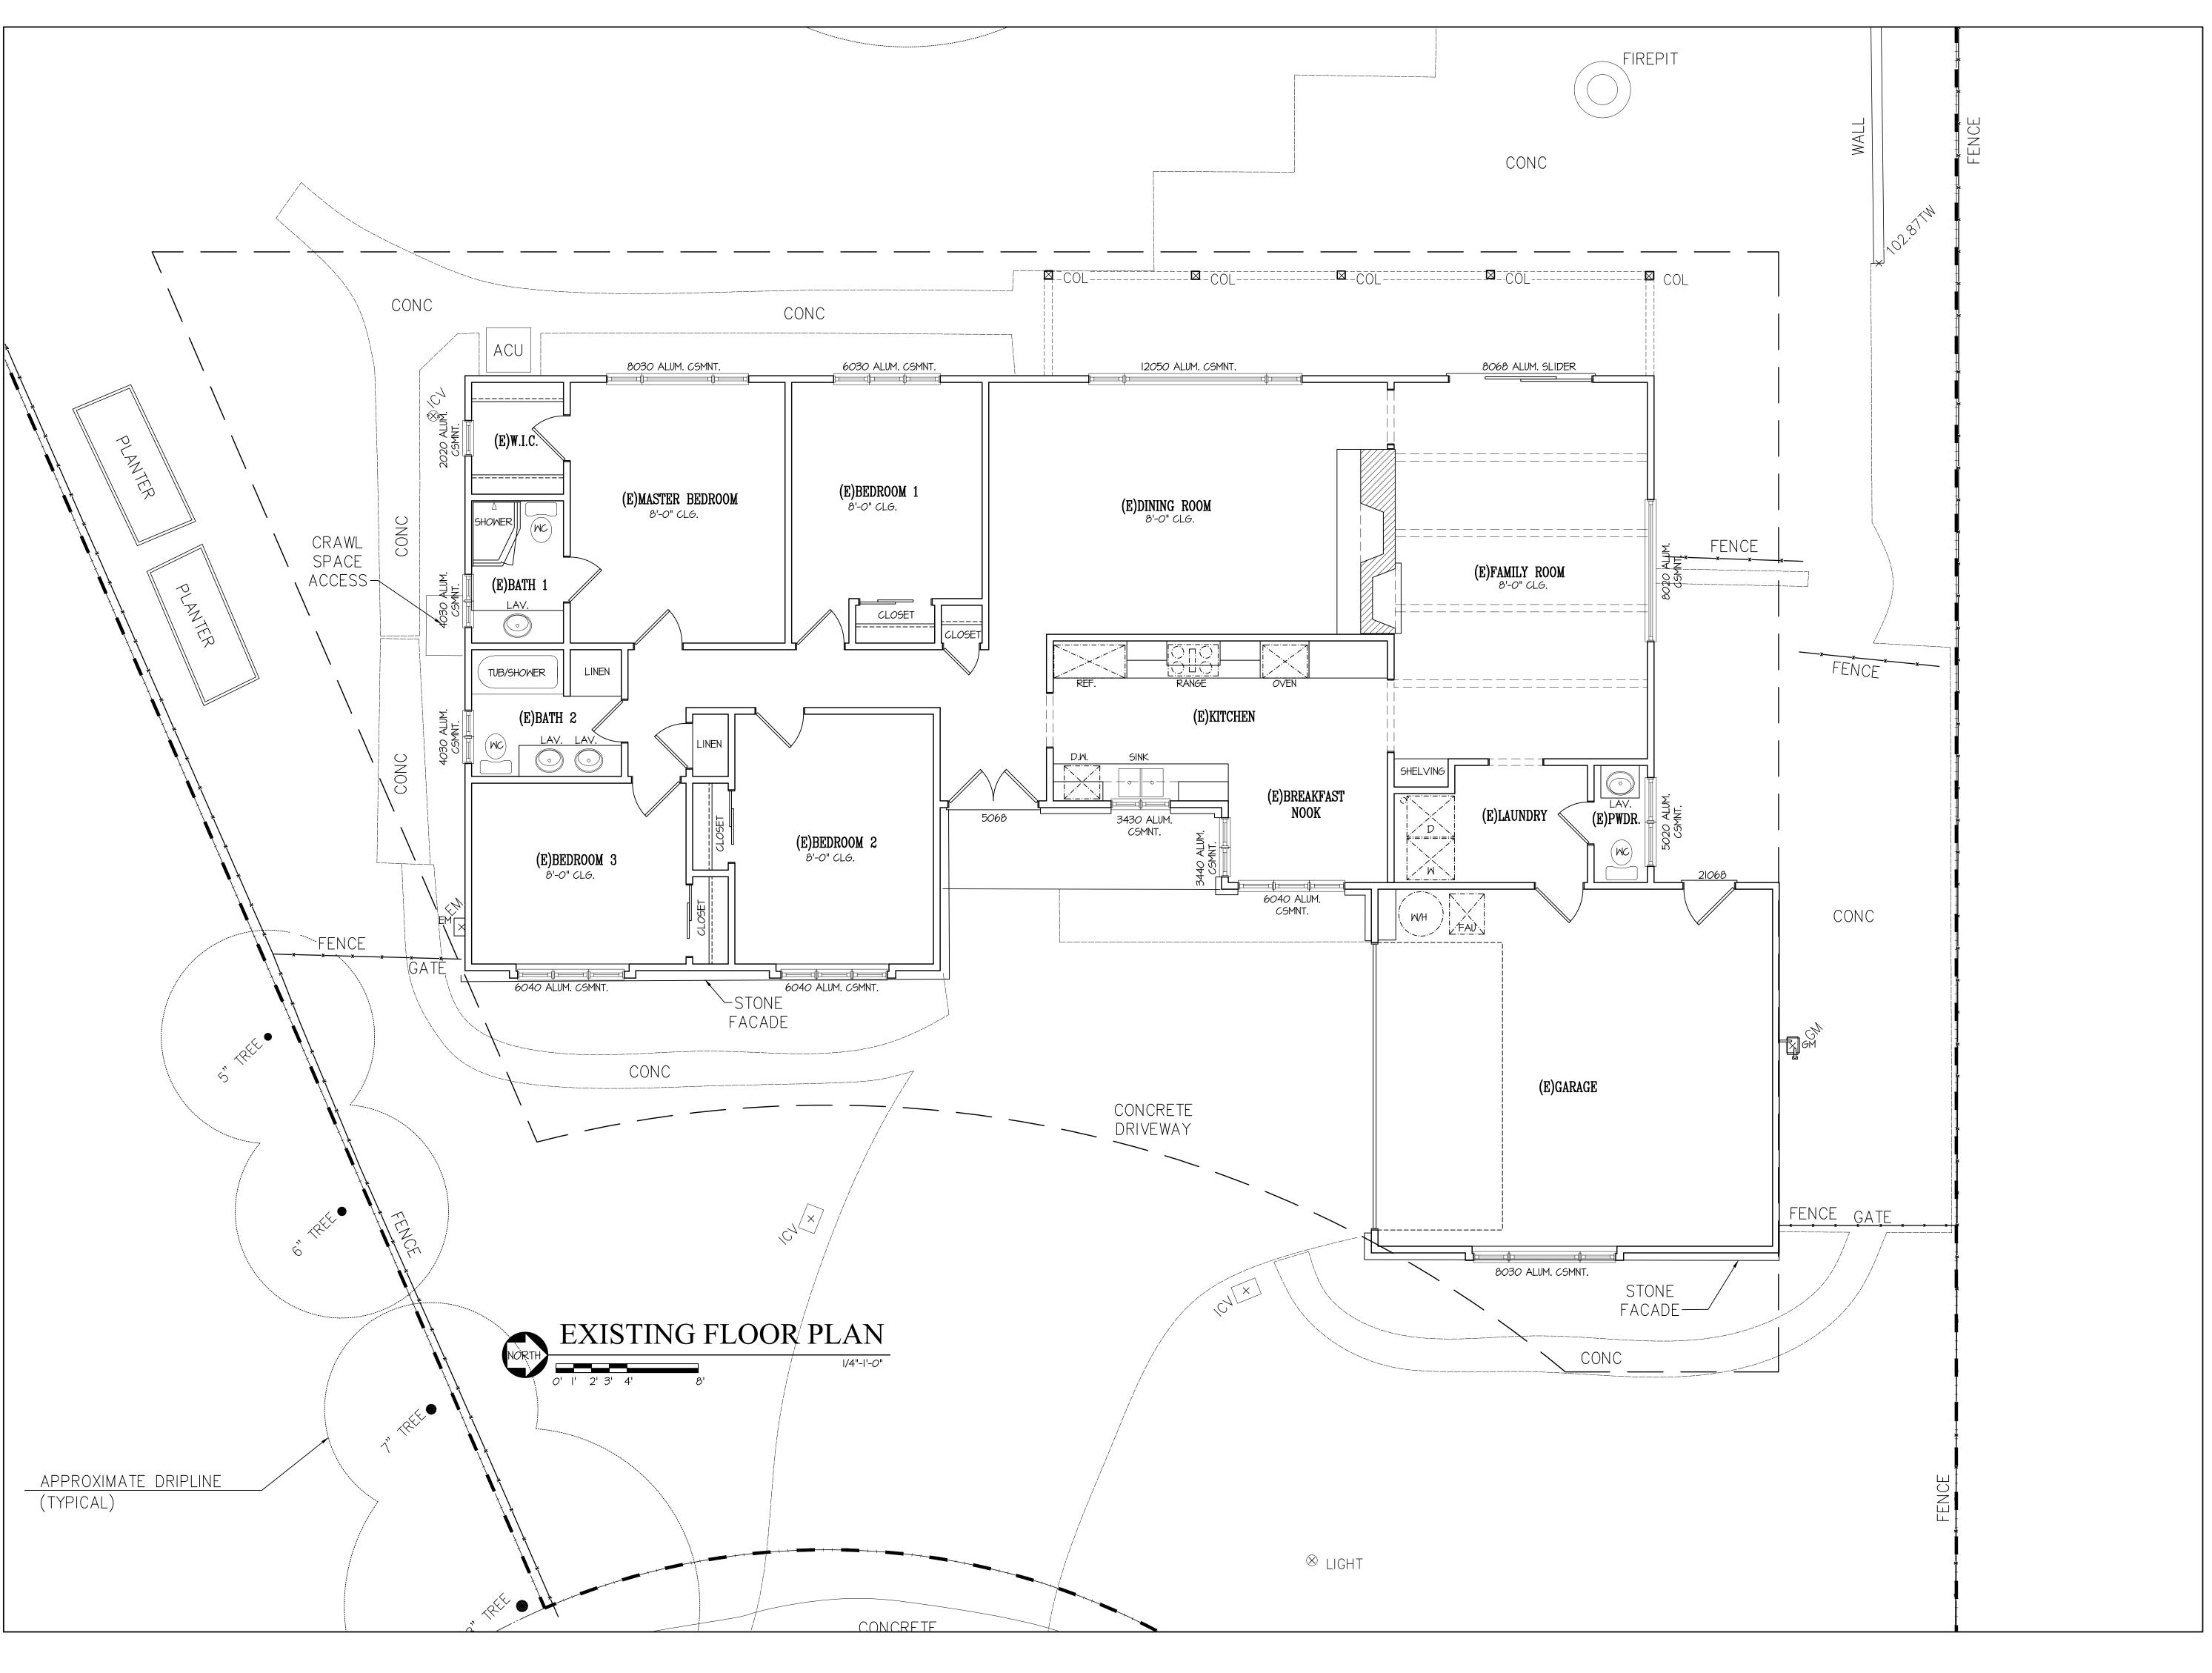

NEW RESIDENCE FOR

> SUKU & NAMRITA CHETTIAR

746 CASA BONITA COURT LOS ALTOS, CA 94024

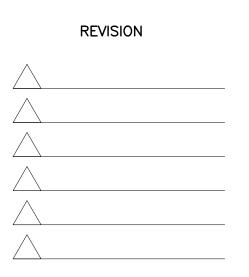



J MALIKSI & ASSOC architecture - interior design

675 MENLO AVENUE MENLO PARK, CA 94025 TEL. NO. 650 323 2902 FAX NO. 650 323 6433



NO. DATE ISSUE

6TM 7-14-23 FOR DESIGN REVIEW

GTM 5-I9-23 FOR DESIGN REVIEW
GTM I-I9-23

ALL DRAWINGS AND MATERIALS APPEARING HEREIN CONSTITUTE THE ORIGINAL AND UNPUBLISHED WORK OF THE ARCHITECT AND MAY NOT BE DUPLICATED, USED OR DISCLOSED WITHOUT THE PRIOR WRITTEN CONSENT OF THE ARCHITECT.

© 2022 JIM MALIKSI & ASSOCIATES

DRAWING TITLE

EXISTING ROOF PLAN


SCALE: N.T.5.


PROJECT NAME: CHETTIAR

CADD FILE NO.

DRAWING NO.

A-1.4

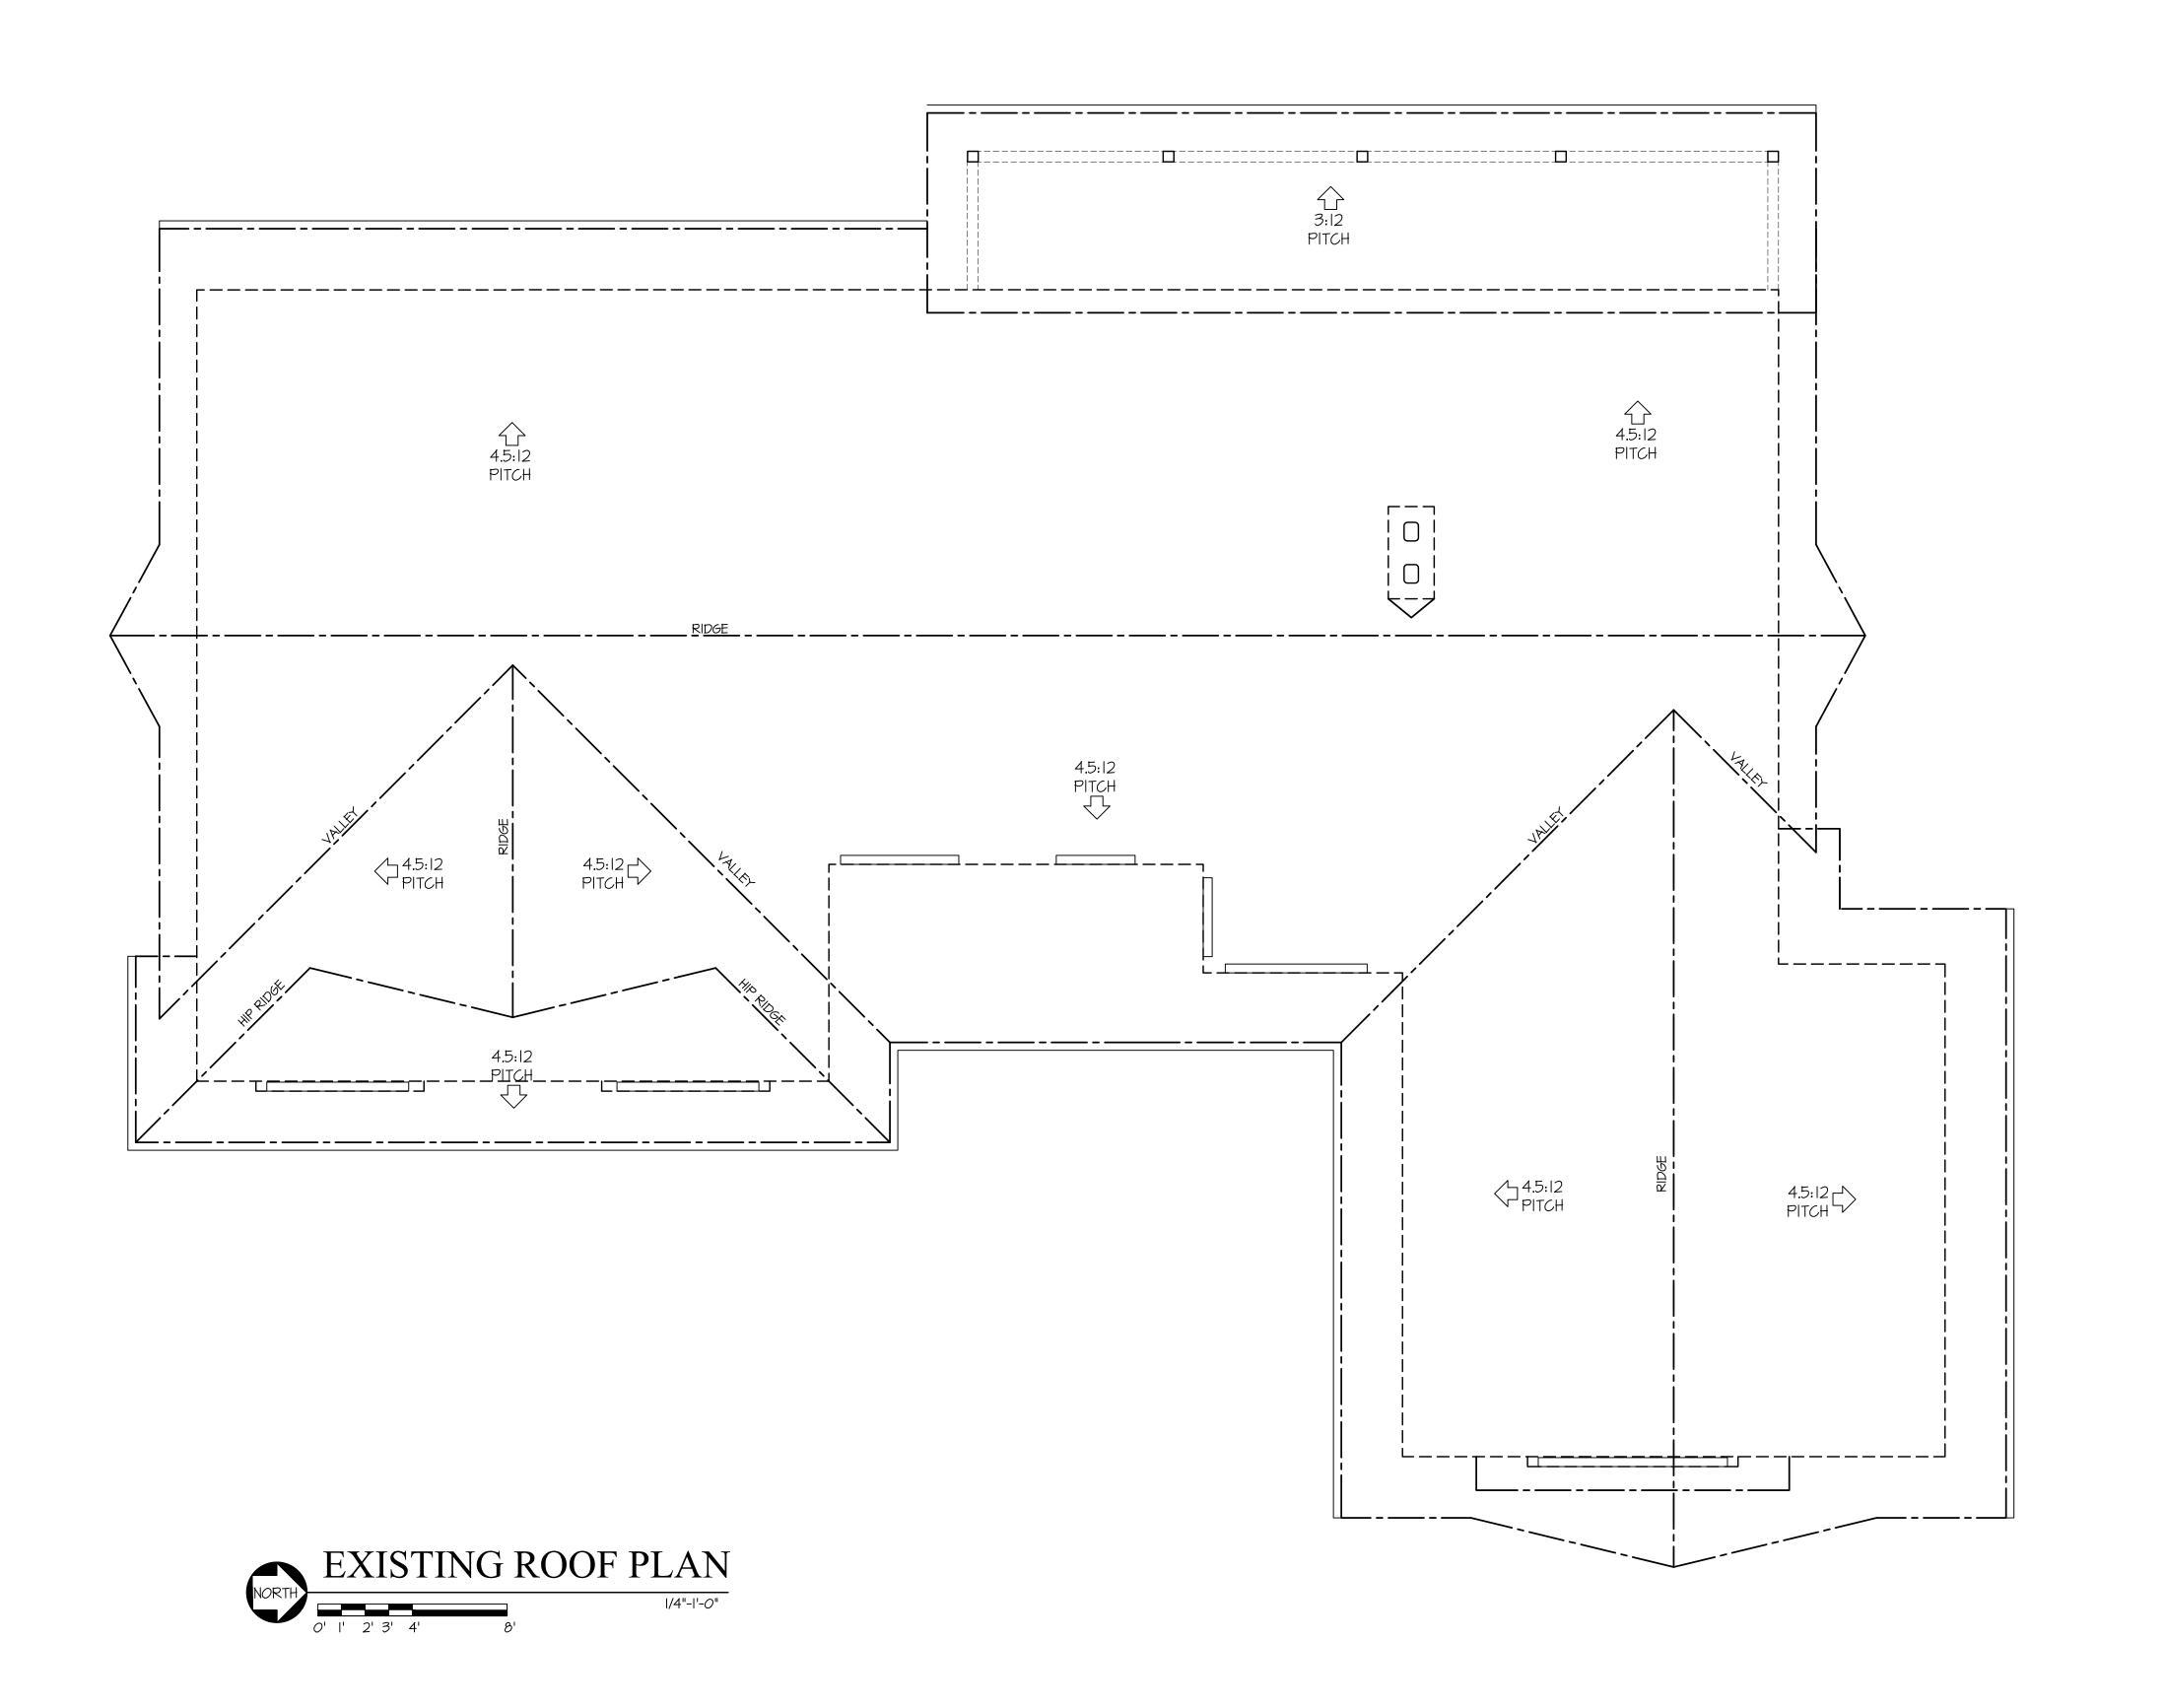

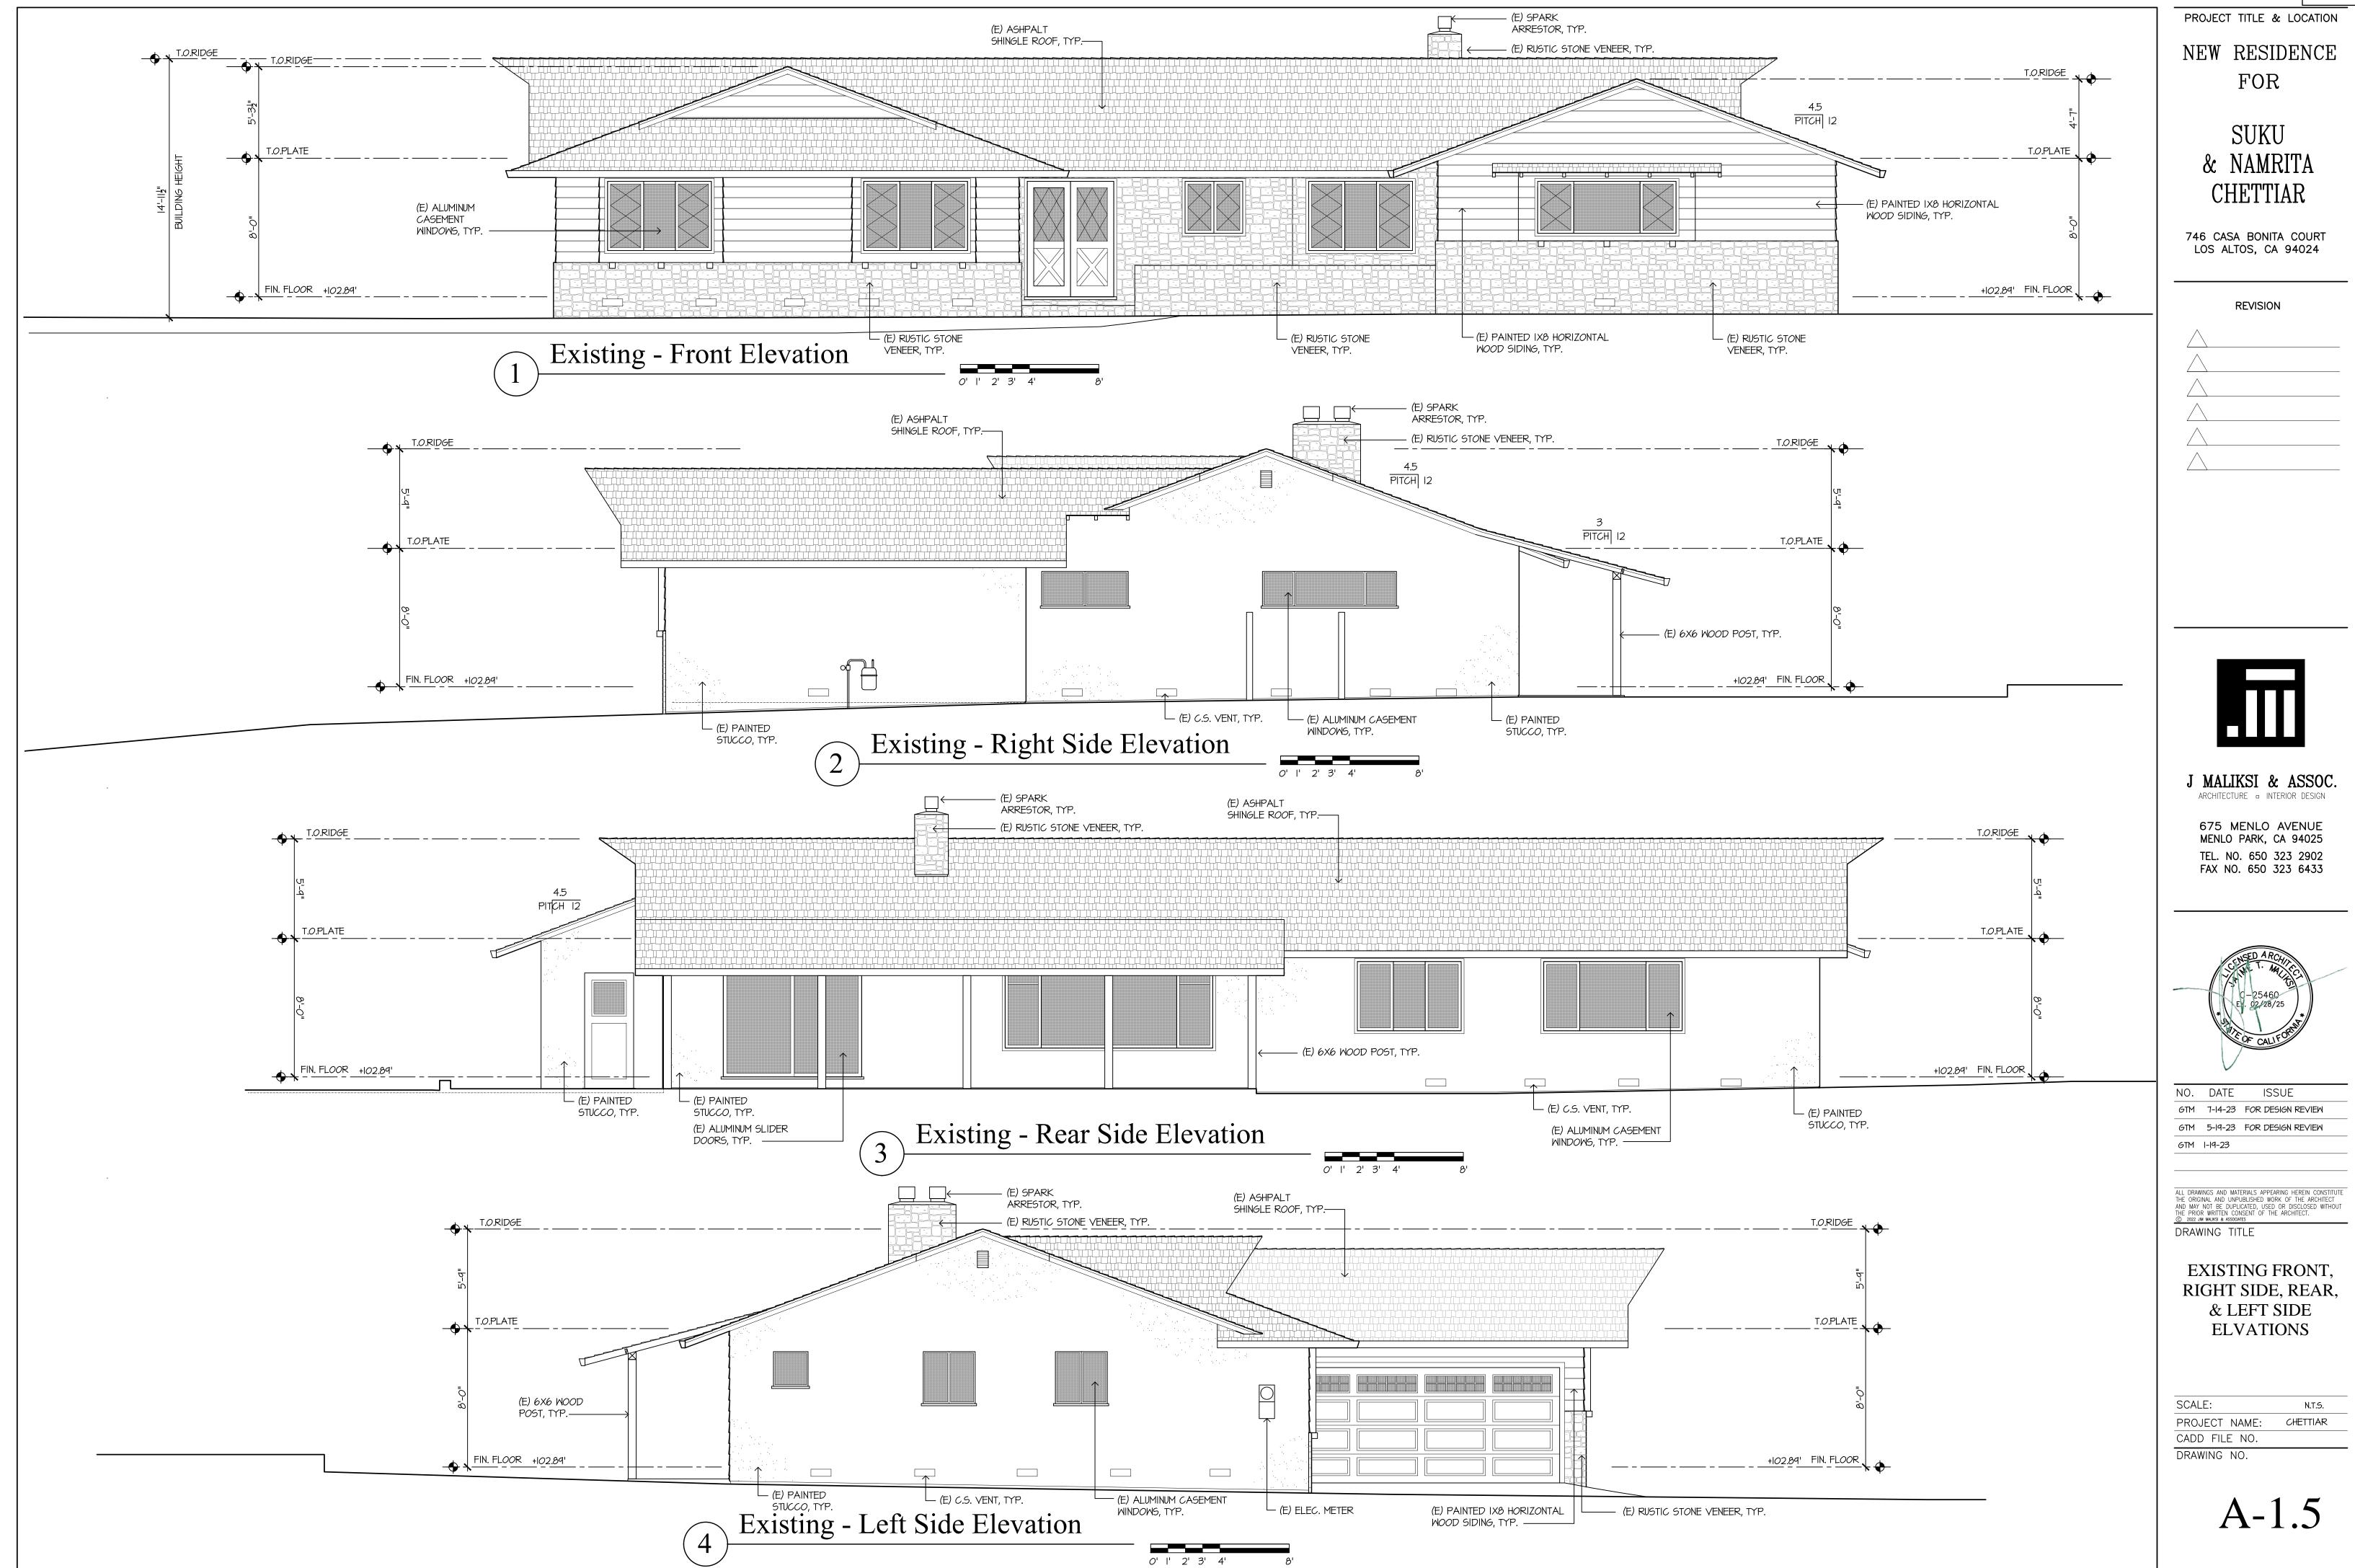

Agenda Item 3.

AREA CALCULATIONS

(FAR) FLOOR AREA RATIO CALCULATIONS

| SECTION | AREA |
|---------|------|
| | |

| BASEMENT (DOES NOT COUNT TOWARDS FAR) | | | | | | |
|---------------------------------------|---------------------|------------|--|--|--|--|
| 1 | 6'-7" X 32'-2" | 211.8 S.F. | | | | |
| 2 | 15'-6" X 35'-1 1/2" | 544.4 S.F. | | | | |

544.4 S.F. 13'-8" X 23'-9" 324.5 S.F. 16'-3 1/2" X 20'-9 1/2" 338.7 S.F. 9'-2 1/2" X 15'-0 1/2" 138.5 S.F.

1557.9 S.F. **TOTAL BASEMENT FLOOR AREA:**

(FAR) FLOOR AREA RATIO CALCULATIONS

| AREA |
|------|
| |

| GROUND | FLOOR |
|--------|--------------|
|--------|--------------|

| 6 | 10'-2" X 5'-11" | 60.1 | S.F. |
|----|------------------------|-------|------|
| 7 | 16'-9" X 20'-8 1/2" | 346.9 | S.F. |
| 8 | 1'-5" X 6'-9" | 9.6 | S.F. |
| 9 | 13'-8 1/2" X 23'-8" | 324.4 | S.F. |
| 10 | 5'-3 1/2" X 27'-8 1/2" | 146.6 | S.F. |
| 11 | 6'-11 1/2" X 24'-9" | 172.2 | S.F. |
| 12 | 9'-4" X 25'-11" | 242.0 | S.F. |
| 13 | 14'-1" X 17'-3" | 242.9 | S.F. |
| 14 | 7'-6" X 11'-5 1/2" | 85.9 | S.F. |
| 15 | 15'-1" X 18'-7 1/2" | 280.9 | S.F. |
| 16 | 7'-4 1/2" X 15'-1 1/2" | 110.9 | S.F. |
| 17 | 10'-6" X 21'-1" | 221.4 | S.F. |
| 18 | 9'-4" X 20'-11" | 195.3 | S.F. |
| 19 | 1'-9" X 22'-1" | 38.6 | S.F. |
| 20 | 7'-3 1/2"X 0'-6 1/2" | 4.0 | S.F. |

TOTAL GROUND FLOOR AREA 2481.7 S.F.

SECOND FLOOR

| 21 | 16'-9"X 13'-10 1/2" | 232.4 S.F. |
|------|---------------------|-------------|
| 22 | 15'-1" X 18'-7 1/2" | 280.9 S.F. |
| 23 | 7'-4" X 15'-1 1/2" | 110.9 S.F. |
| 24 | 5'-4 1/2" X 8'-4" | 44.8 S.F. |
| 25 | 14'-0 1/2" X 40'-6" | 570.4 S.F. |
| ТОТА | L SECOND FLOOR AREA | 1239.4 S.F. |

TOTAL SECOND FLOOR AREA

TOTAL FLOOR AREA: 3721.1 S.F.

35.0%

3721.2 S.F. ALLOWABLE FLOOR AREA 35.0%

LOT COVERAGE

MAIN HOUSE FOOTPRINT 2481.7 S.F.

COVERED PORCH/ PATIOS

(DOES NOT COUNT TOWARDS FAR (FLOOR AREA RATIO)

| 26 | 7'-6" X 5'-9 1/2" | 43.4 S.F. |
|-----------|--------------------------|------------|
| 27 | 23'-10" X 1'-0" | 23.8 S.F. |
| 28 | 8'-9" X 1'-4 1/2' | 12.0 S.F. |
| 29 | 6'-5" X 7'-0" | 45.2 S.F. |
| 30 | 13'-6 1/2' X 8'-0" | 108.3 S.F. |
| (31 | 1'-0" X 7'-5 1/2" | 7.5 S.F. |
| > 32 | 7'-5 1/2" X 22'-2" | 165.4 S.F. |
| (33 | 13'-6 1/2" X 6'-8 1/2' | 90.8 S.F. |
| > 34 | 12'-1 1/2" X 6'-9" | 81.8 S.F. |
| (35 | 13'-6 1/2" X 6'-8 1/2' | 90.8 S.F. |
| | | |
| TOT | AL COVERED PORCH/ PATIOS | 669.0 S.F. |

TOTAL COVERED PORCH/ PATIOS


TOTAL LOT COVERAGE 3150.7 S.F.

29.6%

ALLOWABLE LOT COVERAGE 3189.6 S.F.

30.0%


10632.0 S.F. SITE AREA

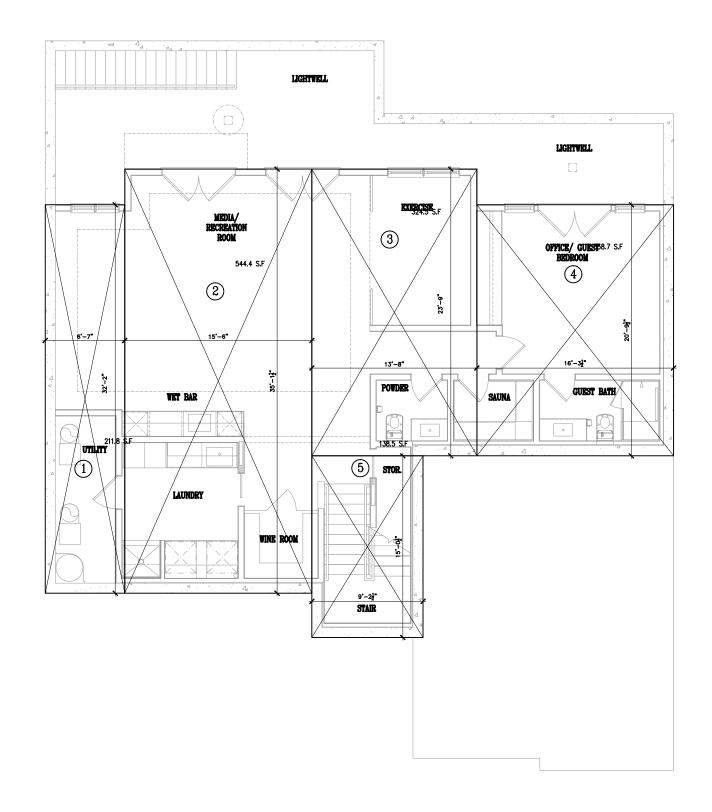

BASEMENT AREA DIAGRAM

LEGEND



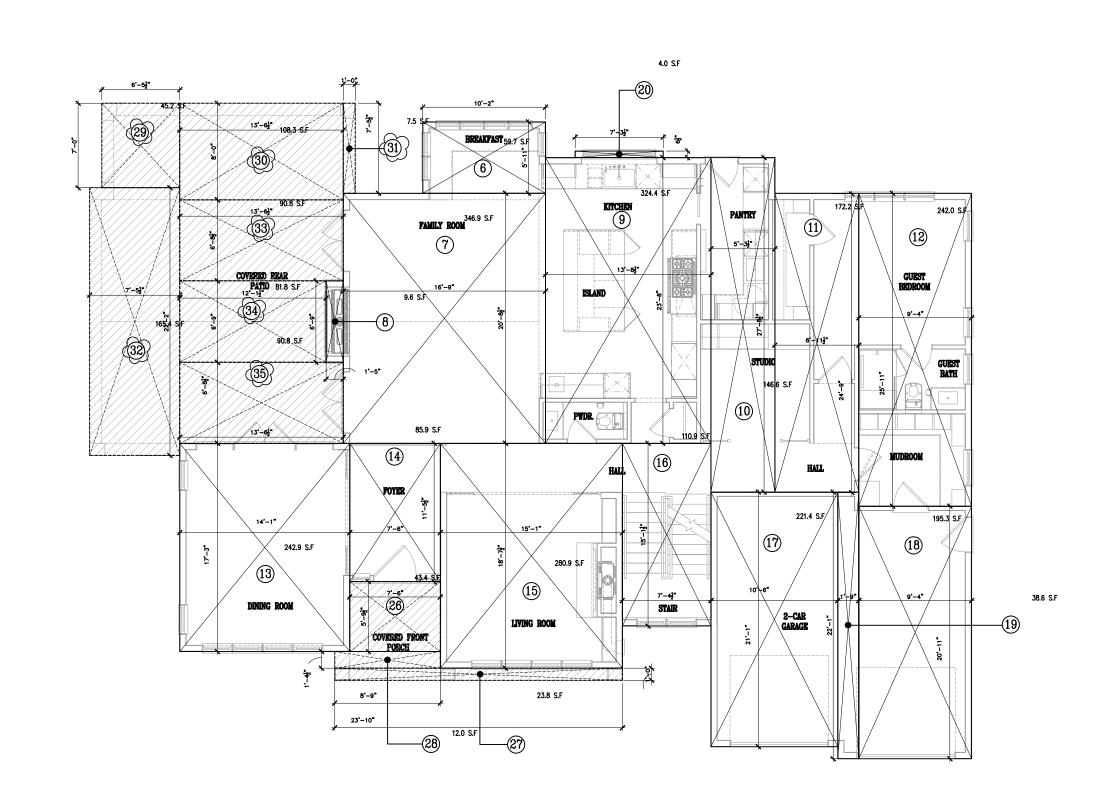

| | | BEDROOM 2 |
|--|-----|----------------------------|
| 44.8 24 Vic. | S.F | BATH 2 |
| MASTER 232.4 S.F 15'-1" 280.9 S.F 15'-1" 280.9 S.F 15'-1" 10.9 | 3 | P VIC. BATH 1 570.4 S.F. |
| MASTER RATH STAIR | | BEDROOM 1 |

GROUND FLOOR AREA DIAGRAM



PROJECT TITLE & LOCATION

NEW RESIDENCE FOR

> SUKU & NAMRITA CHETTIAR

746 CASA BONITA COURT LOS ALTOS, CA 94024

REVISION



J MALIKSI & ASSOC. ARCHITECTURE - INTERIOR DESIGN

675 MENLO AVENUE MENLO PARK, CA 94025 TEL. NO. 650 323 2902 FAX NO. 650 323 6433



NO. DATE ISSUE GTM 7-14-23 FOR DESIGN REVIEW GTM 5-19-23 FOR DESIGN REVIEW 8-30-23 FOR DESIGN REVIEW

DRAWING TITLE

(N) FLOOR AREA DIAGRAM & AREA **CALCULATIONS**

| SCALE: | N.T.S. |
|---------------|----------|
| PROJECT NAME: | CHETTIAR |
| CADD FILE NO. | |
| DRAWING NO. | |

A-1.6

NEW RESIDENCE FOR

> SUKU & NAMRITA CHETTIAR

746 CASA BONITA COURT LOS ALTOS, CA 94024

REVISION

J MALIKSI & ASSOC. ARCHITECTURE - INTERIOR DESIGN

675 MENLO AVENUE MENLO PARK, CA 94025 TEL. NO. 650 323 2902 FAX NO. 650 323 6433



NO. DATE ISSUE GTM 7-14-23 FOR DESIGN REVIEW


GTM 3-8-23

ALL DRAWINGS AND MATERIALS APPEARING HEREIN CONSTITUTE
THE ORIGINAL AND UNPUBLISHED WORK OF THE ARCHITECT
AND MAY NOT BE DUPLICATED, USED OR DISCLOSED WITHOUT
THE PRIOR WRITTEN CONSENT OF THE ARCHITECT.

© 2022 JIM MALIKSI & ASSOCIATES DRAWING TITLE

BASEMENT PLAN

SCALE: N.T.S. PROJECT NAME: CHETTIAR CADD FILE NO. DRAWING NO.

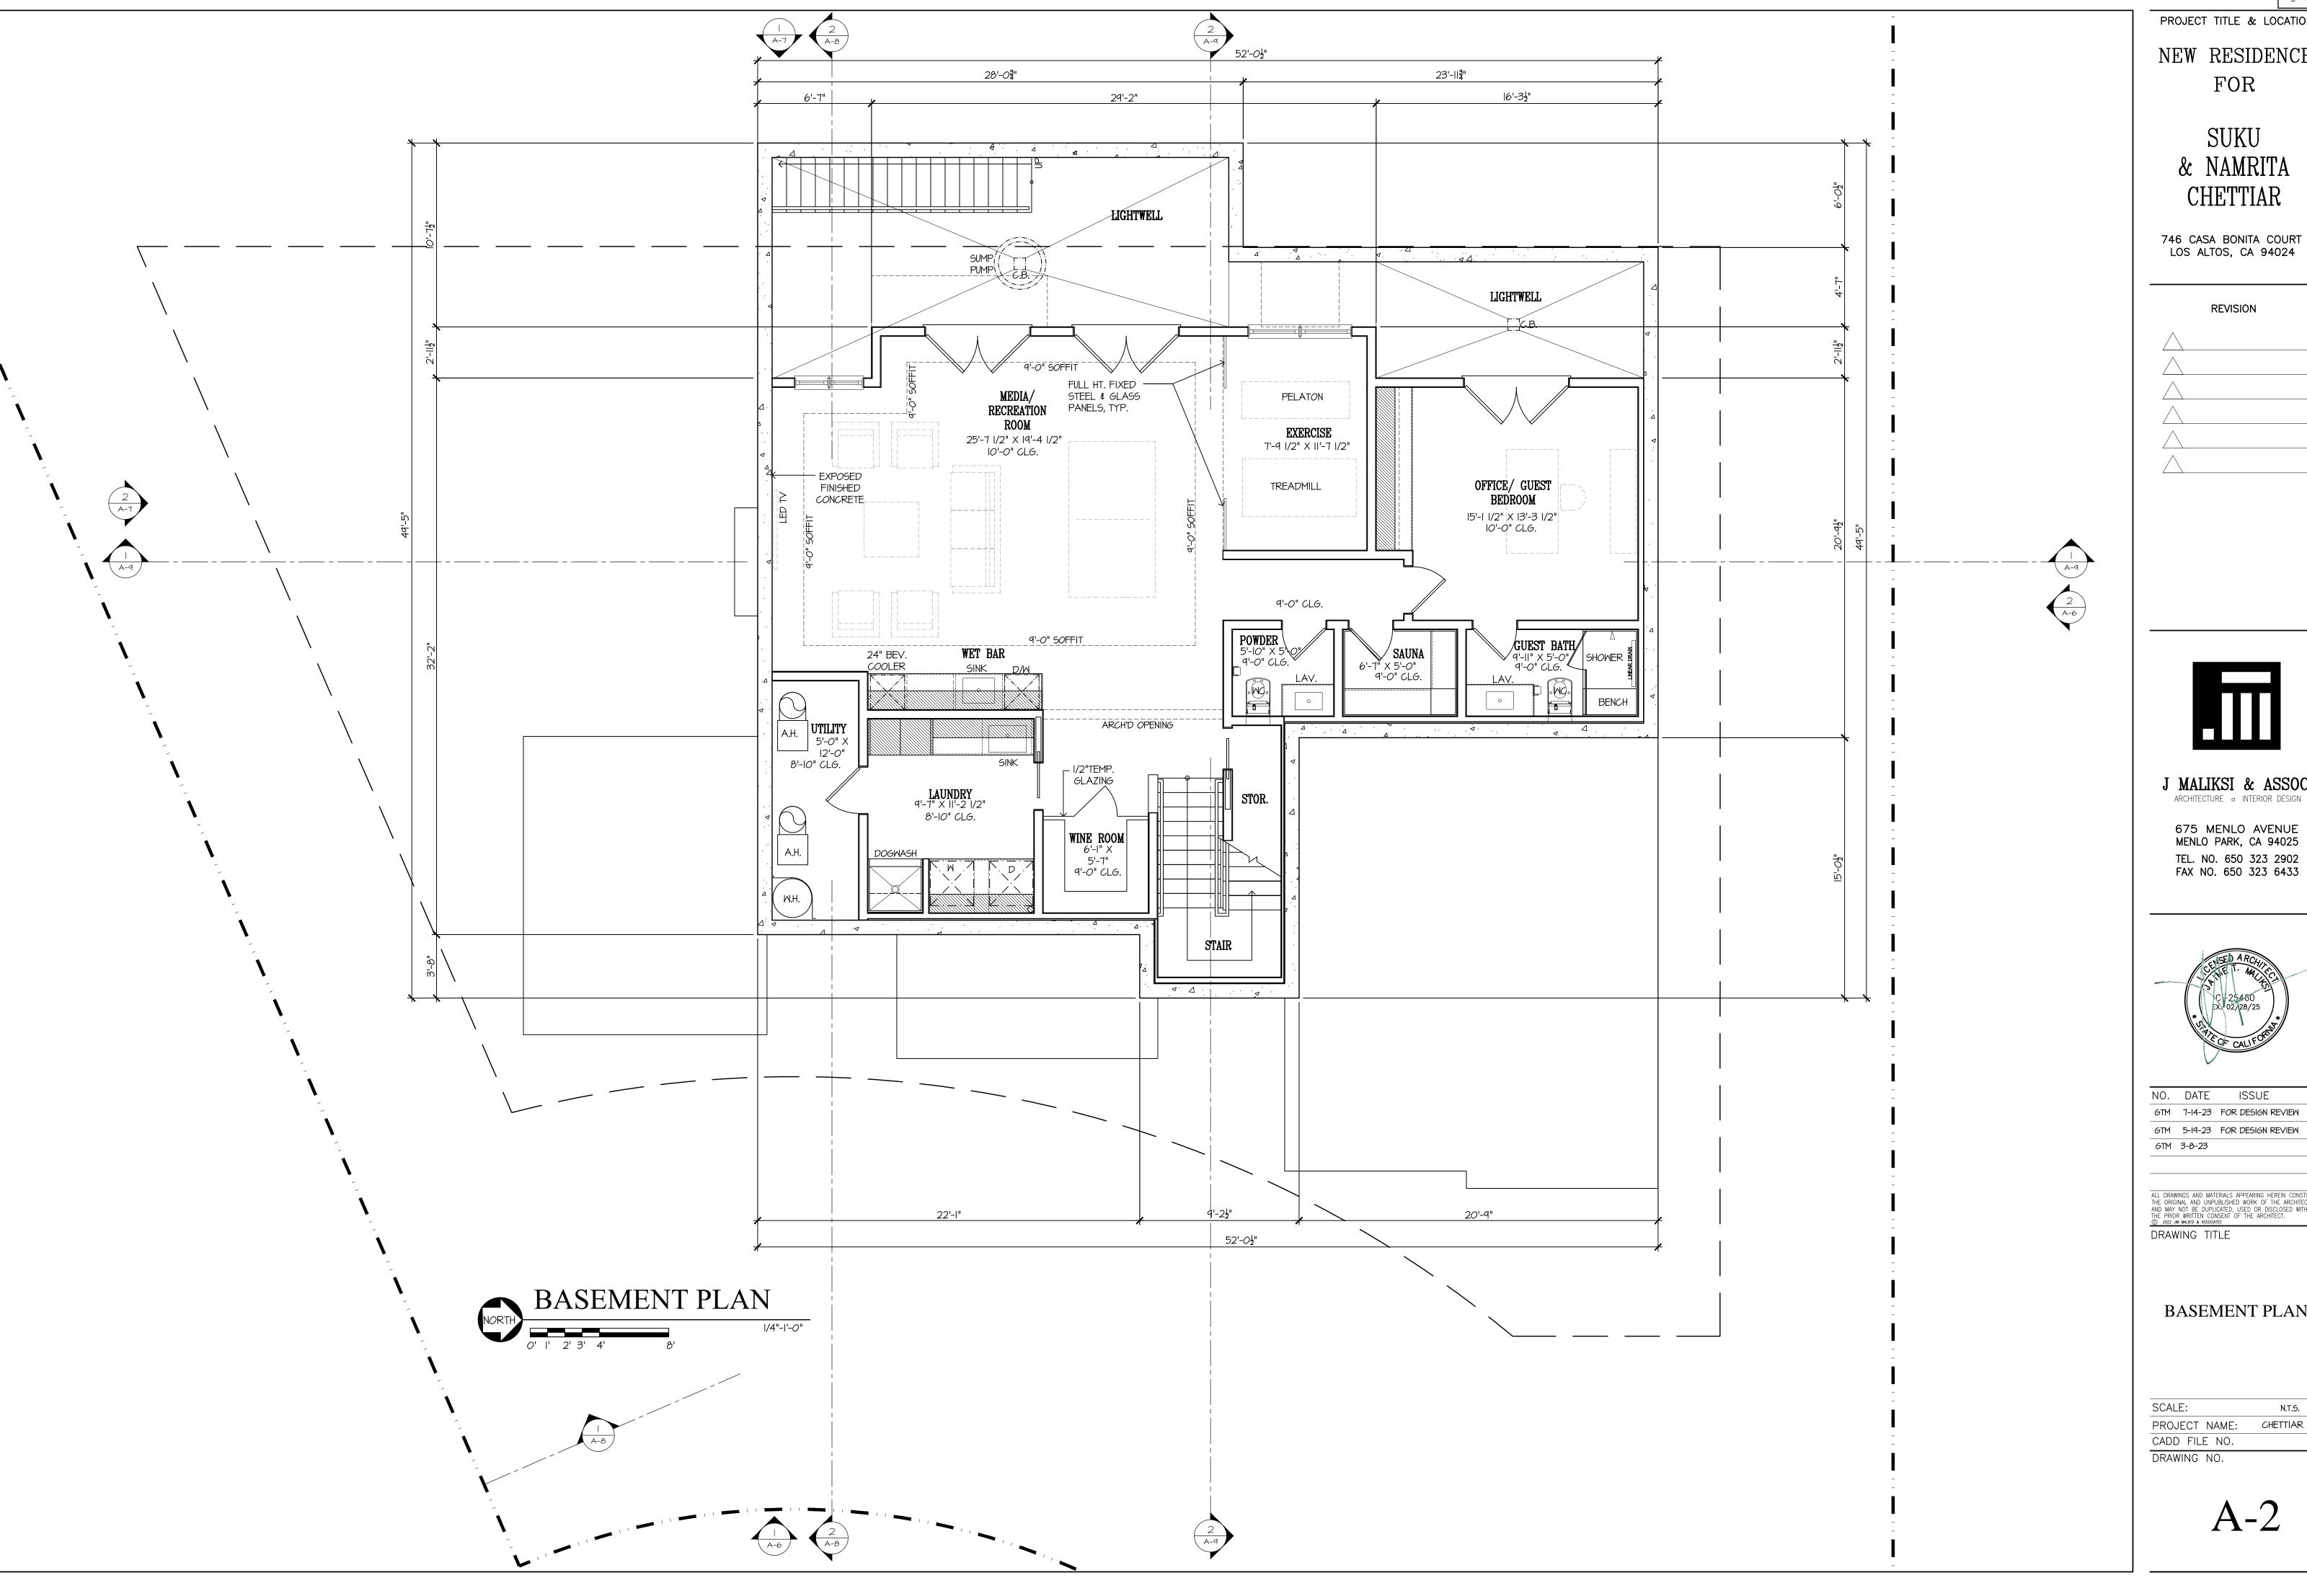

13'-6½"

--- MAKER------

COVERED REAR

resession in the second
DINING ROOM

- 13'-0" X 15'-8"

9'-5" CLG.


PATIO 20-0" X 27'-2" VAULTED

SINK

SEWER EJECTOR PUMP


GROUND FLOOR PLAN

 $\begin{pmatrix} 2 \\ A-7 \end{pmatrix}$

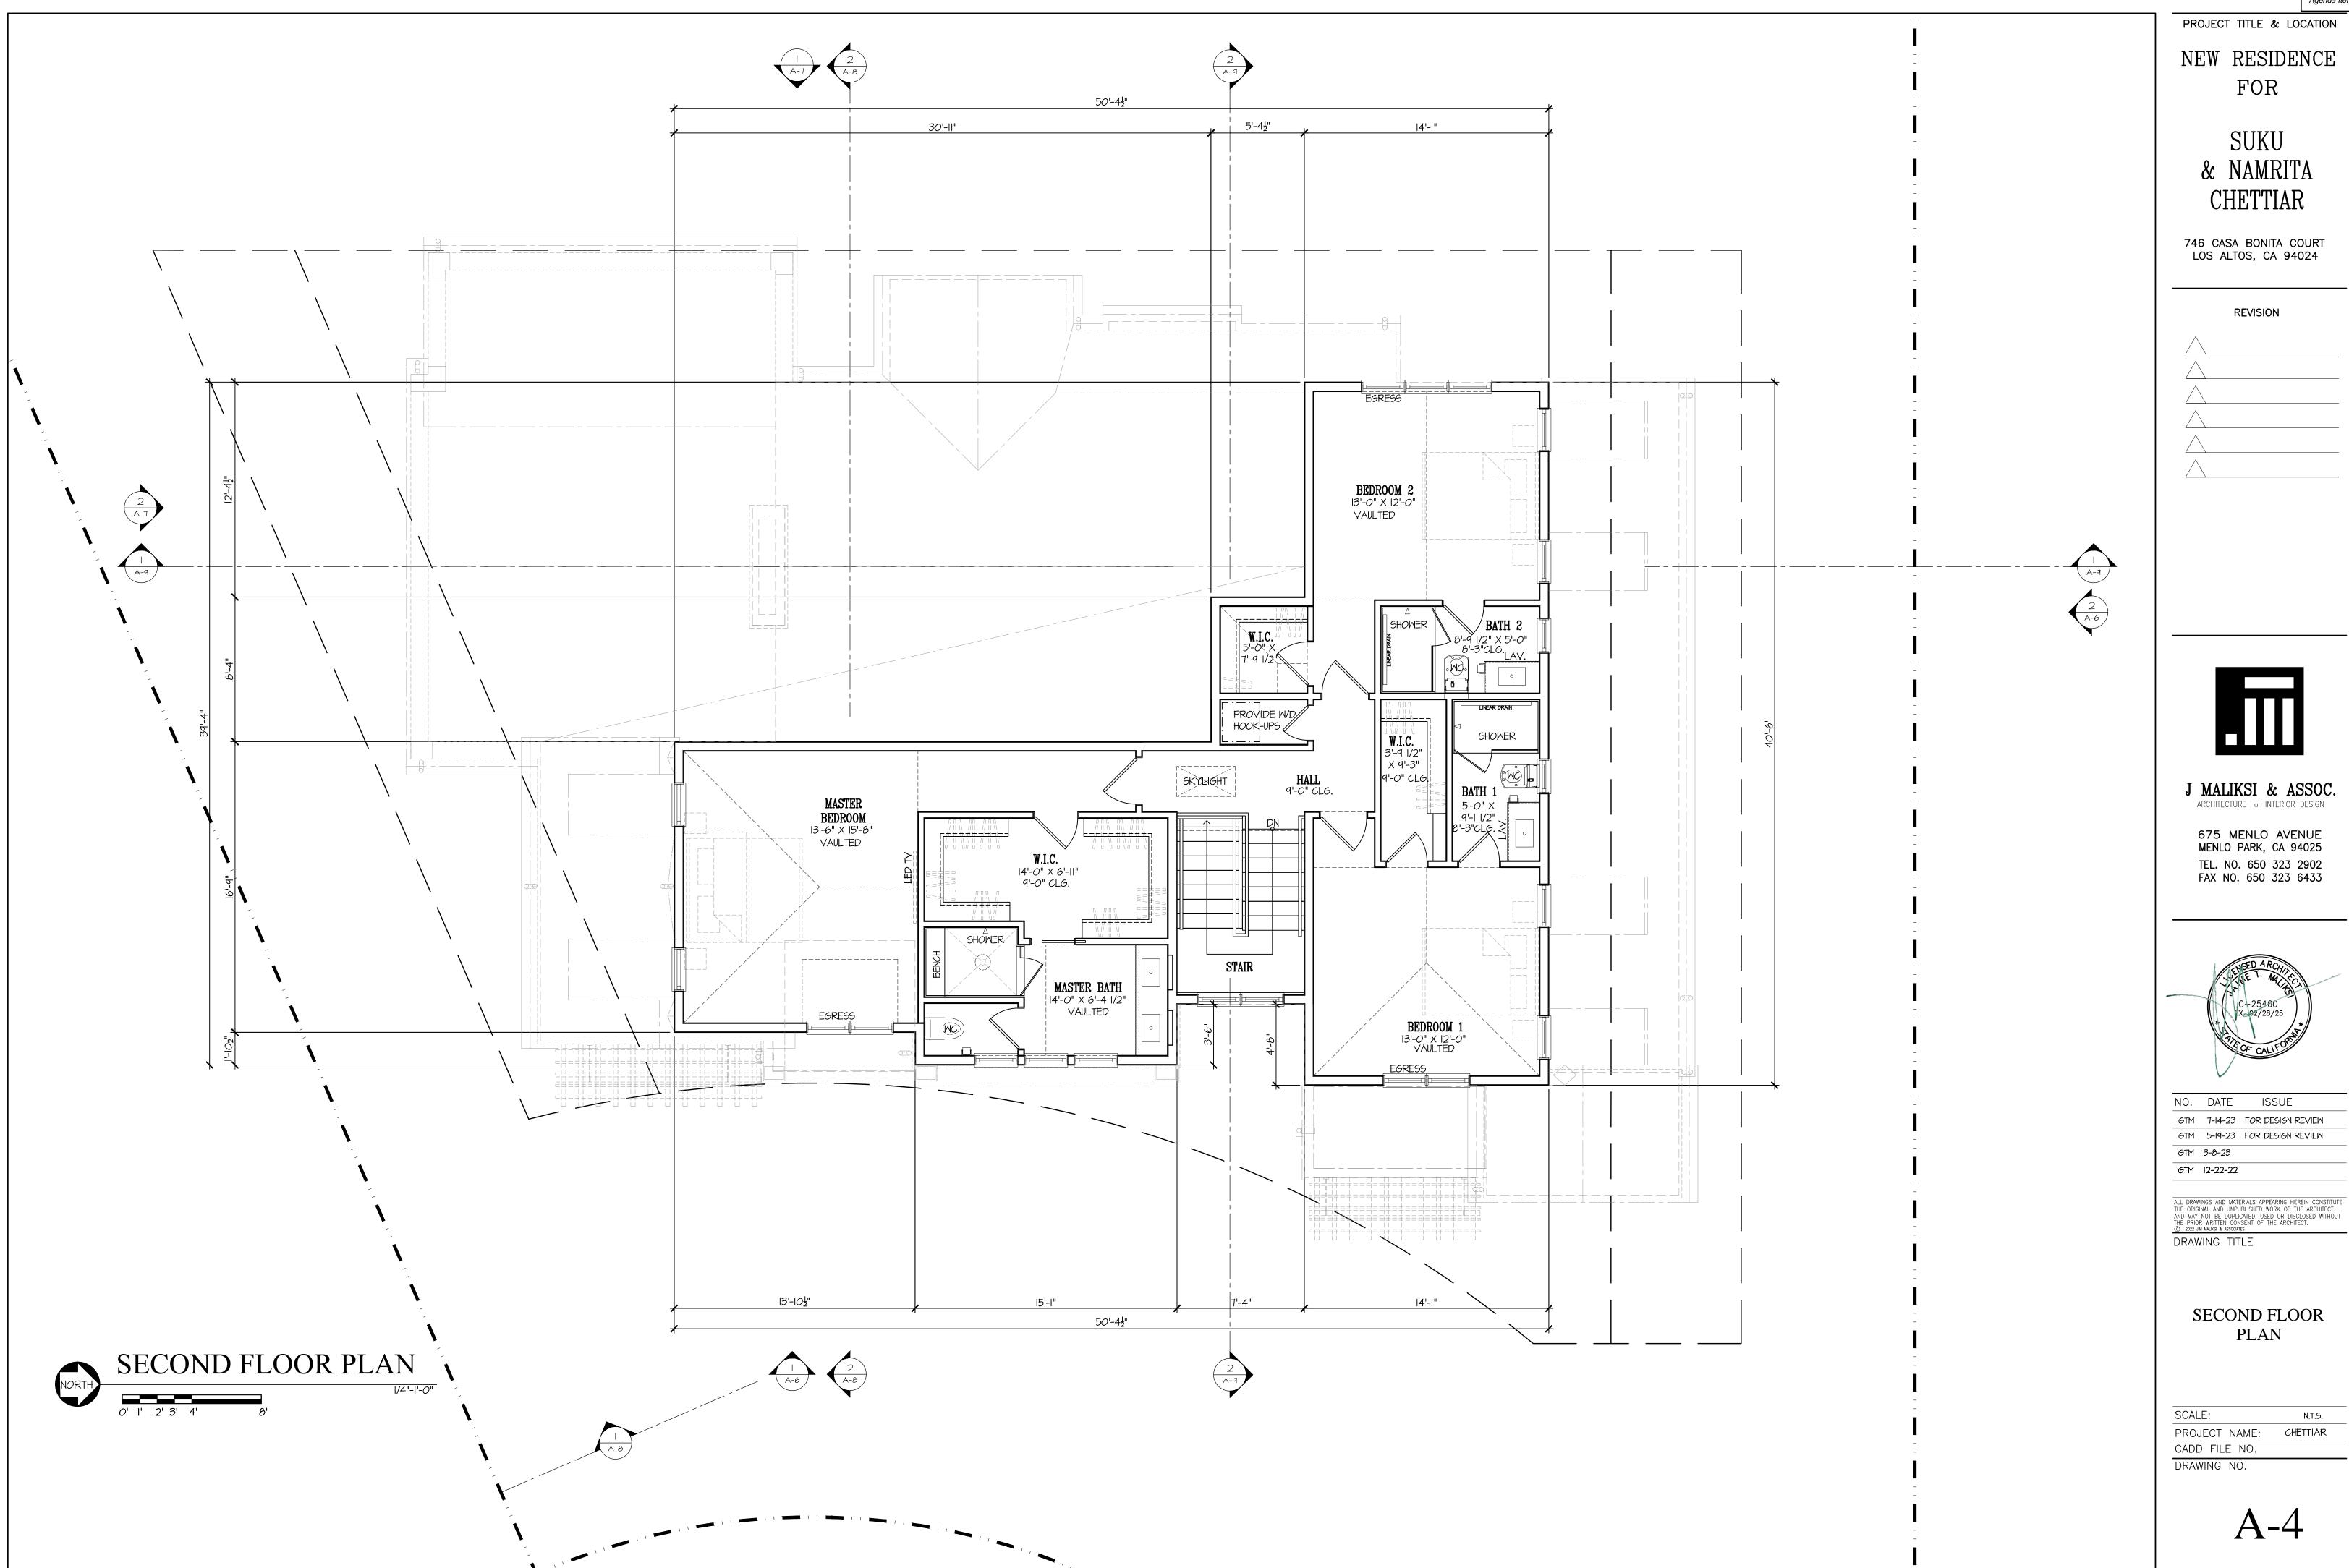



N.T.S. CHETTIAR

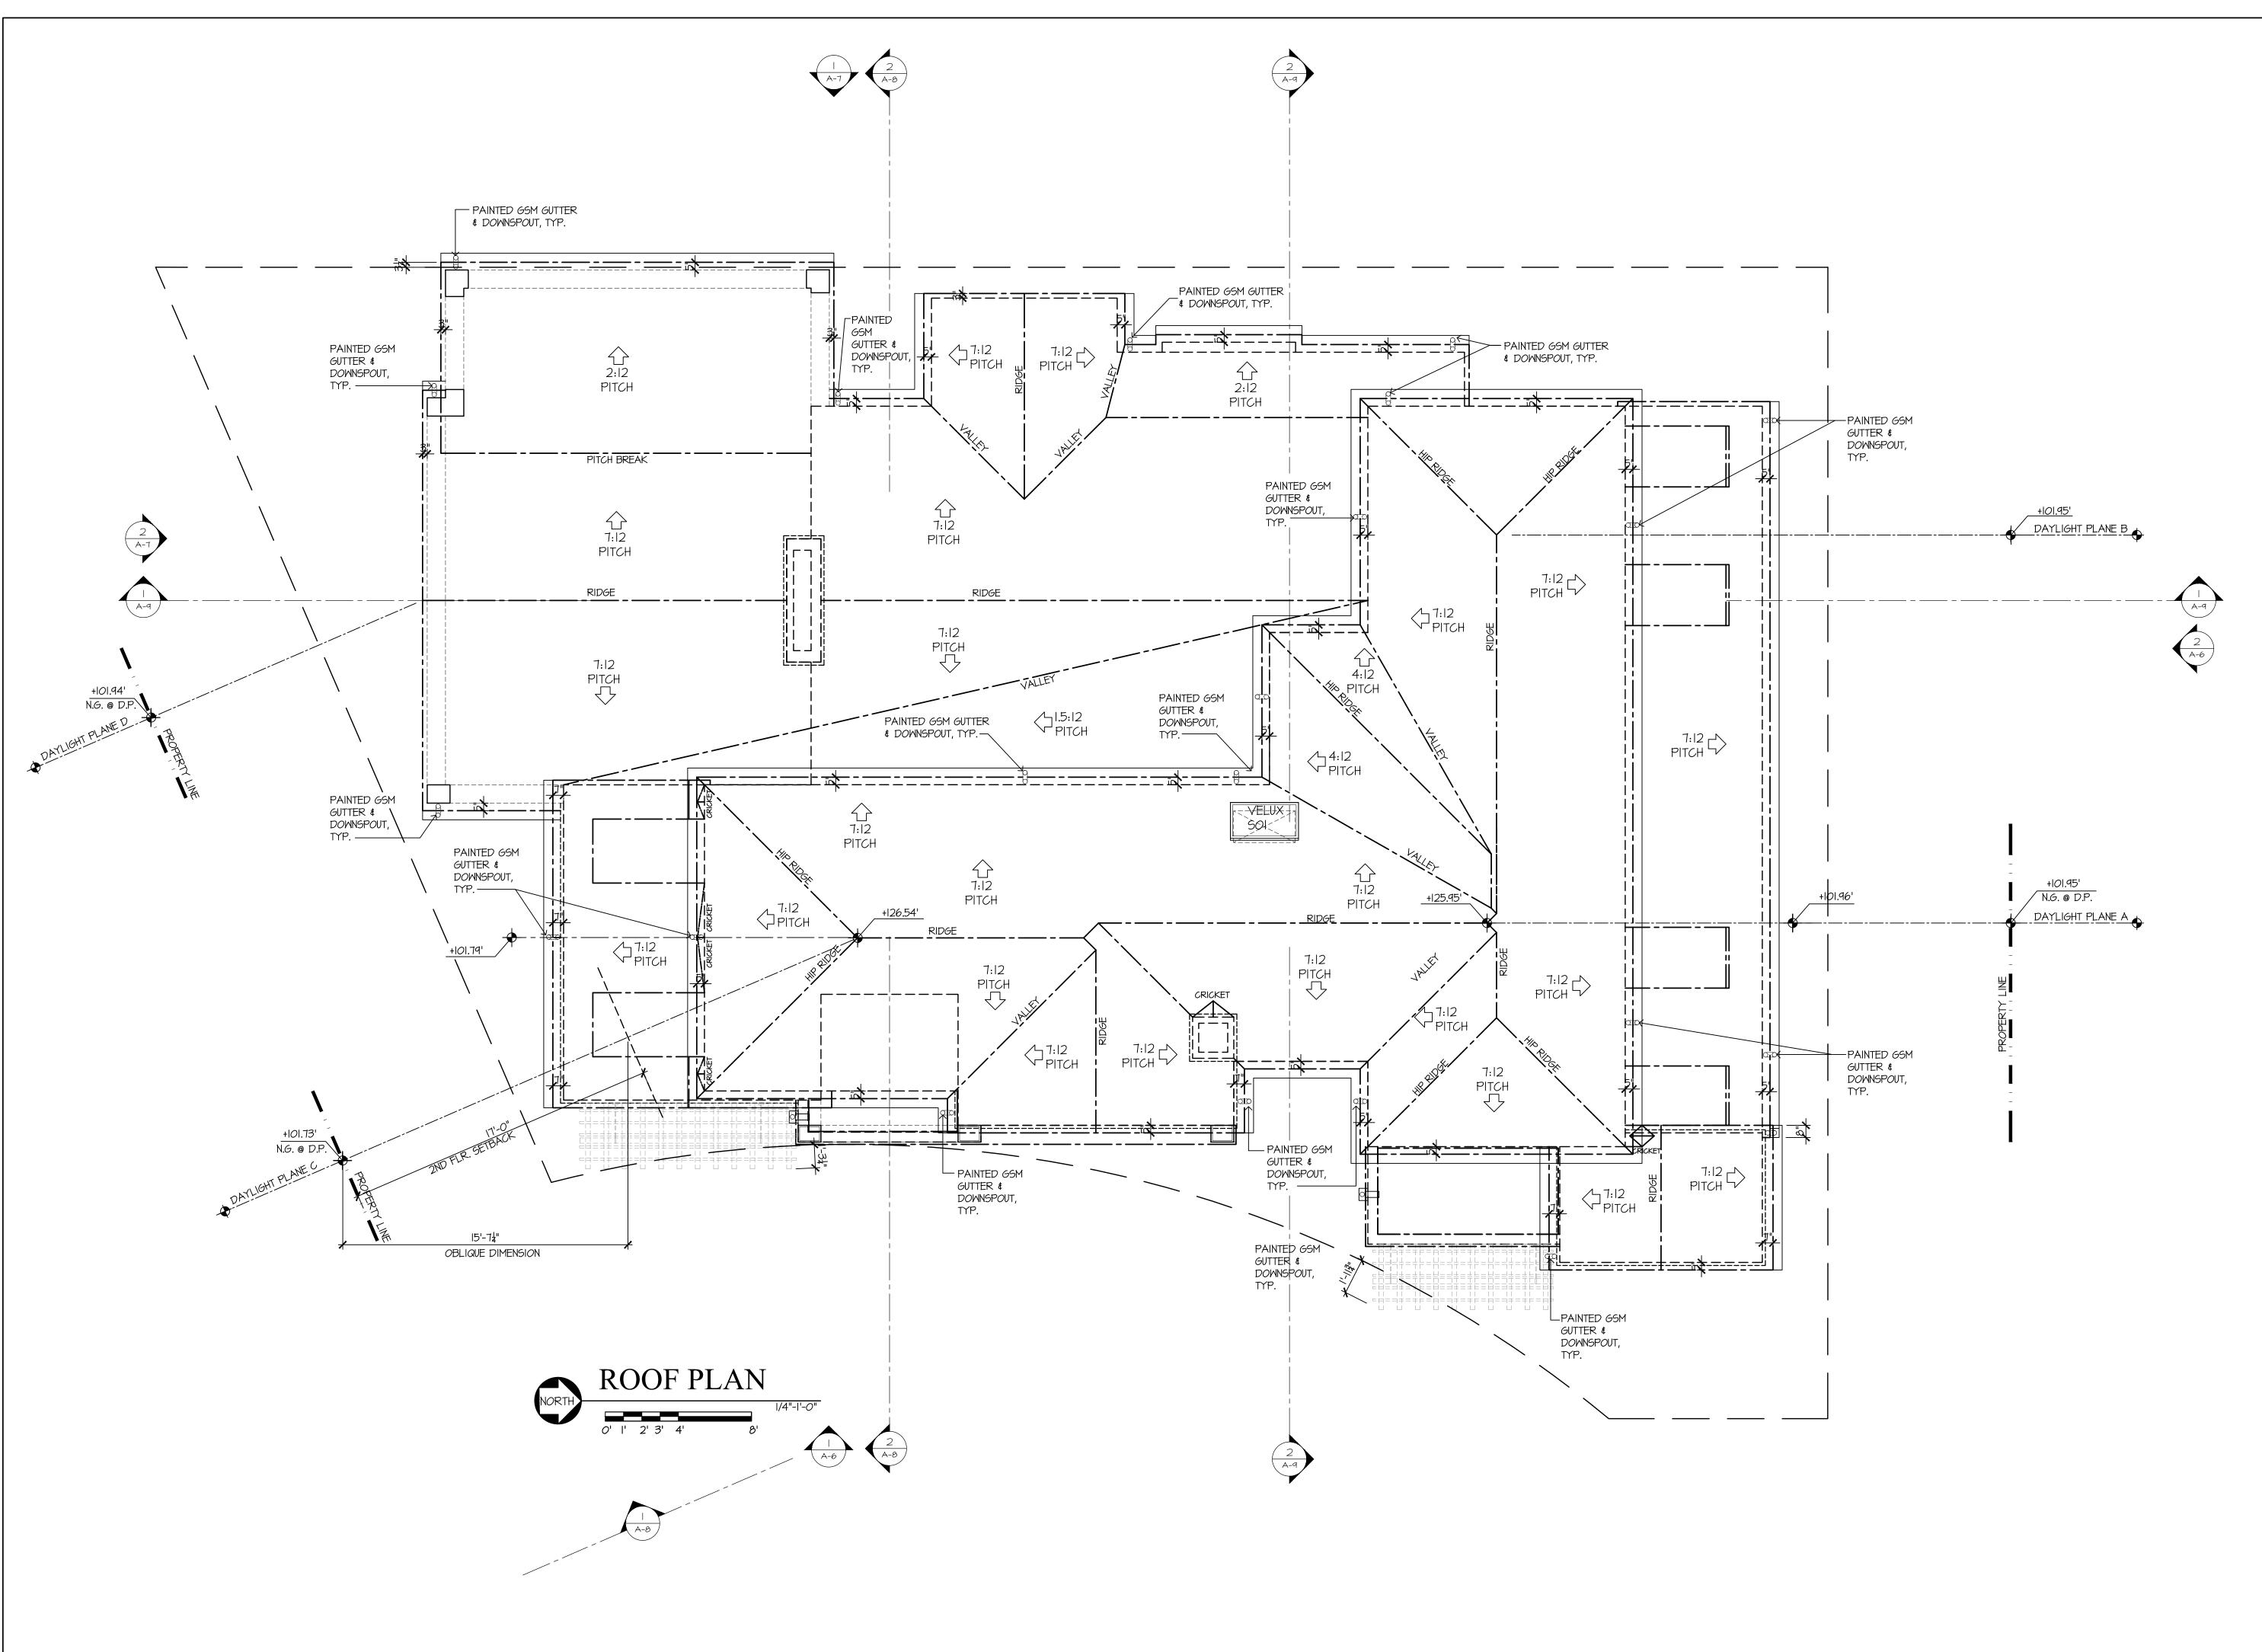

NEW RESIDENCE FOR

> SUKU & NAMRITA CHETTIAR


746 CASA BONITA COURT LOS ALTOS, CA 94024

REVISION



J MALIKSI & ASSOC. ARCHITECTURE - INTERIOR DESIGN

675 MENLO AVENUE MENLO PARK, CA 94025 TEL. NO. 650 323 2902 FAX NO. 650 323 6433

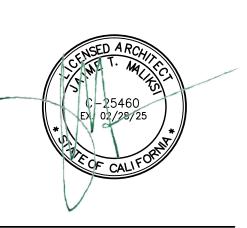

NO. DATE ISSUE GTM 7-14-23 FOR DESIGN REVIEW GTM 5-19-23 FOR DESIGN REVIEW GTM 3-8-23

ALL DRAWINGS AND MATERIALS APPEARING HEREIN CONSTITUTE
THE ORIGINAL AND UNPUBLISHED WORK OF THE ARCHITECT
AND MAY NOT BE DUPLICATED, USED OR DISCLOSED WITHOUT
THE PRIOR WRITTEN CONSENT OF THE ARCHITECT.

© 2022 JIM MALIKSI & ASSOCIATES DRAWING TITLE


ROOF PLAN

SCALE: N.T.S. CHETTIAR PROJECT NAME: CADD FILE NO. DRAWING NO.

NEW RESIDENCE FOR

> SUKU **CHETTIAR**

746 CASA BONITA COURT LOS ALTOS, CA 94024

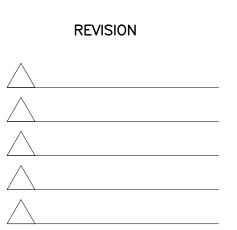

J MALIKSI & ASSOC. ARCHITECTURE - INTERIOR DESIGN

> 675 MENLO AVENUE MENLO PARK, CA 94025 TEL. NO. 650 323 2902 FAX NO. 650 323 6433



NO. DATE ISSUE GTM 7-14-23 FOR DESIGN REVIEW


GTM 5-19-23 FOR DESIGN REVIEW GTM 3-8-23


ALL DRAWINGS AND MATERIALS APPEARING HEREIN CONSTITUTE THE ORIGINAL AND UNPUBLISHED WORK OF THE ARCHITECT AND MAY NOT BE DUPLICATED, USED OR DISCLOSED WITHOUT THE PRIOR WRITTEN CONSENT OF THE ARCHITECT.


© 2022 JIM MALKSI & ASSOCIATES DRAWING TITLE

> **FRONT ELEVATION &** RIGHT SIDE **ELEVATION**

SCALE: N.T.S. PROJECT NAME: CHETTIAR CADD FILE NO. DRAWING NO.

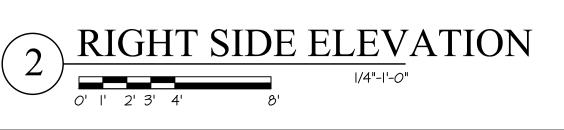

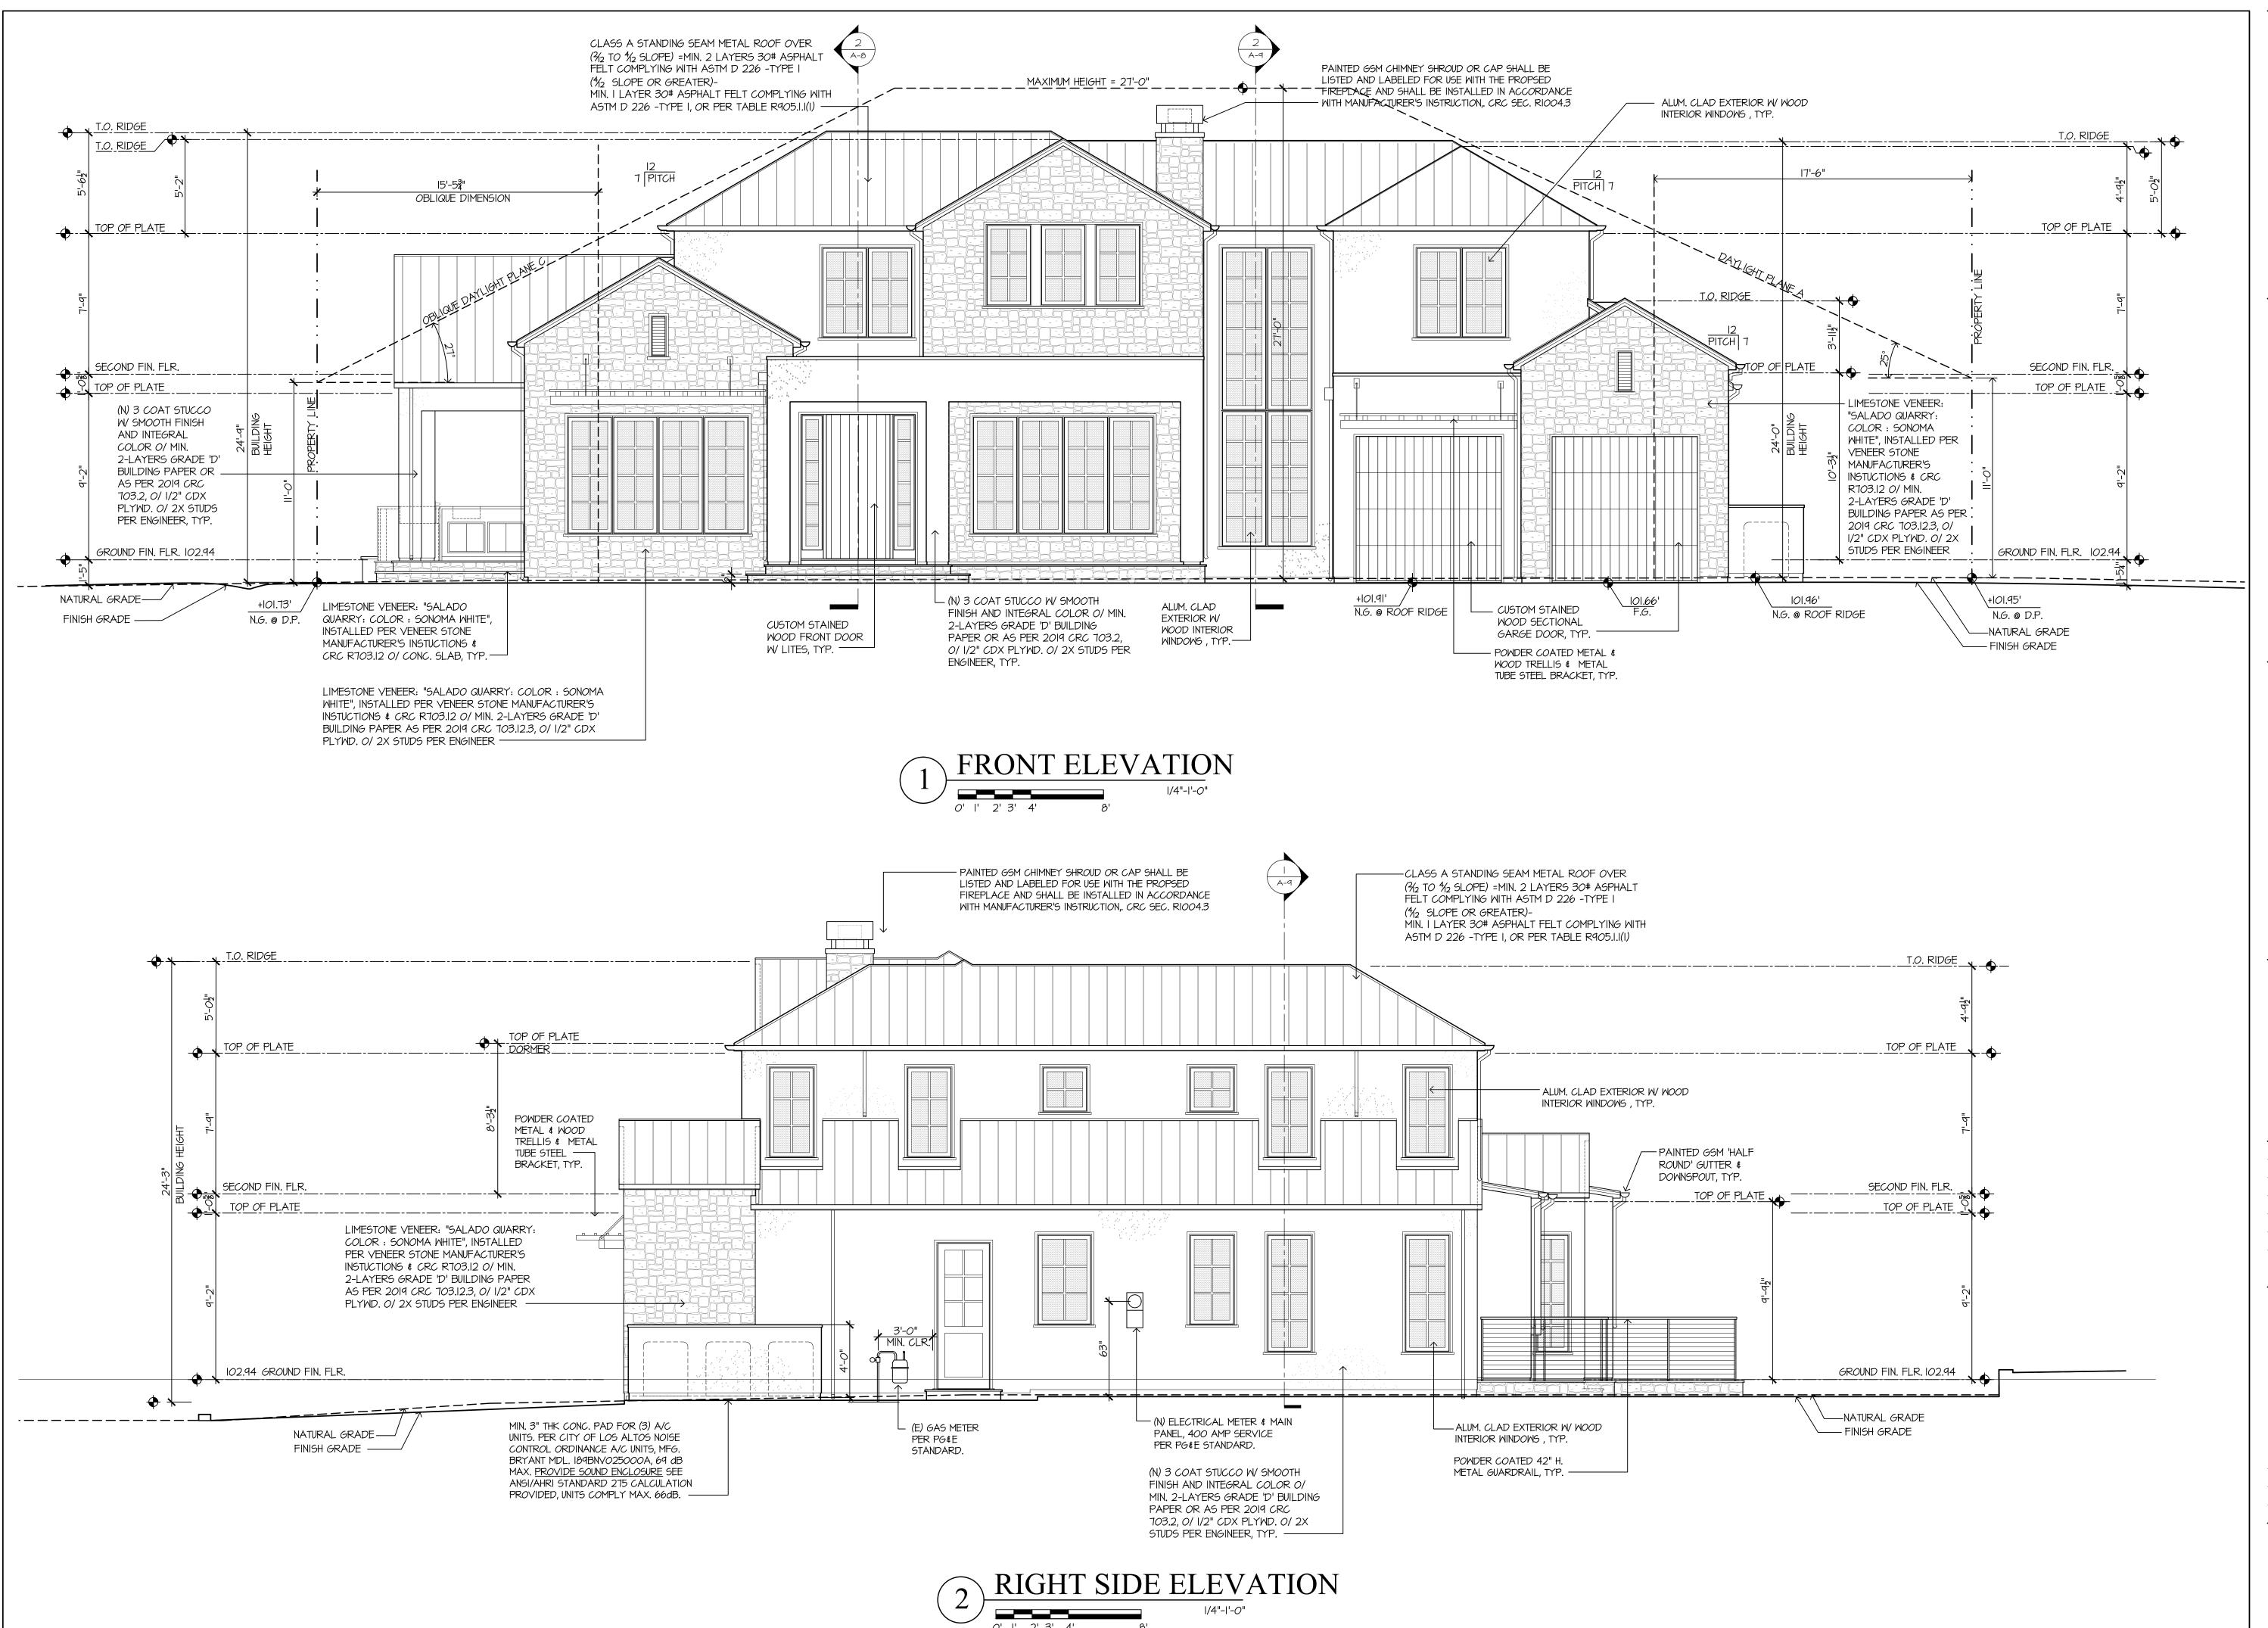

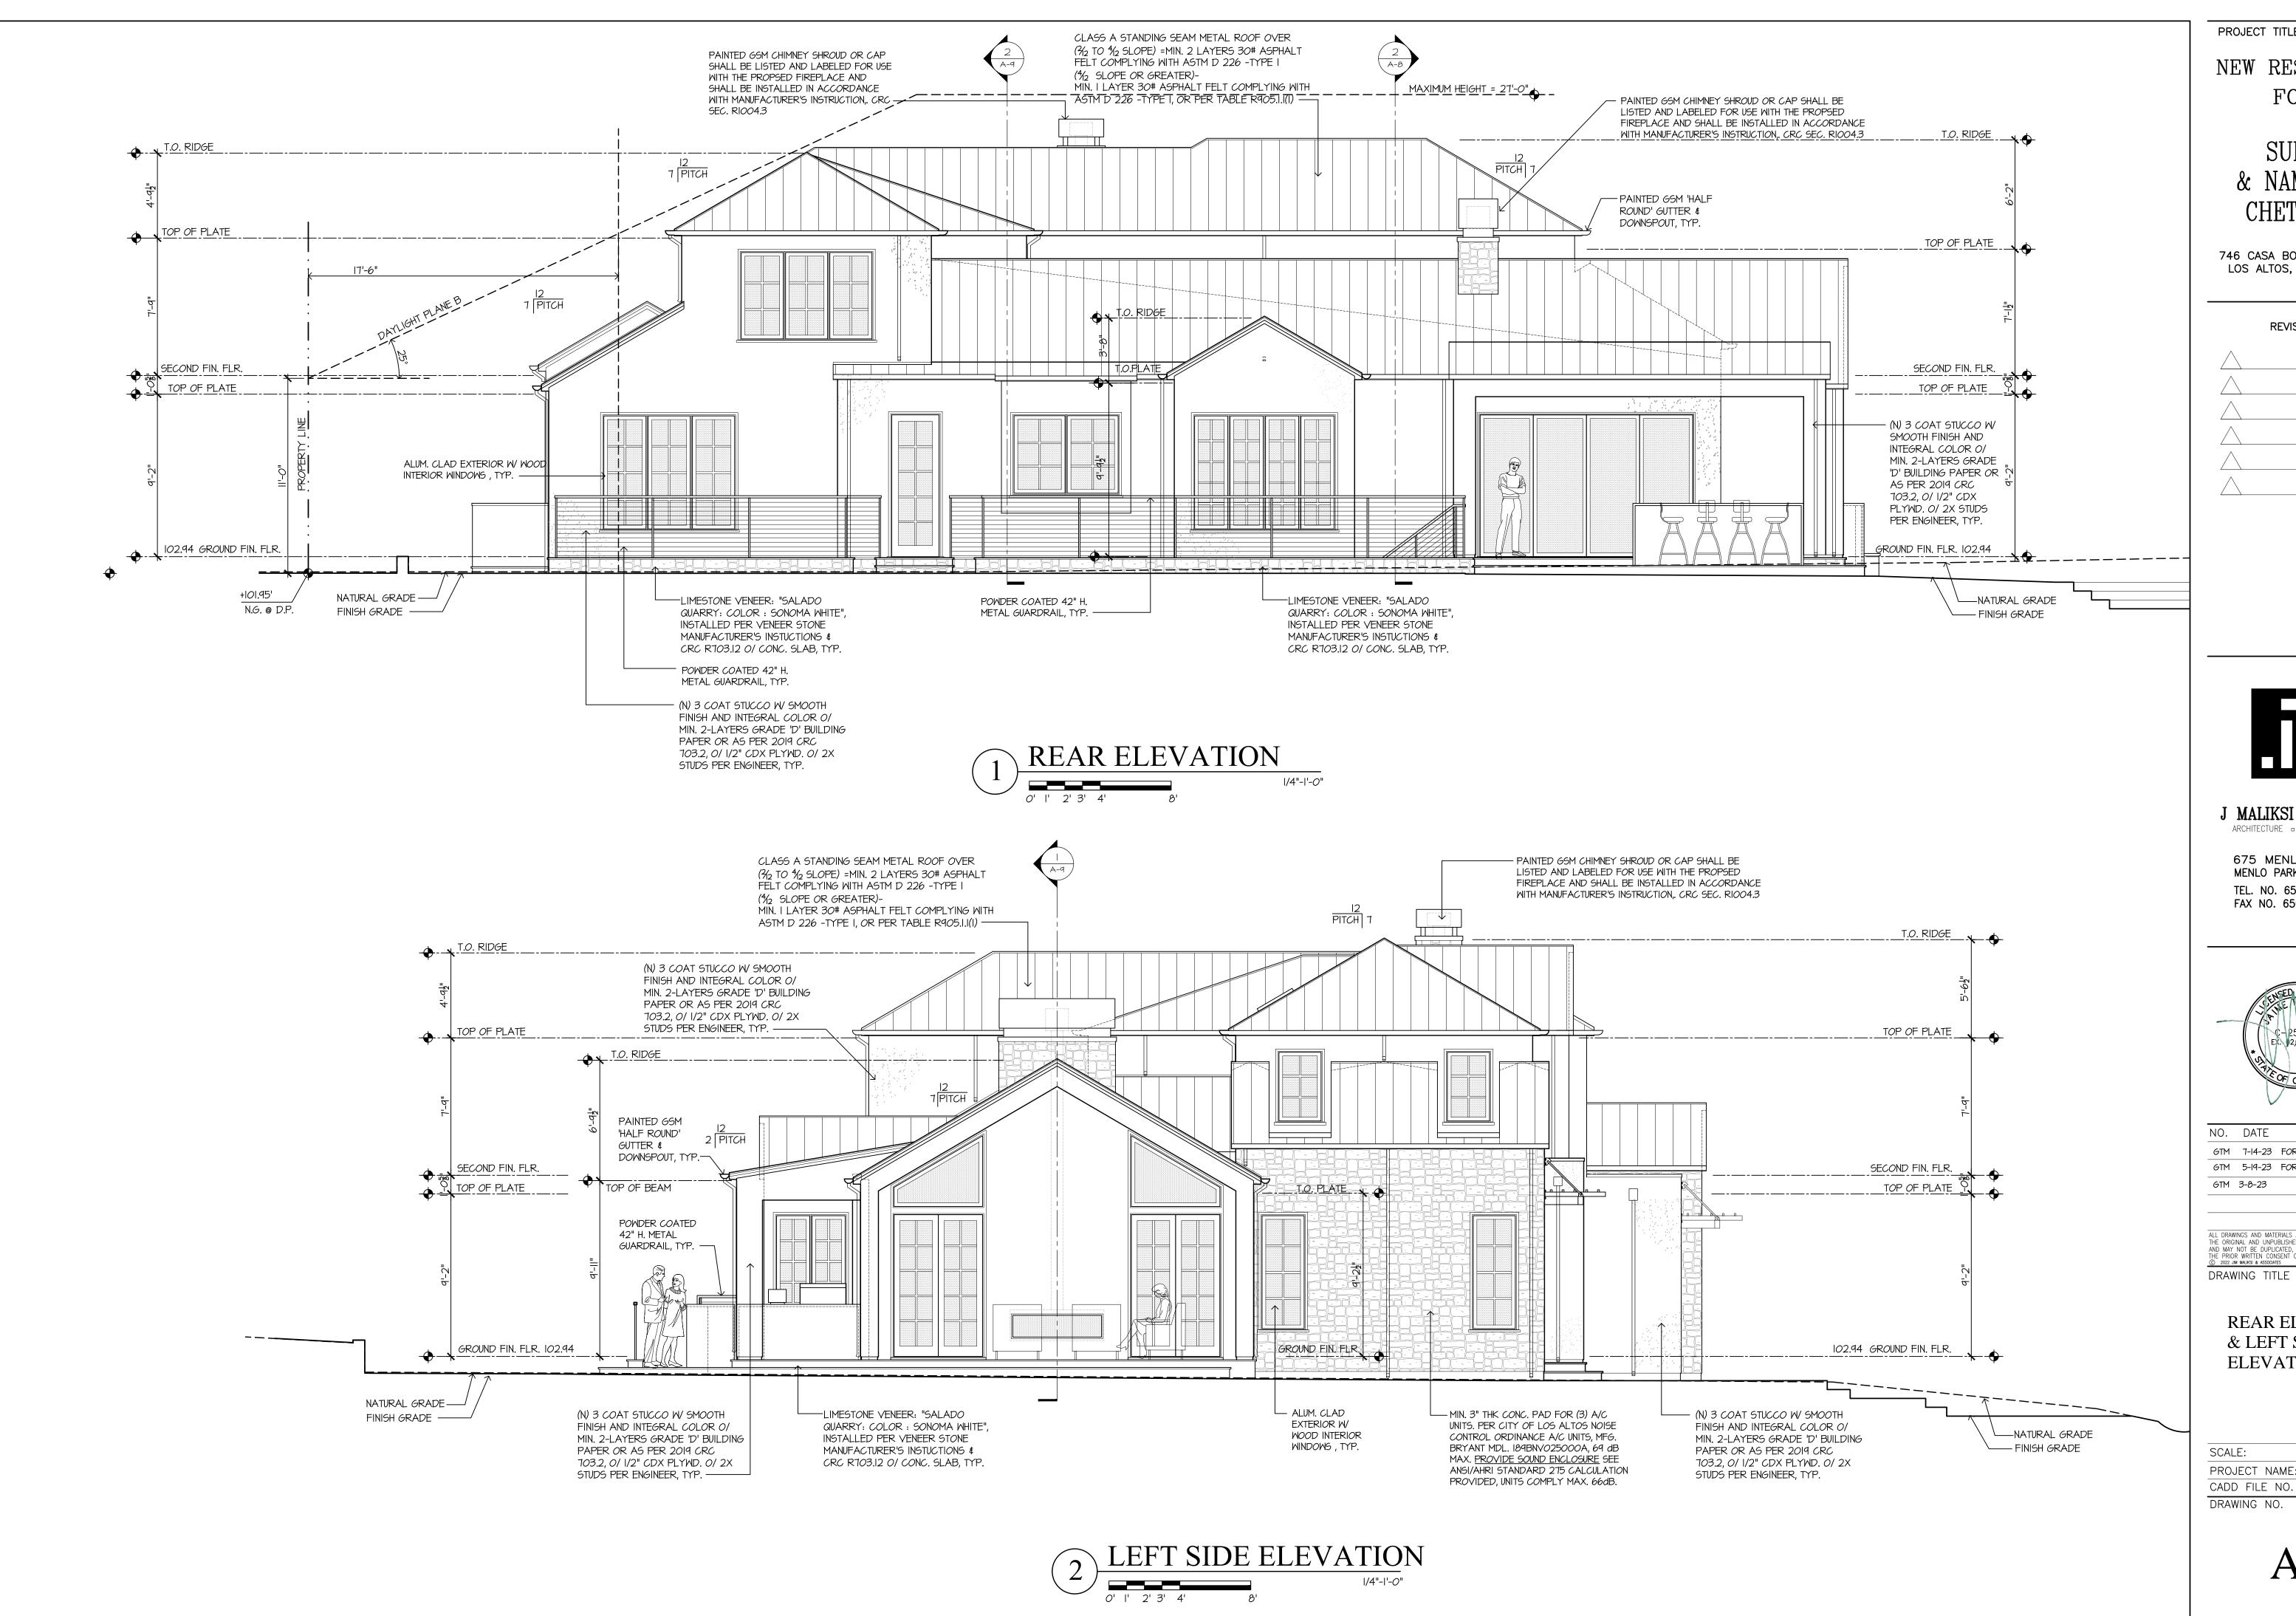

NEW RESIDENCE

FOR

SUKU & NAMRITA CHETTIAR

746 CASA BONITA COURT LOS ALTOS, CA 94024

REVISION



J MALIKSI & ASSOC. ARCHITECTURE - INTERIOR DESIGN

675 MENLO AVENUE MENLO PARK, CA 94025 TEL. NO. 650 323 2902 FAX NO. 650 323 6433



NO. DATE ISSUE GTM 7-14-23 FOR DESIGN REVIEW GTM 5-19-23 FOR DESIGN REVIEW


ALL DRAWINGS AND MATERIALS APPEARING HEREIN CONSTITUTE
THE ORIGINAL AND UNPUBLISHED WORK OF THE ARCHITECT
AND MAY NOT BE DUPLICATED, USED OR DISCLOSED WITHOUT
THE PRIOR WRITTEN CONSENT OF THE ARCHITECT.

© 2022 JIM MALIKSI & ASSOCIATES

REAR ELEVATION & LEFT SIDE **ELEVATION**

SCALE: N.T.S. PROJECT NAME: CHETTIAR CADD FILE NO.

DRAWING NO.

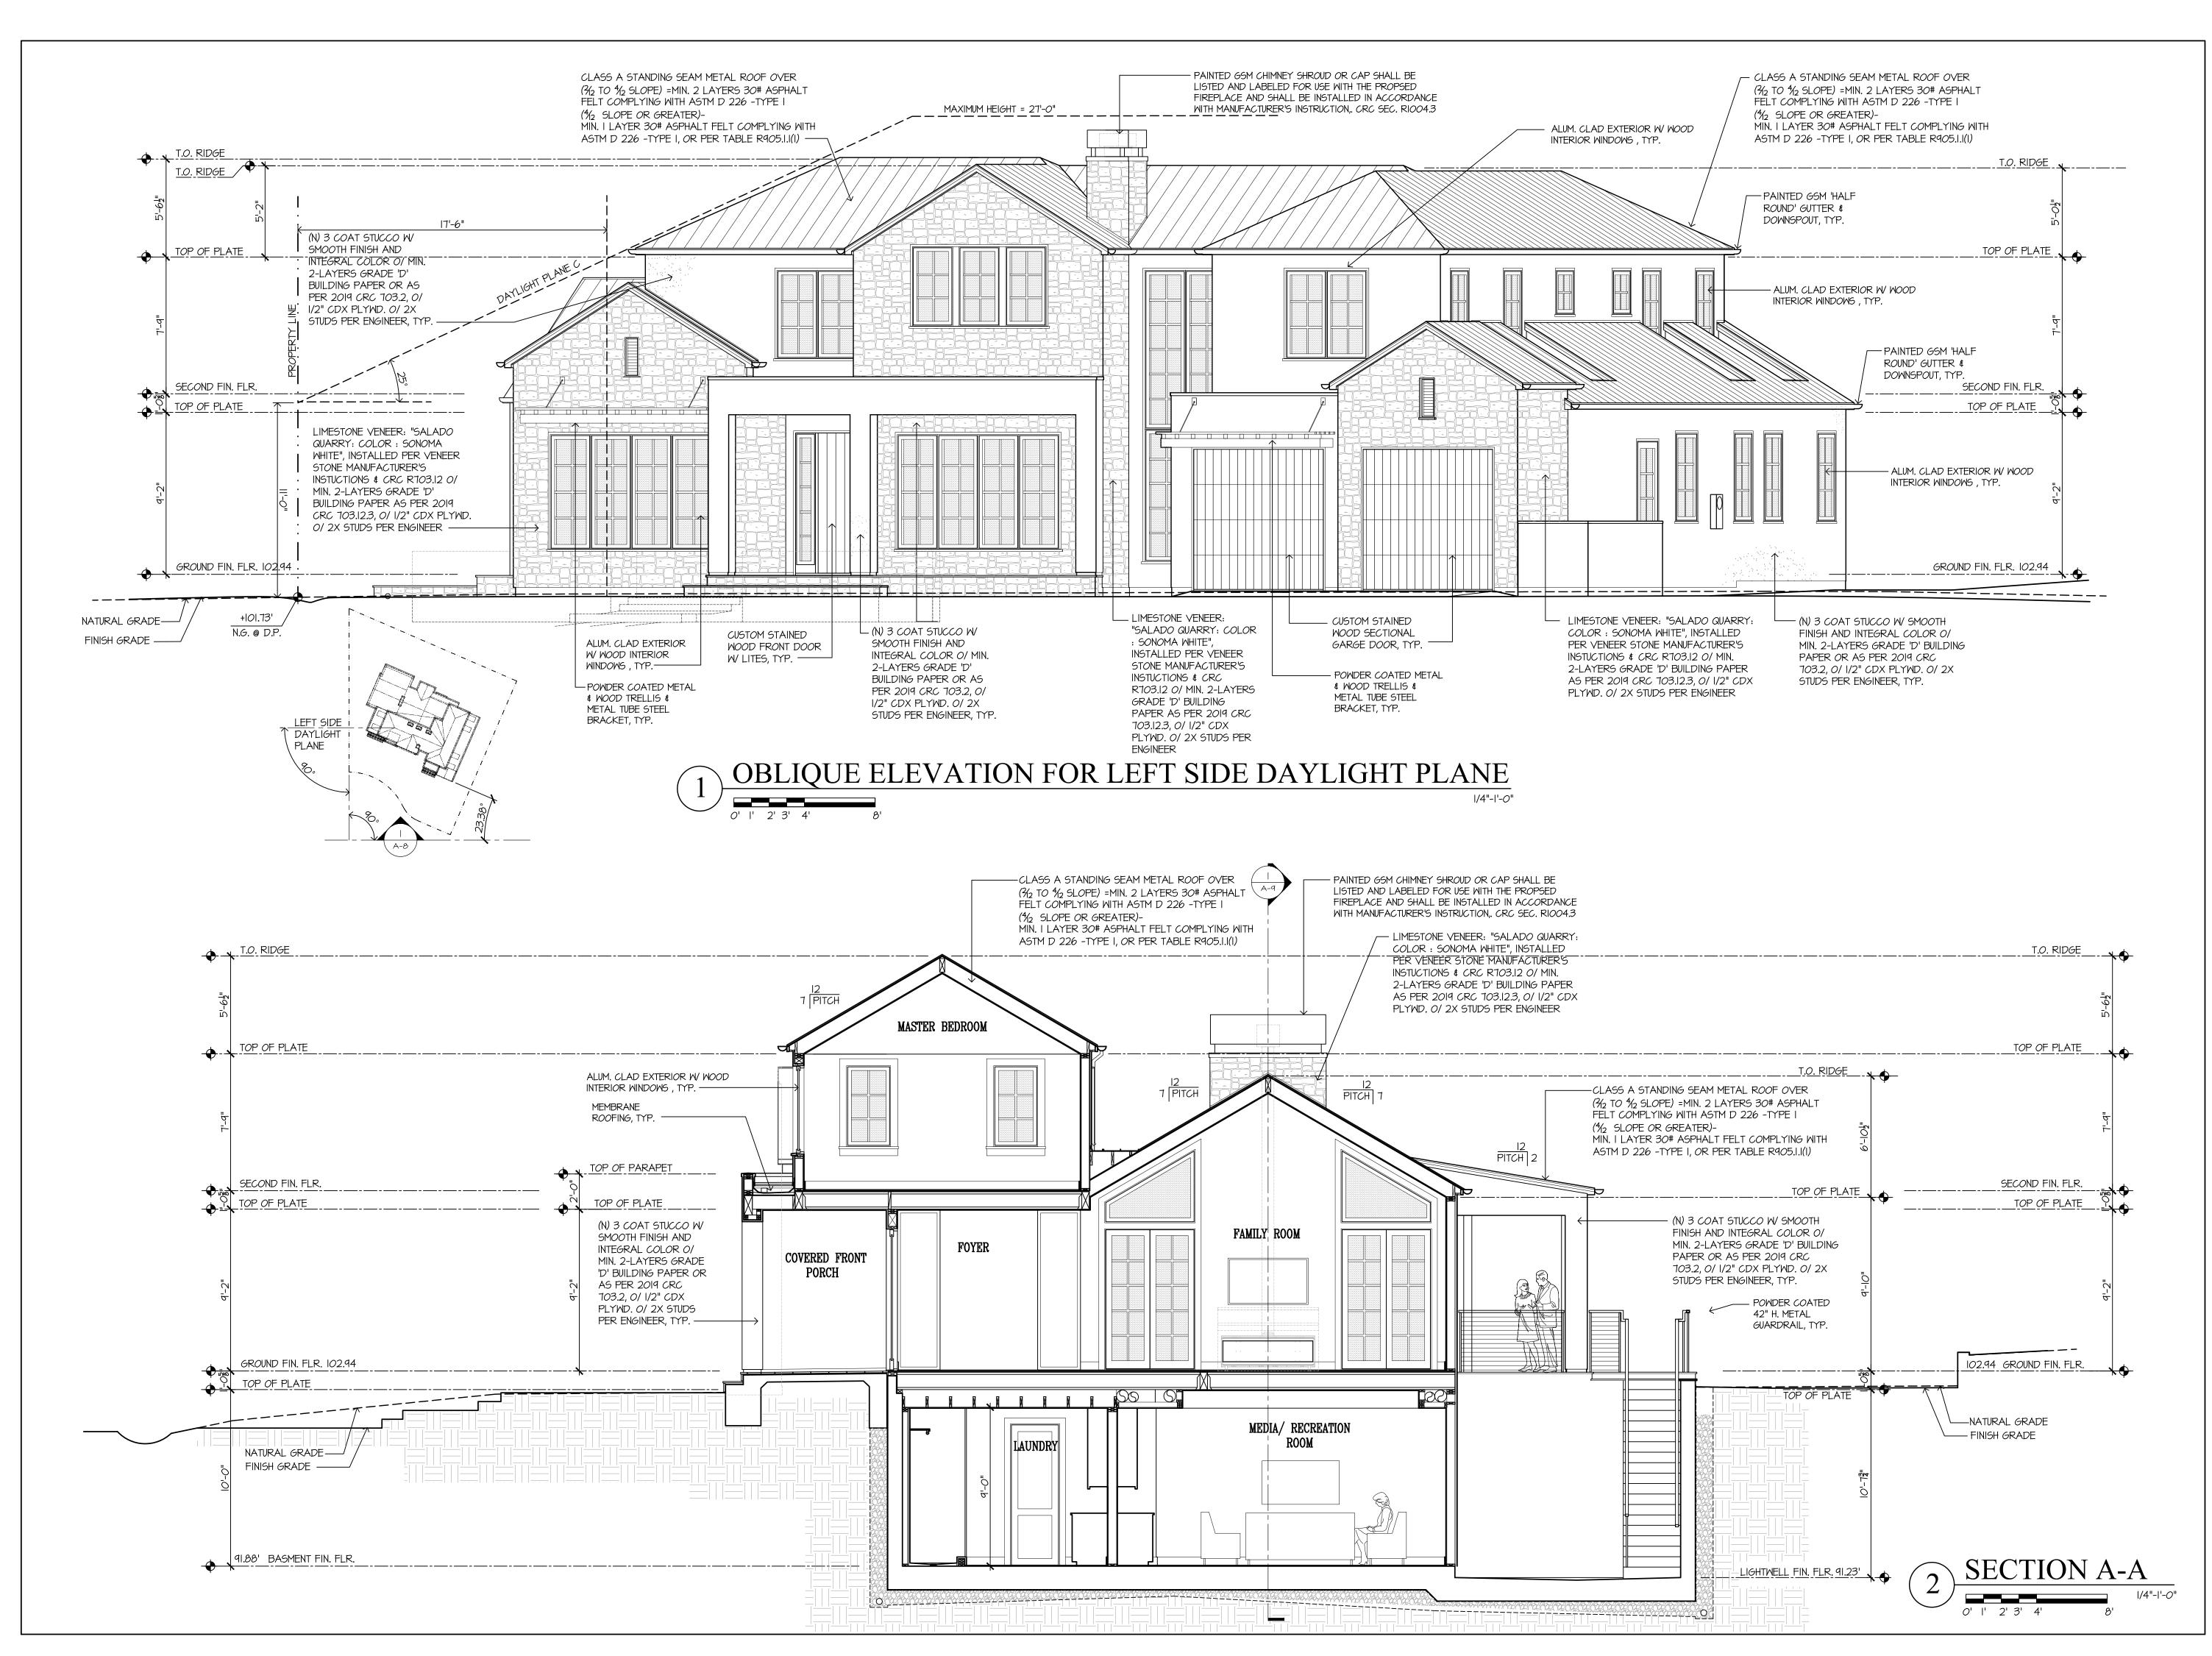

NEW RESIDENCE FOR

SUKU & NAMRITA CHETTIAR

746 CASA BONITA COURT LOS ALTOS, CA 94024


REVISION



J MALIKSI & ASSOC.

ARCHITECTURE - INTERIOR DESIGN

675 MENLO AVENUE MENLO PARK, CA 94025 TEL. NO. 650 323 2902 FAX NO. 650 323 6433

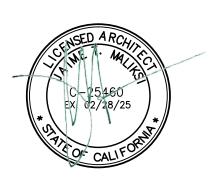

NO. DATE ISSUE

GTM 7-14-23 FOR DESIGN REVIEW

GTM 5-19-23 FOR DESIGN REVIEW

DRAWING TITLE

DRAWING NO.

ALL DRAWINGS AND MATERIALS APPEARING HEREIN CONSTITUTE
THE ORIGINAL AND UNPUBLISHED WORK OF THE ARCHITECT
AND MAY NOT BE DUPLICATED, USED OR DISCLOSED WITHOUT
THE PRIOR WRITTEN CONSENT OF THE ARCHITECT.

© 2022 JIM MALIKSI & ASSOCIATES

OBLIQUE FRONT &
RIGHT SIDE
ELEVATION FOR
DAYLIGHT PLANE


SCALE: N.T.S.

PROJECT NAME: CHETTIAR

CADD FILE NO.

& SECTION A-A

A-8

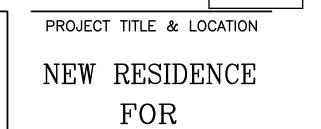

SUKU CHETTIAR

746 CASA BONITA COURT LOS ALTOS, CA 94024

REVISION

J MALIKSI & ASSOC. ARCHITECTURE - INTERIOR DESIGN

> 675 MENLO AVENUE MENLO PARK, CA 94025 TEL. NO. 650 323 2902 FAX NO. 650 323 6433



NO. DATE ISSUE GTM 7-14-23 FOR DESIGN REVIEW

ALL DRAWINGS AND MATERIALS APPEARING HEREIN CONSTITUTE THE ORIGINAL AND UNPUBLISHED WORK OF THE ARCHITECT AND MAY NOT BE DUPLICATED, USED OR DISCLOSED WITHOUT THE PRIOR WRITTEN CONSENT OF THE ARCHITECT.

© 2022 JIM MALKSI & ASSOCIATES

SECTION B-B & SECTION C-C

SCALE: N.T.S. PROJECT NAME: CHETTIAR CADD FILE NO.

