

AGENDA CITY OF LAUREL CITY/COUNTY PLANNING BOARD WEDNESDAY, OCTOBER 20, 2021 5:35 PM CITY COUNCIL CHAMBERS

Public Input: Citizens may address the committee regarding any item of business that is not on the agenda. The duration for an individual speaking under Public Input is limited to three minutes. While all comments are welcome, the committee will not take action on any item not on the agenda.

1. Roll Call

General Items

Approve Meeting Minutes: August 18, 2021
 Approve Meeting Minutes: September 15, 2021

New Business

4. Building Plan Review: City Brew/Chen's Express

Old Business

Other Items

- 5. Project Updates
- 6. Adjourn

Announcements

7. Next Meeting: November 17, 2021

The City makes reasonable accommodations for any known disability that may interfere with a person's ability to participate in this meeting. Persons needing accommodation must notify the City Clerk's Office to make needed arrangements. To make your request known, please call 406-628-7431, Ext. 2, or write to City Clerk, PO Box 10, Laurel, MT 59044, or present your request at City Hall, 115 West First Street, Laurel, Montana.

DATES TO REMEMBER

File Attachments for Item:

2. Approve Meeting Minutes: August 18, 2021



MINUTES CITY OF LAUREL CITY/COUNTY PLANNING BOARD WEDNESDAY, AUGUST 18, 2021 5:35 PM CITY COUNCIL CHAMBERS

Public Input: Citizens may address the committee regarding any item of business that is not on the agenda. The duration for an individual speaking under Public Input is limited to three minutes. While all comments are welcome, the committee will not take action on any item not on the agenda.

1. Roll Call

The chair called the meeting to order at 5:35pm.

Jon Klasna
Gavin Williams
Roger Giese
Dan Koch
Judy Goldsby
Nick Altonaga (City of Laurel)

General Items

2. Approve Meeting Minutes: May 19, 2021

The Chair presented the meeting minutes from the May meeting.

Dan motioned to approve the minutes from the meeting from May 19, 2021. Roger Seconded.

Motion Carried.

3. Approve Meeting Minutes: June 16, 2021

The Chair presented the meeting minutes from the June meeting.

Dan Motioned to approve the minutes from the June 16, 2021, meeting. Jon Seconded.

Motion Carried.

4. Public Hearing: Bitterroot Grove Townhomes Planned Unit Development

The Planning Director presented the staff report and conditions of approval.

The Chair Called for Proponents.

Forrest Mandeville, Columbus, MT, consulting planner working with the developer Darrell Dyer.

Forrest and the developer approved of the stated conditions of approval. Looks forward to getting the ground broken and getting the project built.

The Chair Called for Proponents.

The Chair Called for Proponents.

The Chair Called for Opponents.

The Chair Called for Opponents.

The Chair Called for Opponents.

The Chair called for any questions or comments from the board.

Planning Director reported the Absent Member Ron Benner's comments on the Application via email. The Planning Director responded to those concerns and clarified the processes for annexation and PUD approval.

Gavin Motioned to approve the Annexation of NUTTING BROS SUBD, S10, T02 S, R24 E, BLOCK 6, Lots 1 - 12, and NUTTING BROS SUBD, S10, T02 S, R24 E, BLOCK 7, Lots 1 – 12 with the stated staff conditions.

Dan Seconded.

Motion Carried.

Gavin Motioned to approve the Bitterroot Grove Townhomes Planned Unit Development with the stated staff conditions.

Dan Seconded.

Motion Carried.

5. Public Hearing: Chevrolet Sign Variance

The Planning Director presented his staff report on the variance applications and stated staff conditions.

The Chair Called for Proponents.

Ken Fichtner, Laurel Resident, previous owner of the Laurel Chevrolet: Would like to not remove it, would like to have groups come and use it. He would be happy to display local messages. It is a community asset and not just advertising for the business.

The Chair Called for Proponents.

The Chair Called for Proponents.

The Chair Called for Opponents.

The Chair Called for Opponents.

The Chair Called for Opponents.

The Chair called for discussion from the board.

Jon wanted to clarify the location of the sign.

Gavin noted that the time limit for messages should be 30-seconds to be better suited to highway traffic.

Gavin motioned to approve the Chevrolet Sign Variances with the discussed amended condition of approval.

The Chair provided background as to the motion or quick-moving images of the original

Gavin restated that there were no issues.

Gavin Motioned to approve the Laurel Chevrolet Sign Variances with the amended conditions of approval, limit the changing messages to 30-second limit for messages.

Jon Seconded.

Motion Carried.

6. Public Hearing: Preliminary Plat for Cherry Hills Subdivision, 3rd Filing

The Planning Director presented his staff report on the Annexation and Preliminary Plat of Cherry Hills Subdivison, 3rd Filing.

The Chair Called for Proponents.

Marty Gagnon, Engineer at Morrison-Maierle.

Appreciate the Board taking the project into consideration. Would like to review the stated conditions of approval.

The Chair Called for Proponents.

Gerry Neuman, Current owner of the property.

He stated that he bought the property 20 years ago with the goal of development. Was platted and deplatted prior to him buying it. Had development in mind. Larry, the original engineer, reviewed the original plan and calculations.

Was unable to develop the property due to other projects and other things going on. There were some concerns about water pressure with the Elena Subdivision being developed. The City installed a Pump Station after discussions with the Elena developer and himself. Land was given to the City for the Station with future development in mind.

15 years ago he started the platting process, was at DEQ when the market changed (2008 crisis). Gerry would rather go fishing and play golf than tackle this project. Has decided to develop it and sell it.

Relocating the station had been discussed with the City and contracted engineers. Bottom Line: would like to develop it and sell it off so I can go fishing.

It is a great candidate for development. Willing to take any questions.

The Chair Called for Proponents.

Marty Gagnon had questions about #7, #13, #14.

Planning Director provided a reasoning behind the inclusion of the conditions. These can be updated prior to final adoption by City Council.

The Chair Called for Opponents.

The Chair Called for Opponents.

The Chair Called for Opponents.

The Chair Called for Planning Board member questions. There being none, the chair called for a vote.

Gavin Motioned to Approve the Annexation of the Cherry Hills Subdivision, 3rd Filing, with the stated conditions of approval.

Jon Seconded.

Motion Carried.

Gavin Motioned to the Approve the Preliminary Plat of Cherry Hills Subdivison, 3rd Filing with the stated staff conditions.

Dan asked if West Maryland would be continued.

Marty provided additional information. Originally submitted the delineation report to the ACOE. Decided to pull back the scope of the project to this filing, but plan to expand it across the whole property, including a roadway.

Gavin Motioned to the Approve the preliminary plat of Cherry Hills Subdivision 3rd Filing with the stated staff conditions.

Dan Seconded.

Motion Carried.

New Business

7. Special Review: Nemont Telephone Utility in Residential District

The Planning Director presented the staff report and conditions of approval.

Jim Tuell was present at the meeting. He specified that it will be 10x12x10(h) shed. It is a regen site for the fiberoptic line. Project Telephone is bringing a transport line through Columbus, Park City, Laurel, to Billings.

What is the Route?

 Golf Course Road, Cherry Hills property, West Maryland Lane, East along W 12th Street and across to

Can use sight obscuring slats for the fence.

Will have a generator mounted on a pad for the site, as well as Natural Gas connection.

Everything will be flush with the ground besides the utility shed.

Gavin motioned to approve the Special Review for the Project Telephone utility building with the stated staff conditions.

Evan Seconded.

Motion Carried.

8. Sign Review: Yellowstone Bank Sign Upgrade

Nick presented the Yellowstone Bank sign upgrade designs. These are replacing old signs and installation of new faces.

Gavin Motioned to approve the Yellowstone County sign designs.

Evan Seconded.

Motion Carried.

9. Sign Review: Soda Station

Nick presented details on the soda station property signs.

Gerry Neumann, part owner was present for the discussion.

The Site is temporary. He is in negotiations now to build a second building, permanent. To be bigger than the Dominos pizza.

Want the Soda Station to become part of that structure if they are successful.

The Planning Director noted some of his concerns for the site including signage and weeds.

Gerry would like it to be successful and clean the site up and do a big improvement on it.

Gavin Motioned to approve the Signs for Soda Station.

Roger Seconded.

Motion Carried.

Old Business

Other Items

10. Upcoming Projects

Announcements

11. Adjourn

Dan Motioned to Adjourn the meeting. Roger Seconded. Motion Carried.

Meeting Adjourned at 7:10pm.

12. Next Meeting: September 22, 2021

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DATES TO REMEMBER

File Attachments for Item:

3. Approve Meeting Minutes: September 15, 2021



AGENDA CITY OF LAUREL CITY/COUNTY PLANNING BOARD WEDNESDAY, SEPTEMBER 15, 2021 5:35 PM CITY COUNCIL CHAMBERS

Public Input: Citizens may address the committee regarding any item of business that is not on the agenda. The duration for an individual speaking under Public Input is limited to three minutes. While all comments are welcome, the committee will not take action on any item not on the agenda.

1. Roll Call

The Chair called the meeting to order at 5:35pm.

Jon Klasna
Ron Benner
Gavin Williams
Evan Bruce
Roger Giese
Dan Koch
Judy Goldsby
Nick Altonaga (City of Laurel)

General Items

2. Approve Meeting Minutes: August 18, 2021

Minutes to be pushed to the October Meeting.

3. Public Hearing: NorthWestern Energy Zone Change

The Planning Director summarized the Zone Change request and presented his staff report and suggested conditions of approval.

The Chair called for Opponents.

The Chair called for Opponents.

The Chair called for Opponents.

The Chair called for Proponents.

The Chair called for Proponents.

The Chair Called for Proponents.

Roy Ishkanian, Manager of Lands and Permitting, NW Energy.

3524 Glenfinnan Rd, Billings, MT

We are going through this process. The ultimate approval will be at the MT Public Service Commission. We feel good about this project. The Gas Line is just about wrapped up for this site. Purchased the line from Phillips and rehabbed it to serve the station.

See this as important to keep the price of energy level, instead of having extreme variable prices like we've seen across the country.

Ron Benner: What will the noise level be?

Roy: The noise level will actually be low. The noise will be aimed towards the other industrial uses (CHS and Utility Plants) and not the river or other areas. At approximately 400ft it will be 63 decibels.

Question on staffing levels.

• 15-20 full time.

Ron: accesses to the site?

• Roy: Lindy Lane, Strow Rd, and Sewer Plant Rd. Utilize Lindy as the current primary access for the station that is there right now.

Power generation, supply, and location are all important for this facility.

Judy: Where does Lindy Lane come out to?

• Roy: It comes up to the Frontage Rd.

Nick: Any consideration of annexation?

• Roy: Still being discussed by Project Mangers, but you will be the first call.

Roger: Timeline of development?

• Roy: Expect a 3 year timeline, to be done in 2025.

Ron: One concern seeing this was the access to the site through Sewer Plant Rd. and what the costs might be to improve the roadway?

• Roy: Not planned to improve the roadway at this time. Primary access will be through Lindy Lane.

Judy: If someone were to stand on Sewer Plant road looking towards the site, what would we see?

• Main hall building, stacks, Small administrative building (low rise single story like city hall), as well as parking area.

Ron: Height of the smokestacks?

- Roy: I don't actually know the answer but can get back to Nick with that answer.
- (Roy provided the information via email on 9/16/2021 smokestacks will be 77ft tall).

Gavin Motioned to approve the zone change application for Parcel 1, COS 139 and Parcel 2, COS 1677 with the stated staff conditions

Evan Seconded.

Motion Carried.

4. Public Hearing: 810 W. 7th Street Annexation and Zone Change

Nick presented the findings contained in the Staff report including the stated conditions of approval.

The Chair called for Opponents.

The Chair called for Opponents.

The Chair called for Opponents.

The Chair called for Proponents.

Scott Slothower, 314 1st St. Park City, MT: Nick laid out the situation pretty well. The leech field is extremely small, with the house set back. Not sure how it was initially approved. Worked with Cotter's Sewer to fix it but it was found that the roots from the surrounding trees were choking the leech field making it unusable.

The Chair called for Proponents.

The Chair called for Proponents.

Ron: clarification on addresses?

- We were preparing to sell it last year when the issues with the septic system were found. We ran out of funds last year to continue the process last year. And we are in a better position this year to finalize it.
- The building will go to the Slothowers.

Ron: On the receipt from Cotter's, what if the cost exceeds the \$\$ amount? Will the city have to make up the difference?

- Scott: the not to exceed amount is the Cotter's sewer guarantee that it will NOT exceed that amount.
- From my experience in Steel business, we sometimes give not to exceed amounts as contractors. IF it exceeds that amount, the contractor will eat the amount, That is the assumed intent. This is a BID not to exceed that stated amount.

Ron: Hate to bash the city but the maps are not accurate. The maps on some projects have been COMPLETELY WRONG.

• Scott: Cotter's has located at least part of the water main system.

Members discussed the implications or reasoning behind Not asking adjacent properties to the west to annex as well?

• Nick provided info on his decision not to reach out to adjacent property owners: the adjacent right of way is not punched through fully, it would not be sensible to do a large scale annexation of those houses at this time.

The Chair closed the public hearing.

Ron Motioned to approve the annexation and zoning request for $810~W~7^{th}$ Street with the conditions stated in the staff report.

Evan Seconded.

Motion Carried.

New Business

5. Sign Review: On the Run (Conomart)

Nick presented the Façade and signage changes for the Conoco, (Now, On The Run).

Gain Motioned to approve the proposed changes to the signage and façade of the On The Run building. Evan Seconded.

Motion Carried.

Old Business

Other Items

- 6. Project Update
- Cherry Hills 3rd Filing Approved last night
- Bitterroot Grove Approved. Will be brought to council and Planning Board again
- Golf Course Annexation
- Lucky Louie's Relocation
- Regal Community Park? Fencing along the property? Enforcement concerns.
- Soda Station site concerns
- Zoning and Nuisance Code violations.
- Nuisance properties within the city limits.

Announcements

7. Adjourn

Meeting Adjourned at 6:54pm.

8. Next Meeting: October 20, 2021

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DATES TO REMEMBER

File Attachments for Item:

4. Building Plan Review: City Brew/Chen's Express

LAUREL CITY BREW-CHEN'S EXPRESS

SUITE A - CHEN'S EXPRESS SUITE B - CITY BREW

415 S. 1ST AVENUE LAUREL, MT 59044

ISSUE DATE: 7.2.2021

A&E PROJECT NUMBER: 21017




 $6^{\frac{\text{FRONT ENTRANCE}}{12" = 1'-0"}}$



ARCHITECTURAL ABBREVIATIONS

AB	ANCHOR BOLT	GA	GAUGE	R	RADIUS
ABV	ABOVE	GALV	GALVANIZED	RA	RETURN AIR
A/C	AIR CONDITIONING	GB	GYPSUM BOARD	RB	RUBBER BASE
ACT	ACOUSTICAL CEILING TILE	GC	GENERAL CONTRACTOR	RD	ROOF DRAIN
ADDL	ADDITIONAL	GL	GLASS, GLAZING	RECY	RECYCLE(D)
ADJ	ADJUSTABLE	GWB	GYPSUM WALL BOARD	REF	REFERENCE
AFF	ABOVE FINISH FLOOR	GYP	GYPSUM WALL BOARD		REFRIGERATOR OR
		GIF	GTPSUM	KEFKIG	
ALT	ALTERNATE		HANDIGAD	DEINE	REFRIGERATION
ALUM	ALUMINUM	HC	HANDICAP	REINF	REINFORCE
ARCH	ARCHITECT(URAL)	HDR	HEADER	REQD	REQUIRED
AWN	AWNING	HDW	HARDWARE	RM	ROOM
		HM	HOLLOW METAL	RO	ROUGH OPENING
B/	BOTTOM OF	HORIZ	HORIZONTAL	ROW	RIGHT OF WAY
3D	BOARD	HR	HOUR		
BLDG	BUILDING	HT	HEIGHT	S	SOUTH
BLKG	BLOCKING	HTD	HEATED	SC	SOLID CORE
3M	BEAM OR BENCHMARK	HVAC	HEATING/VENTILATION & AIR	SCH	SCHEDULE
RG	BEARING		CONDITIONING		SCHEDULED
TWN	BETWEEN			SECT	SECTION
BUR	BUILT-UP ROOF	ID	INSIDE DIAMETER	SF	SQUARE FEET
٠.٠	23.2. 3. 1.001	INFO	INFORMATION	SFRM	SPRAY APPLIED FIRE RESISTIVE
AB	CABINET	ISO	ISOCYANURATE	OI IVIVI	MATERIAL MATERIAL
J J	CONTROL JOINT	INSUL	INSULATE / INSULATED / INSULATION	SGL	SINGLE
L L	CENTERLINE	INT	INTERIOR	SHT	SHEET
LG	CEILING	INV	INVERT	SHTG	SHEATHING
CMU	CONCRETE MASONRY UNIT			SIM	SIMILAR
0	CLEAN OUT	JT	JOINT	SPECS	
COL	COLUMN	J-BOX	JUNCTION BOX	SOD	SLAB ON DECK
CONC	CONCRETE			SOG	SLAB ON GRADE
CONT	CONTINUOUS	KIT	KITCHEN	SOH	SAME OPPOSITE HAND
CONST	CONSTRUCTION			SS	STAINLESS STEEL
G	CORNER GUARD	L	LONG / LENGTH	ST	STONE TILE
PT	CARPET	LAM	LAMINATE(D)	STD	STANDARD
SMT	CASEMENT	LAV	LAVATORY	STND	STANDARD
CT	CERAMIC TILE	LF	LINEAR FEET	STL	STEEL
'	CENAINIC TILL	LT	LIGHT		STRUCTURAL
	DEEP	LI	LIOITI	UINUUI	UNCUTURAL
))F	DRINKING FOUNTAIN	MAS	MASONRY	TEMP	TEMPERED
)H	DOUBLE HUNG	MATL	MATERIAL	THK	THICK
DIM(S)	DIMENSIONS	MAX	MAXIMUM		THRESHOLD
ISP	DISPENSER	MECH	MECHANIC(AL)	T.O.	TOP OF
ON	DOWN	MEZZ	MEZZANINE		TOP OF BEAM
)R	DOOR	MFR	MANUFACTURER		TOP OF BEAM
)S	DOWNSPOUT	MH	MANHOLE		TOP OF PLATE
DTL	DETAIL	MIN	MINIMUM	T.O.S.	TOP OF STEEL
)WG	DRAWING	MISC	MISCELLANEOUS	T/	TOP OF
		MO	MASONRY OPENING	T&G	TONGUE AND GROOVE
	EAST	MTL	METAL	TEL	TELEPHONE
Α	EACH			THK	THICK
C	EXISTING COLUMN	N	NORTH	TRANS	TRANSOM
IJ	EXPANSION JOINT	NIC	NOT IN CONTRACT	TV	TELEVISION
LEC	ELECTRICAL	NOM	NOMINAL	TYP	TYPICAL
L	ELEVATION	NTS	NOT TO SCALE		· · - ·
LEV	ELEVATION	5		UL	UNDERWRITERS LABORATORY
Q.	EQUAL	ОС	ON CENTER	UNO	UNLESS NOTED OTHERWISE
QUIP		OD	OUTSIDE DIAMETER OR OVERFLOW	UNU	ONLEGG NOTED OTHERWISE
EWC		OD	DRAIN	VB	VINYL BASE
	ELECTRIC WATER COOLER	ODMO			
XH	EXHAUST	OPNG	OPENING OPPOSITE	VCT	VINYL COMPOSITION TILE
XIST	EXISTING	OPP	OPPOSITE	VERT	VERTICAL
XP	EXPANSION OR EXPOSED	OSB	ORIENTED STRAND BOARD	VEST	VESTIBULE
EXT	EXTERIOR	OVHD	OVERHEAD	VIF	VERIFY IN FIELD
				VP	VENEER PLASTER
ACP	FIRE ALARM CONTROL PANEL	PL	PLATE	VR	VAPOR RETARDER
D	FLOOR DRAIN	PLAM	PLASTIC LAMINATE	VT	VINYL TILE
Έ	FIRE EXTINGUISHER		PLUMBING	VWC	VINYL WALL COVERING
EC	FIRE EXTINGUISHER CABINET	PLYWD	PLYWOOD		
.F.	FINISH FLOOR	PNL	PANEL	W	WIDE OR WEST
IN	FINISH	PNT	PAINT	W/	WITH
IXT	FIXTURE	POLY	POLYESTER OR POLYOLEFIN	WC	WATER CLOSET
LR	FLOOR	PSF	POUNDS PER SQUARE FOOT	WD	WOOD
ND	FOUNDATION	PSI	POUNDS PER SQUARE INCH	WDW	WINDOW
-ии -Р		PT			
	FIRE PROTECTION		PRESSURE TREATED OR POINT	WG	WALL GUARD
R	FRAME	PVMT	PAVEMENT	WH	WATER HEATER
RMG	FRAMING	6 -	OLIA DDV TII T	W/IN	WITHIN
Т	FEET/FOOT OR FIRE TREATED	QT	QUARRY TILE	W/O	WITHOUT
	FOOTING	QTR	QUARTER	WP	WATERPROOF
	FOOTING	QTY	QUANTITY	WR	WATER RESISTANT
TNG				\ A /T	
TG TNG RP	FIBERGLASS REINFORCED			WT	WEIGHT
TNG	FIBERGLASS REINFORCED PANEL			W I WWF	WEIGHT WELDED WIRE FABRIC
TNG RP					
TNG	PANEL				

EXPLANATION OF SYMBOLS

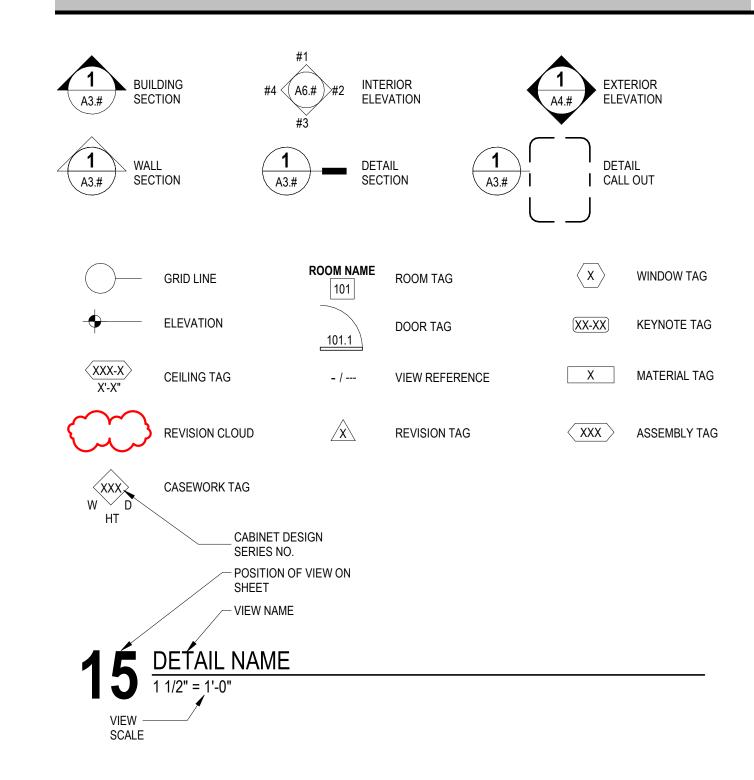

TYPICAL S	HEET VIEV	<u>V NUMBER</u>	<u>ING LAYOU</u>	<u>its</u>
1	2	3	4	
5	6	7	8	
9	10	11	12	
13	14	15	16	
ARCH D (24"x	36")			

1	2	3	4	5					
6	7	8	9	10					
11	12	13	14	15					
16	17	18	19	20					
ARCH E1 (30"x42")									

SUSTAINABILITY NOTES

- REPETITIVE AND/OR INTERMITTENT HIGH-LEVEL NOISE PERMITTED ONLY DURING DAYTIME. AT 50'-0" FROM THE PROJECT BOUNDARY DO NOT EXCEED 70 DB(A) FOR MORE THAN 12 MINUTES IN ANY HOUR.
- MAXIMUM AMBIENT NOISE LEVELS (DB) FOR NOISE AREA AT PROJECT BOUNDARY: DAYLIGHT HOURS 65 DB, NON-DAYLIGHT HOURS 45 DB.
- DEVELOP A WASTE MANAGEMENT PLAN ACCORDING TO ASTM E 1609. PLAN SHALL CONSIST OF WASTE IDENTIFICATION, WASTE REDUCTION WORK PLAN, AND COST/REVENUE ANALYSIS. DISTINGUISH BETWEEN CONSTRUCTION WASTES. INDICATE QUANTITIES BY WEIGHT OR VOLUME, BUT USE SAME UNITS OF MEASURE THROUGHOUT WASTE MANAGEMENT PLAN.
- DEVELOP A WASTE REDUCTION WORK PLAN. IDENTIFY NON-HAZARDOUS DEMOLITION AND CONSTRUCTION WASTE GENERATED BY THE PROJECT AND WHETHER IT WILL BE SALVAGED, RECYCLED, OR DISPOSED OF IN LANDFILL. INCLUDE QUANTITY OF EACH TYPE OF WASTE, QUANTITY FOR EACH MEANS OF RECOVERY, AND HANDLING AND TRANSPORTATION PROCEDURES.
- RECYCLED MATERIALS: DIVERT, AT A MINIMUM, 50% OF RESULTING WASTE FROM A LANDFILL THROUGH SALVAGE AND RECYCLING. SEPARATE RECYCLABLE WASTE

FROM OTHER WASTE MATERIALS, TRASH, AND DEBRIS.

- DEVELOP A CONSTRUCTION IAQ MANAGEMENT PLAN. AT A MINIMUM, SCHEDULE OF INSTALLATION OF INTERIOR FINISHES, IDENTIFY SOURCES OF ODOR AND DUST, NOTE CONSTRUCTION VENTILATION PROVIDED INCLUDING USE OF PERMANENT HVAC SYSTEMS, TYPES OF FILTRATION AND SCHEDULE FOR REPLACEMENT OF FILTERS, CLEANING AND DUST CONTROL PROCEDURES, PRODUCTS REQUIRING MOISTURE PROTECTION, AND SCHEDULE FOR INSPECTION OF STORED MATERIALS.
- DEVELOP A TEMPORARY SEDIMENTATION CONTROL PLAN. INDICATE DEVICES, MEASURES, AND LOCATIONS FOR SEDIMENT CONTROL DEVICES, DESCRIBE CONSTRUCTION ACTIVITIES EFFECTING EROSION, DESCRIBE MONITORING AND MEASURES FOR SEDIMENT CONTROL, DESCRIBE MITIGATION AND RESPONSE TO FAILED EROSION CONTROL MEASURES.
- FIELD APPLICATIONS INSIDE THE WEATHER PROOFING SYSTEM SHALL COMPLY WITH VOC CONTENT LIMITS OF AUTHORITIES HAVING JURISDICTIONS OR SCAQMD RULE 1168, WHICHEVER IS STRICTER.

LOW EMITTING MATERIALS. PAINTS, COATINGS, ADHESIVES AND SEALANTS FOR

- NO SMOKING. SMOKING, VAPING, AND SMOKELESS TOBACCO USE IS NOT PERMITTED WITHIN THE BUILDING, OR WITHIN 25'-0" OF ENTRANCES, OPERABLE WINDOWS, OR OUTDOOR AIR INTAKES.
- CAST-IN-PLACE CONCRETE. PROVIDE STEEL REINFORCING MATERIALS WITH MINIMUM 25% RECYCLED CONTENT. PROVIDE AGGREGATE AND CEMENT EXTRACTED AND/OR MANUFACTURED WITHIN 500 MILES OF PROJECT SITE.
- 11. UNIT MASONRY. PROVIDE BRICK, BLOCK, AGGREGATE, CEMENT, MORTAR, AND
- STRUCTURAL STEEL, STEEL DECKING, FORMED METAL FRAMING, METAL TOILET COMPARTMENTS, AND FORMED METAL WALL AND ROOF PANELS. PROVIDE MATERIALS WITH POST-CONSUMER RECYCLED CONTENT PLUS ONE-HALF OF PRE-

LIME EXTRACTED AND/OR MANUFACTURED WITHIN 500 MILES OF PROJECT SITE.

13. ALL COMPOSITE WOOD PRODUCTS SHALL BE MANUFACTURED WITHOUT ADDED UREA FORMALDEHYDE.

CONSUMER RECYCLED CONTENT NOT LESS THAN 25%.

- ALUMINUM ENTRANCE AND WINDOW SYSTEMS. PROVIDE ALUMINUM MATERIALS WITH POST-CONSUMER RECYCLED CONTENT PLUS ONE-HALF OF PRE-CONSUMER RECYCLED CONTENT NOT LESS THAN 50%.
- PROVIDE GYPSUM BOARD WALL PANELS MANUFACTURED WITHIN 500 MILES OF THE PROJECT SITE.
- 16. RESILIENT HARD SURFACE FLOORING MATERIALS AND THEIR ADHESIVES SHALL BE FLOORSCORE CERTIFIED.
- 17. PLUMBING FIXTURES SHALL BE WATERSENSE CERTIFIED.


PROJECT TEAM


WELLS BUILT 2526 SHILOH RD. BILLINGS, MT 59106

CONTACT: STEVE WELLS

406.794.6465

OWNER	CIVIL ENGINEER, PROJECT LEAD
STEVE ZABAWA ZDEALER@ICLOUD.COM	SANDERSON STEWART 1300 N. TRANSTECH WAY BILLINGS, MT 59102 406.855.8521 CONTACT: BRYAN ALEXANDER
ARCHITECT	MEP ENGINEER
A&E ARCHITECTS 124 NORTH 29th STREET BILLINGS, MT 59101 406.248.2633	SIMPLICITY CONSULTING ENGINEERS & DESIGN, LLC P.O.BOX 81222 BILLINGS, MT 59108-1222 406.861.1205 CONTACT: CORY HASIAK, P.E.
CONTRACTOR	

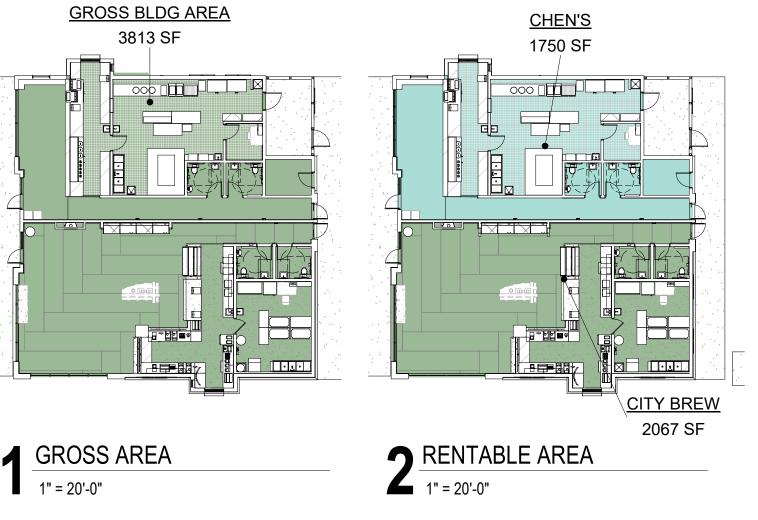

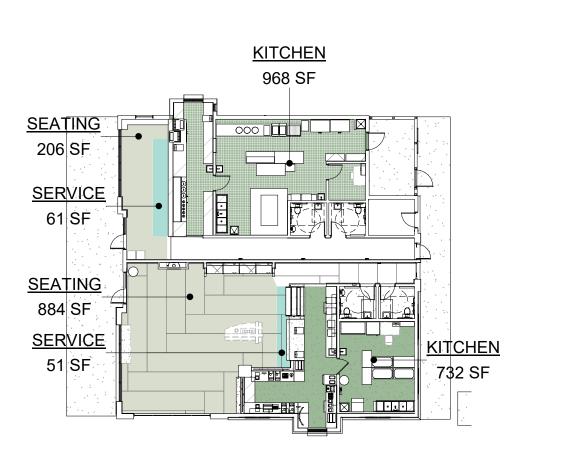

1 LEVEL	. 1			
1" = 20'-0	"			
	OCCUI	PANT LOAD CALCUI	LATION	
SPACE	USE	AREA	OLF	TOTAL OCC LOAD
CITY BREW	SERVICE	51 SF	7 SF	8
CITY BREW	KITCHEN	732 SF	200 SF	4
CITY BREW	SEATING	884 SF	15 SF	59
CITY BREW: 3		1667 SF		71
SHANGHAI	SERVICE	61 SF	7 SF	9
SHANGHAI	SEATING	206 SF	15 SF	14
SHANGHAI	KITCHEN	968 SF	200 SF	5
SHANGHAI: 3		1235 SF	·	28
Grand total: 6		2902 SF		99

ARCHITECTURAL DRAWINGS

GENERAL INFO	SHEET NAME
G0.0	COVER SHEET
G0.1	GENERAL INFORMATION
CIVIL	SHEET NAME
C1.0	EXISTING SITE PLAN
C2.0	SITE UTILITY PLAN
C3.0	GRADING AND DRAINAGE PLAN
C4.0	DETAILS
LANDSCAPE	SHEET NAME
L1.1	LANDSCAPE PLAN
L2.1	PLANTING DETAILS
ARCHITECTURAL	SHEET NAME
A0.1	ASSEMBLY TYPES
A1.1	SITE PLAN
A2.1	LEVEL 1 FLOOR PLAN
A2.2 A3.1	ROOF PLAN ENLARGED CHEN'S EXPRESS PLAN
A3.2	ENLARGED CITY BREW PLAN
A3.10	PLAN DETAILS
A4.1	EXTERIOR ELEVATIONS
A5.1	BUILDING SECTIONS
A5.5 A5.6	WALL SECTIONS WALL SECTIONS
A5.7	WALL SECTIONS WALL SECTIONS
A5.9	HARDI REVEAL SECTION DETAILS
A5.10	SECTION DETAILS
A6.1	INTERIOR ELEVATIONS
A6.2 A6.3	INTERIOR ELEVATIONS
A6.4	INTERIOR ELEVATIONS INTERIOR ELEVATIONS
A6.5	INTERIOR DESIGN DETAILS
A6.8	CASEWORK DETAILS
A7.1	REFLECTED CEILING PLAN
A7.2 A9.1	REFLECTED CEILING PLAN DETAILS SCHEDULES
STRUCTURAL	SHEET NAME
S1.0	FOUNDATION PLAN
S1.1	ROOF FRAMING PLAN
S1.2	MECHANICAL COORDINATION PLAN
S2.0 S2.1	SECTIONS AND DETAILS SECTIONS AND DETAILS
MECHANICAL AND PLUMBING	SHEET NAME
M0.1 M0.2	MECHANICAL LEGEND & SCHEDULES MECHANICAL DETAILS
M0.3	MECHANICAL DETAILS MECHANICAL SPECIFICATIONS
M1.1	BELOW SLAB PLUMBING PLAN
M1.2	PLUMBING ROOF PLAN
M2.1	ENLARGED CHEN'S PLUMBING PLAN
M2.2 M3.1	ENLARGED CITY BREW PLUMBING PLAN ENLARGED CHEN'S EXPRESS MECHANICAL PLAN
M3.2	ENLARGED CITY BREW MECHANICAL PLAN
M3.3	MECHANICAL ROOF PLAN
ELECTRICAL	SHEET NAME
	ELECTRICAL COVER SHEET
E0.1	
E0.2	ELECTRICAL SITE PLAN
E0.2 E1.1	ELECTRICAL SITE PLAN LIGHTING PLAN
E0.2	ELECTRICAL SITE PLAN

ALTERNATE PRICING NOTES

- FIRE SPRINKLER SYSTEM

 CONCTRACTOR TO PROVIDE PRICING FOR FULL SPRINKLER SYSTEM SPRINKLER LINE INTO FIRE ROOM. NO LINE TO STREET, FIRE ALARM OR INTERIOR SPRINKLER SYSTEM WILL BE INCLUDED IN THIS ALTERNATE.

CODE ANALYSIS

CHAPTER 3:

A-2 RESTAURANT AND COFFEE SHOPS

CHAPTER 5: ALOWABLE BUILDING HT = 60 FOR SPRINKLERED BUILDING OCCUPANCY A A-2 OCCUPANCY: SINGLE STORY SPRINKLERED BUILDING, TYPE VB CONSTRUCTION = 24,000 SF

CHAPTER 9: A-2 SPRINKLERS REQUIRED FOR FIRE AREA OCCUPANT LOAD GREATER THAN 100. ACTUAL OCCUPANT LOAD IS 99. NO SPRINKLER SYSTEM REQUIRED. PARKING

1. SEE C2.0 FOR PARKING CALCULATIONS


BUILDING ENVELOPE USES PRESCRIPTIVE COMPLIANCE METHOD TO MEET THE REQUIREMENT OF THE IECC. SEE SHEET G0.2 FOR ASSEMBLY R-VALUES.

SEE ATTACHED COMCHECK FOR COMPLIANCE WITH DOE STANDARDS FOR MECHANICAL, PLUMBING AND LIGHTING.

PERMITS

ase)

AUREL

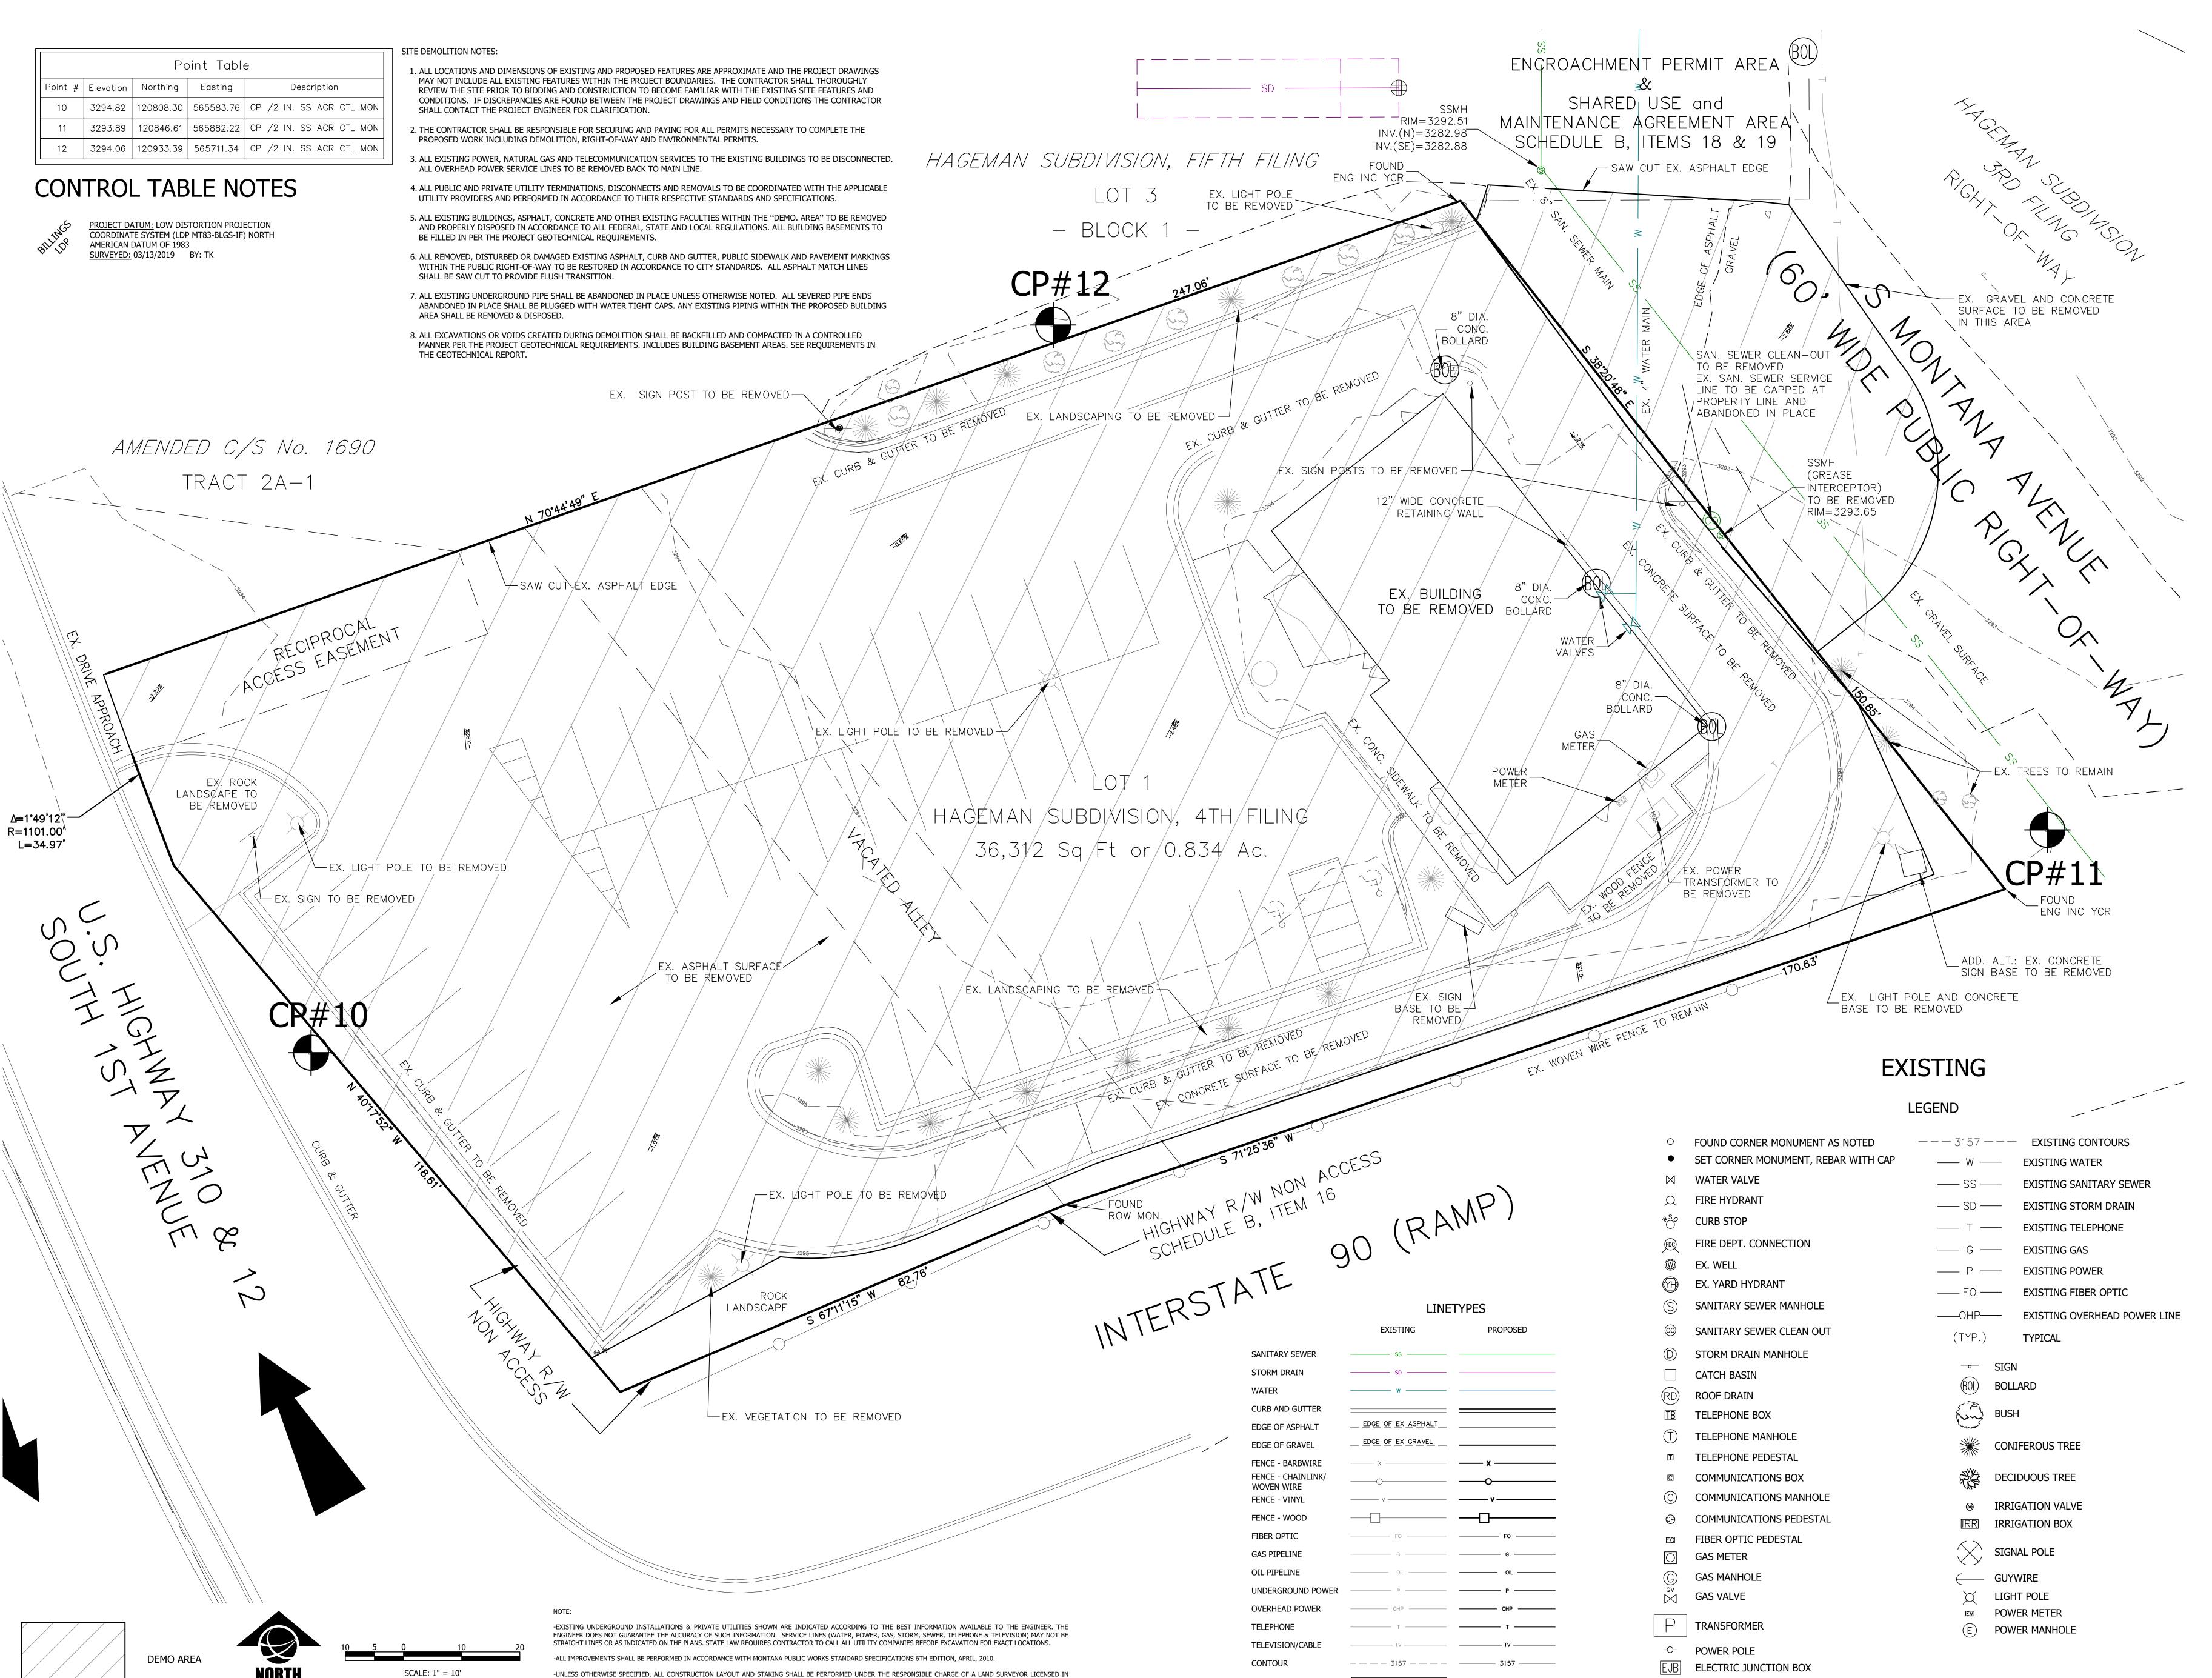


DEMO AREA

E ELECTRIC PEDESTAL

THE STATE WHERE IS PROJECT IS LOCATED AND BY A PARTY CHIEF OR ENGINEERING TECHNICIAN EXPERIENCED IN CONSTRUCTION LAYOUT AND STAKING TECHNIQUES AS


ARE REQUIRED BY THE SPECIFIC TYPE OF WORK BEING PERFORMED.

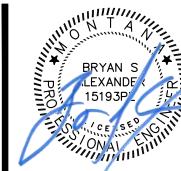




PERMITS AND CONSTRUCTION



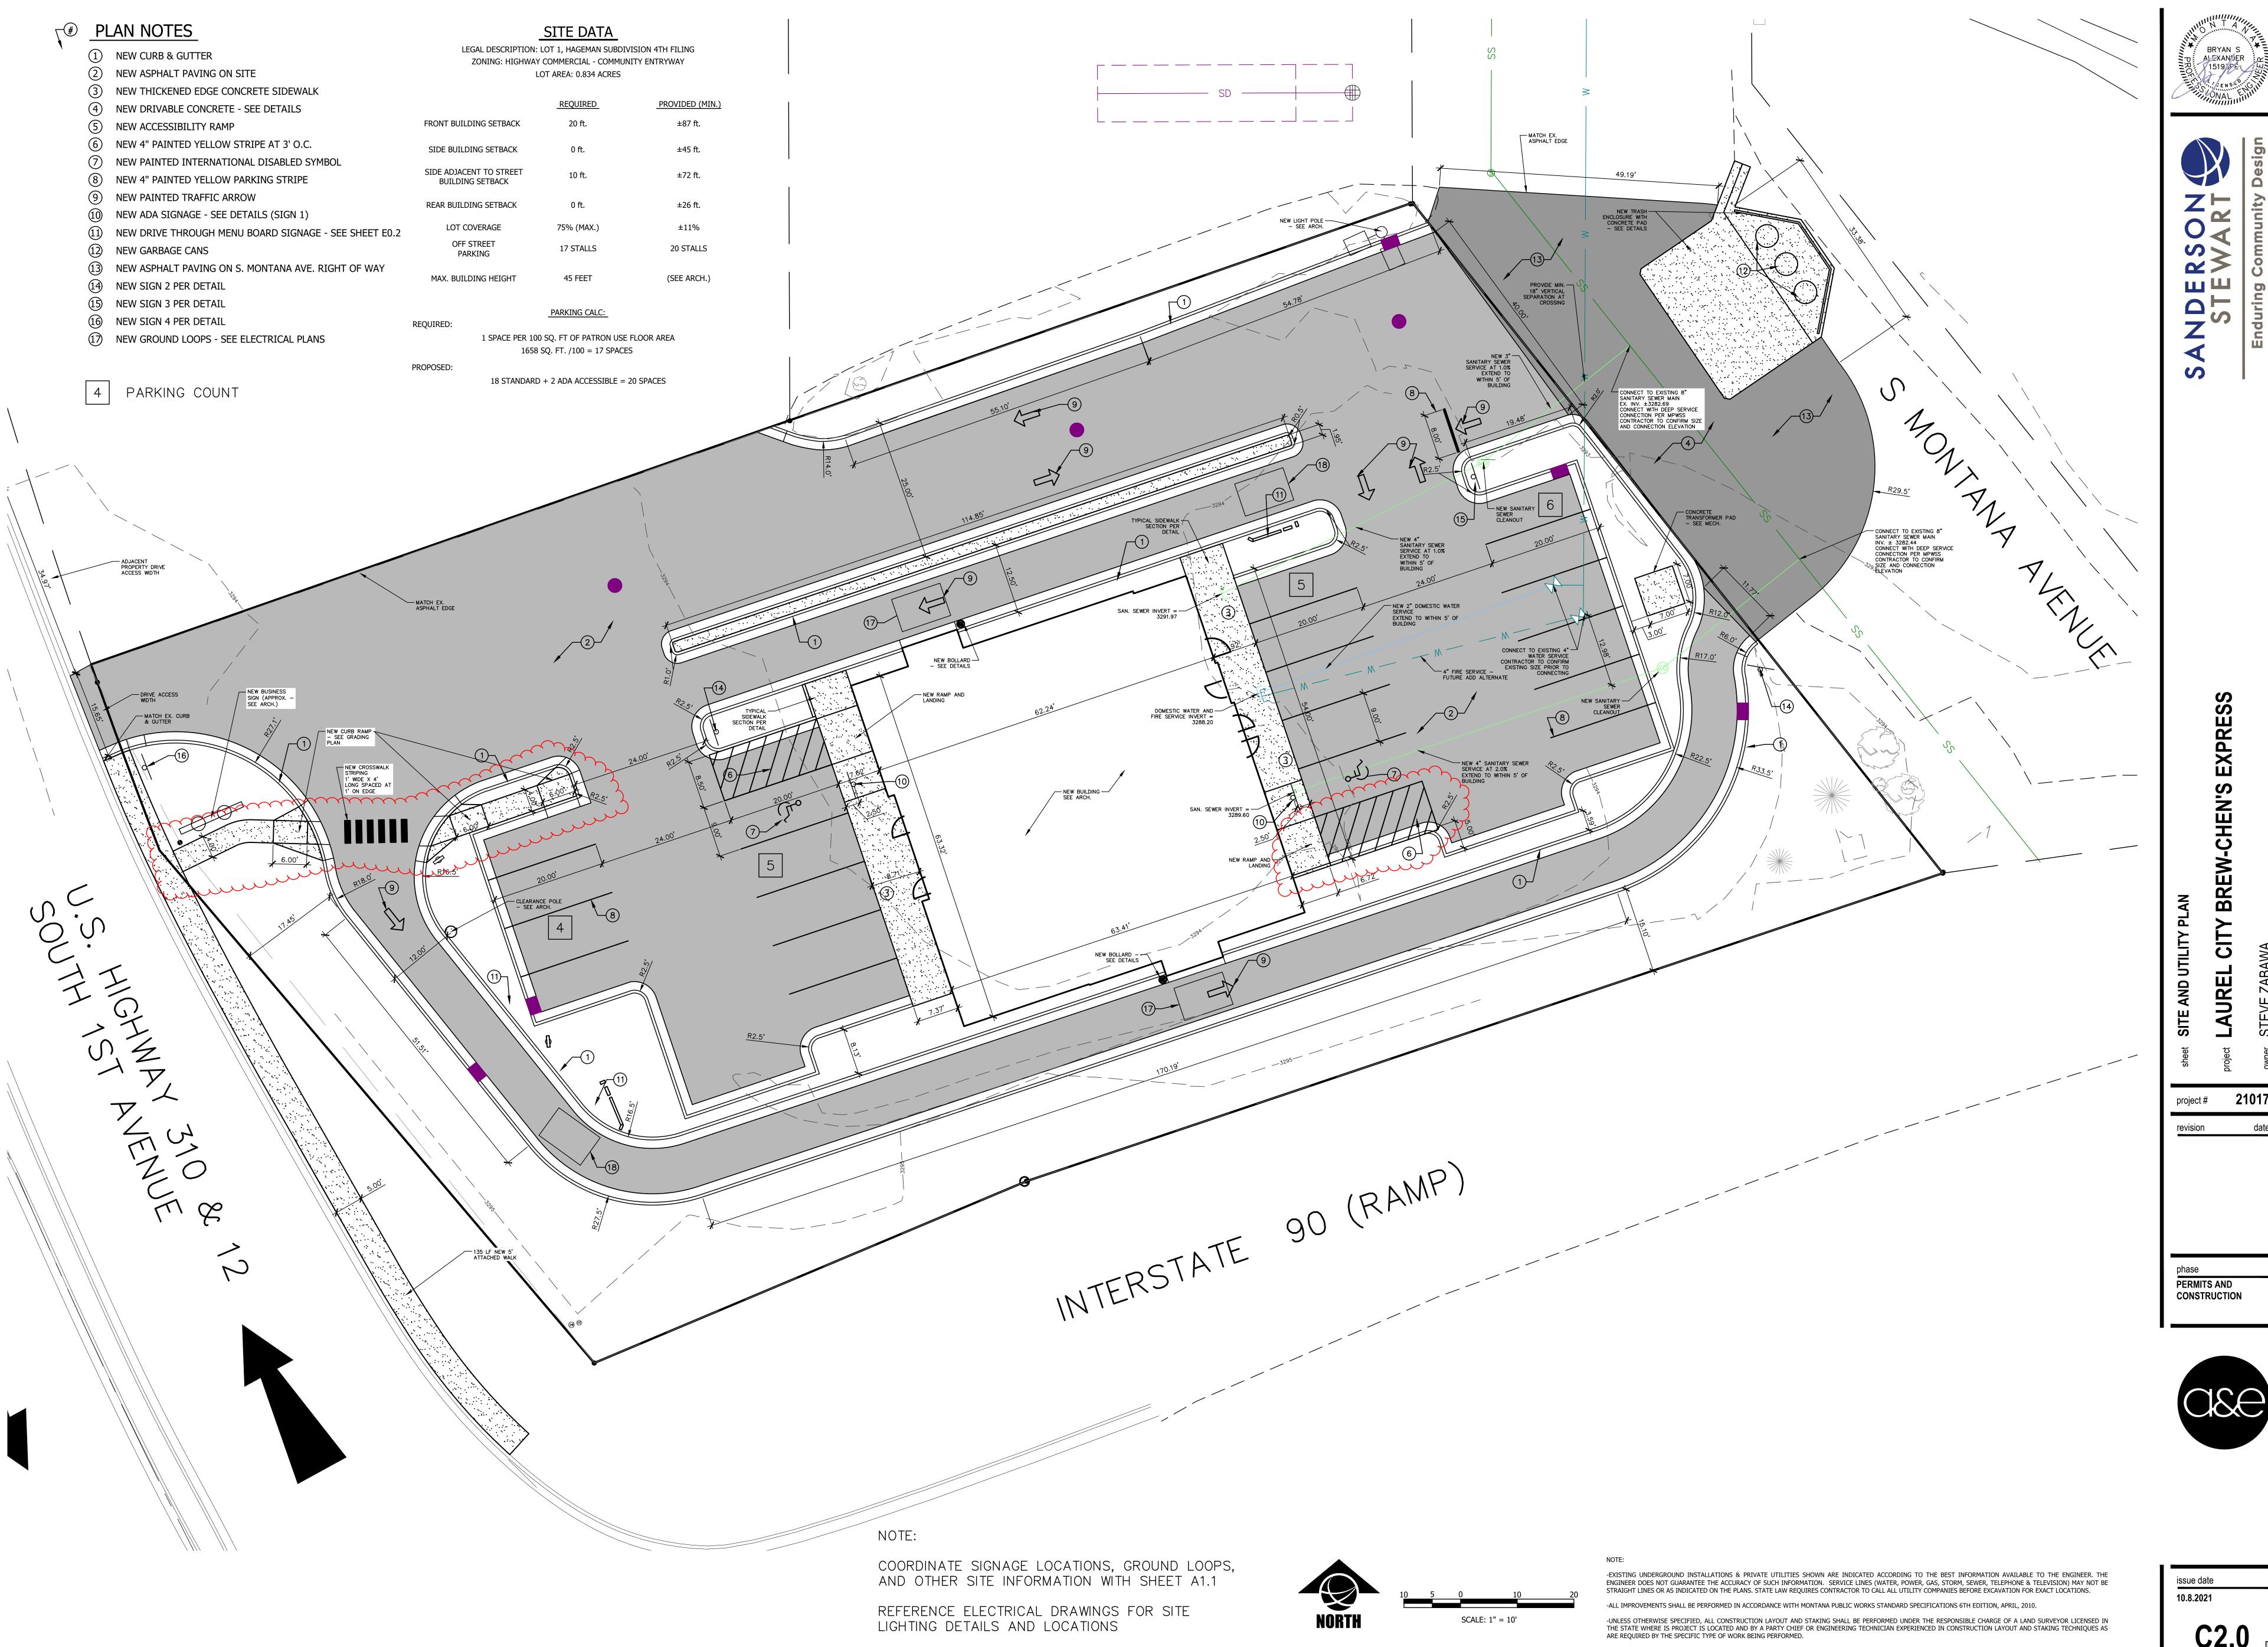







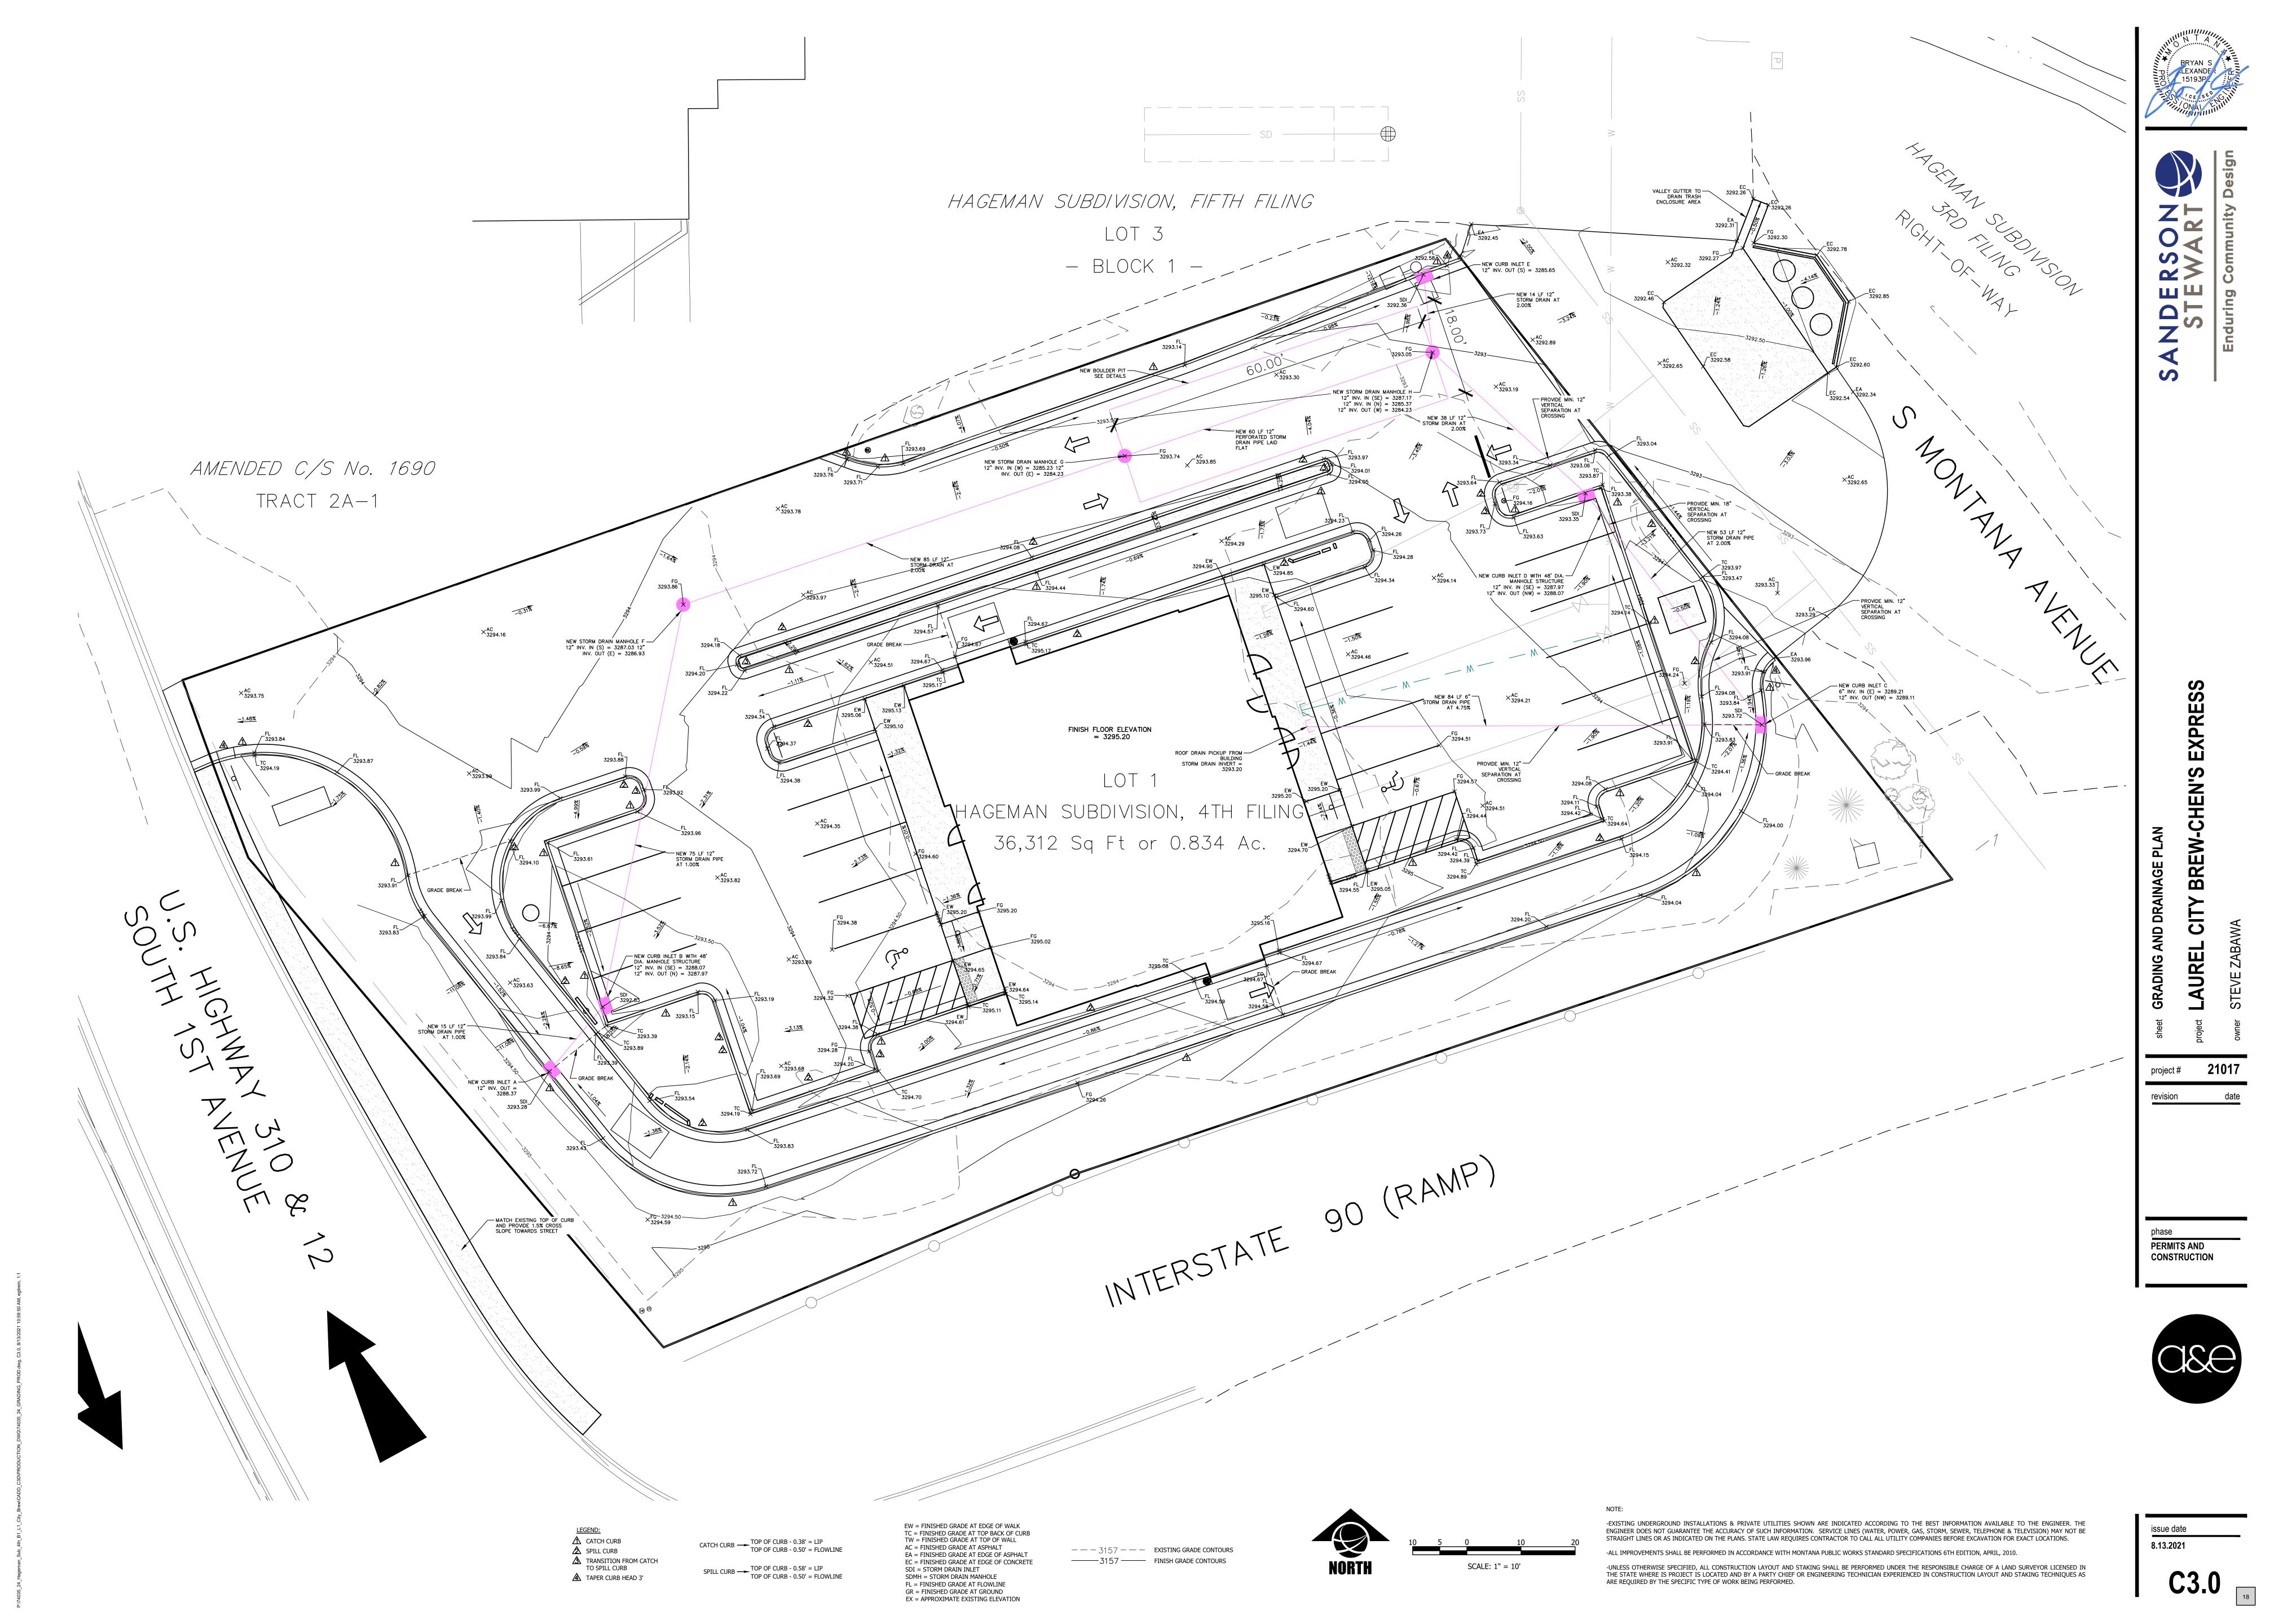


VIEW


PRE

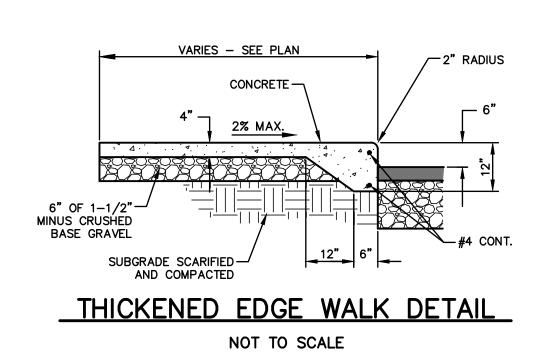

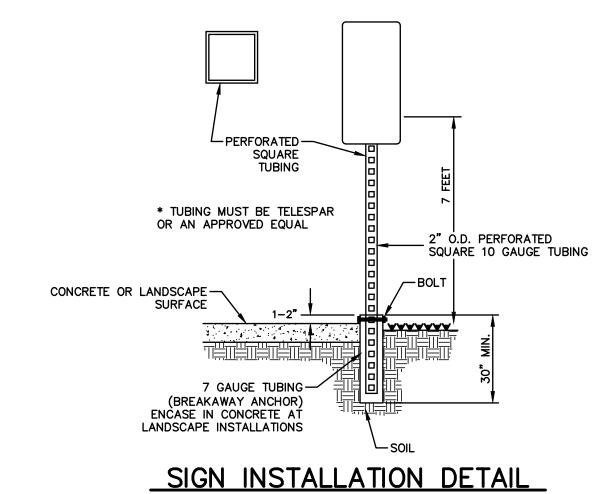

NOT TO SCALE

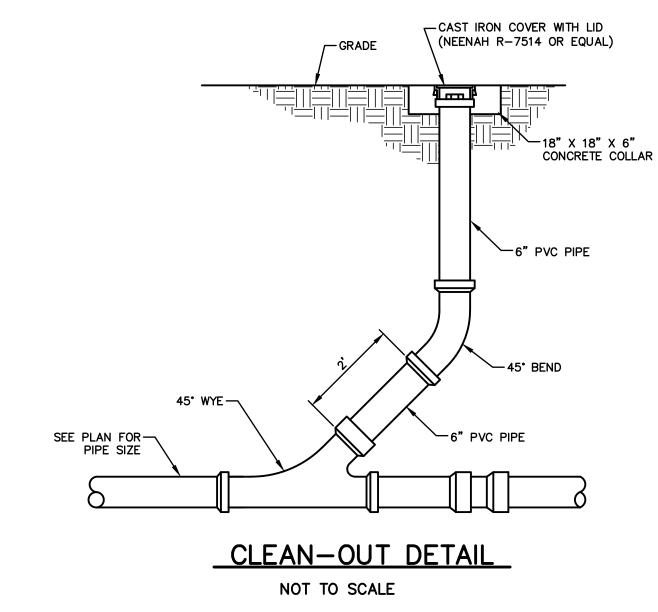

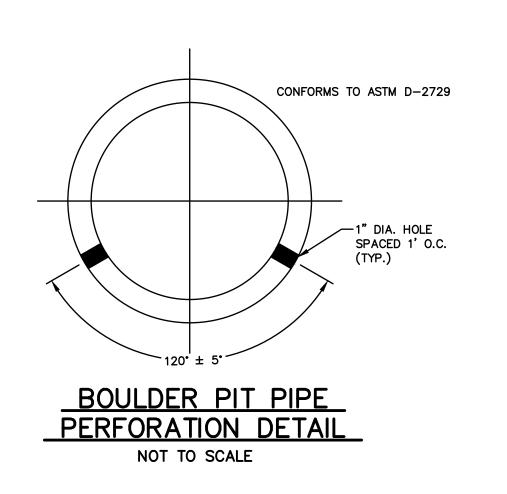


STANDARD CASTING & COVER (SEE PLAN FOR TYPE)

CAP AND VENT HOLE


NOT TO SCALE


RINGS

FLAT SLAB COVER-

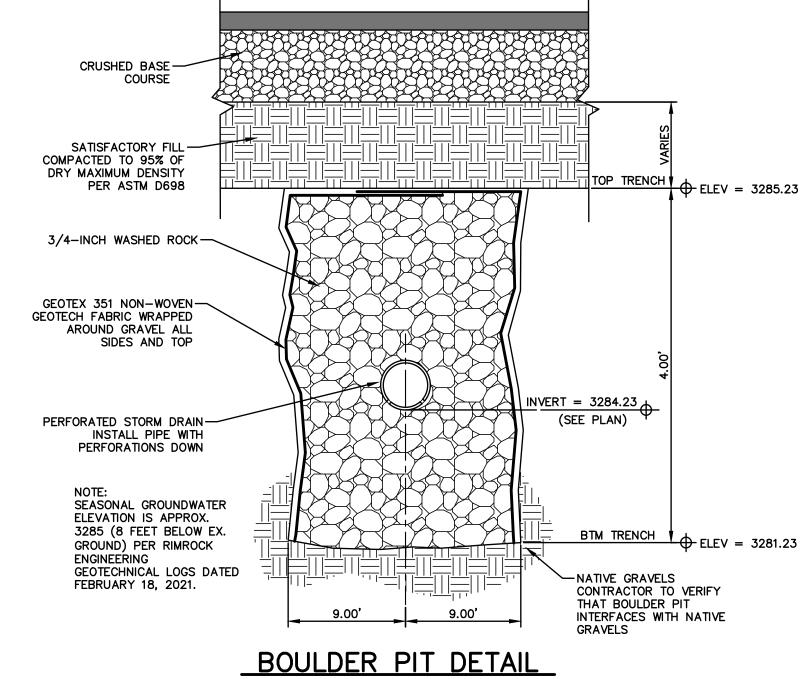


NOT TO SCALE

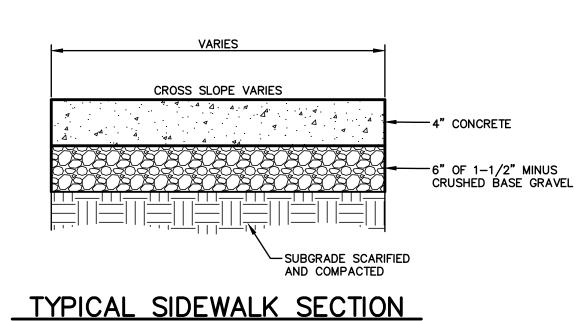


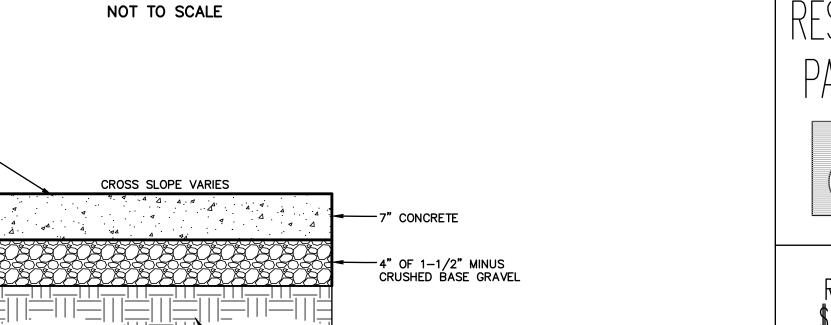



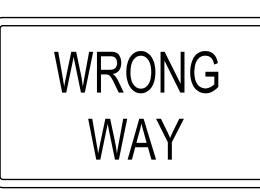


SIGN 2 - POST MOUNTED WRONG WAY

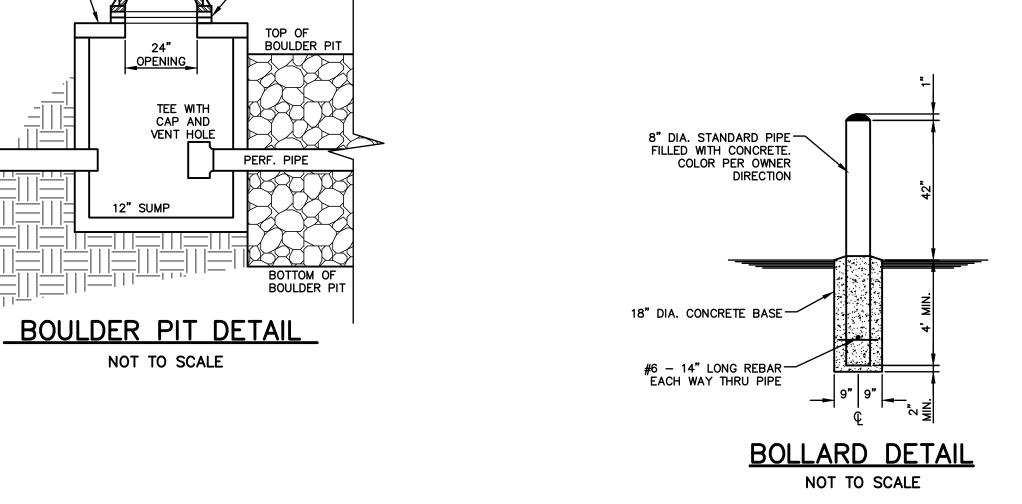

SUBGRADE SCARIFIED AND COMPACTED DUMPSTER PAD CONCRETE NOT TO SCALE

SEAL CONCRETE — AGAINST GREASE ABSORPTION

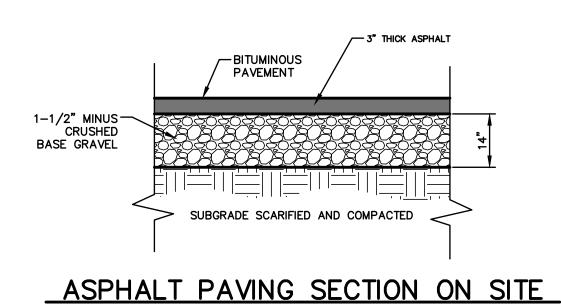





SIGN 3 - POST MOUNTED DRIVE THROUGH

SIGN 1 - POST MOUNTED HANDICAP PARKING





SIGN 4 - POST MOUNTED NO LEFT TURN


-BITUMINOUS PAVEMENT 1-1/2" MINUS — CRUSHED BASE GRAVEL

SUBGRADE SCARIFIED AND COMPACTED

NOT TO SCALE

S. MONTANA AVE ASPHALT SECTION NOT TO SCALE


SIGN DETAILS NOT TO SCALE

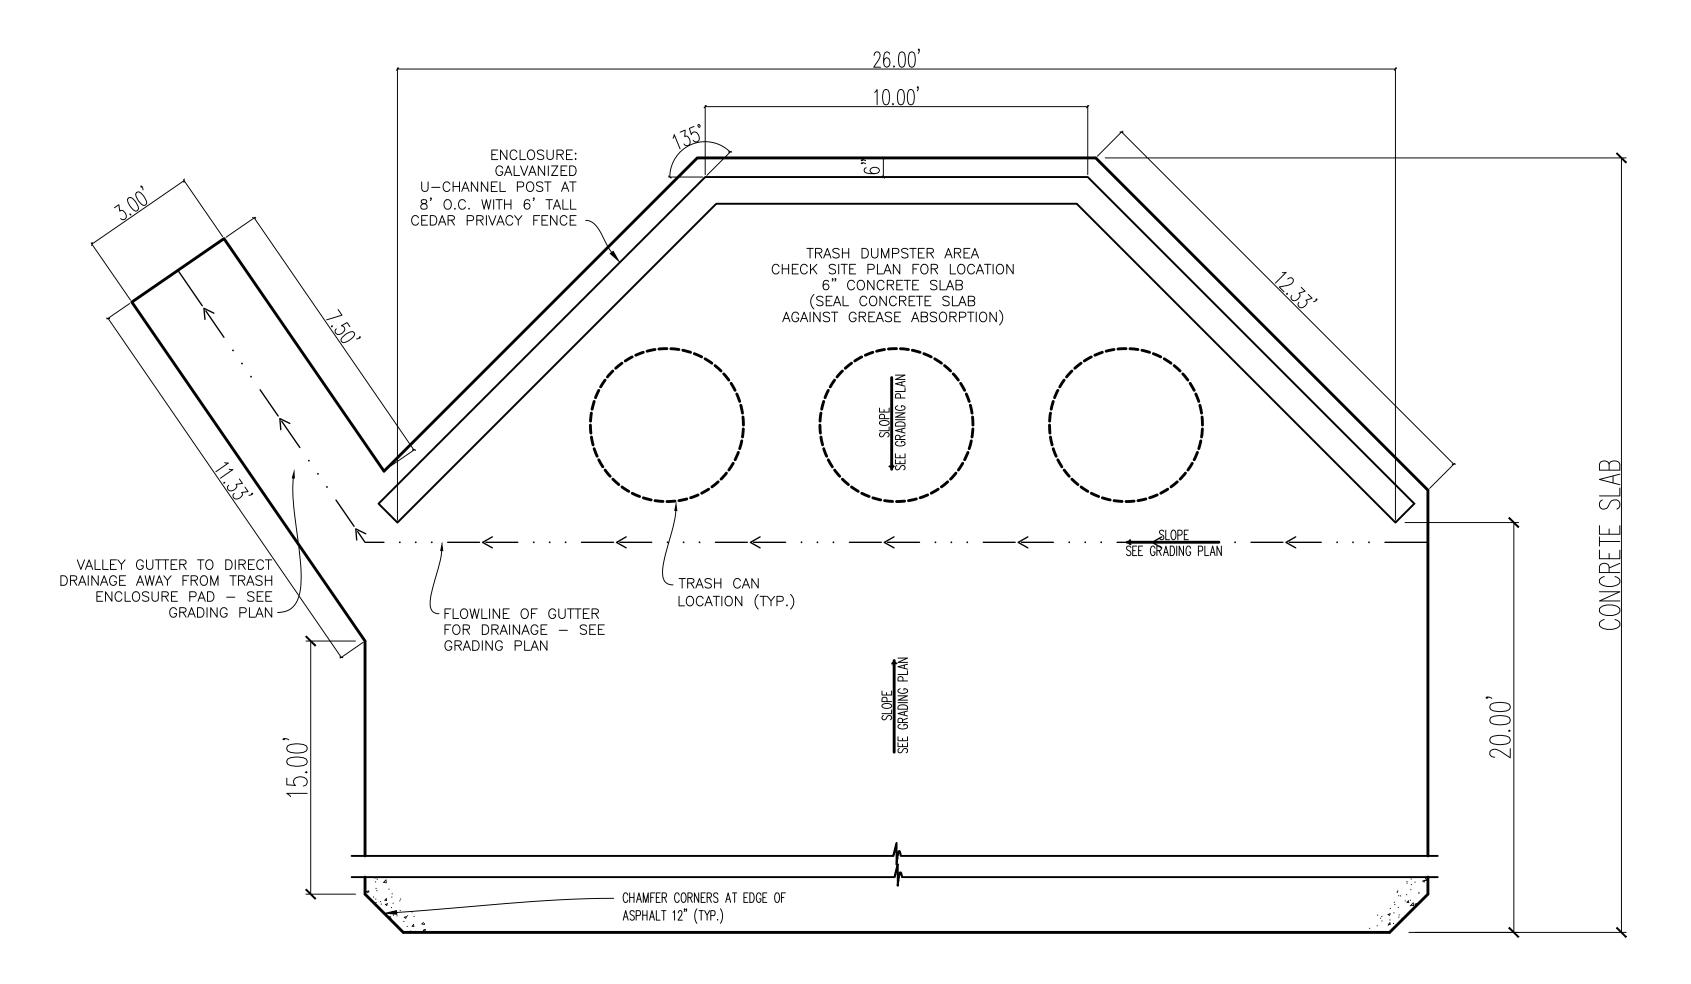

TRASH ENCLOSURE DETAIL NOT TO SCALE

-EXISTING UNDERGROUND INSTALLATIONS & PRIVATE UTILITIES SHOWN ARE INDICATED ACCORDING TO THE BEST INFORMATION AVAILABLE TO THE ENGINEER. THE ENGINEER DOES NOT GUARANTEE THE ACCURACY OF SUCH INFORMATION. SERVICE LINES (WATER, POWER, GAS, STORM, SEWER, TELEPHONE & TELEVISION) MAY NOT BE STRAIGHT LINES OR AS INDICATED ON THE PLANS. STATE LAW REQUIRES CONTRACTOR TO CALL ALL UTILITY COMPANIES BEFORE EXCAVATION FOR EXACT LOCATIONS. -ALL IMPROVEMENTS SHALL BE PERFORMED IN ACCORDANCE WITH MONTANA PUBLIC WORKS STANDARD SPECIFICATIONS 6TH EDITION, APRIL, 2010. -UNLESS OTHERWISE SPECIFIED, ALL CONSTRUCTION LAYOUT AND STAKING SHALL BE PERFORMED UNDER THE RESPONSIBLE CHARGE OF A LAND SURVEYOR LICENSED IN THE STATE WHERE IS PROJECT IS LOCATED AND BY A PARTY CHIEF OR ENGINEERING TECHNICIAN EXPERIENCED IN CONSTRUCTION LAYOUT AND STAKING TECHNIQUES AS ARE REQUIRED BY THE SPECIFIC TYPE OF WORK BEING PERFORMED.

JTILITIES UNDERGROUND LOCATION CENTER MONTANA ONE CALL CALL BEFORE YOU DIG! 1-800-424-5555 www.Callbeforeyoudig.org

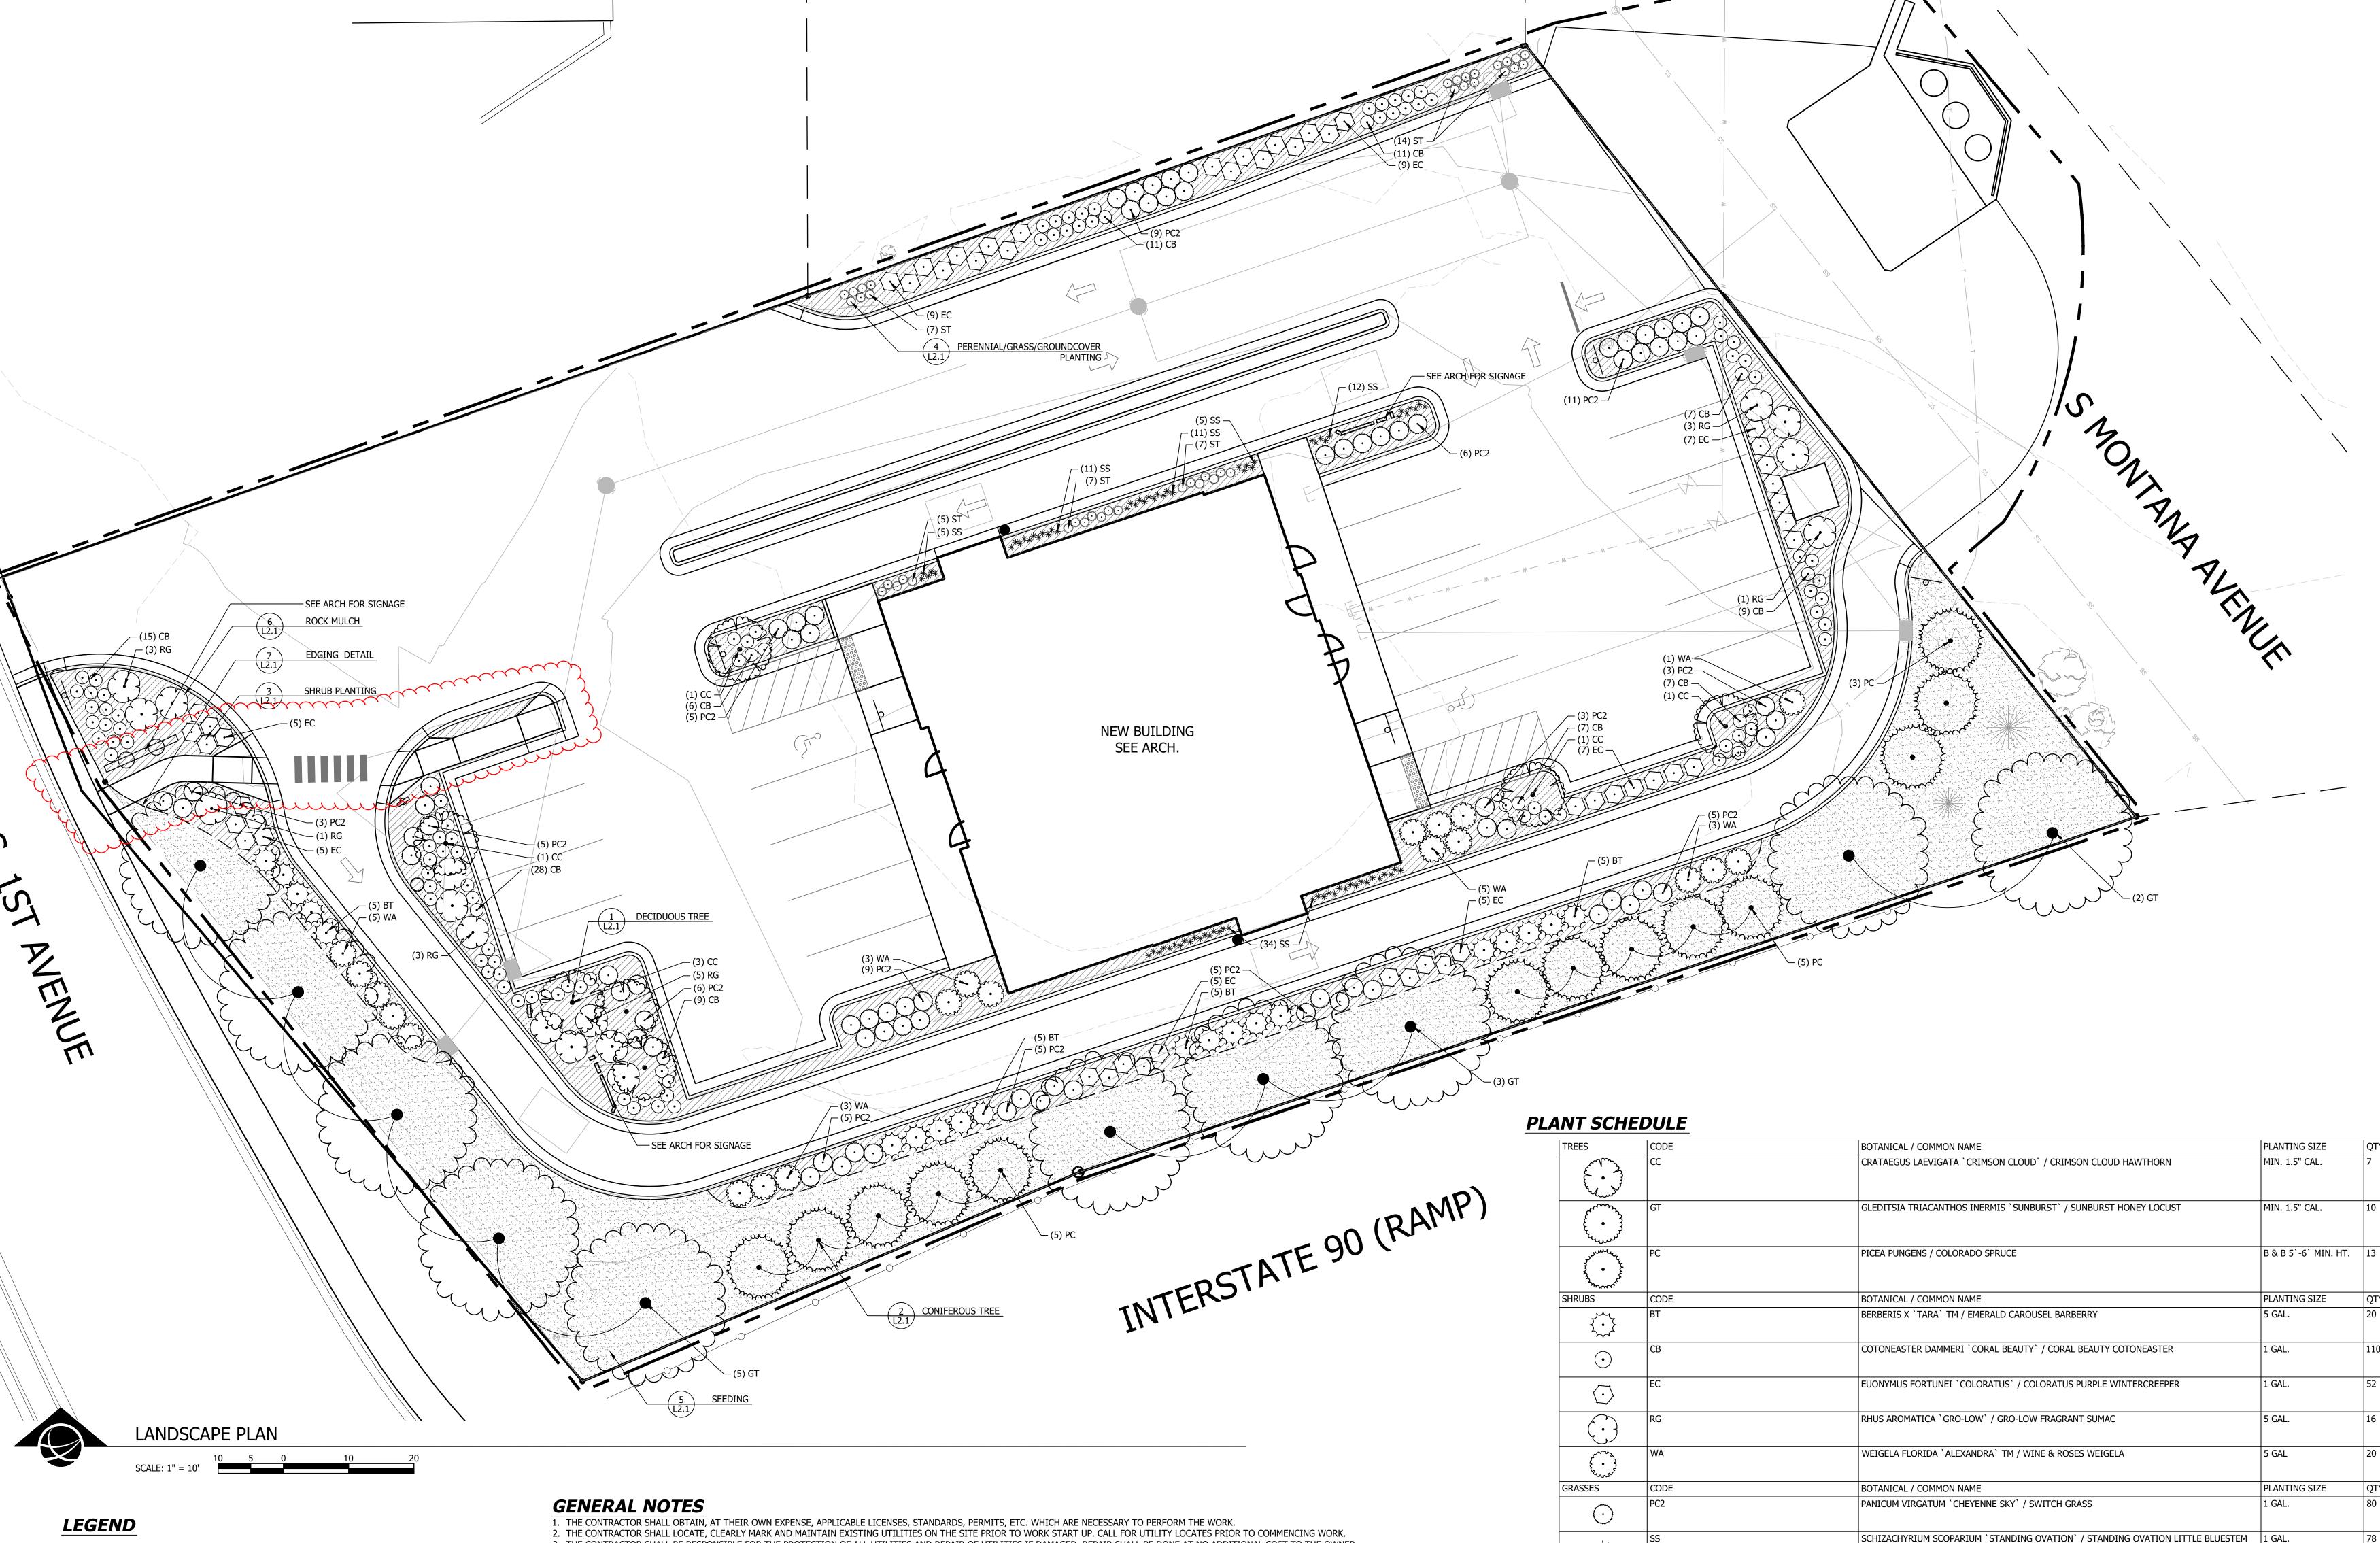

LIMIT OF WORK LANDSCAPE EDGING EXISTING DECIDUOUS TREE

EXISTING CONIFEROUS TREE

3. THE CONTRACTOR SHALL BE RESPONSIBLE FOR THE PROTECTION OF ALL UTILITIES AND REPAIR OF UTILITIES IF DAMAGED. REPAIR SHALL BE DONE AT NO ADDITIONAL COST TO THE OWNER 4. ALL DIMENSIONS SHALL BE FIELD VERIFIED BY CONTRACTOR PRIOR TO CONSTRUCTION. ANY DEVIATION FROM THESE PLANS MUST BE APPROVED BY OWNER OR LANDSCAPE ARCHITECT PRIOR TO

CONSTRUCTION. 5. LIMIT OF WORK IS AS INDICATED ON THE PLANS. 6. COORDINATE SITE ACCESS, STAGING, STORAGE AND CLEANOUT AREAS WITH OWNER'S REPRESENTATIVE.

PLANTING NOTES

1. THE CONTRACTOR IS RESPONSIBLE FOR VERIFYING ALL PLANT QUANTITIES. GRAPHIC QUANTITIES TAKE PRECEDENCE OVER WRITTEN QUANTITIES.

2. ALL EXISTING GRASS STAND AREAS DISTURBED BY CONSTRUCTION OPERATIONS SHALL BE SOIL PREPARED AND SEEDED BY THE CONTRACTOR. 3. EXISTING TURF AREAS THAT ARE DISTURBED DURING CONSTRUCTION, ESTABLISHMENT AND THE MAINTENANCE PERIOD SHALL BE RESTORED WITH NEW SOD TO MATCH EXISTING TURF SPECIES. 4. ALL LANDSCAPE MATERIALS SHALL BE INSTALLED ACCORDING TO SOUND HORTICULTURAL PRACTICES AND AMERICAN NURSERY STANDARDS IN A MANNER DESIGNED TO ENCOURAGE QUICK ESTABLISHMENT AND HEALTHY GROWTH.

5. REPAIR DISTURBED AREAS BENEATH SHRUBS BY HAND. 6. REPAIR AND RESEED STAGING AREA.

7. CONTRACTOR SHALL COORDINATE IRRIGATION AND PLANTING WORK SUCH THAT INSTALLED IRRIGATION EQUIPMENT SHALL NOT CAUSE ADJUSTMENT OF PLANTING LOCATIONS CONTRARY TO THE PLANS. IF IRRIGATION EQUIPMENT IS INSTALLED IN LOCATIONS OBSTRUCTING THE INTENDED LOCATIONS OF THE PLANTINGS, NOTIFY THE LANDSCAPE ARCHITECT FOR CLARIFICATION. 8. THE CONTRACTOR SHALL WARRANTY ALL CONTRACTED WORK AND MATERIALS FOR A PERIOD OF ONE YEAR AFTER SUBSTANTIAL COMPLETION HAS BEEN ISSUED BY THE OWNER'S REPRESENTATIVE FOR THE ENTIRE PROJECT UNLESS OTHERWISE SPECIFIED IN THE CONTRACT DOCUMENTS OR SPECIFICATIONS.

9. PLANTING BEDS TO BE AMENDED WITH A MIN. 12" DEPTH TOP QUALITY TOPSOIL PRIOR TO PLANTING. 10. AREAS TO BE SEEDED OR SODDED TO BE AMENDED WITH A MIN. 4" DEPTH TOP QUALITY TOPSOIL PRIOR TO SEEDING OR SODDING.

SPOROBOLUS HETEROLEPIS 'TARA' / TARA PRAIRIE DROPSEED

5,025 SF


GROUND COVERS | BOTANICAL / COMMON NAME


ROCK MULCH

SEEDING / MOWED LAWN MIX


BOTANICAL / COMMON NAME

CRUSHED ROCK 1" DIA OR SMALLER. 2" DEPTH.

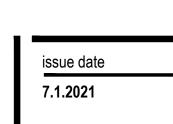

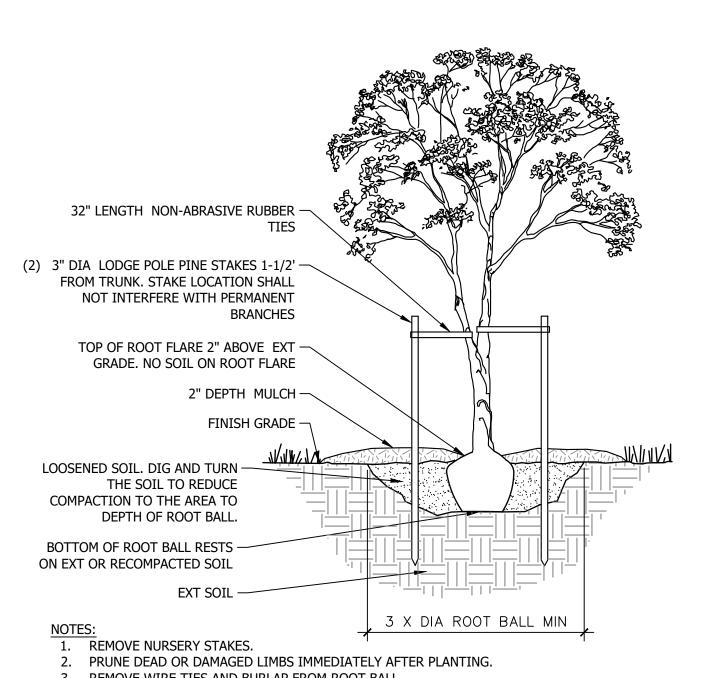

- 4. PRIOR TO MULCHING, LIGHTLY TAMP SOIL AROUND ROOT BALL IN 6" LIFTS TO BRACE TREE. DO NOT OVER COMPACT. WHEN PLANTING PIT HAS BEEN BACKFILLED, POUR WATER AROUND ROOT
- 7. SCARIFY SUBGRADE 12", RAKE SUBGRADE AND REMOVE ALL DEBRIS GREATER THAN 1/2" IN DIA. INCLUDING ROCKS, CONCRETE, ORGANIC DEBRIS, AND OR CONSTRUCTION DEBRIS.

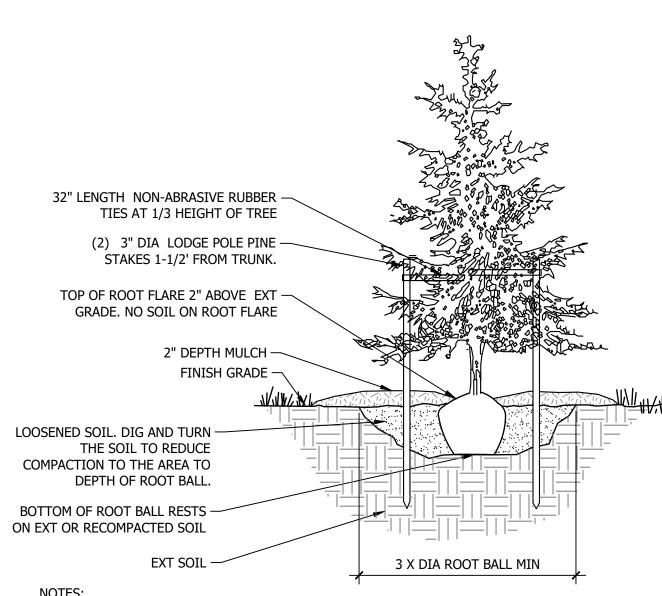

- REMOVE NURSERY STAKES. . PRUNE DEAD OR DAMAGED LIMBS IMMEDIATELY AFTER PLANTING. 3. REMOVE WIRE TIES AND BURLAP FROM TOP 1/2 OF ROOT BALL.
- 4. REMOVE ALL BASKETS. 5. PRIOR TO MULCHING, LIGHTLY TAMP SOIL AROUND ROOT BALL IN 6" LIFTS TO BRACE TREE. DO NOT OVER COMPACT. WHEN PLANTING PIT HAS BEEN BACKFILLED, POUR WATER AROUND ROOT BALL TO SETTLE THE SOIL.
- 6. BACKFILL WITH AMENDED SOIL.
- 7. REMOVE STAKES FOLLOWING FIRST GROWING SEASON. 8. PROVIDE SUPPLEMENTAL WATER FOR THE FIRST YEAR FOLLOWING INSTALLATION.

CONIFEROUS TREE

SHRUB PLANTING



2" DEEP MULCH — KEEP AWAY FROM

CROWN OF PLANT

1. REMOVE SPENT FLOWERS PRIOR TO PLANTING.

2. LOOSEN ROOT MASS AT BOTTOM OF ROOTBALL.

3. STRIP TOP OF ROOTBALL $\frac{1}{4}$ " OF SURFACE GROWING MEDIA AND

COVER WITH $\frac{1}{4}$ " PLANTING MIX PLUS SURFACE MULCH.

4. QUANTITY AND SPACING AS NOTED IN PLANT SCHEDULE.

PERENNIAL/GRASS/GROUNDCOVER PLANTING

∼ SET PLANT AT


- POTTED PLANT

----- PLANTING SOIL MIX

- EXISTING SOIL

ORIGINAL DEPTH



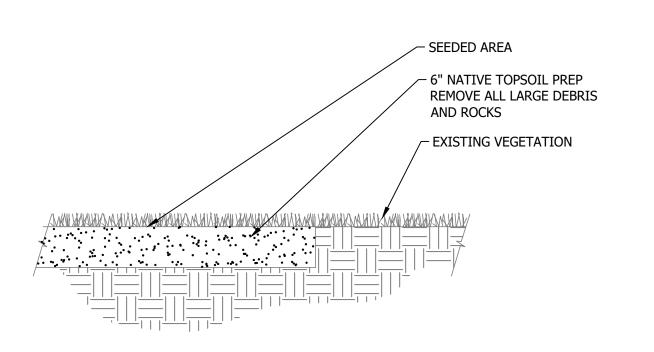

1. SCARIFY SUBGRADE 6", RAKE SUBGRADE AND REMOVE ALL DEBRIS GREATER THAN 1/2" IN DIA. INCLUDING ROCKS, CONCRETE, ORGANIC DEBRIS, AND OR CONSTRUCTION DEBRIS. 2. TOP SOIL SHALL BE 6" AND AMENDED WITH ORGANIC COMPOST.

N.T.S.







2" DEPTH OF ROCK MULCH — WEED BARRIER -COMPACT GRADES ADJACENT TO — EDGING TO AVOID SETTLING METAL STAKES TO LOCK INTO PREFORMED —

LOOPS ON THE EDGING

METAL EDGING —

TOP OF ROOT BALL ----

SHALL BE 1-2" ABOVE

SURROUNDING GRADE

MULCH AWAY FROM TRUNK

2" DEPTH MULCH, KEEP —

REMOVE CONTAINER, -

LIGHTLY SCARIFY

PLANTING SOIL MIX —

PRUNE OUT ALL DAMAGED OR DEAD WOOD.

IMMEDIATELY RETURNED TO SOURCE.

ROOTS

1. SHRUBS WITH BROKEN OR CRUMBLING ROOT BALLS WILL BE REJECTED. CONTAINER


TOP OF MULCH TO BE 1" BELOW ADJ WALKWAY, CURB, EDGING, OR OTHER SURFACE.

6. SCARIFY SUBGRADE 12", RAKE SUBGRADE AND REMOVE ALL DEBRIS GREATER THAN 1/2" IN

DIA. INCLUDING ROCKS, CONCRETE, ORGANIC DEBRIS, AND OR CONSTRUCTION DEBRIS.


4. ALL PLANT MATERIAL TO BE INSPECTED UPON DELIVERY. REJECTED MATERIALS TO BE

REMOVAL WILL NOT BE AN EXCUSE FOR DAMAGED ROOT BALLS.

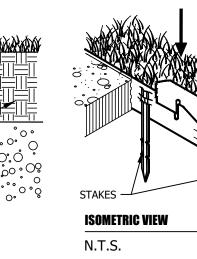


- ROCK MULCH ✓ WEED BARRIER FABRIC EXISTING SUBGRADE



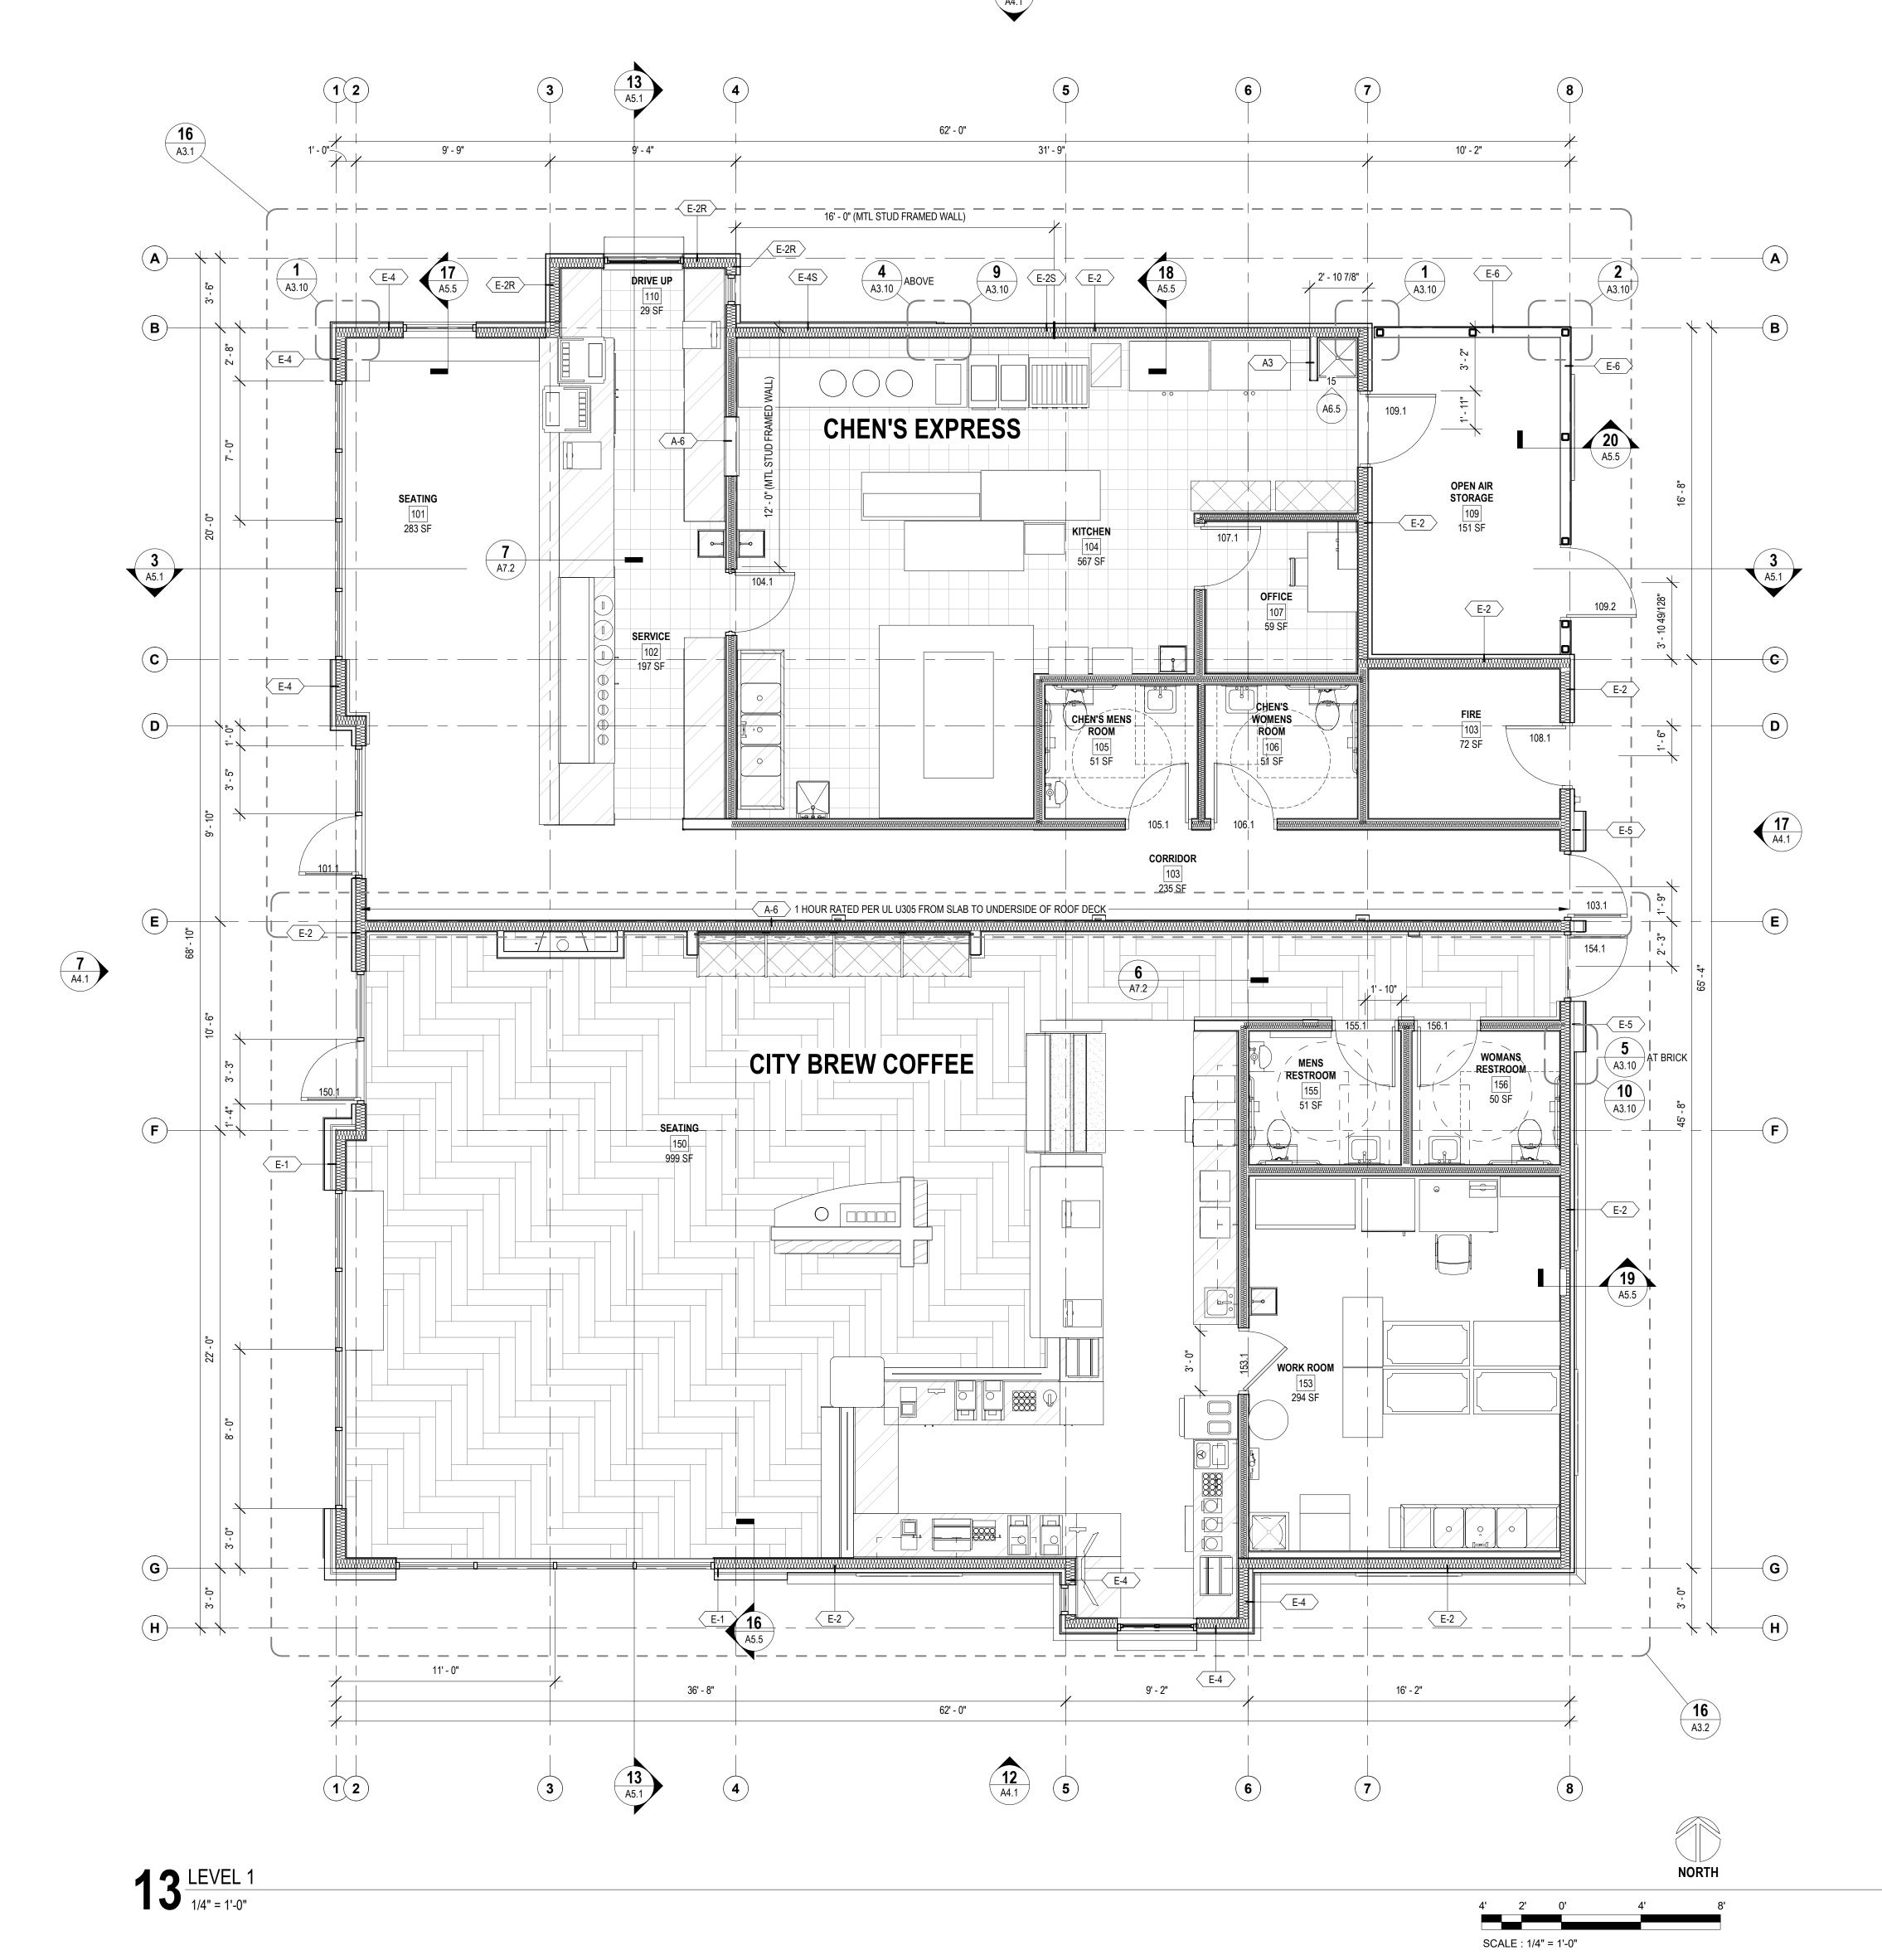

- SEAL PERIMETER

- INSERT ROOFING MEMBRANE FLASHING INTO ROOF

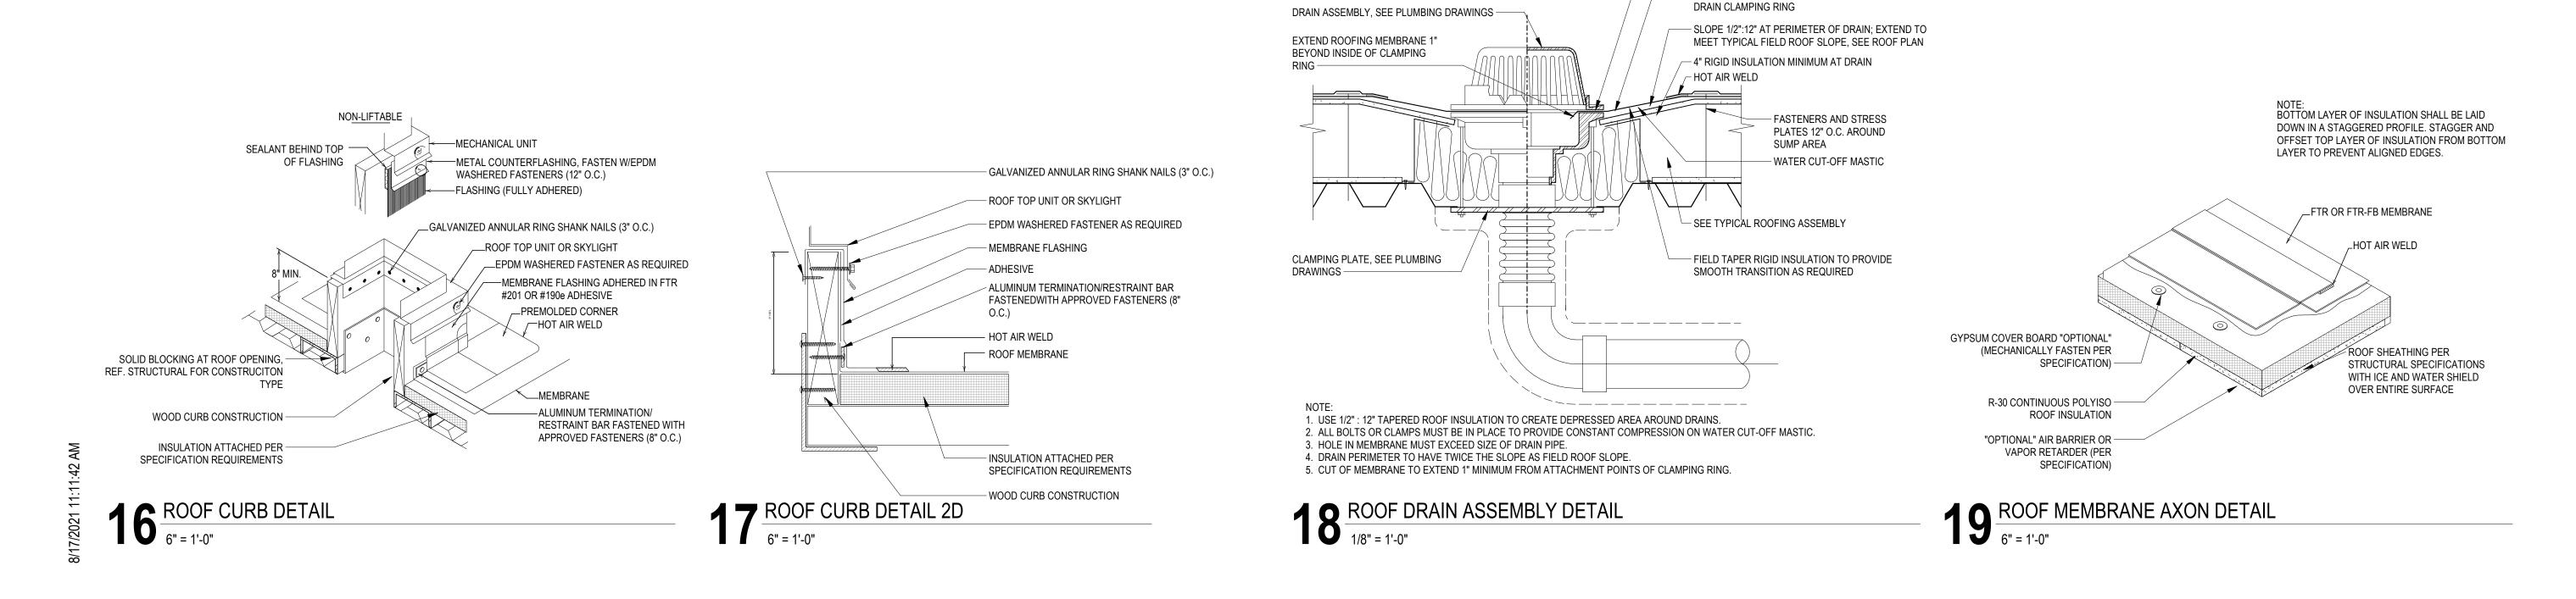

KEYNOTES

WILLIAM E. DUBEAU REG. NO. 2486 BILLINGS MT MT MT

ROOF PLAN NOTES

- PROVIDE ROOF CRICKETS AT ALL UPSLOPE AREAS OF MECHANICAL EQUIPMENT, CURBS AND ROOF
- 2. CRICKETS TO SLOPE POSITIVELY 1/4" MINIMUM PER FOOT FROM HORIZONTAL PLANE.
- MAINTAIN 1/8" PER FOOT MINIMUM FOR ALL CRICKET VALLEYS.
 CRICKETS SHOWN ARE FOR REFERENCE ONLY; CONTRACTOR TO PROVIDE DETAILED LAYOUT PLAN

FOR ARCHITECT'S REVIEW PRIOR TO INSTALLATION.

- 5. ROOF PENETRATIONS OF ANY KIND SHALL NOT BE LOCATED IN CRICKET VALLEYS.
- 6. IN ADDITION TO OPENING AND EQUIPMENT SHOWN ON THIS DRAWING, MECHANICAL AND ELECTRICAL
- 7. INDICATE ADDITIONAL ITEMS PENETRATING THE ROOF ASSEMBLY; PROVIDE APPROPRIATE
- 8. REFERENCE MECH DRAWINGS FOR VENT LOCATIONS, EQUIPMENT LOCATIONS, AND ADDITIONAL

INFORMATION, TYP.


REL CITY BREW-CHEN'S EXPRESS


eject # 21017


phase
PRICING AND



issue date
7.2.2021

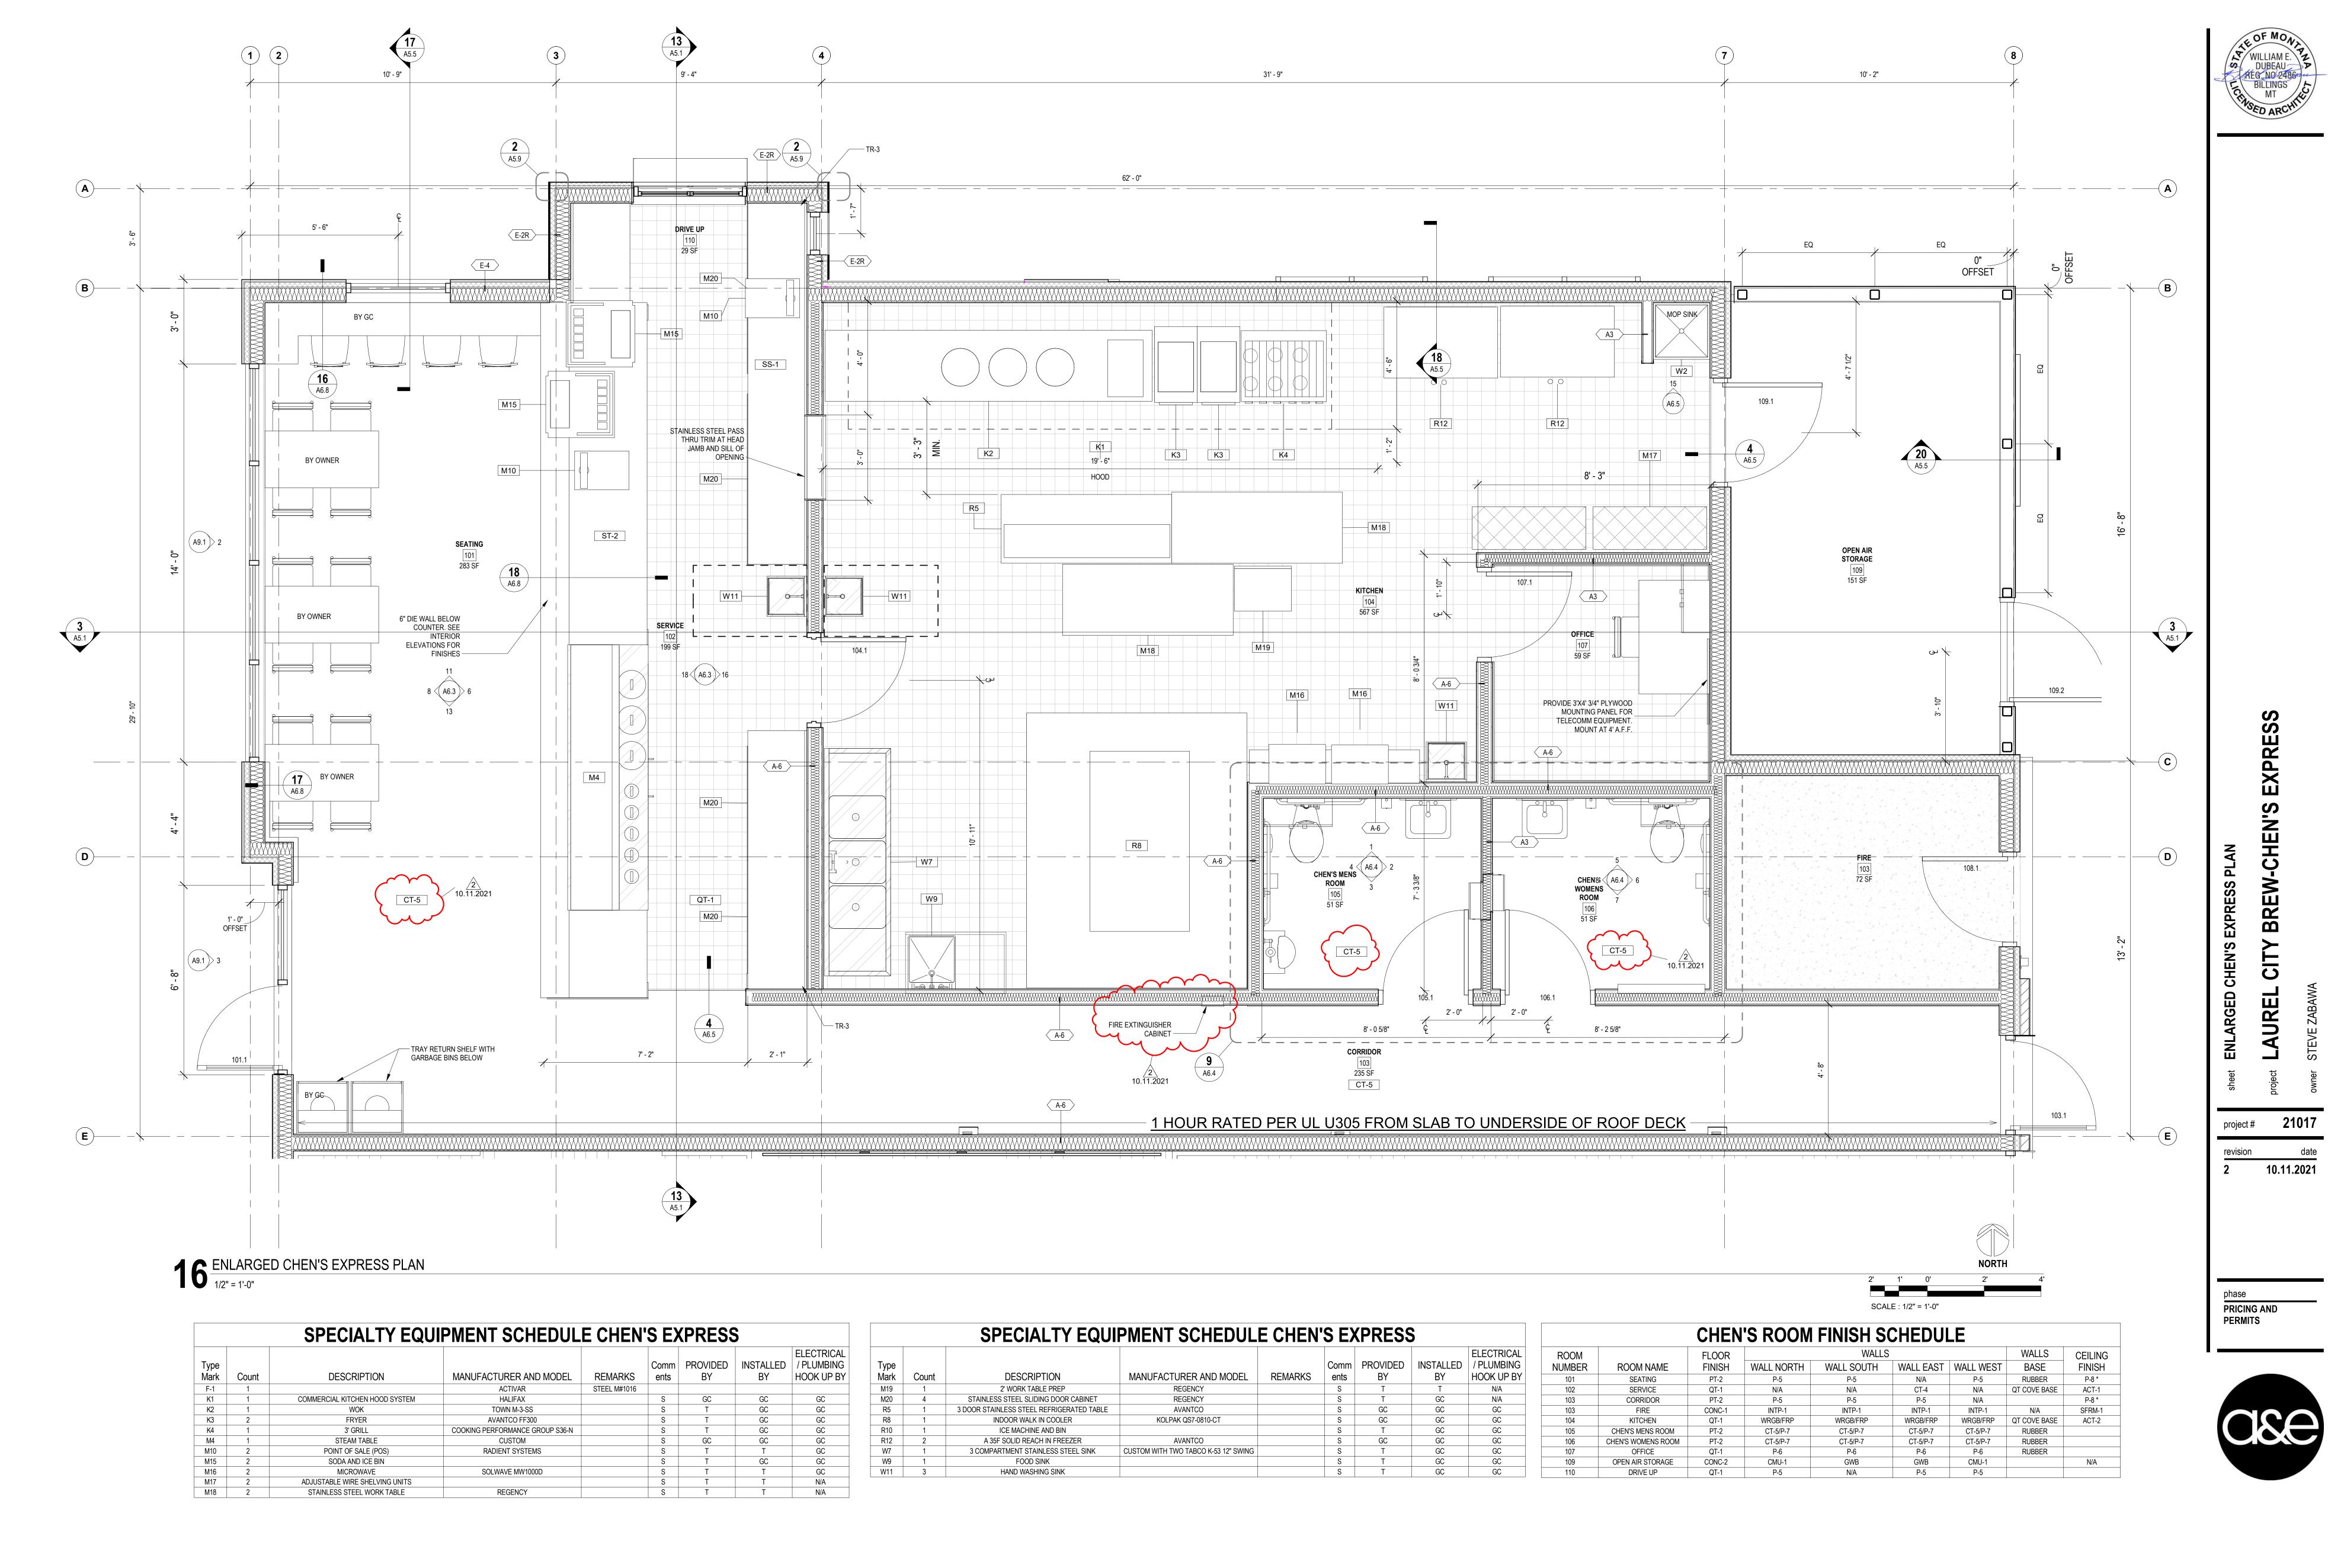

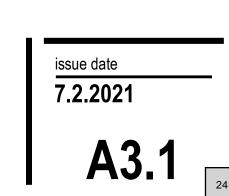

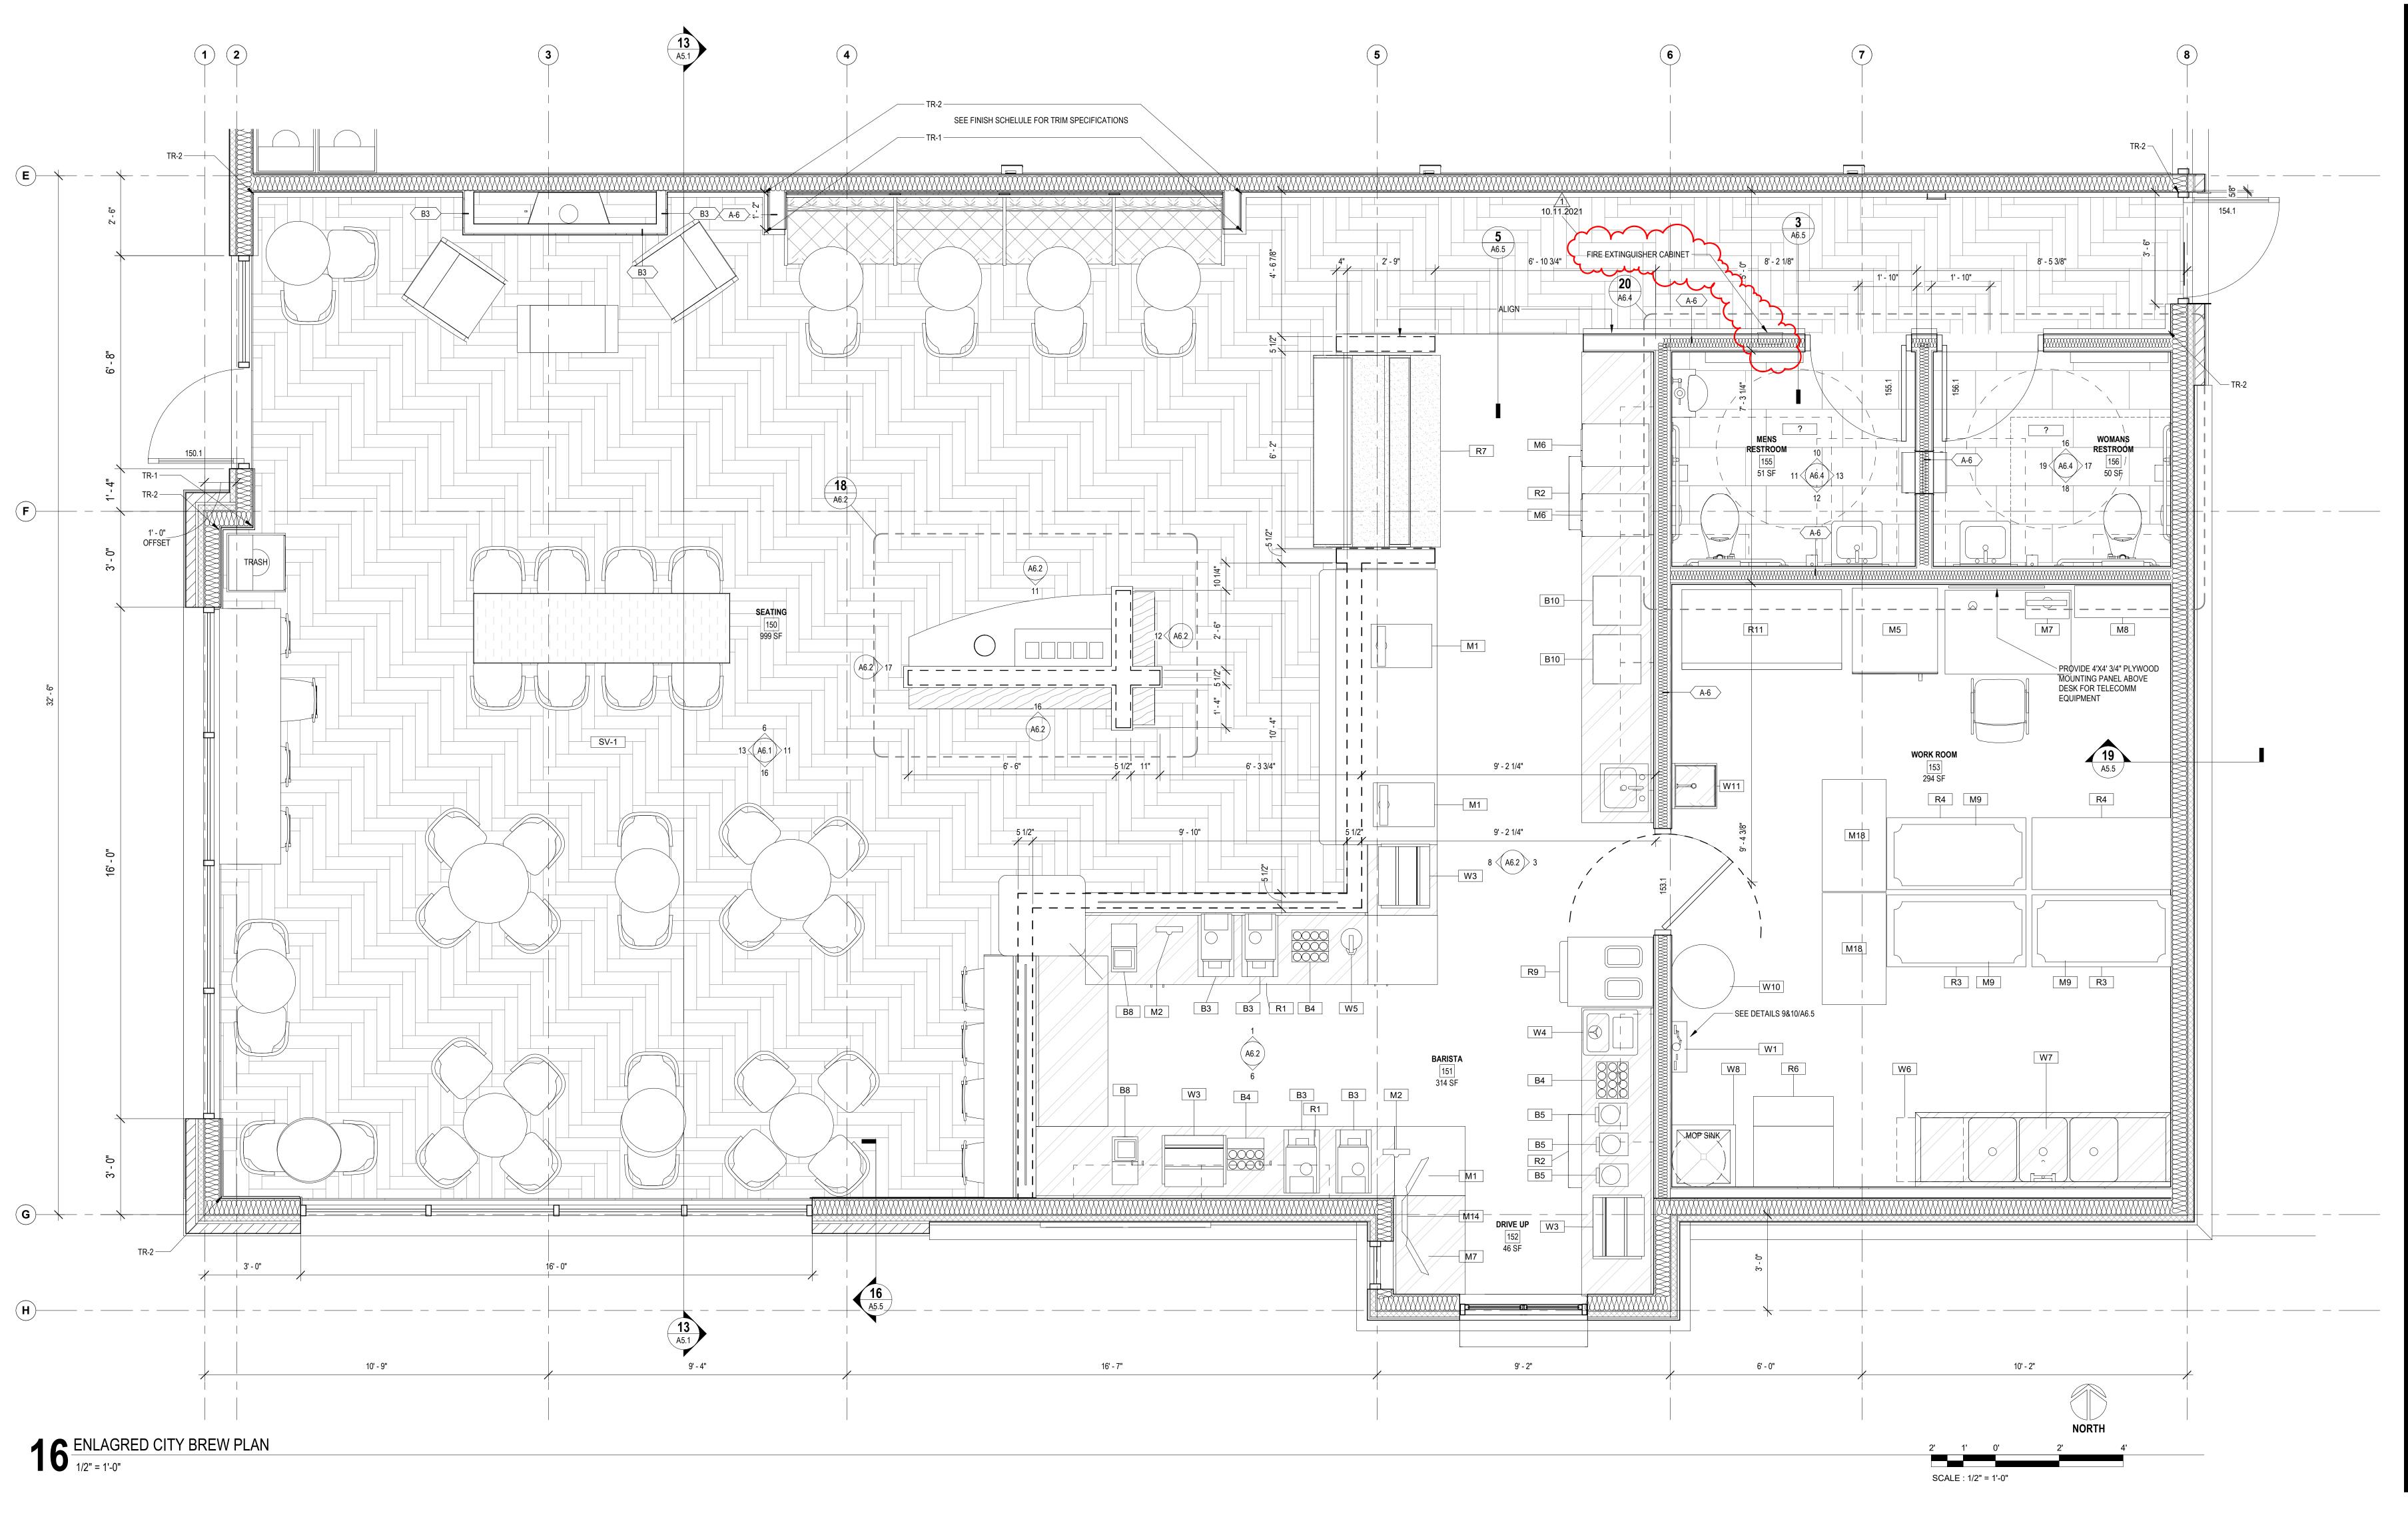

	SPECIALTY EQUIPMENT SCHEDULE CITY BREW									
Type Mark	Count	DESCRIPTION	MANUFATURER	REMARKS	Comments	PROVIDED BY	INSTALLED BY	ELECTRICAL / PLUMBING HOOK UP BY		
В3	4	ESPRESSO MACHINE	FRANKE S700		В	Т	Т	GC		
B4	3	TIRED SYRUP BOTTLE RACK	CUSTOM	CUSTOM FABRICATION BY TENANTS CABINET SHOP	В	Т	Т	-		
B5	3	ON-COUNTER BLENDER	VITAMIX QUIET ONE 36019		В	Т	T	GC		
B8	2	SINGLE BREWER WITH SERVER STAND	BUNN 27850.0006/27825.0000		В	T	T	GC		
B10	2	DOUBLE BREWER WITH SERVER STAND	BUNN 33500.0006/27872.0000		В	T	T	GC		
F-1	1		ACTIVAR	STEEL M#1016						
M1	3	POINT OF SALE (POS)	TOAST		В	T	T	T		
M2	2	KITCHEN DISPLAY	TOAST		В	T	T	Т		
M5	1	ELECTRIC OVEN ON STAND	VULCAN ECO2D		В	T	T	GC		
M6	2	TURBOCHEF MIRCOWAVE OVEN	THE SOTA DOC-1204		В	T	T	GC		
M7	2	DIGITAL WIRELESS COMMUNICATION SYSTEM	3M		В	T	T	Т		
M8	1	METAL LOCKERS	CUSTOM		В	T	T	-		
M9	4	WIRE SHELVING ABOVE REFRIDERATION UNITS	CUSTOM		В	T	T	-		
M13	1	RECESSED FIRE EXTINGUISHER	AMBASSADOR		В	GC	GC	GC		
M14	1	MONITOR	TOAST		В	T	T	T		
M18	2	STAINLESS STEEL WORK TABLE	REGENCY		В	T	Т	N/A		

Type Mark	Count	DESCRIPTION	MANUFATURER	REMARKS	Comments	PROVIDED BY	INSTALLED BY	ELECTRICA PLUMBING HOOK UP B
R1	2	LOW PROFILE UNDER COUNTER REFRIGERATOR 48"	TRUE TUC-48F-LP	2 DOOR	В	T	T	GC
R2	2	LOW PROFILE UNDER COUNTER REFRIGERATOR 27"	TRUE TUC-27-LP	2 DOOR	В	T	T	GC
R3	2	G-SERIES REACH-IN FREEZER	TRAULSEN G22010		В	T	T	GC
R4	2	G-SERIES REACH-IN REFRIDGERATOR	TRAULSEN G20010		В	T	T	GC
R6	1	AIR COOLER ICE MAKER ON STORAGE BIN	MANITOWOC IY-0504A		В	T	Т	GC
R7	1	REFRIDGERATED DISPLAY	REVEAL NR7251RRSSV		В	T	T	GC
R9	1	FROZEN UNCARBONATED BEVERAGE FREEZER	TAYLOR 342		В	T	Т	GC
R11	1	REFRIDGERATOR	TRUE TWT-60		В	T	Т	GC
W1	1	ROS REVERSE OSMOSIS SYSTEM	3M TFS450		В	T	Т	GC
W3	3	DROP IN ICE CHEST	PERLICK 7600A36	CUSTOM INSULATED ICE BIN INTEGRIL WITH SS, TOP BY NSF SHOP	В	Т	Т	-
W4	1	RINSE O' MATIC AND SINK	VITAMIX		В	Т	GC	GC
W5	1	H2O FILLER	T&S BRASS	PIPE OUTLETS TO FLOOR SINK	В	Т	GC	GC
W6	1	DISHWASHER	CMA DISHMACHINES 180UC		В	Т	GC	GC
W7	1	3 COMPARTMENT STAINLESS STEEL SINK	CUSTOM WITH TWO TABCO K-53 12" SWING		В	Т	GC	GC
W8	1	MOP SINK WITH HANGER AND WATER HEATER SHELF	FIAT PRODUCTS		В	GC	GC	GC
W10	1	REVERSE OSMOSIS TANK	3M 55984-09	TANK PROVIDED BY TENANT & INSTALLED BY GC STRAP TANK TO WALL TO MEET SEISMIC REQUIREMENTS	В	T	T	GC
W11	1	HAND WASHING SINK			В	Т	GC	GC

			REW RO	WALLS				
ROOM NUMBER	ROOM NAME	FLOOR FINISH	WALL NORTH	WALL SOUTH	WALL EAST	WALL WEST	BASE	CEILING FINISH
150	SEATING	SV-1	P-1	P-1	P-1	N/A		P-8 *
151	BARISTA	RTF-1	N/A	N/A	CT-1	N/A	RUBBER	ACT-1
152	DRIVE UP	RTF-1	N/A	CT-1	CT-1	CT-1	RUBBER	APC-1
153	WORK ROOM	RTF-1	P-4	P-4	P-4	P-4	RUBBER	ACT-1
154	CORRIDOR	SV-1	P-1	P-1	P-1	N/A		P-8 *
155	MENS RESTROOM	PT-1	CT-2/P-3	CT-2/P-3	CT-2/P-3	CT-2/P-3	RUBBER	APC-1
156	WOMANS RESTROOM	PT-1	CT-2/P-3	CT-2/P-3	CT-2/P-3	CT-2/P-3	RUBBER	APC-1





issue date
7.2.2021

A3.2

MATERIAL LEGEND



WOODSIDING HORIZONTAL DARK GREY HARDIEPLANK LAP SIDING

BRICK GENERAL SHALE, MODULAR BRICK MESQUITE, RUNNING BOND W/SOLDIER COURSE AT PARAPETS & WINDOW HEADS VERTICAL CEDAR T&G SIDING WITH V-GROOVE

> SMOOTH HARDIPANEL WITH EXPOSED PAINTED FASTENERS. SEE ELEVATIONS FOR HARDI REVEAL SYSTEM PATTERN. COLOR 1 (B.O.D. RED) TBD BY ARCHITECT

> SMOOTH HARDIPANEL WITH EXPOSED PAINTED FASTENERS. SEE ELEVATIONS FOR HARDI REVEAL SYSTEM PATTERN. COLOR 2 (B.O.D. BLACK) TBD BY ARCHITECT

KEYNOTES

TUBE STEEL FRAME SURFACE APPLIED TO EXTERIOR WALL POWDER COAT FINISH

STEEL CANOPY WITH TIE ROD SUPPORTS, REF STRUCTURAL STEEL FRAMED WALL MOUNTED AWNING WITH CANVAS COVERING

LAMBS TONGUE OVERFLOW DRAIN THRU WALL SCUPPER READY ACCESS STAINLESS STEEL SHELF MODEL 275

OWNER PROVIDED VINYL GRAPHIC

ELECTRICAL CONTRACTOR

TENANT PROVIDED EXTERIOR SIGNAGE. COORDINATE BLOCKING AND POWER WITH GC &

2 10.11.2021



7.2.2021

MATERIAL LEGEND

WILLIAM E. DUBEAU DUBEA

WOODSIDING HORIZONTAL DARK GREY HARDIEPLANK LAP SIDING

BRICK GENERAL SHALE, MODULAR BRICK MESQUITE, RUNNING BOND W/SOLDIER COURSE AT PARAPETS & WINDOW HEADS

WOODSIDING VERTICAL WOOD SLATES RECLAIMED BARN WOOD SIDING

SMOOTH HARDIPANEL WITH EXPOSED PAINTED FASTENERS. SEE ELEVATIONS FOR HARDI REVEAL SYSTEM PATTERN. COLOR 1 (B.O.D. RED) TBD BY ARCHITECT

SMOOTH HARDIPANEL WITH EXPOSED PAINTED FASTENERS. SEE ELEVATIONS FOR HARDI REVEAL SYSTEM PATTERN. COLOR 2 (B.O.D. BLACK) TBD BY ARCHITECT

KEYNOTES

TUBE STEEL FRAME SURFACE APPLIED TO EXTERIOR WALL POWDER COAT FINISH

D5-02 STEEL CANOPY WITH TIE ROD SUPPORTS, REF STRUCTURAL
D5-06 STEEL FRAMED WALL MOUNTED AWNING WITH CANVAS COVERING

07-01 LAMBS TONGUE OVERFLOW DRAIN THRU WALL SCUPPER
10-15 READY ACCESS STAINLESS STEEL SHELF MODEL 275

3-02 OWNER PROVIDED VINYL GRAPHIC

32-01 FAOX WINDOWS
32-02 TENANT PROVIDED EXTERIOR SIGNAGE. COORDINATE BLOCKING AND POWER WITH GC & ELECTRICAL CONTRACTOR

OR ELEVATIONS

REL CITY BREW-CHEN'S EXPRE

ject# **21017**

phase
PRICING AND



issue date 7.2.2021

STORM DRAINAGE PLAN FOR HAGEMAN SUBDIVISION, FOURTH FILING, LOT 1 CITY BREW & CHEN'S EXPRESS SITE IMPROVEMENTS LAUREL, MONTANA

OVERVIEW NARRATIVE

The purpose of this drainage plan is to quantify storm drainage improvements required for the site improvements on Lot 1 of Hageman Subdivision, Fourth Filing in Laurel, Montana. The project consists of demolition of the existing site and providing new site grading, one new building, asphalt paving, and storm drainage infrastructure to improve existing gravel parking areas. The project also includes asphalt paving of a 30-feet wide lane of South Montana Avenue. The proposed drainage plan consists of surface draining on-site runoff to new curb inlets that divert stormwater to one new boulder pit within the private property. Runoff from the paved South Montana Avenue lane will be directed east by surface flow to the Italian Drain in accordance with existing drainage patterns. The Italian Drain flows southeast and transitions from piped so surface flow just north of the site. This report presents a summary of calculations performed to quantify the storm water runoff for the proposed site. All design criteria and calculations are in accordance with the City of Laurel Design Requirements.

The site is located adjacent to a mapped floodplain area for the Italian Drain. No portion of the improvements is located in Flood Zone AE, the 1% chance flood zone. A small portion of the site is located within Zone X, the 0.2% chance flood zone. No floodplain permitting or mitigation is required for this project.

Specific site information and criteria are described below:

I. Project Information

- **A.** Address: The site is located on South First Avenue immediately north of the westbound I-90 offramp in Laurel, Montana 59044.
- **B.** Legal Description: The site is located on Lot 1 of Hageman Subdivision, Fourth Filing.

- **C. Total Area:** The area of the site is approximately 0.834 acres.
- **D. Existing Impervious Area:** The current site includes an existing building and paved parking lot. No storm drainage infrastructure currently exists on site. The site will be considered undeveloped with no impervious area for the purposes of calculating stormwater storage requirements.

Pervious Area – 0 SF Impervious Area – 35,856 SF

E. Post-Development Impervious Area: As a result of the project improvements the impervious area within the site will be 24,979 SF.

Pervious Area – 10,877 SF Impervious Area – 24,979 SF

II. General Design

The storm water analysis used the Modified Rational method to determine the water storage volumes. A summary of the contributing area is included with the attached calculations.

The City of Laurel Design Requirements call for complete retention of the 10-year, 24-hour, 2.4-inch storm without discharge. The geotechnical report prepared for the site by Rimrock Engineering dated February 18, 2021 shows an average infiltration rate of 25 in/hr measured for the site. A factor of safety of two was applied to that infiltration rate resulting in 12.5 in/hr, which was used in the volume calculations. As shown in the attached calculations and spreadsheet output, the required storage volumes for the design storm is approximately 1,487 cubic feet. The storm water runoff will be stored below ground in one boulder pit with an approximate storage volume of 1,824 cubic feet using a 38-percent porosity.

Boulder Pit

Watershed Area: 0.83 Acres

Storage Volume Required: 1,487 CF

Storage Volume Provided: 60° L x 20° W x 4° D x 0.38 = 1,824 CF

The boulder pits are designed to key directly into the native gravels. No public storm drainage infrastructure currently exists close to the site. During storms larger than the design storm, overflow from the boulder pit will be directed via surface grading eastward over South Montana Ave and into the Italian Drain.

III. Conclusions

The calculations included below show that the storm water drainage system for the Hageman Subdivision Parking Lot Improvements will meet the requirements of the City of Laurel criteria. If all recommendations are implemented as mentioned in this report, storm water impacts will be mitigated.

RUNOFF CALCULATIONS FOR COMMERCIAL SITE DEVELOPMENT UNDER 5 ACRES

Input parameters in light blue

Total Required Storage: 10 year design storm

Surface Type	Area (ft²)	Area (Acres)	Runoff Coefficient (C)*	Frequency Factor (C _f)	C x C _f	Calculation Value (C') =(C x Cf) < or = 1	C' x A (Acres)
Building/Roof	4,030	0.09	0.95	1.00	0.95	0.95	0.08789
Asphalt/Concrete	20,949	0.48	0.95	1.00	0.95	0.95	0.456877
Landscape	10,877	0.25	0.10	1.00	0.10	0.10	0.02497
Totals	35,856	0.82					0.57

^{*}Input values for Runoff Coefficients (C) from 'Runoff Coefficients' tab

Percolation Discharge Rate:

Infiltration Ar	ea	Rate	Discharge
Length (ft)	Width (ft)	(in/hr)	(cfs)
60	20	12.5	0.347

Measured	Allowable*	
min/inch	in/hr	in/hr
2.400	25	12.5

*Equals 50% of measured


Rainfall	Rainfall	unoff Volum	scharge Volun	Site Detention	Peak Flow
Duration, t	Intensity, i	= C _{wd} x SA _j x i x t	= d x t	= Runoff Volume - Discharge Volume	=C*I*A
(min)	(in/hr)	(ft ³)	(ft ³)	(ft ³)	(ft ³ /sec)
0	0.00	0.00	0.00	0.00	0.00
5	6.18	1056.29	104.17	952.13	3.52
10	4.19	1432.32	208.33	1223.99	2.39
15	3.31	1697.25	312.50	1384.75	1.89
20	2.73	1866.46	416.67	1449.79	1.56
25	2.35	2008.32	520.83	1487.49	1.34
30	2.05	2102.33	625.00	1477.33	1.17
35	1.85	2213.43	729.17	1484.26	1.05
40	1.68	2297.18	833.33	1463.85	0.96
45	1.54	2368.97	937.50	1431.47	0.88
50	1.43	2444.17	1041.67	1402.51	0.81
55	1.33	2500.58	1145.83	1354.74	0.76
60	1.26	2584.33	1250.00	1334.33	0.72
120	0.67	2748.41	2500.00	248.41	0.38
180	0.47	2891.99	3750.00		0.27
360	0.27	3322.71	7500.00		0.15
720	0.16	3938.02	15000.00		0.09
1440	0.10	4922.53	30000.00		0.06

Water Quantity Storage: 1,487 ft³

National Flood Hazard Layer FIRMette




Basemap: USGS National Map: Orthoimagery: Data refreshed October, 2020

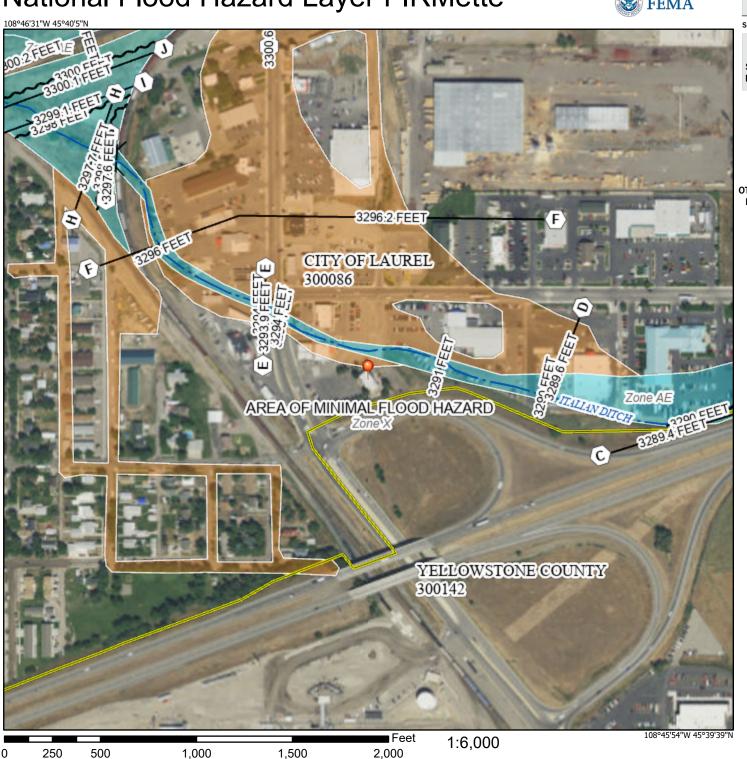

Legend

SEE FIS REPORT FOR DETAILED LEGEND AND INDEX MAP FOR FIRM PANEL LAYOUT

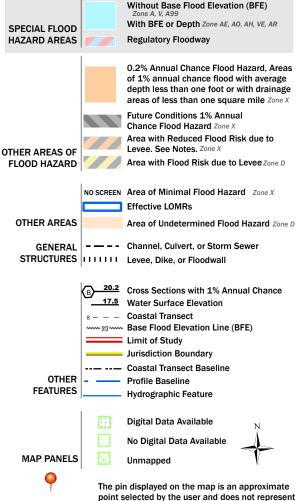

This map complies with FEMA's standards for the use of digital flood maps if it is not void as described below. The basemap shown complies with FEMA's basemap accuracy standards

The flood hazard information is derived directly from the authoritative NFHL web services provided by FEMA. This map was exported on 3/8/2021 at 5:08 PM and does not reflect changes or amendments subsequent to this date and time. The NFHL and effective information may change or become superseded by new data over time.

an authoritative property location.

This map image is void if the one or more of the following map elements do not appear: basemap imagery, flood zone labels, legend, scale bar, map creation date, community idea FIRM panel number, and FIRM effective date. Map in unmapped and unmodernized areas cannot be used regulatory purposes.