

AGENDA CITY OF LAUREL CITY/COUNTY PLANNING BOARD WEDNESDAY, NOVEMBER 17, 2021 5:35 PM CITY COUNCIL CHAMBERS

Public Input: Citizens may address the committee regarding any item of business that is not on the agenda. The duration for an individual speaking under Public Input is limited to three minutes. While all comments are welcome, the committee will not take action on any item not on the agenda.

1. Roll Call

General Items

2. Approve Meeting Minutes: September 15, 2021

3. Approve Meeting Minutes: October 20, 2021

New Business

4. Public Hearing: Annexation Request for 306 W. 12th St (Reschedule)

5. Sign Review: Canyon Creek Brewing

Old Business

<u>6.</u> Project Review: City Brew / Chen's Express

Other Items

7. Adjourn

Announcements

8. Next Meeting: December 15, 2021

The City makes reasonable accommodations for any known disability that may interfere with a person's ability to participate in this meeting. Persons needing accommodation must notify the City Clerk's Office to make needed arrangements. To make your request known, please call 406-628-7431, Ext. 2, or write to City Clerk, PO Box 10, Laurel, MT 59044, or present your request at City Hall, 115 West First Street, Laurel, Montana.

DATES TO REMEMBER

File Attachments for Item:

2. Approve Meeting Minutes: September 15, 2021



AGENDA CITY OF LAUREL CITY/COUNTY PLANNING BOARD WEDNESDAY, SEPTEMBER 15, 2021 5:35 PM CITY COUNCIL CHAMBERS

Public Input: Citizens may address the committee regarding any item of business that is not on the agenda. The duration for an individual speaking under Public Input is limited to three minutes. While all comments are welcome, the committee will not take action on any item not on the agenda.

1. Roll Call

The Chair called the meeting to order at 5:35pm.

Jon Klasna
Ron Benner
Gavin Williams
Evan Bruce
Roger Giese
Dan Koch
Judy Goldsby
Nick Altonaga (City of Laurel)

General Items

2. Approve Meeting Minutes: August 18, 2021

Minutes to be pushed to the October Meeting.

3. Public Hearing: NorthWestern Energy Zone Change

The Planning Director summarized the Zone Change request and presented his staff report and suggested conditions of approval.

The Chair called for Opponents.

The Chair called for Opponents.

The Chair called for Opponents.

The Chair called for Proponents.

The Chair called for Proponents.

The Chair Called for Proponents.

Roy Ishkanian, Manager of Lands and Permitting, NW Energy.

3524 Glenfinnan Rd, Billings, MT

We are going through this process. The ultimate approval will be at the MT Public Service Commission. We feel good about this project. The Gas Line is just about wrapped up for this site. Purchased the line from Phillips and rehabbed it to serve the station.

See this as important to keep the price of energy level, instead of having extreme variable prices like we've seen across the country.

Ron Benner: What will the noise level be?

Roy: The noise level will actually be low. The noise will be aimed towards the other industrial uses (CHS and Utility Plants) and not the river or other areas. At approximately 400ft it will be 63 decibels.

Question on staffing levels.

• 15-20 full time.

Ron: accesses to the site?

• Roy: Lindy Lane, Strow Rd, and Sewer Plant Rd. Utilize Lindy as the current primary access for the station that is there right now.

Power generation, supply, and location are all important for this facility.

Judy: Where does Lindy Lane come out to?

• Roy: It comes up to the Frontage Rd.

Nick: Any consideration of annexation?

• Roy: Still being discussed by Project Mangers, but you will be the first call.

Roger: Timeline of development?

• Roy: Expect a 3 year timeline, to be done in 2025.

Ron: One concern seeing this was the access to the site through Sewer Plant Rd. and what the costs might be to improve the roadway?

• Roy: Not planned to improve the roadway at this time. Primary access will be through Lindy Lane.

Judy: If someone were to stand on Sewer Plant road looking towards the site, what would we see?

• Main hall building, stacks, Small administrative building (low rise single story like city hall), as well as parking area.

Ron: Height of the smokestacks?

- Roy: I don't actually know the answer but can get back to Nick with that answer.
- (Roy provided the information via email on 9/16/2021 smokestacks will be 77ft tall).

Gavin Motioned to approve the zone change application for Parcel 1, COS 139 and Parcel 2, COS 1677 with the stated staff conditions

Evan Seconded.

Motion Carried.

4. Public Hearing: 810 W. 7th Street Annexation and Zone Change

Nick presented the findings contained in the Staff report including the stated conditions of approval.

The Chair called for Opponents.

The Chair called for Opponents.

The Chair called for Opponents.

The Chair called for Proponents.

Scott Slothower, 314 1st St. Park City, MT: Nick laid out the situation pretty well. The leech field is extremely small, with the house set back. Not sure how it was initially approved. Worked with Cotter's Sewer to fix it but it was found that the roots from the surrounding trees were choking the leech field making it unusable.

The Chair called for Proponents.

The Chair called for Proponents.

Ron: clarification on addresses?

- We were preparing to sell it last year when the issues with the septic system were found. We ran out of funds last year to continue the process last year. And we are in a better position this year to finalize it.
- The building will go to the Slothowers.

Ron: On the receipt from Cotter's, what if the cost exceeds the \$\$ amount? Will the city have to make up the difference?

- Scott: the not to exceed amount is the Cotter's sewer guarantee that it will NOT exceed that amount.
- From my experience in Steel business, we sometimes give not to exceed amounts as contractors. IF it exceeds that amount, the contractor will eat the amount, That is the assumed intent. This is a BID not to exceed that stated amount.

Ron: Hate to bash the city but the maps are not accurate. The maps on some projects have been COMPLETELY WRONG.

• Scott: Cotter's has located at least part of the water main system.

Members discussed the implications or reasoning behind Not asking adjacent properties to the west to annex as well?

• Nick provided info on his decision not to reach out to adjacent property owners: the adjacent right of way is not punched through fully, it would not be sensible to do a large scale annexation of those houses at this time.

The Chair closed the public hearing.

Ron Motioned to approve the annexation and zoning request for $810~W~7^{th}$ Street with the conditions stated in the staff report.

Evan Seconded.

Motion Carried.

New Business

5. Sign Review: On the Run (Conomart)

Nick presented the Façade and signage changes for the Conoco, (Now, On The Run).

Gain Motioned to approve the proposed changes to the signage and façade of the On The Run building. Evan Seconded.

Motion Carried.

Old Business

Other Items

- 6. Project Update
- Cherry Hills 3rd Filing Approved last night
- Bitterroot Grove Approved. Will be brought to council and Planning Board again
- Golf Course Annexation
- Lucky Louie's Relocation
- Regal Community Park? Fencing along the property? Enforcement concerns.
- Soda Station site concerns
- Zoning and Nuisance Code violations.
- Nuisance properties within the city limits.

Announcements

7. Adjourn

Meeting Adjourned at 6:54pm.

8. Next Meeting: October 20, 2021

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DATES TO REMEMBER

File Attachments for Item:

3. Approve Meeting Minutes: October 20, 2021



MINUTES CITY OF LAUREL CITY/COUNTY PLANNING BOARD WEDNESDAY, OCTOBER 20, 2021 5:35 PM CITY COUNCIL CHAMBERS

Public Input: Citizens may address the committee regarding any item of business that is not on the agenda. The duration for an individual speaking under Public Input is limited to three minutes. While all comments are welcome, the committee will not take action on any item not on the agenda.

1. Roll Call

No Quorum. No Meeting was held.

General Items

- 2. Approve Meeting Minutes: August 18, 2021
- 3. Approve Meeting Minutes: September 15, 2021

New Business

4. Building Plan Review: City Brew/Chen's Express

Old Business

Other Items

- 5. Project Updates
- 6. Adjourn

Announcements

7. Next Meeting: November 17, 2021

The City makes reasonable accommodations for any known disability that may interfere with a person's ability to participate in this meeting. Persons needing accommodation must notify the City Clerk's Office to make needed arrangements. To make your request known, please call 406-628-7431, Ext. 2, or write to City Clerk, PO Box 10, Laurel, MT 59044, or present your request at City Hall, 115 West First Street, Laurel, Montana.

DATES TO REMEMBER

File Attachments for Item:

5. Sign Review: Canyon Creek Brewing

CONSTRUCTION PERMIT AND APPLICATION CITY OF LAUREL, MONTANA

PERMIT No. 494

Job Address 331 S. Washing ton Owner Canyon Creek Hostons / Sterle Sols	ers Telephone : 860 - 4004
Contractor Epcon Sign Group Address 1/3/ Monad Rd 13/95 59/0/ Telephone 406 - 248 - 740/	Subdivision Lot Block Tract Zoning
City License / 26	Valuation of Project \$ 5000 © Description of Work: / NSTALL A SINGUE
Special Conditions	BULDING ON WESTSISE NON-ILLIAM ALBRED
Occupancy Type of Construction Number of	

BUILDING Approved	fo Issue By	Date	

Application is hereby made to the City of Laurel Building Code Official for a permit subject to the conditions and restrictions set forth. All provisions of laws and ordinances governing this work will be complied with whether specified herein or not. Each person upon whose behalf this application pertains, at whose request and for whose benefit work is performed under or pursuant to any permit issued as a result of this application agrees to, and shall indemnify and hold harmless the City of Laurel, it's officers, agents and employees.

The granting of this permit does not give authority to cancel or violate the provisions of any state or local law regulating construction or the performance of construction.

"Compliance with the requirements of the state building code for physical accessibility to persons with disabilities does not necessarily guarantee compliance with Americans With Disabilities Act of 1990, the Rehabilitation Act of 1978, the Fair Housing Amendments Act of 1988, Title 49, chapter 2, commonly known as the Montana Human Rights Act, or other similar federal, state, or local laws that mandate accessibility to commercial construction or multifamily housing."

Any permit issued as a result of this application becomes null and void if work is not commenced within 180 days of issuance of such permit, unless a written request to extend this time is submitted to the City of Laurel Building Department and approved.

The applicant is responsible for calling to obtain underground line locations 1-800-424-5555 two days before digging.

All general contractors shall have a current City of Laurel business license.

The permit holder is responsible for giving 24 hour notice for required inspections.

I hereby certify I have read this application and the information provided is true and correct to the best of my knowledge.

FEES AND CHARGES

1000-323011 building	\$
1000-323014 plan review	\$
1000-323011 fence	\$
1000-323011 roof	\$
1000-323053 sign	\$
1000-323011 mh install	\$
1000-323011 investigation	\$
1000-323011 re-inspection	\$
1000-322022 utility hook up	\$
5210-343033 SDF water	\$
5310-343033 SDF sewer	\$
other	\$
Total Amount due	\$
Amount Paid	\$

Signature of Applicant ___

Date /1/8/2

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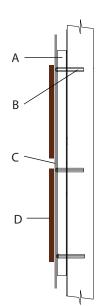
5. Washington

SE 44 S

11



FILMED FACTORY WHITE ALUPANEL.3M VINYL.COMPUTER ROUTED 1" LETTERS AND LOGO.PRIME AND PAINT SMOOTH.MOUNT FLUSH.



A 2"ALUMINUM SQ.TUBE WELDED FRAME

B 3/8" LAGS AND SHIELDS

C 3MM FACTORY ALUPANEL

D 1"HDU COPY AND TRAIN

N.T.S. SINGLE FACE WALL DISPLAY

FINISH COLORS
1 WHITE
2 DARK BROWN

2 DARK BROWN 3M 59 3 BLACK 3M 22 4 YELLOW ORANGE BLEND

SPECIFICATIONS

BASE



SINGLE FACE BUILDING DISPLAY



Chapter 17.26 - COMMUNITY ENTRYWAY ZONING DISTRICT

Sections:

17.26.010 - Intent.

The purpose of the Laurel Entryway Zoning District is to regulate outdoor advertising, outdoor advertising signs, and outdoor signs of all types, to provide fair and comprehensive regulations that will foster a good visual environment for Laurel, enhancing the area in which we live, and creating an aesthetic and enjoyable appearance for our visitors and our residents.

The natural landscape in the Yellowstone Valley is a major influence on the form and character of Laurel. Residents appreciate being able to see the Beartooth Range, the river's corridor of trees, and the large expanse of sky. The intent of the Community Entryway Zoning District (EZD) is to promote attractive, high quality development and to provide an appealing image of the city of Laurel to the traveling public and the people of the community and region. Further, it is the intent of this district to maintain a sensitivity toward existing development while preserving scenic vistas and the pastoral ambience and protecting environmentally sensitive areas. Creativity in meeting these requirements is encouraged with the overall intent of all development representing the image and economy of the Laurel area—and not just a reflection of the same commercial buildings, signage, and parking lots that are seen alongside the interstate across the nation.

Projects in the vicinity of large natural areas/corridors shall be designed to compliment the visual context of the natural area. Techniques include architectural design, site design, use of native landscaping, and choices of colors and building materials shall be utilized in such manner that scenic views across or through the site are protected and man-made facilities are screened from off-site observers and blend with the natural visual character of the area.

This overlay district provides requirements that are in addition to the existing, underlying zoning districts in the jurisdictional area of the city of Laurel and are in addition to the signage standards of the city of Laurel Municipal Sign Code. Except for signage applications, residential uses in the Entryway Zoning District are exempt from the provisions herein.

The intent of this section is to:

- A. Promote a physical landscape that will assist in making Laurel an attractive place to live and work and be inviting to new industries;
- B. Encourage creativity in design and quality in site planning and development;
- C. Reduce the level of adverse impacts from the transportation system on adjoining lands;
- D. Promote development patterns in harmony with the goals and objectives of Laurel's Growth Management Plan;
- H. Promote compatible land use transitions with a sensitivity toward existing residential uses.

Non-commercial/industrial uses falling within the EZD are exempt from the requirements of the EZD except as such requirements pertain to signage.

(Ord. 02-31, 2002)

17.26.030 - Location of district.

The Community Entryway Zoning District (EZD) shall extend three hundred feet on either side of Interstate 90 right-of way as it extends through the Laurel Zoning Jurisdiction Area, an area that extends outside the city municipal limits one mile. Specifically, along the interstate the EZD shall extend as described from the east limit of the extra-territorial zoning boundary west to the limit of the west extra-territorial boundary. The district shall also include that area three hundred feet on either side of the north extra-territorial boundary on Buffalo Trail Road south through Laurel on First Avenue to where First Avenue turns into US Highway 212-310

(Ord. 02-31, 2002)

(Ord. No. O15-03, 5-5-2015)

17.26.040 - Application and approval process.

- A. All plans and applications for development shall be submitted to the city-county planning board. All applications involving signs shall be submitted to the public works department which shall provide a copy thereof to the planning board. All applications must be submitted and signed by the property owner, lessee, the contract purchaser, or the authorized agent of the property owner. Approval is required prior to any construction activity.
- B. Each application shall include, but not be limited to, the following information:
 - 1. The name and address of the property owner;
 - 2. The name and address of the applicant;
 - 3. The legal description of the parcel;
 - 4. A map drawn to scale showing the dimensions, acreage, location of the parcel, north arrow, streets and adjacent land uses;
 - 5. A complete site plan drawn to a scale of no less than 1" = 40' showing the dimensions and locations of all structures, streets, paving, parking, landscaping, signage, waterways or other significant features of the development;
 - 6. Complete elevation drawings drawn to scale including the dimensions and height of the structure;
 - 7. Signage Plan specifications, location, and ground lighting pattern (applications for signs only—see Section 17.26.050); and
 - 8. Application review fee.
- C. Within fifteen working days following the submittal of a complete application, the planning director, other city designee, or the public works department (in the case of signs) shall issue approval for development or sign or a denial of the application, unless the applicant consents in writing to an extension of the review period. Should the application be denied, the applicant shall be notified in writing specifying the reasons for the denial.

(Ord. 02-31, 2002)

17.26.050 - Definitions.

All terms shall have the same meanings as defined elsewhere in the city zoning ordinance or city signage regulations. The standard dictionary meaning shall be applied to terms not otherwise defined.

(Ord. 02-31, 2002)

17.26.052 - Development standards.

A. Signage.

- 1. Review Consideration. Signage in the EZD needs to recognize the relationship between adjacent land uses and the natural features of the location such as existing views and proximity to residences. Although signs perform a function in providing information concerning services, products, and business, a profusion of signs produces a cumulative effect that cancels out individual effectiveness and detracts from the appearance of the community as a whole. All signage shall be reviewed with the following considerations and criteria:
 - a. Use of subdued, low-key colors;
 - b. Location, size, and height that do not obstruct views of the community, the river corridor, traditional open spaces, or the mountains;
 - c. Sign is built of permanent, durable materials;
 - d. Size and location avoids or minimizes the sense of clutter with nearby signs;
 - e. The sign is professionally prepared and finished on both sides;
 - f. The location and placement of the sign will not endanger motorists or pedestrians and does not interfere with the clear vision triangle at street, railroad, or street driveway intersections;
 - The sign will not cover or blanket any prominent view of a structure or façade of historical or architectural significance;
 - h. The sign will not obstruct views of users of adjacent buildings to side yards, yards or to nearby open space;
 - The sign will not negatively impact the visual quality of a public open space such as a recreation facilities, square, plaza, court yard and the like;
 - j. The sign cannot be seen from the Yellowstone River or any city, county or state park or—if it can be seen—it must be located one thousand feet from the boundaries of such spaces.
- 2. Only one sign is allowed per parcel of record and there shall be at least one thousand feet between signs.
- 3. A construction permit is required whenever the sign copy is changed and any alterations to the sign are made.
- 4. Signs shall be limited to one hundred sixty square feet in copy area.
- 5. Non-conforming signs are required to be brought into compliance with this section within six years from the date of adoption of this ordinance or upon the earliest occurrence of the following events.
 - a. The sign is relocated or replaced;

- b. The structure or size of the sign is altered in any way;
- The sign suffers more than fifty percent appraised damage or deterioration or the sign is taken out of service for any reason, such as being knocked down by weather or other means;
- d. If any non-conforming sign is abandoned or voluntarily discontinued for a period of one hundred eighty days, any subsequent use must be in conformity with this ordinance. An abandoned sign is a sign which no longer identifies or advertises a bona fide business, lessor, service, owner, product, or activity, and/or for which no legal owner can be found. An abandoned sign is to be removed by the owner within fifteen days of notice from the public works department.
- 6. No portable signs as described in the city signage ordinance are allowed in the EZD.
- 7. Transit Bus Benches. Transit bus benches, with or without advertising, may be placed within the city right-of-way upon application and approval of the ADA coordinator, the transit administrator and in consultation with the public work director. All benches must comply with any applicable city, state, and or/federal standards or regulations. The city may approve a bench provider, with or without advertising, pursuant to its procurement policy, as amended.
- 8. Lighting. All sign lighting must incorporate cut-off shields to direct light downward. Luminaries shall not be visible from adjacent streets or properties. A sign's lighting will not cause hazardous or unsafe driving conditions for motorists and will not glare, reflect, or spill onto adjacent business or residential areas.

B. Building Design Standards.

- 1. All buildings shall be completed on all sides with one of the following finishing material: brick, fluted block, colored textured block, glass, stucco, architectural concealed fastener metal panels, exterior insulation and finishing systems (i.e., Dryvit, etc.), stone or wood. Exposed seam metal buildings shall be prohibited unless covered with an acceptable finishing material.
- 2. Roofs shall be finished with a material that is architecturally compatible in color and design with the construction of the building. Metal roofs, fascia, and mansards shall be limited to the following: standing seam, metal shakes or shingles and architectural metal treatments. All mechanical equipment placed on top of any roof shall be screened by a parapet or other similar architectural apparatus being at least the height of the mechanical equipment. Pitched roofs are encouraged whenever possible.
- 3. Long, flat facades that front on the interstate highway, First Avenue North or First Avenue South having more than one hundred lineal feet are prohibited. Buildings over one hundred feet in length shall incorporate one of the following: recesses, off-sets, angular forms, landscaping features or other architectural features such as bell towers, clock towers, to provide a visually interesting shape. The break in the facade shall be minimum of eight feet in length. A single uninterrupted length of a facade shall not exceed one hundred lineal feet. It is encouraged that each offset area contains landscaping or other similar amenities which will complement the offset area.

C. Additional Provisions for Commercial Uses.

1. Storage of Merchandise. Any permitted storage of merchandise outside an approved building shall be within an area enclosed with a sight obscuring fence at least six feet in height that is architecturally compatible in color and design with the building. However, promotional

displays, vehicle sales lots and plant materials may be displayed outside of an approved building or enclosed area so long as they are placed appurtenant to a building wherein the business displays the bulk of its goods for sale. In addition, retail nurseries shall be exempt from the enclosure of plant materials, and displayed merchandise shall not include any used equipment. Bufferyards or required landscaping shall not be used for the displaying of merchandise.

- 2. Site Lighting. All outdoor lighting shall be designed, located and mounted at heights no greater than eighteen feet above grade for non-cutoff lights and thirty-five feet above grade for cutoff lights. All outdoor lighting shall be designed and located such that the maximum illumination measured in foot-candles at the property line shall not exceed three-tenths foot-candle for non-cutoff lights and three foot-candles for cutoff lights.
- 3. Storage of Junk. No person shall store junk, partially or completely dismantled vehicles, or salvaged materials in any commercial zone outside a building. In the case of automobile repair shops, such materials must be enclosed within a building or an area having a sight-obscuring fence at least six feet in height.
- 4. Solid Waste Area. All solid waste storage facilities shall be located within an area enclosed with a sight-obscuring fence or wall that is architecturally compatible in color and design with the building.

D. Cell Towers.

No wireless communication facilities are allowed in the entryway zone.

(Ord. 02-31, 2002)

(Ord. No. O11-07, 6-7-2011; Ord. No. O16-02, 2-2-2016)

17.26.054 - Landscaping standards.

Landscaping in the form of trees, shrubs, and groundcover serve several purposes: The softening of harsh building forms and paved areas, the absorption of ground water, the reflection of seasonal color change, the provision of sound barriers (such as around utility substations or industrial yards), and urban wildlife habitat.

A. Landscaping Definitions.

Canopy Tree. A species of tree which normally bears crown foliage no lower than six feet above ground level upon maturity. Minimum size of canopy trees shall be two and one half inches in caliper.

Evergreen Tree or Shrub. A tree or shrub of a species which normally retains leaves / needles throughout the year. Minimum size of evergreen trees shall be five feet in height.

B. Landscaping.

1. Bufferyard Requirements. All commercial/Industrial land uses are required to place a bufferyard (landscaping strip) adjacent to and along the length of I-90, First Avenue North, or First Avenue South on which the use fronts. Such landscaping buffer shall extend from the edge of the public right-of-way. Placement and landscaping design shall be at the discretion of the developer, and the required trees and shrubs may be clustered to enhance the view of the

property from the public right-of-way as long as such uses conform with Section 17.26.052(C) of this code. A local design professional or local nursery must be consulted for assistance with the development of the landscape design. The use of native, drought-tolerant plant material is strongly encouraged. Evergreen trees are encouraged for bufferyards, and canopy trees are encouraged for parking areas. The planting of trees should be done in such a manner as to provide maximum solar efficiency throughout the site.

- a. The developer shall have the option of one of the following three bufferyards. Bufferyard depth is measured from the property line adjacent to the public right-of-way inward. Any buffer area which overlaps another buffer area shall be subtracted from the total to avoid double counting. The number of trees and shrubs required is per one hundred feet of frontage:
- (1) Twenty-five foot wide bufferyard: five Canopy or evergreen trees, ten Shrubs
- (2) Twenty foot wide bufferyard: ten Canopy or evergreen trees, fifteen Shrubs
- (3) Fifteen foot wide bufferyard: fifteen Canopy or evergreen trees, twenty Shrubs
 - b. The following criteria shall also apply to the bufferyards.
 - i. The landscape strip may be contoured. Berming shall be one foot of rise to four feet of run with a minimum of three feet in height. Depressions shall be no lower than the existing grade of the site.
 - ii. All landscaped areas shall contain ground cover such as sod, shrubs, flowerbeds, or organic materials. No more than ten percent of the landscaped area shall contain rock, bark chips, stepping stones, or similar material.
 - iii. All landscaped areas shall be sub-irrigated, maintained, and kept free of weeds, debris, and litter. Failure to do so constitutes a zoning violation. Existing mature trees and shrubs should be preserved and will be credited toward landscaping requirements.
 - iv. Depth of bufferyard shall depend on density of vegetation.
 - v. All new utility lines shall be placed underground.
 - vi. New tree plantings shall not be constructed so as to grow into existing overhead utility lines.
- C. Off-Street Parking Lot Landscaping.

Landscaping shall be provided within all parking areas as follows:

Parking lots containing more than ten spaces shall contain internal areas of landscaping totaling at least ten percent of the parking area. Each planting area shall contain at least three hundred square feet and at least one major tree and groundcover with irrigation. There must be a clearly designated pedestrian route from the parking lot to the street or main entrance.

- 1. A minimum of twenty square feet of landscaped area shall be provided for each parking space on parking lots containing more than ten spaces.
- 2. Two canopy and/or evergreen trees and five shrubs shall be required for every ten parking spaces or component thereof over ten parking spaces.

- 3. All landscaped areas shall contain ground cover such as sod, shrubs, flowerbeds or organic materials. No more than twenty-five percent of the landscaped area shall contain rock, bark chips, stepping stones or similar material.
- 4. The minimum width and/or length of any parking lot landscaped area shall be five feet.
- 5. Internal parking lot landscaping provided shall be proportionately dispersed, at the developer's discretion, in order to define aisles and limit unbroken rows of parking. The maximum horizontal or vertical unbroken length shall be limited to one hundred feet. Landscaped areas provided shall be in a scale proportionate to parking lot.
- 6. Any development that has parking abutting a required bufferyard, may extend the width of parking landscaping plant material. The minimum bufferyard width and that bufferyard a minimum of five feet and include the additional required landscaping material is required in addition to the parking landscaping.
- 7. Protection of Landscaped Areas. Landscaped areas within parking lots or the along perimeter of the property must be protected from vehicular traffic through the use of continuous concrete curbs, extruded asphalt or other approved permanent barriers.
- 8. All new utility lines shall be placed underground.
- D. Commercial Uses Abutting Residential Uses.

All commercial uses abutting residential uses shall install a bufferyard. The bufferyard shall be ten feet wide and shall contain ten evergreen and/or canopy trees and ten shrubs per one hundred lineal feet. A solid fence or wall that is architecturally compatible in color and design with the building shall be required on the property line. The fence height shall be a minimum of six feet. Chain link or other wire fencing material is prohibited.

E. Fractions in the Calculation of Number of Trees and Shrubs.

In the calculation of trees and shrubs for bufferyards or parking landscaping, all fractions shall be rounded to the nearest, highest whole number.

(Ord. 02-31, 2002)

File Attachments for Item:

6. Project Review: City Brew / Chen's Express



LAUREL CITY BREW-CHEN'S EXPRESS

SUITE A - CHEN'S EXPRESS SUITE B - CITY BREW

415 S. 1ST AVENUE LAUREL, MT 59044

ISSUE DATE: 7.2.2021

A&E PROJECT NUMBER: 21017








ARCHITECTURAL ABBREVIATIONS

ARCI	HIECTURAL	ABB	REVIATIONS		
AB	ANCHOR BOLT	GA	GAUGE	R	RADIUS
ABV	ABOVE	GALV	GALVANIZED	RA	RETURN AIR
A/C	AIR CONDITIONING	GB	GYPSUM BOARD	RB	RUBBER BASE
ACT	ACOUSTICAL CEILING TILE	GC	GENERAL CONTRACTOR	RD	ROOF DRAIN
ADDL	ADDITIONAL	GL	GLASS, GLAZING	RECY	RECYCLE(D)
ADJ	ADJUSTABLE	GWB	GYPSUM WALL BOARD	REF	REFERENCÉ
AFF	ABOVE FINISH FLOOR	GYP	GYPSUM	REFRIG	REFRIGERATOR OR
ALT	ALTERNATE				REFRIGERATION
ALUM	ALUMINUM	HC	HANDICAP	REINF	REINFORCE
ARCH	ARCHITECT(URAL)	HDR	HEADER	REQD	REQUIRED
AWN	AWNING ` ´	HDW	HARDWARE	RM	ROOM
		HM	HOLLOW METAL	RO	ROUGH OPENING
B/	BOTTOM OF	HORIZ	HORIZONTAL	ROW	RIGHT OF WAY
BD	BOARD	HR	HOUR	-	
BLDG	BUILDING	HT	HEIGHT	S	SOUTH
BLKG	BLOCKING	HTD	HEATED	SC	SOLID CORE
BM	BEAM OR BENCHMARK	HVAC	HEATING/VENTILATION & AIR	SCH	SCHEDULE
BRG	BEARING		CONDITIONING		SCHEDULED
BTWN	BETWEEN		CONDITIONING	SECT	SECTION
BUR	BUILT-UP ROOF	ID	INSIDE DIAMETER	SF	SQUARE FEET
DOIX	BOILT-OF NOOF	INFO	INFORMATION	SFRM	SPRAY APPLIED FIRE RESISTIVE
CAB	CABINET	ISO	ISOCYANURATE	OI IXW	MATERIAL
CJ	CONTROL JOINT	INSUL	INSULATE / INSULATED / INSULATION	SGL	SINGLE
CL	CENTERLINE	INT	INTERIOR	SHT	SHEET
CLG		INV	INVERT	SHTG	SHEATHING
	CEILING	IIVV	INVERT		
CMU	CONCRETE MASONRY UNIT	1.	IONT	SIM	SIMILAR
CO	CLEAN OUT	JT	JOINT HANDELON BOX	SPECS	SPECIFICATIONS
COL	COLUMN	J-BOX	JUNCTION BOX	SOD	SLAB ON DECK
CONC	CONCRETE	1717	MITOLIEN	SOG	SLAB ON GRADE
CONT	CONTINUOUS	KIT	KITCHEN	SOH	SAME OPPOSITE HAND
	CONSTRUCTION			SS	STAINLESS STEEL
CG	CORNER GUARD	L	LONG / LENGTH	ST	STONE TILE
CPT	CARPET	LAM	LAMINATE(D)	STD	STANDARD
CSMT	CASEMENT	LAV	LAVATORY	STND	STANDARD
CT	CERAMIC TILE	LF	LINEAR FEET	STL	STEEL
		LT	LIGHT	STRUCT	STRUCTURAL
D	DEEP				
DF	DRINKING FOUNTAIN	MAS	MASONRY	TEMP	TEMPERED
DH	DOUBLE HUNG	MATL	MATERIAL	THK	THICK
DIM(S)	DIMENSIONS	MAX	MAXIMUM		THRESHOLD
DISP	DISPENSER	MECH	MECHANIC(AL)	T.O.	TOP OF
DN	DOWN	MEZZ	MEZZANINE		TOP OF BEAM
DR	DOOR	MFR	MANUFACTURER		TOP OF BEAM
DS	DOWNSPOUT	MH	MANHOLE		TOP OF PLATE
DTL	DETAIL	MIN	MINIMUM		TOP OF STEEL
DWG	DRAWING	MISC	MISCELLANEOUS	T/	TOP OF
		MO	MASONRY OPENING	T&G	TONGUE AND GROOVE
Е	EAST	MTL	METAL	TEL	TELEPHONE
EA	EACH			THK	THICK
EC	EXISTING COLUMN	N	NORTH	TRANS	TRANSOM
EJ	EXPANSION JOINT	NIC	NOT IN CONTRACT	TV	TELEVISION
ELEC	ELECTRICAL	NOM	NOMINAL	TYP	TYPICAL
EL	ELEVATION	NTS	NOT TO SCALE		
ELEV	ELEVATOR			UL	UNDERWRITERS LABORATORY
EQ	EQUAL	OC	ON CENTER	UNO	UNLESS NOTED OTHERWISE
EQUIP	EQUIPMENT	OD	OUTSIDE DIAMETER OR OVERFLOW		
EWC	ELECTRIC WATER COOLER		DRAIN	VB	VINYL BASE
EXH	EXHAUST	OPNG	OPENING	VCT	VINYL COMPOSITION TILE
EXIST	EXISTING	OPP	OPPOSITE	VERT	VERTICAL
EXP	EXPANSION OR EXPOSED	OSB	ORIENTED STRAND BOARD	VEST	VESTIBULE
EXT	EXTERIOR	OVHD	OVERHEAD	VIF	VERIFY IN FIELD
					VENEER PLASTER
FACP	FIRE ALARM CONTROL PANEL	PL	PLATE		VAPOR RETARDER
FD	FLOOR DRAIN	PLAM	PLASTIC LAMINATE	VT	VINYL TILE
FE	FIRE EXTINGUISHER		PLUMBING	VWC	VINYL WALL COVERING
FEC	FIRE EXTINGUISHER CABINET		PLYWOOD		
F.F.	FINISH FLOOR	PNL	PANEL	W	WIDE OR WEST
FIN	FINISH	PNT	PAINT	W/	WITH
FIXT	FIXTURE	POLY	POLYESTER OR POLYOLEFIN	WC	WATER CLOSET
FLR	FLOOR	PSF	POUNDS PER SQUARE FOOT	WD	WOOD
FND	FOUNDATION	PSI	POUNDS PER SQUARE INCH	WDW	WINDOW
FP	FIRE PROTECTION	PT	PRESSURE TREATED OR POINT	WG	WALL GUARD
FR	FRAME	PVMT	PAVEMENT	WH	WATER HEATER
FRMG	FRAMING	1 V IVI I	. / . V LIVILI V I	W/IN	WITHIN
FRIVIG	FEET/FOOT OR FIRE TREATED	QT	QUARRY TILE	W/O	WITHOUT
FTG	FOOTING	QTR	QUARRY TILE QUARTER	W/O WP	WATERPROOF
FTNG	FOOTING	QTY	QUANTITY	WP WR	WATER RESISTANT
		ŲΠ	QUANTITI		
FRP	FIBERGLASS REINFORCED PANEL			WT WWF	WEIGHT WELDED WIRE FABRIC
EDT	FIRE RETARDANT TREATED			V V V V I	WELDED WIRE PARKIC
FRT	TINE RETARDANT TREATED			#	NUMBER OR POUND

EXPLANATION OF SYMBOLS

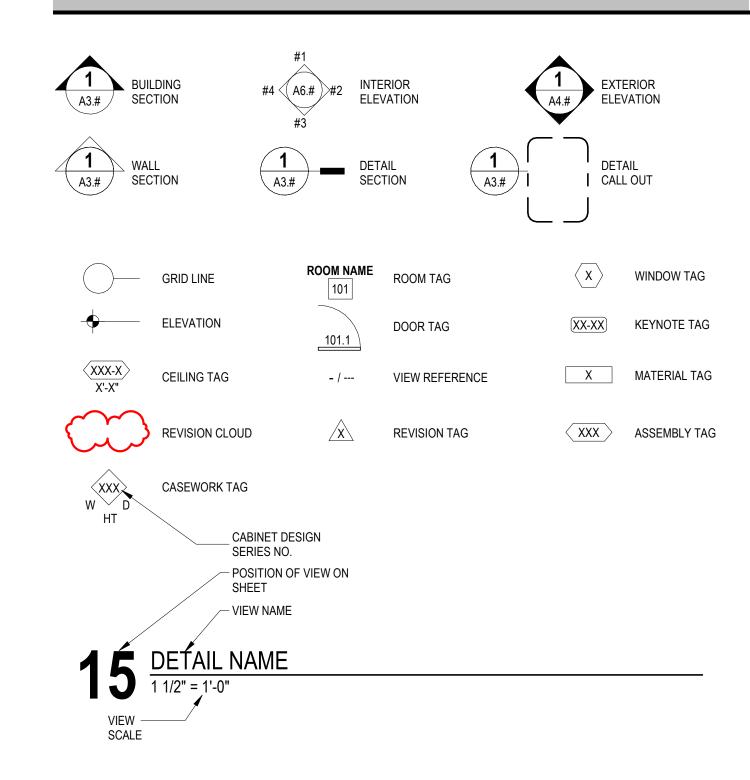

TYPICAL S	HEET VIEV	V NUMBER	ING LAYOU	ΙŢ
1	2	3	4	
5	6	7	8	
9	10	11	12	
13	14	15	16	
ARCH D (24"x	36")			<u> </u>

1	2	3	4	5	
6	7	8	9	10	
11	12	13	14	15	
16	17	18	19	20	
ARCH E1 (30"x42")				

CHEN'S 1750 SF

SUSTAINABILITY NOTES

- REPETITIVE AND/OR INTERMITTENT HIGH-LEVEL NOISE PERMITTED ONLY DURING DAYTIME. AT 50'-0" FROM THE PROJECT BOUNDARY DO NOT EXCEED 70 DB(A) FOR MORE THAN 12 MINUTES IN ANY HOUR.
- MAXIMUM AMBIENT NOISE LEVELS (DB) FOR NOISE AREA AT PROJECT BOUNDARY: DAYLIGHT HOURS 65 DB, NON-DAYLIGHT HOURS 45 DB.
- DEVELOP A WASTE MANAGEMENT PLAN ACCORDING TO ASTM E 1609. PLAN SHALL CONSIST OF WASTE IDENTIFICATION, WASTE REDUCTION WORK PLAN, AND COST/REVENUE ANALYSIS. DISTINGUISH BETWEEN CONSTRUCTION WASTES. INDICATE QUANTITIES BY WEIGHT OR VOLUME, BUT USE SAME UNITS OF MEASURE THROUGHOUT WASTE MANAGEMENT PLAN.
- DEVELOP A WASTE REDUCTION WORK PLAN. IDENTIFY NON-HAZARDOUS DEMOLITION AND CONSTRUCTION WASTE GENERATED BY THE PROJECT AND WHETHER IT WILL BE SALVAGED, RECYCLED, OR DISPOSED OF IN LANDFILL. INCLUDE QUANTITY OF EACH TYPE OF WASTE, QUANTITY FOR EACH MEANS OF RECOVERY, AND HANDLING AND TRANSPORTATION PROCEDURES.
- RECYCLED MATERIALS: DIVERT, AT A MINIMUM, 50% OF RESULTING WASTE FROM A LANDFILL THROUGH SALVAGE AND RECYCLING. SEPARATE RECYCLABLE WASTE

FROM OTHER WASTE MATERIALS, TRASH, AND DEBRIS.

- DEVELOP A CONSTRUCTION IAQ MANAGEMENT PLAN. AT A MINIMUM, SCHEDULE OF INSTALLATION OF INTERIOR FINISHES, IDENTIFY SOURCES OF ODOR AND DUST, NOTE CONSTRUCTION VENTILATION PROVIDED INCLUDING USE OF PERMANENT HVAC SYSTEMS, TYPES OF FILTRATION AND SCHEDULE FOR REPLACEMENT OF FILTERS, CLEANING AND DUST CONTROL PROCEDURES, PRODUCTS REQUIRING MOISTURE PROTECTION, AND SCHEDULE FOR INSPECTION OF STORED MATERIALS.
- DEVELOP A TEMPORARY SEDIMENTATION CONTROL PLAN. INDICATE DEVICES. MEASURES, AND LOCATIONS FOR SEDIMENT CONTROL DEVICES, DESCRIBE CONSTRUCTION ACTIVITIES EFFECTING EROSION, DESCRIBE MONITORING AND MEASURES FOR SEDIMENT CONTROL, DESCRIBE MITIGATION AND RESPONSE TO FAILED EROSION CONTROL MEASURES.
- LOW EMITTING MATERIALS. PAINTS, COATINGS, ADHESIVES AND SEALANTS FOR FIELD APPLICATIONS INSIDE THE WEATHER PROOFING SYSTEM SHALL COMPLY WITH VOC CONTENT LIMITS OF AUTHORITIES HAVING JURISDICTIONS OR SCAQMD RULE 1168, WHICHEVER IS STRICTER.
- NO SMOKING. SMOKING, VAPING, AND SMOKELESS TOBACCO USE IS NOT PERMITTED WITHIN THE BUILDING, OR WITHIN 25'-0" OF ENTRANCES, OPERABLE WINDOWS, OR OUTDOOR AIR INTAKES.
- CAST-IN-PLACE CONCRETE. PROVIDE STEEL REINFORCING MATERIALS WITH MINIMUM 25% RECYCLED CONTENT. PROVIDE AGGREGATE AND CEMENT
- EXTRACTED AND/OR MANUFACTURED WITHIN 500 MILES OF PROJECT SITE. 11. UNIT MASONRY. PROVIDE BRICK, BLOCK, AGGREGATE, CEMENT, MORTAR, AND
- LIME EXTRACTED AND/OR MANUFACTURED WITHIN 500 MILES OF PROJECT SITE. STRUCTURAL STEEL, STEEL DECKING, FORMED METAL FRAMING, METAL TOILET COMPARTMENTS, AND FORMED METAL WALL AND ROOF PANELS. PROVIDE
- MATERIALS WITH POST-CONSUMER RECYCLED CONTENT PLUS ONE-HALF OF PRE-CONSUMER RECYCLED CONTENT NOT LESS THAN 25%. 13. ALL COMPOSITE WOOD PRODUCTS SHALL BE MANUFACTURED WITHOUT ADDED
- UREA FORMALDEHYDE. ALUMINUM ENTRANCE AND WINDOW SYSTEMS. PROVIDE ALUMINUM MATERIALS
- WITH POST-CONSUMER RECYCLED CONTENT PLUS ONE-HALF OF PRE-CONSUMER RECYCLED CONTENT NOT LESS THAN 50%.
- PROVIDE GYPSUM BOARD WALL PANELS MANUFACTURED WITHIN 500 MILES OF THE PROJECT SITE.
- 16. RESILIENT HARD SURFACE FLOORING MATERIALS AND THEIR ADHESIVES SHALL BE FLOORSCORE CERTIFIED.
- 17. PLUMBING FIXTURES SHALL BE WATERSENSE CERTIFIED.

PROJECT TEAM

WELLS BUILT 2526 SHILOH RD. BILLINGS, MT 59106

CONTACT: STEVE WELLS


406.794.6465

OWNER	CIVIL ENGINEER, PROJECT LEAD
STEVE ZABAWA ZDEALER@ICLOUD.COM	SANDERSON STEWART 1300 N. TRANSTECH WAY BILLINGS, MT 59102 406.855.8521 CONTACT: BRYAN ALEXANDER
ARCHITECT	MEP ENGINEER
A&E ARCHITECTS 124 NORTH 29th STREET BILLINGS, MT 59101 406.248.2633	SIMPLICITY CONSULTING ENGINEERS & DESIGN, LLC P.O.BOX 81222 BILLINGS, MT 59108-1222 406.861.1205 CONTACT: CORY HASIAK, P.E.
CONTRACTOR	

NUMBER OR POUND @ AT





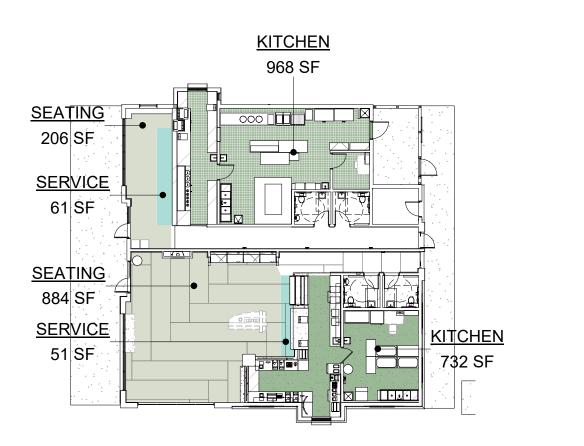

2 LEVEL 1					
1" = 20'-0)"				
	OCCUE	PANT LOAD CALCUI	ATION		
SPACE	USE	AREA	OLF	TOTAL OCC LOAD	
CITY BREW	SERVICE	51 SF	7 SF	8	
CITY BREW	KITCHEN	732 SF	200 SF	4	
CITY BREW	SEATING	884 SF	15 SF	59	
CITY BREW: 3		1667 SF		71	
SHANGHAI	SERVICE	61 SF	7 SF	9	
SHANGHAI	SEATING	206 SF	15 SF	14	
SHANGHAI	KITCHEN	968 SF	200 SF	5	
SHANGHAI: 3		1235 SF	1	28	
Grand total: 6		2902 SF		99	

ARCHITECTURAL DRAWINGS

GENERAL INFO	SHEET NAME
G0.0	COVER SHEET
G0.1	GENERAL INFORMATION
CIVIL	SHEET NAME
C1.0	EXISTING SITE PLAN
C2.0 C3.0	SITE UTILITY PLAN GRADING AND DRAINAGE PLAN
C4.0	DETAILS
LANDSCAPE	SHEET NAME
	LANDOGADE DI AN
L1.1 L2.1	LANDSCAPE PLAN PLANTING DETAILS
LE. 1	I B WING BE IMES
ARCHITECTURAL	SHEET NAME
A0.1	ASSEMBLY TYPES
A1.1	SITE PLAN
A2.1	LEVEL 1 FLOOR PLAN
A2.2	ROOF PLAN
A3.1	ENLARGED CHEN'S EXPRESS PLAN
A3.2	ENLARGED CITY BREW PLAN
A3.10	PLAN DETAILS
A4.1	EXTERIOR ELEVATIONS
A5.1 A5.5	BUILDING SECTIONS WALL SECTIONS
A5.6	WALL SECTIONS WALL SECTIONS
A5.7	WALL SECTIONS
A5.9	HARDI REVEAL SECTION DETAILS
A5.10	SECTION DETAILS
A6.1	INTERIOR ELEVATIONS
A6.2	INTERIOR ELEVATIONS
A6.3	INTERIOR ELEVATIONS
A6.4	INTERIOR ELEVATIONS
A6.5	INTERIOR DESIGN DETAILS
A6.8 A7.1	CASEWORK DETAILS REFLECTED CEILING PLAN
A7.2	REFLECTED CEILING PLAN DETAILS
A9.1	SCHEDULES
STRUCTURAL	SHEET NAME
S1.0	FOUNDATION PLAN
S1.1	ROOF FRAMING PLAN
S1.2	MECHANICAL COORDINATION PLAN
S2.0 S2.1	SECTIONS AND DETAILS SECTIONS AND DETAILS
OZ. I	SECTIONS AND DETAILS
MECHANICAL AND PLUMBING	SHEET NAME
M0.1	MECHANICAL LEGEND & SCHEDULES
M0.2	MECHANICAL DETAILS
M0.3	MECHANICAL SPECIFICATIONS
M1.1	BELOW SLAB PLUMBING PLAN
M1.2	PLUMBING ROOF PLAN
M2.1	ENLARGED CHEN'S PLUMBING PLAN
M2.2	ENLARGED CITY BREW PLUMBING PLAN ENLARGED CHEN'S EXPRESS MECHANICAL PLAN
M3.1 M3.2	ENLARGED CHEN'S EXPRESS MECHANICAL PLAN ENLARGED CITY BREW MECHANICAL PLAN
M3.3	MECHANICAL ROOF PLAN
ELECTRICAL	SHEET NAME
E0.1	ELECTRICAL COVER SHEET
E0.2	ELECTRICAL SITE PLAN
E1.1	LIGHTING PLAN
E2.0	POWER AND SPECIAL SYSTEMS PLAN
E2.1	ROOF ELECTRICAL PLAN

ALTERNATE PRICING NOTES

FIRE SPRINKLER SYSTEM

E2.1 E3.0

CONCTRACTOR TO PROVIDE PRICING FOR FULL SPRINKLER SYSTEM SPRINKLER LINE INTO FIRE ROOM. NO LINE TO STREET, FIRE ALARM OR INTERIOR SPRINKLER SYSTEM WILL BE INCLUDED IN THIS ALTERNATE.

ROOF ELECTRICAL PLAN

ELECTRICAL SCHEDULES AND DETAILS

CODE ANALYSIS

CHAPTER 3:

A-2 RESTAURANT AND COFFEE SHOPS

CHAPTER 5: ALOWABLE BUILDING HT = 60 FOR SPRINKLERED BUILDING OCCUPANCY A A-2 OCCUPANCY: SINGLE STORY SPRINKLERED BUILDING, TYPE VB CONSTRUCTION = 24,000 SF


CHAPTER 9: A-2 SPRINKLERS REQUIRED FOR FIRE AREA OCCUPANT LOAD GREATER THAN 100. ACTUAL OCCUPANT LOAD IS 99. NO SPRINKLER SYSTEM REQUIRED.

PARKING 1. SEE C2.0 FOR PARKING CALCULATIONS

BUILDING ENVELOPE USES PRESCRIPTIVE COMPLIANCE METHOD TO MEET THE


SEE ATTACHED COMCHECK FOR COMPLIANCE WITH DOE STANDARDS FOR MECHANICAL, PLUMBING AND LIGHTING.

REQUIREMENT OF THE IECC. SEE SHEET G0.2 FOR ASSEMBLY R-VALUES.

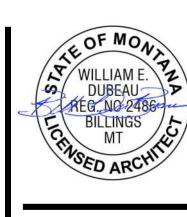

AUREL

PERMITS

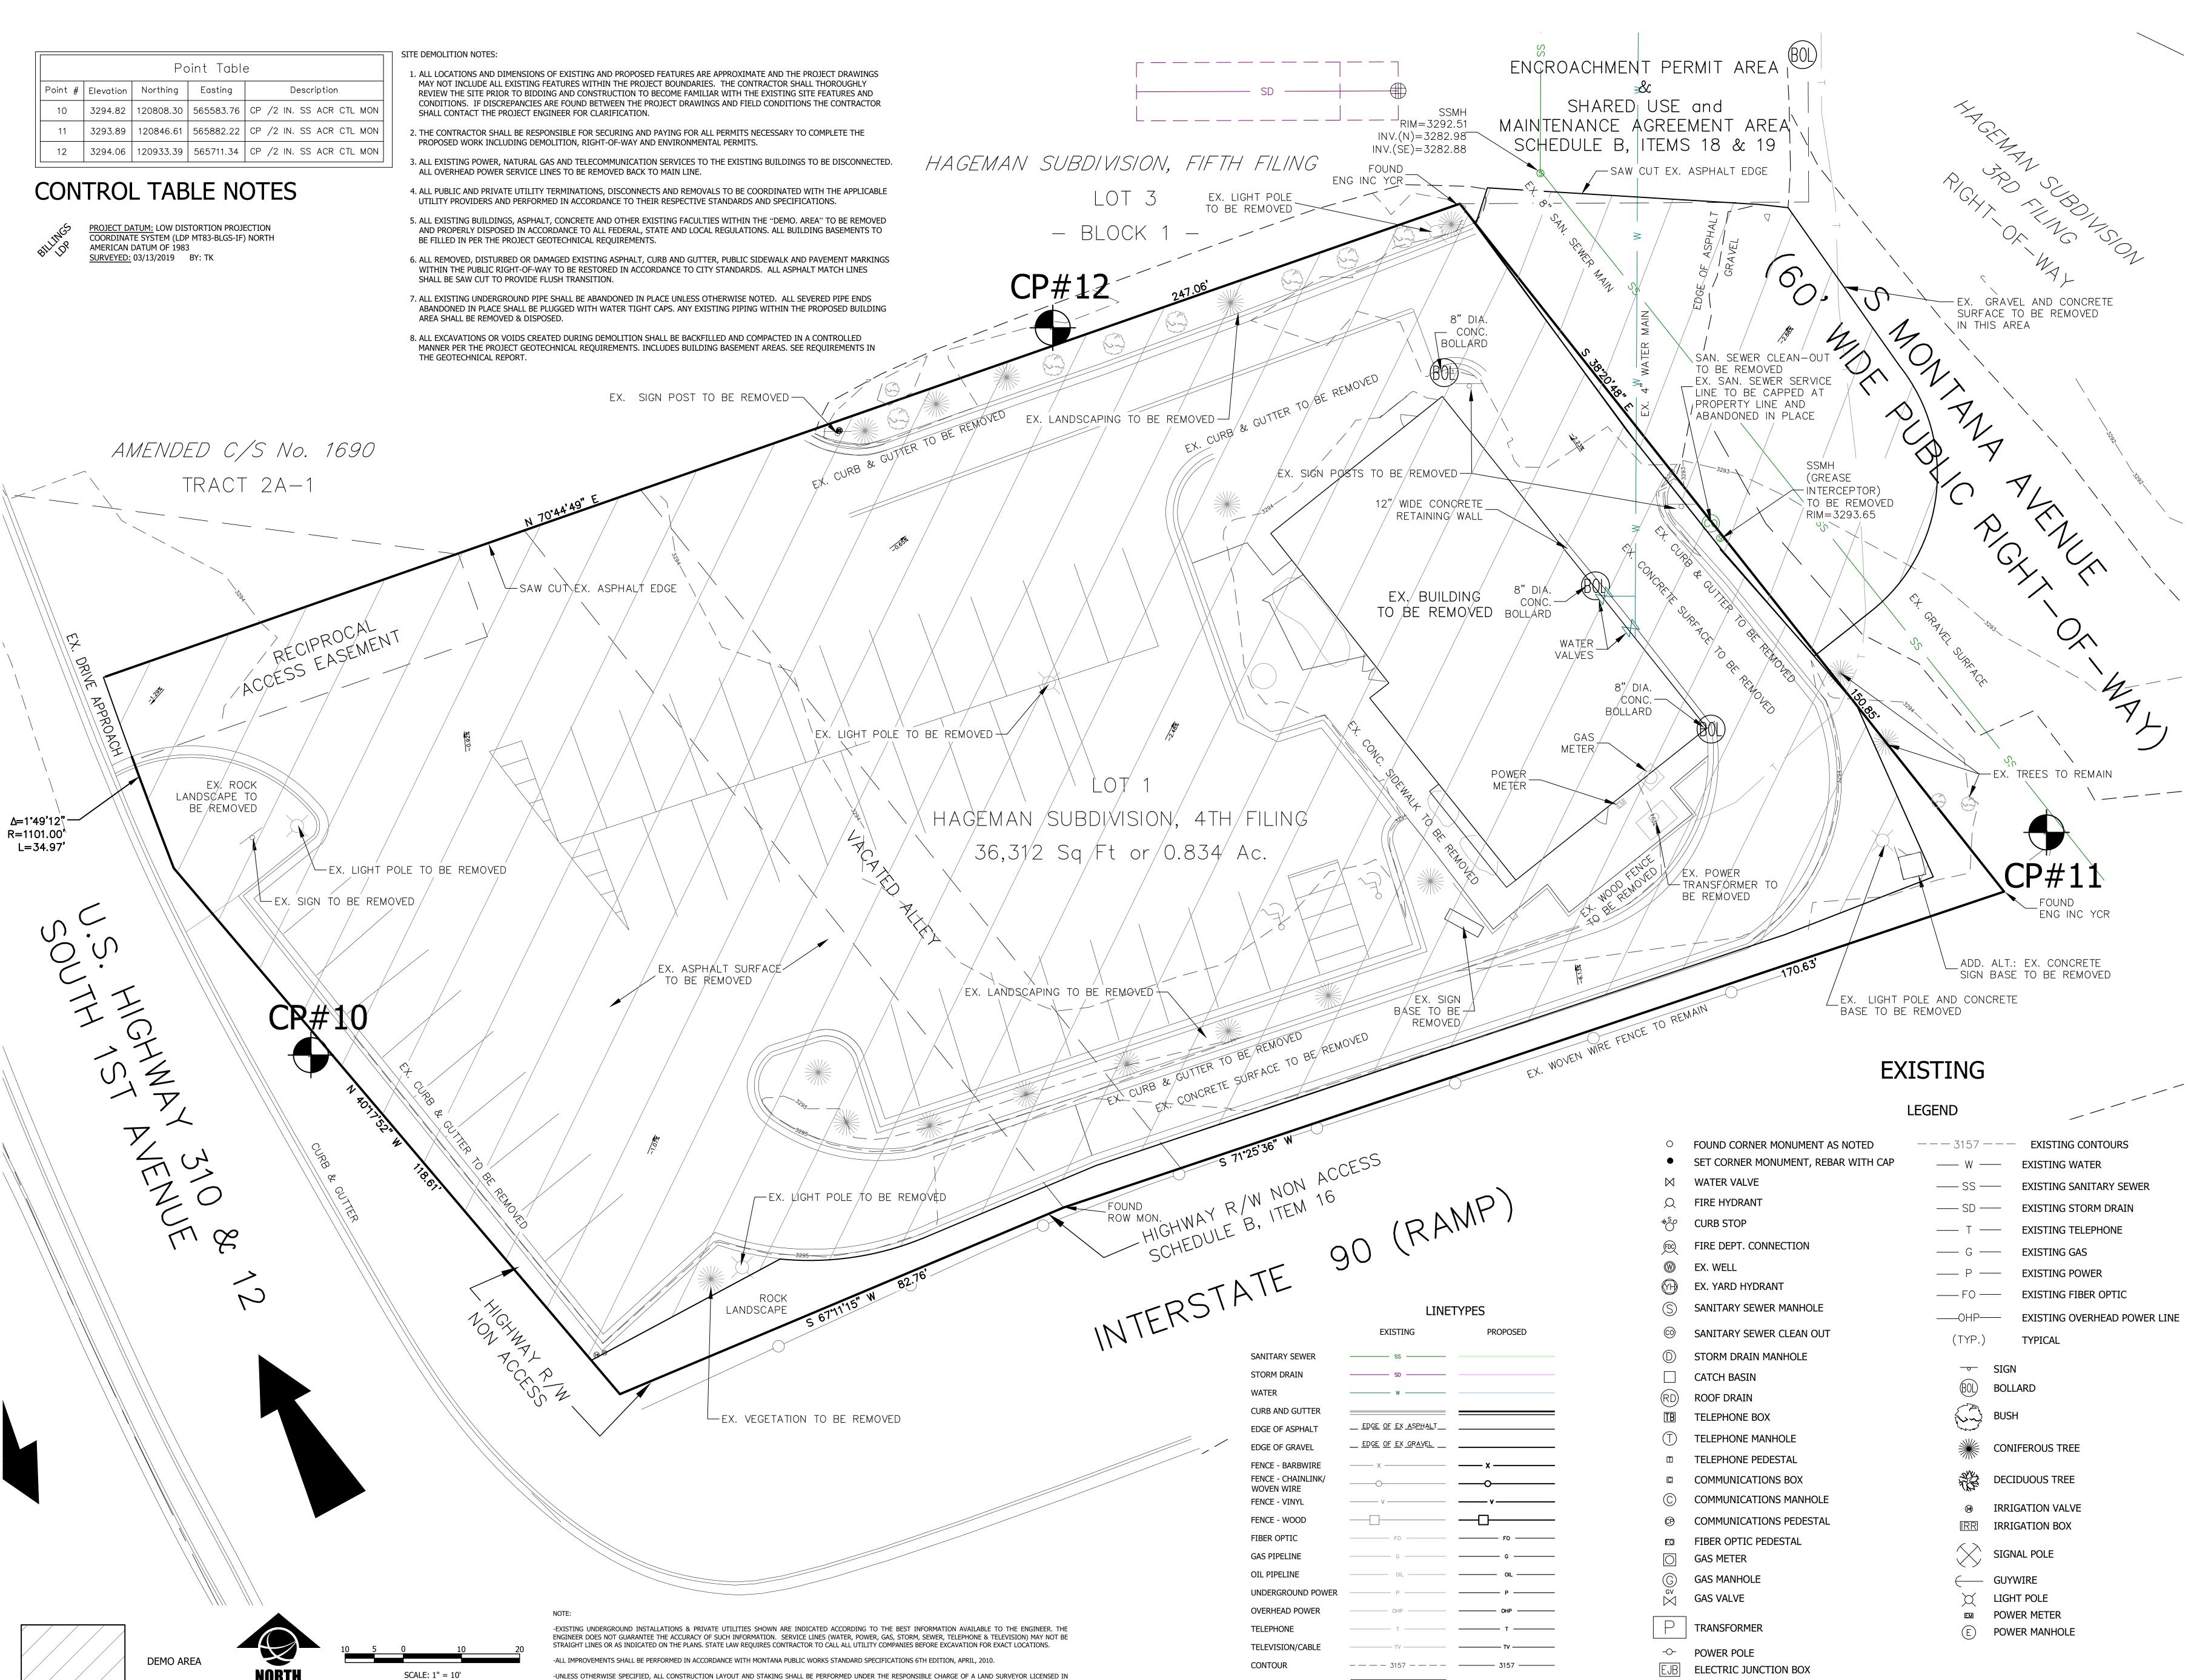


DEMO AREA

E ELECTRIC PEDESTAL

THE STATE WHERE IS PROJECT IS LOCATED AND BY A PARTY CHIEF OR ENGINEERING TECHNICIAN EXPERIENCED IN CONSTRUCTION LAYOUT AND STAKING TECHNIQUES AS

ARE REQUIRED BY THE SPECIFIC TYPE OF WORK BEING PERFORMED.

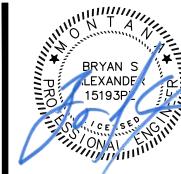







PERMITS AND CONSTRUCTION



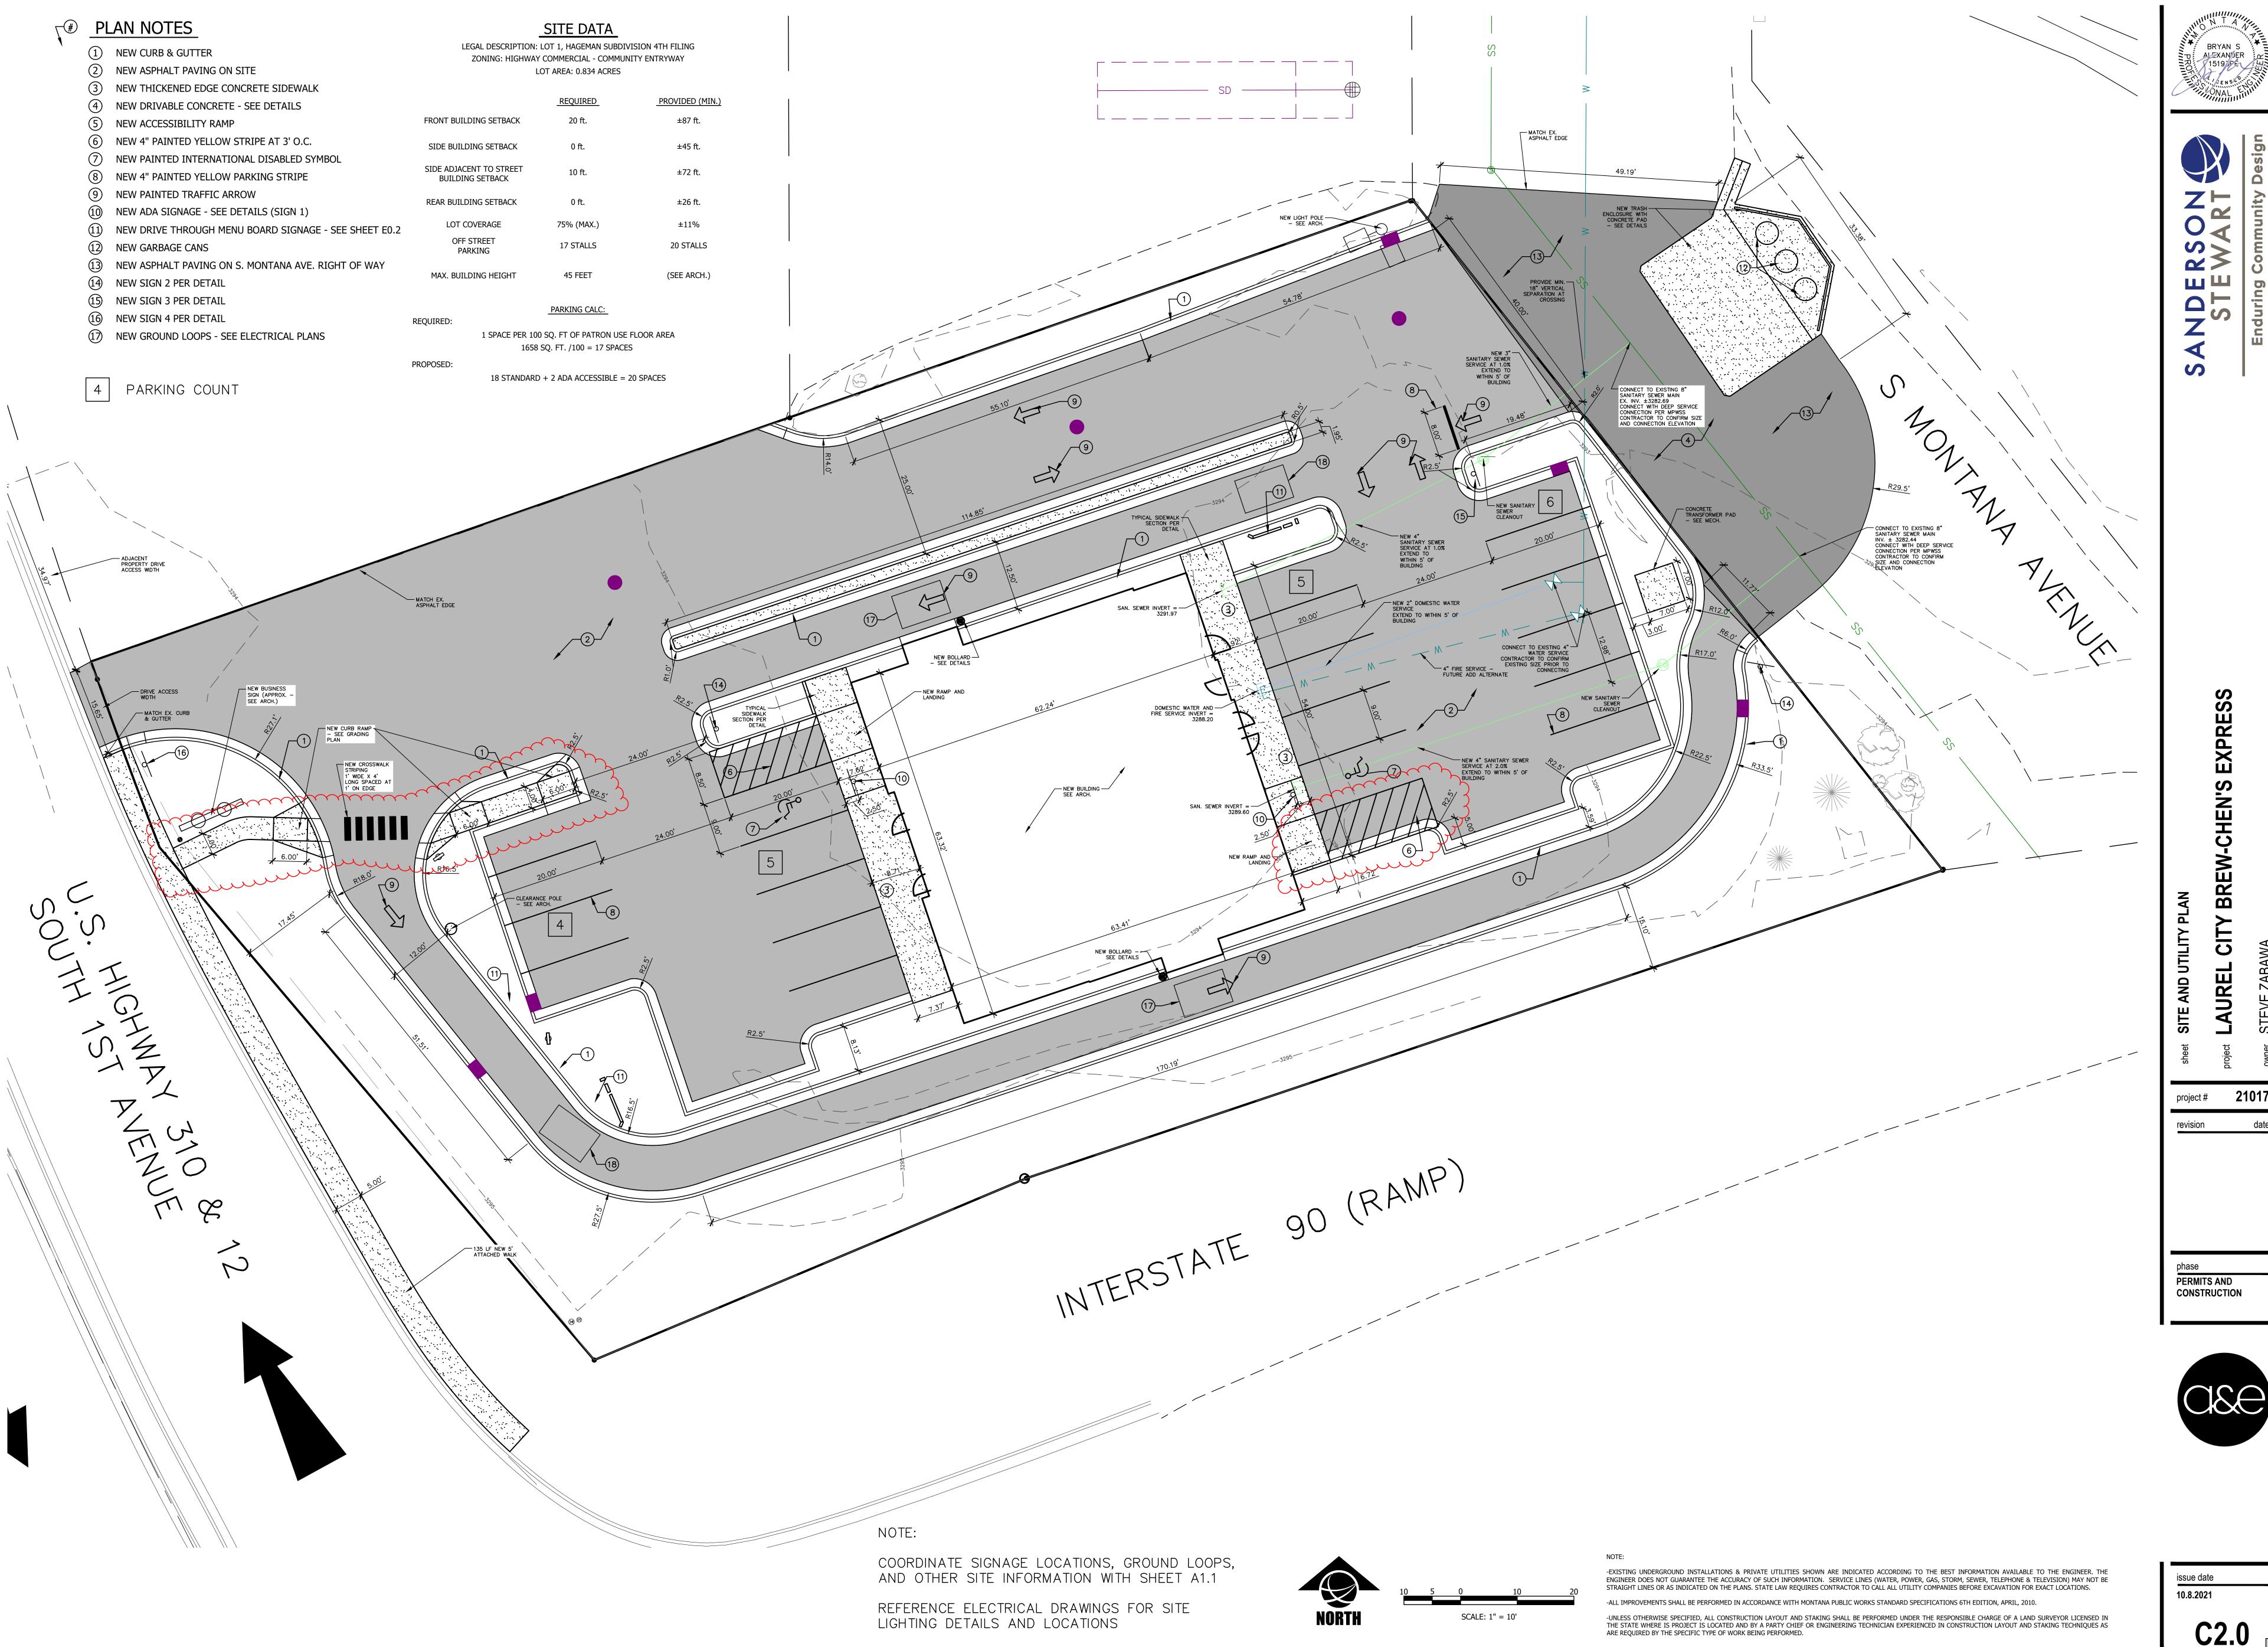





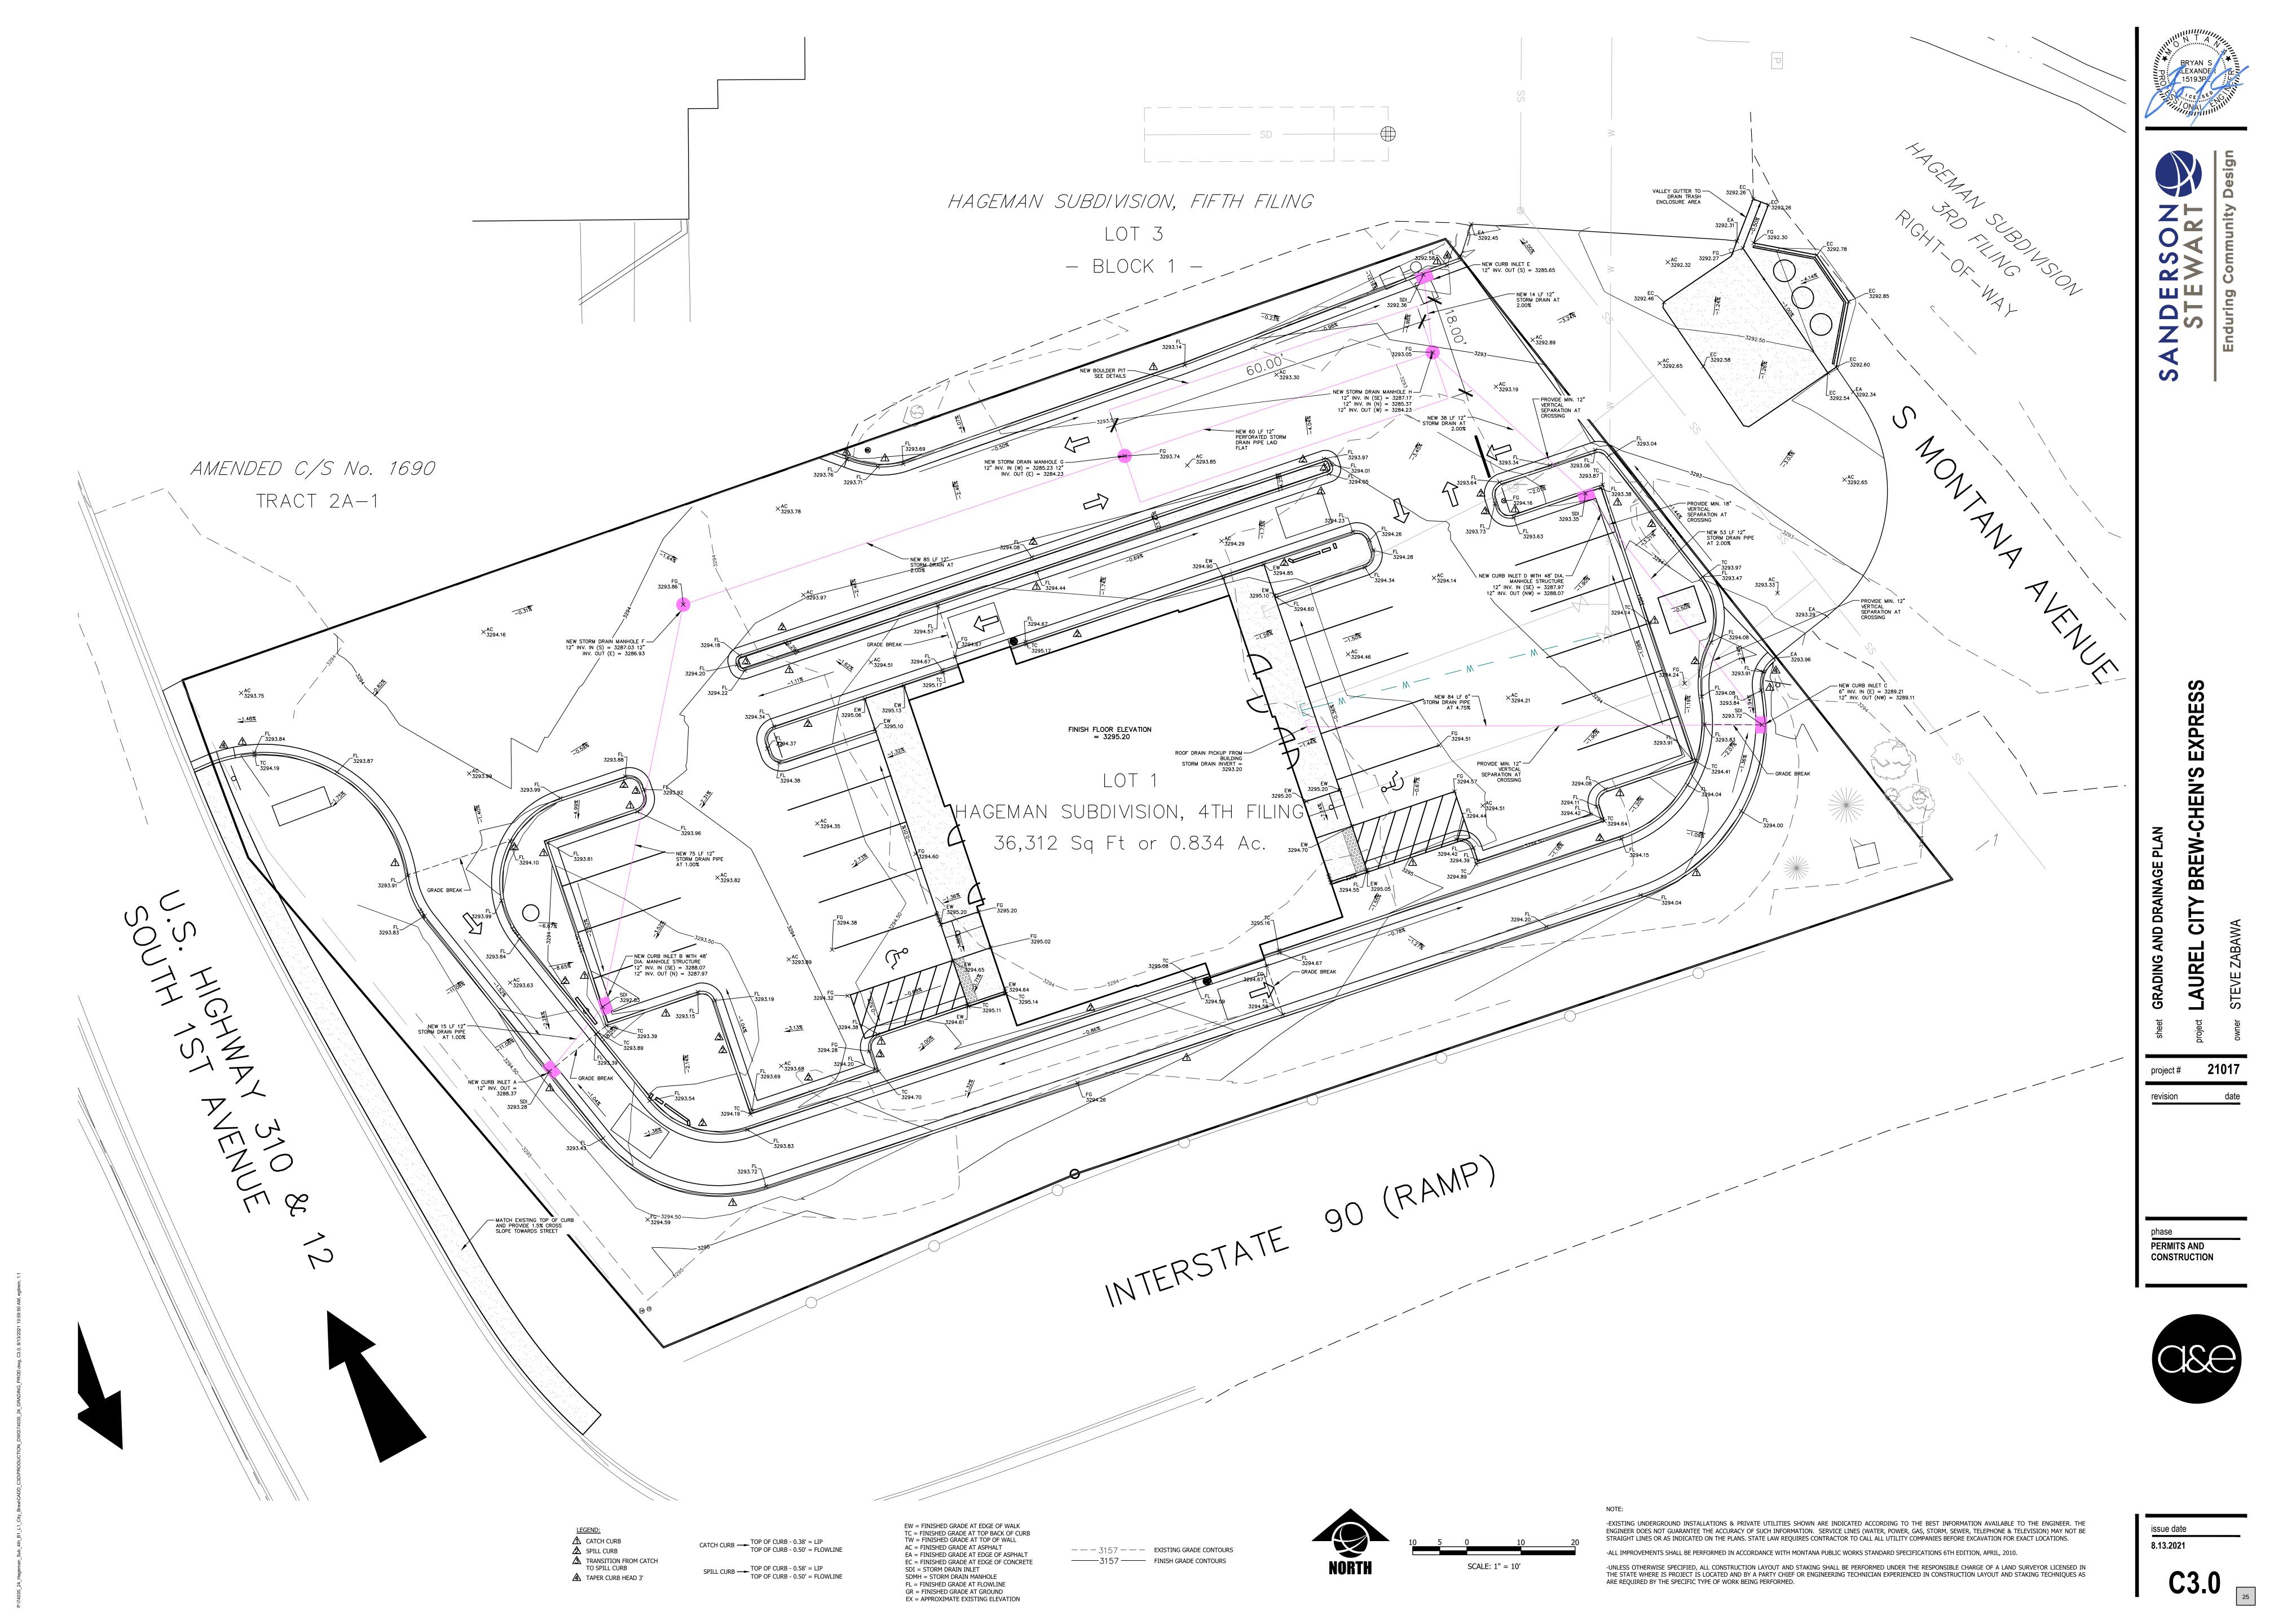



VIEW

PRE

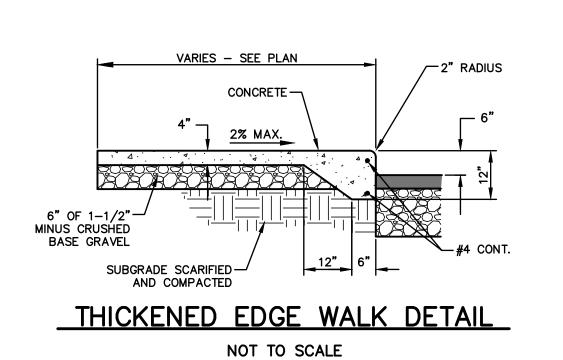

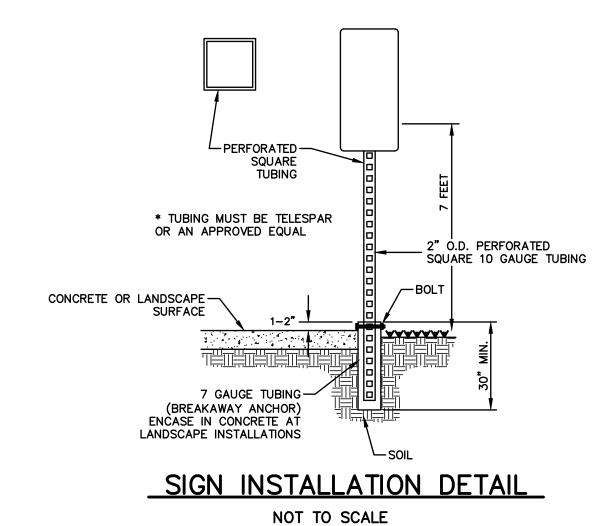


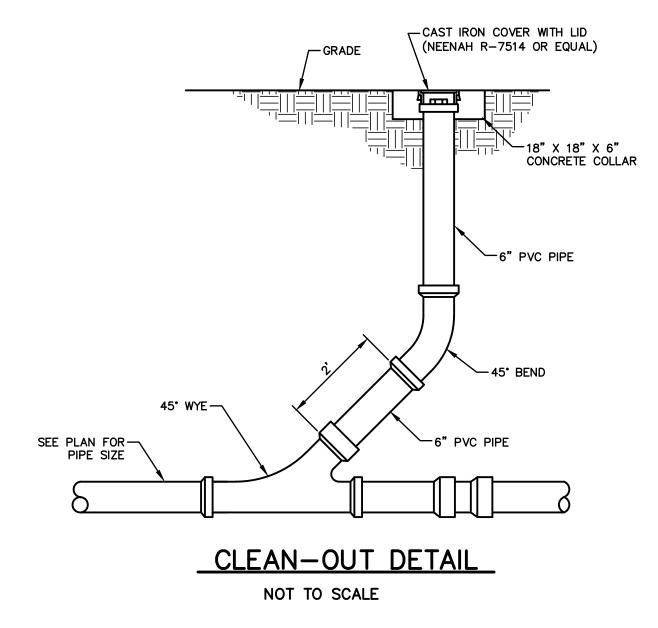


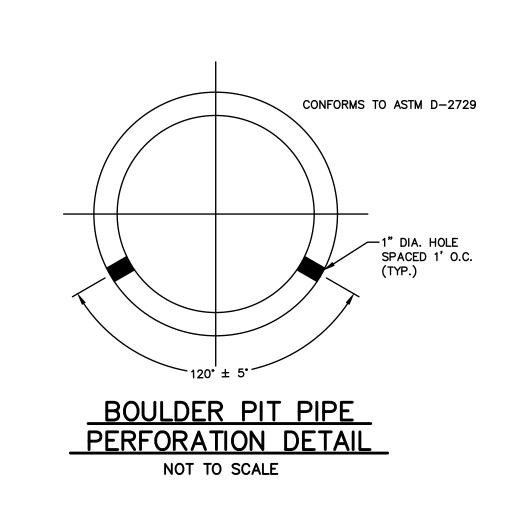

FLAT SLAB COVER-

STANDARD CASTING & COVER (SEE PLAN FOR TYPE)

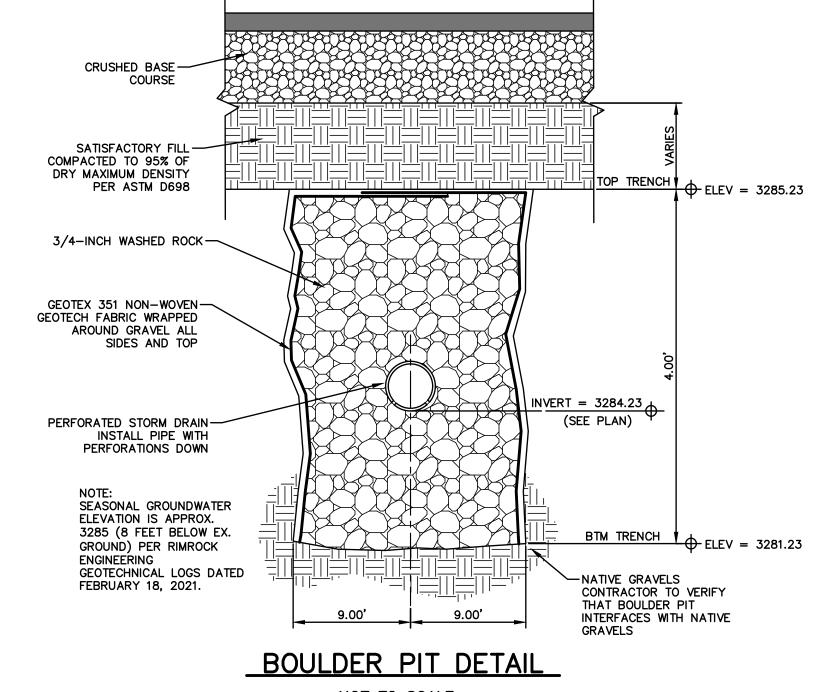


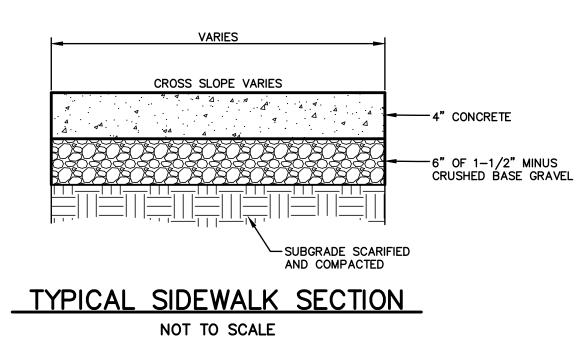





SIGN 1 - POST MOUNTED HANDICAP PARKING


SIGN 3 - POST MOUNTED DRIVE THROUGH

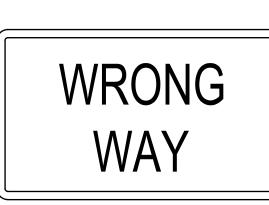

SIGN 2 - POST MOUNTED WRONG WAY

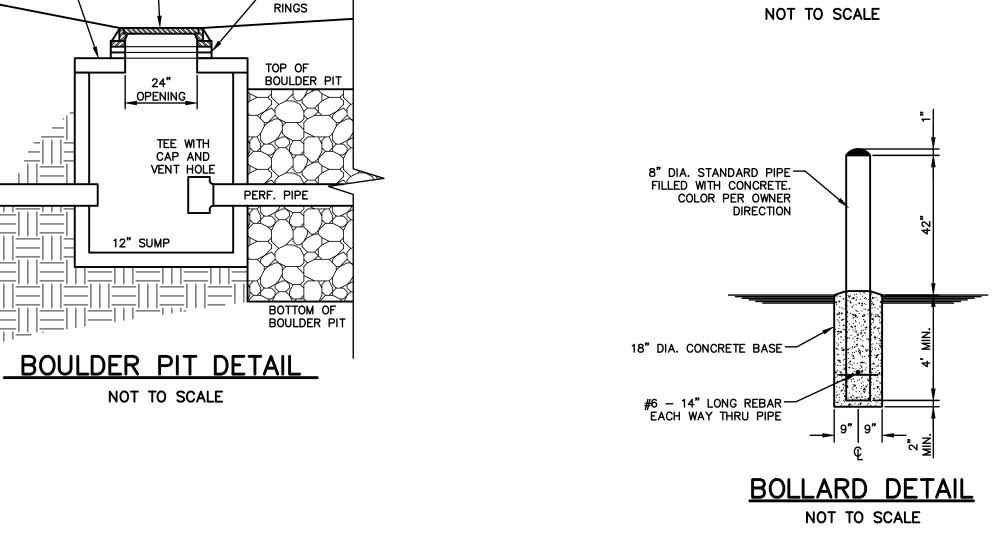

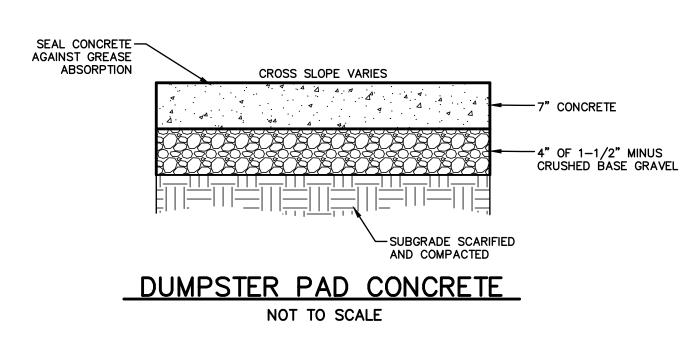

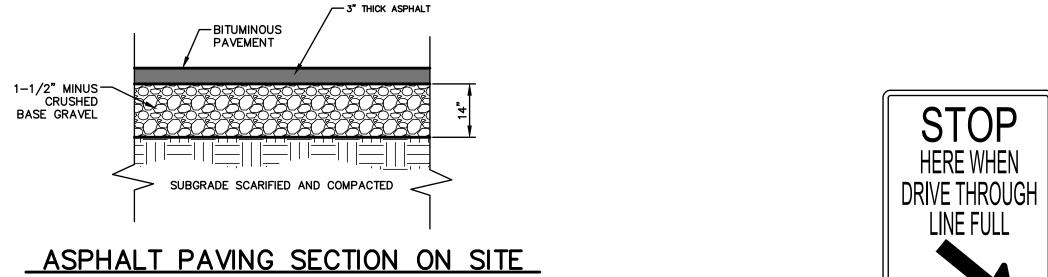











SIGN DETAILS NOT TO SCALE

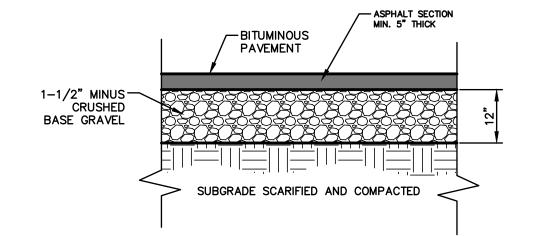

NOT TO SCALE


S. MONTANA AVE ASPHALT SECTION NOT TO SCALE

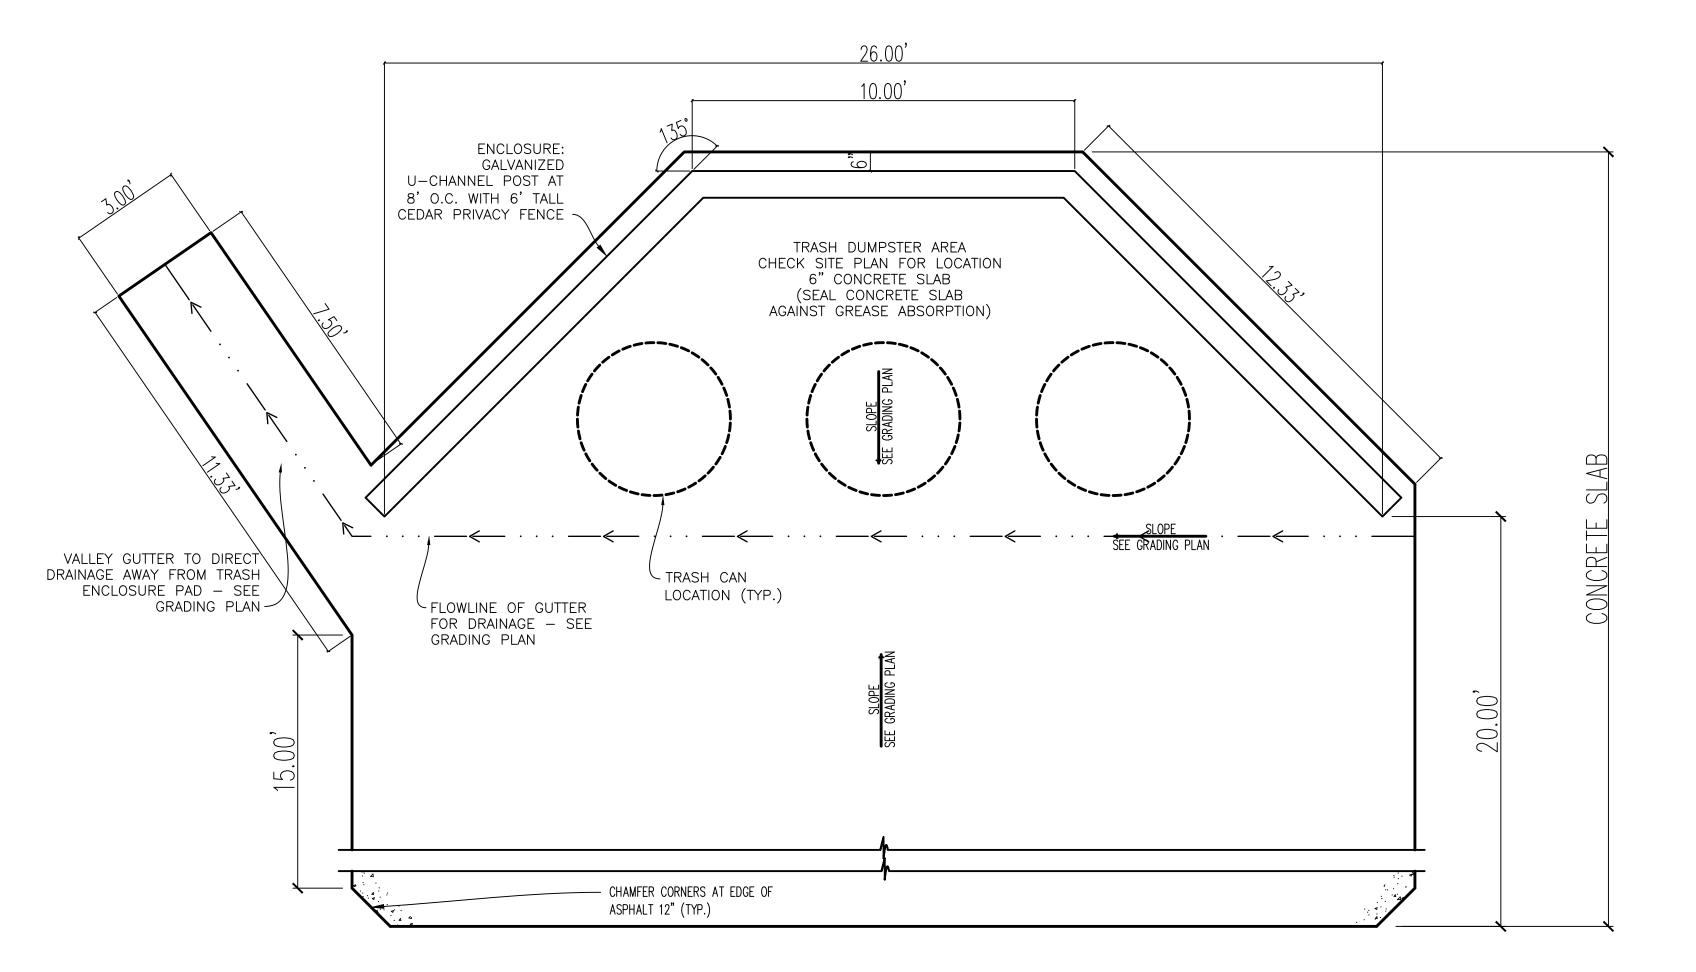


TRASH ENCLOSURE DETAIL NOT TO SCALE

-EXISTING UNDERGROUND INSTALLATIONS & PRIVATE UTILITIES SHOWN ARE INDICATED ACCORDING TO THE BEST INFORMATION AVAILABLE TO THE ENGINEER. THE ENGINEER DOES NOT GUARANTEE THE ACCURACY OF SUCH INFORMATION. SERVICE LINES (WATER, POWER, GAS, STORM, SEWER, TELEPHONE & TELEVISION) MAY NOT BE STRAIGHT LINES OR AS INDICATED ON THE PLANS. STATE LAW REQUIRES CONTRACTOR TO CALL ALL UTILITY COMPANIES BEFORE EXCAVATION FOR EXACT LOCATIONS. -ALL IMPROVEMENTS SHALL BE PERFORMED IN ACCORDANCE WITH MONTANA PUBLIC WORKS STANDARD SPECIFICATIONS 6TH EDITION, APRIL, 2010. -UNLESS OTHERWISE SPECIFIED, ALL CONSTRUCTION LAYOUT AND STAKING SHALL BE PERFORMED UNDER THE RESPONSIBLE CHARGE OF A LAND SURVEYOR LICENSED IN THE STATE WHERE IS PROJECT IS LOCATED AND BY A PARTY CHIEF OR ENGINEERING TECHNICIAN EXPERIENCED IN CONSTRUCTION LAYOUT AND STAKING TECHNIQUES AS ARE REQUIRED BY THE SPECIFIC TYPE OF WORK BEING PERFORMED.



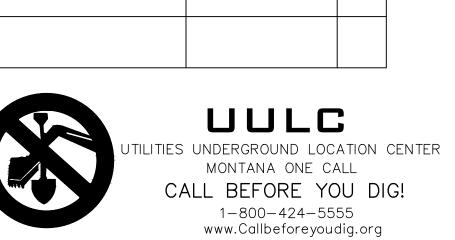

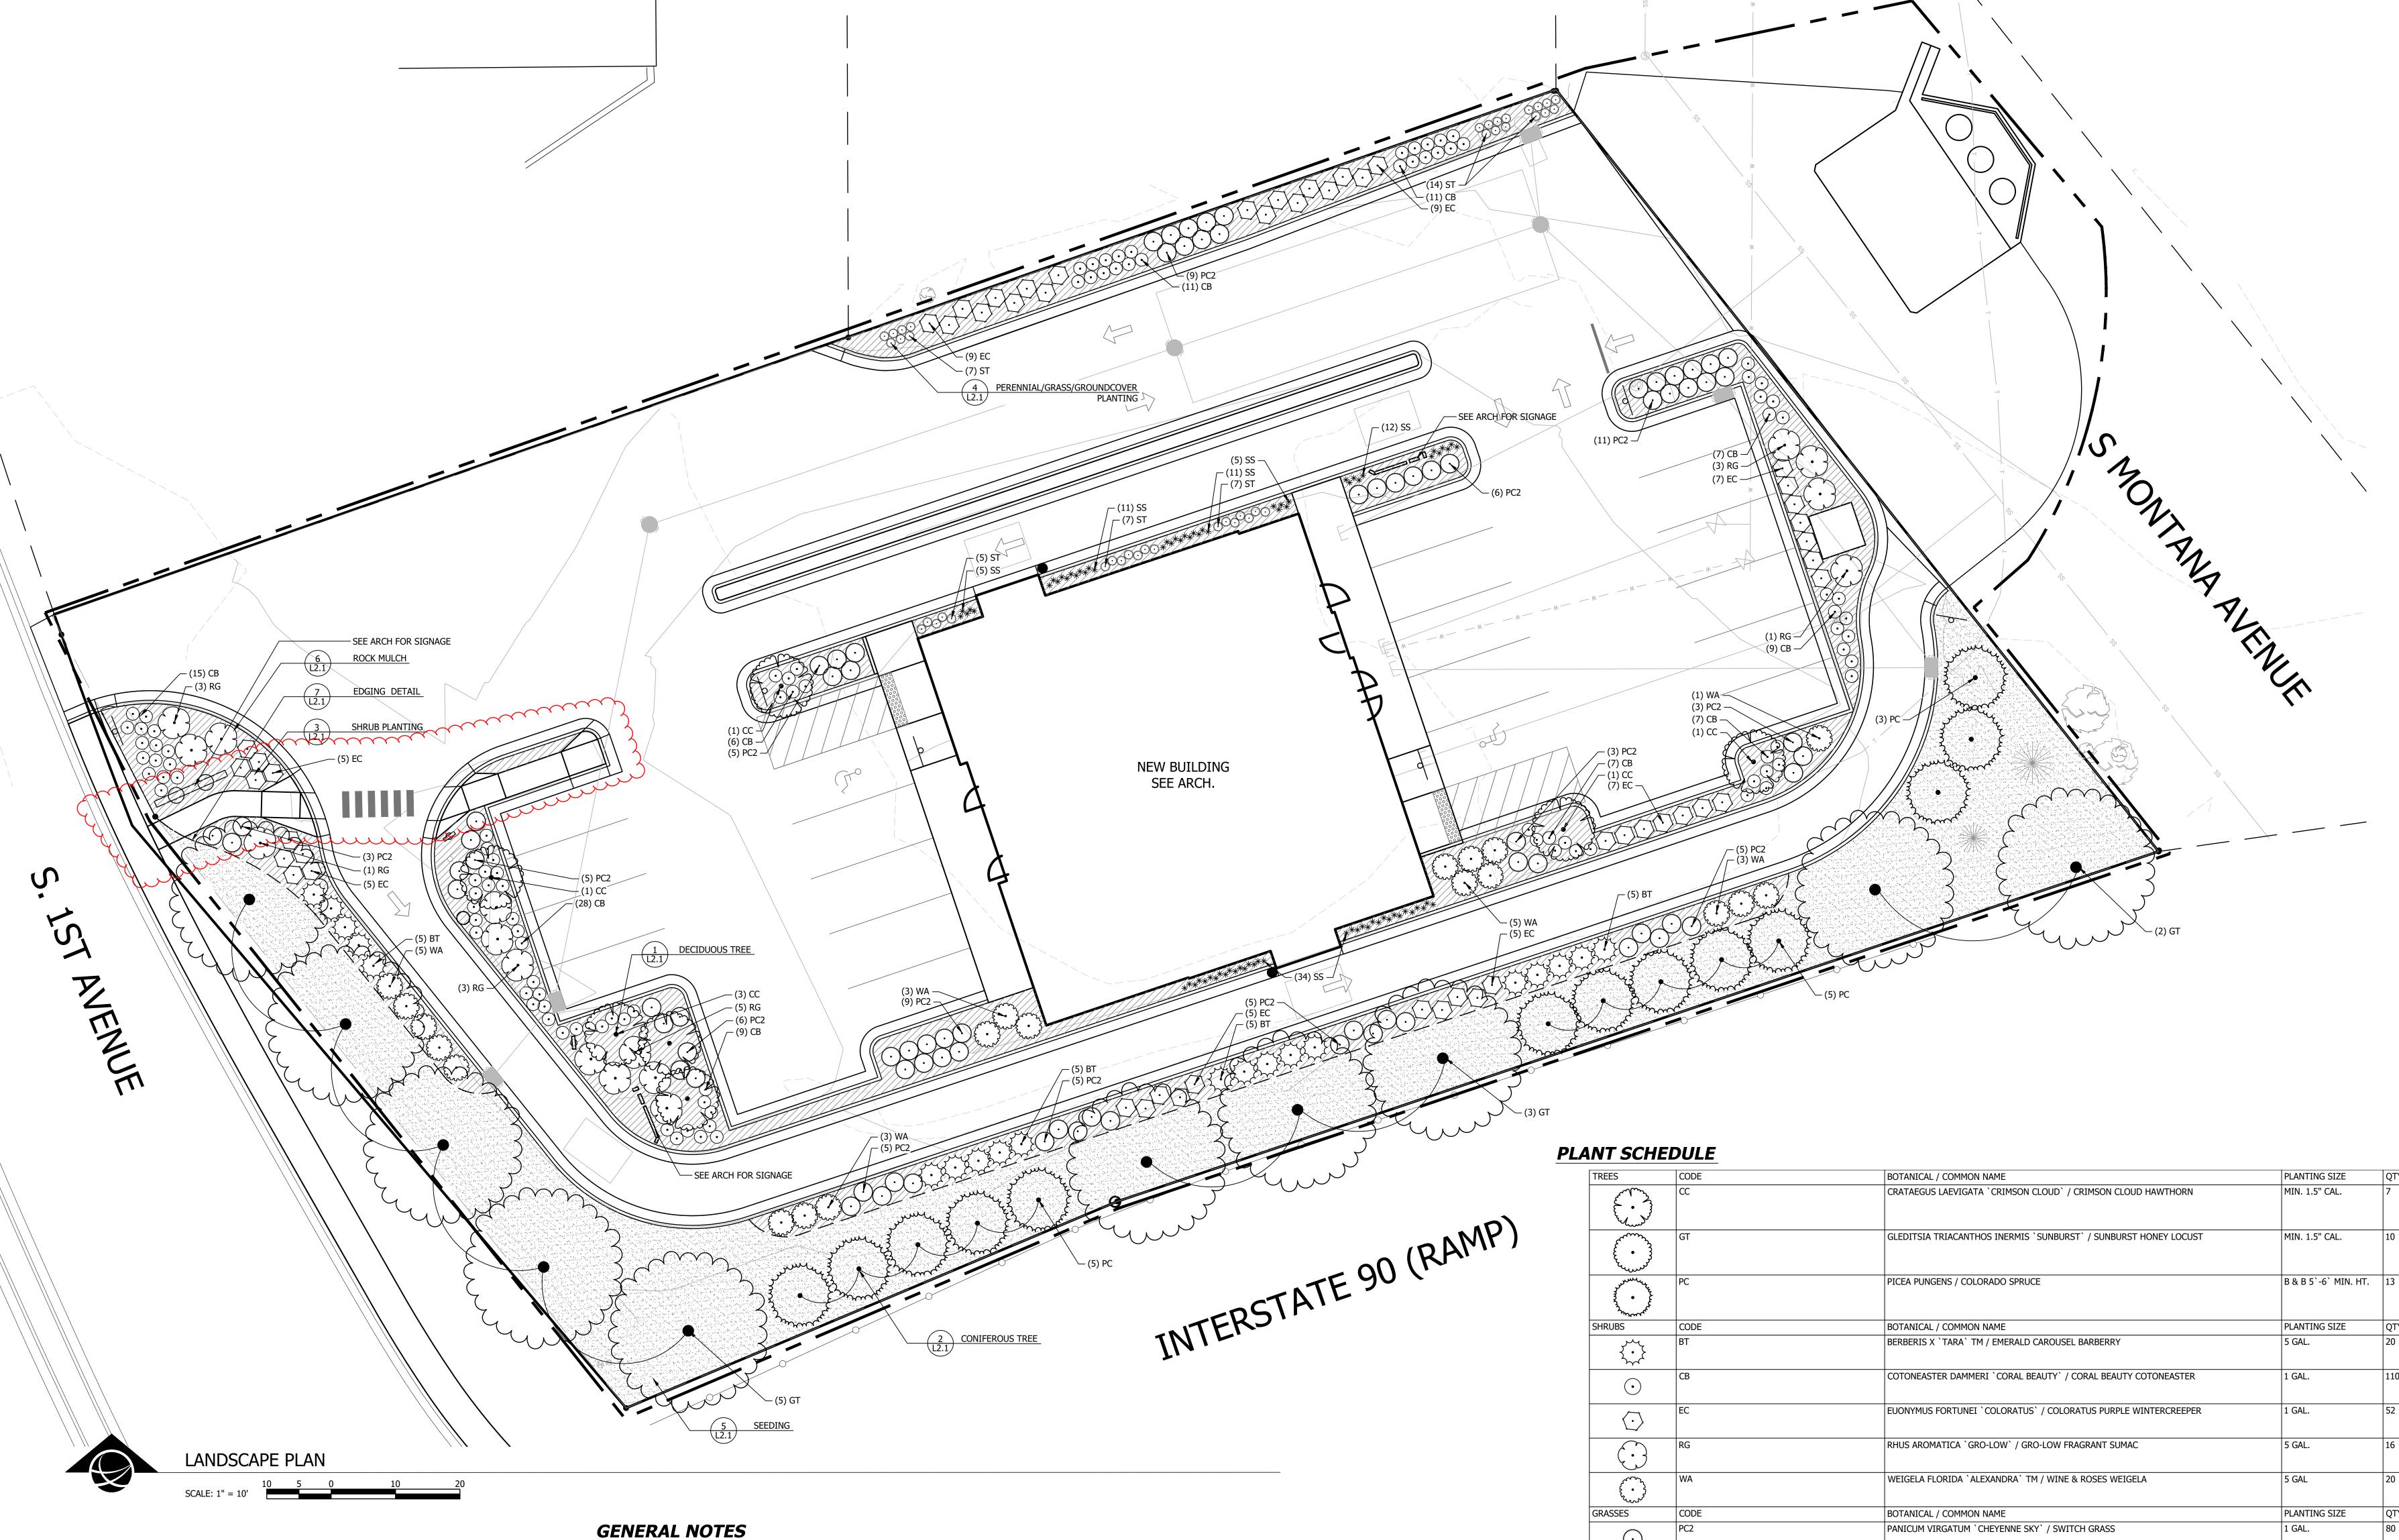

LEGEND

LIMIT OF WORK LANDSCAPE EDGING EXISTING DECIDUOUS TREE

EXISTING CONIFEROUS TREE

1. THE CONTRACTOR SHALL OBTAIN, AT THEIR OWN EXPENSE, APPLICABLE LICENSES, STANDARDS, PERMITS, ETC. WHICH ARE NECESSARY TO PERFORM THE WORK. 3. THE CONTRACTOR SHALL BE RESPONSIBLE FOR THE PROTECTION OF ALL UTILITIES AND REPAIR OF UTILITIES IF DAMAGED. REPAIR SHALL BE DONE AT NO ADDITIONAL COST TO THE OWNER 4. ALL DIMENSIONS SHALL BE FIELD VERIFIED BY CONTRACTOR PRIOR TO CONSTRUCTION. ANY DEVIATION FROM THESE PLANS MUST BE APPROVED BY OWNER OR LANDSCAPE ARCHITECT PRIOR TO CONSTRUCTION.

5. LIMIT OF WORK IS AS INDICATED ON THE PLANS. 6. COORDINATE SITE ACCESS, STAGING, STORAGE AND CLEANOUT AREAS WITH OWNER'S REPRESENTATIVE.

PLANTING NOTES

6. REPAIR AND RESEED STAGING AREA.

1. THE CONTRACTOR IS RESPONSIBLE FOR VERIFYING ALL PLANT QUANTITIES. GRAPHIC QUANTITIES TAKE PRECEDENCE OVER WRITTEN QUANTITIES. 2. ALL EXISTING GRASS STAND AREAS DISTURBED BY CONSTRUCTION OPERATIONS SHALL BE SOIL PREPARED AND SEEDED BY THE CONTRACTOR.

3. EXISTING TURF AREAS THAT ARE DISTURBED DURING CONSTRUCTION, ESTABLISHMENT AND THE MAINTENANCE PERIOD SHALL BE RESTORED WITH NEW SOD TO MATCH EXISTING TURF SPECIES. 4. ALL LANDSCAPE MATERIALS SHALL BE INSTALLED ACCORDING TO SOUND HORTICULTURAL PRACTICES AND AMERICAN NURSERY STANDARDS IN A MANNER DESIGNED TO ENCOURAGE QUICK ESTABLISHMENT AND HEALTHY GROWTH. 5. REPAIR DISTURBED AREAS BENEATH SHRUBS BY HAND.

7. CONTRACTOR SHALL COORDINATE IRRIGATION AND PLANTING WORK SUCH THAT INSTALLED IRRIGATION EQUIPMENT SHALL NOT CAUSE ADJUSTMENT OF PLANTING LOCATIONS CONTRARY TO THE PLANS. IF IRRIGATION EQUIPMENT IS INSTALLED IN LOCATIONS OBSTRUCTING THE INTENDED LOCATIONS OF THE PLANTINGS, NOTIFY THE LANDSCAPE ARCHITECT FOR CLARIFICATION. 8. THE CONTRACTOR SHALL WARRANTY ALL CONTRACTED WORK AND MATERIALS FOR A PERIOD OF ONE YEAR AFTER SUBSTANTIAL COMPLETION HAS BEEN ISSUED BY THE OWNER'S REPRESENTATIVE FOR THE ENTIRE PROJECT UNLESS OTHERWISE SPECIFIED IN THE CONTRACT DOCUMENTS OR SPECIFICATIONS.

9. PLANTING BEDS TO BE AMENDED WITH A MIN. 12" DEPTH TOP QUALITY TOPSOIL PRIOR TO PLANTING. 10. AREAS TO BE SEEDED OR SODDED TO BE AMENDED WITH A MIN. 4" DEPTH TOP QUALITY TOPSOIL PRIOR TO SEEDING OR SODDING.

SCHIZACHYRIUM SCOPARIUM `STANDING OVATION` / STANDING OVATION LITTLE BLUESTEM | 1 GAL.

SPOROBOLUS HETEROLEPIS 'TARA' / TARA PRAIRIE DROPSEED

5,025 SF

GROUND COVERS | BOTANICAL / COMMON NAME


ROCK MULCH

SEEDING / MOWED LAWN MIX

BOTANICAL / COMMON NAME

CRUSHED ROCK 1" DIA OR SMALLER. 2" DEPTH.



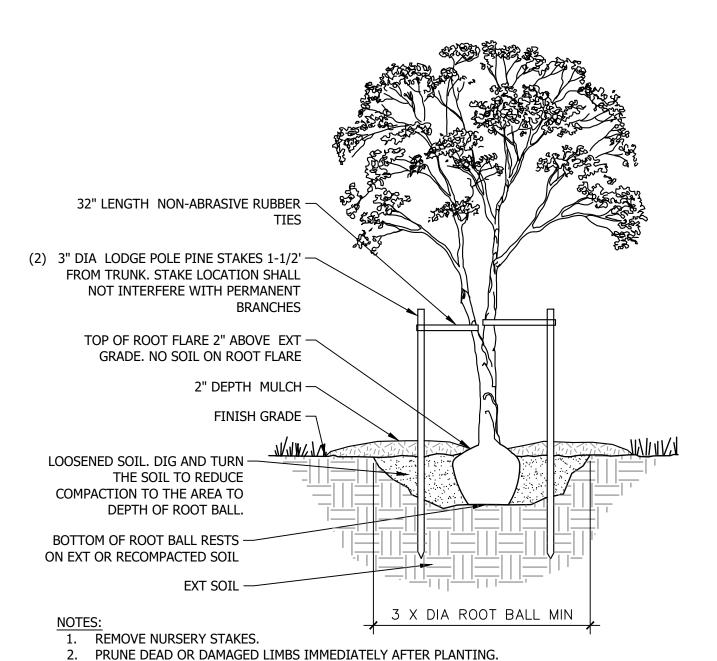


. PRUNE DEAD OR DAMAGED LIMBS IMMEDIATELY AFTER PLANTING.

3. REMOVE WIRE TIES AND BURLAP FROM ROOT BALL. 4. PRIOR TO MULCHING, LIGHTLY TAMP SOIL AROUND ROOT BALL IN 6" LIFTS TO BRACE TREE. DO NOT OVER COMPACT. WHEN PLANTING PIT HAS BEEN BACKFILLED, POUR WATER AROUND ROOT BALL TO SETTLE THE SOIL.

5. BACKFILL WITH AMENDED SOIL. 6. REMOVE STAKES FOLLOWING FIRST GROWING SEASON.

7. SCARIFY SUBGRADE 12", RAKE SUBGRADE AND REMOVE ALL DEBRIS GREATER THAN 1/2" IN DIA. INCLUDING ROCKS, CONCRETE, ORGANIC DEBRIS, AND OR CONSTRUCTION DEBRIS. 8. PROVIDE SUPPLEMENTAL WATER FOR THE FIRST YEAR FOLLOWING INSTALLATION.

DECIDUOUS TREE

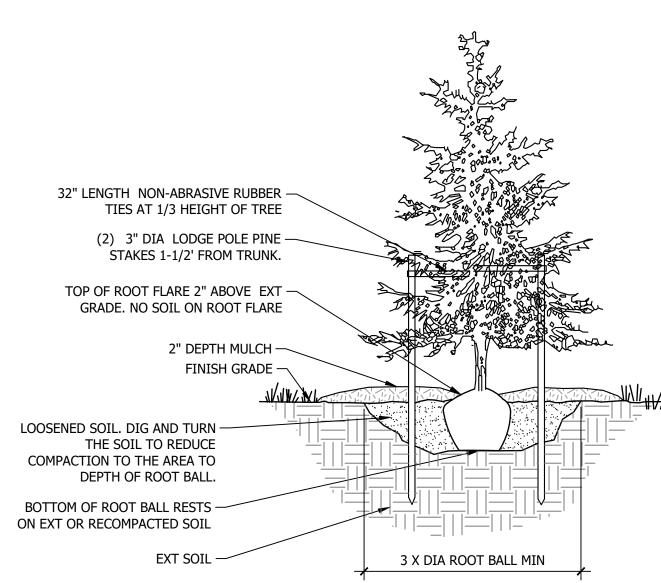

 REMOVE NURSERY STAKES. . PRUNE DEAD OR DAMAGED LIMBS IMMEDIATELY AFTER PLANTING. 3. REMOVE WIRE TIES AND BURLAP FROM TOP 1/2 OF ROOT BALL.


4. REMOVE ALL BASKETS. 5. PRIOR TO MULCHING, LIGHTLY TAMP SOIL AROUND ROOT BALL IN 6" LIFTS TO BRACE TREE. DO NOT OVER COMPACT. WHEN PLANTING PIT HAS BEEN BACKFILLED, POUR WATER AROUND ROOT

8. PROVIDE SUPPLEMENTAL WATER FOR THE FIRST YEAR FOLLOWING INSTALLATION.

BALL TO SETTLE THE SOIL. 6. BACKFILL WITH AMENDED SOIL. 7. REMOVE STAKES FOLLOWING FIRST GROWING SEASON.

CONIFEROUS TREE

ROCK MULCH

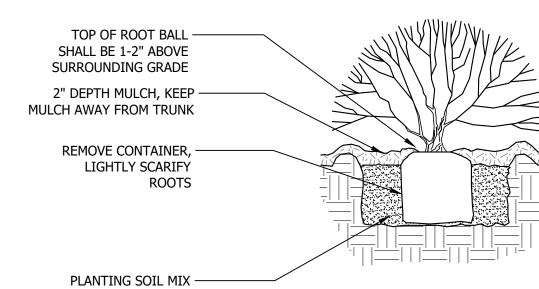

1. SHRUBS WITH BROKEN OR CRUMBLING ROOT BALLS WILL BE REJECTED. CONTAINER


TOP OF MULCH TO BE 1" BELOW ADJ WALKWAY, CURB, EDGING, OR OTHER SURFACE.


6. SCARIFY SUBGRADE 12", RAKE SUBGRADE AND REMOVE ALL DEBRIS GREATER THAN 1/2" IN

DIA. INCLUDING ROCKS, CONCRETE, ORGANIC DEBRIS, AND OR CONSTRUCTION DEBRIS.

4. ALL PLANT MATERIAL TO BE INSPECTED UPON DELIVERY. REJECTED MATERIALS TO BE

REMOVAL WILL NOT BE AN EXCUSE FOR DAMAGED ROOT BALLS.

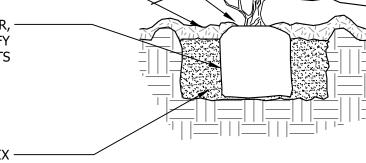

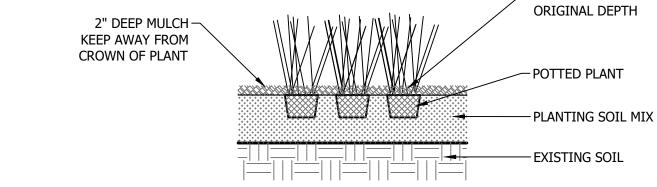

1. REMOVE SPENT FLOWERS PRIOR TO PLANTING.

2. LOOSEN ROOT MASS AT BOTTOM OF ROOTBALL. 3. STRIP TOP OF ROOTBALL $\frac{1}{4}$ " OF SURFACE GROWING MEDIA AND

∼ SET PLANT AT

COVER WITH $\frac{1}{4}$ " PLANTING MIX PLUS SURFACE MULCH. 4. QUANTITY AND SPACING AS NOTED IN PLANT SCHEDULE.

SHRUB PLANTING


PRUNE OUT ALL DAMAGED OR DEAD WOOD.

IMMEDIATELY RETURNED TO SOURCE.

N.T.S.




PERENNIAL/GRASS/GROUNDCOVER PLANTING

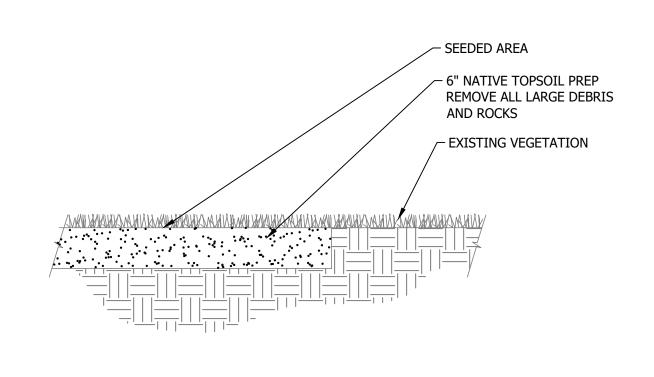

1. SCARIFY SUBGRADE 6", RAKE SUBGRADE AND REMOVE ALL DEBRIS GREATER THAN 1/2" IN DIA. INCLUDING ROCKS, CONCRETE, ORGANIC DEBRIS, AND OR CONSTRUCTION DEBRIS. 2. TOP SOIL SHALL BE 6" AND AMENDED WITH ORGANIC COMPOST.

N.T.S.



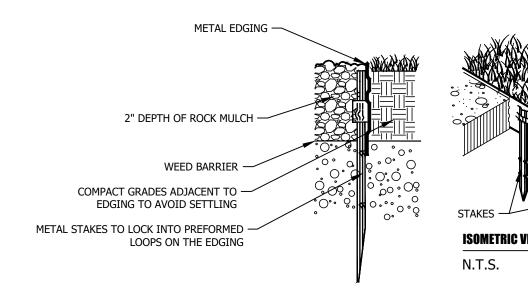


EDGING DETAIL

- ROCK MULCH


✓ WEED BARRIER FABRIC



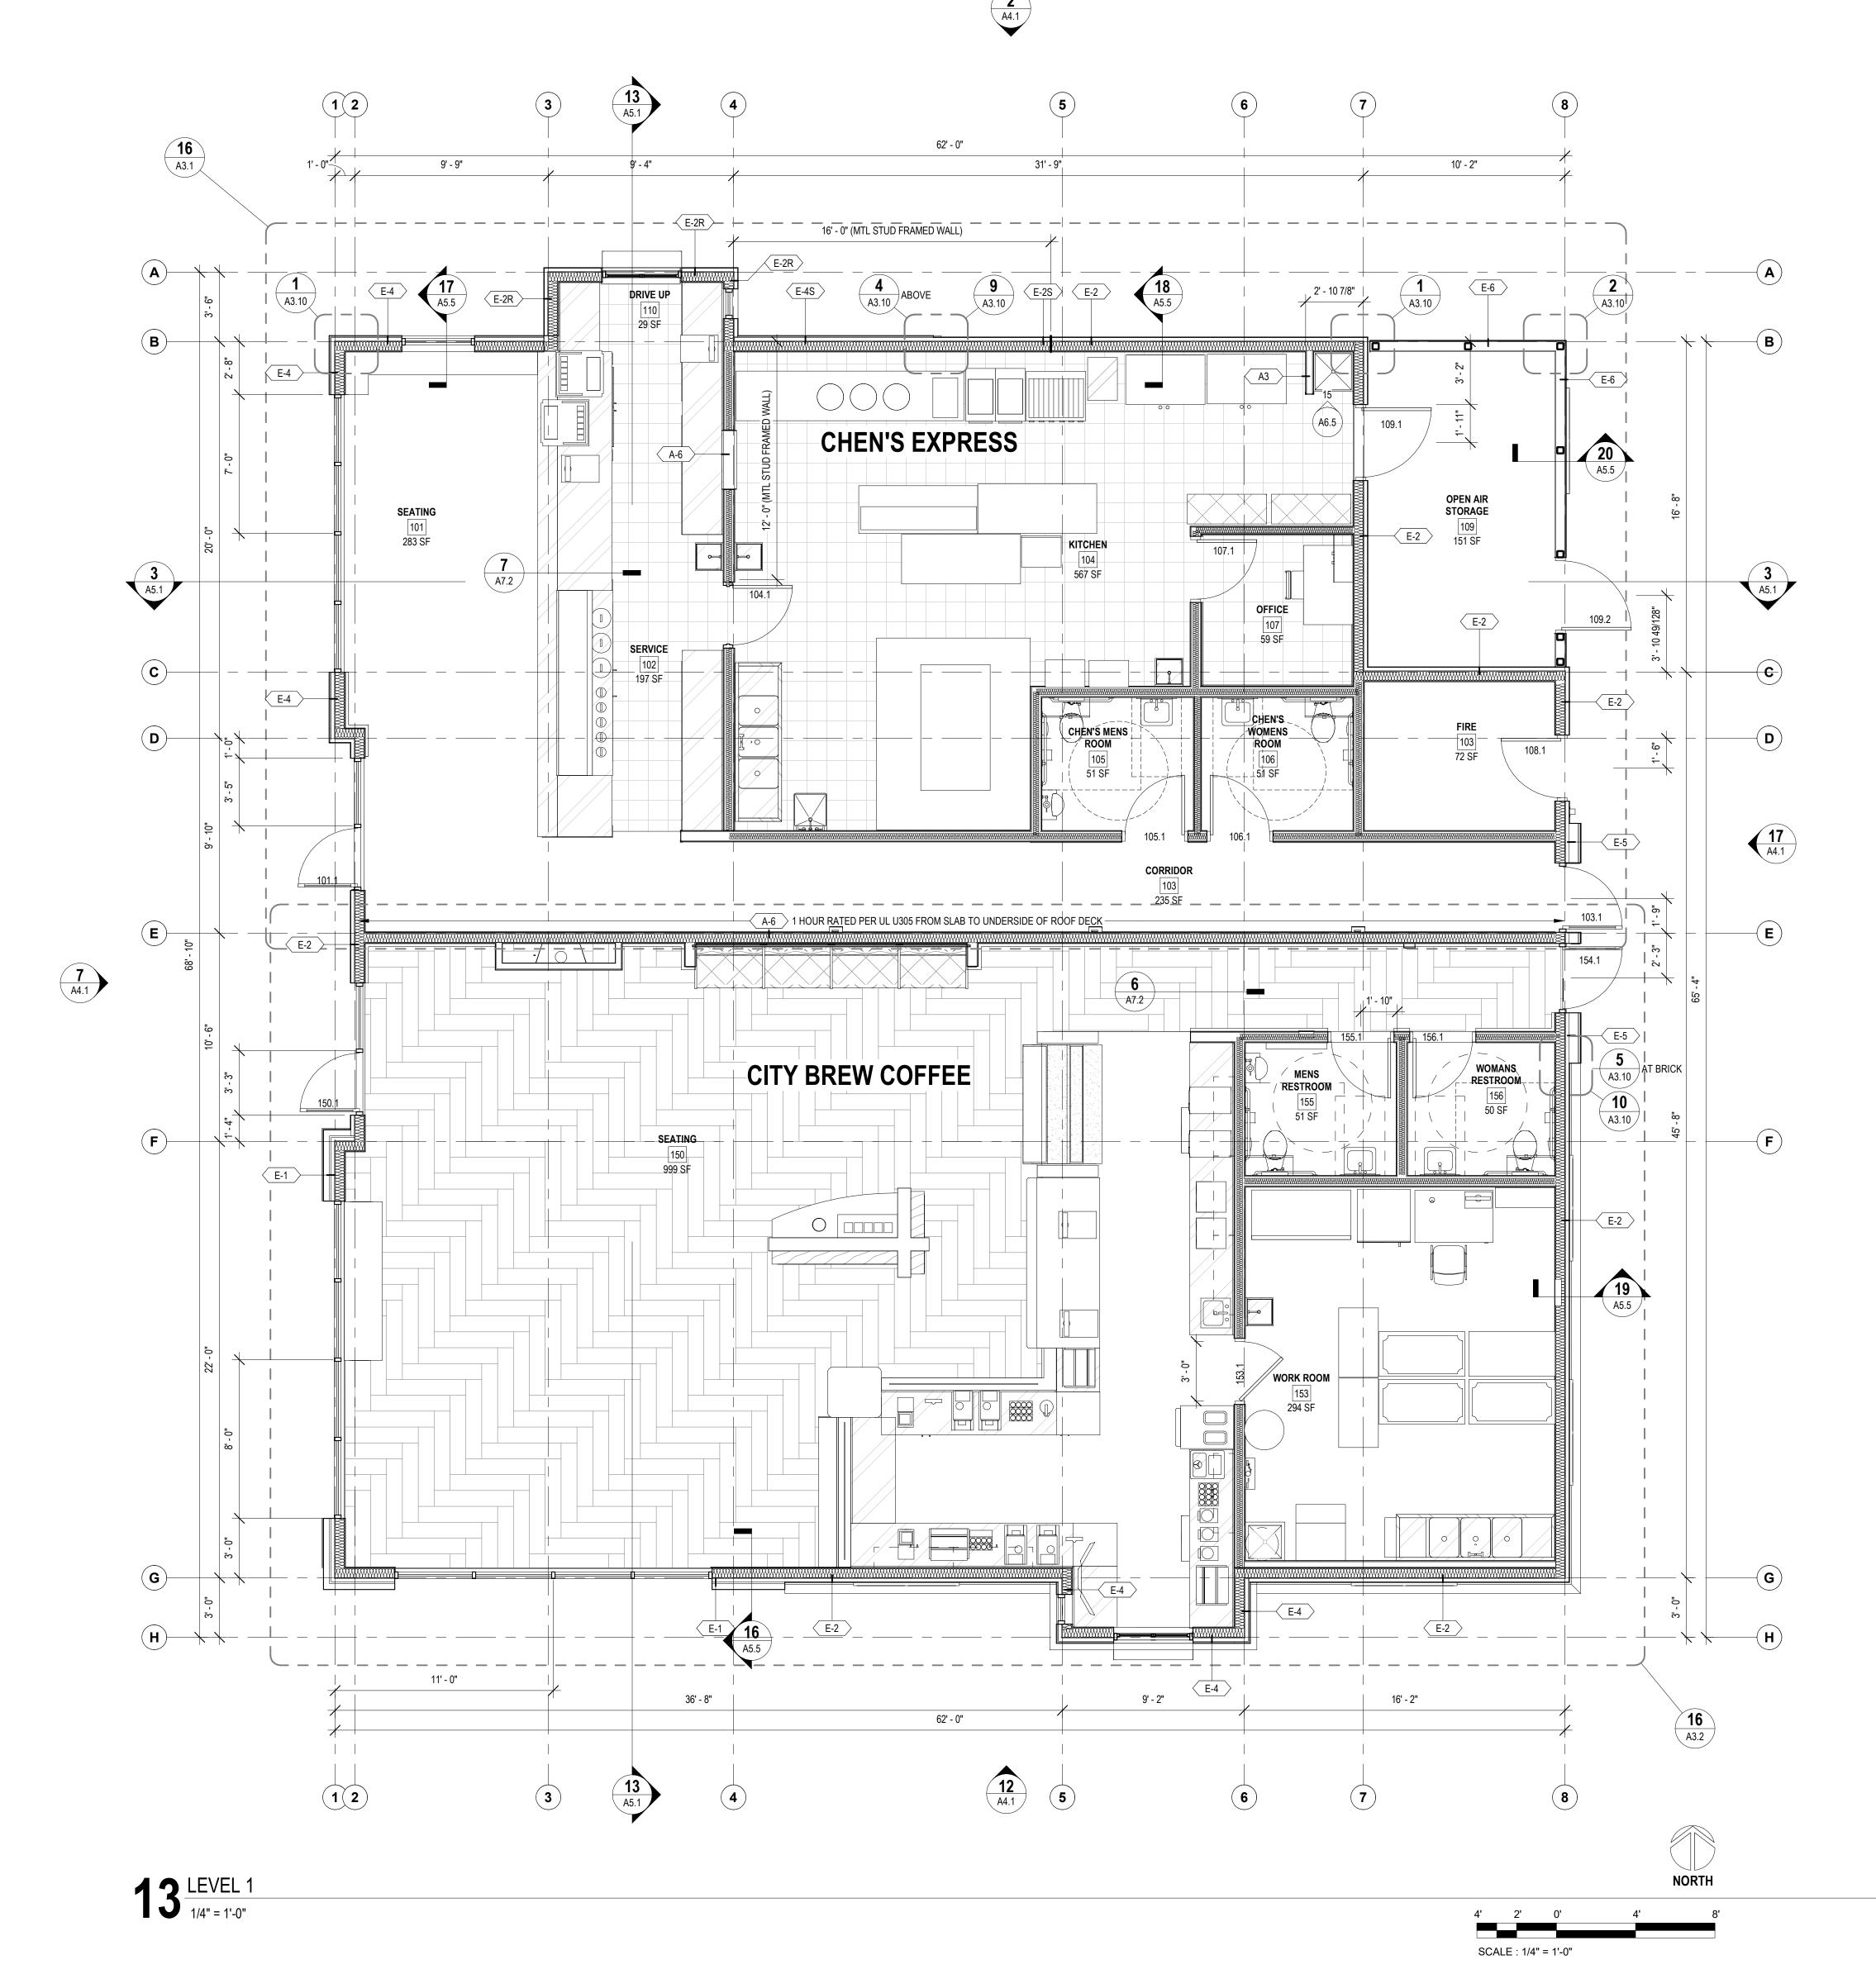

- SEAL PERIMETER

- INSERT ROOFING MEMBRANE FLASHING INTO ROOF

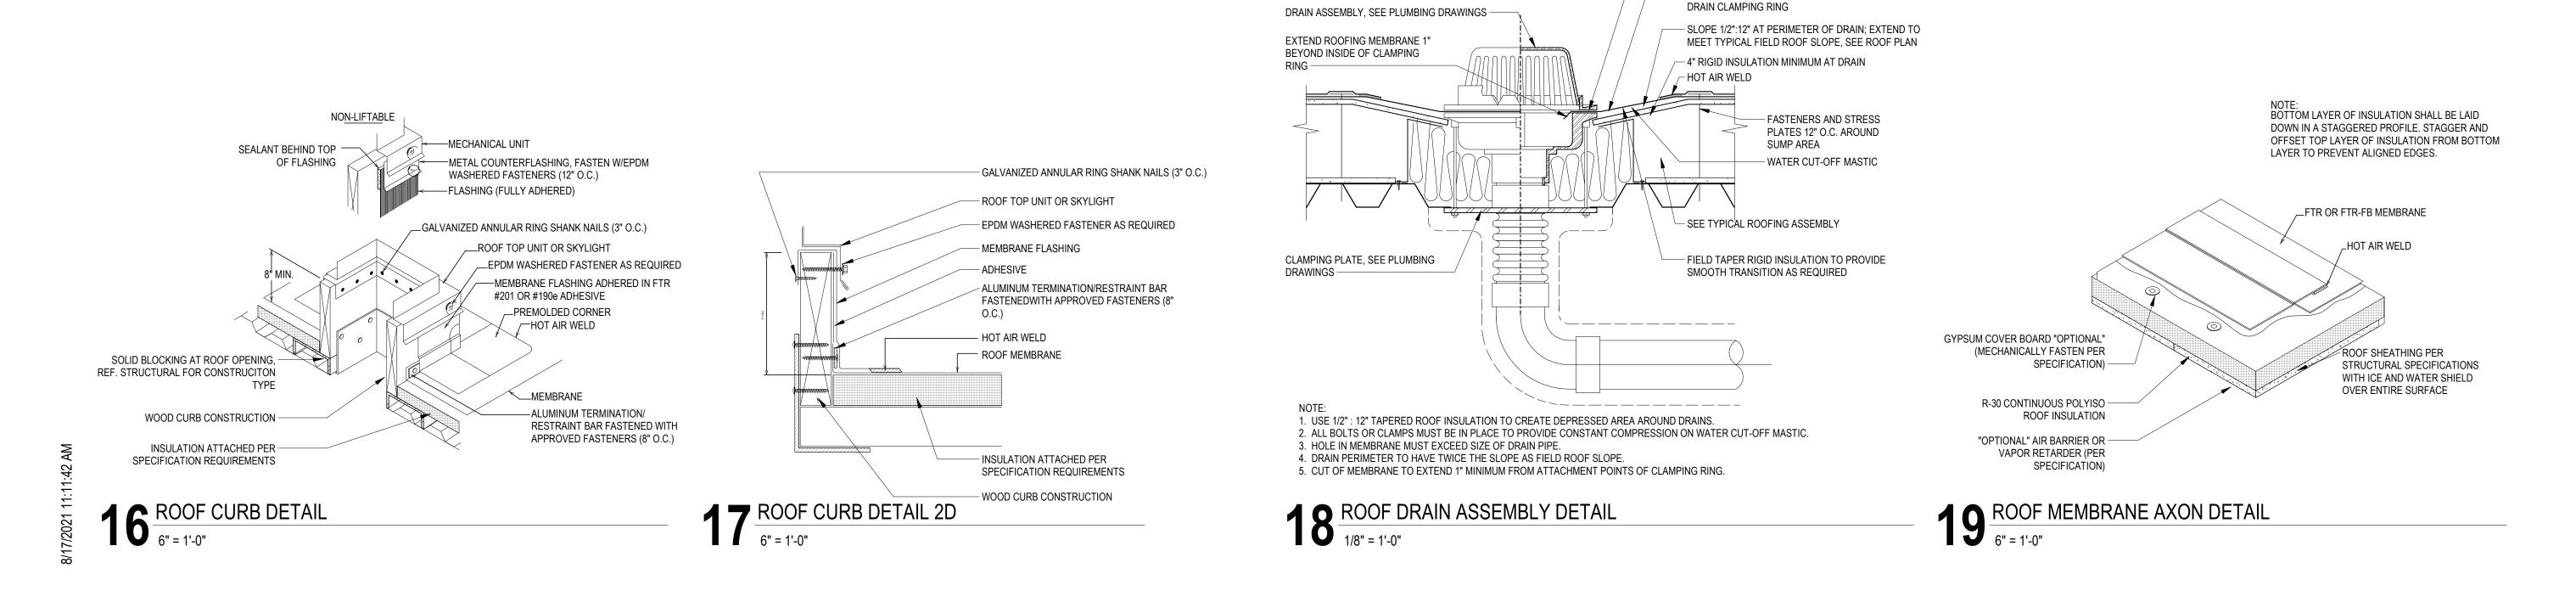

KEYNOTES

ROOF PLAN NOTES


- 1. PROVIDE ROOF CRICKETS AT ALL UPSLOPE AREAS OF MECHANICAL EQUIPMENT, CURBS AND ROOF
- CRICKETS TO SLOPE POSITIVELY 1/4" MINIMUM PER FOOT FROM HORIZONTAL PLANE.
- MAINTAIN 1/8" PER FOOT MINIMUM FOR ALL CRICKET VALLEYS.
- FOR ARCHITECT'S REVIEW PRIOR TO INSTALLATION.

CRICKETS SHOWN ARE FOR REFERENCE ONLY; CONTRACTOR TO PROVIDE DETAILED LAYOUT PLAN


IN ADDITION TO OPENING AND EQUIPMENT SHOWN ON THIS DRAWING, MECHANICAL AND ELECTRICAL

- 5. ROOF PENETRATIONS OF ANY KIND SHALL NOT BE LOCATED IN CRICKET VALLEYS.
- INDICATE ADDITIONAL ITEMS PENETRATING THE ROOF ASSEMBLY; PROVIDE APPROPRIATE
- REFERENCE MECH DRAWINGS FOR VENT LOCATIONS, EQUIPMENT LOCATIONS, AND ADDITIONAL INFORMATION, TYP.



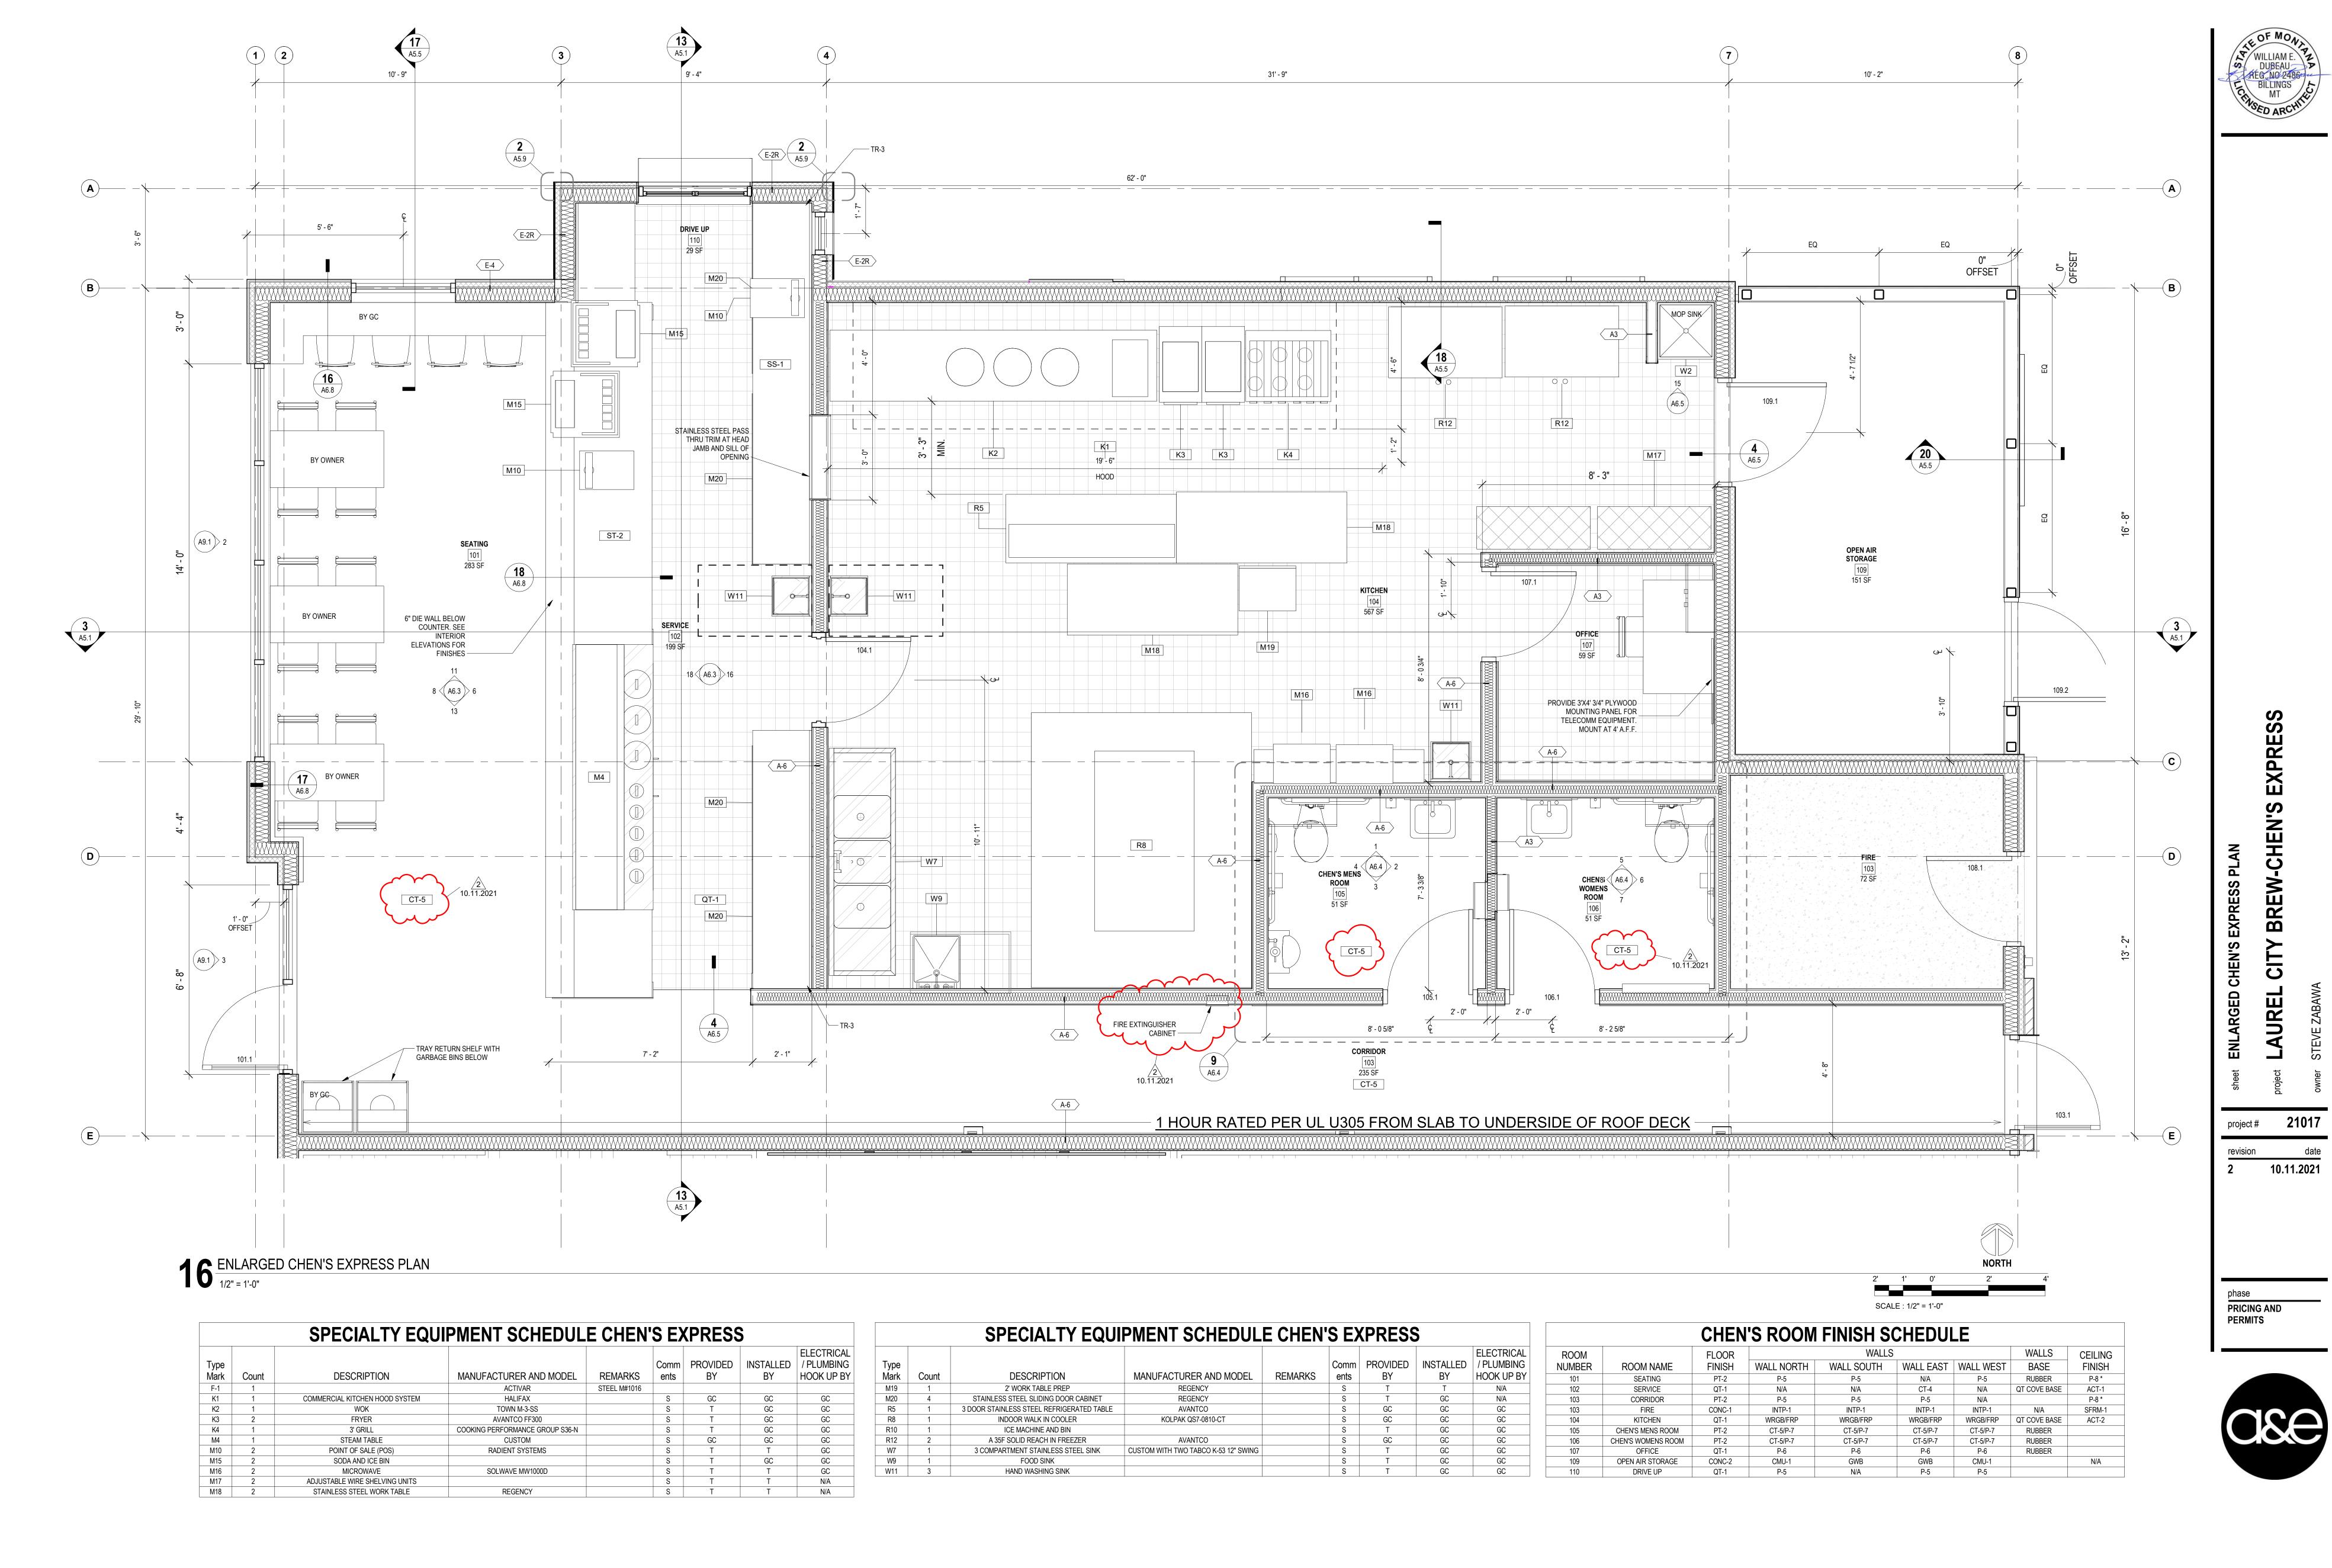

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	SPECIALTY EQUIPMENT SCHEDULE CITY BREW									
Type Mark	Count	DESCRIPTION	MANUFATURER	REMARKS	Comments	PROVIDED BY	INSTALLED BY	ELECTRICAL / PLUMBING HOOK UP BY		
В3	4	ESPRESSO MACHINE	FRANKE S700		В	T	Т	GC		
B4	3	TIRED SYRUP BOTTLE RACK	CUSTOM	CUSTOM FABRICATION BY TENANTS CABINET SHOP	В	Т	Т	-		
B5	3	ON-COUNTER BLENDER	VITAMIX QUIET ONE 36019		В	T	Т	GC		
B8	2	SINGLE BREWER WITH SERVER STAND	BUNN 27850.0006/27825.0000		В	Т	T	GC		
B10	2	DOUBLE BREWER WITH SERVER STAND	BUNN 33500.0006/27872.0000		В	T	T	GC		
F-1	1		ACTIVAR	STEEL M#1016						
M1	3	POINT OF SALE (POS)	TOAST		В	T	T	Т		
M2	2	KITCHEN DISPLAY	TOAST		В	T	T	Т		
M5	1	ELECTRIC OVEN ON STAND	VULCAN ECO2D		В	T	T	GC		
M6	2	TURBOCHEF MIRCOWAVE OVEN	THE SOTA DOC-1204		В	Т	T	GC		
M7	2	DIGITAL WIRELESS COMMUNICATION SYSTEM	3M		В	Т	T	T		
M8	1	METAL LOCKERS	CUSTOM		В	T	T	-		
M9	4	WIRE SHELVING ABOVE REFRIDERATION UNITS	CUSTOM		В	T	T	-		
M13	1	RECESSED FIRE EXTINGUISHER	AMBASSADOR		В	GC	GC	GC		
M14	1	MONITOR	TOAST		В	Т	T	Т		
M18	2	STAINLESS STEEL WORK TABLE	REGENCY		В	Т	Т	N/A		

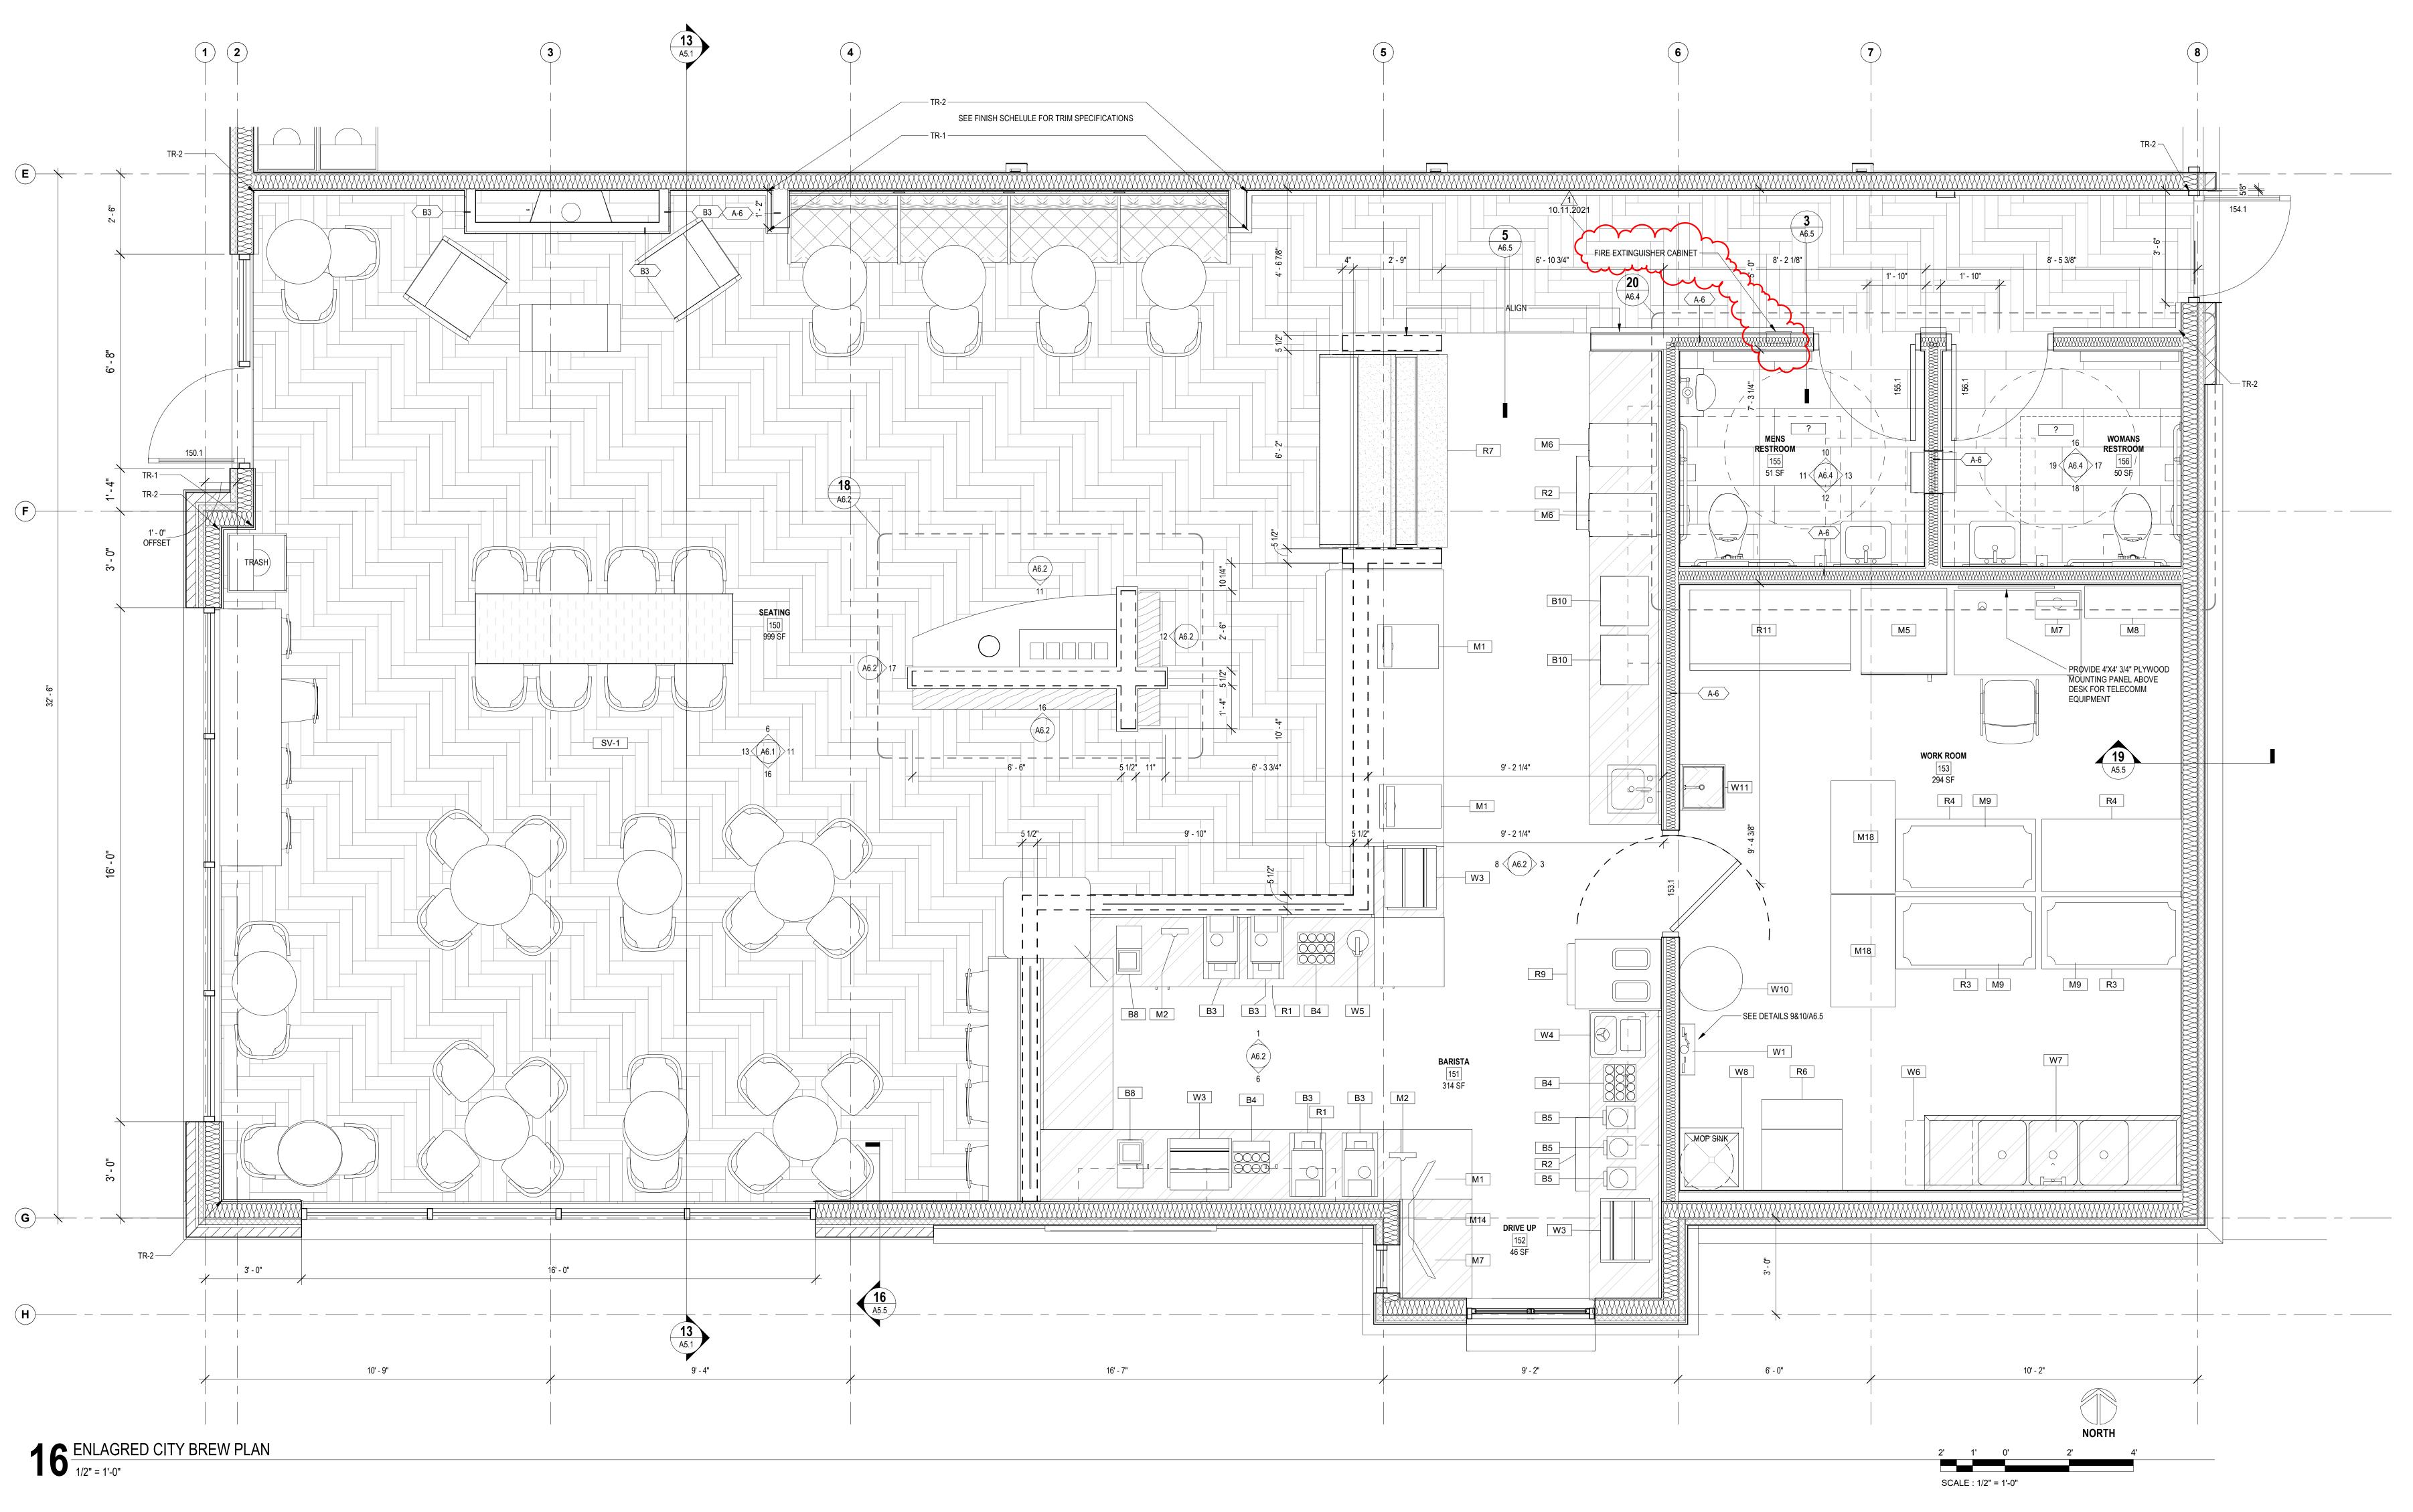Type Mark	Count	DESCRIPTION	MANUFATURER	REMARKS	Comments	PROVIDED BY	INSTALLED BY	ELECTRICA / PLUMBIN HOOK UP E
R1	2	LOW PROFILE UNDER COUNTER REFRIGERATOR 48"	TRUE TUC-48F-LP	2 DOOR	В	T	Т	GC
R2	2	LOW PROFILE UNDER COUNTER REFRIGERATOR 27"	TRUE TUC-27-LP	2 DOOR	В	T	T	GC
R3	2	G-SERIES REACH-IN FREEZER	TRAULSEN G22010		В	T	T	GC
R4	2	G-SERIES REACH-IN REFRIDGERATOR	TRAULSEN G20010		В	Т	T	GC
R6	1	AIR COOLER ICE MAKER ON STORAGE BIN	MANITOWOC IY-0504A		В	T	T	GC
R7	1	REFRIDGERATED DISPLAY	REVEAL NR7251RRSSV		В	T	T	GC
R9	1	FROZEN UNCARBONATED BEVERAGE FREEZER	TAYLOR 342		В	T	T	GC
R11	1	REFRIDGERATOR	TRUE TWT-60		В	T	T	GC
W1	1	ROS REVERSE OSMOSIS SYSTEM	3M TFS450		В	T	T	GC
W3	3	DROP IN ICE CHEST	PERLICK 7600A36	CUSTOM INSULATED ICE BIN INTEGRIL WITH SS, TOP BY NSF SHOP	В	Т	Т	-
W4	1	RINSE O' MATIC AND SINK	VITAMIX		В	Т	GC	GC
W5	1	H2O FILLER	T&S BRASS	PIPE OUTLETS TO FLOOR SINK	В	Т	GC	GC
W6	1	DISHWASHER	CMA DISHMACHINES 180UC		В	Т	GC	GC
W7	1	3 COMPARTMENT STAINLESS STEEL SINK	CUSTOM WITH TWO TABCO K-53 12" SWING		В	Т	GC	GC
W8	1	MOP SINK WITH HANGER AND WATER HEATER SHELF	FIAT PRODUCTS		В	GC	GC	GC
W10	1	REVERSE OSMOSIS TANK	3M 55984-09	TANK PROVIDED BY TENANT & INSTALLED BY GC STRAP TANK TO WALL TO MEET SEISMIC REQUIREMENTS	В	T	Т	GC
W11	1	HAND WASHING SINK			В	Т	GC	GC

			WALLS			WALLS		
ROOM NUMBER	ROOM NAME	FLOOR FINISH	WALL NORTH	WALL SOUTH	WALL EAST	WALL WEST	BASE	CEILING FINISH
150	SEATING	SV-1	P-1	P-1	P-1	N/A		P-8 *
151	BARISTA	RTF-1	N/A	N/A	CT-1	N/A	RUBBER	ACT-1
152	DRIVE UP	RTF-1	N/A	CT-1	CT-1	CT-1	RUBBER	APC-1
153	WORK ROOM	RTF-1	P-4	P-4	P-4	P-4	RUBBER	ACT-1
154	CORRIDOR	SV-1	P-1	P-1	P-1	N/A		P-8 *
155	MENS RESTROOM	PT-1	CT-2/P-3	CT-2/P-3	CT-2/P-3	CT-2/P-3	RUBBER	APC-1
156	WOMANS RESTROOM	PT-1	CT-2/P-3	CT-2/P-3	CT-2/P-3	CT-2/P-3	RUBBER	APC-1



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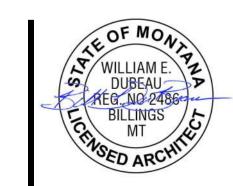
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PERMITS



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A3.2

MATERIAL LEGEND



WOODSIDING HORIZONTAL DARK GREY HARDIEPLANK LAP SIDING

BRICK GENERAL SHALE, MODULAR BRICK
MESQUITE, RUNNING BOND W/SOLDIER COURSE
AT PARAPETS & WINDOW HEADS

VERTICAL CEDAR T&G SIDING WITH V-GROOVE

SMOOTH HAPDIDANEL WITH EXPOSED PAINTED E

SMOOTH HARDIPANEL WITH EXPOSED PAINTED FASTENERS.
SEE ELEVATIONS FOR HARDI REVEAL SYSTEM PATTERN.
COLOR 1 (B.O.D. RED) TBD BY ARCHITECT

SMOOTH HARDIPANEL WITH EXPOSED PAINTED FASTENERS. SEE ELEVATIONS FOR HARDI REVEAL SYSTEM PATTERN. COLOR 2 (B.O.D. BLACK) TBD BY ARCHITECT

KEYNOTES

TUBE STEEL FRAME SURFACE APPLIED TO EXTERIOR WALL POWDER COAT FINISH

5-02 STEEL CANOPY WITH TIE ROD SUPPORTS, REF STRUCTURAL
5-06 STEEL FRAMED WALL MOUNTED AWNING WITH CANVAS COVERING

07-01 LAMBS TONGUE OVERFLOW DRAIN THRU WALL SCUPPER
10-15 READY ACCESS STAINLESS STEEL SHELF MODEL 275

3-02 OWNER PROVIDED VINYL GRAPHIC 2-01 FAUX WINDOWS

2-01 FAUX WINDOWS
2-02 TENANT PROVIDED EXTERIOR SIGNAGE. COORDINATE BLOCKING AND POWER WITH GC & ELECTRICAL CONTRACTOR

LAUREL CITY BREW-CHEN'S EXPR

±# **21017**

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phase
PRICING AND



issue date 7.2.2021

MATERIAL LEGEND

WILLIAM E. DUBEAU PREG. NO 2486
BILLINGS MT

WOODSIDING HORIZONTAL DARK GREY HARDIEPLANK LAP SIDING

BRICK GENERAL SHALE, MODULAR BRICK MESQUITE, RUNNING BOND W/SOLDIER COURSE AT PARAPETS & WINDOW HEADS

WOODSIDING VERTICAL WOOD SLATES RECLAIMED BARN WOOD SIDING

SMOOTH HARDIPANEL WITH EXPOSED PAINTED FASTENERS. SEE ELEVATIONS FOR HARDI REVEAL SYSTEM PATTERN. COLOR 1 (B.O.D. RED) TBD BY ARCHITECT

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