

TOWN OF LAKE LURE

Zoning And Planning Board Regular Meeting

Tuesday, July 16, 2024 at 9:30 AM

Meeting to be held at Town Hall



Agenda

I. Roll Call

II. Approval of Agenda

III. Approval of June 18 meeting minutes

IV. Public comments

V. Old Business

VI. New Business

A. Review of submitted 9 lot, single family residential subdivision Preliminary Plat for Awen, LLC, with town staff approvals, for approval decision by Zoning & Planning Board. Site location between Quail Ridge Road and Kings Drive.

B. Discussion regarding “Protected Mountain Ridges” overlay zones as regulated by section 36-71.

C. Discussion regarding permit eligibility of accessory building without a primary building as defined in section 36-5.

VII. Monthly Department Report

VIII. Adjournment



MINUTES OF THE REGULAR MEETING OF THE TOWN OF LAKE LURE ZONING AND PLANNING BOARD

TUESDAY, JUNE 18, 2024
9:30 A.M.

Present: Randall Nelson, Chair
Dave Keenan
Ken Williams
Charlie Ellis
Scott Doster, Town Council Liaison

Absent: Mac Hillabush

Staff: Michael Williams, Community Development Director
Richard Carpenter, Development and Environmental Review Specialist

The meeting was called to order at 9:33 a.m.

I. ROLL CALL

Pledge of allegiance

II. APPROVAL OF THE AGENDA

Dave Keenan made a motion to approve the agenda as presented, Ken Williams seconded it, and all voted in favor.

III. APPROVAL OF THE MINUTES

Charlie Ellis Made a Motion to approve the minutes from May 21, 2024 as presented Dave Keenan Seconded and all were in favor.

IV. PUBLIC COMMENT

No public comments

V. OLD BUSINESS

- A. Status of Board's recommendation re: amending code of ordinances Chapter 4 (public school to keep goats for educational purposes).

Mike Williams –Addressed the board in regards to the recommendation that was made at the last meeting, for the animals to be used in public schools of Lake Lure was approved by town council – there were some discussions at the regular town council meeting and comments from the audience asking if it was allowed everywhere in the town and the council members specified that the use of the animals were being allowed for educational purposes only. There is only one in town right now and don't anticipate any others and they will have goats and chickens. The chickens are permitted to be there but they don't have any permits yet, they need to be added to the permitted system which Mr. Williams said he is working on that and has been in communications with the school to find out how many chickens they will need.

- B. Status of pending AWEN subdivision proposal.

Mike Williams, informed the board that the subdivision was not a review but talk to Carolina water systems, they said that they don't have the capacity, they can't serve them water but they can give them a fire hydrant – they have septic. They are going to put a six inch line which it's required by our code for future availability they are going to put a water tab, for water storage so they can have the capacity for fire hydrants, because one of the issues that came up were if they go in there without adequate fire protection without hydrants that can potentially can affect the whole town, so they agreed to putting wells and septic's as well as the fire hydrants. And as soon as all of that is in writing then there will be something for the board to review.

- C. Follow-up report relating to last month's "historic overlay" discussion.

Mike Williams shared that there is a group attempting to buy the historic Lake Lure Inn that is evaluating potential historic registration for the property. He reminded board of their discussion at the last meeting regarding "historic overlays" and the consensus was that the Town may want to wait and see what that group's thoughts were since they would own a very significant portion of the overlay area that the board had discussed.

VI. NEW BUSINESS

- A. SUP2024003 for new commercial building at 1804 Memorial Highway

Mike Williams said that Mr. Frank Butera, it still building the previously approved work shop but the building currently does have metal siding. It is not finished yet and he is in the process of making the necessary changes to sheath the metal. The finished siding will be approved hardi-board, because the metal siding is in violation with the towns ordinances. We can't finalize anything until the building is finished. In the meantime, Mr. Butera has purchased a storage shipping container and is using it as a storage building, which is not in compliance with the code. Mr. Frank Butera, mentioned that he will do what the town ask of him to make sure he meets the town ordinances, to be able to establish his business there.

Mike Williams, speaking on the new application, stated that the plans they have so far don't meet the ordinance requirements. His recommendation to the board was to not approve that application because metal storage containers are not permitted under Town Code.

Charlie Ellis Made a motion that permit number SUP2024003 not be considered because the application is incomplete and therefore it cannot be considered at this time, Ken Williams seconded and all voted in favor.

B. SUP2024004 for new commercial building at 2550 Memorial Highway

Mike Williams, reports that the request is to approve a 42' by 70' commercial office building. The building would have a metal frame and similar to the Butera workshop building, but the plans are to have it match the Gorge Outreach building on adjacent property. Board reviewed the copy of the plans, the Development Review recommendation that they get a DOT driveway permit, and Williams reminded the board that their specific consideration should focus on the ordinance design and appearance standards. Williams reviewed a copy of those standards from the Code Book. He stated that the building is a permitted use and that the only reason for the Special Use permit is because our code says that all new commercial buildings should be reviewed.

Dave Keenan made a motion to approve the permit for SUP2024004 for new commercial building at 2550 Memorial. Charlie Ellis seconded – all voted in favor.

VII. MONTHLY DEPARTMENT REPORT

Mike Williams reported that cell tower is projected to be within weeks of breaking ground, probably in July. Also reported that we have two Appalachian State interns working in the town – Megan Pitts is working in our department and with Public Works. She is doing research to update our street right of way information, we have limited information on them. She is also using her Arc GIS skills to help us and Public works with mapping projects. Trey Blackwood – is an intern who is working with the Town Manager. He is in the Master's program, pursuing a career as a Town Manager.


VIII. ADJOURN

Dave Keenan made a motion to adjourn the meeting, Ken Williams seconded all in favor, the meeting ended at 10:22 a.m.

ATTEST

Elba A. Willette, Town Clerk

Randall Nelson, Board Chair

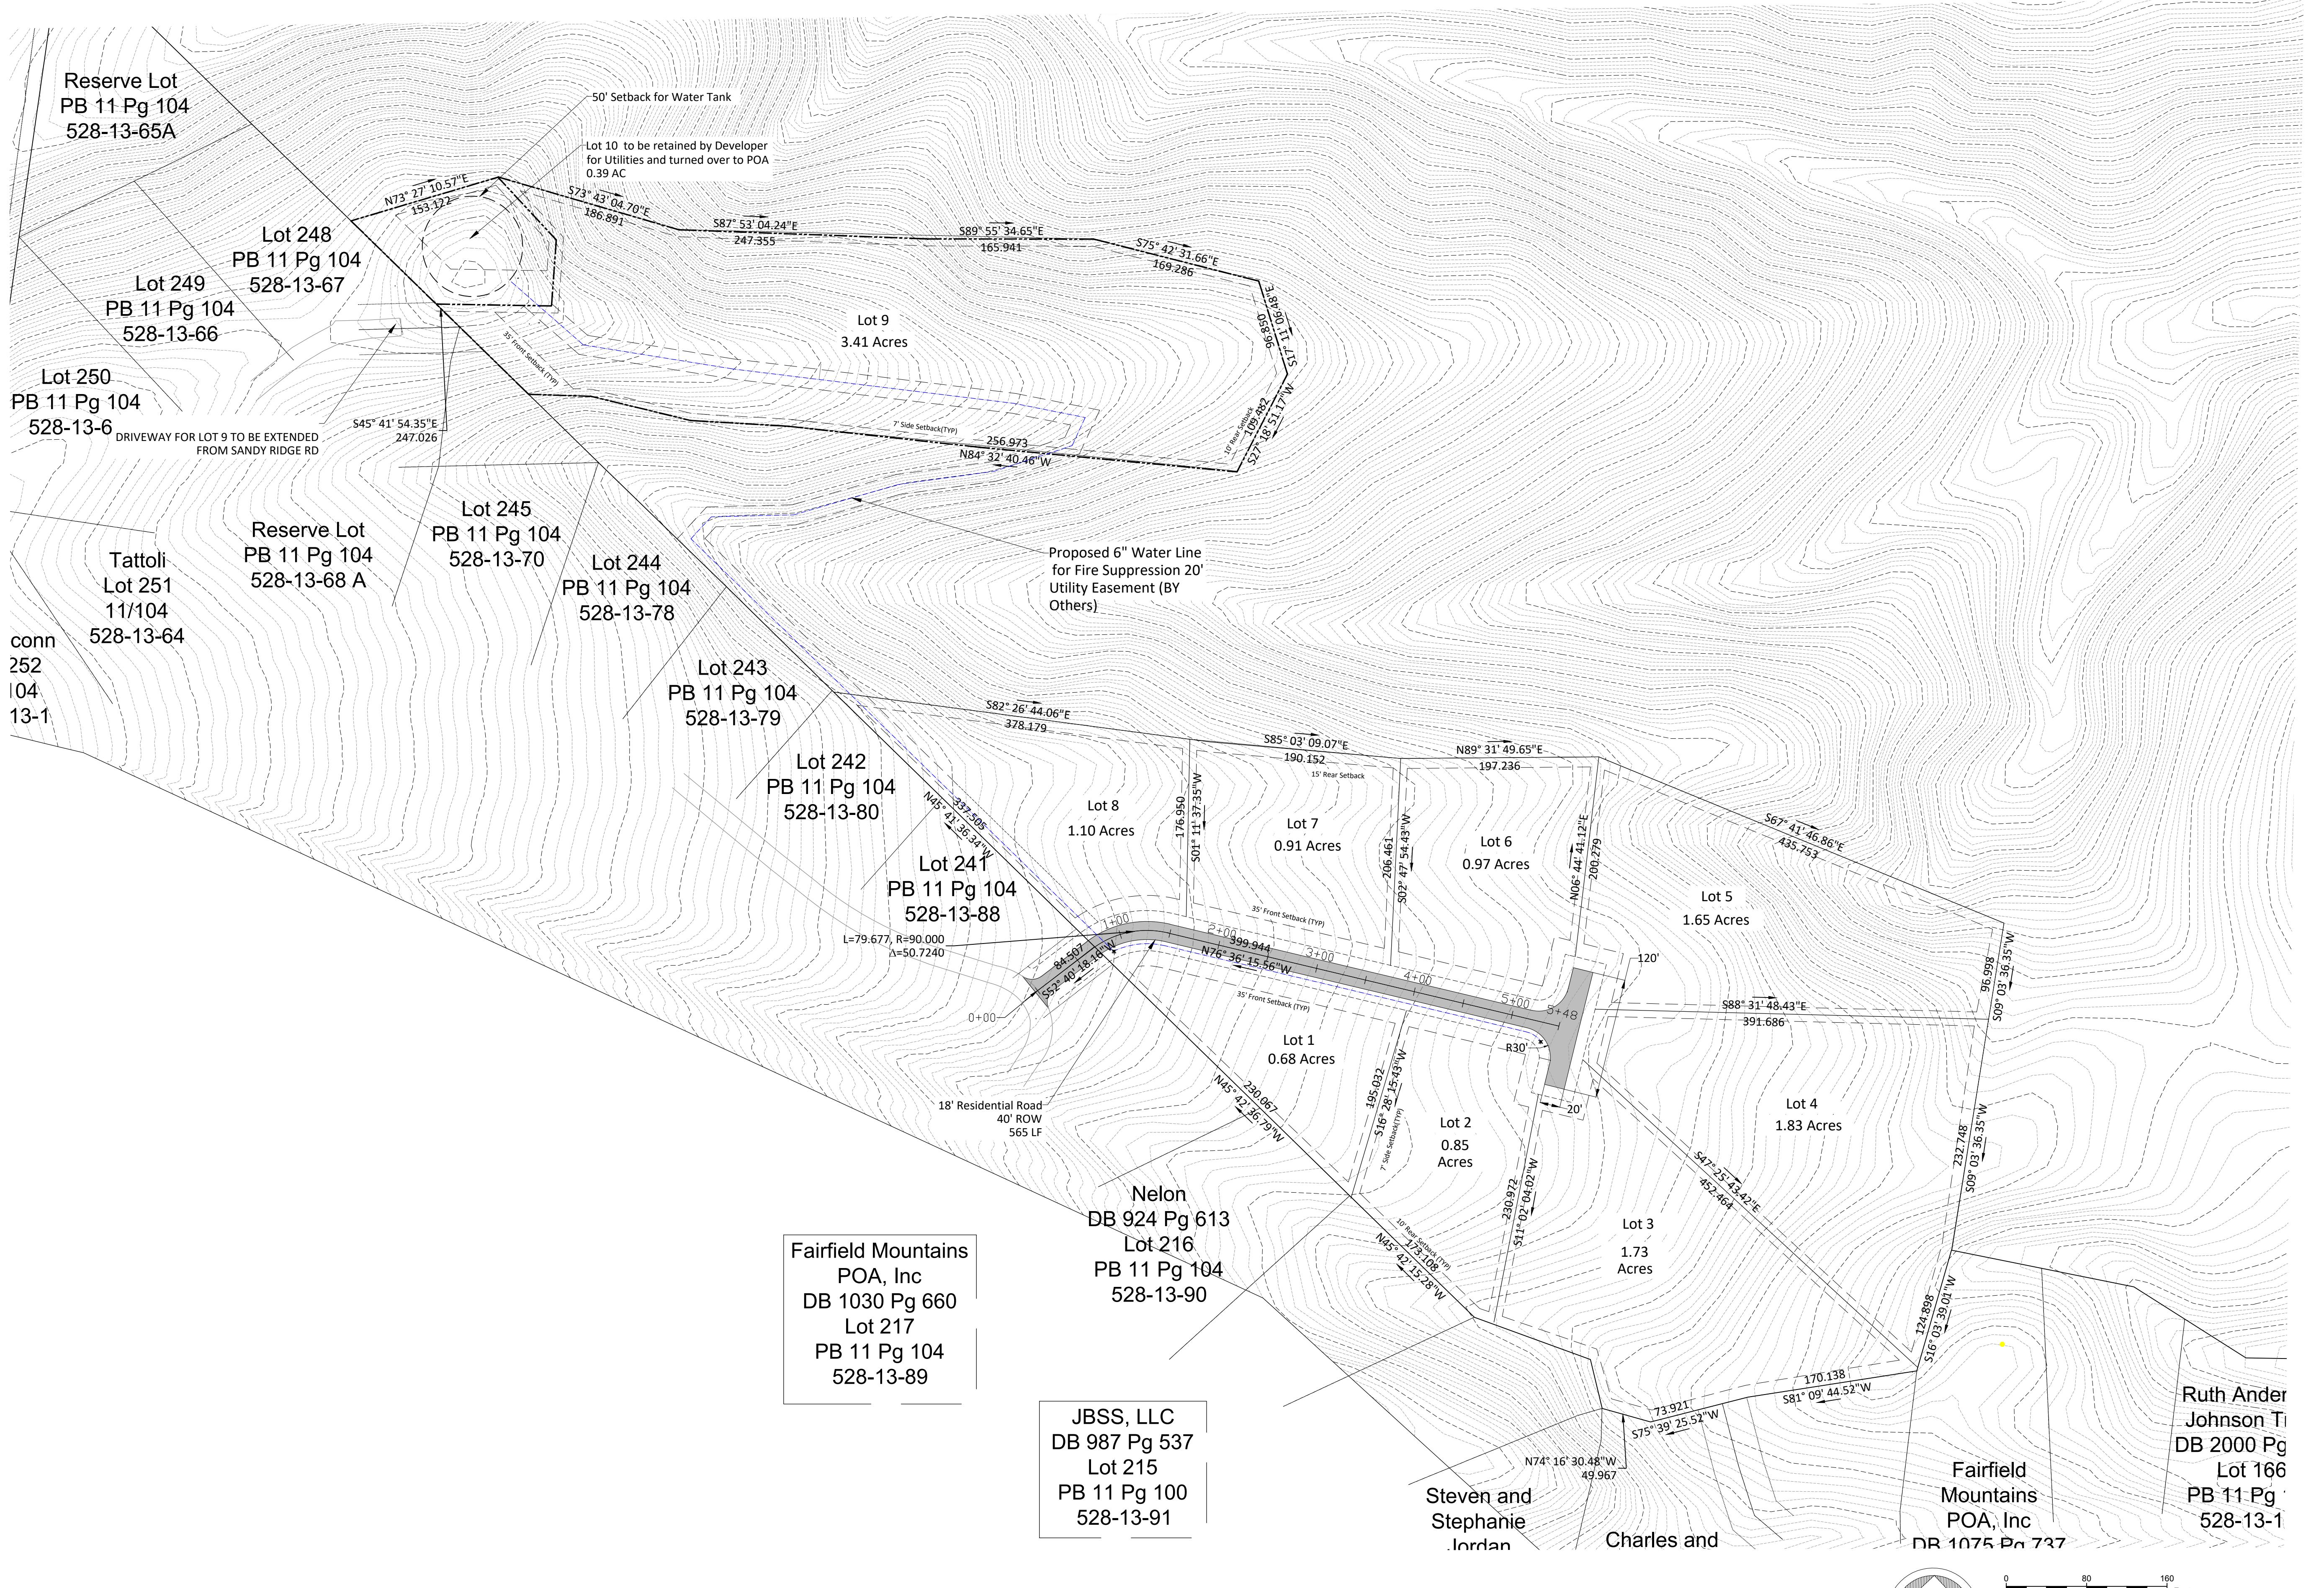

Awen LLC Lots 1-10 Rutherford County, North Carolina

The logo consists of the letters "LRM" in a large, bold, black sans-serif font. To the right of the letters is a circular emblem. The emblem contains a stylized illustration of three evergreen trees with dark trunks and light green needles. Below the trees is a large, bright blue teardrop shape. At the bottom of the circle are three thin, horizontal wavy lines representing water.



Submissions	Date
Preliminary Plat Submittal	03/24/2021
Preliminary Plat Submittal	07/03/2021

Project Number: 412523	Scale= As Noted	Drawn By Checked By GMG	Date: 03-08-2022
		S1	

Submissions	Date
Sediment and Erosion Control Application	02/09/2024
Sediment and Erosion Control /Comments	02/09/2024
Sediment and Erosion Control /Comments	02/26/2024
Preliminary Plat Submittal	03/24/2024



LRM
P.O. BOX 9251
ASHEVILLE, N.C. 28815
Phone: (828) 900-8700
www.landrm.com

Awen LLC Lots 1-10 Rutherford County, North Carolina

Erosion Control Awen Dr

Project Number:
330323

Scale= As Noted

Drawn By
GMG

Checked By
GMG

Date:
02-02-2024


ESC 2

LEGEND


ITEM:	EXISTING PROPERTY LINE
LIMIT OF DISTURBANCE	-----
EXISTING CONTOUR
FINISH CONTOUR
DRAINAGE PIPE (HDPE DBL. WALL)	—
DRAINAGE AREAS
DRAINAGE FLOW DIRECTIONS	→ →
AREA TO STABILIZED WITH GRASS SEED	[dotted pattern]
6.41 OUTLET STABILIZATION STRUCTURE	[cone icon]
6.60 TEMP. SEDIMENT TRAP WITH BAFFLES	[cone icon with baffle]
6.61 SEDIMENT FENCE	[fence icon]
6.06 TEMP. GRAVEL CONST. ENTER/EXIT	[gravel icon]
6.87 CHECK DAM WITH WEIR	→ →
ROCK INLET PROTECTION	[circle icon]
TEMPORARY DIVERSION DITCH	[dashed line icon]
SILT FENCE OUTLET	[dashed line icon]


DRAWN TO SCALE FOR ACRES	
1/4" / 6 FT	24' x 48' = .48 ac
BAFFLES TYP. ALL TST	TYP. "A" Ck max. 0.5 ac
TRAP TYPE AND CHECK LENGTH	TYP. "A" Ck max. 1.0 ac
	TYP. "B" Ck max. 1.5 ac
	TYP. "B" Ck max. 2.0 ac
	TYP. "C" Ck max. 2.5 ac
	TYP. "C" Ck max. 3.0 ac
	TYP. "D" Ck max. 4.0 ac
	TYP. "E" Ck max. 5.0 ac

SEE DESIGN AND DETAILS D-2

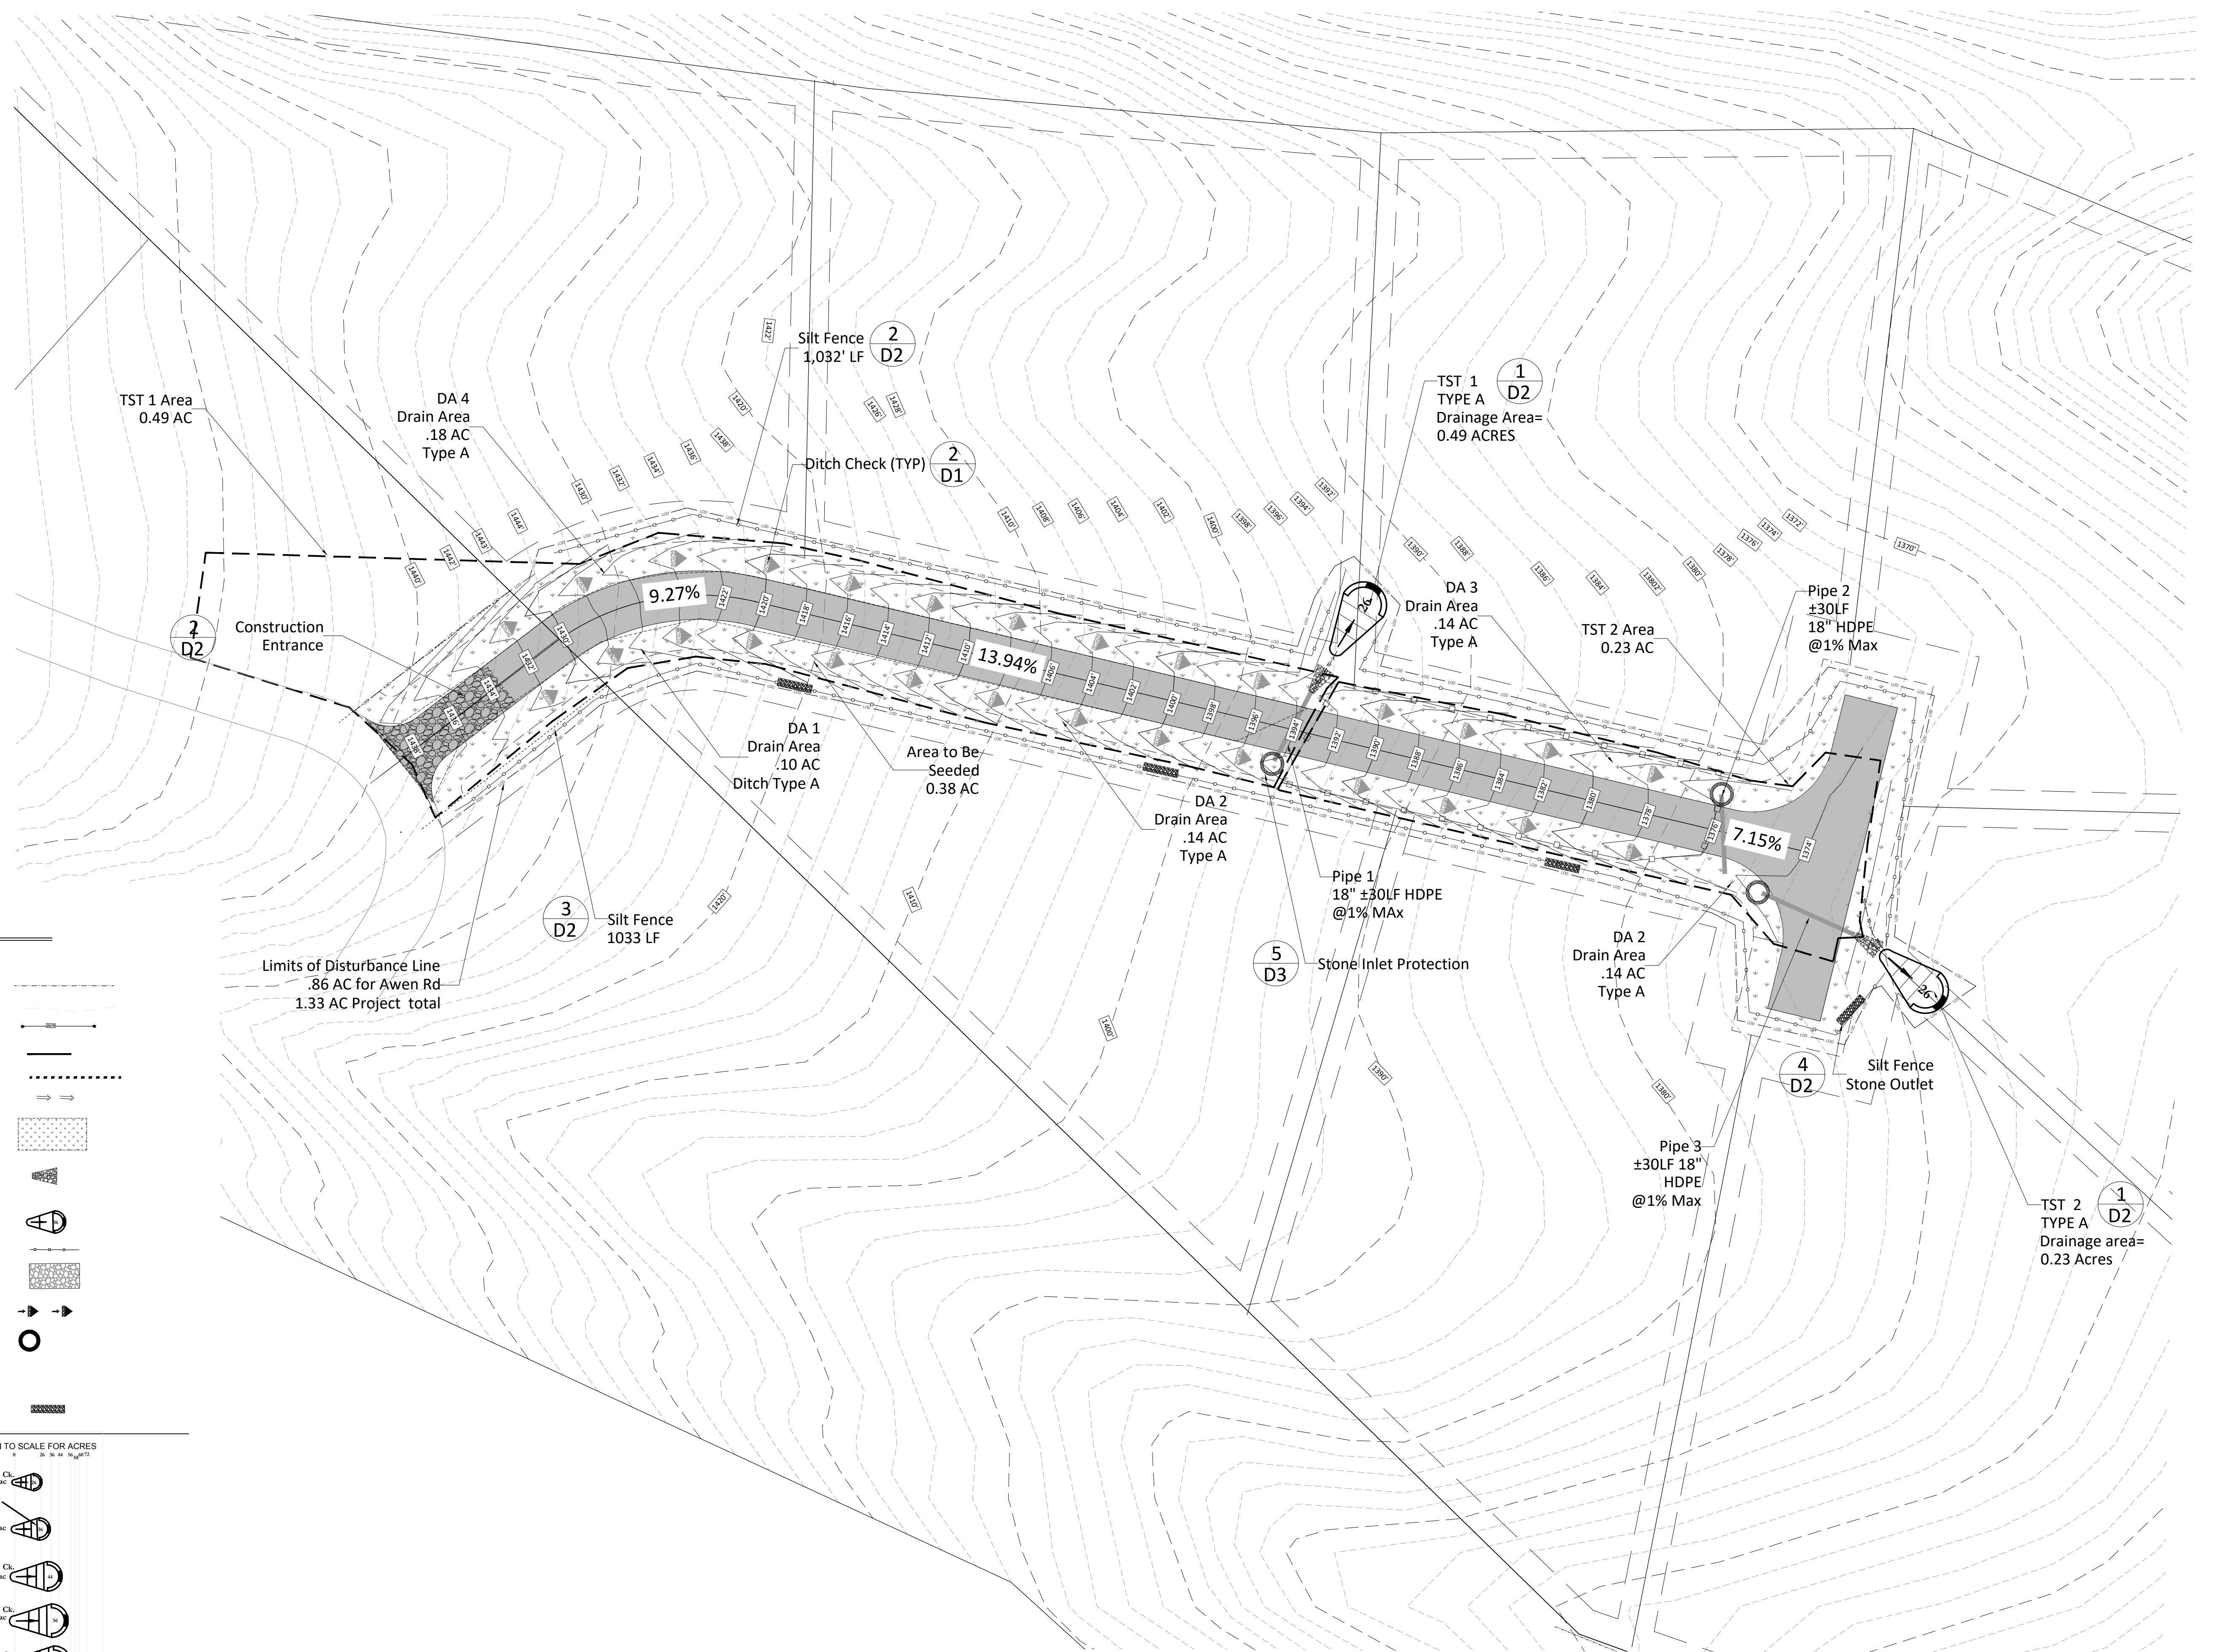


Scale: 1"= 30'-0"

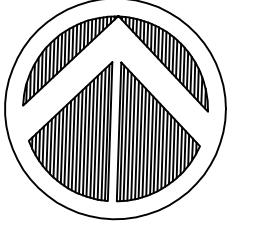

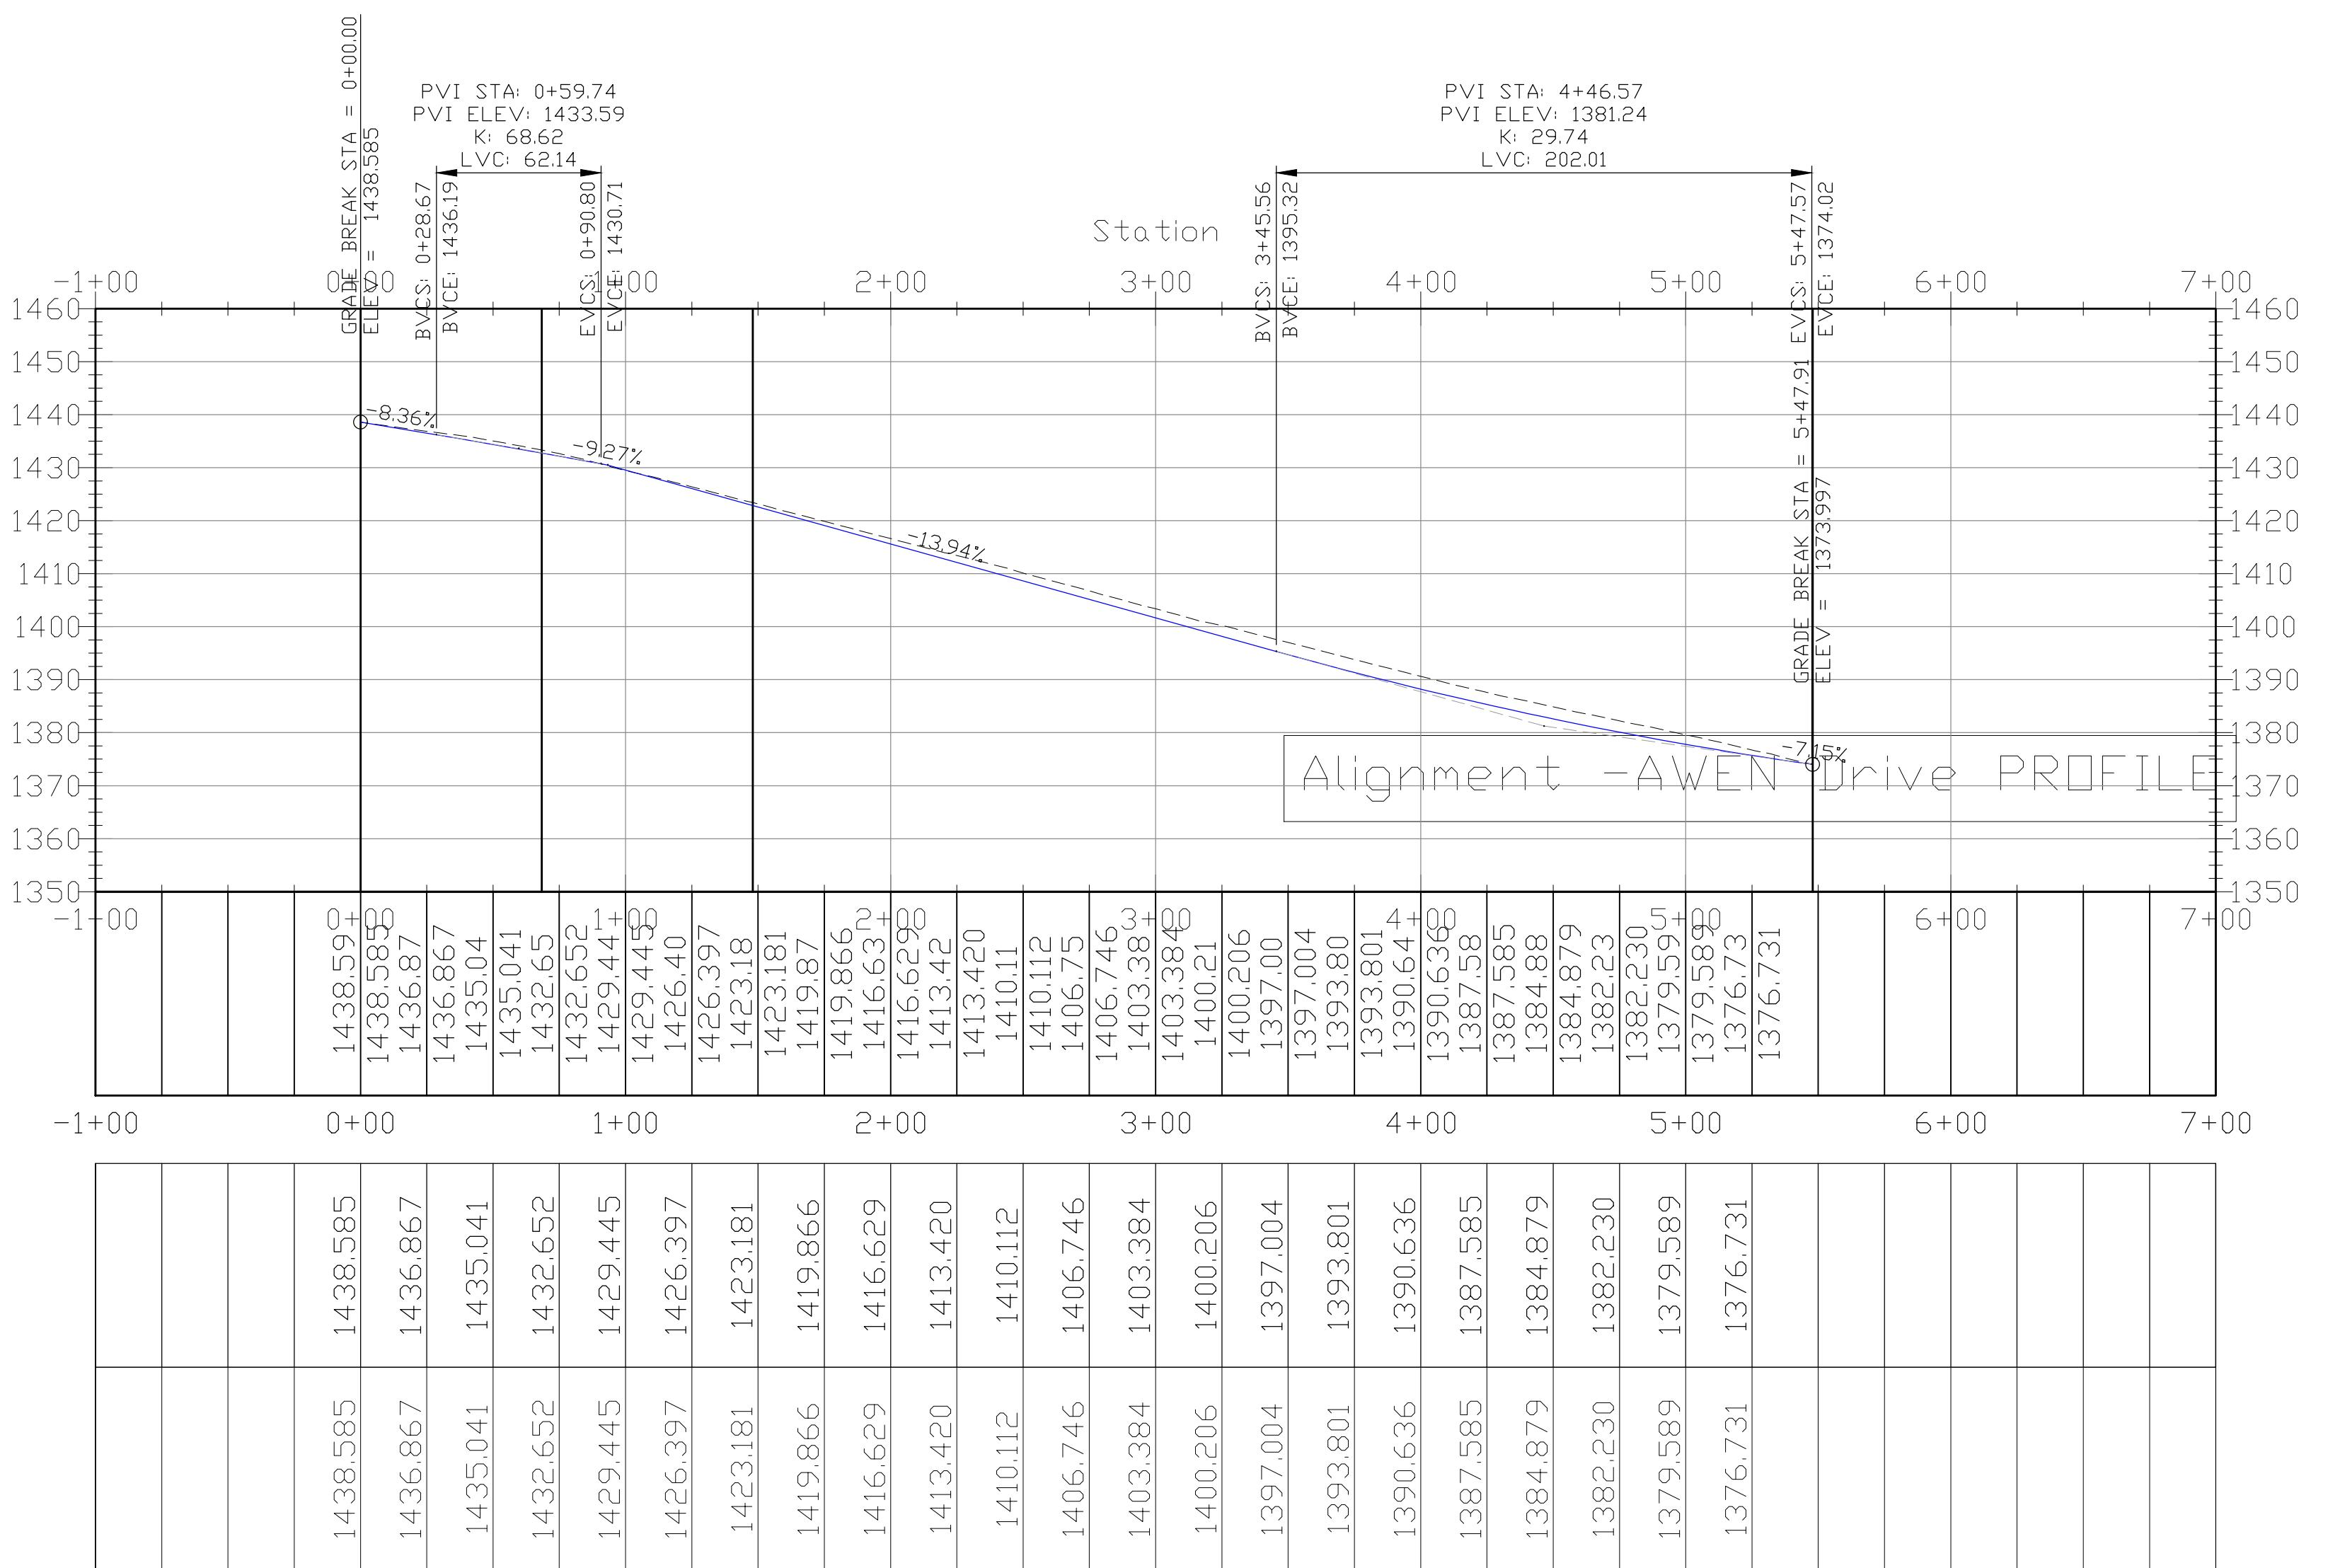

VERTICAL ROAD PROFIL

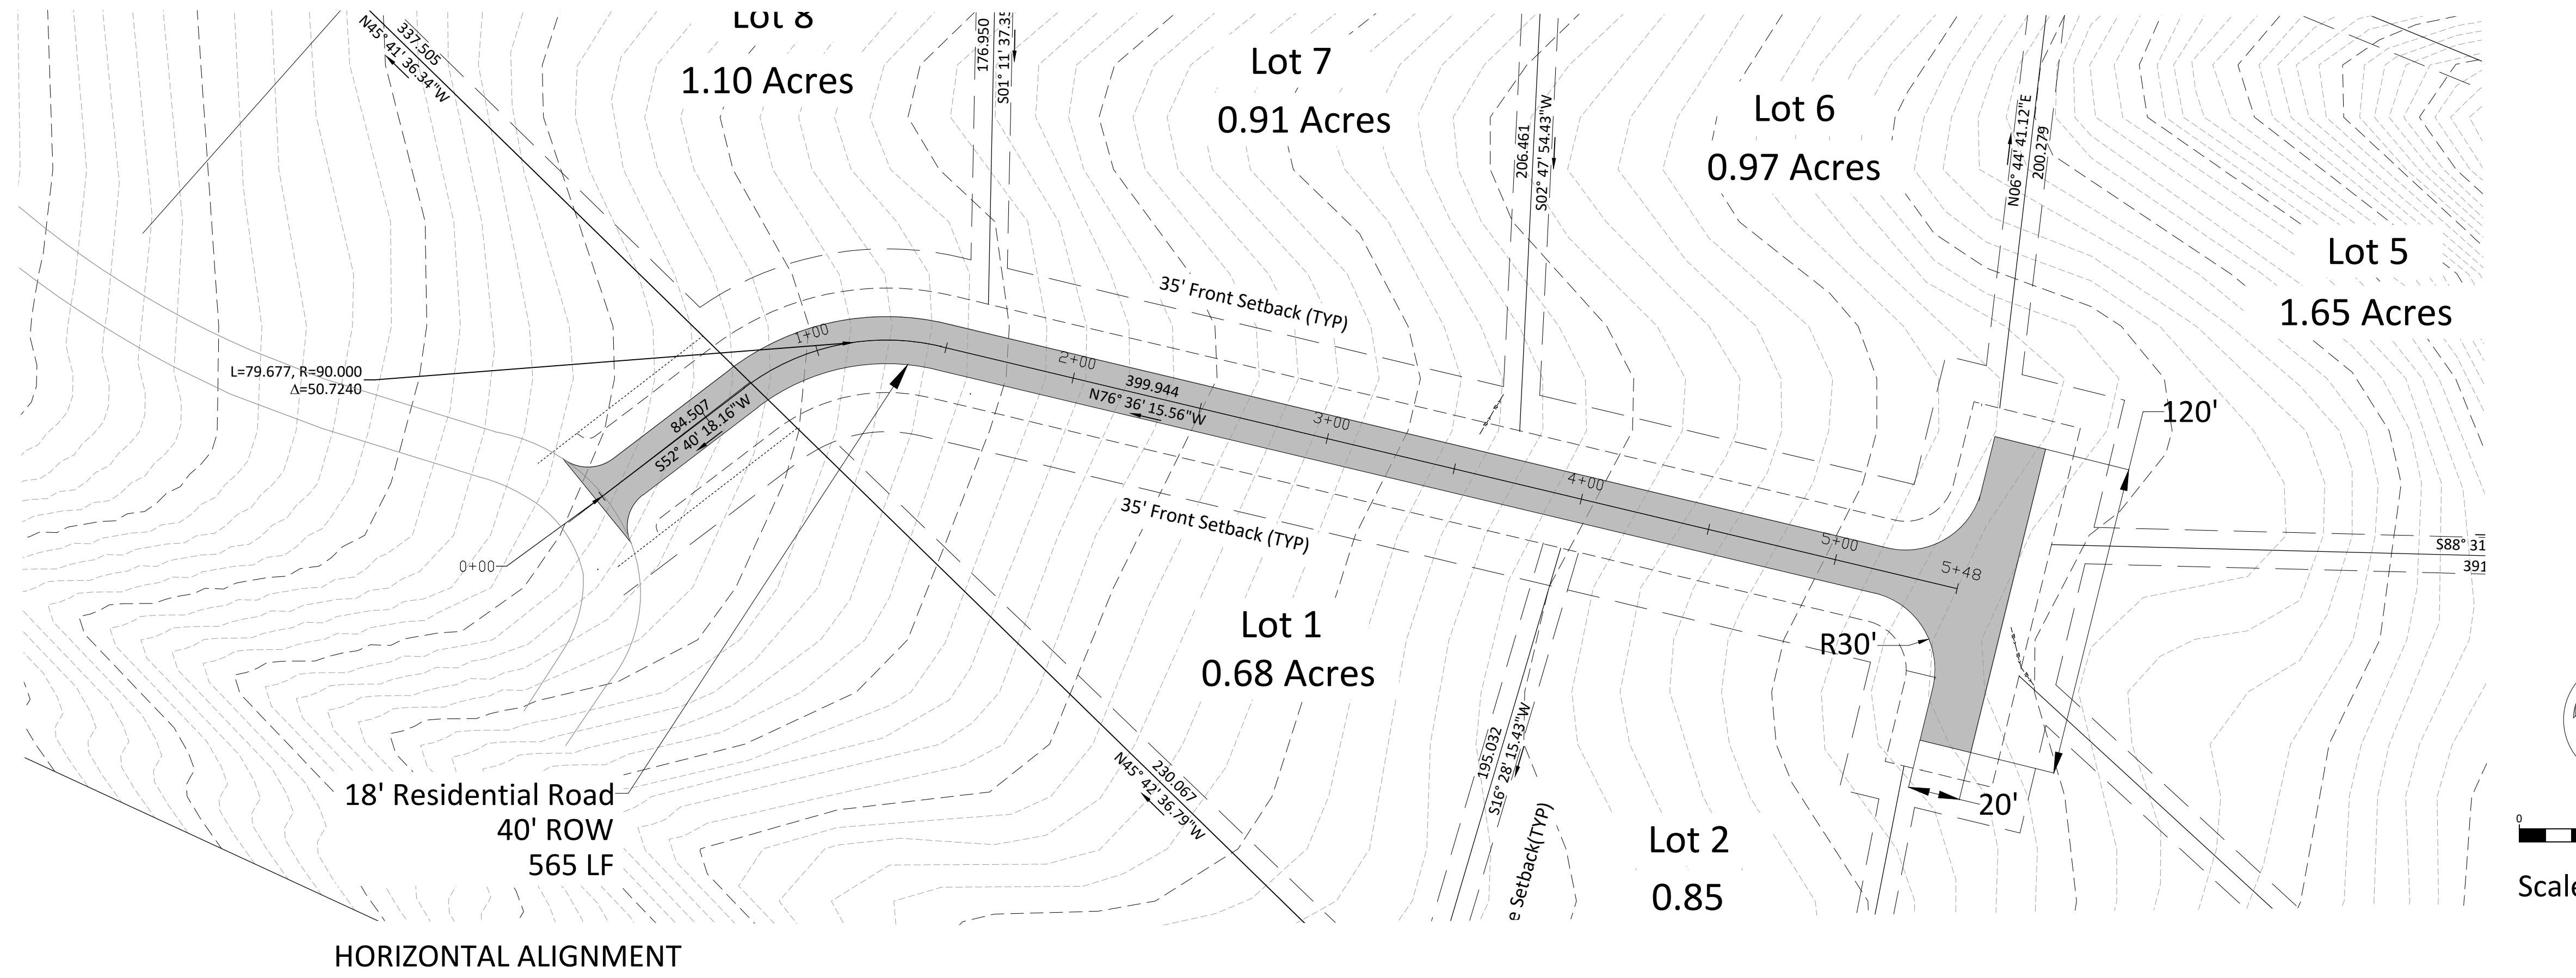

AWEN LLC Lots 1-10 Rutherford County, North Carolina

The logo consists of the letters "LRM" in a large, bold, black sans-serif font. To the right of "LRM" is a circular emblem. The emblem contains three stylized evergreen trees of varying heights. Below the trees is a large, vibrant blue teardrop shape. At the bottom of the circle is a thin, wavy horizontal line representing water.



Submissions	Date
Preliminary Plat Submittal	03/24/2011

Project Number: 330323	AWEN LLC Lots 1-10 Rutherford County, North Carolina	
Scale= As Noted	Drawn By GMG	Checked By
R1	Date: 02-09-2024	Road Profile and Alignment Awen Drive

**Awen LLC Lots 1-10
Rutherford County, North Carolina**

Schematic Utility Plan

Project Number:
4-12523

Scale= As Noted

Checked By



Date:
07-03-2024

U1

Submissions	Date
Preliminary Plat Submittal	03/24/2024
Preliminary Plat Re-Submittal	07/03/2024


Not Far Construction
Driv For Review
GREG GOTSCHE

Project Number: 4-12523	Scale= As Noted
Drawn By GMG	Checked By
Date: 07-03-2024	

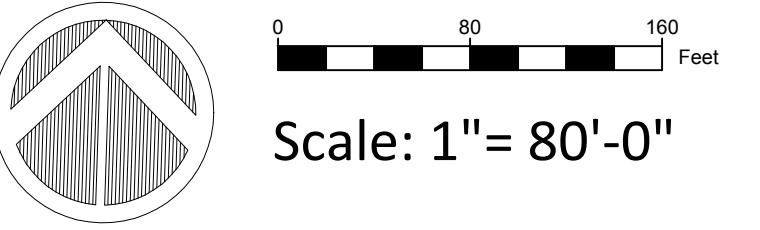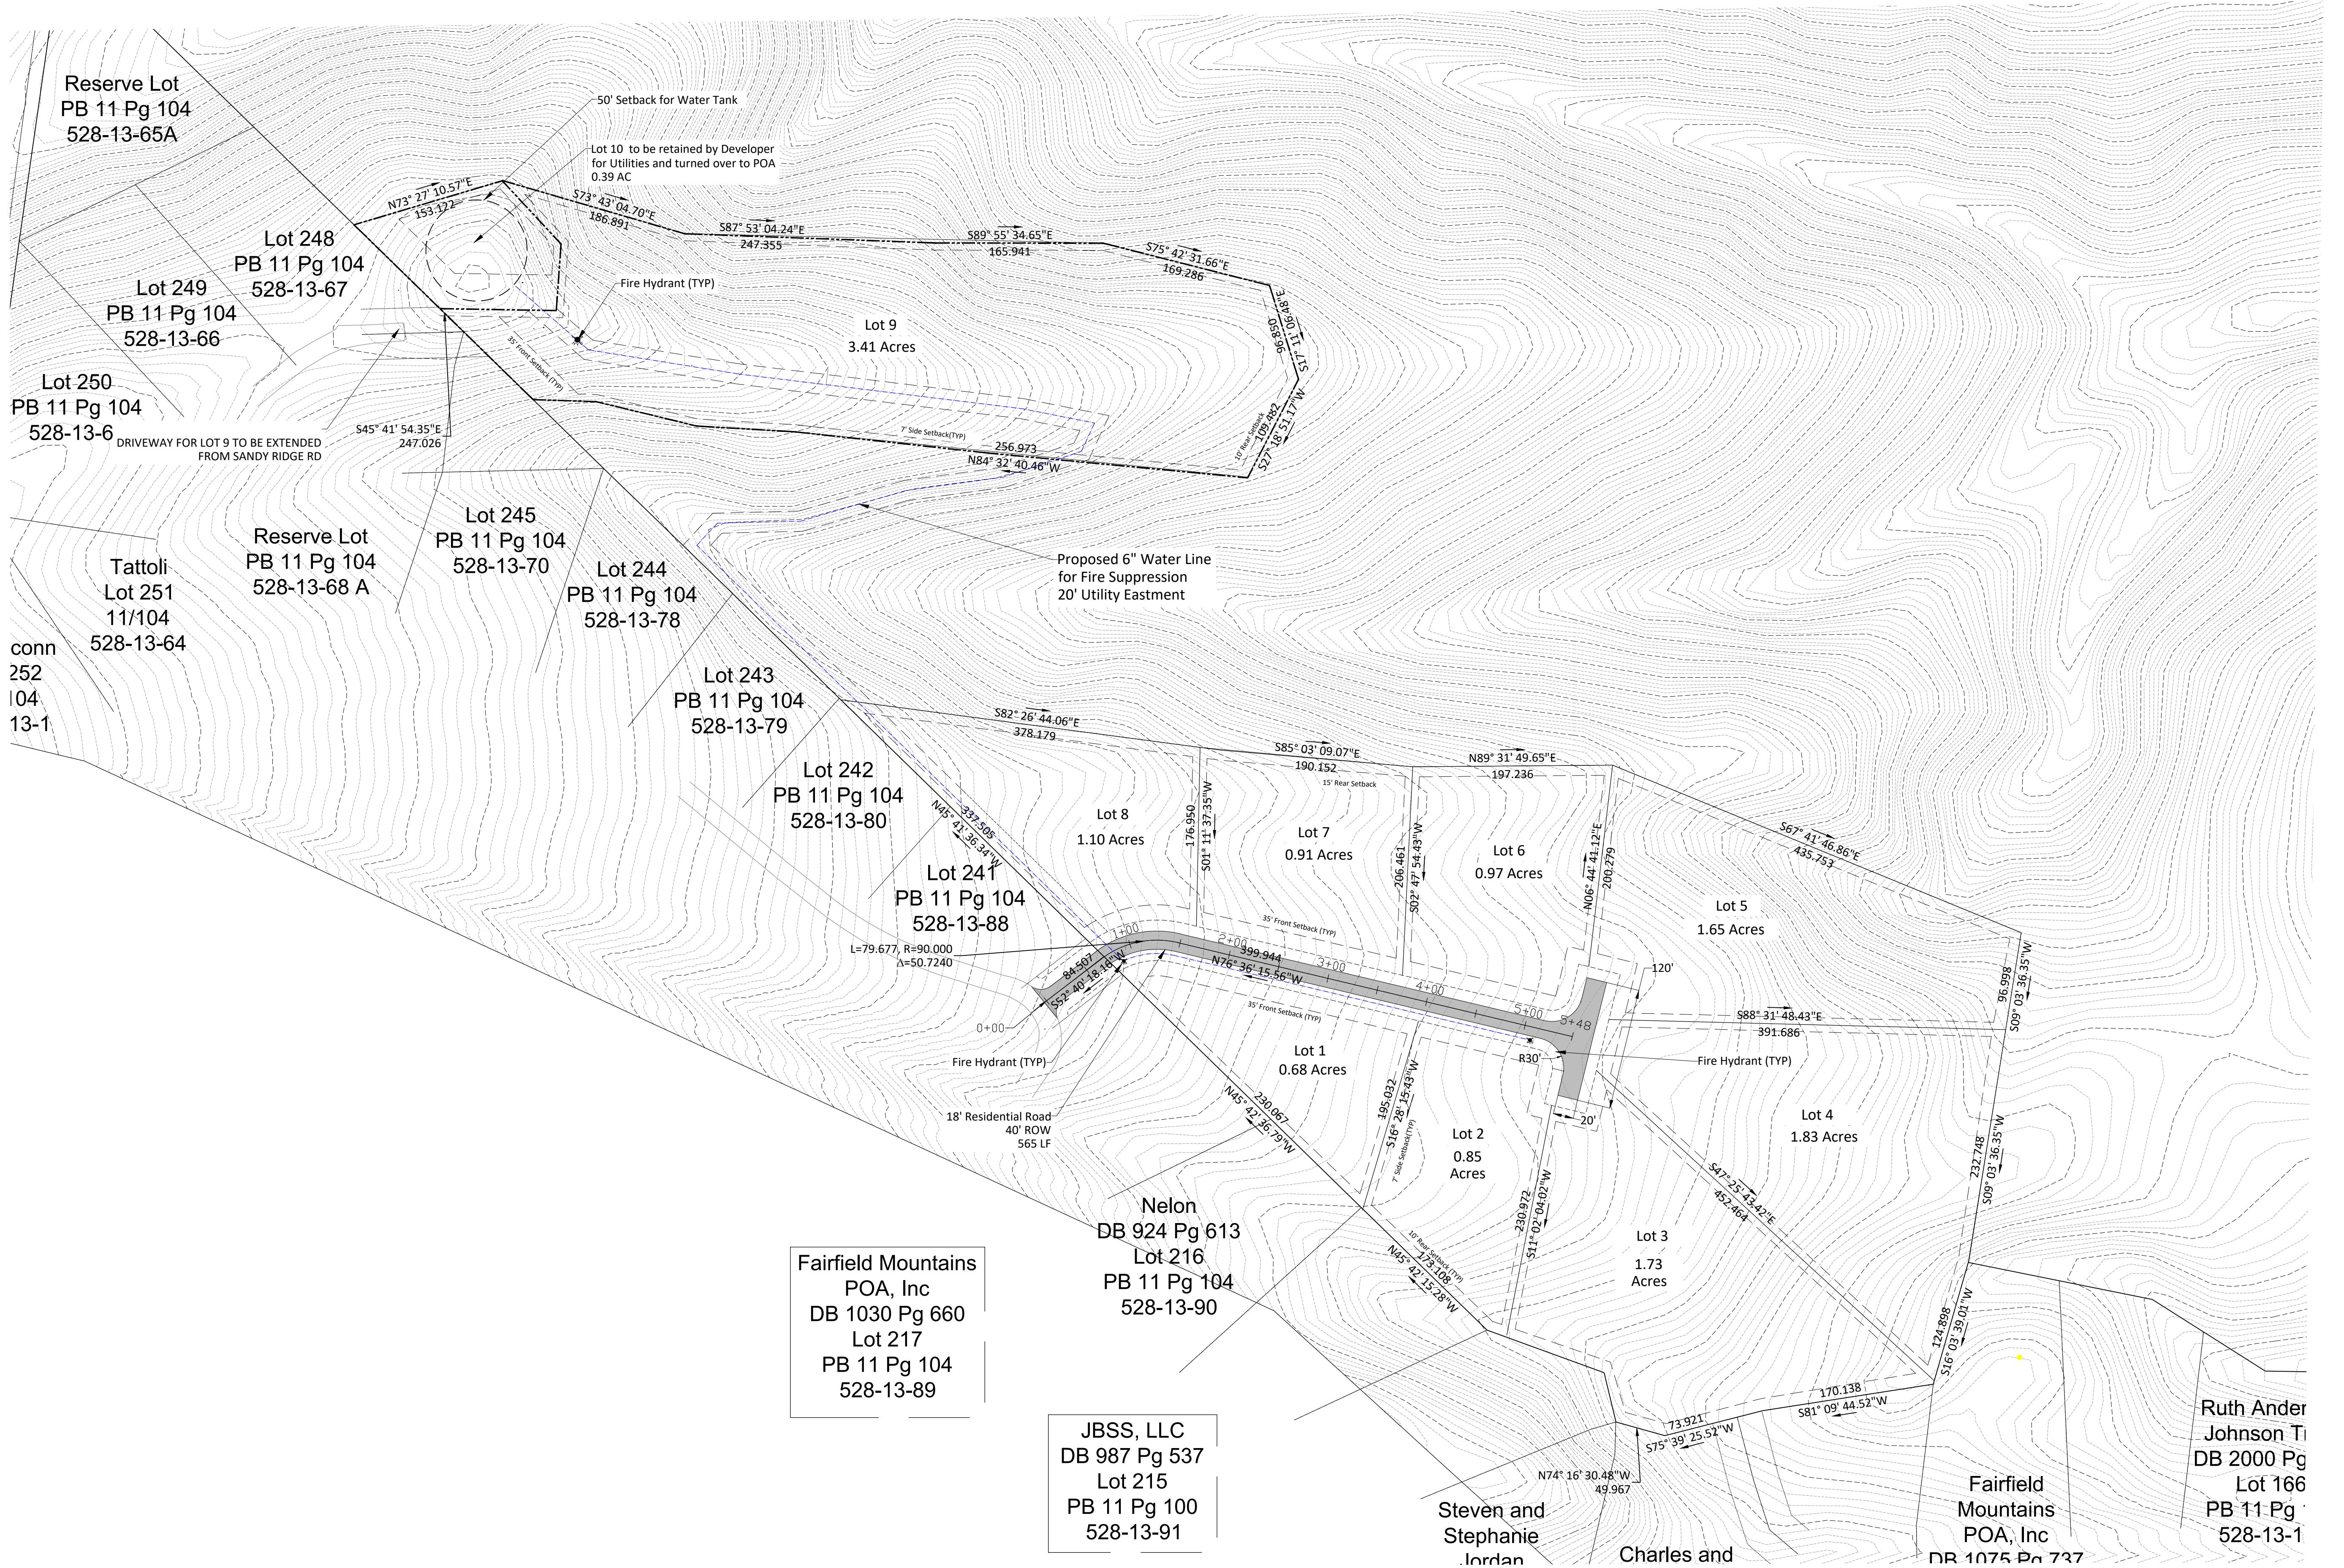

GRASSING

- AREAS TO BE GRASSED SHALL BE DEFINED AS ALL AREAS OF SITE WITHIN THE GRADING LIMITS AND NOT OCCUPIED BY PAVING, CRUSHED STONE SURFACING OR STRUCTURES. GRASSING SHALL INCLUDE FINAL SHAPING, LIMING, FERTILIZING AND SEEDING.
- LIME SHALL BE AGRICULTURAL GRADE, GROUND LIMESTONE, GROUND LIMESTONE SHALL CONTAIN NOT LESS THAN 88% OF CALCIUM CARBONATE CONTENT EQUIVALENT AND SHALL BE SUCH A FINENESS THAT 90% WILL PASS THROUGH A NO. 10 SIEVE AND NOT LESS THAN 50% THROUGH A NO. 50 SIEVE. APPLY A MINIMUM OF 1.5 TONS PER ACRE.
- FERTILIZER SHALL BE GRADE 10-10-10 COMPLETE FERTILIZER OF UNIFORM COMPOSITION, FREE-FLOWING AND SUITABLE FOR APPLICATION WITH EQUIPMENT, DELIVERED TO SITE IN BAGS LABELED WITH MANUFACTURER'S GUARANTEED ANALYSIS, AND SHALL CONFORM TO ALL STATE AND FEDERAL REGULATIONS.
- SEEDS SHALL BE MIXTURE AS APPROVED BY THE ENGINEER AND SHALL MEET REQUIREMENTS OF SEED LAWS OF THE STATE OF NORTH CAROLINA AND THE U.S. DEPARTMENT OF AGRICULTURE RULES AND REGULATIONS UNDER FEDERAL SEED ACT IN EFFECT ON DATE BIDS ARE RECEIVED. SEED SHALL BE DELIVERED IN STANDARD CONTAINERS. SEED WHICH HAS BECOME WET, MOLDY OR DAMAGED IN TRANSIT OR STORAGE WILL NOT BE ACCEPTABLE.
- MULCH SHALL CONSIST OF SMALL GRAIN STRAW OF GOOD QUALITY, CLEAN, FREE OF NOXIOUS WEEDS, AND REASONABLY FREE OF OTHER WEEDS.
- IRRIGATION MAYBE REQUIRED IF NORMAL RAINFALL IS NOT ADEQUATE.
- FERTILIZER 10-10-10 SHALL BE DISTRIBUTED UNIFORMLY AT A RATE OF 500 LBS. PER ACRE AND SHALL BE INCORPORATED INTO SOIL TO A DEPTH OF AT LEAST 2" BY DISCING AND HARRROWING.
- SPREAD SEED AT RATE NOTED TABLES BELOW.
- SPREAD MULCH AT 2 TONS/ACRE.
- IMMEDIATELY AFTER FERTILIZING AND SEEDING HAVE BEEN COMPLETED, ENTIRE AREA SHALL BE COMPACTED BY MEANS OF A CULTIPACKER, ROLLER, OR APPROVED EQUIPMENT WEIGHING APPROXIMATELY 90 LBS. PER LINEAR FOOT OF ROLLER. USE OF SPECIFIED MULCH, APPLIED WITH ASPHALT EMULSION TYPE SS-1, MS-2, RS-1, OR RS-2, SHALL BE USED TO PROTECT SITE AGAINST EROSION.
- AREAS THAT REQUIRE REFERTILIZATION AND/OR RESEEDING WILL BE DESIGNATED BY THE ENGINEER. WHEN ANY PORTION OF SURFACE BECOMES GULLIED OR OTHERWISE DAMAGED FOLLOWING SEEDING, OR SEEDLINGS HAVE BEEN WINTER-KILLED OR OTHERWISE DESTROYED, Affected PORTION SHALL BE REPAIRED TO RE-ESTABLISH CONDITION AND GRADE OF SOIL PRIOR TO SEEDLING AND SHALL BE RESEEDED AS SPECIFIED ABOVE.
- ALL DISTURBED AREAS ARE TO BE GRASSED IMMEDIATELY AFTER CONSTRUCTION IN THE AREA. AT NO TIME WILL AN AREA BE LEFT BARE FOR MORE THAN 14 DAYS AFTER COMPLETION OF CONSTRUCTION.

PERMANENT SEEDING

SEEDING MIXTURES	PLANTING RATE	PLANTING DATE
BAHIA GRASS (ALONE)	40 LBS/AC	MARCH 20 – JUNE 15.
BAHIA GRASS (MIX)*	30 LBS/AC	MARCH 20 – JUNE 15
BERMUDA GRASS (HULLED) (ALONE)	8-12 LBS/AC	APRIL – JULY 15.
BERMUDA GRASS (HULLED) (MIX)*	4-6 LBS/AC	APRIL – JULY 15
FESCUE (KY31) (ALONE)	40 LBS/AC	AUGUST 15 – OCTOBER
FESCUE (KY31) (MIX)*	20 LBS/AC	AUGUST 15 – OCTOBER

TEMPORARY SEEDING

SEEDING MIXTURES	PLANTING RATE	PLANTING DATE
BROWN TOP MILLET (ALONE)	40 LBS/AC	APRIL 20 – AUGUST 15.
BROWN TOP MILLET (MIX)*	10 LBS/AC	APRIL 20 – AUGUST 15.
RYE GRAIN (ALONE)	56 LBS/AC	FEB. – MAR. AUG. 15 – NOV. 20.
RYE GRAIN (MIX)*	10 LBS/AC	FEB. – MAR. AUG. 15 – NOV. 20..
BROWN TOP MILLET (ALONE)	50 LBS/AC	AUGUST 10 – OCTOBER 10
BROWN TOP MILLET (MIX)*	10 LBS/AC	AUGUST 10 – OCTOBER 10

EROSION CONTROL NOTES

- IF NECESSARY, SLOPES, WHICH EXCEED EIGHT (8) VERTICAL FEET SHOULD BE STABILIZED WITH SYNTHETIC OR VEGETATIVE MATS, IN ADDITION TO HYDROSEEDING. IT MAY BE NECESSARY TO INSTALL TEMPORARY SLOPE DRAINS DURING CONSTRUCTION. TEMPORARY BERMS MAY BE NEEDED UNTIL THE SLOPE IS BROUGHT TO GRADE.
- STABILIZATION MEASURES SHALL BE INITIATED AS SOON AS PRACTICABLE IN PORTIONS OF THE SITE WHERE CONSTRUCTION ACTIVITIES HAVE TEMPORARILY OR PERMANENTLY CEASED, BUT IN NO CASE MORE THAN FOURTEEN (14) DAYS AFTER WORK HAS CEASED, EXCEPT AS STATED BELOW. • WHERE STABILIZATION BY THE 14TH DAY IS PRECLUDED BY SNOW COVER OR FROZEN GROUND CONDITIONS STABILIZATION MEASURES MUST BE INITIATED AS SOON AS PRACTICABLE. • WHERE CONSTRUCTION ACTIVITY ON A PORTION OF THE SITE IS TEMPORARILY CEASED, AND EARTH-DISTURBING ACTIVITIES WILL BE RESUMED WITHIN 14 DAYS, TEMPORARY STABILIZATION MEASURES DO NOT HAVE TO BE INITIATED ON THAT PORTION OF THE SITE.
- ALL SEDIMENT AND EROSION CONTROL DEVICES SHALL BE INSPECTED ONCE EVERY CALENDAR WEEK. IF PERIODIC INSPECTION OR OTHER INFORMATION INDICATES THAT A BMP HAS BEEN INAPPROPRIATELY OR INCORRECTLY INSTALLED, THE PERMITTEE MUST ADDRESS THE NECESSARY REPLACEMENT OR MODIFICATION REQUIRED TO CORRECT THE BMP WITHIN 48 HOURS OF IDENTIFICATION.
- PROVIDE SILT FENCE AND/OR OTHER CONTROL DEVICES, AS MAY BE REQUIRED, TO CONTROL SOIL EROSION DURING UTILITY CONSTRUCTION. ALL DISTURBED AREAS SHALL BE CLEANED, GRADED, AND STABILIZED WITH GRASSING IMMEDIATELY AFTER THE UTILITY INSTALLATION. FILL, COVER, AND TEMPORARY SEEDING AT THE END OF EACH DAY ARE RECOMMENDED. IF WATER IS ENCOUNTERED WHILE TRENCHING, THE WATER SHOULD BE FILTERED TO REMOVE SEDIMENT BEFORE BEING PUMPED BACK INTO ANY WATERS OF THE STATE.
- ALL EROSION CONTROL DEVICES SHALL BE PROPERLY MAINTAINED DURING ALL PHASES OF CONSTRUCTION UNTIL THE COMPLETION OF ALL CONSTRUCTION ACTIVITIES AND ALL DISTURBED AREAS HAVE BEEN STABILIZED. ADDITIONAL CONTROL DEVICES MAY BE REQUIRED DURING CONSTRUCTION IN ORDER TO CONTROL EROSION AND/OR OFF-SITE SEDIMENTATION. ALL TEMPORARY CONTROL DEVICES SHALL BE REMOVED ONCE CONSTRUCTION IS COMPLETE AND THE SITE IS STABILIZED.
- THE CONTRACTOR MUST TAKE NECESSARY ACTION TO MINIMIZE THE TRACKING OF MUD ONTO PAVED ROADWAYS FROM CONSTRUCTION AREAS AND THE GENERATION OF DUST. THE CONTRACTOR SHALL DAILY REMOVE MUD/SOIL FROM PAVEMENT, AS MAY BE REQUIRED.
- RESIDENTIAL SUBDIVISIONS REQUIRE EROSION CONTROL FEATURES FOR INFRASTRUCTURE AS WELL AS FOR INDIVIDUAL LOT CONSTRUCTION. INDIVIDUAL PROPERTY OWNERS SHALL FOLLOW THESE PLANS DURING CONSTRUCTION.
- TEMPORARY DIVERSION BERMS AND/OR DITCHES WILL BE PROVIDED AS NEEDED DURING CONSTRUCTION TO PROTECT WORK AREAS FROM UPSLOPE RUNOFF AND/OR TO DIVERT SEDIMENT-LADEN WATER TO APPROPRIATE TRAPS OR STABLE OUTLETS.
- ALL WATERS OF THE STATE (WOS), INCLUDING WETLANDS, ARE TO BE FLAGGED OR OTHERWISE CLEARLY MARKED IN THE FIELD. A DOUBLE ROW OF SILT FENCE IS TO BE INSTALLED IN ALL AREAS WHERE A 50-FOOT BUFFER CAN'T BE MAINTAINED BETWEEN THE DISTURBED AREA AND ALL WOS. A 10-FOOT BUFFER SHOULD BE MAINTAINED BETWEEN THE LAST ROW OF SILT FENCE AND ALL WOS.
- LITTER, CONSTRUCTION DEBRIS, OILS, FUELS, AND BUILDING PRODUCTS WITH SIGNIFICANT POTENTIAL FOR IMPACT (SUCH AS STOCKPILES OF FRESHLY TREATED LUMBER) AND CONSTRUCTION CHEMICALS THAT COULD BE EXPOSED TO STORM WATER MUST BE PREVENTED FROM BECOMING A POLLUTANT SOURCE IN STORM WATER DISCHARGES.
- A COPY OF THE SWPPP, INSPECTIONS RECORDS, AND RAINFALL DATA MUST BE RETAINED AT THE CONSTRUCTION SITE OR A NEARBY LOCATION EASILY ACCESSIBLE DURING NORMAL BUSINESS HOURS, FROM THE DATE OF COMMENCEMENT OF CONSTRUCTION ACTIVITIES TO THE DATE THAT FINAL STABILIZATION IS REACHED.
- INITIATE STABILIZATION MEASURES ON ANY EXPOSED STEEP SLOPE (3H:1V OR GREATER) WHERE LAND-DISTURBING ACTIVITIES HAVE PERMANENTLY OR TEMPORARILY CEASED, AND WILL NOT RESUME FOR A PERIOD OF 7 CALENDAR DAYS.
- MINIMIZE SOIL COMPACTION AND, UNLESS INFEASIBLE, PRESERVE TOPSOIL.
- MINIMIZE THE DISCHARGE OF POLLUTANTS FROM EQUIPMENT AND VEHICLE WASHING, WHEEL WASH WATER, AND OTHER WASH WATERS. WASH WATERS MUST BE TREATED IN A SEDIMENT BASIN OR ALTERNATIVE CONTROL THAT PROVIDES EQUIVALENT OR BETTER TREATMENT PRIOR TO DISCHARGE.
- MINIMIZE THE DISCHARGE OF POLLUTANTS FROM DEWATERING OF TRENCHES AND EXCAVATED AREAS. THESE DISCHARGES ARE TO BE Routed THROUGH APPROPRIATE BMPs (SEDIMENT BASIN, FILTER BAG, ETC.).
- THE FOLLOWING DISCHARGES FROM SITES ARE PROHIBITED. • WASTEWATER FROM WASHOUT OF CONCRETE, UNLESS MANAGED BY AN APPROPRIATE CONTROL. • WASTEWATER FROM WASHOUT AND CLEANOUT OF STUCCO, PAINT, FORM RELEASE OILS, CURING COMPOUNDS AND OTHER CONSTRUCTION MATERIALS; FUELS, OILS, OR OTHER POLLUTANTS USED IN VEHICLE AND EQUIPMENT OPERATION AND MAINTENANCE; AND SOAPS OR SOLVENTS USED IN VEHICLE AND EQUIPMENT WASHING.
- AFTER CONSTRUCTION ACTIVITIES BEGIN, INSPECTIONS MUST BE CONDUCTED AT A MINIMUM OF AT LEAST ONCE EVERY CALENDAR WEEK AND MUST BE CONDUCTED UNTIL FINAL STABILIZATION IS REACHED ON ALL AREAS OF THE CONSTRUCTION SITE.
- IF EXISTING BMPs NEED TO BE MODIFIED OR IF ADDITIONAL BMPs ARE NECESSARY TO COMPLY WITH THE REQUIREMENTS OF THIS PERMIT AND/OR SC's WATER QUALITY STANDARDS, IMPLEMENTATION MUST BE COMPLETED BEFORE THE NEXT STORM EVENT WHENEVER PRACTICABLE. IF IMPLEMENTATION BEFORE THE NEXT STORM EVENT IS IMPRACTICABLE, THE SITUATION MUST BE DOCUMENTED IN THE SWPPP AND ALTERNATIVE BMPs MUST BE IMPLEMENTED AS SOON AS REASONABLY POSSIBLE.
- A PRE-CONSTRUCTION CONFERENCE MUST BE HELD FOR EACH CONSTRUCTION SITE WITH AN APPROVED ON-SITE SWPPP PRIOR TO THE IMPLEMENTATION OF CONSTRUCTION ACTIVITIES. FOR NON-LINEAR PROJECTS THAT DISTURB 10 ACRES OR MORE THIS CONFERENCE MUST BE HELD ON-SITE UNLESS THE DEPARTMENT HAS APPROVED OTHERWISE.
- CONSTRUCTION ENTRANCES TO BE PROVIDED AT ALL LOCATIONS WHERE CONSTRUCTION TRAFFIC ACCESSES PAVED ROADWAYS.
- INLET PROTECTION WILL BE PROVIDED AT ALL EXISTING INLETS THAT RECEIVED FLOWS FROM THE DISTURBED AREAS.
- ALL OFF-SITE BORROW SITES MUST HAVE A SEPERATE NPDES PERMIT.
- THE CONTRACTOR WILL PROVIDE A PORTABLE TOILET IN AN AREA THAT IS NOT ADJACENT TO A WATERWAY OR STORM DRAINAGE.
- THE CONTRACTOR WILL PROVIDE A PLACE FOR CONCRETE TRUCKS TO WASHOUT IS TO BE BURIED ONSITE UNTIL CONSTRUCTION IS COMPLETE. WHEN CONSTRUCTION IS COMPLETE THE WASTE IS TO BE HAULED OFF TO A LANDFILL.

GENERAL NOTES - SITEMARK

- TOPOGRAPHICAL INFORMATION PROVIDED BY NC ONE MAP
- THE CONTRACTOR SHALL VERIFY THE LOCATION AND INVERT ELEVATION OF ALL UNDERGROUND UTILITIES, AND VERIFY PROPERTY CORNERS AND TOPO BEFORE ANY CONSTRUCTION IS BEGUN. CALL UTILITY COMPANIES BEFORE EXCAVATION TO LOCATE ALL BURIED CABLES AND UNDERGROUND UTILITIES.
- THE CONTRACTOR SHOULD NOTIFY THE ENGINEERS FOR A REVIEW SHOULD DISCREPANCIES BE DISCOVERED AT THE SITE OR ON THE DRAWINGS.
- ALL REFERENCE TO SPECIFICATIONS FOR HIGHWAY CONSTRUCTION OR MATERIALS ARE MADE FROM SOUTH CAROLINA STATE HIGHWAY DEPARTMENT'S STANDARD SPECIFICATION, LATEST EDITION.
- ALL DIMENSIONS SHOWN ARE MEASURED FROM OUTSIDE FACE OF BUILDING WALL AND TO FACE OF CURB LINE.
- EARTHWORK SHALL BE TO THE LINES AND GRADES SHOWN. PROOF-ROLLING AND COMPACTION TEST SHALL BE ACCOMPLISHED IN THE FIELD TO TEST ALL AREAS. THE CONTRACTOR SHALL RETAIN THE SERVICES OF A TESTING COMPANY TO TEST ALL AREAS.
- CONTRACTOR SHALL PROTECT ALL TREES THAT ARE TO REMAIN AS MARKED IN THE FIELD BY OWNERS REPRESENTATIVE.
- THE GRADING CONTRACTOR SHALL PROOF-ROLL THE CONSTRUCTION AREA WITH A FULLY-LOADED TANDEM-AXEL DUMP TRUCK, OR APPROVED EQUIPMENT, BY MAKING 2 COMPLETE PASSES IN EACH OF 2 PERPENDICULAR DIRECTIONS. ALL SOFT SPOTS SHALL BE UNDERCUT AND RE-COMPACTED WITH SUITABLE STRUCTURAL FILL MATERIAL.
- THE CONTRACTOR SHALL BE SOLELY AND COMPLETELY RESPONSIBLE FOR CONDITIONS OF THE JOB SITE, INCLUDING SAFETY OF ALL PERSONS AND PROPERTY DURING PERFORMANCE OF THE WORK. THIS REQUIREMENT WILL APPLY CONTINUOUSLY AND WILL NOT BE LIMITED TO NORMAL WORKING HOURS. THE DUTY OF THE ENGINEER TO CONDUCT CONSTRUCTION REVIEW OF THE CONTRACTOR'S PERFORMANCE IS NOT INTENDED TO INCLUDE REVIEW OF THE ADEQUACY OF THE CONTRACTOR'S SAFETY MEASURES, IN, OR NEAR THE CONSTRUCTION SITE. THE CONTRACTOR WILL BE RESPONSIBLE FOR PROVIDING AND MAINTAINING ALL BARRICADES, WARNING SIGNS, FLASHING LIGHTS, AND TRAFFIC CONTROL DEVICES DURING CONSTRUCTION.
- THE CONTRACTOR IS TO COMPLY WITH ALL OSHA REGULATIONS, REQUIREMENTS, AND SAFETY MEETING REQUIREMENTS.
- THE CONTRACTOR SHALL REMOVE ALL TREES AND VEGETATION THAT INTERFERE WITH NEW CONSTRUCTION. REMOVE DEBRIS FROM SITE OR BURN IN ACCORDANCE WITH LOCAL LAWS. THE CONTRACTOR SHALL BE RESPONSIBLE FOR OBTAINING NECESSARY BURNING PERMITS. PROTECT ALL TREES THAT ARE TO REMAIN.
- TOPSOIL SHALL BE STRIPPED TO A DEPTH AS REQUIRED AND STOCKPILED AS DIRECTED BY THE OWNER'S REPRESENTATIVE.
- THE TOP 18" OF FILL SHALL BE COMPACTED TO 98% OF MAXIMUM DRY DENSITY BY THE STANDARD PROCTOR METHOD ASTM D-698. ALL OTHER FILL SHALL BE COMPACTED TO 95% MAXIMUM DRY DENSITY.
- ALL EXCAVATION SHALL BE "CLASSIFIED EXCAVATION". EXCAVATION SHALL BE "CLASSIFIED" AS "COMMON EXCAVATION" OR "ROCK EXCAVATION". ROCK EXCAVATION SHALL BE SUCH MATERIAL WHICH CANNOT BE REMOVED BY MEANS OTHER THAN BY BLASTING OR WITH AN AIR HAMMER. COMMON EXCAVATION SHALL INCLUDE ALL MATERIAL THAT CAN BE RIPPED, BOULDERS, AND ALL OTHER MATERIALS THAT DO NOT FALL IN THE CATEGORY OF ROCK EXCAVATION AS DEFINED ABOVE.
- ROCK EXCAVATION SHALL BE CLASSIFIED AS FOLLOWS:
 - A. MASSIVE ROCK EXCAVATION - ANY MATERIAL WHICH CANNOT BE EXCAVATED WITH A SINGLE TOOTH RIPPER DRAWN BY A CRAWLER TRACTOR HAVING A MINIMUM DRAW BAR RATED AT NOT LESS THAN 53,000 POUNDS (CATAPILLAR D-8 OR EQUIVALENT) AND OCCUPYING AN ORIGINAL VOLUME OF AT LEAST ONE CUBIC YARD OR MORE.
 - B. TRENCH EXCAVATION - ANY MATERIAL WHICH CANNOT BE EXCAVATED WITH A POWER SHOVEL HAVING THE CAPACITY OF AT LEAST THAT OF A CATAPILLAR 225 AND OCCUPYING AN ORIGINAL VOLUME OF AT LEAST 1/2 CUBIC YARD OR MORE.
- THE CLASSIFICATION OF SOILS INCLUDE TOPSOIL, FILL MATERIAL, UNSUITABLE MATERIAL, ROCK EXCAVATION IS THE RESPONSIBILITY OF THE OWNER'S SOIL TESTING FIRM.
- ALL FILL MATERIAL SHALL BE FROM A SOURCE APPROVED BY THE TESTING COMPANY AND SHALL BE FREE OF ROOTS, ORGANICS AND BOULDERS LARGER THAN 1 CUBIC FOOT. FILL SHALL BE PLACED IN 8" LIFTS AND COMPACTED AS SPECIFIED.
- ALL EXISTING SLOPES STEEPER THAN 4:1 THAT WILL RECEIVE FILL SHALL BE PLOWED AND SCARIFIED SO NEW FILL WILL BOND WITH EXISTING SURFACE.
- CONTRACTOR SHALL SCARIFY ALL EXISTING ASPHALT PAVEMENT BEFORE PLACING FILL.
- THE GRADING CONTRACTOR SHALL CONFORM TO ELEVATIONS AND DIMENSIONS SHOWN WITHIN A TOLERANCE OF PLUS OR MINUS 0.10 FEET. (FINAL GRADED SURFACE UNDER BUILDING SLABS SHALL BE WITHIN A TOLERANCE OF 3/8" WHEN MEASURED WITH A 10' STRAIGHT EDGE).
- ALL REINFORCED CONCRETE PIPE (RCP) SHALL BE CLASS III, UNLESS NOTED ON DRAWINGS WITH BELL & SPIGOT ENDS AND SHALL CONFORM TO ALL REQUIREMENTS OF ASTM C 76, LATEST EDITION, INSTALLED WITH FLEXIBLE PLASTIC (BITUMEN) GASKETS AT ALL JOINTS, GASKETS SHALL COMPLY WITH AASHTO M-198 751, TYPE B, AND SHALL BE INSTALLED IN STRICT ACCORDANCE WITH PIPE MANUFACTURER'S RECOMMENDATIONS.
- ALL UTILITY TRENCHES SHALL BE THOROUGHLY COMPACTED AND TESTED TO PREVENT SETTLEMENT AND DAMAGE TO FUTURE PAVEMENT AND STRUCTURES.
- ASPHALT PAVING FOR LIGHT DUTY AREAS SHALL BE CONSTRUCTED ON A PREPARED AND WELL-DRAINED SUBGRADE COMPACTED AS SPECIFIED. THE BASE COURSE SHALL BE CONSTRUCTED WITH 6" COMPACTED THICKNESS STONE BASE. THE SURFACE SHALL BE 2" COMPACTED THICKNESS ASPHALT BINDER AND 2" OF COMPACTED THICKNESS ASPHALT CONCRETE. ALL PAVING WORK (MATERIALS AND CONSTRUCTION) SHALL COMPLY WITH STATE SPECIFICATIONS.
- ALL AREAS NOT COVERED BY BUILDINGS AND PAVEMENT SHALL RECEIVE TOPSOIL AND BE GRASSED IN ACCORDANCE WITH STATE SPECIFICATIONS (OR GRASSED IN ACCORDANCE WITH OWNER'S SPECIFICATIONS).
- CONCRETE CURB AND GUTTER SHALL BE 18" WIDE WITH 6" CURB CONSTRUCTED WITH 3,000 PSI CONCRETE WITH EXPANSION JOINTS AND CONTRACTION JOINTS INSTALLED TO COMPLY WITH S.C.D.H. & P.T. STANDARD SPECIFICATION FOR MATERIALS AND CONSTRUCTION OF CURB AND GUTTER.
- THE GRADING CONTRACTOR SHALL MAINTAIN POSITIVE DRAINAGE AWAY FROM BUILDING AT ALL TIMES. CONTRACTOR SHALL BRING TO THE ATTENTION OF THE ENGINEER ANY AREAS THAT MAY NOT DRAIN PROPERLY DURING CONSTRUCTION.
- GRADING CONTRACTOR SHALL INCLUDE IN COST ALL CUT/FILL NECESSARY FOR EARTHWORK BALANCE. CONTRACTOR SHALL INCLUDE IN COST ALL WETTING/DRYING OF SOILS NECESSARY TO ACHIEVE COMPACTION PER SPECIFICATIONS.
- THE SEQUENCE OF WORK SHALL CONFORM TO THE EROSION CONTROL NARRATIVE.
- THE CONTRACTOR SHALL RETAIN THE SERVICES OF A REGISTERED LAND SURVEYOR TO PROVIDE TO THE OWNER'S REPRESENTATIVE AN AS-BUILT TOPOGRAPHIC MAP DEPICTING ALL GRADES, ALIGNMENTS, AND STRUCTURAL INFORMATION INVOLVED IN THE DETENTION POND.
- THE CONTRACTOR SHALL NOTIFY THE OWNER'S REPRESENTATIVE WHEN INSTRUCTIONS FROM REGULATORY AGENCIES ARE RECEIVED AND COMPLY WITH INSTRUCTIONS AS DIRECTED BY THE OWNER'S REPRESENTATIVE.
- THE CONTRACTOR SHALL CAREFULLY STUDY AND COMPARE THE CONSTRUCTION DOCUMENTS AND SHALL AT ONCE REPORT TO THE ENGINEER ANY INCONSISTENCIES OR OMISSIONS DISCOVERED. THE CONTRACTOR SHALL TAKE FIELD MEASUREMENTS TO VERIFY THAT ALL LOCATIONS ARE CORRECT PRIOR TO COMMENCING CONSTRUCTION.
- THE CONTRACTOR SHALL NOT PERFORM ANY WORK ON ANY UTILITIES OR IN ANY PUBLIC RIGHT-OF-WAYS UNTIL HE HAS OBTAINED COPIES OF ALL NECESSARY ENCROACHMENT AND CONSTRUCTION PERMITS.
- THE CONTRACTOR SHALL BE RESPONSIBLE FOR RELOCATING ANY EXISTING UTILITIES NECESSARY FOR SITE CONSTRUCTION INCLUDING ALL PERMITS AND FEES.
- THE CONTRACTOR SHALL VERIFY BENCH MARK LOCATION AND ELEVATION WITH SURVEYOR BEFORE BEGINNING CONSTRUCTION.
- THE CONTRACTOR SHALL VERIFY THE LOCATIONS OF ALL EASEMENTS ON THE SITE BEFORE PROCEEDING WITH CONSTRUCTION.

Date	Submissions
09/09/2024	Sediment and Erosion Control Application
09/19/2024	Sediment and Erosion Control Comments
09/26/2024	Preliminary Plat Submittal
03/24/2024	Preliminary Plat



AWEN LLC Lots 1-10
Rutherford County, North Carolina
AWEN LLC
Detail Sheet 1

Project Number: 319523
Scale: As Noted
Drawn By: GMG
Date: 09-02-2024
D1


(N.T.S.)
NOTE: THE GRADED DIRT SHALL BE STABILIZED PER GRASSING SPECIFICATIONS ON D-3.
GRASS AND STONE CHECK DATE:
TYPE "C" DITCH
(N.T.S.)
#1
1 D1
NTS


NOTE: DITCH PROFILE FOLLOWS ROAD PROFILE

(N.T.S.)
NOTE: THE GRADED DIRT SHALL BE STABILIZED PER GRASSING SPECIFICATIONS ON D-3.
GRASS AND STONE CHECK DATE:
TYPE "A" DITCH
(N.T.S.)
#1
1 D1
NTS

TOP ELEVATION OF STORMWATER
#57 WASHED STONE
1 MAX.
#1 RIPRAP
VARIABLES
EXISTING SLOPE
KEYED RIPRAP
#57 WASHED STONE
FRONT VIEW
#2
2 DITCH CHECK
D1
NTS

NOTES:
1) HEIGHT & WIDTH DETERMINED BY EXISTING TOPOGRAPHY AND SEDIMENT STORAGE REQUIRED.
2) KEY RIPRAP INTO THE DAM FOR STABILIZATION.

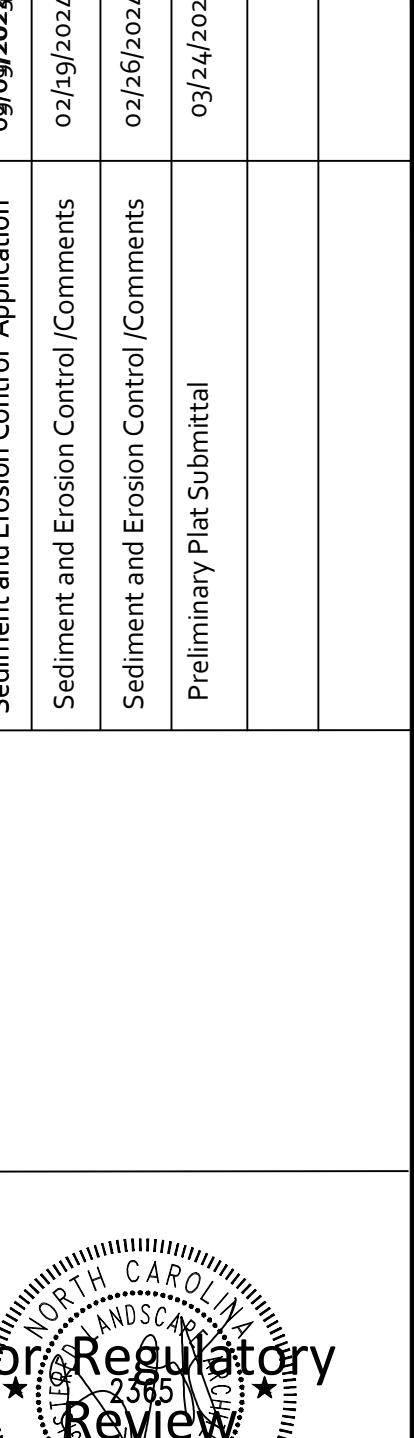

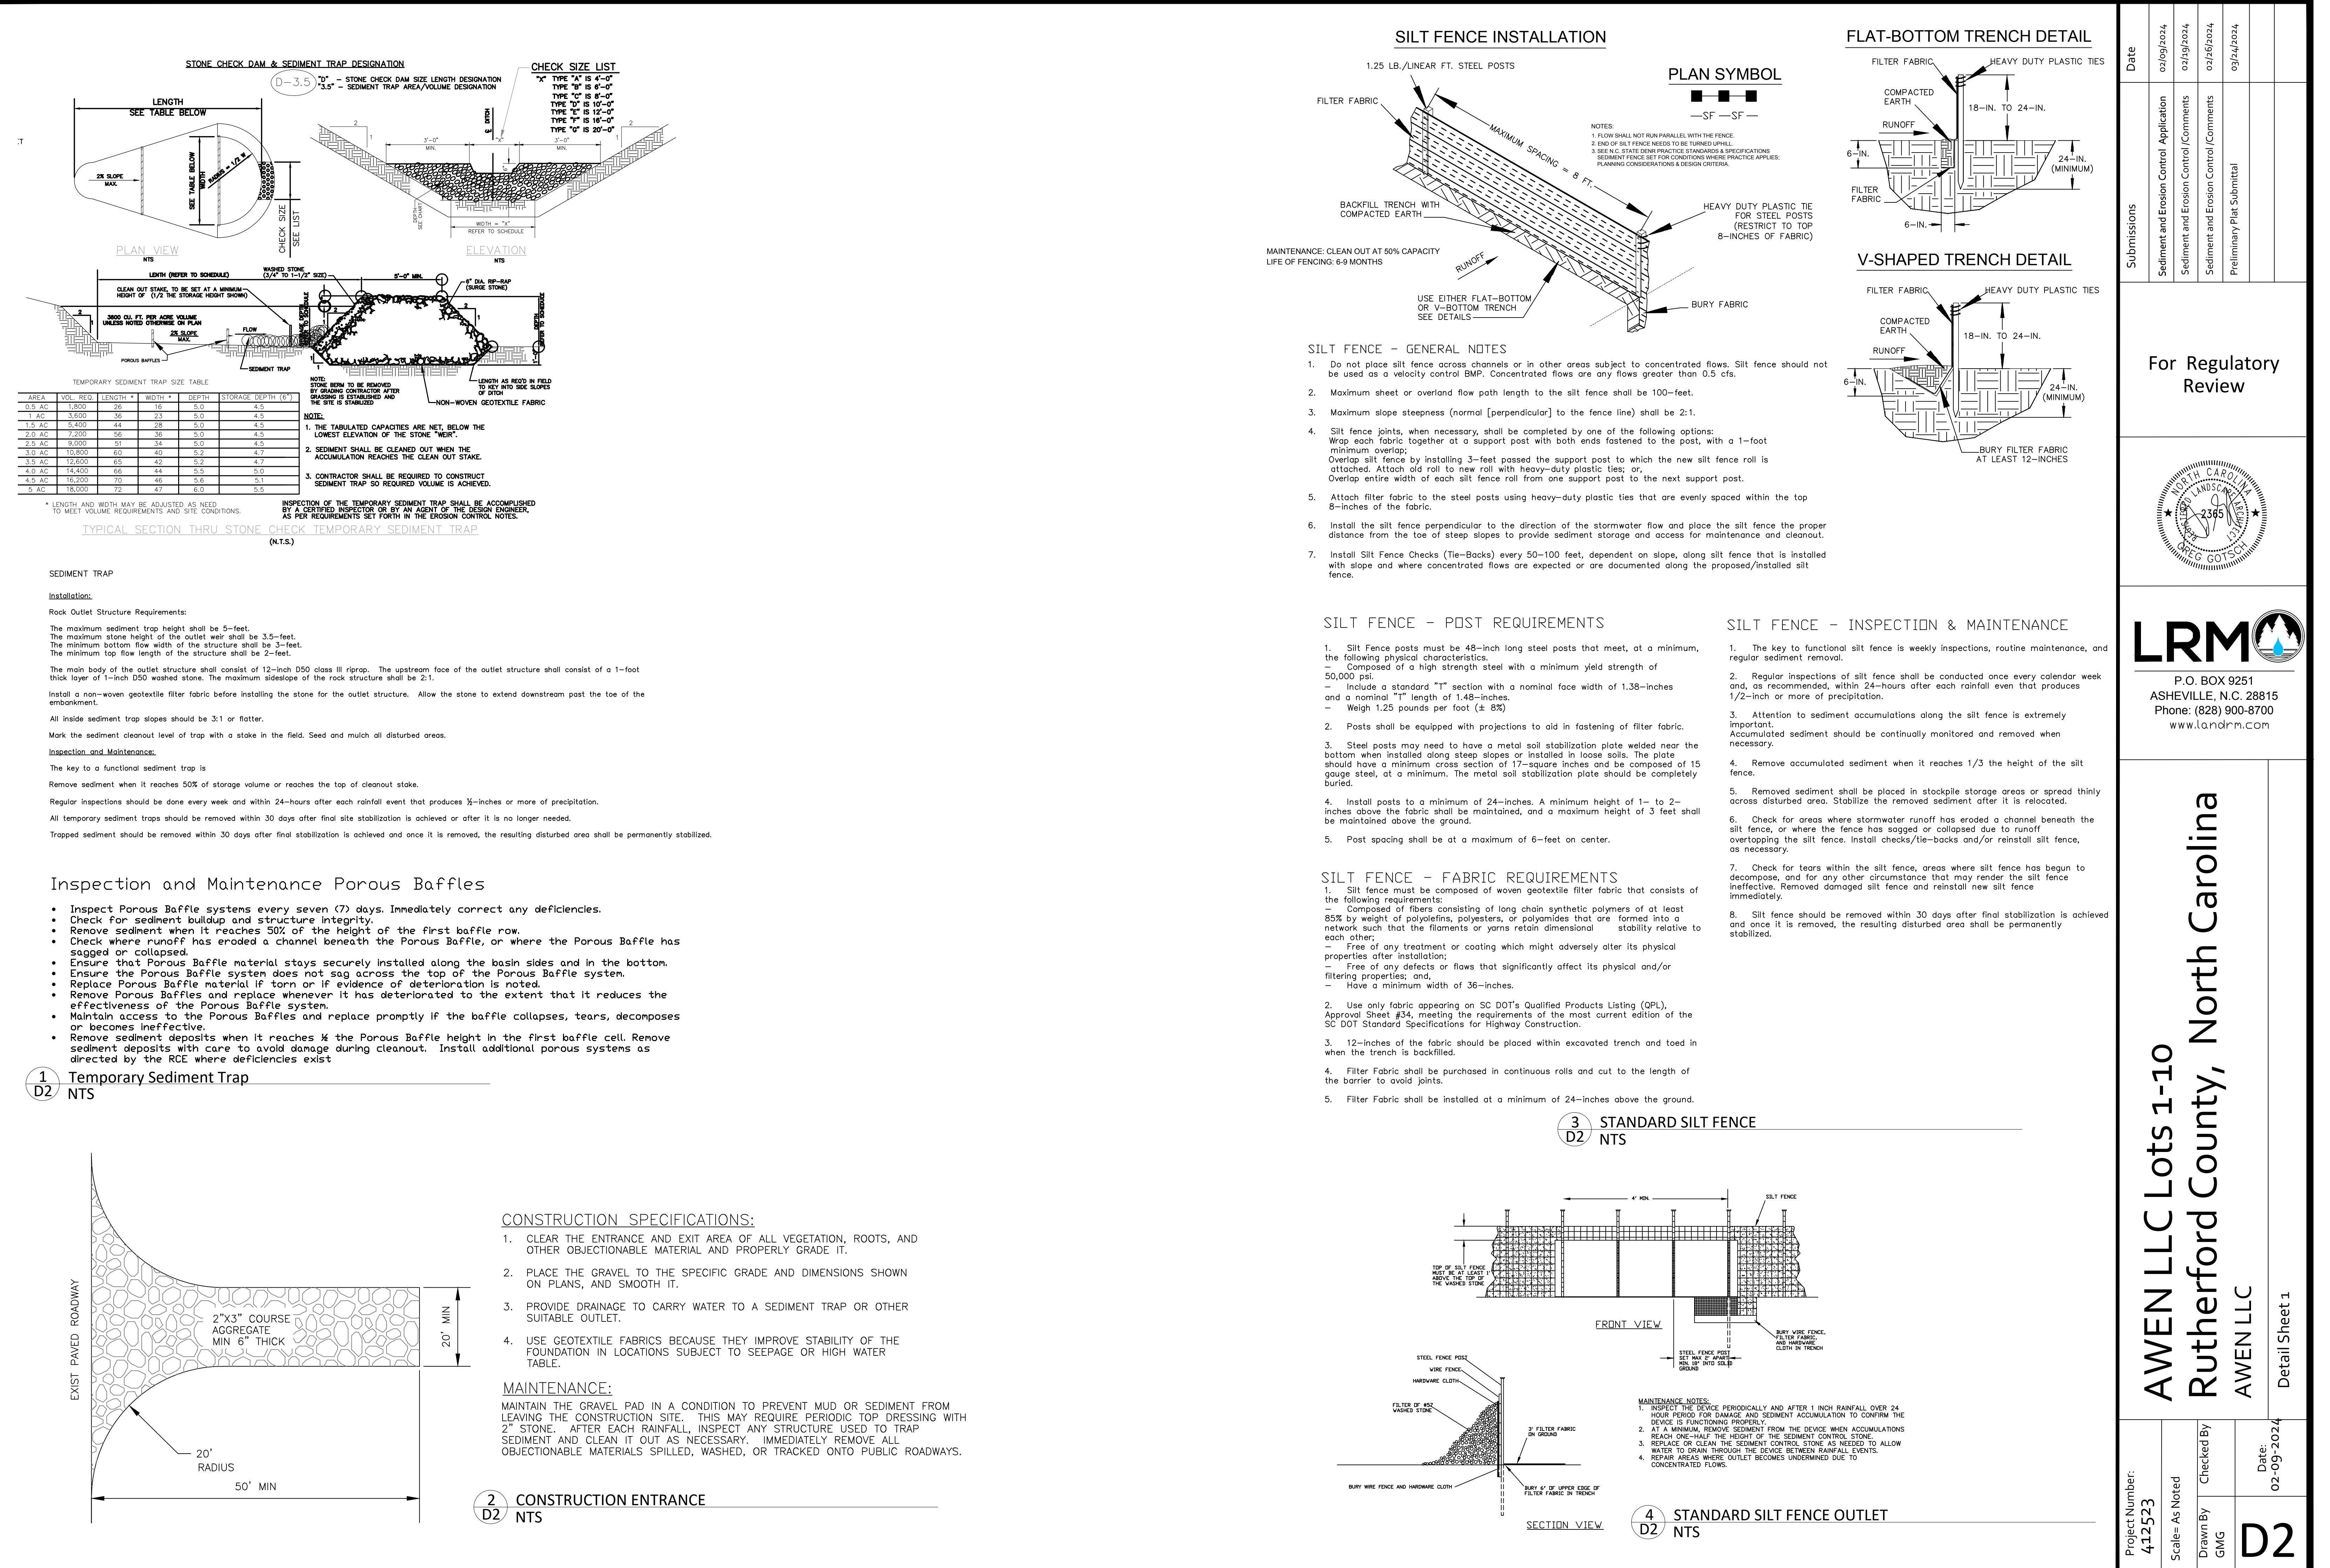



LRM

P.O. BOX 9251
ASHEVILLE, N.C. 28815
Phone: (828) 900-8700
www.landrm.com

AWEN LLC Lots 1-10 Rutherford County, North Carolina

AWEN LLC

Detail Sheet 3

Project Number:
412523



Scale= As Noted

Drawn By
GMG


Checked By
GMG

Date:
03/24/2024

D3

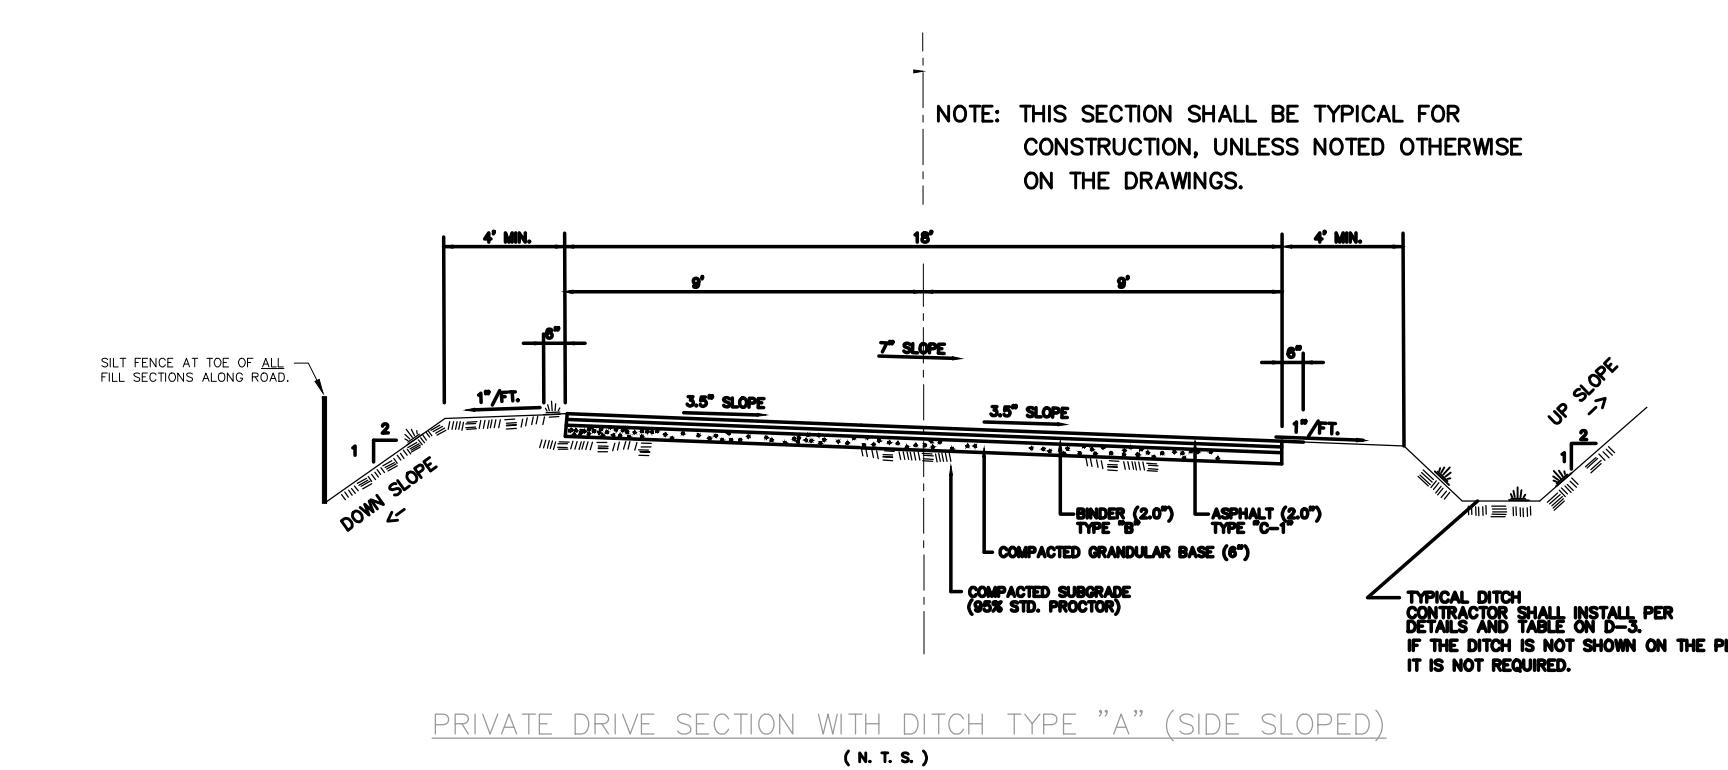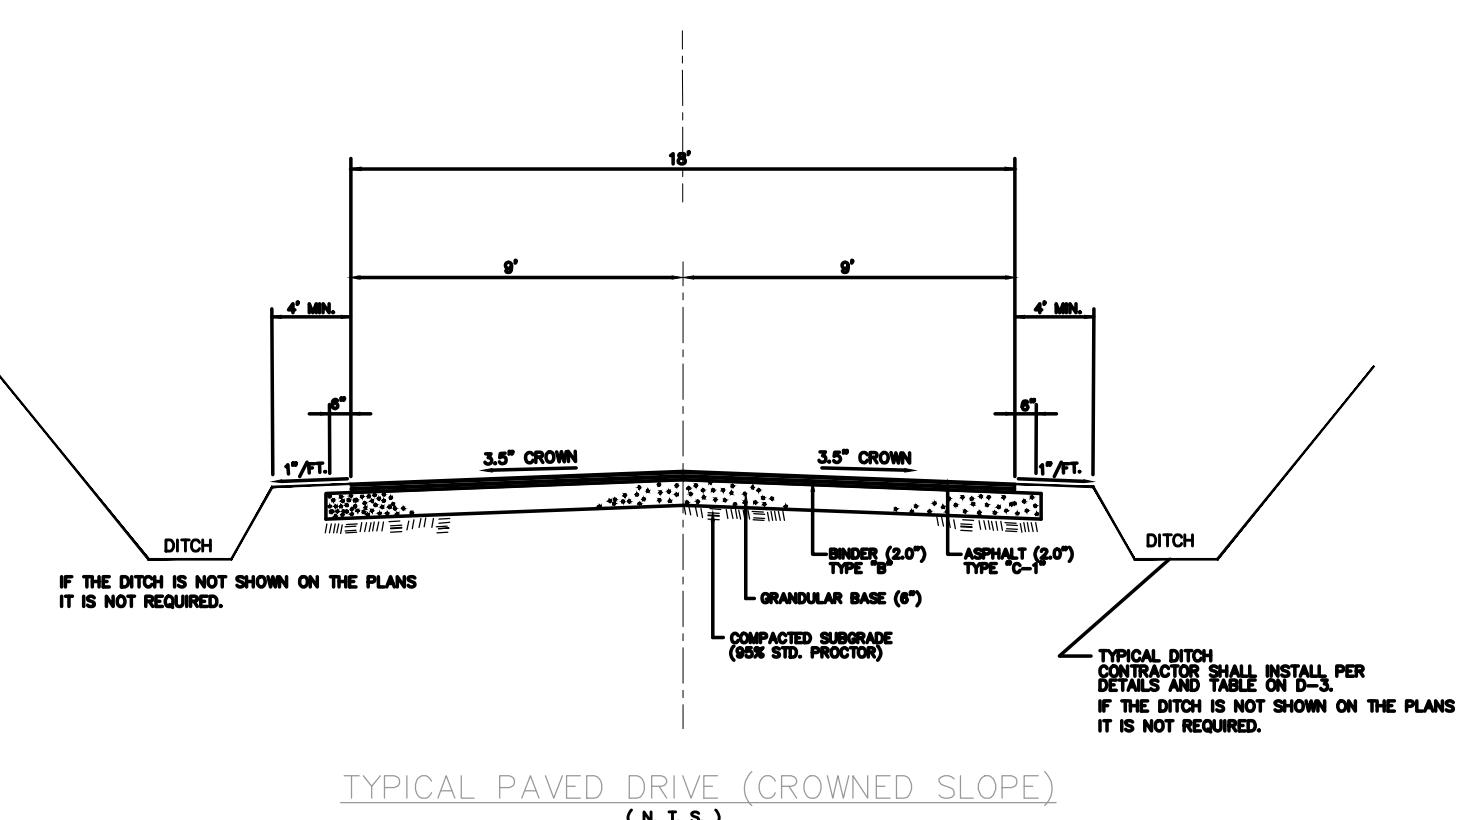

3 TYPICAL ROAD SECTION
D3 NTS

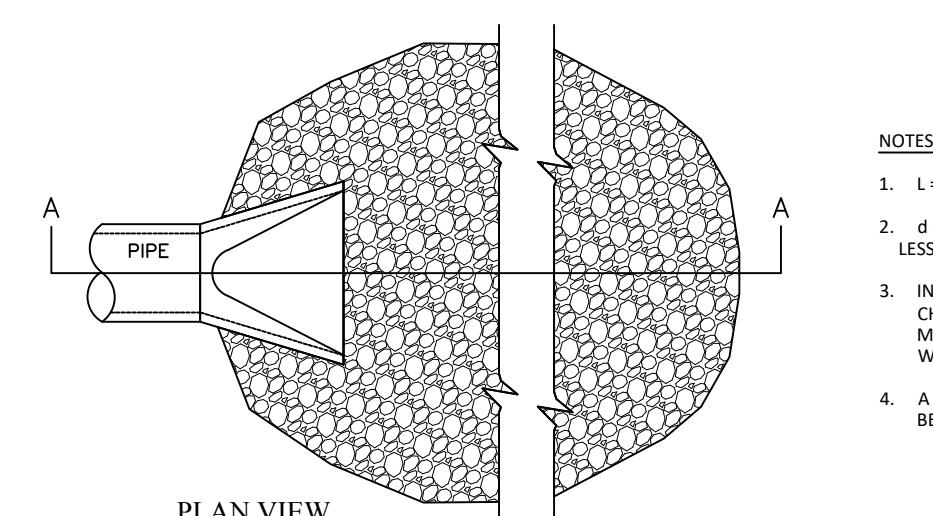


NOTES:

1. L = THE LENGTH OF THE RIPRAP APRON.
2. d = 1.5 TIMES THE MAXIMUM STONE DIAMETER BUT NOT LESS THAN 18 INCHES.
3. IF A CHANNEL DRAIN CHANNEL EXTEND THE APRON UP THE CHANNEL BANKS TO AN ELEVATION OF 15 INCHES ABOVE THE MAXIMUM TAILWATER DEPTH OR TO THE TOP OF THE BANK, WHICHEVER IS LESS.
4. A FILTER BLANKET OR FILTER FABRIC SHOULD BE INSTALLED BETWEEN THE RIPRAP AND SOIL FOUNDATION.

Maintenance Notes:



1. INSPECT RIPRAP OUTLET STRUCTURES WEEKLY AND AFTER SIGNIFICANT (1 INCH OR GREATER) RAINFALL EVENTS TO SEE IF ANY EROSION AROUND OR BELOW THE RIPRAP HAS TAKEN PLACE, OR IF STONES HAVE BEEN DISLODED. IMMEDIATELY MAKE ALL NEEDED REPAIRS TO PREVENT FURTHER DAMAGE.

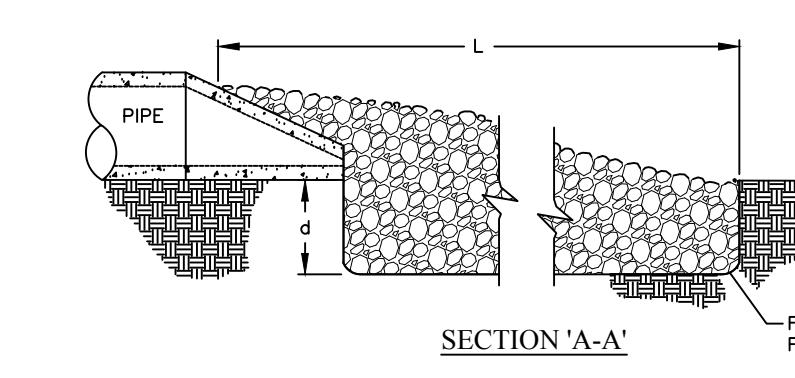

4 RIP RAP APRON
D3 NTS

NOTES:

1. STRUCTURAL STONE SHALL BE CLASS B STONE.
2. SEDIMENT CONTROL STONE SHALL BE NO. 5 OR NO. 57 STONE.
3. DIMENSIONS ARE MINIMUM ACCEPTABLE UNLESS OTHERWISE SPECIFIED BY THE ENGINEER.

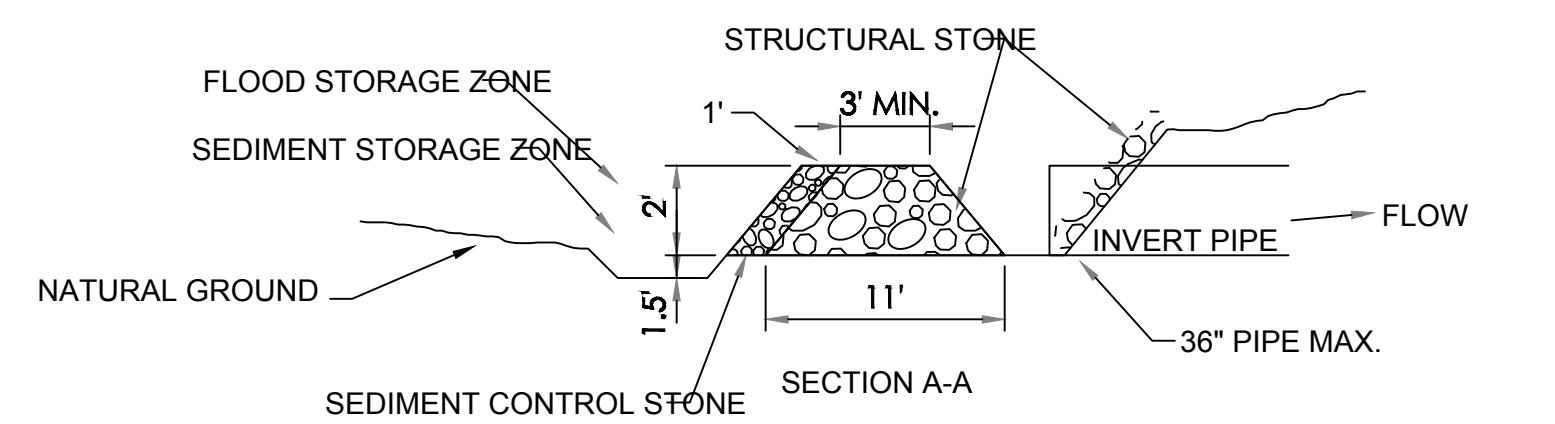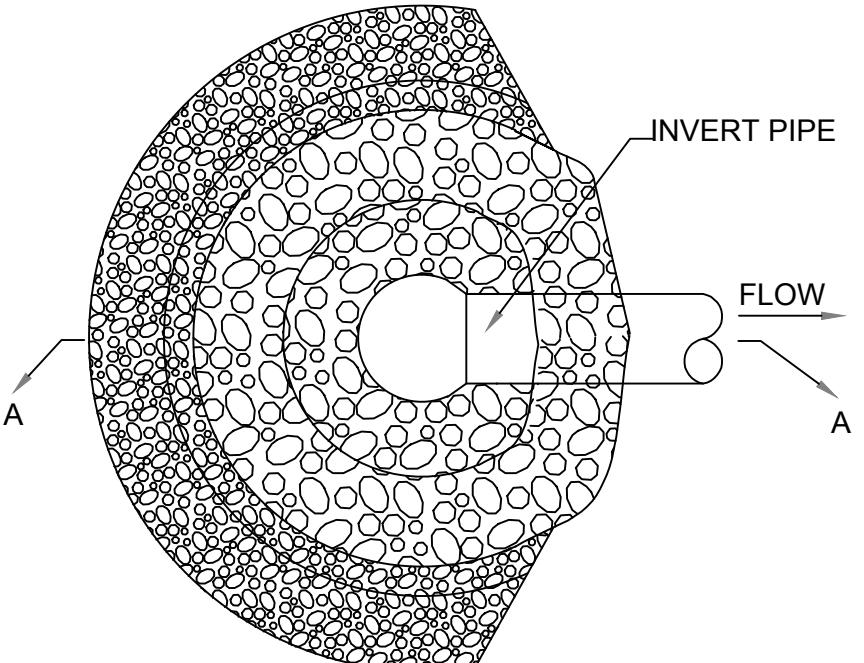

5 INLET PROTECTION DETAIL
D3 NTS

Submissions	Date
Sediment and Erosion Control Application	03/09/2024
Sediment and Erosion Control Comments	03/09/2024
Sediment and Erosion Control/Comments	03/26/2024
Preliminary Plat Submittal	03/24/2024

For Regulatory Review



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Phone: (828) 900-8700
www.landrm.com

AWEN LLC Lots 1-10
Rutherford County, North Carolina

AWEN LLC

Detail Sheet 4

Project Number:	412523	Scale= As Noted	Checked By	Date:
Drawn By	GMG	D4		

Date	01/09/2024
Submissions	Sediment and Erosion Control Application
Sediment and Erosion Control Comments	01/09/2024
Sediment and Erosion Control Comments	01/26/2024
Preliminary Plat Submittal	03/24/2024

GROUND STABILIZATION AND MATERIALS HANDLING PRACTICES FOR COMPLIANCE WITH THE NCG01 CONSTRUCTION GENERAL PERMIT

Implementing the details and specifications on this plan sheet will result in the construction activity being considered compliant with the Ground Stabilization and Materials Handling sections of the NCG01 Construction General Permit (Sections E and F, respectively). The permittee shall comply with the Erosion and Sediment Control plan approved by the delegated authority having jurisdiction. All details and specifications shown on this sheet may not apply depending on site conditions and the delegated authority having jurisdiction.

SECTION E: GROUND STABILIZATION

Required Ground Stabilization Timeframes

Site Area Description	Stabilize within this many calendar days after ceasing land disturbance	Timeframe variations
(a) Perimeter dikes, swales, ditches, and perimeter slopes	7	None
(b) High Quality Water (HQW) Zones	7	None
(c) Slopes steeper than 3:1	7	If slopes are 10' or less in length and are not steeper than 2:1, 14 days are allowed
(d) Slopes 3:1 to 4:1	14	-7 days for slopes greater than 50' in length and with slopes steeper than 4:1 -7 days for perimeter dikes, swales, ditches, perimeter slopes and HQW Zones -10 days for Falls Lake Watershed
(e) Areas with slopes flatter than 4:1	14	-7 days for perimeter dikes, swales, ditches, perimeter slopes and HQW Zones -10 days for Falls Lake Watershed unless there is zero slope

Note: After the permanent cessation of construction activities, any areas with temporary ground stabilization shall be converted to permanent ground stabilization as soon as practicable but in no case longer than 90 calendar days after the last land disturbing activity. Temporary ground stabilization shall be maintained in a manner to render the surface stable against accelerated erosion until permanent ground stabilization is achieved.

GROUND STABILIZATION SPECIFICATION

Stabilize the ground sufficiently so that rain will not dislodge the soil. Use one of the techniques in the table below:

Temporary Stabilization	Permanent Stabilization
<ul style="list-style-type: none"> Temporary grass seed covered with straw or other mulches and tackifiers Hydroseeding Rolled erosion control products with or without temporary grass seed Appropriately applied straw or other mulch Plastic sheeting 	<ul style="list-style-type: none"> Permanent grass seed covered with straw or other mulches and tackifiers Geotextile fabrics such as permanent soil reinforcement matting Hydroseeding Shrubs or other permanent plantings covered with mulch Uniform and evenly distributed ground cover sufficient to restrain erosion Structural methods such as concrete, asphalt or retaining walls Rolled erosion control products with grass seed

POLYACRYLAMIDES (PAMS) AND FLOCCULANTS

- Select flocculants that are appropriate for the soils being exposed during construction, selecting from the NC DWR List of Approved PAMS/Flocculants.
- Apply flocculants at or before the inlets to Erosion and Sediment Control Measures.
- Apply flocculants at the concentrations specified in the NC DWR List of Approved PAMS/Flocculants and in accordance with the manufacturer's instructions.
- Provide ponding area for containment of treated Stormwater before discharging offsite.
- Store flocculants in leak-proof containers that are kept under storm-resistant cover or surrounded by secondary containment structures.

EQUIPMENT AND VEHICLE MAINTENANCE

- Maintain vehicles and equipment to prevent discharge of fluids.
- Provide drip pans under any stored equipment.
- Identify leaks and repair as soon as feasible, or remove leaking equipment from the project.
- Collect all spent fluids, store in separate containers and properly dispose as hazardous waste (recycle when possible).
- Remove leaking vehicles and construction equipment from service until the problem has been corrected.
- Bring used fuels, lubricants, coolants, hydraulic fluids and other petroleum products to a recycling or disposal center that handles these materials.

LITTER, BUILDING MATERIAL AND LAND CLEARING WASTE

- Never bury or burn waste. Place litter and debris in approved waste containers.
- Provide a sufficient number and size of waste containers (e.g. dumpster, trash receptacle) on site to contain construction and domestic wastes.
- Locate waste containers at least 50 feet away from storm drain inlets and surface waters unless no other alternatives are reasonably available.
- Locate waste containers on areas that do not receive substantial amounts of runoff from upland areas and does not drain directly to a storm drain, stream or wetland.
- Cover waste containers at the end of each workday and before storm events or provide secondary containment. Repair or replace damaged waste containers.
- Anchor all lightweight items in waste containers during times of high winds.
- Empty waste containers as needed to prevent overflow. Clean up immediately if containers overflow.
- Dispose waste off-site at an approved disposal facility.
- On business days, clean up and dispose of waste in designated waste containers.

PAINT AND OTHER LIQUID WASTE

- Do not dump paint and other liquid waste into storm drains, streams or wetlands.
- Locate paint washouts at least 50 feet away from storm drain inlets and surface waters unless no other alternatives are reasonably available.
- Contain liquid wastes in a controlled area.
- Containment must be labeled, sized and placed appropriately for the needs of site.
- Prevent the discharge of soaps, solvents, detergents and other liquid wastes from construction sites.

PORTRABLE TOILETS

- Install portable toilets on level ground, at least 50 feet away from storm drains, streams or wetlands unless there is no alternative reasonably available. If 50 foot offset is not attainable, provide relocation of portable toilet behind silt fence or place on a gravel pad and surround with sand bags.
- Provide staking or anchoring of portable toilets during periods of high winds or in high foot traffic areas.
- Monitor portable toilets for leaking and properly dispose of any leaked material. Utilize a licensed sanitary waste hauler to remove leaking portable toilets and replace with properly operating unit.


EARTHEN STOCKPILE MANAGEMENT

- Show stockpile locations on plans. Locate earthen-material stockpile areas at least 50 feet away from storm drain inlets, sediment basins, perimeter sediment controls and surface waters unless it can be shown no other alternatives are reasonably available.
- Protect stockpile with silt fence installed along toe of slope with a minimum offset of five feet from the toe of stockpile.
- Provide stable stone access point when feasible.
- Stabilize stockpile within the timeframes provided on this sheet and in accordance with the approved plan and any additional requirements. Soil stabilization is defined as vegetative, physical or chemical coverage techniques that will restrain accelerated erosion on disturbed soils for temporary or permanent control needs.



NCG01 GROUND STABILIZATION AND MATERIALS HANDLING

EFFECTIVE: 04/01/19

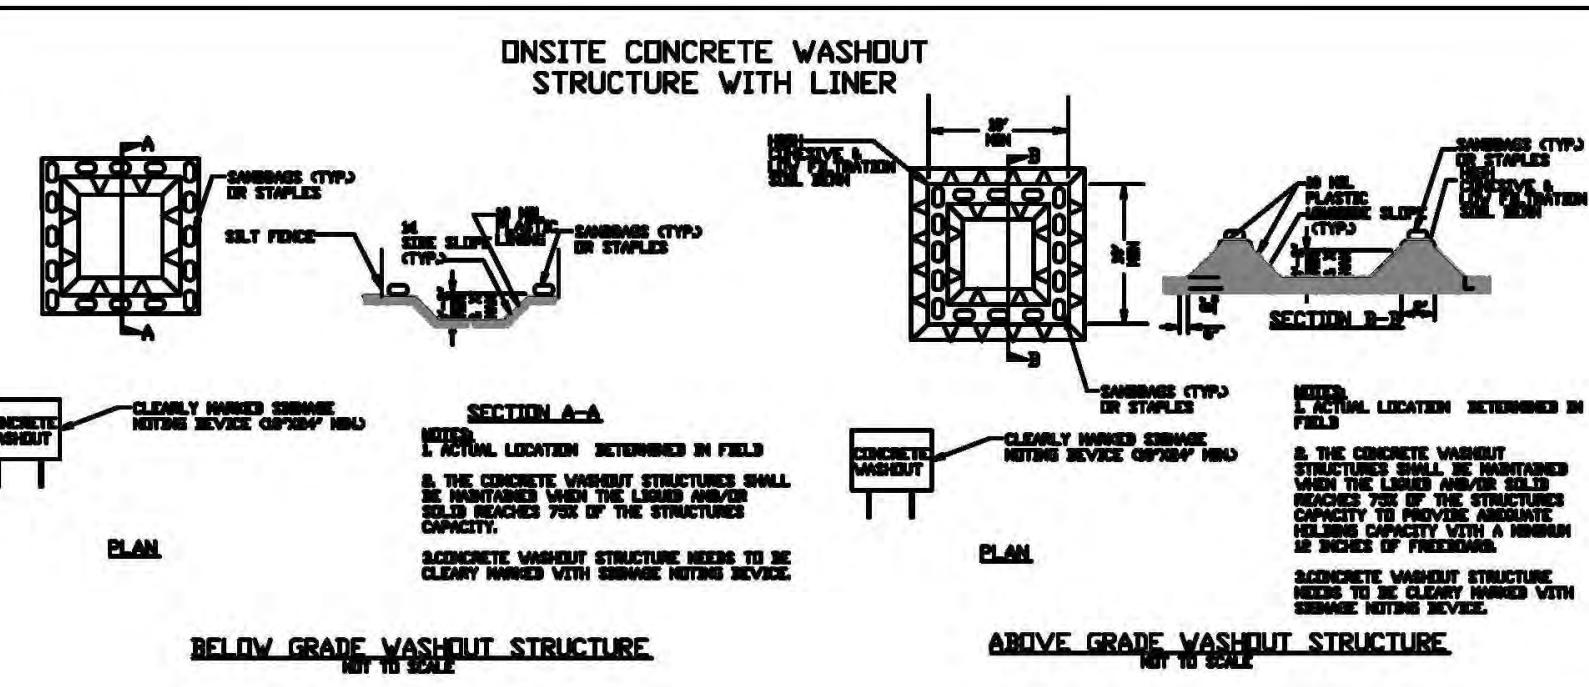

PART III SELF-INSPECTION, RECORDKEEPING AND REPORTING

SECTION A: SELF-INSPECTION

Self-inspections are required during normal business hours in accordance with the table below. When adverse weather or site conditions would cause the safety of the inspection personnel to be in jeopardy, the inspection may be delayed until the next business day on which it is safe to perform the inspection. In addition, when a storm event of equal to or greater than 1.0 inch occurs outside of normal business hours, the self-inspection shall be performed upon the commencement of the next business day. Any time when inspections were delayed shall be noted in the Inspection Record.

Inspect	Frequency (during normal business hours)	Inspection records must include:
(1) Rain gauge maintained in good working order	Daily	Daily rainfall amounts. If no daily rain gauge observations are made during weekend or holiday periods, and no individual-day rainfall information is available, record the cumulative rain measurement for those unattended days (and this will determine if a site inspection is needed). Days on which no rainfall occurred shall be recorded as "zero." The permittee may use another rain-monitoring device approved by the Division.
(2) E&SC Measures	At least once per 7 calendar days and within 24 hours of a rain event \geq 1.0 inch in 24 hours	1. Identification of the measures inspected, 2. Date and time of the inspection, 3. Name of the person performing the inspection, 4. Indication of whether the measures were operating properly, 5. Description of maintenance needs for the measure, 6. Description, evidence, and date of corrective actions taken.
(3) Stormwater discharge outfalls (SDCs)	At least once per 7 calendar days and within 24 hours of a rain event \geq 1.0 inch in 24 hours	1. Identification of the discharge outfalls inspected, 2. Date and time of the inspection, 3. Name of the person performing the inspection, 4. Evidence of indicators of stormwater pollution such as oil sheen, floating or suspended solids or discoloration, 5. Indication of visible sediment leaving the site, 6. Description, evidence, and date of corrective actions taken.
(4) Perimeter of site	At least once per 7 calendar days and within 24 hours of a rain event \geq 1.0 inch in 24 hours	If visible sedimentation is found outside site limits, then a record of the following shall be made: 1. Actions taken to clean up or stabilize the sediment that has left the site limits, 2. Description, evidence, and date of corrective actions taken, and 3. An explanation as to the actions taken to control future releases.
(5) Streams or wetlands onsite or offsite (where accessible)	At least once per 7 calendar days and within 24 hours of a rain event \geq 1.0 inch in 24 hours	If the stream or wetland has increased visible sedimentation or a stream has visible increased turbidity from the construction activity, then a record of the following shall be made: 1. Description, evidence and date of corrective actions taken, and 2. Records of the required reports to the appropriate Division Regional Office per Part III, Section C, Item (2)(a) of this permit.
(6) Ground stabilization measures	After each phase of grading	1. The phase of grading (installation of perimeter E&SC measures, clearing and grubbing, installation of storm drainage facilities, completion of all land-disturbing activity, construction or redevelopment, permanent ground cover), 2. Documentation that the required ground stabilization measures have been provided within the required timeframe or an assurance that they will be provided as soon as possible.

NOTE: The rain inspection resets the required 7 calendar day inspection requirement.

PART II, SECTION G, ITEM (4) DRAW DOWN OF SEDIMENT BASINS FOR MAINTENANCE OR CLOSE OUT

Sediment basins and traps that receive runoff from drainage areas of one acre or more shall use outlet structures that withdraw water from the surface when these devices need to be drawn down for maintenance or close out unless this is infeasible. The circumstances in which it is not feasible to withdraw water from the surface shall be rare (for example, times with extended cold weather). Non-surface withdrawals from sediment basins shall be allowed only when all of the following criteria have been met:

- (a) The E&SC plan authority has been provided with documentation of the non-surface withdrawal and the specific time periods or conditions in which it will occur. The non-surface withdrawal shall not commence until the E&SC plan authority has approved these items,
- (b) The non-surface withdrawal has been reported as an anticipated bypass in accordance with Part III, Section C, Item (2)(c) and (d) of this permit,
- (c) Dewatering discharges are treated with controls to minimize discharges of pollutants from stormwater that is removed from the sediment basin. Examples of appropriate controls include properly sited, designed and maintained dewatering tanks, weir tanks, and filtration systems,
- (d) Vegetated, upland areas of the sites or a properly designed stone pad is used to the extent feasible at the outlet of the dewatering treatment devices described in Item (c) above,
- (e) Velocity dissipation devices such as check dams, sediment traps, and riprap are provided at the discharge points of all dewatering devices, and
- (f) Sediment removed from the dewatering treatment devices described in Item (c) above is disposed of in a manner that does not cause deposition of sediment into waters of the United States.

NCG01 SELF-INSPECTION, RECORDKEEPING AND REPORTING

EFFECTIVE: 04/01/19

PART III SELF-INSPECTION, RECORDKEEPING AND REPORTING

SECTION B: RECORDKEEPING

1. E&SC Plan Documentation

The approved E&SC plan as well as any approved deviation shall be kept on the site. The approved E&SC plan must be kept up-to-date throughout the coverage under this permit. The following items pertaining to the E&SC plan shall be kept on site and available for inspection at all times during normal business hours.

Item to Document	Documentation Requirements
(a) Each E&SC measure has been installed and does not significantly deviate from the locations, dimensions and relative elevations shown on the approved E&SC plan.	Initial and date each E&SC measure on a copy of the approved E&SC plan or complete, date and sign an inspection report that lists each E&SC measure shown on the approved E&SC plan. This documentation is required upon the initial installation of the E&SC measures or if the E&SC measures are modified after initial installation.
(b) A phase of grading has been completed.	Initial and date a copy of the approved E&SC plan or complete, date and sign an inspection report to indicate completion of the construction phase.
(c) Ground cover is located and installed in accordance with the approved E&SC plan.	Initial and date a copy of the approved E&SC plan or complete, date and sign an inspection report to indicate compliance with approved ground cover specifications.
(d) The maintenance and repair requirements for all E&SC measures have been performed.	Complete, date and sign an inspection report.
(e) Corrective actions have been taken to E&SC measures.	Initial and date a copy of the approved E&SC plan or complete, date and sign an inspection report to indicate the completion of the corrective action.

2. Additional Documentation to be Kept on Site

In addition to the E&SC plan documents above, the following items shall be kept on the site and available for inspectors at all times during normal business hours, unless the Division provides a site-specific exemption based on unique site conditions that make this requirement not practical:

- (a) This General Permit as well as the Certificate of Coverage, after it is received.
- (b) Records of inspections made during the previous twelve months. The permittee shall record the required observations on the Inspection Record Form provided by the Division or a similar inspection form that includes all the required elements. Use of electronically-available records in lieu of the required paper copies will be allowed if shown to provide equal access and utility as the hard-copy records.

3. Documentation to be Retained for Three Years

All data used to complete the e-NOI and all inspection records shall be maintained for a period of three years after project completion and made available upon request. [40 CFR 122.41]

PART III SELF-INSPECTION, RECORDKEEPING AND REPORTING

SECTION C: REPORTING

1. Occurrences that Must be Reported

Permittees shall report the following occurrences:

- (a) Visible sediment deposition in a stream or wetland.
- (b) Oil spills if:
 - They are 25 gallons or more,
 - They are less than 25 gallons but cannot be cleaned up within 24 hours,
 - They cause sheen on surface waters (regardless of volume), or
 - They are within 100 feet of surface waters (regardless of volume).
- (c) Releases of hazardous substances in excess of reportable quantities under Section 311 of the Clean Water Act (Ref: 40 CFR 110.3 and 40 CFR 117.3) or Section 102 of CERCLA (Ref: 40 CFR 302.4) or G.S. 143-215.85.
- (d) Anticipated bypasses and unanticipated bypasses.
- (e) Noncompliance with the conditions of this permit that may endanger health or the environment.

2. Reporting Timeframes and Other Requirements


After a permittee becomes aware of an occurrence that must be reported, he shall contact the appropriate Division regional office within the timeframes and in accordance with the other requirements listed below. Occurrences outside normal business hours may also be reported to the Department's Environmental Emergency Center personnel at (800) 858-0368.

Occurrence	Reporting Timeframes (After Discovery) and Other Requirements
(a) Visible sediment deposition in a stream or wetland	<ul style="list-style-type: none"> • Within 24 hours, an oral or electronic notification. • Within 7 calendar days, a report that contains a description of the sediment and actions taken to address the cause of the deposition. Division staff may waive the requirement for a written report on a case-by-case basis. • If the stream is named on the NC 303(d) list as impaired for sediment-related causes, the permittee may be required to perform additional monitoring, inspections or apply more stringent practices if staff determine that additional requirements are needed to assure compliance with the federal or state impaired-waters conditions.
(b) Oil spills and release of hazardous substances per Item 1(b)-(c) above	<ul style="list-style-type: none"> • Within 24 hours, an oral or electronic notification. The notification shall include information about the date, time, nature, volume and location of the spill or release.
(c) Anticipated bypasses (40 CFR 122.41(m)(3)]	<ul style="list-style-type: none"> • A report at least ten days before the date of the bypass, if possible. The report shall include an evaluation of the anticipated quality and effect of the bypass.
(d) Unanticipated bypasses (40 CFR 122.41(m)(3))	<ul style="list-style-type: none"> • Within 24 hours, an oral or electronic notification. • Within 7 calendar days, a report that includes an evaluation of the quality and effect of the bypass.
(e) Noncompliance with the conditions of this permit that may endanger health or the environment[40 CFR 122.41(l)(7)]	<ul style="list-style-type: none"> • Within 24 hours, an oral or electronic notification. • Within 7 calendar days, a report that contains a description of the noncompliance, and its causes; the period of noncompliance, including exact dates and times, and if the noncompliance has not been corrected, the anticipated time noncompliance is expected to continue; and steps taken or planned to reduce, eliminate, and prevent reoccurrence of the noncompliance. [40 CFR 122.41(l)(6)]. • Division staff may waive the requirement for a written report on a case-by-case basis.



Date	Submissions	Sediment and Erosion Control Application	Sediment and Erosion Control Application
09/11/2023		09/01/2024	09/01/2024

Project Number:	Scale= As Noted	Checked By:	Date:
412523	Drawn By: GMG		D5

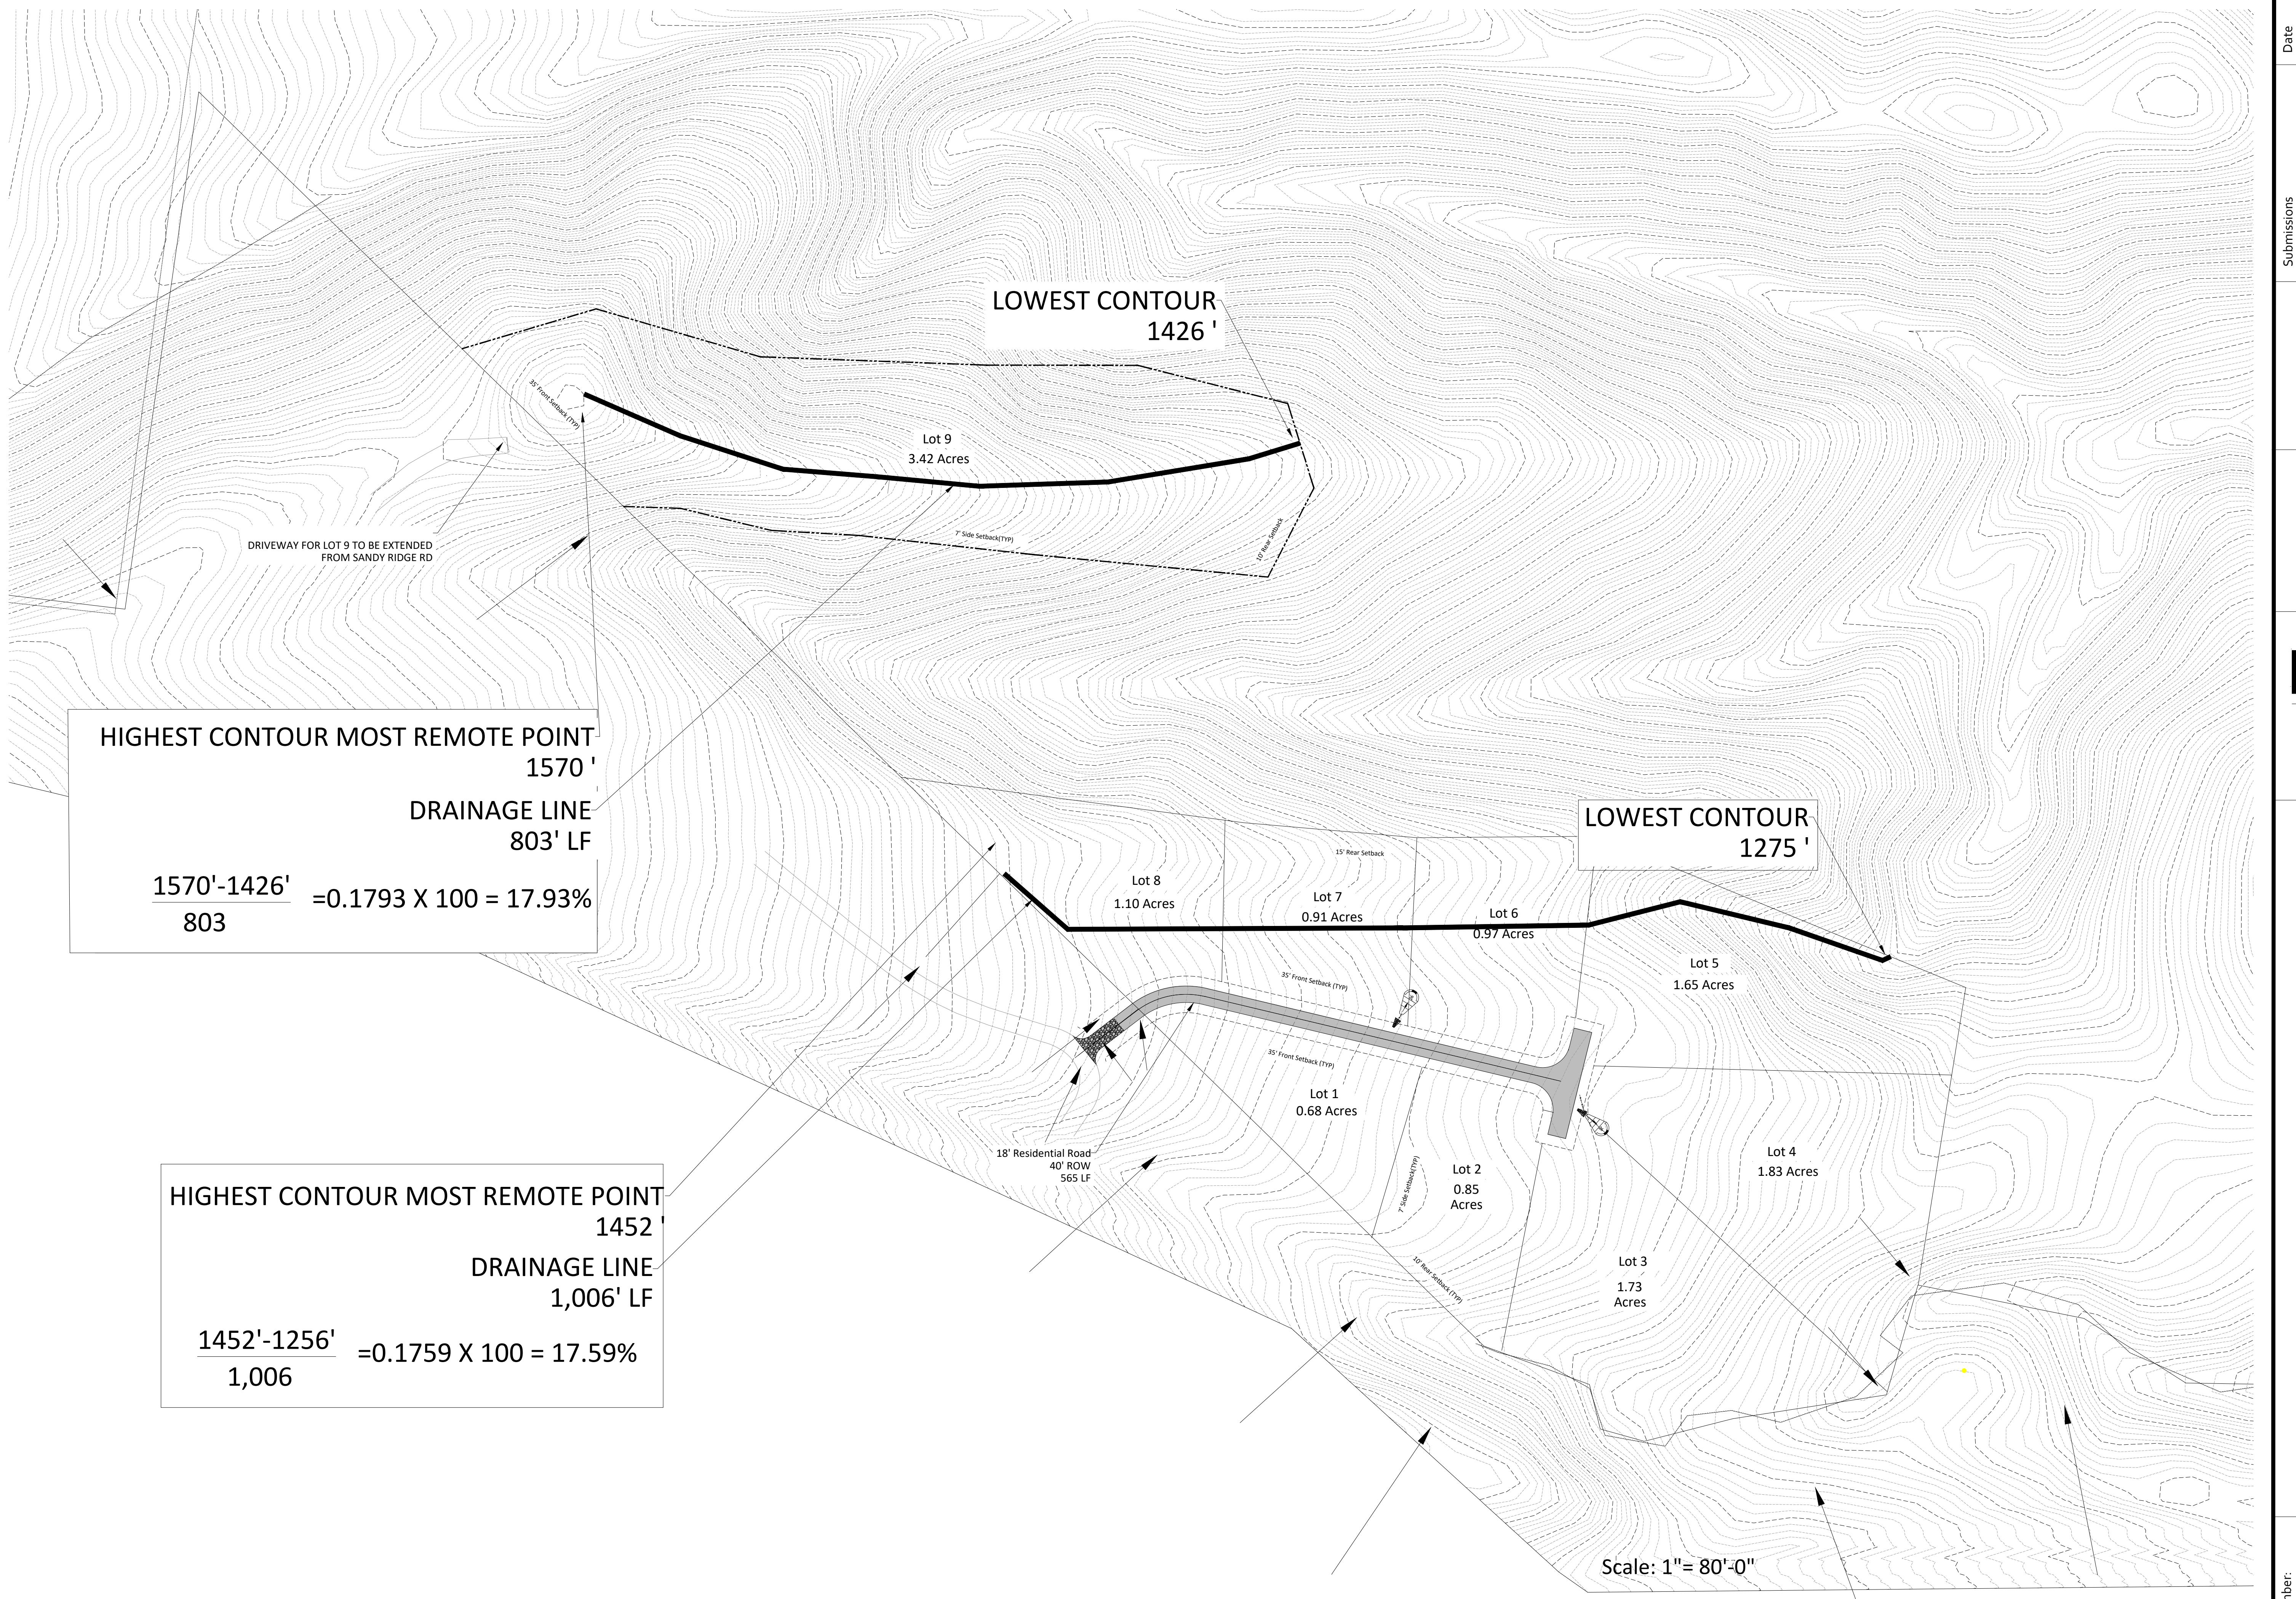

Awen LLC Lots 1-10
Rutherford County, North Carolina

Project Number:
412523


Scale-As Noted

Checked By

Drawn By
GMG

Date:
EXH-1

Submissions	Date
Sediment and Erosion Control Application	01/09/2024
Sediment and Erosion Control/Comments	01/09/2024
Sediment and Erosion Control/Comments	01/26/2024

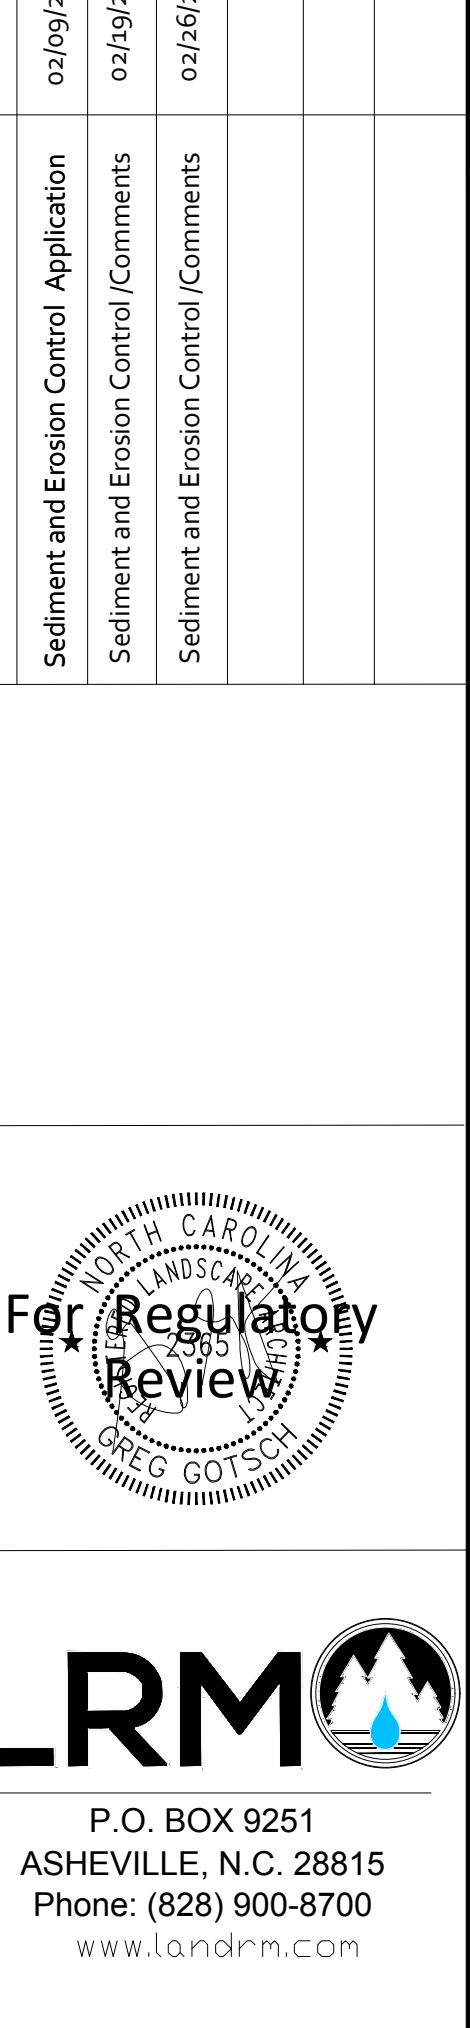



Canopy Coverage Calculation

$x = 385$
 $a = 375 \quad 97\%$
 $b = 5 \quad 1\%$
 $c = 0$
 $d = 0$
 $e = 5 \quad 1\%$

Total Canopy 99% Pre Development
 69 % Canopy Require Post Development
 8 Lot Phase Total = 10.32 AC
 Protection Area= 8.42
 81% Post Development Canopy Coverage


75

AWEN LLC Lots 1-10
Lake Lure, North Carolina
 AWEN LLC

Tree Protection / Canopy Coverage





Project Number:	412523
Scale- As Noted	
Drawn By	Checked By
GMG	

Date:	05-20-2024
TR1	

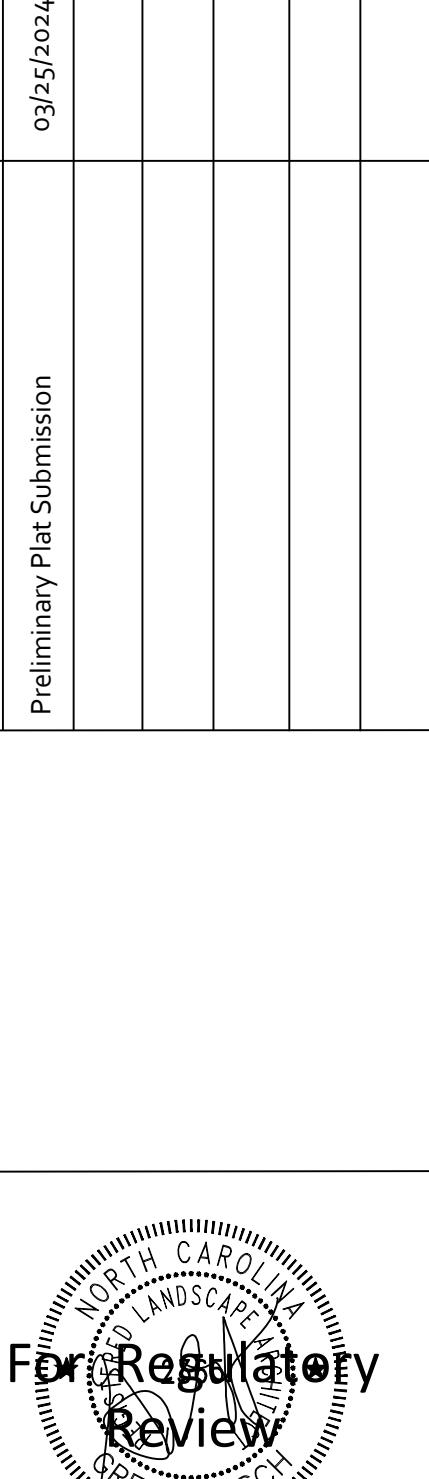Submissions	Date
Preliminary Plat Submission	05/25/2024
For Regulatory Review	
	
LRM	
P.O. BOX 9251	
ASHEVILLE, N.C. 28815	
Phone: (828) 900-8700	
www.landrm.com	

Sec. 36-71. - Protected mountain ridge overlay zones.


- (a) *Intent.* Mountain ridges provide a key sense of place and are a key economic asset for the people of the town. Certain mountain ridges, by virtue of their topography, are particularly visible, and, thus, have greater potential to impact the values listed above. Protected Mountain Ridge Overlay Zones are intended to protect viewsheds associated with prominent mountain ridges from development activities which are likely to adversely impact these assets.
- (b) *Applicability.* There are hereby created the Protected Mountain Ridge Overlay Zones as depicted on the map entitled "Protected Mountain Ridge Overlay Zone Map," which is attached to the ordinance from which this section is derived and which is hereby adopted as if fully set forth in this chapter. Said map shall be attached to the town clerk's copy of this chapter upon adoption and shall be duly incorporated into the zoning map of the town. In addition to complying with all applicable standards of the underlying zoning district, development on lands situated within such overlay zones shall also comply with the standards contained in this section.
- (c) *Building location.* To the extent practicable, each building shall be located so as to minimize its visual impact.
- (d) *Partial screening.* A portion of natural on-site vegetation shall be retained sufficient to partially screen (along 50 percent of the building face, or that achieves 50 percent opacity or more along the building face) the building, structure, use, or activity from views from public roads not serving the building, or landscaping shall be installed and designed to partially screen the building, structure, use, or activity from views from public roads, or other measures have been included in the project and approved by the director to reduce the visual impacts of such development from views from public roads. View corridors from the proposed building to surrounding areas may be provided, but such corridors shall not extend for more than 50 percent of the width of building face between the view sought and the building face from which the view is sought.
- (e) *Tree protection.* Trees which are part of the tree canopy or required screening shall not be removed unless they constitute a danger to person or property and only with written authorization of the tree protection officer.
- (f) *Roofs.* Roof forms and rooflines for new structures shall be broken into a series of smaller building components to reflect the irregular forms of the surrounding mountain or hillside. The slope of the roof shall be oriented in the same direction as the natural slope of the lot. Only nonreflective roofing materials shall be used.

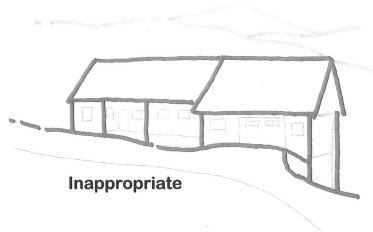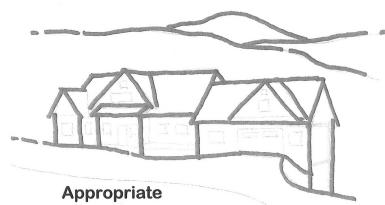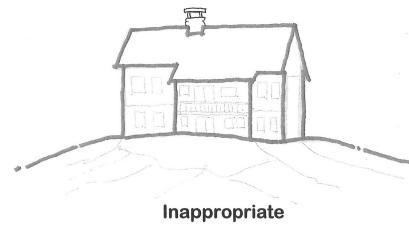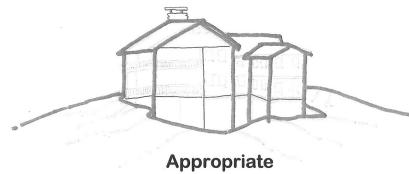

Roof Forms and Roof Lines

(Code 1989, § 92.041; Ord. of 11-18-2008; Ord. of 3-10-2009; Ord. of 10-9-2012; Ord. of 12-9-2014; Ord. of 3-16-2015)

Town of Lake Lure Protected Mountain Ridges

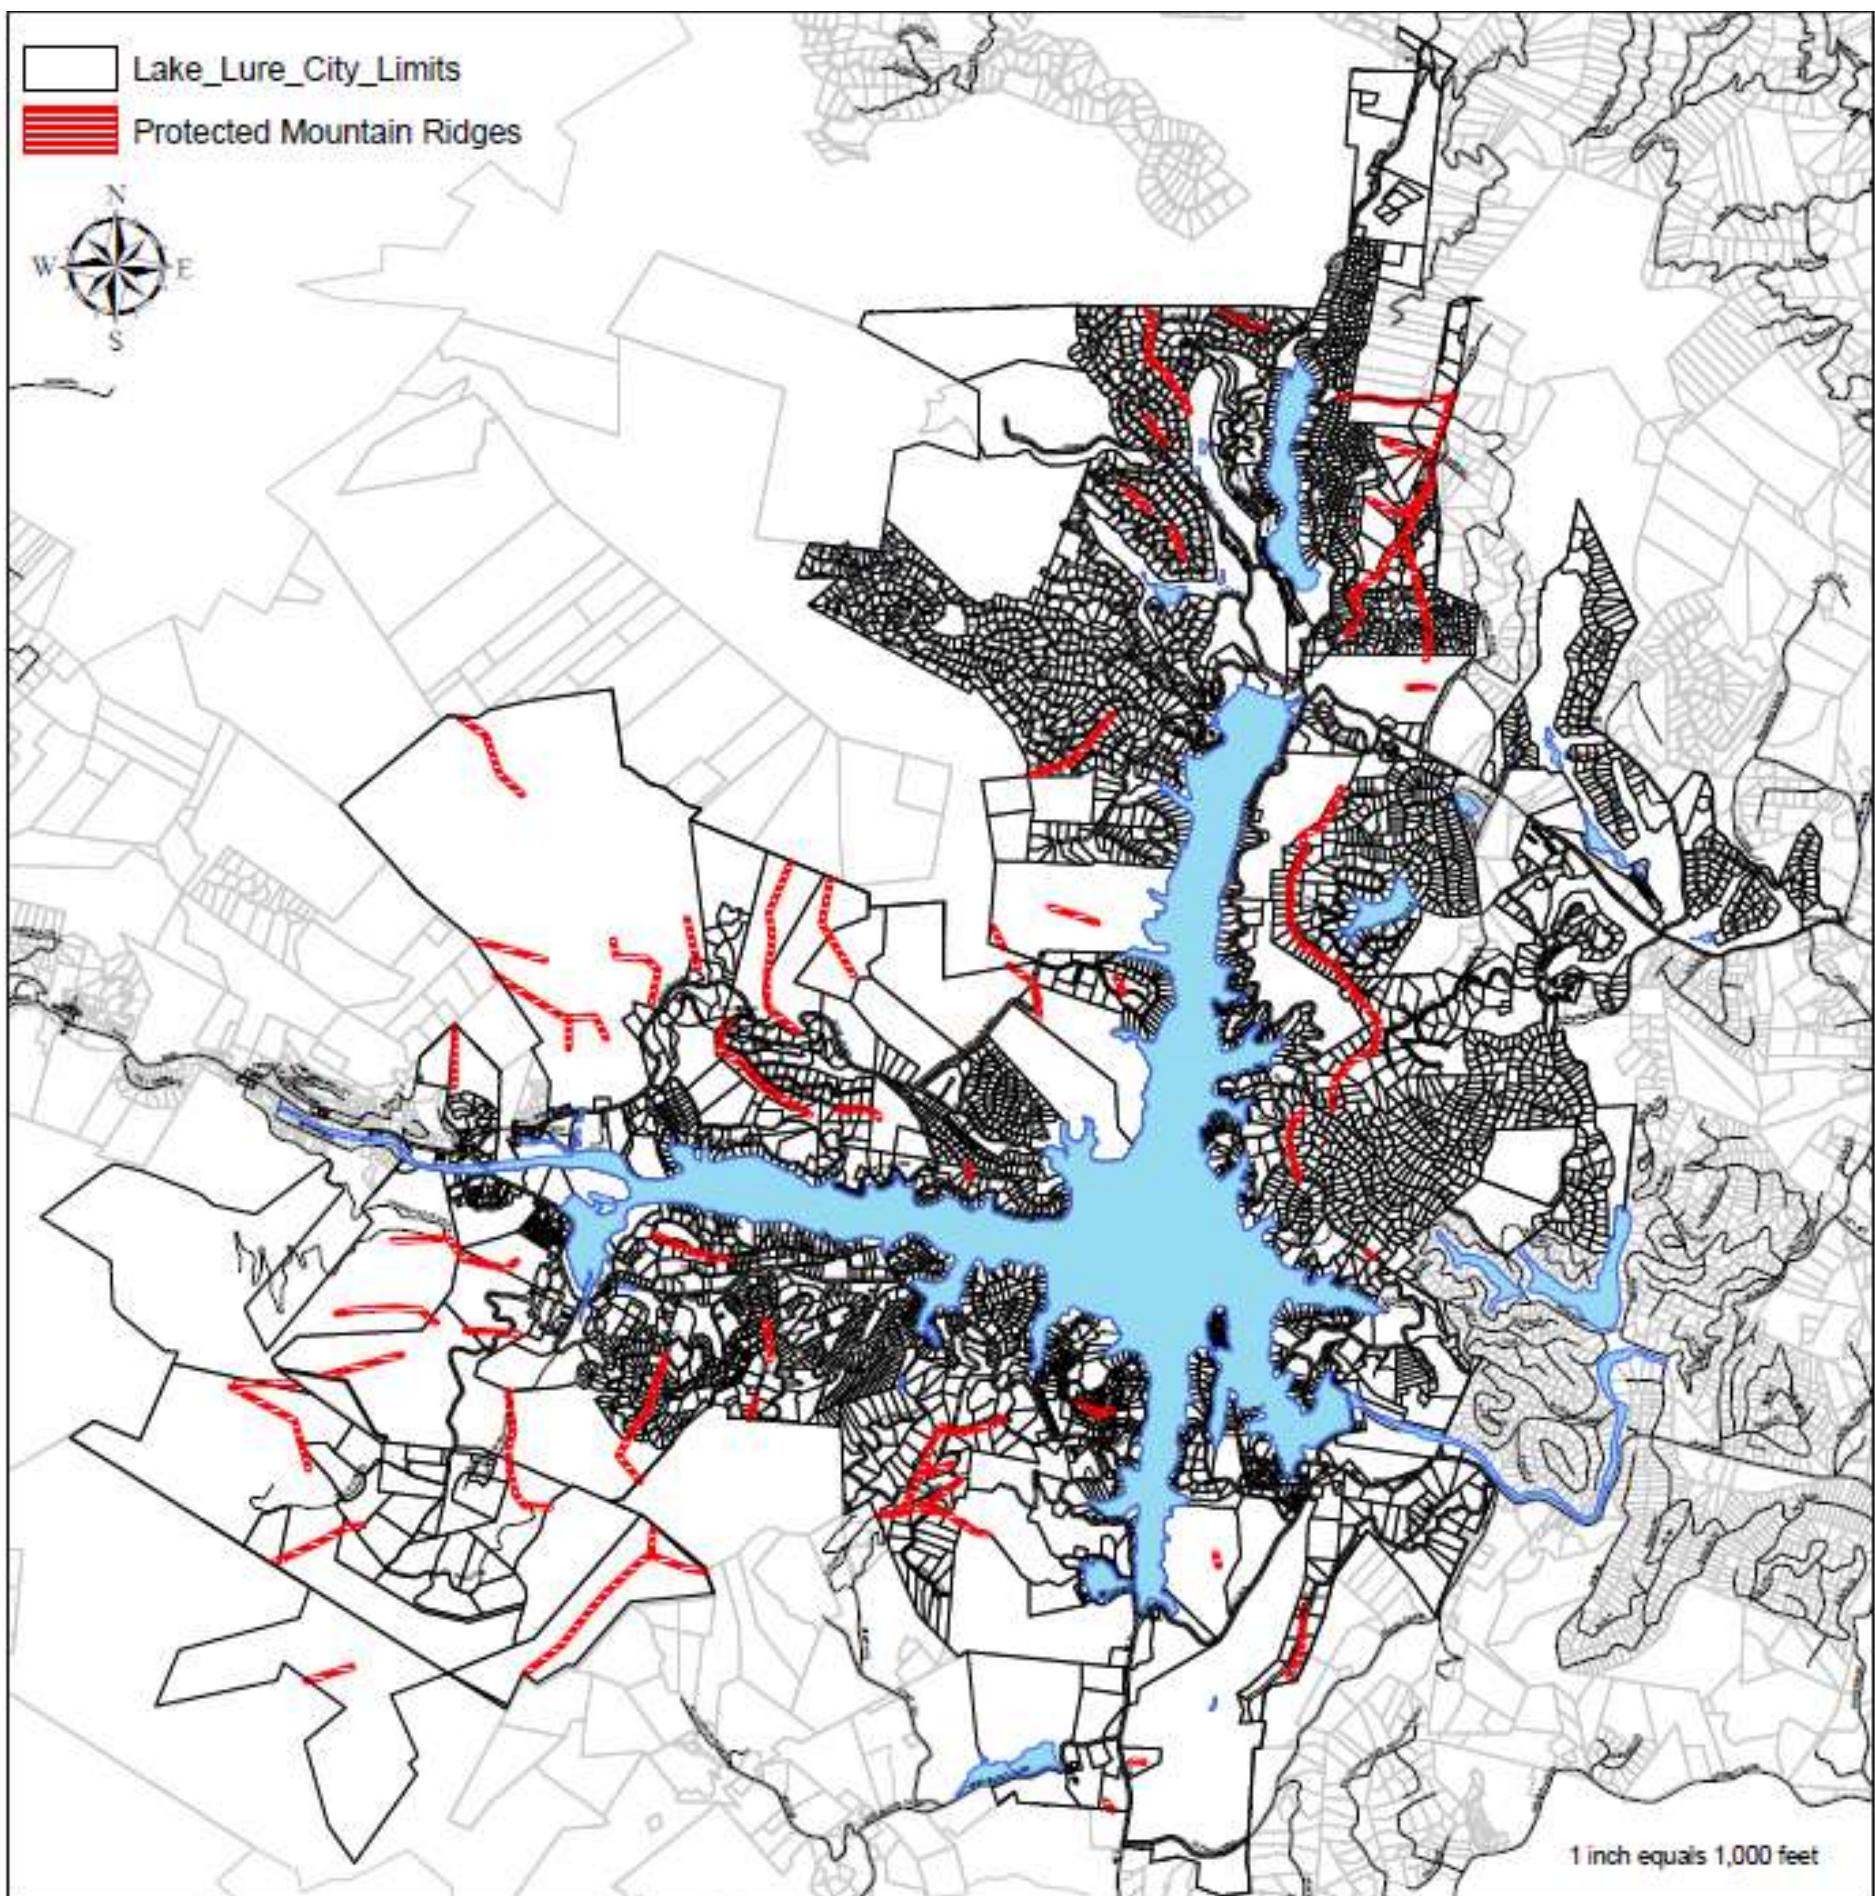

Date Printed: June 20, 2022
Printed by: Town of Lake Lure
Community Development Department

This map was prepared from existing Rutherford County property parcel maps as of June 14, 2022
County property parcel maps as of June 14, 2022 for the sole purpose of presenting information on
Protected Mountain Ridges within the Town of Lake Lure, NC and should not be used for the
transfer of property, easements, or conveyances.

Protected Mountain Ridges were identified using historic view locations (including the Lake, NC 9 and 64/74 intersection, Buffalo Shoals and & 64/74 intersection, and areas in Rumbling Bald Resort) processed using the Town's GIS. Visible ridgelines above 1200' MSL were identified for protection. A ridgeline zone was established by creating a buffer zone of 50 feet from each side of the delineated centerline of the ridge. The Protected Mountain Ridges ordinance can be located in Section 36-71 of the Town Ordinances.

Sec. 36-5. - Definitions.



The following words, terms and phrases, when used in this chapter, shall have the meanings ascribed to them in this section, except where the context clearly indicates a different meaning:

Access structure means a uncovered staircase, walkway or handicap access way no greater than four feet in width and constructed above grade at an elevation no greater than reasonably required by topography to connect the principal structure to the street or shoreline.

Accessory building means a detached building subordinate to the principal building on a lot and used for purposes customarily incidental to the principal building and located on the same lot.



NAME: Mike Williams

POSITION: Community Development Director

REPORT DATE: 7/4/24

PREPARED FOR: Town Manager & Council

SUMMARY OF THE MONTH

*CDD issued 31 permits in June (31 in May, 34 in Apr, 62 in Mar, 43 in Feb, 39 in Jan, 31 in Dec, 31 in Nov, 35 in Oct, 34 in Sept, 39 in Aug, 28 in July, 22 in June, 60 in May). Includes 12 Zoning (May=12, Apr=12, Mar=19, 10=Feb, Jan=19, Dec=16, Nov=12, Oct=12, Sep=7, Aug=13, Jul=13, Jun=9, May=22)

5 Lake Structure-inc. shoreline stabilization (May=4, Apr=8, Mar=16, Feb=9, Jan=8, Dec=1, Nov=1, Oct=2, Sept=4, Aug=4, Jul=2, Jun=2, May=9)

4 Land Disturbance (May=3, Apr=7, 9=Mar, Feb=4, Jan=4, Dec=1, Nov=1, Oct=3, Sept=3, Aug=3, Jul=2, Jun=3, May=3)

and 11 Vacation Rental Operator permit (May=2, Apr=2, Mar=9, Feb=6, Jan=5, Dec=1, Nov=1, Oct=2, Sept=4, Aug=2; Jul=5, Jun=4, May=12, Apr=2, Mar=2, Feb=2, Jan=2, Dec=2, Nov=5, Oct=5, Sept=5, Aug=2, Jul=6, Jun=7). Active VROP's = 467 (total active permits based on our updated permit data)

*Did Final Inspection/issued Certificates of Completion for 17 zoning or lake structure permits. (May=15, Apr=16, Mar=16, Feb=7, Jan=11, Dec=13, Nov=13, Oct=14, Sept=13, Aug=12, Jul=14, Jun=16)

TOP ACCOMPLISHMENTS / PROJECT UPDATES

- 1) Zoning and Planning Board conducted a review of KML Investments, LLC's Special Use Permit package regarding a 2,940sf office building with two office spaces and open area for storage. The board reviews site treatment, building design, relationship of building to site and neighborhood character and other considerations reasonably affecting the appearance of the proposed project. The board approved a recommendation to the Board of Adjustments for approval.
- 2) Board of Adjustments conducted quasi-judicial reviews of two variance requests. First was to reduce setbacks and other an increase in the maximum building height. Both were approved as presented. The board also reviewed the Special Use Permit package for the 2,940sf office building to be located within the Commercial General district that had been recommended for approval by Zoning & Planning. The board approved the Special Use Permit.
- 3) Lake Structure Appeals Board had no new business in June.
- 4) Continued working with Tillman Construction (for AT&T) on the cell tower project. It is still under review of the FCC and construction held pending their release.
- 5) Our college intern has helped our department with GIS mapping projects including zoning and protected mountain ridge mapping and continues researching street right of way information. This has been/will be a great collection of information for permitting and public use. She has also worked with public works on sewer and other infrastructure mapping including physical collection of data points, recording information and mapping.
- 6) We are also working on office space planning in preparation for a staff addition that would require a work space, and means to make the space more functional for our use.