INDUSTRIAL PARK COMMISSION

City of Kaukauna **Hydro View Room** Municipal Services Building 144 W. Second Street, Kaukauna



Thursday, March 27, 2025 at 3:00 PM


AGENDA

In-Person in Common Council Chambers, City of Kaukauna

- 1. Roll Call.
- 2. Approval of Minutes.
 - a. Approve Minutes from February 27th, 2025 Meeting
- Old Business.
- New Business.
 - a. Site Plan Review-1200 Maloney Rd (TEAM Industries)
- 5. Closed Session.
 - Adjourn to Closed Session per Wisconsin State Statutes 19.85(1)(e) to discuss the disposition of public property - lot 7NEW Prosperity Center
 - b. Return to Open Session for possible action
- Other Business.
- 7. Adjourn.

NOTICES

IF REQUESTED THREE (3) DAYS PRIOR TO THE MEETING, A SIGN LANGUAGE INTERPRETER WILL BE MADE AVAILABLE AT NO CHARGE.

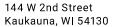

Industrial Park Commission City of Kaukauna **Hydro View Room** Municipal Services Building 144 W. Second Street, Kaukauna



Thursday, February 27, 2025 at 3:00 p.m.

Minutes

In-Person in Hydro View Room, City of Kaukauna

Chair Avanzi called the meeting to order at 3:01 p.m.

1. Roll Call

Members Present: Michael Avanzi, John Sundelius, Ryan Gaffney, Mike Vandeberg, Tony Nytes (online), Dale Eggert

Member(s) Absent: Glen Schilling, Nick Rieth

Other(s) Present: Director Kittel, AP Nelson

Vandeberg made a motion to excuse the absent members. Seconded by Sundelius. Motion passed unanimously.

- 2. Approval of Minutes
- a. Approve Minutes from September 26, 2024

Sundelius made a motion to approve the minutes from September 26, 2024. Seconded by Eggert. Motion passed unanimously.

3. Old Business

None

- 4. New Business
- a. Site Plan Review 1200 Prospect Lane (Eagle Graphics)

Director Kittel provided an overview of the site plan for the addition to the Eagle Graphics building located at 1200 Prospect Lane. Staff has reviewed the plan and confirmed that it is in compliance with all covenants and meets all requirements set forth in city ordinance. Staff recommends approval with the following conditions: prior to issuance of building permits, Stormwater and Erosion Control permits must be obtained from the Engineering Department.

Eggert made a motion to approve the site plan as presented. Seconded by Vandeberg. Nytes recused himself. Motion passed unanimously.

b. Site Plan Review – 2103 Badger Road (Precision Scraping)

Director Kittel provided an overview of the site plan for the addition to the Precisions Scraping building located at 2103 Badger Road. Staff has reviewed

the plan and confirmed that it is in compliance with all covenants and meets all requirements set forth in city ordinance. Staff recommends approval with the following conditions: prior to issuance of building permits, Stormwater and Erosion Control permits must be obtained from the Engineering Department.

Sundelius made a motion to approve the site plan as presented. Seconded by Gaffney. Motion passed unanimously.

c. Facade Change Request – Out Lot 3 New Prosperity Center (101 E County Road JJ)

Director Kittel explained that the original epoxy-coated metal panels approved for the development are not readily available. The developers have checked with three different suppliers of the material and there is an estimated sixth month waiting period for all of them.

Jerry, representing the developers, explained that the only difference between the original metals panels approved and the proposed metal panels is the texture. The proposed metal panels will be similar to their industrial park neighbor, Klink, who obtained a special exception for their use of an alternative facade material.

Kittel added that Out Lot 3 is on the outskirts of the New Prosperity Center and visually would be unlikely to be associated directly with the rest of the area. There are similar notes to the Klink building with the use of semi-hidden fasteners. Overall, the requested change is not out of the realm of what has been approved in the past. Because of the timeline of the development, it is not feasible to wait six months or more for the original material to arrive. Therefore, staff recommends approving the facade change request.

Vandeberg expressed concern about this sort of paneling becoming the standard for the New Prosperity Center due to exceptions such as the one proposed for Out Lot 3 being granted. He asked if it could be clarified in the motion that the approval was due to the sixth month waiting period.

Vandeberg made a motion to allow for the use of the R Panel to replace the metal planning previously approved provided no change to the originally proposed masonry due to the extreme waiting period and the location of the property on the outskirts of the industrial park. Seconded by Gaffney. Motion passed unanimously.

- 5. Other Business
- 6. Adjourn

Sundelius made a motion to adjourn. Seconded by Eggert. Motion passed unanimously, adjourned at 3:18 p.m.




PROPOSED PROJECT FOR:


TEAM INDUSTRIES POSITIONER SHOP

KAUKAUNA, WISCONSIN


PROJECT PERSPECTIVE (NTS) - FOR CONCEPTUAL PROPOSES ONLY!
REFERENCE FLOOR PLANS, ELEVATIONS, SECTIONS, ETC. FOR MORE INFORMATION

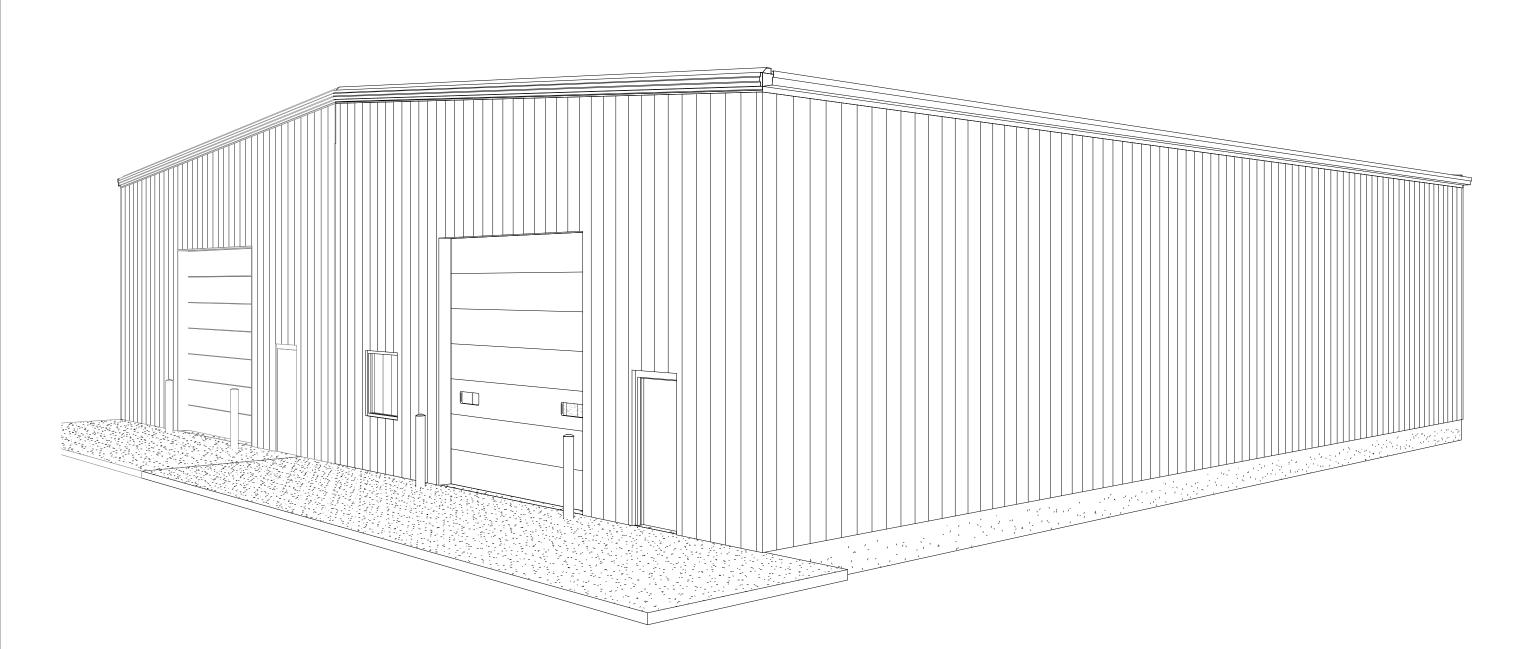

SYMBOLS LEGEND

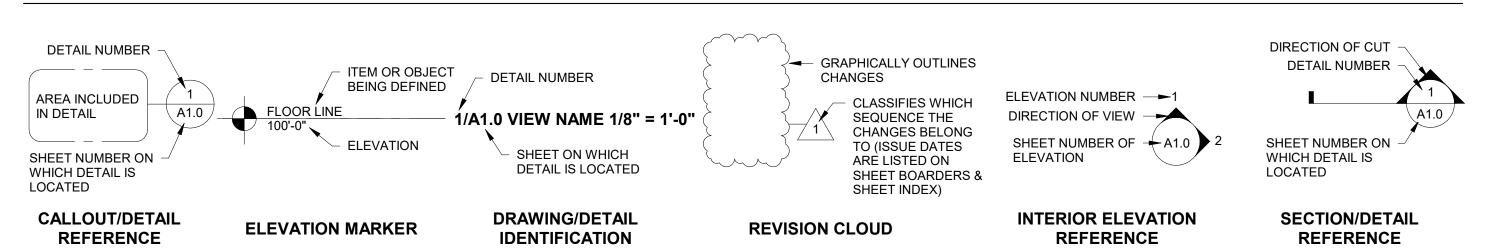

PROJECT LOCATION MAP

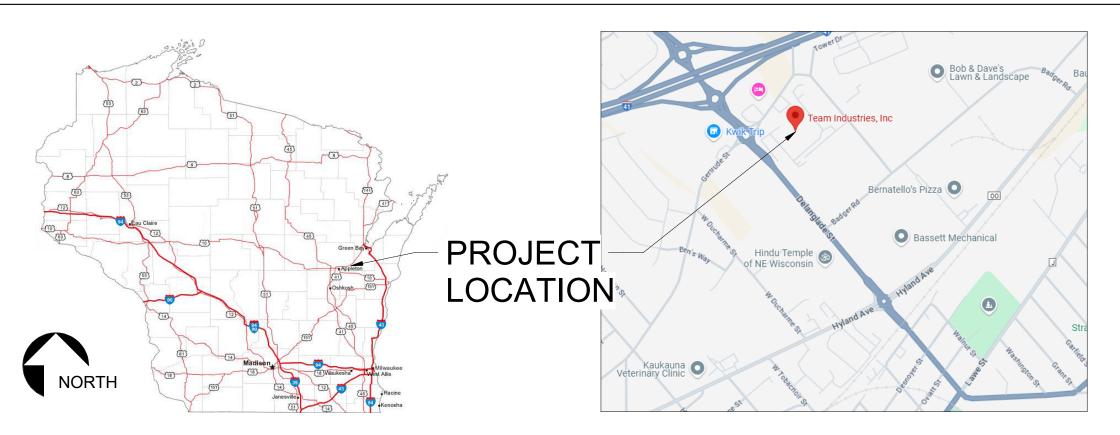

SHEET INDEX

		LATES	LATEST SHEET REVISION					
NUMBER	SHEET NAME / DESCRIPTION	DATE	ISSUED BY	NUMBER				
001 TITLE	I							
T1.0	TITLE SHEET							
002 CIVIL								
C1.0	SITE PLAN							
004 ARCHITEC	TURAL							
A0.1	PLAN NOTES							
A1.0	FLOOR PLAN - DEMO							
A1.1	FLOOR PLAN - PROPOSED							
A1.2	FLOOR PLAN - PROPOSED DIMENSION							
A2.0	ELEVATIONS - EXTERIOR							
A3.0	SECTIONS - BUILDING							
A4.0	SECTIONS - WALL / DETAILS							
A6.1	ROOM FINISH PLAN - PROPOSED							
A6.2	REFLECTED CEILING PLAN - PROPOSED							
A7.0	ROOF PLAN - PROPOSED							
005 STRUCTUR	RAL							
S0.1	FOUNDATION SCHEDULES & DETAILS							
S1.0	FOUNDATION PLAN - EXISTING / DEMO							
S1.1	FOUNDATION PLAN - PROPOSED							
S1.2	ANCHOR BOLT PLAN							
S1.3	ANCHOR BOLT DETAILS							
S4.5	STRUCTURAL METAL STUD DETAILS							

Conditionally **DEPT. OF SAFETY AND PROFESSIONAL** SERVICES **DIVISION OF INDUSTRY SERVICES SEE CORRESPONDENCE**


Building ICC Addition/Alteration - Level 2 DIS-022508255 CB-032500363-PRB 3/24/2025

PROJECT INFORMATION

Team Industries, Inc

ENLARGED MAP

		LATE	LATEST SHEET REVISION					
BER	SHEET NAME / DESCRIPTION	DATE	ISSUED BY	NUMBER				
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)	TITLE SHEET							
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)	SITE PLAN							
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1	PLAN NOTES							
)	FLOOR PLAN - DEMO							
1	FLOOR PLAN - PROPOSED							
2	FLOOR PLAN - PROPOSED DIMENSION							
)	ELEVATIONS - EXTERIOR							
)	SECTIONS - BUILDING							
)	SECTIONS - WALL / DETAILS							
1	ROOM FINISH PLAN - PROPOSED							
2	REFLECTED CEILING PLAN - PROPOSED							
)	ROOF PLAN - PROPOSED							
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1	FOUNDATION SCHEDULES & DETAILS							
)	FOUNDATION PLAN - EXISTING / DEMO							
1	FOUNDATION PLAN - PROPOSED							
2	ANCHOR BOLT PLAN							
3	ANCHOR BOLT DETAILS							
5	STRUCTURAL METAL STUD DETAILS							

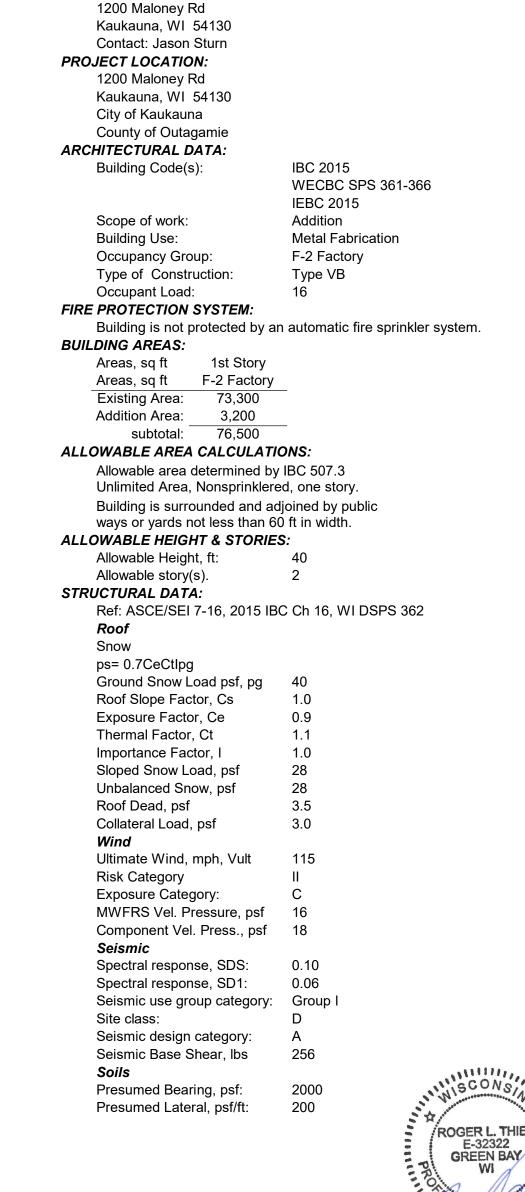



P.O. BOX 13571 GREEN BAY, WI 54307 (920) 498-9300 FAX (920) 498-3033 www.baylandbuildings.com

DESIGN & BUILD GENERAL CONTRACTOR



SCALE VERIFICATION THIS BAR MEASURES 1" ON ORIGINAL ADJUST SCALE ACCORDINGLY

NOTICE OF COPYRIGHT
THESE PLANS ARE COPYRIGHTED AND ARE SUBJECT TO
COPYRIGHT PROTECTION AS AN "ARCHITECTURAL WORK" UNDER
SEC. 102 OF THE COPYRIGHT ACT, 17 U.S.O. AS AMENDED COPYRIGHT PROTECTION ACT OF 1990. THE PROTECTION INCLUDES BUT IS NOT LIMITED TO THE OVERALL FORM AS WELI AS THE ARRANGEMENT AND COMPOSITION OF SPACES AND ELEMENTS OF THE DESIGN. UNDER SUCH PROTECTION, UNAUTHORIZED USE OF THESE PLANS, WORK OR BUILDING REPRESENTED, CAN LEGALLY RESULT IN THE CESSATION OF CONSTRUCTION OR BUILDINGS BEING SEIZED AND/OR MONETARY COMPENSATION TO BAYLAND BUILDINGS, INC.

JOB NUMBER: 24-5934 **PROJECT** JAKE MANCOSKE **EXECUTIVE:** (920) 366-8828 CRP DRAWN BY: 02/24/25

Revision Schedule

No. Revision Description

ISSUED FOR: CHECKED DATE: PRELIMINARY BID SET DESIGN REVIEW SM,JM,CP 02/13/24 CHECKSET X CONSTRUCTION

02/24/2025

TITLE SHEET

BAYLAND BUILDINGS

P.O. BOX 13571 GREEN BAY, WI 54307 (920) 498-9300 FAX (920) 498-3033 www.baylandbuildings.com

DESIGN & BUILD GENERAL CONTRACTOR

PROPOSED BUILDING FOR: TEAM INDUSTRIES TEAM INDUSTRIES POSITIONER SHOP KAUKAUNA, WI

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SEC. 102 OF THE COPYRIGHT ACT, 17 U.S.O. AS AMENDED
DECEMBER 1990 AND KNOWN AS ARCHITECTURAL WORKS
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AS THE ARRANGEMENT AND COMPOSITION OF SPACES AND
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REPRESENTED, CAN LEGALLY RESULT IN THE CESSATION OF
CONSTRUCTION OR BUILDINGS BEING SEIZED AND/OR MONETARY
COMPENSATION TO BAYLAND BUILDINGS, INC.

02/24/25

JOB NUMBER: 24-5934

PROJECT
EXECUTIVE: JAKE MANCOSKE
(920) 366-8828

DRAWN BY: CRP

DATE:
REVISIONS:

ISSUED FOR: CHECKED DATE: BY:

PRELIMINARY

BID SET


DESIGN REVIEW SM,JM,CP 02/13/24

CHECKSET

X CONSTRUCTION

C10

SITE PLAN

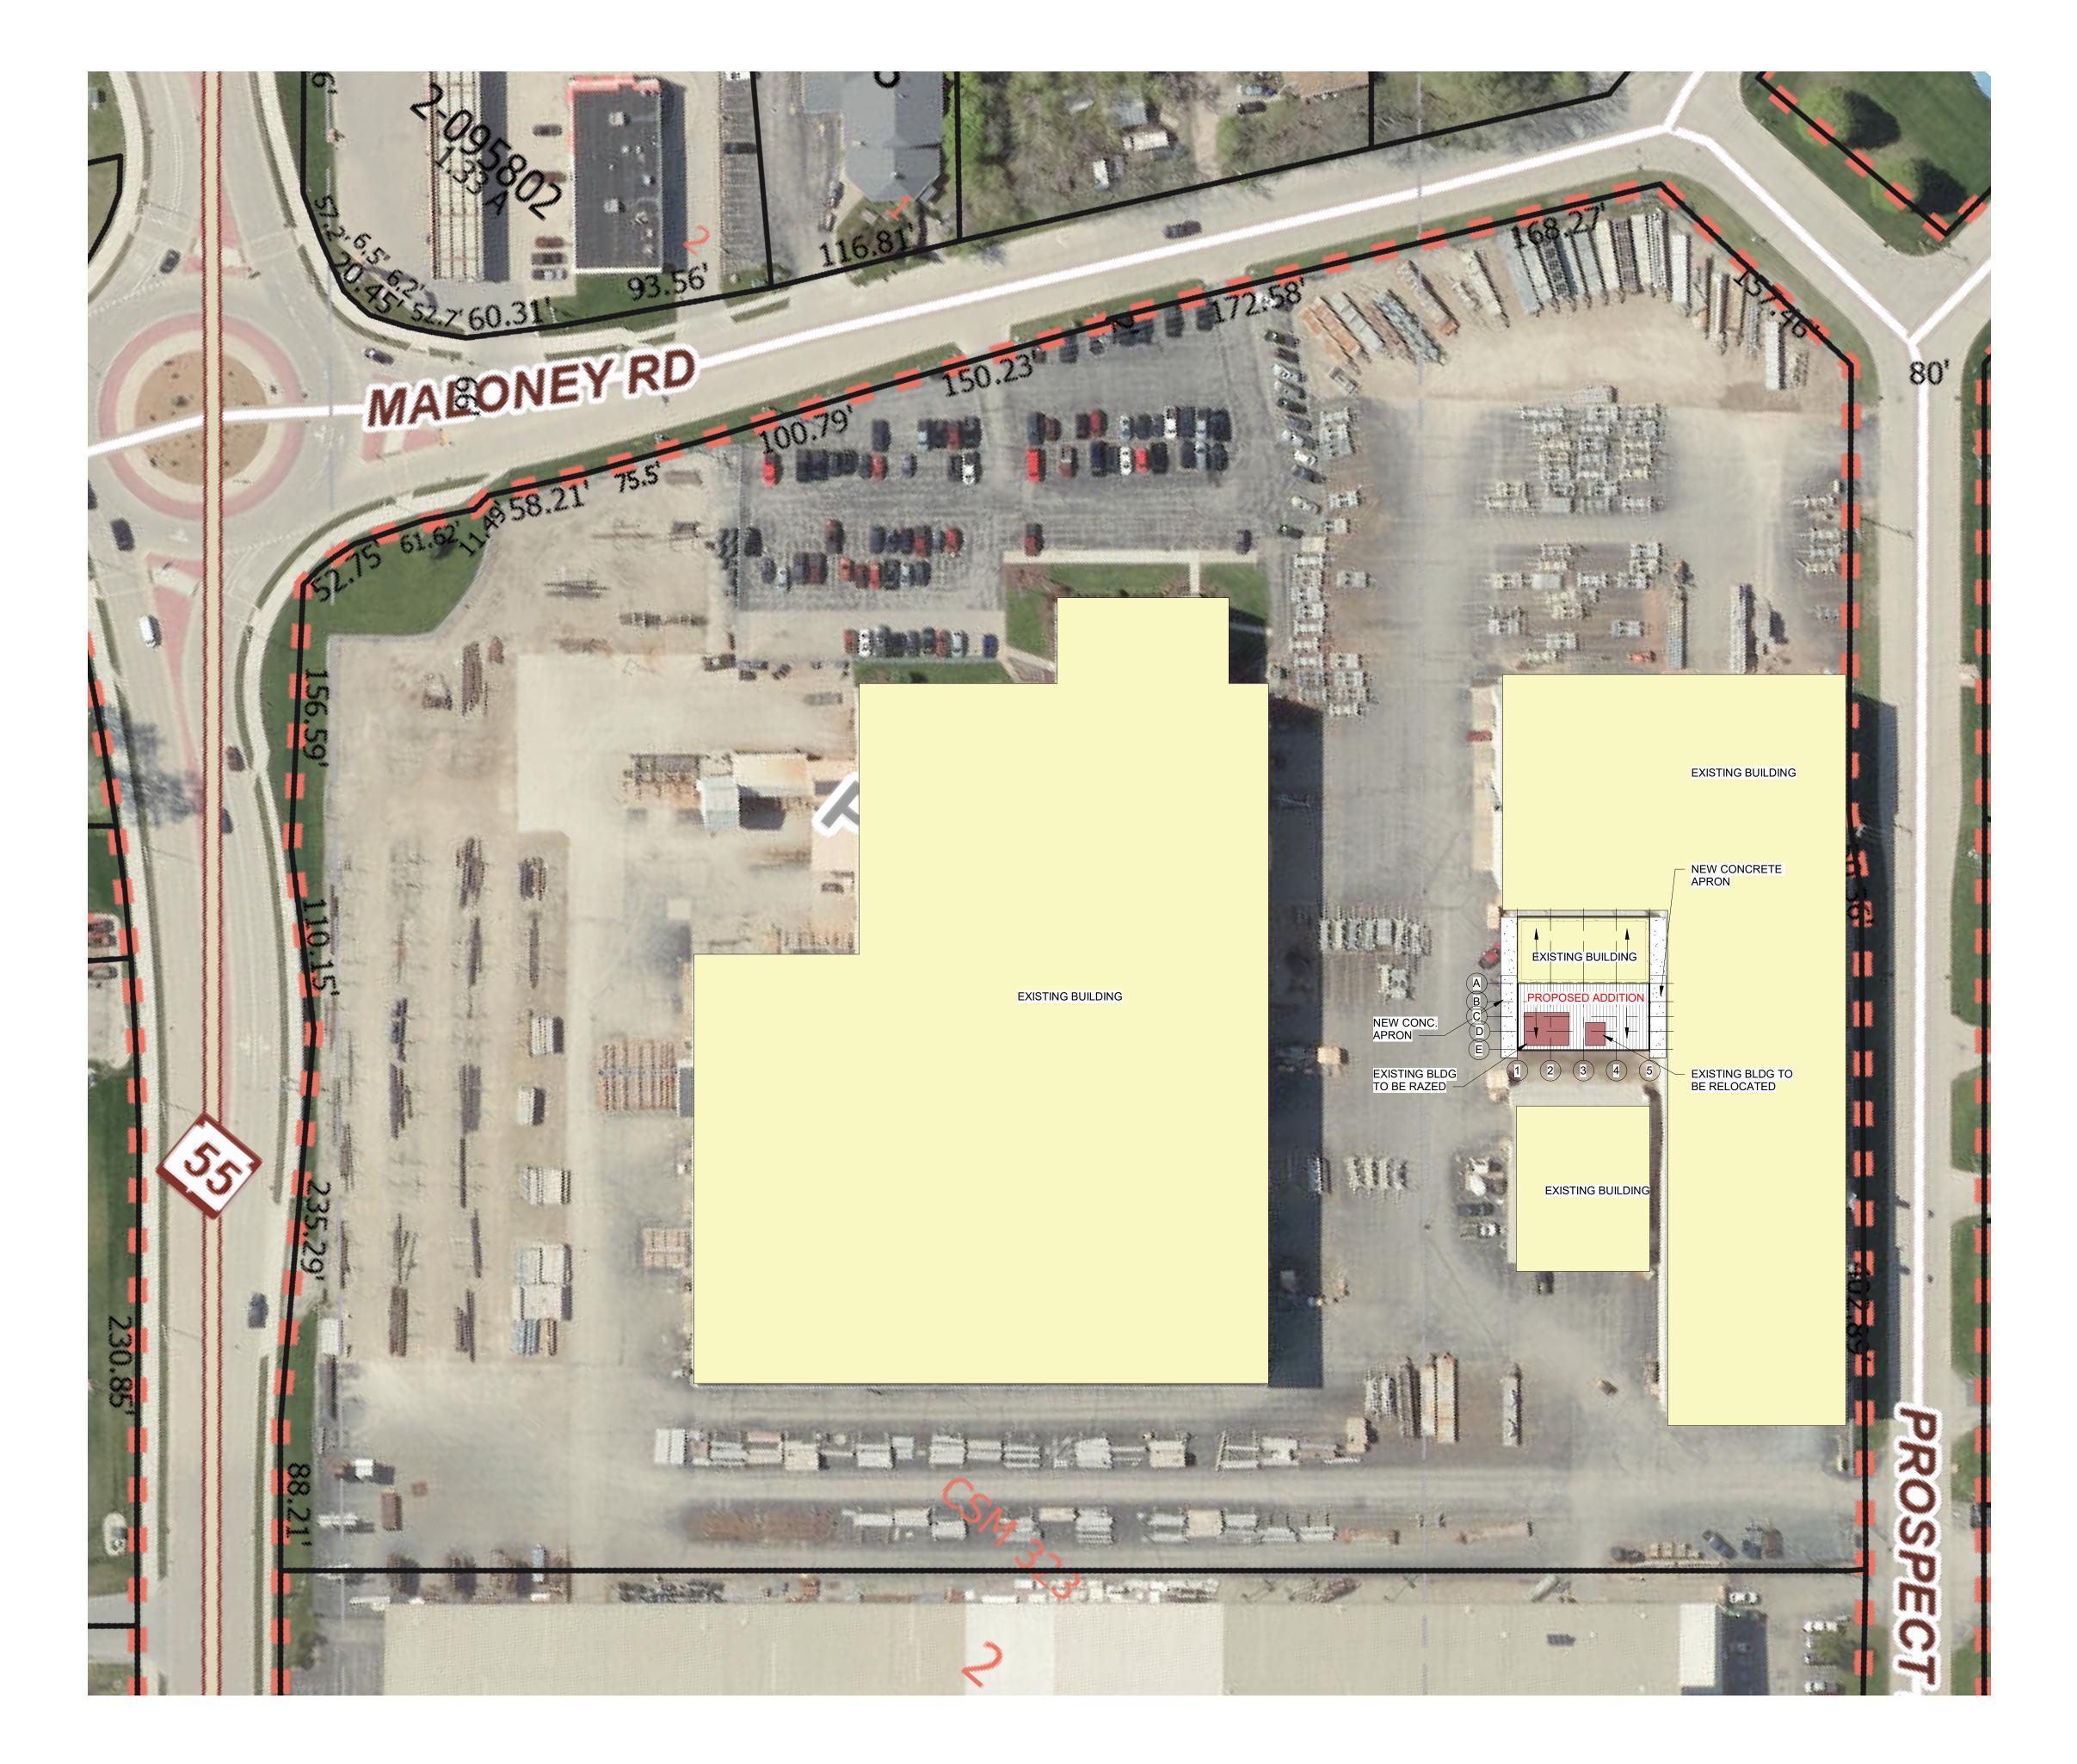

MEANS OF EGRESS ILLUMINATION (IBC 1008)

ILLUMINATION LEVEL UNDER NORMAL POWER. THE MEANS OF EGRESS ILLUMINATION LEVEL WHICH SHALL NOT BE LESS THAN 1 FOOT-CANDLE AT THE WALKING SURFACE DURING ALL PERIODS OF OCCUPANCY, UNLESS MEETING THE EXCEPTION FOR AISLES IN ASSEMBLY USES AND SELECT SLEEPING AND DWELLING UNITS. IN THE EVENT OF POWER SUPPLY FAILURE IN ROOMS AND SPACES THAT REQUIRE TWO OR MORE MEANS OF EGRESS, AN EMERGENCY ELECTRICAL SYSTEM SHALL AUTOMATICALLY ILLUMINATE AISLES, CORRIDORS, AND EXIT ACCESS STAIRWAYS AND RAMPS


FIRE EXTINGUISHERS (IBC 906)

PORTABLE FIRE EXTINGUISHERS SHALL BE SELECTED, INSTALLED, AND MAINTAINED IN ACCORDANCE WITH IBC 906 AND NFPA 10. FOR OCCUPANCIES OF ORDINARY HAZARD THE MAX. TRAVEL DISTANCE TO A FIRE EXTINGUISHER IS 75'.

EGRESS LIGHTING & FIRE EXTINGUISHERS N.T.S.

- ALL NEW CONTROLS FOR USE BY OCCUPANTS SHALL BE MOUNTED BETWEEN 15" A.F.F. MIN. TO 48" A.F.F. MAX. TO TOP EDGE OF OPERATING COMPONENT AND PROVIDE A CLEAR FLOOR SPACE OF 30"x48" AT CONTROLS, OUTLETS, FIXTURES, ETC. CONTROLS LOCATED OVER AN OBSTRUCTION DEEPER THAN 10" MUST BE MOUNTED NO HIGHER THAN 46" A.F.F. ACCESSIBLE CONTROLS MUST NOT REQUIRE TIGHT GRASPING. PINCHING, OR TWISTING OF THE WRIST TO OPERATE. ALL CONTROLS SHALL COMPLY WITH THE CURRENT ADA STANDARDS IN TYPE AND INSTALLATION.
- TAKE MEASURES TO ENSURE THAT EXPOSED EDGES OF CARPET (INCLUDING FLOOR MATS) ARE SECURELY ATTACHED, FASTENED OR WEIGHTED DOWN TO THE FLOOR WITH TRIM ALONG ENTIRE LENGTH OF ALL
- ALL NEW DOORS ALONG THE PATH OF TRAVEL SHALL NOT REQUIRE MORE THAN 5 POUND OF FORCE TO PUSH/PULL OPEN DOORS PER CURRENT ADA
- CONTRACTOR TO CONTRACT WITH PROPERTY'S LIFE SAFETY VENDOR TO FURNISH, INSTALL, AND/OR RELOCATE VISUAL ALARM DEVICES, IF REQUIRED. DEVICES SHALL BE MOUNTED TO 80" A.F.F. TO CENTER OF BOTTOM OR 6" BELOW FINISHED CEILING, WHICHEVER IS LOWER, UNLESS INDICATED OTHERWISE. DEVICES SHALL COMPLY WITH CURRENT ADA STANDARDS, NFPA 72 AND LOCAL/STATE CODES.
- ALL FINISHES, INCLUDING FLOOR FINISHES, SHALL COMPLY WITH CURRENT ADA STANDARDS IN TYPE AND INSTALLATION
- FURNITURE CONFIGURATIONS AT PUBLIC SPACES SHALL FOLLOW THE CLEAR FLOOR SPACE AND CIRCULATION SPACE REQUIREMENTS PER 2010 ADA STANDARDS. SEE ADDITIONAL NOTES THIS SHEET FOR ADDITIONAL INFORMATION AND CLARIFICATIONS
- ALL PUBLIC RESTROOM FIXTURES, ACCESSORIES, ETC. SHALL BE ADA COMPLIANT IN TYPE AND INSTALLATION PER CURRENT ADA STANDARDS. SEE NOTES, ELEVATIONS/DETAILS, AND FIXTURE SCHEDULE FOR ADDITIONAL INFORMATION AND SPECS.
- NOTE THAT ALL ADA INSTALLATION RANGES (i.e. WATER CLOSET DIMENSIONS) AS INDICATED ON THESE DRAWINGS ARE PER CURRENT ADA STANDARDS. LOCAL AND STATE CODES MAY CONFLICT. G.C. SHALL VERIFY DURING PERMIT PROCESS AND/OR PRE-CONSTRUCTION DISCUSSION WITH LOCAL AUTHORITIES.
- GC SHALL COORDINATE WITH PROPERTY SIGNAGE VENDOR TO PROVIDE NEW ADA COMPLIANT SIGNAGE AT ACCESSIBLE DOORS.
- NEW ROOM I.D. AND/OR DIRECTIONAL SIGNAGE SHALL BE TACTILE TYPE MOUNTED AT 48" A.F.F. TO THE BASELINE OF THE LOWEST TACTILE CHARACTERS AND 60" A.F.F. TO THE BASELINE OF THE HIGHEST TACTILE CHARACTER. SIGNAGE TO BE LOCATED AT THE LATCH SIDE OF DOOR, IF THERE IS NO WALL SPACE AT THE LATCH SIDE OF DOOR THEN SIGNAGE SHALL BE LOCATED ON THE NEAREST ADJACENT WALL. SIGNAGE AT DOUBLE DOORS WITH INACTIVE LEAF SHALL BE LOCATED ON THE INACTIVE LEAF. DOUBLE DOORS WITH TWO ACTIVE LEAFS, LOCATE SIGNAGE TO THE RIGHT OF THE RIGHT HAND DOOR PER CURRENT ADA STANDARDS.
- BRAILLE ON SIGNAGE SHALL BE CONTRACTED (GRADE 2) BRAILLE DOTS BETWEEN BRAILLE AND ANY OTHER RAISED CHARACTER, BORDER OR ELEMENT PER CURRENT ADA STANDARDS.
- 12. ALL OBJECTS MOUNTED BETWEEN 27" A.F.F. AND 80" A.F.F. SHALL NOT PROTRUDE MORE THAN 4" FROM THE FACE OF THE WALL PER CURRENT ADA

ADA GENERAL CONSTRUCTION NOTES N.T.S.

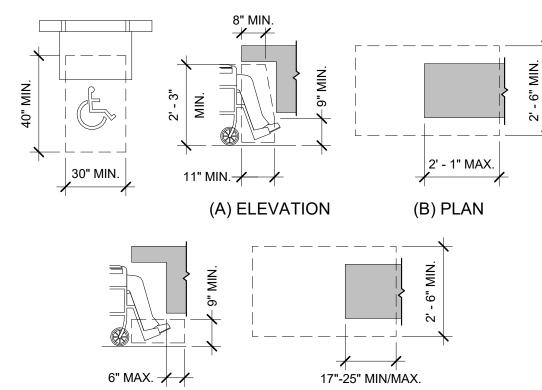

SALES & SERVICE COUNTER (ICC ANSI A117.1)

(A) ELEVATION

904.3.1 PARALLEL APPROACH. A PORTION OF THE COUNTER SURFACE 36 INCHES MINIMUM IN LENGTH AND 36 INCHES MAXIMUM IN HEIGHT ABOVE THE FLOOR SHALL BE PROVIDED. WHERE THE COUNTER SURFACE IS LESS THAN 36 INCHES IN LENGTH, THE ENTIRE COUNTER SURFACE SHALL BE 36 INCHES MAXIMUM IN HEIGHT ABOVE THE FLOOR. A CLEAR FLOOR SPACE COMPLYING WITH SECTION 305, POSITIONED FOR A PARALLEL APPROACH ADJACENT TO THE ACCESSIBLE COUNTER, SHALL BE PROVIDED.

(B) PLAN

SERVICE, DINING, & WORKSURFACE COUNTERS N.T.S. 3 /A0.1

904.3.2 FORWARD APPROACH. A PORTION OF THE COUNTER SURFACE 30 INCHES MINIMUM IN LENGTH AND 36 INCHES MAXIMUM IN HEIGHT ABOVE THE FLOOR SHALL BE PROVIDED. A CLEAR FLOOR SPACE COMPLYING WITH SECTION 305. POSITIONED FOR A FORWARD APPROACH TO THE ACCESSIBLE COUNTER, SHALL BE PROVIDED. KNEE AND TOE CLEARANCE COMPLYING WITH SECTION 306 SHALL BE PROVIDED UNDER THE ACCESSIBLE COUNTER.

<u>DINING SURFACES AND WORK SURFACES</u> (ICC ANSI A117.1)

902.2 CLEAR FLOOR SPACE. A CLEAR FLOOR SPACE COMPLYING WITH SECTION 305, POSITIONED FOR A FORWARD APPROACH, SHALL BE PROVIDED. KNEE AND TOE CLEARANCE COMPLYING WITH SECTION 306 SHALL BE PROVIDED.

902.4 HEIGHT. THE TOPS OF DINING SURFACES AND WORK SURFACES SHALL BE 28 INCHES MINIMUM AND 34 INCHES MAXIMUM IN HEIGHT ABOVE THE FLOOR.

- ANY DEVIATION FROM PLANS SHALL HAVE BEEN CONSULTED WITH AND DOCUMENTED BY THE SUPERVISING PROFESSIONAL OF RECORD.
- THIS IS A DESIGN-BUILD PROJECT. ALL MATERIALS, WORKMANSHIP AND DETAILS SHALL CONFORM TO INDUSTRY STANDARDS. THE SUBCONTRACTOR SHALL FAMILIARIZE HIMSELF WITH THE SPECIFICATIONS REFERENCED HEREIN AND SHALL CLARIFY ANY DISCREPANCIES WITH BAYLAND BUILDINGS, INC. PRIOR TO BEGINNING WORK.
- NON-CONTRACT ITEMS MAY APPEAR ON THESE PLANS THAT ARE DONE BY OTHERS AND ARE NOT PART OF THE BAYLAND BUILDINGS, INC. CONTRACT.
- PLUMBING, ELECTRICAL, & MECHANICAL CONTRACTORS THIS IS A DESIGN BUILD PROJECT. EACH SUBCONTRACTOR SHALL PROVIDE PLANS TO THE PROJECT MANAGER AND THE SUPERVISING PROFESSIONAL FOR REVIEW PRIOR TO THE PLANS BEING SUBMITTED TO THE AUTHORITY HAVING JURISDICTION (AHJ). EACH SUBCONTRACTOR SHALL MAINTAIN A SET OF DRAWINGS AT THE JOB SITE TO RECORD ANY CHANGES TO THE DESIGN. THIS DRAWING OF RECORD AND THE AHJ APPROVED PLANS SHALL BE TURNED OVER TO THE PROJECT MANAGER AT THE END OF THE PROJECT.
- ALL MATERIALS, WORKMANSHIP AND DETAILS SHALL CONFORM TO THE REQUIREMENTS OF THE LATEST EDITION OF THE COMMERCIAL BUILDING
- SUBCONTRACTOR SHALL FAMILIARIZE HIMSELF WITH ALL ARCHITECTURAL MECHANICAL AND ELECTRICAL DRAWINGS TO VERIFY THE LOCATION AND DIMENSIONS OF CHASES, INSERTS, OPENINGS, SLEEVES, REGLETS, DEPRESSIONS AND OTHER PROJECT REQUIREMENTS NOT SHOWN ON THE STRUCTURAL DRAWINGS.
- FIELD VERIFY ALL DIMENSIONS, ELEVATIONS AND CONDITIONS AND NOTIFY THE SUPERVISING PROFESSIONAL OF RECORD OF ANY DISCREPANCIES.
- THE TYPICAL DETAILS SHOWN ON THE DRAWINGS SHALL BE APPLICABLE TO ALL PARTS OF THE CONTRACT DRAWINGS UNLESS SPECIFICALLY NOTED

GENERAL REQUIREMENTS N.T.S.

A.B.('s)

ALUM aluminum ARCH architectural ID insid ASPH asphalt INSUL insu INT inter B.BD base board BBP block between purlins JST(S) joist B-FD bi-folding	ting, ventilating & a/dediameter ulation rior c(s) ckout le inate(d) atory g leg horiz g leg vertical
ASPH asphalt INSUL insu INT inter B.BD base board BBP block between purlins JST(S) joist B-FD bi-folding BD(S) board(s) K.O. know	ulation rior i(s) ckout le inate(d) atory g leg horiz g leg vertical ting
BBP block between purlins JST(S) joist B-FD bi-folding BD(S) board(s) K.O. know	ckout le inate(d) story g leg horiz g leg vertical ting
BD(S) board(s) K.O. know	le inate(d) story g leg horiz g leg vertical ting
	inate(d) atory g leg horiz g leg vertical ting
BL building line L ang BLDG building LAM lami	g leg horiz g leg vertical ting
	g leg vertical ting
BR brace L.L.V. long	-
BRG bearing LTG light BRK brick	chanical
B.S. both sides MECH med	
	nhole cellaneous
CL centerline M.O. mas	sonry opening
C channel CB catch basin N.I.C. not	in contract
C.H. ceiling height N.T.S. not	to scale
C.J. control joint CLG ceiling O.A. over	rall
	center
•	side diameter rhead
CONC concrete O/O out	to out
	ning osite
CONT continue(uous)	
	engineered metal bu meter
	perty line vood
PPE poly	/propylene
d penny PSF pou	nds per square foot nds per square inch
D.F. drinking fountain P.T. pres	ssure treated
· · · · · · · · · · · · · · · · · · ·	ition vinyl chloride
DIM dimension PVMT pay	ement
DN down DR door R radi	us
DS downspout RECP rece	eptacles ove
	se(ion)(s)(d)
EIFS ext. insul. & finish system RH right ELEC electric(al) RM roor	t hand ท
ELEV elevation R.O. roug	gh opening
	t of way uired
EQV equivalent E.W. each way SCH sch	edule
EXG existing SGL sing	ıle
EXP exposed S.O.G. slab EXT exterior SQ squ	on grade
STAG stag	ggered
F.A. fire alarm STD star F.D. floor drain STL stee	ndard el
FE fire extinguisher STR stru	ctural
FEC fire exiting. w/ cabinet FFE finished floor elevation TB ther	mal broke
FLR(G) floor(ing) T&B top	and bottom
	gue and groove of masonry
F.O.M. face of masonry T.O.S. top	of steel
	of steel joist of wall
FTG footing T.S. tube TYP typic	e steel cal
	ess noted otherwise
HC handicapped UTIL utilit	•
	or barrier /I composition tile
	k in closet er heater
	ded wire fabric
/A0.1 ABBREVIATIONS N.T.S.	

2 /A0.1 ABBREVIATIONS N.T.S.

EXIT SIGNS N.T.S.

IBC 1013.1 EXIT SIGNS

EXITS AND EXIT ACCESS DOORS SHALL BE MARKED BY AN APPROVED EXIT SIGN READILY VISIBLE FROM ANY DIRECTION OF EGRESS TRAVEL. THE PATH OF EGRESS TRAVEL TO EXITS AND WITHIN EXITS SHALL BE MARKED BY READILY VISIBLE EXIT SIGNS TO CLEARLY INDICATE THE DIRECTION OF EGRESS TRAVEL IN CASES WHERE THE EXIT OR THE PATH OF EGRESS TRAVEL IS NOT IMMEDIATELY VISIBLE TO THE OCCUPANTS. INTERVENING MEANS OF EGRESS DOORS WITHIN EXITS SHALL BE MARKED BY EXIT SIGNS. EXIT SIGN PLACEMENT SHALL BE SUCH THAT NO POINT IN AN EXIT ACCESS CORRIDOR OR EXIT PASSAGEWAY IS MORE THAN 100 FEET OR THE LISTED VIEWING DISTANCE FOR THE SIGN, WHICHEVER IS LESS, FROM THE NEAREST VISIBLE EXIT SIGN. THE SYMBOL TO DENOTE AN EXIT SIGN LOCATION IS THAT OF A CIRCLE CONTAINING AN "X".

BAYLAND BUILDINGS

P.O. BOX 13571 GREEN BAY, WI 54307

(920) 498-9300 FAX (920) 498-3033

www.baylandbuildings.com

DESIGN & BUILD GENERAL CONTRACTOR

Item 4.a.

SCALE VERIFICATION
THIS BAR MEASURES 1" ON ORIGINAL. ADJUST SCALE ACCORDINGLY

NOTICE OF COPYRIGHT THESE PLANS ARE COPYRIGHTED AND ARE SUBJECT TO COPYRIGHT PROTECTION AS AN "ARCHITECTURAL WORK" UNDER SEC. 102 OF THE COPYRIGHT ACT, 17 U.S.O. AS AMENDED DECEMBER 1990 AND KNOWN AS ARCHITECTURAL WORKS COPYRIGHT PROTECTION ACT OF 1990. THE PROTECTION INCLUDES BUT IS NOT LIMITED TO THE OVERALL FORM AS WELL ELEMENTS OF THE DESIGN. UNDER SUCH PROTECTION. UNAUTHORIZED USE OF THESE PLANS, WORK OR BUILDING REPRESENTED, CAN LEGALLY RESULT IN THE CESSATION OF CONSTRUCTION OR BUILDINGS BEING SEIZED AND/OR MONETARY COMPENSATION TO BAYLAND BUILDINGS, INC.

JOB NUMBER: 24-5934

EXECUTIVE: (920) 366-8828 **DRAWN BY:** CRP

ISSUED FOR: CHECKED DATE:

DESIGN REVIEW SM,JM,CP 02/13/24

PLAN NOTES

PRELIMINARY

BID SET

CHECKSET

X CONSTRUCTION

DATE: 02/24/25

REVISIONS:

DESIGN & BUILD GENERAL CONTRACTOR

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JOB NUMBER: 24-5934

PROJECT
EXECUTIVE: JAKE MANCOSKE
(920) 366-8828

DRAWN BY: CRP
DATE: 02/24/25

REVISIONS:

ISSUED FOR: CHECKED BY:

PRELIMINARY

BID SET


DESIGN REVIEW SM,JM,CP 02/13/24

CHECKSET

X CONSTRUCTION

FLOOR PLAN - DEMO

A1.0

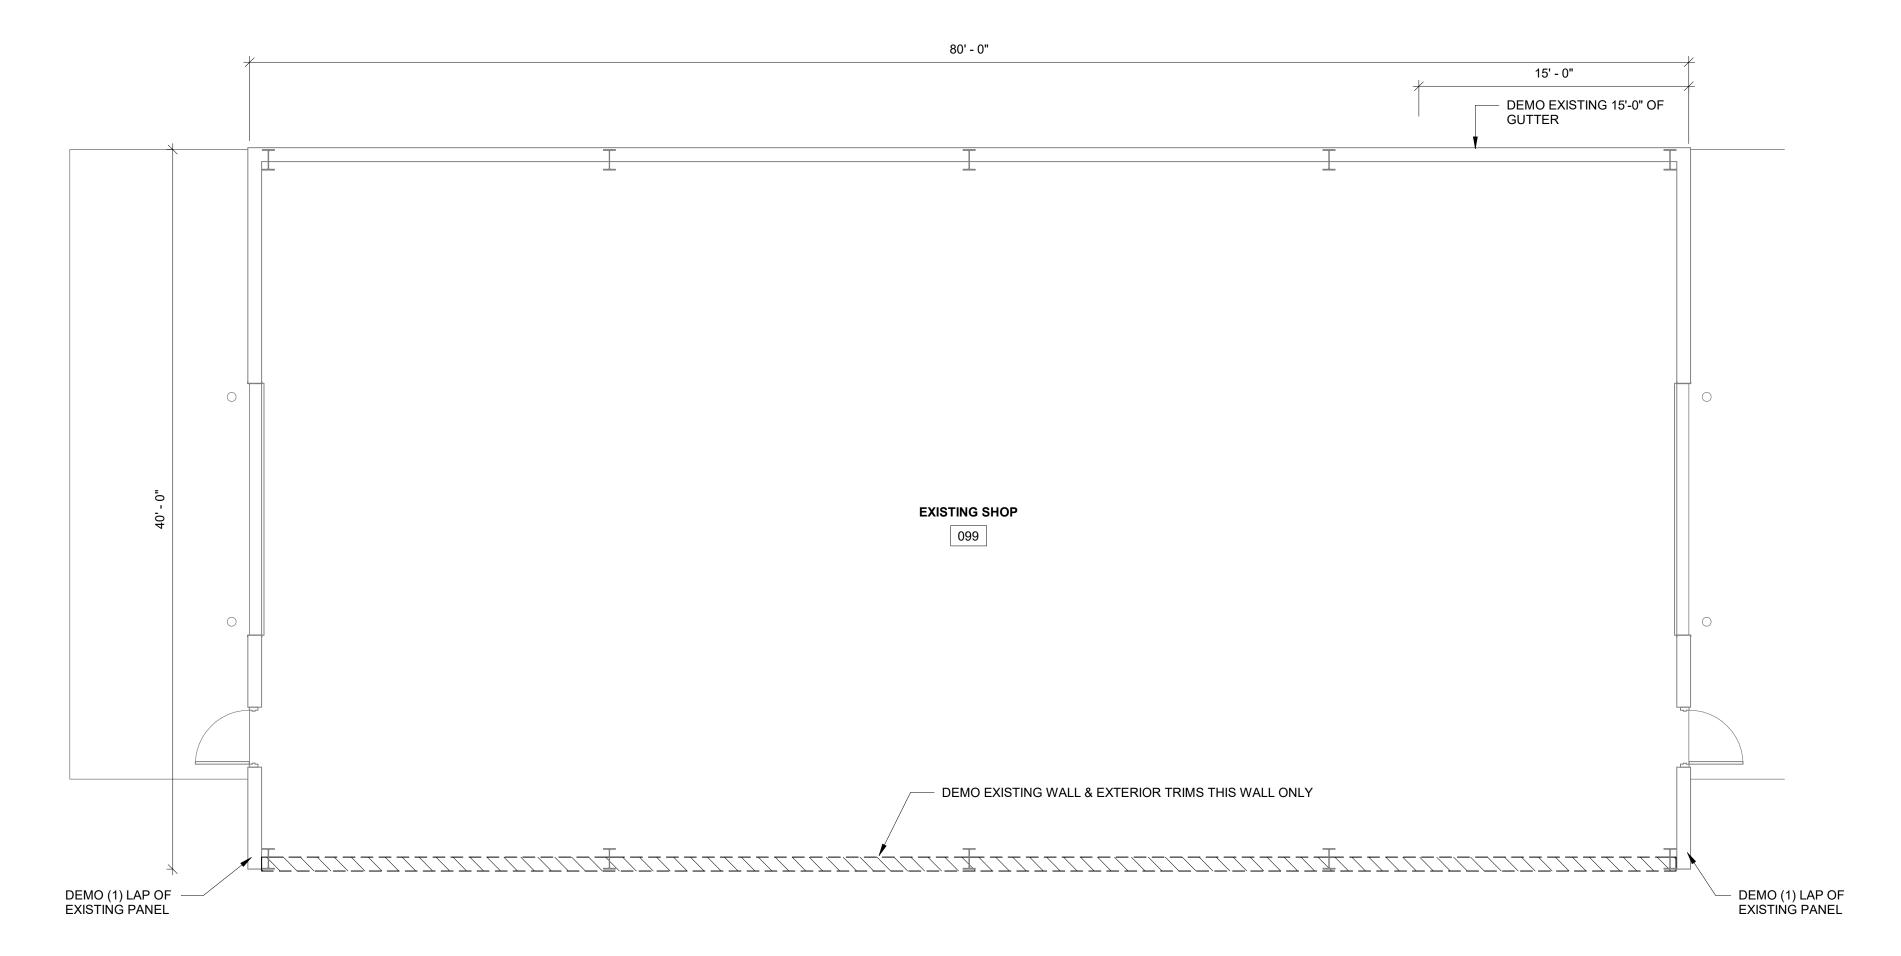

NORTH


	DOOR SCHEDULE														
		DOOR									DOOR HARI	OWARE			
											WALL	WEATHER	PUSH - PULL		
NUMBER	WIDTH	HEIGHT	TYPE	FRAME TYPE F	FIRE RATING	LOCK	PASSAGE	CLOSER	PANIC	PRIVACY	STOP	STRIPPING	HANDLES	SPECIALTY HARDWARE	GENERAL REMARKS
100.1	3' - 0"	7' - 0"	MD1	HM1		•		•						LATCH GUARD / SEALED THRESHOLD	NORTON H-DUTY COLSURE / CONTINOUS HINGE / SCHLAGE COMMERCIAL DUTY LOCKSET
100.2	3' - 0"	7' - 0"	MD1	HM1		-		•						LATCH GUARD / SEALED THRESHOLD	NORTON H-DUTY COLSURE / CONTINOUS HINGE / SCHLAGE COMMERCIAL DUTY LOCKSET
100.3	14' - 0"	14' - 0"	OH2	-											
101.1	3' - 0"	7' - 0"	MD1	HM1											



BAYLAND BUILDINGS

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DESIGN & BUILD GENERAL CONTRACTOR

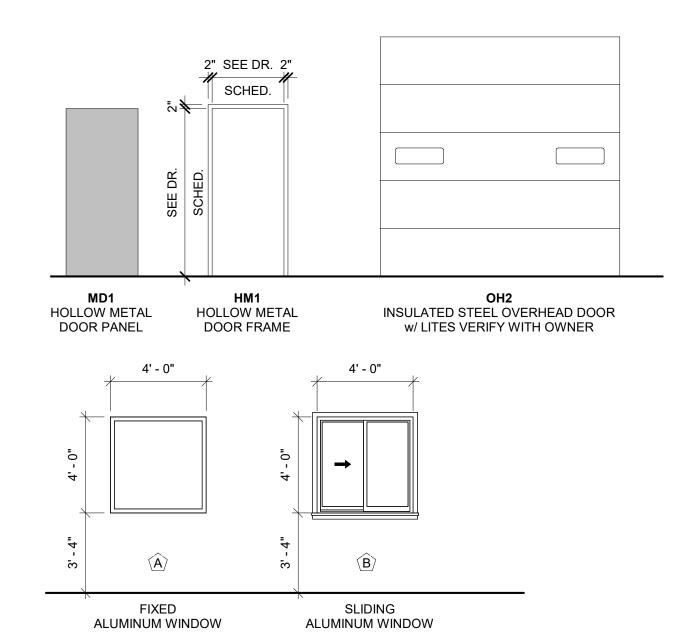

GENERAL NOTES:

1. ANY WINDOW GLAZING BELOW 24" NEEDS TO BE TEMPERED

OR BE CALSSIFIED AS SAFETY GLAZING PER IBC SECTION 2406 SAFETY GLAZING


2. VERIFY INTERIOR WINDOW SILLS & JAMB FINISH


WINDOW THERMAL PERFORMANCE DATA

PRODUCT: GLASS TYPE: NFRC DIRECTORY #: U-FACTOR: SHGC: VT:

MARVIN MODERN SIERIES OR EQ. LOW-E SMARTSUN (2.2mm ANNEALED GLASS), OR EQUAL AND-N-80-00887-00001

0.29 (MIN) 0.19 (MIN) 0.43 (MIN)

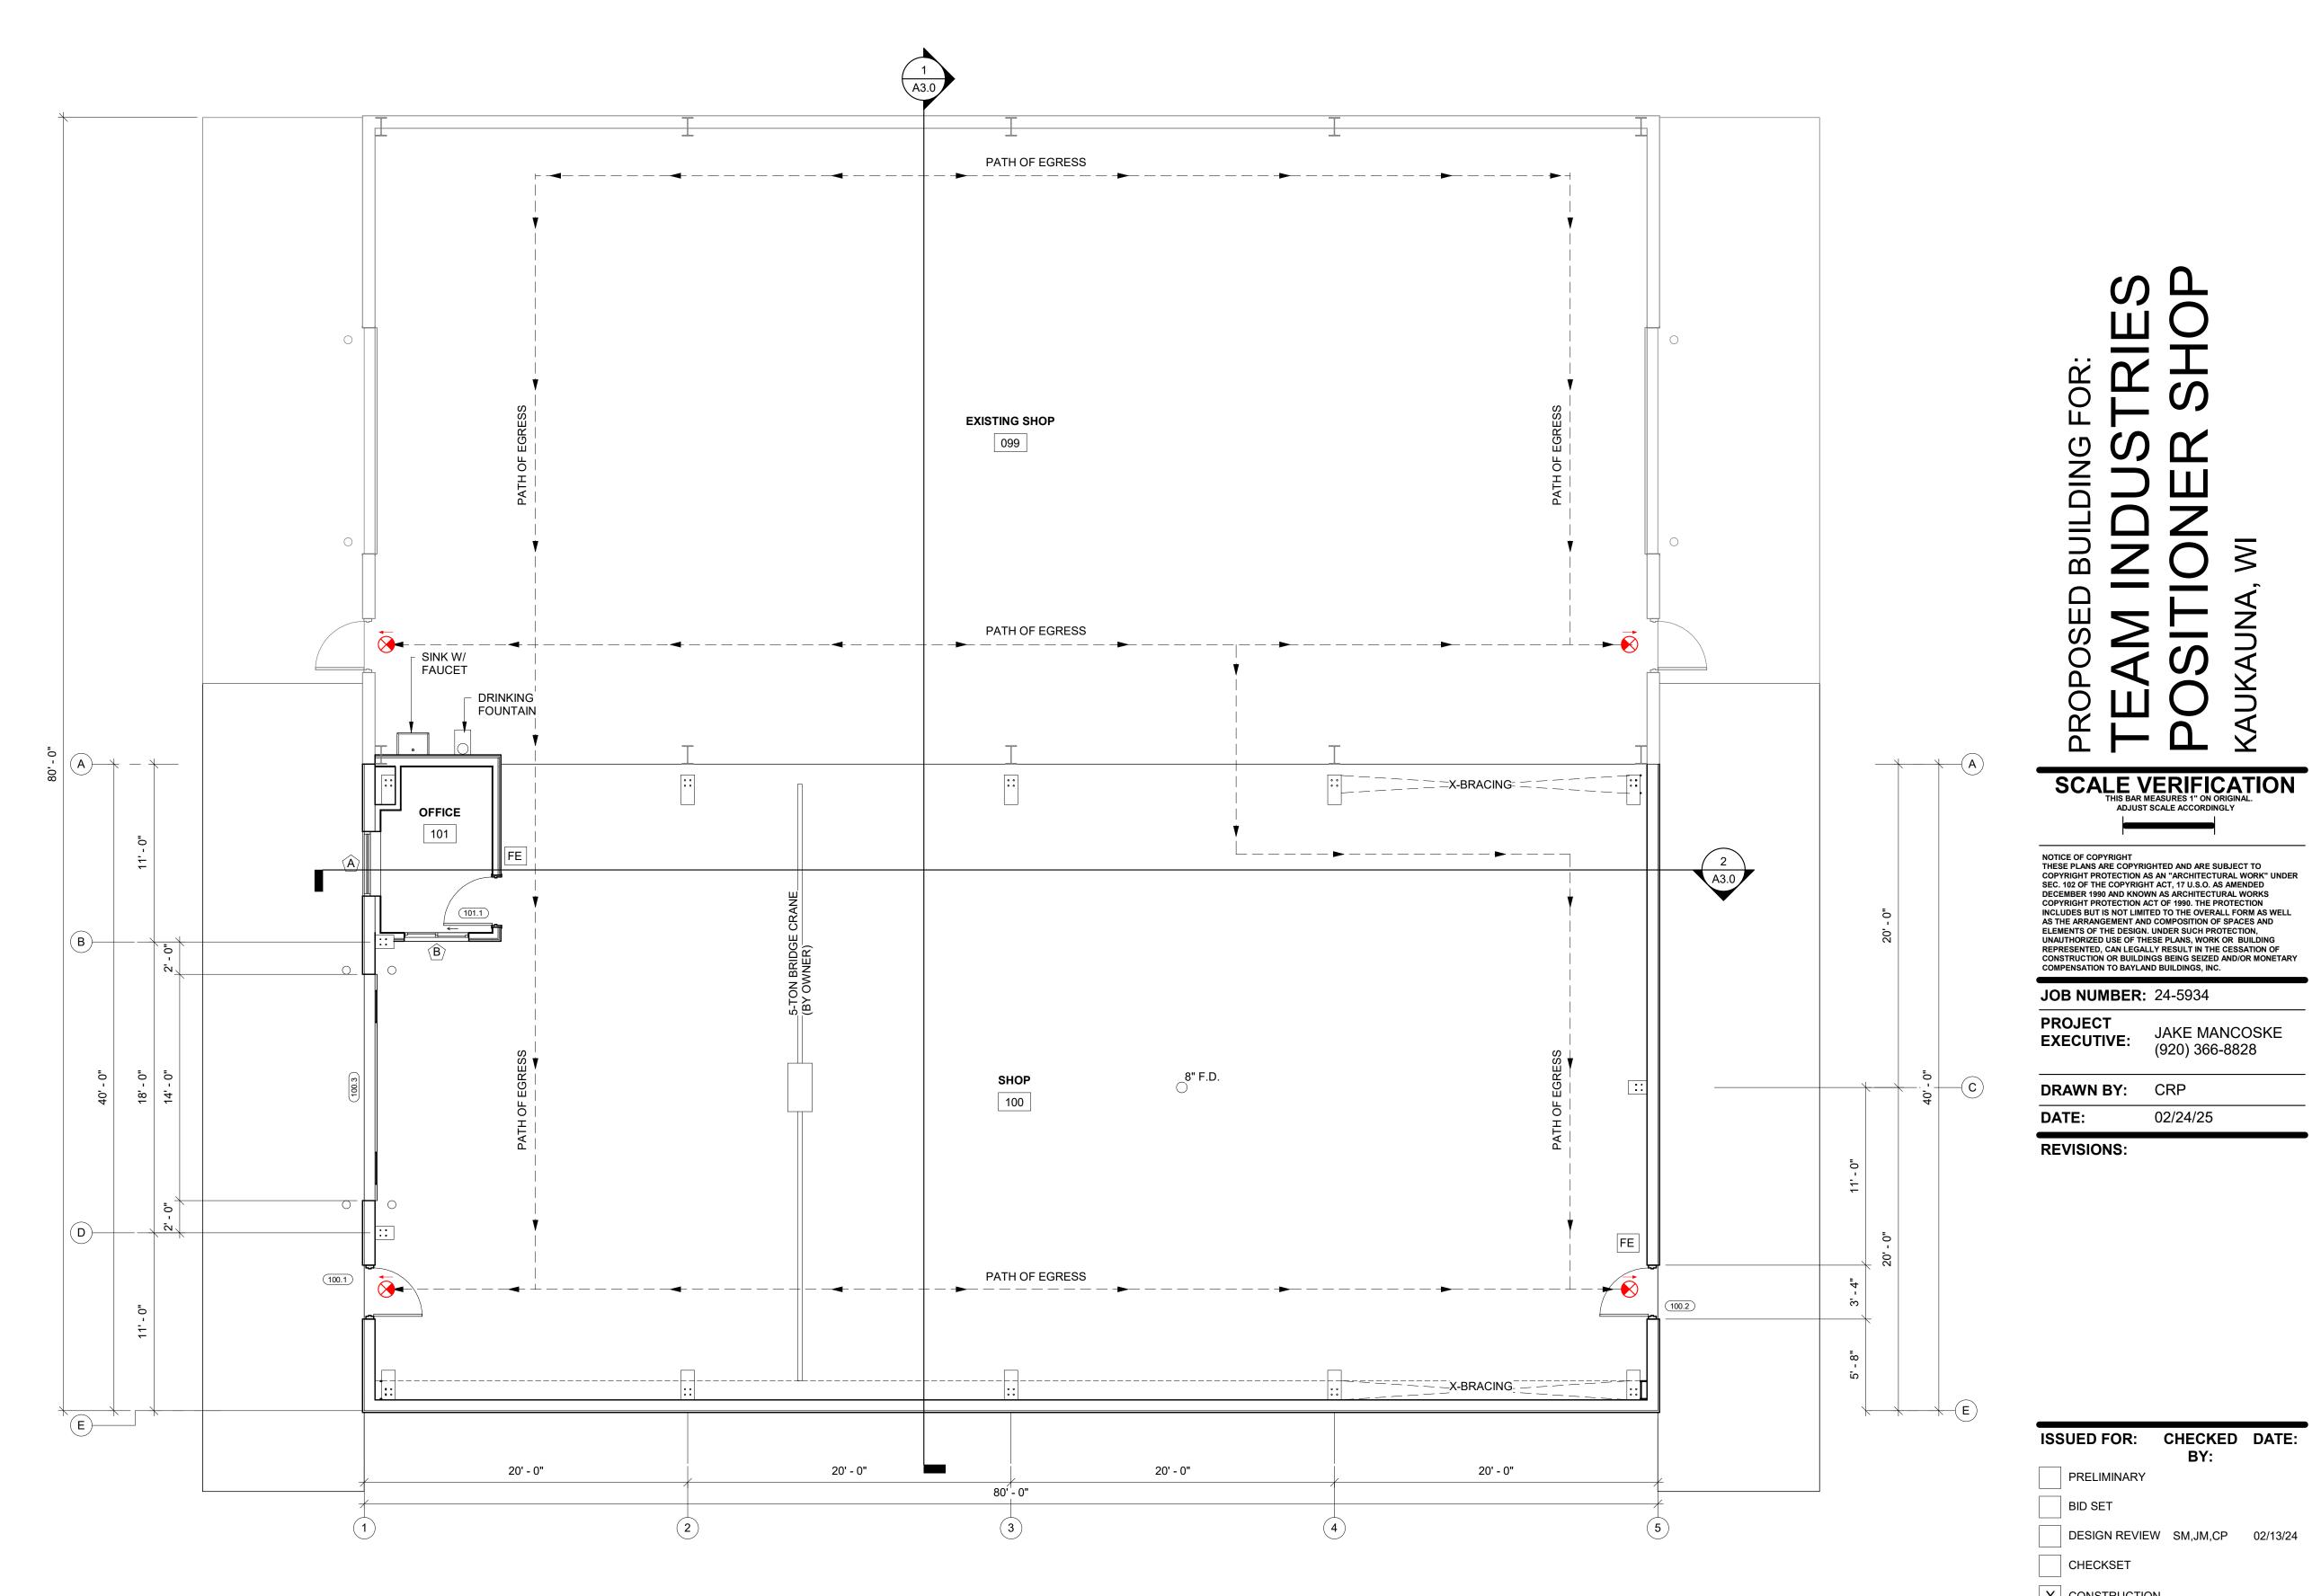

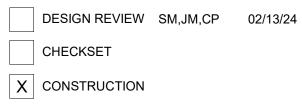

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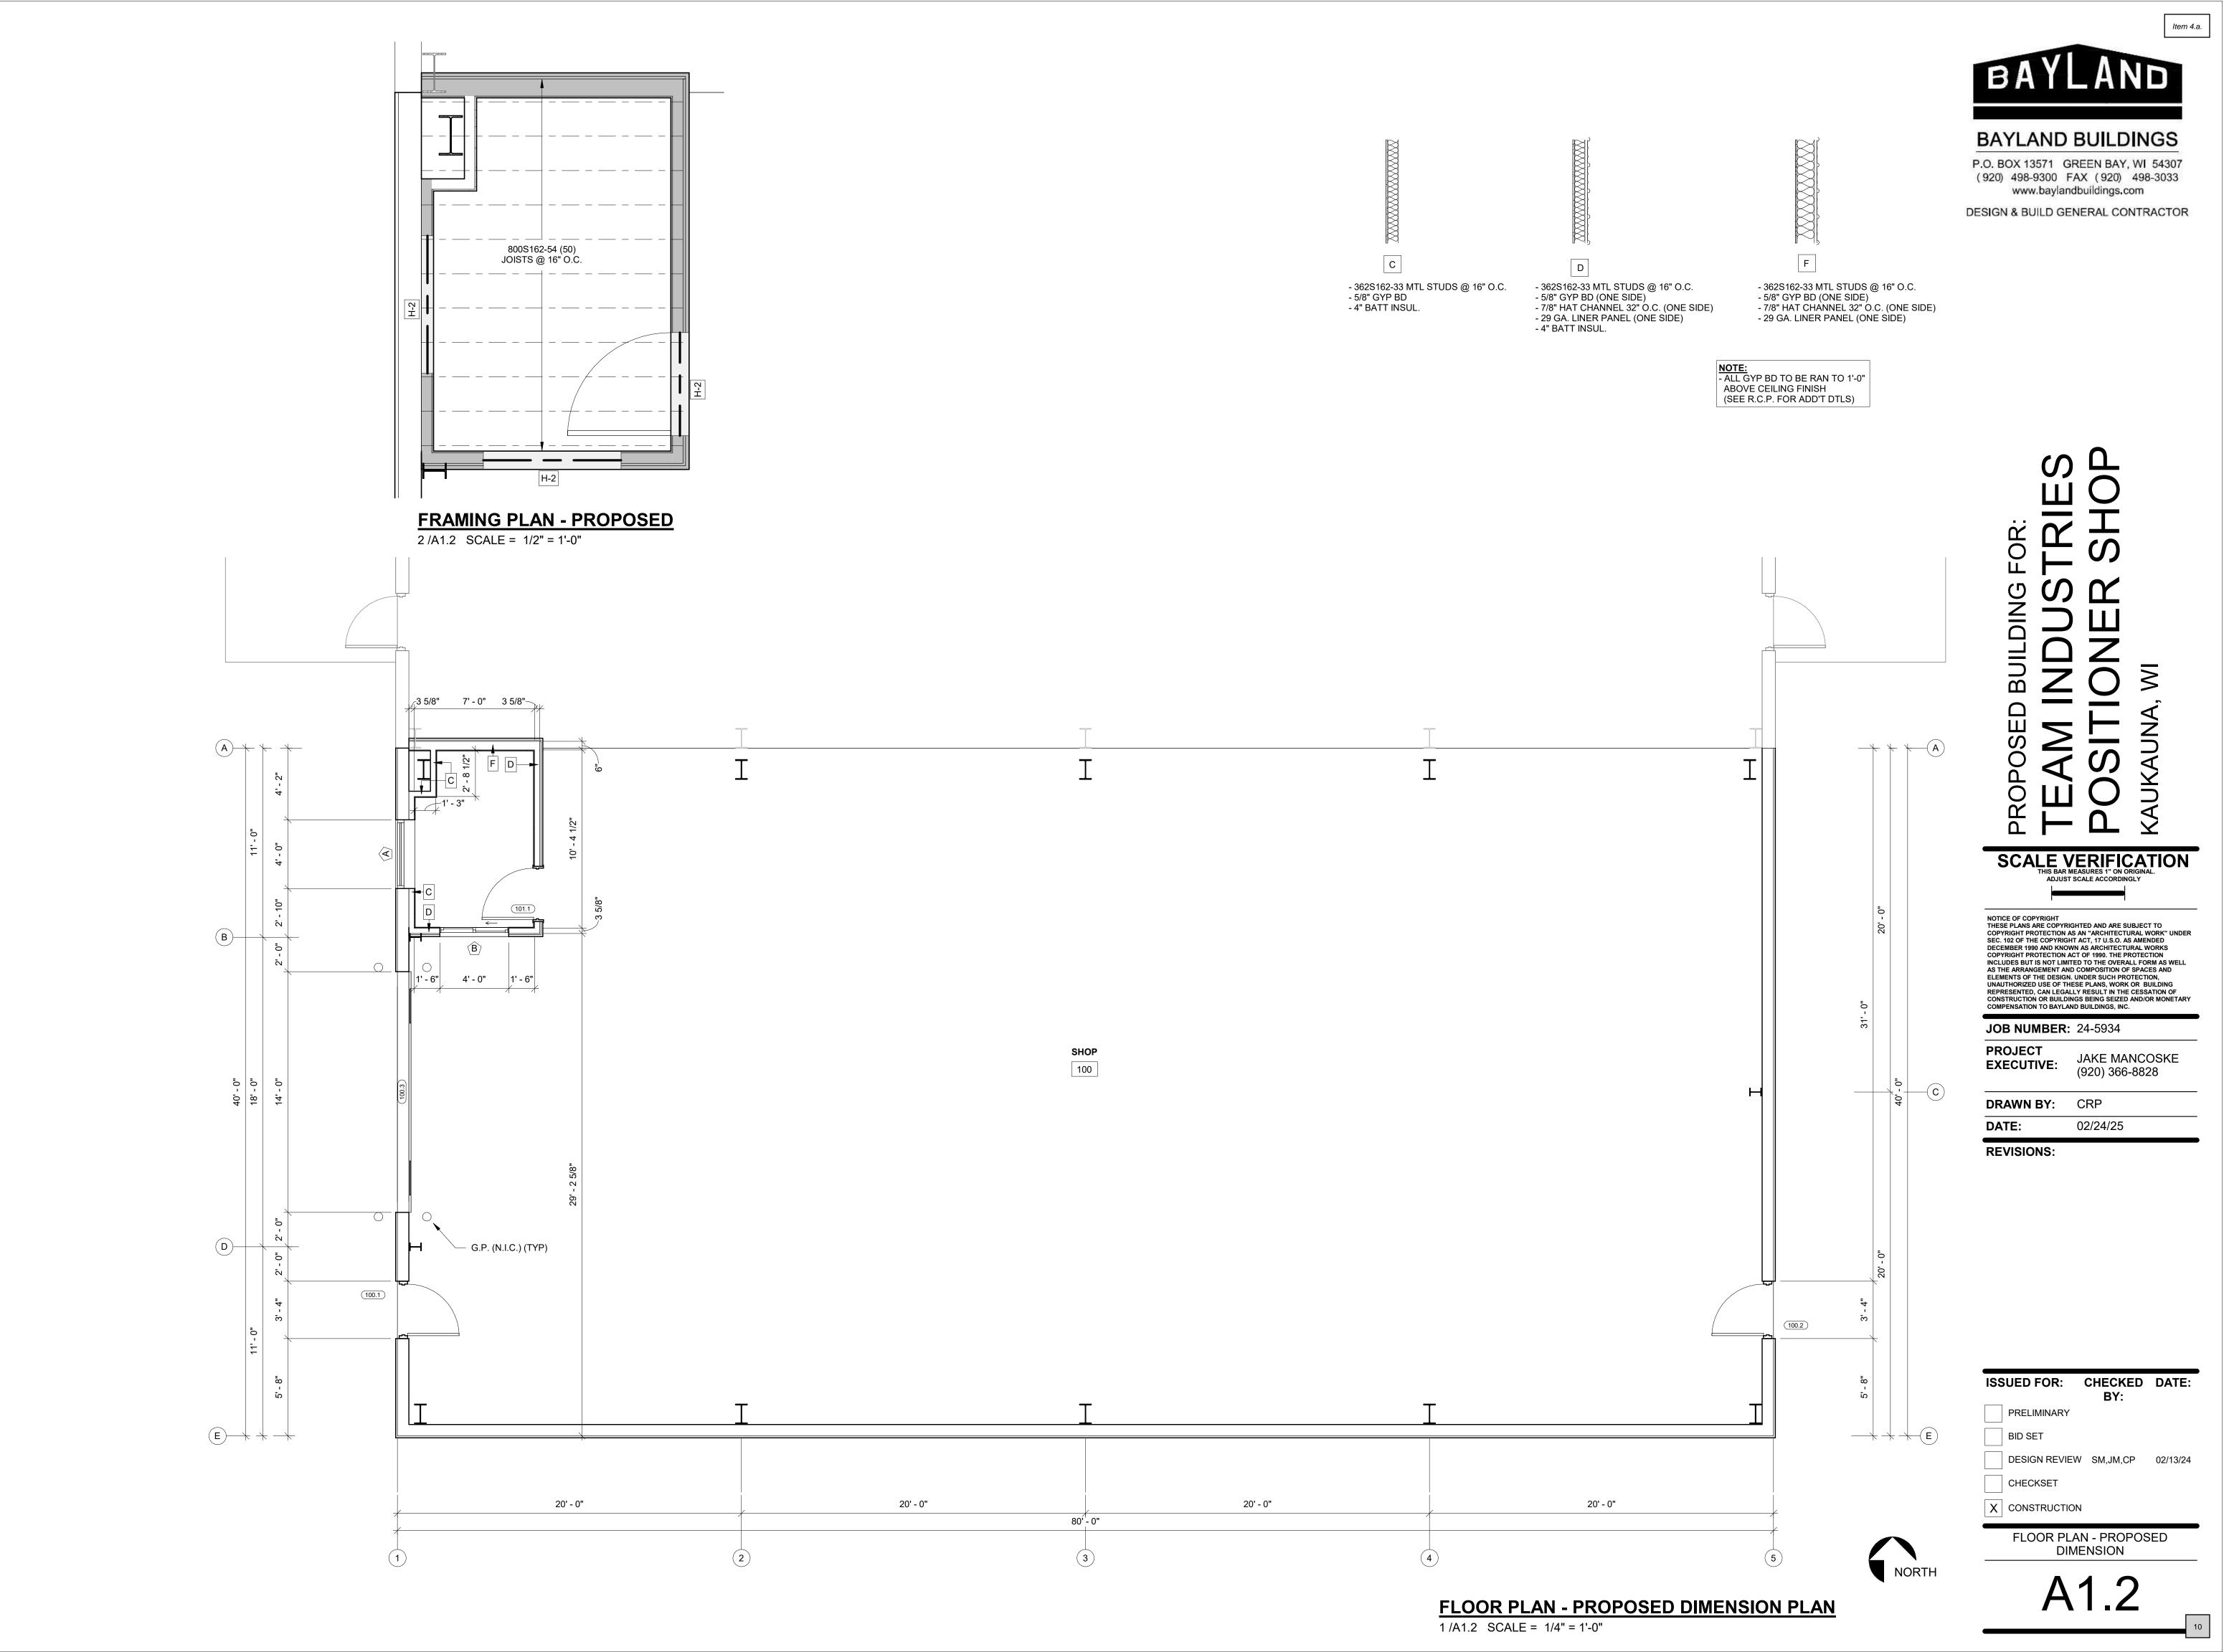
FLOOR PLAN - PROPOSED


JAKE MANCOSKE (920) 366-8828


02/24/25

FLOOR PLAN - PROPOSED

1 /A1.1 SCALE = 3/16" = 1'-0" NORTH



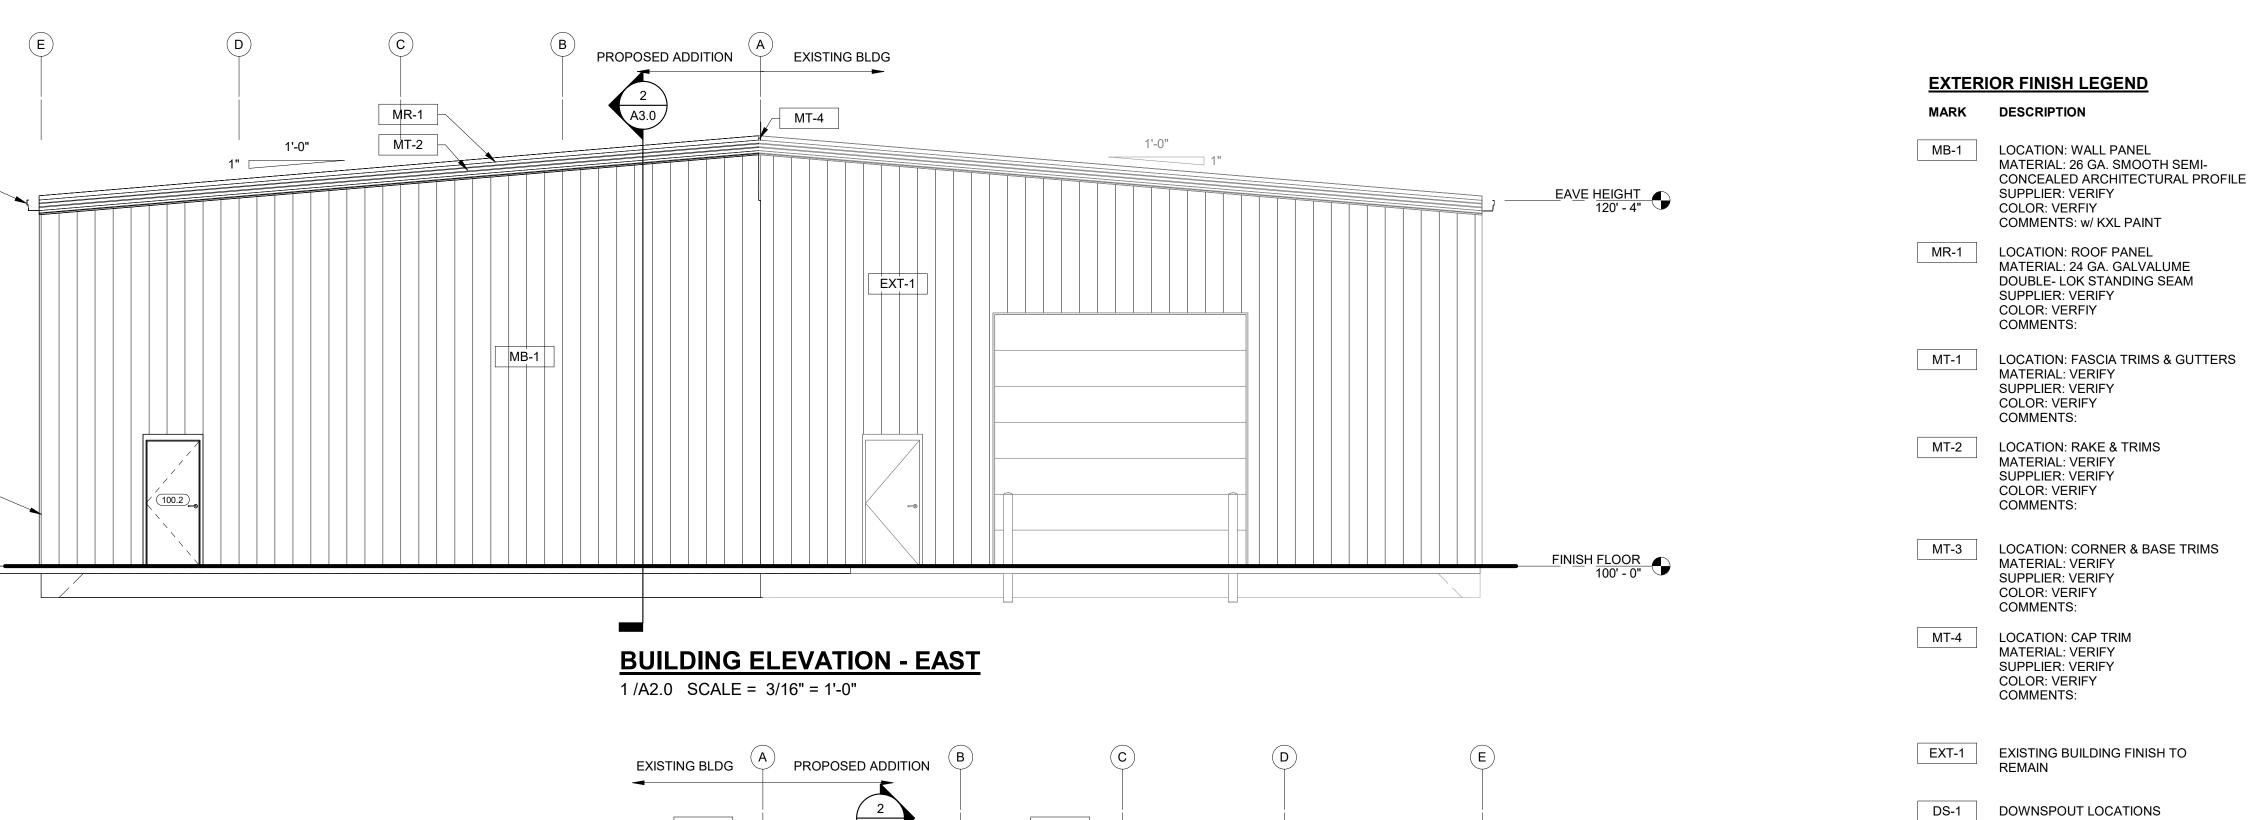

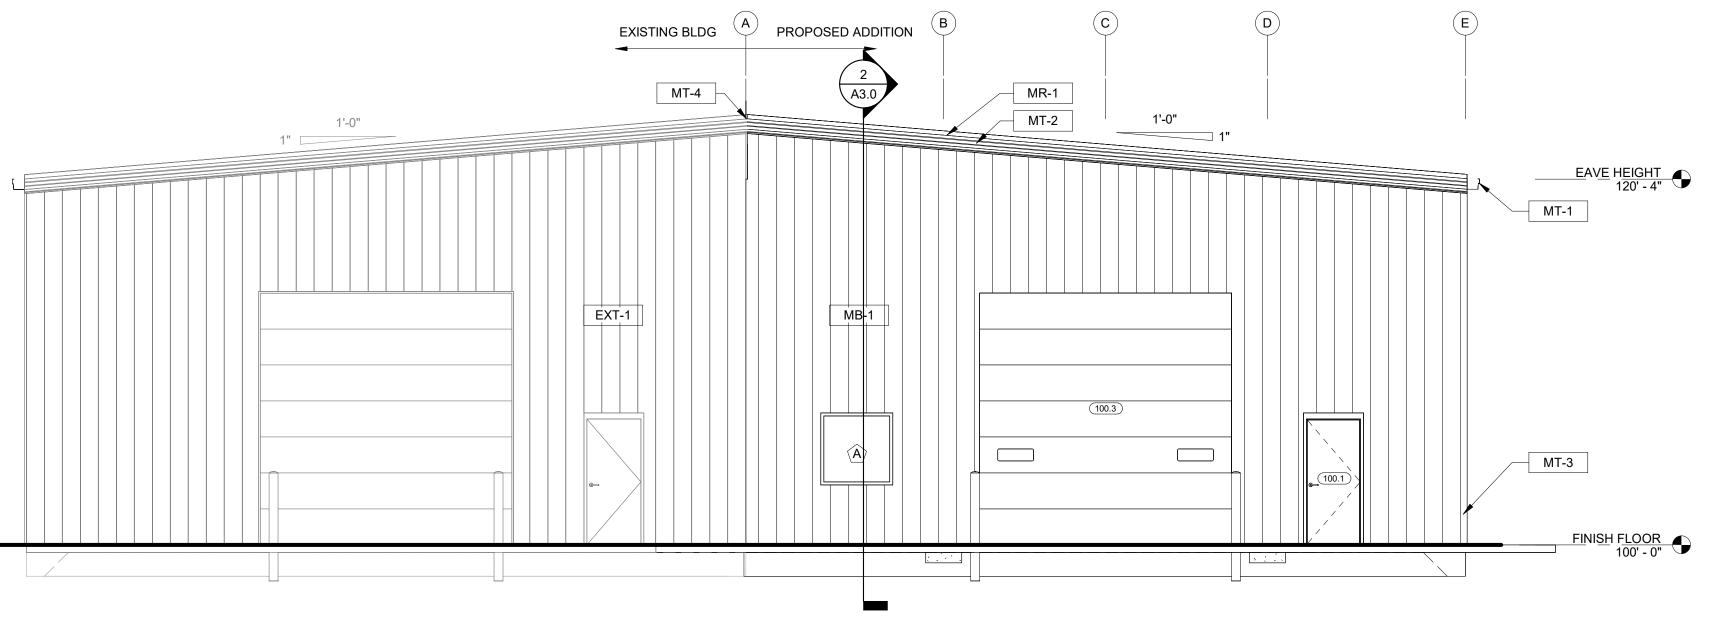

BUILDING ELEVATION - WEST 2/A2.0 SCALE = 3/16" = 1'-0" AND MIT2 MIT2 MIT2 MIT3 MIT4 MIT4 MIT4 MIT4 MIT5 MIT5

BUILDING ELEVATION - SOUTH
3 /A2.0 SCALE = 3/16" = 1'-0"

ROPOSED BUILDING FOR: TEAM INDUSTRI OSITIONER SHAUKAUNA WI

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COMPENSATION TO BAYLAND BUILDINGS, INC.

SCALE VERIFICATION
THIS BAR MEASURES 1" ON ORIGINAL.
ADJUST SCALE ACCORDINGLY

JOB NUMBER: 24-5934

PROJECT
EXECUTIVE: JAKE MANCOSKE
(920) 366-8828

 DRAWN BY:
 CRP

 DATE:
 02/24/25

REVISIONS:

ISSUED FOR: CHECKED DATE:
BY:

PRELIMINARY

BID SET

DESIGN REVIEW SM,JM,CP 02/13/24

CHECKSET

CHECKSET

X CONSTRUCTION


ELEVATIONS - EXTERIOR

A2.0


2/24/2025 4:05:17 PM

MT-1

MT-3

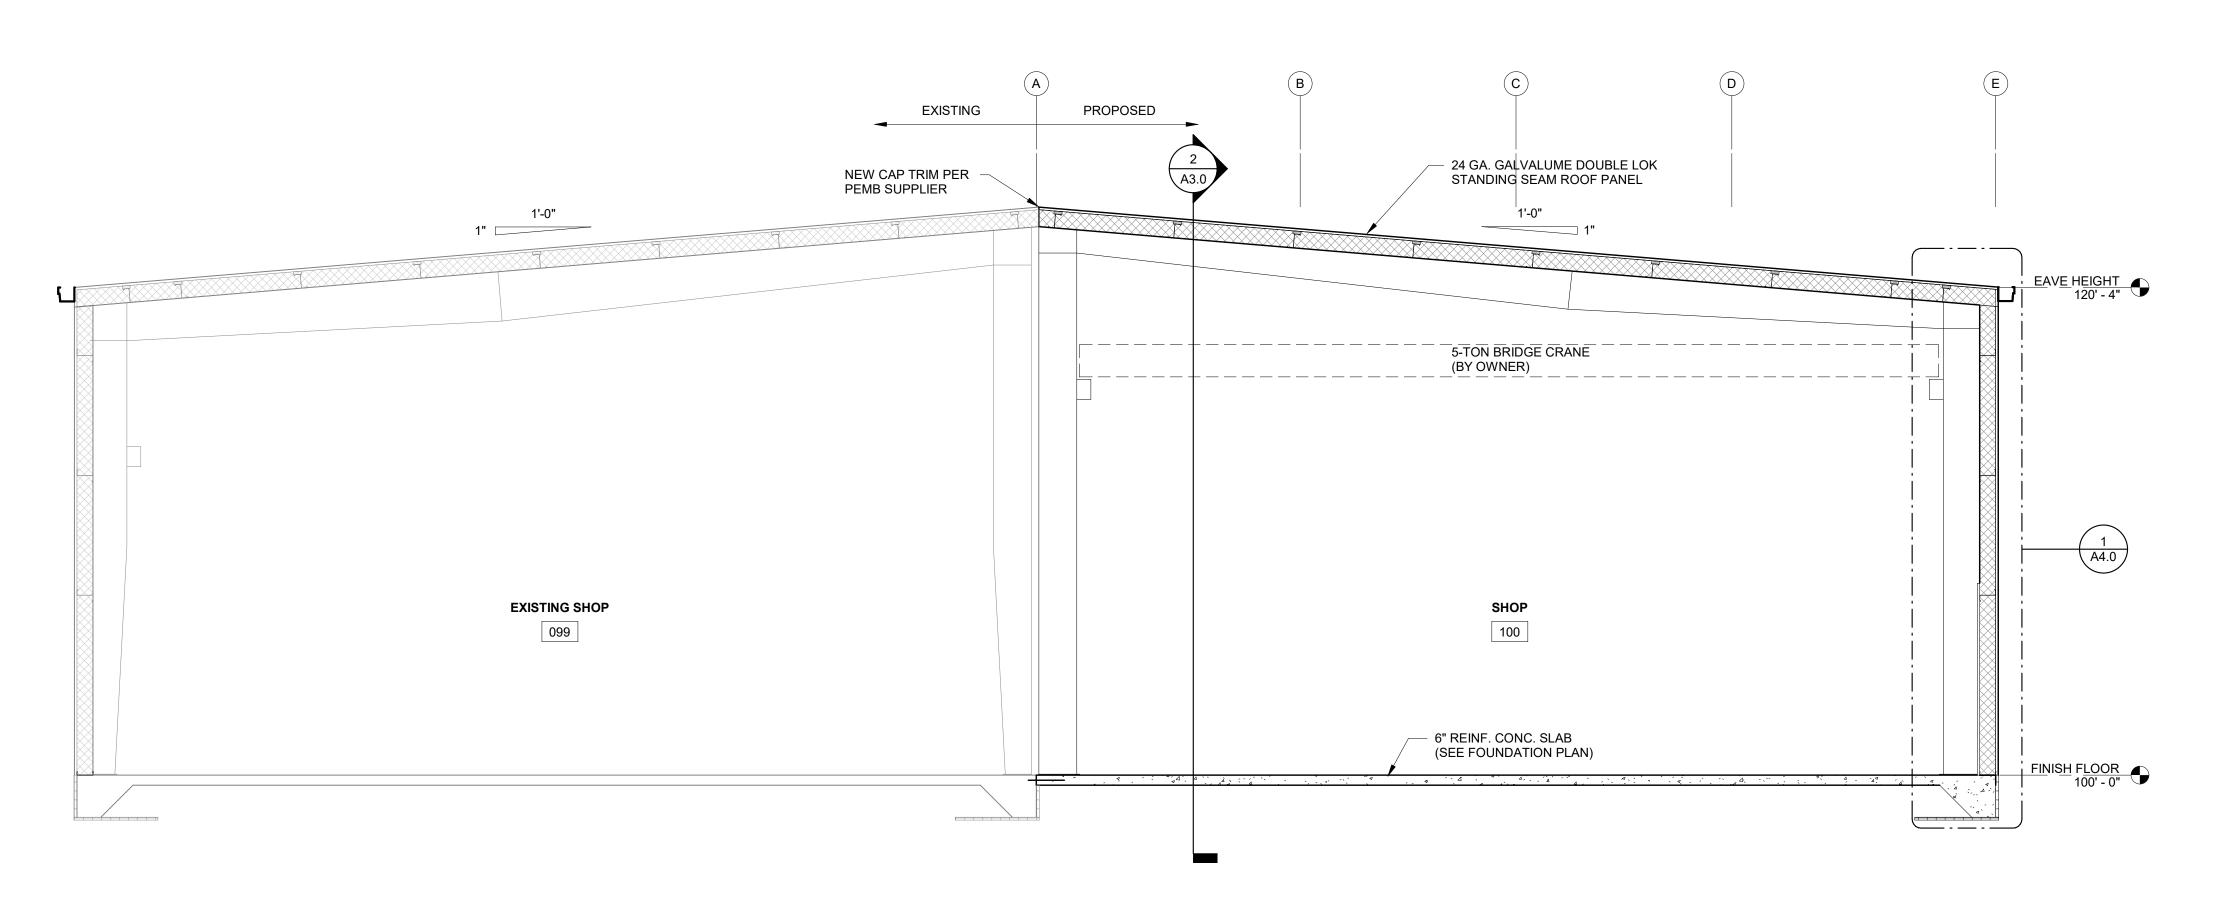

BUILDING SECTION 1 /A3.0 SCALE = 1/4" = 1'-0"

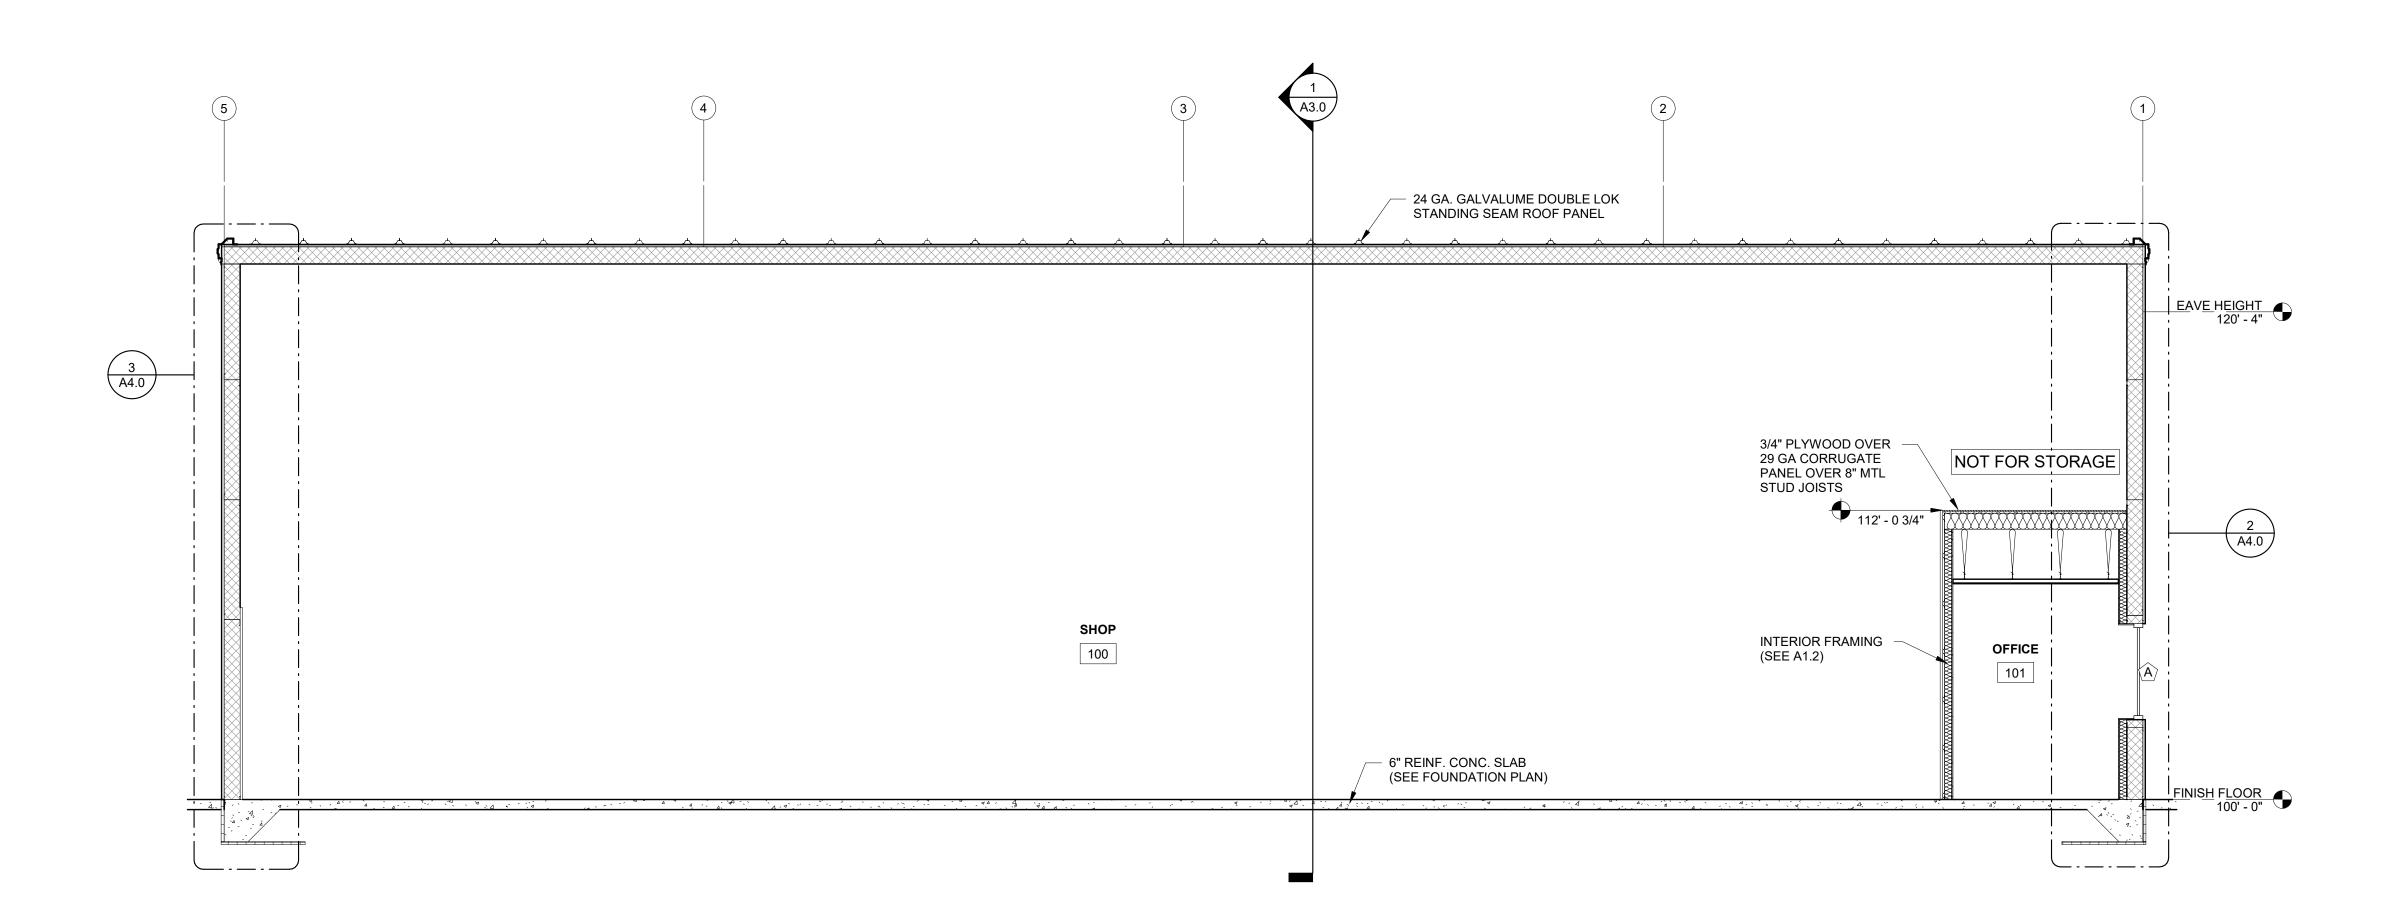

BUILDING SECTION
2 /A3.0 SCALE = 1/4" = 1'-0"



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JOB NUMBER: 24-5934

PROJECT EXECUTIVE:

JAKE MANCOSKE (920) 366-8828

02/24/25

DRAWN BY: CRP DATE:

REVISIONS:

ISSUED FOR: CHECKED DATE:


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SECTIONS - BUILDING



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JOB NUMBER: 24-5934

EXECUTIVE:

(920) 366-8828

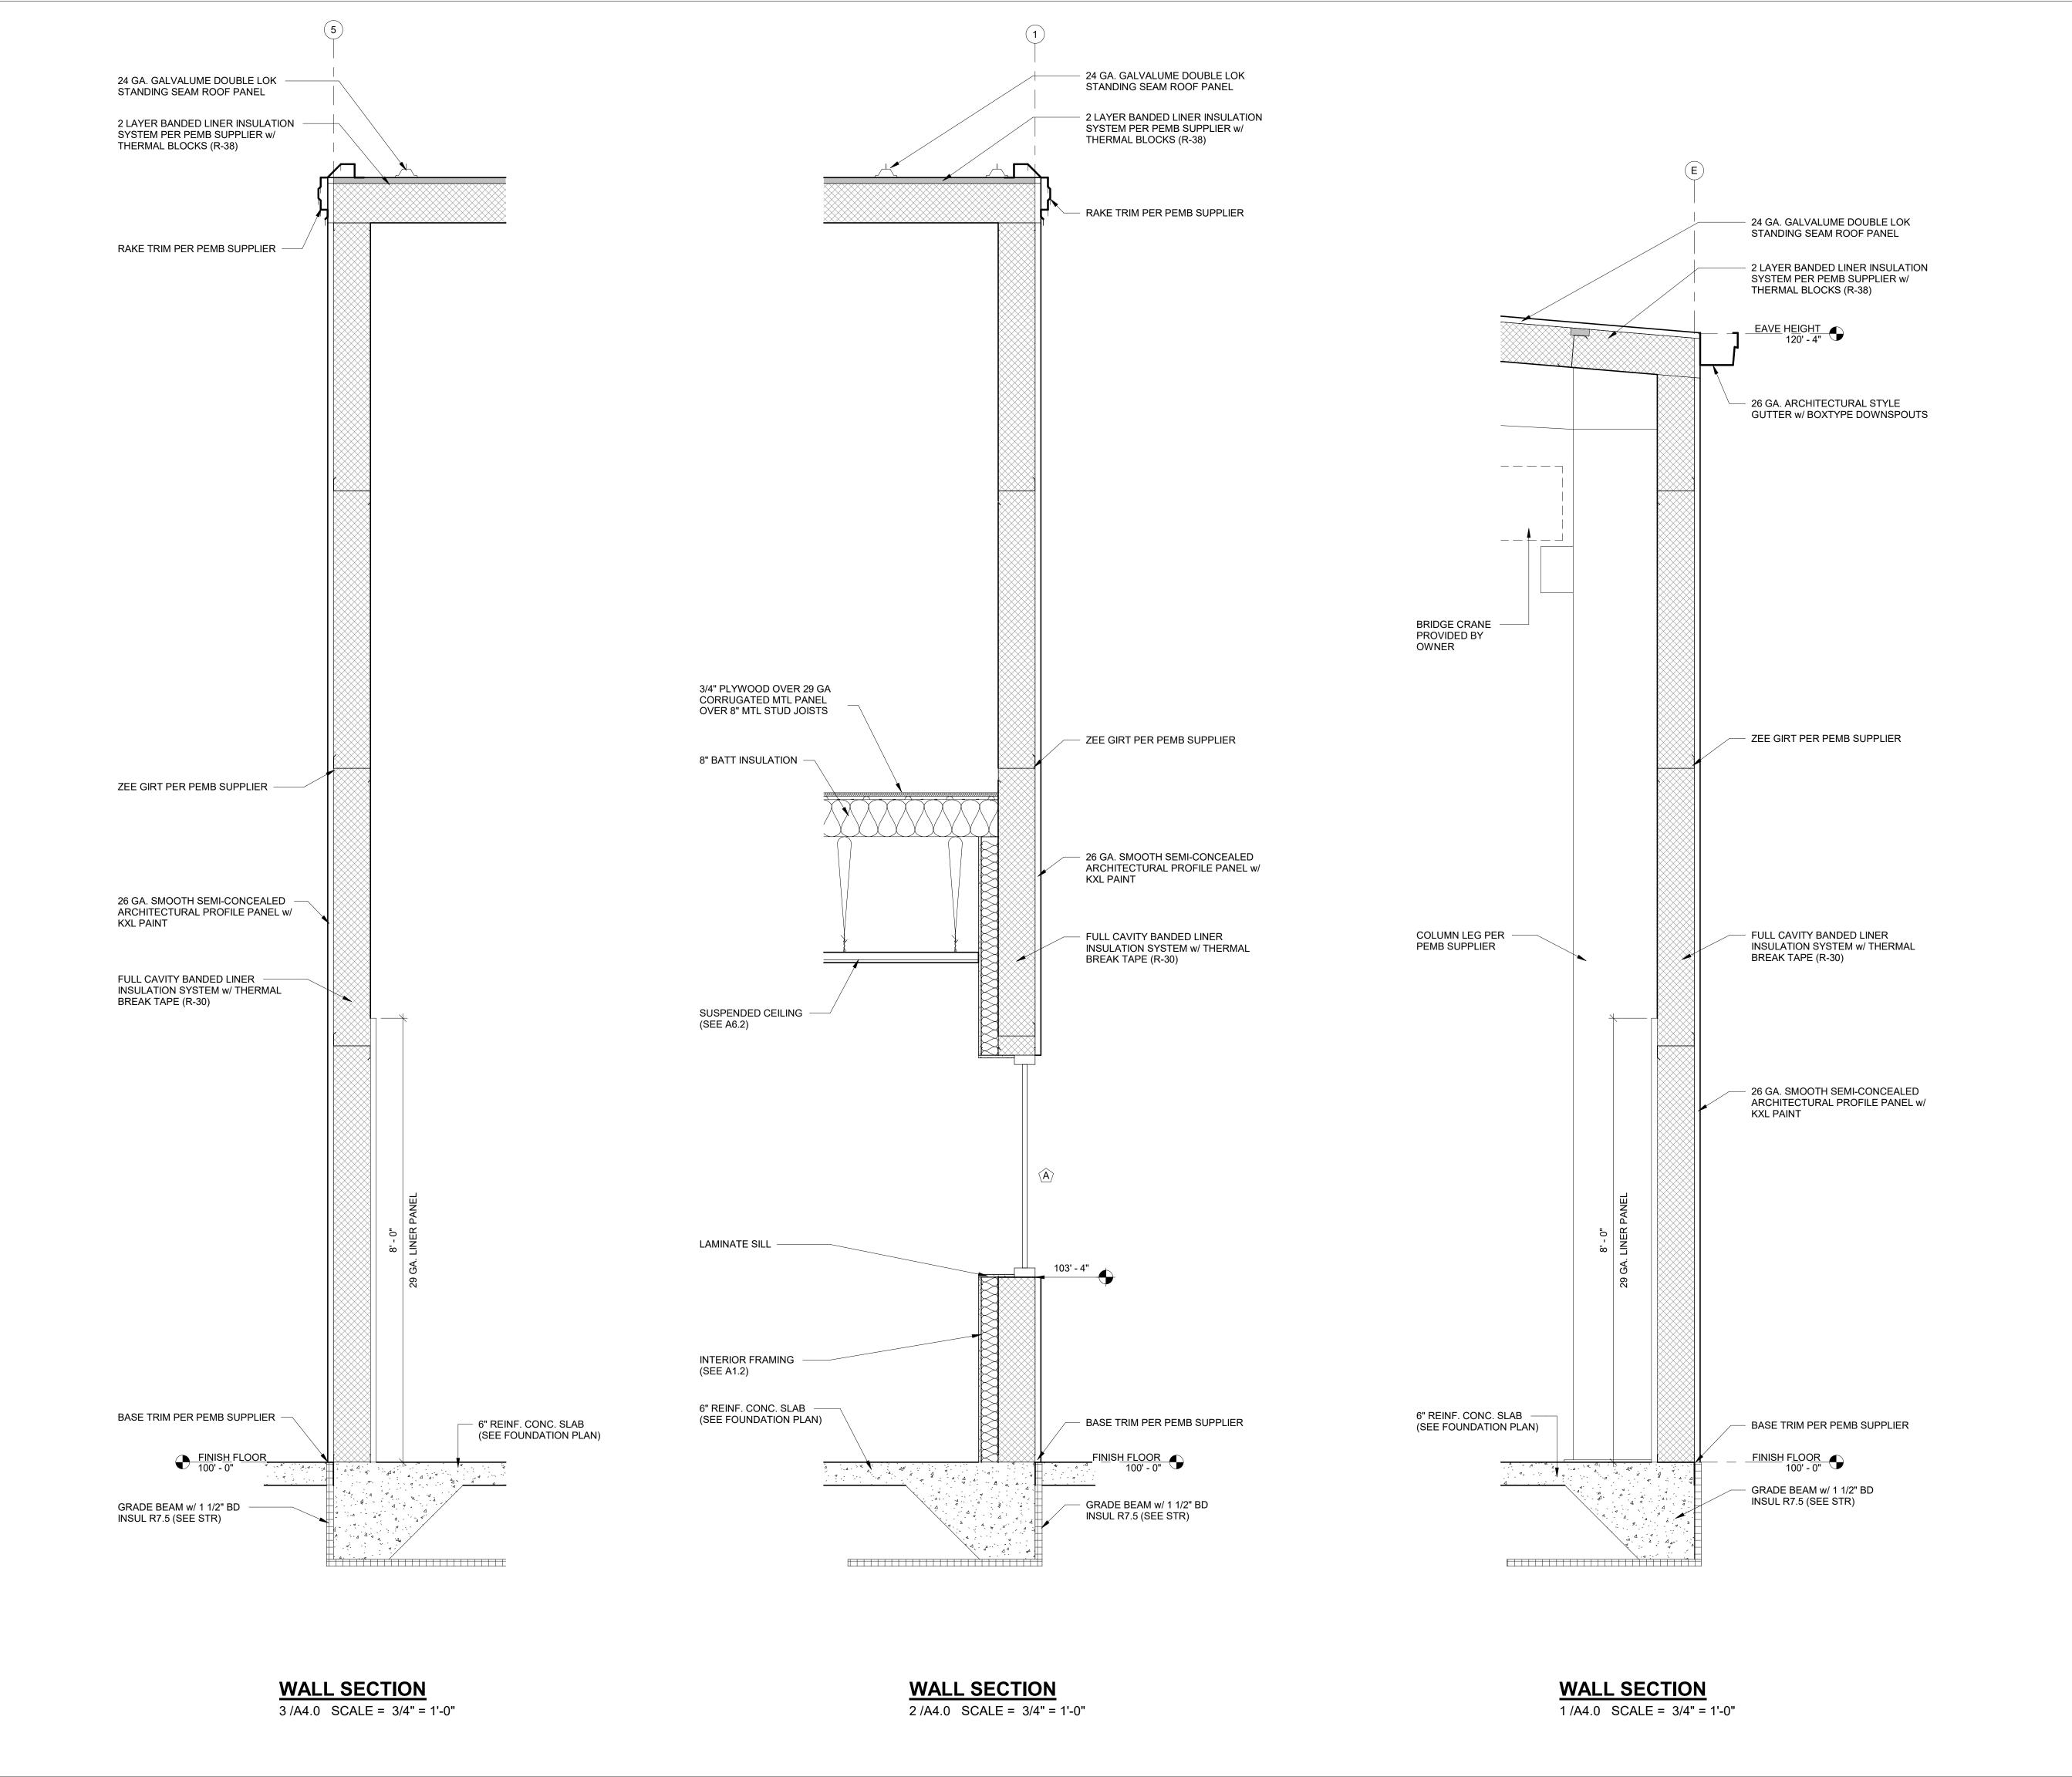02/24/25

DRAWN BY: CRP DATE:

REVISIONS:

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X CONSTRUCTION

SECTIONS - WALL / DETAILS

FINISH GENERAL NOTES

- 1. ALL FINISH SELECTIONS IDENTIFIED IN LEGENDS, SCHEDULES, AND SPECIFICATIONS ARE SUBJECT TO 'OR EQUAL' SUBSTITUTIONS
- U.N.O. FINAL SELECTIONS TO BE SELECTED BY G.C.

 NOTIFY ARCHITECT OF SCHEDULED FINISHES THAT ARE
 UNAVAILABLE OR DISCONTINUED AT THE EARLIEST OPPORTUNITY
 SUCH THAT A SUBSTITUTION CAN BE SELECTED WITHOUT
- JEOPARDIZING THE CONSTRUCTION SCHEDULE.

 3. REFER TO THE MATERIAL SCHEDULE FOR MANUFACTURER,
- PRODUCT/STYLE NAME, COLOR SPECIFICATION.

 INSTALL ALL FINISH MATERIALS IN ACCORDANCE WITH THE MANUFACTURER'S RECOMMENDED SPECIFICATIONS, SURFACE PREPARATION, ADHESIVES AND BACKINGS: INCLUDING WALLCOVERINGS, COATINGS, FLOORING MATERIALS, LAMINATES,
- 5. THE CONTRACTOR SHALL REPAIR ALL ROUGH FLOOR SLAB UNEVENNESS SUITABLE FOR PROPER FLOOR COVERING
- INSTALLATION.

 6. FLOOR MATERIAL TRANSITIONS AT DOOR OPENINGS ARE TO BE CENTERED BELOW THE DOOR IN THE CLOSED POSITION, U.N.O.
- 7. THE PAINTING SUBCONTRACTOR SHALL ENSURE THAT ALL PAINTS COMPLY WITH THE MUNICIPAL & STATE CODES AND BUILDING REGULATIONS FOR LOW VOC EMISSIONS.
- 8. ELECTRICAL SWITCH AND OUTLET COVER PLATES, SURFACE HARDWARE, ETC. SHALL BE INSTALLED AFTER PAINTING AND/OR
- APPLICATION OF WALL COVERINGS AND SPECIFIED CARPET.

 9. STAINED AND PAINTED SURFACES SHALL BE FINISHED SUCH THAT
- JOINTS/IMPERFECTIONS ARE NOT VISIBLE.

 10. CONTRACTOR SHALL NOTIFY ARCHITECT IMMEDIATELY OF ANY
- DISCREPANCIES IN THE FIELD. GC TO GET CLARIFICATION FROM
- ARCHITECT BEFORE CONTINUING WITH ANY WORK.

 11. PROVIDE VINYL TRANSITION STRIPS AT ALL FLOORING MATERIAL
- CHANGES, U.N.O. REFER TO PLAN FOR DETAIL LOCATIONS.

 12. HARD FLOORING GROUT IS TO BE SEALED WITH MANUFACTURER'S
- 13. RUBBER/VINYL BASE SHALL BE STRAIGHT BASE AT ALL LOCATIONS FOR CARPET AND COVE BASE AT TILE AND RESILIENT FLOORS.
- 14. ALL ELECTRICAL PANELS IN THE CORRIDORS SHALL BE PAINTED TO MATCH THE ADJACENT WALL FINISH U.N.O
- 15. PAINT CEILING ACCESS PANELS TO MATCH ADJACENT CEILING
- FINISH.

 16. UNDERSIDE OF SOFFITS (WHERE OCCURS) TO BE PAINTED TO
- RECEIVE FINISH TO MATCH WALL, U.N.O.

 17. FINISH FLOORING TO EXTEND FROM WALL TO WALL INCLUDING
- UNDER CABINETS AND UNDERCABINET EQUIPMENT.

 18. ALL INTERIOR WALL & CEILING FINISHES AND TRIM OF PUBLIC AREAS TO COMPLY WITH CLASS A MATERIAL CLASSIFICATION; FLAME SPREAD RATING 0 TO 25, SMOKE DEVELOPED 200. ALL INTERIOR WALL AND CEILING FINISHES AND TRIM IN NON PUBLIC AREAS TO
- COMPLY WITHCLASS B MATERIAL CLASSIFICATION; FLAME SPREAD RATING 26-75, SMOKE DEVELOPED 450.

 19. ALL PAINTED SURFACES ARE TO RECEIVE A PRIME COAT AND A
- MINIMUM OF TWO COATS FINAL COLOR, U.N.O.
 20. CARPET CONTRACTOR SHALL VERIFY THAT ALL CARPET OF EACH
- VARIETY IS TO BE SHIPPED FROM THE SAME DYE-LOT.

 21. ALL WALLS PAINTED WITH A LATEX PAINT TO HAVE AN EGGSHELL FINISH, U.N.O. REFER TO THE MATERIAL SCHEDULE AND FINISH
- LEGEND FOR MANUFACTURER'S PRODUCT NAME.

 22. GYPSUM BOARD CEILINGS SCHEDULED TO RECEIVE PAINT SHALL
- HAVE A FLAT FINISH, U.N.O.

 PROVIDE ARCHITECT WITH A MINIMUM OF (3) 8" X 10" BRUSH-OUTS
 OF EACH COLOR AND FINISH FOR ARCHITECT'S APPROVAL PRIOR TO
- APPLICATION.


 24. PAINTS AND COATINGS: APPLIED TO INTERIOR WALLS AND CEILINGS
 MUST NOT EXCEED THE VOLATILE ORGANIC COMPOUND (VOC)
- CONTENT LIMITS ESTABLISHED IN GREEN SEAL STANDARD GS-11, PAINTS, 1ST EDITION, MAY 20, 1993.

 25. ANTI-CORROSIVE AND ANTI-RUST PAINTS: APPLIED TO INTERIOR
- FERROUS METAL SUBSTRATES MUST NOT EXCEED THE VOC CONTENT LIMIT OF 250 G/L ESTABLISHED IN GREEN SEAL STANDARD GC-03, ANTI-CORROSIVE PAINTS, 2ND EDITION, JANUARY 7, 1997.

 CLEAR WOOD FINISHES, FLOOR COATINGS, STAINS, PRIMERS, SEALERS, AND SHELLACS: APPLIED TO INTERIOR ELEMENTS MUST
- SEALERS, AND SHELLACS: APPLIED TO INTERIOR ELEMENTS MUST NOT EXCEED THE VOC CONTENT LIMITS ESTABLISHED FOR THOSE COATING TYPES IN SOUTH COAST AIR QUALITY MANAGEMENT DISTRICT (SCAQMD) RULE 1113, ARCHITECTURAL COATINGS, AMENDED FEBRUARY 5, 2016.


FINISH PLAN LEGEND


FLOOR FINISH TRANSITION

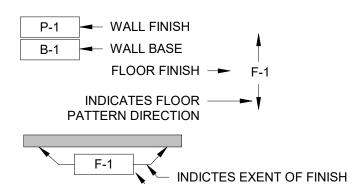

WALL FINISH

MATERIAL LEGEND

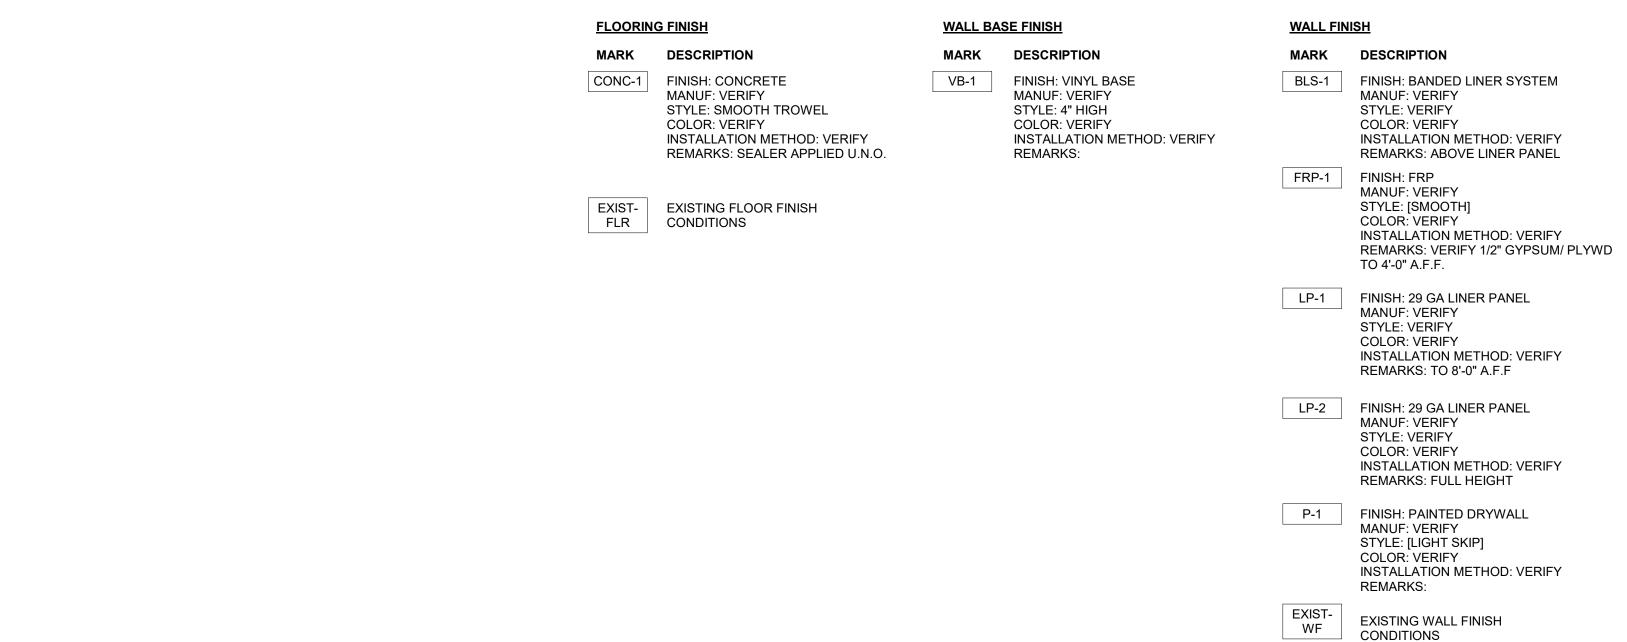

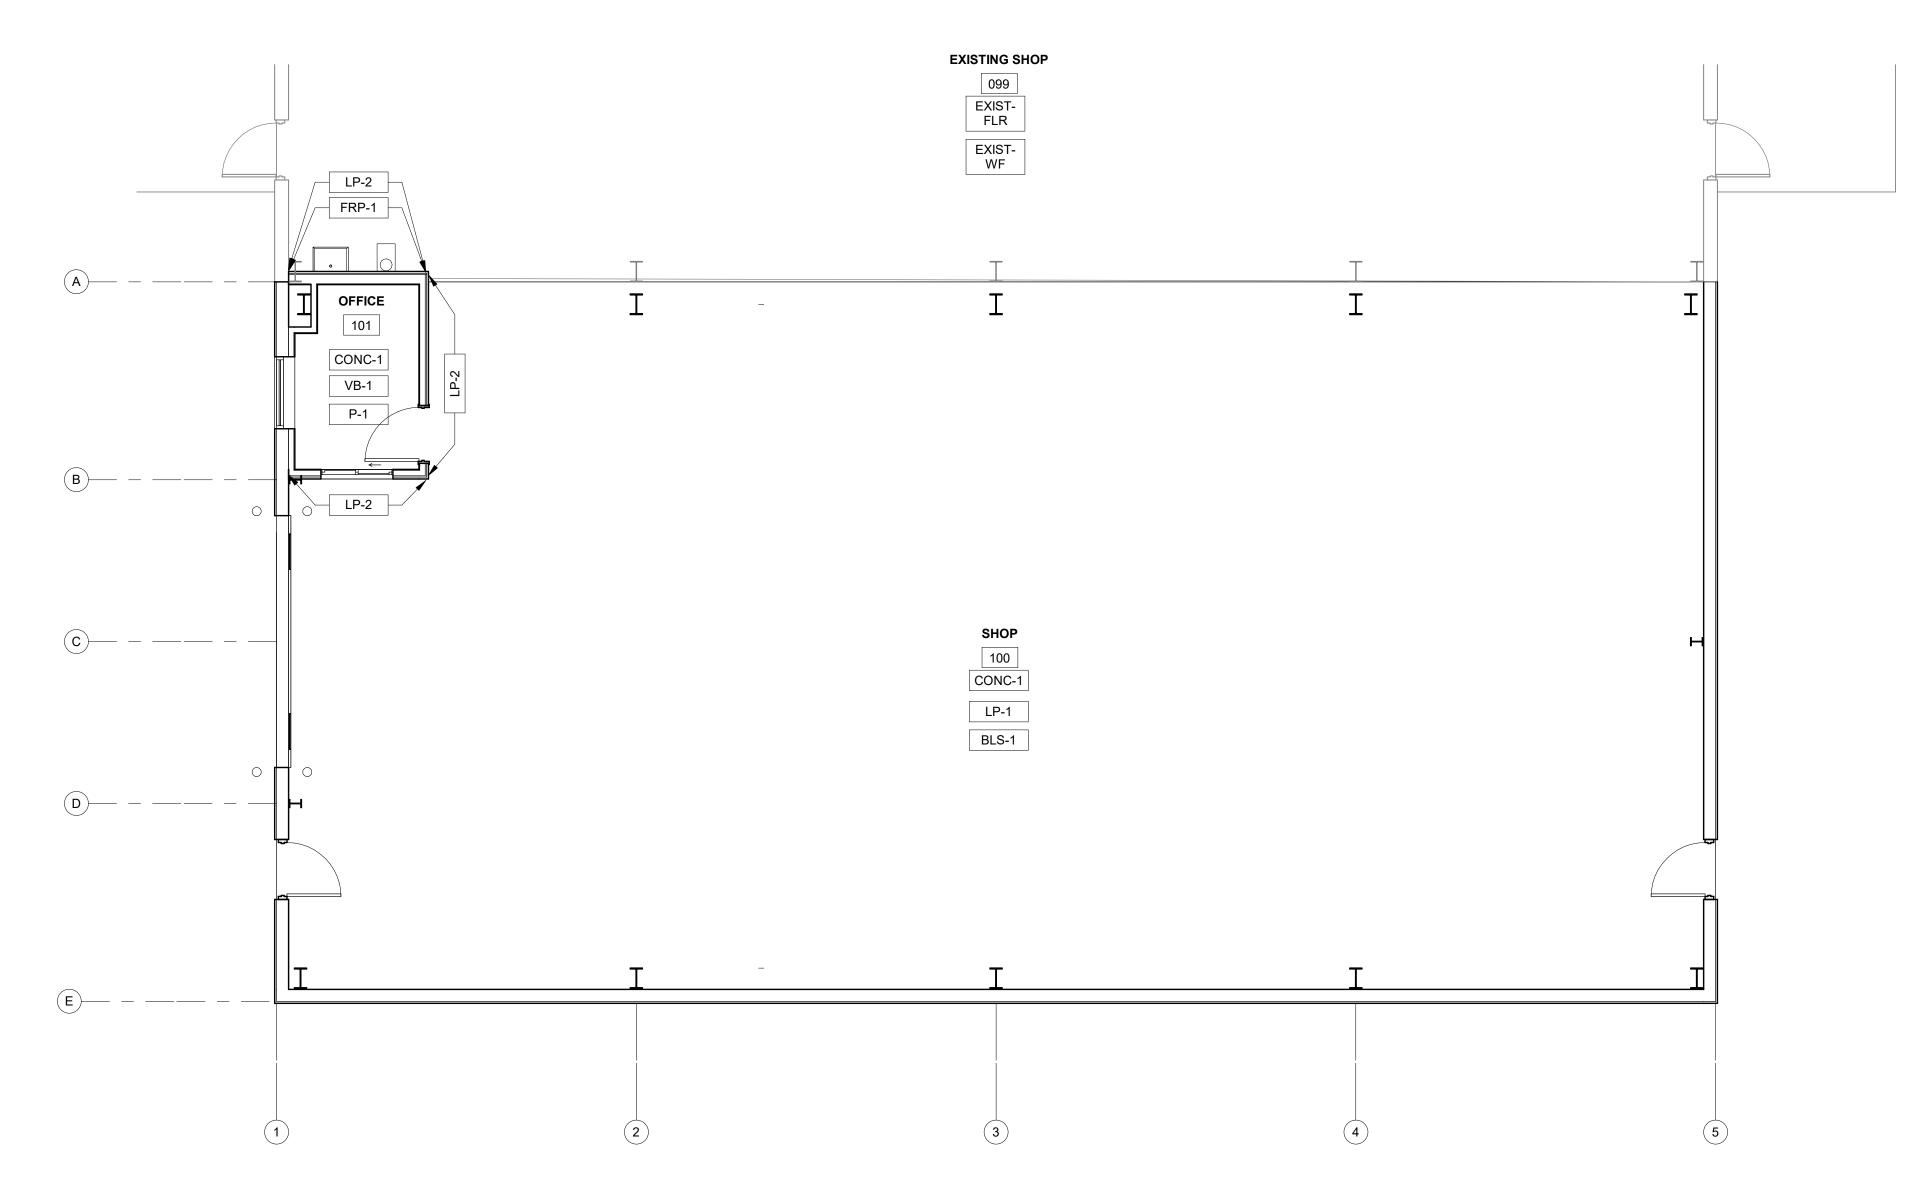





Item 4.a.

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DESIGN & BUILD GENERAL CONTRACTOR

ROPOSED BUILDING FOR: TEAM INDUSTRIES OSITIONER SHOF

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JOB NUMBER: 24-5934

PROJECT
EXECUTIVE: JAKE MANCOS
(920) 366-8828

 DRAWN BY:
 CRP

 DATE:
 02/24/25

REVISIONS:

ISSUED FOR: CHECKED DATE:
BY:
PRELIMINARY
BID SET

DESIGN REVIEW SM,JM,CP 02/13/24

CHECKSET

X CONSTRUCTION

ROOM FINISH PLAN - PROPOSED

A6.1

CEILING FINISH

MARK DESCRIPTION

BLS-1 FINISH: BANDED LINER SYSTEM MANUF: VERIFY

STYLE: VERIFY COLOR: VERIFY INSTALLATION METHOD: VERIFY REMARKS:

ACT-1 FINISH: SUSPENDED ACOUSTICAL CEILING SYSTEM MANUF: VERIFY STYLE: [2x2] STANDARD REVEALED EDGE COLOR: VERIFY
INSTALLATION METHOD: VERIFY
REMARKS: 9'-0" A.F.F.


EXIST-CF EXISTING CEILING FINISH CONDITIONS





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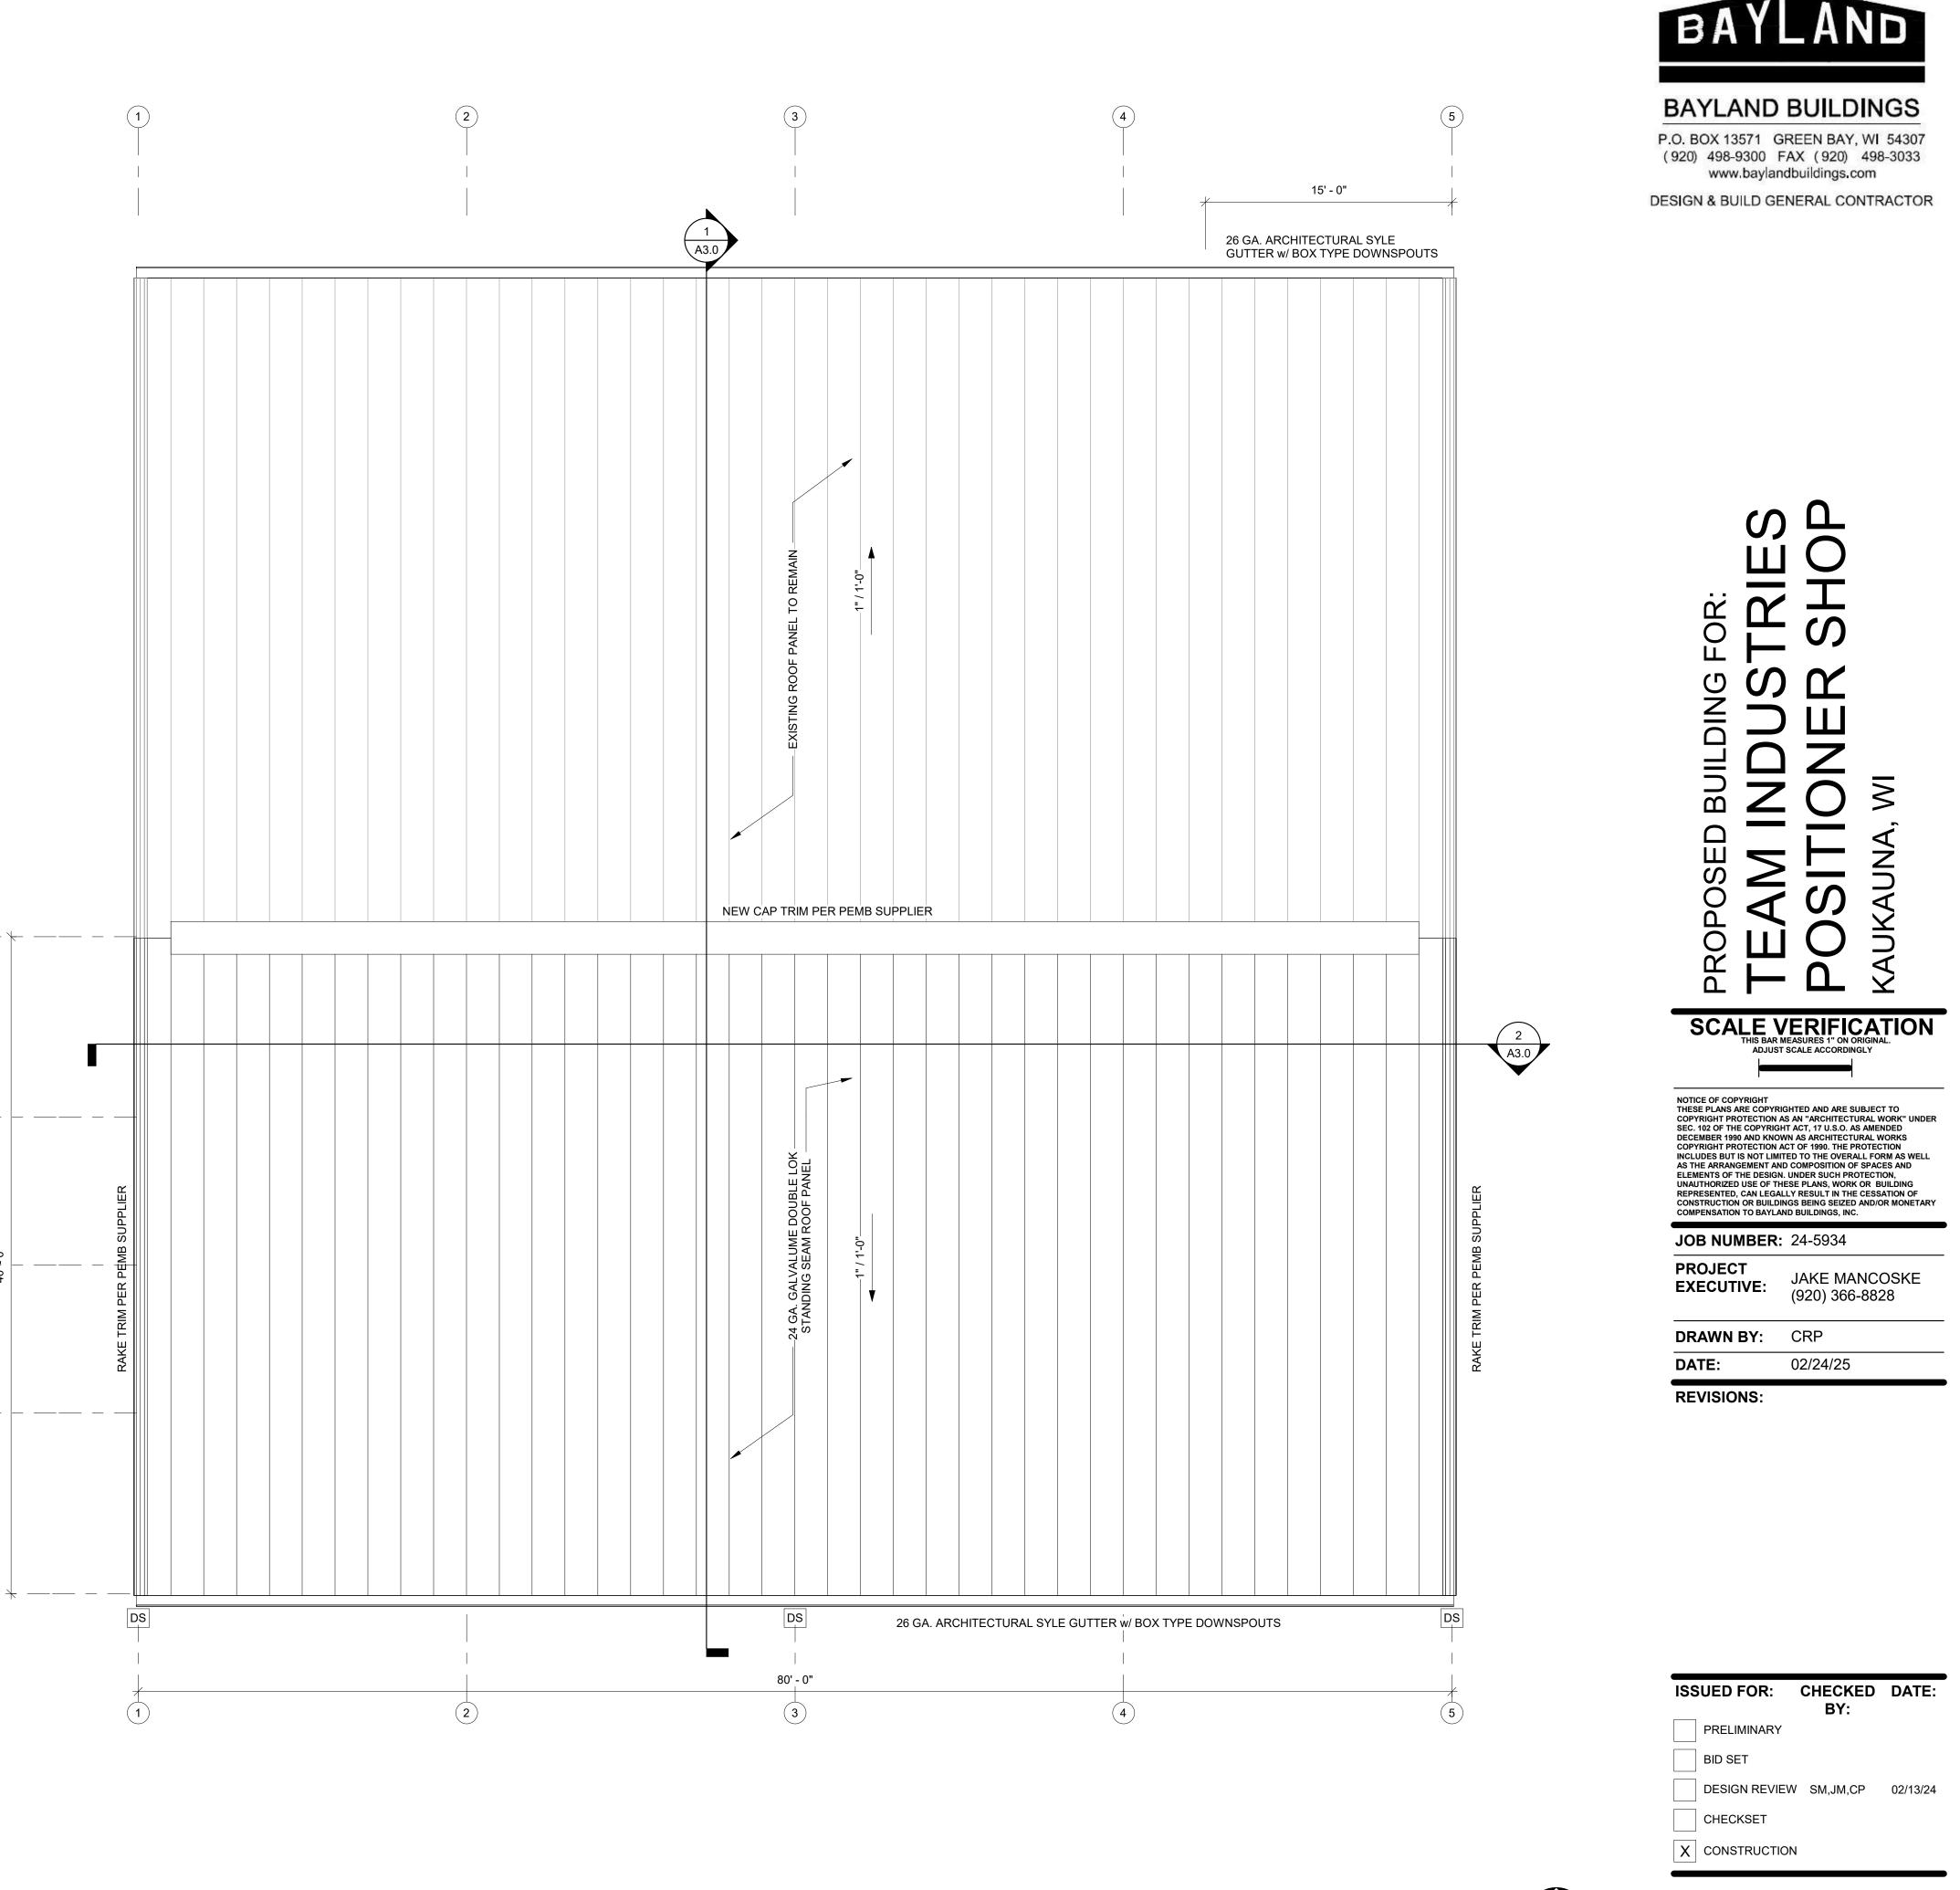
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X CONSTRUCTION

BID SET

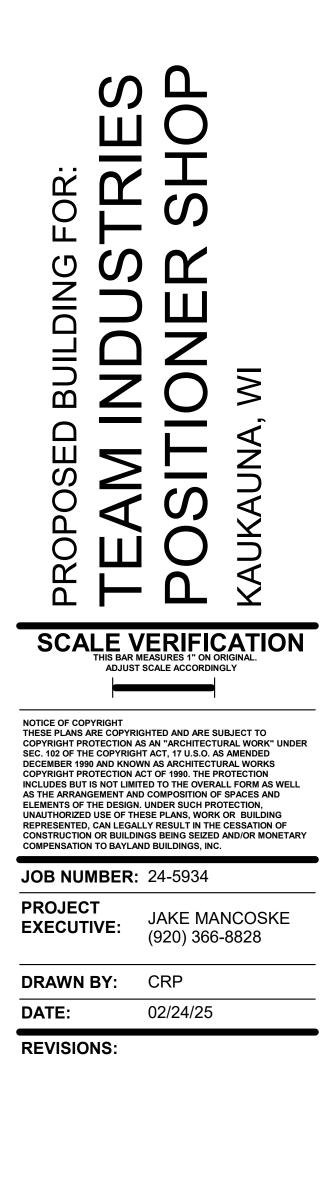

ROOF PLAN - PROPOSED

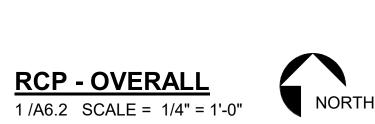ROOF PLAN - PROPOSED

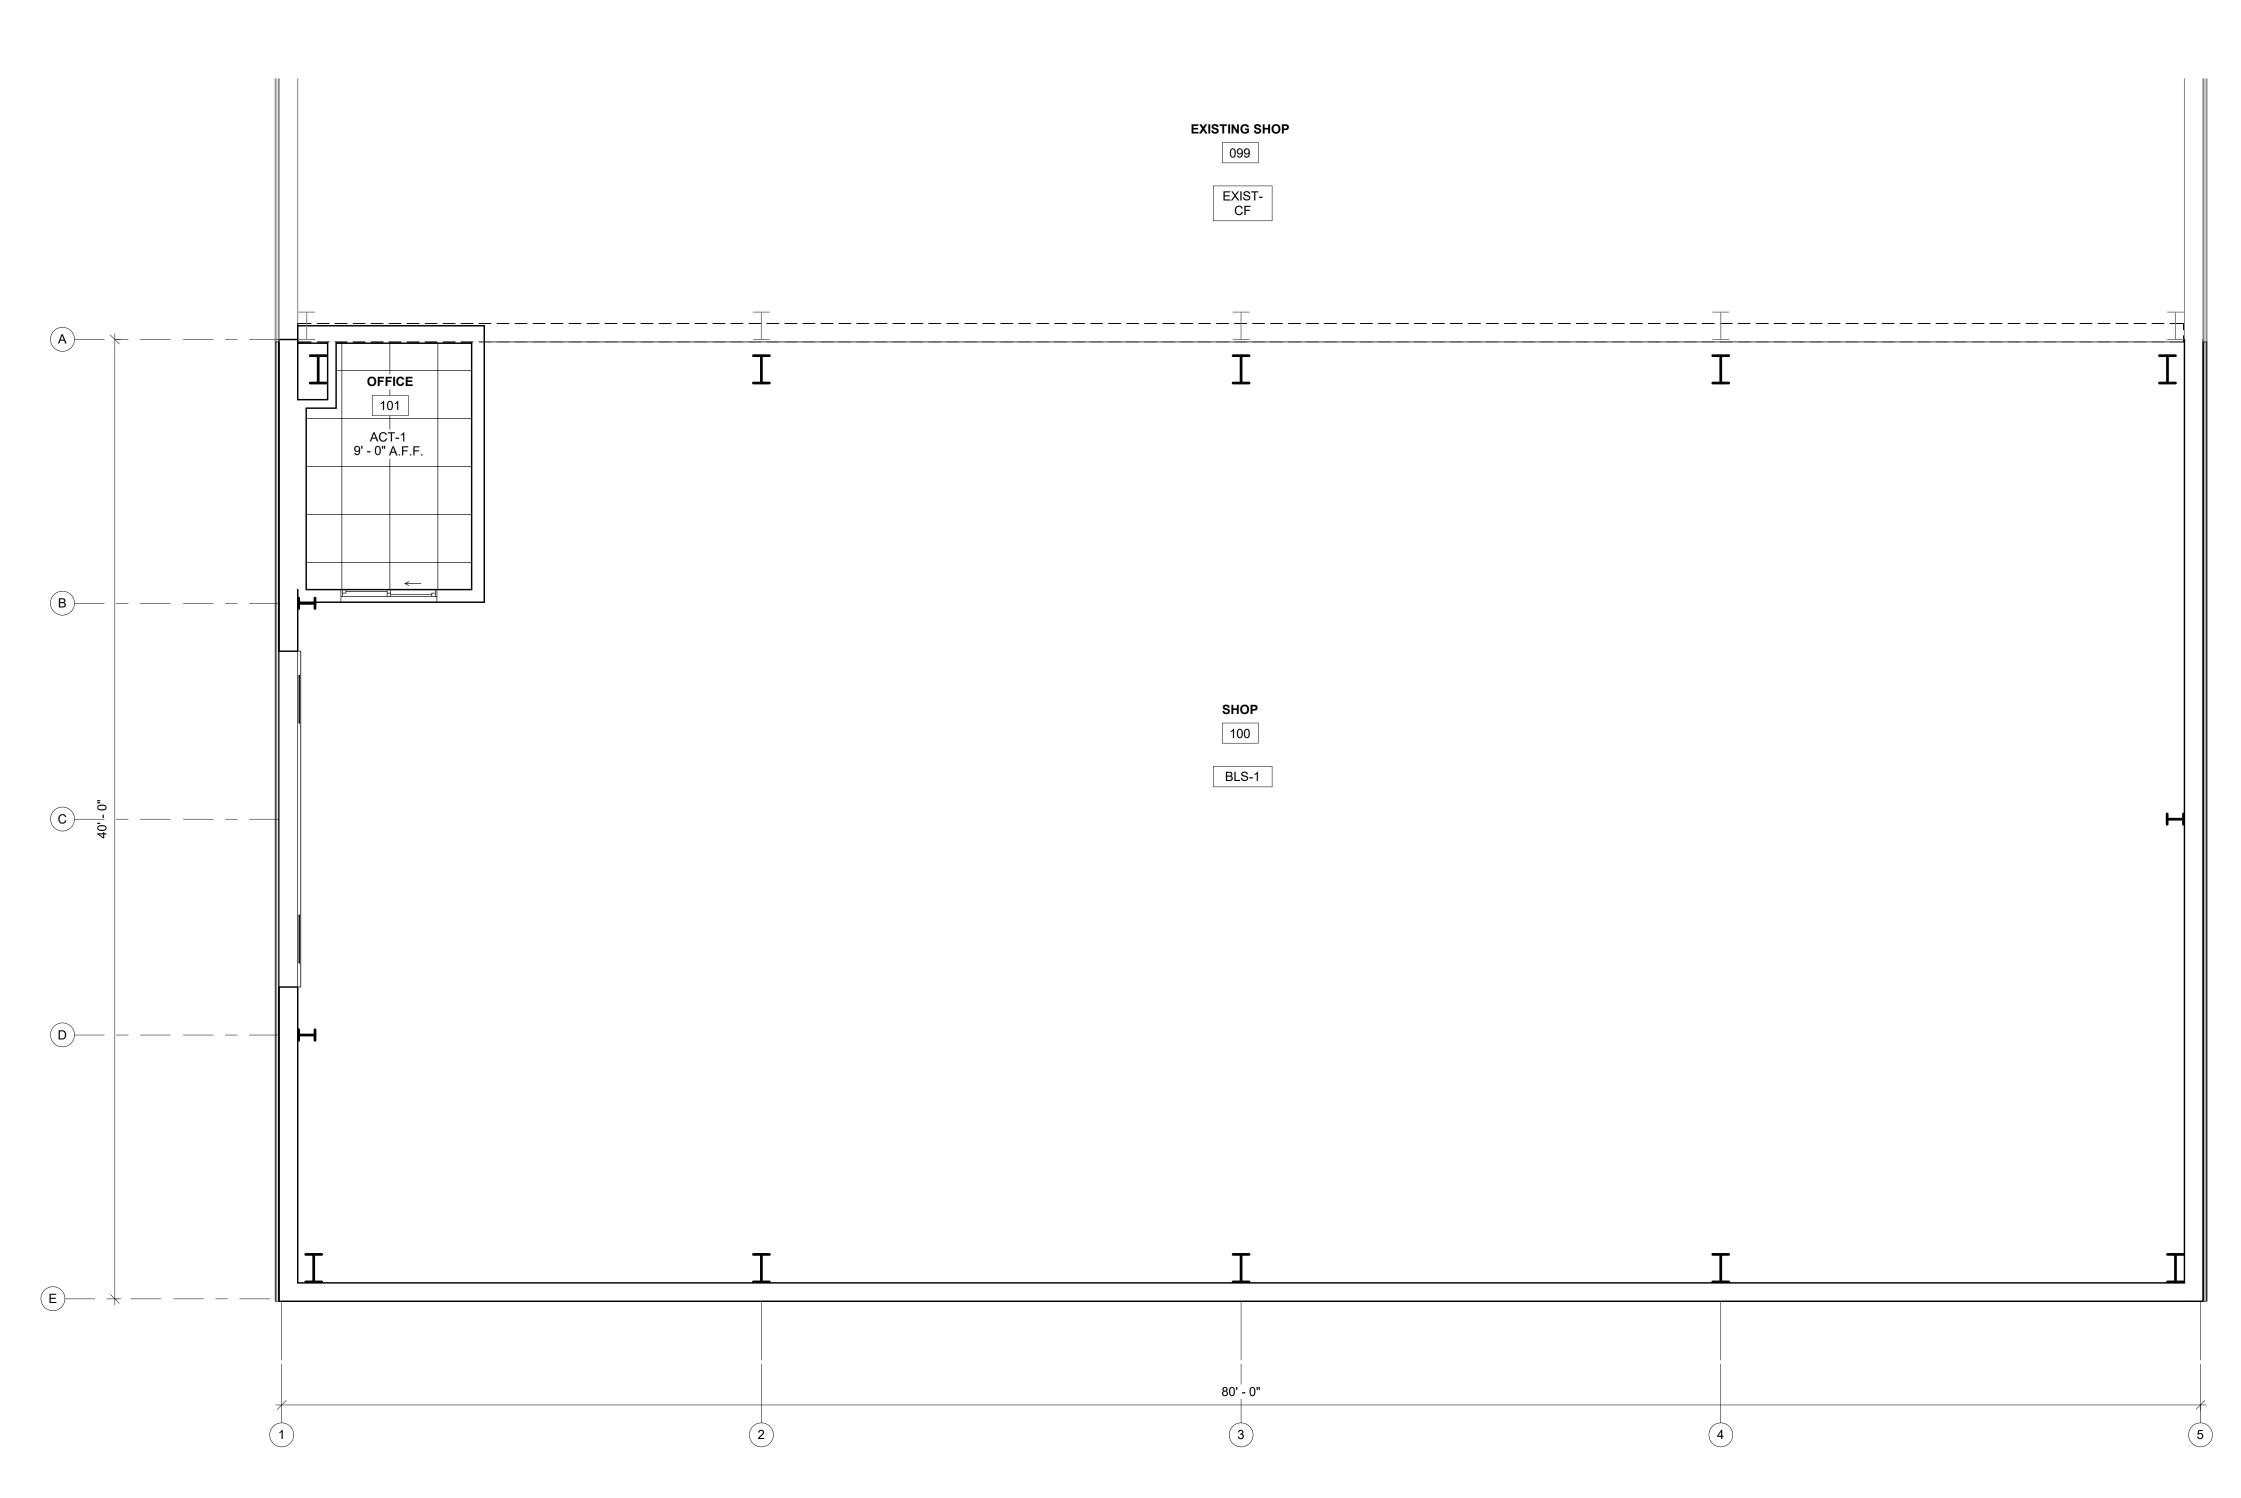1 /A7.0 SCALE = 3/16" = 1'-0" NORTH

1. CONCRETE WORK SHALL CONFORM TO THE LATEST EDITION OF THE FOLLOWING STANDARDS

ACI 301 - "SPECIFICATIONS FOR STRUCTURAL CONCRETE"

ACI MCP - "MANUAL OF CONCRETE PRACTICE" ACI 318 - "BUILDING CODE REQUIREMENTS FOR REINFORCED CONCRETE" ACI 318.1 - "BUILDING CODE REQUIREMENTS FOR STRUCTURAL PLAIN

2. CONCRETE SHALL HAVE A MINIMUM 28-DAY ULTIMATE COMPRESSIVE STRENGTH AS FOLLOWS (U.N.O.):

STRUCTURAL SLABS: 4,000 PSI SLABS-ON-GRADE: 4,000 PSI FOOTINGS AND WALL: 4,000 PS

PRECAST CONCRETE: 5,000 PSI EXTERIOR EXPOSED CONCRETE: 4,000 PSI

3. CONCRETE MIX DESIGN (INCLUDING AGGREGATE SIZE, WATER/CEMENT RATIO, AIR ENTRAINMENT, ADMIXTURES AND SLUMP) SHALL BE SUBMITTED TO THE ENGINEER FOR APPROVAL PRIOR TO COMMENCEMENT OF ANY WORK.

MAXIMUM WATER/CEMENT RATIO IS: 0.50 FOR SLABS ON GRADE 0.54 FOR BELOW GRADE CONCRETE

0.48 FOR EXPOSED CONCRETE 4. CONCRETE TO BE EXPOSED TO THE WEATHER SHALL HAVE AIR-ENTRAINING ADMIXTURE AS REQUIRED TO PROVIDE 4-6% AIR ENTRAINMENT. 5. CONCRETE STRENGTH SHALL BE EVALUATED ACCORDING TO METHOD 1 OR

METHOD 2 AS PRESCRIBED IN ACI 301. THE RESULTS OF THESE ANALYSES SHALL BE SUBMITTED TO THE ENGINEER FOR APPROVAL PRIOR TO ANY WORK. 6. CONTRACTOR SHALL MAKE PROVISIONS TO CAST FOUR TEST CYLINDERS FOR EACH 50 CUBIC YARDS OF CONCRETE PLACED OR FOR ANY ONE DAY'S CONFORMANCE TO ASTM C31 AND TESTING SPECIMENS IN CONFORMANCE TO ASTM

7. CONSTRUCTION JOINTS SHOWN ON THE CONTRACT DRAWINGS SHALL NOT BE ALTERED WITHOUT WRITTEN APPROVAL OF THE SUPERVISING PROFESSIONAL. 8. DRAWINGS SHOWING THE LOCATION OF CONSTRUCTION JOINTS, CONTROL JOINTS AND PLACING SEQUENCE SHALL BE SUBMITTED TO THE ENGINEER FOR APPROVAL PRIOR TO THE PREPARATION OF REINFORCING SHOP DRAWINGS. GROUT USED TO SET PLATES SHALL BE NON-SHRINK AND NON-METALLIC. 10. CONTRACTOR SHALL USE SMOOTH FORMS FOR EXPOSED CONCRETE SURFACES. BOARD FORMS MAY BE USED FOR UNEXPOSED CONCRETE SURFACES. EARTH

FORMS ARE FORBIDDEN. 11. PROVIDE A MINIMUM OF 6" COMPACTED GRANULAR FILL UNDER ALL SLABS-ON-

12. FLATWORK SUBCONTRACTOR SHALL SUBMIT FLOOR SLAB PLACEMENT SEQUENCE TO ENGINEER FOR APPROVAL PRIOR TO BEGINNING WORK.

4/S0.1 CONCRETE NOTES 12" = 1'-0"

1. FOUNDATION WORK FOR THIS PROJECT SHALL CONSIST OF SPREAD FOOTINGS, CONTINUOUS WALL FOOTING AND SLABS-ON-GRADE 2. FOUNDATIONS ARE DESIGNED TO BE SUPPORTED ON APPROVED EXISTING

SUBGRADE OR AN APPROVED COMPACTED STRUCTURAL FILL HAVING A PRESUMED

BEARING CAPACITY OF 2000 PSF. 3. ALL EXTERIOR FOUNDATIONS SHALL BEAR ON APPROVED SUBGRADE AT A MINIMUM DEPTH OF 4'-0" BELOW ADJACENT FINISH EXTERIOR GRADE. 4. FOOTING ELEVATIONS SHOWN ON THE DRAWINGS REPRESENT ESTIMATED DEPTHS AND ARE NOT TO BE CONSTRUED AS LIMITING THE AMOUNT OF EXCAVATION REQUIRED TO REACH SUITABLE BEARING MATERIAL. 5. CONTRACTOR SHALL PROVIDE TEMPORARY SUPPORTS AS REQUIRED TO PREVENT HORIZONTAL MOVEMENT OR VERTICAL SETTLEMENT WHICH WILL ENDANGER ADJACENT STRUCTURES, STREETS OR UTILITIES.

6. CONTRACTOR SHALL PROVIDE CONTROL OF SURFACE AND SUBSURFACE WATER PROMPTLY TO INSURE THAT ALL FOUNDATION WORK IS DONE IN THE DRY. 7. NO FOUNDATION(S) SHALL BE PLACED ON FROZEN SUBGRADE 8. PROTECT IN-PLACE FOUNDATIONS AND SLABS-ON-GRADE FROM FROST PENETRATION UNTIL THE PROJECT IS COMPLETE.

9. FOUNDATION WALLS SHALL BE BRACED DURING BACKFILLING AND COMPACTION OPERATIONS. BRACING SHALL BE LEFT IN POSITION UNTIL PERMANENT STRUCTURAL SUPPORT SYSTEM IS INSTALLED AND APPROVED BY ENGINEER. 10. BACKFILLING SHALL BE DONE SIMULTANEOUSLY ON BOTH SIDES OF WALL

5/S0.1 FOUNDATION NOTES 12" = 1'-0"

1. DETAILING, FABRICATION AND ERECTION OF REINFORCING STEEL SHALL CONFORM TO THE FOLLOWING:

ACL 315 - "DETAILS AND DETAILING OF CONCRETE REINFORCEMENT" ACI 318 - "BUILDING CODE REQUIREMENTS FOR REINFORCED CONCRETE"

MSP2 - "CRSI MANUAL OF STANDARD PRACTICE" AWS D1.4 - "STRUCTURAL WELDING CODE - REINFORCING STEEL" WRI - "WELDED WIRE FABRIC MANUAL OF STANDARD PRACTICE"

2. STEEL REINFORCING BARS SHALL CONFORM TO ASTM A615 (GRADE 60), DEFORMED WELDED WIRE FABRIC SHALL CONFORM TO ASTM A185. 3. REINFORCEMENT FABRICATOR SHALL PROVIDE AND SCHEDULE ON SHOP DRAWINGS ALL REQUIRED REINFORCING STEEL AND THE NECESSARY ACCESSORIES TO HOLD REINFORCEMENT SECURELY IN PLACE AT THE CORRECT LOCATIONS. 4. CLEARANCES FOR REINFORCEMENT: CONCRETE PLACED DIRECTLY ON EARTH (FOOTINGS, SLABS, ETC.) 3" FROM BOTTOM. ALL OTHER CONCRETE PROVIDE 2" CLEAR TO REINFORCING.

5. SUBCONTRACTOR SHALL REFER TO TYPICAL DETAILS SHOWN ON CONTRACT DRAWINGS FOR ADDITIONAL REINFORCEMENT REQUIREMENTS. 6. WHERE REINFORCEMENT IS REQUIRED IN SECTIONS, REINFORCEMENT IS CONSIDERED TYPICAL WHEREVER SECTION APPLIES.

7. WELDED WIRE FABRIC SHALL LAP A MINIMUM OF 6" AND BE TIED TOGETHER. 8. CONTRACTOR SHALL NOTIFY ENGINEER OF COMPLETION OF REINFORCEMENT INSTALLATION AND ALLOW AT LEAST 24 HOURS BEFORE SCHEDULED CONCRETE PLACEMENT FOR ENGINEER TO INSPECT REINFORCEMENT.

6/S0.1 REINFORCEMENT NOTES 12" = 1'-0"

IBC 1809.5 - PROVIDE FROST PROTECTION OF SHALLOW FOUNDATION WITH INSULATION MEETING THE MINIMUM R VALUE, EXTENT AND DEPTH REQUIRED BY ASCE 32 FOR THIS BUILDING SITE. OTHERWISE, PROVIDE NON-FROST-SUSCEPTIBLE SOIL [AS DEFINED BY GRANULAR SOILS OR OTHER APPROVED NON-FROST SUSCEPTIBLE FILL MATERIAL WITH LESS THAN 6% OF MASS PASSING A #200 MESH SIEVE] DOWN TO ANTICIPATED FROST DEPTH, OR OTHER ACCEPTABLE MEANS.

7/S0.1 SHALLOW FOUNDATIONS 12" = 1'-0"

FOUNDATIONS PLACED ON A LAYER OF WELL-DRAINED, UNDISTURBED GROUND OR FILL MATERIAL THAT IS NOT SUSCEPTIBLE TO FROST SHALL HAVE THE THICKNESS OF SUCH A LAYER INCLUDED IN MEETING THE DESIGN FROST DEPTH DEFINED IN SECTION 3.2. UNDISTURBED GRANULAR SOILS OR FILL MATERIAL WITH LESS THAN 6% OF MASS PASSING A #200 (0.074 MM) MESH SIEVE IN ACCORDANCE WITH ASTM D422 AND OTHER APPROVED NON-FROST-SUSCEPTIBLE MATERIALS SHALL BE CONSIDERED NON-FROST-SUSCEPTIBLE. CLASSIFICATION OF FROST SUSCEPTIBILITY OF SOIL SHALL BE DETERMINED BY A SOILS OR GEOTECHNICAL ENGINEER, UNLESS OTHERWISE APPROVED.

8 /S0.1 NON-FROST-SUSCEPTIBLE GROUND OR FILL MATERIAL 12" = 1'-0"

Fy = 60 KS	SI f'c = 3000 P	SI								
BAR SIZE		#3	#4	#5	#6	#7	#8	#9	#10	#11
CLASS A	TOP BARS	13	17	22	26	38	43	48	55	61
SPICE LENGTH	OTHERS	12	13	17	20	29	33	37	42	47
CLASS B SPICE	TOP BARS	17	23	28	34	49	56	63	71	79
LENGTH	OTHERS	13	17	22	26	38	43	48	55	61
Fy = 60 KS	SI f'c = 4000 PS	SI								
BA	AR SIZE	#3	#4	#5	#6	#7	#8	#9	#10	#11
CLASS A SPICE	TOP BARS	12	15	19	22	33	37	42	47	52
LENGTH	OTHERS	12	12	15	17	25	29	32	36	40
CLASS B SPICE	TOP BARS	15	20	24	29	42	48	55	61	68
LENGTH	OTHERS	12	15	19	22	33	37	42	47	52
OTHERWI 2. TABULA	(APPLY LICE LENGTH SE. ATED VALUES	S SHA S ARE	ALL BE	CLAS	SS B U	NLES	S NOT	ED	•	RS

3.TENSION DEVELOPMENT LENGTHS AND TENSION LAP SPLICE

PER ACI 318-05, SECTIONS 12.2.2 AND 12.15, RESPECTIVELY.TABULATED

5. SPLICE AND DEVELOPMENT LENGHTS IN THIS SCHEDULE ARE BASED

SPACING AT LEAST 2.0 BAR

SPACING AT LEAST 3.0 BAR

COVER AT LEAST 1.0 BAR AND C.-C.

VALUES FOR BEAMS AND COLUMNS ARE BASED ON TRANSVERSE

REINFORCEMENT AND CONCRETE COVER MEETING MIN. CODE

4. TOP BARS ARE HORIZONTAL BARS WITH MORE THAN 12" OF

BEAMS OR COLUMNS: COVER AT LEAST 1.0 BAR AND C.-C.

AND NORMAL WEIGHT

LENGTHS ARE CALCULATED


CONCRETE CAST BELOW THE

ON CASE 1 PER CRSI(1996):


REV. 6-13-19

REQUIREMENTS. LENGHTS ARE IN INCHES.


CONCRETE	MIX KEY					
BAYLAND MIX	USE	COMPRESSIVE STRENGTH (PSI)	AGGREGATE (IN.)	AIR (%)	SLAG	
A1	FOOTING / WALL	3,000	3/4	4-8	Y	
A2	FOOTING / WALL	3,500	3/4	4-8	Y	
A3	FOOTING / WALL	4,000	3/4	4-8	Υ	
B1	INTERIOR FLOOR	3,000	3/4	3-4	Υ	
B2	INTERIOR FLOOR	3,000	3/4	3-4	N	
В3	INTERIOR FLOOR	3,500	3/4	3-4	Y	
B4	INTERIOR FLOOR	3,500	3/4	3-4	N	
B5	INTERIOR FLOOR	3,500	1-1/2	3-4	Y	
В6	INTERIOR FLOOR	3,500	1-1/2	3-4	N	
В7	INTERIOR FLOOR	4,000	3/4	3-4	Y	
B8	INTERIOR FLOOR	4,000	3/4	3-4	N	
В9	INTERIOR FLOOR	4,000	1-1/2	3-4	Y	
B10	INTERIOR FLOOR	4,000	1-1/2	3-4	N	
C1	EXTERIOR FLATWORK	4,000	3/4	6 +/- 1.5	Υ	
C2	EXTERIOR FLATWORK	4,500	3/4	6 +/- 1.5	Υ	

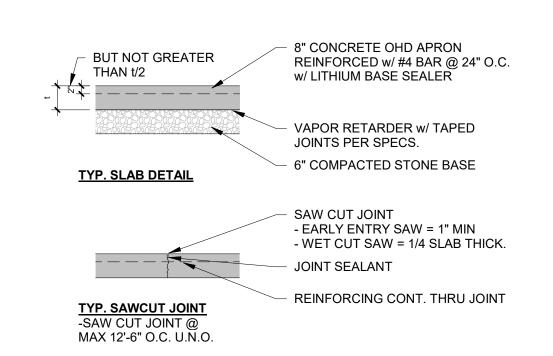


3 /S0.1 TYP. EXTERIOR CONCRETE SLAB - MIX C1 N.T.S.

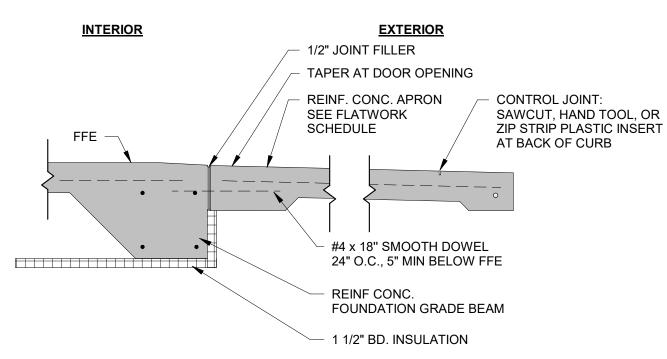

10 /S0.1 APRON DETAIL 3/4" = 1'-0"

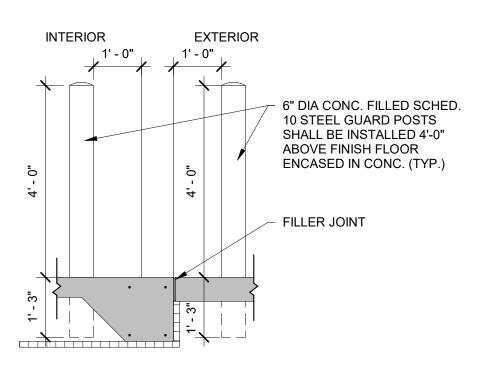


11 /S0.1 BOLLARD DETAIL 1/2" = 1'-0"

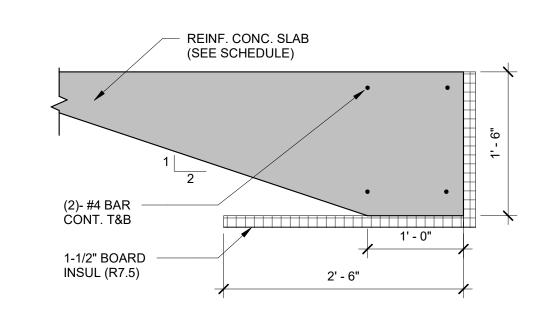


VERIFY SPECIAL BASE TRIM AT STOOP

CONC. SLAB SEE SCHEDULE


12 /S0.1 GRADE BEAM DETAIL N.T.S.

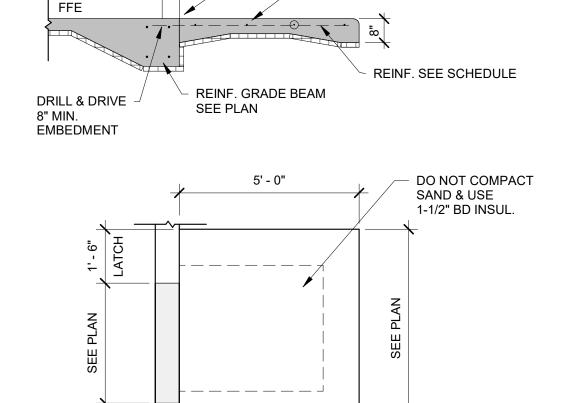

13 /S0.1 GRADE BEAM STOOP PAD @ SERVICE DOOR N.T.S.

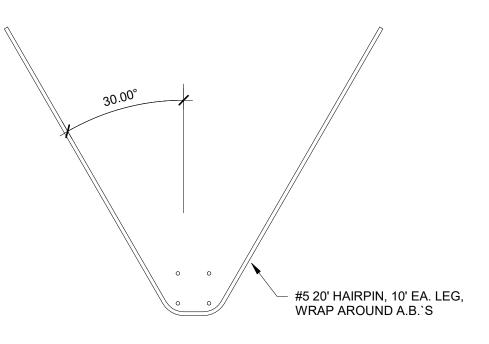

9 /S0.1 HAIRPIN-HP1 3/8" = 1'-0"

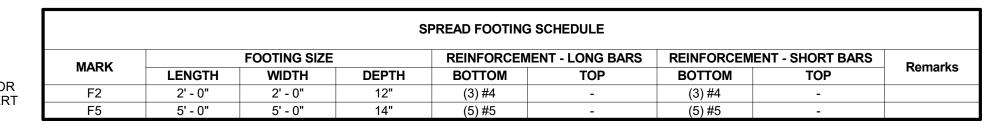



SPREAD FOOTING SCHEDULE NOTES:

ALL FOOTINGS ARE CENTERED ON COLUMN GRID LINE INTERSECTIONS UNLESS DIMENSIONED OTHERWISE SEE TYPICAL SPREAD FOOTING DETAIL FOR TYPICAL CONSTRUCTION & NOTES


SEE FOUNDATION PLAN FOR TOP OF FOOTING ELEVATIONS

SEE FOUNDATION PLAN FOR FOOTING ORIENTATION SEE COLUMN SCHEDULE FOR COLUMN ANCHOR BOLT INFORMATION (WHERE APPLICABLE)

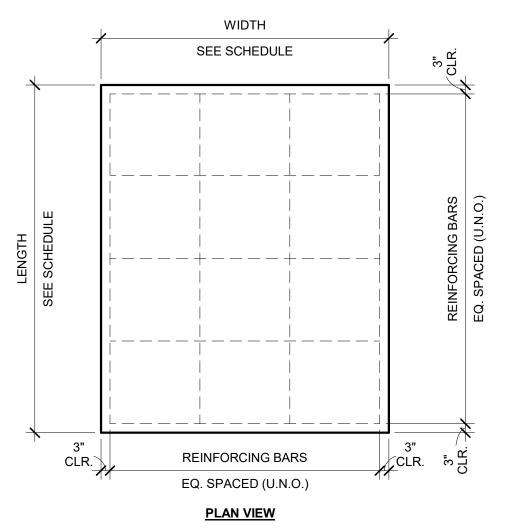

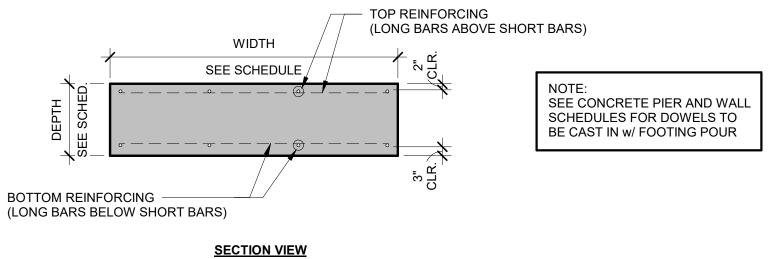

1/S0.1 TYP. SPREAD FOOTING DETAIL - MIX A3 3/8" = 1'-0"

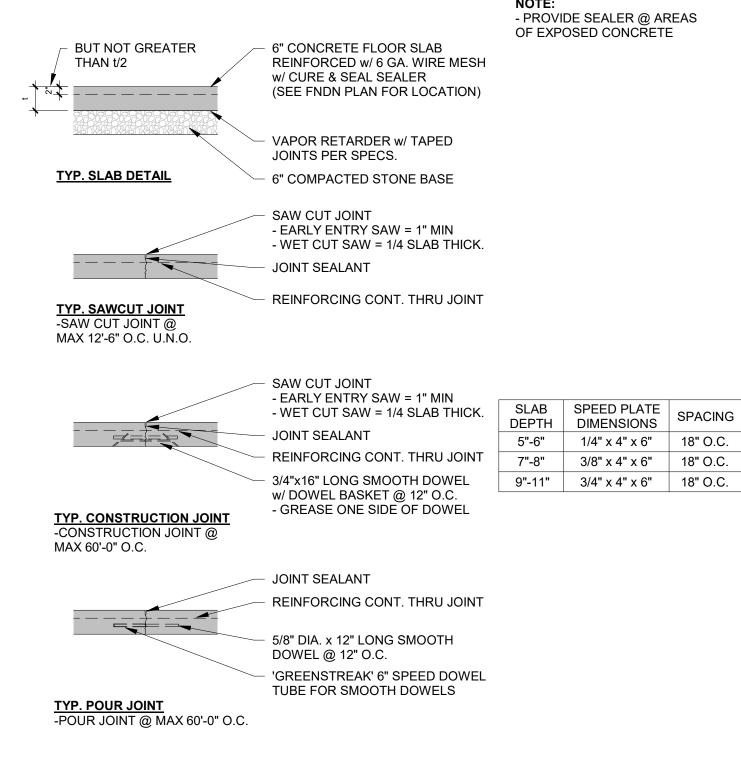


2 /S0.1 TYP. INTERIOR CONCRETE SLAB - MIX B7 1/2" = 1'-0"

Item 4.a.

BAYLAND BUILDINGS

P.O. BOX 13571 GREEN BAY, WI 54307 (920) 498-9300 FAX (920) 498-3033 www.baylandbuildings.com

DESIGN & BUILD GENERAL CONTRACTOR

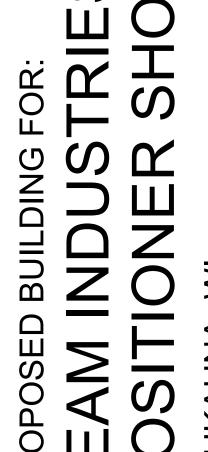

SCALE VERIFICATION THIS BAR MEASURES 1" ON ORIGINAL. ADJUST SCALE ACCORDINGLY

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JOB NUMBER: 24-5934 **PROJECT** JAKE MANCOSKE

(920) 366-8828 **DRAWN BY:** CRP

EXECUTIVE:

DATE: 02/24/25

REVISIONS:

ISSUED FOR: CHECKED DATE:

PRELIMINARY BID SET DESIGN REVIEW SM,JM,CP 02/13/24

CHECKSET X CONSTRUCTION

FOUNDATION SCHEDULES & **DETAILS**

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COMPENSATION TO BAYLAND BUILDINGS, INC.

JOB NUMBER: 24-5934 PROJECT EXECUTIVE: JAKE MANCOSKE (920) 366-8828 DRAWN BY: CRP DATE: 02/24/25 **REVISIONS:**



FOUNDATION PLAN - EXISTING / DEMO
1 /S1.0 SCALE = 1/4" = 1'-0"




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FOUNDATION PLAN - EXISTING / DEMO






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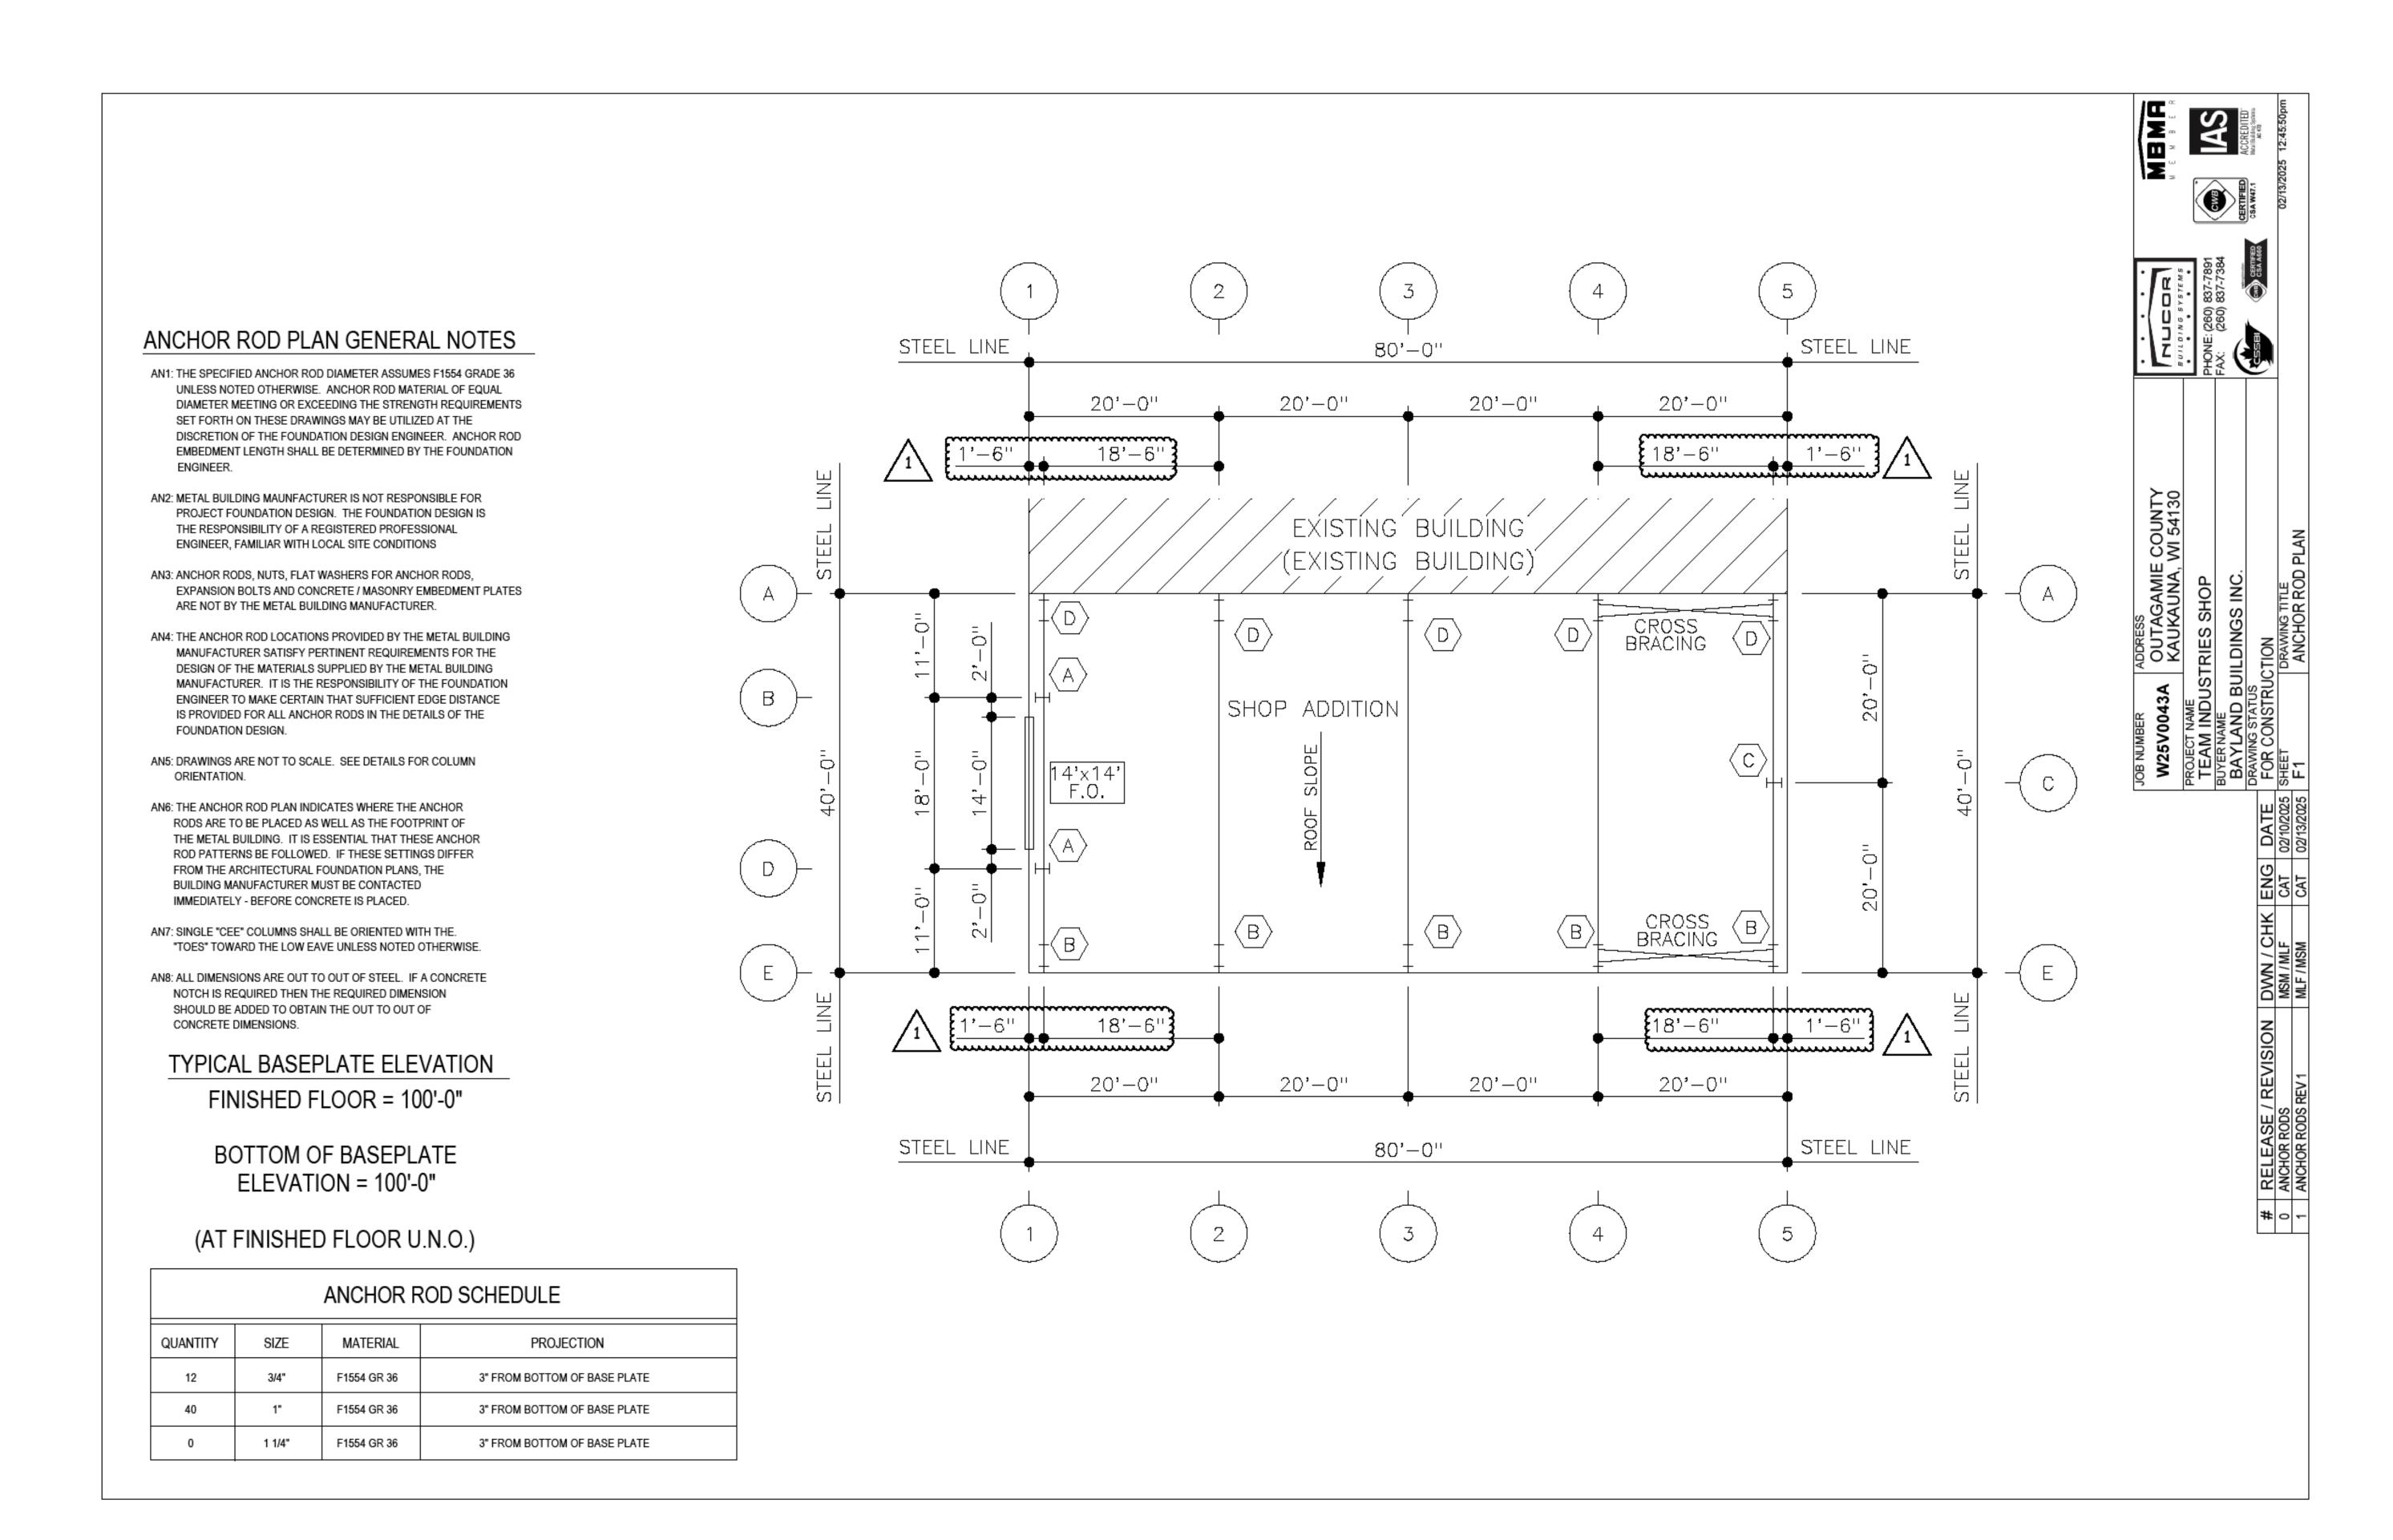
DESIGN & BUILD GENERAL CONTRACTOR

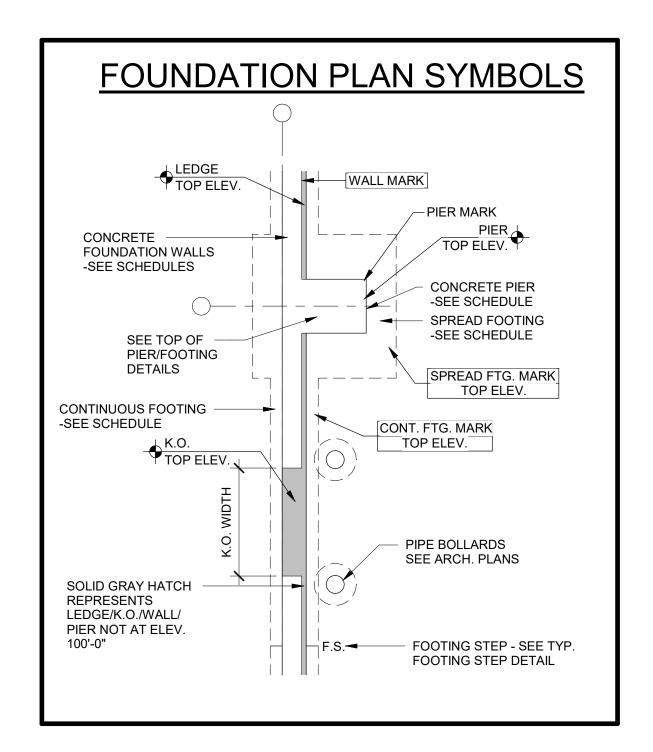

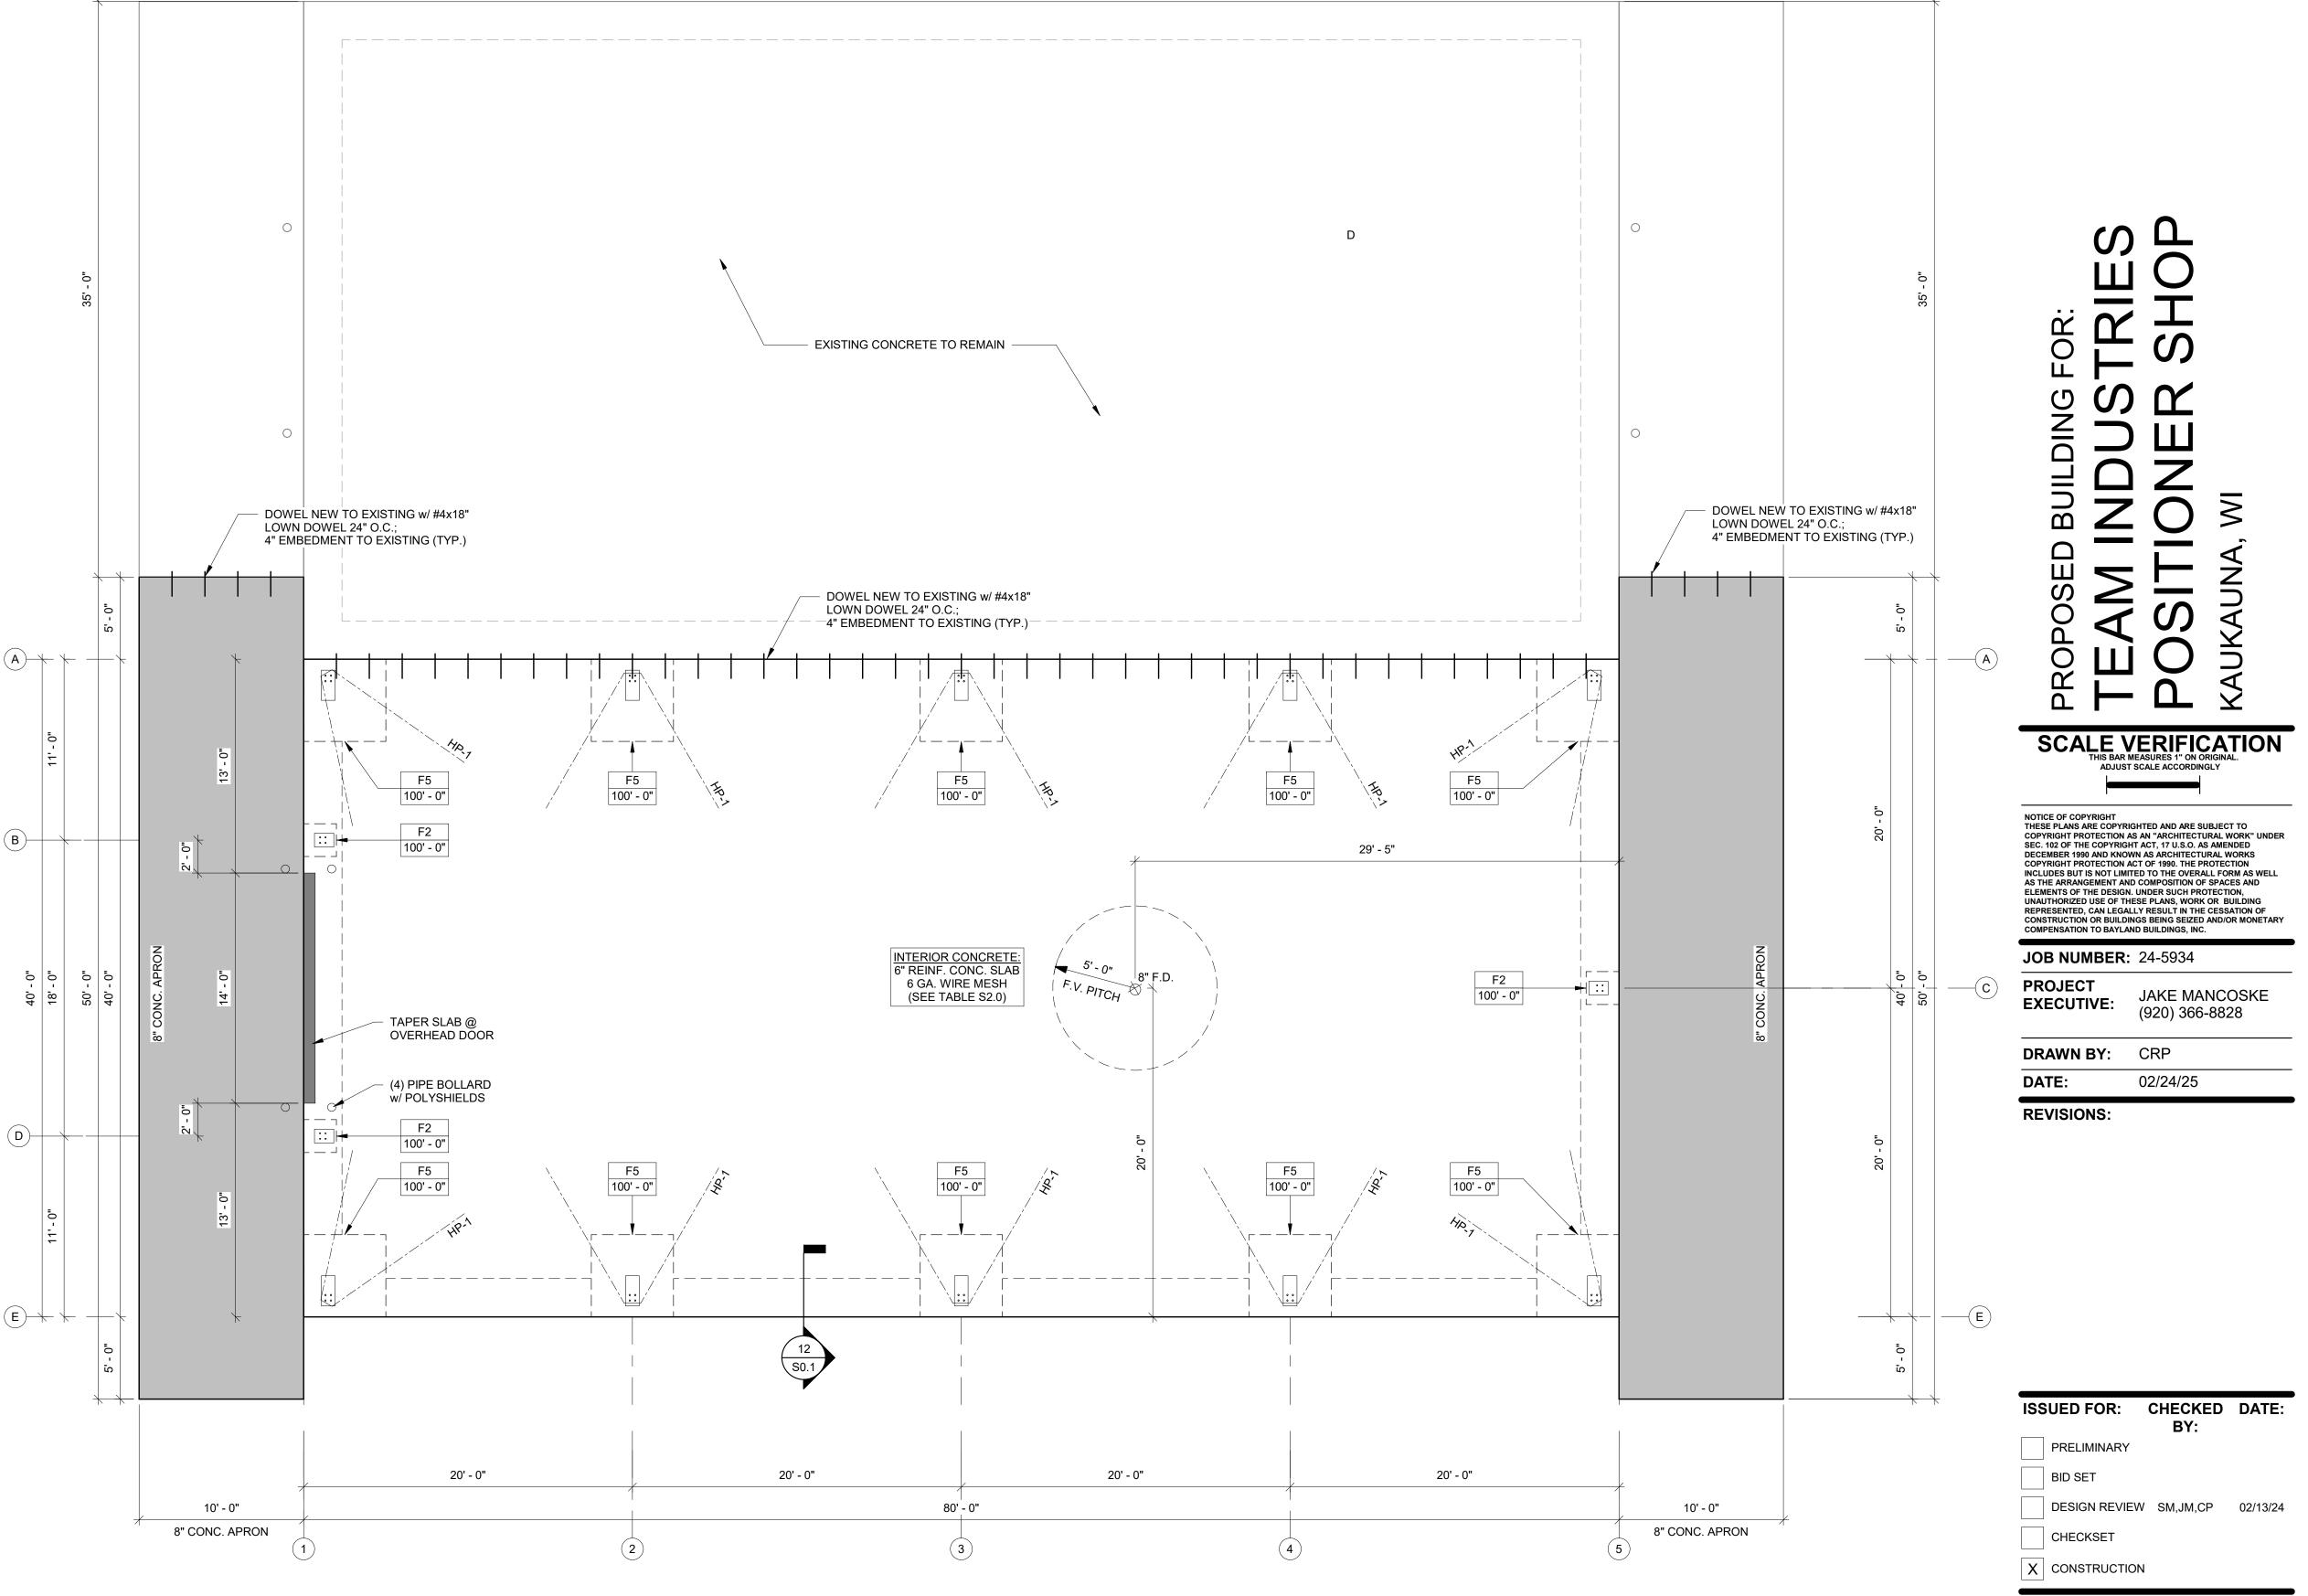

FOUNDATION PLAN - PROPOSED

S1.1



BUILDING REFERENCE LINES

NOTE: ANCHOR BOLT DIMENSIONS PROVIDED BY THE METAL BUILDING MANUFACTURER ARE WITH RESPECT TO THE METAL BUILDING MANUFACTURER'S DEFINITION OF BUILDING LINE. BUILDING LINE CAN DIFFER FROM FOUNDATION LINE. REFERENCE ALL BUILDING PLAN SHEETS WHEN SETTING ANCHOR BOLTS OFF OF REFERENCE LINES

BAYLAND

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02/24/25

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BY:
PRELIMINARY

BID SET


DESIGN REVIEW SM,JM,CP 02/13/24


CHECKSET

X CONSTRUCTION

ANCHOR BOLT PLAN

S_{1.2}

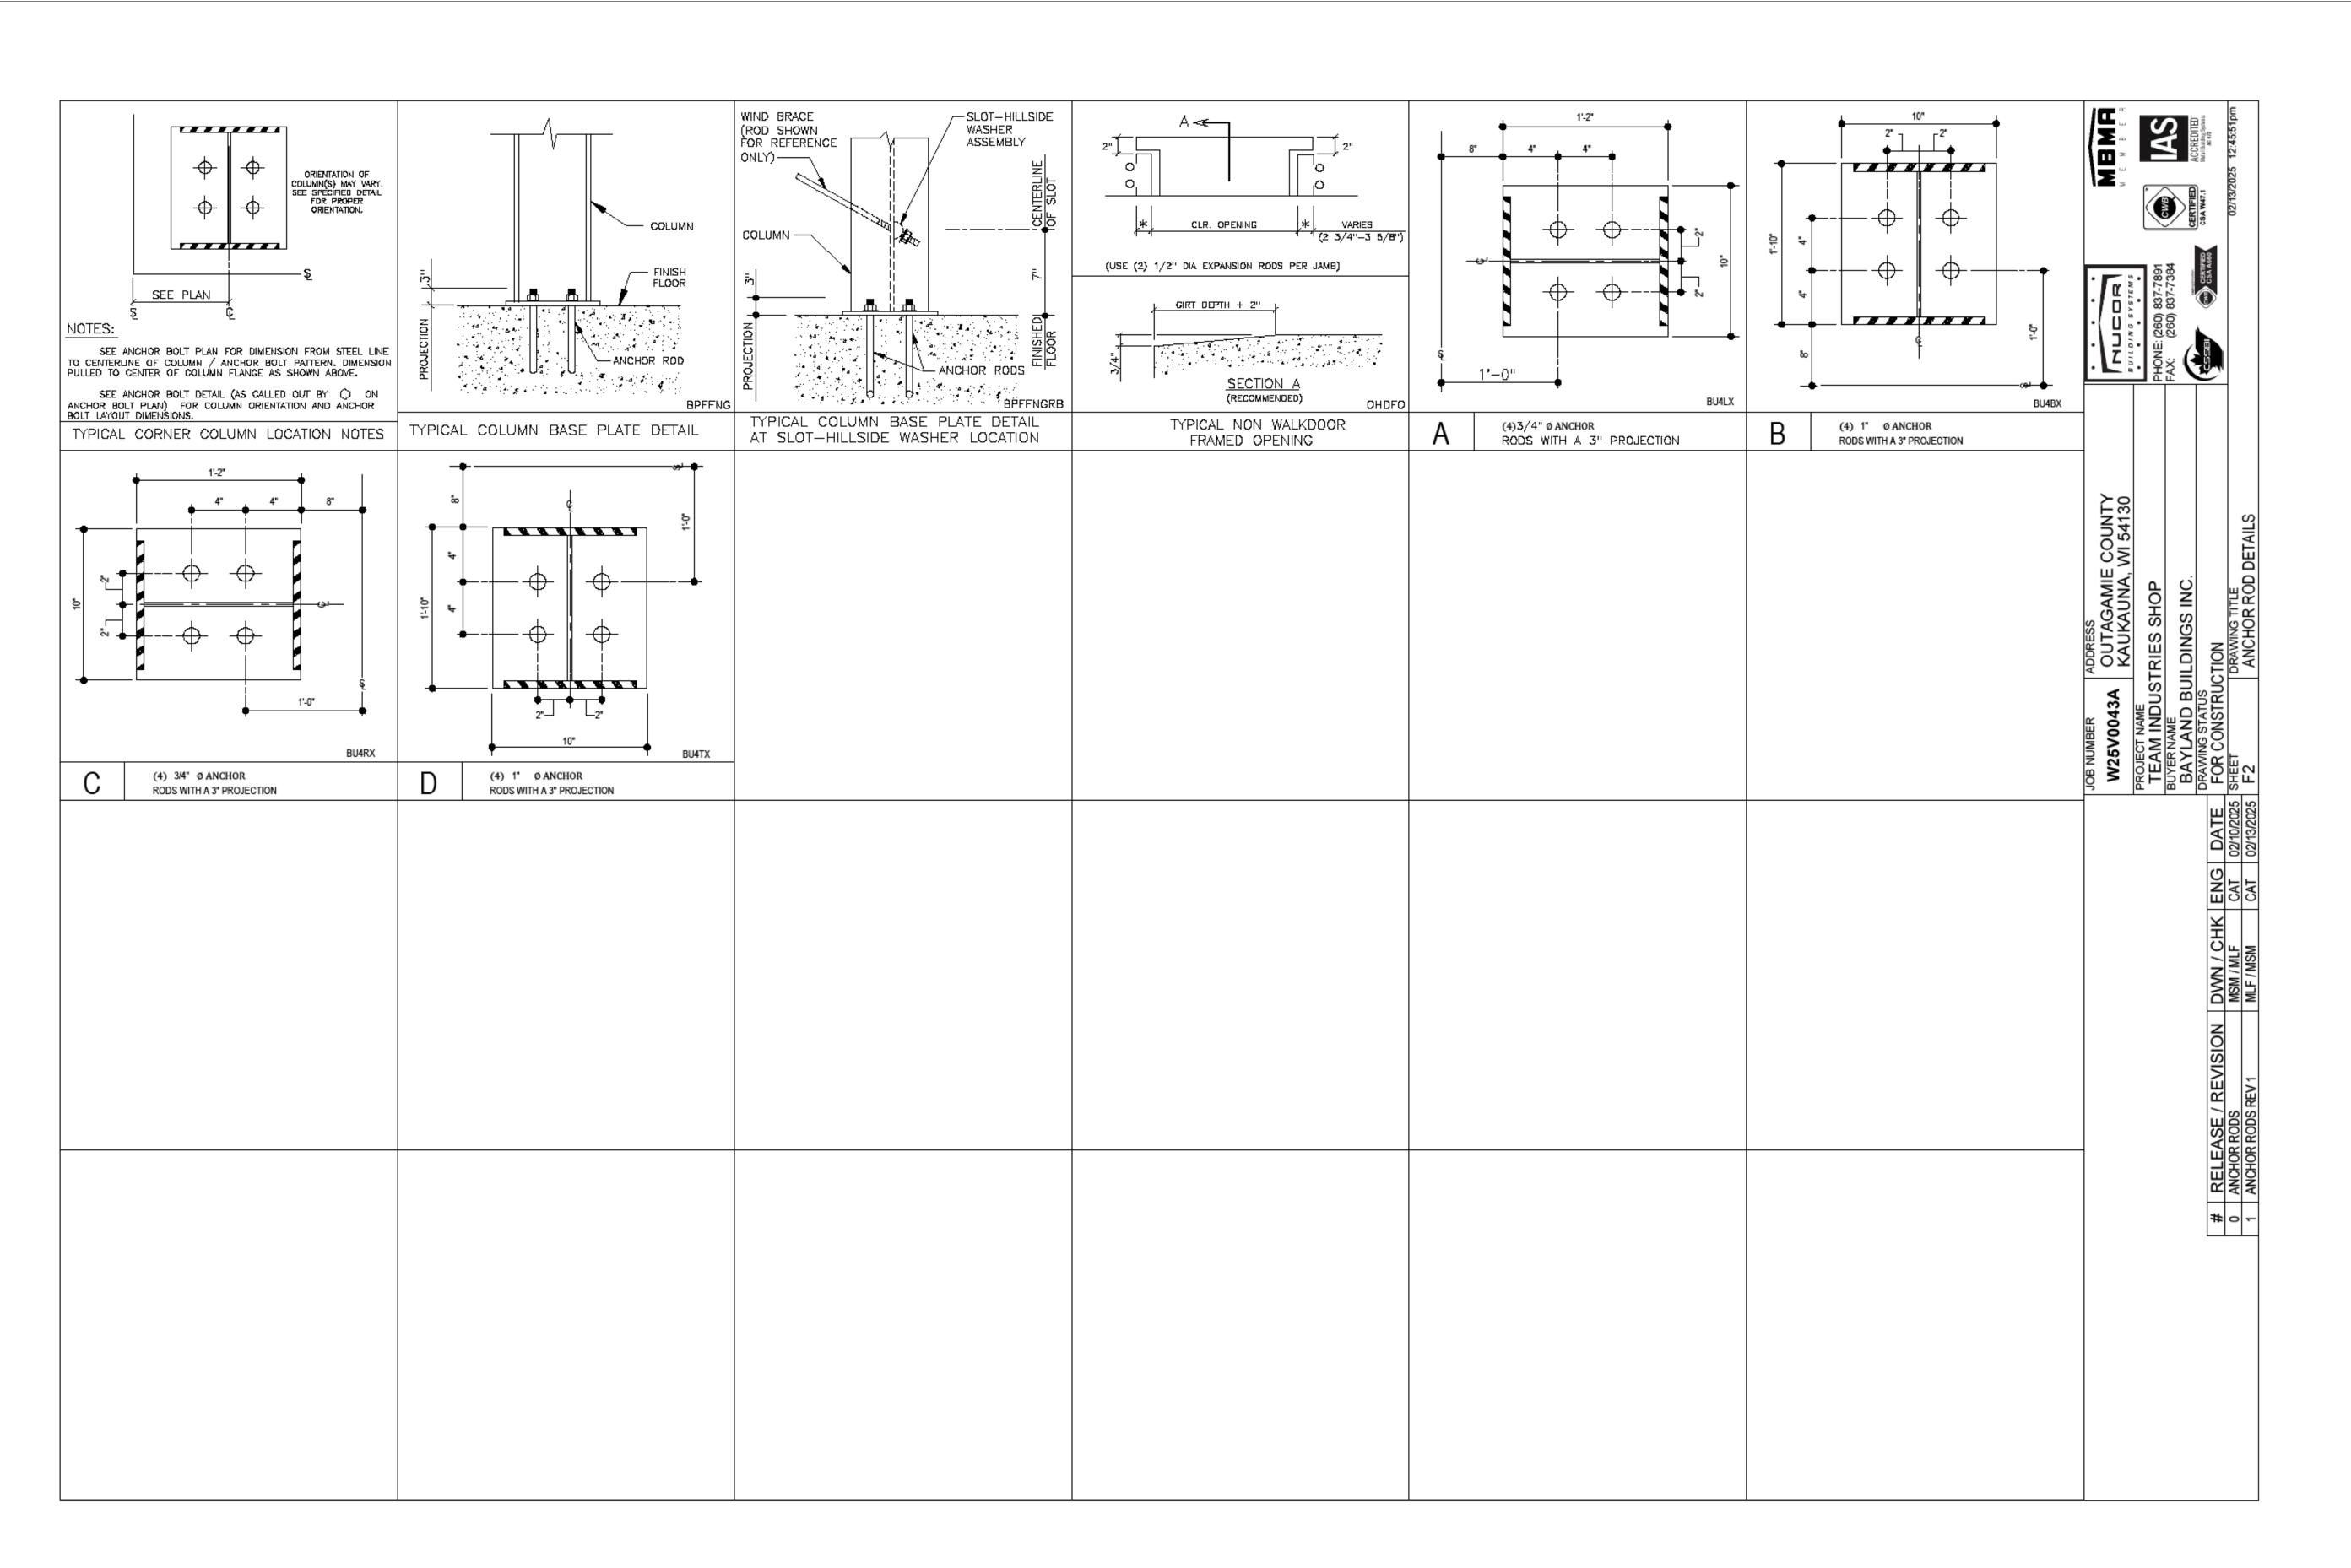

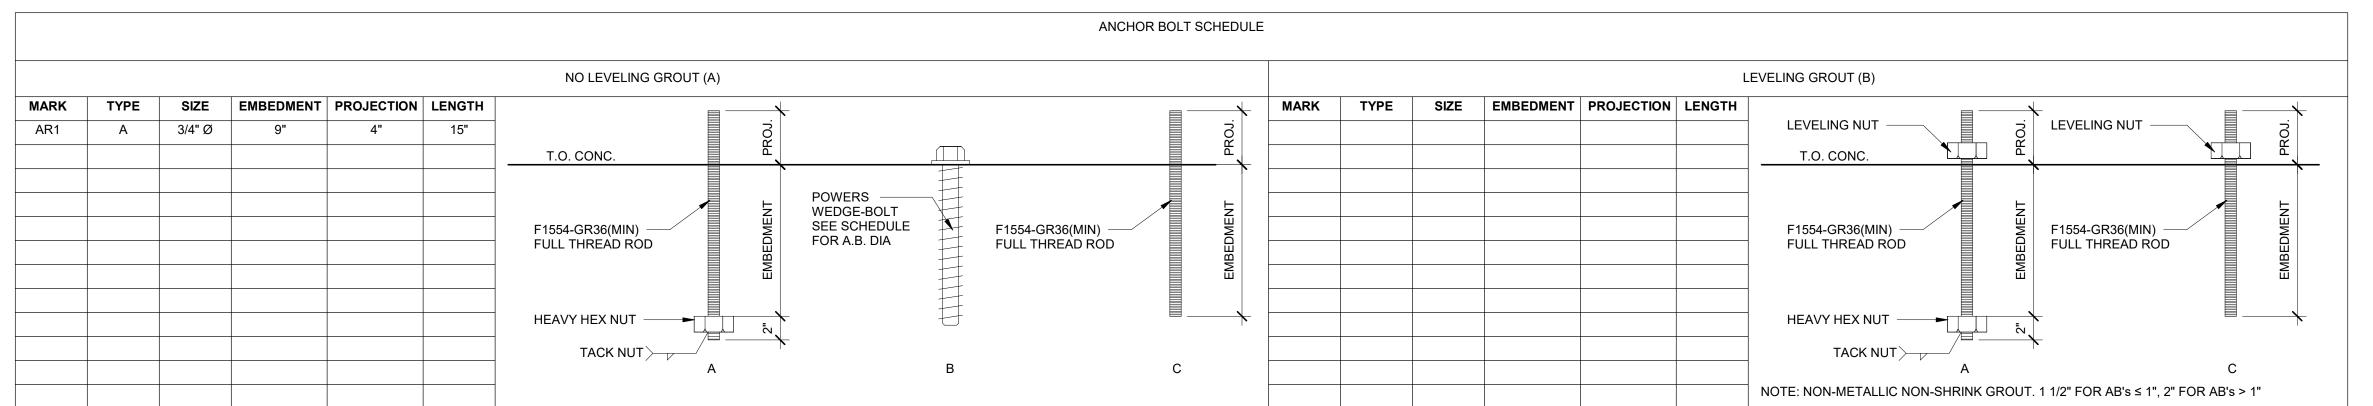



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JOB NUMBER: 24-5934

DRAWN BY: CRP

(920) 366-8828

02/24/25


EXECUTIVE:

DATE:


REVISIONS:

ISSUED FOR:	CHECKED BY:	DATE:				
PRELIMINARY						
BID SET						
DESIGN REVIEW	V SM,JM,CP	02/13/24				
CHECKSET						
X CONSTRUCTIO	N					
ANCHOR BOLT DETAILS						

S1.3

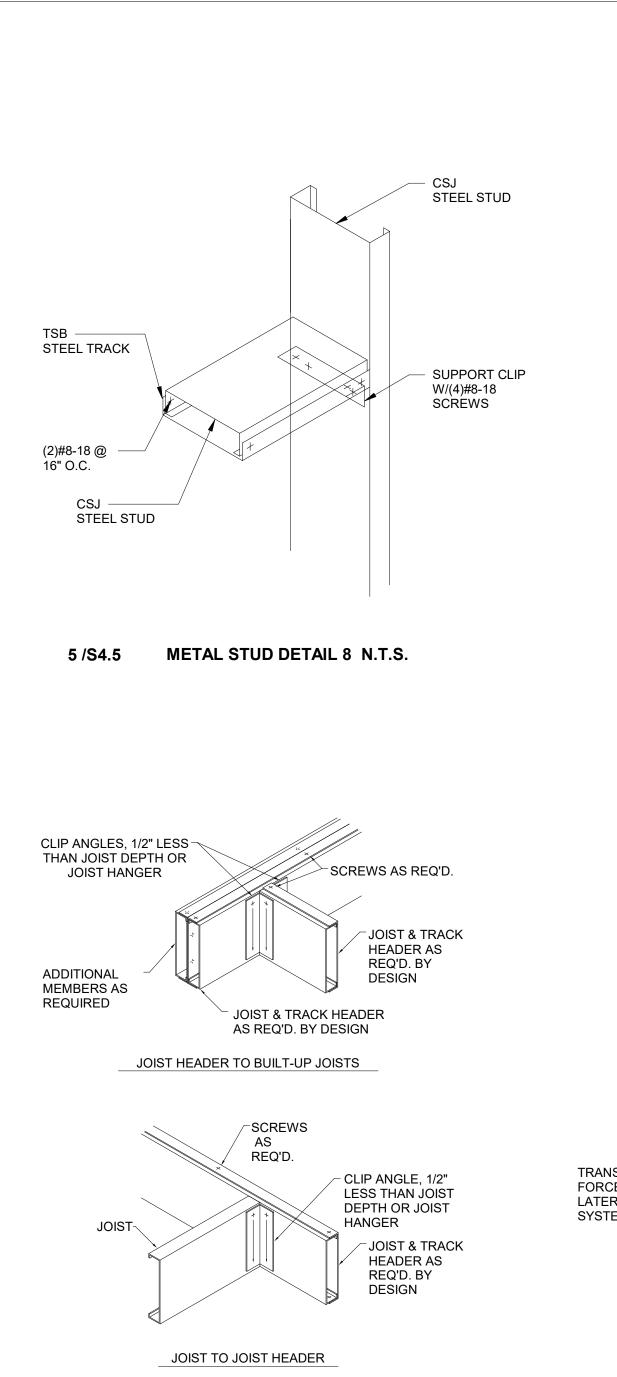

METAL JOIST HEADER DETAIL N.T.S.

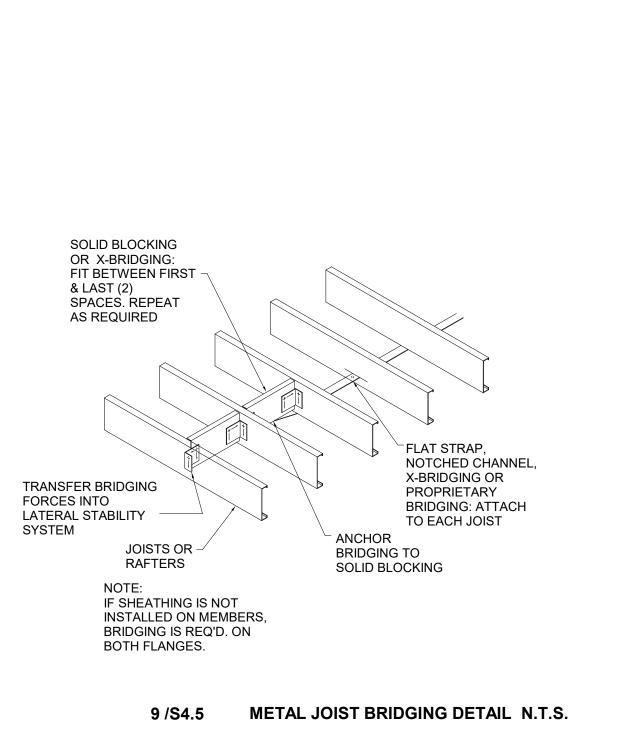

METAL STUD DETAIL 2 N.T.S.

SUPPORT CLIP

W/(2)#8-18 PER


(2)#8-18 HILTI KWIK PRO SÉLF DRILLING SCREWS

6" TSB 16 GA SILL

CRIPPLE STUDS

(1)PER FLANGE

LEG OF CLIP ANGLE

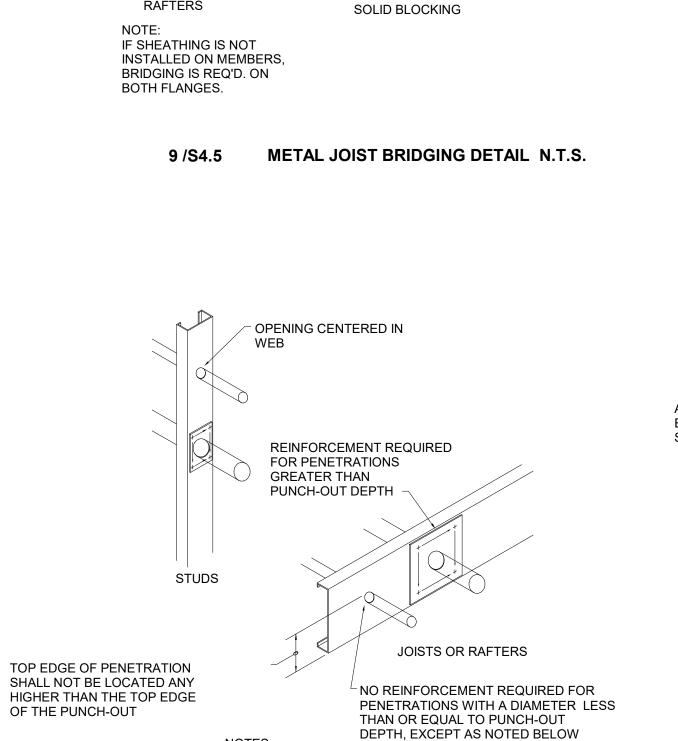


1. FLANGES SHALL NOT BE NOTCHED OR CUT.

3. FOR UNPUNCHED MEMBERS CONSULT THE MANUFACTURER.

METAL STUD PENETRATIONS DETAIL N.T.S.

2. CAPACITY VERIFICATION BY DESIGN IS REQ'D. FOR ANY OPENINGS LOCATED AT CONCENTRATED LOADS AND BEARING ENDS.

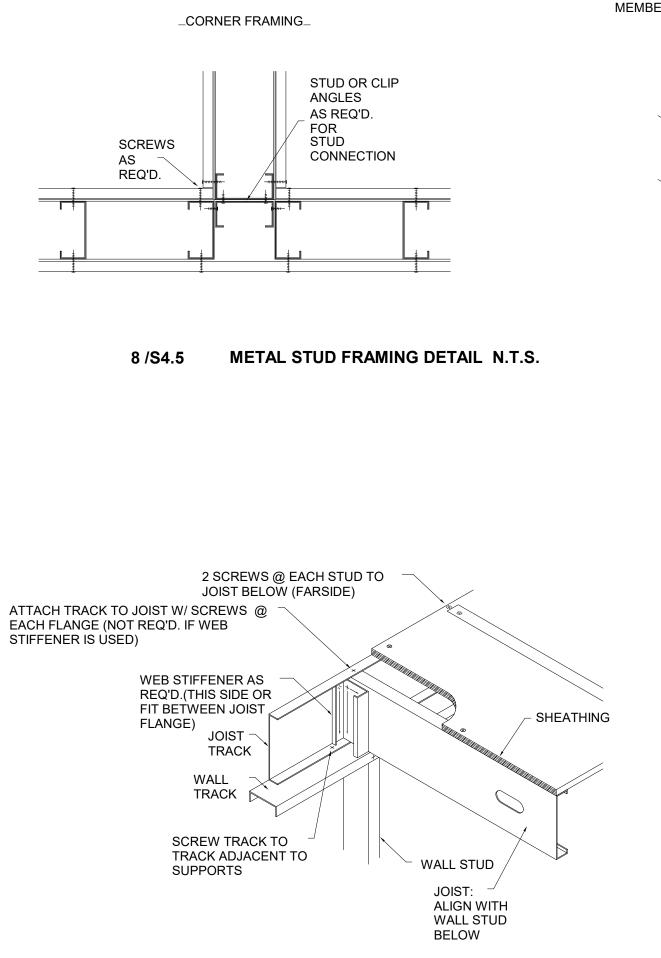

METAL STUD BEARING DETAIL N.T.S.

METAL STUD DETAIL 1 N.T.S.

SCREWS

REQ'D.

SPAZER BRACING -


@ 4'-0" MAX

TYPICAL STUD,

6" CSJ @ 16" O.C.

KING STUD- SEE

HEADER SCHED.

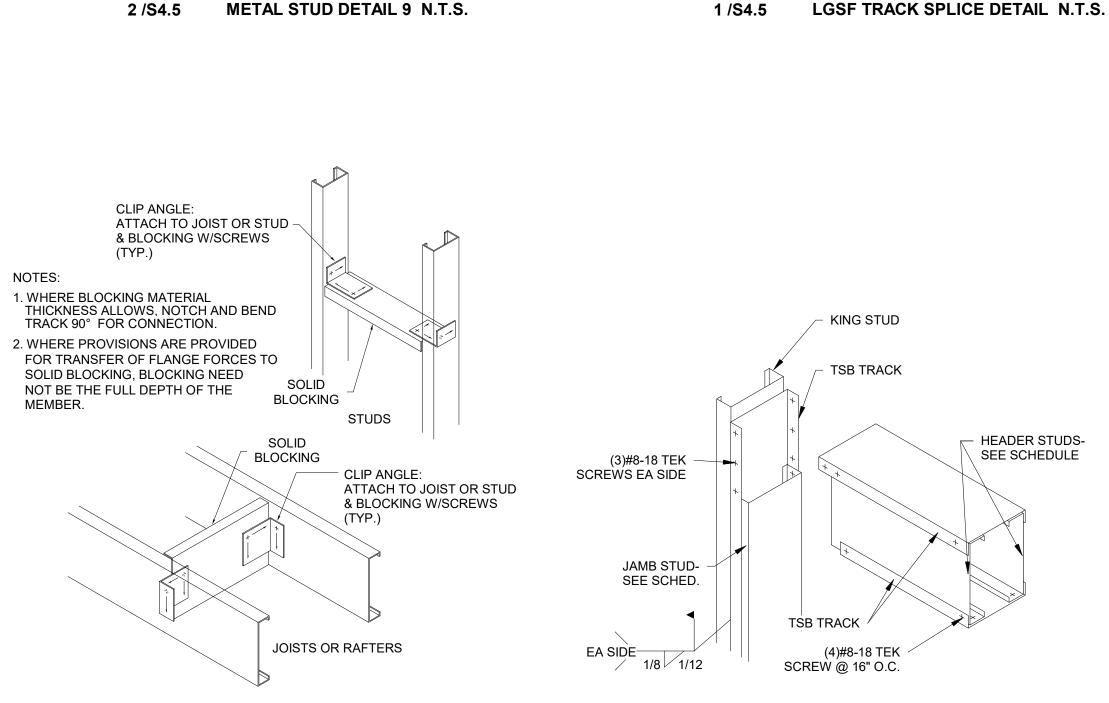

METAL STUD BLOCKING DETAIL N.T.S.

CSJ STEEL STUD

CSJ STEEL

STIFFNER

WEDGE BOLT 3 1/2" EMBED- SEE SHEARWALL SCHED.


FOR SPACING


STUD SECTION FOR

CONC. COMP. FLOOR DECK, SLAB ON GRADE,

OR FOUNDATION WALL

STEEL TRACK

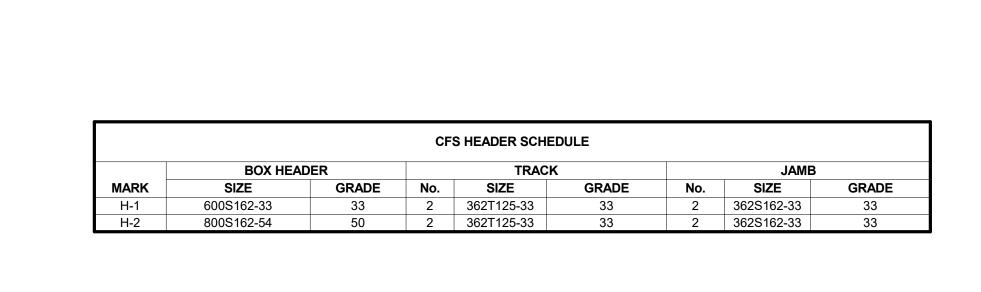

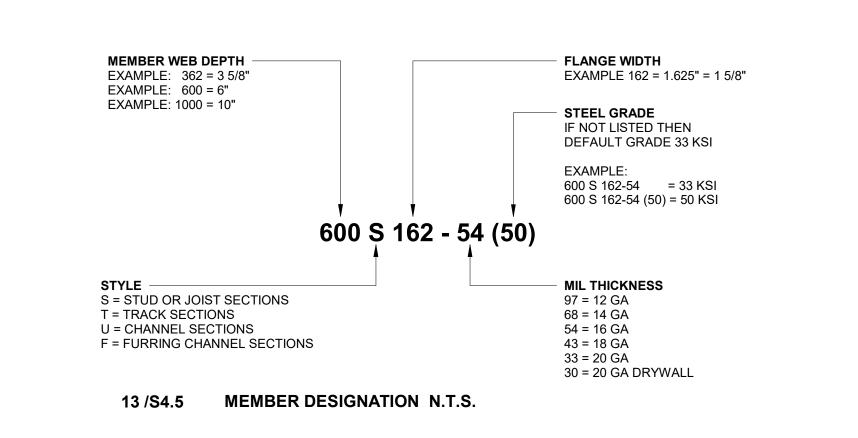



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SCREWS AS REQ'D. (EACH SIDE)

HEADER STUDS-

SEE SCHEDULE

METAL STUD DETAIL 6 N.T.S.

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JAKE MANCOSKE **EXECUTIVE:** (920) 366-8828

DRAWN BY: CRP

02/24/25 DATE:

REVISIONS:

ISSUED FOR: CHECKED DATE: PRELIMINARY

BID SET

DESIGN REVIEW SM,JM,CP 02/13/24 CHECKSET

X CONSTRUCTION

STRUCTURAL METAL STUD DETAILS