PLAN COMMISSION

City of Kaukauna **Council Chambers** Municipal Services Building 144 W. Second Street, Kaukauna




Thursday, March 23, 2023 at 4:00 PM

AGENDA

- 1. Roll Call.
- 2. Approval of Minutes.
 - a. Approve Minutes from February 23, 2023 Meeting
- 3. Public Hearing.
 - a. Special Exception Request Legacy Creekside Apartments; Parcel 322095500
- 4. New Business.
 - a. Special Exception Request Legacy Creekside Apartments; Parcel 322095500
 - b. Site Plan Review Municipal Pool
 - c. Preliminary Plat Review Hurkman Heights 4
 - d. Outdoor Alcoholic Beverage Area Permit Review Alternative Entrance; 313 Dodge
- Other Business.
- 6. Adjourn.

NOTICES

IF REQUESTED THREE (3) DAYS PRIOR TO THE MEETING, A SIGN LANGUAGE INTERPRETER WILL BE MADE AVAILABLE AT NO CHARGE.

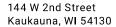



* AMENDED PLAN COMMISSION

City of Kaukauna **Council Chambers** Municipal Services Building 144 W. Second Street, Kaukauna

Thursday, February 23, 2023 at 4:00 PM

MINUTES

In-Person and remote teleconference via ZOOM

1 Roll Call.

> Members present: Michael Avanzi, DPW John Neumeier, Mayor Tony Penterman, Ken Schoenike. Pennie Thiele

Member(s) absent: Giovana Feller, John Moore

Other(s) present: Brian Roebke, Times Villager; David Evers, owner of parcel 030067904; PCDD Joe Stephenson, Associate Planner Lily Paul

Schoenike made a motion to excuse the absent members. Avanzi seconded the motion. The motion passed unanimously.

- 2. Approval of Minutes.
- Approve Minutes from February 9, 2023 Meeting

Neumeier made a motion to rescind his motion on item 3 c of the February 9, 2023 Meeting Minutes. Thiele seconded the motion. All voted ave, 5-0 vote.

Thiele made a motion to approve the minutes as amended, Neumeier seconded the motion. Motion passed unanimously.

- New Business.
- Public Hearing Special Exception Request; Legacy Creekside Apartments

Due to weather conditions, the public hearing was not acted upon.

CSM Review - Commerce Crossing, Evergreen Drive

Associate Planner, Lily Paul presented a certified survey map for the City of Kaukauna that will split parcel 322095700. This CSM is intended to split the large ~15 acre parcel into 3 smaller parcels. These parcels will accommodate the Reserve Development (Lot 1, ~11 acres) and Grand Stay Hotel Development (Lot 3, ~2 acres), leaving one parcel (Lot 2, ~1.9 acres) for future development. DPW Neumeier questioned if Lot 2 was needed for the Reserve Development. PCDD Stephenson said no, and that parcel is large enough for another development.



Neumeier made a motion to approve the CSM and recommend the same to Council. Schoenike seconded the motion. Motion passed unanimously.

c. Discussion - Best use for Parcel 030067904; Corner of CTH CE & HH

AP Paul started the discussion by mentioning that Parcel 030067904, which is located on the North East corner of intersection CTH CE and CTH HH, has been presented to plan commission to possibly be annexed into the City of Kaukauna. Unfortunately, the proposed use, a duplex, is not a great fit for the location due to extensive work to bring water and sewer to the area, and highway setbacks. To avoid bringing utilities to the parcel, it would be wise to find an alternative use for this property. Would public use, like a park and beautification be the best for the area? It has great access off of the CE Trail, and is right on the border of the city limits. There was discussion about cost, and the main users of this area. The owner of the property thinks letting go of the property would benefit both parties. Overall, instead of a vacant parcel or dangerous location for a duplex, creating a beautiful feature as a way to welcome visitor to the city should be explored.

A motion was made by Schoenike to direct staff to put together a concept of a park on the parcel. Neumeier seconded the motion. Motion passed unanimously.

4. Other Business.

Kaukauna will continue to encourage EV Charging locations.

5. Adjourn.

Thiele made a motion to adjourn the meeting. Schoenike seconded the motion. All members present voted aye. Meeting adjourned at 4:27 PM.



MEMO

PLANNING & COMMUNITY DEVELOPMENT

To: Plan Commission

From: Associate Planner Lily Paul

Date: February 6, 2023

Re: Special Exception Request – Legacy Creekside Apartments

Keith Duquaine has submitted an application for a Special Exception Permit for parcel 322095500, located at 950 E Evergreen Drive in Commerce Crossing. The parcel is zoned Commercial Highway District (CHD). The parcel is owned by Duquaine Development.

The applicant is proposing to construct a multi-family complex on the vacant lot. The new development will include 175 living units and over 368 combined indoor and outdoor parking. There will be five buildings, for a proposed total of 2.17 acres of roof area, which is about 18.47% of the lot area. The buildings will be 41 feet 2 1/8 inches tall.

The City of Kaukauna Code of Ordinances, Section 17.22 (4)(e) allows multi-family within the CHD:

17.22 CHD Commercial Highway District

4. Special exception uses and structures.

e. Uses permitted in Residential Multifamily Zoning (RMF). If RMF is the primary use of the site, all applicable standards and requirements from section 17.19 shall apply.

Recommendation:

Finding the special exception to meet all the criteria set forth in Section 17.47 (4) of the City Municipal Code, staff recommends the approval of the special exception to the Plan Commission and same to the Common Council.

UPDATED 3.21.2022



CITY OF KAUKAUNA PLAN COMMISSION

APPLICATION FOR REVIEW

I am requesting a:

Zoning Change

Special Exception Permit

Certified Survey Map Review

Subdivision Plat Review

Petitioner Information:

Name:

Duqueine Development

Address:

4329 Nicolet Prive Green Bay, WI. 54311

Phone Number:

262-302-1675

Owner's Name (if not the petitioner):

Owner's Address:

Address of Parcel in Question: 950 East Evergreen Prive Kaukauna

Property Dimensions (in either SF or Acres):

11.75 gcres t/-

Explain your proposed plans and what you are requesting the Plan Commission approve.

Please also note if there are existing structures on this property:

Multifomily Development

Additional Requirements: For Certified Survey Map and Subdivision Plat Review, professionally drawn maps are required to be submitted. These maps must include all structures. lot lines and streets with distances to each. For Subdivision Plat Review, the proposed street system must be indicated on the face of the preliminary plat to indicate, within a 2,000 foot radius from the exterior border of the plat, how the proposed streets will tie into the existing street system. Maps should be drawn to a scale of not less than 1":1,000'. For Zoning Change requests that would result in split zoning (or two zoning classifications on one parcel), a professionally drawn map meeting the standards above is also required. Additional information may also be requested as may be appropriate per the proposal being made.

Plan Commission Review Fee Schedule:

Lot Division by Certified Survey Map (1-4 lots)	\$10/lot based on total lots
Subdivision Review (5+lots)	\$200
Special Exception Permit	\$100
Rezoning/Zoning Change	\$100
Variance to Subdivision Ordinance	\$50
Planned Unit Subdivision Ordinance	\$200

Please Note: Changes to zoning ordinances, special exception permits and map/plat reviews often require action by multiple governmental bodies. Between multiple meetings and statutory requirements for public hearings and noticing of meetings, sometimes reviews and authorizations can take more than 30 days. Please let staff know of your request as early as possible if you have a specific deadline that you need Plan Commission authorization by.

Signature of Petitioner:

Keith Duquoine

Signature of Owner (if not Petitioner):


DateSubmittedtoCityofKaukauna:

11/26/2023

Please submit by email to lpaul@kaukauna-wi.org or by mail to City of Kaukauna, Attn: Plan Commission, P.O. Box 890, Kaukauna, WI 54130

DUQUAINE DEVELOPMENT

THE LEGACY CREEKSIDE APARTMENTS, LLC CITY OF KAUKAUNA

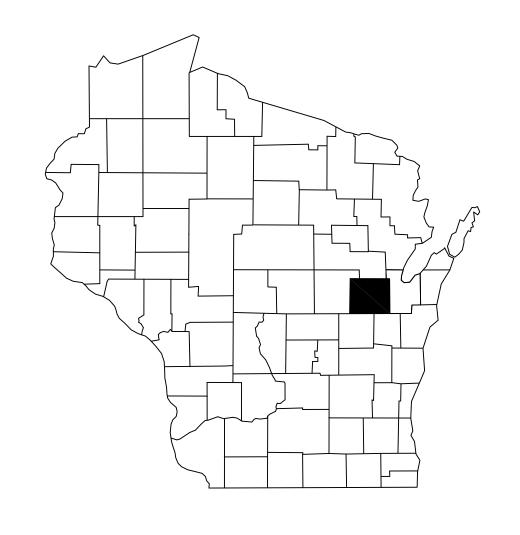

SITE STATISTICS:

	EXISTING SITE (ACRE)	PROPOSED (AC
SITE		
ROOF AREA:	0	2.17 (18.47%
PAVED AREA:	0	2.62 (22.30%
GREEN AREAS:	9.99 (85.02%)	5.20 (44.25%
WATER BODY:	1.76 (14.98%)	1.76 (14.98%
IMPERVIOUS AREA:	0	4.79 (40.77%



Mau & Associates

LAND SURVEYING & PLANNING CIVIL & WATER RESOURCE ENGINEERING

Phone: 920-434-9670 Fax: 920-434-9672

PROJECT INFORMATION

OWNER(S):

DUQUAINE DEVELOPMENT

PROJECT NAME:

THE LEGACY CREEKSIDE APARTMENTS, LLC

PROJECT DESCRIPTION:

175 UNIT APARTMENT BUILDING SITE WITH ATTACHED GARAGES AND EXTERIOR PARKING.

PROJECT LOCATION:

EVERGREEN DRIVE, WEST OF ARBOR WAY

PARCEL NUMBER(S):

322095500

CONTACT INFORMATION

OWNER(S):

DUQUAINE DEVELOPMENT ATTN.: KEITH DUQUAINE, PH.: 920-371-1973 ATTN.: JAKE HOFMANN, PH.: 920-371-8834 4329 NICOLET DRIVE GREEN BAY, WI 54311

ENGINEER:

MAU & ASSOCIATES, LLP CONTACT: DAVID J. MEISTER, P.E. PH.: 920-434-9670 400 SECURITY BLVD. GREEN BAY, WI 54313

SHEET INDEX:

C1.0 TITLE SHEET

C2.0 SITE LAYOUT PLAN

C3.0 EROSION CONTROL PLAN

C4.0 GRADING PLAN
C5.0 SITE UTILITY PLAN

C6.0 NOTES & DETAILS


C7.0 PLANS FOR DSPS


C8.0 EXISTING WATERSHED

C9.0 PROPOSED WATERSHED


C10.0 LANDSCAPE PLAN


1 of 1 SITE SURVEY

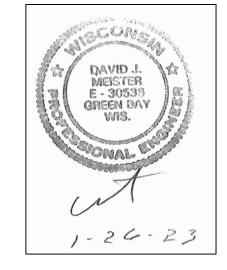

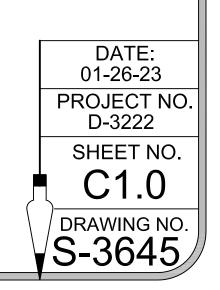



Item 4.a.

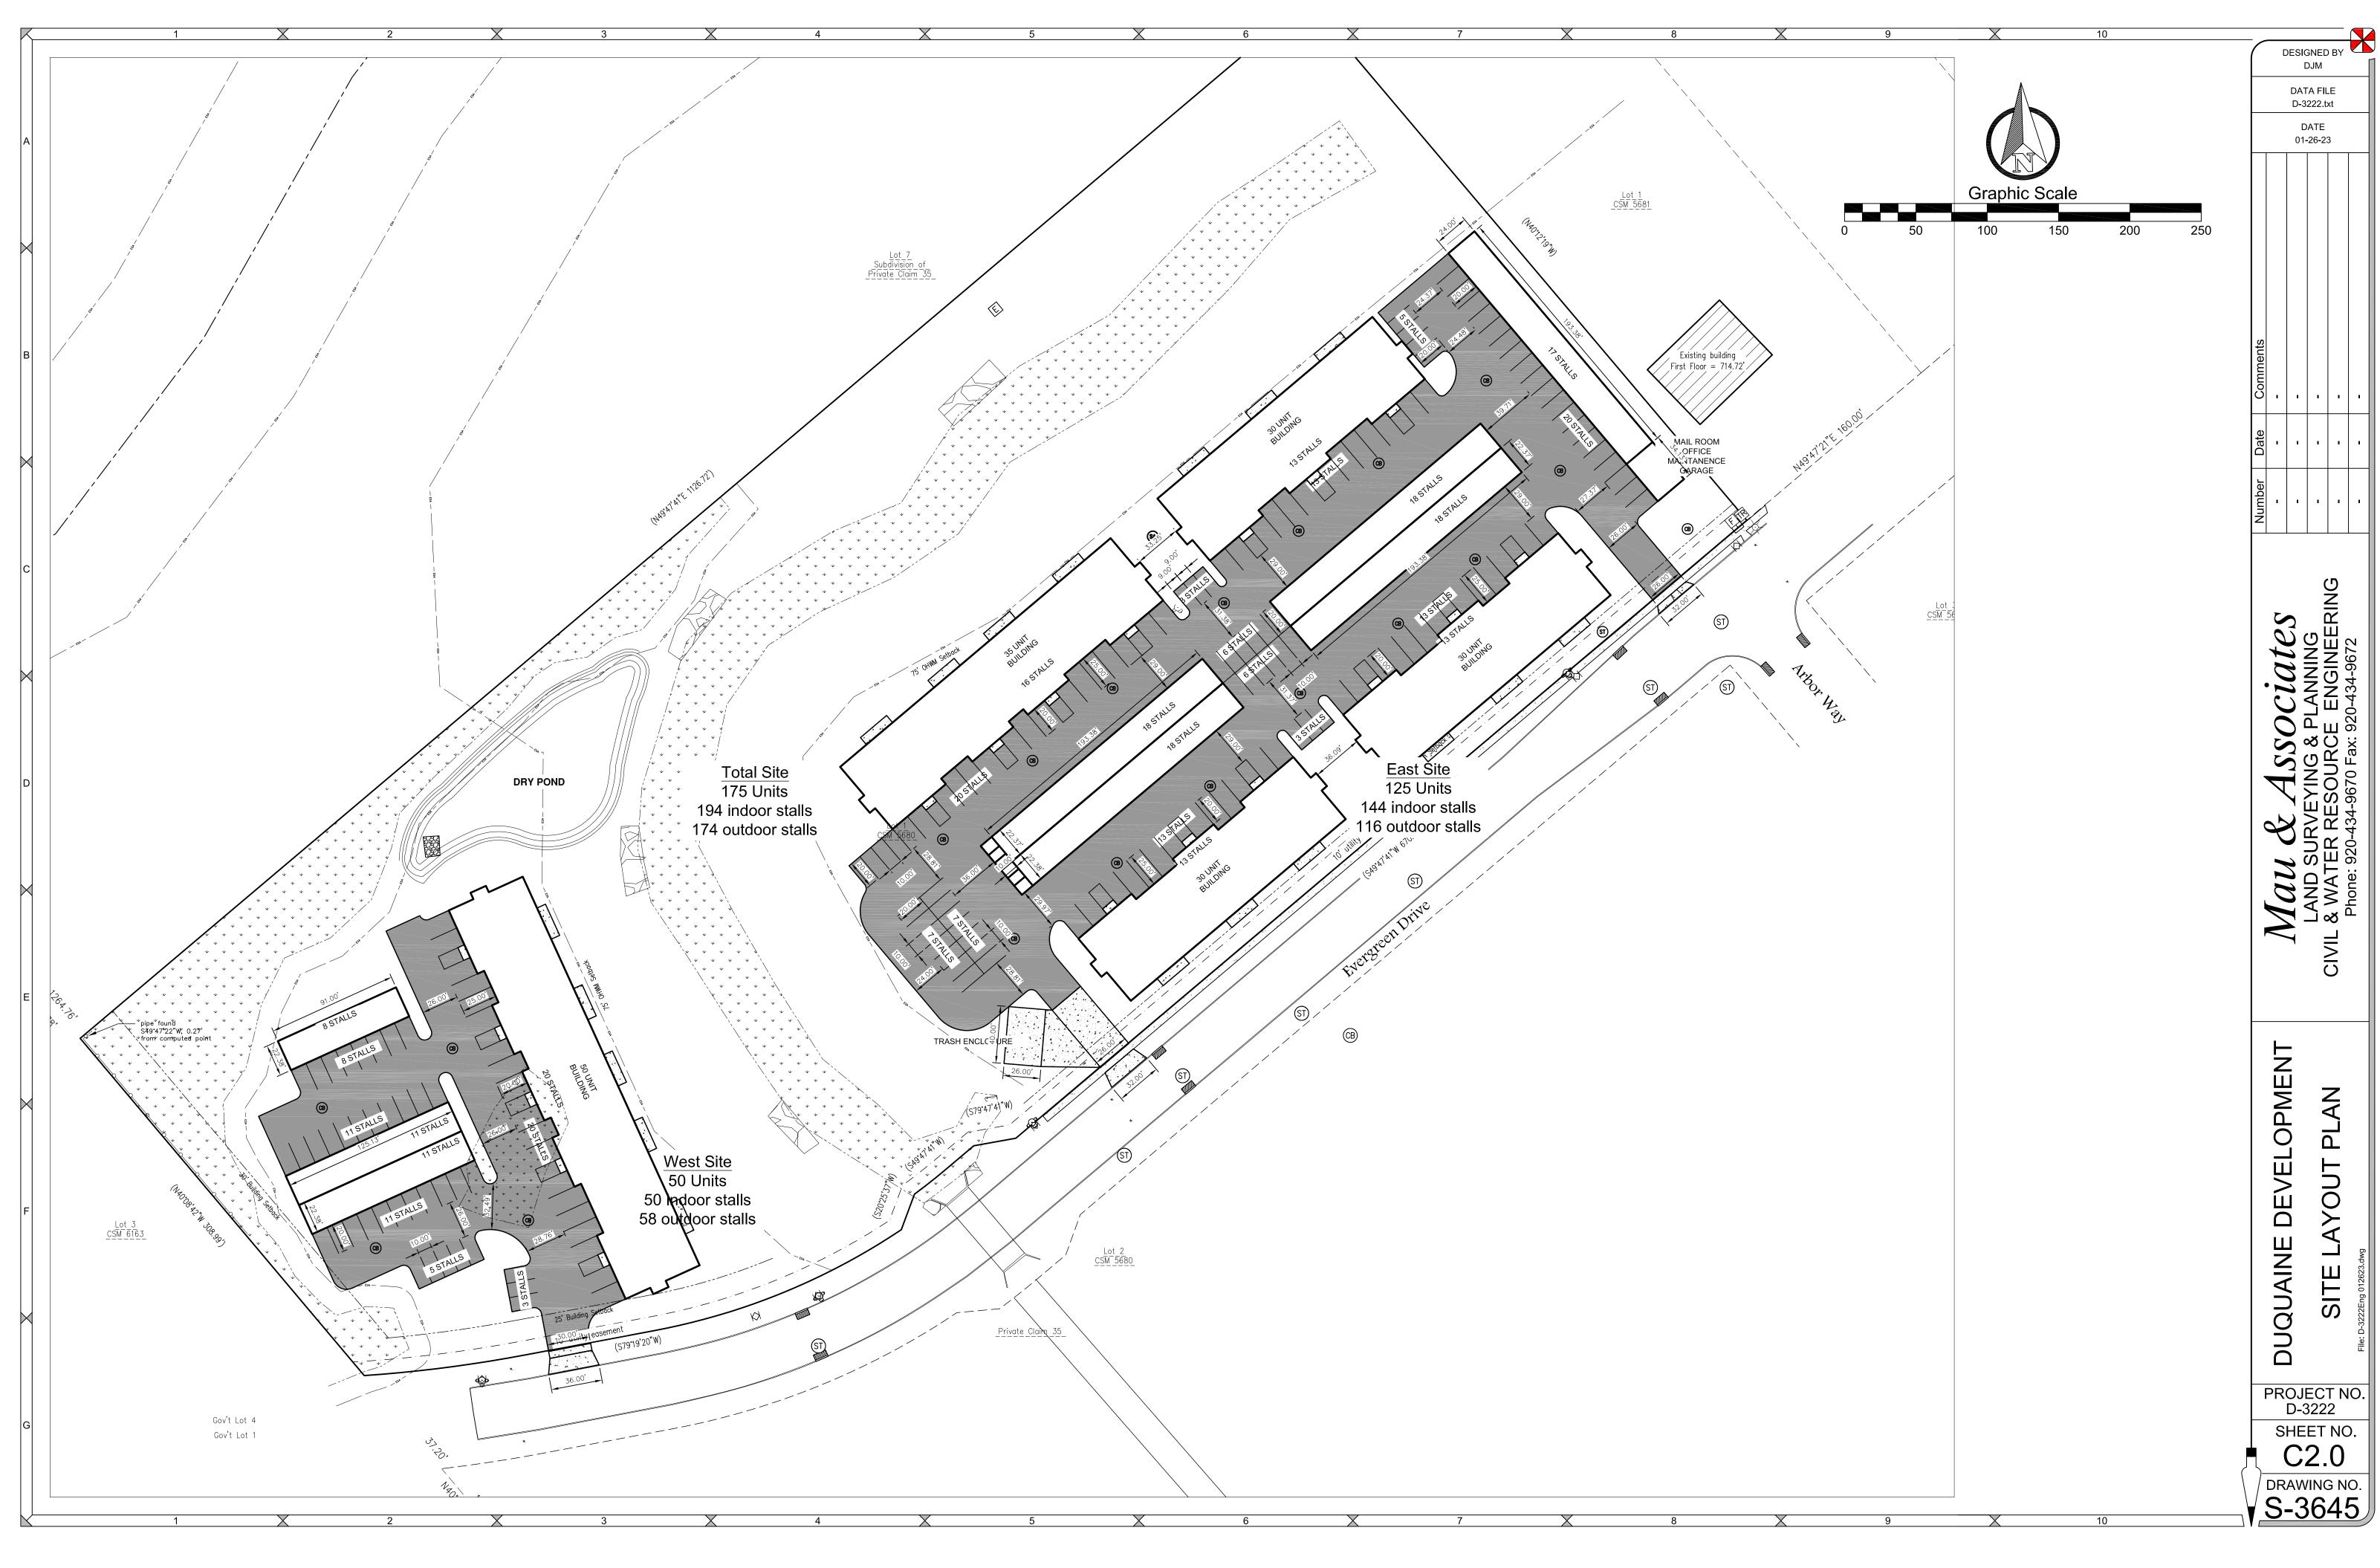

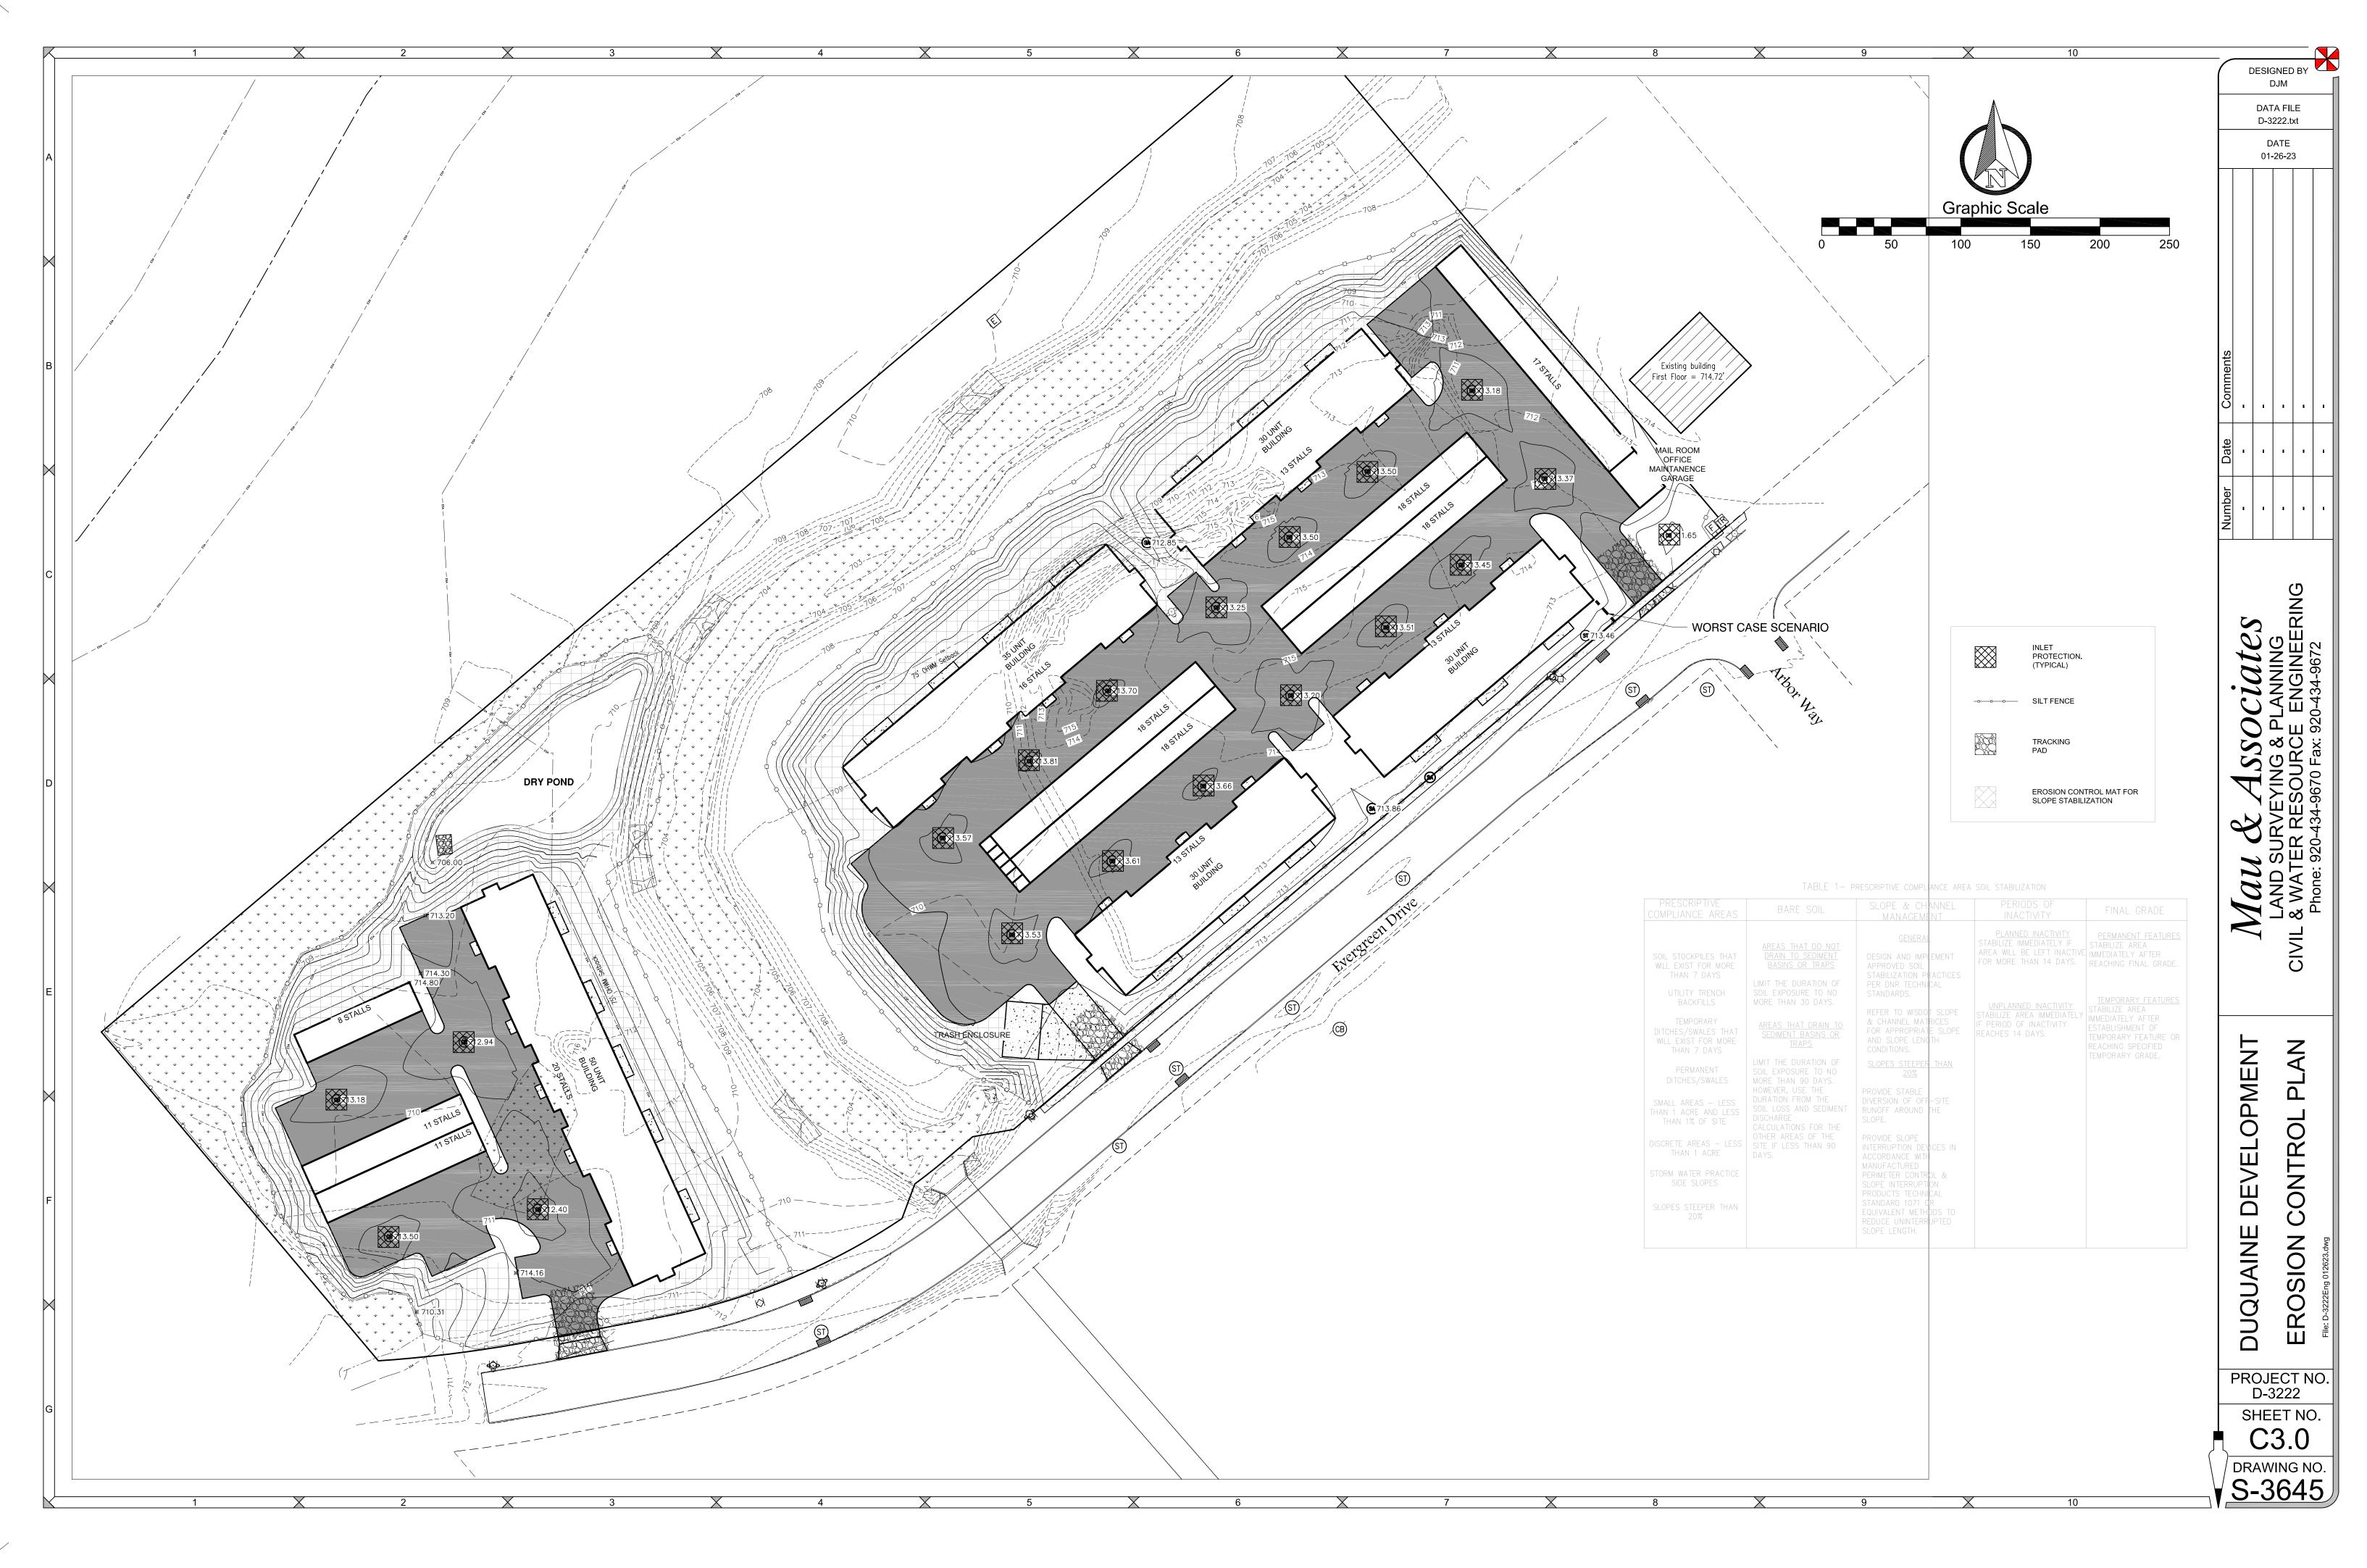

Item 4.a.

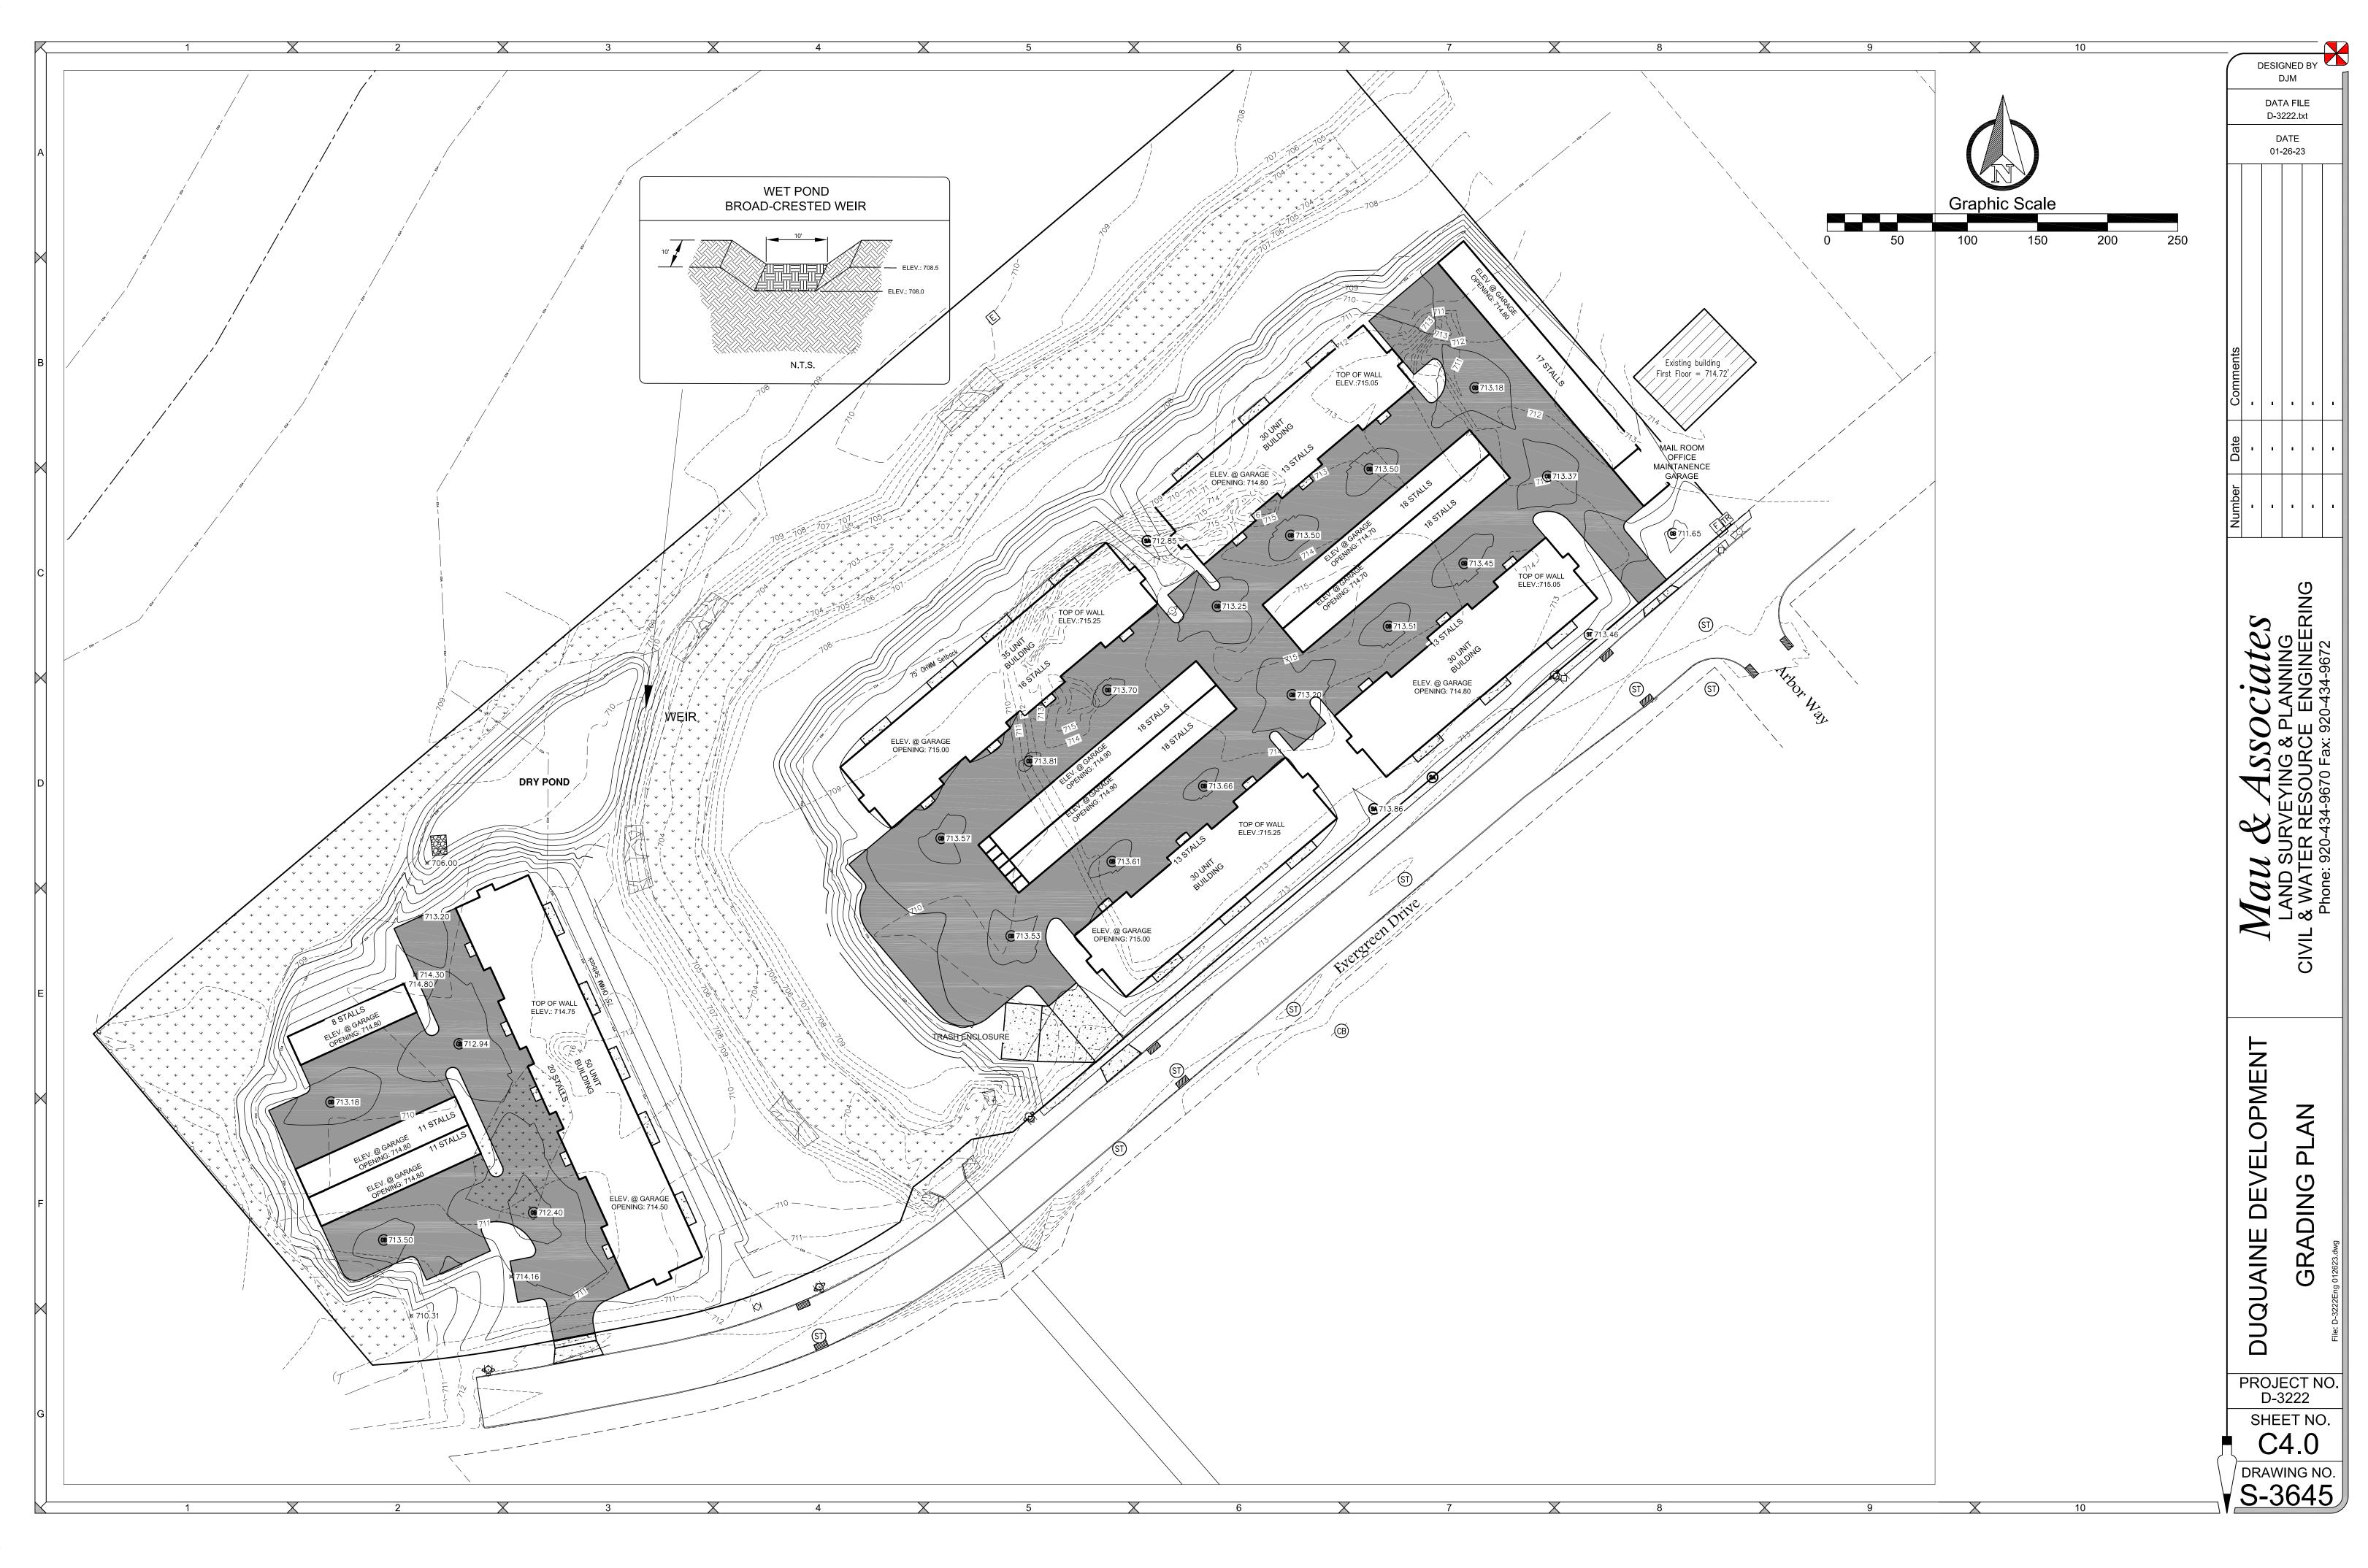

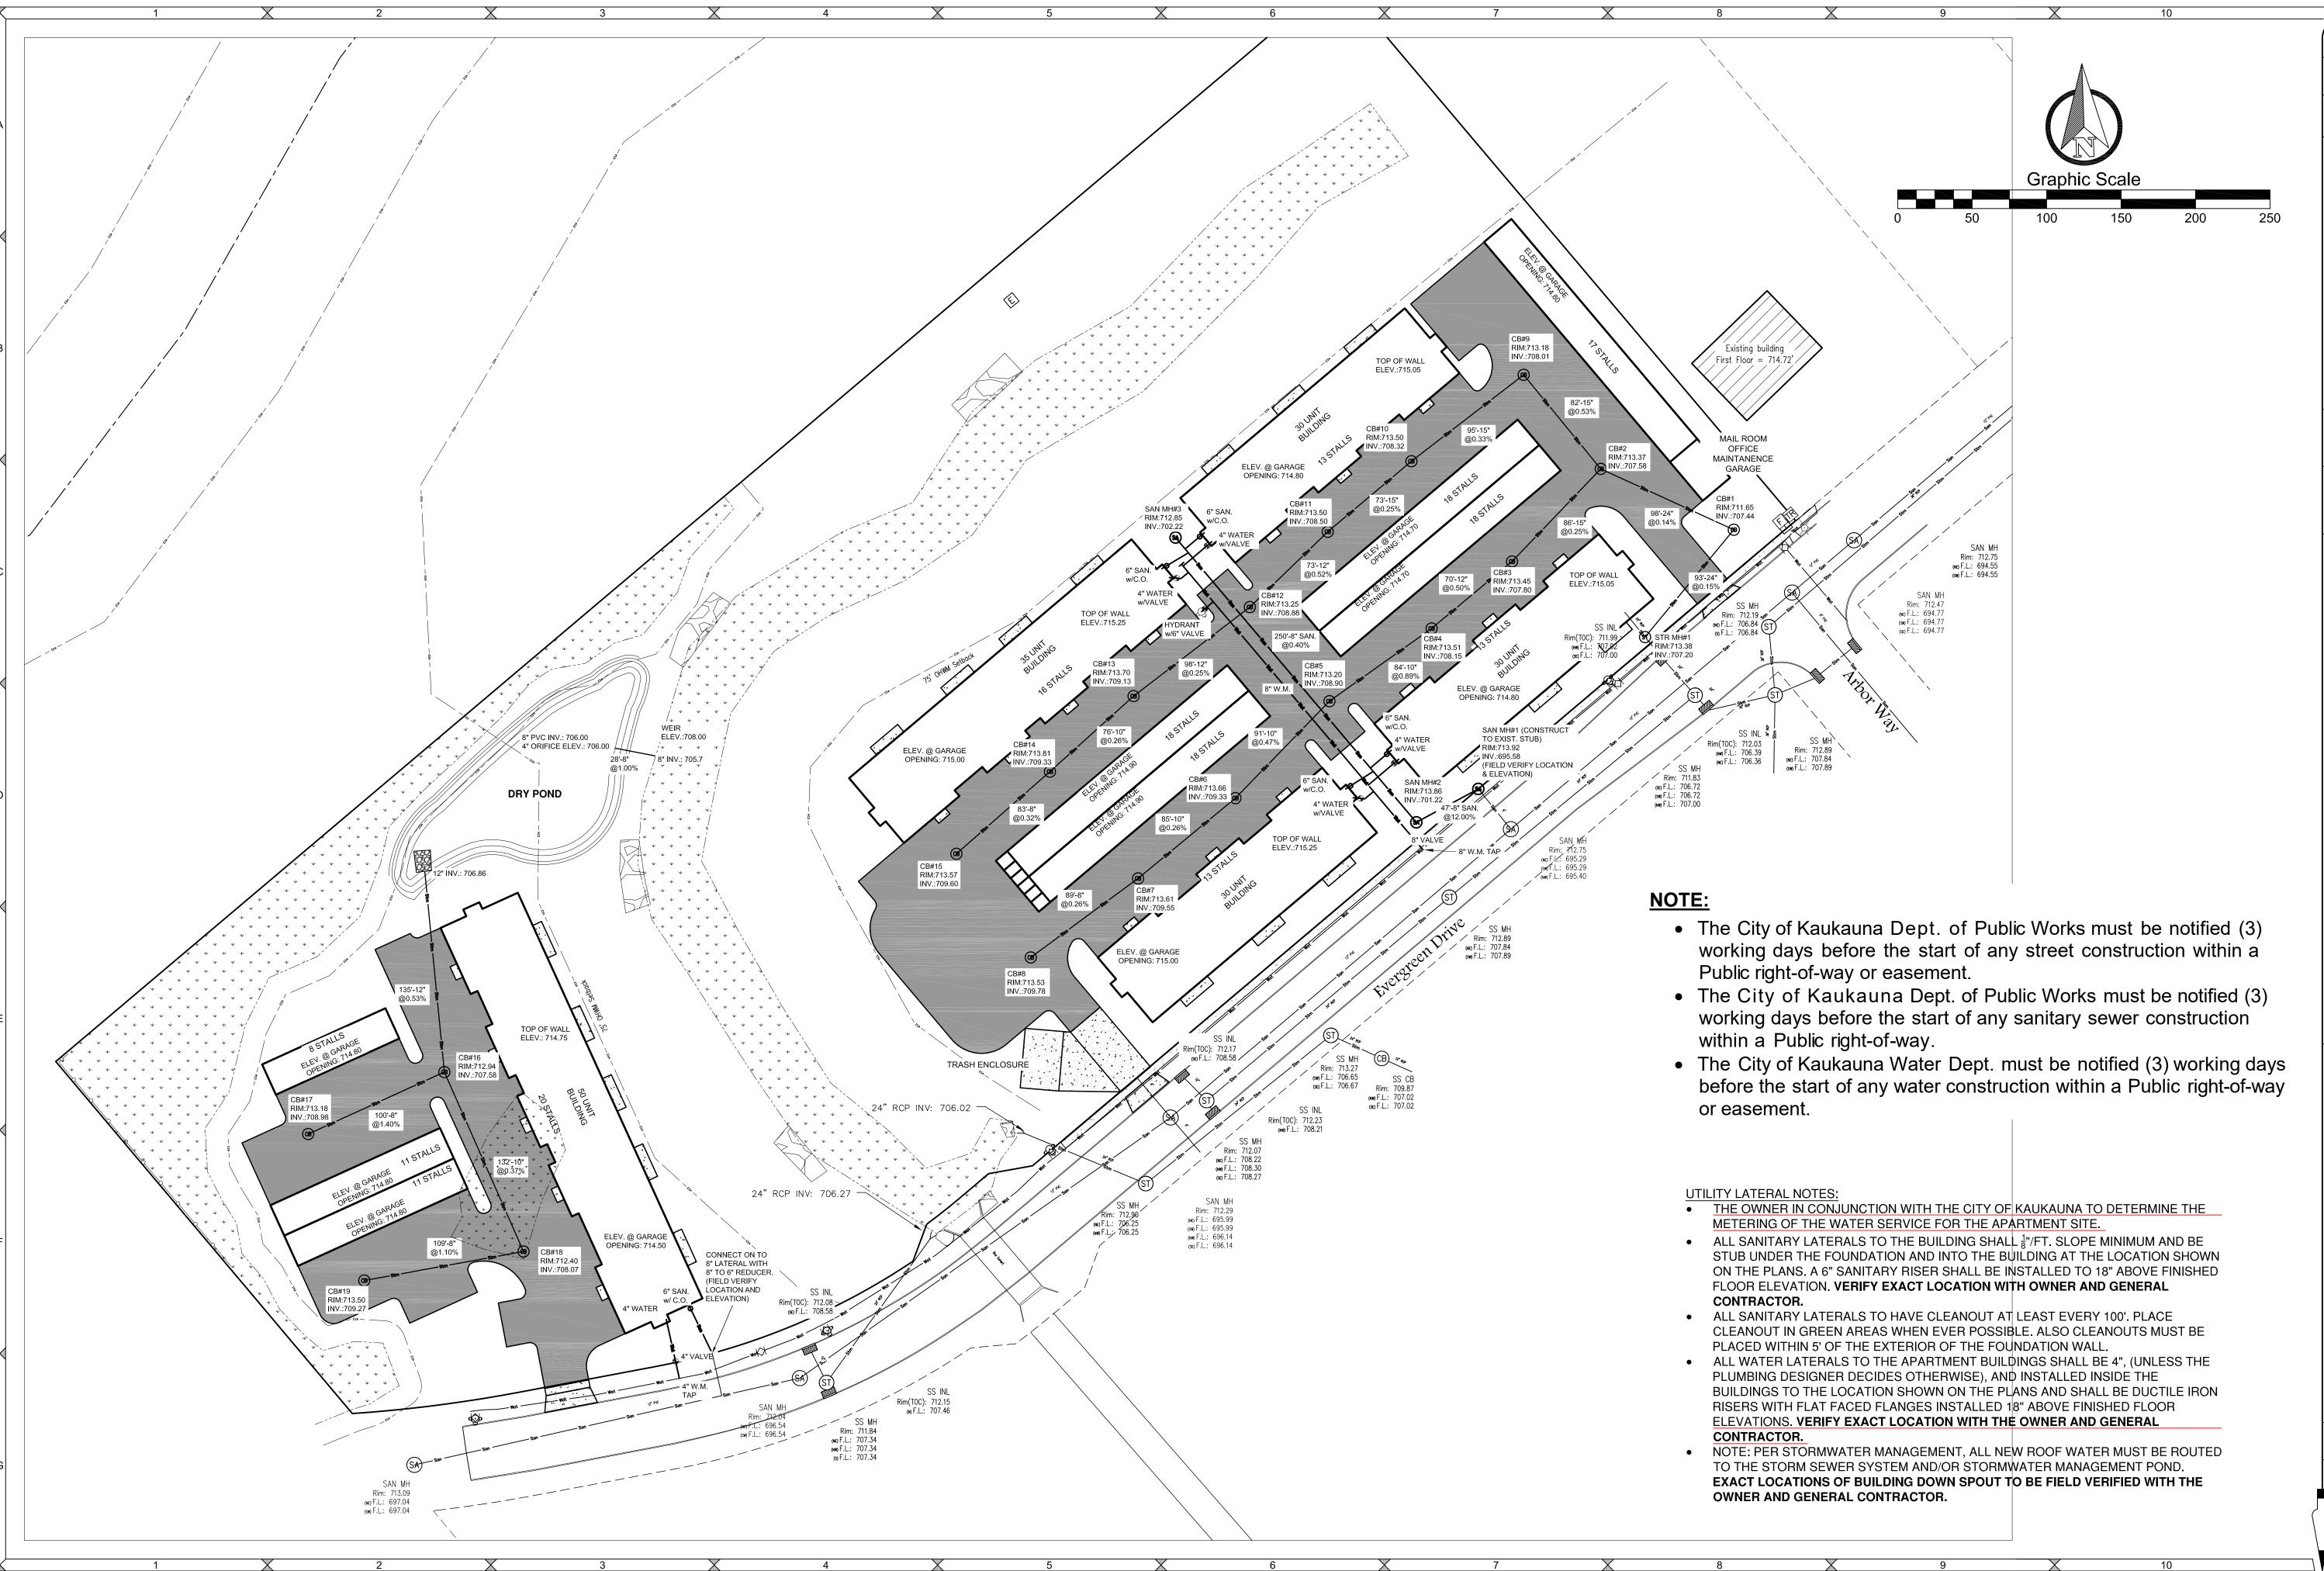

K ASSOCIATES

JRVEYING & PLANNING

R RESOURCE ENGINEERING

10-434-9670 Fax: 920-434-9672

DESIGNED BY DJM

DATA FILE D-3222.txt

DATE 01-26-23

DUQUAINE DEVELOPMENT

PROJECT NO. D-3222
SHEET NO. C5.0

DRAWING NO. S-3645

DESIGNED BY DJM

DATA FILE

D-3222.txt

DATE

01-26-23

THE CONTRACTOR IS RESPONSIBLE FOR INSTALLING AND MAINTAINING EROSION AND SEDIMENT CONTROL MEASURES. ALL EROSION AND SEDIMENT CONTROL PRACTICES SHALL BE ACCORDANCE WITH THE WISCONSIN DEPARTMENT OF NATURAL RESOURCES TECHNICAL STANDARDS AND IF NO STANDARD EXISTS THE WISCONSIN CONSTRUCTION SITE BEST MANAGEMENT PRACTICE HANDBOOK (CURRENT EDITION) SHALL BE REFERENCED. EROSION AND SEDIMENT CONTROL PRACTICES SHALL BE IN PLACE PRIOR TO DISTURBING THE SITE. CONTRACTORS SHALL MINIMIZE THE DURATION AND SIZE OF DISTURBED AREAS TO THE MAXIMUM EXTENT PRACTICABLE. EROSION AND SEDIMENT CONTROL PRACTICES PROPOSED FOR THIS PROJECT ARE DESCRIBED AS FOLLOWS:

SEDIMENT TRACKING FROM CONSTRUCTION SITE:

STONE TRACKING PAD(S) - TECHNICAL STANDARD 1057

STONE TRACKING PADS WILL BE INSTALLED AT ENTRANCES SHOWN ON THE SITE. TRACKING PADS SHALL BE IN PLACE PRIOR TO LAND DISTURBING ACTIVITIES.

WASH WATER FROM VEHICLE AND WHEEL WASHING SHALL BE TREATED BEFORE ENTERING WATERS OF THE STATE.

STREET SWEEPING/CLEANING

SEDIMENT TRACKED FROM THE CONSTRUCTION SITE SHALL BE CLEANED UP AT THE END OF EACH WORK DAY UNLESS THE SEDIMENT PRESENTS A HAZARD. SEDIMENT PRESENTING A HAZARD MUST BE CLEANED UP IMMEDIATELY.

SEDIMENT CARRIED OFF-SITE BY OVERLAND FLOW OR RUNOFF:

SILT FENCE - TECHNICAL STANDARD 1056

SILT FENCE WILL BE INSTALLED DOWN-SLOPE OF ALL DISTURBED AREAS OF THE SITE. THE FENCE SHALL BE INSTALLED ALONG THE CONTOURS AND BE IN-PLACE PRIOR TO LAND DISTURBING ACTIVITIES.

■ SEEDING - TECHNICAL STANDARD 1059; MULCHING - TECHNICAL STANDARD 1058 DISTURBED AREAS OF THE SITE SHALL BE SEEDED AND MULCHED AS SOON AS THEY ARE BROUGHT TO

FINISHED GRADE. IN ADDITION, ANY STOCK PILES IN PLACE FOR 7 DAYS OR MORE SHALL BE SEEDED AND MULCHED.

■ NON-CHANNEL EROSION MAT - TECHNICAL STANDARD 1052

EROSION CONTROL MAT SHALL BE PLACED AS SHOWN ON THE PLANS, AND/OR AS DETERMINED IN THE FIELD, TO PROTECT THE DISTURBED SLOPES FROM EROSION. NON-CHANNEL EROSION MAT SHALL BE INSTALLED AS SOON AS THE SLOPE HAS BEEN BROUGHT TO FINISHED GRADE.

CONSTRUCTION SITE DIVERSION - TECHNICAL STANDARD 1066

WHERE POSSIBLE, THE SITE WILL BE GRADED SUCH THE RUNOFF FROM UNDISTURBED AREAS IS ROUTED AROUND DISTURBED AREAS OF THE SITE.

SEDIMENT CARRIED OFF-SITE BY DEWATERING OPERATIONS:

DEWATERING - TECHNICAL STANDARD 1061

DEWATERING IS NOT ANTICIPATED FOR THIS PROJECT. IF IT IS REQUIRED, DEWATERING SHALL BE IN ACCORDANCE WITH THE DEWATERING TECHNICAL STANDARD. ANY NECESSARY PERMITS SHALL BE OBTAINED PRIOR TO DEWATERING OPERATIONS TAKE PLACE

SEDIMENT ENTERING STORM DRAIN INLETS:

■ STORM DRAIN INLET PROTECTION - TECHNICAL STANDARD 1060

ALL INLETS, PROPOSED AND EXISTING, ACCEPTING RUNOFF FROM DISTURBED AREAS OF THE SITE SHALL HAVE INLET PROTECTION INSTALLED PRIOR TO LAND DISTURBING ACTIVITY WITHIN THE AREA DISCHARGING TO THE INLET.

SEDIMENT BEING CARRIED OFF-SITE BY WIND:

DUST CONTROL - TECHNICAL STANDARD 1068

WHEN REQUIRED, DUST CONTROL MEASURES SHALL BE EMPLOYED TO PREVENT DUST FROM BLOWING OFF-SITE.

CONCRETE WASHOUT

 CONCRETE WASHOUT SHALL BE COLLECTED AND RETAINED, BOTH WATER AND CONCRETE, IN LEAK PROOF CONTAINERS. WASHOUT CAN BE RECYCLED OR REUSED. SEE http://water.epa.gov/polwaste/npdes/swbmp/upload/concretewashout.pdf FOR DETAILS.

INSPECTION AND MAINTENANCE

THE CONTRACTOR IS RESPONSIBLE FOR INSPECTION AND MAINTENANCE OF EROSION AND SEDIMENT CONTROLS UNTIL THE CONSTRUCTION SITE IS PERMANENTLY STABILIZED WITH A DENSE GRASS COVER. THE CONTRACTOR SHALL INSPECT EROSION AND SEDIMENT CONTROLS WEEKLY AND WITHIN 24 HOURS AFTER A RAINFALL EVENT OF 0.5 INCHES OR GREATER. THE CONTRACTOR SHALL INSPECT EROSION AND SEDIMENT CONTROLS FOR STRUCTURAL DAMAGE, SEDIMENT ACCUMULATION, OR ANY OTHER UNDESIRABLE CONDITION. THE CONTRACTOR SHALL REPAIR DAMAGED STRUCTURES PRIOR TO THE END OF EACH WORKING DAY. SEDIMENT SHALL BE REMOVED FROM THE STRUCTURE WHEN THE DEPTH OF SEDIMENT HAS ACCUMULATED TO ONE HALF THE HEIGHT OF THE DEVICE OR AS REQUIRED BY THE APPLICABLE WISCONSIN DEPARTMENT OF NATURAL RESOURCES TECHNICAL STANDARD (CURRENT EDITION).

THE CONTRACTOR SHALL SUMMARIZE WEEKLY INSPECTION AND MAINTENANCE ACTIVITIES ON A WEEKLY INSPECTION REPORT THAT IS AVAILABLE THROUGH THE WDNR.

THE WEEKLY INSPECTION REPORT SHALL INCLUDE THE FOLLOWING MINIMUM INFORMATION:

NAME OF INDIVIDUAL PERFORMING INSPECTION;

DATE, TIME, AND PLACE OF INSPECTION;

A DESCRIPTION OF THE CONSTRUCTION PHASE;

A DESCRIPTION OF EROSION AND SEDIMENT CONTROL INSTALLATIONS;


AND AN ASSESSMENT OF EROSION AND SEDIMENT CONTROL CONDITIONS.

A DESCRIPTION OF EROSION AND SEDIMENT CONTROL MAINTENANCE ACTIVITIES;

THE CONTRACTOR SHALL PROMPTLY FURNISH THE ORIGINAL WEEKLY INSPECTION REPORTS TO THE OWNER, OWNER'S REPRESENTATIVE, OR WISCONSIN DEPARTMENT OF NATURAL RESOURCES WHEN REQUESTED. THE CONTRACTOR SHALL KEEP A COPY OF THE APPROVED EROSION & SEDIMENT CONTROL PLAN, PERMITS, AND WEEKLY INSPECTION REPORTS ON-SITE AT ALL TIMES.

WEEKLY INSPECTIONS AND RAIN EVENT REPORTS SHOULD BE SENT TO "ErosionControl@greenbay.gov"

ALL WASTE FROM THE CONSTRUCTION SITE SHALL BE PROPERLY DISPOSED OF AND NOT BE ALLOWED TO ENTER THE STORM SEWER SYSTEM, DRAINAGE SYSTEM, OR OTHER ENVIRONMENTALLY SENSITIVE AREAS LOCATED WITHIN THE CONSTRUCTION SITE, INCLUDING GARNERS CREEK.

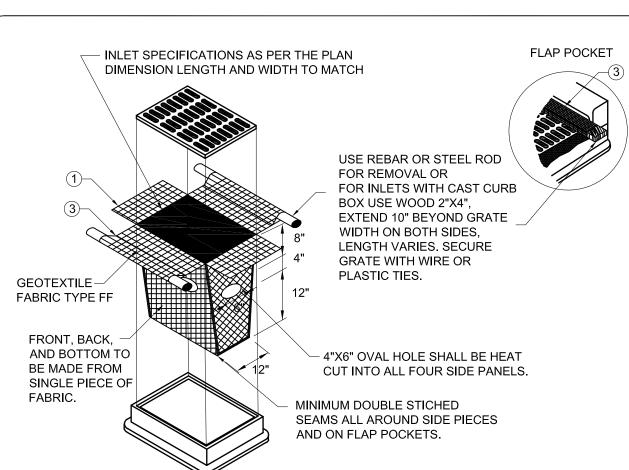

INLET PROTECTION, TYPE D

(CAN BE INSTALLED IN ANY INLET TYPE WITH OR WITHOUT A CURB BOX AS PER NOTE 2)

GENERAL NOTES

MANUFACTURED ALTERNATIVES APPROVED AND LISTED ON THE DEPARTMENT'S EROSION CONTROL PRODUCT ACCEPTABILITY LIST MAY BE SUBSTITUTED. WHEN REMOVING OR MAINTAINING INLET PROTECTION, CARE SHALL BE TAKEN SO THAT THE SEDIMENT TRAPPED ON THE GEOTEXTILE FABRIC DOES NOT FALL INTO THE INLET. ANY MATERIAL FALLING INTO THE INLET SHALL BE REMOVED IMMEDIATELY.

1.) FINISHED SIZE, INCLUDING FLAP POCKETS WHERE REQUIRED, SHALL EXTEND A MINIMUM OF 10" AROUND THE PERIMETER TO FACILITATE MAINTENANCE OR REMOVAL.

2.) FOR INLET PROTECTION, TYPE C (WITH CURB BOX), AN ADDITIONAL 18" OF FABRIC IS WRAPPED AROUND THE WOOD AND SECURED WITH STAPLES. THE WOOD SHALL NOT BLOCK THE ENTIRE HEIGHT OF THE CURB BOX OPENING.

3.) FLAP POCKETS SHALL BE LARGE ENOUGH TO ACCEPT WOOD 2X4.

INSTALLATION NOTES TYPE D


DO NOT INSTALL INLET PROTECTION TYPE D IN INLETS SHALLOWER THAN 30", MEASURED FROM THE BOTTOM OF THE INLET TO THE TOP OF THE GRATE. TRIM EXCESS FABRIC IN THE FLOW LINE TO WITHIN 3" OF THE GRATE. THE INSTALLED BAG SHALL HAVE A MINIMUM SIDE CLEARANCE, BETWEEN THE INLET WALLS AND THE BAG, MEASURED AT


WHERE NECESSARY THE CONTRACTOR SHALL CINCH THE BAG, USING PLASTIC ZIP TIES, TO ACHIEVE THE 3" CLEARANCE. THE TIES SHALL BE PLACED AT A MAXIMUM OF 4" FROM THE BOTTOM OF THE BAG.


THE BOTTOM OF THE OVERFLOW HOLES,


This drawing based on Wisconsin Department of Transportation Standard Detail Drawing 8 E 10-2.

INLET PROTECTION TYPE D

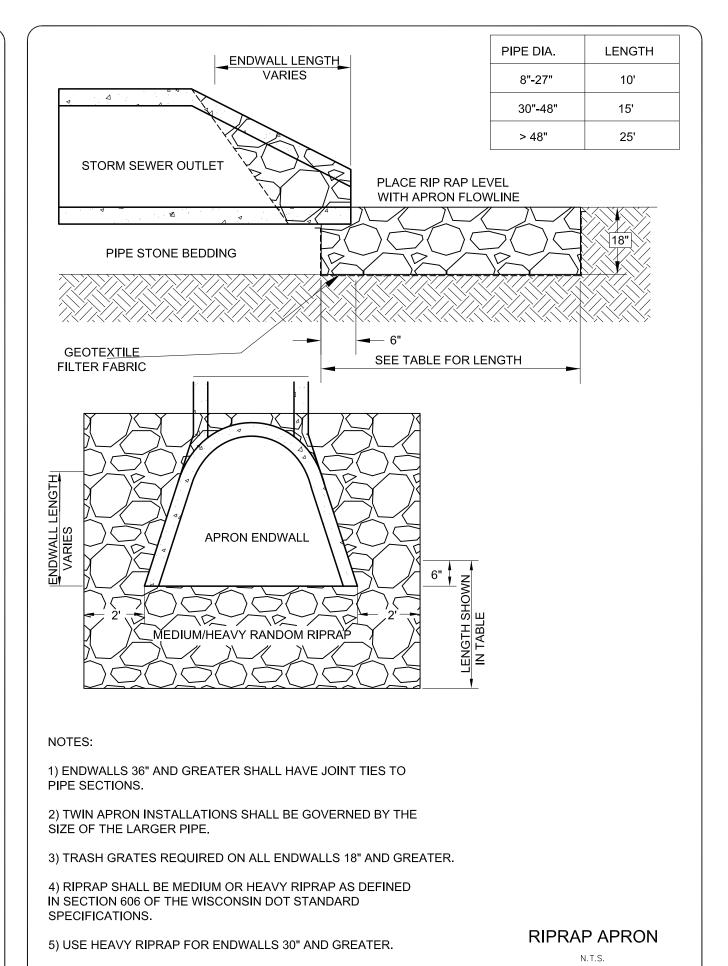

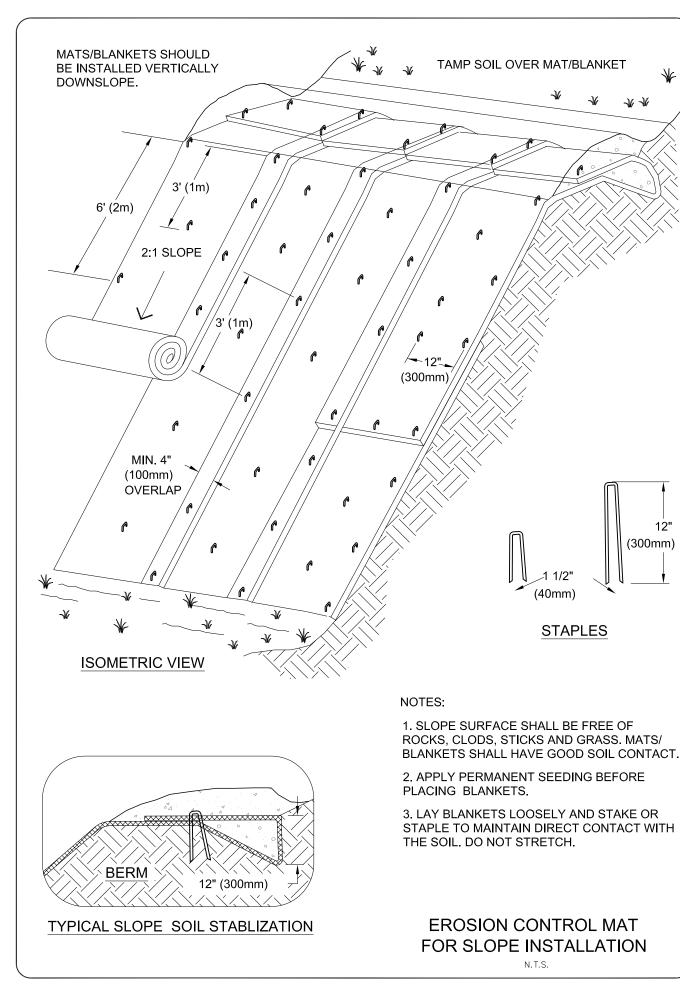

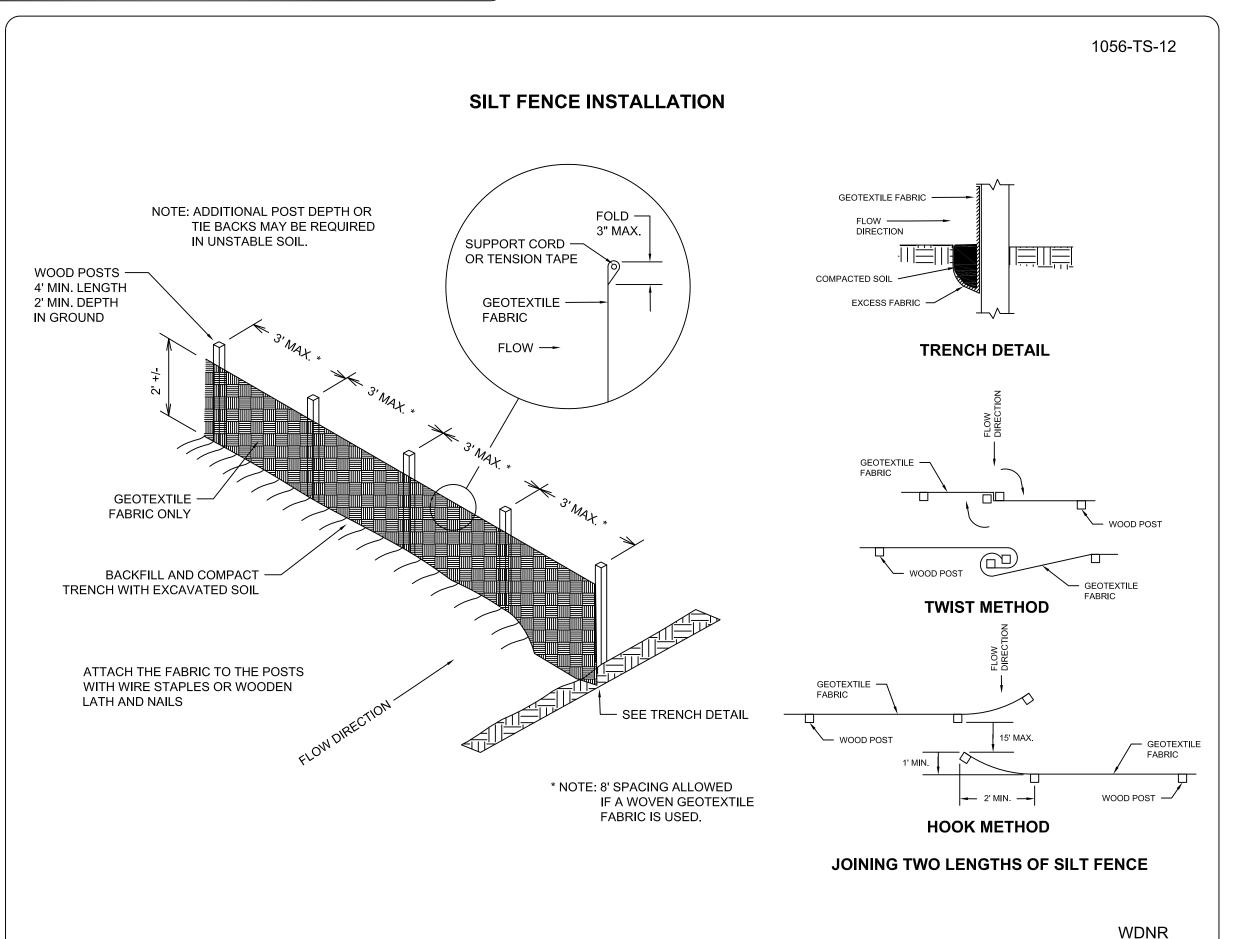

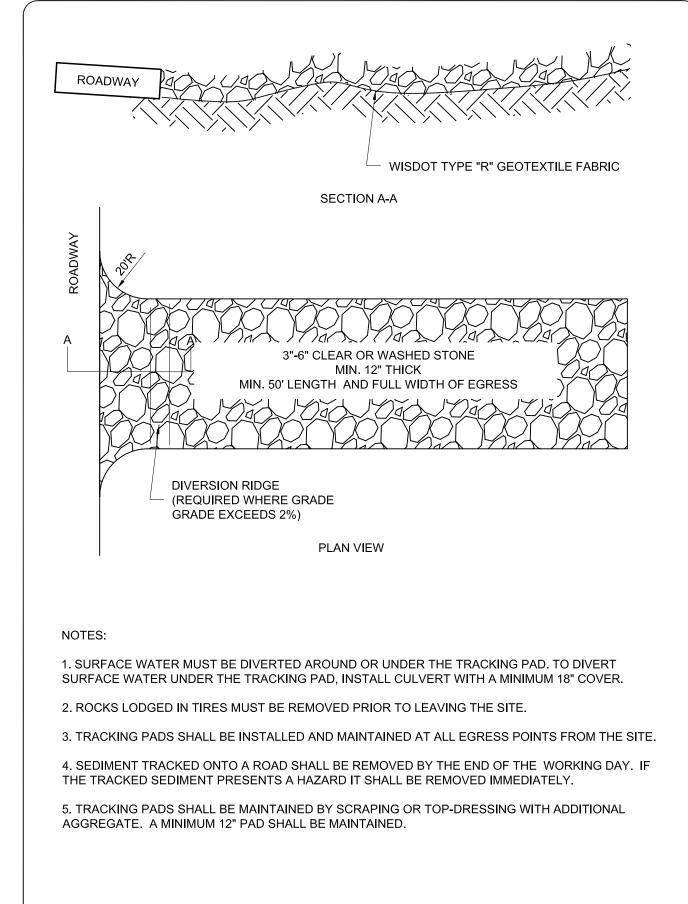

STONE TRACKING PAD

N.T.S.


NOVEMBER 2022




QUAINE


PROJECT NO. D-3222 SHEET NO. C6.0 DRAWING NO.


DESIGNED BY DJM DATA FILE D-3222.txt DATE 01-26-23 100 NOTES: 8" SANITARY MAINS TO BE PVC SDR 3034. 6" SANITARY LATERALS TO BE PVC SDR 3034. 4" SANITARY LATERALS TO BE SCH 40 Mau LAND SU IL & WATE 8", 6" & 4" WATERMAINS TO BE PVC C900. 4" THRU 10" STORM PIPE TO BE PVC SDR 3034. 12" THRU 24" STORM PIPE TO BE PVC OR HDPE DFU: XXXXXXXXXXXXX/18 UNIT
WSFU: XXXXXXXXXXXXXXIV (XXXX GPM) DFU: XXXXXXXXXXX UNIT WSFU: XXXXXXX/9 UNIT (XXXXXXXXXXX GI DEVELOPMENT SP OR 4,510 4,659 24"@0.15% 4,348 4,501 24"@0.14% 1,651 1,663 15"@0.25% ANS 1,394 1,398 12"@0.50% DUQUAINE 1,163 10"@0.89% 1,159 848 10"@0.47% 842 630 10"@0.26% 603 323 350 8"@0.26% 2,469 15"@0.53% 2,466 1,919 1,924 15"@0.33% 1,661 1,663 15"@0.25% 1,430 1,430 12"@0.52% 861 971 12"@0.25% 603 630 10"@0.26% PROJECT NO. 382 382 8"@0.32% D-3222 SHEET NO. 1,434 1,441 12"@0.53% 16 17 259 800 8"@1.40% 18 744 744 10"@0.37% 177 717 8"@1.10% 19 DRAWING NO.

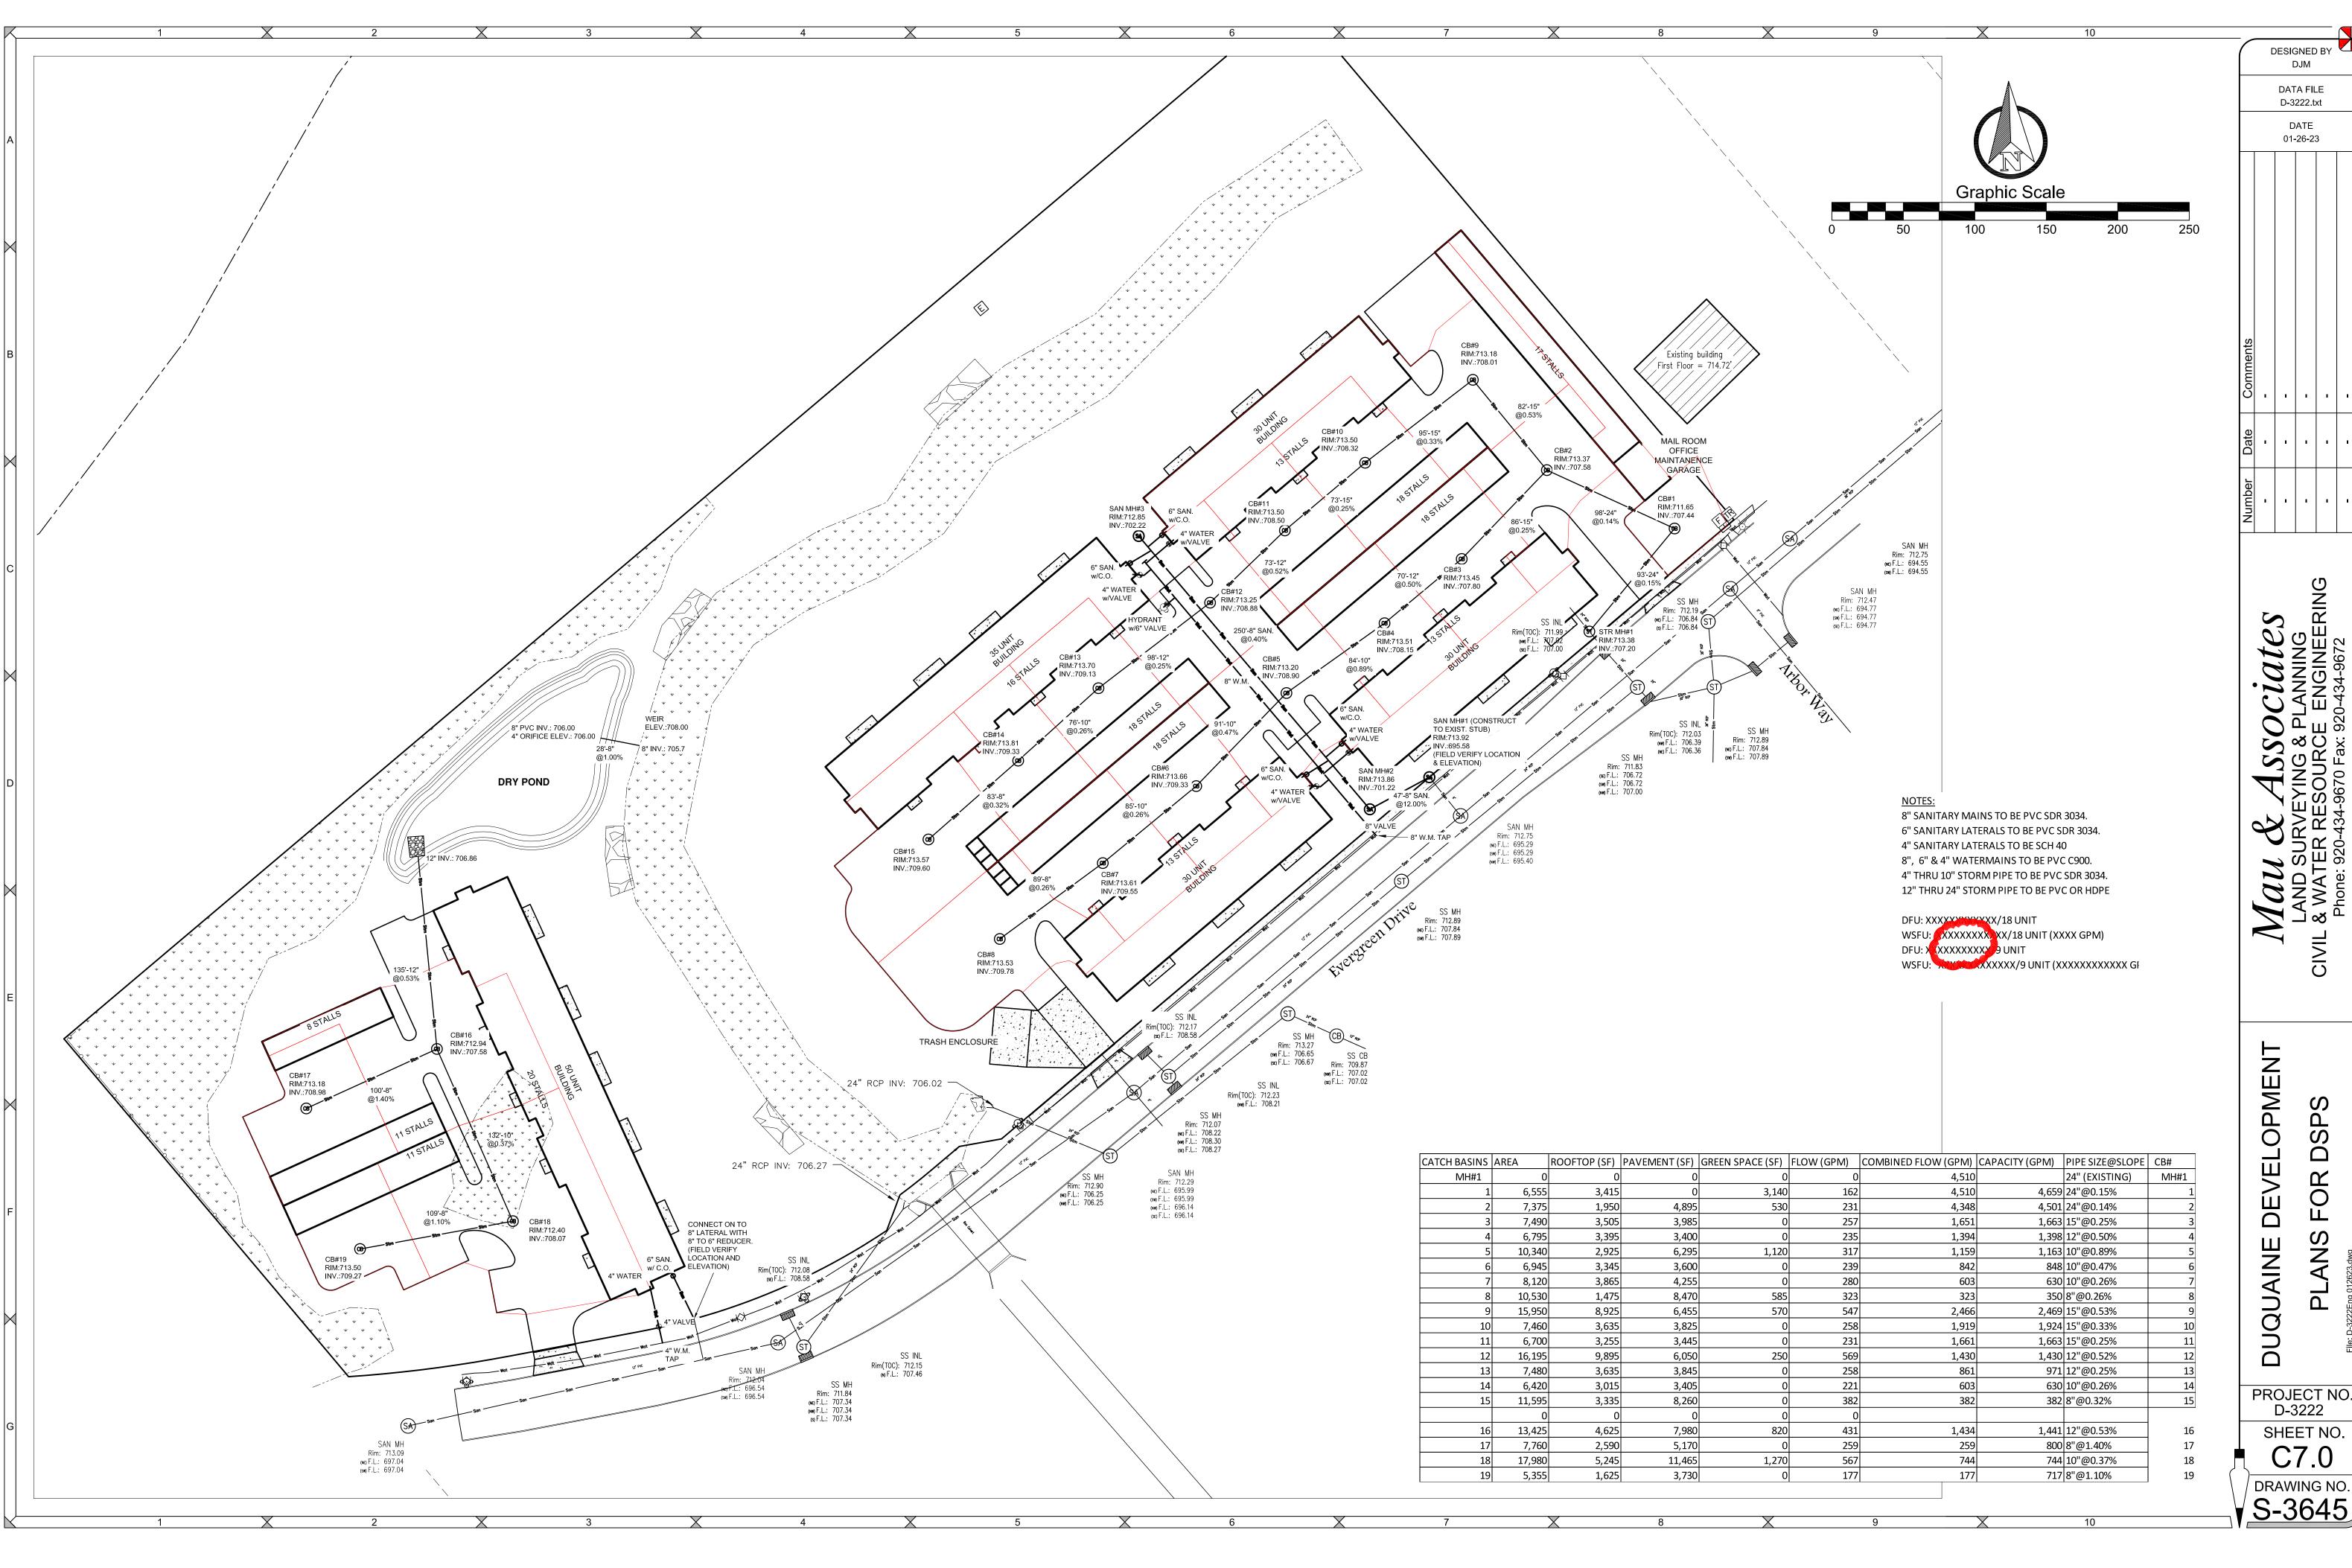


Item 4.a.

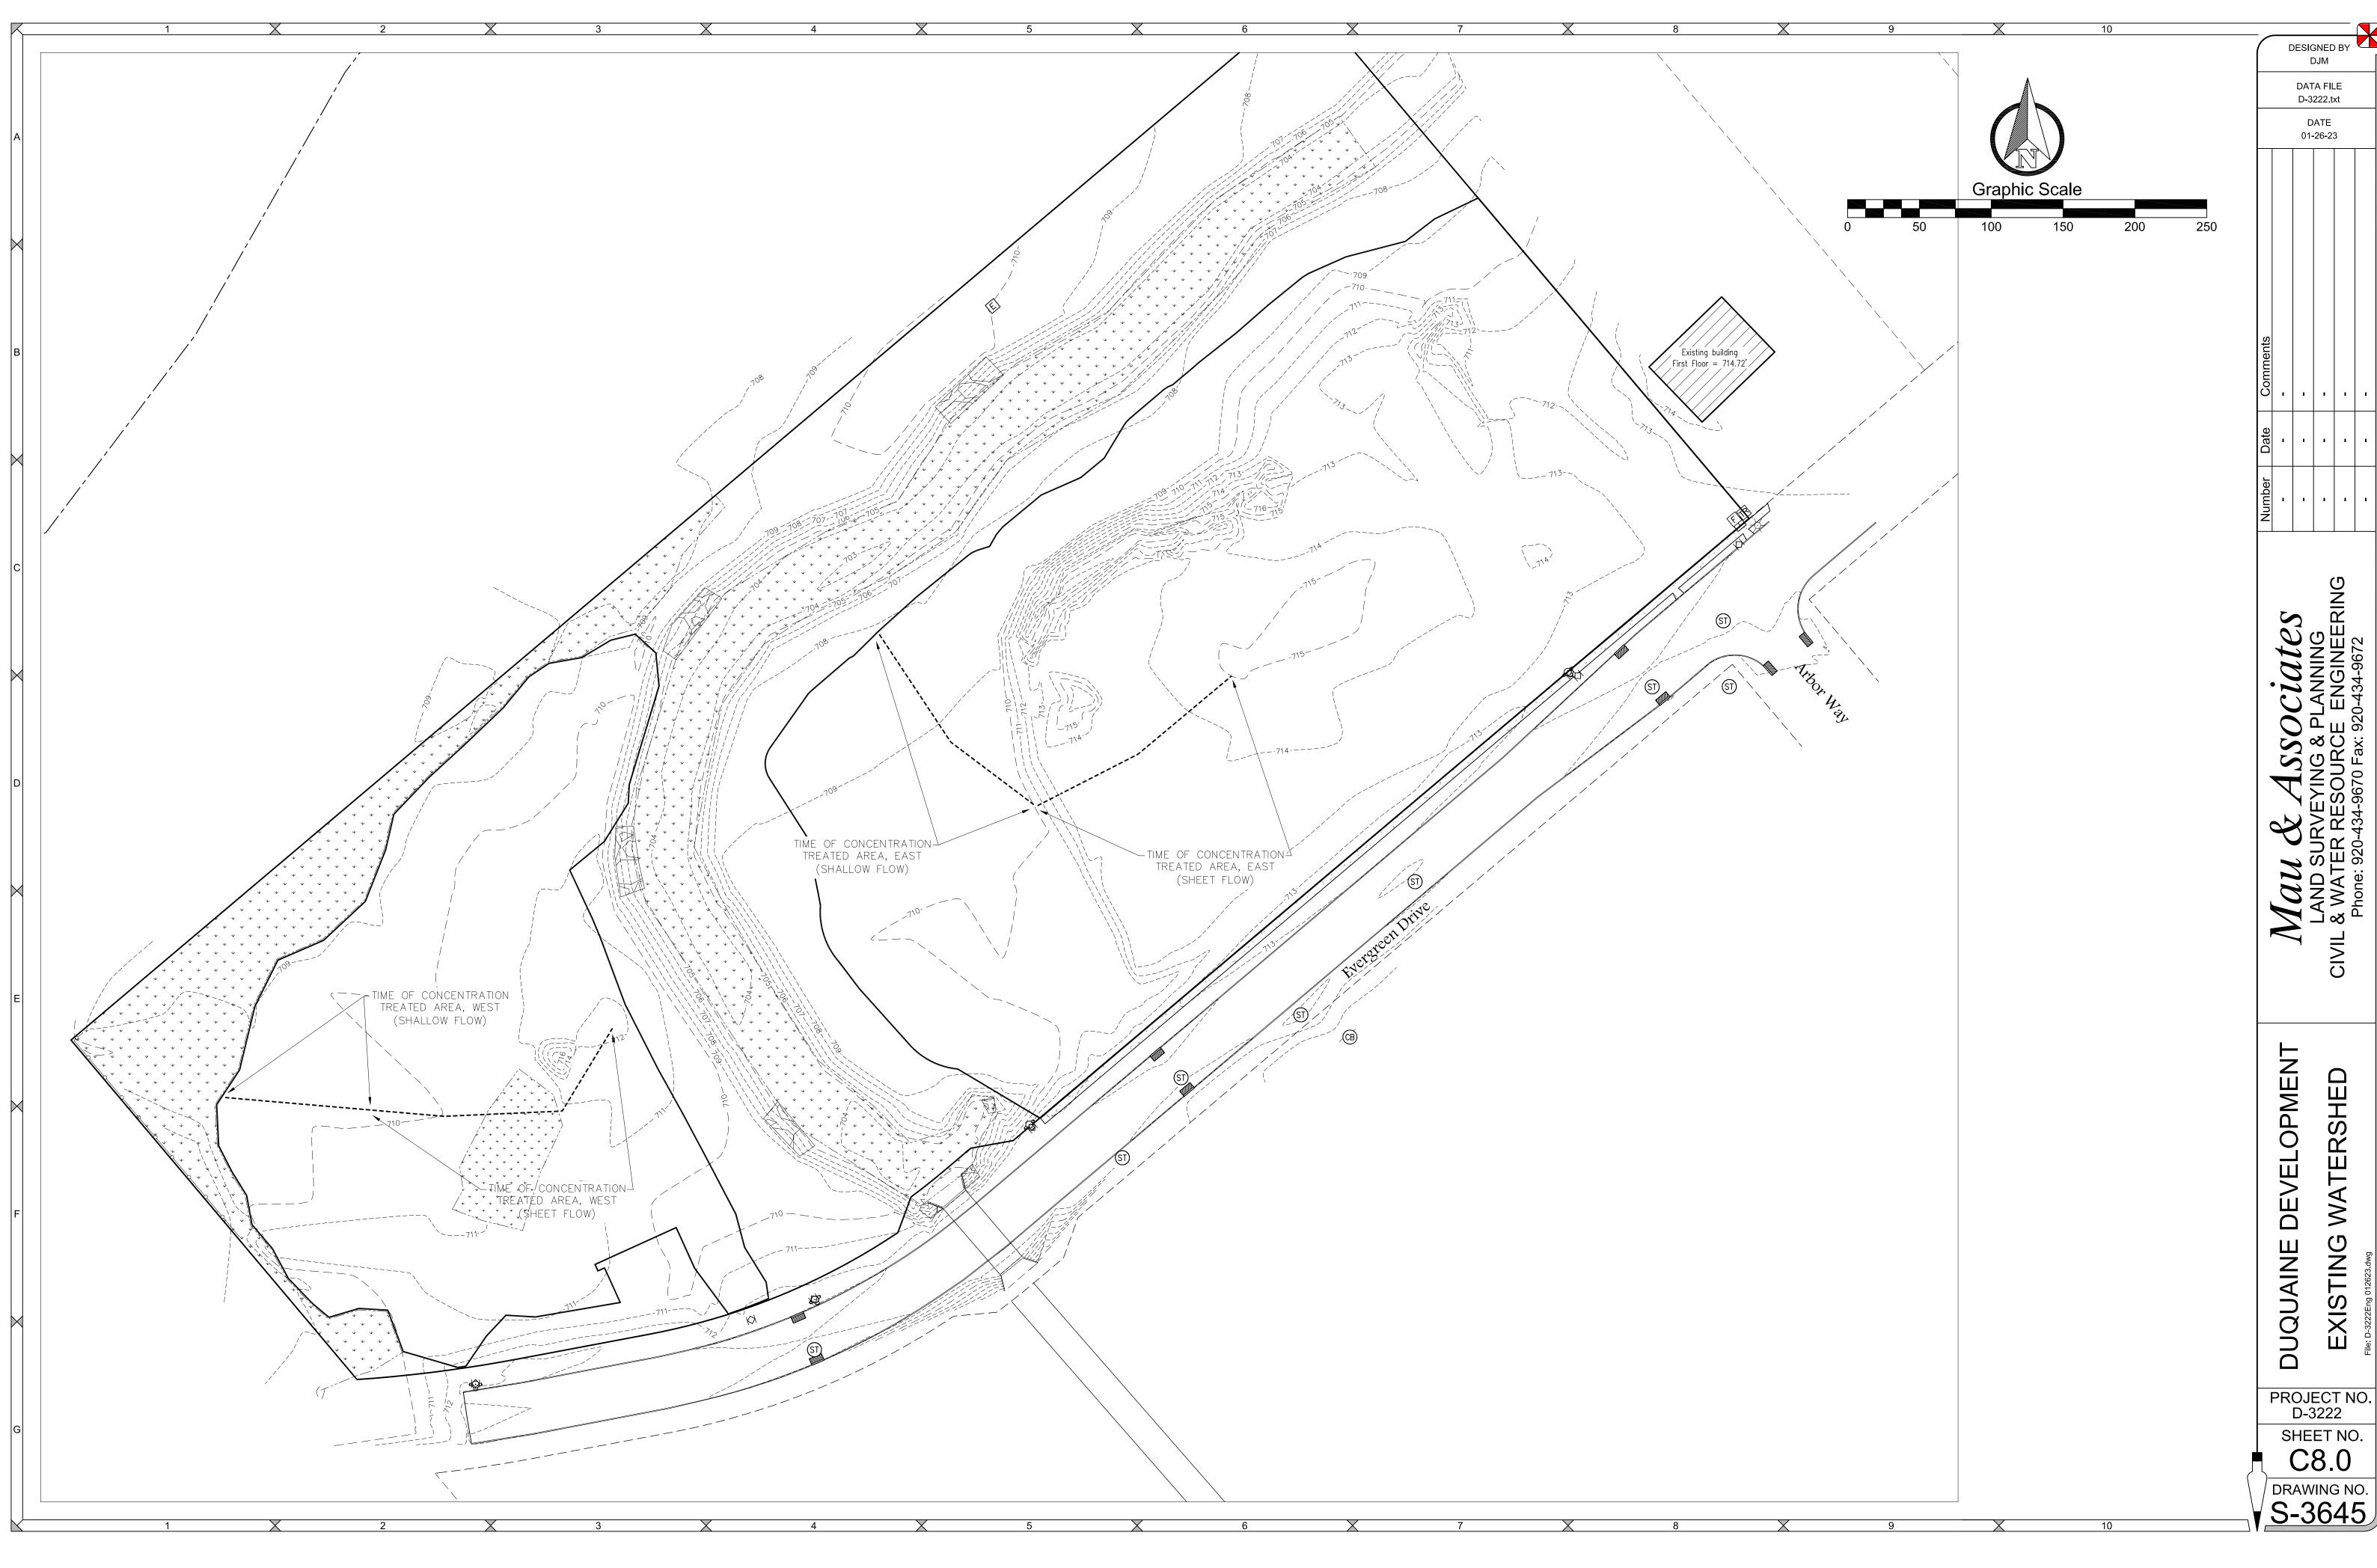

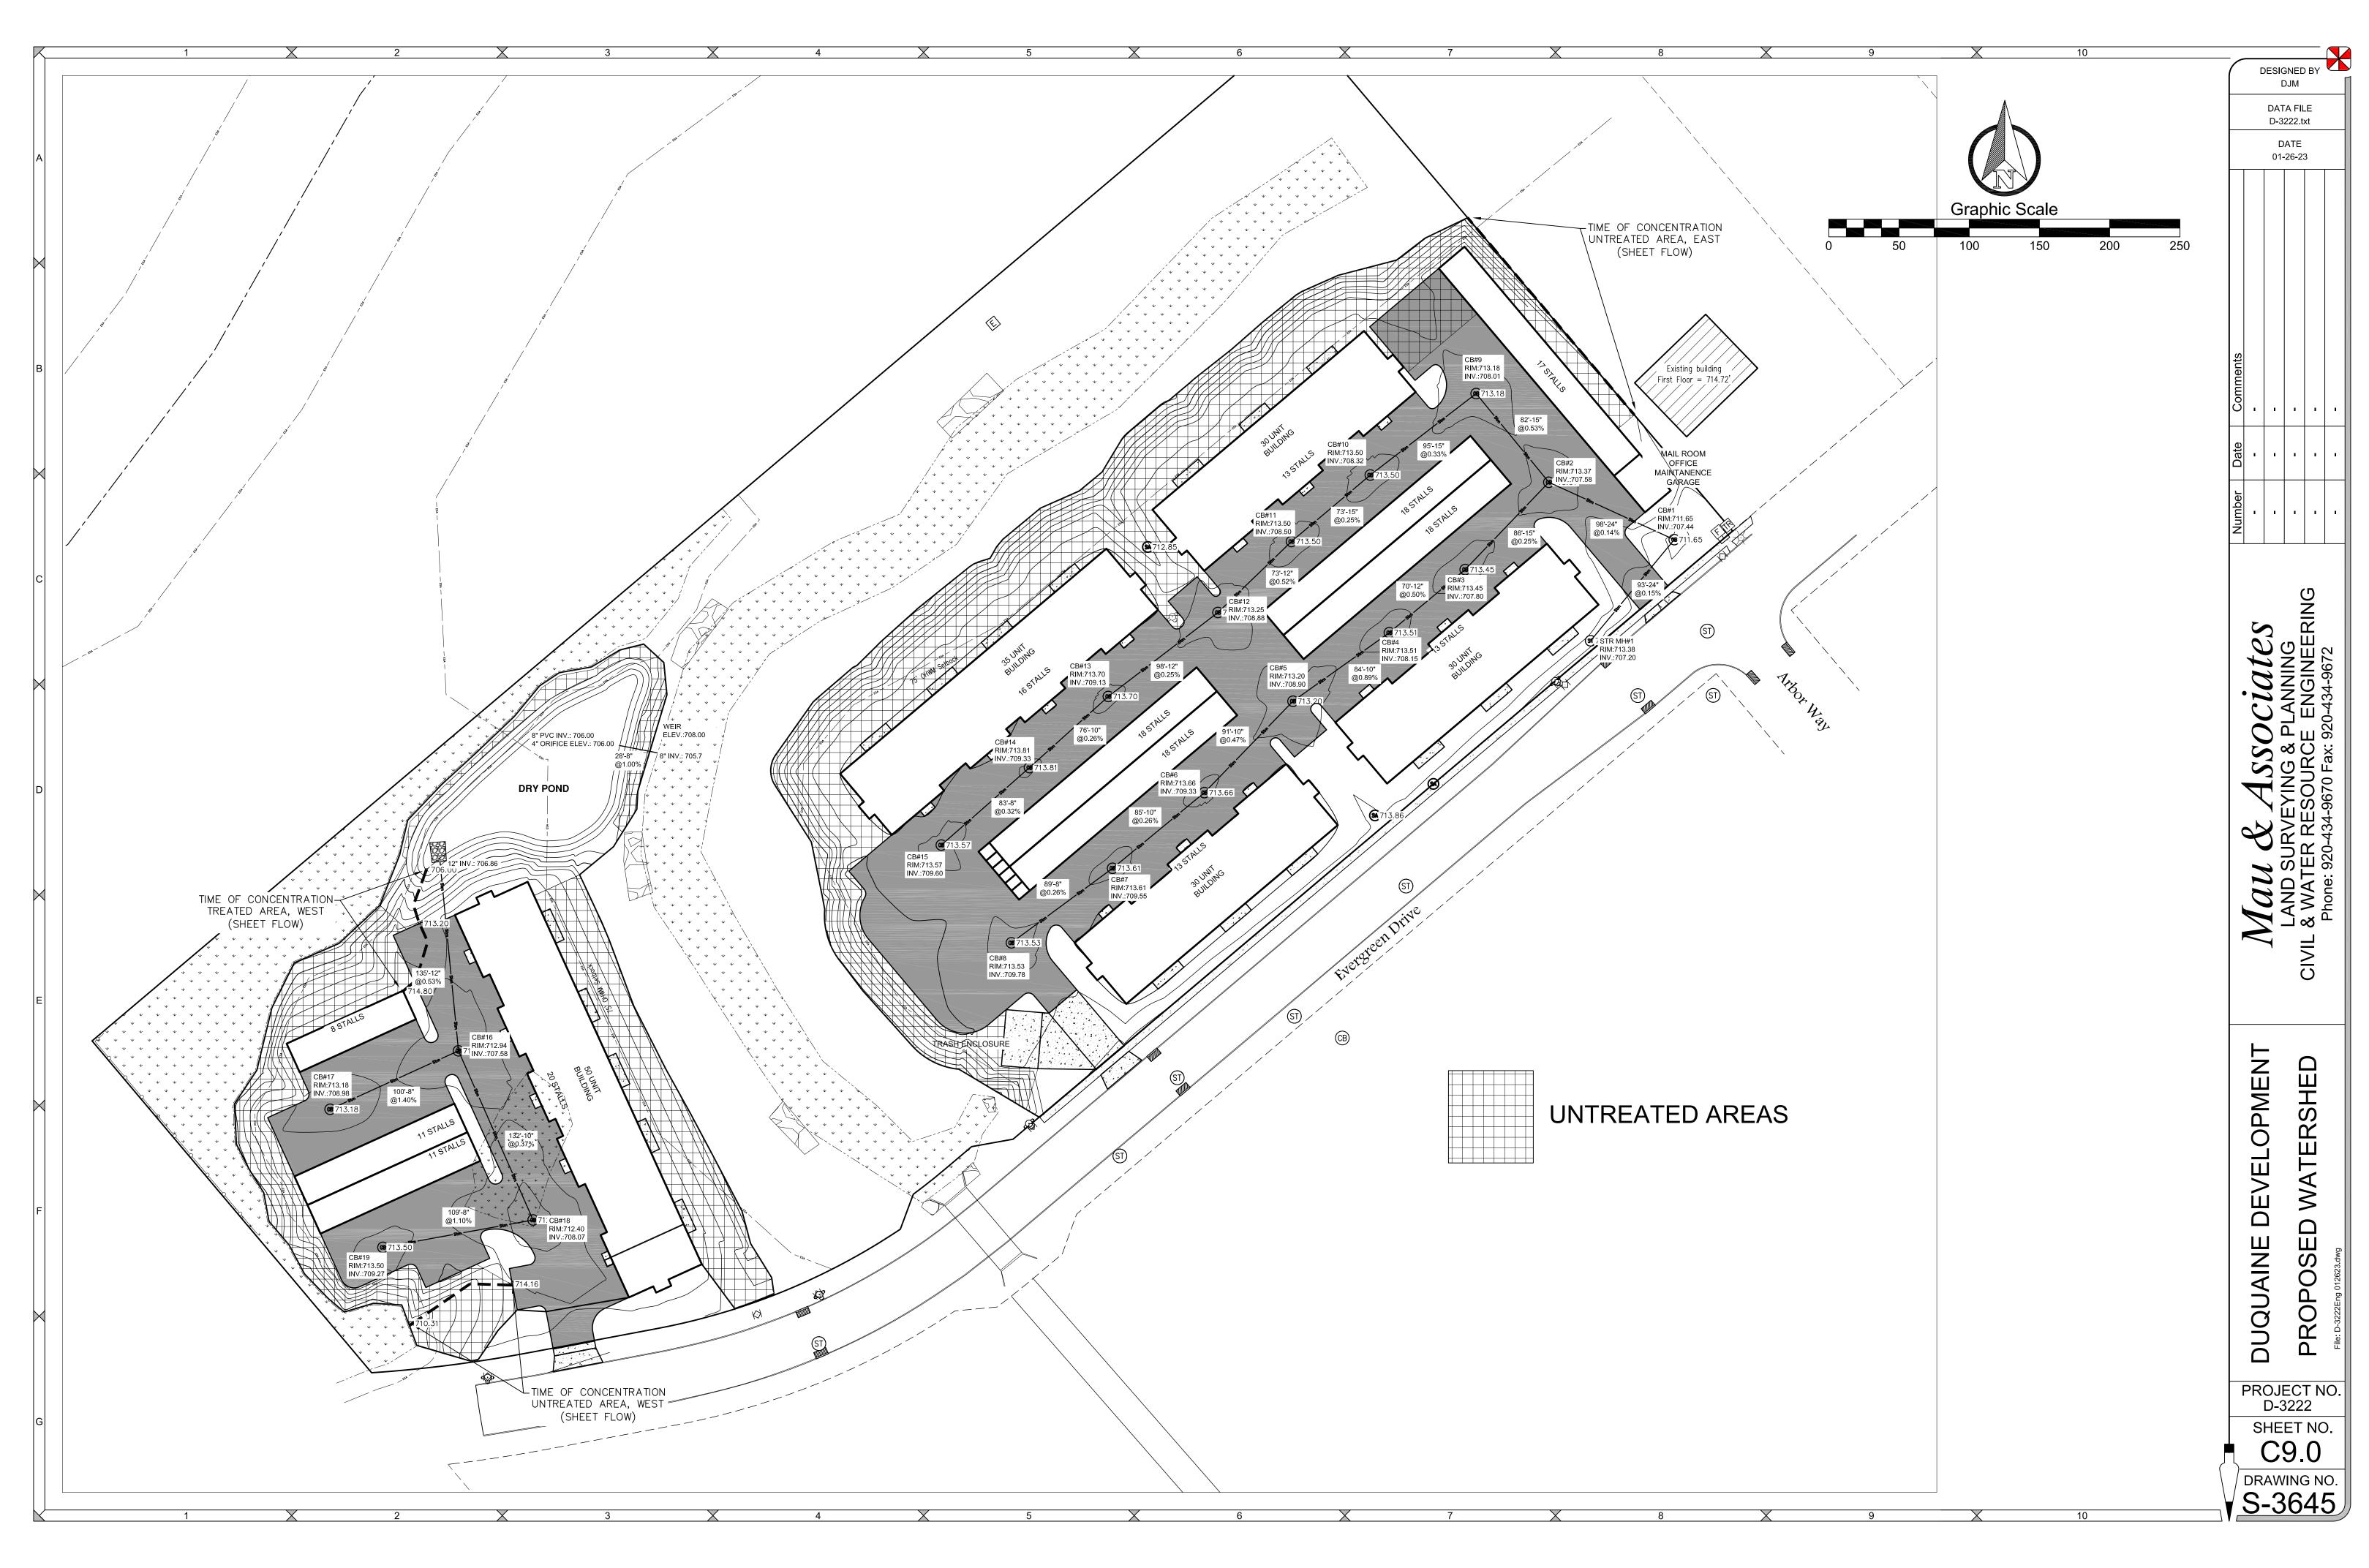

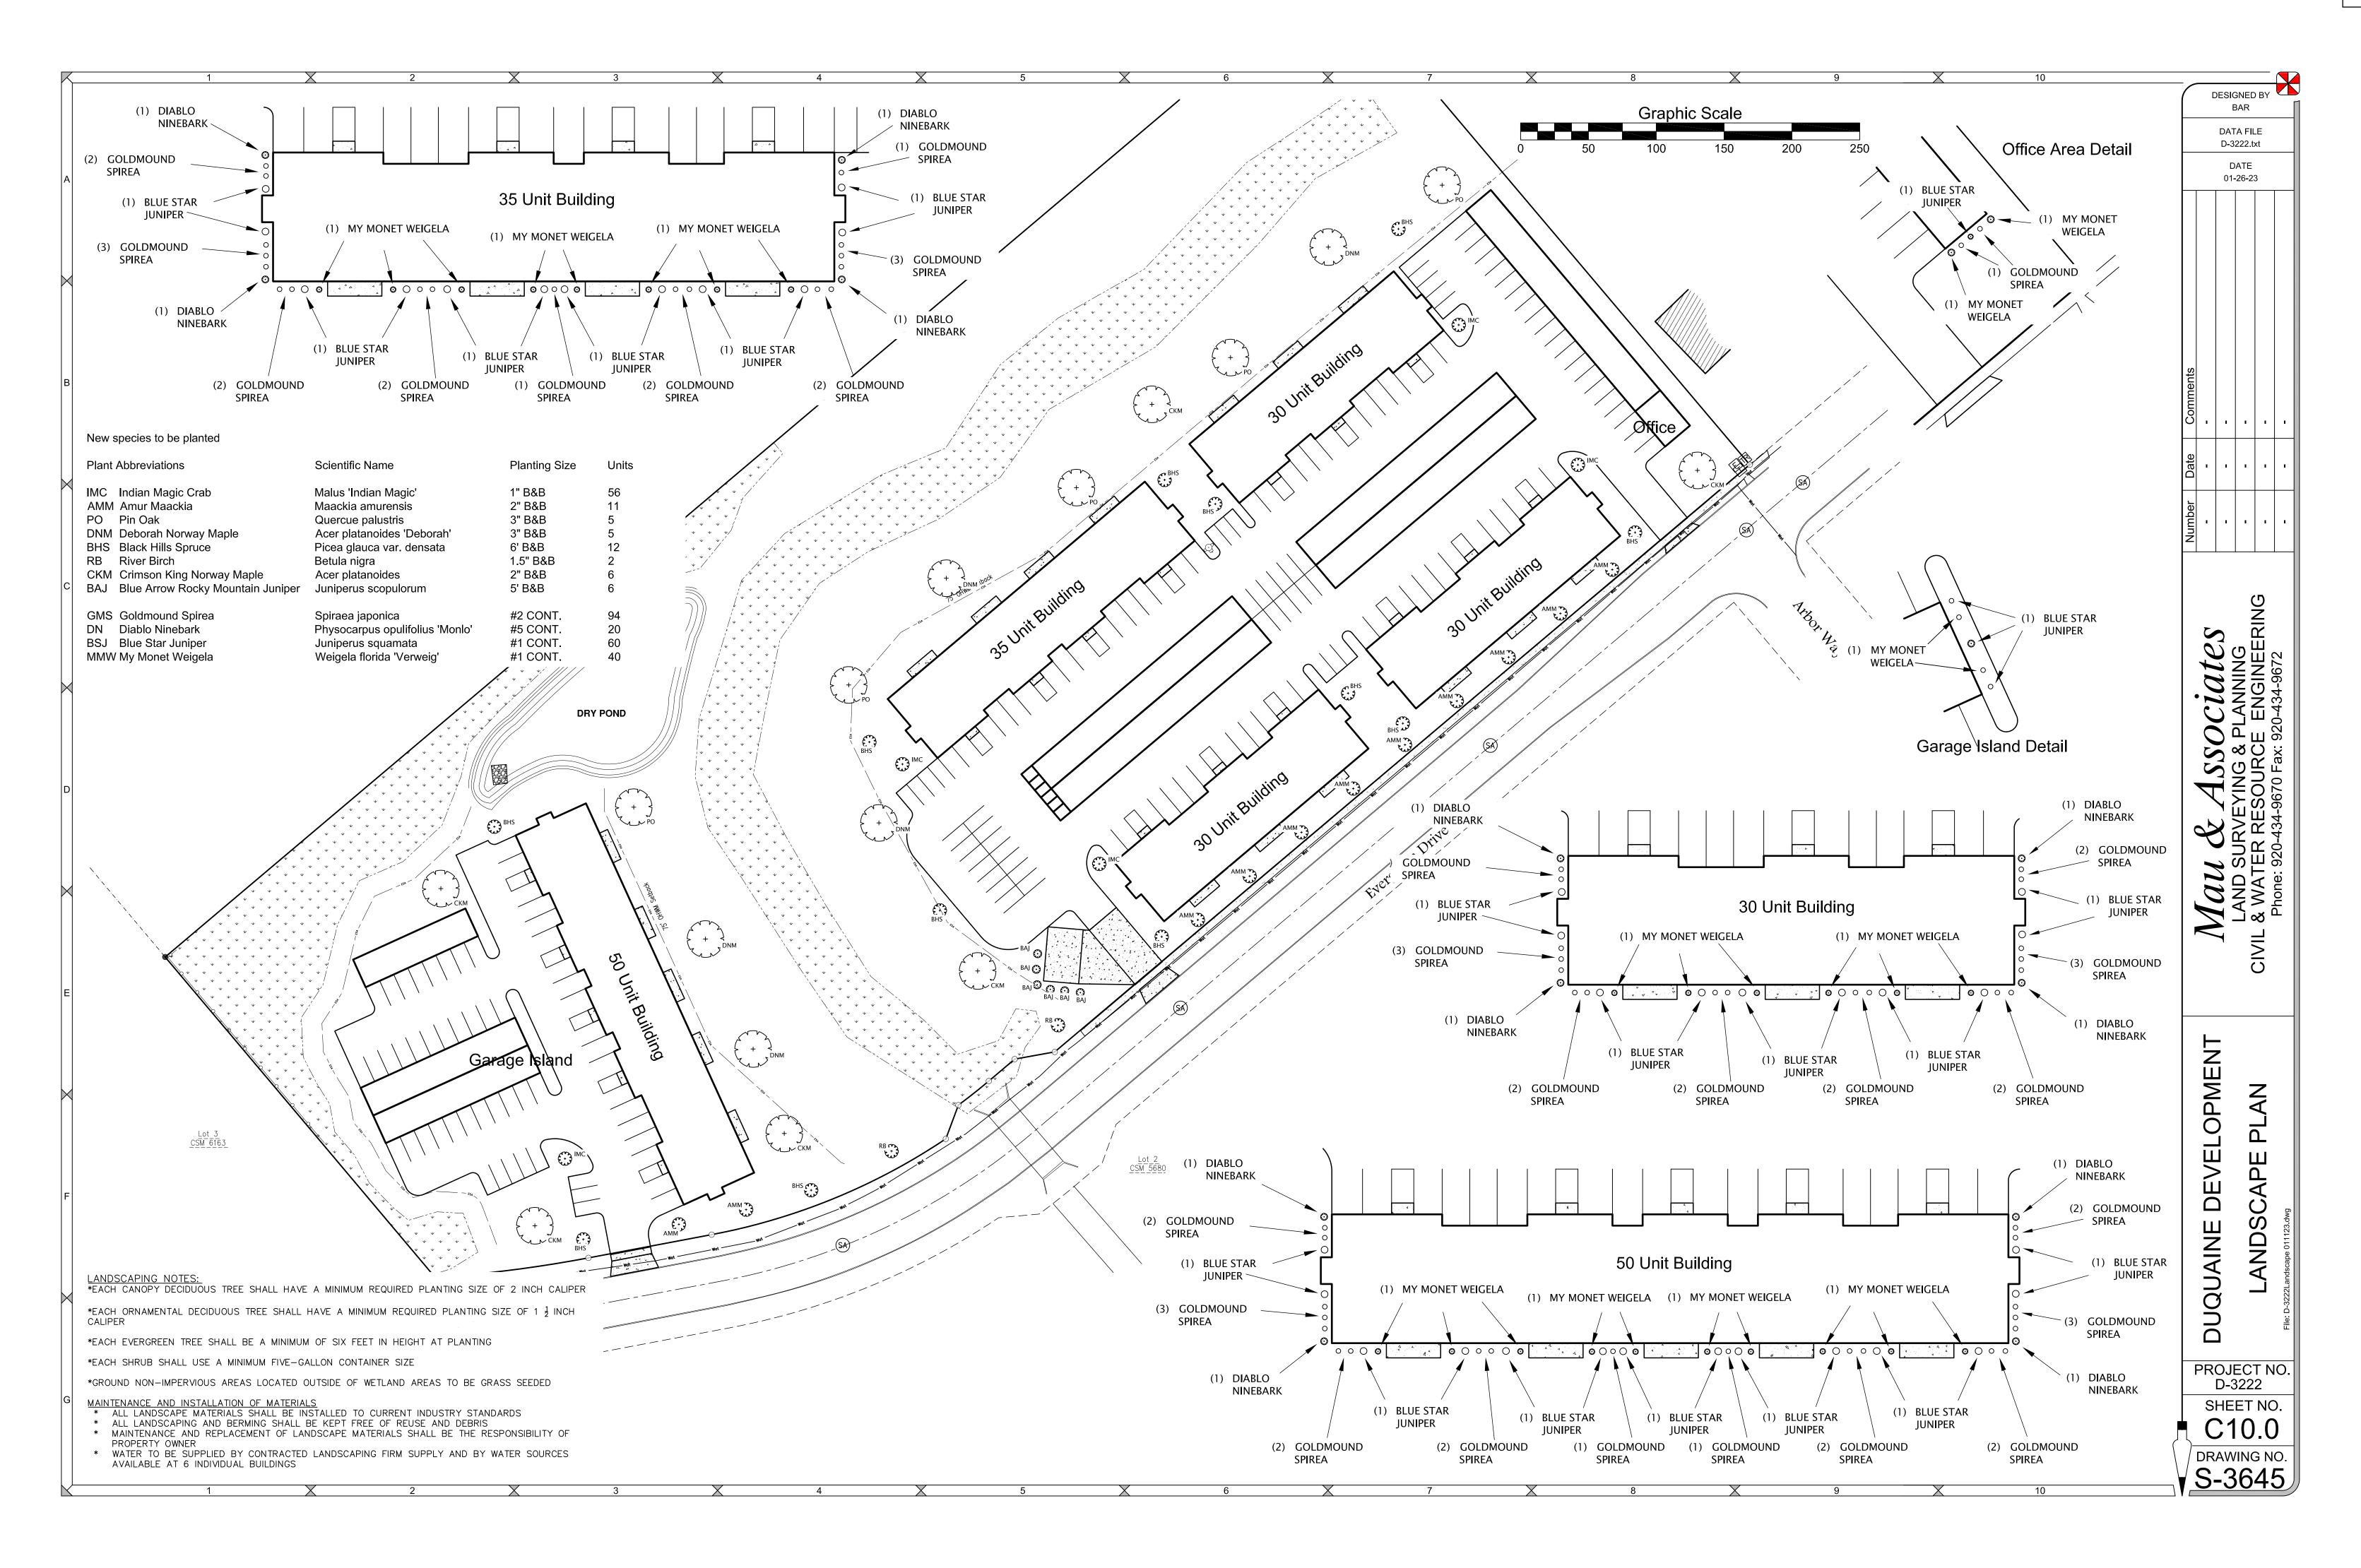

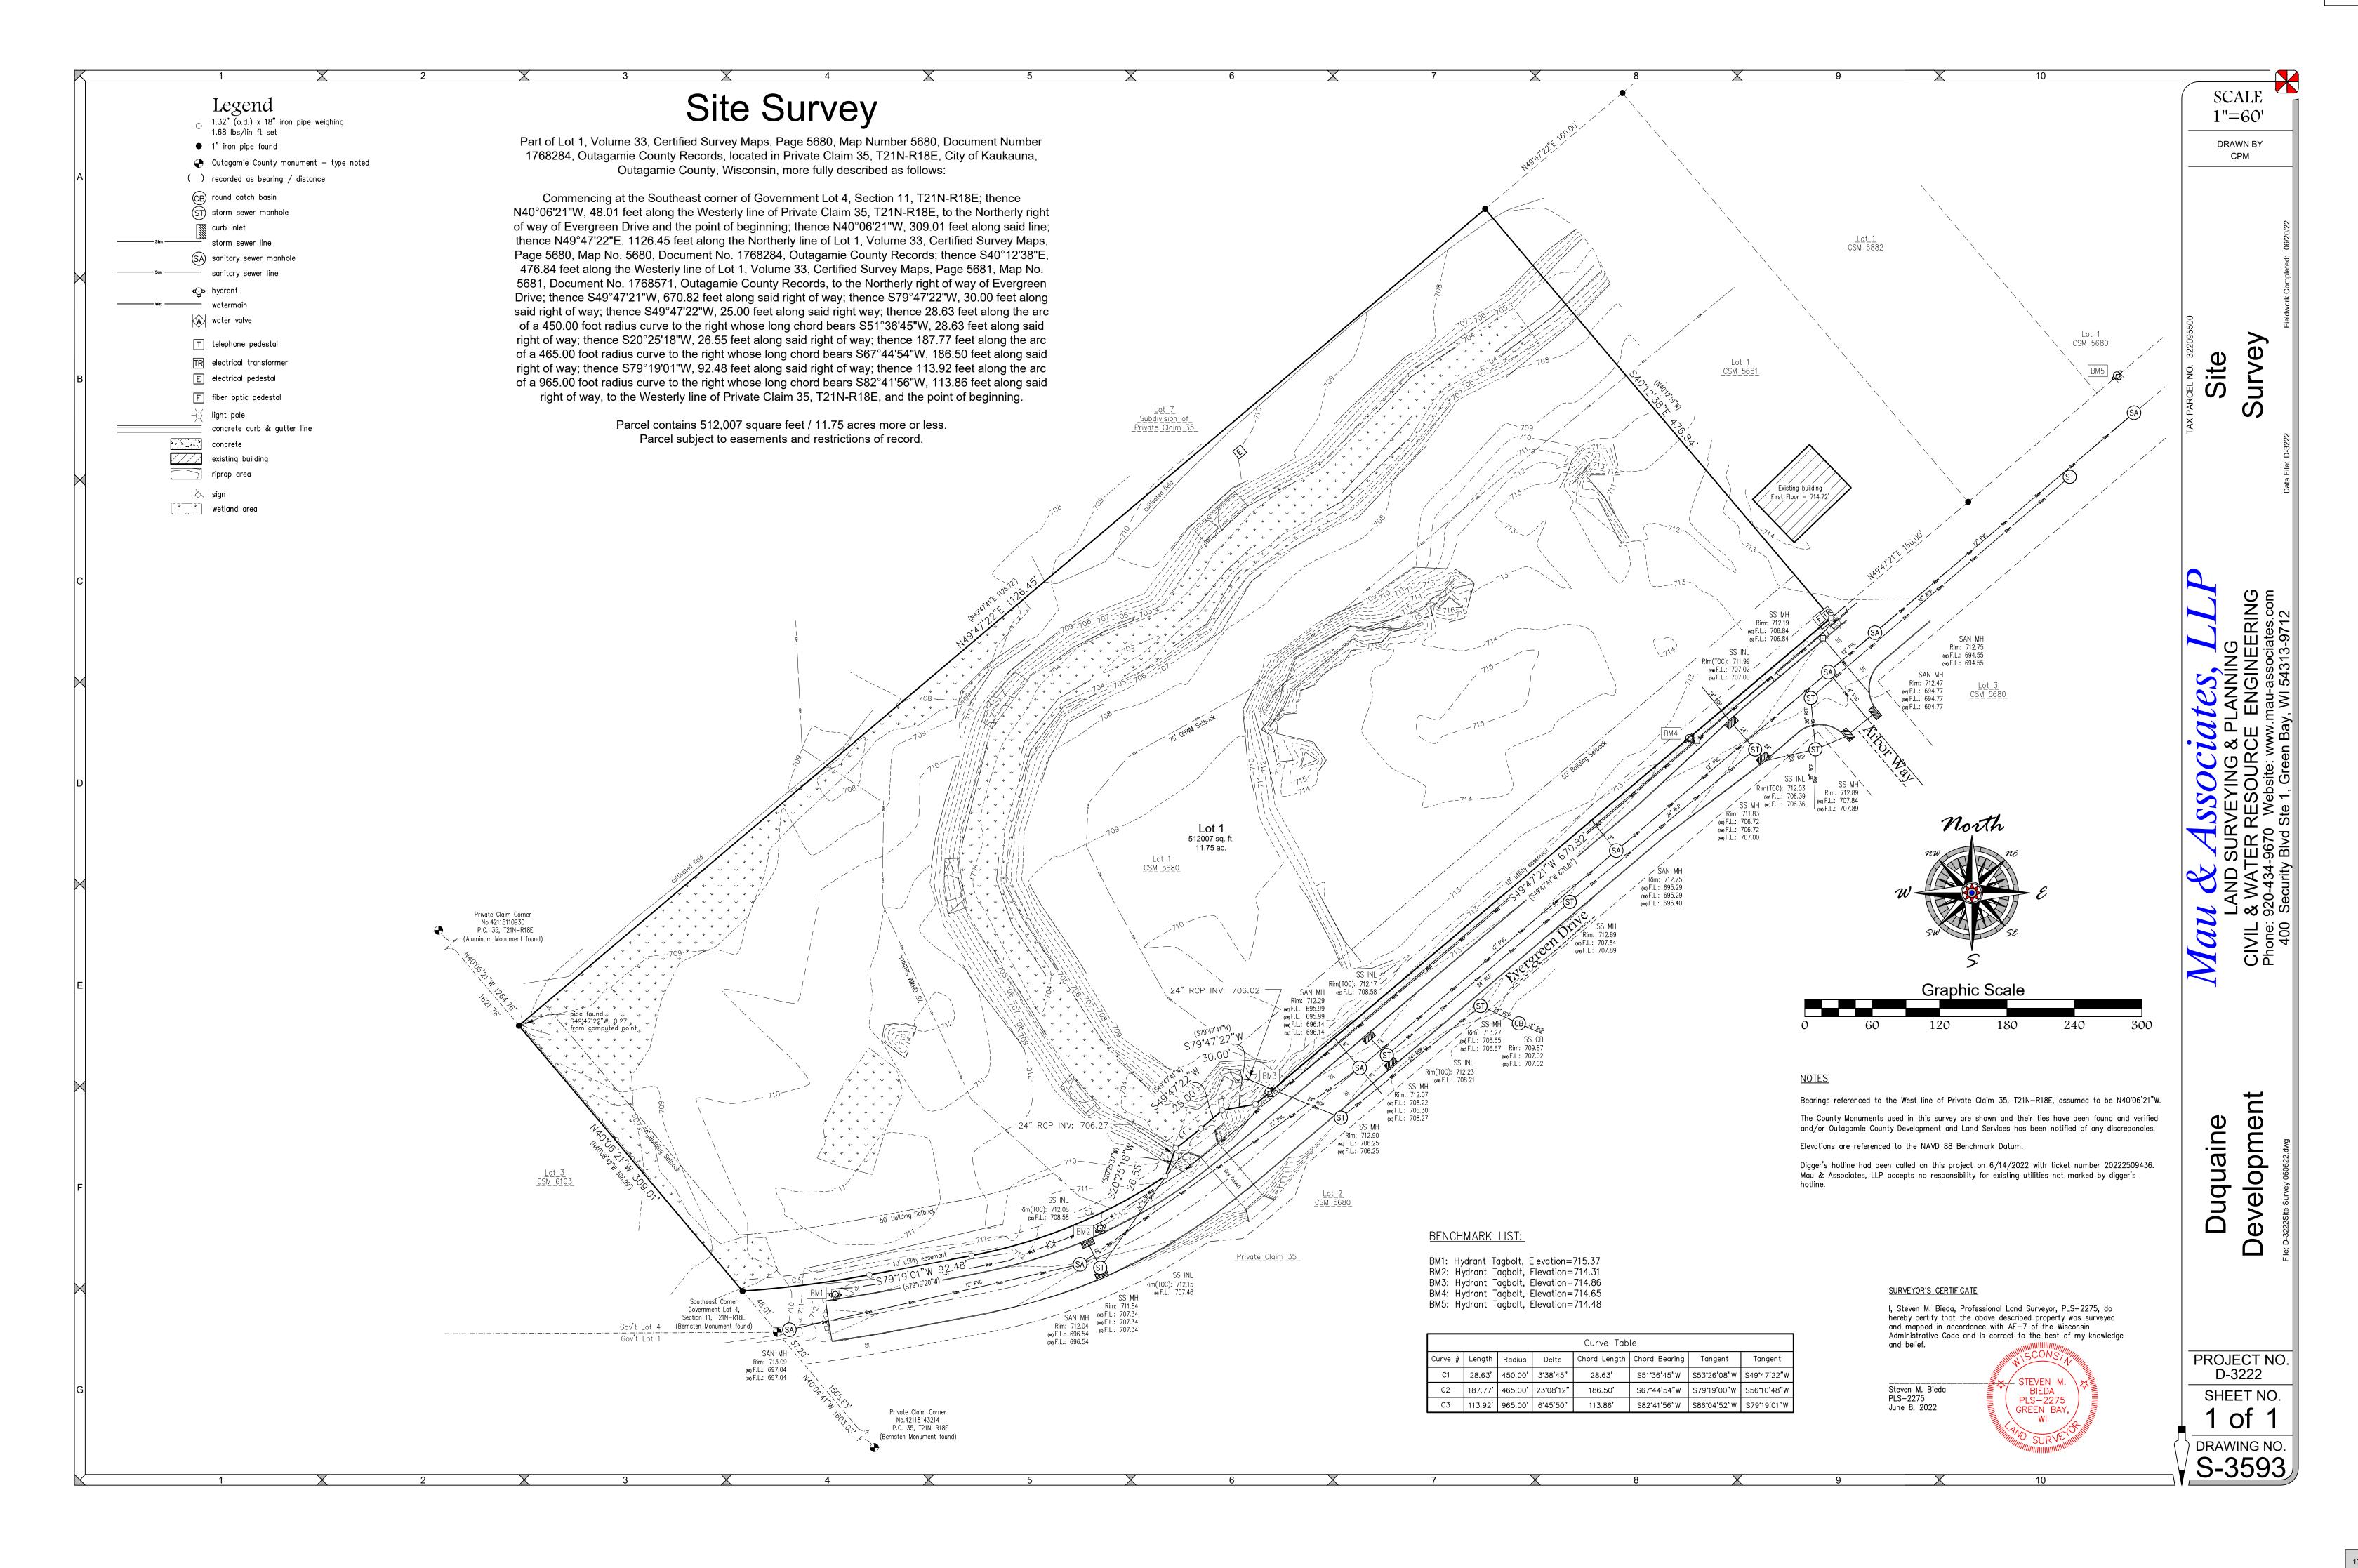






212 BUILDING

30 Unit 3 Story + Mezzanine






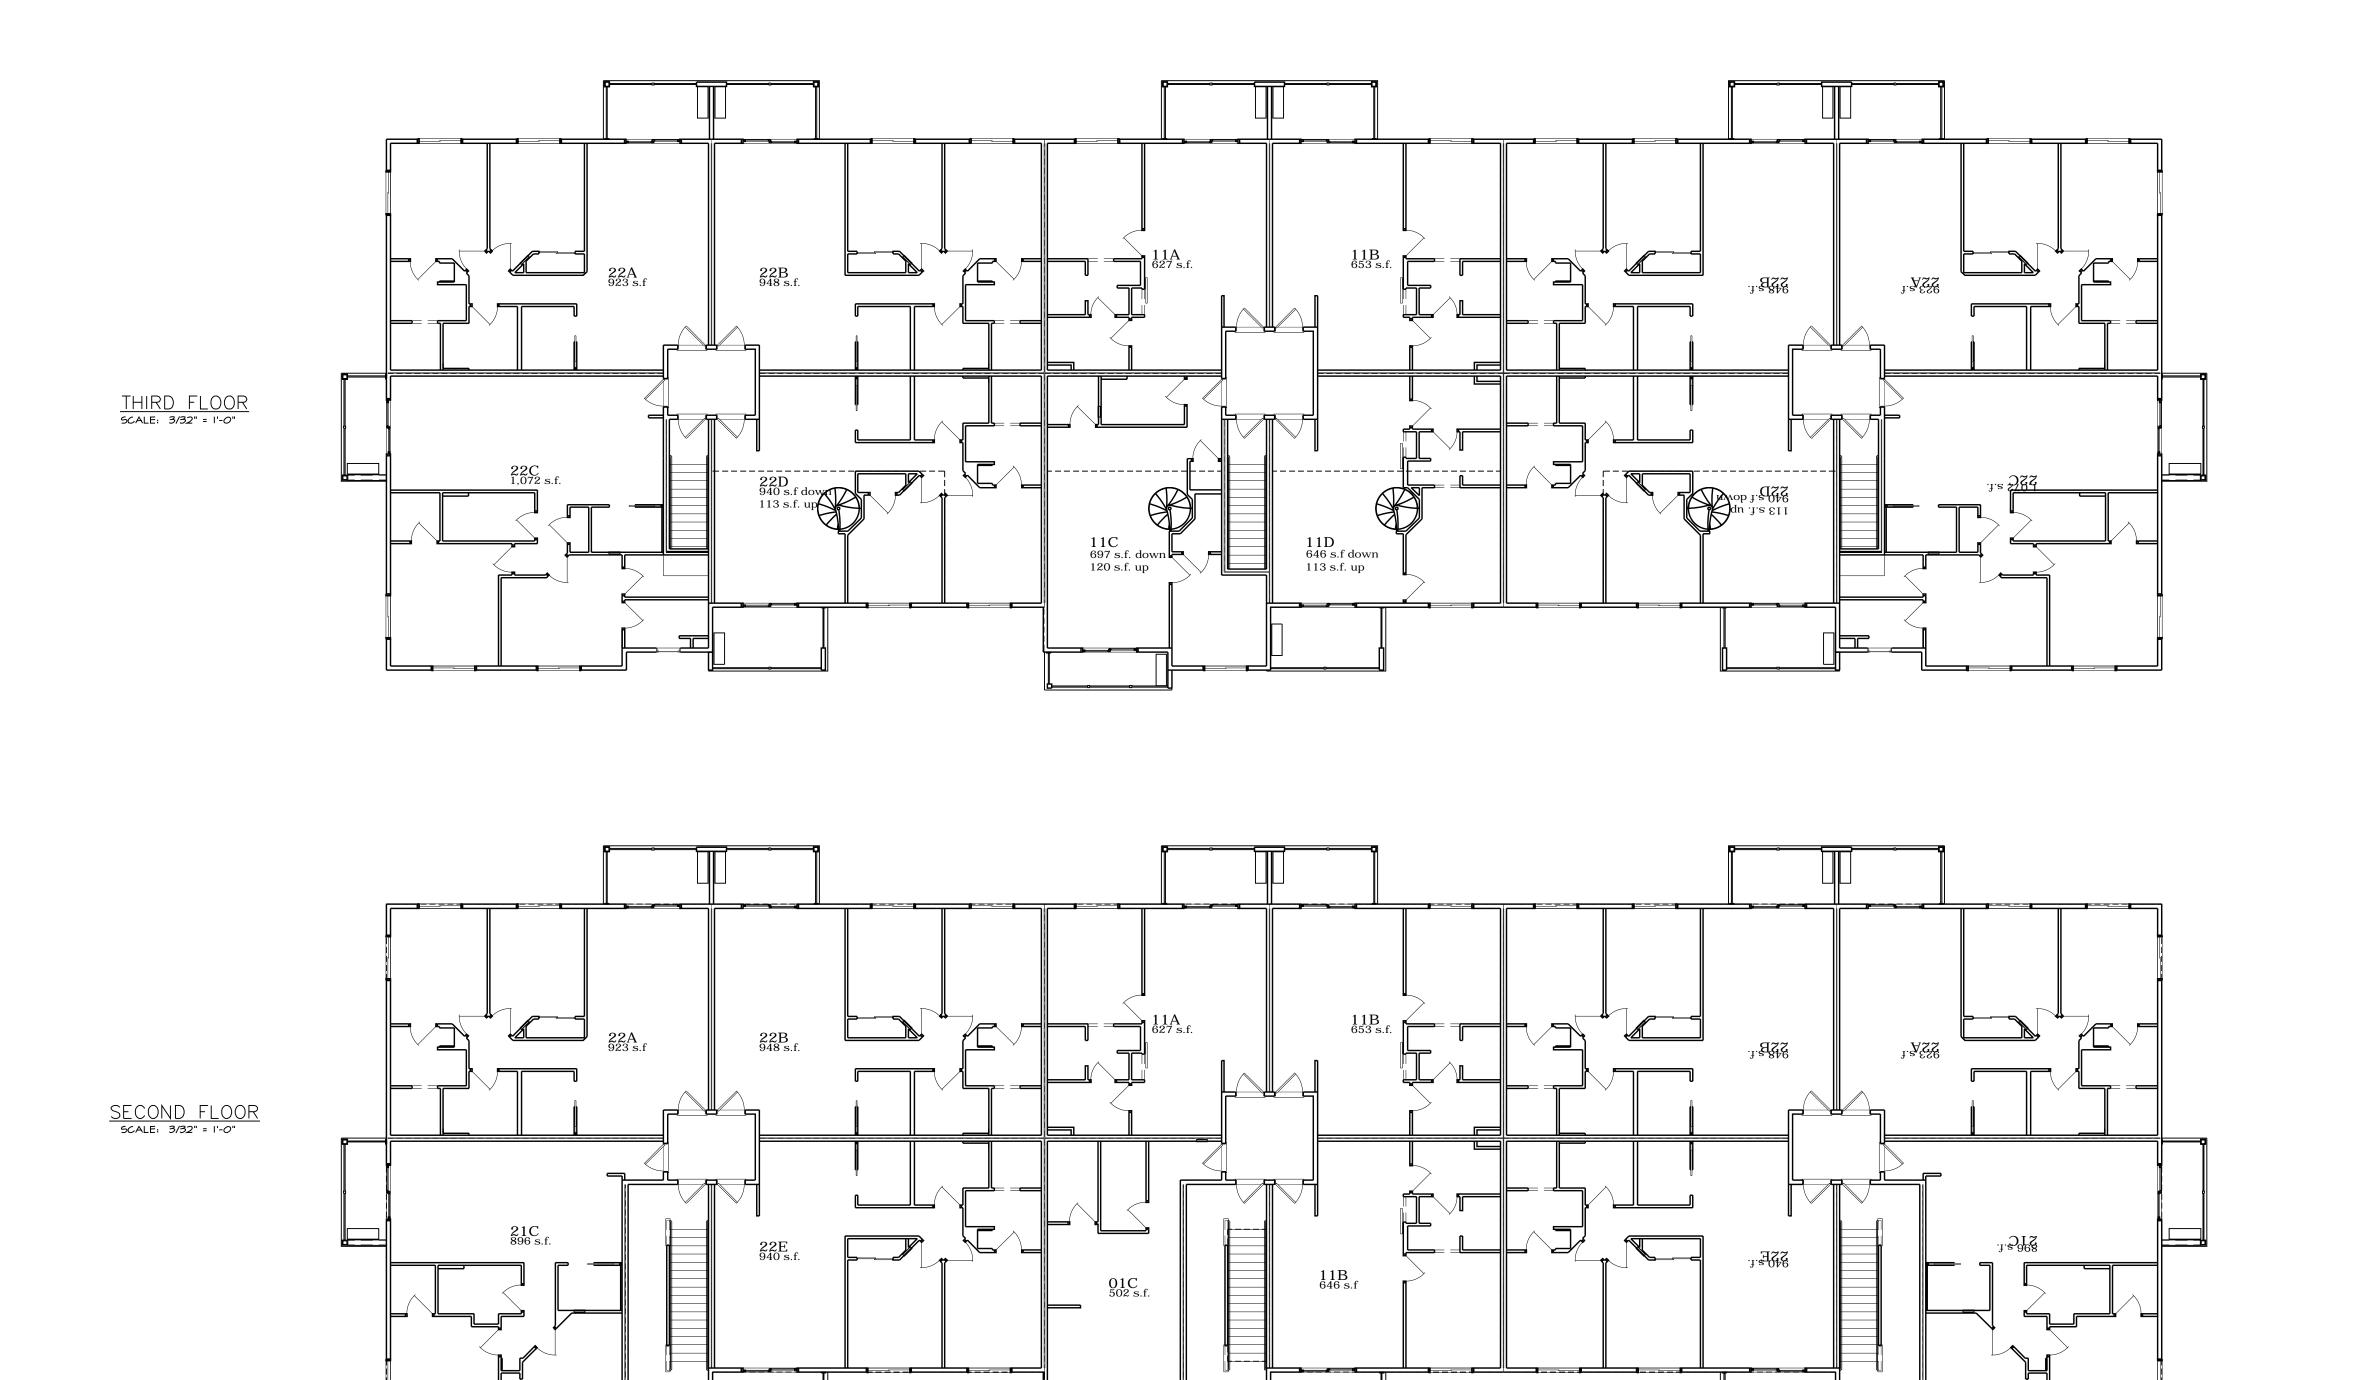

212 BUILDING

30 Unit 3 Story W/ LOFT

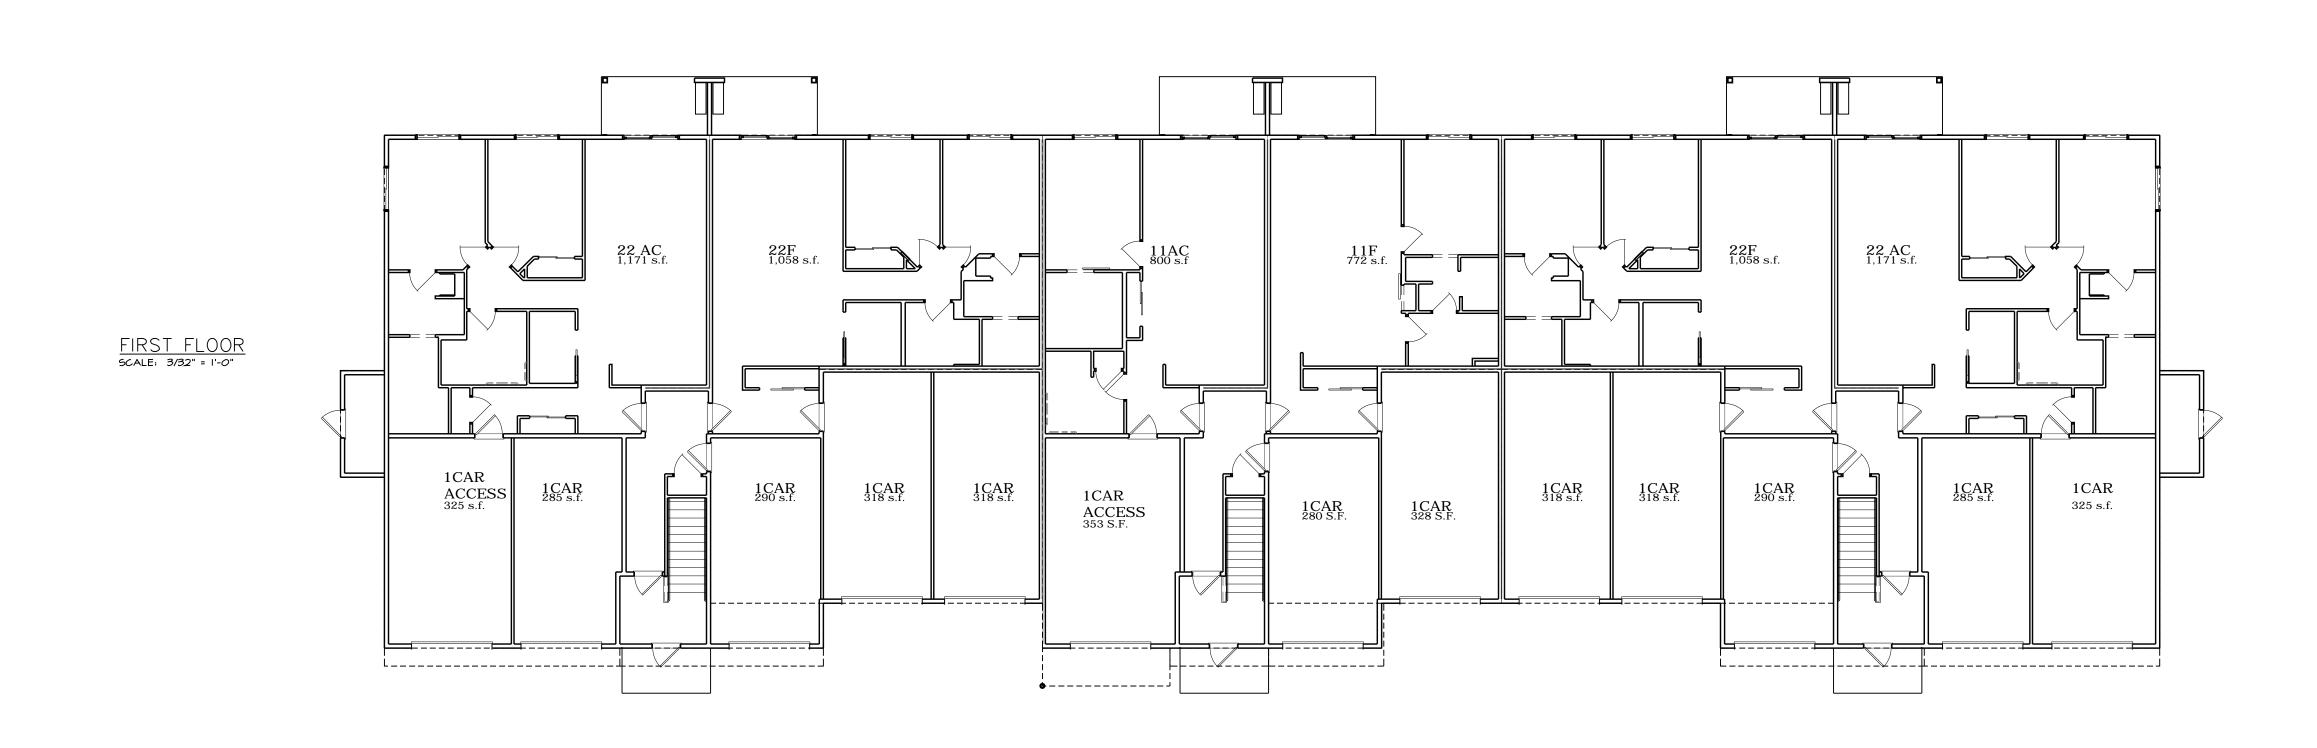



MEMO

PLANNING AND COMMUNITY DEVELOPMENT

To: Plan Commission

From: Associate Planner Lily Paul

Date: March 17, 2023

Re: Site Plan Review – Municipal Pool

The current facility was constructed in 1991. Due to the age of the complex, the City evaluated current and future repair costs versus replacement of facilities, to ensure the best use is made of public funding. In 2020, Staff began working with Parkitecture + Planning, LLC to develop a Master Plan for the facility moving into the future.

This new project brings in new concepts, amenities, and an updated site plan. An additional waterslide, aqua climbing wall, in-water feature, multiple shade structures, 18-hole Mini-golf course, bathhouse/mechanical buildings and Splash Pad will be added to the existing vessel to create a regional destination.

Site Plan Review

Site/Architectural

This is within the institutional Zoning. Setbacks are being met throughout the entire site. The splash pad and mini-golf will be built into the hill going toward the north property line. The new main building will stay within the same area that the existing building is located. The façade of the proposed building uses wood siding and 2 types of smooth face concrete masonry units (CMU), and 2 types of smooth panel siding all in the grey color family. The roof will be metal giving it the longest life, and modern look. The color of the roof is copper penny which resembles a rustic orange and fits well with Kaukauna's orange school colors and city logo. One rendition of the city logo will be featured on the front of the building. There is a smaller building next to the splash which includes additional bathrooms and a mechanical room. That is a simple grey, smooth masonry building with a graphite colored, metal roof. Some nice additions are shade canopies, umbrellas, benches, and picnic tables. Something to consider is a matching the colors of these features with the City Brand Colors. Currently, a royal blue, lime green and purple are used for those features. There are 32 proposed parking spots between the upper and lower lots on site.

Landscape

The landscaping plan meets all requirements with over 15 canopy trees (1 tree per 75 linear feet) in the front yard setback. There is at least one shrub, or a planter bed, for every 5 feet of building street frontage. Many existing trees are helping to meet the landscaping requirement. The planter beds shall be planted with perennial and annual plants for additional beautification.

Lighting

There is no proposed additional lighting.

Stormwater

The developer will work with Engineering Department to complete Erosion Control and Stormwater Management permitting.

Recommendation:

Staff recommends to approve the site plan for The Municipal Pool with the following conditions:

 Prior to issuance of building permits, must obtain Storm Water and Erosion Control permits from Engineering Department





SITE PLAN REVIEW APPLICATION

PROPERTY OWNER	APPLICANT (IF DIFFERENT PARTY THAN
PROPERTY OWNER	OWNER)
Name:	Name:
City of Kaukauna	
Mailing Address:	Mailing Address:
144 W. 2nd St	
Phone:	Phone:
920-766-6330	E., . 1.
Email: tvosters@kaukauna-wi.org	Email:
[tvosters@kaukauria-wi.org	
PROPERTY INFORMATION	
Described the Proposed Project in Detail: The current facility was constructed in 1991. Due to the age of the complex, the City evaluated current ar Staff began working with Parkitecture + Planning, LLC to develop a Master Plan for the facility moving int	nd future repair costs versus replacement of facilities, to ensure the best use is made of public funding. In 2020, to the future.
This new project brings in new concepts, amenities, and an updated site plan. An additional waterslide, a buildings and Splash Pad will be added to the existing vessel to create a regional destination.	qua climbing wall, in-water feature, multiple shade structures, 18-hole Mini-golf course, bathhouse/mechanical
Property Parcel (#):	
325021600	
Site Address/Location:	
607 Dodge Dt Kaukauna	
Current Zoning and Use:	
Institutional (IT)	
Proposed Zoning and Use:	
Institutional (IT)	
Existing Gross Floor Area of Building:	Proposed Gross Floor Area of Building:
	1) 10,330 sf (Main) + 514 sf (Splashpad)
Existing Building Height:	Proposed Building Height:
20 feet (approx)	24 feet (Main) + 11 feet (Splashpad)
Existing Number of Off-Street Parking Spaces:	Proposed Number of Off-Street Parking Spaces:
40	32
Existing Impervious Surface Coverage Percentage:	Proposed Impervious Surface Coverage Percentage
72,168 sf	85,898 sf

I certify that the attached drawings are, to the best of my knowledge, complete and drawn in accordance with all City of Kaukauna codes.

Owner/Agent Signature:	
Owner/Agent Name (printed):	

SITE PLAN REVIEW PROCEDURE

The Plan Review process is required for all new commercial, industrial or multifamily buildings, and building expansions/additions or structures.

Early in the process, consult the Site Application Checklist (below) for a complete list of plan requirements and contact staff in the Planning and Community Development Department for initial direction and assistance. In addition, it is your responsibility to notify utility companies regarding your proposed development.

Completed Site Plans must be submitted 14 business days prior to the intended Plan Commission meeting. Those plans will be distributed amongst various City departments for an initial review. After review, questions, comments, and requested revisions will be returned to the applicant in advance of the Plan Commission meeting.


SITE PLAN CHECKLIST

- ✓ Completed Site Plan application
- ✓ Completed <u>Erosion Control and Stormwater Management Permit application</u> and necessary fees
- ✓ Calculations for sanitary sewer and water
- ✓ Calculations for storm sewer design
- ✓ Site Plan set to include:
 - Site Plan layout and streets, including designated fire lanes
 - o Utilities, grading, and drainage plan
 - Erosion control plan
 - Landscape and lighting plan
 - Architectural elevation and construction details
 - Floor plan set
 - Any other plans or information deemed necessary by the Planning and Community Development

SITE PLAN SUBMISSION

- Email to Lily Paul <u>lpaul@kaukauna-wi.org</u>
- 2. In-person drop off City of Kaukauna, Attn: Lily Paul, 144 W. 2nd Street, Kaukauna, WI 54130

PROJECT LOCATION MAP

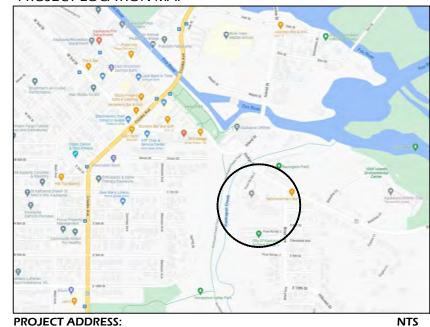

PROJECT ADDRESS: Kaukauna Municipal Pool, 607 Dodge Street, Kaukauna, WI 54130

PROJECT OVERVIEW



SITE LOCATION PLAN NTS

CIVIL ENGINEER: PARKITECTURE + PLANNING 901 DEMING WAY, SUITE 102 MADISON, WI 53717 608.438.4253

LANDSCAPE ARCHITECT: PARKITECTURE + PLANNING

901 DEMING WAY, SUITE 102 MADISON, WI 53717 608.886.6808

PROJECT NUMBER 21.039

ARCHITECT:

ONE DESIGN & ENGINEERING, LLC 202 ASH STREET CAMBRIDGE, WI 53523 608.577.0443

MECHANICAL, PLUMBING, ELECTRICAL: HEIN ENGINEERING GROUP 17 APPLEGATE COURT, SUITE 200 MADISON, WI 53713

608.288.9260

KAUKAUNA POOL RENOVATION CITY OF KAUKAUNA KAUKAUNA, WI

T100 TITLE SHEET C100 EXISTING CONDITIONS PLAN C101 EXISTING SITE PHOTOS C102 EXISTING SITE PHOTOS C110 EXISTING POOL PLANS - EXISTING BUILDING C111 EXISTING POOL PLANS - POOL VESSEL C112 EXISTING POOL PLANS - POOL VESSEL DETAILS C113 EXISTING POOL PLANS - POOL PIPING C110 SITE DEMOLITION PLAN C200 SITE LAYOUT PLAN - OVERVIEW C210 SITE LAYOUT PLAN C211 SITE LAYOUT PLAN C212 SITE LAYOUT PLAN C213 SITE LAYOUT PLAN C214 SITE LAYOUT PLAN C215 SITE LAYOUT PLAN C300 SITE GRADING PLAN - OVERVIEW C310 SITE GRADING & UTILITY PLAN C311 SITE GRADING & UTILITY PLAN C312 SITE GRADING & UTILITY PLAN C314 SITE GRADING & UTILITY PLAN C315 SITE GRADING & UTILITY PLAN C400 SITE UTILITY PLAN C500 SPLASHPAD - CONCRETE LAYOUT PLAN C501 SPLASHPAD - FEATURE LAYOUT PLAN C502 SPLASHPAD - GRADING PLAN C503 SPLASHPAD - PLUMBING PLAN C504 SPLASHPAD - ELECTRICAL & BONDING PLAN C510 SPLASHPAD BLDG FLOORPLAN C511 SPLASHPAD BLDG ELEVATIONS C512 SPLASHPAD BLDG SECTIONS C513 SPLASHPAD BLDG MECH ROOM C515 SPLASHPAD - PLUMBING DIAGRAMS C520 SPLASHPAD DETAILS - CONTROLLER C521 SPLASHPAD DETAILS - MANIFOLD C522 SPLASHPAD DETAILS - RAIN DIVERTER C523-9 SPLASHPAD DETAILS - FEATURES C600 WATERSLIDE - LAYOUT PLAN C601 WATERSLIDE - PIPING PLAN C602 WATERSLIDE - DETAILS C603 WATERSLIDE - FOUNDATION PLAN C610 WATERSLIDE - PLIMP ROOM ADDITION C700 POOL - WATER FEATURE LAYOUT & GRADING C701 POOL - WATER FEATURE PIPING C702 POOL - CONSTRUCTION DETAILS C800 SITE RESTORATION PLAN - OVERVIEW C801 SITE RESTORATION PLAN C802 SITE RESTORATION PLAN C803 SITE RESTORATION PLAN C804 SITE RESTORATION PLAN C805 SITE RESTORATION PLAN C810 SITE RESTORATION DETAILS C811 SITE RESTORATION DETAILS C912 CONSTRUCTION DETAILS A0.0 MECHANICAL SHED A001 CODE PLAN A100 FLOOR PLAN A101 FLOOR PLAN - DIMENSIONS A110 ROOF PLAN A300 BUILDING ELEVATIONS A301 BUILDING ELEVATIONS A302 BUILDING ELEVATIONS A310 BUILDING ELEVATIONS - MATERIALS


A311 BUILDING ELEVATIONS - MATERIALS **INDEX TO DRAWINGS** A320 EXTERIOR RENDERINGS A400 BUILDING SECTIONS A401 BUILDING SECTIONS A410 WALL SECTIONS A411 WALL SECTIONS A600 ENLARGED LOCKER ROOM PLAN A601 ENLARGED LOCKER ROOM ELEVATIONS A602 ENLARGED STAFF LOCKER ROOM PLANS A603 ENLARGED RESTROOM PLANS A610 ENLARGED CONCESSIONS PLAN A700 WALL TYPES & DETAILS A710 DOOR & WINDOW SCHEDULES A720 WINDOW DETAILS A800 REFLECTED CEILING PLAN 1100 INTERIOR FINISH PLAN 1110 INTERIOR SIGNAGE 1200 INTERIOR FINISH DETAILS S001 GENERAL STRUCTURAL NOTES S100 FOUNDATION PLAN S101 SLAB ON GRADE PLAN S210 ROOF FRAMING PLAN S300 FOUNDATION DETAILS E100 FLOOR PLAN - ELECTRICAL LIGHTING FLOOR PLAN - ELECTRICAL POWER/LV E102 ELECTRICAL SITE PLAN E200 ELECTRICAL SCHEDULES & DETAILS H100 FLOOR PLAN - HVAC H101 ATTIC PLAN - HVAC H200 HVAC SCHEDULES & DETAILS P100 FLOOR PLAN - UNDERGROUND PLUMBING P101 FLOOR PLAN - PLUMBING P102 FLOOR PLAN - VENTING P200 PLUMBING - WASTE & VENT RISER P201 PLUMBING - WATER RISER P300 PLUMBING - SCHEDULES & DETAILS

or (800) 242-8511

Item 4.b.

RENOVATION KAUKAUNA POOL 607 Dodge Street Kaukauna, WI 54130

21.039 Project #: Review 3/13/2023 Issued For: Date:

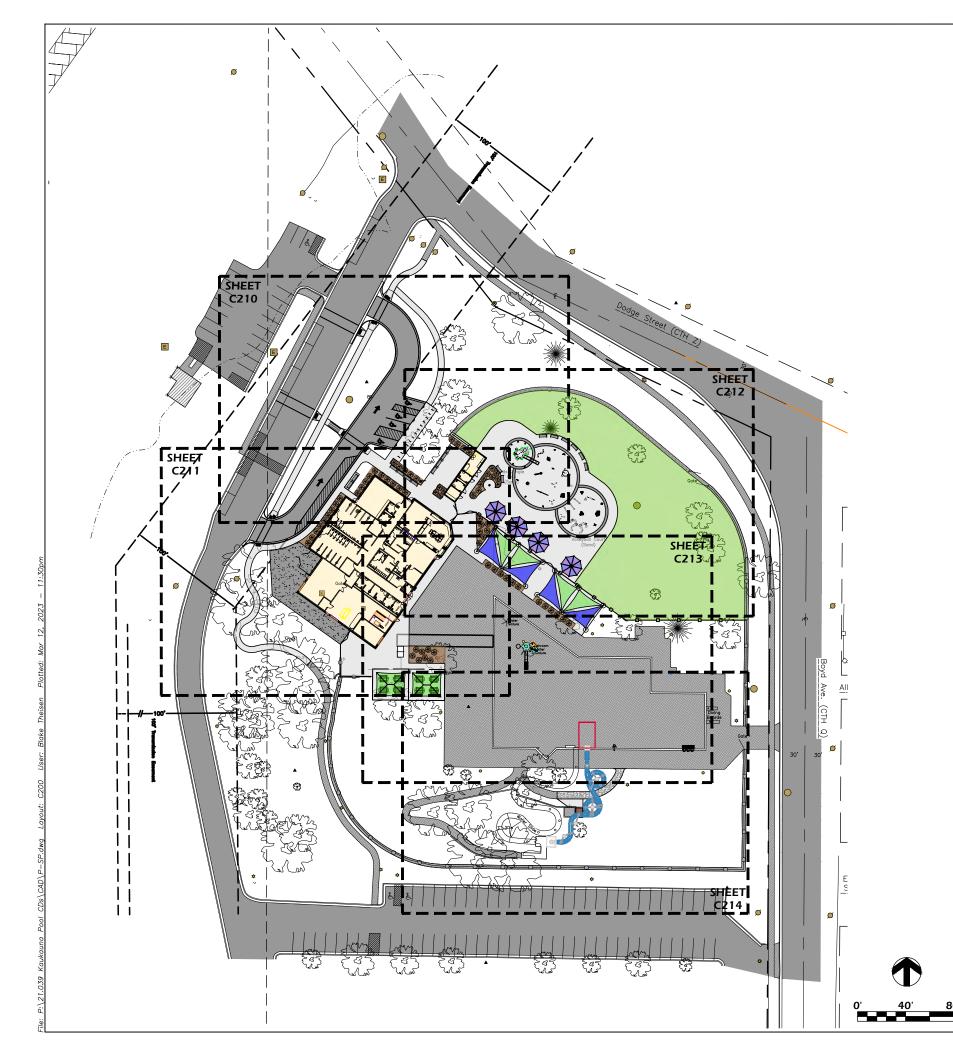

SITE LAYOUT NOTES

- CONTACT DIGGER'S HOTLINE 5 WORKING DAYS PRIOR TO THE START OF CONSTRUCTION.
- ALL PROPOSED DIMENSIONS ARE REFERENCED PARALLEL OR PERPENDICULAR TO THE PROPOSED FEATURES SHOWN. WRITTEN DIMENSIONS SUPERSEDE ANY SCALED DIMENSIONS.
- PROPOSED GRADE AND LEVEL SHALL BE PERIODICALLY REVIEWED IN THE FIELD BY THE OWNER
- CONCRETE JOINTING IS SHOWN FOR DESIGN INTENT. FINAL SCORING PLANS SHALL BE SUBMITTED TO THE A/E FOR REVIEW AS A SHOP SUBMITTAL.
- CONTRACTOR TO IMPORT SOIL AS NEEDED TO PREPARE TURF AREAS. CONTRACTOR TO FINE GRADE ALL AREAS TO FINISH GRADE.
- ANY EXISTING STRUCTURES AND/OR UTILITIES NOT SHOWN ON THESE DOCUMENTS WHICH NEED TO BE REMOVED, RELOCATED, AND OR ADJUSTED SHALL BE THE RESPONSIBILITY OF THE SITE CONTRACTOR AND INCLUDED IN THE BASE BID.
- CONTRACTOR SHALL BE RESPONSIBLE FOR SITE STAKING. DIGITAL PLAN FILES MAY BE AVAILABLE FROM THE A/E.

LANDSCAPE AND RESTORATION NOTES

- CONTRACTOR SHALL MEET EXISTING GRADE AT GRADING LIMITS WITH A SMOOTH AND CONTINUOUS TRANSITION.
- SEED/SOIL PLACEMENT SHALL EXTEND TO THE LIMITS OF CONSTRUCTION DISTURBANCE.
- ALL GENERAL LANDSCAPE AREAS DISTURBED DURING CONSTRUCTION SHALL BE RESTORED WITH 4" MINIMUM TOPSOIL DEPTH AND SEEDED IN ACCORDANCE WITH THE SPECIFICATIONS. THIS SHALL INCLUDE ANY AREAS OUTSIDE OF THE PROJECT LIMITS THAT ARE DISTURBED BY CONTRACTOR ACTIVITY. WATERING SHALL BE BY CITY.



Item 4.b.

ENGINEERING

RENOVATION

ONE DESIGN


OVERVIEW


KAUKAUNA POOL 607 Dodge Street Kaukauna, WI 54130 SITE LAYOUT PLAN


Project #: Issued For: Date:


Review 3/8/2023 Sheet Number


21.039

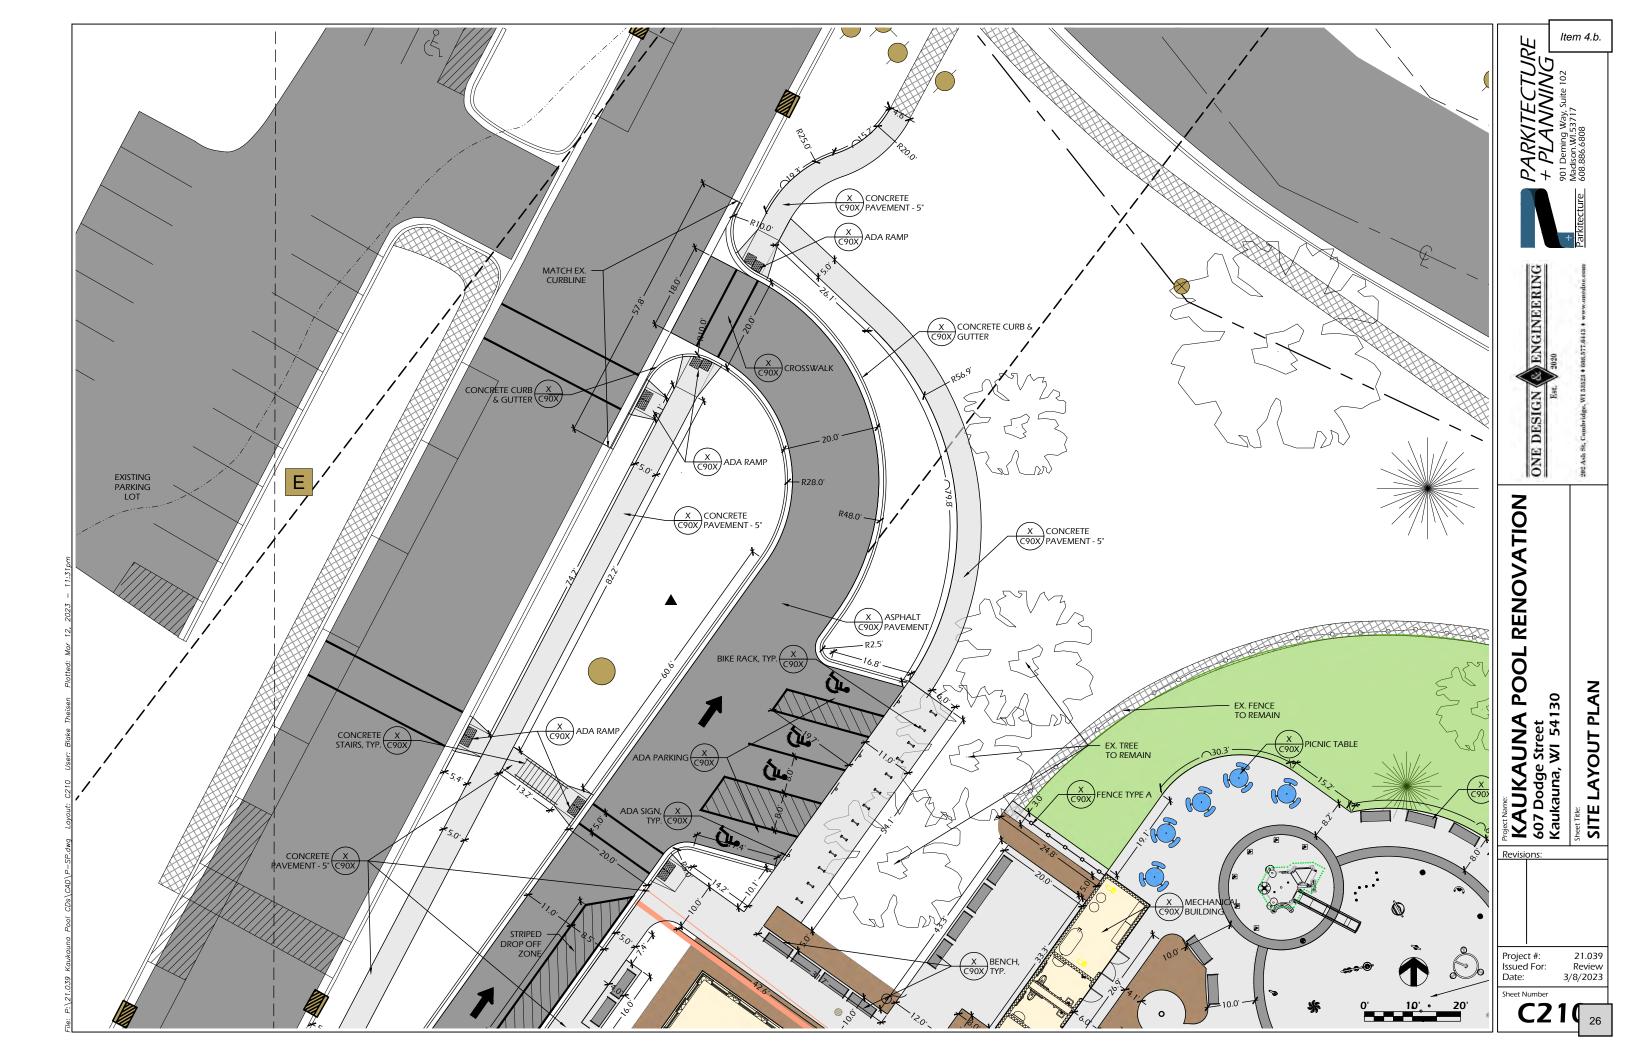


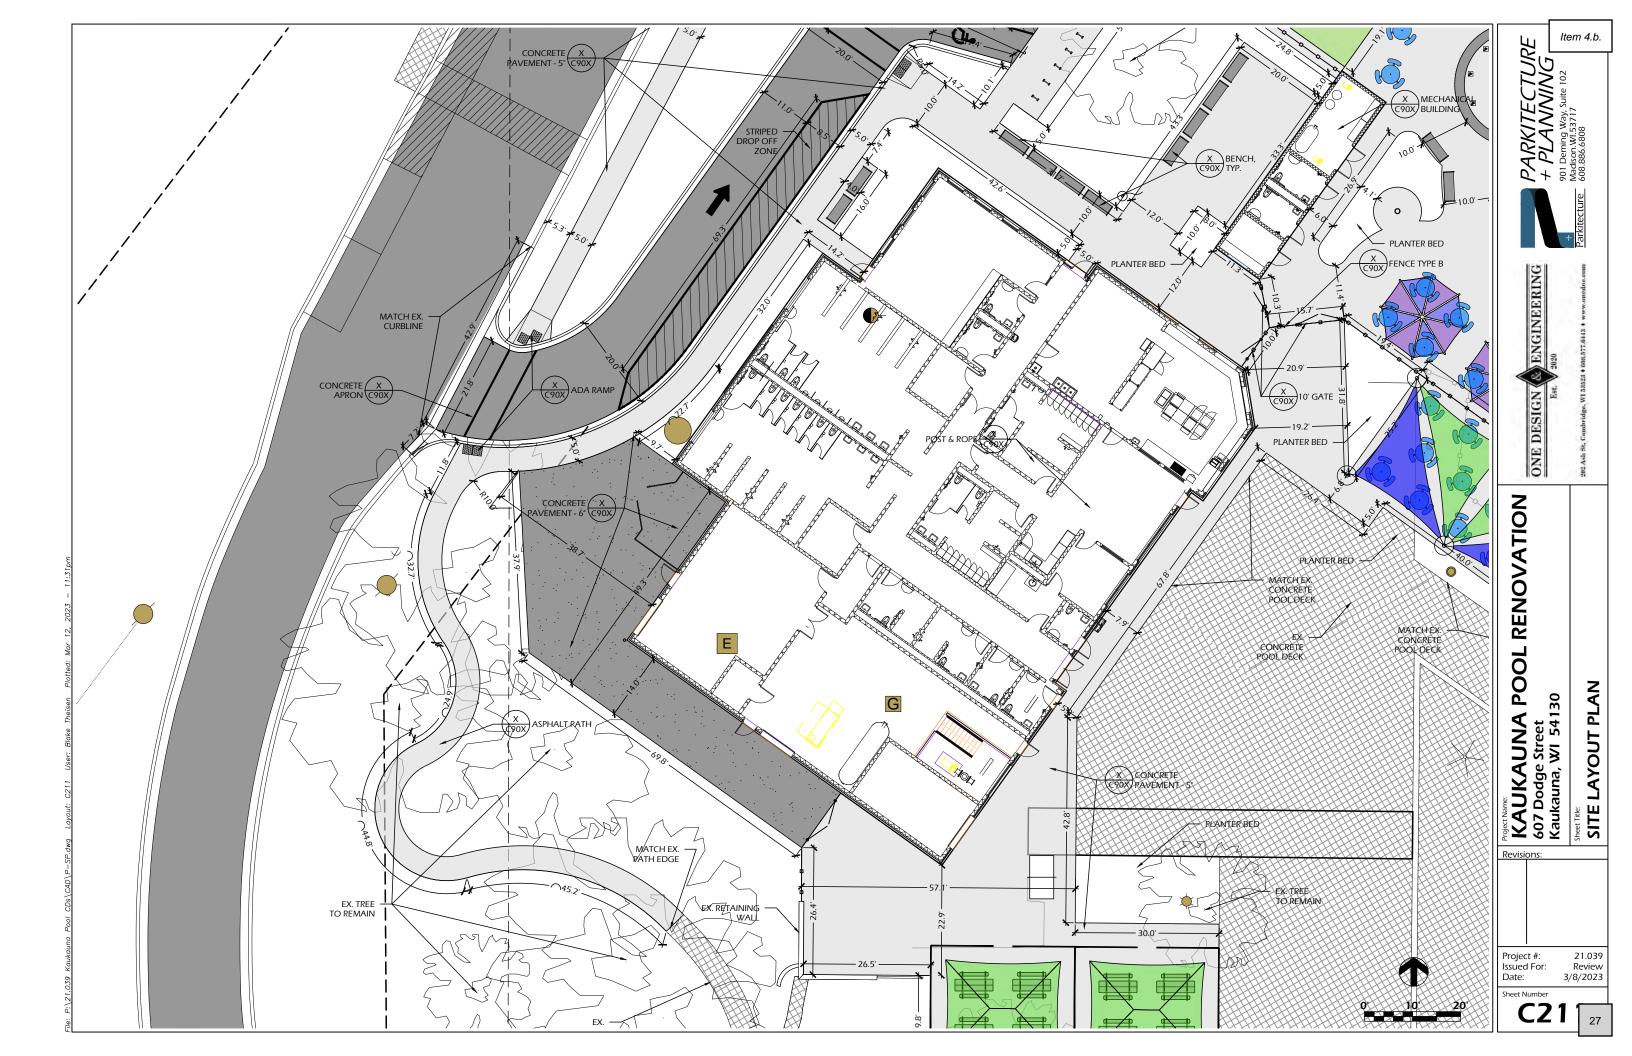

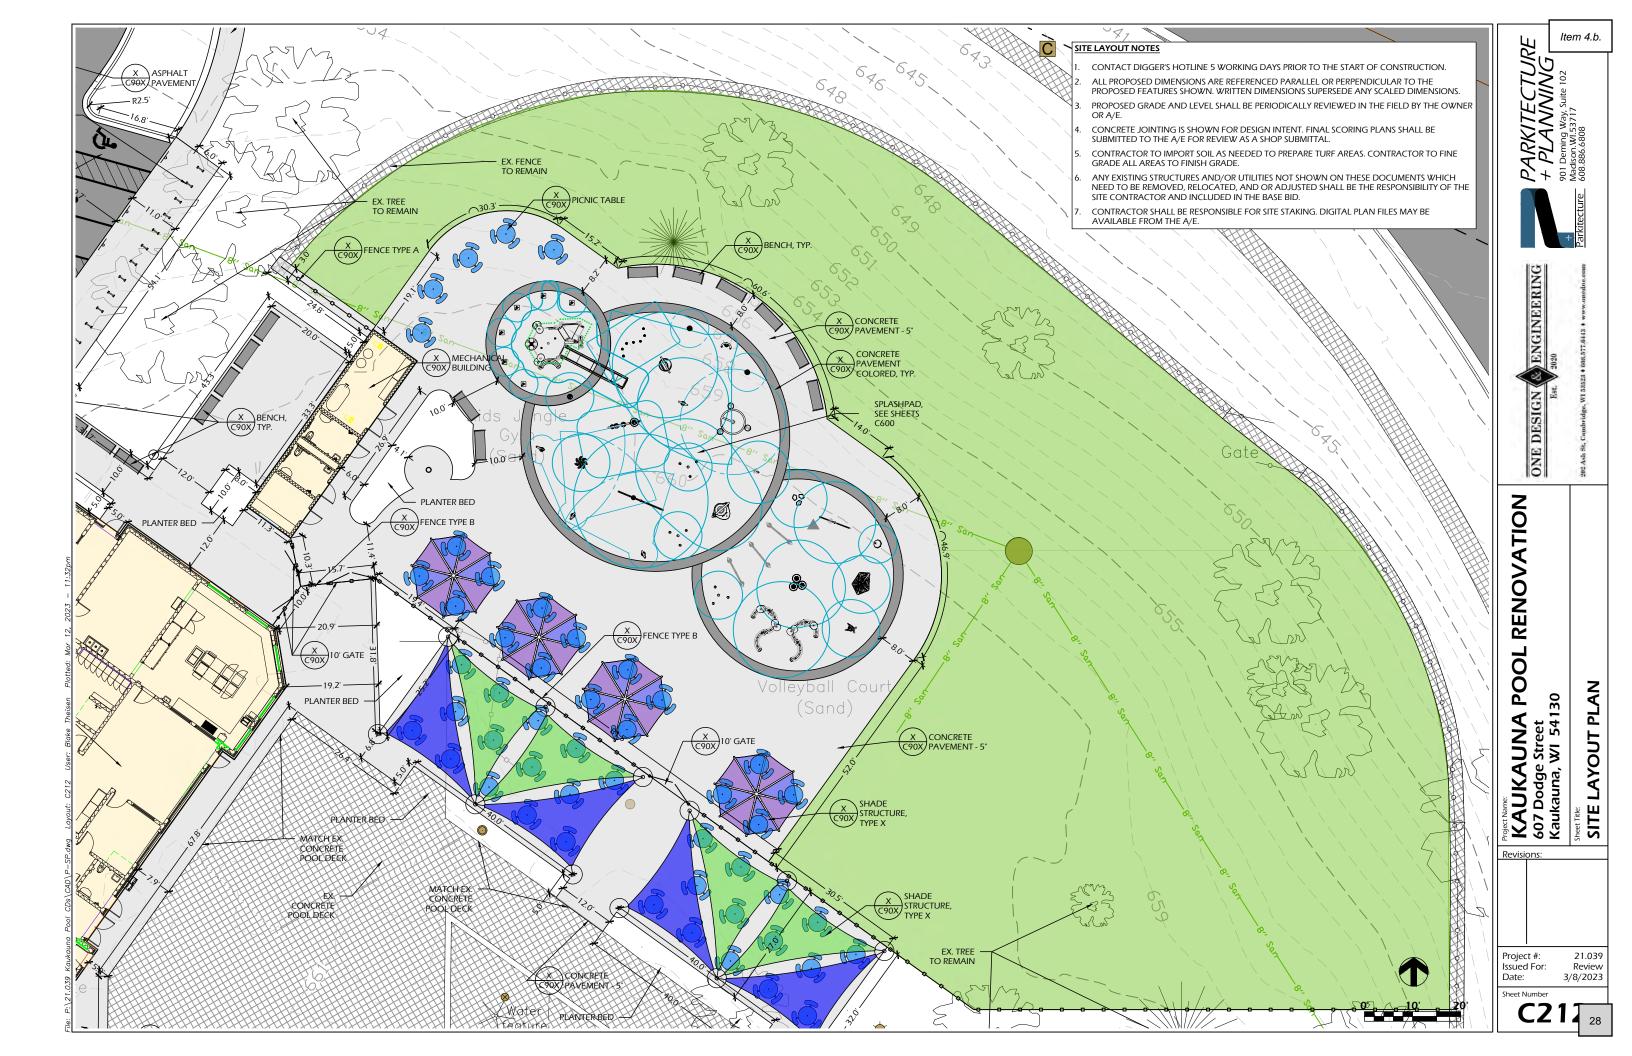

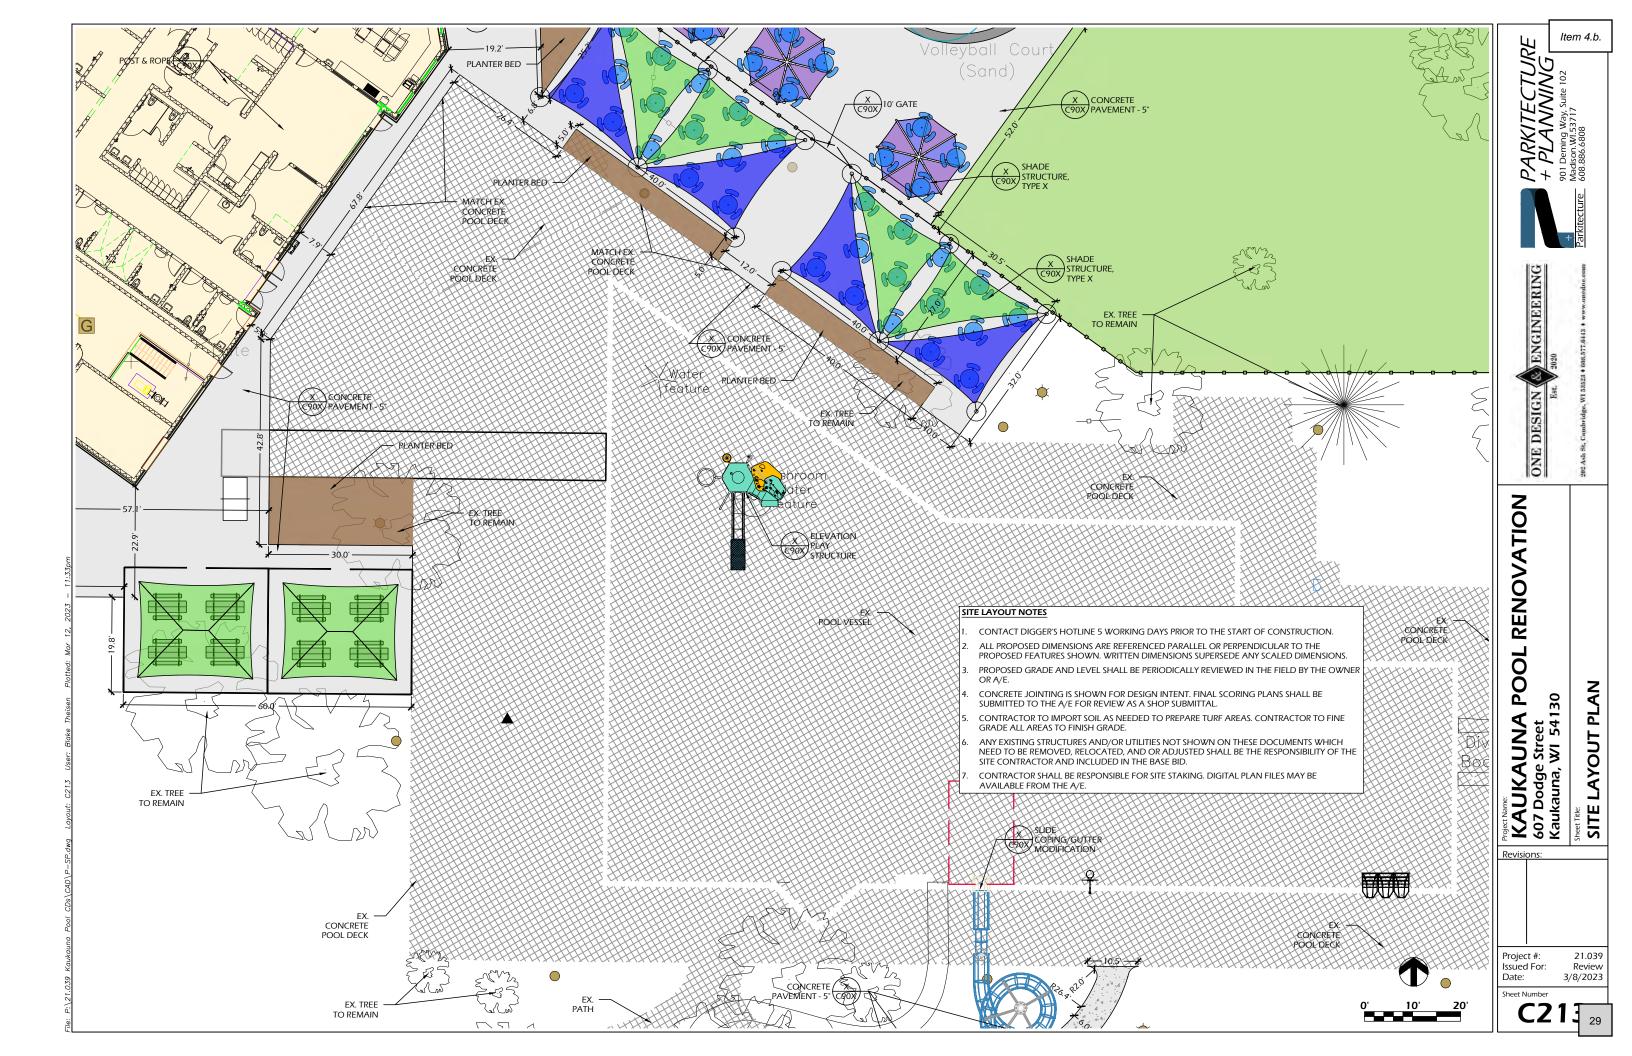

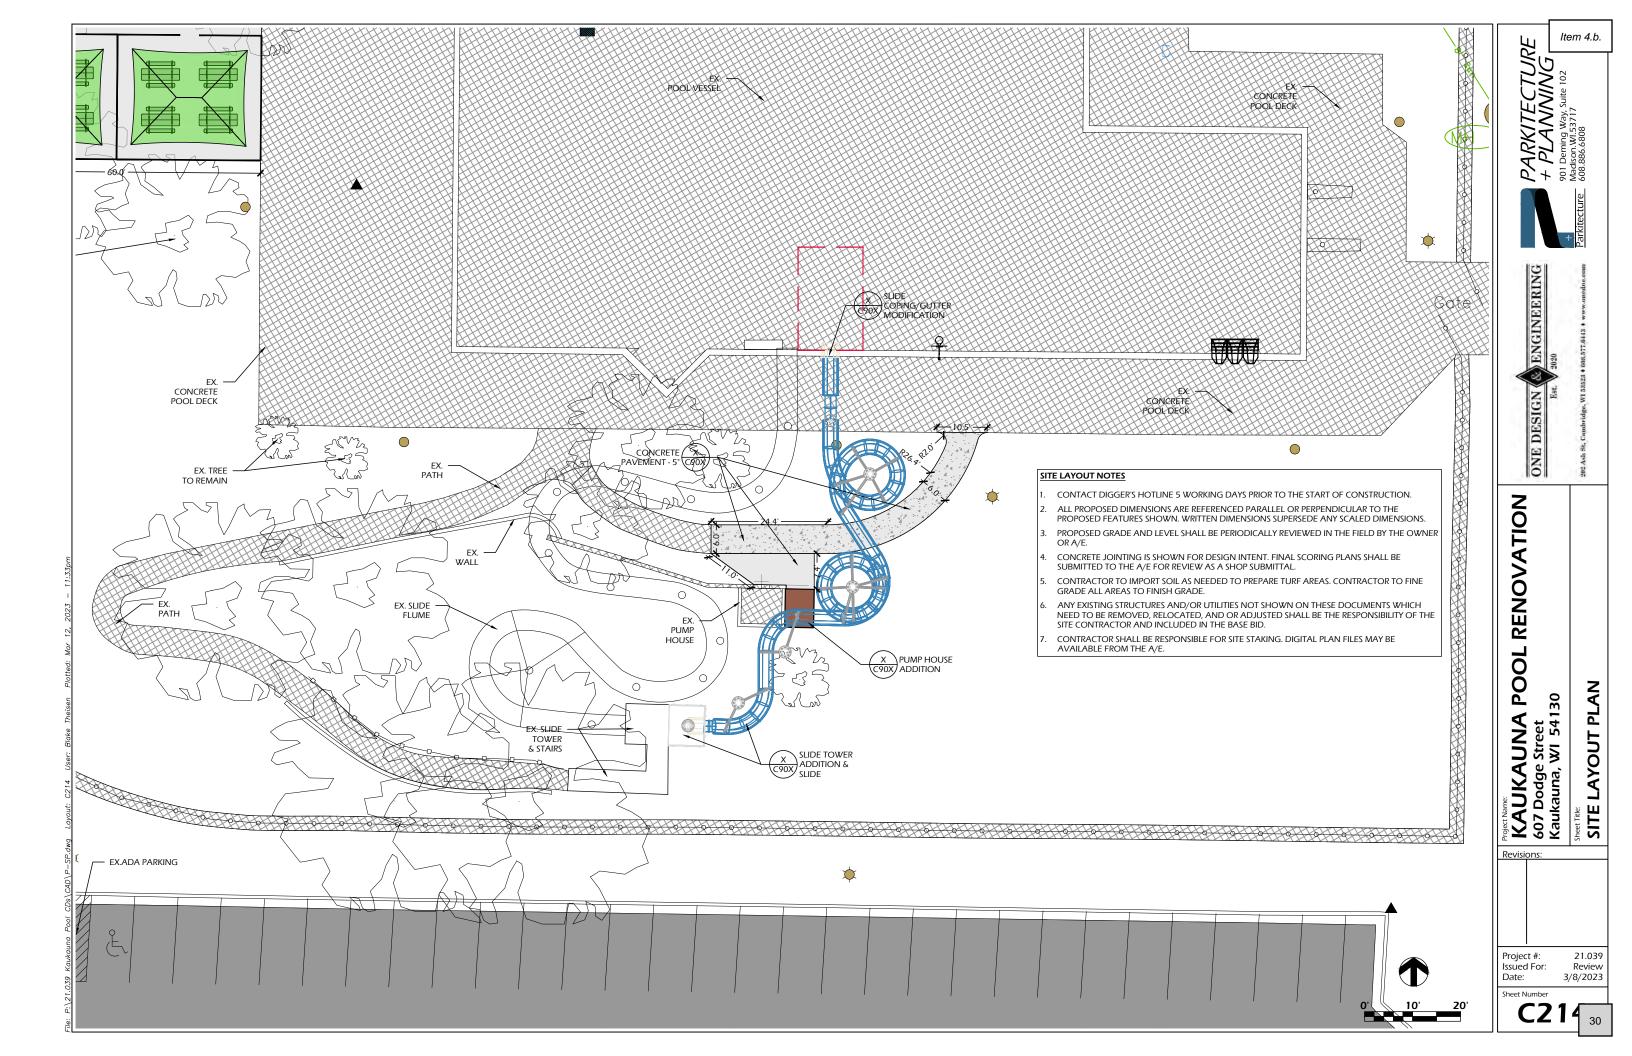

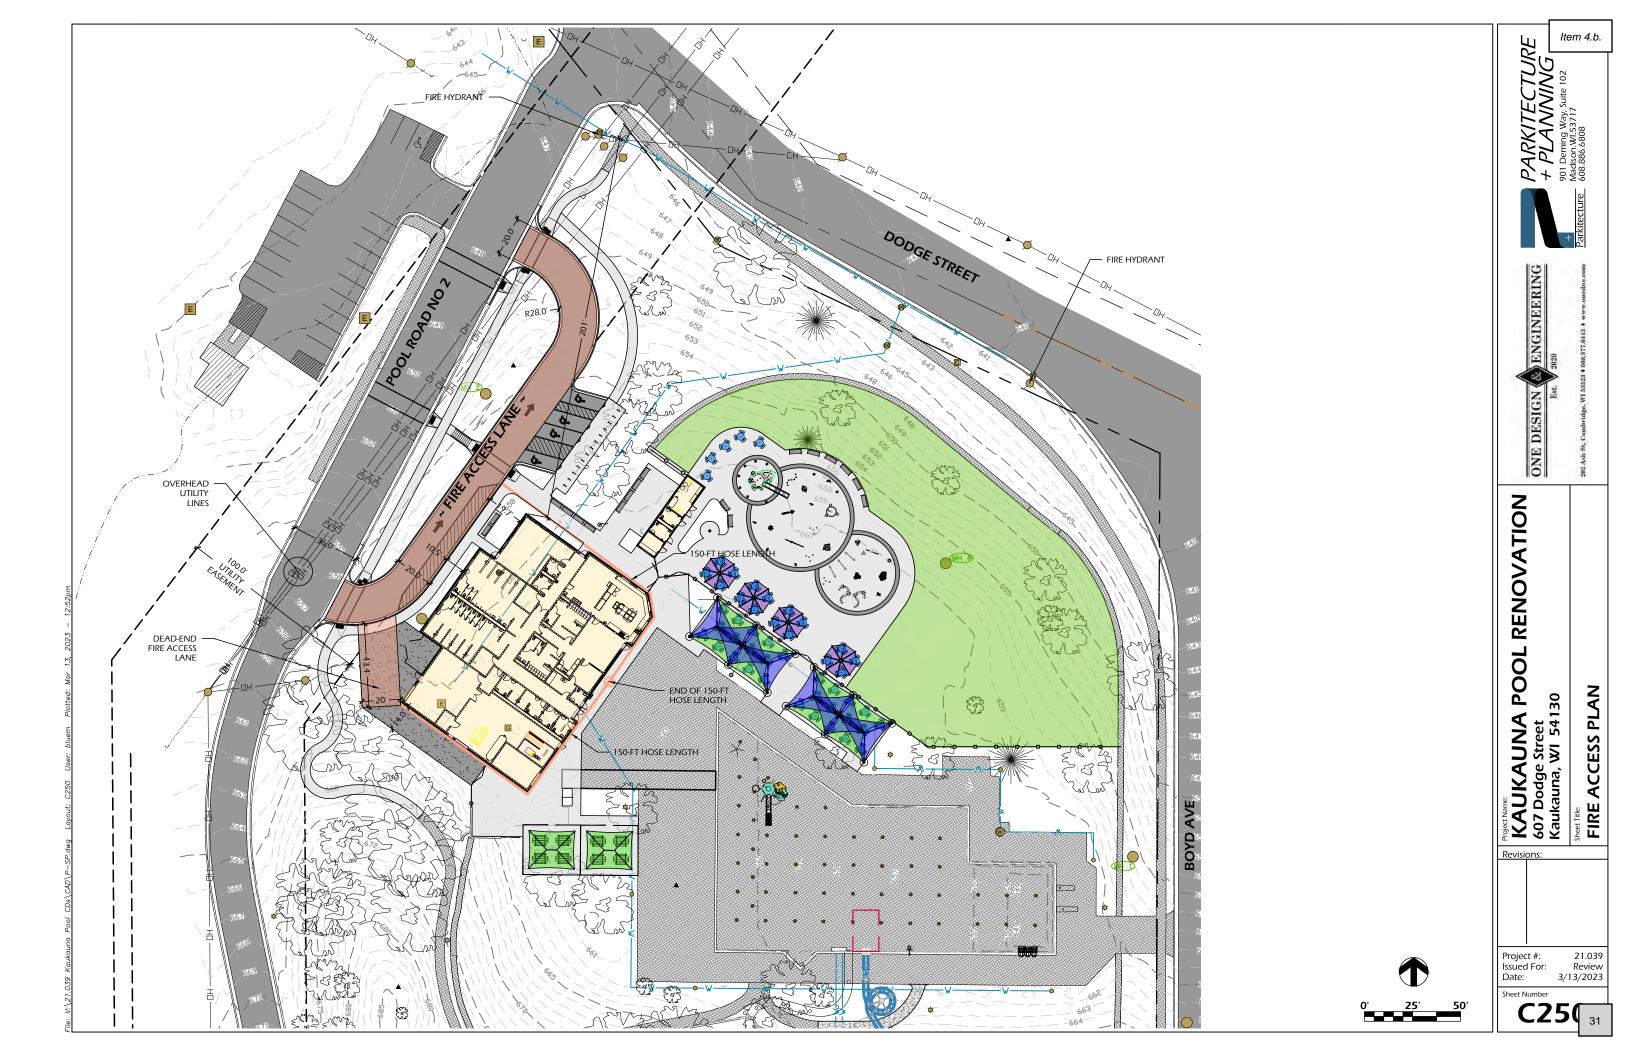

SPLASHPAD DIMENSION

TOTAL AREA: 387 m² 4166 ft²


SPRAY AREA: 3516 ft² 327 m²

GRID SIZE: $10 \times 10 \text{ ft}$ 3 x 3m

PRODUCT LEGEND

REF	PRODUCT	QTY	GPM	LPM
Α	Spray Loop VOR 0519	3	22.5	85.1
В	Spiroo VOR 7799	1	4	15.1
С	Activator N°3 VOR 0611	2	0	0
D	Foaming Geyser N°2 VOR 8084	2	28	105.8
E	Playsafe Drain N°4 VOR 1004	3		
F	Spraylink Jet N°2 VOR 3001	6	30	1 13.4
G	Spraylink Funnel VOR 3008	3	21	79.4
Н	Spraylink Team N°1 VOR 3059	1	11	41.6
I	Spraylink Team №3 VOR 3061	1	11	41.6
J	Spraylink Quad N°2 VOR 3063	1	17.5	66.2
K	Alto №2 VOR 7131	i	12.5	47.3
L	Hop №1 VOR 7133	1	10	37.8
М	Luna Nº1 VOR 7230	1	13.5	51
N	Bobble N°2 VOR 7233	1	21.5	81.3
0	Helio N°3 VOR 7238	1	3	11.3
P	Helio Nº6 VOR 7241	1	13	49.1
Q	Twinsplash VOR 7242	1	12	45.4
R	Cascade Rainforest VOR 7251	1	26	98.3
s	Loop N°2 VOR 7553	2	10	37.8
Ť	Waterbug N°2 VOR 7581	1	6	22.7
U	Astra N°2 VOR 7698	1	7.5	28.4
V	Loop Nº1 VOR 7719	1	5	18.9
w	Silhouette N°1 VOR 7772	1	32.5	122.9
х	Bamboo Twin Cannon VOR 7786	1	3.5	13.2
Υ	Bamboo Ring VOR 7787	1	2	7.6
Z	Helico	1	17	64.3
AA	VOR 7790 Butterfly N°1	1	6.5	24.6
вв	VOR 7792 Helico Nano	1	12.5	47.3
CC	VOR 7798 Standard Elevation L2-450B	1	162	613.1
		QTY	GPM	LPM
	TOTAL	43	524	1970

43 521 1970.5

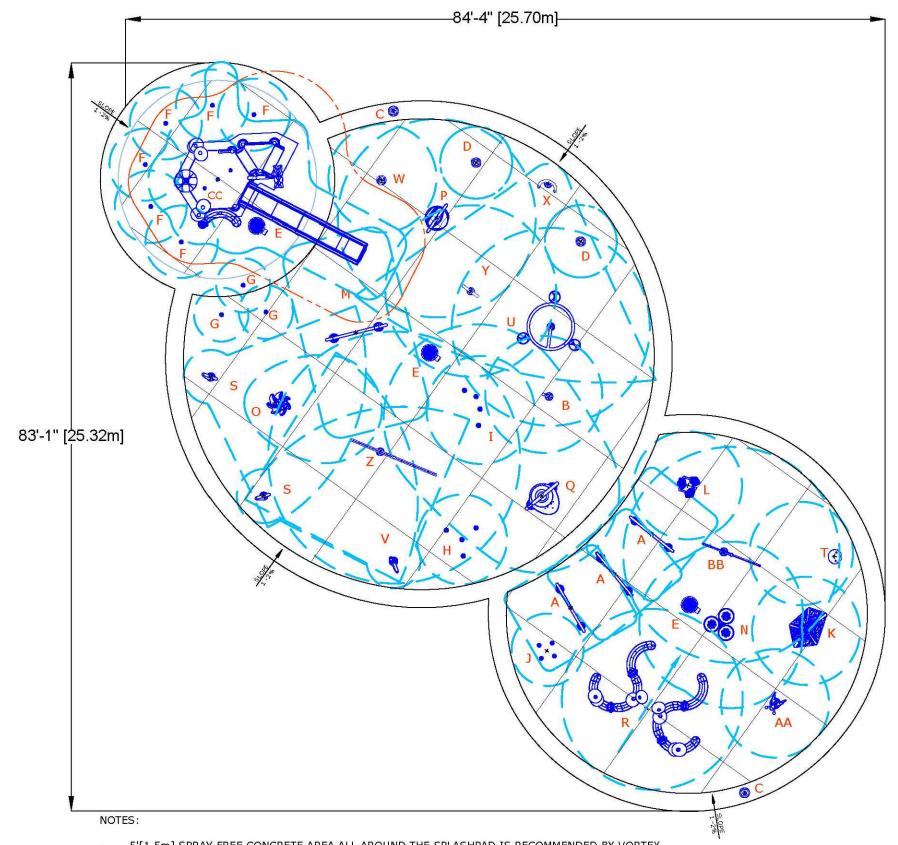

5'[1.5m] SPRAY FREE CONCRETE AREA ALL AROUND THE SPLASHPAD IS RECOMMENDED BY VORTEX. QUANTITY AND LOCATION OF DRAINS BASED ON VORTEX RECOMMENDATIONS.

MODIFICATIONS MAY BE REQUIRED DUE TO SPECIFIC SITE CONDITIONS AND/OR LOCAL CODE.

ADDITIONAL DRAINS BY OTHER MAY BE REQUIRED FOR ELEVATION/PLAYNUK STRUCTURE

Item 4.b.



ONE DESIGN

KAUKAUNA POOL RENOVATION 607 Dodge Street Kaukauna, WI 54130

SPLASHPAD FEATURE LAYOUT

Project #: Issued For: Date:

21.039 Review 9/14/2022

Sheet Number **C50**



ONE DESIGN KAUKAUNA POOL RENOVATION 607 Dodge Street Kaukauna, WI 54130

SPLASHPAD RENDERINGS

Project #: Issued For: Date:

21.039 Review 9/14/2022



ONE DESIGN (

KAUKAUNA POOL RENOVATION 607 Dodge Street Kaukauna, WI 54130

SPLASHPAD RENDERINGS

Project #: Issued For: Date:

21.039 Review 9/14/2022

Sheet Number

CXO 34



ONE DESIGN KAUKAUNA POOL RENOVATION 607 Dodge Street Kaukauna, WI 54130

SPLASHPAD RENDERINGS

Project #: Issued For: Date:

21.039 Review 9/14/2022



ONE DESIGN

KAUKAUNA POOL RENOVATION 607 Dodge Street Kaukauna, WI 54130 SPLASHPAD RENDERINGS

Waterslide finish shown in Classic.

21.039 Review 9/14/2022 Project #: Issued For: Date:

Sheet Number CX04





ONE DESIGN & ENGINEERING


KAUKAUNA POOL RENOVATION 607 Dodge Street Kaukauna, WI 54130

MINIATURE GOLF - CONCEPTUAL PLAN


21.039 Review 9/14/2022 Project #: Issued For: Date:

Sheet Number

EXHIB 37

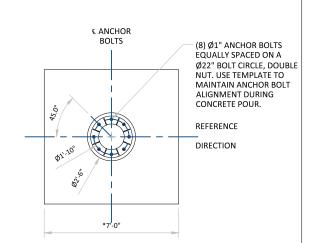


* NOTE: FOOTING SIZE, DEPTH, AND CONFIGURATION SHOWN ARE APPROXIMATE, AND ARE USED FOR ESTIMATING PURPOSES ONLY. ACTUAL DIMENSIONS ARE SUBJECT TO FINAL DESIGN, SITE SPECIFIC SOIL CONDITIONS, AND RIDE CONFIGURATION.

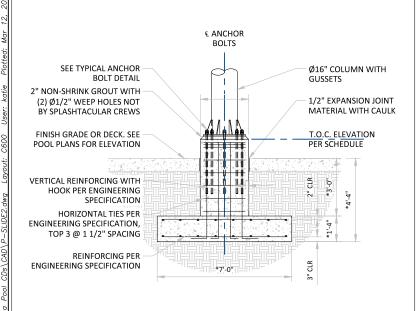




WATERSLIDE PERSPECTIVE C600

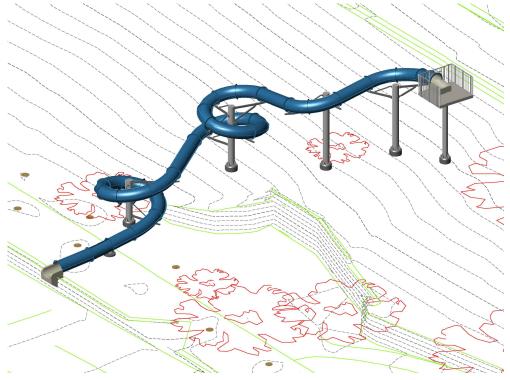

WATERSLIDE PERSPECTIVE

	MARK	SLIDE TYPE	GPM	HEIGHT (ft)	LENGTH (ft)
	Α	32" ENCLOSED BODY SLIDE	300-500	29.70'	190.66'
4		TOTAL LENGTH:			190.66'

Slide height is from finished pool/runout deck to finished start deck. Water level is assumed to be (6) inches BELOW finished pool deck.

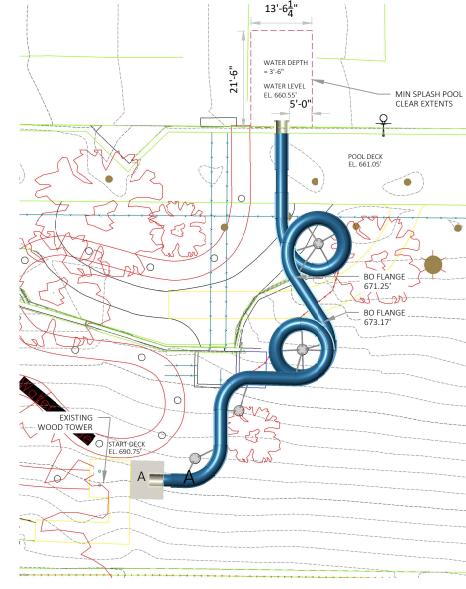

WATERSLIDE PLAN VIEW

Item 4.b.

ENGINEERING ONE DESIGN

RENOVATION 0 **PO**

WATERSLIDE PLAN

Issued For: Date: Review 3/13/2023

C600

PIER DETAIL

SCALE: N.T.S

- ACCUMULATED HEIGHT HAS REACHED ½ THE HEIGHT OF THE CHECK DAM.
- COMPOST MATERIAL TO BE DISPERSED ON SITE. AS DETERMINED BY ENGINEER.

SEDIMENT SOCK

SILT FENCE GENERAL NOTES


TRENCH DETAIL

FOR MANUAL INSTALLATIONS THE TRENCH SHALL BE A MINIMUM OF 4" WIDE & 6" DEEP TO BURY AND ANCHOR THE GEOTEXTILE FABRIC. FOLD MATERIAL TO FIT TRENCH AND BACKFILL & COMPACT TRENCH WITH EXCAVATED SOIL.


SILT FENCE

- 2. WOOD POSTS SHALL BE A MINIMUM SIZE OF 3' LENGTH OF OAK OR HICKORY
- 3. ADDITIONAL POST DEPTH OR TIE BACKS MAY BE REQUIRED IN UNSTABLE SOILS
- DETAILS OF CONSTRUCTION NOT SHOWN ON THIS DRAWING SHALL CONFORM TO THE PERTINENT REQUIREMENTS OF THE SPECIFICATIONS.
- 8" OF FENCE FABRIC REQUIRED BELOW GRADE IN TRENCH PER DNR TECH STD. 1056
- MANUFACTURED ALTERNATIVES APPROVED AND LISTED ON THE WISDOT PRODUCT ACCEPTABILITY LIST (PAL) MAY BE SUBSTITUTED.
- FINISHED SIZE, INCLUDING FLAP POCKETS WHERE REQUIRED, SHALL EXTEND A MINIMUM OF 10" AROUND THE PERIMETER TO FACILITATE MAINTENANCE OR REMOVAL
- 8. FLAP POCKETS SHALL BE LARGE ENOUGH TO ACCEPT WOOD 2"X4"


- 9. EROSION CONTROL SHALL BE PROVIDED IN ACCORDANCE WITH WDNR TECHNICAL STANDARD AND TECHNICAL SPECIFICATIONS.
- 10. CROSS BRACE WITH 2" X 4" WOODEN FRAME OR EQUIVALENT AT TOP OF POSTS AS DIRECTED
- 11. MINIMUM 14 GAUGE WIRE REQUIRED, FOLD FABRIC 3" OVER THE WIRE AND STAPLE OR PLACE WIRE RINGS ON 12" C.C.
- 12. WIRE SUPPORT FENCE SHALL BE 14 GAUGE MINIMUM WOVEN WIRE WITH A MAXIMUM MESH SPACING OF 6". SECURE TOP OF GEOTEXTILE FABRIC TO TOP OF FENCE WITH STAPLES OR
- 13. GEOTEXTILE FABRIC SHALL BE REINFORCED WITH AN INDUSTRIAL POLYPROPYLENE NETTING WITH A MAXIMUM MESH SPACING OF 3/4" OR EQUAL. A HEAVY DUTY NYLON TOP SUPPORT CORD OR EQUIVALENT IS REQUIRED. (TYPE A)
- 14. STEEL POSTS SHALL BE STUDDED "TEE" OR "U" TYPE WITH A MINIMUM WEIGHT OF 1.28 LBS./LIN. FT. IWITHOUT ANCHOR! FIN ANCHORS SUFFICIENT TO RESIST POST MOVEMENT ARE REQUIRED. WOOD POSTS SHALL BE A MINIMUM SIZE OF 1 1/8" X 1 1/8" OF OAK OR HICKORY.
- CONSTRUCT SILT FENCE FROM A CONTINUOUS ROLL, IF POSSIBLE, BY CUTTING LENGTHS TO AVOID JOINTS. IF A JOINT IS NECESSARY, USE ONE OF THE FOLLOWING TWO METHODS: A.J TWIST METHOD - OVERLAP THE END POSTS AND TWIST, OR ROTATE, AT LEAST 180 DEGREES, B:) HOOK METHOD - HOOK THE END OF EACH SILT FENCE LENGTH.

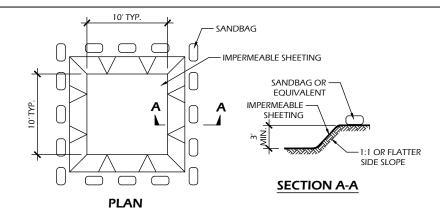

EXCAVATED WASHOUT STRUCTURE

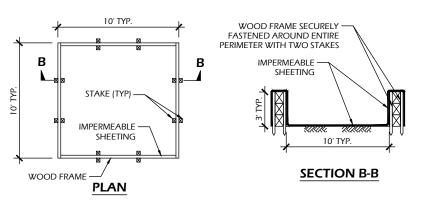

WASHOUT STRUCTURE WITH WOOD PLANKS

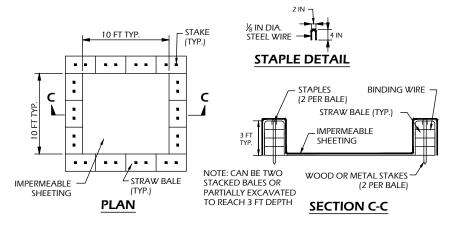

CONSTRUCTION SPECIFICATIONS

TEMPORARY CONCRETE WASHOUT STRUCTURE SHALL BE USED TO WASH DOWN CONCRETE TRUCK CHUTES AND OTHER EQUIPMENT AFTER USE TO PREVENT WASHDOWN WATER FROM POLLUTING THE SITE.

WASHOUT STRUCTURE WITH STRAW BALES

- 2. LOCATE WASHOUT STRUCTURE A MINIMUM OF 50 FEET AWAY FROM OPEN CHANNELS, STORM DRAIN INLETS, SENSITIVE AREAS, WETLANDS, BUFFERS AND WATER COURSES AND AWAY FROM CONSTRUCTION
- 3. SIZE WASHOUT STRUCTURE FOR VOLUME NECESSARY TO CONTAIN WASH WATER AND SOLIDS AND MAINTAIN AT LEAST 4 INCHES OF FREEBOARD. TYPICAL DIMENSIONS ARE 10 FEET X 10 FEET X 3 FEET DEEP.
- 4. PREPARE SOIL BASE FREE OF ROCKS OR OTHER DEBRIS THAT MAY CAUSE TEARS OR HOLES IN THE LINER. FOR LINER, USE 10 MIL OR THICKER UV RESISTANT, IMPERMEABLE SHEETING, FREE OF HOLES AND TEARS OR OTHER DEFECTS THAT COMPROMISE IMPERMEABILITY OF THE MATERIAL.
- 5. PROVIDE A SIGN FOR THE WASHOUT IN CLOSE PROXIMITY TO THE FACILITY
- KEEP CONCRETE WASHOUT STRUCTURE WATER TIGHT. REPLACE IMPERMEABLE LINER IF DAMAGED (E.G., RIPPED OR PUNCTURED). EMPTY OR REPLACE WASHOUT STRUCTURE THAT IS 75 PERCENT FULL, AND DISPOSE OF ACCUMULATED MATERIAL PROPERLY. DO NOT REUSE PLASTIC LINER. WET-VACUUM STORED LIQUIDS THAT HAVE NOT EVAPORATED AND DISPOSE OF IN AN APPROVED MANNER. PRIOR TO FORECASTED RAINSTORMS, REMOVE LIQUIDS OR COVER STRUCTURE TO PREVENT OVERFLOWS. REMOVE HARDENED SOLIDS, WHOLE OR BROKEN UP, FOR DISPOSAL OR RECYCLING. MAINTAIN RUNOFF DIVERSION AROUND EXCAVATED WASHOUT STRUCTURE UNTIL STRUCTURE IS REMOVED.



CONCRETE WASHOUT STRUCTURE (TEMP)

REN DETAIL **AUKAUNA POOL** CONSTRUCTION

OVATION

Item 4.b.


21.039 Issued For: Reviev 3/13/2023

Sheet Numbe

Date:

SILT FENCE OR SEDIMENT SOCK SCALE: NTS

C900

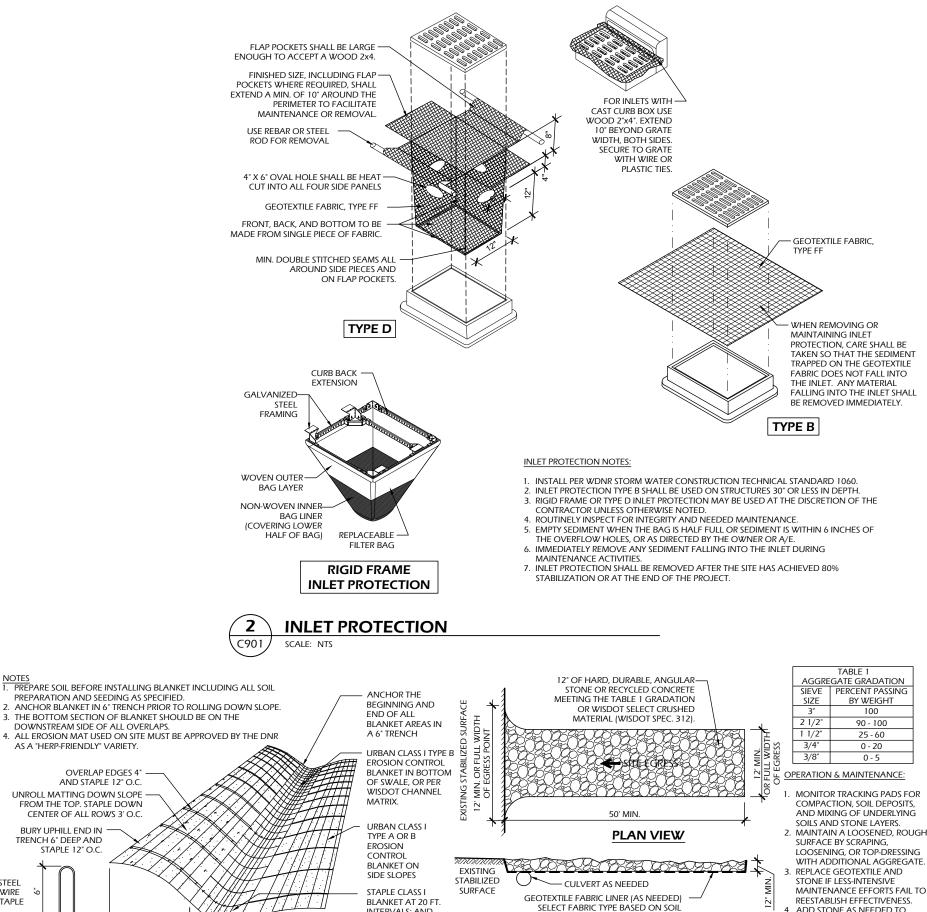

CONDITIONS & VEHICLE LOADING

STONE TRACKING PAD

SCALE: NTS

PROFILE VIEW

INTERVALS: AND

AT ALL OVERLAP

JOINTS 24" O.C.

VARIES

BURY UPHILL END IN

STAPLE 12" O.C.

SCALE: NTS

VARIES

EROSION MAT

TRENCH 6" DEEP AND

STEEL

STAPLE

C901

Item 4.b.



ONE DESIGN

AUKAUNA POOL RENOVATION

DETAIL!

CONSTRUCTION

ADD STONE AS NEEDED TO

CRUSHED CULVERTS UNDER

5. REPLACE DAMAGED OR

TRACKING PAD.

THICKNESS

MAINTAIN THE MINIMUM PAD


Project #: Issued For: Date:


3/13/2023

Sheet Number

21.039

Review

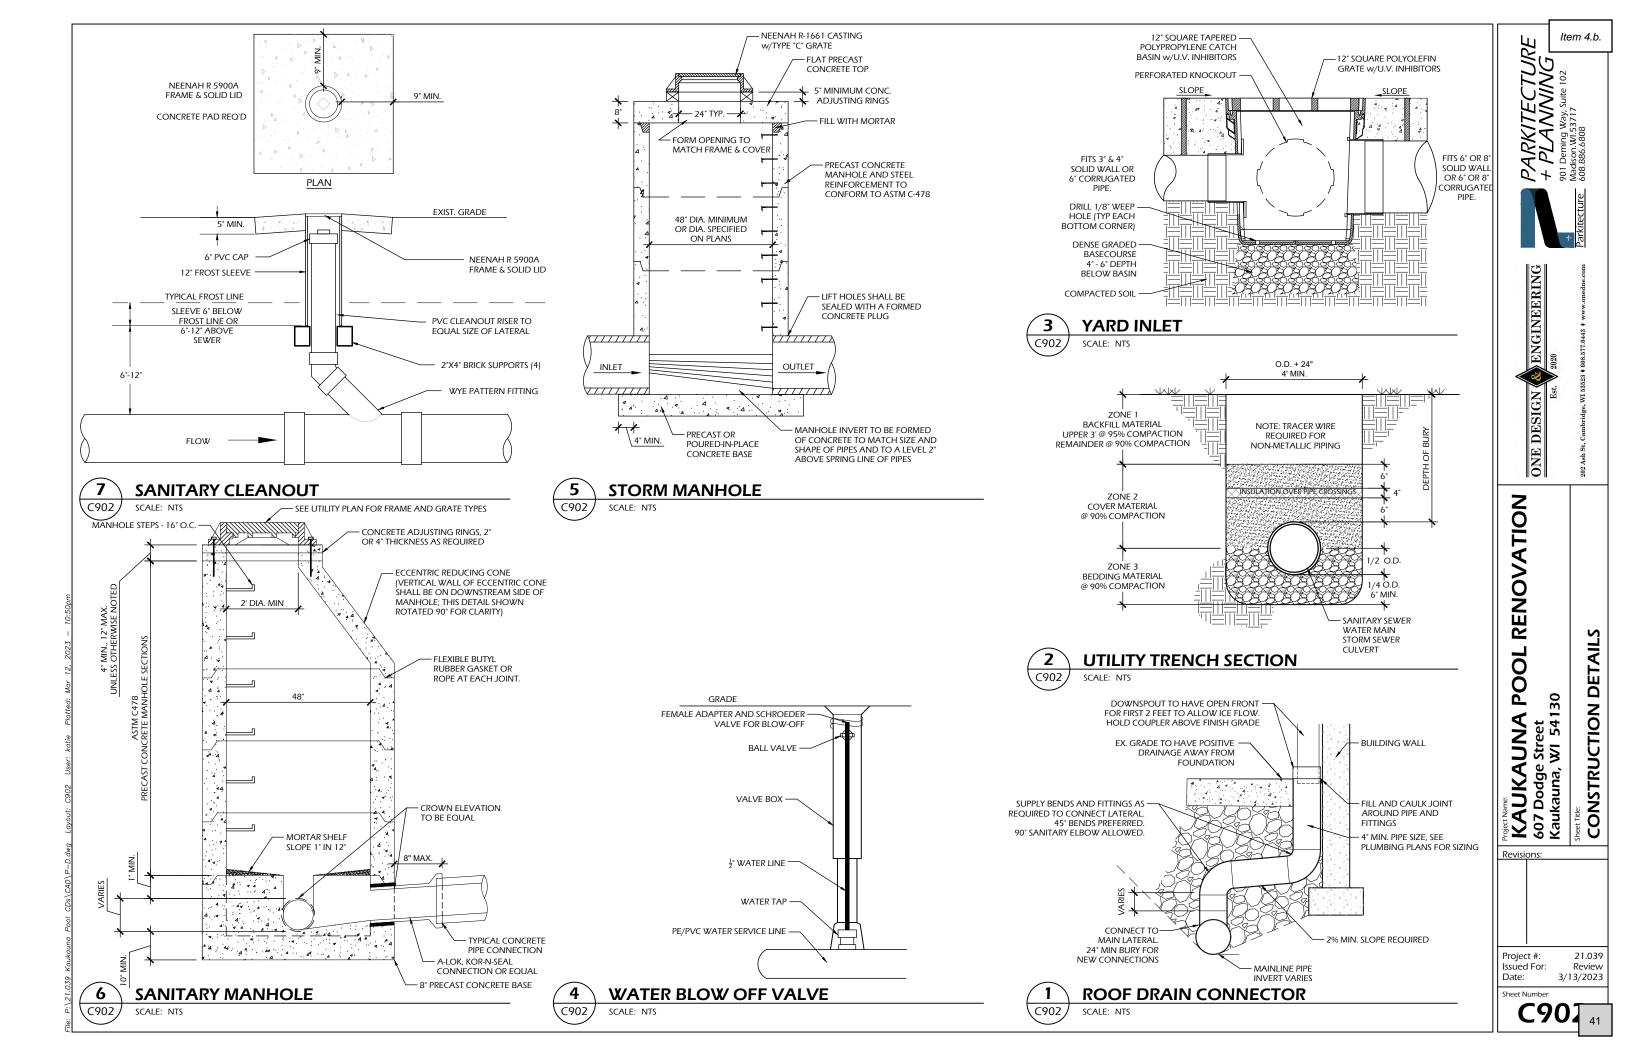

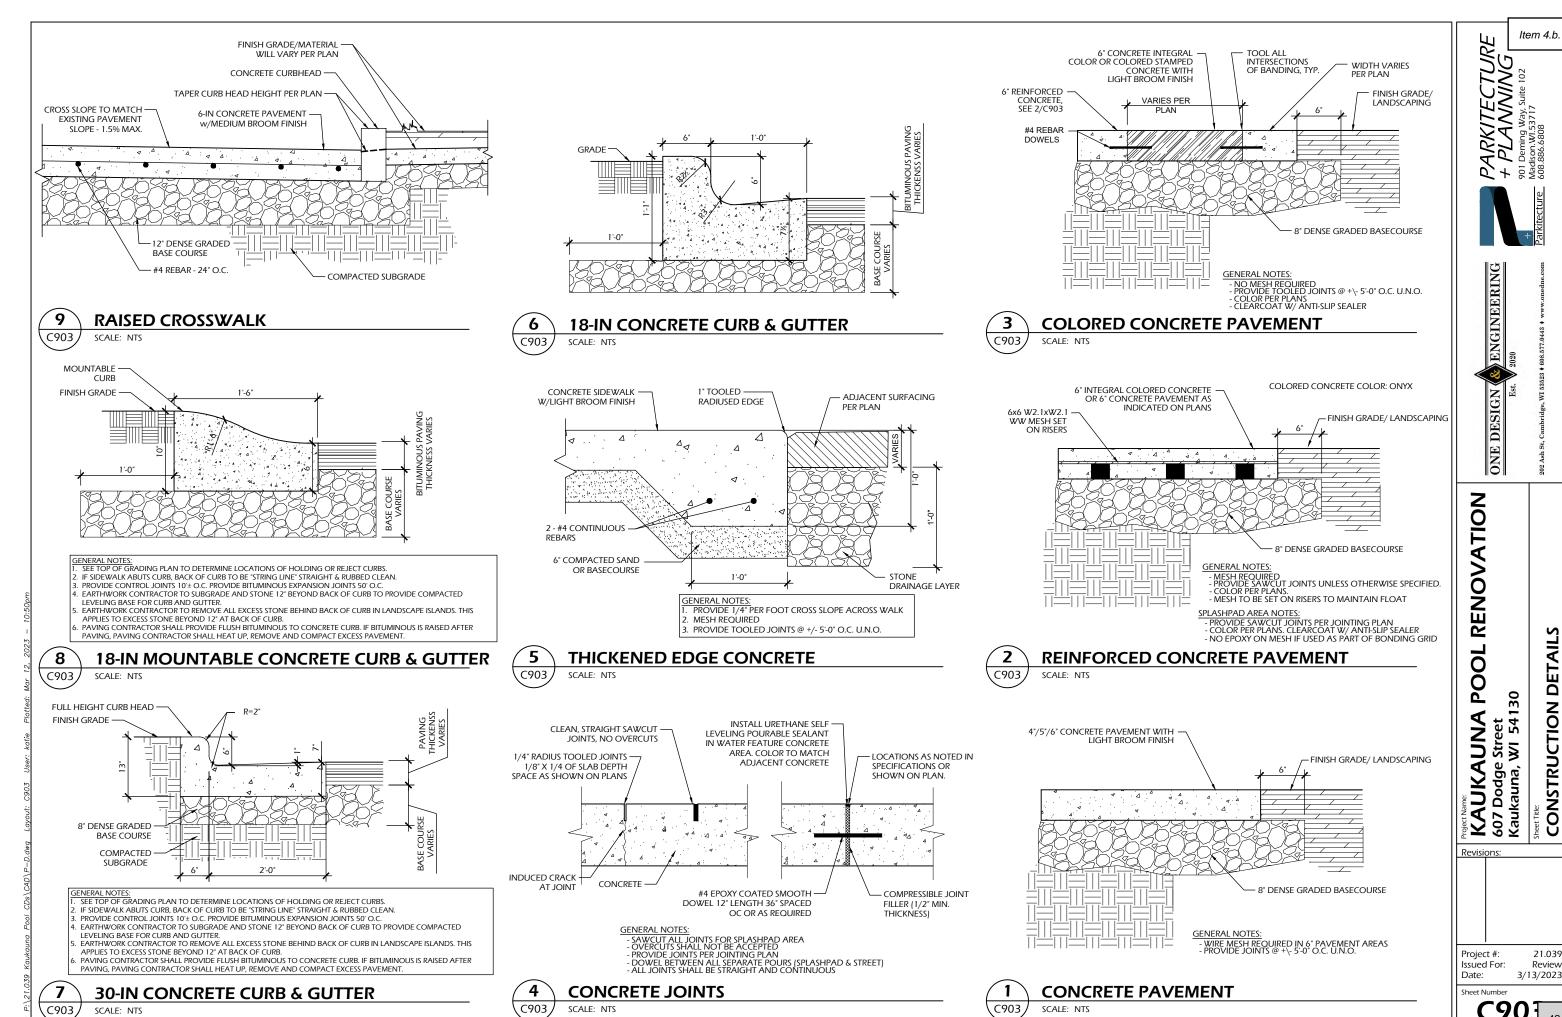


SCALE: NTS

CONSTRUCTION DETAILS

21.039

Review

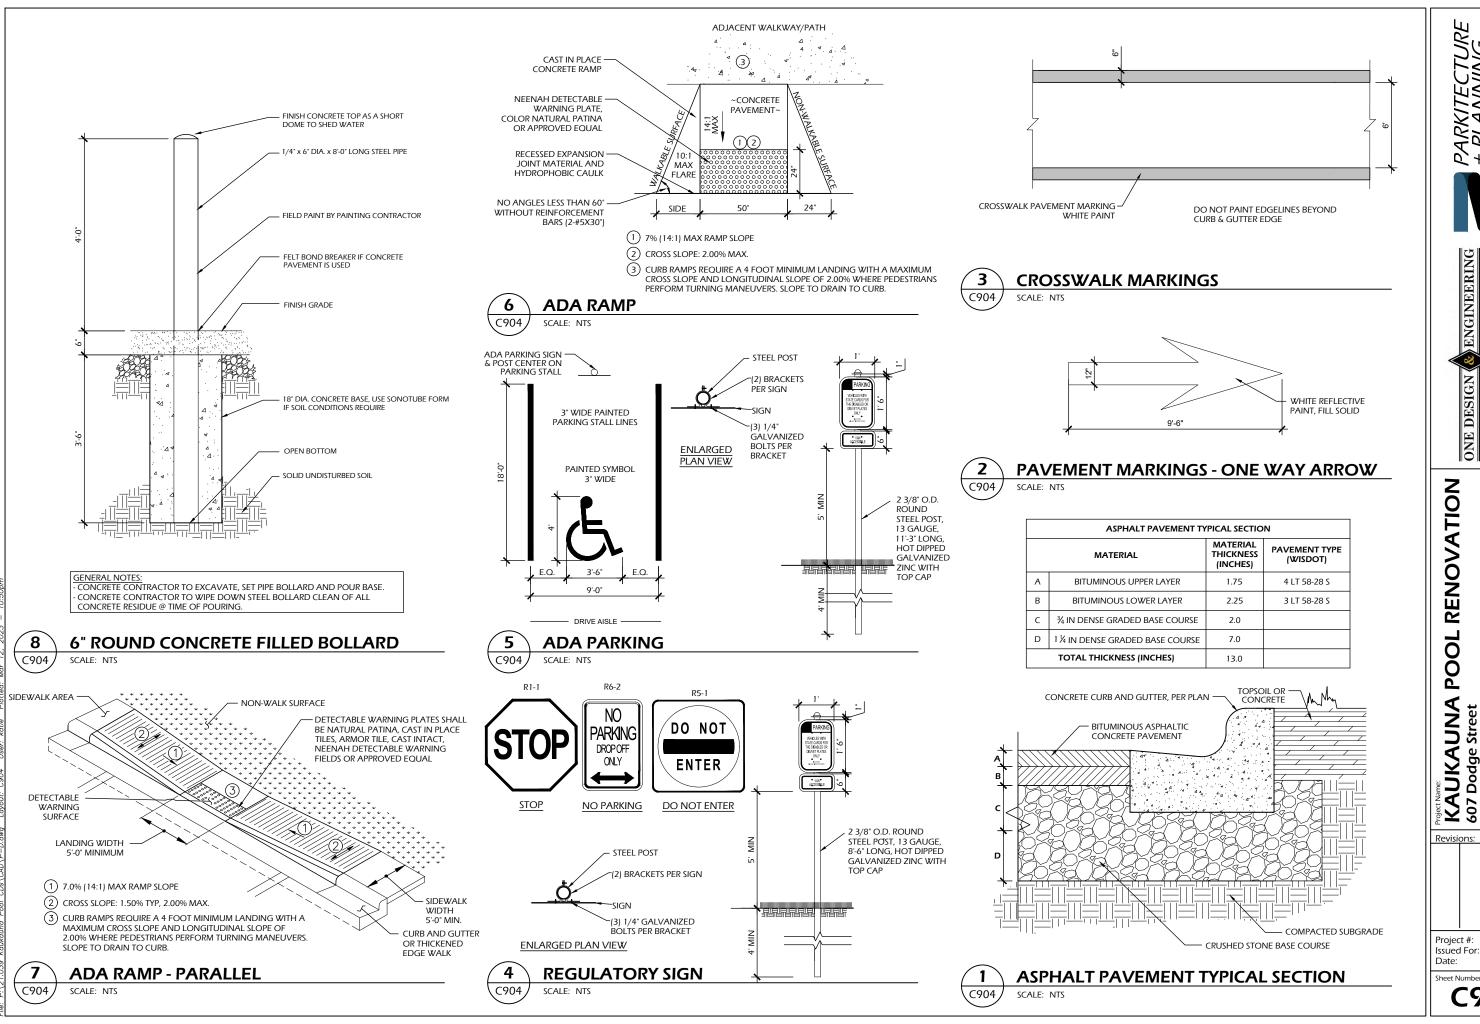


CONSTRUCTION DETAILS


3/13/2023

Sheet Numbe

21.039

Review

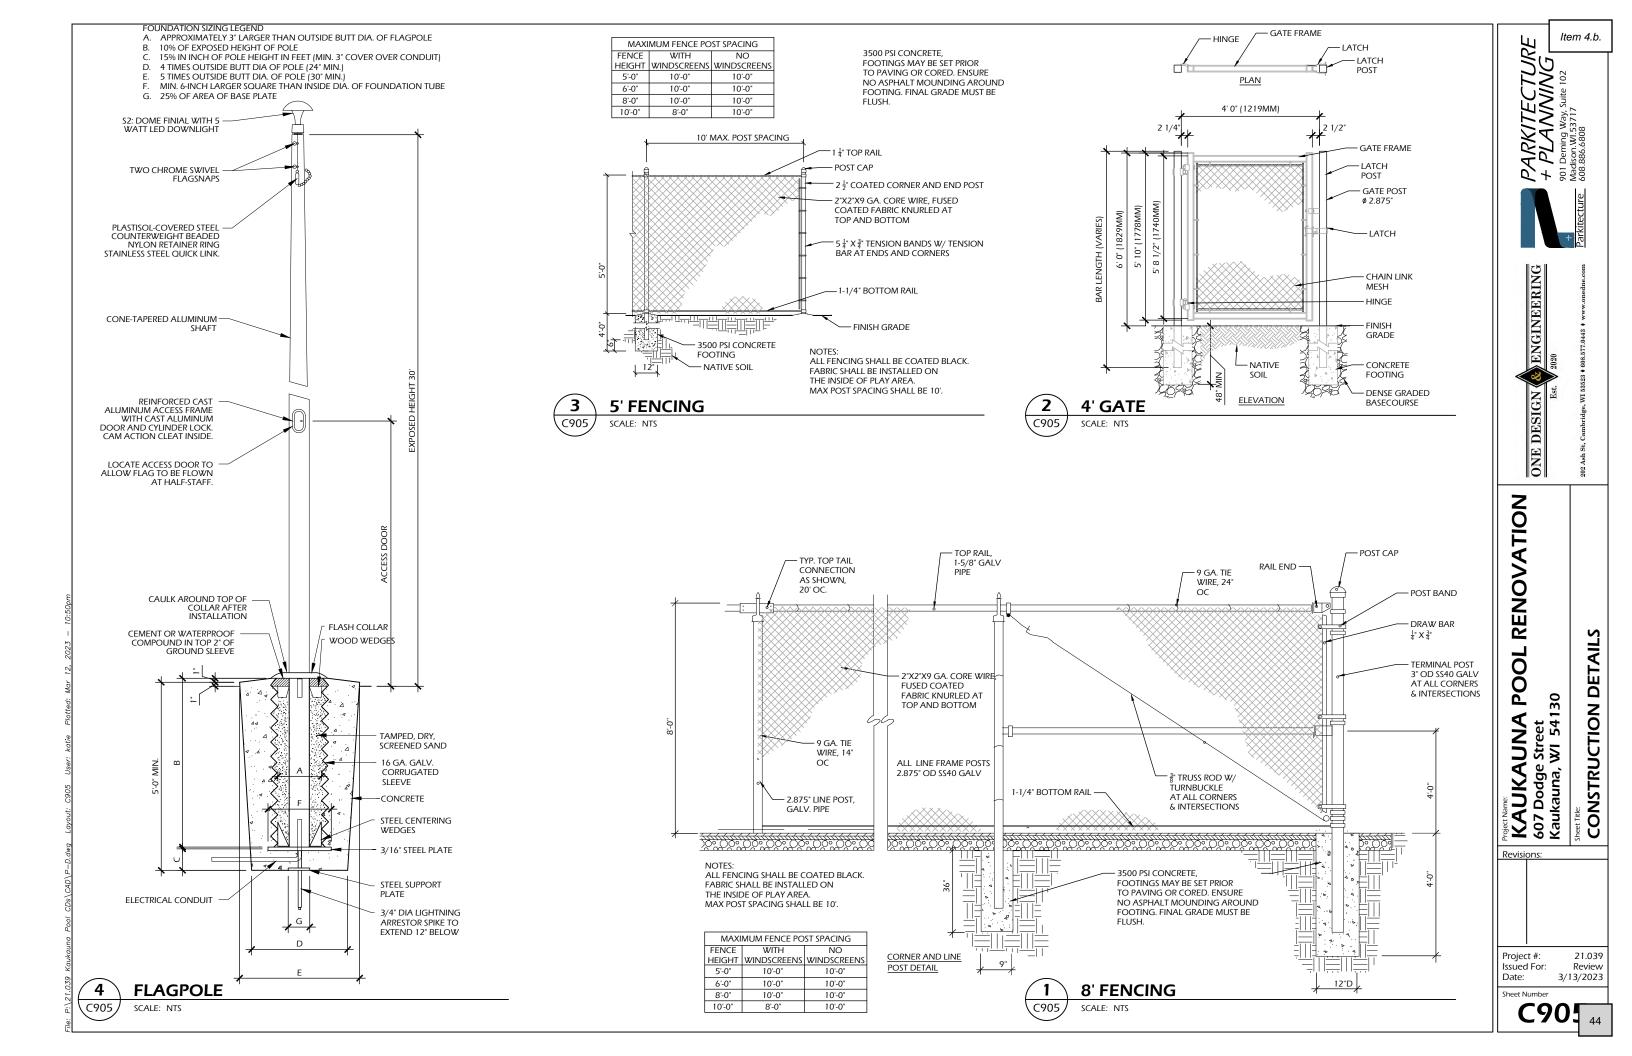

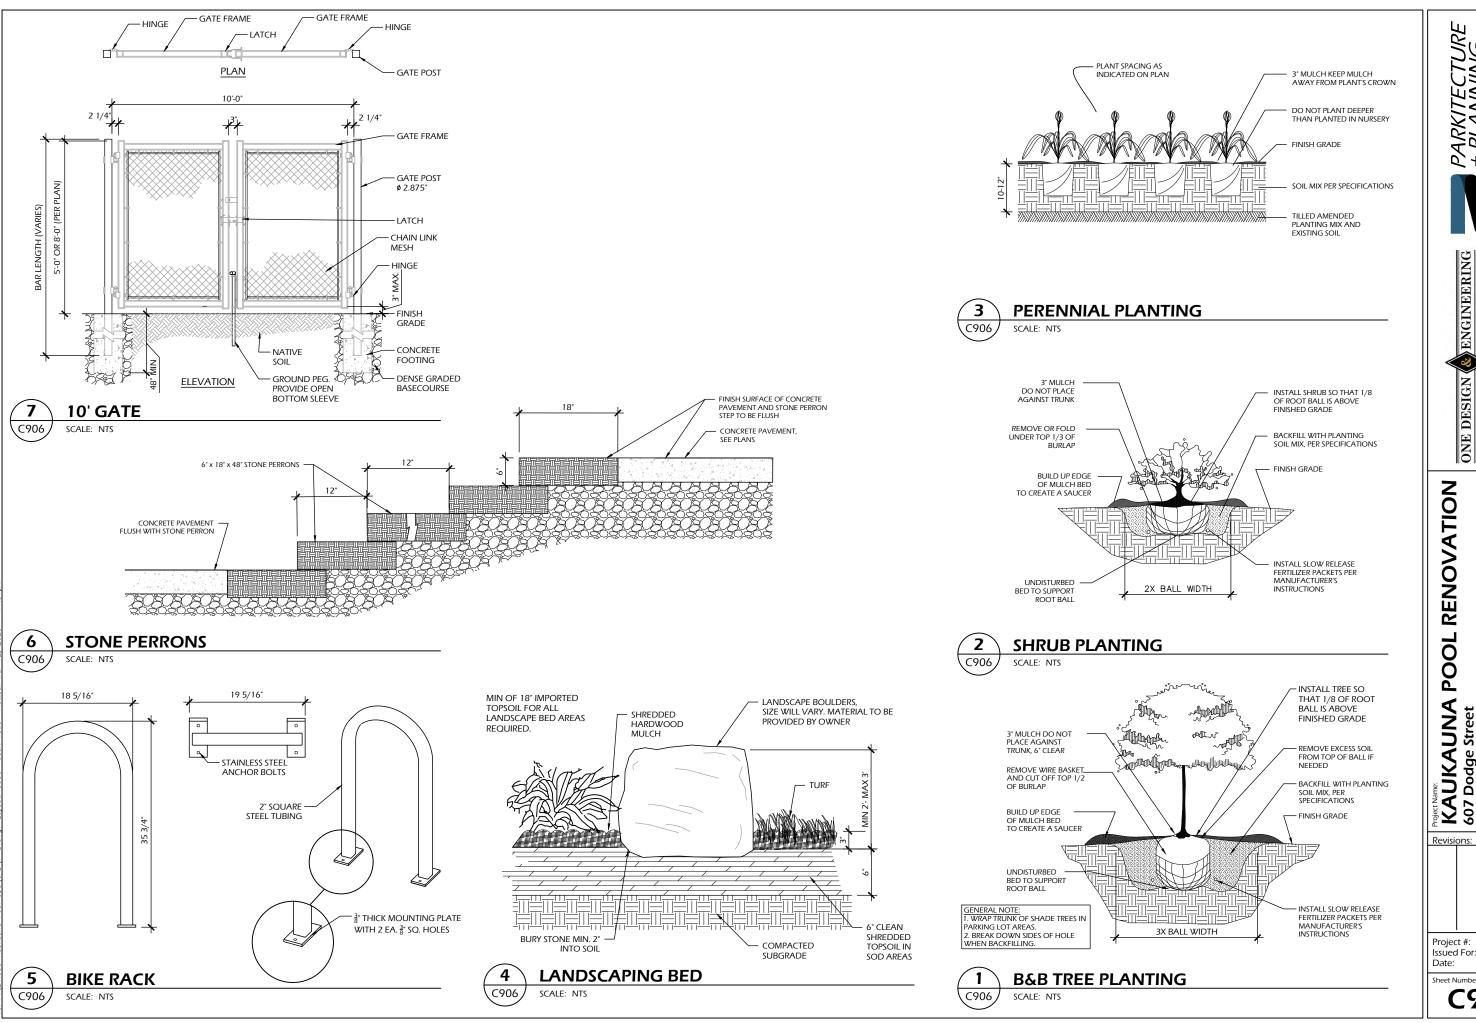



KAUKAUNA POOL RENOVATION 607 Dodge Street Kaukauna, WI 54130


CONSTRUCTION DETAILS

21.039 Project #: Review 3/13/2023 Issued For:

Sheet Number

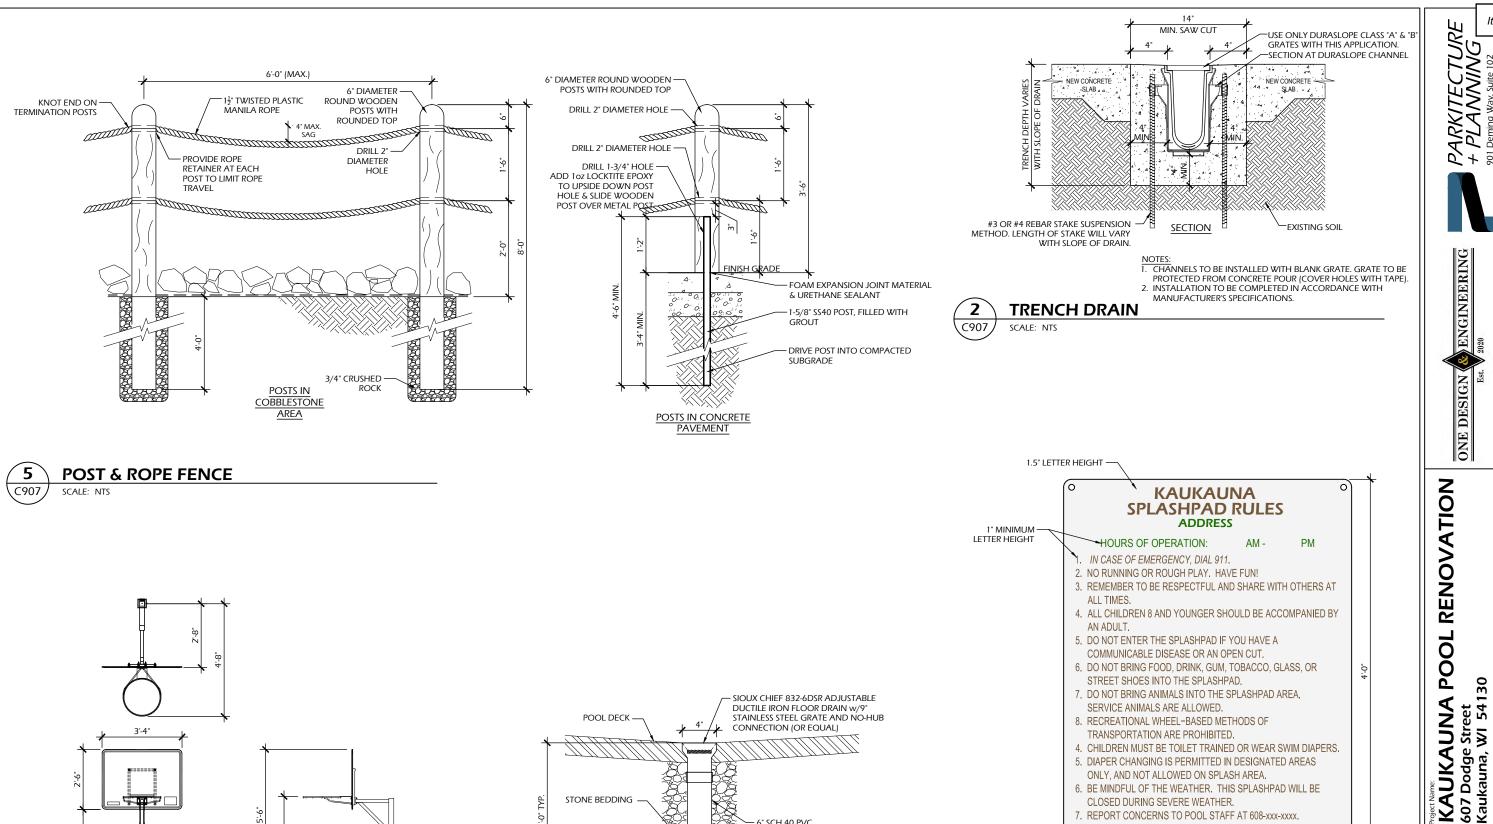

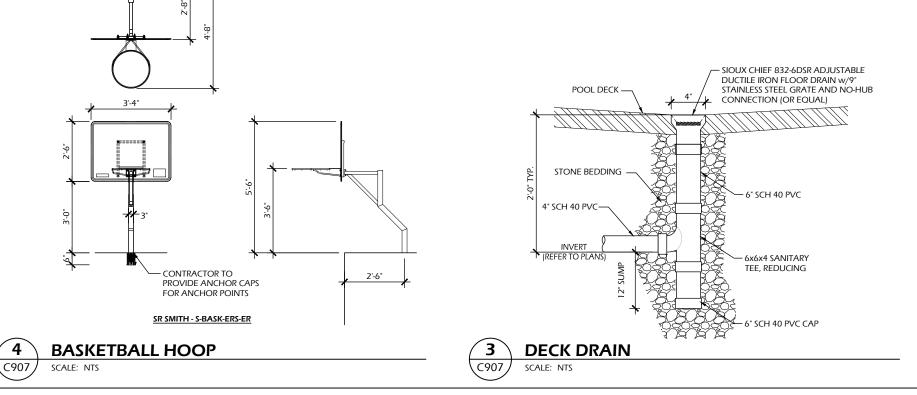

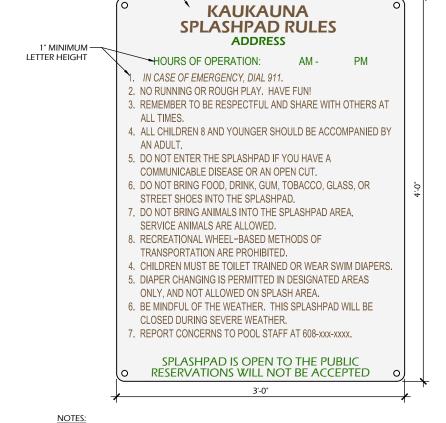

5. COLORS SHALL BE DETERMINED BY OWNER AND A/E DURING SUBMITTALS.

SPLASHPAD RULES SIGN

C907

SCALE: NTS

Revisions 1. SIGN SHALL BE AN ALUMINUM BOARD WITH SHEET VINYL 2. MOUNT TO RIGID METAL POLES WITH TAMPERPROOF FASTENERS. 3. SIGN SHALL BE LEVEL. 21.039 Project #: 4. FINAL LOCATION TO BE APPROVED BY OWNER. Review

Issued For: 3/13/2023 Date:


Sheet Number

CONSTRUCTION DETAILS

Item 4.b.

ENGINEERING

ONE DESIGN

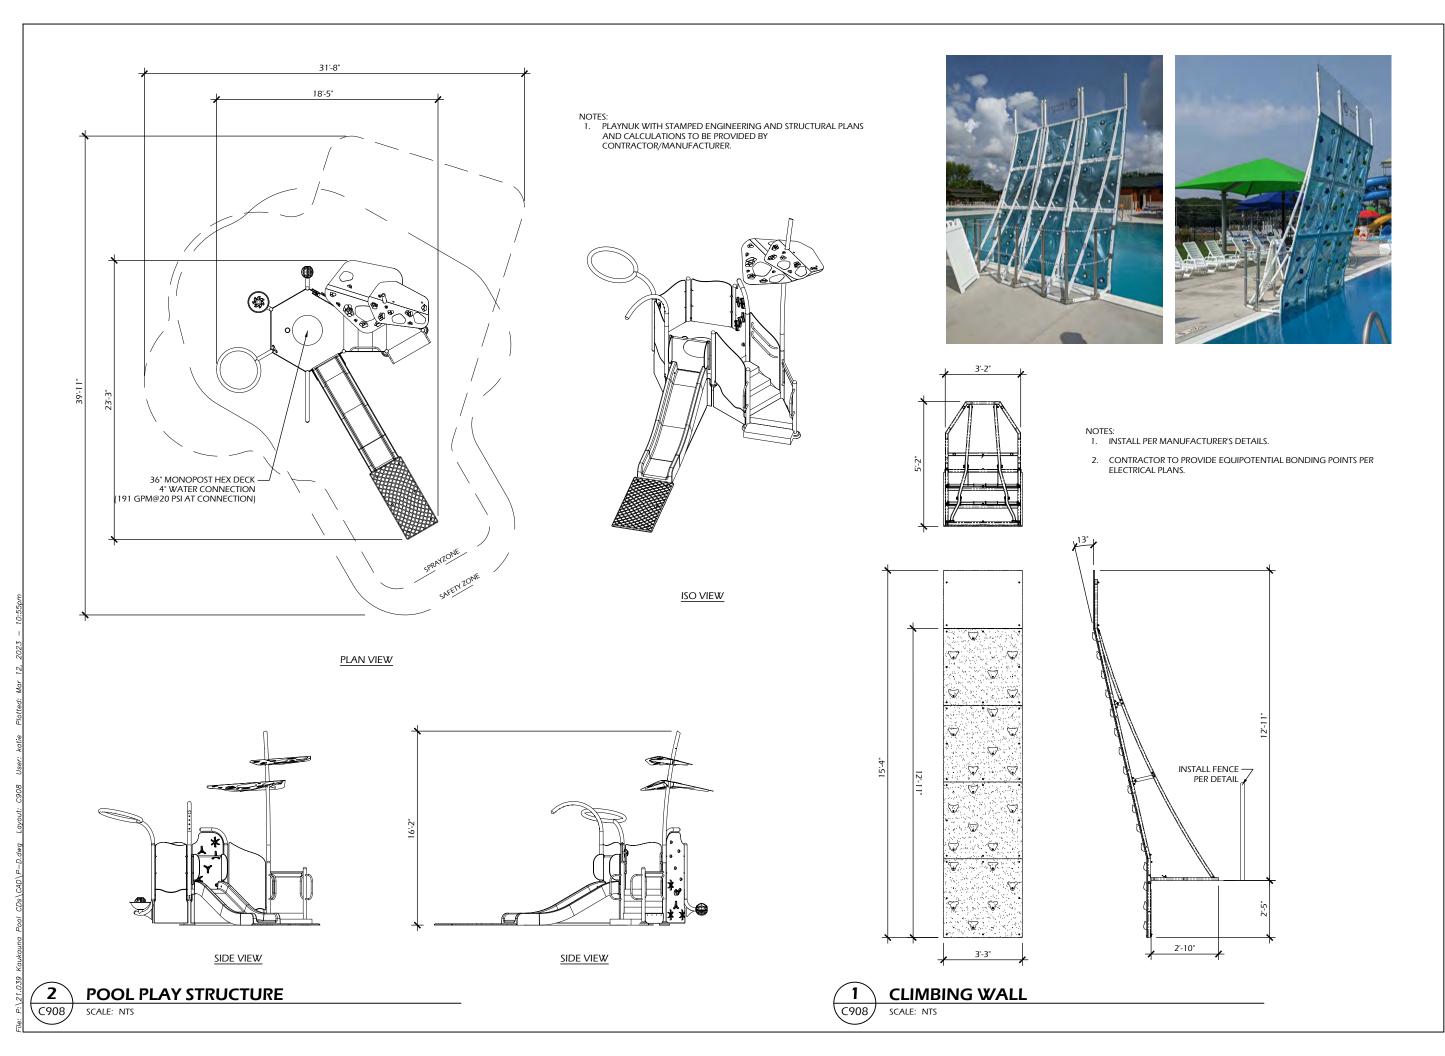

ONE DESIGN & ENGINEERING


KAUKAUNA POOL RENOVATION 607 Dodge Street Kaukauna, WI 54130


CONSTRUCTION DETAILS

21.039

Project #: Issued For: Date: Review 3/13/2023

Sheet Number

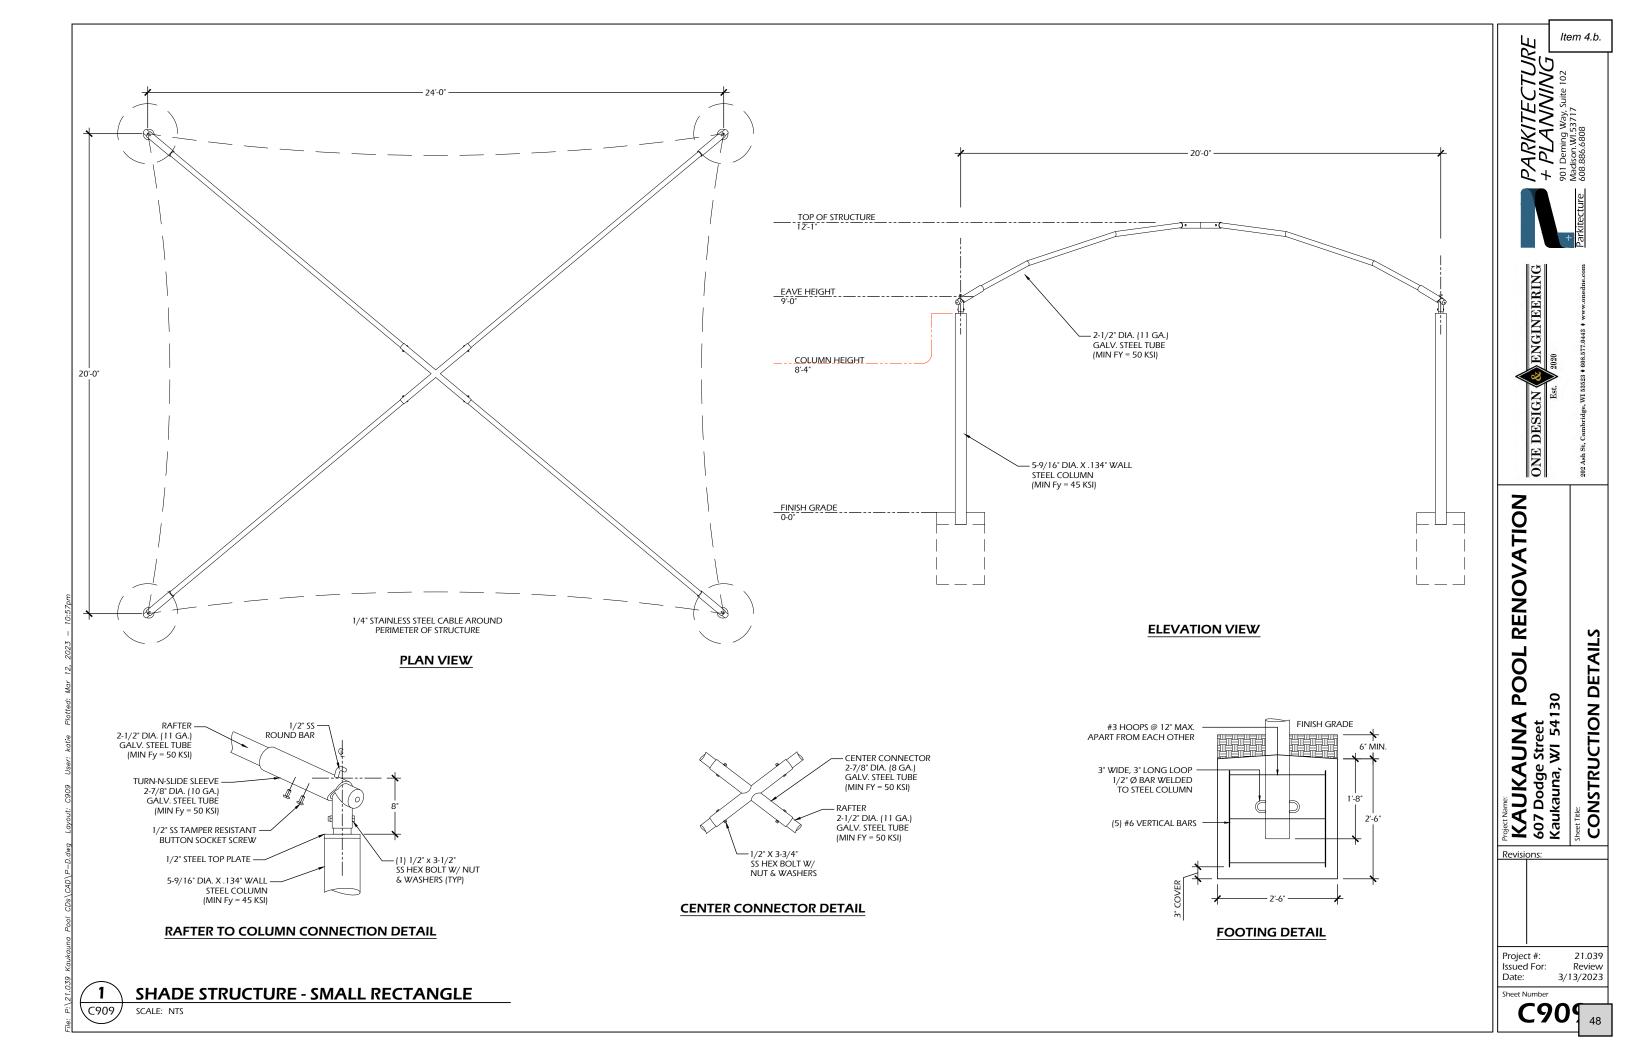

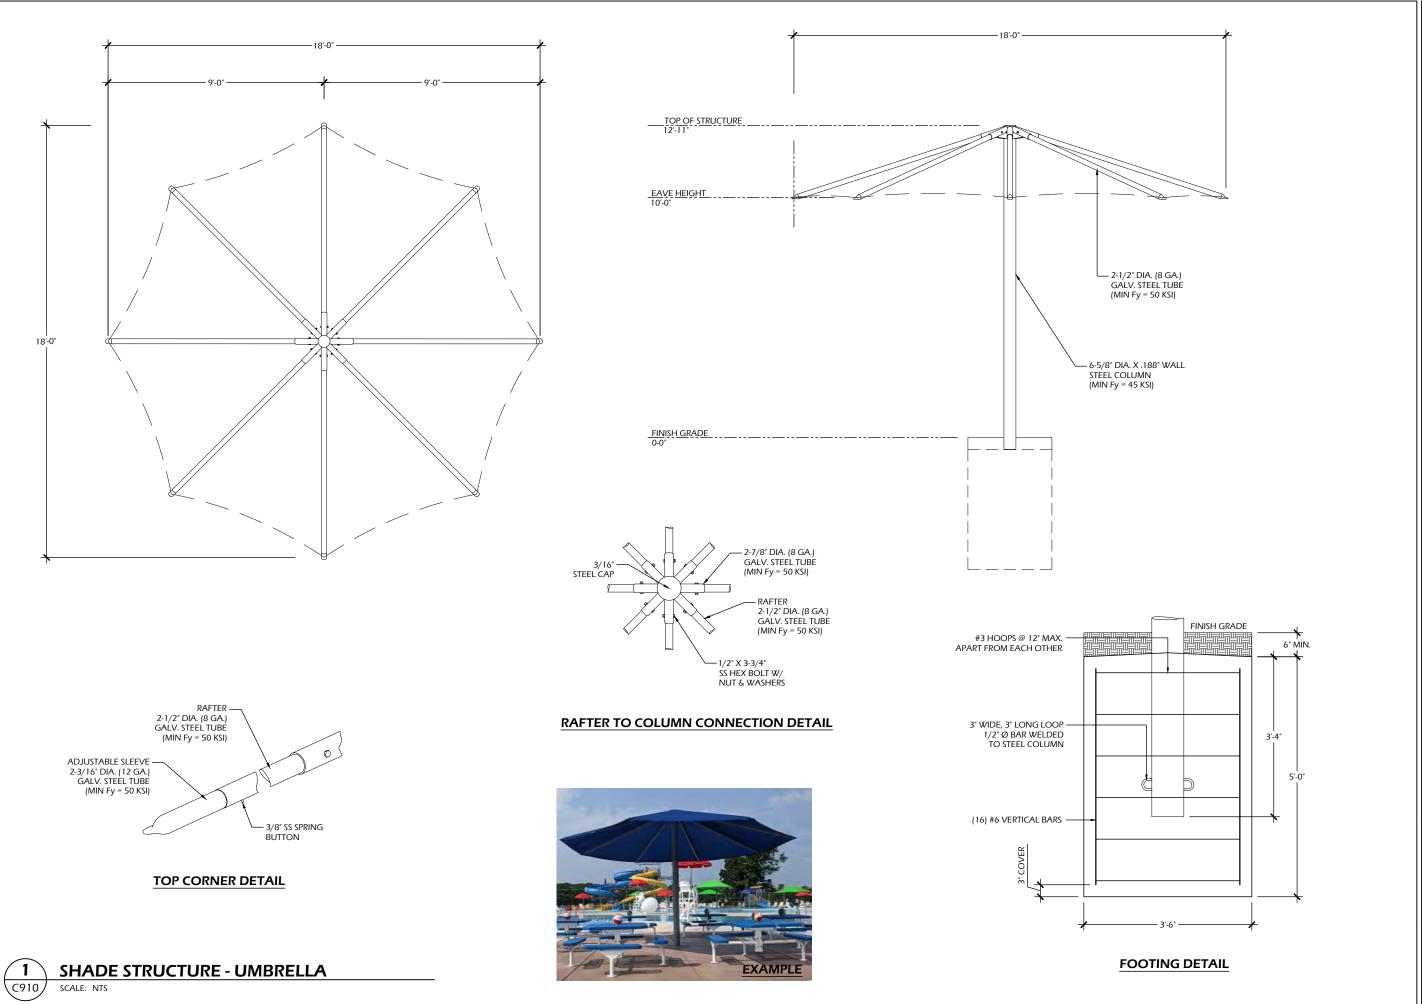



ONE DESIGN KAUKAUNA POOL RENOVATION 607 Dodge Street Kaukauna, WI 54130

CONSTRUCTION DETAILS

21.039 Review 3/13/2023 Project #: Issued For: Date:

Sheet Number

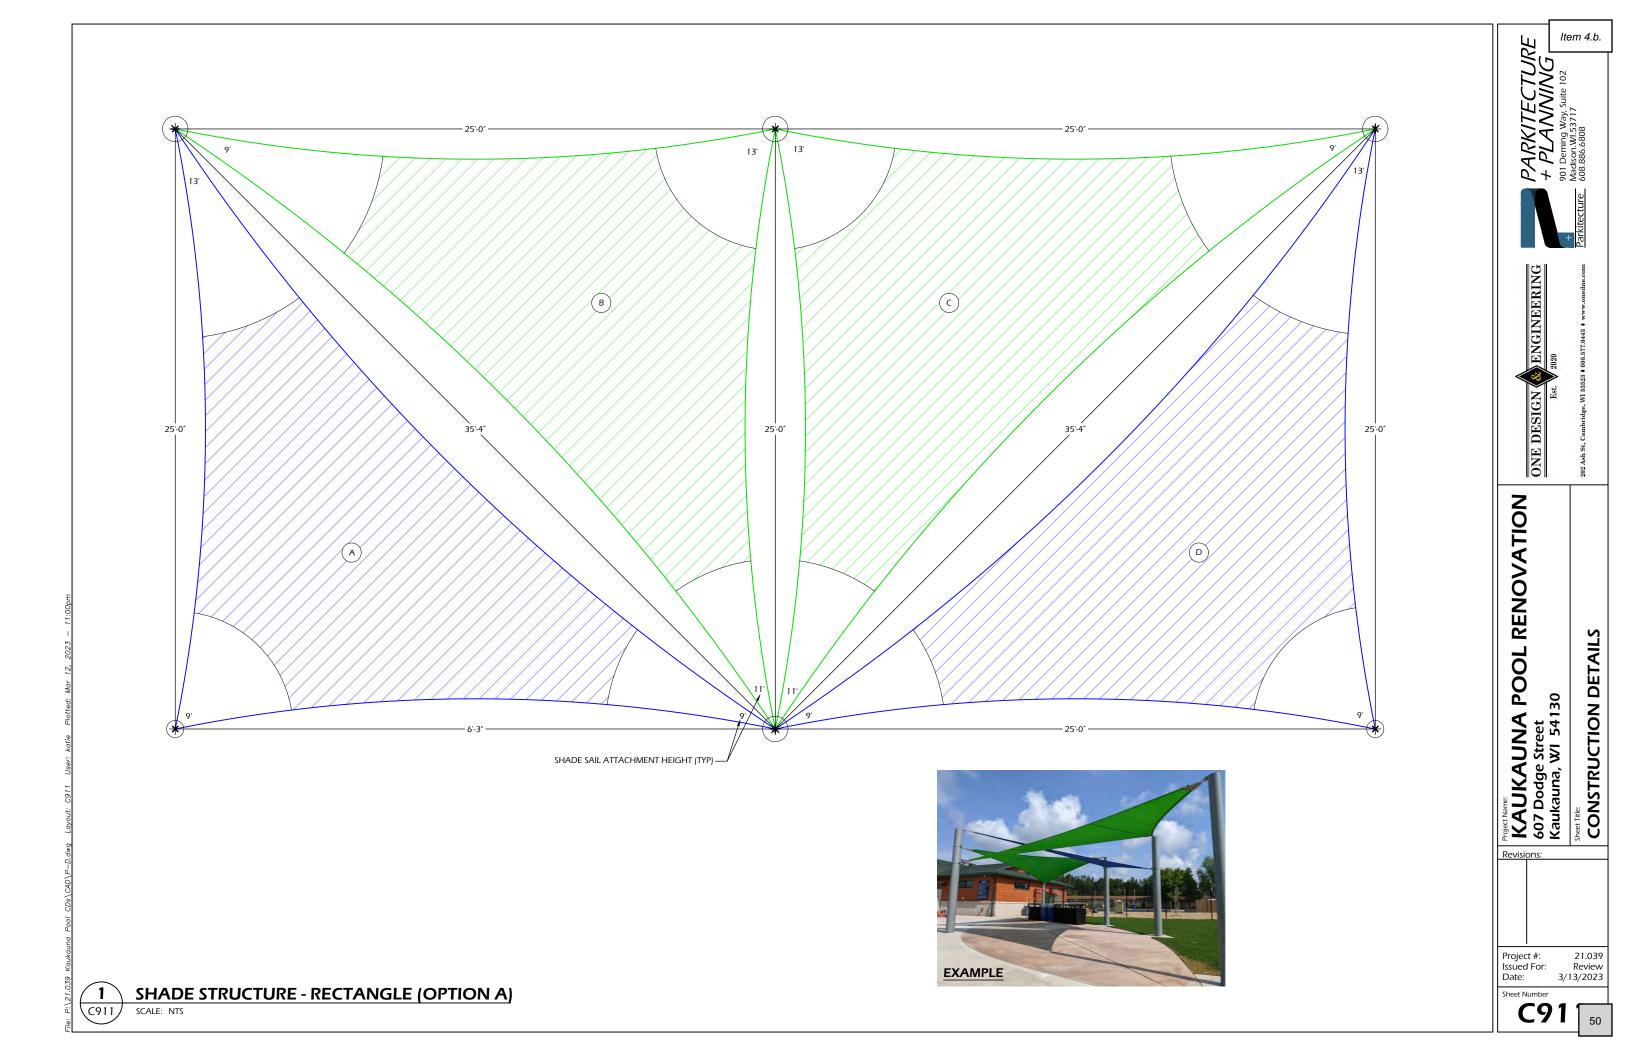


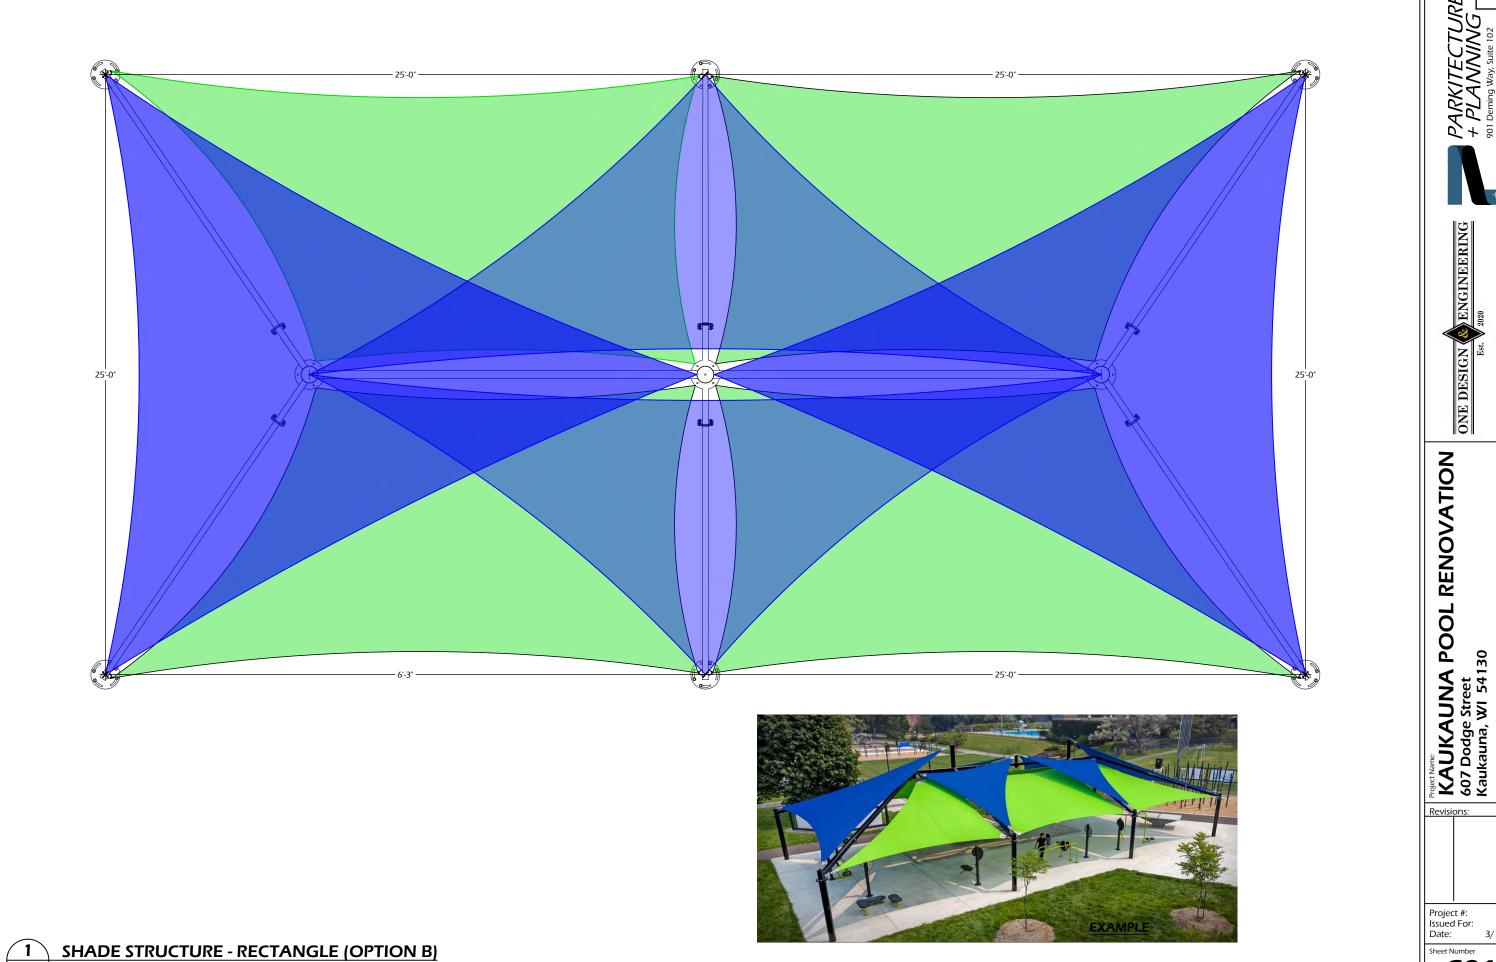


CONSTRUCTION DETAILS

21.039 Review 3/13/2023

SCALE: NTS

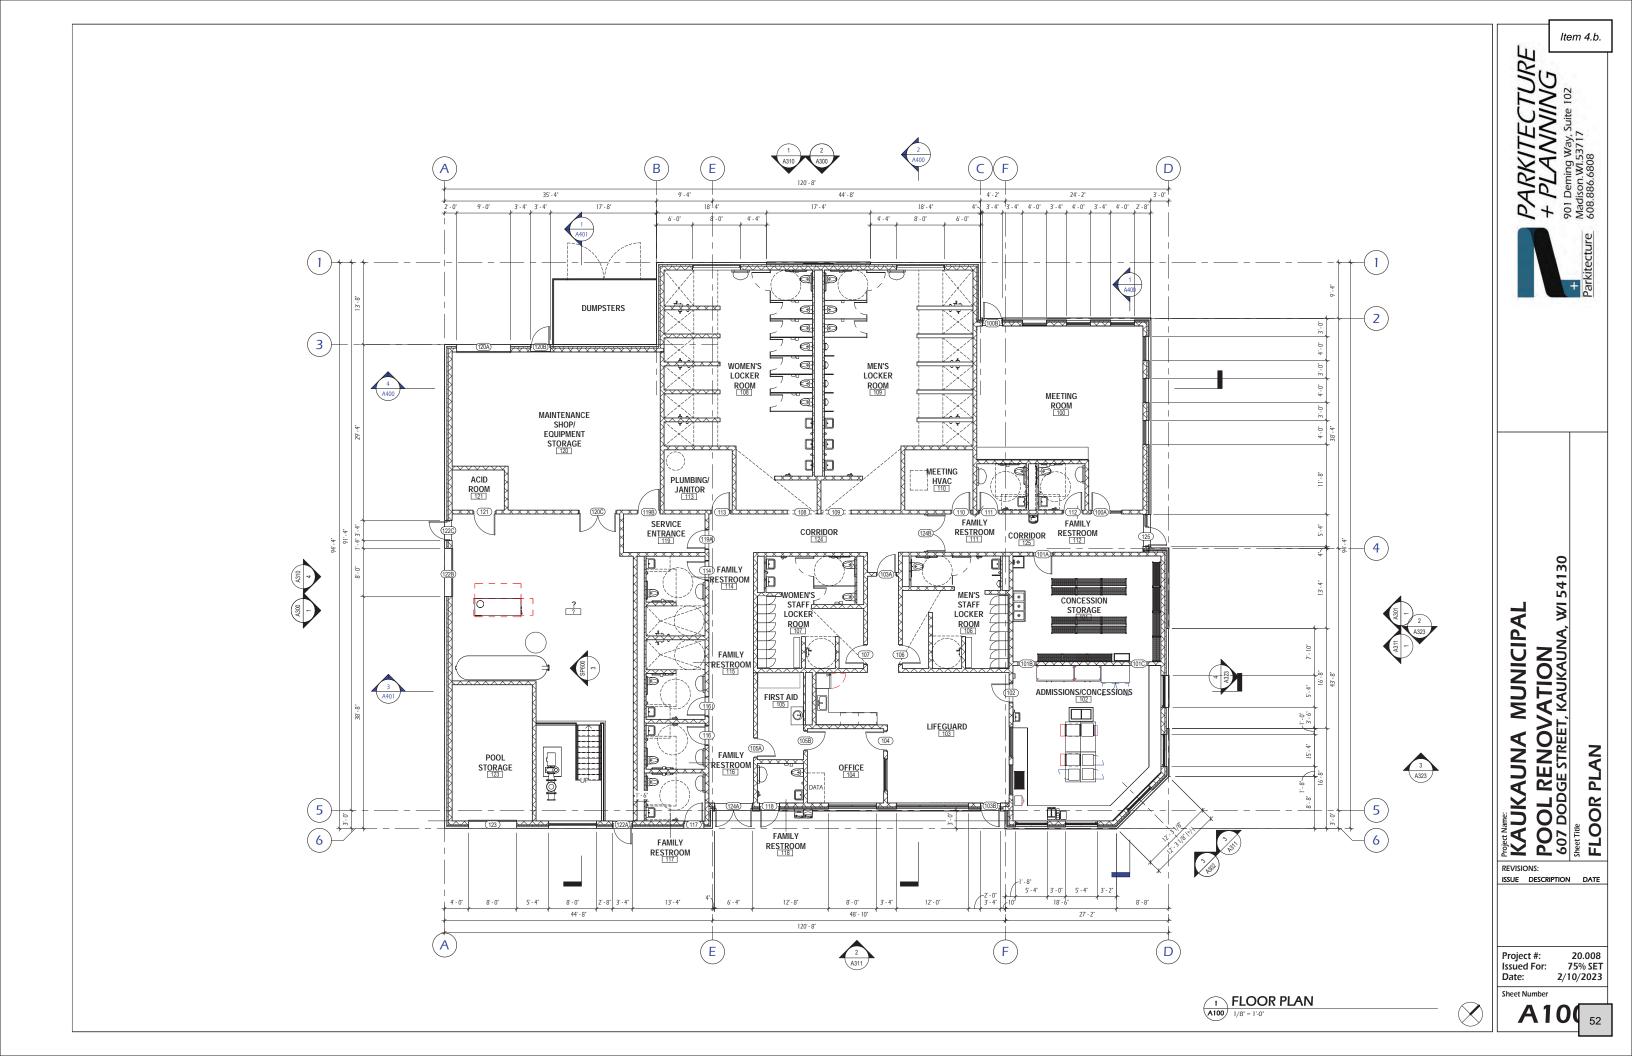

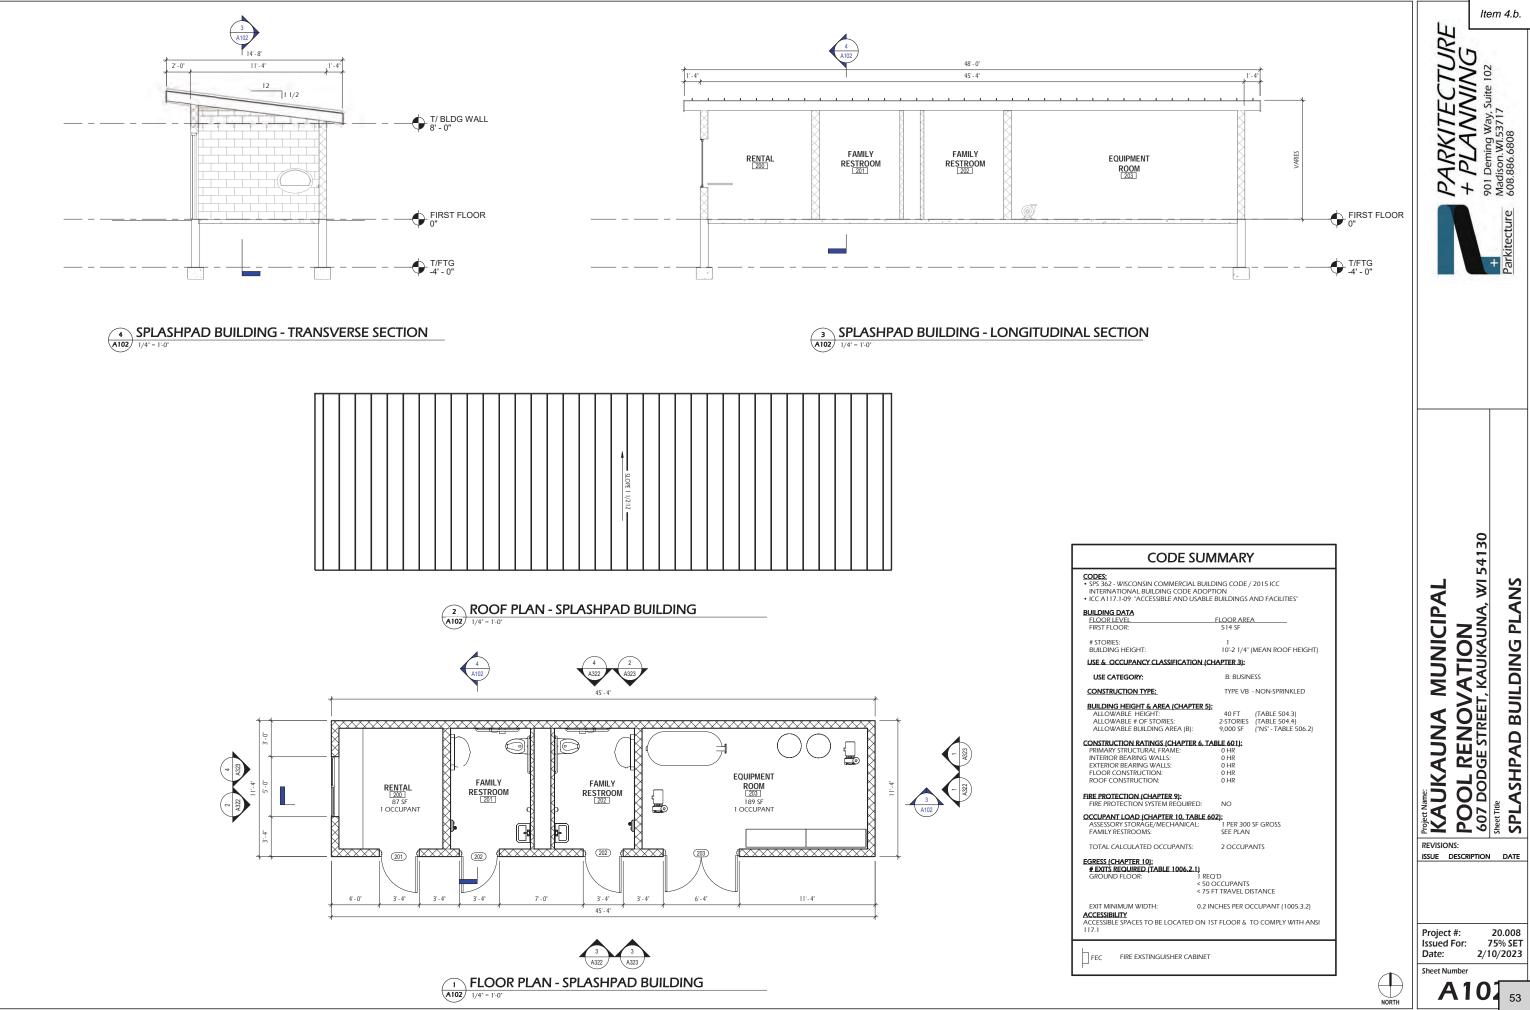

Sheet Number

20.008 75% SET 2/10/2023

Item 4.b.





NORTHWEST ELEVATION



NORTHEAST ELEVATION



20.008 75% SET 2/10/2023

Project #: Issued For: Date: Sheet Number

REVISIONS:
ISSUE DESCRIPTION DATE

Project Name:

KAUKAUNA MUNICIPAL

SOOL RENOVATION
607 DODGE STREET, KAUKAUNA, WI 54130

Street Title

EXTERIOR RENDERINGS







Project Name:

KAUKAUNA MUNICIPAL

FOOL RENOVATION
607 DODGE STREET, KAUKAUNA, WI 54130

Sheet Trie

EXTERIOR RENDERINGS


ROOFING (R-2) (KYNAR - GRAPHITE



MASONRY (M-2) (ECHO)


	EXTERIOR MATERIALS			
MARK DESCRIPTION COLOR		NOTES		
AA1	ANNODIZED ALUMINUM	BLACK	4	
M1	SMOOTH-FACE MASONRY	BLACK GRANITE	2	
M2	SMOOTH-FACE MASONRY	ECHO	2	
P1	PAINTED FINISH	BLACK		
R1	ROOF & ROOF ACCESSORIES	COPPER PENNY	3	
R2	ROOF & ROOF ACCESSORIES	GRAPHITE	3	
S1	VERTICAL PANELS (SMOOTH)	GRAPHITE	1	
S2	VERTICAL PANELS (SMOOTH)	LIGHT GREY	1	
S3	VERTICAL WOOD - ASH	WEATHERED	1	
T1	HROIZONTAL TRIM BOARD	GRAPHITE	3	

- 1. COLOR SELECTED FROM LP BUILDING SOLUTIONS STANDARD COLORS.
- COLOR SELECTED FROM COUNTY MATERIALS "PREMIER ULTRA" SERIES BURNISHED BLOCK STANDARD COLORS.
- 3. COLOR SELECTED FROM PAC-CLAD STANDARD COLORS.
- 4. COLOR SELECTED FROM KAWNEER ANNODIZED ALUMINUM STANDARD COLORS.

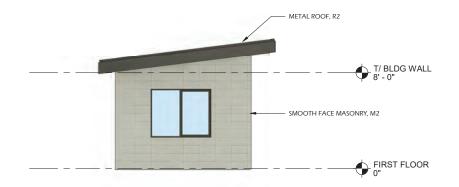





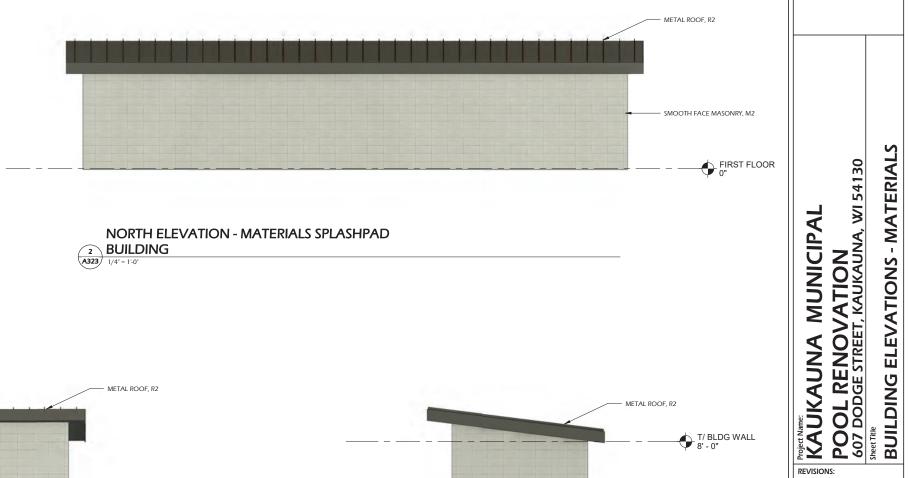


NORTH ELEVATION - MATERIALS SPLASHPAD

2 BUILDING A323 1/4" = 1'-0"



SOUTH ELEVATION - MATERIALS SPLASHPAD 3 BUILDING
1/4* = 1:0*

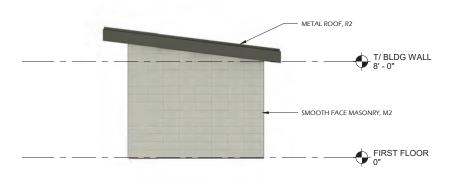

EAST ELEVATION - MATERIALS (SPLASHPAD

1 BUILDING) A323 1/4" = 1'-0"

20.008 75% SET 2/10/2023 Project #: Issued For: Date:

ISSUE DESCRIPTION DATE

Sheet Number

REVISIONS:

Item 4.b.





MEMO

PLANNING AND COMMUNITY DEVELOPMENT

To: Plan Commission

From: Lily Paul, Associate Planner

Date: March, 17, 2023

Re: Preliminary Plat Review - Hurkman Heights 4

Hurkman Heights is a development South of Highway 41 on the north end of the city. Hurkman Heights is a 26-unit single-family development that has been built out in 4 phases. Plan Commission has reviewed a previous plat for this phase. Plan Commission gave direction to the developer to provide for more traffic circulation and found the long dead-end road to be a safety concern.

Since then, a new plat has been created that provides traffic circulation and a secondary exit to the subdivision. Setter Drive has been extended west and will link existing Setter Drive and Ben's Way. One concern is the ability for Lot 95 to safely back out of their future driveway. The end of Setter Drive should gain an easement and create a bulb, instead of a dead end road. This extension betters the safety and traffic concerns and will provide a joining of the various phases of Hurkman Heights Subdivision.

Recommendation:


Approval of the Hurkman Heights Phase 4 Preliminary Plat, and recommend the same to the common council with the following conditions:


- 1. A bulb is installed at the west end of Setter Drive for access to Lot 95
- Prior to construction all applicable permits and approvals are obtained from Public Works, City Building Inspector, and DNR.

Preliminary Plat of

Hurkman Heights 4

All of Lot 71 Hurkaman Heights 3 and part of Lots 12 & 18 and all of Lot 16, In the Subdivision of Private Claim 35 in 1858, Township 21 North, Range 18 East, City of Kaukauna, Outagamie County, Wisconsin

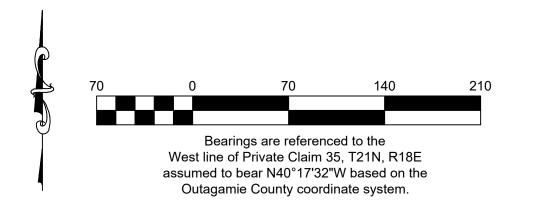

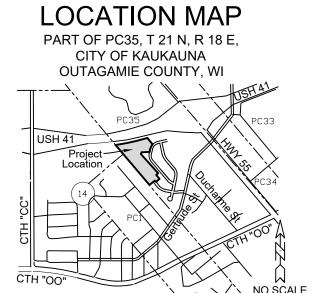

SUPPLEMENTARY DATA Total Area = 502,523 SF 11.5363 acres R/W Area = 105,354 SF 2.4186 acres
,
Net Area = 397,169 SF 9.1177 acres
Number of Lots = 27
Average lot size = 11,250 SF
Typical lot dimension = 90'x 125'
Lineal feet of street = 1,844 LF
Existing zoning = RSF
Proposed zoning = RSF
Approving Authorities
City of Kaukauna
Objecting Authorities
Department of Administration
Department of Transportation
NOTES
Utility and Drainage Easements
will be shown on Final Plat

SURVEYOR'S CERTIFICATE

Storm Structures						
Structure	#	Rim	Inv	Size	Material	Direction
MH	Α	724.31	719.40	8"	PVC	SE
MH	В	719.97	715.32	10"	PVC	SE
СВ	С	719.14	715.50	12"	PVC	SW
MH	D	718.75	714.21	12"	PVC	SE
INL	Ε	718.45	715.00	12"	PVC	SW
INL	F	718.44	715.00	12"	PVC	NE

tructure	#	Rim	Inv	Size	Material	Direction
MH	1	723.73	716.10	8"	PVC	SE
MH	2	720.01	711.55	8"	PVC	SE
MH	3	719.04	708.75	8"	PVC	SE
			708.64	8"	PVC	NW

Sanitary Structures

I, James R. Sehloff, hereby certify that this Preliminary Plat is a 85 11,000 SF correct representation of all existing land divisions and features, and that I have complied with the preliminary plat requirements for the City of Kaukauna. 11,500 SF James R. Sehloff, R.L.S. No. S-2692 Date 11,500 SF 82/ 11,000 SF LINE TABLE /11,000 SF Line Bearing L1 N 11°50'18" W 21.40' L2 N 20°04'14" E 39.71' L3 N 40°17'32" W 49.74' LEGEND **CURVE TABLE**

87 24,125 SF

11,000 SF

93 10,905 SF

> **97** 11,500 SF

> > N 78°36'44" E

S 51°13'33" W

Curve Radius Chord Direction Chord Length Arc Length Central Angle Tangent Bearing-in Tangent Bearing-out

0°51'20"

63°35'04"

N 79°28'04" E

S 12°21'31" E

88.02'

144.27'

136.98'

C1 | 5894.65' | N 79°02'24" E

130.00' S 19°26'01" W

Setter Drive

BENCHMARKS	(NAVD	88	Datur

M 0	NGS Bench	mark
	PID PN0153	}
	Flov	712 26

BM 1 Fire Hydrant, Tag Bolt Lots 17/18 S R/W Ben's Way Elev 722.56

BM 2 Fire Hydrant, Tag Bolt
West End of Ben's Way (NW Corner Lot 21)

Elev 720.53

BM 3 Fire Hydrant, Tag Bolt
North End of Rusty Street (NE Corner Lot 26)
Elev 723.06

BM 4 Fire Hydrant, Tag Bolt Boxer Street (Lot 74/ Lot 75) Elev 718.84

BM 5 Fire Hydrant, Tag Bolt
Boxer Street, ±65 South of Lot 71
Elev 717.92

BM 6 Fire Hydrant, Tag Bolt Setter Drive(NW Corner Lot 52) Elev 718.39

—CATV—CATV—	Underground Cable TV
—F0 ———F0 ———	Underground Fiber Optic
— San—— San——	Sanitary Sewer
—	Storm Sewer
—E——E——	Underground Electric
—G——G——	Underground Gas Line
	Underground Telephone
vv	Water Main
800	Index Contour
 799	Intermediate Contour

$\overline{\bigcirc}$	Sanitary MH / Tank / Base	€	C	CATV Pedest
8	Clean Out / Curb Stop / P	ull Box	G	Gas Regulato
	Storm Manhole		Δ	1¼" Rebar Fo
	Inlet		0	¾" Rebar Foι
0	Catch Basin / Yard Drain			1" Iron Pipe F
(0)	Water MH / Well		lack	Government (
Ω	Hydrant		٠	Benchmark
		*	* * * * * * * * * * * * * * * * * * *	Wetlands

File: 4562Plat Ph4.dwg Date: 03/08/2023 Drafted By: Jim Sheet: 1 of 1



www.davel.pro
3/8/2023 10:48 AM J:\Projects\4562l&h\dwg\Civil 3D\4562Plat Ph4.dwg Printed by: ji



MEMO

PLANNING AND COMMUNITY DEVELOPMENT

To: Plan Commission

From: Lily Paul, Associate Planner

Date: March 17, 2023

Re: Outdoor Alcoholic Beverage Area Alternative Entrance – 313 Dodge

Building owner Mark Abel and business owner Kyle Megna are working with contractors to expand their current Outdoor Alcoholic Beverage Area (Patio/Deck/Beer Garden). This patio will connect to their current raised deck and be built entirely over the driveway of the property. The driveway is not used for vehicular service. The driveway has been used as an outdoor service area through a COVID-19 Temporary Outdoor Seating Permit. The extension for that permit has ended and this new construction will make it a permanent structure under their Outdoor Alcoholic Beverage Area Permit that they renew yearly with their liquor license.

Please find attached the site plan for the deck (Exhibit 4). The site plan shows an ADA wheel chair ramp built on the west side of the property leading to the entrance. There is a stair about half way up the ramp as well leading to the entrance. There will be a 6 foot - 8 foot high fence installed on the western property line, as the use of the neighboring house is residential. This complies with section 12.03(11)(c)(2) of the City of Kaukauna Code of Ordinances. There is additional landscaping proposed along with existing landscaping that meets requirements.

Now, 313 Dodge is seeking an alternative entrance to their building. The current site plan shows entrance to the outdoor alcoholic beverage area, first, before entrance through the Main Entrance of the premises. According to the City of Kaukauna Code of Ordinances 12.03 (11)(e)(1):

Access to the outdoor entertaining area shall only be through the main entrance to the Class B intoxicating liquor, Class B fermented malt beverage; and Class C premises. The outdoor entertaining area shall be equipped with a locking system on a fire exit that meets applicable fire codes. In cases where site configuration or parcel shape prevent a single entrance to the outdoor beverage area through the main entrance of the building, the Plan Commission may review the outdoor beverage area site plan and approve alternative entrances.

To be incompliance with code, there would have to be an apparatus, like a gate, restricting access to the outdoor patio starting at the step (Exhibit 5). This would force entrance to the building before the outdoor alcoholic beverage area, but also eliminate service to tables in a section that was originally proposed (Exhibit 6). 313 Dodge feels that with an improvement like this, utilizing the space as intended is ideal. The layout of the building effects the location of the main entrance. The entrance faces north which makes it difficult to abide by the code. It is up to the Plan Commission to approve alternative entrances for situations similar to this.





SITE PLAN REVIEW APPLICATION

PROPERTY OWNER	APPLICANT (IF DIFFERENT PARTY THAN OWNER)			
Name:	Name:			
313 Dodge 640	0.000			
Mailing Address:	Mailing Address:			
2216 Nottingham Ln	Kankauna CITS413			
Phone: 920-585-1736 Mg	Phone: Phone: Phone: Phone: Touck: Phone: Phone:			
Email: Mark@abelins.com	Email: Tackie@abelins.com			
PROPERTY INFORMATION				
	bee attached			
Property Parcel (#): 324012600	2			
Site Address/Location:				
Current Zoning and Use:				
Current Zoning and Use:				
Proposed Zoning and Use:				
Existing Gross Floor Area of Building Paties	(Temp)			
Existing Gloss Floor Area of Shifting 74743.	SF			
Proposed Gross Floor Area of Building: Pa+20.".				
Existing Building Height:				
Proposed Building Height:				
Existing Number of Off-Street Parking Spaces:				
Proposed Number of Off-Street Parking Spaces:				
Existing Impervious Surface Coverage Percentage:				
Proposed Impervious Surface Coverage Percentage:				

I certify that the attached drawings are, to the best of my knowledge, complete and drawn in accordance with all City of Kaukauna codes.

Owner/Agent Signature:

Owner/Agent Name (Printed):

SITE PLAN REVIEW PROCEDURES

Site Plan Review is an administrative process that can take up to 15 working business days after a submittal deadline. Plan Review process is **required** for all new commercial, industrial or multifamily buildings, and building expansions / additions or structures.

Early in the process, consult the Site Application Checklist (attached) for a complete list of plan requirements and contact staff in the Planning and Community Development Department for initial direction and assistance. In addition, it is your responsibility to notify utility companies regarding your proposed development.

Prior to the 10 day submittal deadline, a preliminary set of plans should be submitted to the Planning and Community Development Department, those plans will then be distributed amongst variouse departments for an initial review. Feedback will be given to the applicant after the initial review. To allow for the submittal of 100% completed plans.

Submit a set of plans, a digital copy of the plans in PDF or compatible format, and one of each application: Site Plan, Erosion Control, and Stormwater Utility Service Application. The Site Plan Set shall include Site, Utility, Grading, Drainage, Erosion Control, Landscape, Architectural Elevations, Photometric Information, Road and Driveway widths, Material composition of road and driveways, Parking Plans, Hydrant Locations (public and private), Distances of Buildings (length, width, and distance from sidewalks, roads and driveways. Additionally, please indicate if the property will be utilizing a Knox Box. This application should be submitted to the Application Coordinator listed below.

After review by City Departments, questions, comments and requested revisions will be returned to the applicant in advance of the Plan Commission meeting.

SITE PLAN REVIEW CONTACTS:

Application Coordinator/Planning Dept

Lily Paula

lpaul@kaukauna-wi.org 920-766-6315

McMahon and Associates inspection@kaukauna-wi.org

920-766-6325

Public Works review:

Inspections review:

John Neumeier

jneumeier@kaukana-wi.org

920-766-6305

SITE PLAN CHECKLIST

- Completed Site Plan application
- Completed Erosion Control Permit application and necessary fees
- Completed Stormwater Utility Service application
- Completed Construction Site Stormwater Management form
- Calculations for sanitary sewer and water
- Calculations for storm sewer design
- Site Plan set (hard copy or digital) to include:
 - o Site Plan layout and streets, including designated fire lanes
 - o Utilities, grading and drainage plan
 - o Erosion control plan
 - o Landscape and lighting plan
 - o Architectural elevation and construction details
 - o Floor plan set
 - o Any other plans or information deemed necessary by Community Development
- A digital copy of the Site Plan Set in PDF or compatible format by electronic mail or digital dropbox submission

SITE PLAN SUBMISSION

By mail/in-person drop off: City of Kaukauna, Attn: Lily Paul, 144 W. 2nd Street,

Kaukauna, WI 54130

Electronically remit materials Attn: Lily Paul to: lpaul@kaukauna-wi.org

Narrative Description:

The intention of this project is to provide an improved patio layout as well as a more level area for tables and seating. It will provide better separation of the patio area from the street sidewalk by removing the "driveway" and creating an elevated patio as currently exists to the east of the driveway. The ADA accessible entrance ramp will be relocated to the west side of the property adjacent to the single-family residence. A solid vinyl fence is proposed at the west edge of the ramp extending from the rear of the single-family residence to the front setback of the residence as shown on the site plan. In discussions with the neighbor, it was verbally agreed to install the fence 8 ft high from the south fence termination point to the north side of the 1st floor windows. From this point the fence would be lowered to 6 ft. There was also a verbal agreement that the space between the fence and home would be landscaped with a stone mulch to avoid turf maintenance in this area. The current driveway apron will be removed, and barrier curb installed. The apron would be replaced by a 6 ft wide paved area in the terrace for delivery access from the street.

313 DODGE OUTDOOR PATIO IMPROVEMENTS CITY OF KAUKAUNA

OUTAGAMIE COUNTY, WISCONSIN MCM # T0094-09-22-00725



UTILITIES

WE ENERGIES JIM QUINN (ELECTRIC) KENNETH VAN OSS (GAS) 800 SOUTH LYNNDALE DRIVE P.O. BOX 1699 APPLETON, WI 54912 (920) 380–3401 (ELECTRIC) (920) 380–3318 (GAS)

CONTACT INFORMATION

VINCE LEBRUN 221 WEST WASHINGTON STREET FLOOR 4 APPLETON, WI 54911 (920) 735-3252 V11253@att.com

TIME WARNER CABLE VINCE ALBIN 1001 KENNEDY AVENUE PO BOX 145 KIMBERLY, WI 54136-0145 vince.albin@twcable.com

TOWN OF MENASHA, UTILITY DISTRICT STEVE LAABS (SANITARY SEWER) JEFF ROTH (WATER)
2340 AMERICAN DRIVE NEENAH, WI 54956 (920) 739-5120 stevel@town-menasha.com jeffr@town-menasha.com

RANDY GALLOW, STREET SUPERINTENDENT 2000 MUNICIPAL DRIVE NEENAH, WI 54956

LEE REIBOLD 1445 McMAHON DRIVE NEENAH, WI 54956 (920) 751-4200 Ireibold@mcmgrp.com

DNR LIAISON

DEPARTMENT OF NATURAL RESOURCES BOBBI JO FISCHER 427 EAST TOWER DRIVE SUITE 100 WAUTOMA, WI 54982 (920) 787-4686 x3007 Bobbi.Fischer@Wisconsin.gov







SHEET INDEX


- 1 EXISTING CONDITIONS
- 2 SITE LAYOUT PLAN
- 3 SITE GRADING PLAN


FEBRUARY, 2023

PROJECT

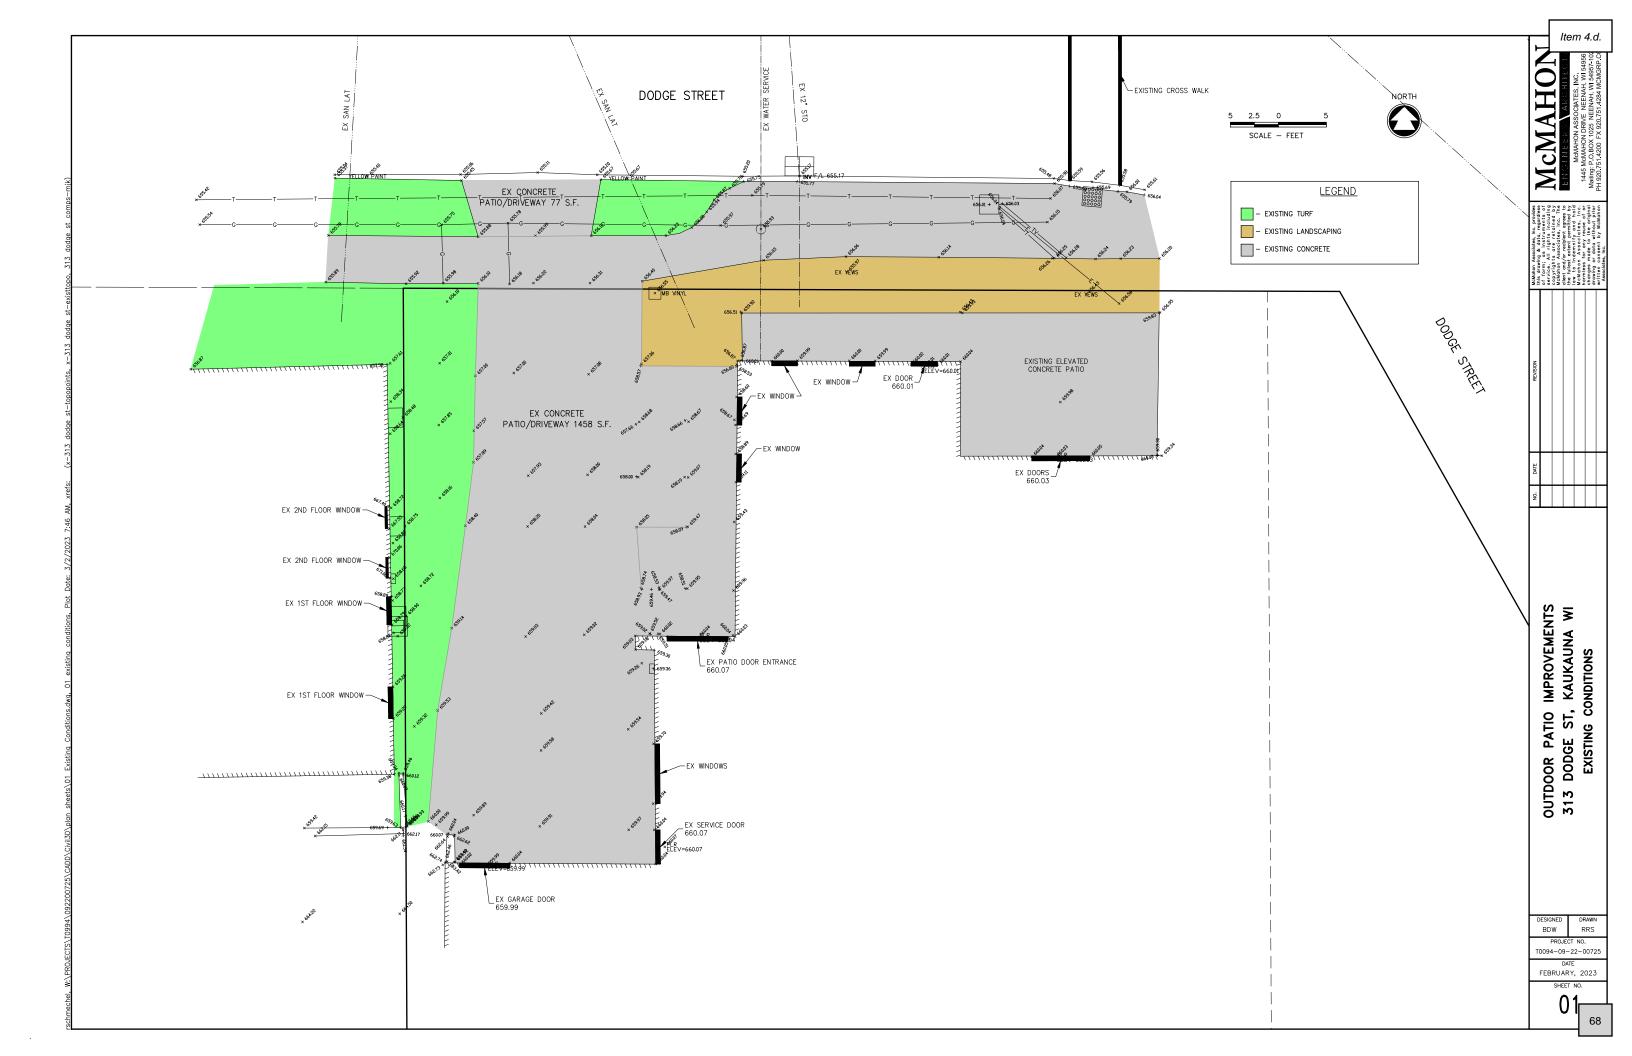

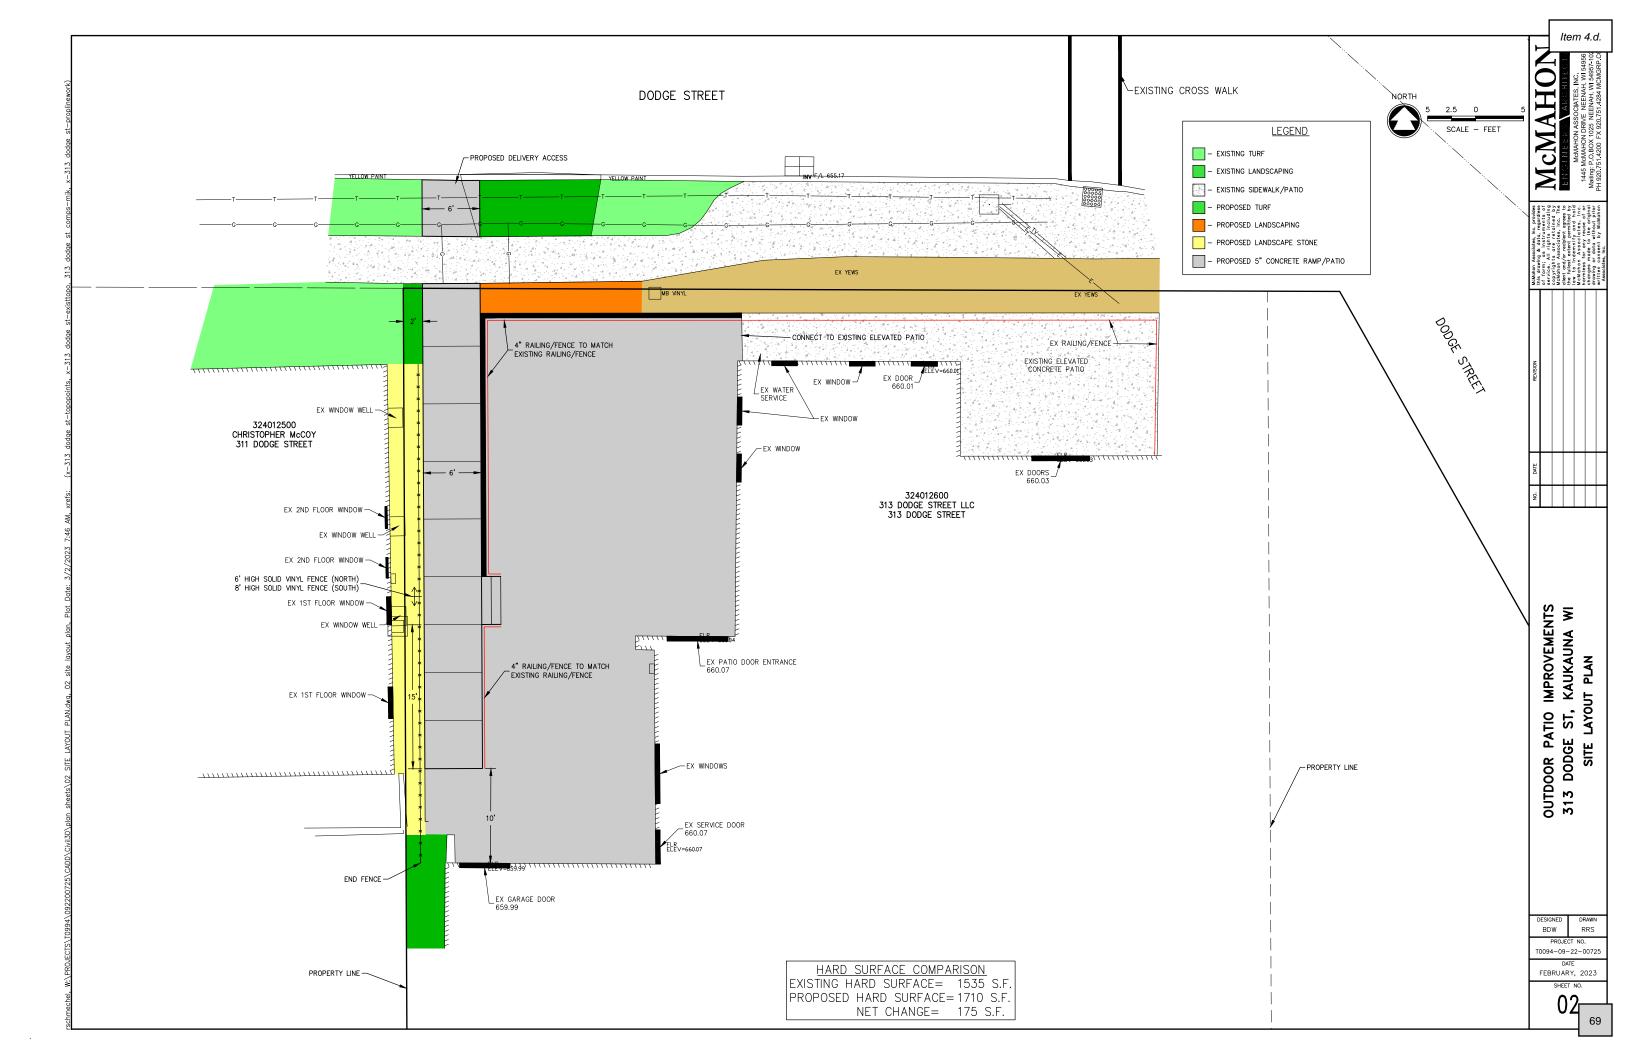

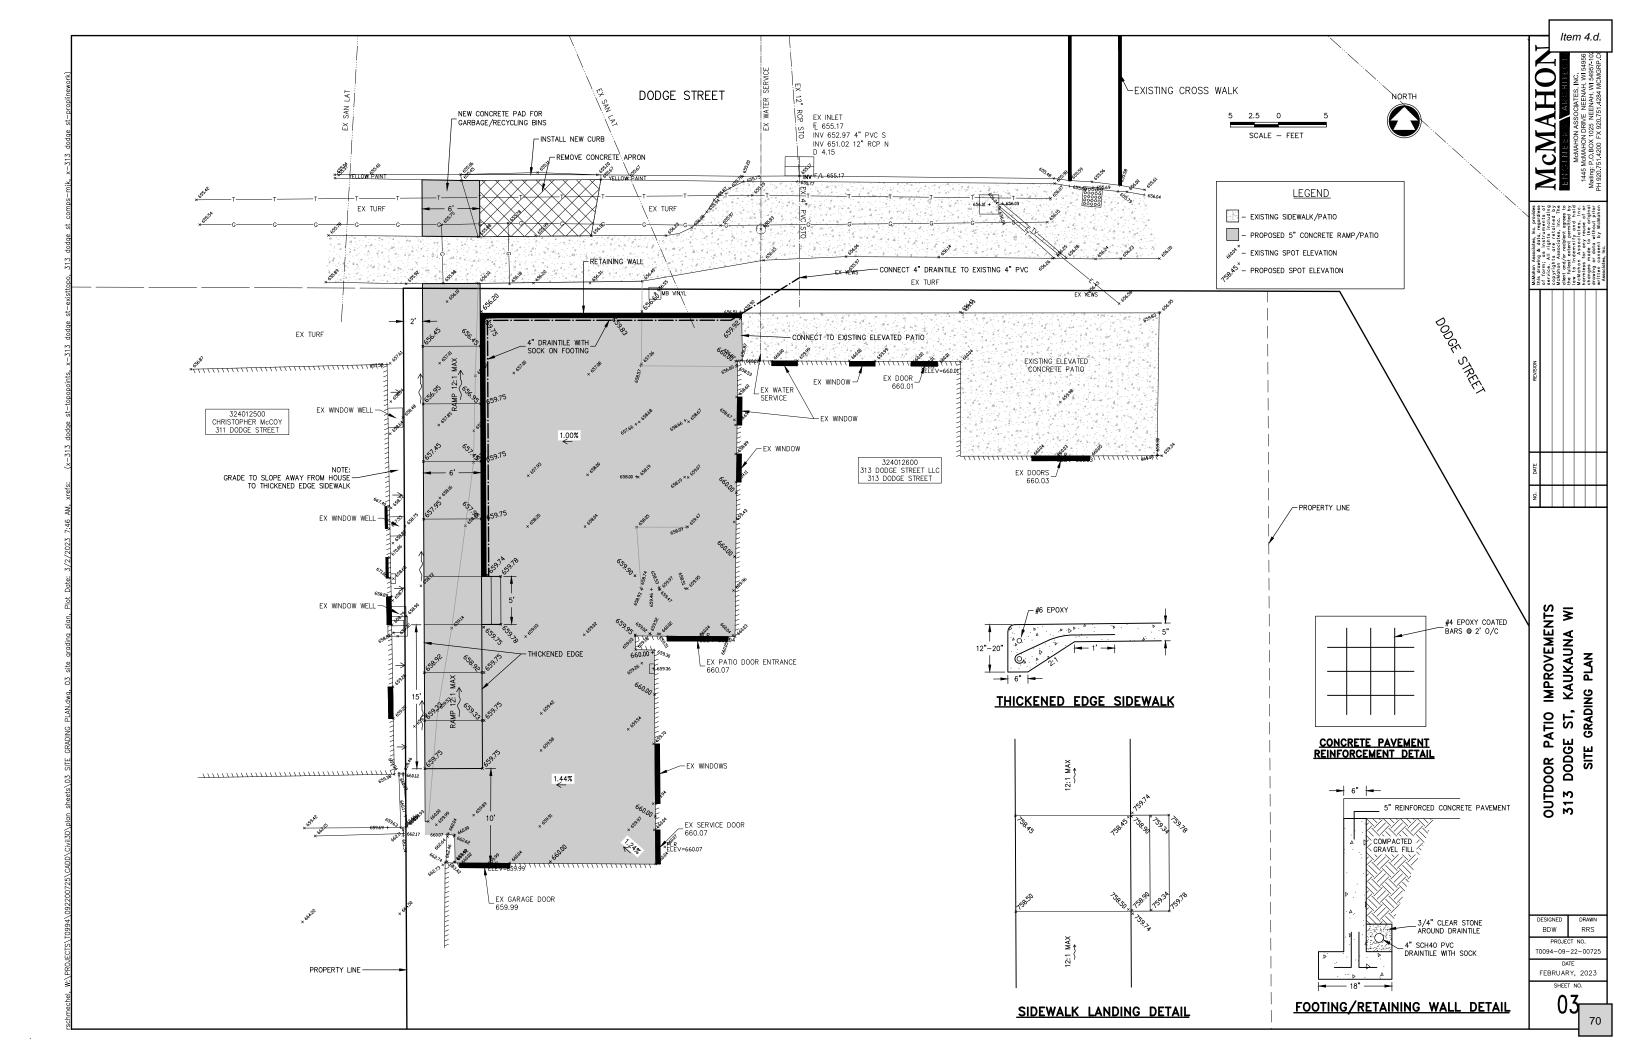

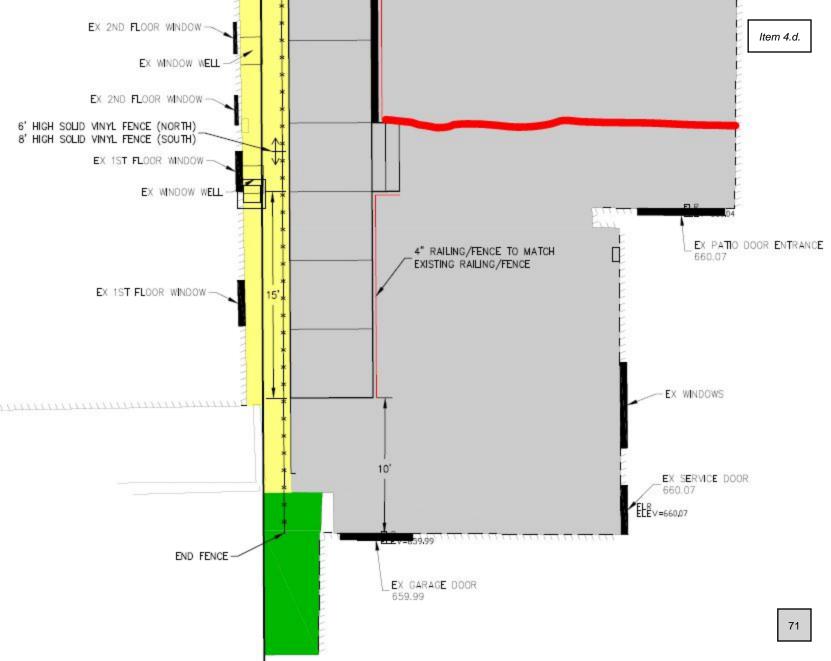

SHEET NO.

A212