## PLAN COMMISSION

City of Kaukauna **Council Chambers** Municipal Services Building 144 W. Second Street, Kaukauna



Thursday, November 09, 2023 at 4:00 PM

#### **AGENDA**

- 1. Roll Call.
- 2. Approval of Minutes.
  - a. Approve Minutes from October 19, 2023 Meeting
- 3. New Business.
  - a. Park Donation Application Review Tree Donation at Dog Park
  - b. Site Plan Review Ahlstrom Thilmany Facility Boiler Building
  - c. Donation Discussion
  - d. Facade Discussion
- 4. Other Business.
- 5. Adjourn.

#### **NOTICES**

IF REQUESTED THREE (3) DAYS PRIOR TO THE MEETING, A SIGN LANGUAGE INTERPRETER WILL BE MADE AVAILABLE AT NO CHARGE.



## PLAN COMMISSION

City of Kaukauna **Council Chambers** Municipal Services Building 144 W. Second Street, Kaukauna

Thursday, October 19, 2023 at 4:00 PM

#### **MINUTES**

#### Roll Call. 1.

Members present: Michael Avanzi, Giovanna Feller, DPW John Neumeier, Mayor Tony Penterman. Pennie Thiele

Member(s) absent: John Moore, Ken Schoenike

Other(s) present: Associate Planner Lily Paul, PCDD Joe Stephenson, Dave Stubbs Keller

Thiele made a motion to excuse the absent members. Avanzi seconded the motion. The motion passed unanimously.

#### Approval of Minutes.

Approve Minutes from October 5, 2023 meeting

Feller made a motion to approve the minutes from October 5, 2023 meeting. Neumeier seconded the motion. The motion passed unanimously.

#### New Business.

Site Plan Review - Berker's Dental & Brain Balance Addition - 1403 Arbor Way

AP Lily presented a 2,452 square foot addition for Brain Balance onto Berkers Family Dentistry building in Commerce Crossing. The addition will match the existing building. It will add multiple work rooms, offices and a restroom for the business. The parking will be expanded to add 32 extra parking spots. Lighting and landscaping are all adequate, just need plans to keep on file. A new façade ordinance does require 10% of public facing walls to obtain masonry finishing. Since there is a substantial addition to the building, the current building and addition need to meet this code. Dave Stubbs from Keller Inc, agent for the owner, inquired if there can be an exception for the facade. Unfortunately, the code language does not allow that and the commission does not hold the power to do so. Variances can be requested from the Zoning Board of Appeals, but since this is not a hardship, staff would not be in favor of approving the variance.

Neumeier made a motion to approve the site plan for Berkers Dentistry & Brain Balance with the following conditions:

- Storm water and Erosion control permits are obtained from Engineering Dept. before building permits are issued
- Landscaping plan is provided
- Lighting plan is provided
- Façade requirements are met

Feller seconded the motion. The motion passed unanimously.

#### 4. Other Business.

There was no other business.

#### 5. Adjourn.

Avanzi made a motion to adjourn the meeting. Thiele seconded the motion. The motion passed unanimously. Meeting adjourned at 4:15 PM.





# **MEMO**

## PLANNING & COMMUNITY DEVELOPMENT

To: Plan Commission

Lily Paul, Associate Planner From:

Date: November 3, 2023

Park Donation Application Review Re:

A Park Donation Application has been submitted by Paula and Brian Jacobs. They are proposing an Autumn Blaze Maple Tree be installed at the Dog Park. A plaque will not be included at this time.

#### **Staff Recommendation**

Staff recommends to approve the Tree Donation for Paula and Brian Jacobs and direct staff to work with the donors to pick a precise location.



#### UPDATED 11.07.2022



## APPLICATION FOR PARK DONATION

Donor Name: Paula & Brian Jacobs.

Phone Number: 920 858 1128

Address: 1051 Dodge st Kankauna.

Email Address: JACOBS BRIAN &ORGMAIL. Com

Proposed Location: Dog Park

Type of Donation: Tree Blaze Maple.

Cambridge Bench

Picnic Table

**Book Exchange** Tree Y

Garbage Receptacle

Other Item (Please Describe)

Inscription Text (If Applicable)

Please attach any necessary photos or documents with this form

Park Donations to the City of Kaukauna are considered outright and unrestricted donations. The City of Kaukauna does not guarantee the permanency of the accepted donation. If a memorial must be relocated, Department staff will attempt to notify the donor in writing at the address shown on this form. Donations may be tax deductible (please consult an accountant). The donor declares to have read the Parks Donation Policy and Guidelines. The donor understands and agrees with the conditions set forth in this policy and agrees to any conditions required by City staff or elected officials.

By signing below, I acknowledge that I have read and understand the Parks Donation Policy and Guidelines





# **MEMO**

## PLANNING AND COMMUNITY DEVELOPMENT

To: Plan Commission

Associate Planner Lily Paul From:

November 3, 2023 Date:

Re: Site Plan Review - Ahlstrom Thilmany Facility Boiler Building

This project consists of a new boiler enclosure addition to an existing f-1 occupancy paper Manufacturing facility. Building is unoccupied except for occasional maintenance. Boiler is operated remotely from an existing control room. Building is not being heated for human occupancy, but rather to meet the operating environmental requirements of the boiler.

#### Site Plan Review

#### Site/Architectural

This site plan adheres to all setbacks within the Industrial District.

#### Facade

24 gauge metal wall panel is the exterior of the building.

#### Landscape

Not applicable.

#### Lighting

Adequate lighting will be installed above all doors.

#### Stormwater

The developer will work with the Engineering Department to complete Erosion Control and Stormwater Management permitting.

#### Recommendation:

Staff recommends to approve the site plan for Ahlstrom Thilmany with the following conditions:

Prior to issuance of building permits, must obtain Stormwater and Erosion Control permits from Engineering Department

# AHLSTROM PB4 BOILER

KAUKAUNA, WI

# PROJECT DESCRIPTION

#### PROJECT DESCRIPTION:

THIS PROJECT CONSISTS OF A NEW BOILER ENCLOSURE ADDITION TO AN EXISTING F-1 OCCUPANCY PAPER MANUFACTRING FACILITY. MODERATE HAZARD. BUILDING IS UNOCCUPIED EXCEPT FOR OCCASIONAL MAINTENANCE. BOILER IS OPERATED REMOTELY FROM AN EXISTING CONTROL ROOM. BUILDING IS NOT BEING HEATED FOR HUMAN OCCUPANCY, BUT RATHER TO MEET THE OPERATING ENVIRONMENTAL REQUIREMENTS OF THE BOILER.

## APPLICABLE BUILDING CODES:

2015 INTERNATIONAL BUILDING CODE — WISCONSIN 2015 INTERNATIONAL MECHANICAL CODE 2015 INTERNATIONAL ENERGY CONSERVATION CODE 2015 INTERNATIONAL FIRE CODE

## APPLICABLE STANDARDS:

2015 NFPA 13

BUILDING IS NOT REQUIRED TO BE ACCESSIBLE PER IBC SECTION 1103.2.9

## BUILDING USE & OCCUPANCY:

OCCUPANCY CLASSIFICATION = F-1, FACTORY. MODERATE HAZARD. DESIGN OCCUPANT LOAD:

F OCCUPANCY = 100 SF/PERSON 4850 SF/100 = 49 PERSONS

## **CONSTRUCTION TYPE:**

CONSTRUCTION TYPE = 2B, FULLY SPRINKLED PER NFPA 13

## HEIGHT & AREA LIMITATIONS:

NEW CONSTRUCTION IS ADDITION TO EXISTING FACILITY THAT COMPLIES WITH REQUIREMENTS OF UNLIMITED AREA BUILDING PER IBC CHAPTER 507.

## BUILDING HEIGHT = 39'-0" (PER IBC 202)

## BUILDING SIZE:

NEW CONSTRUCTION, SINGLE STORY = 4851 SF

## NUMBER OF EMPLOYEES:

NO ADDITIONAL EMPLOYEES ARE BEING ADDED AS THE RESULT OF THIS WORK

## EXIT DISTANCES:

FULLY SPRINKLED, F-1 = 400 FEET PER IBC 1017.2.2 MAXIMUM COMMON PATH OF TRAVEL = 100 FEET MAXIMUM DEAD END COORIDOR LENGTH = 50 FEET BUILDING IS 77 FEET LONG

## ACCESSIBILE ROUTE:

BUILDING IS NOT REQUIRED TO BE ACCESSIBLE PER IBC SECTION 1103.2.9

## PLUMBING FIXTURES:

THERE ARE NO PLUMBING FIXTURES BEING ADDED AS PART OF THIS WORK.
NO NEW PLUMBING FIXTURES INCLUDED. EXISTING FACILITIES MEET REQUIREMENTS

## MEANS OF EGRESS:

7. EQUIPMENT LOADS

REFERENCE EQUIPMENT VENDOR DATA


OCCUPANCY LOAD PER TABLE 1004.1.2 (49) 9.8" REQ'D MEANS OF EGRESS ILLUMINATION SHALL COMPLY WITH SECTION IBC 1008

# CODE COMPLIANCE & PROJECT DATA

## <u>DESIGN LOADS</u>

1. ROOF SNOW LOAD		8. SEISMIC DESIGN DATA	
GROUND SNOW LOAD, Pg	40 PSF	SITE CLASS	D
SNOW EXPOSURE FACTOR, Ce	1.0	RISK CATEGORY	П
SNOW IMPORTANCE FACTOR, Is	1.0	SEISMIC DESIGN CATEGORY, SDC	Α
SNOW THERMAL FACTOR, Ct	1.0	SEISMIC IMPORTANCE FACTOR, le	1.0
SNOW THERMAL FACTOR (SNOW SHELF), Ct	1.2	SPECTRAL RESPONSE ACCELERATION	
FLAT ROOF SNOW LOAD, Pf	34 PSF	SHORT PERIODS, Ss	0.056
RAIN ON SNOW SURCHARGE, Prs	0 PSF	SPECTRAL RESPONSE ACCELERATION	
SNOW DRIFT	SEE SHEET 30473	1-SECOND PERIODS, S1	0.035
		SPECTRAL RESPONSE COEFFICIENT,	
2. GROUND FLOOR LIVE LOAD	400 PSF	SHORT PERIOD, Sds	0.059
		SPECTRAL RESPONSE COEFFICIENT,	
3. ROOF LIVE LOAD	20 PSF	1-SECOND PERIOD, Sd1	0.056
(ROOF LIVE LOAD REDUCTIONS ARE NOT ALLOWE	ED)		
		BASIC SEISMIC FORCE RESISTING SYSTEM FOR BUIL	DING:
4. COLLATERAL LOADS		STEEL SYSTEM NOT SPECIFICALLY DETAILED FOR	SEISMIC
ROOF	15 PSF	RESISTANCE (R=3)	
PIPE RACKS (PER LEVEL)	30 PSF		
		ANALYSIS PROCEDURE	
5. WIND DESIGN DATA		EQUIVALENT LATERAL FORCE METHOD	
BASIC WIND SPEED, ASCE 7-10 (3 SEC GUS	ST) 115 MPH		
WIND IMPORTANCE FACTOR, IW	1.0	9. ALLOWABLE NET SOIL BEARING CAPACITIES	
WIND EXPOSURE	В	FOUNDATION ON NEWLY PACKED STRUCTURAL FILL	
INTERNAL PRESSURE COEFFICIENT, GCpi	0.18 (+/-)	OR LIMESTONE BEDROCK	6 KSF
COMPONENTS AND CLADDING DESIGN	VARIES		
6. FLOOD DESIGN	N/A		
	.,, .,		

# SITE PLAN

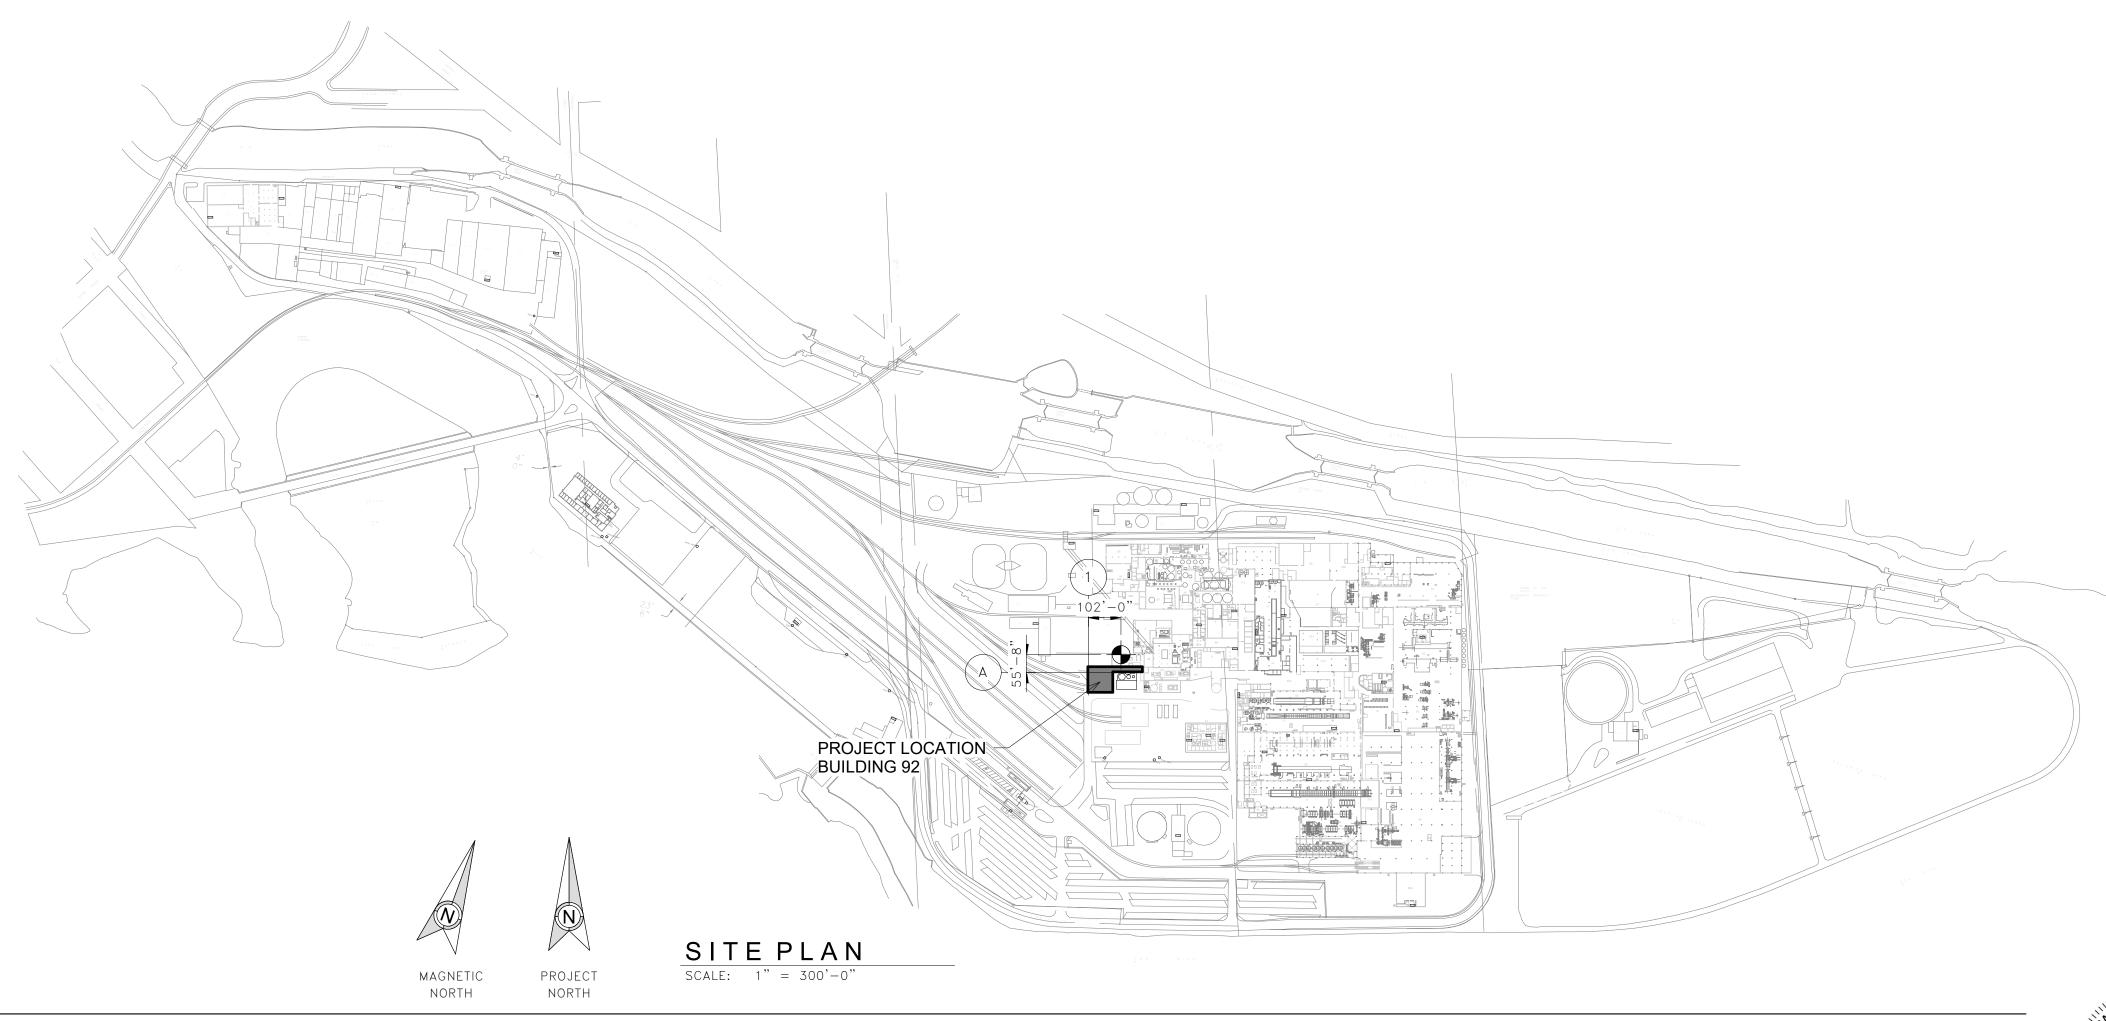


	DRAWING INDEX
DWG #	DESCRIPTION
30470	COVER SHEET
30471	DRAWING INDEX
30472	ROOF WIND UPLIFT DIAGRAM
30473	SNOW DRIFT LOADING DIAGRAM
30474	GROUND FLOOR PLAN
30475	ROOF PLAN
30476	EXTERIOR ELEVATIONS
30477	EXTERIOR ELEVATIONS
30478	BUILDING SECTION
30479	DETAILS
30480	DOOR SCHEDULE AND DETAILS
30483	FOUNDATION PLAN
30484	GROUND FLOOR SLAB PLAN
30485	FOUNDATION ELEVATIONS
30486	EQUIPMENT ANCHORAGE LAYOUT PLAN
30487	FOUNDATION SECTIONS
30488	U-DRAIN DETAILS
30489	CONCRETE DETAILS
30490	COLUMN PIER SCHEDULE AND DETAILS
30491	ANCHOR ROD SCHEDULE
30493	ROOF FRAMING PLAN
30494	ROOF FRAMING PLAN
30495	FRAMING ELEVATIONS
30496	FRAMING ELEVATIONS
30497	PIPE BRIDGE PLANS
30498	PIPE BRIDGE SECTIONS
30500	STEEL SECTIONS
30501	STEEL DETAILS
30502	TYP. ROOF TRUSS/SWAY FRAME CONNX DETAILS
30503	TYP. BUILDING CONNX DETAILS
30504	TYP. BUILDING CONNX DETAILS
30505	PIPE BRIDGE CONNX DETAILS





Digitally signed by Brent J. Robinson Location: Baisch Engineering Inc. Kaukau Reason: I attest to the accuracy and integr this document. Contact Info: brobinson@baisch.com 9207663521 Date: 2023.10.20 11:59:31-05'00'


				ENGI 09 HYLAND AVE AUKAUNA, WI 5- (920)-766-352	4130	PROJECT NUME DRAWING NUM DRAWING CODI	BER: 30470	D E O F	Freeze not for Cons Bid not for Construct Reference not for Construction Construction Record	ction
						REFERENC	CES		DI	WG. NO.
						<b>7</b> A	HLS'	TRO	MC	
							POWER			
				E	B84 BC		D BUILDING OVER SHEE		ATION	
			SCAL	_E:			JOB NO. K	W042313	7	ISSUE NO.
CONSTRUCTION	10/20/23	BRH	DATE	E: 10/13/23	3		PLOT DATE:			0.1
DESCRIPTION	DATE	BY	DWN.	BRH	ENGR.	BJR	SERVICE LOCA	ATION	FILE NO.	SIZE
REVISIONS			CH.	LJS	APP.		X	_	30470	- C

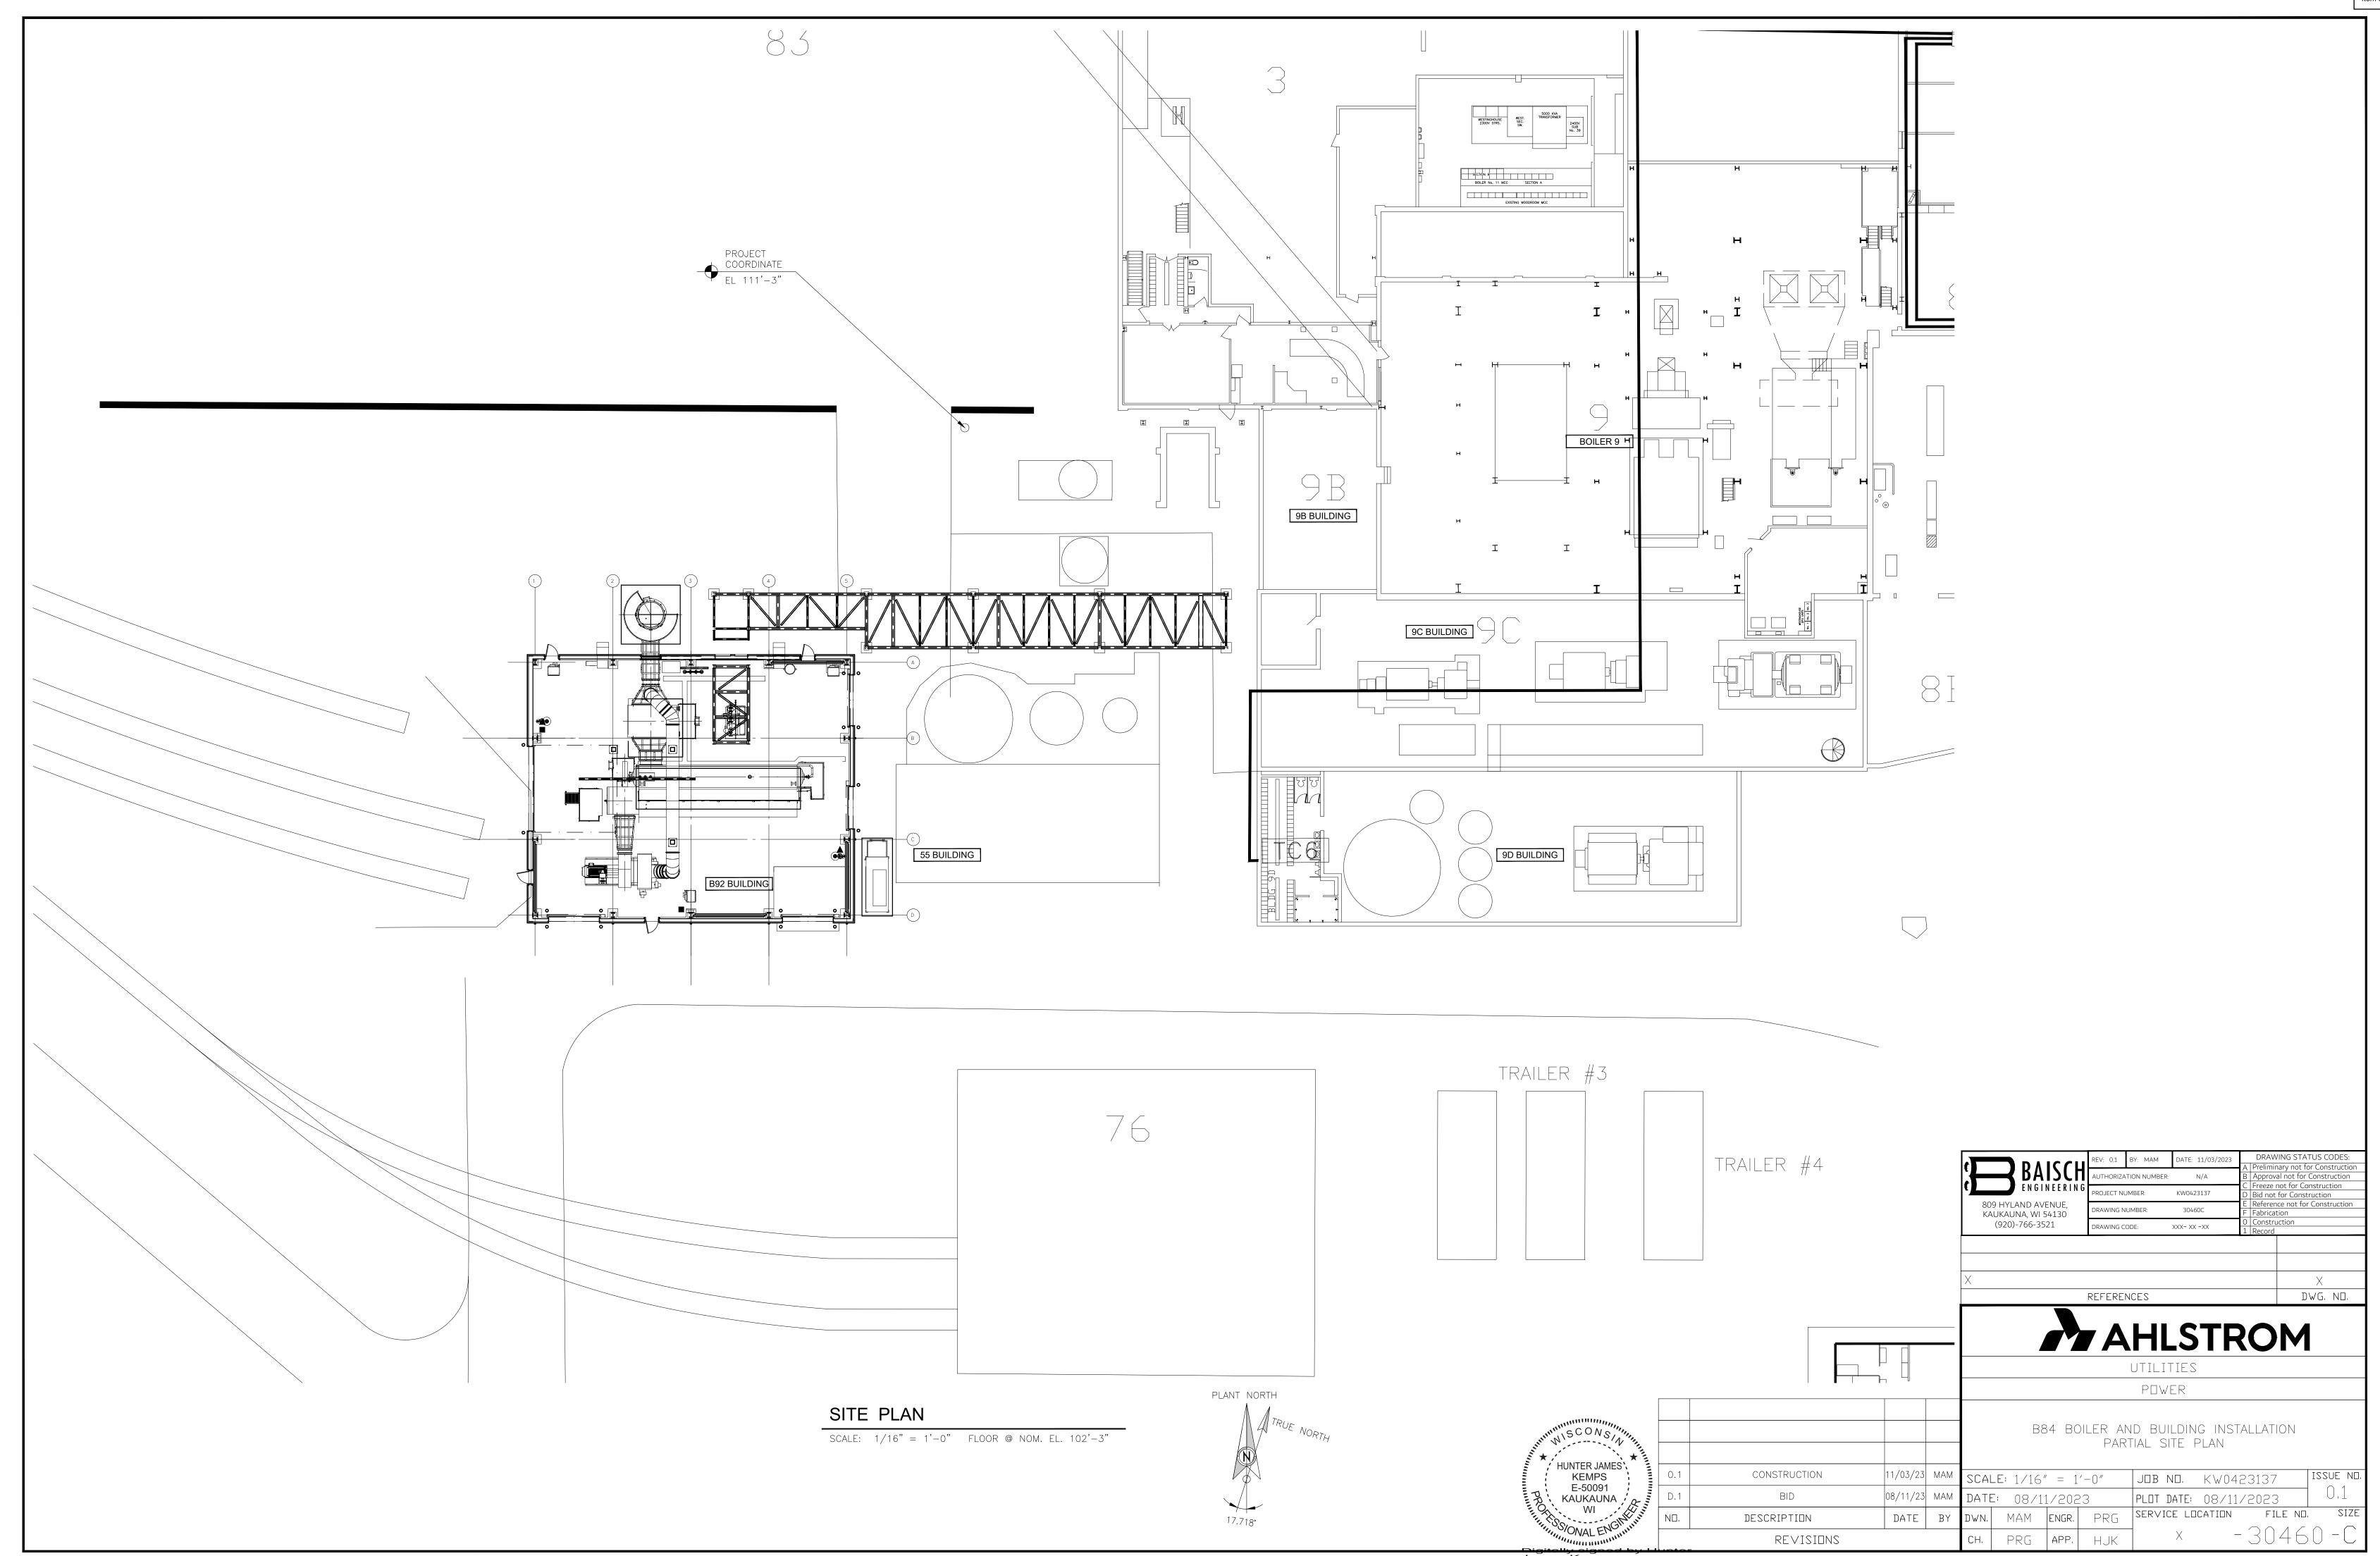


James Kemps
DN: E=hkemps@baisch.com,
CN=Hunter James Kemps,
O=Baisch Engineering Inc.,
L=Kaukauna, S=Wisconsin,
C=US

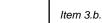

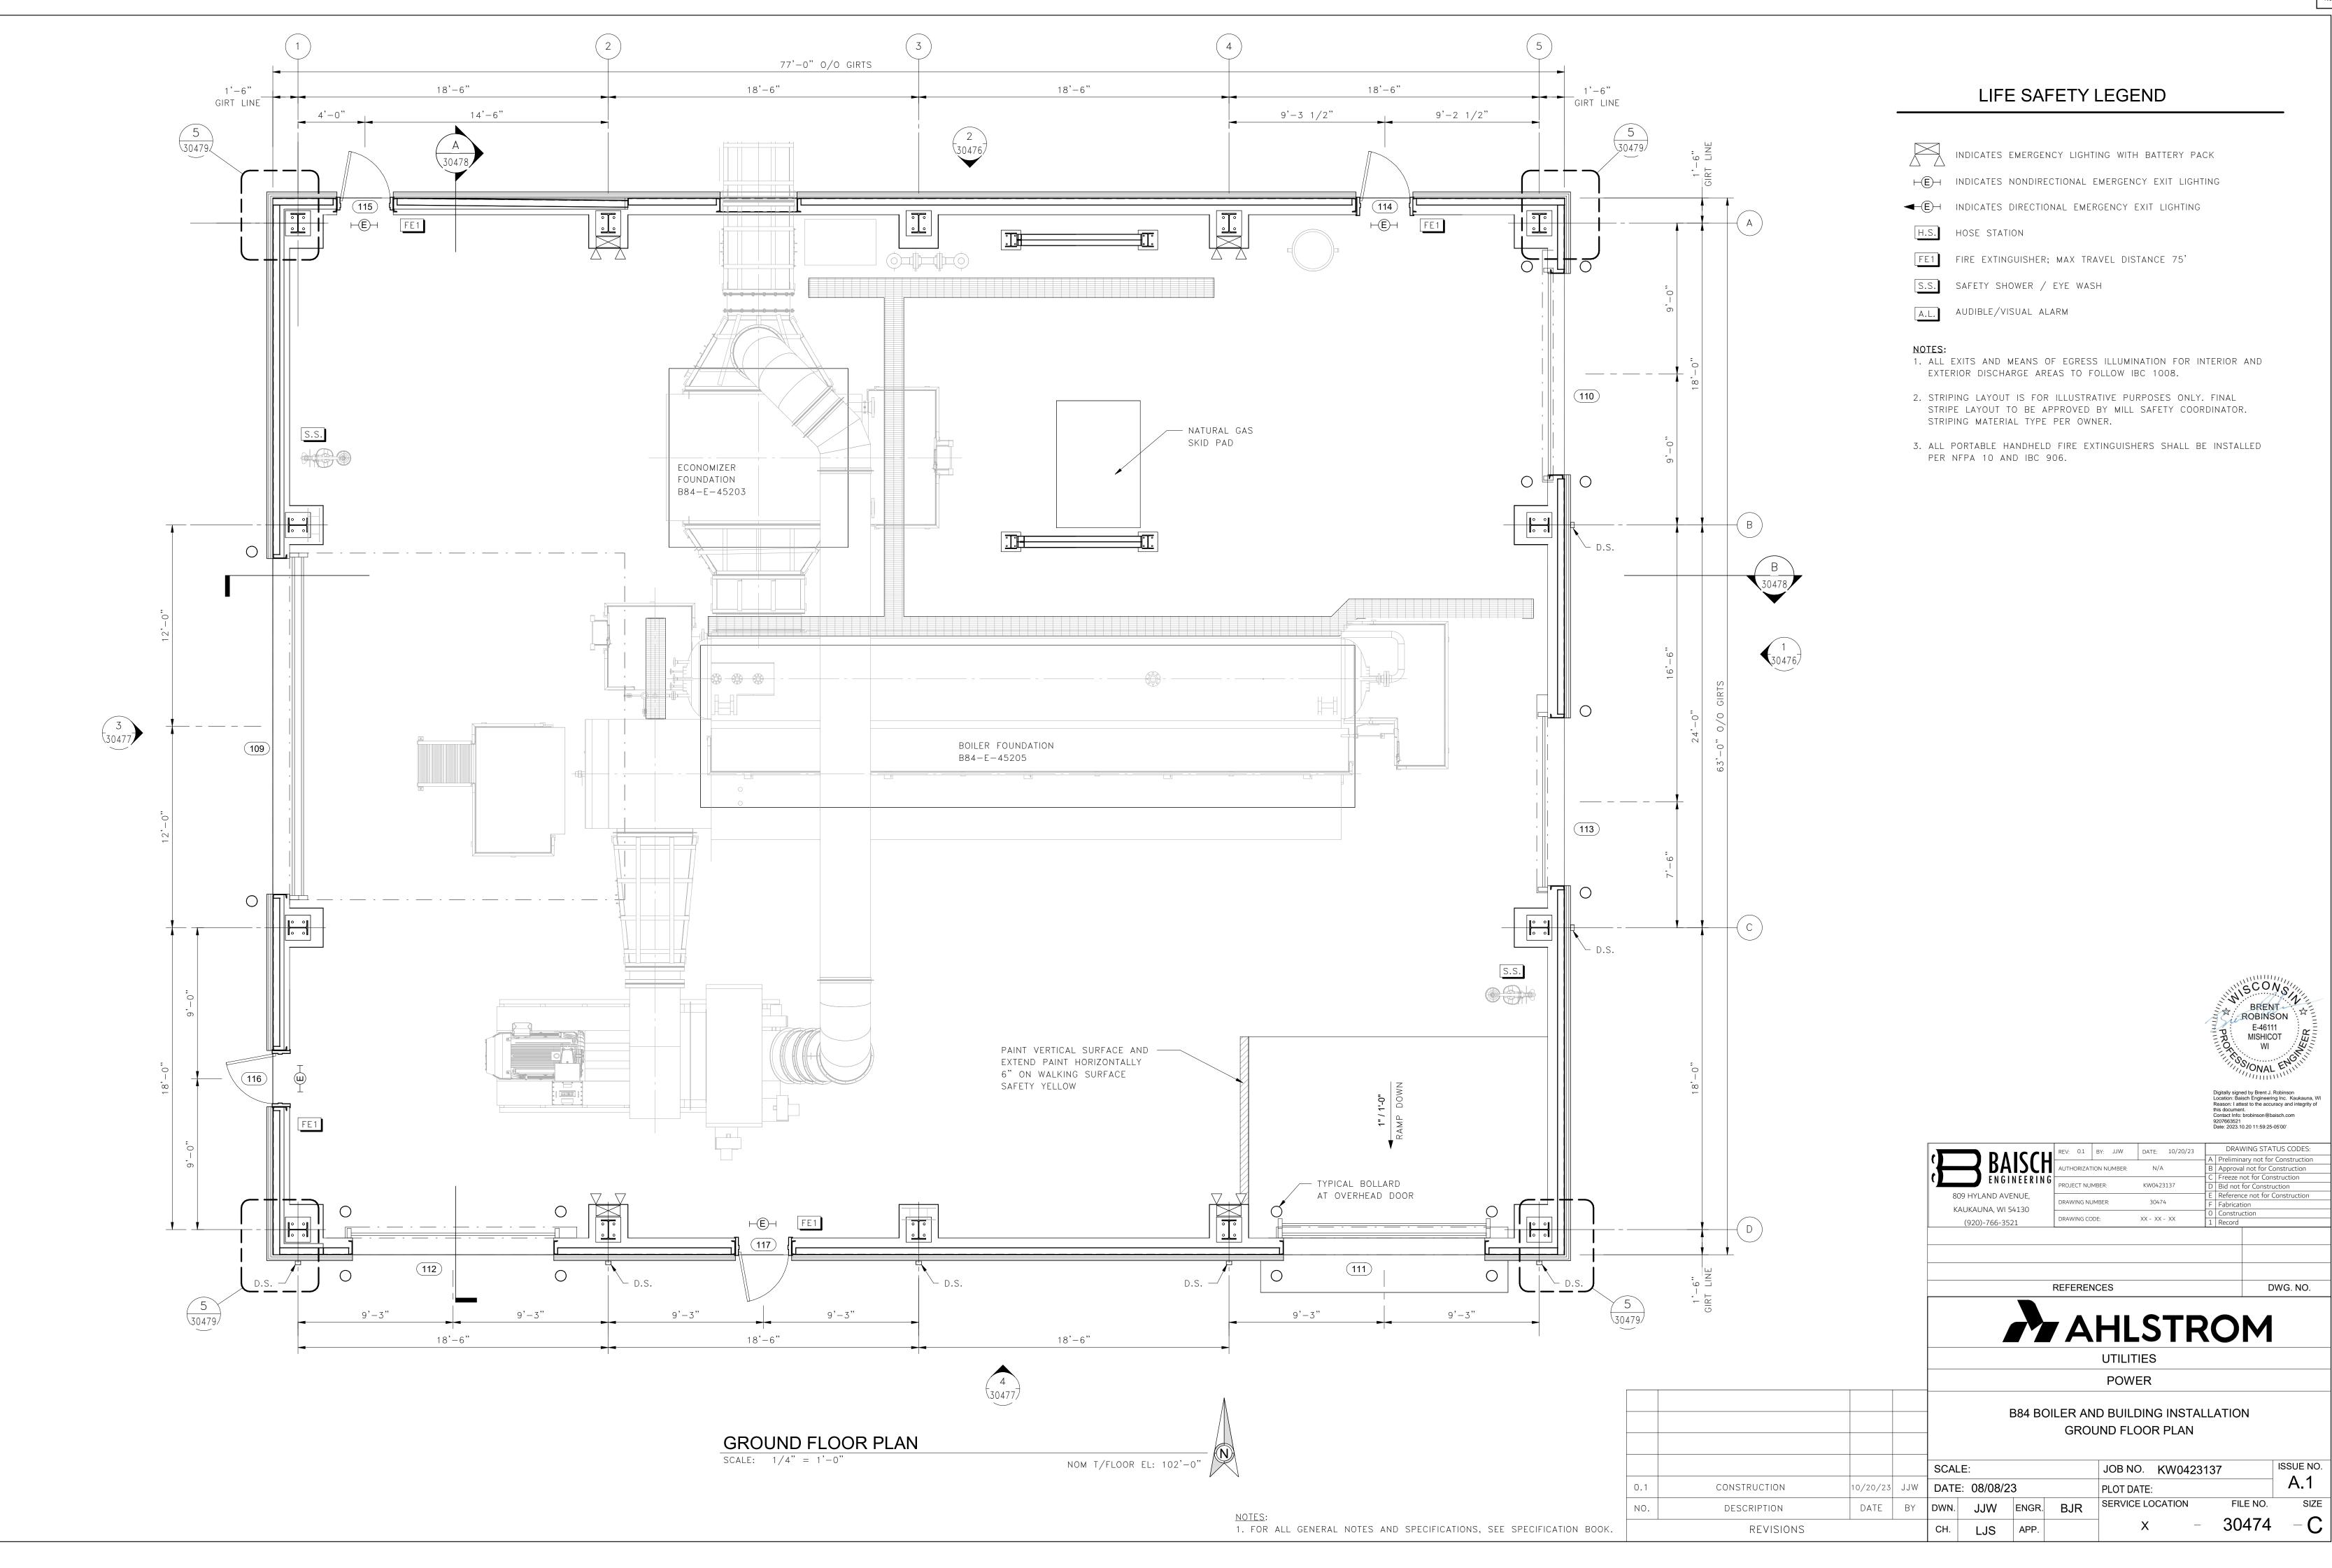


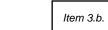

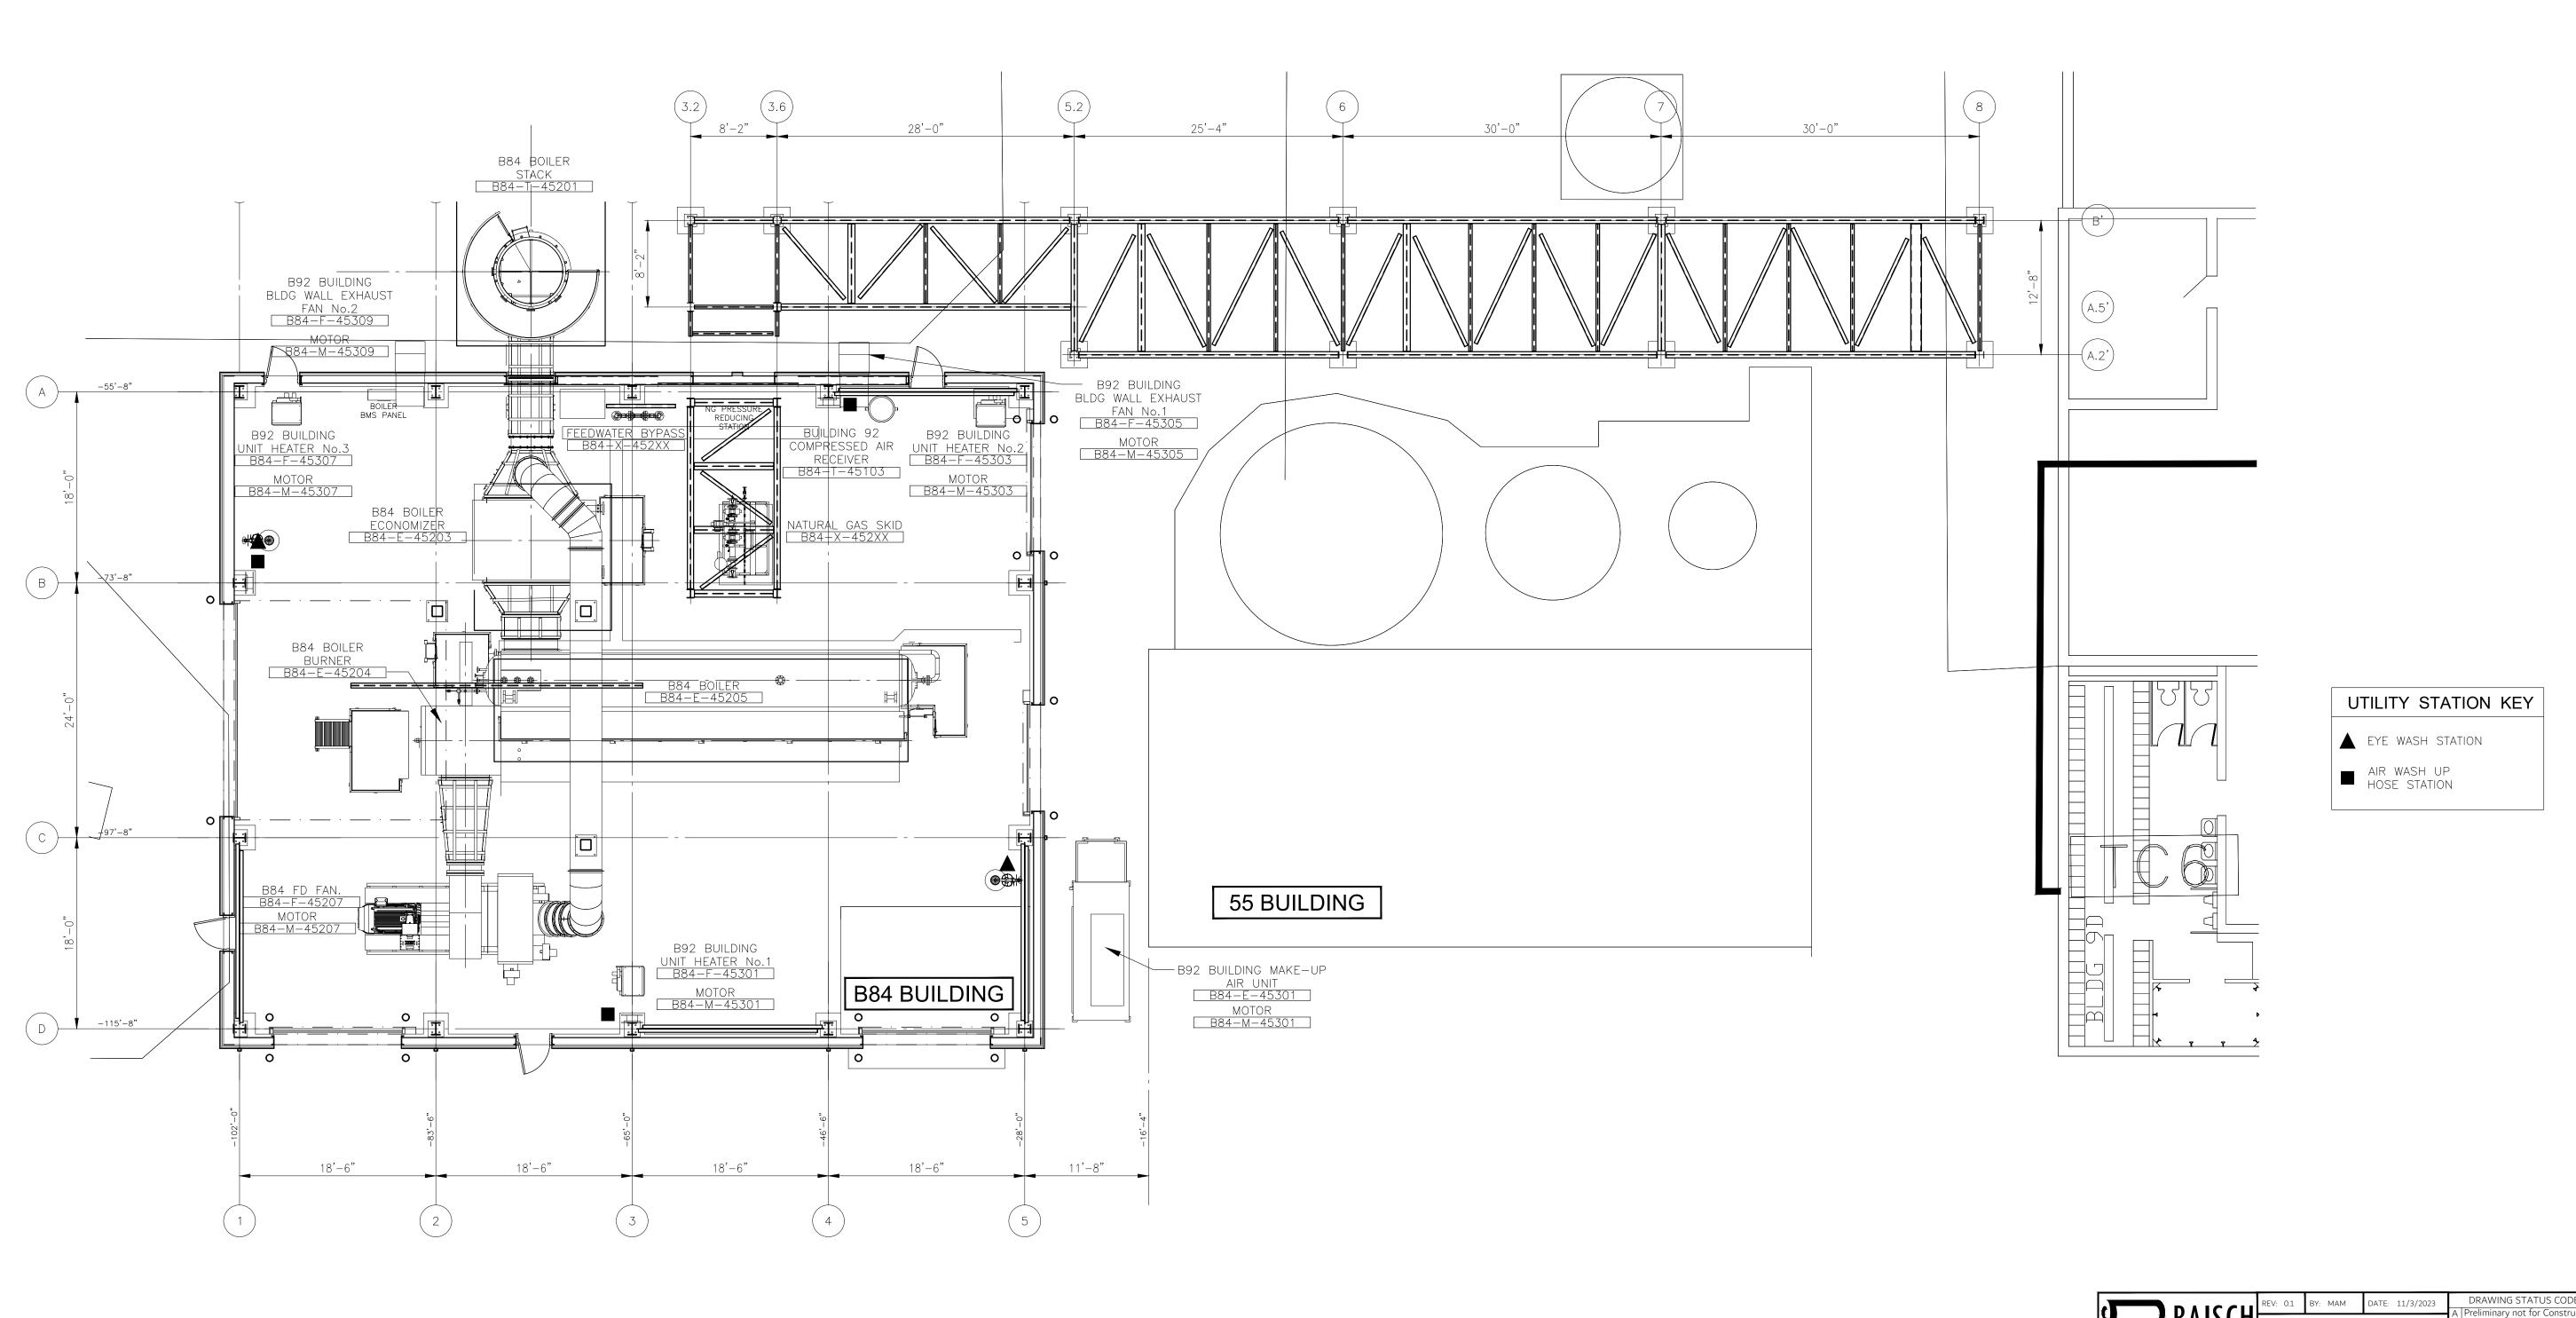






SCALE: 1/8" = 1'-0" FLOOR @ NOM. EL. 102'-3" (UNLESS NOTED OTHERWISE) FLOOR AREA = APPROX. 4851 SF

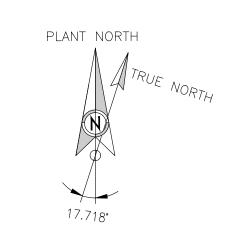




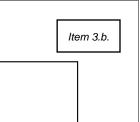

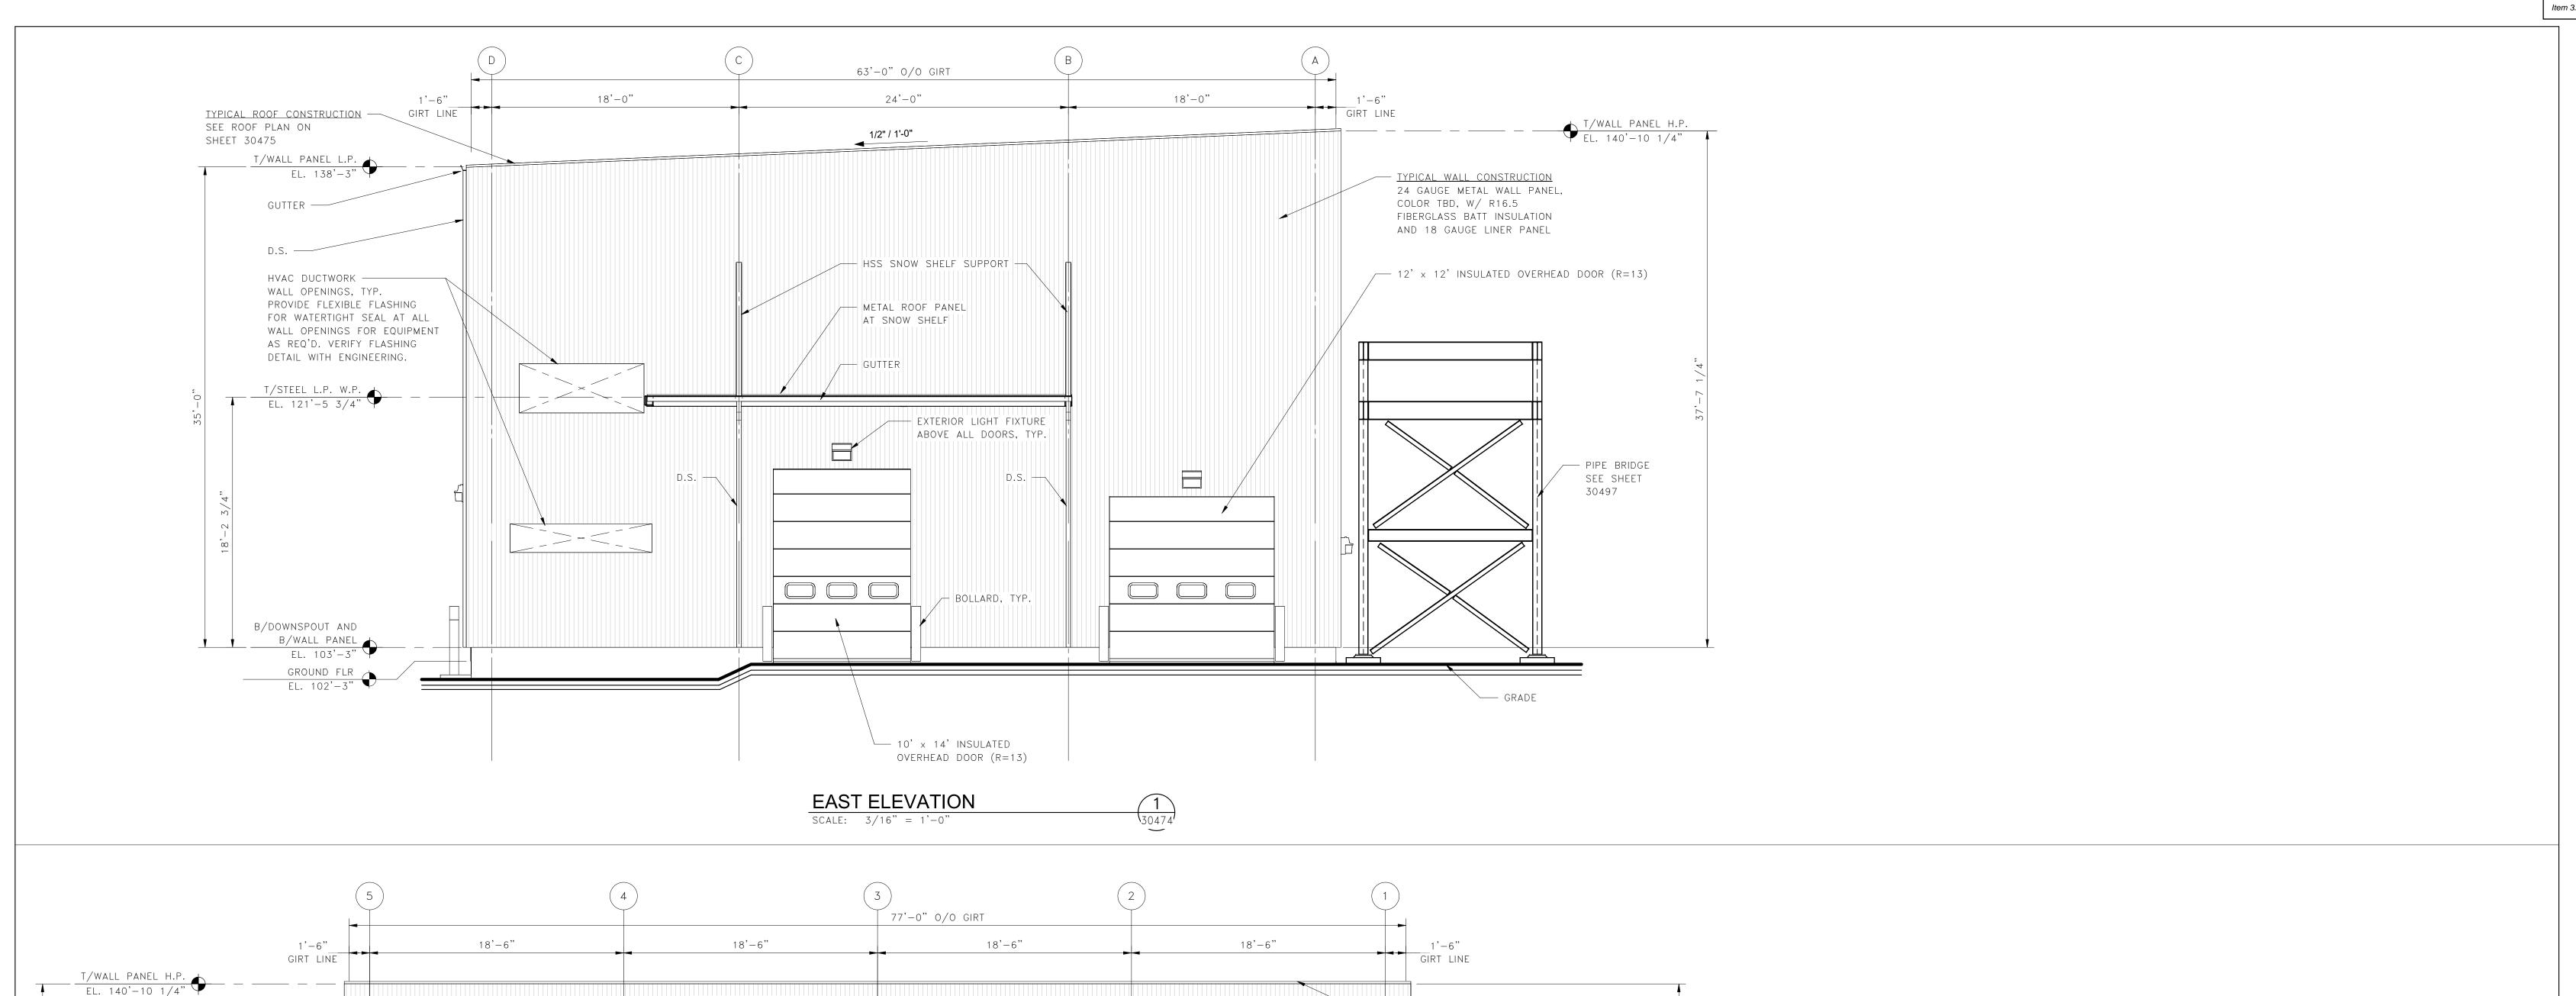

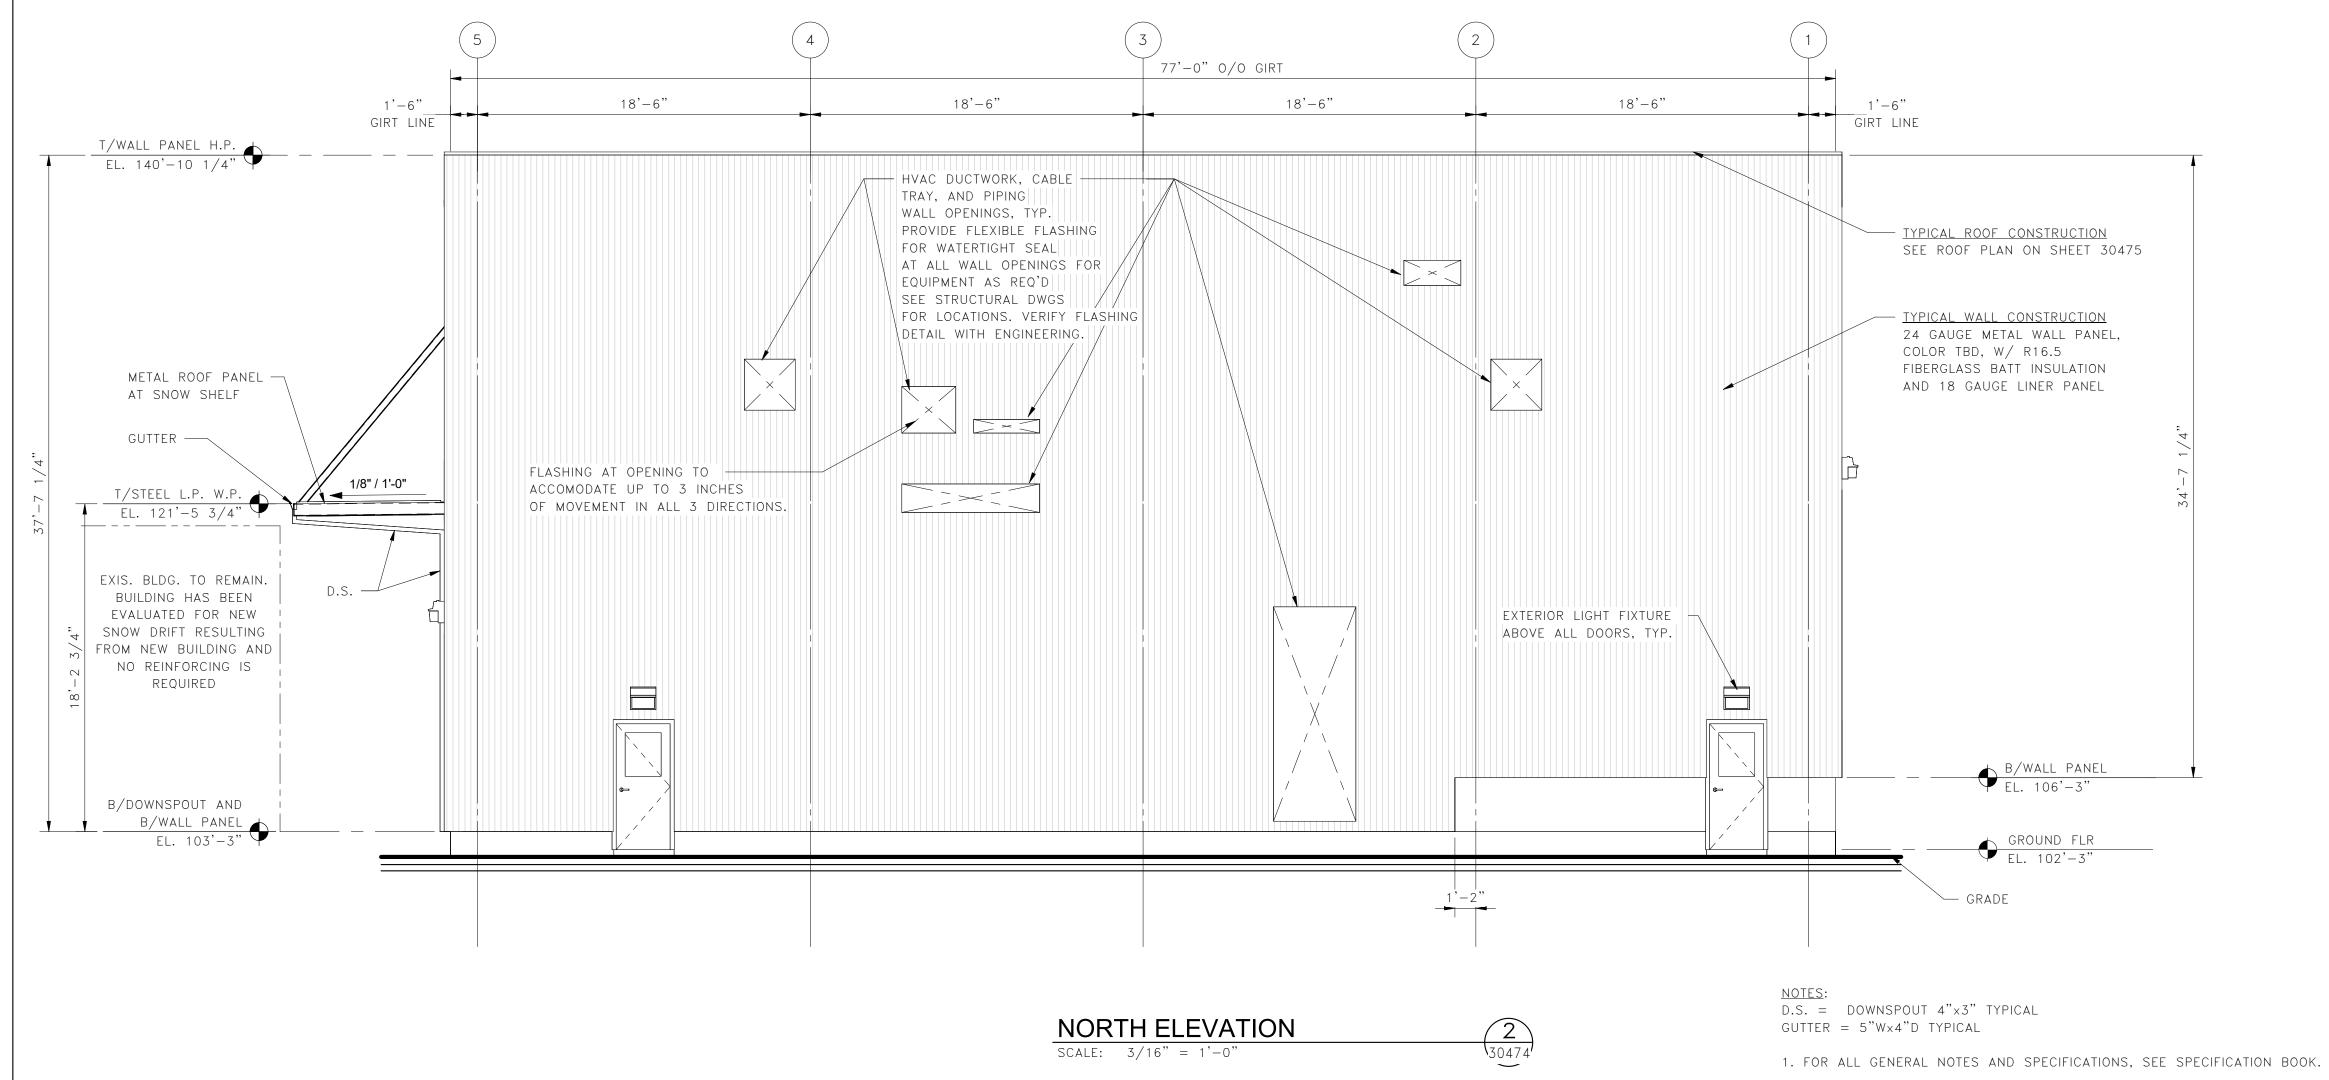

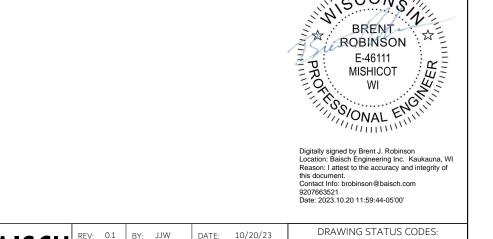

A Preliminary not for Construction

				AUTHORIZATION N		Approval not for Co	
		( <u>)                                     </u>	ENGINEERING	PROJECT NUMBER:		Freeze not for Con  Bid not for Constru	
			809 HYLAND AVENUE,	PROJECT NOMBER:		Reference not for Constru	
			·	DRAWING NUMBER		Fabrication	CONSTRUCTION
			KAUKAUNA, WI 54130	DRAWING CODE:		Construction	
			(920)-766-3521	DRAWING CODE:	1	Record	
				REFERENCE			DWG. NO.
				7 <b>Δ</b> F	HLSTR	OM	
					JTILITIES	<u> </u>	
				L			
				ILER AND	JTILITIES		
		SCA		ILER AND EXTERIO	JTILITIES POWER BUILDING INSTALL	.ATION	ISSUE NO.
0.1	CONSTRUCTION		B84 BO	ILER AND EXTERIO	JTILITIES  POWER  BUILDING INSTALL  OR ELEVATIONS  JOB NO. KW042313  PLOT DATE:	ATION	ISSUE NO.
0.1 NO.	CONSTRUCTION DESCRIPTION		B84 BO	ILER AND EXTERIO	JTILITIES  POWER  BUILDING INSTALL  OR ELEVATIONS  JOB NO. KW042313	.ATION	ISSUE NO. A.1 SIZE

