INDUSTRIAL PARK COMMISSION

City of Kaukauna **Hydro View Room** Municipal Services Building 144 W. Second Street, Kaukauna



Wednesday, September 03, 2025 at 3:30 PM

AGENDA

In-Person in Hydro View Room, City of Kaukauna

- 1. Roll Call.
- 2. Approval of Minutes.
 - a. Approve Minutes from May 7, 2025
- 3. Old Business.
- New Business.
 - <u>a.</u> Site Plan Review Bassett Mechanical (1215 Hyland Avenue)
 - b. Site Plan Review Accurate Machine (1901 Hyland Avenue)
 - c. Site Plan Review Team Industries (1200 Maloney Road)
- 5. Other Business.
- 6. Adjourn.

NOTICES

IF REQUESTED THREE (3) DAYS PRIOR TO THE MEETING, A SIGN LANGUAGE INTERPRETER WILL BE MADE AVAILABLE AT NO CHARGE.



Industrial Park Commission City of Kaukauna **Hydro View Room** Municipal Services Building 144 W. Second Street, Kaukauna

Wednesday, May 7, 2025 at 3:00 p.m.



Minutes

In-Person in Hydro View Room, City of Kaukauna

Sundelius called the meeting to order at 3:00 p.m.

1. Roll Call

Members Present: Michael Avanzi (Virtual), Ryan Gaffney, Dale Eggert, Glen Schilling, John Sundelius

Member(s) Absent: Mike Vandeberg, Tony Nytes, Nick Rieth

Other(s) Present: Director Kittel, Associate Planner Nelson, Representatives from Alliance Construction & Design, Representative from Keller

Schilling made a motion to excuse the absent members. Seconded by Eggert. Motion passed unanimously.

- 2. Approval of Minutes
 - a. Approve Minutes from March 27, 2025 Schilling made a motion to approve the minutes from March 27, 2025. Seconded by Eggert. Motion passed unanimously.
- 3. Old Business None
- New Business
 - a. Resource Guide

Director Kittel presented the resource guide he put together for Industrial Park Commission members. The guide includes links to meeting minutes and agendas, ordinances, the comprehensive plan, the strategic plan, and industrial park maps. Staff plan to update the guide on a yearly basis.

b. Site Plan Review – 1900 Tower Drive (Quick Transport) Director Kittel provided an overview of the site plan for the creation of a 30,000 square foot warehouse for Quick Transport for their property located at 1900 Tower Drive. The warehouse will be located at the rear of the property. Quick Transport is also proposing adding a third driveway onto Tower Drive. This would improve truck traffic and allow for better maneuvering. The proposed driveway is located far enough away from the existing driveway to not be a cause for concern. Staff has reviewed the plan and confirmed that it is in compliance with all covenants and meets all requirements set forth in city ordinance. Staff recommends approval with the following conditions: prior to issuance of building permits, Stormwater and Erosion Control permits must be obtained from the Engineering Department.

Schilling made a motion to approve the site plan as presented with the condition that, prior to issuance of building permits, Stormwater and Erosion Control permits are obtained from the Engineering Department. Seconded by Gaffney. Motion passed unanimously.

c. Site Plan Review – 1801 Progress Way (G&G Machine)
Director Kittel provided an overview of the site plan for an 8,455 square foot addition to the G&G Machine building located at 1801 Progress Way.
The addition will match the existing facade and should blend into the building. Staff has reviewed the plan and confirmed that it is in compliance with all covenants and meets all requirements set forth in city ordinance. Staff recommends approval with the following conditions: prior to issuance of building permits, Stormwater and Erosion Control permits must be obtained from the Engineering Department.

Schilling asked what the purpose of the addition is.

Kittel stated that the addition will primarily be used for shipping and quality control purposes.

Eggert made a motion to approve the site plan as presented with the condition that, prior to issuance of building permits, Stormwater and Erosion Control permits are obtained from the Engineering Department. Seconded by Gaffney. Motion passed unanimously.

Other Business

None

6. Adjourn

Eggert made a motion to adjourn. Seconded by Schilling. Motion passed unanimously. Adjourned at 3:10 p.m.



MEMO

PLANNING AND COMMUNITY DEVELOPMENT

To: Industrial Park Commission

From: Adrienne Nelson, Associate Planner

Date: August 27, 2025

Re: Site Plan Review – Bassett Mechanical (1215 Hyland Avenue)

Bassett Mechanical is a design and manufacturing business for industrial refrigeration, HVAC, plumbing, business automation and controls, metal fabricating, and service solutions. This project will add an additional 12,342 square feet to their existing building.

Site Plan Review:

Site/Architectural: 17.32 (10) Supplementary District Regulations & Applicable Zoning

All setback requirements for the Industrial Park District (IPD) are being met and all ordinances are being complied with to include zoning requirements. The current Bassett Mechanical building has a height of 26' and the height of the addition will be the same. There are currently 336 off-street parking spaces.

Landscape: 17.52 Landscaping Requirements

There are ten canopy trees located on the property. There are no plans to remove these during the construction process. Landscaping requirements are being met.

Lighting:

Fully shielded light fixtures will be added to points of ingress/egress to the addition.

Stormwater: 22 Stormwater Management

The Erosion Control and Stormwater Management permit has received approval from the Engineering Department.

Ingress/Egress:

No concerns with traffic at this time.

Public Safety:

No concerns noted from Fire/Police at this time.

Façade: <u>17.53 Façade Standards</u>

The proposed site elevations meet façade requirements.

Staff Recommendation:

Staff recommend approval of the development as presented.





SITE PLAN REVIEW APPLICATION

PROPERTY OWNER	APPLICANT (IF DIFFERENT PARTY THAN OWNER)
Name:	Name:
X Kim Bassett , Bassett Kaukauna LLC	Same
Mailing Address:	Mailing Address:
1215 E. Hyland Avenue, Kaukauna, WI 54130	
Phone:	Phone:
X 920-462-1850 (Adam Kloehn)	
Email:	Email:
X c/o adam.kloehn@bassettmechanical.com	

PROPERTY INFORMATION

Describe the Proposed Project in Detail:

The project consists of a 12,342 sq. ft. building addition on the northwest side of the existing building.

Propety Parcel (#):

322073100

Site Address/Location:

1215 E. Hyland Avenue

Current Zoning and Use:

Industrial Park District (IPD); Shop and office space for a mechanical contracting business.

Proposed Zoning and Use:

Same

Existing Gross Floor Area of Building:	Proposed Gross Floor Area of Building:
265,350 sf +/-	277,692 +/- sf +/-
Existing Building Height:	Proposed Building Height:
26' Above Existing First Floor	Same
Existing Number of Off-Street Parking Spaces:	Proposed Number of Off-Street Parking Spaces:
336 +/-	336 +/-
Existing Impervious Surface Coverage	Proposed Impervious Surface Coverage Percentage:
Percentage:	85.1% +/-
85.1% +/-	


I certify that the attached drawing	gs ar / e, to the best of	my knowledge, complet	e and drawn in	accordance wit	:h all City of
Kaukauna codes.		A			

Owner/Agent Signature: X

Owner/Agent Name (printed): X

144 W 2nd Street Kaukauna, WI 54130 920.766.6300 kaukauna.gov



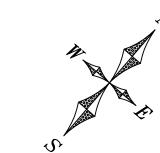

SCALE IN FEET
0' 25' 50' 100'

PROJECT INFORMATION

PROJECT DESCRIPTION
102' X 121' (12,342 S.F.)
BUILDING ADDITION

OWNER Bassett Kaukauna LLC

HASSETT KAUKAUNA ELC 1215 E HYLAND AVE. KAUKAUNA, WI 54130 CONTACT: ADAM KLOEHN 920-462-1850

PARCEL NOS. 322073100

LEGAL DESCRIPTION

PART LOT 1, CERTIFIED SURVEY MAP NO. 3651, CITY OF KAUKAUNA, OUTAGAMIE COUNTY, WISCONSIN

LOT SIZE 896,127 S.F. (20.57 AC)

PARCEL ZONING INDUSTRIAL PARK DISTRICT (IPD)

ZONING ORDINANCE SETBACKS

FRONT YARD SETBACK: 50'
SIDE YARD SETBACK: 10' (30' AGGREGATE)
REAR YARD SETBACK: 25'

PROPOSED USES
SHOP & OFFICE SPACE FOR A
MECHANICAL CONTRACTING BUSINESS

LOT COVERAGE (PER AIR PHOTOS)

			-	
	EXISTING	CHANGE	NEW TOTAL	% OF SITE
BUILDINGS	265,350 S.F.	+12,342 S.F.	277,692 S.F.	31%
PAVEMENT/CONCRETE	497,355 S.F.	-12,342 S.F.	485,013 S.F.	54.1%
IMPERVIOUS	762,705 S.F.	+0.00 S.F.	762,705 S.F.	85.1%
OPEN SPACE	133,422 S.F.	-0.00, S.F.	133,422 S.F.	14.9%
TOTAL	896,127 S.F.	0 S.F.	896,127 S.F.	100%

<u>PARKING</u>

EXISTING: 336 SPACES ± PROPOSED: 336 SPACES ± (NO CHANGE)

INDEX

C1.1 - Site Plan

C1.2 - Drainage - Grading - Erosion Control Plan

PLAN PREPARED BY: SCHULER & ASSOCIATES, INC 2711 N. MASON STREET, SUITE F (920) 734-9107 PROJECT NO. 25-4857

CONSOLIDATED
CONSTRUCTION CO., INC.

800-642-6774 www.1call2build.com Appleton, WI Columbus, WI Rapid City, SD Bismarck, ND

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<u>STAMPS</u>



TT MECHANICAL 2025

ISSUED FOR REVIEW:
8-8-2025
ISSUED FOR BID:

ISSUED FOR PERMIT:

ISSUED FOR CONSTRUCTION:

ISSUED REVISIONS

Revision Date Rev. Description


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PROJECT #:


C1.1

MJF

SHEET TITLE SITE PLAN



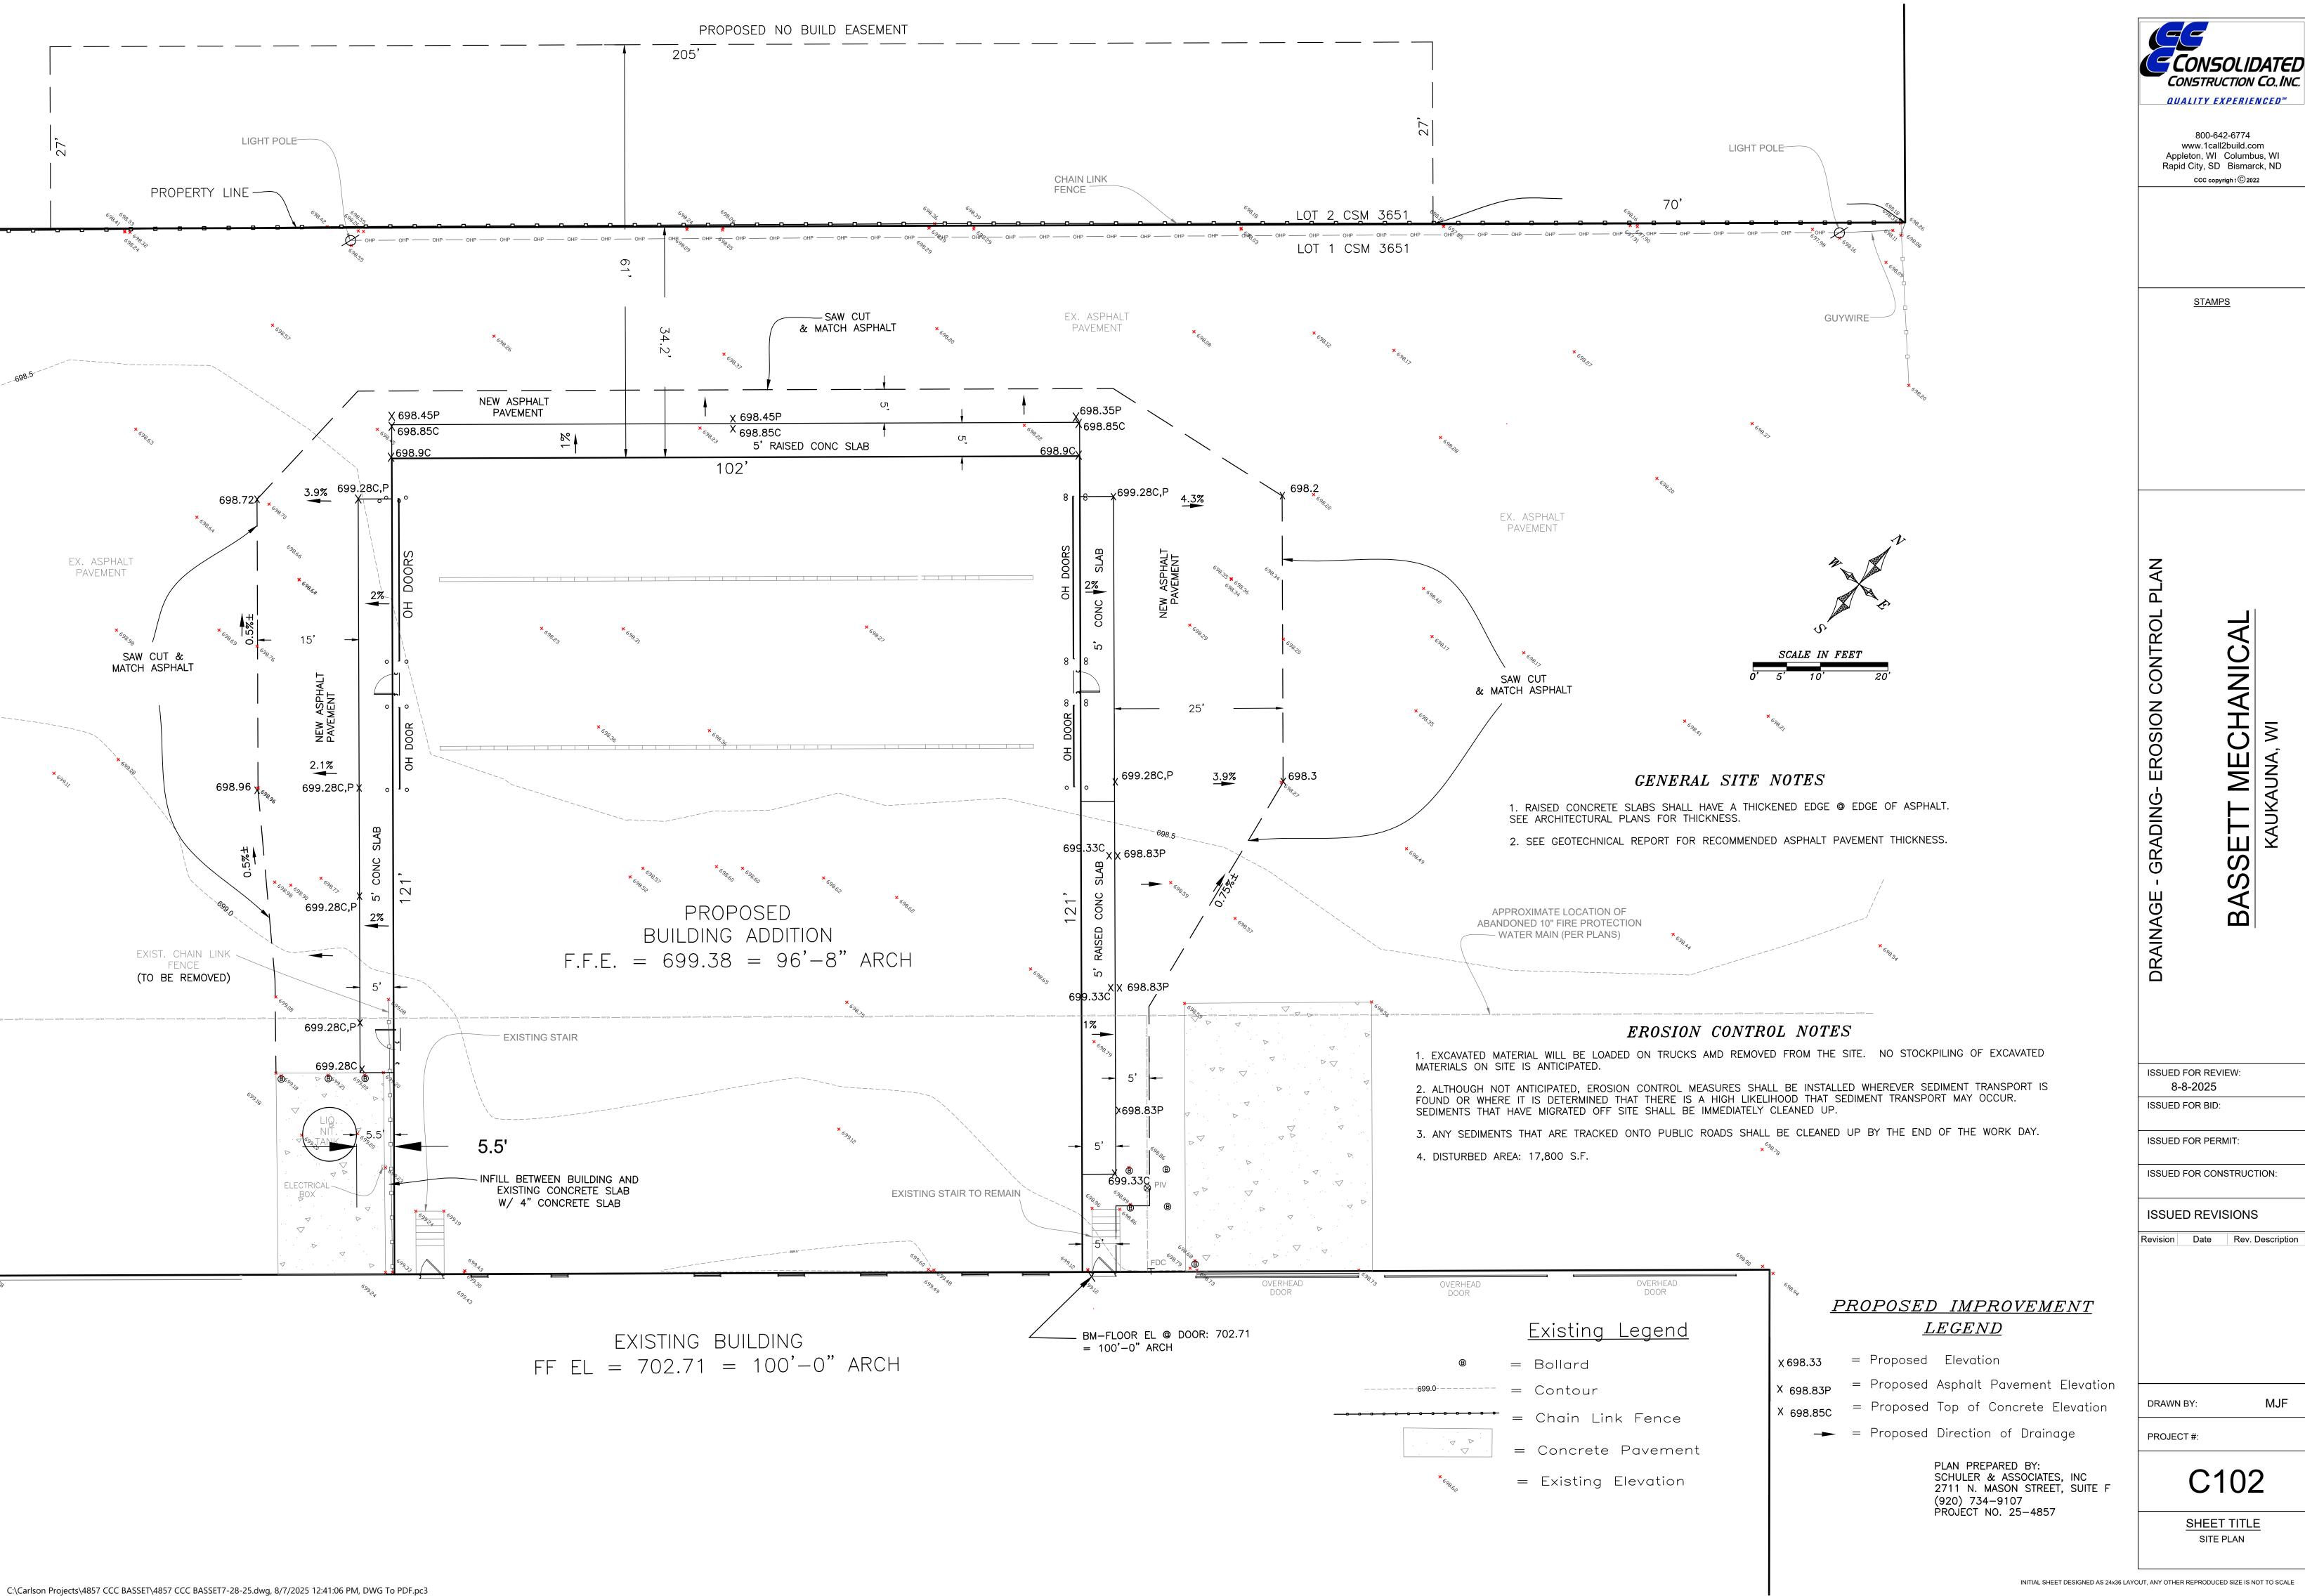

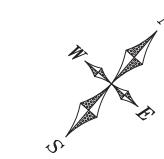

PROJECT INFORMATION

PROJECT DESCRIPTION 102' X 121' (12,342 S.F.) BUILDING ADDITION

OWNER Bassett Kaukauna llc 1215 E HYLAND AVE.
KAUKAUNA, WI 54130
CONTACT: ADAM KLOEHN 920-462-1850

PARCEL NOS. 322073100

LEGAL DESCRIPTION

PART LOT 1, CERTIFIED SURVEY MAP NO. 3651, CITY OF KAUKAUNA, OUTAGAMIE COUNTY, WISCONSIN

LOT SIZE 896,127 S.F. (20.57 AC)

PARCEL ZONING INDUSTRIAL PARK DISTRICT (IPD)

ZONING ORDINANCE SETBACKS

FRONT YARD SETBACK: 50' SIDE YARD SETBACK: 10' (30' AGGREGATE) REAR YARD SETBACK: 25'

PROPOSED USES SHOP & OFFICE SPACE FOR A MECHANICAL CONTRACTING BUSINESS

LOT COVERAGE (PER AIR PHOTOS)

			-	
	EXISTING	CHANGE	NEW TOTAL	% OF SITE
BUILDINGS	265,350 S.F.	+12,342 S.F.	277,692 S.F.	31%
PAVEMENT/CONCRETE	497,355 S.F.	-12,342 S.F.	485,013 S.F.	54.1%
IMPERVIOUS	762,705 S.F.	+0.00 S.F.	762,705 S.F.	85.1%
OPEN SPACE	133,422 S.F.	-0.00, S.F.	133,422 S.F.	14.9%
TOTAL	896,127 S.F.	0 S.F.	896,127 S.F.	100%

PARKING

EXISTING: 336 SPACES ± PROPOSED: 336 SPACES ± (NO CHANGE)

<u>INDEX</u>

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SHEET TITLE

MJF

CONSTRUCTION CO., INC. QUALITY EXPERIENCEDSM

800-642-6774 www.1call2build.com Appleton, WI Columbus, WI Rapid City, SD Bismarck, ND

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<u>STAMPS</u>

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ISSUED FOR REVIEW: 8-8-2025 ISSUED FOR BID:

ISSUED FOR PERMIT:

ISSUED FOR CONSTRUCTION:

ISSUED REVISIONS

Revision Date Rev. Description

DRAWN BY:

PROJECT #:

C1.1

SITE PLAN

CONSTRUCTION CO., INC. QUALITY EXPERIENCED™

> 800-642-6774 www.1call2build.com Appleton, WI Rapid City, SD Bismarck, ND

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<u>STAMPS</u>

ERATION

ADDI⁻

ISSUED FOR REVIEW:

ISSUED FOR BID:

ISSUED FOR PERMIT:

ISSUED FOR CONSTRUCTION:

ISSUED REVISIONS

Revision Date Rev. Description

PROJECT #:


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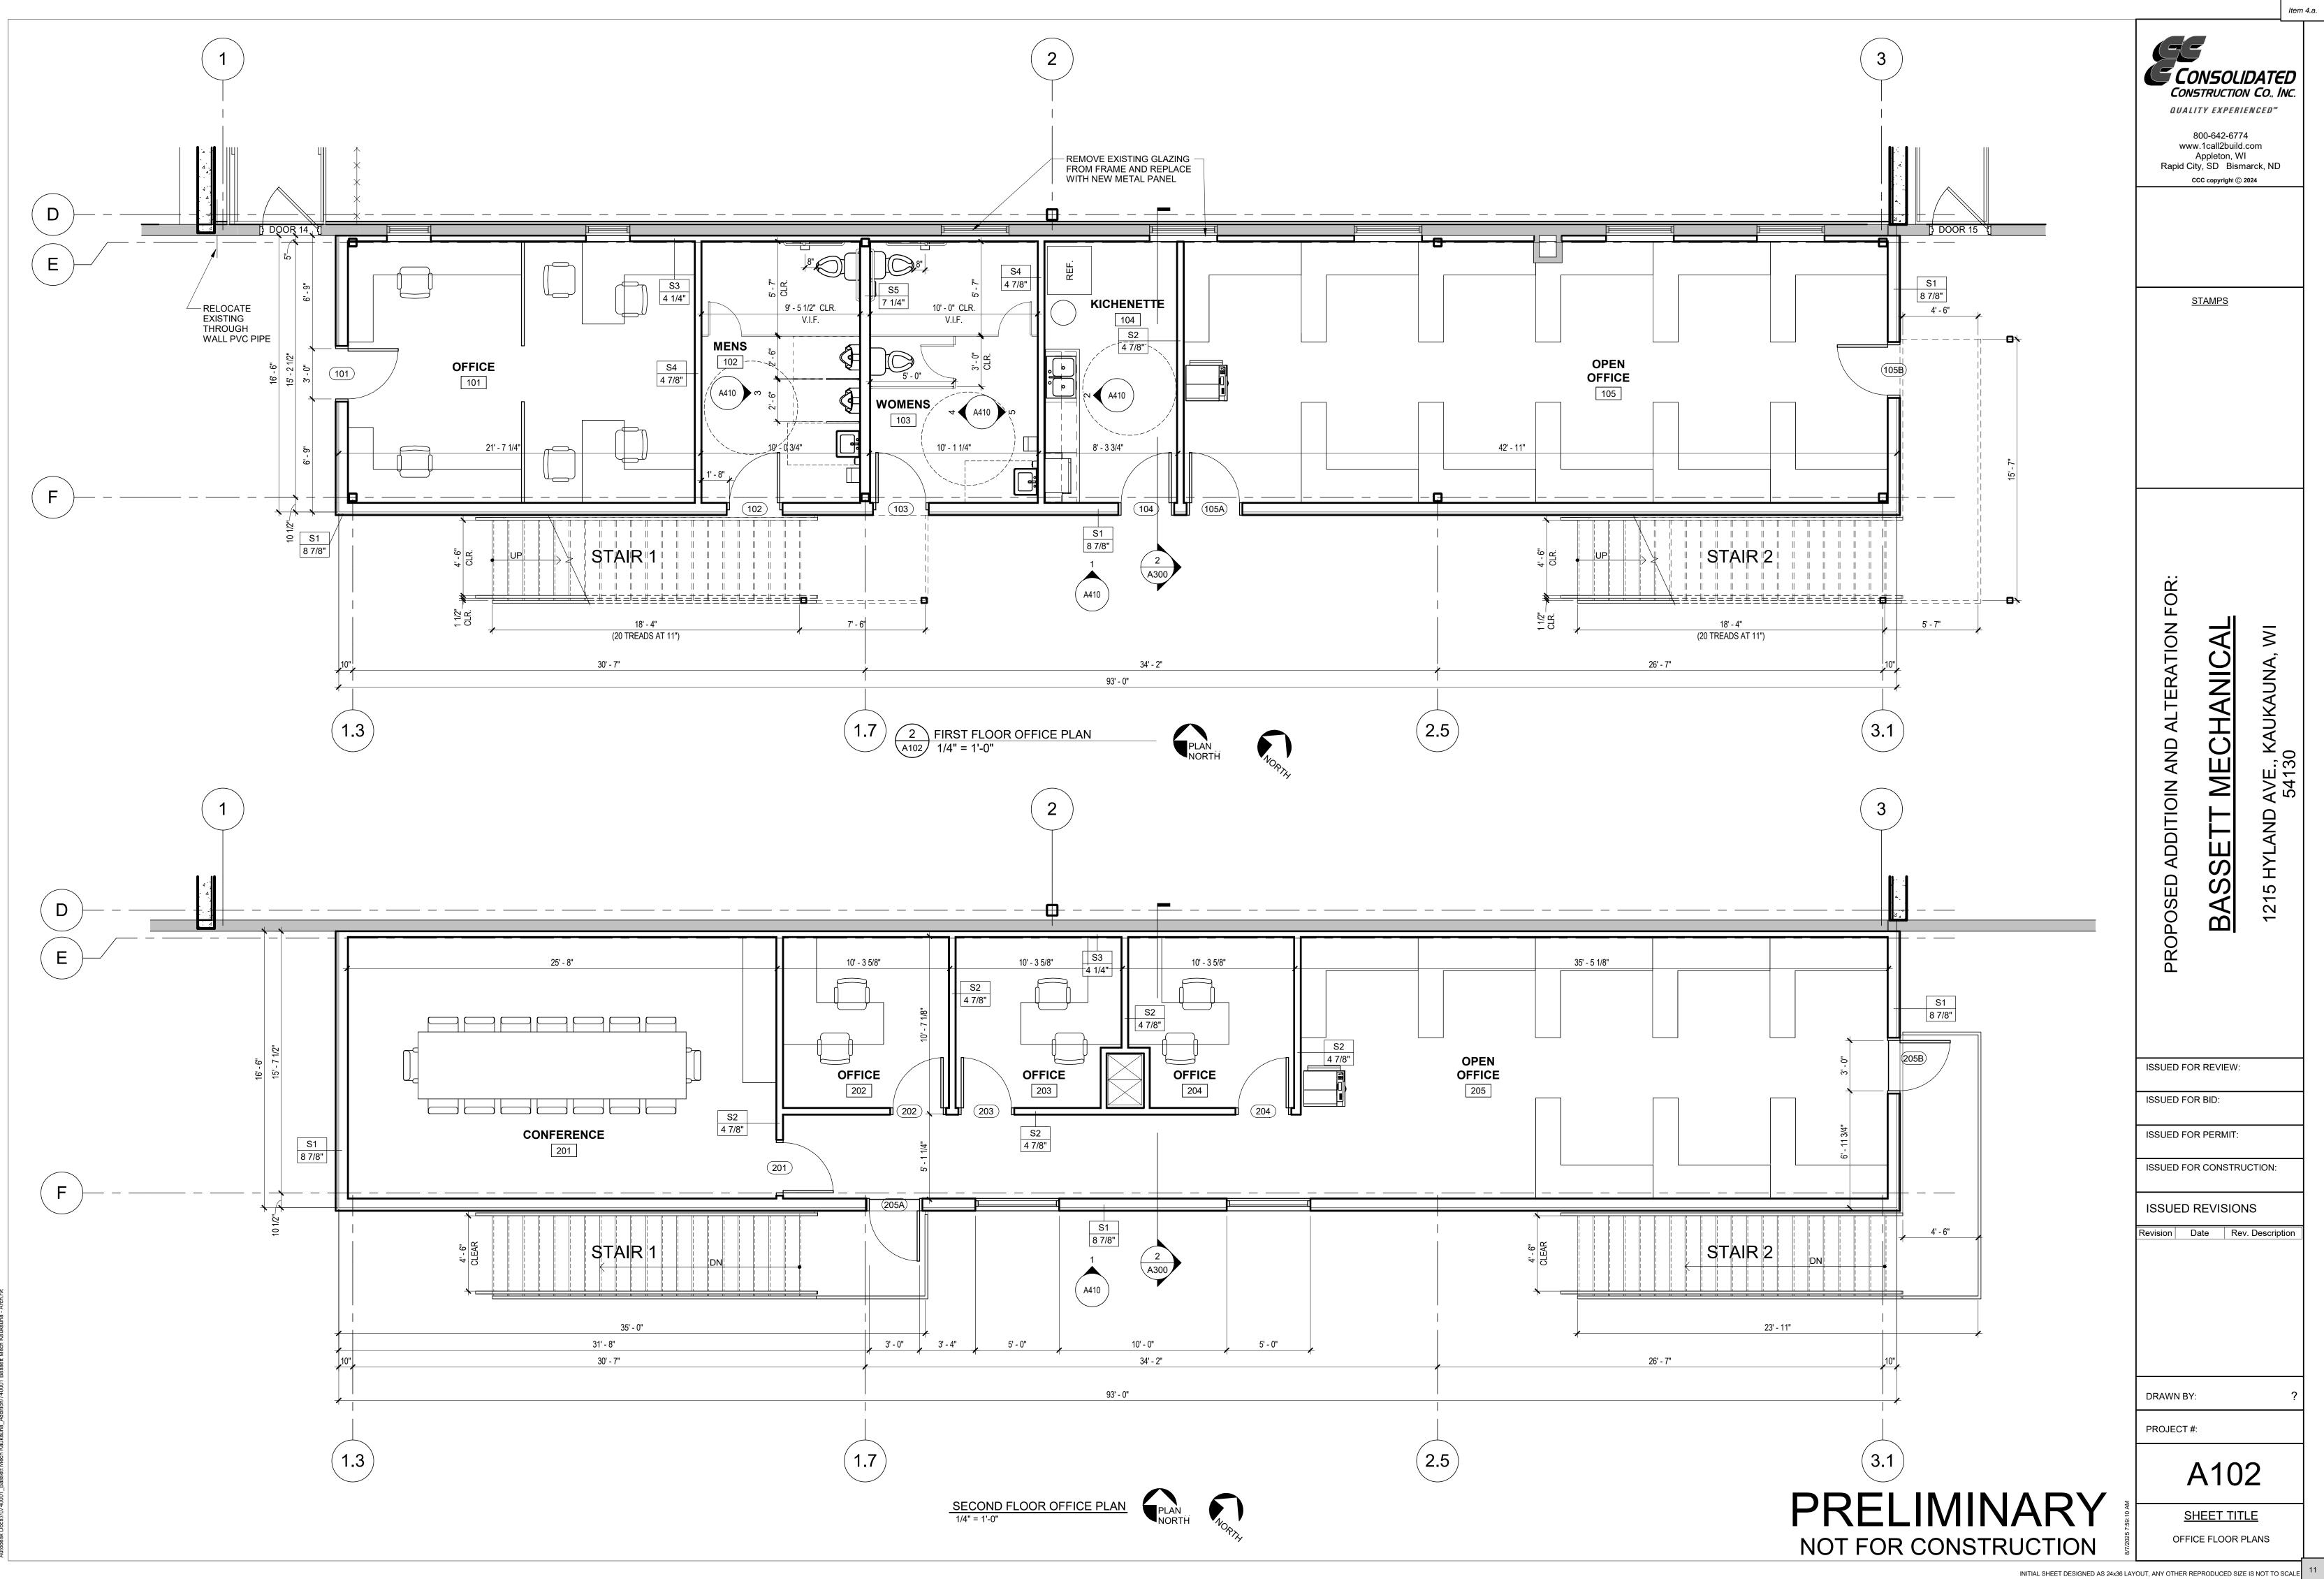
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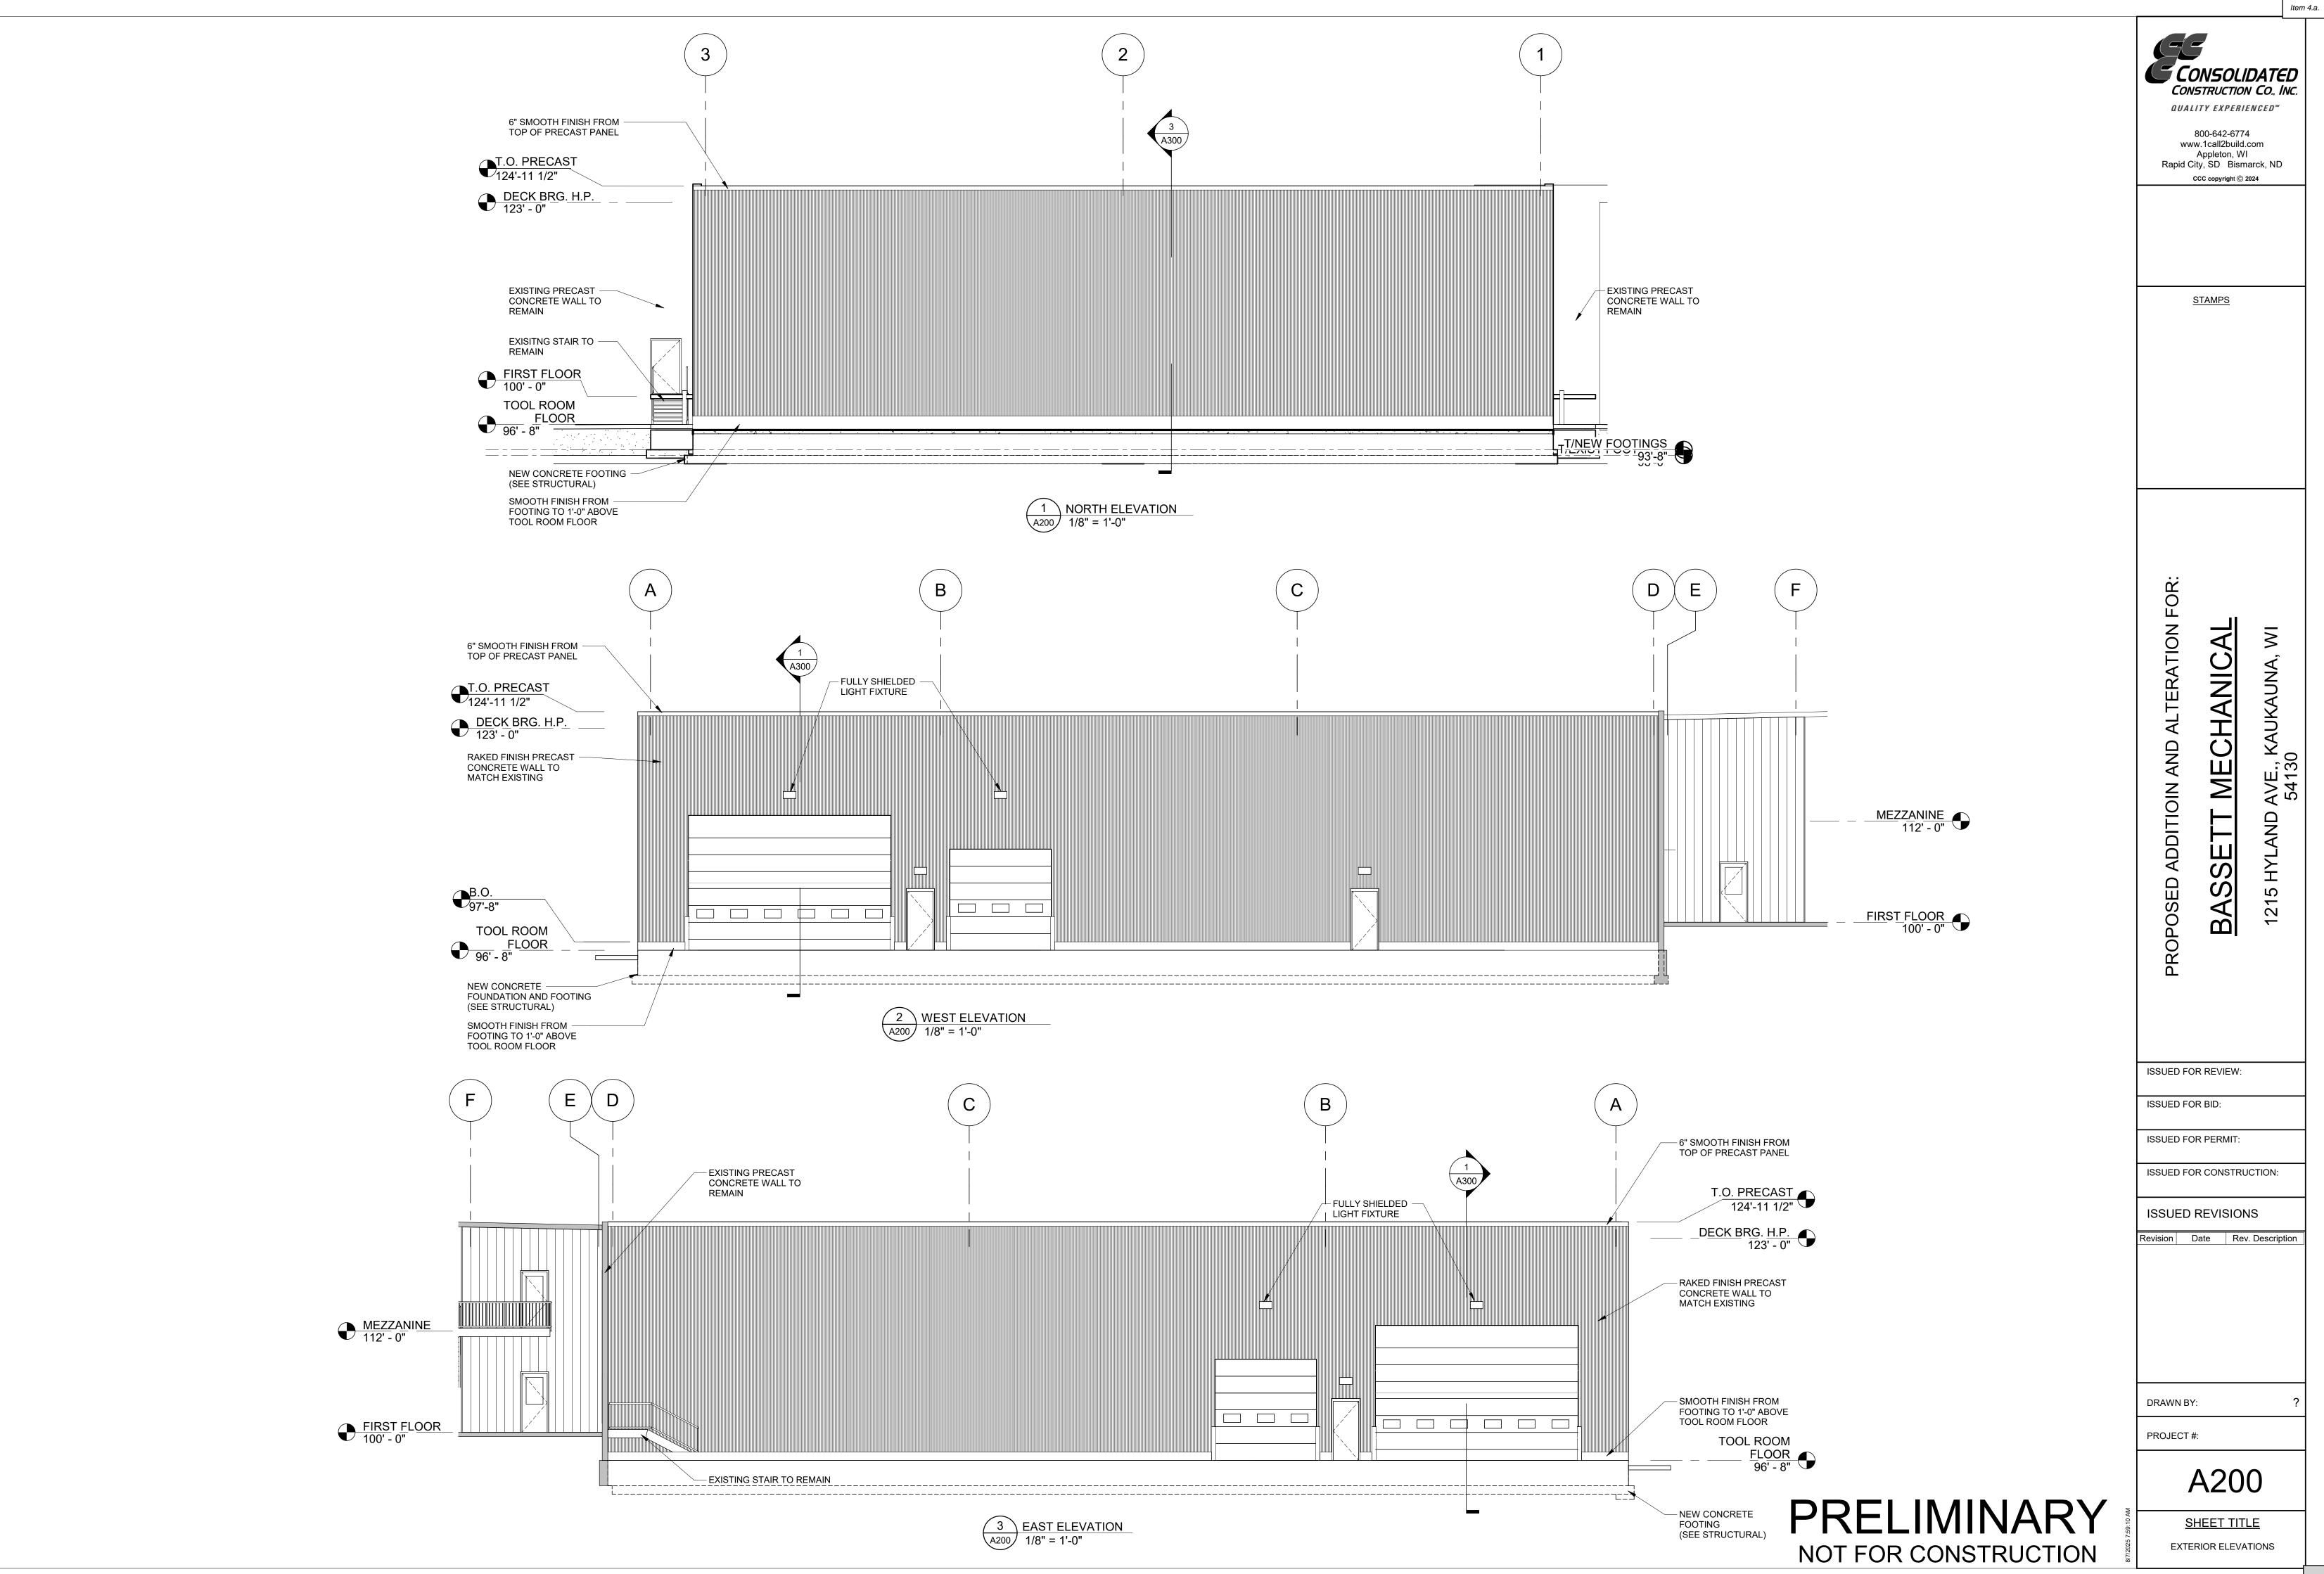
SHEET TITLE

FIRST FLOOR PLAN

NOT FOR CONSTRUCTION INITIAL SHEET DESIGNED AS 24x36 LAYOUT, ANY OTHER REPRODUCED SIZE IS NOT TO SCALE 10





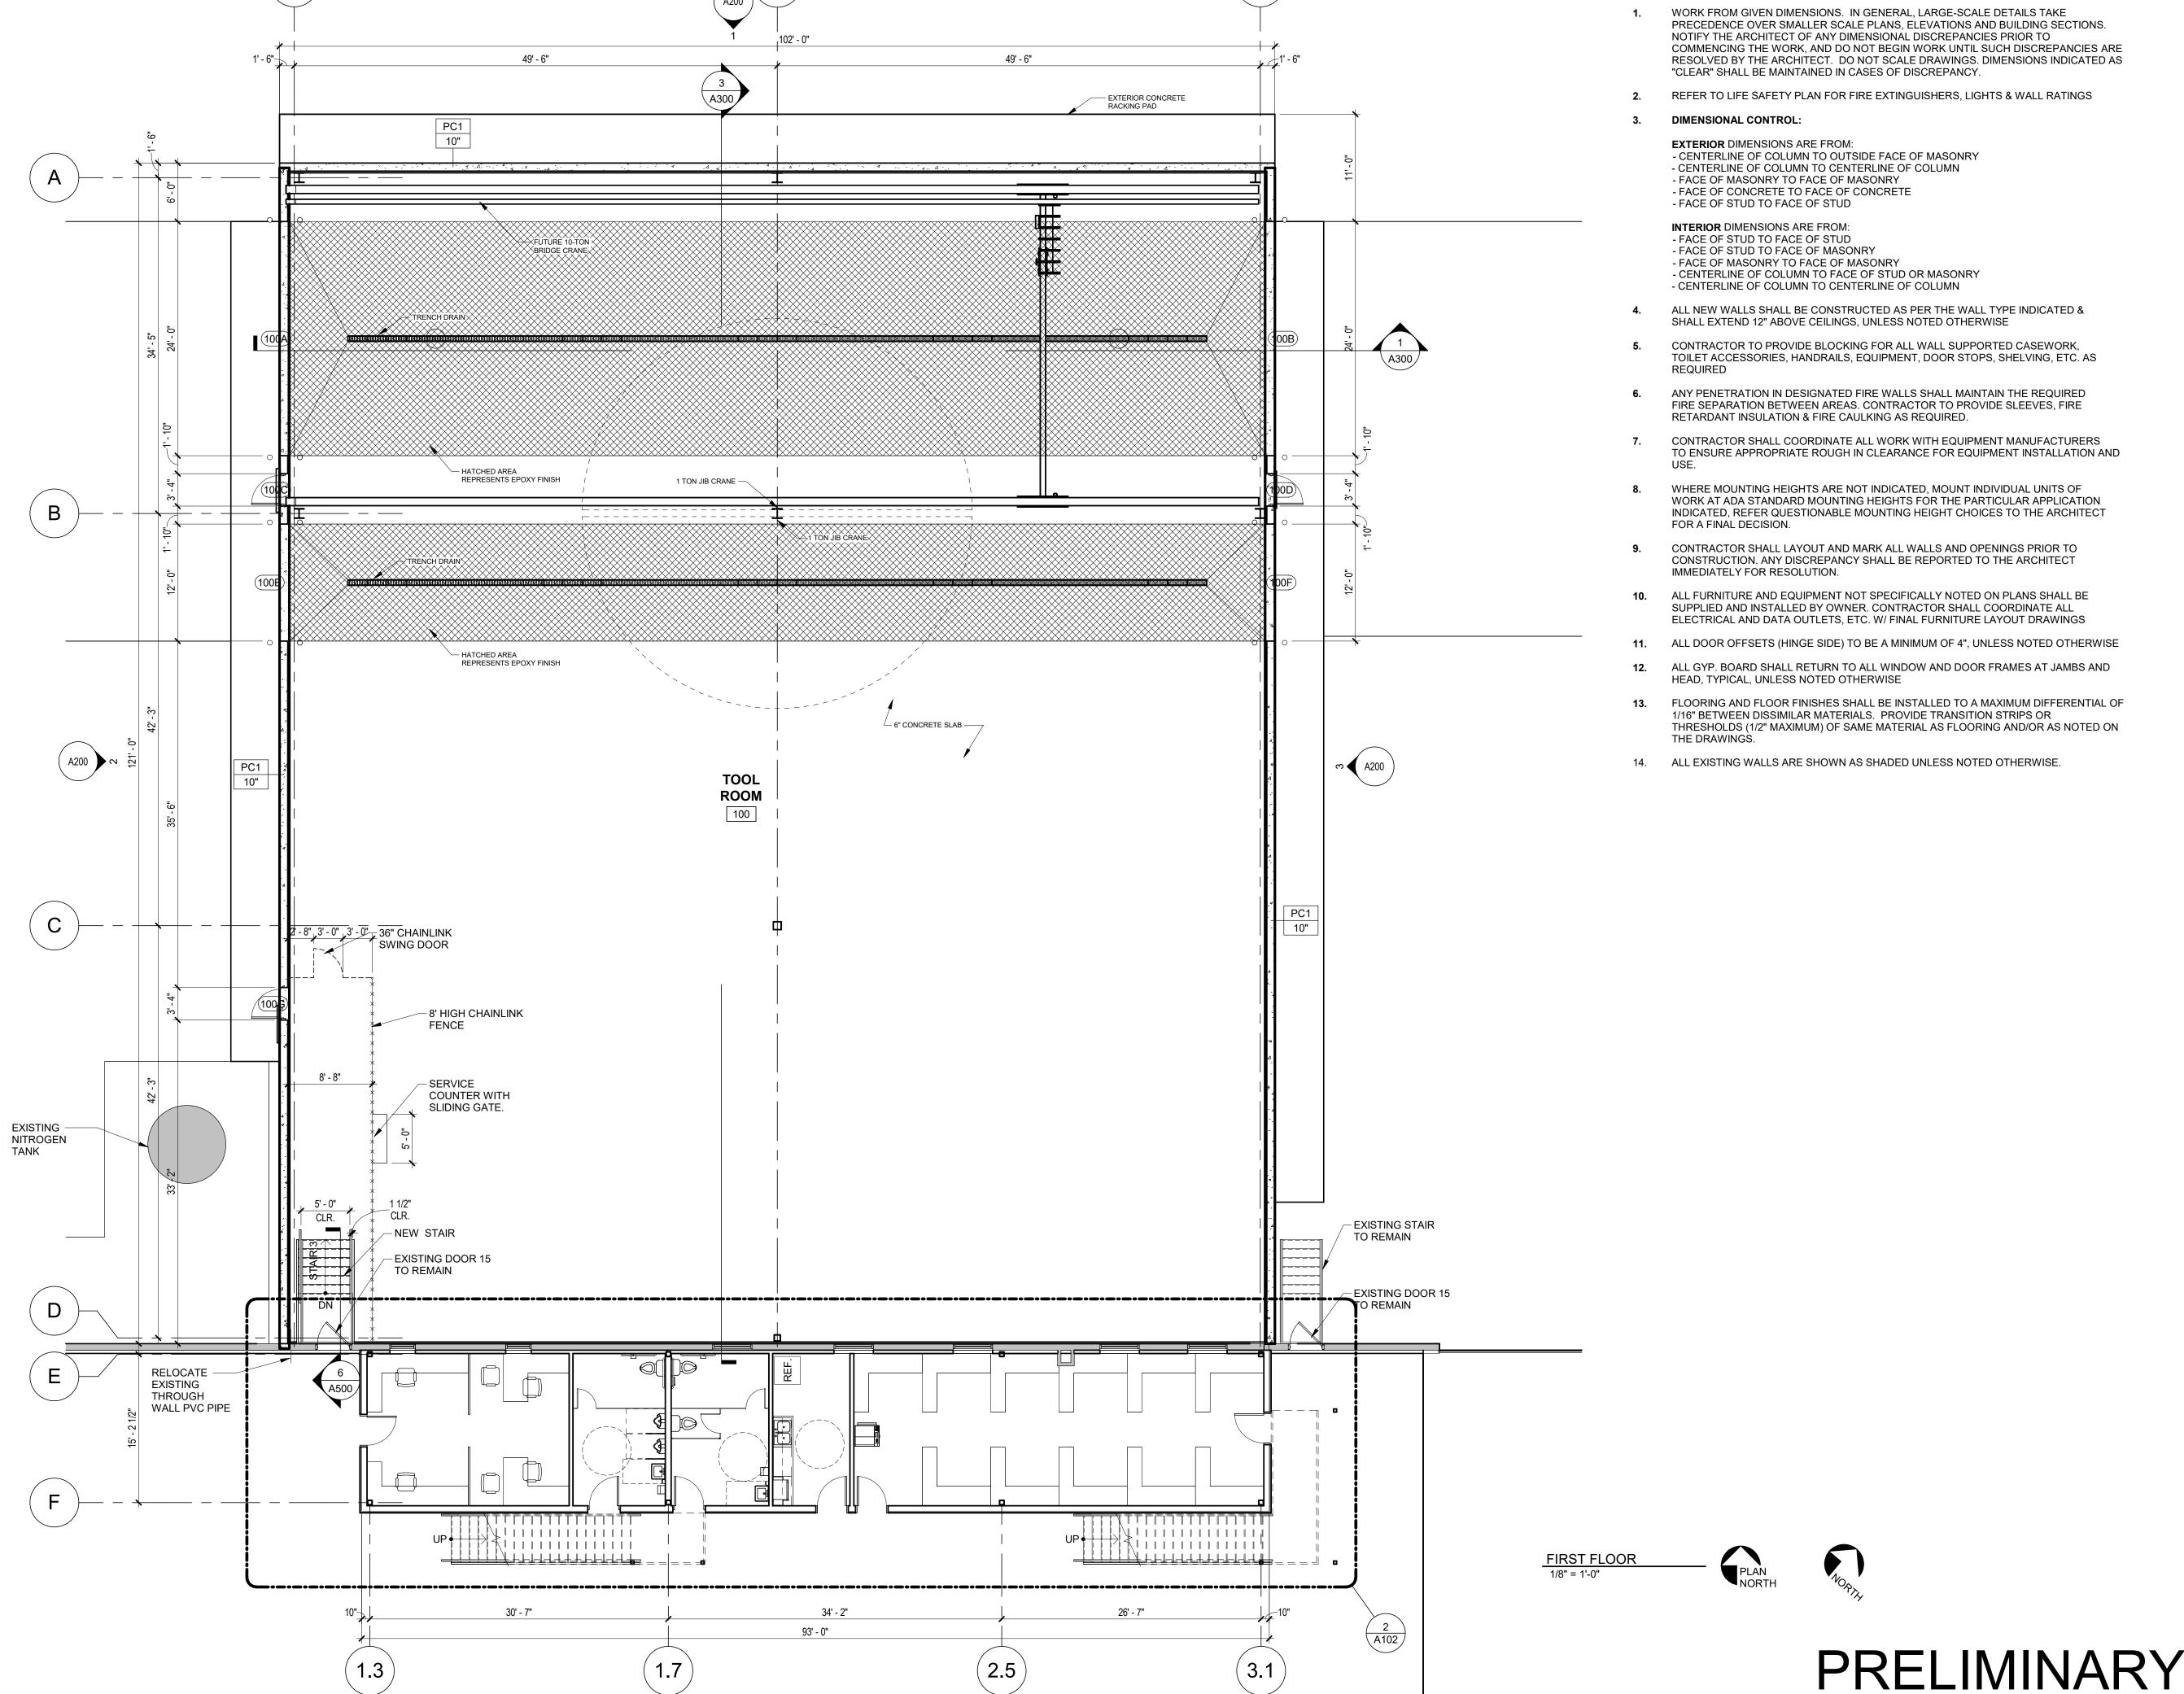

CONSTRUCTION CO., INC.

INITIAL SHEET DESIGNED AS 24x36 LAYOUT, ANY OTHER REPRODUCED SIZE IS NOT TO SCALE 12



TCP's Select Series LED Full Cutoff Wall Pack takes outdoor lighting to the next level. Two different wattage packages and three color temperatures give 18 possible combinations to perfectly illuminate any outdoor space. Utilize these wall packs in building perimeters, security lighting, entrances, and exits.

The bronze aluminum housing features an elegant heat sink design that allows the fixture to operate without overheating. It comes with 0-10V dimming standard, is -40°C to 40°C temperature rated, IP65 wet location rated, and offers CRI greater than 70.

Reasons to choose the Select Series LED Full Cutoff Wall Pack from TCP

- Delivers bright, white light with excellent uniformity
- IP65 wet location rated for outdoor use
- Color temperature and wattage selectable
- Durable construction with die-cast aluminum housing and impact-resistant polycarbonate lens
- Integrated photocell maximizes energy efficiency

Ideal Applications

- Site Lighting
- Security Lighting

Entrances

Perimeters












Specifications

Input Line Voltage	120-277V
Input Line Frequency (Hz)	50/60Hz
Wattage (W)20	/30/40W or 50/60/80W
Lumens (L)2600/3900/520	00L or 6500/7800/10400L
Lumens per Watt (LPW)	130 LPW
CCT	3000K/4000K/5000K
Rated Life	50,000 hours
Minimum Starting Temperature	40°C (-40°F)
Maximum Operating Temperature	40°C (104°F)
CRI	>70
Ratings	cULus wet location rated
Controls	0-10V Dimming (standard)

Up to 9 CCT and wattage combinations per SKU. Internal switches maintain wet location rating.

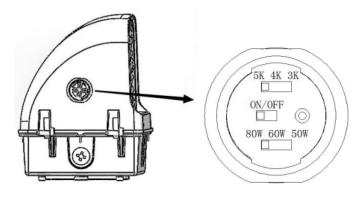

Integrated photocell is standard

BUG Ro	ating
SFWUZDSW4CCT	B2-U0-G1
SFWUZDSW7CCT	B3-U0-G2

Replacement Strategy

ТҮРЕ	WATTAGE*	ENERGY SAVINGS (%)
TCP LED Select Series Full Cutoff Wall Pack	40W	_
100W-150W Metal Halide	100W	60%
TCP LED Select Series Full Cutoff Wall Pack	50W	_
100W-150W Metal Halide	150W	67%
TCP LED Select Series Full Cutoff Wall Pack	60W	_
175W Metal Halide	175W	66%
TCP LED Select Series Full Cutoff Wall Pack	80W	_
200W Metal Halide	200W	60%

^{*}Actual wattage may differ by +/-5%, when operating between 120-277V +/-10%.

NOTE: Charts show system lumens (delivered lumens), NOT straight lamp lumen output.

This is calculated as follows:

System lumens = mean lumens x # lamps x ballast factor x luminaire efficiency factor















Applications

This product family can be effectively used in outdoor wall mount locations, commercial, industrial, retail and healthcare exterior lighting, parking lot, cargo door, high wall, area, security, etc.

Construction

- Die-cast aluminum housing
- Impact-resistant polycarbonate lens
- Durable bronze powder coat
- Same footprint as existing HID wall packs
- Operating Temperature: -40°C to 40°C
- Four knockouts available for wiring


Electrical


- IP65 wet location rated
- Easy-to-access wiring compartment
- System rated for long 50,000 hour life
- Efficiently delivers up to 130 LPVV

Optics

- High light transmittance polycarbonate lens
- Delivers bright, white light and excellent uniformity
- Low glare optics provide excellent visibility
- Full cut off optics provide Dark Sky conformance

Dimensions

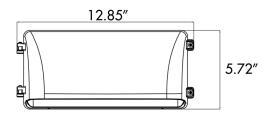

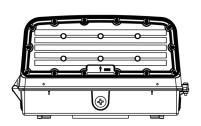



Item Number	
Notes	Туре



Catalog Ordering	Matrix	Example: SFWUZI	DSW4CCT	
FAMILY	VOLTAGE	CONTROLS	LUMEN PACKAGE (Power)	SELECTABLE COLOR TEMPERATURE
SFW – Selectable Full Cutoff Wall Pack	U – 120V-277V	ZD – 0-10V Dimming	SW4 – 5200/3900/2600L (40/30/20W) SW7 – 10400/7800/6500L (80/60/50W)	CCT – 30/40/50K











TECHNOLOGY CAST IN A BEAUTIFUL LIGHT

For over 20 years, TCP has been designing, developing and delivering energy-efficient lighting into the market. Thanks to our cutting-edge technology and manufacturing expertise, we have shipped billions of high quality lighting products. With TCP, you can count on a lighting product that is designed to meet the needs of the market - that transforms your surroundings and envelopes you in warmth - lighting that generates beauty with every flip of the switch.

Sales:	Catalog Number:
Date:	Туре:
Model:	Notes:
Project:	MTCD.
Rep:	TCP we know light.™



EROSION CONTROL AND STORMWATER MANAGEMENT PERMIT APPLICATION

Applicant Informa							
Applicant Name (Indiv., Org. or Entity) Bassett Kaukauna LLC			Authorized Repres X Kim Bass		^{Title} ^X Men		
Mailing Address 12	Mailing Address 1215 E. Hyland Avenue		^{City} Kaukauna		State WI	Postal Code 54130	
E-mail Address	ehn@bassettmechan		Telephone (include area code) X 920-462-1850 (Adam Kloehn)		Fax (include area code)		
Landowner Inform	nation (if different than Appl	icant)					
Name (Organization of	or Entity) Same		Contact Person		Title		
Mailing Address			City		State	Postal Code	
E-mail Address			Telephone (include	area code)	Fax (includ	e area code)	
		Engineer / Co			Agent / Ot		
Name (Organization of	or ^{Entity)} Schuler & Asso	ciates, Inc.	Contact Person Je	effrey Rustick	920-734-9	(include area code) 1107	
Mailing Address 271	1 N. Mason Stree	t, Suite F	City Appleto	n	State WI	Postal Code 54914	
Project or Site Loc	cation						
Site Name (Project):	Bassett Mechani	cal Buildir	ng Addition	Parcel Numbers: 32			
	215 E. Hyland			Plat / CSM / Lot No.	Part o	f Lot 1, CSM 3651	
	es (check all that apply)						
	I < 1 acre or 43,560 sq.ft. Dis					ft. Impervious Area (SM1) ft. Impervious Area (SM2)	
Total Disturbed Area				sq.ft. x \$0.0002/	sq.ft. (EC2) = \$	
		0	sq.ft. x \$0.0025 / sq.ft. (SM2) = \$) = \$ 0	
		Base Fee	e: \$200 (EC1), \$250 (EC2), \$200 (SM1), \$500 (SM2) = \$ 200				
				Total Appl			
Duration of Land Dist	urbance	12		weeks x \$25 / week	(EC1, EC2) = \$ 300	
Start Date	March 23, 2026		Ва	se Fee: \$250 (EC2),	\$500 (SM2)) = \$ 0	
End Date	June 15, 2026		<u></u>	Total Insp	spection Fee = \$		
		TOTAL PERI	MIT FEE (Applicati	on Fee + Inspection	Fee) = \$ 5	500	
Certification & Per							
contained in this form and/or permit may res	and attachments is true and sult in notices, fines / forfeituallowner of the property. I here	d accurate. I ur res, stop work o eby give the Dire	nderstand that failu rders, permit revoca ector of Public Worl	re to comply with any ation, and cease & des ks or designee, permis	or all of the sist orders. ssion to ent	I certify that the information provisions of the ordinances er and inspect the property to oper notice to the landowner.	
Applicant Signature			Date S	igned			
Landowner Signature (required)			Date X		e Signed		
LEAVE BLANK - FOR MUNICIPAL USE ONLY							
Date Application Rece	eived:		Fee Received	\$	Receipt No:		
Construction Site ID / Permit No:			Date Issued:		Issued E	By:	



MEMO

PLANNING AND COMMUNITY DEVELOPMENT

To: Industrial Park Commission

From: Adrienne Nelson, Associate Planner

Date: August 28, 2025

Re: Site Plan Review – Accurate Machine (1901 Hyland Avenue)

Accurate Machine is a manufacturing business that produces parts for different facets of machining. This project will add an additional 6,000 square feet to their existing building.

Site Plan Review:

Site/Architectural: 17.32 (10) Supplementary District Regulations & Applicable Zoning

All setback requirements for the Industrial Park District (IPD) are being met and all ordinances are being complied with to include zoning requirements. The current Accurate Machine building has a height of 19' and the height of the addition will be the same. There is space for off-street parking on-site, but no official stalls are painted.

Landscape: 17.52 Landscaping Requirements

The developer will work with the Planning and Community Development Department to complete a landscaping plan.

Lighting:

This addition is not adding any lighting.

Stormwater: 22 Stormwater Management

The developer will work with the Engineering Department to complete Erosion Control and Stormwater Management permitting. An application was received and is currently in the review process.

Ingress/Egress:

No concerns with traffic at this time.

Public Safety:

No concerns noted from Fire/Police at this time.

Façade: 17.53 Façade Standards

The proposed site elevations meet façade requirements.

Staff Recommendation:

Staff recommend approval of the development with the following conditions:

- Prior to issuance of building permits, must obtain Stormwater and Erosion Control permits from the Engineering Department
- Prior to issuance of building permits, must have a landscaping plan approved by the Director of Planning and Community Development.





SITE PLAN REVIEW APPLICATION

PROPERTY OWNER	APPLICANT (IF DIFFERENT PARTY THAN OWNER)
Name: James Effa	Name: Andy Wassmann (Keller Inc.)
Mailing Address: 1901 Hyland Avenue	Mailing Address: N216 State Road 55
Phone: (920) 766-7720	Phone: (920) 427-4467
Email: jim@accuratemachine.net	Email: awassmann@kellerbuilds.com

23.6%						
Existing Impervious Surface Coverage Percentage:	Proposed Impervious Surface Coverage Percentage: 27.8%					
Existing Number of Off-Street Parking Spaces: 0	Proposed Number of Off-Street Parking Spaces: 0					
Existing Building Height: 19ft	Proposed Building Height: 19ft					
Existing Gross Floor Area of Building: 12,528	Proposed Gross Floor Area of Building: 18,528					
Proposed Zoning and Use: Industrial Park						
Current Zoning and Use: Industrial Park						
Site Address/Location: 1901 E. Hyland Avenue Kauka	una, WI 54130					
Propety Parcel (#): 322091200						
Describe the Proposed Project in Detail: Machining Addition						
PROPERTY INFORMATION						

certify that the attached drawings are, to the best of	my knowledge	, complete and	drawn in	accordance	with all (City of
Kaukauna codes.						

Owner/Agent Signature: _	Andy Wassmann BY 5-US - Color September 2016 com, O-Kelder Design Color September 2016 com, O-Kelder Design Color	
Owner/Agent Name (print	_{ed):} Andy Wassmann (Keller Inc.)	

SITE PLAN REVIEW PROCEDURE

The plan review process is required for all new commercial, industrial, or multifamily buildings, as well as for building expansions/additions to structures.

Early in the process, consult the site application checklist shown below for a complete list of plan requirements and contact staff in the Planning and Community Development Department for initial direction and assistance. In addition, it is your responsibility to notify utility companies regarding your proposed development.

Completed site plans must be submitted 14 business days prior to the intended Plan Commission meeting. Those plans will be distributed amongst various city departments for an initial review. After review, questions, comments, and requested revisions will be returned to the applicant in advance of the Plan Commission meeting.

SITE PLAN CHECKLIST

- ✓ Completed site plan application
- ✓ Completed <u>erosion control and stormwater management permit application</u> and necessary fees
- ✓ Calculations for sanitary sewer and water
- ✓ Calculations for storm sewer design
- ✓ Site plan set to include:
 - Site plan layout and streets, including designated fire lanes
 - Utilities, grading, and drainage plan
 - o Erosion control plan
 - Landscape and lighting plan
 - o Architectural elevation and construction details
 - Floor plan set
 - Any other plans or information deemed necessary by the Planning and Community Development Department

SITE PLAN SUBMISSION

1. Email the Planning and Community Development Department at planning@kaukauna.gov

OR

2. Drop off in-person or send by mail to City of Kaukauna, Attn: Planning and Community Development Department, 144 W. 2nd Street, Kaukauna, WI 54130

SHEET INDEX

C1.0	CONCEPTUAL SITE PLAN
A1.0	FLOOR PLAN
A2.0	ELEVATIONS
A3.0	SECTIONS

S1.0 FOUNDATION PLAN

BUILDING & FIRE AREA SQUARE FOOTAGES

FLOOR AREAS	EXISTING	NEW	SUB-TOTAL
SECOND FLOOR	S.F.	S.F.	S.F.
FIRST FLOOR	12,528 S.F.	6,000 S.F.	18,528 S.F.
CANOPIES (COLUMN SUPPORTED)	S.F.	S.F.	S.F.
BASEMENT	S.F.	S.F.	S.F.
BUILDING AREA SUB-TOTALS	12,528 S.F.	6,000 S.F.	18,528 S.F.
MEZZANINES	S.F.	S.F.	S.F.
FIRE AREA TOTALS	12,528 S.F.	6,000 S.F.	18,528 S.F.
REMODEL AREA TOTALS	S.F.	% OF BUIL	DING AREA

BUILDING CODE ANALYSIS

APPLICABLE CODES 2015 International Building Code ASHRAE Standard 90.1-2013 or 2015 IEBC (Level # Alteration)		endments)
OCCUPANCY F-2		
Accessory Use		
Incidental Use		
High-Piled Combustible Storage Hazardous Materials Multiple Control Areas	N N N	Ö
HEIGHT & AREA Building Height: 17'-0" Number of Stories: 1 Total Building Area: 18,528 S.F. Total Fire Area: 18,528 S.F. Mixed/Separated Occupancies Unlimited Area Building	Maximum Maximum	Allowed: 55'-0" Allowed: 1 Allowed: UNLIMITED S.F. aximum Allowed: UNLIMITED S
CONSTRUCTION TYPE Construction Classification Fire Separation Distance	IIB _'"	
FIRE PROTECTION SYSTEMS		
Assumed Sprinkler Type Fire Alarm System	NONE NO	
MEANS OF EGRESS Occupant Load Panic Hardware YES/NO		
STRUCTURAL DESIGN Risk Category Design Loads Roof Live Load Walk-on IMP Ceiling Live Lo Steel Framing Collateral Load Wood Truss Top Chord Dead Bottom Chord Lo Mezzanine/Second Floor/Ba Live Load Point Load (Part Snow Load Criteria Ground Snow Lo Exposure Factor Thermal Factor Wind Loads Wind Load Surface Roughness Exposure Category Earthquake Load Criteria Soil Site Class Ss	d Load pad semen iition) pad (Pg) r (Ce)	II 20 psf psf psf 3 psf psf psf psf psf psf 1.0 1.0 115 MPH B B D .063 .042
PLUMBING SYSTEMS Mens WC Required Womens WC Required Drinking Fountain Required Other Source	1 1 YES NO	

SITE INFORMATION


SITE	E CONTENT Building Size Hard Surface Green Space Parcel Size (Approx.) Parking Provided Area of Disturbance	-, -, -, -, St -,	S.F S.F S.F alls		% % Acre	:S
ZON	Property Zoning Setbacks Hard Surface Setback Coverage Limit Greenspace Requirement Parking Required Refuse Enclosure RTU SCREENING	nt		 FY -'" % % Stalls YES/NO)	RY -'

NO BOILERS OVER 15 PSI AND 10 HORSEPOWER

PROPOSED FOR:

ACCURATE MACHINE

EXISTING BUILDING 12,528 S.F. RELOCATE EXISTING AIR CONDITIONER UNITS PROPOSED ADDITION CONDITIONER UNITS

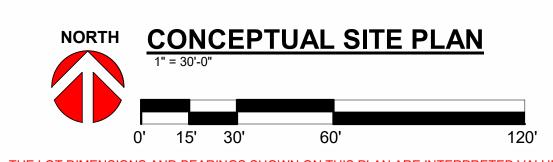

THE LOT DIMENSIONS AND BEARINGS SHOWN ON THIS PLAN ARE INTERPRETED VALUES. BACKGROUND INFORMATION TAKEN FROM LOCAL GIS DATE. AERIAL IMAGERY AND/OR CLIENT PROVIDED INFORMATION, EASEMENTS, STREAMS AND ROADS ARE APPROXIMATE IN NATURE. FOLLOW UP INVESTIGATION WITH

WISCONSIN



N216 State Road 55 P.O. Box 620 Kaukauna, WI 54130 PHONE (920) 766-5795 / FAX (608) 318-2337

W204 N11509 Germantown, WI 53022 PHONE (715) 849-3141 FAX (715) 849-3181 1-800-236-2534 FAX (262) 250-9740

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2 | 08.21.2025 3 08.28.2025

distributed, disclosed or made available to

PROJECT MANAGER: **DESIGNER:**

T. TISLAU INTERIOR DESIGNER:


DRAWN BY: EXPEDITOR:

Z SUPERVISOR: PRELIMINARY NO:

CONTRACT NO:


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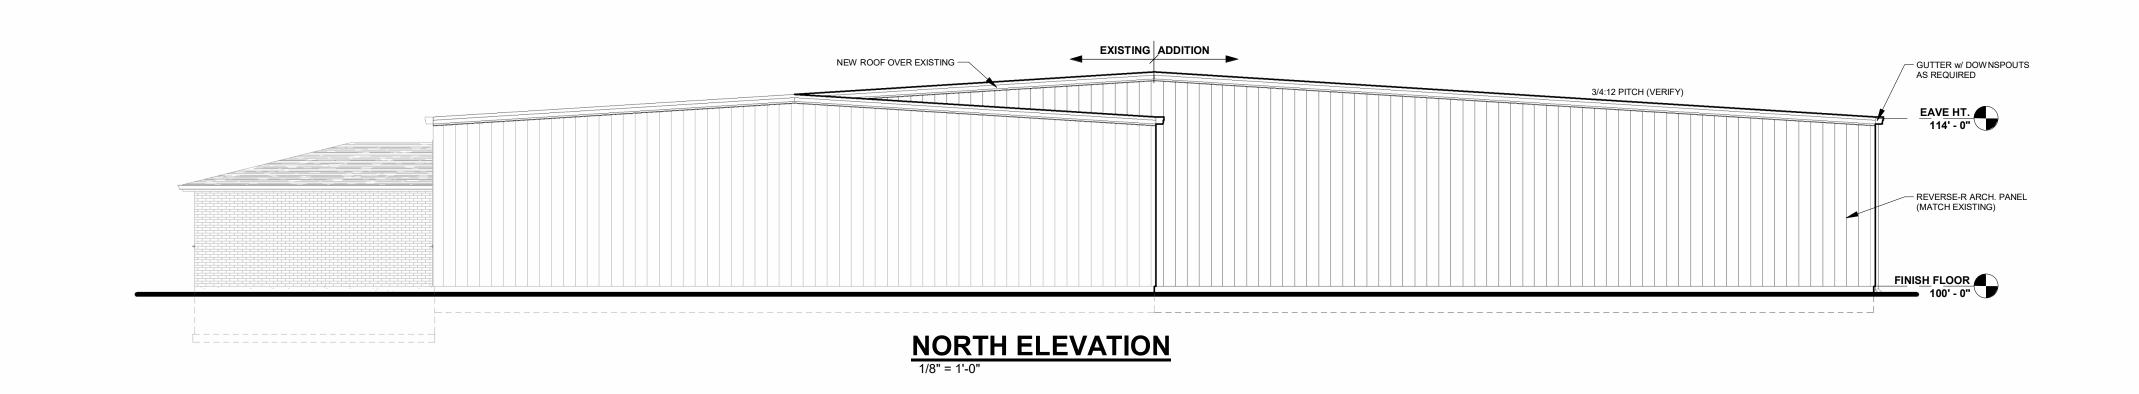
KUAKAUNA,




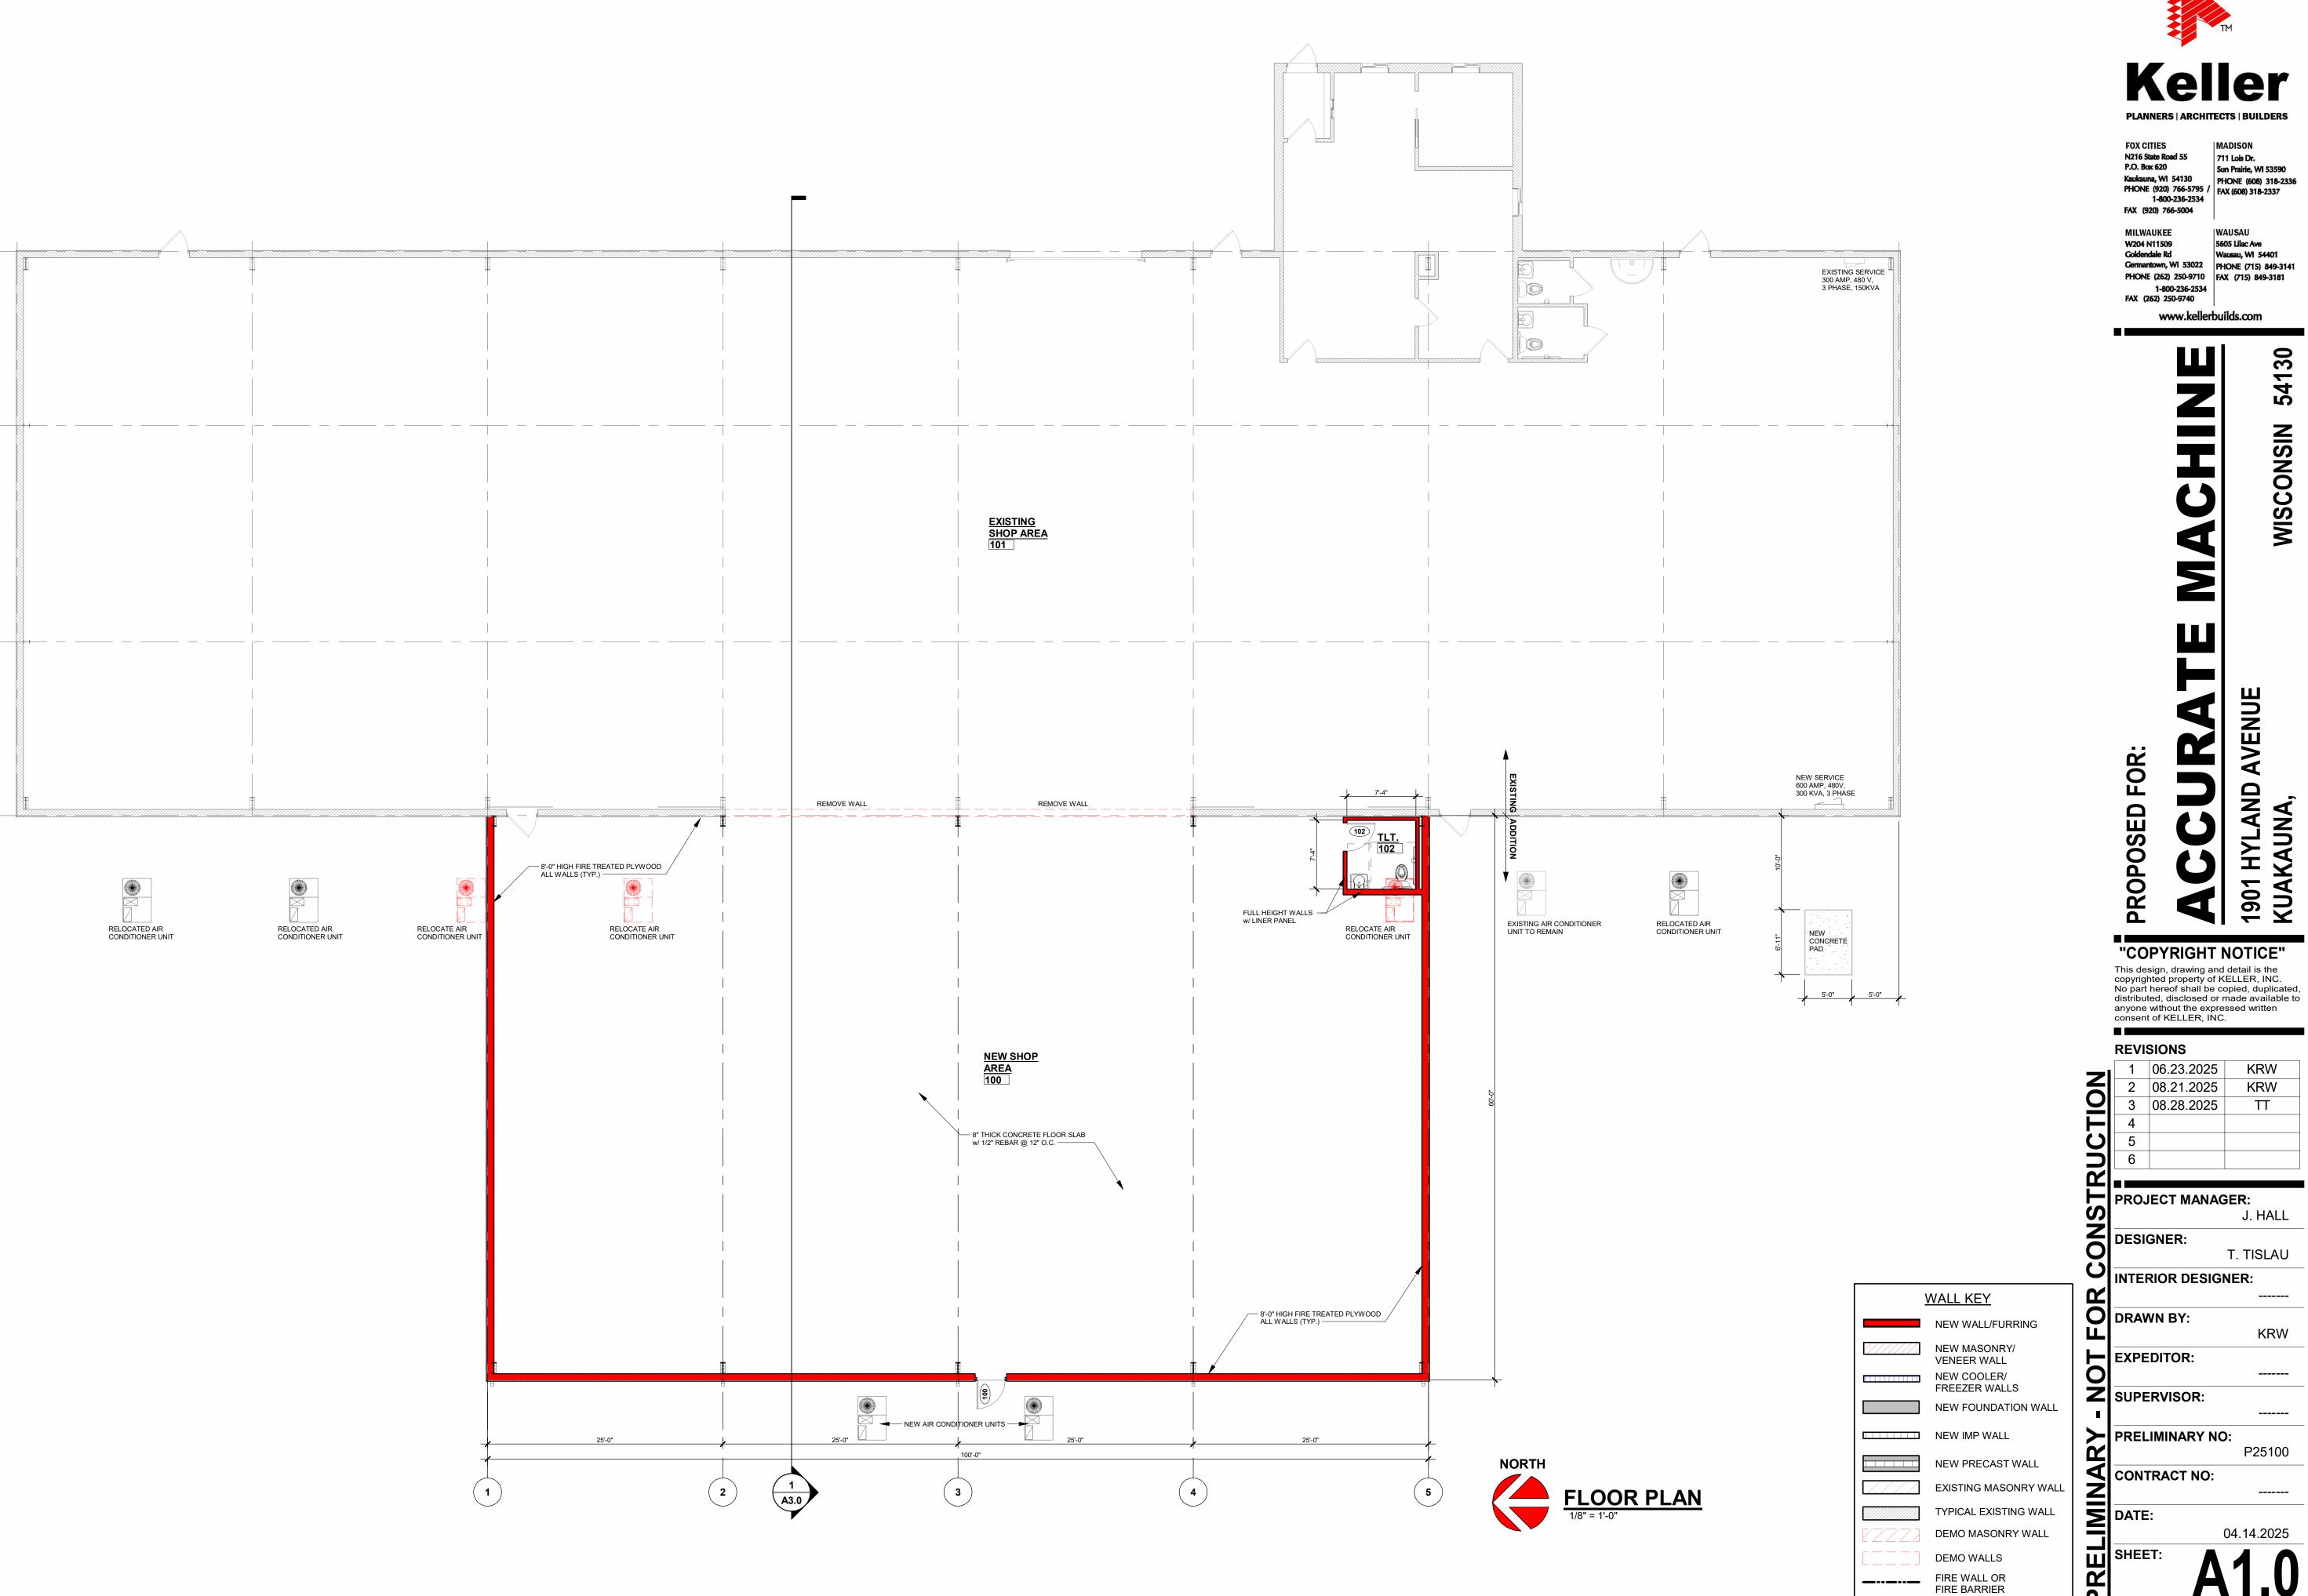


	REVI	SIONS	
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Y	PRO.	JECT MANAG	ER:
<u> </u>	PRO	JECT MANAG	GER: J. HALL
ONSIK		JECT MANAG	J. HALL
ON O	DESI	GNER:	J. HALL T. TISLAU
CONS	DESI		J. HALL T. TISLAU
OK CONSIK	DESI	GNER:	J. HALL T. TISLAU
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FOX CITIES
N216 State Road 55
P.O. Box 620
Kaukauna, WI 54130
PHONE (920) 766-5795 /
1-800-236-2534 FAX (920) 766-5004

MILWAUKEE
W204 N11509
Goldendale Rd
Germantown, WI 53022
PHONE (262) 250-9710
1-800-236-2534
FAX (262) 250-9740
WAUSAU
WAUSAU
Wausau, WI 54401
PHONE (715) 849-3141
FAX (715) 849-3181

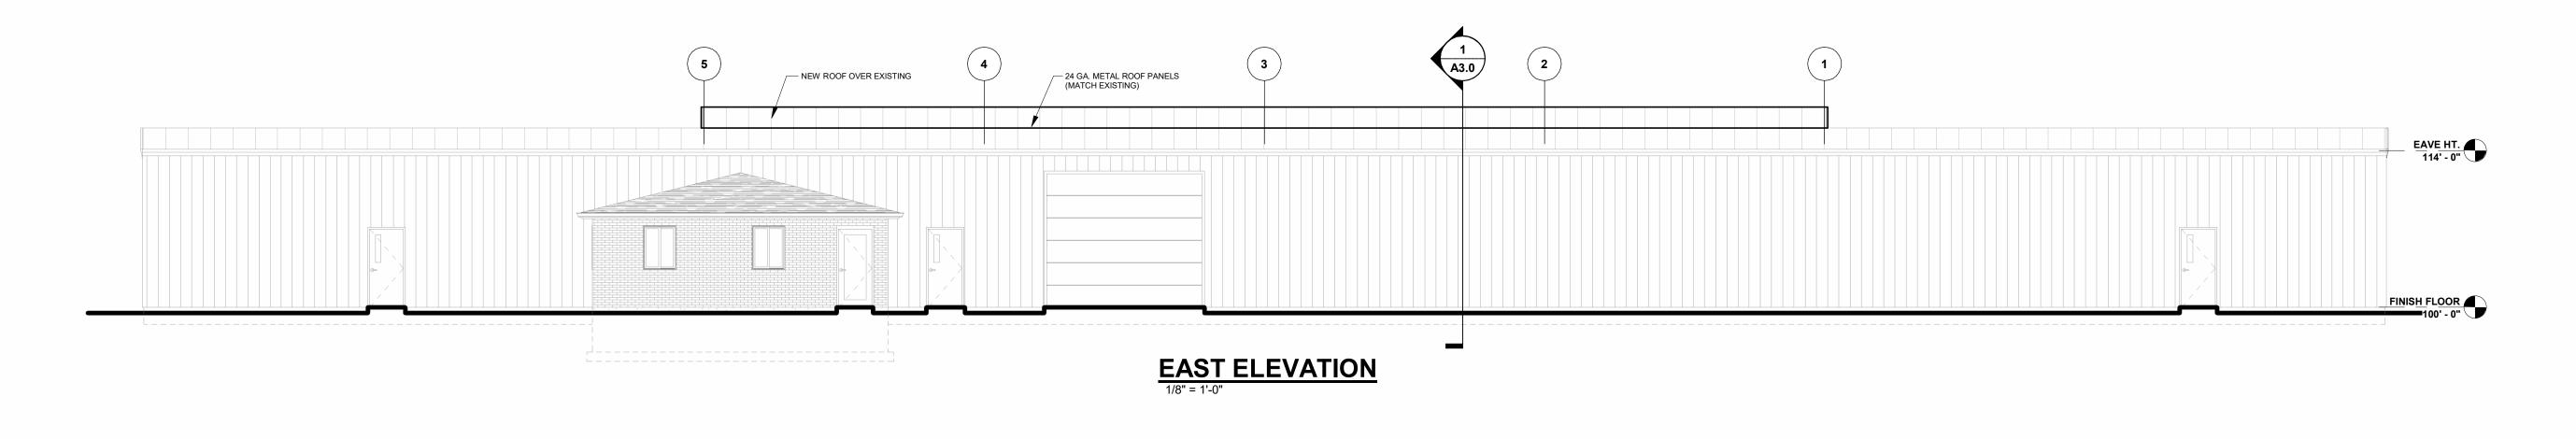www.kellerbuilds.com

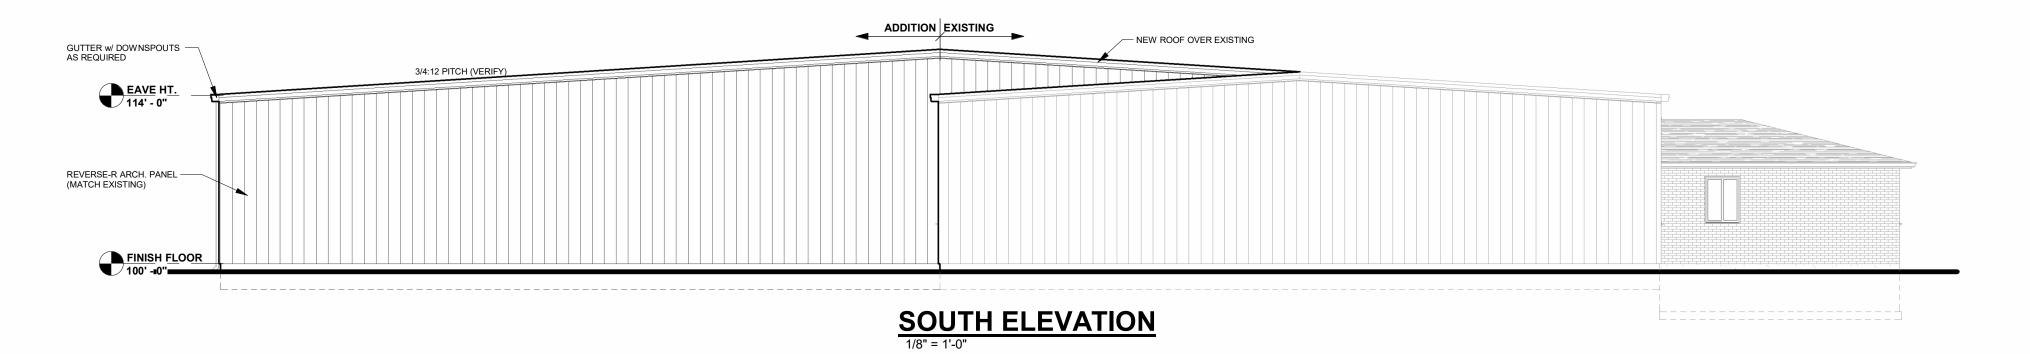WISCONSIN
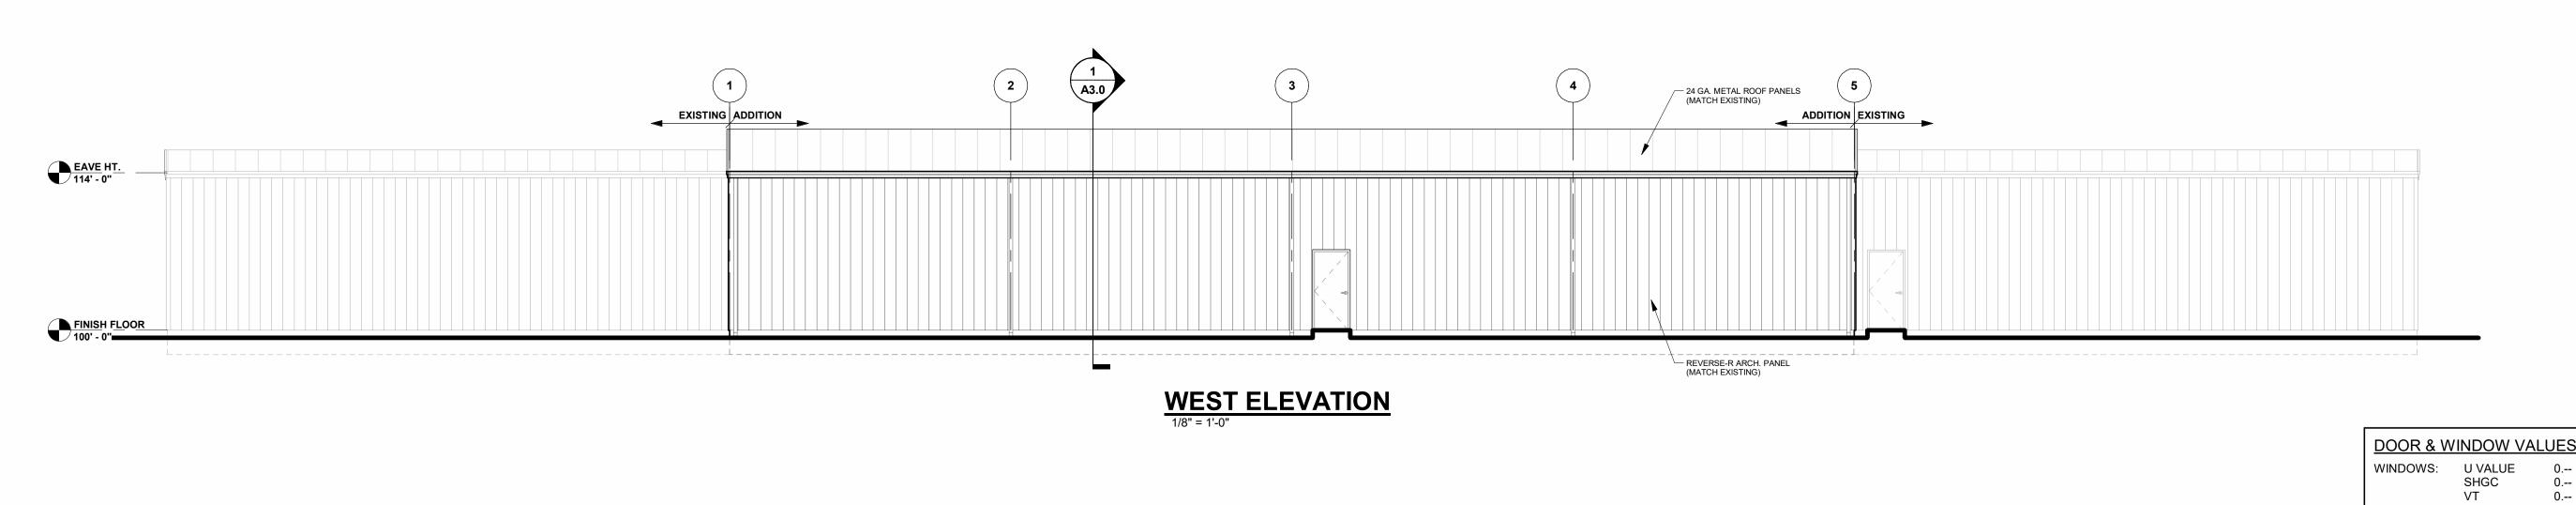
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FOR:

PROPOSED

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	REVI	SIONS	
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	PRO	JECT MANAG	ER:

	6			
ISTI	PROJ	IECT MA	NAGE	R: J. H <i>P</i>
ON	DESI	GNER:	Т	TISI

T. TISLAU INTERIOR DESIGNER:

DRAWN BY: KRW

EXPEDITOR: Z SUPERVISOR:

> PRELIMINARY NO: P25100

0.--0.--0.--

0.--0.--

U VALUE

U VALUE

U VALUE SHGC

VT

WINDOWS:

DOORS: (SWINGING)

O.H. DOORS: (NON-SWINGING)

DOORS: (>50% GLAZING)

CONTRACT NO:

DATE:

SHEET:

04.14.2025



FOX CITIES N216 State Road 55 P.O. Box 620 711 Lois Dr. Kaukauna, WI 54130 PHONE (920) 766-5795 / 1-800-236-2534 FAX (920) 766-5004

5605 Lilac Ave

MILWAUKEE W204 N11509 Goldendale Rd Wausau, WI 54401
PHONE (262) 250-9710
1-800-236-2534
FAX (262) 250-9740

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54130 **WISCONSIN**

FOR:

PROPOSED

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PROJECT MANAGER: J. HALL

DESIGNER: T. TISLAU

INTERIOR DESIGNER:

DRAWN BY:

EXPEDITOR:


Z SUPERVISOR:

KRW

PRELIMINARY NO: P25100 CONTRACT NO:


DATE:

04.14.2025

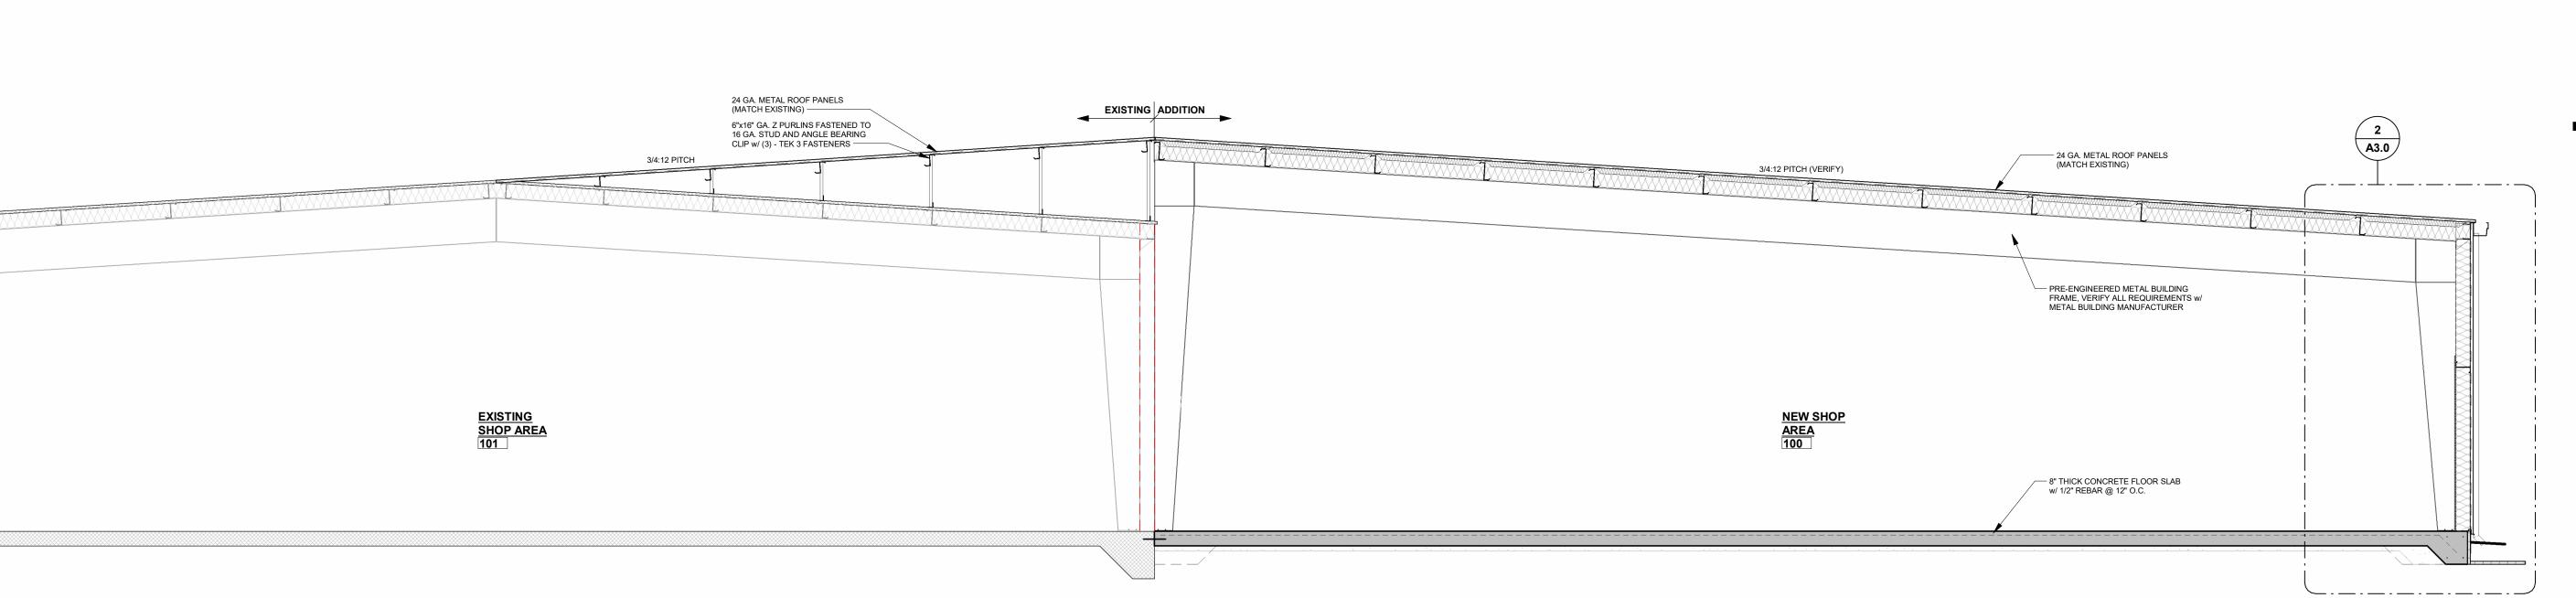

BUILDING SECTION

1/4" = 1'-0"

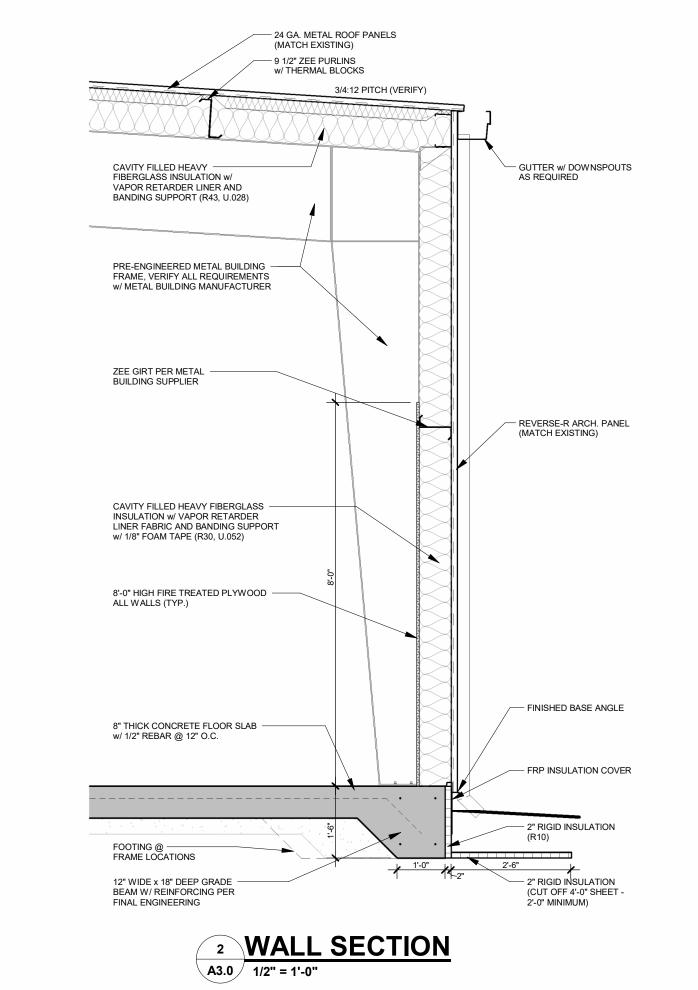

KAUKAUNA **/550 NST

EROSION CONTROL AND STORMWATER MANAGEMENT PERMIT APPLICATION

Applicant Information						
Applicant Name (Indiv., Org. or Entity) Keller Ir	Inc. Authorized Representative Jesse Hall		entative	Title Project Manager		
Mailing Address N216 State Road	55 °	^{city} Kaukauna			Postal Code 54130	
E-mail Address jhall@kellerbuilds.com		Telephone (include area code) (920) 438-9316		Fax (include area code) (920) 766-5004		
Landowner Information (if different than Applicant)						
Name (Organization or Entity) Accurate Machin	e Co.			sident		
Mailing Address 1901 Hyland Ave	nue	ity Kauka	una State WI Postal Code 54130			
E-mail Address jim@accuratemachine.		elephone (include 320) 766-7720	area code)	Fax (include area code) (920) 766-9399		
	gineer / Con			Agent / Ot		
Name (Organization or Entity) Tom Vand Handel C	orp C	Contact Person Rick Van Handel (920) 585-3771 Telephone (include area code)		3771		
Mailing Address 1830 E. Edgewood Dri	ve c	Applet	on	State WI	Postal Code 54913	
Project or Site Location	0.0000000000000000000000000000000000000					
Site Name (Project): Accurate Machi	ne Co	0.	Parcel Numbers: 3	322091200		
Address / Location: 1901 E. Hyland Avenue Kaul	kauna, W	1 54130	Plat / CSM / Lot No.	6		
Permit Type & Fees (check all that apply)						
Erosion Control < 1 acre or 43,560 sq.ft. Disturbe Erosion Control ≥ 1 acre or 43,560 sq.ft. Disturbe					t. Impervious Area (SM1) t. Impervious Area (SM2)	
Total Disturbed Area	22,000 sq.ft. x \$0.0002/sq.ft. (EC2) = \$					
New Impervious Area) = \$		
*** (Applement of the Control of the	Base Fee:	\$200 (EC1), \$25	(EC2), \$200 (SM1),	\$500 (SM2)	= \$ 400.00	
			Total App	lication Fee	s = \$ 400.00	
Duration of Land Disturbance	a kanangan kanangan malaminin kanangan sa kanangan kanangan kanangan kanangan kanangan kanangan kanangan kanan	1	weeks x \$25 / week	(EC1, EC2)) = \$ 875.00	
Start Date 9/15/20205	Base Fee: \$250 (EC2), \$500 (SM2) = \$					
End Date 6/5/2026	Total inspection Fee = \$ 875.00					
	TAL PERM	IIT FEE (Applicati	on Fee + Inspection	Fee) = \$ 1	.275.00	
Certification & Permission						
Certification: I hereby certify that I am the landowner contained in this form and attachments is true and acc and/or permit may result in notices, fines / forfeitures, s	urate. Tund op work ord ve the Direc	derstand that failui ders, permit revoca ctor of Public Worl	e to comply with any ation, and cease & de as or designee, perm	r or all or the esist orders. ission to ent	er and inspect the property to	
evaluate this permit application determine compliance with ordinances, and perform correct Applicant Signature.			Date	Date Skined		
Landøwner Signature (required)	***************************************			Signed		
anna 1 Etta 9-2-25						
LEAVE BLANK FOR MUNICIPAL USE ONLY Fee Received S Receipt No:						
Date Application Received:		Fee Received \$			***************************************	
Construction Site ID / Permit No:		Date Issued:		Issued E	7 7-	

PLEASE CONTACT CITY OF KAUKAUNA ENGINEERING DEPARTMENT AT 920-766-6305 WITH QUESTIONS.



MEMO

PLANNING AND COMMUNITY DEVELOPMENT

To: Industrial Park Commission

From: Adrienne Nelson, Associate Planner

Date: August 27, 2025

Re: Site Plan Review – Team Industries (1200 Maloney Road)

Team Industries is a pipe and vessel fabrication business. This project will add an additional 1,800 square feet to their existing building.

Site Plan Review:

Site/Architectural: 17.32 (10) Supplementary District Regulations & Applicable Zoning

All setback requirements for the Industrial Park District (IPD) are being met and all ordinances are being complied with to include zoning requirements. The current Team Industries building has a height of 37' 3 ½" and the height of the addition will be 22' to 23' 3". There are currently 118 off-street parking spaces.

Landscape: 17.52 Landscaping Requirements

There will be no change in landscaping.

Lighting:

This addition is not adding any lighting.

Stormwater: 22 Stormwater Management

This addition will not require an Erosion Control and Stormwater Management permit.

Ingress/Egress:

No concerns with traffic at this time.

Public Safety:

No concerns noted from Fire/Police at this time.

Façade: <u>17.53 Façade Standards</u>

The proposed site elevations meet façade requirements.

Staff Recommendation:

Staff recommend approval of the development as presented.





SITE PLAN REVIEW APPLICATION

PROPERTY OWNER	APPLICANT (IF DIFFERENT PARTY THAN OWNER)
Name:	Name:
Team Industries (Jason Sturn)	David OBrien (Bayland Buildings Inc.)
Mailing Address: 1200 Maloney Road Kaukauna WI 54130	Mailing Address: PO Box 13571 Green Bay WI 54307
Phone:	Phone:
920-462-1158	920-371-6200
Email:	Email:
jsturn@teamind.com	dobrien@baylandbuildings.com

PROPERTY INFORMATION	
Describe the Proposed Project in Detail:	
60' X 30' 1,800 SF addition	
Propety Parcel (#):	
322090800	
Site Address/Location:	
1200 Malony Road	
Current Zoning and Use:	
Proposed Zoning and Use:	
Existing Gross Floor Area of Building:	Proposed Gross Floor Area of Building:
130,000 +/-	1800
Existing Building Height:	Proposed Building Height:
37'-3 1/2"	22' low eave 23'-3" high eave
Existing Number of Off-Street Parking Spaces:	Proposed Number of Off-Street Parking Spaces:
	118
Existing Impervious Surface Coverage	Proposed Impervious Surface Coverage Percentage:
Percentage:	No change
No change	
I certify that the attached drawings are, to the best of m	ny knowledge, complete and drawn in accordance with all City of

Kaukauna codes.	
Owner/Agent Signature:	
Owner/Agent Name (printed): David OBrien	

SITE PLAN REVIEW PROCEDURE

The plan review process is required for all new commercial, industrial, or multifamily buildings, as well as for building expansions/additions to structures.

Early in the process, consult the site application checklist shown below for a complete list of plan requirements and contact staff in the Planning and Community Development Department for initial direction and assistance. In addition, it is your responsibility to notify utility companies regarding your proposed development.

Completed site plans must be submitted 14 business days prior to the intended Plan Commission meeting. Those plans will be distributed amongst various city departments for an initial review. After review, questions, comments, and requested revisions will be returned to the applicant in advance of the Plan Commission meeting.

SITE PLAN CHECKLIST

- ✓ Completed site plan application
- ✓ Completed erosion control and stormwater management permit application and necessary fees
- ✓ Calculations for sanitary sewer and water
- ✓ Calculations for storm sewer design
- ✓ Site plan set to include:
 - o Site plan layout and streets, including designated fire lanes
 - Utilities, grading, and drainage plan
 - o Erosion control plan
 - Landscape and lighting plan
 - o Architectural elevation and construction details
 - Floor plan set
 - Any other plans or information deemed necessary by the Planning and Community Development Department

SITE PLAN SUBMISSION

1. Email the Planning and Community Development Department at planning@kaukauna.gov

OR

2. Drop off in-person or send by mail to City of Kaukauna, Attn: Planning and Community Development Department, 144 W. 2nd Street, Kaukauna, WI 54130

P.O. BOX 13571 GREEN BAY, WI 54307 (920) 498-9300 FAX (920) 498-3033 www.baylandbuildings.com

DESIGN & BUILD GENERAL CONTRACTOR

PROPOSED BUILDING SCALE VERIFICATION
THIS BAR MEASURES 1" ON ORIGINAL.
ADJUST SCALE ACCORDINGLY

WISCONSIN; COUNTY

NOTICE OF COPYRIGHT
THESE PLANS ARE COPYRIGHTED AND ARE SUBJECT TO
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AS THE ARRANGEMENT AND COMPOSITION OF SPACES AND
ELEMENTS OF THE DESIGN. UNDER SUCH PROTECTION,
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REPRESENTED, CAN LEGALLY RESULT IN THE CESSATION OF
CONSTRUCTION OR BUILDINGS BEING SEIZED AND/OR MONETARY
COMPENSATION TO BAYLAND BUILDINGS, INC.

JOB NUMBER: * **PROJECT**

EXECUTIVE: (920) 366-8828

DRAWN BY: DPO 5-29-2025 DATE:

REVISIONS:

ISSUED FOR: CHECKED DATE:


X PRELIMINARY BID SET

DESIGN REVIEW

CHECKSET CONSTRUCTION

SITE PLAN



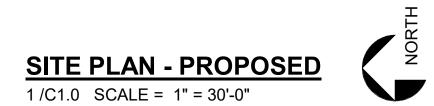

BAYLAND BUILDINGS

P.O. BOX 13571 GREEN BAY, WI 54307 (920) 498-9300 FAX (920) 498-3033 www.baylandbuildings.com

PROPOSED BUILDING FOR:

SCALE VERIFICATION
THIS BAR MEASURES 1" ON ORIGINAL.
ADJUST SCALE ACCORDINGLY

NOTICE OF COPYRIGHT
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CONSTRUCTION OR BUILDINGS BEING SEIZED AND/OR MONETARY
COMPENSATION TO BAYLAND BUILDINGS, INC.

JAKE MANCOSKE (920) 366-8828

5-29-2025

JOB NUMBER: *

DRAWN BY: DPO


PROJECT

DATE:

EXECUTIVE:

REVISIONS:

DESIGN & BUILD GENERAL CONTRACTOR

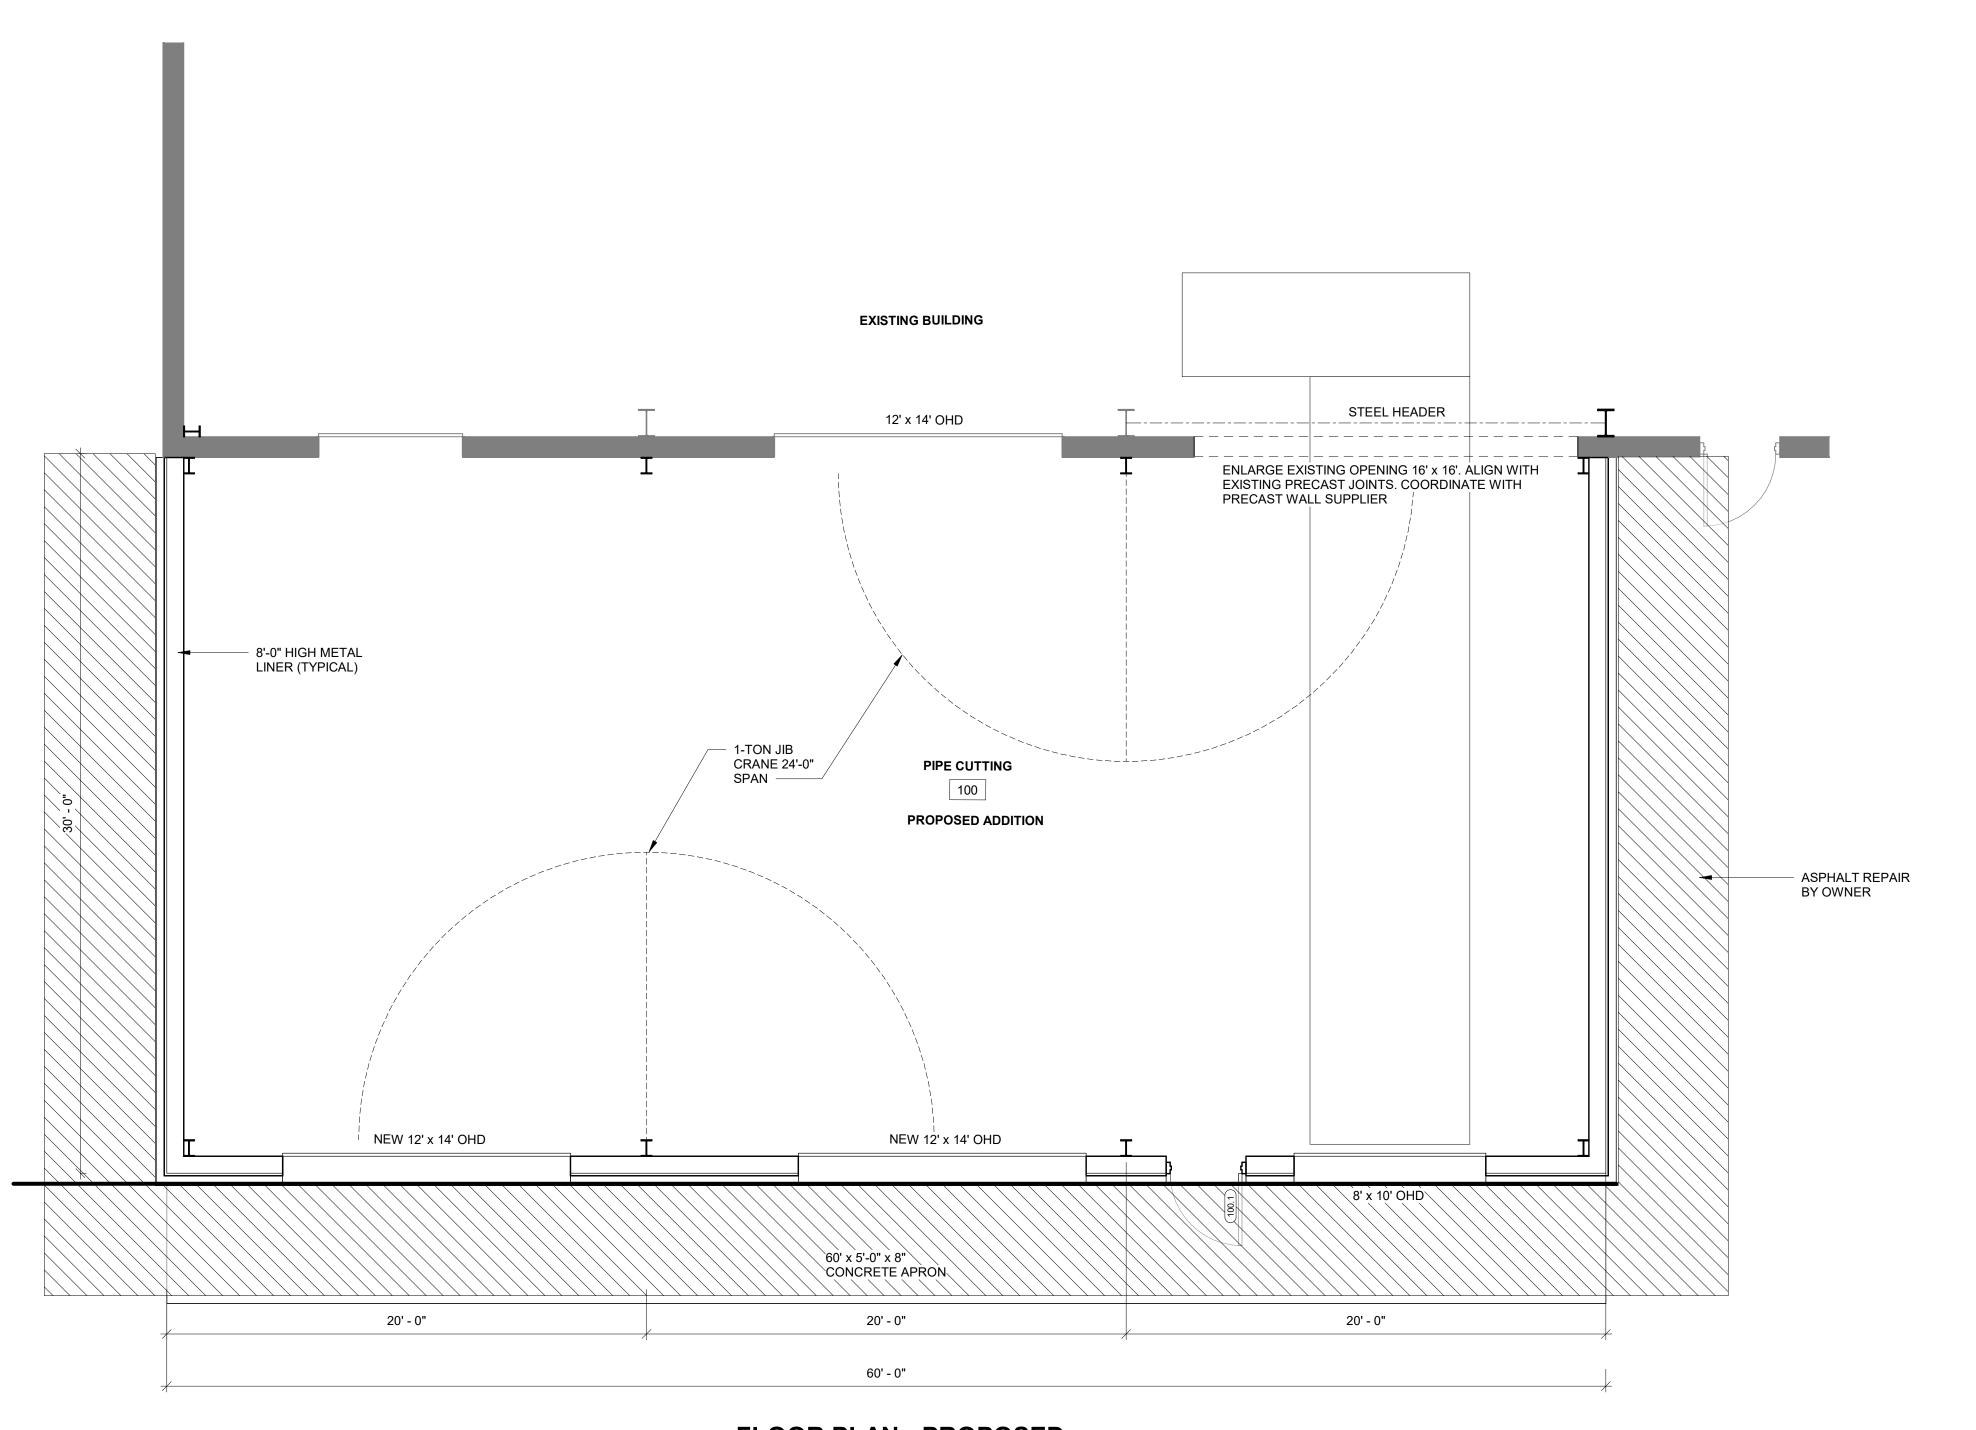

FLOOR PLAN - PROPOSED

1 /A1.0 SCALE = 1/4" = 1'-0"

PLAN NOTES:

1) ALL DIMENSIONS ARE FROM FACE OF STUD TO FACE OF STUD (U.N.O.)



ISSUED FOR: CHECKED DATE:
BY:

X PRELIMINARY

BID SET

DESIGN REVIEW

CHECKSET

CONSTRUCTION


FLOOR PLAN - PROPOSED

A1.0


BAYLAND BUILDINGS

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DESIGN & BUILD GENERAL CONTRACTOR

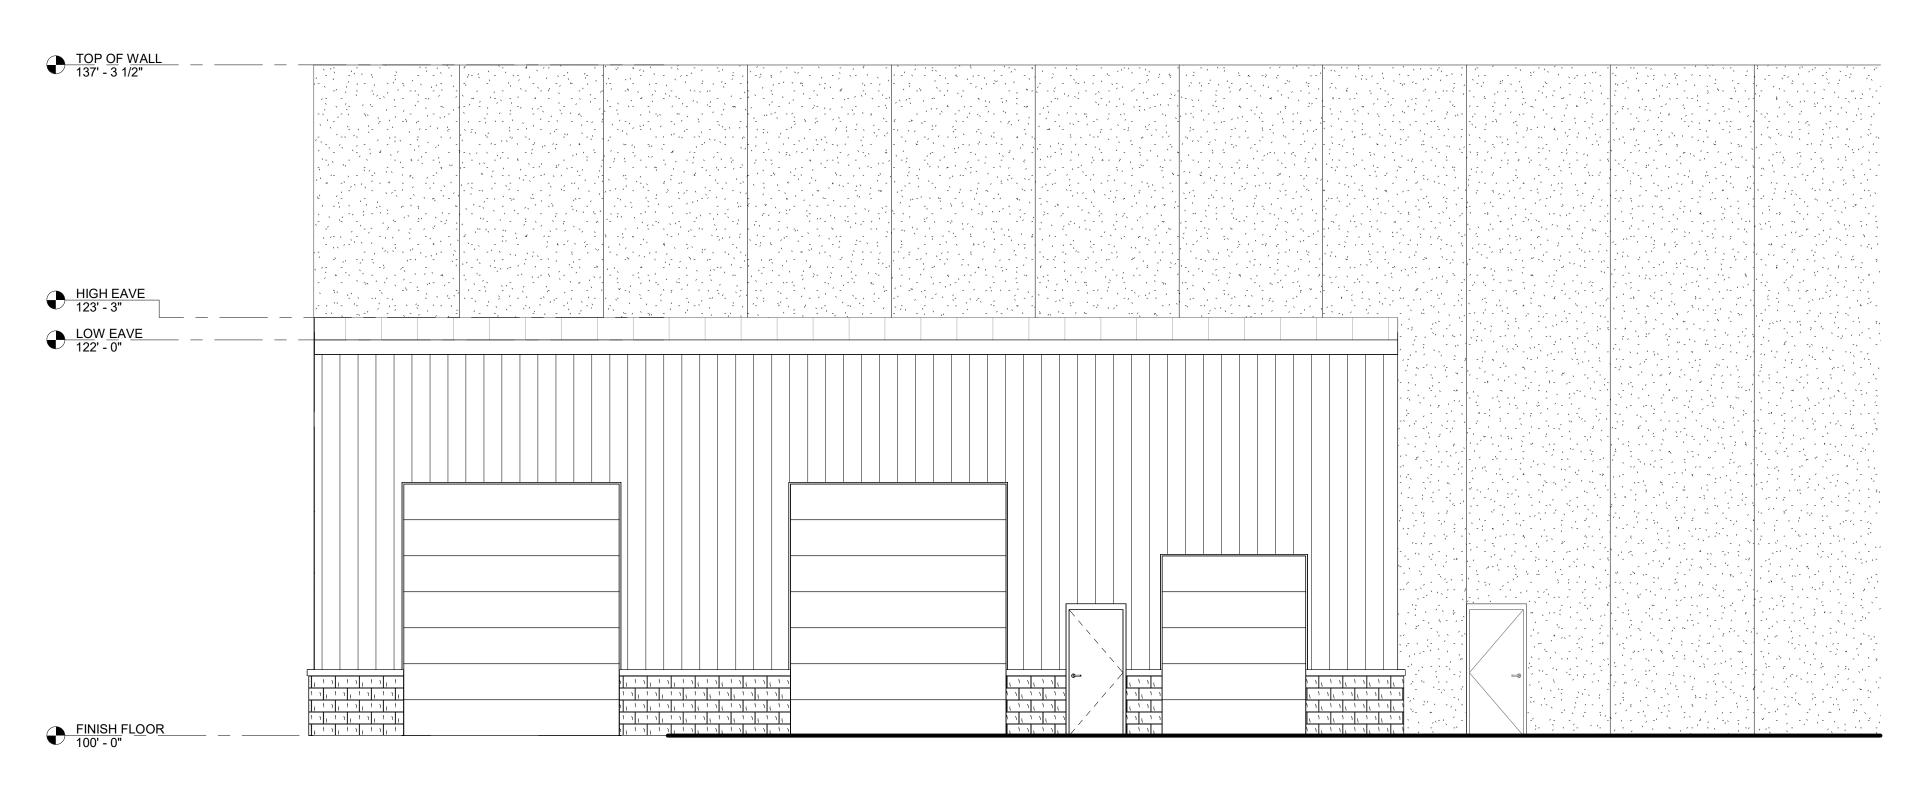

BUILDING ELEVATION - WEST 2 /A2.0 SCALE = 3/16" = 1'-0"

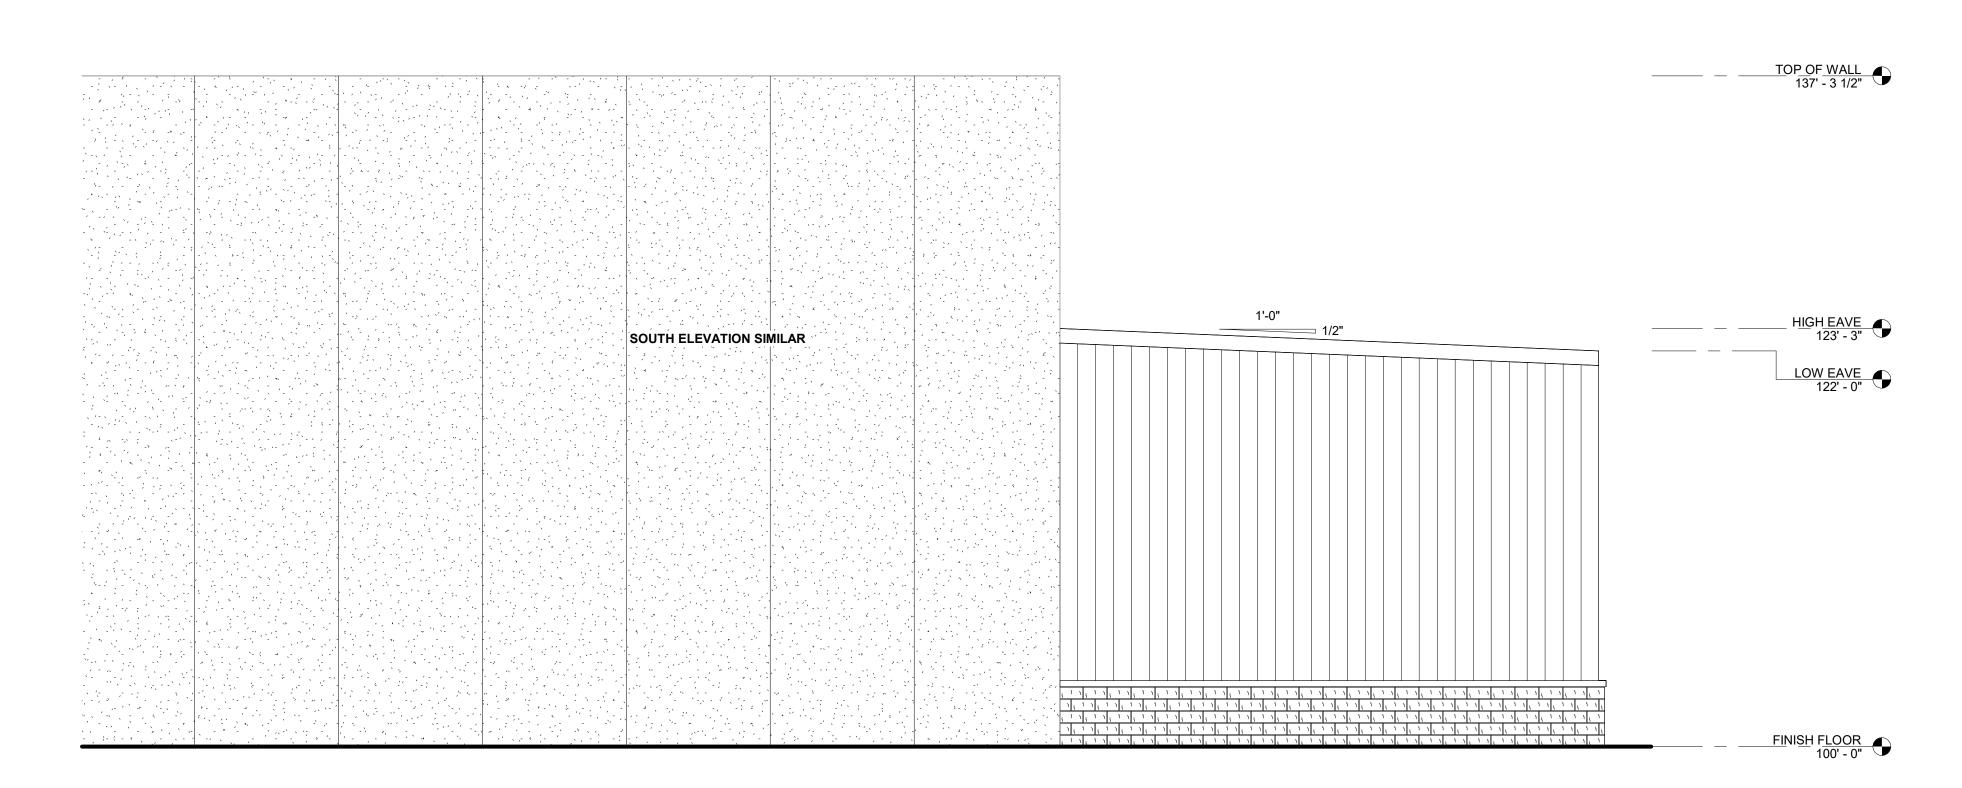

BUILDING ELEVATION - NORTH 3 /A2.0 SCALE = 3/16" = 1'-0"

PROPOSED BUILDING FOR: 4205 25 SCALE VERIFICATION
THIS BAR MEASURES 1" ON ORIGINAL.
ADJUST SCALE ACCORDINGLY

WISCONSIN; COUNTY OF:

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COMPENSATION TO BAYLAND BUILDINGS, INC.

JOB NUMBER: * **PROJECT** JAKE MANCOSKE (920) 366-8828

EXECUTIVE:

DRAWN BY: DPO DATE: 5-29-2025

REVISIONS:

ISSUED FOR: CHECKED DATE: X PRELIMINARY BID SET DESIGN REVIEW CHECKSET

CONSTRUCTION

ELEVATION - EXTERIOR