

CITY OF HENDERSONVILLE TREE BOARD - REGULAR MEETING AND VIA ZOOM

Operations Center - Assembly Room | 305 Williams St. | Hendersonville NC 28792 Tuesday, March 15, 2022 – 2:00 PM

AGENDA

1. CALL TO ORDER

2. APPROVAL OF AGENDA

- 3. Approval of the February 15, 2022 Minutes
- A. February 15, 2022 Minutes

4. **NEW BUSINESS**

- A. Public Relations Update Mary Jo Padgett
- B. Bee City Update Patrice German; Kim Bailey
- C. Spring Planting Projects:
 - A. Oklawaha Greenway Trail
 - B. Wolf Chase
 - C. 9th Avenue
- D. Vegetation Removal Permit Application 225 N. Main Street
- E. Renewal Maintenance Contract for Bee Mural & Bearcat Loop
- F. Conditional Zoning District Hawkins Pointe Apartments
- <u>G.</u> Conditional Zoning District White Pine Villas Apartments
- H. Conditional Zoning District Duncan Terrace Apartments

5. OLD BUSINESS

A. Changes to City Ordinances/Zoning Concerning Trees

6. OTHER BUSINESS

- A. Utility Update
- B. Tree Board Budget Expenditures
- C. Vice Chairperson

D. Staff Comments

7. ADJOURNMENT

The City of Hendersonville is committed to providing accessible facilities, programs and services for all people in compliance with the Americans with Disabilities Act (ADA). Should you need assistance or an accommodation for this meeting please contact the City Clerk no later than 24 hours prior to the meeting at 697-3005.



CITY OF HENDERSONVILLE TREE BOARD - REGULAR MEETING (AND VIA ZOOM)

Operations Center - Assembly Room | 305 Williams St. | Hendersonville NC 28792 Tuesday, February 15, 2022 – 2:00 PM

MINUTES

1. CALL TO ORDER

The meeting was called to order at 2:02 pm.

2. APPROVAL OF AGENDA

The agenda was approved. Motion by Glenn Lange, Vote - All Ayes.

3. APPROVAL OF MINUTES

A. January 26, 2022 Minutes

The January 26, 2022 minutes were approved as written. Motion by Mark Madsen, Vote - All Ayes.

4. NEW BUSINESS

A. Public Relations Update - Mary Jo Padgett

Mary Jo provided an update via email and discussed the items during the meeting. The Tree Walk on 3rd Avenue and 4th Avenue was a big success. Mary Jo sent a "Thank You" note to City Council. Bee City USA will now be managed by Patrice German (Bullington Gardens). An education event will be held on March 10th at 5 pm and Mary Jo need two volunteers and an MC. Mary Jo covered the calendar of events.

B. Bee City Update - Patrice German

Patrice German will be replacing Kim Bailey as Bee City USA Coordinator. There are a few items that need to be finished for the agreement such as insurance. A press release will be coming out soon, maybe Friday, announcing the change. Patrice will continue to have a presence at the Farmer's Market, Bee Bold, and with the Henderson County Beekeeper's Association plus other events.

C. Earth Care Ministry - Richard Bobb

Richard Bobb discussed the Earth Care Ministry through Trinity Presbyterian Church. The have about thirty active members who are willing to volunteer to help the Tree Board.

D. Rezoning: Conditional Zoning District – Southgate Apartments (P21-62-CZD) – Matthew Manley, AICP – Planning Manager

This project has reduced the size of the buildings, parking lot, and impervious surfaces on the site. They are keeping the same number of proposed trees and shrubs as they had planned for under the original project.

A motion was made by Glenn Lange, vote - All Ayes:

Motion: Based on the following guiding city code documents (the Municipal Code, Chapter 46, Article IV, Division 1,Trees & Shrubs, Section 46, 116 & 117; the Zoning Code, Article XV Buffering, Screening & Landscaping Sections 15-1, A &C and 15-4 A; the Subdivision Ordinance, Purpose and Intent, Section1.04, Part H; and the Comprehensive Plan, Vision Statement and Section 3.3, Goal NR-1, Strategy 1.2 and Goal NR-2, Strategy 2.3) and the City Council's adoption (Feb., 2021) of core values and beliefs as guiding principles as they apply to protection of natural resources and the prioritization of existing tree canopy, the Tree Board recommends the following development conditions be placed on this property:

1. Plant slope area with diverse and appropriate species of native upland small maturing or understory trees, shrubs (both with proper spacing) and herbaceous plants.

2. All preserved trees must be protected from construction activities as prescribed in the zoning code 15-4c regardless of use for a tree credit.

3. Attempt to eradicate invasive plant species found on the property as listed in the Recommended Landscape Species List for Street Trees and Land Development Projects.

E. Rezoning: Conditional Rezoning: Apple Ridge Affordable Housing (P22-08-CZD) - *Tyler Morrow, Planner II*

A discussion was held concerning this project. The developer stated that there were about 182 trees that were 12 inches or larger and they were likely removing 47 trees, most of the trees that will be removed are Pine Trees. The developer will attempt to save a few of the trees to be removed but they were unsure if they could be saved so they added them to the list of trees that will be removed.

A motion was made by Glenn Lange, vote - All Ayes.

Motion: Based on the following guiding city code documents (the Municipal Code, Chapter 46, Article IV, Division 1,Trees & Shrubs, Section 46, 116 & 117; the Zoning Code, Article XV Buffering, Screening & Landscaping Sections 15-1, A &C and 15-4 A; the Subdivision Ordinance, Purpose and Intent, Section1.04, Part H; and the Comprehensive Plan, Vision Statement and Section 3.3, Goal NR-1, Strategy 1.2 and Goal NR-2, Strategy 2.3) and the City Council's adoption (Feb., 2021) of core values and beliefs as guiding principles as they apply to protection of natural resources and the prioritization of existing tree canopy, the Tree Board recommends the following development conditions be placed on this property:

1. Preserve as many 12" or larger canopy trees as possible.

2. All preserved trees must be protected from construction activities as prescribed in the

zoning code 15-4c regardless of use for a tree credit.

3. Either through Conserving Carolina or a landscape architect provide and implement a vegetative planting plan that will enhance the existing stream corridors, reduce erosion, provide filtration and infiltration of stormwater from turf managed areas, and enhance wildlife habitat in the 20-foot transition zone along both sides of the streams on the property, in any other areas not within lot lines along the streams, and beyond proposed retaining wall along multi-family units. For this development condition, the Tree Board recommends the use of diverse and appropriate species of native upland and lowland trees, shrubs, and perennial herbaceous plants (including warm season grasses, sedges, and plants important to pollinators).

4. Attempt to eradicate invasive plant species throughout the property as listed in the Recommended Landscape Species List for Street Trees and Land Development Projects.

F. Collaboration with Environmental & Sustainability Board - Glenn Lange

The Environmental Sustainability Board is interested in working with the Tree Board on a variety of things such as ordinance changes and zoning changes. The two boards are collecting information and will continue having conversations about working together.

G. Possible Tree & Shrub Planting on Greenway

A discussion was held about planting trees and shrubs along the Oklawaha Greenway Trail between 7th Avenue and North Main Street in order to replace some of the trees that have died or fell and been removed. Mark Madson had identified locations to plant about 52 trees. It was proposed to work with volunteers to plant the trees, City Staff would work with the Tree Board to purchase the trees and dig the holes once the locations had been staked. The project could be split into phases. Funds from the current budget could be used to purchase the trees and soil amendments or they could apply for grants. Once the trees are planted, city staff could GPS the trees so we would have a record of the trees, where they are planted and record the species. Additional discussions will be held.

Tom Wooten will print two copies of the Oklawaha Greenway Trail map of the proposed area for Mark and Glenn. Tom will also email a pdf of the area to Mark and Glenn.

5. OLD BUSINESS

A. Changes to City Ordinances/Zoning Concerning Trees - Glenn Lange

No Action Taken.

B. NeighborWoods

Debbie Roundtree has some property owners who are interested in this program.

C. Pollinator Bed Traffic Island Four Seasons Boulevard

No action taken. Plan to move forward with the RFP in the spring.

6. OTHER BUSINESS

A. Utility Update

No utility update.

B. Tree Board Budget Expenditures and FY 2022/2023 Request

Tom Wooten provided an update in the agenda packet for the upcoming budget. Tom will email the current budget to the Tree Board (the update he submitted in the agenda packet did not contain all of the information necessary for an update).

C. Staff Comments

No Staff Comments.

7. ADJOURNMENT

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City of Hendersonville Public Works Department (828-697-3084)

Application For Selective Vegetation Removal Permit

Application is hereby made in accordance with City of Hendersonville Ordinance Article IV Section 46-120 (b) Permit required for removal of trees or scrubs.

Name of Firm/Individual: Address:

Telephone Number:

Property Owner Name:

Mrd Mrs JASON KrAus

Reason for Request: Overgrown Tree in front of Building in planter

The owner of this property is offering to pay for this trees remained installing a new treeps plantings.

Exact Location of Area and Describe which vegetation is to be removed: (attach sketch/drawing) <u>The large Holy Tree in front of Bldg in A plantar on the side walk on MAMSt</u> 225 N. Main St

Applicant's Signature


Application is hereby Approved subject to the attached considerations:


Director, Public Works

Date

Tree Board Member

Date

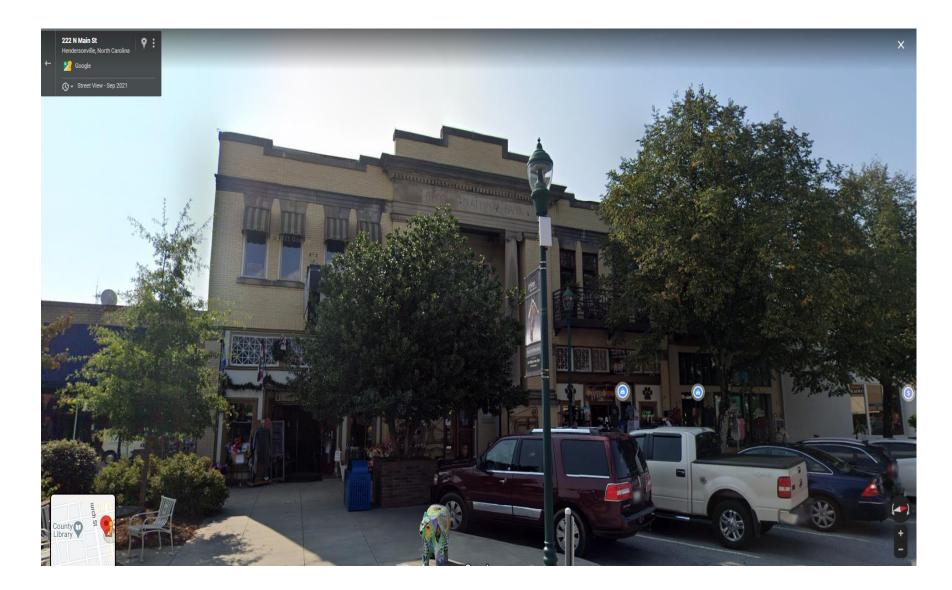

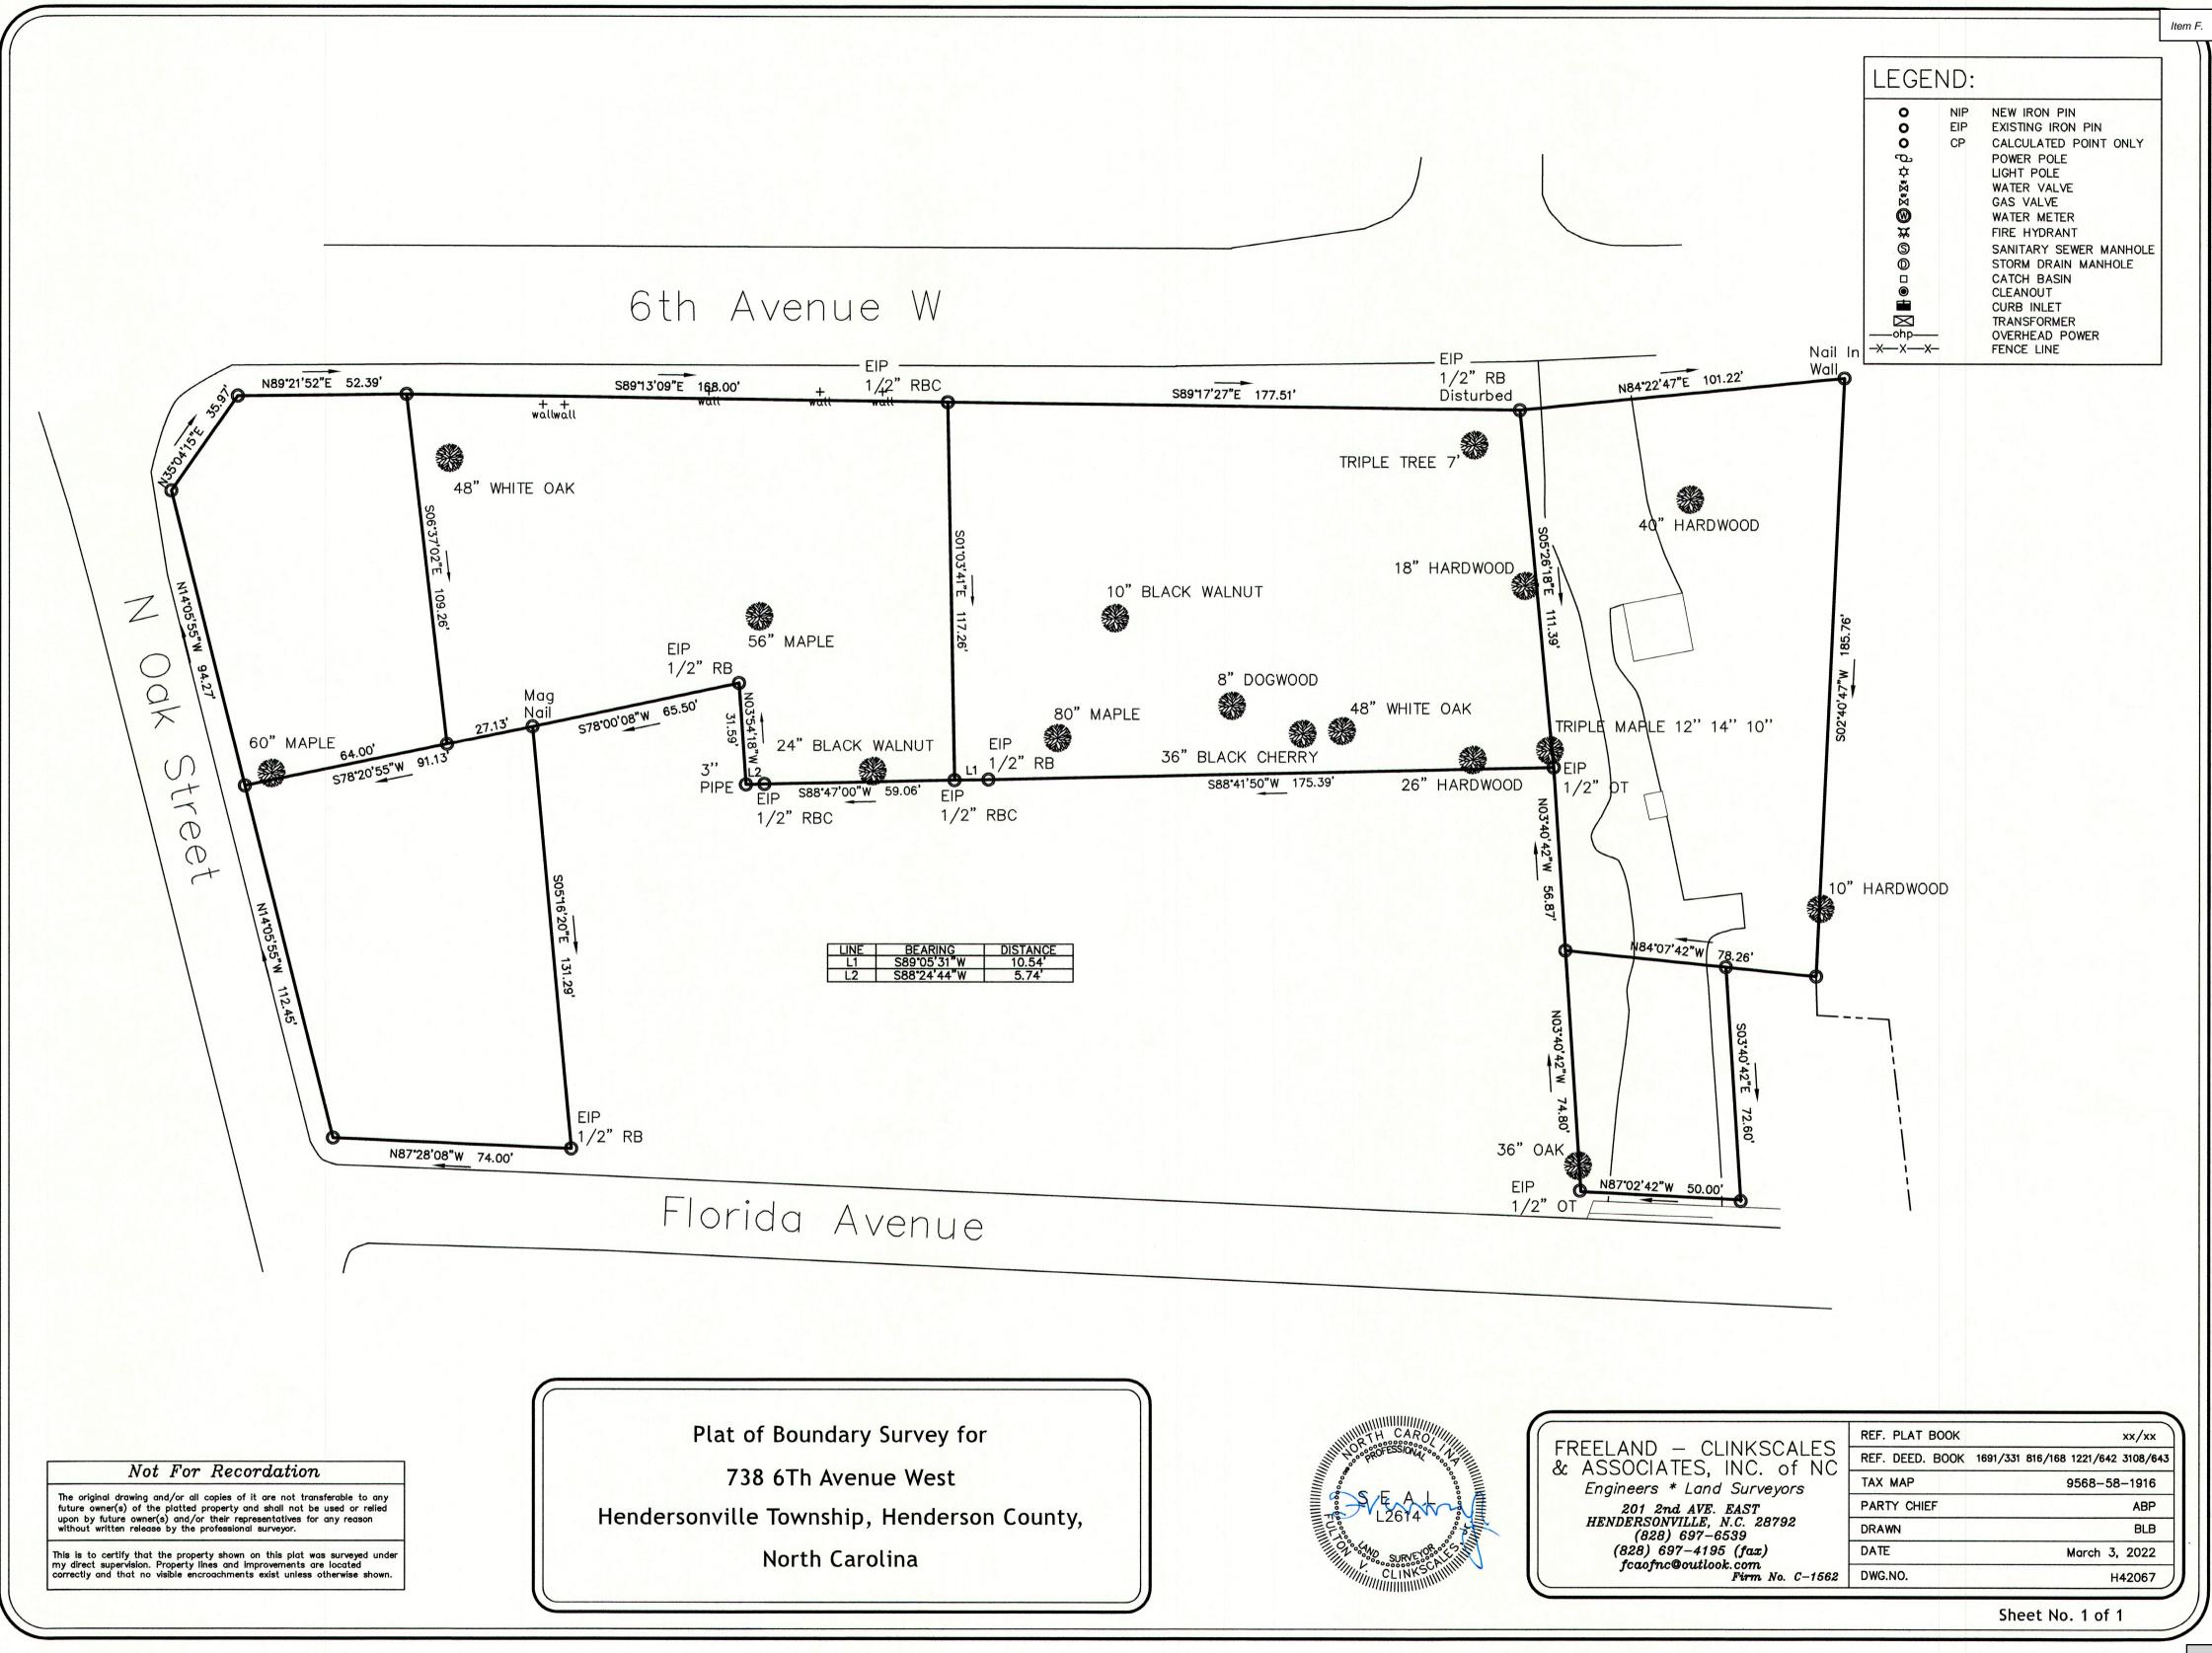



UNIT
52 T
(12) (5) (10) (8) (2) (2)
(6) (5) (1) (1)



HAWKINS POINTE

SENIOR LIVING

T MIX

Total Units:

Unit 1B	(1 BR, Type B Accessible with Tub)	660 sf
Unit 1LB	(1 BR, Type B Accessible with Tub)	672 sf
Unit 1B-C	(1 BR, Type B Accessible with Curb Shower)	660 sf
Unit 1LB-C	(1 BR, Type B Accessible with Curb Shower)	672 sf
Unit 1A W/	TUB (1 BR, Type A Accessible)	660 sf
Unit 1LA-S	W/ ROLL-IN SHOWER (1 BR, Type A Accessible)	672 sf
	(Includes Audio–Visual Impairment Accommodation Designated Unit)	ns in
Unit 2B	(2 BR, Type B Accessible with Tub)	901 sf
Unit 2B-C	(2 BR, Type B Accessible with Curb Shower)	901 sf
Unit 2A W/	TUB (2 BR, Type A Accessible)	901 sf
Unit 2A-S	W/ ROLL-IN SHOWER (2 BR, Type A Accessible)	901 sf

(Includes Audio-Visual Impairment Accommodations)

BUILDING AREAS

Total Net Area: 55,535 sf Total Gross Area: 55,841 sf

AMENITIES

Laundry Room, Mail Area, Office, Indoor Sitting Areas, Multipurpose Rm w/ Kitchen, Gazebo, Covered Patio w/ Seating, Computer Room, Balcony w/ Seating, Exercise Room


HAWKINS POINTE


Hendersonville, North Carolina


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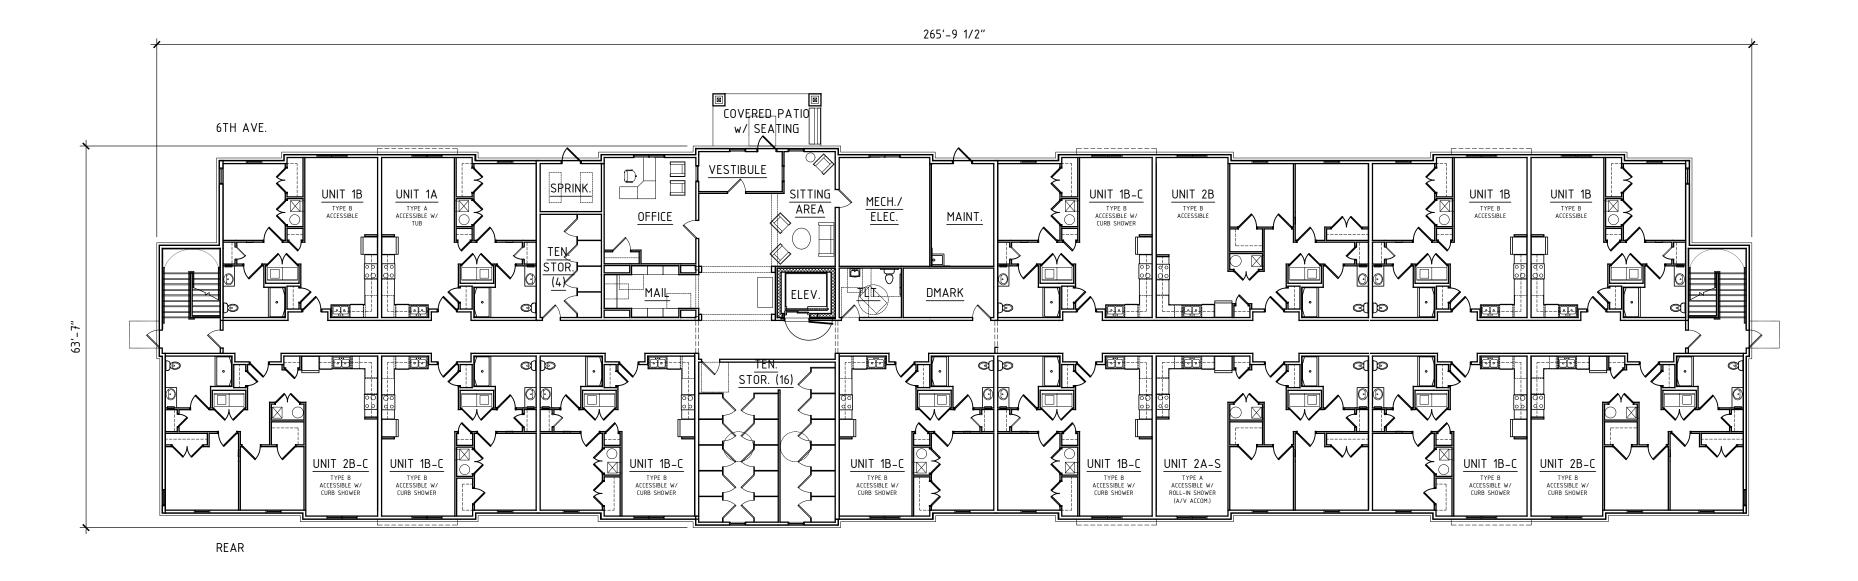
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Item F.





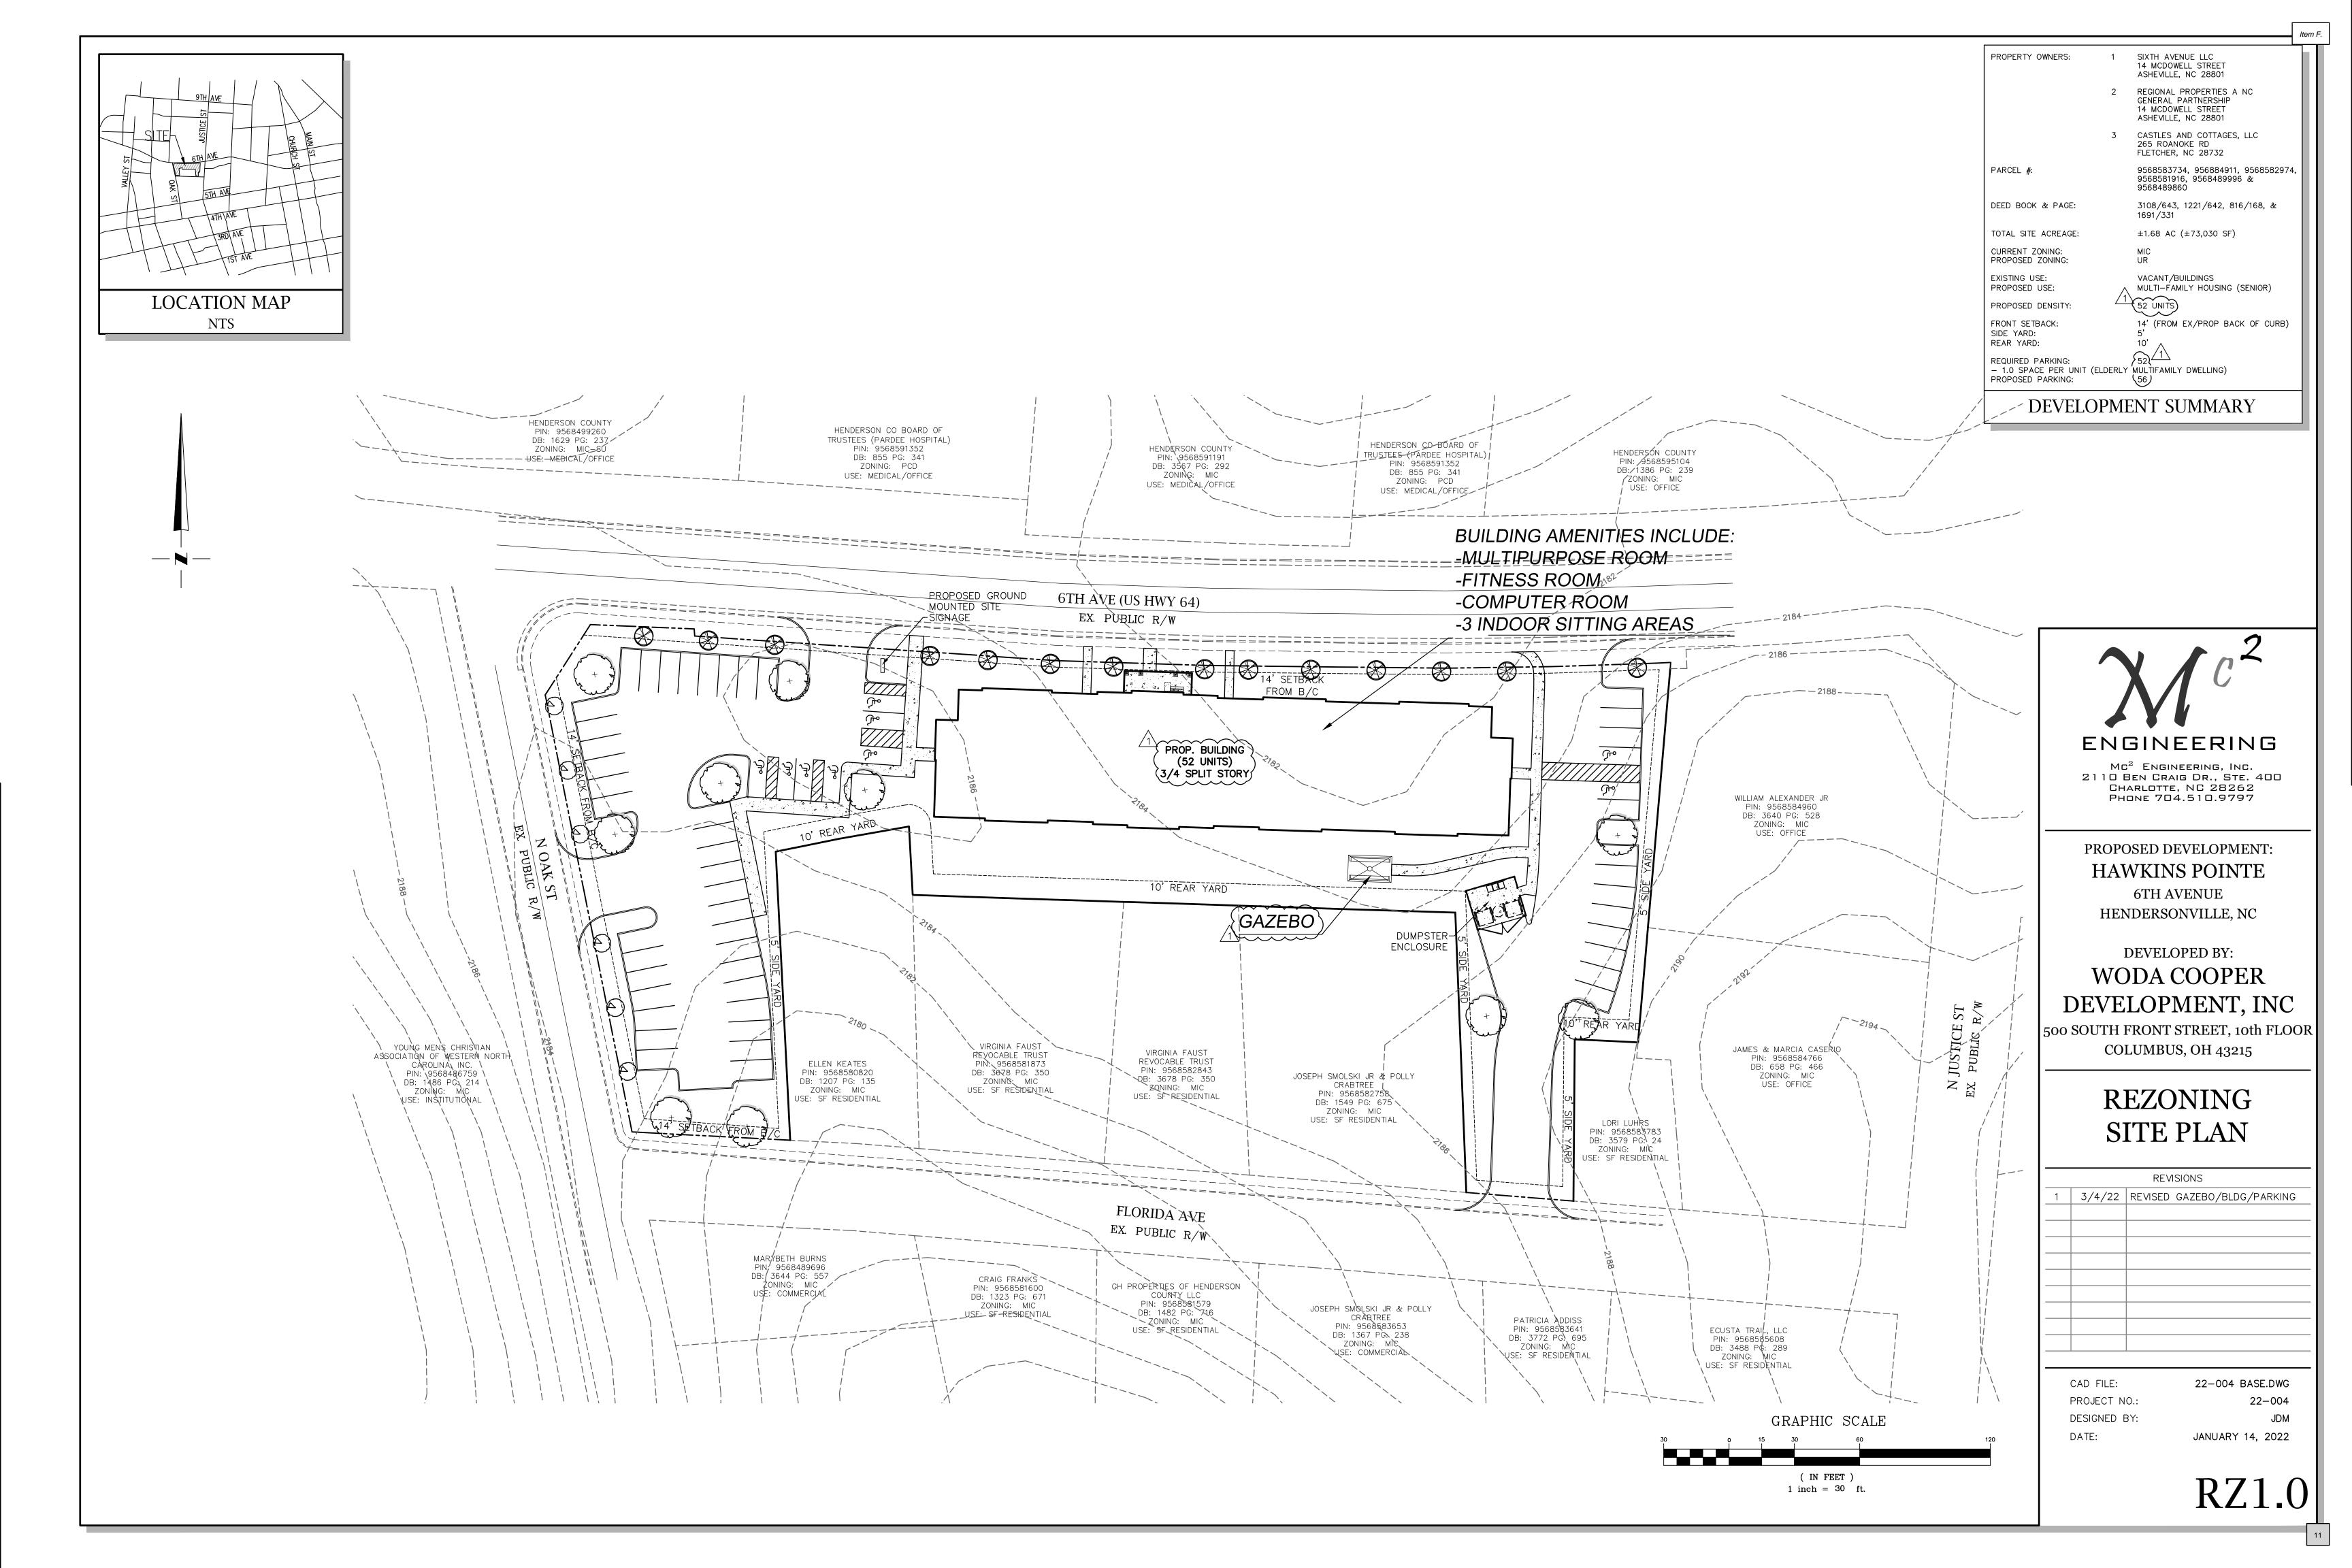

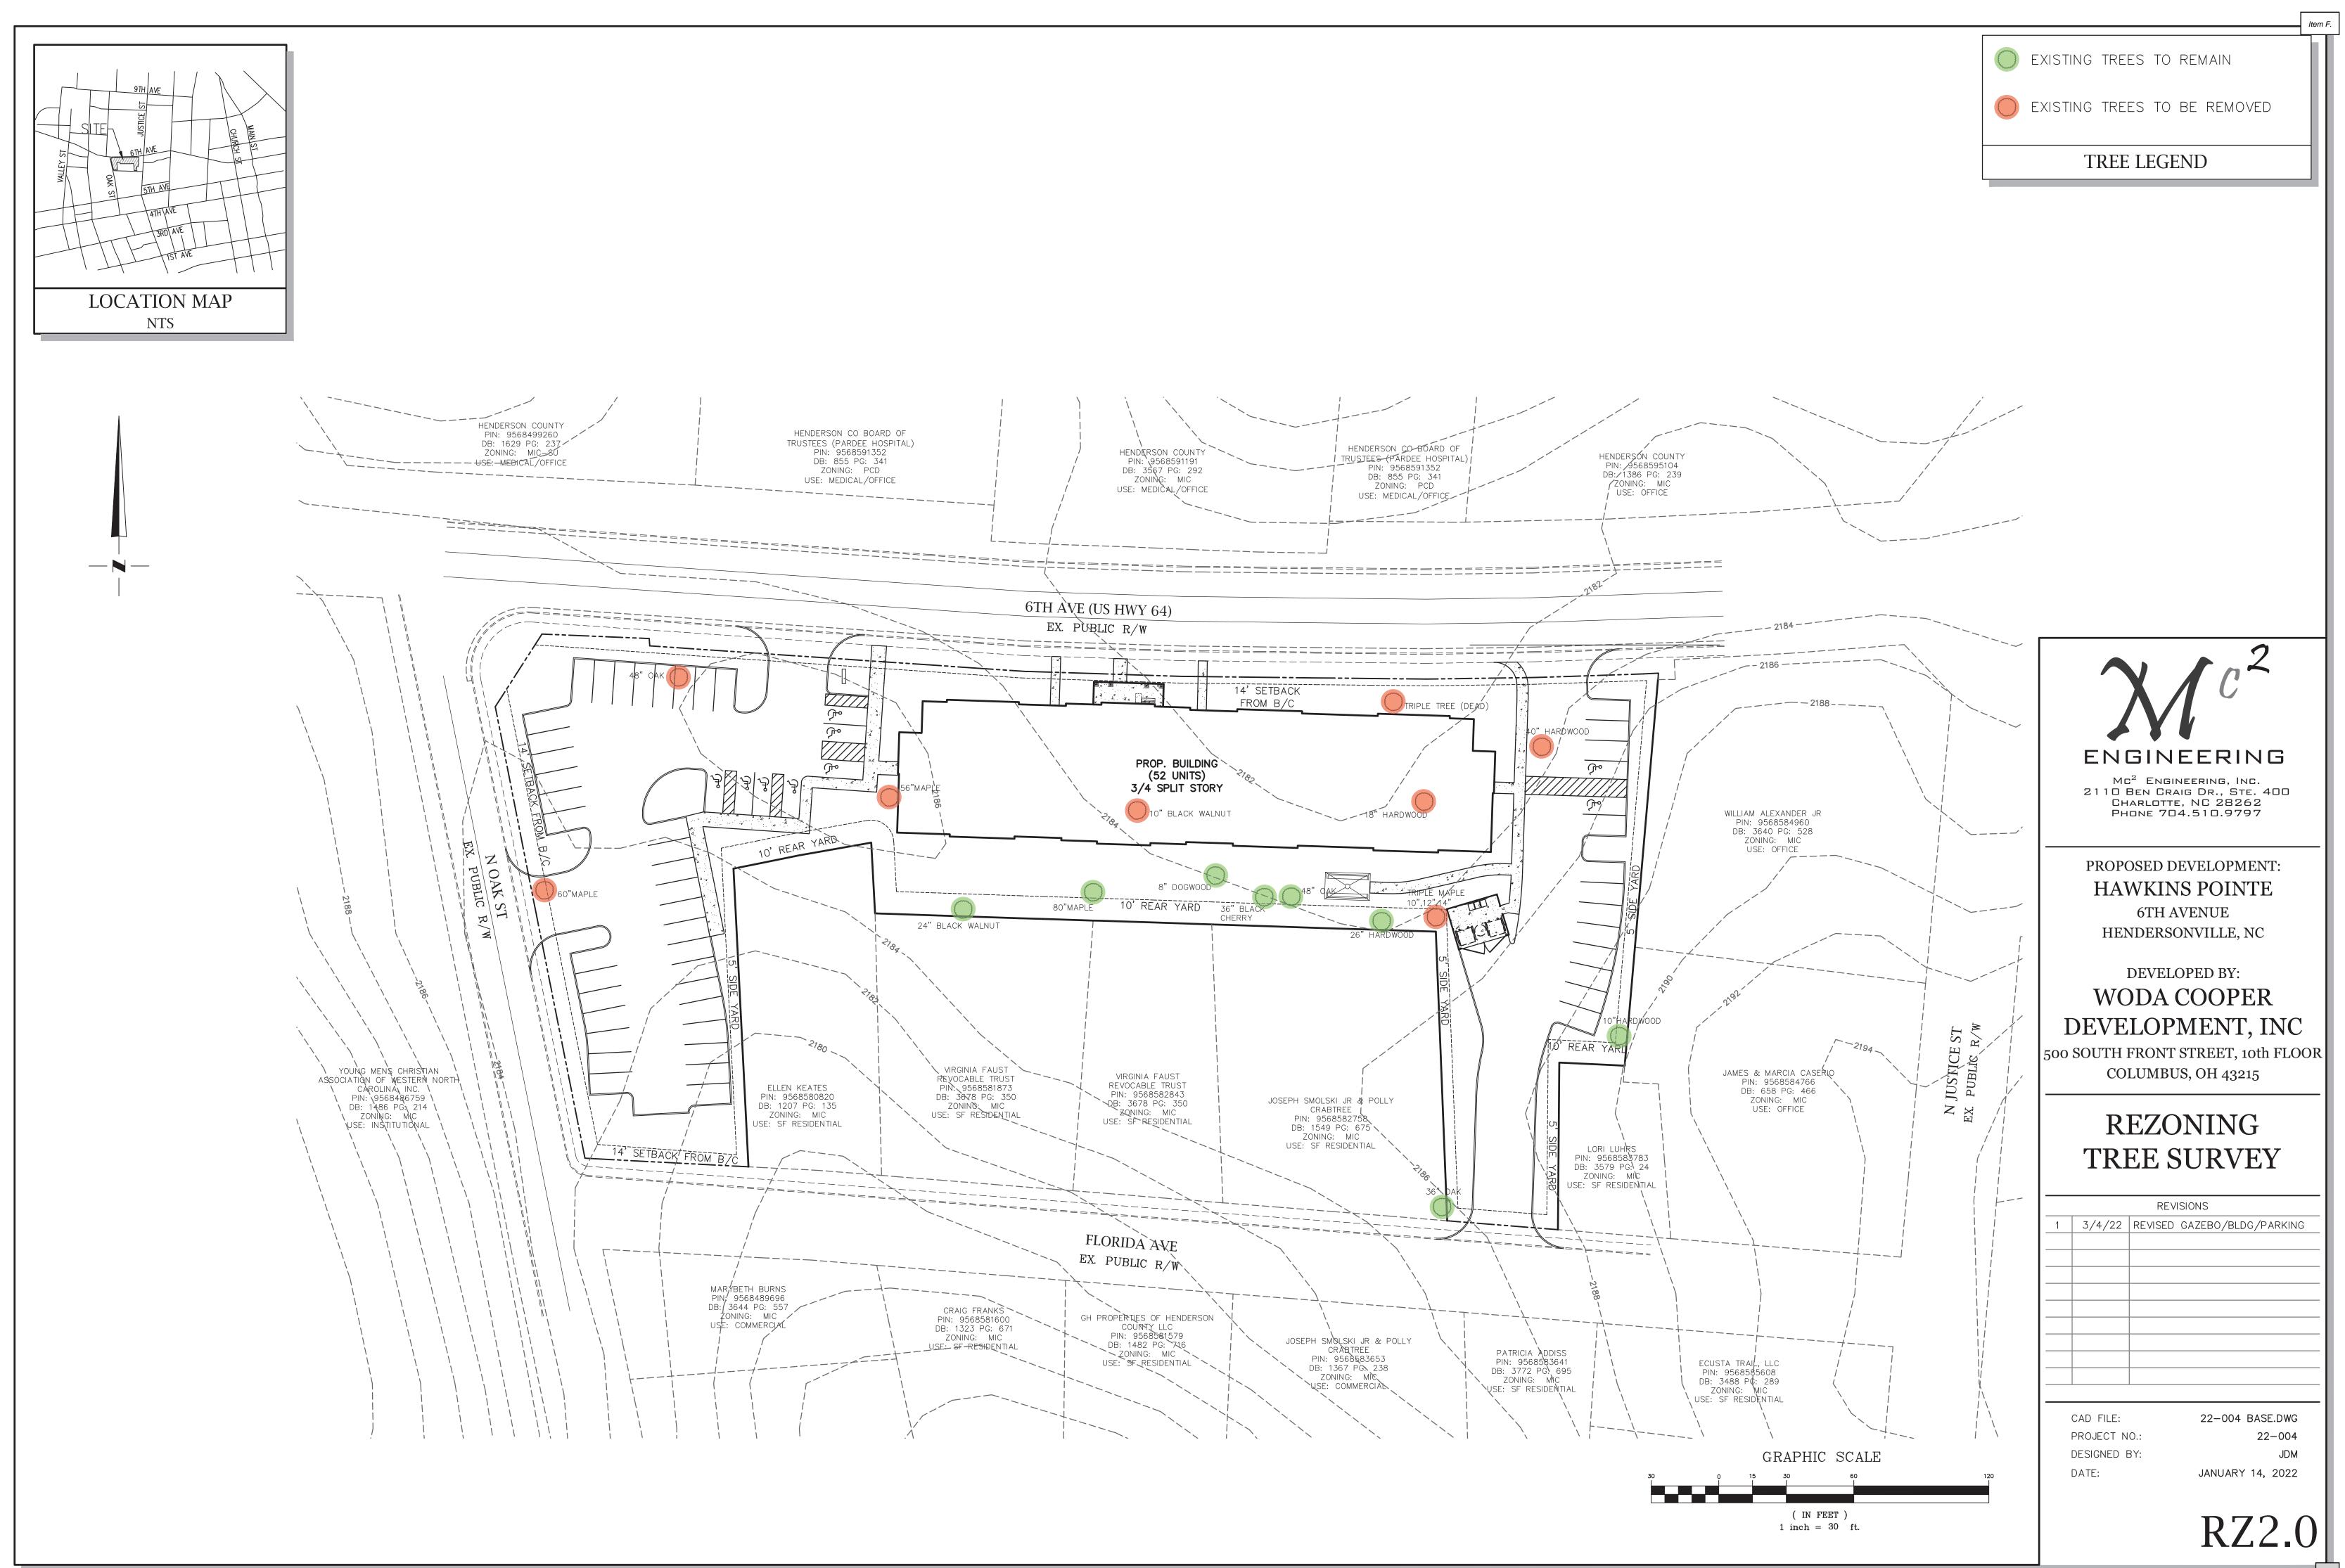

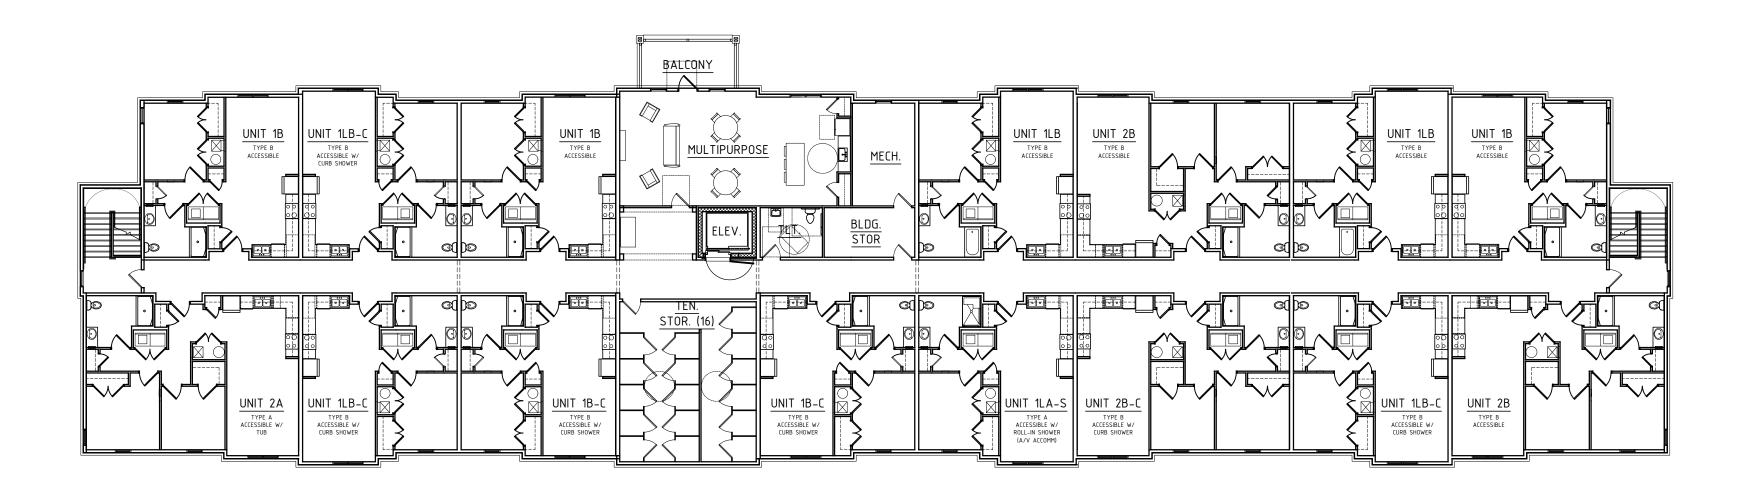

SECOND FLOOR PLAN




FIRST FLOOR PLAN


HAWKINS POINTE

Hendersonville, North Carolina

FLOOR PLANS

A1.1

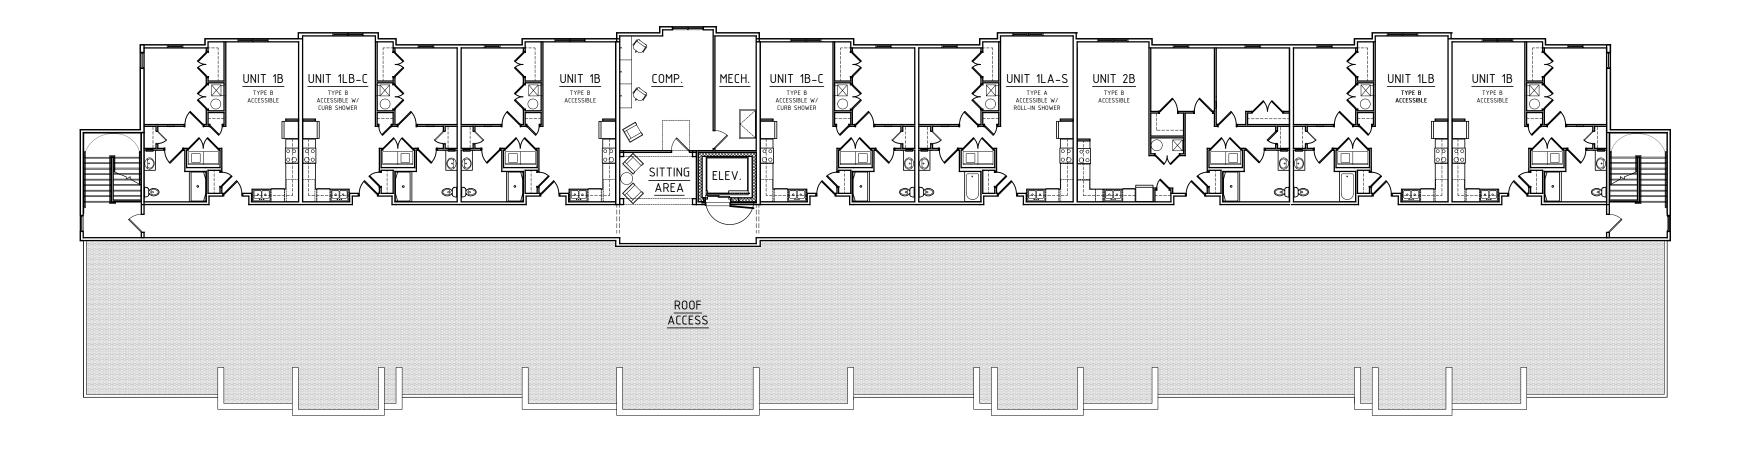

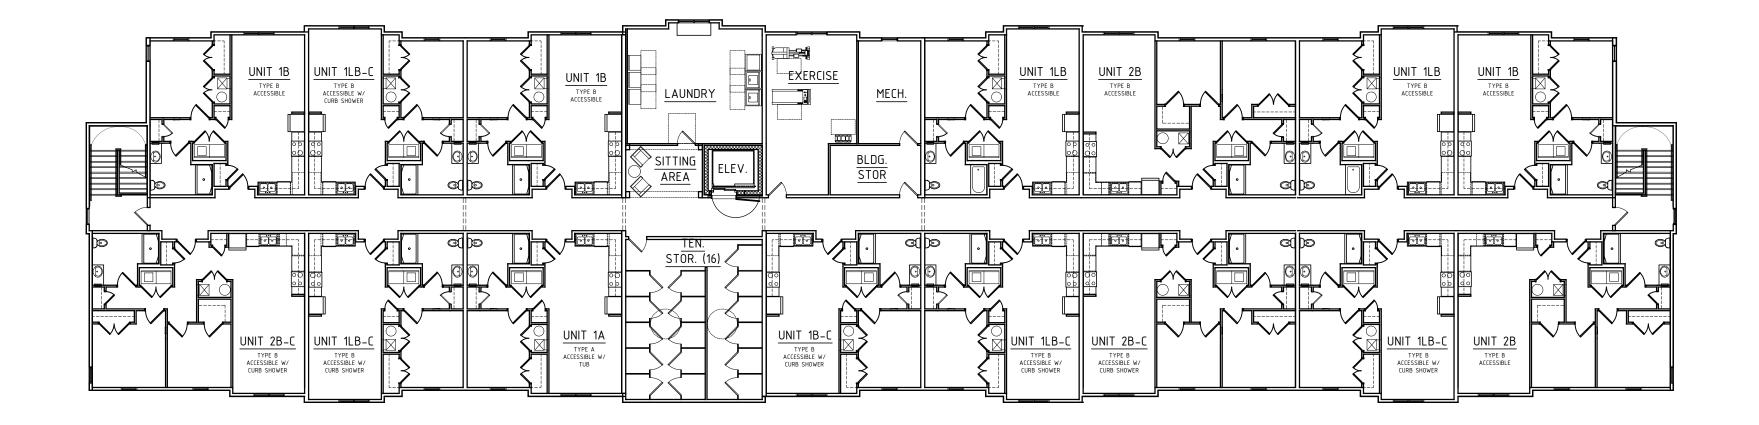



FOURTH FLOOR PLAN

THIRD FLOOR PLAN


HAWKINS POINTE

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Hendersonville, North Carolina

FLOOR PLANS A1.2



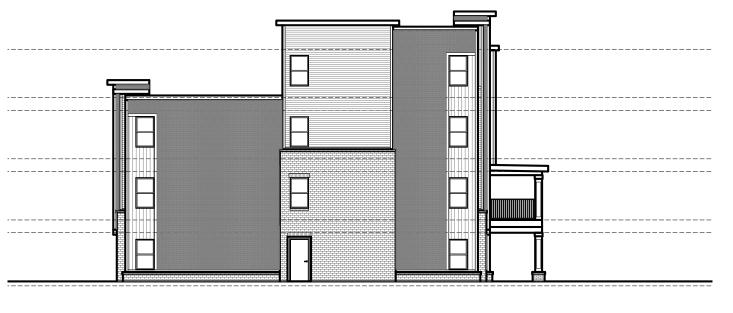

LEFT ELEVATION 1/16" = 1'-0"







REAR ELEVATION



RIGHT ELEVATION

FRONT ELEVATION (6TH AVE)

BUILDING MATERIALS:

GUTTERS & DOWNSPOUTS - ALUMINUM (WHITE)

SIDING & TRIM – VINYL LAP SIDING (TWO COLORS) AND TRIM (TYP.)

<u>ACCENT SIDING</u> - VERTICAL VINYL SIDING <u>WINDOWS</u> - VINYL W/ WIDE TRIM

MASONRY – BRICK VENEER W/ CONTINUOUS ROWLOCK CAP


COLUMNS – FIBER CEMENT BOARD & TRIM (WHITE) OVER BRICK

HAWKINS POINTE

Hendersonville, North Carolina

ELEVATIONS

A1.3

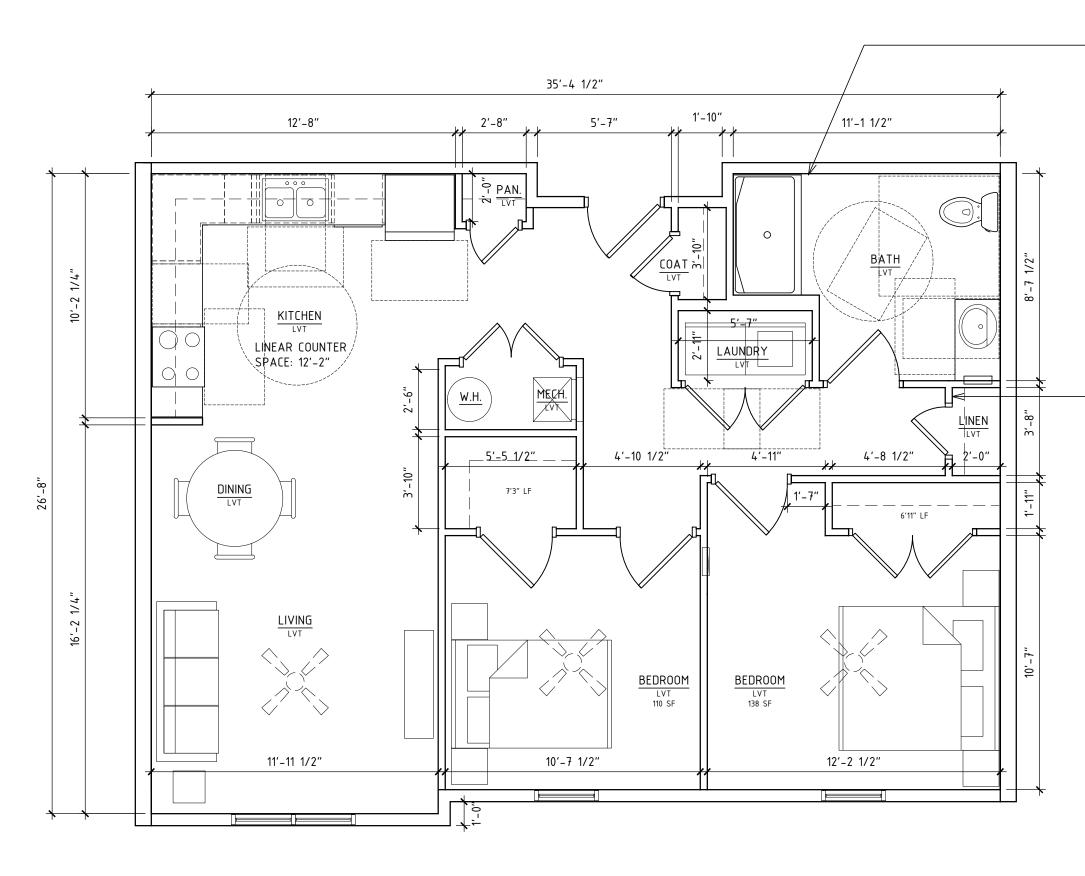

UNIT TYPE 2B, 2B-C, 2A & 2A-S - TWO BEDROOM UNIT PLAN 1/16" = 1'-0" 901 SF



NOTE: WINDOWS VARY THROUGHOUT THE BUILDING. SEE BUILDING PLANS AND ELEVATIONS FOR WINDOW SIZES AND LOCATIONS FOR EACH UNIT.

UNIT 1B-C & UNIT 2B-C TO HAVE CURB SHOWER.

UNIT 1A W/ TUB & UNIT 2A W/ TUB TO HAVE ACCESSIBLE TUB WITH REMOVABLE SEAT.

UNIT 1A-S W/ ROLL-IN SHOWER & UNIT 2A-S W/ ROLL-IN SHOWER TO HAVE ACCESSIBLE 3'-0"x5'-0" ROLL-IN SHOWER.


(SEE BUILDING PLANS FOR UNIT DESIGNATIONS.)

- UNIT 1B & 1B-C TO HAVE (1) 2'-0" DOOR AT LINEN CLOSET

UNIT 1A & 1A-S TO HAVE (2) 1'-6" DOORS AT LINEN CLOSET

UNIT 1B & 1B-C TO HAVE (1) 2'-0" CLOSET

UNIT 1A & 1A-S TO HAVE (2) 1'-6" DOORS AT LINEN CLOSET

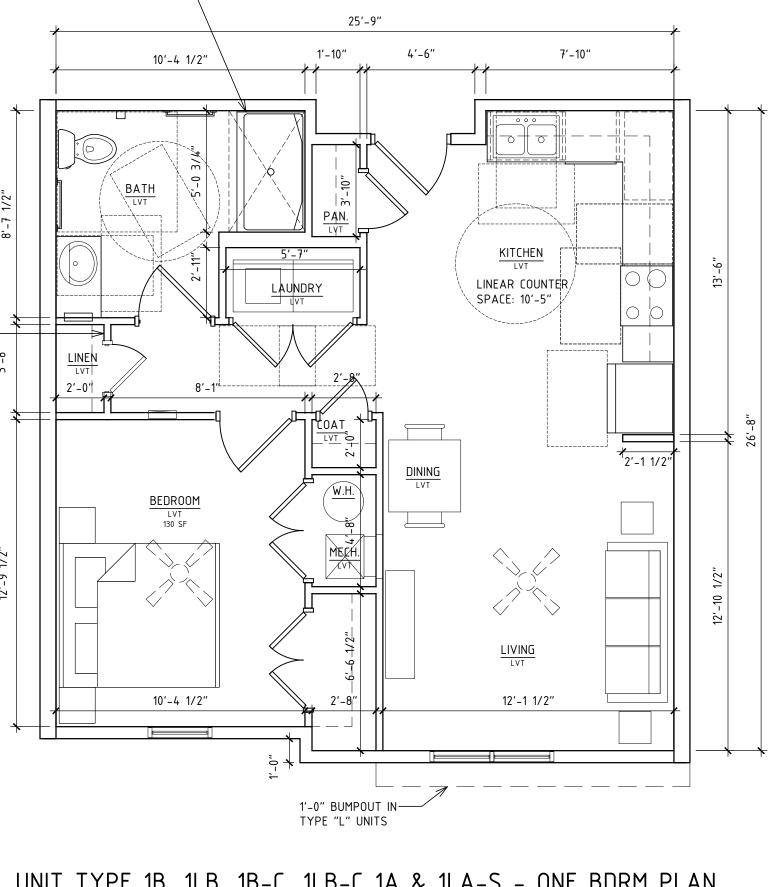

UNIT TYPE 1B, 1LB, 1B-C, 1LB-C 1A & 1LA-S - ONE BDRM PLAN 1/16" = 1'-0"

660 SF/672 SF


HAWKINS POINTE

Hendersonville, North Carolina


UNIT PLANS


A1.4


Item F.

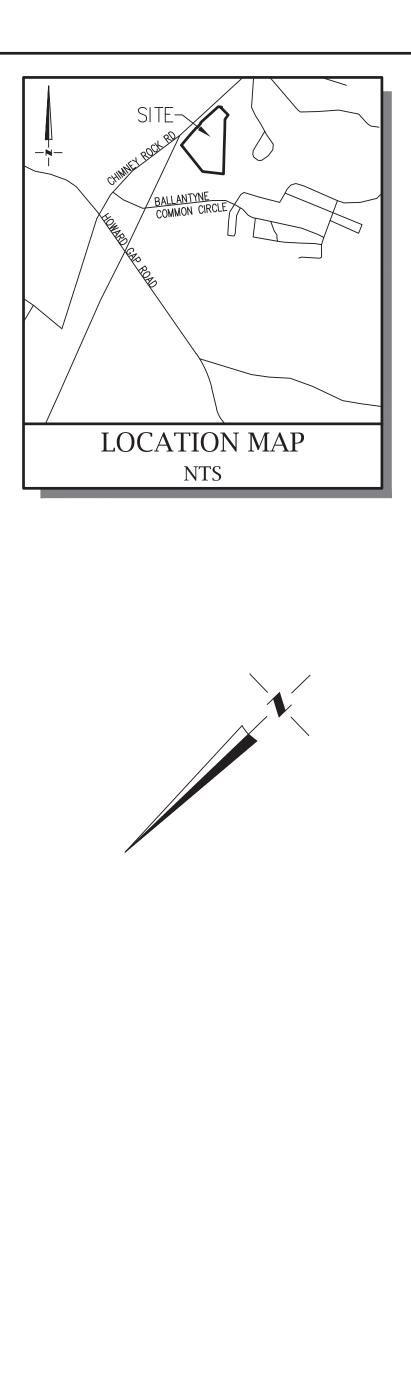



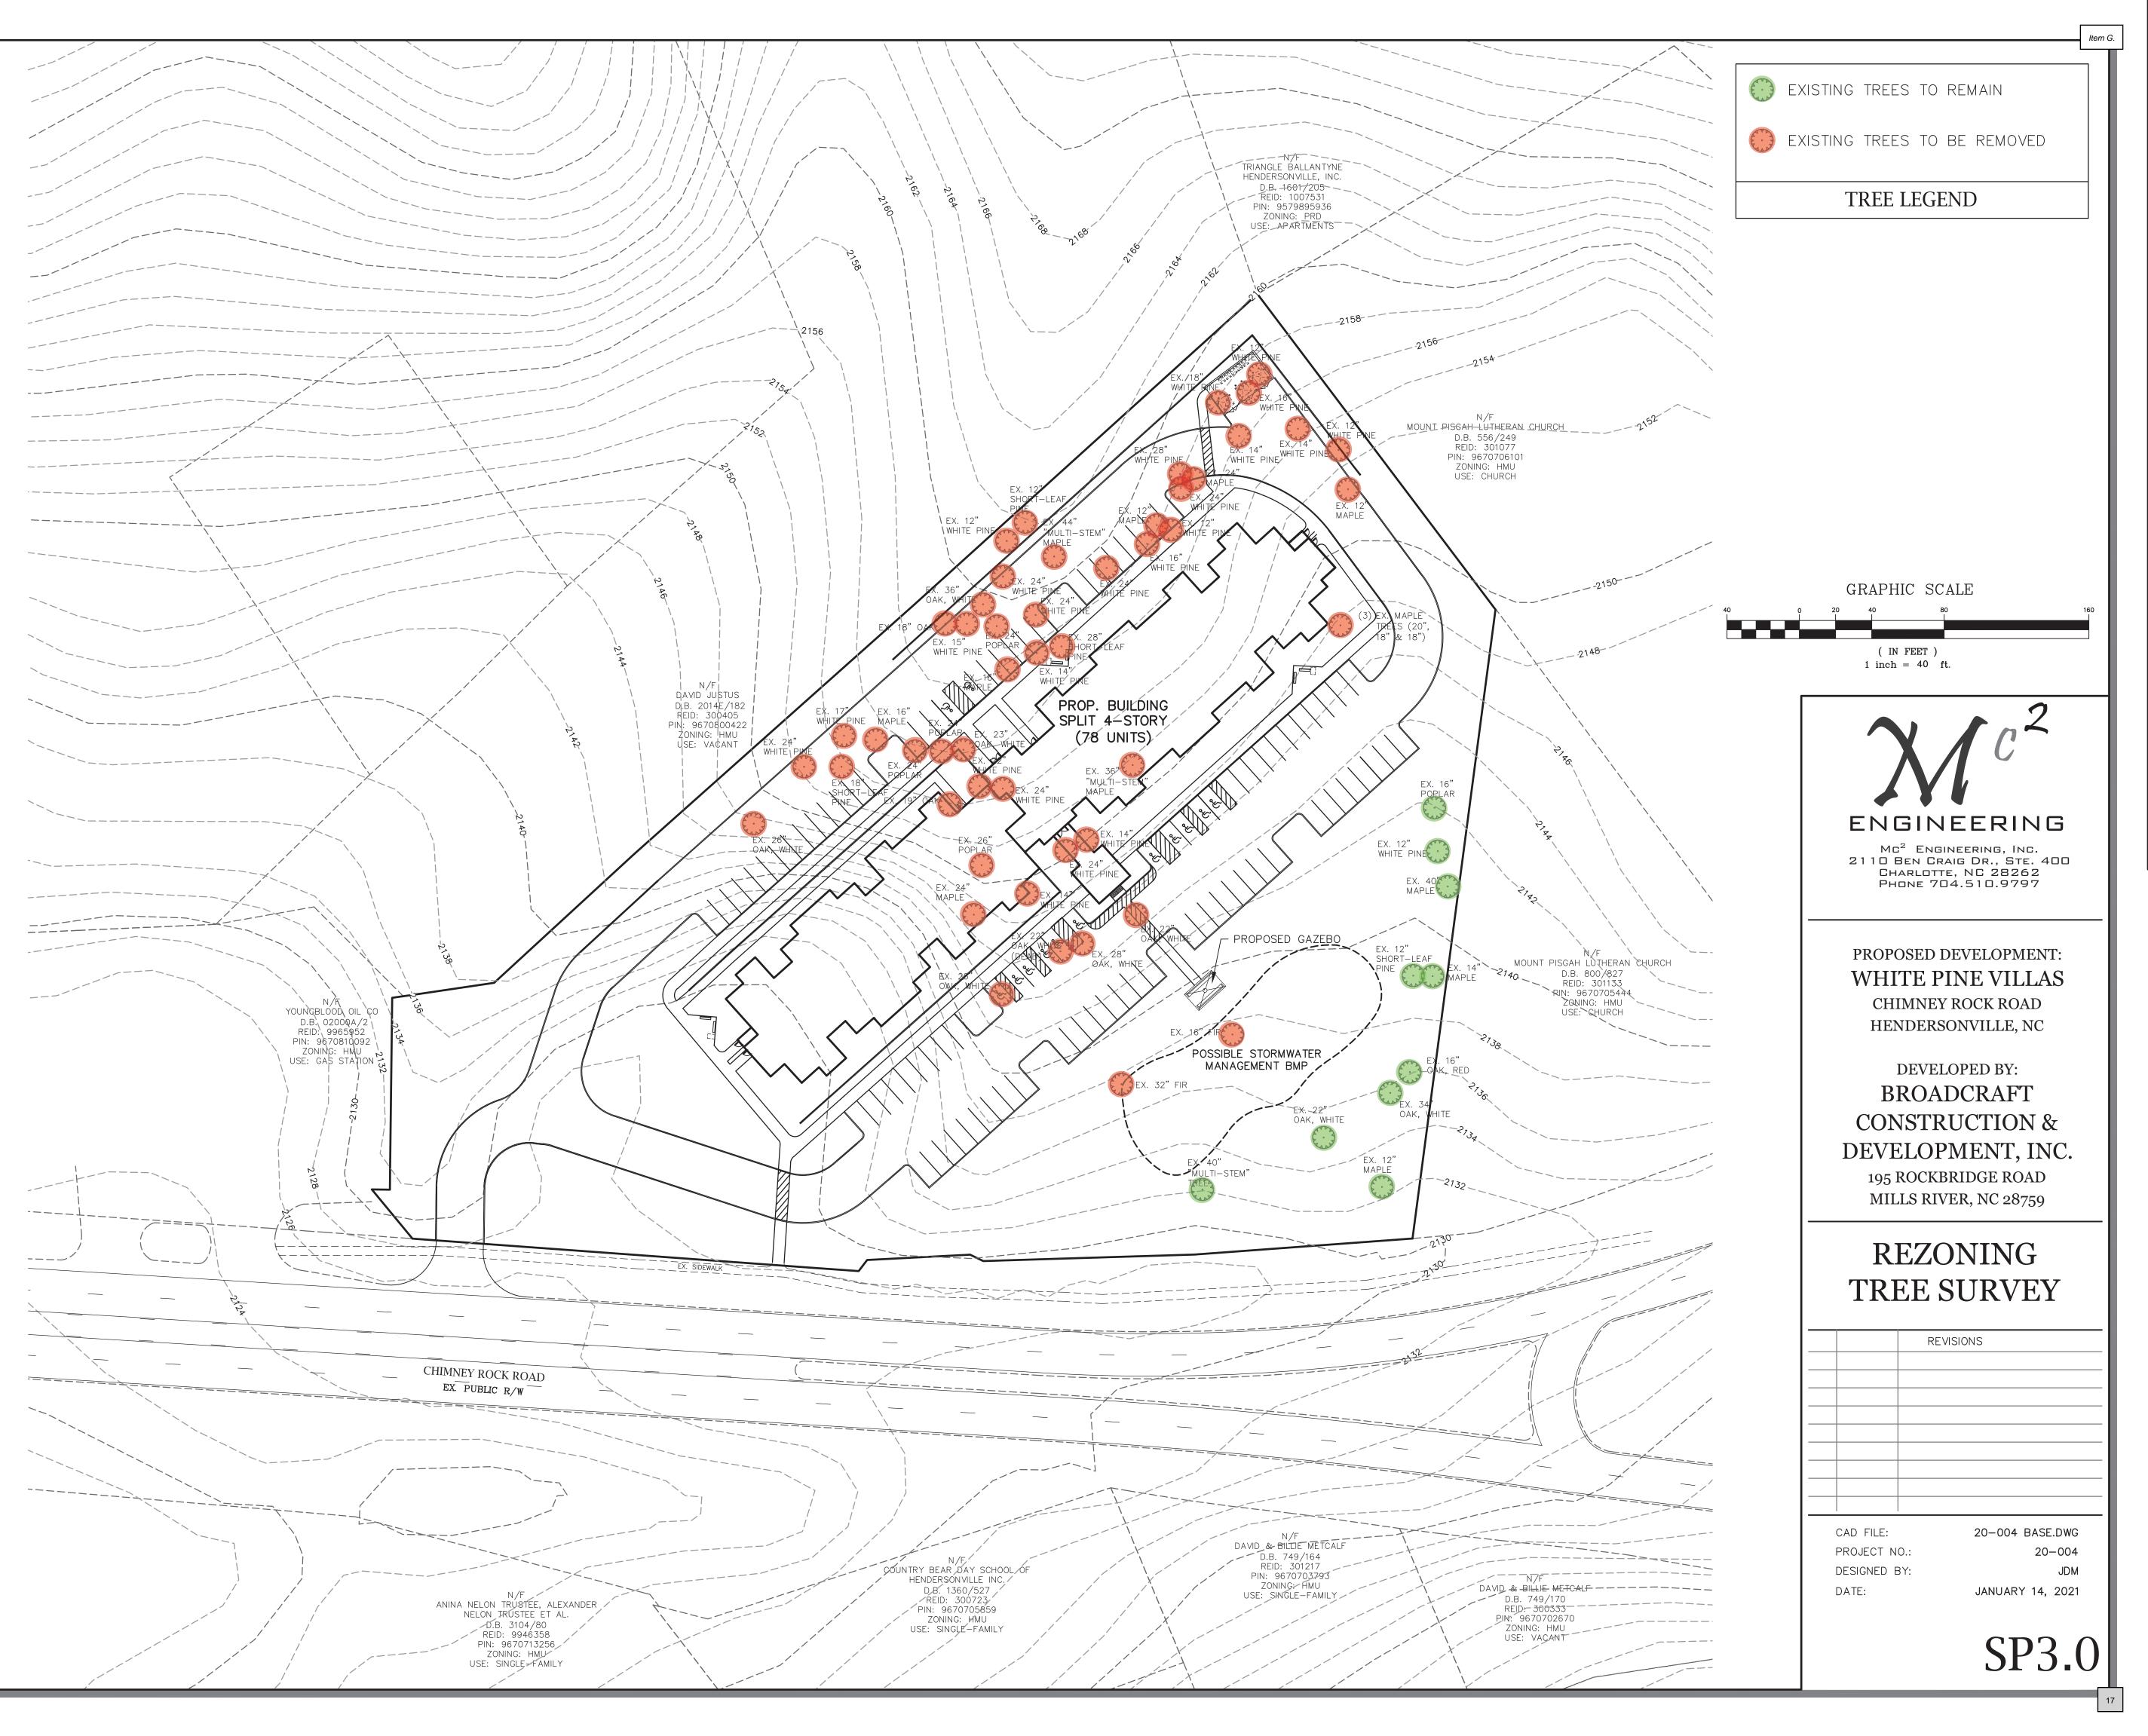

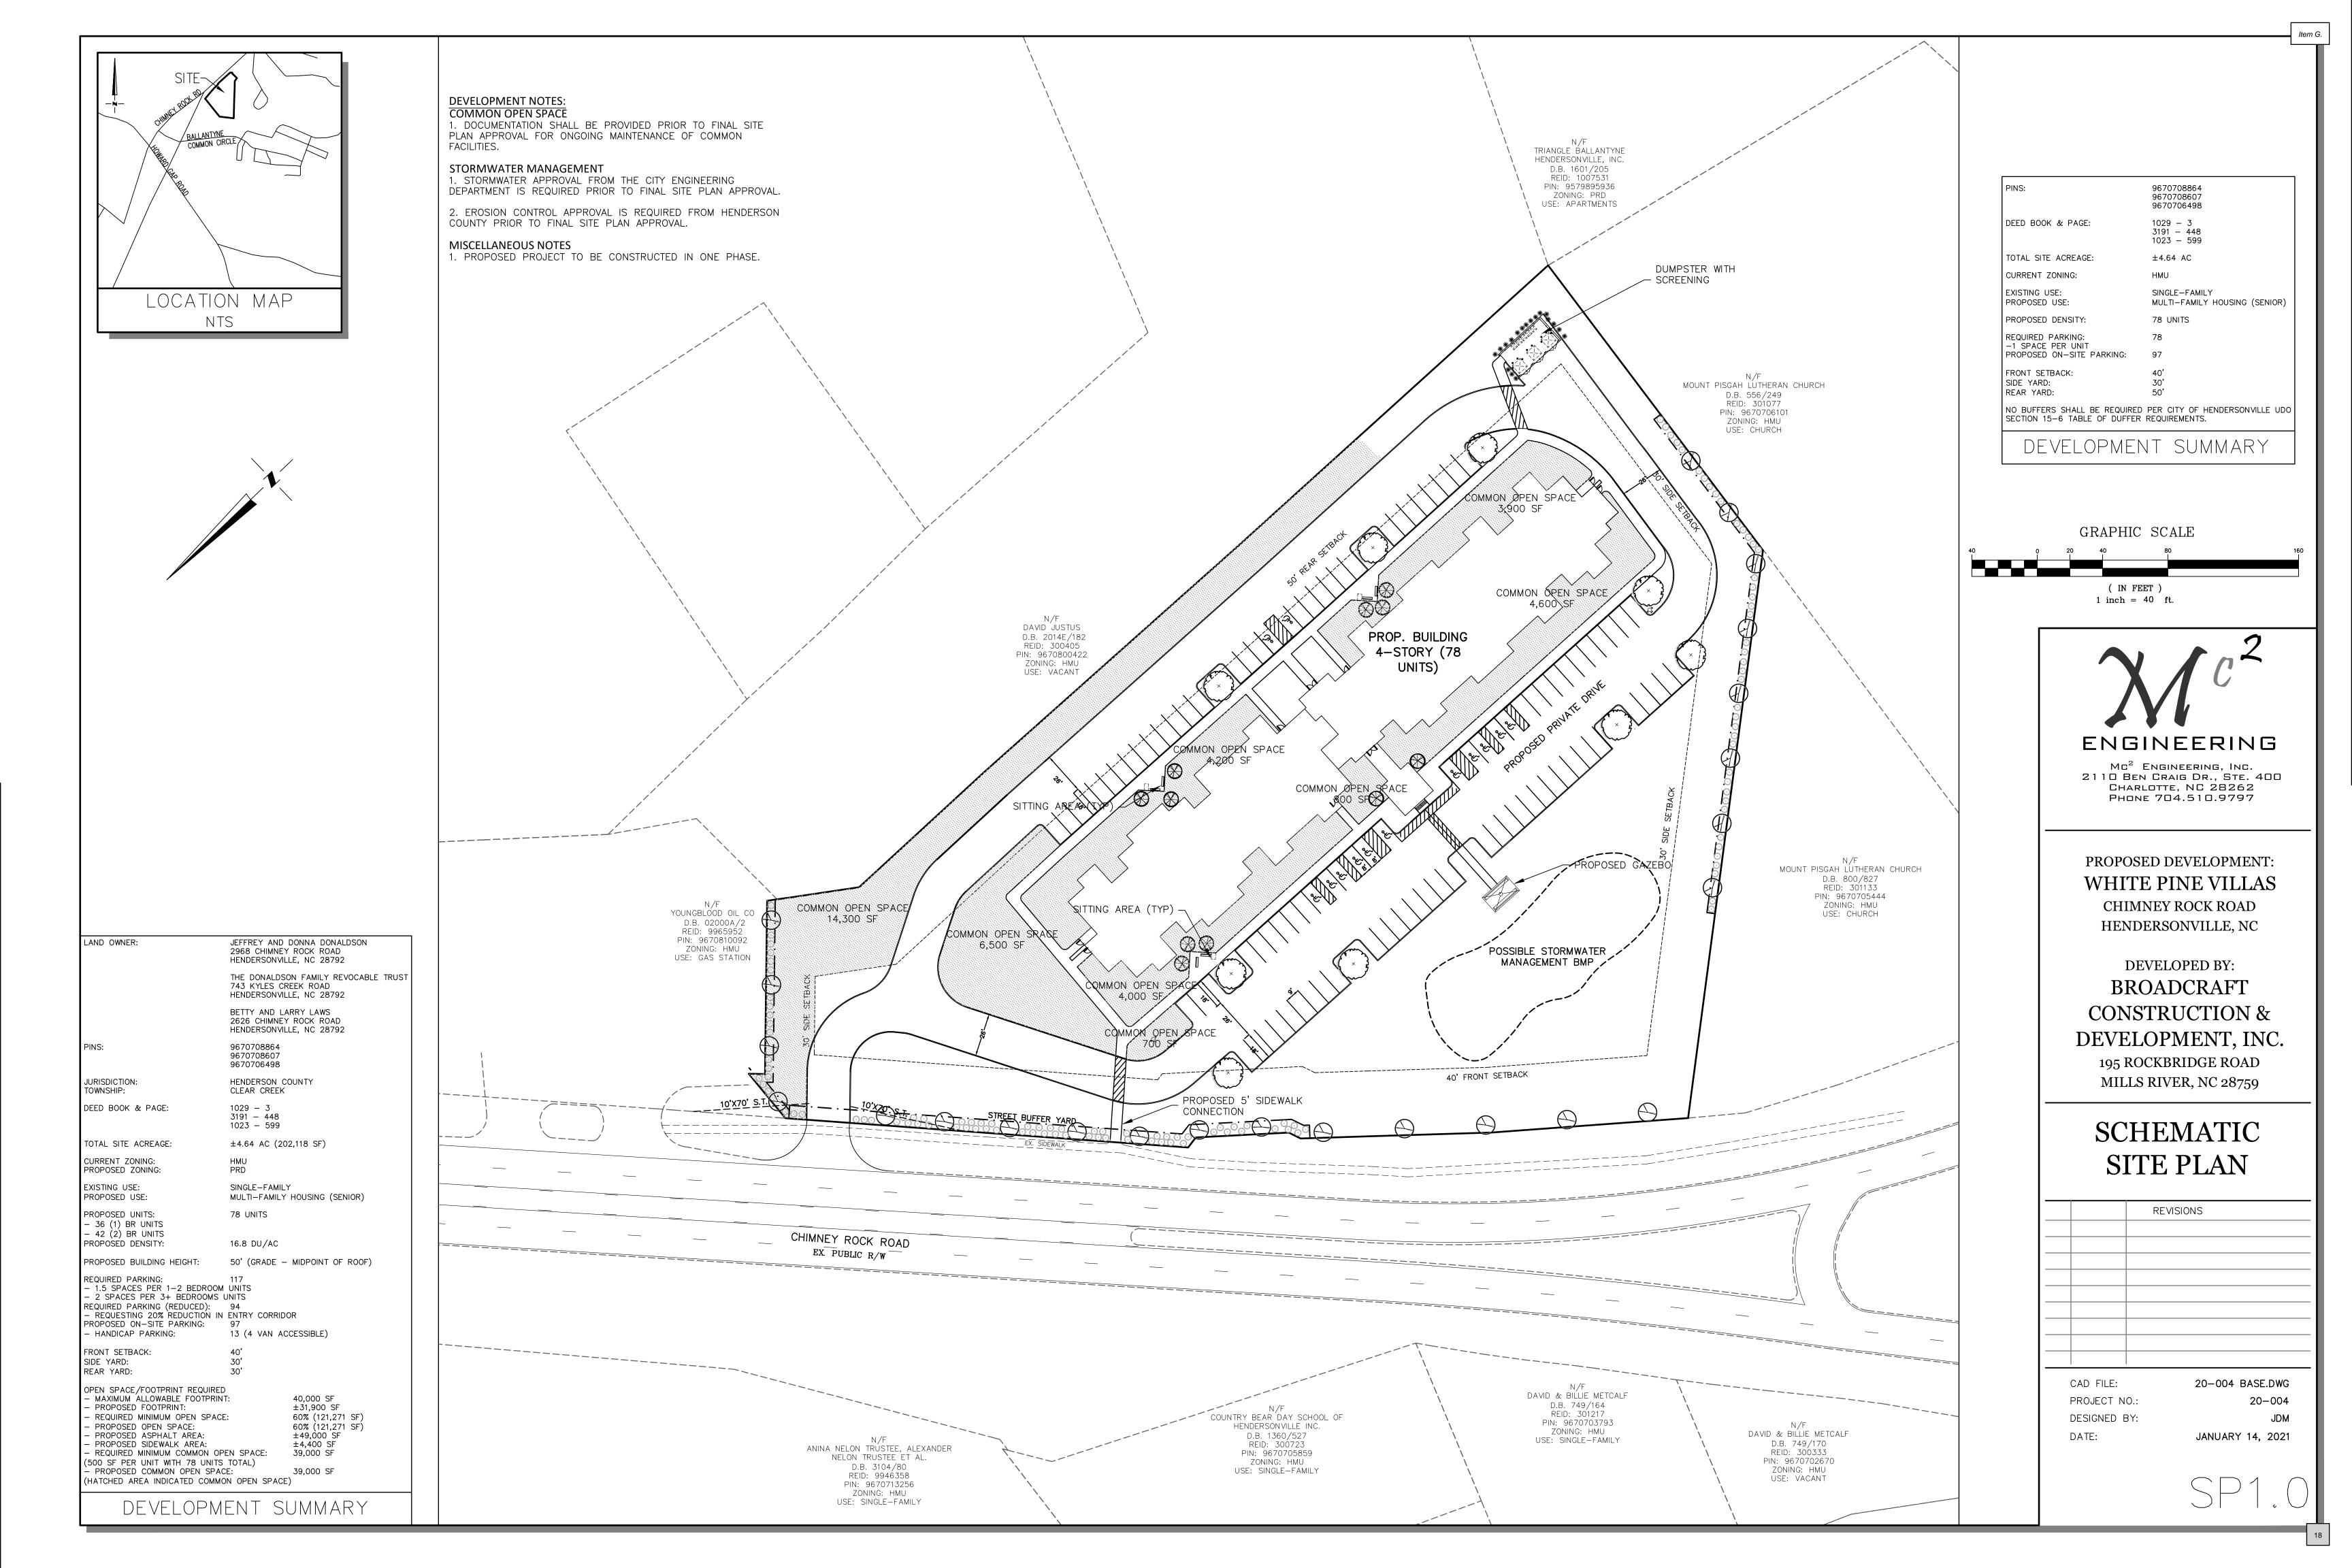

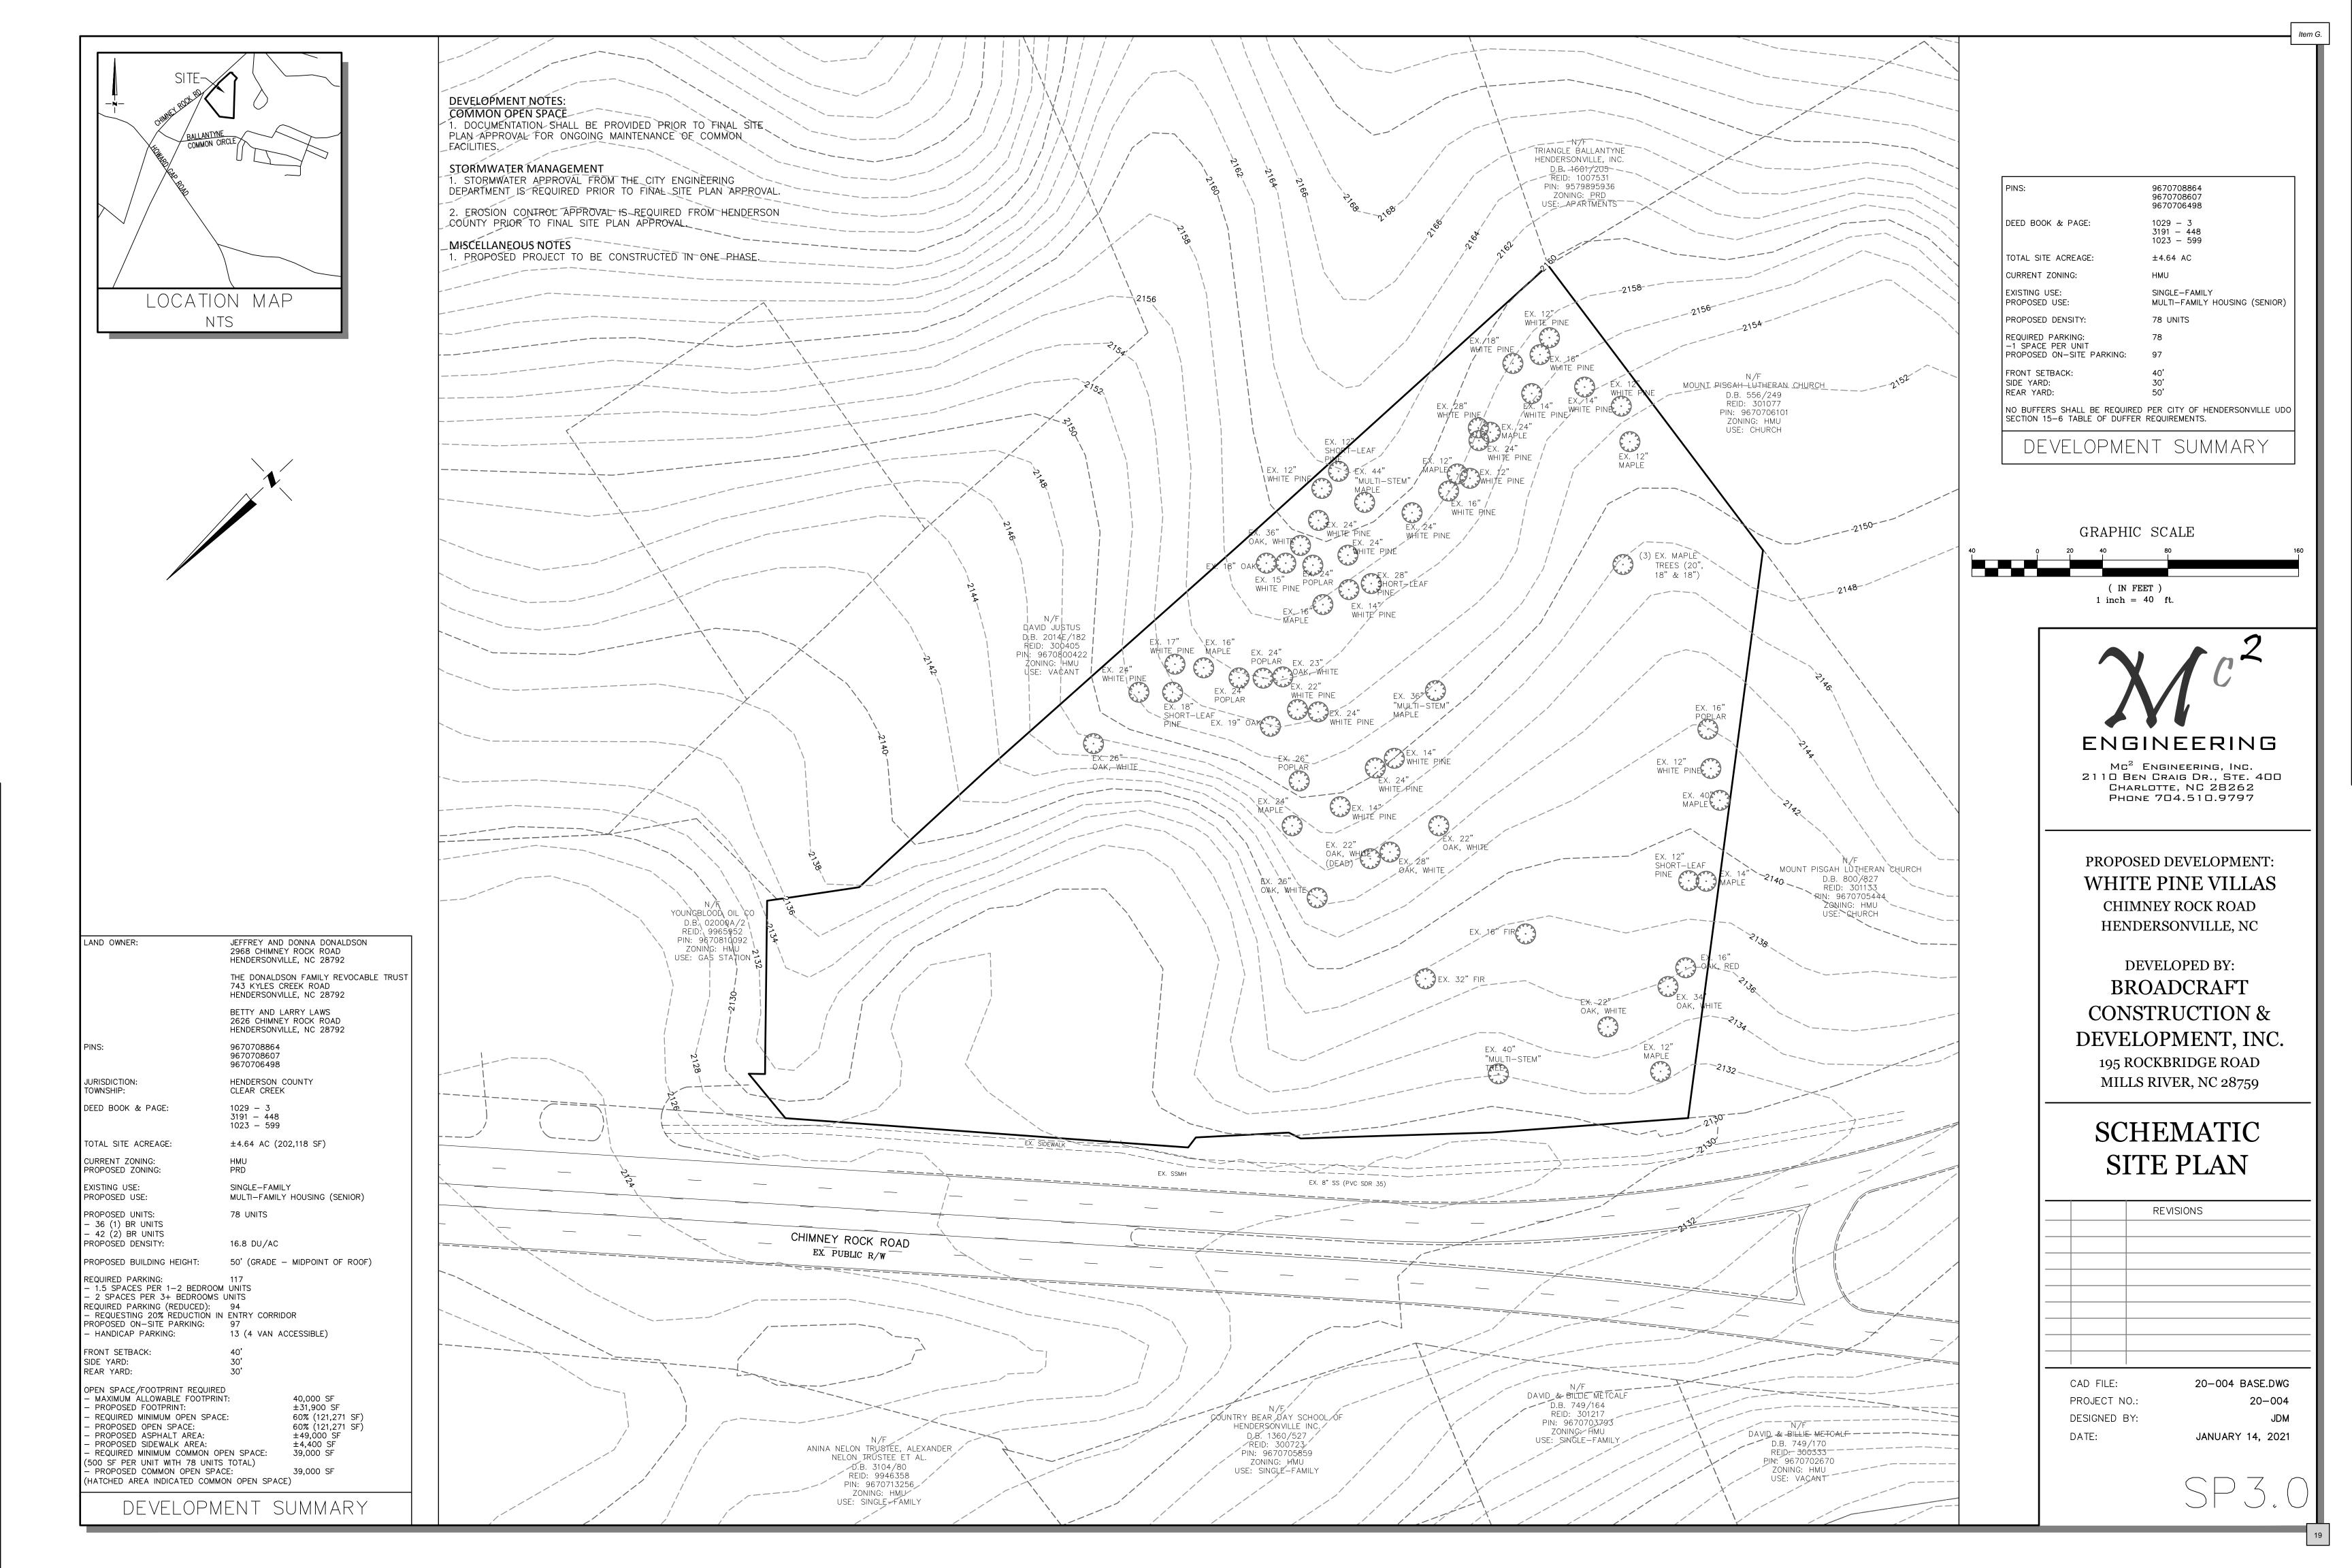



BASED ON CODE OF ORDINANCES CITY OF HENDERSONVILLE, NC - SECTION 15-6: BUFFERYARDS TABLE OF BUFFER REQUIREMENTS • PROPOSED LAND USE

- RESIDENTIAL DWELLING,
- MULTI-FAMILY PRD

ADJACENT LAND USE

- NE PROPERTY -TELECOMMUNICATIONS TOWER
- C3 COMMERCIAL
- (NO BUFFERYARD REQUIRED) SE ADJACENT PROPERTY-
- CHURCH (R20 RESIDENTIAL)
- (NO BUFFERYARD REQUIRED)
- ALL OTHER ADJACENT LAND USE ABUTS ROADWAYS

PARKING LANDSCAPE REQUIREMENTS

BASED ON CODE OF ORDINANCES CITY OF HENDERSONVILLE , NC - SECTION 15-9: LANDSCAPING FOR VEHICULAR USE AREAS

- A) PERIMETER AND INTERIOR PLANTINGS
 1 TREE AND 2 SHRUBS PER 4,000 SQ. FT. OF VEHICULAR USE AREA
 • AT LEASE 75% OF THE REQUIRED PARKING.
- AT LEASE 75% OF THE REQUIRED PARKING LOT TREES MUST BE BROADLEAF CANOPY TREES.
- TOTAL VEHICULAR USE AREA 75,009 SF
 75,435 SF / 4,000 SF = 19 TREES REQUIRED
- 38 SHRUBS REQUIRED - 20 CANOPY TREES PROVIDED 100% - 0 NON-CANOPY TREES PROVIDED 0%
- 19 TOTAL TREES PROVIDED
 59 SHRUBS PROVIDED
- B) PLANTING STRIPS
- WHEN A VEHICULAR USE AREA LOT IS LOCATED WITHIN 100 FEET OF AN ABUTTING PROPERTY AND NO BUFFERYARD IS REQUIRED, A PLANTING STRIP WHICH IS A MINIMUM OF FIVE FEET WIDE SHALL BE PLANTED BETWEEN THE VEHICULAR USE AREA AND THE ABUTTING PROPERTY.
- ONE LARGE EVERGREEN OR DECIDUOUS TREE AND FIVE EVERGREEN OR DECIDUOUS SHRUBS SHALL BE PLANTED FOR EVERY 40 LINEAR FEET OF PROPERTY LINE THAT PARALLELS THE VEHICULAR USE AREA.
- TOTAL LF OF ADJACENT PROPERTY 269 LF
- 269 LF / 40 LF = 7 LARGE TREES REQUIRED
 34 SHRUBS REQUIRED
 8 LARGE TREES PROVIDED
- 34 SHRUBS PROVIDED

SCALE: 1"=50'

PLANT SCHEDULE

C) BUFFERING FROM STREET

LE BUR

QUE TLA

B & B - 1 ILE SCH

3 gal - 8

C 1429

- VEHICULAR USE AREAS GREATER THAN 4,000 FT2 ANY PORTION OF WHICH IS LOCATED WITHIN 50 FEET OF THE RIGHT-OF-WAY OF A STREET MUST BE BUFFERED FROM THE STREET.
- THE BUFFER SHALL BE AT LEAST THREE FEET HIGH AT MATURITY AND CAN CONSIST OF PLANT MATERIAL ALONE.

В&В-

ULM CKV 🤉

B&B-1

EUO FOR

4"pot - 162

STORMWATER

ANAGEMEN


EUO FOR

- 4"pot - 140

- A VEGETATIVE BUFFER SHALL CONSIST OF AT LEAST ONE EVERGREEN OR DECIDUOUS SHRUB PLANTED FOR EVERY FIVE LINEAR FEET OF BUFFER REQUIRED.
- TOTAL LF OF ADJACENT PROPERTY 72 LF
 72 LF / 5 LF = 15 SHRUBS REQUIRED
- 15 SHRUBS PROVIDED

IREES	<u>OTY</u>	BOTANICAL / COMMON NAME	CONT	CAL	<u>SIZE</u>
ACE OCG	6	ACER RUBRUM `OCTOBER GLORY` / OCTOBER GLORY MAPLE	B&B	2" CAL.	
COR R57	12	CORNUS X 'RUTCAN' TM / CONSTELLATION FLOWERING DOGWOOD	15 GAL		6` MIN
	3 3	CRYPTOMERIA JAPONICA "RADICANS" / RADICANS CRYPTOMERIA	15 GAL		6° MIN
JUN BUR	3 8		15 GAL		6` MIN
QUE TLA	8 12		B&B	2"CAL	
thu eme Ulm pri	12 8		7 GAL	2"CAL	
			B&B		
	6	ULMUS PARVIFOLIA 'SMALL FRYE' / 'SMALL FRYE'	B&B	2" CAL.	
VIT SHO	12	VITEX AGNUS-CASTUS 'SHOAL CREEK' / SHOAL CREEK CHASTE TREE	7 GAL		6` MIN
SHRUBS	QTY	BOTANICAL / COMMON NAME	CONT	SIZE	
ABE LIR	60	ABELIA X GRANDIFLORA `LITTLE RICHARD` / LITTLE RICHARD ABELIA	3 GAL		
AZA A16	98	AZALEA X 'ROBLED' TM / AUTUMN CHIFFON ENCORE AZALEA	3 GAL		
CAM THE	12	Camellia Japonica `White by the gate` / White by the gate camellia	7 GAL		
CEP FAS	72	CEPHALOTAXUS HARRINGTONIA `FASTIGIATA` / COLUMNAR PLUM YEW	3 GAL		
CHA DWH	24	Chamaecyparis obtusa `dwarf hinoki` / dwarf hinoki false cypress	5 GAL		
DIS MYR	116	DISTYLIUM MYRICOIDES / BLUE LEAF ISU	3 GAL		
HYD LI2	28	hydrangea paniculata `little lime` / little lime hydrangea	3 GAL		
ILE CA2	119	ILEX CORNUTA `CARISSA` / CARISSA HOLLY	3 GAL		
ILE BUR	23	ILEX CORNUTA 'BURFORDII NANA' / DWARF BURFORD HOLLY	3 GAL	18" HT. MIN.	
ILE SCH	143	ILEX VOMITORIA `SCHILLINGS DWARF` / DWARF YAUPON HOLLY	3 GAL	18" HT. MIN.	
LIR BI2	230	LIRIOPE MUSCARI `BIG BLUE` / BIG BLUE LILYTURF	1 GAL		
NAN GUL	61	NANDINA DOMESTICA 'GULF STREAM' TM / GULF STREAM HEAVENLY BAMBOO	5 GAL		
PAN SHE	12	PANICUM VIRGATUM `SHENENDOAH` / BURGUNDY SWITCH GRASS	3 GAL		
TER HLE	86	TERNSTROEMIA GYMNANTHERA 'BLTG01' TM / MONTAGUE CLEYERA	5 GAL		
Thu deg	26	THUJA OCCIDENTALIS `DEGROOT`S SPIRE` / DEGROOT`S SPIRE ARBORVITAE	7 GAL		
GROUND COVERS	QTY	BOTANICAL / COMMON NAME	CONT		
CYN DAC	155,045 SF	CYNODON DACTYLON `419` / 419 HYBRID BERMUDA GRASS	SOD		
EUO FOR	1,090	EUONYMUS FORTUNEI / WINTERCREEPER	4"POT		

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REFERENCE NOTES SCHEDULE

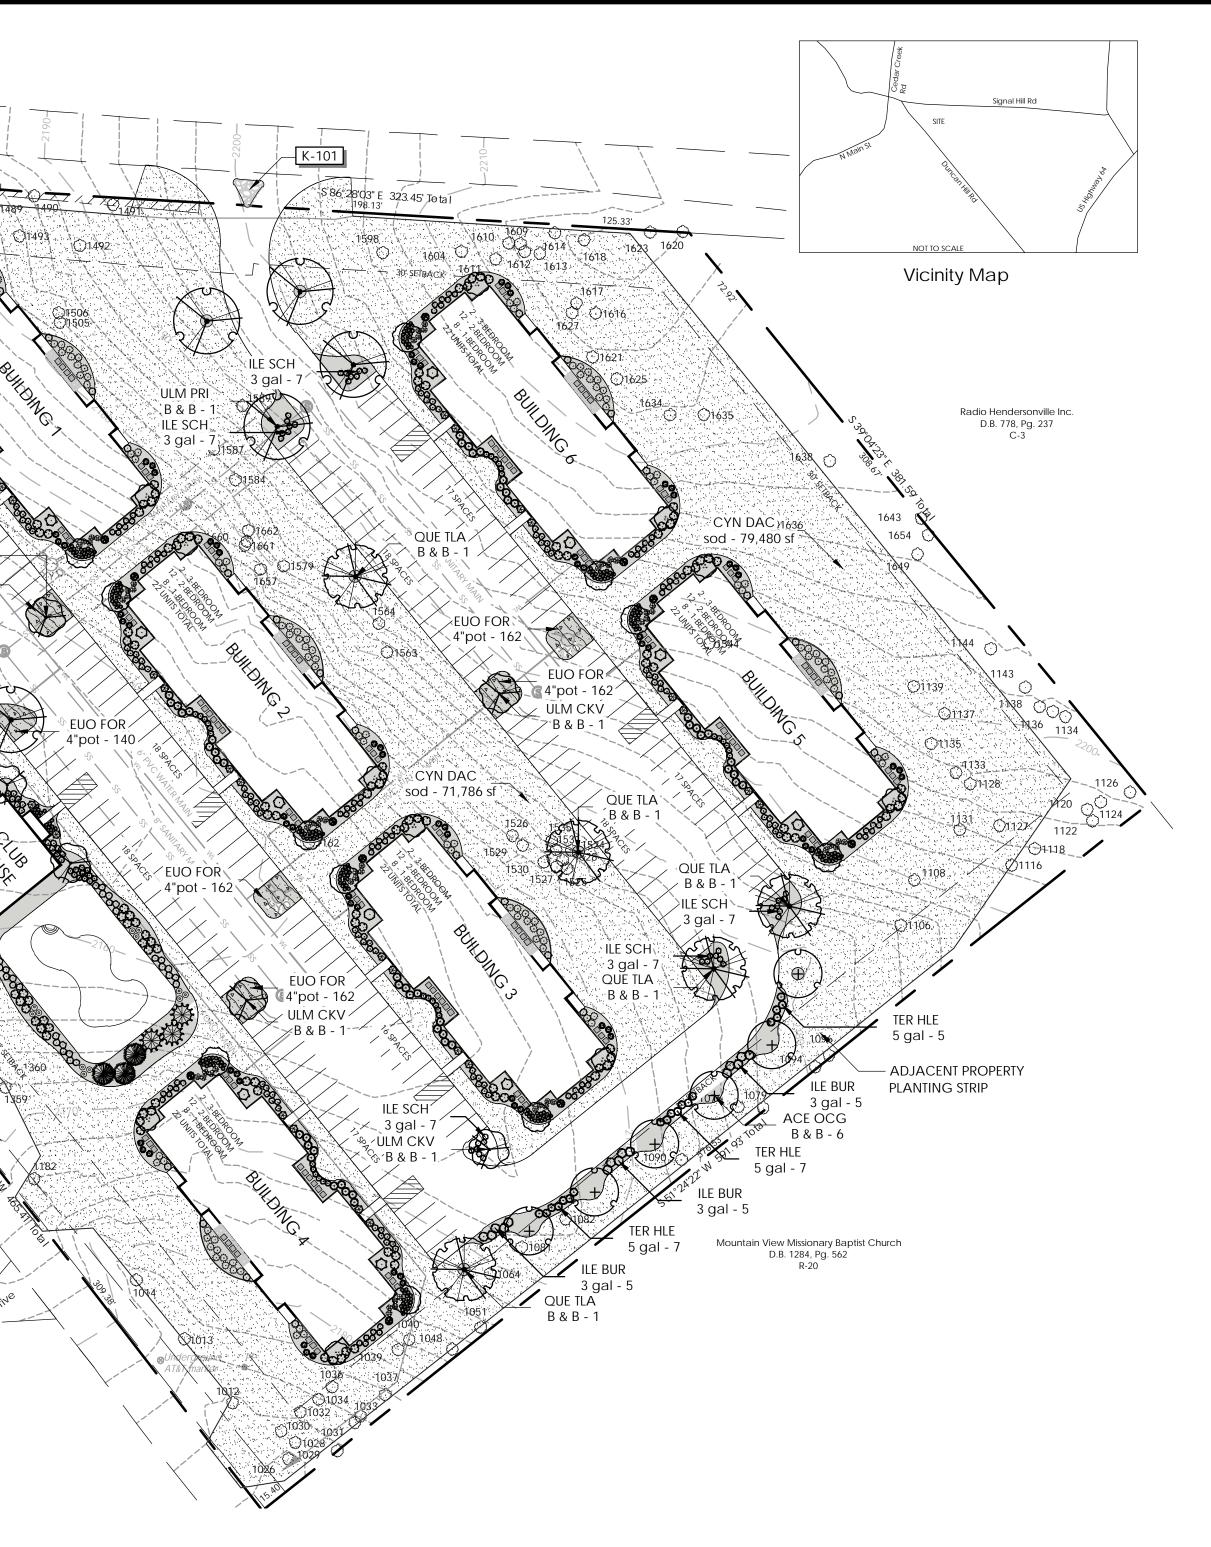SYMBOL	32 EXTERIOR IMPROVEMENTS DESCRIPTION	QTY	DETAIL
32-02	STEEL EDGING	145 LF	
SYMBOL	32 EXTERIOR IMPROVEMENTS DESCRIPTION	QTY	DETAIL
	TRIPLE HAMMERED HARDWOOD MULCH (3" THICK)	269.53 CY	
	ROCK		DETAIL
<u>SYMBOL</u>	DESCRIPTION	<u>OTY</u>	DETAIL
	TAN CREEK STONE - 3-4" SIZE (WITH FILTER FABRIC)	16.33 CY	

PLANTING NOTES:

- MATERIALS LIST WAS PREPARED FOR ESTIMATING PURPOSES, CONTRACTOR SHALL MAKE OWN QUANTITY TAKE-OFF USING DRAWINGS AND SPECIFICATIONS TO DETERMINE QUANTITIES TO HIS SATISFACTION, REPORTING PROMPTLY ANY DISCREPANCIES WHICH MAY EFFECT BIDDING.
 ROOT TYPES MAY BE FREELY SUBSTITUTED IN CASE OF BALLED AND BURLAPPED OR CONTAINER GROWN. ALL PLANT
- MATERIAL MUST ADHERE TO ANSI Z60.1-2004 (AMERICAN STANDARD FOR NURSERY STOCK) SPECIFICATIONS FOR ROOT BALLS AND CONTAINER SIZES. 3. CONTRACTOR TO VERIFY THAT ALL PLANT MATERIALS ARE AVAILABLE AS SPECIFIED WHEN BID/PROPOSAL IS SUBMITTED.
- CONTRACTOR TO VERIFY THAT <u>ALL</u> PLANT MATERIALS ARE AVAILABLE AS SPECIFIED WHEN BID/PROPOSAL IS SUBMITTED.
 UNLESS SPECIFICALLY NOTED, ALL PLANTS SHALL BE OF SPECIMEN QUALITY, EXCEPTIONALLY HEAVY, SYMMETRICAL, AND SO TRAINED OR FAVORED IN DEVELOPMENT AND APPEARANCE AS TO BE UNQUESTIONABLY AND OUTSTANDINGLY SUPERIOR IN FORM, COMPACTNESS AND SYMMETRY. THEY SHALL BE SOUND, HEALTHY, VIGOROUS, WELL BRANCHED AND DENSELY FOLIATED WHEN IN LEAF; FREE OF DISEASE AND INSECTS, EGGS OR LARVAE; AND SHALL HAVE HEALTHY, WELL-DEVELOPED ROOT SYSTEMS. THEY SHALL BE FREE FROM PHYSICAL DAMAGE OR OTHER CONDITIONS THAT WOULD PREVENT VIGOROUS GROWTH.
- <u>SUBSTITUTIONS OF PLANT MATERIALS WILL NOT BE PERMITTED UNLESS AUTHORIZED IN WRITING BY THE LANDSCAPE</u> <u>ARCHITECT.</u> IF PROOF IS SUBMITTED IN WRITING THAT A PLANT SPECIFIED IS NOT OBTAINABLE, CONSIDERATION WILL BE GIVEN TO THE NEAREST AVAILABLE SIZE OR SIMILAR VARIETY, WITH A CORRESPONDING ADJUSTMENT OF THE CONTRACT PRICE.
 PLANTS SHALL CONFORM TO THE MEASUREMENTS SPECIFIED, EXCEPT TAT PLANTS LARGER THAN THOSE SPECIFIED MAY BE
- USED IF APPROVED BY THE LANDSCAPE ARCHITECT IN WRITING. USE OF LARGER PLANTS SHALL NOT INCREASE THE CONTRACT PRICE. IF LARGER PLANTS ARE APPROVED, THE ROOT BALL SHALL BE INCREASED IN PROPORTION TO THE SIZE OF THE PLANT.
 7. ROOT FLARE OF PLANT MATERIAL MUST BE AT OR SLIGHTLY HIGHER THAN EXISTING GRADE. PULL MULCH BACK 6 IN. FROM
- ROOT FLARE.
 8. TREES WITH MULTIPLE LEADERS, UNLESS SPECIFIED, WILL BE REJECTED. TREES WITH A DAMAGED OR CROOKED LEADER, BARK ABRASIONS, SUNSCALD, DISFIGURING KNOTS, INSECT DAMAGE, CUTS OF LIMBS OVER 20 MM (¾ IN.) IN DIAMETER THAT ARE NOT COMPLETELY CLOSED OR FLUSH PRUNING CUTS THAT DO NOT PRESERVE THE COLLAR AT THE BRANCH WILL BE REJECTED.
- TREE PLANTING DETAILS AND SPECIAL PROVISIONS FOR PLANTING MUST BE FOLLOWED. DETAILS ARE PROVIDED ON THIS SHEET.
 CONTRACTOR SHALL TEST SOIL pH AND CONDITIONS FOR ALL SOD AREAS TO INSURE THAT PROPER SOIL REQUIREMENTS
- ARE MET FOR THE SODDED LAWN. SOIL SHALL BE AMENDED BY CONTRACTOR AS INDICATED BY SOIL TEST AND SPECIFICATIONS TO ACHIEVE PROPER SOIL CONDITIONS. ALL PLANT BEDS TO RECEIVE 3" DEEP HARDWOOD MULCH, PULLED 6" AWAY FROM THE TRUNK.
- ALL PLANT BEDS TO RECEIVE 3" DEEP HARDWOOD MULCH, PULLED 6" AWAY FROM THE TRUNK.
 CONTRACTOR TO MAINTAIN THE PLANTINGS AND CONTROL WEEDS IN MULCH AREAS THROUGH THE DURATION OF CONSTRUCTION UNTIL FINAL ACCEPTANCE.
- 13. ALL PLANT BED AND SOD AREAS TO RECEIVE 100% IRRIGATION COVERAGE .
- IN THE PLANT SCHEDULE, PLANTS NOTED AS "SPECIMEN", SHALL BE SELECTED BY THE LANDSCAPE ARCHITECT AT THE NURSERY OR PHOTOS OF THE PLANTING STOCK SHALL BE SUBMITTED TO THE LANDSCAPE ARCHITECT FOR APPROVAL.
 PREEMERGENT HERBICIDE SHALL BE APPLIED TO PLANTING AREAS PRIOR TO LANDSCAPE INSTALLATION AND ACCORDING TO MANUFACTURER'S INSTRUCTIONS.
- PLANT BED SHALL BE TESTED FOR pH AND AMENDED PRIOR TO INSTALLATION.
 ALL PLANT MATERIAL SHALL CONFORM TO STANDARD SET FORTH BY "AMERICAN STANDARDS FOR NURSERY STOCK" ANSI Z60.1-2004 PUBLISHED BY THE AMERICAN NURSERY AND LANDSCAPE ASSOCIATION.
- 18. ALL PLANT MATERIAL SHALL BE PROTECTED DURING TRANSPORT AND DELIVERY TO JOB SITE WITH SHADE CLOTH OR OTHER ACCEPTABLE MEANS OF WINDBURN PREVENTION.
 10. ANY SUBSTITUTIONS IN SIZE AND COD DUANT MATERIAL MUST BE ADDROVED BY THE LANDSCAPE ADDULTE CTREEORE
- ANY SUBSTITUTIONS IN SIZE AND/OR PLANT MATERIAL MUST BE APPROVED BY THE LANDSCAPE ARCHITECT BEFORE PLANTING CAN BEGIN.
 ALL TREES MUST BE STRAIGHT TRUNK, FULL HEADED, AND MEET ALL REQUIREMENTS SPECIFIED.
- PRIOR TO CONSTRUCTION, THE CONTRACTOR IS RESPONSIBLE FOR LOCATING ALL UNDERGROUND UTILITIES AND SHALL AVOID DAMAGE TO ALL UTILITIES DURING CONSTRUCTION. SHOULD THE CONTRACTOR CAUSE DAMAGE TO ANY UTILITIES NECESSARY REPAIRS SHALL BE MADE AS QUICKLY AS PRACTICABLE, AT CONTRACTOR'S EXPENSE.
 ALL ELEMENTS OF LANDSCAPING SHALL BE INSTALLED SO AS TO MEET ALL APPLICABLE ORDINANCES AND CODES
- REQUIREMENTS.
 23. CONTRACTOR SHALL ASSURE DRAINAGE AND PERCOLATION OF PLANTING PITS PRIOR TO INSTALLATION OF PLANT MATERIAL. CONTRACTOR IS RESPONSIBLE FOR THE REPLACEMENT OF ALL PLANTS LOST DUE TO INADEQUATE DRAINAGE
- CONDITIONS.
 24. BALLED AND BURLAP MATERIAL SHALL HAVE THE TOP ONE HALF (1/2) OF THE BURLAP AND STRAPS REMOVED.
 25. CONTRACTORS SHALL REFER TO THE LANDSCAPE PLANTING DETAILS, PLANTS LISTS, GENERAL NOTES AND THE PLANTING
- SPECIFICATIONS FOR COMPLETE LANDSCAPE PLANTING INSTRUCTIONS.
 26. TURF GRASS SHALL BE PLANTED AFTER ALL PLANTS ARE INSTALLED AND MULCHED. SEED AND/OR SOD BED PREPARATIONS BY MEANS OF PULVERIZATION TO LOOSEN SOIL. SMOOTH AND FINE GRADE AREA REMOVING ANY ROCKS, ROOTS, TRASH, AND CLODS OVER ENTIRE AREA.
- 27. THE CONTRACTOR IS RESPONSIBLE FOR MAINTAINING IN FULL ALL PLANTING AREAS (INCLUDING WATERING, SPRAYING, MULCHING, MOWING, FERTILIZING, ETC.) UNTIL THE OWNER AND LANDSCAPE ARCHITECT ACCEPT CONSTRUCTION IN FULL AT THE END FOR THE ESTABLISHED PERIOD.
 28. CONTRACTOR TO GUARANTEE PLANT MATERIAL FOR 12 MONTHS ESTABLISHMENT PERIOD FOLLOWING DATE OF

IRRIGATION NOTES

COMPLETED CONSTRUCTION.

THE CONTRACTOR TO PROVIDE AN IRRIGATION SYSTEM THAT CONFORMS TO THE FOLLOWING STANDARDS AND THE ACCOMPANYING SPECIFICATIONS .

- THE CONTRACTOR SHALL:
- 1. CONTRACTOR SHALL PROVIDE AN IRRIGATION LAYOUT PLAN FOR OWNER APPROVAL BEFORE CONSTRUCTION.
- 1 SET OF AS-BUILT IRRIGATION DRAWINGS AFTER CONSTRUCTION IS COMPLETE AND APPROVED BY OWNER.
 ENSURE ALL LANDSCAPE SHRUB AREAS ARE DRIP IRRIGATED.
- PROVIDE 2 SETS OF AS-BUILT IRRIGATION DRAWINGS AFTER CONSTRUCTION IS COMPLETE AND APPROVED BY THE OWNER.
 PROVIDE APPROVED BACKFLOW PREVENTER AND COORDINATE THE INSTALLATION OF 1" METER SERVICE FOR IRRIGATION SYSTEM UNLESS OTHERWISE PROVIDED BY THE G.C..
- PROVIDE AUTOMATIC TIMER CONTROL AND RELATED ITEMS SUCH AS RAIN/FREEZE SENSOR AS SPECIFIED.
 ENSURE THAT ALL TRENCHING IS OUTSIDE OF TREE DRIP LINE IF POSSIBLE AND NO ROCKS, DEBRIS OR SHARP OBJECTS SHALL BE BACKFILLED IN THE TRENCH.
- FLUSH ALL PIPING PRIOR TO INSTALLATION OF SPRINKLERS.
 COORDINATE THE LOCATION AND INSTALL ALL IRRIGATION SLEEVES UNDER ALL PAVEMENT PRIOR TO PAVING (MIN. SCHEDULE 40 4" SLEEVE).
- REVIEW AND FAMILIARIZE A REPRESENTATIVE OF THE OWNER WITH ALL SETTINGS AND FEATURES OF THE IRRIGATION SYSTEM. ALL DOCUMENTATION SUCH AS MANUALS SHALL BE PROVIDED TO THE OWNER AT THIS TIME.
 PROVIDE A 1 YEAR WARRANTY OF PRODUCTS AND WORKMANSHIP TO INCLUDE WINTERIZING AND FOLLOWING STARTUP AS
- REQUIRED BY LOCATION.
 12. CLEAN UP AND DISPOSE OF ALL DEBRIS, WASTE AND EXCESS CONSTRUCTION MATERIALS PRIOR TO FINAL ACCEPTANCE OF THE SYSTEM BY THE OWNER.
- THE IRRIGATION SYSTEM SHALL: 1. PROVIDE 100% COVERAGE OF ALL NEW PLANT BEDS & SOD AREAS .
- PROVIDE 100% COVERAGE OF ALL NEW PLANT BEDS & SOD AREA
 HAVE ALL VALVES LOCATED IN PLANTED BEDS IF POSSIBLE.
- HAVE A MINIMUM OF 18" OF COVER ON ALL MAINLINES AND A MINIMUM OF 12" OF COVER ON ALL LATERALS.
 SHALL NOT HAVE ANY SPRAY HEADS OR PIPING IN SCDOT RIGHTS OF WAY


LANDSCAPE ARCHITECT: The LandArt Design Group, Inc. P.O. Box 3161 Spartanburg, SC 29304 Phone: (864) 585-7500 Fax: (864) 585-3808 Tipton Pitts, ASLA tip@landartdesigngroup.com



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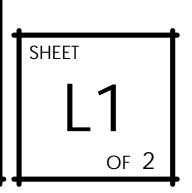



OVERALL LANDSCAPE PLAN

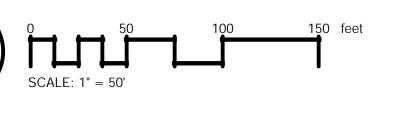


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v1 0,	OVERALL LANDSCAPE PLAN JOB #: 19012-00 DATE: 02/28/22 DRAWN: BB APPROVED:	

Item H.



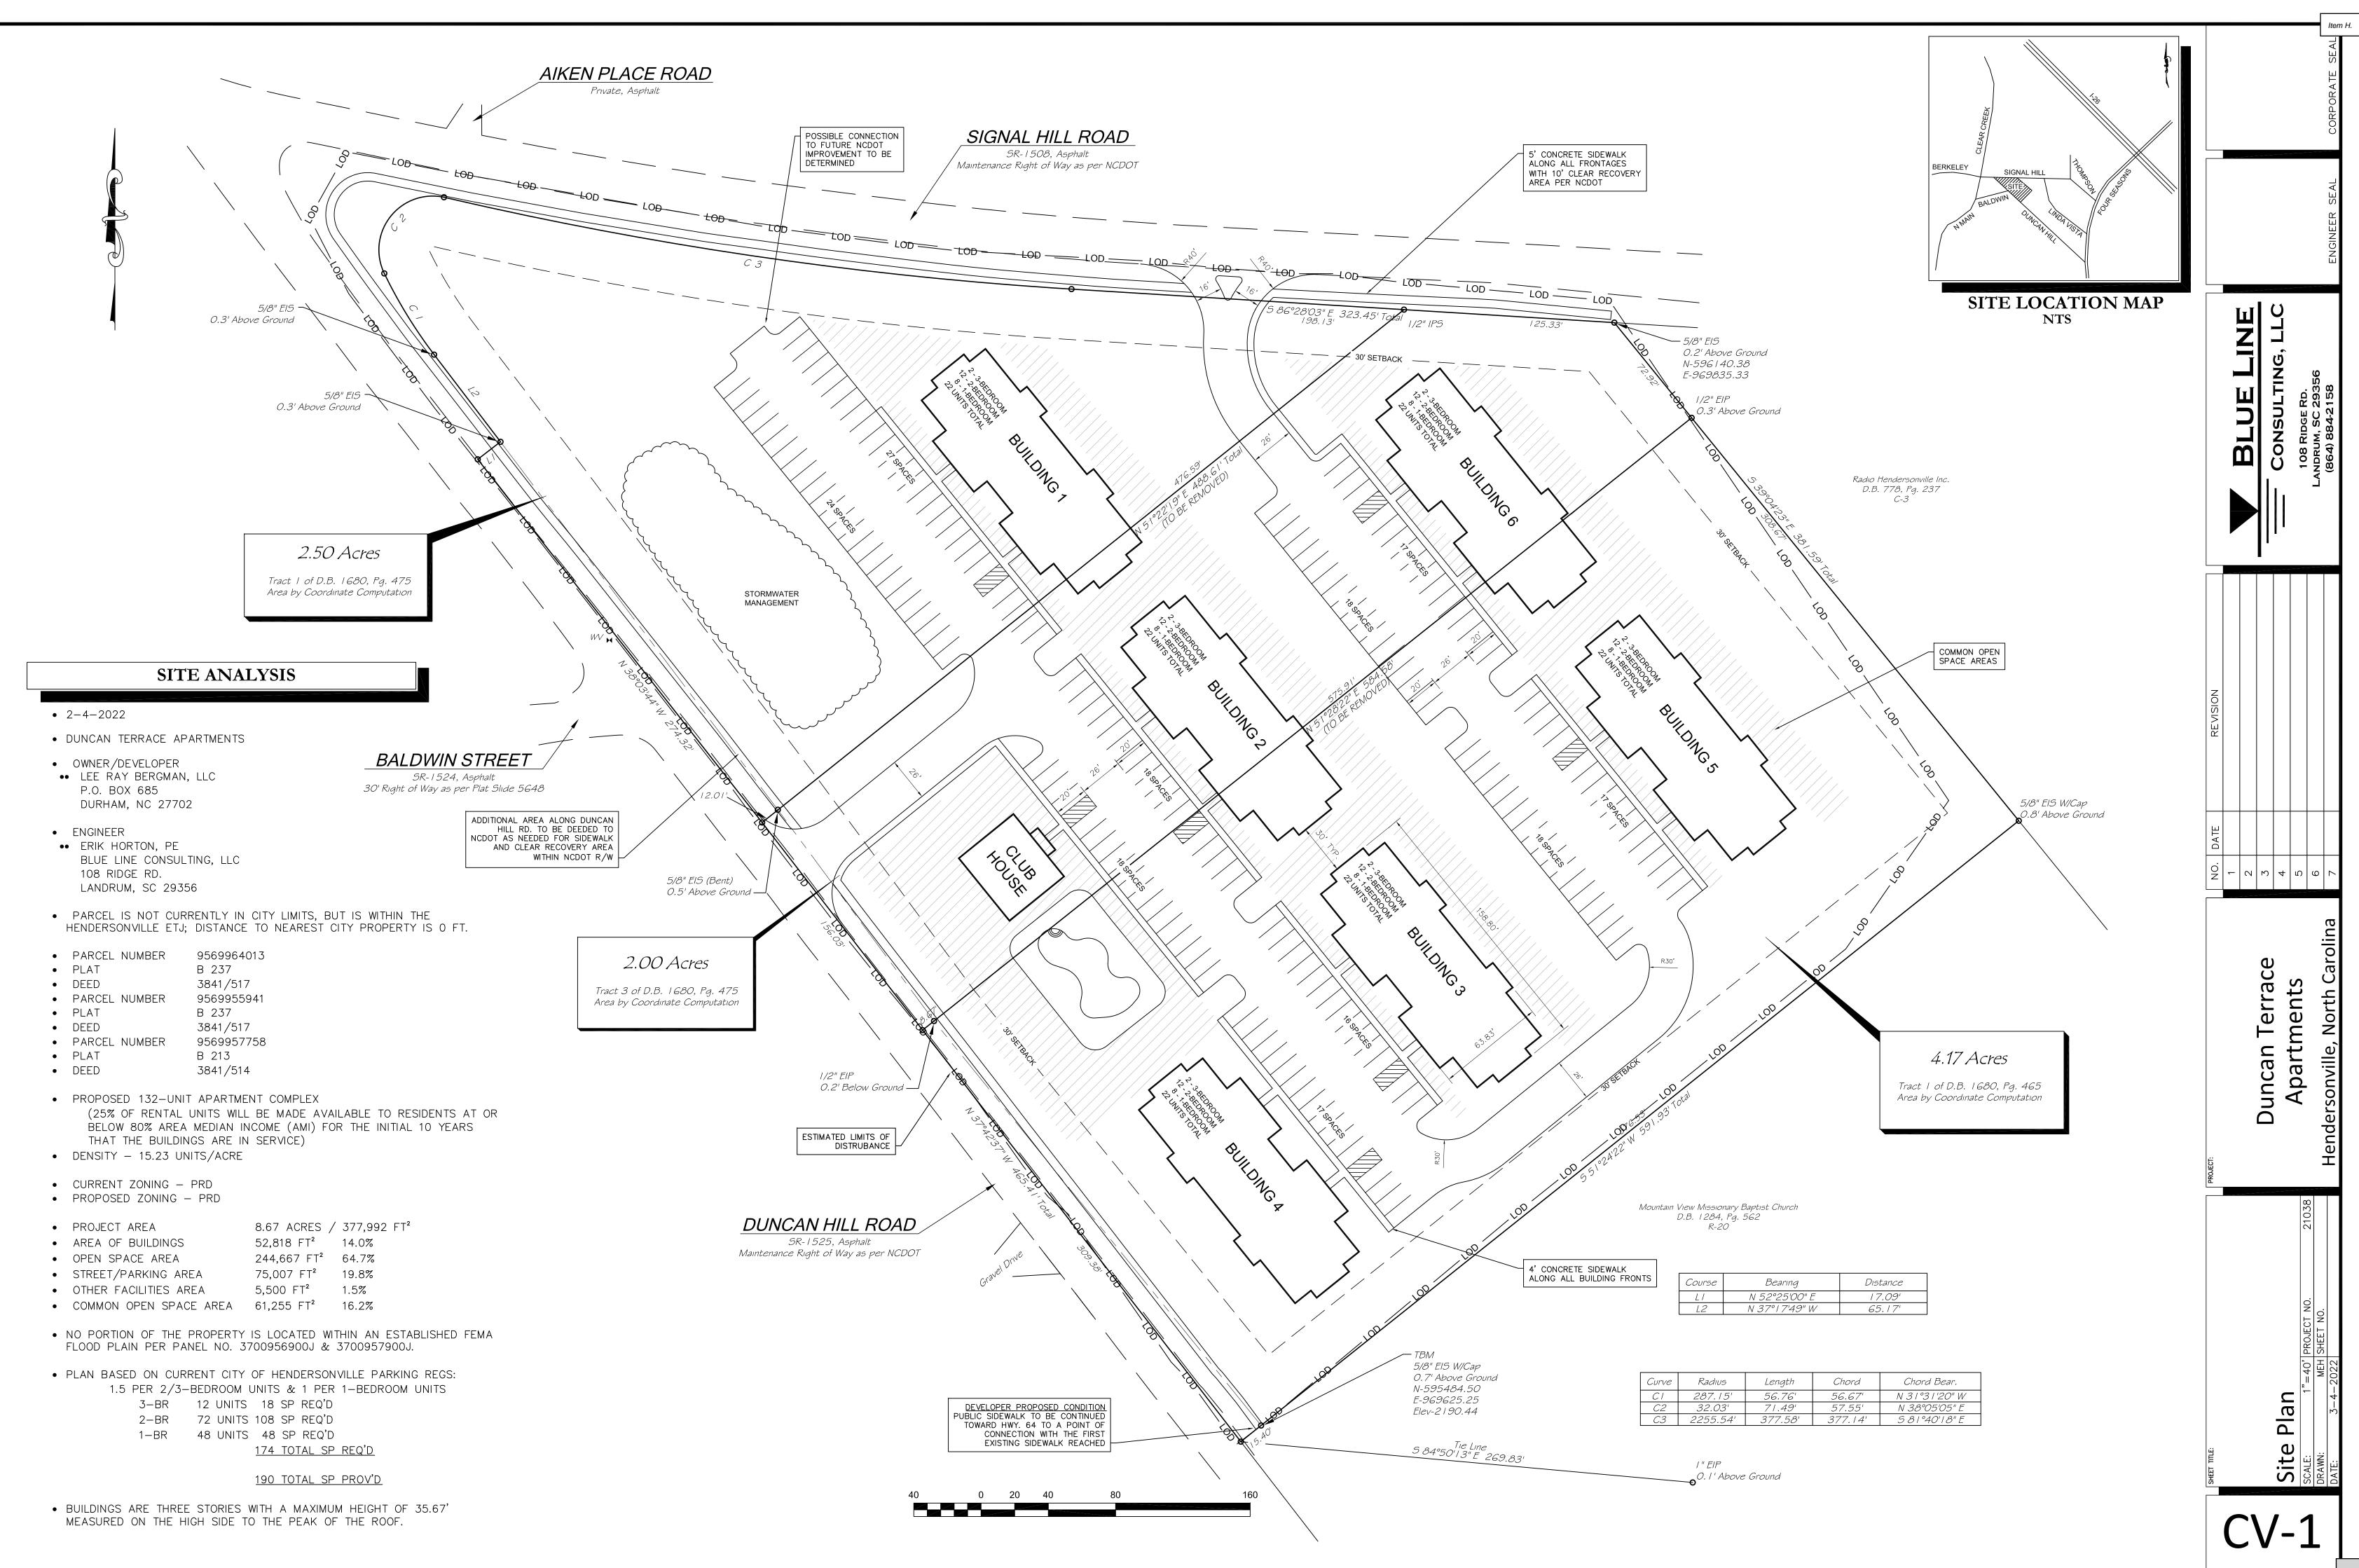

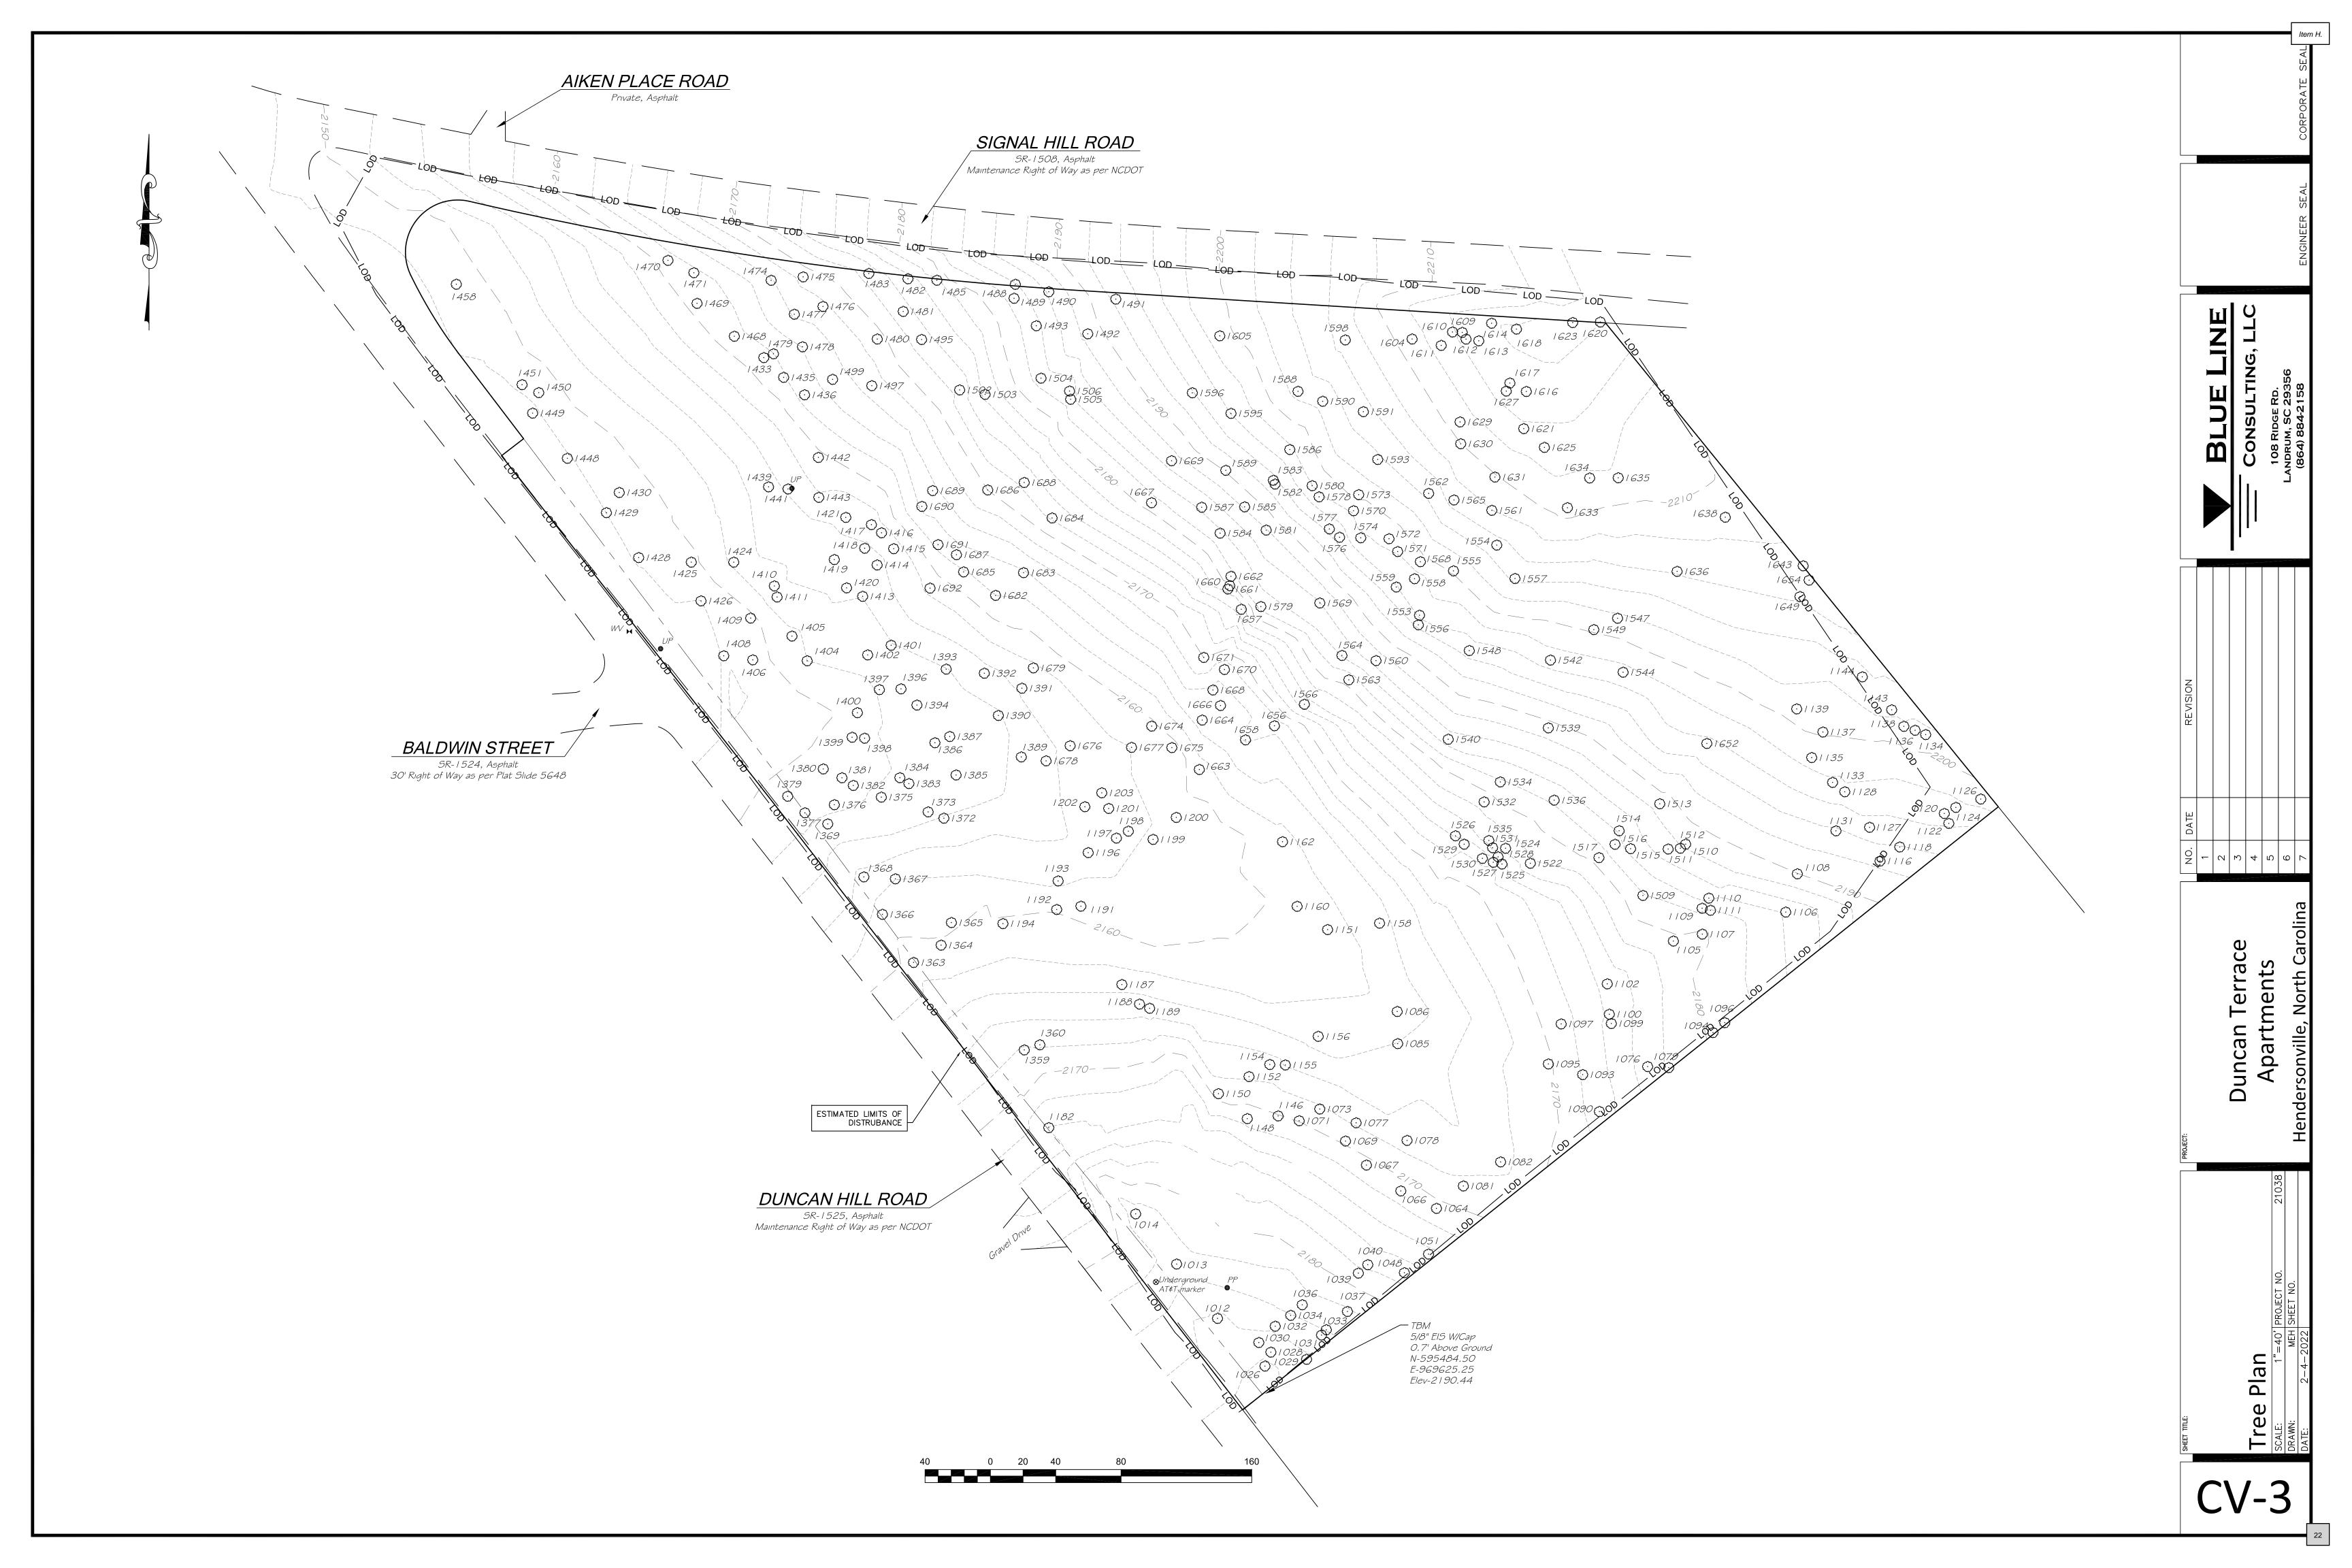

Point	Description
1012	I 2" Maple
1012	36" Maple
1013	32" Maple
1026	30" OAK
1028	20" PINE
1029	14" OAK
1030	14" OAK
1031	1 2" PINE
1032	/ 6" OAK
1033	1 O" PINE
1034	I O" PINE
1036	I G" PINE
1037	24" OAK
1039	1 2" PINE
1040	I 2" PINE
1048	16" OAK + 10" LOCUST
1051	1 2" PINE
1064	I O" PINE
1066	I 8" POPLAR
1067	1 6" OAK
1069	18" OAK
1071	1 <i>8" O</i> AK
1073	I O" LOCUST
1076	20" PINE
1077	I O" HICKORY
1078	I O" HICKORY
1079	22" OAK
1081	I O" POPLAR
1082	12" + 10" POPLAR
1085	30" OAK
1086	1 4" PINE
1090	I O" POPLAR
1093	I O" POPLAR
1094	I 2" MAPLE
1095	I O" POPLAR
1096	I O" POPLAR
1097	I O" MAPLE
1099	30" PINE
1100	30" PINE
1102	I 4" POPLAR
1105	30" OAK
1106	22" OAK 10" + 20" MAPLE
1107	
108 109	<i>1 8" POPLAR x 3</i> 26" OAK
1110	20" PINE
1///	I 2" BEECH x 2
1116	14" OAK
1118	30" OAK
1120	24" OAK
1120	22" OAK 22" OAK
1122	22" OAR 24" MAPLE
1124	34" PINE + 30" OAK
1126	I O" PINE
1127	I O'' PINE
1131	I O'' PINE
1133	I O" PINE


1121	22" OAK
34 35	22" OAK 1 0" PINE
1136	40" OAK
1137	1 4" PINE
1138	24" OAK
1139	I 4" PINE
1143	42" + 22" OAK
1144	30" OAK
1146	I O" POPLAR
1148	1 O" OAK
1150	1 2" OAK
1151	1 O" POP
1152	20" POP
1154	I 2" HICKORY
1155	I O" HICKORY
1156	I O" POPLAR
1158	I O" PINE
1160	I O" POPLAR
1162	1 0" POPLAR
1182	22" POPLAR
1187	16" + 10" MAPLE
	$\frac{10}{10} = \frac{10}{10} $
1188	16" OAK x 2
1189	10" HICKORY
1191	10" OAK
1192	22" OAK
1193	18" OAK
1194	I O" POPLAR
1196	22" POPLAR
1197	26" + 14" MAPLE x 2
1198	I O" HICKORY
1199	1 O" OAK
1200	I O" POPLAR
1201	1 O" OAK
1202	I 2" BIRCH
1203	I 2" HICKORY
1359	1 0" OAK x 2
1360	1 4" OAK
1363	26" OAK
1364	I O" POPLAR
1365	8" OAK
1366	40" OAK
1367	20" CEDAR
1368	36" OAK
1360	1 0" OAK
	I 2" HICKORY
1372	
1373	I O" HICKORY
1375	1 2" HICKORY
1376	10" OAK
1377	ΙΟ" ΟΑΚ
1379	10" OAK x 2
1380	40" PINE
1381	Ι Ο" ΟΑΚ
1382	1 O" OAK
1383	I O" HICKORY
1384	Ι Ο" ΟΑΚ
1385	I O" POPLAR x 2
1386	I O" MAPLE
1387	I O" POPLAR
1389	8" POPLAR
,000	

Point	Description
	,
1390	8" POPLAR
1391	I 4" HICKORY
1392	I G" HICKORY
1393	I G" HICKORY
1394	I 2" HICKORY
1396	I 6" HICKORY / I 2" HICKORY
1397	8" OAK
1398	1 6" OAK
1399	40" PINE
1400	I O" PINE
1401	1 4" OAK
1402	22" OAK
1404	I 6" POPLAR
1405	48" OAK
1406	24" HOLLY
1408	I 2" CEDAR
1409	8" HICKORY
1410	I G" HICKORY
1411	I 4" CEDAR
1413	10" OAK
1414	10" OAK
1415	18" OAK
1416	14" OAK / 10" OAK
1417	8" BIRCH
1418	16" OAK
1419	I 4" HICKORY
1420	16" OAK
1421	10" OAK x 2
1424	20" OAK
1425	36" PINE
1426	8" OAK
1428	10" OAK
1429	8" OAK
1430	8" OAK
1433	14" OAK x 2
1435	I G" HICKORY
1436	14" OAK
1439	I G" HICKORY
1441	8" PINE
1442	8" OAK
1443	16" OAK / 12" OAK
1448	8" OAK
1449	6" POPLAR
1450	8" OAK
1451	OAK CLUSTER
1458	OAK CLUSTER
1468	I 4" HICKORY
1469	1 О" ОАК х 2
1470	1 2" OAK
1471	Ι Ο" ΟΑΚ
1474	22" POPLAR
1475	40" OAK
1476	8" OAK
1477	I O" HICKORY
1478	16" OAK
1479	1 2" POPLAR / 1 2" OAK
1480	1 2" POPLAR
, ,00	


1481	I O" HICKORY
1482	1 2" POPLAR / 1 2" POPLAR
1483	POPLAR CLUSTER
1485	POPLAR CLUSTER
1488	MAPLE CLUSTER
1489	I O" HICKORY
1490	I O" POPLAR x 2
1491	1 2" POPLAR
1492	I 4" POPLAR
1493	10" OAK
1495	16" OAK
1497	I O" HICKORY
1499	1 2" OAK
1502	10" OAK
1503	I O" HICKORY
1504	I 4" PΦPLAR
1505	8" POPLAR
1506	I O" HICKORY
1509	30" MAPLE
1510	I 4" POPLAR
1511	I O" POPLAR
1512	I O" PINE / I 2" PINE
1513	I O" LOCUST
1514	1 2" PINE
1515	I O" POPLAR
1516	I O" POPLAR
1517	I O" POPLAR
1522	40" PINE
1524	1 2" OAK
1525	20" OAK
1526	20" ОАК х З
1527	1 8" OAK
1528	I O" POPLAR
1529	20" OAK
1530	30" OAK
	20" OAK
1531	
1532	I O" BIRCH
1534	14" POPLAR
1535	20" OAK
1536	I O" PINE
1539	I O" PINE
1540	36" PINE
1542	22" OAK
1544	I 4" PINE
1547	I 4" PINE
1548	22" OAK
1549	1 4" PINE
1553	34" PINE
1554	1 4" PINE
1555	8" PINE
1556	26" OAK
1557	22" OAK
1558	10" OAK
1559	18" HOLLY
1560	36" PINE
1561	20" OAK
1562	8" OAK x 2
1563	I G" PINE
1564	20" PINE
-	

Point	Description
1564	20" PINE
1565	20" POPLAR
1566	22" OAK
1568	8" OAK
1569	24" PINE / 22" PINE
1570	I O" POPLAR
1571	I 8" PINE
1572	I 2" HOLLY
1573	I 2" POPLAR
1574	I 8" PINE
1576	I O" PINE
1577	I O" POPLAR
1578	Ι Ο" ΟΑΚ
1579	24" PINE
1580	I G" PINE
1581	I 4" PINE
1582	24" POPLAR
1583	1 6" OAK
1584	20" PINE
1585	1 2" PINE
1586	I 2" PINE x 2
1587	36" PINE x2
1588	36" OAK x2
1589	12" PINE
1590	ΙΟ" ΟΑΚ
1591	10" OAK
1593	10" OAK
1595	48" OAK
1596	12" POPLAR
1598	36" OAK
1604	10" OAK
1605	14" OAK
1609	I O" MAPLE
1610	10" MAPLE 10" OAK
1612	12" OAK
1613	10" OAK
1613	10" OAK
1616	10" OAK
1617	I O" BIRCH
1618	20" PINE
1620	10" OAK
1621	I O" BIRCH
1623	10" OAK
1625	I O" BIRCH
1627	I 4" PINE / I O" BIRCH
1629	I O" PINE
1630	1 <i>0" ОАК</i>
1631	I O" MAPLE
1633	24" OAK
1634	1 2" PINE / 1 2" OAK
1635	1 2" OAK
1636	I O" POPLAR
1638	1 0" PINE / 1 0" PINE
1643	24" OAK
1649	HOLLY CLUSTER
1652	I 2" POPLAR

1654	24" OAK
1656	I OPOPLAR x 2
1657	24" PINE
1658	26" PINE
1660	I 8" PINE
1661	I 8" PINE
1662	20" PINE
1663	<i>30" POPLAR</i>
1664	I O" MAPLE
1666	I 4" PINE
1667	8" POPLAR x 2
1668	1 0" OAK / 20" OAK
1669	I O" MAPLE
1670	I O" POPLAR
1671	1 4" OAK
1674	I G" MAPLE
1675	16" MAPLE x 3
1676	1 O" OAK
1677	I O" POPLAR
1678	I 2" BIRCH
1679	Ι Ο" ΟΑΚ
1682	20" OAK
1683	I 4" POPLAR
1684	I O" PINE
1685	1 2" OAK
1686	I O" HICKORY
1687	I 2" POPLAR
1688	I O" POPLAR
1689	I 4" MAPLECLUSTER
1690	1 6" OAK
1691	I 2" MAPLECLUSTER
1692	I 4" HICKORY

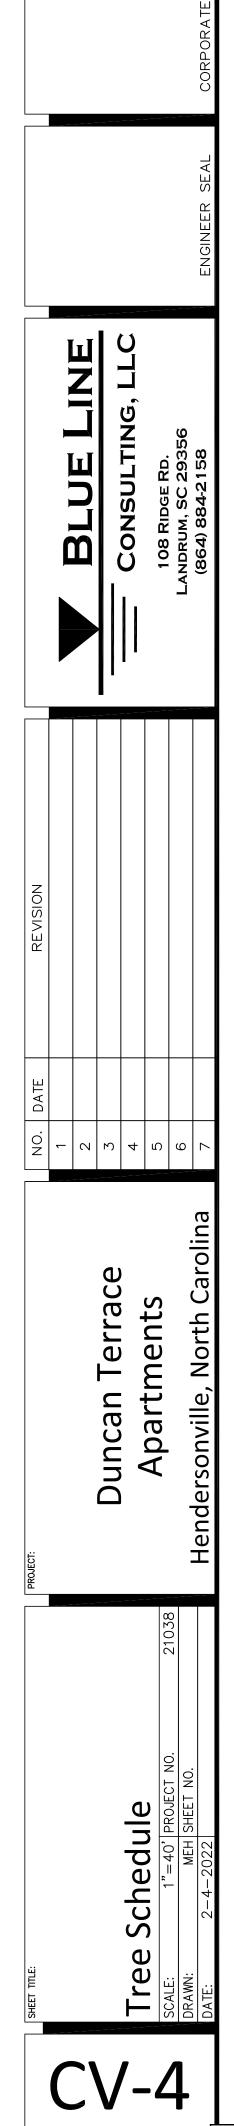

Item H.

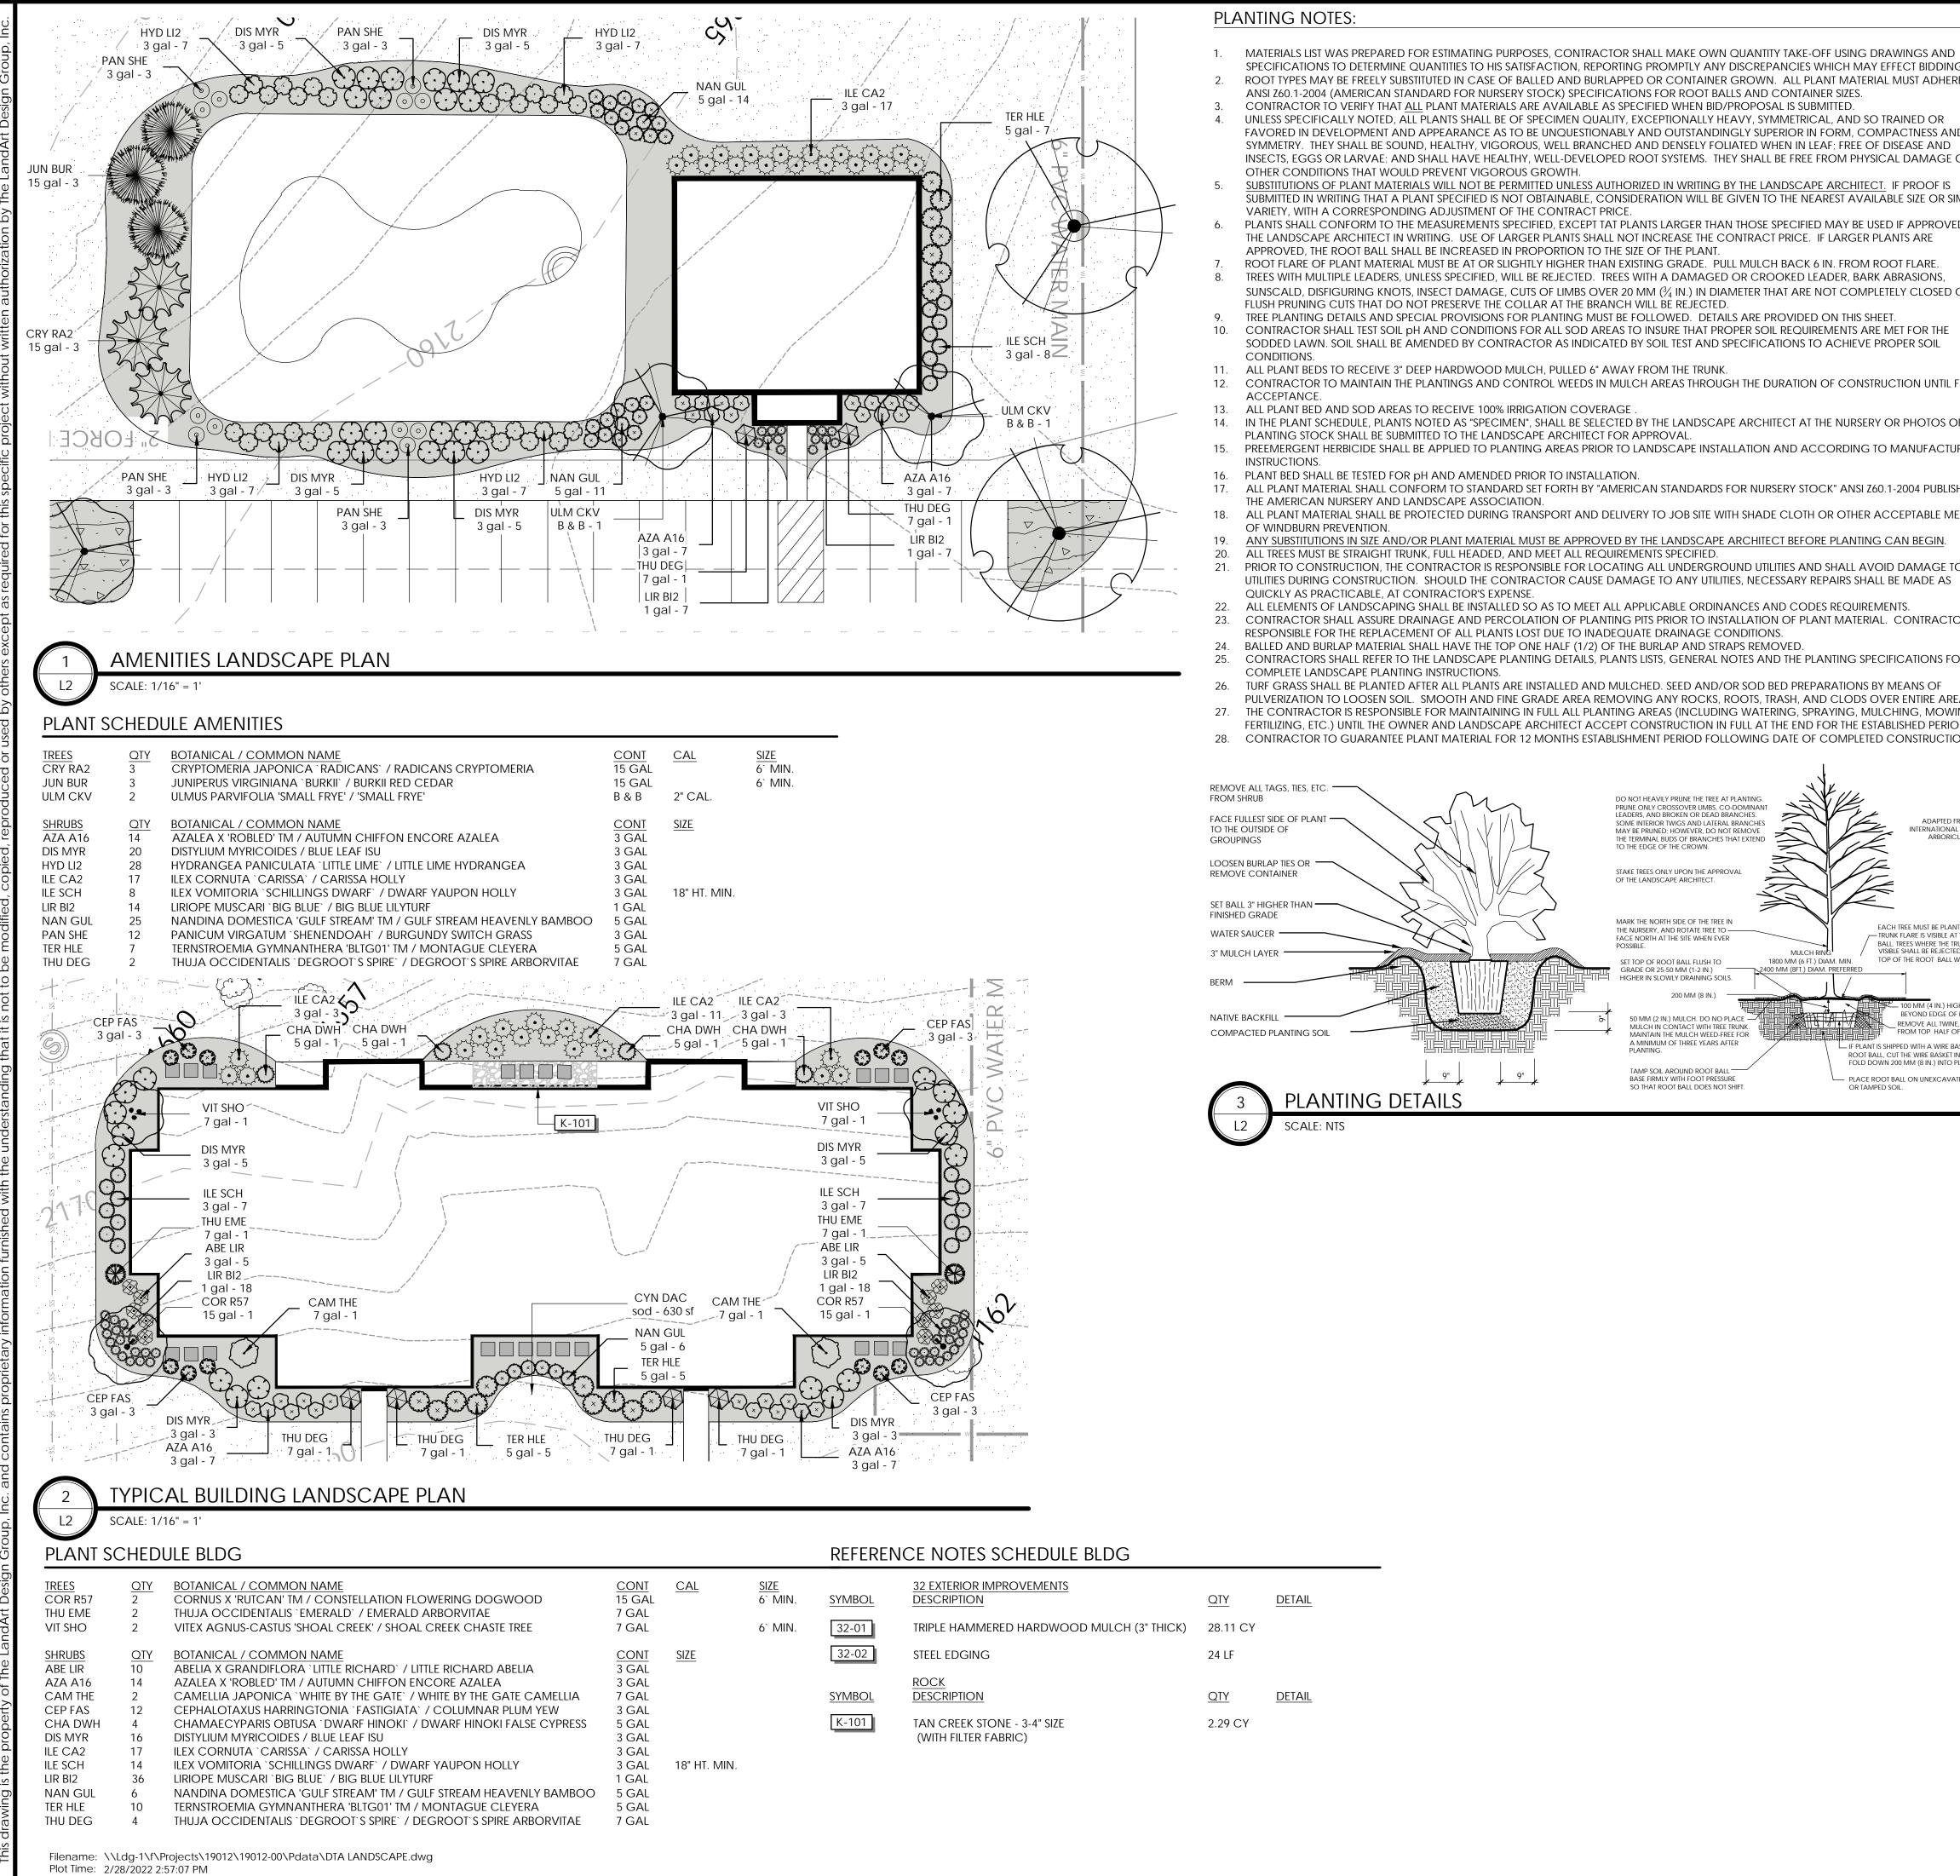

QTY	DETAIL
28.11 CY	
24 LF	
<u>QTY</u>	DETAIL
2.29 CY	
	28.11 CY 24 LF <u>QTY</u>

IRRIGATION NOTES

		IRRIGATION NOTES	
THE CONTRACTOR BUILD CONTRACTOR BUILD CONTRACT	D NG.		
 STANDAY OF A DATA AND A DATA AN		1. CONTRACTOR SHALL PROVIDE AN IRRIGATION LAYOUT PLAN FOR OWNER APPROVAL BEFORE	
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BUILD FOR THE CONTENT TO A DESCRIPTION AND THE ADDRESS OF THE ADDR) E OR	4. PROVIDE 2 SETS OF AS-BUILT IRRIGATION DRAWINGS AFTER CONSTRUCTION IS COMPLETE AND APPROVED	
BUILD FOR THE CONTENT TO A DESCRIPTION AND THE ADDRESS OF THE ADDR	S	5. PROVIDE APPROVED BACKFLOW PREVENTER AND COORDINATE THE INSTALLATION OF 1" METER SERVICE	
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BUILD FOR THE CONTENT TO A DESCRIPTION AND THE ADDRESS OF THE ADDR	/ED BY		
BUILD FOR THE CONTENT TO A DESCRIPTION AND THE ADDRESS OF THE ADDR		8. FLUSH ALL PIPING PRIOR TO INSTALLATION OF SPRINKLERS.	
URER'S SHEED BY AFAINS ICO ALL STOR ICO ALL ICO ALL		PAVING (MIN. SCHEDULE 40, 4" SLEEVE).	
URER'S SHEED BY AFAINS ICO ALL STOR ICO ALL ICO ALL) OR	IRRIGATION SYSTEM. ALL DOCUMENTATION SUCH AS MANUALS SHALL BE PROVIDED TO THE OWNER AT THIS	I A A I
URER'S SHEED BY AFAINS ICO ALL STOR ICO ALL ICO ALL		11. PROVIDE A 1 YEAR WARRANTY OF PRODUCTS AND WORKMANSHIP TO INCLUDE WINTERIZING AND	ШÜŽ
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URER'S SHEED BY AFAINS ICO ALL STOR ICO ALL ICO ALL			A C Z
URER'S SHEED BY AFAINS ICO ALL STOR ICO ALL ICO ALL	_ FINAL	1. PROVIDE 100% COVERAGE OF ALL NEW PLANT BEDS & SOD AREAS .	
URER'S SHEED BY AFAINS ICO ALL STOR ICO ALL ICO ALL		3. HAVE A MINIMUM OF 18" OF COVER ON ALL MAINLINES AND A MINIMUM OF 12" OF COVER ON ALL	
URER'S SHEED BY AFAINS ICO ALL STOR ICO ALL ICO ALL	OF THE		
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OD. ION. ARBORTIE (GREEN) MOTE: USE ARBORTKIE (GREEN) MOTE: USE ARBORTKIE (GREEN) MAUUFACTURER'S DIRECTIONS MANUFACTURER'S DIRECTIONS MANUFACTURER'S DIRECTIONS MANUFACTURER'S DIRECTIONS MANUFACTURER'S DIRECTIONS MANUFACTURER'S DIRECTIONS MANUFACTURER'S DIRECTIONS MARY AS ISON DIP 1/3 OF ROOT BALL MARY A	REA.		
NON. ARBORTIE (GREEN) NOTE: USE ARBORT/E (GREEN) NOTE: USE ARBORT/E (GREEN) NOTE: USE ARBORT/R (GREEN) NOTE:	VING, IOD.		
REMOVE ALL BURLAP AND WIRE BASKET FROM TOP 1/3 OF ROOT BALL WATER SAUCER ST BALL 2' HIGHER THAN FINISHED GRADE 3' MULCH LAYER BERM (OF ROOT BALL WATER SAUCER ST MULCH LAYER BERM (3) 2x4 STAKES, 2'6' LONG PLANTING FOLL (ATED (ATED (ATED (ATED (ATER SAUCER) (C) (C) (C) (C) (C) (C) (C) (C) (C) (C)	ION.		
REMOVE ALL BURLAP AND WIRE BASKET FROM TOP 1/3 OF ROOT BALL WATER SAUCER ST BALL 2' HIGHER THAN FINISHED GRADE 3' MULCH LAYER BERM (OF ROOT BALL WATER SAUCER ST MULCH LAYER BERM (3) 2x4 STAKES, 2'6' LONG PLANTING FOLL (ATED (ATED (ATED (ATED (ATER SAUCER) (C) (C) (C) (C) (C) (C) (C) (C) (C) (C)			
REMOVE ALL BURLAP AND WIRE BASKET FROM TOP 1/3 OF ROOT BALL WATER SAUCER ST BALL 2' HIGHER THAN FINISHED GRADE 3' MULCH LAYER BERM (OF ROOT BALL WATER SAUCER ST MULCH LAYER BERM (3) 2x4 STAKES, 2'6' LONG PLANTING FOLL (ATED (ATED (ATED (ATED (ATER SAUCER) (C) (C) (C) (C) (C) (C) (C) (C) (C) (C)			55C 289
REMOVE ALL BURLAP AND WIRE BASKET FROM TOP 1/3 OF ROOT BALL WATER SAUCER ST BALL 2' HIGHER THAN FINISHED GRADE 3' MULCH LAYER BERM (of ROOT BALL NR. CPPE AND WIRE, AND BURLAP OF ROOT BALL BASKET AROUND THE THE OUT RACES AND D PLANTING FOLL (ATED		NOTE: USE ARBOR/KNOT	
REMOVE ALL BURLAP AND WIRE BASKET FROM TOP 1/3 OF ROOT BALL WATER SAUCER ST BALL 2' HIGHER THAN FINISHED GRADE 3' MULCH LAYER BERM (OF ROOT BALL WATER SAUCER ST MULCH LAYER BERM (3) 2x4 STAKES, 2'6' LONG PLANTING FOLL (ATED (ATED (ATED (ATED (ATER SAUCER) (C) (C) (C) (C) (C) (C) (C) (C) (C) (C)	NAL SOCIETY OF RICULTURE		/ Sparts / Sparts / Info
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SET BALL 2" HIGHER THAN FINISHED GRADE 3" MULCH LAYER WILCH LAYER BERM (3) 2x4 STAKES, 2'6" LONG PLANTING SOIL ATED SHEET TITLE: AMENITY AND BUILDING PLAN JOB #: 19012-00 DATE: 02/28/22 DRAWN: BB	TRUNK FLARE IS NOT		
3" MULCH LAYER AMENITY AND BUILDING PLAN NGR. ROPE AND WIRE, AND BUILDING BERM JOB #:: (3) 2x4 STAKES, 2'6" LONG JOB #:: PLANTING SOIL J2" W.C. J2" W.C. 12" MEDIAN 24" MEDIAN BBR DRAWN: BBR BBR		SET BALL 2" HIGHER THAN — X MIN X M	SHEET TITLE:
OF ROOT BALL NE, ROPE AND WIRE, AND BURLAD OF ROOT BALL BASKET AROUND THE TIN FOUR PLACES AND D PLANTING HOLE. (3) 2x4 STAKES, 2'6" LONG JOB #: 19012-00 Marcel PLANTING SOIL JIP W.C. 12" W.C. 24" MEDIAN JOB #: 19012-00 DATE: 02/28/22 DATE: 02/28/22 DRAWN: BB<	HIGH EARTH SAUCER	3" MULCH LAYER	AMENITY AND
Basket AROUND THE TIN FOUR PLACES AND D PLANTING SOIL (3) 2x4 STAKES, 2'6" LONG JOB #: 19012-00 PLANTING SOIL 12" W.C. 24" MEDIAN 24" MEDIAN	of Root Ball. Ine, Rope and Wire, An		
Delanting Hole. PLANTING SOIL PLANTING SOIL DATE: J 12" W.C. J 12" W.C. 24" MEDIAN 24" MEDIAN DRAWN: BB	BASKET AROUND THE		
12" W.C. 12" W.C. 02/28/22 24" MEDIAN 24" MEDIAN DRAWN: BB BB	o planting hole.		
DRAWN: BB	VAIEU		02/28/22
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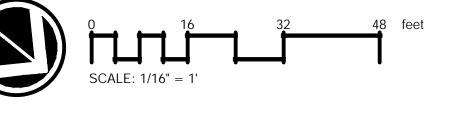
LANDSCAPE ARCHITECT: The LandArt Design Group, Inc. P.O. Box 3161 Spartanburg, SC 29304 Phone: (864) 585-7500 Fax: (864) 585-3808 Tipton Pitts, ASLA tip@landartdesigngroup.com






Call before you dig.

AMENITIY AND BUILDING PLAN



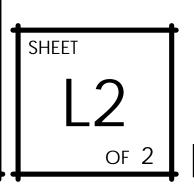

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Item H.

	Budget Date	Transaction	Reserved Transaction Amount
Four Seasons Blvd Mowing	7/7/21	8277	1,400.00USD
Four Seasons Blvd Mowing	8/3/21	8378	1,850.00USD
Four Seasons Blvd Mowing	10/5/21	8628	1,400.00USD
Kelsey Jarvis - Pollinator Bed Maint.	8/30/21	083021	245.00USD
Kelsey Jarvis - Pollinator Bed Maint.	12/1/21	120121	437.50USD
Tree Purchase - BB Barnes	8/25/21	TXN00052099	179.98USD
Tree Purchase - BB Barnes	9/15/21	TXN00052411	1,034.87USD
Bags of Mulch for NeighborWoods	10/8/21	TXN00052702	98.90USD
Bags of Mulch for NeighborWoods	10/18/21	TXN00052799	16.65USD
PR Services - MJP	9/21/21	092121	183.75USD
PR Services - MJP	11/17/21	110921	463.75USD
PR Services - MJP	1/5/22	010422	210.00USD
PR Services - MJP	3/9/22		726.25USD
Tree Pruning Bearcat Blvd - MM	9/17/21	2113	150.00USD
Environmental Education Alliance - ESB	10/9/21	100921	435.00USD
Arbor Day Membership	11/8/21	TXN00052969	20.00USD
Bill Leatherwood - Bearcat Loop Trees	12/28/21	376	2,475.00USD
Flagstone for Bee Mural Pollinator Bed	1/12/22	211129TB	45.33USD

Reservation Category	Reserved
Payables expenditures	1,400.00
Payables expenditures	1,850.00
Payables expenditures	1,400.00
	4,650.00
Payables expenditures	245.00
Payables expenditures	437.50
	<u>682.50</u>
Payables expenditures	179.98
Payables expenditures	1,034.87
Payables expenditures	98.90
Payables expenditures	16.65
	1,330.40
Payables expenditures	183.75
Payables expenditures	463.75
Payables expenditures	210.00
	726.25
	1,583.75
Payables expenditures	150.00
	150.00
Payables expenditures	435.00
	435.00
Payables expenditures	20.00
	20.00
Payables expenditures	2,475.00
	2,475.00
Payables expenditures	45.33
	45.33
Total Spent	11,371.98
Tree Board Budget	43,250.00
Balance Remaining	31,878.02