

### **PLANNING & ZONING COMMISSION MEETING**

Tuesday, September 26, 2023 at 6:00 PM

# **Agenda**

- 1. Call to Order
- 2. Consideration and Approval of Minutes
  - A) Consideration And Approval Of August 22, 2023 Minutes
- 3. New Site Plan Considerations
  - A) Discussion and Consideration of Four Seasons Drapery and Hardware Site Plan
- 4. New Business
- 5. Old Business
  - A) Architectural Controls
- 6. Next Meeting
  - A) The Next Planning and Zoning Meeting Will Be Held on October 24, 2023
- 7. Adjourn



#### **PLANNING & ZONING COMMISSION MEETING**

Tuesday, August 22, 2023, at 6:00 PM

#### **Minutes**

#### Call to Order

Chairman Greer called the meeting to order.

The following Commissioners were present: Commissioner Andrew Duggar, Commissioner Phillips King, Commissioner Katrina Myricks, Commissioner Kayce Saik and Commissioner Tim Slattery. Commissioner Sam McGaugh participated via phone conference.

City Employees Mike McCollum, Bridgette Smith and City Attorney Zach Giddy were present.

# **Consideration and Approval of Minutes**

Commissioner Katrina Myrick made the motion to approve the July 25, 2023, minutes.

Commissioner Tim Slattery second the motion.

The motion carried and was approved by all Commissioners.

#### **New Business**

Election of New Officers for the Planning and Zoning Commission.

Commissioner Melanie Greer nominated Commissioner Sam McGaugh for Chariman.

Commissioner Andrew made the motion to elect Commissioner Sam McGaugh as the Chairman.

Commissioner Tim Slattery second the motion.

The motion carried and was approved by all Commissioners.

Commissioner Kayce Saik nominated Commissioner Melanie Greer for Vice-Chairman.

Commissioner Phillips King made the motion to elect Commissioner Melanie Greer as the Vice-Chairman.

Commissioner Kayce Saik second the motion.

The motion carried and was approved by all Commissioners.

### **New Site Plan Considerations**

Discussion and Consideration of Four Seasons Drapery and Hardware Site Plan.

Commissioner Tim Slattery made the motion to table the discussion until the next scheduled meeting.

Commissioner Phillips King second the motion.

The motion was carried and approved by all Commissioners.

The Commissioners discussed compiling a list of items to discuss at the next Planning and Zoning meeting regarding the requirements for future development and building regulations.

Commissioner Phillips King requested the Building Department input at the next board meeting to discuss the changes or requirements to shielding the back of the building/structures for future building projects.

## **Next Meeting**

The Next Planning and Zoning Meeting Will Be Held on September 26, 2023

# Adjourn

Commissioner Tim Slattery motioned the meeting to adjourn.

Commissioner Andrew Duggar seconded the motion.

The motion carried and was approved by all Commissioners.

The Chairman declared the motion carried.

| WITNESS OUR HANDS, this the | day of,2023             |
|-----------------------------|-------------------------|
|                             |                         |
|                             | MELANIE GREER, Chairman |

SAM MCGAUGH, Vice Chairman/Secretary

# City of Gluckstadt

| Application for Sit  | te Plan Review   |
|--|--|
| Subject Property Address: 259 YANDE  | LL Rd CANTON, MS 3904  |
| Parcel #: 082 H-27 - 023/25.00   | Book 3468, Page 481  |
| Owner: Four Seasons Land Holdings LLC Address: 115 Claiborne St. Madison, MS 39110 | Applicant: Tim Hillhouse  Address: 115 Claiborne St  Madison, MS 39110 |
| Phone #: 601-624-6780 E-Mail: Tin Hillhouse 2 gmail. com                           | Phone #: 601-624-6780 E-Mail: TinHillhouse Domail con                  |
| Current Zoning District: C1-A  | L-MailTAKTITIMOVSE wg-Mail I WH  |
| Acreage of Property (If applicable): 0.94  |  |
| Use sought of Property: Business + Pron  | Acsional Office  |
|  |  |

### Requirements of Applicant:

- 1. Copy of written legal description.
- 2. Site Plan as required in Sections 807-810 of City of Gluckstadt Zoning Ordinance
- 3. Color Rendering & Elevations at time of submittal

Requirements for Site Plan Submittal (Refer to Section 807, Gluckstadt Zoning Ordinance)

Nine (9) copies of the site plan shall be prepared and submitted to the Zoning Administrator.

Digital copies are acceptable. Three (3) hard copies are required.

#### Site Plan Specifications (Section 809, Zoning Ordinance)

- A. Lot Lines (property lines)
- B. Zoning of the adjacent lots
- C. The names of owners of adjacent lots
- D. Rights of way existing and proposed streets, including streets shown on the adopted Throughfares plan
- E. Access ways, curb cuts, driveways, and parking, including number of parking spaces to be provided
- F. All existing and proposed easements
- G. All existing and proposed water and sewer lines. Also, the location of all existing and proposed fire hydrants.
- H. Drainage plan showing existing and proposed storm drainage facilities. The drainage plan shall indicate adjacent off site drainage courses and projected storm water flow rates from off-site and on-site sources.

- 1. Contours at vertical intervals of five (5) feet or less.
- J. Floodplain designation, according to FEMA Maps.
- K. Landscaped areas and planting screens.
- L. Building lines and the locations of all structures, existing and proposed
- M. Proposed uses of the land and buildings, if known
- N. Open space and recreation areas, where required.
- O. Area in square feet, and/or square acres of parcel
- P. Proposed gross lot coverage in square feet
- Q. Number and type of dwelling units where proposed
- R. Location of sign structures and drawings. (Section 701)
- S. Location of garbage dumpster and enclosure. (Section 406.06)
- T. Any other data necessary to allow for a through evaluation of the proposed use, including a traffic study.

Applicant shall be present at the monthly meeting of the Planning and Zoning Commission when site plan is on the agenda for consideration; additionally, applicant shall be present at the Mayor and Board of Alderman meeting when the site plan is on the agenda for final approval.

Applicant is responsible for complying with all applicable requirements of the Gluckstadt Zoning Ordinance.

Site Plans shall be submitted by the 5:00 pm on the 5<sup>th</sup> day of the month, immediately preceding the next regular meeting of the Planning and Zoning Commission. No Exceptions.

Once submitted to the Planning & Zoning Administrator for approval to add to the Planning and Zoning Commission's agenda, no amendments or changes shall be made to the site plan. If you wish to submit changes, you will be required to resubmit by the 5<sup>th</sup> of the following month for the next monthly meeting of the Planning and Zoning Commission.

Attestation: By signing this application, the applicant agrees to all the terms and conditions laid out in this document. Approval of site plan is subject to Board approval.

| Ti de               | 2-26-23 |
|---------------------|---------|
| Applicant Signature | Date    |

# OFFICE USE ONLY

Date Received: 5 - 2 - 20 23

Application Complete & Approved to Submit to P&Z Board (please check):

| Yes | No |
|-----|----|
|     |    |

Signature:


Planning & Zoning Administrator (or Authorized Representative)


|          | -  | Gluckstadt Requirement for Site Plan Checklist for Con<br>Variances and Rezoning | ditional Use | e, Dimensional |
|----------|----|--|--------------|----------------|
|          |    | variances and resemble   | Completed    | Uncompleted    |
| ķ        | 1  | Property Lines and lot numbers   | 1/           |                |
| :        |    | Zoning of adjacent lots  | V            |                |
|          |    | Names of owners of adjacent lots within 160 feet                                 | V            |                |
|          | J  | Rights of Way for existing and proposed streets including                        |              |                |
| k        |    | streets on the adopted throughfares plan   |              |                |
|          | 4  | <u> </u>   |              |                |
|          |    | Accessways, curbcuts, driveways and parking (Including                           |              |                |
|          | _  | number of parking spaces to be provided) and loading                             |              |                |
|          | _  | areas.   |              |                |
| <b>k</b> | 6  | All existing and proposed easements  | V            |                |
|          |    | All existing and proposed water and sanitary sewer lines,                        |              |                |
|          | -, |  |              |                |
|          |    | also the location of existing and proposed fire hydrants.                        |              |                |
|          |    | A drainage plan showing all existing and proposed storm                          |              |                |
|          |    | drain facilities. The drainage plan shall indicate adjacent                      | 1/           |                |
|          |    |  |              |                |
|          |    | off-site drainage courses and projected storm water run-                         |              |                |
|          | _  | off rates from on-site, off-site sources.  | 1/           |                |
|          | 9  | Contours at five feet or less  |              |                |
|          |    | Flood zone designations according to maps prepared by                            |              |                |
|          |    | the federal Emergency Management Agency , Federal                                |              |                |
|          |    | Insurance Administration, and any proposed floodway                              |              |                |
|          | 10 | modifications.   |              |                |
|          | 11 | Landscaped Areas and Planting Screens  |              |                |
|          |    | Building Lines and the location of all structures existing and                   | 1/           |                |
|          | 12 | proposed.  |              |                |
|          | 13 | Proposed use of the land and buildings if known                                  | V            |                |
|          | 14 | Open Space and Recreational areas when required                                  |              |                |
|          | _  | Area of the parcel in square feet or acres                                       | V            |                |
|          | 16 | Proposed gross lot coverage of buildings and structures                          | V            |                |
|          |    |  | W/A          |                |
|          | 17 | Number and type of dwelling units (where proposed)                               | 777          |                |
|          |    | Location of sign structures and drawing, ect in accordance                       |              |                |
|          | 18 | with section 701 of the Zoning Ordinance   |              |                |
|          | 13 | A development plan (Section 809.04 when staging                                  | /2           |                |
|          | 19 | development is proposed  | N/1/+        |                |
|          |    | Any additional data necessary to allow for a thorough                            | (            |                |
|          |    | evaluation of the proposed use to include traffic and                            |              |                |
|          | 20 | drainage study's.  |              |                |
|          | -  | Proposed elevations indicating the general design, style,                        |              |                |
|          | 21 | and architecture of the building or structure.                                   |              |                |

| 22 | construction of the exterior of buildings and structures.    |   |  |
|----|--|---|--|
|    |  | , |  |
|    | Number of stories and total square feet, including a         |   |  |
| 23 | notation as to the square footage on each floor or level.    |   |  |
| 24 | Proposed height in feet.                                     |   |  |
|    |  | , |  |
|    | Photographs, renderings, color slides, models and similar    |   |  |
|    | items may be presented by the applicant at his discretion.   |   |  |
| _  | Refuse and service areas                                     | V |  |
| 27 | Number of regular and ADA parking spaces.                    |   |  |
| 28 | 1000:1 scale vicinty Map                                     |   |  |
| 29 | Graphic Scale and North Arrow                                | V |  |
| 30 | Provide a PDF digital copy of the Site plan                  |   |  |
|    | Additional Requirements for Conditional Use                  |   |  |
|    | Screening and buffering with reference to type, dimension    |   |  |
| 31 | and character.   |   |  |
| 32 | Required yards and open space                                |   |  |
|    | General compatibility with adjacent properties and other     |   |  |
| 33 | properties in the district                                   |   |  |
|    | Any advise impacts to nearby properties or the community     |   |  |
| 34 | at large.  |   |  |
|    | Is lighting that spills onto or is directed toward adjacent  |   |  |
| 35 | property addressed   |   |  |
|    |  |   |  |
|    | Is noise generated by the conditional use have a negative    |   |  |
|    | impact upon the peaceful use and enjoyment of adjacent       |   |  |
| 36 | properties or surrounding neighborhoods.                     |   |  |
|    | I noise generated by patrons , customers, clients, or users  |   |  |
|    | of the conditional use have a negative impact upon the       |   |  |
|    | peaceful enjoyment of adjacent properties or                 |   |  |
| 37 | neighborhoods.   |   |  |
|    | Will the proposed conditional use have a cluttered           |   |  |
|    | appearance as a result of site design, signage or other      |   |  |
|    | features that may be visible from the street or adjoining    |   |  |
| 38 | properties.  |   |  |
| 37 | Provide the hours of operation or frequent use.              |   |  |
|    |  |   |  |
|    | Is there a negative impact to natural features, such as tree |   |  |
| 39 | cover, drainage courses, flooding and erosion.               |   |  |

# FOUR SEASONS DRAPERY & HARDWARE

# GLUCKSTADT, MISSISSIPPI

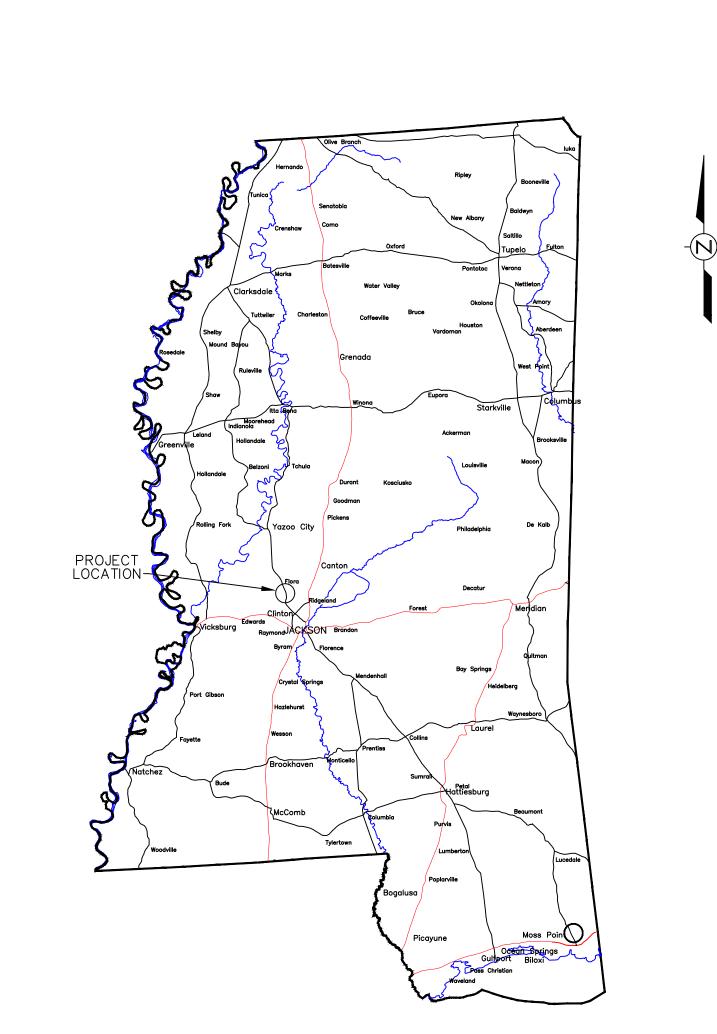

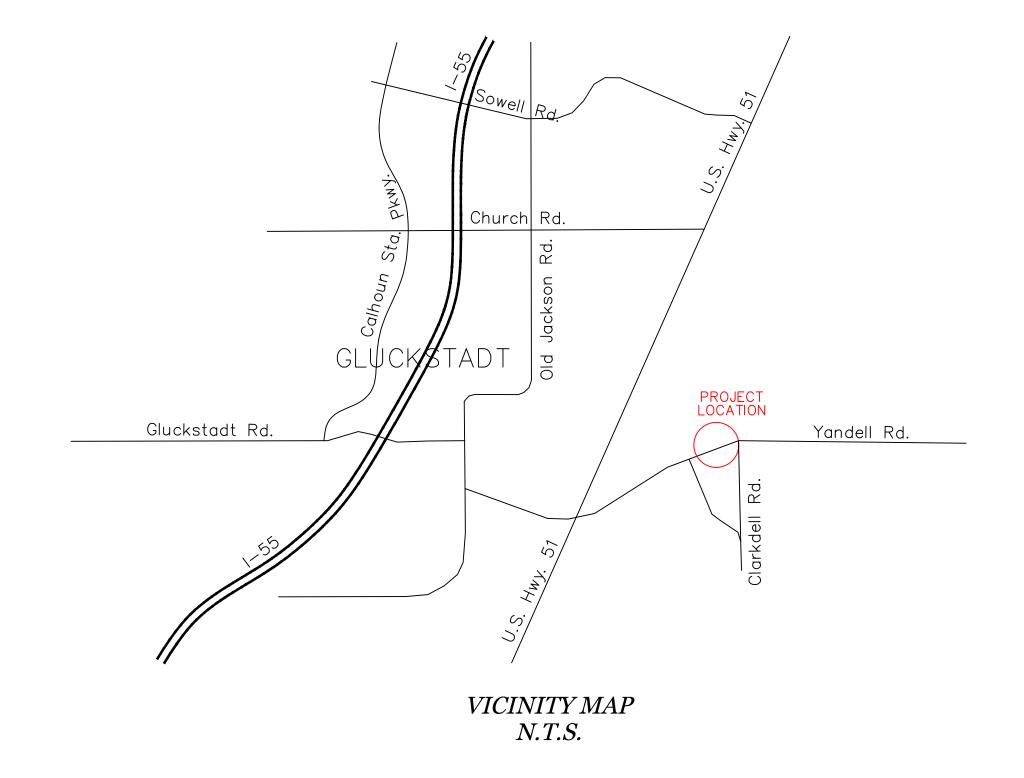


# DRAWING INDEX


| DRAWING NO. | DESCRIPTION             |  |  |  |
|-------------|-------------------------|--|--|--|
| C-1         | COVER SHEET             |  |  |  |
| C-2         | SITE LOCATION MAP       |  |  |  |
| C-3         | SITE BOUNDARY & TOPO    |  |  |  |
| C-4         | SITE & UTILITY PLAN     |  |  |  |
| C-5         | GRADING & DRAINAGE PLAN |  |  |  |
| C-6         | SITE DETAILS            |  |  |  |


MAY 2023




SHEET NUMBER

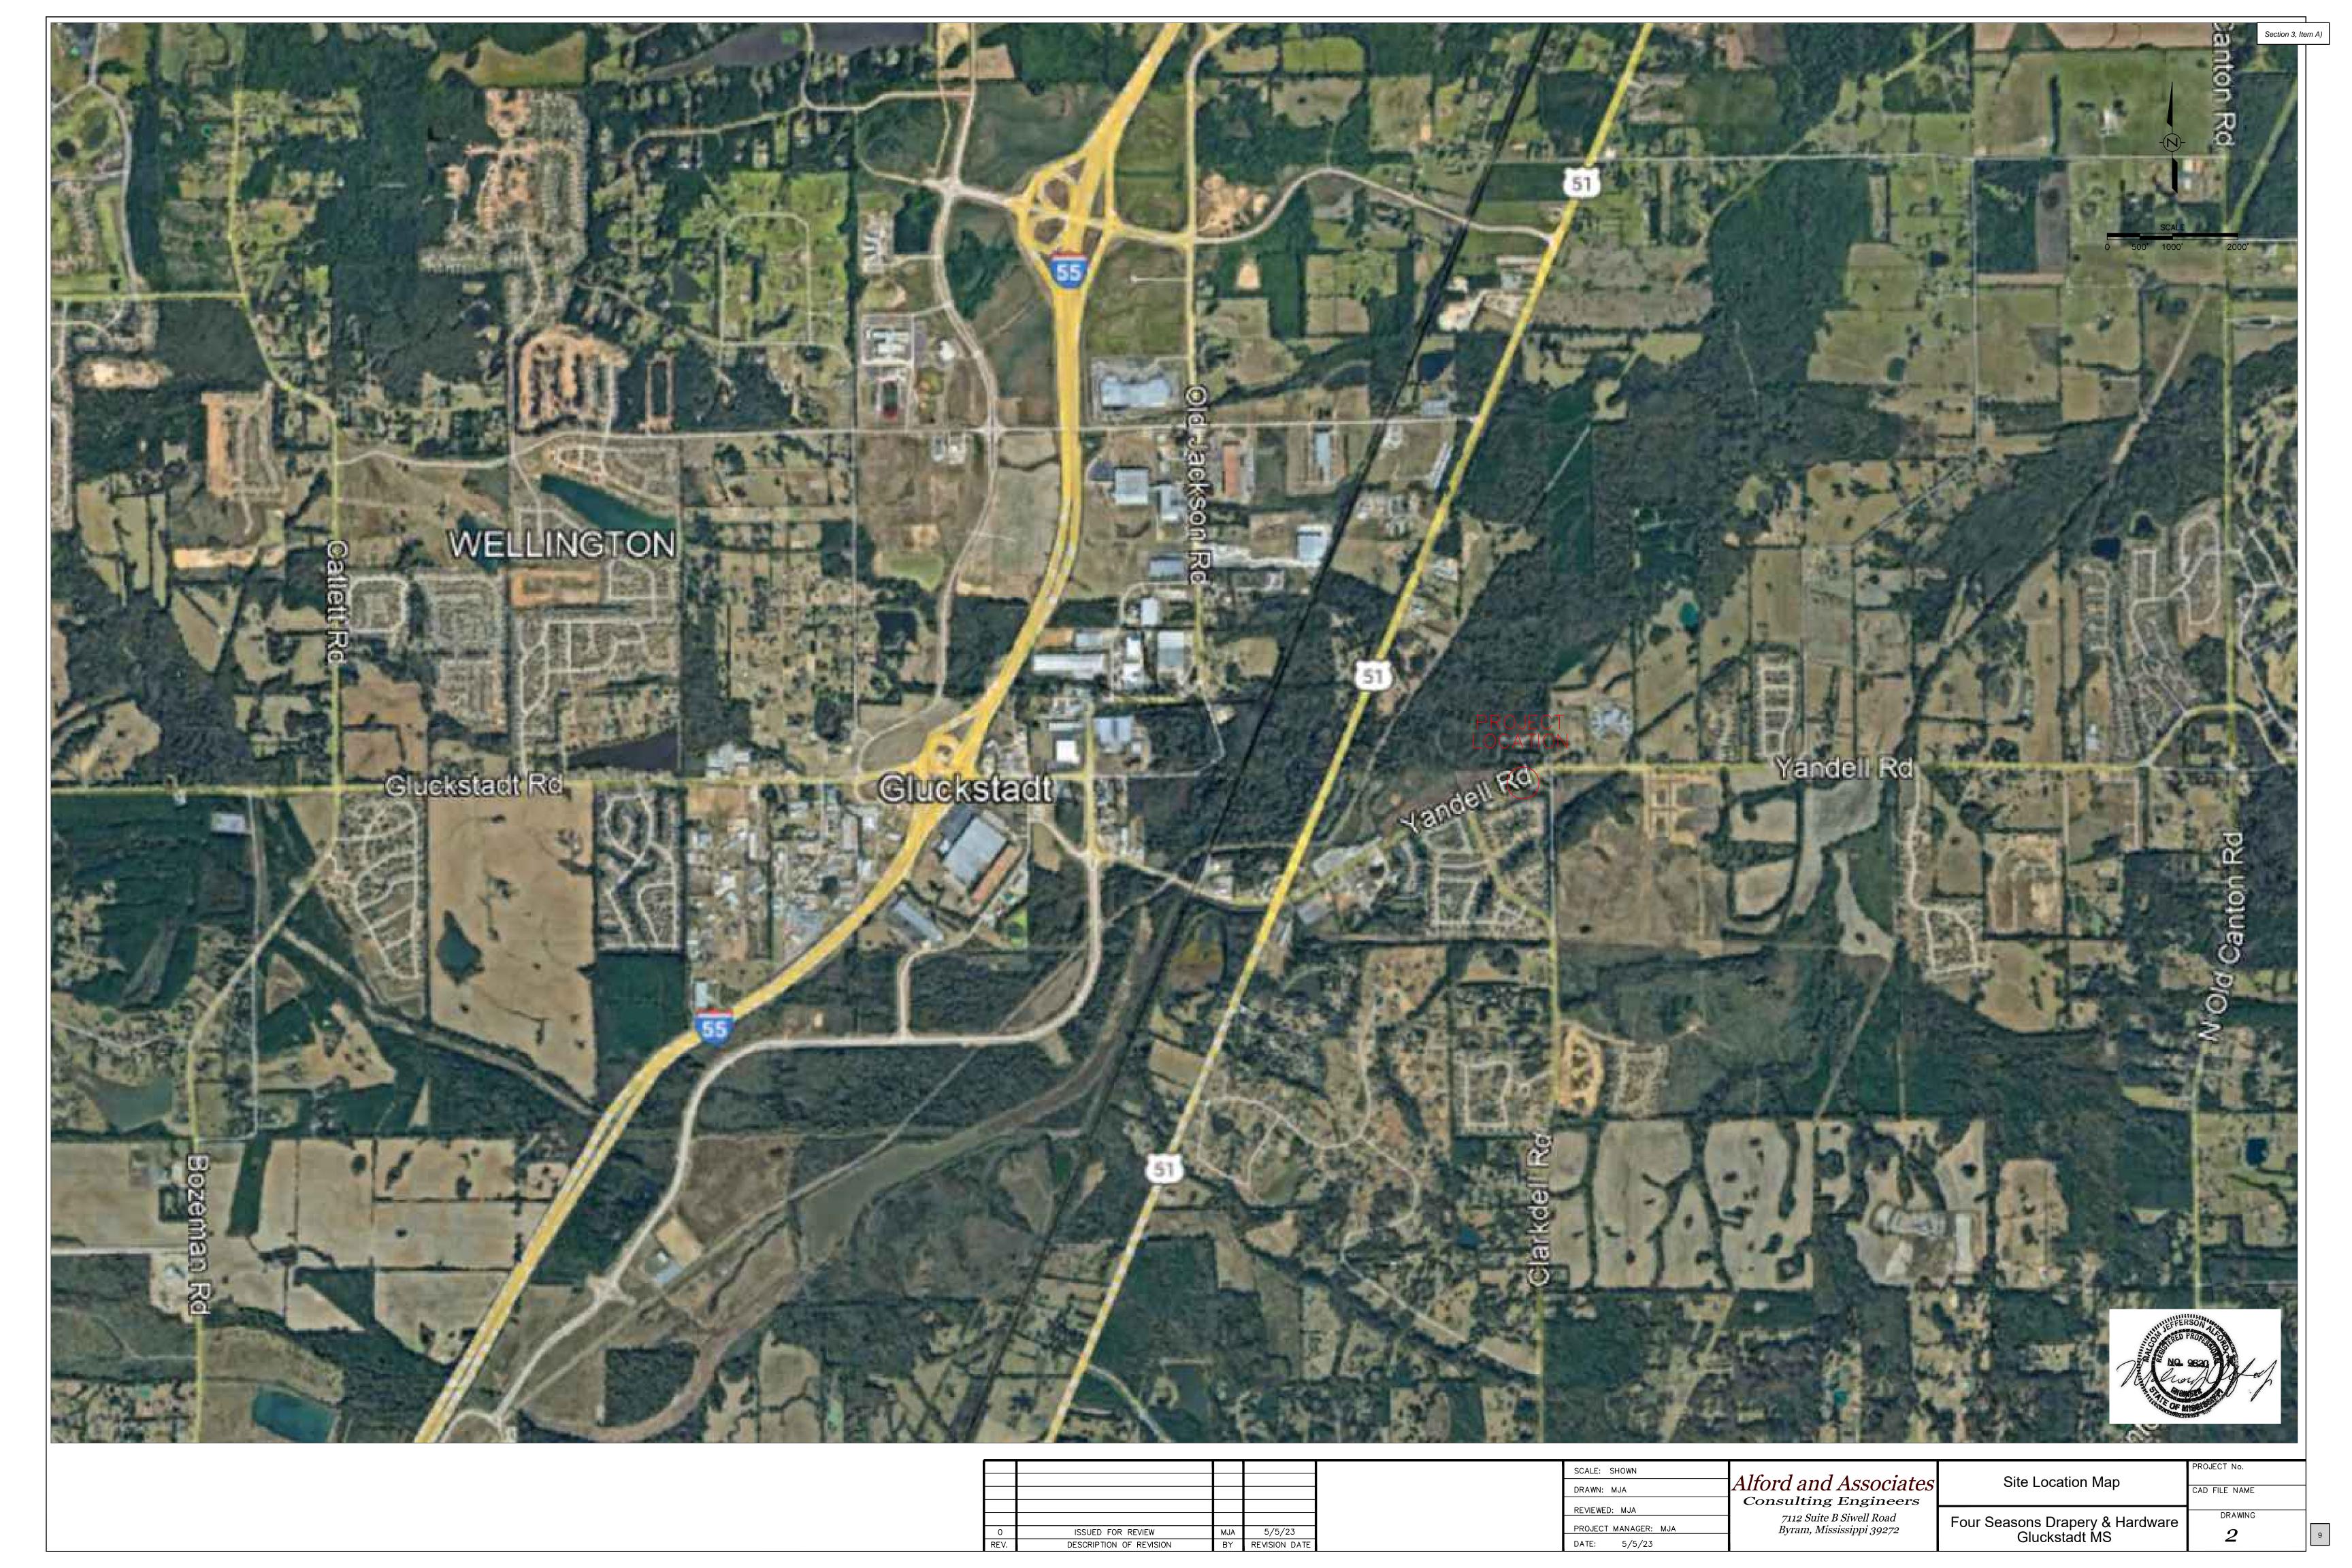

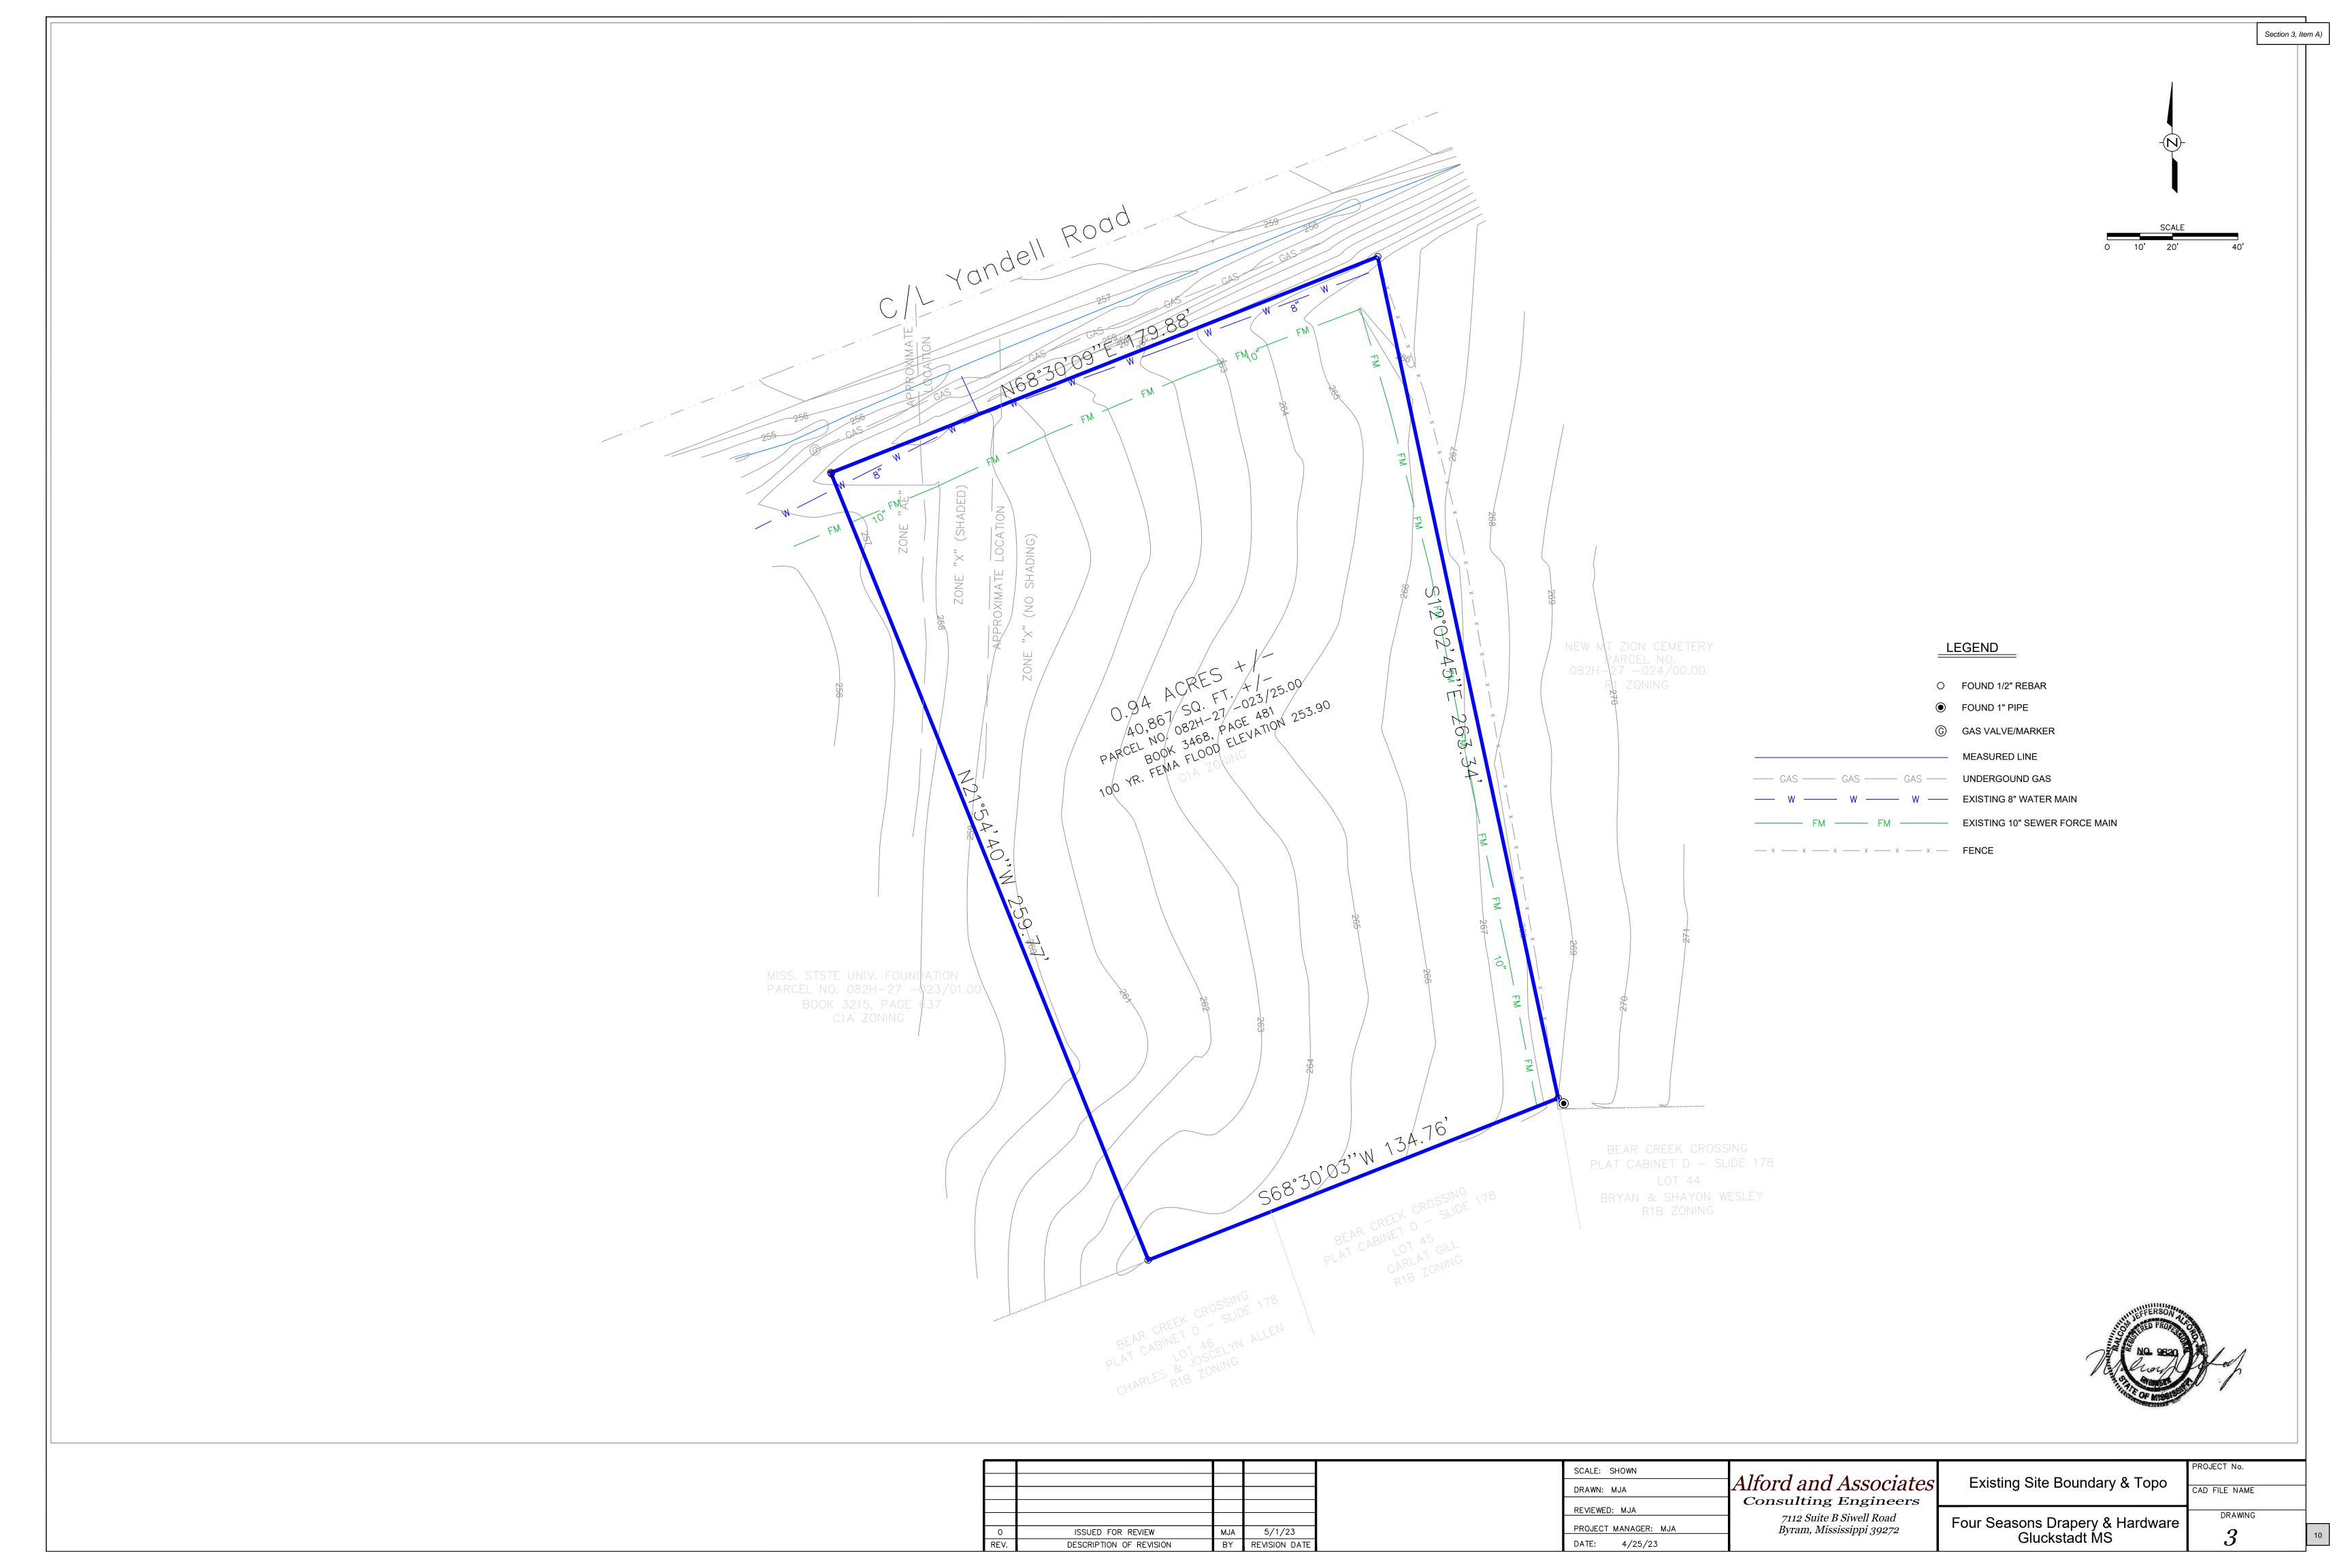

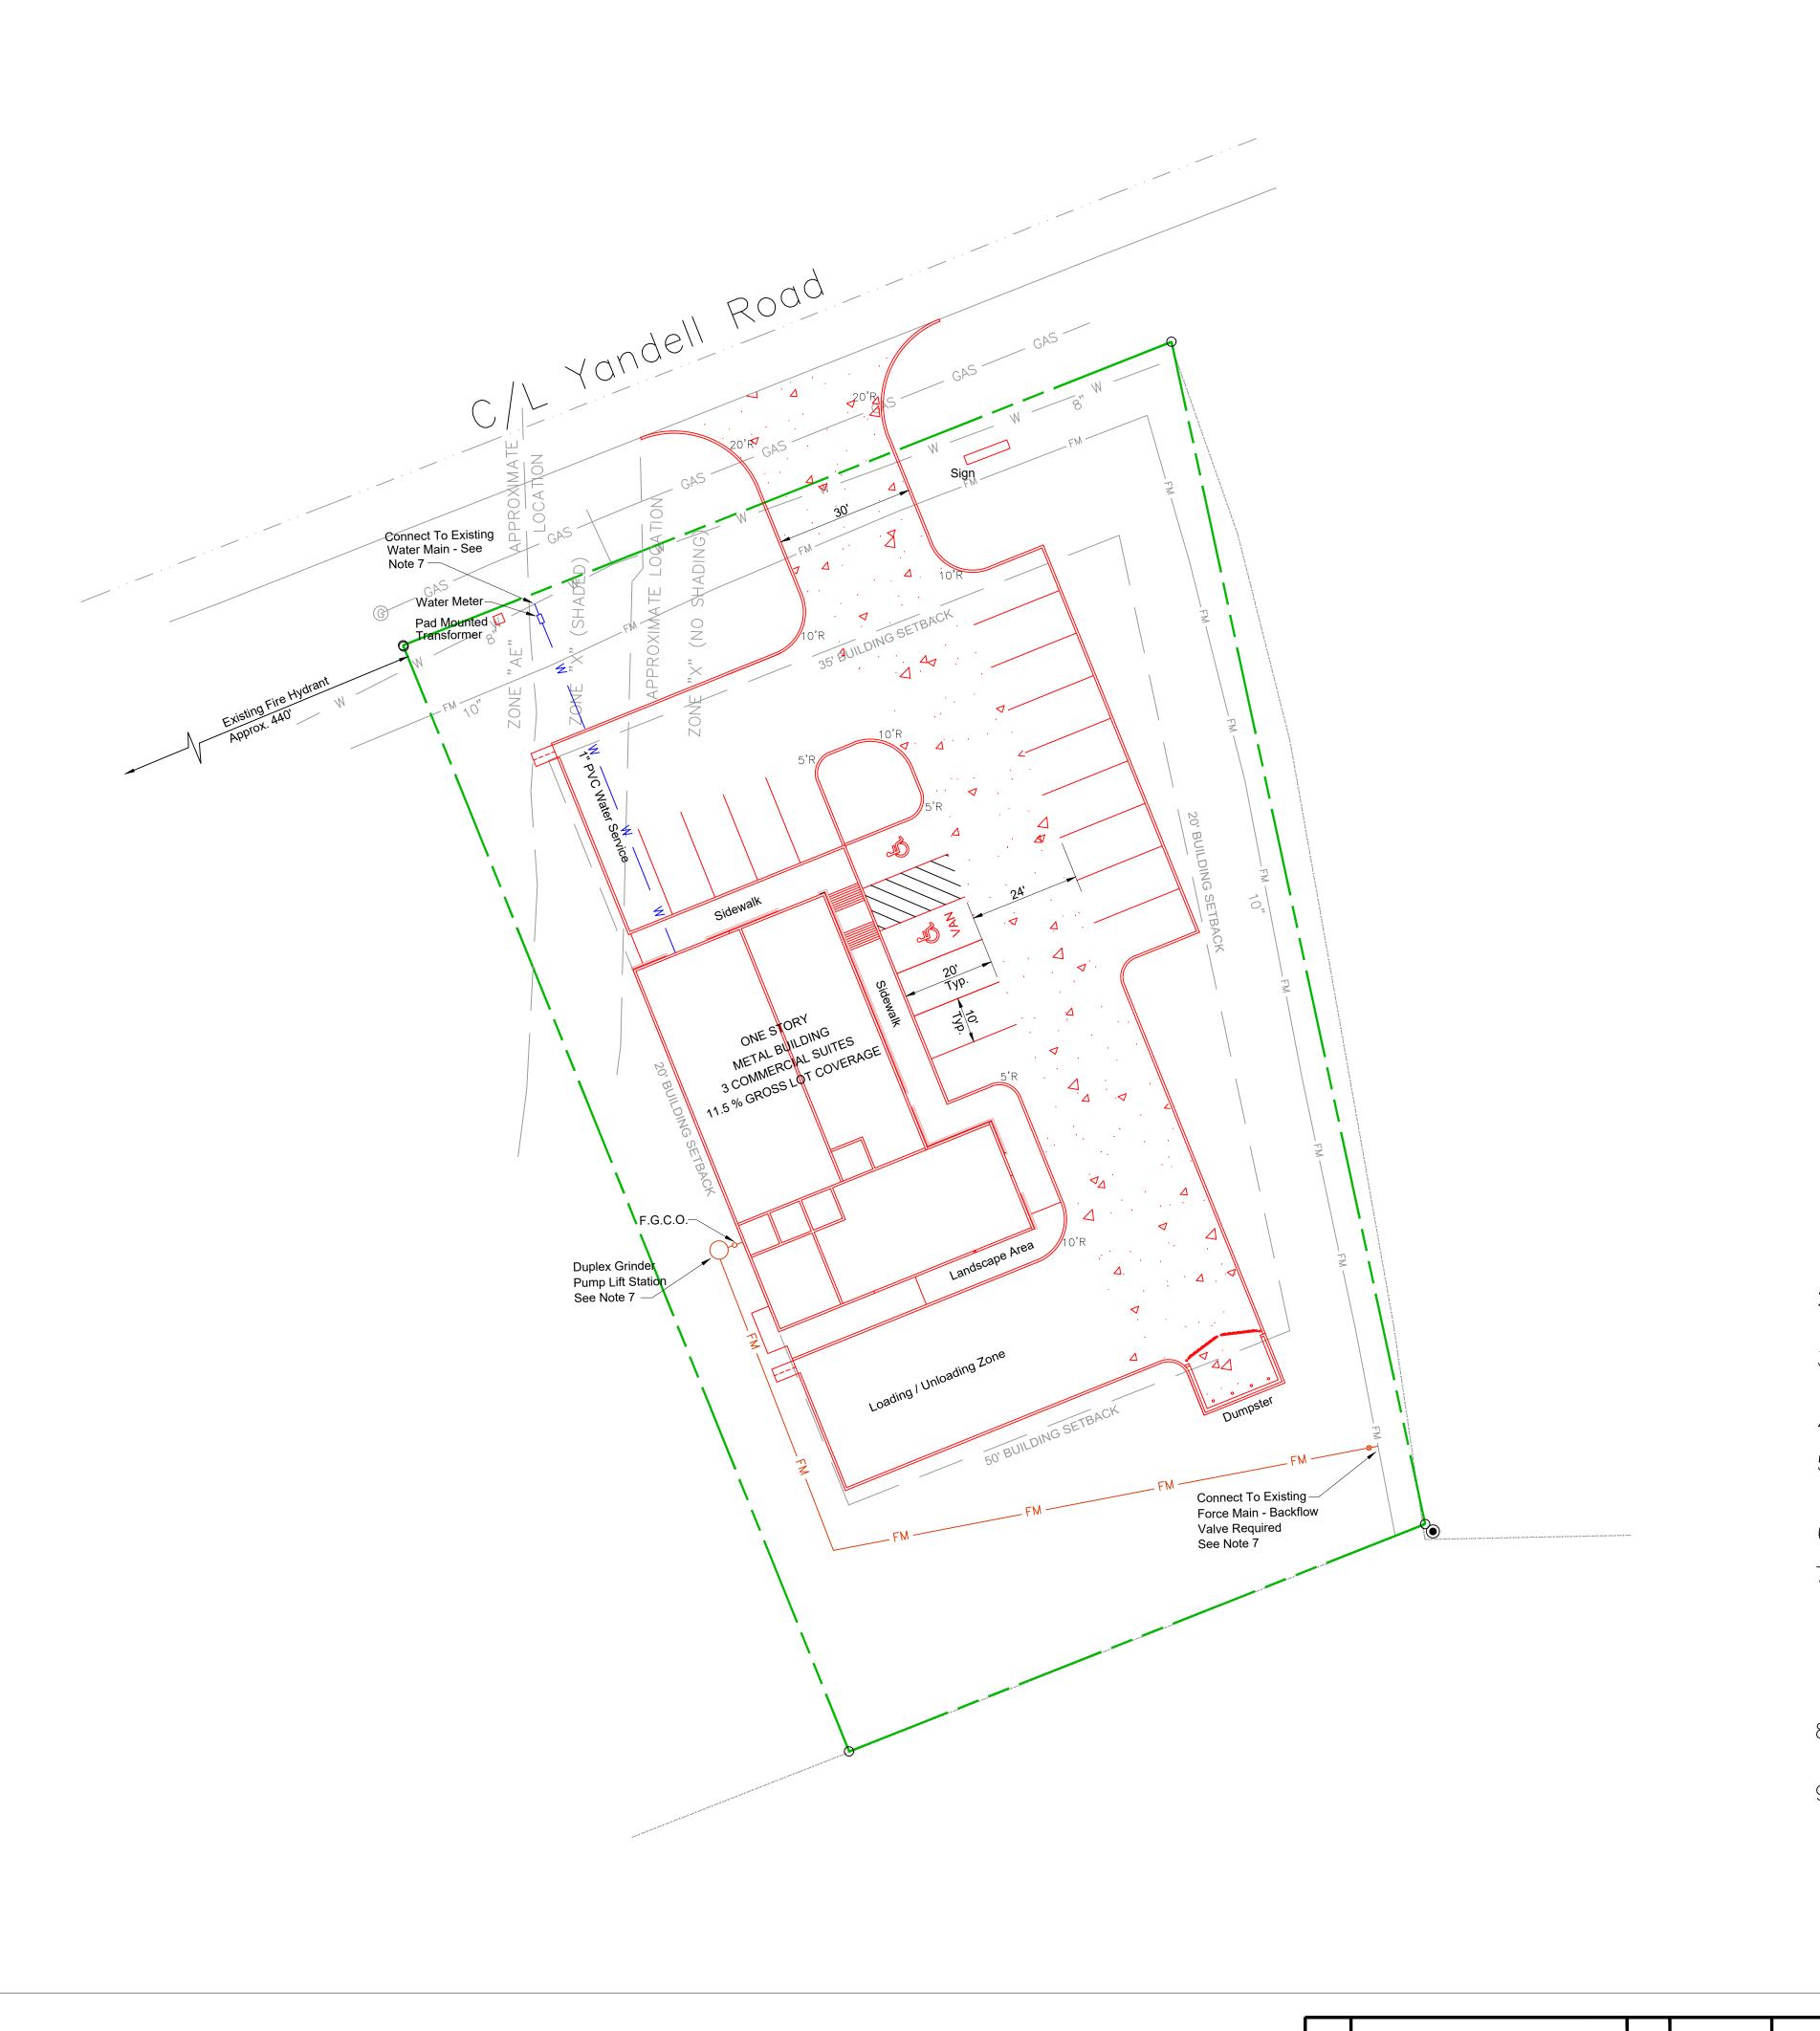

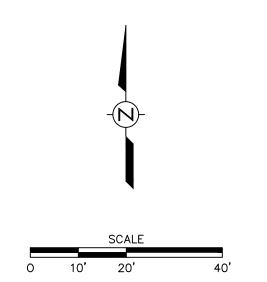

# LEGEND




# GENERAL NOTES

- 1. ALL EXCAVATION, OVER EXCAVATION, BACKFILL AND COMPACTION OF FILL MATERIAL SHALL FOLLOW RECOMMENDATIONS OF GEOTECHNICAL REPORT, PROVIDED BY OTHERS. SEE GEOTECH REPORT FOR PAVING RECOMMENDATIONS.
- 2. HANDICAPPED PARKING SPACES, AND ROUTE TO BUILDING SHALL BE 2% MAX. SLOPE.
- 3. CONTRACTOR SHALL NOTIFY MISSISSIPPI 811 BEFORE ANY EXCAVATION TO HAVE UNDERGROUND UTILITIES LOCATED.
- 4. RADII SHOWN ARE TO THE PROPOSED EDGE OF CONCRETE, OR FACE CURB.
- 5. ALL EXPOSED NON PARKING/DRIVE AREAS SHALL BE SEEDED AND MULCHED AFTER CONSTRUCTION.
- 6. ANY CONCRETE PAVING SHALL HAVE SAW CUT JOINTS AT 12.5' ON CENTERS.
- 7. WATER AND SEWER SERVICE PROVIDED BY BEAR CREEK WATER ASSOCIATION. SERVICES SHALL BE FIELD LOCATED TO REQUIRED INLET/OUTLET LOCATIONS. WATER & SEWER CONNECTIONS SHALL BE PER BEAR CREEK W.A. DUPLEX GRINDER PUMP LIFT STATION TO BE SIZED FOR MAXIMUM SEWER FLOWS AND SIZED FOR EXISTING FORCE MAIN FLOW AND HEAD CONDITIONS.
- 8. TOTAL PROPOSED SITE AREA 0.94 AC. 0.43 AC. HARD SURFACE, 0.51 AC. GRASS.
- 9. MAJORITY OF PROPERTY LOCATED IN FEMA FLOOD ZONE X PER FLOOD MAP 28089C0451F, EFFECTIVE DATE 3-17-10. NORTHWEST CORNER IN FLOOD ZONE AE. 100 YR. BASE FLOOD ELEV. 253.90.



|    |                         |     |               | SCALE: SHOWN         |                          |                                 | PR  |
|----|-------------------------|-----|---------------|----------------------|--------------------------|---------------------------------|-----|
|    |                         |     |               | DRAWN: MJA           | Alford and Associates    | Site & Utility Plan             | CAI |
|    | DRAINAGE REVISIONS      | MJA | 5/10/23       | REVIEWED: MJA        | Consulting Engineers     |                                 |     |
|    | REVISIONS PER CITY      | MJA | 5/5/23        |                      | 7112 Suite B Siwell Road | Four Seasons Drapery & Hardware |     |
| 0  | ISSUED FOR REVIEW       | MJA | 5/1/23        | PROJECT MANAGER: MJA | Byram, Mississippi 39272 | Gluckstadt MS                   |     |
| FV | DESCRIPTION OF REVISION | RY  | REVISION DATE | DATE: 4/26/23        |                          | Oluchsiaut MO                   |     |

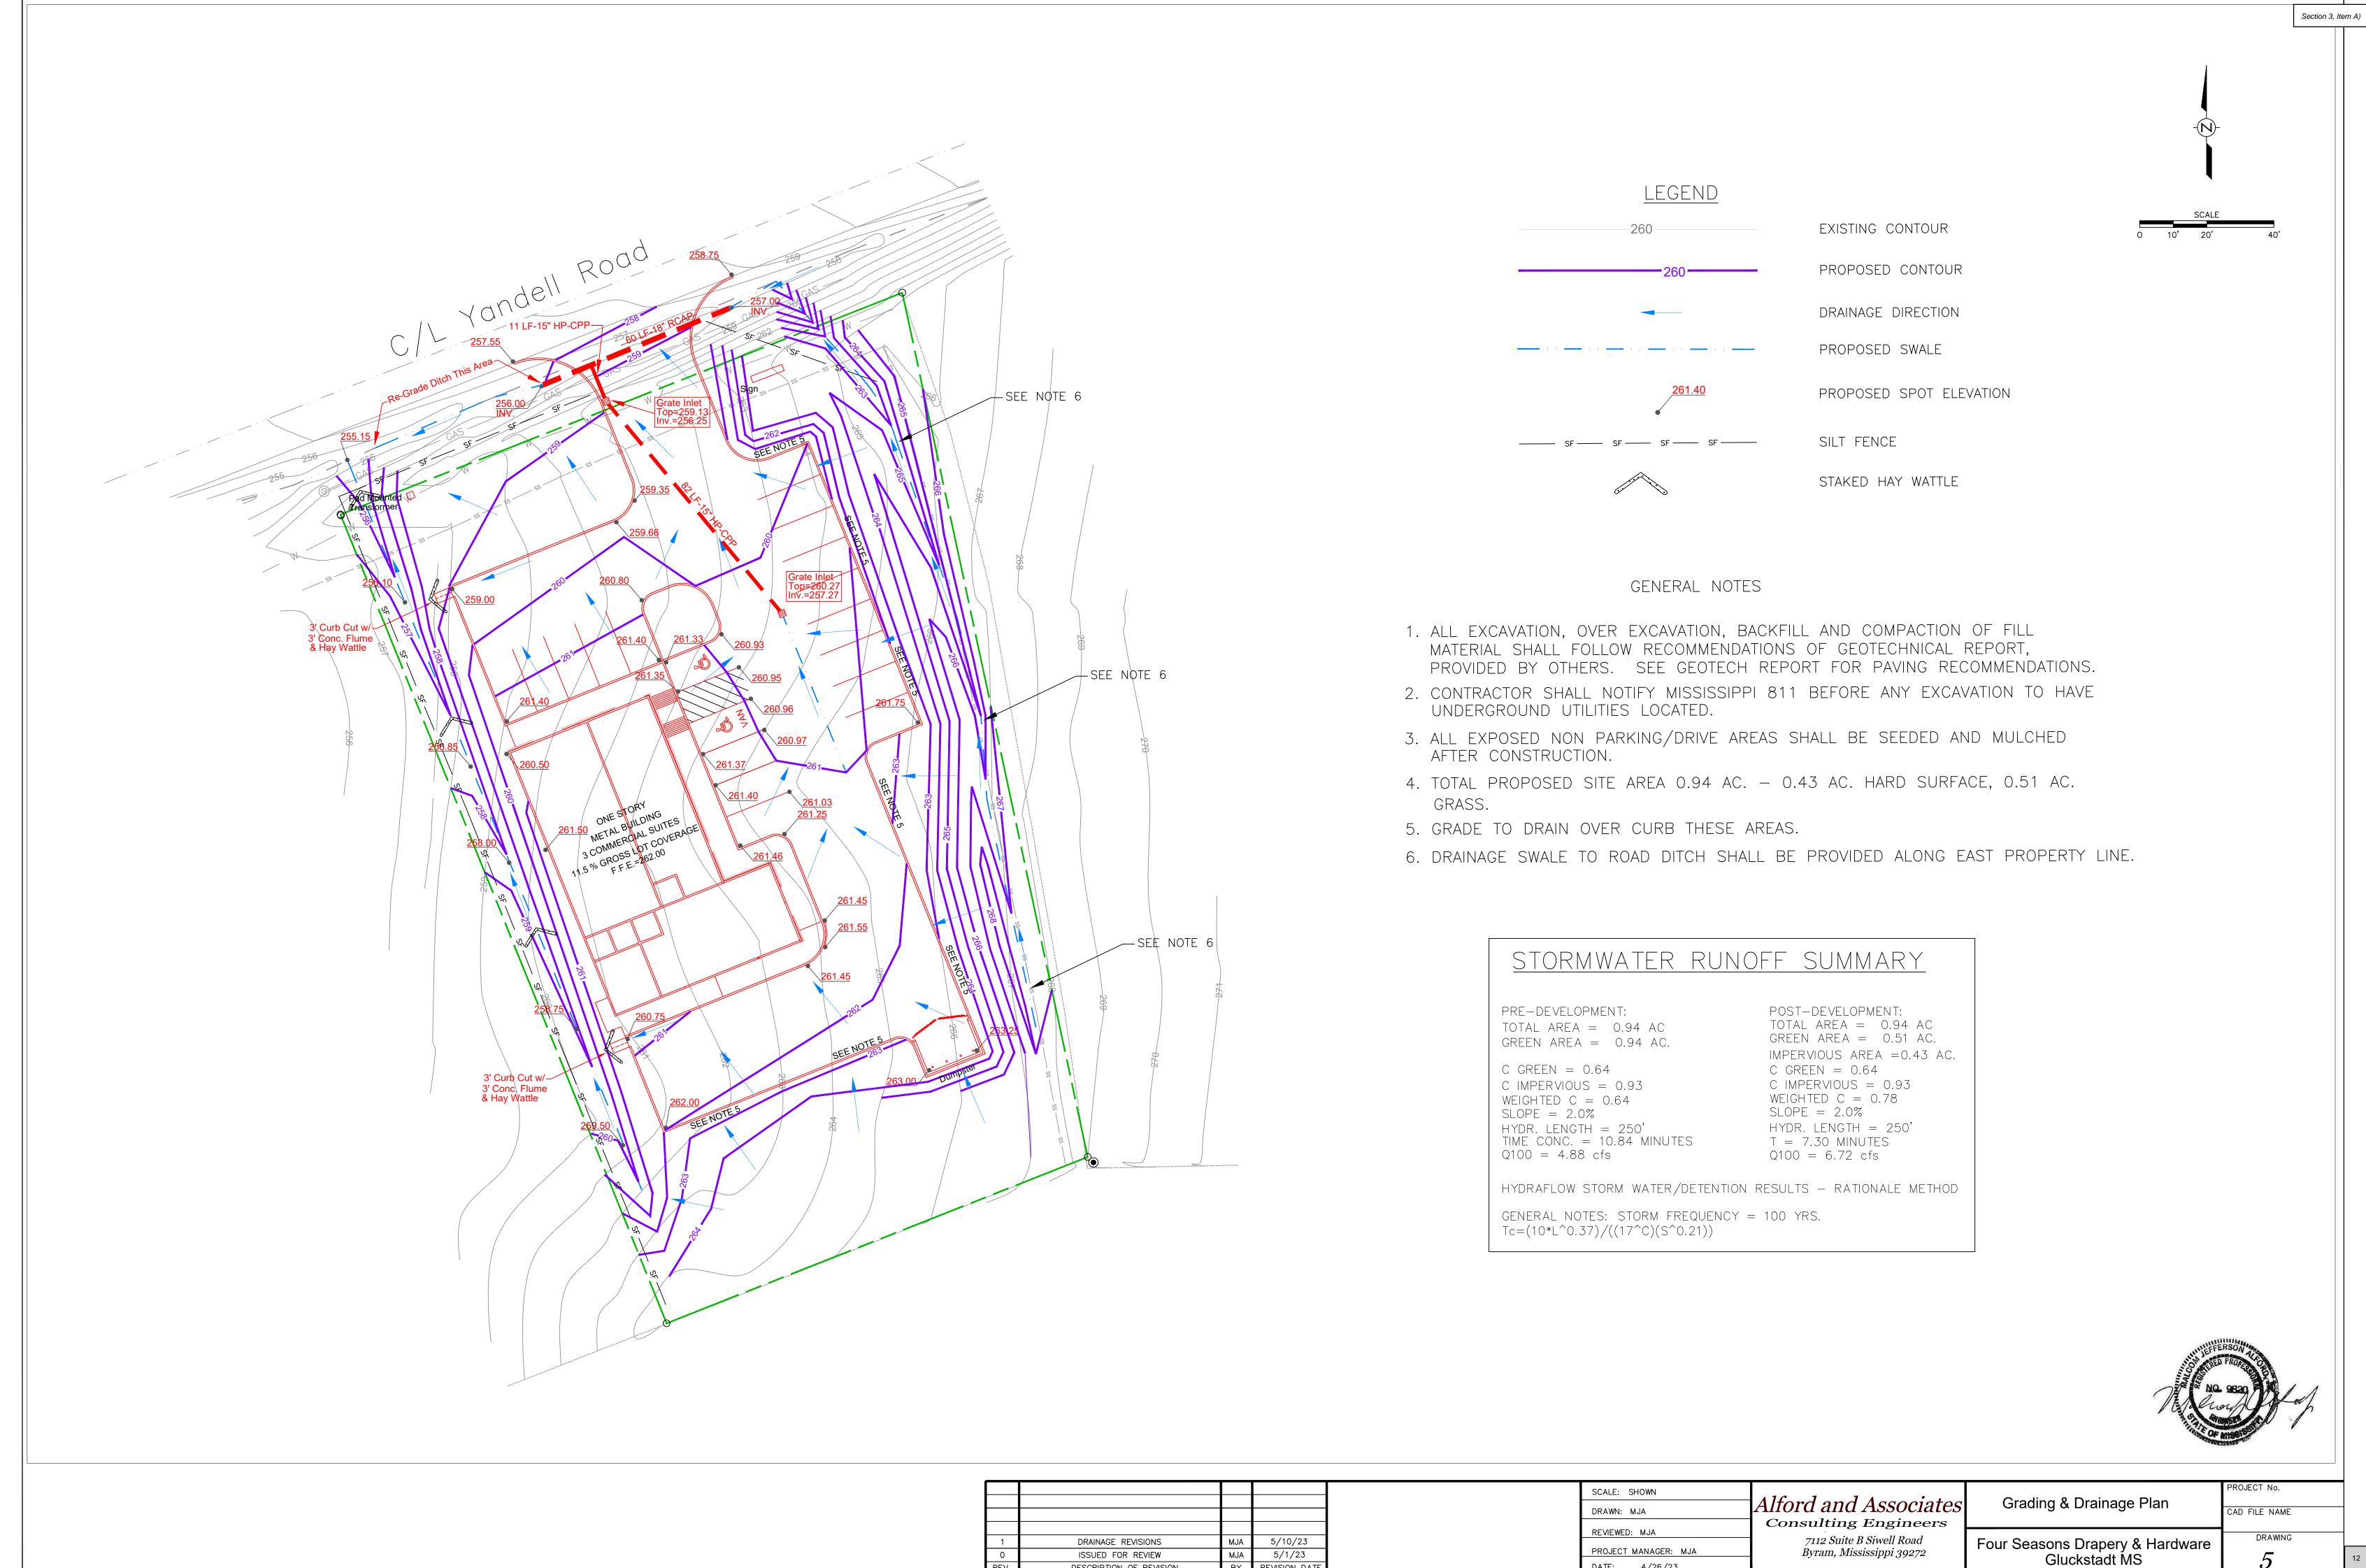

DRAINAGE REVISIONS

ISSUED FOR REVIEW

DESCRIPTION OF REVISION

5/10/23


5/1/23


REVISION DATE

PROJECT MANAGER: MJA

DATE: 4/26/23

5

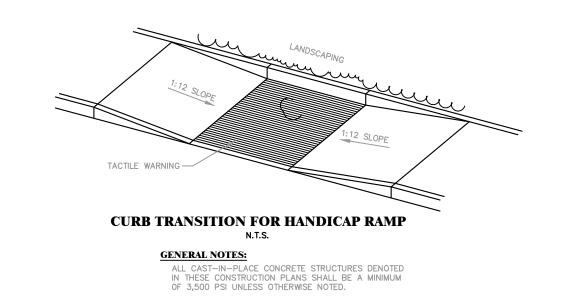


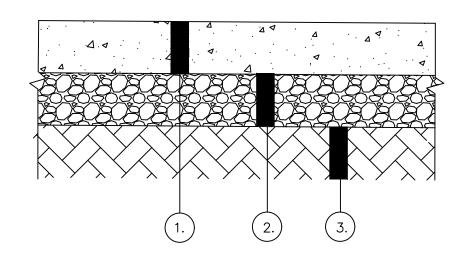

- 1.) 5" MIN. 4000 PSI CONCRETE
- 2. 6" MIN. CRUSHED AGGREGATE (#610 GRADATION),
- 3. COMPACTED SUBGRADE SEE GEOTECH REPORT FOR EXCAVATION AND COMPACTION REQUIREMENTS


  NOTE: REFER TO GEOTECHNICAL REPORT FOR PAVING DETAILS/RECOMMENDATIONS



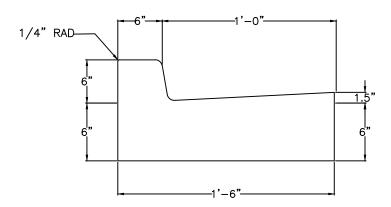

NOTE:
DUMMY JOINTS WILL BE MADE AT 10' INTERVALS.
EXPANSION JOINTS WILL BE MADE AT 40' INTERVALS
AND PRECUT JOINT MATERIAL TEMPLATES WILL
BE USED IN ALL EXPANSION JOINTS.

# STAND-UP CURB AND GUTTER

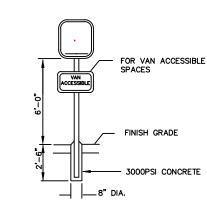

NOTES:


1. HANDICAP PARKING SIGN SHALL CONFORM TO ALL GOVERNING REGULATIONS


2. HANDICAP SIGN SHALL BE 12"x18"x.080", FASTENED WITH TWO EACH 3/8" CADMIUM BOLTS,NUTS AND WASHERS.

3. POST SHALL BE 1.75"x3—1/2" HEAVY DUTY GALVANIZED.

4. CONTRACTOR SHALL INSTALL A HANDICAP PARKING SIGN AT EACH HANDICAP PARKING SPACE.

# HANDICAP SIGN NOT TO SCALE

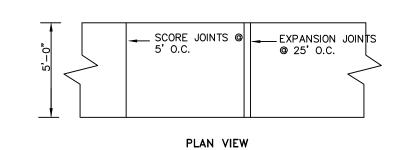


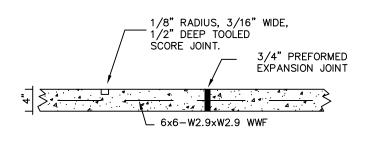


CONTRACTOR MAY OMIT WELDED WIRE FABRIC IF CONCRETE CONTAINS FIBROUS REINFORCEMENT.

CONCRETE SHALL HAVE 3000 PSI AT 28 DAYS.


# SIDEWALK

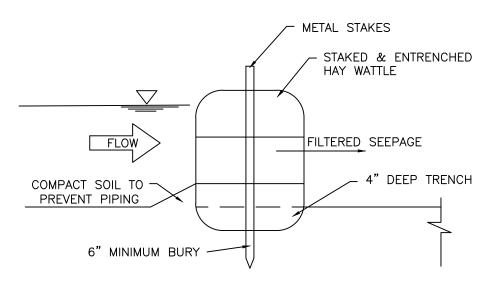

# HAY WATTLE INSTALLATION SCALE: SHOWN

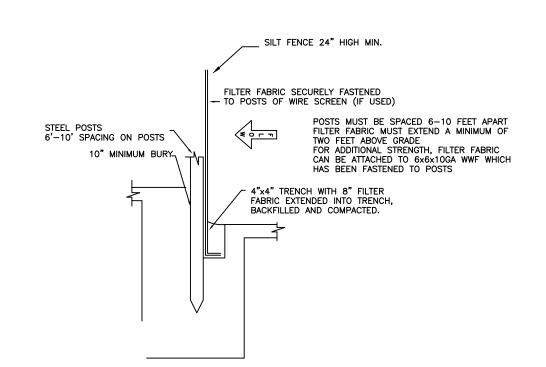

# SILT FENCE TYPICAL SECTION

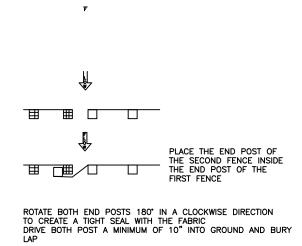

# ATTACHING TWO SILT FENCES

# SILT FENCE MAINTENANCE PLAN

- CARE SHALL BE TAKEN TO MINIMIZE THE MOVEMENT OF SEDIMENT INTO ALL STORM DRAIN APPURTENANCES AND PUBLIC STREETS UNTIL THE IMPERVIOUS MATERIAL (ROAD/PARKING AREA SURFACE) IS APPLIED.
- 2. A DROP INLET SEDIMENT TRAP WITH PERIMETER SILT FENCING OR PROPERLY INSTALLED HAYBALE BARRIERS IS THE RECOMMENDED METHOD OF INLET PROTECTION. SEDIMENT WILL BE REMOVED FROM THE EXCAVATED DROP INLET SEDIMENT TRAP AND RESTORED TO THE ORIGINAL DEPTH WHEN SEDIMENT ACCUMULATION HAS REACHED HALF THE DEPTH OF THE
- 3. ALL EROSION AND SEDIMENT CONTROL MEASURES WILL BE CHECKED FOR STABILITY AND OPERATIONAL INTEGRITY FOLLOWING EVERY RUNOFF PRODUCING RAINFALL BUT IN NO CASE, LESS THAN EVERY WEEK. ANY NECESSARY REPAIRS WILL BE MADE IMMEDIATELY TO MAINTAIN THE MEASURE'S PERFORMANCE AS DESIGNATED.
- 4. SEDIMENT WIL BE REMOVED FROM THE UPSTREAM FACE OF THE SILT FENCE WHEN IT REACHES A MAXIMUM SIX—INCH (6") DEPTH AT THE FENCE. THE FENCE WILL BE REPLACED AS NECESSARY TO MAINTAIN A BARRIER.
- 5. SILT FENCE POSTS SHALL BE ALTERNATING STEEL.



|      |                         |     |               | SCALE: SHOWN     |  | JECT No.  |
|------|-------------------------|-----|---------------|------------------|--|-----------|
|      |                         |     |               | DRAWN: MJA       |  | FILE NAME |
|      |                         |     |               | REVIEWED: MJA    | Consulting Engineers                                     | DRAWING   |
|      |                         |     |               | PROJECT MANAGER: | 7112 Suite B Siwell Road Four Seasons Drapery & Hardware | DRAWING   |
| 0    | ISSUED FOR REVIEW       | MJA | 5/1/23        |                  | Byram, Mississippi 39272  Gluckstadt MS                  | 6         |
| REV. | DESCRIPTION OF REVISION | BY  | REVISION DATE | DATE: 4/26/23    |  | •         |

# **Hydrograph Return Period Recap**

Proj. file: Yandell Rd. 50223.gpw


| Hyd. | Hydrograph       | Inflow |      | Peak Outflow (cfs) |      |      |       |       |       | Hydrograph |             |
|------|------------------|--------|------|--------------------|------|------|-------|-------|-------|------------|-------------|
| No.  | type<br>(origin) | Hyd(s) | 1-Yr | 2-Yr               | 3-Yr | 5-Yr | 10-Yr | 25-Yr | 50-Yr | 100-Yr     | description |
|      | Rational         |        |      | 2.67               |      | 3.16 | 3.52  | 4.05  | 4.47  | 4.88       | Pre         |
|      | Rational         |        |      | 3.81               |      | 4.44 | 4.91  | 5.62  | 6.17  | 6.72       | Post        |
|      |                  |        |      |                    |      |      |       |       |       |            |             |
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|      |                  |        |      |                    |      |      |       |       |       |            |             |
|      |                  |        |      |                    |      |      |       |       |       |            |             |

Run date: 05-05-2023

4246 01-25-2023 Drawn by L McCombs Checked by U Pineda

Scale 1/4" = 1'-0"


1 Left Elevation Copy 1 1/4" = 1'-0"

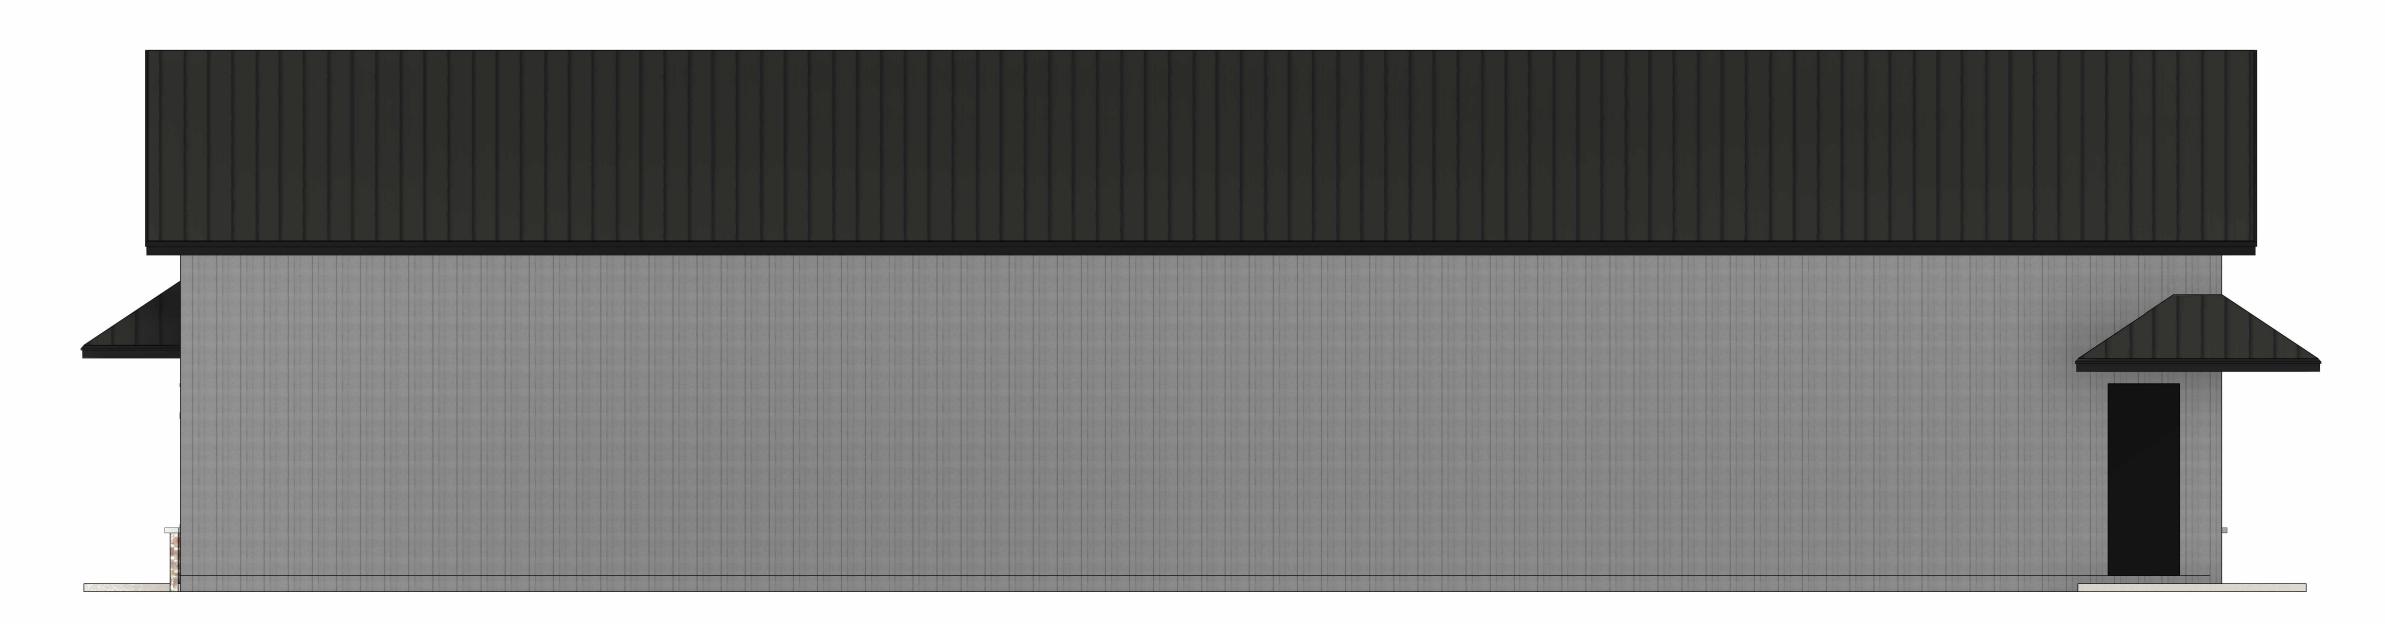

Right Elevation Copy 1
1/4" = 1'-0"



Quality Custom Designs and Stock Plans www.designstudioplans.com

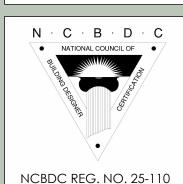

NCBDC REG. NO. 25-110

Rendered

Elevations

4246 Date 01-25-2023
Drawn by L McCombs Checked by U Pineda

Scale 1/4" = 1'-0"





3 Rear Elevation Copy 1 1/4" = 1'-0"

# DESICAN S'I'UDIO (), IN () 745 AVIGNON DRIVE, SUITE A, RIDGELAND MS 39157 PHONE: (601) 898-9710 FAX: (601) 898-9712

Cover Sheet

Project 4246

Date 09-14-2023

Drawn by L McCombs


Checked by U Pineda

Scale



A Metal Building Designed for
Four Seasons Drapery & Hardware, LLC.



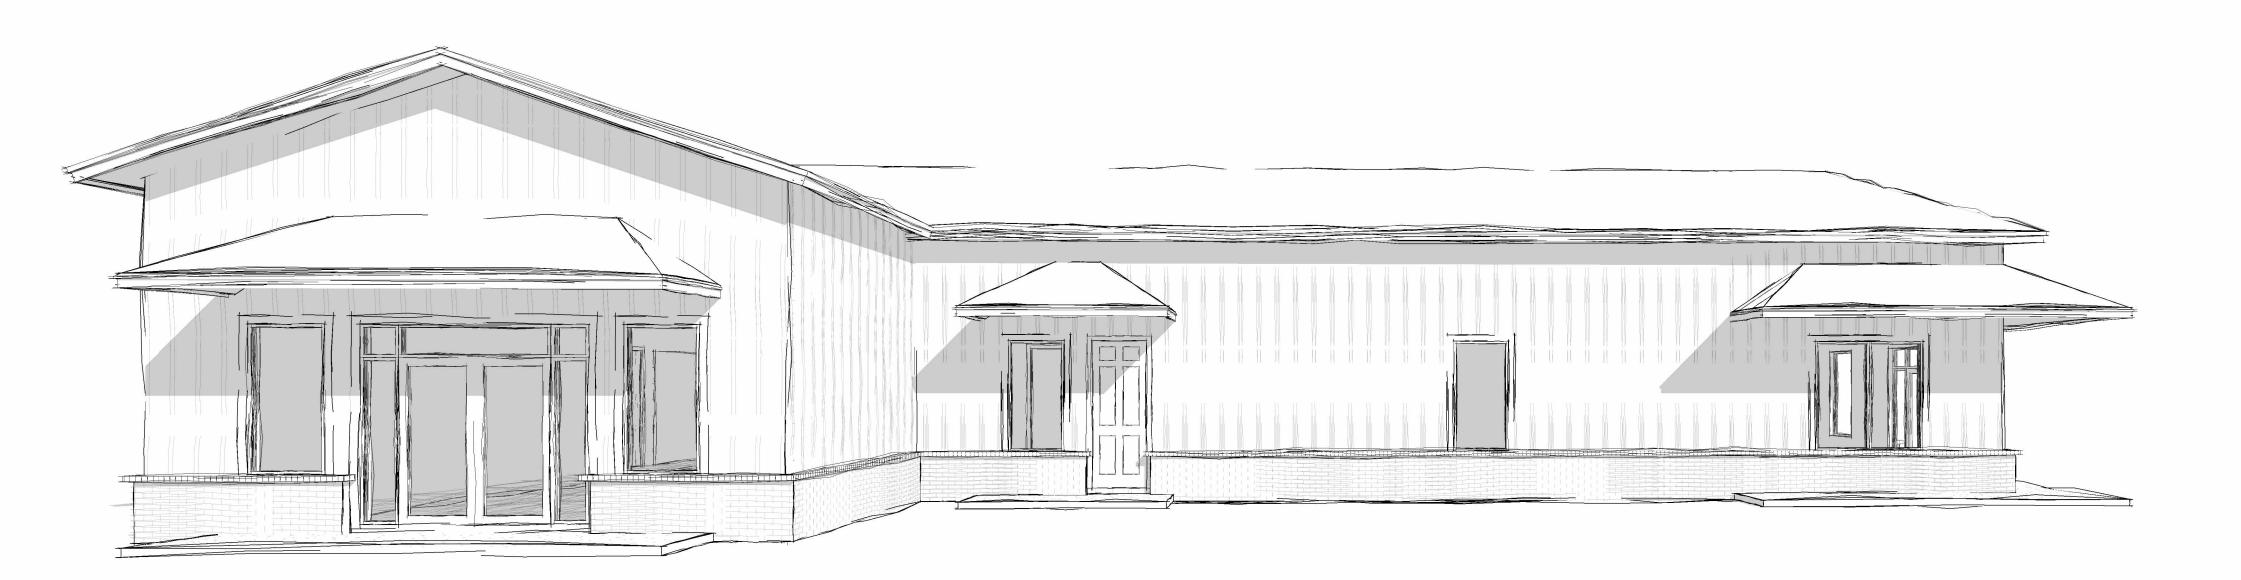

54' - 9 1/8" 60' - 0" 20' - 0" 50' BUILDING SETBACK Loading / Unloading Zone PARCEL NO. 082H-27-023/01.00 MISSISSIPPI STATE UNIVERSITY METAL BUILDING 3 COMMERCIAL SUITES 11.5 % GROSS LOT COVERAGE 24' - 0" 20' - 0" 35' BUILDING SETBACK PARKING STANDARD SPACES: 17 HANDICAPPED SPACES: 2 30' - 0" TOTAL PARKING SPACES: 19 YANDELL ROAD (40' R.O.W.)

PARCEL NO. 082H-27-024/00.00 NEW MT. ZION CEMETERY

# SYMBOLS:

PROPERTY LINE \_\_\_\_ - \_\_\_PL\_\_\_ - \_\_\_ ----- SETBACK -----SETBACK LINE — — EASEMENT EASEMENT LINE CENTERLINE OF STREET SWALE -SWALE SILT FENCE \_\_\_\_\_\_\_

**ELEVATION MARK** 

FIN. EL.: XX.XX' (FINISHED GRADE ELEVATION)

DRAINAGE DIRECTION

NORTH ARROW





ALL IMPROVEMENTS SHOWN ARE PROPOSED. BUILDING DIMENSIONS ARE TO THE OUTSIDE FACE OF BRICK ON PLOT PLAN ONLY.

GRADING OF ENTIRE LOT SHALL HAVE A MINIMUM OF 2% SLOPE FOR PROPER DRAINAGE.

FINISH FLOOR ELEVATION SHALL BE A MINIMUM OF 8" ABOVE ADJACENT FINISH GRADE ELEVATION

THE PROPERTY LINE (WHICHEVER IS LESS) SHALL BE A MINIMUM OF 17" LOWER THAN FINISH FLOOR

FINISH GRADE (INCLUDING SOD) AT A 10'-0" PERIMETER DISTANCE FROM THE BUILDING OR MID-DISTANCE

ALL CURVED LOT DIMENSIONS ARE CHORD LENGTH UNLESS OTHERWISE NOTED. <u>SIDEWALKS</u>

ALL SIDEWALKS SHALL BE CONSTRUCTED OF PORTLAND CEMENT CONCRETE, WITH A COMPRESSIVE STRENGTH OF 3000 P.S.I. IN TWENTY EIGHT DAYS.

ALL SIDEWALKS ARE TO HAVE A WIDTH AND SHALL BE CONSTRUCTED AS PER THE LOCATION SHOWN ON THESE PLANS.

ALL SIDEWALKS SHALL BE SCORED TO A DEPTH OF 3/4" AT FOUR (4) FOOT INTERVALS, WITH EXPANSION JOINTS PLACED AT TWENTY (20) FOOT INTERVALS.

EXPANSION JOINTS SHALL BE CONSTRUCTED OF 1/2" THICK PRE-MOLDED EXPANSION MATERIAL WITH ALL CORNERS TO BE FORMED BY EXPANSION JOINTS.

ANY SIDEWALK OR ACCESSIBLE ROUTE THAT IS NOT AT A LEVEL ELEVATION AT ITS INTERSECTION WITH A DRIVEWAY OR STREET WILL BE REQUIRED TO INSTALL A CURB RAMP AT A MAXIMUM SLOPE OF 1:12, WITH A MAXIMUM RISE OF 30" AND A MINIMUM LEVEL STRAIGHT CURB OF 48".

THE TEXTURE OF THE DRIVEWAY AND INTERSECCION HANDICAP RAMP SURFACES SHALL BE CONSTRUCTED OF NON-SLIP SURFACE, ACCOMPLISHED BY "BROOMING" THE RAMP SURFACES AND GROOVING ONE INCH SPACINGS AT RIGHT ANGLE DIRECTIONS. GROVES ARE TO BE APPROXIMATELY 1/4" X 1/8" WIDE.

SIDEWALK SHALL BE SLOPED 1" TOWARDS THE STREET.

**DRIVEWAYS** 


(INCLUDING SOD).

ALL DRIVEWAYS BETWEEN THE STREET AND PROPERTY LINE CONNECTING WITH AN EXISTING ROADWAY ARE TO BE CONSTRUCTED IN ACCORDANCE WITH DETAIL AS SHOWN IN THIS PLAN UNLESS OTHEWISE SPECIFIED BY LOCAL ORDINANCE OR SUBDIVISION COVENANTS.

Plot Plan


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Scale As indicated



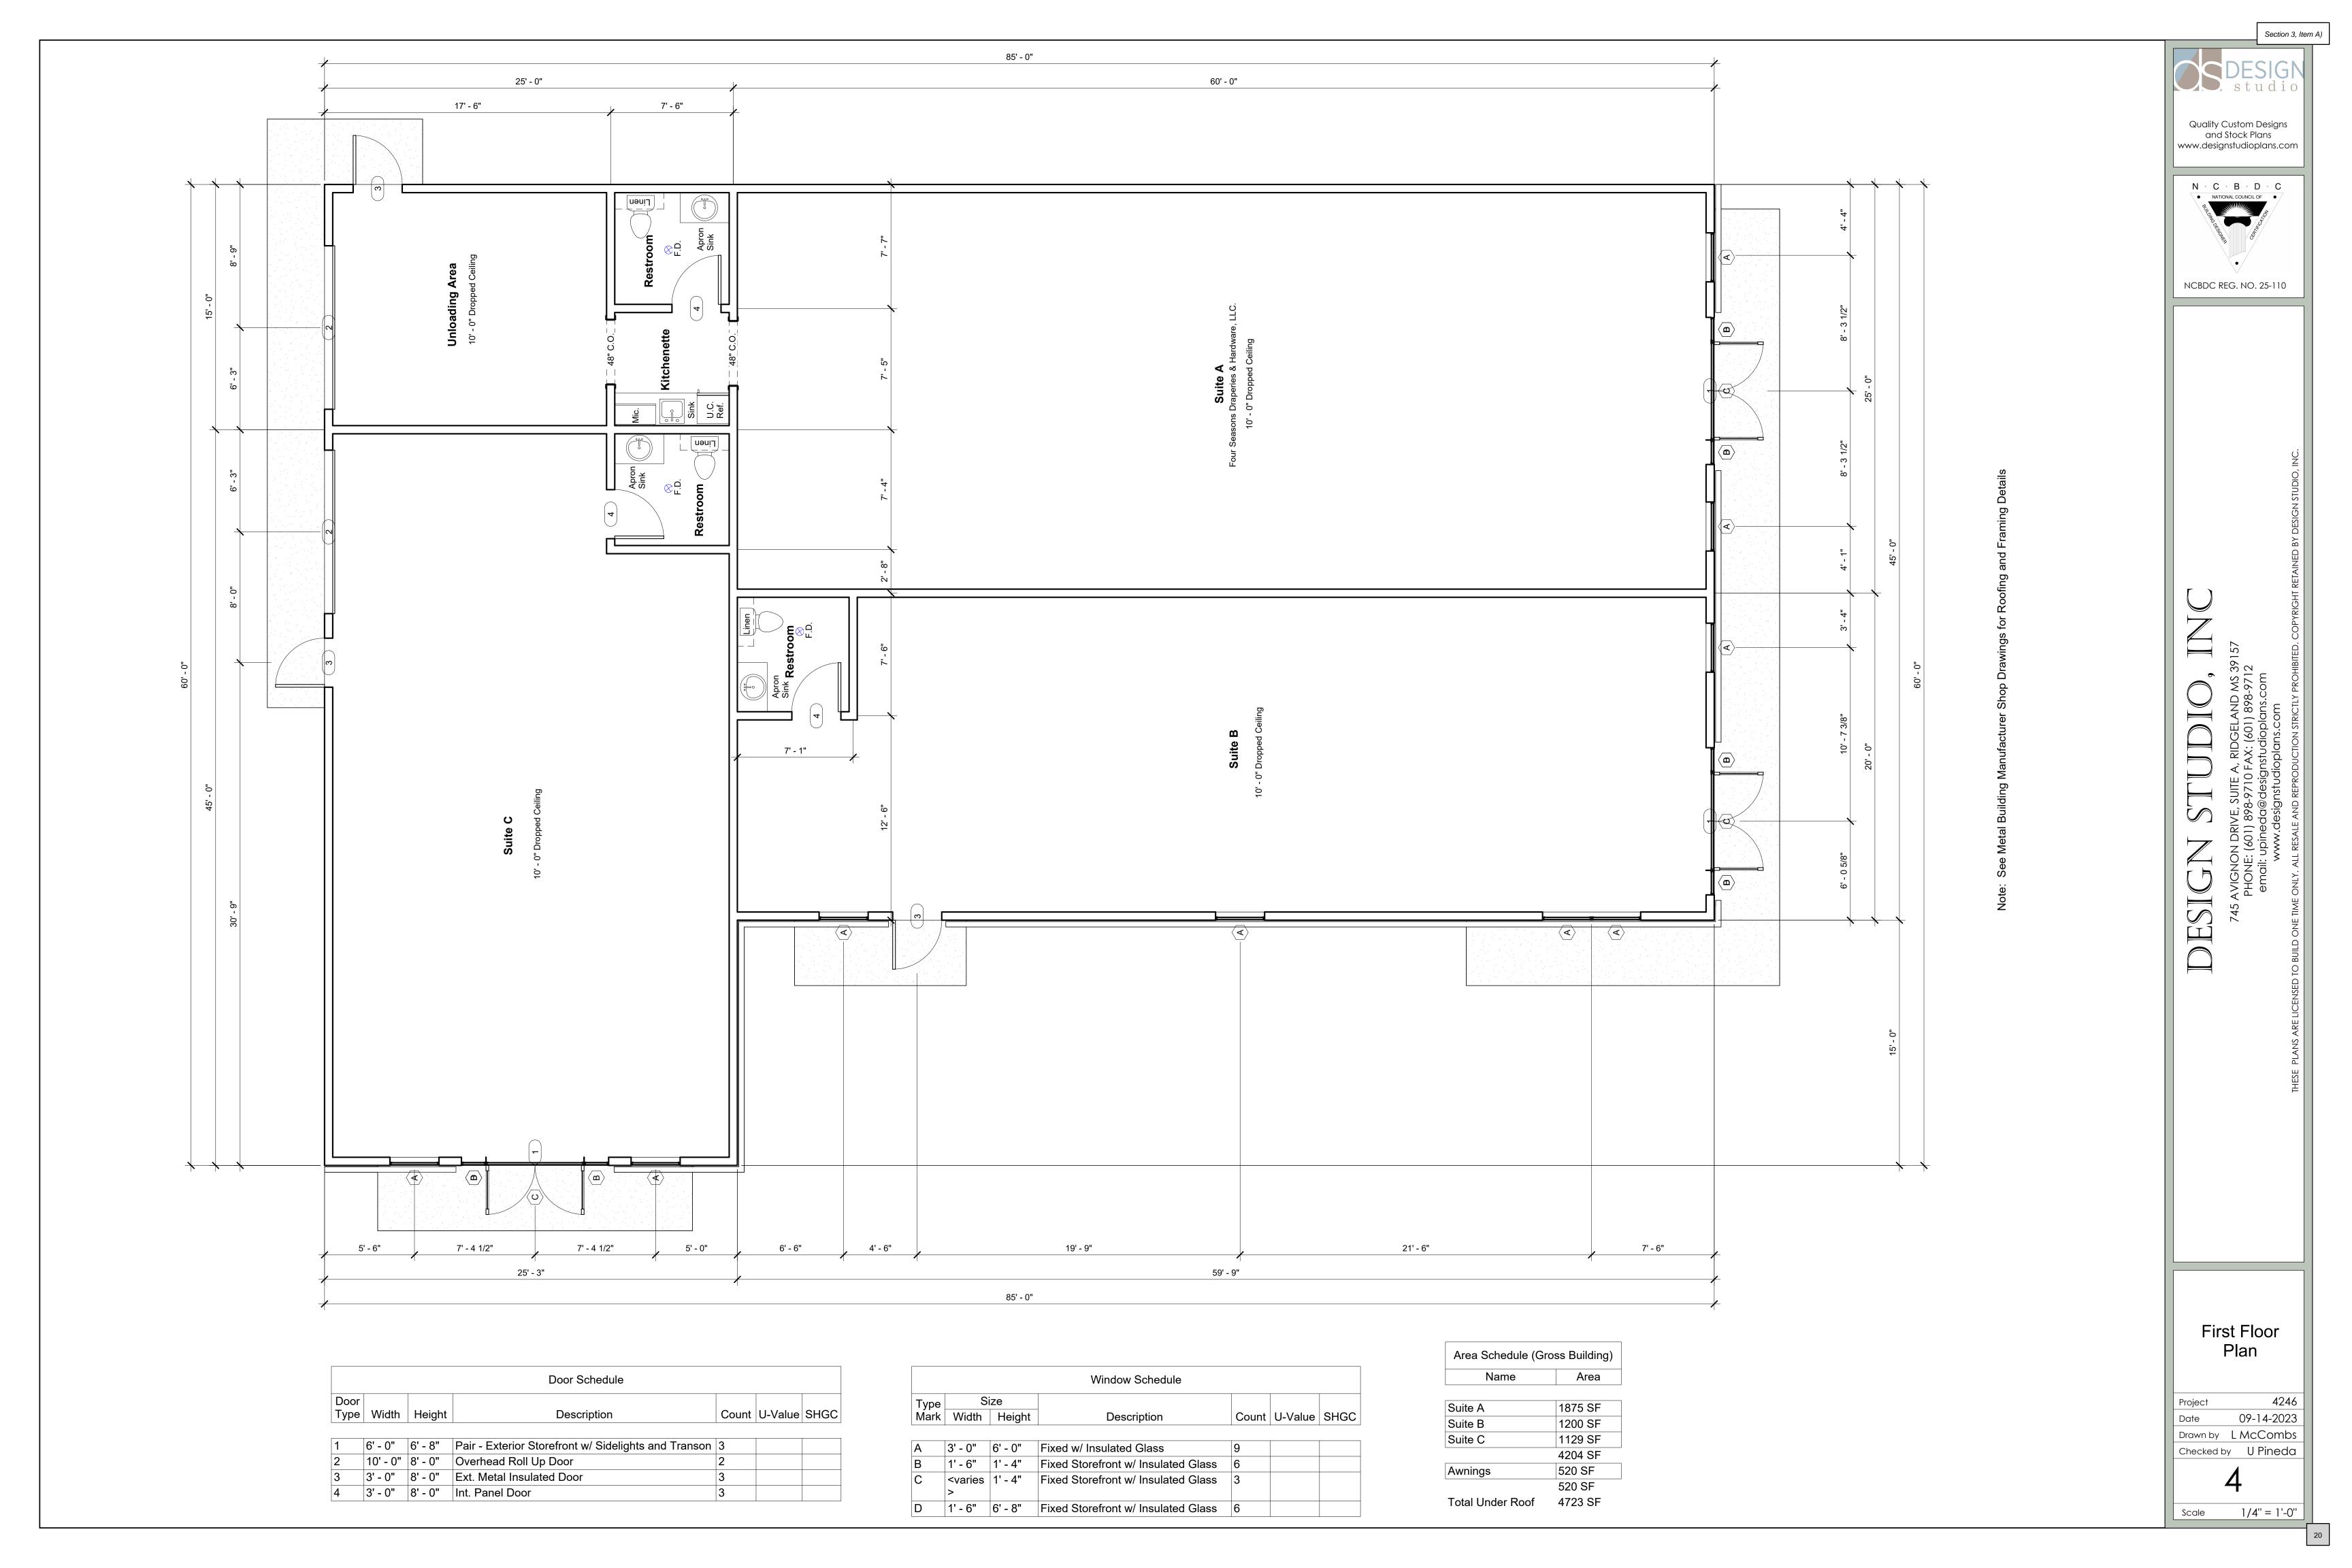

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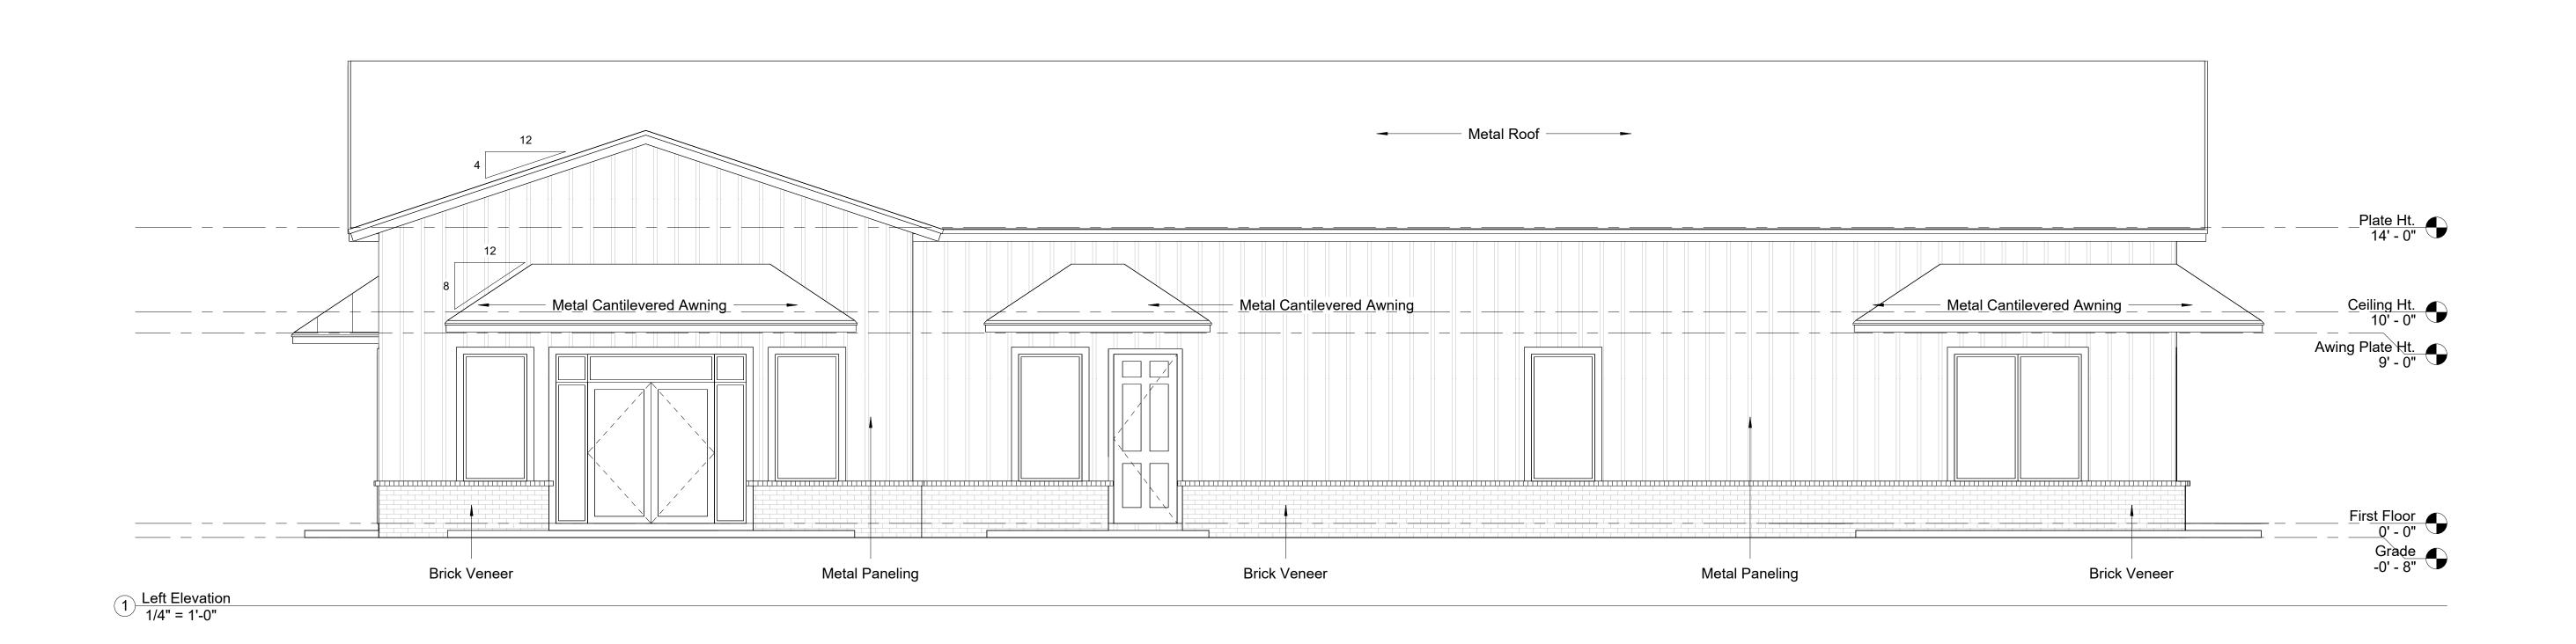
Exterior


**Elevations** 

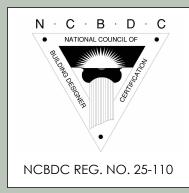4246 Date 09-14-2023

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1/4" = 1'-0"



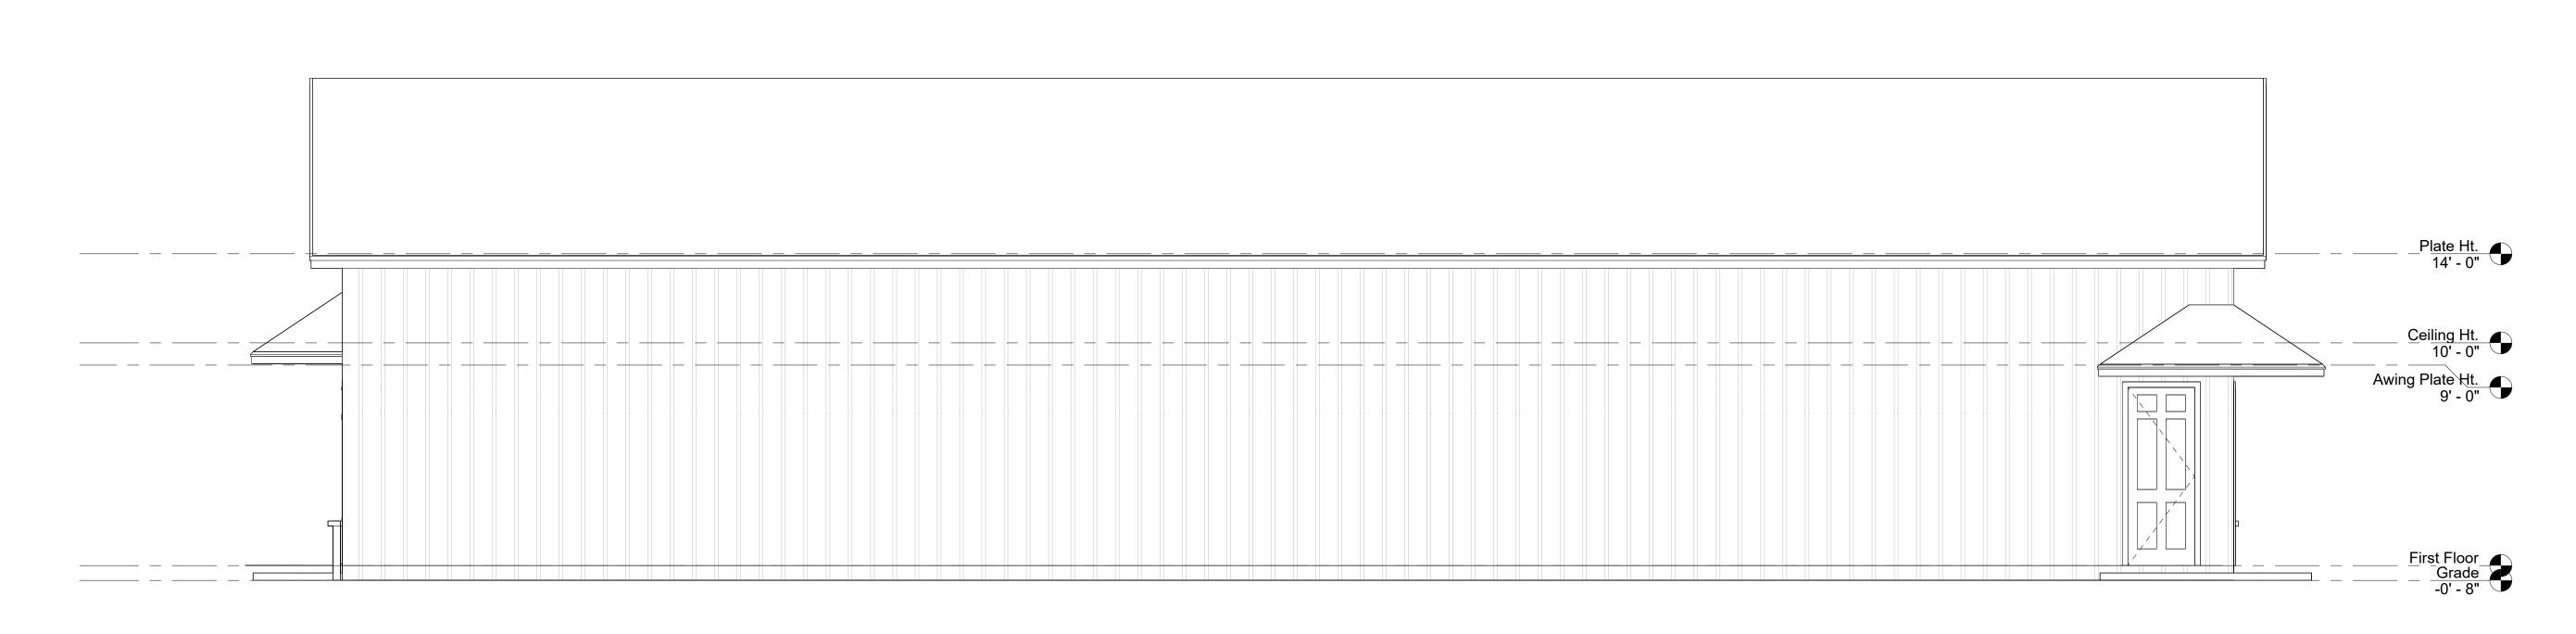

2 Right Elevation 1/4" = 1'-0"


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NCBDC REG. NO. 25-110



#### ELECTRICAL SYMBOLS SYMBOL DESCRIPTION **SYMBOL** DESCRIPTION SINGLE POLE SWITCH SURFACE CEILING FIXTURE THREE WAY SWITCH RECESSED CEILING FIXTURE www.designstudioplans.com FOUR WAY SWITCH RECESSED SWIVEL CEILING FIXTURE DIMMER SWITCH HANGING HALOGEN FIXTURE RECESSED MINIATURE HALOGEN 110 VOLT DUPLEX CONVENIENCE OUTLET WALL MOUNTED FIXTURE GROUND FAULT INTERRUPTER OUTLET $\Rightarrow$ WATERPROOF GFIC OUTLET FIXTURE WITH PULL SWITCH RECESSED BASEBOARD FIXTURE 110 VOLT DUPLEX SPLIT WIRE OUTLET 220 VOLT DUPLEX CONVENIENCE OUTLET FLOOD LIGHT FLOURESCENT FIXTURE 110 VOLT FOURPLEX OUTLET FLOUR. FIXT. UNDER CABINET 110 VOLT DUPLEX FLOOR OUTLET TV TELEVISION OUTLET CEILING FAN -TELEPHONE OUTLET COMPUTER OUTLET EXHAUST FAN CARBON MONOXIDE /SMOKE DETECTOR ELECTRICAL PANEL, METER BOX EXIT SIGN METER BOX OVERHEAD GARAGE DOOR OPENER

# **ELECTRICAL NOTES**

- MIN. WIRE SIZE SHALL BE #14 AWG COPPER. INSULATION SHALL BE THW, YHWN/THHN OR XHHW. SERVICE ENTRANCE CONDUCTOR SHALL BE 2-2-2-4 SER. AL. GROUNDING CONDUCTOR TO BE #6 SOLID COPPER (100A SERVICE) OR #4 SOLID COPPER (200A SERVICE).
- GROUNDING METHOD TO BE 2 5/8" (8'-0" LONG) GALVANIZED STEEL GROUND RODS, 6'-0" APART.
- UNLESS NOTED OTHERWISE ALL BRANCH CIRCUIT WIRING SHALL BE TYPE NM CABLE ABOVE CEILINGS, BETWEEN ABOVE CEILINGS, BETWEEN FLOORS OR IN STUD WALL CAVITIES.
- SERVICE PANEL SHALL INCLUDE THE FOLLOWING NUMBER OF CIRCUITS: 1. ONE 15 AMPERE BRANCH CIRCUIT OF EACH 600 SQUARE FEET FOR LIGHTING AND GENERAL PURPOSE
- RECEPTACLES.
- 2. TWO 20 AMPERE BRANCH CIRCUITS FOR SMALL APPLIANCES. 3. ONE 20 AMPERE BRANCH CIRCUIT FOR THE LAUNDRY.
- 4. ONE BRANCH CIRCUIT FOR THE RANGE OR COOKTOP. 5. ONE BRANCH CIRCUIT FOR AIR CONDITIONING AND HEATING.
- PROVIDE THE MAXIMUM AVAILABLE FAULT CURRENT.
- WIRING BELOW SLAB SHALL BE INSTALLED IN CONDUIT. CONDUIT SHALL BE RIGID GALVANIZED STEEL.
- PVC CONDUIT INSTALLED BELOW GRADE WITH NO HARD COVER SHALL BE PROTECTED WITH 2" MIN. CONCRETE COVERAGE ON ALL SIDES.
- ALL WIRING IN ATTIC SHALL BE LAID OUT NEATLY, SECURELY FASTENED TO STRUCTURE, AND SHALL NOT
- INTERFERE WITH FLOORING OF ATTIC OR ACCESS REQUIREMENTS FOR EQUIPMENT.
- CONNECTIONS TO FURNACES, CONDENSING UNITS AND OTHER MOTORS OR VIBRATING MACHINERY SHALL BE MADE
- WITH FLEXIBLE CONDUIT (LIQUID-TIGHT IF EXPOSED TO WEATHER) AND STRANDED WIRE, THHN/THWN.
- UNLESS NOTED OTHERWISE ALL LIGHT SWITCHES SHALL BE 44" (48" ACCESSIBLE) A.F.F.
- RECEPTACLES SHALL BE INSTALLED PER THE FOLLOWING TABLE:
- REG. WALL OUTLET 15" (18" ACCESSIBLE) BATH WALL OUTLET
- 8" ABOVE COUNTER CLOSET HTG. UNITS & REFRIGERATORS 36" KITCHEN WALL 2. ELECTRICAL CONTRACTOR SHALL MARK ALL CIRCUITS FOR ELECTRICAL WIRING
- SYSTEM AT EACH MAIN DISCONNECT.
- ALL 3-WAY SWITCHES MUST HAVE 14/3 WITH GROUND.
- GROUND FAULT CIRCUIT INTERRUPTER SHALL BE INSTALLED IN ALL BATHROOMS, GARAGES AND OUTDOOR OUTLETS. GROUND FAULT RECEPTORS IN KITCHEN SHALL BE CIRCUITED SEPARATELY FROM ALL OTHER GFCI OUTLETS SMOKE DETECTORS SHALL BE WIRED TOGETHER AND TO THE A.C. POWER SYSTEM AND BATTERY BACKUP.
- 17. ARC FAULT CIRCUIT INTERRUPTER BREAKERS SHALL BE INSTALLED IN ALL BEDROOMS OUTLETS, INCLUDING POWER SUPPLY TO SMOKE DETECTOR.
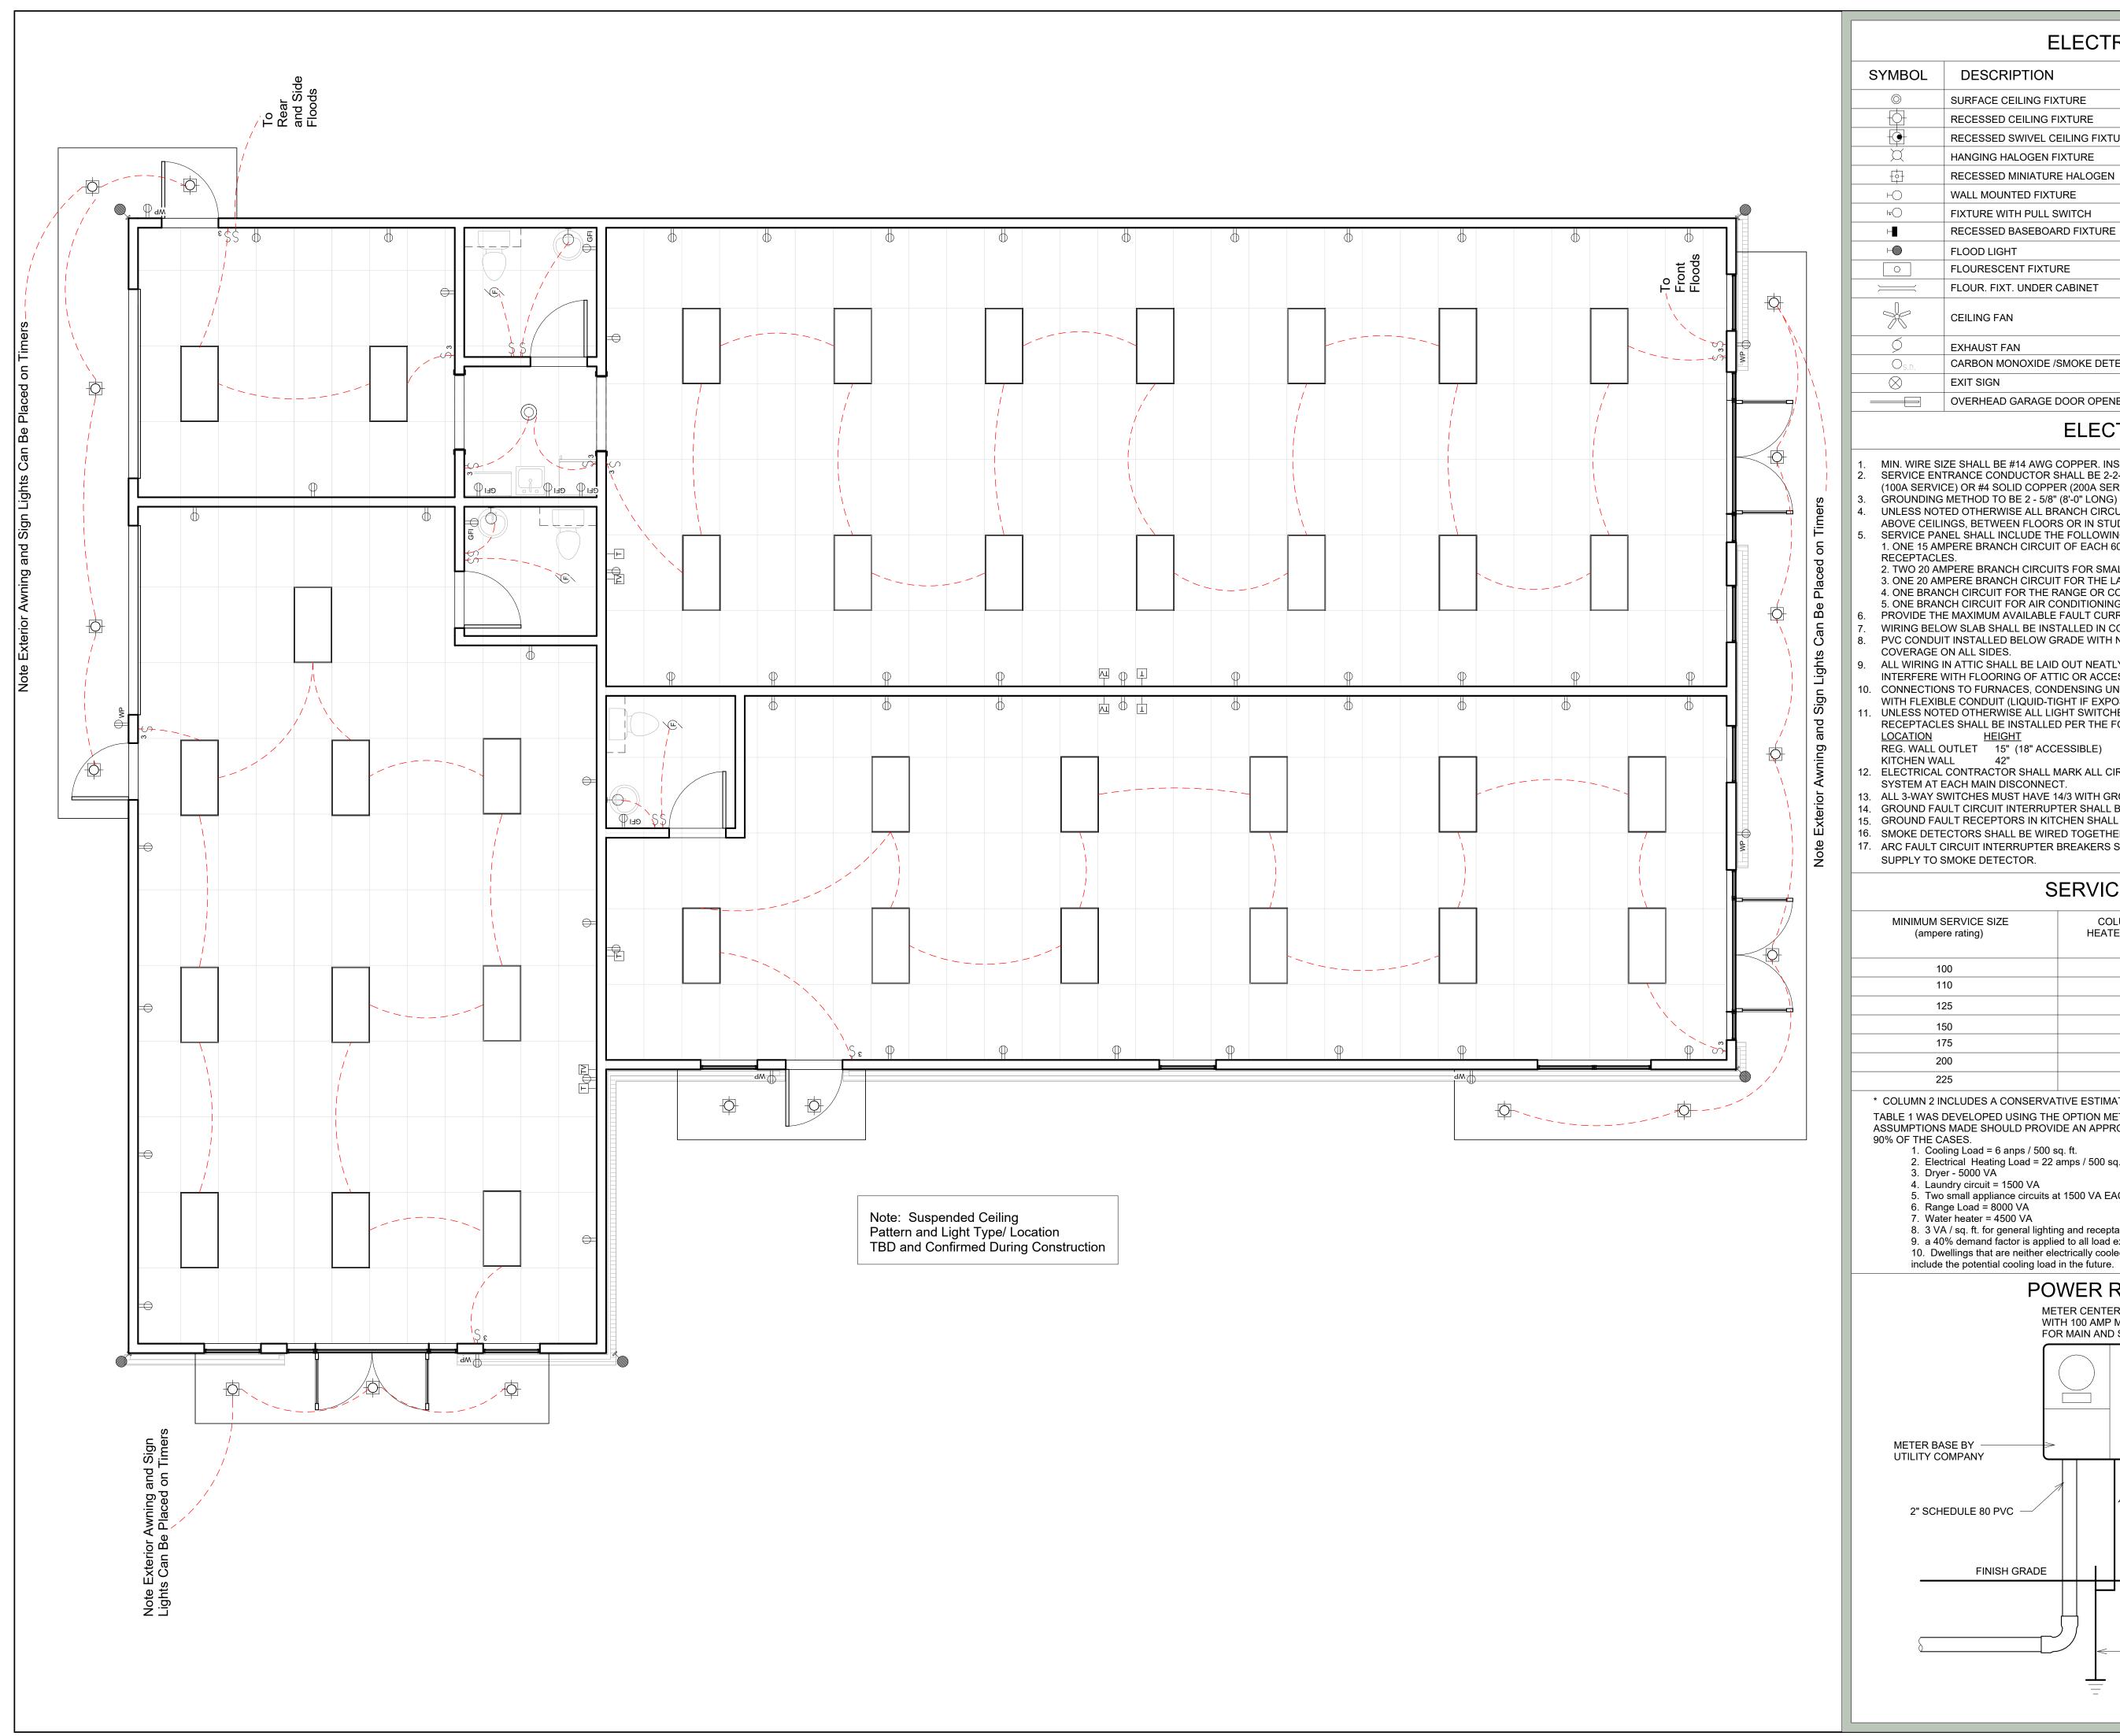
# SERVICE SIZE GUIDE


| MINIMUM SERVICE SIZE (ampere rating) | COLUMN 1 (Electric Heat)<br>HEATED AND COOLED AREA<br>(square feet) | COLUMN 2 * HEATED AND COOLED AREA (square feet) |  |  |
|--------------------------------------|---|---|--|--|
| 100                                  | 850   | 2,250   |  |  |
| 110                                  | 1,100   | 2,850   |  |  |
| 125                                  | 1,450   | 3,700   |  |  |
| 150                                  | 2,000   | 5,150   |  |  |
| 175                                  | 2,550   | 6,650   |  |  |
| 200                                  | 3,150   | 8,100   |  |  |
| 225                                  | 3,700   | 9,600   |  |  |
|                                      |   |   |  |  |

\* COLUMN 2 INCLUDES A CONSERVATIVE ESTIMATE FOR ELECTRIC COOLING LOAD.

TABLE 1 WAS DEVELOPED USING THE OPTION METHOD AND USING THE FOLLOWING ASSUMPTIONS, THE ASSUMPTIONS MADE SHOULD PROVIDE AN APPROXIMATE ANSWER THAT WILL EQUAL OR EXCEED CODE MORE THAN

- 1. Cooling Load = 6 anps / 500 sq. ft.
- 2. Electrical Heating Load = 22 amps / 500 sq. ft. 3. Dryer - 5000 VA
- 4. Laundry circuit = 1500 VA 5. Two small appliance circuits at 1500 VA EACH
- 6. Range Load = 8000 VA 7. Water heater = 4500 VA
- 8. 3 VA / sq. ft. for general lighting and receptacles
- 9. a 40% demand factor is applied to all load except cooling and heating over first 10,000 VA 10. Dwellings that are neither electrically cooled or heated shall have the service sized to

# POWER RISER DIAGRAM

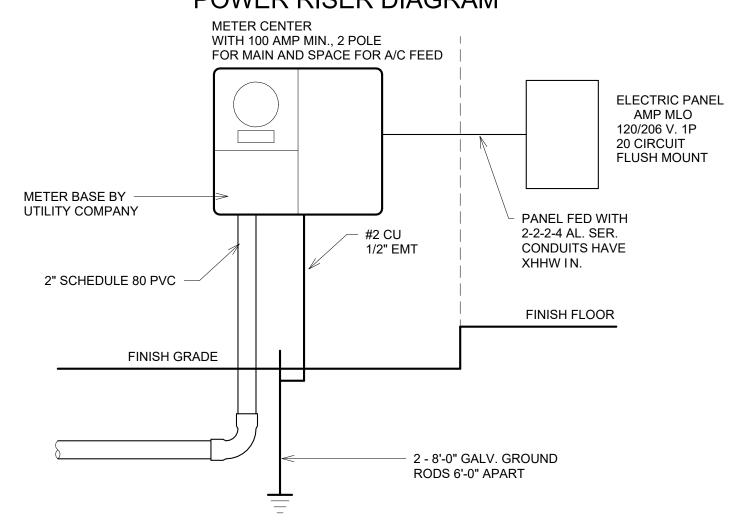


Electrical

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Rendered Elevations

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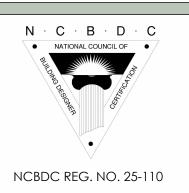
Scale 1/4" = 1'-0"



1 Front Elevation Copy 1 1/4" = 1'-0"

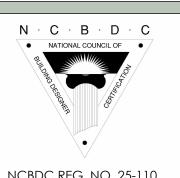

3 Rear Elevation Copy 1 1/4" = 1'-0"



Rendered


Elevations

4246 09-14-2023 Drawn by L McCombs Checked by U Pineda

Scale 1/4" = 1'-0"



1 Left Elevation Copy 1 1/4" = 1'-0"

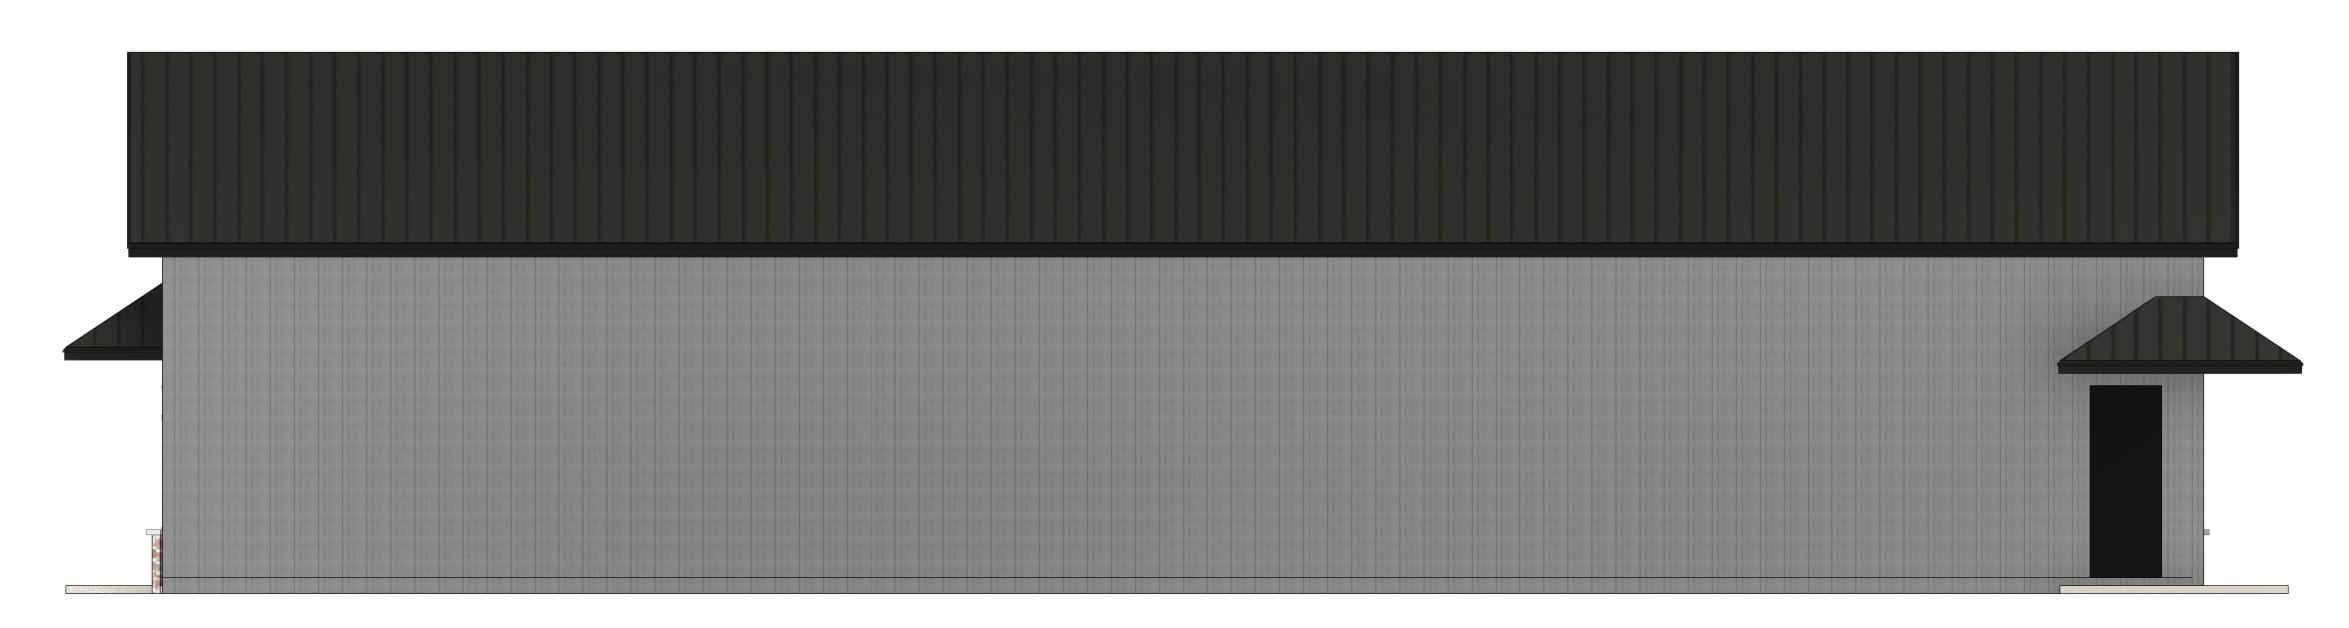

Right Elevation Copy 1
1/4" = 1'-0"



# **CITY OF GLUCKSTADT**

# MISSISSIPPI PLANNING AND ZONING ADMINISTRATOR

#### **MEMORANDUM**

TO: Mayor & Board of Alderman

FROM: William Hall, Planning and Zoning Administrator

**DATE:** 09/18/2023

**SUBJECT:** Architectural Controls

The discussion of architectural appeal came up during the August 22<sup>nd</sup>, 2023 meeting. Several concerns were voiced about the design of buildings and the ability of the board(s) to require building features such as roof top screening, specific regionally inspired architectural design, and other aesthetically pleasing features. The building department was tasked with further research into the extent of control either the Planning and Zoning Board or the Architectural Review Board would have in the influence of building design within the city limits.