

Design Review Committee Meeting Agenda Tuesday, July 12, 2022, 4:00 PM REMOTE MEETING PARTICIPATION

NOTE: The City welcomes public meeting citizen participation. TTY Relay Service: 711. In compliance with the ADA, if you need special assistance to participate in a meeting, contact the City Clerk's office at (360) 834-6864, 72 hours prior to the meeting so reasonable accommodations can be made (28 CFR 35.102-35.104 ADA Title 1)

To Participate Remotely:

OPTION 1 -

- 1. Go to www.zoom.us and download the app or click "Join A Meeting" and use Meeting ID 820 7642 7295
- 2. Or, from any device click https://us06web.zoom.us/j/82076427295

OPTION 2 - Join by phone (audio only):

1. Dial 877-853-5257 and enter meeting ID# 820 7642 7295

CALL TO ORDER

ROLL CALL

INTRODUCTIONS

MEETING ITEMS

1. Camas Station (File No.DR22-02)

Presenter: Lauren Hollenbeck, Senior Planer

CLOSE OF MEETING



STAFF REPORT

Camas Station

Major Design Review (DR22-02)

Related File: CUP22-02

TO Design Review Committee

FROM Lauren Hollenbeck, Senior Planner

LOCATION Northwest corner of NW 16th Avenue and NW Brady Road

Parcel Number 127357000

APPLICANT Howard Bode

CK Designs, LP

APPLICABLE LAW: This land use application submitted February 24, 2022, is vested to the land use regulations and development standards in effect on the effective date of the Camas Municipal Code (CMC) Title 16 Environment, Title 17 Land Development and Title 18, specifically (but not limited to): Chapter 18.11 - Parking, Chapter 18.13 - Landscaping, Chapter 18.18 - Site Plan Review, Chapter 18.19 Design Review, and Chapter 18.43 Conditional Use Permit

Summary

The applicant is currently seeking design review approval for the construction of a 7,350 square foot convenience store/car wash and 12 pump gas station, a 3,900 square foot drive thru coffee shop/retail building, a 2,800 square foot retail building including associated landscaping, parking, utilities, and other improvements such as electrical vehicle charging stalls and vacuum stalls.

The site is bounded by NW Brady Road on its east side and NW 16th Avenue on its south side. The adjoining property to the north is undeveloped and to the west was previously used for commercial purposes. Access is provided at the northeast corner of the site from NW Brady Road and the southwest corner of the site from NW 16th Avenue.

The subject property is zoned Community Commercial (CC). Adjoining properties to the north and west are zone Regional Commercial (RC). Properties to the east across NW Brad Road are zoned Single-Family Residential (R-12) to include single-family residences. Property to the south across NW 16th Avenue is zoned Neighborhood Park (NP) to include Prune Hill Park.

The site's topography is relatively flat in the southeast corner with a gentle slope that descends to the north. The site is currently undeveloped and covered with trees, shrubs and grass.

DR22-02 Camas Station Page 1 of 2

Purpose

Design Review is required under CMC Chapter 18.19. Design review is not intended to determine the appropriate use on a parcel but rather review a proposed development for compliance with City codes and plans related to landscaping, architectural elevations, and other elements relative to required improvements. The recommendations from the Design Review Committee (DRC) must consider the design review standards from the Design Review Manual and Camas Municipal Code (CMC). An enclosed checklist is to help guide you in your review but refer to the manual for specific details regarding the standards.

Standard and Specific Commercial & Mixed Use Design Principles and Guidelines

The standard and specific commercial & mixed uses principles and guidelines are required and must be demonstrated to have been satisfied in overall intent for design review approval. The standard design guidelines are developed to assist a project in meeting the established principles and each guideline should be adequately addressed. If the proposal cannot meet a specific guideline, then an explanation should be provided by the applicant as to why and how it will be mitigated to satisfy the intent of the design principles. The development guidelines include five major categories: 1) Landscaping and Screening, 2) Architecture, 3) Massing and Setbacks, 4) Historic & Heritage Preservation, and 5) Circulation and Connections. The Design Review Checklist is enclosed to help guide the DRC in reviewing the standard applicable specific design review principles and guidelines.

Recommendation

That the Design Review Committee reviews the submitted materials, deliberates, and forwards a recommendation to staff for a final decision.

DR22-02 Camas Station Page 2 of 2




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Clark County, WA. GIS - http://gis.clark.wa.gov

Vicinity Map



using this information.

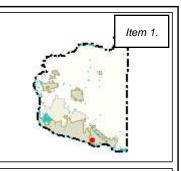

Legend

Taxlots

All Roads

Interstate or State Route

Arterial


Collector

Private or Other

Cities Boundaries

Urban Growth Boundaries

Notes:

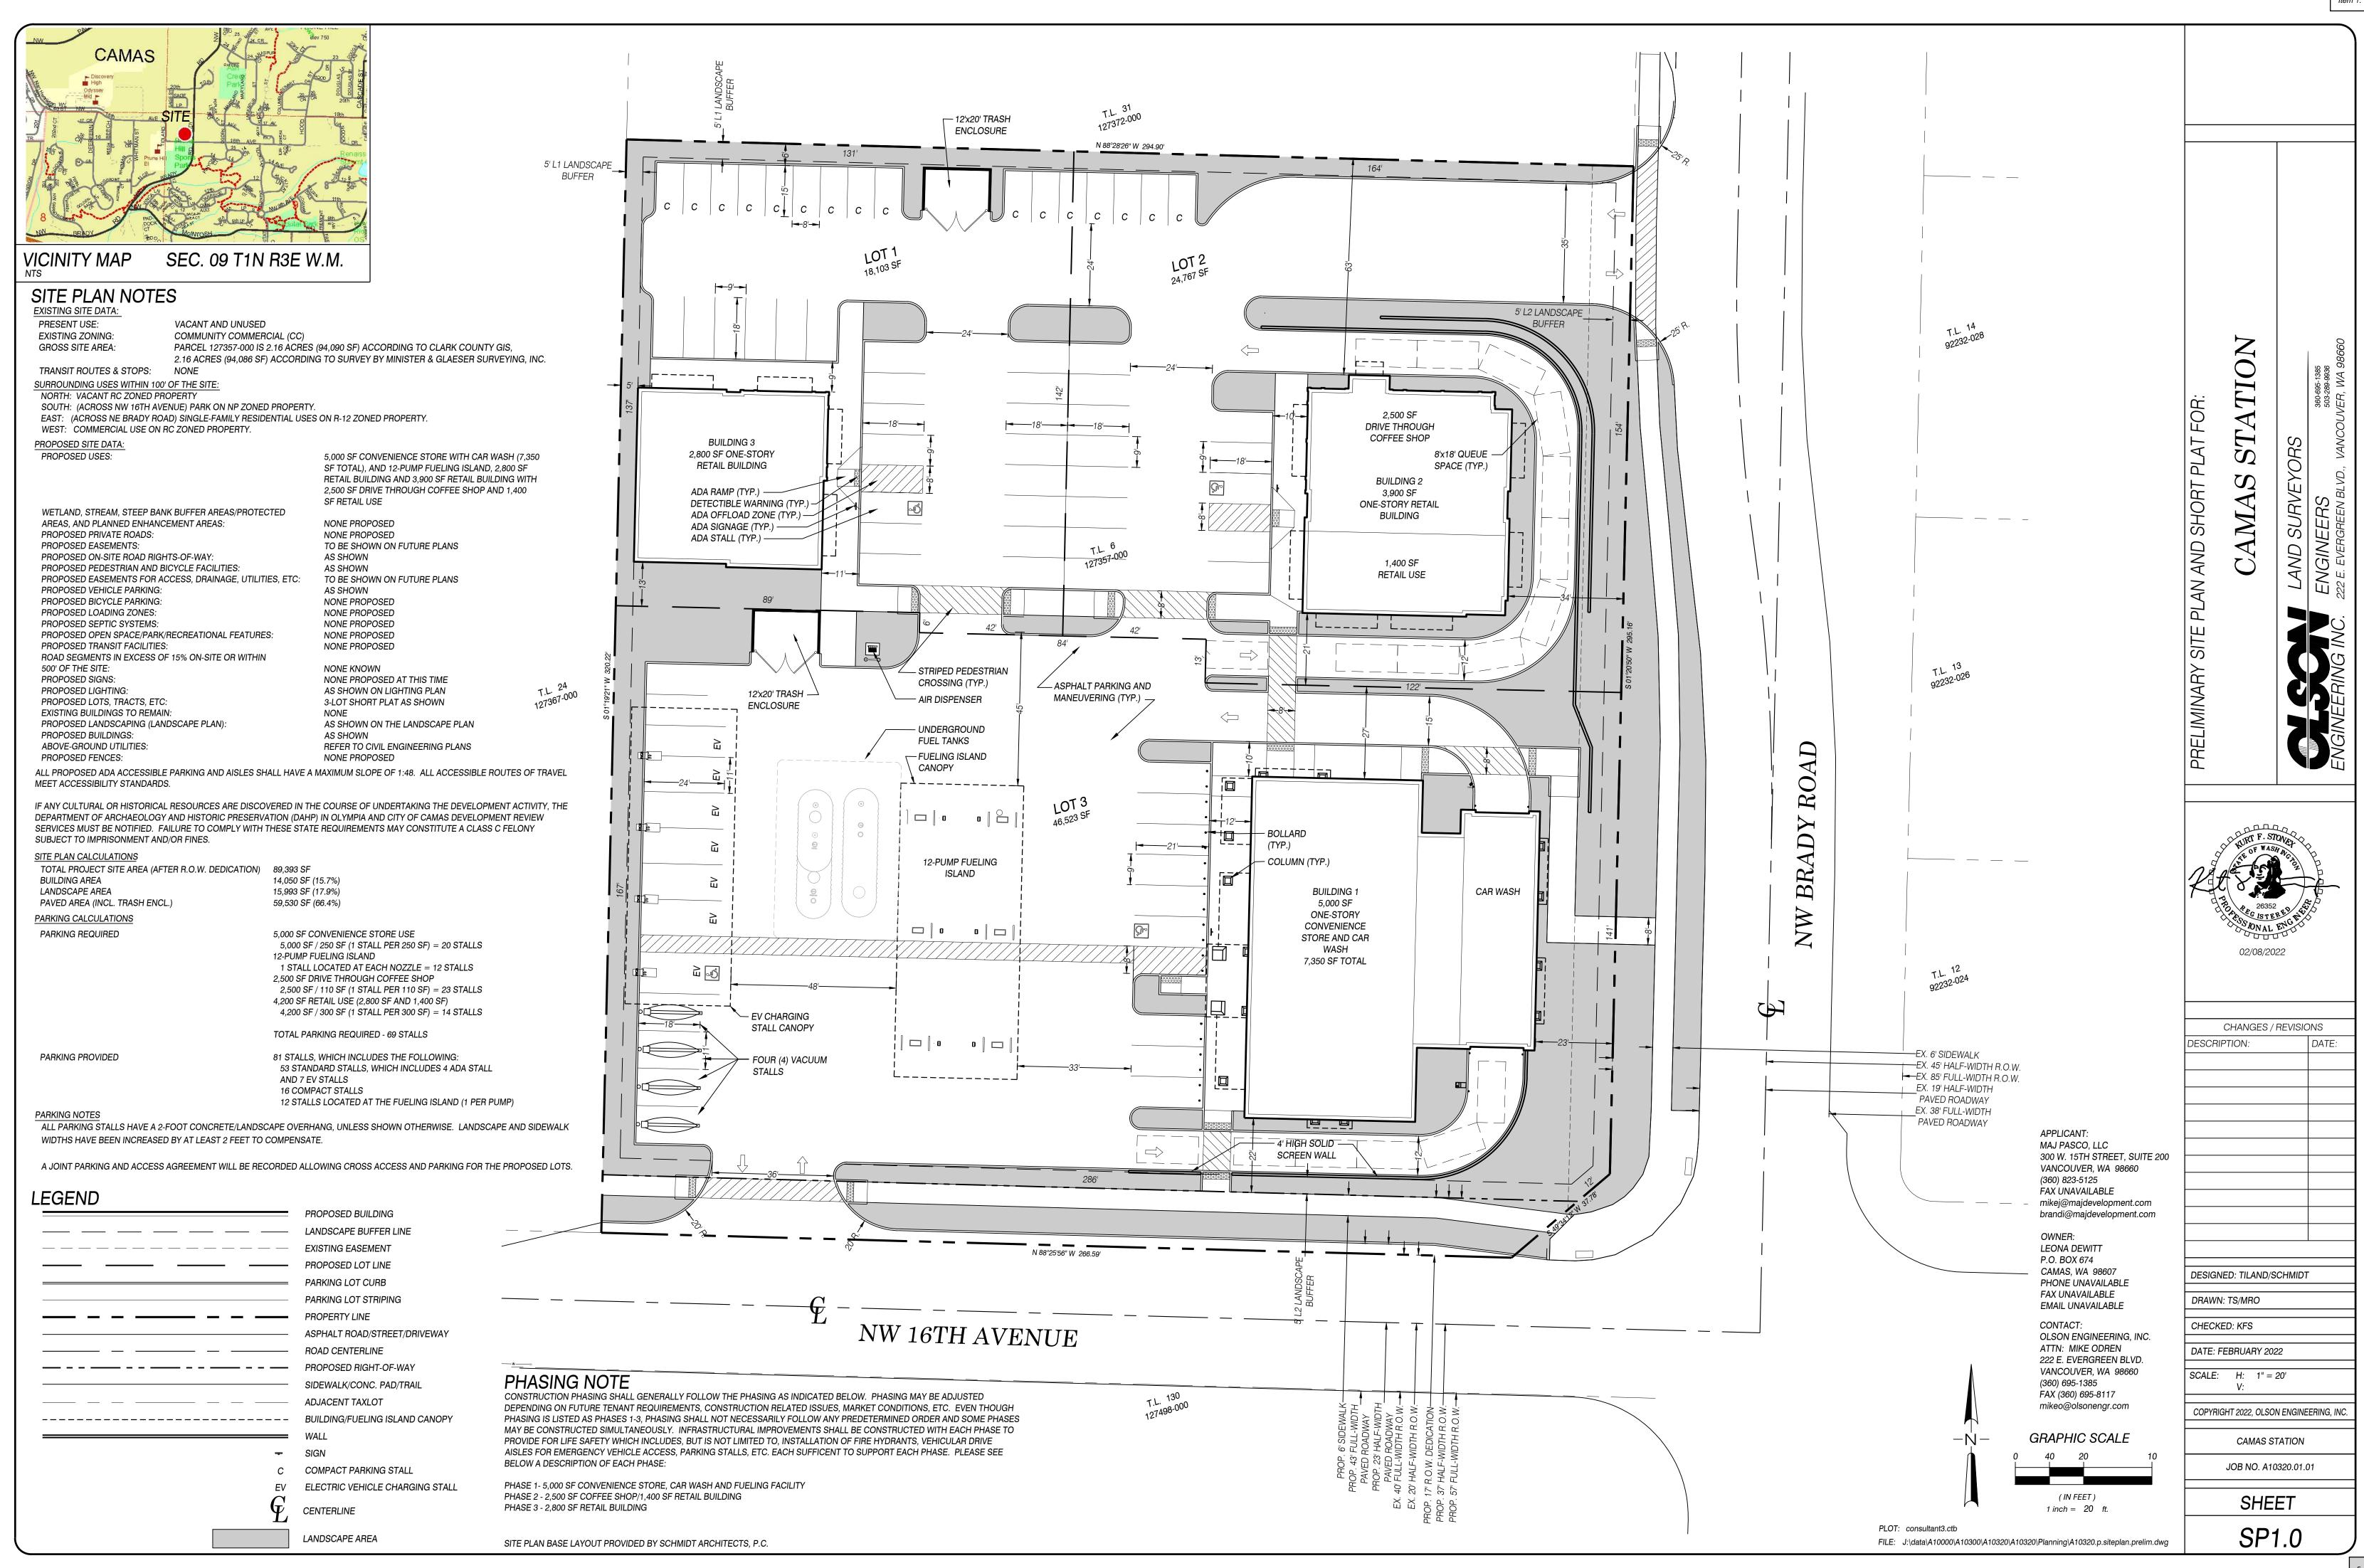


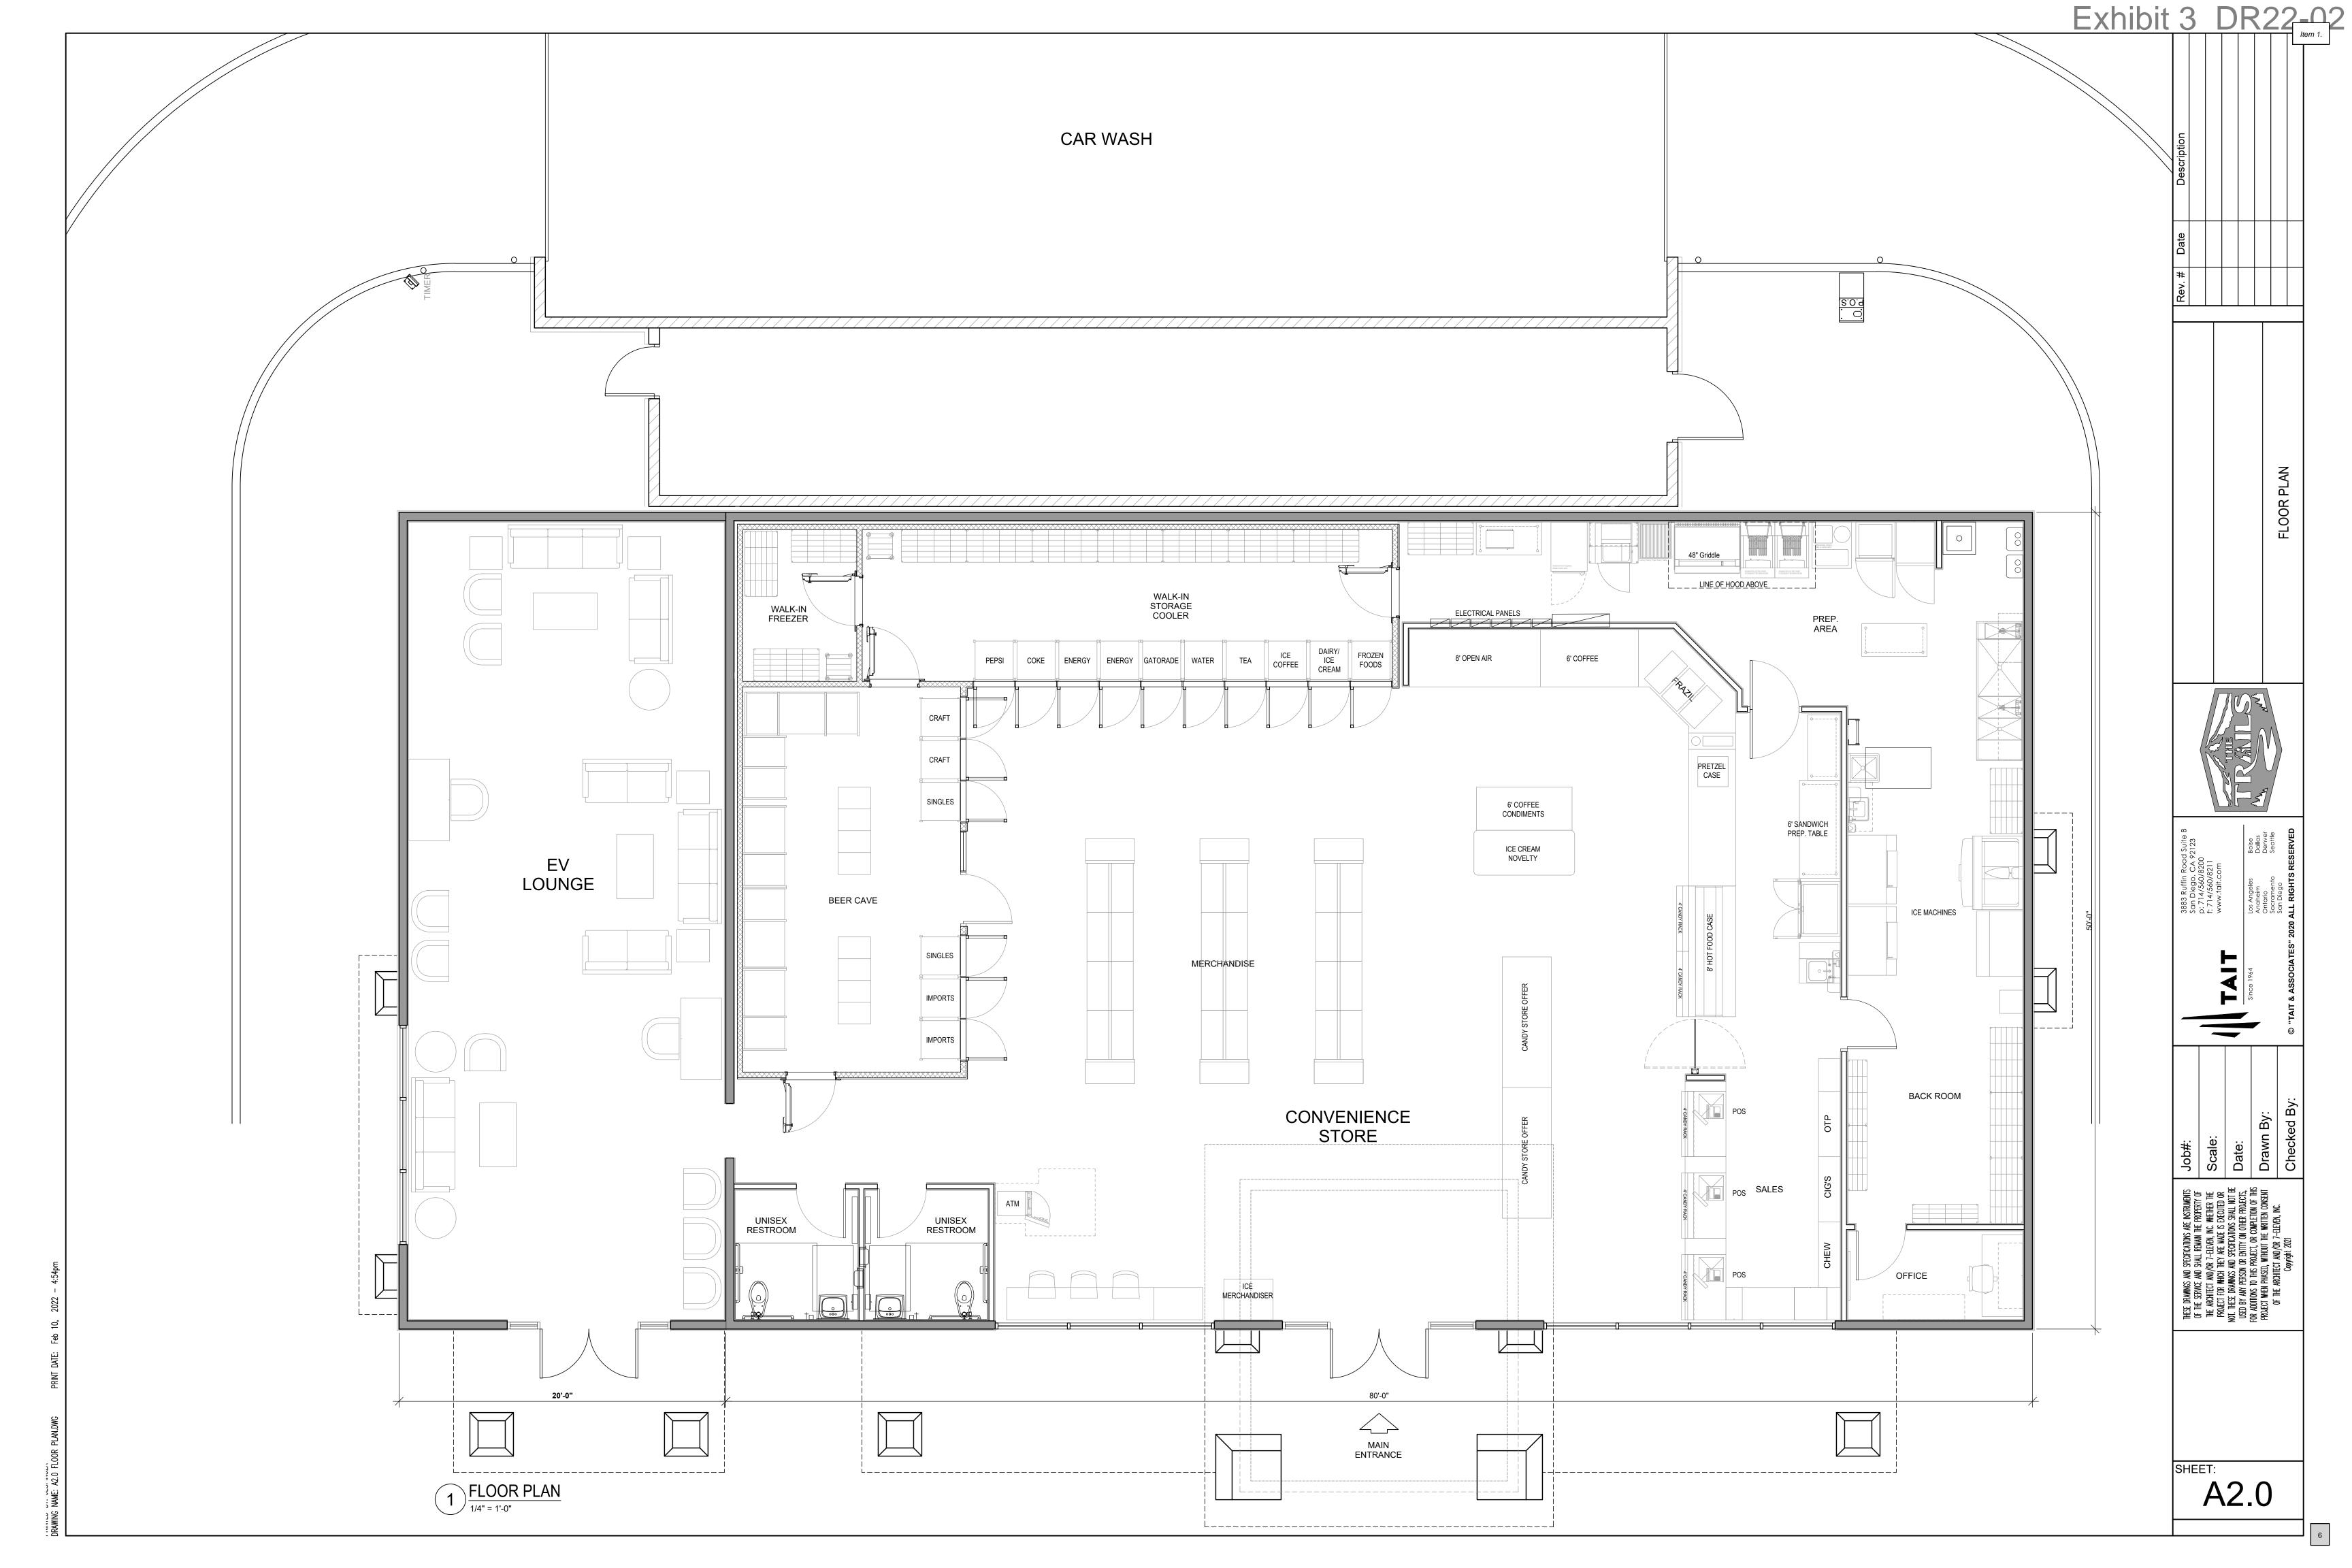




Exhibit 3 DR22_02 LEGEND 1 MATERIAL FINISH MATERIALS PAINT OVER 7/8" THICK, 3-COAT CEMENT PLASTER SPAN-LOK HP METAL ROOFING / SIDING 6" SHIP LAPPED CEDAR SIDING/SOFFIT +24'-0"____ — T.O. RIDGE PRE-FINISH "DARK BRONZE" METAL CAP, TYP. 5 ILLUMINATED SIGNAGE - BY OTHERS 6 STONE VENEER 7 DARK BRONZE ALUMINUM STOREFRONT SYSTEM 8 GLAZING +11'-0" B.O. STORE CANOPY 9 DARK BRONZE BRAKE METAL / PRE FINISHED FACIA FINISH A MFR: SHERWIN WILLIAMS
COLOR: SW 1046 "ANONYMOUS" - MFR: SHERWIN WILLIAMS
COLOR: SW 6991 "BLACK MAGIC" MFG: OLYMPIC
MATERIAL: STAIN
COLOR: 713 OXFORD BROWN MFG: CORONADO STONE
COLOR: ANTIQUE CREAM "QUICKSTACK" 6 D F MFG: DURA TECH COLOR: MATTE BLACK 2 EXTERIOR ELEVATION - SOUTH

1/4" = 1'-0" F MFG: SHERWIN WILLIAMS
COLOR: SW 4048 MASON BRICK $\begin{array}{c|c}
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C & \end{array}$ $\begin{array}{c|c}
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C & \end{array}$ +19'-6" T.O. PARAPET - -+10'-0" B.O. CARWASH CANOPY ⊕±0'-0" FINISH FLOOR EXTERIOR ELEVATION - EAST
1/4" = 1'-0" A3.1




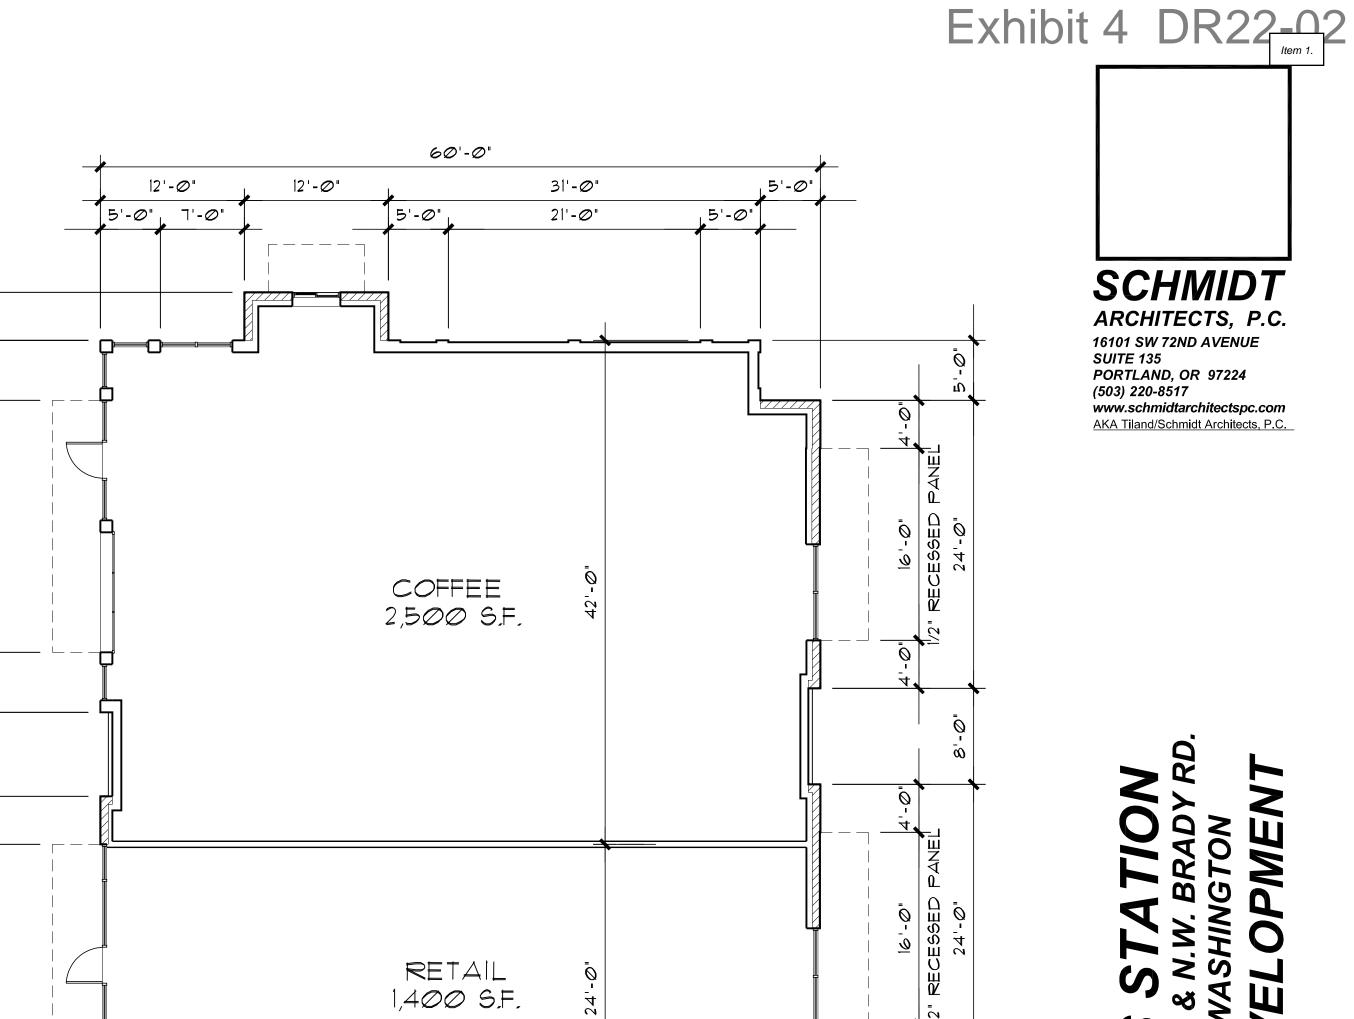

18'-0"



PROJECT NO. 2021-154 DATE:
02-03-2022
DRAWN BY:
GAH
CHECKED BY:
FMS REVISIONS 2021-154-design plans.dwg

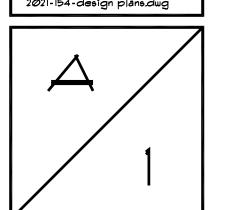



SOUTH ELEVATION (COFFEE)



2 WEST ELEVATION (COFFEE)



3 NORTH ELEVATION (COFFEE)



4 EAST ELEVATION (COFFEE)

MARK	MATERIAL	MANUFACTURER	DESCRIPTION/ COLOR	NOTES
P-1	PAINT	SHERWIN WILLIAMS	#7046 "ANONYMOUS"	STUCCO
P-2	PAINT	SHERWIN WILLIAMS	*6991 "BLACK MAGIC"	CANOPIES
M-1	4" HI BRICK	MUTUAL MATERIALS	INCA	FIELD
M-2	4" HI BRICK	MUTUAL MATERIALS	EBONY	SOLDIER & ACCENT COURSE
S-1	STAIN	OLYMPIC	*713 "OXFORD BROWN"	6" SHIP LAPPED CEDAR SIDING SOFFIT


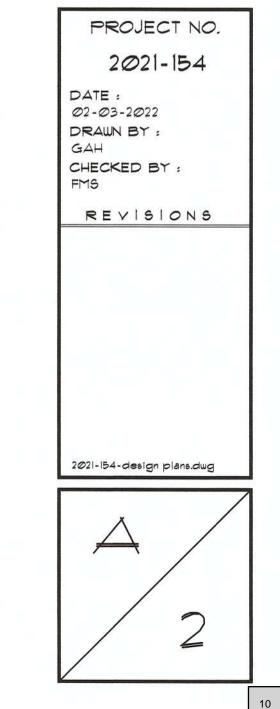


Exhibit 4 DR22_02

www.schmidtarchitectspc.com

Exhibit 5 DR22-02

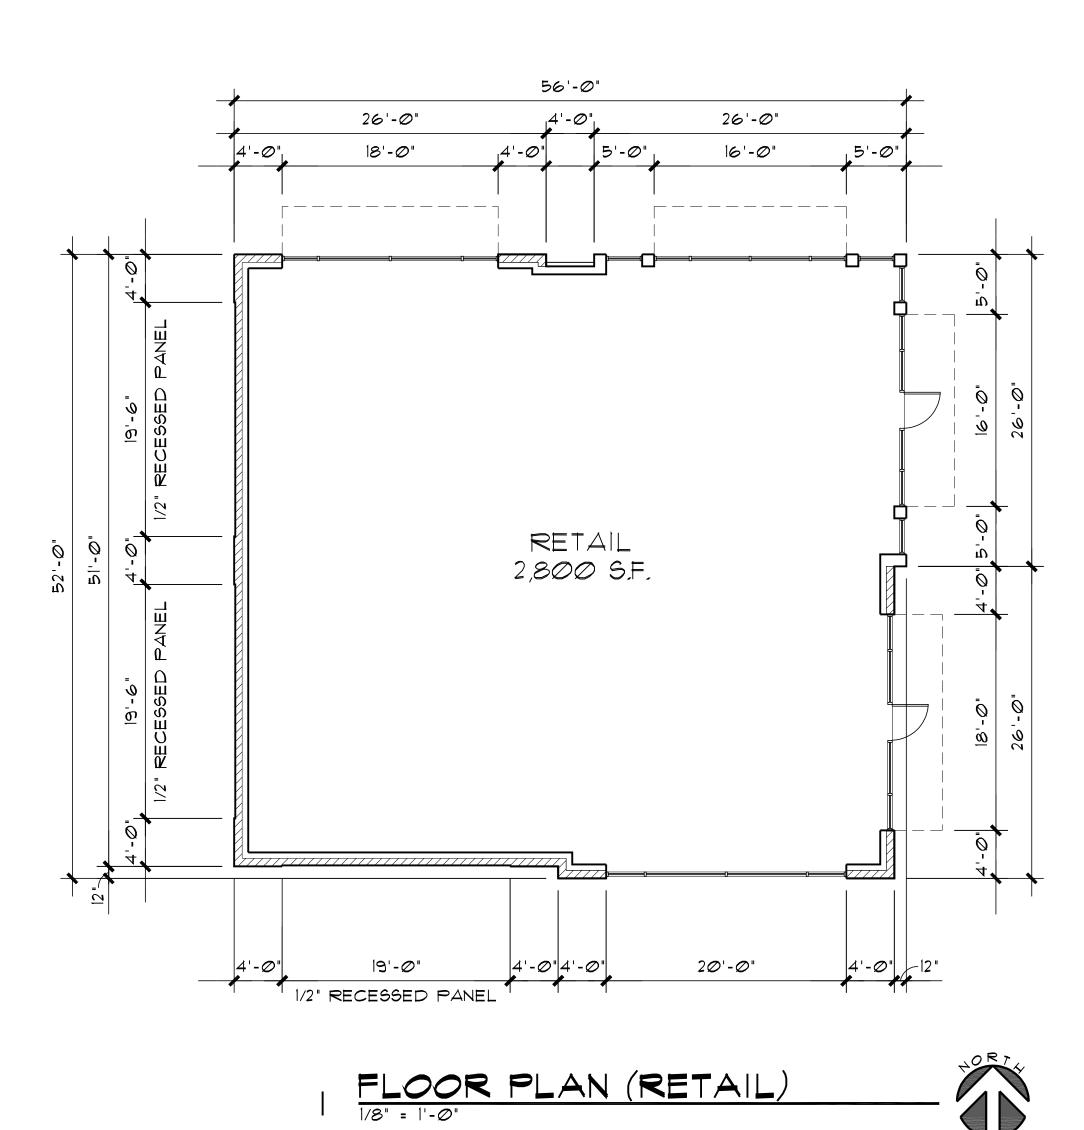

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STON

SCHWIDT
ARCHITECTS, P.C.
16101 SW 72ND AVENUE
SUITE 135
PORTLAND, OR 97224
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www.schmidtarchitectspc.com
AKA Tiland/Schmidt Architects, P.C.

CAMAS, WASHINGTON

PROJECT NO.


2021-154

DATE:
02-03-2022

DRAWN BY:
GAH
CHECKED BY:
FMS

REVISIONS

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NORTH ELEVATION (RETAIL)

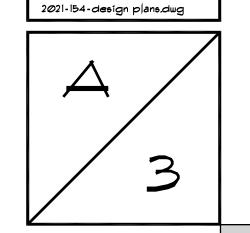

3 SOUTH ELEVATION (RETAIL)

PRE-FINISHED 'DARK
BRONZE' METAL CAPTYP.

(M-I) FIELD MASONRY
W/ 12' RECESSED
(M-2) ACCENT BANDS
4 SOLDIER COURSETYP.

(S-I) STAINED CEDAR
SIDING- TYP.

DARK BRONZE MUT.

(S-I) STAINED CEDAR
SIDING- TYP.

DARK BRONZE MUM.
STORERRONT W/ CLEAR
GLASS- TYP.

DARK BRONZE ALUM.
STORERRONT W/ CLEAR
GLASS- TYP.

FIN. FLR.

I/00'-0'

FIN. FLR.

EAST ELEVATION (RETAIL)



4 WEST ELEVATION (RETAIL)

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S-1	STAIN	OLYMPIC	#713 "OXFORD BROWN"	6" SHIP LAPPED CEDAR SIDING



Exhibit 5 DR22_02

SCHMIDT

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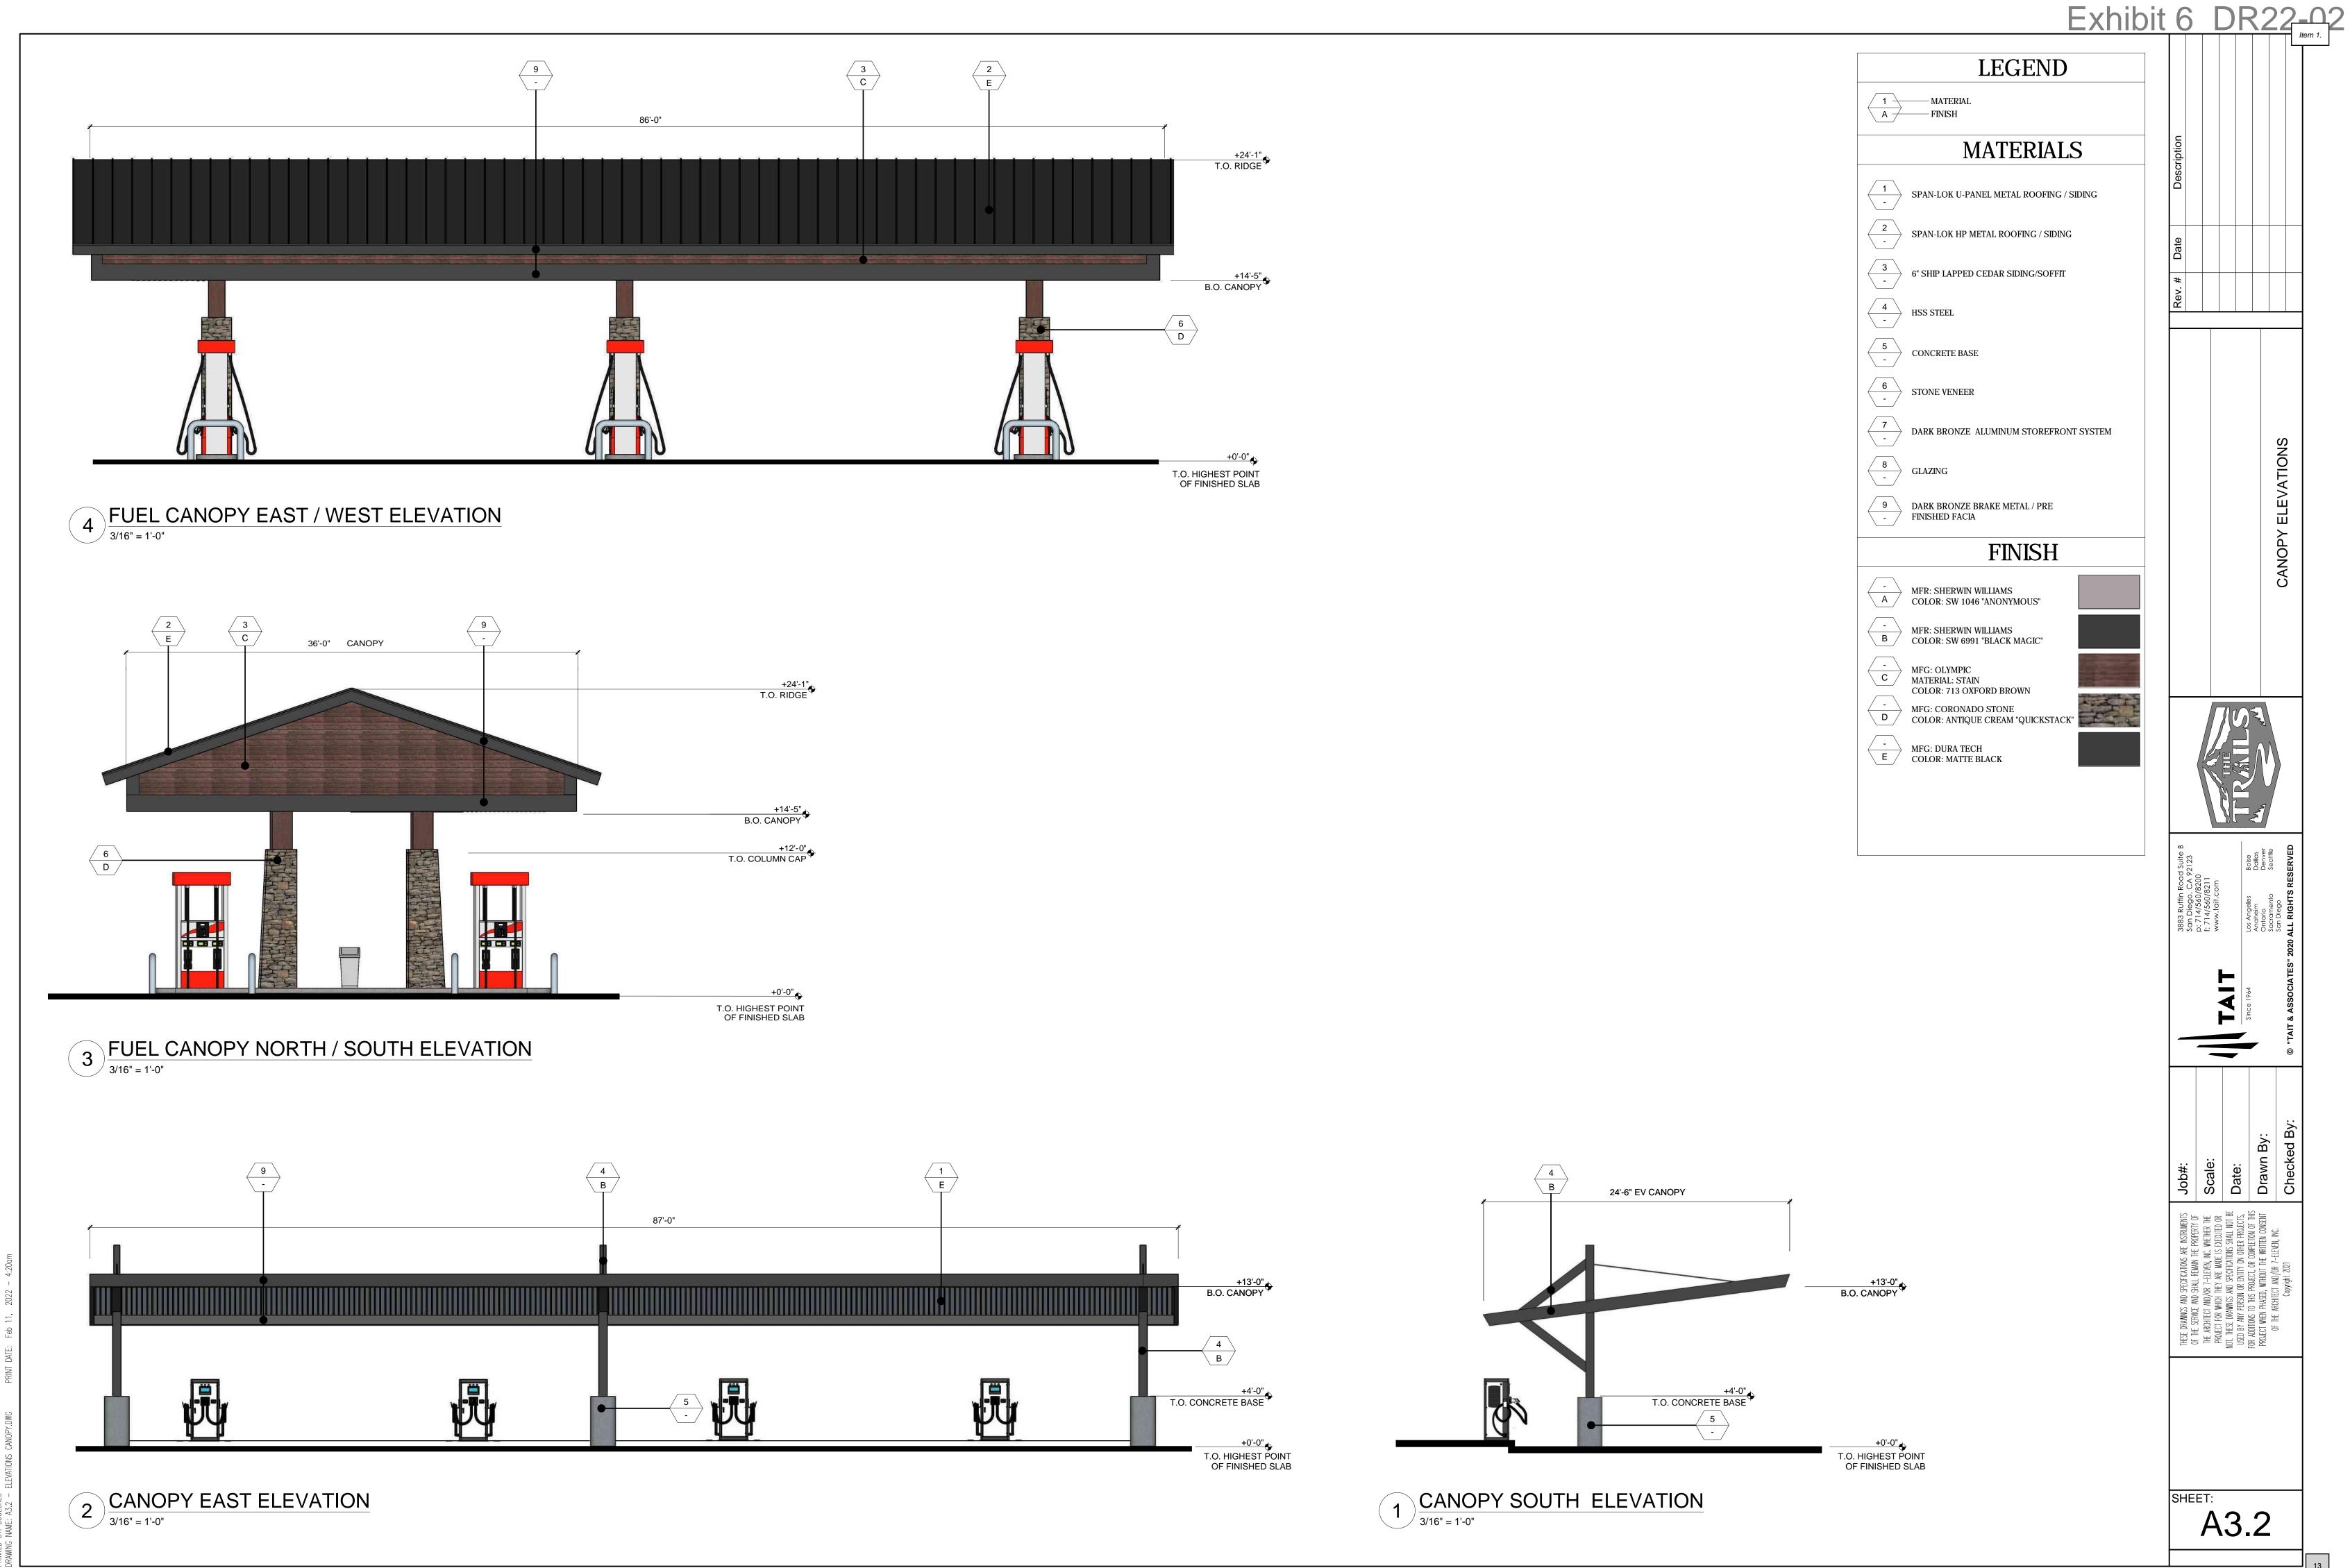
DATE:
02-03-2022
DRAWN BY:
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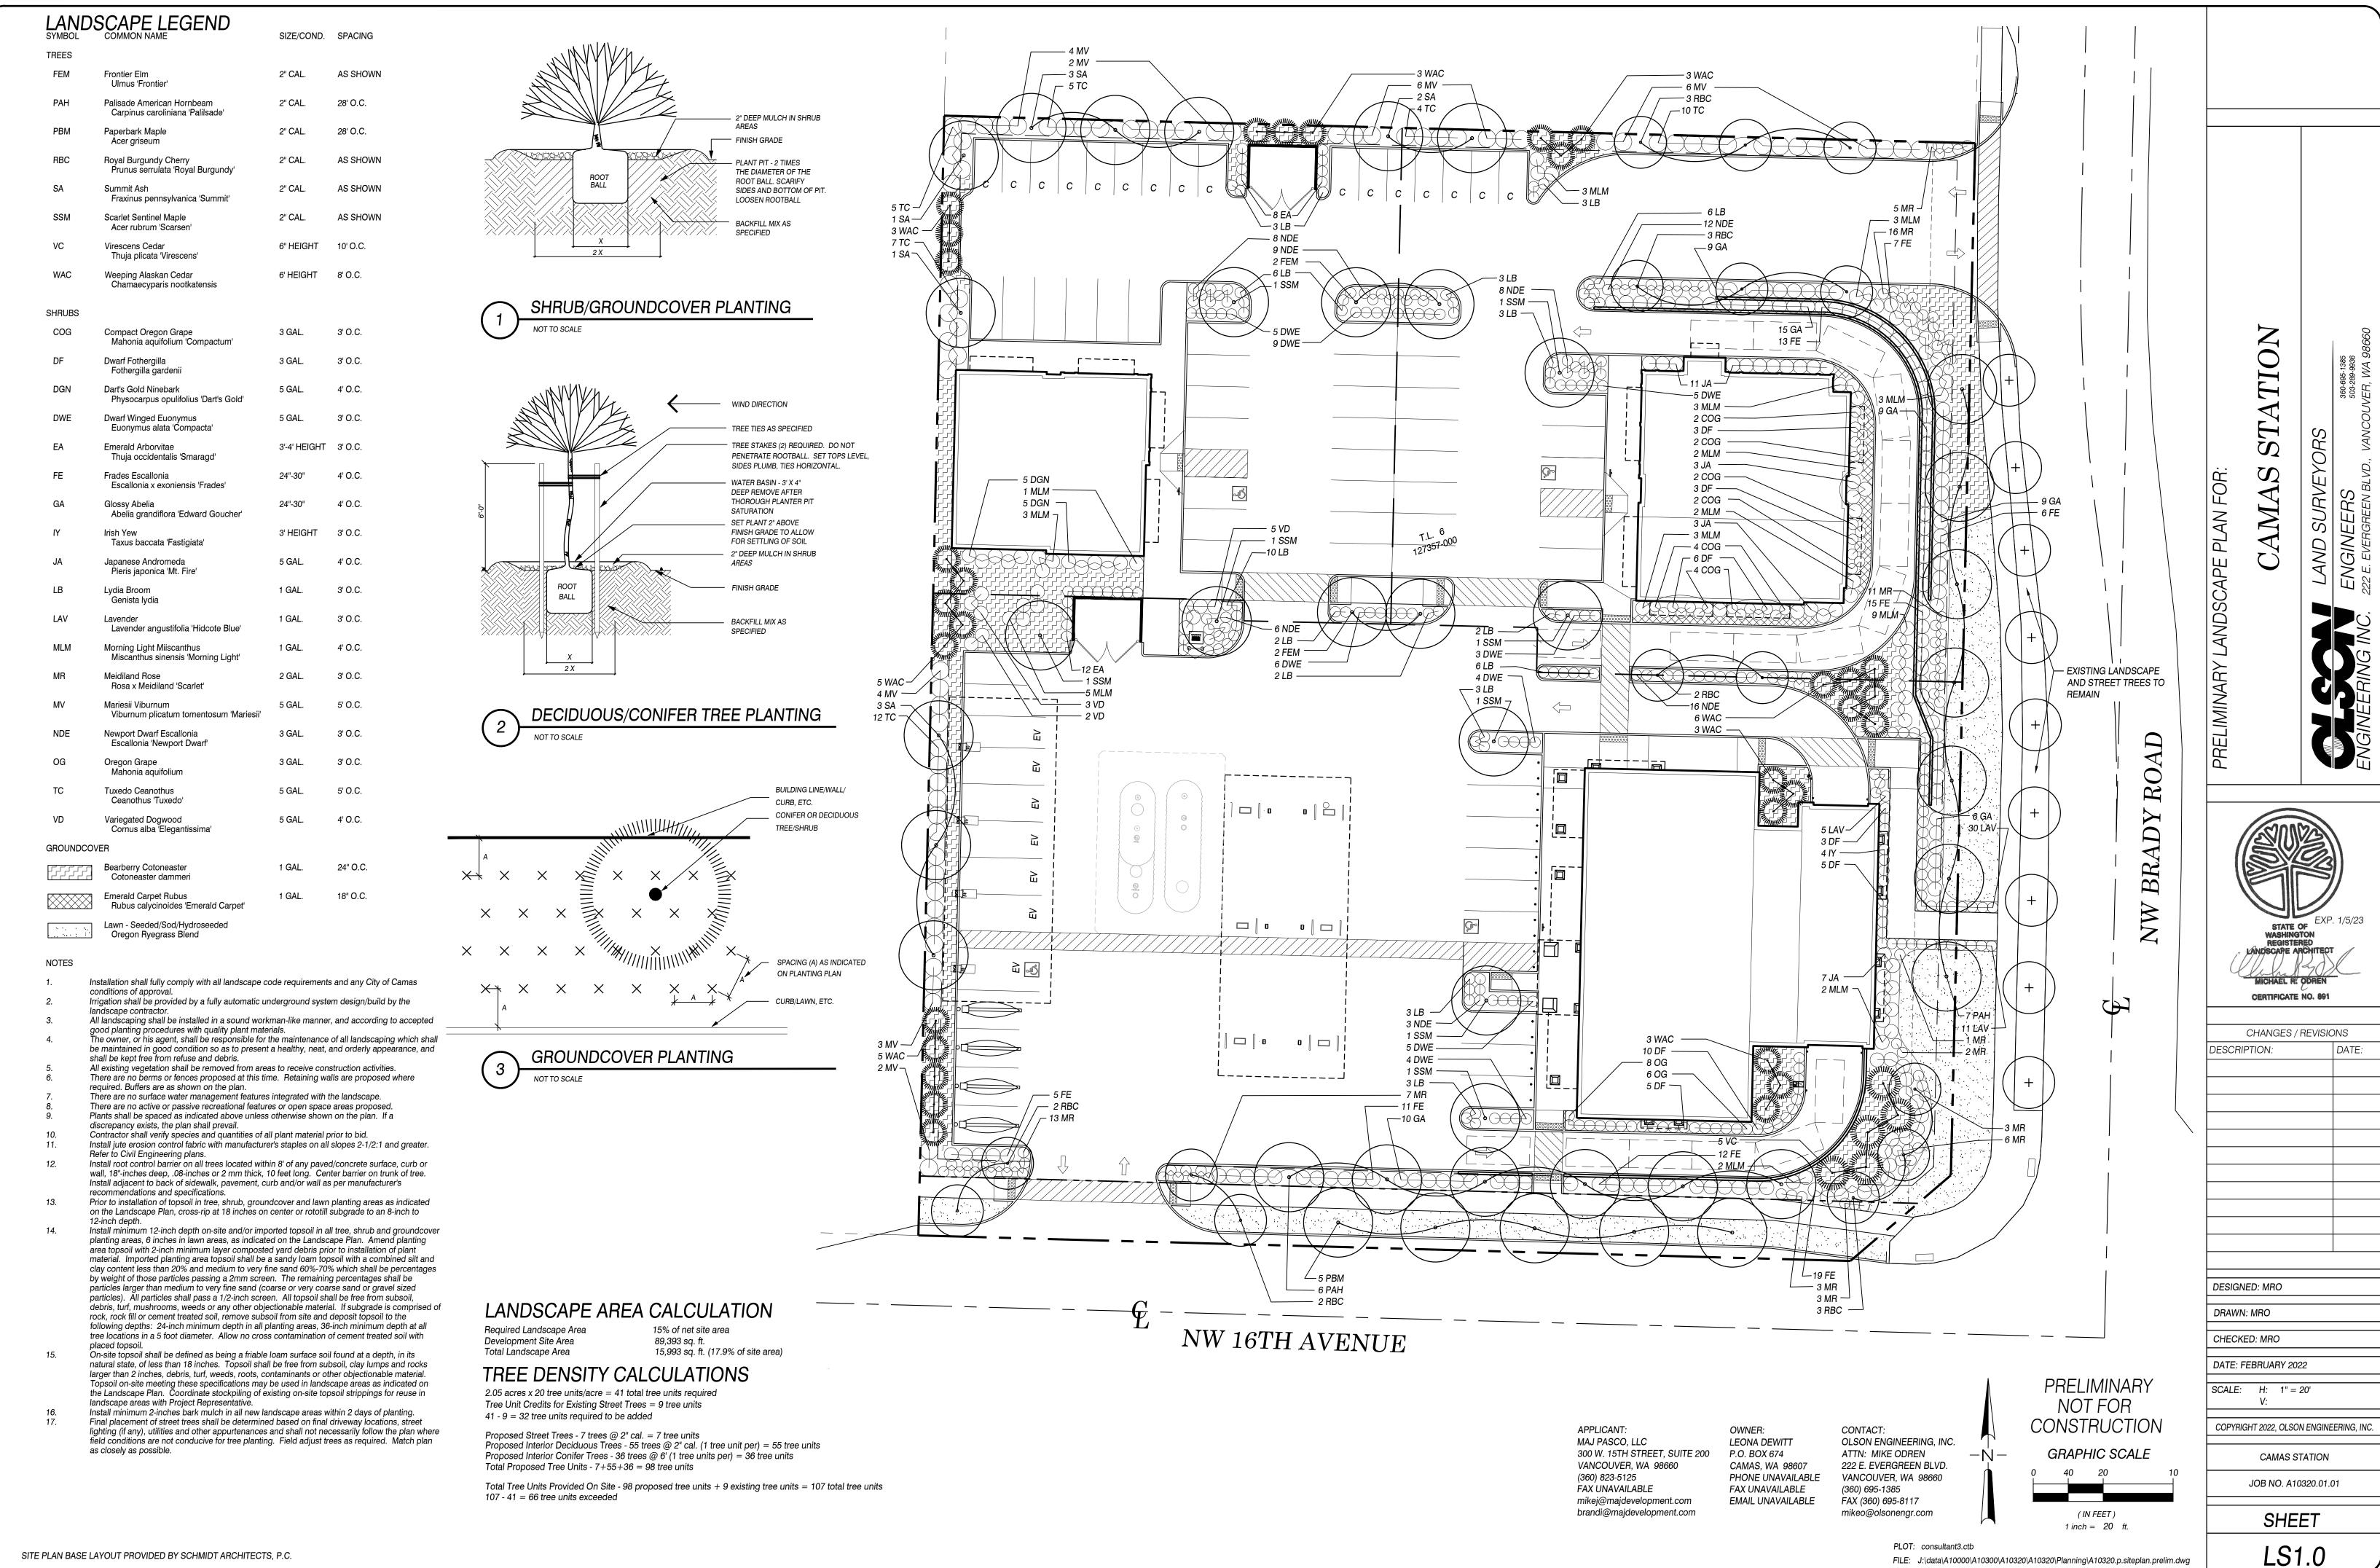
REVISIONS

2021-154-design plans.dwg

PROJECT NO.

2021-154





LIGHTING SCHEDULE

CREE #XSPW-B-WM-3ME-4L-57K-UL-WH

CREE #CPY250-B-DM-F-C-UL-WH-57K

CREE #CPY250-B-DM-F-B-UL-WH-57K

CREE #XSPLG-D-HT-4ME-24L-57K7-UL-SV-N (NUMBER AND CONFIGURATION SHOWN ON PLANS)

TYPE <u>DESCRIPTION</u>


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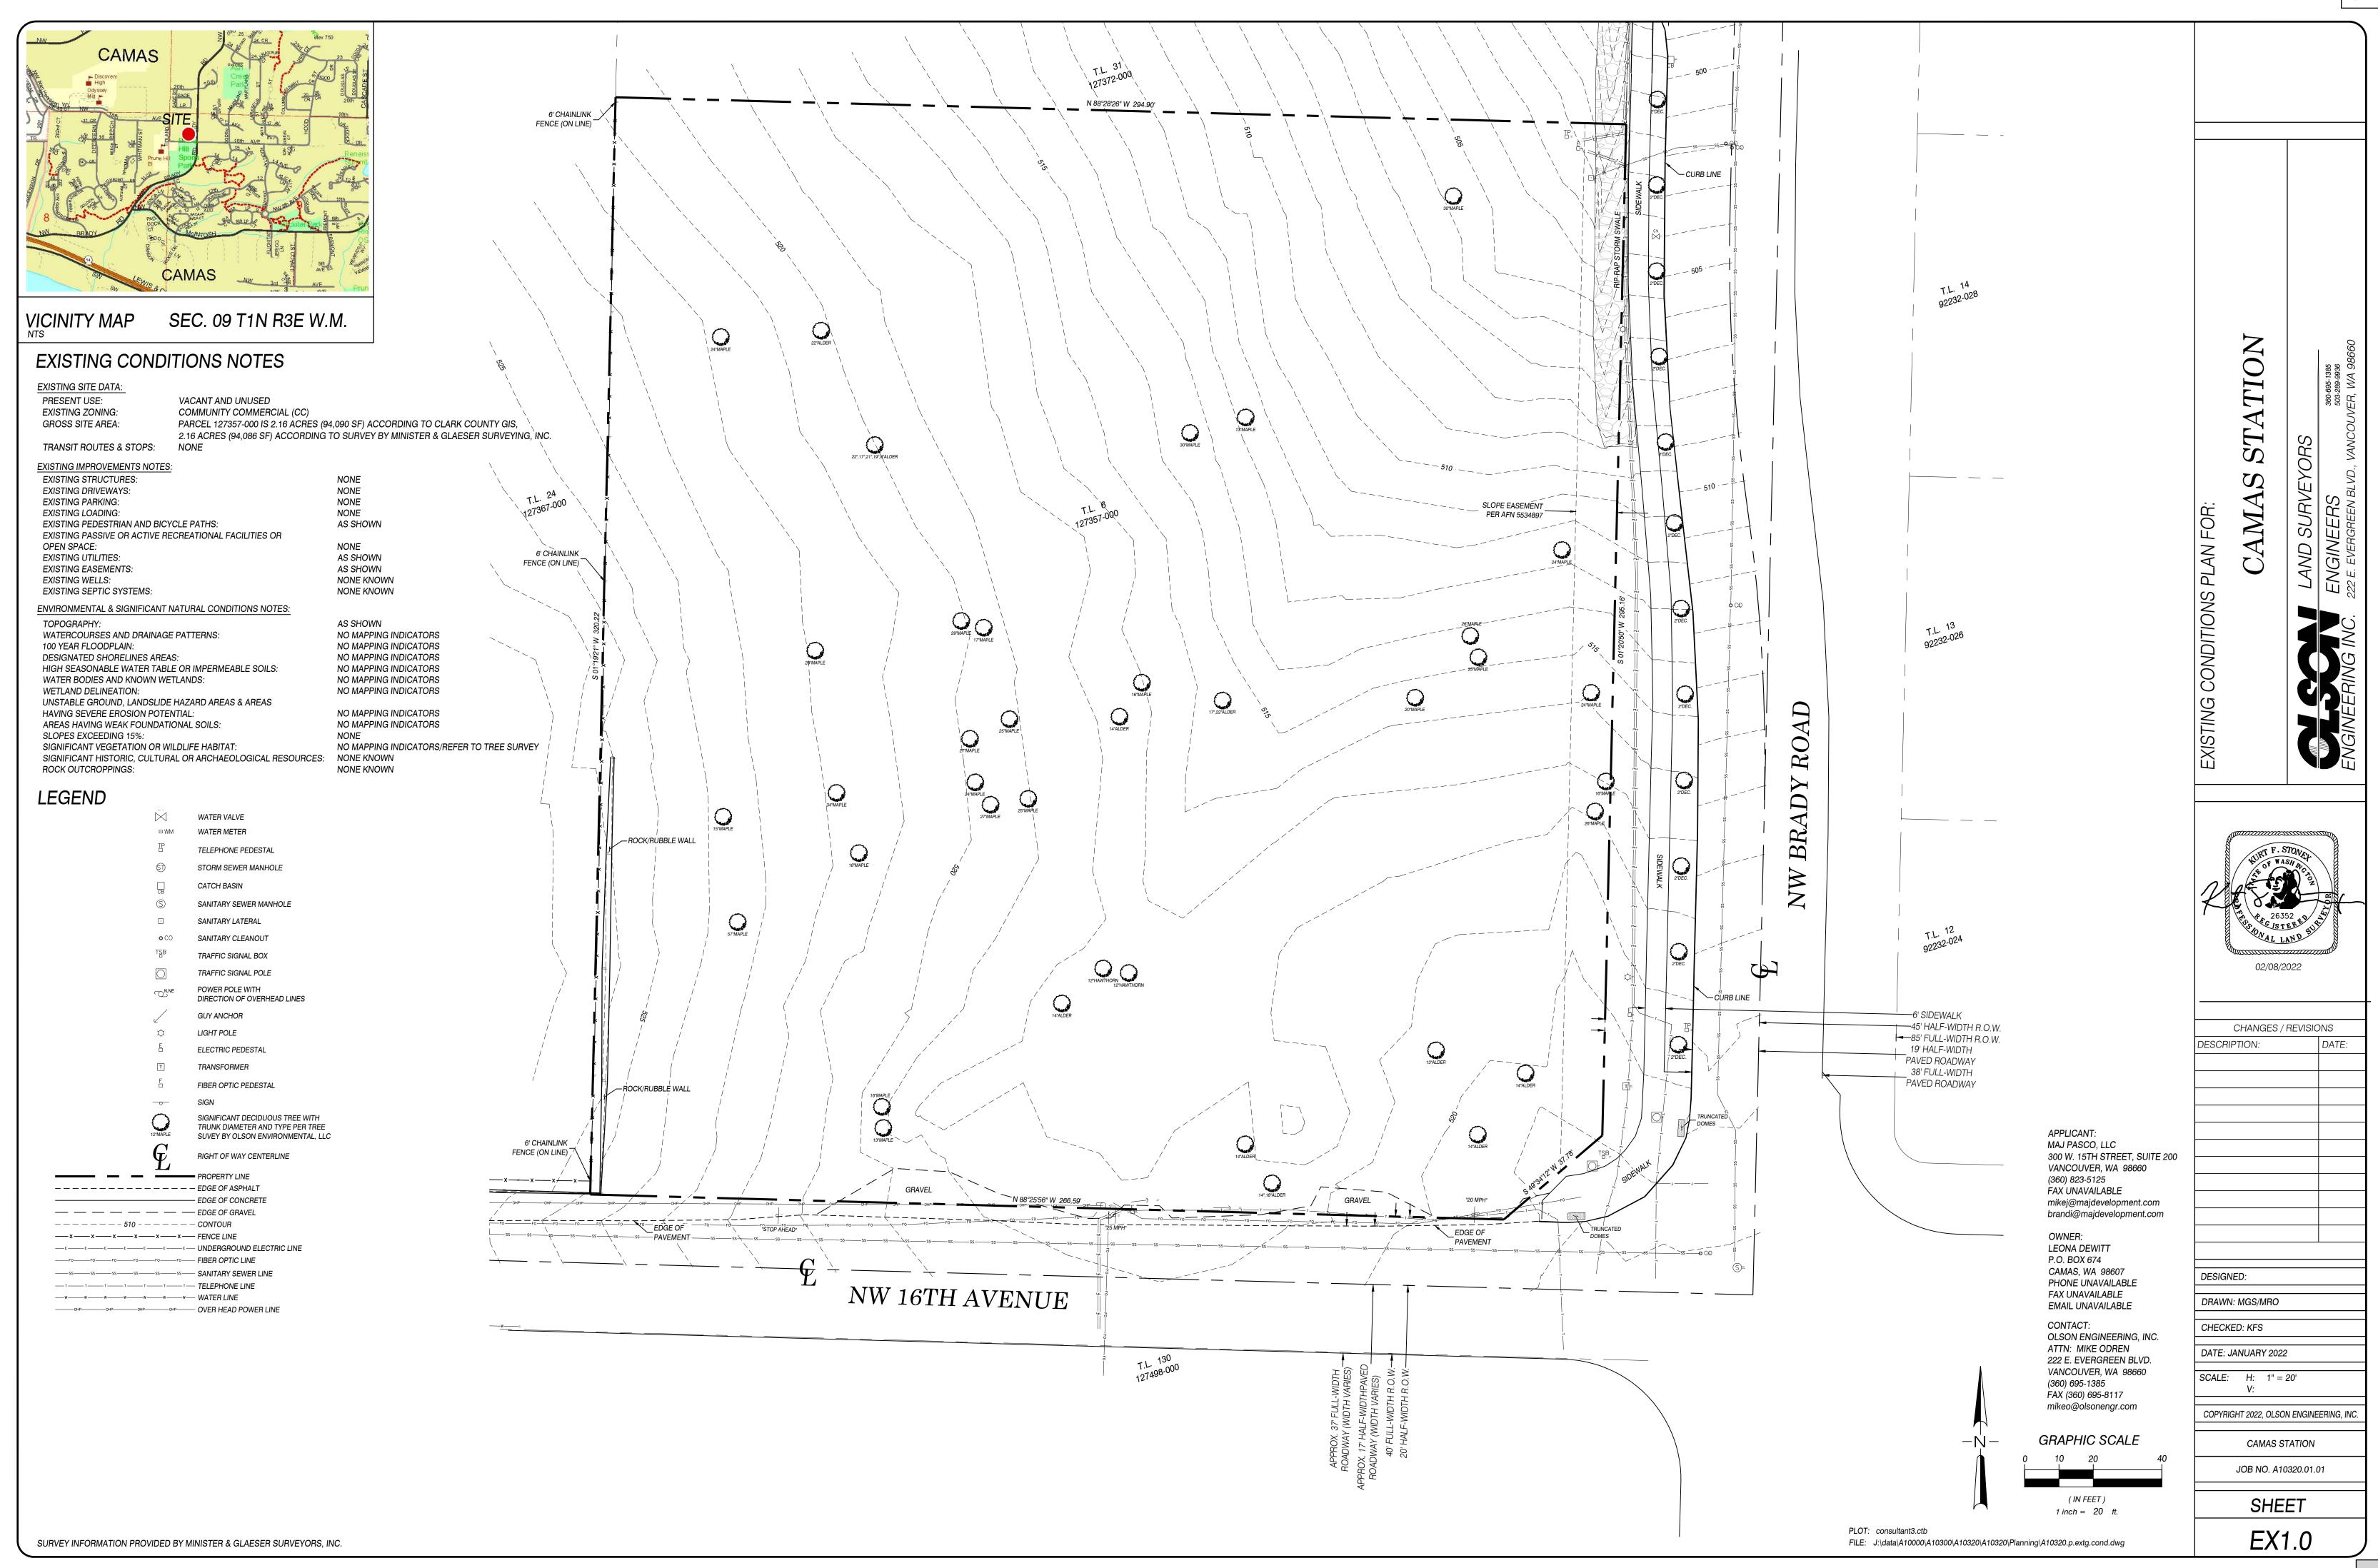
DRAWN BY: KH
CHECKED BY: SL

REVISIONS

SITE PHOTOMETRIC

E / 1.0



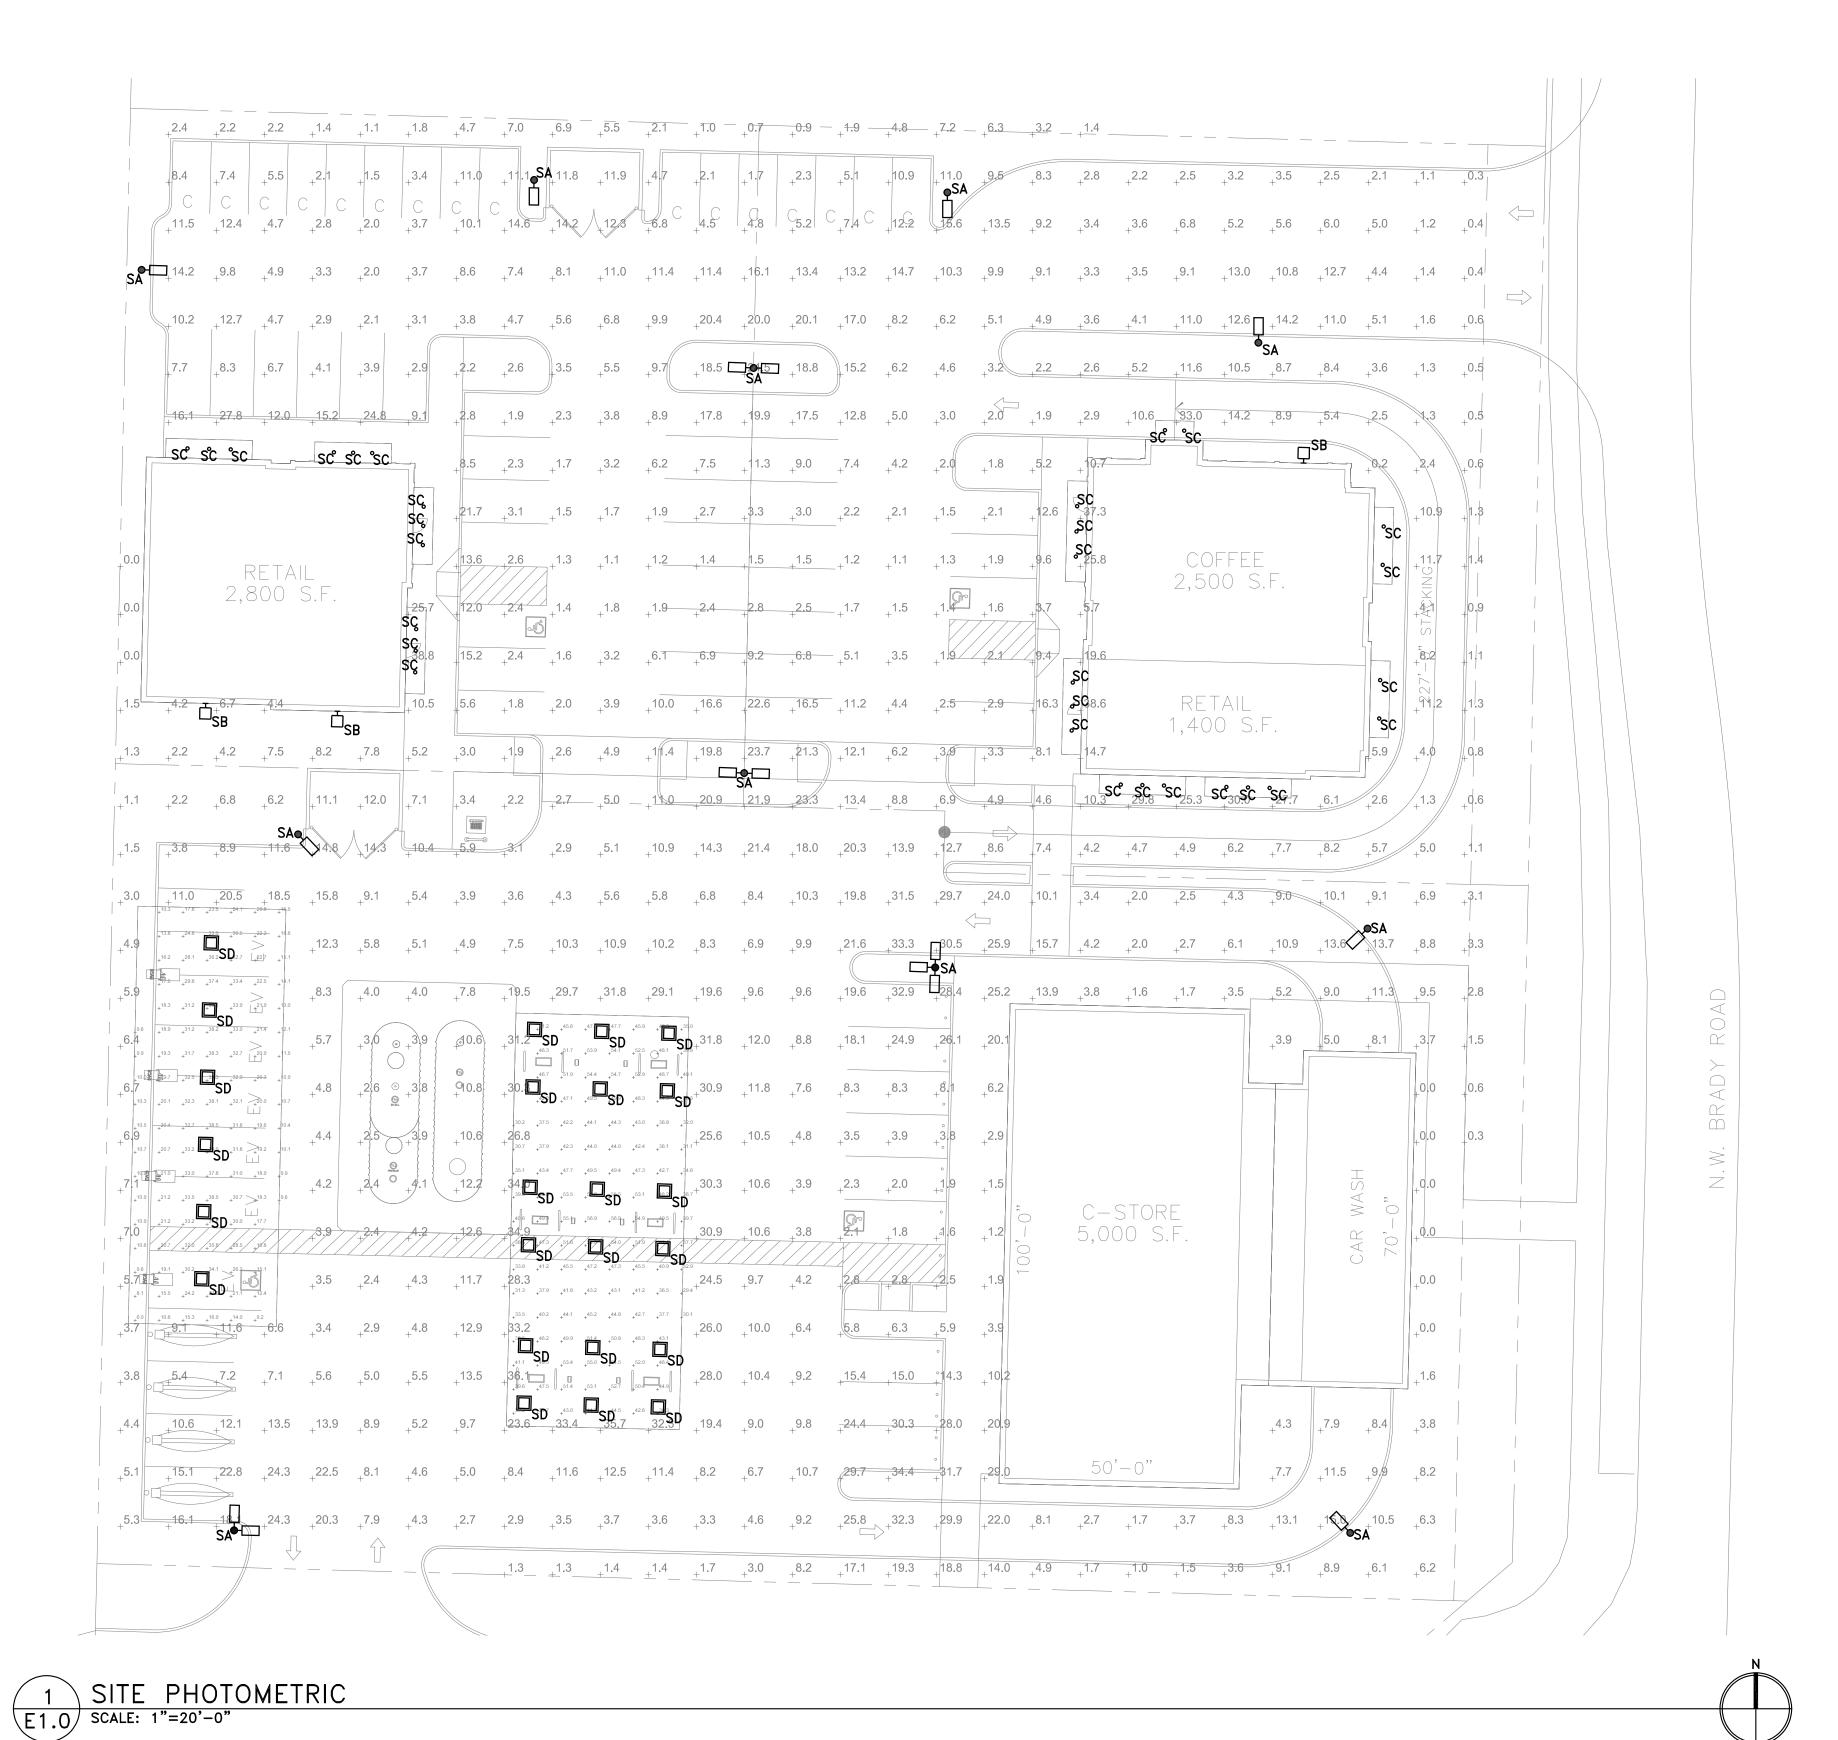



Community Development Department
616 NE Fourth Avenue Camas, WA 98607

Design Review Checklist- DR22-02 Camas Station

The purpose of this sheet is to provide a simplified and expedited review of the design review principles and guidelines using objective review standards. The standards are intended as tool for the decision-maker in making findings that the proposal either achieves compliance with the intent of the principles or reasonably mitigates any conflict. When reviewing the check sheet, the proposal should as a whole "comply" with the standards and thus be generally consistent with the overriding principles. [Yes = In Compliance; No = Not In Compliance; NA = Not Applicable]

Standard Principles and Guidelines

ARCH	HITECT	URE		
Yes	No	NA	Principles and Guidelines	Comments
			Corrugated materials, standing seam, T-1 11, or similar	
			siding materials are avoided unless it produces a high	
			visual (or aesthetic) quality.	
			Buildings walls or fences visible from roadways are	
			articulated in order to avoid a blank look.	
			The use of bold colors has been avoided unless used as	
			minor accents.	
			Higher density/larger structures abutting lower density	
			residential structures have been designed to mitigate	
			size and scale differences.	
LAND	SCAPI	ING AI	ND SCREENING	
Yes	No	NA	Principles and Guidelines	Comments
			Vegetation for landscaping includes native, low	
			maintenance plantings. Significant trees are retained if	
			feasible.	
			Trees planted along streetscapes with overhead power	
			lines include only those trees identified on the City's	
			Tree list.	
			Landscaping, including trees, shrubs, and vegetative	
			groundcover, is provided to visually screen and buffer	

DESIGN REVIEW CHECKLIST

Item 1.

the use from adjoining less intense uses including parking. Proposed fencing is incorporated into the landscaping so as to have little or no visual impact. Signs located on buildings or incorporated into the landscaping are unobtrusive and vandal resistant. If illuminated they are front lit. Landscape lighting - low voltage, non-glare, indirect lighting is directed, hooded or shielded away from neighboring properties. Street lighting (poles, lamps) is substantially similar or architecturally more significant than other street lighting existing on the same street and do not conflict with any City approved street lighting plans for the street. Parking and building lighting is directed away from surrounding properties through the use of hooding, shielding, siting and/or landscaping. Outdoor furniture samples are consistent with the overall project design. Existing trees over 6" dbh that are not required to be removed to accommodate the proposed development are retained and incorporated into the landscape plan. Rock outcropping's, forested areas and water bodies are retained. HISTORIC AND HERITAGE PRESERVATION Yes No NA Principles and Guidelines The use of Historic Markers, information kiosks, project names, architectural features, or other elements of the project promote the historic heritage of the site or surrounding area.					
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Yes No NA Principles and Guidelines Comments The use of Historic Markers, information kiosks, project names, architectural features, or other elements of the project promote the historic heritage of the site or The use of Historic Markers, information kiosks, project names, architectural features, or other elements of the project promote the historic heritage of the site or				retained.	
The use of Historic Markers, information kiosks, project names, architectural features, or other elements of the project promote the historic heritage of the site or	HISTO	ORIC A	ND HE	ERITAGE PRESERVATION	
names, architectural features, or other elements of the project promote the historic heritage of the site or	Yes	No	NA	Principles and Guidelines	Comments
project promote the historic heritage of the site or				The use of Historic Markers, information kiosks, project	
				names, architectural features, or other elements of the	
surrounding area				project promote the historic heritage of the site or	
Sarrounding area.				surrounding area.	

DESIGN REVIEW CHECKLIST

Item 1.

Specific Principles and Guidelines

	COMMERCIAL & MIXED USES					
ARCH	ARCHITECTURE					
Yes	No	NA	Principles and Guidelines	Comments		
			Office and retail buildings provide a minimum solid to			
			void ratio of 60%/40%			
			The development is built with a residential feel (i.e. size,			
			scale, and materials compatible with neighboring			
			buildings) if surrounded by residential areas or adjacent			
			to residentially zoned properties.			
			Buildings over two stories have the third story and above			
			offset from the first two stories, if surrounding			
			developments are less than three stories or land use			
			designations on adjacent zones do not allow more than			
			three story development.			
LAND	SCAPI		SCREENING			
Yes	No	NA	Principles and Guidelines	Comments		
			Intersections are illuminated, but not dominated by			
			lighting. Lighting is incorporated into the landscape and			
			illuminates the quality of the natural environment.			
			Street light poles and lamps are compatible with other			
			nearby lighting on the same street.			
			Parking spaces are clustered in small groupings and			
			separated by landscaping to create a pedestrian friendly,			
			park like environment.			
	ETSCA	1				
Yes	No	NA	Principles and Guidelines	Comments		
			On-site parking areas are located to the interior of the			
			development unless site development proved			
			prohibitive.			
			Parking areas are screened with landscaping.			
			Buildings are placed close to streets and roads unless site			
			constraints made it impossible, or characteristics of the			
			surrounding properties already developed made it			

DESIGN REVIEW CHECKLIST

Item 1.

	incompatible. Otherwise, retail frontage setbacks do not exceed 25 feet from back of curb.	
	Window and door placement provides a high degree of transparency at the lower levels of the building and maximize visibility of pedestrian active uses.	
\	Each use/activity in a development containing multiple uses/activities is integrated in a manner that achieves a seamless appearance or creates a cohesive development.	
	Watering system will maintain proposed landscaping for a period to ensure that plants are well established.	
	New streets intersecting commercial properties are designed to create a safe environment. "Coving" techniques and "round-a-bouts" were considered for traffic calming when appropriate.	

Camas Station (DR22-02) Index of Exhibits

Exhibit	Title/Description	Document
No.		Date
1	Vicinity Map	
2	Preliminary Site Plan & Short Plat	2/8/22
3	Building 1 Floor Plan & Elevations	2/3/22
4	Building 2 Floor Plan & Elevation	2/3/22
5	Building 3 Floor Plan & Elevation	2/3/22
6	Canopy Elevations	2/11/22
7	Preliminary Landscape Plan	
8	Lighting Plan	1/24/22
9	Existing Conditions Plan	2/8/22
10	Design Review Checklist	