

## Design Review Committee Meeting Agenda Tuesday, August 01, 2023, 4:00 PM REMOTE MEETING PARTICIPATION

NOTE: The City welcomes public meeting citizen participation. TTY Relay Service: 711. In compliance with the ADA, if you need special assistance to participate in a meeting, contact the City Clerk's office at (360) 834-6864, 72 hours prior to the meeting so reasonable accommodations can be made (28 CFR 35.102-35.104 ADA Title 1)

## To Participate Remotely:

**OPTION 1 -** 1. Go to www.zoom.us and download the app or click "Join A Meeting" and use Meeting ID – 822 4078 4594 2. Or, from any device click https://us06web.zoom.us/j/82240784594

**OPTION 2 -** Join by phone (audio only): 1. Dial 877-853-5257 and enter meeting ID# 822 4078 4594

#### **CALL TO ORDER**

#### **ROLL CALL**

#### INTRODUCTIONS

#### **MEETING ITEMS**

1. Camas Meadows Hole 9 Ph 1 Mixed Use Development (CUP23-01) Presenter: Madeline Sutherland, Planner

#### **CLOSE OF MEETING**



## **STAFF REPORT**

Camas Meadows Hole 9 Mixed-Use Development Major Design Review (File no. DR23-03) Consolidated File: CUP23-01, SUB23-01, SPRV23-02, CA23-03, SEPA23-03, ARCH23-02

<u>TO</u>	Design Review Committee
FROM	Madeline Sutherland, Planner
<u>LOCATION</u>	4525 NW Camas Meadows Drive Parcel Numbers: 175980000, 172973000, 172963000, 986035734, 986035733, 172970000, & 986026906

APPLICABLE LAW: This land use application was submitted on April 4, 2023, and resubmitted on April 24, 2023. Applicable Camas Municipal Code (CMC) chapters include Title 17 Land Development and Title 18, specifically (but not limited to): Chapter 18.11 - Parking, Chapter 18.13 - Landscaping, Chapter 17.11 – Subdivisions, Chapter 18.43 Conditional Use Permits, Chapter 18.18 - Site Plan Review, Chapter 18.19 Design Review, and Chapter 18.55 Administrative Procedures.

#### **Summary**

The applicant is currently seeking design review approval to construct 77 detached and attached single-family homes with a 6,600 square foot commercial building. Other amenities include landscaping, pedestrian pathways, and parking.

The site is located along NW Camas Meadows Drive, at 4525 NW Camas Meadows Drive. To the north is Camas Meadows Golf Course, directly west is the golf course parking lot and restaurant, and to the south are Light Industrial/Business Park buildings. Further west are single-family and multifamily residences known as Village at Camas Meadows. The site contains several trees and vegetation.

#### **Purpose**

Design Review is required under CMC Chapter 18.19. Design review is not intended to determine the appropriate use of a parcel but rather review a proposed development for compliance with City codes and plans related to landscaping, architectural elevations, and other elements relative to required improvements. The recommendations from the Design Review Committee (DRC) must consider the design review standards from the Design Review Manual and Camas Municipal Code (CMC). An enclosed checklist is to help guide you in your review but refer to the manual for specific details regarding the standards.

#### Standard and Specific Commercial and Residential Design Principles and Guidelines

The standard and specific commercial and residential principles and guidelines for single family residences, townhomes and a commercial building are required and must be demonstrated to have been satisfied in overall intent for design review approval. The standard design guidelines are developed to assist a project in meeting the established principles and each guideline should be adequately addressed. If the proposal cannot meet a specific guideline, then an explanation should be provided by the applicant as to why and how it will be mitigated to satisfy the intent of the design principles. The development guidelines include five major categories: 1) Landscaping and Screening, 2) Architecture, 3) Massing and Setbacks, 4) Historic & Heritage Preservation, and 5) Circulation and Connections. The Design Review Checklist is enclosed to help guide the DRC in reviewing the standard applicable specific design review principles and guidelines.

#### **Recommendation**

That the Design Review Committee reviews the submitted materials, deliberates, and forwards a recommendation to staff for a final decision.



Community Development Department | Planning Division 616 NE Fourth Ave, Camas, WA 98607 360-817-1568 | permits@cityofcamas.us

General Application Form Camas Meadows Hole 9 Ph 1 Mixed Use Development

Case Number: CUP23-01

		Applic	ant Inform	ation		
Applicant/Contact::	Romano Developmen	t (Stacey Shields)			Phone:	(360) 904-4759
	Last	First				
Address:	4660 NE 77th Ave	enue			Suite 200	
	Street Address				Apartment/L	Init #
	Vancouver				WA	98662
	City				State	ZIP Code
Email Address:	Stacey@romanofi	nancial.com				
		Drono	utu Informa	tion		
A	4711 4615 4555 4		rty Informa		886026-906 1729	70-000, 986035-733, 896035-734, 172963-000, 172973-000, 1
Property Address:		525 Unit A & B NW Ca	mas Meadows	s Drive		
	Street Address Camas				County Asses WA	sor # / Parcel #
						98607
7	<i>City</i> Mixed Use (MX)		-		State	ZIP Code
Zoning District	WINED USE (WIN)		5	ite Size	13.01 acres	s (601,725 square feet)
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Date Submitted: 4/4/23	Pre-Application Date:		\$43,646.80 Receipt #744288	
Madeline Sutherland Staff: Relat	PA22-49 DR23-03 ed Cases #ARCH23-02 SEPA23-03	Electronic Copy Submitted	4/4/23 by CK Validation of Fees	
	CUP23-01 SPRV23-02 CA23-03		Revised: 01/09/2023	

Exhibit 1 DR23-03

ARCH23- CUP23-0 CA23-03 DR23-03
CUP23-0 CA23-03
CUP23-0 CA23-03
CUP23-0 CA23-03
CA23-03
DR23-03
DR23-03
DR23-03
5125-05
SUB23-0 <sup>2</sup>
50625-0
SEPA23-0
DEFAZS-U
רכי וחסי
SPRV23-

**Total Fees Due:** 

<sup>\$</sup> 43,646.80

Exhibit 1 DR23-03

ltem 1.

City of Camas 616 NE 4th Avenue Camas, WA 98607 360-834-2462 Finance Office Hours: Monday-Friday 9:00 - 5:00 p.m. Date/Time 04/03/2023 04:21 PM Receipt No. 00744288 Receipt Date 04/03/2023 43,646.80 CR plan arc/rev archaeoligal rev 300.00 iew fire/subr Fire Subdyn/PRD 384.00 Review crit/sens critical/sensitv 848.00 e areas sepa 886.00 sepa fees designrev design review 2,598.00 site-plrv site plan review 3,594.80 cond.use conditional use 7,938.00 permit plat plat fees - plan 27,098.00 ning 0.00 Cash: Other: 43,646.80 0.00 they a Check: 43,646.80 Total: 43,646.80 Change: 0.00 Check No: # 2363, CAMAS MEADOWS HOLE 9 PH1 ROMANO DEVELOPMENT, INC Customer #: 000000 Cashier: ckafouros

Station: IS02475

Item 1.

# CITY OF CAMAS DESIGN REVIEW NARRATIVE

# CAMAS MEADOWS A MIXED-USE DEVELOPMENT

#### APPLICANT AND DEVELOPER:

Romano Development 4660 NE 77<sup>th</sup> Avenue, Suite 200 Vancouver, WA. 98662 Project Contact: <u>Stacey@romanofinancial.com</u> 360.904.4759

#### LEGAL COUNSEL:

Steve Morasch Landerholm, PS 805 Broadway Street, Suite 1000 Vancouver, WA 98660 <u>Steve@landerholm.com</u> 360.558.5912



#### Item 1.

#### BACKGROUND

Camas Meadows is a proposed mixed-use development in the City of Camas. The Applicant is seeking design review approval for the construction of 40 townhome lots and one commercial lot. The project also includes 37 detached single-family lots, which are not required to undergo the design review process.

The development will gain access from NW Camas Meadows Drive along the south frontage of the site in two access points, with access to the individual lots through an internal street and alley network. The project will include landscaping, lighting, utilities and pedestrian amenities such as sidewalks, multiple pedestrian paths, green spaces and a pocket park. The proposed building types provide for a variety of architectural features, such as varied color and material palettes and articulated roof lines.

#### **EXISTING CONDITIONS**

The project site is located at 4525 NW Camas Meadows Drive, Camas, WA. 98607. The property contains 8.8 acres and is identified as parcels: 175980000, 172973000, 172963000, 986035734, 986035733, 172970000 and 9860269-06. The property is located in the SW ¼ of Township 2 North, Range 3 East, Willamette Meridian. The site is zoned Mixed Use (MX) and is currently vacant with no structures on-site.

Neighboring properties are zoned Light Industrial/Business Park (LI/BP) to the north, east, south, and west; and Residential (MF-18) to the southeast. Surrounding properties are a diverse blend and include:

North, east and west: Camas Meadows Golf Course South: Commercial business park

The site slopes to the north, with slopes ranging from 3-18% based on GIS data. The site is mostly covered in field grass and Himalayan blackberries, with trees dispersed across the site.

#### **DESIGN REVIEW CRITERIA**

CMC 18.19.050 – This proposal is subject to the requirements of the Camas Design Review Manual: Gateways, Commercial, Mixed Use and Multifamily Uses, originally dated 2001 and revised March 2016. The following statements demonstrate how these requirements are met with this proposal.

A. Standard Principles.

1. Landscaping shall be done with a purpose. It shall be used as a tool to integrate the proposed development into the surrounding environment.

Response: A landscape plan has been prepared in accordance with the City of Camas landscaping requirements that exceeds city standards. It also aesthetically blends the development into the surrounding environment by featuring open greenspaces and one pocket park that protects the existing white oaks while providing a vegetated space for residents to enjoy. The landscaping has been designed to minimize maintenance and water usage while providing a variety of plantings and trees for diversity and color throughout the year. Please refer to the landscape plan prepared by AKS Engineering and Forestry, LLC (AKS).

2. All attempts shall be made at minimizing the removal of significant natural features. Significant natural features shall be integrated into the overall site plan.

Response: A critical areas assessment and preliminary Oregon white oak mitigation plan were prepared by AKS and approved by Washington State Department of Fish and Wildlife. The report includes details on impacts to Oregon white oaks existing on site and mitigation of these impacts. Please refer to the report for additional information on how the Applicant is preserving many of these white oaks.

3. Buildings shall have a "finished" look. Any use of panelized materials shall be integrated into the development in a manner that achieves a seamless appearance.

Response: The townhome buildings and commercial building will have a "finished" look and will be composed of similar material and dark color tones to complement one another while maintaining individual character. See the preliminary building elevations and materials board included in this application for reference.

4. A proposed development shall attempt to incorporate or enhance historic/heritage elements related to the specific site or surrounding area.

Response: This site is similar to an infill development as it is surrounded by developed office/industrial uses to the south and a golf course. Historic white oaks have been preserved onsite with ample open space as shown on the site plan and further depicted on the landscape plan prepared by AKS.

- B. Specific Principles.
  - 1. Gateways.

a. Gateways shall be devoid of freestanding signs. Preexisting freestanding signs will be subject to removal at the time of any new development, redevelopment, or major rehabilitation on the site. Exemptions include approved directional or community information signage as approved by the city.

# **Response:** There are no proposed freestanding signs associated with this project.

b. Business signage not placed on buildings shall be integrated into the landscaping/streetscaping of the subject property.

Response: No commercial signage is proposed as part of this project. Future signage will be applied for by the user of said brewery with the building permit package. Future signage will meet the City of Camas code.

c. Permanent signage within a gateway shall be standardized in a manner that creates a consistent look within the gateway in question.

Response: Any monument sign for the subdivision and commercial lot shall be vandalism-resistant and surrounded by vegetation in order to soften its appearance, while acting as a means of wayfinding. Signage will be used effectively and efficiently to ensure limited use and will meet City of Camas code.

d. The surface of pedestrian walkways within intersections shall be accentuated with a unique character.

**Response: All pedestrian walkways and sidewalks will meet City of Camas code.** 

e. A consistent streetscape lighting scheme shall be used.

Response: The project will provide adequate site lighting for safe navigation at night in all circulation and parking areas. Any required street lighting will be compatible and shielded to protect future uses and the adjoining development to the south from unnecessary glare. Future lighting plans will meet City of Camas code.

2. Commercial and Mixed Uses.

a. On-site parking areas shall be placed to the interior of the development unless site development proves prohibitive. All on-site parking areas along adjacent roadways shall be screened with landscaping. Downtown commercial and mixeduse areas shall not be required to provide on-site parking.

**Response:** Two onsite parking lots (Tract C and G) are proposed that will provide 15 surplus parking spaces in the townhome area of the project.

Parking provided for lot 78, the commercial lot, was a little more difficult to accommodate due to the natural configuration of this triangle-shaped lot and the inability to have direct access onto Camas Meadows Drive. The building and patio area were placed on the west side of the lot to capture the views of the golf course and to better integrate into the environment. These wellplanned improvements are intended to connect those who are living, walking and working on the property with those from the surrounding neighborhoods.

The Applicant is proposing wide landscape setbacks buffers where the commercial lot buffers single family lots in an effort to ease the transition between the different uses. Furthermore, ample landscaping and a 6' tall wood fence has been provided to meet the L3 buffer requirement.

b. Buildings shall be used to define the streetscape unless site conditions prove prohibitive.

Response: The development proposes a truly mixed development, offering a neighborhood local brewery/pub, and a mix of housing options. These include attached townhomes and standard detached homes that are oriented in such a way to provide a connected and cohesive project offering a diversity of housing.

The commercial lot provides a place for patrons to walk, play and eat. The building's exterior contains elements designed to enhance the pedestrian environment including sidewalks, functional and decorative lighting, rain protection, landscaping and architectural detailing that complements the existing charm that Camas is known for. Please refer to the building elevations and renderings.

c. Structures abutting, located in, or located near less intensive uses or zoned areas (such as commercial developments next to residential areas) shall be designed to mitigate size and scale differences.

Response: This project redevelops an underutilized site with uses and scales appropriate for the area and meets the needs of the City's by helping address its housing shortage. The townhome lots line the fronting street, NW Camas Meadows Drive. The single family lots are located along the golf course where residents can take advantage of the expansive views. The commercial lot is on the west side of the project, adjacent to the street, with the existing commercial users just to the south of Camas Meadows Drive.

d. Developments containing a multiple of uses/activities shall integrate each use/activity in a manner that achieves a seamless appearance, or creates a cohesive development.

Response: As previously discussed, this development provides a mix of product and uses, offering diversity and a unique neighborhood. Similar materials will be used to create a cohesive feel throughout the development so that the different housing and commercial products blend. The materials will provide varying tones and textures which are complementary. Please refer to the elevations for additional information.

e. Mixed-use developments that place uses throughout the site (horizontal development) shall organize elements in a manner that minimizes their impact on adjacent lower intensity uses.

Response: The lower intensity uses are located on the north side of the site, abutting the golf course. The townhome product and commercial lot is located near the street, on the south and west side of the development.

f. Walls shall be broken up to avoid a blank look and to provide a sense of scale.

Response: Currently, two retaining walls are proposed for the stormwater facility, these walls do not exceed 6 feet. Given the existing topography of the site, there is a potential for additional retaining walls to be constructed. The locations of potential walls for residential lots are unknown at this time. Any walls to be constructed will be included on the final engineering plans; however, it is not anticipated that any walls will be over 6 feet in height. All appropriate permits will be obtained for any proposed walls.

g. Outdoor lighting shall not be directed off-site.

Response: The site will be provided with adequate site lighting for safe navigation at night in all circulation and parking areas. Any street lighting required will be compatible and shielded. Future lighting plans will meet the City of Camas code.

#### 3. Multifamily

a. Stacked Housing.

i. All on-site parking areas shall be screened with landscaping. Parking spaces shall be clustered in small groups of no more than six to ten spaces.

ii. Stacked houses abutting or located in single-family residentially zoned areas shall be designed to mitigate size and scale differences.

iii. Walls shall be articulated in order to avoid a blank look and to provide a sense of scale.

iv. Detached garages shall be located to the rear of stacked unit(s) so as not to be directly viewable from a public street.

v. Attached garages shall account for less than fifty percent of the front face of the structure. Garages visible from the street shall be articulated by architectural features, such as windows, to avoid a blank look.

**Response:** These provisions do not apply to this project as there are no multifamily units proposed.

b. Townhomes and Rowhouses.

All on-site parking areas (excluding driveways and garages) shall be screened with landscaping.
 Response: Two onsite parking lots are provided to accommodate a total of 15 spaces. Ample landscaping, such as maples and laurels, is provided to buffer the

spaces. Ample landscaping, such as maples and laurels, is provided adjoining lots.

ii. Buildings shall be used to define the streetscape unless site conditions prove prohibitive.

Response: Proposed residences are designed to provide an appealing street scale with windows and front walkways at street grade. Furthermore, some residences offer balconies and utilize alternating siding types and colors as well as extruded portions of the facade to provide an appealing, modern feel.

The brewery facade uses multiple materials, colors and forms to provide architectural interest and define the streetscape.

- iii. When appropriate, structures abutting or located in single-family residentially zoned areas shall be designed to mitigate size and scale differences.
  Response: The site is not located in or abutting any single-family zoned areas; the zoning designation is MX.
- iv. Walls shall be articulated in order to avoid a blank look and to provide a sense of scale.
   Response: The two-story buildings have been designed to provide a sense of scale and the materials and design provide for a modern feel and generate visual interest. Please refer to the attached building elevations for additional

information.

v. Detached garages shall be located to the rear of the townhouse or rowhouse unit(s) so as not to be directly viewable from a public street.

## Response: The proposal does not include detached garages.

vi. vi. Attached garages shall account for less than fifty percent of the front face of the structure. Garages visible from the street shall be articulated by architectural features, such as windows, to avoid a blank look.

**Response:** Attached garages will account for less than fifty percent of the front face of each townhome. Garages are articulated with panelized, frosted glazing, complementary of the structures' modern design.

- c. Duplex, Triplex and Four-Plex.
  - i. Garages shall account for less than fifty percent of the front face of the structure. Garages visible from the street shall be articulated by architectural features, such as windows, to avoid a blank look.

#### Item 1.

#### **Response:** These provisions do not apply to this project.

#### CONCLUSION

The Camas Meadows development is a mixed-use development that provides housing opportunities to the growing City. The project develops an underutilized site with uses and scale appropriate for the area and meets the needs of the City by helping address the housing shortage. The commercial/retail elements blend from an aesthetic perspective and provide supporting uses to local community and adjacent developments.

The proposed townhome use will provide a middle housing product that is lacking in the City, as well as providing housing immediately adjacent to existing and proposed business park developments, to provide the opportunity for a live-work environment that will provide for the use of transportation options other than a motorized vehicle. The proposed restaurant will provide for jobs within the development, as well as a destination for residents of the new development, and users of the golf course and adjacent businesses.

Furthermore, the proposal complies with applicable City of Camas code provisions and furthers the goals of the adopted Comprehensive Plan. The project proposes to provide all required public infrastructure and services including sewer, storm water, municipal water and transportation improvements.


# CAMAS MEADOWS

VICINTY MAPS Camas Meadows Subdivision Romano Capital

Item 1.

## LOCATION

4525 NW Camas Meadows Dr Camas, Washington 98607

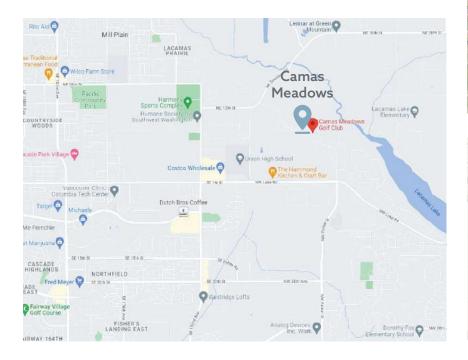





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Item 1.

## PRELIMINARY SITE PLAN

Camas Meadows Subdivision Romano Capital




**CAMAS MEADOWS** 

\*The detached Single Family Residences do not require design review approval. Request is for townhomes and the commercial lot.

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## TREE PLAN

SITE AREA: TOTAL TREE U EXISTING TREES PROPOSED SIT TOTAL TREE U (RETAINED AND PRESERVED)

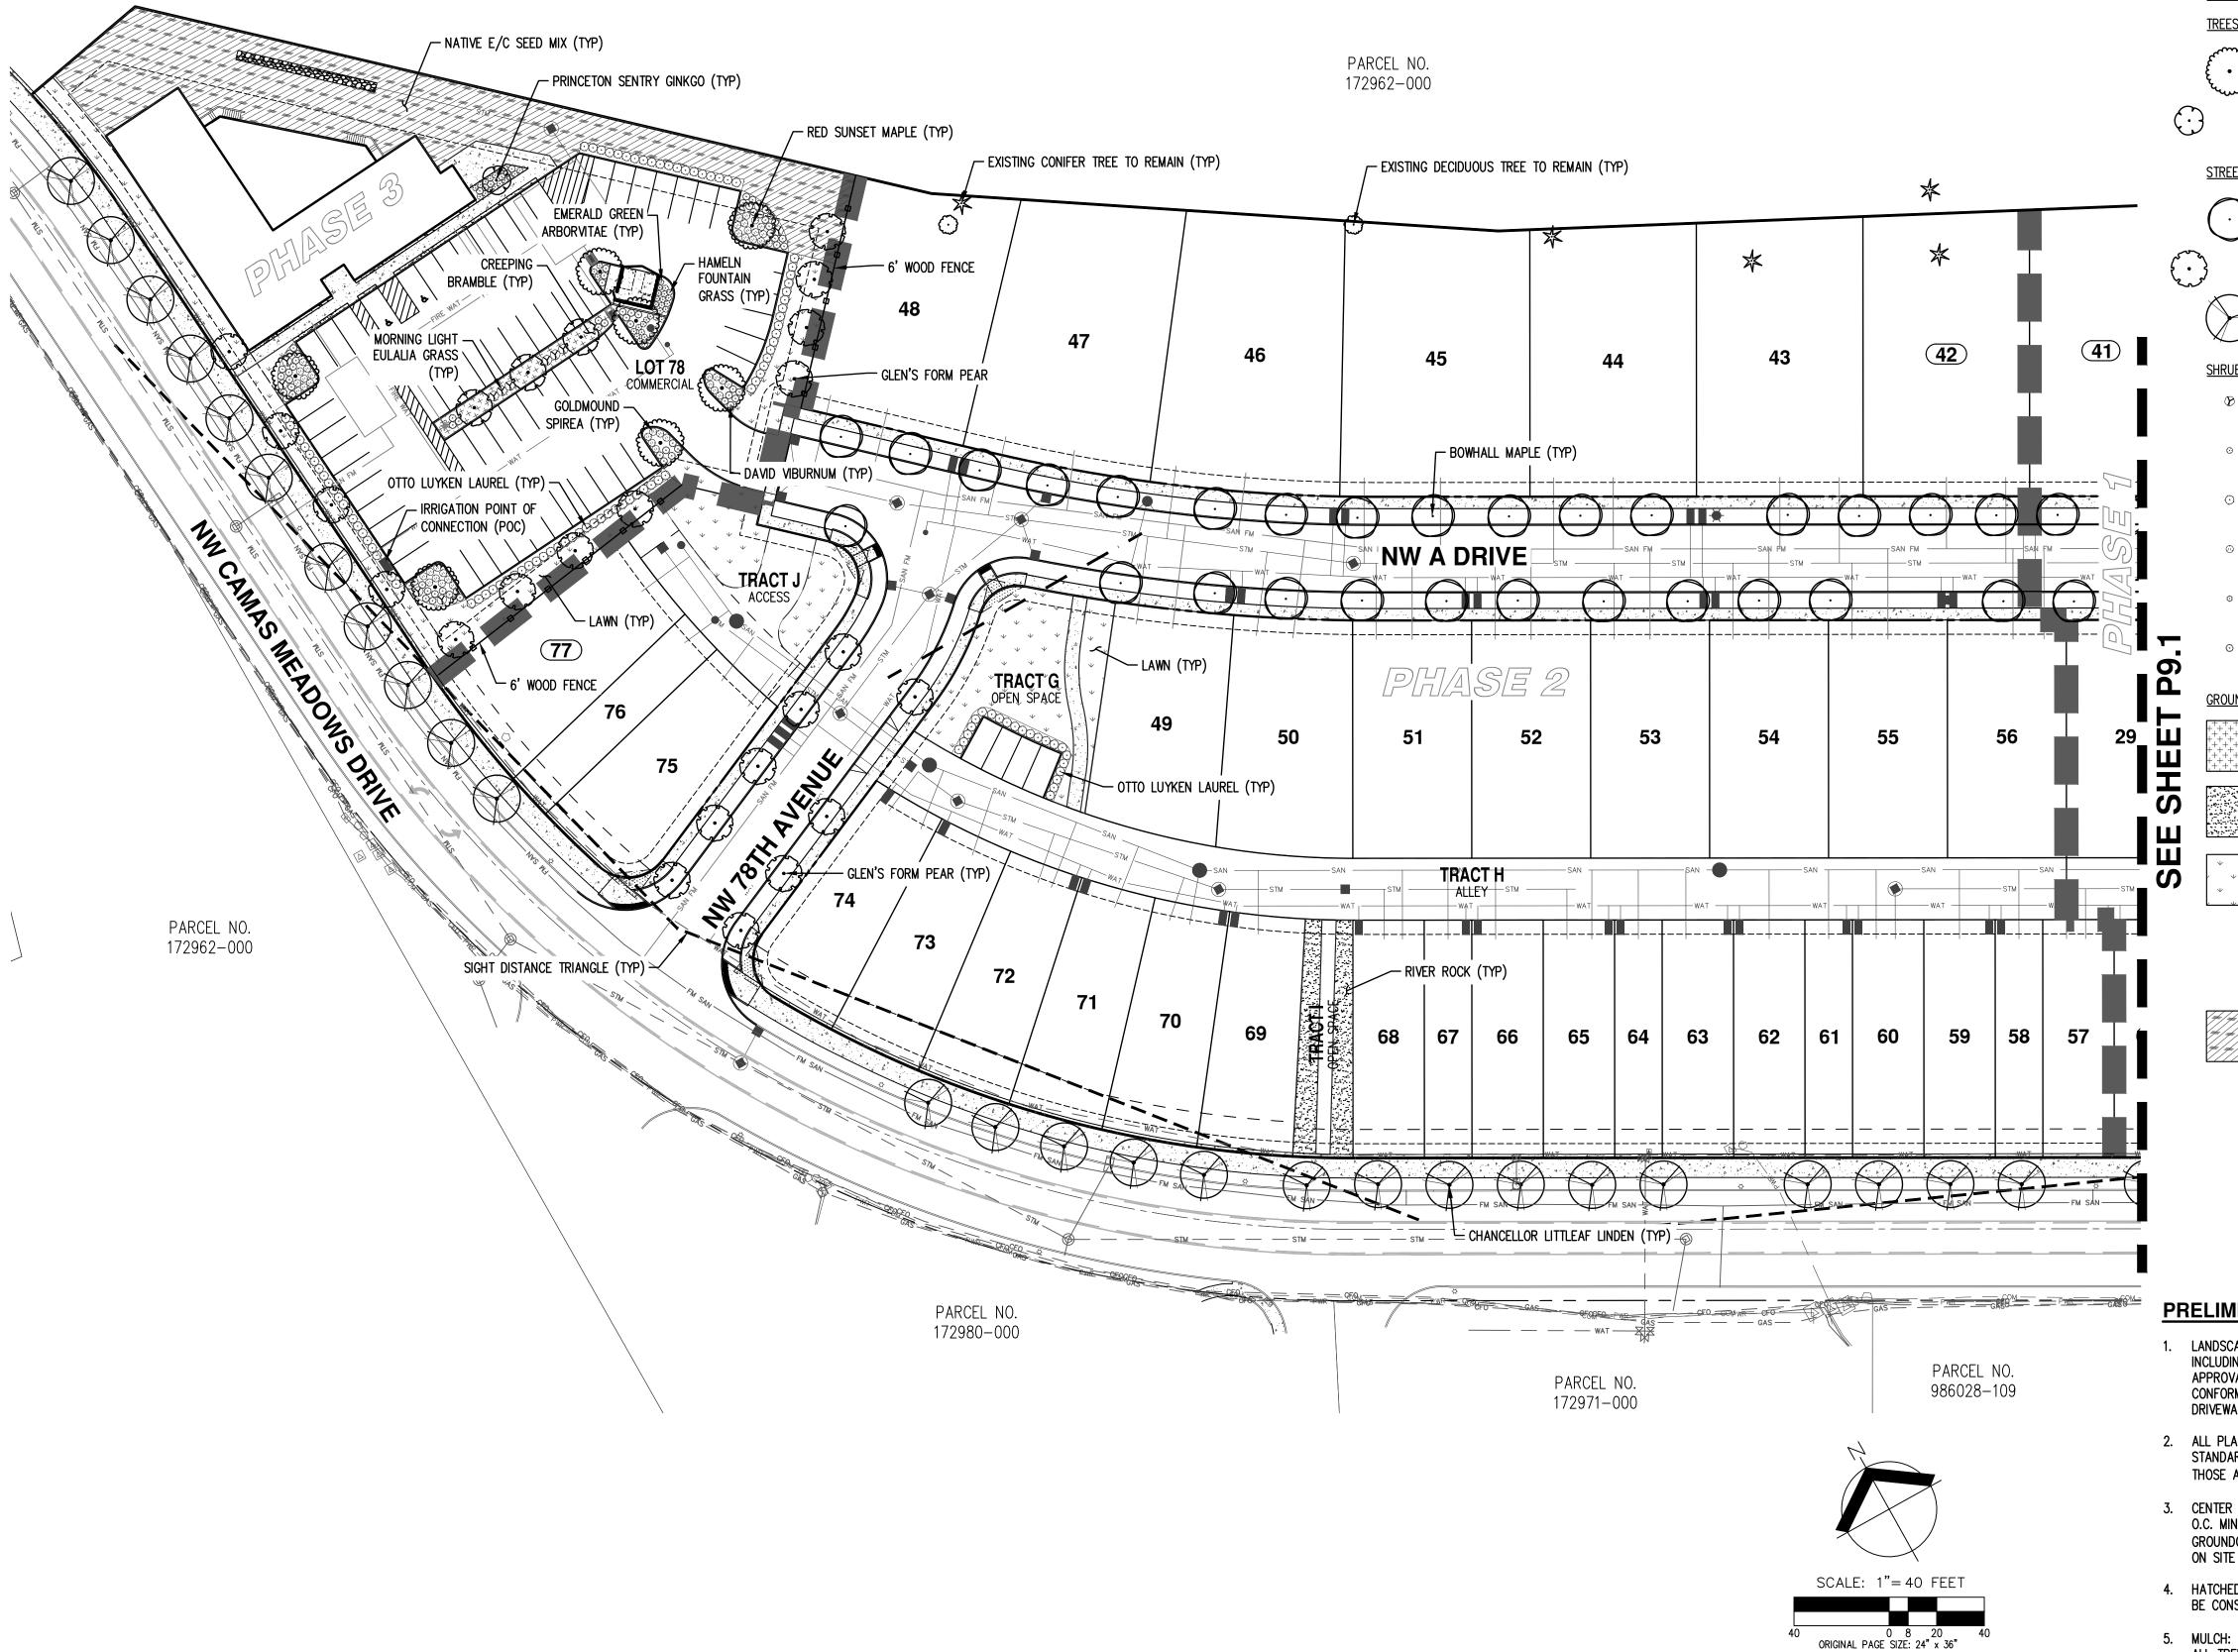PR

RELIN	IINARY	PLANT SCHEDULE	Ξ		
<u>ES</u>	QTY	BOTANICAL NAME	COMMON NAME	SIZE/CONTAINER	<u>SPACING</u>
• 33 • • • • • • • • • • • • • • • • • •	11	ACER RUBRUM 'FRANKSRED' TM	RED SUNSET MAPLE	2" CAL. B&B	AS SHOWN
	1	GINKGO BILOBA 'PRINCETON SENTRY'	PRINCETON SENTRY GINKGO	2" CAL. B&B	AS SHOWN
<u>EET TREES</u>	QTY	BOTANICAL NAME	COMMON NAME	<u>SIZE/CONTAINER</u>	<u>SPACING</u>
.)	61	ACER RUBRUM 'BOWHALL'	BOWHALL RED MAPLE	2" CAL. B&B	30'o.c.
	42	PYRUS CALLERYANA 'GLEN'S FORM' TM	GLEN'S FORM PEAR	2" CAL. B&B	30'o.c.
$\mathbf{E}$	44	TILIA CORDATA 'CHANCOLE' TM	CHANCELLOR LITTLELEAF LINDEN	2" CAL. B&B	30'o.c.
UBS	<u>QTY</u>	BOTANICAL NAME	COMMON NAME	SIZE/CONTAINER	<u>SPACING</u>
B	12	MISCANTHUS SINENSIS 'MORNING LIGHT'	MORNING LIGHT EULALIA GRASS	1 GAL CONT.	48" o.c.
3	42	PENNISETUM ALOPECUROIDES 'HAMELN'	HAMELN FOUNTAIN GRASS	1 GAL CONT.	30" o.c.
Ð	145	PRUNUS LAUROCERASUS 'OTTO LUYKEN'	OTTO LUYKEN ENGLISH LAUREL	3 GAL CONT.	48" o.c.
Ð	46	SPIRAEA X BUMALDA 'GOLDMOUND'	GOLD MOUND SPIREA	2 GAL CONT.	36" o.c.
0	6	THUJA OCCIDENTALIS 'SMARAGD'	EMERALD GREEN ARBORVITAE	5'-6' HT. CONT.	30" o.c.
€	73	VIBURNUM DAVIDII	DAVID VIBURNUM	2 GAL CONT.	36" o.c.
UND COVERS	<u>QTY</u>	BOTANICAL NAME	COMMON NAME	SIZE/CONTAINER	<u>SPACING</u>
+ + + + + + + +	147	RUBUS CALYCINOIDES	CREEPING BRAMBLE	1 GAL CONT.	24" o.c.
	±1,910 SF	RIVER ROCK			
↓ ↓ ↓	±13,889 SF	LAWN – NORTHWEST SUPREME LAWN SEE – LOLIUM PERENNE VAR DASHER 3 (DAS – LOLIUM PERENNE VAR CUTTER II (CUT – FESTUCA RUBRA VAR GARNET (GARNE – FESTUCA RUBRA SPP FALLAX VAR WIN	HER 3 PERENNIAL RYEGRASS) 35% TER II PERENNIAL RYEGRASS) 35% T CREEPING RED FESCUE) 15%	,	
		APPLY AT A ARTE OF 8 LBS. PER 1,000	SF OR AS RECOMMENDED BY SUPP	PLIER	
	±22,482 SF	NATIVE E/C SEED MIX – SUNMARK SEED – HORDEUM BRACHYANTHERUM (MEADOW – BROMUS CARINATUS (CALIFORNIA BROM – FESTUCA RUBRA RUBRA (NATIVE RED – DESCHAMPSIA CESPITOSA (TUFTED HAI – AGROSTIS EXERATA (SPIKE BENTGRASS –	/ BARLEY) 40% ME) 35% FESCUE) 20% RGRASS) 3%		

APPLY AT A RATE OF 1 LB. PER 1,000 SF OR AS RECOMMENDED BY SUPPLIER ECOLIVE ORGANICS SHALL BE ADDED TO SEED MIX AT A RATE OF 1.5 LBS. PER 1,000 SF

## **PRELIMINARY LANDSCAPE NOTES**

1. LANDSCAPE PLAN IS PRELIMINARY AND INTENDED TO SHOW DESIGN INTENT ONLY. REVISIONS OR SUBSTITUTIONS, INCLUDING CHANGES TO PLANT LOCATION, QUANTITIES, TYPES, AND SIZES MAY BE NECESSARY PRIOR TO FINAL APPROVAL BASED ON PLANT AVAILABILITY, SITE CONDITIONS, UTILITY CONFLICTS, ETC. ALL SUBSTITUTIONS SHALL CONFORM TO CITY OF CAMAS LANDSCAPE DESIGN STANDARDS. STREET TREES WILL BE UPDATED TO AVOID FUTURE DRIVEWAY DROPS.

2. ALL PLANTS AND PLANTINGS SHALL CONFORM TO CITY OF CAMAS DESIGN STANDARDS AND TO AMERICAN NURSERY STANDARDS ANSI Z60.1. PLANT IN ACCORDANCE WITH ACCEPTED BEST-PRACTICE INDUSTRY STANDARDS SUCH AS THOSE ADOPTED BY THE WASHINGTON ASSOCIATION OF LANDSCAPE PROFESSIONALS (WALP).

3. CENTER TREES IN PLANTER STRIPS AND LANDSCAPE PLANTING BEDS WHERE POSSIBLE. KEEP OTHER TREE TRUNKS 3' O.C. MINIMUM FROM CURBS, SIDEWALKS, AND OTHER PAVING OR CENTERED IN PLANTING ISLAND. KEEP SHRUBS AND GROUNDCOVER A MINIMUM OF 24" O.C. FROM PAVING AND 3' O.C. FROM TREES. ADJUST PLANTINGS AS NECESSARY ON SITE TO AVOID CONFLICT WITH UTILITIES, HYDRANTS, LIGHT POLES, METERS, ETC..

4. HATCHED AREAS ARE MEANT TO CONVEY GENERAL PLANT LOCATION. PLANT COVERAGE, SPACING, AND LAYOUT SHALL BE CONSISTENT WITH THE SPACING LISTED IN THE PLANT LEGEND FOR FULL COVERAGE.

5. MULCH: APPLY 3" DEEP WELL-AGED MEDIUM GRIND OR SHREDDED DARK HEMLOCK BARK MULCH UNDER AND AROUND ALL TREES AND SHRUBS IN PLANTER STRIP AREAS NOT INCLUDED AS STORMWATER FACILITIES OR LAWN. WHERE TREES ARE IN LAWN AREAS, A MINIMUM 3' DIAMETER MULCH RING SHALL BE USED AROUND THE TREE TO PROTECT THE TRUNK FROM MOWER DAMAGE. CARE SHALL BE TAKEN TO AVOID COVERING FOLIAGE OR ROOT CROWNS OF PLANTS. PLANTS SHALL BE PLANTED AT A DEPTH TO ACCOMMODATE BARK MULCH APPLICATION.

6. IRRIGATION FOR HEALTHY PLANT ESTABLISHMENT AND SURVIVAL IS RECOMMENDED AND SHALL BE 'DESIGN-BUILD' BY LANDSCAPE CONTRACTOR.

7. REFER TO SHEET P5.0 FOR PRELIMINARY TREE PLAN.

	13.81 AC
UNITS REQUIRED (13.81AC X 20):	276
ES RETAINED/(TREE UNITS):	15/(149.5)
TE TREES/(TREE UNITS):	159
UNITS:	308.5
ND PRESERVED)	000.0

# Exhibit 5 DR23-03



## PLAN DIVIS Ο Ē UB SHING БП 4 S SC S 4 $\geq$ AND 3 0 4 S \_ 4 Ω ¥Σ RELIMINAR Ш 4 U C Ο ທ ЦО Ž 4 4 $\geq$ M M E C D



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JOB NUMBER:	9030
DATE:	3/2/2023
DESIGNED BY:	TEB
DRAWN BY:	TEB
CHECKED BY:	MPA

**P9.0** 



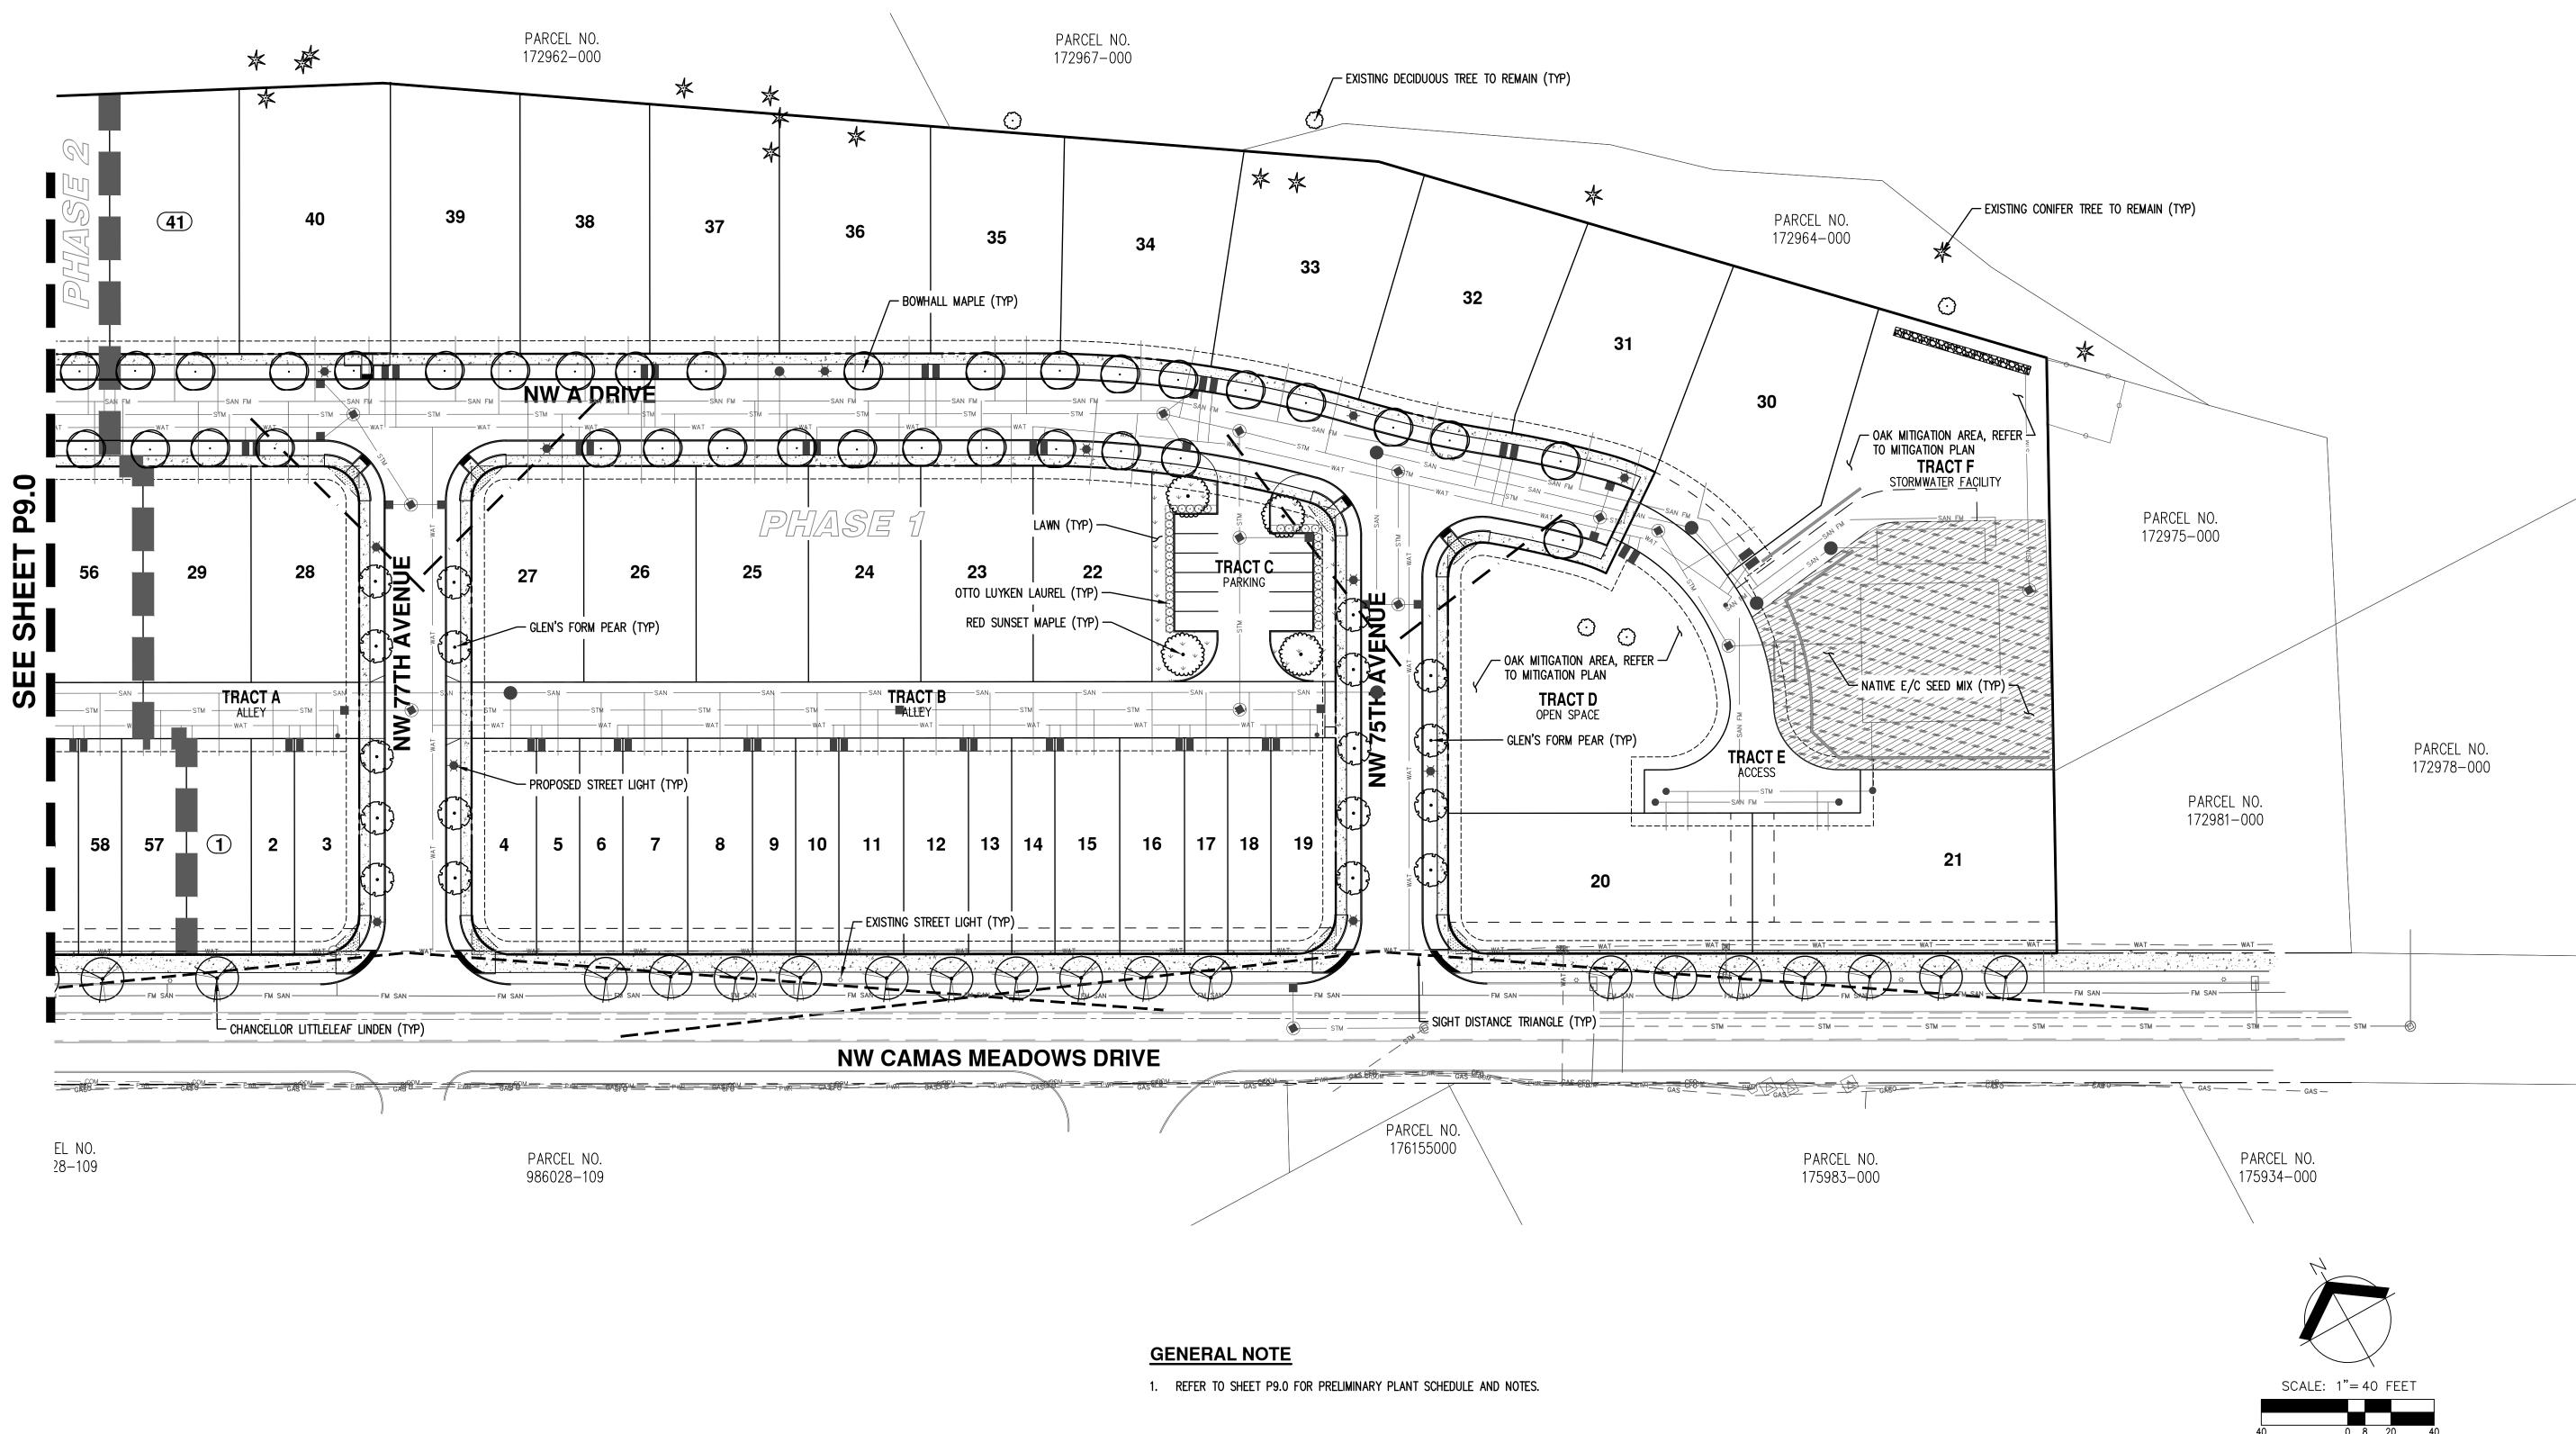


Exhibit 5 DR<u>23-0</u>3

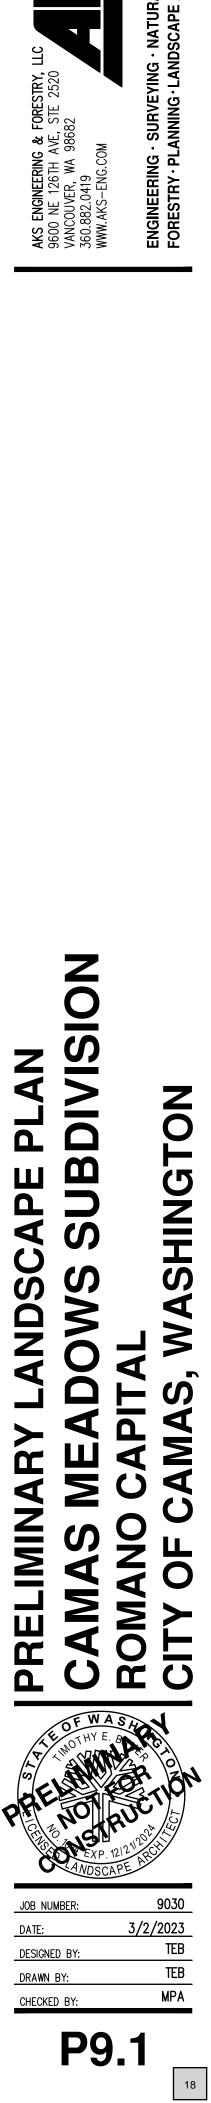

ORIGINAL PAGE SIZE: 24" x 36"

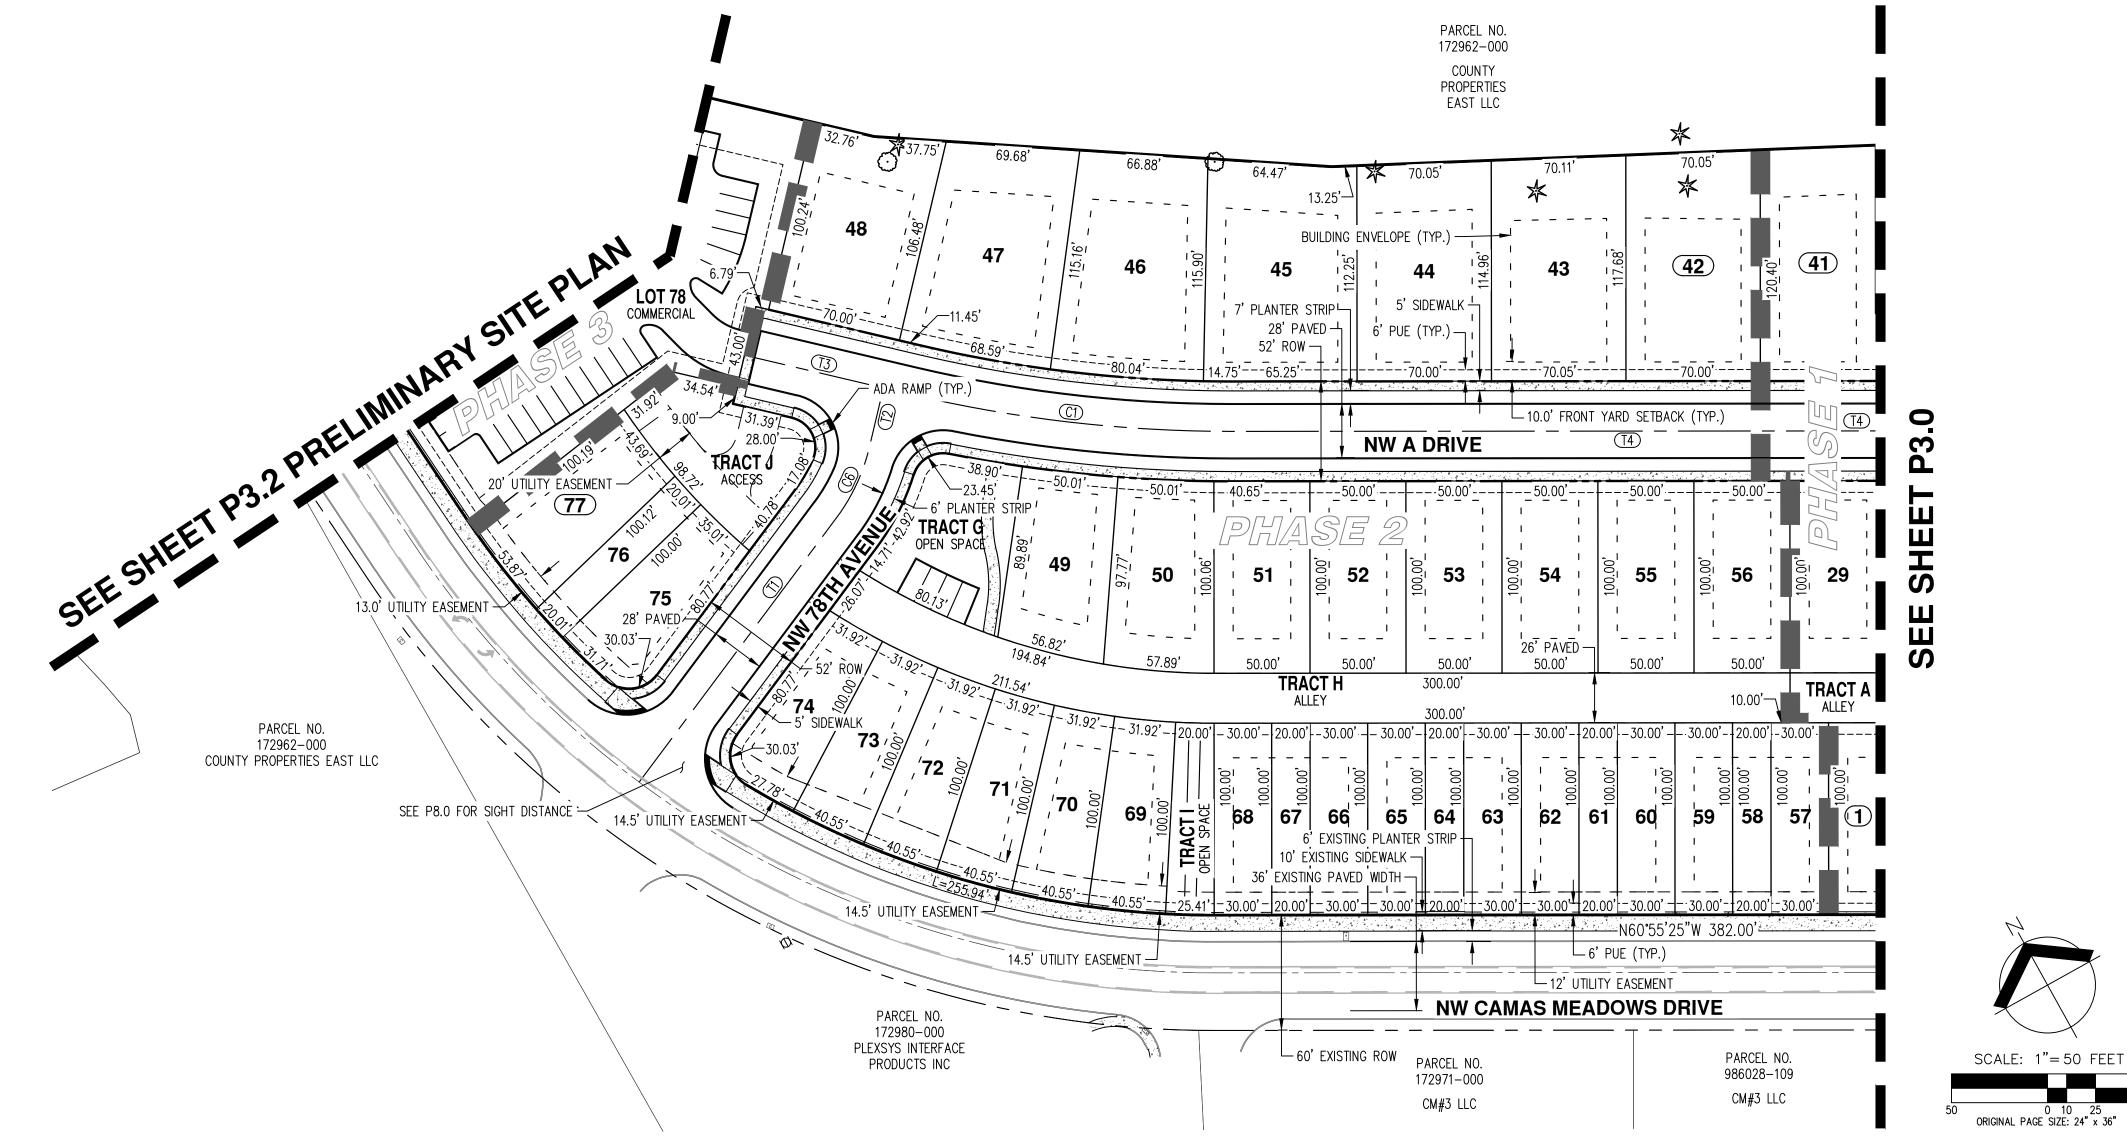

PARCEL AREA TABLE			
PARCEL #	AREA (SF)		
42	8,333		
43	8,149		
44	7,952		
45	8,949		
46	8,531		
49	5,010		
50	5,358		
51	5,000		
52	5,000		
53	5,000		
54	5,000		
55	5,000		
56	5,000		
57	3,000		
58	2,000		
59	3,000		
60	3,000		

PARCEL AREA TABLE		
PARCEL #	AREA (SF)	
61	2,000	
62	3,000	
63	3,000	
64	2,000	
65	3,000	
66	3,000	
67	2,000	
68	3,000	
69	3,624	
70	3,624	
71	3,624	
72	3,624	
73	3,624	
74	3,892	
75	4,242	
76	2,001	
77	4,878	

LAYOUT: P3.1
P3.0.DWG
9030
FILE:
DRAWING
AKS



## SITE STATISTICS

PARCEL ZONE: GROSS AREA: TOTAL ROW DEDICATION: MINIMUM LOT AREA: MAXIMUM LOT AREA: PROPOSED AVERAGE LOT AREA: 4,714 SF

MIXED USE (MX) 13.81 AC (601,725 SF) 96,852 SF (2.22 AC) 2,000 SF 9,915 SF

## LOT STATISTICS ATTACHED REAR LOAD: DETACHED FRONT LOAD: **COMMERCIAL**

## **DEVELOPMENT STANDARDS**

MINIMUM FRONT YARD SETBACK: 10 FEET GARAGE SETBACK:

TOTAL LOTS:

MINIMUM SIDE YARD: MINIMUM STREET SIDE YARD: MINIMUM REAR YARD:

5 FEET FROM FRONT OF DWELLING 10 FEET 10 FEET 25 FEET

## **RESIDENTIAL PARKING STATISTICS**

REQUIRED PARKING:	1 SPACE/5 LOTS
PROPOSED PARKING:	15 SPACES (77 LOTS/5 LOTS/SPACE)
TRACT C:	11 SPACES
TRACT G:	4 SPACES
TOTAL PROPOSED;	15 SPACES

40

37

TRACT	PURPOSE	AREA
TRACT A	ALLEY	2,600 SF
TRACT B	ALLEY	10,400 SF
TRACT C	OPEN SPACE/PARKING	7,590 SF
TRACT D	OPEN SPACE	13,804 SF
TRACT E	ACCESS	5,117 SF
TRACT F	STORMWATER FACILITY	23,425 SF
TRACT G	OPEN SPACE/PARKING	5,123 SF
TRACT H	ALLEY	13,083 SF
TRACT I	OPEN SPACE	2,270 SF
TRACT J	OPEN SPACE/ACCESS	4,981 SF
TOTAL		88,393 SF

## **APPLICANT/CONTACT**

ROMANO DEVELOPMENT, LLC CONTACT: STACEY SHIELDS 4610 NE 77TH AVENUE, SUITE 102 VANCOUVER, WA 98682 PH: (360) 904-4759 EMAIL: STACEY@ROMANOFINANCIAL.COM

OWNERS LOFTS AT CAMAS MEADOWS PHASE I LLC 2370 E 3RD LOOP SUITE 100 VANCOUVER, WA 98661

LOFTS AT CAMAS MEADOWS PHASE II LLC 2370 E 3RD LOOP SUITE 100 VANCOUVER, WA 98661

VANPORT MANUFACTURING INC & HERTRICH ADOLF PO BOX 97 BORING OR, 97009

PEDWAR DEVELOPMENT GROUP LLC 4711 NW CAMAS MEADOWS DRIVE CAMAS, WA 98607

## ENGINEER/PLANNER/ARBORIST/ SURVEY/LANDSCAPE **ARCHITECT/BIOLOGIST**

AKS ENGINEERING & FORESTRY, LLC. CONTACT: MICHAEL ANDREOTTI 9600 NE 126TH AVENUE, SUITE 2520 VANCOUVER, WA 98682 PH: 360-882-0419 FAX: 360-882-0426 E-MAIL: ANDREOTTIM@AKS-ENG.COM

PROPERTY DESCRIPTION

LOCATED IN THE NORTHWEST AND SOUTHWEST 1/4 OF SECTION 28, TOWNSHIP 2 NORTH, RANGE 3 EAST AND THE NORTHEAST 1/4 OF SECTION 29, TOWNSHIP 2 NORTH, RANGE 3 EAST, WILLAMETTE MERIDIAN, CLARK COUNTY, WASHINGTON. PROPERTY SERIAL NO.'S 175980-000, 172973-000, 172963-000, 986035-734, 986035-733, 172970-000, & 986026-906.

## **EXISTING LAND USE** UNDEVELOPED ZONED MIXED USE (MX)

**PROJECT PURPOSE** PHASED MIXED USE SUBDIVISION WITH 77 SINGLE-FAMILY RESIDENTIAL LOTS AND ONE COMMERCIAL LOT WITH ASSOCIATED ROAD AND OTHER SITE IMPROVEMENTS.

SITE AREA 13.81 AC (601,725 SF)

## **GENERAL NOTES**

- 1. TOTAL SITE AREA IS 13.81 ACRES (600,725 SQUARE FEET).
- 2. NO WETLAND, STREAM, OR STEEP BANK BUFFER AREAS, OR PROTECTED AREAS EXIST ON SITE.
- 3. NO PLANNED ENHANCEMENT AREAS ARE PROPOSED.
- 4. NO STRUCTURES EXIST ON SITE.
- 5. NO TRANSIT FACILITIES ARE PROPOSED.
- 6. NO BICYCLE FACILITIES BEYOND THOSE LOCATED IN THE RIGHT-OF-WAY ARE PROPOSED.
- 7. NW 75TH AVENUE, NW 77TH AVENUE, NW 78TH AVENUE, AND NW A DRIVE ARE PUBLIC WITH ASPHALT SURFACING.
- 8. NO ROADS ON OR WITHIN 500 FEET OF THE SITE PROPOSED TO PROVIDE SITE ACCESS ARE IN EXCESS OF 15% GRADE.
- 9. NW CAMAS MEADOWS DRIVE IS PUBLIC WITH ASPHALT SURFACING.
- 10. SIGHT DISTANCE TRIANGLES ARE SHOWN ON SHEET P8.0.
- 11. ALL PROPOSED EASEMENTS ARE SHOWN ON THE PLANS. 12. NO HARD LANDSCAPING FEATURES ARE PROPOSED.
- 13. SEE SHEETS P9.0 AND 9.1 FOR LANDSCAPE PLANS.
- 14. THE DEVELOPMENT PROPOSES TO SUBDIVIDE SEVEN PARCELS INTO 77 ATTACHED AND DETACHED SINGLE-FAMILY LOTS, AND ONE COMMERCIAL LOT.
- 15. THE DEVELOPMENT WILL CONSTRUCT FOUR INTERNAL STREETS. PROPOSED STREETS TO INCLUDE A 52-FOOT RIGHT-OF-WAY, 28-FOOT PAVED WIDTH, 7-FOOT PLANTER STRIP, AND 5-FOOT DETACHED SIDEWALK PER CITY OF CAMAS STANDARD DETAIL ST3.
- 16. SURFACE MATERIAL FOR ALL PROPOSED ROADWAYS IS ASPHALT.
- 17. ALL PROPOSED HOMES WILL BE CONSTRUCTED WITH FIRE SPRINKLERS.
- 18. ALL LOTS WILL BE SERVED WITH PUBLIC SANITARY SEWER AND WATER BY CITY OF CAMAS. WATER AND SEWER WILL BE EXTENDED FROM THE LINES IN NW CAMAS MEADOWS DRIVE INTO THE SITE.
- 19. STORMWATER FROM SUBDIVISION WILL BE COLLECTED ON SITE AND CONVEYED TO A MECHANICAL FILTER VAULT AND UNDERGROUND DETENTION IN TRACT TRACT F PRIOR TO DISCHARGING AT THE NORTHEAST CORNER OF THE SITE. STORMWATER FROM COMMERCIAL LOT WILL BE COLLECTED ON SITE AND CONVEYED TO MECHANICAL FILTER CATCH BASINS AND UNDERGROUND DETENTION PRIOR TO DISCHARGING AT THE NORTH CORNER OF THE SITE. STORMWATER TO BE DESIGNED PER CITY OF CAMAS STANDARDS.
- 20. OPEN SPACE/PARKING TRACTS C & G TO BE OWNED AND MAINTAINED BY THE HOME OWNERS ASSOCIATION (HOA).
- 21. ACCESS TRACTS A, B, E, & H TO BE OWNED AND MAINTAINED BY THE HOA.
- 22. STORMWATER FACILITIES IN TRACT F TO BE OWNED AND MAINTAINED BY THE HOA. STORMWATER FACILITIES IN COMMERCIAL LOT TO PRIVATELY OWNED AND MAINTAINED.
- 23. OPEN SPACE/ACCESS TRACT J TO BE OWNED AND MAINTAINED BY THE HOA.
- 24. OPEN SPACE TRACTS D & I TO BE OWNED AND MAINTAINED BY THE HOA.
- 25. BUILDING ENVELOPES SHALL BE PER DEVELOPMENT STANDARDS TABLE.
- 26. LOTS 1-19 AND 57-77 WILL BE REAR LOAD ATTACHED TOWNHOMES. 27. LOTS 20, 21, AND 30-48 WILL BE FRONT LOADED STANDARD DETACHED
- HOMES.
- 28. LOTS 22-29 AND 49-56 WILL EITHER BE REAR LOADED OR FRONT LOADED STANDARD DETACHED HOMES, LOT ACCESS WILL BE BASED ON FINAL GRADING. 29. NW CAMAS MEADOWS FRONTAGE IMPROVEMENTS WILL INCLUDE:
- REPLACEMENT OF DAMAGED CURB AND SIDEWALK. GRIND AND INLAY AT NW 75TH AVENUE AND NW 77TH AVENUE.


CENTERLINE TANGENT TABLE		
LINE #	LENGTH	DIRECTION
T1	171.70	S65°51'46.18"W
T2	31.67	S42°22′23.73"W
T3	88.24	S47° 37' 36.27"E
T4	704.72	S60° 55' 25.29"E
T5	282.00	S29°04'34.71"W
T6	255.50	S29°04'34.71"W

CENTERLINE CURVE TABLE			
CURVE #	ARC LENGTH	DELTA	RADIUS
C1	169.42	13 <b>°</b> 17'49"	730.00
C2	143.24	16 <b>°</b> 24'49"	500.00
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C6	41.00	23 <b>°</b> 29'22"	100.00

THE PURPOSE OF THIS PRELIMINARY PLAT IS TO SHOW THE PROPOSED LOT DIMENSIONS AND AREAS FOR PLANNING PURPOSES. THIS IS NOT AN OFFICIAL PLAT AND IS NOT TO BE USED FOR SURVEY PURPOSES.

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Exhibit 6 DR23-03




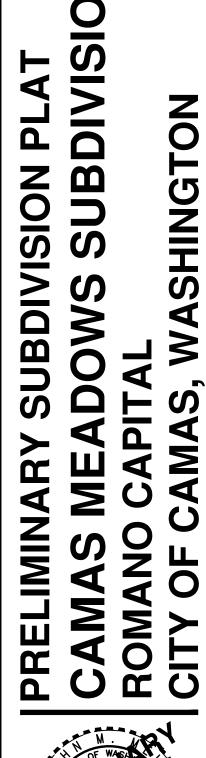

JOB NUMBER:	9030
DATE:	3/2/2023
DESIGNED BY:	DJL
DRAWN BY:	DJL
CHECKED BY:	JMM



19

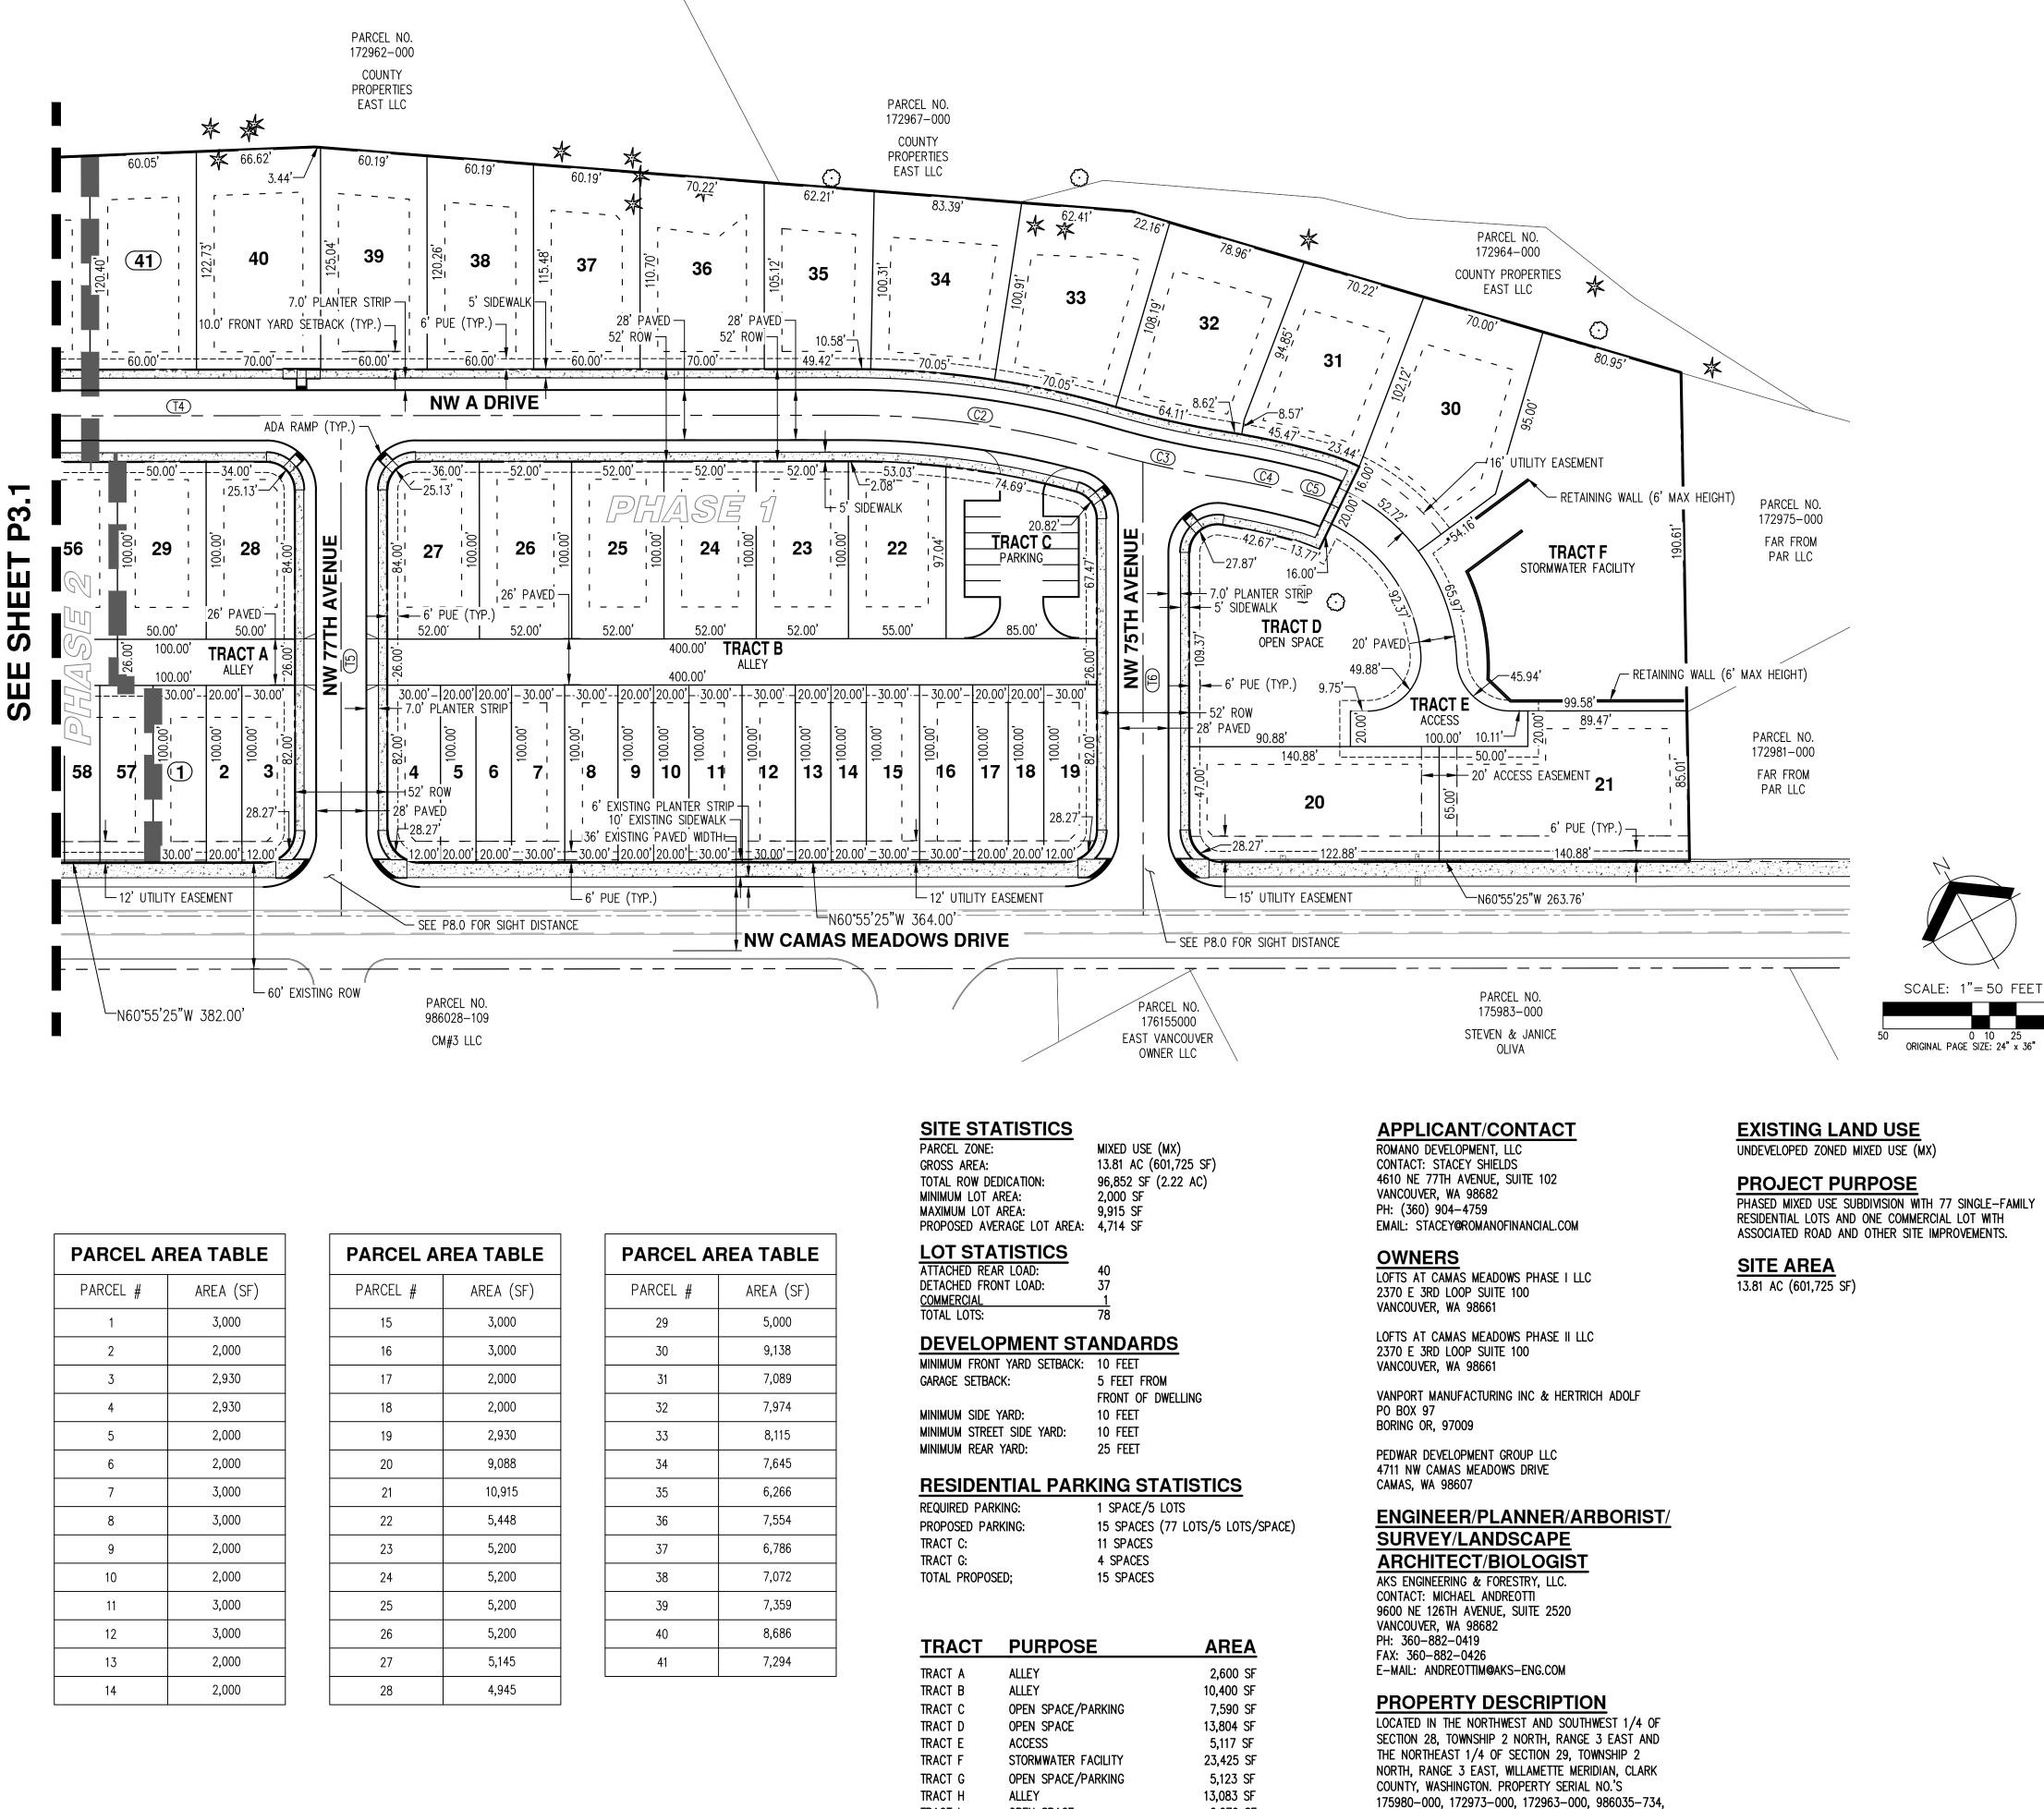

TRACT I

TRACT

TOTAL

OPEN SPACE

OPEN SPACE/ACCESS

2,270 SF

4,981 SF

88,393 SF

986035-733, 172970-000, & 986026-906.

PARCEL AREA TABLE	
PARCEL #	AREA (SF)
1	3,000
2	2,000
3	2,930
4	2,930
5	2,000
6	2,000
7	3,000
8	3,000
9	2,000
10	2,000
11	3,000
12	3,000
13	2,000
14	2,000

PARCEL AREA TABLE		
PARCEL #	AREA (SF)	
15	3,000	
16	3,000	
17	2,000	
18	2,000	
19	2,930	
20	9,088	
21	10,915	
22	5,448	
23	5,200	
24	5,200	
25	5,200	
26	5,200	
27	5,145	
28	4,945	

PARCEL AREA TABL	
PARCEL #	AREA (SF)
29	5,000
30	9,138
31	7,089
32	7,974
33	8,115
34	7,645
35	6,266
36	7,554
37	6,786
38	7,072
39	7,359
40	8,686
41	7,294

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- GRIND AND INLAY AT NW 75TH AVENUE AND NW 77TH AVENUE.

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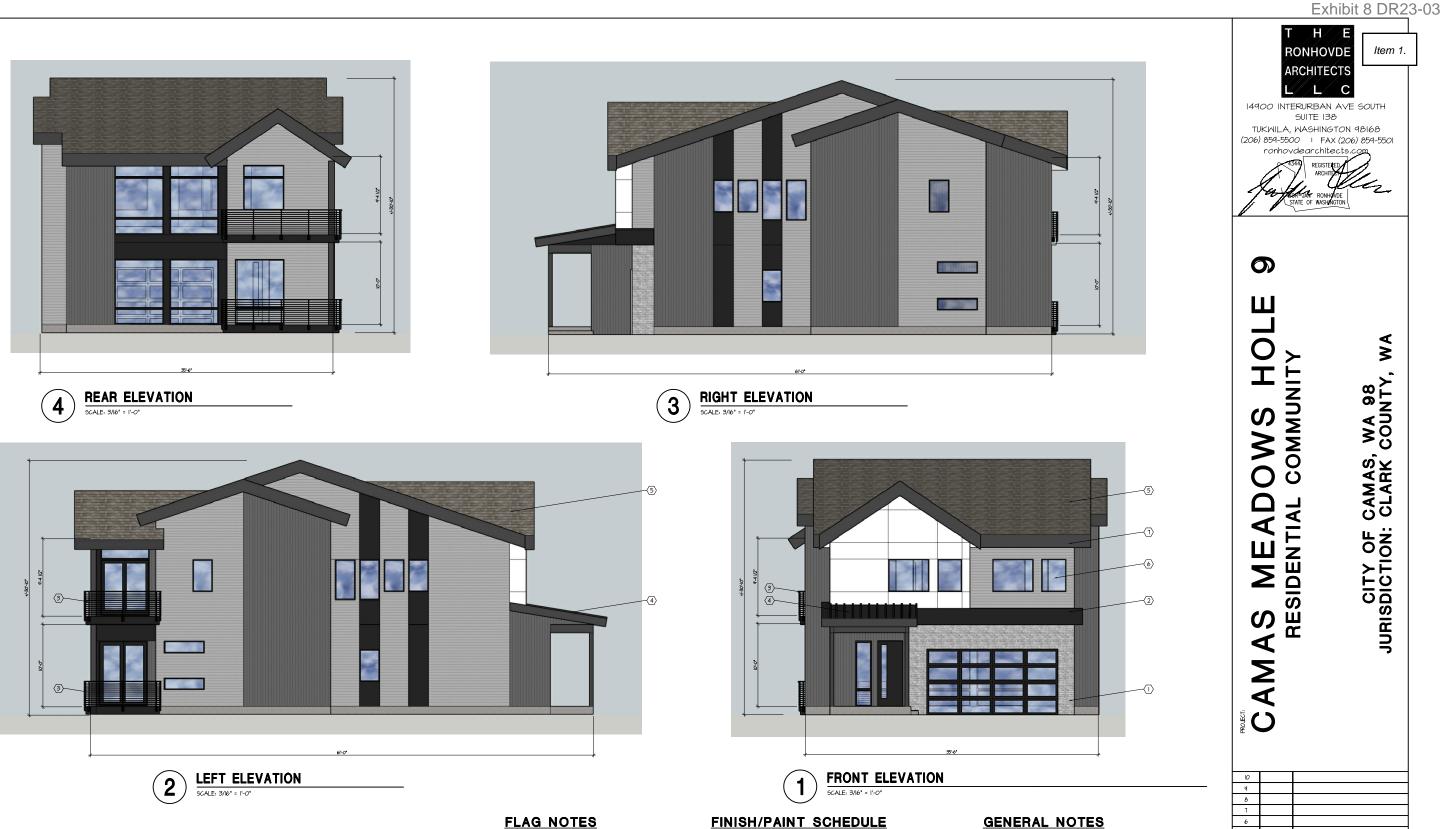
JOB NUMBER:	9030
DATE:	3/2/2023
DESIGNED BY:	DJL
DRAWN BY:	DJL
CHECKED BY:	JMM







Exhibit 7 DR23-03 /H/ /EItem 1. RONHOVDE ARCHITECTS С 14900 INTERURBAN AVE SOUTH SUITE 138 TUKWILA, WASHINGTON 98168 (206) 859-5500 | FAX (206) 859-5501 ronhovdearchitects.com STATE OF WASHINGTON 0 Ш ≺ O 3  $\succ$ I COMMUNIT CAMAS, WA 98 CLARK COUNTY, SMO AS MEAD RESIDENTIAL CITY OF JURISDICTION: CAMA: 10 ٩ 8 1 6 5 4 3 2 NO. DATE DESCRIPTION REVISIONS SHEET CONTENTS: **EXTERIOR ELEVATIONS** 20FT 2-CAR TOWNHOME JOB NO .: 2022.45 SHEET NO. DRAWN BY: LWG 21 **A4** CHECKED BY: T.R. DATE:





 $\langle \Box \rangle$ 

6

 $\langle \overline{1} \rangle$ 

BLACK/GRAY BRICK "BASE" ~ (ALT-HARDIE ARTISAN "SHIP-LAP")

STEPPED OR METAL WRAPPED FASCIA - COLOR MEDIUM GREY


METAL WRAPED ACCENT BELLY BAND - COLOR BLACK

3 PRE-FINISHED METAL RAILING - COLOR BLACK

A PRE-FINISHED METAL ROOFING - COLOR BLACK

VINYL WINDOWS - COLORED BLACK

5 COMPOSITION ASPHALT SHINGLES

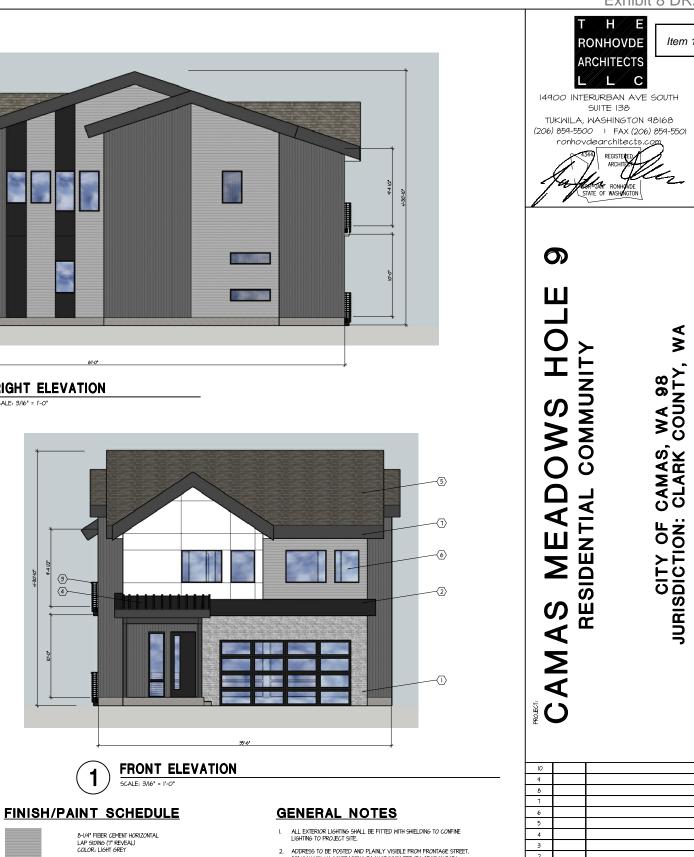

HARDIE MULTI GROOVE VERTICAL PANEL SIDING COLOR: MEDIUM GREY

HARDIE ARTISAN SHIPLAP SIDING OR HARDIE PANEL COLOR: WHITE

HARDIE ARTISAN SHIPLAP SIDING OR HARDIE PANEL COLOR: BLACK

ADDRESS TO BE POSTED AND PLAINLY VISIBLE FROM FRONTAGE STREET. (27 HIGH MIN, W CONTRACTING BACKGROUND) FER IFC SECTION 505. (CONTRACTOR TO PROVIDE 22 STAMPED ALMINIM NUMBER/ADDRESS WITH EXPANSION AUCLORS IN CONCRETE)

KNOX EMPROBECT ACCESS KEY BOX IS REQUIRED FOR BUILDING, WITH SPECIFIC MOMINIA LOCATIONS APPROVED BY THE CITY FIRE DEPARTMENT. RECESSED MONT KEY BOXES ARE REQUIRED. BUILDING ACCESS KEYS SHALL BE MARKED AND PLACED IN BOX PRIOR TO FINAL INSPECTION TO ENGRE DEMRESENCY ACCESS. THE BUILDING ONRER/OCCEMENTS SHALL PROVIDE REPLACEMENT KEYS MEMORYER LOCKS ARE CHANGED.

#### 2018 IRC CONSTRUCTION TYPE: VB

FOR LOTS 40 THRU 54

JOB NO .: 2022.45 DRAWN BY: LWS CHECKED BY: TJR DATE:

SINGLE FAMILY

NO. DATE DESCRIPTION

**EXTERIOR ELEVATIONS** 

2

1

REVISIONS

SHEET CONTENTS:

SHEET NO. A4.

22












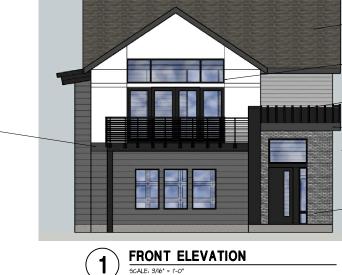



- $\langle 1 \rangle$ BLACK/GRAY BRICK "BASE" ~ (ALT-HARDIE ARTISAN "SHIP-LAP") METAL WRAPED ACCENT BELLY BAND - COLOR BLACK
- 3 PRE-FINISHED METAL RAILING COLOR BLACK
- PRE-FINISHED METAL ROOFING COLOR BLACK
   COMPOSITION ASPHALT SHINGLES
- 6 VINYL WINDOWS - COLORED BLACK
- ⊘ STEPPED OR METAL WRAPPED FASCIA - COLOR MEDIUM GREY



8-1/4" FIBER CEMENT HORIZONTAL LAP SIDING (1" REVEAL) COLOR: LIGHT GREY

Hardie Artisan Shiplap Siding Or Hardie Panel Color: White


Hardie Multi Groove Vertical Panel Siding Color: Medium Grey

HARDIE ARTISAN SHIPLAP SIDING OR HARDIE PANEL COLOR: BLACK

2018 IRC





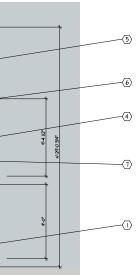

## **GENERAL NOTES**

I. ALL EXTERIOR LIGHTING SHALL BE FITTED WITH SHIELDING TO CONFINE LIGHTING TO PROJECT SITE.

ADDRESS TO BE POSTED AND PLAINLY VISIBLE FROM FRONTAGE STREET. (27 HIGH MIN, W CONTRACTING BACKGROUND) FER IFC SECTION 505. (CONTRACTOR TO PROVIDE 22 STAMPED ALMINIM NUMBER/ADDRESS WITH EXPANSION AUCLORS IN CONCRETE)

3. KNOX EMERGENCY ACCESS KEY BOX IS REQUIRED FOR BUILDING, WITH SPECIFIC MOUNTING LOCATIONS APPROVED BY THE CITY FIRE DEPARTMENT. RECESSED MONT KEY BOOSS ARE REQUIRED. BUILDING ACCESS KEYS SHALL BE MARKED AND PLACED IN BOX PRICK TO FINAL INSPECTION TO BURKE DIMERSENCY ACCESS. THE BUILDING MONREO/CUERNITS SHALL PROVIDE REPLACEMENT KEYS WHENEVER LOCKS ARE CHANGED.

# CONSTRUCTION TYPE: VB

## FOR LOTS 26 THRU 36


Exhibit 9 DR23-03 H/E RONHOVDE Item 1. ARCHITECTS С Δ 14900 INTERURBAN AVE SOUTH SUITE 138 TUKWILA, WASHINGTON 98168 (206) 859-5500 | FAX (206) 859-5501 ronhovdearchitects.com STATE OF WASHINGTON 0 Ш 0 H ≺ 3 COMMUNITY CAMAS, WA 98 CLARK COUNTY, SMO AD CAMAS MEAD RESIDENTIAL CITY OF JURISDICTION: 10 ٩ 8 7 6 5 4 3 2 1 NO. DATE DESCRIPTION REVISIONS SHEET CONTENTS: **EXTERIOR ELEVATIONS** 30ft SINGLE FAMILY JOB NO .: 2022.45 SHEET NO. DRAWN BY: LWS 23


**A4** 


CHECKED BY: TJR

DATE:




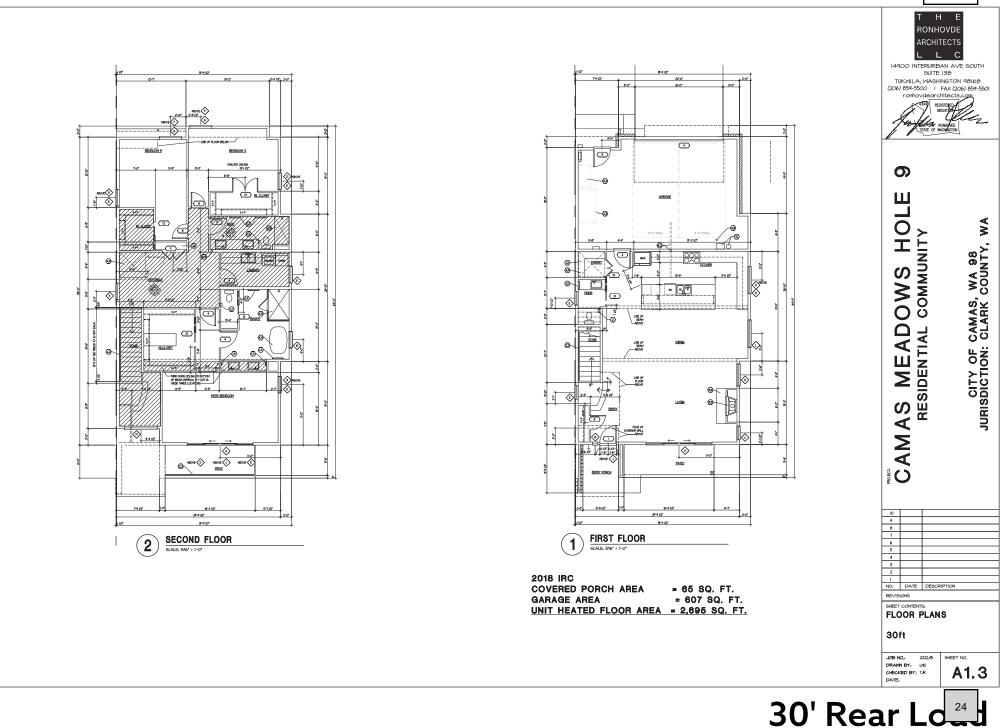

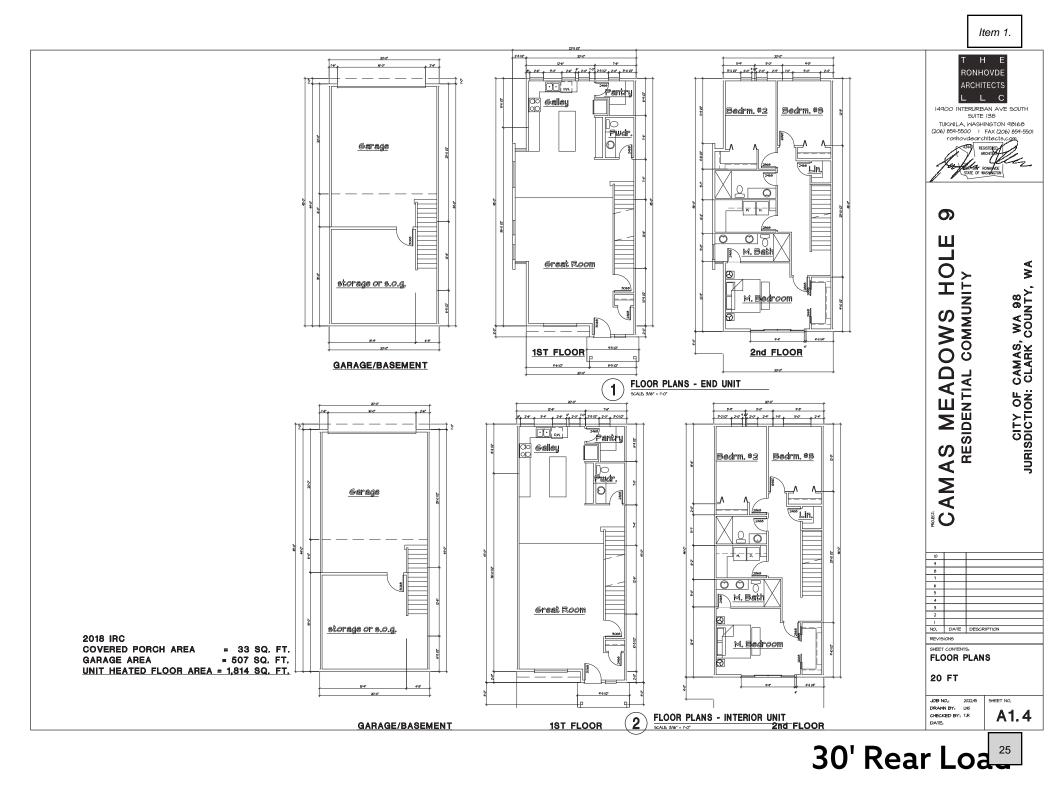

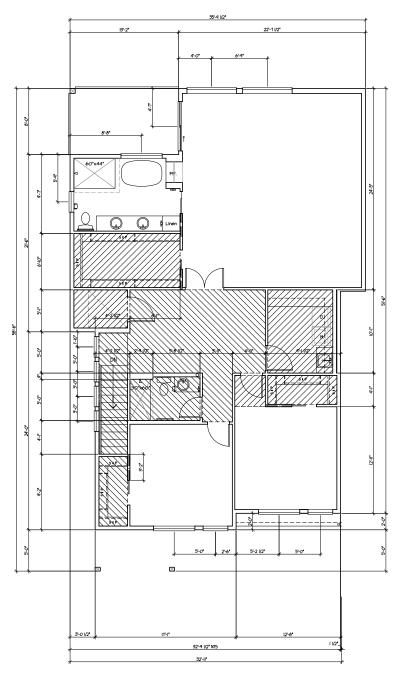



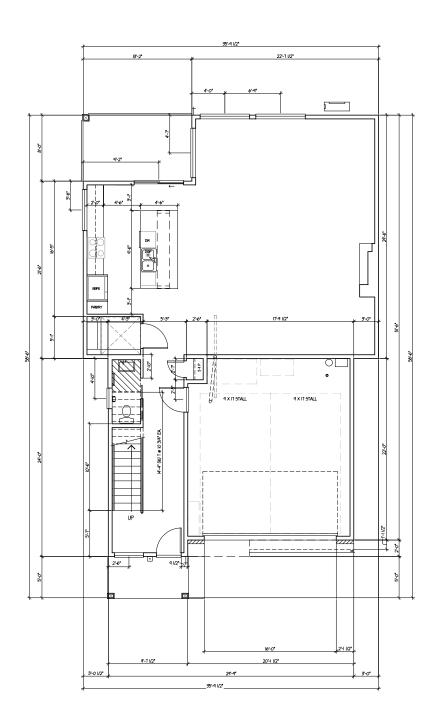


FIRST FLOOR SCALE: 3/16" = 1'-0"


> 2018 IRC COVERED PORCH AREA GARAGE AREA UNIT HEATED FLOOR AREA = 2,756 SQ. FT.


SFR PLAN HAS 3,192 SQ.FT. (INCLUDING GARAGE) MAXIMUM FAR IS 0.5


FOR LOTS 40 THRU 54

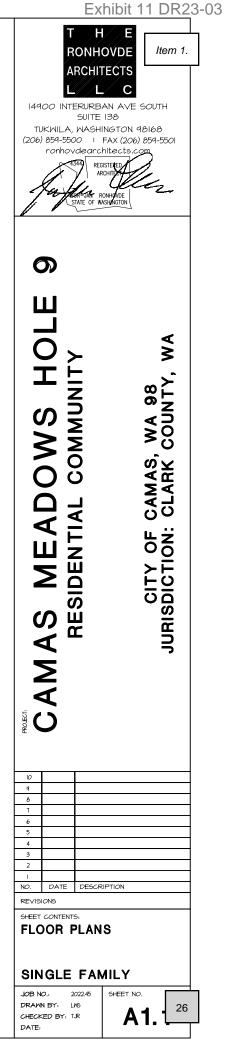


= 258 SQ. FT. = 436 SQ. FT.

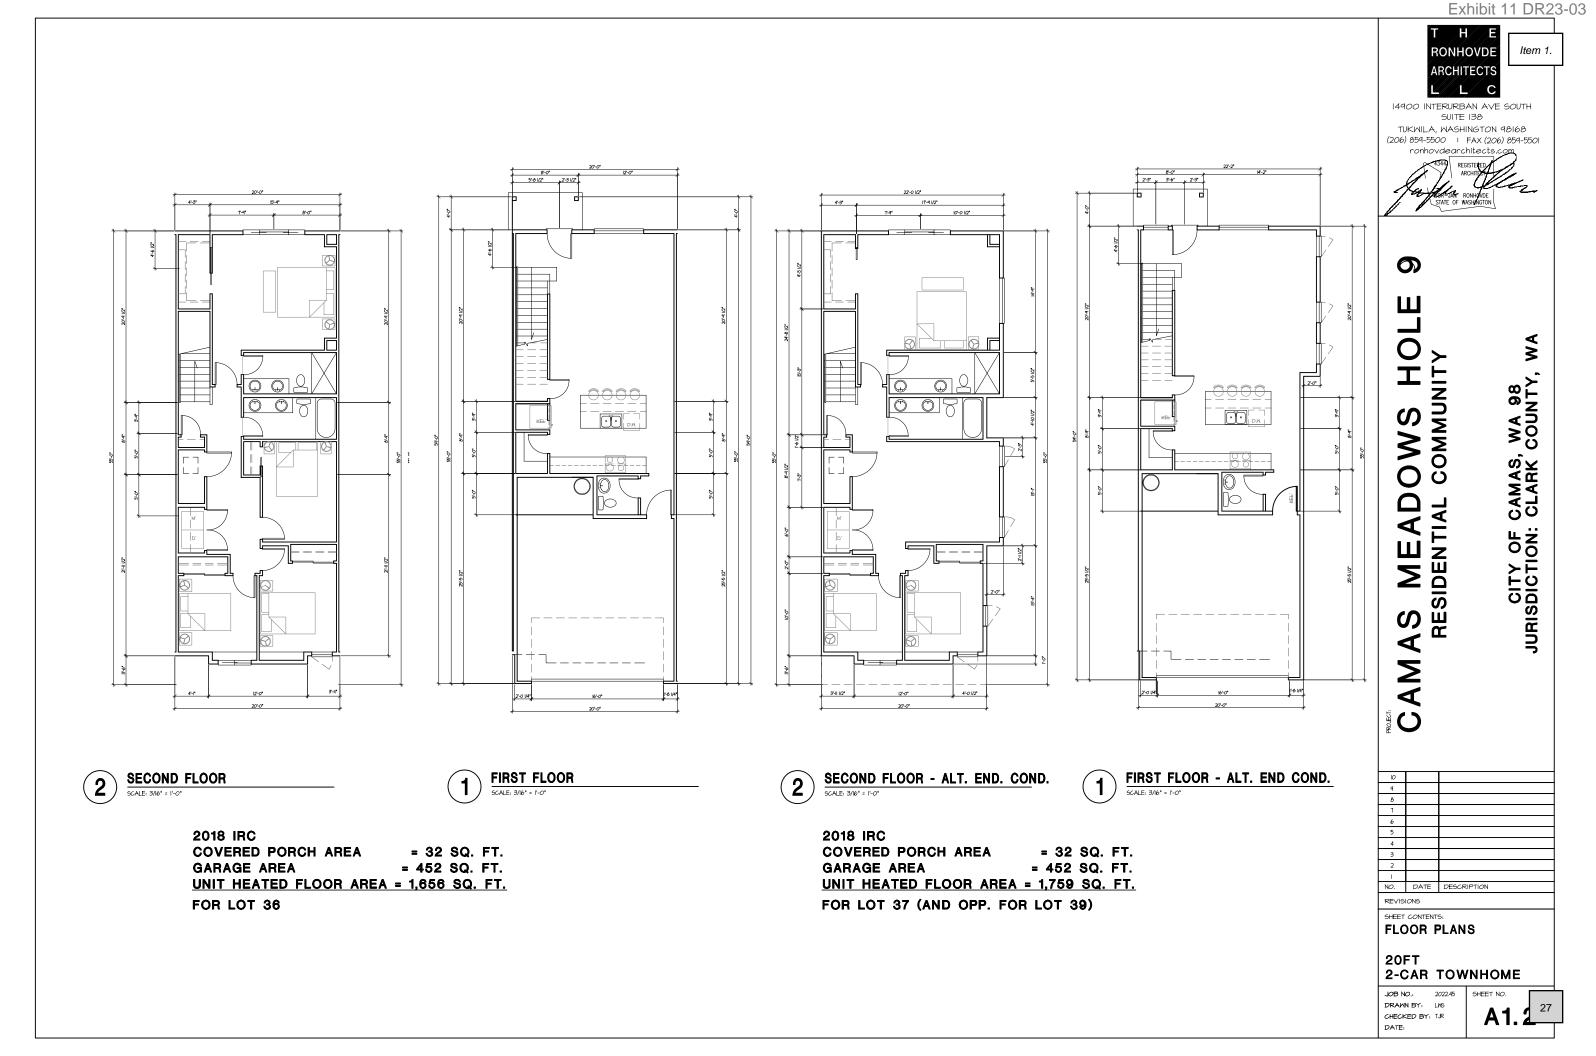


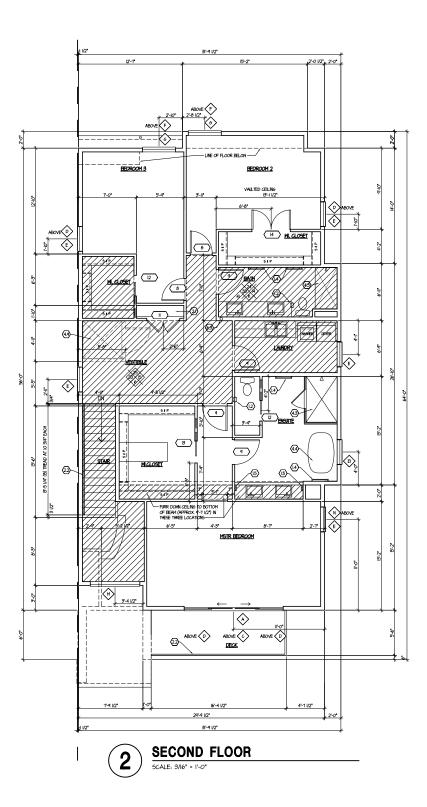


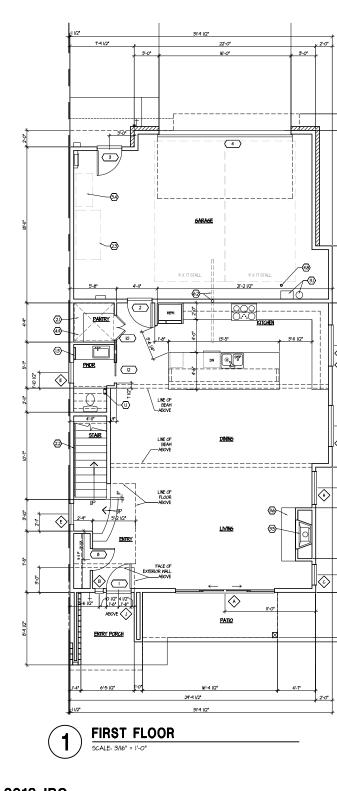


2018 IRC	
COVERED PORCH AREA	= 65 SQ. FT.
GARAGE AREA	= 607 SQ. FT.
UNIT HEATED FLOOR AREA	= 2,695 SQ. FT.

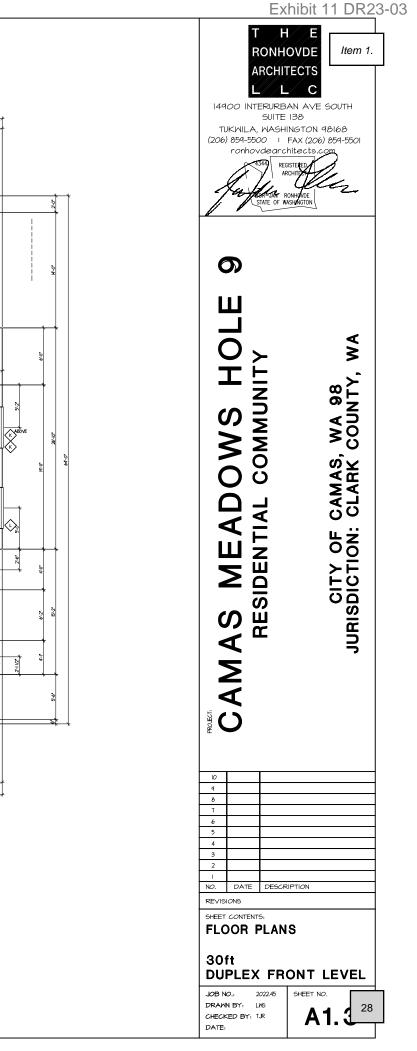

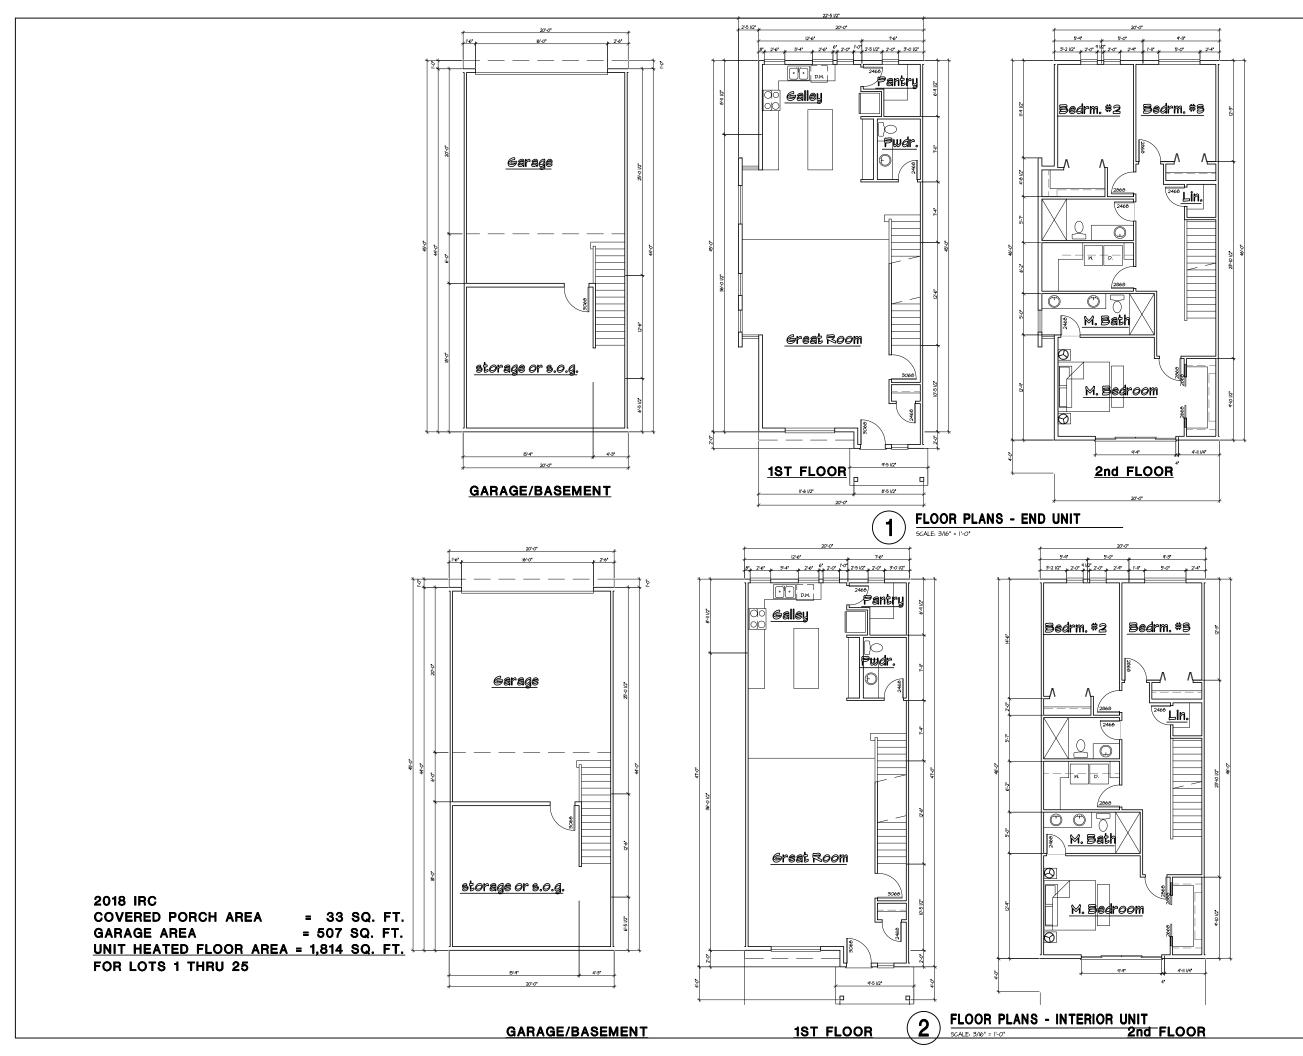

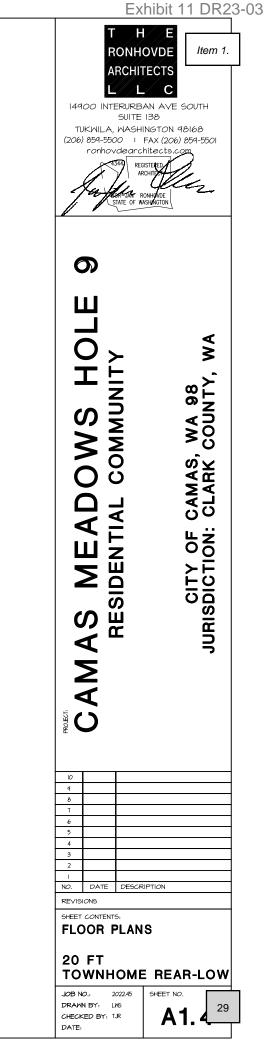

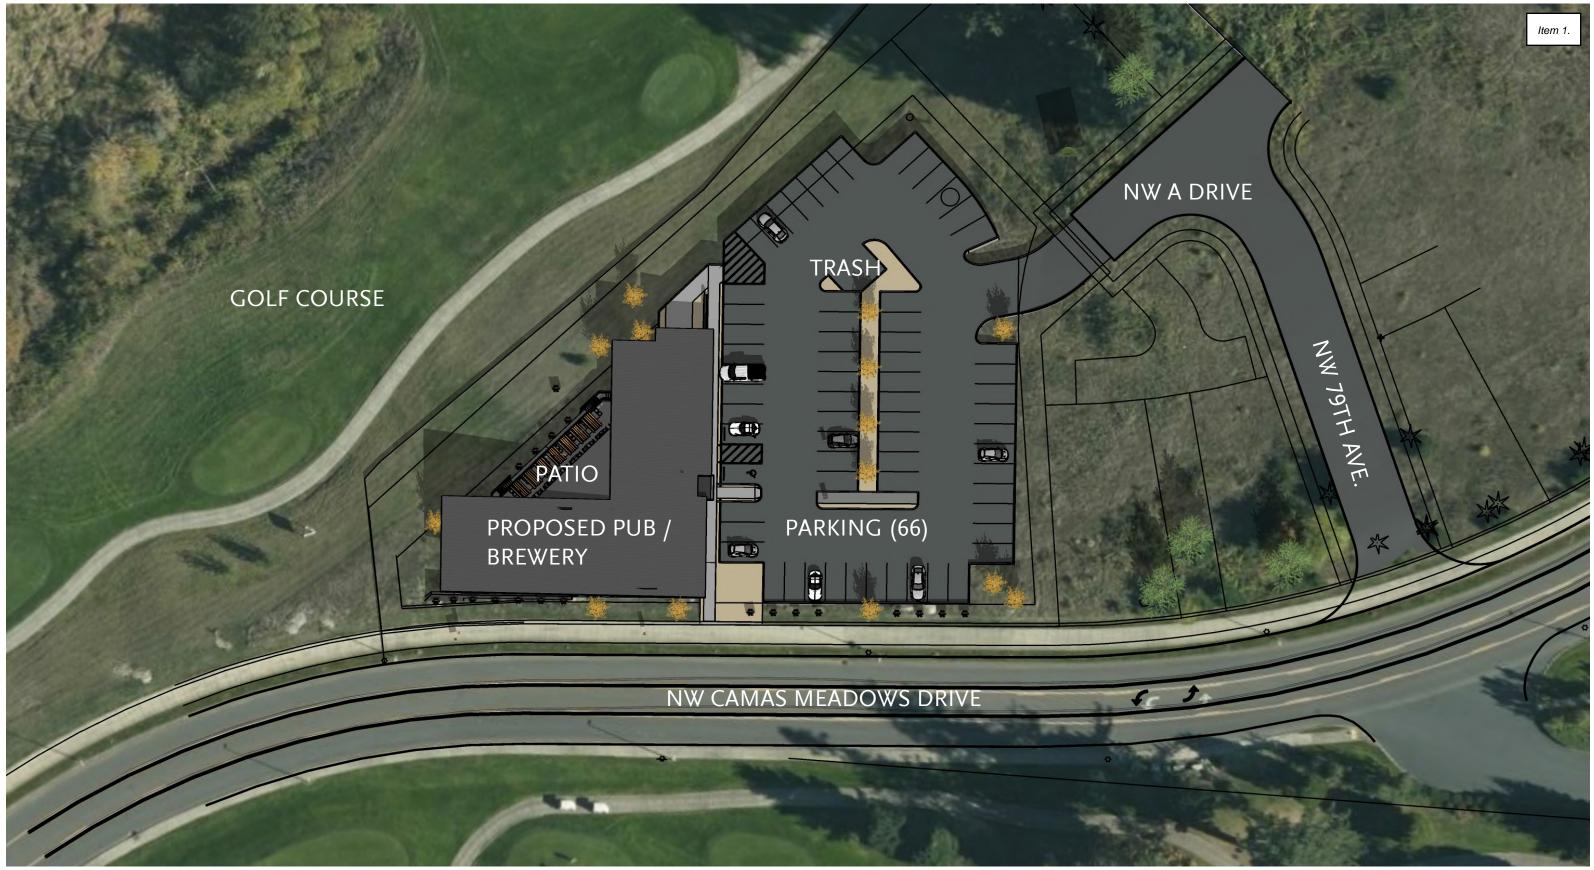




#### Exhibit 12 DR23-03

## 1. SITE PLAN NTS





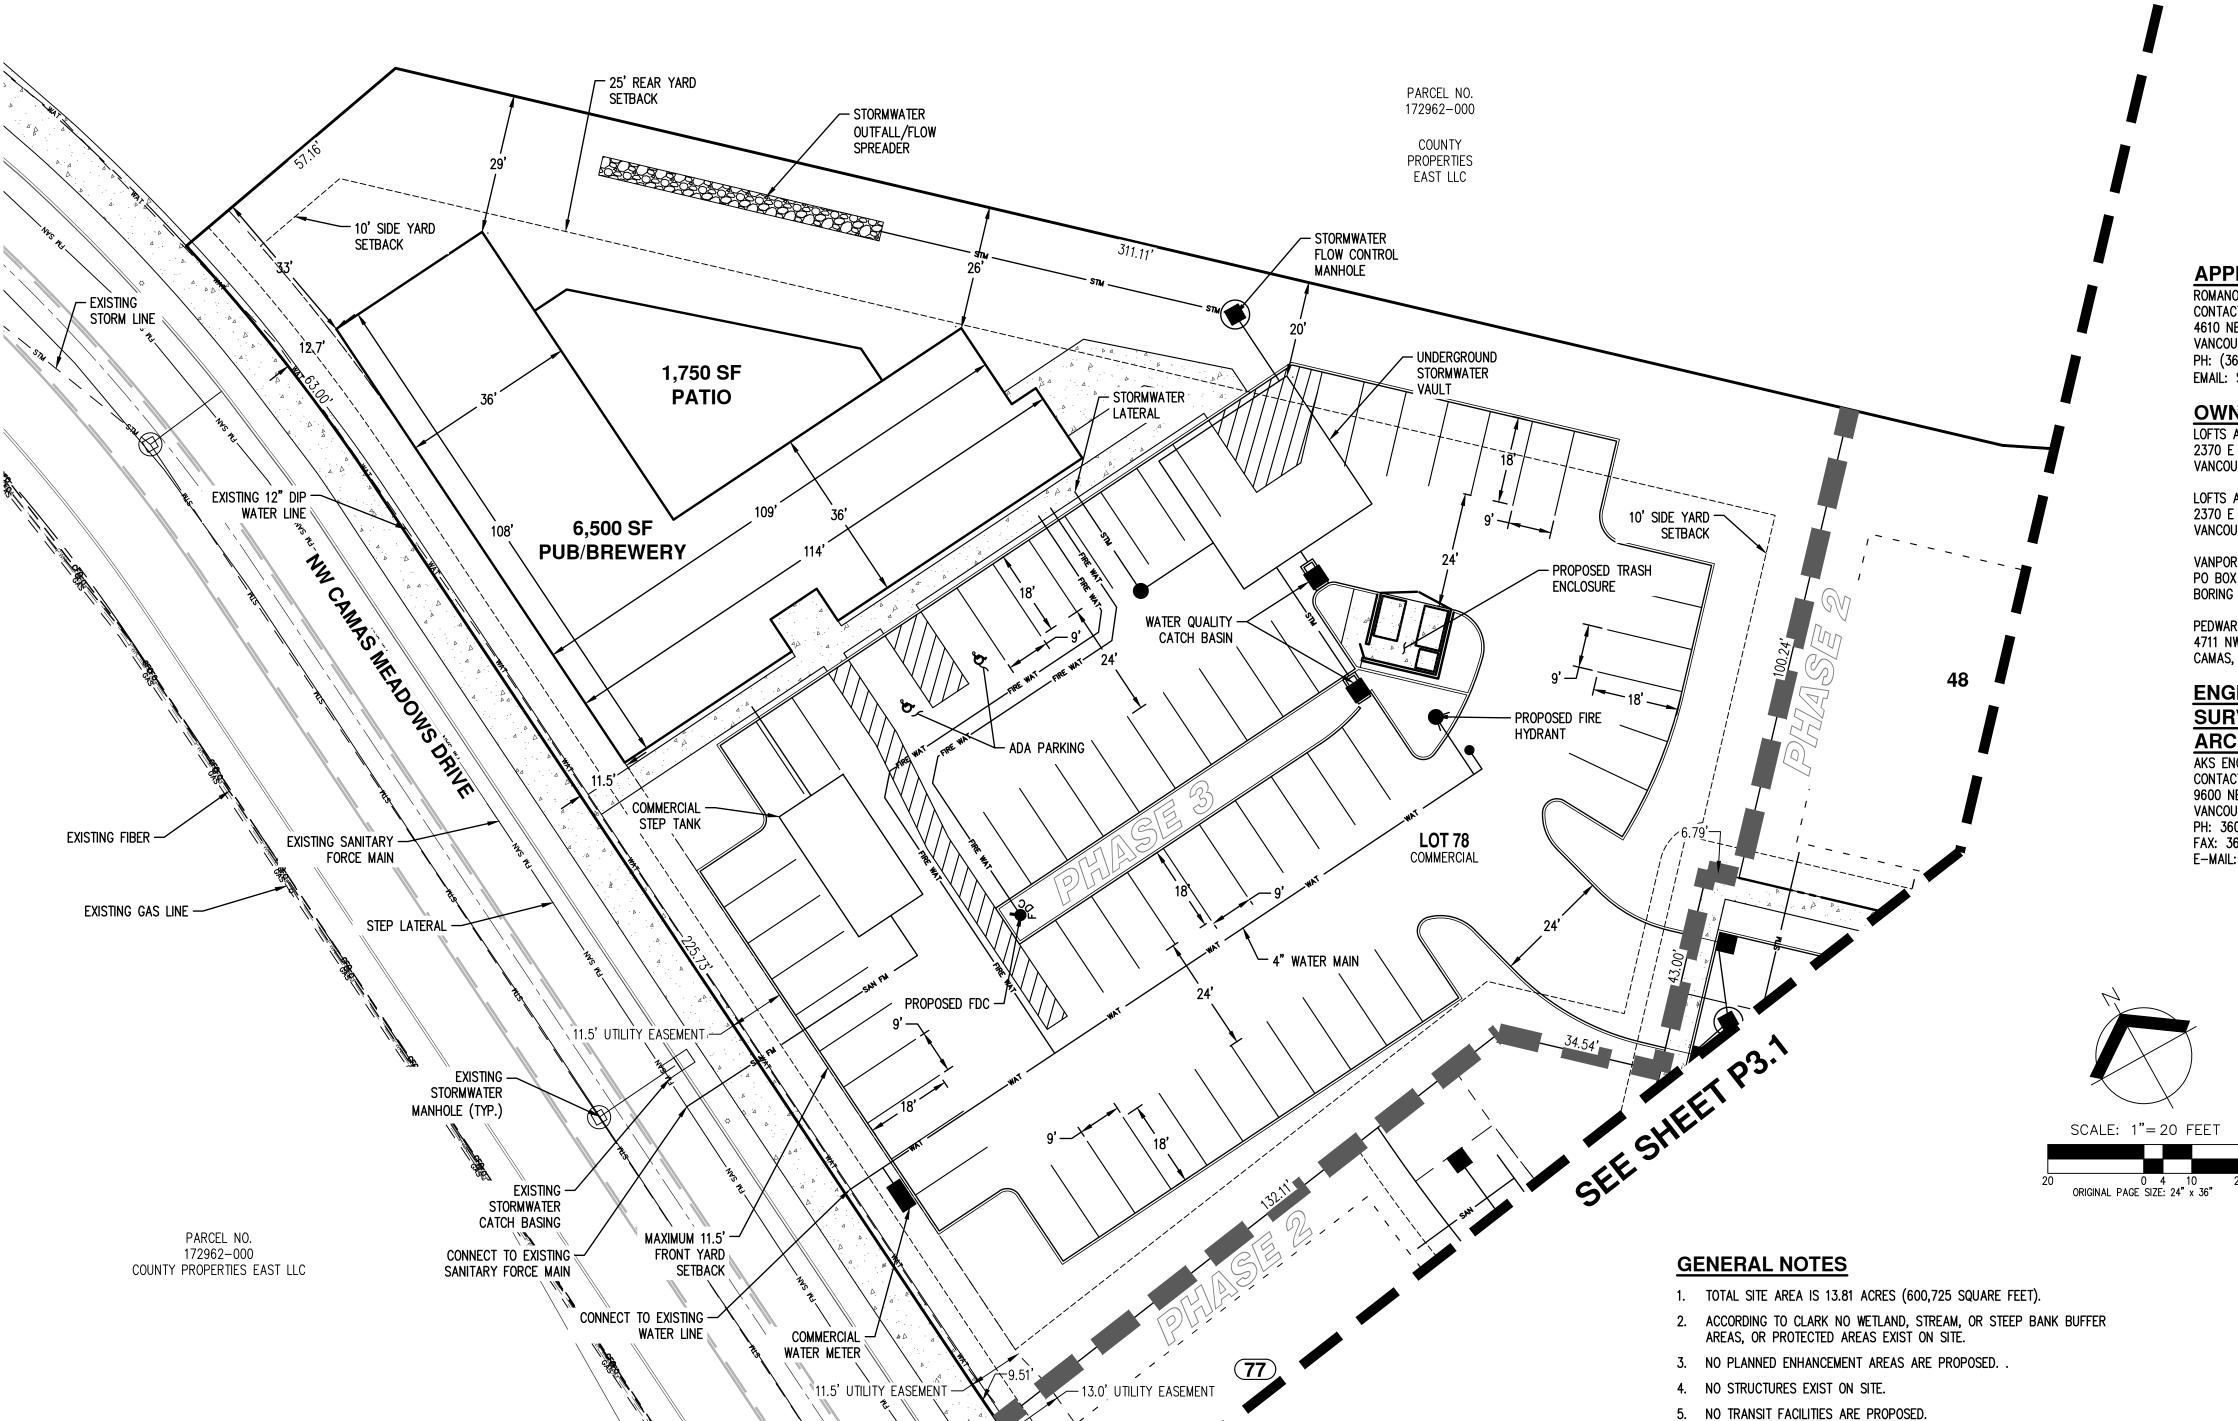

- 6. NO BICYCLE FACILITIES BEYOND THOSE LOCATED IN THE RIGHT-OF-WAY ARE PROPOSED.
- 7. NW 75TH AVENUE, NW 77TH AVENUE, NW 78TH AVENUE, AND NW A DRIVE ARE PUBLIC WITH ASPHALT SURFACING.
- 8. NO ROADS ON OR WITHIN 500 FEET OF THE SITE PROPOSED TO PROVIDE SITE ACCESS ARE IN EXCESS OF 15% GRADE.
- 9. NW CAMAS MEADOWS DRIVE IS PUBLIC WITH ASPHALT SURFACING.
- 10. SIGHT DISTANCE TRIANGLES ARE SHOWN ON SHEET P8.0.
- 11. ALL PROPOSED EASEMENTS ARE SHOWN ON THE PLANS.
- 12. NO HARD LANDSCAPING FEATURES ARE PROPOSED.
- 13. SEE SHEETS P9.0 AND 9.1 FOR LANDSCAPE PLANS.
- 14. STRUCTURE SQUARE FEET IS NOTED/SHOWN ON THE PLAN.
- 15. SEE ARCHITECTURAL PLANS INCLUDED IN THE APPLICATION SUBMITTAL PACKAGE FOR BUILDING ELEVATIONS AND FLOOR PLANS.
- 16. RECYCLABLE AND SOLID WASTE STORAGE IS SHOWN ON THE PLANS.
- 17. SEE SHEETS 10.0 AND 10.1 FOR OUTDOOR LIGHTING PLANS.
- 18. LOT 78, COMMERCIAL LOT, WILL BE SERVED WITH PUBLIC SANITARY SEWER AND WATER BY CITY OF CAMAS. WATER AND SEWER WILL BE EXTENDED FROM THE LINES IN NW CAMAS MEADOWS DRIVE INTO THE SITE.
- 19. STORMWATER WILL BE COLLECTED ON SITE AND CONVEYED TO MECHANICAL FILTER CATCH BASINS AND UNDERGROUND DETENTION PRIOR TO DISCHARGING AT THE NORTH CORNER OF THE SITE. STORMWATER TO BE DESIGNED PER CITY OF CAMAS STANDARDS.
- 20. STORMWATER FACILITIES TO BE PRIVATELY OWNED AND MAINTAINED.
- 21. NW CAMAS MEADOWS FRONTAGE IMPROVEMENTS WILL INCLUDE: REPLACEMENT OF DAMAGED CURB AND SIDEWALK.

## **APPLICANT/CONTACT**

ROMANO DEVELOPMENT, LLC CONTACT: STACEY SHIELDS 4610 NE 77TH AVENUE, SUITE 102 VANCOUVER, WA 98682 PH: (360) 904-4759 EMAIL: STACEY@ROMANOFINANCIAL.COM

## <u>OWNERS</u>

LOFTS AT CAMAS MEADOWS PHASE I LLC 2370 E 3RD LOOP SUITE 100 VANCOUVER, WA 98661

LOFTS AT CAMAS MEADOWS PHASE II LLC 2370 E 3RD LOOP SUITE 100 VANCOUVER, WA 98661

VANPORT MANUFACTURING INC & HERTRICH ADOLF PO BOX 97 BORING OR, 97009

PEDWAR DEVELOPMENT GROUP LLC 4711 NW CAMAS MEADOWS DRIVE CAMAS, WA 98607

## ENGINEER/PLANNER/ARBORIST/ SURVEY/LANDSCAPE

**ARCHITECT/BIOLOGIST** AKS ENGINEERING & FORESTRY, LLC. CONTACT: MICHAEL ANDREOTTI 9600 NE 126TH AVENUE, SUITE 2520 VANCOUVER, WA 98682 PH: 360-882-0419 FAX: 360-882-0426 E-MAIL: ANDREOTTIM@AKS-ENG.COM

## SITE STATISTICS

PARCEL ZONE:	MIXED USE (MX)
GROSS AREA:	13.81 AC (601,725 \$
TOTAL ROW DEDICATION:	95,084 SF (2.18 AC
MINIMUM LOT AREA:	2,000 SF
MAXIMUM LOT AREA:	9,157 SF
PROPOSED AVERAGE LOT AREA:	4,620 SF

## **DEVELOPMENT STANDARDS**

NIMUM SIDE YARD:	10 FEET
NIMUM STREET SIDE YARD:	11.5 FEI
NIMUM REAR YARD:	25 FEET
XIMUM FRONT YARD:	10 FEET

## **COMMERCIAL PARKING STATISTICS** RECHIRED PARKING STALLS (6 500/100)

REQUIRED PARKING STALLS (6,500/100):	65
PROPOSED STANDARD PARKING STALLS (9' X 18'):	64
PROPOSED ADA PARKING STALLS (9' X 18'):	2
TOTAL PROPOSED PARKING STALLS:	66

## **COMMERCIAL LOT STATISTICS**

ZONE:	MIXED USE (MX)
GROSS SITE AREA:	52,616 SF (1.21 AC)
ROW DEDICATION:	N/A
NET PROJECT AREA:	52,616 SF (1.21 AC)
DISTURBED AREA:	52,616 SF (1.21 AC)
PROPOSED BUILDING AREA:	6,500 SF
LANDSCAPED AREA:	19,326 SF (36.7%)
IMPERVIOUS AREA	33,290 SF (63.3 <b>%</b> )

## **PROPERTY DESCRIPTION**

LOCATED IN THE NORTHWEST AND SOUTHWEST 1/4 OF SECTION 28, TOWNSHIP 2 NORTH, RANGE 3 EAST AND THE NORTHEAST 1/4 OF SECTION 29, TOWNSHIP 2 NORTH, RANGE 3 EAST, WILLAMETTE MERIDIAN, CLARK COUNTY, WASHINGTON. PROPERTY SERIAL NO.'S 175980–000, 172973–000, 172963–000, 986035–734, 986035–733, 172970–000, & 986026–906.

**EXISTING LAND USE** UNDEVELOPED ZONED MIXED USE (MX)

## **PROJECT PURPOSE**

PHASED MIXED USE SUBDIVISION WITH 77 SINGLE-FAMILY RESIDENTIAL LOTS AND ONE COMMERCIAL LOT WITH ASSOCIATED ROAD AND OTHER SITE IMPROVEMENTS.

SITE AREA 13.81 AC (601,725 SF)

# Exhibit 13 DR23-03



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JOB NUMBER:	9030
DATE:	3/2/2023
DESIGNED BY:	DJL
DRAWN BY:	DJL
CHECKED BY:	JMM

**P3.2** 

## ARIAL VIEW OF SOUTH ELEVATION AND PARKING LOT

## ARIAL VIEW OF NORTH / EAST PATIO FACING GOLF COURSE











NW CAMAS MEADOWS DRIVE FACADE - WEST ELEVATION



ENTRY FACING PARKING - SOUTH ELEVATION







NORTH WEST CORNER VIEW




SOUTH WEST CORNER VIEW








EAST ELEVATION

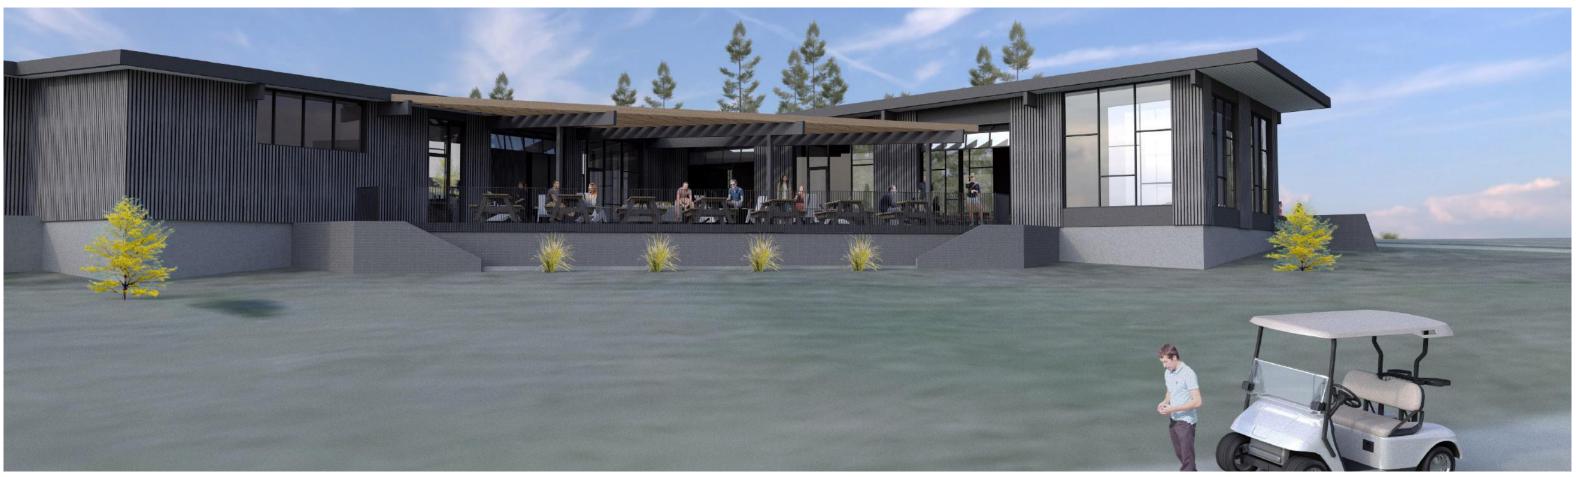

NORTH EAST PATIO FACING GOLF COURSE






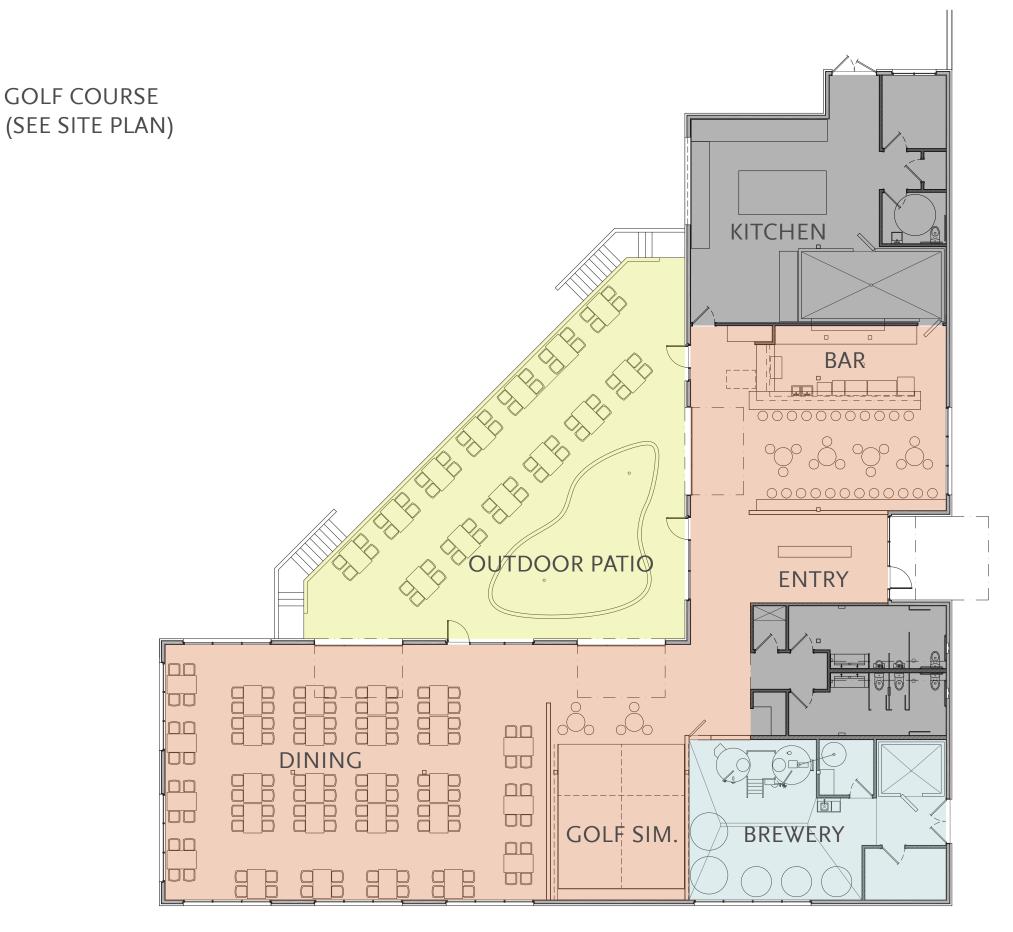

STEELHEAD


ARCHITECTURE

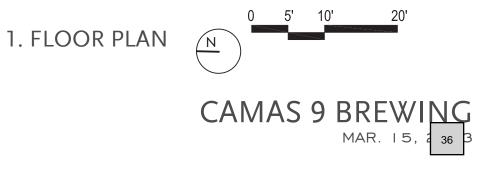

AREAS (SF):	
RESTAURANT + BAR	3,557
BREWERY	865
KITCHEN	1,126
BATHROOMS / SUPPORT	506
GOLF SIMULATOR	432
TOTAL	6,486 sf

PARKING (SEE SITE PLAN)


Item 1.

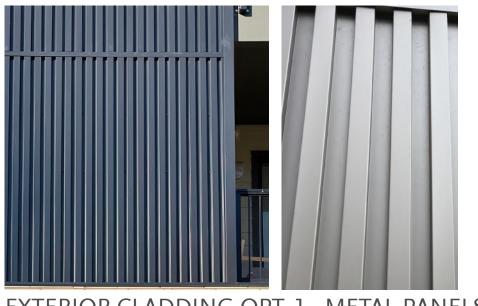

EXTERIOR CLADDING OPT. 1 - METAL PANELS



EXTERIOR CLADDING OPT. 2 CEMENTITOUS BOARD + BATTEN

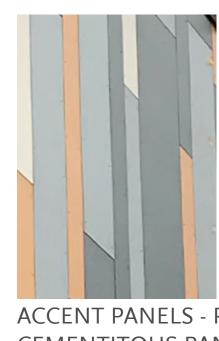



STOREFRONT WINDOWS - BLACK ANODIZED FINISH



STANDING SEAM METAL ROOF



Exhibit 16 DR23-03

ltem 1.

## ACCENT PANELS - PAINTED CEMENTITOUS PANELS




Exhibit 17 DR23-03

# CAMAS MEADOWS

## MATERIAL BOARD

Camas Meadows Subdivision Romano Capital Item 1.

 GARAGE DOOR
 WINDOW

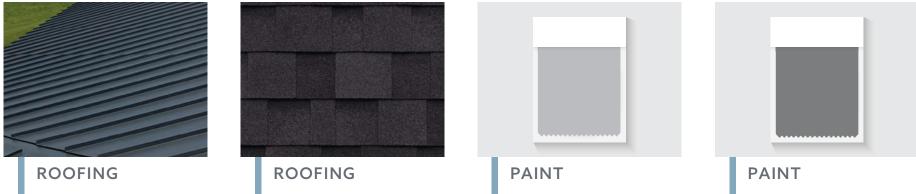

## DESIGN REVIEW CHECKLIST

## DR23-03 Camas Meadows Hole 9 Mixed Use Development

The purpose of this sheet is to provide a simplified and expedited review of the design review principles and guidelines using objective review standards. The standards are intended as a tool for the decision-maker in making findings that the proposal either achieves compliance with the intent of the principles or reasonably mitigates any conflict. When reviewing the check sheet, the proposal should as a whole "comply" with the standards and thus be generally consistent with the overriding principles. [Yes = In Compliance; No = Not In Compliance; NA = Not Applicable]

## Standard Principles and Guidelines

ARCH	ARCHITECTURE				
Yes	No	NA	Principles and Guidelines	Comments	
			Corrugated materials, standing seam, T-1 11, or similar siding		
			materials are avoided unless it produces a high visual (or		
			aesthetic) quality.		
			Buildings walls or fences visible from roadways are articulated		
			in order to avoid a blank look.		
			The use of bold colors has been avoided unless used as minor		
			accents.		
			Higher density/larger structures abutting lower density		
			residential structures have been designed to mitigate size and		
			scale differences.		
LAND	SCAPI	NG AI	ND SCREENING		
Yes	No	NA	Principles and Guidelines	Comments	
			Vegetation for landscaping includes native, low maintenance		
			plantings. Significant trees are retained if feasible.		
			Trees planted along streetscapes with overhead power lines		
			include only those trees identified on the City's Tree list.		
			Landscaping, including trees, shrubs, and vegetative		
			groundcover, is provided to visually screen and buffer the use		
			from adjoining less intense uses including parking.		
			Proposed fencing is incorporated into the landscaping so as to		
			have little or no visual impact.		
			Signs located on buildings or incorporated into the landscaping		

-					
			are unobtrusive and vandal resistant. If illuminated they are front lit.		
			Landscape lighting - low voltage, non-glare, indirect lighting is		
			directed, hooded or shielded away from neighboring		
			properties.		
			Street lighting (poles, lamps) is substantially similar or		
			architecturally more significant than other street lighting		
			existing on the same street and do not conflict with any City		
			approved street lighting plans for the street.		
			Parking and building lighting is directed away from		
			surrounding properties through the use of hooding, shielding,		
			siting and/or landscaping.		
			Outdoor furniture samples are consistent with the overall		
			project design.		
			Existing trees over 6" dbh that are not required to be removed		
			to accommodate the proposed development are retained and		
-			incorporated into the landscape plan. Rock outcropping's, forested areas and water bodies are		
			retained.		
HISTO	ORIC A	ND H	ERITAGE PRESERVATION		
Yes	No	NA	Principles and Guidelines	Comments	
			The use of Historic Markers, information kiosks, project		
			names, architectural features, or other elements of the project		
			promote the historic heritage of the site or surrounding area.		

## Specific Principles and Guidelines

			GATEWAYS AND CORRIDORS	
SIGN	AGE			
Yes	No	NA	Principles and Guidelines	Comments
			Gateways are devoid of free-standing signs. Preexisting freestanding signs are proposed for removal at the time of development, redevelopment, or major rehabilitation on the site.	
			Permanent signage within a gateway are standardized to create a consistent look in terms of size, color, and materials.	

STRE	ETSCA	PE			
/es	No	NA	Principles and Guidelines	Comments	
			The main public entrance is oriented toward the public right-of-		
			way.		
			Pedestrian walkways connect each building's front entry with		
			the sidewalk.		
			Bike lanes are provided and link public areas with		
			neighborhoods and other local and regional bicycle corridors.		
			Alternative transportation, such as attractive bus stop shelters,		
			bicycle parking, etc. are provided.		
			Trees, planting strips or bioswales are used for separating		
			vehicles and pedestrian movements.		
			Street trees no less than two inches in diameter are planted		
			within planter strips or tree wells at a spacing that creates the		
			appearance of a continuous canopy at tree maturation.		
			The surface of pedestrian walkways within intersections are		
			accentuated with a unique character (i.e. pattern stone,		
			exposed aggregate, stamped concrete, etc.)		
			Buildings are placed as close to streets and roads as the zoning		
			code allows.		
			On-site parking is located to the rear or the side of the building.		
			A consistent iconic streetscape lighting scheme is used that		
			portrays the primary development period, architecture		
			characteristics, or predetermined theme as identified in a		
			concept plan, sub-area plan, or master plan recognized by the		
			City.		
AND.	SCAP	ING			
'es	No	NA	Principles and Guidelines	Comments	
			Landscaping adjacent to the public right of way provides		
			multiple layers of plantings, including canopy trees, understory		
			trees, shrubs and groundcover.		
			Hanging baskets provided along building frontages add visual		
			interest and the bottom of the basket is a minimum of 80 inches		
			above the finished grade of the sidewalk.		
			Median planting design/plant selection create a unique and		
			cohesive streetscape design.		

			COMMERCI	AL	
ARCH	ITECT	URE			
Yes	No	NA	Principles and Guidelines	Comments	
			Office and retail buildings provide a minimum solid to void ratio		
			of 60%/40%		
			The development is built with a residential feel (i.e. size, scale,		
			and materials compatible with neighboring buildings) if		
			surrounded by residential areas or adjacent to residentially		
			zone properties.		
			Buildings over two stories have the third story and above offset		
			from the first two stories, if surrounding developments are less		
			than three stories or land use designations on adjacent sites do		
			not allow more than three story development.		
		1	SCREENING	-	
Yes	No	NA	Principles and Guidelines	Comments	
			Intersections are illuminated, but not dominated by lighting.		
			Lighting is incorporated into the landscape and illuminates the		
			quality of the natural environment. Street light poles and lamps		
			are compatible with other nearby lighting on the same street.		
			Parking spaces are clustered in small groupings and separated		
			by landscaping to create a pedestrian friendly, park like		
CTDE	FTCCAL		environment.		
	ETSCA	1			
Yes	No	NA	Principles and Guidelines	Comments	
			On-site parking areas are located to the interior of the		
			development unless site development proved prohibitive.		
			Otherwise, parking areas are screened with landscaping.		
			Buildings are placed close to streets and roads unless site		
			constraints made it impossible or characteristics of the surrounding properties already developed made it		
			incompatible. Otherwise, retail frontage setbacks do not exceed 25 feet from back of curb.		
			Window and door placement provides a high degree of		
			transparency at the lower levels of the building and maximize		
			visibility of pedestrian active uses.		
			Each use/activity in a development containing multiple		
			uses/activities is integrated in a manner that achieves a		
	1	L		l	

Item 1.

			seamless appearance or creates a cohesive development.		
			New streets intersecting commercial properties are designed to		
			create a safe environment. "Coving" techniques and "round-a-		
			bouts" were considered for traffic calming when appropriate.		
			MULTI-FAMI	LY	
Yes	No	NA	Principles and Guidelines	Comments	
2	. TO	WNHC	DMES AND ROWHOUSES		
			All on-site parking areas (excluding driveways & garages) are		
			screened with landscaping.		
			Buildings are brought up to the road to help define		
			traffic/pedestrian movements.		
			Structures abutting or located in single family residentially		
			zoned areas are designed to mitigate size and scale differences		
			when appropriate.		
			Walls are articulated in order to avoid a blank look and provide		
			a sense of scale including a minimum solid to void ratio of		
			70%/30%.		
			Detachable garages are located to the rear of the townhouse or		
			rowhouse unit(s) so as not to be directly viewable from a public		
			street.		
			Attached garages account for less than 50% of the front face of		
			the structure. Garages visible from the street are articulated by		
			architectural features, such as windows, to avoid a blank look.		
			Green belts are used to separate different uses whenever		7
			possible.		
			Vertical intensity of landscaping increases as the height of the		
			structure increases.		