

Town of Beaufort, NC

701 Front St. - P.O. Box 390 - Beaufort, N.C. 28516 252-728-2141 - 252-728-3982 fax - www.beaufortnc.org

Town of Beaufort Planning Board Regular Meeting 6:00 PM Monday, June 21, 2021 - Held Virtually via Zoom due to the COVID-19 Pandemic Monthly Meeting

Call to Order

Roll Call

Agenda Approval

Minutes Approval

1. Minutes Approval from the May 17, 2021 Meeting

Public Hearing

- 1. Request to Rezone 100 Fairview Drive and 1310 Live Oak Street from B-1 General Business to TCA Townhomes, Condominiums and Apartments
- 2. Case #20-17 Special Use Permit for a Gas/Service Station at 1550 Lennoxville Road

New Business

- 1. Site Plan Front Street Village Transportation Center
- 2. Preliminary Plat Front Street Village
- 3. Final Plat Palmetto Plantation @ Olde Beaufort Village, Phase 2
- 4. Case #21-20 Final Plat Live Oak Commons

Public Comment

Commission / Board Comments

Staff Comments

Adjourn



Town of Beaufort, NC

701 Front St. - P.O. Box 390 - Beaufort, N.C. 28516 252-728-2141 - 252-728-3982 fax - www.beaufortnc.org

Town of Beaufort Planning Board Regular Meeting 6:00 PM Monday, May 17, 2021 - Held Virtually via Zoom due to the COVID-19 Pandemic Minutes

Call to Order

Chair Neve called the May 17, 2021 meeting to order at 6:00 p.m.

Roll Call

Present for the meeting were Ryan Neve, Ralph Merrill, John LoPiccolo, Paula Gillikin, and Diane Meelheim. Members not in attendance were Jeff Vreugdenhill and Aaron Willis. Secretary Winn informed the Board that Aaron Willis notified her of his absence earlier and declared a quorum present for the meeting.

Also present for the meeting were Kyle Garner, Kate Allen, Denice Winn, Town Attorney Arey Grady, Town Attorney Jill Quattlebaum, and Commissioner Hollinshed.

Agenda Approval

Chair Neve asked for any modifications to the agenda. Hearing none, he asked for a motion to approve the agenda as presented. Vice Chair Merrill made a motion to approve the agenda as presented. Member Meelheim made the second. Secretary Winn conducted a roll call vote which passed unanimously with five of five members present in favor.

Minutes Approval

1. Minutes Approval for the April 19, 2021 Planning Board Meeting

Chair Neve reminded the Board that a revised version of the minutes was sent out earlier in the afternoon and asked the Board for any additional modifications to the minutes as presented. Member Gillikin referenced a grammatical correction she submitted. Secretary Winn confirmed that the corrections were included in the revised minutes distributed earlier in the afternoon.

Member Gillikin made a motion to approve the minutes as amended. Member Meelheim made the second. Secretary Winn conducted a roll call vote. Five of five members present voted unanimously to approve the minutes as amended.

Public Hearing

Modify/Revise the Existing Planned Unit Development (PUD) for Front Street Village

Chair Neve opened discussion for Case Number 21-16, a PUD Amendment for Front Street Village.

Kyle Garner added that John Wade, Arendell Engineers, is in attendance and is the engineer that has been working on the project.

Kyle Garner presented the staff report on behalf of the Town. He explained that the request before the Board tonight is a modification to the PUD for Front Street Village (2500 Front Street). He added that a site plan and preliminary plat will be coming before the Board at the next Planning Board meeting.

Mr. Garner explained that the request tonight is for a zoning change from B-3 to R-8 for the expansion of single family residential lots. The B-3 zone originally included in portions of Phases II and III of the site included parking and is now proposed as single family residential. He explained that the owner is requesting a reduction in the overall parking spaces to 398, noting the original approval included 631 spaces, which would be a reduction of 233 parking spaces. He further added that the owner is requesting a reduction in the overall number of resort dwellings from 202 to seven; a reduction of 195 resort dwellings. Mr. Garner explained that the owner is requesting an expansion of the original 11 single family lots to a proposed thirty-four (34) single family lots for a total increase of 23 single family dwellings.

Mr. Garner presented the current zoning of the subject property and surrounding properties, as well as the future land use classifications of the surrounding properties. He also presented the original site plan that was approved in 2008.

Mr. Garner reminded the Board of height variances that were included in the initial approval. While the majority of structures in this PUD are limited to 35 feet in height, there are a few structures that were allowed up to 40 feet in height and are shown in blue/purple on slide 9 of the presentation. Mr. Garner also presented a spreadsheet showing Phases I, II, III, and IV as well as the status and any modifications made to the original proposal. Mr. Garner also pointed out that what is on the ground is quite in line with what was originally proposed.

Mr. Garner explained that planning staff reviewed the request and recommends approval as the current zoning and future land use plan are consistent with the proposed modification.

Chair Neve asked if the applicant or applicant's representative had anything more to add. Mr. Bucky Oliver thanked the Board for their time, noting that Mr. Garner's presentation hit all of the main points.

Chair Neve asked if any Board members had any questions for the applicant or town staff. Vice-Chair Merrill said that it is unclear exactly what area is being rezoned. He said that the packet materials indicated that it was 16.2 acres, while the presentation said that it was in Phase IV, but nothing was provided showing exact boundaries of the area requested to be rezoned. Mr. Garner explained that the area under consideration is actually in the northern portion of Phase III. He said that the original approval included parking spaces and additional resort style dwellings and as such were zoned commercial. He explained that the request is to modify the zoning to match what is in Phase II with single family dwellings.

Chair Neve asked if this would require a plat modification. Mr. Garner presented a slide showing the original approval. He explained that the area under consideration is the B-3 area on the north side of the property, as well as a portion of the RMF area to the northeast.

Mr. Garner added that a preliminary plat should be forthcoming on the agenda next month to reflect these changes. In addition, he added that a site plan for the transportation center is forthcoming.

Chair Neve asked if Mr. Garner's explanation satisfied his question. Vice Chair Merrill said that the boundaries are not clearly defined and should be. Mr. Oliver asked Mr. Garner if he could show the specific area under consideration. Mr. Garner showed the Board the proposed preliminary plat for the area and showed the areas under consideration with his mouse pointer. Chair Neve thanked Mr. Garner for the additional information. Mr. Garner suggested Mr. John Wade create a map clearly showing the proposed areas to be rezoned prior to the Board of Commissioner's meeting where it will consider the request.

Chair Neve asked if the Board had any additional questions for the applicant or town staff. Member Gillikin asked if the areas no longer proposed as development would remain open space or if there were other plans for it. Mr. Bucky Oliver said that the areas would remain natural, mainly due to the wetlands. Member Merrill asked the applicant to speak to the remaining parking spaces and the allocation thereof. Mr. Oliver said that the revised plans meet the necessary parking requirements based on the reduced number of overall dwellings. Chair Neve said that he anticipates seeing a reduction in impervious surface coverage on the forthcoming preliminary plat. Mr. Oliver agreed.

Chair Neve asked for a motion regarding the request. Member Merrill reiterated the need for a map showing the specific area being rezoned. Beyond that, Member Merrill said that he felt it was a good proposal.

Member Merrill made a motion to recommend approval of the request contingent upon the applicant providing a more detailed map clearly identifying the boundaries of the area to be rezoned prior to consideration by the Board of Commissioners, noting that the request does comply with the Future Land Use Map. Member Gillikin made the second. Secretary Winn conducted a roll call vote. The motion passed unanimously.

2. Case No. 21-13. Text Amendment modifying language in the Land Development Ordinance & Subdivision Ordinance to meet the Statutory Changes Per 160D.

Chair Neve explained that the text of this request is not up for debate, as it is based on the new 160D statutes. If approved, the request will then be vetted by the town attorney.

Mr. Kyle Garner provided a brief background of the changes before the Board, noting that the changes were made by the consultant, Stewart. He further added that the changes have not been fully vetted by the attorneys. He said that the deadline for compliance with the new statutes is July 1st, and that staff will request the Board of Commissioners authorize the attorney to review the proposed changes at the upcoming Work Session.

Mr. Garner said that he wanted to discuss/highlight a few proposed changes, some of which the Board has considered in the past. The first would be the additional requirement for an applicant to hold a neighborhood meeting as a part of any rezoning request. Mr. Garner explained that this is something staff currently recommends to applicants, but by making it a part of the ordinance, it would be required rather than optional.

Mr. Garner then explained permit choice. For example, if Member Meelheim submitted an application and staff is in the midst of a text amendment, the new law would give her the choice to use the ordinance as it was or as it was amended. Mr. Garner then provided a brief history of the planning statutes, noting that this is a big overhaul as there have not been many changes to the statutes regulating planning and development in decades.

Mr. Garner then gave a presentation regarding the 160D updates. (A copy of the presentation is included in the meeting packet materials and is incorporated herein by reference). Following the presentation, discussion ensued. Mr. Garner reiterated that the attorneys would review the document prior to its adoption.

Chair Neve asked the Board for any questions; there were none. Mr. Arey Grady, Town Attorney, agreed with Mr. Garner's presentation and added that there will likely be technical corrections going forward.

Chair Neve asked if anyone in attendance would like to speak for the public hearing. No members of the public asked to speak.

Vice Chair Merrill asked for clarification as Mr. Grady said that 160D is not law yet, but Mr. Garner said that it had to be adopted by July 1, 2021 to be in compliance. Mr. Grady explained that the statute was effective January 1, but allowed a six month grace period to implement the changes which ends July 1, 2021.

Member LoPiccolo asked if the proposed structure is required, or if there could be changes/additions going forward, noting that some of these changes bypass the Planning Board review. Mr. Garner thanked Member LoPiccolo for his question, and reiterated that the attorneys will be vetting the document. Mr. Grady added that there are some elements that are written in stone, but other elements do have flexibility depending on the jurisdiction's preference.

Vice Chair Merrill asked if, based on the changes in the ordinance, final plats would come before the Planning Board. Mr. Garner said that as it stands right now, subdivisions and site plans would be a quasi-judicial proceeding. Discussion ensued.

Member Gillikin made a motion to approve the text amendments as presented, contingent upon town attorney review. Member Meelheim seconded the motion. Secretary Winn conducted a roll call vote. The motion passed unanimously.

New Business

 To recommend approval or denial to the Board of Commissioners for the Site Plan for East Port II Apartments proposing 48 apartment units (8-One bedrooms; 20-Two Bedrooms; and 20-Three bedrooms).

Mr. Garner gave a presentation on the request. He explained that the applicant wishes to construct three multi-family buildings that will contain 48 total units with a total square footage of 31,948 square feet. Mr. Garner added that the request would require sewer allocation through the Public Services Department based on the recently adopted sewer allocation policy. Mr. Garner then showed the proposed layout and landscaping plan of the proposal. He added that these are very similar to the existing units at Eastport at the Park. Staff has reviewed the request and believes that the proposal meets the design criteria required in the Land Development Ordinance and as such recommends approval of the request.

Chair Neve asked the applicant and the applicant's representative if they had anything else to add to the presentation. Mr. Chase Cullipher, The Cullipher Group, did not have anything additional to add, but added that he is available for any questions the Board may have. Discussion ensued. Chair Neve asked about the retaining wall shown on the plans. Mr. Cullipher said that the geotechnical recommended placing 2 feet of fill on the site, and the retaining wall will be in place for stormwater to drain properly.

Chair Neve asked for any additional questions or a motion on the request. Vice Chair Merrill made a motion to recommend approval of the site plan as presented, as well as the sewer allocation as requested. Member Meelheim seconded the motion. Secretary Winn conducted a roll call vote. The motion passed unanimously.

Public Comment

There were none.

Commission / Board Comments

Member Meelheim thanked staff for their hard work.

Member Gillikin said that the items on the agenda tonight were full of important things. She added that she is excited to see additional open space in Front Street Village, as well as the forthcoming affordable housing.

Chair Neve thanked staff for their efforts putting together such a thorough packet.

Staff Comments

Mr. Garner thanked the Board for their time and willingness to make challenging decisions. He added that the agenda next month will have at least two items, potentially more.

Adjourn

Member LoPiccolo made a motion to adjourn. Member Gillikin seconded the motion.	Secretary Winn
conducted a roll call vote. The motion passed unanimously.	

Ryan Neve, Chair	
Denice Winn, Board Secretary	



Staff Report

To: From:	Planning Board Kate Allen		•		Date: Meeting Date:	6/9/2021 6/21/2021
		Case N	umber 2	1-18		
Summar	ry of Request:	_	1 General E		v Drive and 1310 Liv CA Townhomes, Con	
		Ba	ckground			
Location	n(s) & PIN			·	N 730615626574000) PIN 73061562554600	
Owner Applica	nt		t Properties Limited Pa	– NM, LLC artnership		
Current	Zoning	B-1 Ger	neral Busine	ess		
Lot(s) Si	ze & Conformity Status	Confo Road 2. 0.653 Confo Road	acres or 28 orming Lot Frontage –	of Record Fairview Dr 4,444.68 ft ²	reet 95.83°	
Existing	Land Use	Vacant				
	Future Land Use Map mendment Required	Medium ⊠ Yes	Density Ro		sity Residential	
Adjoinir	ng Land Use & Zoning	North South East West	B-1; Con R-8; Resi R-8; Resi R-8; Resi	dential dential		
Special I	Flood Hazard Area	☐ Yes	⊠ No	Shade	d X	
	I tilities ater wer	⊠ Avai ⊠ Avai			vailable vailable	
Addition	nal Information	See Staf	f Comment	S		
Request	ted Action	Provide	consisten	cy statemen	at and recommendat	ion to the

Board of Commissioners

Staff Comments

The total area of the two lots combined is 1.589 acres (+/-). Based on the maximum density of 12 units per acre, the maximum number of units possible, if approved, is 19.

The current **B-1 General Business District Standards**

Minimum Lot Size	5,000 Square Feet	Setb	acks
Minimum Lot Width	60 Feet	Front	30 Feet
Maximum Building Height	40 Feet	Rear	15 Feet
Maximum Impervious	N/A	Side	15 Feet

The requested TCA Townhomes, Condominiums and Apartments District Standards

Minimum Lot Size	2,750 Square Feet	Seth	oacks
Minimum Lot Width	80 Feet	Front	25 Feet
Maximum Building Height	35 Feet	Rear	30 Feet
Maximum Impervious	N/A	Side	8 Feet
		ROW Side	15 Feet

Consistency Statement & CAMA Core Land Use Plan Amendment

In accordance with NCGS § 160A-383, the consistency statement must include one of the following:

- A statement recommending approval of the zoning amendment and describing its consistency with the CAMA Core Land Use Plan
- A statement recommending denial of the zoning amendment and describing its inconsistency with the CAMA Core Land Use Plan
- A statement recommending approval of the zoning amendment containing the following:
 - Declaration that the approval is also deemed an amendment to the CAMA Core Land Use Plan
 - An explanation of the change in conditions the board took into consideration when recommending approval

CAMA Core Land Use Plan – Future Land Use Classifications

Current: Medium Density Residential

The Medium Density Residential classification is intended to delineate lands where the predominant land use is higher density single-family residential developments and/or two-family developments. The residential density within this classification is generally 3 to 5 dwelling units per acre. Minimum lot sizes vary from 8,000 to 10,000 square feet unless a larger minimum lot area is required by the health department for land uses utilizing septic systems. Land uses within Medium Density Residential-designated areas are generally compatible with the R-8, Medium Density Residential, R-8A Single-family Medium Density Residential Waterfront; R8-MH Residential Manufactured Home Park/Recreational Vehicle Park; and H-BD, Historic Business Zoning Districts. Public water

is widely available and sewer service is required to support the higher residential densities in this classification. Streets with the capacity to accommodate higher traffic volumes are also necessary to support Medium Density Residential development.

Requested: High Density Residential

The High Density Residential classification is intended to delineate lands where the predominant land use is higher density single-family residential developments and/or multifamily developments. The residential density within this classification is generally 6 to 16 dwelling units per acre. The minimum lot size is 2,750 square feet per unit unless a larger minimum lot area is required by the health department for land uses utilizing septic systems. Land uses within High Density Residential-designated areas are generally compatible with the RC-5, Residential Cluster Development and the RS-5, Residential Single-Family 5 Development Zoning Districts. Public water and sewer service is required to support the residential densities in this classification. Streets with the capacity to accommodate higher traffic volumes are also necessary to support High Density Residential development.

Attachments:

- 1. Property Owners Within 100 Feet
- 2. Vicinity Map
- 3. Aerial Map
- 4. Current Zoning Map
- 5. Future Land Use Map
- 6. Flood Hazard Areas Map
- 7. LDO Excerpts B-1 General Business District
- 8. LDO Excerpts TCA Townhomes, Condominiums and Apartments District
- 9. Application as Submitted

3

OWNER

ANNIE L JONES COMPANY INC O'BERRY, WALTER S IV ETUX M. MORRIS FAMILY VENTURES LLC CROBAR, SANDRA K WPJS PROPERTIES LLC RECKER, BRIAN E ETUX EMILY W BEAUFORT PROPERTIES-NM LLC BEAUFORT PROPER HOLDINGS LLC **BICKLEY, JENNIFER LYNN** BOYETTE, TRENT CHRISTIAN ETAL DARRESS, ROBERT L ETUX MARIA L SCHMIDT, ALVA R ETUX DIANE BULLOCK, THOMAS M ETUX JANE GARRIS, ROBERT J SR ETUX KAREN GARNER, EUGENE M JR ETUX DIANNE DIXON, JOSEPH CARL HILL, GEORGE STEPHEN TARR, CYNTHIA RAE


MAILING ADDRESS

120 JERICHO DRIVE 127 CIRCLE DRIVE PO BOX 12587 128 CIRCLE DRIVE PO BOX 88 1311 LIVE OAK STREET PO BOX 10189 2441 HWY 70 E **102 FAIRVIEW DRIVE 104 FAIRVIEW ROAD** 1307 LIVE OAK STREET 1305 LIVE OAK ST 209 GEORGE ST 108 POPLAR RIDGE ROAD **173 JACKSON DRIVE 201 GEORGE STREET** 1904 SNOWY EGRET DRIVE 1322 HWY 101

CITY STATE ZIP

BEAUFORT NC 28516 BEAUFORT NC 28516 NEW BERN NC 28561 BEAUFORT NC 28516 WINTERVILLE NC 28590 BEAUFORT NC 28516 WILMINGTON NC 28404 BEAUFORT NC 28516 GOLDSBORO NC 27534 BEAUFORT NC 28516 BEAUFORT NC 28516 MOREHEAD CITY NC 28557 BEAUFORT NC 28516

Vicinity Map

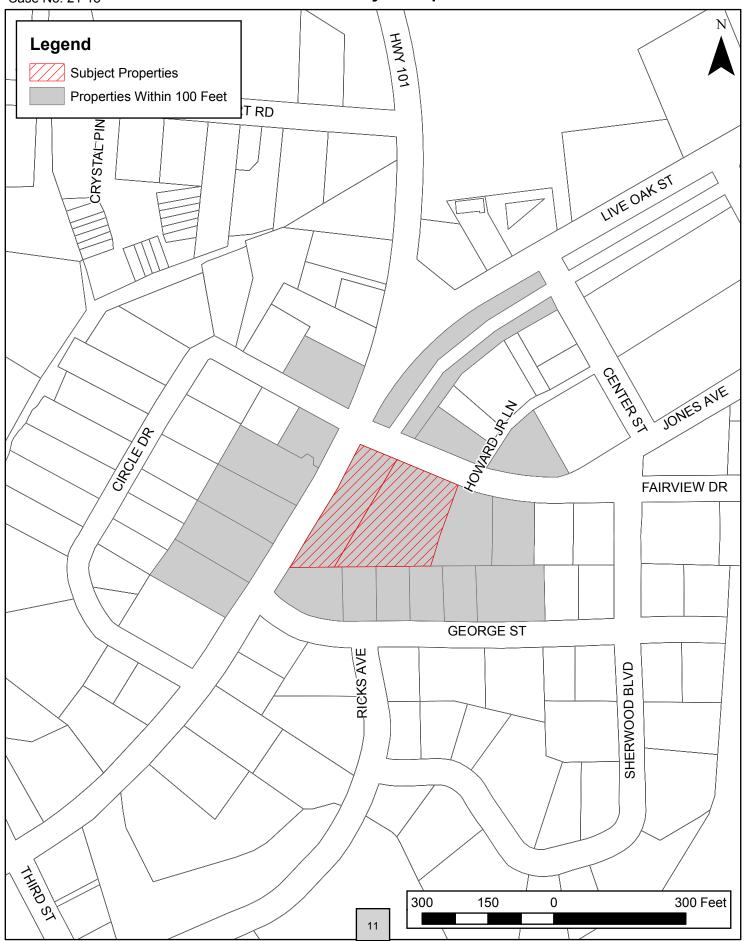


Aerial Map

Case No. 21-18







Zoning Map

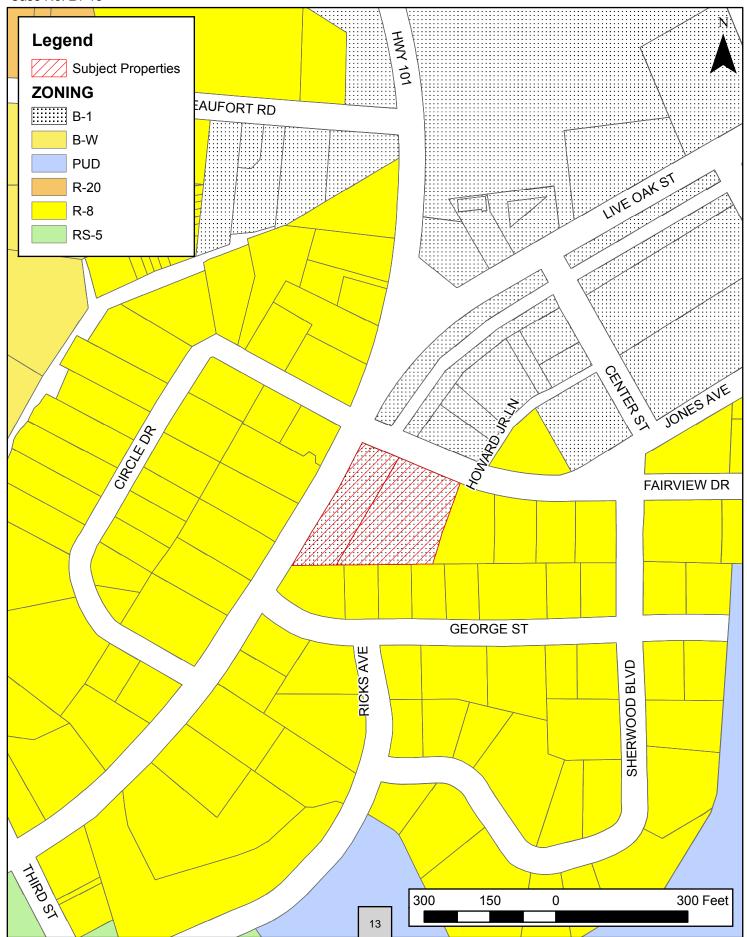

Future Land Use Map

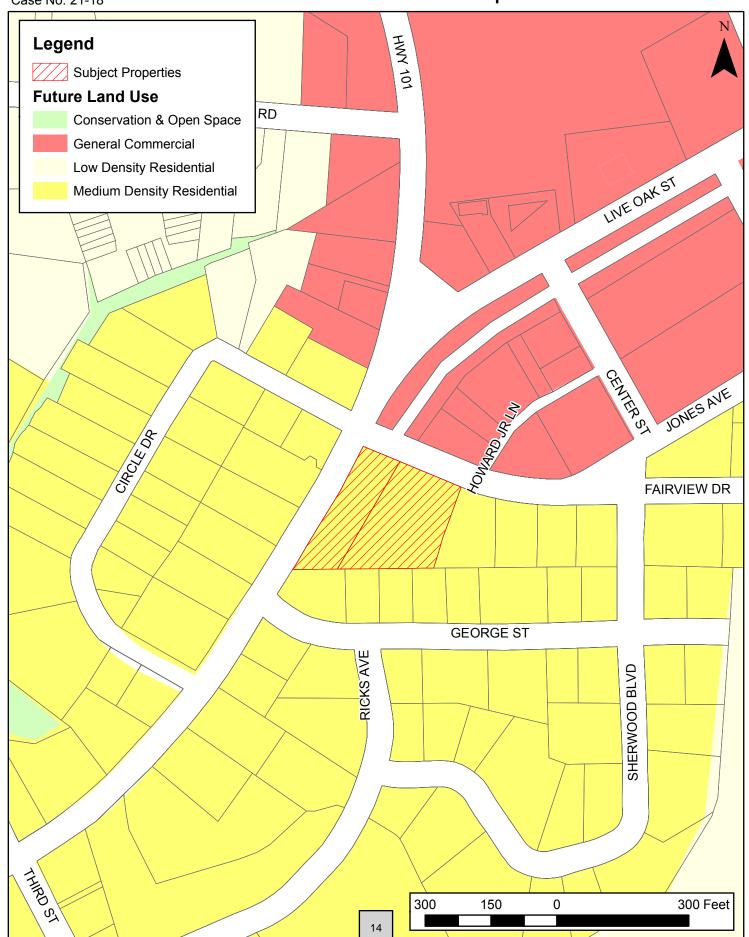

Special Flood Hazard Areas Map

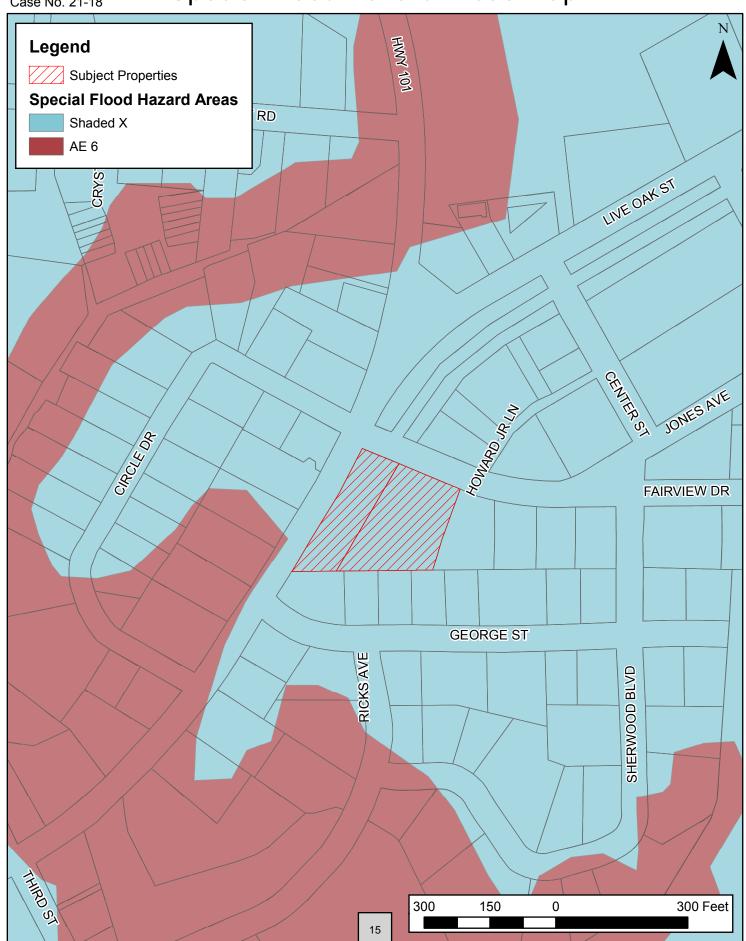

C) B-1 General Business District.

The General Business District is established as the district in which a wide variety of sales and service facilities may be provided to the general public. This district will be located throughout the Town's planning jurisdiction.

1) Minimum Lot Size.

All lots in the B-1 district shall be a minimum of five thousand square feet (5,000 ft²).

2) Minimum Lot Width.

All lots in the B-1 district shall have a minimum lot width of sixty feet (60') at the minimum building line.

3) Building Setback and Building Height Requirements and Limitations.

Subject to the exceptions allowed in this Ordinance, each structure on a lot in this zoning district shall be set back from the boundary lines of the lot at least the distances provided in the tables set forth in this section. The building height limitation in this district is provided in the tables set forth in this section.

Table 9-5 Lot Requirements

District	Front Setback (Right-of-Way)	Rear Setback	Side Setback	Building Height Limitation
B-1	30 feet	15 feet	15 feet	40 feet

4) Accessory Building Setback Requirements.

All accessory buildings must comply with the setback requirements as set forth in section 2-F of this Ordinance, section 6 of this Ordinance, section 15 of this Ordinance, and all sections of this Ordinance.

5) Permitted Uses.

Amusement Establishment

Antenna Co-Location on Existing

Tower

Aquaculture

Assisted Living

Athletic Field, Public

Bed & Breakfast

Boat Sales/Rentals

Car Wash

Club, Lodge, or Hall

Commercial Indoor Recreation Facility

Community Garden

Concealed (Stealth) Antennae &

Towers

Convenience Store Day Care Center

Dock

Dry Boat Storage

Financial Institution

Government/Non-Profit Owned/

Operated Facilities & Services

Hospital

Hotel or Motel

Kennel, Indoor Operation Only

Library

Liquor Store

Moped/Golf Cart Sales/Rentals

Mortuary/Funeral Home/Crematorium

Motor Vehicle Sales/Rentals

Museum

Neighborhood Recreation Center,

Public

Nursing Home

Office: Business, Professional, or

Medical

Other Building-Mounted Antennae &

Towers

Outdoor Retail Display/Sales

Park, Public Parking Lot Parking Structure

Personal Service Establishment Pool Hall or Billiard Hall

Produce Stand/Farmers' Market

Public Safety Station Public Utility Facility Religious Institution

Resource Conservation Area

Restaurant with Drive-Thru Service Restaurant with Indoor Operation

Retail Store

Satellite Dish Antenna

Signs, Commercial Free-Standing Tavern/Bar/Pub with Indoor Operation

Temporary Construction Trailer

Theater, Small

Transportation Facility

Utility Minor

Vehicle Charging Station

Vehicle Service

6) Special Uses (Special Uses text may be found in section 20 of this Ordinance).

Adult-Oriented Retail Establishment Commercial Outdoor Amphitheater

Commercial Outdoor Recreation

Facility

Commercial Waterfront Facility

Gas/Service Station Golf Driving Range

Hazardous Material Storage

Kennel, Indoor/Outdoor Operation

Manufacturing, Light

Marina

Microbrewery Microdistillery Mini-Storage Mixed Use

Outdoor Amphitheater, Public

Outdoor Storage

Preschool

Restaurant with Outdoor Operation

School, K-12

School, Post-Secondary

Tavern/Bar/Pub with Outdoor Operation

Theater, Large Utility Facility

Wholesale Establishment

SECTION 8 Transitional Zoning Districts

A) TCA Townhomes, Condominiums, Apartments District.

This district is established to provide a high density district in which the primary uses are multifamily residences and duplexes. Uses in this district which require potable water or sanitary sewer must be connected to both municipal water and municipal sewer.

1) Maximum Overall Density.

The TCA district shall have a maximum density of twelve units per acre.

2) Minimum Lot Size.

All lots in the TCA district shall be a minimum of two thousand, seven hundred, and fifty square feet (2,750 ft²) per dwelling unit.

3) Minimum Lot Width.

All lots in the TCA district shall have a minimum lot width of eighty feet (80') at the minimum building line.

4) Building Setback and Building Height Requirements and Limitations.

Subject to the exceptions allowed in this Ordinance, each structure on a lot in this zoning district shall be set back from the boundary lines of the lot at least the distances provided in the tables set forth in this section. The building height limitation in this district is provided in the tables set forth in this section.

Table 8-1 Interior Lot Requirements

District	Front Setback (Right-of-Way)	Rear Setback	Side Setbacks	Building Height Limitation
TCA	25 feet	25 feet	8 feet	35 feet

Table 8-2 Corner Lot Requirements

District	Designated Front (Right-of-Way) Setback	Designated Side (Right-of-Way) Setback	Rear Setback	Side Setback	Building Height Limitation
TCA	25 feet	15 feet	30 feet	8 feet	35 feet

Table 8-3 Double Frontage Lot Requirements

District	Designated Front (Right-of-Way) Setback	Designated Rear (Right-of-Way) Setback	Side Setbacks	Building Height Limitation
TCA	25 feet	15 feet	8 feet	35 feet

5) Accessory Building Setback Requirements.

All accessory buildings must comply with the lot setback requirements as set forth in section 2-F, section 6, section 15, and all the other sections of this Ordinance.

6) Covenants.

In any development proposing common areas, jointly-used structures, or private streets, restrictive and protective covenants which provide for party wall rights, harmony of external design, continuing maintenance of building exteriors, grounds, or other general use improvements and similar matters, shall be submitted to the Town and approved by the BOC. Condominium development must submit evidence of compliance with the North Carolina Condominium Act.

7) Permitted Uses.

Antenna Co-Location on Existing

Tower

Assisted Living

Athletic Field, Public

Carport

Community Garden

Concealed (Stealth) Antennae &

Towers
Dock
Dormitory

Dwelling, Duplex/Townhome

Dwelling, Multi-Family Garage, Private Detached

Government/Non-Profit Owned/ Operated Facilities & Services

Group Home

Home Occupation

Neighborhood Recreation Center

Indoor/Outdoor, Private

Neighborhood Recreation Center,

Public

Nursing Home Park, Public

Public Safety Station Public Utility Facility

Resource Conservation Area

Shed

Signs, Commercial Free-Standing Temporary Construction Trailer

Utility Minor

Vehicle Charging Station

8) Special Uses (Special Uses text may be found in section 20 of this Ordinance).

Athletic Field, Private

Dwelling, Single-Family

Golf Course, Privately-Owned

Golf Driving Range Hotel or Motel

Marina Mixed Use

Outdoor Amphitheater, Public Personal Service Establishment

Preschool

Religious Institution

Restaurant with Drive-Thru Service

Restaurant with Indoor Operation Restaurant with Outdoor Operation

Retail Store

Satellite Dish Antennas School, Post-Secondary Tavern/Bar/ Pub with Indoor

Operation

Tavern/Bar/ Pub with Outdoor

Operation Theater, Small

Transportation Facility

Utility Facility



THE CULLIPHER GROUP, P.A.

ENGINEERING & SURVEYING SERVICES

HESTRON PLAZA TWO 151-A NC HWY 24 MOREHEAD CITY, NC 28557 P:(252) 773-0090 F:(252) 773-0243

LETTER OF TRANSMITTAL

та.			DATE June 1, 2021
To:			JOB NO. PM1070~012
Town of B	eautort		JOB NO. PINTO70~012
			ATTENTION Kyle Garner
			RE: 100 Fairview Drive & 1310 Live Oak Street
			Rezoning Request
			##************************************
WF ARF	SENDING YOU	ŀ	
COPIES	DATE	NO.	DESCRIPTION
1	5/28/2021	30273831	Fee \$300.00
1	5/27/2021		Application for an Amendment to the Beaufort Zoning Map
1			Rezoning Request
12	5/27/2021	R.0	Rezoning Request B-1 to TCA Map
		<u>'</u>	
THESE AR	RE TRANSMIT	TED as che	ecked below:
	r approval		Resubmitcopies for approvalcopies for distribution
	r your use		Submitcopies for distribution
	requested		For review and comment
	OR BIDS DUE RINTS RETURNEI		N TO US
٠٠٠٠	MINIS REPORTE	D ALTER LOA	114 10 03
DENTABRO	Rezonina reauest	for nianning hos	ard approval. Please contact Ron Cullipher with any questions or comments. Thank you.
LIVIAINI	7.0201111g 1040001	Tor planting boo	and approval. I loade contact for earlights with any questions of comments. Thank you.
, 			
COPY TO_			- CLONED
			SIGNED

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Town of Beaufort

701 Front St. • P.O. Box 390 • Beaufort, N.C. 28516 252-728-2141 • 252-728-3982 fax www.beaufortnc.org

APPLICATION FOR AN AMENDMENT TO THE BEAUFORT ZONING MAP

Instructions:

Please complete the application below, include all the required attachments and the \$300.00 for Rezoning request with no Land Use Plan Change or \$400.00 for Rezoning Request with Land Use Plan Change and return to the Beaufort Town Hall, 701 Front Street or P.O. Box 390, Beaufort, N.C., 28516. Incomplete applications will not be processed and will be returned to the applicant. Please contact Planning and Inspections at 252-728-2142 if there are any questions.

APPLICANT INFORMATION	110400000000000000000000000000000000000
Applicant Name: <u>Pamperco Limites</u> 1	PARTNERS 14-P
Applicant Address: 308 Sneet Power Kon) BENFORT, NC 28511
Applicant Name: Pamerico Lionites / Applicant Address: 308 Steel Point Kods Phone Number: 252 - 723 - 9210 Email:	1 TAYLORD STANCE grand.
Property Owner Name: BEAUFORT PROPERTIES - NM,	
Address of Property Owner: 1131-B MILITARY LUTDE	F RD WILMINGTON, NC 28405
Phone Number: <u>910 256 2211 x 1125</u> Email: (
PROPERTY INFORMATION	<u>ON</u>
Property Address: 100 FAIRVIEW DR + 1310	LIVE OAK STREET
Property Address: <u> 100 </u>	54 6000 ock Number:
Size of Property (in square feet or acres): 0. 936 Acres	
Current Zoning: B-I Requested Zonin	
Current Use of Property: Residential Vacant Comm	
Lack Just	5-27-2021
Applicant Signature	Date of Applicant's Signature
	5/25/2021
Property Owner Signature (if different than applicant)	Date of Owner's Signature

An application fee of \$300.00 for Rezoning request with no Land Use Plan Change or \$400.00 for Rezoning Request with Land Use Plan Change, either in cash, money order, or check made payable to the "Town of Beaufort," should accompany this application. Payments can be made in person on the day of submittal and at such time, a credit card can be used to make the payment. Credit card payments are subject to a 3% extra fee.

REZONING REQUEST

1310 LIVE OAK ST & 100 FAIRVIEW DR.

BEAUFORT, NORTH CAROLINA

CURRENT ZONING B-1 COMMERCIAL

PROPOSED ZONING TCA- TOWNHOMES, CONDOMINIUMS AND APARTMENTS

PROPERTY OWNER:

BEAUFORT PROPERTIES- NM, LLC

PO BOX 10189

WILMINGTON, NC 28404

APPLICANT:

PAMPLICO LIMITED PARTNERSHIP

JACK TAYLOR

PIN NO.S

730615625546000, 73061526574000

BACKGROUND: THESE PROPERTIES ARE THE FORMER LOCATION OF A GAS STATION THAT WAS DEMOLISHED SOMETIME AFTER 2004. THE PROPERTY HAS REMAINED VACANT SINCE THAT TIME. THESE PROPERTIES WERE A PORTION OF JONES VILLAGE AS PLATTED IN 1956. THE TOWN OF BEAUFORT APPEARS TO HAVE INSTALLED THEIR FIRST WASTEWATER TREATMENT PLANT IN 1969, WELL AFTER JONES VILLAGE WAS PLATTED. LOT SIZES IN THIS AREA WOULD HAVE REQUIRED SEPTIC SYSTEMS AT THAT TIME AND AS SUCH REQUIRED LARGER LOT SIZES TO ACCOMMODATE THE SEPTIC SYSTEMS.


THESE PROPERTIES ARE CURRENTLY ZONED B-1 WHICH ADJOINS R-8 PROPERTY TO THE EAST, SOUTH AND WEST (WEST BEING ACROSS LIVE OAK STREET) ALONG WITH B-1 PROPERTY TO THE NORTH. THE B-1 ZONE COMMERCIAL ZONE ALLOWS FOR A LOT OF HIGH INTENSITY USES WHILE THE PROPOSED TCA ZONING WOULD BE MORE RESTRICTIVE AND A BETTER TRANSITION ABUTTING THE R-8 ZONING.

FUTURE LAND USE PLAN: THE TOWN OF BEAUFORT FUTURE LAND USE PLAN SHOWS THIS AREA AS A MEDIUM DENSITY RESIDENTIAL AREA. SO, THE TRANSITION FROM COMMERCIAL TO RESIDENTIAL WAS IDENTIFIED AS A GOAL IN THE LATEST PLAN. THE MEDIUM DENSITY RESIDENTIAL IS DESCRIBED AS 3 TO 5 UNITS PER ACRE BUT DOESN'T SPECIFICALLY TAKE INTO ACCOUNT THAT PROPERTIES THAT HAVE MUNICIPAL SEWER CAPABILITY WOULD SUPPORT HIGHER DENSITIES. TCA ZONING DISTRICTS APPEAR TO HAVE BEEN CREATED AFTER THE CURRENT LAND USE PLAN. SEVERAL PROPERTIES HAVE BEEN REZONED TO TCA WITH DENSITIES UPTO 12 UNITS/ACRE. SHOULD THE REZONING BE APPROVED THE PLAN WOULD BE TO UTILIZE THE UPPER LIMITS OF THE ALLOWABLE DENSITY. THE LAND USE PLAN IS FROM 2006 AND THE NEW ZONING ORDINANCE WAS ADOPTED IN 2013 SO THE LUP DID NOT IDENTIFY THE OPPORTUNITIES FOR MORE FLEXIBILTY IN RESIDENTIAL USES.

PROMOTE PUBLIC HEALTH, SAFETY OR GENERAL WELFARE FOR THE TOWN OF BEAUFORT: THESE COMMERCIAL PROPERTIES IF REZONED TO TCA WOULD ALLOW MULTI-FAMILY DEVELOPMENT TO BE CONSTRUCTED TO CURRENT BUILDING CODES AND ZONING ORDINANCES WHICH ARE DESIGNED TO PROMOTE PUBLIC HEALTH AND SAFETY FOR THE TOWN OF BEAUFORT.

Property Owners within 100' of 100 Fairview Drive (730615626574000) & 1310 Live Oak Street (730615625546000)

1.	Annie L Jones Company Inc NCPIN: 730615627985000	120 Jericho Drive Beaufort, NC 28516
2.	Morris Family Ventures LLC NCPIN: 730615627791000	PO Box 12587 New Bern, NC 28561
3.	WPJS Properties LLC NCPIN: 730615629659000	PO Box 88 Winterville, NC 28590
4.	Bickley, Jennifer Lynn NCPIN: 730615628524000	102 Fairview Drive Beaufort, NC 28516
5.	Boyette, Trent Christian etal NCPIN: 730615629513000	104 Fairview Drive Beaufort, NC 28516
6.	Garris, Robert J Sr. etux Karen NCPIN: 730619628305000	108 Poplar Ridge Road Goldsboro, NC 27534
7.	Garner, Eugene M Jr. etux Dianne NCPIN: 730619627325000	173 Jackson Drive Beaufort, NC 28516
8.	Dixon, Joseph Carl NCPIN: 730619626345000	201 George Street Beaufort, NC 28516
9.	Hill, George Stephen NCPIN: 730619625376000	1904 Snowy Egret Drive Morehead City, NC 28557
10.	Tarr, Cynthia Rae NCPIN: 730619624396000	1322 Hwy 101 Beaufort, NC 28516
	•	· ·
11.	NCPIN: 730619624396000 Schmidt, Alva R etux Diane	Beaufort, NC 28516 1305 Live Oak Street
11 .	NCPIN: 730619624396000 Schmidt, Alva R etux Diane NCPIN: 730619622319000 Darress, Robert L etux Maria L	Beaufort, NC 28516 1305 Live Oak Street Beaufort, NC 28516 1307 Live Oak Street
11.12.13.	NCPIN: 730619624396000 Schmidt, Alva R etux Diane NCPIN: 730619622319000 Darress, Robert L etux Maria L NCPIN: 730619622486000 Beaufort Proper Holdings LLC	Beaufort, NC 28516 1305 Live Oak Street Beaufort, NC 28516 1307 Live Oak Street Beaufort, NC 28516 2441 Hwy 70 E
11.12.13.14.	NCPIN: 730619624396000 Schmidt, Alva R etux Diane NCPIN: 730619622319000 Darress, Robert L etux Maria L NCPIN: 730619622486000 Beaufort Proper Holdings LLC NCPIN: 730615623517000 Recker, Brian E etux Emily W	Beaufort, NC 28516 1305 Live Oak Street Beaufort, NC 28516 1307 Live Oak Street Beaufort, NC 28516 2441 Hwy 70 E Beaufort, NC 28516 1311 Live Oak Street

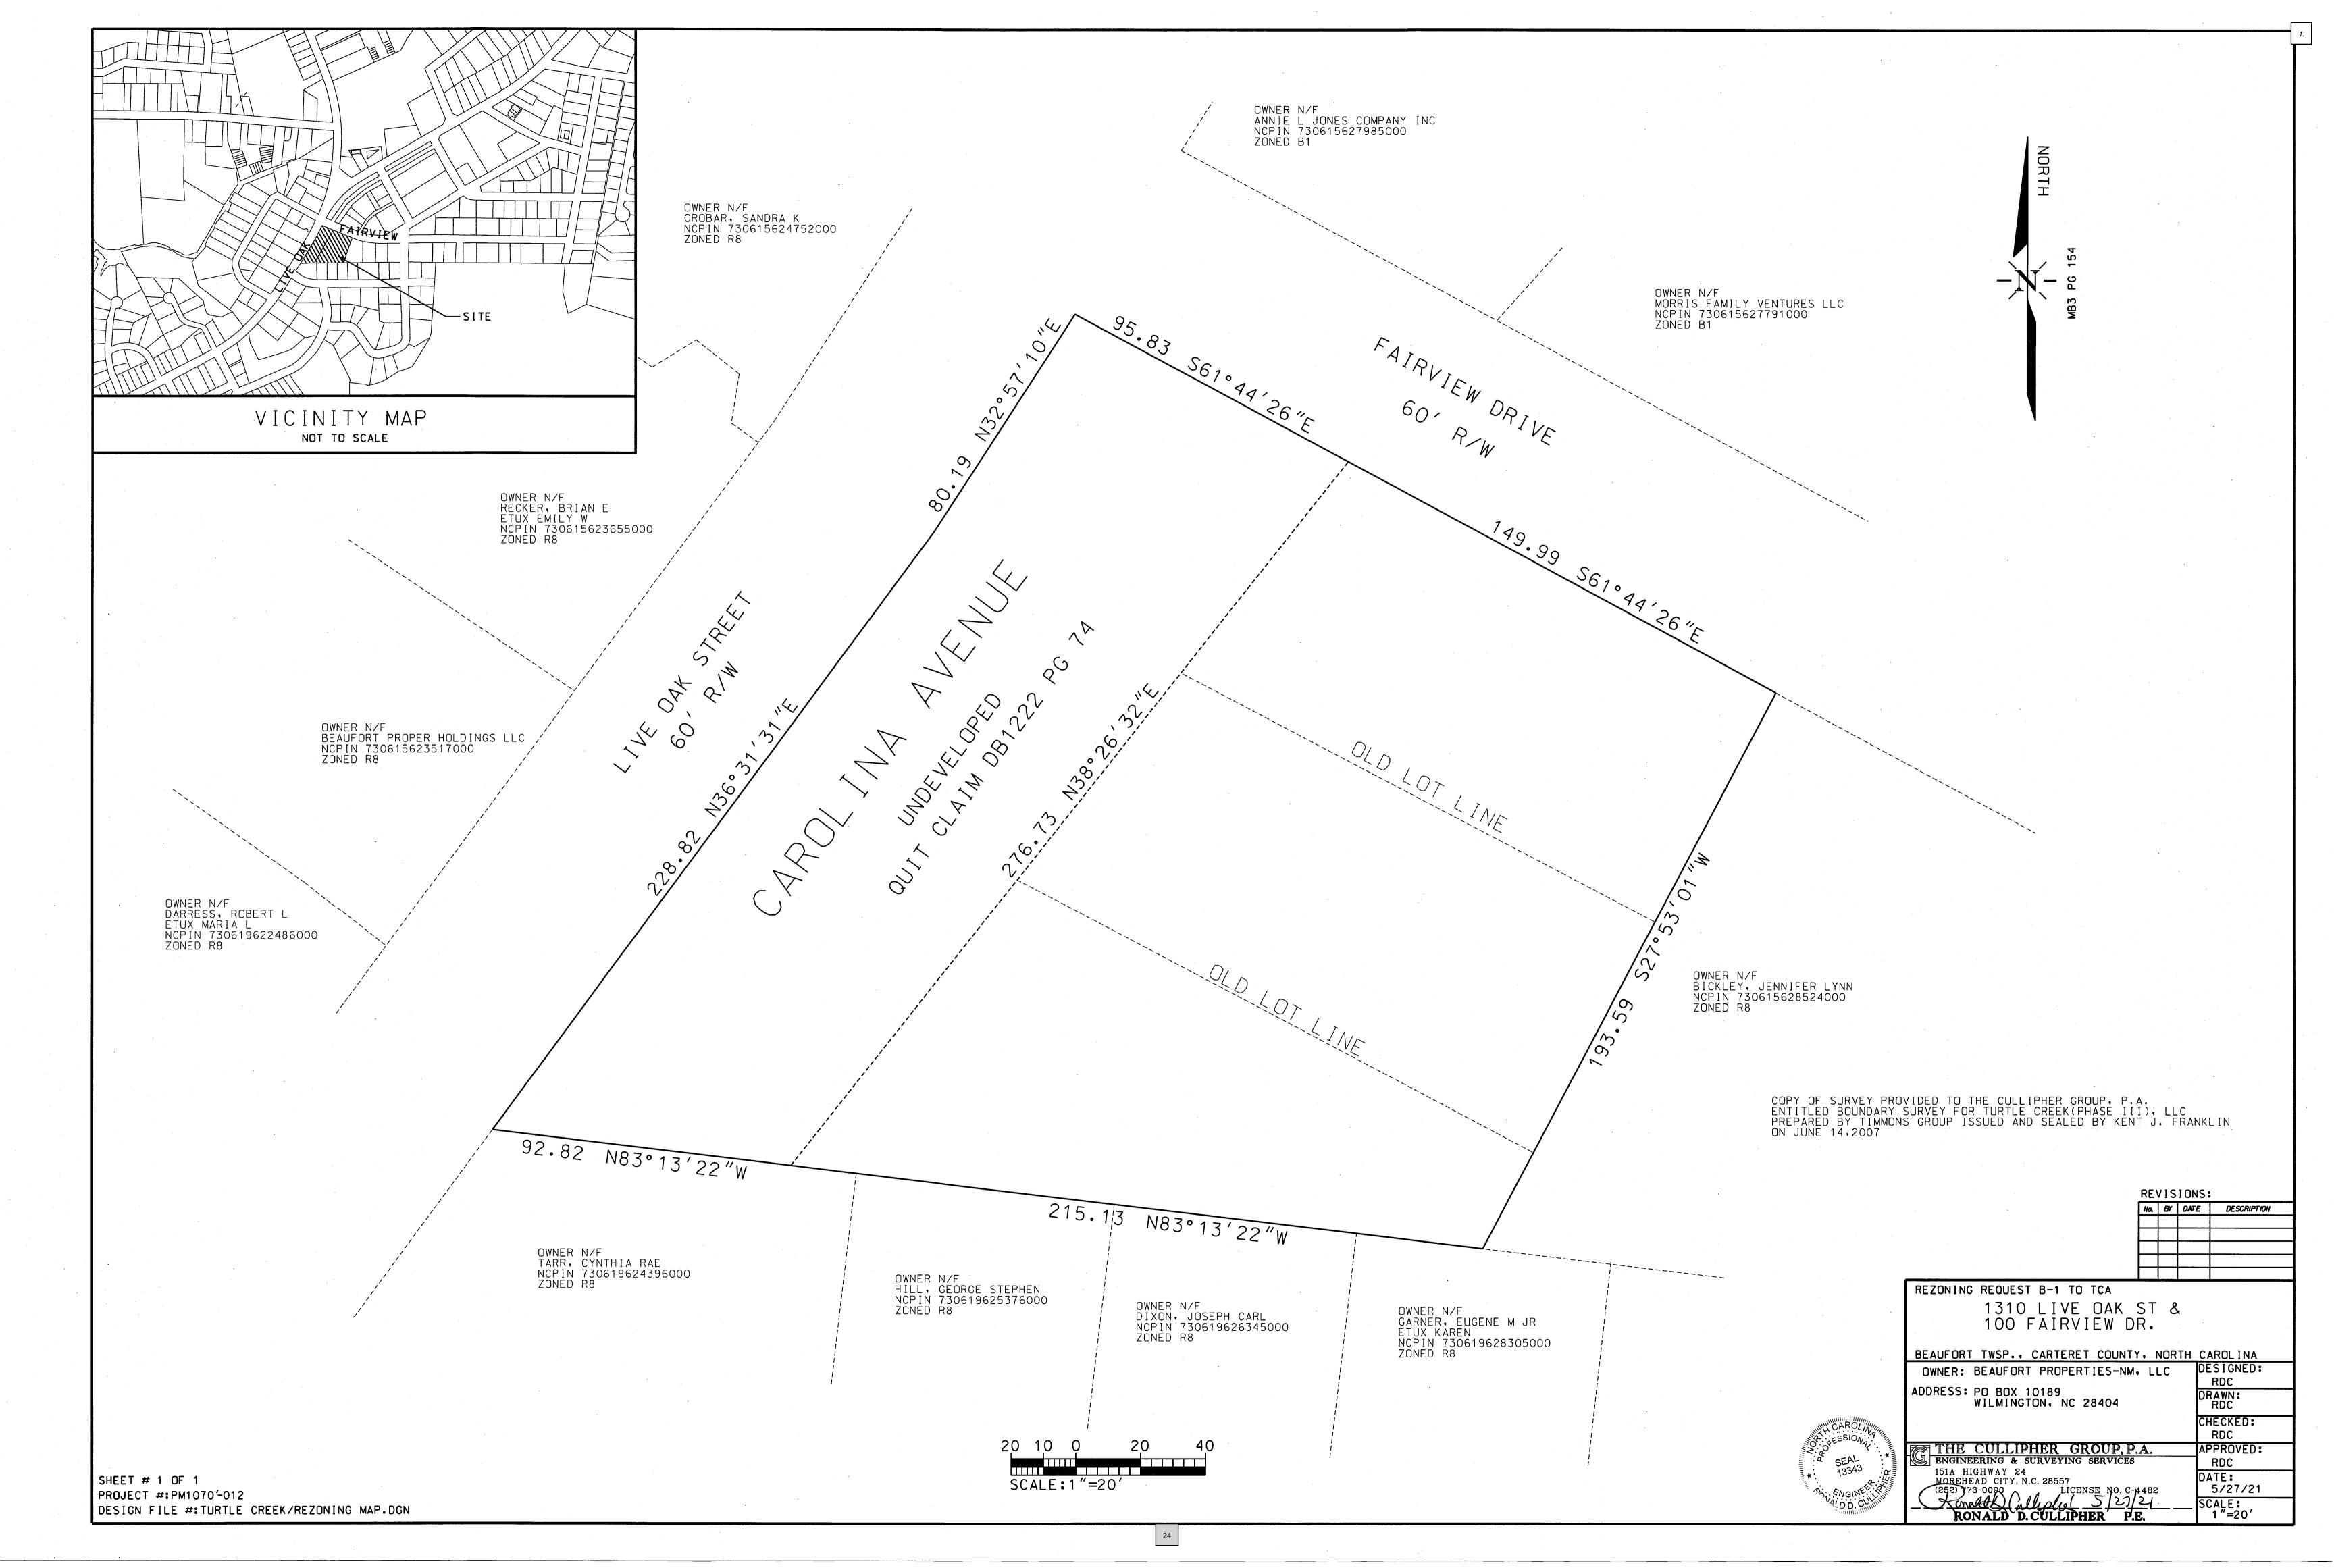



Town of Beaufort, NC

701 Front St. - P.O. Box 390 - Beaufort, N.C. 28516 252-728-2141 - 252-728-3982 fax - www.beaufortnc.org

Town of Beaufort Planning Board Regular Meeting 6:00 PM Monday, June 21, 2021 – Virtual Meeting via Zoom

AGENDA CATEGORY: New Business

SUBJECT: Case #20-17 Special Use Permit for a Gas/Service Station at 1550

Lennoxville Road

BRIEF SUMMARY:

The applicant wishes to apply for a Special Use Permit for a Gas/Service Station for 1550 Lennoxville Road. A description of the operation is included the packet and Staff Report.

REQUESTED ACTION:

Recommendation to Board of Commissioners

EXPECTED LENGTH OF PRESENTATION:

20 Minutes

SUBMITTED BY:

Kyle Garner, AICP

Planning & Inspections Director

BUDGET AMENDMENT REQUIRED:

N/A

PLANNING BOARD STAFF REPORT

To: Planning Board Members

From: Kyle Garner, AICP, Planning Director

Date: June 4, 2021

Case No.: 21-17

THE REQUEST: Special Use Permit for Jim Dandy Community Store

BACKGROUND:

Location: 1550 Lennoxville Road

Owner: Sara Austin
Applicant: Jim Dandy Stores

Requested Action: Provide Recommendation to Board of Commissioners

CAMA Land Use: Medium Density Residential

PIN: 730507699596000

Size: .478 Acres

Existing Land Use: Austin vet. Clinic

Adjoining Land Use & Zoning: North - Single-Family Residences; Zoned R-8 (Briar Patch)

South – Beaufort Walk Subdivision – Zoned TR (Transitional)

West - The Oaks Subdivision - Zoned RC-5

East – Single-Family Residences; Zoned R-8 (Ocean)

SPECIAL INFORMATION: This is an existing building and a vet business already exists. Prior to

the vet office the site was previously used as a convenience store

operation for over 20 years.

<u>Public Utilities:</u> Water Existing Service

Sanitary Sewer Existing Service

ACTION:

1. Provide consistency statement to the Board of Commissioners; and

2. Provide comments, concerns and suggestions to the Board of Commissioners



STAFF COMMENTS:

This application is for a Special Use Permit for Gas/Service Station per the Light Industrial Zoning District. This is an existing building and a vet business already exists. Prior to the vet office the site was previously used as a convenience store operation for over 20 years. Even though the use is not consistent with the future land use plan the use is consistent with the current zoning in place with a Special Use Permit.

Section 6-F - Height & Area Suplements & Exceptions allows the encroachment of the canopy to the property line (Lennoxville Road) See Section 6-F Exhibit.

Section 20-B - Special Use Permits (Special Use Permit Application Procedures) requires a complete application to include a site plan.

SECTION 20 Special Use Permit (*Town of Beaufort Land Development Ordinance*)

E) Required Findings

- 1) In addition to any other findings or requirements as specified by any other section of this Ordinance, before any application for a special use may be granted or denied, the BOC shall make each of the following findings:
 - a) The proposed use is an allowable special use in the zoning district it is being located within;
 - b) The application is complete;
 - c) The location and character of the use will be in conformity with the Town's land use plan and other comprehensive planning elements;
 - d) Streets, driveways, parking lots, traffic control, and any other traffic circulation features shall be designed and provided in accordance with current traffic engineering standards and Town regulations and found to be adequate for the proposed special use;
 - e) The proposed special use will not substantially injure the value of adjoining or abutting properties;
 - f) The proposed special use will be compatible and in harmony with adjoining land uses and the development patterns of the immediate area; and,
 - g) The proposed use will not materially endanger the public health or safety of the community if located where proposed and developed according to the submitted and approved plan.



CAMA Core Land Use Plan

Generally, growth and land development is anticipated to occur in all future land use categories except for the Conservation/Open Space classification. The type and density/intensity of projected development varies within each Future Land Use Map classification. Future Land Use projections are delineated in Figure 8, Future Land Use Map. The Future Land Use Map classifications are considered part of the Land Use Plan's policy.

Future Land Use Map Classifications

- Medium Density Residential Classification. The Medium/High Density Residential classification encompasses approximately 0.8 square miles (483 acres) or about 10 Percent of the total planning jurisdiction. The majority of the properties classified as Medium Density Residential are generally located immediately surrounding the Beaufort downtown area as well as north and east of the downtown area.
- The Medium Density Residential classification is intended to delineate lands where the predominant land use is higher density single-family residential developments and/or two-family developments. The residential density within this classification is generally 3 to 5 dwelling units per acre. Minimum lot sizes vary from 8,000 to 10,000 square feet unless a larger minimum lot area is required by the health department for land uses utilizing septic systems. Land uses within Medium Density Residential designated areas are generally compatible with the R-10, One or Two-family Residential; R-10MH, Single-family Residential and Manufactured Home; R-8, Medium Density Residential; and R-8A Single-family Medium Density Residential zoning districts. Public water is widely available and sewer service is required to support the higher residential densities in this classification. Streets with the capacity to accommodate higher traffic volumes are also necessary to support Medium Density Residential development.
- o The Town's goals and policies support the use of land in Medium Density-classified areas for single-family and two-family dwellings where adequate public utilities and streets are available or can be upgraded to support the higher residential densities encouraged in this classification.

Use of the Future Land Use Plan Map to Guide Development

In preparing the Future Land Use Map, consideration was given to land development objectives and policies, land suitability, and the ability to provide the infrastructure to support growth and development. The Future Land Use Map depicts the general location of projected patterns of future land uses. The Future Land Use Map is a plan or guideline for the future.

The ultimate use and development of a particular parcel of land will be determined by property owners' desires, overall market conditions, implementation tools employed by the Town to regulate land use and development (such as the Town's zoning ordinance, subdivision regulations, flood hazard regulations), the absence of specific natural constraints to development, and the availability of the necessary infrastructure (water, sewer, roads, etc.) to support development. Consequently, even though the Future Land



particular location, many factors come into play to determine if the projected use is appropriate and the land can be developed as projected. Also, formal amendments to the zoning ordinance and subdivision ordinance will be required to specifically authorize the type of mixed use development envisioned in this Land Use Plan.

Achieving the projected patterns of land use indicated by the Future Land Use Map will be greatly impacted by timing. Much of the projected land use indicated on the Future Land Use Map will not come to fruition without market demand. Therefore, market and economic conditions must be conducive for growth and development. While the Land Use Plan attempts to provide a general expectation of growth based upon projected population change, it simply cannot predict the economic future. The demand for houses, businesses, industries, etc. will fluctuate widely with economic conditions.

The timing of the provision of infrastructure improvements, particularly water and sewer services and roads, will also have a tremendous impact on growth and development. Development will occur where infrastructure is available or can be made available to sustain that development. Consequently, achieving the Future Land Use Map land use projections will depend in large part upon if and when infrastructure is provided. The provision of public infrastructure depends upon the capability to provide the service and demand for the service. Economic climate will be a major factor in both the capability to make infrastructure available and the level of service demand (*Core Land Use Plan*, Section IV: Plan for the Future, pg. 100).

Guide for Land Use Decision Making

The Land Use Plan, as adopted by the elected officials of the Town of Beaufort and as may be amended from time to time, will serve as the primary guide upon which to make land use policy decisions. Every land use policy decision, such as a rezoning request or approval of a conditional or special use permit, will be measured for consistency with the goals, policies, and recommendations of the Plan. The elected officials, Planning Board, Board of Adjustment, and Town staff should utilize the Land Use Plan as the basic policy guide in the administration of the zoning ordinance, subdivision regulations, and other land development regulatory tools. Persons involved in the land development business as well as the general public can also utilize the Land Use Plan to guide private decisions regarding land use and land development.


The policy statements and recommendations of the Land Use Plan can also be of assistance to the elected officials in making long-range decisions regarding such matters as the provision of municipal services, thoroughfare planning, storm water planning and management, implementation of economic development strategies, recreational facility planning, and preparation of capital and operating budgets.


It should be noted, however, that the Land Use Plan is one of a variety of guides in making a public policy decision. The Plan should be viewed as a tool to aid in decision making and not as the final decision (*Core Land Use Plan*, Section V: Tools for Managing Development, pg. 102).




Exhibits:

- B- Vicinity Map
- C Zoning Map
- D CAMA Land Use Map
- E Application
- F Site Plan
- G Elevation Drawing
- H List of Property Owners within 200 feet
- I Section 6-F (LDO)

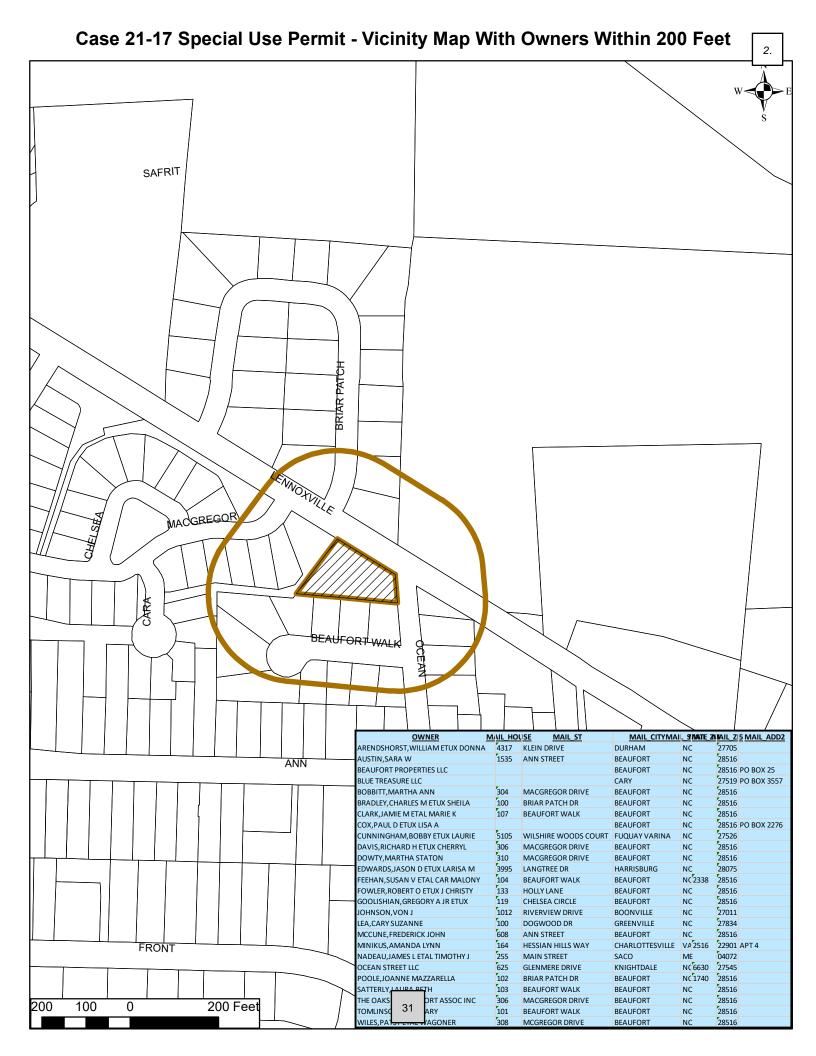

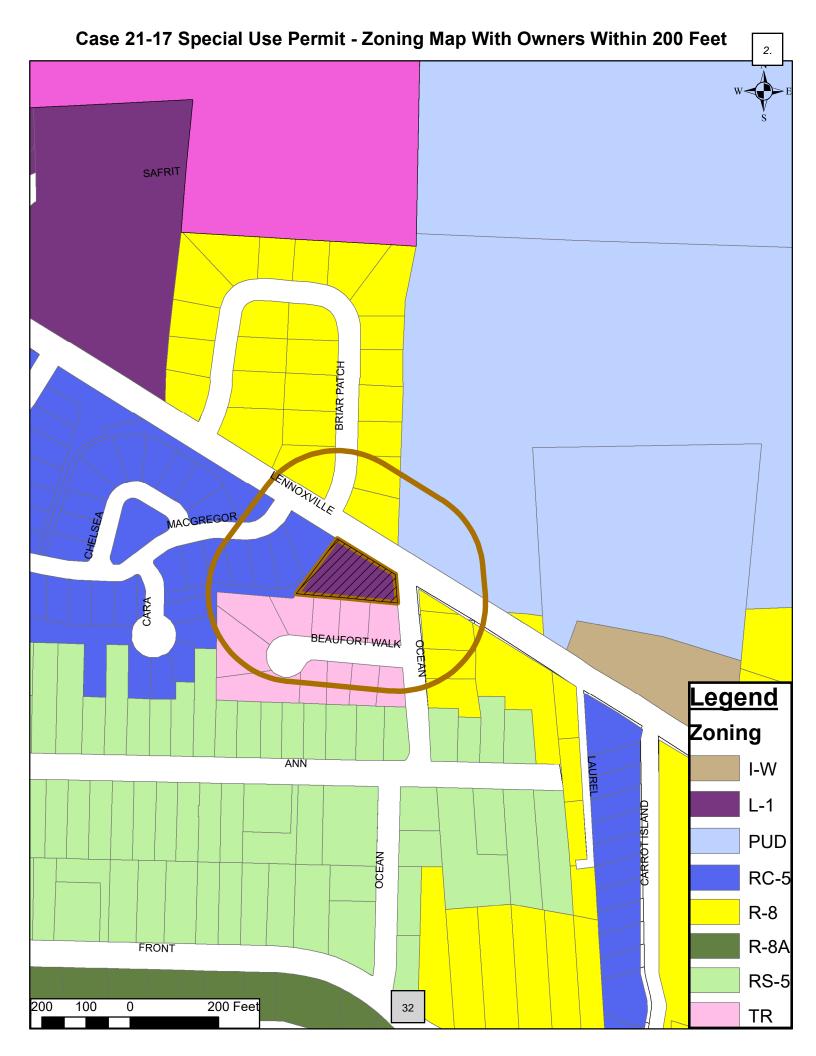

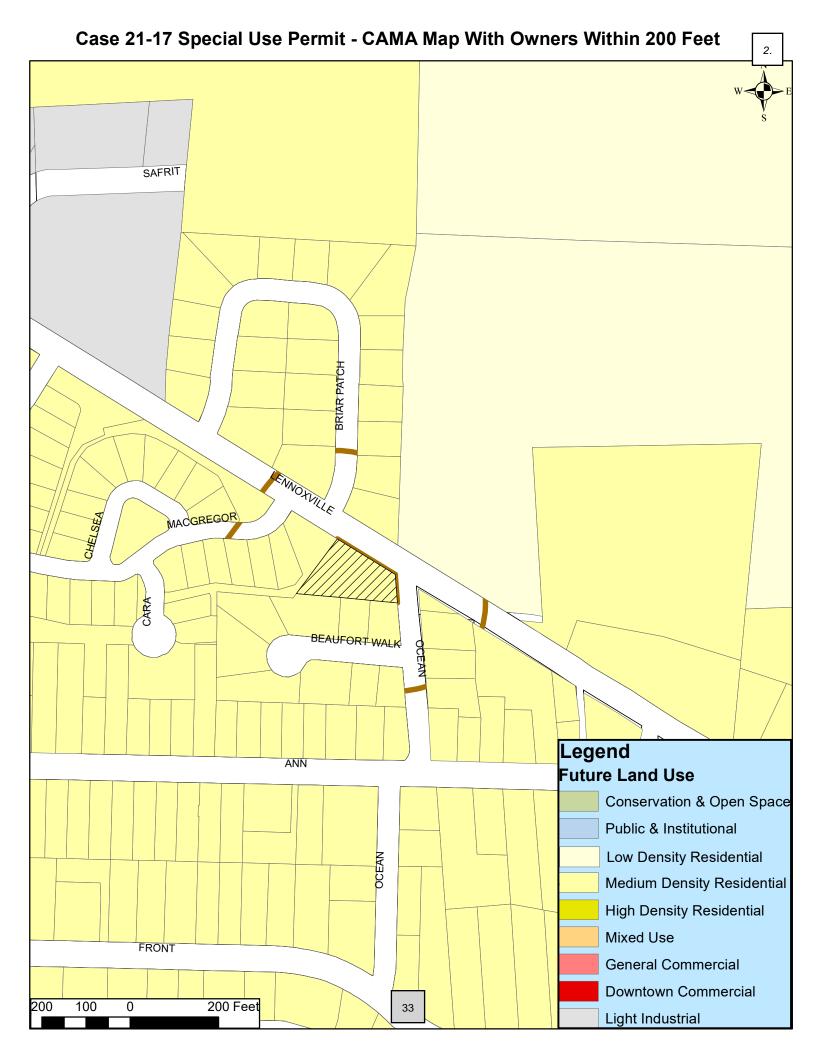



APPLICATION FOR A SPECIAL USE PERMIT

Instructions:

Please complete the form below including all required attachments, a **\$400.00** application **fee,** and return to the Beaufort Town Hall; 701 Front Street; P.O. Box 390; Beaufort, N.C.; 28516. Incomplete applications will not be processed but will be returned to the applicant. Please call Planning and Inspections at (252) 728-2142 if there are any questions.

APPLICANT INFORMATION
Applicant Name: Jim Dandy Stores
Applicant Address: 812 Anendell Street Morehead City NC 2855
Phone Number: 152-247-6962 Email: jmdavisoil @outlook.com
Property Owner Name: Sara W. Austin
Address of Property Owner: 1550 Lennosville Road Beautort NC 288
Phone Number: 252-838-9028 Email:N/A
PROPERTY INFORMATION
Property Address: 1550 Lennorville Road Beautot NC 28516
15-Digit PIN:
Size of Property (in square feet or acres):478 Acascurrent Zoning:
Current Use of Property: Veterinarian Requested Use: Convenience Store
An application fee of \$400.00 , either in cash, money order, or check made payable to the "Town of Beaufort" must accompany this application (a credit card payment can be made in person at Town Hall). The complete application, payment, and supporting materials must be received by Town Staff at least 15 working days prior to a regularly scheduled Planning Board meeting date.
Please refer to the Town's Land Development Ordinance , Sections 20 & 27, and all other pertinent sections of the Ordinance for information required to accompany this application. Any plans or documents submitted should be submitted in an electronic or digital format and one printed color copy of such documents submitted with the application. The town's website address is www.beaufortnc.org .
J.M. Jan 11 5-17-21
pplicant Signature Date of Applicant's Signature 6-1-21
roperty Owner Signature (if different than above) Date of Owner's Signature
DFFICE USE ONLY Revised 8/2020
Pate: Reviewed for Completeness By:

ate Deemed Complete and Accepted: _____

Received by:____

Members of the Beaufort Planning Board,

As part of a planned real estate purchase between Dr. Sara Austin and my family's business, J.M. Davis Industries Inc. dba "Jim Dandy Stores" and "Davis Fuels", I am pleased to apply for a special use permit for 1550 Lennoxville Road. Our intention is to adapt the existing Austin Veterinary Clinic building and parking area into a community store and filling station. This intended use is permissible within the current L-I zoning but requires a special use permit.

Our company was founded in 1939 by my grandfather, with its original location strategically positioned on the Beaufort waterfront where Still Water Café is today. In the years since we have slowly and purposefully grown through mergers and acquisitions remaining ever mindful to never lose focus of our values and our long standing commitment to the communities we support and call home. My mother is from Beaufort and grew up in the Easton House directly across from our old office. Previously a long-time resident of Ann Street, mom recently moved out to Olga Road to be closer to me (also on Olga) and my sister who recently bought in Tiffany Woods.

Since my childhood, Beaufort has undergone many subtle but significant changes. I remember at one point Beaufort had six convenience stores, 3 of which my family owned or operated. Over time, a combination of factors including planned highway improvements, more suitable uses, and unfavorable lease agreements left us without a location in our home town. I have been patiently searching for the right property to mark our return home, and I know I have found it at 1550 Lennoxville Road. The location is ideal for countless reasons but most notably for its proximity to a developed and ever-growing residential area that would undoubtedly benefit from our services. While we still own and operate 8 other locations, this store would be different in most every way to not only our other locations, but also to the traditional convenience store concept you likely are most familiar with. Our vision for this location is not as a typical "convenience store" but instead as a quaint community store with gasoline and diesel fuel as an additional offering. Our greatest commitment will be to create a store front stocked with goods and capable of services that fit our town in every visible and perceivable way.

As you are already aware, the Town of Beaufort is in critical need of an additional location to fuel vehicles with regular gasoline, non-ethanol gasoline, highway diesel, and even diesel exhaust fluid...all of which we intend to provide. Also, amongst our offering will be fresh, made to order biscuits and sandwiches, fried chicken for boaters, premium coffee and beverage offerings, snacks and all the daily essentials. We do not see value in extended hours of operation. We like to open early for our patrons that commute to Cherry Point or perhaps those that might be headed out fishing but we close early at night. Our outside lighting will be controlled by photo - cell sensors and adjusted to provide sufficient and safe lighting with minimal to zero effect on the surrounding properties during those hours they are switched on. In times of emergency such as hurricanes, we will be prepared to support our entire community, its residents, and most importantly our emergency services with all the goods and services detailed above powered by an existing, enclosed super quiet generator.

Additional improvements we intend to make include, but are not limited to, replacement of the old fence along the back property line, refreshed landscaping with native plants and trees, and a canopy to shelter our customers while they fuel their vehicles. Our focus will be to create and maintain a concept that fits seamlessly into the existing neighborhood while also providing daily and potentially critical needs to the town and its residents.

We welcome any questions, comments, or concerns that may arise during the review process. Thank you kindly for your consideration of this request,

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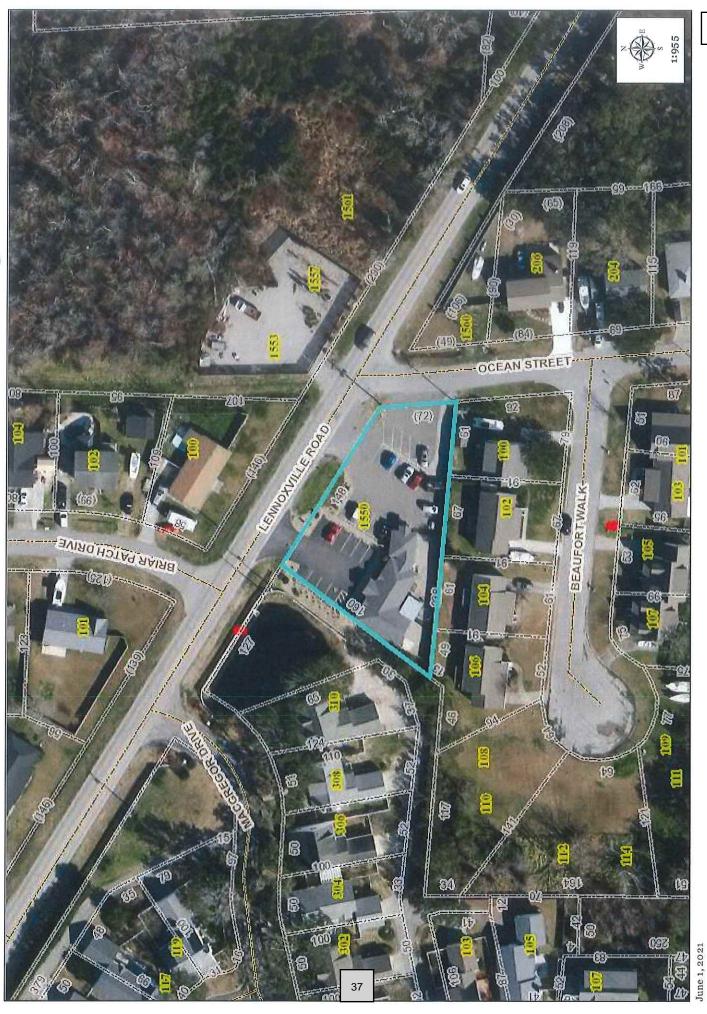
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arteret County, N.C.

C



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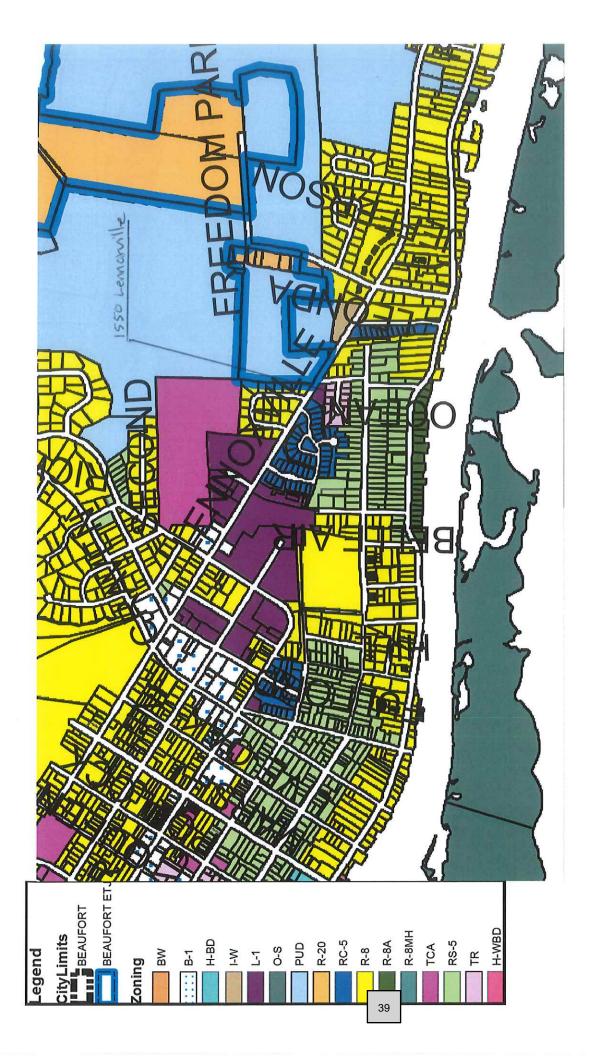
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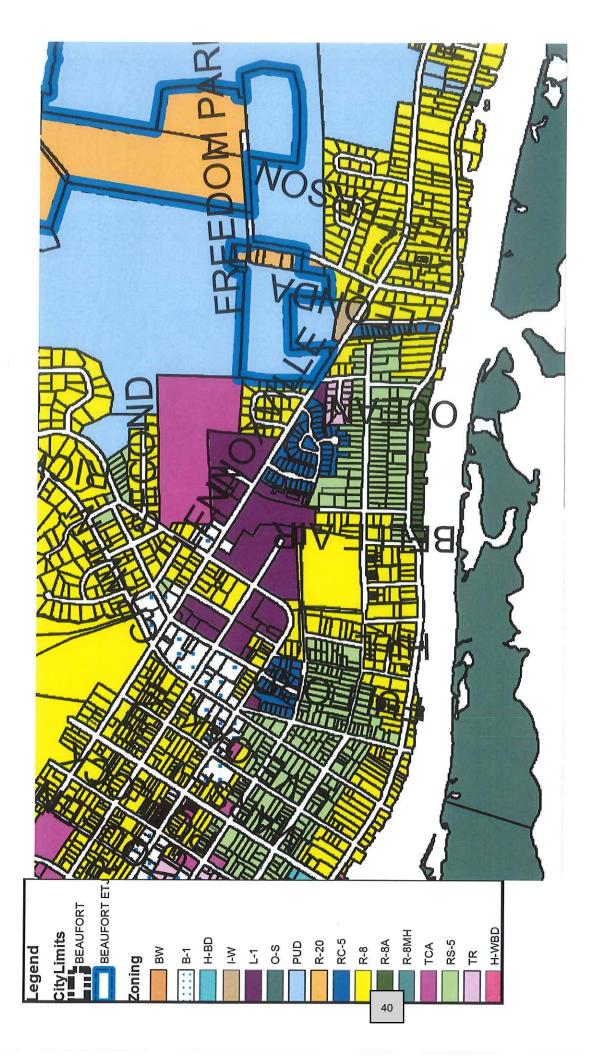
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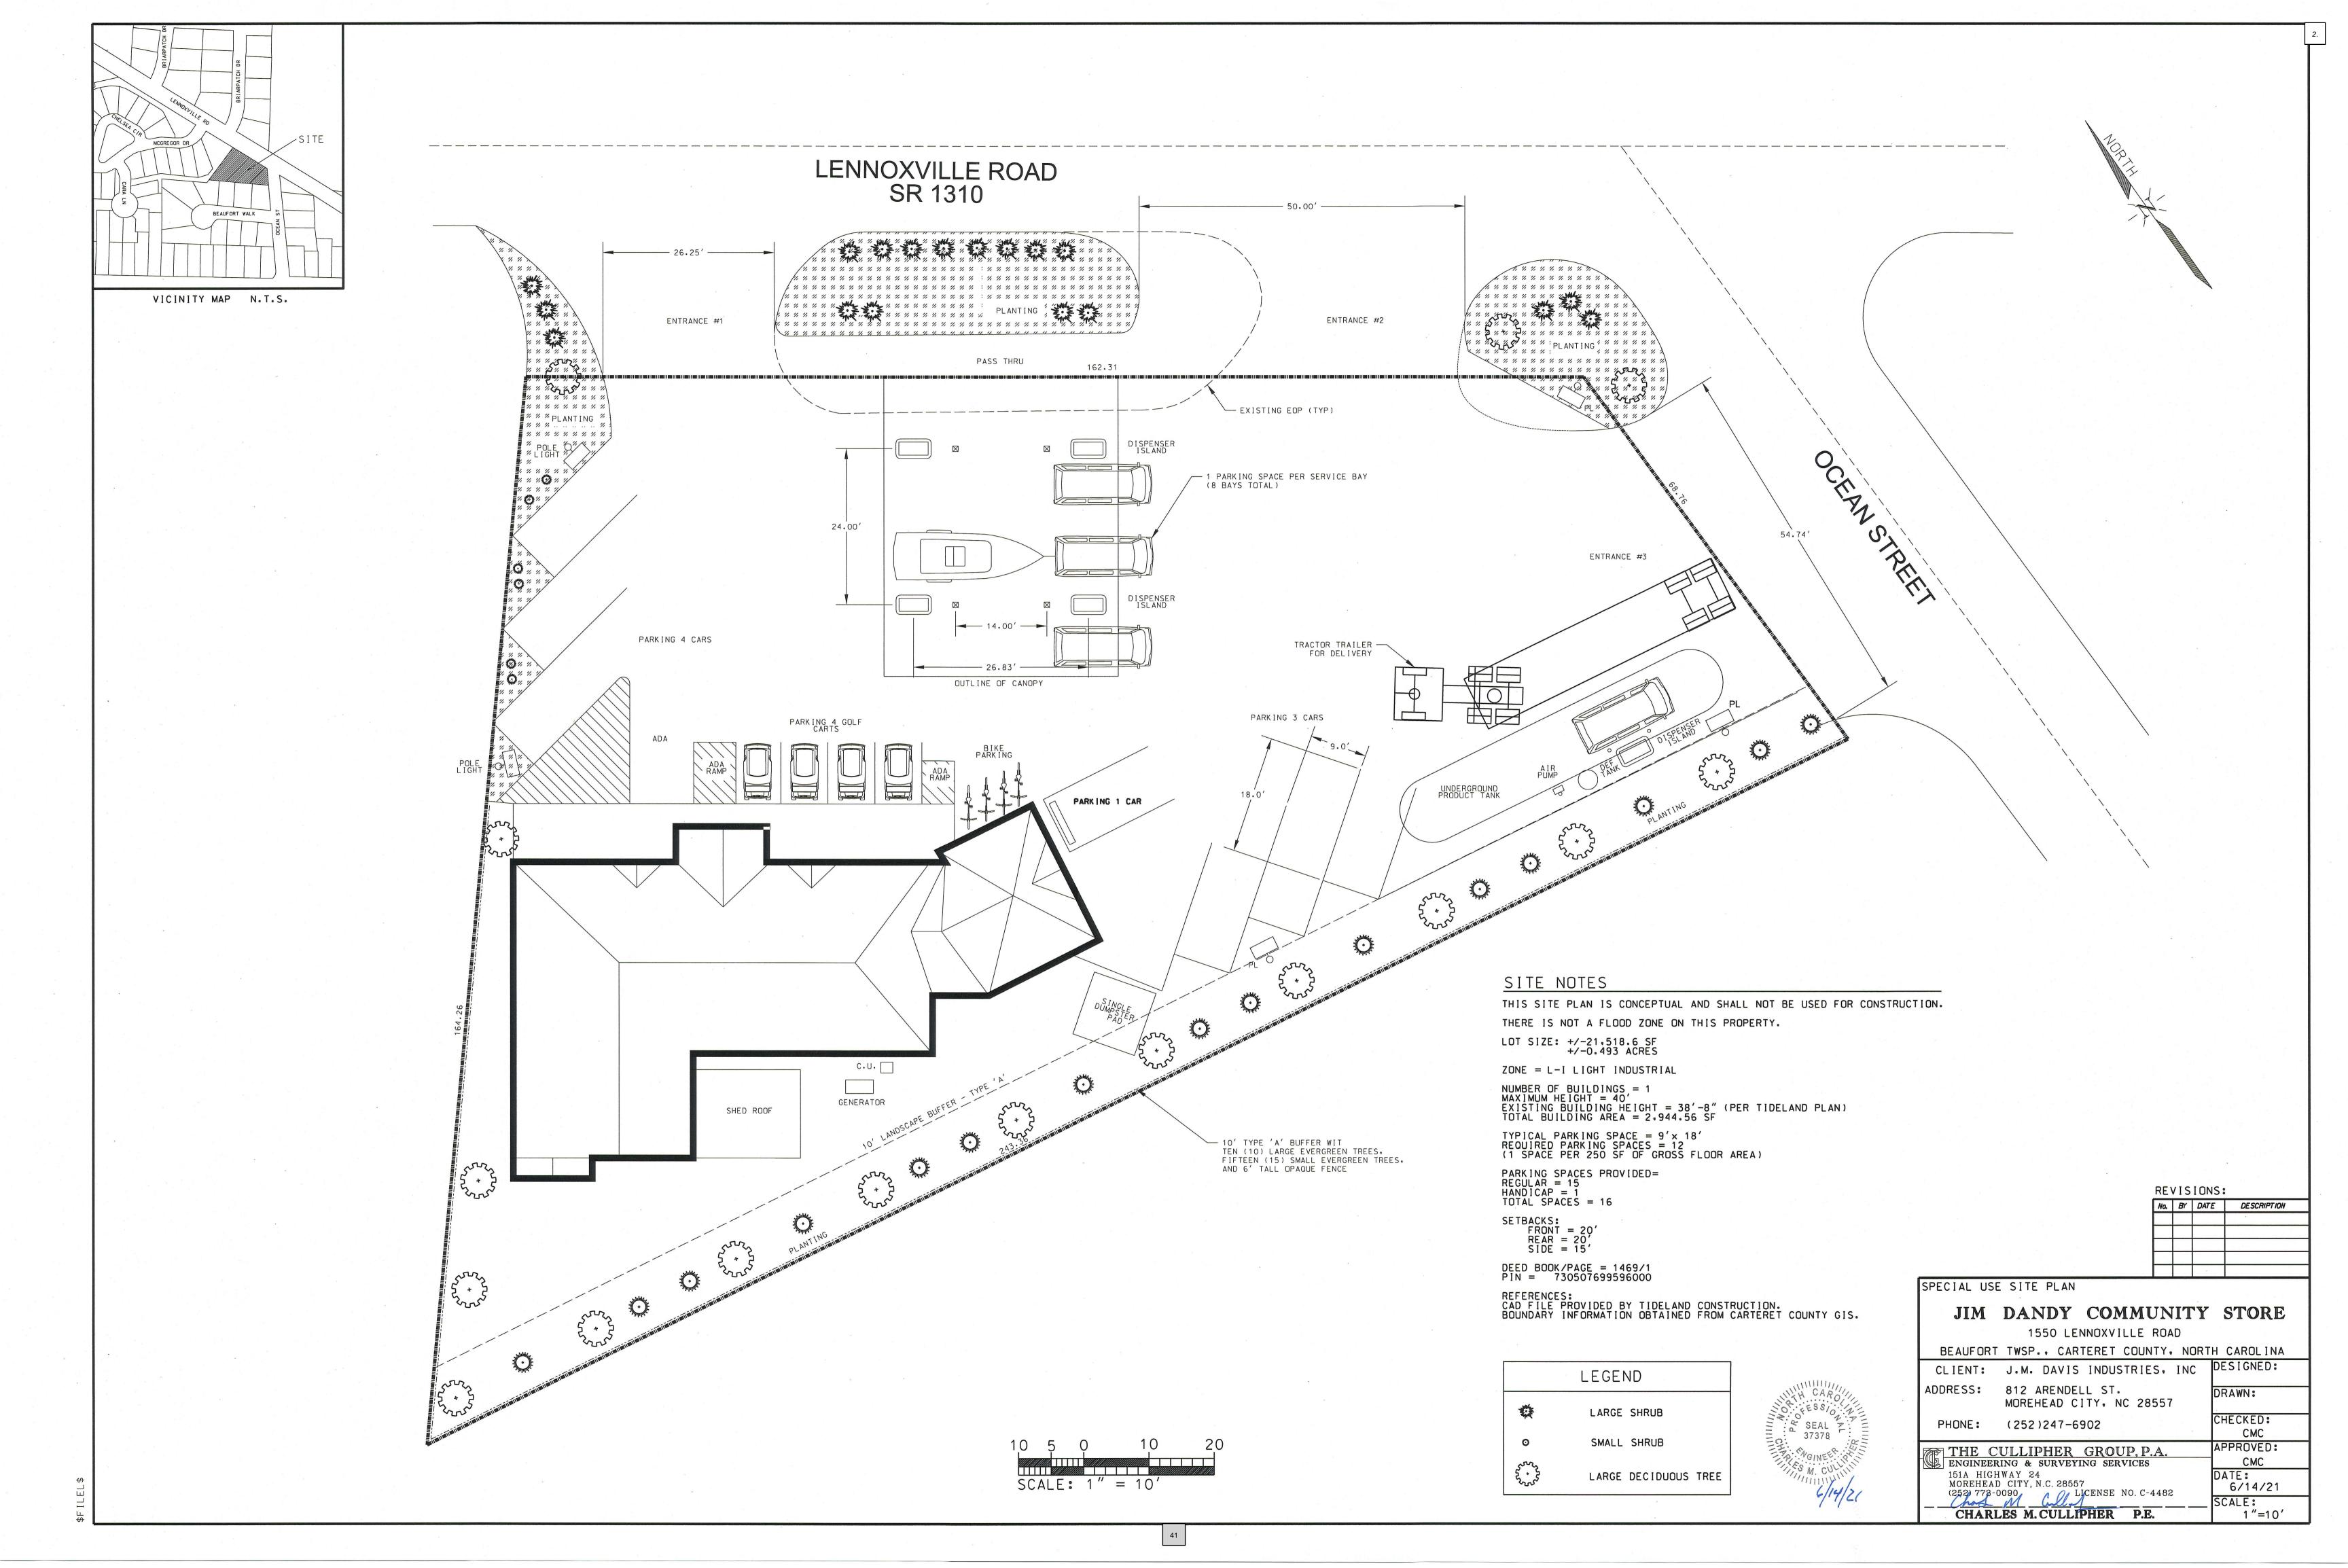


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2.







EXISTING FRONT ELEVATION OF AUSTIN VETERINARY SCALE: 1/4" = 1'-0"

M JBC

AS NOTED

A NEW PROPOSED SITE PLAN FOR:


JIM DANDY #4

AUSTIN VETERINARY 1550 LENNOXVILLE ROAD BEAUFORT, NORTH CAROLINA



42

WILL CLARK (P): 252-814-7979 (E): wclark@tidelandco.com

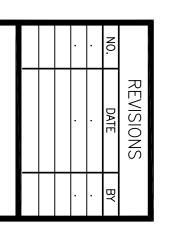

<u>OWNER</u>	AIL_HO	<u>MAIL_ST</u>	MAIL_CITY	L_S'VAIL_Z	MAIL_ZI MAIL_ADD2
ARENDSHORST, WILLIAM ETUX DONNA	4317	KLEIN DRIVE	DURHAM	NC	27705
AUSTIN,SARA W	1535	ANN STREET	BEAUFORT	NC	28516
BEAUFORT PROPERTIES LLC			BEAUFORT	NC	28516 PO BOX 25
BLUE TREASURE LLC			CARY	NC	27519 PO BOX 3557
BOBBITT,MARTHA ANN	304	MACGREGOR DRIVE	BEAUFORT	NC	28516
BRADLEY,CHARLES M ETUX SHEILA	100	BRIAR PATCH DR	BEAUFORT	NC	28516
CLARK, JAMIE M ETAL MARIE K	107	BEAUFORT WALK	BEAUFORT	NC	28516
COX,PAUL D ETUX LISA A			BEAUFORT	NC	28516 PO BOX 2276
CUNNINGHAM, BOBBY ETUX LAURIE	5105	WILSHIRE WOODS COURT	FUQUAY VARINA	NC	27526
DAVIS, RICHARD H ETUX CHERRYL	306	MACGREGOR DRIVE	BEAUFORT	NC	28516
DOWTY,MARTHA STATON	310	MACGREGOR DRIVE	BEAUFORT	NC	28516
EDWARDS,JASON D ETUX LARISA M	3995	LANGTREE DR	HARRISBURG	NC	28075
FEEHAN,SUSAN V ETAL CAR MALONY	104	BEAUFORT WALK	BEAUFORT	NC 2338	28516
FOWLER, ROBERT O ETUX J CHRISTY	133	HOLLY LANE	BEAUFORT	NC	28516
GOOLISHIAN, GREGORY A JR ETUX	119	CHELSEA CIRCLE	BEAUFORT	NC	28516
JOHNSON,VON J	1012	RIVERVIEW DRIVE	BOONVILLE	NC	27011
LEA,CARY SUZANNE	100	DOGWOOD DR	GREENVILLE	NC	27834
MCCUNE, FREDERICK JOHN	608	ANN STREET	BEAUFORT	NC	28516
MINIKUS,AMANDA LYNN	164	HESSIAN HILLS WAY	CHARLOTTESVILLE	VA 2516	22901 APT 4
NADEAU, JAMES L ETAL TIMOTHY J	255	MAIN STREET	SACO	ME	04072
OCEAN STREET LLC	625	GLENMERE DRIVE	KNIGHTDALE	NC 6630	27545
POOLE, JOANNE MAZZARELLA	102	BRIAR PATCH DR	BEAUFORT	NC 1740	28516
SATTERLY,LAURA BETH	103	BEAUFORT WALK	BEAUFORT	NC	28516
THE OAKS AT BEAUFORT ASSOC INC	306	MACGREGOR DRIVE	BEAUFORT	NC	28516
TOMLINSON,RITA MARY	101	BEAUFORT WALK	BEAUFORT	NC	28516
WILES,PATSY ETAL WAGONER	308	MCGREGOR DRIVE	BEAUFORT	NC	28516

SECTION 6 Height and Area Exceptions and Supplements

The following requirements or regulations qualify or supplement, as the case may be, the zone regulations or requirements appearing elsewhere in this Ordinance.

A) Allowed Projections into Required Yards.

Certain architectural features, fences, walls, and hedges may project into required yards as follows as long as the corner lot visibility provisions as specified in subsection D of this section shall be observed;

- 1) Cornices, eaves, and sills not more than two feet (2') into any required yard;
- 2) Balconies, bay windows, and chimneys not more than three feet (3') into any required yard;
- 3) Planted buffer strips, hedges, fences, or walls, not exceeding four feet (4') in height, shall be exempt from the front yard and front building setback line requirements of this Ordinance;
- 4) Planted buffer strips, hedges, fences, or walls, not exceeding six feet (6') in height, erected in side and rear yards shall be exempt from the yard and building setback requirements of this Ordinance; and,
- 5) Open or enclosed fire escapes, outside stairways, balconies, and other necessary unenclosed projections, protruding into a minimum yard not more than thirty-two inches (32") may be permitted where such projections are so placed as not to obstruct the light and ventilation.
- 6) Paved driveways and walkways at grade as long as all impervious surface limits are met.
- 7) Trees, shrubs, and vegetation.
- 8) Every part of a required yard shall be open from its lowest point to the sky unobstructed except as permitted in sections A-1 through A-7 of this subsection.
- 9) When adjacent lots of record are under single control by a lease agreement or a combination of ownership and lease agreement, temporary structures such as manufactured homes, manufactured offices, utility buildings, accessory buildings, etc., may extend across any common lot line(s) of the adjacent lots of record under such lease agreement. The location of such structures shall not conflict with any off-street parking requirements, on-site traffic circulation, or other applicable regulatory codes. Upon the expiration of the lease agreement, such structure must be removed to conform to the standard side or rear yard setbacks of the district within sixty days of expiration of the lease agreement.

B) Vacant Lot Exceptions.

If a vacant lot is adjacent to an existing lot containing an existing dwelling on the lot, and such dwelling is situated less than the required front building setback line, the required minimum front building setback line for the vacant lot shall be a line projected along the front wall of the main building to the adjacent lot and across the vacant lot. In cases where existing dwellings are situated on both sides of the vacant lot and each exists less than the

required minimum front building setback line, the required minimum front building setback line for the vacant lot shall not be less than the average of the two front building setbacks of the existing dwellings.

C) Board Action.

In the case of a housing project consisting of a group of two or more buildings to be constructed on a plot of ground of at least two acres and not subdivided into the customary streets and lots, and where the existing or contemplated street and layout makes it impractical to apply the requirements of this Ordinance to the individual buildings in such housing project(s), the application of such requirements for such housing project(s) may be adjusted by the Board of Adjustment (BOA) in a manner which will be in harmony with the characteristics of the neighborhood, will substantially insure the same kind of occupancy, when the density of land use will be no higher than allowed by this Ordinance, and a standard of open space will be at least as high as required by this Ordinance in the district in which such proposed project is to be located. In no case shall the BOA authorize a use, a building height, or a building area prohibited in the district where the housing project is to be located, provided; however, the BOA shall not exercise the authority permitted by this subsection unless or until the Board of Commissioners (BOC) has approved such housing project(s) after receiving a recommendation from the planning board.

D) Height Restrictions.

- 1) Height restrictions will be determined by the specific zoning district whether inside the Town corporate limits or within the ETJ area.
- 2) Fixtures and architectural features which are not capable of occupation, such as chimneys, cupolas, domes, elevator shafts, heating and air conditioning equipment, solar collectors, and similar equipment, fixtures and devices and antennae, and which extend no more than ten feet (10') above the highest point on the structure, shall be allowed if the base of such architectural feature or fixture has a square footage which is ten percent (10%) or less than the square footage of the highest habitable floor on the structure.
- 3) Any nonconforming residential structure in a specific zoning district which exceeds the height limitation for its specific zoning district and is damaged or destroyed by fire, flood, wind, or act of God, may be rebuilt to the dimension of such building or structure as it existed prior to the damage or destruction and according to the North Carolina State Building Codes.
- 4) Any building or structure in existence on the effective date of this Ordinance may be raised the minimum amount necessary to bring the structure into compliance with the prescriptive minimum flood elevation as determined by the National Flood Insurance program regulations, notwithstanding raising such building or structure will increase its overall height above the building height limitations established herein.

E) Exemptions.

In addition to those fixtures and architectural features allowed to extend above the maximum height limits provide in subsection D-2 of this section, the following are also exempted from the building height limit established in this Ordinance:

- 1) School gymnasiums,
- 2) The Carteret County Courthouse,
- 3) Public utility poles and towers (except towers may be subject to other limits or procedures in this Ordinance),
- 4) Municipal and public water towers,
- 5) Permitted communication towers,
- 6) Bell towers, steeples, and spires on structures used for religious purposes, elevator shafts, chimneys, and similar structural appendages not intended for occupancy or storage;
- 7) Flagpoles.

F) Canopies.

A canopy in a conforming nonresidential land use which is totally or partially supported by a structural pillar (upright support), such as but not limited to a canopy over gasoline pumps, may extend to the street right-of-way line or property line of a nonresidential use or nonresidential zone, provided such pillar is located at least ten feet (10') from a property line and the canopy is open on all four sides. Any side of a canopy may be enclosed provided the enclosed side meets the required building setback lines established herein.



Town of Beaufort, NC

701 Front St. - P.O. Box 390 - Beaufort, N.C. 28516 252-728-2141 - 252-728-3982 fax - www.beaufortnc.org

Town of Beaufort Planning Board Regular Meeting 6:00 PM Monday, June 21, 2021 – Virtual Meeting via Zoom

AGENDA CATEGORY: New Business

SUBJECT: Site Plan – Front Street Village – Transportation Center

BRIEF SUMMARY:

The applicant wishes to construct a 16,500 square foot Transportation Center as approved as part of the original PUD approval in 2008. Elevation Drawings for the center were approved in 2014 and are included as attachments in this proposal. As part of the Town's new sewer allocation policy the applicant is requesting 100 gallons of allocation for this project that has already been taken into consideration by the Towns Engineer. In addition to Planning Staff, the Town Engineer and Fire Chief have reviewed the plans for compliance. The applicants Engineer will also be available to answer questions regarding the proposed transportation center.

REQUESTED ACTION:

Recommendation to Board of Commissioners

EXPECTED LENGTH OF PRESENTATION:

10 Minutes

SUBMITTED BY:

Kyle Garner, AICP

Planning & Inspections Director

BUDGET AMENDMENT REQUIRED:

N/A

STAFF REPORT



To: Planning Board Members

From: Kyle Garner, AICP, Town Planner

Date: June 15, 2021

Project 2361 Lennoxville Road– Site Plan – Front Street Village – Transportation Center

THE QUESTION: To recommend approval or denial to the Board of Commissioners for the Site

Plan for the "Transportation Center" for Front Street Village.

BACKGROUND: This site currently is used as a gravel parking facility for the Beaufort Hotel & Bistro as well as the Dry Stack Facilities

Location: 2361 Lennoxville Road Owners: Front Street Village, LLC

Requested Action: To recommend approval or denial to the Board of Commissioners

Existing Zoning PUD (Planned Unit Development)
Pin #: 731505185229000, 731505187504000

Size: 5.76 acres (250,906 sq. ft.)

Building Square Footage: 16,500 Square Feet Existing Land Use: Gravel parking facility

PUBLIC UTILITIES & WORKS:

Water: Town of Beaufort Sanitary Sewer: Town of Beaufort

OPTIONS:

- 1. Recommend approval of the Site Plan
- 2. Recommend denial of the Site Plan based on specific failures to meet requirements of the LDO.

ATTACHMENTS:

- A. Vicinity Map
- B. Site Plan Transportation Center
- C. Elevation Drawings
- D. 2014 Approval Letter for Elevation Drawings

2361 Lennoxville Road – Site Plan Front Street Village – Transportation Center

Staff Comments:

The applicant wishes to construct a 16,500 square foot Transportation Center as approved as part of the original PUD approval in 2008. Elevation Drawings for the center were approved in 2014 and are included as attachments in this proposal. As part of the Town's new sewer allocation policy the applicant is requesting 100 gallons of allocation for this project that has already been taken into consideration by the Towns Engineer. In addition to Planning Staff, the Town Engineer and Fire Chief have reviewed the plans for compliance.

Conclusion

This project meets the design criteria required in the LDO as the street system and storm water system will be private and the responsibility of the Owners Association.

FRONT STREET VILLAGE TRANSPORTATION CENTER-SITE PLAN-PHASE II AND PRELIMINARY PLAT PHASE IV

BEAUFORT, NORTH CAROLINA

CARTERET COUNTY

DRAWINGS COVER SHEET NOTES AND ABBREVIATIONS PHASE IV PRELIMINARY PLAN & PHASE II-SITE PLAN -TRANSPORTATION CENTER GRADING PLAN C5 OF 18 UTILITY PLAN C6 OF 18 EAST GREAT EGRET WAY SEWER A PLAN & PROFILE - STA 0+00 TO 5+48 C7 OF 18 EAST GREAT EGRET WAY SEWER A PLAN & PROFILE - STA 5+48 TO 10+11 C8 OF 18 SEWER B PLAN AND PROFILE C9 OF 18 RUNWAY ROAD PLAN AND PROFILE STATIONS 0+00 TO 4+65 C10 OF 18 RUNWAY ROAD PLAN AND PROFILE STATIONS 4+65 TO 10+00 C12 OF 18 LANDSCAPING PLAN C13 OF 18 DIMENSIONS PLAN C14 OF 18 EROSION AND SEDIMENT CONTROL PLAN C15 OF 18 **EROSION AND SEDIMENT CONTROL DETAILS** C16 OF 18 DETAILS SHEET 1 OF 2 C17 OF 18 DETAILS SHEET 2 OF 2 C18 OF 18

PROJECT DATA

NAME OF PROJECT:
FRONT STREET VILLAGE
TRANSPORTATION CENTER-SITE PLAN-PHASE II
AND PRELIMINARY PLAT PHASE IV
BEAUFORT. NORTH CAROLINA

PREPARED BY:
ARENDELL ENGINEERS
1004 ARENDELL STREET
MOREHEAD CITY, NC 28557
PHONE: (252) 622-4338
EMAIL: BILL@ARENDELLENGINEERS.COM


FRONT STREET VILLAGE, LLC 2400 LENNOXVILLE ROAD BEAUFORT, NC 28570

SURVEYOR:
JAMES I. PHILLIPS LAND SURVEYING
PO BOX 2103
379 ARRINGTON RD,
BEAUFORT, NC 28516
PHONE: (252) 728-5848
EMAIL: JIP3@COSTALNET.COM

DATUMS:

VERTICAL: NAVD88

HORIZONTAL: NC STATE PLANE COORDINATE SYSTEM

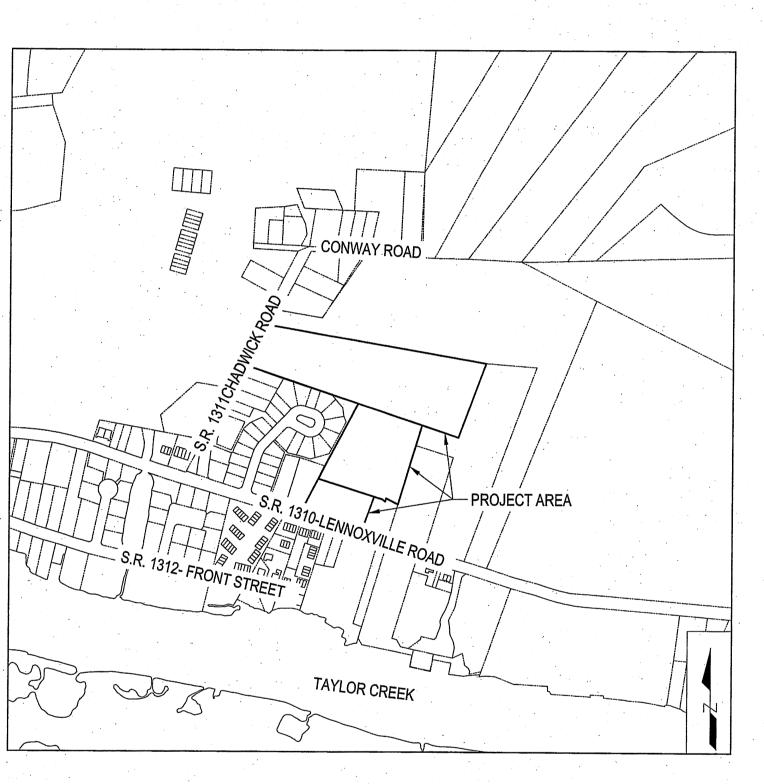

VICINITY MAP

SCALE: 1" = 5000'

TOWN OF BEAUFORT SITE DATA BLOCK OF FEATURES

PROPOSED USE:	34 SINGLE FAMILY HOMES AND TRANSPORTATION CENTER
SQUARE FOOTAGE PROPOSED:	34 SINGLE FAMILY HOMES WITH APPROXIMATELY 2,000 SF FOOTPRINT TRANSPORTATION CENTER WITH APPROXIMATELY 16,500 SF FOOTPRIN
SITE ZONING:	PUD, TRANSPORTATION CENTER B-1, RESIDENTIAL LOTS R-8
TOTAL LOT ACREAGE:	16.20 ACRES NORTH OF LENNOXVILLE ROAD
ACREAGE TO BE DISTURBED:	11.55 ACRES NORTH OF LENNOXVILLE ROAD

DEVELOPMENT PARKING REQUIRED:

ED: SEE PARKING SUMMARY TABLE 1259:443, 1645:118, 1510:484

DEED BOOK:PAGE NUMBER
PARCEL ID NUMBER:

731505187915000, 731505284836000, 731505187504000, 731505185229000

STREET LENGTHS EAST GREAT EGRET WAY RUNWAY ROAD

FLOOD ZONE:

1,255 LF 1,000 LF

ZONE X

	KING SUMMARY TABLE -		**
	Total Gross Parking	g Spaces	
PHASE I			
Location	Units	Requirement	Total Spaces
South Drystack	213 Slips	1 Space per 4 Slips	53
Chandlery	NOTES IN THE TOTAL PROPERTY STOCK AND THE WARREST CONTROL OF THE STOCK AND AN ACCOUNT OF THE STOCK AND AN ACCOUNT OF THE STOCK AND ACCOUNT OF THE	2	777777777777777777777777777777777777777
Upsta	CONTROL DE LA CO	22.5 Spaces per 1,000 SF	51
Downsta		3.5 Spaces per 1,000 SF	8
Offic	ce 2 Employees	2 Spaces	2
		Total	114
PHASE IIC & IID			
Location	Units	Requirement	Total Spaces
Guest Wing			
Room	ns 129	1 Space per Room +5	134
Employee	es 9 per Day Shift	1 per Employee	9
Bistro		The second secon	
Ballroo	m 4,477 Square Feet	22.5 Spaces per 1,000 SF	101
1st Floor Porch Terrad		1 Space per 4 Seats	24
2nd Floor Porch/Terrac		The first area of the second s	A CONTRACTOR OF THE PROPERTY O
4 Bridal Suite	4 Suites	1 Space per Room	4
Bistro & B		1 Space per 4 Seats	24
Board Roo	er er en before en	22.5 Spaces per 1,000 SF	r reservation de la company de
Residential Units	7 Units	1.5 Spaces per Unit	
Employees incl. Transportation	ere and for the commence of th	The second secon	The state of the s
Center (Phase I & II, Minus Inn)		1 per Empleyes	00
Jones (Fridos Facili, militas fini)	20 Limployees	1 per Employee	20
PHASE IIIA		Total	334
Location	Units	Demina	
North Drystack	237 Slips	Requirement	Total Spaces
THE PROPERTY OF THE PROPERTY O	THE DESCRIPTION OF THE PROPERTY OF THE PROPERT	1 Space per 4 Slips	59
PHASE IV			
Location	Units		
34 Residential Lots		Requirement	Total Spaces
54 Residential Lots	34 Units	2 spaces per Unit	68
	TO THE OWN THE A SECTION OF A S	Phases I, II, III, & IV Total	575
TO THIS STATE AND A STATE OF THE STATE OF TH	THE STATE OF THE S	A MANAGEMENT PLANS AND	
	Reductions		
PHASE 1			
Location	Parking Spaces Allocated	Reduction	Total Reduction
South Drystack	53	0.9 per Space	
KARANDAN PARANDAN PARA	53 	0.9 per Space	48
Chandlery		The second secon	48
Chandlery Upstair	S 51	0.4 per Space	48 20
Chandlery	15 51	0.4 per Space 0.4 per Space	48
Chandlery Upstair Downstair	S 51	0.4 per Space	48 20
Chandlery Upstair Downstair	51 8	0.4 per Space 0.4 per Space Total	48 20 3 71
Chandlery Upstair Downstair PHASE 2 Location	s 51 s 8	0.4 per Space 0.4 per Space Total	20 3 71 Total Reduction
Chandlery Upstair Downstair PHASE 2 Location	51 8	0.4 per Space 0.4 per Space Total 0 0.35 per Space	20 3 71 Total Reduction 56
Chandlery Upstair Downstair PHASE 2 Location Bistro	s 51 s 8	0.4 per Space 0.4 per Space Total	20 3 71 Total Reduction
Chandlery Upstair Downstair PHASE 2 Location Bistro PHASE IIIA	Parking Spaces Allocated 160	0.4 per Space 0.4 per Space Total 0 0.35 per Space Total	20 3 71 Total Reduction 56 56
Upstair Downstair PHASE 2 Location Bistro PHASE IIIA Location	Parking Spaces Allocated 160 Parking Spaces Allocated	0.4 per Space 0.4 per Space Total 0 0.35 per Space Total Reduction	20 3 71 Total Reduction 56 56 Total Spaces
Chandlery Upstair Downstair PHASE 2 Location Bistro PHASE IIIA	Parking Spaces Allocated 160 Parking Spaces Allocated 59	0.4 per Space 0.4 per Space Total 0 0.35 per Space Total Reduction 0.9 per Space	20 3 71 Total Reduction 56 56 Total Spaces 53
Upstair Downstair PHASE 2 Location Bistro PHASE IIIA Location	Parking Spaces Allocated 160 Parking Spaces Allocated 59	0.4 per Space 0.4 per Space Total 0 0.35 per Space Total Reduction	20 3 71 Total Reduction 56 56 Total Spaces
Upstair Downstair PHASE 2 Location Bistro PHASE IIIA Location North Drystack	Parking Spaces Allocated 160 Parking Spaces Allocated 59 Phase	0.4 per Space 0.4 per Space Total 0 0.35 per Space Total Reduction 0.9 per Space es 1, 2, & 3A Reduction Total	20 3 71 Total Reduction 56 56 Total Spaces 53
Upstair Downstair PHASE 2 Location Bistro PHASE IIIA Location North Drystack	Parking Spaces Allocated 160 Parking Spaces Allocated 59 Phase	0.4 per Space 0.4 per Space Total 0 0.35 per Space Total Reduction 0.9 per Space es 1, 2, & 3A Reduction Total	20 3 71 Total Reduction 56 56 Total Spaces 53
Upstair Downstair PHASE 2 Location Bistro PHASE IIIA Location North Drystack	Parking Spaces Allocated 160 Parking Spaces Allocated 59	0.4 per Space 0.4 per Space Total 0 0.35 per Space Total Reduction 0.9 per Space es 1, 2, & 3A Reduction Total hases I, II, III, & IV	20 3 71 Total Reduction 56 56 Total Spaces 53
Upstair Downstair PHASE 2 Location Bistro PHASE IIIA Location North Drystack	Parking Spaces Allocated 160 Parking Spaces Allocated 59 Phase Quired Parking Spaces for Pl	0.4 per Space 0.4 per Space Total 0 0.35 per Space Total Reduction 0.9 per Space es 1, 2, & 3A Reduction Total hases I, II, III, & IV 575	20 3 71 Total Reduction 56 56 Total Spaces 53
Upstair Downstair PHASE 2 Location Bistro PHASE IIIA Location North Drystack	Parking Spaces Allocated 160 Parking Spaces Allocated 59 Phase Quired Parking Spaces for Pl Gross Parking Required (Spaces)	0.4 per Space 0.4 per Space Total 0 0.35 per Space Total Reduction 0.9 per Space es 1, 2, & 3A Reduction Total hases I, II, III, & IV	20 3 71 Total Reduction 56 56 Total Spaces 53

PRELIMINARY PLAT FOR
PHASE IV FOR
FRONT STREET VILLAGE
NOT FOR CONSTRUCTION

BE REPRODUCED OR USED FOR ANY PROJECT IN WHOLE OR IN PART WITHOUT EXPRESS WRITTEN PERMISSION.

PROJECT MANAGER:

DESIGNED:

THIS DRAWING IS THE PROPERTY OF

DRAWN BY:

CHECKED:

SCALE: NOT TO SCALE

DATE: 03/29/2021



1004 Arendell Street Morehead City, NC 28557 (252) 622-4338 Fax: (252) 622-4505

Www.arendellengineers.com
North Carolina Certification No. C-1509
OWNER:

FRONT STREET VILLAGE, LLC 2400 LENNOXVILLE ROAD BEAUFORT, NC 28516


PROJECT:


FRONT STREET VILLAGE
TRANSPORTATION CENTER-SITE
PLAN-PHASE II
AND PRELIMINARY PLAT PHASE IV
BEAUFORT, NORTH CAROLINA

CARTERET COUNTY, NC

DRAWING:

COVER SHEET

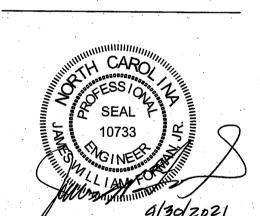

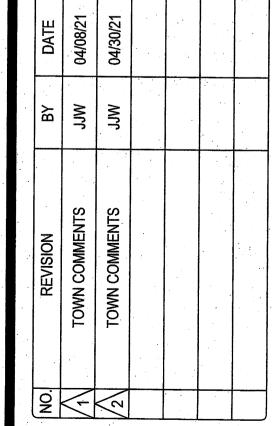

SHEET NO:

C

OF: 18 JOB NO.

19138

Know what's below.
Call before you dig.

GENERAL NOTES: CONTRACT DOCUMENTS. CONSTRUCTION SEQUENCE ALL AREAS SHALL BE FERTILIZED & SEEDED AS NECESSARY TO OBTAIN AND MAINTAIN A VIGOROUS DENSE TURF COVER. CONTACT PERSON RESPONSIBLE FOR MAINTENANCE IS BUCKY OLIVER, OWNER, (919) 349-5588.

PROJECT IS LOCATED IN THE WHITE OAK RIVER BASIN. LOCATION OF EXISTING ABOVE GROUND AND UNDERGROUND UTILITIES AND FACILITIES ARE NOT NECESSARILY SHOWN ON THE DRAWINGS, AND WHERE SHOWN, THE ACCURACY OF LOCATION IS NOT VERIFIED. BEFORE STARTING WORK, CONTRACTOR SHALL CONFIRM LOCATION OF ALL UNDERGROUND UTILITIES AND FACILITIES. CONTRACTOR SHALL BE RESPONSIBLE FOR REPAIR OR REPLACEMENT OF DAMAGE TO ABOVE GROUND AND UNDERGROUND UTILITIES. CONTRACTOR SHALL PRESERVE ANY PROPERTY MARKER PIPES, IRONS, OR MONUMENTS. WASTE OR EXCESS MATERIALS SHALL BECOME THE PROPERTY OF THE CONTRACTOR AND SHALL BE DISPOSED OF IN ACCORDANCE WITH ALL APPLICABLE FEDERAL, STATE, AND LOCAL REGULATIONS. TESTING AND INSPECTION OF COMPACTION AND MATERIALS SHALL BE BY AN INDEPENDENT TESTING AGENCY DESIGNATED AND PAID FOR BY THE OWNER. CONTRACTOR SHALL BE RESPONSIBLE FOR SCHEDULING TESTING REQUIRED BY THE 6. NO TRENCHES SHALL BE LEFT OPEN OVERNIGHT. OBTAIN PLAN APPROVAL AND OTHER APPLICABLE PERMITS. SCHEDULE A PRE-CONSTRUCTION CONFERENCE WITH REGULATORY PERSONNEL ONE WEEK BEFORE BEGINNING GRADING OR GROUND DISTURBING ACTIVITIES AT THE SITE. CONTACT NCDEQ 910-796-7215. INSTALL TEMPORARY SILT FENCING AND CONSTRUCTION ENTRANCE AS INDICATED ON THE PLANS OR AS INSTRUCTED BY THE ENGINEER OR LAND QUALITY PERSONNEL. INSTALL STORMWATER SYSTEM INCLUDING DROP INLETS AND AT THE SAME TIME THE DROP INLET PROTECTION AND OUTLET PROTECTION AS INDICATED ON THE PLANS OR AS INSTRUCTED BY THE ENGINEER OR LAND QUALITY PERSONNEL. FILL AND GRADE SITE AS REQUIRED AND INSTALL EITHER PERMANENT OR TEMPORARY STABILIZATION WITHIN 14 DAYS ESTIMATED TIME BETWEEN BEGINNING WORK AND FINAL STABILIZATION - 9 MONTHS TO COMPLETION.

RYE (GRAIN) FOR SLOPES 2:1 OR STEEPER, ADD 30 LBS/AC SERICEA LESPEDEZA EROSION CONTROM MEASURES MAINTENANCE PLAN ALL EROSION AND SEDIMENT CONTROL MEASURES SHALL BE CHECKED FOR STABILITY AND EFFECTIVE OPERATIONS AND 15 LBS WEEPING LOVEGRASS FOLLOWING EVERY RUNOFF PRODUCING RAINFALL EVENT OR AT LEAST ONCE PER WEEK. REPAIRS REQUIRED SHALL BE COMPLETED IMMEDIATELY TO THE DIMENSION AND FUNCTIONS INDICATED ON THE PLANS. SEDIMENT SHALL BE REMOVED FROM BEHIND THE SEDIMENT FENCING WHEN IT BECOMES 6 INCHES DEEP AT THE FENCE. THE FENCE SHALL BE REPLACED OR REPAIRED AS NECESSARY TO MAINTAIN AN EFFECTIVE BARRIER.

EROSION & SEDIMENT CONTROL NOTES: CONTACT THE NCDEQ, LAND QUALITY SECTION, ONE WEEK PRIOR TO LAND DISTURBING ACTIVITY, AND ONE WEEK PRIOR TO FINAL INSPECTION.

A COPY OF THE APPROVED SEDIMENT AND EROSION CONTROL PLAN SHALL BE MAINTAINED AT THE SITE. DISTURBED AREAS ARE DELINEATED ON THE DRAWINGS AND DETERMINED BY DIGITAL METHODS. PRIOR TO COMMENCING LAND DISTURBING ACTIVITIES IN AREAS OTHER THAN THOSE INDICATED ON THE PLANS, BUT NOT LIMITED TO OFFSITE BORROW AND DISPOSAL AREAS, CONTRACTOR SHALL SUBMIT A SUPPLEMENTARY EROSION CONTROL PLAN TO THE ENGINEER FOR REVIEW AND APPROVAL BY THE LAND QUALITY SECTION.

EROSION AND SEDIMENT CONTROL MEASURES SHALL BE INSPECTED FOR DAMAGE AND EFFECTIVE OPERATIONS FOLLOWING EVERY RAINFALL EVENT OR AT LEAST ONCE PER WEEK. REPAIRS SHALL BE COMPLETED IMMEDIATELY TO DIMENSION AND FUNCTIONS INDICATED ON THE PLANS

CONTRACTOR RESPONSIBLE FOR INSTALLATION OF ADDITIONAL EROSION AND SEDIMENT CONTROL MEASURES NECESSARY TO MAINTAIN EROSION AND CONTROL AS DETERMINED BY THE OWNER, ENGINEER, OR REGULATORY PERSONNEL.

ALL DISTURBED AREAS TO DRAIN TO APPROVED SEDIMENT CONTROL MEASURES AT ALL TIMES DURING LAND DISTURBING ACTIVITIES AND UNTIL PERMANENT STABILIZATION IS ESTABLISHED.

DURING DEWATERING ACTIVITIES, WATER SHALL BE PUMPED INTO AN APPROVED FILTERING DEVICE OR DIRECTED TO EXISTING EROSION CONTROL MEASURE. CONSTRUCTION ACTIVITIES SHALL MEET CONDITIONS OF DWQ GENERAL CONSTRUCTION PERMIT (NCG01). COMPLIANCE SHALL MEET THE FOLLOWING CONDITIONS:

1) G	PERIMETER DIKES, SWALES,	ABILIZATION TIME FRAME 7 DAYS	STABILIZATION TIME FRAME EXCEPTIONS NONE	
	DITCHES, AND SLOPES			
	HIGH QUALITY WATER (HQW) ZONES	7 DAYS	NONE	
	SLOPES STEEPER THAN 3:1	7 DAYS	IF SLOPES ARE 10' OR LESS IN LENGTH AND ARE NOT STEEPER THAN 2:1, 14 DAYS ARE ALLOWED.	
	SLOPES 3:1 OR FLATTER	14 DAYS	7 DAYS FOR SLOPES GREATER THAN 50 FEET IN LENGTH.	
	ALL OTHER AREAS WITH SLOPES FLATTER THAN 4:1	14 DAYS	NONE (EXCEPT FOR PERIMETERS AND HQW ZONES)	

• DEDICATED AREAS FOR DEMOLITION, CONSTRUCTION, AND OTHER WASTES MUST BE LOCATED 50' FROM STORM DRAINS AND STREAMS UNLESS NO REASONABLE ALTERNATIVES AVAILABLE. • EARTHEN-MATERIAL STOCKPILES MUST BE LOCATED 50' FROM STORM DRAINS AND STREAMS UNLESS NO REASONABLE ALTERNATIVES AVAILABLE.

• CONCRETE MATERIALS MUST BE CONTROLLED TO AVOID CONTACT WITH SURFACE WATERS, WETLANDS, OR BUFFERS.

• SOIL STORAGE OR STOCKPILE AREAS SHALL BE LOCATED 50 FT. FROM STORM DRAIN INLETS AND SWALES OR DITCHES.

AC ACRE DIP DUCTILE IRON PIPE LEGEND EX EXISTING F/F FACE OF CURB TO FACE OF CURB CENTERLINE © CENTERLINE LF LINEAR FEAT EXISTING ELEVATION CONTOUR **EXISTING FIRE HYDRANT** MH MANHOLE □ SEWER DOGHOUSE MANHOLE N/F NOW OR FORMERLY — DA — DA — LIMITS OF DISTURBANCE SEWER MANHOLE PVC POLYVINYL CHLORIDE ___ PROPERTY LINE SEWER SERVICE R RADIUS _____ | 5.00' | _ _ _ _ PROPOSED ELEVATION CONTOUR ROW RIGHT OF WAY -ss---- SANITARY SEWER GRAVITY MAIN STA STATION — FM — FM — SANITARY SEWER FORCE MAIN W/ WITH WL WATERLINE ____w ___w ___w ___w ___w WATERLINE Ø DIAMETER _____ 404 ____ 404 ____ 404 ____ 404 ____ WETLANDS BOUNDARY PROPOSED SPOT ELEVATION

TEMPORARY STABILIZATION SEEDING SCHEDULE

SEED BED PREPARATION LIME

2 TONS/AC 1,000 LBS/AC 10-10-20 500 LBS/AC (AFTER SEEDING) 0-20-0 200 GAL/TON OF MULCH ASPHALT TACK

SEEDING MIXTURE

(FEBRUARY 1 - APRIL 30) 50 LBS/AC TALL FESCUE 10 LBS/AC PENSACOLA BAHIAGRASS 50 LBS/AC KOREAN OR KOBE LESPEDEZA (SCARIFIED)

(MAY 1 - AUGUST 31) 50 LBS/AC TALL FESCUE 5 LBS/AC WEEPING LOVEGRASS 50 LBS/AC KOREAN OR KOBE LESPEDEZA (SCARIFIED) 25 LBS/AC **BROWNTOP MILLET**


(SEPTEMBER 1 - JANUARY 31) 60 LBS/AC TALL FESCUE KOREAN OR KOBE LESPEDEZA (UNSCARIFIED) 60 LBS/AC 25 LBS/AC

LANDSCAPING MIXTURE

(JANUARY 1 - MARCH 31) COMMON BERMUDAGRASS (UNHULLED) 20 LBS/AC (APRIL 1 - JULY 31) 12 LBS/AC COMMON BERMUDAGRASS (HULLED)

MOEHRING GROUP HOLDING LP NE FAMILY LOTS TRANSPORTATION CENTER SEA GROVE SUBDIVISION MOEHRING GROUP HOLDING LP HHH LENNOXVILLE ROAD MOEHRING GROUP TOWN OF HOLDING LP **BEAUFORT** FRONT STREET -

> **VICINITY MAP** SCALE: 1" = 150'

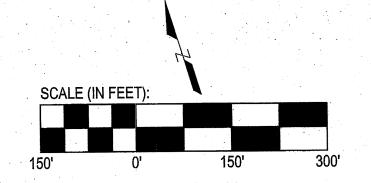

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PRELIMINARY PLAT FOR

PHASE IV FOR

FRONT STREET VILLAGE

NOT FOR CONSTRUCTION

PERMISSION. PROJECT MANAGER:

DESIGNED: DRAWN BY: CHECKED:

SCALE: DATE: 03/29/2021



1004 Arendell Street Morehead City, NC 28557 (252) 622-4338 Fax: (252) 622-4505

www.arendellengineers.com North Carolina Certification No. C-1509

FRONT STREET VILLAGE, LLC 2400 LENNOXVILLE ROAD BEAUFORT, NC 28516

PROJECT:

FRONT STREET VILLAGE TRANSPORTATION CENTER-SITE PLAN-PHASE II AND PRELIMINARY PLAT PHASE IV BEAUFORT, NORTH CAROLINA

CARTERET COUNTY, NC


DRAWING:


NOTES AND ABBREVIATIONS


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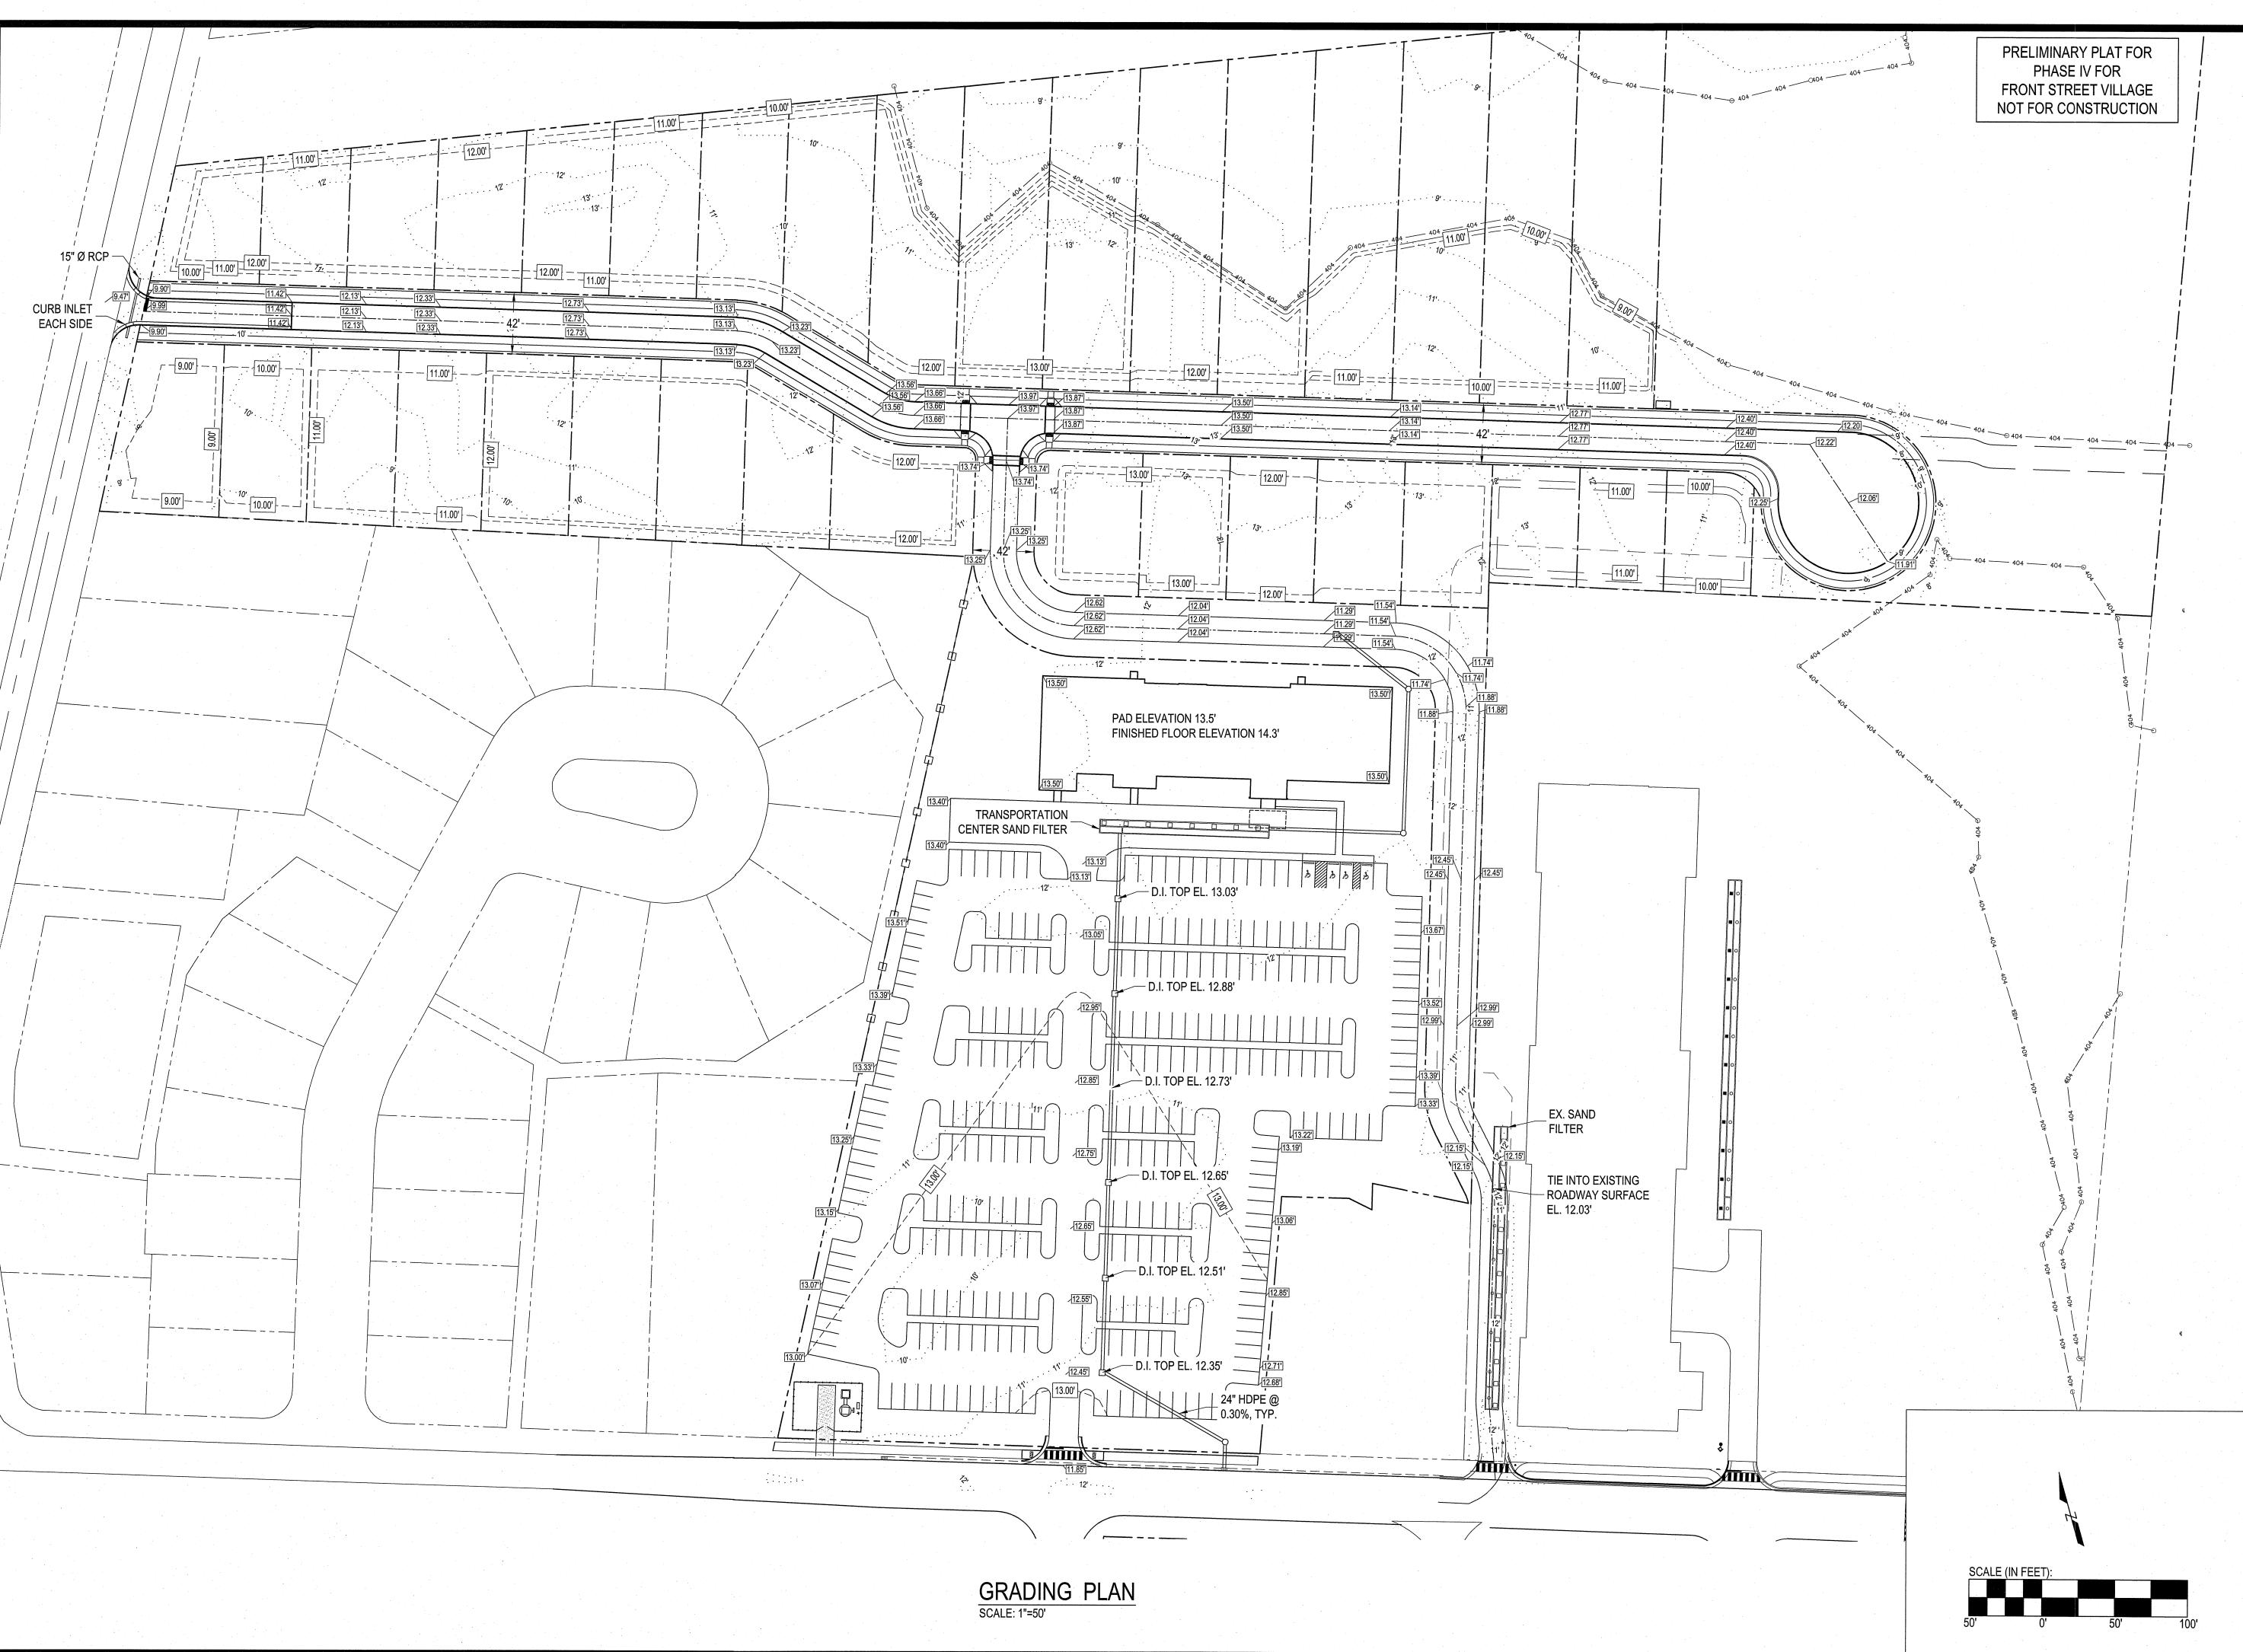
19138

JOB NO.



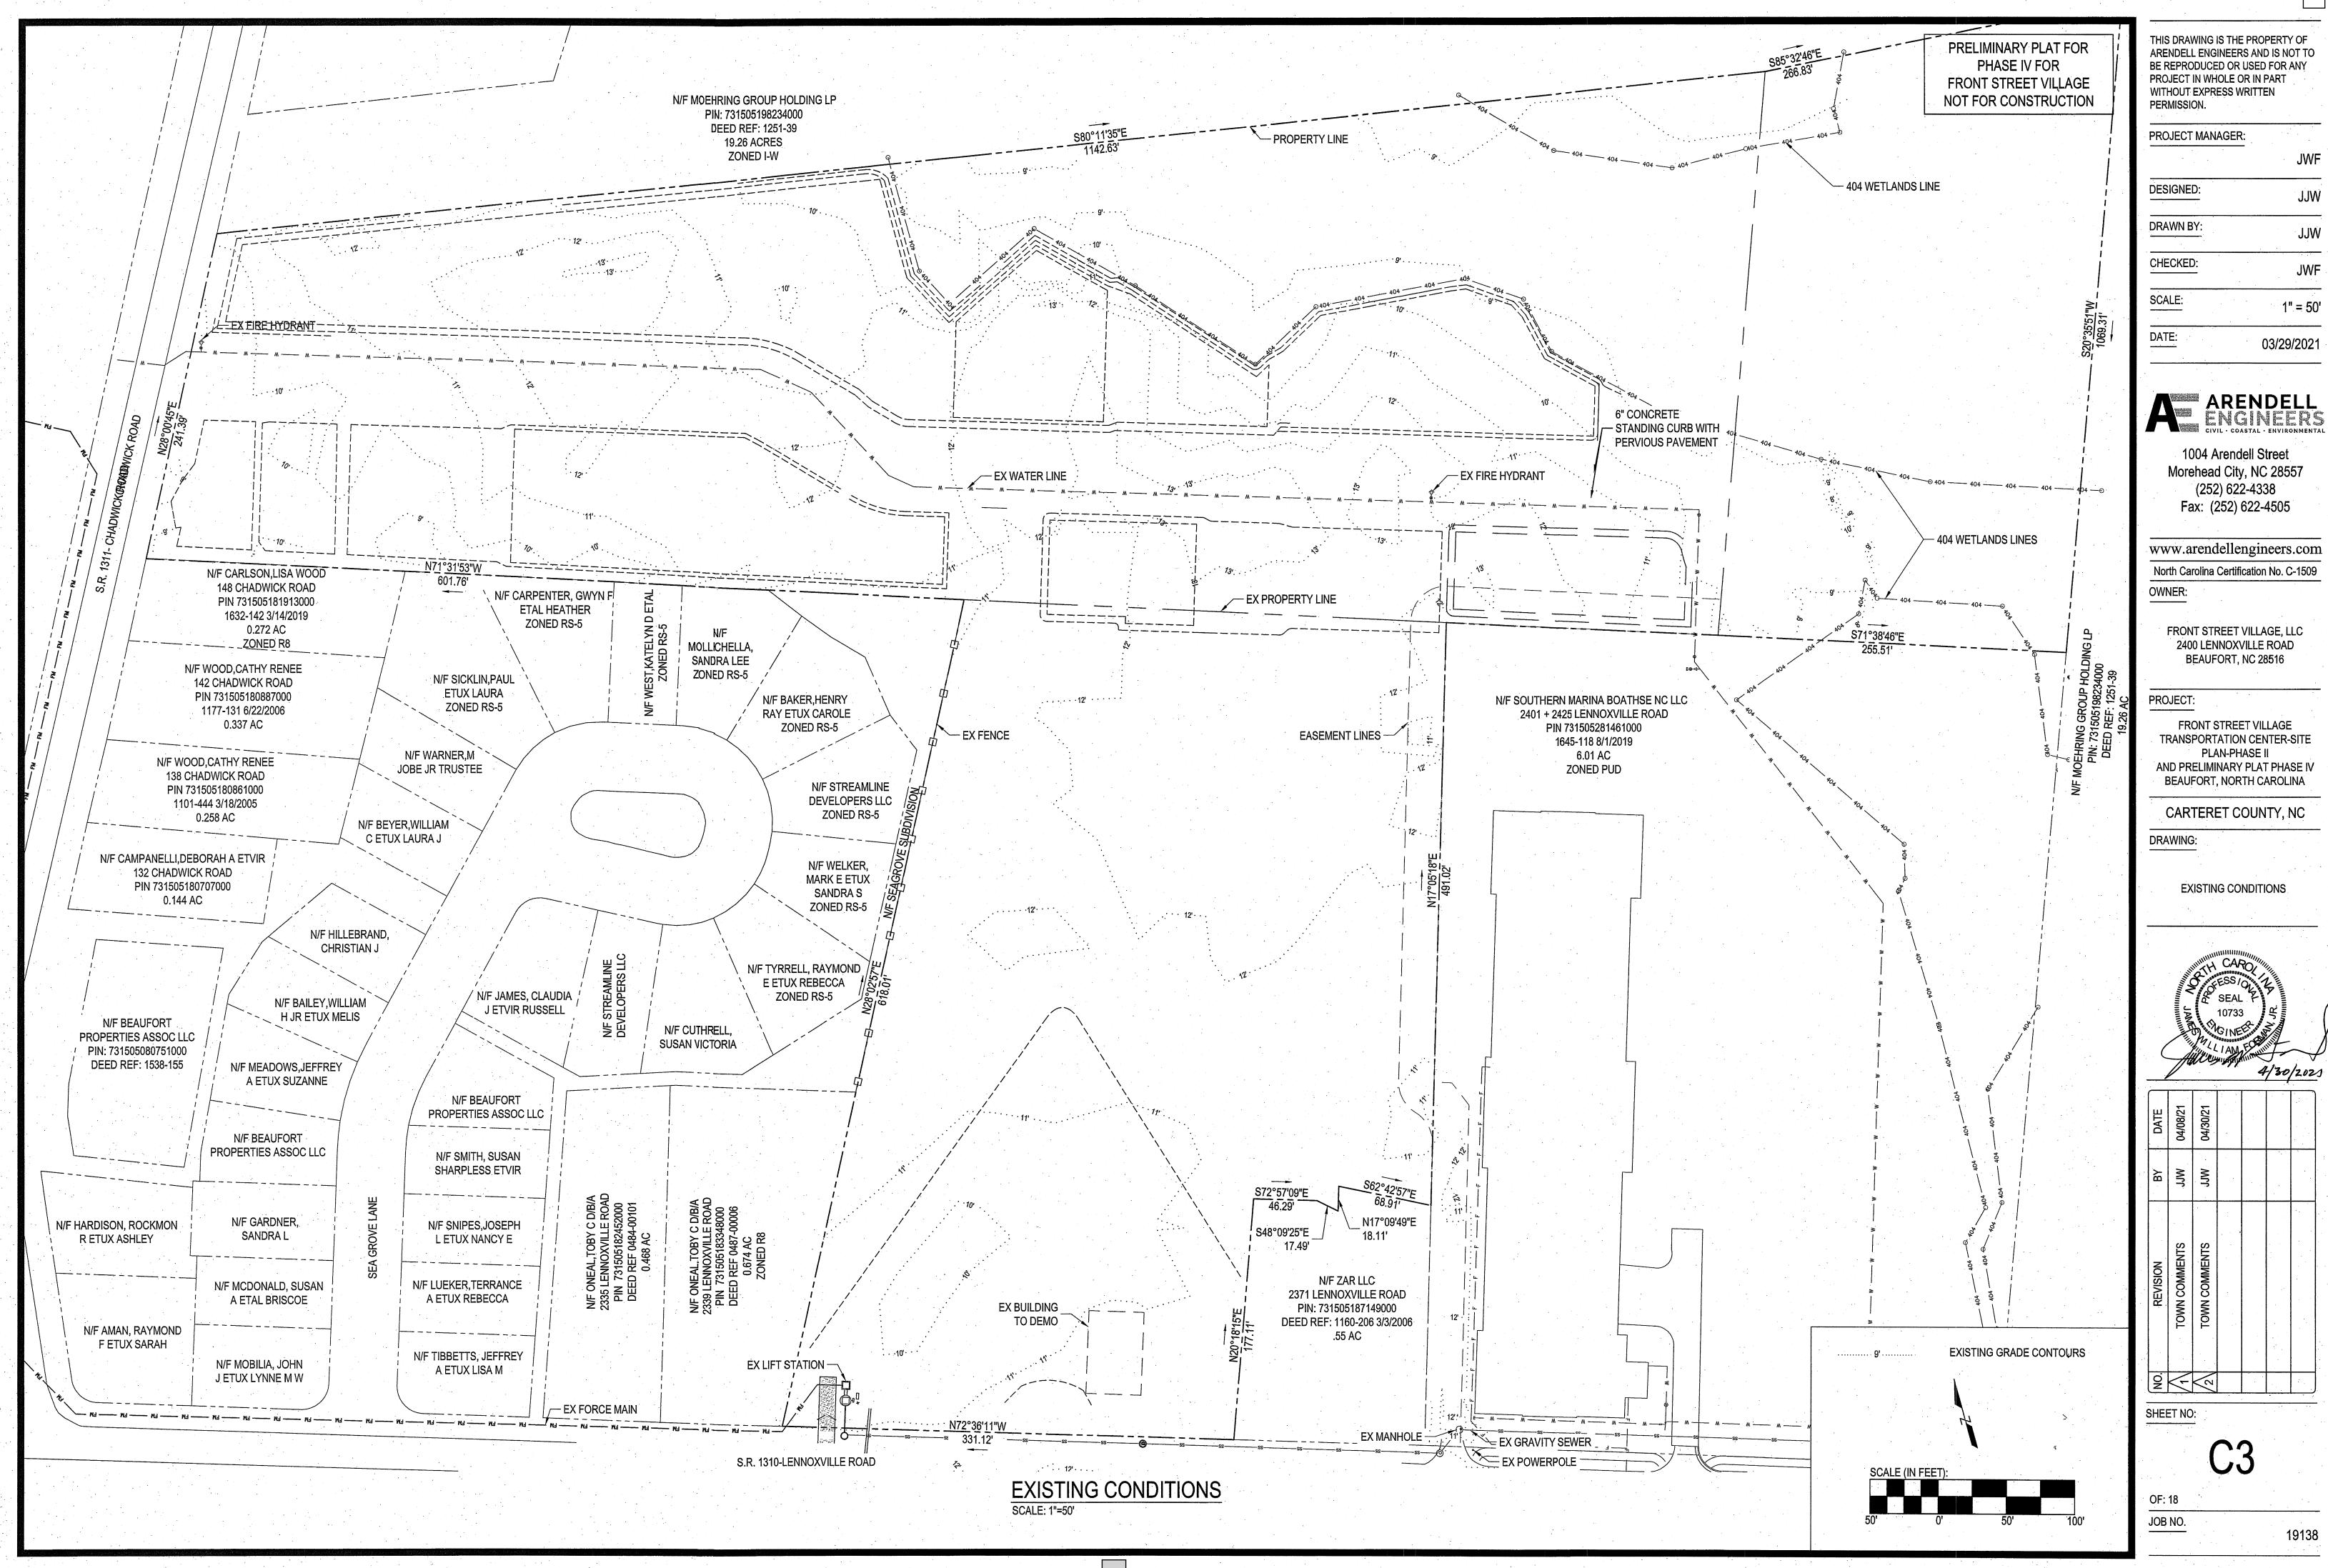

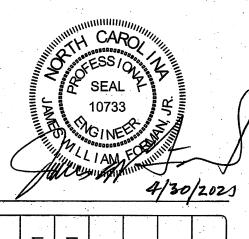

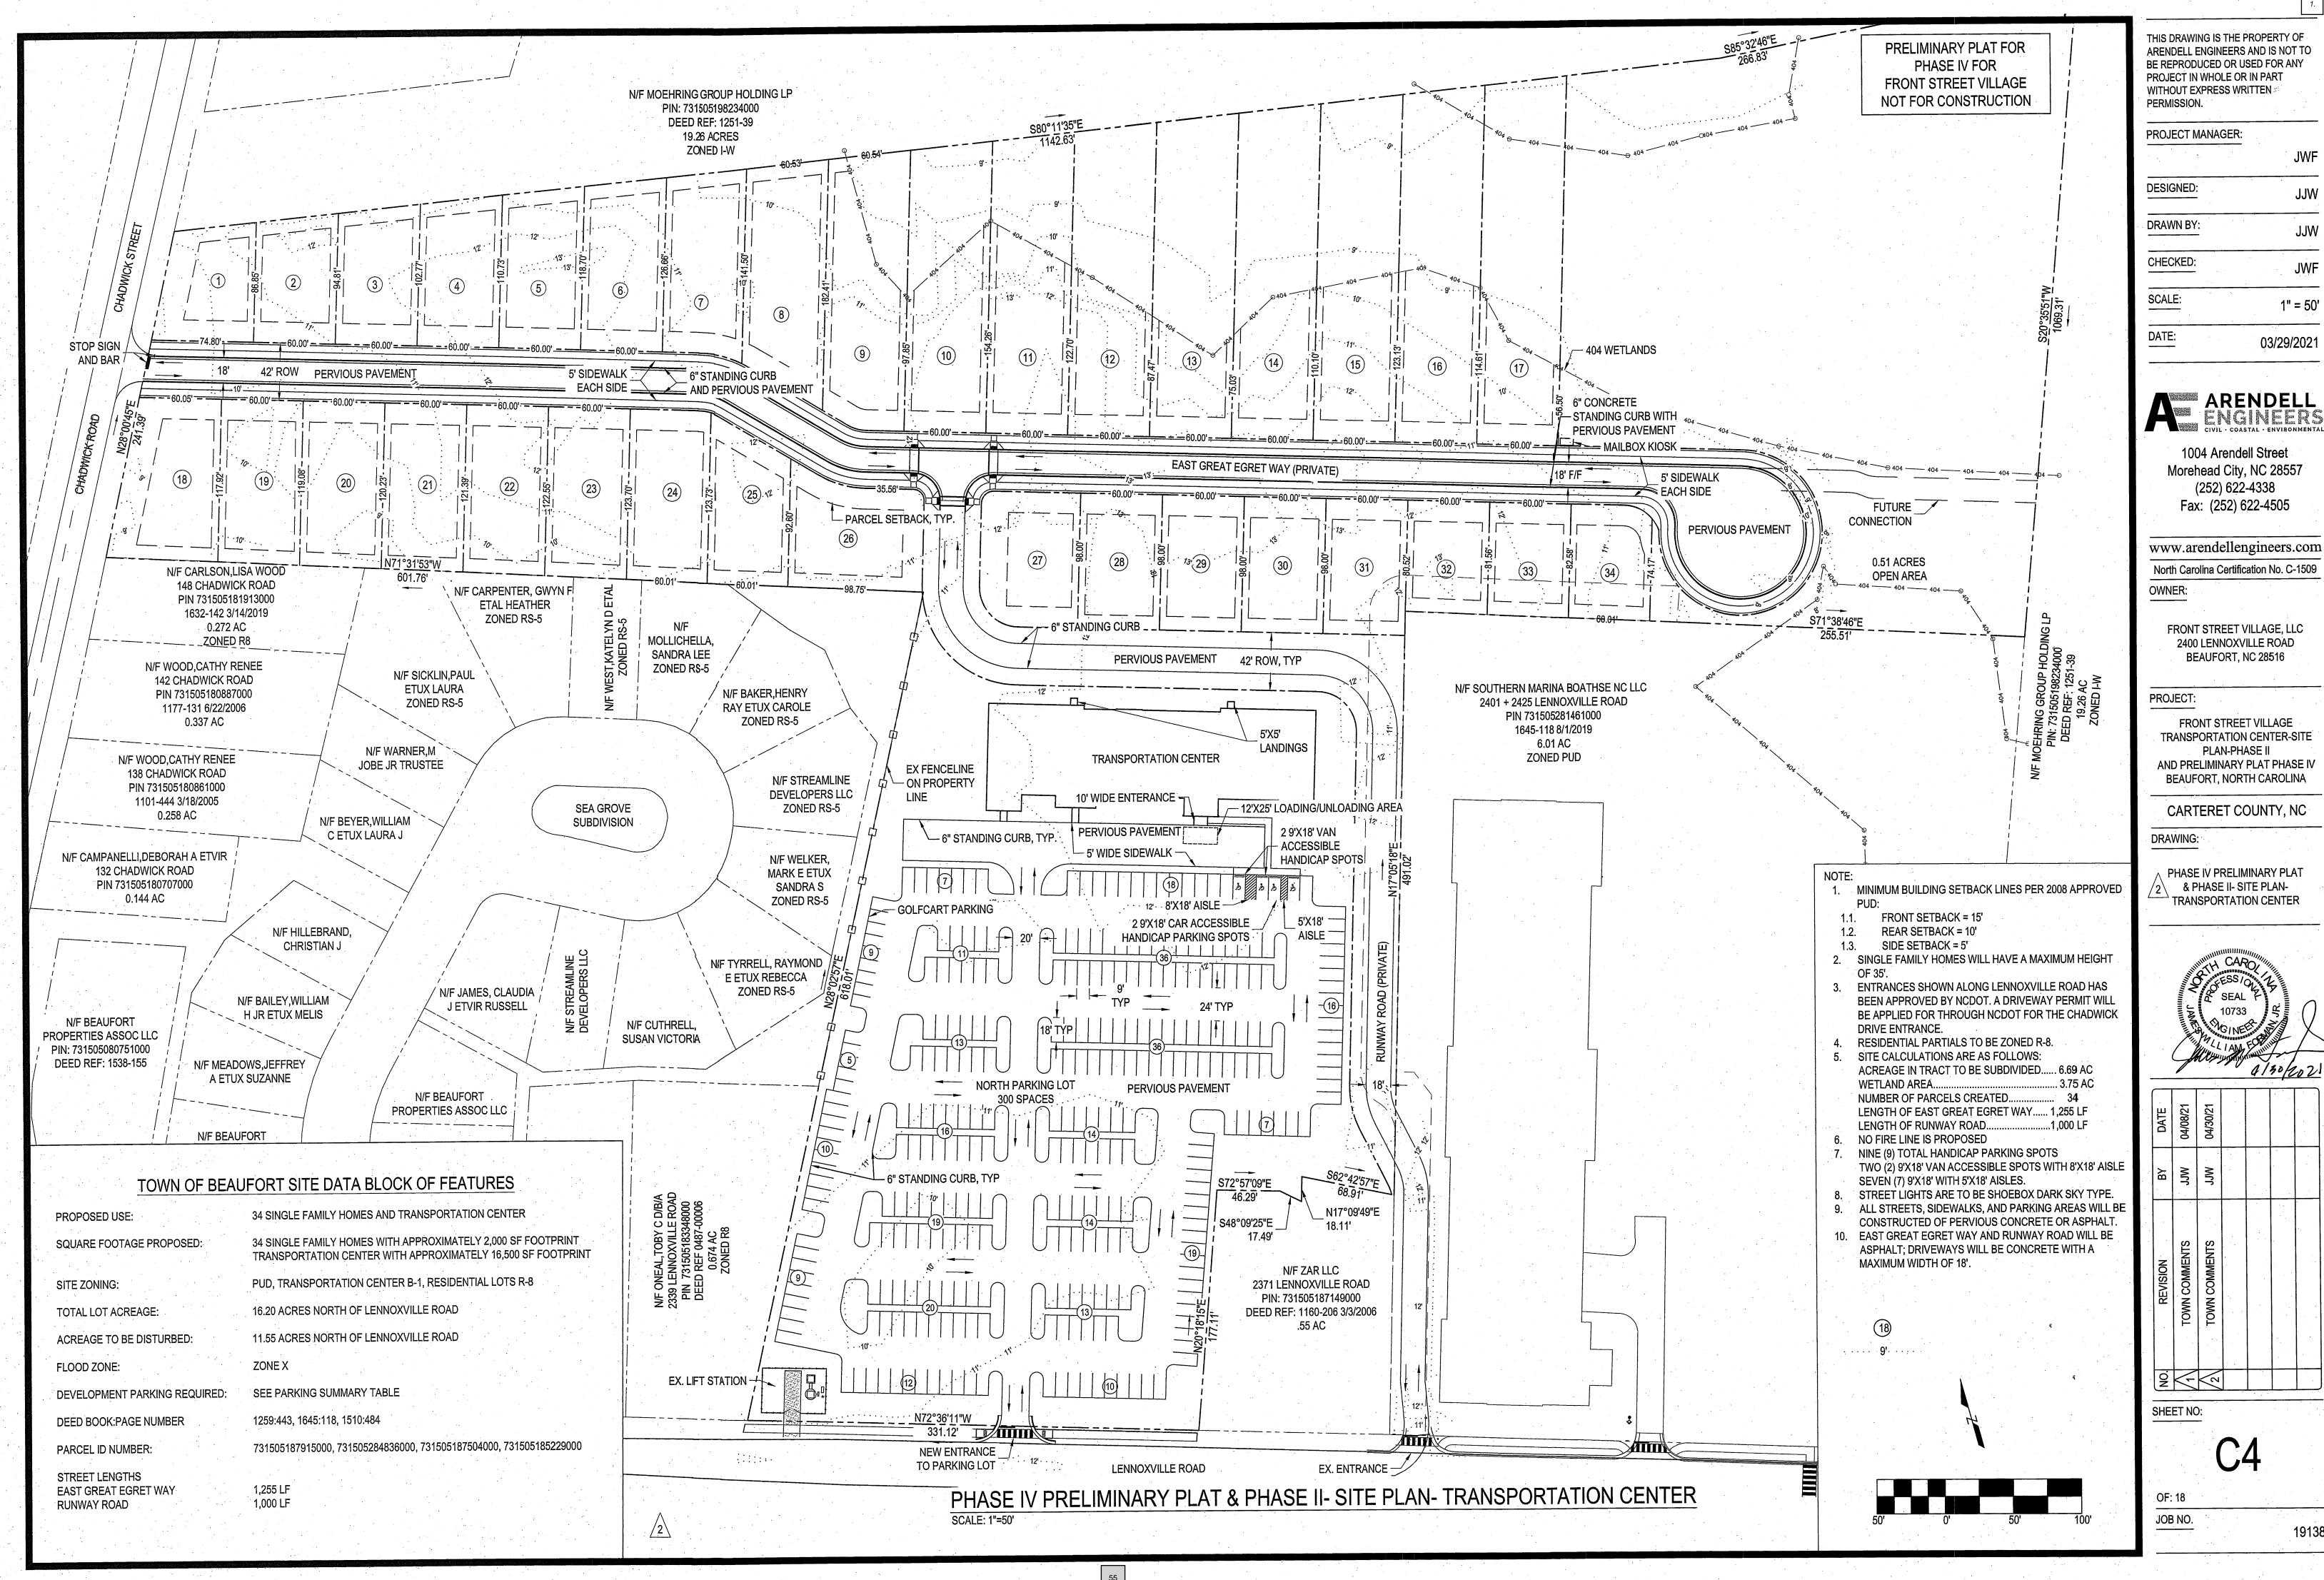

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PROJECT MANAGER:

DESIGNED:

DRAWN BY:

JJW

<u>CHECKED:</u>

<u>SCALE:</u>

1" = 50'

DATE: 03/29/2021

ARENDELL ENGINEERS CIVIL - COASTAL - ENVIRONMENTAL

> 1004 Arendell Street Morehead City, NC 28557 (252) 622-4338 Fax: (252) 622-4505

Www.arendellengineers.com

North Carolina Certification No. C-1509

OWNER:

FRONT STREET VILLAGE, LLC 2400 LENNOXVILLE ROAD BEAUFORT, NC 28516


PROJECT:

FRONT STREET VILLAGE
TRANSPORTATION CENTER-SITE
PLAN-PHASE II
AND PRELIMINARY PLAT PHASE IV
BEAUFORT, NORTH CAROLINA

CARTERET COUNTY, NC

DRAWING:

3 GRADING PLAN

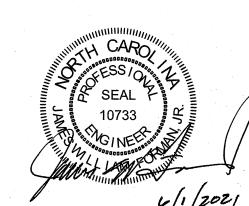


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DATE	04/08/21	04/30/21	06/01/21			
ВУ	Mff	Mſſ	Mff			
REVISION	TOWN COMMENTS	TOWN COMMENTS	TOWN COMMENTS			
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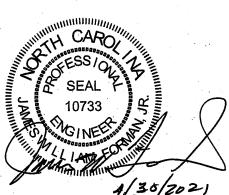
SHEET NO:


C5

JOB NO.

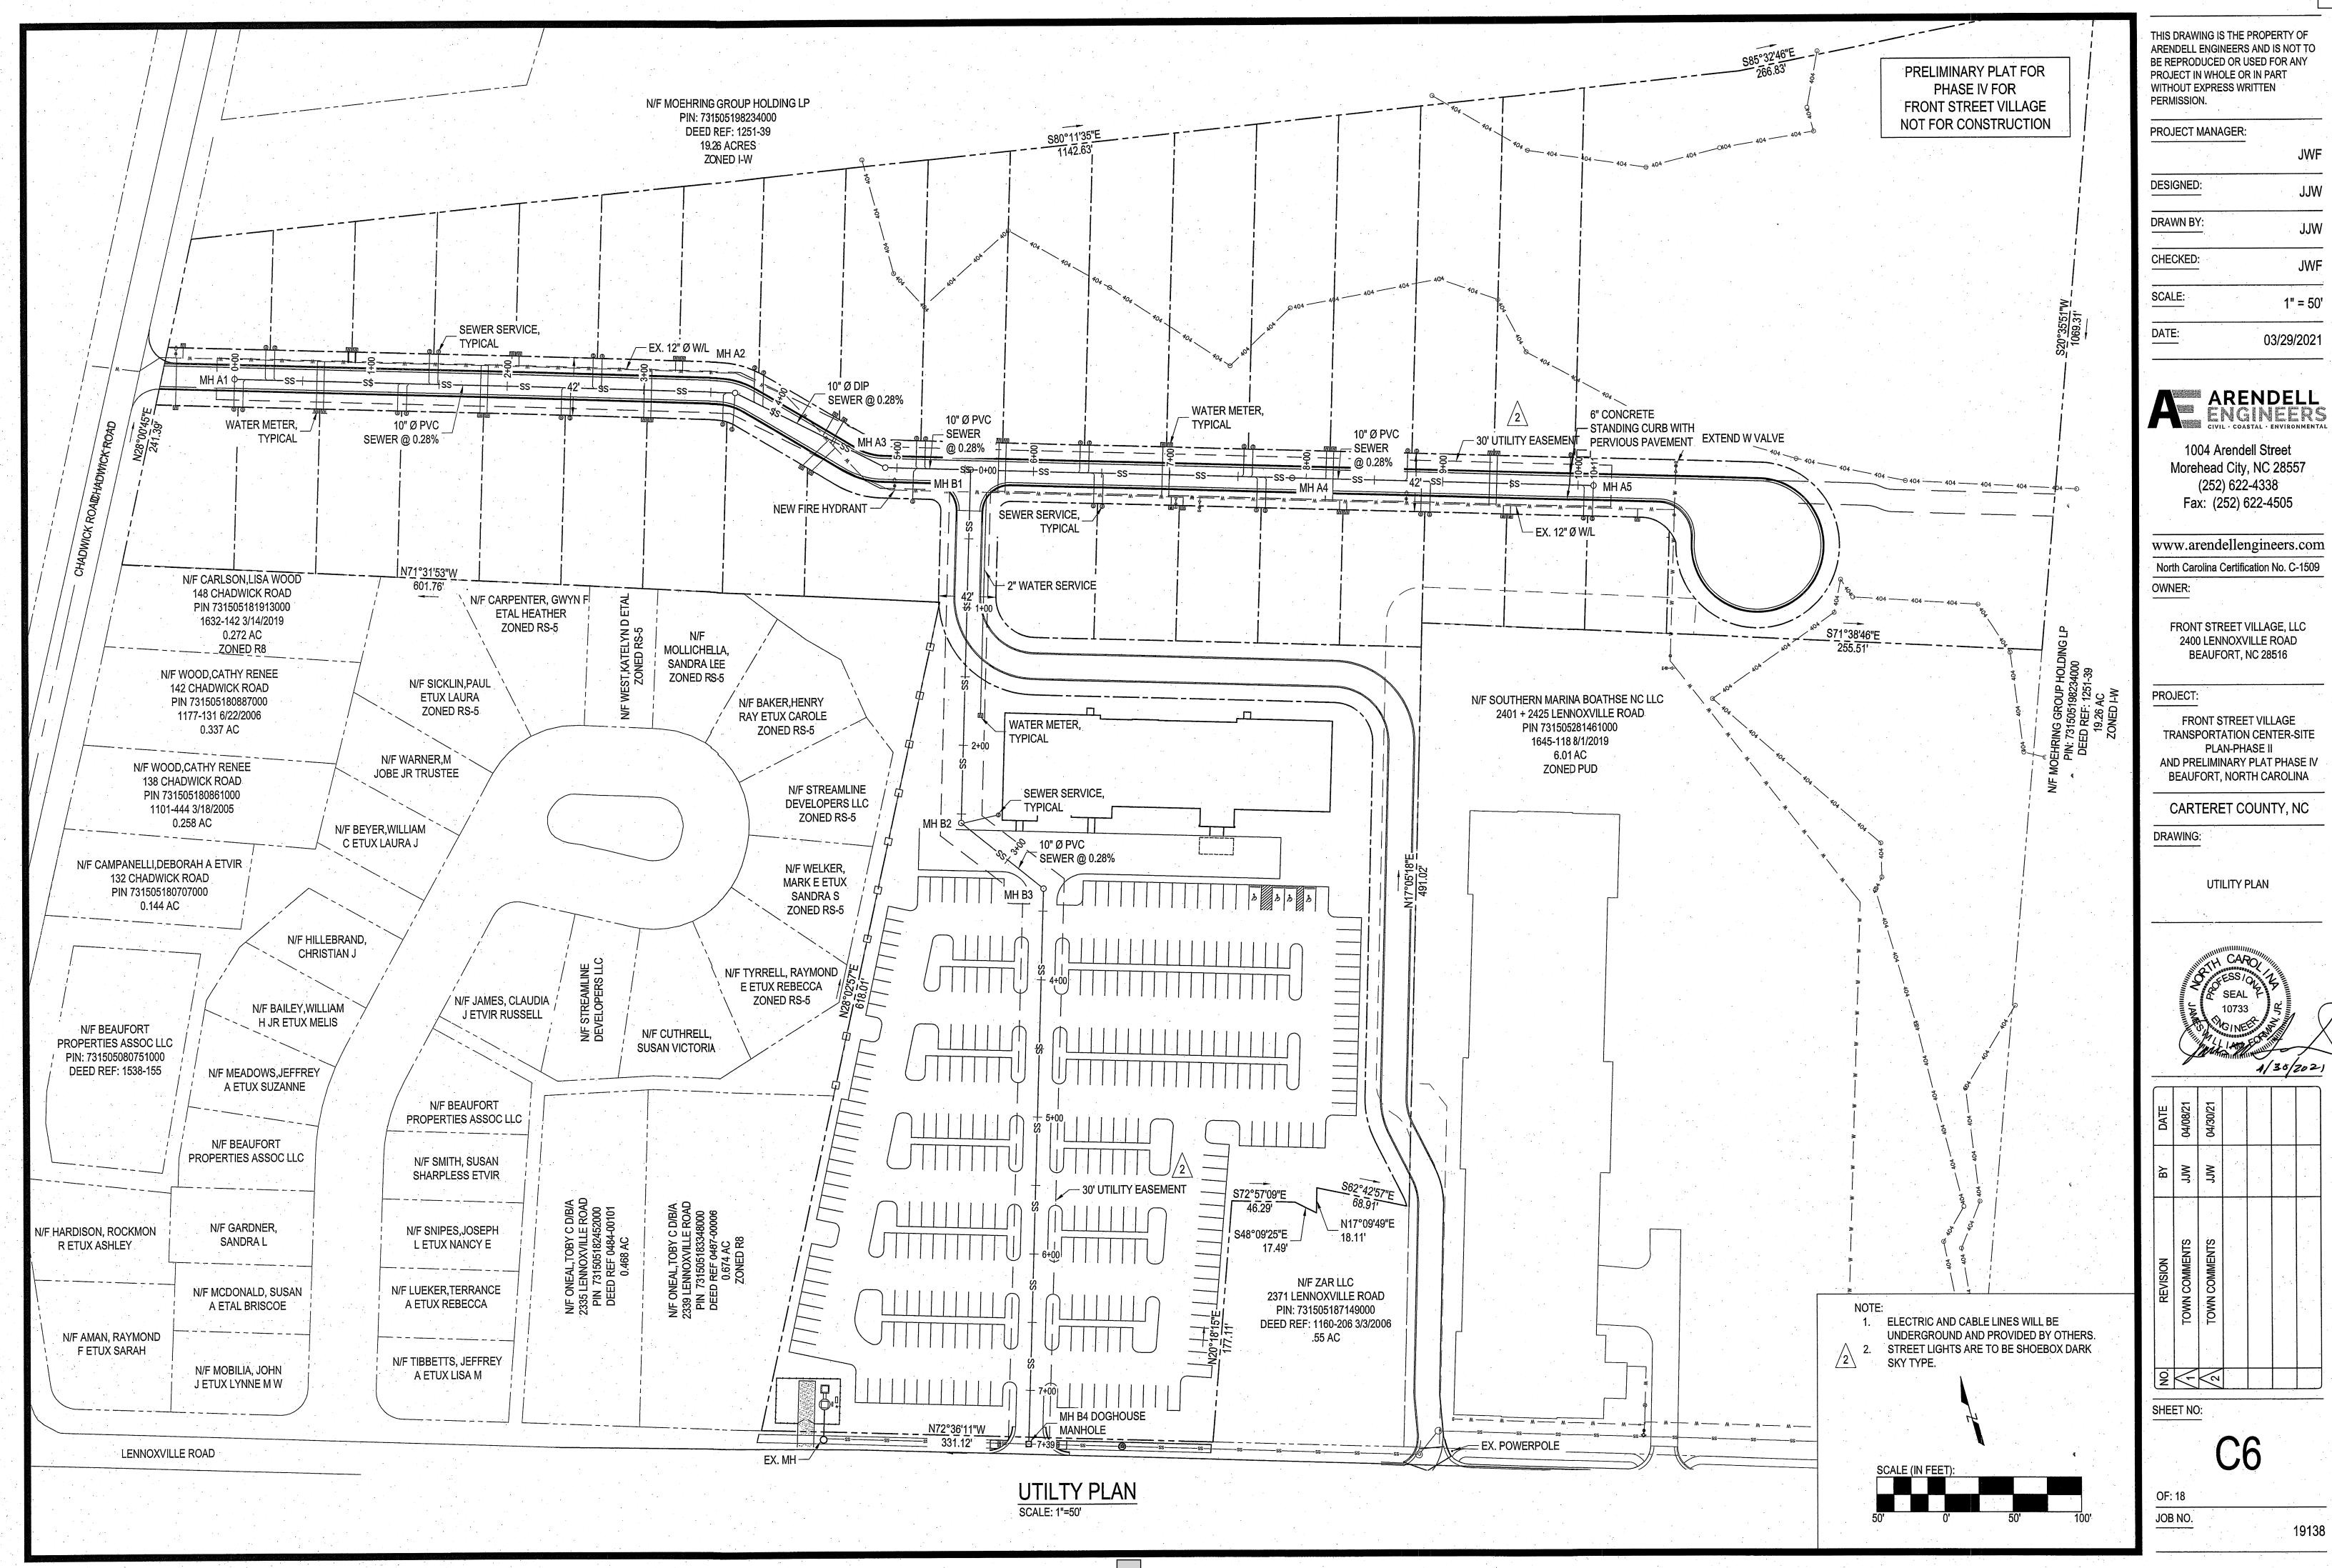

JWF



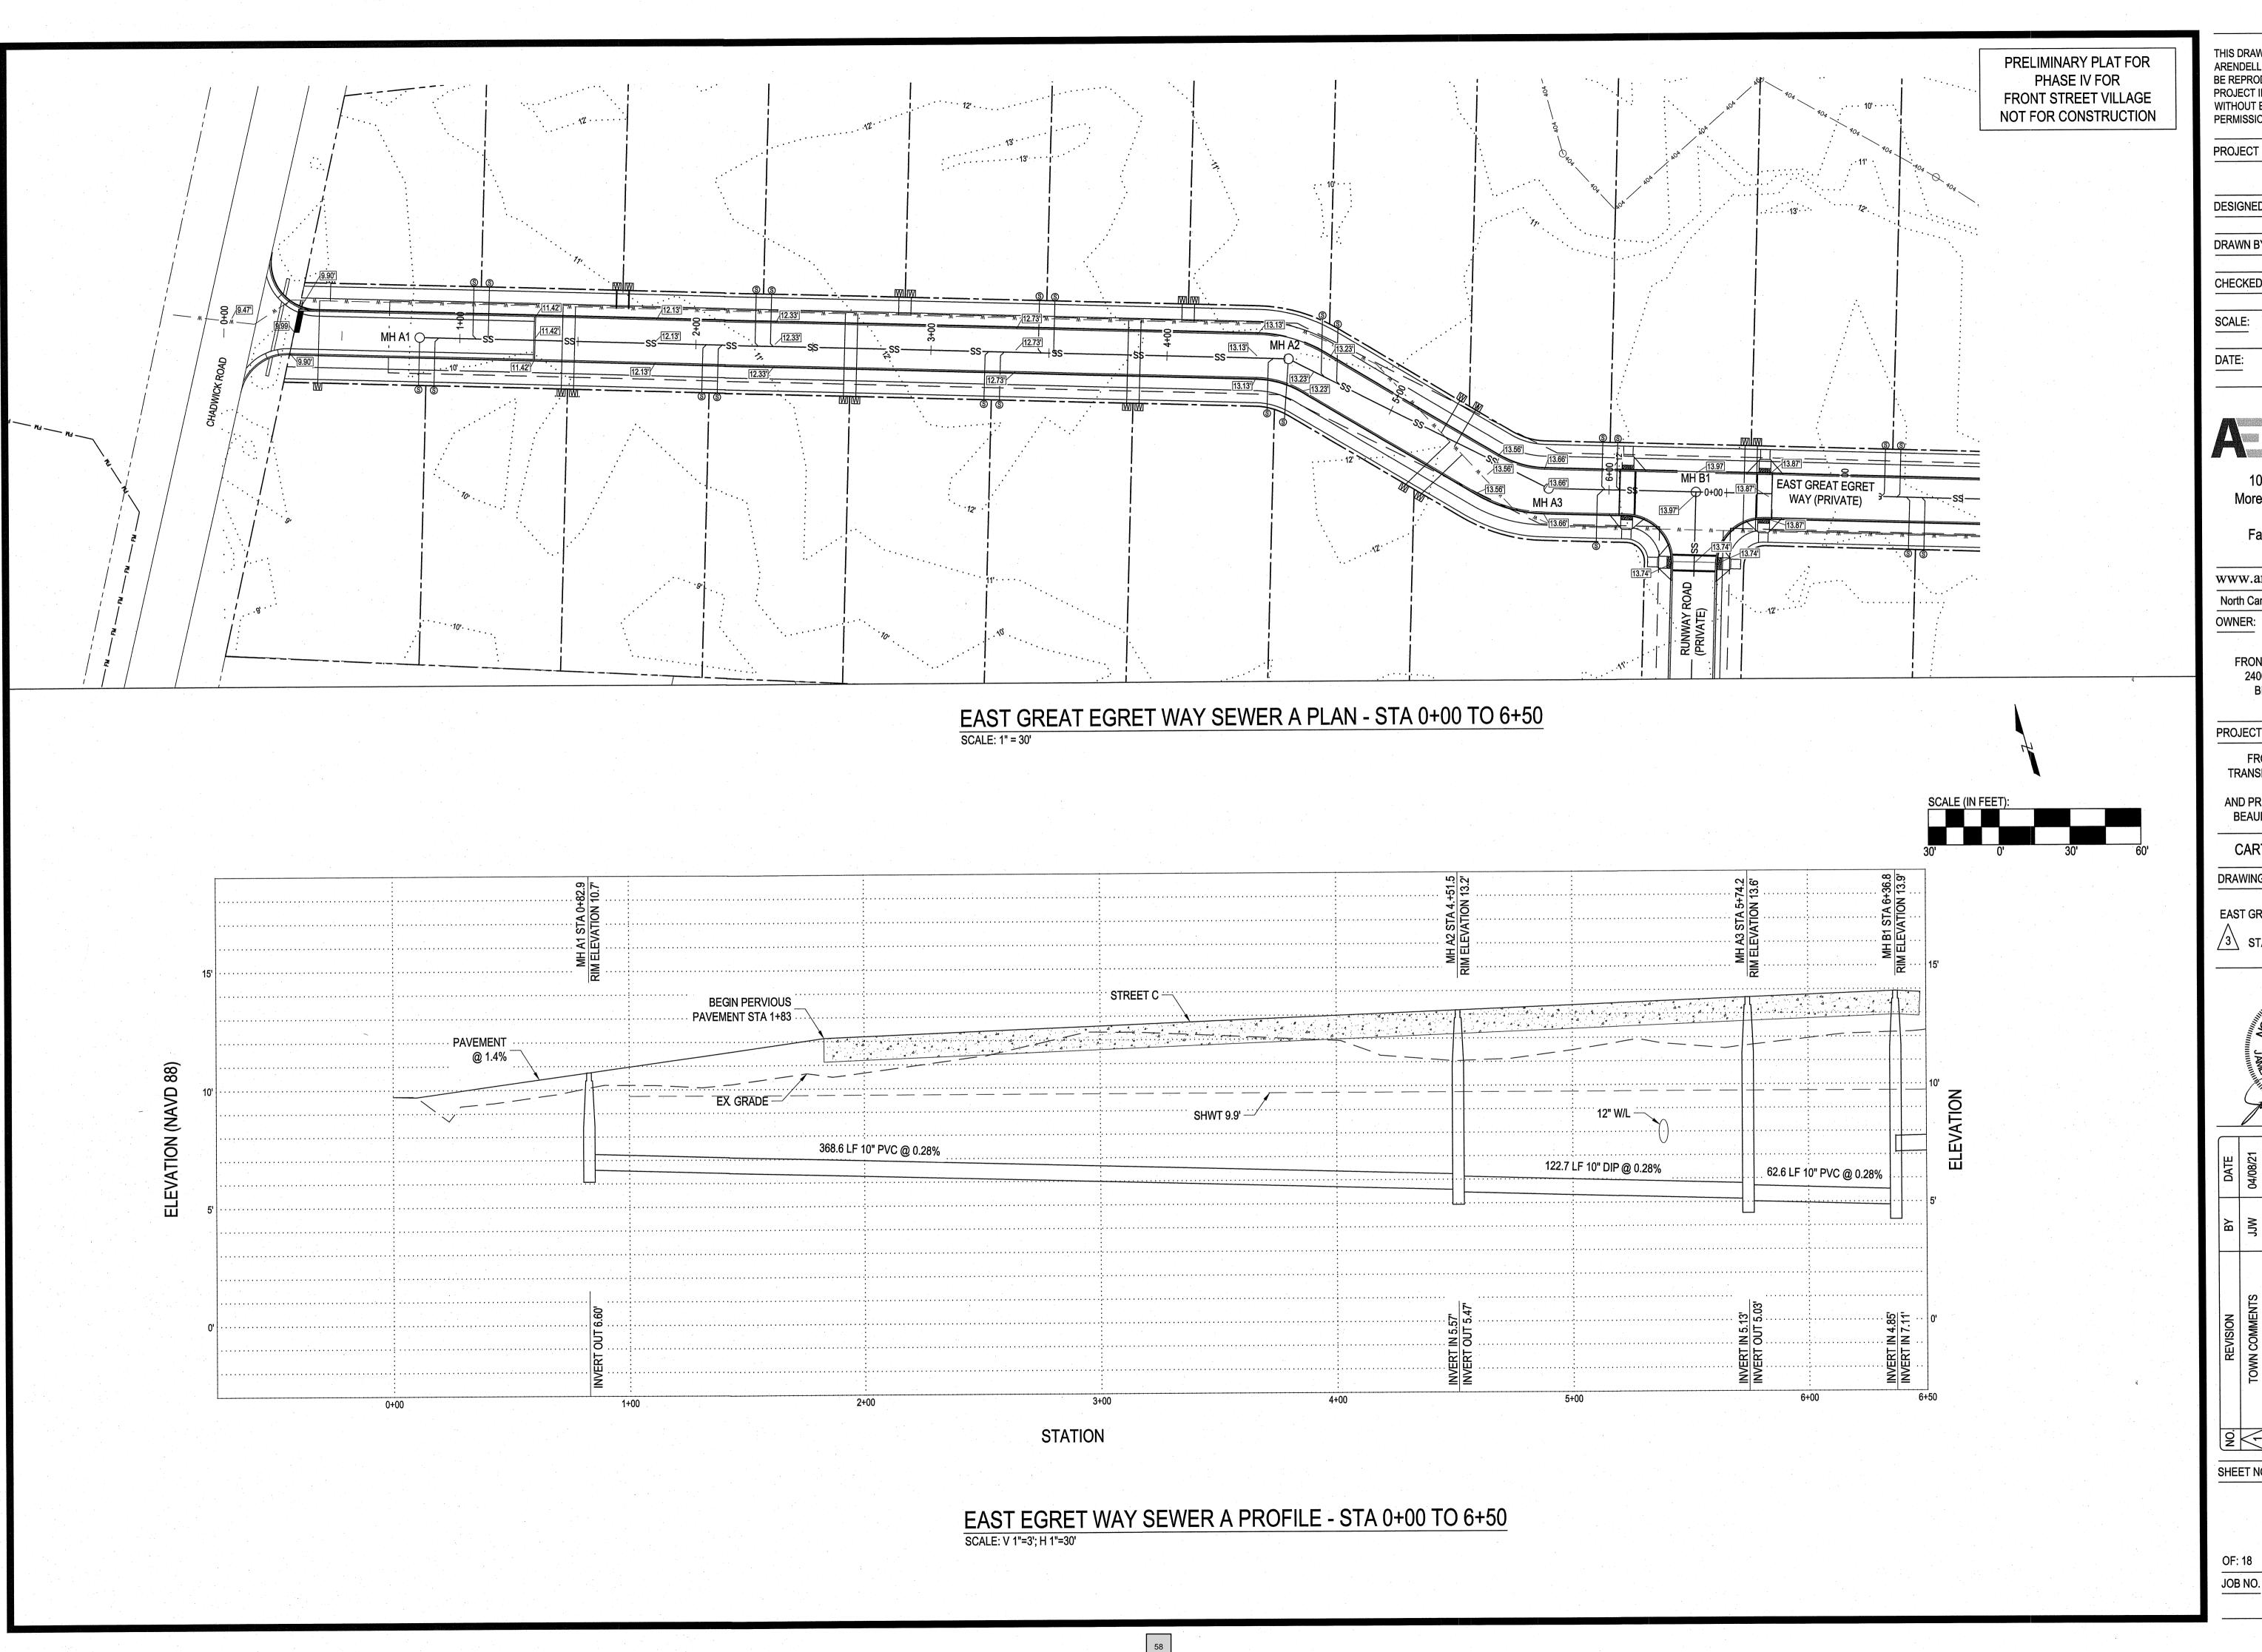

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PROJECT MANAGER:

	JWF
DESIGNED:	JJW
DRAWN BY:	JJW
CHECKED:	JWF
SCALE:	1" = 30'

ARENDELL ENGINEERS

03/29/2021

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> FRONT STREET VILLAGE, LLC 2400 LENNOXVILLE ROAD BEAUFORT, NC 28516

PROJECT:


FRONT STREET VILLAGE TRANSPORTATION CENTER-SITE AND PRELIMINARY PLAT PHASE IV BEAUFORT, NORTH CAROLINA

CARTERET COUNTY, NC

DRAWING:

EAST GREAT EGRET WAY SEWER A PLAN & PROFILE


STATIONS 0+00 TO 6+50

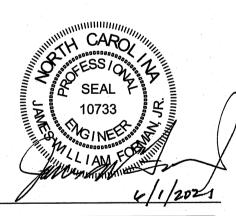

<u>S</u>	REVISION	ВУ	DATE
\leq	TOWN COMMENTS	JJW	04/08/21
\	TOWN COMMENTS	WLL	04/30/21
€	TOWN COMMENTS	WCC	06/01/21

SHEET NO:

OF: 18

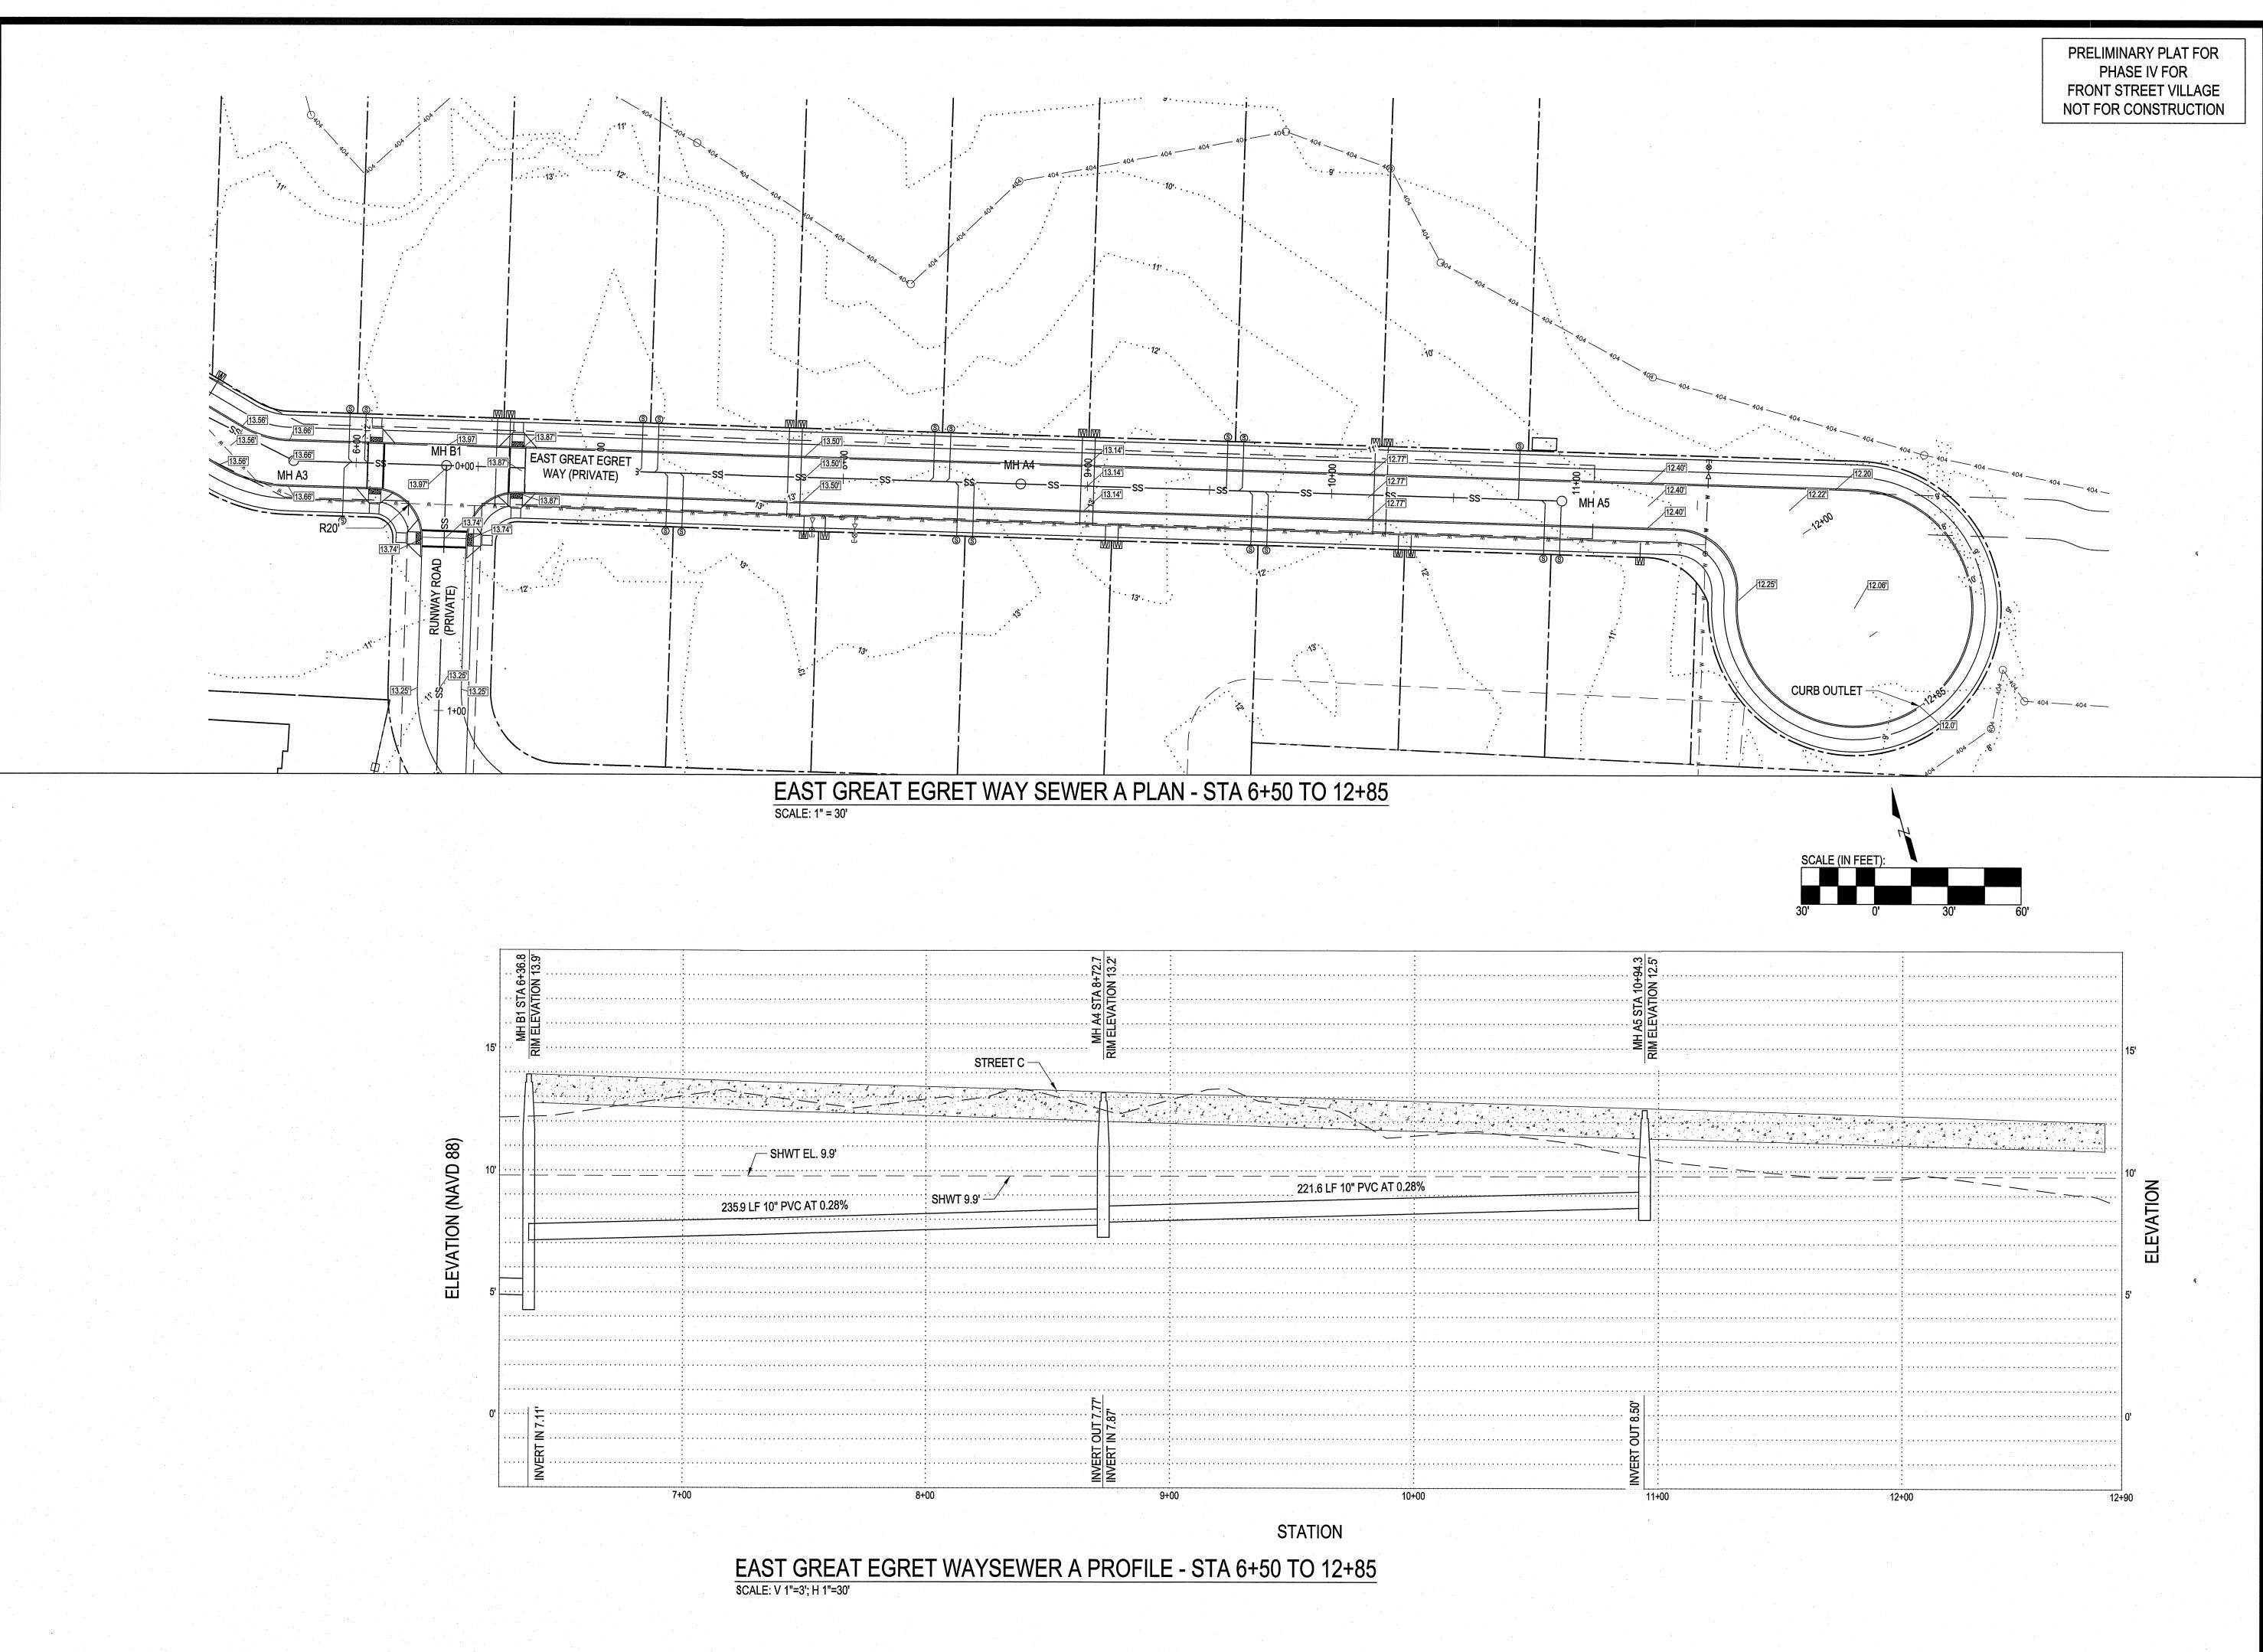

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PROJECT MANAGER:

	JWF
DESIGNED:	JJW
DRAWN BY:	JJW
CHECKED:	JWF
SCALE:	1" = 30'
DATE:	03/29/2021

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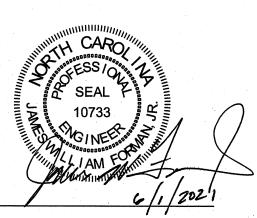
PROJECT:

FRONT STREET VILLAGE
TRANSPORTATION CENTER-SITE
PLAN-PHASE II
AND PRELIMINARY PLAT PHASE IV
BEAUFORT, NORTH CAROLINA

CARTERET COUNTY, NC

DRAWING:

EAST GREAT EGRET WAY SEWER A
PLAN AND PROFILE
STATIONS 6+50 TO 12+85




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SHEET NO:

C8

OF: 18 JOB NO.

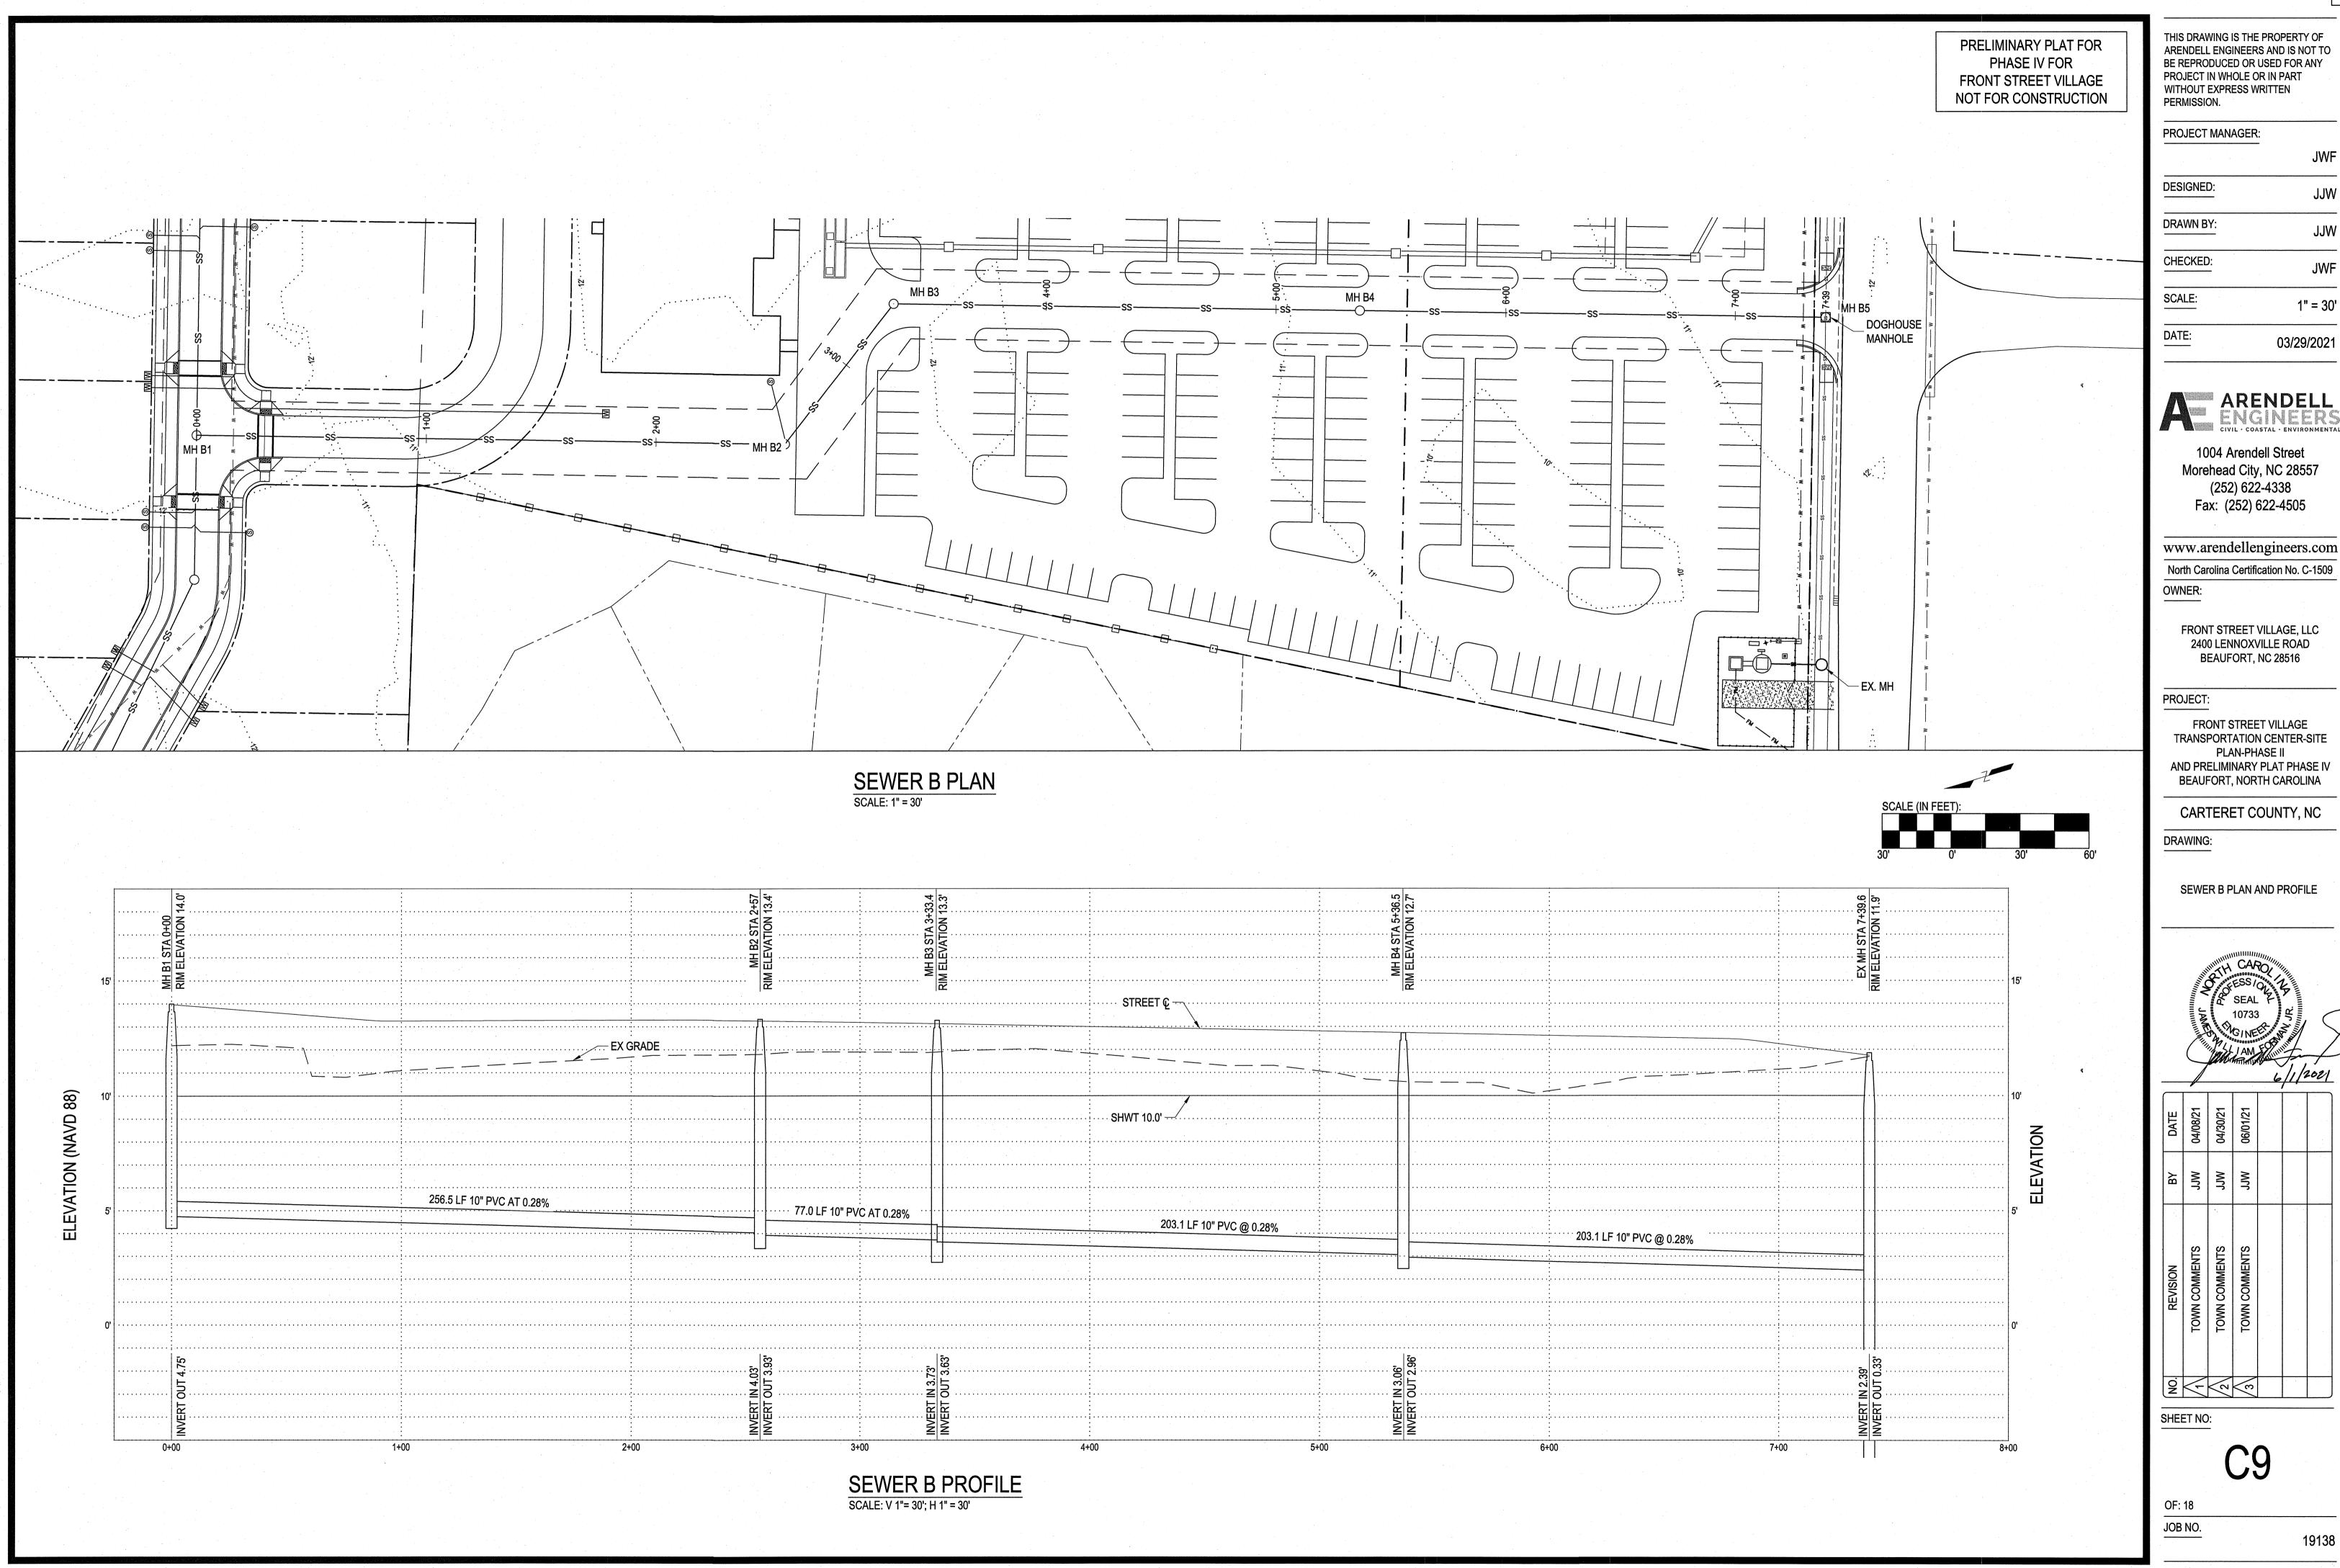

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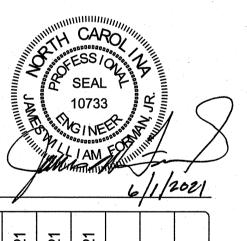
DESIGNED:	JJW
DRAWN BY:	JJW
CHECKED:	JWF
SCALE:	1" = 30
	1 - 00

ARENDELL ENGINEERS CIVIL - COASTAL - ENVIRONMENTAL


www.arendellengineers.com North Carolina Certification No. C-1509

FRONT STREET VILLAGE, LLC 2400 LENNOXVILLE ROAD

TRANSPORTATION CENTER-SITE AND PRELIMINARY PLAT PHASE IV



Š.	REVISION	ВҮ	DATE
₹	TOWN COMMENTS	MCC	04/08/21
$\sqrt{2}$	TOWN COMMENTS	MCC	04/30/21
$\sqrt{3}$	TOWN COMMENTS	MCC	06/01/21

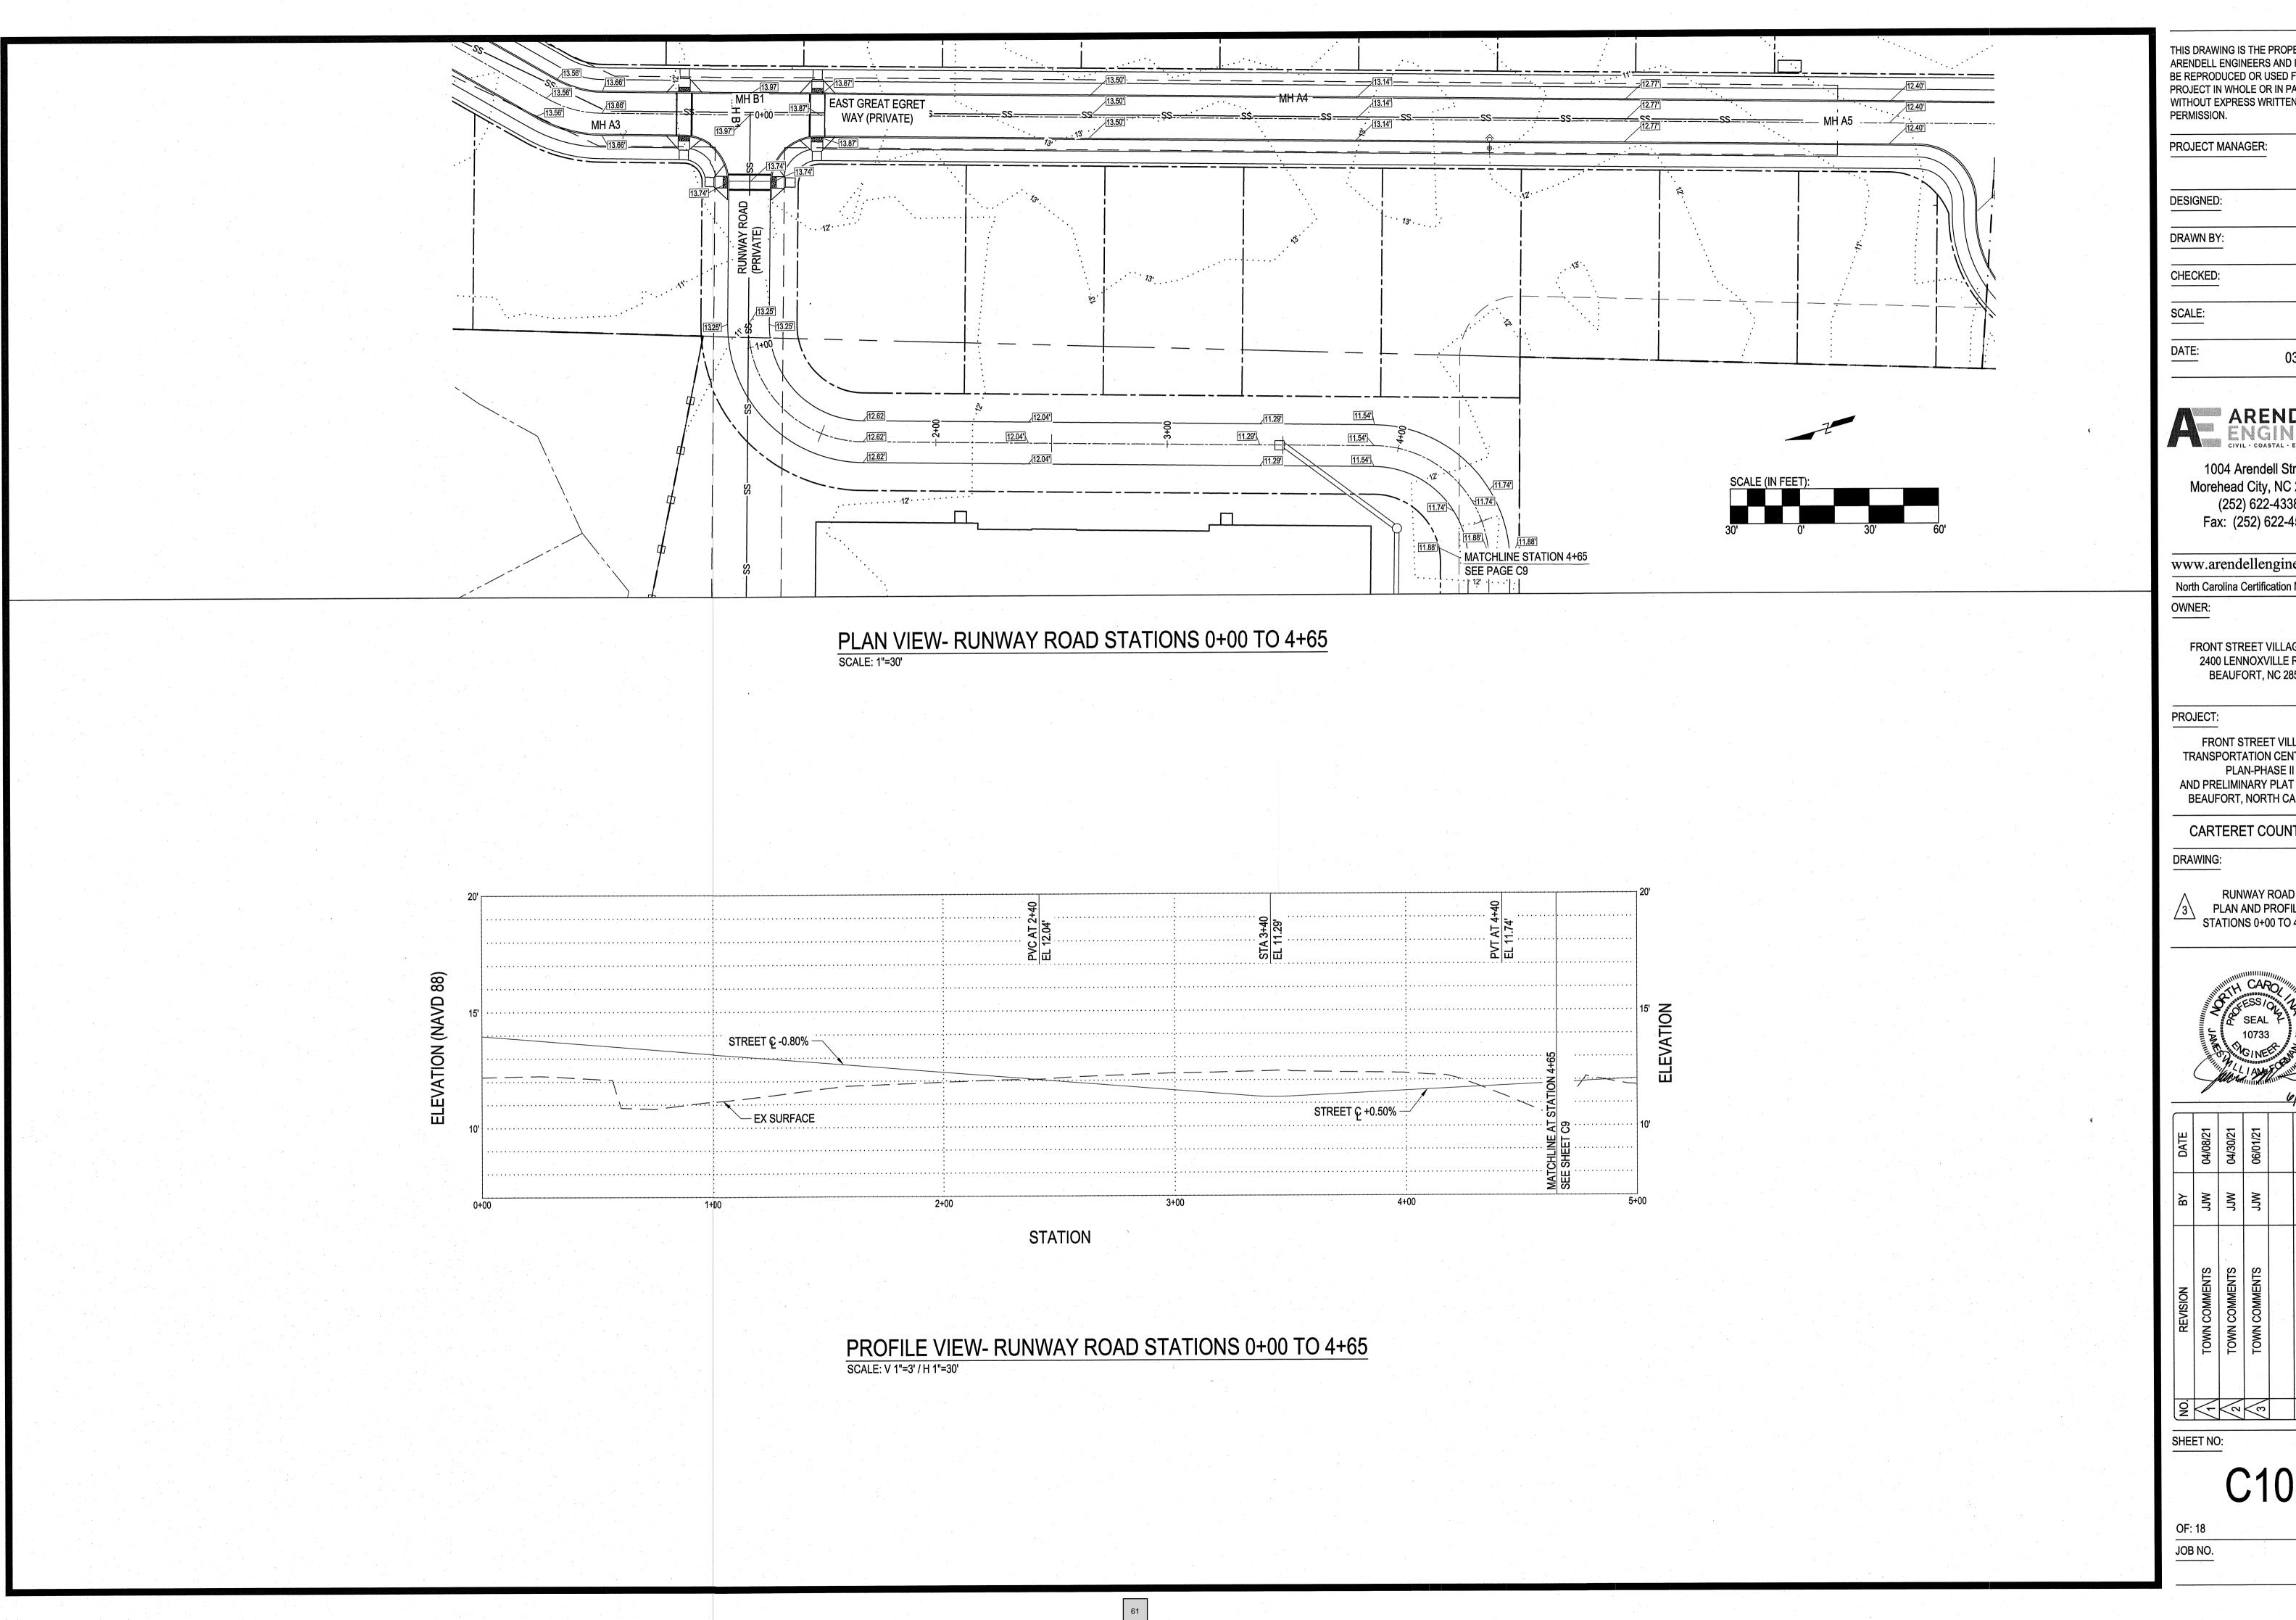

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1" = 30'



03/29/2021

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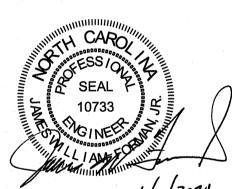
www.arendellengineers.com North Carolina Certification No. C-1509

FRONT STREET VILLAGE, LLC 2400 LENNOXVILLE ROAD BEAUFORT, NC 28516


FRONT STREET VILLAGE TRANSPORTATION CENTER-SITE PLAN-PHASE II AND PRELIMINARY PLAT PHASE IV BEAUFORT, NORTH CAROLINA

CARTERET COUNTY, NC


PLAN AND PROFILE STATIONS 0+00 TO 4+65



DATE	04/08/21	04/30/21	06/01/21		
ВУ	MCC	MCC	WLL		
REVISION	TOWN COMMENTS	TOWN COMMENTS	TOWN COMMENTS		
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PLAN VIEW- RUNWAY ROAD STATIONS 4+65 TO 10+00 SCALE: 1"=30"

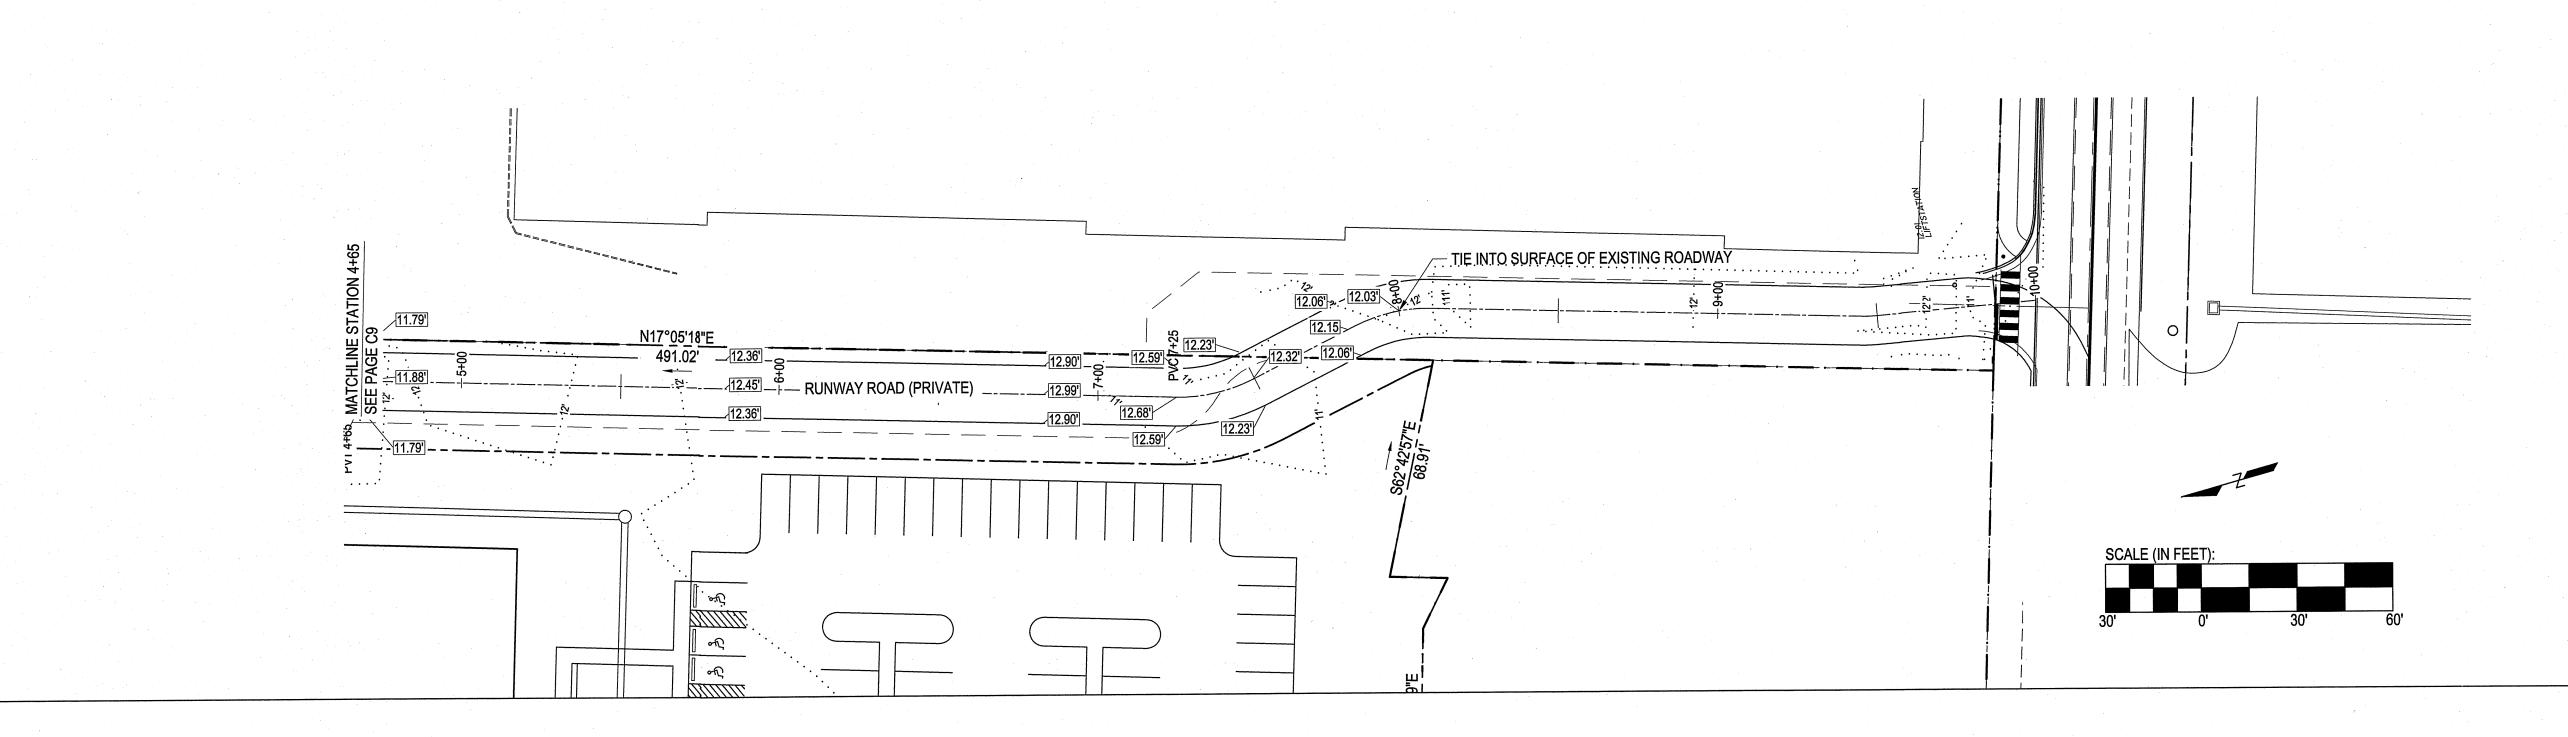

PROFILE VIEW- RUNWAY ROAD STATIONS 4+65 TO 10+00 SCALE: V 1"=3' /H 1"=30'
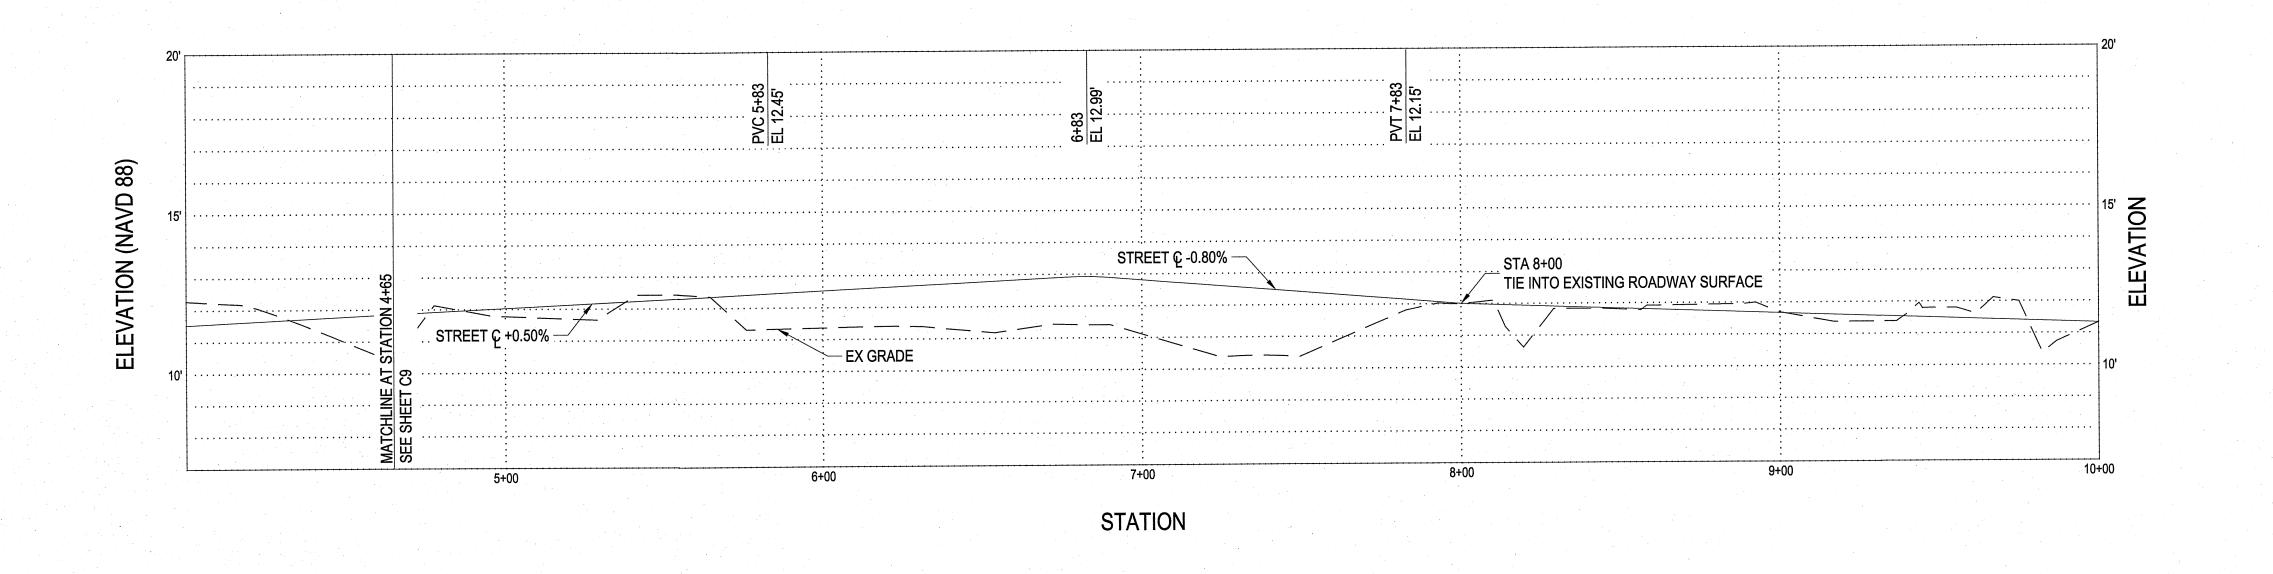
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PROJECT MANAGER:

JW.

DESIGNED:

DRAWN BY:

CHECKED:

SCALE: 1" = 30'

DATE: 03/29/2021

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North Carolina Certification No. C-1509
OWNER:

FRONT STREET VILLAGE, LLC 2400 LENNOXVILLE ROAD BEAUFORT, NC 28516


PROJECT:

FRONT STREET VILLAGE
TRANSPORTATION CENTER-SITE
PLAN-PHASE II
AND PRELIMINARY PLAT PHASE IV
BEAUFORT, NORTH CAROLINA

CARTERET COUNTY, NC

DRAWING:

RUNWAY ROAD
PLAN AND PROFILE
STATIONS 4+65 TO 10+00

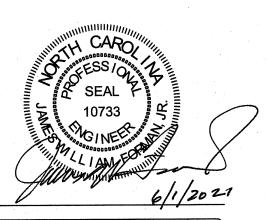

 NO.
 REVISION
 BY
 DATE

 1
 TOWN COMMENTS
 JJW
 04/08/21

 2
 TOWN COMMENTS
 JJW
 06/01/21

 3
 TOWN COMMENTS
 JJW
 06/01/21


SHEET NO:

C1

OF: 18

JOB NO.

PRELIMINARY PLAT FOR PHASE IV FOR

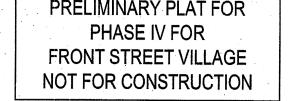

PROJECT MANAGER: DESIGNED: DRAWN BY: CHECKED: JWF SCALE: 1" = 30' 03/29/2021

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FRONT STREET VILLAGE, LLC 2400 LENNOXVILLE ROAD BEAUFORT, NC 28516

PROJECT:

STD. NO.

2.02

SEE ENCASEMENT DETALS


2.06

FRONT STREET VILLAGE TRANSPORTATION CENTER-SITE PLAN-PHASE II AND PRELIMINARY PLAT PHASE IV BEAUFORT, NORTH CAROLINA

CARTERET COUNTY, NC

DRAWING:

UTILITY DETAILS

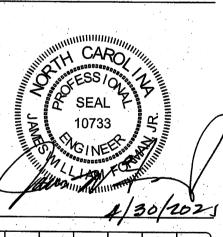

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DATE	04/08/21	04/30/21		
ВУ	Mff	Mff		
REVISION	TOWN COMMENTS	TOWN COMMENTS		
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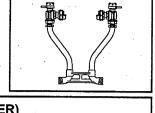
19138

OF: 18 JOB NO.

SHEET NO:


SUBMITTAL INFORMATION


40 Series Resetter - (VBB42-xxW-BI-NL style)



ANGLE BALL VALVE BY *ANGLE BALL VALVE (5/8" X 3/4" METER)

5/8" METER THREAD INLET AND OUTLET

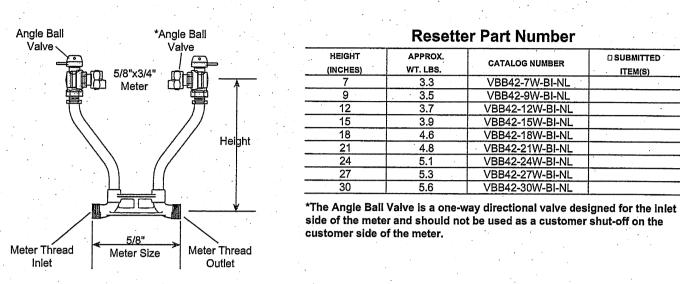

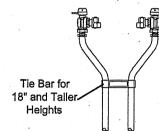

Bottom Bar Meter Thread Size

FEATURES

All brass that comes in contact with potable water conforms to AWWA Standard C800

(UNS NO C89833)

• Brass components that do not come in contact with potable water conform to AWWA Standard C800 (ASTM B-62 and ASTM B-584, UNS NO C83600 - 85-5-5-5)

The product has the letters "NL" cast into the main body for proper identification

Saddle nuts hold the meter in place for tightening

• Tie Bar is standard for 18" and taller resetter heights (40 Series) • Conforms to AWWA C700 for Meter Threads

• 13/16" Copper risers provide more flow capacity

· All Ford Setters are assembled with lead-free solder

• Copper conforms to ASTM B-75, Copper Alloy #122

5/8" meter thread on bottom bar


The Ford Meter Box Company considers the information in this submittal form to be correct at the time of publication. Item and option availability,


including specifications, are subject to change without notice. Please verify that your product information is current.


The Ford Meter Box Company, Inc.
P.O. Box 443, Wabash, Indiana U.S.A. 46992-0443
Phone: 260-563-3171 / Fax: 800-826-3487
Overseas Fax: 260-563-0167


TOWN OF BEAUFORT

STANDARDS

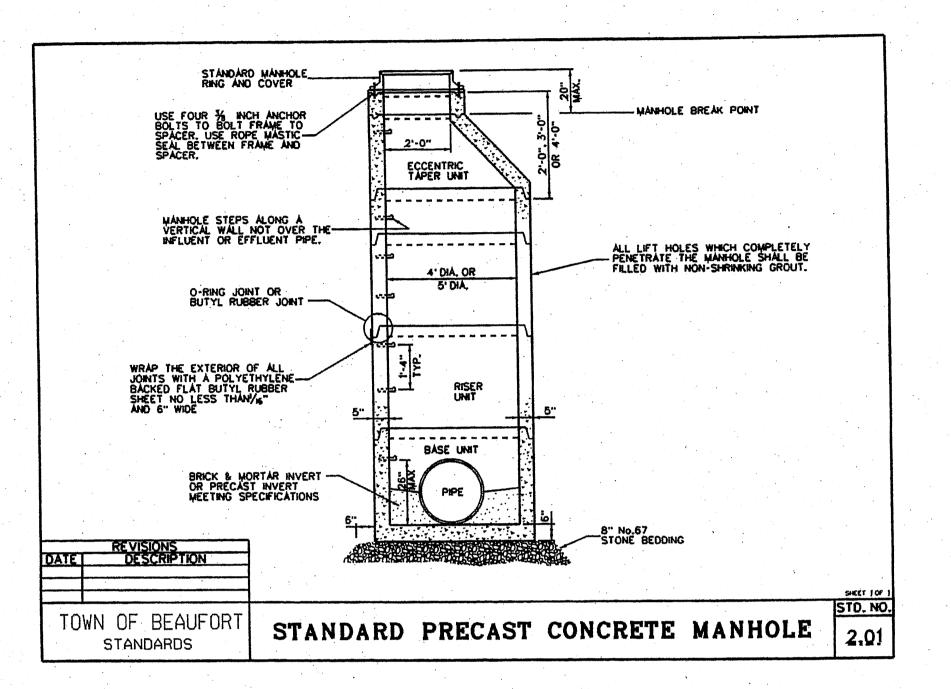

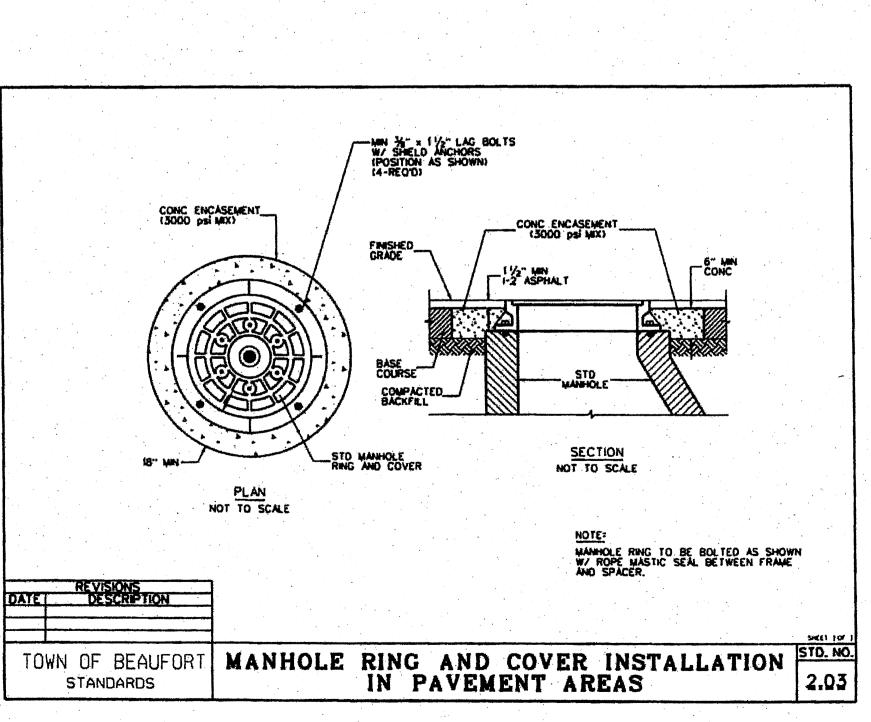

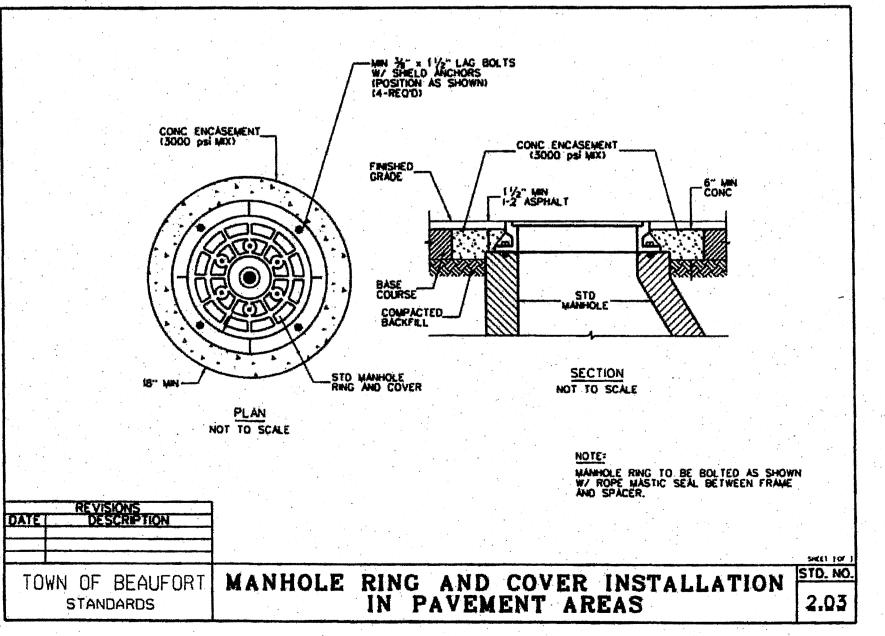

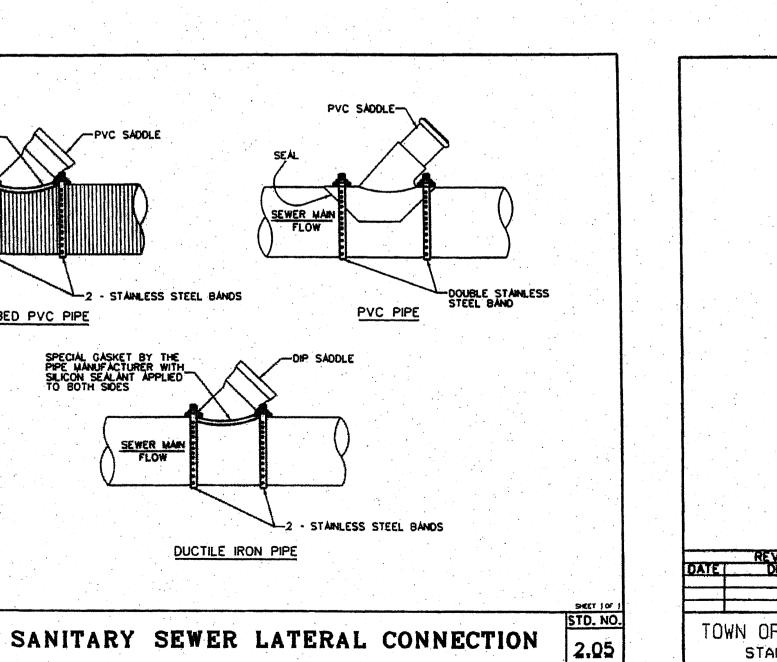

PLAN NOT TO SCALE MINIMUM AVERAGE WEIGHT REVISIONS DESCRIPTION 120 LBS. 300 LBS. COVER TOTAL TOWN OF BEAUFORT MANHOLE RING AND COVER STANDARDS

CLEAN OUT
FOR PAVED AND WELL
MAINTAINED AREAS

TOP VIEW

SANITARY SEWER TAP AND SERVICE

-TOP OF COVER

BOTTOM OF COVER-

CLÁSS 30 CÁST IRON MEETING ÁSTM Á-48 WITH FULL BITUMINOUS COÁTING, OR DUCTILE IRON ÁSTM Á-536, GRÁDE 65-45-12

TWO 1" DIA HOLES REQUIRED UNLESS MANHOLES ARE TO-BE WATER TIGHT

1. SERVICE LINES BETWEEN 14 FEET AND
20 FEET IN DEPTH SHALL REQUIRE CLASS I
BEDDING IN ACCORDANCE WITH SPECIFICATIONS
FOR FLEXIBLE PIPE SERVICES.
2. SERVICE LINES GREATER THAN 20 FEET
OR LESS THAN 3 FEET IN DEPTH MUST
BE DUCTLE IRON,

REVISIONS DESCRIPTION

TOWN OF BEAUFORT

STANDARDS

SIDE VIEW

PVC PIPE RIBBED PYC PIPE STAINLESS STEEL BANDS DUCTILE IRON PIPE REVISIONS DESCRIPTION

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	_ JWF		
DESIGNED:	JJW		
DRAWN BY:	JJW		
CHECKED:	JWF		
SCALE:	1" = 50'		
DATE:	03/29/2021		

ARENDELL

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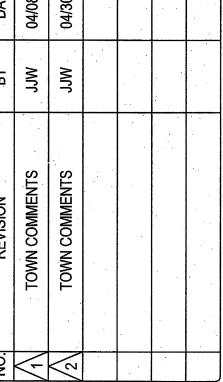
2400 LENNOXVILLE ROAD BEAUFORT, NC 28516

FRONT STREET VILLAGE TRANSPORTATION CENTER-SITE PLAN-PHASE II AND PRELIMINARY PLAT PHASE IV BEAUFORT, NORTH CAROLINA

CARTERET COUNTY, NC


LANDSCAPING PLAN





JJW JJW JWF 1" = 50'

JOB NO.

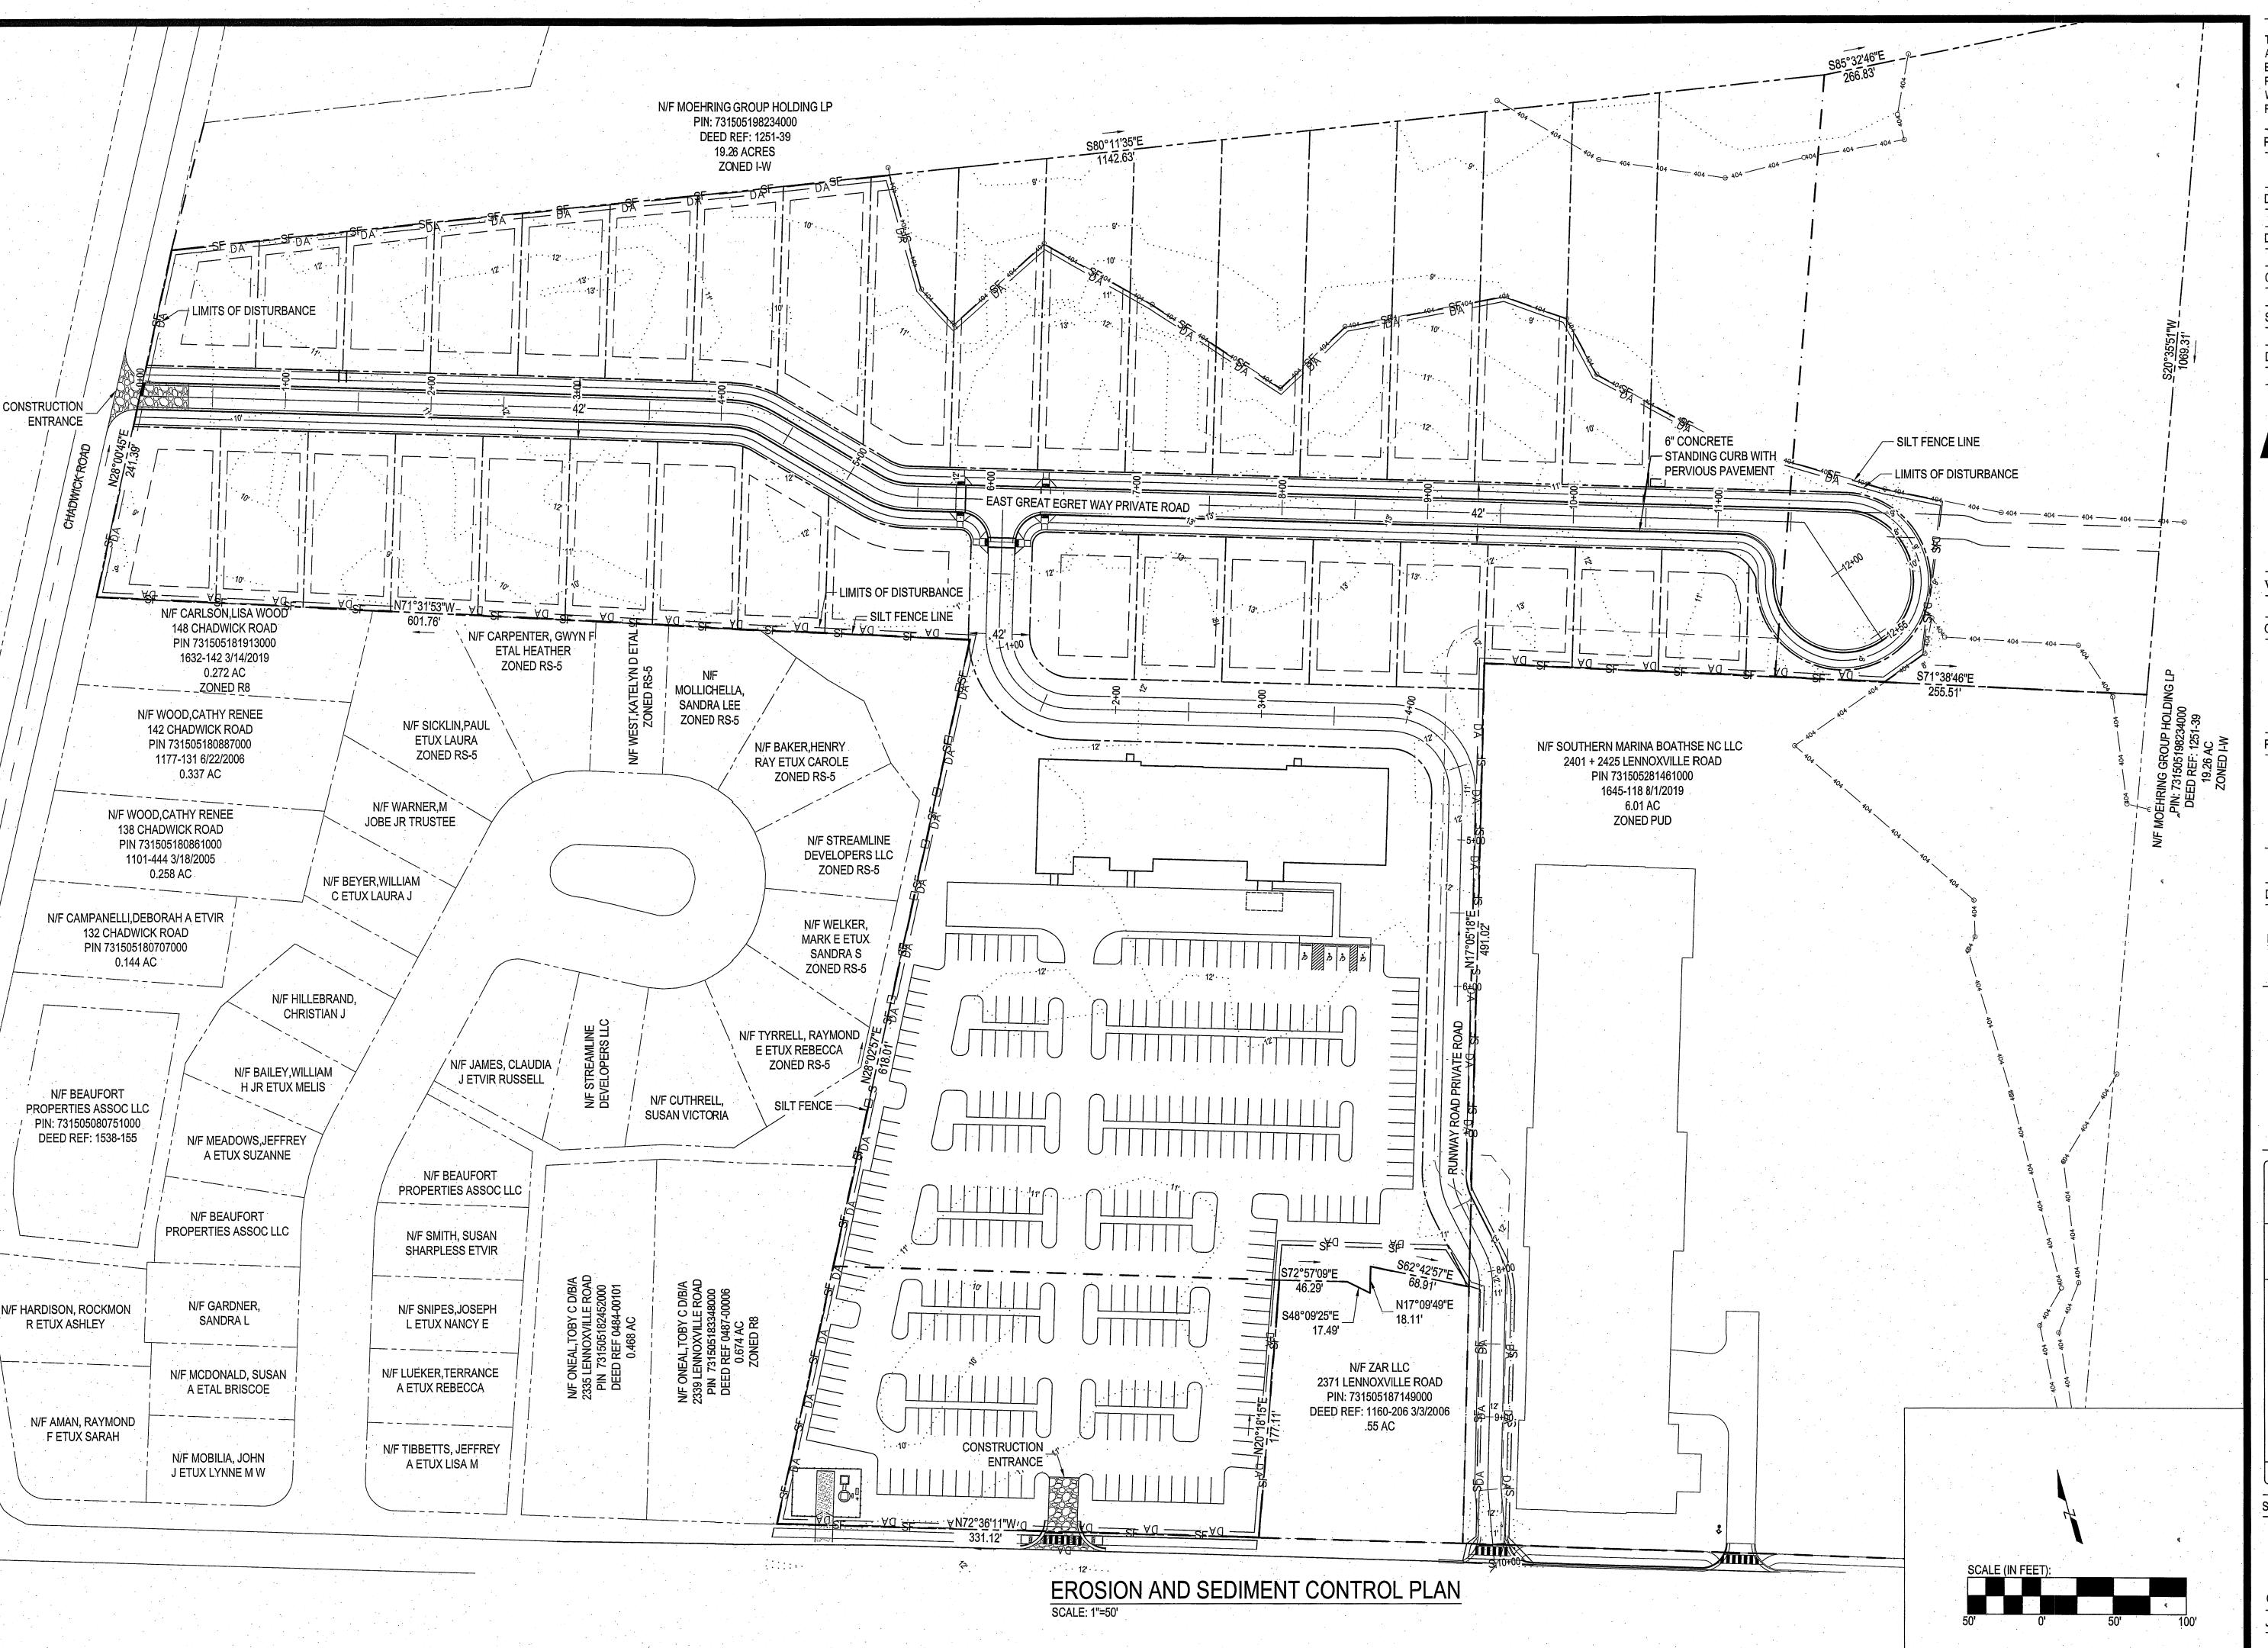

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PROJECT MANAGER:

JWF

DESIGNED:

JJW

DRAWN BY:

JJW

CHECKED:

JWF

SCALE:

1" = 50'

DATE:

03/29/2021

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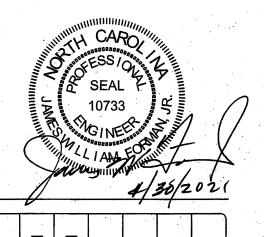
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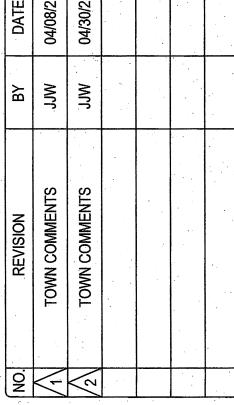
FRONT STREET VILLAGE
TRANSPORTATION CENTER-SITE
PLAN-PHASE II
AND PRELIMINARY PLAT PHASE IV
BEAUFORT, NORTH CAROLINA

CARTERET COUNTY, NC

DRAWING:

EROSION AND SEDIMENT CONTROL PLAN





SHEET NO:

C15

OF: 18 JOB NO.

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DESIGNED: DRAWN BY: CHECKED:

SCALE: 03/29/2021

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www.arendellengineers.com North Carolina Certification No. C-1509

OWNER:

FRONT STREET VILLAGE, LLC 2400 LENNOXVILLE ROAD BEAUFORT, NC 28516


PROJECT:


FRONT STREET VILLAGE TRANSPORTATION CENTER-SITE PLAN-PHASE II AND PRELIMINARY PLAT PHASE IV BEAUFORT, NORTH CAROLINA

CARTERET COUNTY, NC

DRAWING:

EROSION AND SEDIMENT CONTROL DETAILS

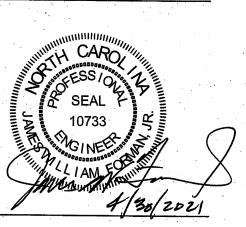

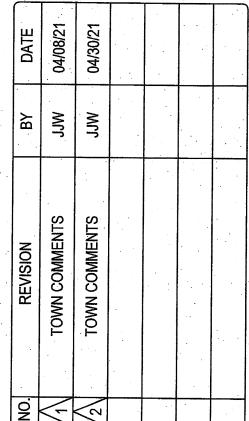

SHEET NO:

19138

OF: 18 JOB NO.

STEP 1 DRIVE 5' STEEL POSTS 24" INTO GROUND AND EXCAVATE A 8"x6" TRENCH ON UPHILL SIDE OF POST LINE. STEP 2
ATTACH WIRE FENCE TO POSTS THEN ATTACH FILTER
FABRIC TO WIRE FENCE AND EXTEND BOTTOM OF BOTH 8"
INTO TRENCH AND 4" FORWARD. STEP 3
BACKFILL TRENCH (SEE NOTE) TO ANCHOR FENCE BOTTOM SO RUNOFF IS FORCED THROUGH NOT UNDER FENCE. - WIRE FENCE " HOG WIRE" _ AND FILTER FABRIC BURIED 8" DEEP AND 4" FORWARD
ALONG THE TRENCH NOTES:

1. SEE EROSION CONTROL GENERAL NOTES.

2. FILTER FABRIC BOTTOM SHALL BE PLACED 8" IN TRENCH AND 4 " FORWARD AND SECURED BY EITHER WASHED STONE EXTENDING A MINIMUM OF 6" ABOVE GROUND LEVEL DR TAMPED SOIL BACKFILL MATERIAL TO GROUND LEVEL OR HIGHER.

> TEMPORARY SILT FENCE SCALE: NOT TO SCALE

CONSTRUCTION ENTRANCE

2"-3" COARSE AGGREGATE _/ (# 57 STONE)

SCALE: NOT TO SCALE

6" MINIMUM TOTAL THICKNESS —

EROSION AND SEDIMENT CONTROL DETAILS

NOT TO SCALE

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PROJECT MANAGER:

DESIGNED: DRAWN BY: CHECKED: JWF

SCALE: NTS DATE:

03/29/2021

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PROJECT:

FRONT STREET VILLAGE TRANSPORTATION CENTER-SITE PLAN-PHASE II AND PRELIMINARY PLAT PHASE IV BEAUFORT, NORTH CAROLINA

CARTERET COUNTY, NC

DRAWING:


DETAILS SHEET 1 OF 2

SHEET NO:

OF: 18

19138

JOB NO.

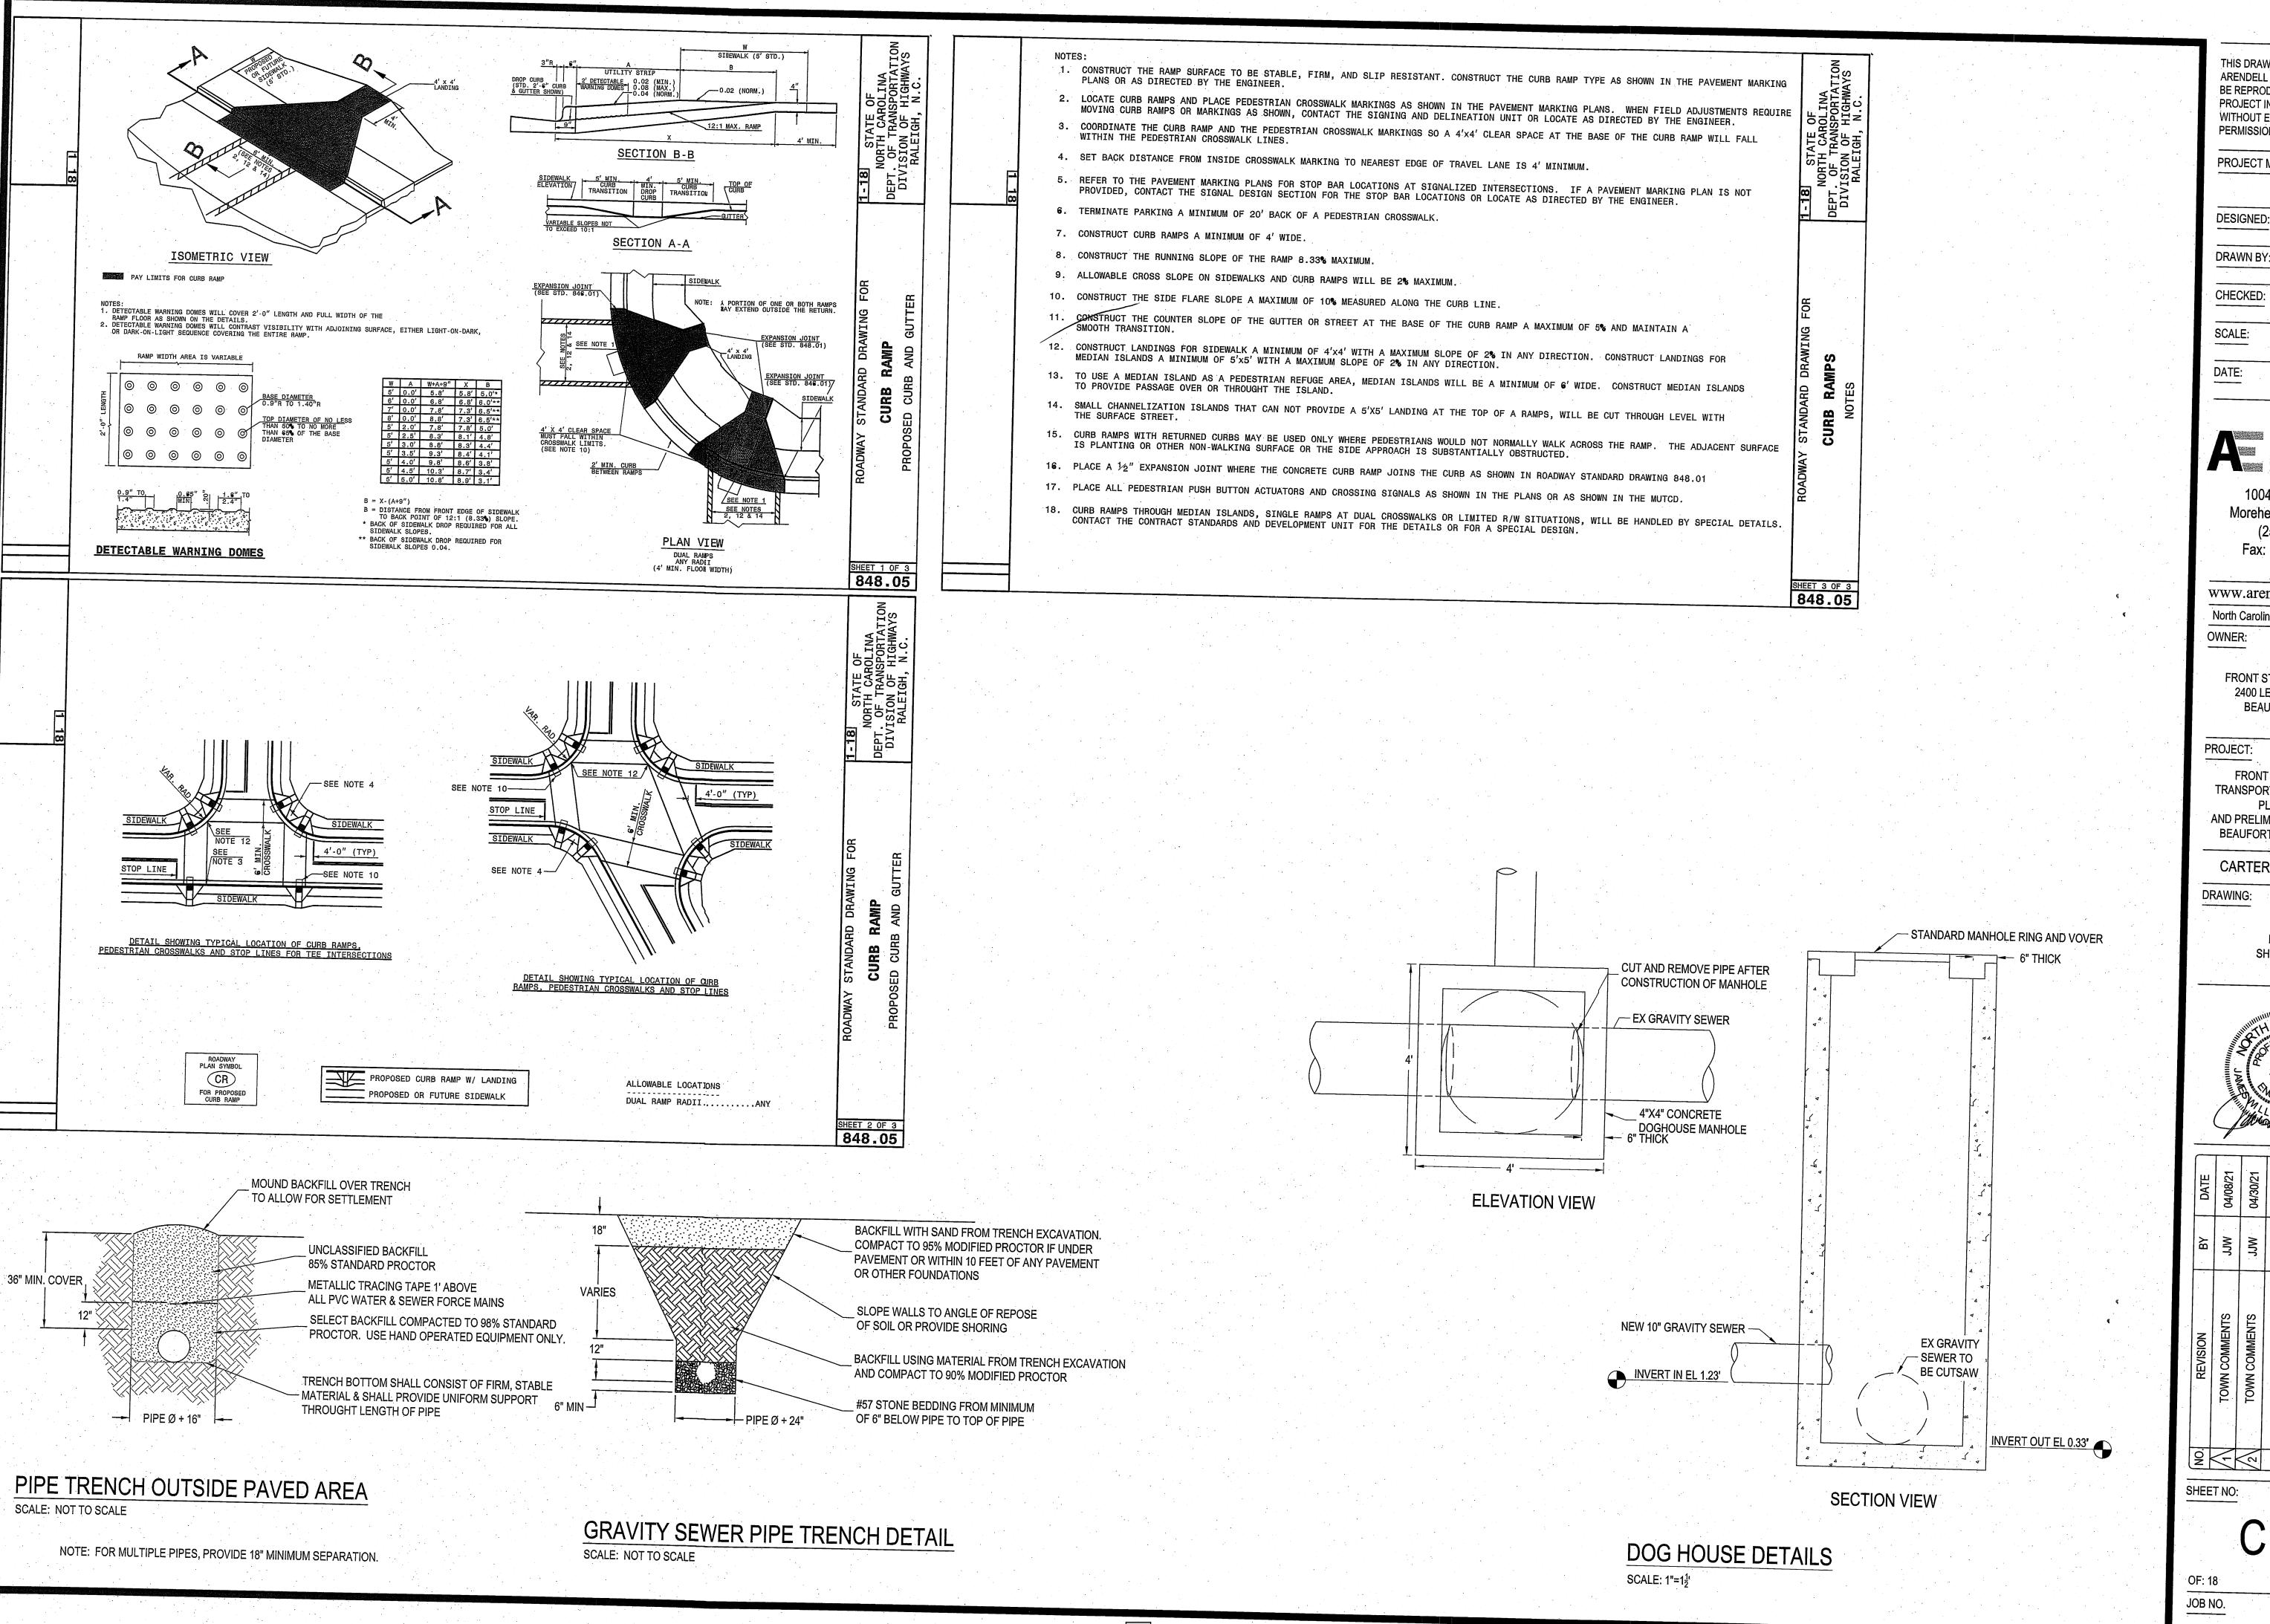

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PROJECT MANAGER: DESIGNED: DRAWN BY: CHECKED: SCALE: 03/29/2021

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www.arendellengineers.com North Carolina Certification No. C-1509

FRONT STREET VILLAGE, LLC 2400 LENNOXVILLE ROAD BEAUFORT, NC 28516

PROJECT:

FRONT STREET VILLAGE TRANSPORTATION CENTER-SITE PLAN-PHASE II AND PRELIMINARY PLAT PHASE IV BEAUFORT, NORTH CAROLINA

CARTERET COUNTY, NC

DRAWING:

DETAILS SHEET 2 OF 2

SHEET NO:

OF: 18

JOB NO.



TRANSPORTATION CENTER STAINED CYPRESS BOARD & BATTEN

ORIGINAL SUBMITTAL 19 NOV. 2012









TRANSPORTATION CENTER STAINED CYPRESS BOARD & BATTEN

REVISED 27 OCTOBER 2014





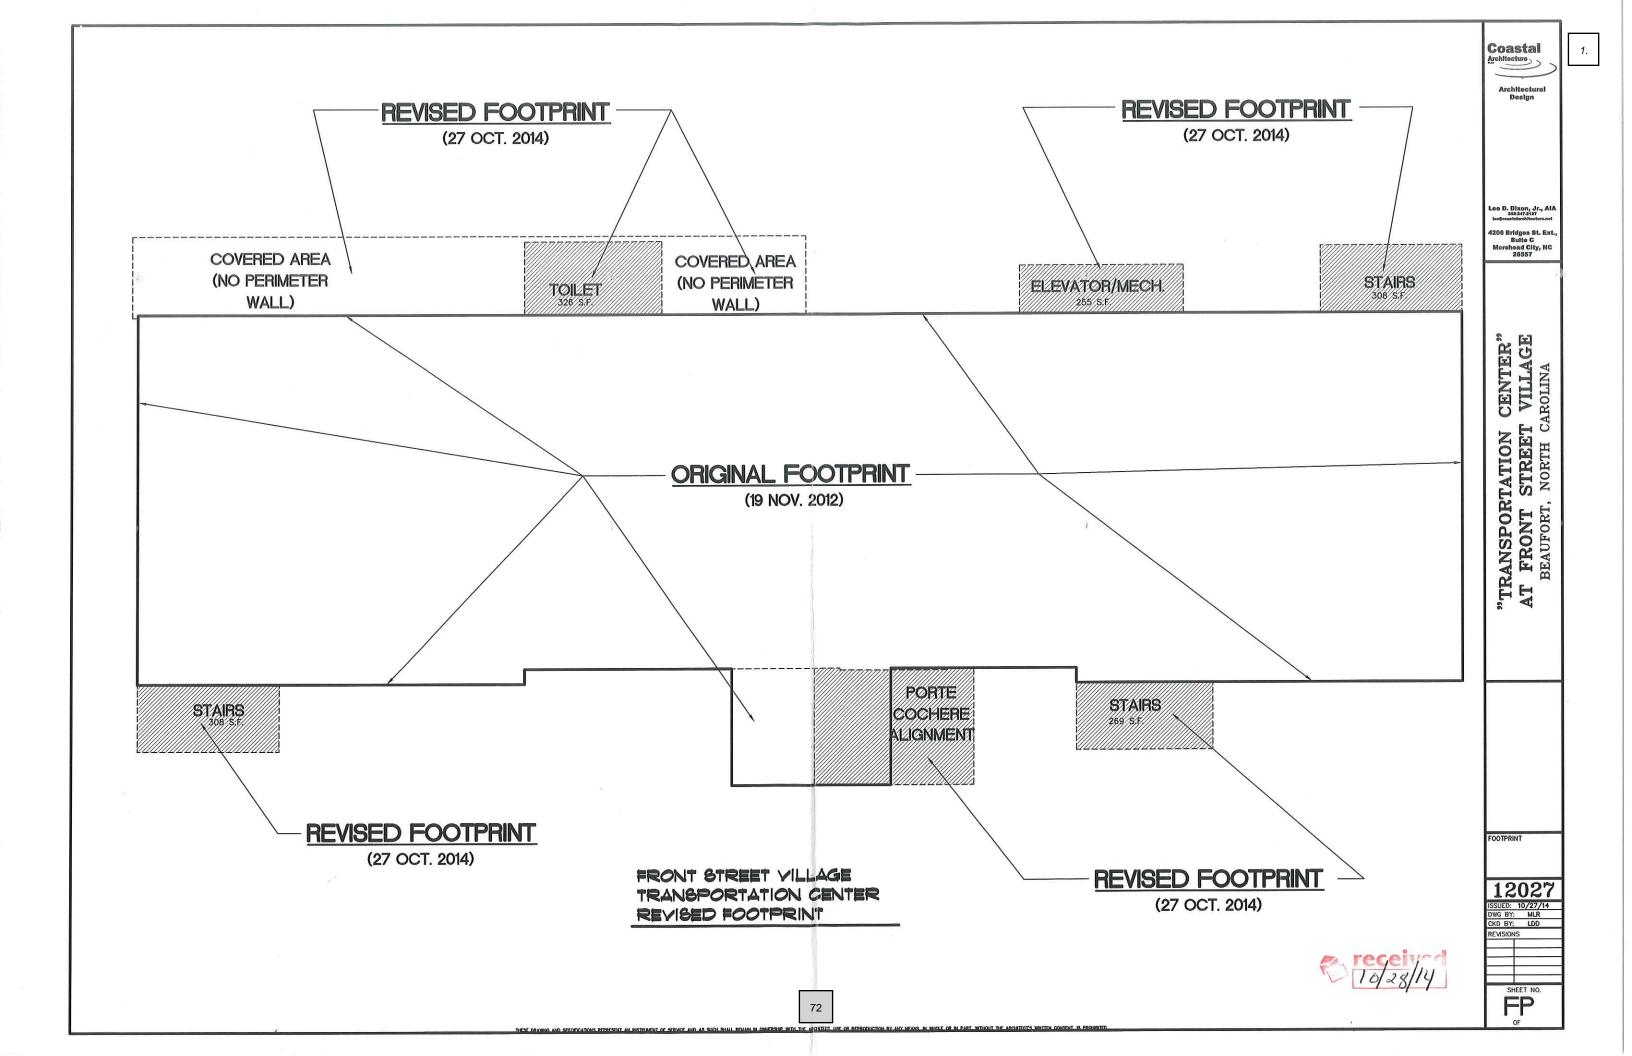

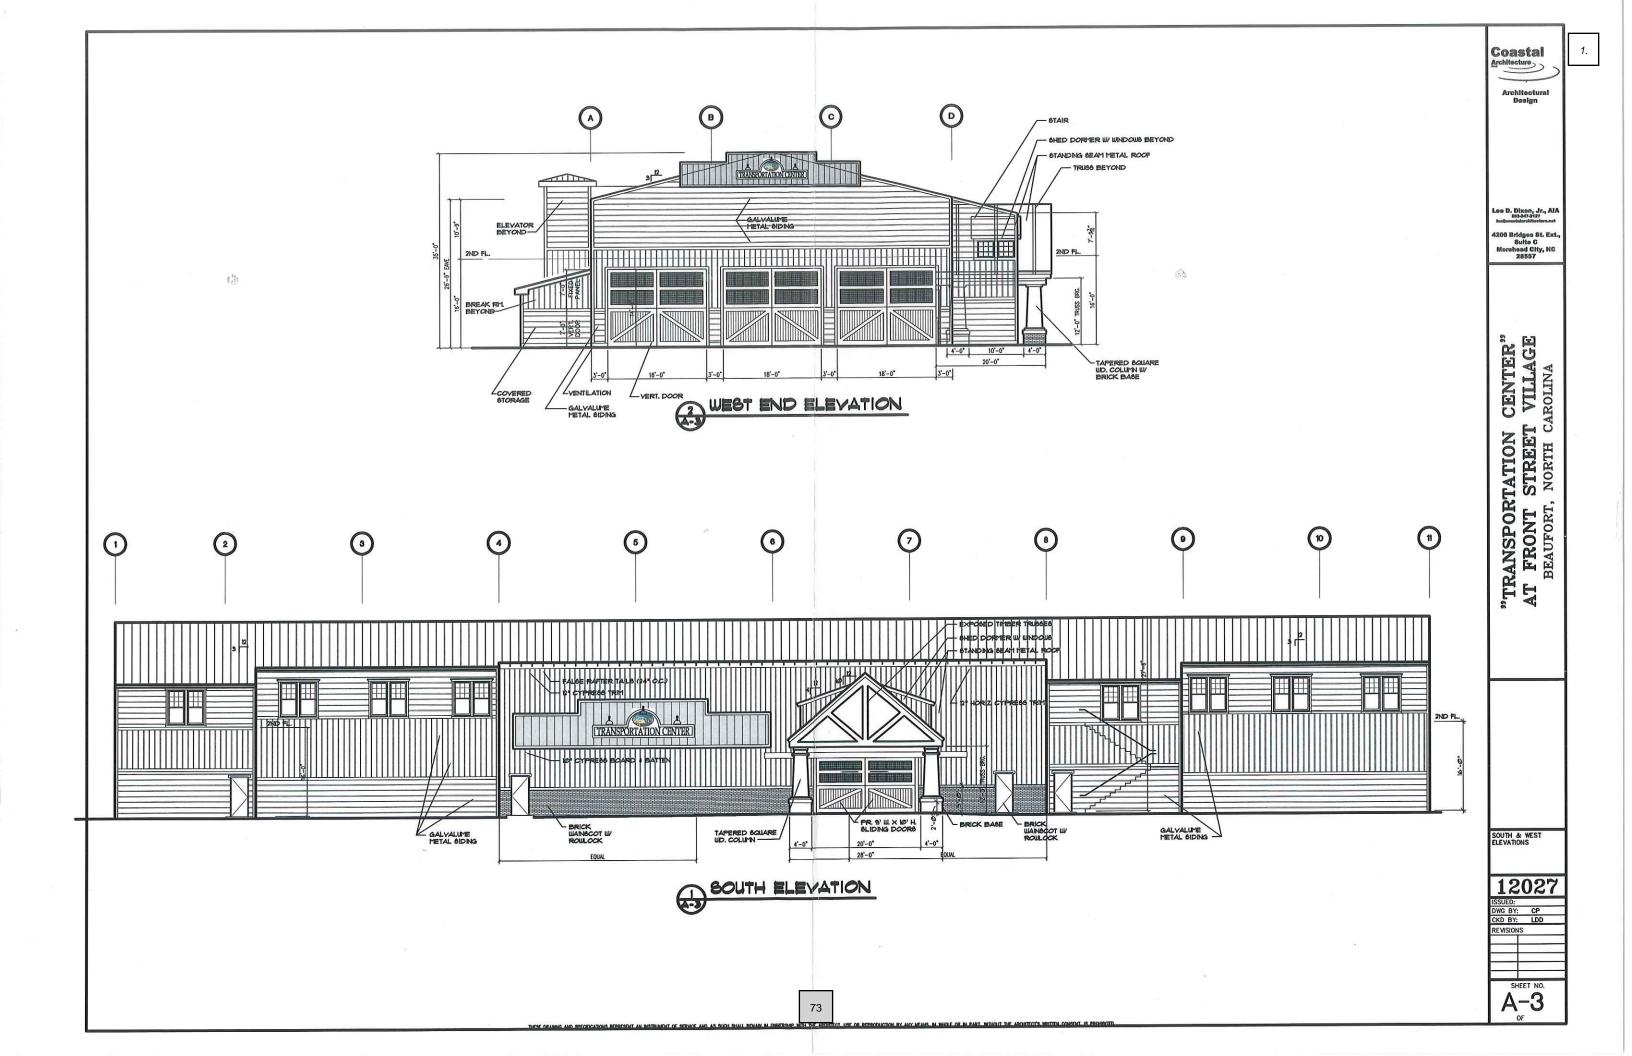

TOWN OF BEAUFORT

Planning and Inspections Department

215 Pollock Street, P.O. Box 390 Beaufort, N.C. 28516 (252) 728-2142, (252) 728-3982 fax www.beaufortnc.org

December 9, 2014

Mr. Lee Dixon Coastal Architecture 4206 Bridges Street Ext. Morehead City, NC 28557

RE: Front Street Village – PUD – Revision to Building Elevation for the Proposed Transportation Center Phase II-C &D – Beaufort NC

Dear Mr. Dixon:

The Beaufort Board of Commissioners met on Monday, December 8, 2014, and approved your proposed revision to the proposed Transportation Center building plan to include the shifting of the vehicle entrance/exit to align with Front Street as per NCDOT request as well as the addition of second floor windows and stairs as shown on the submitted elevation drawings. Prior to construction we request that all State environmental permits be submitted to us as well as any other pertinent permits. We also require that prior to beginning any construction, your general contractor meet with the Town's Public Works Director and Building Inspector.

If you have any questions, please e-mail me at k.garner@beaufortnc.org or call (252) 728-2142.

Sincerely,

Kyle Garner, AICP

Town Planner



Kyle Garner, AICP, Town Planner



Town of Beaufort, NC

701 Front St. - P.O. Box 390 - Beaufort, N.C. 28516 252-728-2141 - 252-728-3982 fax - www.beaufortnc.org

Town of Beaufort Planning Board Regular Meeting 6:00 PM Monday, June 21, 2021 – Virtual Meeting via Zoom

AGENDA CATEGORY: New Business

SUBJECT: Preliminary Plat – Front Street Village

BRIEF SUMMARY:

The applicant wishes to subdivide a 10.44 Acre Tract into 34 Lots Single-Family. As part of the Town's new sewer allocation policy the applicant is requesting 12,240 gallons of allocation for this project that has already been taken into consideration by the Towns Engineer. In addition to Planning Staff the applicants Engineer will also be available to answer questions regarding the proposed infrastructure.

REQUESTED ACTION:

Recommendation to Board of Commissioners

EXPECTED LENGTH OF PRESENTATION:

10 Minutes

SUBMITTED BY:

Kyle Garner, AICP

Planning & Inspections Director

BUDGET AMENDMENT REQUIRED:

N/A

STAFF REPORT

To: Beaufort Planning Board Members

From: Kyle Garner, AICP, Town Planner

Date: June 11 2021

Project Front Street Village Phase IV – Preliminary Plat

THE QUESTION: Subdivide a 10.44 Acre Tract into 34 Lots

BACKGROUND:

Location: Chadwick Road

Owners: Front Street Village, LLC

Requested Action: Subdivide a 10.44 acre tract into 34 lots

Existing Zoning PUD (R-8)
Size: 10.44 Acres
Existing Land Use: Undeveloped

Adjoining Land Use & North & East – By undeveloped property owned by Atlantic

Zoning: Veneer, zoned IW – Industrial Warehouse

South – By vacant commercial property zoned PUD (B-1) to be used as the Transportation Center for Front Street Village West – Across Chadwick Road by Beau Coast Development,

Zoned PUD

SPECIAL INFORMATION: These plans w

These plans were originally included in the 2008 approved PUD and the design/layout has changed very slightly. As part of the Town's new sewer allocation policy the applicant is requesting 12,240 gallons of allocation for this project that has already been taken into consideration by the Towns Engineer. It should be noted that the streets and storm water system are to be private and will be maintained by the Home Owners Association. Additionally staff request that a note to that affect be included on the Final Plat and in the neighborhood covenants for the proposed subdivision. In addition to Planning Staff, the Town Engineer and Fire Chief have

reviewed the plans for compliance.

Public Utilities & Works:

Water: Town Water Sanitary Sewer: Town Sewer

OPTIONS:

- 1. Approve the request as presented.
- 2. Deny the request.

ATTACHMENTS:

Attachment A - Vicinity Map Attachment B – Preliminary Plat

Attachment C – Applicant Information

\\BEAUFORT-SERVER\Town Hall Share\Planning & Inspecting Share\04 - Planning Board\2021\06.21.2021\Case # 21-12 Preliminary Plat - Front Street Village - Phase IV\Preliminary Plat - Front Street Village - Phase



PRELIMINARY PLAT FOR FRONT STREET VILLAGE PHASE IV FOR FRONT STREET VILLAGE NOT FOR CONSTRUCTION TRANSPORTATION CENTER-SITE PLAN-PHASE II AND PRELIMINARY PLAT PHASE IV BEAUFORT, NORTH CAROLINA

CARTERET COUNTY

DRAWINGS

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UTILITY PLAN	C6 OF 18
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PROJECT DATA

NAME OF PROJECT: FRONT STREET VILLAGE TRANSPORTATION CENTER-SITE PLAN-PHASE II AND PRELIMINARY PLAT PHASE IV BEAUFORT, NORTH CAROLINA

PREPARED BY: ARENDELL ENGINEERS 1004 ARENDELL STREET MOREHEAD CITY, NC 28557 PHONE: (252) 622-4338 EMAIL: BILL@ARENDELLENGINEERS.COM

FRONT STREET VILLAGE, LLC 2400 LENNOXVILLE ROAD BEAUFORT, NC 28570

SURVEYOR: JAMES I. PHILLIPS LAND SURVEYING PO BOX 2103 379 ARRINGTON RD. BEAUFORT, NC 28516 PHONE: (252) 728-5848 EMAIL: JIP3@COSTALNET.COM

DATUMS: VERTICAL: NAVD88 HORIZONTAL: NC STATE PLANE COORDINATE SYSTEM

- PROJECT AREA - S.R. 1312- FRONT STREET TAYLOR CREEK

VICINITY MAP

SCALE: 1" = 5000'

TOWN OF BEAUFORT SITE DATA BLOCK OF FEATURES

PROPOSED USE:	34 SINGLE FAMILY HOMES AND TRANSPORTATION CENTER			
SQUARE FOOTAGE PROPOSED:	34 SINGLE FAMILY HOMES WITH APPROXIMATELY 2,000 SF FOOTPRINT TRANSPORTATION CENTER WITH APPROXIMATELY 16,500 SF FOOTPRIN			
SITE ZONING:	PUD, TRANSPORTATION CENTER B-1, RESIDENTIAL LOTS R-8			
TOTAL LOT ACREAGE:	16.20 ACRES NORTH OF LENNOXVILLE ROAD			
ACREAGE TO BE DISTURBED:	11.55 ACRES NORTH OF LENNOXVILLE ROAD			
FLOOD ZONE:	ZONE X			

DEVELOPMENT PARKING REQUIRED: DEED BOOK:PAGE NUMBER

SEE PARKING SUMMARY TABLE 1259:443, 1645:118, 1510:484

PARCEL ID NUMBER:

731505187915000, 731505284836000, 731505187504000, 731505185229000

STREET LENGTHS **EAST GREAT EGRET WAY** RUNWAY ROAD

1,255 LF 1,000 LF


	NG SUMMARY TABLE -	The second secon	
DUAGET	Total Gross Parkin	g Spaces	
PHASE I	l leite		
Location South Devoted	Units	Requirement	Total Spaces
South Drystack	213 Slips	1 Space per 4 Slips	53
Chandlery		терия в принципальный принценти и принценти и принценти	a intermedial department and months are proportional transfer to the proportion of t
Upstairs	Services according to the contract of the cont	22.5 Spaces per 1,000 SF	51
Downstairs		3.5 Spaces per 1,000 SF	8
Office	2 Employees	2 Spaces	2
PHASE IIC & IID	And a distribution of the control of	Total	114
Location	l laita		
Guest Wing	Units	Requirement	Total Spaces
Rooms	129		a management to the control of the c
Employees		1 Space per Room +5	134
Bistro	9 per Day Shift	1 per Employee	9
Ballroom	1 177 Saucro Foot		and the second s
1st Floor Porch Terrace		22.5 Spaces per 1,000 SF	101
2nd Floor Porch/Terrace	\$2000000000000000000000000000000000000	1 Space per 4 Seats	24
4 Bridal Suites		nariannania de manaria de la comencia de manaria de manaria de la comencia de la comencia de la comencia de la	***************************************
Bistro & Bar		1 Space per Room	4
Board Room	325 Square Feet	1 Space per 4 Seats	. xarqaanin aanaa
Residential Units	7 Units	22.5 Spaces per 1,000 SF	~~~~~~~~~~~~~~~~~~~~~~~~~~~~~~~~~~~~~~
Employees incl. Transportation	TO THE STATE OF TH	1.5 Spaces per Unit	11
Center (Phase I & II, Minus Inn)	20 Employees		
Center (Filase I & II, Milius IIIII)	20 Employees	1 per Employee	20
PHASE IIIA	The second state of the second	Total	334
Location	Lloito		
North Drystack	Units	Requirement	Total Spaces
	237 Slips	1 Space per 4 Slips	· 59
PHASE IV			
Location	Units	Dogwing	T 0
34 Residential Lots	34 Units	Requirement	Total Spaces
. Hooladiitai Edd	O4 Office	2 spaces per Unit	68
	AND THE THE WASTERN AND THE CONTRACT OF THE CO	Phases I, II, III, & IV Total	575
A POSICIONAMENTA COMPANIA PROPERTY AND CONTROL OF THE CONTROL OF T		Andrews are consistent to the constitution of	era era est reconstituisca e reconstituis e comen em acconstituisca con esta acceptante con constituis de cons
2110000	Reductions		
PHASE 1			
Location	Parking Spaces Allocated	Reduction	Total Reduction
South Drystack	53	0.9 per Space	48
Chandlery			
Upstairs	51	0.4 per Space	20
Downstairs	8	0.4 per Space	3
PHASE 2		Total	71
	Doubling Constant All		
Location	Parking Spaces Allocated	0	Total Reduction
Bistro	160	0.35 per Space	56
PHASE IIIA		Total	56
	Porking Cooper Allegated		
Location Location	Parking Spaces Allocated	Reduction	Total Spaces
North Drystack	59	0.9 per Space	53
	Phas	es 1, 2, & 3A Reduction Total	180
	and the second of the second o		The same commencer control of the co
	ired Parking Spaces for P		
	Gross Parking Required (Spaces)		
	Reductions		

395

398

Total

Spaces Provided

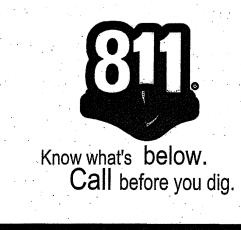

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OF: 18 JOB NO.

19138

DESIGNED:

PROJECT MANAGER:

NOT TO SCALE

03/29/2021



1004 Arendell Street Morehead City, NC 28557 (252) 622-4338 Fax: (252) 622-4505


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FRONT STREET VILLAGE, LLC

CARTERET COUNTY, NO

DRAWING:



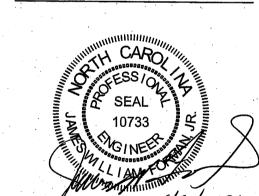

SHEET NO:

GENERAL NOTES: PROJECT IS LOCATED IN THE WHITE OAK RIVER BASIN. LOCATION OF EXISTING ABOVE GROUND AND UNDERGROUND UTILITIES AND FACILITIES ARE NOT NECESSARILY SHOWN ON THE DRAWINGS, AND WHERE SHOWN, THE ACCURACY OF LOCATION IS NOT VERIFIED. BEFORE STARTING WORK, CONTRACTOR SHALL CONFIRM LOCATION OF ALL UNDERGROUND UTILITIES AND FACILITIES. CONTRACTOR SHALL BE RESPONSIBLE FOR REPAIR OR REPLACEMENT OF DAMAGE TO ABOVE GROUND AND UNDERGROUND UTILITIES. CONTRACTOR SHALL PRESERVE ANY PROPERTY MARKER PIPES, IRONS, OR MONUMENTS. WASTE OR EXCESS MATERIALS SHALL BECOME THE PROPERTY OF THE CONTRACTOR AND SHALL BE DISPOSED OF IN ACCORDANCE WITH ALL APPLICABLE FEDERAL, STATE, AND LOCAL REGULATIONS. TESTING AND INSPECTION OF COMPACTION AND MATERIALS SHALL BE BY AN INDEPENDENT TESTING AGENCY DESIGNATED AND PAID FOR BY THE OWNER. CONTRACTOR SHALL BE RESPONSIBLE FOR SCHEDULING TESTING REQUIRED BY THE CONTRACT DOCUMENTS. 6. NO TRENCHES SHALL BE LEFT OPEN OVERNIGHT. CONSTRUCTION SEQUENCE OBTAIN PLAN APPROVAL AND OTHER APPLICABLE PERMITS. SCHEDULE A PRE-CONSTRUCTION CONFERENCE WITH REGULATORY PERSONNEL ONE WEEK BEFORE BEGINNING GRADING OR GROUND DISTURBING ACTIVITIES AT THE SITE. CONTACT NCDEQ 910-796-7215. INSTALL TEMPORARY SILT FENCING AND CONSTRUCTION ENTRANCE AS INDICATED ON THE PLANS OR AS INSTRUCTED BY THE ENGINEER OR LAND QUALITY PERSONNEL. INSTALL STORMWATER SYSTEM INCLUDING DROP INLETS AND AT THE SAME TIME THE DROP INLET PROTECTION AND OUTLET PROTECTION AS INDICATED ON THE PLANS OR AS INSTRUCTED BY THE ENGINEER OR LAND QUALITY PERSONNEL. FILL AND GRADE SITE AS REQUIRED AND INSTALL EITHER PERMANENT OR TEMPORARY STABILIZATION WITHIN 14 DAYS ESTIMATED TIME BETWEEN BEGINNING WORK AND FINAL STABILIZATION - 9 MONTHS TO COMPLETION. EROSION CONTROM MEASURES MAINTENANCE PLAN ALL EROSION AND SEDIMENT CONTROL MEASURES SHALL BE CHECKED FOR STABILITY AND EFFECTIVE OPERATIONS FOLLOWING EVERY RUNOFF PRODUCING RAINFALL EVENT OR AT LEAST ONCE PER WEEK. REPAIRS REQUIRED SHALL BE COMPLETED IMMEDIATELY TO THE DIMENSION AND FUNCTIONS INDICATED ON THE PLANS. SEDIMENT SHALL BE REMOVED FROM BEHIND THE SEDIMENT FENCING WHEN IT BECOMES 6 INCHES DEEP AT THE FENCE. THE FENCE SHALL BE REPLACED OR REPAIRED AS NECESSARY TO MAINTAIN AN EFFECTIVE BARRIER. ALL AREAS SHALL BE FERTILIZED & SEEDED AS NECESSARY TO OBTAIN AND MAINTAIN A VIGOROUS DENSE TURF COVER. CONTACT PERSON RESPONSIBLE FOR MAINTENANCE IS BUCKY OLIVER, OWNER, (919) 349-5588. **EROSION & SEDIMENT CONTROL NOTES:** CONTACT THE NCDEQ, LAND QUALITY SECTION, ONE WEEK PRIOR TO LAND DISTURBING ACTIVITY, AND ONE WEEK PRIOR TO FINAL INSPECTION. A COPY OF THE APPROVED SEDIMENT AND EROSION CONTROL PLAN SHALL BE MAINTAINED AT THE SITE. DISTURBED AREAS ARE DELINEATED ON THE DRAWINGS AND DETERMINED BY DIGITAL METHODS. PRIOR TO COMMENCING LAND DISTURBING ACTIVITIES IN AREAS OTHER THAN THOSE INDICATED ON THE PLANS, BUT NOT LIMITED TO OFFSITE BORROW AND DISPOSAL AREAS, CONTRACTOR SHALL SUBMIT A SUPPLEMENTARY EROSION CONTROL PLAN TO THE ENGINEER FOR REVIEW AND APPROVAL BY THE LAND QUALITY SECTION. EROSION AND SEDIMENT CONTROL MEASURES SHALL BE INSPECTED FOR DAMAGE AND EFFECTIVE OPERATIONS FOLLOWING EVERY RAINFALL EVENT OR AT LEAST ONCE PER WEEK. REPAIRS SHALL BE COMPLETED IMMEDIATELY TO DIMENSION AND FUNCTIONS INDICATED ON THE PLANS CONTRACTOR RESPONSIBLE FOR INSTALLATION OF ADDITIONAL EROSION AND SEDIMENT CONTROL MEASURES NECESSARY TO MAINTAIN EROSION AND CONTROL AS DETERMINED BY THE OWNER, ENGINEER, OR REGULATORY PERSONNEL. STABILIZATION IS ESTABLISHED. 1) GROUND STABILIZATION: STABILIZATION TIME FRAME <u>SITE AREA DESCRIPTION</u> PERIMETER DIKES, SWALES, DITCHES, AND SLOPES 7 DAYS HIGH QUALITY WATER (HQW) ZONES 7 DAYS **SLOPES STEEPER THAN 3:1** 14 DAYS SLOPES 3:1 OR FLATTER 14 DAYS ALL OTHER AREAS WITH SLOPES FLATTER THAN 4:1 BUILDING WASTES HANDLING: • NO PAINT OR LIQUID WASTES IN STREAM OR STORM DRAINS. REASONABLE ALTERNATIVES AVAILABLE. • CONCRETE MATERIALS MUST BE CONTROLLED TO AVOID CONTACT WITH SURFACE WATERS, WETLANDS, OR BUFFERS. • SOIL STORAGE OR STOCKPILE AREAS SHALL BE LOCATED 50 FT. FROM STORM DRAIN INLETS AND SWALES OR DITCHES.

9.87' PROPOSED SPOT ELEVATION

TEMPORARY STABILIZATION SEEDING SCHEDULE SEED BED PREPARATION 2 TONS/AC LIME 1,000 LBS/AC 10-10-20 500 LBS/AC (AFTER SEEDING) 0-20-0 200 GAL/TON OF MULCH ASPHALT TACK SEEDING MIXTURE (FEBRUARY 1 - APRIL 30) 50 LBS/AC TALL FESCUE 10 LBS/AC PENSACOLA BAHIAGRASS 50 LBS/AC KOREAN OR KOBE LESPEDEZA (SCARIFIED) (MAY 1 - AUGUST 31) 50 LBS/AC TALL FESCUE 5 LBS/AC WEEPING LOVEGRASS 50 LBS/AC KOREAN OR KOBE LESPEDEZA (SCARIFIED) 25 LBS/AC **BROWNTOP MILLET** (SEPTEMBER 1 - JANUARY 31) 60 LBS/AC TALL FESCUE KOREAN OR KOBE LESPEDEZA (UNSCARIFIED) 60 LBS/AC 25 LBS/AC RYE (GRAIN) FOR SLOPES 2:1 OR STEEPER, ADD 30 LBS/AC SERICEA LESPEDEZA AND 15 LBS WEEPING LOVEGRASS LANDSCAPING MIXTURE (JANUARY 1 - MARCH 31) 20 LBS/AC COMMON BERMUDAGRASS (UNHULLED) (APRIL 1 - JULY 31) 12 LBS/AC COMMON BERMUDAGRASS (HULLED)

ALL DISTURBED AREAS TO DRAIN TO APPROVED SEDIMENT CONTROL MEASURES AT ALL TIMES DURING LAND DISTURBING ACTIVITIES AND UNTIL PERMANENT DURING DEWATERING ACTIVITIES, WATER SHALL BE PUMPED INTO AN APPROVED FILTERING DEVICE OR DIRECTED TO EXISTING EROSION CONTROL MEASURE. CONSTRUCTION ACTIVITIES SHALL MEET CONDITIONS OF DWQ GENERAL CONSTRUCTION PERMIT (NCG01). COMPLIANCE SHALL MEET THE FOLLOWING CONDITIONS: STABILIZATION TIME FRAME EXCEPTIONS NONE IF SLOPES ARE 10' OR LESS IN LENGTH AND ARE NOT STEEPER THAN 2:1, 14 DAYS ARE ALLOWED. 7 DAYS FOR SLOPES GREATER THAN 50 FEET IN LENGTH. NONE (EXCEPT FOR PERIMETERS AND HQW ZONES) • DEDICATED AREAS FOR DEMOLITION, CONSTRUCTION, AND OTHER WASTES MUST BE LOCATED 50' FROM STORM DRAINS AND STREAMS UNLESS NO • EARTHEN-MATERIAL STOCKPILES MUST BE LOCATED 50' FROM STORM DRAINS AND STREAMS UNLESS NO REASONABLE ALTERNATIVES AVAILABLE.

					AC	ACRE
	:		LEGEND		DIP	DUCTILE IRON PIPE
			<u>LLOLIND</u>		EX	EXISTING
	ဋ	CENTERLINE —		CENTERLINE	F/F	FACE OF CURB TO FACE OF CURB
	♦	EXISTING FIRE HYDRANT	5'	EXISTING ELEVATION CONTOUR	LF	LINEAR FEAT
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	0	SEWER MANHOLE —	— DA —— DA —— DA ——	LIMITS OF DISTURBANCE	N/F	NOW OR FORMERLY
	©	SEWER SERVICE —		PROPERTY LINE	PVC	POLYVINYL CHLORIDE
	™	WATER SERVICE		PROPOSED ELEVATION CONTOUR	R	RADIUS
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			— FM — FM — FM —	SANITARY SEWER FORCE MAIN	STA	STATION
			— SF —— SF ——	SILT FENCE	W/	WITH
٠.			wwwwww	WATERLINE	WL	WATERLINE
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					5.00	PROPOSED SPOT ELEVATION
						· · · · · · · · · · · · · · · · · · ·

FRONT STREET VILLAGE NOT FOR CONSTRUCTION MOEHRING GROUP HOLDING LP N FAMILY LOTS ☐ TRANSPORTATION SEA GROVE SUBDIVISION MOEHRING GROUP HOLDING LP AHHO. /|----|-----| LENNOXVILLE ROAD MOEHRING GROUP TOWN OF HOLDING LP **BEAUFORT** FRONT STREET -**VICINITY MAP** SCALE: 1" = 150' SCALE (IN FEET)

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PRELIMINARY PLAT FOR

PHASE IV FOR

PROJECT MANAGER:

DESIGNED: DRAWN BY: CHECKED:

SCALE: DATE: 03/29/2021

ARENDELL CIVIL GOASTAL FRANCISCHE

1004 Arendell Street Morehead City, NC 28557 (252) 622-4338 Fax: (252) 622-4505

www.arendellengineers.com North Carolina Certification No. C-1509

FRONT STREET VILLAGE, LLC 2400 LENNOXVILLE ROAD BEAUFORT, NC 28516


PROJECT:

FRONT STREET VILLAGE TRANSPORTATION CENTER-SITE PLAN-PHASE II AND PRELIMINARY PLAT PHASE IV BEAUFORT, NORTH CAROLINA

CARTERET COUNTY, NC

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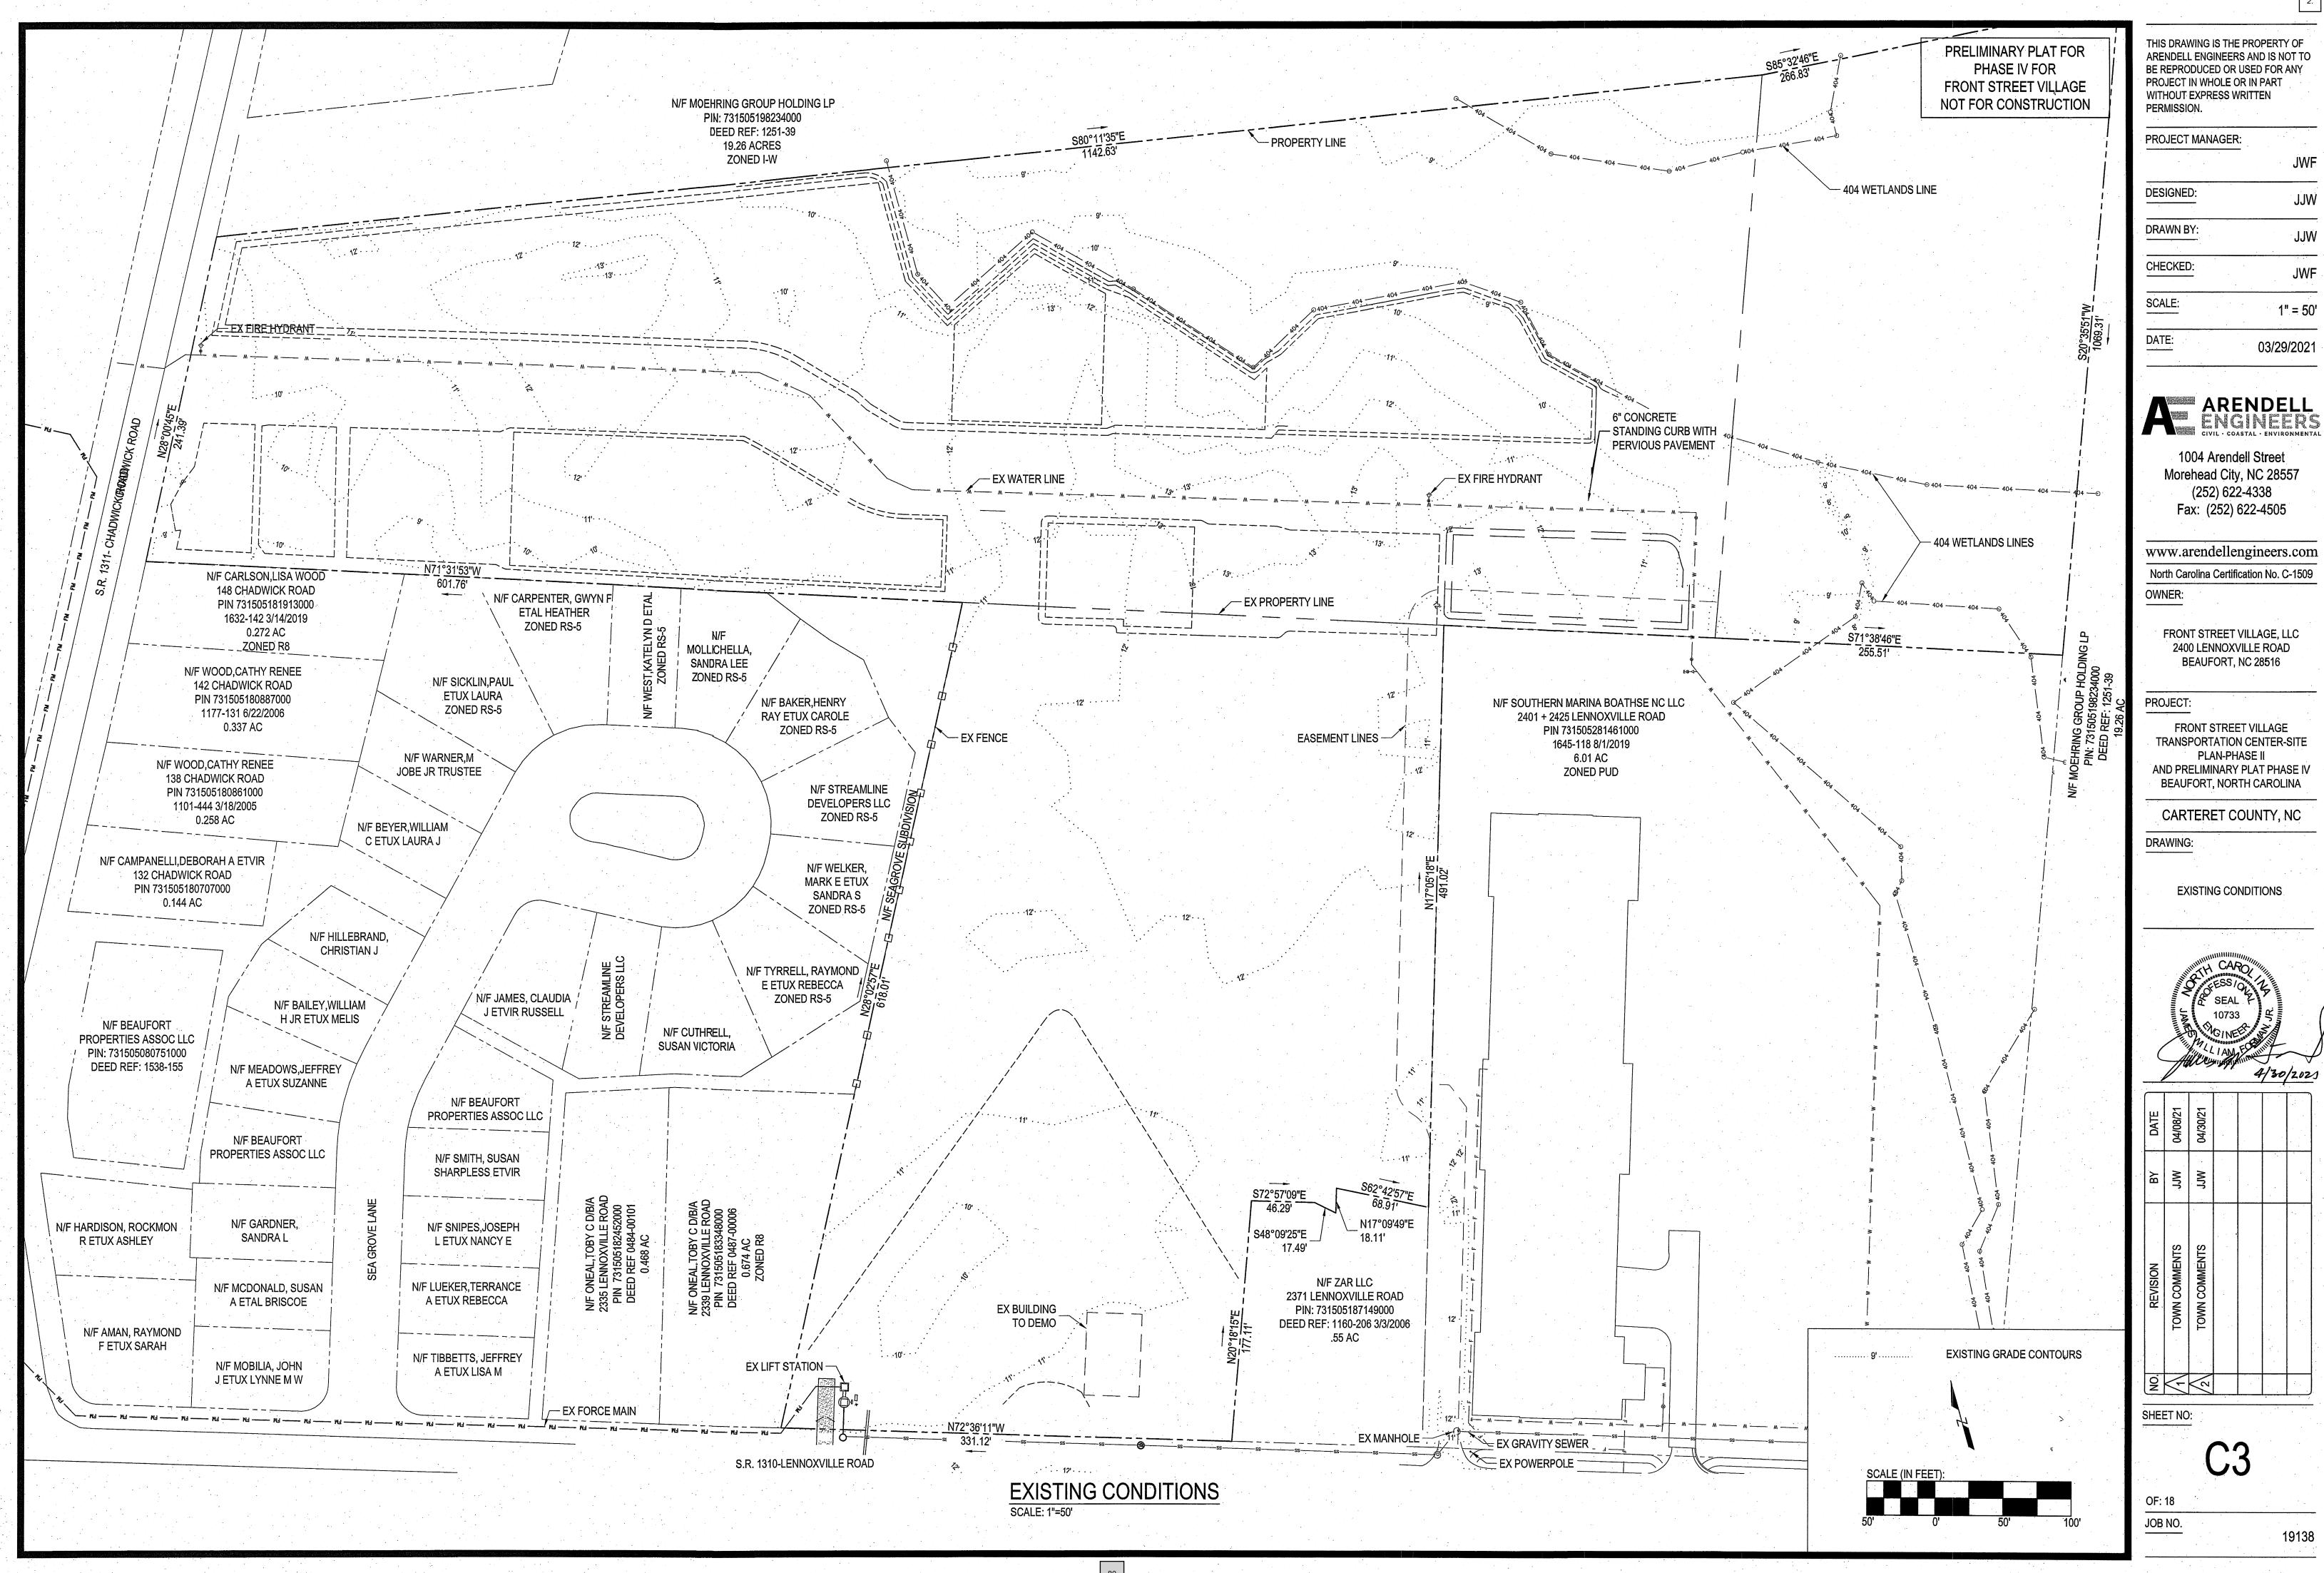
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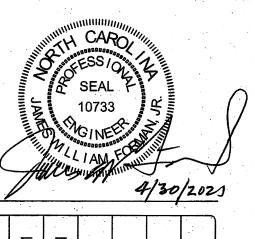



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JOB NO.

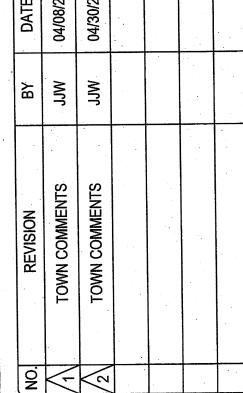





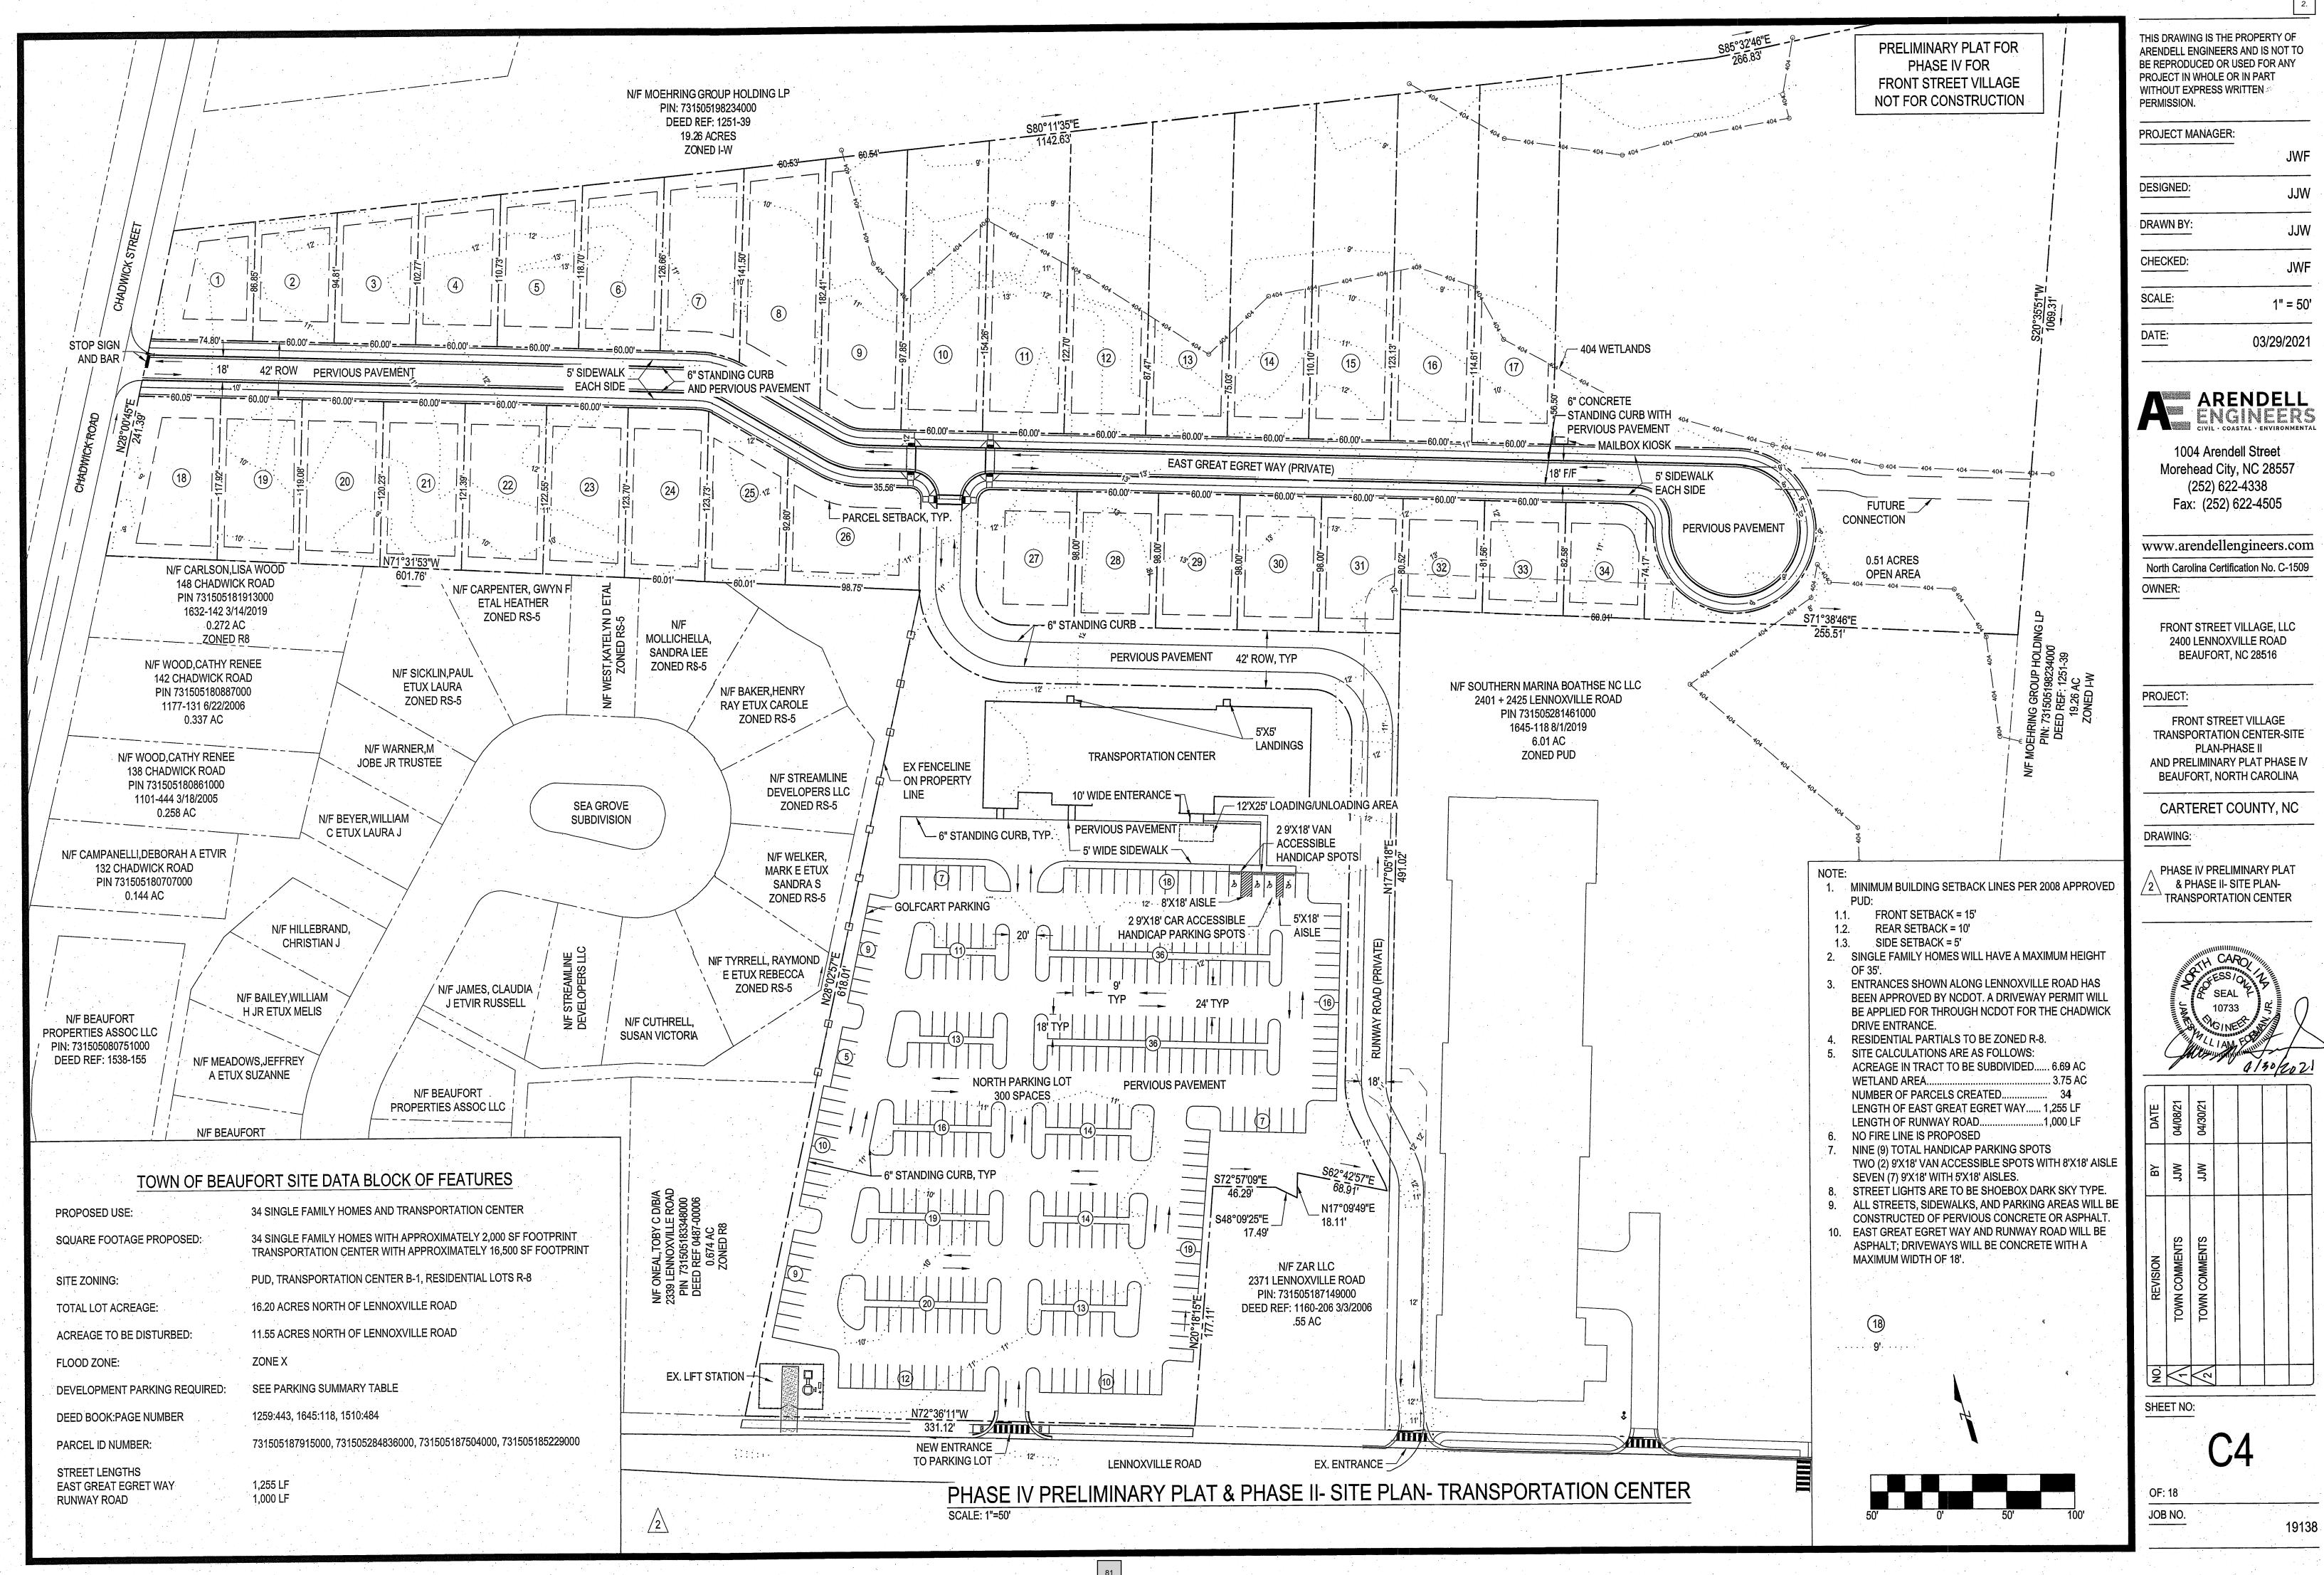

ARENDELL ENGINEERS CIVIL - COASTAL - ENVIRONMENTAL

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OWNER:

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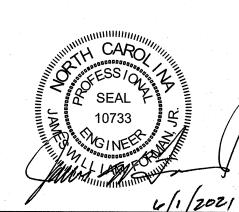
PROJECT:

FRONT STREET VILLAGE
TRANSPORTATION CENTER-SITE
PLAN-PHASE II
AND PRELIMINARY PLAT PHASE IV
BEAUFORT, NORTH CAROLINA

CARTERET COUNTY, NC

DRAWING:

3 GRADING PLAN




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	REVISION	TOWN COMMENTS	TOWN COMMENTS	TOWN COMMENTS			
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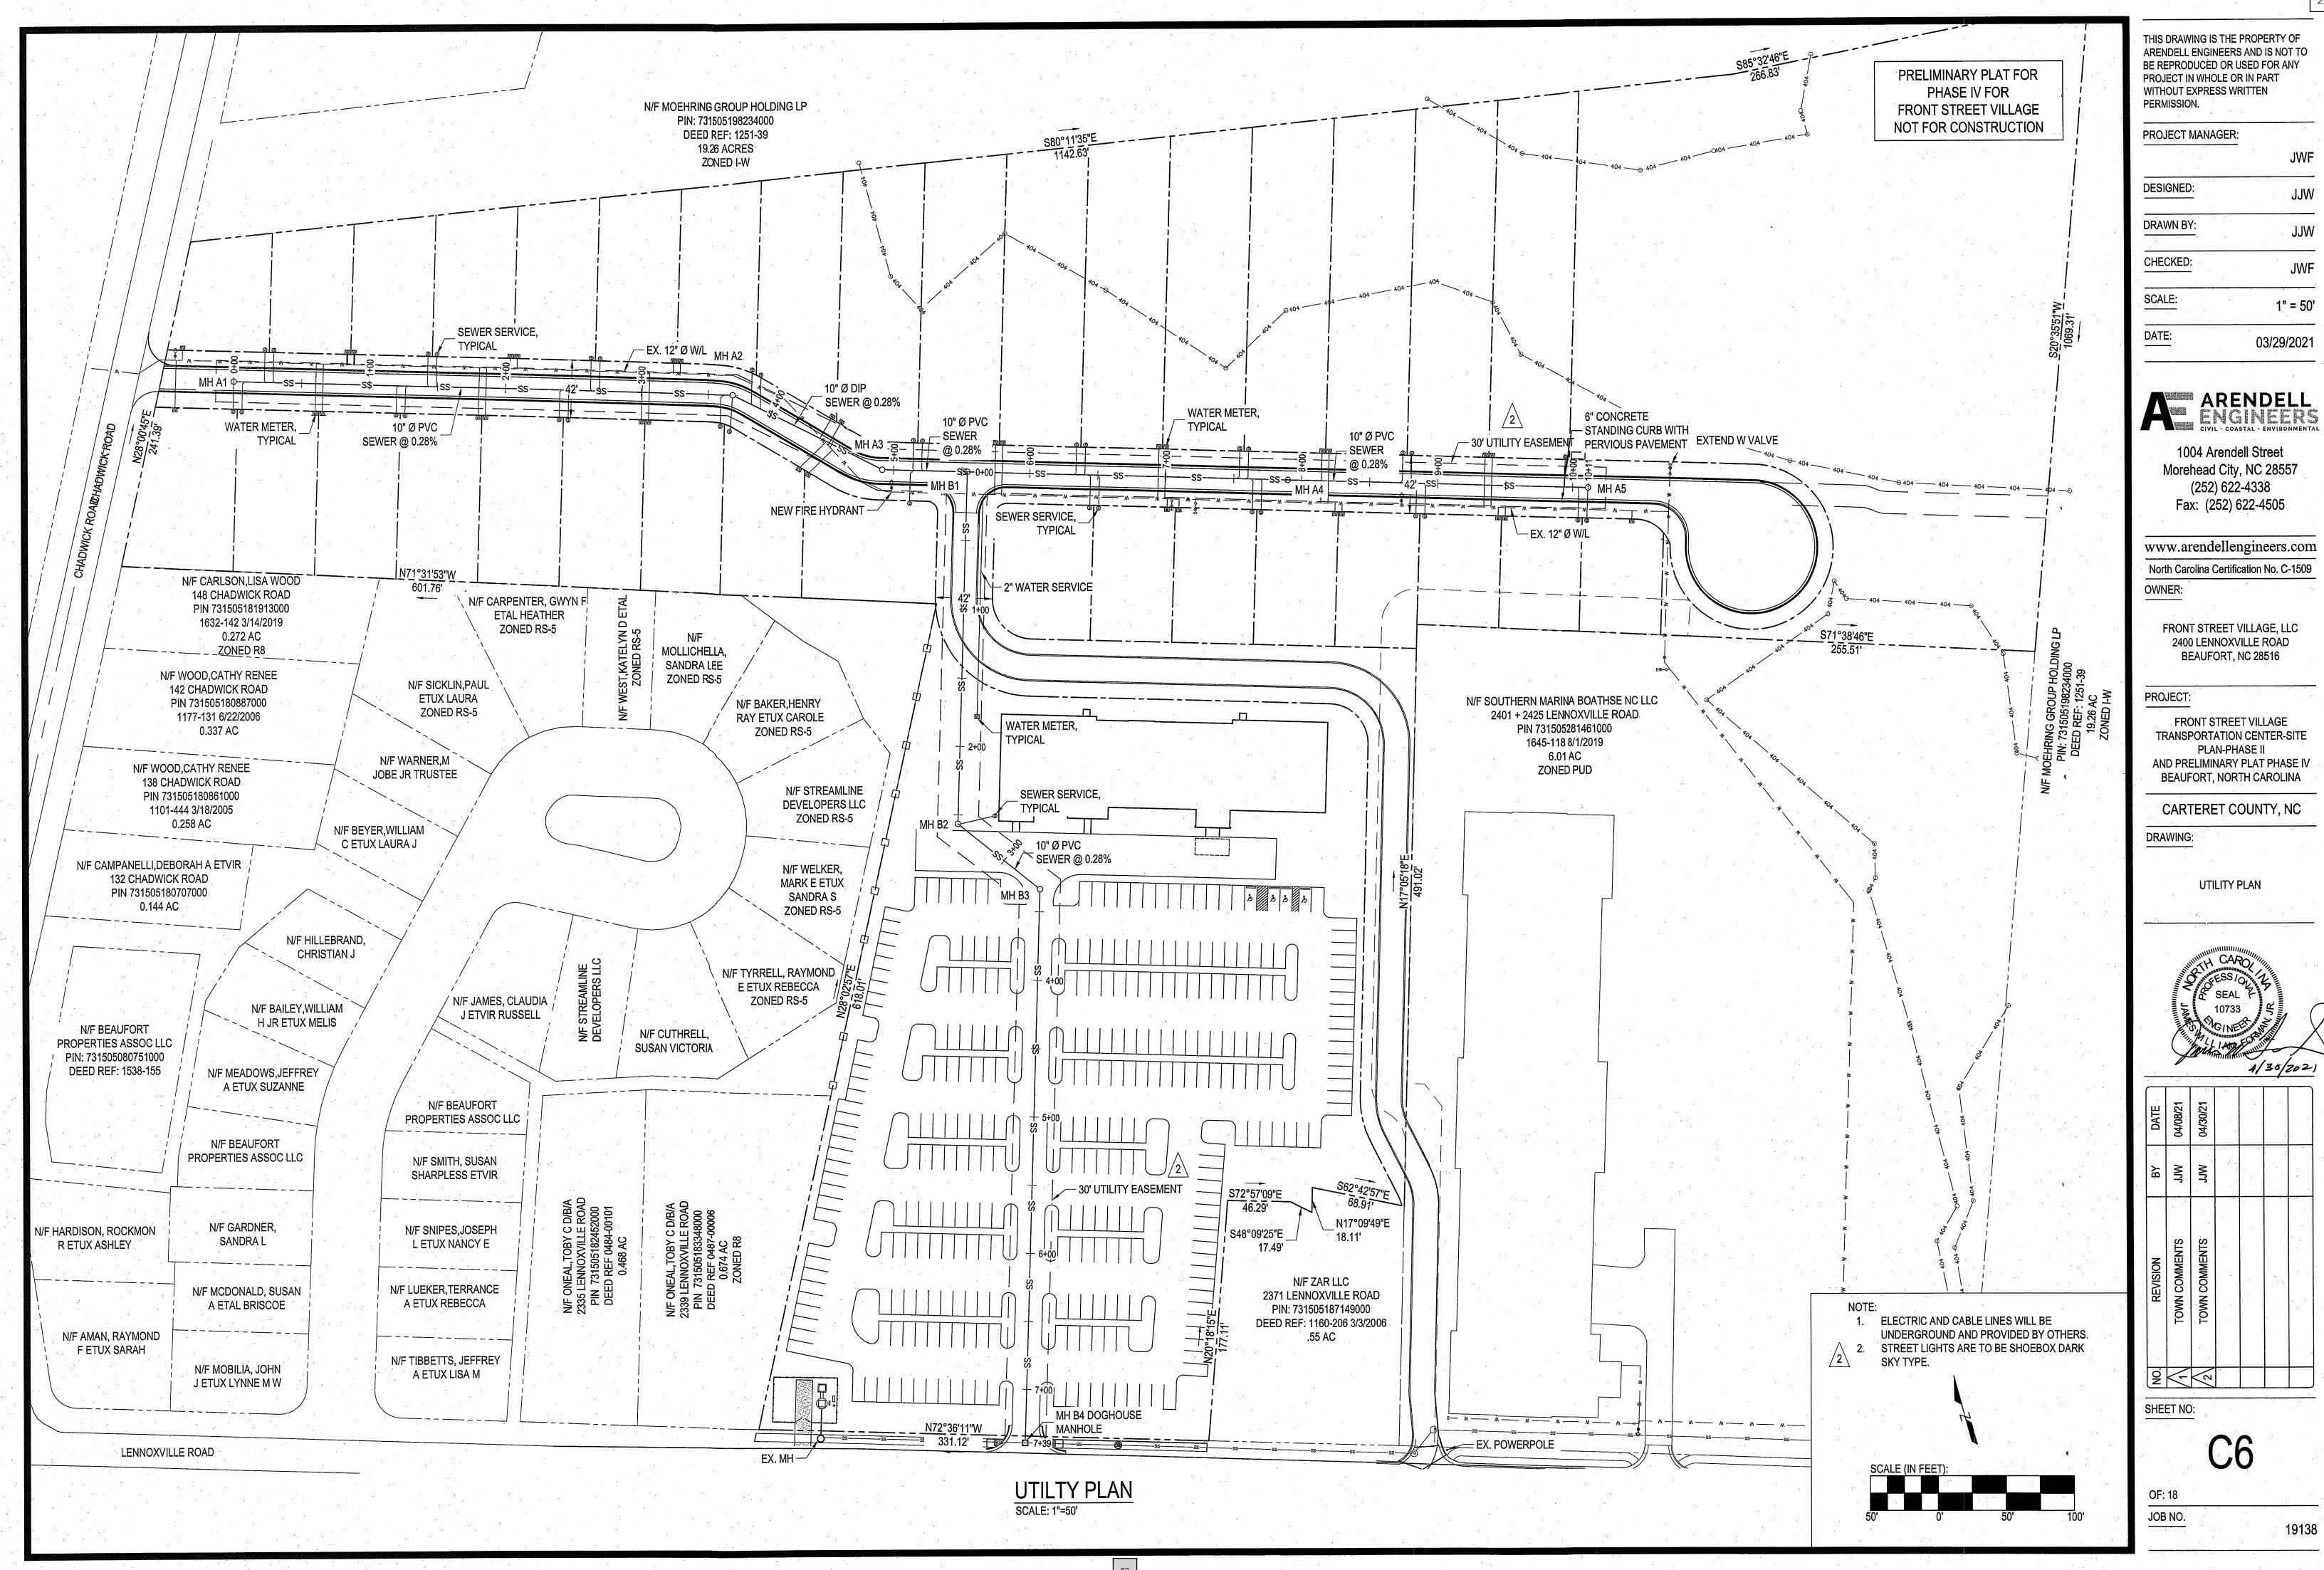
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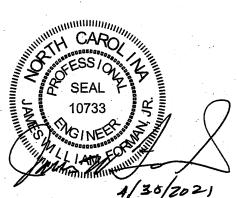
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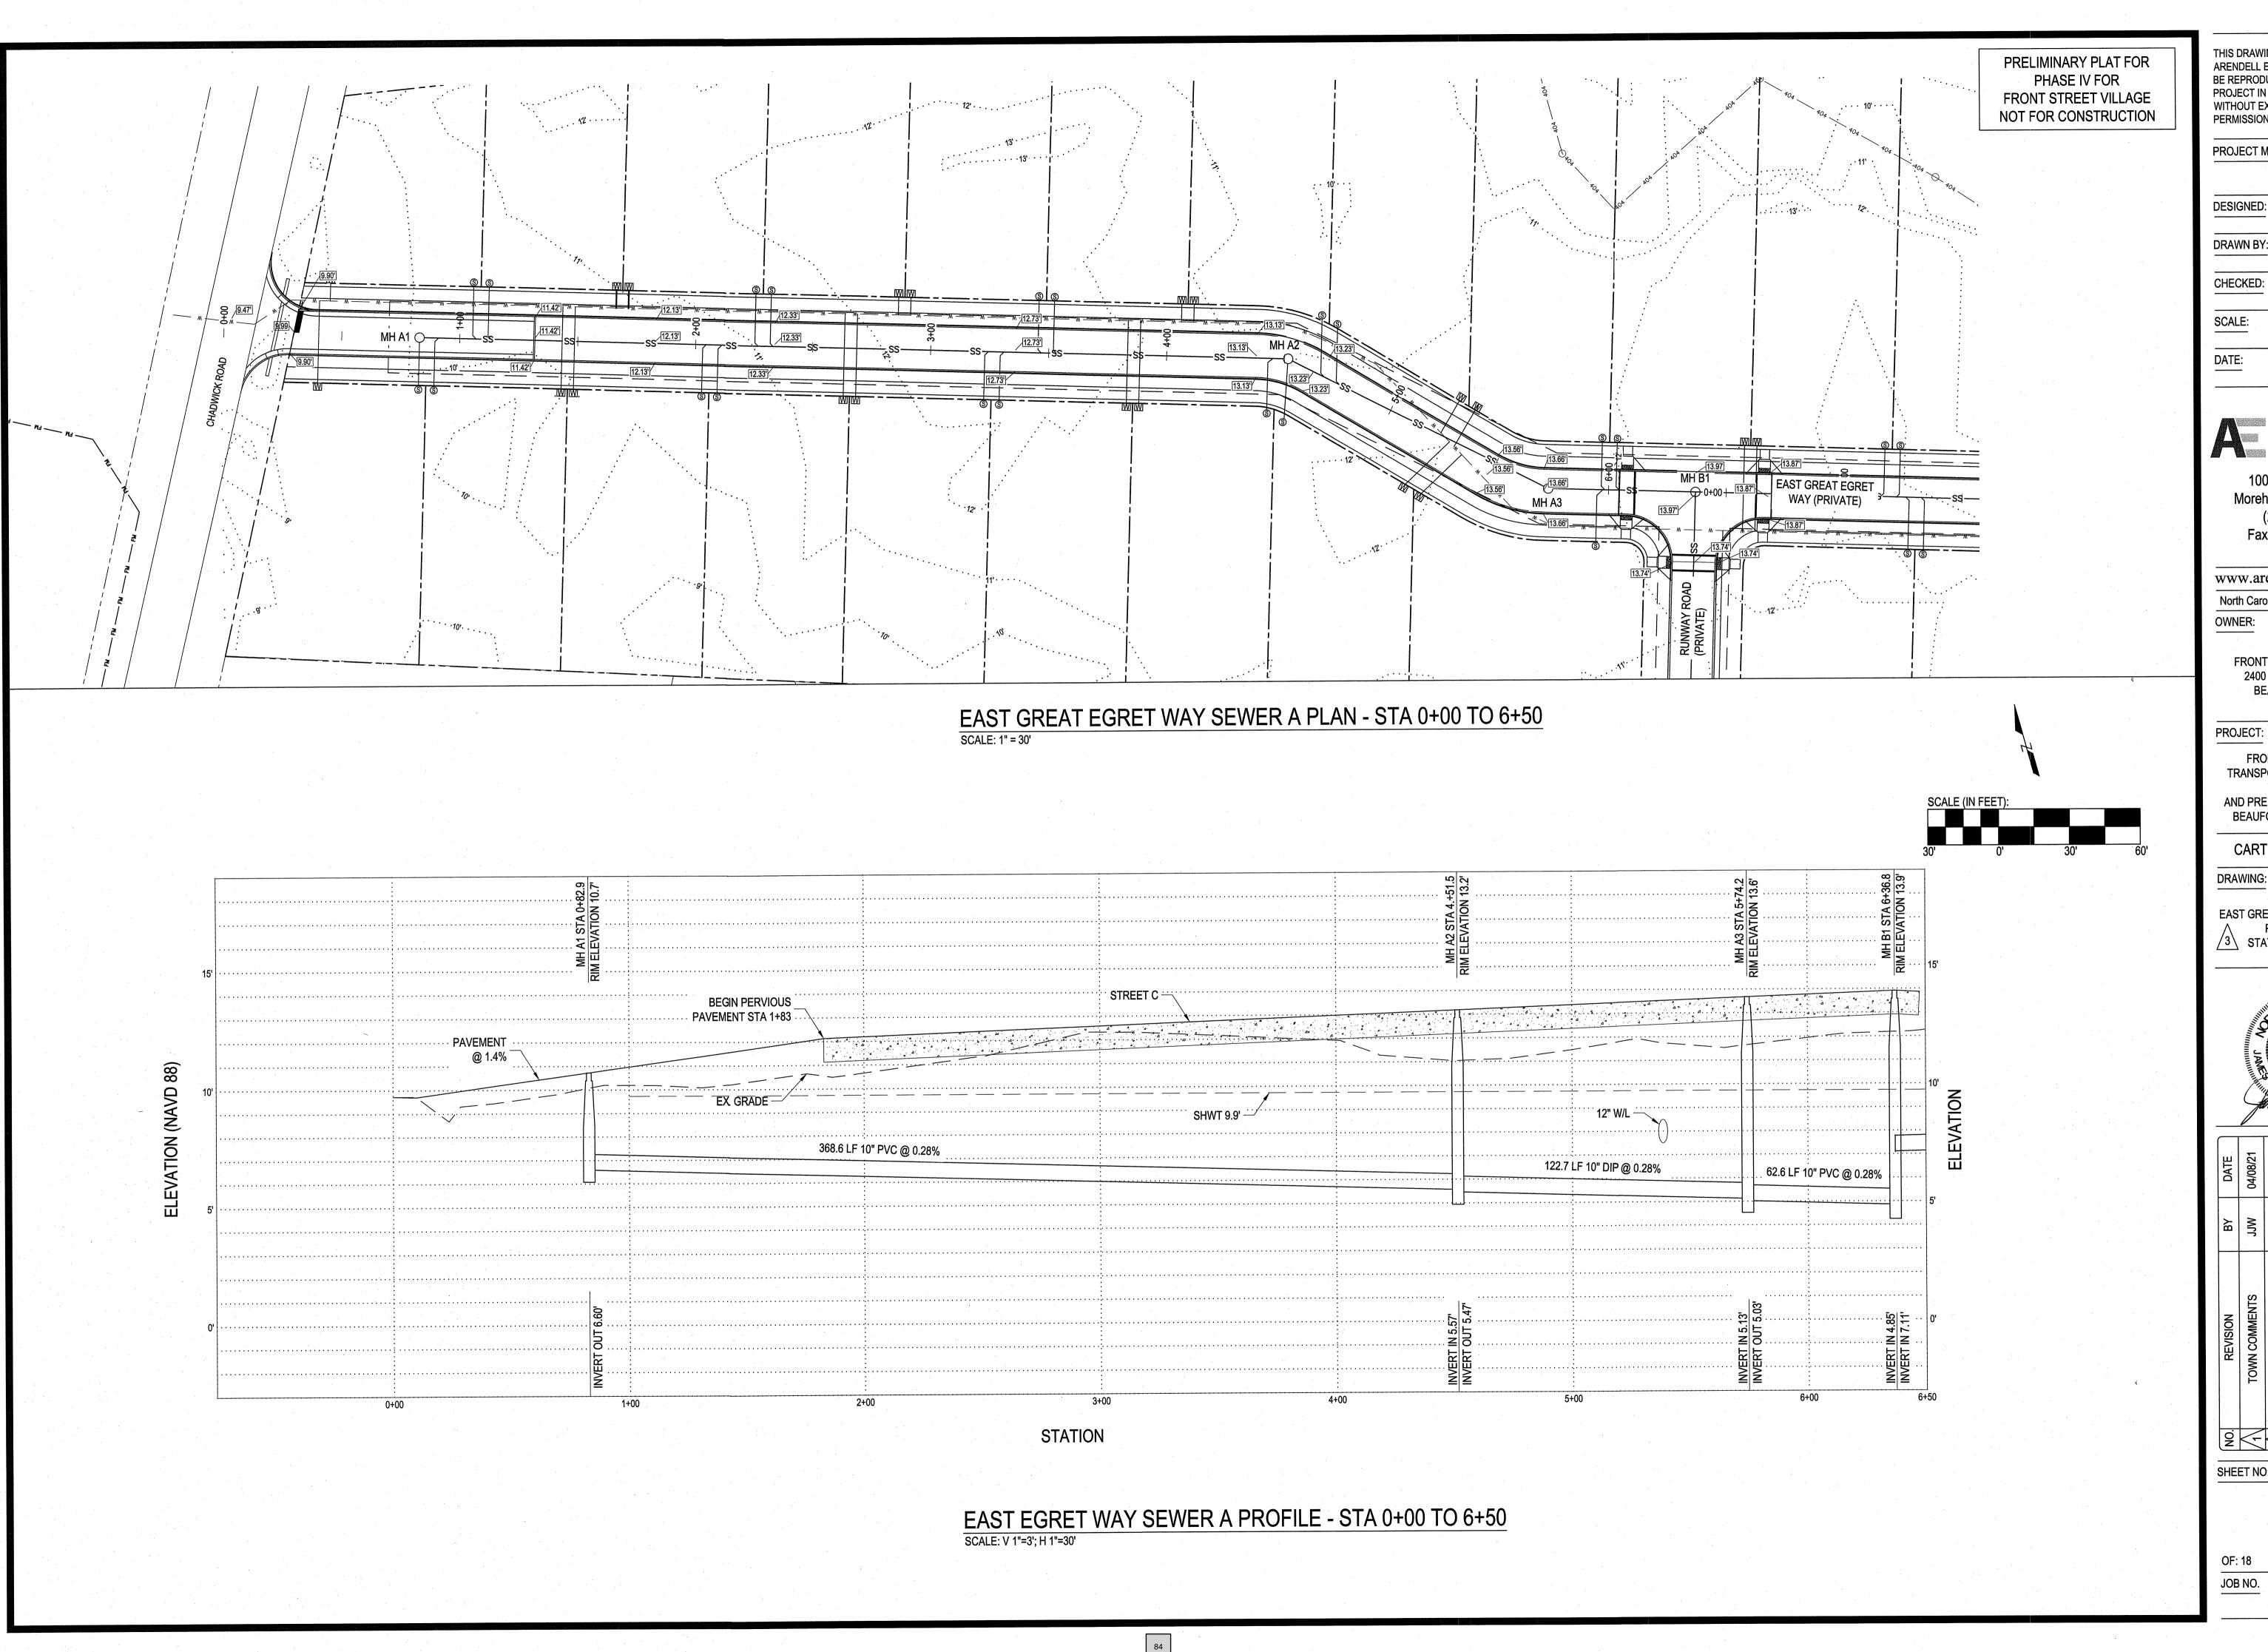




JWF

1" = 50' 03/29/2021



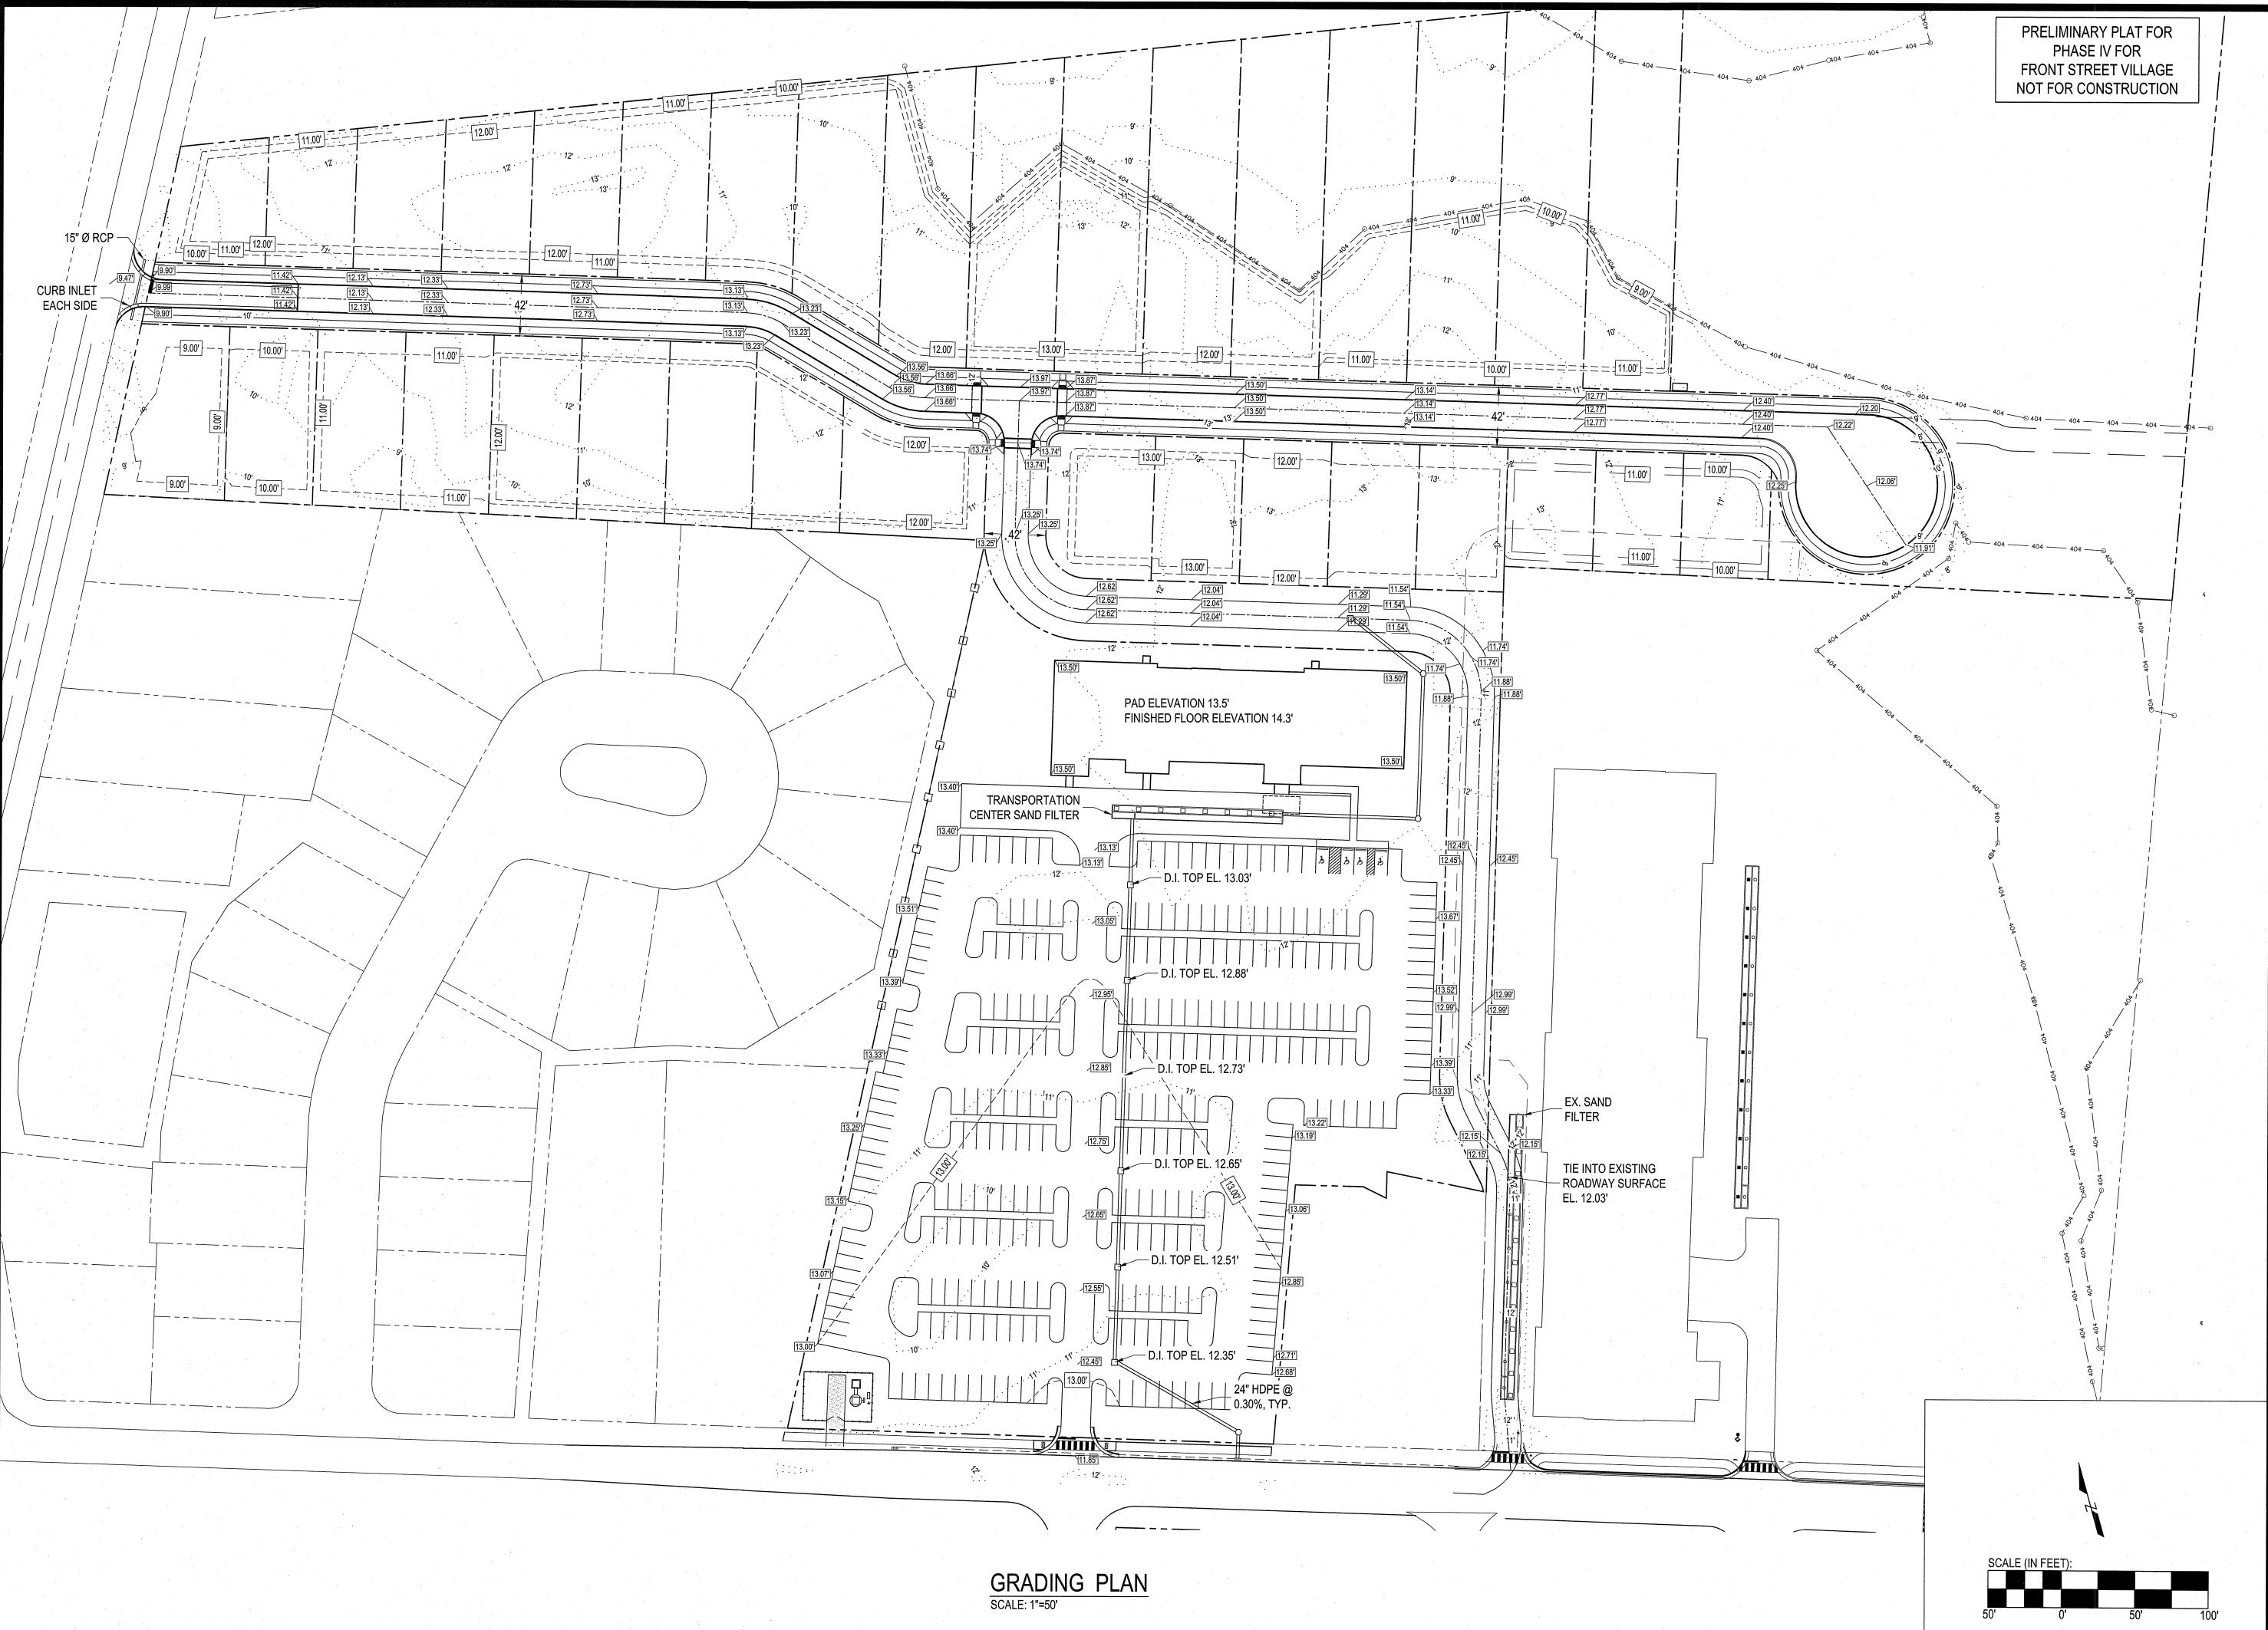

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PROJECT MANAGER:

	JWF
DESIGNED:	JJW
DRAWN BY:	JJW
CHECKED:	JWF
SCALE:	1" = 30'

ARENDELL ENGINEERS

03/29/2021

1004 Arendell Street Morehead City, NC 28557 (252) 622-4338 Fax: (252) 622-4505

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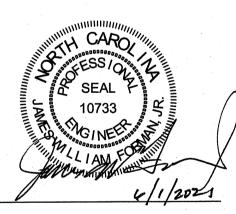
FRONT STREET VILLAGE TRANSPORTATION CENTER-SITE AND PRELIMINARY PLAT PHASE IV BEAUFORT, NORTH CAROLINA

CARTERET COUNTY, NC

DRAWING:

EAST GREAT EGRET WAY SEWER A PLAN & PROFILE


STATIONS 0+00 TO 6+50



DATE	04/08/21	04/30/21	06/01/21		
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REVISION	TOWN COMMENTS	TOWN COMMENTS	TOWN COMMENTS		
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OF: 18



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PROJECT MANAGER:

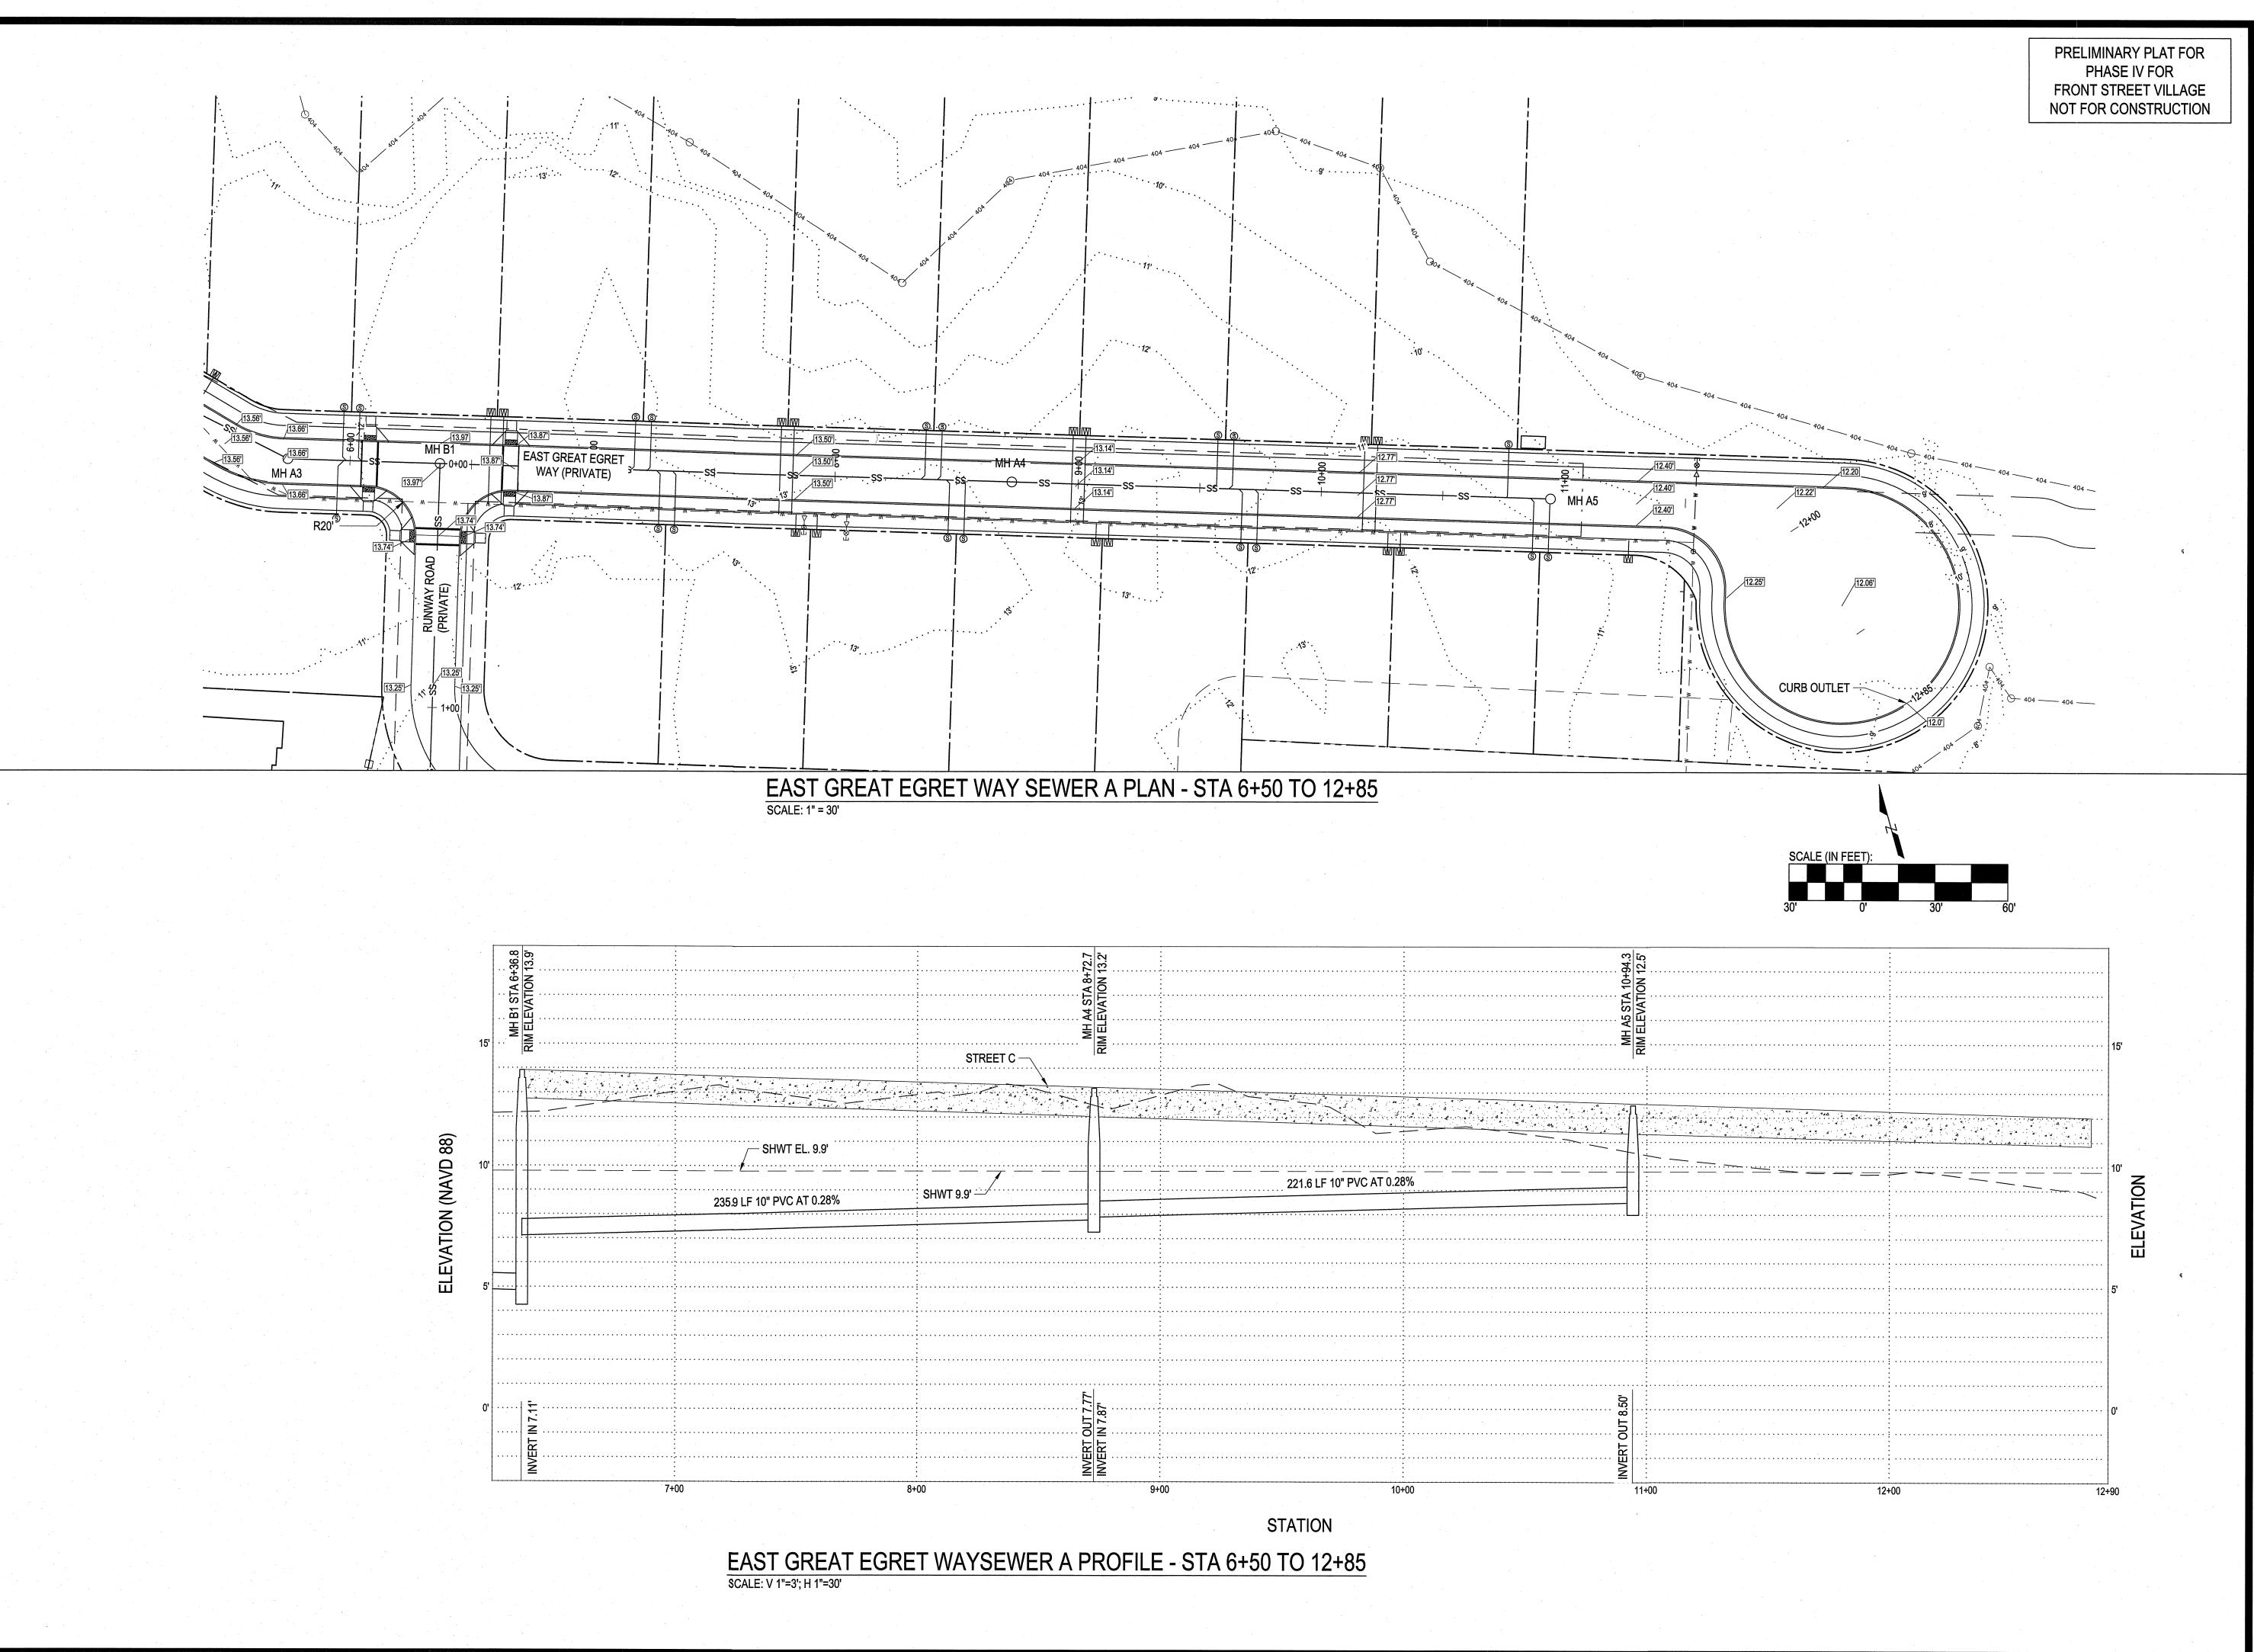	JWF
DESIGNED:	JJW
DRAWN BY:	JJW
CHECKED:	JWF
SCALE:	1" = 30'
DATE:	03/29/2021

ARENDELL ENGINEERS CIVIL - COASTAL - ENVIRONMENTAL

1004 Arendell Street Morehead City, NC 28557 (252) 622-4338 Fax: (252) 622-4505

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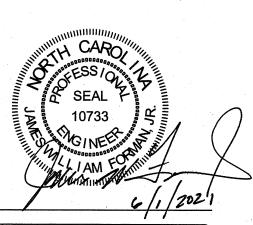
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FRONT STREET VILLAGE
TRANSPORTATION CENTER-SITE
PLAN-PHASE II
AND PRELIMINARY PLAT PHASE IV
BEAUFORT, NORTH CAROLINA

CARTERET COUNTY, NC

DRAWING:

EAST GREAT EGRET WAY SEWER A
PLAN AND PROFILE
STATIONS 6+50 TO 12+85




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OF: 18 JOB NO.



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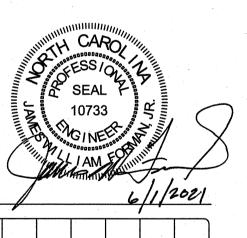
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SIGNED:	JJW
AWN BY:	JJW
ECKED:	JWF
ALE:	411 001


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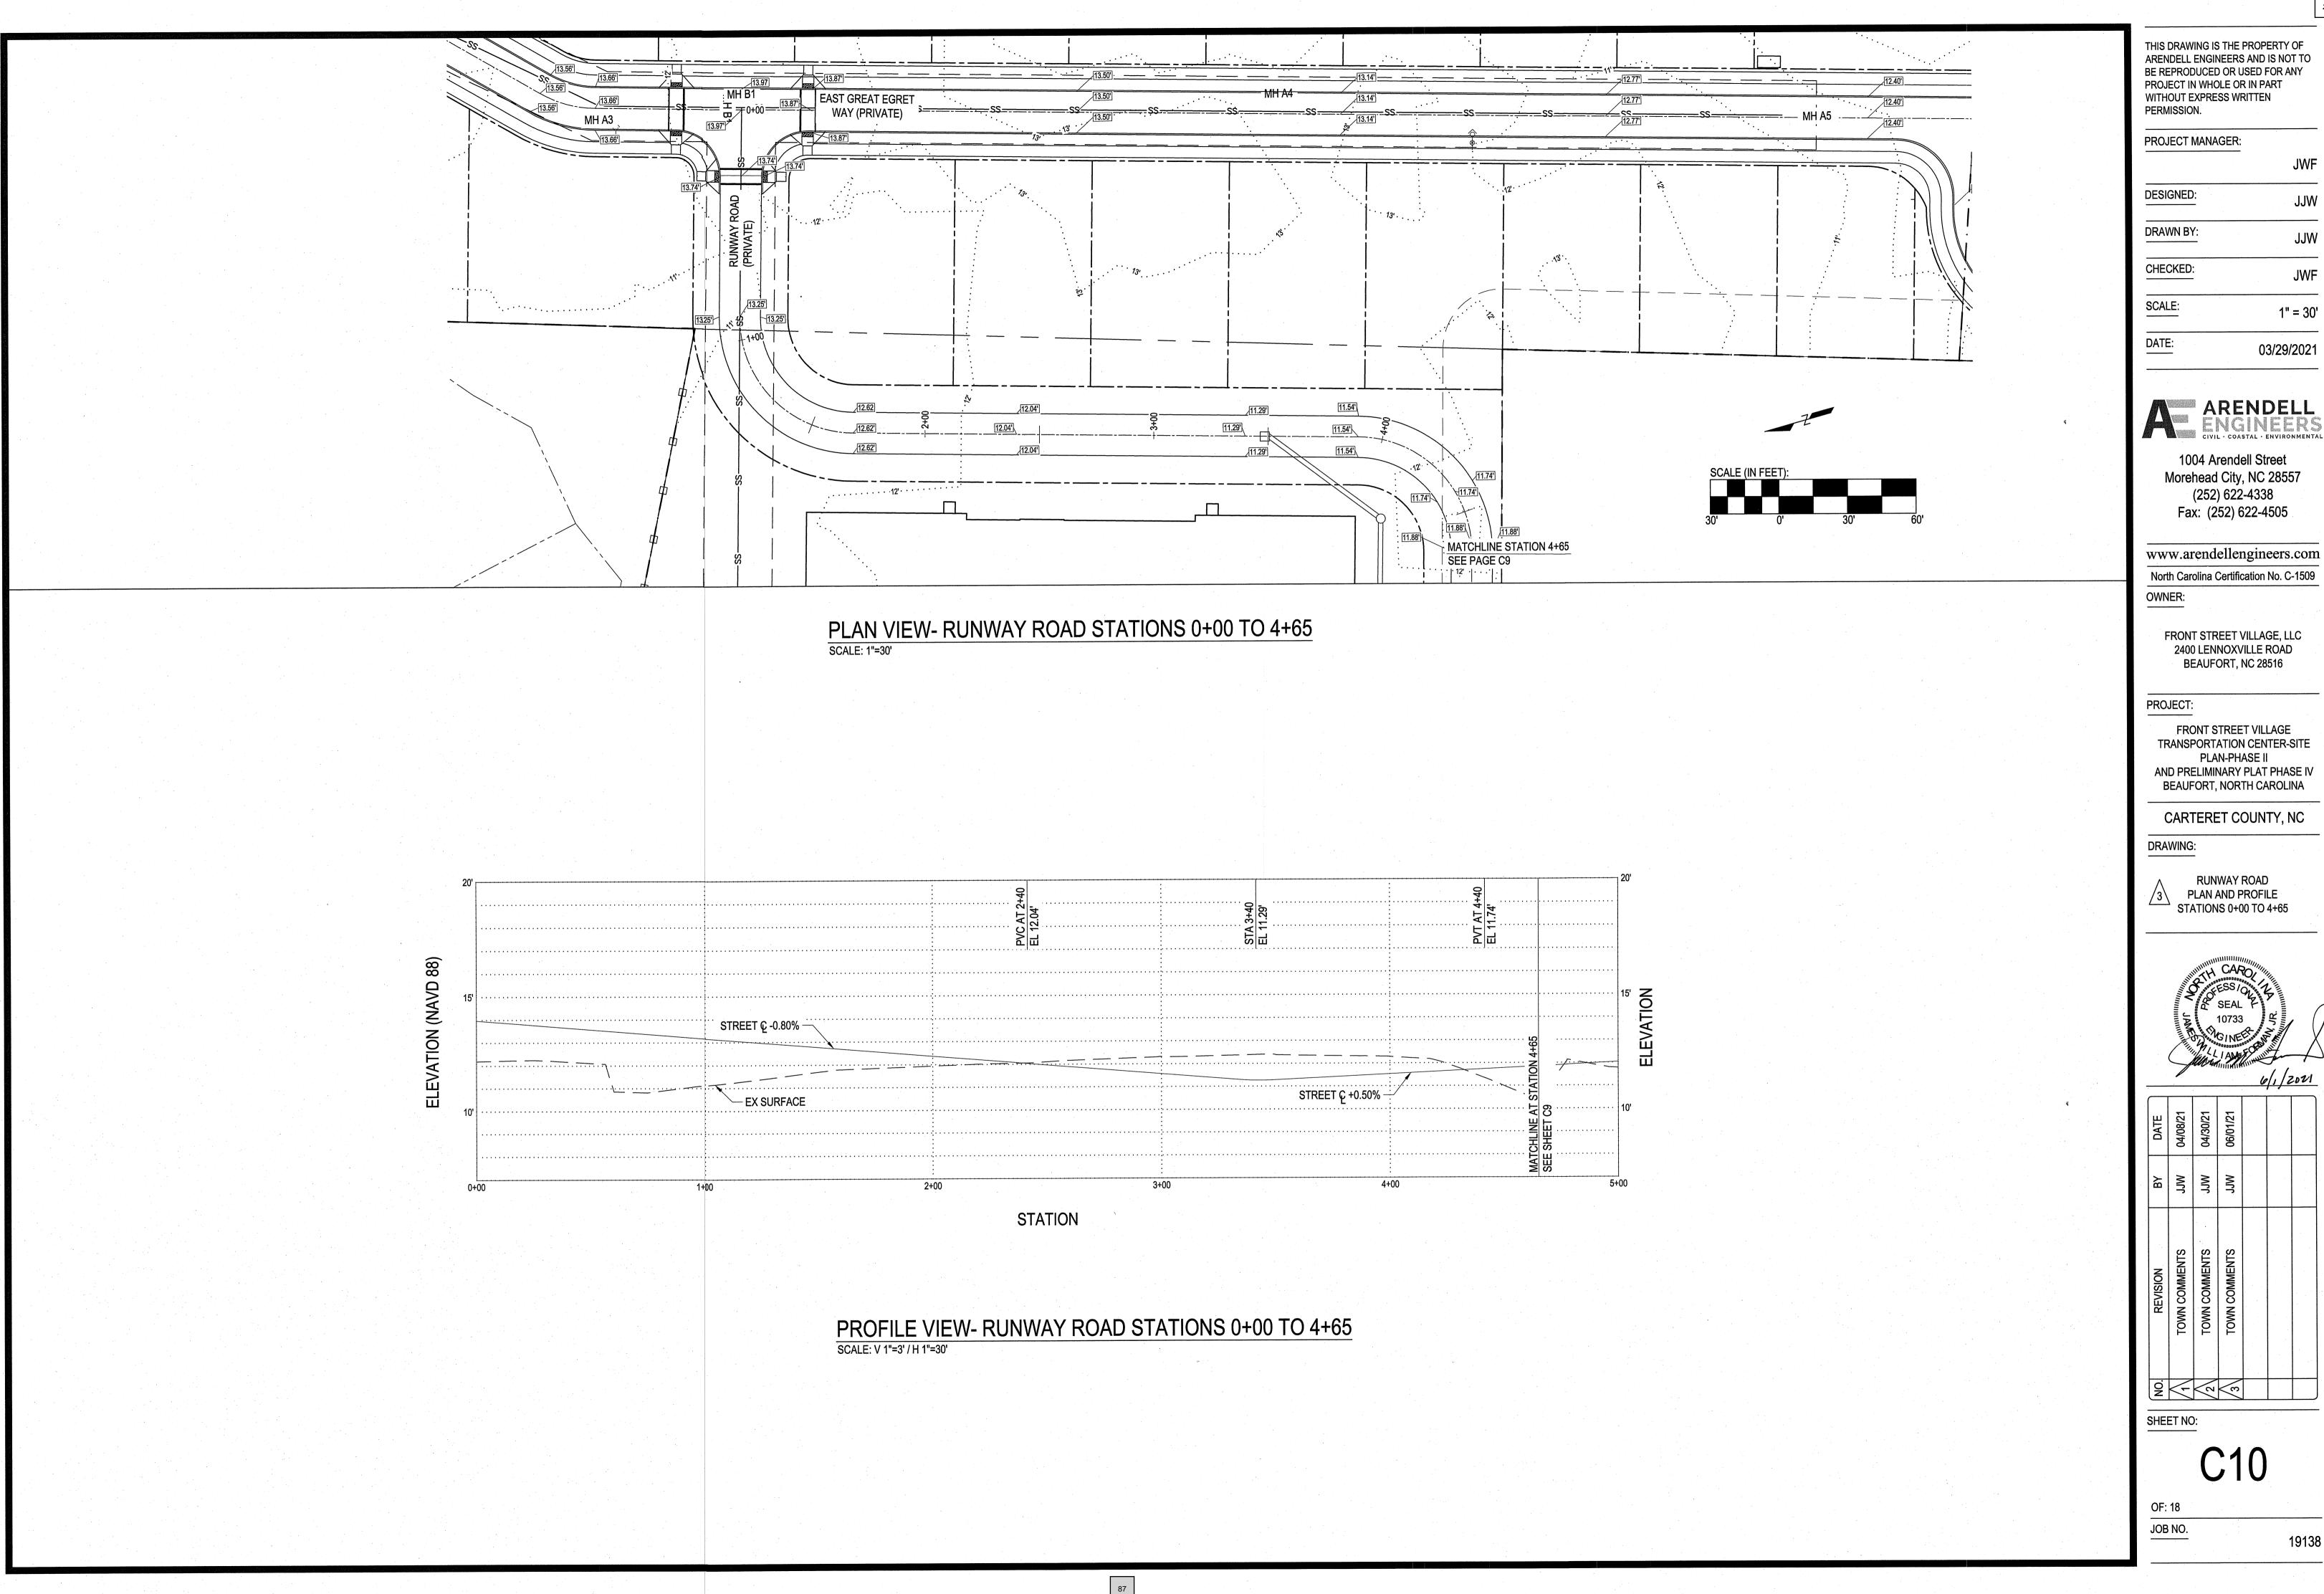
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FRONT STREET VILLAGE, LLC 2400 LENNOXVILLE ROAD

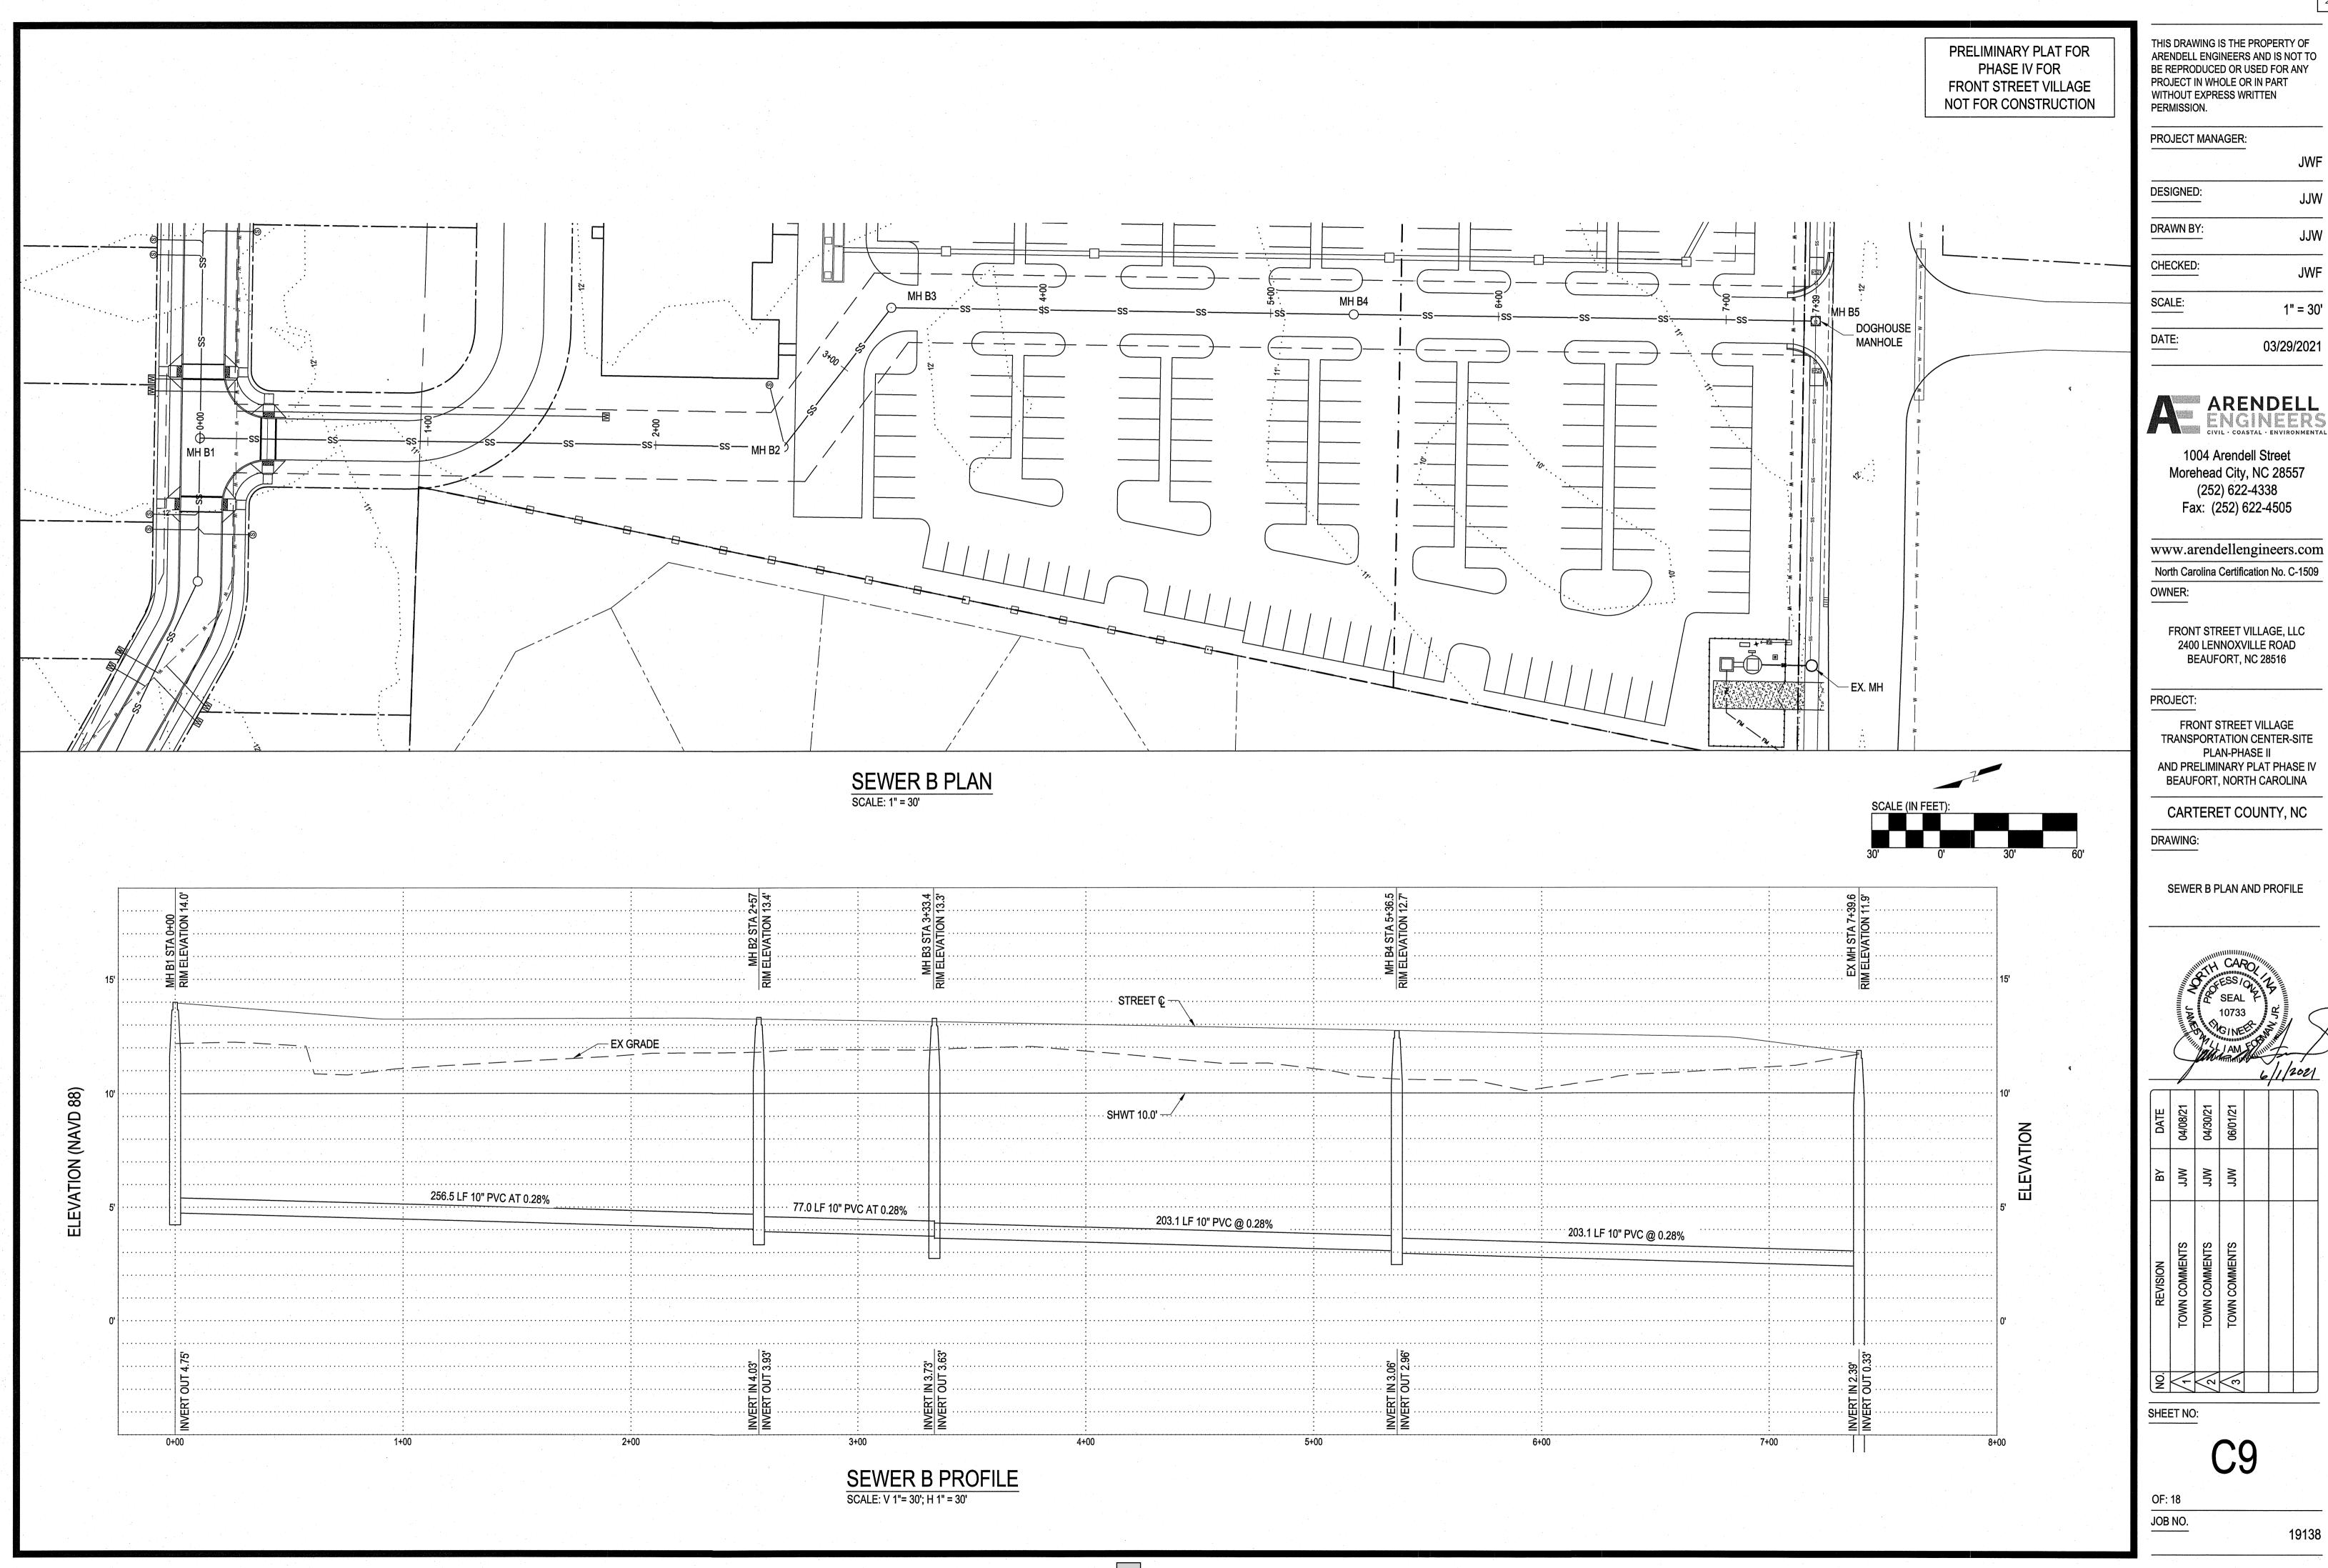TRANSPORTATION CENTER-SITE AND PRELIMINARY PLAT PHASE IV





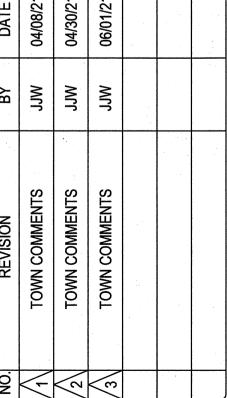

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1" = 30'



03/29/2021

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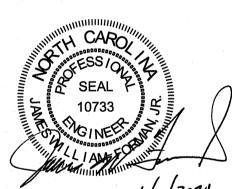
North Carolina Certification No. C-1509

FRONT STREET VILLAGE, LLC 2400 LENNOXVILLE ROAD BEAUFORT, NC 28516


FRONT STREET VILLAGE TRANSPORTATION CENTER-SITE PLAN-PHASE II AND PRELIMINARY PLAT PHASE IV BEAUFORT, NORTH CAROLINA

CARTERET COUNTY, NC


PLAN AND PROFILE STATIONS 0+00 TO 4+65



DATE	04/08/21	04/30/21	06/01/21		
ВУ	JJW	MCC	WCC		
REVISION	TOWN COMMENTS	TOWN COMMENTS	TOWN COMMENTS		
9	-	2	3		

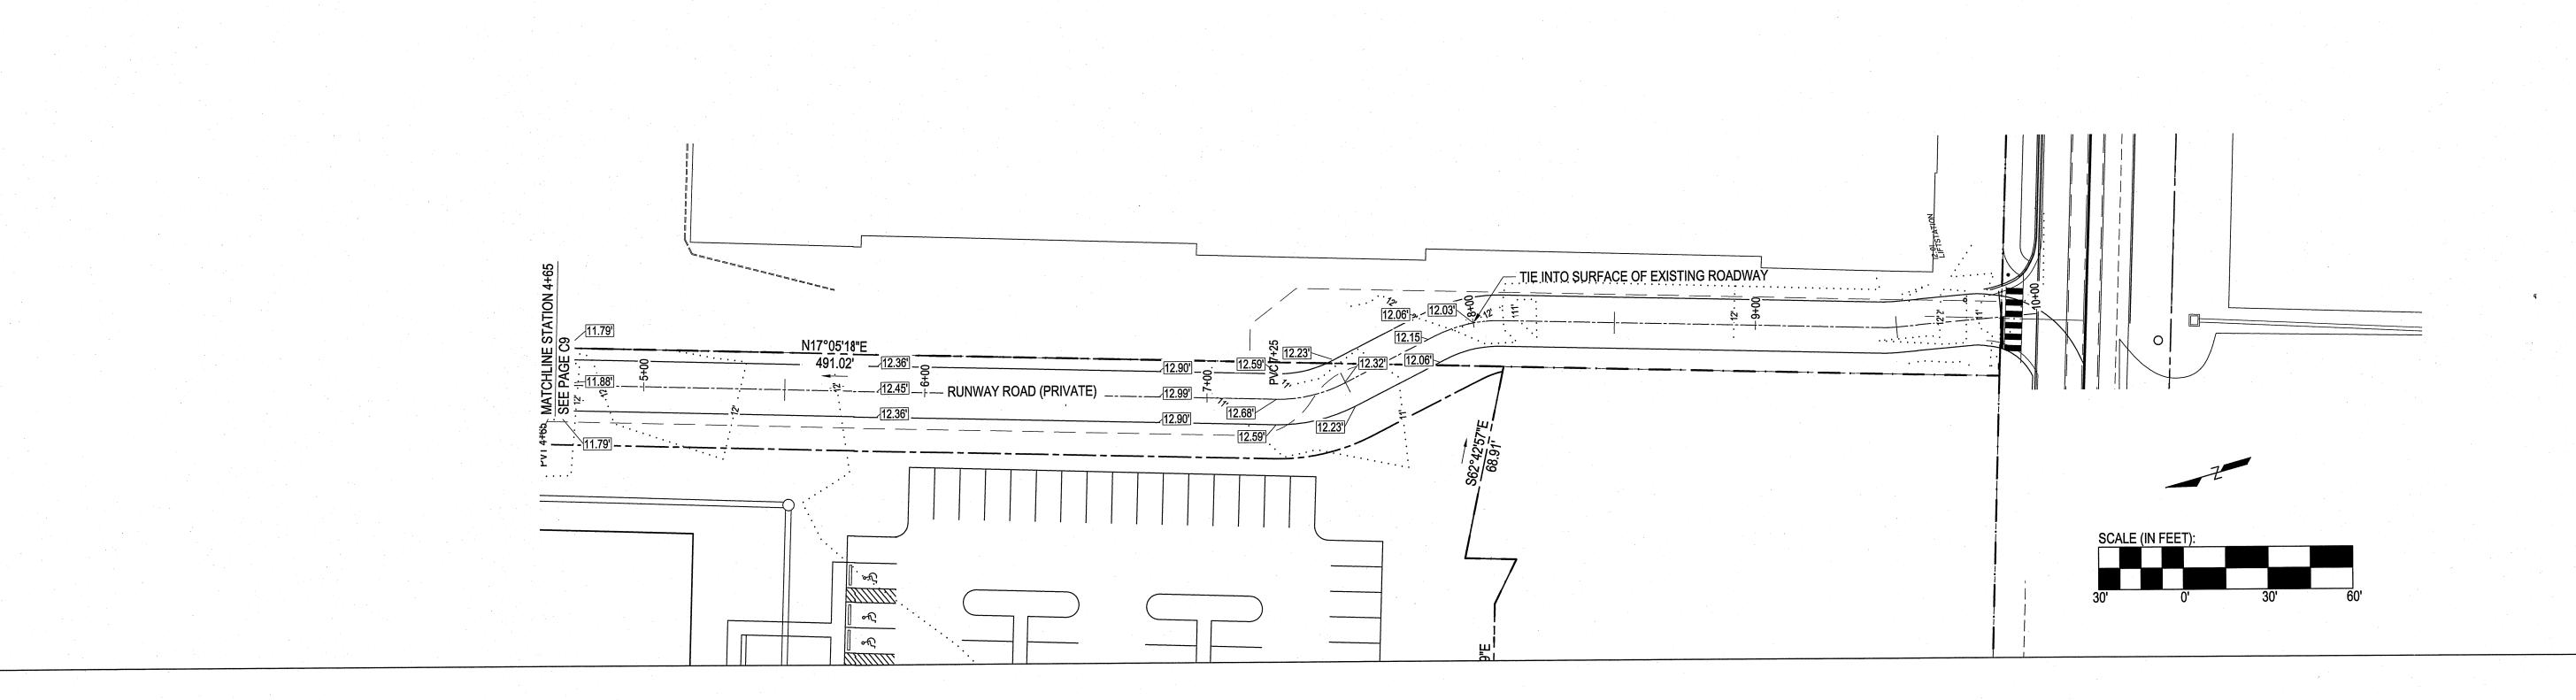

PLAN VIEW- RUNWAY ROAD STATIONS 4+65 TO 10+00 SCALE: 1"=30"

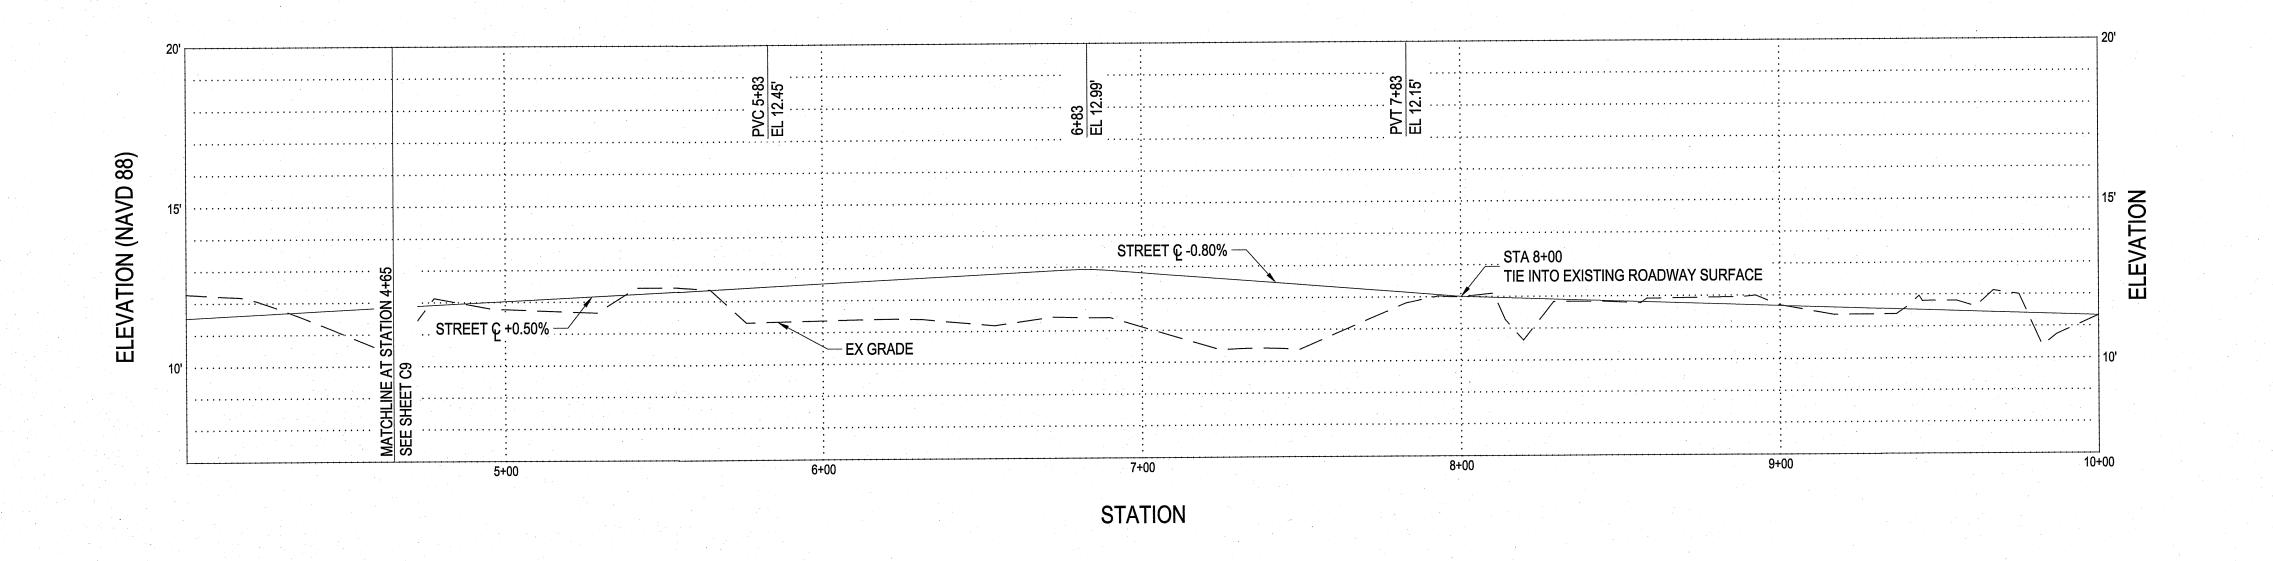

PROFILE VIEW- RUNWAY ROAD STATIONS 4+65 TO 10+00 SCALE: V 1"=3' /H 1"=30'

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PROJECT MANAGER:

DESIGNED:

DRAWN BY:

CHECKED:

SCALE:

1" = 30'

DATE:

03/29/2021

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OWNER:

FRONT STREET VILLAGE, LLC 2400 LENNOXVILLE ROAD BEAUFORT, NC 28516


PROJECT:

FRONT STREET VILLAGE
TRANSPORTATION CENTER-SITE
PLAN-PHASE II
AND PRELIMINARY PLAT PHASE IV
BEAUFORT, NORTH CAROLINA

CARTERET COUNTY, NC

DRAWING:

RUNWAY ROAD
PLAN AND PROFILE
STATIONS 4+65 TO 10+00

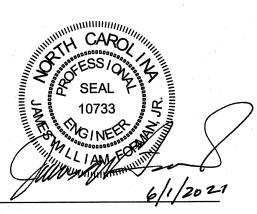

NO. REVISION BY DATE 1 TOWN COMMENTS JJW 04/08/21 2 TOWN COMMENTS JJW 06/01/21 3 TOWN COMMENTS JJW 06/01/21	<u> </u>				 	
TOWN COMMENTS TOWN COMMENTS TOWN COMMENTS	DATE	04/08/21	04/30/21	06/01/21		
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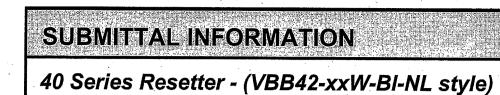
SHEET NO:

C1

OF: 1


JOB NO.

PRELIMINARY PLAT FOR PHASE IV FOR FRONT STREET VILLAGE NOT FOR CONSTRUCTION



ANGLE BALL VALVE BY *ANGLE BALL VALVE (5/8" X 3/4" METER)

5/8" METER THREAD INLET AND OUTLET

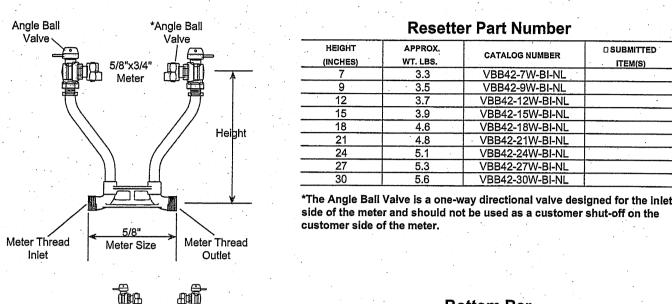




Bottom Bar Meter Thread Size


FEATURES


- All brass that comes in contact with potable water conforms to AWWA Standard C800
- (UNS NO C89833)
- Brass components that do not come in contact with potable water conform to AWWA Standard C800 (ASTM B-62 and ASTM B-584, UNS NO C83600 - 85-5-5-5)
- The product has the letters "NL" cast into the main body for proper identification
- Saddle nuts hold the meter in place for tightening
- Tie Bar is standard for 18" and taller resetter heights (40 Series)
- Conforms to AWWA C700 for Meter Threads • 13/16" Copper risers provide more flow capacity
- · All Ford Setters are assembled with lead-free solder
- Copper conforms to ASTM B-75, Copper Alloy #122 5/8" meter thread on bottom bar
- The Ford Meter Box Company considers the information in this submittal form to be correct at the time of publication. Item and option availability,


including specifications, are subject to change without notice. Please verify that your product information is current.


The Ford Meter Box Company, Inc.
P.O. Box 443, Wabash, Indiana U.S.A. 46992-0443
Phone: 260-563-3171 / Fax: 800-826-3487
Overseas Fax: 260-563-0167

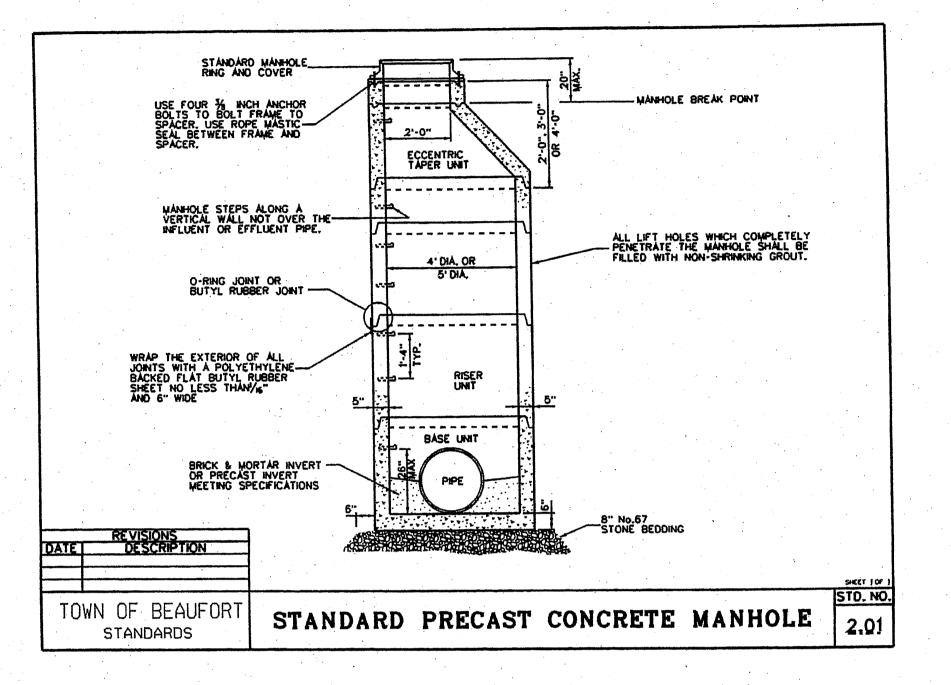

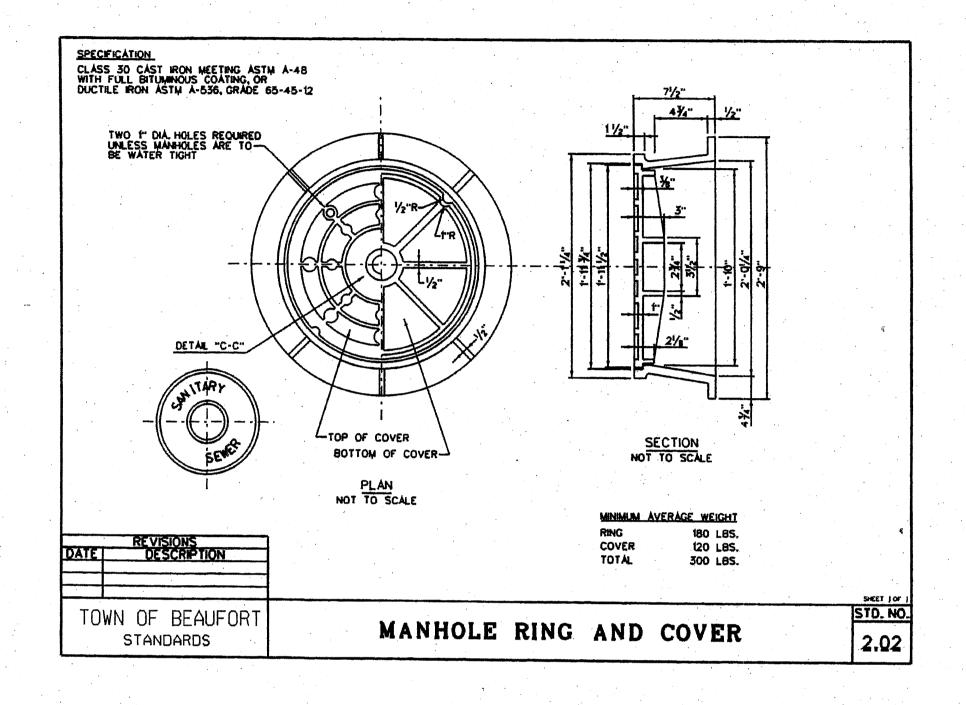

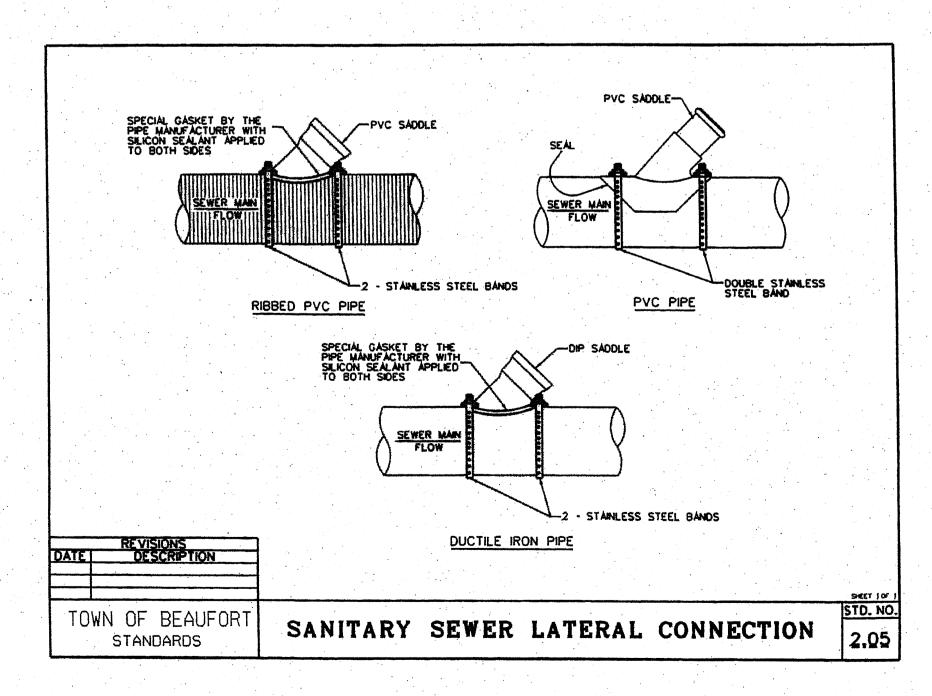

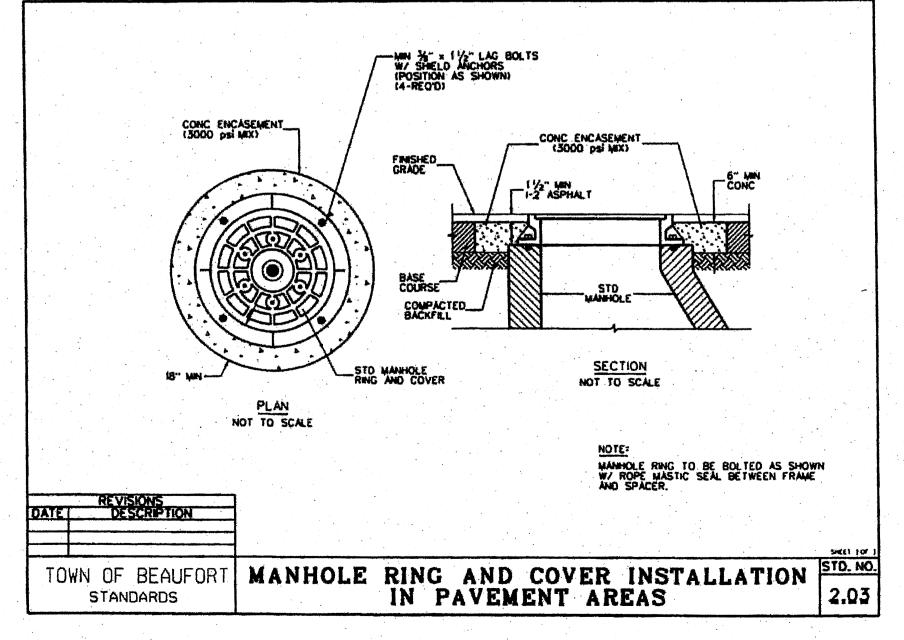

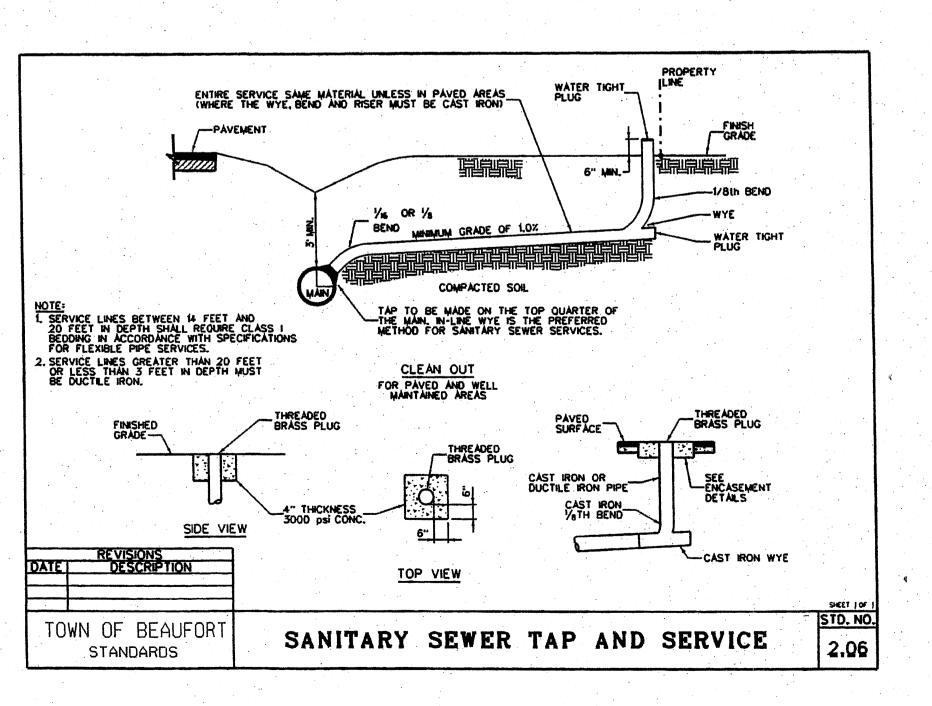

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PROJECT MANAGER: DESIGNED: DRAWN BY:

CHECKED: JWF SCALE: 1" = 30'

03/29/2021

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www.arendellengineers.com North Carolina Certification No. C-1509 OWNER:

FRONT STREET VILLAGE, LLC 2400 LENNOXVILLE ROAD BEAUFORT, NC 28516

PROJECT:


FRONT STREET VILLAGE TRANSPORTATION CENTER-SITE PLAN-PHASE II AND PRELIMINARY PLAT PHASE IV BEAUFORT, NORTH CAROLINA

CARTERET COUNTY, NC


DRAWING:

UTILITY DETAILS



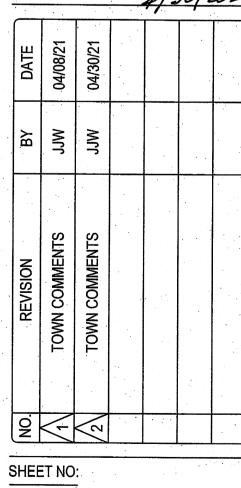

OF: 18 JOB NO.

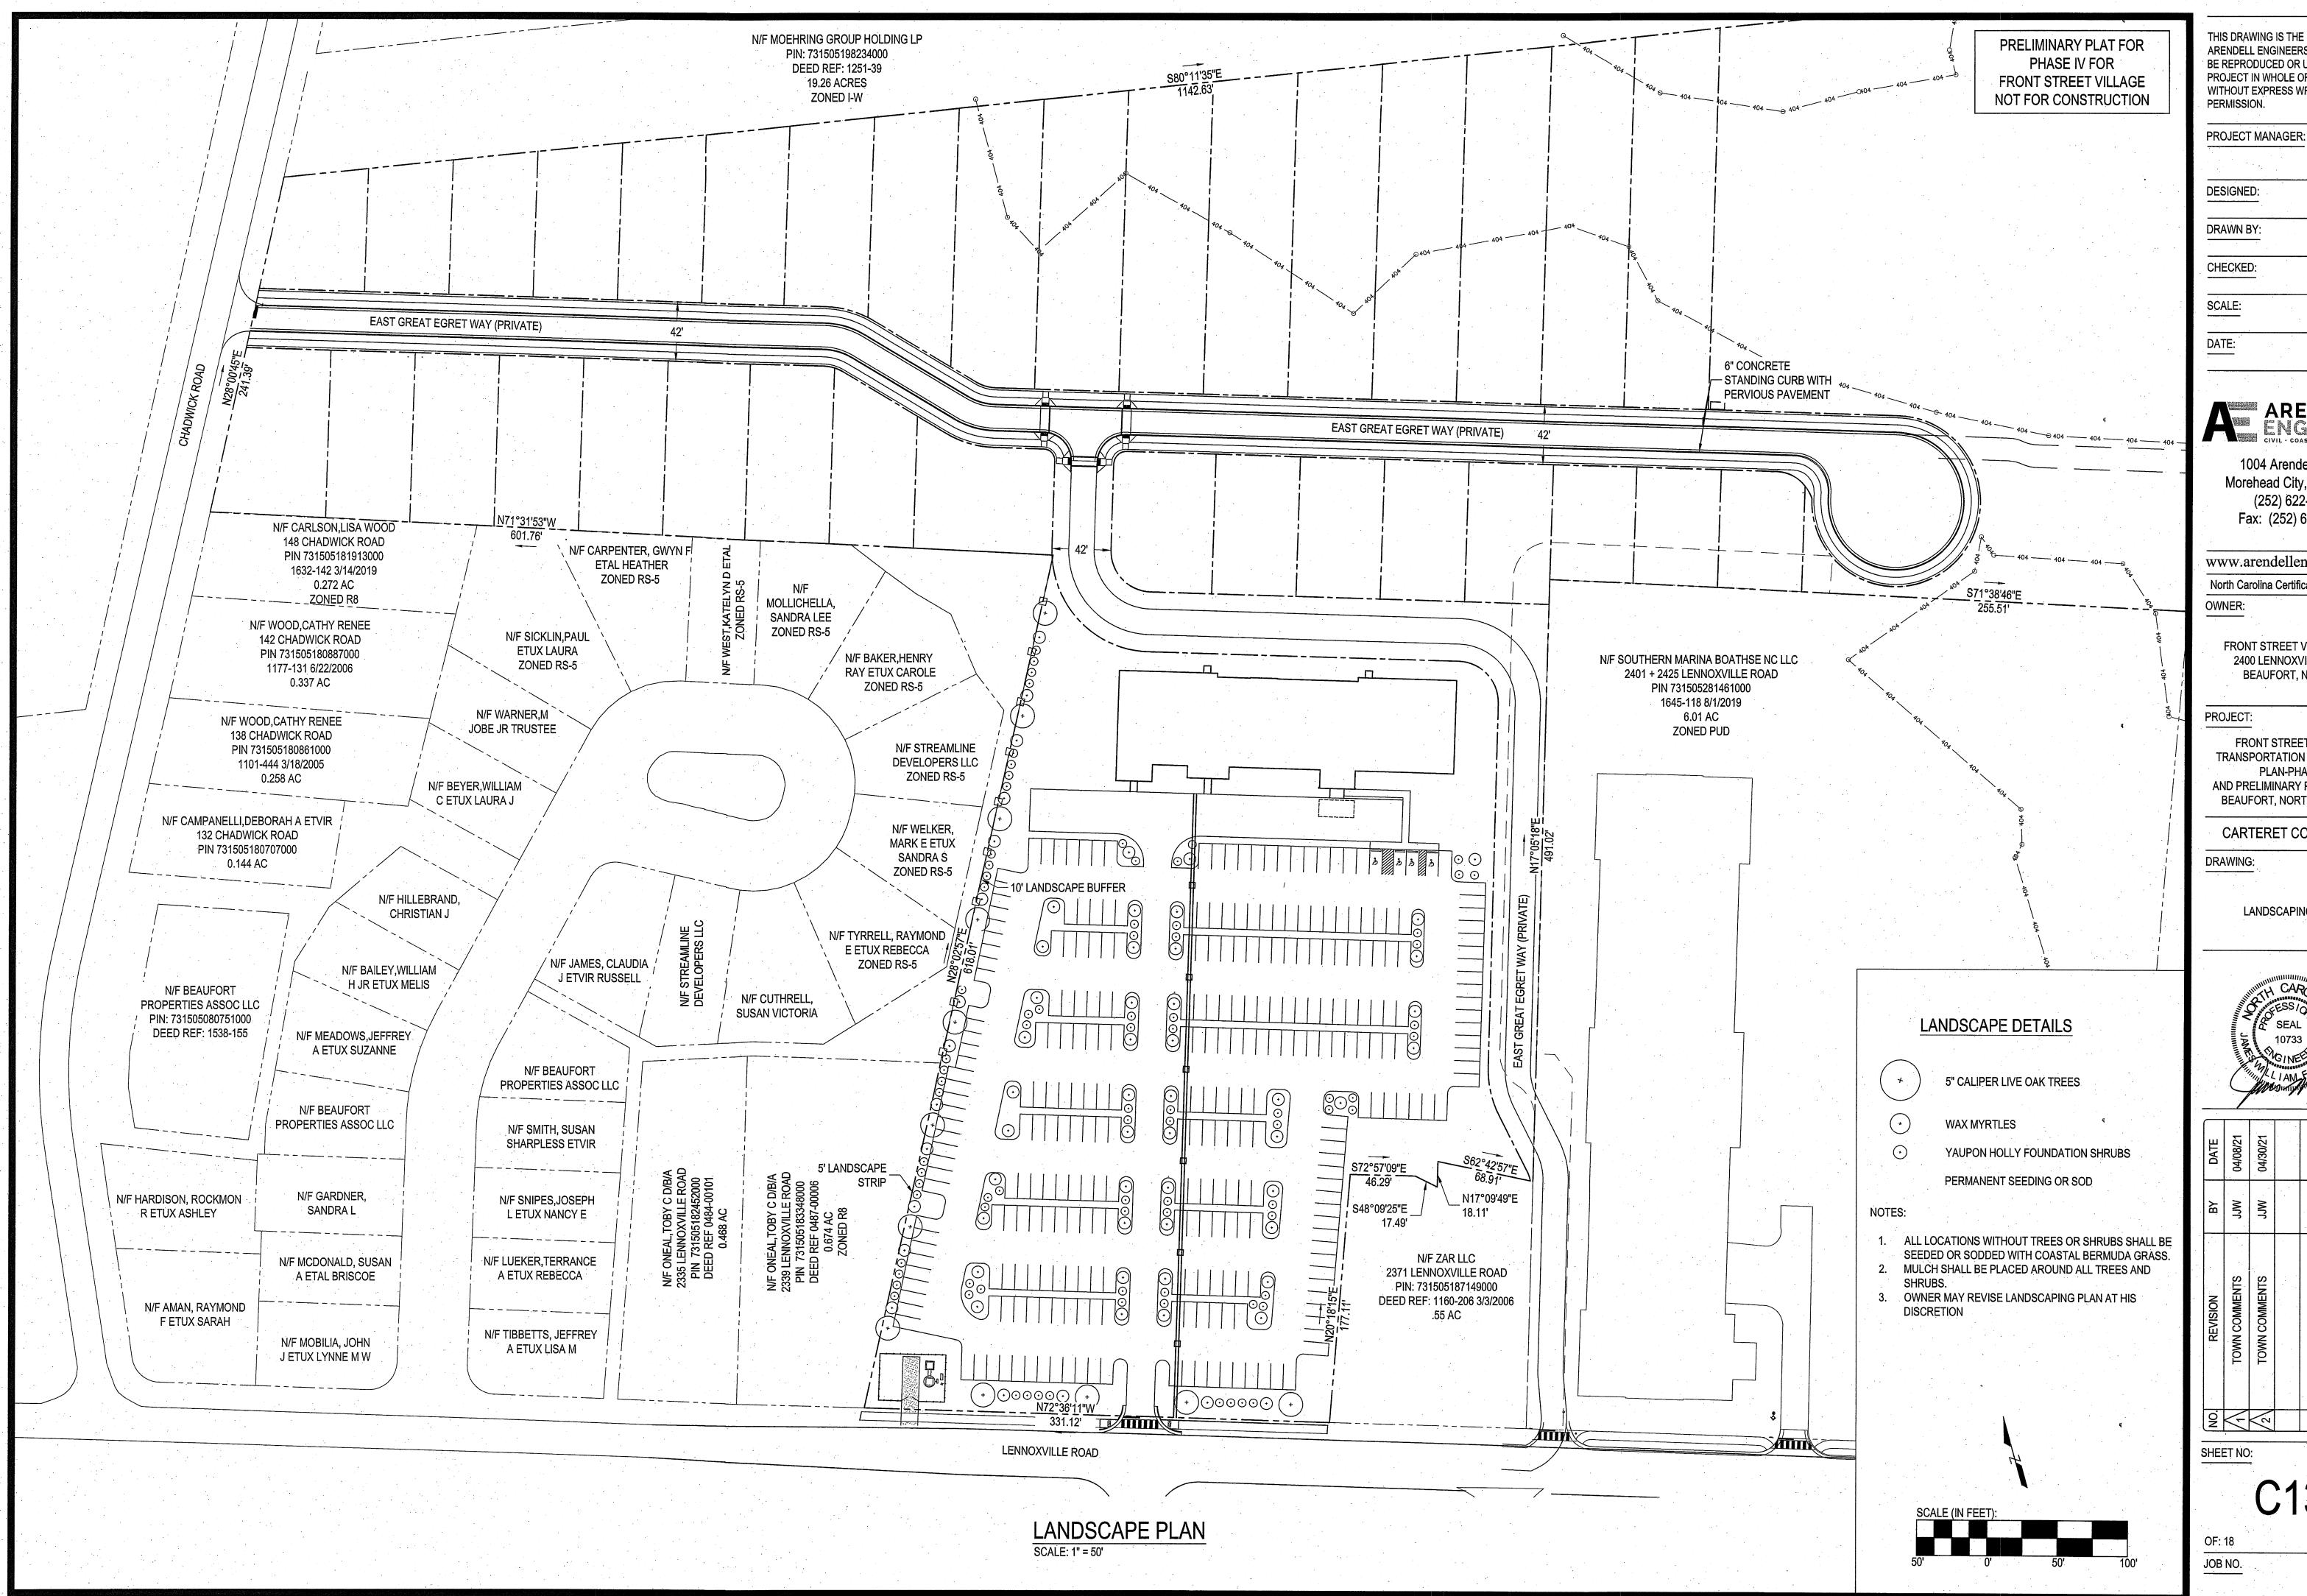

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I NOOLOT WANTAGE	\.
	_ JWF
DESIGNED:	JJW
DRAWN BY:	JJW
CHECKED:	JWF
SCALE:	1" = 50'
DATE:	03/29/2021

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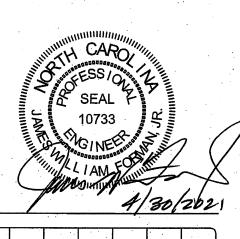
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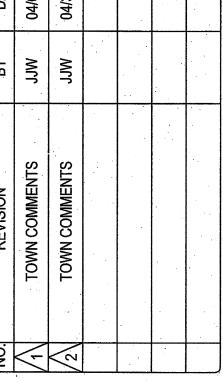
FRONT STREET VILLAGE, LLC 2400 LENNOXVILLE ROAD BEAUFORT, NC 28516


FRONT STREET VILLAGE TRANSPORTATION CENTER-SITE PLAN-PHASE II AND PRELIMINARY PLAT PHASE IV BEAUFORT, NORTH CAROLINA

CARTERET COUNTY, NC

LANDSCAPING PLAN





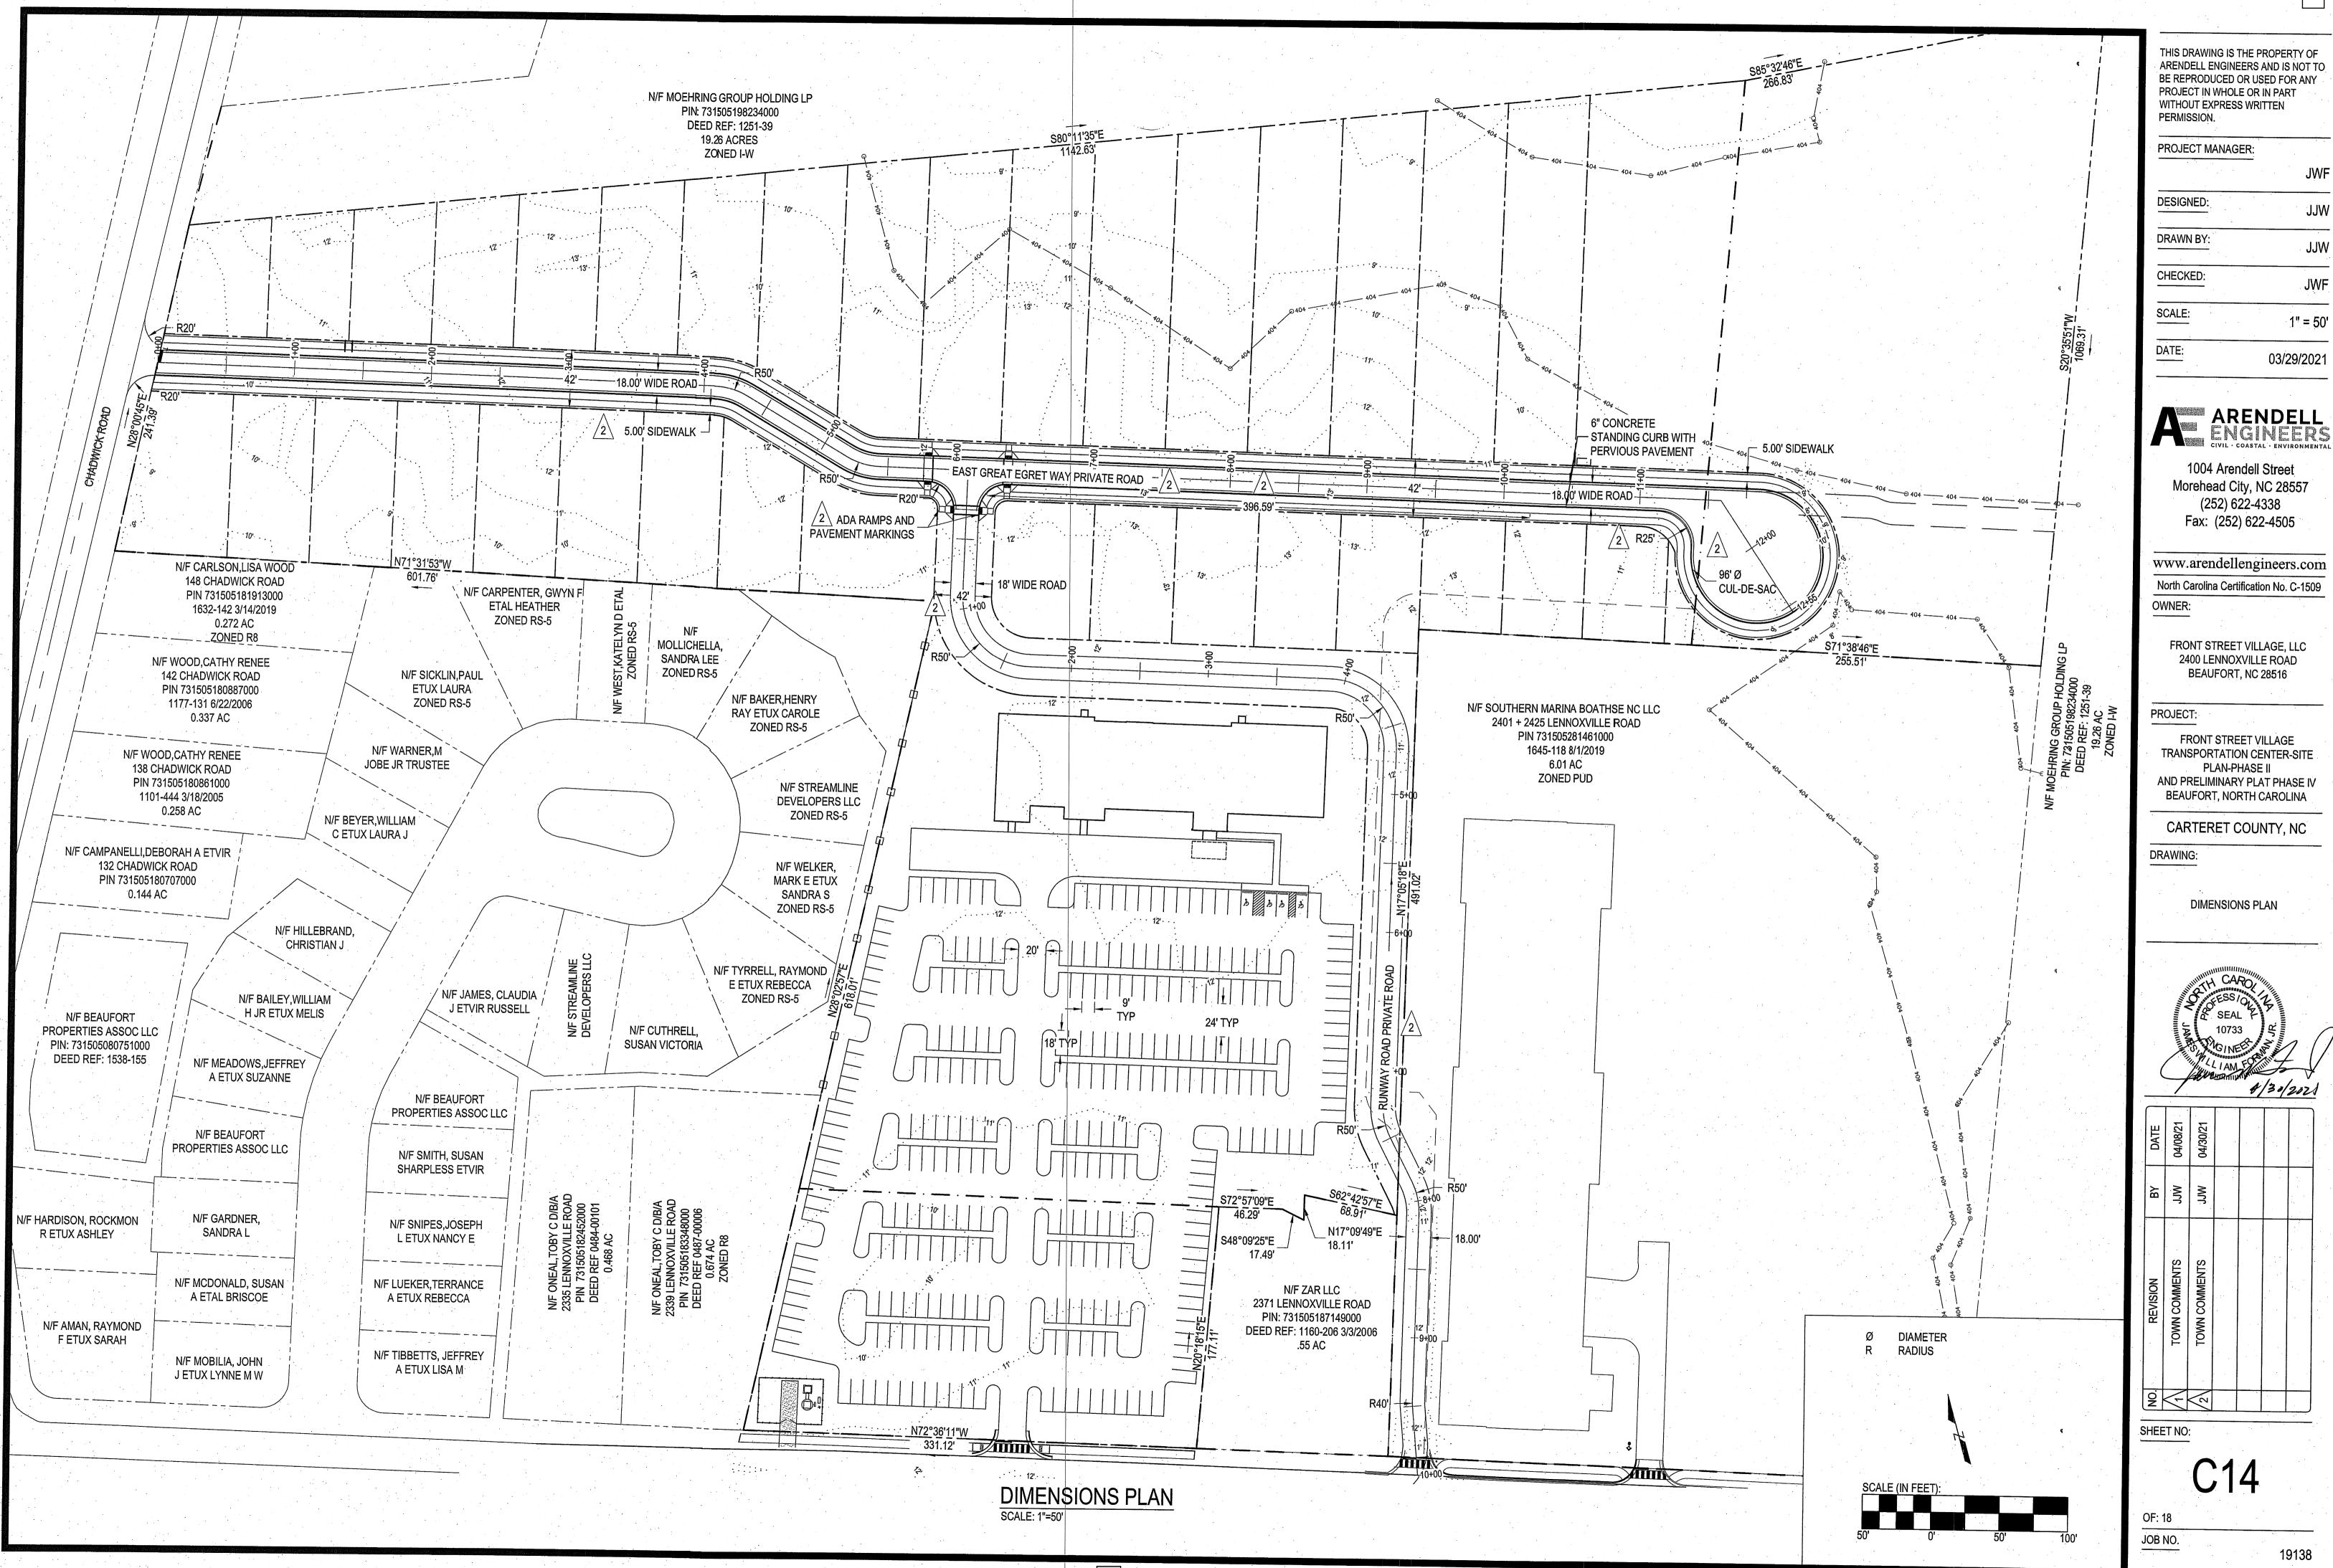


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JWF JJW JJW JWF 1" = 50'

North Carolina Certification No. C-1509

1/30/2021

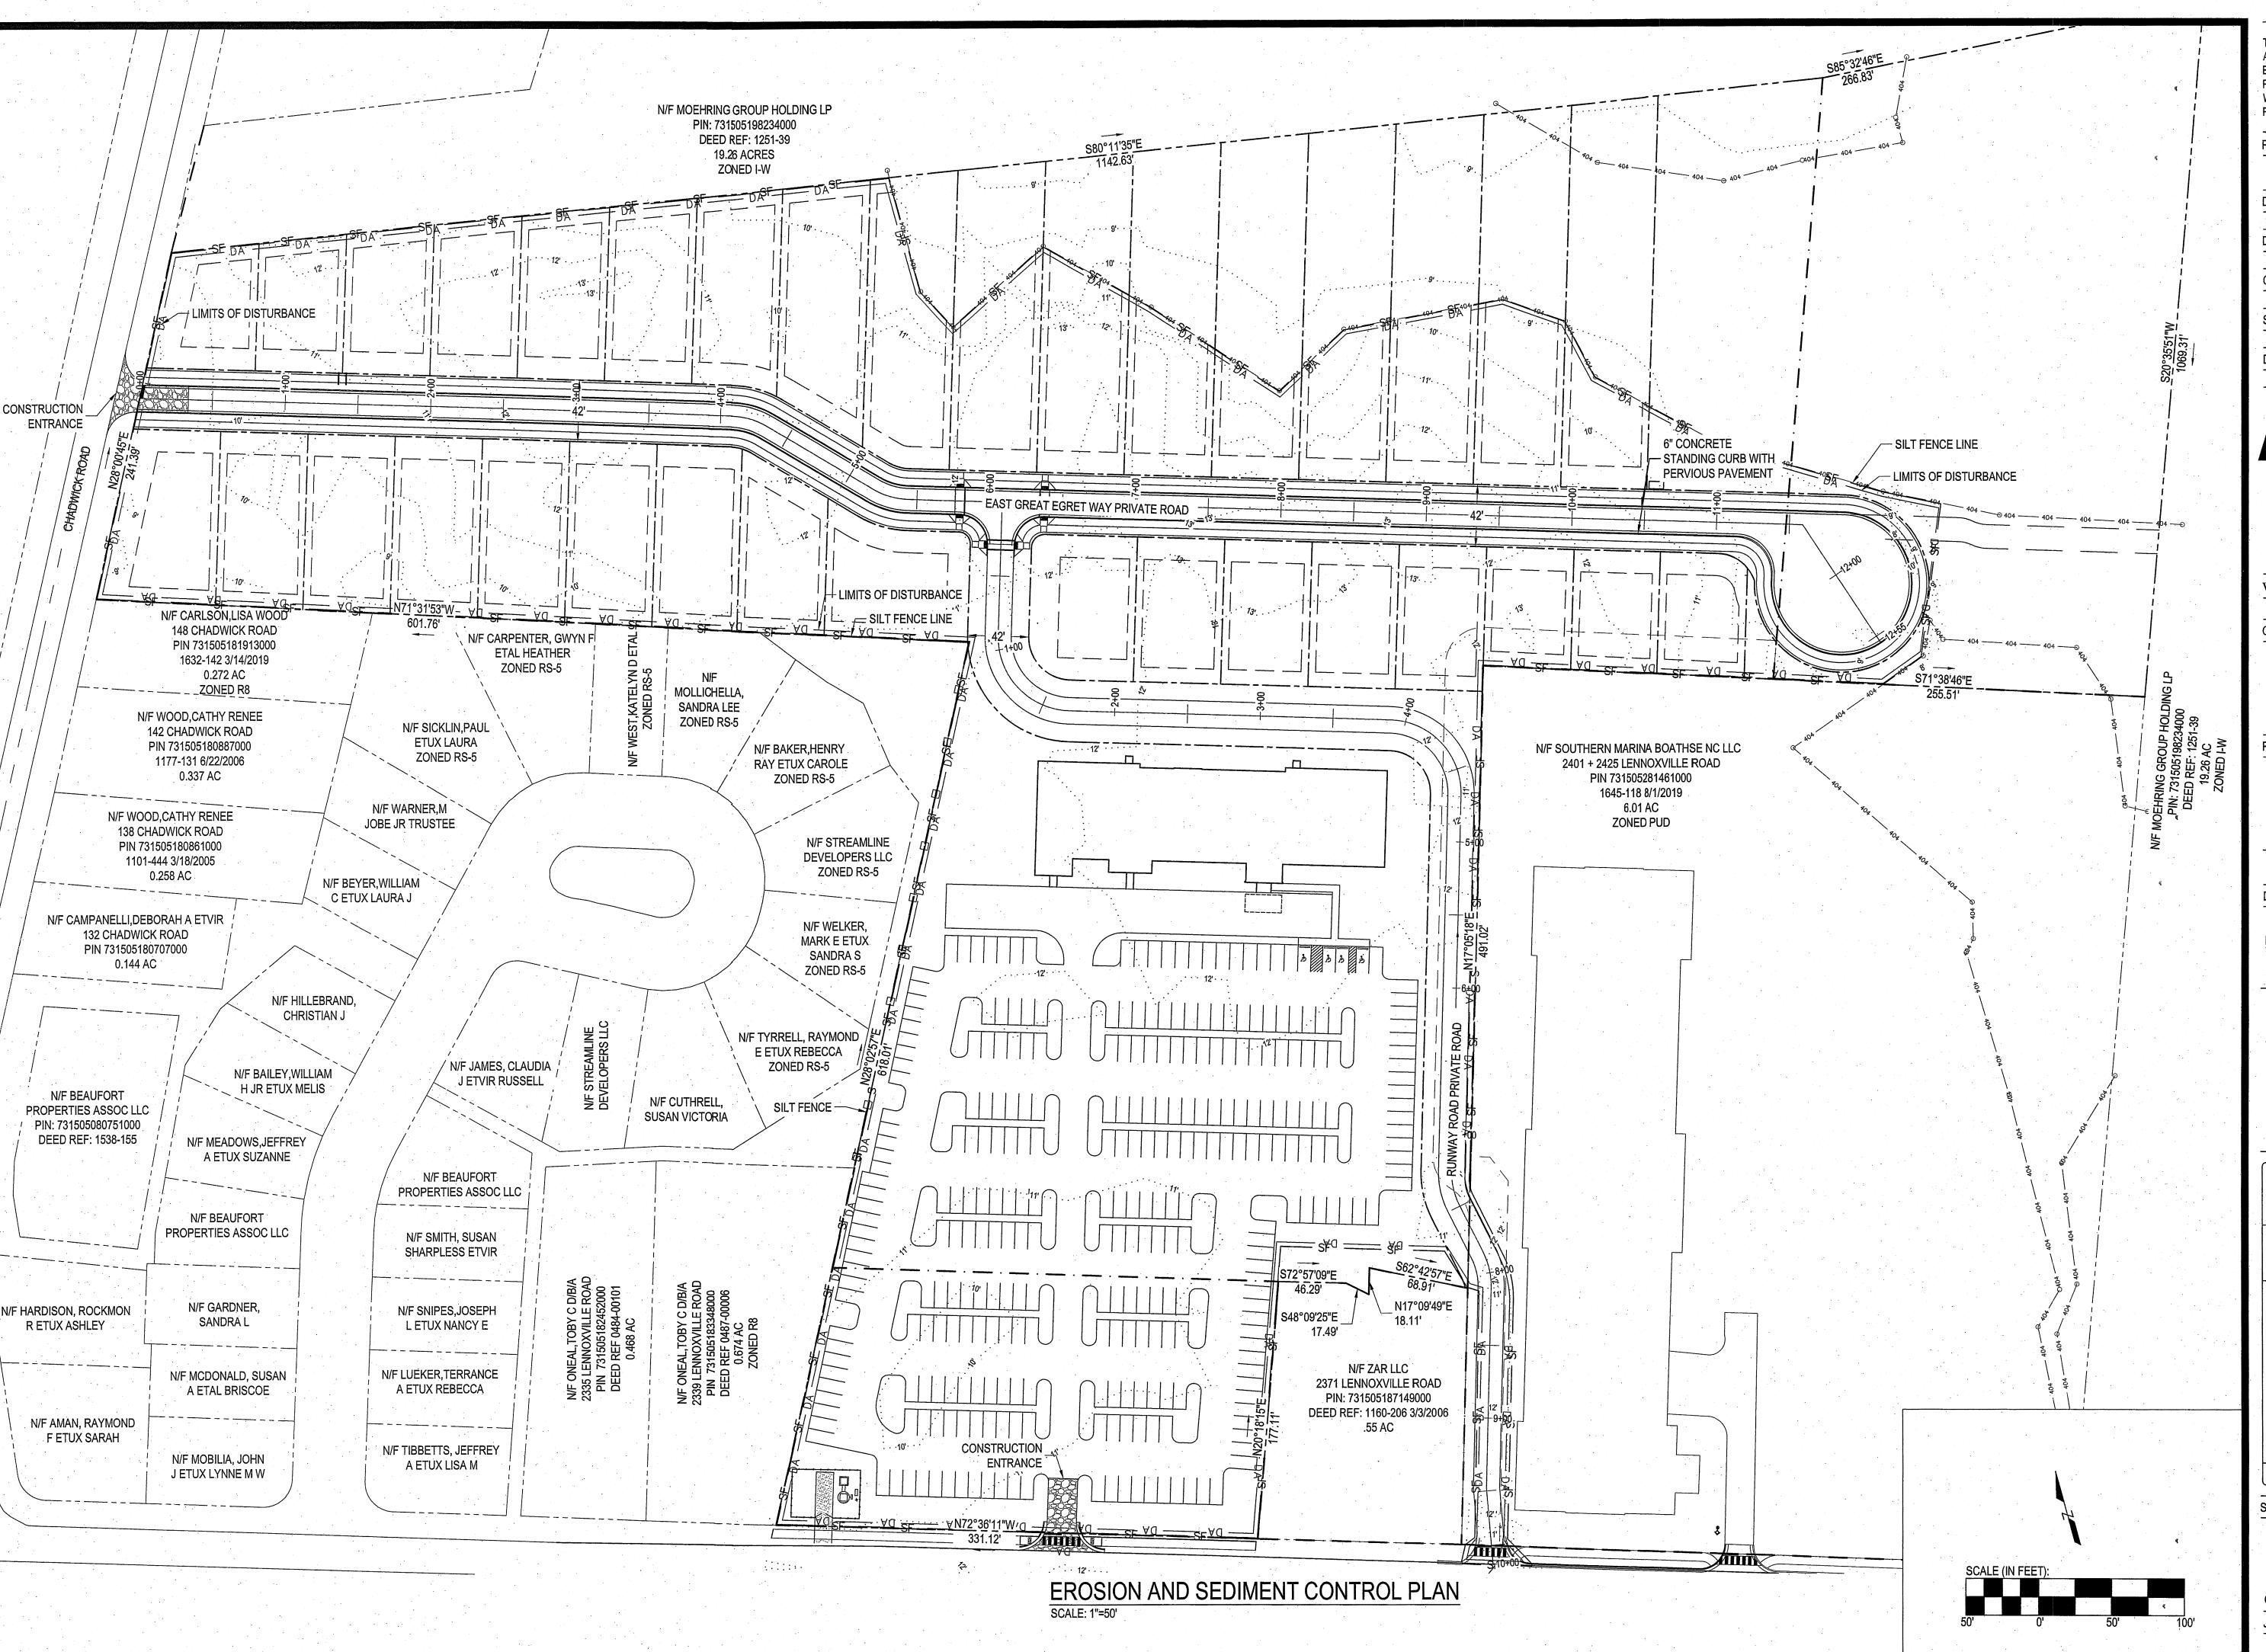

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 PROJECT MANAGER:

 JWF

 DESIGNED:
 JJW

 DRAWN BY:
 JJW

 CHECKED:
 JWF

 SCALE:
 1" = 50'

 DATE:
 03/29/2021

ARENDELL EN CIVIL - COASTAL - ENVIRONMENTAL

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North Carolina Certification No. C-1509
OWNER:

FRONT STREET VILLAGE, LLC 2400 LENNOXVILLE ROAD BEAUFORT, NC 28516


PROJECT:


FRONT STREET VILLAGE
TRANSPORTATION CENTER-SITE
PLAN-PHASE II
AND PRELIMINARY PLAT PHASE IV
BEAUFORT, NORTH CAROLINA

CARTERET COUNTY, NC

DRAWING:

EROSION AND SEDIMENT CONTROL PLAN

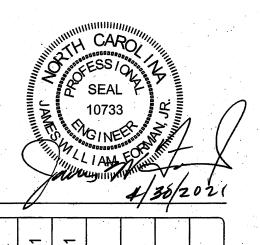

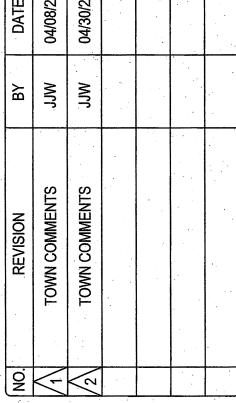


SHEET NO:

C15

OF: 18

JOB NO.

STEP 1 DRIVE 5' STEEL POSTS 24" INTO GROUND AND EXCAVATE A 8"x6" TRENCH ON UPHILL SIDE OF POST LINE. STEP 2
ATTACH WIRE FENCE TO POSTS THEN ATTACH FILTER
FABRIC TO WIRE FENCE AND EXTEND BOTTOM OF BOTH 8"
INTO TRENCH AND 4" FORWARD. STEP 3
BACKFILL TRENCH (SEE NOTE) TO ANCHOR FENCE BOTTOM SO RUNOFF IS FORCED THROUGH NOT UNDER FENCE. - WIRE FENCE " HOG WIRE" AND FILTER FABRIC BURIED 8" DEEP AND 4" FORWARD ALONG THE TRENCH NOTES:
1. SEE EROSION CONTROL GENERAL NOTES.
2. FILTER FABRIC BOTTOM SHALL BE PLACED 8" IN TRENCH AND 4 " FORWARD AND SECURED BY EITHER WASHED STONE EXTENDING A MINIMUM OF 6" ABOVE GROUND LEVEL DR TAMPED SOIL BACKFILL MATERIAL TO GROUND LEVEL OR HIGHER.

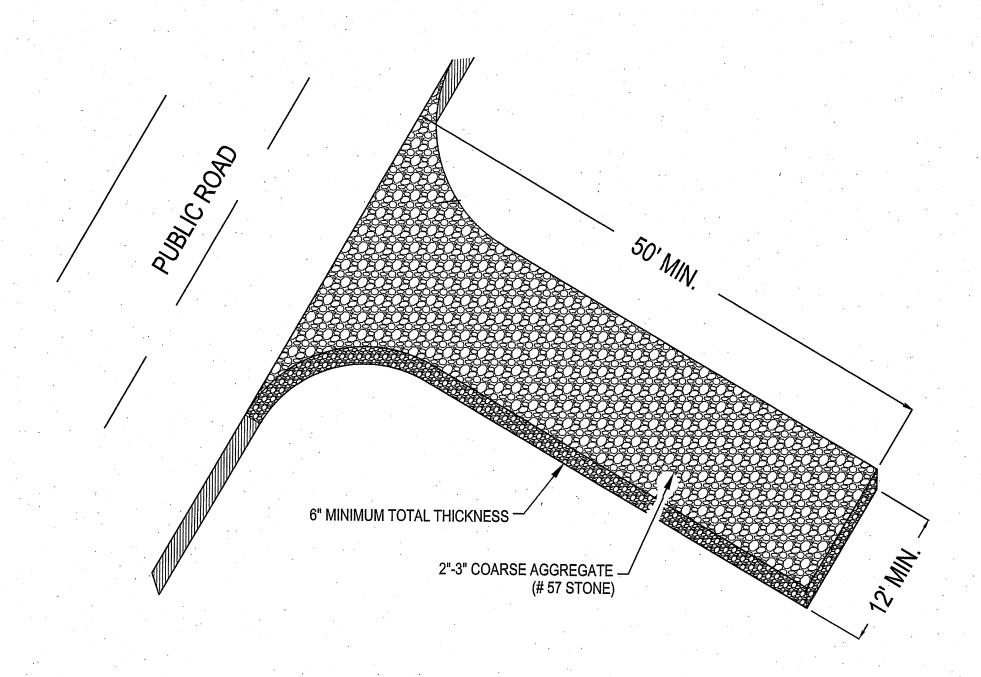

TEMPORARY SILT FENCE SCALE: NOT TO SCALE

CONSTRUCTION ENTRANCE SCALE: NOT TO SCALE

EROSION AND SEDIMENT CONTROL DETAILS NOT TO SCALE

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PROJECT MANAGER:

	*
	JWF
DESIGNED:	JJW
DRAWN BY:	JJW
CHECKED:	JWF
SCALE:	NTS
DATE:	03/29/2021



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FRONT STREET VILLAGE, LLC 2400 LENNOXVILLE ROAD

BEAUFORT, NC 28516


PROJECT:

FRONT STREET VILLAGE TRANSPORTATION CENTER-SITE PLAN-PHASE II AND PRELIMINARY PLAT PHASE IV BEAUFORT, NORTH CAROLINA

CARTERET COUNTY, NC

DRAWING:

EROSION AND SEDIMENT CONTROL DETAILS

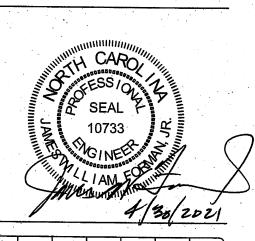

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\leq	TOWN COMMENTS	MCC	04/08/21
$\sqrt{2}$	TOWN COMMENTS	JJW	04/30/21

SHEET NO:

OF: 18

JOB NO.

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PROJECT MANAGER:

DESIGNED:

DRAWN BY:

JJW

CHECKED:

SCALE: NTS

DATE: 03/29/2021

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North Carolina Certification No. C-1509

OWNER:

FRONT STREET VILLAGE, LLC 2400 LENNOXVILLE ROAD BEAUFORT, NC 28516

PROJECT:

FRONT STREET VILLAGE
TRANSPORTATION CENTER-SITE
PLAN-PHASE II
AND PRELIMINARY PLAT PHASE IV
BEAUFORT, NORTH CAROLINA

CARTERET COUNTY, NC

DRAWING:

DETAILS


SHEET 1 OF 2

CAROLINIA CAROLI

SHEET NO:

C1

OF: 18 JOB NO.

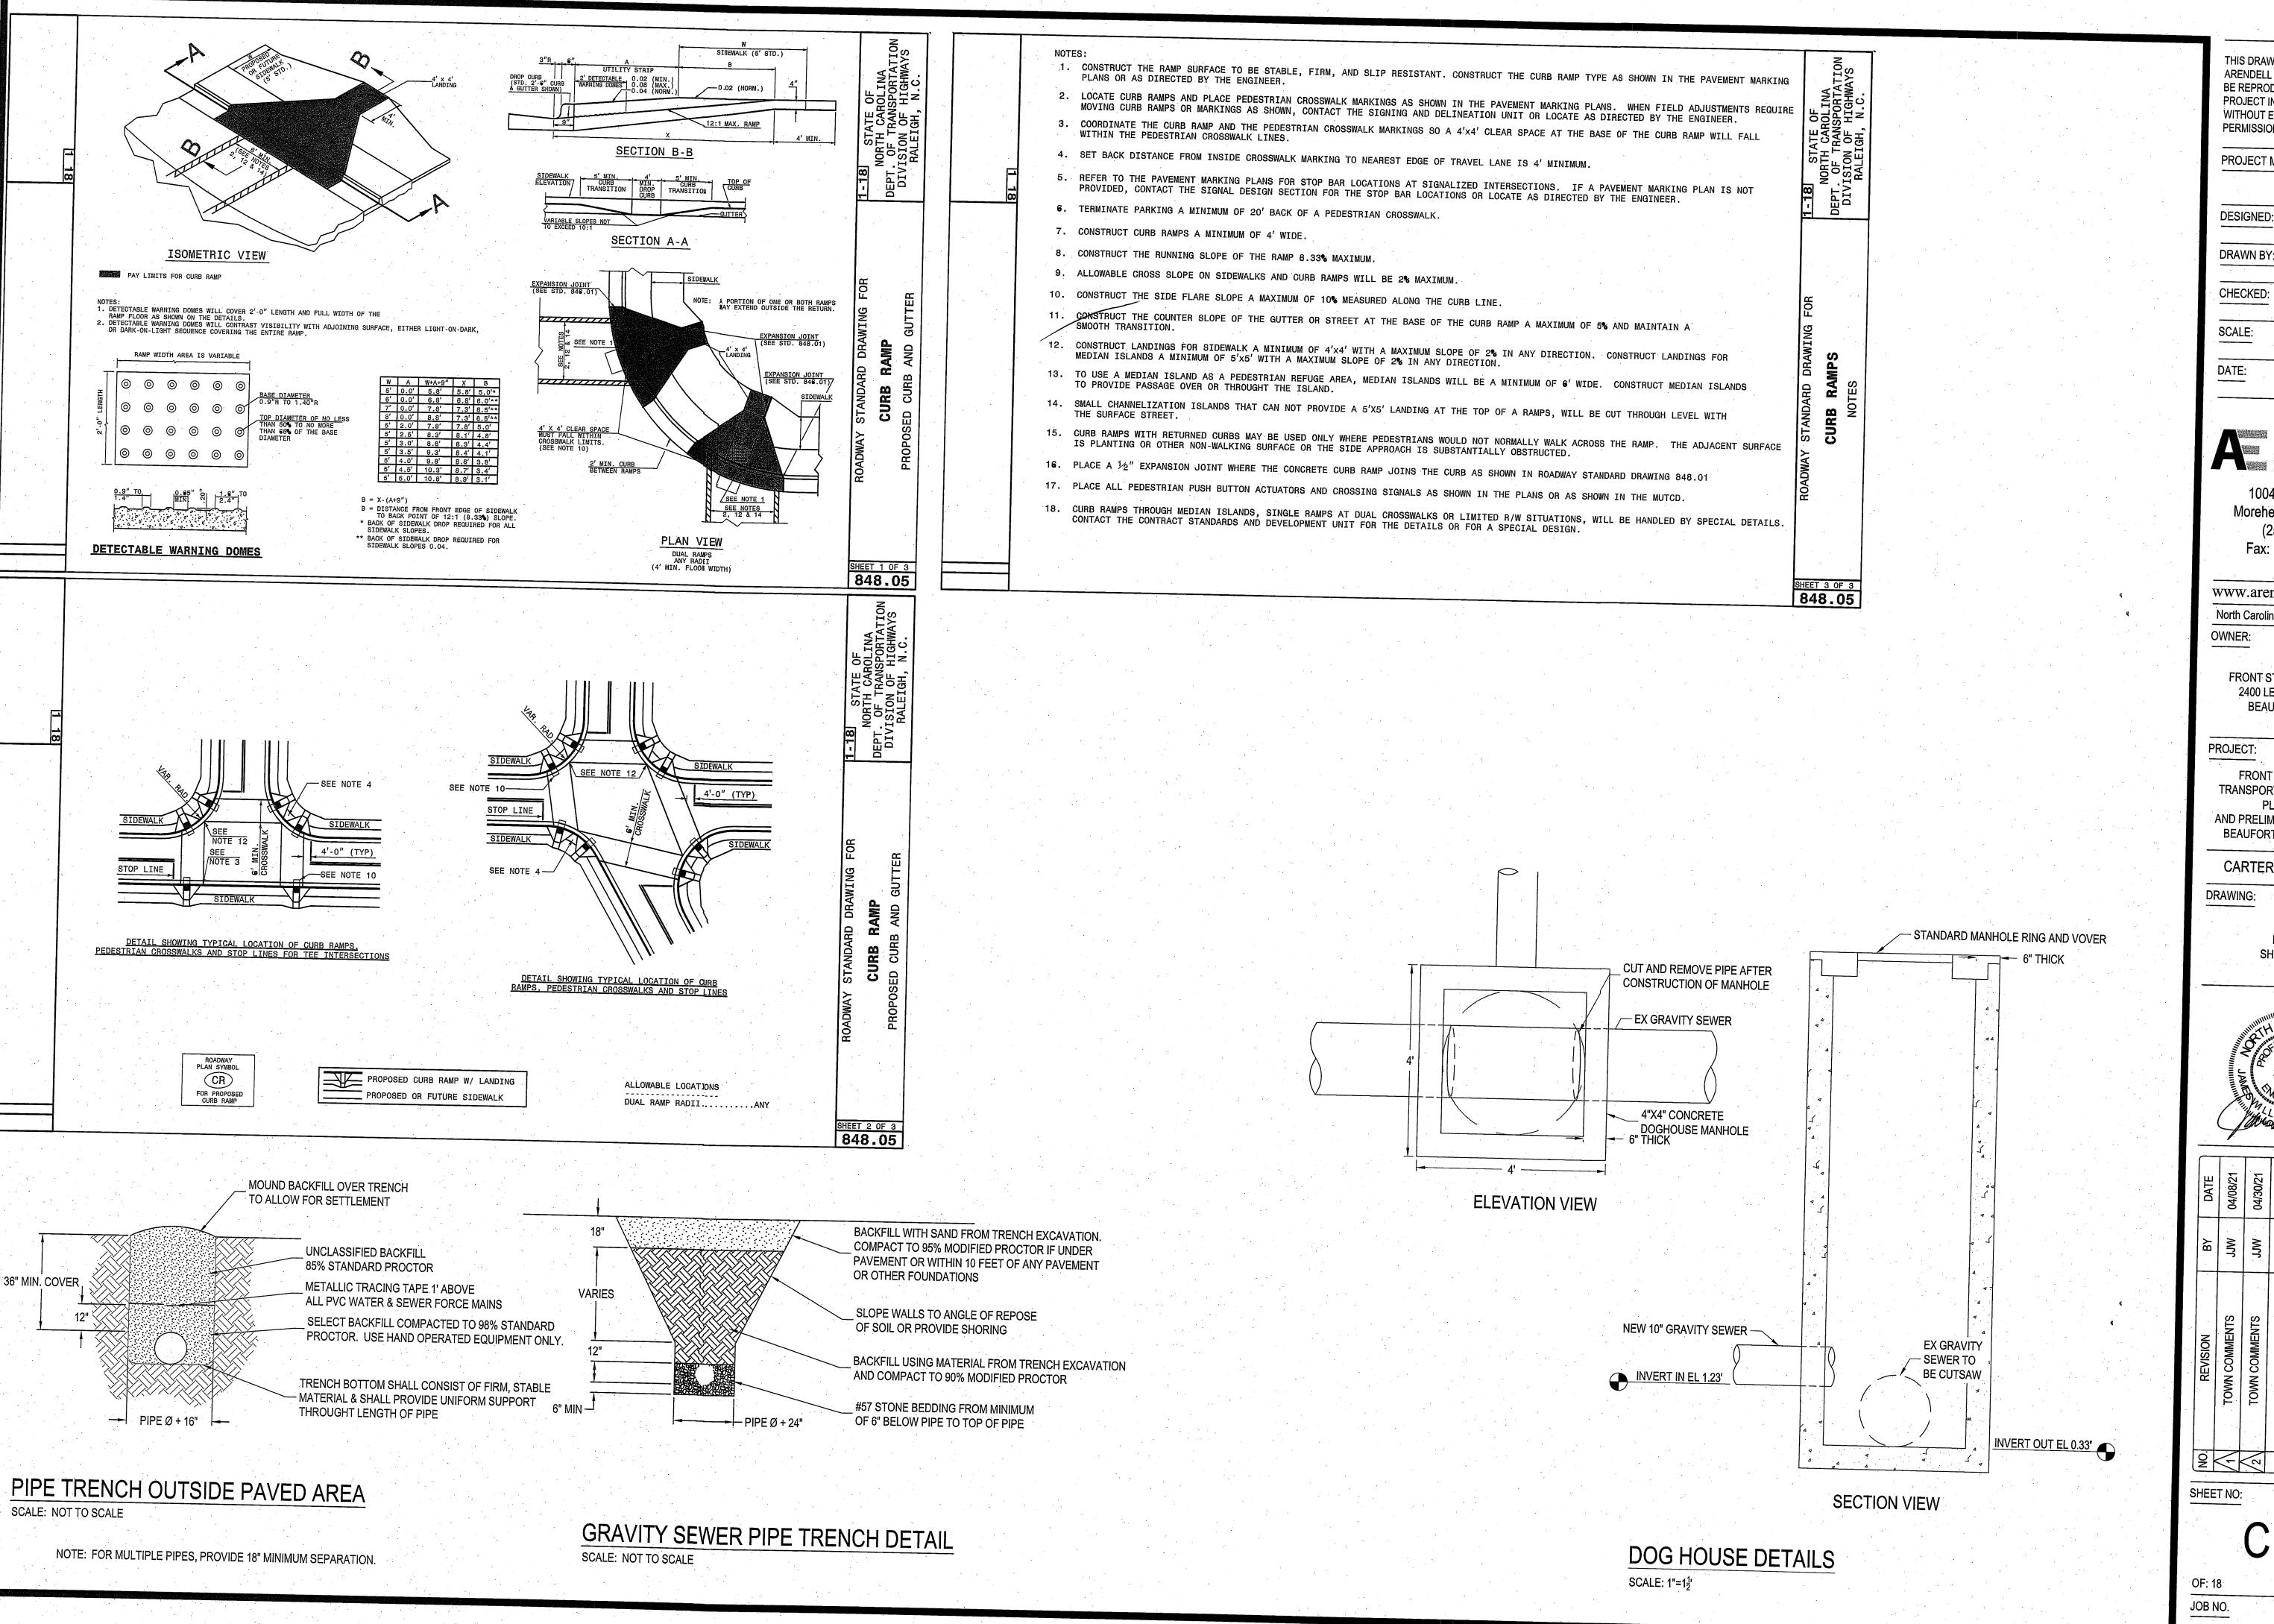

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PROJECT MANAGER: DESIGNED: DRAWN BY: CHECKED: SCALE: 03/29/2021

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FRONT STREET VILLAGE, LLC 2400 LENNOXVILLE ROAD BEAUFORT, NC 28516

PROJECT:


FRONT STREET VILLAGE TRANSPORTATION CENTER-SITE PLAN-PHASE II AND PRELIMINARY PLAT PHASE IV BEAUFORT, NORTH CAROLINA

CARTERET COUNTY, NC

DRAWING:

DETAILS

SHEET 2 OF 2

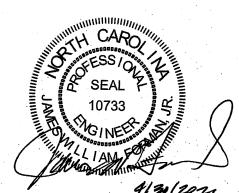

SHEET NO:

OF: 18 JOB NO.



April 30, 2021

Mr. Kyle Garner, Town Planner Town of Beaufort Planning and Inspections Department 701 Front Street Beaufort, NC 28516

Phone: (252) 728-2142 Email: k.garner@beaufortnc.org

Front Street Village (19138)
Revision to PUD & Site Plan Submittal
Beaufort, North Carolina

Dear Kyle:

Re:

On behalf of Front Street Village (FSV), please find enclosed the revised submittal documents for a modification to the current site plan approval for the transportation center and revision to the PUD for the development of 34 single-family lots for the referenced project. This submittal has been revised per the Town's comments. The Owner is proposing modifications to the northern portion of the project.

The following revisions have been made based on the Town of Beaufort's comments:

PUD Modification Request/Zoning

- 1. The Owner is requesting a zoning change from B-3 to R-8 for the expansion of the single family residential lots. The B-3 zoning originally included in portions of Phases II & III of the site which included parking and is now proposed as single family residential.
- 2. The Owner is requesting a reduction in the overall parking spaces to 398. The original PUD approval in 2008 included 631 spaces. This is a reduction of 233 parking spaces.
- 3. The Owner is requesting a reduction in the overall number of resort dwellings. If approved, there will only be seven (7) resort dwellings that are constructed south of Lennoxville Road. The approved PUD included 202 resort dwellings. This is a reduction of 195 resort dwellings.
- 4. The Owner is requesting an expansion of the original eleven (11) single family lots to a proposed thirty-four (34) single family lots, an increase of twenty-three (23) lots that were approved in the original 2008 PUD.
- 5. An Application for a Preliminary Subdivision Plat is included with this submittal.

Revise Submitted Plans

- 1. The title on Sheet C1 has been revised to "Front Street Village Transportation Center Site Plan Phase II with Preliminary Phase IV."
- 2. The drawing title on Sheet C4 has been revised to Phase IV Preliminary Plat & Phase II Site Plan Transportation Center.

Preliminary Plat Revisions – Sheet C4

- 1. The street names have been revised to "East Great Egret Way" and "Runway Road" and will remain private per the approved PUD.
- 2. Zoning has been labeled as R-8 for the single family lots.
- 3. Site calculations have been added to include the acreage in tract to be subdivided between lots 1 34 and the wetland area, total number of parcels created, and linear feet of the proposed streets.
- 4. A note has been added indicating that the street lights will be shoebox dark sky type.
- 5. The "Site Data Block" has been added to this sheet.
- 6. The seal of James W. Forman, Jr., P.E. has been added to this sheet and all applicable plan sheets.
- 7. The interior "B-1" zoning has been added to the site data block.
- 8. A concrete driveway approximately 20' long and 18' wide will be constructed for each residential unit.
- 9. Type of parking area surface has been added to the sheet.
- 10. No fire lanes are proposed in front of the transportation center.
- 11. Four (4) handicap parking spaces and dimensions have been added to the large parking lot south of the Transportation Center. In addition, there are twelve (12) handicap spaces located in the development south of Lennoxville Road.
- 12. The location of the loading/unloading zone has been added.
- 13. Access points for the transportation center have been added.
- 14. Traffic arrows for the streets and parking lot have been added.

Fire Department Comments

- 1. The diameter of the cul-de-sac has been increased to 96' in diameter.
- 2. The hammerhead roadway in front of the proposed Transportation Center is to be used to allow for truck access and turn-around.
- 3. The middle hydrant was mislabeled as existing and is currently shown as being proposed.

Town Engineer Comments

1. Pervious pavement will be used in Transportation Center parking lot and all streets and sidewalks and has been designed to provide in-pavement storage capacity for the 1.5" designed rainfall. Overflow from the Transportation Center parking lot will be collected via catch basins and piped to the existing pipe network in Lennoxville Road. Runoff from the Transportation Center Building will be treated through a sand filter and piped to the Lennoxville Road pipe network.

The stormwater and grading plan proposed is shown as preliminary but meeting the State's regulations. Final stormwater design will be completed once the Owner receives preliminary plat approval from the Town of Beaufort. A stormwater permit issued by the State of North Carolina will be applied for prior to land disturbing activities.

Preliminary runoff calculations are provided with this submittal for the three (3) drainage areas including the existing conditions and post-construction conditions. The use of pervious pavements will allow water to infiltrate into the ground and runoff from the houses will be directed towards the pervious pavement. Proposed contours are now shown on the plan and runoff from the site will not be directed towards neighboring properties.

Ms. Kyle Garner Front Street Village (19138) Revision to PUD and Site Plan Submittal Beaufort, North Carolina

- 2. Sewer Allocation. Per the Second Amendment to Preannexation, Infrastructure, and Reimbursement Agreement and Agreement Relating to Preannexation, Infrastructure, and Reimbursement Agreement between the Town of Beaufort and Blue Treasure, LLC and Front Street Village, a total of 324,000 gallons per day of sewer would be allocated between the Blue Treasure development and Front Street Village. 115,668 gallons per day would be allocated to Front Street Village as stated in the Amendment. The cumulative total proposed wastewater flow for Front Street Village with this submittal is 53,233 gallons per day prior to any flow reduction factors being included. The wastewater flow estimate spreadsheet is included with this submittal.
- 3. Proposed contours are now shown on Sheet C5 Grading Plan.
- 4. East Great Egret Way and Runway Road will remain private. The streets will have a width of 18' with a 42' right-of-way per the approved PUD in 2008.
- 5. A doghouse manhole detail has been included with the plans.
- 6. Water & sewer main trench details have been included with the plans.
- 7. ADA ramps have been added on either side of the intersection between East Egret Way and Runway Road.
- 8. Sheet C12 Dimension Plan has been revised.

We appreciate your review of the enclosed documents at your earliest possible convenience. If you have any questions or need additional information concerning this submittal, please give me a call.

Sincerely,

ARENDELL ENGINEERS

James W. (Bill) Forman, Jr., P.E.

President

Attachments

CC: Bucky Oliver, Front Street Village, LLC

ARENDELL 1004 Arendell Street Morehead City, NC 28557 (252) 622-4338 N.C. Certification No. C-1509

	ALLOCATED WA	STEWATE	R FLOWS	USED AS O	F APRIL 30.	, 2021 ⁽³⁾						
			ASES 1, 2,		Phase 1	Phase 2A	Phase 2B	Phase 2C	Phase 2D	Dhasa 2F	Phase 3A	Phase
Facility	Wastewater Flows (1)	Units	gpd	Total	Flows	Flows	Flows	Flows	Flows	Flows	Flows	Flow
Phase 1												
Boat Storage #1	40 4/-1:-	040	40	0400	0400							
Ory Storage - 213 slips w/o bathhouse Boat House - 8 employees	10 gpd/slip 25 gpd/employee/shift	213 8	10 25	2130 200	2130 200							
Boat House	25 gpd/employee/smit	°	25	200	200							
Convenience Store w/o food prep	250 gpd / plumbing fixture	9	250	2250	2250							
Caterers Kitchen - 455 s.f.	50 gpd / 100 s.f of floor space	4.55	50	228	228							
Meeting Room & Covered Porch - 150 seats	Banquet Dining Hall - 30 gal/seat	150	30	4500	4500							
		Pha	se 1 Total	Flow (gpd)	9,308							
Phase 2A												
Pool - Pool users from Inn counted in Inn flows, Users from Marina Club (2)	10 and/assess	20	10	200		200						
Marina Slips	10 gpd/person	20	10	200		200						
0 Full Service Slips	10 gpd/slip w/o bathhouse	20	10	200		200						
Residential units	51 1											
000A 2 BR Unit	120 gpd/bedroom	2	120	240		240						
000B 3 BR Unit	120 gpd/bedroom	3	120	360		360						
001A 2BR Unit	120 gpd/bedroom	2	120	240		240						
001B 3BR Unit 002A 2BR Unit	120 gpd/bedroom	3	120 120	360		360						
007A 2BR Unit	120 gpd/bedroom 120 gpd/bedroom	2 2	120	240 240		240 240						
007B 3BR Unit	120 gpd/bedroom	3	120	360		360						
	,			2A Total FI	ow (gpd)	2,440						1202-0-1
	ALLOCATED WASTEW		OWS REMA 2D, 2E, 3A		BE USED		2,040					
Phase 2B	THACE	,,	.,, 0A									
istro												
Meeting space Multi Purpose 1208 s.f.												
all Room 4673 s.f.							,					
oard Room 320 s.f.												
otal Meeting Space 6201 s.f.	5gpd/person	620	5	3,100			3,100					
ooms, 4	120 gpd/room	4	120	480			480					
ffices - 10 employees	25 gpd/day/employee	10	25	250			250					
ood & Drink Facilities												
ar - 55 seats	20 gal/seat	55	20	1,100			1,100					
estaurant - 146 seats	40 gal/seat	146	40	5,840			5,840					
mployees - 12	25 gpd/day/employee	12	25	300			300					
ransportation & Welcome Center	05	4.0		050								
eception Area & warehouse - 10 employees/shift olf cart barn - 10 employees	25 gpd/employee 25 gpd/day/employee	10	25 25	250 250			250 250					
on cart barn - 10 employees	25 gpu/day/employee	"	23	230			250					
				Phase :	2B Total Flo	w (gpd)	11,570					
Phase 2C												
duest Wing dooms, 129	120 gpd/room	129	120	15,480				15,480				
mployees, maximum shift - 9 employees	25 gal/employee/shift	9	25	225				225				
					Phase 2C T	otal Flow (g	pd)	15,705				
Phase 2D Multi-Family - Deleted from Project		Γ										
						Phase 2	D Total Flo	w (gpd)	0			
Phase 2E esidential units												
005A 2 BR Unit	120 gpd/bedroom	0	120	0						0		
005B-3-BR Unit	120-gpd/bedroom	0	120	0						0		
007A 2 BR Unit	120 gpd/bedroom	0	120	0						0		
007B 3 BR Unit	120 gpd/bedroom	0	120	0						0		
009A 2 BR Unit 009B 3 BR Unit	120 gpd/bedroom 120 gpd/bedroom	0	120 120	0						0		
011A 2 BR Unit	120 gpd/bedroom	0	120	9						0		
011B-3 BR Unit	120 gpd/bedroom	0	120	0						ě l		
032 2BR Unit	120 gpd/bedroom	0	120	θ						θ		
034A 2BR Unit	120-gpd/bedroom	0	120	0						0		
934B 3 BR Unit	120-gpd/bedroom	Đ	120	0			Phase 2	E Total Flo	w (gpd)	0		
Phase 3A				т			I				T	
pat Storage												
nase 3 - Dry stack - 237 boats	10 gpd/slip w/o bathhouse	237	10	2,370				Phase 3	A Total Flo	w (and)	2,370 2,370	
					-	The state of the s	The second second	i ilase s	I Stall 101	(aba)	2,070	
Phase 4												
1,600 SF 2 BR units	120-gpd/bedroom	0	120	θ								0
ommunity Center	or		,	· [
blic Bathrooms	325 gpd/fixture	0	325	θ								0
esidential - Single Family	200		200	10.045								
ngle family 34-3 BR units	360 gpd/unit	34	360	12,240					Phase 4	4 Total Flow	/ (gpd)	12,24
		DD 4	SE TOTAL	S (and) (1)	9,308	2,440	11 570	15 705				
	CHMMIII		ASE TOTAL		9,308	2,440 11,748	11,570 23,318	15,705 39,023	0 39,023	0 39,023	2,370 41,393	12,24 53,63
	PHASE TOTALS WITH 33				6,204	1,627	7,713	10,469	0	0 0	1,580	8,15
	CUMMULATIVE PHASE	TOTAL W	/33% REDI	JCTION (2)	6,204	7,831	15,543	26,012	26,012	26,012	27,592	35,75
	TOTA	L FLOW	TO LIFT ST	ATION #1	9,508							
			TO LIFT ST		15,905						1	
	тотл		TO LIFT ST		31,685						1	
	DDO IECT TOTAL WITH A		ECT TOTA		53,633							
	PROJECT TOTAL WITH 33	% FLOW	TEURCHO	^{رم} (gpa) (۲/	35,755							

⁽¹⁾ Wastewater flows in accordance with NCAC 15A 02T .0114

^{(2) 33%} flow reduction achieved by use of flow reducing fixtures throughout the project (3) Used allocation defined as use for facilities constructed, under construction, and proposed facilities.



APPLICATION FOR A PRELIMINARY SUBDIVISION PLAT Instructions:

Please complete the form below and include all required attachments, including the \$250.00 application fee and return to the Beaufort Town Hall, 701 Front Street or P.O. Box 390, Beaufort, N.C., 28516. Incomplete applications will not be processed but will be returned to the applicant. Please contact Planning and Inspections at 252-728-2142 if there are any questions.

	APPLICANT INFOR	RMATION
Applicant Name: Feor St	WET VILLAGE LLC	
Applicant Address: 2150 L	ENNOXUILLE ROAD	
Phone Number: 919-349-56	ලින	Email: BULLY CUETCRAFT. COM
Property Owner Name: F2	ut Steckt Village l	LL
Address of Property Owner:	2400 LENNOWILLE	EOAD
Phone Number: <u>919 - 349 - 55</u>	588	Email: BUCKTE DETCRAFT. COM
	PROPERTY INFOR	<u>MATION</u>
Property Address: 2361 LEA	UNOXUILE BOAD	
15-Digit PIN #: 1315051879	215000,731505284	731505187504000, 731505185229 1834000, Lot/Block#:, 731505185229
Size of Property (in square fe		.
Applicant Signature		Date of Signature
Property Owner Signature (if different	ent than above)	Date of Signature
payable to the "Town of payment can be made	Beaufort" must accomp in person at Town materials must be re	h, money order, or check made pany this application (a credit card Hall). The complete application, ceived by Town Staff at least 15 Board meeting date.
the Ordinance for the infor one digital/electronic copy preliminary plat	mation required to ac	ce, and all other pertinent sections of company this application. We require of any plans submitted for the
OFFICE USE ONLY		Revised 8/2020
Date:	Reviewe	ed for Completeness By:
Received by:	Date Deemed	Complete and Accepted:



Town of Beaufort, NC

701 Front St. - P.O. Box 390 - Beaufort, N.C. 28516 252-728-2141 - 252-728-3982 fax - www.beaufortnc.org

Town of Beaufort Planning Board Regular Meeting 6:00 PM Monday, June 21, 2021 – Virtual Meeting via Zoom

AGENDA CATEGORY: New Business

SUBJECT: Final Plat – Palmetto Plantation @ Olde Beaufort Village,

Phase 2

BRIEF SUMMARY:

The applicant wishes to subdivide a 1.11 Acre Tract into 4 Lots Single-Family. Sewer allocation, Bond & recreation Fee Information ins included in the Staff Report for this project. In addition to Planning Staff the applicants Engineer will also be available to answer questions regarding the proposed infrastructure.

REQUESTED ACTION:

Recommendation to Board of Commissioners

EXPECTED LENGTH OF PRESENTATION:

10 Minutes

SUBMITTED BY:

Kyle Garner, AICP

Planning & Inspections Director

BUDGET AMENDMENT REQUIRED:

N/A



STAFF REPORT



To: Planning Board Members

From: Kyle Garner, AICP, Town Planner

Date: June 4, 2021

Case No. 21-19 Palmetto Plantation @ Olde Beaufort Village, Phase 2 – Final Plat

THE QUESTION: Subdivide a 1.11 acre tract into 4 Single-Family Residential Lots.

BACKGROUND: The preliminary plat for this area was approved in July 2018 for installation of infrastructure improvements.

Location: Professional Park Drive

Owners: Mercer building & Design, Inc.

Requested Action: Subdivide a 1.11 Acre Tract into 4 Lots

Existing Zoning RS-5
Size: 1.11 acres

Amount of Open Space: 0.00 Acres

Amount of Open Space: 0.00 Acres Existing Land Use: Undeveloped

SPECIAL INFORMATION:

- As part of the Final Plat process the infrastructure can be either installed or bonded through a financial guarantee process to ensure completion of the project. The applicant has chosen to request to bond the infrastructure improvement and has submitted cost estimates for the complete cost of improvements totaling \$70,656.67 (See estimated cost of improvement sheet from engineer).
- No sewer allocation request is being made for this project due to its approval prior to the January 11, 2021 Wastewater Allocation Policy's adoption by the Board of Commissioners.
- Since this project is part of a subdivision recreation fees will be required in the amount of \$806.40.

Public Utilities:

Water: Town Of Beaufort Sanitary Sewer: Town Of Beaufort Case No.: 21-19

Location: Professional Park Drive

Page: 1


OPTIONS:

- 1. Recommend approval the Final Plat for Palmetto Plantation @ Olde Beaufort Village, Phase 2
- 2. Recommend approval the Bond Request for Palmetto Plantation @ Olde Beaufort Village, Phase 2
- 3. Deny the request

Attachments:

- Attachment A Vicinity Map
- Attachment B Final Plat for Palmetto Plantation @ Olde Beaufort Village, Phase 2
- Attachment C Bond Estimates
- Attachment D Approved Preliminary Plat for Palmetto Plantation @ Olde Beaufort Village, Phase 2



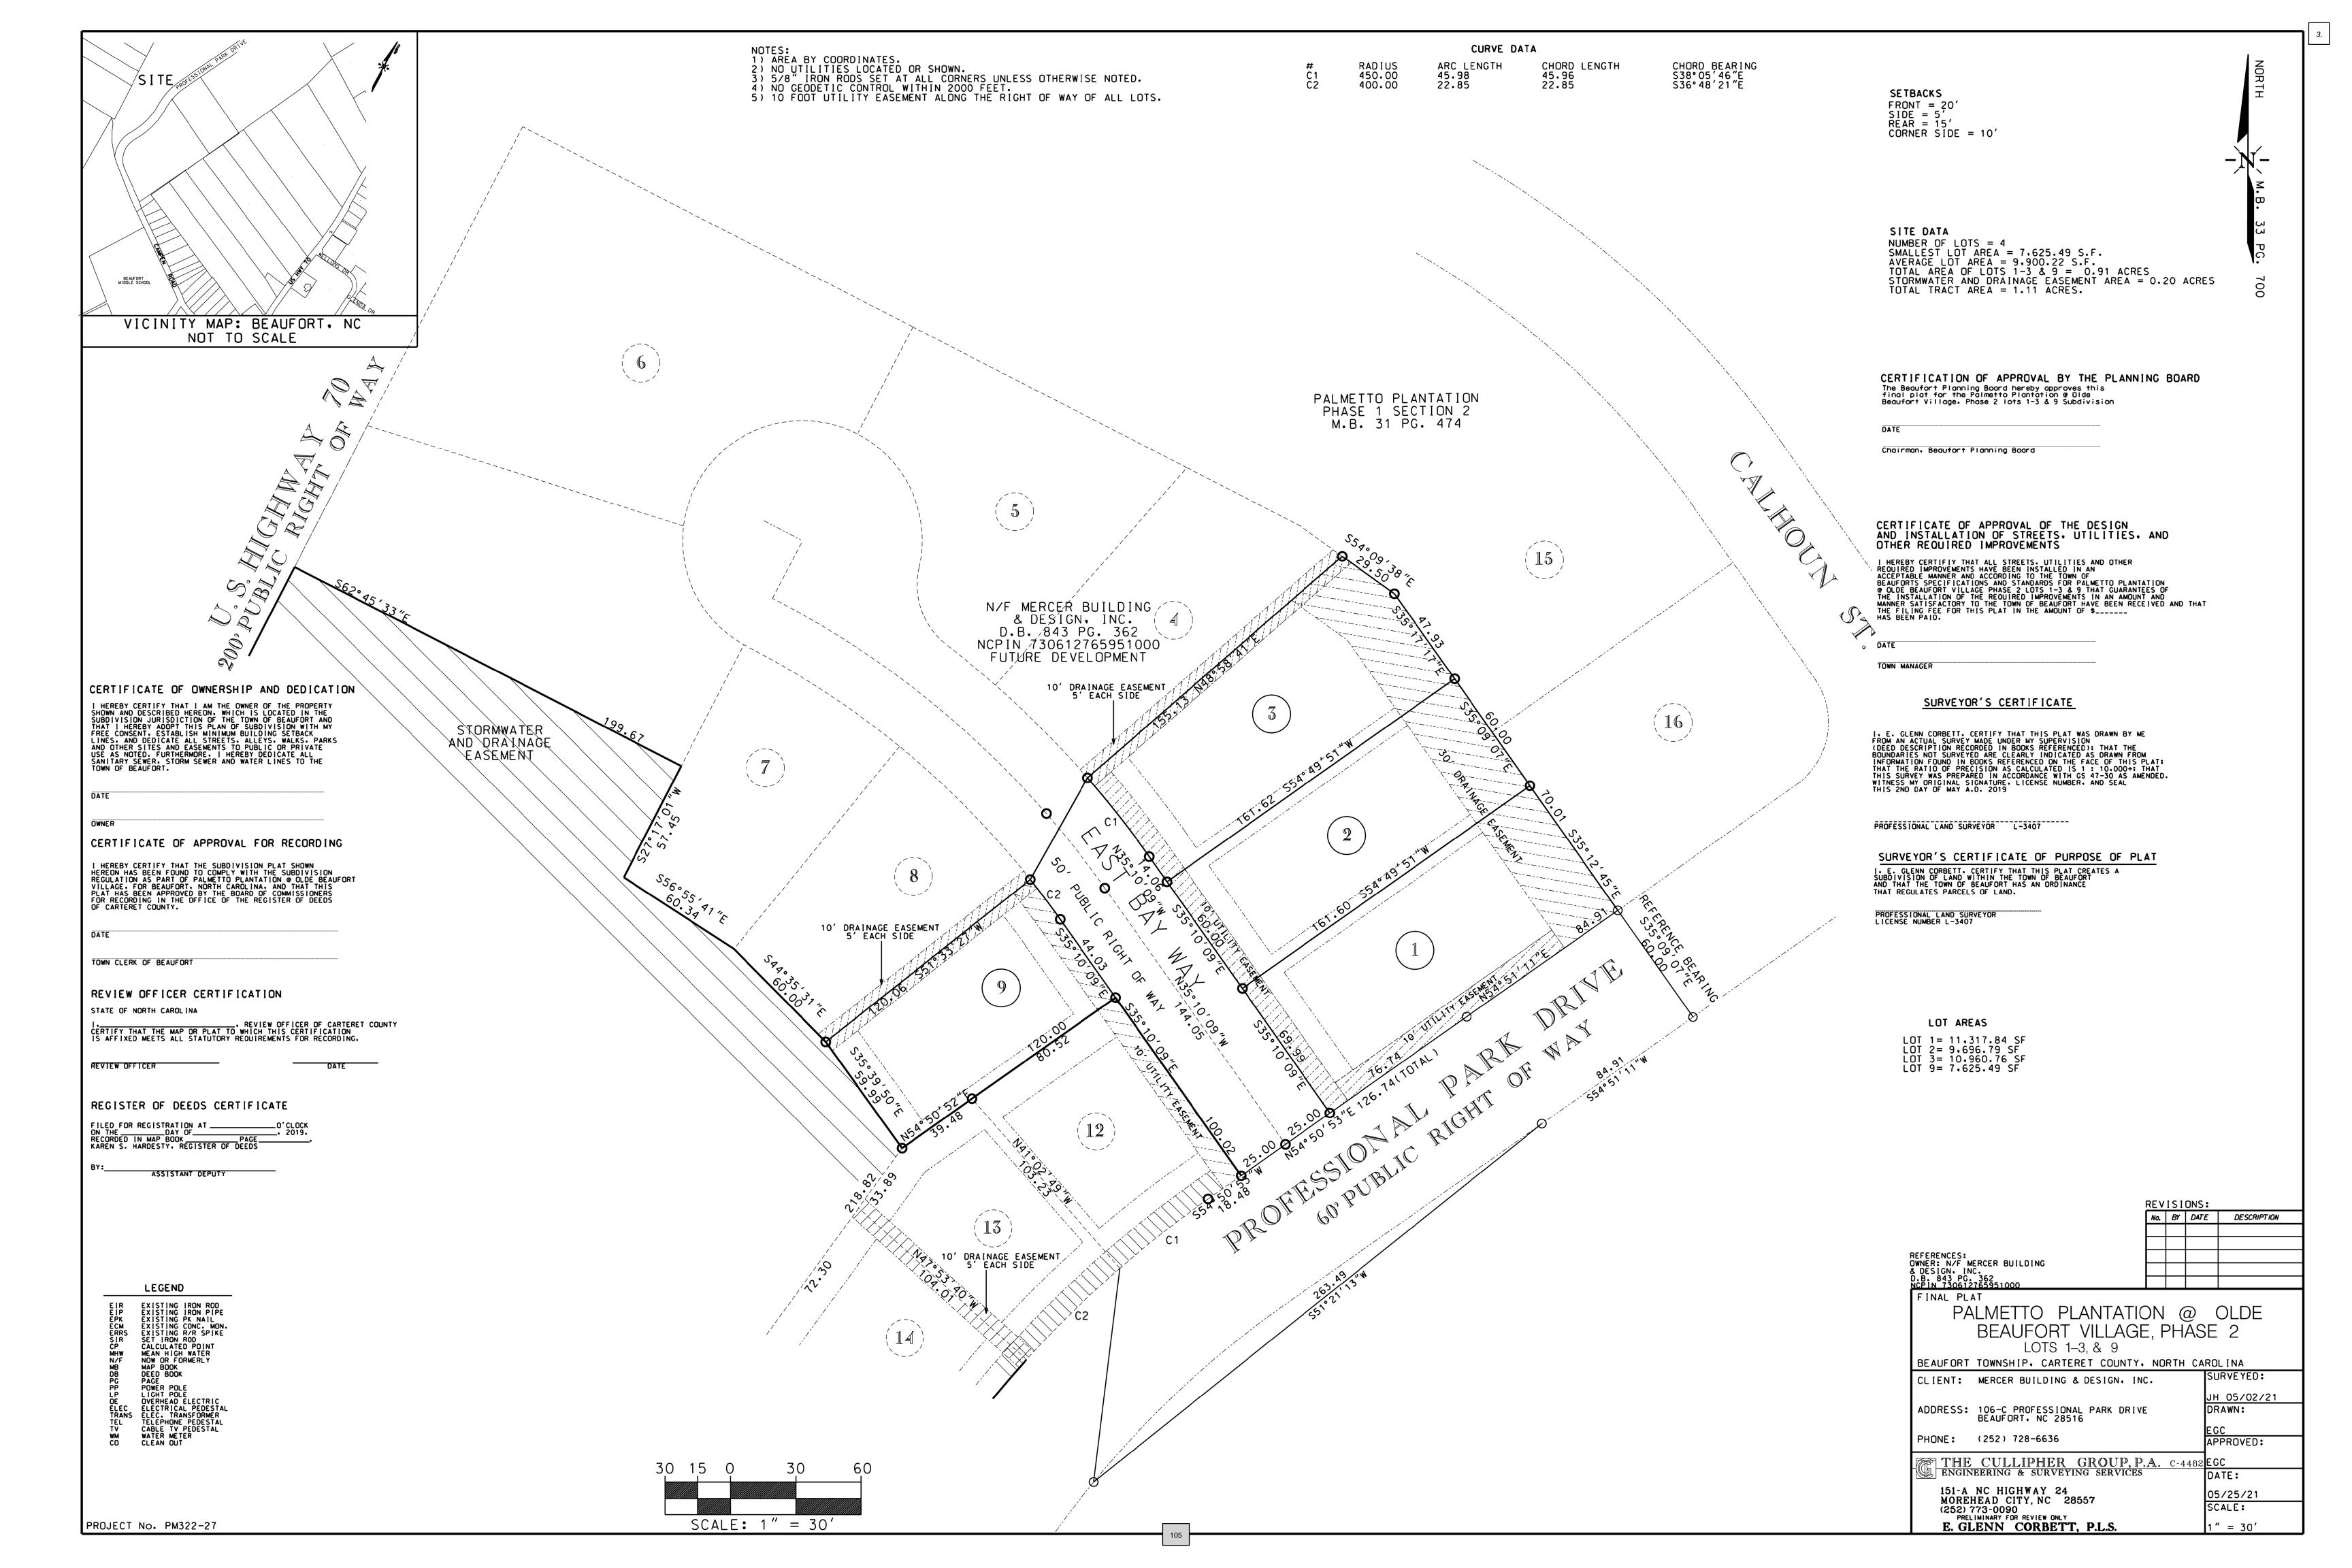



APPLICATION FOR A FINAL SUBDIVISION PLAT

Instructions:

Please complete the form below and include all required attachments, including the \$250.00 application fee and return to the Beaufort Town Hall, 701 Front Street or P.O. Box 390, Beaufort, N.C., 28516. Incomplete applications will not be processed but will be returned to the applicant. Please contact Planning and Inspections at 252-728-2142 if there are any questions.

APPLICANT INFORMATION

AFFL	ICANT IN ORMATION
Applicant Name: Mercer Building	& Design, Inc
Applicant Address: 106-C Profess	sional Park Drive, Beaufort, NC 28516
Phone Number: (252) 728-6636	Email: garym @ mercer reathying .com
Property Owner Name: Same	
Address of Property Owner:	
Phone Number:	Email:
PROF	PERTY INFORMATION
Property Address: Not Listed	
15-Digit PIN: 730612765951000	Lot/Block Number:
Size of Property (in square feet or acres	s): 1.11 acres Current Zoning: RS-5
Applicant Signature	Date of Applicant's Signature
Property Owner Signature (if different than appl	President 05-26-2021
Property Owner Signature (if different than appl	cant) Date of Owner's Signature
payable to the "Town of Beaufo payment can be made in pe payment, and supporting mate	either in cash, money order, or check made ort" must accompany this application (a credit card rson at Town Hall). The complete application, rials must be received by Town Staff at least 15 ng Board scheduled meeting date.
Ordinance for the information required /digital copy on one printed copy of ar	ite address is www.beaufortnc.org.
OFFICE USE ONLY	Revised 08/2020
Date:	Reviewed for Completeness By:
Received by:	Date Deemed Complete and Accepted:



THE CULLIPHER GROUP, P.A. ENGINEERING & SURVEYING SERVICES

SURETY COST ESTIMATE PALMETTO PLANTATION @ OLDE BEAUFORT VILLAGE PHASE 2 LOTS 1-3 & 9

I.	WATER DISTRIBUTION SYSTEM A. 6" PVC WATER B. FIRE HYDRANT ASSEMBLE C. 2" TEMPORARY BLOW OFF D. WATER SERVICES	190 LF @ \$17.50/LF 1 EA @ \$5500.00 EA 1 EA @ \$1500.00 3 EA @ \$700.00 SUBTOTAL 1	\$3325.00 \$5500.00 \$1500.00 \$2100.00 \$12425.00
II.	SEWER COLLECTION SYSTEM		
	A. SEWER SERVICE	1 EA @ \$425.00/EA	\$ 425.00
III.	ROADWAY AND DRAINAGE A. CATCH BASINS B. DROP INLET C. 15" RCP D. 24" RCP E. 5' SIDEWALKS F. 24" C&G G. SELECT FILL H. 6" STONE BASE I. 2" ASPHALT J. SEEDING	3 EA @ \$1750.00 EA 1 EA @ \$1500.00 EA 187 LF @ \$27.00/LF 187 LF @ \$43.00/LF 430 LF @ \$20.00/LF 430 LF @ \$17.00/LF 380 CY @ \$12.00/CY 500 SY @ \$13.50/SY 500 SY @ \$16.50/SY 1 AC @ \$2500.00/AC	\$5250.00 \$1500.00 \$5049.00 \$8041.00 \$8600.00 \$7310.00 \$4560.00 \$6750.00 \$8250.00
, (1)	TH CAROUN	SUBTOTAL III. SUBTOTAL I,II,III SURETY MARKUP 25% TOTAL	\$57810.00 \$70660.00

13343 Rohald D. Cullipher, P.E.

Date

HESTRON PLAZA TWO 151-A NC HWY 24 MOREHEAD CITY, NC 28557 (252) 773-0090

BOND ESTIMATE



Town of Beaufort 701 Front Street Beaufort, NC 28516 (252) 728-2141 www.beafortnc.org

00110 10	
PROJECT NAME:	PALMETTO PLANTATION @ OLDE BEAUFORT VILLAGE PH2 LOTS 1-3,9
OWNER:	MERCER BUILDING AND DESIGN INC
ENGINEER:	THE CULLIPHER GROUP, PA
ENGINEER PHONE NO.:	252-773-0090
ENGINEER EMAIL:	ron@tcgpa.com
DATE:	6/1/2021

UNLESS OTHERWISE SPECIFIED ALL BONDS ARE FOR THE BODY OF THE PLAT

SIGNATURE AND SEAL OF SUBMITTING ENGINEER



I, Ronald D Collibbs a Registered Licensed Professional, do hereby vertify that I have personally supervised the measurement thereof and that the quantities expressed herein represent an accurate measurement of the work to be completed on this project. This bond estimate covers all the infrastructure improvements on the project referenced above. Please sign below

LINEAR FEET: WIDTH: UNIT COST (Dollars/SY) TOTAL:

STREET PAVEMENT	LINEAR FEET:	WIDTH:	NIT COST ollars/SY)	TOTAL:
Final Asphalt Surface Course				\$ -
Initial Asphalt Suface Course				\$ -
Asphalt Intermediate Course				\$ -
Asphalt Base Course	204.5	22	16.5	\$ 8,248.17
Aggregate Base Course	204.5	22	\$ 13.50	\$ 6,748.50
				\$
				\$ -
			Subtotal	\$ 14,996.67

STREET INCIDENTALS	QUANTITY:	UNIT:	UNIT COST:	TOTAL:	
Street Signs		Each		\$	-
Street Trees (40' O.C.)		Each		\$	-
Street Lights		Each		\$	-
Pavement Striping		LF		\$	-
, 9				\$	-
		2		\$	-
			Subtotal	\$	-

CURBING & SIDEWALK:	QUANTITY:	UNIT:	UN	NIT COST:	TOTAL:
2'-6" Standard Curb		LF			\$ -
2'-6" Rolled curb		LF			\$ -
4' Wide Sidewalk		LF			\$ -
5' Wide Sidewalk	430	LF	\$	20.00	\$ 8,600.00
Driveway Aprons	7	Each			\$ _
Handicap Ramp		Each			\$ -
24" Rolled Curb	430	LF	\$	17.00	\$ 7,310.00
					\$ -
		•		Subtotal	\$ 15,910.00

SANITARY SEWER	QUANTITY:	UNIT:	UNIT COST:	TOTAL:	
8" PVC Gravity Sewer		LF		\$	-
8" DIP Gravity Sewer		LF	7	\$	-
10" PVC Gravity Sewer		LF		\$	-
10" DIP Gravity Sewer		LF		\$	-
12" PVC Gravity Sewer		LF .		\$	-
12" DIP Gravity Sewer		LF		\$	-
15" PVC Gravity Sewer		LF	i	\$	-
15" DIP Gravity Sewer		LF		\$	-
2" PVC Force Main		LF		\$	-
4" PVC Force Main		LF		\$	-
4" DIP Force Main		LF		\$	-
6" PVC Force Main		LF		\$	-
6" DIP Force Main		LF		\$	-
8" PVC Force Main		LF		\$	-
8" DIP Force Main		LF		\$	-
4'0" Dia. Manhole		LF ,		\$	-
5'0" Dia Manhole		LF		\$	-
Service Laterals, Main to Cleanout	1	Each	\$ 425.00	\$	425.00
Pump Station		Lump Sum		\$	-
·				\$	-
				\$	-
				\$	-
			Subtotal	\$	425.00

WATER	QUANTITY:	UNIT:	UN	IT COST:	TOTAL:
2" PVC Water Main		LF			\$ -
4" PVC Water Main		LF			\$ -
4" DIP Water Main		LF			\$ -
6" PVC Water Main	190	LF	\$	17.50	\$ 3,325.00
6" DIP Water Main		LF			\$ -
8" PVC Water Main		LF			\$ -
8" DIP Water Main		LF			\$ -
10" PVC Water Main		LF			\$ -
10" DIP Water Main		LF			\$ -
12" PVC Water Main		LF			\$ -
12" DIP Water Main		/ LF			\$ -
2" Valve (includes Curb Box)		Each			\$ -
4" Valve (includes Curb Box)		Each			\$ -
6" Valve (includes Curb Box)		Each		(4)	\$ -
8" Valve (includes Curb Box)		Each			\$ -
10" Valve (includes Curb Box)		Each			\$ -
12" Valve (includes Curb Box)		Each			\$ -


Fire Hydrant (includes Hydrant Leg &	1	Each	١	5,500.00	\$	5,500.00
Valve)	1	EdCII	۶	3,300.00	٧	3,300.00
Vaults		Each			\$	· -
Manholes		Each			\$	-
Fittings		Lump Sum			\$	-
Service Connections (includes Tap, Service Tubing, Meter Box and Meter Setter)	3	Each	\$	700.00	\$	2,100.00
2" TEMPORARY BLOWOFF	1	Each	\$	1,500.00	\$	1,500.00
					\$	-
					\$	-
				Subtotal	\$	12,425.00


DRAINAGE	QUANTITY:	UNIT:	UNIT COST:	TOTAL:
15" RCP	187	LF	\$ 27.00	\$ 5,049.00
15" Dual Wall HDPE		LF		\$ -
15" Dual Wall Polyproplene		LF		\$ -
18" RCP		LF		\$ -
18" Dual Wall HDPE		LF		\$ -
18" Dual Wall Polyproplene		LF		\$ -
24" RCP	187	LF	\$ 43.00	\$ 8,041.00
24" Dual Wall HDPE		LF		\$ -
24" Dual Wall Polyproplene		LF		\$ -
30" RCP		LF		\$ -
30" Dual Wall HDPE		LF		\$ -
30" Dual Wall Polyproplene		LF		\$ -
36" RCP		LF		\$ -
36" Dual Wall HDPE		LF		\$ -
36" Dual Wall Polyproplene		LF		\$ -
42" RCP		LF		\$ -
42" Dual Wall HDPE		LF		\$ -
42" Dual Wall Polyproplene		LF		\$ -
48" RCP	1	LF		\$ -
48" Dual Wall HDPE		LF		\$ -
48" Dual Wall Polyproplene		LF		\$ -
15" FES		Each		\$ -
18" FES		Each		\$ -
24" FES		Each		\$ -
30" FES		Each		\$ -
36" FES		Each		\$ -
42" FES		Each		\$ -
48" FES		Each		\$ -
Curb Inlet	3	Each	\$ 1,750.00	\$ 5,250.00
Yard Inlet	1	Each	\$ 1,500.00	\$ 1,500.00
Manhole (0'-6' Deep)		Each		\$ -
Select Fill	380	CY	\$ 12.00	
Seeding	1	Acre	\$ 2,500.00	
				\$ -
			Subtotal	\$ 26,900.00


TOTAL ESTIMATE \Rightarrow


\$70,656.67




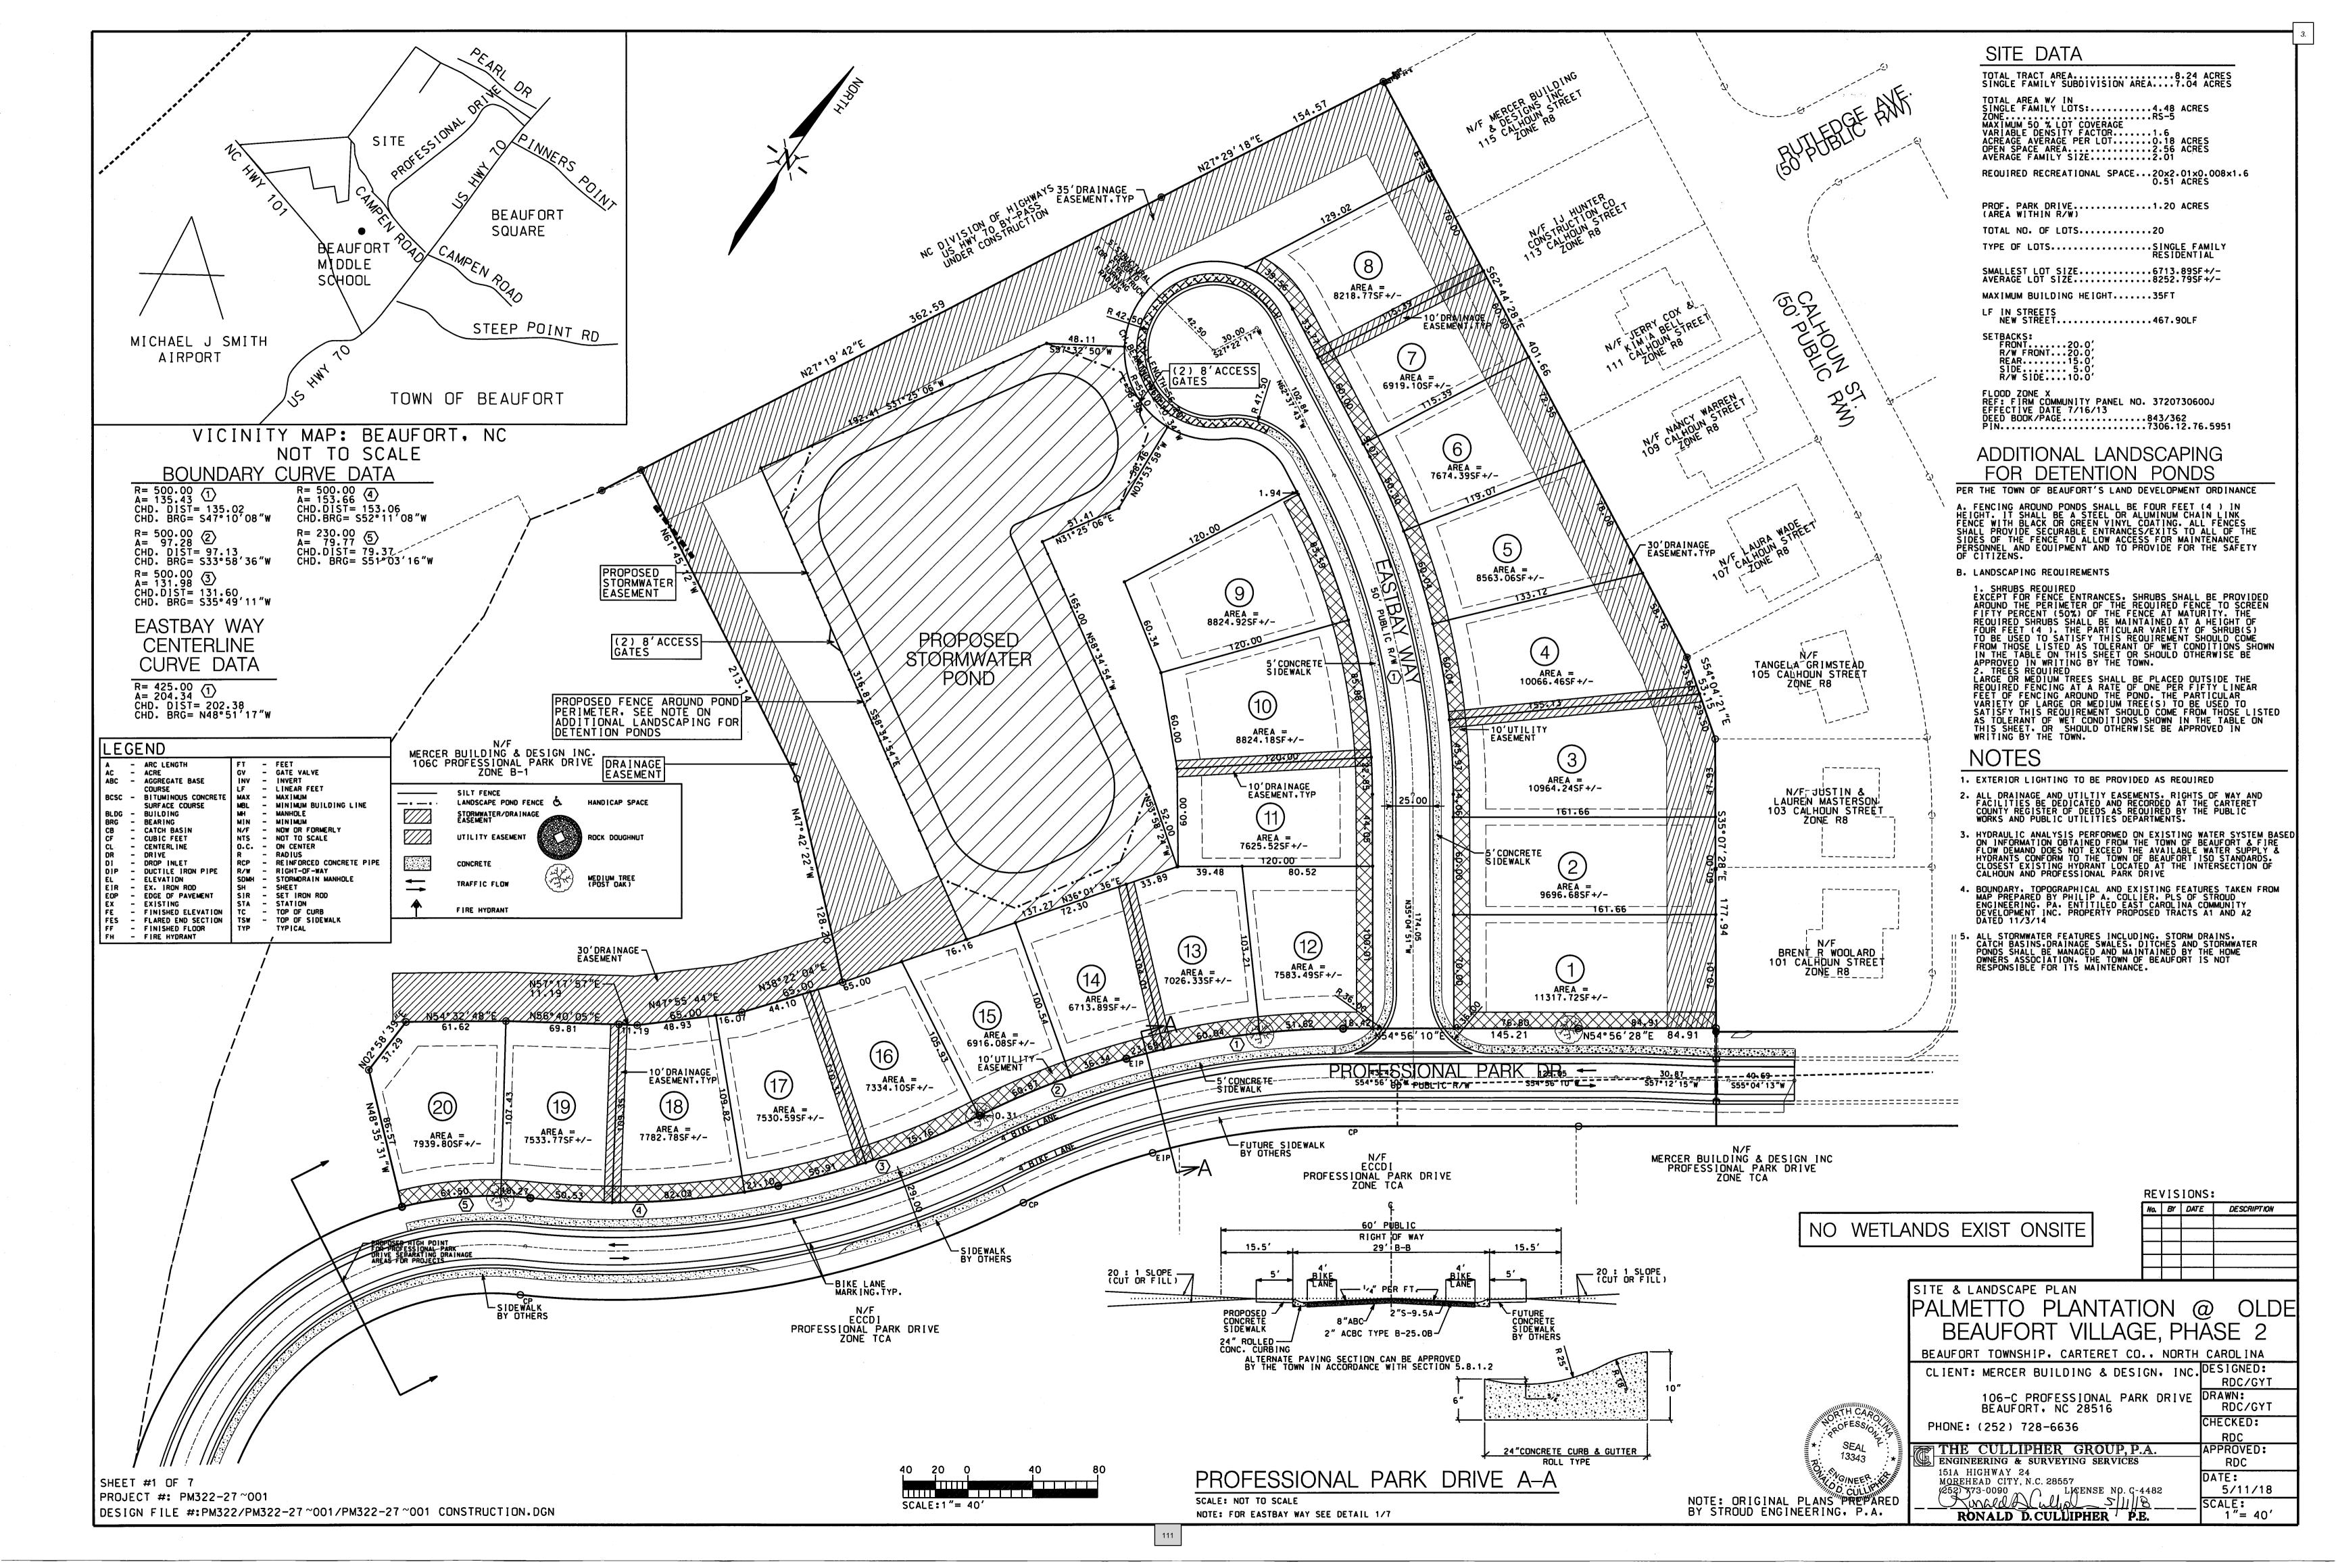


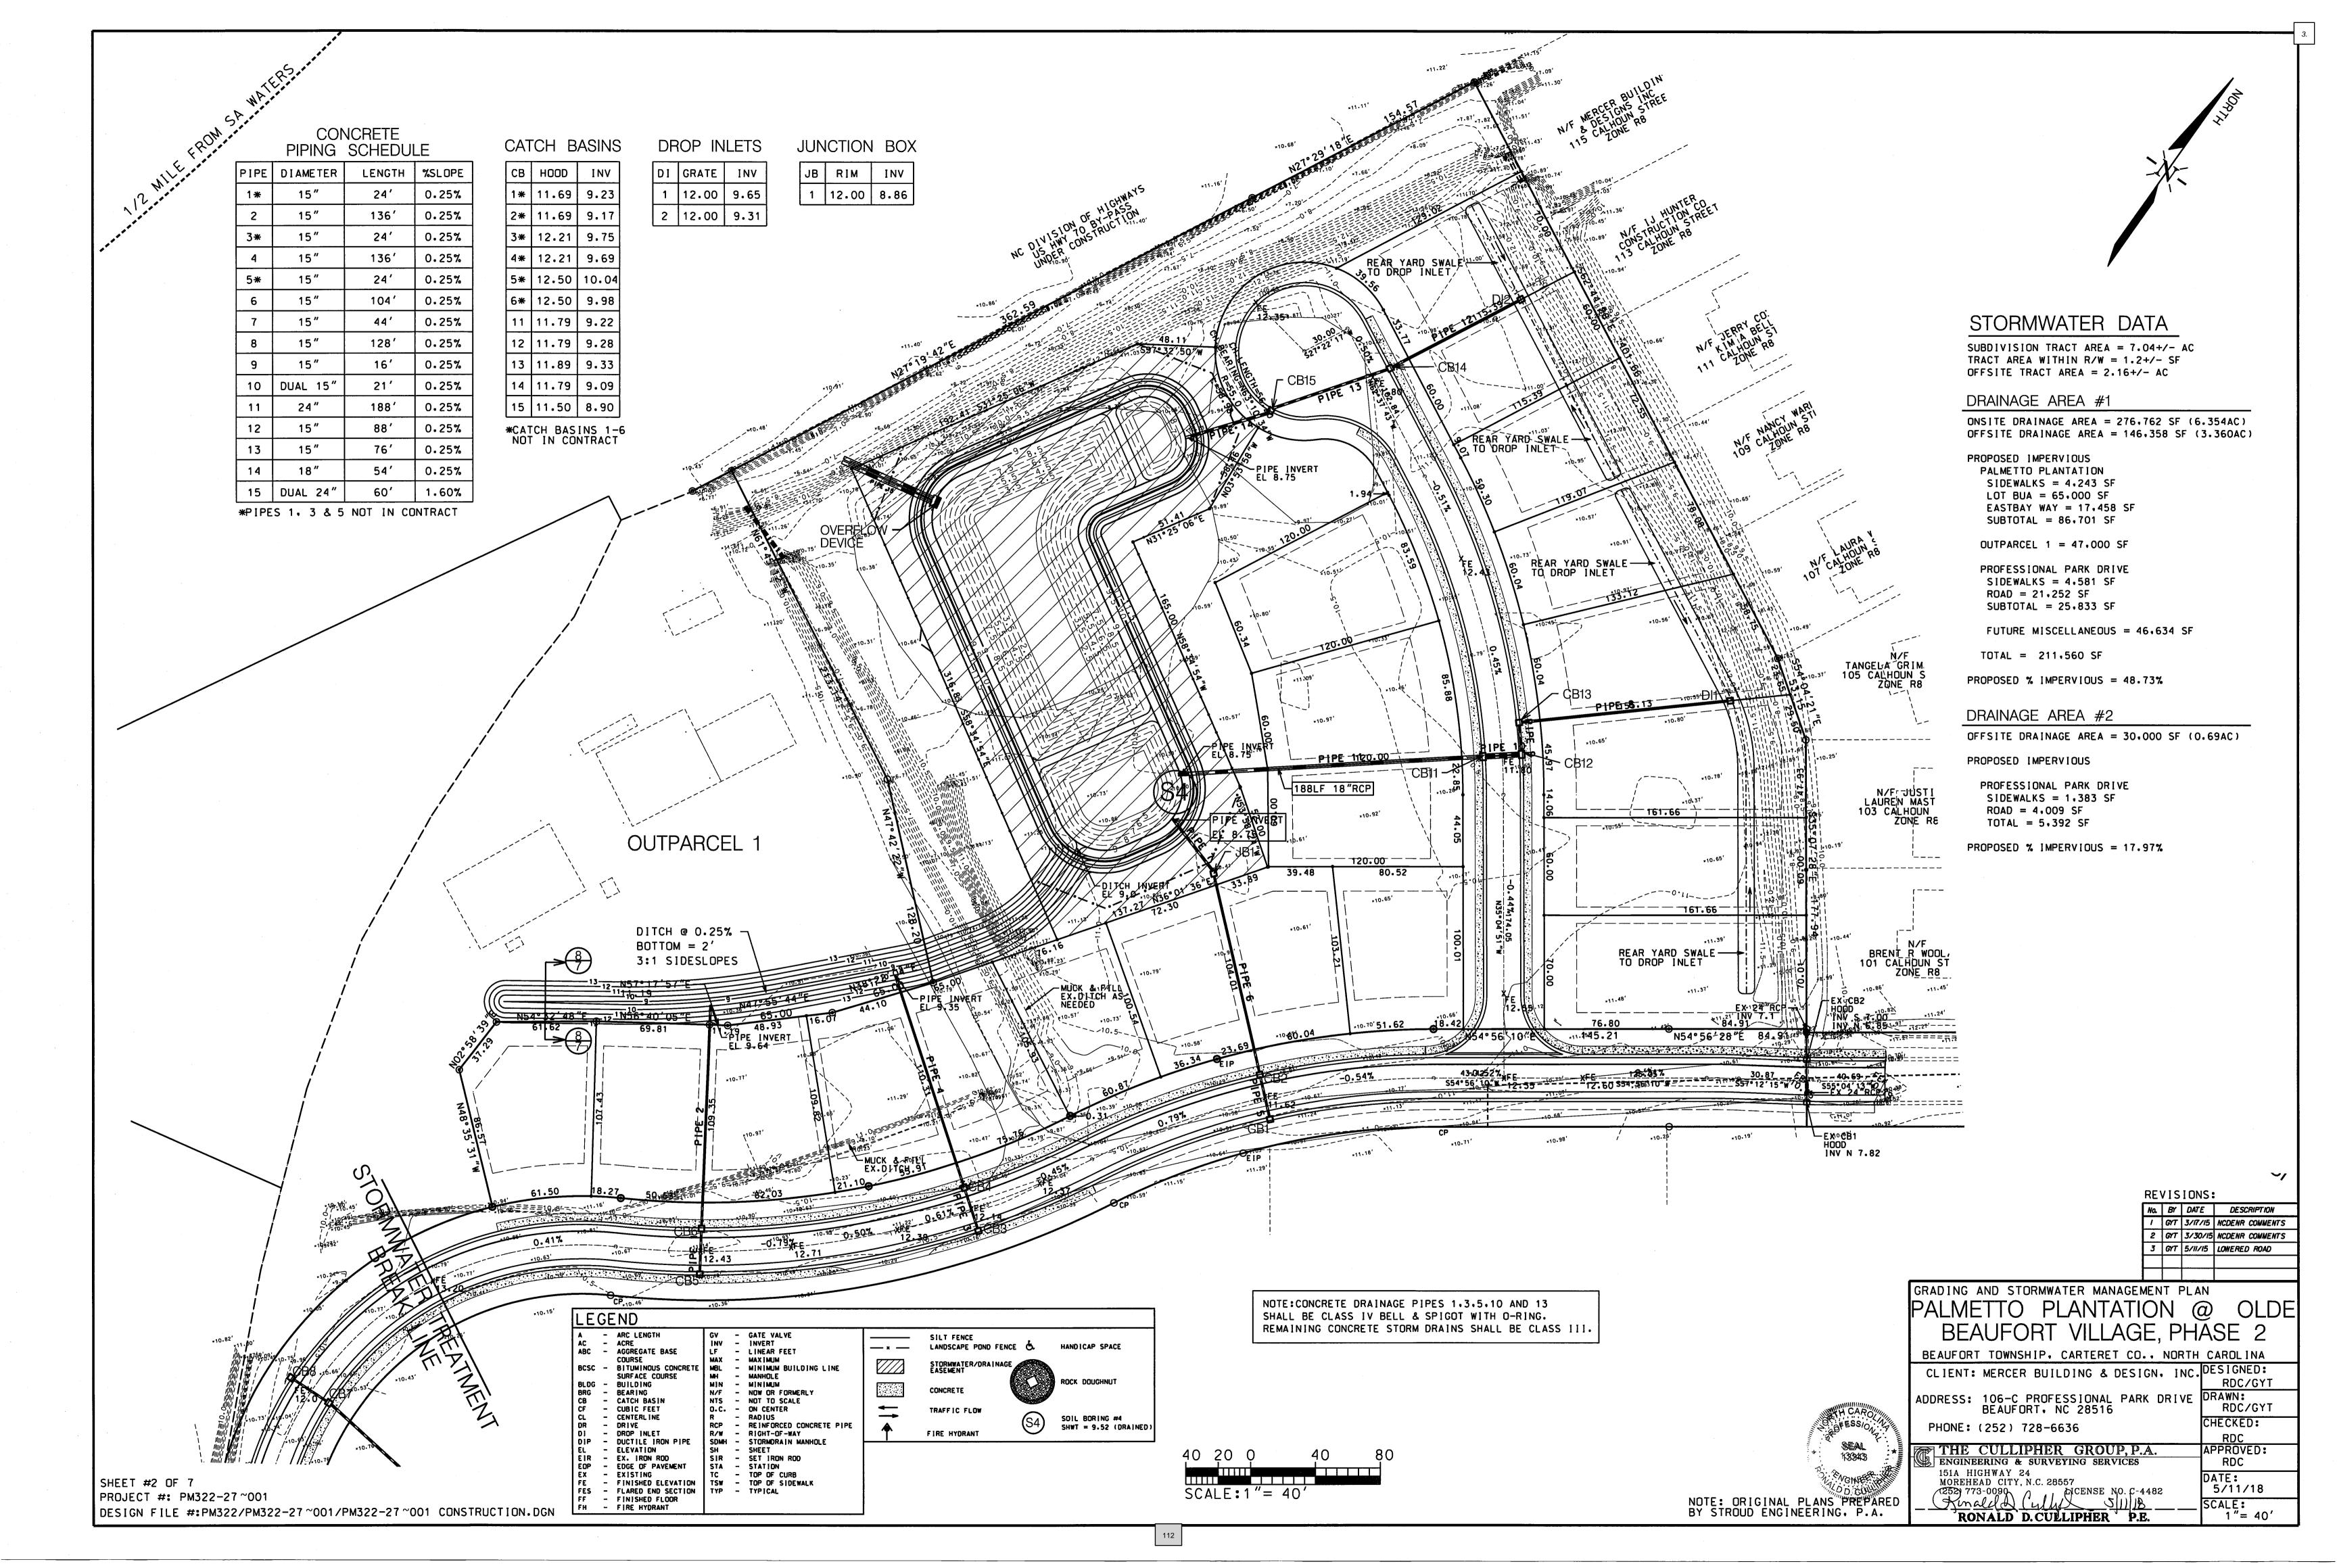

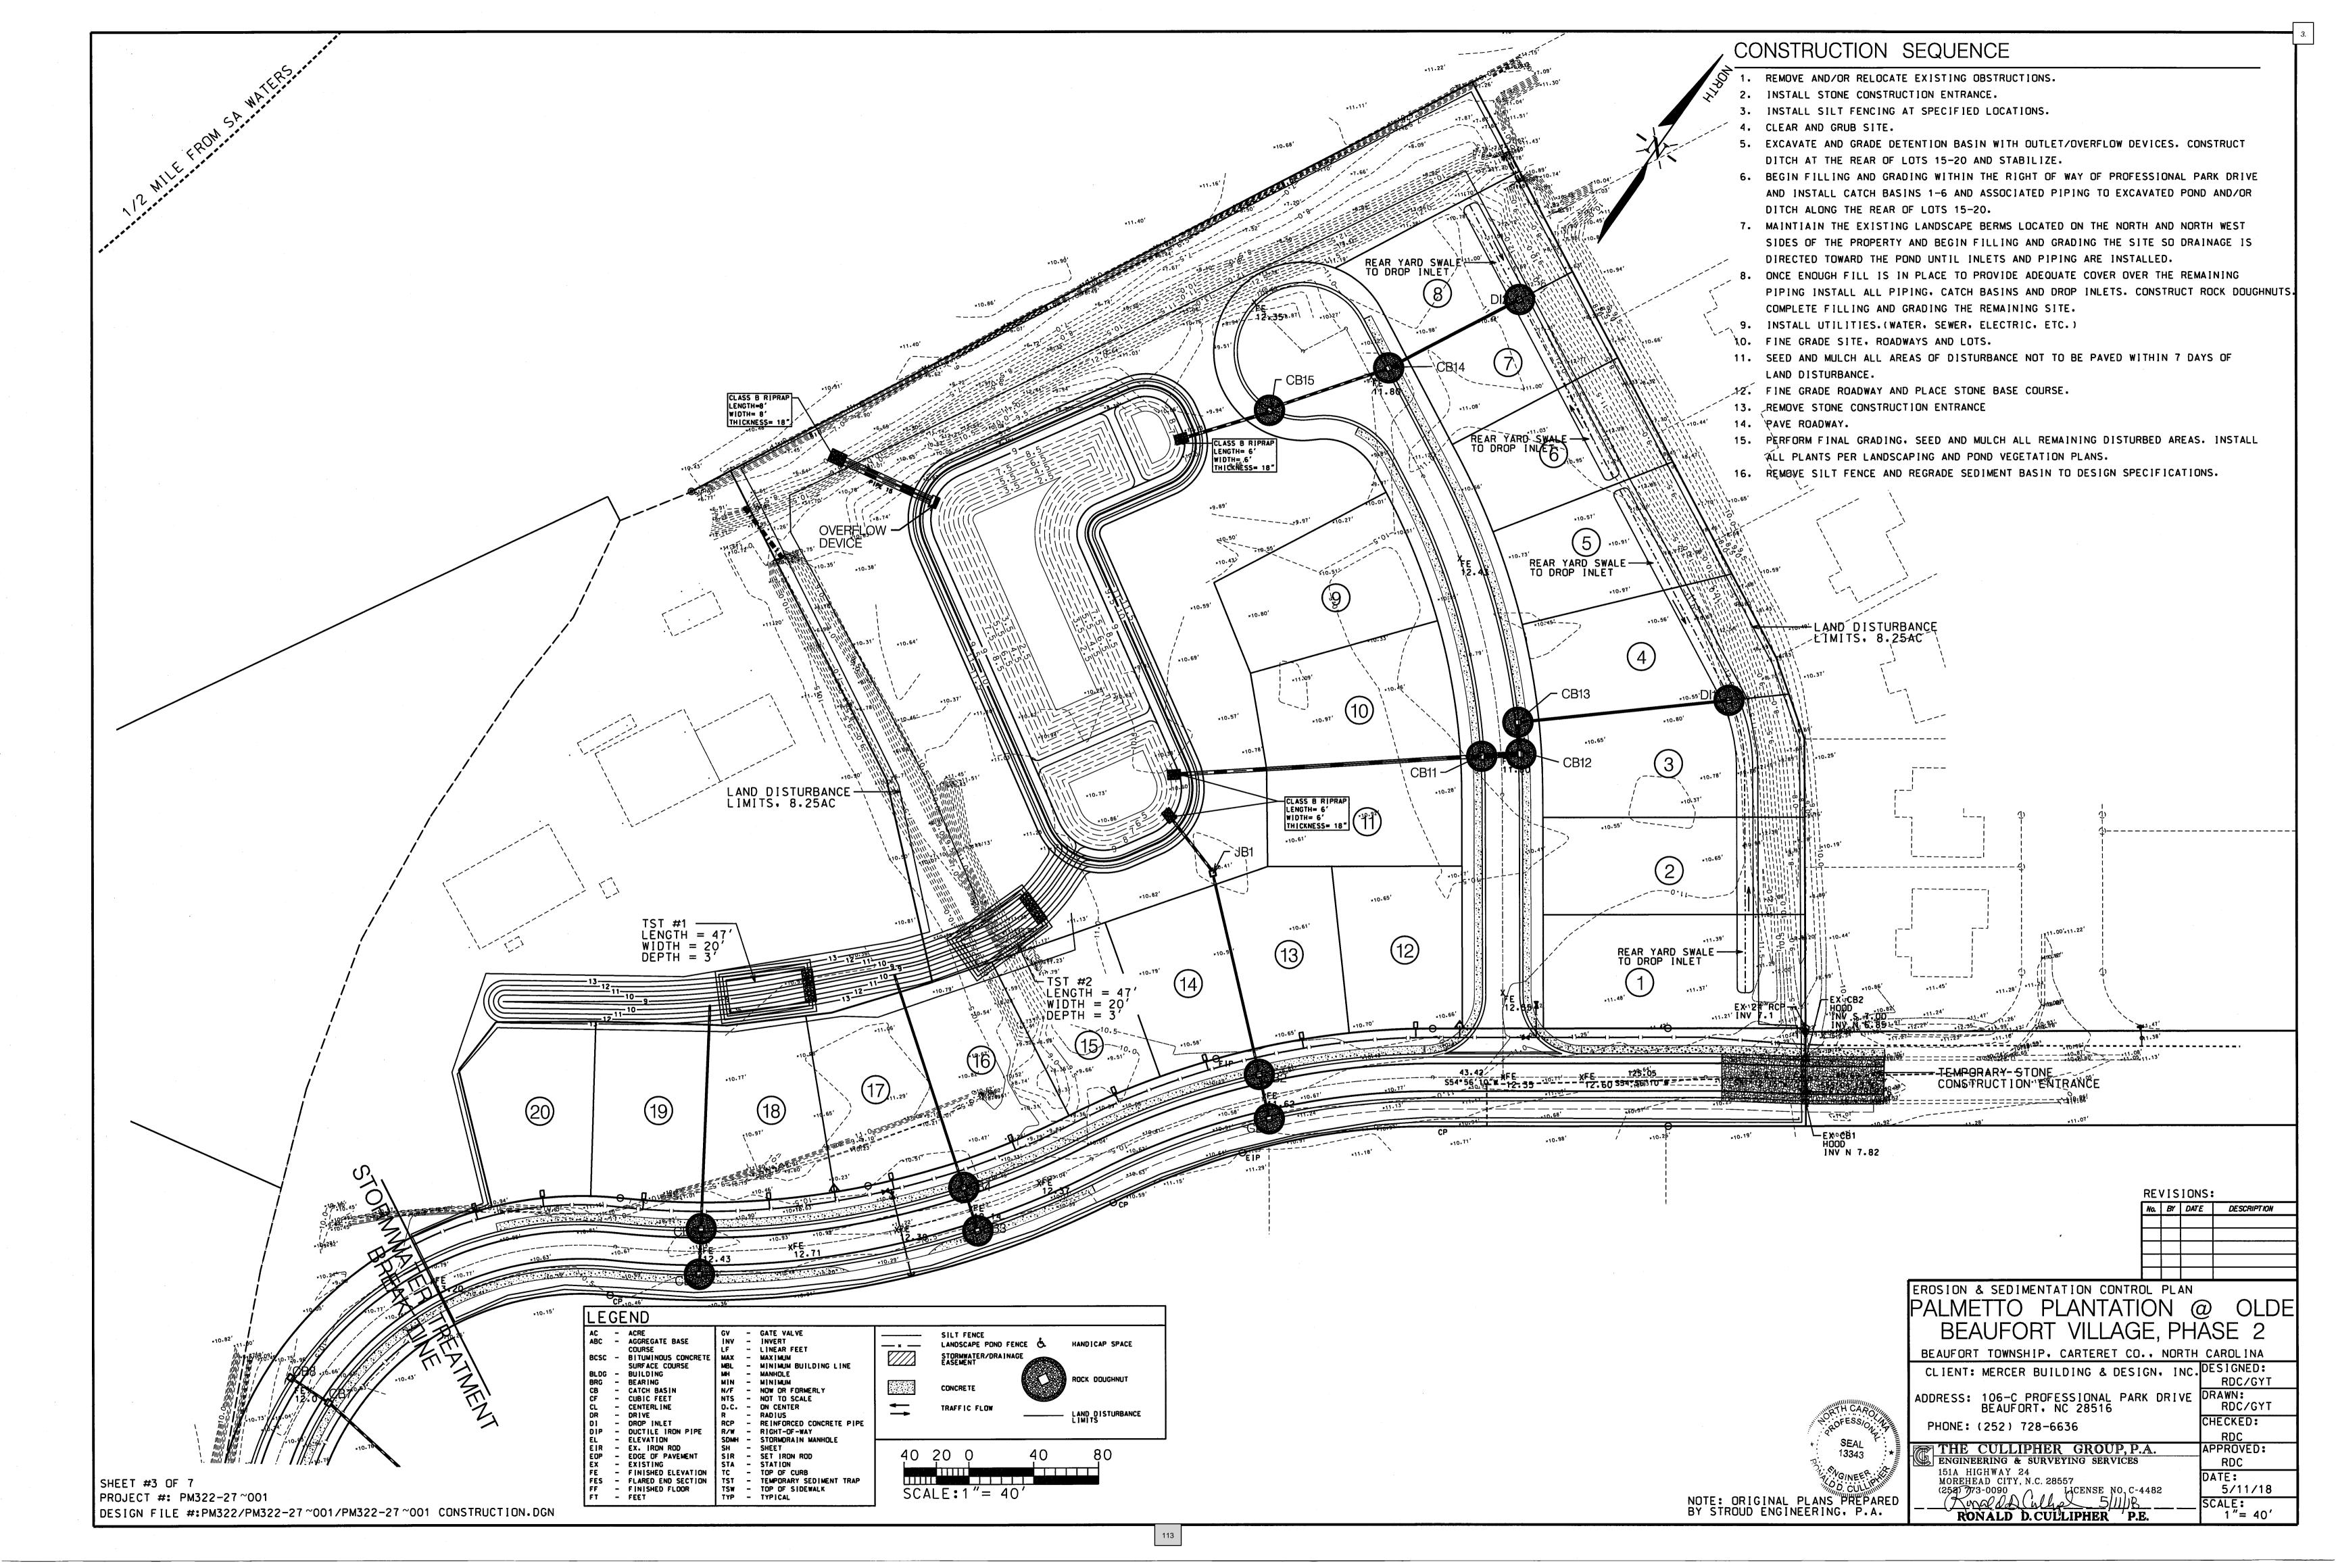

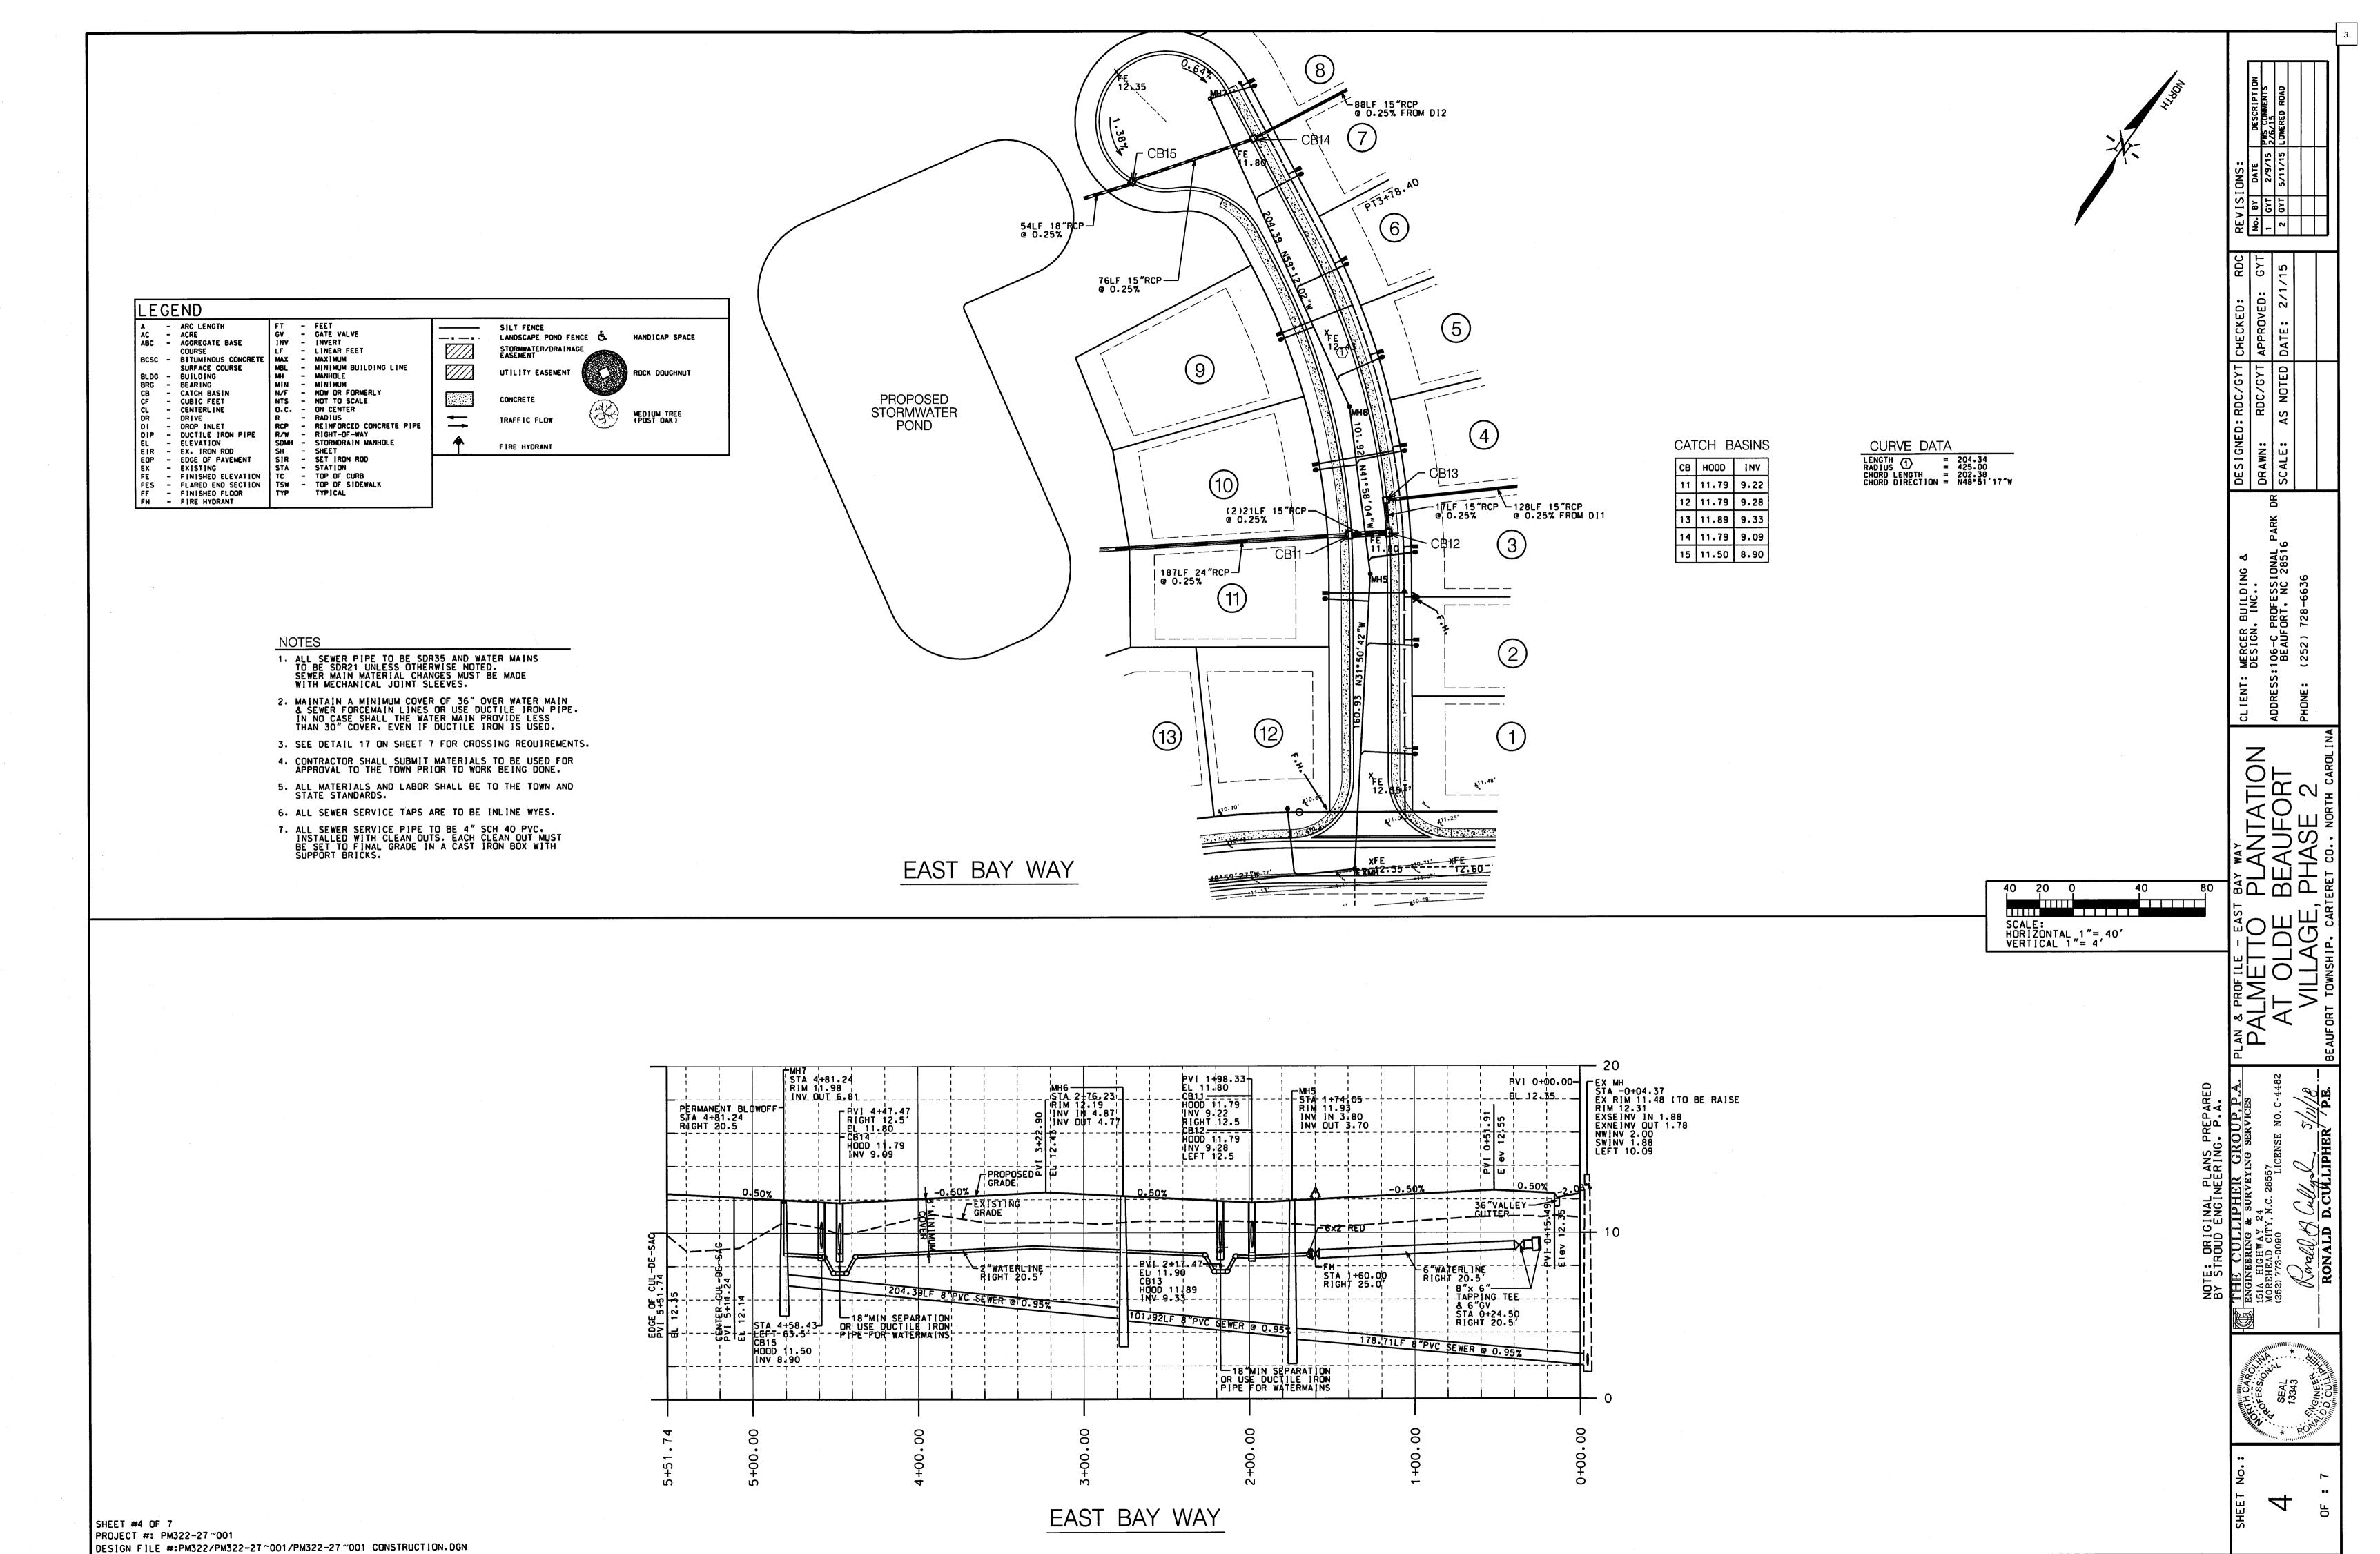

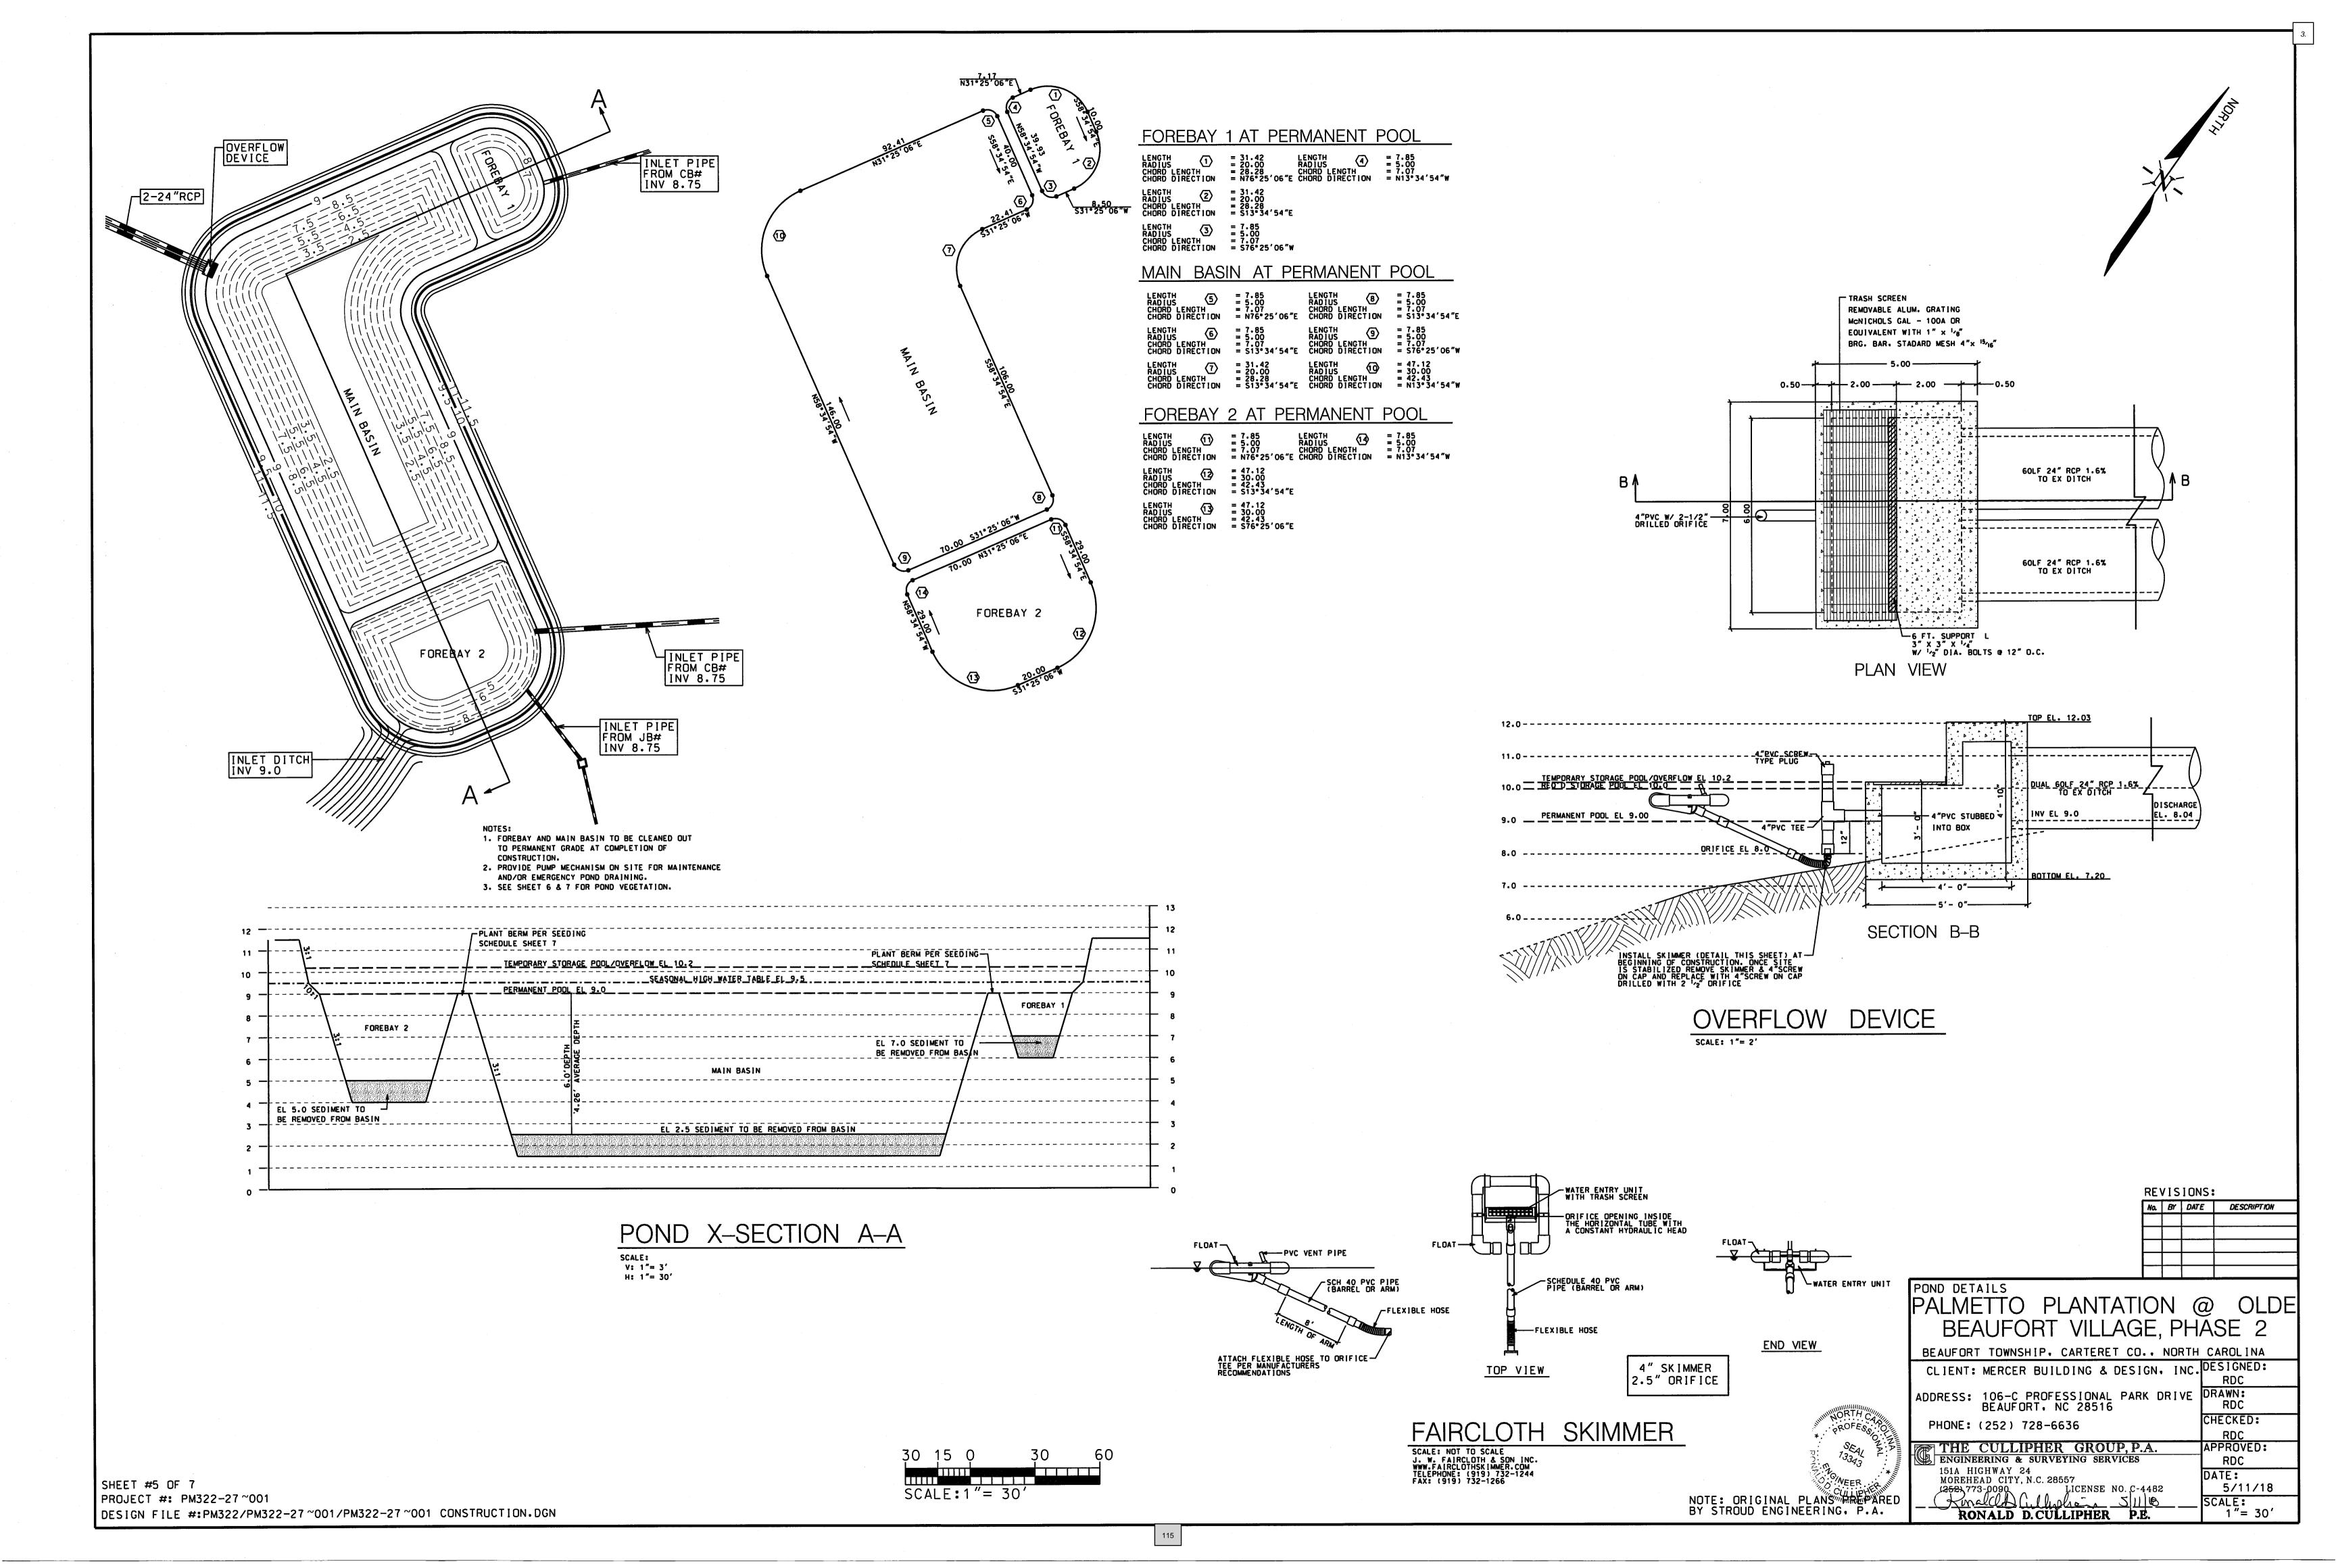

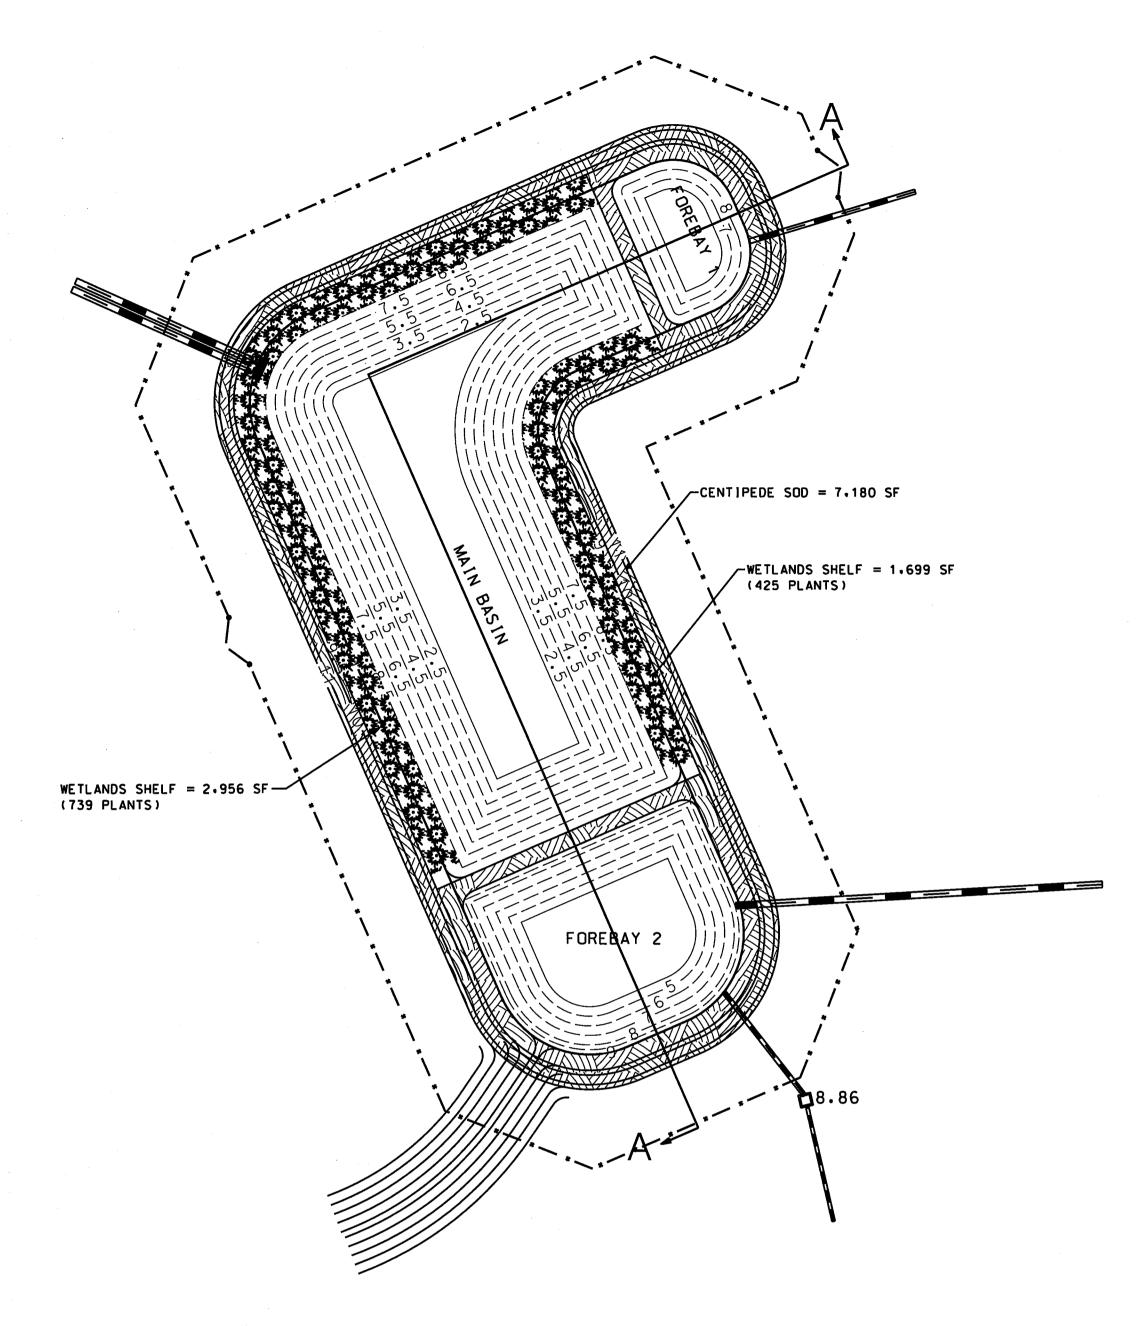

LEGEND

WETLANDS PLANTS



CENTIPEDE SOD

MINIMUM PLANT MATERIAL QUANTITIES AND PLANT SIZES PER 200 SF OF SHELF AREA (MINIMUM OF 3 SPECIES):

1. 50 HERBACEOUS PLANTS AT LEAST 4 CUBIC-INCH CONTAINER = 1164 HERBACEOUS PLANTS (SPECIES SHOWN ON THIS SHEET)

ACORUS SUBCORDATUM

SHALLOW WATER

BOTANI CAL NAME

HERBACEOUS PLANTS

SCIRPUS CYPERINUS

ZIZANIOPSIS MILIACEA

SWEETFLAG ALISMA SUBCORDATUM WATER PLANTAIN HYDROLEA QUADRI VALVIS WATERPOD IRIS VIRGINICA BLUE FLAG IRIS JUNCUS EFFUSUS VAR. PYLAEI OR SOLUTUS SOFT RUSH LUDWIGIA SPP. PRIMROSE WILLOW PELTANDRA VIRGINICA ARROW ARUM PONTEDERIA CORDATA PI CKERELWEED SAGITTARIA LATIFOLIA DUCK POTATO SAGITTARIA LANCIFOLIA BULLTONGUE SAURURUS CERNUUS LIZARD'S TAIL SOFT STEM BULRUSH SCHOENOPLECTUS TABERNAEMONTANI SCHOENOPLECTUS AMERICANUS THREE-SQUARE BULRUSH SCHOENOPLECTUS PUNGENS VAR. PUNGENS

COMMON NAME

WOOLGRASS

GIANT CUTGRASS

SHALLOW LAND

WETLAND PLANT RECOMMENDATIONS

COMMON NAME BOTANI CAL NAME

HERBACEOUS PLANTS

ASCLEPIAS INCARNATA CAREX TENERA CHELONE GLABRA **EUPATORI ADELPHUS DUBI US** EUPATORI ADELPHUS FI STULOSUS EUPATORI ADELPHUS MACULATUS HIBISCUS COCCINEUS HIBISCUS LAEVIS KOSTELETZKYA VIRGINICA LOBELIA CARDINALIS LOBELIA ELONGATA LOBELIA SIPHILITICA RHYNCHOSPORA COLORATA SACCHARUM BALDWINII

SWAMP MILKWEED OUILL SEDGE WHITE TURTLEHEAD DWARF JOE PYE WEED JOE PYE WEED SPOTTED TRUMPETWEED SCARLET ROSE MALLOW HALBERDLEAF ROSEMALLOW SEASHORE MALLOW CARDINAL FLOWER LONGLEAF LOBELIA GREAT BLUE LOBELIA STARRUSH WHITETOP NARROW PLUMEGRASS

	VEGETA	TION SCHEDULE	
WETLAND AREA	SO FT IN WETLAND AREA	PLANT CATEGORY	PLANTS OF CATEGORY IN WETLAND AREA
WETLANDS PLANTS	4653	HERBACEOUS PLANTS	1164

PLANT REQUIREMENTS:

- 1. SELECT PLANTS FROM THE WETLAND PLANT LIST ABOVE.
- 2. A MINIMUM OF THREE (3) DIVERSE SPECIES OF SHALLOW WATER EMERGENT AND SHALLOW LAND HERBACEOUS VEGETATION.
- 3. A MINIMUM TWO-YEAR WARRANTY PERIOD STIPULATING REQUIREMENTS FOR PLANT SURVIVAL/REPLACEMENT. AT THE END OF THE FIRST YEAR AND AGAIN AT THE END OF THE TWO-YEAR WARRANTY PERIOD. ALL
- PLANTS THAT DO NOT SURVIVE MUST BE REPLACED. 4. THE DESIGN FOR PLANTINGS SHALL MINIMIZE THE NEED FOR HERBICIDES, FERTILIZERS. PESTICIDES. OR SOIL AMENDMENTS AT ANY TIME BEFORE. DURING AND AFTER CONSTRUCTION AND ON A LONG TERM BASIS. PLANTINGS SHALL BE DESIGNED TO MINIMIZE THE NEED FOR MOWING, PRUNING AND
- I RRI GATI ON. 5. PLANT MATERIAL SHOULD BE PURCHASED FROM A SIMILAR PROVENANCE OR LOCAL SOURCE TO ENSURE SURVIVABILITY.

GENERAL NOTES:

- 1. TOPSOIL FROM THE SITE WILL BE SPREAD ACROSS THE SHALLOW WATER AND SHALLOW LAND
- ZONES PRIOR TO PLACEMENT OF PLANTS. 2. WET DETENTION BASINS SHOULD INCORPORATE SEVERAL (MINIMUM OF THREE (3) DIVERSE SPECIES OF SHALLOW WATER EMERGENT AND SHALLOW LAND HERBACEOUS VEGETATION ON THE VEGETATED SHELF.
- 3. SPACING SHOULD BE APPROXIMATELY 24" 36" CENTERS, YIELDING COVERAGE IN APPROXIMATELY
- 1-2 YEARS, RESPECTIVELY. 4. TURF GRASS SHOULD BE MAINTAINED ON THE TOPS OF BERMS AND ON THE EXTERIOR SLOPES OF CONTAINMENT BERMS.

SOIL SPECIFICATIONS

SOILS USED WITHIN A STORMWATER BMP MUST ADHERE TO THE FOLLOWING REQUIREMENTS:

- 1. THE SOIL MIX MUST BE UNIFORM AND FREE OF STONES, STUMPS, ROOTS, OR OTHER
- SIMILAR MATERIAL GREATER THAN 2 INCHES. 2. SOIL TEXTURE OF THE MIX USED FOR STORMWATER WETLANDS SHOULD BE LOAMY SAND,
- WITH NO MORE THAN 10% CLAY (USDA SOIL TEXTURAL CLASSIFICATION). 3. A MINIMUM ORGANIC CONTENT OF 10% BY DRY WEIGHT FOR AREAS PLANTED WITH WOODY
- SPECIES AND 5% FOR TURF AREAS. 4. THE PH SHOULD BE BETWEEN 5.5 AND 7.0. IF THE PH FALLS OUTSIDE OF THIS RANGE. IT MAY BE MODIFIED WITH LIME TO INCREASE THE PH OR IRON SULFATE AND SULFUR TO LOWER THE PH. THE LIME OR IRON SULFATE MUST BE MIXED UNIFORMLY INTO THE SOIL
- 5. TOPSOIL STOCKPILE LOCATION (IF USING ON-SITE SOILS) OR SOURCE OF TOPSOIL IF IMPORTED TO THE SITE. SOIL ANALYSIS FOR ALL TOPSOIL TO BE USED WITHIN A BMP

PLANTING SPECIFICATIONS:

- 1. FOR EROSION CONTROL PLANTING AND BANK STABILIZATION (UPLAND AREA) FOLLOW EROSION
- CONTROL SEEDING SCHEDULE. 2. UTILIZE A 90-DAY SLOW RELEASE FERTILIZER TABLET FOR PLANTS.
- 3. PLACE 3 OR 4 INCHES OF QUALITY TOPSOIL TO THE SHALLOW LAND AND SHALLOW WATER REGIONS. THE PROJECT CAN UTILIZE THE EXISTING TOPSOIL BY STOCK PILING ON SITE AND AMENDING SOIL
- AS NECESSARY BASED ON SOIL ANALYSIS RESULTS. 4. THE DETENTION POND MUST BE STABILIZED WITHIN 14 DAYS OF CONSTRUCTION. CONSIDER CONSTRUCTION SEQUENCING SO THAT
- PLANTS CAN BE PLANTED AND THE POND CAN BE BROUGHT ONLINE WITHIN 14 DAYS.

PLANTING SEASONS:

HERBACEOUS PLANTS (SHALLOW LAND)....OCTOBER TO JUNE HERBACEOUS PLANTS (SHALLOW WATER)....APRIL TO JUNE (RECOMMENDED) MID-SEPTEMBER TO MID-OCTOBER

GRASSES..... YEAR ROUND PLANTING OUT OF SEASON IS NOT RECOMMENDED. IF CONSTRUCTION SCHEDULE

AND PLANTING SCHEDULE DO NOT CORRESPOND, STABILIZE BANKS (UPLAND AREA AND SHALLOW LAND) WITH APPROPRIATE TEMPORARY COVER CROP AND EROSION CONTROL MATTING UNTIL APPROPRIATE PLANTING SEASON.

PLANTS SHOULD BE INSTALLED AS LARGE DRIFTS (I.E. MASSES OF A SINGLE SPECIE) WITHIN THEIR RESPECTIVE PLANTING AREA. OVERLAPPING OR WEAVING OF THE PLANTING AREA EDGES IS RECOMMENDED.

ALL PLANTS SHALL BE DIRECTLY DESCENDED FROM INDIVIDUALS GROWING WILD WITHIN 100 MILES OF THE PROJECT SITE. IF SUITABLE STOCK CANNOT BE OBTAINED. PLANTS OF OTHER GENETIC PROVENANCE MAY BE UTILIZED WITH THE APPROVAL OF THE LOCAL REGULATORY AGENCY.

IRRIGATION MAY BE NECESSARY FOR SHALLOW LAND AND WATER ZONES IF PROLONGED DROUGHT DRAWS WATER LEVELS 6" OR MORE BELOW NORMAL POOL DURING THE FIRST SUMMER FOLLOWING PLANT INSTALLATION.

DO NOT PLANT CATTAILS. CATTAILS, ALTHOUGH A WETLAND PLANT, PROVIDE A HAVEN FOR MOSQUITOES AND WILL TAKE OVER AND CROWD OUT OTHER VITAL VEGETATION.

SCALE:1"= 30



REVISIONS:

No. BY DATE DESCRIPTION

DRAWN:

CHECKED:

RDC

SCALE:

5/11/18

1"= 30'

BEAUFORT VILLAGE, PHASE 2 BEAUFORT TOWNSHIP, CARTERET CO., NORTH CAROLINA CLIENT: MERCER BUILDING & DESIGN. INC. DESIGNED: ADDRESS: 106-C PROFESSIONAL PARK DRIVE BEAUFORT. NC 28516

PHONE: (252) 728-6636 🏹 THE CULLIPHER GROUP, P.A. ENGINEERING & SURVEYING SERVICES 151A HIGHWAY 24


13343

NOTE: ORIGINAL PLANS PREPARED BY STROUD ENGINEERING, P.A.

MOREHEAD CITY, N.C. 28557 LICENSE NO. C-4482 (252) 773-0090 RONALD D. CULLIPHER P.E.

SHEET #6 OF 7 PROJECT #: PM322-27~001 DESIGN FILE #:PM322/PM322-27~001/PM322-27~001 CONSTRUCTION.DGN



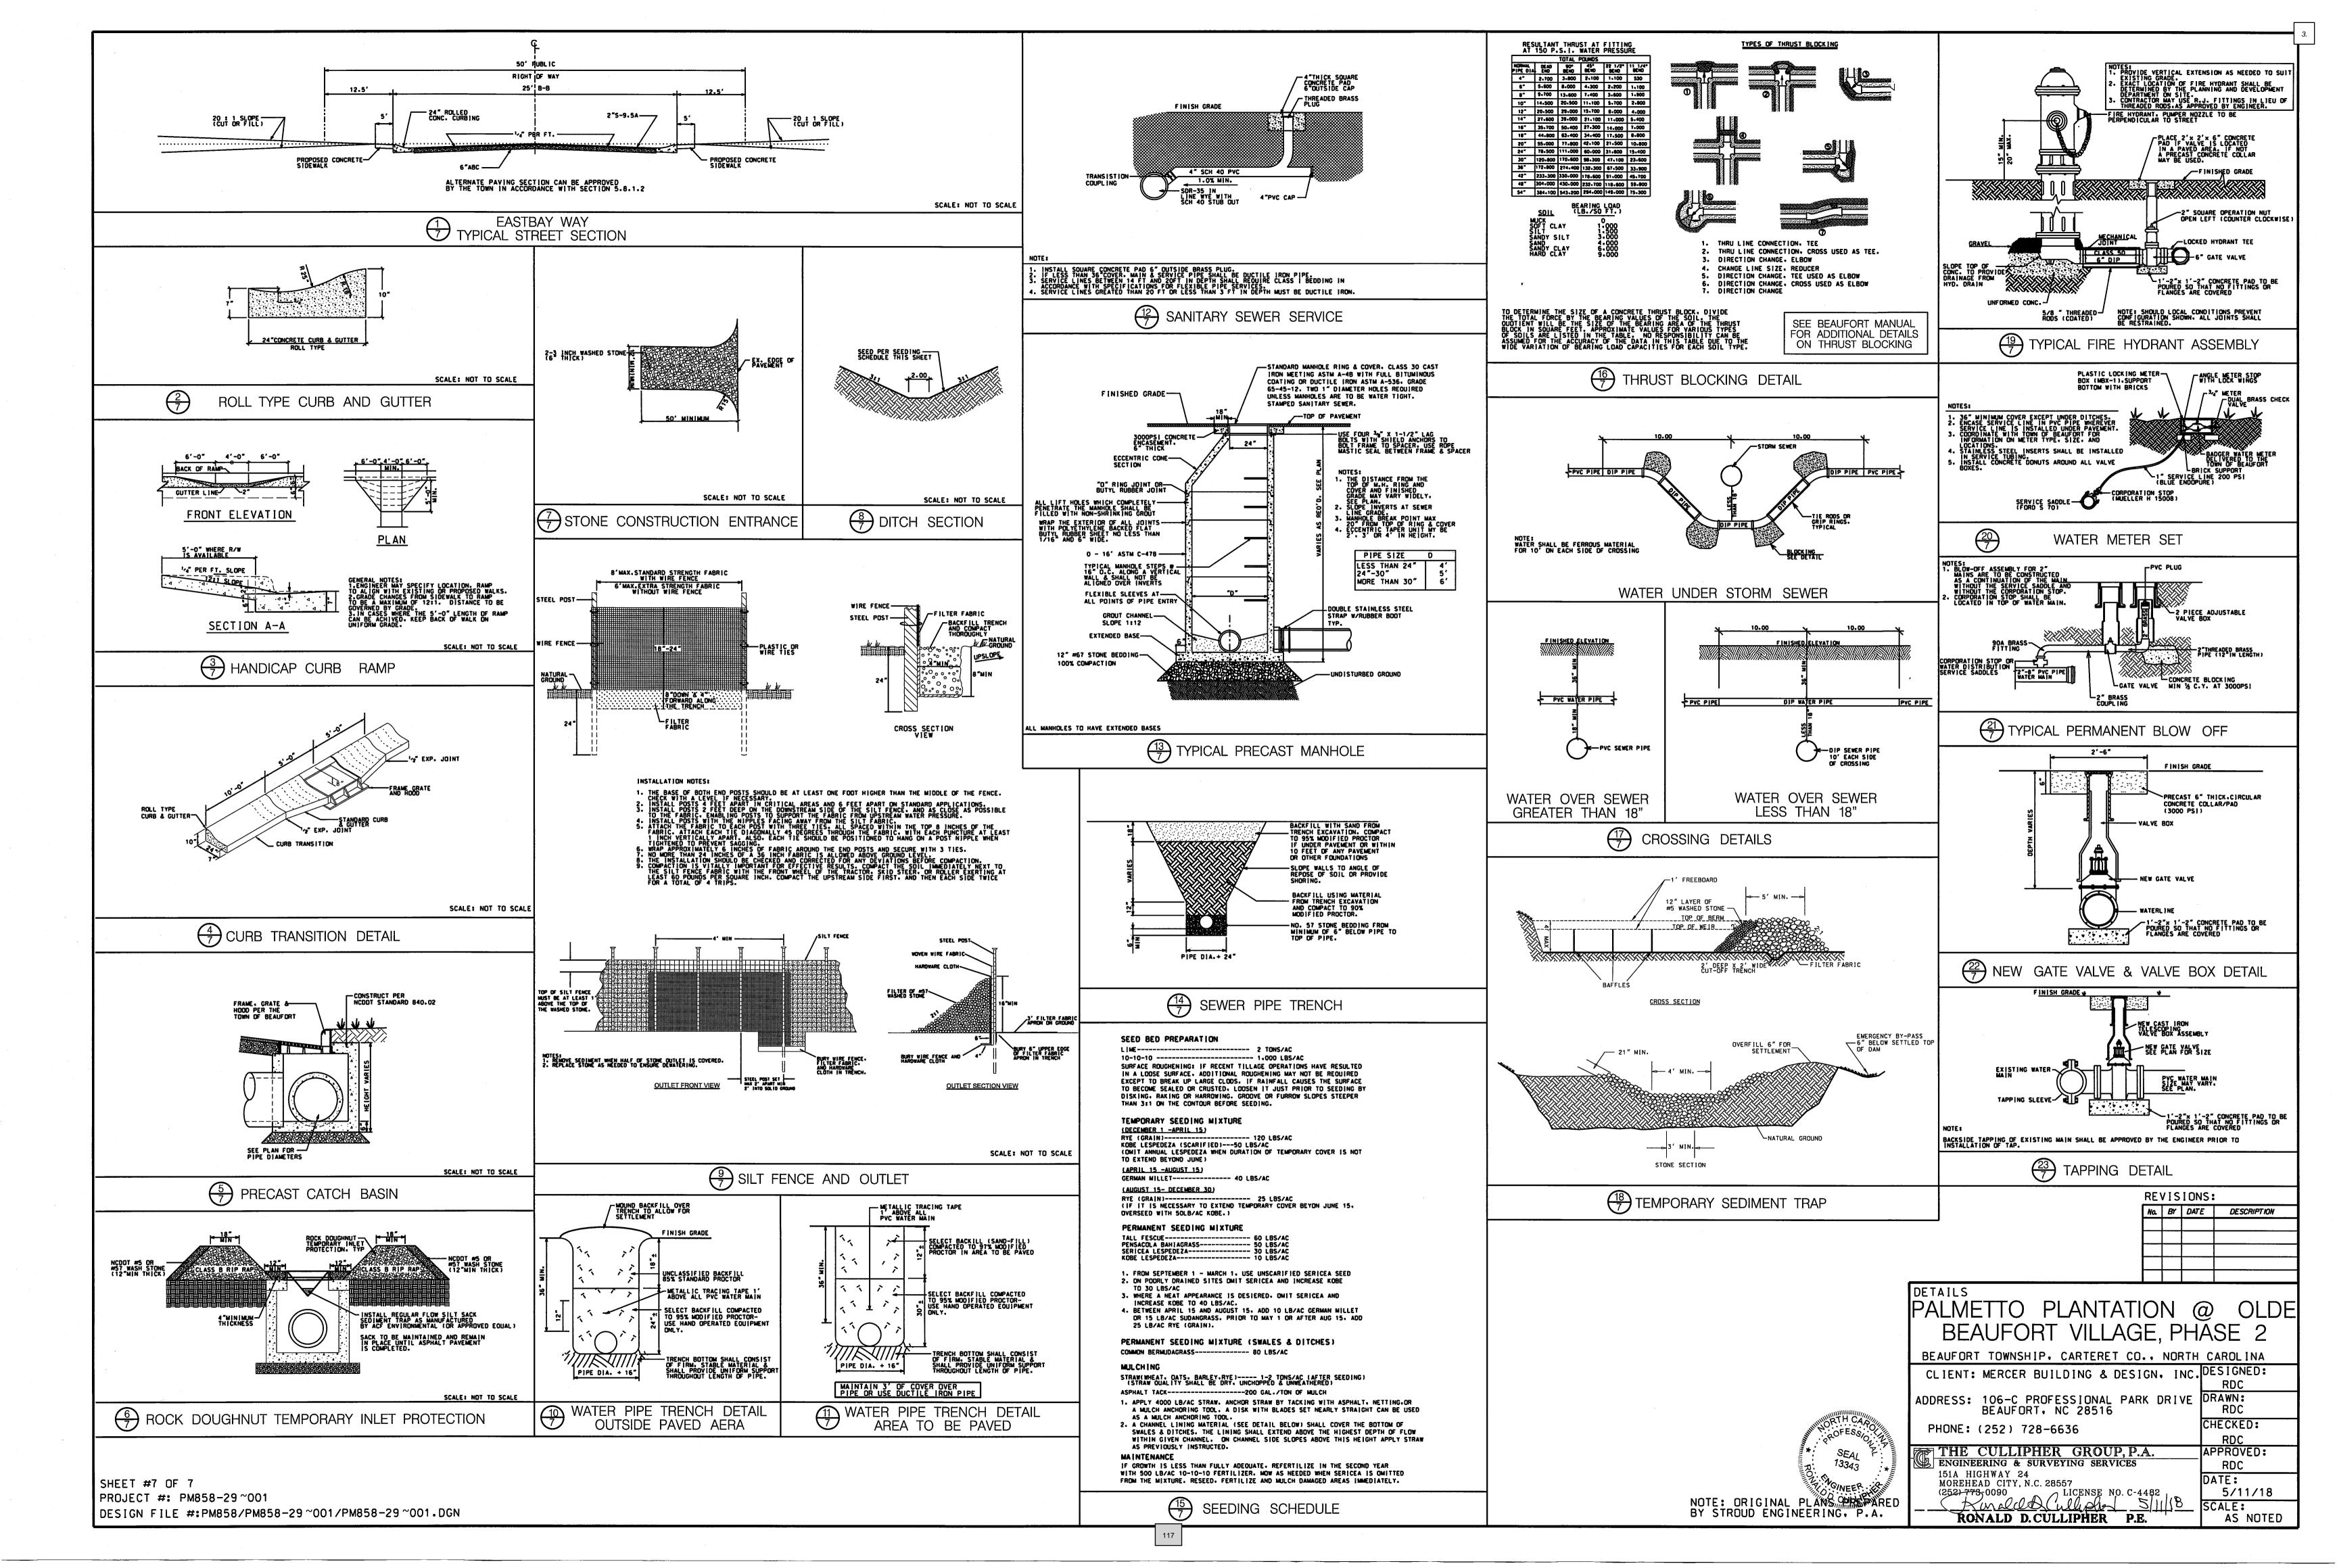



Town of Beaufort, NC

701 Front St. - P.O. Box 390 - Beaufort, N.C. 28516 252-728-2141 - 252-728-3982 fax - www.beaufortnc.org

Town of Beaufort Planning Board Regular Meeting 6:00 PM Monday, June 21, 2021 – Virtual Meeting via Zoom

AGENDA CATEGORY: New Business

SUBJECT: Case #21-20 Final Plat – Live Oak Commons

BRIEF SUMMARY:

The Cullipher Group has submitted the Final Plat for Live Oak Commons showing a 1.28 acre tract into 8 single-family lots. Also, the applicant has submitted Bond information to consider as well as a recreation fee in lieu of in the amount of \$1,843.20.

REQUESTED ACTION:

Recommendation to Board of Commissioners

EXPECTED LENGTH OF PRESENTATION:

10 Minutes

SUBMITTED BY:

Kyle Garner, AICP

Planning & Inspections Director

BUDGET AMENDMENT REQUIRED:

N/A



STAFF REPORT



To: Planning Board Members

From: Kyle Garner, AICP, Town Planner

Date: June 4, 2021

Case No. 21-20 Live Oak Commons – Final Plat

THE QUESTION: Subdivide a 1.28 acre tract into 8 Single-Family Residential Lots.

BACKGROUND: The preliminary plat for this area was approved in September 2020 for installation of infrastructure improvements.

Location: 1107 & 1111 Live Oak Street

Owners: New Vision Trust

Requested Action: Subdivide a 1.28 Acre Tract into 8 Lots

Existing Zoning RS-5
Size: 1.28 acres

Amount of Open Space: N/A

Existing Land Use: Undeveloped

SPECIAL INFORMATION:

- As part of the Final Plat process the infrastructure can be either installed or bonded through a financial guarantee process to ensure completion of the project. The applicant has chosen to request to bond the infrastructure improvement and has submitted cost estimates for the complete cost of improvements totaling \$18,533.33 (See estimated cost of improvement sheet from engineer).
- No sewer allocation request is being made for this project due to its approval prior to the January 11, 2021 Wastewater Allocation Policy's adoption by the Board of Commissioners.
- Since this project is part of a subdivision recreation fees will be required in the amount of \$1,843.20.

Public Utilities:

Water: Town Of Beaufort Sanitary Sewer: Town Of Beaufort Case No.: 21-20

Location: 1107 & 1111 Live Oak Street

Page: 1


OPTIONS:

- 1. Recommend approval the Final Plat for Live Oak Commons
- 2. Recommend approval the Bond Request for Live Oak Commons
- 3. Deny the request

Attachments:

- Attachment A Vicinity Map
- Attachment B Final Plat for Live Oak Commons
- Attachment C Bond Estimates



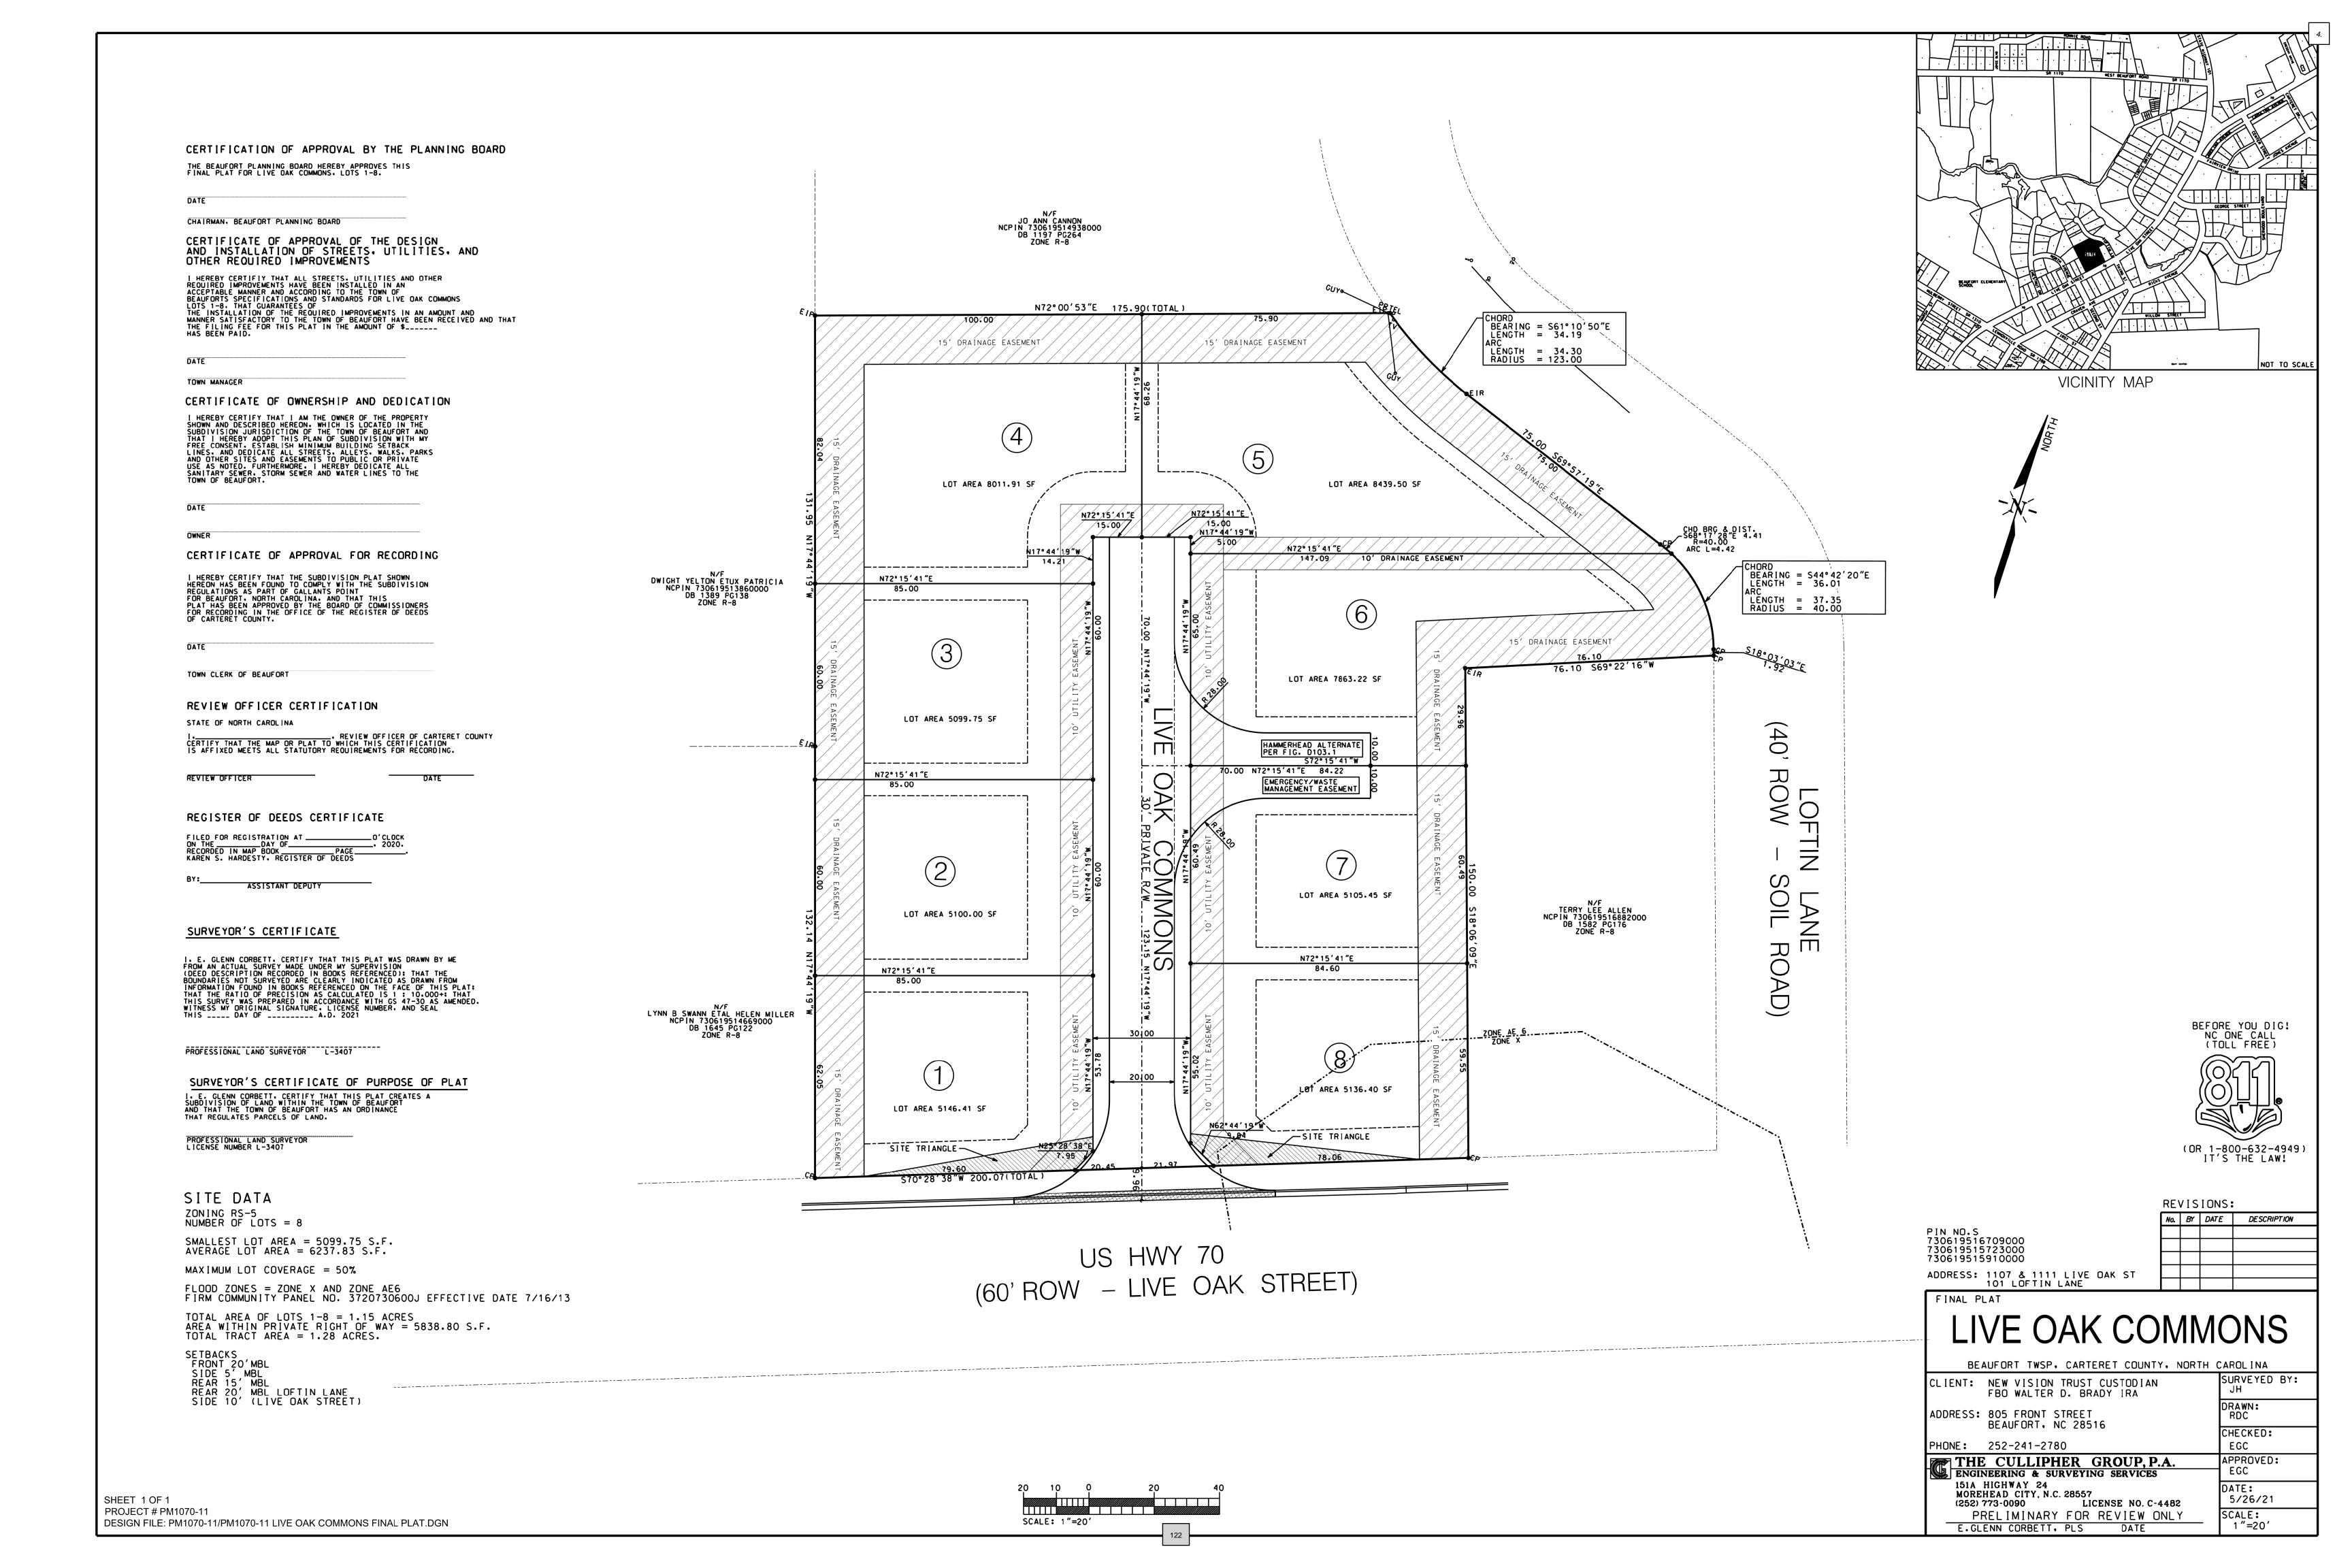

BOND ESTIMATE



Town of Beaufort 701 Front Street Beaufort, NC 28516 (252) 728-2141 www.beafortnc.org

DOND LS	
PROJECT NAME:	LIVE OAK COMMONS
OWNER:	NEW VISION TRUST CUSTODIAN FBO WALTER D. BRADY, IRA
ENGINEER:	THE CULLIPHER GROUP, P.A.
ENGINEER PHONE NO.:	252-773-0090
ENGINEER EMAIL:	ron@tcgpa.com
DATE:	6/1/2021

UNLESS OTHERWISE SPECIFIED ALL BONDS ARE FOR THE BODY OF THE PLAT

SIGNATURE AND SEAL OF SUBMITTING ENGINEER



a Registered Licensed Professional, do hereby vertify that I have personally supervised the measurement thereof and that the quantities expressed herein represent an accurate measurement of the work to be completed on this project. This bond estimate covers all the infrastructure improvements on the project referenced above.

andded Culliphet 6/1/21

Please sign below

UNIT COST STREET PAVEMENT LINEAR FEET: WIDTH: TOTAL: (Dollars/SY) \$ 20 \$ Final Asphalt Surface Course 260 16.50 9,533.33 Initial Asphalt Suface Course \$ Asphalt Intermediate Course \$ \$ Asphalt Base Course \$ Aggregate Base Course \$ \$ Subtotal 9,533.33

STREET INCIDENTALS	QUANTITY:	UNIT:	UNIT COST:	TOTAL:	
Street Signs		Each		\$	-
Street Trees (40' O.C.)		Each		\$	-
Street Lights		Each		\$	-
Pavement Striping		LF		\$	-
				\$	-
				\$	-
			Subtotal	\$	

CURBING & SIDEWALK:	QUANTITY:	UNIT:	UNIT COST:	TOTAL:
2'-6" Standard Curb		LF	. 7	\$ -
2'-6" Rolled curb		LF		\$ -
4' Wide Sidewalk	4	LF		\$ -
5' Wide Sidewalk	150	LF	\$ 20.00	\$ 3,000.0
Driveway Aprons		Each		\$ -
Handicap Ramp	-	Each		\$ -
			¥	\$ -
				\$ -
			Subtotal	\$ 3,000.0

SANITARY SEWER	QUANTITY:	UNIT:	UNIT COST:	TOTAL:
8" PVC Gravity Sewer		LF		\$ - 1
8" DIP Gravity Sewer		LF		\$ -
10" PVC Gravity Sewer		LF		\$ -
10" DIP Gravity Sewer		LF		\$ -
12" PVC Gravity Sewer		LF		\$ -
12" DIP Gravity Sewer		LF		\$ -
15" PVC Gravity Sewer		LF		\$ -
15" DIP Gravity Sewer		LF		\$ -
2" PVC Force Main		LF		\$ -
4" PVC Force Main		LF		\$ -
4" DIP Force Main		LF		\$ -
6" PVC Force Main		LF		\$ -
6" DIP Force Main		LF		\$ -
8" PVC Force Main		LF		\$ -
8" DIP Force Main		LF		\$ -
4'0" Dia. Manhole		LF		\$ -
5'0" Dia Manhole		LF		\$ -
Service Laterals, Main to Cleanout		Each		\$ -
Pump Station		Lump Sum		\$ -
Testing and Final As-builts	1	Lump Sum	\$ 3,000.00	\$ 3,000.00
				\$ -
				\$ -
			Subtotal	\$ 3,000.00

WATER	QUANTITY:	UNIT:	UNIT COST:	TO	ΓAL:
2" PVC Water Main		LF		\$	-
4" PVC Water Main		LF		\$	-
4" DIP Water Main		LF	4	\$	-
6" PVC Water Main		LF	,	\$	-
6" DIP Water Main		LF		\$	-
8" PVC Water Main		ĹF		\$	-
8" DIP Water Main		LF		\$	-
10" PVC Water Main		LF		\$	-
10" DIP Water Main		LF		\$	-
12" PVC Water Main		LF		\$	_
12" DIP Water Main		LF		\$	-
2" Valve (includes Curb Box)		Each		\$	-
4" Valve (includes Curb Box)		Each		\$	-
6" Valve (includes Curb Box)		Each		\$	-
8" Valve (includes Curb Box)	·	Each		\$	-
10" Valve (includes Curb Box)		Each		\$	-
12" Valve (includes Curb Box)		Each		\$	-

			Subtotal	\$	3,000.00
				\$	_
				\$	-
Testing and Final As-Builts`	1	Lump Sum	\$ 3,000.00	\$	3,000.00
Service Connections (includes Tap, Service Tubing, Meter Box and Meter Setter)		Each		\$	-
Fittings		Lump Sum		\$	_
Manholes		Each		\$	-
Vaults		Each		\$	-
Valve)		Lacii		7	
Fire Hydrant (includes Hydrant Leg &		Each		4	_

DRAINAGE	QUANTITY:	UNIT:	UNIT COST:	TOTAL:
15" RCP		LF		\$ -
15" Dual Wall HDPE		LF		\$ -
15" Dual Wall Polyproplene		LF		\$ -
18" RCP		LF		\$ -
18" Dual Wall HDPE		LF		\$ -
18" Dual Wall Polyproplene		LF		\$ -
24" RCP		LF		\$ -
24" Dual Wall HDPE		LF		\$ -
24" Dual Wall Polyproplene		LF		\$ -
30" RCP		LF		\$ -
30" Dual Wall HDPE		LF		\$ -
30" Dual Wall Polyproplene		LF		\$ -
36" RCP		LF		\$ -
36" Dual Wall HDPE		LF		\$ -
36" Dual Wall Polyproplene		LF		\$ -
42" RCP		LF		\$ -
42" Dual Wall HDPE		LF		\$ -
42" Dual Wall Polyproplene		LF		\$ -
48" RCP		LF		\$ -
48" Dual Wall HDPE		LF		\$ -
48" Dual Wall Polyproplene		LF		\$ -
15" FES		Each		\$ -
18" FES		Each		\$ -
24" FES		Each		\$ -
30" FES		Each		\$ -
36" FES		Each		\$ -
42" FES		Each		\$ -
48" FES		Each		\$ -
Curb Inlet		Each		\$ -
Yard Inlet		Each		\$ -
Manhole (0'-6' Deep)		Each		\$ -
				\$ -
				\$ -
				\$ -
			Subtotal	\$ -

TOTAL ESTIMATE ⇒

\$18,533.33